
06-15-12 LETTING ITEM 144

HIGHWAY STANDARDS, SEE SHEET NO. 2

	INDEX OF SHEETS
SHEET #	DESCRIPTION
1	TITLE
2	GENERAL NOTES AND STANDARDS
3	SUMMARY OF QUANTITIES
4	TYPICAL CROSS SECTIONS
5	TYPICAL CROSS SECTIONS
6-9	RESURFACING AND PAVEMENT MARKING PLANS
10	WOODWARD AVENUE/BOUGHTON ROAD DETECTOR LOOP PLAN
11	SCHEDULES
12	TC 10 TRAFFIC CONTROL AND PROTECTION FOR SIDE ROADS, INTERSECTIONS, AND DRIVEWAYS (DISTRICT 1)
13	TC 13 TYPICAL PAVEMENT MARKINGS (DISTRICT 1)
14	BD 24 CURB OR CURB AND GUTTER REMOVAL AND REPLACEMENT (DISTRICT 1)
15	BD 32 BUTT JOINT AND HMA TAPER DETAILS (DISTRICT 1)
16	TS 07 DETECTOR LOOP INSTALLATION DETAILS FOR ROADWAY RESURFACING (DISTRICT 1)

PROJECT IS LOCATED IN THE VILLAGE OF WOODRIDGE

		TRAFFIC INFORMATION
CLASSIFICA	TION	URBAN COLLECTOR
DESIGN SPI	EED =	45 MPH
POSTED SP	EED =	40 MPH
ADT (2010)		14,000
100'	200'	300' 1" = 100'
10'	20'	30' 1" = 10'
50'	100	

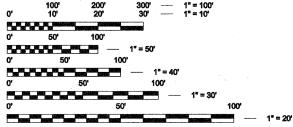

FULL SIZE PLANS HAVE BEEN PREPARED USING STANDARD ENGINEERING SCALES. REDUCED SIZED PLANS WILL NOT CONFORM TO STANDARD SCALES. IN MAKING MEASUREMENTS ON REDUCED PLANS. THE ABOVE SCALES MAY BE USED.

PLANS PREPARED BY:
VILLAGE OF WOODRIDGE
DEPARTMENT OF PUBLIC WORKS

J.U.L.I.E

JOINT UTILITY LOCATION INFORMATION FOR EXCAVATION 1-800-892-0123 OR 811

CONTRACT 63703

STATE OF ILLINOIS DEPARTMENT OF TRANSPORTATION DIVISION OF HIGHWAYS PLANS FOR PROPOSED

FEDERAL AID HIGHWAY


FAU ROUTE 2593 (WOODWARD AVENUE)
INTERSTATE 55 BRIDGE TO BOUGHTON ROAD
RESURFACING

SECTION: 12-00069-00-RS PROJECT NO: M-9003(970) VILLAGE OF WOODRIDGE DUPAGE COUNTY

JOB NO:C-91-267-12

GROSS AND NET LENGTH =

7,191 FEET (1.36 MI)

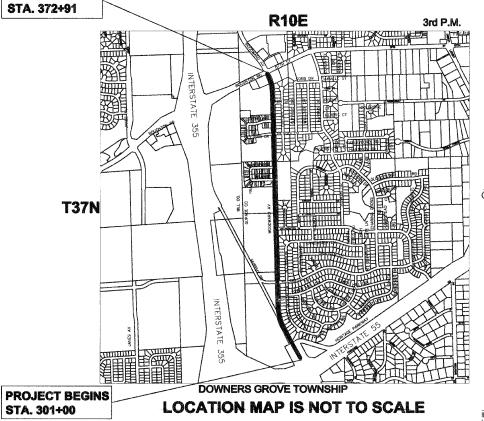

PROJECT ENDS

SCHUA D. STRONG BOARD REGISTERD PROFESSIONAL ENGINEER



CONTRACT 63703





PRINTED BY THE AUTHORITY
OF THE STATE OF ILLINOIS

COUNTY	SECTION	TOTAL SHEETS	SHEET#
DUPAGE	12-00069-00-RS	16	1

SHEET NO.

GENERAL NOTES

SPECIFICATIONS, STANDARDS AND SPECIAL PROVISIONS:

ALL CONSTRUCTION SHALL BE PERFORMED IN ACCORDANCE WITH THE ILLINOIS DEPARTMENT OF TRANSPORTATION "STANDARD SPECIFICATIONS FOR ROAD AND BRIDGE CONSTRUCTION", ADOPTED JANUARY 1, 2012 (HEREINAFTER REFERRED TO AS THE STANDARD SPECIFICATIONS); THE "SUPPLEMENTAL SPECIFICATIONS AND **RECURRING SPECIAL PROVISIONS ", ADOPTED JANUARY 1, 2012; THE LATEST EDITION OF THE "ILLINOIS MANUAL ON UNIFORM TRAFFIC CONTROL DEVICES FOR** STREETS. THE "DETAILS" ON THE PLANS AND THE "SPECIAL PROVISIONS" INCLUDED IN THE CONTRACT DOCUMENTS. ANY REFERENCE TO STANDARDS THROUGHOUT THE PLANS OR SPECIAL PROVISIONS SHALL BE INTERPRETED AS THE LATEST STANDARD OF THE ILLINOIS DEPARTMENT OF TRANSPORTATION.

PROJECT START:

ON SUNDAY, AUGUST 19, 2012 THE ROTARY CLUB OF WOODRIDGE WILL BE HOSTING ITS ANNUAL TRIATHLON WHICH WILL TAKE PLACE WITHIN THE LIMITS OF CONSTRUCTION OF THIS PROJECT. IT SHALL BE A REQUIREMENT OF THE CONTRACT THAT NO WORK BEGIN ON THIS PROJECT UNTIL MONDAY AUGUST 20, 2012 AT THE EARLIEST.

PROJECT COORDINATION:

THE CONTRACTOR SHALL NOTIFY THE VILLAGE OF WOODRIDGE AT 630-719-4753 AT LEAST 72 HOURS IN ADVANCE OF BEGINNING WORK AND SHALL COORDINATE ALL CONSTRUCTION OPERATIONS WITH THE ENGINEER. ATTENTION IS CALLED TO SECTION 701 OF THE STANDARD SPECIFICATIONS AND THE SPECIAL PROVISIONS FOR TRAFFIC CONTROL AND PROTECTION. THE STORAGE OF EQUIPMENT AND/OR MATERIALS WITHIN THE RIGHT-OF-WAY OF ANY STREET AND/OR PARK PROPERTY SHALL REQUIRE PRIOR APPROVAL OF THE ENGINEER.

ALL CONSTRUCTION PERSONNEL WILL BE REQUIRED TO WEAR FLORESCENT ORANGE, FLUORESCENT YELLOW/GREEN, OR A COMBINATION OF FLORESCENT ORANGE AND FLUORESCENT GREEN/YELLOW SAFETY VESTS MEETING THE REQUIREMENTS OF THE STANDARDS INSTITUTE SPECIFICATION ANSI/ISEA 107-1999 FOR THE CONSPICUITY CLASS 2 GARMENTS AT ALL TIMES WHILE ON THE **CONSTRUCTION SITE.**

TRAFFIC CONTROL AND MAINTENANCE:

THE CONTRACTOR SHALL SCHEDULE HIS WORK SO THAT ONLY ONE TEMPORARY LANE CLOSURE ON ONE STREET IN ONE DIRECTION IS IMPLEMENTED AT A TIME. A LANE CLOSURE WILL ONLY BE PERMITTED DURING CONSTRUCTION OPERATIONS AND IN ACCORDANCE WITH THE APPLICABLE IDOT STANDARDS. THE CONTRACTOR SHALL FURNISH, ERECT, AND MAINTAIN ALL SIGNS, BARRICADES AND OTHER TRAFFIC CONTROL DEVICES, INCLUDING FLAGGERS, REQUIRED TO MAINTAIN TRAFFIC FLOW.

HIGHWAY STANDARDS STANDARD# DESCRIPTION TANDARD SYMBOLS, ABBREVIATIONS AND PATTERNS LIRB RAMPS FOR SIDEWALKS 424001-06 424006 DIAGONAL CURB RAMPS 442201-03 LIASS D PATCHES 606001-04 ONCRETE CURB TYPE B AND COMBINATION CONCRETE CURB AND GUTTER 701006-03 OFF-ROAD OPERATIONS 2L, 2W, 15' TO 24' FROM PAVEMENT EDGE 701011-02 OFF-ROAD MOVING OPERATIONS 2L 2W DAY ONLY URBAN LANE CLOSURE. MULTILANE. 1W OR 2W WITH NONTRAVERSABLE MEDIAN 701601-07 URBAN LANE CLOSURE MULTILANE INTERSECTION 701701-08 ANE CLOSURE MULTILANE 1W OR 2W CROSSWALK OR SIDEWALK CLOSURE 701801-05 RAFFIC CONTROL DEVICES YPICAL PAVEMENT MARKINGS DETECTOR LOOP INSTALLATIONS 886006-01 TYPICAL LAYOUTS FOR DETECTION LOOPS

REVISED 3/20/2012 DESIGNED - AF **VILLAGE OF WOODRIDGE** DRAWN - AF **DEPARTMENT OF PUBLIC WORKS** CHECKED - JDS 1 Plaza Drive, Woodridge IL 60517 (con) DATE - 1/24/2012

STATE OF ILLINOIS **DEPARTMENT OF TRANSPORTATION**

COUNTY TOTAL SHEETS **GENERAL NOTES** RTE. **AND STANDARDS** 12-00069-00-RS DUPAGE 2593 CONTRACT NO. 63703 SCALE: NONE STA. ILLINOIS FEDERAL AID PROJECT

SAW CUTTING FOR REMOVAL:

THE CONTRACTOR SHALL MAKE ALL FULL DEPTH SAW CUT AT THE EDGE OF PAVEMENT ADJACENT TO THE REMOVAL OF ALL CONCRETE CURB OR COMBINATION CONCRETE CURB AND GUTTER. THE CONTRACTOR SHALL MAKE ALL FULL DEPTH SAW CUTS REQUIRED FOR THE REMOVAL OF CONCRETE CURB AND GUTTERS, SIDEWALKS, AND DRIVEWAYS AS SPECIFIED, OR AS DIRECTED BY THE ENGINEER. THE COST SHALL BE CONSIDERED INCLUDED IN THE COST FOR REMOVAL OF THE SPECIFIED ITEM IN THE CONTRACT.

BASE COURSE CLEANING:

PRIOR TO APPLYING THE HOT-MIX ASPHALT PRIME COAT, THE BASE SURFACE INCLUDING GUTTERS SHALL BE CLEANED OF LOOSE GRINDINGS, LEAVES, OF ALL DUST, DIRT, WEEDS AND OTHER FOREIGN MATERIALS. ALL CRACK FILL MATERIAL SHALL BE REMOVED IN ITS ENTIRETY ALONG THE CURB LINE. COST TO BE CONSIDERED INCLUDED IN THE COST OF THE HOT-MIX ASPHALT SURFACE WORK.

CLEAN-UP AND DISPOSAL:

THE CONTRACTOR SHALL MAINTAIN THE SITE IN A CLEAN AND ORDERLY MANNER. DEBRIS AND ANY SURPLUS MATERIAL SHALL BE REMOVED AND RESTORATION SHALL PROCEED AS THE WORK PROCEEDS. IF THE ENGINEER SO DIRECTS, THE CONTRACTOR SHALL STOP ALL OTHER WORK AND CONCENTRATE ON CLEAN-UP AND RESTORATION. DEBRIS AND SURPLUS MATERIAL SHALL BE DISPOSED OF BY THE CONTRACTOR OFF-SITE.

THE CONTRACTOR SHALL CONFINE OPERATIONS WITHIN THE CONSTRUCTION LIMITS OF THE PROJECT. ANY DAMAGE INSIDE AND OUTSIDE OF SAID CONSTRUCTION LIMITS SHALL BE REPAIRED AT THE CONTRACTOR'S EXPENSE.

PROPERTY ACCESS:

DURING CONSTRUCTION, ALL SIGNS, BARRICADES, AND TEMPORARY PAVEMENT MARKINGS SHALL CONFORM TO THE ILLINOIS MUTCD. VEHICULAR ACCESS TO LOCAL PROPERTIES WILL BE MAINTAINED AT ALL TIMES DURING CONSTRUCTION. EXCEPT WHEN CONSTRUCTION OPERATIONS OCCUR DIRECTLY ON OR IN FRONT OF DRIVEWAYS. IN THIS CASE, FLAG PERSONS WILL BE USED TO DIRECT AND CONTROL TRAFFIC.

WATER SUPPLY/USEAGE:

THE INDEPENDENT USE OF PRIVATE WATER SPIGOTS IS STRICTLY PROHIBITED. THE CONTRACTOR SHALL BE RESPONSIBLE FOR OBTAINING WATER FROM AN APPROVED SOURCE (FIRE HYDRANT). IT SHALL BE THE CONTRACTOR'S RESPONSIBILITY TO OBTAIN A WATER (HYDRANT) METER FROM THE VILLAGE OF WOODRIDGE FOR THE PURPOSES OF TRACKING WATER USAGE.


SUMMARY OF QUANTITIES


CODE NO	ПЕМ	UNIT	TOTAL QUANTITY CONSTRUCTION
			CODE 0005
21101615	TOPSOIL FURNISH AND PLACE, 4"	SQ YD	500
25000110	SEEDING, CLASS 1A	ACRE	0.15
25000400	NITROGEN FERTILIZER NUTRIENT	POUND	20
25000500	PHOSPHORUS FERTILIZER NUTRIENT	POUND	20
25000600	POTASSIUM FERTILIZER NUTRIENT	POUND	20
25100630	EROSION CONTROL BLANKET	SQYD	500
40600100	BITUMINOUS MATERIALS (PRIME COAT)	GALLON	9909
40600300	AGGREGATE (PRIME COAT)	TON	150
40600400	MIXTURE FOR CRACKS, JOINTS, AND FLANGEWAYS	TON	40
40600827	POLYMERIZED LEVELING BINDER (MACHINE METHOD), IL-4.75, N50	TON	2775
40600895	CONSTRUCTING TEST STRIP	EACH	2
40600982	HOT-MIX ASPHALT SURFACE REMOVAL - BUTT JOINT	SQ YD	593
40603340	HOT-MIX ASPHALT SURFACE COURSE, MIX "D", N70	TON	4856
42400200	PORTLAND CEMENT CONCRETE SIDEWALK 5 INCH	SQFT	2151
42400800	DETECTABLE WARNINGS	SQFT	224
44000160	HOT-MIX ASPHALT SURFACE REMOVAL, 2 3/4"	SQ YD	49547
44000500	COMBINATION CURB AND GUTTER REMOVAL	FOOT	2095
44000600	SIDEWALK REMOVAL	SQFT	2151
44201705	CLASS D PATCHES, TYPE II, 5 INCH	SQ YD	100
44201709	CLASS D PATCHES, TYPE III, 5 INCH	SQ YD	310
44201711	CLASS D PATCHES, TYPE IV, 5 INCH	SQ YD	800
60255500	MANHOLES TO BE ADJUSTED	EACH	2


CODE NO	ПЕМ	UNIT	TOTAL QUANTITY CONSTRUCTION
			CODE 0005
60260100	INLETS TO BE ADJUSTED	EACH	20
60603800	COMBINATION CONCRETE CURB AND GUTTER, TYPE B-6.12	FOOT	242
60604400	COMBINATION CONCRETE CURB AND GUTTER, TYPE B-6.18	FOOT	250
60605000	COMBINATION CONCRETE CURB AND GUTTER, TYPE B-6.24	FOOT	1603
67100100	MOBILIZATION	LSUM	1
70102630	TRAFFIC CONTROL AND PROTECTION, STANDARD 701601	LSUM	1
70102635	TRAFFIC CONTROL AND PROTECTION, STANDARD 701701	LSUM	1
70102640	TRAFFIC CONTROL AND PROTECTION, STANDARD 701801	LSUM	1
70106800	CHANGEABLE MESSAGE SIGN	CAL MO	2
70300100	SHORT TERM PAVEMENT MARKING	FOOT	1000
70300210	TEMPORARY PAVEMENT MARKING LETTERS AND SYMBOLS	SQFT	1440
70300220	TEMPORARY PAVEMENT MARKING - LINE 4"	FOOT	8000
70300280	TEMPORARY PAVEMENT MARKING - LINE 24"	FOOT	780
70301000	WORK ZONE PAVEMENT MARKING REMOVAL	SQFT	500
78000100	THERMOPLASTIC PAVEMENT MARKING - LETTERS AND SYMBOLS	SQFT	480
78000200	THERMOPLASTIC PAVEMENT MARKING - LINE 4"	FOOT	18482
78000400	THERMOPLASTIC PAVEMENT MARKING - LINE 6"	FOOT	3350
78000600	THERMOPLASTIC PAVEMENT MARKING - LINE 12"	FOOT	954
78000650	THERMOPLASTIC PAVEMENT MARKING - LINE 24"	FOOT	260
88600600	DETECTOR LOOP REPLACEMENT	FOOT	632
			L


* INDICATES SPECIALTY ITEM

		DESIGNED - AF	REVISED 3/20/2012		9	UMMA	RY OF	F.A.P	SECTION	COUNTY	TOTAL SHEETS	SHEET NO.
VILLAGE OF WOODRIDGE DEPARTMENT OF PUBLIC WORKS	*	DRAWN - AF		STATE OF ILLINOIS				RTE.				
1 Plaza Drive, Woodridge IL 60517 mg raom		CHECKED - JDS		DEPARTMENT OF TRANSPORTATION	•	MANT		2593	12-00069-00-RS	DUPAGE	16 CONTRACT	T NO. 63703
1 Field Dilve, Woodinge it 00017 assess		DATE - 1/24/2012			SCALE: NONE	STA.	TO STA.			ILLINOIS		ND PROJECT

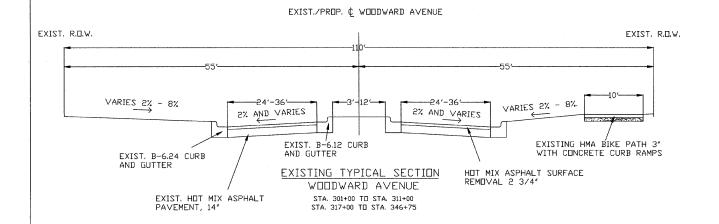

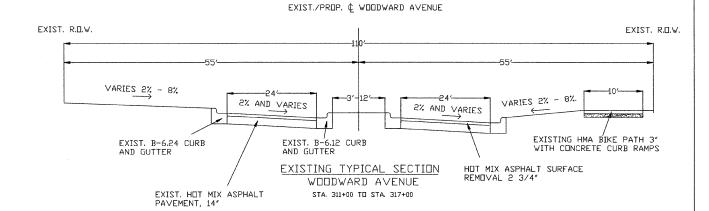

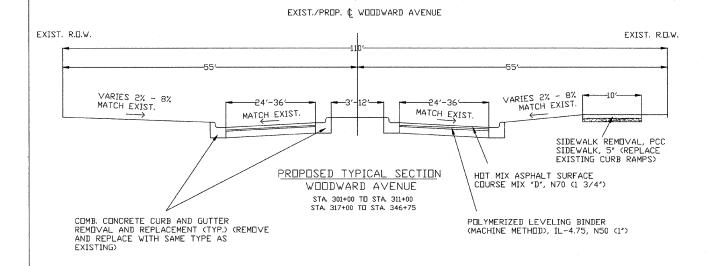

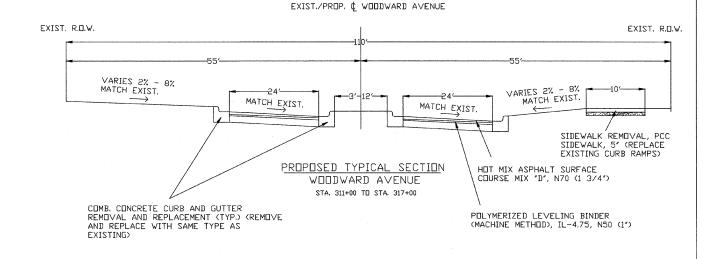


NOTE: MILLING TO BE DONE PRIOR TO PATCHING.


CROSS SECTIONS ARE NOT TO SCALE


	C	DESIGNED - AF	REVISED 3/20/2012
VILLAGE OF WOODRIDGE DEPARTMENT OF PUBLIC WORKS		DRAWN - AF	
1 Plaza Drive, Woodridge IL 60517 (850) 716-1753		CHECKED - JDS	
T Flaza Dilve, vvoodilage iL 00317 mag mains	C	DATE - 1/24/2012	


STATE OF ILLINOIS
DEPARTMENT OF TRANSPORTATION

TYPICAL ODGE SECTIONS	F.A.P RTE.	SECTION	cou	NTY	TOTAL SHEETS	SHEET NO.
TYPICAL CROSS SECTIONS	2593	12-00069-00-RS	DUP	AGE	16	4
		, .			CONTRACT	NO. 63703
SCALE: NONE STA. 301+00 TO STA. 346+75				ILLINOIS	FEDERAL A	D PROJECT

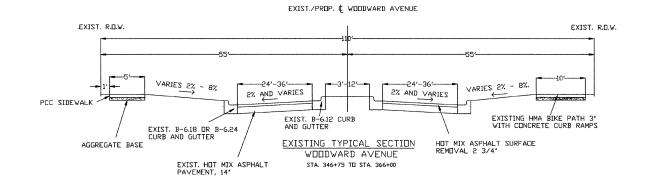

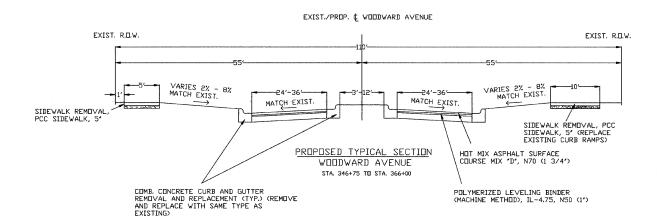

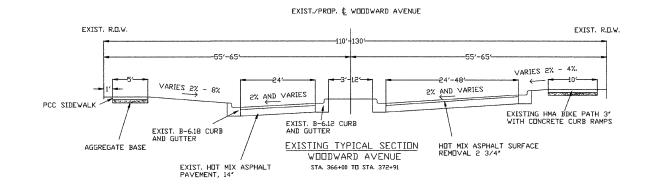


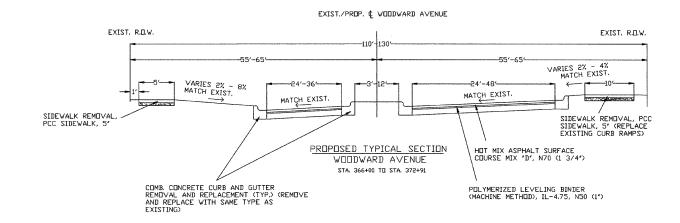



NOTE: MILLING TO BE DONE PRIOR TO PATCHING.


CROSS SECTIONS ARE NOT TO SCALE

1811 4 05 05 WOODDIDG5	DESIGNED - AF	REVISED 3/20/2012				SECTION	COUNTY	TOTAL SHEETS	SHEET NO.
VILLAGE OF WOODRIDGE DEPARTMENT OF PUBLIC WORKS	 DRAWN - AF		STATE OF ILLINOIS	TYPICAL CROSS SECTIONS	RTE. 2593	12-00069-00-RS	DUPAGE	16	F.
1 Plaza Drive, Woodridge IL 60517 (888) 719-0739	CHECKED - JDS		DEPARTMENT OF TRANSPORTATION		2050	12-00003-00-103	DOFAGE	CONTRACT	NO. 63703
Traza birro, vrobanago iz boori (as, mais	ĐATE - 1/24/2012			SCALE: NONE STA. 346+75 TO STA. 372+91			ILLINOIS	FEDERAL A	

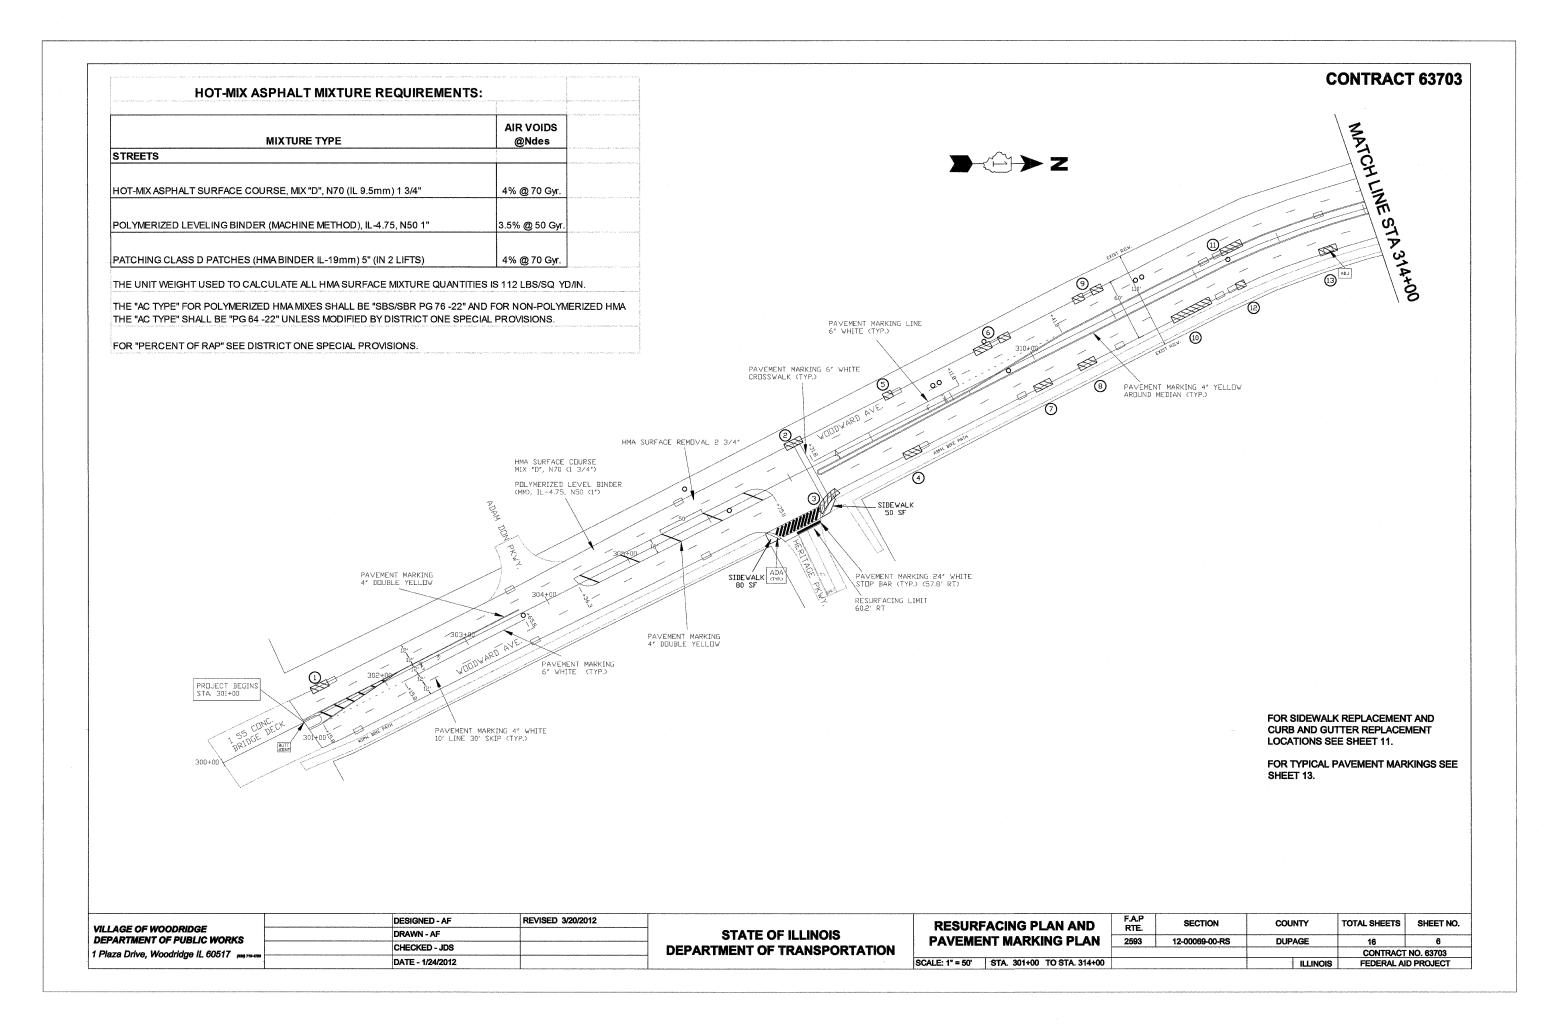

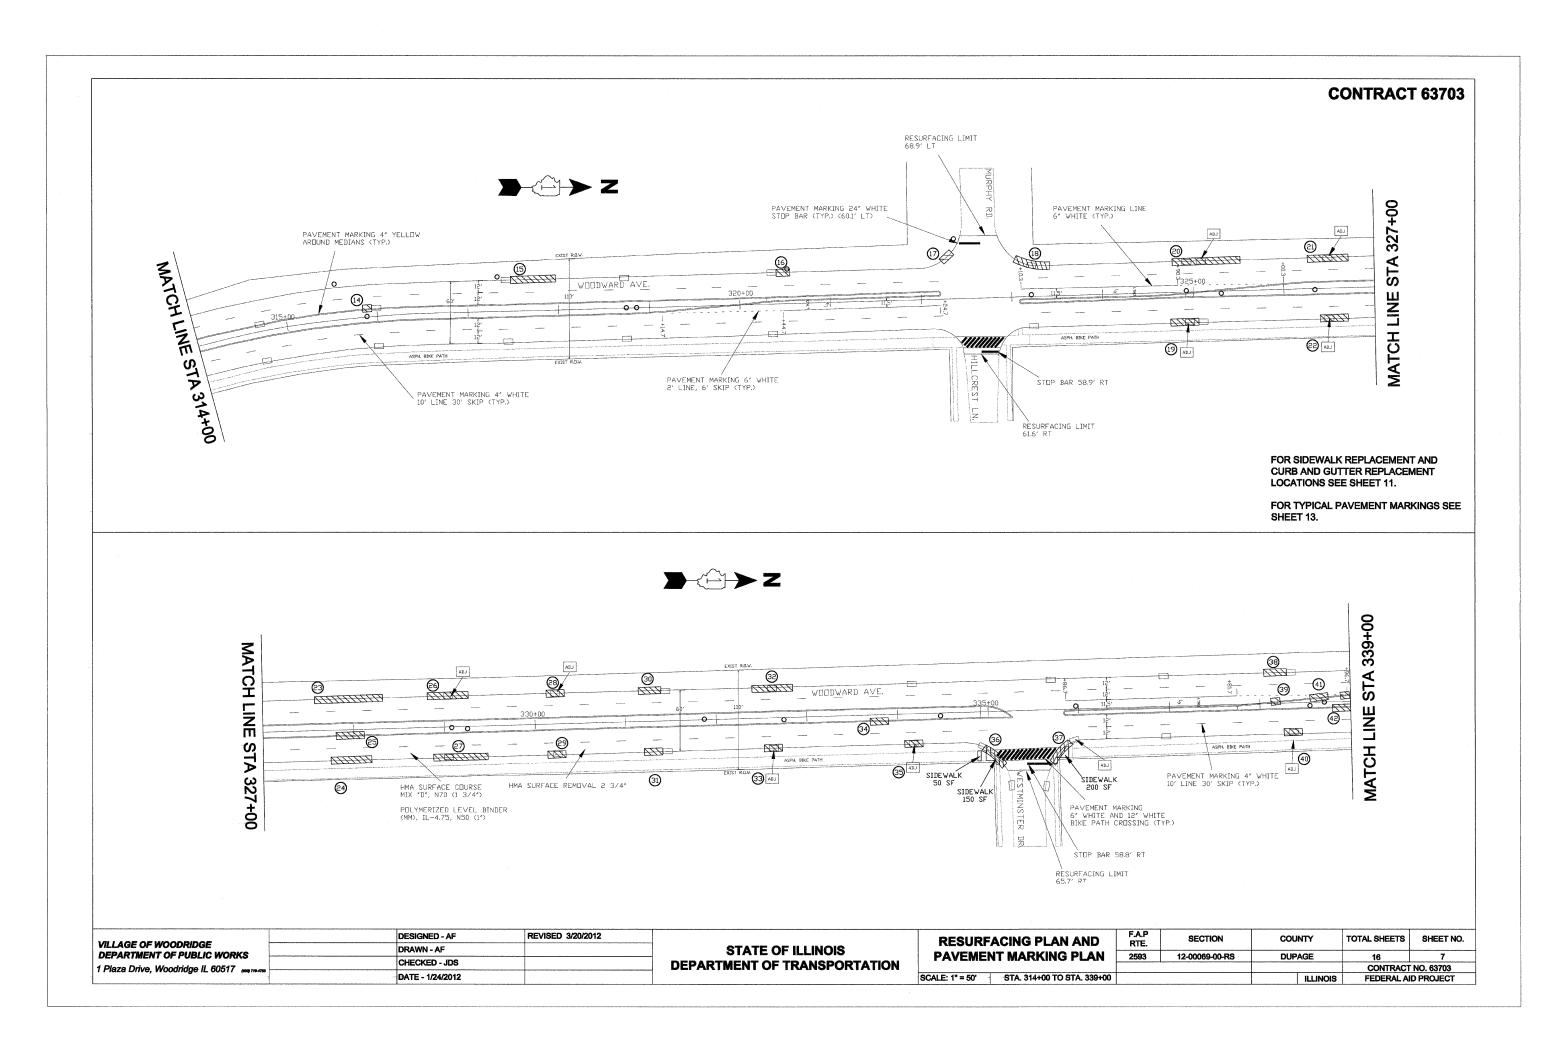

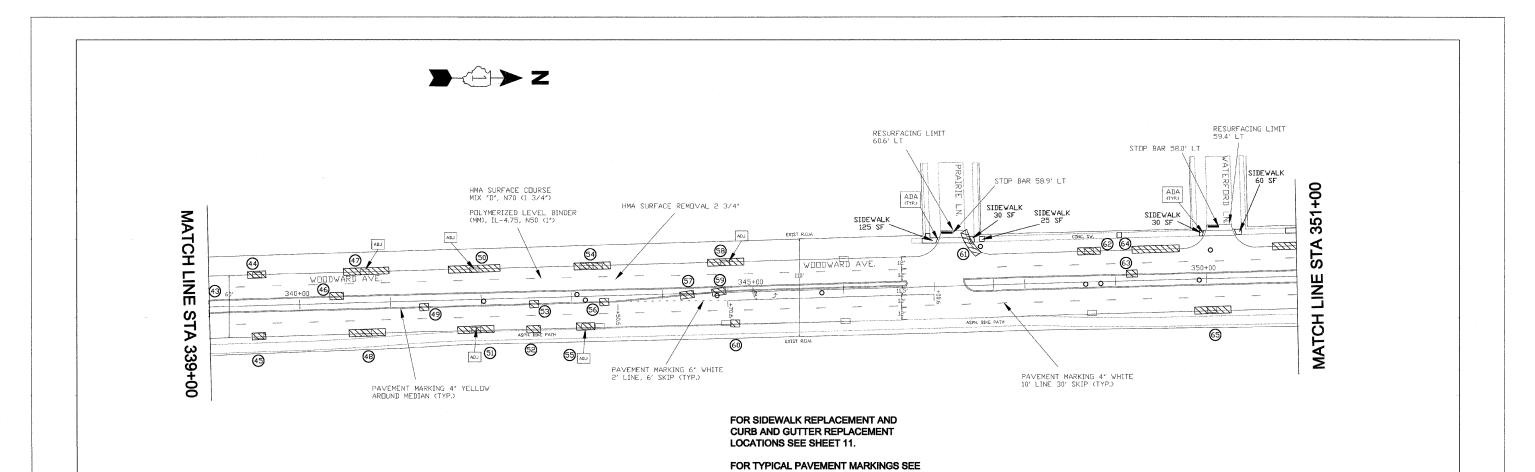

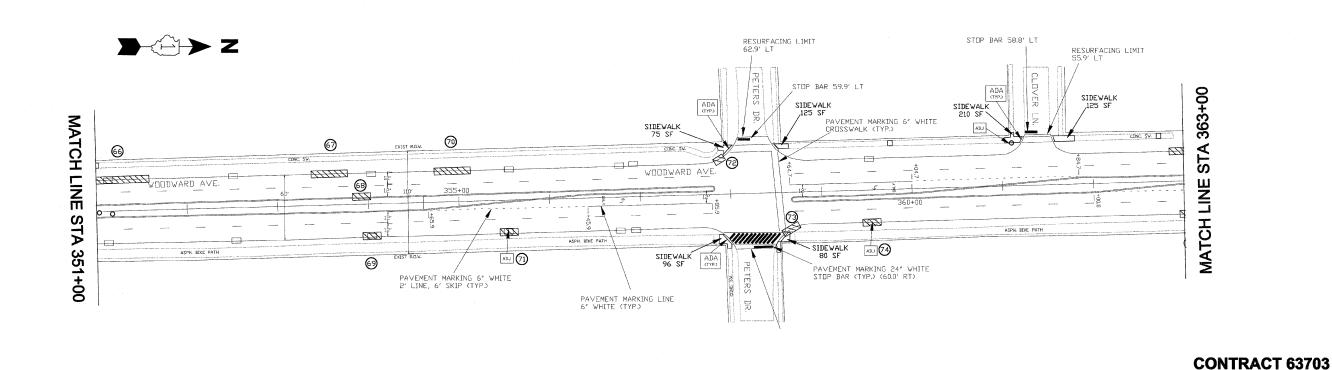

STATE OF ILLINOIS

DEPARTMENT OF TRANSPORTATION

DESIGNED - AF

CHECKED - JDS

DATE - 1/24/2012

DRAWN - AF

VILLAGE OF WOODRIDGE

DEPARTMENT OF PUBLIC WORKS

1 Plaza Drive, Woodridge IL 60517 (809779-1

REVISED 3/20/2012

F.A.P RTE.

2593

SECTION

12-00069-00-RS

COUNTY

DUPAGE

TOTAL SHEETS

CONTRACT NO. 63703 FEDERAL AID PROJECT

SHEET NO.


RESURFACING PLAN AND

PAVEMENT MARKING PLAN


SCALE: 1" = 50' STA. 339+00 TO STA. 363+00

FOR SIDEWALK REPLACEMENT AND CURB AND GUTTER REPLACEMENT LOCATIONS SEE SHEET 11.

FOR TYPICAL PAVEMENT MARKINGS SEE SHEET 13.

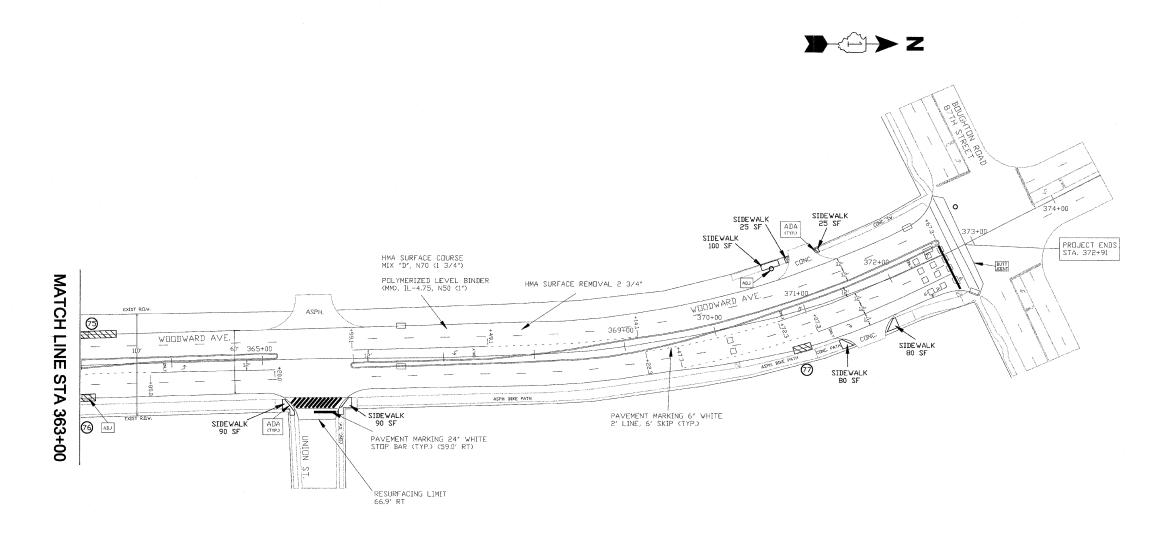

WILLAGE OF WOODPIDGE	DES	SIGNED - AF	REVISED 3/20/2012		RESURI	FACING PLAN AND	F.A.P	SECTION	COUNTY	TOTAL SHEETS	SHEET NO.
VILLAGE OF WOODRIDGE DEPARTMENT OF PUBLIC WORKS	DR/	RAWN - AF		STATE OF ILLINOIS		NT MARKING PLAN	2503	12-00069-00-RS	DUPAGE	16	
1 Plaza Drive, Woodridge IL 60517 (1000) 170-1703	СН	HECKED - JDS		DEPARTMENT OF TRANSPORTATION	1 VA FINITE	NI WARRING I LAN	2000	12-00003-00-10	DOLAGE	CONTRACT	NO. 63703
	DAT	ATE - 1/24/2012			SCALE: 1" = 50'	STA. 363+00 TO STA. 372+91			ILLINOIS	FEDERAL AIL	D PROJECT

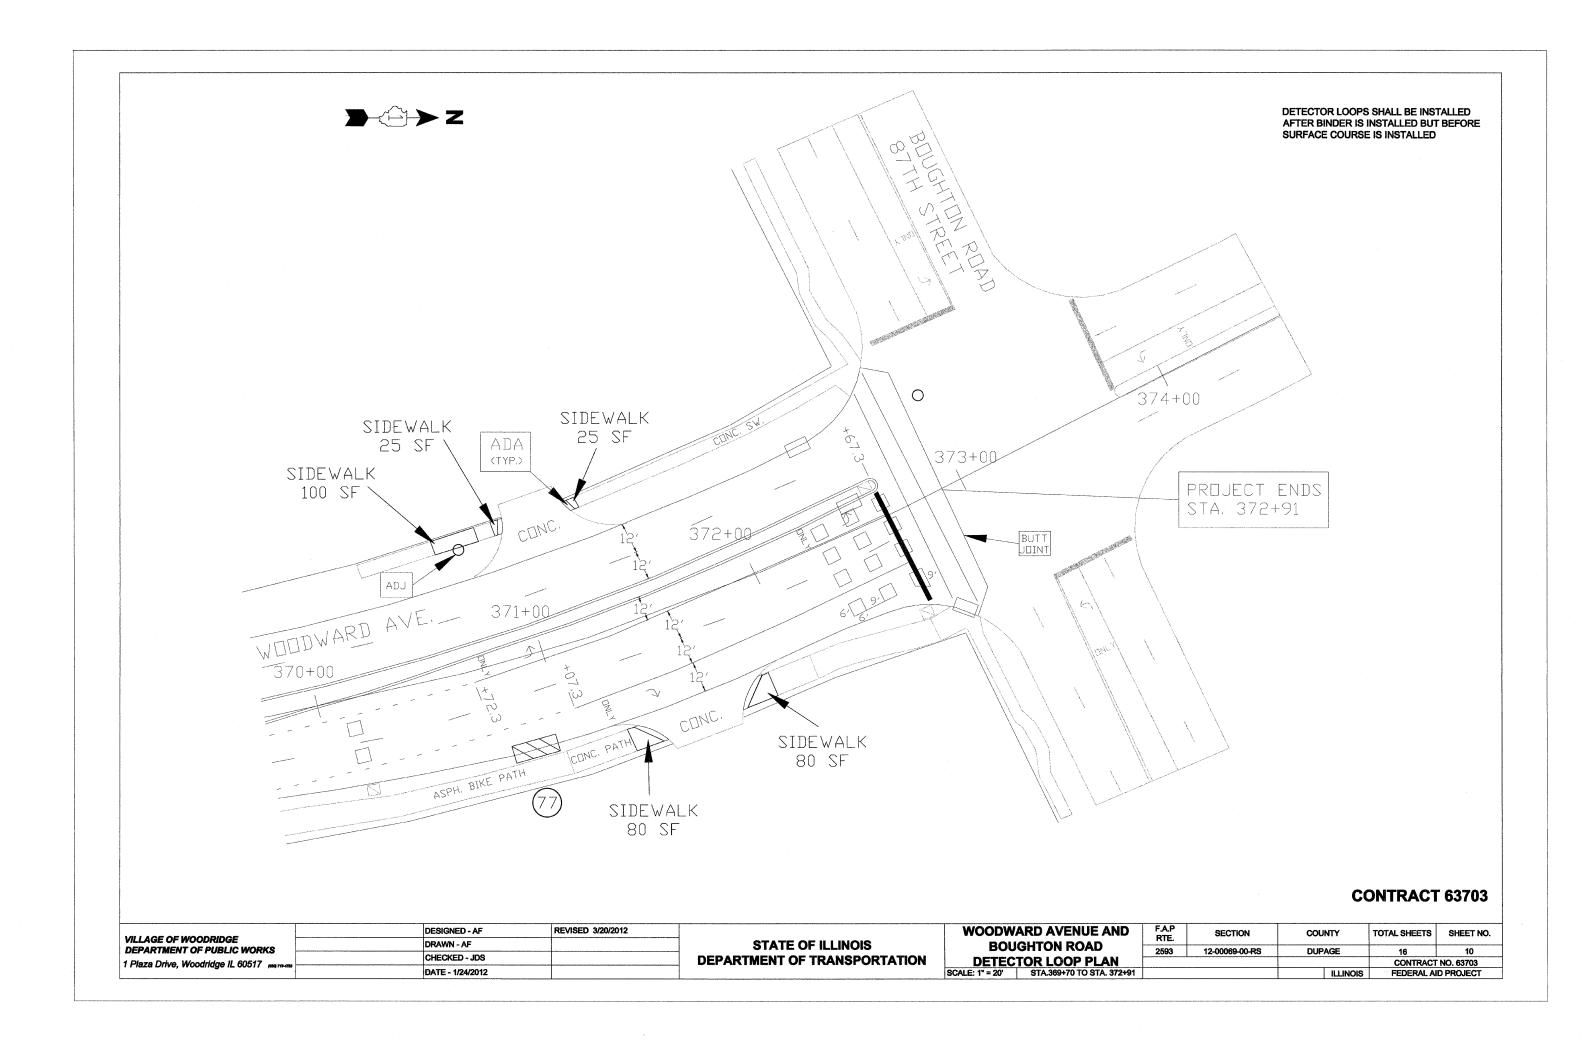

	nan man an manga man man kapanan manahan pan maha		60603800	60604400	60605000	44000500
			COMBINATION CONCRETE			COMBINATION
			CURB AND GUTTER,	CURB AND GUTTER,	CURB AND GUTTER,	CURB AND GUTTER
oc	description of the second of the second of the second of		TYPE B-6.12	TYPE B-6.18	TYPE B-6.24	REMOVAL
#	STA.	SIDE	LENGTH (FT)	LENGTH (FT)	LENGTH (FT)	LENGTH (FT)
1	301+20	LT			20	20
2	307+20	LT			20	20
3	307+20	RT			25	25
4	308+20	RT			15	15
5	308+40	LT			. 10	10
6	309+50	LT			43	43
7	309+90	RT			20	20
8	310+45	RT			20	20
9	310+75	LT			35	35
10	311+60	RT			47	47
11	312+40	LT	25			25
12	312+40	RT			10	10
13	313+40	.RT			20	.20
14	315+90	LT	10			10
15	317+50	LT			50	50
16	320+50	LT			15	15
17	322+20	LT			10	10
18	323+20	LT			15	15
19	324+80	RT			31	31
20	324+85	LT			75	75
21	326+30	ŁT]		45	45
22	326+45	RT			32	32
23	327+65	LT	1		70	70
24	327+80	RT			42	42
25	327+90	RT	30			30
26	328+80	LT	1		43	43
27	328+90	RT			60	60
28	330+15	LT			20	20
29	330+15	RT			20	20
30	331+20	LT			25	25
		 				
31	331+25	RT			20	20
32	332+40	LT			40	40
33	332+60	RT	ļ		15	15
34	333+75	RT	20			20
35	334+15	RT			15	15
36	335+00	RT			30	30
37	335+80	RT			30	30
38	338+10	LT			27	27
39	338+15	LT	10			10
40	338+40	RT			20	20
41	338+60	LT	15			15
42	338+80	RT	15			15
43	338+95	LT	10			10
44	339+55	LT			20	20
45	339+55	RT			15	15
46	340+40	LT	15			15
47	340+55	LT			50	50
48	340+55	RT			40	40
49	340+70	RT	10			10
50	341+65	LT			57	57
51	341+80	RT			40	40
52	342+50	RT			10	10
53	341+95	RT	10		1	10
54	343+05	LT			44	44
55	343+10	RT	<u> </u>		20	20
56	343+40	RT	10			10
57	344+30	RT	15			15
58	344+58	LT			45	45
59	344+60	RT	15			15
50	344+70	RT			10	10
51	347+40	LT			25	25
52	348+75	LT	1		15	15
53	349+20	LT	12			12
54	349+25	LT	14		52	52
55	349+85	RT			40	40
56	350+80	LT			85	85
57	353+45	LT	<u> </u>	45	0.5	45
	353+85		70	45		
58		LT	20	20		20
59	353+90	RT		20		20
70	354+75	LT	ļ	40		40
71	355+45	RT	L	15		15
72	356+90	LT		10		10
73	359+65	RT	_	20		20
74	359+55	RT		15		15
75	362+85	LT		55		55
76	362+90	RT		15		15
77	370+80	RT		15		15

	L		BUTT JOINT			40600982
			(MEASURED FROM CENTERLINE	PAVEMENT	PAVEMENT	HOT MIX ASPHALT SURFACE
			OF WOODWARD AVE.)	BUTT JOINT LENGTH	BUTT JOINT WIDTH	REMOVAL - BUTT JOINT
STA.	SIDE	LOCATION	(FT.)	(FT)	(FT)	(SQ. YD.)
301+00		I 55 CONC. BRIDGE DECK EDGE		48	10	53
306+95	RT	HERITAGE PARKWAY	60.2	45	10	50
322+60	LT	MURPHY ROAD	68.9	42	10	47
322+60	RT	HILLCREST LANE	61.6	39	10	43
335+40	RT	WESTMINSTER DRIVE	65.7	47	10	52
347+30	LT	PRAIRIE LANE	60.6	28	10	31
350+20	LT	WATERFORD LANE	59.4	28	10	31
358+30	LT	PETERS DRIVE	62.9	34	10	38
358+30	RT	PETERS DRIVE	61.0	43	10	48
361+40	LT	CLOVER LANE	55.9	29	10	32
365+50	RT	UNION STREET	66.9	41	10	46
372+91		BOUGHTON ROAD		110	10	122
A ACCORDANGE A STREET OF THE STREET						593
						SY


		42400200	42400800	44000600
AND ADDRESS OF THE AD		PCC	DETECTABLE	SIDEWALK
		SIDEWALK, 5"	WARNINGS	REMOVAL
STA	SIDE	(SQ. FT)	(SQ. FT)	(SQ. FT)
306+50	RT	80	16	80
307+25	RT	50	16	50
334+95	RT	50	0	50
335+05	RT	150	16	150
335+80	RT	200	16	200
346+95	LT	125	8	125
347+40	LT	30	8	30
347+50	LT	25	0	25
349+10	LT	25	0	25
349+95	LT	30	8	30
350+40	LT	60	8	60
351+00	LT	75	0	75
358+00	LT	75	8	75
358+00	RT	96	16	96
358+50	LT	125	8	125
358+50	RT	80	16	80
359+80	LT	25	0	25
361+10	LT	210	8	210
361+65	LT	125	8	125
362+65	LT	25	0	25
365+20	RT	90	16	90
365+80	RT	90	16	90
370+80	LT	100	0	100
371+00	LT	25	8	25
371+15	RT	80	8	80
371+20	LT	25	8	25
371+70	RT	80	8	80
		2151	224	2151
į		SQ FT	SQ FT	SQ FT

	DRAINAGE AND UTILITY STRUCTURE SCHEDULE									
		60255500	60260100							
		MANHOLES TO	INLETS TO							
		BE ADJUSTED	BE ADJUSTED							
STA	SIDE	(EACH)	(EACH)	COMMENTS						
313+50	RT		1	DETERIORATED RINGS						
324+95	RT		1	DETERIORATED RINGS						
325+05	Ľ		1	DETERIORATED RINGS						
326+50	RT		1	DETERIORATED RINGS						
326+50	LT		1	-1"						
329+00	LT		1	DETERIORATED RINGS						
330+10	LT		1	DETERIORATED RINGS						
332+75	RT		1	DETERIORATED RINGS						
334+15	RT		1	DETERIORATED RINGS						
335+95	RT	,	1	DETERIORATED RINGS						
338+40	RT		1	DETERIORATED RINGS						
340+80	LT		1	DETERIORATED RINGS						
341+95	LT		1	-1"						
341+95	RT		1	DETERIORATED RINGS						
342+10	RT		1	DETERIORATED RINGS						
343+20	RT		1	-1"						
344+75	LT		1	DETERIORATED RINGS						
355+50	RT		1	DETERIORATED RINGS						
359+60	RT		1	DETERIORATED RINGS						
361+10	LT	1		ADJUST FOR SIDEWALK						
363+10	RT		1	DETERIORATED RINGS						
370+90	LT	1		ADJUST FOR SIDEWALK						
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	Anna Carlo Carlo State Carlo Car	EACH	EACH							

		DESIGNED - AF	REVISED 3/20/2012
	VILLAGE OF WOODRIDGE DEPARTMENT OF PUBLIC WORKS	DRAWN - AF	
j	1 Plaza Drive, Woodridge IL 60517 (89) 719-4753	CHECKED - JDS	
	I Flaza Dilve, Woodhage IL 00017 (as) 716-718	DATE - 1/24/2012	

STATE OF ILLINOIS
DEPARTMENT OF TRANSPORTATION

	F.A.P RTE.	SECTION	cou	NTY	TOTAL SHEETS	SHEET NO.
SCHEDULES	2593	12-00069-00-RS	DUPAGE		16	11
					CONTRACT	NO. 63703
SCALE: NONE STA. TO STA.				ILLINOIS	FEDERAL A	ID PROJECT

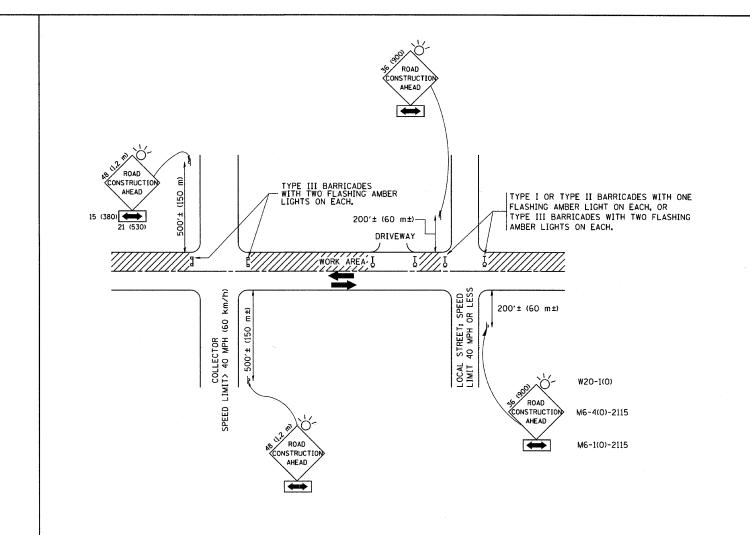

TRAFFIC CONTROL AND PROTECTION FOR SIDE ROADS, INTERSECTIONS, AND DRIVEWAYS

NOTES:

- A. FOR NO LANE RESTRICTION ON THE SIDE ROAD OR DRIVEWAYS
- 1. SIDE ROAD WITH A SPEED LIMIT OF 40 MPH (60 km/h) OR LESS AS SHOWN ON THE DRAWING AND AS DIRECTED BY THE ENGINEER:
- O) ONE ROAD CONSTRUCTION AHEAD SIGN 36 x 36 (900x900) WITH A FLASHER AND FLAG MOUNTED ON IT APPROXIMATELY 200' (60 m) IN ADVANCE OF THE MAIN ROUTE.
- b) THE CLOSED PORTION OF THE MAIN ROUTE SHALL BE PROTECTED BY BLOCKING WITH TYPE I, TYPE II OR TYPE III BARRICADES, 1/3 OF THE CROSS SECTION OF THE CLOSED PORTION.
- 2. SIDE ROAD WITH A SPEED LIMIT GREATER THAN 40 MPH (60 km/h) AS SHOWN ON THE DRAWING AND AS DIRECTED BY THE ENGINEERS
- a) ONE ROAD CONSTRUCTION AHEAD SIGN 48 x 48 (1.2 m x 1.2 m) WITH A FLASHER MOUNTED ON IT APPROXIMATELY 500' (150 m) IN ADVANCE OF THE MAIN ROLITE.
- b) THE CLOSED PORTION OF THE MAIN ROUTE SHALL BE PROTECTED BY BLOCKING WITH TYPE III BARRICADES, 1/2 OF THE CROSS SECTION OF THE CLOSED PORTION.
- 3. WHEN THE SIDE ROAD LIES BETWEEN THE BEGINNING OF THE MAINLINE SIGNING AND THE WORK ZONE, A SINGLE HEADED ARROW (M6-1) SHALL BE USED IN LIEU OF THE DOUBLE HEADED ARROW (M6-4).

B. FOR A LANE CLOSURE ON A SIDE ROAD OR DRIVEWAY:

- USE APPLICABLE PORTIONS OF THE TYPICAL APPLICATION OF TRAFFIC CONTROL DEVICES (STD. 701501, STD. 701606 OR THE APPROPRIATE STANDARD). THE SPACING OF SIGNS AND BARRICADES SHALL BE ADJUSTED FOR FIELD CONDITIONS AS DIRECTED BY THE ENGINEER. THE DIRECTIONAL ARROW SHALL BE COVERED OR REMOVED WHEN NO LONGER CONSISTENT WITH THE SIDE ROAD LANE CLOSURE.
- C. ADVANCE WARNING SIGNS ARE TO BE OMITTED ON DRIVEWAY UNLESS OTHERWISE NOTED.
- D. THE TRAFFIC CONTROL AND PROTECTION FOR SIDE ROADS, INTERSECTIONS, AND DRIVEWAYS SHALL BE INCIDENTAL TO THE COST OF SPECIFIED TRAFFIC CONTROL STANDARDS OR ITEMS.


All dimensions are in millimeters (inches) unless otherwise shown.

FILE NAME = USER NAME = goglionobt DESIGNED - LHA REVISED - J. OBERLE 10-18-95
Wi\diststd\22x34\tcl0xdgn - REVISED - A. HOUSEH 03-06-96
PLOT SCALE = 50.000 '/ IN. CHECKED - REVISED - A. HOUSEH 10-15-96
PLOT DATE = 1/4/2008 DATE - 06-89 REVISED - T. RAMMACHER 01-06-00

STATE OF ILLINOIS
DEPARTMENT OF TRANSPORTATION

TRAFFIC CONTROL AND PROTECTION FOR SIDE ROADS, INTERSECTIONS, AND DRIVEWAYS

SCALE: NONE SHEET NO. 1 OF 1 SHEETS STA. TO STA.

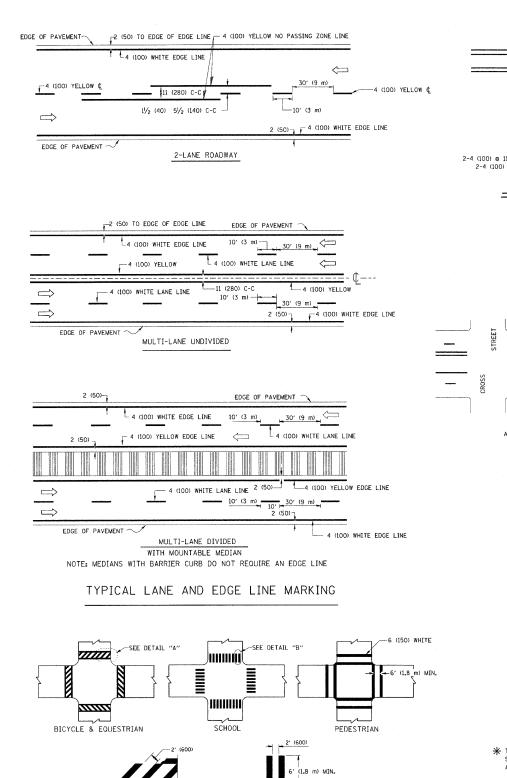


2-4 (100) YELLOW @ 11 (280) C-C

NO DIAGONALS

4' (1.2 m) OUTSIDE TO OUTSIDE OF LINES


2-4 (100) YELLOW @ 11 (280) C-C

4' (1.2 m) WIDE MEDIANS ONLY

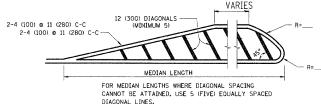


DIAGONAL LINE SPACING: 50' (15 m) C-C (LESS THAN 30MPH (50 km/h))
75' (25 m) C-C 30MPH (50 km/h) TO 45MPH (70 km/h))
150' (45 m) C-C (MORE THAN 45MPH (70 km/h))

MEDIANS OVER 4' (1.2 m) WIDE

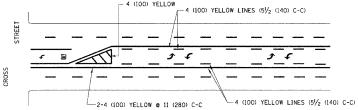


A MINIMUM OF TWO PAIRS OF TURN ARROWS SHALL BE USED, WHITE IN COLOR. ADDITIONAL PAIRS SHALL BE PLACED AT 200' (60 m) TO 300' (90 m) INTERVALS.

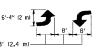

MEDIAN WITH TWO-WAY LEFT TURN LANE

TYPICAL PAINTED MEDIAN MARKING

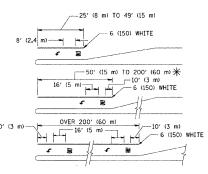


FULL SIZE LETTERS 8' (2.4 m) AND ARROWS SHALL BE USED. \P AREA = 15.6 SO. FT. (1.5 m²) M AREA = 20.8 SO. FT. (1.9 m²)

* TURN LANES IN EXCESS OF 400' (120 m) IN LENGTH MAY HAVE AN ADDITIONAL SET OF ARROW - "ONLY" INSTALLED MIDWAY BETWEEN THE OTHER TWO SETS OF ARROW - "ONLY".

TYPICAL LEFT (OR RIGHT) TURN LANE

TYPICAL TURN LANE MARKING

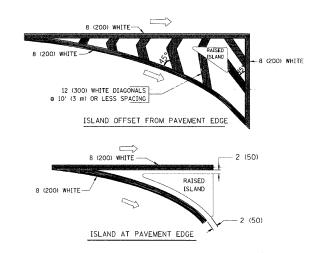

TYPICAL ISLAND MARKING

TYPE OF MARKING	WIDTH OF LINE	PATTERN	COLOR	SPACING / REMARKS
CENTERLINE ON 2 LANE PAVEMENT	4 (100)	SKIP-DASH	YELLOW	10' (3 m) LINE WITH 30' (9 m) SPACE
CENTERLINE ON MULTI-LANE UNDIVIDED PAVEMENT	2 @ 4 (100)	SOLID	YELLOW	11 (280) C-C
NO PASSING ZONE LINES: FOR ONE DIRECTION FOR BOTH DIRECTIONS	4 (100) 2 @ 4 (100)	SOLID SOLID	YELLOW YELLOW	5½ (140) C-C FROM SKIP-DASH CENTERLINE 11 (280) C-C OMIT SKIP-DASH CENTERLINE BETWEEN
LANE LINES	4 (100) 5 (125) ON FREEWAYS	SKIP-DASH SKIP-DASH	WHITE WHITE	10' (3 m) LINE WITH 30' (9 m) SPACE
DOTTED LINES (EXTENSIONS OF CENTER, LANE OR TURN LANE MARKINGS)	SAME AS LINE BEING EXTENDED	SKIP-DASH	SAME AS LINE BEING EXTENDED	2' (600) LINE_WITH 6' (1.8 m) SPACE
EDGE LINES	4 (100)	SOLID	YELLOW-LEFT WHITE-RIGHT	OUTLINE MOUNTABLE MEDIANS IN YELLOW; EDGE LINES ARE NOT USED NEXT TO BARRIER CURB
TURN LANE MARKINGS	6 (150) LINE; FULL SIZE LETTERS & SYMBOLS (8' (2.4m))	SOLID	WHITE	SEE TYPICAL TURN LANE MARKING DETAIL
TWO WAY LEFT TURN MARKING	2 @ 4 (100) EACH DIRECTION	SKIP-DASH AND SOLID	YELLOW	10' (3 m) LINE WITH 30' (9 m) SPACE FOR SKIP-DASH; 5½ (140) C-C BETWEEN SOLID LINE AND SKIP-DASH LINE
	8' (2.4m) LEFT ARROW	IN PAIRS	WHITE	SEE TYPICAL TWO-WAY LEFT TURN MARKING DETAIL
CROSSWALK LINES (PEDESTRIAN) A. DIAGONALS (BIKE & EQUESTRIAN) B. LONGITUDINAL BARS (SCHOOL)	2 g 6 (150) 12 (300) g 45° 12 (300) g 90°	SOLID SOLID SOLID	WHITE WHITE WHITE	NOT LESS THAN 6' (1.8 m) APART 2' (600) APART 2' (600) APART 5EE TYPICAL CROSSWALK MARKING DETAILS.
STOP LINES	24 (600)	SOLID	WHITE	PLACE 4' (1.2 m) IN ADVANCE OF AND PARALLEL TO CROSSWALK, IF PRESENT. OTHERWISE, PLACE AT DESIRED STOPPING POINT. PARALLEL TO CROSSROAD CENTERLINE, WHERE POSSIBLE
PAINTED MEDIANS	2 & 4 (100) WITH 12 (300) DIAGONALS & 45° NO DIAGONALS USED FOR 4' (1,2 m) WIDE MEDIANS	SOLID	YELLOW: TWO WAY TRAFFIC WHITE: ONE WAY TRAFFIC	11 (280) C-C FOR THE DOUBLE LINE SEE TYPICAL PAINTED MEDIAN MARKING.
GORE MARKING AND CHANNELIZING LINES	8 (200) WITH 12 (300) DIAGONALS @ 45°	SOLID	WHITE	DIAGONALS: 15' (4.5 m) C-C (LESS THAN 30MPH (50 km/h)) 20' (6 m) C-C (30MPH (50 km/h) TO 45MPH (70 km/h)) 30' (9 m) C-C (0VER 45MPH (70 km/h))
RAILROAD CROSSING	24 (600) TRANSVERSE LINES; "RR" IS 6' (1.8 m! LETTERS; 16 (400) LINE FOR "X"	SOLID	WHITE	SEE STATE STANDARD 780001 AREA OF: "R"=3.6 SQ. FT. (0.33 m²) EACH "X"=54.0 SQ. FT. (5.0 m²)
SHOULDER DIAGONALS	12 (300) @ 45°	SOLID	WHITE - RIGHT YELLOW - LEFT	50' (15 m) C-C (LESS THAN 30MPH (50 km/h)) 75' (25 m) C-C (30 MPH (50 km/h) TO 45MPH (70 km/h)) 150' (45 m)- C-C (0VER 45MPH (70 km/h))

FOR FURTHER DETAILS ON PAVEMENT MARKING REFER TO STANDARD SPECIFICATIONS FOR ROAD AND BRIDGE CONSTRUCTION AND STATE STANDARD 780001.

All dimensions are in inches (millimeters) unless otherwise shown.

FILE NAME =	USER NAME = drivakosgn	DESIGNED	~	EVERS	REVISED	-T. RAMMACHER	10-27-94
c:\pw_work\pwidot\drivakosgn\d0108315\tc	13.dgn	DRAWN	-		REVISED	-C. JUCIUS	09-09-09
	PLOT SCALE = 50.000 '/ IN.	CHECKED	-		REVISED	-	
	PLOT DATE = 9/9/2009	DATE	-	03-19-90	REVISED	-	

─12 (300) WHITE

DETAIL "B"


6 (150) WHITE

TYPICAL CROSSWALK MARKING

DETAIL "A"

STATE OF ILLINOIS
DEPARTMENT OF TRANSPORTATION


			F.A RTE.	SECTION	COUNTY	TOTAL SHEETS	SHEET NO.		
TYPICAL PAVEMENT MARKINGS				2593	12-00069-00-RS	DUPAGE	16	1.3	
ITFICAL FAVENCINI MARKINGS						TC-13	CONTRACT	NO. 63	703
SCALE: NONE	SHEET NO. 1 OF 1	SHEETS	STA.	TO STA.	FED. RO	DAD DIST. NO. 1 ILLINOIS FED. AL	D PROJECT		

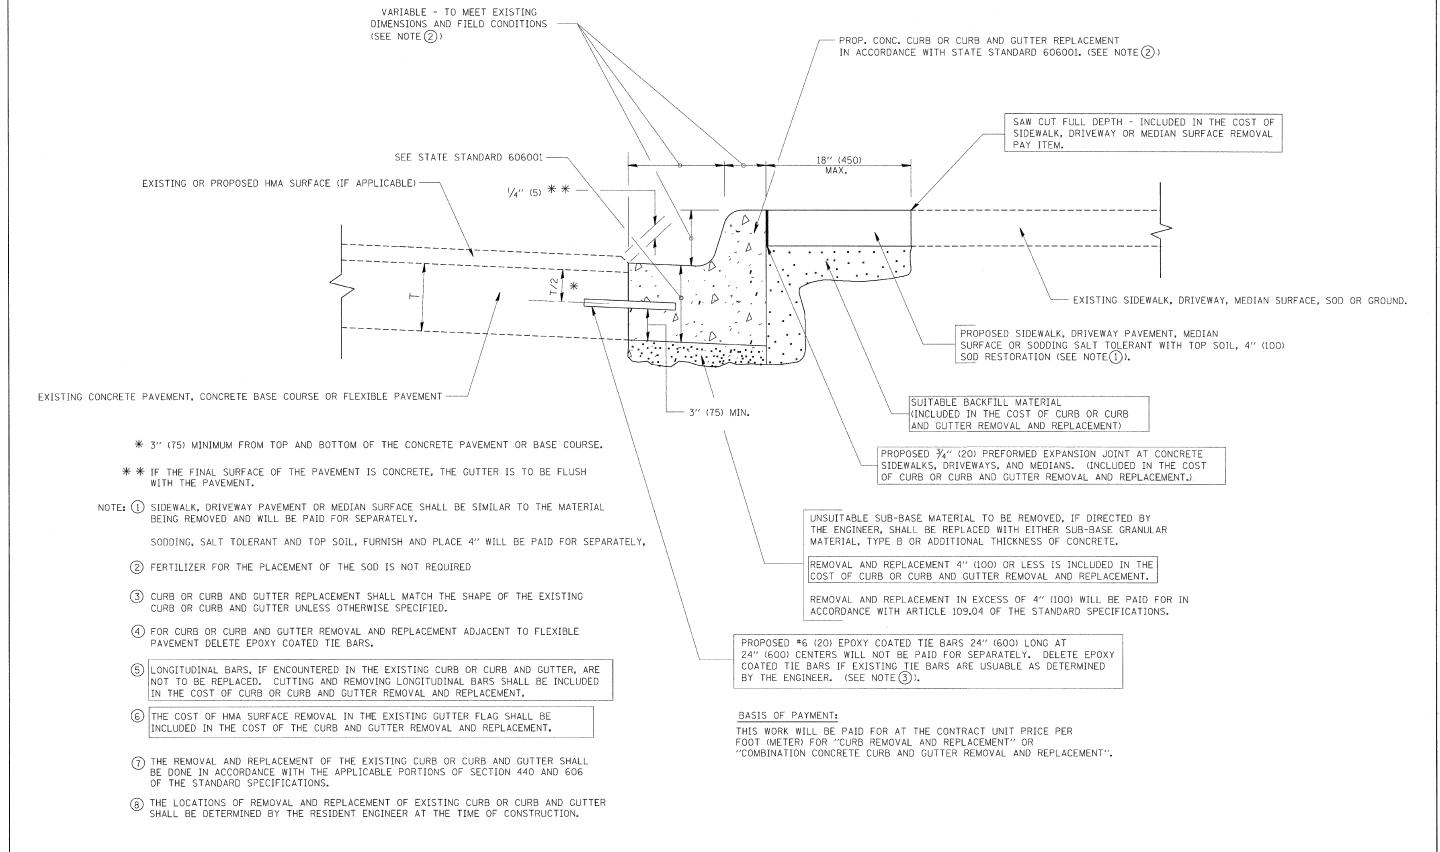


CURB OR CURB AND GUTTER REMOVAL AND REPLACEMENT

ALL DIMENSIONS ARE IN INCHES (MILLIMETERS) UNLESS OTHERWISE SHOWN.

ſ	FILE NAME =	USER NAME = drivakosgn	DESIGNED - A. HOUSEH	REVISED - R. SHAH 10-03-96		CURB OR CURB AND GUTTER	F.A. SECTION	COUNTY TOTAL SHEET SHEETS NO.
	c:\pw_work\pwidot\drivakosgn\d0108315\bd	4.dgn	DRAWN -	REVISED - A. ABBAS 03-21-97	STATE OF ILLINOIS		2593 12-00069-00-RS	DUPAGE 16 14
		PLOT SCALE = 50.000 '/ IN.	CHECKED -	REVISED - M. GOMEZ 01-22-01	DEPARTMENT OF TRANSPORTATION	REMOVAL AND REPLACEMENT	BD600-06 (BD-24)	CONTRACT NO. 63703
		PLOT DATE = 12/15/2009	DATE - 03-11-94	REVISED - R. BORO 12-15-09		SCALE: NONE SHEET NO. 1 OF 1 SHEETS STA. TO STA.		AID PROJECT

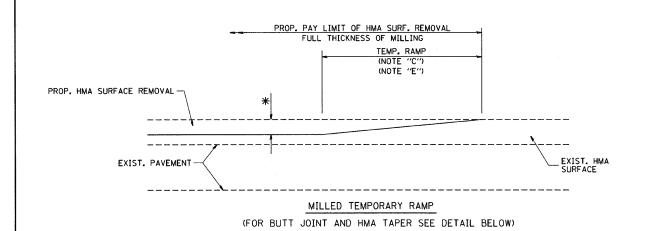

OPTION 1

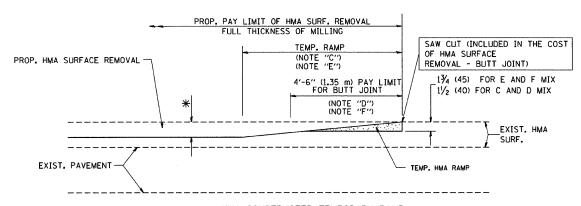


HMA CONSTRUCTED TEMPORARY RAMP

(FOR BUTT JOINT AND HMA TAPER SEE DETAIL BELOW)

OPTION 2

TYPICAL TEMPORARY RAMP

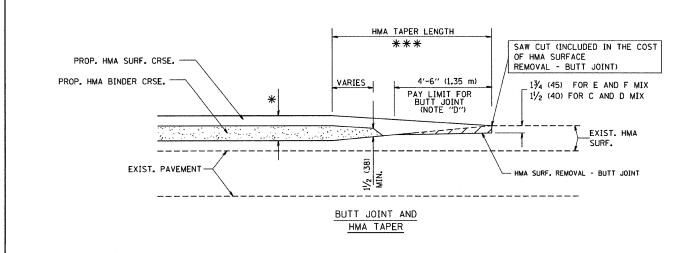

TYPICAL BUTT JOINT AND HMA TAPER FOR MILLING AND RESURFACING


FILE NAME = USER NAME = gaglanobt DESIGNED - M. DE YONG REVISED - R. SHAH 10-25-94


W:\diststd\22x34\bd32.dgn DRAWN - REVISED - A. ABBAS 03-21-97

PLOT SCALE = 50.0000 '/ IN. CHECKED - REVISED - M. GOMEZ 04-06-01

PLOT DATE = 1/4/2008 DATE - 06-13-90 REVISED - R. BORO 01-01-07

STATE OF ILLINOIS DEPARTMENT OF TRANSPORTATION

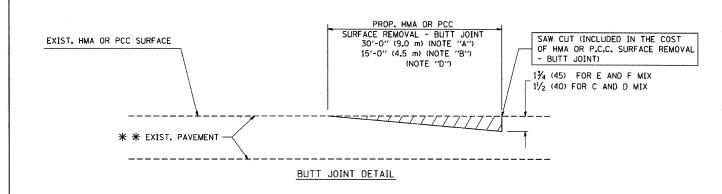

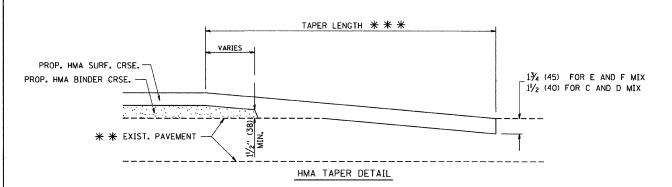

TYPICAL BUTT JOINT AND HMA TAPER FOR RESURFACING ONLY

* * PC CONCRETE, HMA OR HMA RESURFACED PAVEMENT.

NOTES

- A: MAINLINE ROADWAYS AND MAJOR SIDE ROADS.
- B: MINOR SIDE ROADS.
- C: THE TEMP. RAMP SHALL BE CONSTRUCTED IMMEDIATELY UPON REMOVAL OF THE EXISTING HMA SURFACE.
- D: THE BUTT JOINT SHALL BE CONSTRUCTED IMMEDIATELY PRIOR TO PLACING THE PROPOSED HMA COURSES.
- E: TAPER THE TEMP. RAMP AT A RATE OF 3'-0" (900 mm) PER 1 INCH (25 mm) OF MILLING THICKNESS.
- F: INSTALLATION AND REMOVAL OF THE 4'-6" (1.35 m) TEMP. RAMP IS INCLUDED IN COST OF HMA SURFACE REMOVAL BUTT JOINT
- G: SEE ARTICLE 406.08 AND 406.14 OF THE STANDARD SPECIFICATIONS FOR "HMA AND/OR PCC SURFACE REMOVAL, BUTT JOINT".
- * SEE TYPICAL SECTIONS FOR MILLING THICKNESS.
- ** * * * 20'-0" (6.1 m) PER 1 (25) RESURFACING (NOTE "A") 10'-0" (3.0 m) PER 1 (25) RESURFACING (NOTE "B")

BASIS OF PAYMENT:

THE BUTT JOINT WILL BE PAID FOR AT THE CONTRACT UNIT PRICE PER SQUARE YARD (SQUARE METER) FOR "HOT-MIX ASPHALT SURFACE REMOVAL - BUTT JOINT" OR FOR "PORTLAND CEMENT CONCRETE SURFACE REMOVAL- BUTT JOINT".

ALL DIMENSIONS ARE IN INCHES (MILLIMETERS) UNLESS OTHERWISE SHOWN.

PROVIDE A PAVEMENT REPLACEMENT NOTE WHICH SHOULD EQUAL 3' (900 mm) X WIDTH OF PAVED SHOULDER. PAVED OR NON-PAVED SHOULDER PAVED OR NON-PAVED SHOULDER 1'' (25 mm) UNIT DUCT TRENCHED TO E/P ** * * UNIT DUCT IS TO BE SHOWN ON PLAN SHEETS BUT SHALL NOT BE INCLUDED IN THE PAY ITEMS.

LEFT TURN LANES WITH MEDIANS VOLUME DENSITY ("FAR OUT" DETECTION) ON SAME APPROACH

(PROTECTED / PERMITTED LEFT TURN PHASING)


HANDHOLE LOCATION MAY
VARY DEPENDING ON GEOMETRICS
AND DESIGN OF TRAFFIC SIGNALS,
HEAVY-DUTY HANDHOLES TO BE
HEAVY-DUTY HANDHOLES TO BE

HANDHOLE LOCATION MAY
VARY DEPENDING ON GEOMETRICS
AND DESIGN OF TRAFFIC SIGNALS,
HEAVY-DUTY HANDHOLES TO BE
USED WHEN THE MEDIAN IS
MOUNTABLE, REFER TO STANDARD
BI40OIT OT ENSURE THAT HANDHOLE
FITS IN MEDIAN.

TRENCHED 1" (25 mm)

UNIT DUCT (3) **

*

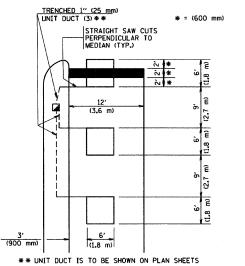


BUT SHALL NOT BE INCLUDED IN THE PAY ITEMS.

NOTE: DUAL LEFT TURNS NOT SHOWN REFER TO PLAN SHEET FOR DETECTOR LOOP REPLACEMENT

LEFT TURN LANES WITHOUT MEDIANS VOLUME DENSITY ("FAR OUT" DETECTION) ON SAME APPROACH

(PROTECTED / PERMITTED LEFT TURN PHASING)

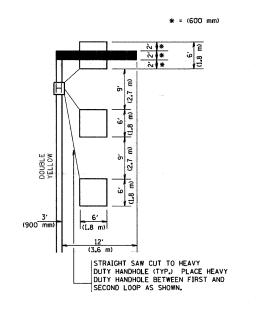



NOTE: DUAL LEFT TURNS NOT SHOWN REFER TO PLAN SHEET FOR DETECTOR LOOP REPLACEMENT

SCALE: NONE

ARTERIAL-VOLUME DENSITY ("FAR OUT" DETECTION)
CROSS STREET-VOLUME DENSITY ("FAR OUT" DETECTION)

ARTERIAL-VOLUME DENSITY ("FAR OUT" DETECTION)
CROSS STREET-NON VOLUME DENSITY ("UPTIGHT" PRESENCE DETECTION)

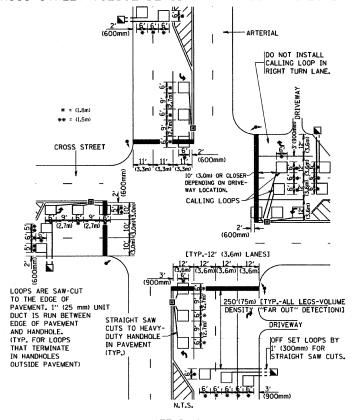

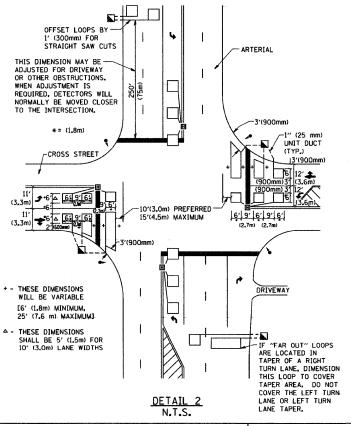

NOTES:

VEHICLES LOOP DETECTORS

- * ALL LEAD IN CABLE SHALL BE TWO CONDUCTOR NO. 14 TWISTED. SHIELDED.
- * EACH DETECTOR LOOP SHALL HAVE ITS OWN SAW CUT FROM THE LOOP TO THE EDGE OF PAVEMENT OR TO A HANDHOLE IN THE PAVEMENT.
- * EACH DETECTOR LOOP SHALL HAVE ITS OWN ONE INCH (25 mm) UNIT DUCT BETWEEN THE EDGE OF PAVEMENT AND THE FIRST HANDHOLE OR JUNCTION BOX. EACH UNIT DUCT RUN SHALL BE SHOWN ON THE PLANS BY THE DESIGNER, BUT SHALL NOT BE PAID FOR SEPARATLY. THIS ITEM IS INCIDENTAL TO THE PAY ITEM FOR DETECTOR LOOPS.
- * ONE DIMENSION OF <u>ALL</u> DETECTOR LOOPS SHALL BE SIX FEET (1.8-m)-
- * EACH LANE OF NON-LOCKING, PRESENCE DETECTION AND EACH LANE OF A DOUBLE LEFT TURN LANE REQUIRES A SEPARATE INDUCTIVE LOOP DETECTOR AND LEAD IN CABLE.
- * WHEN NON-LOCKING, PRESENCE DETECTION IS USED, MORE THAN ONE LOOP PER LANE IS REQUIRED BEHIND THE STOP BAR (i.e. 1-1/2, 1-3/4, 2).
- * WHEN SYSTEM LOOPS ARE REQUIRED ON AN APPROACH OF AN INTERSECTION, THE LOOPS USED FOR VOLUME DENSITY AND INTERSECTION TIMING SHALL ALSO BE USED AS SYSTEM DETECTORS. EACH ONE OF THESE TYPE OF LOOPS REQUIRES A SEPARATE TWO CONDUCTOR NO. 14 TWISTED SHIELDED CABLE AND A SEPARATE INDUCTIVE LOOP DETECTOR WHEN NEW CONTROLLERS ARE UTILIZED. THE DESIGNER SHALL LABEL THESE TYPES OF LOOPS AS "INTERSECTION AND SAMPLING (SYSTEM) DETECTORS" ON THE SIGNAL LAYOUT, THE INTERCONNECT PLAN AND THE SYSTEM CABLE PLAN. WHEN AN EXISTING CONTROLLER IS UTILIZED FOR THIS TYPE OF DETECTION, THE PAY ITEM "INDUCTIVE LOOP DETECTOR WITH SYSTEM OUTPUT" SHOULD BE USED.

PLACEMENT OF DETECTORS

THE FOLLOWING FIGURES REPRESENT THE MOST COMMON DETECTOR LOOP LOCATIONS AND SIZES. ADJUSTMENTS WILL BE NECESSARY FOR SPECIFIC GEOMETRIC CONSIDERATIONS.

LOCATIONS AND DEMENSIONS OF DETECTOR LOOPS ARE REQUIRED ON $\underline{\mathsf{ALL}}$ SIGNAL LAYOUT PLAN SHEETS.

"FAR OUT" DETECTION REFERS TO LOCKING, PRESENCE TYPE DETECTION LOCATED IN THRU LANES, RIGHT TURN LANES, AND RIGHT TURN LANE TAPER AREAS (IF APPLICABLE), USUALLY 250' (75 m) IN ADVANCE OF STOP BARS. "UPTIGHT" DETECTION REFERS TO NON-LOCKING PRESENCE TYPE DETECTION LOCATED IN ALL LANES AND 10'-15' (3.0 m-4.5 m) BEHIND THE CROSSING STREET'S EDGE OF PAVEMENT EXTENDED.

NOTE:

ALL DETAILS AND NOTES SHOWN ARE FROM THE I.D.O.T. DISTRICT 1
TRAFFIC SIGNAL DESIGN GUIDELINES DATED JANUARY 1995

THIS DRAWING HAS BEEN PREPARED TO ASSIST THE RESIDENT ENGINEER FOR ALL ROADWAY RESURFACING OR S.M.A.R.T. PROJECTS WHERE THE DIMENSIONS ARE NOT SHOWN ON THE PLANS AND THE FINAL LOCATIONS FOR CROSSWALKS OR STOP BARS ARE NOT DETERMINED.

	FILE NAME =	USER NAME = gaglianobt	DESIGNED -	REVISED -
1	Wi\diststd\22x34\ts07.dgn		DRAWN -	REVISED -
		PLOT SCALE = 50.0000 '/ IN.	CHECKED - R.K.F.	REVISED -
		PLOT DATE = 1/4/2008	DATE -	REVISED -

STATE OF ILLINOIS
DEPARTMENT OF TRANSPORTATION

DISTRICT 1 - DETECTOR LOOP INSTALLATION	
DETAILS FOR ROADWAY RESURFACING	2593
DETAILS FOR NOADWAT BESON AGING	
SHEET NO. 1 OF 1 SHEETS STA. TO STA.	FFD. RO