06-15-12 LETTING ITEM 008

FOR INDEX OF SHEETS, SEE SHEET NO. 2

TRAFFIC DATA

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0

EXISTING ADT = 7.800 - 13.600SPEED LIMIT = 30 - 50 MPH

EXISTING ADT = 8.900 - 14.700SPEED LIMIT = 35 - 45 MPH

EXISTING ADT = 5.600 - 10.300SPEED LIMIT = 55 MPH

EXISTING ADT = 12.500 - 17.300 SPEED LIMIT = 55 MPH


EXISTING ADT = 5.700 - 7.800 SPEED LIMIT = 35-55 MPH

EXISTING ADT = 9.600SPEED LIMIT = 45 MPH

EXISTING ADT = 7.400 - 9.300SPEED LIMIT = 40 - 55 MPH

EXISTING ADT = 12,200 SPEED LIMIT = 55 MPH

THE PROJECT IS LOCATED IN THE CITIES OF ELGIN, GENEVA, AND ST. CHARLES AND IN THE VILLAGES OF CAMPTON HILLS, EAST DUNDEE, LILY LAKE, MONTGOMERY, PINGREE GROVE SUGAR GROVE AND WEST DUNDEE.

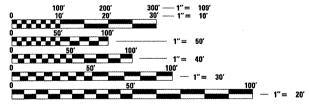

ENGINEERING SCALES. REDUCED SIZED PLANS WILL NOT CONFORM TO STANDARD SCALES, IN MAKING MEASUREMENTS ON REDUCED PLANS, THE ABOVE SCALES MAY BE USED.

JOINT UTILITY LOCATION INFORMATION FOR EXCAVATION 1-800-892-0123 OR 811


PROJECT ENGINEER: PETER JOHNSTON (GRAEF) 773–399–0112 PROJECT MANAGER: KEN ENG (IDOT) 847-705-4247

STATE OF ILLINOIS

DEPARTMENT OF TRANSPORTATION DIVISION OF HIGHWAYS

PROPOSED HIGHWAY PLANS

VARIOUS ROUTES SECTION 2011-025-GRR VARIOUS LOCATIONS IN KANE COUNTY GUARDRAIL IMPROVEMENTS PROJECT : H5IP-0005 (891) KANE COUNTY C-91-493-11

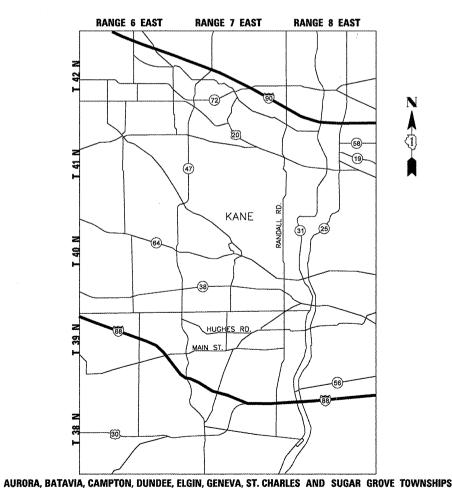



GREEF 8501 W. Higgins Road; Suite 280 Chicago, Illinois 60671

KANE 19 1 2011-025-GRR ILLINOIS CONTRACT NO. 60P25

D-91-493-11



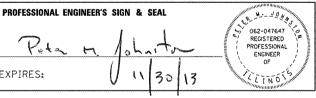

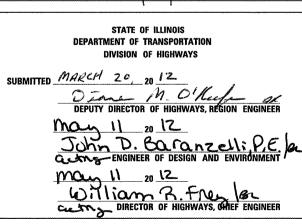

PRINTED BY THE AUTHORITY OF THE STATE OF ILLINOIS

CONTRACT NO. 60P25

INDEX OF SHEETS

SHEET

DESCRIPTION

1 COVER SHEET

2 INDEX. HIGHWAY STANDARDS, AND GENERAL NOTES

3 SUMMARY OF QUANTITIES

4 LOCATION MAP

5-15 ROADWAY PLAN

16 CURB OR CURB AND GUTTER REMOVAL AND REPLACEMENT (BD24)

17 DETAILS FOR DEPRESSED CURB AND GUTTER AND SHOULDER TREATMENT AT 181 TY 1 SPL (8034).

18 TRAFFIC CONTROL AND PROTECTION FOR SIDE ROADS, INTERSECTIONS, AND DRIVEWAYS (TC 10)

19 ARTERIAL ROAD INFORMATION SIGNING (TC22)

HIGHWAY STANDARDS

STD NO. TITLE

630001-10 STEEL PLATE BEAM GUARDRAIL

630101 - 09 GUARDRAIL MOUNTED ON EXISTING CULVERTS

630201-06 PCC/HMA STABILIZATION AT STEEL PLATE BEAM GUARDRAIL

630301 - 05 SHOULDER WIDENING FOR TYPE 1 (SPECIAL) GUARDRAIL TERMINALS

631011-09 TRAFFIC BARRIER TERMINAL, TYPE 2.

631031-10 TRAFFIC BARRIER TERMINAL, TYPE 6

635006-03 REFLECTOR AND TERMINAL MARKER PLACEMENT

835011 - 02 REFLECTOR MARKER AND MOUNTING DETAILS

701006 - 03 OFF-ROAD OPERATIONS, 2L, 2W, 15 (4.5 m) TO 24" (600 mm) FROM PAVEMENT EDGE

701101-02 OFF-ROAD OPERATIONS, MULTILANE, 15 (4.5 m) TO 24" (600 mm) FROM PAVEMENT EDGE

701301 - 04 LANE CLOSURE, 2L, 2W, SHORT TIME OPERATIONS

701328 - 04 LANE CLOSURE, 2L, 2W, PAYEMENT WIDENING, FOR SPEEDS > 45 MPH

701422-04 LANE CLOSURE, MULTILANE, FOR SPEEDS × 45 MPH TO 55 MPH

701901 - 02 TRAFFIC CONTROL DEVICES

GENERAL NOTES

- BEFORE STARTING ANY EXCAVATION, THE CONTRACTOR SHALL CALL "J.U.L.L.E."
 AT 800-892-0123 OR "CUAN" (CHICAGO UTILITY ALERT NETWORK), 312-744-7000
 FOR FIELD LOCATIONS OF BURIED ELECTRIC, TELEPHONE AND GAS FACILITIES
 (48 HOUR NOTIFICATION IS REQUIRED).
- THE CONTRACTOR SHALL COORDINATE CONSTRUCTION ACTIVITIES WITH UTILITY COMPANIES AND LOCAL AGENCIES.
- 3. THE CONTRACTOR WILL NOT BE ALLOWED TO SET UP A YARD OR FIELD OFFICE ON STATE PROPERTY WITHOUT WRITTEN PERMISSION FROM THE DEPARTMENT.
- THE CONTRACTOR SHALL CONTACT THE TRAFFIC CONTROL SUPERVISOR AT (847) 705-4470 A MINIMUM 72 HOURS IN ADVANCE OF BEGINNING WORK.
- 5. WHEN GUARDRAIL POSTS ARE PLACED BEHIND CONCRETE HEADWALLS, THE POSTS SHALL NOT BE PLACED TO BLOCK THE DRAINAGE OPENING.
- 6. THE CONTRACTOR SHALL ONLY PERFORM WORK ON ONE SIDE OF THE ROAD AT ANY TIME.
- THE CONTRACTOR SHALL SUSPEND GUARDRAIL REMOVAL OPERATIONS WHENEVER THE AMOUNT OF REMOVED GUARDRAIL EXCEEDS TWO DAYS PRODUCTION TO REPLACE THE GUARDRAIL.

UBBON 10% STATE

	v	- 32	0.000	LIRBAN	iñ% SIVii
	PAY ITEM NUMBER	DESCRIPTION	UNIT	TOTAL QUANTITY	0021 SAFETY
	20200600	EXCAVATING AND GRADING EXISTING SHOULDER	UNIT	52	52
	21101615	TOPSOIL FURNISH AND PLACE, 4"	SQ YO	2,485	2,485
	25000210	SEEDING, CLÁSS ZA	ACRE	0.47	0.47
	25000400	NITROGEN FERTILIZER NUTRIENT	POUND	45	45.
	25000500	PHOSPHORUS FERTILIZER NUTRIENT	POUND	46	45
					Marie.
	25000600	POTASSIUM FERTILIZER NUTRIENT	POUND	45	*, 4 5 :
	25100630	EROSION CONTROL BLANKET	SQYD	2,295	2,295
	25200110	SODDING, SALT TOLERANT	έ Ω γρ	189	189
	42001800	PROTECTIVE COAT	8Q YD	100	150
	44000500	COMBINATION CURB AND GUTTER REMOVAL	FOOT	449	449
	Rafficial that the second seco			*	
	48101620	AGGREGATE SHOULDERS, TYPE B 10%	sayo	3,480	3,480
-	160605000	COMBINATION CONCRETE CURB AND GUTTER, TYPE 8-6:24	FOOT	449	449
	63000001	STEEL PLATE BEAM GUARD RAIL, TYPE A 6 FOOT POSTS	FOOT	500	500
	63100045	TRAFFÍC BARRIER TÉRMINAL, TYPE 2	ÉACH	<u>.</u>	

4.	44.96.35	W 4- 1	5 Acres	5.	Autoria Autoria	5.90	Sec. 2011	22.00
*	TYPE 1	1.7	TEC	C.1	PECIAL	TV	m	28.4
		NX.2	120	100			3.8.2	1471

Δ NON-PARTICIPATING (100% STATE)

				UKBAN	10% STA
	Y ITEM JMBER	DESCRIPTION	UNIT	TOTAL QUANTITY	0021 SAFETY
5	3100085	TRAFFIC BARRIER TERMINAL, TYPE 6	EAOH	4.	4
6	3100167	TRAFFIC BARRIER TERMINAL, TYPE 1 (SPECIAL) TANGENT	EACH	\$ 51	6
6	3200310	ĞUARDRAIL REMOVAL	FÖÖŤ	2,806	2,806
6	7000400	ENGINEERS FIELD OFFICE, TYPE A	CALMO		•
6	7100100	MOBILIZATION	LSUM	je je	3.4
7/	0100320	TRAFFIC CONTROL AND PROTECTION, STANDARD 701422	LSUM	j	
			2 2		
7	0100500	TRAFFIC CONTROL AND PROTECTION, STANDARD 701326	LSUM	1	
7	8200420	GUARDRAIL MARKERS, TYPE B	EACH	8	8
7	8201000	TERMINAL MARKER DIRECT APPLIED	EACH	62	œ.
×	2503160	MOWING	ÜNIT	207	207
Z	0030850	TEMPORARY INFORMATION SIGNING	SQFT	207	257
z	0048665	RAILROAD PROTECTIVE LIABILITY INSURANCE	LSUM		


^{*} DENOTES SPECIALTY ITEM

GRaEF 8501 W. Higgins Rood; Suite 280 Chicago, Illinois 60631 (773) 399-0112	USER NAME = _USER_	DESIGNED -	EF	REVISED -	
		DRAWN	EF	REVISED -	
		PLOT SCALE = 100 '/ IN.	CHECKED -	RS	REVISED -
		PLOT DATE = 3/26/2012	DATE	03/22/2012	REVISED -

STATE	OF	ILLINOIS	
DEPARTMENT (DF 1	TRANSPORTATION	

	GUARDRAIL IMPROVEMENT	F.A. RTE.	SECTION	COUNTY	TOTAL SHEETS	SHEET NO.		
	SUMMARY OF QU	٠	2011-025-GRR	KANE	19	3		
	JOHNMAN OF W	+ V.	ARIOUS ROUTES	CONTRACT	NO. 6	0P25		
SCALE: 50	SHEET NO. 1 OF 1 SHEETS	STA.	TO STA.		ILLINOIS FED. AI	D PROJECT		,

Δ NON-PARTICIPATING (100% STATE)

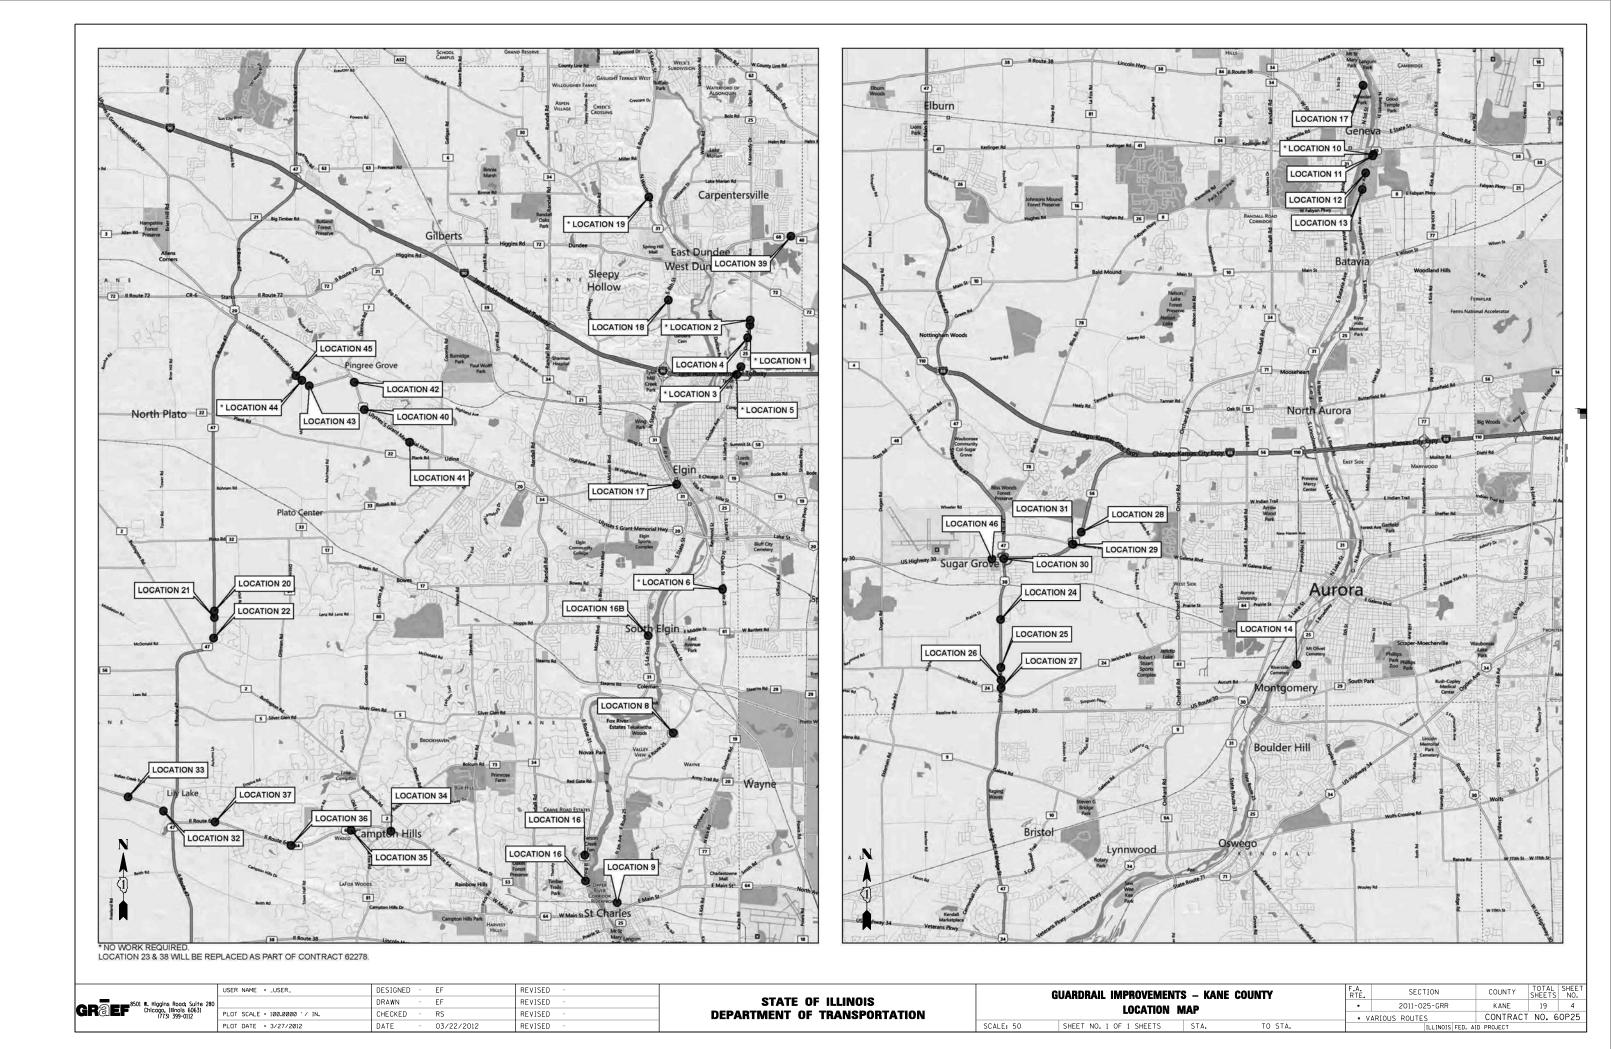

STATE OF ILLINOIS

DEPARTMENT OF TRANSPORTATION

DESIGNED - EAF

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USER NAME = _USER_

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PLOT DATE = 3/19/2012

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REVISED

TOTAL SHEET NO.

CONTRACT NO. 60P25

COUNTY

KANE

2011-025-GRR

* VARIOUS ROUTES

GUARDRAIL IMPROVEMENTS - KANE COUNTY

ROADWAY PLANS

SCALE: 1" = 30' SHEET NO. 1 OF 11 SHEETS STA.

GRAEF 8501 W. Higgins Road; Suite 280 Chicago, Illinois 60631 (773) 399-0112


- EAF REVISED - RS - 03/22/2012 PLOT SCALE = 60.0000 '/ IN. CHECKED REVISED REVISED PLOT DATE = 3/19/2012


DEPARTMENT OF TRANSPORTATION


ROADWAY PLANS SCALE: 1" = 30' SHEET NO. 2 OF 11 SHEETS STA.

COUNTY TOTAL SHEET NO.

KANE 19 6 2011-025-GRR CONTRACT NO. 60P25 * VARIOUS ROUTES

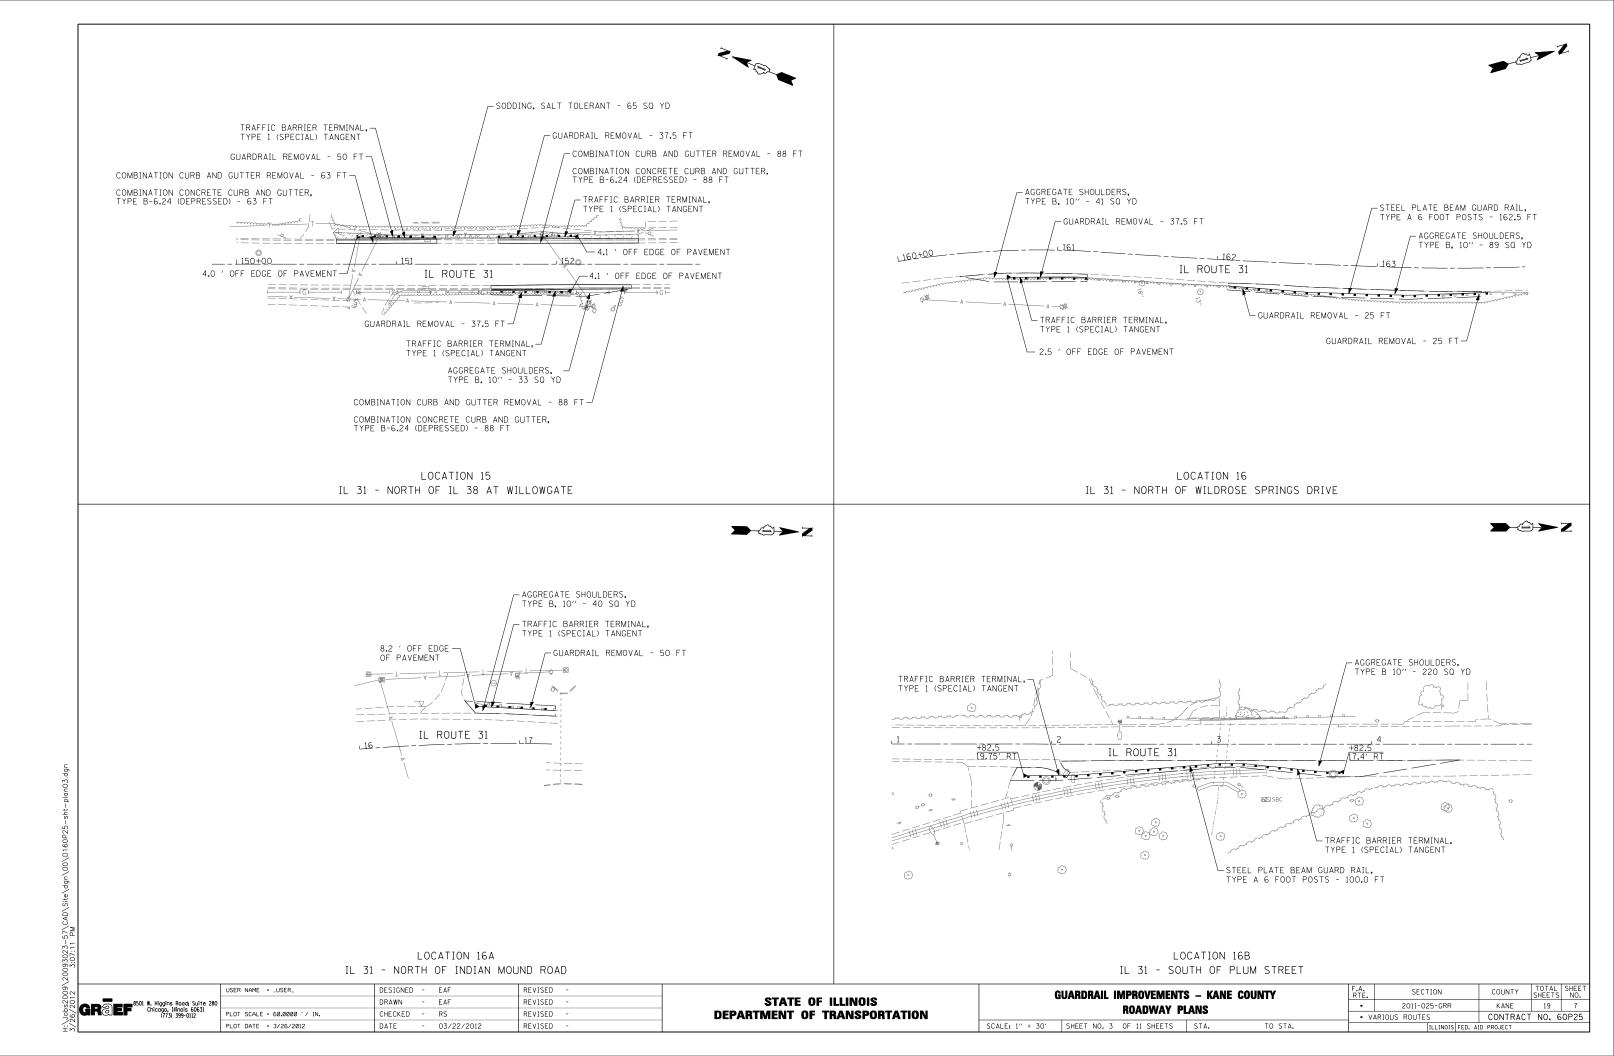

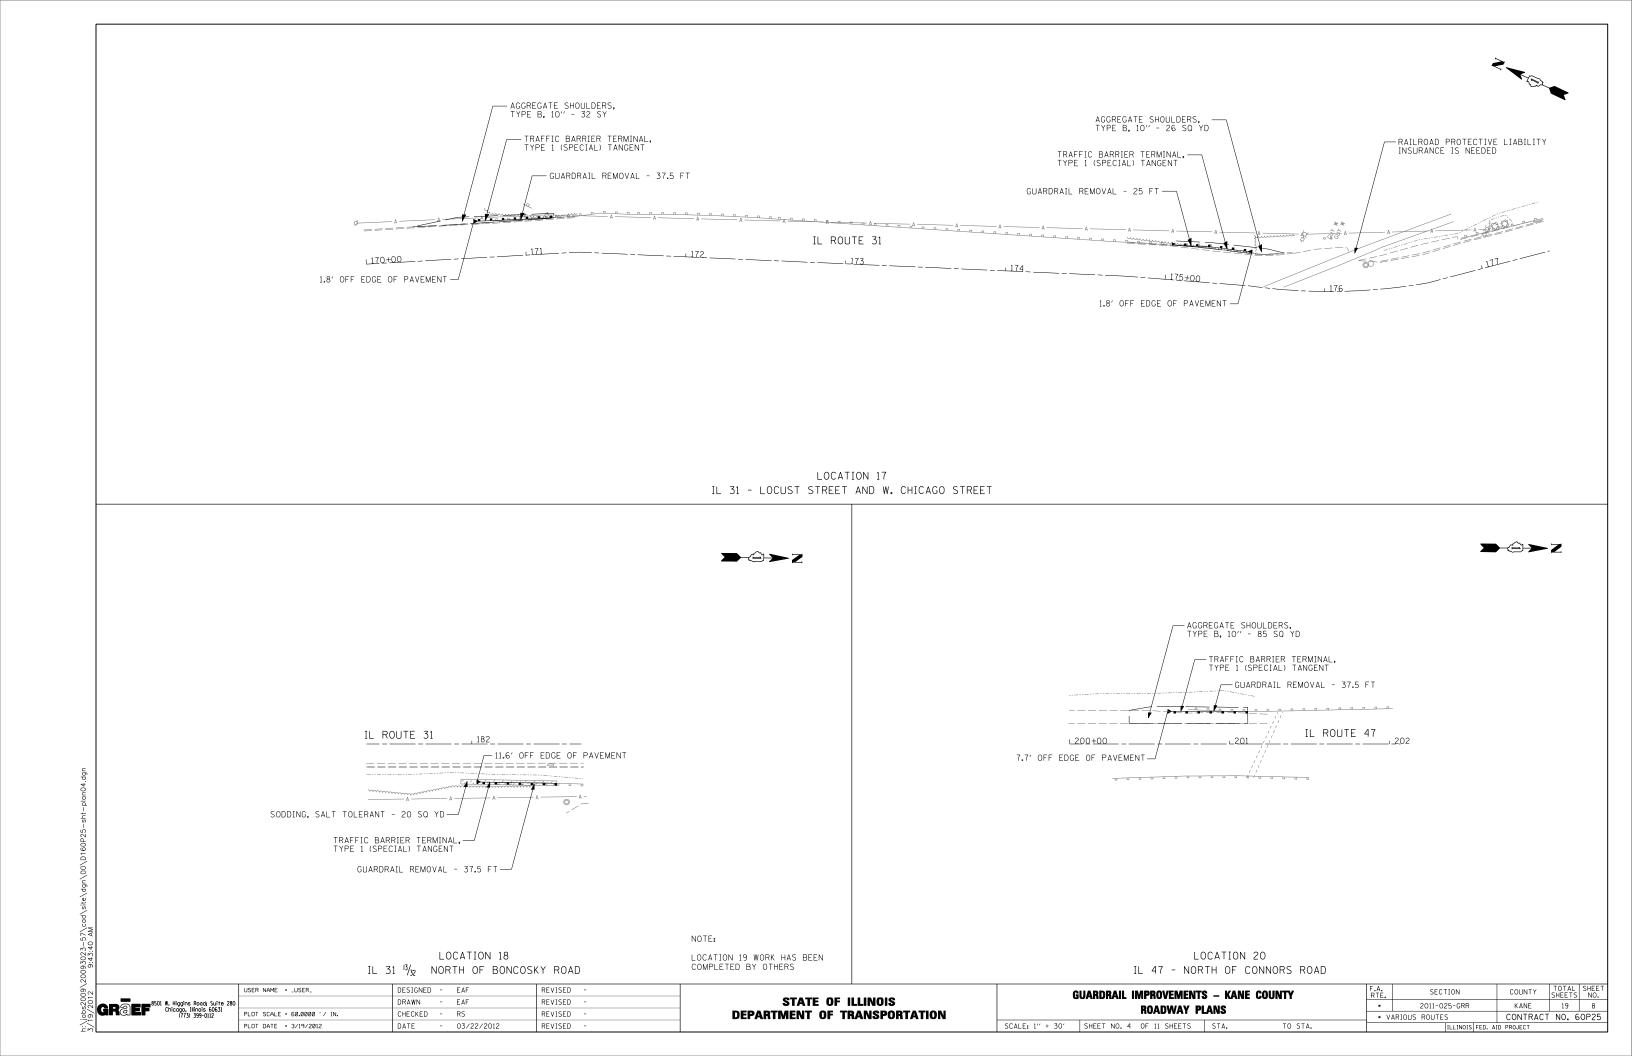

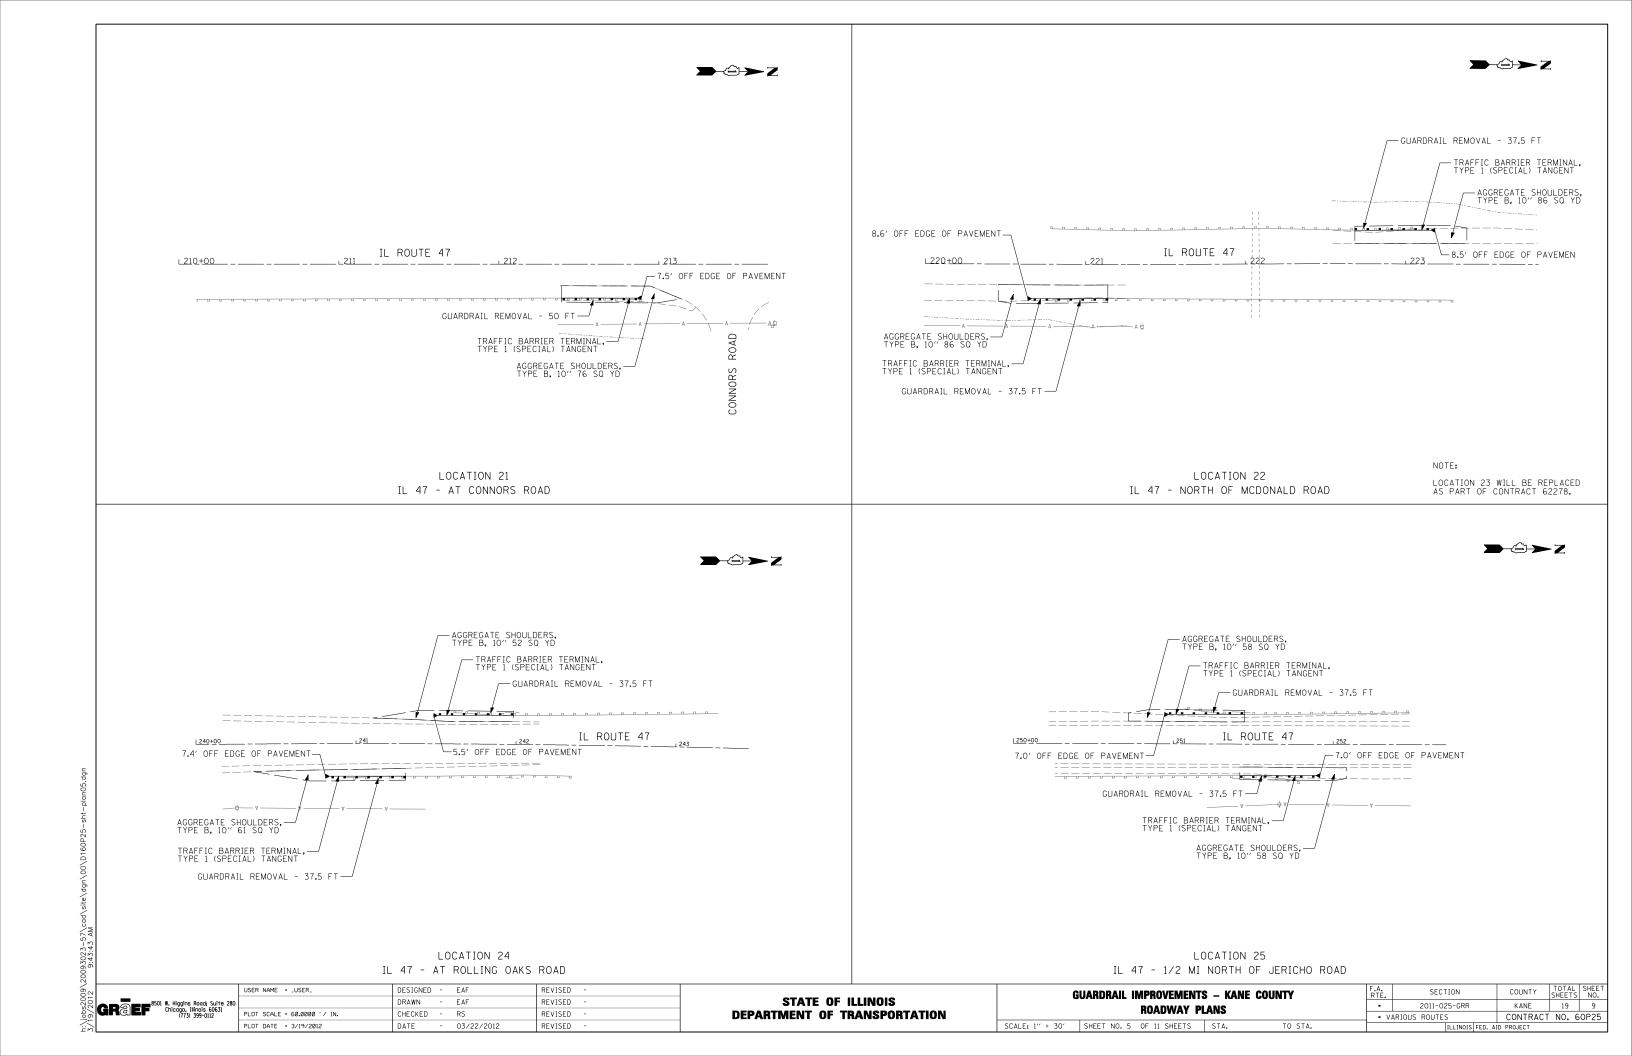

6.3' OFF EDGE OF PAVEMENT

AGGREGATE SHOULDERS,
TYPE B, 10" 61 SO YD

IL ROUTE 47

AGGREGATE SHOULDERS,
TYPE B, 10" 64 SO YD


GUARDRAIL REMOVAL - 37.5 FT

TRAFFIC TERMINAL BARRIER,
TYPE B, 10" 64 SO YD

TRAFFIC TERMINAL BARRIER,
TYPE I (SPECIAL) TANGENT

LOCATION 26 IL 47 - 1/4 MI NORTH OF JERICHO ROAD

→⊕→Z

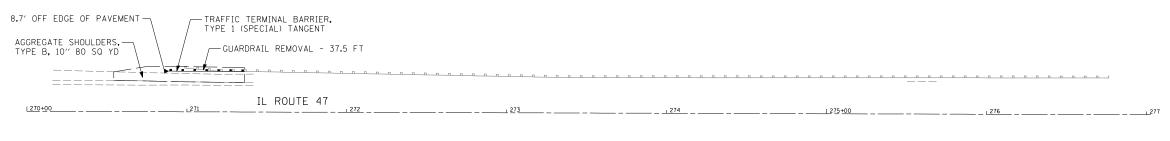

LOCATION 27 IL 47 - 500' NORTH OF JERICHO ROAD

GRAEF 8501 W. Higgins Road; Sulte 280 Chicago, Illinois 60631 (773) 399-0112

STATE OF ILLINOIS DEPARTMENT OF TRANSPORTATION

GUARDRAIL IMPROVEMENTS - KANE COUNTY
ROADWAY PLANS


SCALE: 1" = 30' SHEET NO. 6 OF 11 SHEETS STA. TO STA.


F.A. SECTION COUNTY SHEETS NO.


2011-025-GRR KANE 19 10


• VARIOUS ROUTES CONTRACT NO. 60P25


SCALE: 1" = 30' SHEET NO. 6 OF 11 SHEETS STA. TO STA.

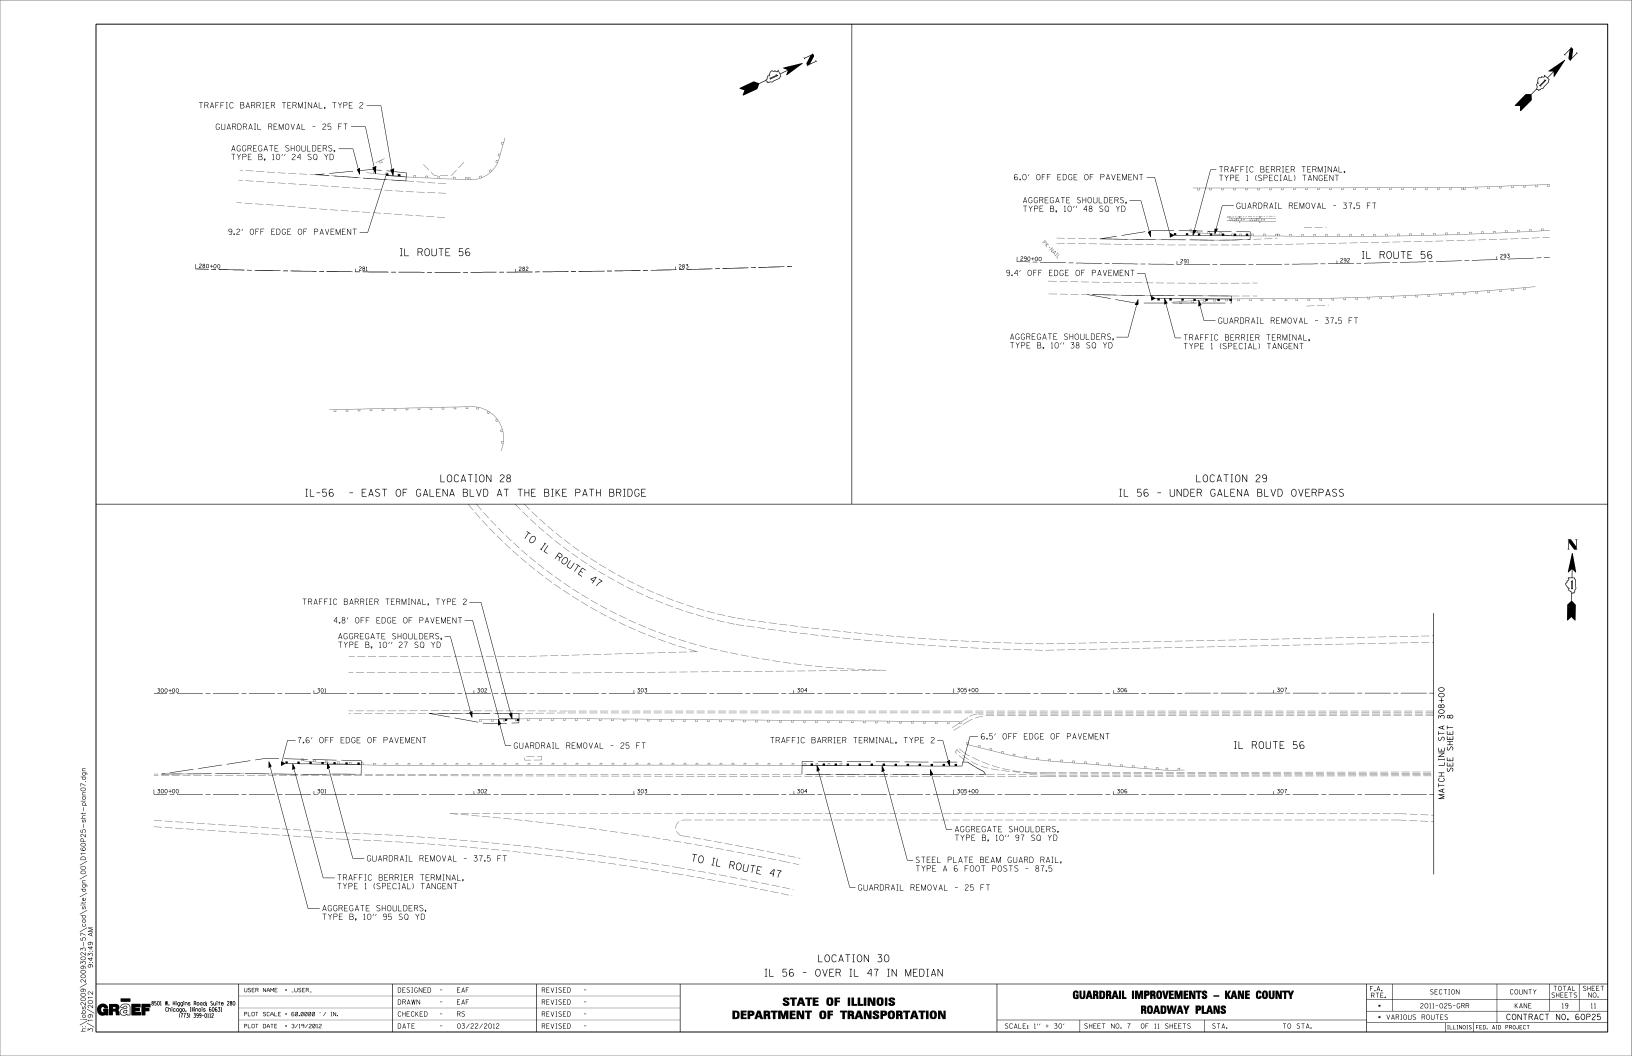


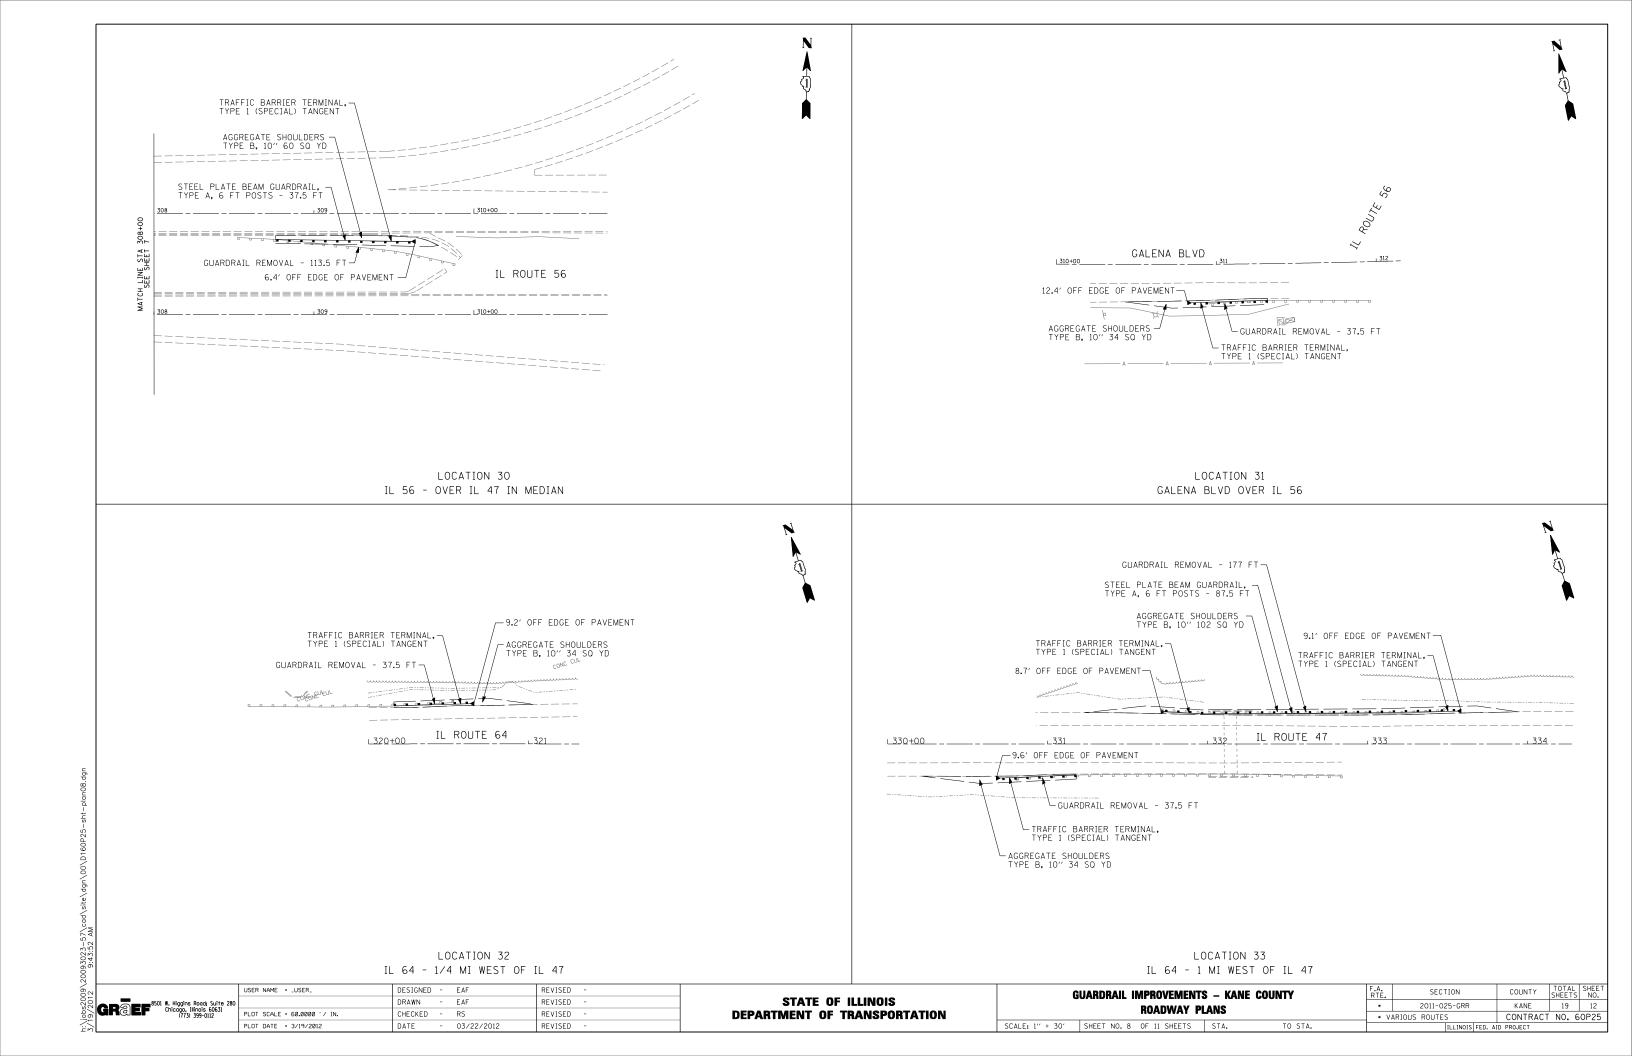

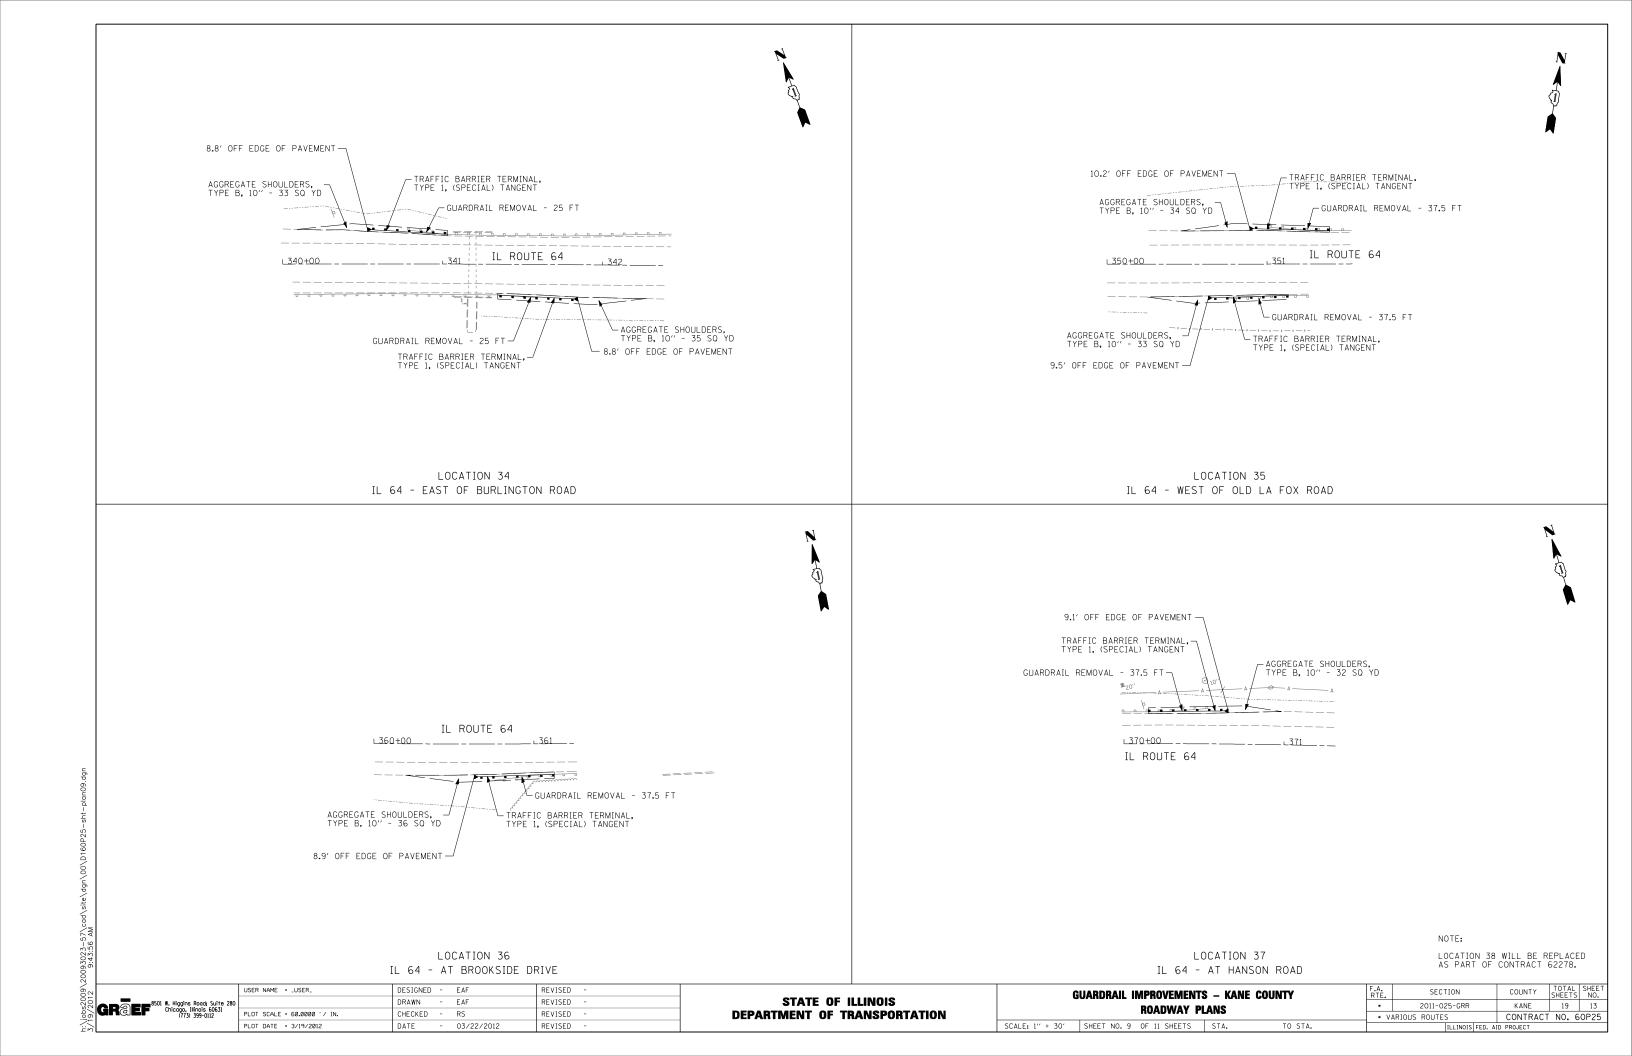

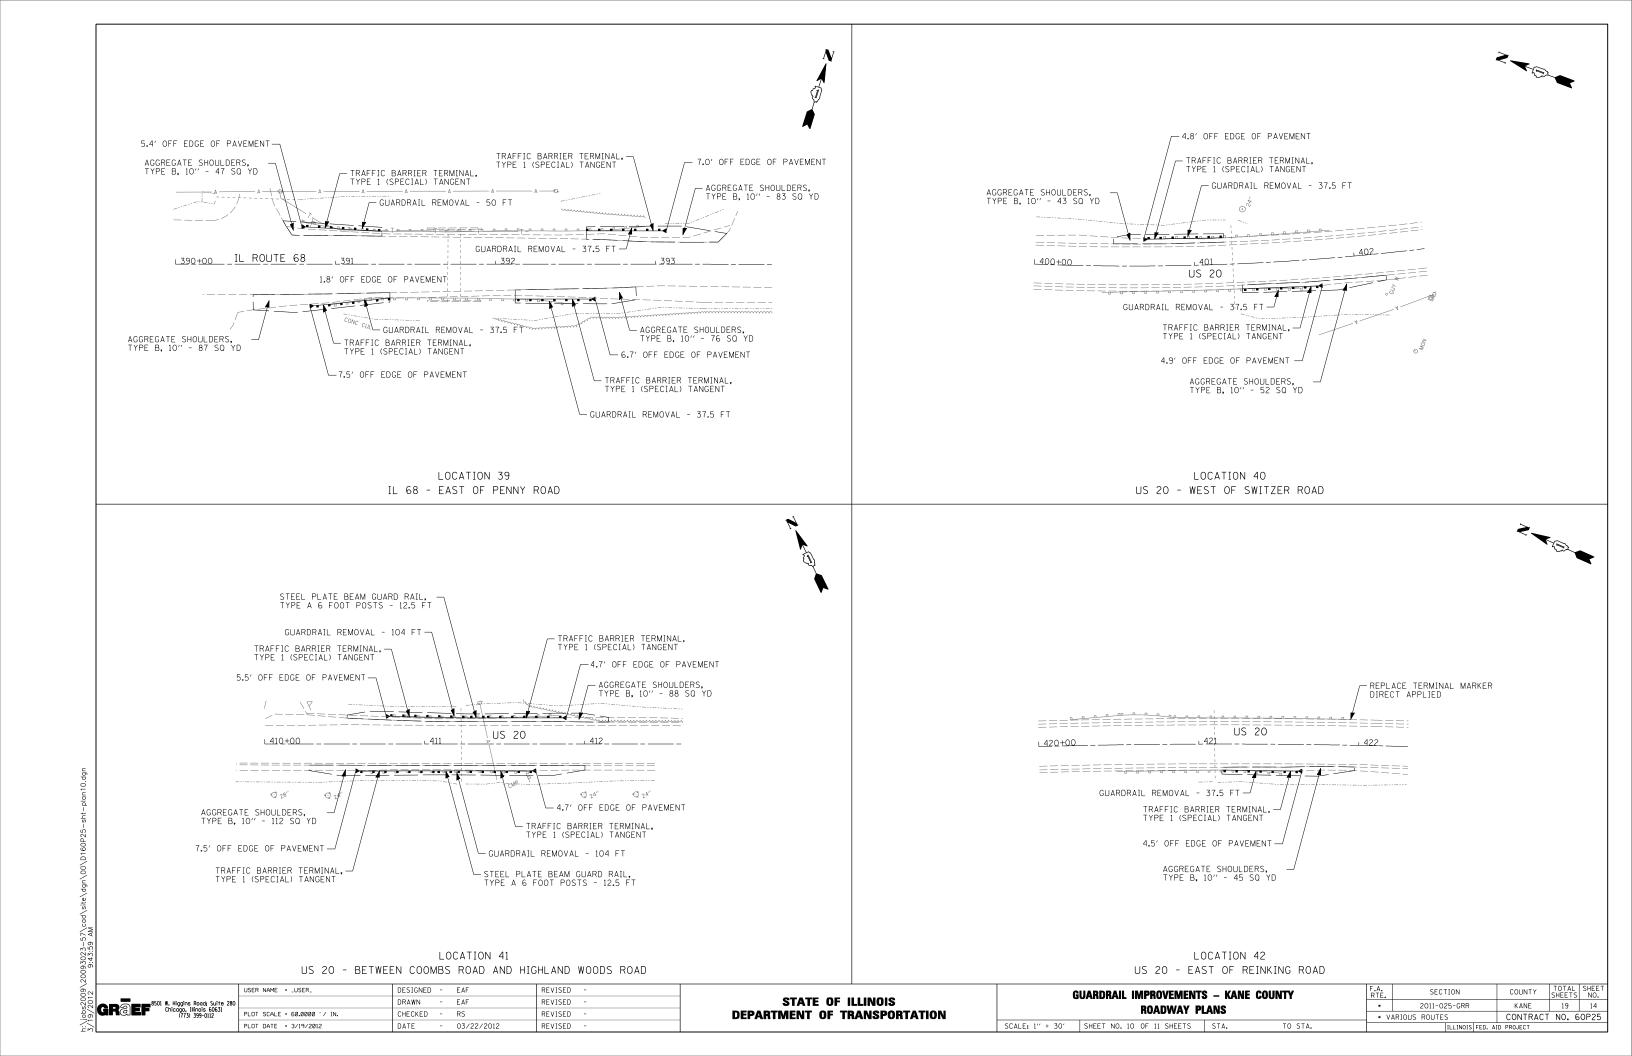

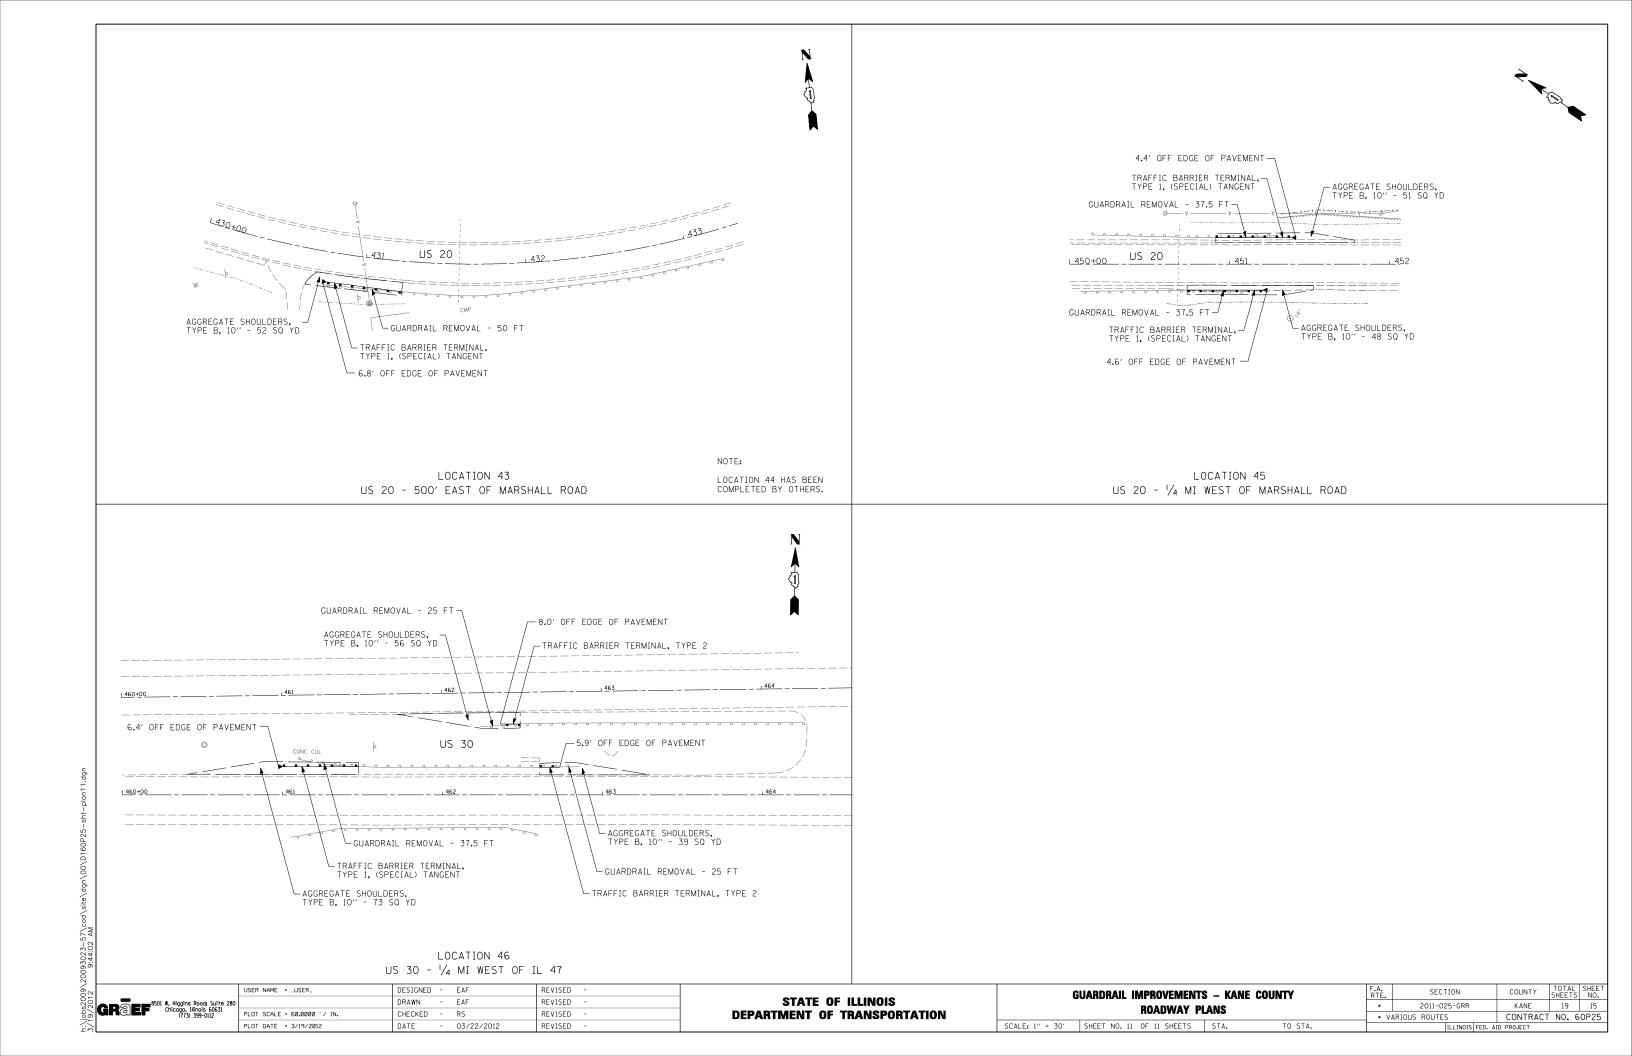

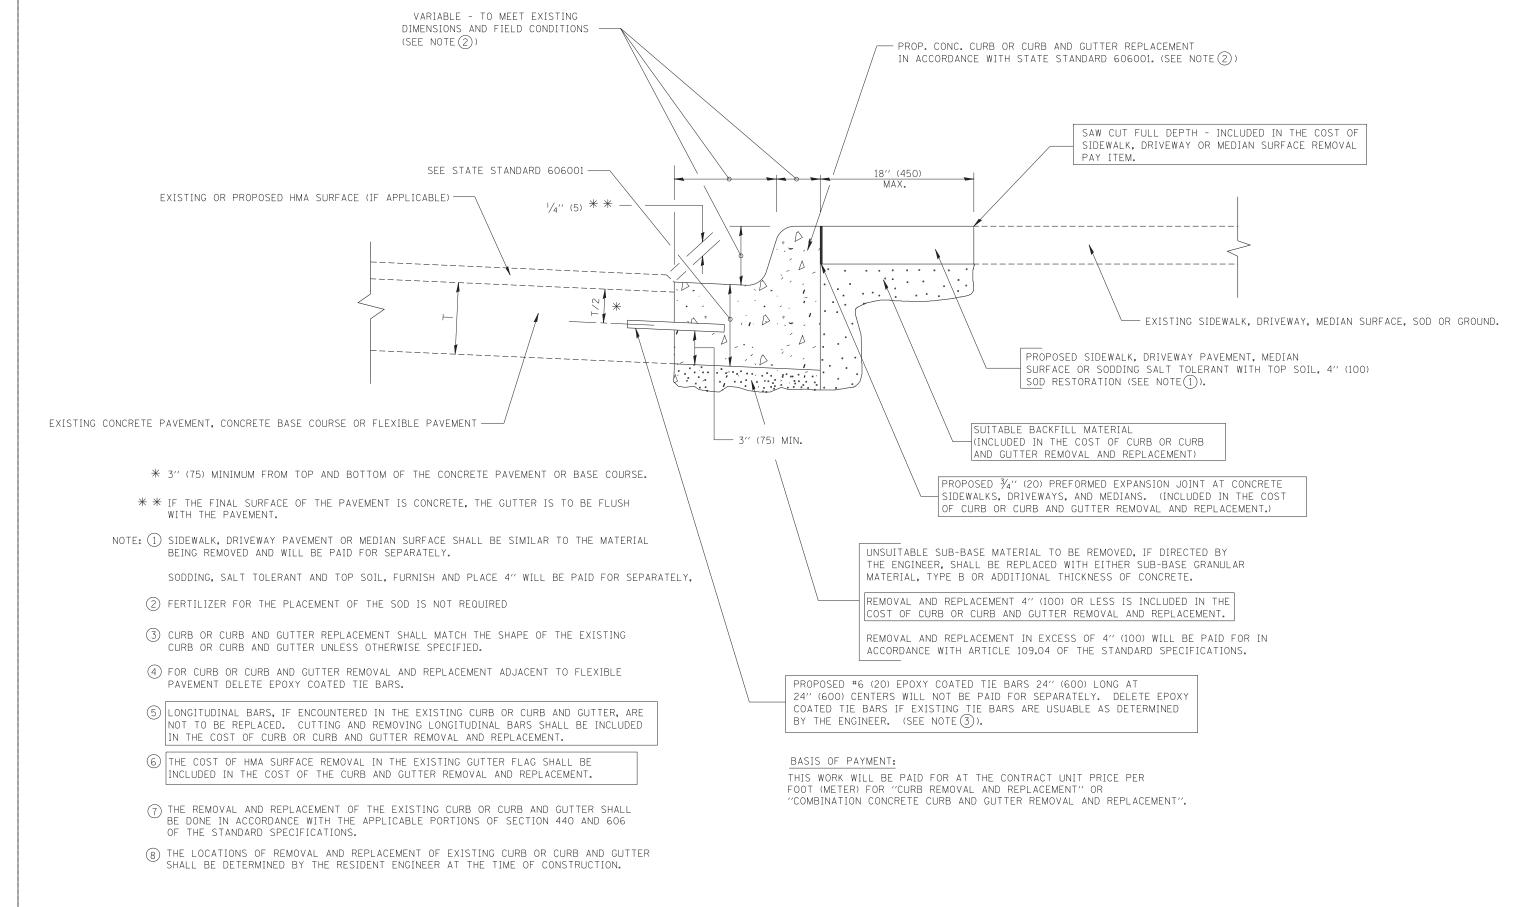


CURB OR CURB AND GUTTER REMOVAL AND REPLACEMENT

ALL DIMENSIONS ARE IN INCHES (MILLIMETERS)
UNLESS OTHERWISE SHOWN.

* VARIOUS ROUTES

FILE NAME = USER NAME = drivakosgn	DESIGNED - A. HOUSEH	REVISED - R. SHAH 10-03-96		CURB OR CURB AND GUTTER	F.A. SECTION COUNTY TOTAL SHEET
c:\pw_work\pwidot\drivakosgn\d0108315\bd24.dgn	DRAWN -	REVISED - A. ABBAS 03-21-97	STATE OF ILLINOIS		* 2011-025-GRR KANE 19 16
PLOT SCALE = 50.000 '/ IN.	CHECKED -	REVISED - M. GOMEZ 01-22-01	DEPARTMENT OF TRANSPORTATION	REMOVAL AND REPLACEMENT	BD600-06 (BD-24) CONTRACT NO. 60P25
PLOT DATE = 12/15/2009	DATE - 03-11-94	REVISED - R. BORO 12-15-09		SCALE: NONE SHEET NO. 1 OF 1 SHEETS STA. TO STA	

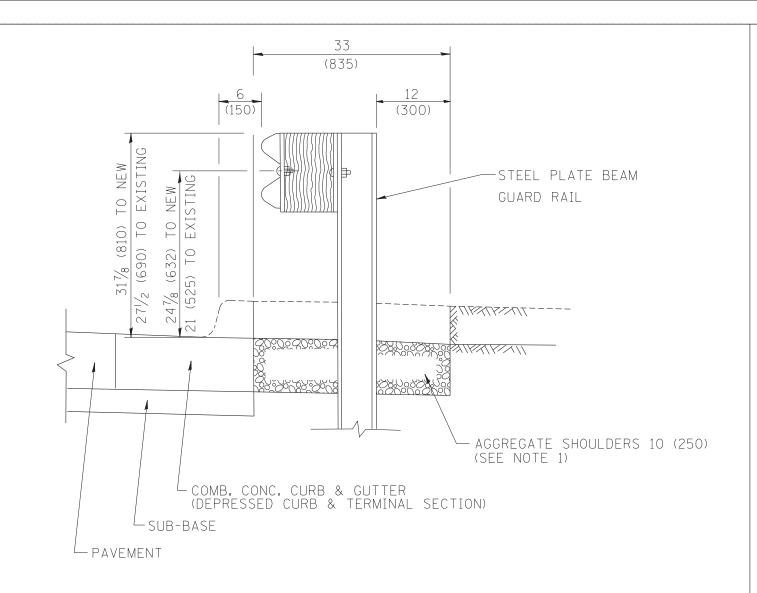

SECTION A-A


NOTES: 1. THE AGGREGATE SHOULDER, 10" OR HMA SHOULDER, 6" (IF REQUIRED) SHALL EXTEND UNDER THE TRAFFIC BARRIER TERMINAL.

- 2. "EXISTING" GUARDRAIL REFERS TO CONNECTING TERMINAL SECTION TO GUARD RAILING PRIOR TO THE MIDWEST GUARDRAIL SYSTEM.
- 3. THE CONTRACTOR SHALL VERIFY THE TYPE/HEIGHT OF GUARDRAIL IN-PLACE BEFORE ORDERING THE NEW TERMINAL SECTION.

 COST INCLUDED WITH THE COST OF THE TERMINAL. THE TERMINAL SECTION HEIGHT TO BE PLACED MUST MATCH THE HEIGHT OF THE IN-PLACE GUARDRAIL.

DETAILS FOR STEEL PLATE BEAM
GUARD RAIL ADJACENT TO CURB AND GUTTER

[FOR ROADWAY SPEED 35 MPH (60 kmh) TO 45 MPH (70 kmh)]

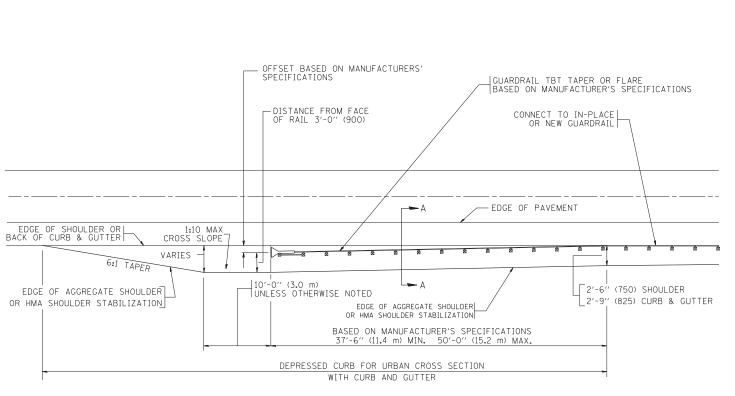

DEPRESSED CURB AND GUTTER AND SHOULDER TREATMENT AT TBT TY. 1 SPL.

BASIS OF PAYMENT: HMA SHOULDERS 6 (150) (IF REQUIRED) WILL BE

PAID FOR AT THE CONTRACT UNIT PRICE
PER SQUARE YARD (SQUARE METER) FOR
"HOT-MIX ASPHALT SHOULDERS 6" (150 mm)".

STEEL PLATE BEAM GUARD RAIL AND TRAFFIC BARRIER TERMINAL, OF THE TYPE SPECIFIED WILL BE PAID FOR SEPARATELY.

TBT = TRAFFIC BARRIER TERMINAL


ALL DIMENSIONS ARE IN INCHES (MILLIMETERS) UNLESS OTHERWISE SHOWN. $* \ various \ routes$

FILE NAME = DESIGNED - M. DE YONG REVISED - E. GOMEZ 08-28-00 USER NAME = drivakosqn c:\pw_work\PWIDOT\DRIVAKOSGN\d0108315\bd34.dan DRAWN REVISED R. BORO 01-01-07 CHECKED REVISED R. BORO 12-08-2008 PLOT DATE = 9/21/2009 R. BORO 09-14-2009 DATE 09-22-90 REVISED

STATE OF ILLINOIS
DEPARTMENT OF TRANSPORTATION

DETAILS FOR DEPRESSED CURB & GUTTER AND
SHOULDER TREATMENT AT TBT TY 1 SPL

SCALE: NONE SHEET NO. 1 OF 1 SHEETS STA. TO STA.

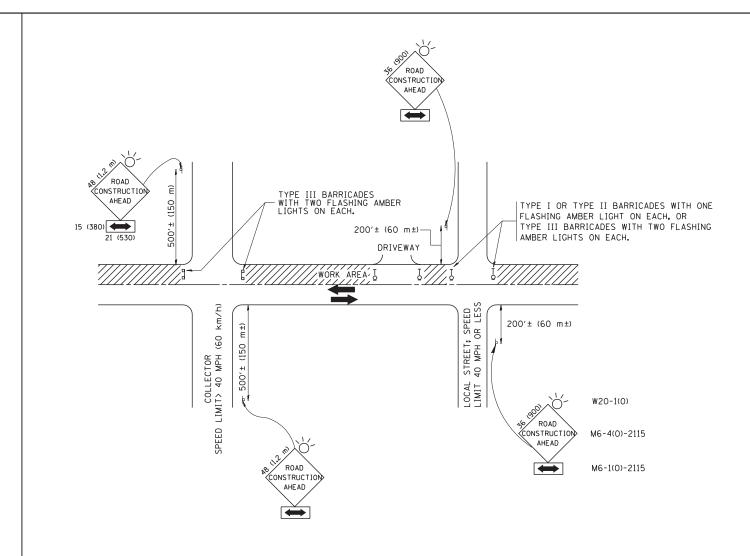

TRAFFIC CONTROL AND PROTECTION FOR SIDE ROADS, INTERSECTIONS, AND DRIVEWAYS

NOTES:

- A. FOR NO LANE RESTRICTION ON THE SIDE ROAD OR DRIVEWAYS
- 1. SIDE ROAD WITH A SPEED LIMIT OF 40 MPH (60 km/h) OR LESS AS SHOWN ON THE DRAWING AND AS DIRECTED BY THE ENGINEER:
- O) ONE ROAD CONSTRUCTION AHEAD SIGN 36 x 36 (900x900) WITH A FLASHER AND FLAG MOUNTED ON IT APPROXIMATELY 200' (60 m) IN ADVANCE OF THE MAIN ROUTE.
- b) THE CLOSED PORTION OF THE MAIN ROUTE SHALL BE PROTECTED BY BLOCKING WITH TYPE I, TYPE II OR TYPE III BARRICADES, 1/3 OF THE CROSS SECTION OF THE CLOSED PORTION.
- 2. SIDE ROAD WITH A SPEED LIMIT GREATER THAN 40 MPH (60 km/h) AS SHOWN ON THE DRAWING AND AS DIRECTED BY THE ENGINEER:
- a) ONE **road construction ahead** SIGN 48 \times 48 (1.2 m \times 1.2 m) WITH A FLASHER MOUNTED ON IT APPROXIMATELY 500' (150 m) IN ADVANCE OF THE MAIN ROUTE.
- b) THE CLOSED PORTION OF THE MAIN ROUTE SHALL BE PROTECTED BY BLOCKING WITH TYPE III BARRICADES, 1/2 OF THE CROSS SECTION OF THE CLOSED PORTION.
- 3. WHEN THE SIDE ROAD LIES BETWEEN THE BEGINNING OF THE MAINLINE SIGNING AND THE WORK ZONE, A SINGLE HEADED ARROW (M6-1) SHALL BE USED IN LIEU OF THE DOUBLE HEADED ARROW (M6-4).

SCALE: NONE

B. FOR A LANE CLOSURE ON A SIDE ROAD OR DRIVEWAY:

USE APPLICABLE PORTIONS OF THE TYPICAL APPLICATION OF TRAFFIC CONTROL DEVICES (STD. 701501, STD. 701606 OR THE APPROPRIATE STANDARD). THE SPACING OF SIGNS AND BARRICADES SHALL BE ADJUSTED FOR FIELD CONDITIONS AS DIRECTED BY THE ENGINEER. THE DIRECTIONAL ARROW SHALL BE COVERED OR REMOVED WHEN NO LONGER CONSISTENT WITH THE SIDE ROAD LANE CLOSURE.

- C. ADVANCE WARNING SIGNS ARE TO BE OMITTED ON DRIVEWAY UNLESS OTHERWISE NOTED.
- D. THE TRAFFIC CONTROL AND PROTECTION FOR SIDE ROADS, INTERSECTIONS, AND DRIVEWAYS SHALL BE INCIDENTAL TO THE COST OF SPECIFIED TRAFFIC CONTROL STANDARDS OR ITEMS.

All dimensions are in millimeters (inches) unless otherwise shown. * VARIOUS ROUTE

COUNTY


TOTAL SHEET NO.

FILE NAME = DESIGNED - LHA USER NAME = gaglianobt REVISED - J. OBERLE 10-18-95 W:\diststd\22x34\tc10.dan DRAWN REVISED - A. HOUSEH 03-06-96 CHECKED REVISED A. HOUSEH 10-15-96 PLOT DATE = 1/4/2008 DATE REVISED -T. RAMMACHER 01-06-0 06-89

STATE OF ILLINOIS DEPARTMENT OF TRANSPORTATION

SECTION TRAFFIC CONTROL AND PROTECTION FOR 2011-025-GRR SIDE ROADS, INTERSECTIONS, AND DRIVEWAYS TC-10 SHEET NO. 1 OF 1 SHEETS STA.

KANE CONTRACT NO. 60P25 FED. ROAD DIST. NO. 1 | ILLINOIS | FED. AID PROJECT

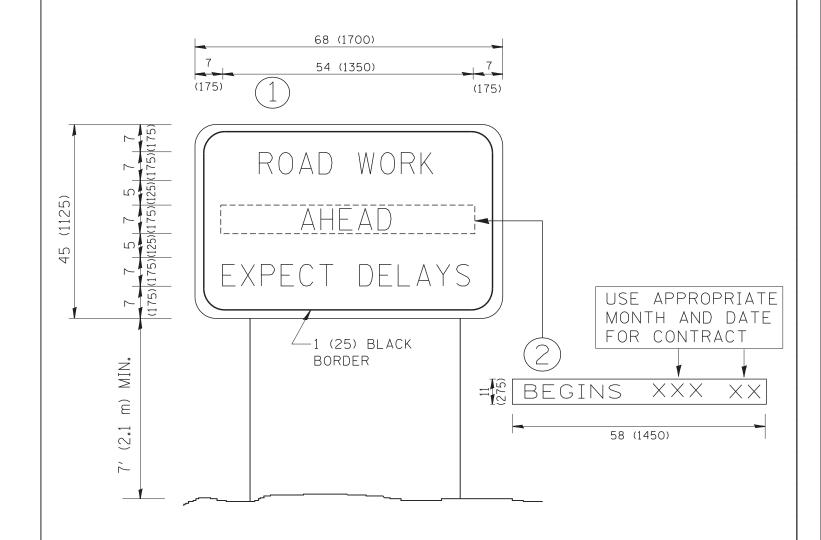

NOTES:

- 1. USE BLACK LETTERING ON ORANGE BACKGROUND.
- 2. ERECT SIGNS IN ADVANCE OF THE LOCATION FOR THE "ROAD CONSTRUCTION AHEAD" SIGN AT LOCATIONS AS DIRECTED BY THE ENGINEER.
- 3. ERECT SIGN (1) WITH INSTALLED PANEL (2) ONE WEEK PRIOR TO THE START OF CONSTRUCTION.
- 4. REMOVE PANEL (2) SOON AFTER THE START OF CONSTRUCTION.
- 5. SEE SPECIAL PROVISION FOR "TEMPORARY INFORMATION SIGNING" FOR ADDITIONAL INFORMATION.
- 6. ONE SIGN ASSEMBLY EQUALS 25.70 SQ. FT. (2.3 SQ. M.)
- 7. SHALL BE PAID FOR AS TEMPORARY INFORMATION SIGNING.

ALL DIMENSIONS ARE IN INCHES (MILLIMETERS) UNLESS OTHERWISE SHOWN.

* VARIOUS ROUTES

FILE NAME =	USER NAME = gaglianobt	DESIGNED -	REVISED	-	R. MIRS 09-15-97
W:\diststd\22x34\tc22.dgn		DRAWN -	REVISED	-	R. MIRS 12-11-97
	PLOT SCALE = 50.000 '/ IN.	CHECKED -	REVISED	- T.	RAMMACHER 02-02-99
	PLOT DATE = 1/4/2008	DATE -	REVISED	-	C. JUCIUS 01-31-07

STATE	0F	ILLINOIS
DEPARTMENT	0F	TRANSPORTATION

ARTERIAL ROAD						F.A RTE.	SECTION	COUNTY	
	INFORMATION SIGN						*	201-025-GRR	KANE
								TC-22	CONTRAC
	SCALE: NONE	SHEET NO. 1	OF 1	SHEETS	STA.	TO STA.	FED. R	D PROJECT	

201-025-GRR KANE TC-22 CONTRACT NO. 60P25