11A


# DUPAGE AIRPORT AUTHORITY WEST CHICAGO, ILLINOIS

DU075 TOTAL SHEET = 6

CONSTRUCTION PLANS FOR **DUPAGE AIRPORT** 

AIRFIELD LIGHTING CONTROL AND MONITORING SYSTEM (ALCMS)

> A.I.P. PROJECT: 3-17-0017-B20 ILLINOIS PROJECT: DPA-3674

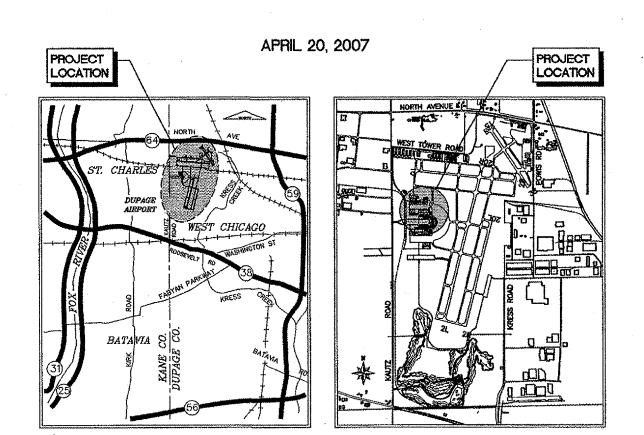


## **DUPAGE AIRPORT**

TOWNSHIP: 40 NORTH RANGE: 9 EAST DUPAGE COUNTY

WAYNE TOWNSHIP (SECTIONS: 31)

DESIGN AIRCRAFT APPROACH CATEGORY D DESIGN AIRCRAFT GROUP III

CALL JULIE BEFORE EXCAVATING 1-800-892-0123

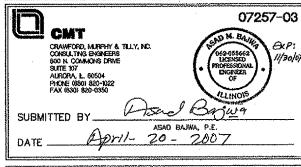




## INDEX TO SHEETS

- 1 COVER SHEET 2 SITE PLAN
- ALCMS BLOCK DIAGRAM AIRFIELD LIGHTING VAULT PLAN
- AIR TRAFFIC CONTROL TOWER (ATCT) PLAN
- 6 ELECTRICAL DETAILS


LOCATION MAP


SITE PLAN

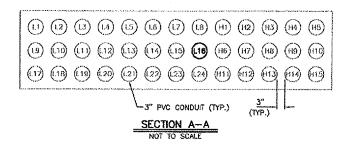

DUCT BANK NOMENCLATURE

***************************************	DOCT BANK NOWENCEATORE					
L1-L24	LOW VOLTAGE DUCTS	H1-H15 HIGH VOLTAGE DUCTS				
DUCT	USAGE	DUCT	USAGE			
L1-L12	RESERVED FOR FAA USE	H1-H5	SPARES			
£13~L15	SPARES	H6-H10	SPARES			
L16	PROPOSED 1-12 STRAND MULTI-MODE FIBER OPTIC CABLE	H51.	EXISTING 4#8, 5KV, L-824 AIRFIELD HOMERUNS FOR RUNWAY 1R-19L AND RUNWAY			
L17	EXISTING 2 FIBER OPTIC DATA CABLES FOR PLC CONTROLS.	H12	1L-19R (CIRCUITS 11 AND 13).  EXISTING 4#8. 5KV. L-824			
L18	EXISTING 9#1 THWN, 1#12 GND. CIRCUITS (PDP-2-1), (PDP-2-2) AND (PDP-2-3) FOR EXIST. APRON LIGHTS.	812	AIRFIELD HOMERUNS FOR CENTERLINE RUNWAY 1L-19R AND TOUCHDOWN ZONE RUNWAY 1L-19R (CIRCUITS 17 AND 18).			
L19	EXISTING 14#10 THWN, 1#12 GND. FOR REMOTE APRON LIGHTING CONTROL STATION	H13	EXISTING 4#8, SKV, L-824 AIRFIELD HOMERUNS FOR TAXIWAY "X" AND TAXIWAY "W" (CIRCUITS 12 AND 14).			
L20	EXISTING 8#4 THWN, 1#12 GND. CIRCUITS (LP-3), (LP-4),(LP-5) AND (LP-6) FOR EXISTING WINDCONES.	H14	EXISTING 4#8, 5KV, L-824 ARFIELD HOMERUNS FOR TAXIWAY "R" AND TAXIWAY "6" (CIRCUITS 15 AND 16).			
1.21	EXISTING 4#4 THWN, 1#12 GND. CIRCUITS (LP-1) AND (LP-2) FOR EXISTING PAVEMENT SENSORS.	H15	SPARE.			
L22-L24	SPARES					

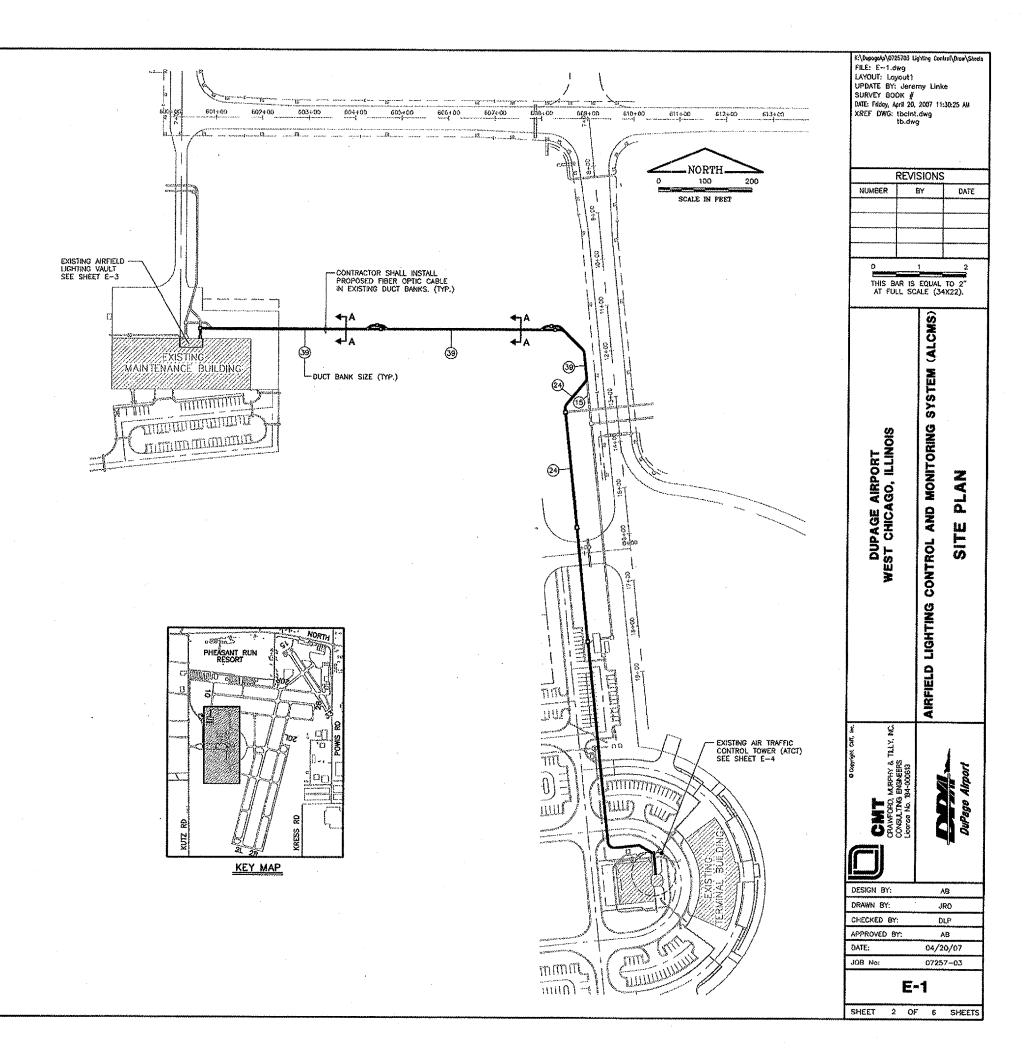

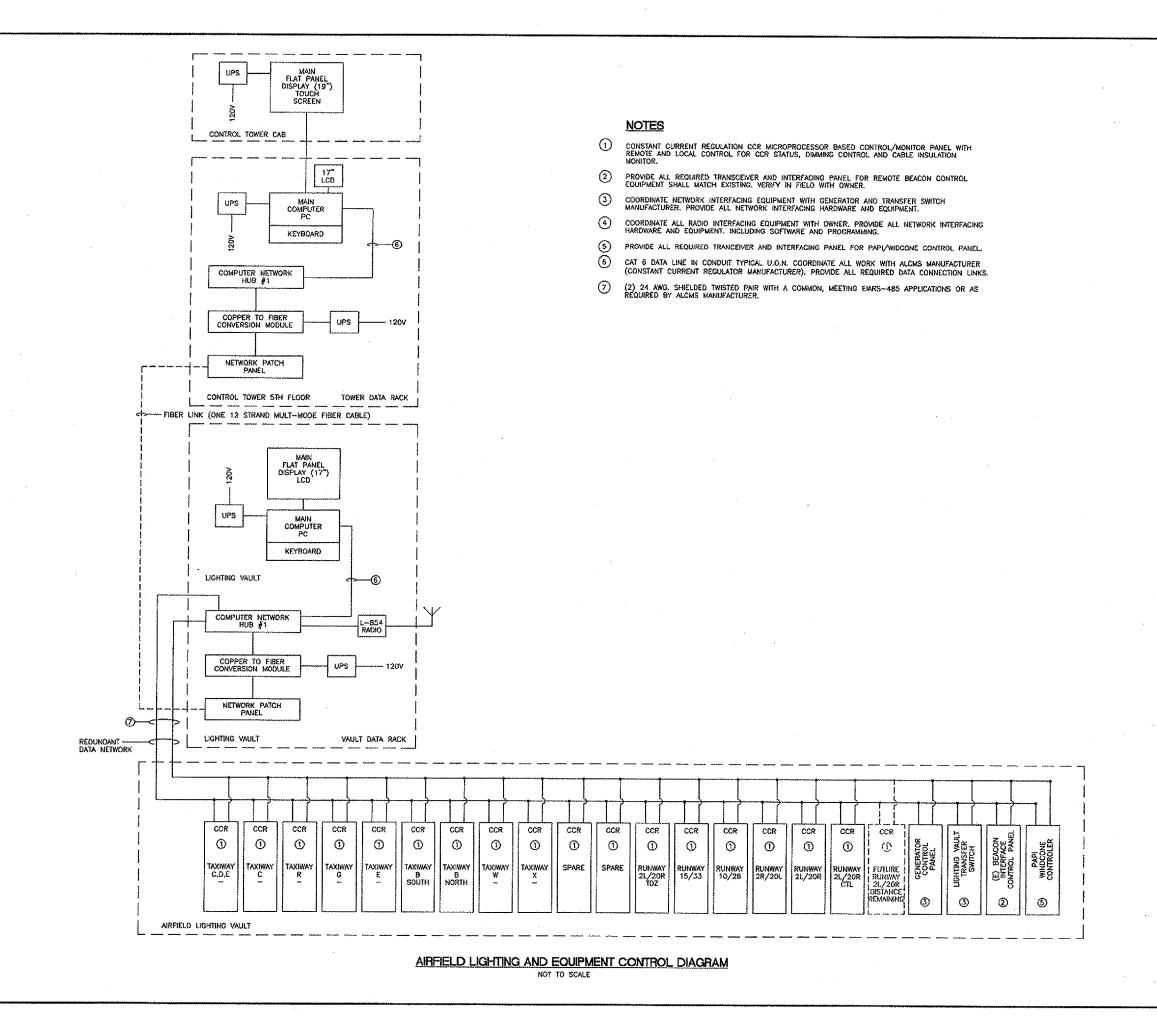


K:\Dupogod\0725703 Ugiting Contro\Drea\Sheets
File: E-2.dwg
LAYOUT: Loyout1
UPDATE BY: Jeremy Linke
SURVEY BOOK #
BATE: fridgy, April 20, 2007 11:30:46 AN
XREF DWG: tbeint.dwg
1b.dwg

REVISIONS					
NUMBER	BY	DATE			
		l			

THIS BAR IS EQUAL TO 2" AT FULL SCALE (34X22).

SYSTEM MONITORING DIAGRA DUPAGE AIRPORT WEST CHICAGO, ILLINOIS OCK X AND 집 CONTROL ALCMS AIRFIELD LIGHTING CANTORD, MARPHY & TI CONSULTING ENGNEERS Ucense No. 184-000613 DESIGN BY: AB DRAWN BY: JRO CHECKED BY: DLP APPROVED BY: AB DATE: 04/20/07 J08 No: 07257-03

E-2
SHEET 3 OF 6 SHEETS

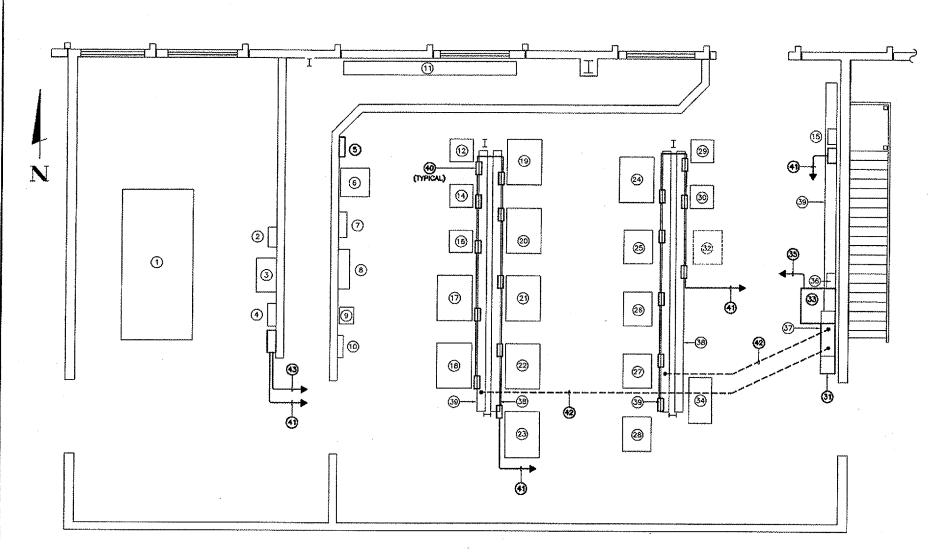

## PROPOSED AIRFIELD VAULT MODIFICATIONS 1/4"=1'-0"

#### NOTES:

- 1. ALL PROPOSED WORK OR ITEMS BEING MODIFIED ARE SHOWN IN BOLD, ALL OTHER ITEMS SHOWN ARE FOR
- 2. PROPOSED ALCMS RACK SHALL BE SUPPLIED WITH WHEELS. NEW CONTROL SYSTEM SHALL BE OPERATIONAL AND TESTED PRIOR TO THE REMOVAL OF EXISTING PLC CABINET. PROVIDE SUFFICIENT CABLE SLACK REQUIRED FOR ALCMS RACK TO BE OPERATIONAL.
- 3. INSTALL 2-20A, 1-POLE CIRCUIT BREAKERS IN LIGHTING PANEL FOR PROPOSED ALCMS.
- 4. INSTALL POWER AND CONTROL WIRES BETWEEN INTERFACE CONTROL PANEL AND GENERATOR, A.T.S., BEACON CONTROL, L-854 RADIO CONTROLLER AND PAPI/WINDCONE CONTROLLER PER ALCMS MANUFACTURER.
- 5. INSTALL 12"x12" WIREWAY 24" AFF. EXTEND EXISTING CONDUIT. MATCH EXISTING CONDITIONS,
- 6. CUT 30" LENGTH OF EXISTING WIREWAY TO INSTALL ALCMS RACK.
- INSTALL AND WIRE NEW INTERFACE CONTROL PANEL AND IRMS FOR FUTURE REGULATOR FOR RUNWAY 2L/20R DISTANCE REMAINING SIGN CIRCUIT.

#### AIRFIELD VAULT NOMENCLATURE

- EXISTING 430 KW (537.5 KVA) STAND-BY GENERATOR SET.
- 2 EXISTING 800A, 480V, 3¢ UTILITY MAIN DISCONNECT.
- (3) EXISTING BOOA, 480V, 30 AUTOMATIC TRANSFER SWITCH.
- (4) EXISTING 800A, 480V, 3p GENERATOR SET MAIN DISCONNECT.
- (3) EXISTING 208Y/120 VAC, 34, 4W, LIGHTING PANEL - SEE NOTE 3.
- (6) EXISTING 75 KVA, 480-208Y/120 VAC TRANSFORMER.
- (7) EXISTING 480V, 30 POWER DISTRIBUTION PANEL POP-2.
- (8) EXISTING 480V, 30 POWER DISTRIBUTION PANEL POP-1.
- (9) EXISTING 480V, 30, 480V DELTA TO 480Y/277 VAC TRANSFORMER.
- 10 EXISTING 480Y/277V POWER DISTRIBUTION PANEL.
  - EXISTING HIGH VOLTAGE "HOMERUN" WIREWAY.
- 12 EXISTING 480 VAC, 10 KW, RW 15-33 REGULATOR,
- (3) NOT USED.

(1)

- (14) EXISTING 30KW, 480V, RUNWAY 10/28 REGULATOR.
- (15) EXISTING PAPI/WINDCONE CONTROL PANEL
- **(6)** EXISTING 480 VAC, 10 KW, RUNWAY 2R/20L REGULATOR.
- (17) EXISTING 480 VAC, 20 KW, RUNWAY 2L/20R REGULATOR.
- (18) EXISTING 480 VAC, 30 KW, RUNWAY 2L/20R CENTERLINE REGULATOR.
- (19) EXISTING 480 VAC, 30 KW, RUNWAY 2L/20R TOUCHDOWN ZONE REGULATOR.
- 20) EXISTING 480 VAC. 30 KW. SPARE REGULATOR.
- 21) EXISTING 480 VAC, 30 KW, SPARE REGULATOR.
- (22) EXISTING 480 VAC, 30 KW, TAXIWAY C REGULATOR.
- (23) EXISTING 480 VAC, 30 KW, TAXIWAY W REGULATOR.
- (24) EXISTING 480 VAC, 20 KW, TAXIWAY R REGULATOR.
- EXISTING 480 VAC, 15 KW, TAXIWAY G REGULATOR.
- (26) EXISTING 480 VAC. 15 KW. TAXIWAY E REGULATOR.
- 2 EXISTING 480 VAC. 10 KW, TAXIWAY B-SOUTH REGULATOR.
- EXISTING 480 VAC, 10 KW, TAXIWAY 8-NORTH REGULATOR.
- 29 EXISTING 480 VAC. 10 KW. TAXIWAY C REGULATOR.
- 30) EXISTING 480 VAC, 15 KW, TAXIWAY C, D, E-EAST REGULATOR.
  - PROPOSED 12"x12" WIREWAY SEE NOTE 5.
- (32) FUTURE 480V AC, 10 KW RUNWAY 2L/20R RDR (SEE HOTE 7).
- (3) PROPOSED ALCHS RACK - SEE NOTE 2.
- EXISTING WORK BENCH.

(31)

- PROPOSED 4 #12 THWN, 2 #12 GND. IN 3/4" CONDUIT TO LIGHTING PANEL.
- EXISTING L-854 RADIO CONTROLLER TO BE RELOCATED.
- EXISTING PLC CONTROL CABINET TO BE REMOVED.
- (38) EXISTING 8" x 8" HIGH VOLTAGE (5 KV) WIREWAY.
- EXISTING 8" x 8" LOW VOLTAGE (600V) WIREWAY SEE NOTE 6.
  - PROPOSED INTERFACE CONTROL PANEL AND INSULATION RESISTANCE MONITOR, TYPICAL FOR EACH CCR, BEACON, GENERATOR AND PAPI/WINDCONE CONTROLLERS.
- PROPOSED (2) 24 AWG SHIELDED TWISTED PAIRS IN 1" CONDUIT TO ALCMS RACK.
- PROPOSED 2 \$10 THWN, 1 \$12 GND. IN EXISTING CONDUIT FOR 120V UPS POWER TO (40)
- PROPOSED 2 \$10 THWN, 1 \$12 GND. IN 3/4" CONDUIT TO ALCHS RACK.

FILE: E-3.dwg LAYOUT: Lavout1 UPDATE BY: Jeremy Linke SURVEY BOOK # DATE: Friday, April 20, 2007 11:31:04 AM XREF DWG: tbcln1.dwg lb.dwg

REVISIONS						
NUMBER	BY	DATE				
		400000000000000000000000000000000000000				
	<del>10 ir Addillanden addillan</del> as					
0	1	2				

THIS BAR IS EQUAL TO 2' AT FULL SCALE (34X22).

SYSTEM MONITORING DUPAGE AIRPORT LIGHTIN 28 LIGHTING AIRFIELD


DESIGN BY AB DRAWN BY 480 CHECKED BY: APPROVED BY: DATE: 04/20/07 JOB No: 07257-03

E-3

SHEET 4 OF 6 SHEETS


### **NOTES**

- CONTRACTOR SHALL COORDINATE ALL WORK IN THE EXISTING CONTROL TOWER WITH THE FAA ARWAYS FACILITIES REPRESENTATIVES AND THE RESIDENT ENGINEER, CONTRACTOR SHALL GIVE A MINIMUM OF 2 DAYS NOTICE PRIOR TO BEGINNING WORK IN THE EXISTING TOWER.
- CONTRACTOR SHALL REMOVE EXISTING CONTROL WIRING FROM CONDUIT AFTER PROPOSED FIBER OPTIC CABLES AND ALCS HAVE SEEN INSTALLED AND OPERATIONAL.
- 3. CONTRACTOR SHALL PULL PROPOSED FIBER OPTIC CABLES THROUGH EXISTING CABLE CHASE.
- 4. CONTRACTOR SHALL REMOVE EXISTING CONTROL CABLES IN TOWER FOR EXISTING AIRFIELD LIGHTING CONTROLS ONCE NEW AIRFIELD LIGHTING CONTROL SYSTEM IN TOWER IS COMPLETELY OPERATIONAL. CONTRACTOR SHALL ROUTE PROPOSED FIBER OPTIC CABLES IN EXISTING CABLE CHASE.
- 5. CONTRACTOR SHALL REMOVE EXISTING CONTROL CABLES AND FLEXIBLE CONDUIT FROM TOWER CAB AFTER ALCMS HAS BEEN INSTALLED AND OPERATIONAL CONTRACTOR SHALL RUN PROPOSED FIBER OPTIC CABLES IN 2-2" FLEXIBLE CONDUITS ALONG ROUTE OF EXISTING CONTROL CABLES.
- 6. CONTRACTOR SHALL REMOVE EXISTING CONTROL CONSOLE AND INSTALL PROPOSED COUNTER TOP AND FLUSH MOUNTED TOUCHSCREEN IN ITS PLACE, CONTRACTOR SHALL MAKE NECESSARY MODIFICATIONS TO EXISTING CABINET WORK TO PROVIDE A COMPLETE AND OPERATIONAL SYSTEM TO THE SATISFACTION OF THE ENGINEER AND TOWER CHIEF, PROPOSED COUNTER TOP SHALL BE CUSTOM WOOD CONSOLE OF SIZE AND FINISH TO MATCH THE EXISTING COUNTER OR AS DIRECTED BY TOWER CHIEF.
- 7, PROVIDE UPS AND RECEPTACLE FOR TOUCHSCREEN MONITOR IN THE TOWER CAB.
- 8. ALL PROPOSED WORK IN EXISTING TOWER SHALL BE INCLUDED IN THE UNIT BID PRICE FOR L-890 ALCMS.
- 9. PROPOSED ALCMS RACK SHALL BE SUPPLIED WITH WHEELS. NEW CONTROL SYSTEM SHALL BE OPERATIONAL AND TESTED PRIOR TO THE REMOVAL OF EXISTING PLC CABINET. PROVIDE SUFFICIENT CABLE SLACK REQUIRED FOR ALCMS RACK TO BE OPERATIONAL.

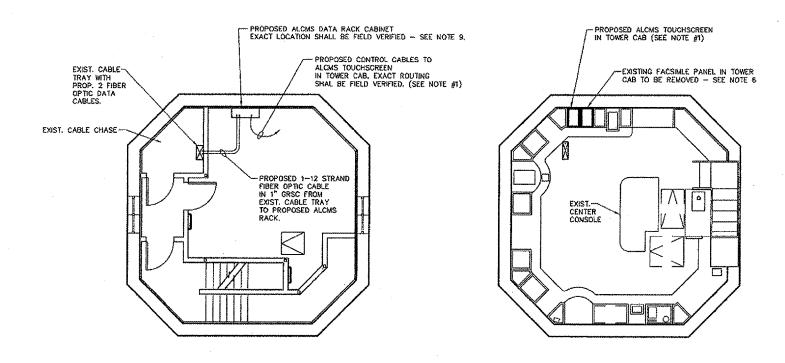

## FIFTH FLOOR PLAN VIEW NO SCALE

## CONTROL TOWER CAB LAYOUT PLAN VIEW NO SCALE

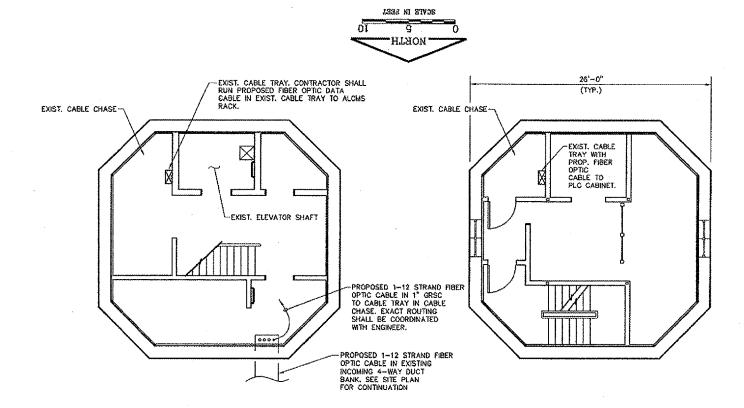

GROUND LEVEL PLAN VIEW

TYPICAL INTERMEDIATE LEVEL PLAN VIEW

(TYP. 0F 4)
NO SCALE


K-NupopeAp\07 FILE: E-4. LAYOUT: La UPDATE BY SURVEY BG DATE: Friday, XREF DWG:  NUMBER	dwg yout1 : Jerer OK # April 20, tbclnt. tb.dwg	my Link 2007 11: .dwg	e 31:25 AM			
THIS BAR IS EQUAL TO 2" AT FULL SCALE (34X22).						
DUPAGE AIRPORT WEST CHICAGO, ILLINOIS		URFIELD LIGHTING CONTROL AND MONITORING SYSTEM (ALCMS)	AIR TRAFFIC CONTROL TOWER (ATCT) PLAN			
***************************************		~				
CMT RPHY & THEY WO	CONSILTING ENGREERS LICENSE NO. 184-000513		DuPage Airport			
	CONSULTING ENGNEERS LICENSE NO. 184-000813		DuPage Airport			
DESIGN BY:	CONSULTAGE ENGANEERS License No. 184-000513		Ourage Airport			
DESIGN BY:		J				
DESIGN BY: DRAWN BY: CHECKED B APPROVED		J D	RO LP AB			
DESIGN BY: DRAWN BY: CHECKED B	Y:	J D	RO LP 48 20/07			
DESIGN BY: DRAWN BY: CHECKED B APPROVED DATE:	Y:	04/2 0725	RO LP 48 20/07			

#### NOTES

- INSTALL PROPOSED INTERFACE CONTROL PANEL AND IRMS PANEL ON UNITSTRUT, MATCH EXISTING CONDITIONS. COORDINATE SIZE AND CONDUIT OPENINGS WITH ALCMS MANUFACTURER.
- INSTALL MALE AND FEMALE L-823 CONNECTOR TO CONNECT AIRFIELD LIGHTING CIRCUITS IN HIGH VOLTAGE WIREWAY.
- PROPOSEO S-1 CUT-OUT SHALL BE SCO SERIES BY SIEMENS OR EQUAL. CONNECT SECONDARY SIDE OF THE S-1 CUT-OUT TO IRMS PANEL PER ALCMS MANUFACTURER.


## **EQUIPMENT NOMENCLATURE**

- 1 EXISTING EQUIPMENT MOUNTING PLATE TO REMAIN.
- (2) EXISTING REGULATOR DISCONNECT SWITCH TO REMAIN.
- (3) EXISTING RUNWAY/TAXIWAY INDICATOR LIGHT TO BE RELOCATED.
- 4 EXISTING GROUNDING SWITCH TO BE REMOVED.
- (5) EXISTING S-1 PLUG CUT-OUT TO BE REMOVED.
- PROPOSED INTERFACE CONTROL PANEL SEE NOTE 1.
- 7 PROPOSED INSULATION RESISTANCE MEASURING SYSTEM (IRMS) SEE NOTE 1.
- (8) EXISTING LOW VOLTAGE AND HIGH VOLTAGE 12"x12" WIREWAY SEE NOTE 2.
- (9) EXISTING INCOMING AND OUTGOING 600V POWER CABLES IN FLEX CONDUIT TO LOW VOLTAGE WIREWAY.
- (10) EXISTING 4 #8 5KV AIRFIELD LIGHTING CABLES IN FLEX CONDUIT TO HIGH VOLTAGE WIREWAY.
- 11) PROPOSED (2) 24 AWG SHIELDED TWISTED PAIRS IN 1° GRS CONDUIT.
- (2) PROPOSED DATA CABLES IN 1" GRS CONDUIT.
- PROPOSED 2 #8 SKV, 1-824 TYPE C AIRFIELD LIGHTING CABLES IN 1" FLEX CONDUIT TO HIGH VOLTAGE WIREWAY.
- PROPOSED 2 \$10 THWN, 1 \$12 GND. IN 3/4" FLEX CONDUIT TO LOW VOLTAGE WIREWAY FOR UPS POWER.
- PROPOSED 2 #8 5KV, 1-824 TYPE C CABLES IN 1" FLEX CONDUCT TO S-1 PLUG CUT-OUT.
- 16 PROPOSED 1" TX CONDUIT BODY WITH GASKET AND COVER.
- (17) PROPOSED DATA/CONTROL CABLES (AS REQUIRED BY ALCMS MANUFACTURER) IN 1" CONDUIT TO EXISTING REGULATOR.
- (18) PROPOSED S-1 CUT-OUT. SEE NOTE 3.

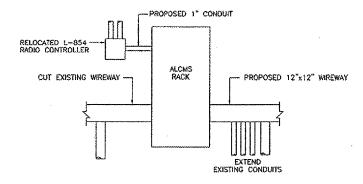


ALCMS RACK ELEVATION

NOT TO SCALE

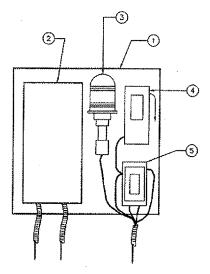

## EXISTING EQUIPMENT MOUNTING PLATE DETAIL NOT TO SCALE

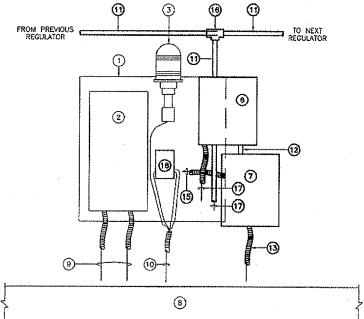

# TYPICAL INTERFACE CONTROL AND IRMS PANEL MOUNTING DETAIL

NOT TO SCALE

K:\DupageAp\0725703 Lighting Control\Draw\Sheets FILE: E-5.dwg LAYOUT: Loyout1 UPDATE BY: Jim Chse SURVEY BOOK # DATE: Thursdoy, April 19, 2007 9:15:38 AN XREF DWG: tbcint.dwg tb.dwg REVISIONS NUMBER 84 THIS BAR IS EQUAL TO 2" AT FULL SCALE (34X22). SYSTEM MONITORING AILS DUPAGE AIRPORT WEST CHICAGO, ILLINOIS ō ELECTRICAL CONTROL AND LIGHTING AIRFIELD

GRAWFORD MURPHY & TLLY, NC.
CONSULTING ENGREERS
LOGNSON IN R4-000618

BY

BY

DuPage Althort

 DESIGN BY:
 AB

 DRAWN BY:
 JRO

 CHECKED BY:
 DLP

 APPROVED BY:
 AB

 DATE:
 04/20/07

 JOB No:
 07257-03

E-5

SHEET 6 OF 6 SHEETS