STATE OF ILLINOIS

DEPARTMENT OF TRANSPORTATION

DIVISION OF HIGHWAYS

PROPOSED HIGHWAY PLANS

F.A.I. ROUTE 55 (INTERSTATE 55) WIDENING AND RESURFACING FROM F.A.I. ROUTE 80 TO BLACK ROAD

SECTION: 99 (1&2) WRS PROJECT NO.: IM-055-6(228)250

WILL COUNTY C-91-093-05 STA 402 + 65.07 PROJECT ENDS US NOUTE 52 OVER 1-55 PIER CHASHWALL MODIFICATION S.M. 999-4842 IL-59 OVER 1-55 STA 187 + 28.21 (NORTHBOUND) STA 186 + 03.53 (SOUTHBOUND PROJECT BEGINS

I-55 ENOSS LENGTH OF PROJECT = 21,861.44 feet (4.103 miles)
I-55 NET LENGTH OF PROJECT = 21,861.44 feet (4.103 miles)



ENGINEERS/ARCHITECTS/PLANNERS

SECTION COUNTY 99 (1&2) WRS

D-91-093-05




STATE OF ILLEWOIS DEPARTMENT OF TRANSPORTATION

Dione O'KAGLICA DEPUTY DIRECTOR OF HIGHWAYS REGION ENGINEER

PRINTED BY THE AUTHORITY OF THE STATE OF ILLINOIS

A Rev. 5-31-07

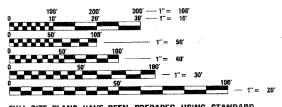

FOR INDEX OF SHEETS, SEE SHEET NO. 2

= 83,000

TRAFFIC DATA

IL 59 to U.S. 52 = 56,000 U.S. 52 to U.S. 30 = 60,000

POSTED SPEED: 65 mph

US 6 to 1-80

I-80 to IL 59

ENGINEERING SCALES, REDUCED SIZED PLANS WILL NOT CONFORM TO STANDARD SCALES. IN MAKING MEASUREMENTS ON REDUCED PLANS, THE ABOVE SCALES MAY BE USED.

JOINT UTILITY LOCATION INFORMATION FOR EXCAVATION 1-800-892-0123

CONTRACT NO. 62895

2. THE CONTRACTOR SHALL COORDINATE CONSTRUCTION ACTIVITIES WITH AFFECTED UTILITY COMPANIES AND MUNICIPALITIES.

3. THE CONTRACTOR WILL NOT BE ALLOWED TO SET UP A YARD OR FIELD OFFICE ON STATE PROPERTY WITHOUT WRITTEN PERMISSION FROM THE DEPARTMENT.

4. BARRICADES: THE CONTRACTOR SHALL PROVIDE AND INSTALL TWO (2) WEIGHTED SAND BAGS ON EACH TYPE I OR TYPE II BARRICADE USED - ONE (1) WEIGHTED SAND BAG ACROSS EACH

5. WHEN ARTIFICIAL LIGHTING IS USED IN NIGHT OPERATIONS THE CONTRACTOR SHALL EXERCISE THE UTMOST PRECAUTIONS IN PREVENTING ADVERSE VISIBILITY TO THE MOTORING

6. BARRIER WALL MARKERS, TYPE C SHALL BE INSTALLED ON MEDIAN CONCRETE BARRIER WALL AND PARAPETS AT A HEIGHT OF 28 INCHES FROM THE TOP OF SHOULDER TO THE BOTTOM OF THE REFLECTOR AND SPACED AT 50 FEET CENTER-TO-CENTER ON CURVES AND 100 FEET CENTER-TO-CENTER ON TANGENTS OR AS DIRECTED BY THE TRAFFIC OPERATIONS FIELD ENGINEER. THE BARRIER WALL MARKERS SHALL BE INSTALLED DURING STAGE I, PRIOR TO OPENING THE WIDENED PAVEMENT TO TRAFFIC.

7. CONTRACTS 60B85, 60B86, 62895, 60B46, 62896 AND 60B47 ARE EXPECTED TO RUN SIMULTANEOUSLY. TRAFFIC CONTROL AND OTHER CONSTRUCTION OPERATIONS BETWEEN THESE SIX CONTRACTS SHALL BE COORDINATED THROUGHOUT THE DURATION OF THE PROJECT IN ORDER TO PROVIDE A SAFE AND EFFICIENT WORK ENVIRONMENT. THIS WORK SHALL BE INCLUDED IN THE COST FOR "TRAFFIC CONTROL AND PROTECTION (EXPRESSWAYS)".

8. A PAINT STRIPE SHALL BE APPLIED TO THE FACE OF BARRIER WALL ADJACENT TO ALL DRAINAGE STRUCTURES. THE STRIPE SHALL BE 4" WIDE BY 12 INCHES LONG AND EXTEND VERTICALLY AT 90 DEGREES FROM THE TOP EDGE OF THE BARRIER. THE PAINT WILL BE SPECIFIED AS ORANGE PAINT. THE COST OF THE STRIPE IS TO BE INCLUDED IN THE COST OF THE CONCRETE BARRIER OF TYPE AND SIZE SPECIFIED.

9. THE LIMIT SHOWN ON THE PLANS BETWEEN THE PAY ITEMS "BITUMINOUS CONCRETE SHOULDER REMOVAL" IN THE MEDIAN AND "HOT-MIX ASPHALT SURFACE REMOVAL 3-1/2" " ON THE MAINLINE PAVEMENT IS BASED ON THE THEORETICAL EDGE OF PAVEMENT LINE WHICH IS LOCATED AT 20' FROM THE I-55 CENTERLINE. THE EXISTING MAINLINE PAVEMENT IN BOTH THE NB AND SB DIRECTIONS CONSISTS OF A PCC BASE WITH A BITUMINOUS OVERLAY. THE CONTRACTOR SHALL REMOVE THE EXISTING BITUMINOUS SHOULDER TO THE EDGE OF THE EXISTING PCC BASE COURSE TO THE SATISFACTION OF THE ENGINEER. THE COST FOR THIS WORK INCLUDING ANY ADDITIONAL SET UPS SHALL BE INCLUDED IN THE CONTRACT UNIT PRICE FOR "BITUMINOUS CONCRETE SHOULDER REMOVAL". IN ADDITION, THE COST TO REPAIR ANY DAMAGE TO THE EXISTING MAINLINE PAVEMENT INCLUDING RAVELING OF THE EXISTING BITUMINOUS OVERLAY AS A RESULT OF THIS WORK SHALL BE INCLUDED IN THE CONTRACT UNIT PRICE FOR "BITUMINOUS CONCRETE SHOULDER REMOVAL"

10. DURING THE 2007 CONSTRUCTION SEASON, THE CONTRACTOR SHALL REMOVE THE REFLECTIVE ELEMENT FROM ALL RAISED REFLECTIVE PAVEMENT MARKERS THAT CONFLICT WITH THE TEMPORARY TRAFFIC LANES AS DIRECTED BY THE ENGINEER, PRIOR TO TRANSFERRING TRAFFIC INTO THE TRAFFIC CONFIGURATION SHOWN FOR THE TYPICAL SECTION FOR WINTER SHUTDOWN AT THE END OF THE 2007 CONSTRUCTION SEASON, THE CONTRACTOR SHALL REPLACE THE REFLECTIVE ELEMENT WITH A NEW REFLECTIVE ELEMENT. DURING THE 2008 CONSTRUCTION SEASON IN AREAS BEYOND THE PAVEMENT MILLING AND RESURFACING LIMITS, THE CONTRACTOR SHALL REMOVE THE REFLECTIVE FLEMENT FROM ALL RAISED REFLECTIVE PAVEMENT MARKERS THAT CONFLICT WITH THE TEMPORARY TRAFFIC LANES AS DIRECTED BY THE ENGINEER. THE CONTRACTOR SHALL REPLACE THE REFLECTIVE ELEMENT WITH A NEW REFLECTIVE ELEMENT AT THE END OF THE PROJECT. THE COST OF REMOVAL AND REPLACEMENT OF THE REFLECTIVE ELEMENT SHALL BE INCLUDED IN THE CONTRACT UNIT PRICE FOR "REPLACEMENT REFLECTOR."

11. THE VARIABLE WIDTH CONCRETE GUTTER ADJACENT TO THE DRAINAGE STRUCTURES SHALL NOT BE CONSTRUCTED UNTIL AFTER THE FRAME AND GRATE ARE ADJUSTED TO THE FINAL GRADE IN STAGE II. THE COST TO REMOVE THE H.M.A. SHOULDER PAVEMENT CONSTRUCTED DURING STAGE I IN THE AREA OF THIS VARIABLE WIDTH PORTION OF THE CONCRETE GUTTER AND THE COST OF THE ADDITIONAL WIDTH OF CONCRETE GUTTER GREATER THAN 10" AS SHOWN AT THE DRAINAGE STRUCTURES SHALL BE INCLUDED IN THE CONTRACT UNIT PRICE PER FOOT FOR CONCRETE GUTTER.

DELIVERED BY THE CONTRACTOR TO THE NEAREST IDOT MAINTENANCE FACILITY, TEMPORARY STORAGE AND DELIVERY SHALL BE INCLUDED IN THE CONTRACT UNIT PRICE FOR "GUARDRAIL 13. BUTT JOINTS WILL BE INSTALLED AT THE END OF ALL RESURFACING (WHERE RESURFACING

MEETS EXISTING PAVEMENT) IN ACCORDANCE WITH THE "BUTT JOINT AND BITUMINOUS TAPER

ANY GUARDRAIL REMOVED AND DEEMED SALVAGEABLE BY THE RESIDENT ENGINEER SHALL BE

14. THE BITUMINOUS MATERIAL PRIME COAT QUANTITIES HAVE BEEN DETERMINED USING A RATE OF 0.10 GAL/SQ. YD.

DETAILS" SHEET INCLUDED IN THE PLANS, UNLESS OTHERWISE SPECIFIED.

GENERAL NOTES (CONT.)

15. PRIOR TO STARTING MILLING AND RESURFACING OF THE OUTSIDE SHOULDER IN AREAS ADJACENT TO GUARDRAIL, THE CONTRACTOR SHALL DETERMINE IF THE RAIL ELEMENT OF THE GUARDRAIL WILL NEED TO BE REMOVED TO COMPLETE THIS WORK TO THE SATISFACTION OF THE ENGINEER. IF DEEMED NECESSARY, THE CONTRACTOR SHALL REMOVE THE RAIL ELEMENT THE RESPECTIVE GUARDRAIL SECTIONS AND RE-ERECT THE RAIL ELEMENT ON THE SAME DAY IT WAS REMOVED. THE COST FOR THIS WORK WILL BE INCLUDED IN THE CONTRACT UNIT PRICE FOR "HOT-MIX ASPHALT SURFACE REMOVAL (VARIABLE DEPTH)." ANY GUARDRAIL FEATURES DAMAGED DURING CONSTRUCTION SHALL BE REPAIRED OR REPLACED AT THE

16. PAVEMENT PATCHING QUANTITIES HAVE BEEN INCLUDED IN THE CONTRACT TO ACCOMMODATE THE IMPROVEMENT OF PAVEMENT WHICH SHOWS SIGNS OF FAILURE OR EXCESSIVE CRACKING. THE ENGINEER WILL DETERMINE THE AREAS TO BE PATCHED IN ACCORDANCE WITH THE DISTRICT ONE DETAIL BD-22 FOR "PAVEMENT PATCHING FOR BITUMINOUS SURFACED PAVEMENT." QUANTITIES FOR "HOT-MIX ASPHALT REMOVAL OVER PATCHES" AND "HOT-MIX ASPHALT REPLACEMENT OVER PATCHES" ARE BASED ON THIS WORK BEING DONE AFTER THE MILLING OF THE MAINLINE PAVEMENT HAS BEEN COMPLETED. IF THE CONTRACTOR ELECTS TO PATCH THE PAVEMENT PRIOR TO COMPLETING THE MILLING OF THE MAINLINE PAVEMENT, THE ADDITIONAL DEPTH OF "HOT-MIX ASPHALT REMOVAL OVER PATCHES" AND THE ADDITIONAL TONNAGE REQUIRED FOR "HOT-MIX ASPHALT REPLACEMENT OVER PATCHES" WILL NOT BE MEASURED FOR PAYMENT.

17. IF THE OUTSIDE THROUGH LANE NEXT TO EXISTING EXIT/ENTRANCE RAMP IS MILLED, THE CONTRACTOR SHALL NOT LEAVE A GRADE DIFFERENTIAL BETWEEN MILLED LANES AND EXISTING RAMP SURFACE GREATER THAN 1" FOR SPEEDS > 45 MPH AND 1-1/2" FOR SPEEDS 45 MPH OR LESS. A 12" WIDE TEMPORARY RAMP SHALL BE CONSTRUCTED IMMEDIATELY UPON REMOVAL OF THE EXISTING BITUMINOUS SURFACE AS DIRECTED BY THE ENGINEER. THE LENGTH OF THE TEMPORARY RAMP WILL BE MEASURED AND THE AREA CALCULATED BY MULTIPLYING THE LENGTH BY ONE FOOT. THIS WORK SHALL BE PAID FOR AT THE CONTRACT UNIT PRICE PER SQ YD FOR "HOT-MIX ASPHALT SURFACE REMOVAL - BUTT JOINT."

18. BASED ON RESULTS OF 98 PAVEMENT CORES TAKEN DURING 2005, THE AVERAGE THICKNESS OF BITUMINOUS OVERLAY IS APPROXIMATELY 7 INCHES IN BOTH DESIGN SECTIONS, FORTY NINE (49) CORES WERE TAKEN IN EACH DIRECTION OF TRAVEL STARTING AT THE I-80 INTERCHANGE TO THE WEBER ROAD INTERCHANGE. THE THICKNESS OF OVERLAY RANGES FROM

19. THE CONTRACTOR SHALL INSTALL NEW DELINEATOR POSTS AND REFLECTORS AT THE LOCATIONS SHOWN IN THE PLANS FOR "DELINEATORS" AND AS SPECIFIED BY THE ENGINEER. THE CONTRACTOR SHALL REMOVE AND DISPOSE OF THE EXISTING DELINEATOR POSTS AND REFLECTORS IN ACCORDANCE WITH THE APPLICABLE PORTIONS OF ARTICLE 202.03 OF THE STANDARD SPECIFICATIONS. THE COST FOR REMOVAL AND DISPOSAL OF THE EXISTING DELINEATOR POSTS AND REFLECTORS WILL NOT BE PAID FOR SEPARATELY BUT SHALL BE INCLUDED IN THE CONTRACT UNIT PRICE FOR "DELINEATORS."

20. POROUS GRANULAR EMBANKMENT, SUBGRADE (PGES) HAS BEEN PROVIDED FOR USE AT THE LOCATIONS INDICATED FOR SOILS THAT TEND TO BE UNSUITABLE OR UNSTABLE. THE ACTUAL NEED FOR THE REMOVAL AND REPLACEMENT WITH PGES WILL BE DETERMINED IN THE FIELD AT THE TIME OF CONSTRUCTION BY THE GEOTECHNICAL ENGINEER. ALL POTENTIALLY UNSTABLE SOILS SHOULD BE TESTED WITH A STATIC CONE PENETROMETER AND TREATED IN ACCORDANCE WITH ARTICLE 301.04 AND THE IDOT SUBGRADE STABILITY MANUAL. IF UNSTABLE AND/OR UNSUITABLE MATERIAL IS NOT ENCOUNTERED, THEN THE QUANTITY SHALL BE DEDUCTED AND NO ADDITIONAL COMPENSATION WILL BE DUE TO THE CONTRACTOR.

21. TWO WEEKS PRIOR TO PLACING PERMANENT PAVEMENT MARKINGS, CONTACT MS, CORA MATHIS. AREA FIELD ENGINEER, AT (847) 485-6475.

22. THE PROPOSED BRIDGE PIER FOR THE FUTURE ILLINOIS ROUTE 59 EXIT RAMP BRIDGE OVER I-55 (S.N. 099-4642) SHALL BE CONSTRUCTED USING THE HORIZONTAL AND VERTICAL CONTROL INFORMATION SHOWN ON SHEET 258.

COUNTY TOTAL SHEET SHEETS NO. SECTION 55 99 (1&2) WRS WILL 334 3 STA. TO STA. FED. ROAD DIST. NO. ILLINOIS FED. AID PROJECT

DRAINAGE NOTES

1. THE STATION AND OFFSET OF THE DRAINAGE STRUCTURES ADJACENT TO CONCRETE BARRIER TO THE EDGE OF THE FRAME ADJACENT TO THE CONCRETE BARRIER. THE STATION AND OFFSET OF ALL OTHER DRAINAGE STRUCTURES ARE TO THE CENTER OF THE FRAME

2. STATION OFFSETS AND RIM/GRATE ELEVATIONS FOR DRAINAGE STRUCTURES ADJACENT TO THE BARRIER BASE ARE BASED ON A 3 FOOT WIDE BARRIER BASE THAT IS CONSTRUCTED SYMMETRICAL ABOUT THE CENTERLINE. THE CONTRACTOR SHALL ADJUST THE ELEVATIONS AND OFFSET LOCATIONS SHOWN ON THE PLANS FOR ALL DRAINAGE STRUCTURES INSTALLED ALONG THE CONCRETE BARRIER AS NECESSARY TO ACCOMMODATE THE VARIABLE BARRIER BASE WIDTHS THAT ARE NEEDED TO ACCOMMODATE NORTHBOUND AND SOUTHBOUND ELEVATION DIFFERENTIALS. THIS COST OF THIS WORK SHALL BE INCLUDED IN THE COST FOR THE APPLICABLE DRAINAGE STRUCTURES, FOR ADDITIONAL BARRIER BASE INFORMATION, SEE TYPICAL SECTIONS AND STANDARDS.

INVERT ELEVATIONS FOR EXISTING PIPES HAVE BEEN SHOWN ON THE PLANS WHEN SURVEY INFORMATION WAS AVAILABLE. THE CONTRACTOR SHALL VERIFY THE INVERT ELEVATIONS FOR EXISTING PIPES IN THE FIELD AT THE TIME OF CONSTRUCTION AND SHALL NOTIFY THE ENGINEER OF ANY DISCREPANCIES.

4. FOR INSTALLATION OF PROPOSED DRAINAGE STRUCTURES IN EXISTING SEWERS A PORTION OF THE EXISTING PIPE SHALL BE CUT AND REMOVED. THE PROPOSED STRUCTURE SHALL BE PROVIDED WITH ADEQUATELY SIZED OPENINGS SUCH THAT THE EXISTING PIPE MAY BE CONNECTED AT ITS EXISTING INVERT ELEVATION. THE COST OF THIS WORK WILL NOT BE PAID FOR SEPARATELY, BUT SHALL BE INCLUDED IN THE CONTRACT UNIT PRICE EACH FOR THE TYPE AND KIND OF DRAINAGE STRUCTURE TO BE INSTALLED.

5. FOR PROPOSED STORM SEWER OR PIPE CULVERT CONNECTIONS TO EXISTING PIPES, BOX CULVERTS, OR STRUCTURES, THE CONNECTION AND REMOVAL OF CONCRETE TO MAKE NECESSARY HOLES IN THE EXISTING PIPES, EXISTING BOX CULVERTS, OR EXISTING STRUCTURES WILL NOT BE PAID FOR SEPARATELY, BUT SHALL BE INCLUDED IN THE CONTRACT UNIT PRICE PER FOOT FOR STORM SEWERS OR PIPE CULVERTS OF THE DIAMETER, TYPE, AND CLASS SPECIFIED, AND OF THE PARTICULAR KIND OF MATERIAL WHEN SPECIFIED.

REMOVAL OF MANHOLES, CATCH BASINS AND ANY OTHER EXISTING DRAINAGE STRUCTURES IN THE EXISTING MEDIAN DITCH OF I-55 OR ELSEWHERE ON THE I-55 EXPRESSWAY, SHALL BE PAID FOR AT THE CONTRACT UNIT PRICE EACH FOR "REMOVING MANHOLES", REGARDLESS OF SHAPE, DEPTH OR SIZE OF THE STRUCTURE, EXCEPT FOR MEDIAN INLET BOXES WHICH SHALL BE PAID SEPARATELY AS "MEDIAN INLET BOX REMOVAL."

TOP OF GRATE ELEVATIONS FOR EXISTING STRUCTURES SHOWN ON THE PLANS WERE DETERMINED BY COMPUTER TERRAIN MODELING. THE RESIDENT ENGINEER MAY REVISE THE TOP OF GRATE ELEVATIONS AT THE TIME OF CONSTRUCTION BASED ON FIELD CONDITIONS.

REMOVAL OF EXISTING UNDERDRAINS AND HEADWALLS FOR UNDERDRAINS WILL NOT BE PAID FOR SEPARATELY, BUT SHALL BE INCLUDED IN THE CONTRACT UNIT PRICE PER CU. YD. FOR FARTH EXCAVATION.

9. DURING STAGE I, THE FRAMES AND GRATES CONSTRUCTED ADJACENT TO THE CONCRETE BARRIER SHALL BE SET FLUSH WITH THE LEVEL OF THE BINDER COURSE AND THE GRATES SHALL BE BOLTED DOWN. IMMEDIATELY PRIOR TO PLACING THE SURFACE COURSE DURING STAGE III OR AS DIRECTED BY THE ENGINEER, THE BOLTS AND ASSOCIATED HARDWARE SHALL BE REMOVED AND THE FRAMES AND GRATES SHALL BE ADJUSTED TO THE FINAL SURFACE ELEVATION IN ACCORDANCE WITH SECTION 603 "ADJUSTING FRAMES AND GRATES OF DRAINAGE AND UTILITY STRUCTURES." THE BOLTS AND ASSOCIATED HARDWARE SHALL BE DELIVERED TO THE I-55 BOLINGBROOK MAINTENANCE YARD AT 151 EAST SOUTH FRONTAGE ROAD, BOLINGBROOK, IL 60440 (PHONE #630.739.5641). THE COST OF BOLTING THE GRATES DURING STAGE I AND THEN REMOVING THE BOLTS AND ASSOCIATED HARDWARE AND DELIVERING THEM TO THE IDOT MAINTENANCE FACILITY SHALL BE INCLUDED IN THE CONTRACT UNIT PRICE FOR FRAMES AND GRATES OF THE TYPE SPECIFIED.

> ILLINOIS DEPARTMENT OF TRANSPORTATION FAI ROUTE 55 (I-80 TO BLACK ROAD) REVISIONS NAME WIDENING AND RESURFACING DATE GENERAL NOTES AND DRAINAGE NOTES

SCALE: N.T.S. DATE 02/23/07

DRAWN BY AG CHECKED BY DDH

1 Rev. 5-31-07

TENG & ASSOCIATES, INC. ENGINEERS/ARCHITECTS/PLANNERS CHICAGO, ILLINOIS

F.A.I. RTE.	SECTION	Į.	COUNTY			SHEETS	SHEET NO.
55	99 (1&2) WRS			WILI	-	334	4
STA.			го	STA.			
FED. RO	AD DIST. NO.	ILLIN	0IS	FED.	AID	PROJECT	•

CONTRACT NO. 62895

		(1001. JA										
			STATE	} <u>~~</u>	PROP	EXIST IL 59	US 52					
			URBAN	ROADWAY	IL 59			SIGNING		LIGHTING		
CODE NO.	ITEM	UNIT	QUANTITY				099-0139 SFTY-2A		1 1 1 1 1 1 1 1 1 1 1 1 1 1 1 1 1 1 1	Y030-1E		
20100110	TREE REMOVAL (6 TO 15 UNITS DIAMETER)	UNIT	97	97								
20100210	TREE REMOVAL (OVER 15 UNITS DIAMETER)	UNIT	170	170								
20101000	TEMPORARY FENCE	FOOT	1312	1312						1		
20200100	EARTH EXCAVATION	CU YD	29571	29571						 		
20201200	REMOVAL AND DISPOSAL OF UNSUITABLE MATERIAL	CU YD	22614	22614								
20700420	POROUS GRANULAR EMBANKMENT, SUBGRADE	CU YD	5851	5851						<u> </u>		
20800150	TRENCH BACKFILL	CU YD	3694	3694								
21001000	GEOTECHNICAL FABRIC FOR GROUND STABILIZATION	SQ YD	21618	21618								
21101625	TOPSOIL FURNISH AND PLACE, 6"	SQ YD	7924	7924								
21101815	COMPOST FURNISH AND PLACE, 4"	SQ YD	24941	24941		1						
	SEEDING, CLASS 2A	ACRE	1.67	1.67								
	SEEDING, CLASS 4	ACRE	4.51	4.51								
	NITROGEN FERTILIZER NUTRIENT	POUND	150	150								
	PHOSPHORUS FERTILIZER NUTRIENT	POUND	150	150						-		
	POTASSIUM FERTILIZER NUTRIENT	POUND	150	150								
		ACRE	0.64	0,64								
	SEEDING, CLASS 4B (MODIFIED)	ACRE	7.57	7.57						1		
25100115	MULCH, METHOD 2									1		
25100630	EROSION CONTROL BLANKET	SQ YD	29927	29927								
	TEMPORARY EROSION CONTROL SEEDING	POUND	693	693								
	TEMPORARY DITCH CHECKS	EACH	31	31								
	INLET AND PIPE PROTECTION	EACH	4	4								
28000510	INLET FILTERS	EACH	272	272								
28100105	STONE RIPRAP, CLASS A3	SQ YD	156	156								
28100107	STONE RIPRAP, CLASS A4	SQ YD	132	132			1					
28200200	FILTER FABRIC	SQ YD	132	132								
31101400	SUB-BASE GRANULAR MATERIAL, TYPE B 6"	SQ YD	3522	3522								
35501316	HOT-MIX ASPHALT BASE COURSE, 8"	SQ YD	89656	89656								
35501330	HOT-MIX ASPHALT BASE COURSE, 11 1/2"	SQ YD	3262	3262								
40600200	BITUMINOUS MATERIALS (PRIME COAT)	TON	196	196								
40600300	AGGREGATE (PRIME COAT)	TON	144	144	1							
40600400	MIXTURE FOR CRACKS, JOINTS, AND FLANGEWAYS	TON	49.8	49.8								
40600895	CONSTRUCTING TEST STRIP	EACH	6	6						-		
40600982	HOT-MIX ASPHALT SURFACE REMOVAL - BUTT JOINT	SQ YD	1893	1893						1		
40601005	HOT-MIX ASPHALT REPLACEMENT OVER PATCHES	TON	741	741								
40603340	HOT-MIX ASPHALT SURFACE COURSE, MIX "D", N70	TON	4079	4079								
42001300	PROTECTIVE COAT	SQ YD	2657	2657								
44000100	PAVEMENT REMOVAL	SQ YD	389	389								
44000163	HOT-MIX ASPHALT SURFACE REMOVAL, 3 1/2"	SQ YD	126313	126313								
	HOT-MIX ASPHALT SURFACE REMOVAL, VARIABLE DEPTH	SQ YD	38472	38472								
	BITUMINOUS CONCRETE SHOULDER REMOVAL	SQ YD	30472	30472						+		
	HOT-MIX ASPHALT REMOVAL OVER PATCHES, 3 1/2"	SQ YD	3779	3779								
	PORTLAND CEMENT CONCRETE SHOULDER REMOVAL	SQ YD	644	644								
44201761	CLASS D PATCHES, TYPE I, 10 INCH	SQ YD	687	687								
	CLASS D PATCHES, TYPE II, 10 INCH	SQ YD	2171	2171								
	CLASS D PATCHES, TYPE III, 10 INCH	SQ YD	325	325								
		SQ YD	44	44	ļ	<u> </u>						
44201771	CLASS D PATCHES, TYPE IV, 10 INCH	30110	1 77	77								

ILLINOIS DEPARTMENT OF TRANSPORTATION FAI ROUTE 55 (I-80 TO BLACK ROAD) WIDENING AND RESURFACING SUMMARY OF QUANTITIES

SCALE: N.T.S. DATE 03/22/07 TENG DRAWN BY AG
CHECKED BY DDH
TENG & ASSOCIATES, INC.
ENGINEERS/ARCHITECTS/PLANNERS
OHICAGO, ILLINOIS

44201771 CLASS D PATCHES, TYPE IV

A Rev. 5-31-07

			~~~~							
			100% STATE	}^	PROP	EXIST			· · · · · · · · · · · · · · · · · · ·	
		T (	LIRBAN	ROADWAY	IL 59	IL 59	US 52	SIGNING		LIGHTING
CODE NO.	ITEM	UNIT	QUANTITY		099-4642 X271-2A	099-0030 SETY-2A				Y030-1E
	STRIP REFLECTIVE CRACK CONTROL TREATMENT	FOOT	126935	126935	7212 27		011127			
48101600	AGGREGATE SHOULDERS, TYPE B 8"	SQ YD	1662	1662						
50105220	PIPE CULVERT REMOVAL	FOOT	576	576						
50200100	STRUCTURE EXCAVATION	CU YD	103	41	58		4			
50300225	CONCRETE STRUCTURES	CU YD	91.7	5.5	60.2	4.6	21.4			
50800105	REINFORCEMENT BARS	POUND	10460	3190	7110			160		
50800205	REINFORCEMENT BARS, EPOXY COATED	POUND	21930		18720	440	2770			
51500100	NAME PLATES	EACH	1		1					
51602000	PERMANENT CASING	FOOT	63	63						
<del>*</del> 51603000	DRILLED SHAFT IN SOIL	CU YD	38.8	11.5	27.3					
<b>*</b> 51604000	DRILLED SHAFT IN ROCK	CU YD	3.0		3.0					
54213657	PRECAST REINFORCED CONCRETE FLARED END SECTIONS 12"	EACH	4	4						
54213663	PRECAST REINFORCED CONCRETE FLARED END SECTIONS 18"	EACH	5	5						
54213669	PRECAST REINFORCED CONCRETE FLARED END SECTIONS 24"	EACH	7	7						
54213681	PRECAST REINFORCED CONCRETE FLARED END SECTIONS 36"	EACH	2	2						
54214509	PRECAST REINFORCED CONCRETE FLARED END SECTIONS, EQUIVALENT ROUND-SIZE 24"	EACH	4	4						
54215979	REINFORCED CONCRETE PIPE ELBOW 24"	EACH	18	18						
54247130	GRATING FOR CONCRETE FLARED END SECTION 24"	EACH	3	3						
54247170	GRATING FOR CONCRETE FLARED END SECTION 36"	EACH	1	1						
54248130	GRATING FOR CONCRETE FLARED END SECTION EQUIVALENT ROUND-SIZE 24"	EACH	3	3						
55019600		FOOT	486	486						
	STORM SEWERS, TYPE 1, REINFORCED CONCRETE CULVERT, STORM DRAIN, AND SEWER PIPE, CLASS IV 18"	FOOT	135	135						
***************************************	STORM SEWERS, TYPE 1, REINFORCED CONCRETE CULVERT, STORM DRAIN, AND SEWER PIPE, CLASS II 48"	FOOT	9	9						
55021600	STORM SEWERS, TYPE 2, REINFORCED CONCRETE CULVERT, STORM DRAIN, AND SEWER PIPE, CLASS III 12"	FOOT	2027	2027						
55021700	STORM SEWERS, TYPE 2, REINFORCED CONCRETE CULVERT, STORM DRAIN, AND SEWER PIFE, CLASS III 15"	FOOT	4936	4936						
55021800	STORM SEWERS, TYPE 2. REINFORCED CONCRETE CULVERT, STORM DRAIN, AND SEWER PIPE, CLASS III 18"	FOOT	5073	5073						
55021900	STORM SEWERS, TYPE 2. REINFORCED CONCRETE CULVERT, STORM DRAIN, AND SEWER PIPE, CLASS III 21"	FOOT	856	856						
	STORM SEWERS, TYPE 2, REINFORCED CONCRETE CULVERT, STORM DRAIN, AND SEWER PIPE, CLASS III 24"	FOOT	2360	2360						
55022100	STORM SEWERS, TYPE 2, REINFORCED CONCRETE CULVERT, STORM DRAIN, AND SEWER PIPE, CLASS III 27"	FOOT	148	148						
55022200	STORM SEWERS, TYPE 2, REINFORCED CONCRETE CULVERT, STORM DRAIN, AND SEWER PIPE, CLASS III 30"	FOOT	81	81						
	STORM SEWERS, TYPE 2, REINFORCED CONCRETE CULVERT, STORM DRAIN, AND SEWER PIPE, CLASS III 36"	FOOT	299	299						
55034200		FOOT	164	164						
	STORM SEWERS, TYPE 1, REINFORCED CONCRETE ELLIPTICAL PIPE, SPAN 30, RISE 19	FOOT	245	245						
		FOOT	2219	2219						
55035400 55035600	STORM SEWERS, TYPE 2, REINFORCED CONCRETE ELLIPTICAL PIPE, SPAN 38, RISE 24	FOOT	805	805						
7		FOOT	2031	2031						
55039700		FOOT	16	16						
55100500										
	STORM SEWER REMOVAL 15"	FOOT	392	392						
	STORM SEWER REMOVAL 18"	FOOT								
55101200	STORM SEWER REMOVAL 24"	FOOT	249	249						
552A0900		FOOT	73 105	73						
58600100		CU YD		102	1028	183	, 1143			
	CONCRETE SEALER	SQ FT	2354	1	1028	183	, 1143			
60100060		EACH	70001	1						
60107700	PIPE UNDERDRAINS 6"	FOOT	30991	30991						

| CONTRACT NO. 62895
F.A.I.	SECTION	COUNTY	SHEETS	NO.
55	99 (18.2) WRS	WILL	334	5
STA.	TO STA.			
FED. ROAD DIST. NO.	ILLINOIS	FED. AID	PROJECT	

ILLINOIS DEPARTMENT OF TRANSPORTATION FAI ROUTE 55 (1-80 TO BLACK ROAD) WIDENING AND RESURFACING

SUMMARY OF QUANTITIES

SCALE: N.T.S. DATE 03/22/07 DRAWN BY AG

CHECKED BY DDH
TENG & ASSOCIATES, INC.
ENGINEERS/ARCHITECTS/PLANNERS
CHICAGO, ILLINOIS

1 Rev. 5-31-07

"NBD991A001.DGN, "NSO8GIA001.DGN, "NSO061A001.DGN 3-21-2007, 15:17:58 GARCIAAZ S:NDOCUMENT 023

60108200 PIPE UNDERDRAINS 6" (SPECIAL)

O 100 / STATE

* SPECIAL IT LIEMS

ORBAN, 90% FEBERAL, 10% STATE

A

PLOT DATE = \$DATE\$
FILE NAME = \$FILEL\$
PLOT SCALE = \$SCALE\$
USER NAME = \$USER\$

			L URBAH	ĵ	IL 59	IL 59	US 52			,
			TOTAL	ROADWAY	099-4642	099-0030	099-0139	SIGNING		LIGHTING
CODE NO.	ITEM	UNIT			X271-2A	SFTY-2A	SFTY-2A	Y002-1C		Y030-1E
	CATCH BASINS, TYPE A, 4'-DIAMETER, TYPE 9 FRAME AND GRATE	EACH	4	4						
60201310	CATCH BASINS, TYPE A, 4'-DIAMETER, TYPE 20 FRAME AND GRATE	EACH	196	196						
60201320	CATCH BASINS, TYPE A, 4'-DIAMETER, TYPE 21 FRAME AND GRATE	EACH	12	12						
60205010	CATCH BASINS, TYPE A, 5'-DIAMETER, TYPE 20 FRAME AND GRATE	EACH	41	41						
60205020	CATCH BASINS, TYPE A, 5'-DIAMETER, TYPE 21 FRAME AND GRATE	EACH	11	11						
60219000	MANHOLES, TYPE A, 4'-DIAMETER, TYPE 8 GRATE	EACH	1	1						
60221100	MANHOLES, TYPE A, 5'-DIAMETER, TYPE 1 FRAME, CLOSED LID	EACH	2	2						
60221700	MANHOLES, TYPE A, 5'-DIAMETER, TYPE 8 GRATE	EACH	1	1						
	MANHOLES, TYPE A, G'-DIAMETER, TYPE 20 FRAME AND GRATE	EACH	3	3						
	FRAMES AND GRATES TO BE ADJUSTED	EACH	270	270						
		EACH	23	23						
	REMOVING MANHOLES	FOOT	120	120						
	CONCRETE CURB, TYPE B									
60602200	CONCRETE GUTTER	FOOT	28196	28196						
60618320	CONCRETE MEDIAN SURFACE, 6 INCH	SQ FT	687	687						
60621600	CONCRETE MEDIAN, TYPE SM	SQ FT	761	761						
63000000	STEEL PLATE BEAM GUARD RAIL, TYPE A	FOOT	1050	1050						
63100085	TRAFFIC BARRIER TERMINAL, TYPE 6	EACH	3	3						
63100167	TRAFFIC BARRIER TERMINAL TYPE 1, SPECIAL (TANGENT)	EACH	5	5						
63200310	GUARDRAIL REMOVAL	FOOT	15503	15503						
	REMOVE AND RE-ERECT STEEL PLATE BEAM GUARD RAIL, TYPE A	FOOT	125	125						
	DELINEATORS	EACH	130	130						
	CONCRETE BARRIER TRANSITION	FOOT	1558	1558						
		FOOT	21336	21336						
	CONCRETE BARRIER BASE									
	SHOULDER RUMBLE STRIP	FOOT	75472	75472						
67100100	MOBILIZATION	L SUM	11	1						
70106800	CHANGEABLE MESSAGE SIGN	CAL MO	54	54						
70300520	PAVEMENT MARKING TAPE, TYPE III 4"	FOOT	237148	237148						
70300530	PAVEMENT MARKING TAPE, TYPE III 5"	FOOT	29036	29036						
70300550	PAVEMENT MARKING TAPE, TYPE III 8"	FOOT	36160	36160						
70300560	PAVEMENT MARKING TAPE, TYPE III 12"	FOOT	2357	2357						
70301000	WORK ZONE PAVEMENT MARKING REMOVAL	SQ FT	84411	84411					<u> </u>	
70400100	TEMPORARY CONCRETE BARRIER	FOOT	43852	43852						
72000100	SIGN PANEL - TYPE 1	SQ FT	17					17		
	SIGN PANEL - TYPE 2	SQ FT	383					383		
	SIGN PANEL - TYPE 3 (SEE NOTE) A	SQ.FT	2503					2503		
	REMOVE SIGN PANEL ASSEMBLY - TYPE A	EACH	9					9		
			33					33		
	REMOVE SIGN PANEL ASSEMBLY - TYPE B	EACH								
	REMOVE SIGN PANEL - TYPE 3	SQ FT	2018			<u> </u>		2018		
	RELOCATE SIGN PANEL ASSEMBLY - TYPE B	EACH	1					1		
72600100	MILE POST MARKER ASSEMBLY	EACH	5					5		
72700100	STRUCTURAL STEEL SIGN SUPPORT - BREAKAWAY	POUND	257					257		
73000100	WOOD SIGN SUPPORT	FOOT	786					786		-
73400100	CONCRETE FOUNDATIONS	CU YD	1.4					1.4		
73700100	REMOVE GROUND-MOUNTED SIGN SUPPORT	EACH	2	ļ				2		
73700200	REMOVE CONCRETE FOUNDATION - GROUND MOUNT	EACH	2					2		
78000200	THERMOPLASTIC PAVEMENT MARKING - LINE 4"	FOOT	77,547	77,541	$\supset \Lambda$					
1		1	1	-	1	1	1	1	1	

STATE A

URBAH "

PROP EXIST IL 59 IL 59

CONTRACT NO. 62895

| F.A.I. | SECTION | COUNTY | SHEET | NO. 55 | 99 (18.2) WRS | WILL | 334 | 6 |
| STA. | TO STA. FED. ROAD DIST. NO. ILLINOIS FED. AID PROJECT

NOTE:

TYPE 3 SIGN PANELS WHICH REQUIRE TYPE ZZ SHEETING WILL BE 100% PAID FOR BY STATE FUNDS. THE REST WILL BE PAID FOR BY 90% FEDERAL FUNDS AND 10% STATE FUNDS. A QUANTITY OF 1091 SQ FT OF ITEM NO. 72000300, SIGN PANEL - TYPE 3 REQUIRES TYPE ZZ RETROREFLECTIVE SHEETING.

ILLINOIS DEPARTMENT OF TRANSPORTATION FAI ROUTE 55 (1-80 TO BLACK ROAD) WIDENING AND RESURFACING

SUMMARY OF QUANTITIES III

SCALE: N.T.S. DATE 03/22/07

DRAWN BY AG CHECKED BY DDH TENG & ASSOCIATES, INC. ENGINEERS/ARCHITECTS/PLANNERS CHICAGO, ILLINOIS

AREV. 5-31-07

PLOT DATE = \$DATE\$
FILE NAME = \$FILEL\$
PLOT SCALE = \$SCALE\$
USER NAME = \$USER\$

CONTRACT NO. 62895 SECTION COUNTY

55 99 (1&2) WRS WILL 334 7 STA. TO STA. FED. ROAD DIST. NO. ILLINOIS FED. AID PROJECT

IL 59 IL 59 TOTAL ROADWAY 099-4642 099-0030 099-0139 SIGNING 0UANTITY 1000-2A X271-2A SFTY-2A SFTY-2A Y002-1C LIGHTING Y030-1E CODE NO. 22325 22325 * 78000500 THERMOPLASTIC PAVEMENT MARKING - LINE 8 FOOT FOOT 4246 4246 78000600 THERMOPLASTIC PAVEMENT MARKING - LINE 12 FOOT 467 467 78003110 PREFORMED PLASTIC PAVEMENT MARKING, TYPE B - LINE 4" FOOT 22081 22081 78003120 PREFORMED PLASTIC PAVEMENT MARKING, TYPE B - LINE 5' FOOT 53266 53266 * 78005110 EPOXY PAVEMENT MARKING - LINE 4" FOOT 34599 34599 * 78005120 EPOXY PAVEMENT MARKING - LINE 5" 2502 * 78005140 EPOXY PAVEMENT MARKING - LINE 8" 3135 3135 * 78005150 EPOXY PAVEMENT MARKING - LINE 12" FOOT 78008210 POLYUREA PAVEMENT MARKING TYPE I - LINE 4" 14955 14955 FOOT 78008220 POLYUREA PAVEMENT MARKING TYPE I - LINE 5" 2488 2488 78100100 RAISED REFLECTIVE PAVEMENT MARKER EACH 2567 2567 78100300 REPLACEMENT REFLECTOR EACH 2474 2474 EACH 8639 8639 78200100 MONODIRECTIONAL PRISMATIC BARRIER REFLECTOR 78200410 GUARDRAIL MARKERS, TYPE A EACH 526 526 EACH * 78200530 BARRIER WALL MARKERS, TYPE C * 78201000 TERMINAL MARKER - DIRECT APPLIED SQ FT 31262 31262 ***** 78300100 PAVEMENT MARKING REMOVAL 78300200 RAISED REFLECTIVE PAVEMENT MARKER REMOVAL TRENCH AND BACKFILL FOR ELECTRICAL WORK FOOT 1635 * 81900200 * 82102400 LUMINAIRE, SODIUM VAPOR, HORIZONTAL MOUNT, 400 WATT EACH * 83050810 LIGHT POLE, ALUMINUM, 47.5 FT. M.H., 15 FT. MAST ARM FOOT 66.5 * 83600200 LIGHT POLE FOUNDATION, 24" DIAMETER EACH * 83800505 BREAKAWAY DEVICE, COUPLING, WITH ALUMINUM SKIRT * 84200800 POLE FOUNDATION, REMOVED * 84400105 RELOCATE EXISTING LIGHTING UNIT EACH 1126 X0322256 TEMPORARY INFORMATION SIGNING GALLON 2.5 X0322323 WEED CONTROL, TEASEL 47610 47610 X0322729 MATERIAL TRANSFER DEVICE X0322936 REMOVE EXISTING FLARED END SECTION X0323426 SEDIMENT CONTROL, DRAINAGE STRUCTURE INLET FILTER CLEANING CAL MO 15 X0323574 MAINTENANCE OF LIGHTING SYSTEM X0323879 X0323973 2268 2268 SEDIMENT CONTROL, SILT FENCE X0323974 FOOT 1973 1973 SEDIMENT CONTROL, SILT FENCE MAINTENANCE SQ FT 382 X0323988 TEMPORARY SOIL RETENTION SYSTEM EACH X0324045 SEDIMENT CONTROL, STABILIZED CONSTRUCTION ENTRANCE REMOVAL EACH 2 X0324685 TEST STRIP (STONE MATRIX ASPHALT) SQ YD 1864 1864 X0324774 SEDIMENT CONTROL, STABILIZED CONSTRUCTION ENTRANCE SQ YD 1864 1864 X0324775 SEDIMENT CONTROL, STABILIZED CONSTRUCTION ENTRANCE MAINTENANCE X0484300 MEDIAN INLET BOX REMOVAL 25991 25991 X4066580 POLYMERIZED HOT-MIX ASPHALT SURFACE COURSE, STONE MATRIX ASPHALT, N80 X4066685 POLYMERIZED HOT-MIX ASPHALT BINDER COURSE, STONE MATRIX ASPHALT, N80 TON 21619 21619 519 519 X6370920 CONCRETE BARRIER, SINGLE FACE, 42 INCH HEIGHT X6370940 CONCRETE BARRIER, DOUBLE FACE, 42 INCH HEIGHT FOOT 19259 19259 L SUM 1 X7011015 TRAFFIC CONTROL AND PROTECTION (EXPRESSWAYS) X7013820 TRAFFIC CONTROL SURVEILLANCE, EXPRESSWAYS CAL DA 330 330

100%.)A

US 52

URBAN

ILLINOIS DEPARTMENT OF TRANSPORTATION FAI ROUTE 55 (I-80 TO BLACK ROAD) WIDENING AND RESURFACING

SUMMARY OF QUANTITIES

SCALE: N.T.S. DATE 03/22/07 TENG

CHECKED BY DDH TENG & ASSOCIATES, INC. ENGINEERS/ARCHITECTS/PLANNERS CHICAGO, ILLINOIS

DRAWN BY AG

A Rev. 5-31-07

DATE NAME SCALE NAME

PLOT FILE PLOT USER

STATE URBAN EXIST IL 59 IL 59 US 52 TOTAL ROADWAY 099-4642 099-0030 099-0139 SIGNING LIGHTING QUANTITY 1000-2A X271-2A SFTY-2A SFTY-2A Y002-1C Y030-1E CODE NO. XX002870 AGGREGATE SHOULDERS, TYPE B (SPECIAL) SQ YD 11102 11102 268 268 XX003988 TEMPORARY CONCRETE BARRIER REMOVAL XX005472 DRAINAGE STRUCTURE SPECIAL Z0001050 AGGREGATE SUBGRADE 12" SQ YD 99436 99436 L SUM Z0013798 CONSTRUCTION LAYOUT Z0018500 DRAINAGE STRUCTURES TO BE CLEANED Z0030150 IMPACT ATTENUATORS (NON-REDIRECTIVE), TEST LEVEL 3 Z0030260 IMPACT ATTENUATORS, TEMPORARY (FULLY REDIRECTIVE, NARROW), TEST LEVEL 3 EACH Z0030330 IMPACT ATTENUATORS, RELOCATE (FULLY REDIRECTIVE), TEST LEVEL 3 Z0056220 SAND MODULE IMPACT ATTENUATOR TO BE REMOVED F00T 40 Z0068400 STEEL CASINGS 42" 4000 4000 \ SQ YD 89656 89656 3550/288 HOT-MIX ASPHALT BASE COURSE, 2 1/2" X0325733 TEMPORARY ASPHALT WEDGE SQ YD 2147 2147 X0325741 REINFORCED CONCRETE PIPE ELBOW, SPAN 30 RISE 19

* XX006937 GROUND ROD, 5/8" X 10 FT. EACH EACH 1635 * X0325740 UNIT DUCT, 600V, 3-1/C NO. 2, 1/C NO. 4 GROUND, (EPR-TYPE RHW), 1 1/2" DIA. POLYETHYLENE TON 109 109 X4421000 PARTIAL DEPTH PATCHING 5Q YO 970 970 S X4422025 PARTIAL DEPTH REMOVAL Z" SPECIALTY LIEMS

URBAN, 90% FEDERAL, 10% STATE

CONTRACT NO. 62895 STA. TO STA. FED. ROAD DIST. NO. ILLINOIS FED. AID PROJECT

ILLINOIS DEPARTMENT OF TRANSPORTATION FAI ROUTE 55 (I-80 TO BLACK ROAD) WIDENING AND RESURFACING

# SUMMARY OF QUANTITIES


SCALE: N.T.S. DATE 03/22/07 DRAWN BY AG CHECKED BY DDH

1 Rev. 5-31-07

Reve

TENG & ASSOCIATES, INC. ENGINEERS/ARCHITECTS/PLANNERS CHICAGO, ILLINOIS

DATE = SDATE\$
NAME = SFILEL\$
SCALE = SSCALE\$
NAME = \$USER\$

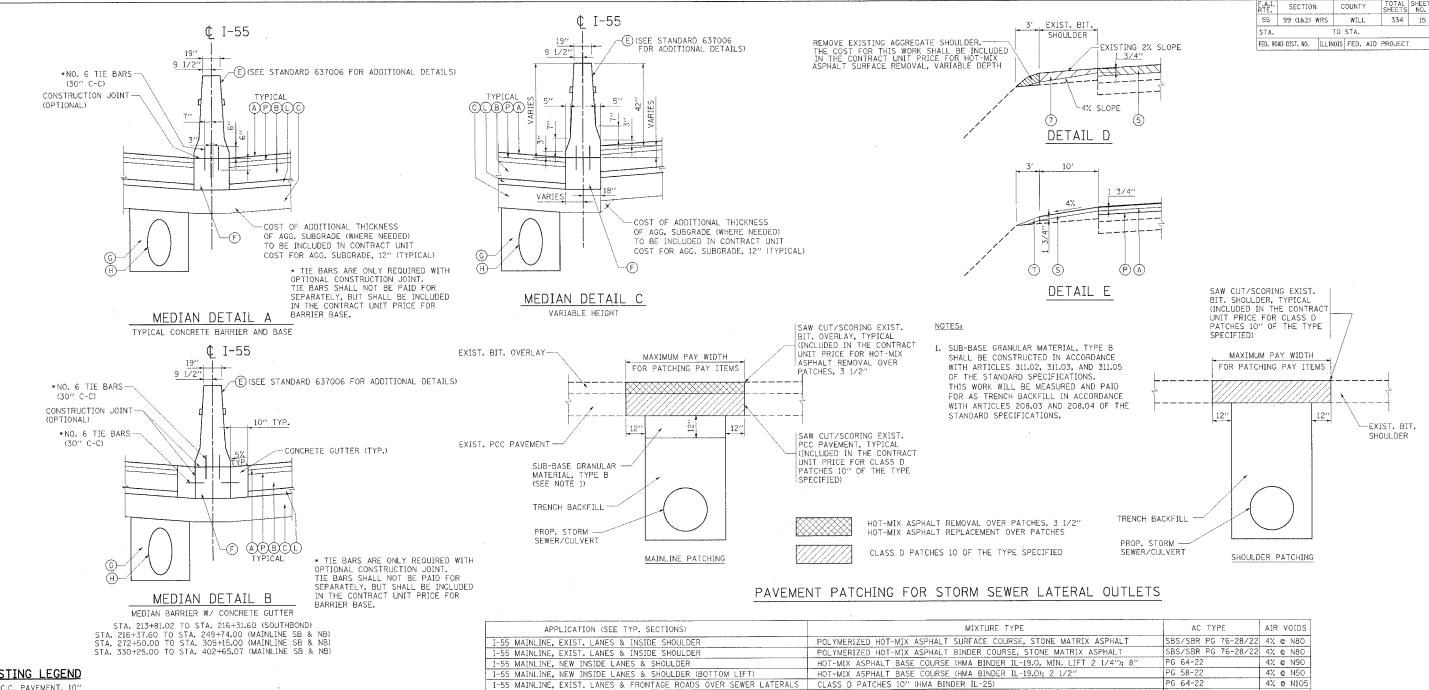

## EXISTING LEGEND

1) P.C.C. PAVEMENT, 10"

- (2) BITUMINOUS RESURFACING 7"
- (3) BITUMINOUS SHOULDER 10"
- (4) AGGREGATE SHOULDER
- (5) HOT-MIX ASPHALT SURFACE REMOVAL, 3 1/2"
- (6) NOT USED
- (7) HOT-MIX ASPHALT SURFACE REMOVAL, VARIABLE DEPTH (8) POLYMERIZED BITUMINOUS CONCRETE SURFACE COURSE, SUPERPAVE, IL-19, N90 2"
- BITUMINOUS CONCRETE BINDER COURSE, SUPERPAVE, IL-19, N90. 15"
- 10 BITUMINOUS SHOULDERS, SUPERPAVE, 17"
- (1) STABILIZED SUB-BASE 4"
- 12 PIPE UNDERDRAINS 6"
- (13) AGGREGATE SUBGRADE 12"
- (14) NOT USED
- (5) BITUMINOUS SHOULDER

# PROPOSED LEGEND

- (A) POLYMERIZED HOT-MIX ASPHALT SURFACE COURSE, STONE MATRIX ASPHALT, N80; 1 3/4"
- (B) HOT-MIX ASPHALT BASE COURSE, 8"
- © AGGREGATE SUBGRADE, 12"
- (D) EMBANKMENT
- (E) CONCRETE BARRIER, DOUBLE FACE, 42" HEIGHT
- (F) BARRIER BASE
- (G) TRENCH BACKFILL
- (H) STORM SEWER
- (I) STRIP REFLECTIVE CRACK CONTROL TREATMENT
- (J) TOPSOIL FURNISH AND PLACE, 6"

### (K) SEEDING, CLASS 2A

- (L) HOT-MIX ASPHALT BASE COURSE, 2 1/2"
- M NOT USED

I-55 MAINLINE, EXIST. LANES

- (N) NOT USED
- (0) AGGREGATE SHOULDERS, TYPE B, 8"
- P POLYMERIZED HOT-MIX ASPHALT BINDER COURSE, STONE MATRIX ASPHALT, N80: 1 3/4"

I-55 MAINLINE, EXIST. LANES & FRONTAGE ROADS OVER SEWER LATERALS

I-55 MAINLINE, EXIST. OUTSIDE SHLD; A.I.S.'; TEMPORARY ASPHALT WEDGE; PARTIAL DEPTH PATCHING ACCIDENT INVESTIGATION SITES (A.I.S.')

- (a) PIPE UNDERDRAINS 6" (SEE DRAINAGE PLANS FOR LOCATIONS)
- R NOT USED
- S HOT-MIX ASPHALT SURFACE COURSE, MIX "D", N 70; 1 3/4"
- T AGGREGATE SHOULDERS, TYPE B (SPECIAL)
- (U) SHOULDER RUMBLE STRIP

### NOTES:

1) THE UNIT WEIGHT USED TO CALCULATE THE PLAN QUANTITY FOR STONE MATRIX ASPHALT SURFACE COURSE IS 135 LBS/SQ YD/INCH THICKNESS.
2) THE UNIT WEIGHT USED TO CALCULATE ALL

HOT-MIX ASPHALT REPLACEMENT OVER PATCHES (HMA BINDER IL-25)

HOT-MIX ASPHALT SURFACE COURSE, MIX "D", N 70 (IL 9.5 mm)

HOT-MIX ASPHALT BASE COURSE (HMA BINDER IL-19); 11 1/2"

- HOT-MIX ASPHALT SURFACE MIXTURE QUANTITIES IS 112 LBS/SQ YD/INCH THICKNESS.
- * 3) WHEN RAP EXCEEDS 20%, THE NEW ASPHALT BINDER IN THE MIX SHALL BE PG 58-22.

LLINOIS FA	I		
			REVISIONS
		DATE	NAME
		5/15/07	<u> </u>
DE.			
M			
1412			
N.T.S.	SCALE:		
05/15/0	DATE		
'EN	T		

PG 64-22

G 64-22

3 64-22

PG 64-22 *

IS DEPARTMENT OF TRANSPORTATION FAI ROUTE 55 (I-80 TO BLACK ROAD) WIDENING AND RESURFACING

4% @ N105

4% p N105

4% @ N70

4% @ N70


TYPICAL SECTIONS IIXTURE REQUIREMENTS

DRAWN BY JFS CHECKED BY DOH TENG & ASSOCIATES, INC. ENGINEERS/ARCHITECTS/PLANNERS CHICAGO, ILLINOIS

CONTRACT NO. 62895

PLOT FILE PLOT USER

(6) SPBGR (SEE PLANS FOR LOCATIONS)

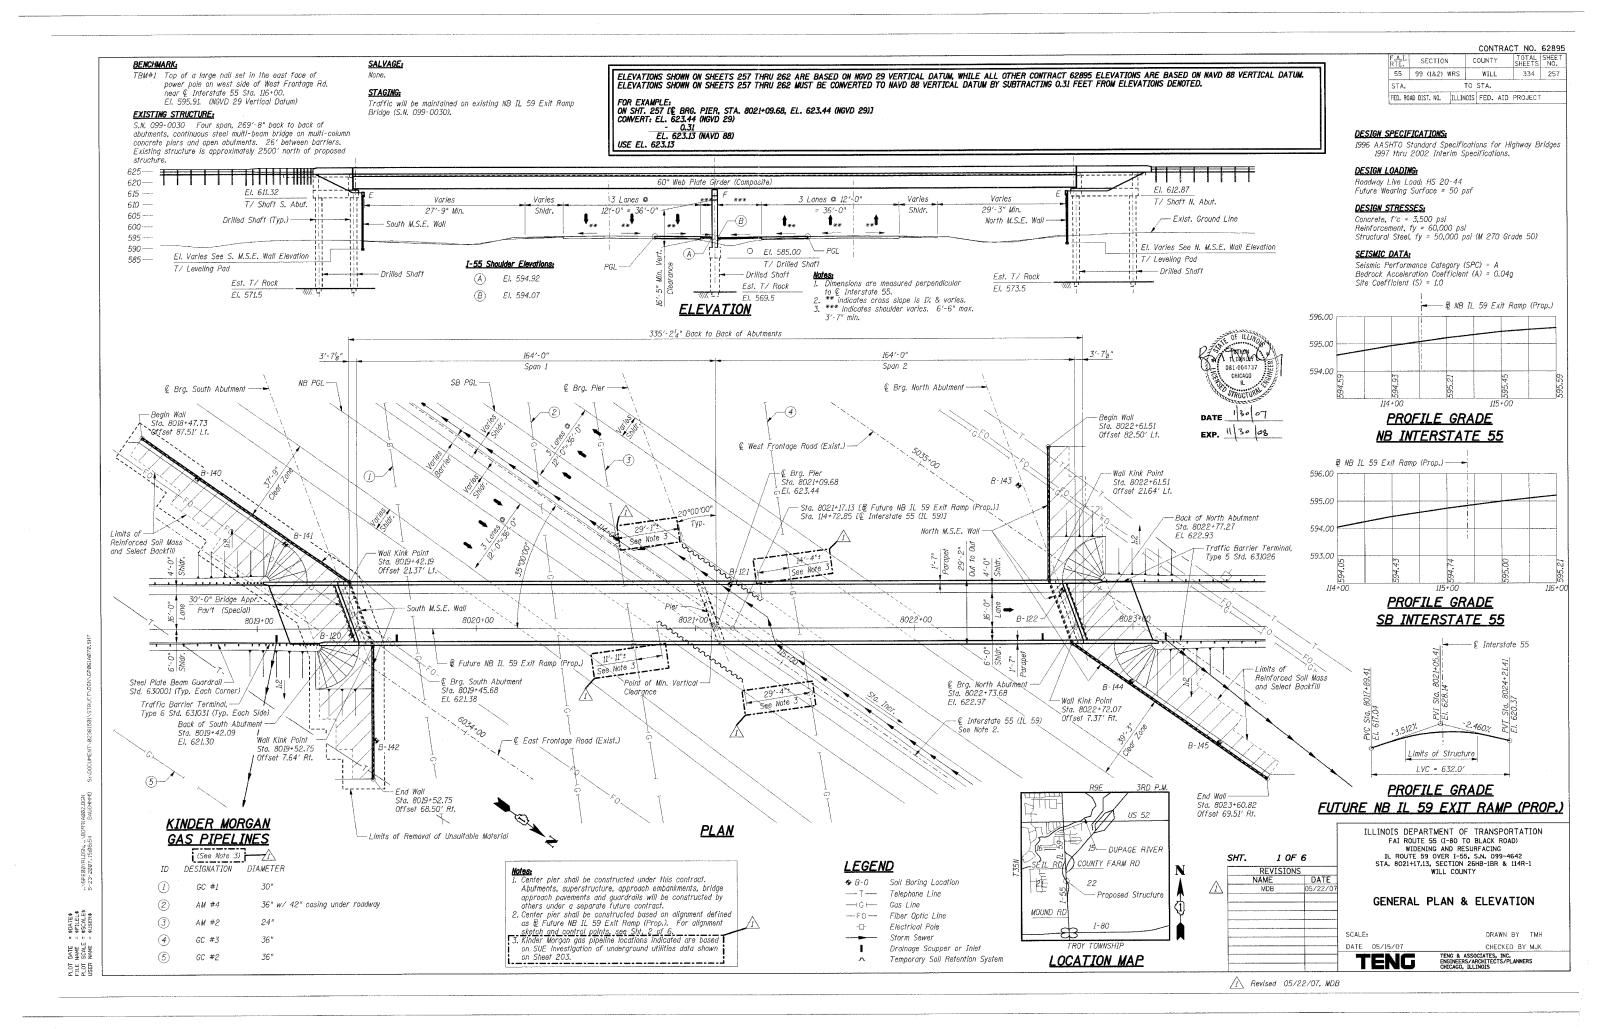

Total

60.2

7.110

18,720

382

27.3

3.0

#### COUNTY TOTAL SHEETS NO. SECTION 55 99 (1&2) WRS WILL 334 258 TO STA. FED. ROAD DIST. NO. ILLINOIS FED. AID PROJECT

Super

Sub

60.2

7,110

18,720

382

3.0

Cu Yd

Lbs

Lbs

Each

# GENERAL NOTES

- 1. Reinforcement Bars shall conform to the requirements of ASTM A 706 Gr 60 (IL Modified). See Special Provisions.
- 2. Reinforcement bars designated (E) shall be epoxy coated.
- 3. Bearing seat surfaces shall be constructed or adjusted to the designated elevations within a tolerance of \(^{l}_{9}\) Inch. Adjustment shall be made by grinding the surface.
- Concrete Sealer shall be applied to the designated areas of the pier.

E. Frontage Rd.

LEGEND:


• PK Nail

Sta 114+31.79 -

■ Iron Rod w/ Yellow Cap

### INDEX OF SHEETS

- GENERAL PLAN AND ELEVATION

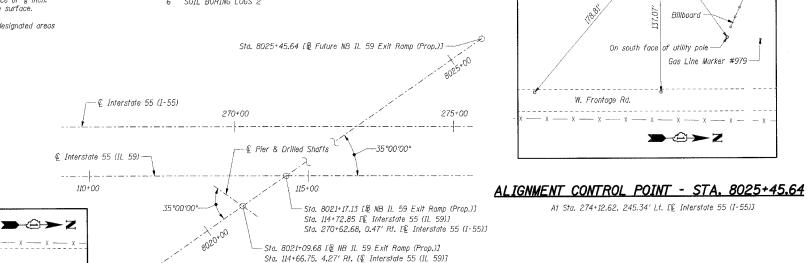

# € INTERSTATE 55 (IL 59) ALIGNMENT SKETCH

Future NB IL 59 Exit Ramp (Prop.)

**→**②→ Z

- NB I-55 Shoulder Line (Exist.)

-Sta. 8017+71.16 [B Future NB IL 59 Exit Ramp (Prop.)]

- SB I-55 Shoulder Line (Exist.)

--- € Interstate 55 (IL 59)

Drilled Shaft (Typ.)

Sta. 114+90.70


(NOT TO SCALE)

GENERAL NOTES, INDEX OF SHEETS; AND TOTAL BILL OF MATERIAL

SUBSTRUCTURE LAYOUT; DRILLED SHAFT DETAILS AND SCHEDULE

SOIL BORING LOGS L

SOIL BORING LOGS 2

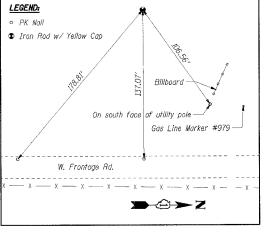

At Sta. 274+12.62, 245.34' Lt. [@ Interstate 55 (I-55)]

ELEVATIONS SHOWN ON SHEETS 257 THRU 262 ARE BASED ON

BY SUBTRACTING 0.31 FEET FROM ELEVATIONS DENOTED.

FOR EXAMPLE:

USE EL. 623.13

CONVERT: EL. 623.44 (NGVD 29)

~ 0.31

EL. 623.13 (NAVD 88)

257 THRU 262 MUST BE CONVERTED TO NAVD 88 VERTICAL DATUM

ON SHT. 257 [@ BRG. PIER, STA. 8021+09.68, EL. 623.44 (NGVD 29)]

NGVD 29 VERTICAL DATUM, WHILE ALL OTHER CONTRACT 62895 ELEVATIONS

ARE BASED ON NAVD 88 VERTICAL DATUM. ELEVATIONS SHOWN ON SHEETS

# B FUTURE NB IL 59 EXIT RAMP (PROP.) ALIGNMENT CONTROL POINTS

BILL OF MATERIAL - S.N. 099-4642

Ali	Ignment	Station	Offset	Northing	Easting
₿ NB IL 59	Exit Ramp (Prop.)	8017+71.16	0.00	1761260.12	1021501.93
₿ NB IL 59	Exit Ramp (Prop.)	8025+45.64	0.00	1761880.44	1021038.37

Structure Excavation

Concrete Structures

Reinforcement Bars

Drilled Shaft in Soil

Drilled Shaft in Rock Concrete Sealer

Reinforcement Bars, Epoxy Coated

Temporary Soll Retention System

- 1. Interstate 55 Stations shown on Sheets 257 thru 262 are based on the alignment defined on this sheet and denoted as  $\P$  Interstate 55 (IL 59), while all other Contract 62895 Interstate 55 stations are based on the alignment defined on shts, 34 thru 42 and denoted as  $\mathbb{Q}$  Interstate 55 (I-55) on this sheet.
- 2. Northings and Eastings indicated are based on the horizontal control system for this contract (Contract 62895).

## ALIGNMENT CONTROL POINT - STA. 8017+71.16


At Sta. 267+79.31, 198.89' Rt. [@ Interstate 55 (I-55)]

Drilled Shaft Cap

Sta. 114+42.70 -

LEGEND:

\$~~~~~~~** 

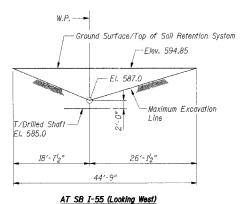

 $\rightarrow \bigcirc \rightarrow Z$ 

W.P. — → - Ground Surface/Top of Soll Retention System — Elev. 595.1 — El. 586.5 Maximum Excavation Line T/Drilled Shaft EI. 585.0 48'-0"

#### AT NB I-55 (Looking East)

# TEMPORARY SOIL RETENTION SYSTEM PLAN

Sta. 114+76.54 ---

See Sht. 1 of 6 for location of Kinder Morgan Gas Pipelines relative to Temporary Soil Retention System. Temporary Soll Retention System

# TEMPORARY SOIL RETENTION SYSTEM ELEVATIONS


A cantilevered sheet pilling design does not appear feasible and additional members or other refention systems may be necessary. The Contractor shall submit a temporary soil retention system design including plan details and calculations for review and

STATION 114+72.85 BUILT 20__ BY STATE OF ILLINOIS F.A.I. RT. 55 SEC. 26HB-1BR & 114R-1 LOADING HS20 STR. NO. 099-4642

### NAME PLATE

See Std. 515001

See Sht. 4 of 6 for location.

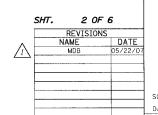

ILLINOIS DEPARTMENT OF TRANSPORTATION FAI ROUTE 55 (I-80 TO BLACK ROAD) WIDENING AND RESURFACING
IL ROUTE 59 OVER I-55, S.N. 099-4642
STA. 8021+17.13, SECTION 26HB-1BR & 114R-1
WILL COUNTY

GENERAL NOTES, INDEX OF SHEETS & TOTAL BILL OF MATERIAL

SCALE:

DRAWN BY TMH CHECKED BY MJK TENG & ASSOCIATES, INC. ENGINEERS/ARCHITECTS/PLANNERS CHICAGO. ILLINOIS

/1 Revised 05/22/07, MDB

DATE NAME SCALE NAME PLOT FILE PLOT USER