STATE OF ILLINOIS
DEPARTMENT OF TRANSPORTATION
DIVISION OF HIGHWAYS

PROPOSED HIGHWAY PLANS

F.A.P. ROUTE 533: ILL ROUTE 176
SECTION: 2004–117 RS
RESURFACING (DETOUR ROUTE)


MILLSTREAM ROAD (IL 176 TO GARDEN VALLEY ROAD)

GARDEN VALLEY ROAD (MILLSTREAM ROAD TO NORTH UNION ROAD)

NORTH UNION ROAD (GARDEN VALLEY ROAD TO IL 176)

MCHENRY COUNTY

C-91-052-05

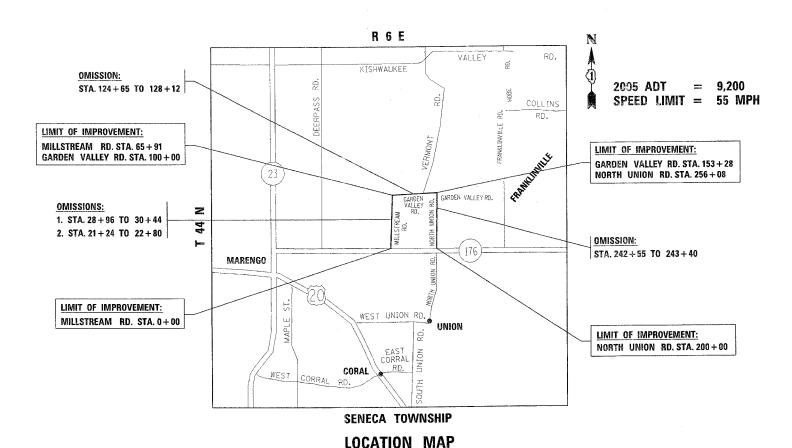

GROSS LENGTH OF IMPROVEMENT = 17,527 FEET = 3.3 MILES NET LENGTH OF IMPROVEMENT = 16,791 FEET = 3.2 MILES

FULL SIZE PLANS HAVE BEEN PREPARED USING STANDARD ENGINEERING SCALES. REDUCED SIZED PLANS WILL NOT CONFORM TO STANDARD SCALES. IN MAKING MEASUREMENTS ON REDUCED PLANS, THE ABOVE SCALES MAY BE USED.

FOR INDEX OF SHEETS, SEE SHEET NO. 2

IMPROVEMENT LOCATED IN UNINCORPORATED MCHENRY COUNTY

J.U.L.I.E.
JOINT UTILITY LOCATION INFORMATION FOR EXCAVATION
1-800-892-0123

CONTRACT NO. 62873

(847)

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ENGINEER:


PREPARATION

ANTENNESS OF THE STATE OF THE S

F.A.P. SECTION COUNTY TOTAL SHEETS NO. 533 2004-117 RS MCHENRY **26** 1

D-91-488-01



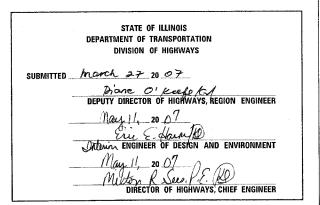

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F.A.P.	SECTION	COUNTY	TOTAL SHEETS	SHEET NO.
533	2004-117 RS	MCHENRY	26	2
STA.	. 1	O STA.		
FED. ROA	D DIST. NO. 1 ILLING	IS HIGHWAY	PROJECT	7

INDEX OF SHEETS

- COVER SHEET
- INDEX OF SHEETS, STATE STANDARDS, AND GENERAL NOTES
- SUMMARY OF QUANTITIES
- EXISTING AND PROPOSED TYPICAL SECTIONS
- 5-11 ROADWAY AND PAVEMENT MARKING PLANS
- PAVEMENT PATCHING FOR HMA SURFACED PAVEMENT
- BUTT JOINT AND HMA TAPER DETAILS
- TRAFFIC CONTROL AND PROTECTION FOR SIDE ROADS. INTERSECTIONS AND DRIVEWAYS
- TRAFFIC CONTROL & PROTECTION AT TURN BAYS (TO REMAIN OPEN TO TRAFFIC)
- TYPICAL APPLICATIONS RAISED REFLECTIVE PAVEMENT MARKERS (SNOW-PLOW RESISTANT)
- DISTRICT ONE TYPICAL PAVEMENT MARKINGS
- TEMPORARY INFORMATION SIGNING
- PAVEMENT MARKING LETTERS & SYMBOLS FOR TRAFFIC STAGING

COLUMN 1: LOCATION FROM PLANS

COLUMN 2: CUT QUANTITIES

COLUMN 3: FILL QUANTITIES

20-26 CROSS SECTIONS

GENERAL NOTES

BEFORE STARTING ANY EXCAVATION, THE CONTRACTOR SHALL CALL "JULIE" AT 1-800-892-0123 FOR FIELD LOCATIONS OF BURIED ELECTRIC, TELEPHONE AND GAS FACILITIES. (48 HOURS NOTIFICATION IS REQUIRED)

THE CONTRACTOR SHALL COORDINATE CONSTRUCTION ACTIVITIES WITH UTILITY COMPANIES, SENECA TOWNSHIP, AND MCHENRY COUNTY.

THE CONTRACTOR WILL NOT BE ABLE TO SET UP A YARD OR FIELD OFFICE ON STATE PROPERTY WITHOUT THE WRITTEN PERMISSION OF THE DEPARTMENT.

ALL HOT-MIX ASPHALT PAVEMENT PATCHING SHALL BE CLASS D

THE UNIT WEIGHT (CONVERSION FACTOR) QUOTED IS FOR ESTIMATING PLAN QUANTITIES ONLY. ACTUAL QUANTITIES TO FULFILL CONTRACT REQUIREMENTS WILL BE DETERMINED BASED ON UNIT WEIGHT OF APPROVED MIX DESIGN, PLAN DIMENSIONS, AND DENSITY LIMITATIONS, MAXIMUM PAYMENT WILL BE COMPUTED BASED ON WEIGHT AVERAGE DENSITIES OF THE IN-PLACE MIXTURE.

BUTT JOINTS WILL BE INSTALLED AT THE ENDS OF ALL RESURFACING (WHERE RESURFACING MEETS EXISTING PAVEMENT). IN ACCORDANCE WITH THE "BUTT JOINT AND HMA TAPER DETAILS" SHEETS INCLUDED IN THE PLANS UNLESS OTHERWISE SPECIFIED.

THE RESIDENT ENGINEER SHALL CONTACT DEBBIE HANLEN, AREA TRAFFIC ENGINEER, AT (847) 438-2300 A MINIMUM OF 72 HOURS PRIOR TO PLACEMENT OF PERMANENT PAVEMENT MARKINGS.

COLUMN 4: EARTH EXCAVATION THAT IS TO BE USED AS FILL

WAS DETERMINED TO BE 15%

EXCAVATION NEEDED

COLUMN 5: COLUMN 4 - COLUMN 3, POSITIVE QUANTITY=

COLUMN 6: TOPSOIL FURNISH AND PLACE = AREA OF SEEDING

MATERIAL IN THE EMBANKMENT, SHRINKAGE FACTOR

EXTRA EXCAVATION, NEGATIVE QUANTITY= FURNISHED

WHEN MILLED PAVEMENT IS OPEN TO TRAFFIC, THE MAXIMUM GRADE DIFFERENTIAL BETWEEN PASSES OF THE MILLING MACHINE SHALL NOT EXCEED 11/2 INCHES WHERE THE SPEED LIMIT IS 45 MPH OR LESS AND 1 INCH WHERE THE SPEED LIMIT IS OVER 45 MPH WITHOUT WRITTEN APPROVAL FROM THE RESIDENT ENGINEER. A MAXIMUM GRADE DIFFERENTIAL OF 3 INCHES MAY BE ALLOWED IF THE EDGE OF THE MILLING IS SLOPED A MINIMUM OF 1:3 (V:H).

SCHEDUL	E OF QUAI	NTITIES (EA	ARTHWORK)		
. 1	2	3	4	5	6
IL 176 (DETOUR ROUTE)	EARTH EXCAVATION (CU YD)	EMBANKMENT (CU YD)	ADJUSTMENT FOR SHRINKAGE (CU YD)	FURNISHED EXCAVATION (CU YD)	TOP SOIL FURNISH AND PLACE (SQ YD)
MILLSTREAM RD.: STA. 64+41 - STA. 65+21	12.98	16:11	11.03	-5.08	263
GARDENVALLEY RD.: STA. 100+20 - STA. 101+60	12.32	22.22	10.47	-11.75	
IL 176: STA. 500+20 - STA. 500+80	15.21	7.24	12.93	5.69	
NORTH UNION RD.: STA. 699+65 TO STA. 200+85	12.18	14.93	10.35	-4.58	168
TOTAL	52.69	60.50	44.78	-15.72	431

STATE STANDARDS

000001-04 STANDARD SYMBOLS, ABBREVIATIONS, AND PATTERNS

420001-06 PAVEMENT JOINTS

442201-02 CLASS C & D PATCHES

482011-02 HMA SHOULDER STRIPS/SHLDRS, WITH RESURFACING OR WIDENING AND RESURFACING PROJECTS

630001-07 STEEL PLATE BEAM GUARDRAIL

635006-02 REFLECTOR AND TERMINAL MARKER PLACEMENT

635011-01 REFLECTOR MARKER AND MOUNTING DETAILS

701006-02 OFF-ROAD OPERATIONS, 2L, 2W 4.5M (15') TO PAVEMENTEDGE,

FOR SPEEDS ≥ 45 MPH

701011-0! OFF-ROAD MOVING OPERATIONS, 2L, 2W DAY ONLY, FOR SPEEDS ≥ 45 MPH

701301-02 LANE CLOSURE, 2L, 2W, SHORT TIME OPERATIONS

701306-01 LANE CLOSURE, 2L, 2W SLOW MOVING OPERATIONS DAY ONLY,

FOR SPEED > 45 MPH

702001-06 TRAFFIC CONTROL DEVICES

REVISION NAME	S DATE	ILLINOIS DE	PARTMENT OF TH	RANSPORTATION	4
IVAING	- UNIC	DET	OUR FOR BRIDGE	OVER	
	_		NCH KISHWAUKEE		176
			F SHEETS, GENER ND STATE STAND		
		7	ID STATE STATE	ANDS	
		SCALE: VERT. HORIZ.		DRAWN BY	
		DATE 4/3/2007		CHECKED BY	

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CONTRACT NO. 62873

F.A.P. RTE.	SECTION		COUNT	Υ	TOTAL SHEETS	SHEET NO.
533	2004-117 RS		MCHEN	RY	26	3
FED.	ROAD DIST. NO. 1	ILL	INOIS	HIG	HWAY PRO	JECT


	SUMMARY OF QUANTITIES				(CONSTRUCT	ION TYPE	CODE			SUMMARY OF QUANTITIES				 CONSTRUCT	ION TYPE	CODE	
CODE NO	ITEM	UNIT	URBAN TOTAL QUANTITIES 100-1.5TATE	ROADWAY	·		:			CODE NO	ITEM	UNIT	URBAN TOTAL QUANTITIES 1001.5TATE	ROADWAY				
0200100	EARTH EXCAVATION	CU YD	53	53						* 63100167	TRAFFIC BARRIER TERMINAL TYPE 1, SPECIAL (TANGENT)	EACH	18	18				
0201006	GRADING AND SHAPING SHOULDERS	UNIT CU YD	368 16	368 16						¥ 63100169	TRAFFIC BARRIER TERMINAL TYPE 1, SPECIAL (FLARED)	EACH	1	. 1				
20400800	FURNISHED EXCAVATION TOPSOIL FURNISH AND PLACE, 4"	SQ YD	431	431						63200310	GUARDRAIL REMOVAL	FOOT	875	875				
5000210	SEEDING, CLASS 2A	ACRE	0. 10	0.10			}			★ 63304385	TRAFFIC BARRIER TERMINAL REMOVAL,	EACH	18	18				•
5000400	NITROGEN FERTILIZER NUTRIENT	POUND	10	10						67000400	TYPE 1	CAL MO	3	3				
5000500	PHOSPHORUS FERTILIZER NUTRIENT	POUND	10	10						67000400	ENGINEER'S FIELD OFFICE, TYPE A MOBILIZATION	L SUM	,	1		2.		
5000600	POTASSIUM FERTILIZER NUTRIENT	POUND	10	10						70100450	TRAFFIC CONTROL AND PROTECTION.	L SUM	1	1		a.		,
5100630	EROSION CONTROL BLANKET	SQ ,YD	431	431							STANDARD 701201							
5200200	SUPPLEMENTAL WATERING	UNIT	6	6	2.1	institution of the second	- 3173 -	· · · · · · · · · · · · · · · · · · ·		70100460	TRAFFIC CONTROL AND PROTECTION, STANDARD 701306	L SUM	1	1	 			
8000250	TEMPORARY EROSION CONTROL SEEDING	POUND	10	10						70100600	TRAFFIC CONTROL AND PROTECTION, STANDARD 701336	L SUM	1	1				:
8000300 8000400	TEMPORARY DITCH CHECKS PERIMETER EROSION BARRIER	EACH FOOT	30 355	355						70103815	TRAFFIC CONTROL SURVEILLANCE	CAL DA	10	10				
101200	SUB-BASE GRANULAR MATERIAL, TYPE B 4"	SQ YD	165	165						70300100	SHORT-TERM PAVEMENT MARKING	FOOT	10300	10300				
600704	HOT-MIX ASPHALT BASE COURSE WIDENING,	SQ YD	240	240			Wildering Control			70300220	TEMPORARY PAVEMENT MARKING - LINE 4"	FOOT	44210	44210				
0600200	BITUMINOUS MATERIALS (PRIME COAT)	TON	19	19					-	70300260	TEMPORARY PAVEMENT MARKING - LINE 12"	FOOT	340	340				-
0600300	AGGREGATE (PRIME COAT)	TON	95	95						70300280	TEMPORARY PAVEMENT MARKING	FOOT	18	18				
0600400	MIXTURE FOR CRACKS, JOINTS, AND FLANGEWAYS	TON	5	. 5							- LINE 24"							,
0600895	CONSTRUCTING TEST STRIP	EACH	2	2				,		70301000	WORK ZONE PAVEMENT MARKING REMOVAL	SQ FT	18206	18206				
600982	HOT-MIX ASPHALT SURFACE REMOVAL - BUTT JOINT	SQ YD	262	262						★ 78000200	THERMOPLASTIC PAVEMENT MARKING - LINE 4"	FOOT	44210	44210				
0601005	HOT-MIX ASPHALT REPLACEMENT OVER PATCHES	TON	35	35						≭ 78000600	THERMOPLASTIC PAVEMENT MARKING - LINE 12"	FOOT	340	340				
0603335	HOT-MIX ASPHALT SURFACE COURSE, MIX "D", N50	TON	4010	4010			. :			★ 78000650	THERMOPLASTIC PAVEMENT MARKING - LINE 24"	FOOT	18	18				,
4000151	HOT-MIX ASPHALT SURFACE REMOVAL,	SQ YD	47285	47285						* 78100100	RAISED REFLECTIVE PAVEMENT MARKER GUARDRAIL MARKERS, TYPE A	EACH EACH	273	273 18				
1002212	HOT-MIX ASPHALT REMOVAL OVER PATCHES,	SQ YD	200	200						¥ 78200410 ★ 78201000	TERMINAL MARKER - DIRECT APPLIED	EACH	18	18				
4201741	3"	SQ YD	200	200			,			X0322256	TEMPORARY INFORMATION SIGNING	SQ FT	102.8	102.8				
4201741 8102100	CLASS D PATCHES, TYPE II, 8 INCH AGGREGATE WEDGE SHOULDER, TYPE B	TON	1472	1472						X4067107	POLYMERIZED LEVELING BINDER (MACHINE METHOD), IL-4.75, N50	TON	3980	3980				
	STEEL PLATE BEAM GUARD RAIL, TYPE A	FOOT	875	875														
				- / -														

* - SPECIALTY ITEM

REVISIONS
NAME DATE

ILLINOIS DEPARTMENT OF TRANSPORTATION SUMMARY OF QUANTITIES

PLOT DATE: 4/3/2007

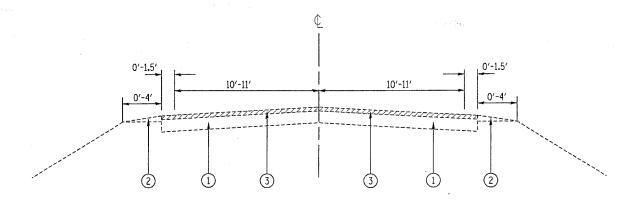


EXISTING TYPICAL CROSS SECTION

MILLSTREAM RD.: STA. 00+00 TO STA. 21+24 STA. 22+80 TO STA. 28+96 STA. 30+44 TO STA. 65+91

GARDEN VALLEY RD.: STA. 100+00 TO STA. 124+65

STA. 128+12 TO STA. 153+28

NORTH UNION RD.: STA. 200+00 TO STA. 242+55 STA. 243+40 TO STA. 265+00

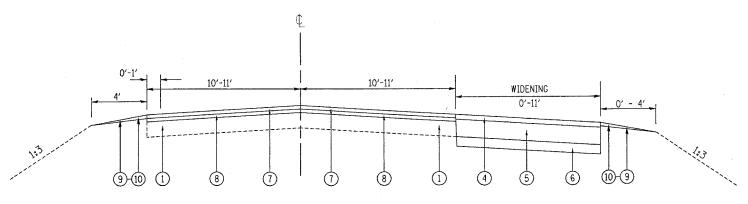

PROPOSED TYPICAL CROSS SECTION

MILLSTREAM RD.: STA. 00+00 TO STA. 21+24 STA. 22+80 TO STA. 28+96 STA. 30+44 TO STA. 65+91

577. 35 TT 15 5 TT 35 TE

GARDEN VALLEY RD.: STA. 100+00 TO STA. 124+65 STA. 128+12 TO STA. 153+28

NORTH UNION RD.: STA. 200+00 TO STA. 242+55

STA. 243+40 TO STA. 265+00

(6) PROF

LEGEND

5) PROPOSED HMA BASE COURSE WIDENING, 7"
6) PROPOSED SUB-BASE GRANULAR MATERIAL TYPE B, 4"

PROPOSED HMA SURFACE REMOVAL, 1/2"

PROPOSED WIDENING HMA SURFACE COURSE, MIX "D", N50, 2 "

7 PROPOSED HMA SURFACE COURSE, MIX "D", N70, $1\frac{1}{2}$ "

EXISTING HMA PAVEMENT, 6"±

EXISTING AGGREGATE SHOULDER

PROPOSED POLYMERIZED LEVELING BINDER (MACHINE METHOD), 11-4.75, 150, 11/2"

9) PROPOSED AGGREGATE SHOULDERS, TYPE B

10) PROPOSED GRADING & SHAPING SHOULDERS

HOT-MIX ASPHALT MIXTURE REQUIREMENTS

, , , , , , , , , , , , , , , , , , , ,	MIXTURE TYPE	AC/PG	AIR VOIDS (%)
ROADWAY	POLYMERIZED LEVELING BINDER (MACHINE METHOD), IL-4.75, N50	SBS/SBR PG 76-28/-22	4% © 50 GYR
ROADWAI	HOT-MIX ASPHALT SURFACE COURSE, MIX "D", N50, IL 9.5 MM	PG 64-22	4% @ 50 GYR
PATCHING	CLASS D PATCHES, IL-19, 8"	PG 64-22/ 58-22*	4% @ 70 GYR
77770712770	HOT-MIX ASPHALT REPLACEMENT OVER PATCHES	PG 64-22/ 58-22*	4% @ 70 GYR
WIDENING	HOT-MIX ASPHALT BASE COURSE WIDENING, 7"	PG 64-22/ 58-22*	4% @ 50 GYR
SHOULDER	HOT-MIX ASPHALT SHOULDERS, 8"	PG 64-22/ 58-22*	4% @ 70 GYR

UNIT WEIGHT USED TO CALCULATE ALL HMA SURFACE MIXTURE QUANTITIES IS 112 LBS/SQ YD/IN

*WHEN RAP EXCEEDS 20%, THE NEW ASPHALT BINDER IN THE MIX SHALL BE PG 58-22

NOTE:


THESE ROUTES ARE CLASSIFIED AS CLASS II TRUCK ROUTE. THEREFORE, TO ACCOMMODATE THE TURNS OF TRUCKS, THE PROPOSED WIDENINGS ARE AT TURN RADII ONLY.

REVISIONS	THE THOIS DEPARTMENT OF TRANSPORTATION					
NAME DATE	TELLINOIS DEPARTME	ILLINOIS DEPARTMENT OF TRANSPORTATION				
	DETOUR FOR	R BRIDGE OVER				
	THE SOUTH BRANCH KI	SHWAUKEE RIVER ON IL-176				
	EXISTING	AND PROPOSED				
	TYPICA	L SECTIONS				
	SCALE: VÉRT.	DRAWN BY				
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CONTRACT NO. 62873 STA. 0+00 TO STA. 13+61 $\rightarrow \oplus \rightarrow Z$ FED. ROAD DIST. NO. 1 ILLINOIS HIGHWAY PROJECT IL. RTE. 176 IMPROVEMENT LIMIT STA. 00+00 STA. 800+00 BACK = STA. 00+00 FORWARD PROPOSED HMA SURFACE REMOVAL, 1/2" (TYP.) (WIDENING)
PROP. 2' HMA SURFACE COURSE,
MIX 'D', N50_
PROP. 1" HMA BASE COURSE WIDENING
PROP. SUB-BASE GRANULAR MATERIAL
TYPE B, 4" PROPOSED STEEL PLATE BEAM GUARDRAIL, TYPE A PROPOSED HOT-MIX ASPHALT SURFACE COURSE, MIX "D", N50, 11/2" 13+61 MILLSTREAM RD. PROPOSED POLYMERIZED LEVELING BINDER (MACHINE METHOD), IL-4.75, N50, 11/2" TRAFFIC BARRIER TERMINAL, TYPE 1, (SPECIAL TANGENT) 4" WHITE EDGE LINE (TYP.) +55 EXIST. R.O.W. EXIST. R.O.W. DUNHAM ROAD S LINE MATCH EXIST. R.O.W. 4" SOLID YELLOW LANE LINE 10' DASH @ 30' SPACING (TYP.) 12' 12' 1 PROP. GRADING & SHAPING SHOULDERS PROP. AGGREGATE WEDGE SHOULDER, TYPE 8 (TYP.) RTE. 176 ILLINOIS DEPARTMENT OF TRANSPORTATION MILLSTREAM RD
DETOUR FOR BRIDGE OVER
THE SOUTH BRANCH KISHWAUKEE RIVER ON IL-176 ROADWAY AND PAVEMENT MARKING PLAN SCALE: VERT. 1" = 50' HORIZ. 1" = 50' DATE 3/29/2007 DRAWN BY CHECKED BY 3/29/2007 c:\projects\di4710i\di4880iaa.m32

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CONTRACT NO. 62873 STA. 58+89 TO STA. 111+06 FED. ROAD DIST. NO. 1 ILLINOIS HIGHWAY PROJECT 111+06 MILLSTREAM RD. 4" YELLOW SKIP DASH LANE LINE 10' DASH @ 30' SPACING (TYP.) - 12" WHITE LINES, 5 & 51/2' SPACING C-C (TYP.) GARDEN VALLEY RD. IMPROVEMENT LIMIT EXIST. R.O.W. ST STA. 65+91 MATCHLINE 24" WHITE STOP BAR (TYP.) -PROP. GRADING & SHAPING SHOULDERS EXIST. R.O.W. PROP. AGGREGATE WEDGE SHOULDER. TYPE B (TYP.) PROPOSED HMA SURFACE REMOVAL, 4" SOLID YELLOW NO PASSING ZONE LINE 4" WHITE EDGE LINE (TYP.) _SEEDING CLASS 2A WITH EROSION CONTROL BLANKET e 51/2" C-C FROM SKIP DASH (TYP.) -SEE DETAIL BELOW PROPOSED HOT-MIX ASPHALT SURFACE COURSE, MIX "D", N50, 11/2" PROPOSED POLYMERIZED LEVELING BINDER (MACHINE METHOD), IL-4.75, N50, 11/2" PERIMETER EROSION BARRIER R.O.W. 4" SOLID WHITE EDGE LINE (TYP.) MILLSTREAM GARDEN VALLEY RD. EXIST. R.O.W. RD. PROPOSED
EDGE OF HMA PAVEMENT 2 CENTER CURVE R1=60' R2=345' (WIDENING) PROP. 2' HMA SURFACE COURSE, MIX "D", NSO
PROP. 1" HMA BASE COURSE WIDENING
PROP. SUB-BASE GRANULAR MATERIAL TYPE B, 4" 4" SOLID YELLOW LANE LINE 10' DASH @ 30' SPACING (TYP.) 4" WHITE EDGE LINE 2 CENTER CURVE R1=55' R2=450' CURVE DETAIL SCALE = 20PROP. GRADING & SHAPING SHOULDERS PROP. AGGREGATE WEDGE SHOULDER, TYPE B (TYP.) MATCHLINE STA. 58+89 ILLINOIS DEPARTMENT OF TRANSPORTATION MILLSTREAM RD. / GARDEN VALLEY RD. DETOUR FOR BRIDGE OVER THE SOUTH BRANCH KISHWAUKEE RIVER ON IL-176 ROADWAY AND PAVEMENT MARKING PLAN SCALE: VERT. 1" = 50' DRAWN BY DATE 3/29/2007 CHECKED BY

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CONTRACT NO. 62873 RTE. SECTION COUNTY SHEETS NO.


533 2004-117 RS MCHENRY 26 8 PROPOSED HMA SURFACE REMOVAL, 1/2" (TYP.) STA. 111+06 TO STA. 141+31 FED. ROAD DIST. NO. 1 ILLINOIS HIGHWAY PROJECT PROPOSED HOT-MIX ASPHALT SURFACE COURSE, MIX "D", N50, 11/2" - 4" SOLID DOUBLE YELLOW LINE (TYP.) 111+06 4" YELLOW SKIP DASH LANE LINE 10' DASH & 30' SPACING (TYP.) PROPOSED POLYMERIZED LEVELING BINDER (MACHINE METHOD), IL-4.75, N50, $1\frac{1}{2}$ " 121+16 GARDEN VALLEY RD. EXIST. R.O.W. ST S MATCHL] EXIST. R.O.W. MATCHL PROP. GRADING & SHAPING SHOULDERS 4" SOLID YELLOW NO PASSING ZONE LINE € 51/2" C-C FROM SKIP DASH (TYP.) PROP. AGGREGATE WEDGE SHOULDER, TYPE B (TYP.) 4" WHITE EDGE LINE (TYP.) PROPOSED HMA SURFACE REMOVAL, 1/2" (TYP.) TRAFFIC BARRIER TERMINAL, TYPE 1, (SPECIAL TANGENT) PROPOSED HOT-MIX ASPHALT SURFACE COURSE, MIX "D". N50, $1\frac{1}{2}$ " PROPOSED STEEL PLATE BEAM GUARDRAIL, TYPE ARDEN VALLEY RD. 4" YELLOW SOLID NO PASSING ZONE LINE € 51/2" C-C FROM SKIP DASH (TYP.) PROPOSED POLYMERIZED LEVELING BINDER (MACHINE METHOD), IL-4.75, N50, 11/2" EXIST. R.O.W. - LIMIT OF RESURFACING BRIDGE MATCHL] EXIST. R.O.W. LIMIT OF SOLID WHITE EDGE LINE (TYP.) RESURFACING PROP. GRADING & SHAPING SHOULDERS TRAFFIC BARRIER TERMINAL, KIST PROP. AGGREGATE WEDGE SHOULDER, TYPE B (TYP.) TYPE 1, (SPECIAL TANGENT) PROPOSED STEEL PLATE BEAM GUARDRAIL, TYPE A VERMONT PROP. GRADING & SHAPING SHOULDERS PROP. AGGREGATE WEDGE SHOULDER, TYPE B (TYP.) 4" YELLOW SKIP DASH LANE LINE 10' DASH @ 30' SPACING (TYP.) 141+31 131+24 GARDEN VALLEY RD. R = 30'-EXIST. R.O.W. STA. S MATCHLINE MATCHLINE EXIST. R.O.W. PROPOSED HMA SURFACE REMOVAL, 1/2" (TYP.) -4" WHITE EDGE LINE (TYP.) PROPOSED HOT-MIX ASPHALT SURFACE COURSE, MIX "D", N50, 11/2" REVISIONS NAME ILLINOIS DEPARTMENT OF TRANSPORTATION PROPOSED POLYMERIZED LEVELING BINDER (MACHINE METHOD), IL-4.75, N50, 11/2" GARDEN VALLEY RD. DETOUR FOR BRIDGE OVER
THE SOUTH BRANCH KISHWAUKEE RIVER ON IL-176 ROADWAY AND PAVEMENT MARKING PLAN SCALE: VERT. HORIZ. 1" = 50' DRAWN BY DATE 3/29/2007 CHECKED BY c:\projects\di47i0i\di4880laa.m32
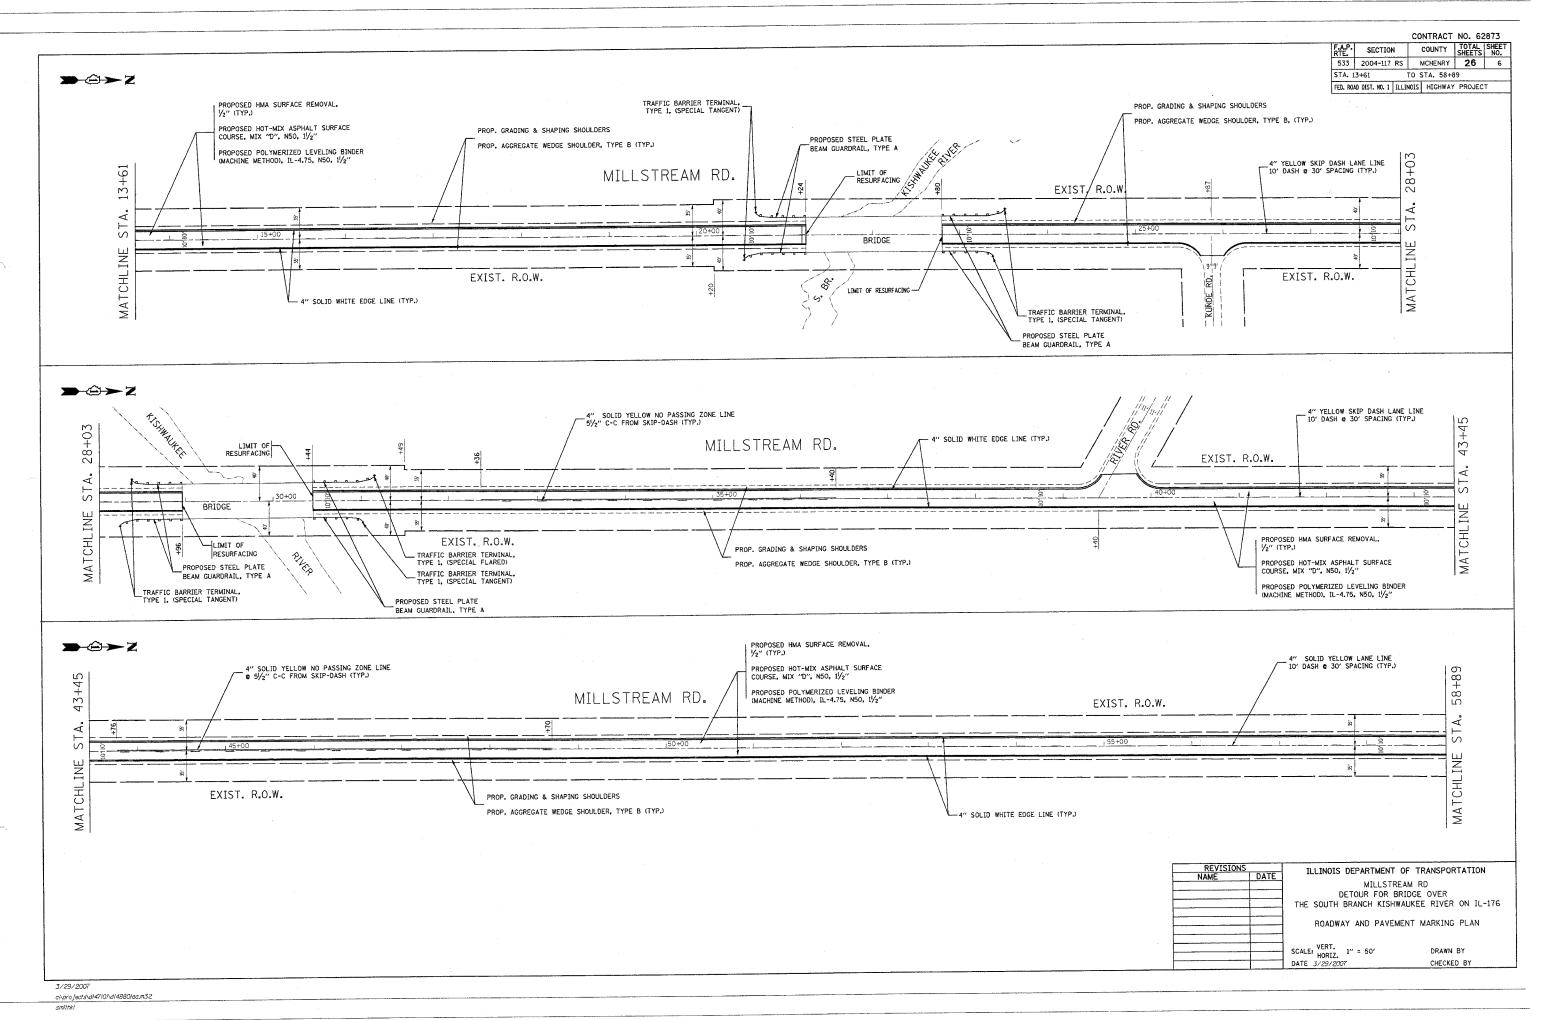
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CONTRACT NO. 62873 F.A.P. SECTION COUNTY TOTAL SHEET NO.

533 2004-117 RS MCHENRY 26 9 COUNTY TOTAL SHEET SHEETS NO. STA. 141+31 TO STA. 258+50 FED. ROAD DIST. NO. 1 ILLINOIS HIGHWAY PROJECT IMPROVEMENT LIMIT GARDEN VALLEY RD. STA. 153+28 4" SOLID YELLOW LANE LINE 10' DASH @ 30' SPACING (TYP.) +31 GARDEN VALLEY RD. EXIST. R.O.W. MATCHLINE EXIST. R.O.W. PROP. GRADING & SHAPING SHOULDERS (WIDENING) PROP. 2' HMA SURFACE COURSE, MIX 'D'', NSO _ PROP. 7" HMA BASE COURSE WIDENING PROP. SUB-BASE GRANULAR MATERIAL TYPE B, 4" PROP. AGGREGATE SHOULDER, TYPE B (TYP.) 4" SOLID WHITE EDGE LINE (TYP.) -PROPOSED HMA SURFACE REMOVAL, PROPOSED HOT-MIX ASPHALT SURFACE COURSE, MIX "D", N50, 11/2" PROPOSED POLYMERIZED LEVELING BINDER (MACHINE METHOD), IL-4.75, N50, 11/2" NORTH 4" SOLID WHITE EDGE LINE (TYP.) -NOINU 4" SOLID YELLOW LANE LINE 10' DASH @ 30' SPACING (TYP.) EXIST. R.O.W. PROP. GRADING & SHAPING SHOULDERS PROP. AGGREGATE SHOULDER, TYPE B (TYP.) MATCHLINE STA. 258+50 (END OF PLAN SHEET 10) ILLINOIS DEPARTMENT OF TRANSPORTATION GARDEN VALLEY RD. / NORTH UNION RD.
DETOUR FOR BRIDGE OVER
THE SOUTH BRANCH KISHWAUKEE RIVER ON IL-176 ROADWAY AND PAVEMENT MARKING PLAN SCALE: VERT. 1" = 50' DRAWN BY DATE 3/29/2007 CHECKED BY 3/29/2007 c:\projects\di47i0i\di4880iaa.m32

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CONTRACT NO. 62873 RTE. SECTION COUNTY TOTAL SHEET NO. 533 2004-117 RS MCHENRY **26** 11 **>**-©**>**Z STA. 200+00 TO STA. 213+23 FED. ROAD DIST. NO. 1 ILLINOIS HIGHWAY PROJECT IMPROVEMENT LIMIT STA. 699+44 STA. 700+00 BACK = PROP. GRADING & SHAPING SHOULDERS 4" SOLID YELLOW LANE LINE 10' DASH @ 30' SPACING (TYP.) STA. 200+00 FORWARD PROP. AGGREGATE WEDGE SHOULDER, TYPE B (TYP.) MATCHLINE STA, 213+23 (START OF PLAN SHEET 10) NORTH UNION RD. EXIST. R.O.W. NORTH UNION RD. = EXIST. R.O.W. SEE DETAIL SEEDING CLASS 2A WITH EROSION CONTROL BLANKET PROPOSED HMA SURFACE REMOVAL, - 4" SOLID WHITE EDGE LINE (TYP.) PROPOSED HOT-MIX ASPHALT SURFACE COURSE, MIX "D", N50, 11/2" PERIMETER EROSION BARRIER PROPOSED POLYMERIZED LEVELING BINDER (MACHINE METHOD), IL-4.75, N50, 11/2" NORTH UNION RD. 700+00 IL. RTE. EXIST, R.O.W. PROPOSED

EDGE OF HMA SHOULDER

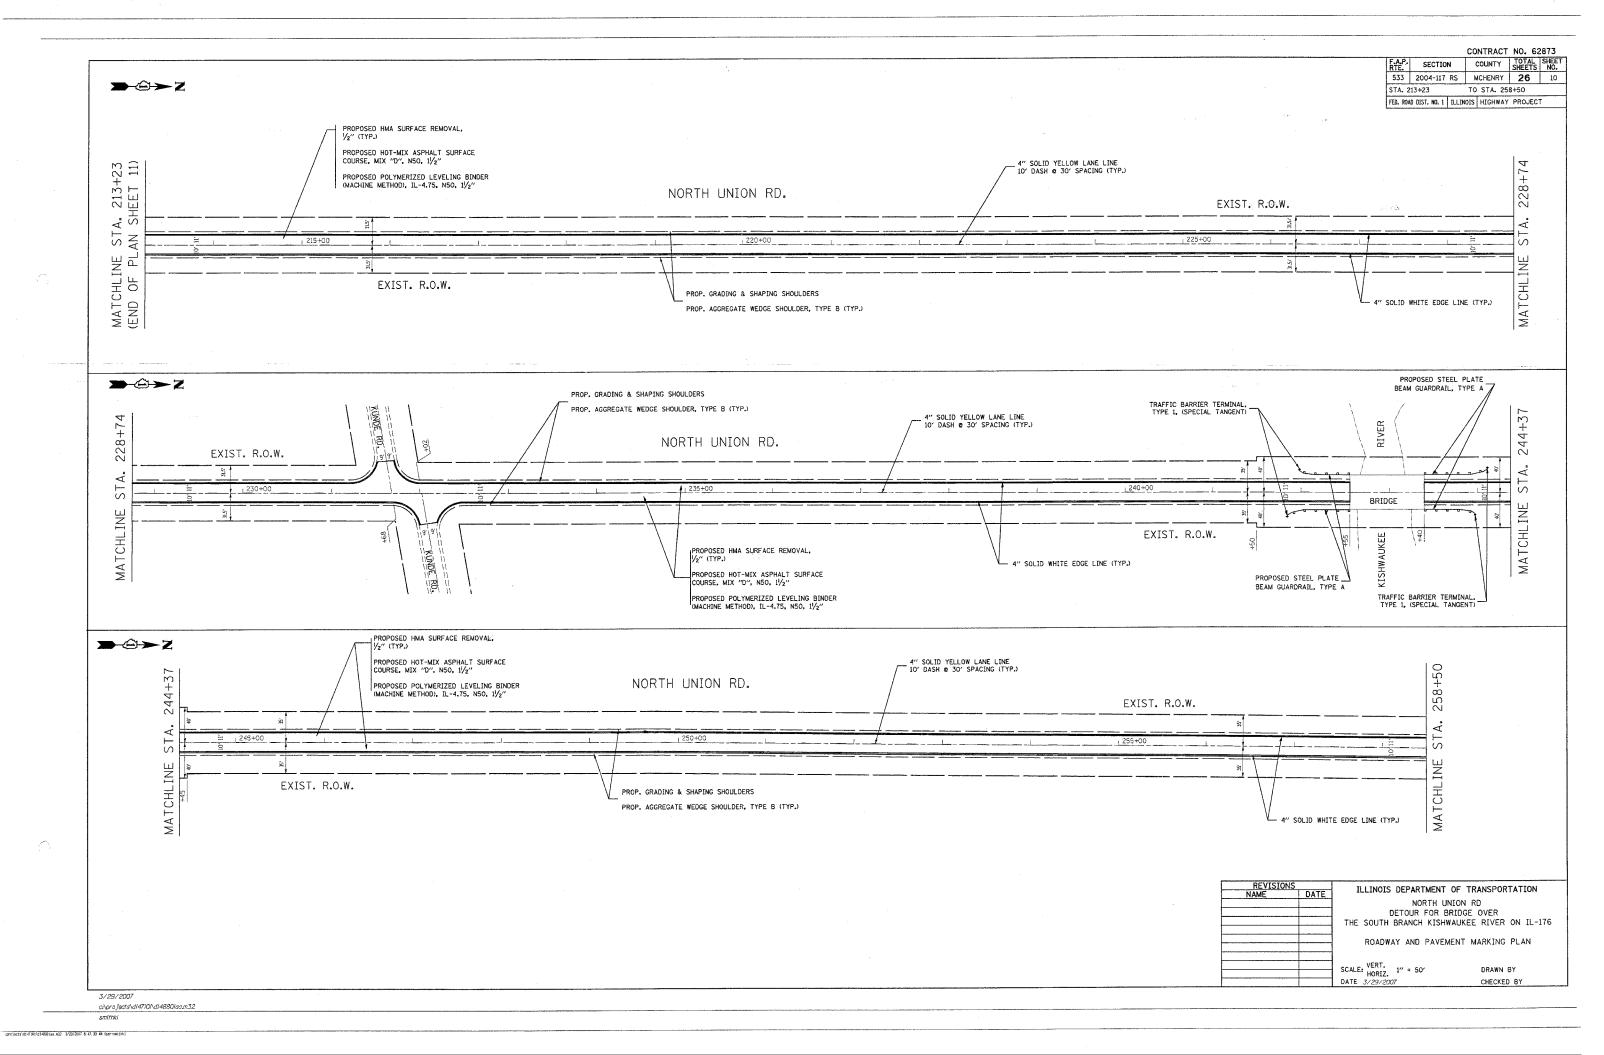
2 CENTER CURVE

R1=40 R2=335 UTILITY I (WIDENING) PROP. 2' HMA SURFACE COURSE, MIX "D", N50 PROP. 7" HMA BASE COURSE WIDENING PROP. SUB-BASE CRANULAR MATERIAL TYPE B, 4" THERMOPLASTIC PAVEMENT MARKING ILLINOIS DEPARTMENT OF TRANSPORTATION 4" WHITE EDGE LINE 2 CENTER CURVE R1=45' R2=400' NORTH UNION RD DETOUR FOR BRIDGE OVER THE SOUTH BRANCH KISHWAUKEE RIVER ON IL-176 ROADWAY AND PAVEMENT MARKING PLAN CURVE DETAIL SCALE = 20SCALE: VERT. 1" = 50' HORIZ. 1" = 50' DATE 3/29/2007 DRAWN BY CHECKED BY 3/29/2007 c:\projects\di47i0I\di4880laa.m32

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COUNTY TOTAL SHEE SHEETS NO. SECTION 533 2004-117 RS MCHENRY **26** 12 TO STA. FED. ROAD DIST. NO. 1 ILLINOIS FED. AID PROJECT



NOTES:

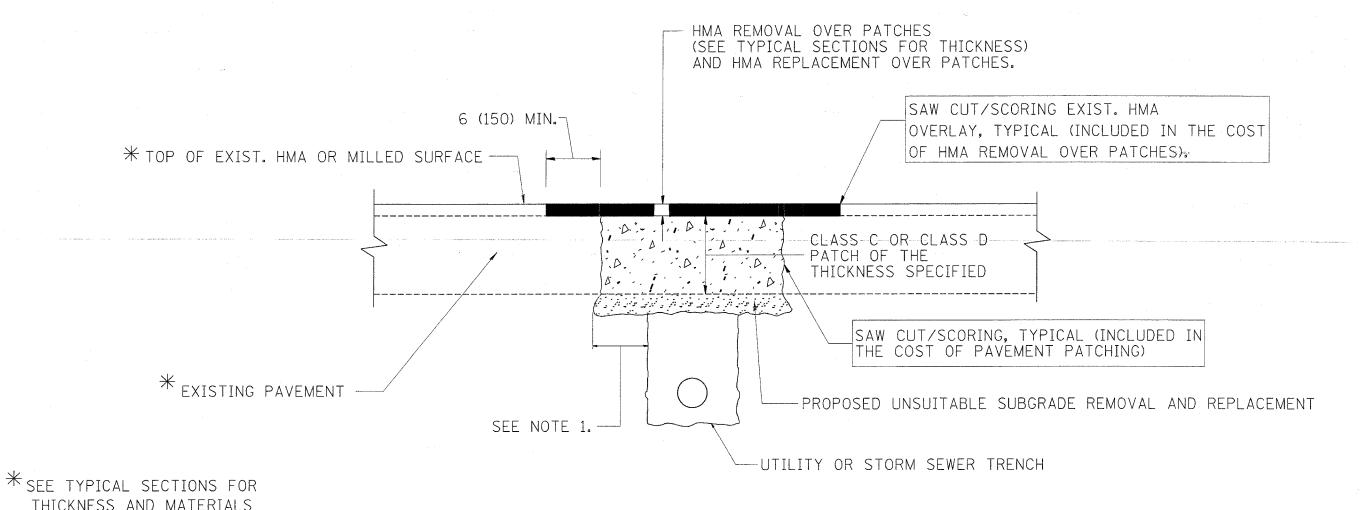1. THE WIDTH OF THE FULL DEPTH PATCH OVER A TRENCH SHALL BE 12 (300) WIDER ON EACH SIDE OF THE TRENCH.

Sec.

2. FOR METHOD OF MEASUREMENT AND BASIS OF PAYMENT, SEE RECURRING SPECIAL PROVISION "PATCHING WITH HOT-MIX ASPHALT OVERLAY REMOVAL".

SEQUENCE OF CONSTRUCTION

- 1. REMOVE THE EXISTING HMA MATERIAL OVER THE AREA TO BE PATCHED.
- 2. REMOVE AND REPLACE FULL DEPTH PATCHES
- 3. REPLACE HMA MATERIAL OVER THE AREA TO BE PATCHED.

ALL DIMENSIONS ARE IN INCHES (MILLIMETERS) UNLESS OTHERWISE SHOWN.

REVISION	ONS
NAME	DATE
R. SHAH	10/25/94
R. SHAH	01/14/95
R. SHAH	03/23/95
R. SHAH	04/24/95
A. HOUSEH	03/15/96
A. ABBAS	03/21/97
A. ABBAS	01/20/98
ART ABBAS	04/27/98
R. BORO	01/01/07

ILLINOIS DEPARTMENT OF TRANSPORTATION

PAVEMENT PATCHING FOR HMA SURFACED PAVEMENT


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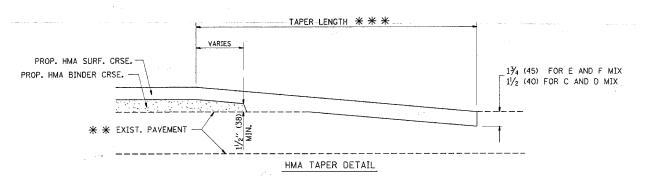
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| CONTRACT NO. 62873 | F.A.P. | SECTION | COUNTY | SHEET | NO. 533 | 2004-117 RS | MCHENRY | 26 | 13 | STA. | TO STA. | FED. ROAD DIST. NO. 1 | ILLINOIS | FED. AID | PROJECT |





TYPICAL BUTT JOINT AND HMA TAPER FOR RESURFACING ONLY

* * PC CONCRETE, HMA OR HMA RESURFACED PAVEMENT.

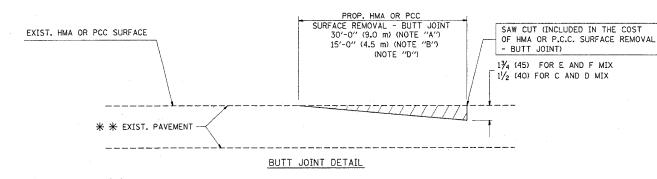NOTES

- A: MAINLINE ROADWAYS AND MAJOR SIDE ROADS.
- B: MINOR SIDE ROADS.
- C: THE TEMP. RAMP SHALL BE CONSTRUCTED IMMEDIATELY UPON REMOVAL OF THE EXISTING HMA SURFACE.
- D: THE BUTT JOINT SHALL BE CONSTRUCTED IMMEDIATELY PRIOR TO PLACING THE PROPOSED HMA COURSES.
- E: TAPER THE TEMP. RAMP AT A RATE OF 3'-0" (900 mm) PER 1 INCH (25 mm) OF MILLING THICKNESS.
- F: INSTALLATION AND REMOVAL OF THE 4'-6" (1.35 m) TEMP. RAMP IS INCLUDED IN COST OF HMA SURFACE REMOVAL BUTT JOINT
- G: SEE ARTICLE 406.08 AND 406.14 OF THE STANDARD SPECIFICATIONS FOR "HMA AND/OR PCC SURFACE REMOVAL, BUTT JOINT".
- * SEE TYPICAL SECTIONS FOR MILLING THICKNESS.
- $\mbox{\em \star}\mbox{\em \star}$

ALL DIMENSIONS ARE IN INCHES (MILLIMETERS) UNLESS OTHERWISE SHOWN.

BASIS OF PAYMENT:

THE BUTT JOINT WILL BE PAID FOR AT THE CONTRACT UNIT PRICE PER SQUARE YARD (SQUARE METER)
FOR "HOT-MIX ASPHALT SURFACE REMOVAL - BUTT JOINT" OR FOR "PORTLAND CEMENT CONCRETE SURFACE REMOVAL- BUTT JOINT".

	REVISIONS		
	NAME	DATE	
M.	DE YONG	6-13-90	
M.	DE YONG	7-3-90	
M.	DE YONG	3-27-92	
R.	SHAH	09/09/94	
R.	SHAH	10/25/94	
Α.	ABBAS	03/21/97	
М.	GOMEZ	04/06/01	
R.	BORO	01/01/07	sc
			30

ILLINOIS DEPARTMENT OF TRANSPORTATION

BUTT JOINT AND HMA TAPER DETAILS

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BD400-05 (VI=BD32) REVISION DATE: 01/01/07

F.A.P. SECTION COUNTY 533 2004-117 RS MCHENRY 26 14 TO STA. FED. ROAD DIST. NO. ILLINOIS FED. AID PROJECT TYPE III BARRICADES WITH TWO FLASHING AMBER LIGHTS ON EACH. CONSTRUCTION AHEAD TYPE I OR TYPE II BARRICADES WITH ONE FLASHING AMBER LIGHT ON EACH, OR TYPE III BARRICADES WITH TWO FLASHING 200'± (60 m±)-AMBER LIGHTS ON EACH. DRIVEWAY 200'± (60 m±) (60 STREET; COLLECTOR LIMIT> 40 MPH (LOCAL LIMIT 30 ROAD W20-1(0) SPEED CONSTRUCTION M6-4(0)-2115 AHEAD M6-1(0)-2115

TRAFFIC CONTROL AND PROTECTION FOR SIDE ROADS, INTERSECTIONS, AND DRIVEWAYS

NOTES:

- A. FOR NO LANE RESTRICTION ON THE SIDE ROAD OR DRIVEWAYS
- 1. SIDE ROAD WITH A SPEED LIMIT OF 40 MPH (60 km/h) OR LESS AS SHOWN ON THE DRAWING AND AS DIRECTED BY THE ENGINEER:
- Q) ONE ROAD CONSTRUCTION AHEAD SIGN 36 x 36 (900x900) WITH A FLASHER AND FLAG MOUNTED ON IT APPROXIMATELY 200' (60 m) IN ADVANCE OF THE MAIN ROUTE.
- b) THE CLOSED PORTION OF THE MAIN ROUTE SHALL BE PROTECTED BY BLOCKING WITH TYPE I. TYPE II OR TYPE III BARRICADES, 1/3 OF THE CROSS SECTION OF THE CLOSED PORTION.
- SIDE ROAD WITH A SPEED LIMIT GREATER THAN 60 km/h (40 MPH) AS SHOWN ON THE DRAWING AND AS DIRECTED BY THE ENGINEER:
- g) ONE ROAD CONSTRUCTION AHEAD SIGN 48 \times 48 (1.2 m \times 1.2 m) WITH A FLASHER MOUNTED ON IT APPROXIMATELY 500' (150 m) IN ADVANCE OF THE MAIN ROUTE.
- b) THE CLOSED PORTION OF THE MAIN ROUTE SHALL BE PROTECTED BY BLOCKING WITH TYPE III BARRICADES, 1/2 OF THE CROSS SECTION
- 3. WHEN THE SIDE ROAD LIES BETWEEN THE BEGINNING OF THE MAINLINE SIGNING AND THE WORK ZONE, A SINGLE HEADED ARROW (M6-1) SHALL BE USED IN LIEU OF THE DOUBLE HEADED ARROW (MG-4).

- B. FOR A LANE CLOSURE ON A SIDE ROAD OR DRIVEWAY:
- USE APPLICABLE PORTIONS OF THE TYPICAL APPLICATION OF TRAFFIC CONTROL DEVICES (STD. 701501, STD. 701606 OR THE APPROPRIATE STANDARD). THE SPACING OF SIGNS AND BARRICADES SHALL BE ADJUSTED FOR FIELD CONDITIONS AS DIRECTED BY THE ENGINEER. THE DIRECTIONAL ARROW SHALL BE COVERED OR REMOVED WHEN NO LONGER CONSISTENT WITH THE SIDE ROAD LANE CLOSURE.
- C. ADVANCE WARNING SIGNS ARE TO BE OMITTED ON DRIVEWAY UNLESS
- D. THE TRAFFIC CONTROL AND PROTECTION FOR SIDE ROADS, INTERSECTIONS, AND DRIVEWAYS SHALL BE INCIDENTAL TO THE COST OF SPECIFIED TRAFFIC

All dimensions are in millimeters (inches) unless otherwise shown.

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1	10/18/95	J. OBERLE
1 6	03/06/96	A. HOUSEH
5	10/15/96	A. HOUSEH
]	01/06/00	T. RAMMACHER
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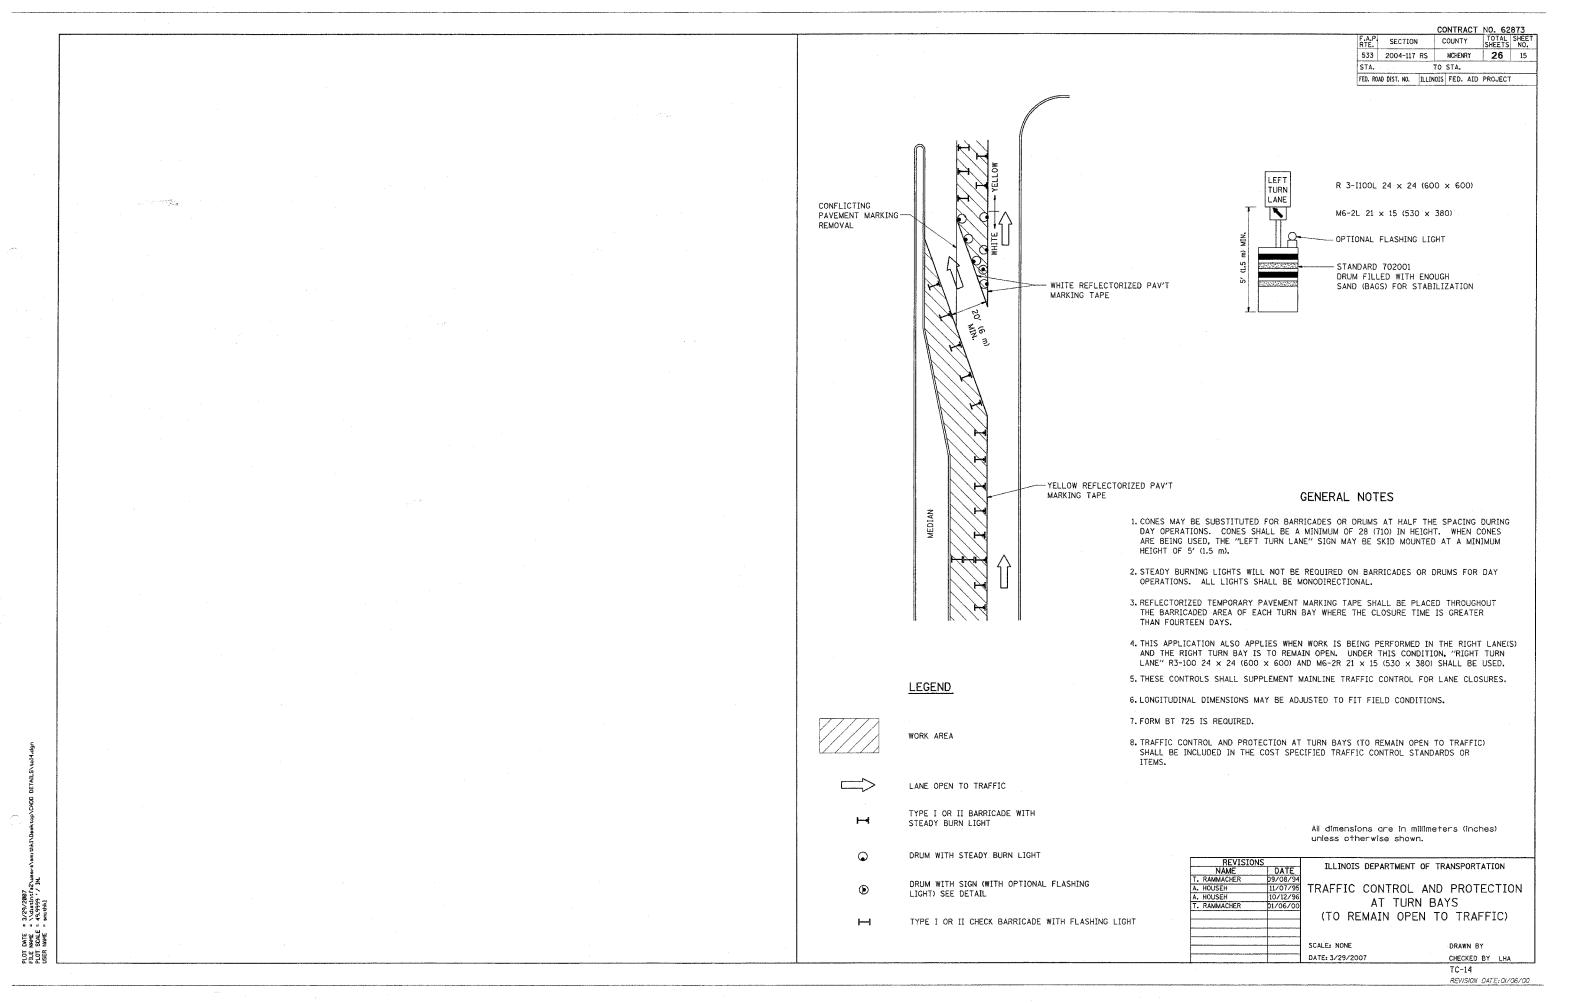
ILLINOIS DEPARTMENT OF TRANSPORTATION TRAFFIC CONTROL AND PROTECTION FOR SIDE ROADS, INTERSECTIONS, AND

DRIVEWAYS

DATE: 3/29/2007

CHECKED BY TC-10

REVISION DATE: 01/06/00





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CONTRACT NO. 62873 COUNTY SHEETS NO. F.A.P. SECTION 533 2004-117 RS MCHENRY **26** 16 FED. ROAD DIST. NO. ILLINOIS FED. AID PROJECT 80' (24 m) O.C. 3 @ 40' (12 m) O.C. 80' (24 m) 0,C. SEE NOTE B \Leftrightarrow *** REDUCE TO 40' (12 m) O.C. ON CURVES WITH POSTED OR ADVISORY SPEED 45 M.P.H. (70 km/h) OR LESS. 40' (12 m) O.C. TWO-LANE/TWO-WAY SEE NOTE A-LANE REDUCTION TRANSITION TWO-WAY LEFT TURN W4-2 80' (24 m) O.C. SEE NOTE B SEE NOTE B SYMBOLS GENERAL NOTES MARKERS USED WITH DASHED LINES SHALL BE CENTERED IN THE GAP BETWEEN SEGMENTS. ---- YELLOW STRIPE \Rightarrow WHITE STRIPE 2. MARKERS USED ADJACENT TO SOLID LINES SHALL BE OFFSET 2 TO 3 (50 TO 75) TOWARD TRAFFIC AS SHOWN. ONE-WAY AMBER MARKER 3. MARKERS THROUGH TANGENTS LESS THAN 500' (150 m) IN LENGTH BETWEEN CURVES SHALL BE INSTALLED AT THE LESSER OF THE TWO CURVE SPACINGS. ONE-WAY CRYSTAL MARKER (W/O) TWO-WAY AMBER MARKER SEE NOTE A-MULTI-LANE/UNDIVIDED LANE MARKER NOTES SEE NOTE A - REDUCE TO 40' (12 m) O.C. ON CURVES WHERE ADVISORY SPEEDS ARE 10 M.P.H (20 km/h) LOWER THAN POSTED SPEEDS. MULTI-LANE/DIVIDED A. USE DOUBLE LANE LINE MARKERS SPACED AS SHOWN. DESIGN NOTES 1. DOUBLE LANE LINE MARKERS SHALL BE USED UNLESS SPECIFIED OTHERWISE. 2. EXCEPT AS SHOWN ON THE LANE REDUCTION TRANSITION AND FREEWAY EXIT RAMP DETAIL, MARKERS ARE NOT TO BE SPECIFIED ON RIGHT EDGE 3. THE EXACT MARKER LIMITS, SPACING, AND COLOR SHOULD BE INCLUDED IN THE PLANS. 4. MARKERS SHOULD NOT BE USED ALONGSIDE CURBS EXCEPT FOR EXTREMELY MINIMUM OF 3 W
EQUALLY SPACED --- 3 @ 80' (24 m) O.C. SHORT SECTIONS OF CURBS WHERE NOT MORE THAN TWO MARKERS WOULD BE 3 @ 80' (24 m) O.C. INVOLVED. 3 @ 40' (12 m) 0.C. 0.C. ___ \Rightarrow 40' (12 m) O.C. All dimensions are in millimeters (inches) unless otherwise shown. ILLINOIS DEPARTMENT OF TRANSPORTATION * SEE TWO-LANE/TWO-WAY WHERE MARKERS CONTINUE ** WHERE THE MEDIAN WIDTH IS 6' (2 m) OR LESS USE TWO-WAY MARKERS. TYPICAL APPLICATIONS RAISED REFLECTIVE PAVEMENT MARKERS (SNOW-PLOW RESISTANT) LEFT TURN SCALE: NONE DRAWN BY CADD DATE: 3/29/2007 CHECKED BY

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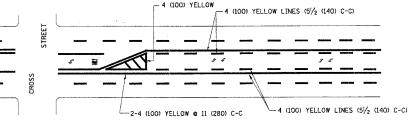





MEDIAN LENGTH FOR MEDIAN LENGTHS WHERE DIAGONAL SPACING CANNOT BE ATTAINED, USE 5 (FIVE) EQUALLY SPACED DIAGONAL LINES.
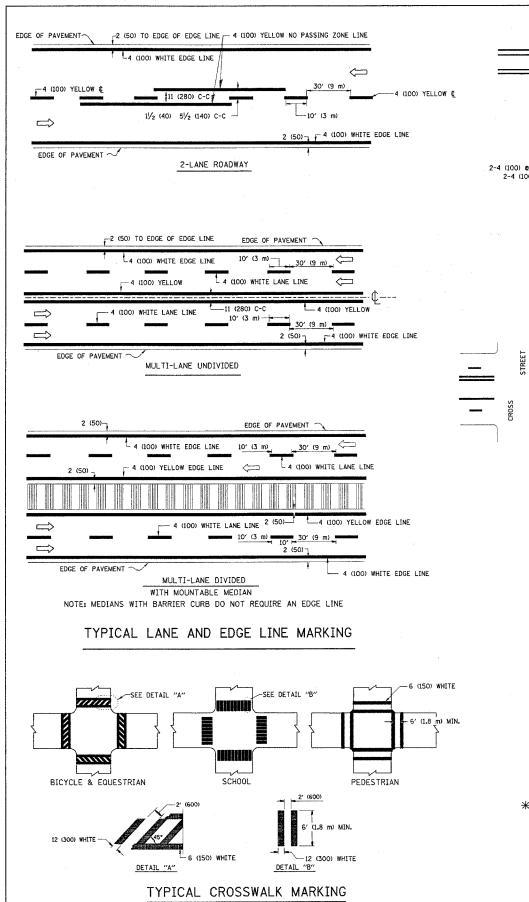
> DIAGONAL LINE SPACING: 50' (15 m) C-C (LESS THAN 30MPH (50 km/h)) 75' (25 m) C-C 30MPH (50 km/h) T0 45MPH (70 km/h)) 150' (45 m) C-C (MORE THAN 45MPH (70 km/h))

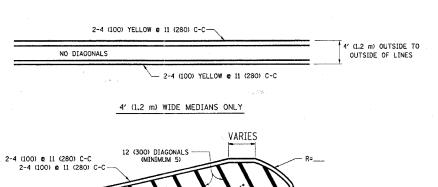MEDIANS OVER 4' (1.2 m) WIDE




A MINIMUM OF TWO PAIRS OF TURN ARROWS SHALL BE USED, WHITE IN COLOR. ADDITIONAL PAIRS SHALL BE PLACED AT 200' (60 m) TO 300' (90 m) INTERVALS.

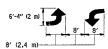

MEDIAN WITH TWO-WAY LEFT TURN LANE

TYPICAL PAINTED MEDIAN MARKING

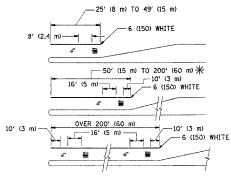


* TURN LANES IN EXCESS OF 400' (120 m) IN LENGTH MAY HAVE AN ADDITIONAL SET OF ARROW - "ONLY" INSTALLED MIDWAY BETWEEN THE OTHER TWO SETS OF ARROW - "ONLY".

TYPICAL LEFT (OR RIGHT) TURN LANE

TYPICAL TURN LANE MARKING

CONTRACT NO. 62873

F.A.P. SECTION COUNTY TOTAL SHEETS NO. NO. 533 2004-117 RS MCHENRY 26 17 8 (200) WHITE-STA. TO STA. FED. ROAD DIST. NO. ILLINOIS FED. AID PROJECT (200) WHITE

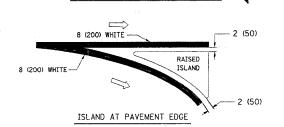

ISLAND OFFSET FROM PAVEMENT EDGE

12 (300) WHITE DIAGONALS @ 10' (3 m) OR LESS SPACING

TYPICAL ISLAND MARKING

TYPE OF MARKING	WIDTH OF LINE	PATTERN	COLOR	SPACING / REMARKS
CENTERLINE ON 2 LANE PAVEMENT .	_4 (100)	SKIP-DASH	YELLOW	10' (3 m) LINE WITH 30' (9 m) SPACE
CENTERLINE ON MULTI-LANE UNDIVEDED PAVEMENT	2 @ 4 (100)	SOLID	YELLOW	11 (280) C-C
NO PASSING ZONE LINES: FOR ONE DIRECTION FOR BOTH DIRECTIONS	4 (100) 2 & 4 (100)	SOLID SOLID	YELLOW YELLOW	5/ ₂ (140) C-C FROM SKIP-DASH CENTERLINE II (280) C-C OMIT SKIP-DASH CENTERLINE BETWEEN
LANE LINES	4 (100) 5 (125) ON FREEWAYS	SKIP-DASH SKIP-DASH	WHITE WHITE	10' (3 m) LINE WITH 30' (9 m) SPACE
DOTTED LINES (EXTENSIONS OF CENTER, LANE OR TURN LANE MARKINGS)	SAME AS LINE BEING EXTENDED	SKIP-DASH	SAME AS LINE BEING EXTENDED	2' (600) LINE WITH 6' (1.8 m) SPACE
EDGE LINES	4 (100)	SOLID	YELLOW-LEFT WHITE-RIGHT	OUTLINE MOUNTABLE MEDIANS IN YELLOW: EDGE LINES ARE NOT USED NEXT TO BARRIER CURB
TURN LANE MARKINGS	6 (150) LINE; FULL SIZE LETTERS & SYMBOLS (8' (2.4m))	SOLID	WHITE	SEE TYPICAL TURN LANE MARKING DETAIL
TWO WAY LEFT TURN MARKING	2 @ 4 (100) EACH DIRECTION	SKIP-DASH AND SOLID	YELLOW	10' (3 m) LINE WITH 30' (9 m) SPACE FOR SKIP-DASH; 5½ (140) C-C BETWEEN SOLID LINE AND SKIP-DASH LINE
	8' (2.4m) LEFT ARROW	IN PAIRS	WHITE	SEE TYPICAL TWO-WAY LEFT TURN MARKING DETAIL
CROSSWALK LINES (PEDESTRIAN) A. DIAGONALS (BIKE & EQUESTRIAN) B. LONGITUDINAL BARS (SCHOOL)	2 @ 6 (150) 12 (300) @ 45° 12 (300) @ 90°	SOLID SOLID SOLID	WHITE WHITE WHITE	NOT LESS THAN 6' (1.8 m) APART 2' (600) APART 2' (600) APART SEE TYPICAL CROSSWALK MARKING DETAILS.
STOP LINES	24 (600)	SOLID	WHITE	PLACE 4' (1.2 m) IN ADVANCE OF AND PARALLEL TO CROSSMALK, IF PRESENT. OTHERMISE, PLACE AT DESIRED STOPPING POINT. PARALLEL TO CROSSROAD CENTERLINE, WHERE POSSIBLE
PAINTED MEDIANS	2 @ 4 (100) WITH 12 (300) DIAGONALS @ 45° NO DIAGONALS USED FOR 4' (1.2 m) WIDE MEDIANS	SOLID	YELLOW: TWO WAY TRAFFIC WHITE: ONE WAY TRAFFIC	11 (280) C-C FOR THE DOUBLE LINE SEE TYPICAL PAINTED MEDIAN MARKING.
GORE MARKING AND CHANNELIZING LINES	8 (200) WITH 12 (300) DIAGONALS @ 45°	SOLID	WHITE	DIAGONALS: 15' (4.5 m) C-C (LESS THAN 30MPH (50 km/h)) 20' (6 m) C-C 30MPH (50 km/h) TO 45MPH (70 km/h)) 30' (9 m) C-C (OVER 45MPH (70 km/h))
RAILROAD CROSSING	24 (600) TRANSVERSE LINES; "RR" IS 6' (1.8 m) LETTERS; 16 (400) LINE FOR "X"	SOLID	WHITE	SEE STATE STANDARD 780001 AREA OF: "R"=3.6 SQ. FT. (0.33 m²) EACH "X"=54.0 SQ. FT. (5.0 m²)
SHOULDER DIAGONALS	12 (300) @ 45°	SOLID	WHITE - RIGHT YELLOW - LEFT	50' (15 m) C-C (LESS THAN 30MPH (50 km/h)) 75' (25 m) C-C (30 MPH (50 km/h) TO 45MPH (70 km/h)) 150' (45 m) C-C (OVER 45MPH (70 km/h))

FOR FURTHER DETAILS ON PAVEMENT MARKING REFER TO STANDARD SPECIFICATIONS FOR ROAD AND BRIDGE CONSTRUCTION AND STATE STANDARD 780001.

All dimensions are in millimeters (inches) unless otherwise shown.

ILLINOIS DEPARTMENT OF TRANSPORTATION

REVISIO	
NAME	DATE
EVERS	03-19-90
T. RAMMACHER	10-27-94
ALEX HOUSEH	10-09-96
ALEX HOUSEH	10-17-96
T. RAMMACHER	01-06-00
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DISTRICT ONE TYPICAL PAVEMENT MARKINGS


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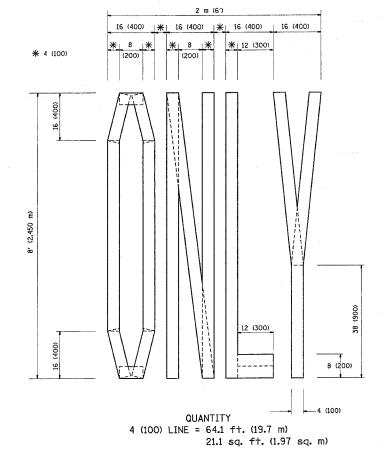
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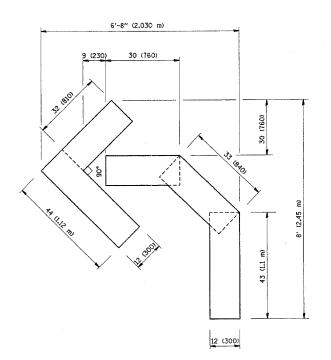
REVISION DATE: 01/06/00

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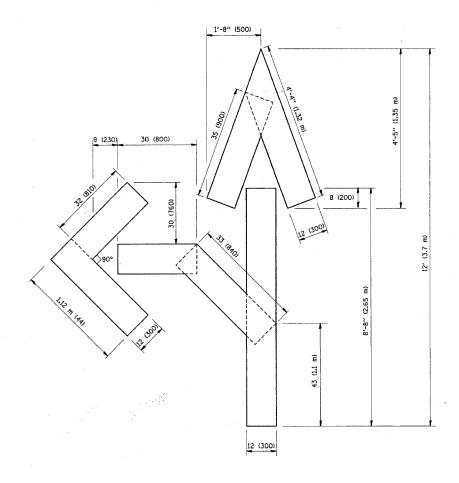






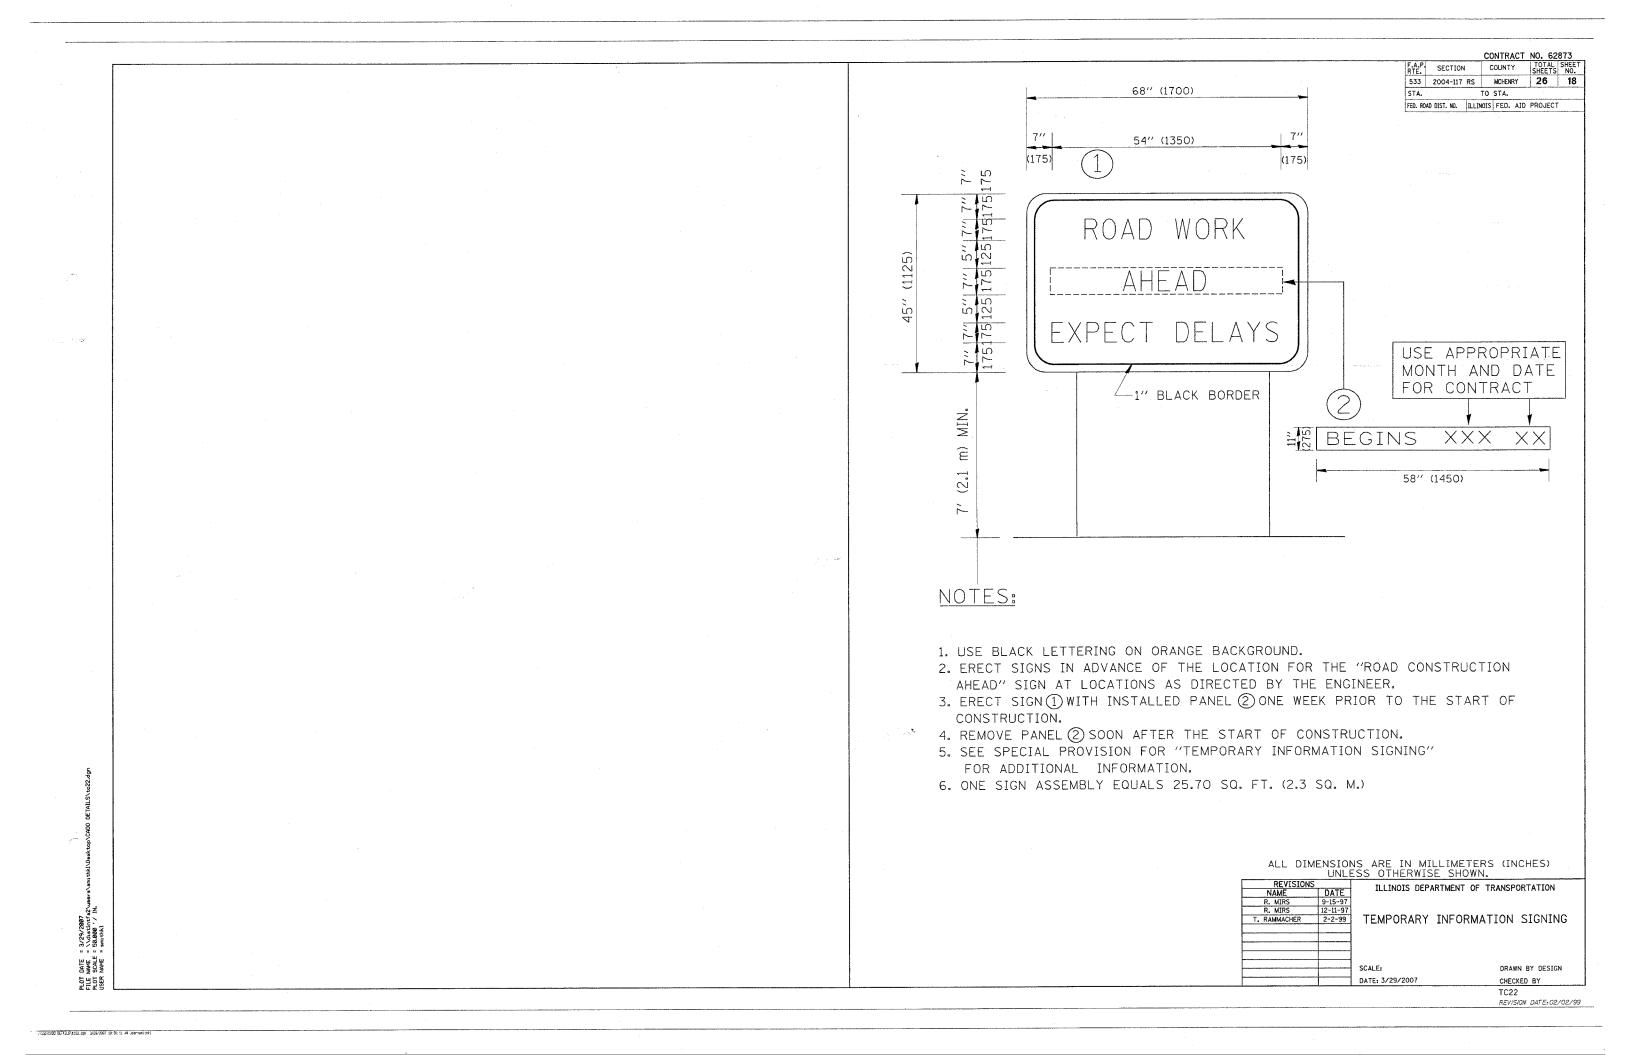

QUANTITY 4 (100) LINE = 45.5 ft. (13.9 m) 15.2 sq. ft. (1.39 sq. m)



QUANTITY 4 (100) LINE = 82.5 ft. (25.3 m) 27.5 sq. ft. (2.53 sq. m)

All dimensions are in millimeters (inches) unless otherwise shown.

NAME	DATE
T. RAMMACHER	09/18/94
J. OBERLE	06/01/96
T. RAMMACHER	06/05/96
T. RAMMACHER	11/04/97
T. RAMMACHER	03/02/9
E. GOMEZ	08/28/00

ILLINOIS DEPARTMENT OF TRANSPORTATION

PAVEMENT MARKING LETTERS AND SYMBOLS FOR TRAFFIC STAGING

SCALE: NONE DATE: 3/29/2007 DRAWN BY CADD CHECKED BY

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REVISION DATE: 08/28/00

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