


CHECKED - MS REVISED PLOT DATE = \$DATE\$ DATE - 3/22/2024 REVISED

DEPARTMENT OF TRANSPORTATION


SCALE: 1"=20" SHEET NO. OF SHEETS STA.

492 201 CONTRACT NO. 62N40

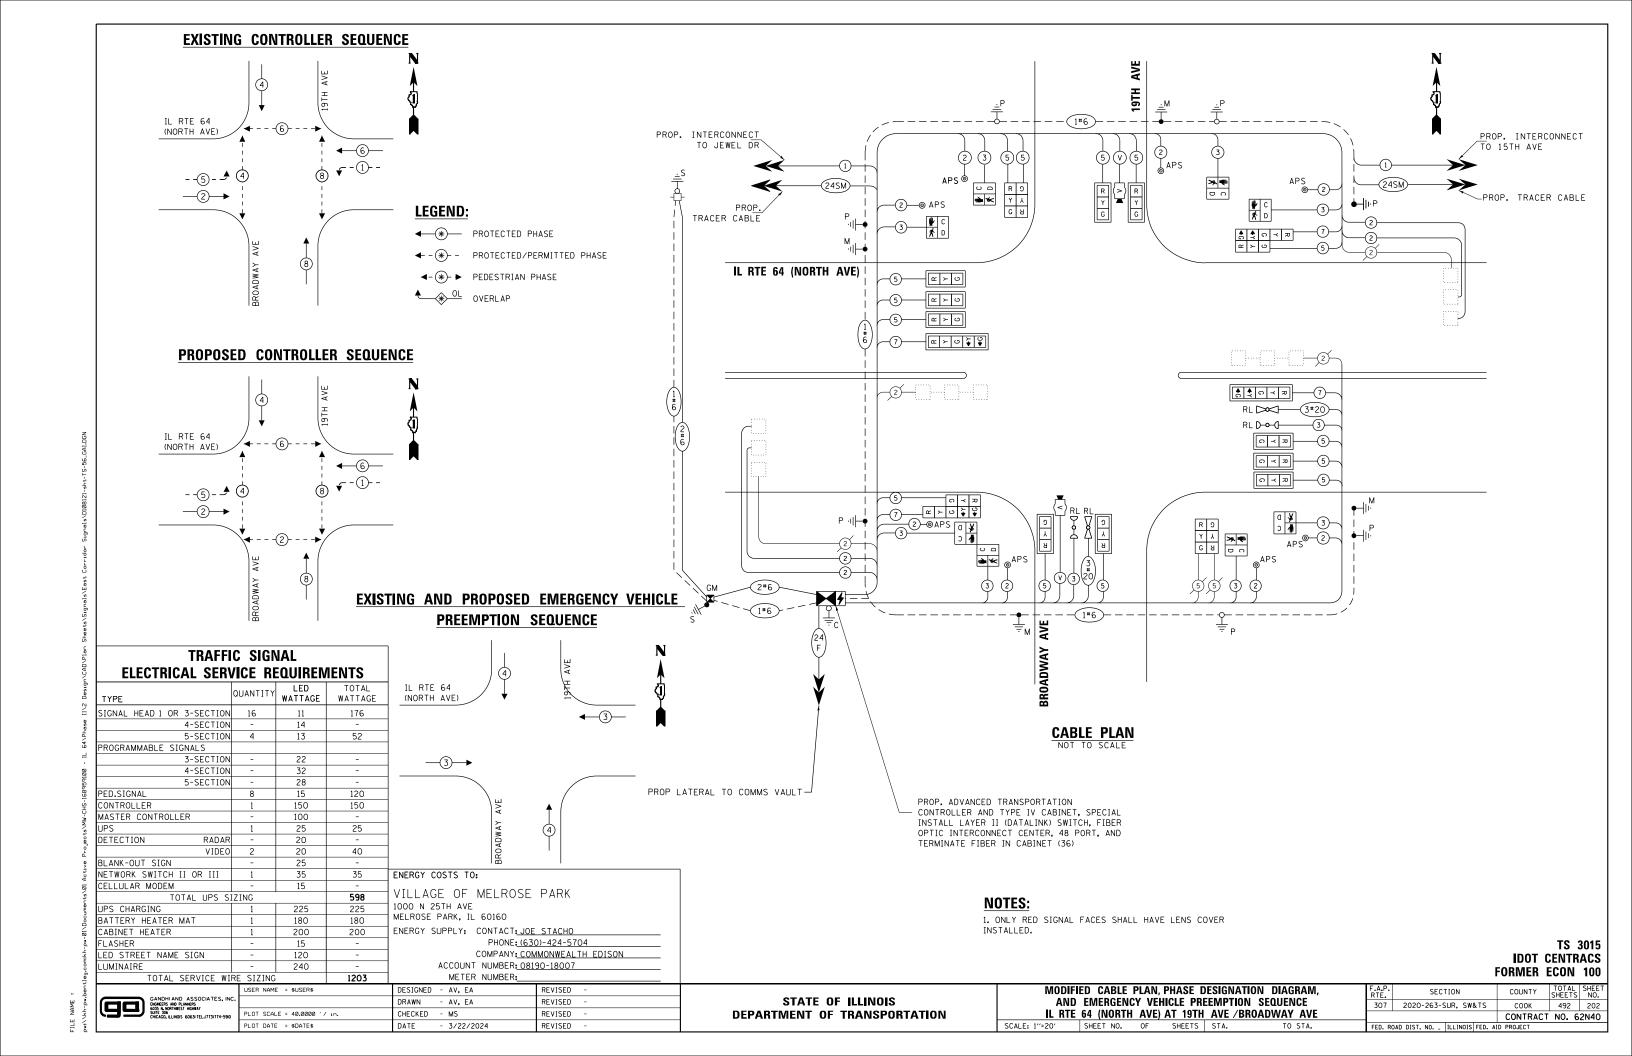




| DESIGN | AREA | SIGN PANEL | SHEETING | QTY. |
|--------|---------|------------|----------|----------|
| SERIES | (SQ FT) | TYPE | TYPE | REQUIRED |
| D | 12.5 | 2 | ZZ | |

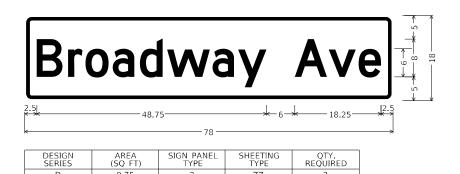

NOTE: INSTALL SIGN BACK TO BACK ON EASTBOUND MAST ARM

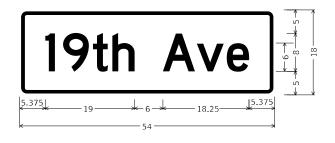

| | DESIGN | AREA | SIGN PANEL | SHEETING | QTY. | |
|---|--------|---------|------------|----------|----------|--|
| | SERIES | (SQ FT) | TYPE | TYPE | REQUIRED | |
| ſ | D | 6.75 | 1 | ZZ | 2 | |

NOTE: INSTALL SIGN BACK TO BACK ON WESTBOUND MAST ARM

NOTE: FOR ADDITIONAL DESIGN AND INSTALLATION INFORMATION PLEASE SEE DISTRICT ONE MAST ARM MOUNTED STREET NAME SIGNS DETAIL (TS-02).

SCHEDULE OF QUANTITIES


| ITEM DESCRIPTION | UNITS | TOTAL |
|--|-------|-------|
| SIGN PANEL - TYPE 1 | SQ FT | 13.5 |
| SIGN PANEL - TYPE 2 | SQ FT | 44.5 |
| UNDERGROUND CONDUIT, GALVANIZED STEEL, 2" DIA. | FOOT | 28 |
| UNDERGROUND CONDUIT, GALVANIZED STEEL, 3" DIA. | FOOT | 92 |
| UNDERGROUND CONDUIT, GALVANIZED STEEL, 4" DIA. | FOOT | 124 |
| MAINTENANCE OF EXISTING TRAFFIC SIGNAL INSTALLATION | EACH | 1 |
| ELECTRIC CABLE IN CONDUIT, SIGNAL NO. 14 2C | FOOT | 1098 |
| ELECTRIC CABLE IN CONDUIT, SIGNAL NO. 14 3C | FOOT | 1439 |
| ELECTRIC CABLE IN CONDUIT, SIGNAL NO. 14 5C | FOOT | 2504 |
| ELECTRIC CABLE IN CONDUIT, SIGNAL NO. 14 7C | FOOT | 713 |
| ELECTRIC CABLE IN CONDUIT, LEAD-IN, NO. 14 1 PAIR | FOOT | 1548 |
| ELECTRIC CABLE IN CONDUIT, SERVICE, NO. 6 2C | FOOT | 385 |
| ELECTRIC CABLE IN CONDUIT, EQUIPMENT GROUNDING CONDUCTOR, NO. 6 1C | FOOT | 643 |
| TRAFFIC SIGNAL POST, GALVANIZED STEEL 16 FT. | EACH | 3 |
| STEEL MAST ARM ASSEMBLY AND POLE, 24 FT. | EACH | 1 |
| STEEL MAST ARM ASSEMBLY AND POLE, 30 FT. | EACH | 1 |
| STEEL MAST ARM ASSEMBLY AND POLE, 55 FT. | EACH | 1 |
| STEEL MAST ARM ASSEMBLY AND POLE, 62 FT. | EACH | 1 |
| CONCRETE FOUNDATION, TYPE A | FOOT | 12 |
| CONCRETE FOUNDATION, TYPE E 30-INCH DIAMETER | FOOT | 23. 5 |
| CONCRETE FOUNDATION, TYPE E 36-INCH DIAMETER | FOOT | 15 |
| CONCRETE FOUNDATION, TYPE E 42-INCH DIAMETER | FOOT | 21 |
| DRILL EXISTING HANDHOLE | EACH | 12 |
| SIGNAL HEAD, LED, 1-FACE, 3-SECTION, MAST ARM MOUNTED | EACH | 10 |
| SIGNAL HEAD, LED, 1-FACE, 3-SECTION, MAST ANN MODITED | EACH | 6 |
| SIGNAL HEAD, LED, 1-FACE, 5-SECTION, BRACKET MOUNTED | EACH | 2 |
| SIGNAL HEAD, LED, 1-FACE, 5-SECTION, MAST ARM MOUNTED | EACH | 2 |
| PEDESTRIAN SIGNAL HEAD, LED, 1-FACE, BRACKET MOUNTED WITH COUNTDOWN TIMER | EACH | 8 |
| TRAFFIC SIGNAL BACKPLATE, LOUVERED, FORMED PLASTIC | EACH | 12 |
| INDUCTIVE LOOP DETECTOR | EACH | 8 |
| RELOCATE EXISTING EMERGENCY VEHICLE PRIORITY SYSTEM, DETECTOR UNIT | EACH | 2 |
| RELOCATE EXISTING EMERGENCY VEHICLE PRIORITY SYSTEM, DETECTOR ONLY | EACH | 1 |
| REMOVE ELECTRIC CABLE FROM CONDUIT | FOOT | 7866 |
| REMOVE EXISTING TRAFFIC SIGNAL EQUIPMENT | EACH | 1 |
| REBUILD EXISTING HANDHOLE | EACH | 1 |
| | | 4 |
| REMOVE EXISTING CONCRETE FOUNDATION EMERGENCY VEHICLE PRIORITY SYSTEM LINE SENSOR CABLE, NO. 20 3/C | FOOT | 285 |
| | | |
| CENTRACS LICENSE EXPANSION | EACH | 1 |
| UNINTERRUPTABLE POWER SUPPLYAND CABINET, SPECIAL | EACH | 1 |
| SERVICE INSTALLATION, GROUND MOUNTED, METERED | EACH | 1 |
| LAYER II (DATALINK) SWITCH | EACH | 1 7.0 |
| TERMINATE FIBER IN CABINET | EACH | 36 |
| PEDESTRIAN SIGNAL POST, 10 FT. | EACH | 2 |
| VIDEO VEHICLE DETECTION SYSTEM, SINGLE APPROACH | EACH | 2 |
| ADVANCED TRANSPORTATION CONTROLLER AND TYPE IV CABINET, SPECIAL | EACH | 1 |
| ACCESSIBLE PEDESTRIAN SIGNALS | EACH | 8 |
| CONCRETE FOUNDATION, TYPE A 12-INCH DIAMETER | FOOT | 8 |
| LED SIGNAL FACE, LENS COVER | EACH | 20 |
| FIBER OPTIC INTERCONNECT CENTER, 48 PORT | EACH | 1 |


* 100% COST TO THE VILLAGE OF MELROSE PARK

TS 3015 IDOT CENTRACS FORMER ECON 100

| Kimley»Hori |
|-------------------------------|
| |
| 4201 WINFIELD ROAD, SUITE 600 |
| WARRENVILLE, IL 60555 |
| PHONE: 630-487-5550 |

| USER NAME = Joel.Turk | DESIGNED | - | AMK | REVISED - |
|---------------------------|----------|---|-----------|-----------|
| | DRAWN | - | JJT | REVISED - |
| PLOT SCALE = 2.0000 / in. | CHECKED | - | SS | REVISED - |
| PLOT DATE = 3/22/2024 | DATE | - | 3/22/2024 | REVISED - |

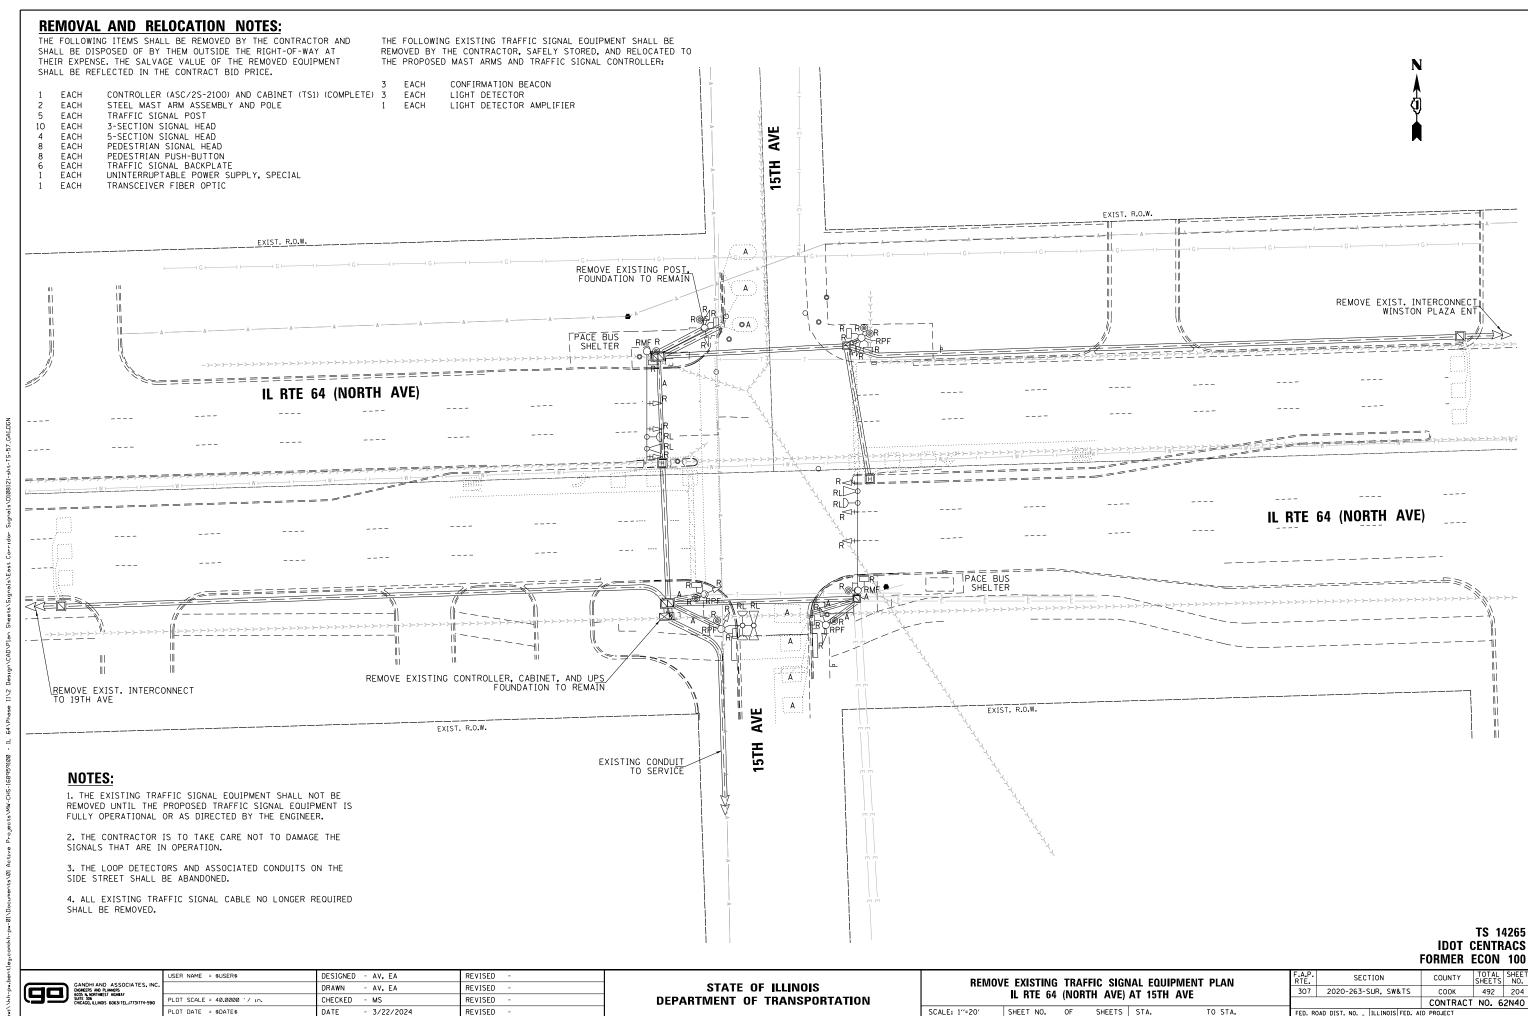


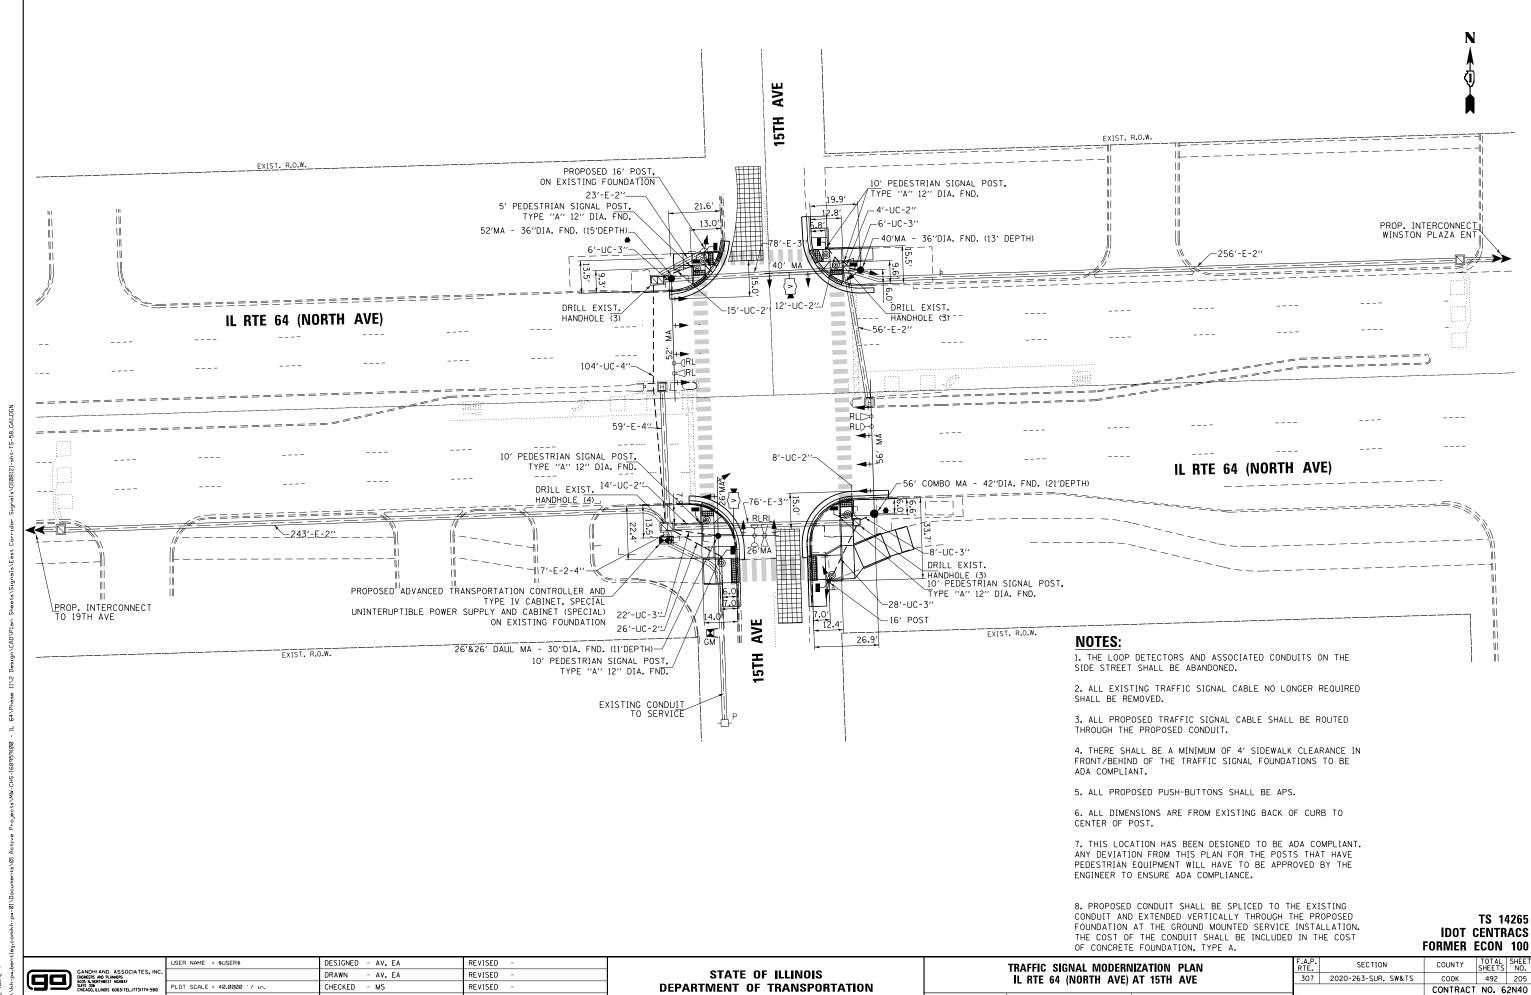

SCALE: 1"=20"

SHEET NO. OF SHEETS STA.

- 3/22/2024

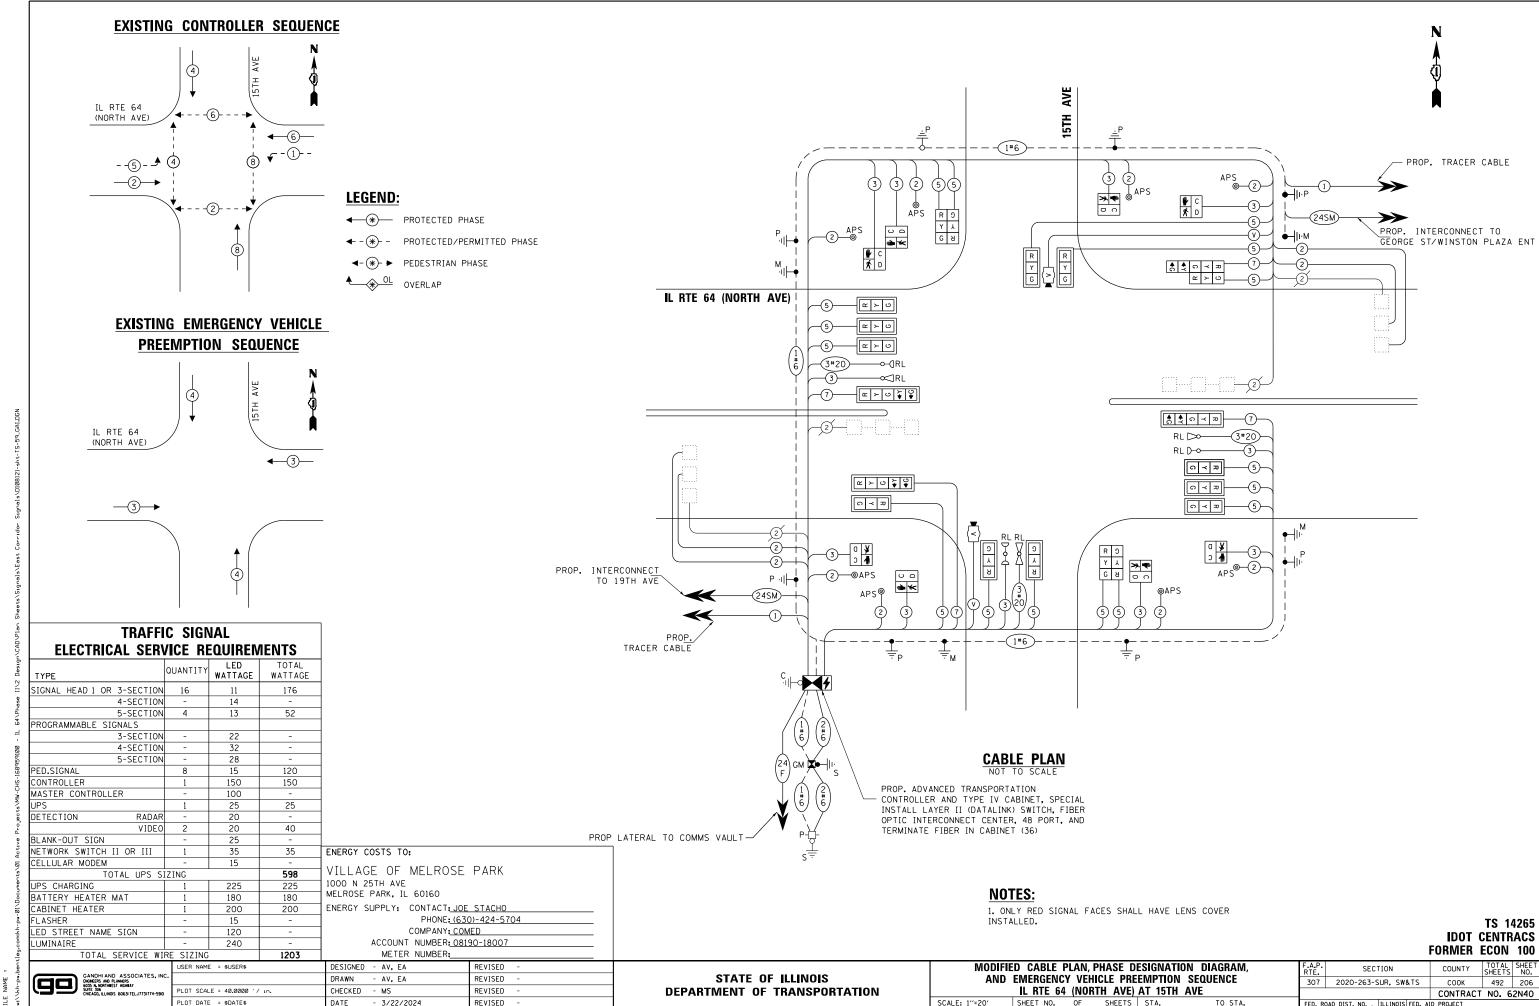


SIGN PANEL - TYPE 1 OR TYPE 2

ALL DIMENSIONS ARE IN INCHES UNLESS OTHERWISE NOTED



| DESIGN | AREA | SIGN PANEL | SHEETING | QTY. |
|--------|---------|------------|----------|----------|
| SERIES | (SQ FT) | TYPE | TYPE | REQUIRED |
| D | 12.5 | 2 | ZZ | |

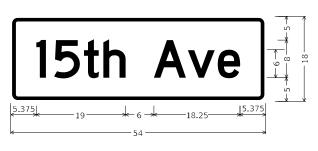

| DESIGN | AREA | SIGN PANEL | SHEETING | QTY. |
|--------|---------|------------|----------|----------|
| SERIES | (SQ FT) | TYPE | TYPE | REQUIRED |
| D | 6.75 | 1 | ZZ | 2 |

NOTE: FOR ADDITIONAL DESIGN AND INSTALLATION INFORMATION PLEASE SEE DISTRICT ONE MAST ARM MOUNTED STREET NAME SIGNS DETAIL (TS-02).

SCHEDULE OF QUANTITIES

| ITEM DESCRIPTION | UNITS | TOTAL QTY. |
|---|-------|---------------|
| SIGN PANEL - TYPE 1 | SQ FT | 13.5 |
| SIGN PANEL - TYPE 2 | SQ FT | 25 |
| UNDERGROUND CONDUIT, GALVANIZED STEEL, 2" DIA. | FOOT | 79 |
| UNDERGROUND CONDUIT, GALVANIZED STEEL, 3" DIA. | FOOT | 70 |
| UNDERGROUND CONDUIT, GALVANIZED STEEL, 4" DIA. | FOOT | 104 |
| MAINTENANCE OF EXISTING TRAFFIC SIGNAL INSTALLATION | EACH | 1 |
| ELECTRIC CABLE IN CONDUIT, SIGNAL NO. 14 2C | FOOT | 1198 |
| ELECTRIC CABLE IN CONDUIT, SIGNAL NO. 14 3C | FOOT | 1774 |
| ELECTRIC CABLE IN CONDUIT, SIGNAL NO. 14 5C | FOOT | 2873 |
| ELECTRIC CABLE IN CONDUIT, SIGNAL NO. 14 7C | FOOT | 766 |
| ELECTRIC CABLE IN CONDUIT, LEAD-IN, NO. 14 1 PAIR | FOOT | 1528 |
| ELECTRIC CABLE IN CONDUIT, SERVICE, NO. 6 2C | FOOT | 179 |
| ELECTRIC CABLE IN CONDUIT, EQUIPMENT GROUNDING CONDUCTOR, NO. 6 1C | FOOT | 849 |
| TRAFFIC SIGNAL POST, GALVANIZED STEEL 16 FT. | EACH | 2 |
| STEEL MAST ARM ASSEMBLY AND POLE, 40 FT. | EACH | 1 |
| STEEL MAST ARM ASSEMBLY AND POLE, 52 FT. | EACH | 1 |
| STEEL MAST ARM ASSEMBLY AND POLE, 52 FT. | EACH | 1 |
| | | 8 |
| CONCRETE FOUNDATION, TYPE A | FOOT | |
| CONCRETE FOUNDATION, TYPE E 30-INCH DIAMETER | FOOT | 11 |
| CONCRETE FOUNDATION, TYPE E 36-INCH DIAMETER | FOOT | 28 |
| CONCRETE FOUNDATION, TYPE E 42-INCH DIAMETER | FOOT | 21 |
| DRILL EXISTING HANDHOLE | EACH | 13 |
| SIGNAL HEAD, LED, 1-FACE, 3-SECTION, MAST ARM MOUNTED | EACH | 11 |
| SIGNAL HEAD, LED, 1-FACE, 3-SECTION, BRACKET MOUNTED | EACH | 5 |
| SIGNAL HEAD, LED, 1-FACE, 5-SECTION, BRACKET MOUNTED | EACH | 1 |
| SIGNAL HEAD, LED, 1-FACE, 5-SECTION, MAST ARM MOUNTED | EACH | 3 |
| PEDESTRIAN SIGNAL HEAD, LED, 1-FACE, BRACKET MOUNTED WITH COUNTDOWN TIMER | EACH | 8 |
| TRAFFIC SIGNAL BACKPLATE, LOUVERED, FORMED PLASTIC | EACH | 14 |
| INDUCTIVE LOOP DETECTOR | EACH | 8 |
| RELOCATE EXISTING EMERGENCY VEHICLE PRIORITY SYSTEM, DETECTOR UNIT | EACH | 3 |
| RELOCATE EXISTING EMERGENCY VEHICLE PRIORITY SYSTEM, PHASING UNIT | EACH | 1 |
| REMOVE ELECTRIC CABLE FROM CONDUIT | FOOT | 8880 |
| REMOVE EXISTING TRAFFIC SIGNAL EQUIPMENT | EACH | 1 |
| REMOVE EXISTING CONCRETE FOUNDATION | EACH | 6 |
| EMERGENCY VEHICLE PRIORITY SYSTEM LINE SENSOR CABLE, NO. 20 3/C | FOOT | 512 |
| CENTRACS LICENSE EXPANSION | EACH | 1 |
| UNINTERRUPTABLE POWER SUPPLY AND CABINET, (SPECIAL) | EACH | 1 |
| SERVICE INSTALLATION, GROUND MOUNTED, METERED | EACH | 1 |
| LAYER II (DATALINK) SWITCH | EACH | 1 |
| TERMINATE FIBER IN CABINET | EACH | 36 |
| PEDESTRIAN SIGNAL POST, 10 FT. | EACH | 5 |
| PEDESTRIAN SIGNAL POST, 5 FT. | EACH | 1 |
| VIDEO VEHICLE DETECTION SYSTEM, SINGLE APPROACH | EACH | 2 |
| FIBER OPTIC INTERCONNECT CENTER, 48 PORT | EACH | 1 |
| ADVANCED TRANSPORTATION CONTROLLER AND TYPE IV CABINET, SPECIAL | EACH | 1 |
| ACCESSIBLE PEDESTRIAN SIGNALS | EACH | 8 |
| | | 24 |
| CONCRETE FOUNDATION, TYPE A 12-INCH DIAMETER | FOOT | |
| LED SIGNAL FACE, LENS COVER | EACH | 20 |
| STEEL MAST ARM ASSEMBLY AND POLE WITH DUAL MAST ARMS, 26 FT. AND 26 FT. | EACH | 1 |

* 100% COST TO THE VILLAGE OF MELROSE PARK


TS 14265 IDOT CENTRACS FORMER ECON 100

COOK 492 207

CONTRACT NO. 62N40

| Kimley»Horn | |
|---|--|
| © 2023 KIMLEY-HORN AND ASSOCIATES, INC. | |
| 4201 WINFIELD ROAD, SUITE 600 | |
| WARRENVILLE, IL 60555 | |
| PHONE: 630-487-5550 | |
| WWW KIM EY-HORN COM | |

| USER NAME = Joel.Turk | DESIGNED - | - | AMK | REVISED - | |
|--------------------------|------------|---|-----------|-----------|--|
| | DRAWN - | - | JJT | REVISED - | |
| PLOT SCALE = 2 0000 / in | CHECKED - | - | SS | REVISED - | |
| PLOT DATE = 3/22/2024 | DATE - | - | 3/22/2024 | REVISED - | |

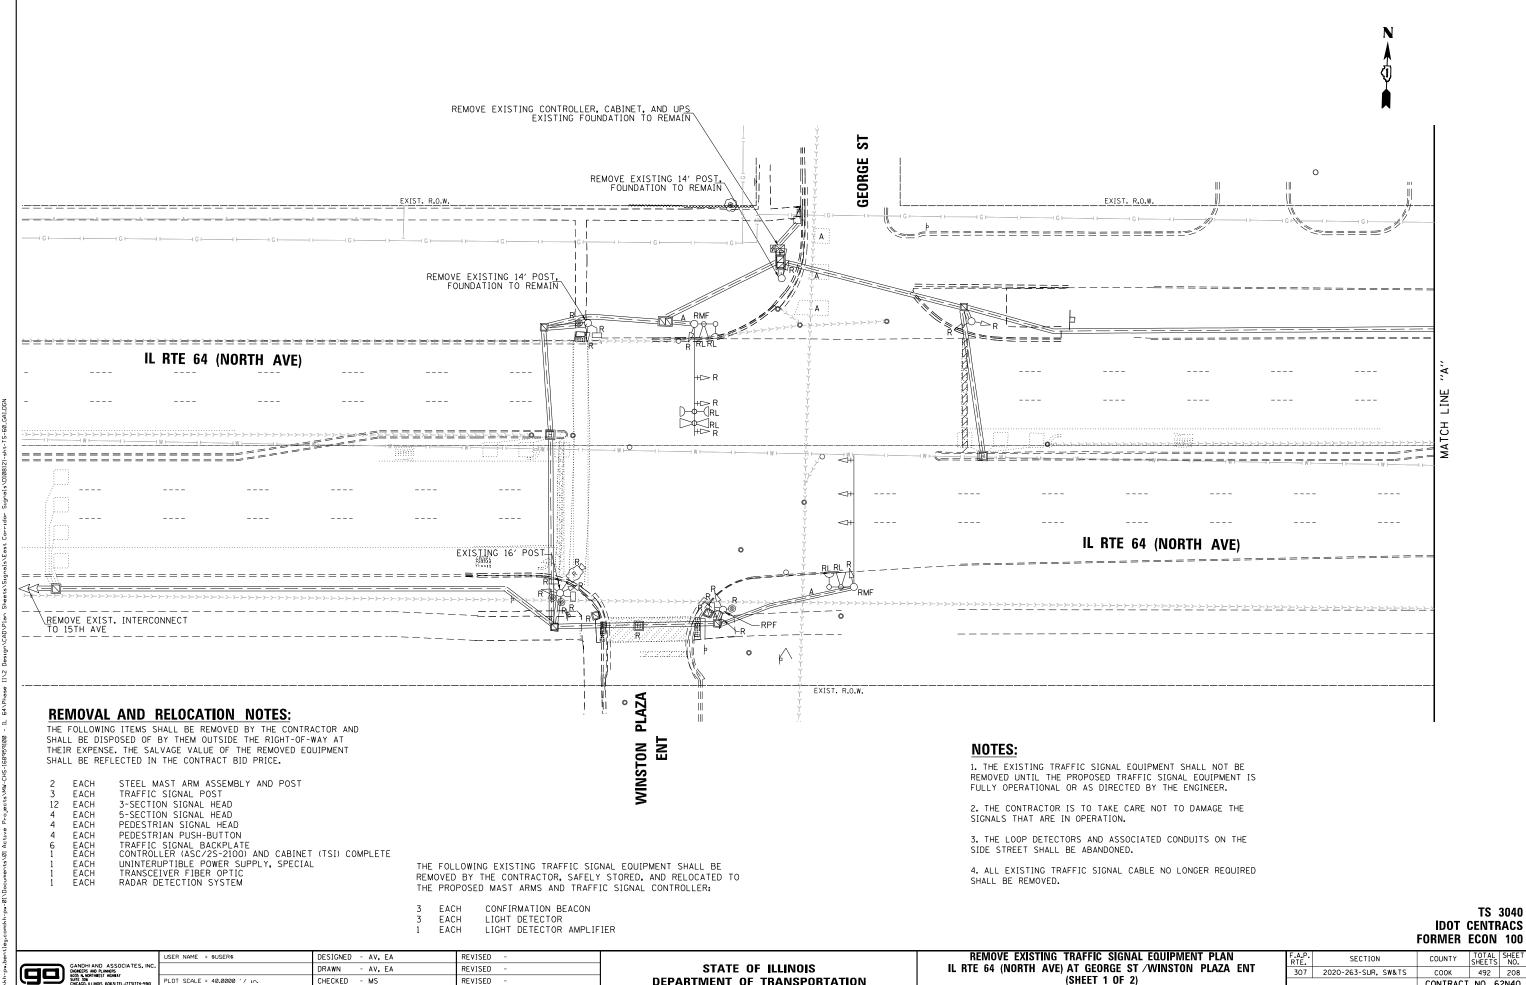

DEPARTMENT OF TRANSPORTATION

(SHEET 1 OF 2)

SCALE: 1"=20" SHEET NO. OF SHEETS STA.


CONTRACT NO. 62N40

CHECKED - MS

- 3/22/2024

DATE

REVISED

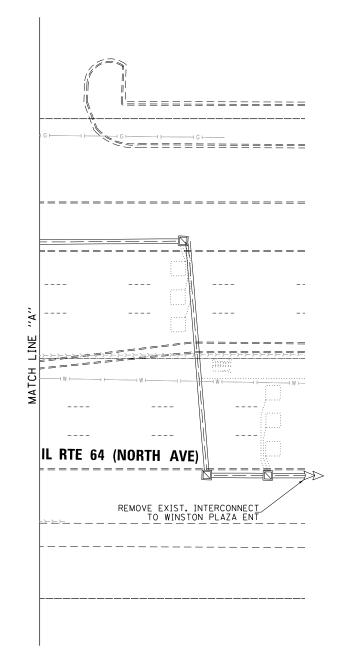


TS 3040 IDOT CENTRACS FORMER ECON 100

| 99 | GANDHI AND ASSOCIATES, ENGREERS AND PLANNERS 6035 NL ADRITHEST HIGHBAY SUITE 306 CHICAGO, ILLINOIS 60631 TEL.1773)774-9 |
|----|---|


| | USER NAME = \$USER\$ | DESIGNED - AV, EA | REVISED - | |
|---|------------------------------|-------------------|-----------|--|
| ٠ | | DRAWN - AV, EA | REVISED - | |
| | PLOT SCALE = 40.0000 ' / 10. | CHECKED - MS | REVISED - | |
| | PLOT DATE = \$DATE\$ | DATE - 3/22/2024 | REVISED - | |
| | | | | |

STATE OF ILLINOIS DEPARTMENT OF TRANSPORTATION

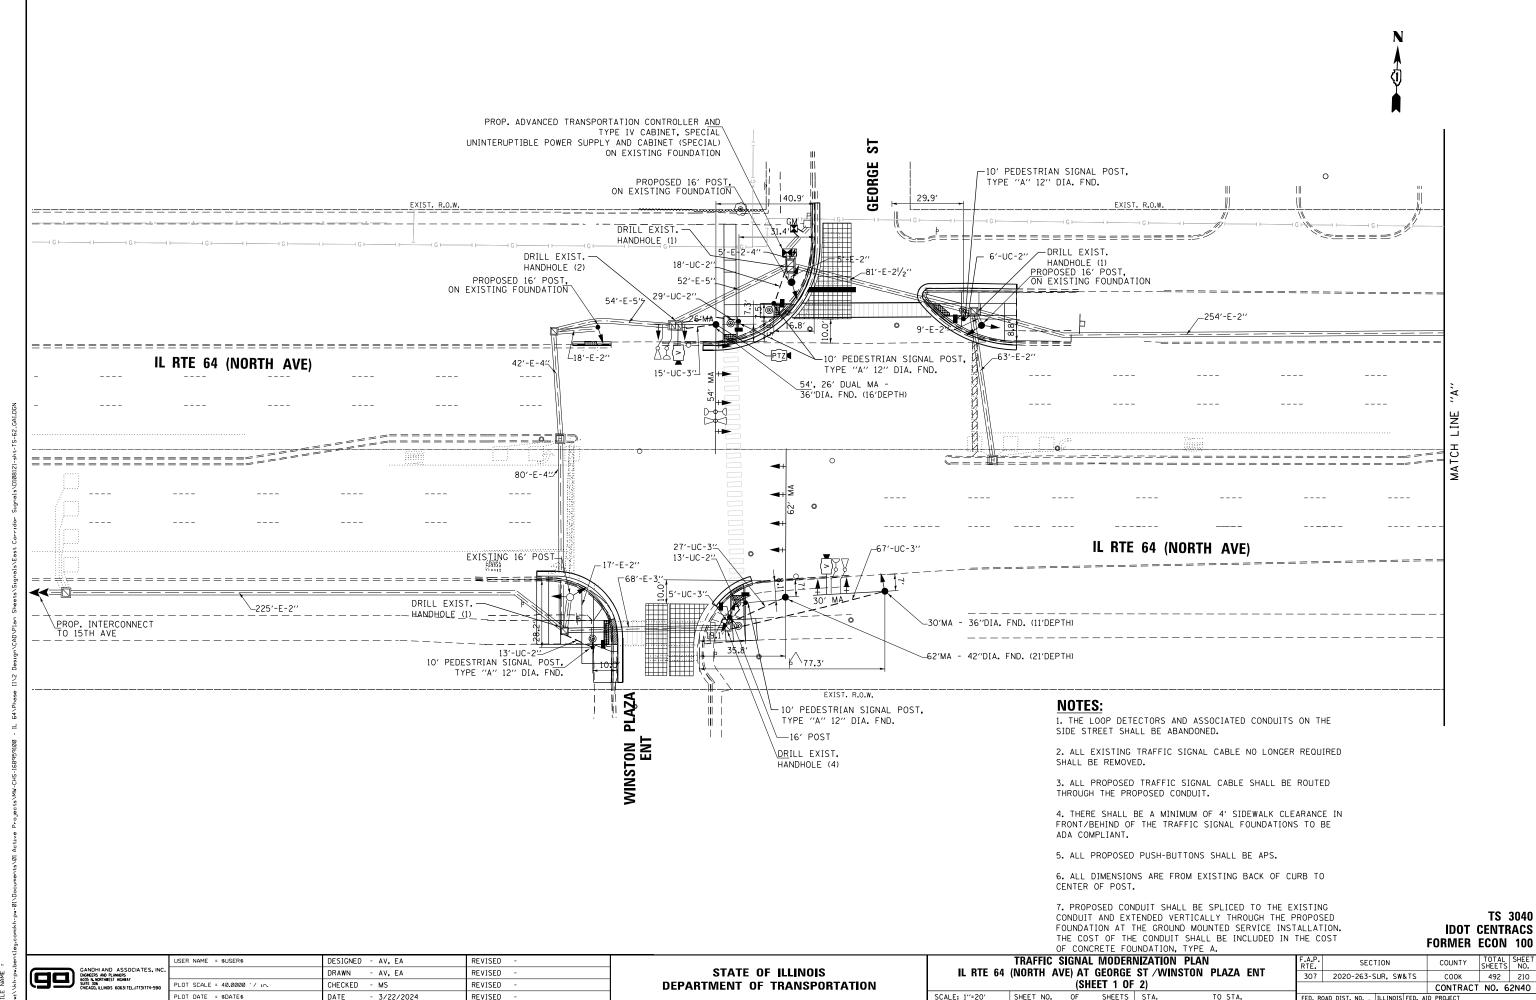

DATE

- 3/22/2024

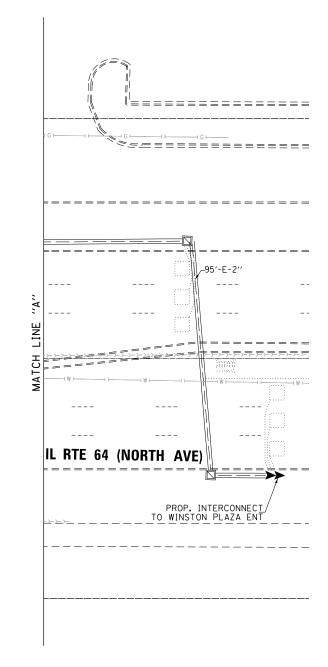


TS 3040 IDOT CENTRACS FORMER ECON 100

| 90 | GANDHI AND ASSOCIATES, ENGREERS AND PLANKERS 6035 N. ADRIHUEST HIGHBAY SUITE 306 CHICAGO, ILLINOIS 60631 TEL.(1773)774-5 |
|----|--|

| | USER NAME = \$USER\$ | DESIGNED - AV, EA | REVISED - | |
|---|-----------------------------|-------------------|-----------|--|
| • | | DRAWN - AV, EA | REVISED - | |
| | PLOT SCALE = 40.0000 '/ in. | CHECKED - MS | REVISED - | |
| | PLOT DATE = \$DATE\$ | DATE - 3/22/2024 | REVISED - | |
| | | | | |

STATE OF ILLINOIS DEPARTMENT OF TRANSPORTATION

| | | | TAL MODERNIZATION TEAM | | | F.A.P. RTE. | SECTION | COUNTY | TOTAL SHEETS | SHEE NO. |
|---|-----------|----|------------------------|------|---------------------|----------------|------------------------------|-----------|-----------------|-------------|
| IL RTE 64 (NORTH AVE) AT GEORGE ST /WINSTON PLAZA ENT | | | | 307 | 2020-263-SUR, SW&TS | соок | 492 | 211 | | |
| (SHEET 2 OF 2) | | | | | | | CONTRACT | NO. | 62N4(| |
| SCALE: 1"=20" | SHEET NO. | OF | SHEETS | STA. | TO STA. | FED. RO | AD DIST. NO ILLINOIS FED. AI | D PROJECT | | |
| | • | | • | • | | | • | | | |

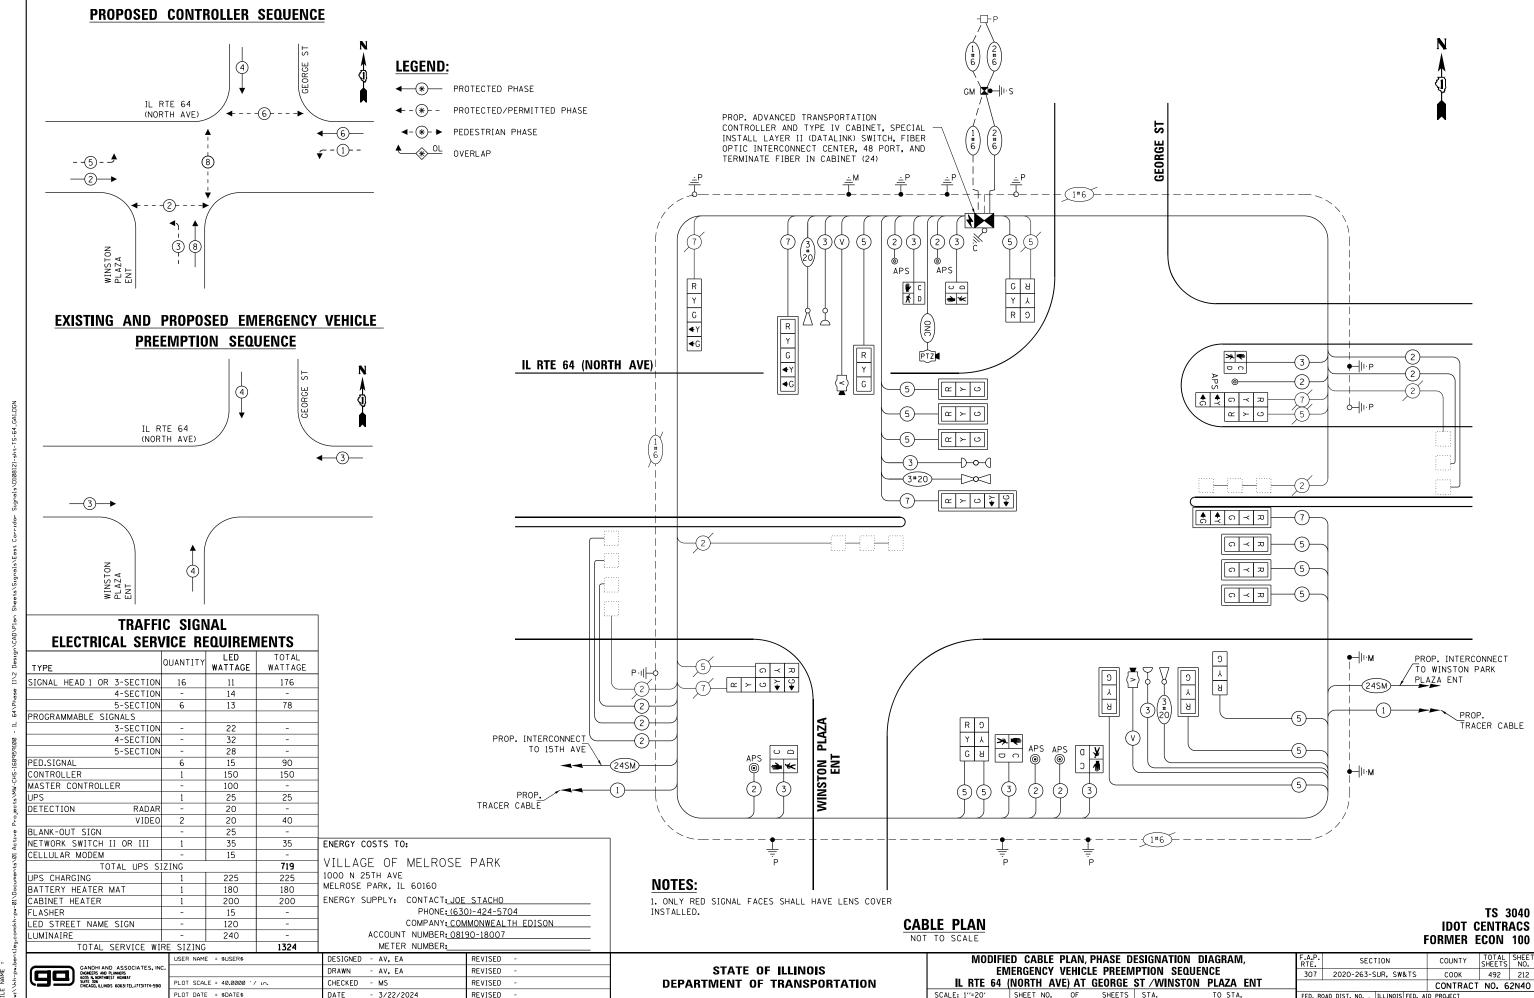



ALL DIMENSIONS ARE IN INCHES UNLESS OTHERWISE NOTED




| DESIGN SERIES | AREA (SQ FT) | SIGN PANEL TYPE | SHEETING TYPE | QTY. REQUIRED |
|------------------|-----------------|--------------------|------------------|------------------|
| D | 12.5 | 2 | 77 | 2 |



| 12 | 32.8 | 875 ——— | -*- 6- *- 9.12 | 5 📥 12 — | * 12 — | * 12 → |
|------------------|-----------------|--------------------|--------------------------------------|------------------|-------------------|-------------------|
| < | | | 96 —— | | | |
| DESIGN SERIES | AREA (SQ FT) | SIGN PANEL TYPE | SHEETING TYPE | QTY. REQUIRED | | |

D 20 2

NOTE: INSTALL THIS SIGN ON THE WESTBOUND MAST ARM.

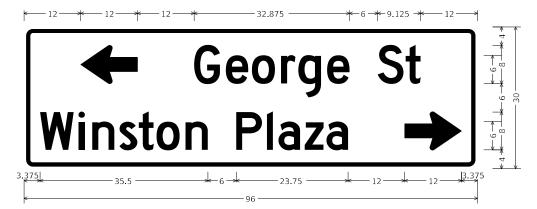

| DESIGN SERIES | AREA (SQ FT) | SIGN PANEL TYPE | SHEETING TYPE | QTY. REQUIRED |
|------------------|-----------------|--------------------|------------------|------------------|
| D | 20 | 2 | ZZ | 1 |

NOTE: INSTALL THIS SIGN ON THE EASTBOUND MAST ARM.

NOTE: FOR ADDITIONAL DESIGN AND INSTALLATION INFORMATION PLEASE SEE DISTRICT ONE MAST ARM MOUNTED STREET NAME SIGNS DETAIL (TS-02).

SCHEDULE OF QUANTITIES

| ITEM DESCRIPTION | UNITS | TOTAL OTY. |
|---|-------|---------------|
| SIGN PANEL - TYPE 2 | SQ FT | 65 |
| UNDERGROUND CONDUIT, GALVANIZED STEEL, 2" DIA. | FOOT | 82 |
| UNDERGROUND CONDUIT, GALVANIZED STEEL, 3" DIA. | FOOT | 114 |
| MAINTENANCE OF EXISTING TRAFFIC SIGNAL INSTALLATION | EACH | 1 |
| ELECTRIC CABLE IN CONDUIT, SIGNAL NO. 14 2C | FOOT | 1352 |
| ELECTRIC CABLE IN CONDUIT, SIGNAL NO. 14 3C | FOOT | 2165 |
| ELECTRIC CABLE IN CONDUIT, SIGNAL NO. 14 5C | FOOT | 4046 |
| ELECTRIC CABLE IN CONDUIT, SIGNAL NO. 14 7C | FOOT | 776 |
| ELECTRIC CABLE IN CONDUIT, LEAD-IN, NO. 14 1 PAIR | FOOT | 2287 |
| ELECTRIC CABLE IN CONDUIT, SERVICE, NO. 6 2C | FOOT | 41 |
| ELECTRIC CABLE IN CONDUIT, EQUIPMENT GROUNDING CONDUCTOR, NO. 6 1C | FOOT | 487 |
| TRAFFIC SIGNAL POST, GALVANIZED STEEL 16 FT. | EACH | 4 |
| STEEL MAST ARM ASSEMBLY AND POLE, 30 FT. | EACH | 1 |
| STEEL MAST ARM ASSEMBLY AND POLE, 62 FT. | EACH | 1 |
| CONCRETE FOUNDATION, TYPE A | FOOT | 8 |
| CONCRETE FOUNDATION, TYPE E 36-INCH DIAMETER | FOOT | 27 |
| CONCRETE FOUNDATION, TYPE E 42-INCH DIAMETER | FOOT | 21 |
| DRILL EXISTING HANDHOLE | EACH | 9 |
| SIGNAL HEAD, LED, 1-FACE, 3-SECTION, MAST ARM MOUNTED | EACH | 9 |
| SIGNAL HEAD, LED, 1-FACE, 3-SECTION, BRACKET MOUNTED | EACH | 7 |
| SIGNAL HEAD, LED, 1-FACE, 5-SECTION, BRACKET MOUNTED | EACH | 3 |
| SIGNAL HEAD, LED, 1-FACE, 5-SECTION, MAST ARM MOUNTED | EACH | 3 |
| PEDESTRIAN SIGNAL HEAD, LED, 1-FACE, BRACKET MOUNTED WITH COUNTDOWN TIMER | EACH | 6 |
| TRAFFIC SIGNAL BACKPLATE, LOUVERED, FORMED PLASTIC | EACH | 12 |
| INDUCTIVE LOOP DETECTOR | EACH | 9 |
| RELOCATE EXISTING EMERGENCY VEHICLE PRIORITY SYSTEM, DETECTOR UNIT | EACH | 3 |
| RELOCATE EXISTING EMERGENCY VEHICLE PRIORITY SYSTEM, PHASING UNIT | EACH | 1 |
| REMOVE ELECTRIC CABLE FROM CONDUIT | FOOT | 12025 |
| REMOVE EXISTING TRAFFIC SIGNAL EQUIPMENT | EACH | 1 |
| REMOVE EXISTING HANDHOLE | EACH | 3 |
| REMOVE EXISTING CONCRETE FOUNDATION | EACH | 3 |
| EMERGENCY VEHICLE PRIORITY SYSTEM LINE SENSOR CABLE, NO. 20 3/C | FOOT | 771 |
| CENTRACS LICENSE EXPANSION | EACH | 1 |
| OUTDOOR RATED NETWORK CABLE | FOOT | 123 |
| UNINTERRUPTABLE POWER SUPPLYAND CABINET, SPECIAL | EACH | 1 |
| SERVICE INSTALLATION, GROUND MOUNTED, METERED | EACH | 1 |
| REMOTE CONTROLLED VIDEO SYSTEM | EACH | 1 |
| LAYER II (DATALINK) SWITCH | EACH | 1 |
| TERMINATE FIBER IN CABINET | EACH | 24 |
| PEDESTRIAN SIGNAL POST, 10 FT. | EACH | 4 |
| VIDEO VEHICLE DETECTION SYSTEM, SINGLE APPROACH | EACH | 2 |
| FIBER OPTIC INTERCONNECT CENTER, 48 PORT | EACH | 1 |
| ADVANCED TRANSPORTATION CONTROLLER AND TYPE IV CABINET, SPECIAL | EACH | 1 |
| ACCESSIBLE PEDESTRIAN SIGNALS | EACH | 6 |
| CONCRETE FOUNDATION, TYPE A 12-INCH DIAMETER | FOOT | 16 |
| LED SIGNAL FACE, LENS COVER | EACH | 22 |
| CAMERA MOUNTING ASSEMBLY | EACH | 1 |
| STEEL MAST ARM ASSEMBLY AND POLE WITH DUAL MAST ARMS, 26 FT. AND 54 FT. | EACH | 1 |

* 100% COST TO THE VILLAGE OF MELROSE PARK

TS 3040 IDOT CENTRACS FORMER ECON 100

Kimley >>> Horn

9 2023 HIMEN-USPS MAD ARDOCUTED, INC.
ADDI WHITEID ROWN, BUTTE MD.
WARRISH, ILE, IL 10855
PHONE EXALER ASSO

| USER NAME = Joel,Turk | DESIGNED - | - | AMK | REVISED | - |
|--------------------------|------------|---|-----------|---------|---|
| | DRAWN - | - | JJT | REVISED | - |
| PLOT SCALE = 2.0000 / in | CHECKED - | - | SS | REVISED | - |
| PLOT DATE = 3/22/2024 | DATE - | - | 3/22/2024 | REVISED | - |


SIGN PANEL - TYPE 1 OR TYPE 2


ALL DIMENSIONS ARE IN INCHES UNLESS OTHERWISE NOTED



| DESIGN | AREA | SIGN PANEL | SHEETING | QTY. |
|--------|---------|------------|----------|----------|
| SERIES | (SQ FT) | TYPE | TYPE | REQUIRED |
| D | 12.5 | 2 | ZZ | 2 |

NOTE: FOR ADDITIONAL DESIGN AND INSTALLATION INFORMATION PLEASE SEE DISTRICT ONE MAST ARM MOUNTED STREET NAME SIGNS DETAIL (TS-02).

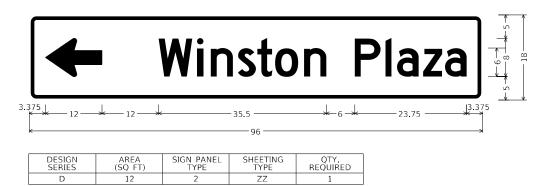

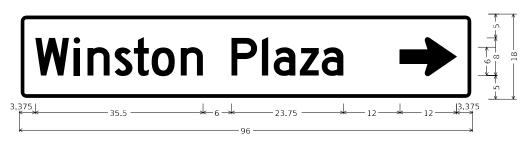

| DESIGN | AREA | SIGN PANEL | SHEETING | QTY. |
|--------|---------|------------|----------|----------|
| SERIES | (SQ FT) | TYPE | TYPE | REQUIRED |
| D | 12 | 2 | ZZ | 1 |

SCHEDULE OF QUANTITIES

| ITEM DESCRIPTION | UNITS | TOTAL QTY. |
|--|-------|---------------|
| MAINTENANCE OF EXISTING TRAFFIC SIGNAL INSTALLATION | EACH | 1 |
| ELECTRIC CABLE IN CONDUIT, SERVICE, NO. 6 2C | FOOT | 86 |
| ELECTRIC CABLE IN CONDUIT, EQUIPMENT GROUNDING CONDUCTOR, NO. 6 1C | FOOT | 86 |
| CONCRETE FOUNDATION, TYPE A | F00T | 4 |
| INDUCTIVE LOOP DETECTOR | EACH | 9 |
| RELOCATE EXISTING EMERGENCY VEHICLE PRIORITY SYSTEM, PHASING UNIT | EACH | 1 |
| REMOVE EXISTING TRAFFIC SIGNAL EQUIPMENT | EACH | 1 |
| CENTRACS LICENSE EXPANSION | EACH | 1 |
| UNINTERRUPTABLE POWER SUPPLYAND CABINET, SPECIAL | EACH | 1 |
| SERVICE INSTALLATION, GROUND MOUNTED, METERED | EACH | 1 |
| LAYER II (DATALINK) SWITCH | EACH | 1 |
| TERMINATE FIBER IN CABINET | EACH | 24 |
| FIBER OPTIC INTERCONNECT CENTER, 48 PORT | EACH | 1 |
| ADVANCED TRANSPORTATION CONTROLLER AND TYPE IV CABINET, SPECIAL | EACH | 1 |
| ACCESSIBLE PEDESTRIAN SIGNALS | EACH | 2 |


* 100% COST TO THE VILLAGE OF MELROSE PARK


TS 8800 IDOT CENTRACS FORMER ECON 100

| Kimley >>> Hore © 2022 HULEY +- ON AND ASSOCIATES, INC. 4201 WHITELD ROAD SUITE 600 WARREWILLE, 10555 |
|--|
| PHONE: 630-487-5550 |
| WWW.KIMLEY HORN,COM |
| |

| USER NAME = Joel.Turk | DESIGNED | - | AMK | REVISED - |
|--------------------------|----------|---|-----------|-----------|
| | DRAWN | - | JJT | REVISED - |
| PLOT SCALE = 2 0000 / in | CHECKED | - | SS | REVISED - |
| PLOT DATE = 3/22/2024 | DATE | - | 3/22/2024 | REVISED - |

| WAST ANN WOOMIED STILLT WANE SIGNS | | | | F.A.P. RTE | SEC ⁻ | ПОИ | | COUNTY | TOTAL SHEETS | SHE | | |
|------------------------------------|--|-------|----------|---------------|------------------|-----|------------|----------|-----------------|------------|----------|------|
| | AND SCHEDULE OF QUANTITIES IL RTE 64 (NORTH AVE) AND WINSTON PLAZA | | | | | 307 | 2020-264-S | UR,SW8 | TS | соок | 492 | 218 |
| IL | KIE 64 (1 | NOKIH | AVE) ANL | MINZIO | N PLAZA | | | | | CONTRAC | T NO. 62 | 2N40 |
| | SHEET 1 | OF | SHEETS | STA. | TO STA. | | | ILLINOIS | FED. A | ID PROJECT | | |

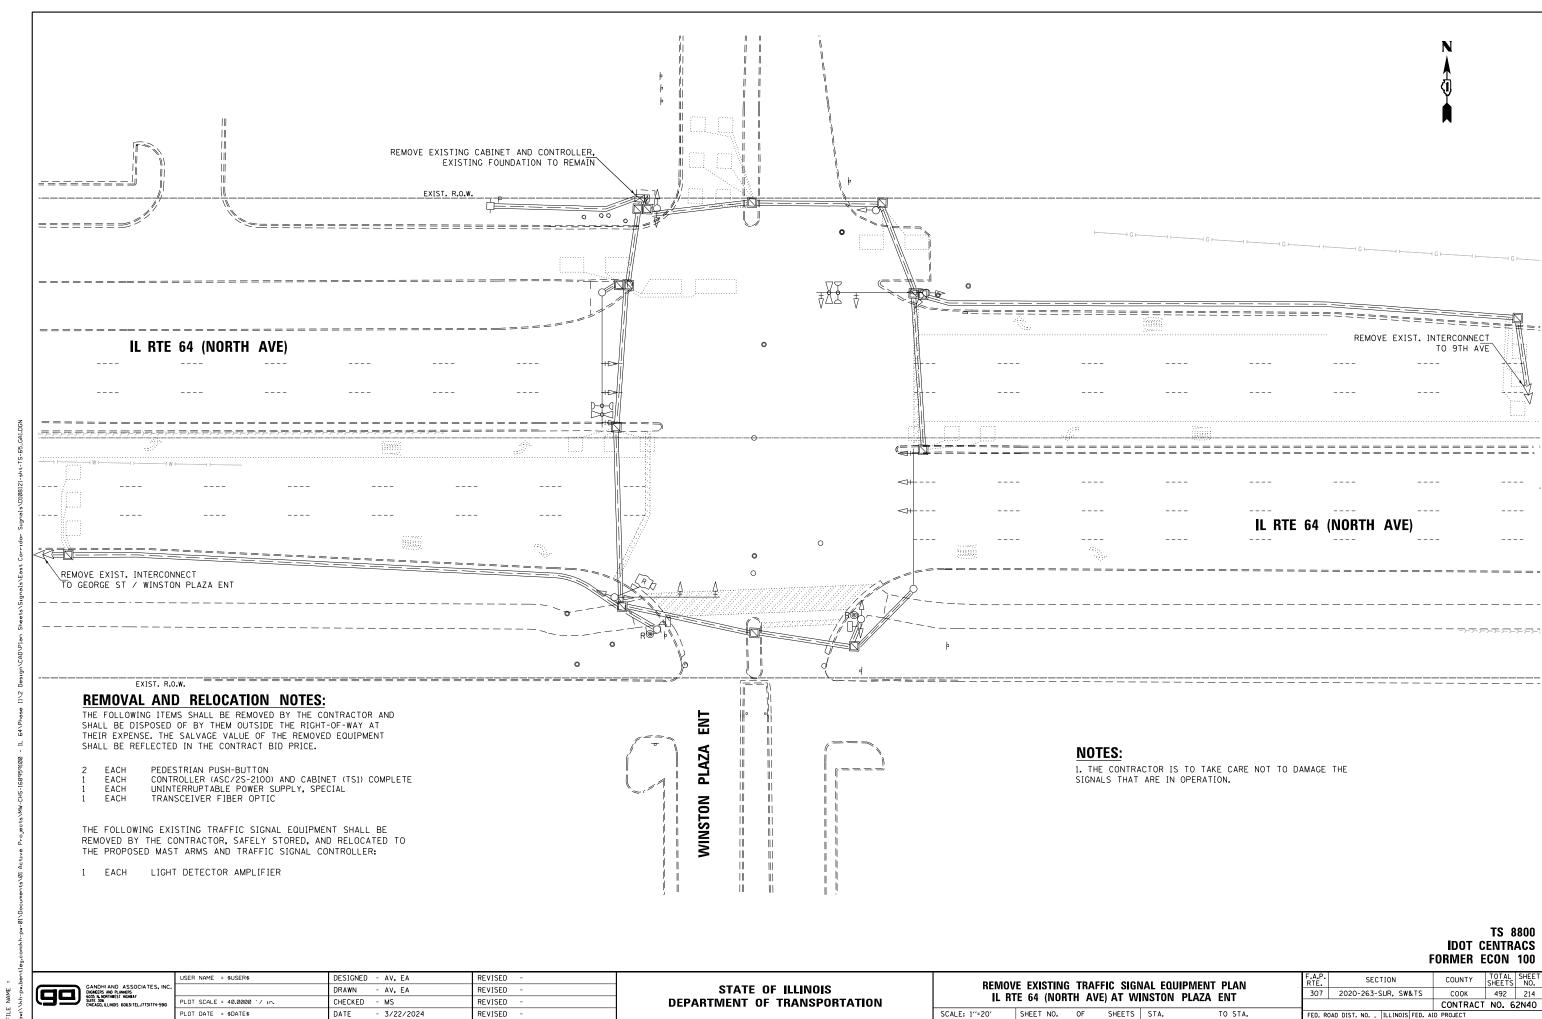


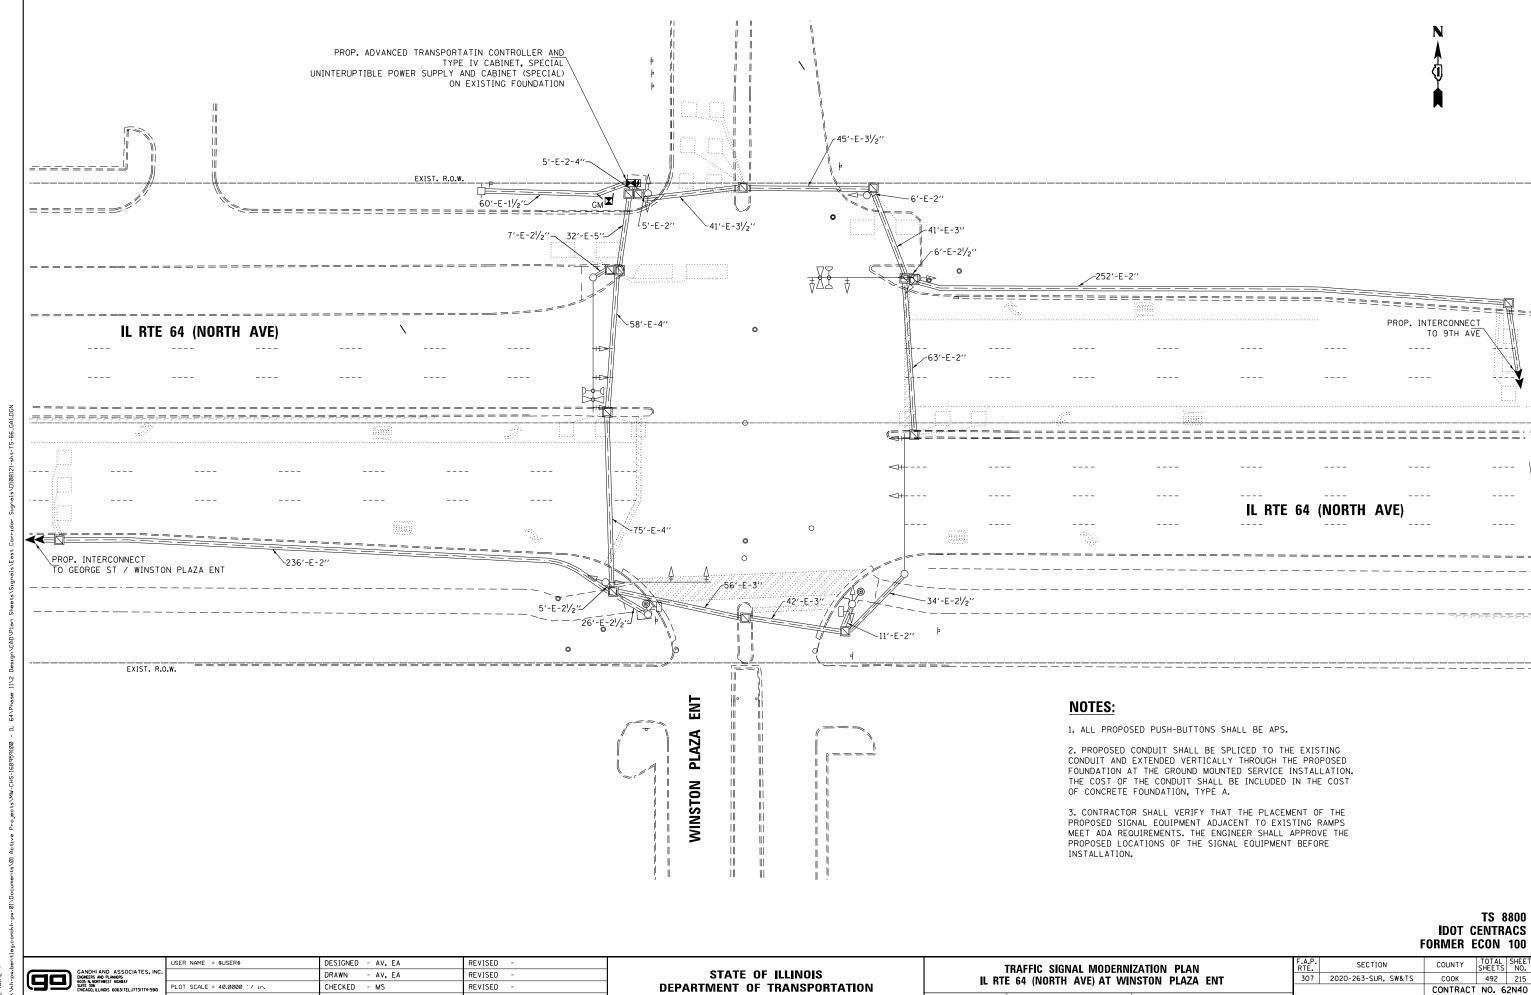


SCALE: 1"=20" SHEET NO. OF SHEETS STA.

DATE

- 3/22/2024

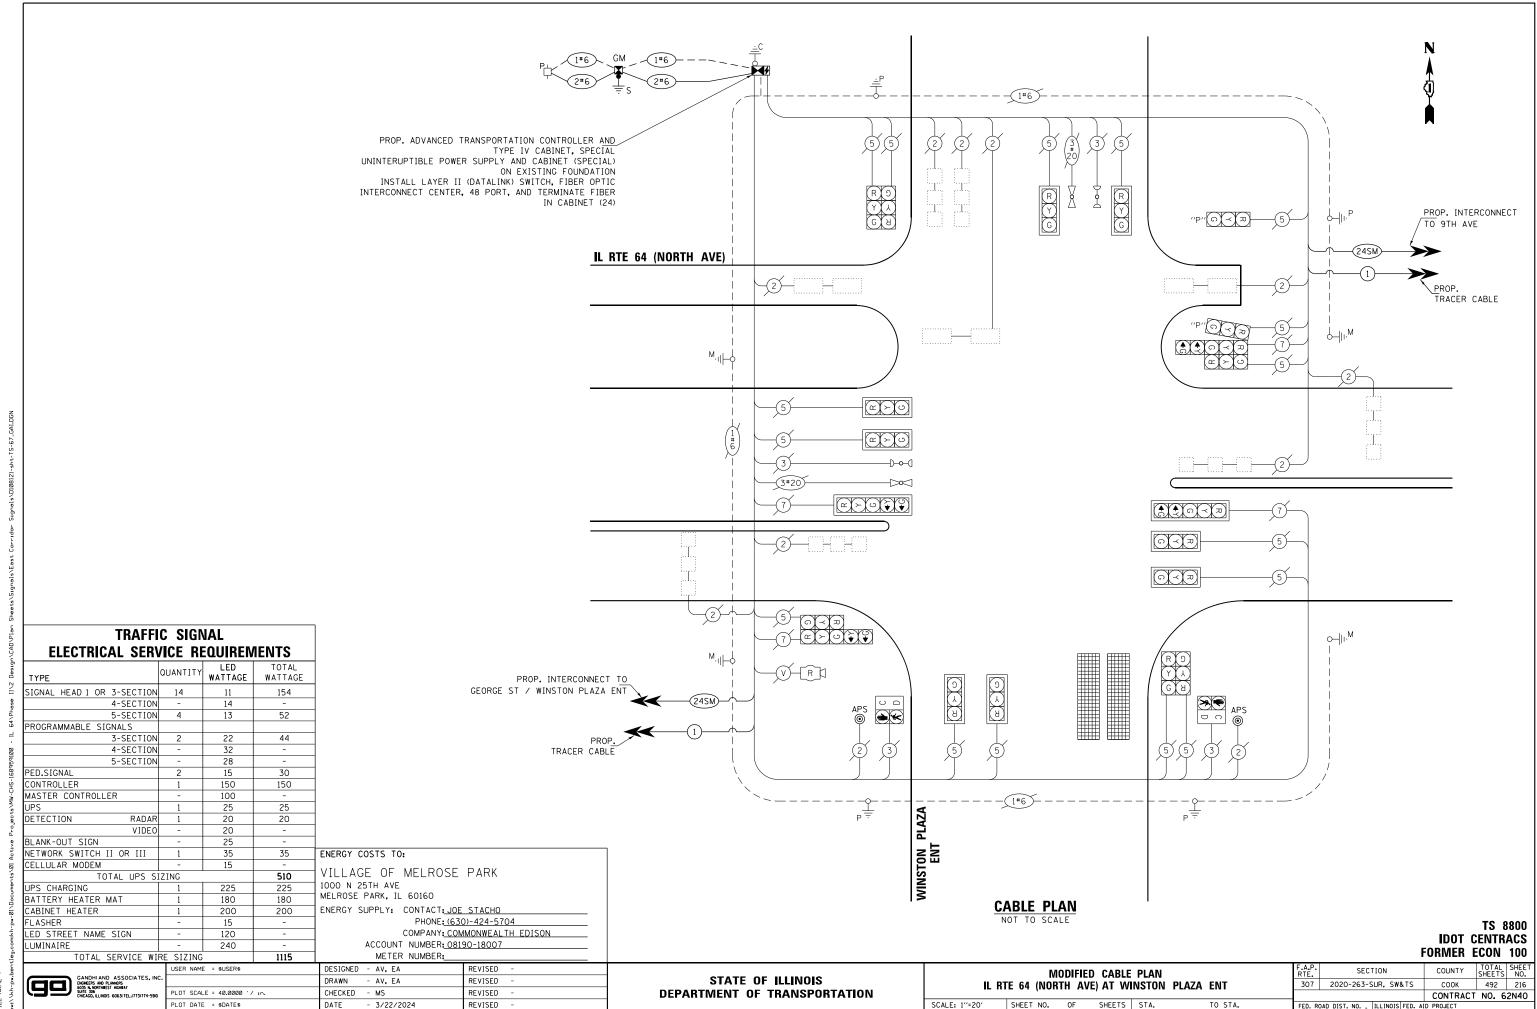

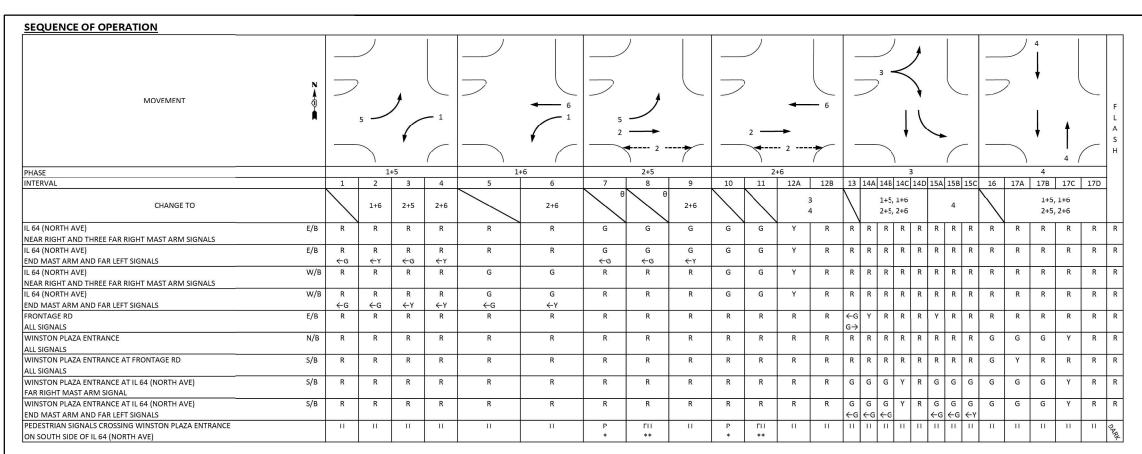

PHASES 2+6 SHALL BE PLACED ON RECALL

* TO APPEAR ONLY UPON PUSHBUTTON ACTUATION

** FLASHING HAND IS TO TERMINATE AT THE COMPLETION OF THE PEDESTRIAN INTERVAL CLEARANCE

P = ILLUMINATED PERSON = WALK

FH = ILLUMINATED FLASHING HAND = FLASHING DON'T WALK

H = ILLUMINATED SOLID HAND = DON'T WALK

 θ THE WALK OR FLASHING DON'T WALK INTERVAL MAY FINISH TIMING IN THE BIDIRECTIONAL STRAIGHT THROUGH MOVEMENT IF THE LEFT ARROW TIME IS NOT SUFFICIENT TO COMPLETE WALK OR FLASHING DON'T WALK INTERVALS


WALK AND FLASHING DON'T WALK TIMINGS TO BE SET ONLY ON PHASES WHERE WALK AND FLASHING DON'T WALK ARE INDICATED IN THE SEQUENCE OF OPERATION

| EMERGENCY VEHICLE PREEMPTION SEQUENCE OF OPERATI | <u>0N</u> | | | | | | | | | | | | | | | | | | | | | | | | | PREEMPTOR NUMBER 3 | PREEMPTOR NUMBER 4 | |
|--|--------------|---------|----|----|---------|---------|---------|------------|------------|----|----|----|----|---------|---------|----|----|----|------------|---------|----|----|----|----|-----|-----------------------|-----------------------|--------------------------------|
| CHANGE FROM NORMAL SEQUENCE OF OPERATION INTERVAL NUMBER | 1 | 5 | | 5 | 7 | , | | 7 | | 10 | | 10 | | | 1 | .3 | | | 13 | | | 1 | .6 | | 16 | | | |
| EMERGENCY VEHICLE PREEMPTION SEQUENCE OF OPERATION INTERVAL NUMBER | 1A | 1B | 1C | 1D | 1E | 1F | 1G | 1H | 1 J | 1K | 1L | 1M | 1N | 1P | 1Q | 1R | 15 | 1T | 1 U | 1V | 1W | 1X | 1Y | 1Z | 1AA | 2 | 3 | CLEAR TO NORMAL SEQUENCE |
| CHANGE TO EMERGENCY VEHICLE PREEMPTION SEQUENCE OF OPERATION INTERVAL NUMBER | 2 OR 3 | 2 | 1D | 3 | 1F | 2 | 1H | 1 J | 3 | 2 | 1M | 1N | 3 | 1Q | 1R | 15 | 2 | 1U | 1V | 3 | 1X | 1Y | 1Z | 2 | 3 | | | ◊ |
| IL 64 (NORTH AVE) E/B NEAR RIGHT AND THREE FAR RIGHT MAST ARM SIGNALS | R | R | R | R | G | G | G | Y | R | G | G | Υ | R | R | R | R | R | R | R | R | R | R | R | R | R | G | R | ◊ |
| IL 64 (NORTH AVE) E/B END MAST ARM AND FAR LEFT SIGNALS | R ←Y | R | R | R | G ←G | G ←Y | G ←G | Υ | R | G | G | Υ | R | R | R | R | R | R | R | R | R | R | R | R | R | G | R | ◊ |
| IL 64 (NORTH AVE) NEAR RIGHT AND THREE FAR RIGHT MAST ARM SIGNALS W/B | R | G | Υ | R | R | R | R | R | R | G | G | Υ | R | R | R | R | R | R | R | R | R | R | R | R | R | G | R | \lambda |
| IL 64 (NORTH AVE) END MAST ARM AND FAR LEFT SIGNALS | 100000 | G ←Y | Υ | R | R | R | R | R | R | G | G | Υ | R | R | R | R | R | R | R | R | R | R | R | R | R | G | R | ◊ |
| FRONTAGE RD E/B ALL SIGNALS | R | R | R | R | R | R | R | R | R | R | R | R | R | Υ | R | R | R | Υ | R | R | R | R | R | R | R | R | R | \lambda |
| WINSTON PLAZA ENTRANCE N/B ALL SIGNALS | R | R | R | R | R | R | R | R | R | R | R | R | R | R | R | R | R | R | R | R | G | G | Υ | R | G | R | G | ◊ |
| WINSTON PLAZA ENTRANCE AT FRONTAGE RD S/B ALL SIGNALS | R | R | R | R | R | R | R | R | R | R | R | R | R | R | R | R | R | R | R | R | Υ | R | R | R | G | R | G | ◊ |
| WINSTON PLAZA ENTRANCE AT IL 64 (NORTH AVE) S/B FAR RIGHT MAST ARM SIGNAL | R | R | R | R | R | R | R | R | R | R | R | R | R | G | G | Υ | R | G | G | G | G | G | Υ | R | G | R | G | ◊ |
| WINSTON PLAZA ENTRANCE AT IL 64 (NORTH AVE) END MAST ARM AND FAR LEFT SIGNALS | R | R | R | R | R | R | R | R | R | R | R | R | R | G ←G | G ←G | | R | | G ←G | G ←Y | | G | Υ | R | G | R | G | ◊ |
| PEDESTRIAN SIGNALS CROSSING WINSTON PLAZA ENTRANCE ON SOUTH SIDE OF IL 64 (NORTH AVE) | Н | Н | Н | Н | FH | Н | FH | Н | Н | FH | FH | Н | Н | Н | Н | Н | Н | Н | Н | Н | Н | Н | Н | H | Н | Н | Н | ◊ |

♦ EMERGENCY VEHICLE SEQUENCE SHALL PROVIDE THE PROPER CLEARANCE INTERVAL TO RESUME THE NORMAL SEQUENCE OF OPERATION OR PROPER CLEARANCE INTERVAL TO DISPLAY A DIFFERENT EMERGENCY VEHICLE PREEMPTION INTERVAL AFTER EMERGENCY VEHICLE PREEMPTION INTERVAL 2 OR 3 IS TERMINATED.

TS 8800 IDOT CENTRACS FORMER ECON 100

| USER NAME = \$USER\$ | DESIGNED - AR | REVISED - | | SEQUENCE OF OPERATION AND | F.A.P. SECTION | COUNTY SHEET |
|-----------------------------|------------------|-----------|------------------------------|--|-------------------------------------|--------------------|
| | DRAWN - | REVISED - | STATE OF ILLINOIS | EMERGENCY VEHICLE PREEMPTION SEQUENCE OF OPERATION | 307 2020-263-SUR, SW&TS | COOK 492 217 |
| PLOT SCALE = 40.0000 '/ in. | CHECKED - | REVISED - | DEPARTMENT OF TRANSPORTATION | IL RTE 64 (NORTH AVE) AT WINSTON PLAZA ENT | ' | CONTRACT NO. 62N40 |
| PLOT DATE = \$DATE\$ | DATE - 9/20/2023 | REVISED - | | SCALE: 1"=20" SHEET NO. OF SHEETS STA. TO STA. | FED. ROAD DIST. NO ILLINOIS FED. AI | ID PROJECT |

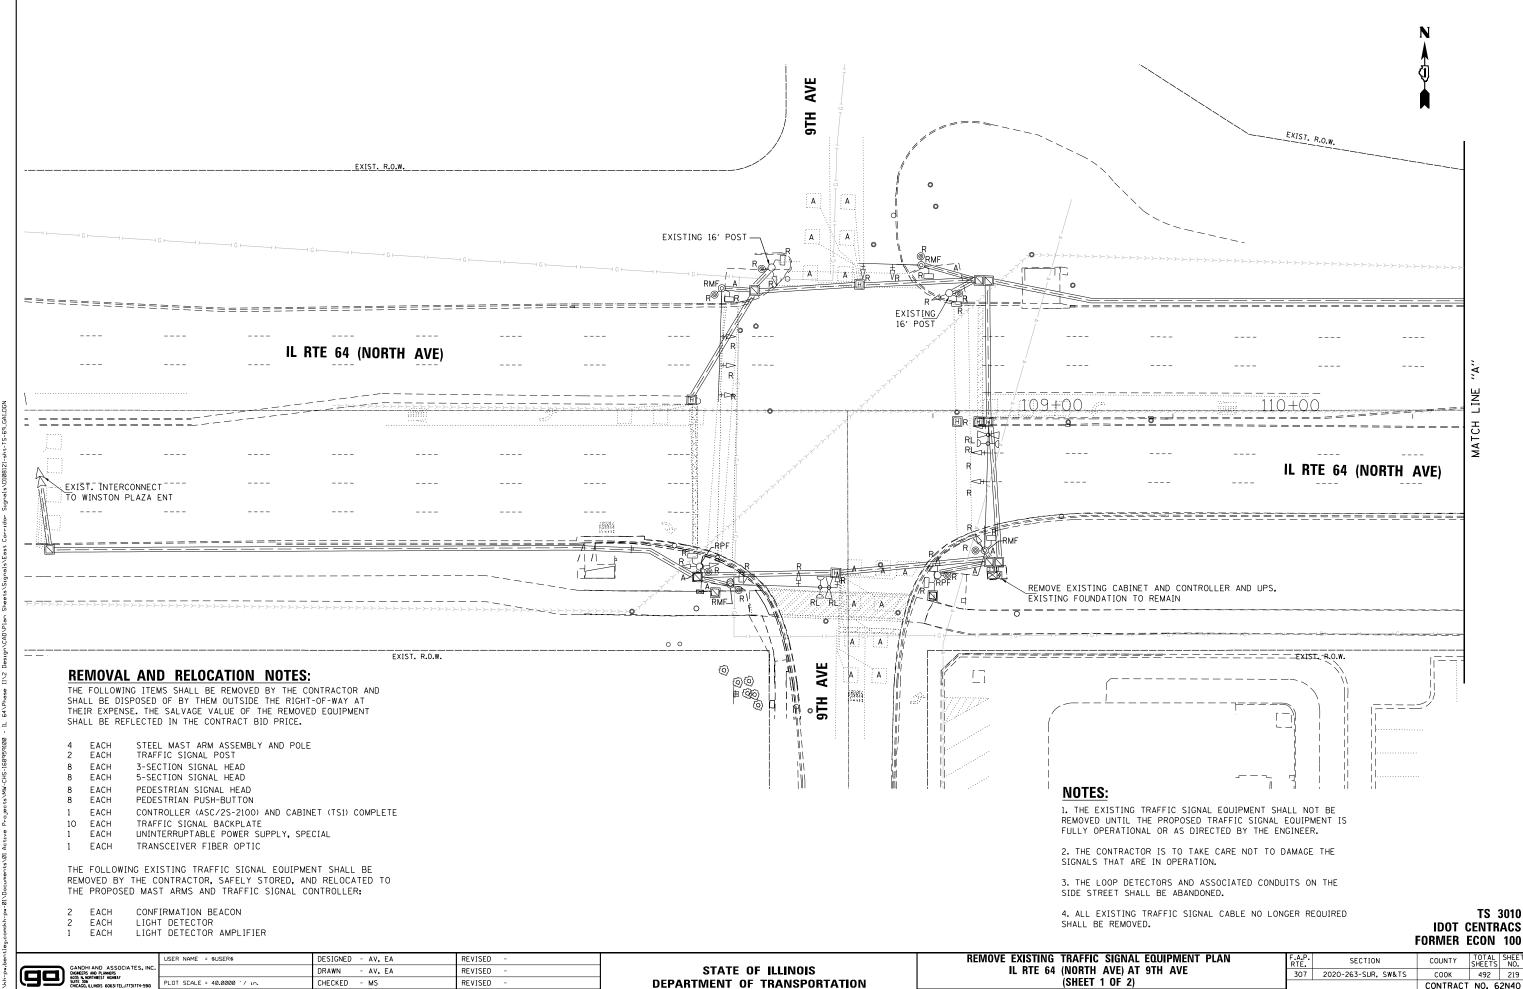

DEPARTMENT OF TRANSPORTATION

(SHEET 1 OF 2)

SCALE: 1"=20' SHEET NO. OF SHEETS STA.


CONTRACT NO. 62N40

LOT SCALE = 40.0000 '/ in.

CHECKED - MS

- 3/22/2024

REVISED

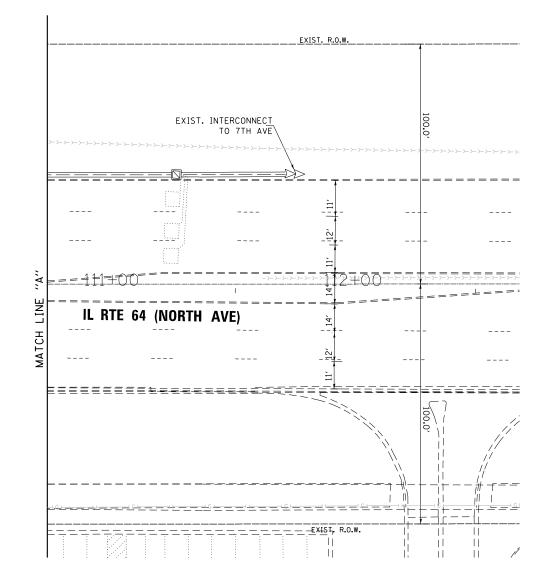


| | TS 3010 CENTRACS ECON 100 |
|--------|---------------------------------|
| COUNTY | TOTAL SHEET SHEETS NO. |

| GANDHI AND ASSOCIATES, INC. DIGGERS AND R. MOGRS 605; N. MORTHALTS HORBAY SONCIAGO, ILLNO'S 6063/TEL4173/174-590 |
|--|
|--|

| | USER NAME = \$USER\$ | DESIGNED - AV, EA | REVISED - |
|---|-----------------------------|-------------------|-----------|
| ٠ | | DRAWN - AV, EA | REVISED - |
| | PLOT SCALE = 40.0000 '/ in. | CHECKED - MS | REVISED - |
| | PLOT DATE = \$DATE\$ | DATE - 3/22/2024 | REVISED - |
| | | | |

STATE OF ILLINOIS DEPARTMENT OF TRANSPORTATION REMOVE EXISTING TRAFFIC SIGNAL EQUIPMENT PLAN IL RTE 64 (NORTH AVE) AT 9TH AVE (SHEET 2 OF 2)

SCALE: 1"=20" SHEET NO. OF SHEETS STA. TO STA.

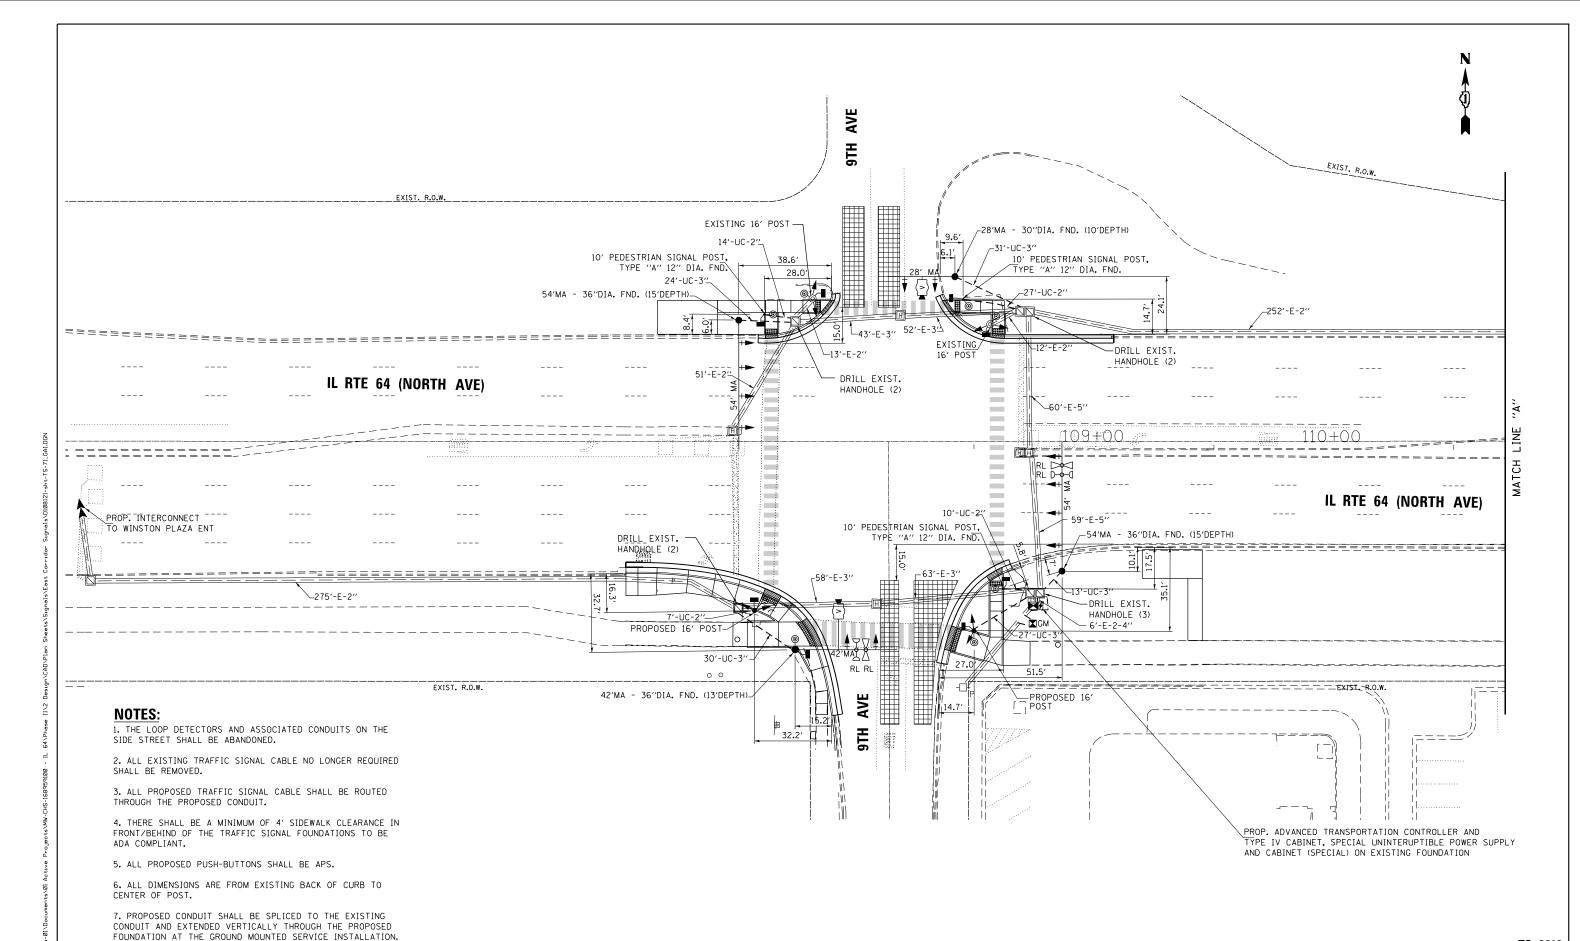

TS 3010 IDOT CENTRACS FORMER ECON 100

GANDHI AND ASSOCIATES, INC.
DIXECTS AND PLANETS
SOSS IN ARTHUST HIGHAY
SUIE SAS
DHICAGO, LLINOS 6063 TEL.1773/74-590
PLC

THE COST OF THE CONDUIT SHALL BE INCLUDED IN THE COST

OF CONCRETE FOUNDATION, TYPE A.

STATE OF ILLINOIS
DEPARTMENT OF TRANSPORTATION

TRAFFIC SIGNAL MODERNIZATION PLAN
IL RTE 64 (NORTH AVE) AT 9TH AVE (SHEET 1 OF 2)

SCALE: 1"=20" SHEET NO. OF SHEETS STA. TO STA.

FED. ROAD DIST. NO. - ILLINOIS


| USER NAME = \$USER\$ DESIGNED - AV, EA REVISED - | |
|--|--|
| DRAWN - AV, EA REVISED - | |
| PLOT SCALE = 40.0000 '/ in. CHECKED - MS REVISED - | |
| PLOT DATE = \$DATE\$ DATE - 3/22/2024 REVISED - | |

STATE OF ILLINOIS
DEPARTMENT OF TRANSPORTATION

TRAFFIC SIGNAL MODERNIZATION PLAN IL RTE 64 (NORTH AVE) AT 9TH AVE (SHEET 2 OF 2) SCALE: 1"=20" SHEET NO. OF SHEETS STA.

TS 3010 IDOT CENTRACS FORMER ECON 100

| | | | EXIST. R.O.W. | · - | |
|----------------|----------------------------|------------------------|-------------------------|----------------|---------------------------------------|
| >->->->->->->- | PROP. I | NTERCONNECT TO 7TH AVE | ->->->->->- | 0.00.00 | .>-> |
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| IL RTE 64 (I | NORTH AVE) | | | | |
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STATE OF ILLINOIS

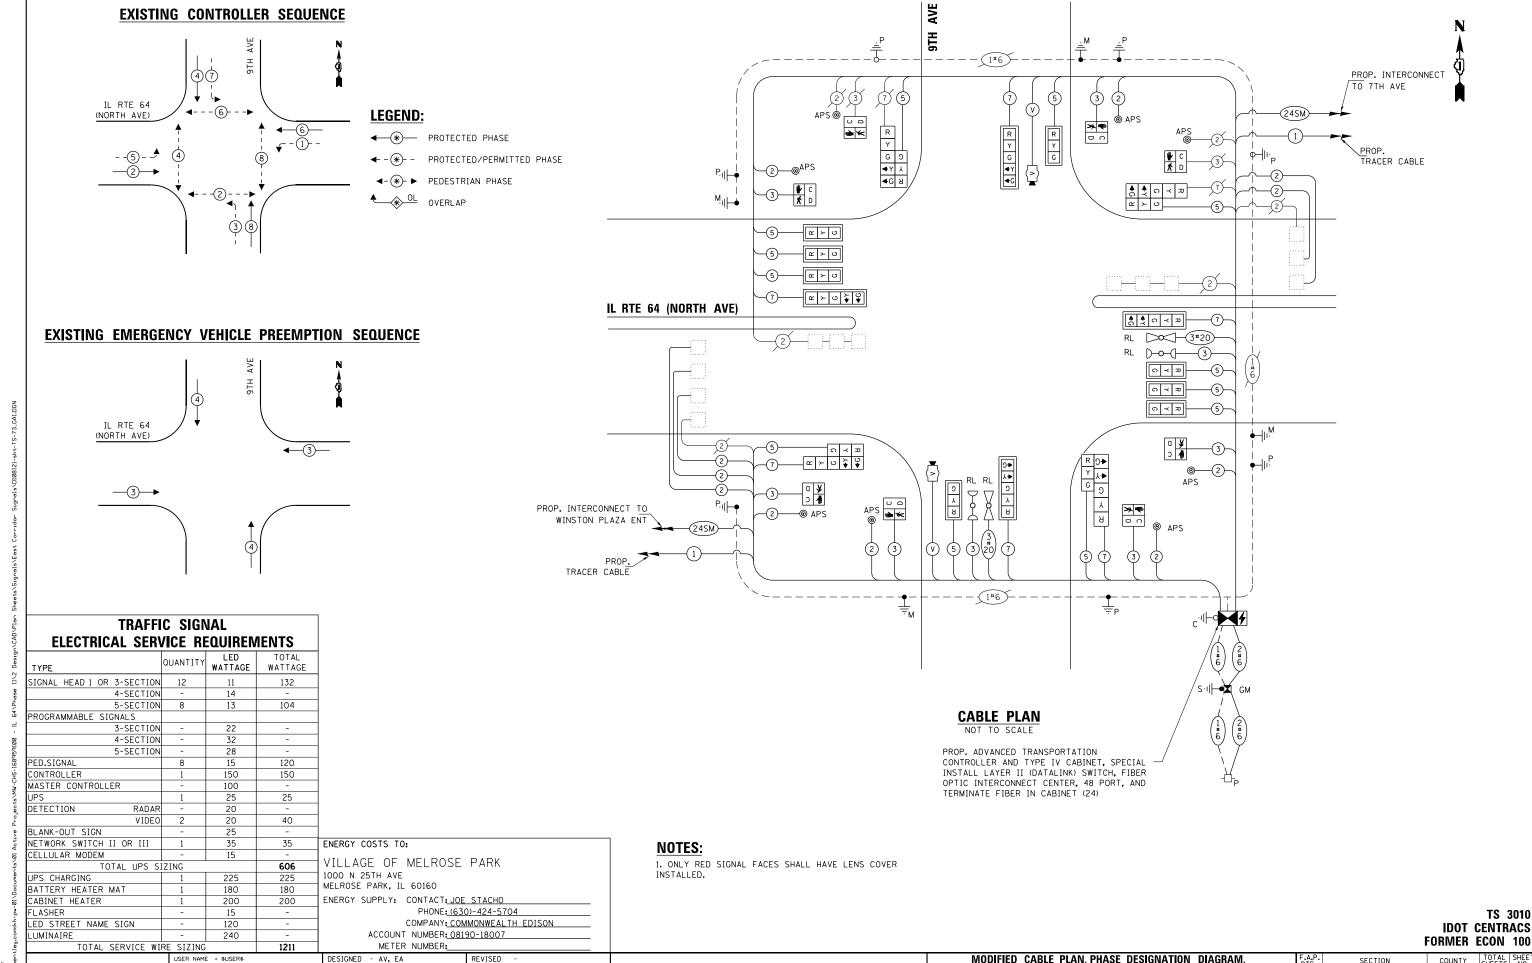DEPARTMENT OF TRANSPORTATION

SECTION

307 2020-263-SUR, SW&TS

AND EMERGENCY VEHICLE PREEMPTION SEQUENCE

IL RTE 64 (NORTH AVE) AT 9TH AVE

SHEET NO. OF SHEETS STA.

COUNTY

COOK 492 223

CONTRACT NO. 62N40

ENGNERS AND PLANNERS
6035 N. NORTHIREST HIGHBAY
SUITE 306
CHICAGO, ILLINOIS 60631 TEL.17

ORAWN

CHECKED

DATE

PLOT DATE = \$DATE\$

- AV, EA

- 3/22/2024


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REVISED

REVISED

| *5.25 ** | 25.25 | * 6 * | —— 18.25 — | |
|---------------------|-------|----------------------------|------------|-------------|
| < | | 60 | | |
| | | | | |

| DESIGN | AREA | SIGN PANEL | SHEETING | QTY. |
|--------|---------|------------|----------|----------|
| SERIES | (SQ FT) | TYPE | TYPE | REQUIRED |
| D | 12.5 | 2 | ZZ | |

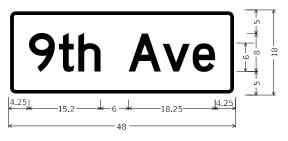

| DESIGN | AREA | SIGN PANEL | SHEETING | QTY. |
|--------|---------|------------|----------|----------|
| SERIES | (SQ FT) | TYPE | TYPE | REQUIRED |
| D | 6.0 | 1 | ZZ | |

NOTE: FOR ADDITIONAL DESIGN AND INSTALLATION INFORMATION PLEASE SEE DISTRICT ONE MAST ARM MOUNTED STREET NAME SIGNS DETAIL (TS-02).

SCHEDULE OF QUANTITIES

| ITEM DESCRIPTION | UNITS | TOTA QTY |
|---|-------|-------------|
| SIGN PANEL - TYPE 1 | SQ FT | 12 |
| SIGN PANEL - TYPE 2 | SQ FT | 25 |
| UNDERGROUND CONDUIT, GALVANIZED STEEL, 2" DIA. | FOOT | 74 |
| UNDERGROUND CONDUIT, GALVANIZED STEEL, 3" DIA. | FOOT | 123 |
| MAINTENANCE OF EXISTING TRAFFIC SIGNAL INSTALLATION | EACH | 1 |
| ELECTRIC CABLE IN CONDUIT, SIGNAL NO. 14 2C | FOOT | 2294 |
| ELECTRIC CABLE IN CONDUIT, SIGNAL NO. 14 3C | FOOT | 1349 |
| ELECTRIC CABLE IN CONDUIT, SIGNAL NO. 14 5C | FOOT | 2275 |
| ELECTRIC CABLE IN CONDUIT, SIGNAL NO. 14 7C | FOOT | 118 |
| ELECTRIC CABLE IN CONDUIT, LEAD-IN, NO. 14 1 PAIR | FOOT | 855 |
| ELECTRIC CABLE IN CONDUIT, SERVICE, NO. 6 2C | FOOT | 65 |
| ELECTRIC CABLE IN CONDUIT, EQUIPMENT GROUNDING CONDUCTOR, NO. 6 1C | FOOT | 396 |
| TRAFFIC SIGNAL POST, GALVANIZED STEEL 16 FT. | EACH | 2 |
| STEEL MAST ARM ASSEMBLY AND POLE, 28 FT. | EACH | 1 |
| STEEL MAST ARM ASSEMBLY AND POLE, 42 FT. | EACH | 1 |
| STEEL MAST ARM ASSEMBLY AND POLE, 54 FT. | EACH | 2 |
| CONCRETE FOUNDATION, TYPE A | FOOT | 12 |
| CONCRETE FOUNDATION, TYPE E 30-INCH DIAMETER | FOOT | 10 |
| CONCRETE FOUNDATION, TYPE E 36-INCH DIAMETER | FOOT | 43 |
| DRILL EXISTING HANDHOLE | EACH | 9 |
| SIGNAL HEAD, LED, 1-FACE, 3-SECTION, MAST ARM MOUNTED | EACH | 8 |
| SIGNAL HEAD, LED, 1-FACE, 3-SECTION, BRACKET MOUNTED | EACH | 4 |
| SIGNAL HEAD, LED, 1-FACE, 5-SECTION, BRACKET MOUNTED | EACH | 4 |
| SIGNAL HEAD, LED, 1-FACE, 5-SECTION, MAST ARM MOUNTED | EACH | 4 |
| PEDESTRIAN SIGNAL HEAD, LED, 1-FACE, BRACKET MOUNTED WITH COUNTDOWN TIMER | EACH | 8 |
| TRAFFIC SIGNAL BACKPLATE, LOUVERED, FORMED PLASTIC | EACH | 12 |
| <u> </u> | | |
| INDUCTIVE LOOP DETECTOR | EACH | 9 |
| RELOCATE EXISTING EMERGENCY VEHICLE PRIORITY SYSTEM, DETECTOR UNIT | EACH | 2 |
| RELOCATE EXISTING EMERGENCY VEHICLE PRIORITY SYSTEM, PHASING UNIT | EACH | 1 |
| REMOVE ELECTRIC CABLE FROM CONDUIT | FOOT | 854 |
| REMOVE EXISTING TRAFFIC SIGNAL EQUIPMENT | EACH | 1 |
| REMOVE EXISTING HANDHOLE | EACH | 1 |
| REMOVE EXISTING CONCRETE FOUNDATION | EACH | 6 |
| EMERGENCY VEHICLE PRIORITY SYSTEM LINE SENSOR CABLE, NO. 20 3/C | FOOT | 332 |
| CENTRACS LICENSE EXPANSION | EACH | 1 |
| UNINTERRUPTABLE POWER SUPPLYAND CABINET, SPECIAL | EACH | 1 |
| SERVICE INSTALLATION, GROUND MOUNTED, METERED | EACH | 1 |
| LAYER II (DATALINK) SWITCH | EACH | 1 |
| TERMINATE FIBER IN CABINET | EACH | 24 |
| PEDESTRIAN SIGNAL POST, 10 FT. | EACH | 3 |
| VIDEO VEHICLE DETECTION SYSTEM, SINGLE APPROACH | EACH | 2 |
| FIBER OPTIC INTERCONNECT CENTER, 48 PORT | EACH | 1 |
| ADVANCED TRANSPORTATION CONTROLLER AND TYPE IV CABINET, SPECIAL | EACH | 1 |
| ACCESSIBLE PEDESTRIAN SIGNALS | EACH | 8 |
| CONCRETE FOUNDATION, TYPE A 12-INCH DIAMETER | FOOT | 12 |
| LED SIGNAL FACE, LENS COVER | EACH | 20 |

* 100% COST TO THE VILLAGE OF MELROSE PARK


TS 3010 IDOT CENTRACS FORMER ECON 100

COOK 492 224

CONTRACT NO. 62N40

| Kimley Horn |
|---|
| © 2023 KIMLEY HORN AND ASSOCIATES, INC. |
| 4201 WINFIELD ROAD, SUITE 600 |
| WARRENVILLE, IL 60555 |
| PHONE: 630-487-5550 |
| WWW.KIMLEY-HORN.COM |


| USER NAME = Joel.Turk | DESIGNED | - | AMK | REVISED - | |
|--------------------------|----------|---|-----------|-----------|--|
| | DRAWN | - | JJT | REVISED - | |
| PLOT SCALE = 2 0000 / in | CHECKED | - | SS | REVISED - | |
| PLOT DATE = 3/22/2024 | DATE | - | 3/22/2024 | REVISED - | |

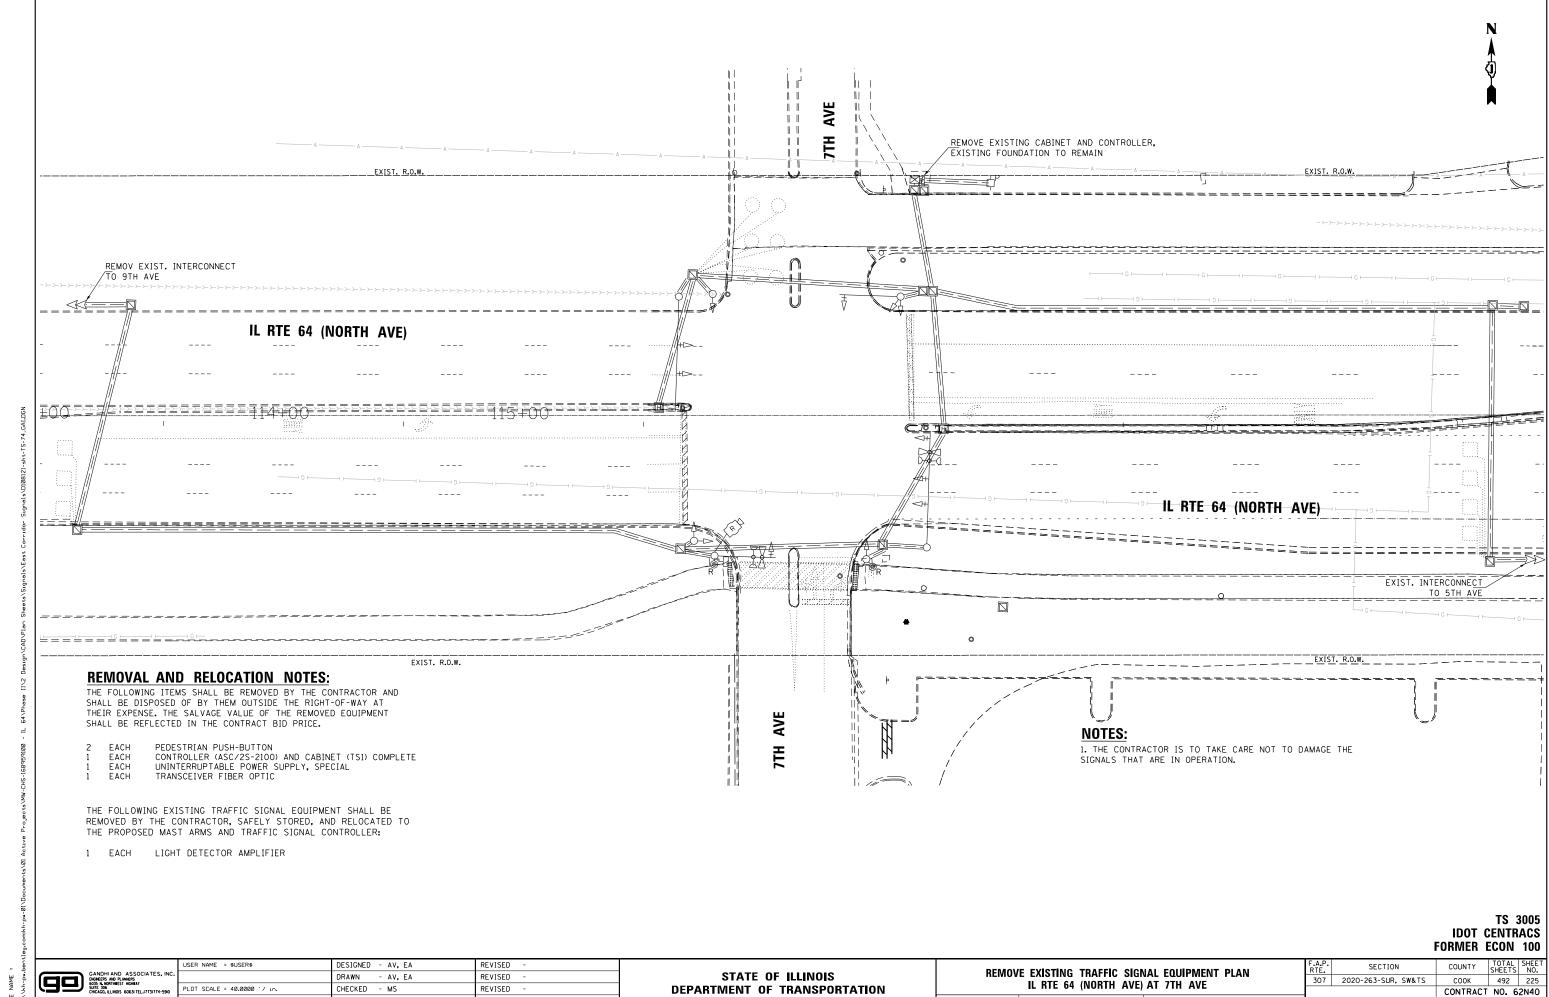


SCALE: 1"=20" SHEET NO. OF SHEETS STA.

DATE

- 3/22/2024

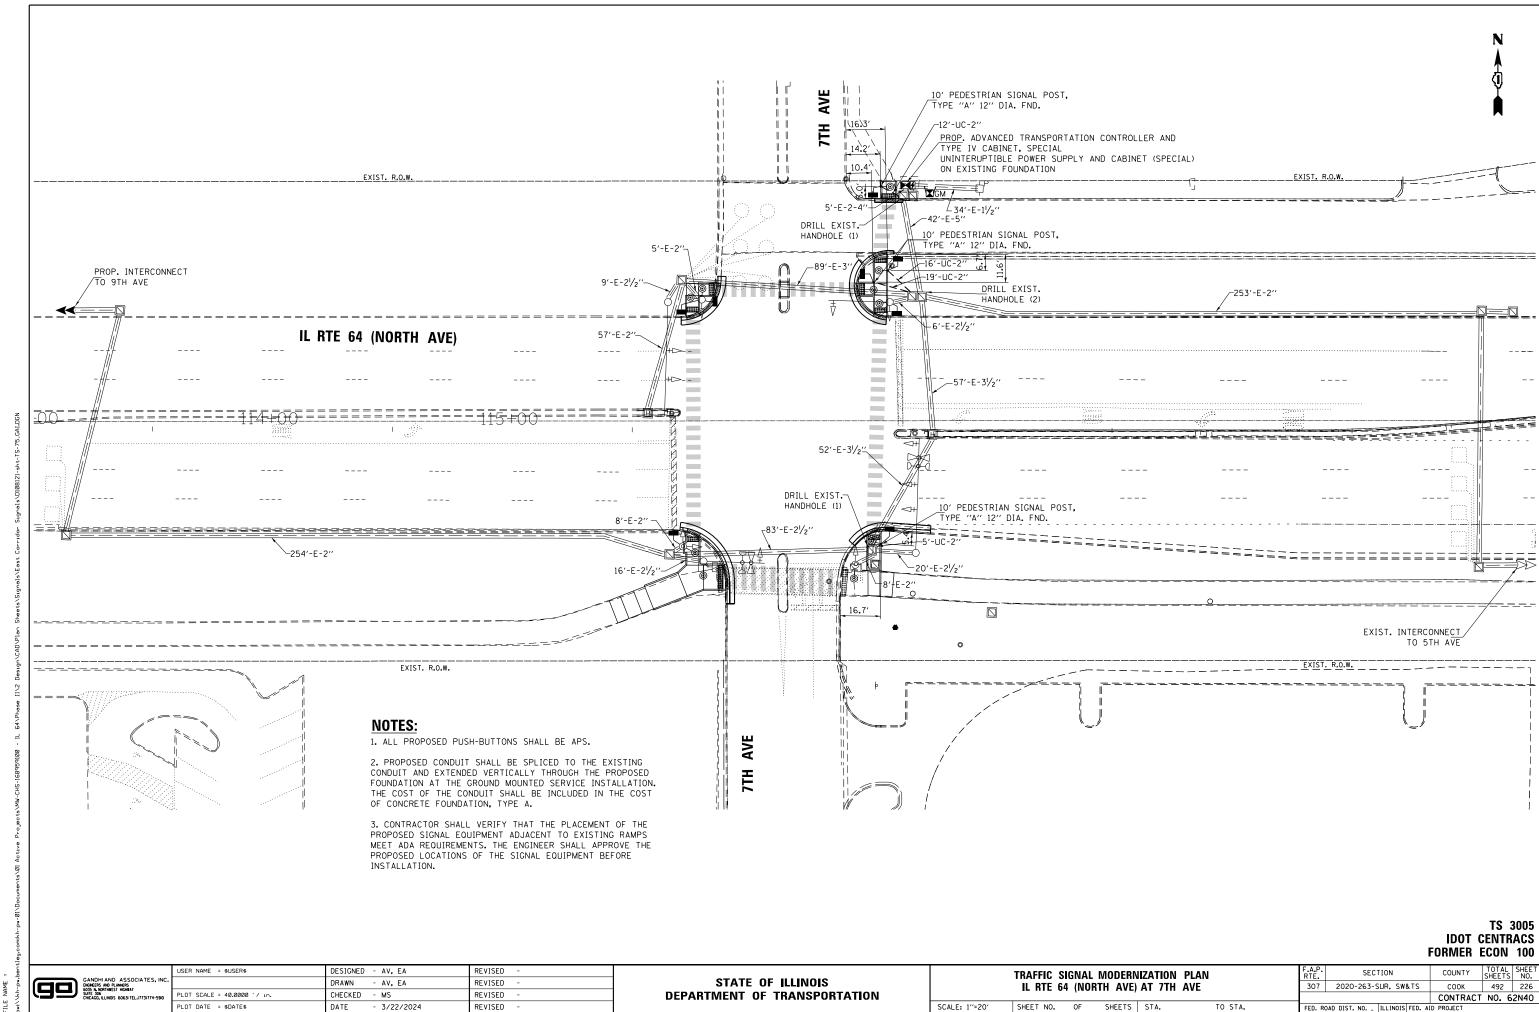

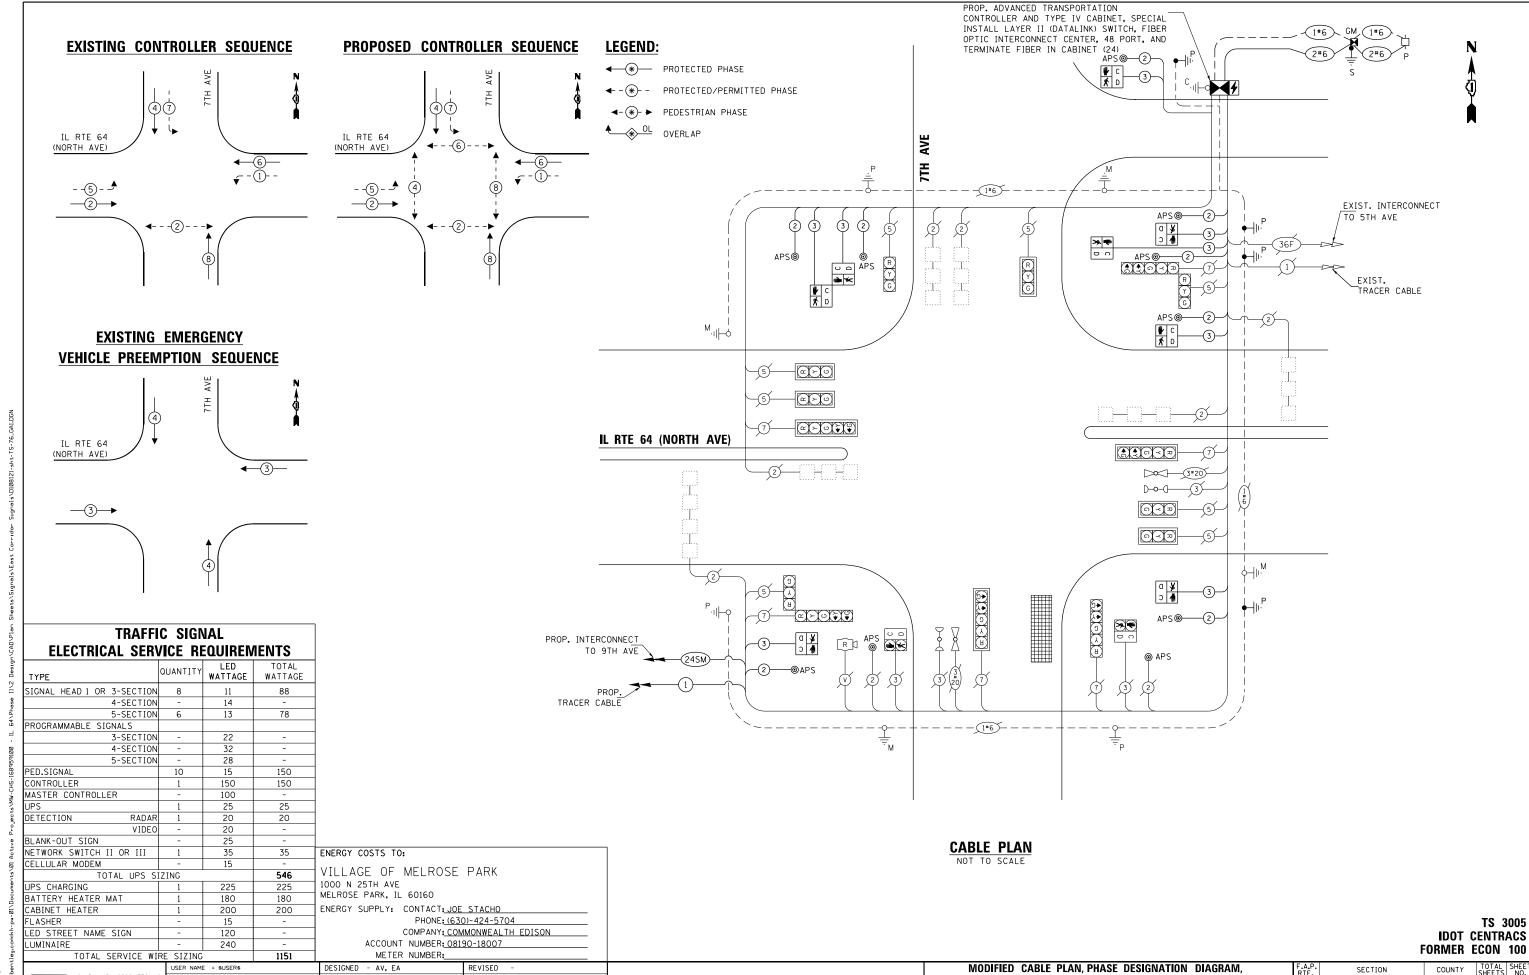

STATE OF ILLINOIS

DEPARTMENT OF TRANSPORTATION

AND EMERGENCY VEHICLE PREEMPTION SEQUENCE

IL RTE 64 (NORTH AVE) AT 7TH AVE

SHEET NO. OF SHEETS STA.

307 2020-263-SUR, SW&TS

COOK 492 227

CONTRACT NO. 62N40

FILE NAME =

ENGNERS AND PLANNERS
6035 N. NORTHIREST HIGHBAY
SUITE 306
CHICAGO, ILLINOIS 60631 TEL.17

LOT SCALE = 40.0000 '/ in.

PLOT DATE = \$DATE\$

DRAWN - AV, EA

- 3/22/2024

CHECKED - MS

DATE

REVISED


REVISED

SIGN PANEL - TYPE 1 OR TYPE 2

ALL DIMENSIONS ARE IN INCHES UNLESS OTHERWISE NOTED



| DESIGN | AREA | SIGN PANEL | SHEETING | QTY. |
|--------|---------|------------|----------|----------|
| SERIES | (SQ FT) | TYPE | TYPE | REQUIRED |
| D | 12.5 | 2 | ZZ | |

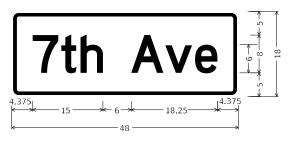

| DESIGN | AREA | SIGN PANEL | SHEETING | QTY. |
|--------|---------|------------|----------|----------|
| SERIES | (SQ FT) | TYPE | TYPE | REQUIRED |
| D | 6.0 | 1 | ZZ | |

NOTE: FOR ADDITIONAL DESIGN AND INSTALLATION INFORMATION PLEASE SEE DISTRICT ONE MAST ARM MOUNTED STREET NAME SIGNS DETAIL (TS-02).

SCHEDULE OF QUANTITIES

| ITEM DESCRIPTION | UNITS | TOTAL OTY. |
|---|-------|---------------|
| UNDERGROUND CONDUIT, GALVANIZED STEEL, 2" DIA. | FOOT | 52 |
| MAINTENANCE OF EXISTING TRAFFIC SIGNAL INSTALLATION | EACH | 1 |
| ELECTRIC CABLE IN CONDUIT, SIGNAL NO. 14 2C | FOOT | 1235 |
| ELECTRIC CABLE IN CONDUIT, SIGNAL NO. 14 3C | FOOT | 1291 |
| ELECTRIC CABLE IN CONDUIT, SERVICE, NO. 6 2C | FOOT | 60 |
| ELECTRIC CABLE IN CONDUIT, EQUIPMENT GROUNDING CONDUCTOR, NO. 6 1C | FOOT | 176 |
| CONCRETE FOUNDATION, TYPE A | FOOT | 4 |
| DRILL EXISTING HANDHOLE | EACH | 4 |
| PEDESTRIAN SIGNAL HEAD, LED, 1-FACE, BRACKET MOUNTED WITH COUNTDOWN TIMER | EACH | 8 |
| INDUCTIVE LOOP DETECTOR | EACH | 6 |
| RELOCATE EXISTING EMERGENCY VEHICLE PRIORITY SYSTEM, PHASING UNIT | EACH | 1 |
| REMOVE EXISTING TRAFFIC SIGNAL EQUIPMENT | EACH | 1 |
| CENTRACS LICENSE EXPANSION | EACH | 1 |
| UNINTERRUPTABLE POWER SUPPLYAND CABINET, SPECIAL | EACH | 1 |
| SERVICE INSTALLATION, GROUND MOUNTED, METERED | EACH | 1 |
| LAYER II (DATALINK) SWITCH | EACH | 1 |
| TERMINATE FIBER IN CABINET | EACH | 24 |
| PEDESTRIAN SIGNAL POST, 10 FT. | EACH | 4 |
| FIBER OPTIC INTERCONNECT CENTER, 48 PORT | EACH | 1 |
| ADVANCED TRANSPORTATION CONTROLLER AND TYPE IV CABINET, SPECIAL | EACH | 1 |
| ACCESSIBLE PEDESTRIAN SIGNALS | EACH | 10 |
| CONCRETE FOUNDATION, TYPE A 12-INCH DIAMETER | FOOT | 16 |

* 100% COST TO THE VILLAGE OF MELROSE PARK


TS 3005 IDOT CENTRACS FORMER ECON 100


COOK 492 228


CONTRACT NO. 62N40

| Kimley»Horn |
|---|
| © 2023 KIMLEY HORN AND ASSOCIATES, INC. |
| 4201 WINFIELD ROAD, SUITE 600 |
| WARRENVILLE, IL 60555 |
| PHONE: 630-487-5550 |
| WWW.KIMLEY-HORN.COM |

| USER NAME = Joel.Turk | DESIGNED | - | AMK | REVISED - | |
|--------------------------|----------|---|-----------|-----------|--|
| | DRAWN | - | JJT | REVISED - | |
| PLOT SCALE = 2 0000 / in | CHECKED | - | SS | REVISED - | |
| PLOT DATE = 3/22/2024 | DATE | - | 3/22/2024 | REVISED - | |

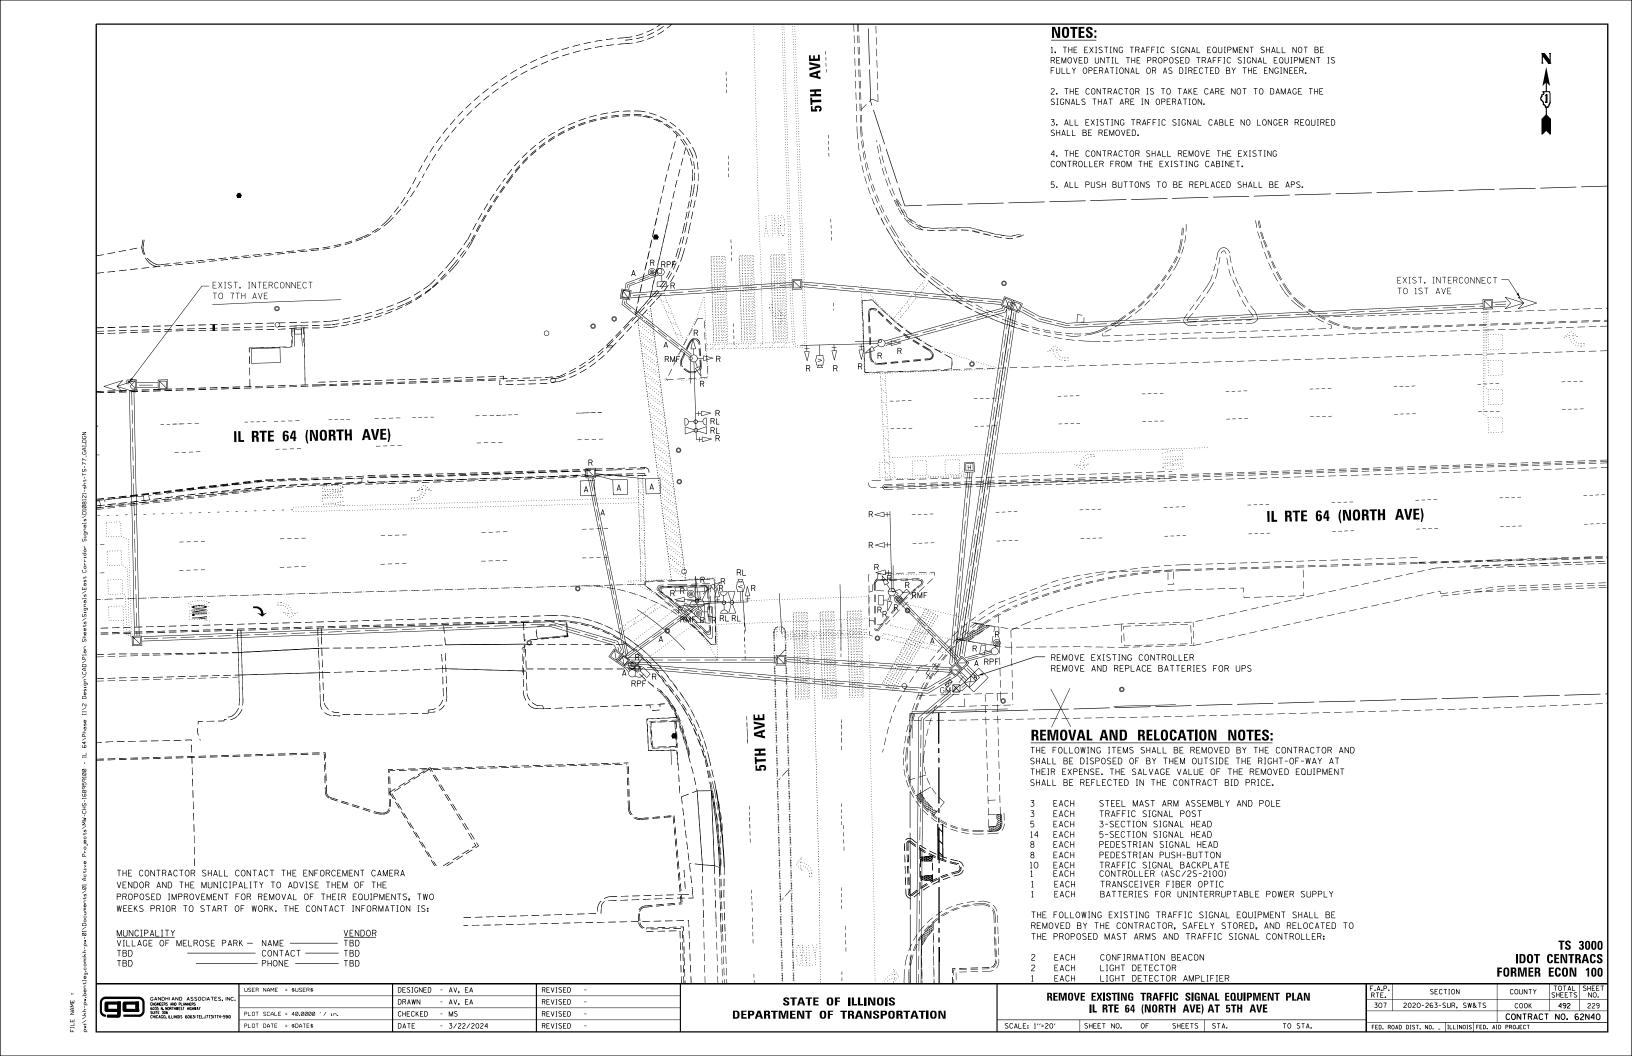

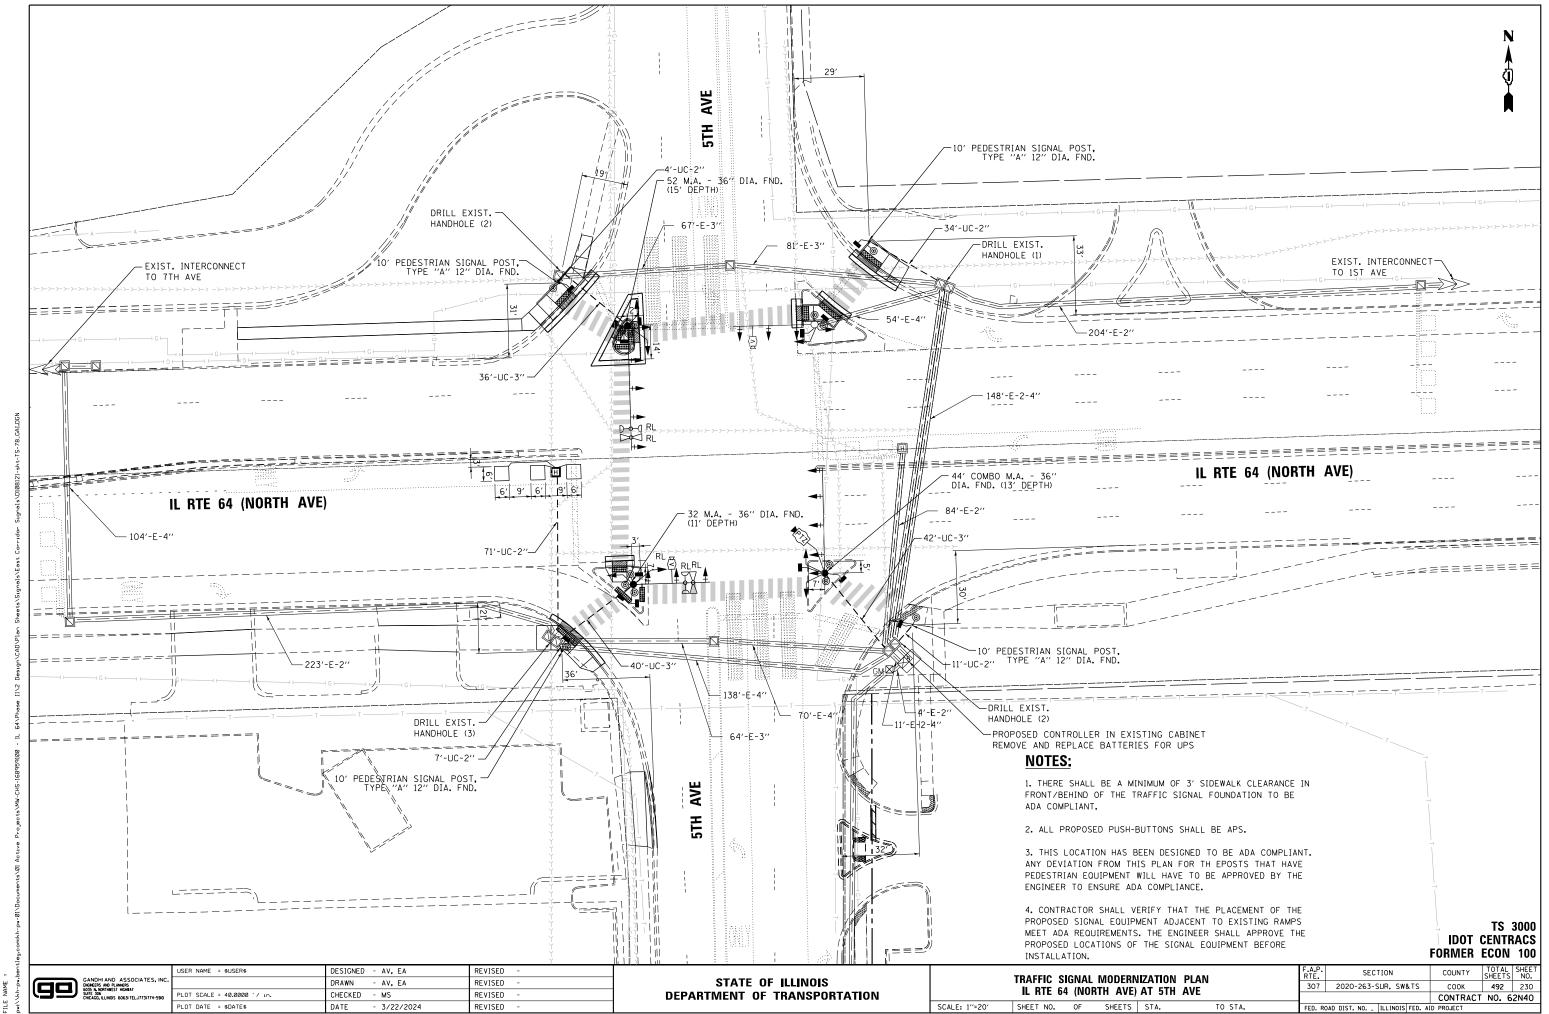

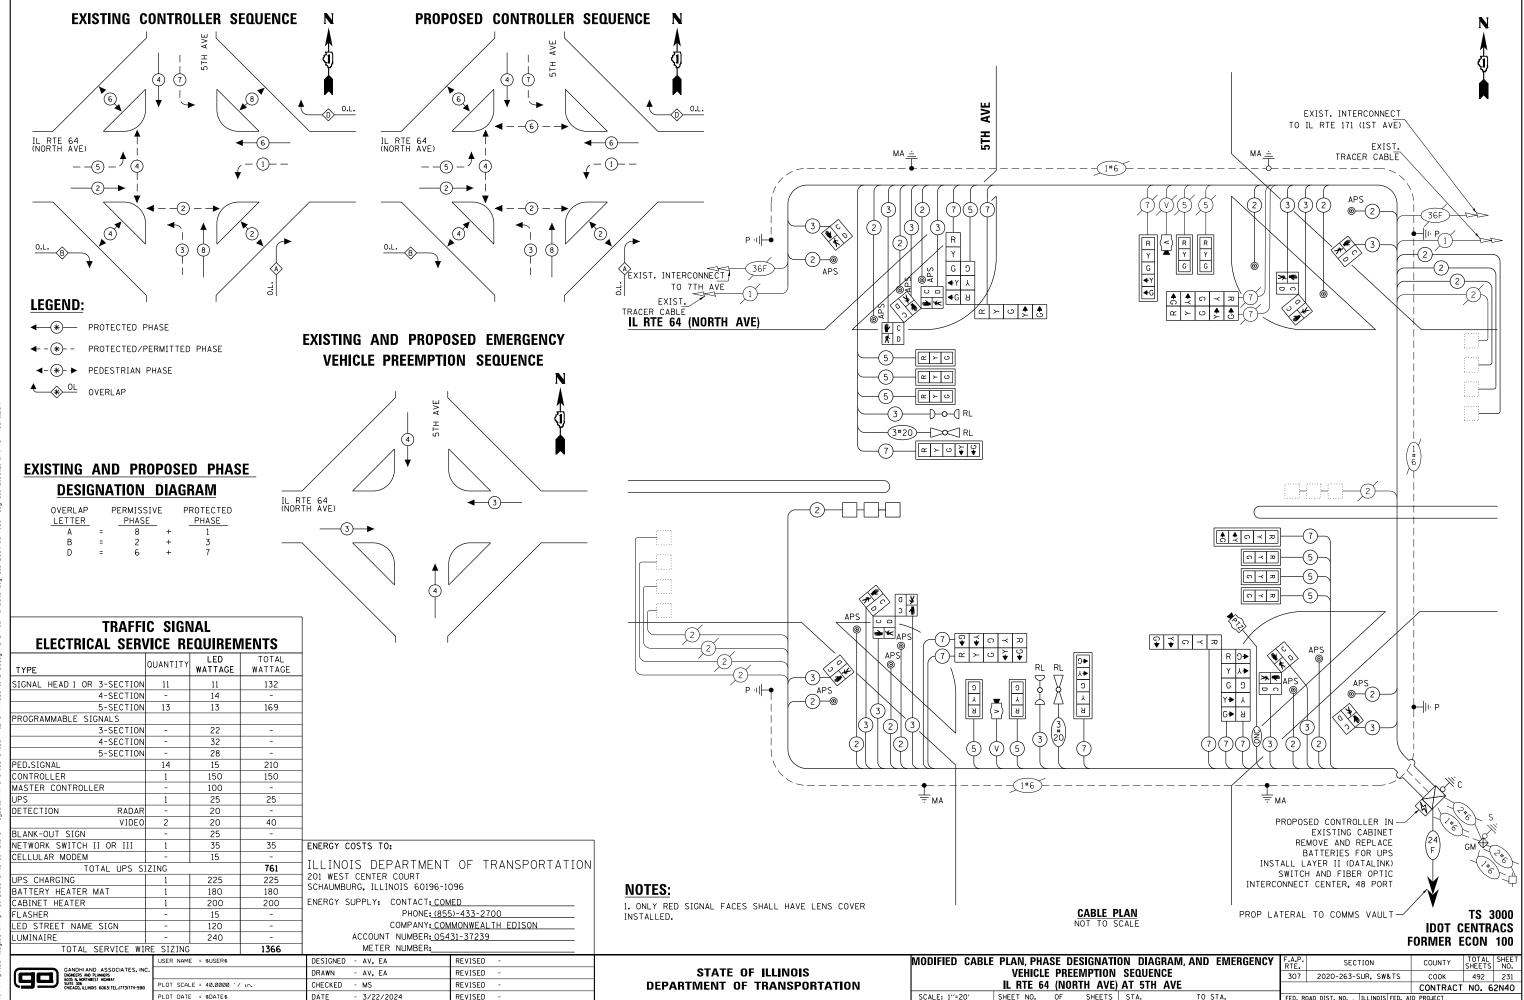

TO STA.

PLOT DATE = \$DATE\$

DATE


- 3/22/2024

SIGN PANEL - TYPE 1 OR TYPE 2

ALL DIMENSIONS ARE IN INCHES UNLESS OTHERWISE NOTED



| DESIGN SERIES | AREA (SQ FT) | SIGN PANEL TYPE | SHEETING TYPE | QTY. REQUIRED |
|------------------|-----------------|--------------------|------------------|------------------|
| D | 12.5 | 2 | 77 | 2 |

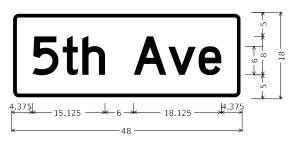

| DESIGN | AREA | SIGN PANEL | SHEETING | QTY. |
|--------|---------|------------|----------|----------|
| SERIES | (SQ FT) | TYPE | TYPE | REQUIRED |
| D | 6.0 | 1 | ZZ | |

NOTE: FOR ADDITIONAL DESIGN AND INSTALLATION INFORMATION PLEASE SEE DISTRICT ONE MAST ARM MOUNTED STREET NAME SIGNS DETAIL (TS-02).

SCHEDULE OF QUANTITIES


| ITEM DESCRIPTION | UNITS | TOTA QTY. |
|---|-------|--------------|
| SIGN PANEL - TYPE 1 | SQ FT | 12 |
| SIGN PANEL - TYPE 2 | SQ FT | 25 |
| UNDERGROUND CONDUIT, GALVANIZED STEEL, 2" DIA. | FOOT | 128 |
| UNDERGROUND CONDUIT, GALVANIZED STEEL, 3" DIA. | FOOT | 118 |
| MAINTENANCE OF EXISTING TRAFFIC SIGNAL INSTALLATION | EACH | 1 |
| ELECTRIC CABLE IN CONDUIT, SIGNAL NO. 14 2C | FOOT | 3351 |
| ELECTRIC CABLE IN CONDUIT, SIGNAL NO. 14 3C | FOOT | 4155 |
| ELECTRIC CABLE IN CONDUIT, SIGNAL NO. 14 5C | FOOT | 2533 |
| ELECTRIC CABLE IN CONDUIT, SIGNAL NO. 14 7C | FOOT | 2379 |
| ELECTRIC CABLE IN CONDUIT, LEAD-IN, NO. 14 1 PAIR | FOOT | 1459 |
| ELECTRIC CABLE IN CONDUIT, EQUIPMENT GROUNDING CONDUCTOR, NO. 6 1C | FOOT | 253 |
| STEEL MAST ARM ASSEMBLY AND POLE, 32 FT. | EACH | 1 |
| STEEL MAST ARM ASSEMBLY AND POLE, 52 FT. | EACH | 1 |
| STEEL COMBINATION MAST ARM ASSEMBLY AND POLE, 44 FT. | EACH | 1 |
| CONCRETE FOUNDATION, TYPE E 36-INCH DIAMETER | FOOT | 39 |
| DRILL EXISTING HANDHOLE | EACH | 8 |
| SIGNAL HEAD, LED, 1-FACE, 3-SECTION, MAST ARM MOUNTED | EACH | 10 |
| SIGNAL HEAD, LED, 1-FACE, 3-SECTION, BRACKET MOUNTED | EACH | 1 |
| SIGNAL HEAD, LED, 1-FACE, 5-SECTION, BRACKET MOUNTED | EACH | 9 |
| SIGNAL HEAD, LED, 1-FACE, 5-SECTION, MAST ARM MOUNTED | EACH | 4 |
| PEDESTRIAN SIGNAL HEAD, LED, 1-FACE, BRACKET MOUNTED WITH COUNTDOWN TIMER | EACH | 14 |
| TRAFFIC SIGNAL BACKPLATE, LOUVERED, FORMED PLASTIC | EACH | 14 |
| INDUCTIVE LOOP DETECTOR | EACH | 4 |
| DETECTOR LOOP, TYPE I | FOOT | 101 |
| RELOCATE EXISTING TRAFFIC SIGNAL EQUIPMENT | EACH | 1 |
| RELOCATE EXISTING EMERGENCY VEHICLE PRIORITY SYSTEM, DETECTOR UNIT | EACH | 2 |
| MODIFY EXISTING CONTROLLER CABINET | EACH | 1 |
| REMOVE ELECTRIC CABLE FROM CONDUIT | FOOT | 1425 |
| REMOVE EXISTING TRAFFIC SIGNAL EQUIPMENT | EACH | 1 |
| REMOVE EXISTING HANDHOLE | EACH | 1 |
| REMOVE EXISTING CONCRETE FOUNDATION | EACH | 6 |
| EMERGENCY VEHICLE PRIORITY SYSTEM LINE SENSOR CABLE, NO. 20 3/C | FOOT | 715 |
| CENTRACS LICENSE EXPANSION | EACH | 1 |
| OUTDOOR RATED NETWORK CABLE | FOOT | 111 |
| REMOTE CONTROLLED VIDEO SYSTEM | EACH | 1 |
| LAYER II (DATALINK) SWITCH | EACH | 1 |
| PEDESTRIAN SIGNAL POST, 10 FT. | EACH | 4 |
| FIBER OPTIC INTERCONNECT CENTER, 48 PORT | EACH | 1 |
| FULL-ACTUATED CONTROLLER IN EXISTING CABINET | EACH | 1 |
| ACCESSIBLE PEDESTRIAN SIGNALS | EACH | 14 |
| LED SIGNAL FACE, LENS COVER | EACH | 24 |
| CONCRETE FOUNDATION, TYPE A 12-INCH DIAMETER | FOOT | 16 |
| REMOVE AND REPLACE BATTERIES FOR UNINTERRUPTABLE POWER SUPPLY, EXTENDED | EACH | 1 |

* 100% COST TO THE VILLAGE OF MELROSE PARK

TS 3000 IDOT CENTRACS FORMER ECON 100



| USER NAME = Joel.Turk | DESIGNED | - | AMK | REVISED - | |
|--------------------------|----------|---|-----------|-----------|--|
| | DRAWN | - | JJT | REVISED - | |
| PLOT SCALE = 2.0000 / in | CHECKED | - | SS | REVISED - | |
| PLOT DATE = 3/22/2024 | DATE | - | 3/22/2024 | REVISED - | |

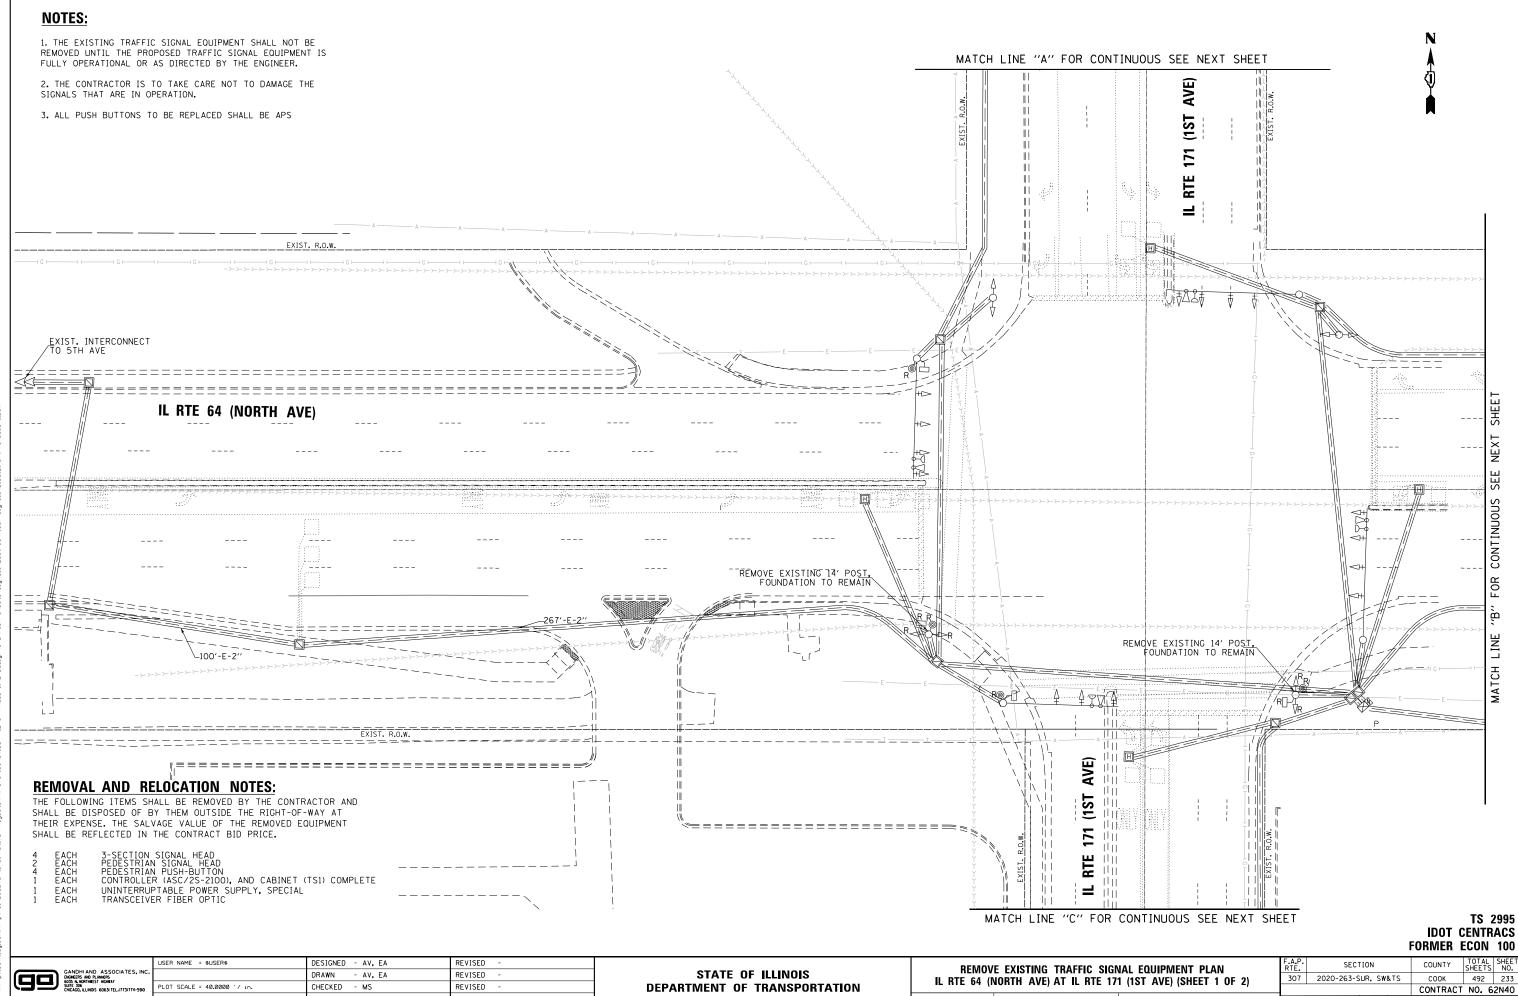

SCALE: 1"=20" SHEET NO. OF SHEETS STA.

pw:\\kh-pw.bentl


DATE

- 3/22/2024

REVISED

PLOT DATE = \$DATE\$

50.0′ | | 12.0' | 12.0' | 12.0' | 10.0' | 10.0' | | 12.0' | 12.0' | 11.0' | | AVE) | | | IL RTE 64 (NORTH AVE) MATCH LINE "A" FOR CONTINUOUS SEE PREVIOUS SHEET MATCH LINE "C" FOR CONTINUOUS SEE PREVIOUS SHEET 11.0′, 11.0′, 6′, 11.0′, 11.0′, 11.0′, 11.0′, 11.0′ REMOVE EXIST. INTERCONNECT TO POLK PLAZA 3**1111 1** EXIST. R.O.W. AVE) RTE TS 2995 **IDOT CENTRACS** FORMER ECON 100 USER NAME = \$USER\$ DESIGNED - AV, EA REVISED SECTION REMOVE EXISTING TRAFFIC SIGNAL EQUIPMENT PLAN GANDHI AND ASSOCIATES, I ENGRERS AND PLANGERS OF NORTH AND STATE OF THE SOCIATION OF THE SO STATE OF ILLINOIS DRAWN - AV, EA REVISED 307 2020-263-SUR, SW&TS COOK 492 234 IL RTE 64 (NORTH AVE) AT IL RTE 171 (1ST AVE) (SHEET 2 OF 2) PLOT SCALE = 40.0000 '/ in. CHECKED - MS REVISED **DEPARTMENT OF TRANSPORTATION** CONTRACT NO. 62N40 REVISED SCALE: 1"=20" SHEET NO. OF SHEETS STA. - 3/22/2024

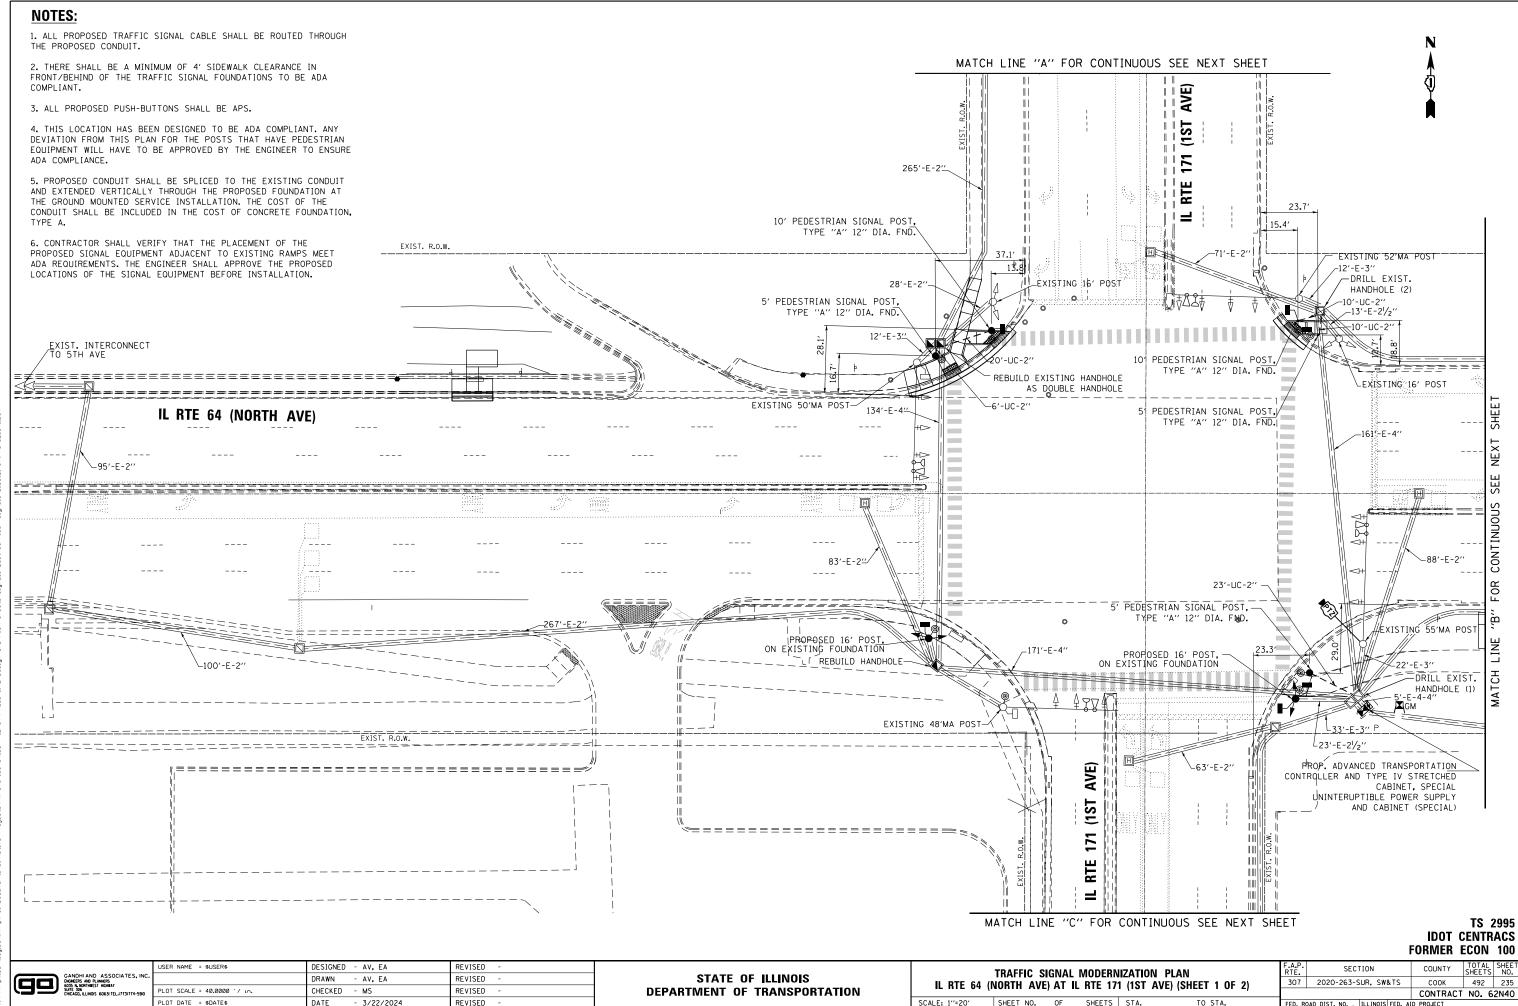


265'-E-2'' AVE) | | | IL RTE 64 (NORTH AVE) MATCH LINE "A" FOR CONTINUOUS SEE PREVIOUS SHEET MATCH LINE "C" FOR CONTINUOUS SEE PREVIOUS SHEET 11.0′, 11.0′, 6′, 11.0′, 11.0′, 11.0′, 11.0′, 11.0′ <u>5|∭|</u> ∐||||| PROP. INTERCONNECT "_203′-E-2′′ EXIST. R.O.W. AVE) RTE TS 2995 **IDOT CENTRACS** FORMER ECON 100 USER NAME = \$USER\$ DESIGNED - AV, EA REVISED SECTION TRAFFIC SIGNAL MODERNIZATION PLAN GANDHI AND ASSOCIATES, I ENGRERS AND PLANGERS OF NORTH AND STATE OF THE SOCIATION OF THE SO STATE OF ILLINOIS DRAWN - AV, EA REVISED 307 2020-263-SUR, SW&TS COOK 492 236 IL RTE 64 (NORTH AVE) AT IL RTE 171 (1ST AVE) (SHEET 2 OF 2) PLOT SCALE = 40.0000 '/ in. CHECKED - MS REVISED **DEPARTMENT OF TRANSPORTATION** CONTRACT NO. 62N40

SCALE: 1"=20" SHEET NO. OF SHEETS STA.

REVISED

- 3/22/2024

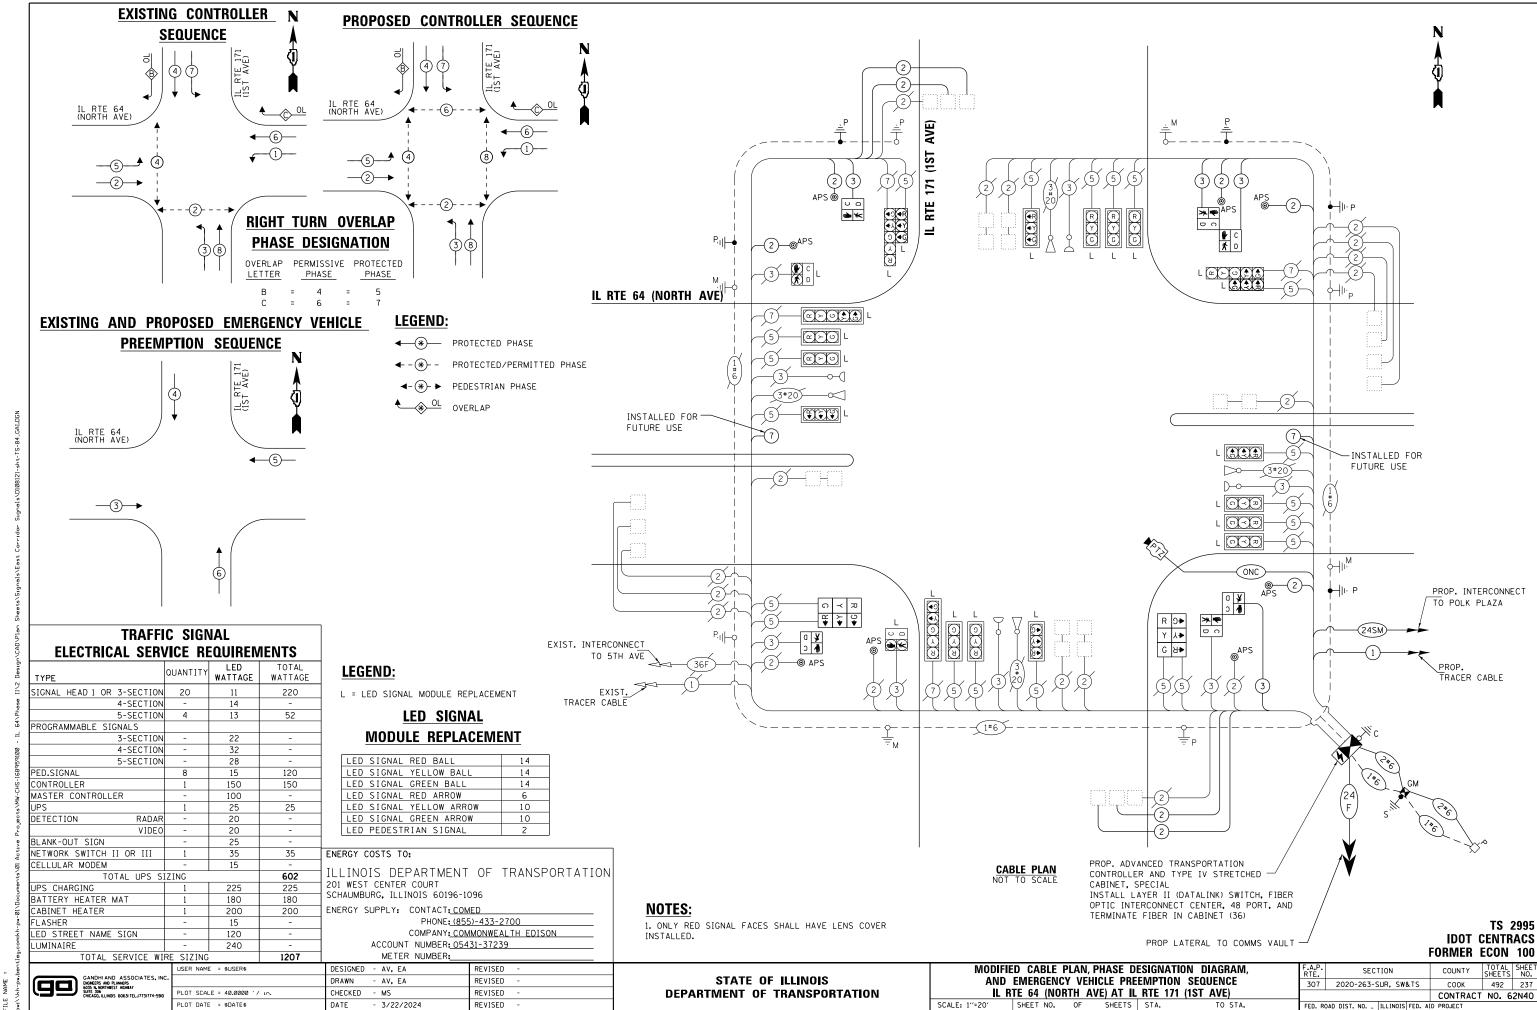

SCHEDULE OF QUANTITIES


| ITEM DESCRIPTION | UNITS | TOTA QTY. |
|---|-------|--------------|
| UNDERGROUND CONDUIT, GALVANIZED STEEL, 2" DIA. | FOOT | 69 |
| HANDHOLE | EACH | 1 |
| MAINTENANCE OF EXISTING TRAFFIC SIGNAL INSTALLATION | EACH | 1 |
| ELECTRIC CABLE IN CONDUIT, SIGNAL NO. 14 2C | FOOT | 1210 |
| ELECTRIC CABLE IN CONDUIT, SIGNAL NO. 14 3C | FOOT | 876 |
| ELECTRIC CABLE IN CONDUIT, SIGNAL NO. 14 7C | FOOT | 555 |
| ELECTRIC CABLE IN CONDUIT, LEAD-IN, NO. 14 1 PAIR | FOOT | 178 |
| ELECTRIC CABLE IN CONDUIT, SERVICE, NO. 6 2C | FOOT | 91 |
| ELECTRIC CABLE IN CONDUIT, EQUIPMENT GROUNDING CONDUCTOR, NO. 6 1C | FOOT | 233 |
| TRAFFIC SIGNAL POST, GALVANIZED STEEL 16 FT. | EACH | 2 |
| CONCRETE FOUNDATION, TYPE A | FOOT | 4 |
| DRILL EXISTING HANDHOLE | EACH | 3 |
| SIGNAL HEAD, LED, 1-FACE, 3-SECTION, BRACKET MOUNTED | EACH | 4 |
| PEDESTRIAN SIGNAL HEAD, LED, 1-FACE, BRACKET MOUNTED WITH COUNTDOWN TIMER | EACH | 6 |
| INDUCTIVE LOOP DETECTOR | EACH | 19 |
| RELOCTE EXISTING EMERGENCY VEHICLE PRIORITY SYSTEM, PHASING UNIT | EACH | 1 |
| REMOVE EXISTING TRAFFIC SIGNAL EQUIPMENT | EACH | 1 |
| REBUILD EXISTING HANDHOLE | EACH | 2 |
| CENTRACS LICENSE EXPANSION | EACH | 1 |
| OUTDOOR RATED NETWORK CABLE | FOOT | 65 |
| UNINTERRUPTABLE POWER SUPPLYAND CABINET, SPECIAL | EACH | 1 |
| SERVICE INSTALLATION, GROUND MOUNTED, METERED | EACH | 1 |
| REMOTE CONTROLLED VIDEO SYSTEM | EACH | 1 |
| LAYER II (DATALINK) SWITCH | EACH | 1 |
| TERMINATE FIBER IN CABINET | EACH | 36 |
| PEDESTRIAN SIGNAL POST, 10 FT. | EACH | 2 |
| PEDESTRIAN SIGNAL POST, 5 FT. | EACH | 3 |
| FIBER OPTIC INTERCONNECT CENTER, 48 PORT | EACH | 1 |
| ADVANCED TRANSPORTATION CONTROLLER AND TYPE IV STRETCHED CABINET, SPECIAL | EACH | 1 |
| ACCESSIBLE PEDESTRIAN SIGNALS | EACH | 8 |
| CONCRETE FOUNDATION, TYPE A 12-INCH DIAMETER | FOOT | 20 |
| LED SIGNAL FACE, LENS COVER | EACH | 24 |
| CAMERA MOUNTING ASSEMBLY | EACH | 1 |
| LED SIGNAL MODULE REPLACEMENT | EACH | 68 |
| LED PEDESTRIAN SIGNAL MODULE REPLACEMENT | EACH | 2 |


* 100% COST TO THE VILLAGE OF MELROSE PARK


TS 2995 IDOT CENTRACS FORMER ECON 100

| | | US |
|--|---|----|
| | GANDHI AND ASSOCIATES, INC. ENGNEERS AND PLANNERS | |
| | 6035 N. NORTHWEST HIGHWAY Suite 306 Chicago, Illinois 60631 Tel.(773)774-5910 | Ρl |
| | | Pl |

| | USER NAME = \$USER\$ | DESIGNED - AV, EA | REVISED - | |
|---|-----------------------------|-------------------|-----------|--|
| ٠ | | DRAWN - AV, EA | REVISED - | |
| | PLOT SCALE = 40.0000 '/ in. | CHECKED - MS | REVISED - | |
| | PLOT DATE = \$DATE\$ | DATE - 3/22/2024 | REVISED - | |
| | | | • | |

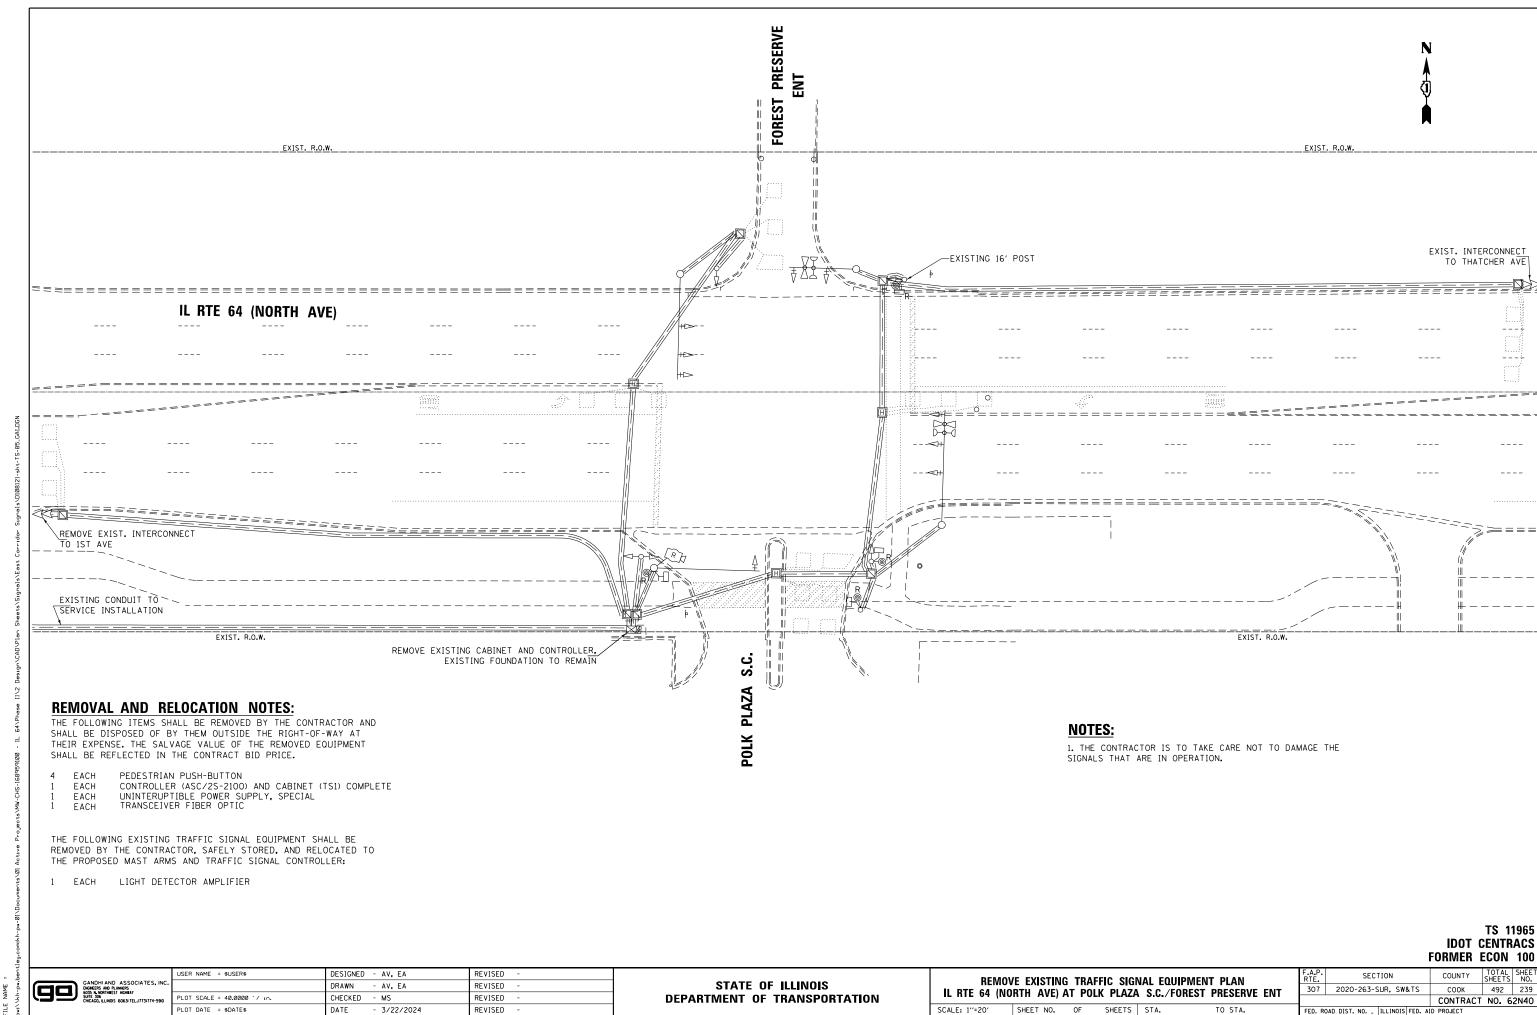

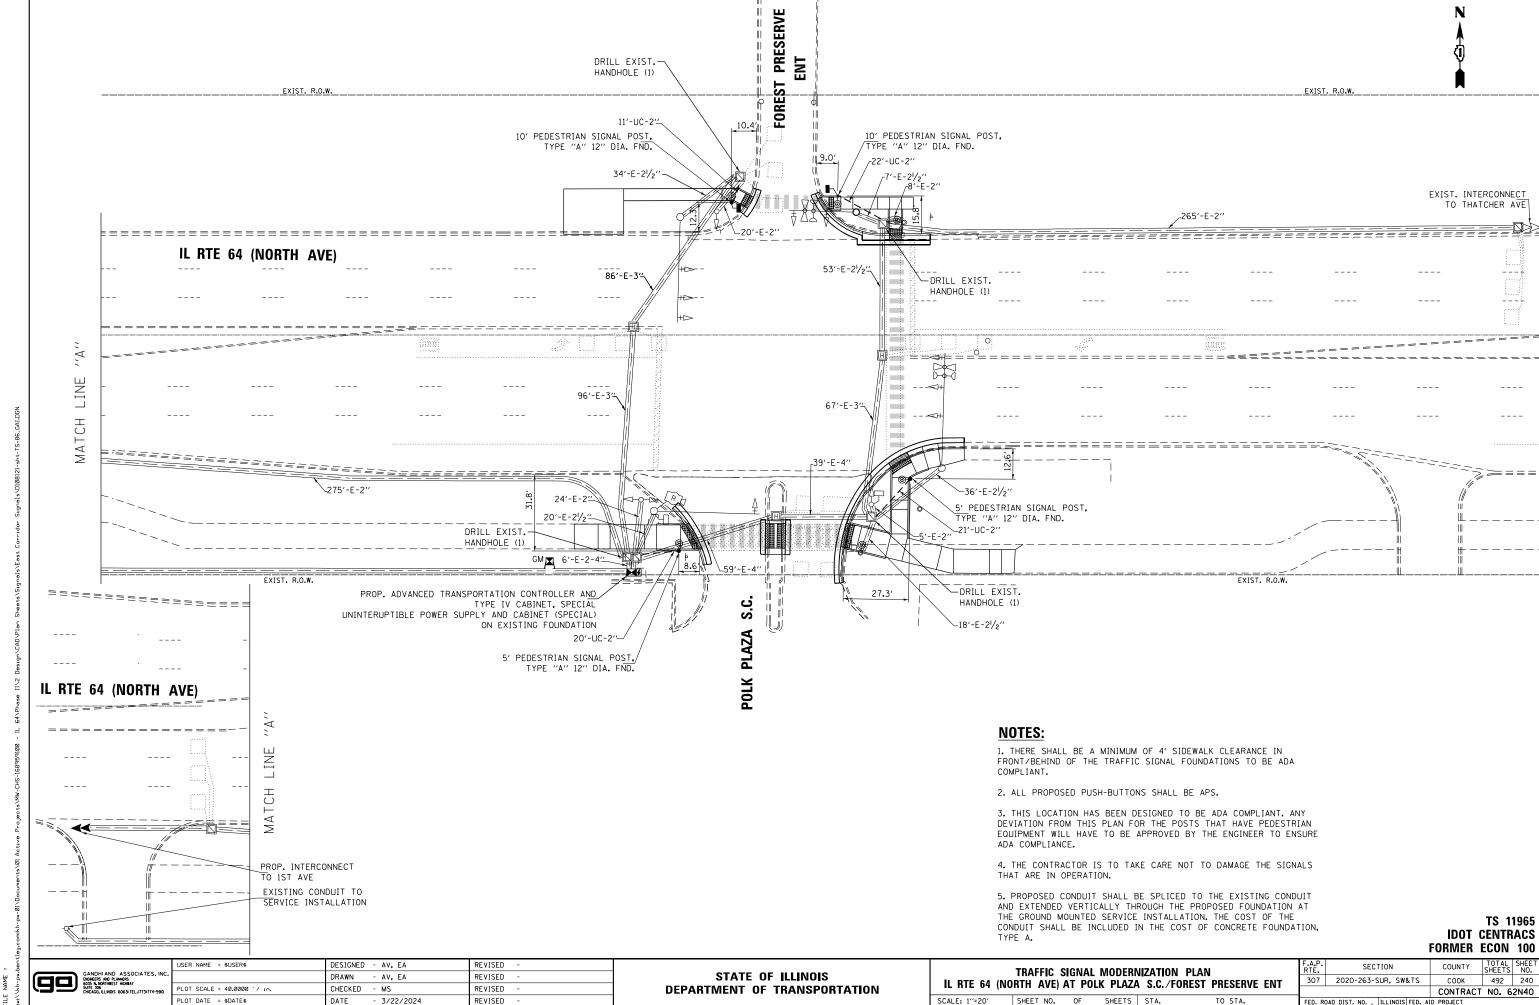

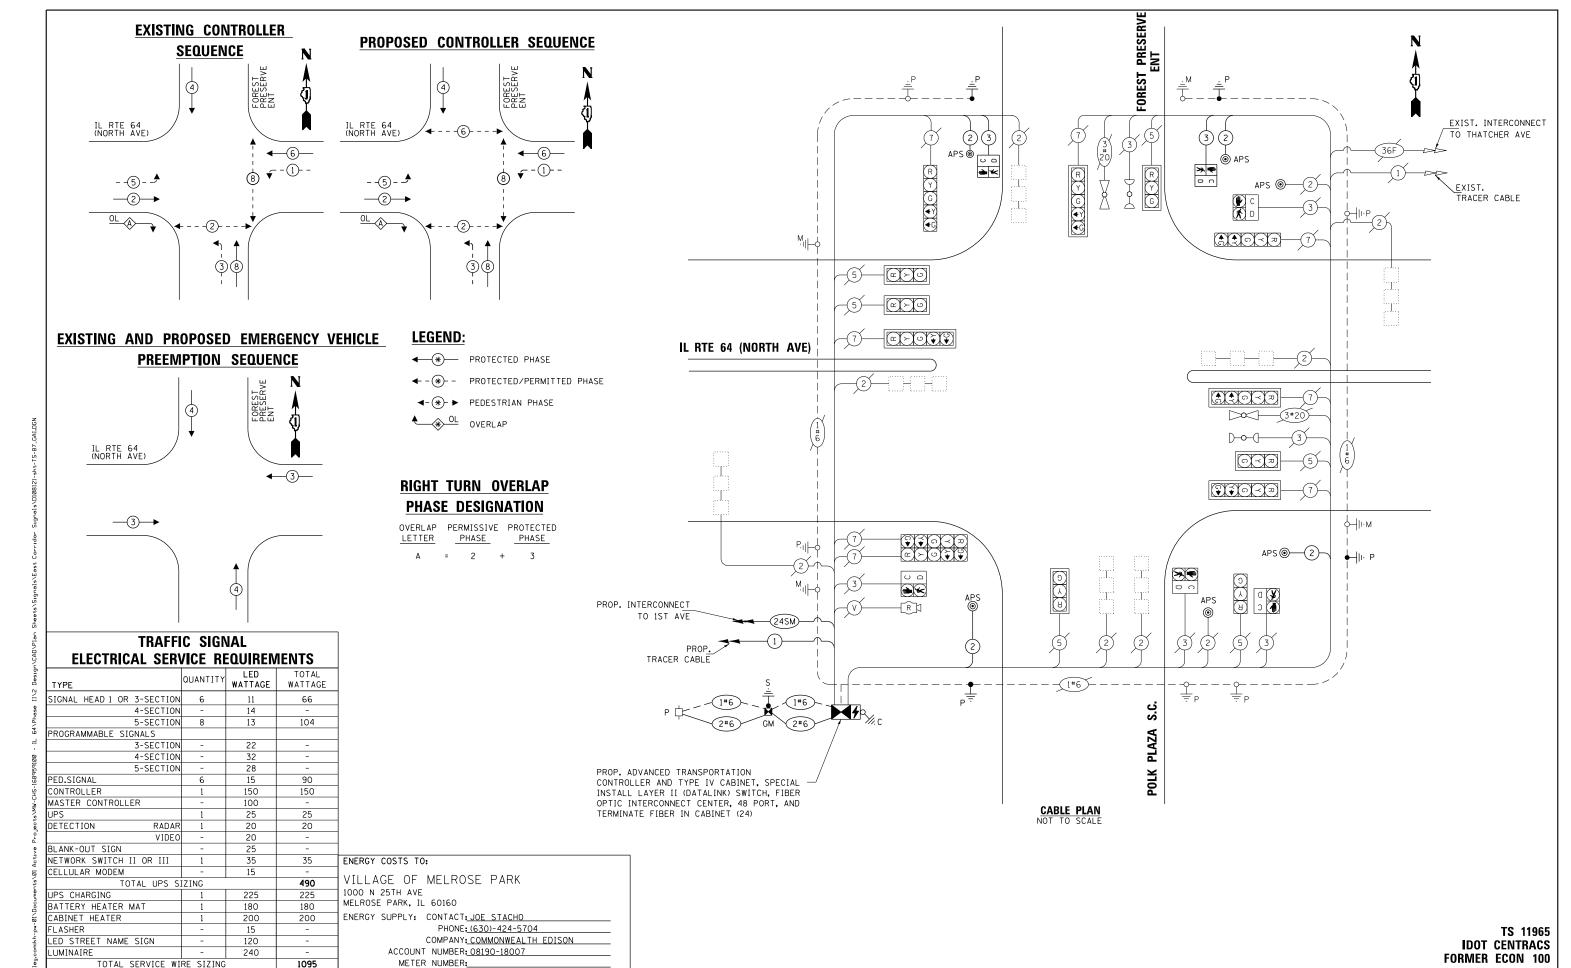

FILE NAME =

ENGNEERS AND PLANNERS
6035 N. MORTHREST HIGHBAY
SUITE 306
CHICAGO, ILLINOIS 60631 TEL.17

USER NAME = \$USER\$

PLOT DATE = \$DATE\$

DESIGNED - AV, EA

- AV, EA

- 3/22/2024

- MS

DRAWN

CHECKED

DATE

REVISED

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REVISED

STATE OF ILLINOIS
DEPARTMENT OF TRANSPORTATION


MODIFIED CABLE PLAN, PHASE DESIGNATION DIAGRAM,
AND EMERGENCY VEHICLE PREEMPTION SEQUENCE
IL RTE 64 (NORTH AVE) AT POLK PLAZA S.C./FOREST PRESERVE ENT
SCALE: 1"#20" | SHEET NO. OF SHEETS | STA. TO STA.

SIGN PANEL - TYPE 1 OR TYPE 2

ALL DIMENSIONS ARE IN INCHES UNLESS OTHERWISE NOTED



| DESIGN | AREA | SIGN PANEL | SHEETING | QTY. |
|--------|---------|------------|----------|----------|
| SERIES | (SQ FT) | TYPE | TYPE | REQUIRED |
| D | 12.5 | 2 | ZZ | |

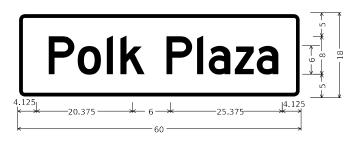

| DESIGN | AREA | SIGN PANEL | SHEETING | QTY. |
|--------|---------|------------|----------|----------|
| SERIES | (SQ FT) | TYPE | TYPE | REQUIRED |
| D | 7.5 | 1 | ZZ | |

NOTE: FOR ADDITIONAL DESIGN AND INSTALLATION INFORMATION PLEASE SEE DISTRICT ONE MAST ARM MOUNTED STREET NAME SIGNS DETAIL (TS-02).

SCHEDULE OF QUANTITIES


| ITEM DESCRIPTION | UNITS | TOTAL QTY. |
|---|-------|---------------|
| UNDERGROUND CONDUIT, GALVANIZED STEEL, 2" DIA. | FOOT | 74 |
| MAINTENANCE OF EXISTING TRAFFIC SIGNAL INSTALLATION | EACH | 1 |
| ELECTRIC CABLE IN CONDUIT, SIGNAL NO. 14 2C | FOOT | 752 |
| ELECTRIC CABLE IN CONDUIT, SIGNAL NO. 14 3C | FOOT | 505 |
| ELECTRIC CABLE IN CONDUIT, SERVICE, NO. 6 2C | FOOT | 326 |
| ELECTRIC CABLE IN CONDUIT, EQUIPMENT GROUNDING CONDUCTOR, NO. 6 1C | FOOT | 442 |
| CONCRETE FOUNDATION, TYPE A | FOOT | 4 |
| DRILL EXISTING HANDHOLE | EACH | 4 |
| PEDESTRIAN SIGNAL HEAD, LED, 1-FACE, BRACKET MOUNTED WITH COUNTDOWN TIMER | EACH | 2 |
| INDUCTIVE LOOP DETECTOR | EACH | 7 |
| * RELOCATE EXISTING EMERGENCY VEHICLE PRIORITY SYSTEM, PHASING UNIT | EACH | 1 |
| REMOVE ELECTRIC CABLE FROM CONDUIT | FOOT | 200 |
| REMOVE EXISTING TRAFFIC SIGNAL EQUIPMENT | EACH | 1 |
| CENTRACS LICENSE EXPANSION | EACH | 1 |
| UNINTERRUPTABLE POWER SUPPLYAND CABINET, SPECIAL | EACH | 1 |
| SERVICE INSTALLATION, GROUND MOUNTED, METERED | EACH | 1 |
| LAYER II (DATALINK) SWITCH | EACH | 1 |
| TERMINATE FIBER IN CABINET | EACH | 24 |
| PEDESTRIAN SIGNAL POST, 10 FT. | EACH | 2 |
| PEDESTRIAN SIGNAL POST, 5 FT. | EACH | 2 |
| FIBER OPTIC INTERCONNECT CENTER, 48 PORT | EACH | 1 |
| ADVANCED TRANSPORTATION CONTROLLER AND TYPE IV CABINET, SPECIAL | EACH | 1 |
| ACCESSIBLE PEDESTRIAN SIGNALS | EACH | 6 |
| CONCRETE FOUNDATION, TYPE A 12-INCH DIAMETER | FOOT | 16 |


* 100% COST TO THE VILLAGE OF MELROSE PARK


TS 11965 IDOT CENTRACS FORMER ECON 100

| Kimley» Horn |
|---|
| © 2023 KIMLEY-HORN AND ASSOCIATES, INC. |
| 4201 WINFIELD ROAD, SUITE 600 |
| WARRENVILLE, IL 60555 |
| PHONE: 630-487-5550 |
| WWW.KIMLEY-HORN.COM |

| | | | | | _ |
|--------------------------|----------|---|-----------|-----------|---|
| USER NAME = Joel.Turk | DESIGNED | - | AMK | REVISED - | |
| | DRAWN | - | JJT | REVISED - | |
| PLOT SCALE = 2 0000 / in | CHECKED | - | SS | REVISED - | |
| PLOT DATE = 3/22/2024 | DATE | - | 3/22/2024 | REVISED - | |

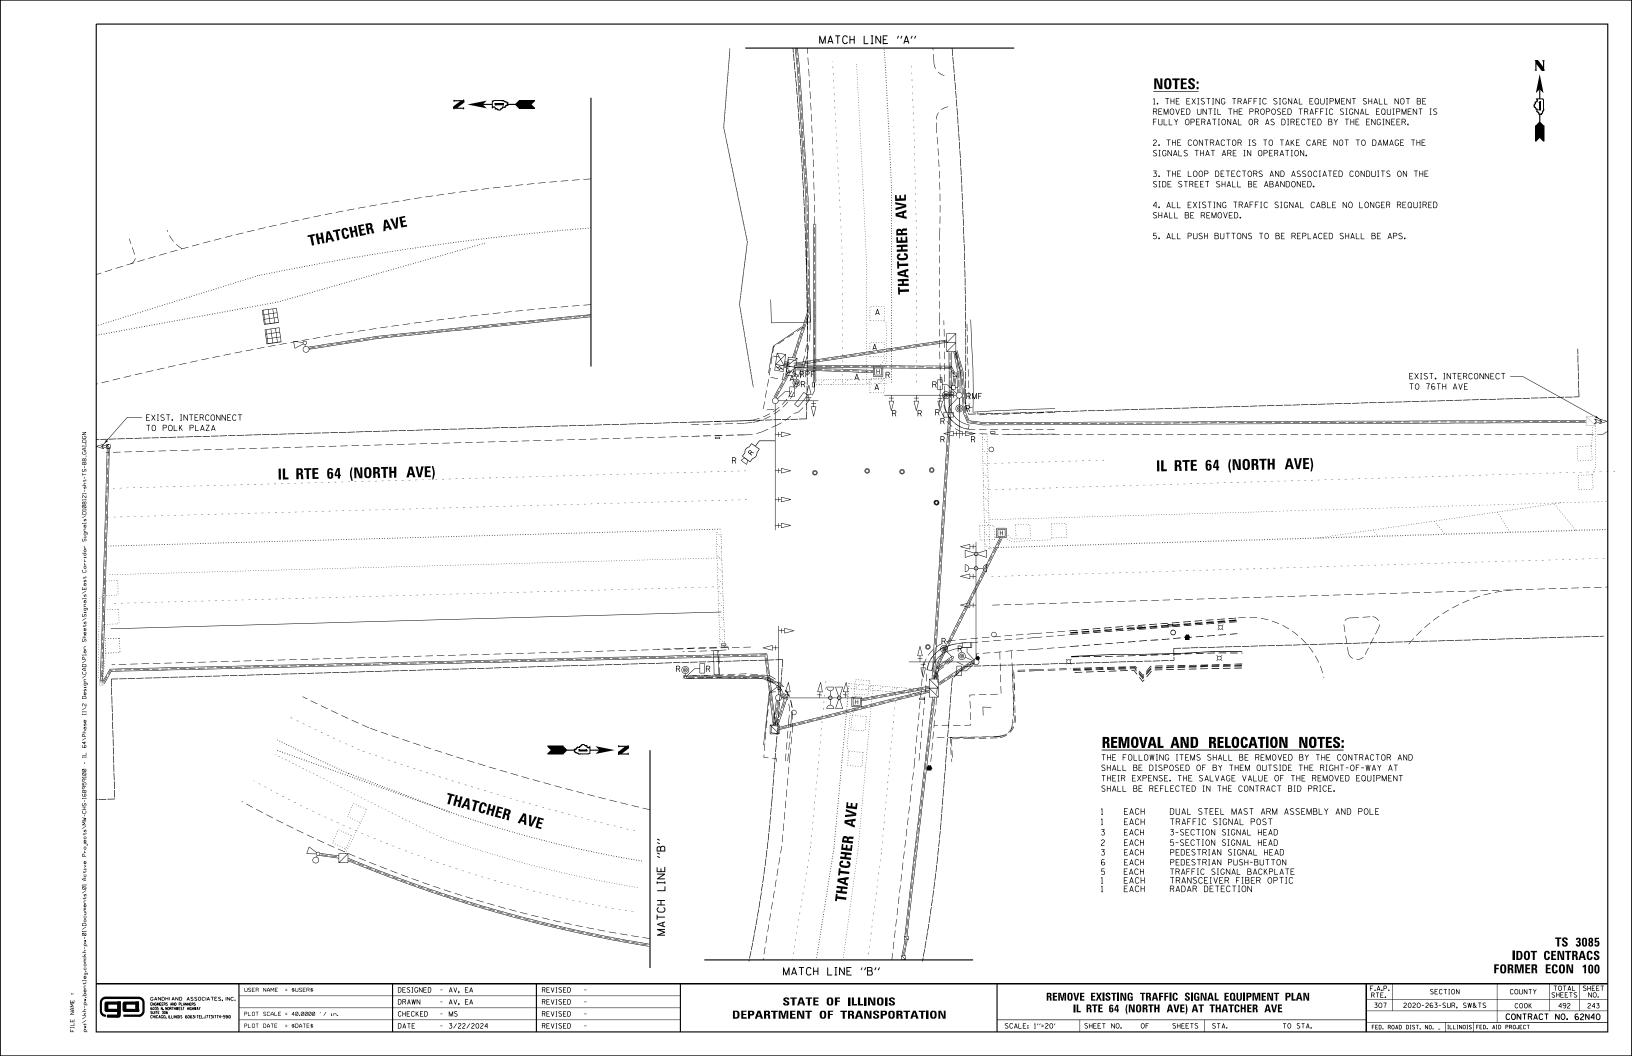

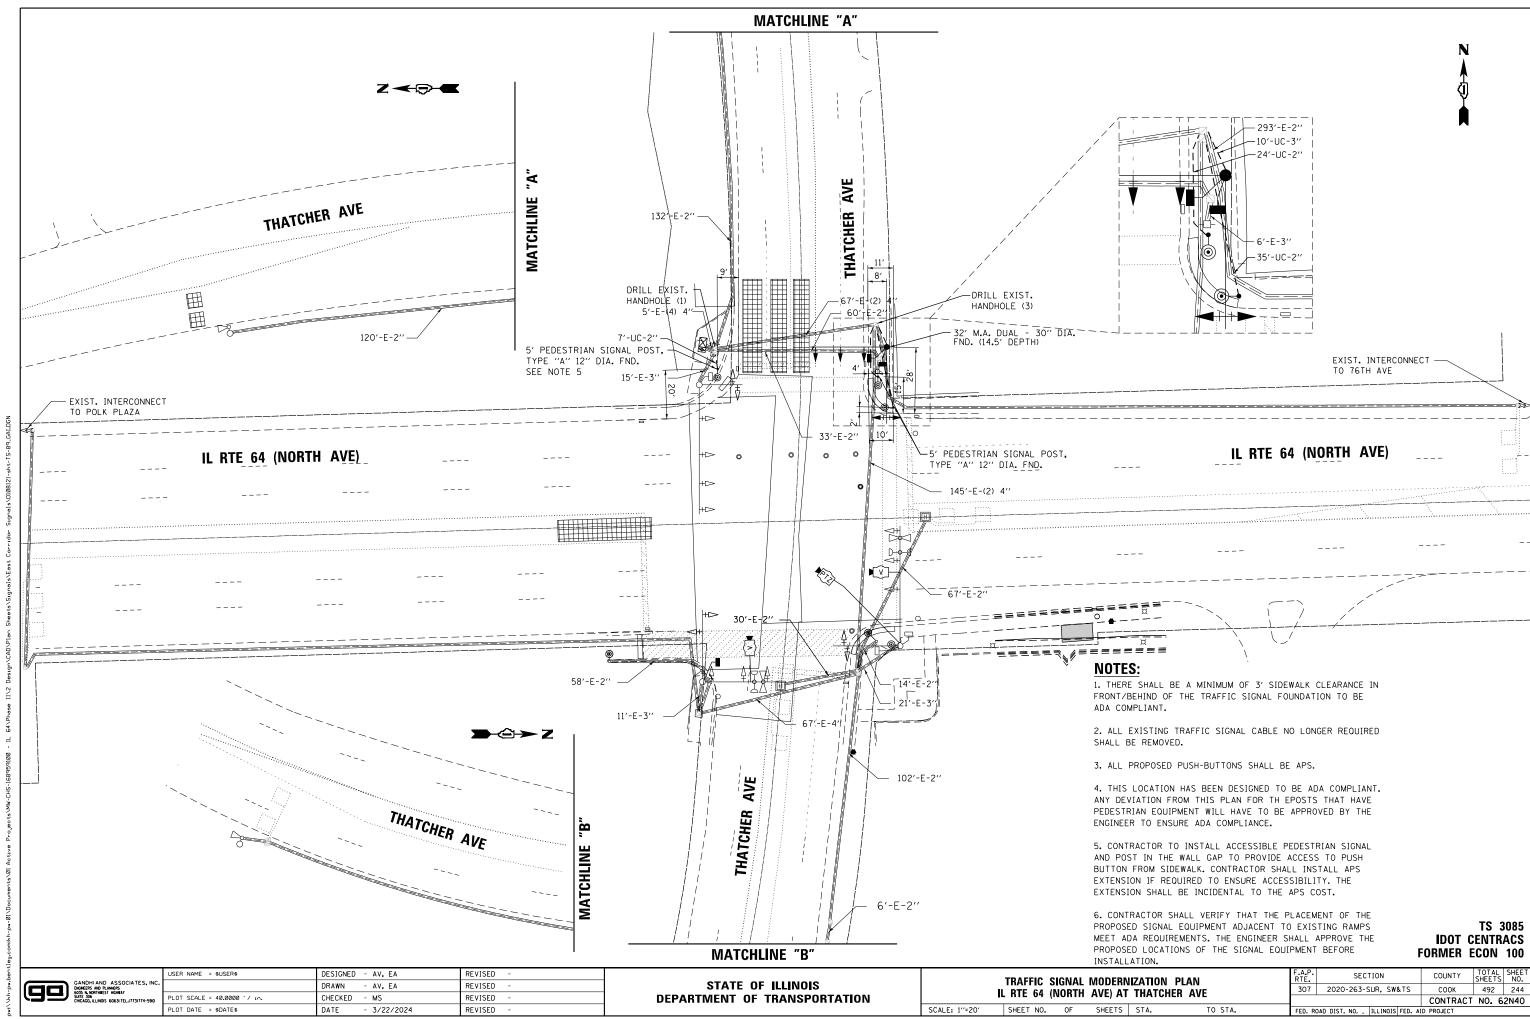

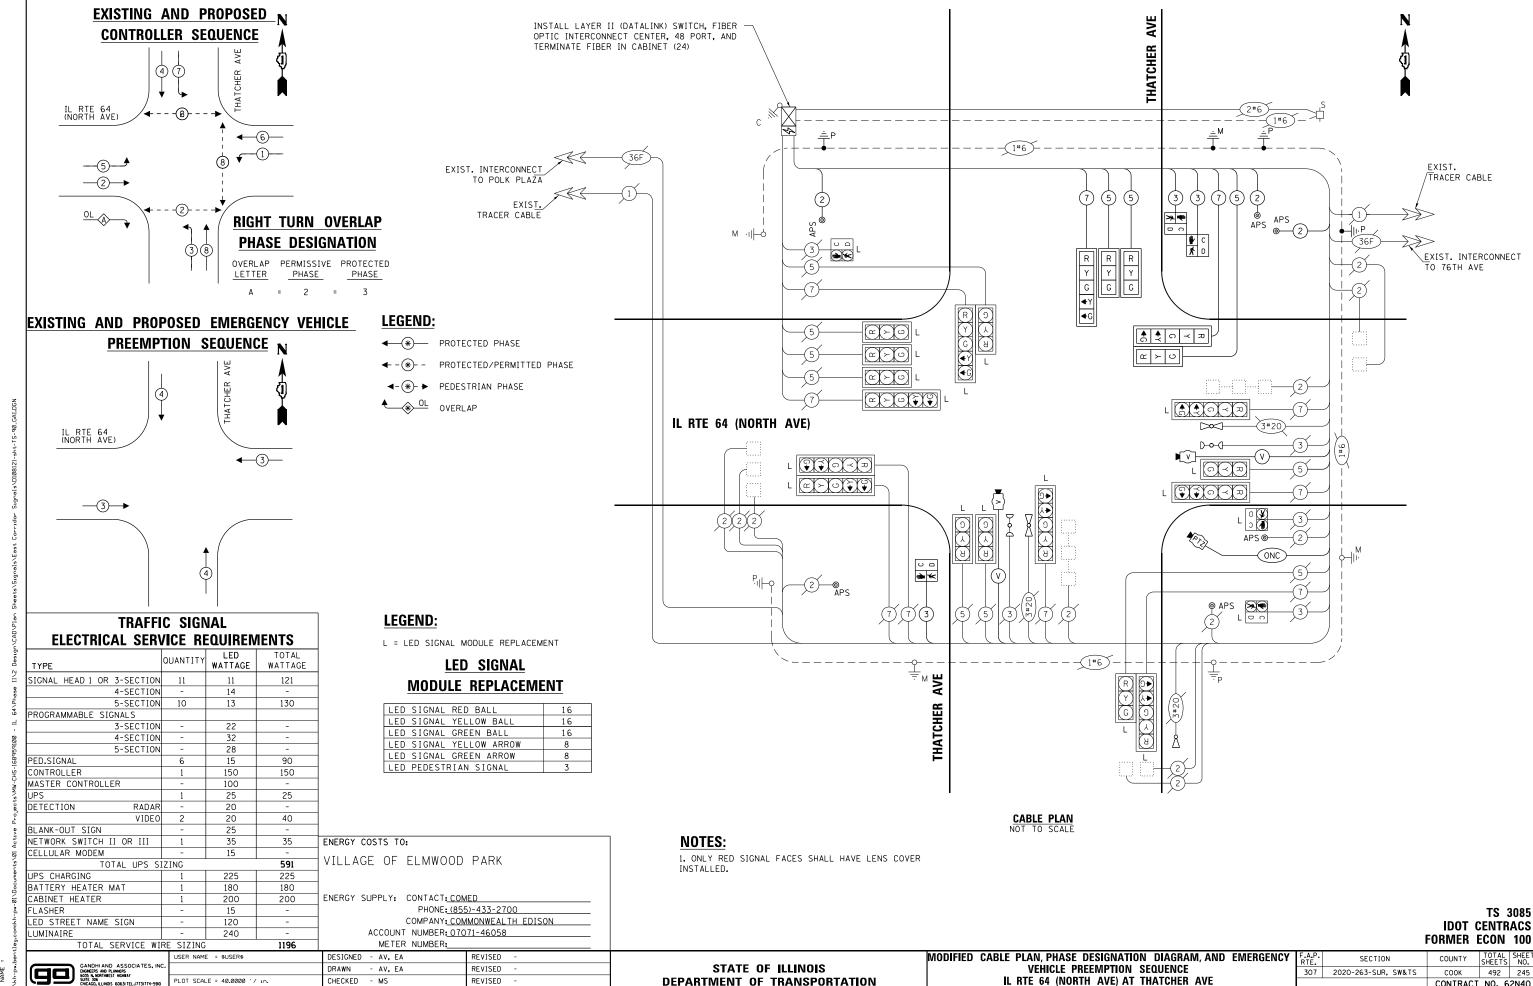

SCALE: 1"=20' SHEET NO. OF SHEETS STA.

CONTRACT NO. 62N40

PLOT DATE = \$DATE\$

DATE

- 3/22/2024

SIGN PANEL - TYPE 1 OR TYPE 2

ALL DIMENSIONS ARE IN INCHES UNLESS OTHERWISE NOTED



| DESIGN | AREA | SIGN PANEL | SHEETING | QTY. |
|--------|---------|------------|----------|----------|
| SERIES | (SQ FT) | TYPE | TYPE | REQUIRED |
| D | 12.5 | 2 | ZZ | |

Thatcher Ave

ZZ

NOTE: FOR ADDITIONAL DESIGN AND INSTALLATION INFORMATION PLEASE SEE DISTRICT ONE MAST ARM MOUNTED STREET NAME SIGNS DETAIL (TS-02).

SCHEDULE OF QUANTITIES

| ITEM DESCRIPTION | UNITS | TOTAL QTY. |
|---|-------|---------------|
| SIGN PANEL - TYPE 2 | SQ FT | 12.5 |
| UNDERGROUND CONDUIT, GALVANIZED STEEL, 2" DIA. | FOOT | 66 |
| UNDERGROUND CONDUIT, GALVANIZED STEEL, 3" DIA. | FOOT | 10 |
| MAINTENANCE OF EXISTING TRAFFIC SIGNAL INSTALLATION | EACH | 1 |
| ELECTRIC CABLE IN CONDUIT, SIGNAL NO. 14 2C | FOOT | 313 |
| ELECTRIC CABLE IN CONDUIT, SIGNAL NO. 14 3C | FOOT | 252 |
| ELECTRIC CABLE IN CONDUIT, SIGNAL NO. 14 5C | FOOT | 457 |
| ELECTRIC CABLE IN CONDUIT, SIGNAL NO. 14 7C | FOOT | 325 |
| ELECTRIC CABLE IN CONDUIT, EQUIPMENT GROUNDING CONDUCTOR, NO. 6 1C | FOOT | 128 |
| STEEL MAST ARM ASSEMBLY AND POLE WITH DUAL MAST ARMS, 32 FT. | EACH | 1 |
| CONCRETE FOUNDATION, TYPE E 30-INCH DIAMETER | FOOT | 14.5 |
| DRILL EXISTING HANDHOLE | EACH | 4 |
| SIGNAL HEAD, LED, 1-FACE, 3-SECTION, MAST ARM MOUNTED | EACH | 3 |
| SIGNAL HEAD, LED, 1-FACE, 5-SECTION, MAST ARM MOUNTED | EACH | 2 |
| PEDESTRIAN SIGNAL HEAD, LED, 1-FACE, BRACKET MOUNTED WITH COUNTDOWN TIMER | EACH | 3 |
| TRAFFIC SIGNAL BACKPLATE, LOUVERED, FORMED PLASTIC | EACH | 5 |
| MODIFY EXISTING CONTROLLER CABINET | EACH | 1 |
| REMOVE ELECTRIC CABLE FROM CONDUIT | FOOT | 1523 |
| REMOVE EXISTING TRAFFIC SIGNAL EQUIPMENT | EACH | 1 |
| REMOVE EXISTING CONCRETE FOUNDATION | EACH | 2 |
| CENTRACS LICENSE EXPANSION | EACH | 1 |
| OUTDOOR RATED NETWORK CABLE | FOOT | 302 |
| REMOTE CONTROLLED VIDEO SYSTEM | EACH | 1 |
| LAYER II (DATALINK) SWITCH | EACH | 1 |
| TERMINATE FIBER IN CABINET | EACH | 24 |
| UPGRADE EXISTING CONTROLLER TO NTCIP SPECIAL | EACH | 1 |
| PEDESTRIAN SIGNAL POST, 5 FT. | EACH | 3 |
| VIDEO VEHICLE DETECTION SYSTEM, SINGLE APPROACH | EACH | 2 |
| FIBER OPTIC INTERCONNECT CENTER, 48 PORT | EACH | 1 |
| POWER OVER ETHERNET EXTENDER | EACH | 1 |
| ACCESSIBLE PEDESTRIAN SIGNALS | EACH | 6 |
| CONCRETE FOUNDATION, TYPE A 12-INCH DIAMETER | FOOT | 12 |
| LED SIGNAL FACE, LENS COVER | EACH | 21 |
| ELECTRIC METER | EACH | 1 |
| REMOVE AND REPLACE BATTERIES FOR UNINTERRUPTABLE POWER SUPPLY, EXTENDED | EACH | 1 |
| LED SIGNAL MODULE REPLACEMENT | EACH | 64 |
| LED PEDESTRIAN SIGNAL MODULE REPLACEMENT | EACH | 3 |


TS 3085 IDOT CENTRACS FORMER ECON 100

COOK 492 246

CONTRACT NO. 62N40

| Kimley Morn |
|---|
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| 4201 WINFIELD ROAD, SUITE 600 |
| WARRENVILLE, IL 60555 |
| PHONE: 630-487-5550 |
| WWW.KIMLEY-HORN.COM |

| | | | | | _ |
|--------------------------|----------|---|-----------|-----------|---|
| USER NAME = Joel.Turk | DESIGNED | - | AMK | REVISED - | |
| | DRAWN | - | JJT | REVISED - | |
| PLOT SCALE = 2 0000 / in | CHECKED | - | SS | REVISED - | |
| PLOT DATE = 3/22/2024 | DATE | - | 3/22/2024 | REVISED - | |

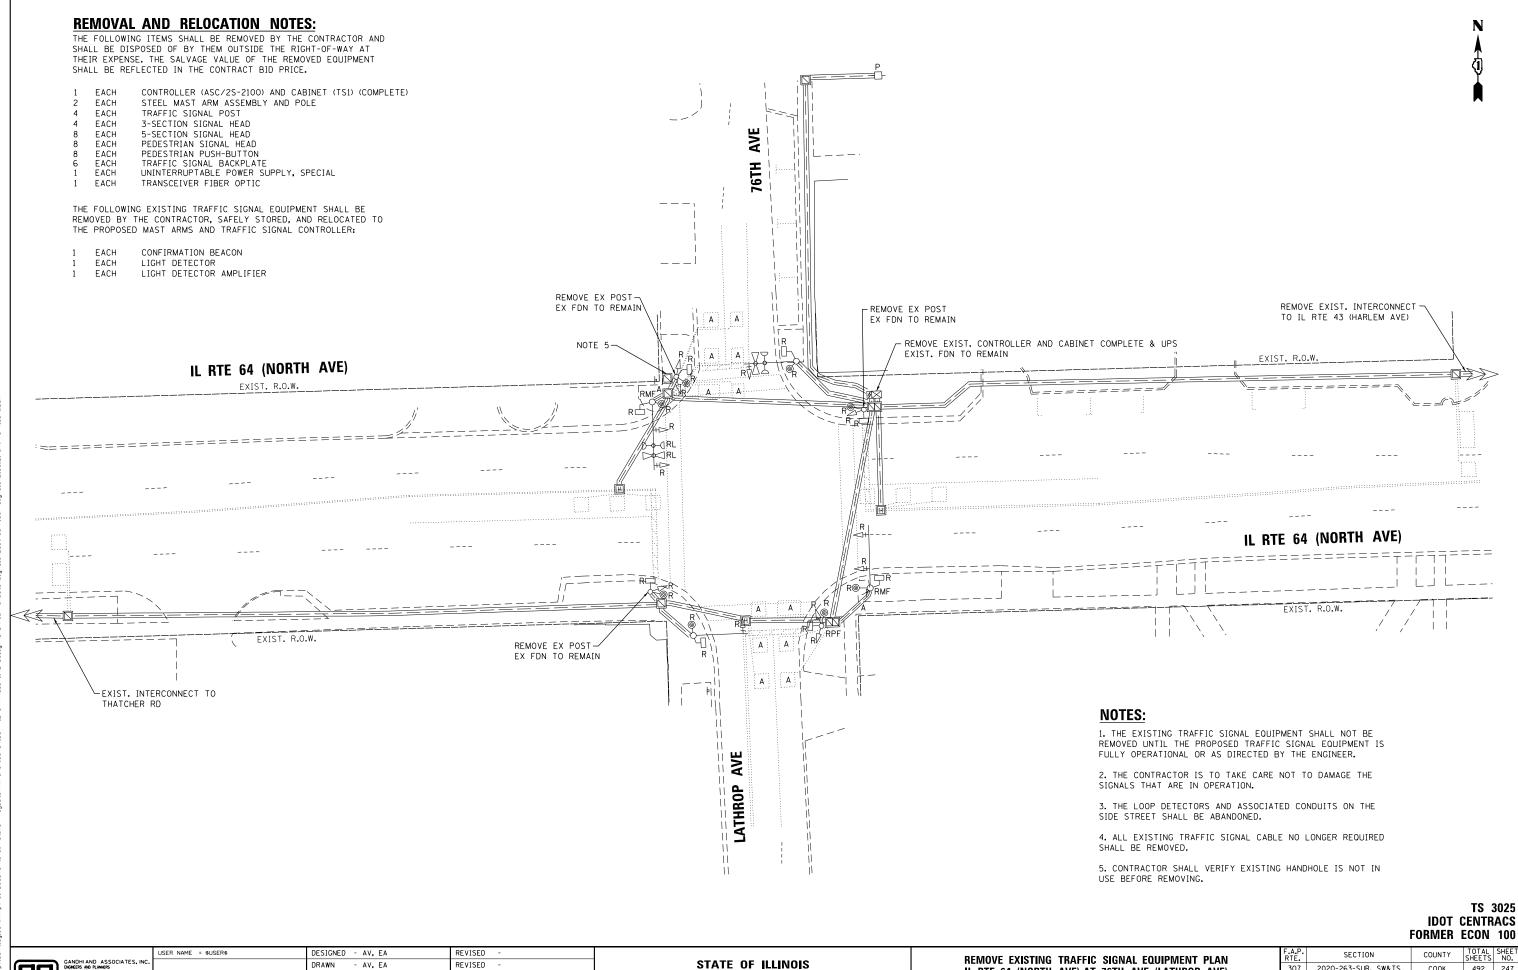


ENGNEERS AND PLANMERS
ENGNEERS AND PLANMERS
SOUTH 306
CHICAGO, ILLINOIS 60631 TELL

CHECKED - MS REVISED DATE - 3/22/2024 REVISED

DEPARTMENT OF TRANSPORTATION

REMOVE EXISTING TRAFFIC SIGNAL EQUIPMENT PLAN IL RTE 64 (NORTH AVE) AT 76TH AVE (LATHROP AVE) SCALE: 1"=20" SHEET NO. OF SHEETS STA.

307 2020-263-SUR, SW&TS COOK 492 247 CONTRACT NO. 62N40

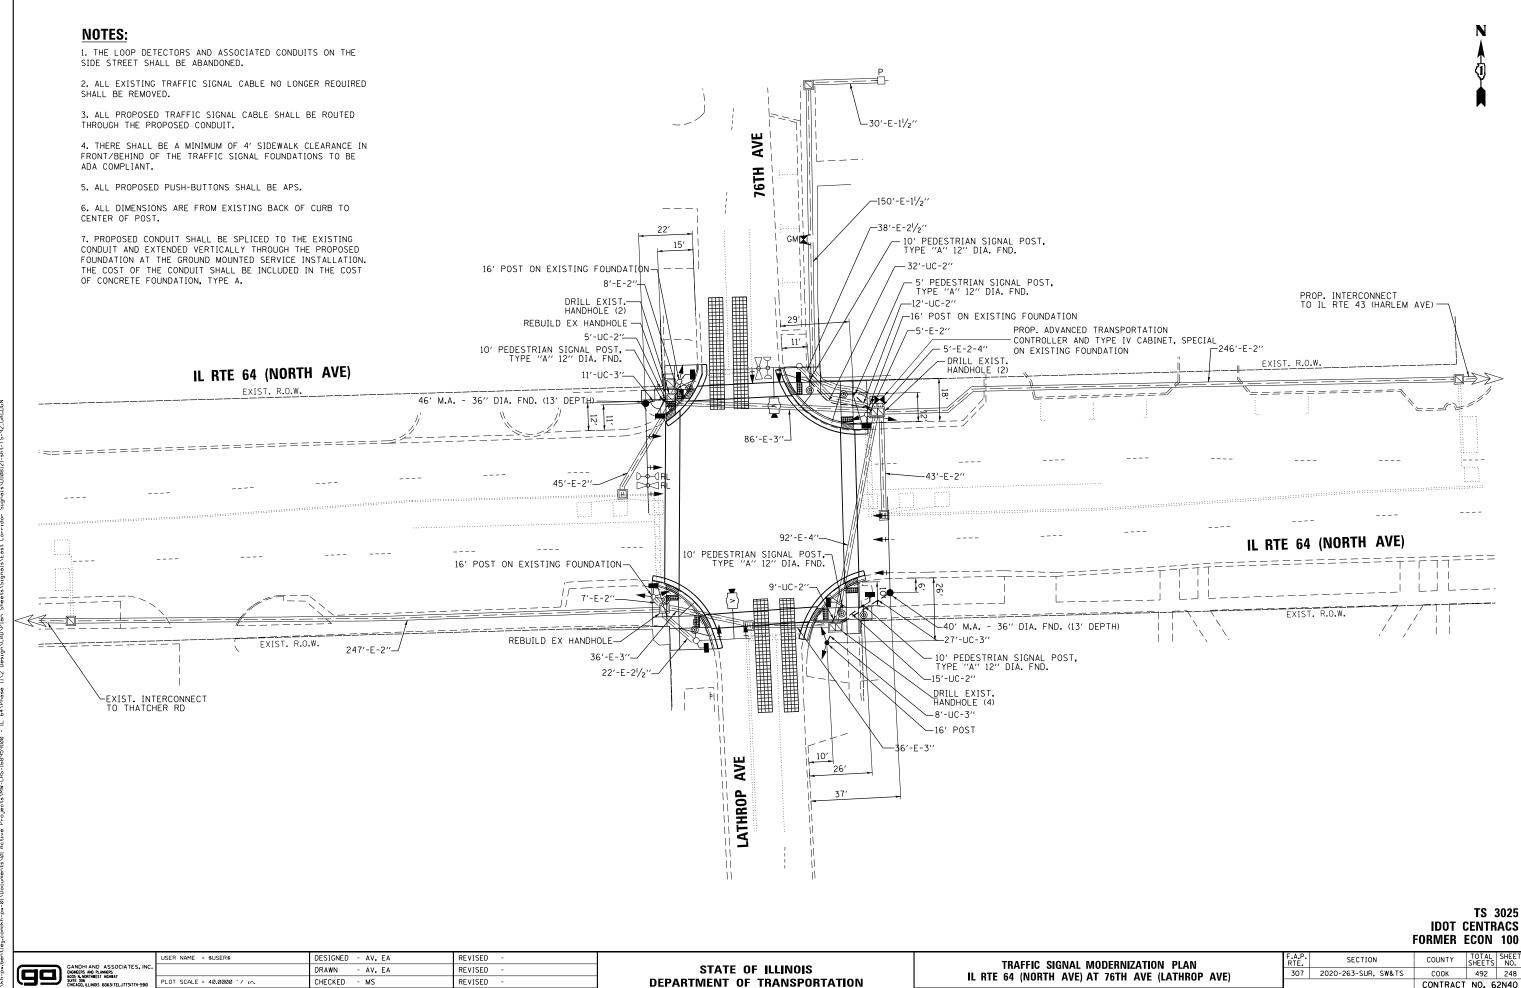


CONTRACT NO. 62N40

SHEET NO. OF SHEETS STA.

DATE

- 3/22/2024

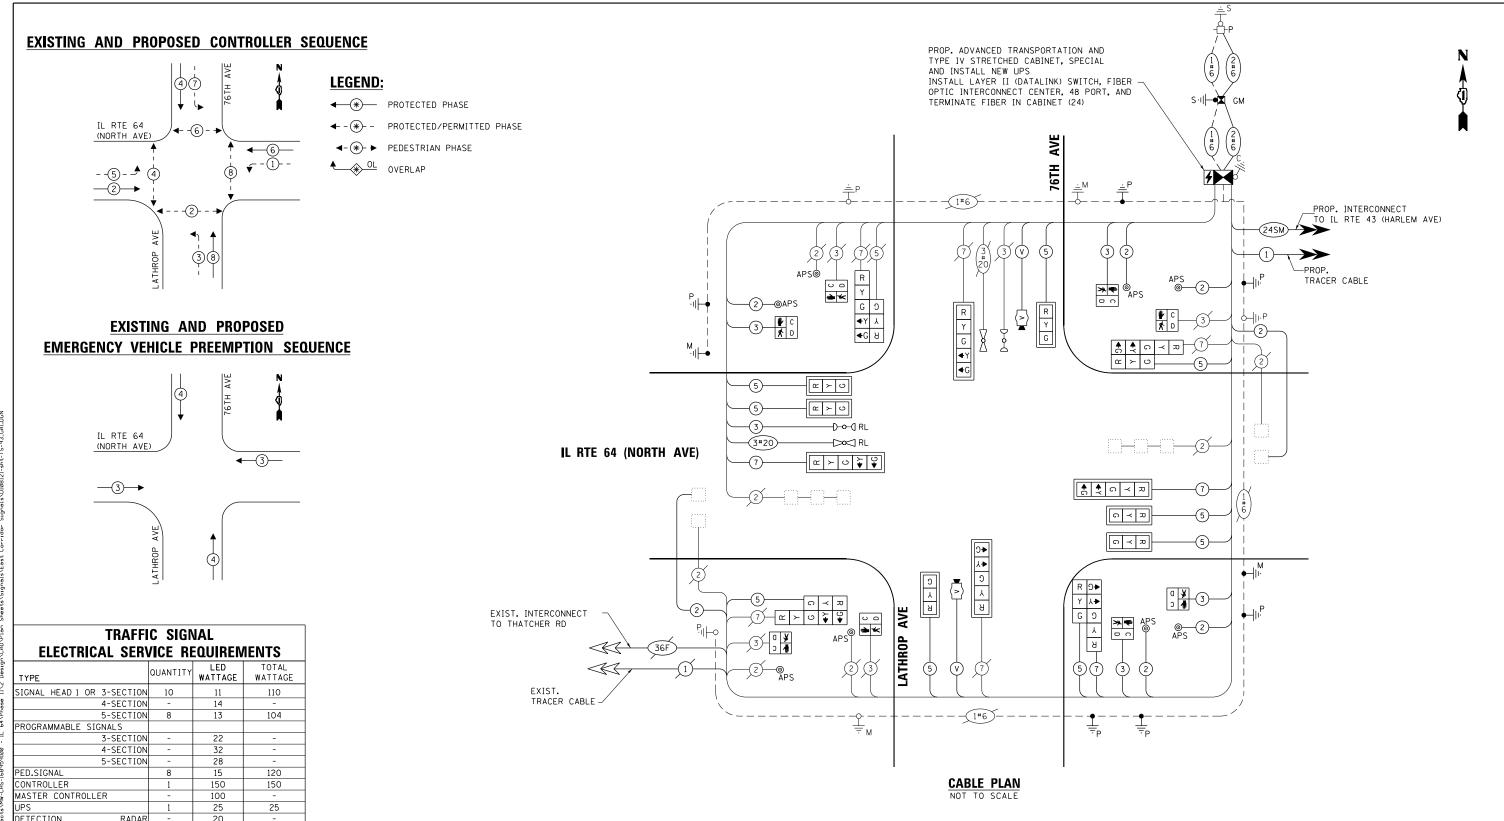

RADAR DETECTION 20 20 40 BLANK-OUT SIGN NETWORK SWITCH II OR III 35 35 CELLULAR MODEM 584 225 180 UPS CHARGING 225 BATTERY HEATER MAT 180 CABINET HEATER 200 200 FLASHER 15 LED STREET NAME SIGN 120

TOTAL SERVICE WIRE SIZING

240

1189

ENERGY COSTS TO: VILLAGE OF ELMWOOD PARK 2501 N MANNHEIM ROAD FRANKLIN PARK, IL 60131 ENERGY SUPPLY: CONTACT: JOE STACHO

PHONE: (630) 424-5704 COMPANY: COMMONWEALTH EDISON ACCOUNT NUMBER: 07071-46058 METER NUMBER:

> STATE OF ILLINOIS **DEPARTMENT OF TRANSPORTATION**

MODIFIED CABLE PLAN, PHASE DESIGNATION DIAGRAM, AND EMERGENCY VEHICLE PREEMPTION SEQUENCE IL RTE 64 (NORTH AVE) AT 76TH AVE (LATHROP AVE)

FORMER ECON 100 COUNTY COOK 492 249

IDOT CENTRACS

TS 3025

USER NAME = \$USER\$ DESIGNED - AV, EA REVISED DRAWN - AV, EA REVISED LOT SCALE = 40.0000 '/ in. CHECKED - MS REVISED PLOT DATE = \$DATE\$ DATE REVISED - 3/22/2024

1. ONLY RED SIGNAL FACES SHALL HAVE LENS COVER

INSTALLED.

SECTION 307 2020-263-SUR, SW&TS CONTRACT NO. 62N40 SCALE: 1"=20" SHEET NO. OF SHEETS STA.


LUMINAIRE

ENGNERS AND PLANNERS
6035 N. NORTHIREST HIGHBAY
SUITE 306
CHICAGO, ILLINOIS 60631 TEL.17


SIGN PANEL - TYPE 1 OR TYPE 2

ALL DIMENSIONS ARE IN INCHES UNLESS OTHERWISE NOTED



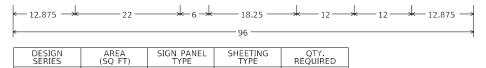



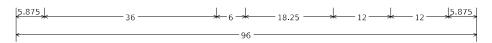

| DESIGN | AREA | SIGN PANEL | SHEETING | QTY. |
|--------|---------|------------|----------|----------|
| SERIES | (SQ FT) | TYPE | TYPE | REQUIRED |
| D | 20 | 2 | ZZ | 1 |

NOTE: FOR ADDITIONAL DESIGN AND INSTALLATION INFORMATION PLEASE SEE DISTRICT ONE MAST ARM MOUNTED STREET NAME SIGNS DETAIL (TS-02).

SCHEDULE OF QUANTITIES


| ITEM DESCRIPTION | UNITS | TOTAL QTY. |
|---|-------|---------------|
| SIGN PANEL - TYPE 2 | SQ FT | 40 |
| UNDERGROUND CONDUIT, GALVANIZED STEEL, 2" DIA. | FOOT | 71 |
| UNDERGROUND CONDUIT, GALVANIZED STEEL, 3" DIA. | FOOT | 46 |
| MAINTENANCE OF EXISTING TRAFFIC SIGNAL INSTALLATION | EACH | 1 |
| ELECTRIC CABLE IN CONDUIT, SIGNAL NO. 14 2C | FOOT | 536 |
| ELECTRIC CABLE IN CONDUIT, SIGNAL NO. 14 3C | FOOT | 708 |
| ELECTRIC CABLE IN CONDUIT, SIGNAL NO. 14 5C | FOOT | 1520 |
| ELECTRIC CABLE IN CONDUIT, SIGNAL NO. 14 7C | FOOT | 552 |
| ELECTRIC CABLE IN CONDUIT, LEAD-IN, NO. 14 1 PAIR | FOOT | 743 |
| ELECTRIC CABLE IN CONDUIT, SERVICE, NO. 6 2C | FOOT | 206 |
| ELECTRIC CABLE IN CONDUIT, EQUIPMENT GROUNDING CONDUCTOR, NO. 6 1C | FOOT | 439 |
| TRAFFIC SIGNAL POST, GALVANIZED STEEL 16 FT. | EACH | 4 |
| STEEL MAST ARM ASSEMBLY AND POLE, 40 FT. | EACH | 1 |
| STEEL MAST ARM ASSEMBLY AND POLE, 46 FT. | EACH | 1 |
| CONCRETE FOUNDATION, TYPE A | FOOT | 8 |
| CONCRETE FOUNDATION, TYPE E 36-INCH DIAMETER | FOOT | 26 |
| DRILL EXISTING HANDHOLE | EACH | 8 |
| SIGNAL HEAD, LED, 1-FACE, 3-SECTION, MAST ARM MOUNTED | EACH | 6 |
| SIGNAL HEAD, LED, 1-FACE, 3-SECTION, BRACKET MOUNTED | EACH | 4 |
| SIGNAL HEAD, LED, 1-FACE, 5-SECTION, BRACKET MOUNTED | EACH | 4 |
| SIGNAL HEAD, LED, 1-FACE, 5-SECTION, MAST ARM MOUNTED | EACH | 4 |
| PEDESTRIAN SIGNAL HEAD, LED, 1-FACE, BRACKET MOUNTED WITH COUNTDOWN TIMER | EACH | 8 |
| TRAFFIC SIGNAL BACKPLATE, LOUVERED, FORMED PLASTIC | EACH | 10 |
| INDUCTIVE LOOP DETECTOR | EACH | 6 |
| RELOCATE EXISTING EMERGENCY VEHICLE PRIORITY SYSTEM, DETECTOR UNIT | EACH | 1 |
| RELOCATE EXISTING EMERGENCY VEHICLE PRIORITY SYSTEM, PHASING UNIT | EACH | 1 |
| REMOVE ELECTRIC CABLE FROM CONDUIT | FOOT | 1946 |
| REMOVE EXISTING TRAFFIC SIGNAL EQUIPMENT | EACH | 1 |
| REBUILD EXISTING HANDHOLE | EACH | 2 |
| REMOVE EXISTING CONCRETE FOUNDATION | EACH | 3 |
| EMERGENCY VEHICLE PRIORITY SYSTEM LINE SENSOR CABLE, NO. 20 3/C | FOOT | 185 |
| CENTRACS LICENSE EXPANSION | EACH | 1 |
| UNINTERRUPTABLE POWER SUPPLY AND CABINET, SPECIAL | EACH | 1 |
| SERVICE INSTALLATION, GROUND MOUNTED, METERED | EACH | 1 |
| LAYER II (DATALINK) SWITCH | EACH | 1 |
| TERMINATE FIBER IN CABINET | EACH | 24 |
| PEDESTRIAN SIGNAL POST, 10 FT. | EACH | 4 |
| PEDESTRIAN SIGNAL POST, 5 FT. | EACH | 1 |
| VIDEO VEHICLE DETECTION SYSTEM, SINGLE APPROACH | EACH | 2 |
| FIBER OPTIC INTERCONNECT CENTER, 48 PORT | EACH | 1 |
| ADVANCED TRANSPORTATION CONTROLLER AND TYPE IV CABINET, SPECIAL | EACH | 1 |
| ACCESSIBLE PEDESTRIAN SIGNALS | EACH | 8 |
| LED SIGNAL FACE, LENS COVER | EACH | 18 |
| CONCRETE FOUNDATION, TYPE A 12-INCH DIAMETER | FOOT | 20 |


* 100% COST TO THE VILLAGE OF ELMWOOD PARK


TS 3025 IDOT CENTRACS FORMER ECON 100



| USER NAME = Joel.Turk | DESIGNED - AMK | REVISED - |
|---------------------------|------------------|-----------|
| | DRAWN - JJT | REVISED - |
| PLOT SCALE = 2.0000 / in. | CHECKED - SS | REVISED - |
| PLOT DATE = 3/22/2024 | DATE - 3/22/2024 | REVISED - |

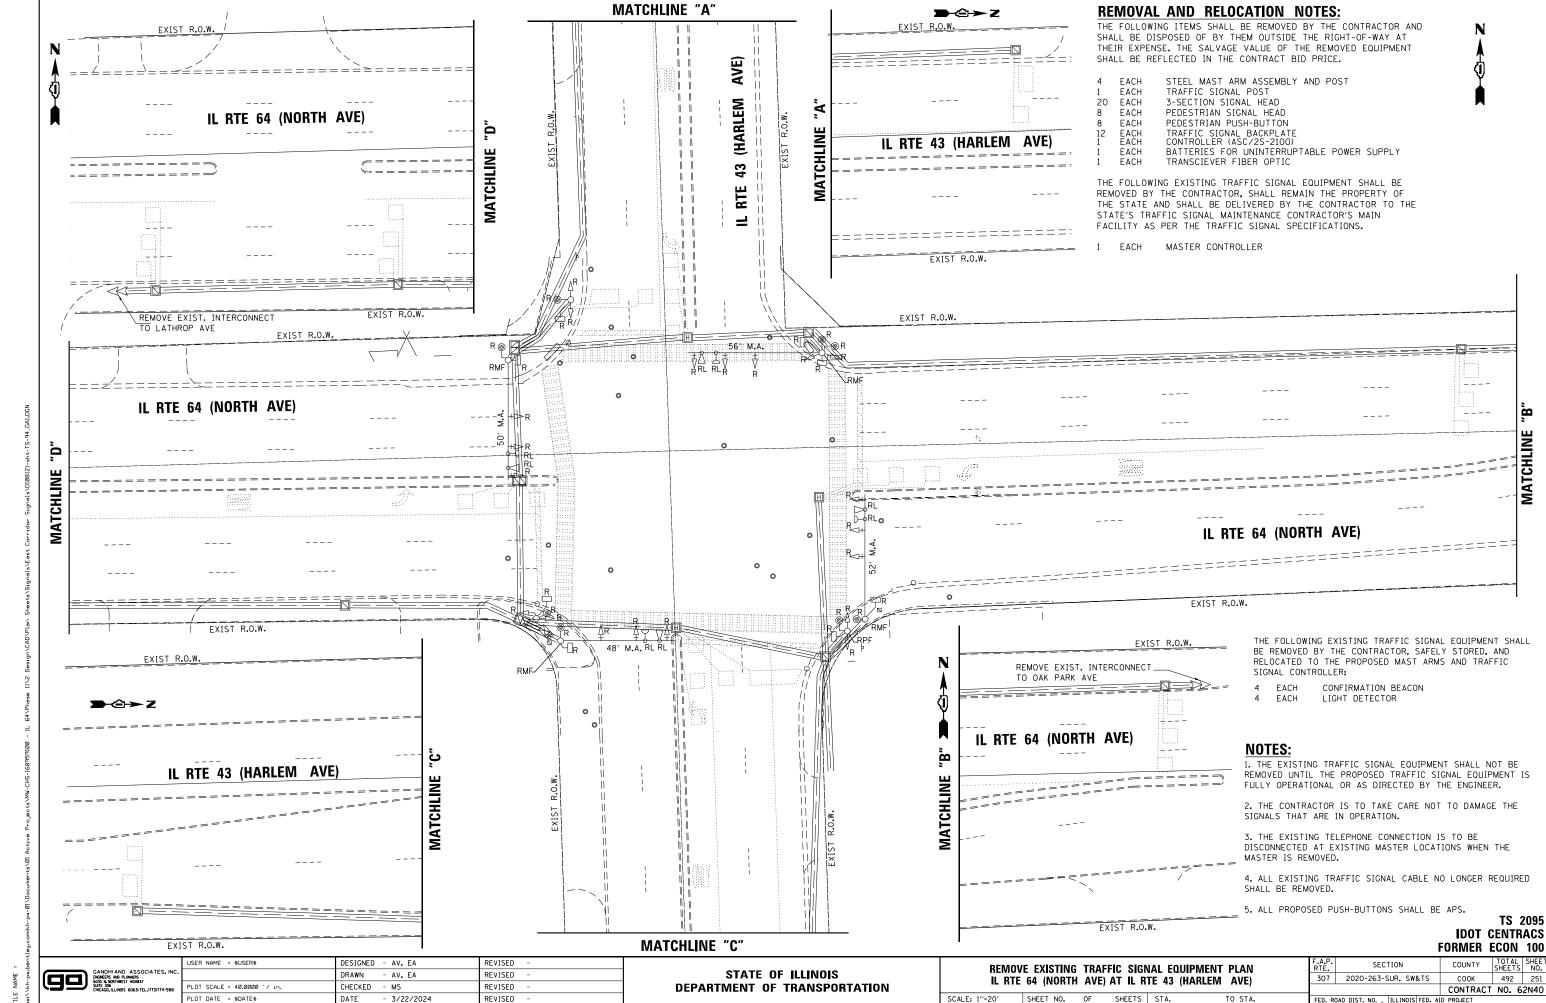

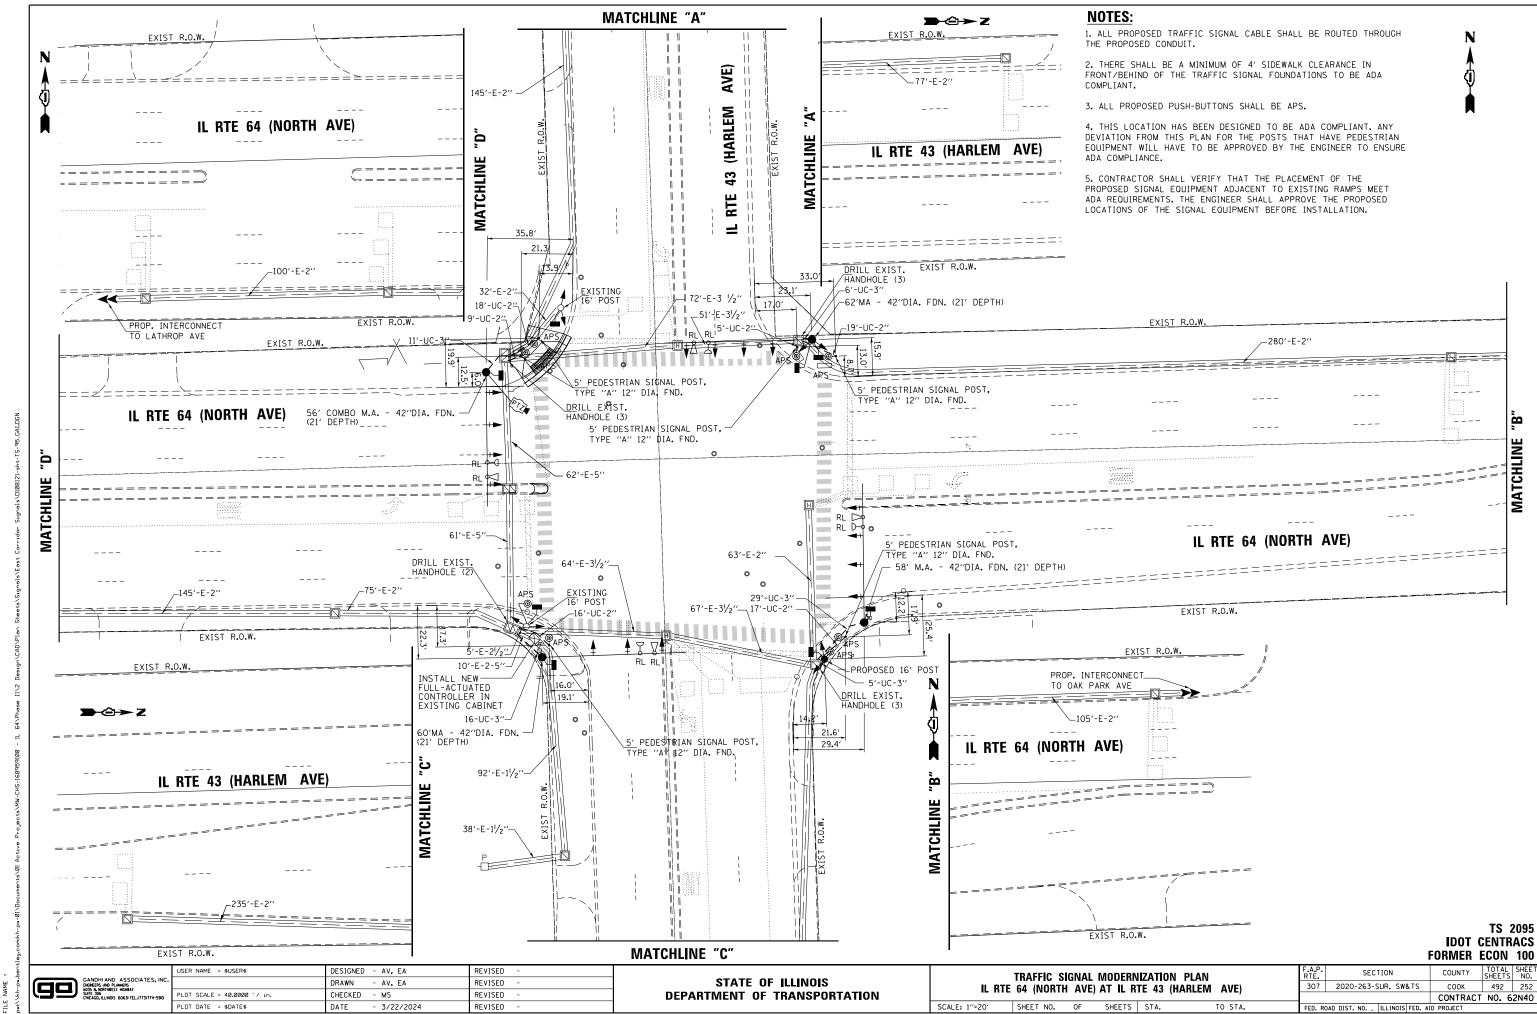

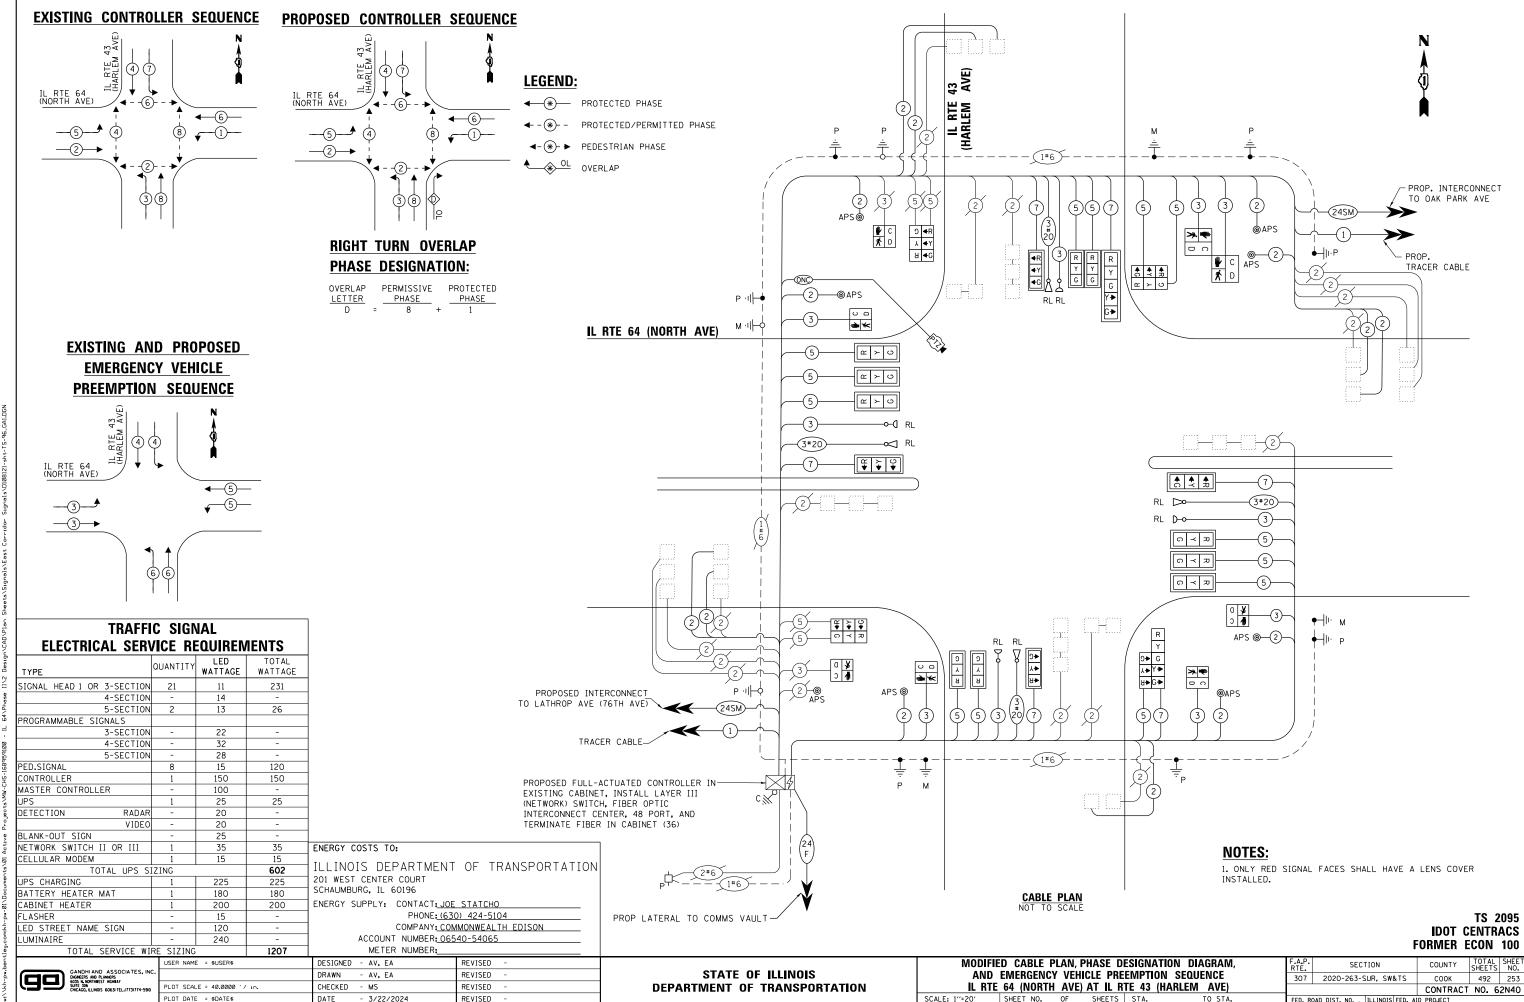

pw:\\kh-pw.bentler

SIGN PANEL - TYPE 1 OR TYPE 2

ALL DIMENSIONS ARE IN INCHES UNLESS OTHERWISE NOTED



| DESIGN | AREA | SIGN PANEL | SHEETING | QTY. |
|--------|---------|------------|----------|----------|
| SERIES | (SQ FT) | TYPE | TYPE | REQUIRED |
| D | 12.5 | 2 | ZZ | |



DESIGN AREA (SQ FT) TYPE TYPE REQUIRED D 13.75 2 ZZ 2

SCHEDULE OF QUANTITIES

| ITEM DESCRIPTION | UNITS | TOTA QTY. |
|---|-------|--------------|
| UNDERGROUND CONDUIT, GALVANIZED STEEL, 2" DIA. | FOOT | 195 |
| UNDERGROUND CONDUIT, GALVANIZED STEEL, 3" DIA. | FOOT | 67 |
| MAINTENANCE OF EXISTING TRAFFIC SIGNAL INSTALLATION | EACH | 1 |
| ELECTRIC CABLE IN CONDUIT, SIGNAL NO. 14 2C | FOOT | 1469 |
| ELECTRIC CABLE IN CONDUIT, SIGNAL NO. 14 3C | FOOT | 2318 |
| ELECTRIC CABLE IN CONDUIT, SIGNAL NO. 14 5C | FOOT | 3002 |
| ELECTRIC CABLE IN CONDUIT, SIGNAL NO. 14 7C | FOOT | 1580 |
| ELECTRIC CABLE IN CONDUIT, LEAD-IN, NO. 14 1 PAIR | FOOT | 2932 |
| ELECTRIC CABLE IN CONDUIT, EQUIPMENT GROUNDING CONDUCTOR, NO. 6 1C | FOOT | 388 |
| TRAFFIC SIGNAL POST, GALVANIZED STEEL 16 FT. | EACH | 1 |
| STEEL MAST ARM ASSEMBLY AND POLE, 56 FT. | EACH | 1 |
| STEEL MAST ARM ASSEMBLY AND POLE, 60 FT. | EACH | 1 |
| STEEL MAST ARM ASSEMBLY AND POLE, 62 FT. | EACH | 1 |
| STEEL COMBINATION MAST ARM ASSEMBLY AND POLE. 56 FT. | EACH | 1 |
| CONCRETE FOUNDATION, TYPE A | FOOT | 4 |
| CONCRETE FOUNDATION, TYPE E 42-INCH DIAMETER | FOOT | 84 |
| DRILL EXISTING HANDHOLE | EACH | 11 |
| SIGNAL HEAD, LED, 1-FACE, 3-SECTION, MAST ARM MOUNTED | EACH | 14 |
| SIGNAL HEAD, LED, 1-FACE, 3-SECTION, BRACKET MOUNTED | EACH | 7 |
| SIGNAL HEAD, LED, 1-FACE, 5-SECTION, BRACKET MOUNTED | EACH | 1 |
| SIGNAL HEAD, LED, 1-FACE, 5-SECTION, MAST ARM MOUNTED | EACH | 1 |
| PEDESTRIAN SIGNAL HEAD, LED, 1-FACE, BRACKET MOUNTED WITH COUNTDOWN TIMER | EACH | 8 |
| TRAFFIC SIGNAL BACKPLATE, LOUVERED, FORMED PLASTIC | EACH | 15 |
| INDUCTIVE LOOP DETECTOR | EACH | 23 |
| RELOCATE EXISTING EMERGENCY VEHICLE PRIORITY SYSTEM, DETECTOR UNIT | EACH | 4 |
| REMOVE ELECTRIC CABLE FROM CONDUIT | FOOT | 1251 |
| REMOVE EXISTING TRAFFIC SIGNAL EQUIPMENT | EACH | 1 |
| REMOVE EXISTING CONCRETE FOUNDATION | EACH | 6 |
| EMERGENCY VEHICLE PRIORITY SYSTEM LINE SENSOR CABLE, NO. 20 3/C | FOOT | 1004 |
| CENTRACS LICENSE EXPANSION | EACH | 1 |
| OUTDOOR RATED NETWORK CABLE | FOOT | 257 |
| REMOTE CONTROLLED VIDEO SYSTEM | EACH | 1 |
| TERMINATE FIBER IN CABINET | EACH | 36 |
| PEDESTRIAN SIGNAL POST. 5 FT. | EACH | 6 |
| LAYER III (NETWORK) SWITCH | EACH | 1 |
| FIBER OPTIC INTERCONNECT CENTER, 48 PORT | EACH | 1 |
| POWER OVER ETHERNET EXTENDER | EACH | 1 |
| FULL-ACTUATED CONTROLLER IN EXISTING CABINET | EACH | 1 |
| ACCESSIBLE PEDESTRIAN SIGNALS | EACH | 8 |
| LED SIGNAL FACE, LENS COVER | EACH | 23 |
| CONCRETE FOUNDATION, TYPE A 12-INCH DIAMETER | FOOT | |
| | EACH | 20 |
| ELECTRIC METER | _ | 1 |
| REMOVE AND REPLACE BATTERIES FOR UNINTERRUPTABLE POWER SUPPLY, EXTENDED | EACH | 1 |

* 100% COST TO THE VILLAGE OF ELMWOOD PARK

TS 2095 IDOT CENTRACS FORMER ECON 100

Kimley» Horn


D 2022 HALEY-HORN AND ABSOCIATES, INC.

WANNING I.E. II. 00000

WANNING I.E. III. 00000

WANNING I.E. III. 00000

| USER NAME = Joel.Turk | DESIGNED | - | AMK | REVISED - | |
|--------------------------|----------|---|-----------|-----------|--|
| | DRAWN | - | JJT | REVISED - | |
| PLOT SCALE = 2 0000 / in | CHECKED | - | SS | REVISED - | |
| PLOT DATE = 3/22/2024 | DATE | - | 3/22/2024 | REVISED - | |

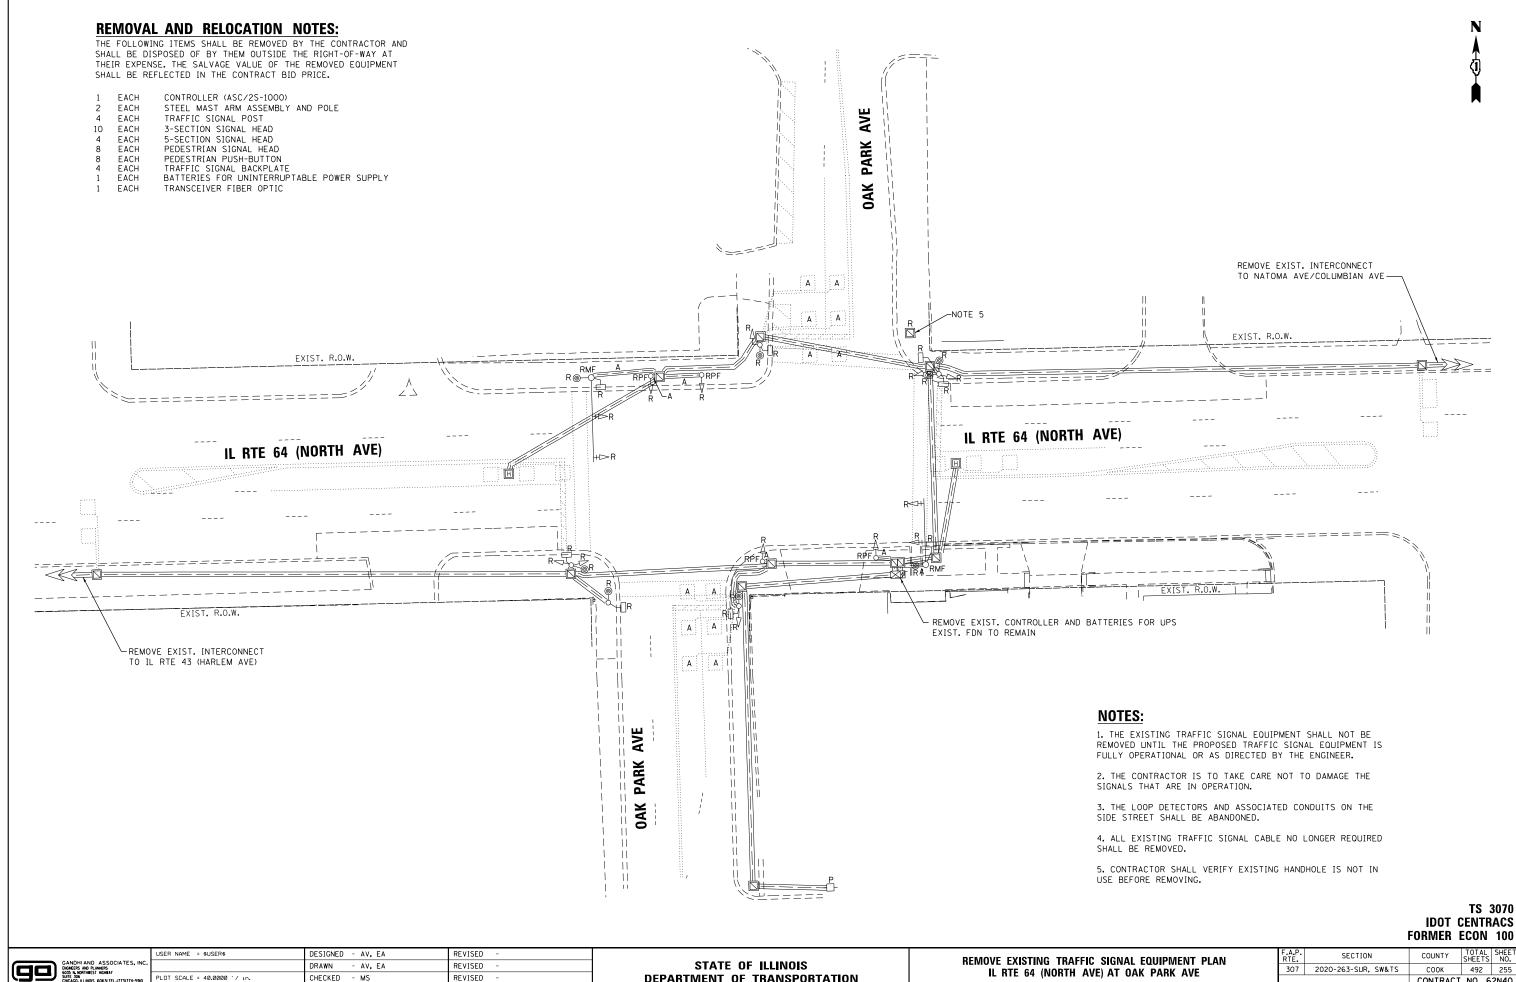

DEPARTMENT OF TRANSPORTATION

SCALE: 1"=20" SHEET NO. OF SHEETS STA.


CONTRACT NO. 62N40

CHECKED - MS

- 3/22/2024

DATE

REVISED

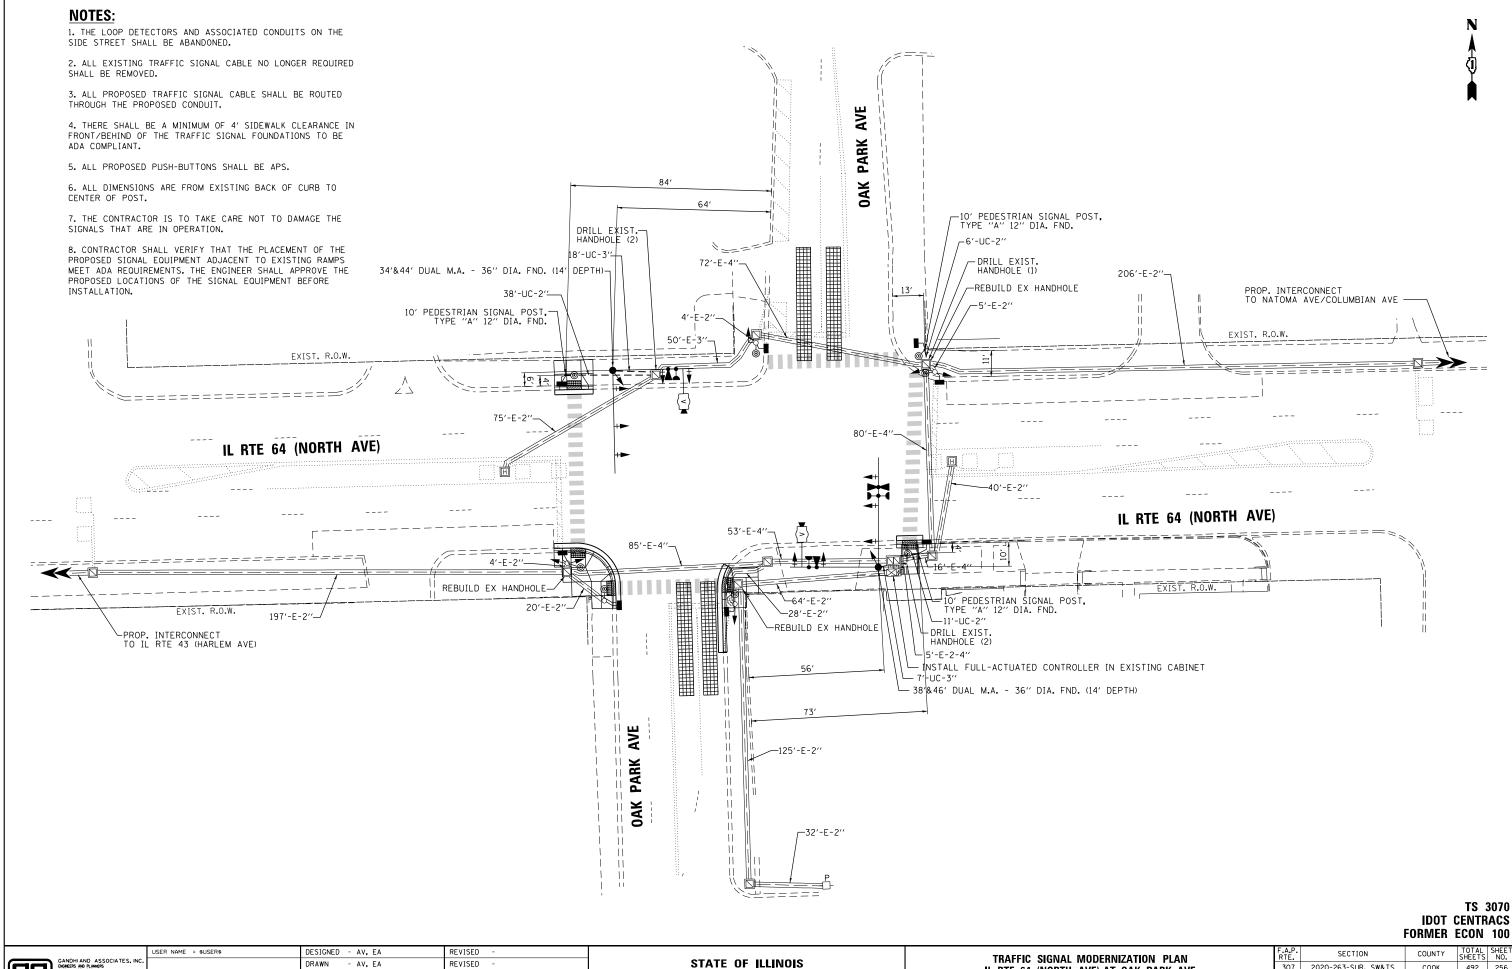

DEPARTMENT OF TRANSPORTATION

307 2020-263-SUR, SW&TS

IL RTE 64 (NORTH AVE) AT OAK PARK AVE

SHEET NO. OF SHEETS STA.

SCALE: 1"=20"

COOK

492 256

CONTRACT NO. 62N40

ENGNEERS AND PLANMERS
ENGNEERS AND PLANMERS
SOUTH 306
CHICAGO, ILLINOIS 60631 TELL

LOT SCALE = 40.0000 '/ in.


CHECKED

DATE

- MS

- 3/22/2024

REVISED

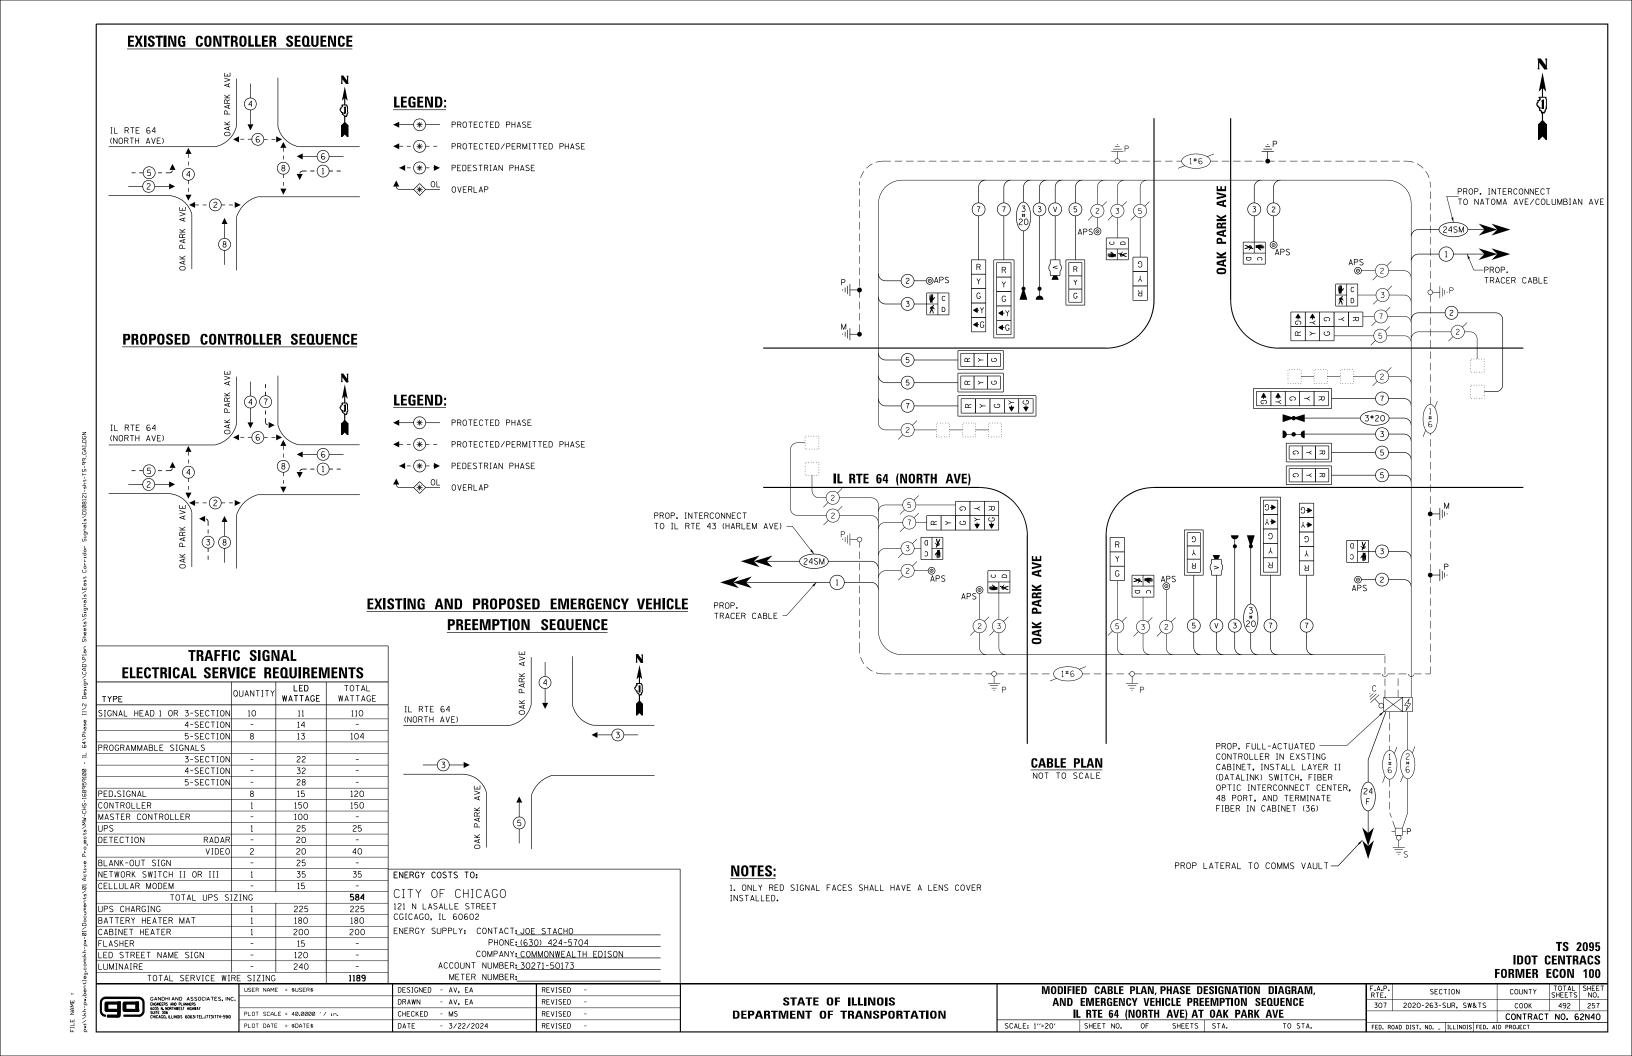

SIGN PANEL - TYPE 1 OR TYPE 2

ALL DIMENSIONS ARE IN INCHES UNLESS OTHERWISE NOTED



| DESIGN SERIES | AREA (SQ FT) | SIGN PANEL TYPE | SHEETING TYPE | QTY. REQUIRED | |
|------------------|-----------------|--------------------|------------------|------------------|--|
| D | 12.5 | 2 | ZZ | 2 | |

Oak Park Ave 4.25 18 6 21.25 78 DESIGN SERIES (SQ FT) AREA SIGN PANEL SHEETING TYPE REQUIRED OTY. TYPE REQUIRED

NOTE: FOR ADDITIONAL DESIGN AND INSTALLATION INFORMATION PLEASE SEE DISTRICT ONE MAST ARM MOUNTED STREET NAME SIGNS DETAIL (TS-02).

9.75

SCHEDULE OF QUANTITIES


| ITEM DESCRIPTION | UNITS | TOTAL OTY. |
|---|-------|---------------|
| SIGN PANEL - TYPE 2 | SQ FT | 44.5 |
| UNDERGROUND CONDUIT, GALVANIZED STEEL, 2" DIA. | FOOT | 55 |
| UNDERGROUND CONDUIT, GALVANIZED STEEL, 3" DIA. | FOOT | 25 |
| MAINTENANCE OF EXISTING TRAFFIC SIGNAL INSTALLATION | EACH | 1 |
| ELECTRIC CABLE IN CONDUIT, SIGNAL NO. 14 2C | FOOT | 489 |
| ELECTRIC CABLE IN CONDUIT, SIGNAL NO. 14 3C | FOOT | 1014 |
| ELECTRIC CABLE IN CONDUIT, SIGNAL NO. 14 5C | FOOT | 1199 |
| ELECTRIC CABLE IN CONDUIT, SIGNAL NO. 14 7C | FOOT | 1163 |
| ELECTRIC CABLE IN CONDUIT, LEAD-IN, NO. 14 1 PAIR | FOOT | 338 |
| ELECTRIC CABLE IN CONDUIT, EQUIPMENT GROUNDING CONDUCTOR, NO. 6 1C | FOOT | 157 |
| STEEL MAST ARM ASSEMBLY AND POLE WITH DUAL MAST ARMS, 38 FT. AND 46 FT. | EACH | 1 |
| CONCRETE FOUNDATION, TYPE E 36-INCH DIAMETER | FOOT | 28 |
| DRILL EXISTING HANDHOLE | EACH | 5 |
| SIGNAL HEAD, LED, 1-FACE, 3-SECTION, MAST ARM MOUNTED | EACH | 6 |
| SIGNAL HEAD, LED, 1-FACE, 3-SECTION, BRACKET MOUNTED | EACH | 4 |
| SIGNAL HEAD, LED, 1-FACE, 5-SECTION, BRACKET MOUNTED | EACH | 4 |
| SIGNAL HEAD, LED, 1-FACE, 5-SECTION, MAST ARM MOUNTED | EACH | 4 |
| PEDESTRIAN SIGNAL HEAD, LED, 1-FACE, BRACKET MOUNTED WITH COUNTDOWN TIMER | EACH | 8 |
| TRAFFIC SIGNAL BACKPLATE, LOUVERED, FORMED PLASTIC | EACH | 10 |
| INDUCTIVE LOOP DETECTOR | EACH | 6 |
| LIGHT DETECTOR | EACH | 3 |
| LIGHT DETECTOR AMPLIFIER | EACH | 1 |
| REMOVE ELECTRIC CABLE FROM CONDUIT | FOOT | 2496 |
| REMOVE EXISTING TRAFFIC SIGNAL EQUIPMENT | EACH | 1 |
| REBUILD EXISTING HANDHOLE | EACH | 3 |
| REMOVE EXISTING HANDHOLE | EACH | 1 |
| REMOVE EXISTING CONCRETE FOUNDATION | EACH | 6 |
| ELEMERGENCY VEHICLE PRIORITY SYSTEM LINE SENSOR CABLE, NO. 20 3/C | FOOT | 504 |
| CENTRACS LICENSE EXPANSION | EACH | 1 |
| LAYER II (DATALINK) SWITCH | EACH | 1 |
| TERMINATE FIBER IN CABINET | EACH | 36 |
| PEDESTRIAN SIGNAL POST, 10 FT. | EACH | 3 |
| VIDEO VEHICLE DETECTION SYSTEM, SINGLE APPROACH | EACH | 2 |
| FIBER OPTIC INTERCONNECT CENTER, 48 PORT | EACH | 1 |
| FULL-ACTUATED CONTROLLER IN EXISTING CABINET | EACH | 1 |
| ACCESSIBLE PEDESTRIAN SIGNALS | EACH | 8 |
| LED SIGNAL FACE, LENS COVER | EACH | 18 |
| CONCRETE FOUNDATION, TYPE A 12-INCH DIAMETER | FOOT | 12 |
| ELECTRIC METER | EACH | 1 |
| REMOVE AND REPLACE BATTERIES FOR UNINTERRUPTABLE POWER SUPPLY, EXTENDED | EACH | 1 |
| STEEL MAST ARM ASSEMBLY AND POLE WITH DUAL MAST ARMS, 34 FT. AND 44 FT. | EACH | 1 |

* 100% COST TO THE CITY OF CHICAGO

TS 3070 IDOT CENTRACS FORMER ECON 100



| 1 | USER NAME = Joel.Turk | DESIGNED | - | AMK | REVISED | - |
|---|--------------------------|----------|---|-----------|---------|---|
| | | DRAWN | - | JJT | REVISED | - |
| | PLOT SCALE = 2.0000 / in | CHECKED | - | SS | REVISED | - |
| | PLOT DATE = 3/22/2024 | DATE | - | 3/22/2024 | REVISED | - |

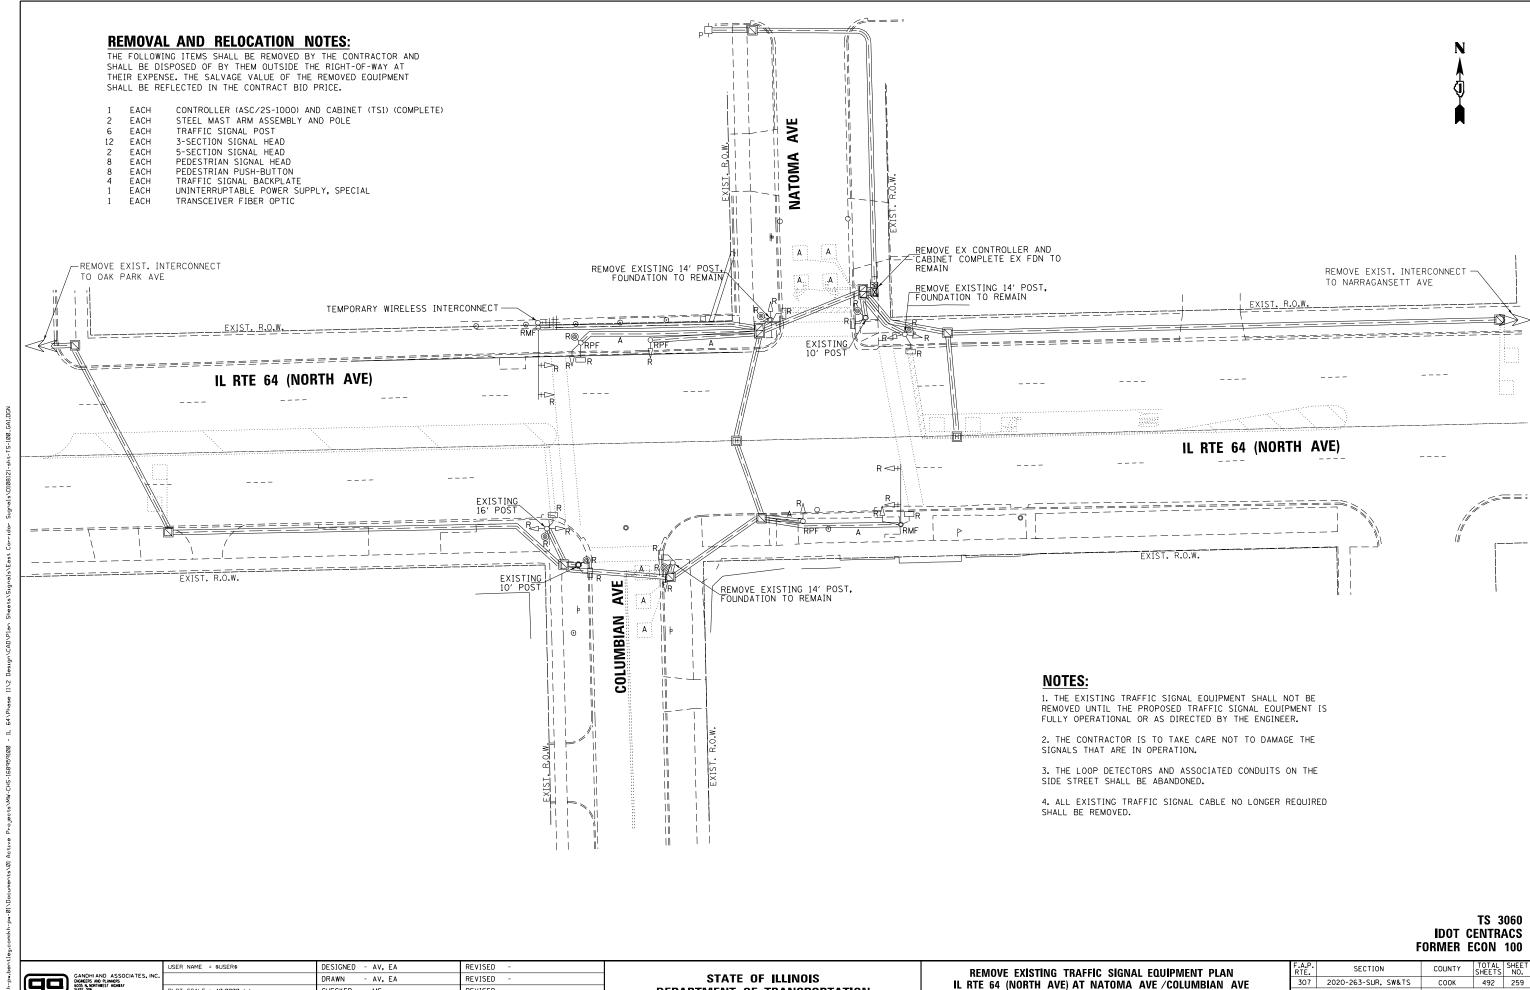


ENGNERS AND PLANNERS
ENGNERS AND PLANNERS
ENGS IN NORTHREST HIGHBAY
SUITE 306
CHICAGOLILLINGIS 60631 TEL.(7)

CHECKED - MS REVISED DATE - 3/22/2024 REVISED

DEPARTMENT OF TRANSPORTATION

SCALE: 1"=20" SHEET NO. OF SHEETS STA.


CONTRACT NO. 62N40

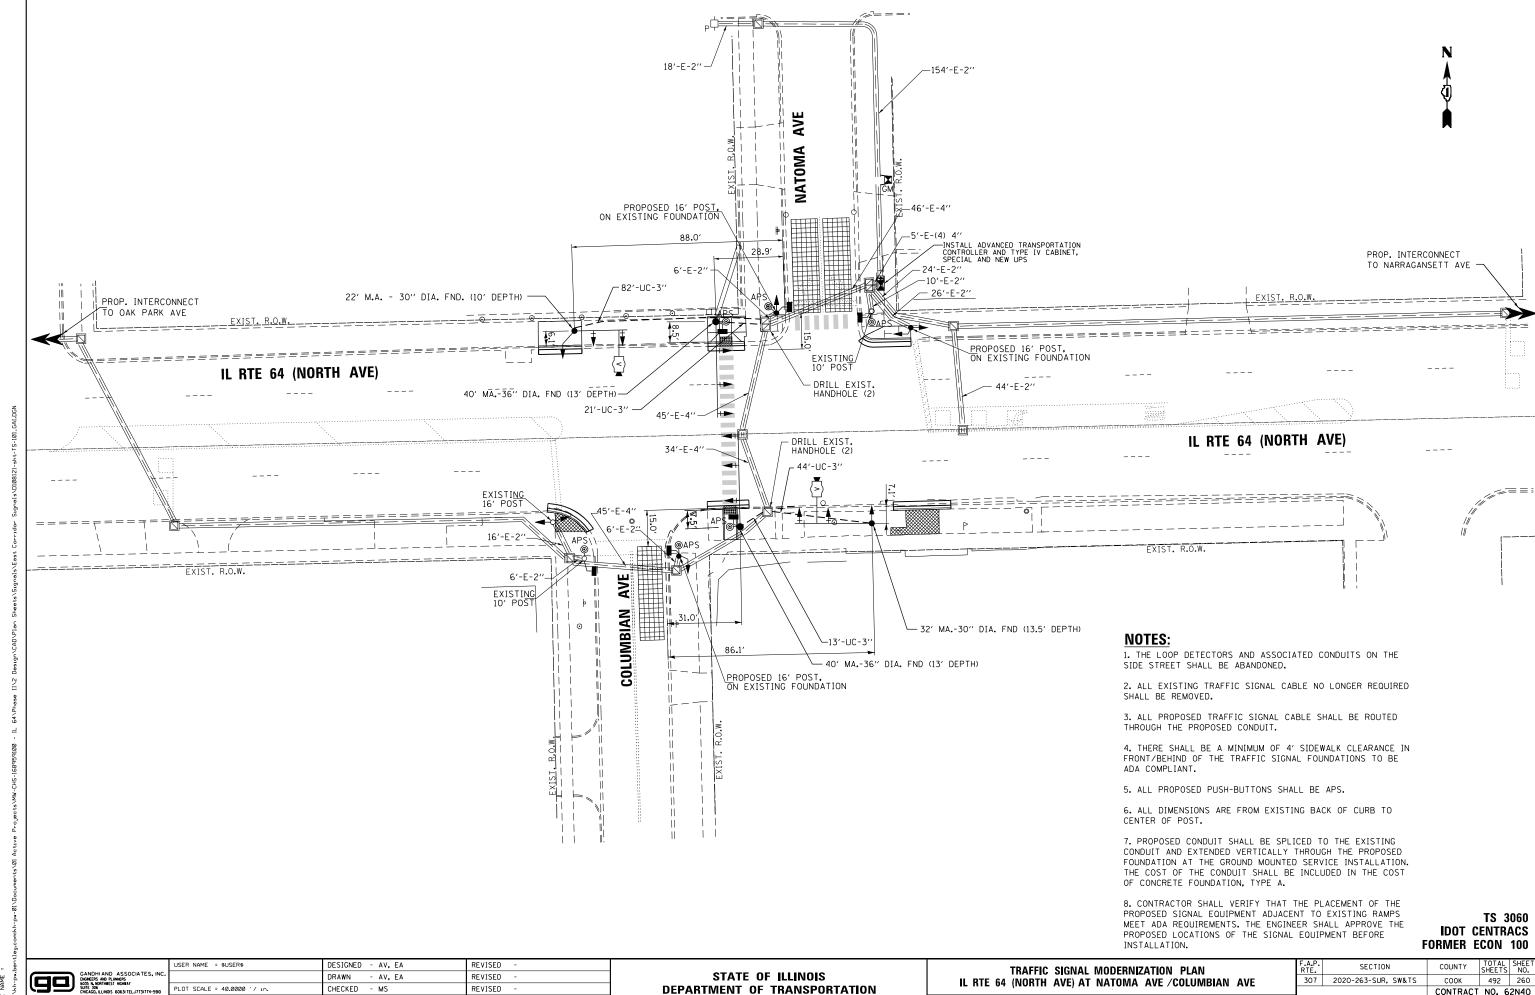

SCALE: 1"=20" SHEET NO. OF SHEETS STA.

CONTRACT NO. 62N40

- 3/22/2024

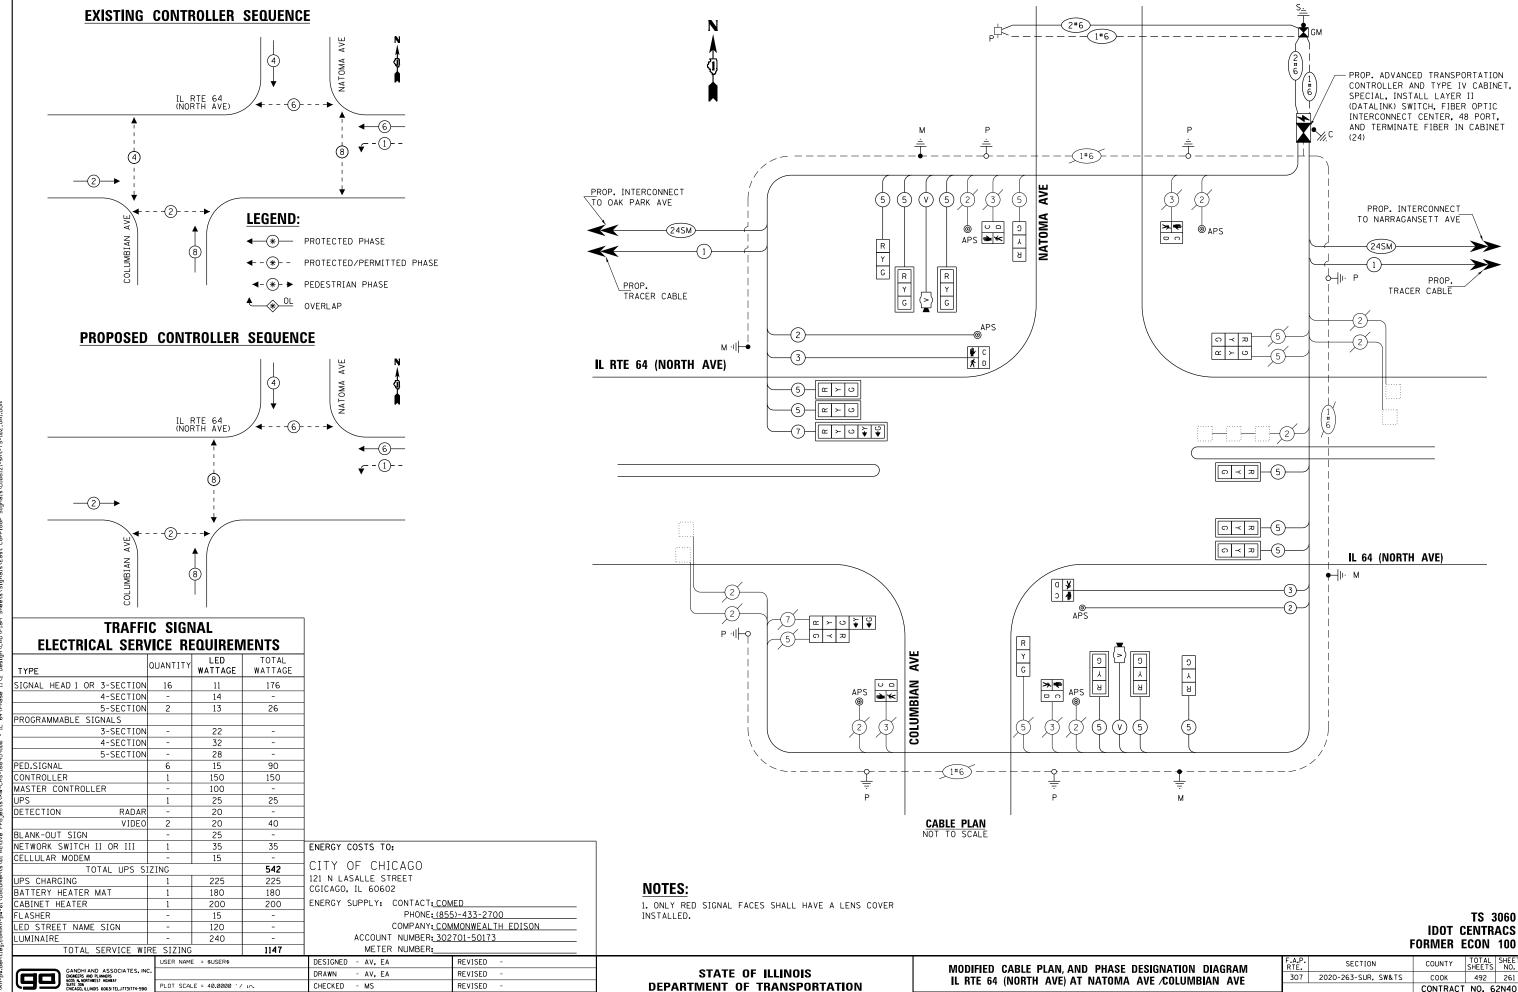

SCALE: 1"=20" SHEET NO. OF SHEETS STA.

CONTRACT NO. 62N40

DATE

- 3/22/2024

REVISED


PLOT DATE = \$DATE\$




ALL DIMENSIONS ARE IN INCHES UNLESS OTHERWISE NOTED



| DESIGN | AREA | SIGN PANEL | SHEETING | OTY. |
|--------|---------|------------|----------|----------|
| SERIES | (SO ET) | TYPE | TYPE | REQUIRED |
| D | 12.5 | 2 | 77 | |

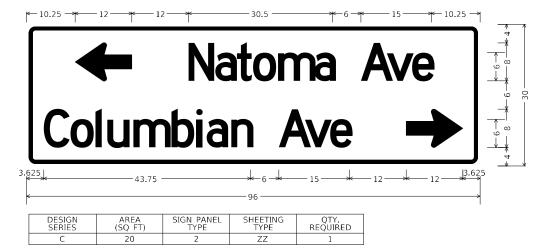

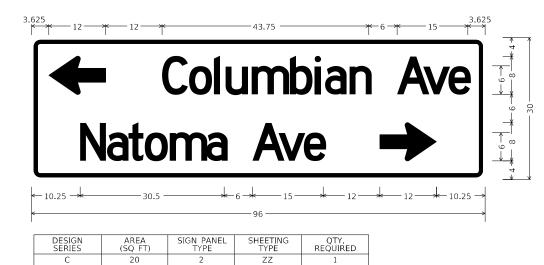

NOTE: FOR ADDITIONAL DESIGN AND INSTALLATION INFORMATION PLEASE SEE DISTRICT ONE MAST ARM MOUNTED STREET NAME SIGNS DETAIL (TS-02).


SCHEDULE OF QUANTITIES

| ITEM DESCRIPTION | UNITS | TOTAL OTY. |
|---|-------|---------------|
| SIGN PANEL - TYPE 2 | SQ FT | 65 |
| UNDERGROUND CONDUIT, GALVANIZED STEEL, 3" DIA. | FOOT | 160 |
| MAINTENANCE OF EXISTING TRAFFIC SIGNAL INSTALLATION | EACH | 1 |
| ELECTRIC CABLE IN CONDUIT, SIGNAL NO. 14 2C | FOOT | 306 |
| ELECTRIC CABLE IN CONDUIT, SIGNAL NO. 14 3C | FOOT | 320 |
| ELECTRIC CABLE IN CONDUIT, SIGNAL NO. 14 5C | FOOT | 2358 |
| ELECTRIC CABLE IN CONDUIT, SIGNAL NO. 14 7C | FOOT | 163 |
| ELECTRIC CABLE IN CONDUIT, SERVICE, NO. 6 2C | FOOT | 228 |
| ELECTRIC CABLE IN CONDUIT, EQUIPMENT GROUNDING CONDUCTOR, NO. 6 1C | FOOT | 442 |
| TRAFFIC SIGNAL POST, GALVANIZED STEEL 16 FT. | EACH | 3 |
| STEEL MAST ARM ASSEMBLY AND POLE, 22 FT. | EACH | 1 |
| STEEL MAST ARM ASSEMBLY AND POLE, 32 FT. | EACH | 1 |
| STEEL MAST ARM ASSEMBLY AND POLE, 40 FT. | EACH | 2 |
| CONCRETE FOUNDATION, TYPE A | FOOT | 4 |
| CONCRETE FOUNDATION, TYPE E 30-INCH DIAMETER | FOOT | 23.5 |
| CONCRETE FOUNDATION, TYPE E 36-INCH DIAMETER | FOOT | 26 |
| DRILL EXISTING HANDHOLE | EACH | 4 |
| SIGNAL HEAD, LED, 1-FACE, 3-SECTION, MAST ARM MOUNTED | EACH | 9 |
| SIGNAL HEAD, LED, 1-FACE, 3-SECTION, BRACKET MOUNTED | EACH | 7 |
| SIGNAL HEAD, LED, 1-FACE, 5-SECTION, BRACKET MOUNTED | EACH | 1 |
| SIGNAL HEAD, LED, 1-FACE, 5-SECTION, MAST ARM MOUNTED | EACH | 1 |
| PEDESTRIAN SIGNAL HEAD, LED, 1-FACE, BRACKET MOUNTED WITH COUNTDOWN TIMER | EACH | 6 |
| TRAFFIC SIGNAL BACKPLATE, LOUVERED, FORMED PLASTIC | EACH | 10 |
| INDUCTIVE LOOP DETECTOR | EACH | 5 |
| REMOVE ELECTRIC CABLE FROM CONDUIT | FOOT | 3337 |
| REMOVE EXISTING TRAFFIC SIGNAL EQUIPMENT | EACH | 1 |
| REMOVE EXISTING CONCRETE FOUNDATION | EACH | 5 |
| CENTRACS LICENSE EXPANSION | EACH | 1 |
| SERVICE INSTALLATION, GROUND MOUNTED, METERED | EACH | 1 |
| LAYER II (DATALINK) SWITCH | EACH | 1 |
| TERMINATE FIBER IN CABINET | EACH | 24 |
| VIDEO VEHICLE DETECTION SYSTEM, SINGLE APPROACH | EACH | 2 |
| FIBER OPTIC INTERCONNECT CENTER, 48 PORT | EACH | 1 |
| ADVANCED TRANSPORTATION CONTROLLER AND TYPE IV CABINET, SPECIAL | EACH | 1 |
| UNINTERRUPTABLE POWER SUPPLY, SPECIAL | EACH | 1 |
| ACCESSIBLE PEDESTRIAN SIGNALS | EACH | 6 |
| LED SIGNAL FACE, LENS COVER | EACH | 18 |

TS 3060 IDOT CENTRACS FORMER ECON 100

| Kimley Morn |
|---|
| © 2023 KIMLEY-HÖRN AND ASSOCIATES, INC. |
| 4201 WINFIELD ROAD, SUITE 600 |
| WARRENVILLE, IL 60655 |
| PHONE: 630-487-5550 |
| WWW.KIM.EY-HORN.COM |

| USER NAME = Joel.Turk | DESIGNED | - | AMK | REVISED | - |
|--------------------------|----------|---|-----------|---------|---|
| | DRAWN | - | JJ⊤ | REVISED | - |
| PLOT SCALE = 2.0000 / in | CHECKED | - | SS | REVISED | - |
| PLOT DATE = 3/22/2024 | DATE | - | 3/22/2024 | REVISED | - |
| | | | | | |

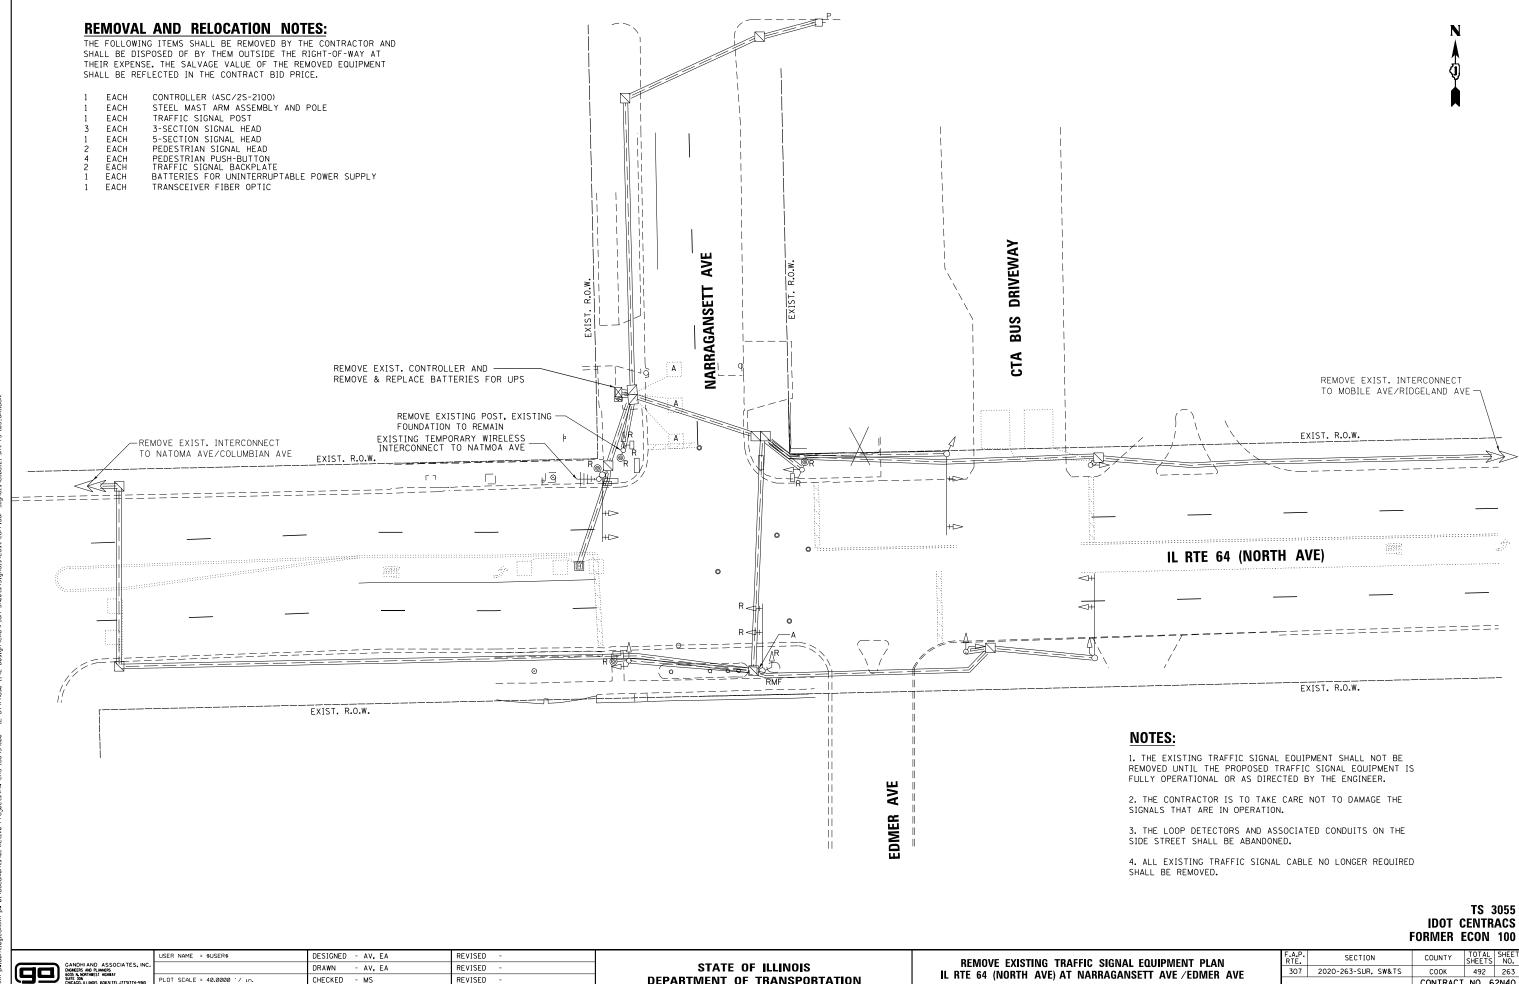

DEPARTMENT OF TRANSPORTATION

SCALE: 1"=20" SHEET NO. OF SHEETS STA.

CONTRACT NO. 62N40

LOT SCALE = 40.0000 '/ in.


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DATE

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- 3/22/2024

REVISED




SCALE: 1"=20" SHEET NO. OF SHEETS STA.

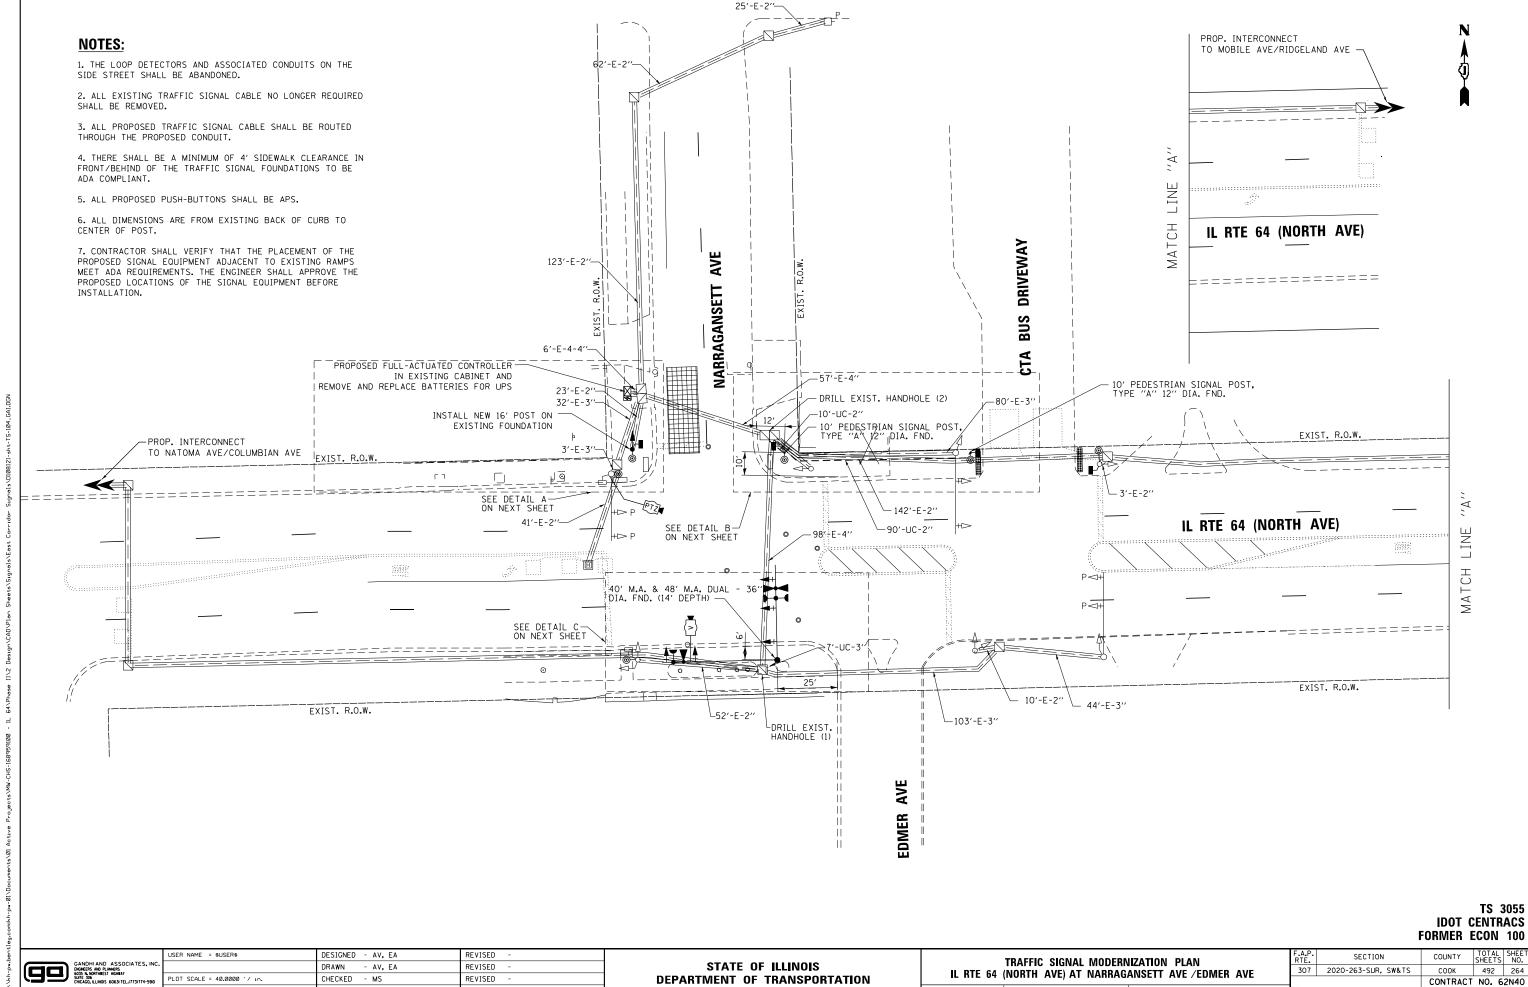PLOT DATE = \$DATE\$

DATE

- 3/22/2024

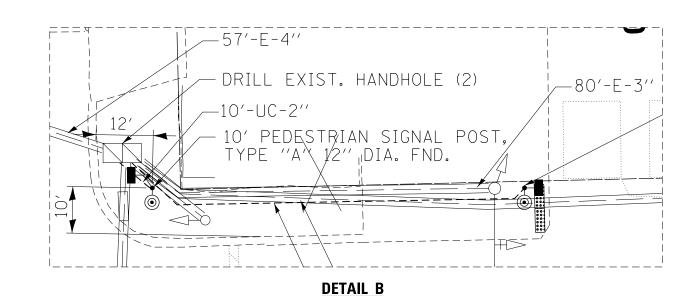

40' M.A. & 48' M.A. DUAL - 36"

DIA. FND. (14' DEPTH)

DETAIL C

TS 3055 IDOT CENTRACS FORMER ECON 100

| | UJLII |
|--|-------|
| GANDHI AND ASSOCIATES, INC. ENGREES AND PLANERS 6035 N. NORTHEEST HOHRAY | |
| SUIT 306 SUIT 306 CHICAGO, ILLINOIS 6063I TEL.(773)774-5910 | PLOT |
| | PLOT |


| | USER NAME = \$USER\$ | DESIGNED - AV, EA | REVISED - |
|----|-----------------------------|-------------------|-----------|
| c. | | DRAWN - AV, EA | REVISED - |
| , | PLOT SCALE = 40.0000 '/ in. | CHECKED - MS | REVISED - |
| | PLOT DATE = \$DATE\$ | DATE - 3/22/2024 | REVISED - |
| | | | |

STATE OF ILLINOIS DEPARTMENT OF TRANSPORTATION

| | | TRAFFIC S | IGNAI | MODERN | IIZATION | N PIAN | RTE. | SE |
|---|------------------|---|-------|--------|----------|-----------------------------|---------|---------------|
| ı | II RTF 64 (NOR | RTE 64 (NORTH AVE) AT NARRAGANSETT AVE /EDMER AVE-DETAILS | | | | | | |
| ı | 12 1112 01 (1101 | /\\-/, /\ | | | /\\. | , resilient title bettilles | | |
| | SCALE: 1"=10" | SHEET NO. | OF | SHEETS | STA. | TO STA. | FED. RO | DAD DIST. NO. |

pw:\\kh-pw.bent]eu.com:kh-pw-l

nts/01 Active Projects/MW-CHS-168959100 - IL 64\Phas

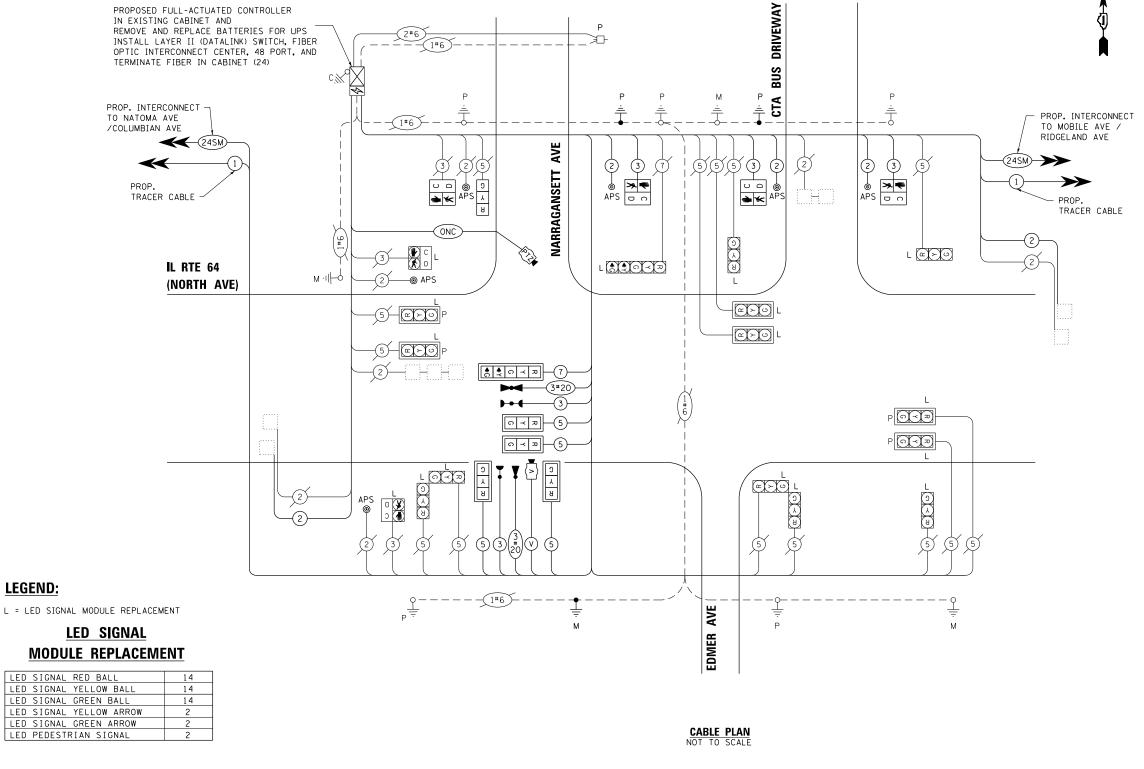

TRAFFIC SIGNAL **ELECTRICAL SERVICE REQUIREMENTS**

QUANTITY LED TOTAL WATTAGE WATTAGE

| | SIGNAL HEAD 1 OR 3-SECTION | 14 | 11 | 154 |
|---|----------------------------|------|-----|-----|
| | 4-SECTION | - | 14 | - |
| | 5-SECTION | 2 | 13 | 26 |
| | PROGRAMMABLE SIGNALS | | | |
| 1 | 3-SECTION | 4 | 22 | 88 |
| 3 | 4-SECTION | - | 32 | - |
| 2 | 5-SECTION | - | 28 | - |
| 3 | PED.SIGNAL | 6 | 15 | 90 |
| 2 | CONTROLLER | 1 | 150 | 150 |
| | MASTER CONTROLLER | ı | 100 | - |
| 3 | UPS | 1 | 25 | 25 |
| 2 | DETECTION RADAR | - | 20 | - |
| | VIDEO | 1 | 20 | 20 |
| | BLANK-OUT SIGN | - | 25 | - |
| 3 | NETWORK SWITCH II OR III | 1 | 35 | 35 |
| 3 | CELLULAR MODEM | 1 | 15 | - |
| 3 | TOTAL UPS SI | ZING | | 588 |
| | UPS CHARGING | 1 | 225 | 225 |
|) | BATTERY HEATER MAT | 1 | 180 | 180 |
| Š | CABINET HEATER | 1 | 200 | 200 |
| | FLASHER | ı | 15 | - |
| | LED STREET NAME SIGN | ı | 120 | - |
| 5 | LUMINAIRE | - | 240 | - |

LEGEND:

| LED | SIGNAL RED BALL | 14 |
|-----|---------------------|----|
| LED | SIGNAL YELLOW BALL | 14 |
| LED | SIGNAL GREEN BALL | 14 |
| LED | SIGNAL YELLOW ARROW | 2 |
| LED | SIGNAL GREEN ARROW | 2 |
| LED | PEDESTRIAN SIGNAL | 2 |

ILLINOIS DEPARTMENT OF TRANSPORTATION

PHONE: (855)-433-2700 COMPANY: COMMONWEALTH EDISON

ACCOUNT NUMBER: 01360-83102

NOTES:

1. ONLY RED SIGNAL FACES SHALL HAVE A VISOR HEATER INSTALLED.

> TS 3055 IDOT CENTRACS **FORMER ECON 100**

METER NUMBER: TOTAL SERVICE WIRE SIZING DESIGNED - AV, EA REVISED DRAWN - AV, EA REVISED ENGNEERS AND PLANNERS
6035 N. MORTHREST HIGHBAY
SUITE 306
CHICAGO, ILLINOIS 60631 TEL.17 LOT SCALE = 40.0000 '/ in. CHECKED - MS REVISED DATE PLOT DATE = \$DATE\$ - 3/22/2024 REVISED


ENERGY COSTS TO:

201 WEST CENTER COURT SCHAUMBURG, IL 60196

ENERGY SUPPLY: CONTACT: COMED

STATE OF ILLINOIS **DEPARTMENT OF TRANSPORTATION**

MODIFIED CABLE PLAN, PHASE DESIGNATION DIAGRAM, EMERGENCY SECTION RTE. 307 2020-263-SUR, SW&TS VEHICLE PREEMPTION SEQUENCE COOK 492 266 IL RTE 64 (NORTH AVE) AT NARRAGANSETT AVE /EDMER AVE CONTRACT NO. 62N40 SCALE: 1"=20" SHEET NO. OF SHEETS STA.

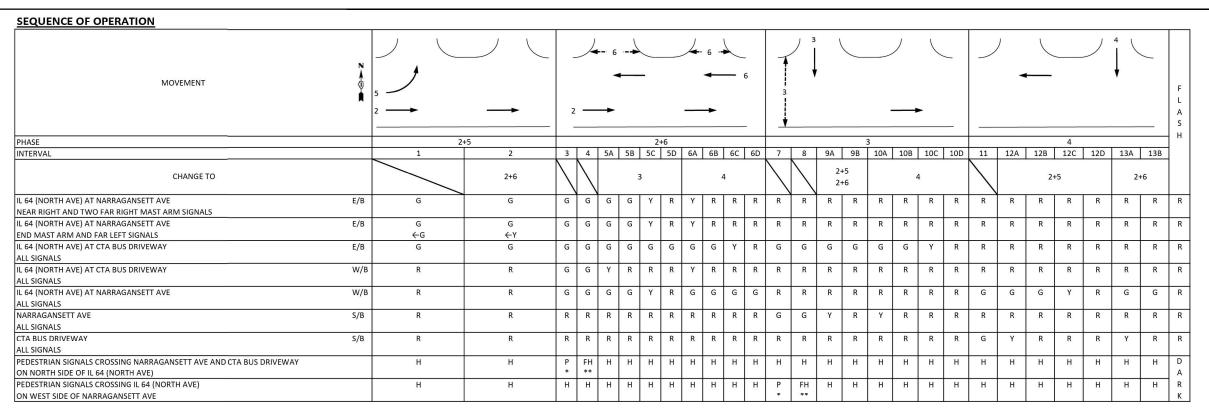

PHASES 2+6 SHALL BE PLACED ON RECALL

* TO APPEAR ONLY UPON PUSHBUTTON ACTUATION

** FLASHING HAND IS TO TERMINATE AT THE COMPLETION OF THE PEDESTRIAN INTERVAL CLEARANCE

P = ILLUMINATED PERSON = WALK

FH = ILLUMINATED FLASHING HAND = FLASHING DON'T WALK

H = ILLUMINATED SOLID HAND = DON'T WALK

WALK AND FLASHING DON'T WALK TIMINGS TO BE SET ONLY ON PHASES WHERE WALK AND FLASHING DON'T WALK ARE INDICATED IN THE SEQUENCE OF OPERATION

| EMERGENCY VEHICLE PREEMPTION SEQUENCE OF OPERATION | | | | | | | | | | | | | | | | | | | | | PREEMPTOR NUMBER 3 | PREEMPTOR NUMBER 4 | |
|--|-----|---------|----|----|----|----|----|----|------------|------------|----|----|----|----|----|----|----|----|------------|------------|-----------------------|-----------------------|--------------------------------|
| CHANGE FROM NORMAL SEQUENCE OF OPERATION INTERVAL NUMBER | | 1 | : | L | 3 | | | 3 | | | | 7 | | 7 | 1 | 1 | | 1 | .1 | | | | |
| EMERGENCY VEHICLE PREEMPTION SEQUENCE OF OPERATION INTERVAL NUMBER | | 1A | 1B | 1C | 1D | 1E | 1F | 1G | 1H | 1 J | 1K | 1L | 1M | 1N | 1P | 1Q | 1R | 15 | 1 T | 1 U | 2 | 3 | CLEAR TO NORMAL SEQUENCE |
| CHANGE TO EMERGENCY VEHICLE PREEMPTION SEQUENCE OF OPERATION INTERVAL NUMBER | | 2 | 1C | 3 | 2 | 1F | 1G | 1H | 1 J | 3 | 1L | 1M | 2 | 3 | 1Q | 2 | 15 | 1T | 10 | 3 | | | ♦ |
| IL 64 (NORTH AVE) AT NARRAGANSETT AVE NEAR RIGHT AND TWO FAR RIGHT MAST ARM SIGNALS | E/B | G | Υ | R | G | G | G | G | Υ | R | R | R | R | R | R | R | R | R | R | R | G | R | ♦ |
| IL 64 (NORTH AVE) AT NARRAGANSETT AVE END MAST ARM AND FAR LEFT SIGNALS | E/B | G ←Y | Υ | R | G | G | G | G | Y | R | R | R | R | R | R | R | R | R | R | R | G | R | ♦ |
| IL 64 (NORTH AVE) AT CTA BUS DRIVEWAY ALL SIGNALS | E/B | G | G | G | G | G | G | G | G | G | G | G | G | G | R | R | R | R | R | R | G | G | ◊ |
| IL 64 (NORTH AVE) AT CTA BUS DRIVEWAY ALL SIGNALS | W/B | R | R | R | G | G | Υ | R | R | R | R | R | R | R | R | R | R | R | R | R | G | R | ◊ |
| IL 64 (NORTH AVE) AT NARRAGANSETT AVE ALL SIGNALS | W/B | R | R | R | G | G | G | G | Y | R | R | R | R | R | G | G | G | G | Υ | R | G | R | ◊ |
| NARRAGANSETT AVE ALL SIGNALS | S/B | R | R | R | R | R | R | R | R | R | G | Υ | R | G | R | R | R | R | R | R | R | G | ◊ |
| CTA BUS DRIVEWAY ALL SIGNALS | S/B | R | R | R | R | R | R | R | R | R | R | R | R | R | Υ | R | Υ | R | R | R | R | R | ◊ |
| PEDESTRIAN SIGNALS CROSSING NARRAGANSETT AVE AND CTA BUS DRIVEWAY ON NORTH SIDE OF IL 64 (NORTH AVE) | | Н | Н | Н | FH | FH | Н | Н | Н | Н | Н | Н | Н | Н | Н | Н | Н | Н | Н | Н | Н | Н | ◊ |
| PEDESTRIAN SIGNALS CROSSING IL 64 (NORTH AVE) ON WEST SIDE OF NARRAGANSETT AVE | | Н | Н | Н | Н | Н | Н | Н | Н | Н | FH | Н | Н | FH | Н | Н | Н | Н | Н | Н | Н | Н | ◊ |


♦ EMERGENCY VEHICLE SEQUENCE SHALL PROVIDE THE PROPER CLEARANCE INTERVAL TO RESUME THE NORMAL SEQUENCE OF OPERATION OR PROPER CLEARANCE INTERVAL TO DISPLAY A DIFFERENT EMERGENCY VEHICLE PREEMPTION INTERVAL AS A SI S TERMINATED.

TS 3055 IDOT CENTRACS FORMER ECON 100

| USER NAME = \$USER\$ | DESIGNED - AR | REVISED - | | SEQUENCE OF OPERATION AND | F.A.P. SECTION | COUNTY TOTAL SHEET |
|------------------------------|------------------|-----------|------------------------------|--|-------------------------------------|--------------------|
| | DRAWN - | REVISED - | STATE OF ILLINOIS | EMERGENCY VEHICLE PREEMPTION SEQUENCE OF OPERATION | 307 2020-263-SUR, SW&TS | COOK 492 267 |
| PLOT SCALE = 40.0000 ' / in. | CHECKED - | REVISED - | DEPARTMENT OF TRANSPORTATION | IL RTE 64 (NORTH AVE) AT NARRAGANSETT AVE | · · | CONTRACT NO. 62N40 |
| PLOT DATE = \$DATE\$ | DATE - 9/20/2023 | REVISED - | | SCALE: 1"=20" SHEET NO. OF SHEETS STA. TO STA. | FED. ROAD DIST. NO ILLINOIS FED. AI | ID PROJECT |



| DESIGN | AREA | SIGN PANEL | SHEETING | QTY. |
|--------|---------|------------|----------|----------|
| SERIES | (SQ FT) | TYPE | TYPE | REQUIRED |
| D | 12.5 | 2 | ZZ | |

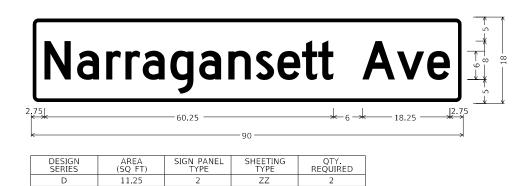

NOTE: FOR ADDITIONAL DESIGN AND INSTALLATION INFORMATION PLEASE SEE DISTRICT ONE MAST ARM MOUNTED STREET NAME SIGNS DETAIL (TS-02).

SCHEDULE OF QUANTITIES

| ITEM DESCRIPTION | UNITS | TOTAL OTY. |
|--|-------|---------------|
| SIGN PANEL - TYPE 2 | SQ FT | 23.75 |
| RELOCATE SIGN PANEL - TYPE 2 | SQ FT | 24 |
| UNDERGROUND CONDUIT, GALVANIZED STEEL, 2" DIA. | FOOT | 100 |
| UNDERGROUND CONDUIT, GALVANIZED STEEL, 3" DIA. | FOOT | 7 |
| MAINTENANCE OF EXISTING TRAFFIC SIGNAL INSTALLATION | EACH | 1 |
| ELECTRIC CABLE IN CONDUIT, SIGNAL NO. 14 2C | FOOT | 549 |
| ELECTRIC CABLE IN CONDUIT, SIGNAL NO. 14 3C | FOOT | 1089 |
| ELECTRIC CABLE IN CONDUIT, SIGNAL NO. 14 5C | FOOT | 1012 |
| ELECTRIC CABLE IN CONDUIT, SIGNAL NO. 14 7C | FOOT | 260 |
| ELECTRIC CABLE IN CONDUIT, LEAD-IN, NO. 14 1 PAIR | FOOT | 934 |
| ELECTRIC CABLE IN CONDUIT, EQUIPMENT GROUNDING CONDUCTOR, NO. 6 1C | FOOT | 124 |
| TRAFFIC SIGNAL POST, GALVANIZED STEEL 16 FT. | EACH | 1 |
| STEEL MAST ARM ASSEMBLY AND POLE WITH DUAL MAST ARMS, 40 FT. AND 48 FT. | EACH | 1 |
| CONCRETE FOUNDATION, TYPE E 36-INCH DIAMETER | FOOT | 14 |
| DRILL EXISTING HANDHOLE | EACH | 3 |
| SIGNAL HEAD, LED, 1-FACE, 3-SECTION, MAST ARM MOUNTED | EACH | 4 |
| SIGNAL HEAD, LED, 1-FACE, 3-SECTION, BRACKET MOUNTED | EACH | 1 |
| SIGNAL HEAD, LED, 1-FACE, 5-SECTION, MAST ARM MOUNTED | EACH | 1 |
| PEDESTRIAN SIGNAL HEAD, LED, 1-FACE, BRACKET MOUNTED WITH COUNTDOWN TIMER | EACH | 4 |
| TRAFFIC SIGNAL BACKPLATE, LOUVERED, FORMED PLASTIC | EACH | 5 |
| INDUCTIVE LOOP DETECTOR | EACH | 2 |
| LIGHT DETECTOR | EACH | 2 |
| LIGHT DETECTOR AMPLIFIER | EACH | 1 |
| REMOVE ELECTRIC CABLE FROM CONDUIT | FOOT | 3211 |
| REMOVE EXISTING TRAFFIC SIGNAL EQUIPMENT | EACH | 1 |
| REMOVE EXISTING CONCRETE FOUNDATION | EACH | 1 |
| EMERGENCY VEHICLE PRIORITY SYSTEM LINE SENSOR CABLE, NO. 20 3/C | FOOT | 519 |
| CENTRACS LICENSE EXPANSION | EACH | 1 |
| OUTDOOR RATED NETWORK CABLE | FOOT | 194 |
| REMOTE CONTROLLED VIDEO SYSTEM | EACH | 1 |
| LAYER II (DATALINK) SWITCH | EACH | 1 |
| TERMINATE FIBER IN CABINET | EACH | 24 |
| PEDESTRIAN SIGNAL POST. 10 FT. | EACH | 2 |
| | EACH | 1 |
| VIDEO VEHICLE DETECTION SYSTEM, SINGLE APPROACH LED SIGNAL FACE VISOR HEATER | | 20 |
| | EACH | |
| FIBER OPTIC INTERCONNECT CENTER, 48 PORT FULLY-ACTUATED CONTROLLER IN EXISTING CABINET | EACH | 1 |
| | EACH | 6 |
| ACCESSIBLE PEDESTRIAN SIGNALS CONCRETE FOUNDATION, TYPE A 12-INCH DIAMETER | EACH | 8 |
| | FOOT | _ |
| ELECTRIC METER | EACH | 1 |
| CAMERA MOUNTING ASSEMBLY | EACH | 1 |
| REMOVE AND REPLACE BATTERIES FOR UNINTERRUPTABLE POWER SUPPLY, EXTENDED | EACH | 1 |
| LED SIGNAL MODULE REPLACEMENT | EACH | 46 |
| LED PEDESTRIAN SIGNAL MODULE REPLACEMENT | EACH | 2 |

* 100% COST TO THE CITY OF CHICAGO

TS 3055 IDOT CENTRACS FORMER ECON 100

Kimley» Horn

D 2022 HMLEY-1000 AAD ABDICATES, INC.


D 2022 HMLEY-1000 AAD ABDICATES, INC.


D 1000 HMLE IN GAUGE STATE

D 1000 HMLEY AAD ABDICATES, INC.


WANTAN EF-ARBORICOM

| USER NAME = Joel.Turk | DESIGNED | - | AMK | REVISED - |
|--------------------------|----------|---|-----------|-----------|
| | DRAWN | - | JJT | REVISED - |
| PLOT SCALE = 2.0000 / in | CHECKED | - | SS | REVISED - |
| PLOT DATE = 3/22/2024 | DATE | - | 3/22/2024 | REVISED - |

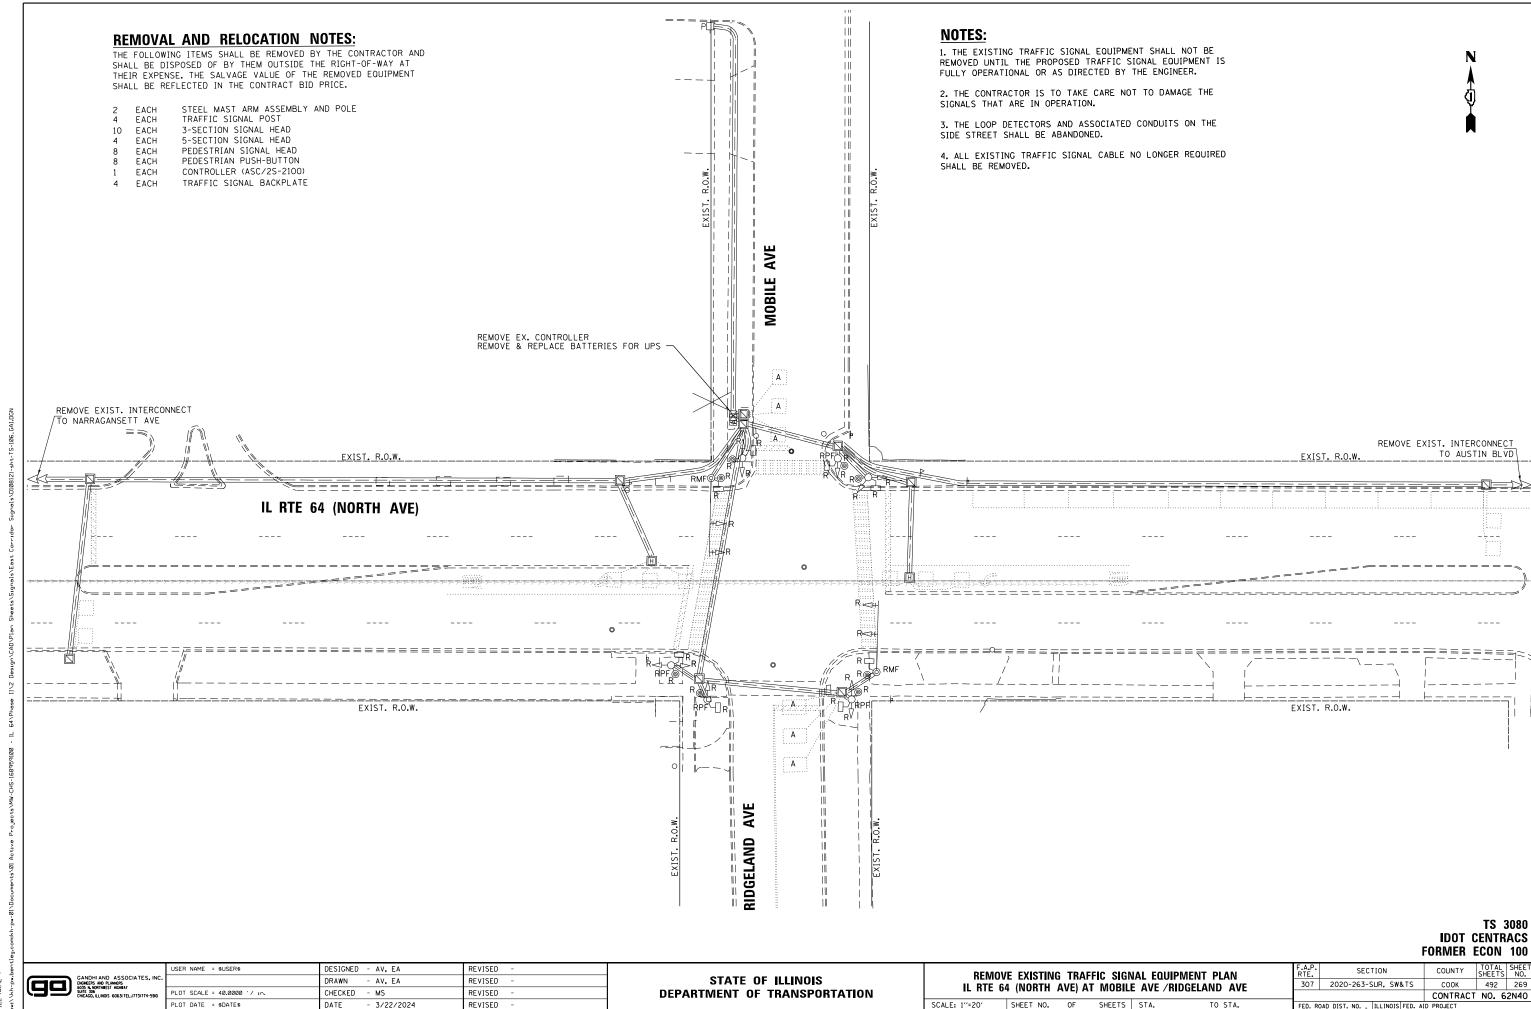


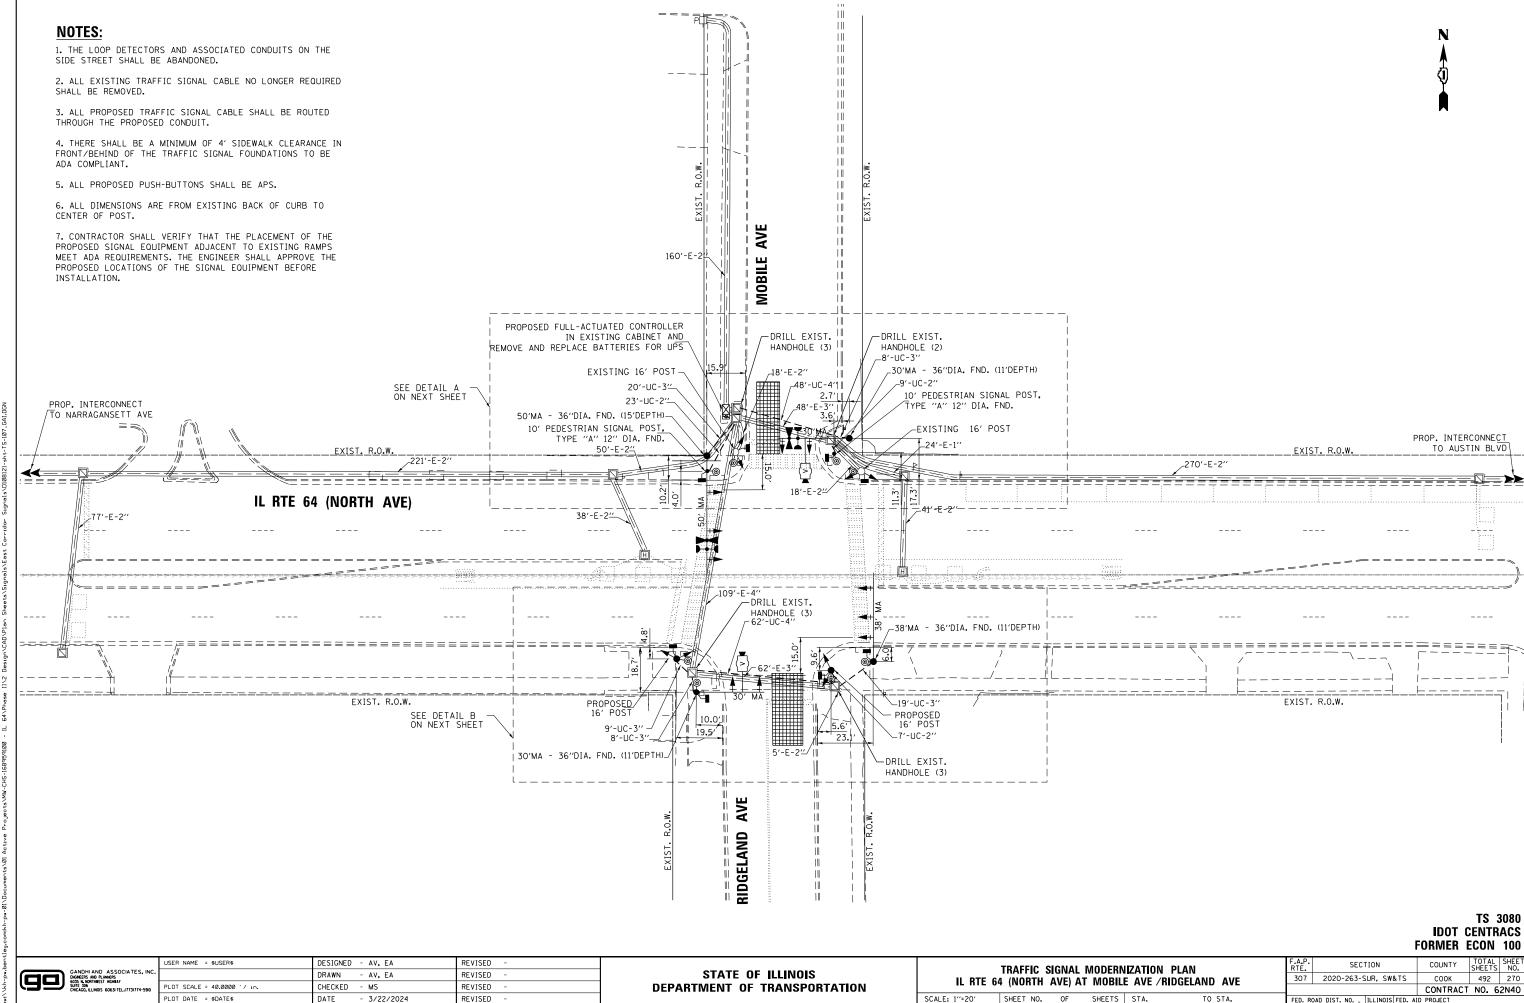

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<u>DETAIL A</u>

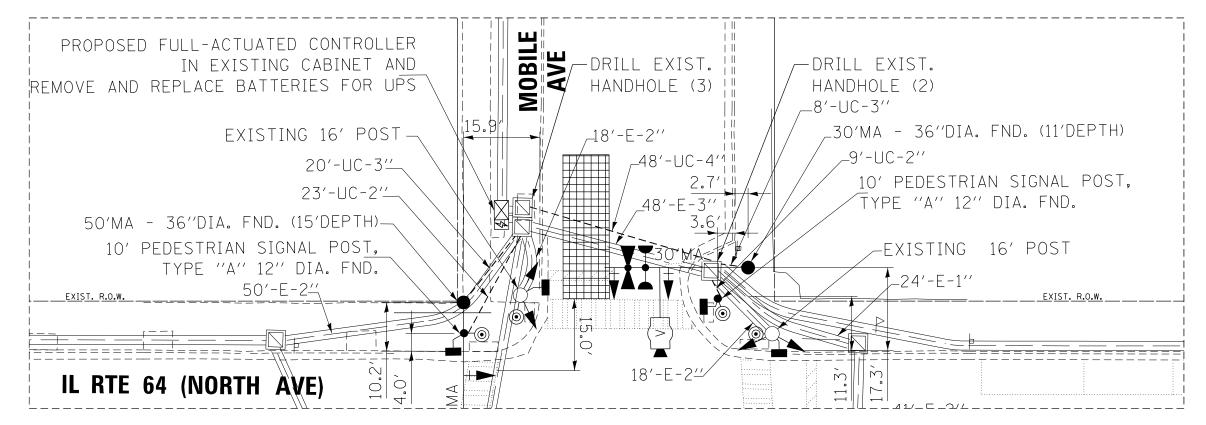


TS 3080 IDOT CENTRACS FORMER ECON 100
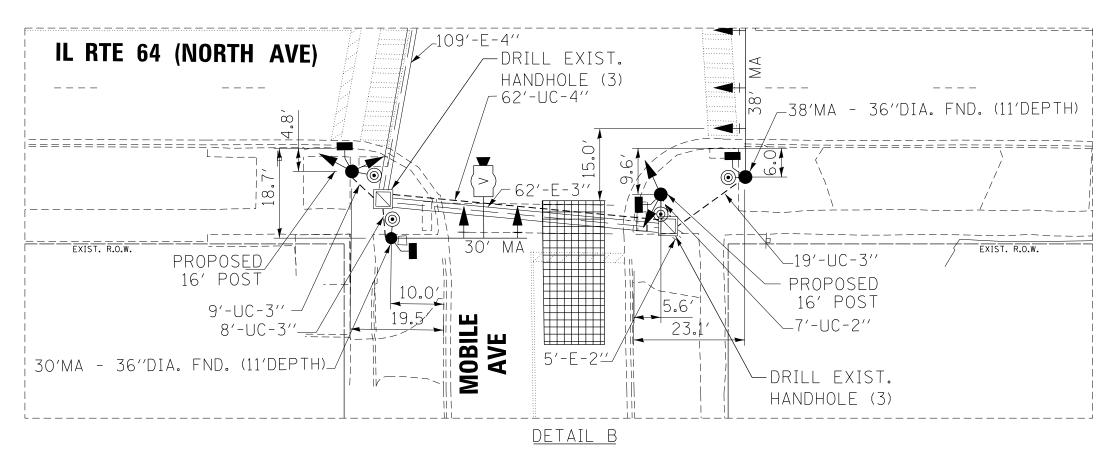
| | USER NAME = \$USER\$ | DESIGNED - AV, EA | REVISED - |
|---|------------------------------|-------------------|-----------|
| ٠ | | DRAWN - AV, EA | REVISED - |
| | PLOT SCALE = 40.0000 ' / 10. | CHECKED - MS | REVISED - |
| | PLOT DATE = \$DATE\$ | DATE - 3/22/2024 | REVISED - |
| _ | | | |

STATE OF ILLINOIS
DEPARTMENT OF TRANSPORTATION

| | | | | | IZATION PL E /RIDGELAN | AN ND AVE-DETAILS | |
|---------------|-------|-----|----|--------|---------------------------|----------------------|---|
| SCALE: 1"=20" | SHEET | NO. | OF | SHEETS | STA. | TO STA. | _ |

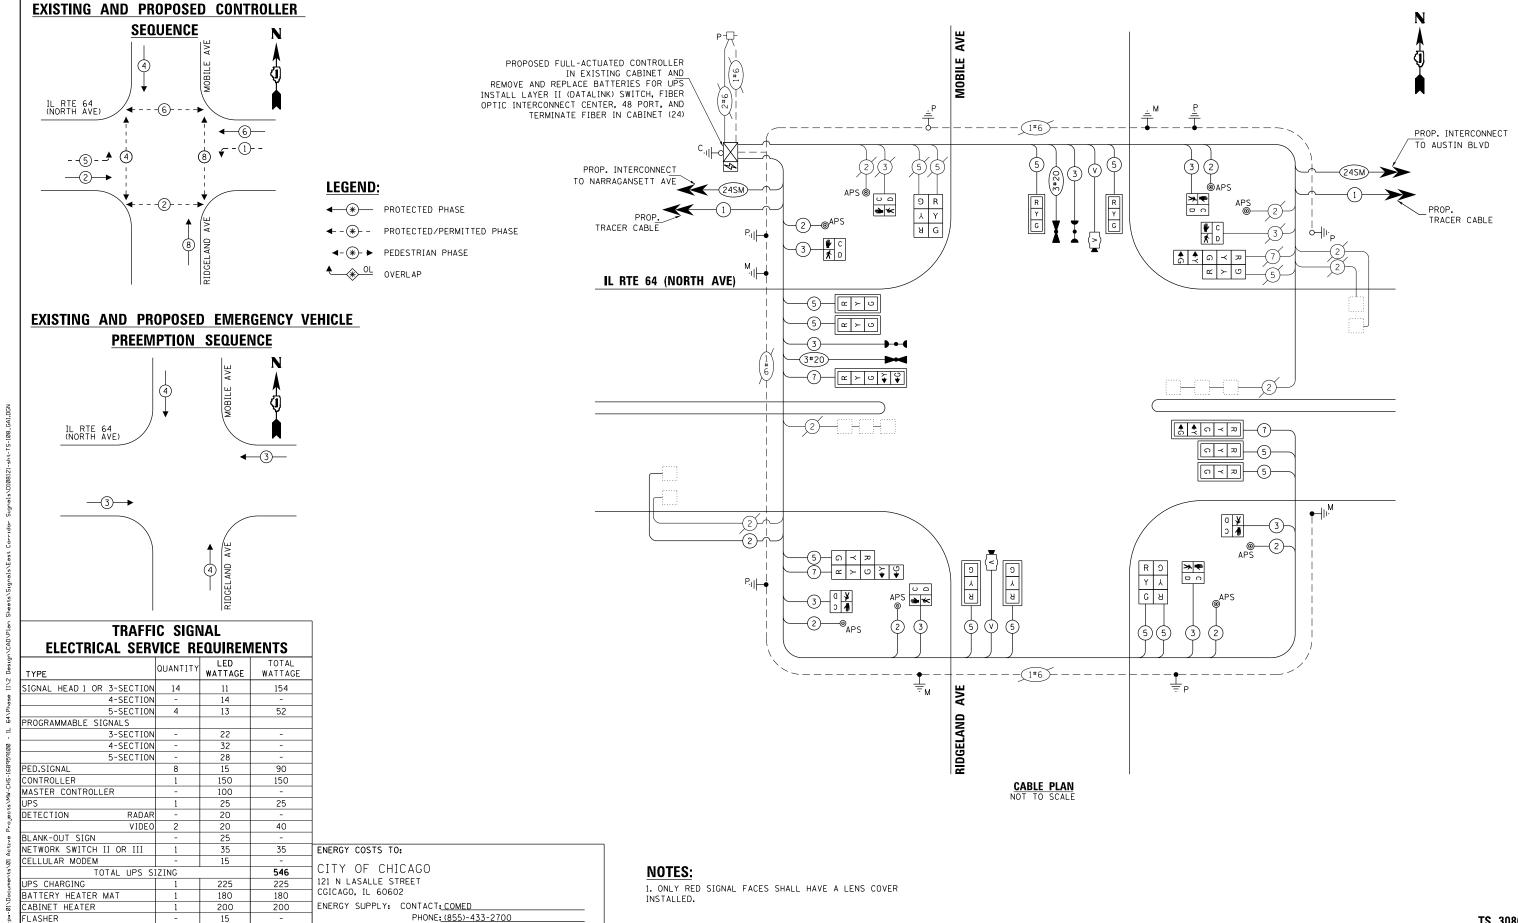

STATE OF ILLINOIS

DEPARTMENT OF TRANSPORTATION

TS 3080

IDOT CENTRACS

COOK 492 272

CONTRACT NO. 62N40

FORMER ECON 100

COUNTY

SECTION

307 2020-263-SUR, SW&TS

MODIFIED CABLE PLAN, PHASE DESIGNATION DIAGRAM,

AND EMERGENCY VEHICLE PREEMPTION SEQUENCE

IL RTE 64 (NORTH AVE) AT MOBILE AVE /RIDGELAND AVE

SHEET NO. OF SHEETS STA.

LED STREET NAME SIGN

ENGNEERS AND PLANNERS
6035 N. MORTHREST HIGHBAY
SUITE 306
CHICAGO, ILLINOIS 60631 TEL.17

TOTAL SERVICE WIRE SIZING

LUMINAIRE

120

240

LOT SCALE = 40.0000 '/ in.

USER NAME = \$USER\$

PLOT DATE = \$DATE\$

COMPANY: COMMONWEALTH EDISON

REVISED

REVISED

REVISED

REVISED

ACCOUNT NUMBER: 30271-50173

METER NUMBER:

DESIGNED - AV, EA

DRAWN - AV, EA

- 3/22/2024

CHECKED - MS

DATE



ALL DIMENSIONS ARE IN INCHES UNLESS OTHERWISE NOTED




| DESIGN SERIES | AREA (SQ FT) | SIGN PANEL TYPE | SHEETING TYPE | QTY. REQUIRED |
|------------------|-----------------|--------------------|------------------|------------------|
| D | 12.5 | 2 | 77 | 2 |



| 5.375 | 40.25 | | *-6-* | — 15 — * | - 12 | * | — 12 — | 5.375 |
|------------------|-----------------|------------|------------------|---------------------|------|---|--------|----------|
| < | | | 96 | | | | | → |
| DESIGN SERIES | AREA (SO ET) | SIGN PANEL | SHEETING TYPE | QTY. REQUIRED | | | | |

NOTE: FOR ADDITIONAL DESIGN AND INSTALLATION INFORMATION PLEASE SEE DISTRICT ONE MAST ARM MOUNTED STREET NAME SIGNS DETAIL (TS-02).



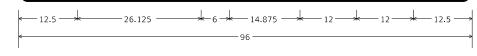

| DESIGN | AREA | SIGN PANEL | SHEETING | QTY. |
|--------|---------|------------|----------|----------|
| SERIES | (SQ FT) | TYPE | TYPE | REQUIRED |
| С | 20 | 1 | ZZ | 1 |

NOTE: FOR ADDITIONAL DESIGN AND INSTALLATION INFORMATION
PLEASE SEE DISTRICT ONE MAST ARM MOUNTED STREET NAME
SIGNS DETAIL (TS-02).

SCHEDULE OF QUANTITIES

| ITEM DESCRIPTION | UNITS | TOTAL QTY. |
|---|-------|---------------|
| SIGN PANEL - TYPE 2 | SQ FT | 65 |
| RELOCATE SIGN PANEL - TYPE 1 | SQ FT | 36 |
| UNDERGROUND CONDUIT, GALVANIZED STEEL, 2" DIA. | FOOT | 45 |
| UNDERGROUND CONDUIT, GALVANIZED STEEL, 3" DIA. | FOOT | 69 |
| UNDERGROUND CONDUIT, GALVANIZED STEEL, 4" DIA. | FOOT | 110 |
| MAINTENANCE OF EXISTING TRAFFIC SIGNAL INSTALLATION | EACH | 1 |
| ELECTRIC CABLE IN CONDUIT, SIGNAL NO. 14 2C | FOOT | 902 |
| ELECTRIC CABLE IN CONDUIT, SIGNAL NO. 14 3C | FOOT | 1172 |
| ELECTRIC CABLE IN CONDUIT, SIGNAL NO. 14 5C | FOOT | 1958 |
| ELECTRIC CABLE IN CONDUIT, SIGNAL NO. 14 7C | FOOT | 548 |
| ELECTRIC CABLE IN CONDUIT, LEAD-IN, NO. 14 1 PAIR | FOOT | 391 |
| ELECTRIC CABLE IN CONDUIT, EQUIPMENT GROUNDING CONDUCTOR, NO. 6 1C | FOOT | 191 |
| TRAFFIC SIGNAL POST, GALVANIZED STEEL 16 FT. | EACH | 2 |
| STEEL MAST ARM ASSEMBLY AND POLE, 30 FT. | EACH | 2 |
| STEEL MAST ARM ASSEMBLY AND POLE, 38 FT. | EACH | 1 |
| STEEL MAST ARM ASSEMBLY AND POLE, 50 FT. | EACH | 1 |
| CONCRETE FOUNDATION, TYPE A | FOOT | 8 |
| CONCRETE FOUNDATION, TYPE E 36-INCH DIAMETER | FOOT | 48 |
| DRILL EXISTING HANDHOLE | EACH | 11 |
| SIGNAL HEAD, LED, 1-FACE, 3-SECTION, MAST ARM MOUNTED | EACH | 8 |
| SIGNAL HEAD, LED, 1-FACE, 3-SECTION, WAST AND MOUNTED | EACH | 6 |
| SIGNAL HEAD, LED, 1-FACE, 5-SECTION, BRACKET MOUNTED | EACH | 2 |
| SIGNAL HEAD, LED, 1-FACE, 5-SECTION, MAST ARM MOUNTED | EACH | 2 |
| PEDESTRIAN SIGNAL HEAD, LED, 1-FACE, BRACKET MOUNTED WITH COUNTDOWN TIMER | EACH | 8 |
| TRAFFIC SIGNAL BACKPLATE, LOUVERED, FORMED PLASTIC | EACH | 10 |
| INDUCTIVE LOOP DETECTOR | EACH | 1 |
| | | |
| LIGHT DETECTOR | EACH | 2 |
| LIGHT DETECTOR AMPLIFIER | EACH | 1 |
| MODIFY EXISTING CONTROLLER CABINET | EACH | 1 |
| REMOVE ELECTRIC CABLE FROM CONDUIT | FOOT | 4463 |
| REMOVE EXISTING TRAFFIC SIGNAL EQUIPMENT | EACH | 1 |
| REMOVE EXISTING CONCRETE FOUNDATION | EACH | 5 |
| EMERGENCY VEHICLE PRIORITY SYSTEM LINE SENSOR CABLE, NO. 20 3/C | FOOT | 229 |
| CENTRACS LICENSE EXPANSION | EACH | 1 |
| LAYER II (DATALINK) SWITCH | EACH | 1 |
| TERMINATE FIBER IN CABINET | EACH | 24 |
| PEDESTRIAN SIGNAL POST, 10 FT. | EACH | 2 |
| VIDEO VEHICLE DETECTION SYSTEM, SINGLE APPROACH | EACH | 2 |
| FIBER OPTIC INTERCONNECT CENTER, 48 PORT | EACH | 1 |
| FULL-ACTUATED CONTROLLER IN EXISTING CABINET | EACH | 1 |
| ACCESSIBLE PEDESTRIAN SIGNALS | EACH | 8 |
| CONCRETE FOUNDATION, TYPE A 12-INCH DIAMETER | FOOT | 8 |
| LED SIGNAL FACE, LENS COVER | EACH | 18 |
| ELECTRIC METER | EACH | 1 |
| REMOVE AND REPLACE BATTERIES FOR UNINTERRUPTABLE POWER SUPPLY, EXTENDED | EACH | 1 |

* 100% COST TO THE CITY OF CHICAGO

IL

TS 3080 IDOT CENTRACS FORMER ECON 100

COOK 492 273


CONTRACT NO. 62N40

Kimley» Horn

9 2023 PIMLEY-10'09 AND A GOOD, CHETE, INC.
40 WARRENVILE II. 00055
PHONE GOOD-475509

| USER NAME = Joel.Turk | DESIGNED | - | AMK | REVISED | - |
|--------------------------|----------|---|-----------|---------|---|
| | DRAWN | - | JJ⊤ | REVISED | - |
| PLOT SCALE = 2.0000 / in | CHECKED | - | SS | REVISED | - |
| PLOT DATE = 3/22/2024 | DATE | - | 3/22/2024 | REVISED | - |
| | | | | | |


| MASI ANN MODIVIED STREET MAINE SIGNS | F.A.P. RTE | SECTION | |
|--|---------------|--------------------|----|
| AND SCHEDULE OF QUANTITIES | 307 | 2020-264-SUR,SW&TS | Ī |
| RTE 64 (NORTH AVE) AND MOBILE AVE /RIDGELAND AVE | | | Π |
| SHEET 1 OF SHEETS STA. TO STA. | | TILLINOIS FED A | in |

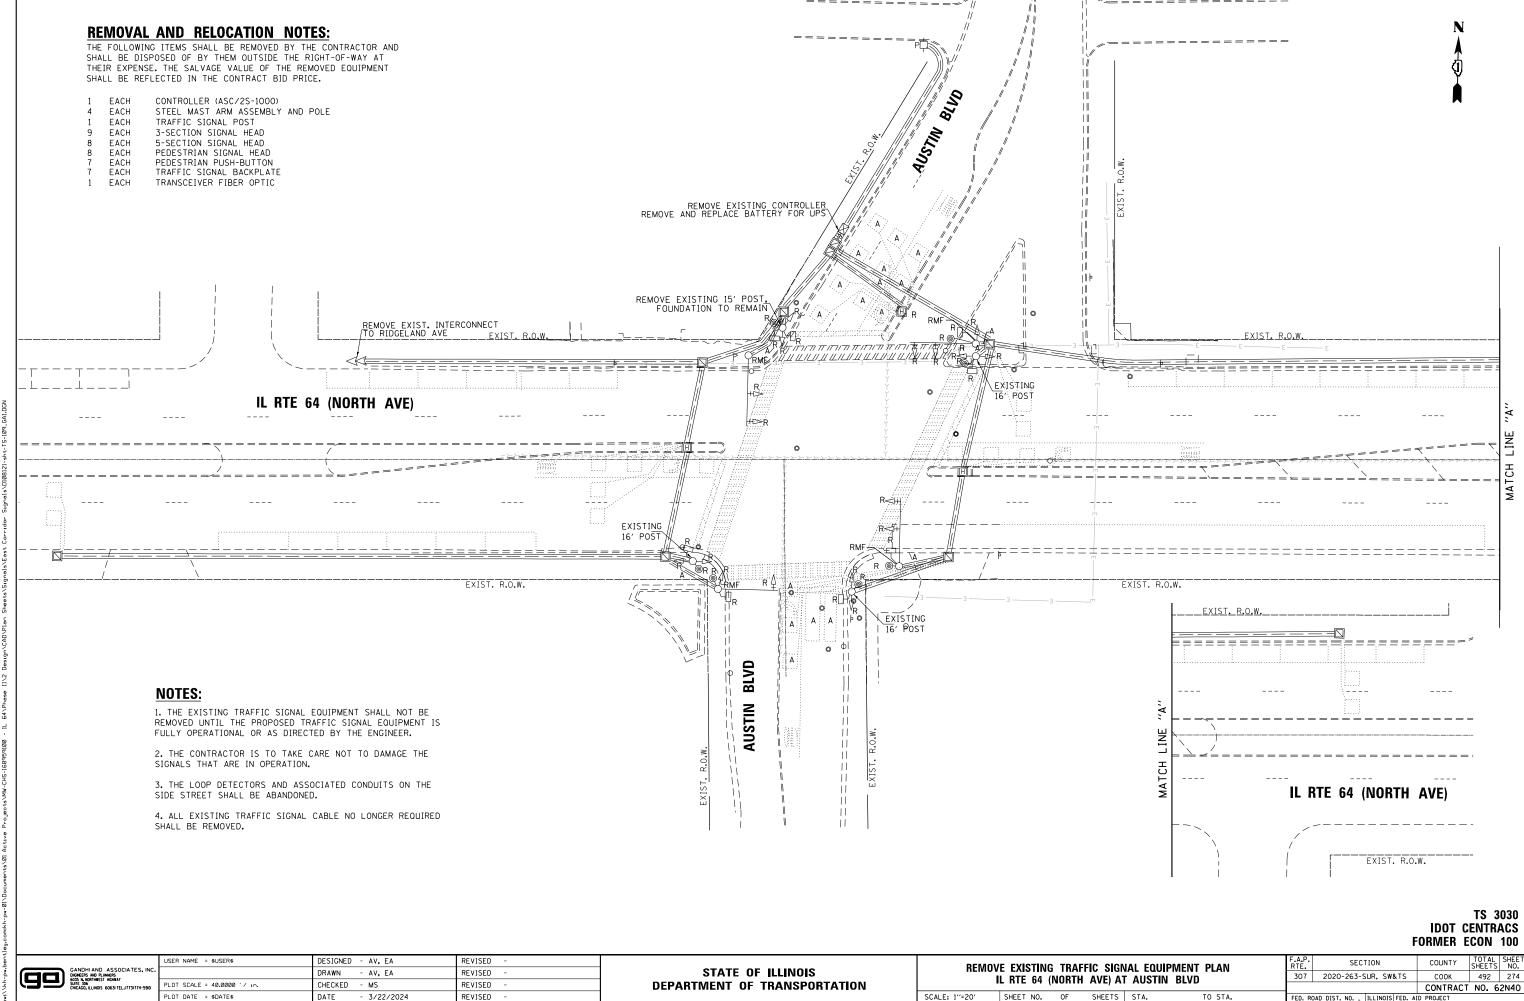

PLOT DATE = \$DATE\$

DATE


- 3/22/2024

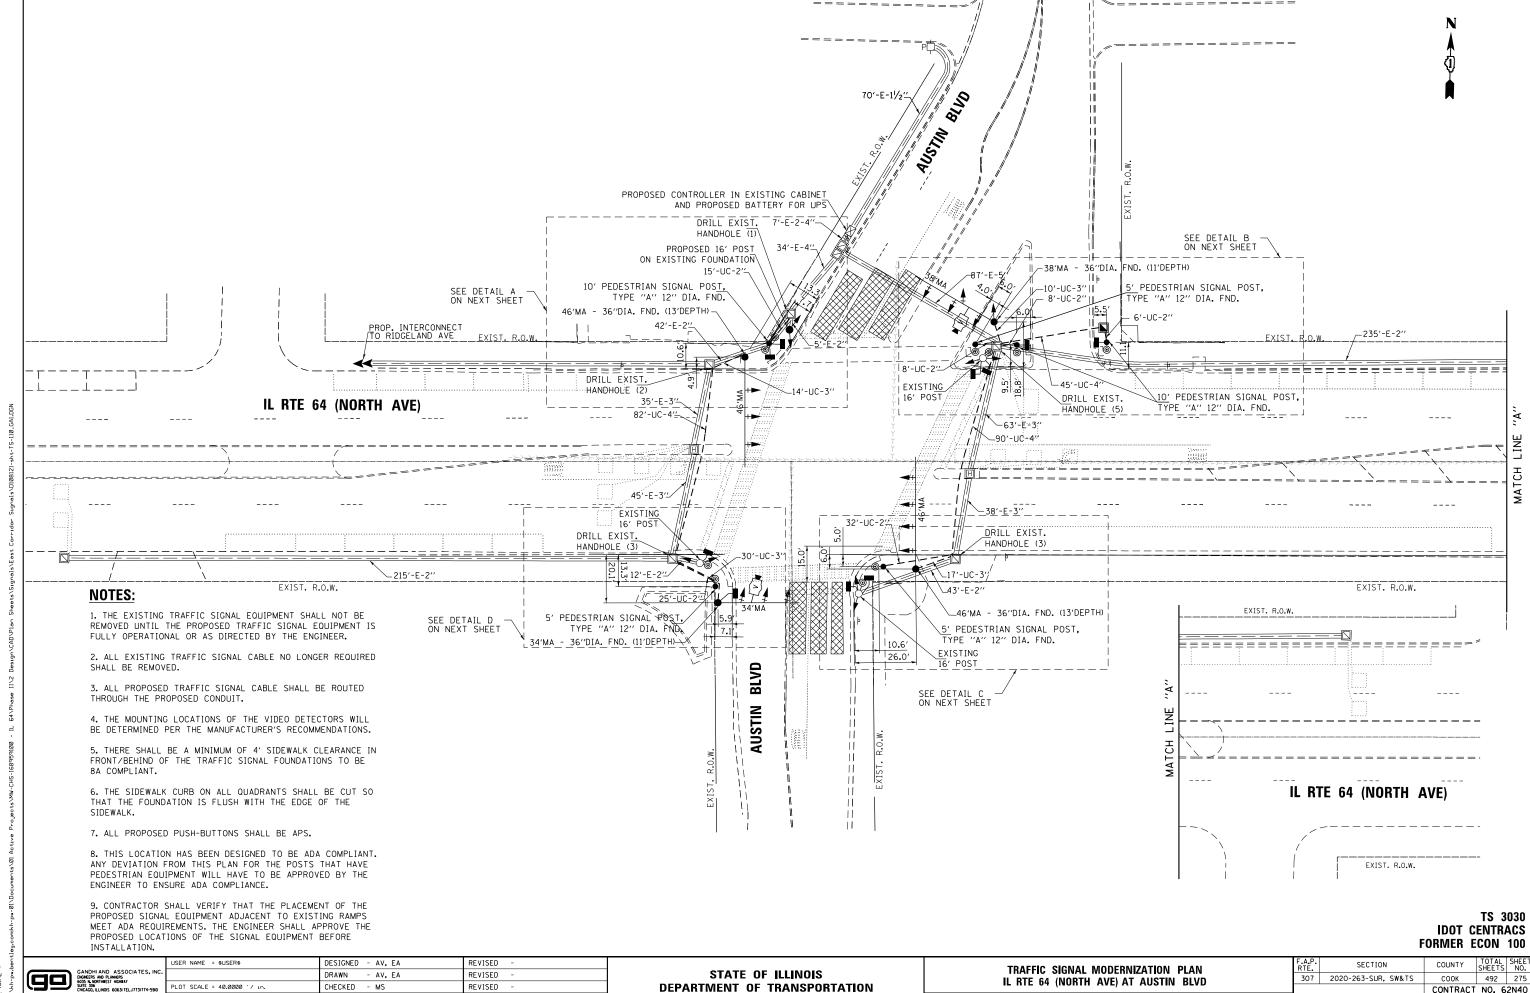


CONTRACT NO. 62N40


SHEET NO. OF SHEETS STA.


- 3/22/2024

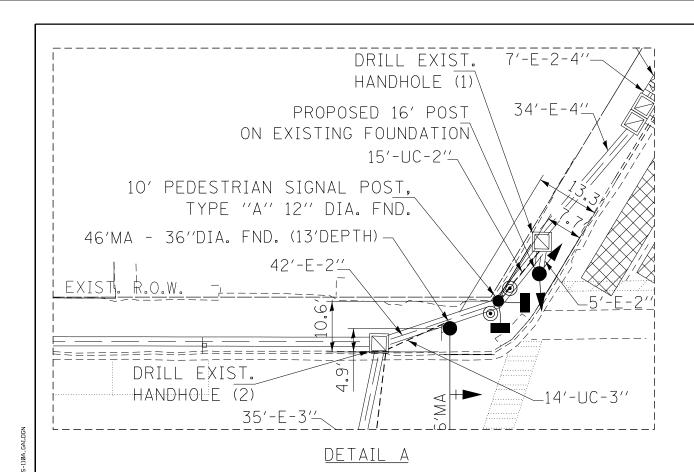

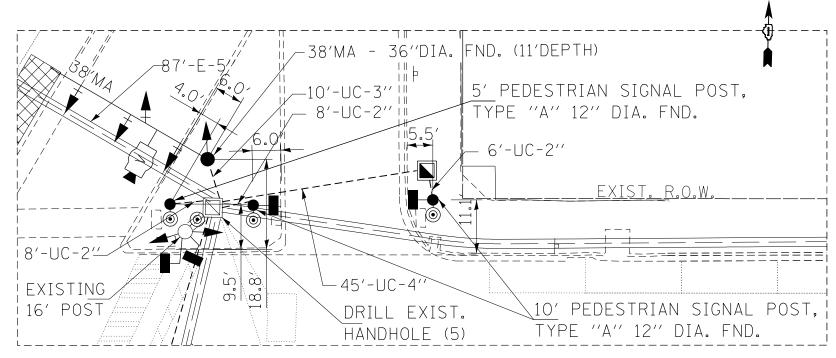

DETAIL B

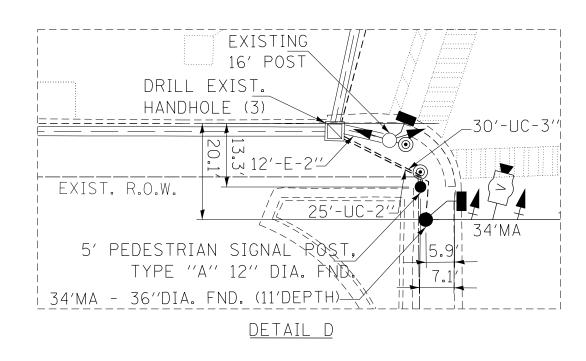

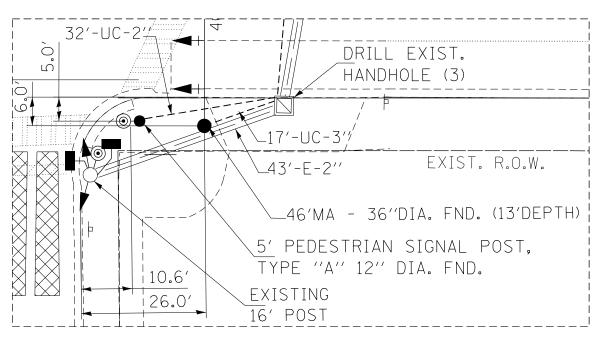

DETAIL C

TS 3030 IDOT CENTRACS **FORMER ECON 100**


| | USER |
|---|--------|
| GANDHIAND ASSOCIATES, INC. ENGNEERS AND PLANNERS 6035 N. NORTHIREST HICHBAY | |
| SUITE 306 CHICAGO, ILLINOIS 60631 TEL.(773)774-5910 | PLOT S |
| | PLOT (|

| | USER NAME = \$USER\$ | DESIGNED - AV, EA | REVISED - | |
|---|-----------------------------|-------------------|-----------|---|
| ٠ | | DRAWN - AV, EA | REVISED - | |
| | PLOT SCALE = 40.0000 '/ 10. | CHECKED - MS | REVISED - | |
| | PLOT DATE = \$DATE\$ | DATE - 3/22/2024 | REVISED - | |
| | | | | Ξ |

STATE OF ILLINOIS **DEPARTMENT OF TRANSPORTATION**

| | TRAFFIC SI | GNAL | MODERN | IZATIO | | F.A.P. RTE. | SECTION | cour |
|---------------|-------------|------|-----------|--------|--------------|----------------|------------------------------|----------|
| | | | | | BLVD-DETAILS | 307 | 2020-263-SUR, SW&TS | CO |
| ·- ··· | L 04 (NOIII | | בן או אטי | 01114 | DEVD-DETAILS | | | CONT |
| SCALE: 1"=10" | SHEET NO. | OF | SHEETS | STA. | TO STA. | FED. R | DAD DIST. NO ILLINOIS FED. A | D PROJEC |

00K 492 276 NTRACT NO. 62N40

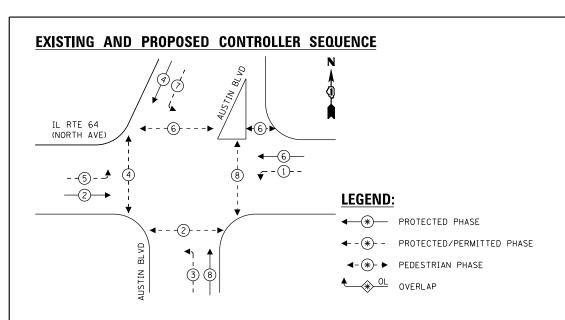

| TRAFFIC SIGNAL | | | | | | | | | |
|----------------------------|---------------------------------|----------------|------------------|--|--|--|--|--|--|
| ELECTRICAL SERV | ELECTRICAL SERVICE REQUIREMENTS | | | | | | | | |
| TYPE | QUANTITY | LED WATTAGE | TOTAL WATTAGE | | | | | | |
| SIGNAL HEAD 1 OR 3-SECTION | 15 | 11 | 165 | | | | | | |
| 4-SECTION | - | 14 | - | | | | | | |
| 5-SECTION | 8 | 13 | 104 | | | | | | |
| PROGRAMMABLE SIGNALS | | | | | | | | | |
| 3-SECTION | - | 22 | - | | | | | | |
| 4-SECTION | - | 32 | - | | | | | | |
| 5-SECTION | - | 28 | - | | | | | | |
| PED.SIGNAL | 10 | 15 | 150 | | | | | | |
| CONTROLLER | 1 | 150 | 150 | | | | | | |
| MASTER CONTROLLER | - | 100 | - | | | | | | |
| UPS | 1 | 25 | 25 | | | | | | |
| DETECTION RADAR | - | 20 | - | | | | | | |
| VIDEO | 2 | 20 | 40 | | | | | | |
| BLANK-OUT SIGN | - | 25 | - | | | | | | |
| NETWORK SWITCH II OR III | 1 | 35 | 35 | | | | | | |
| CELLULAR MODEM | - | 15 | - | | | | | | |
| TOTAL UPS S | IZING | | 669 | | | | | | |
| UPS CHARGING | 1 | 225 | 225 | | | | | | |
| BATTERY HEATER MAT | 1 | 180 | 180 | | | | | | |

200

15

120

240


200

ENERGY COSTS TO:

CITY OF CHICAGO

121 N LASALLE STREET
CGICAGO, IL 60602

ENERGY SUPPLY: CONTACT: COMED
PHONE: (855)-433-2700
COMPANY: COMMONWEALTH EDISON
ACCOUNT NUMBER: 302701-50173
METER NUMBER:

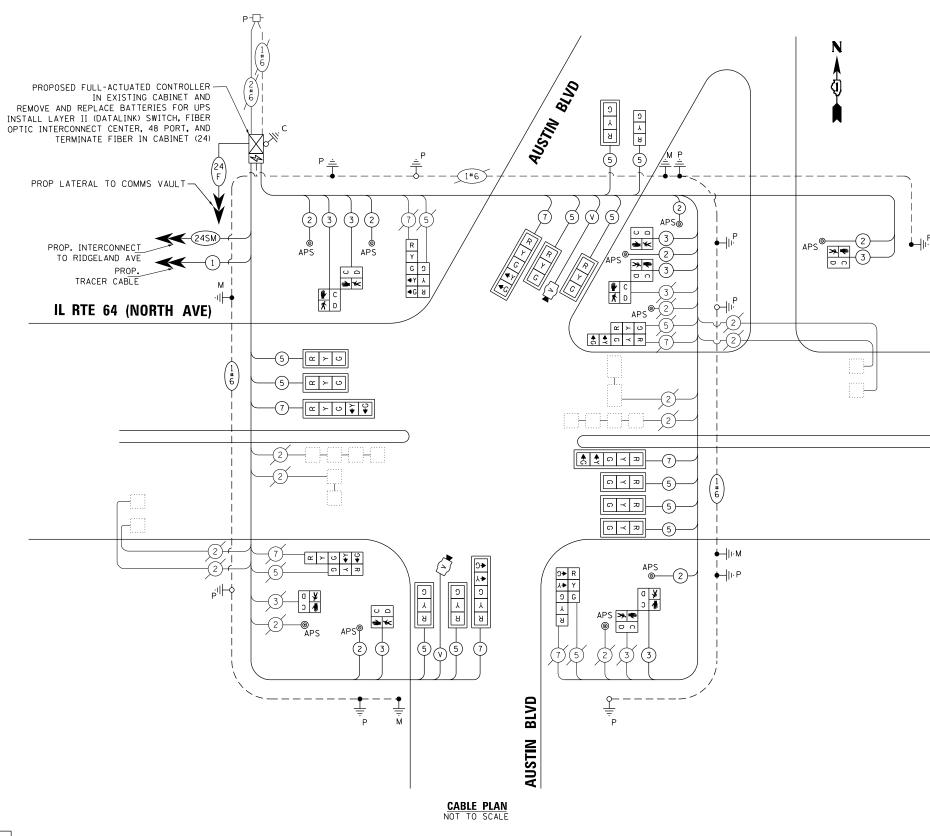

NOTES:

1. ONLY RED SIGNAL FACES SHALL HAVE A LENS COVER INSTALLED.

TS 3030 IDOT CENTRACS FORMER ECON 100

STATE OF ILLINOIS
DEPARTMENT OF TRANSPORTATION

MODIFIED CABLE PLAN AND PHASE DESIGNATION DIAGRAM
IL RTE 64 (NORTH AVE) AT AUSTIN BLVD
E: 1"=20" | SHEET NO. OF SHEETS | STA. TO STA.

CABINET HEATER

LED STREET NAME SIGN

TOTAL SERVICE WIRE SIZING

FLASHER


LUMINAIRE

SIGN PANEL - TYPE 1 OR TYPE 2

ALL DIMENSIONS ARE IN INCHES UNLESS OTHERWISE NOTED



| DESIGN | AREA | SIGN PANEL | SHEETING | QTY. |
|--------|---------|------------|----------|----------|
| SERIES | (SQ FT) | TYPE | TYPE | REQUIRED |
| D | 12.5 | 2 | ZZ | |

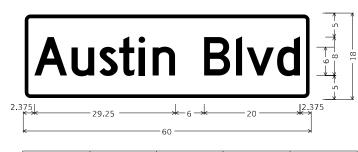

 DESIGN SERIES
 AREA (SQ FT)
 SIGN PANEL TYPE
 SHEETING TYPE
 QTY. REQUIRED

 D
 7.5
 1
 ZZ
 2

NOTE: FOR ADDITIONAL DESIGN AND INSTALLATION INFORMATION PLEASE SEE DISTRICT ONE MAST ARM MOUNTED STREET NAME SIGNS DETAIL (TS-02).


SCHEDULE OF QUANTITIES

| ITEM DESCRIPTION | UNITS | TOTAL OTY. |
|---|-------|---------------|
| SIGN PANEL - TYPE 1 | SQ FT | 15 |
| SIGN PANEL - TYPE 2 | SQ FT | 25 |
| UNDERGROUND CONDUIT, GALVANIZED STEEL, 2" DIA. | FOOT | 99 |
| UNDERGROUND CONDUIT, GALVANIZED STEEL, 3" DIA. | FOOT | 54 |
| UNDERGROUND CONDUIT, GALVANIZED STEEL, 4" DIA. | FOOT | 217 |
| HANDHOLE | EACH | 1 |
| MAINTENANCE OF EXISTING TRAFFIC SIGNAL INSTALLATION | EACH | 1 |
| ELECTRIC CABLE IN CONDUIT, SIGNAL NO. 14 2C | FOOT | 1107 |
| ELECTRIC CABLE IN CONDUIT, SIGNAL NO. 14 3C | FOOT | 1164 |
| ELECTRIC CABLE IN CONDUIT, SIGNAL NO. 14 5C | FOOT | 2299 |
| ELECTRIC CABLE IN CONDUIT, SIGNAL NO. 14 7C | FOOT | 936 |
| ELECTRIC CABLE IN CONDUIT, EQUIPMENT GROUNDING CONDUCTOR, NO. 6 1C | FOOT | 480 |
| TRAFFIC SIGNAL POST, GALVANIZED STEEL 16 FT. | EACH | 1 |
| STEEL MAST ARM ASSEMBLY AND POLE, 34 FT. | EACH | 1 |
| STEEL MAST ARM ASSEMBLY AND POLE, 38 FT. | EACH | 1 |
| STEEL MAST ARM ASSEMBLY AND POLE, 46 FT. | EACH | 2 |
| CONCRETE FOUNDATION, TYPE A | FOOT | 4 |
| CONCRETE FOUNDATION, TYPE E 36-INCH DIAMETER | FOOT | 48 |
| DRILL EXISTING HANDHOLE | EACH | 1 4 |
| SIGNAL HEAD, LED, 1-FACE, 3-SECTION, MAST ARM MOUNTED | EACH | 10 |
| SIGNAL HEAD, LED, 1-FACE, 3-SECTION, BRACKET MOUNTED | EACH | 5 |
| SIGNAL HEAD, LED, 1-FACE, 5-SECTION, BRACKET MOUNTED | EACH | 4 |
| SIGNAL HEAD, LED, 1-FACE, 5-SECTION, MAST ARM MOUNTED | EACH | 4 |
| PEDESTRIAN SIGNAL HEAD, LED, 1-FACE, BRACKET MOUNTED WITH COUNTDOWN TIMER | EACH | 10 |
| TRAFFIC SIGNAL BACKPLATE, LOUVERED, FORMED PLASTIC | EACH | 14 |
| MODIFY EXISTING CONTROLLER CABINET | EACH | 1 |
| REMOVE ELECTRIC CABLE FROM CONDUIT | FOOT | 5985 |
| REMOVE EXISTING TRAFFIC SIGNAL EQUIPMENT | EACH | 1 |
| REMOVE EXISTING HANDHOLE | EACH | 1 |
| REMOVE EXISTING CONCRETE FOUNDATION | EACH | 4 |
| CENTRACS LICENSE EXPANSION | EACH | 1 |
| LAYER II (DATALINK) SWITCH | EACH | 1 |
| TERMINATE FIBER IN CABINET | EACH | 24 |
| PEDESTRIAN SIGNAL POST, 10 FT. | EACH | 3 |
| PEDESTRIAN SIGNAL POST, 5 FT. | EACH | 2 |
| VIDEO VEHICLE DETECTION SYSTEM, SINGLE APPROACH | EACH | 2 |
| FIBER OPTIC INTERCONNECT CENTER, 48 PORT | EACH | 1 |
| FULL-ACTUATED CONTROLLER IN EXISTING CABINET | EACH | 1 |
| ACCESSIBLE PEDESTRIAN SIGNALS | EACH | 10 |
| LED SIGNAL FACE, LENS COVER | EACH | 23 |
| CONCRETE FOUNDATION, TYPE A 12-INCH DIAMETER | FOOT | 20 |
| ELECTRIC METER | EACH | 1 |
| REMOVE AND REPLACE BATTERIES FOR UNINTERRUPTABLE POWER SUPPLY, EXTENDED | EACH | 1 |

TS 3030 IDOT CENTRACS FORMER ECON 100

| Kimley%Horn |
|---|
| © 2023 KIMLEY HORN AND ASSOCIATES, INC. |
| 4201 WINFIELD ROAD, SUITE 600 |
| WARRENVILLE, IL 60555 |
| PHONE: 630-487-5550 |
| WANTEN BY HODN COM |

| USER NAME = Joel.Turk | DESIGNED | - | AMK | REVISED - | |
|--------------------------|----------|---|-----------|-----------|---|
| | DRAWN | - | JJT | REVISED - | |
| PLOT SCALE = 2.0000 / in | CHECKED | - | SS | REVISED - | |
| PLOT DATE = 3/22/2024 | DATE | - | 3/22/2024 | REVISED - | |
| | | | | | • |

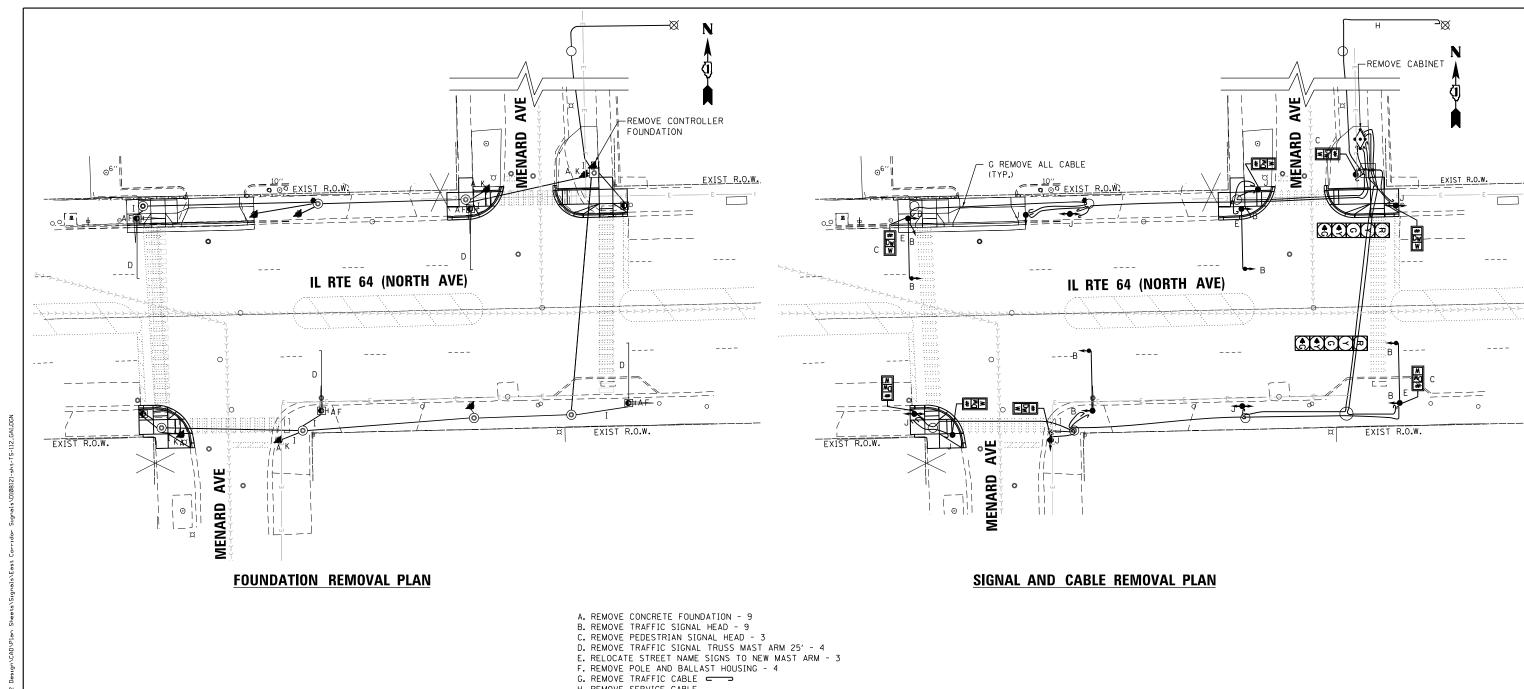

- H. REMOVE SERVICE CABLE

 I. ABANDON CONDUIT FROM MANHOLE/HANDHOLE TO POLE OR CABINET
- J. REMOVE JUNCTION BOX 8
 K. REMOVE TRAFFIC SIGNAL POST 4

TS 14309


USER NAME = \$USER\$ DESIGNED - AV, EA REVISED DRAWN - AV, EA REVISED LOT SCALE = 40.0000 '/ in. CHECKED - MS REVISED DATE REVISED - 3/22/2024

STATE OF ILLINOIS **DEPARTMENT OF TRANSPORTATION** REMOVE EXISTING TRAFFIC SIGNAL EQUIPMENT PLAN IL RTE 64 (NORTH AVE) AT MENARD AVE SHEET NO. OF SHEETS STA.

COUNTY TOTAL SHEET NO.

COOK 492 279

CONTRACT NO. 62N40 SECTION RTE. 3207 2020-263-SUR, SW&TS

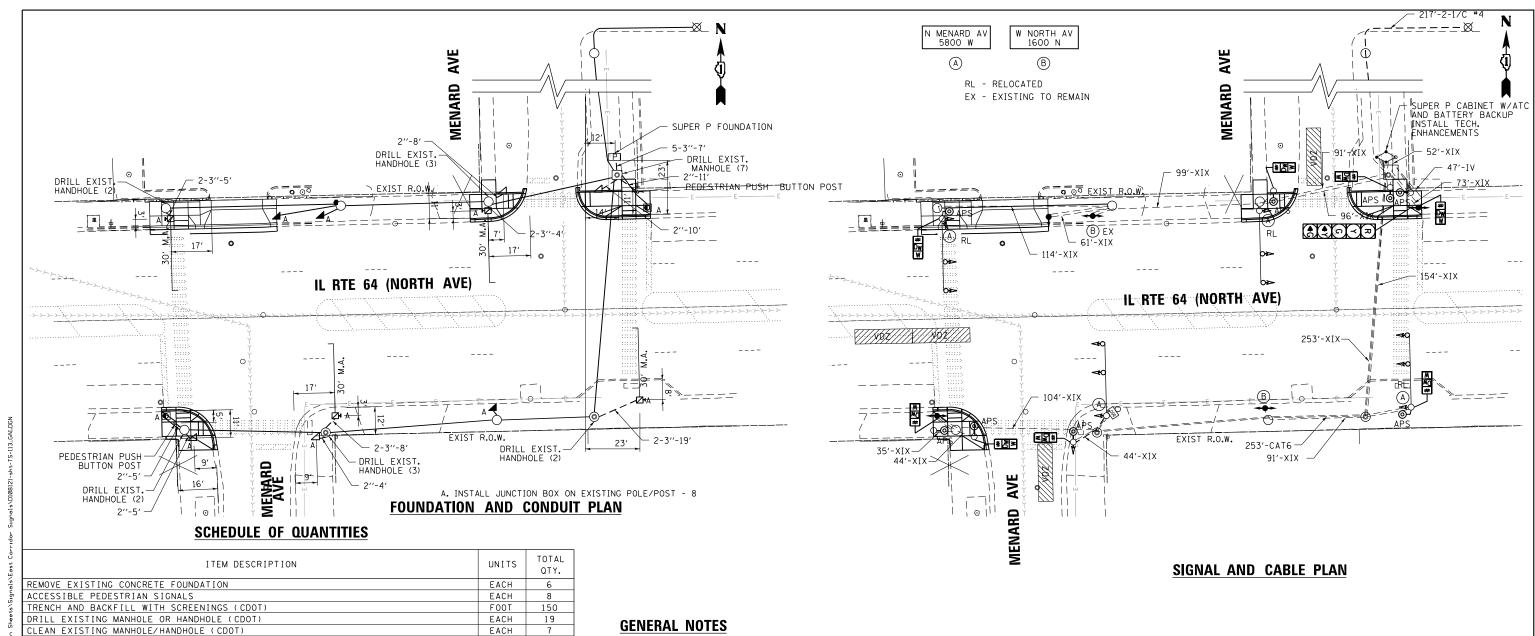

- SEE STANDARD DRAWING 826 FOR CDOT TRAFFIC SIGNAL AND LIGHTING SYMBOLS.
- CLEAN ALL EXISTING HANDHOLES/MANHOLES.

FOOT

FOOT

FOOT

EACH EACH

EACH

EACH

FOOT

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EACH

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FOOT

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EACH

43

107

1101

4

772

434

12


4

82

1276

- ROD AND CLEAN ALL EXISTING CONDUITS.
 TEMPORARILY CONNECT ALL SIGNALS WITH AERIAL HARNESS CABLE (8C#16) DURING REMOVAL OF EXISTING CABLE AND INSTALLATION
- OF NEW CABLE. TRAFFIC SIGNAL HEADS MOUNTED ON MAST ARMS SHALL BE A
- MINIMUM OF 15 FEET ABOVE THE TRAVELED ROADWAY WHEN MEASURED TO THE BOTTOM OF THE SIGNAL HOUSING.
- THE LOCATION OF THE 360 DEGREE VIDEO DETECTION CAMERA SHALL BE CONFIRMED BY CDOT DEO.
- INSTALL NEW JUNCTION BOXES ON ALL EXISTING TRAFFIC SIGNAL POLES AND POSTS.
- CONTRACTOR TO INSTALL RIO-3 SIGNS FOR ALL ACCESSIBLE PEDESTRIAN SIGNALS WITH ARROW POINTED TOWARDS CROSSWALK. ANY JUNCTION BOX IN CONFLICT WITH THE PROPOSED ACCESSIBLE PEDESTRIAN SIGNAL OR SIGN SHALL BE RELOCATED ON THE POLE. THIS WORK SHALL BE INCIDENTAL TO THE ACCESSIBLE PEDESTRIAN SIGNAL INSTALLATION
- PEDESTRIAN SIGNAL INSTALLATION.

 10. CONTRACTOR SHALL VERIFY THAT THE PLACEMENT OF THE PROPOSED SIGNAL EQUIPMENT ADJACENT TO EXISTING RAMPS MEET ADA REQUIREMENTS. THE ENGINEER SHALL APPROVE THE PROPOSED LOCATIONS OF THE SIGNAL EQUIPMENT BEFORE INSTALLATION.

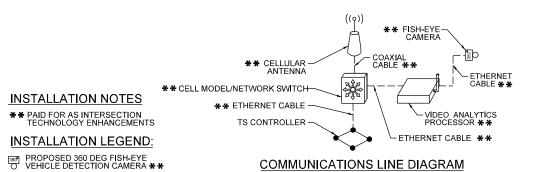

IL RTE 64 (NORTH AVE) AT MENARD AVE

SHEET NO. OF SHEETS STA.

TS 14309 COUNTY TRAFFIC SIGNAL MODERNIZATION PLAN AND SCHEDULE OF QUANTITIES

307 2020-263-SUR, SW&TS

COOK

492 280

CONTRACT NO. 62N40

JSER NAME = \$USER\$ REVISED DESIGNED - AV. EA DRAWN - AV. EA REVISED ENGRERS AND PLANKES
6035 N. NORTHBEST HIGHBAY
SUITE 306
CHICAGO ILLINOIS 6063 TSU LOT SCALE = 40.0000 '/ in. CHECKED - MS REVISED REVISED - 3/22/2024

STATE OF ILLINOIS **DEPARTMENT OF TRANSPORTATION**

CONDUIT IN TRENCH, 2" PVC (SCHEDULE 40) (CDOT)

CONDUIT IN TRENCH, 3" PVC (SCHEDULE 40) (CDOT)

RACK, SECONDARY, AERIAL 2-WIRE (CDOT)
WIRE, AERIAL, 1/C NO. 6 (CDOT)

ELECTRIC CABLE IN CONDUIT, 1/C NO. 4 (CDOT)

PEDESTRIAN PUSH BUTTON POST (5') (CDOT)
MAST ARM, TRAFFIC, STEEL MONOTUBE, 30 FOOT (CDOT

REMOVE EXISTING TRAFFIC SIGNAL EQUIPMENT (CDOT)

TRAFFIC SIGNAL POST, ALUMINUM, 17 FOOT (CDOT)

ELECTRIC CABLE IN CONDUIT, #18 4/C (CDOT

STREET NAME SIGNS (CDOT)

REMOVE JUNCTION BOX, TSS 18 (CDOT)

RELOCATE STREET NAME SIGN (CDOT)

ELECTRIC CABLE IN CONDUIT, #14 19/C (CDOT)

INTERSECTION TECHNOLOGY ENHANCEMENTS (CDOT)

RELOCATE EXISTING STREET LUMINAIRE (CDOT)

ROD AND CLEAN DUCT IN EXISTING CONDUIT SYSTEM (CDOT)

POLE, STEEL, 34′6″, ANCHOR BASE, 11″D, 3 GAUGE (CDOT)

COUNTDOWN PEDESTRIAN TRAFFIC SIGNAL (BRACKET MOUNTED) (CDOT

JUNCTION BOX, POLE OR POST MOUNTED (CAST ALUMINUM) (CDOT

MAINTENANCE OF EXISTING TRAFFIC SIGNAL INSTALLATION (CDOT)

CONCRETE FOUNDATION FOR BASE MOUNTED "SUPER P" CABINET (CDOT)


ATC CONTROLLER, TRAFFIC, 16 LOAD BAY, "SUPER P" CABINET, UPS (CDOT

CONCRETE FOUNDATION, 20" DIAMETER, 3/4" ANCHOR RODS (CDOT)
CONCRETE FOUNDATION, 30" DIAMETER, 17 1/4" BOLT CIRCLE, 1 1/4" A.R. (CDOT)


SIGNAL HEAD, POLYCARBONATE, LED, 3-SECTION, BRACKET MOUNTED (1-FACE) (CDOT)

SIGNAL HEAD, POLYCARBONATE, LED, 3-SECTION, MAST ARM MOUNTED (1-FACE) (CDOT)

SIGNAL HEAD, POLYCARBONATE, LED, 5-SECTION, MAST ARM MOUNTED (1-FACE) (CDOT)

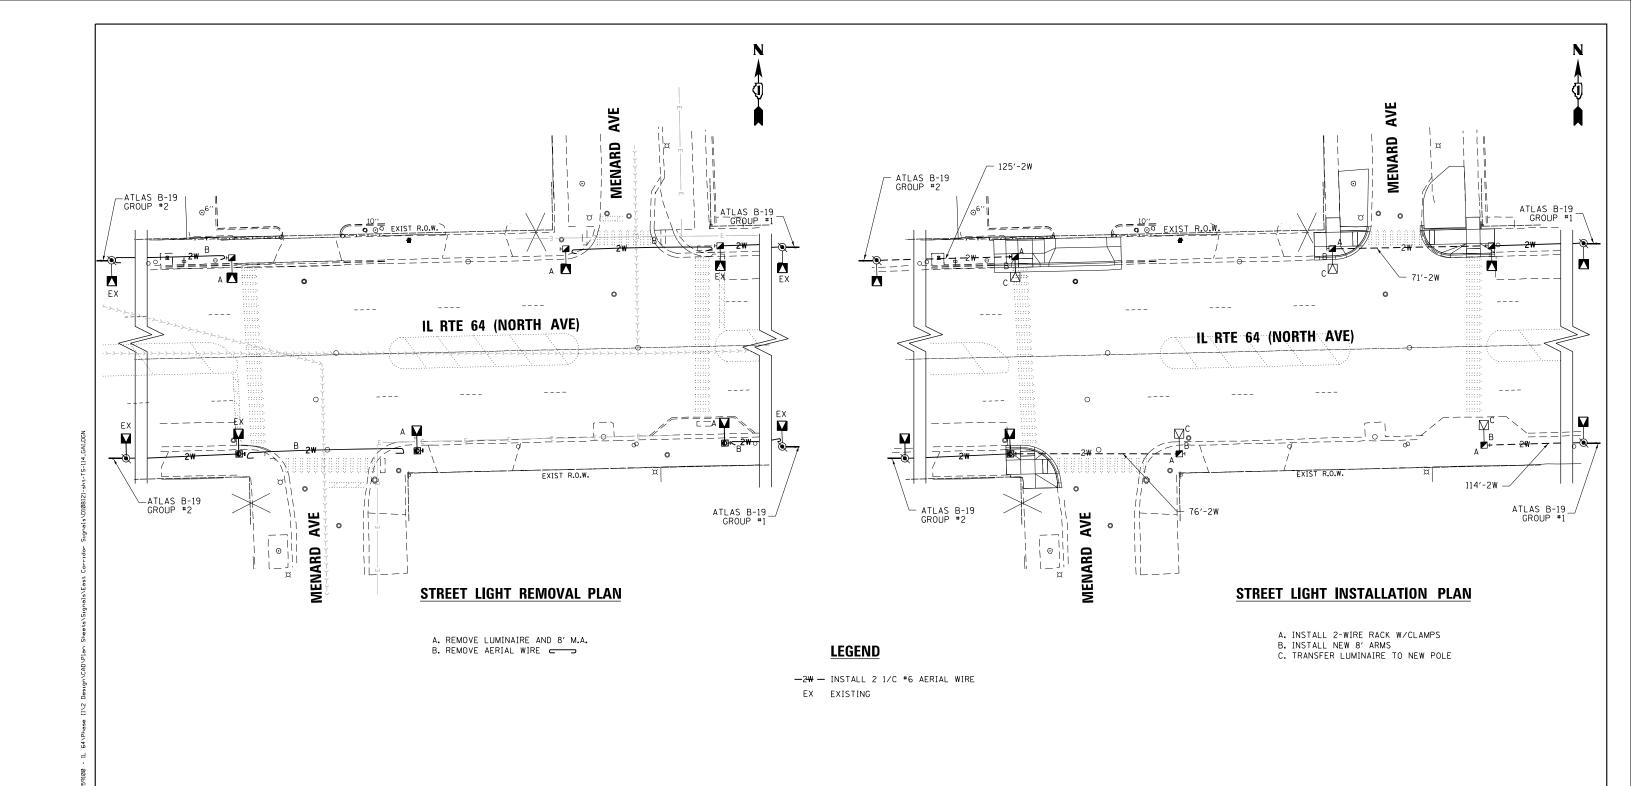

COUNTY | TOTAL SHEET NO. | COOK | 492 | 281 | CONTRACT NO. 62N40 USER NAME = \$USER\$ DESIGNED - AV, EA REVISED F.A.P. SECTION 307 2020-263-SUR, SW&TS LIGHTING REMOVAL AND INSTALLATION PLAN STATE OF ILLINOIS DRAWN - AV, EA REVISED IL RTE 64 (NORTH AVE) AT MENARD AVE PLOT SCALE = 40.0000 '/ in. CHECKED - MS REVISED **DEPARTMENT OF TRANSPORTATION** DATE REVISED SHEET NO. OF SHEETS STA. - 3/22/2024

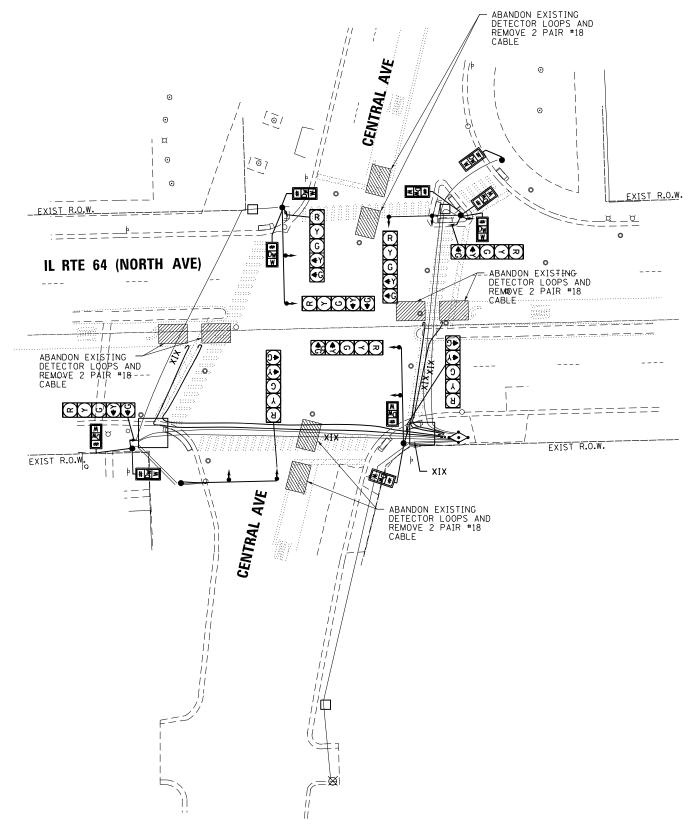

SIGNAL AND CABLE REMOVAL PLAN

TS 12559

GANDHI AND ASSOCIATES, IF BYGREEFS AND PLANNERS GOST MORTHEST HORIZON SUITE SOG CHACOO, ILLINOIS 6063 TEL. 1773)774-59

USER NAME = \$USER\$ DESIGNED - AV, EA REVISED DRAWN - AV, EA REVISED PLOT SCALE = 40.0000 '/ in. CHECKED - MS REVISED DATE - 3/22/2024 REVISED


STATE OF ILLINOIS **DEPARTMENT OF TRANSPORTATION**

TRAFFIC SIGNAL REMOVAL PLAN IL RTE 64 (NORTH AVE) AT CENTRAL AVE SCALE: 1"=20" SHEET NO. OF SHEETS STA.

COUNTY TOTAL SHEETS NO.

COOK 492 282

CONTRACT NO. 62N40 F.A.P. SECTION 307 2020-263-SUR, SW&TS TO STA.

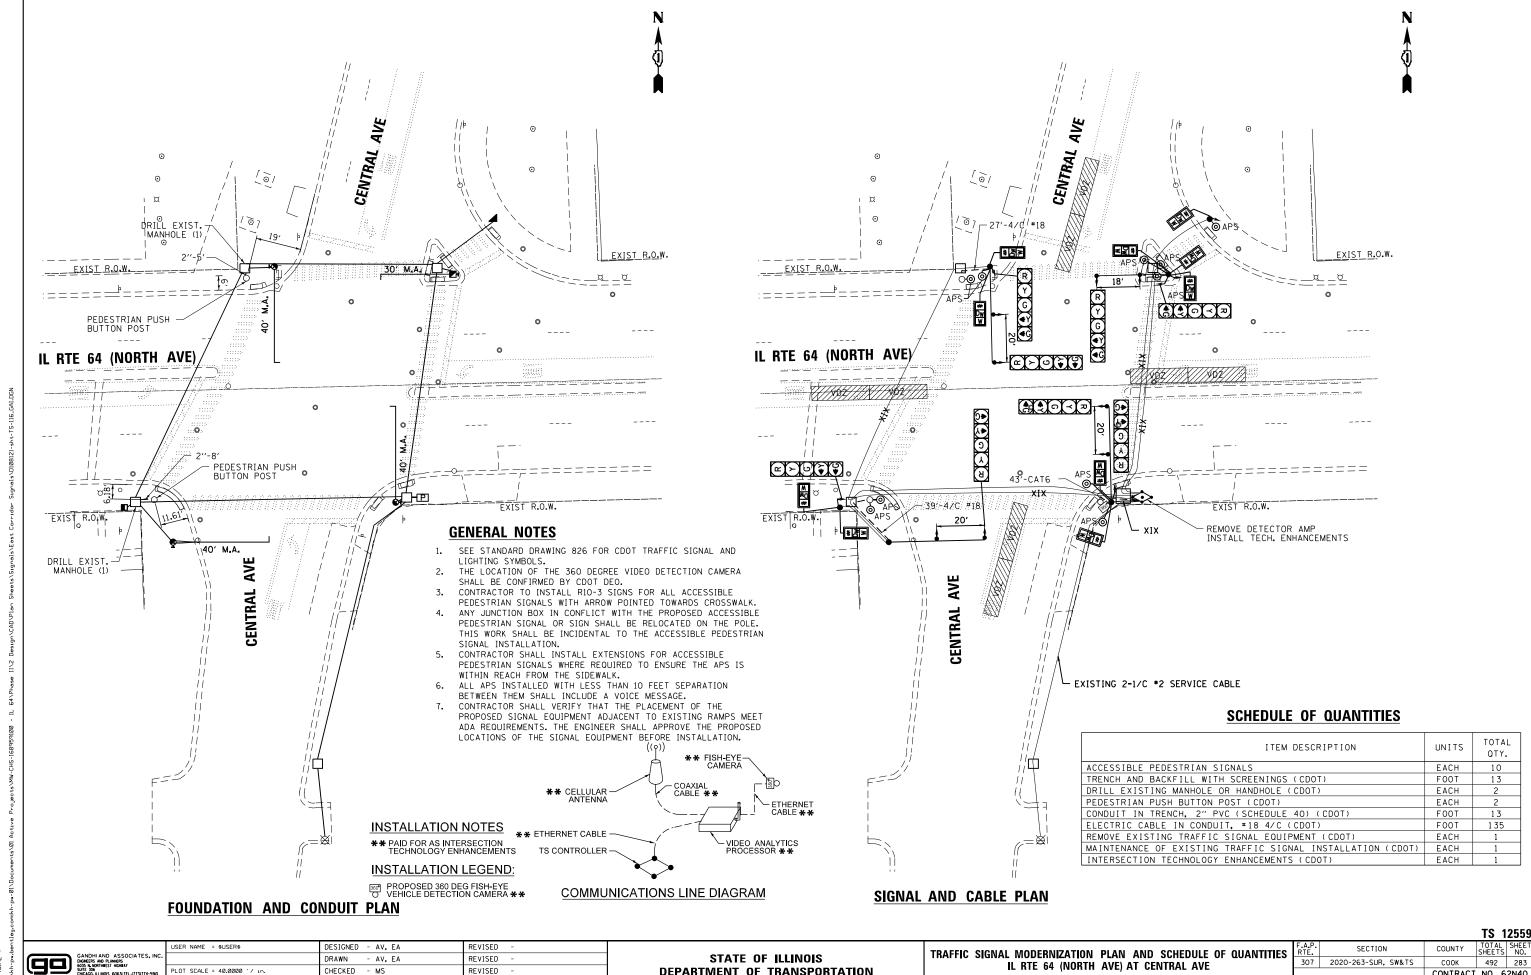

DEPARTMENT OF TRANSPORTATION

IL RTE 64 (NORTH AVE) AT CENTRAL AVE

SCALE: 1"=20" SHEET NO. OF SHEETS STA.


CONTRACT NO. 62N40

LOT SCALE = 40.0000 '/ in.

CHECKED

- MS

- 3/22/2024

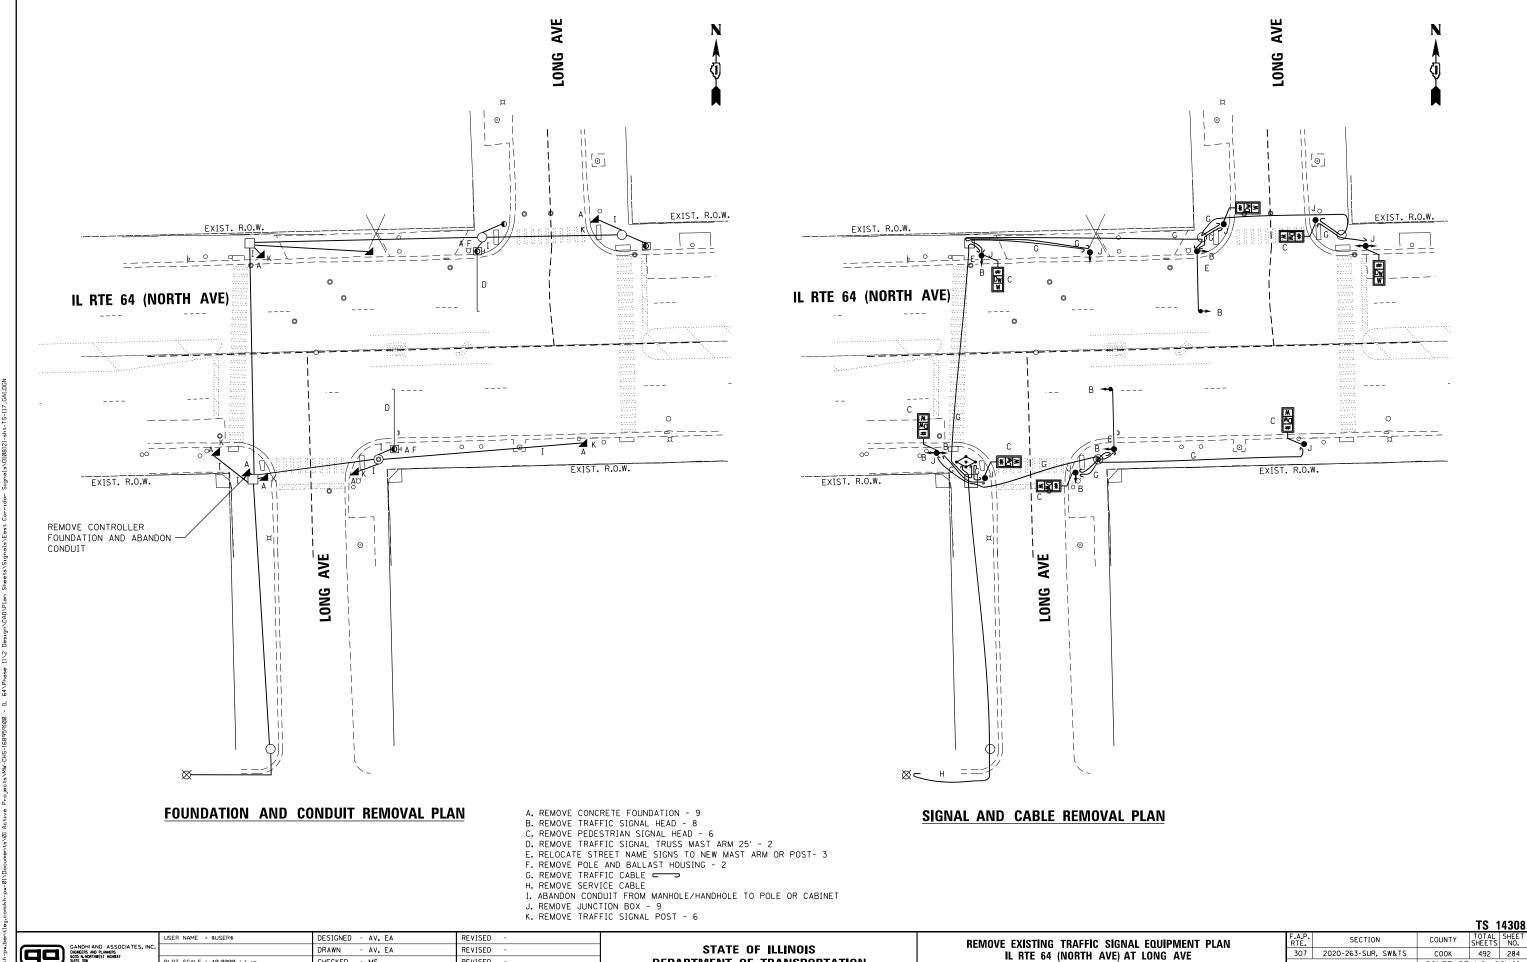

STATE OF ILLINOIS

DEPARTMENT OF TRANSPORTATION

SECTION

F.A.P. SECTION
307 2020-263-SUR, SW&TS

REMOVE EXISTING TRAFFIC SIGNAL EQUIPMENT PLAN

IL RTE 64 (NORTH AVE) AT LONG AVE

SCALE: 1"=20" SHEET NO. OF SHEETS STA.

COUNTY

соок

CONTRACT NO. 62N40

USER NAME = \$USER\$

LOT SCALE = 40.0000 '/ in.

DESIGNED - AV, EA

DRAWN - AV, EA

- 3/22/2024


CHECKED - MS

DATE

REVISED

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REVISED

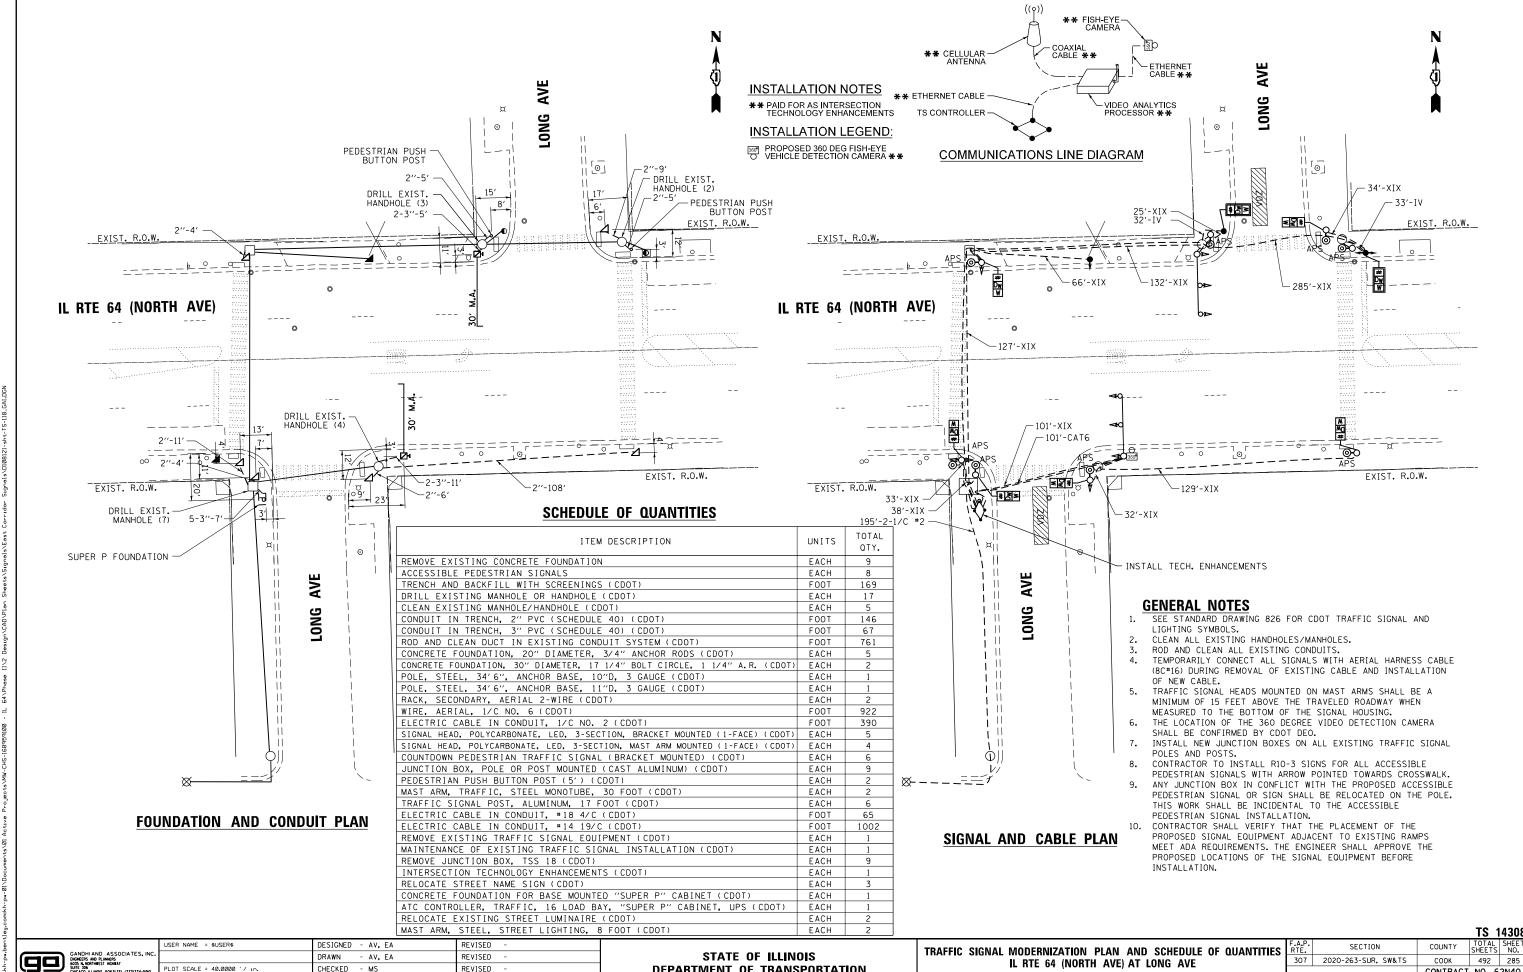

DEPARTMENT OF TRANSPORTATION

SCALE: 1"=20"

SHEET NO. OF SHEETS STA.

CONTRACT NO. 62N40


CHECKED - MS

- 3/22/2024

DATE

REVISED

- 3/22/2024

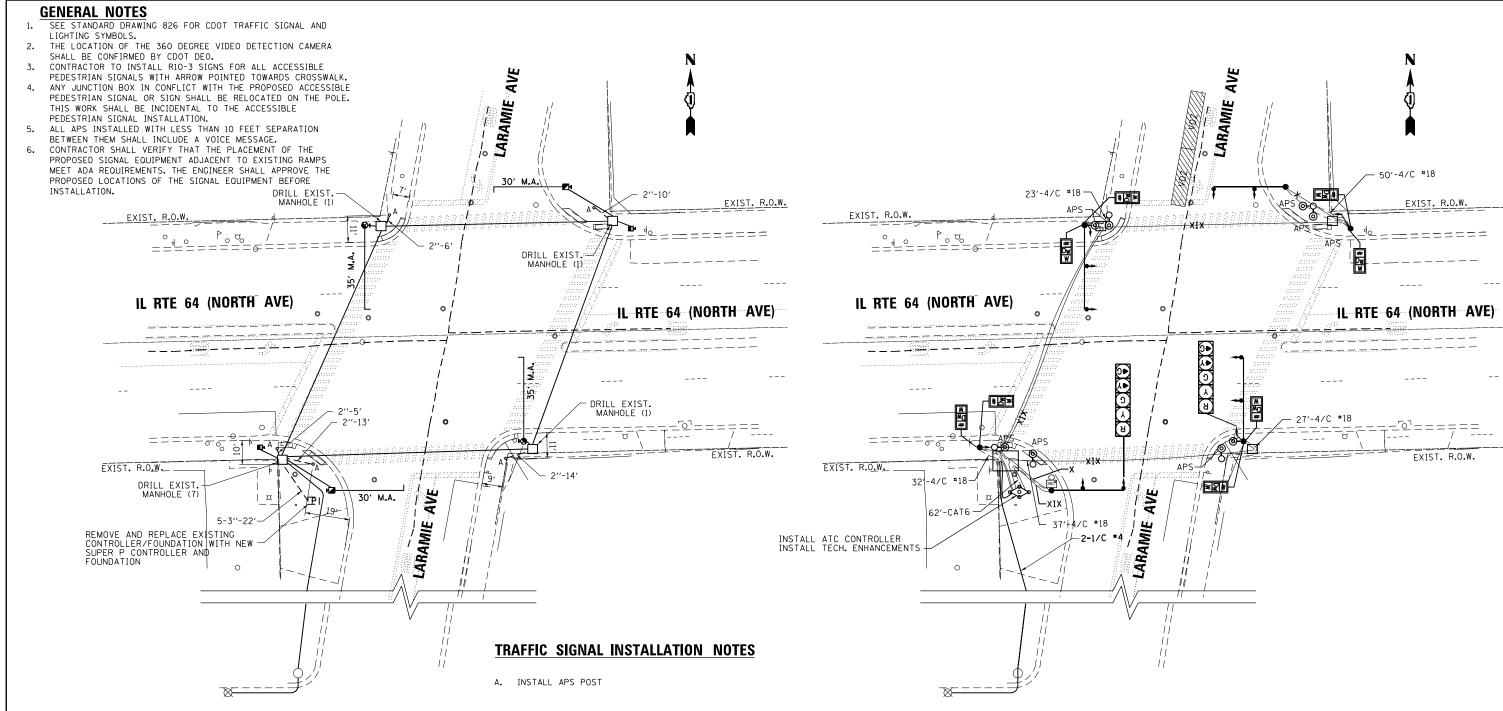

FOUNDATION AND CONDUIT PLAN

SIGNAL AND CABLE PLAN

INSTALLATION NOTES

** PAID FOR AS INTERSECTION TECHNOLOGY ENHANCEMENTS

INSTALLATION LEGEND:

PROPOSED 360 DEG FISH-EYE
VEHICLE DETECTION CAMERA **

CAMERA ** CELLULAR ANTENNA ** ETHERNET CABLE VIDEO ANALYTICS PROCESSOR ** TS CONTROLLER **COMMUNICATIONS LINE DIAGRAM**

| ITEM DESCRIPTION | UNITS | TOTAL QTY. |
|---|-------|---------------|
| ACCESSIBLE PEDESTRIAN SIGNALS | EACH | 8 |
| TRENCH AND BACKFILL WITH SCREENINGS (CDOT) | FOOT | 70 |
| DRILL EXISTING MANHOLE OR HANDHOLE (CDOT) | EACH | 10 |
| CONDUIT IN TRENCH, 2" PVC (SCHEDULE 40) (CDOT) | FOOT | 48 |
| CONDUIT IN TRENCH, 3" PVC (SCHEDULE 40) (CDOT) | FOOT | 110 |
| CONCRETE FOUNDATION FOR BASE MOUNTED "SUPER P" CABINET (CDOT) | EACH | 1 |
| PEDESTRIAN PUSH BUTTON POST (5') (CDOT) | EACH | 5 |
| ELECTRIC CABLE IN CONDUIT, #18 4/C (CDOT) | FOOT | 206 |
| ATC CONTROLLER, TRAFFIC, 16 LOAD BAY, "SUPER P" CABINET, UPS (CDOT) | EACH | 1 |
| REMOVE EXISTING TRAFFIC SIGNAL EQUIPMENT (CDOT) | EACH | 1 |
| MAINTENANCE OF EXISTING TRAFFIC SIGNAL INSTALLATION (CDOT) | EACH | 1 |
| INTERSECTION TECHNOLOGY ENHANCEMENTS (CDOT) | EACH | 1 |


SCHEDULE OF QUANTITIES

TS 12920 SHEET NO. 287 2N40

| | USER NAME = \$USER\$ | DESIGNED - AV, EA | REVISED - |
|---------|-----------------------------|-------------------|-----------|
| s, INC. | | DRAWN - AV, EA | REVISED - |
| 4-5910 | PLOT SCALE = 40.0000 '/ in. | CHECKED - MS | REVISED - |
| | PLOT DATE = \$DATE\$ | DATE - 3/22/2024 | REVISED - |
| | | | |

STATE OF ILLINOIS **DEPARTMENT OF TRANSPORTATION**

| | | | | | 13 12 | .J |
|---|------------|----------------|------------------------------|-----------|-----------------|---------|
| TRAFFIC SIGNAL MODERNIZATION PLAN AND SCHEDULE OF | OUANTITIES | F.A.P. RTE. | SECTION | COUNTY | TOTAL SHEETS | HZ 1 |
| IL RTE 64 (NORTH AVE) AT LARAMIE AVE | | 307 | 2020-263-SUR, SW&TS | соок | 492 | 2 |
| TE TILE OF (HOTTIFF FOLLY AT EXTENSIVE FOLL) | | | | CONTRACT | NO. 62 | 2N |
| SCALE: 1"=20" SHEET NO. OF SHEETS STA. TO ST | Α. | FED. RO | AD DIST, NO ILLINOIS FED. AI | D PROJECT | | |

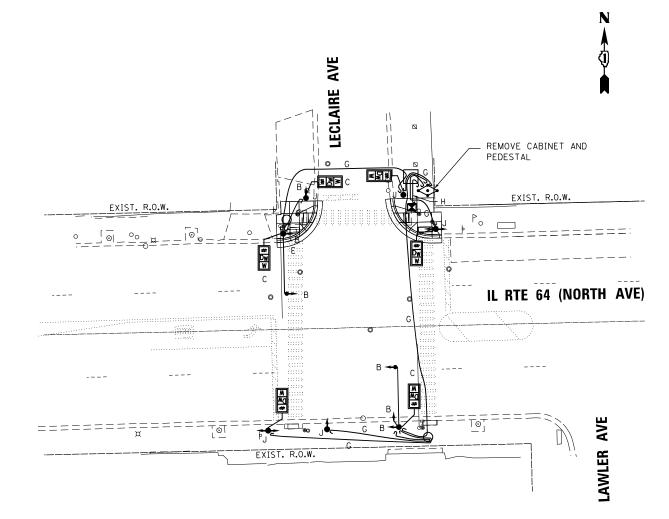

FOUNDATION AND CONDUIT REMOVAL PLAN

SIGNAL AND CABLE REMOVAL PLAN

GANDHIAND ASSOCIATES, INC.
DORAGES AND RAMMED SOCIATES, INC.
DORAGES AND R


GENERAL NOTES

- SEE STANDARD DRAWING 826 FOR CDOT TRAFFIC SIGNAL AND LIGHTING SYMBOLS.
- CLEAN ALL EXISTING HANDHOLES/MANHOLES.
- ROD AND CLEAN ALL EXISTING CONDUITS.
- TEMPORARILY CONNECT ALL SIGNALS WITH AERIAL HARNESS CABLE (8C#16) DURING REMOVAL OF EXISTING CABLE AND INSTALLATION OF NEW CABLE.
- TRAFFIC SIGNAL HEADS MOUNTED ON MAST ARMS SHALL BE A MINIMUM OF 15 FEET ABOVE THE TRAVELED ROADWAY WHEN MEASURED TO THE BOTTOM OF THE SIGNAL HOUSING.

 THE LOCATION OF THE 360 DEGREE VIDEO DETECTION CAMERA
- SHALL BE CONFIRMED BY CDOT DEO.
 INSTALL NEW JUNCTION BOXES ON ALL EXISTING TRAFFIC SIGNAL POLES AND POSTS.
- CONTRACTOR TO INSTALL R10-3 SIGNS FOR ALL ACCESSIBLE PEDESTRIAN SIGNALS WITH ARROW POINTED TOWARDS CROSSWALK.
- ANY JUNCTION BOX IN CONFLICT WITH THE PROPOSED ACCESSIBLE PEDESTRIAN SIGNAL OR SIGN SHALL BE RELOCATED ON THE POLE. THIS WORK SHALL BE INCIDENTAL TO THE ACCESSIBLE PEDESTRIAN SIGNAL INSTALLATION.
- CONTRACTOR SHALL VERIFY THAT THE PLACEMENT OF THE PROPOSED SIGNAL EQUIPMENT ADJACENT TO EXISTING RAMPS MEET ADA REQUIREMENTS. THE ENGINEER SHALL APPROVE THE PROPOSED LOCATIONS OF THE SIGNAL EQUIPMENT BEFORE INSTALLATION.

TOTAL UNITS ITEM DESCRIPTION QTY. REMOVE EXISTING CONCRETE FOUNDATION EACH ACCESSIBLE PEDESTRIAN SIGNALS EACH TRENCH AND BACKFILL WITH SCREENINGS (CDOT) FOOT 77 DRILL EXISTING MANHOLE OR HANDHOLE (CDOT) EACH 11 CLEAN EXISTING MANHOLE/HANDHOLE (CDOT) EACH FOOT CONDUIT IN TRENCH, 3" PVC (SCHEDULE 40) (CDOT) FOOT 67 ROD AND CLEAN DUCT IN EXISTING CONDUIT SYSTEM (CDOT) FOOT 465 CONCRETE FOUNDATION, 20" DIAMETER, 3/4" ANCHOR RODS (CDOT) FACH CONCRETE FOUNDATION, 30" DIAMETER, 16 1/2" BOLT CIRCLE, 1 1/2" A.R. (CDOT) EACH POLE, STEEL, 34'6", ANCHOR BASE, 10"D, 3 GAUGE (CDOT) RACK, SECONDARY, AERIAL 2-WIRE (CDOT) EACH EACH 706 WIRE, AERIAL, 1/C NO. 6 (CDOT) FOOT ELECTRIC CABLE IN CONDUIT, 1/C NO. 4 (CDOT) SIGNAL HEAD, POLYCARBONATE, LED. 3-SECTION, BRACKET MOUNTED (1-FACE) (CDOT) FOOT 64 SIGNAL HEAD, POLYCARBONATE, LED, 3-SECTION, MAST ARM MOUNTED (1-FACE) (CDOT) FACH <u> COUNTDOWN PEDESTRIAN TRAFFIC SIGNAL (BRACKET MOUNTED) (CDOT)</u> EACH JUNCTION BOX, POLE OR POST MOUNTED (CAST ALUMINUM) (CDOT) EACH PEDESTRIAN PUSH BUTTON POST (5') (CDOT) EACH MAST ARM, TRAFFIC, STEEL MONOTUBE, 26 FOOT (CDOT) EACH MAST ARM, TRAFFIC, STEEL MONOTUBE, 35 FOOT (CDOT) EACH MAST ARM, TRAFFIC, STEEL MONOTUBE, 40 FOOT (CDOT) EACH ELECTRIC CABLE IN CONDUIT, #18 4/C (CDOT) FOOT 125 ELECTRIC CABLE IN CONDUIT, #14 19/C (CDOT) FOOT 481 REMOVE EXISTING TRAFFIC SIGNAL EQUIPMENT (CDOT) EACH MAINTENANCE OF EXISTING TRAFFIC SIGNAL INSTALLATION (CDOT) EACH REMOVE JUNCTION BOX, TSS 18 (CDOT) EACH INTERSECTION TECHNOLOGY ENHANCEMENTS (CDOT) EACH RELOCATE STREET NAME SIGN (CDOT) EACH CONCRETE FOUNDATION FOR BASE MOUNTED "SUPER P" CABINET (CDOT) ATC CONTROLLER, TRAFFIC, 16 LOAD BAY, "SUPER P" CABINET, UPS (CDOT) EACH EACH RELOCATE EXISTING STREET LUMINAIRE (CDOT) EACH MAST ARM, STEEL, STREET LIGHTING, 8 FOOT (CDOT)

TRAFFIC SIGNAL INSTALLATION NOTES

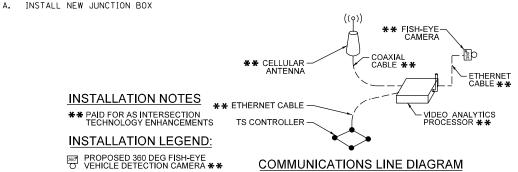

IL RTE 64 (NORTH AVE)


TS 13895

ENGRERS AND PLANKES
6035 N. NORTHBEST HIGHBAY
SUITE 306
CHICAGO ILLINOIS 6063 TSU

DESIGNED - AV. EA REVISED DRAWN - AV. EA REVISED CHECKED REVISED REVISED - 3/22/2024

STATE OF ILLINOIS **DEPARTMENT OF TRANSPORTATION** TRAFFIC SIGNAL MODERNIZATION PLAN AND SCHEDULE OF QUANTITIES IL RTE 64 (NORTH AVE) AT LECLAIRE AVE /LAWLER AVE SCALE: 1"=20" SHEET NO. OF SHEETS STA.

COUNTY 307 2020-263-SUR, SW&TS COOK 492 289 CONTRACT NO. 62N40

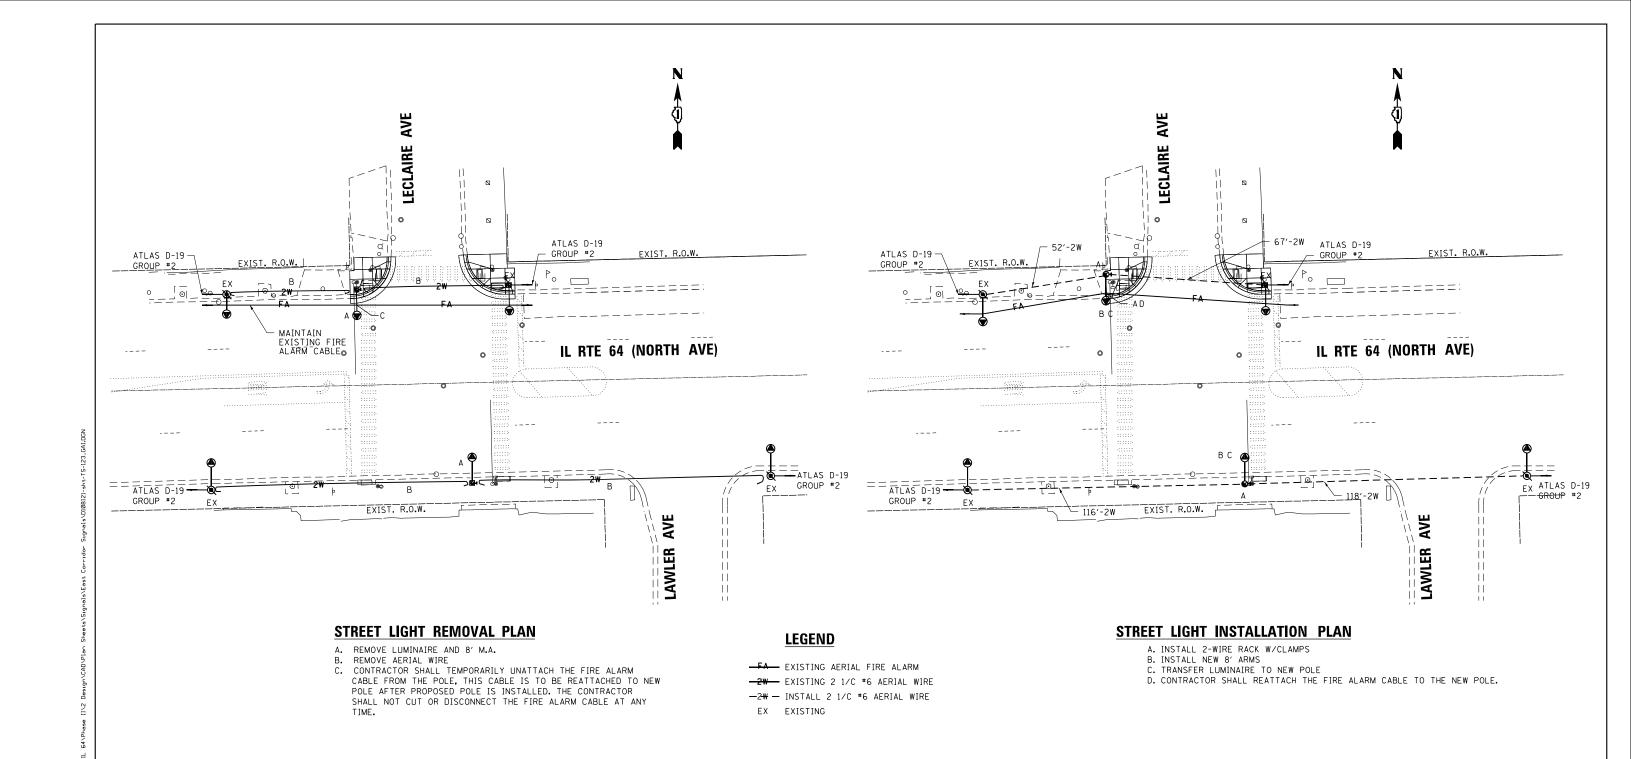

GANDHI AND ASSOCIATES, INC.
DECRETS AND PLANESS
SUBJ. Nacional ST Morian
OH.C.O., ALMOS 6063 TEL./173/74-590

 USER NAME = SUSERS
 DESIGNED - AV, EA
 REVISED

 DRAWN - AV, EA
 REVISED


 PLOT SCALE = 40.0000 '/ in.
 CHECKED - MS
 REVISED

 PLOT DATE = SDATES
 DATE - 3/22/2024
 REVISED

STATE OF ILLINOIS
DEPARTMENT OF TRANSPORTATION

LIGHTING MODIFICATION PLAN
IL RTE 64 (NORTH AVE) AT LECLAIRE AVE /LAWLER AVE

SCALE: 1"=20" SHEET NO. OF SHEETS STA. TO STA.

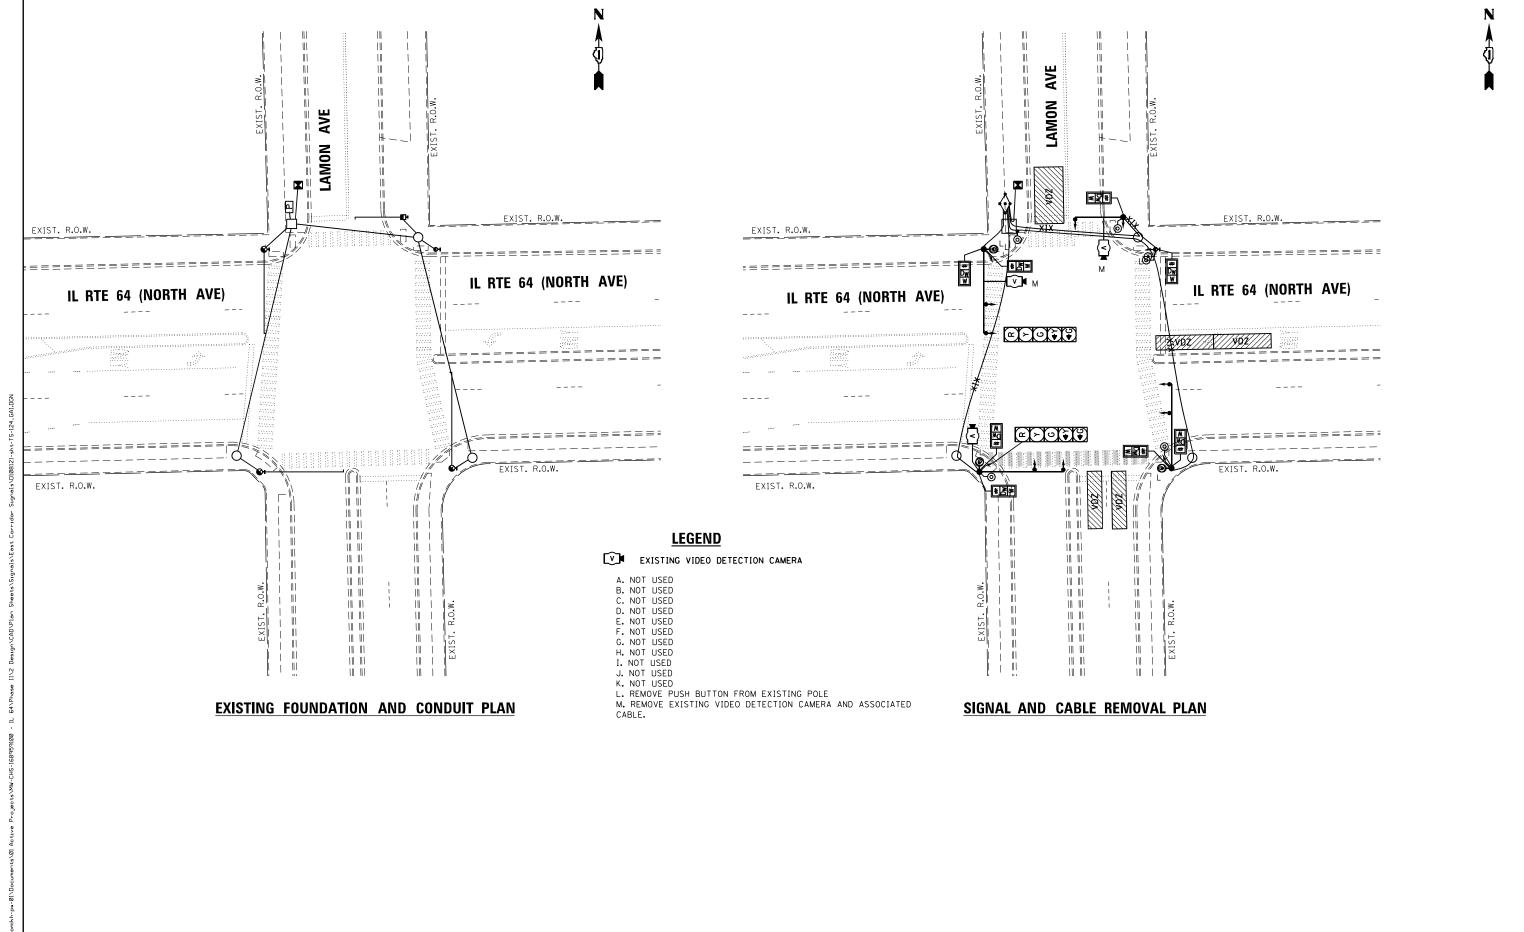


pw:\\kh-pw.bentley.com

ASSOCIATES, INC. ERS IGHBAY 0631 TEL.(773)774-5910

STATE OF ILLINOIS
DEPARTMENT OF TRANSPORTATION

REMOVE EXISTING TRAFFIC SIGNAL EQUIPMENT PLAN IL RTE 64 (NORTH AVE) AT LAMON AVE

SCALE: 1"=20" SHEET NO. OF SHEETS STA. TO STA.

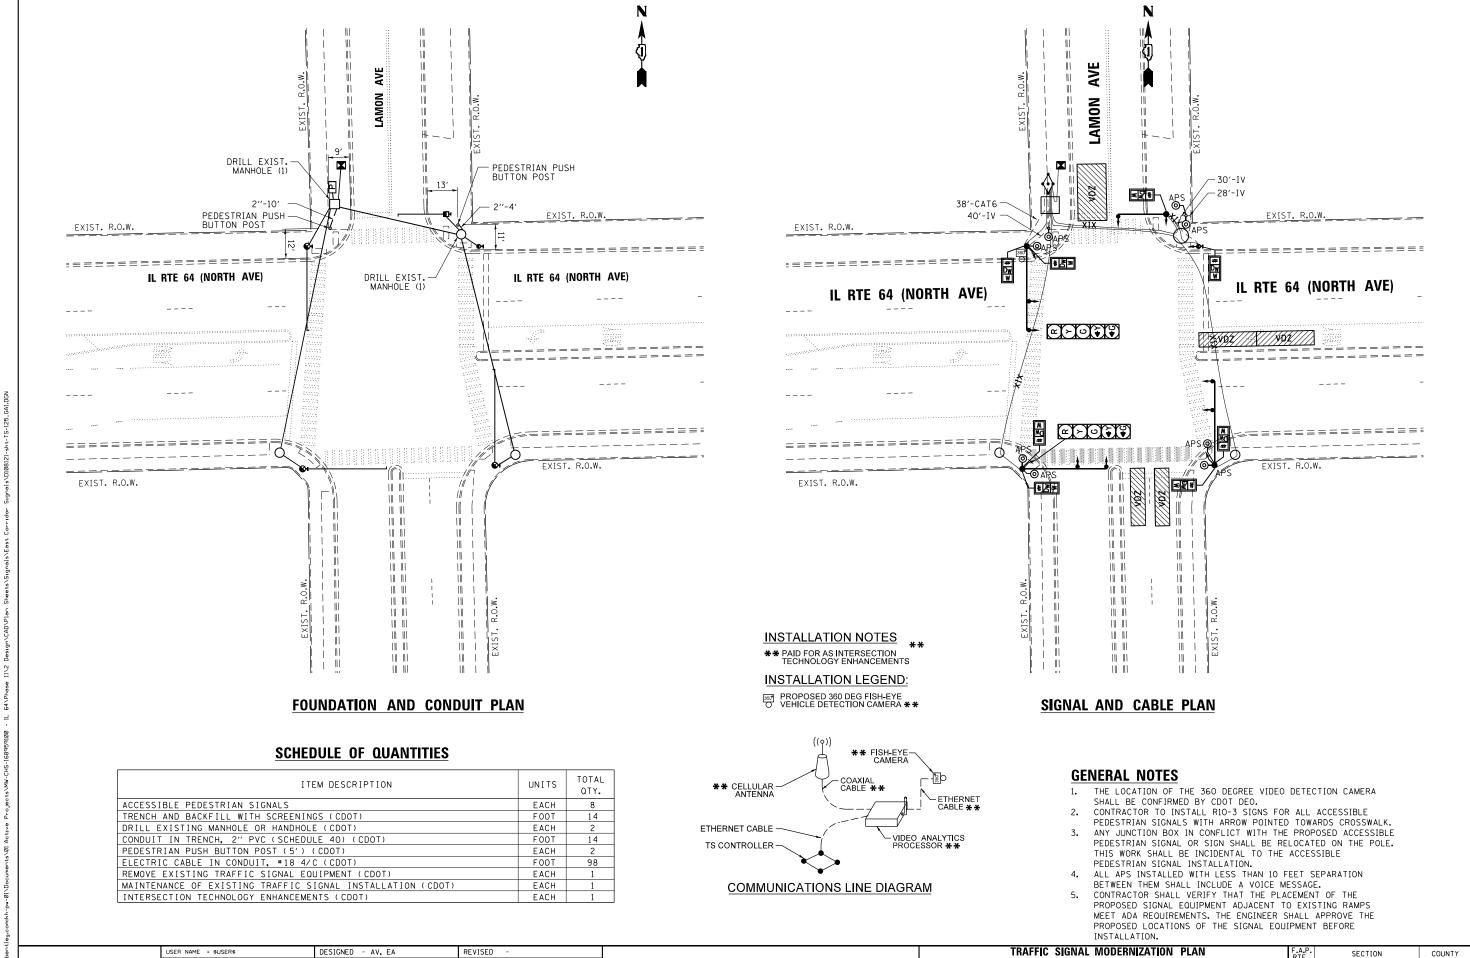

STATE OF ILLINOIS

DEPARTMENT OF TRANSPORTATION

AND SCHEDULE OF QUANTITIES

IL RTE 64 (NORTH AVE) AT LAMON AVE

SHEET NO. OF SHEETS STA.

307 2020-263-SUR, SW&TS

COOK

492 292

CONTRACT NO. 62N40

GANDHI AND ASSOC ENGRERS AND PLAMES 6035 N. NORTHIEST HIGHBAY SUITE 306 CHICAGO, ILLINOIS 60631 TELA

DESIGNED - AV, EA

- AV, EA

- 3/22/2024

- MS

DRAWN


CHECKED

REVISED

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REVISED

USER NAME = \$USER\$

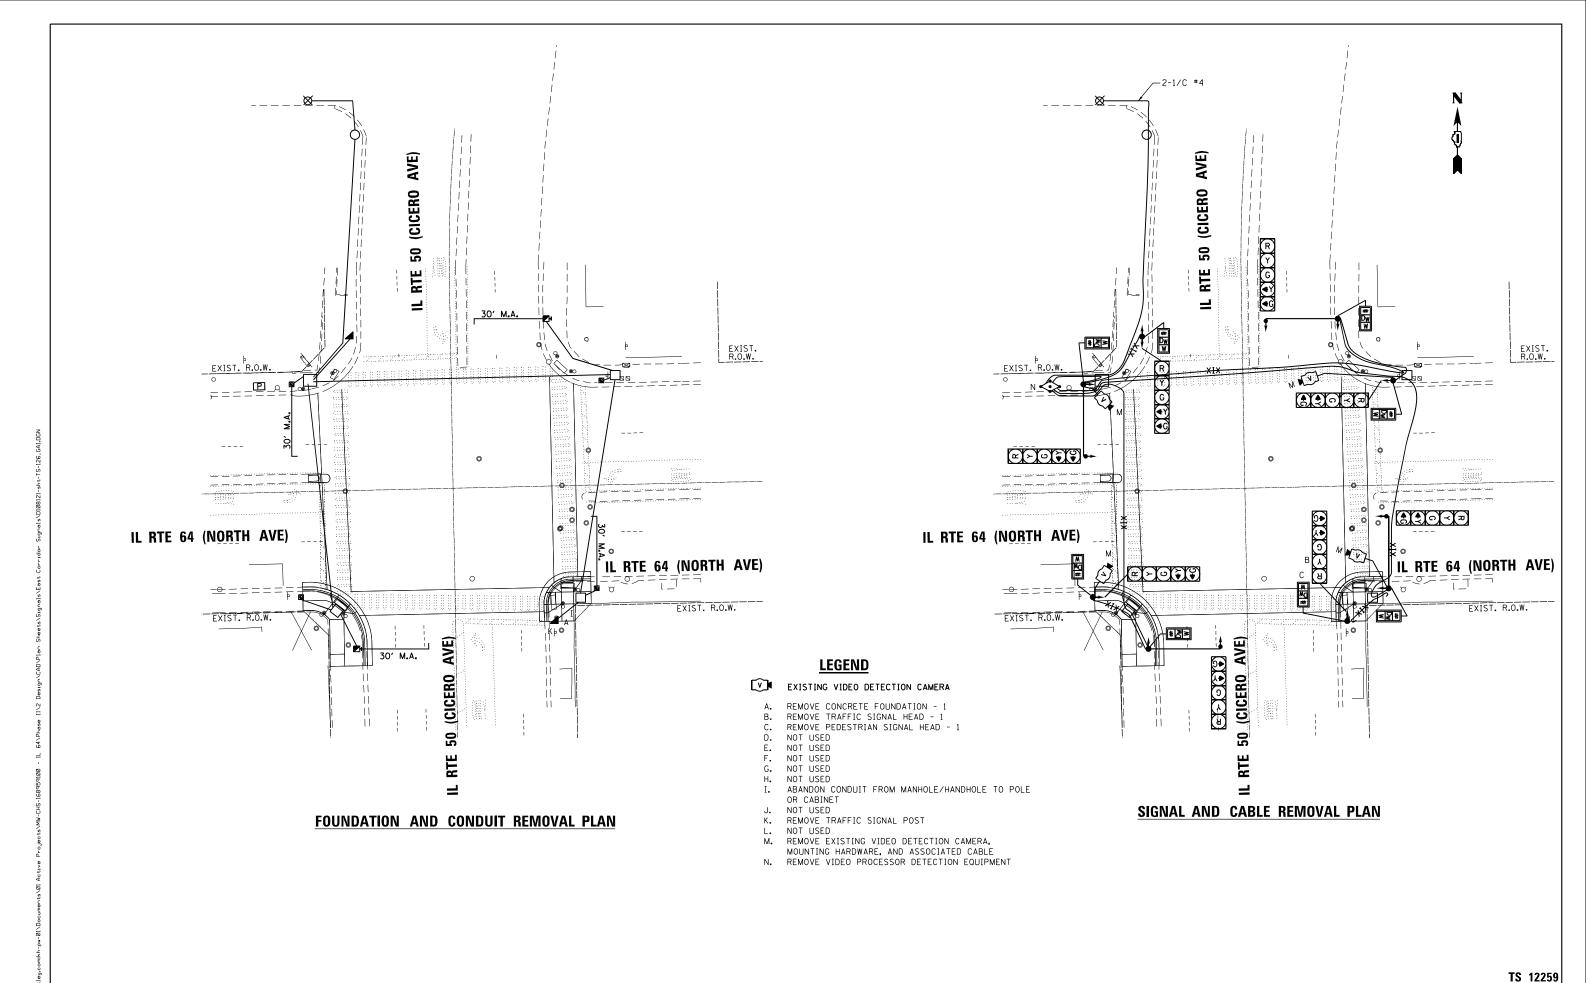


GANDHI AND ASSOCIATES, INC.
DIORETS AND R. MINETS
503 b. MORTHESTS HOMAY
SOLE DIORETS. HOMAY
CHEANOR, LLINOS 6069 TEL.17731774-590

STATE OF ILLINOIS
DEPARTMENT OF TRANSPORTATION

TRAFFIC SIGNAL REMOVAL PLAN
IL RTE 64 (NORTH AVE) AT IL RTE 50 (CICERO AVE)

SCALE: 1"=20" SHEET NO. OF SHEETS STA. TO STA.

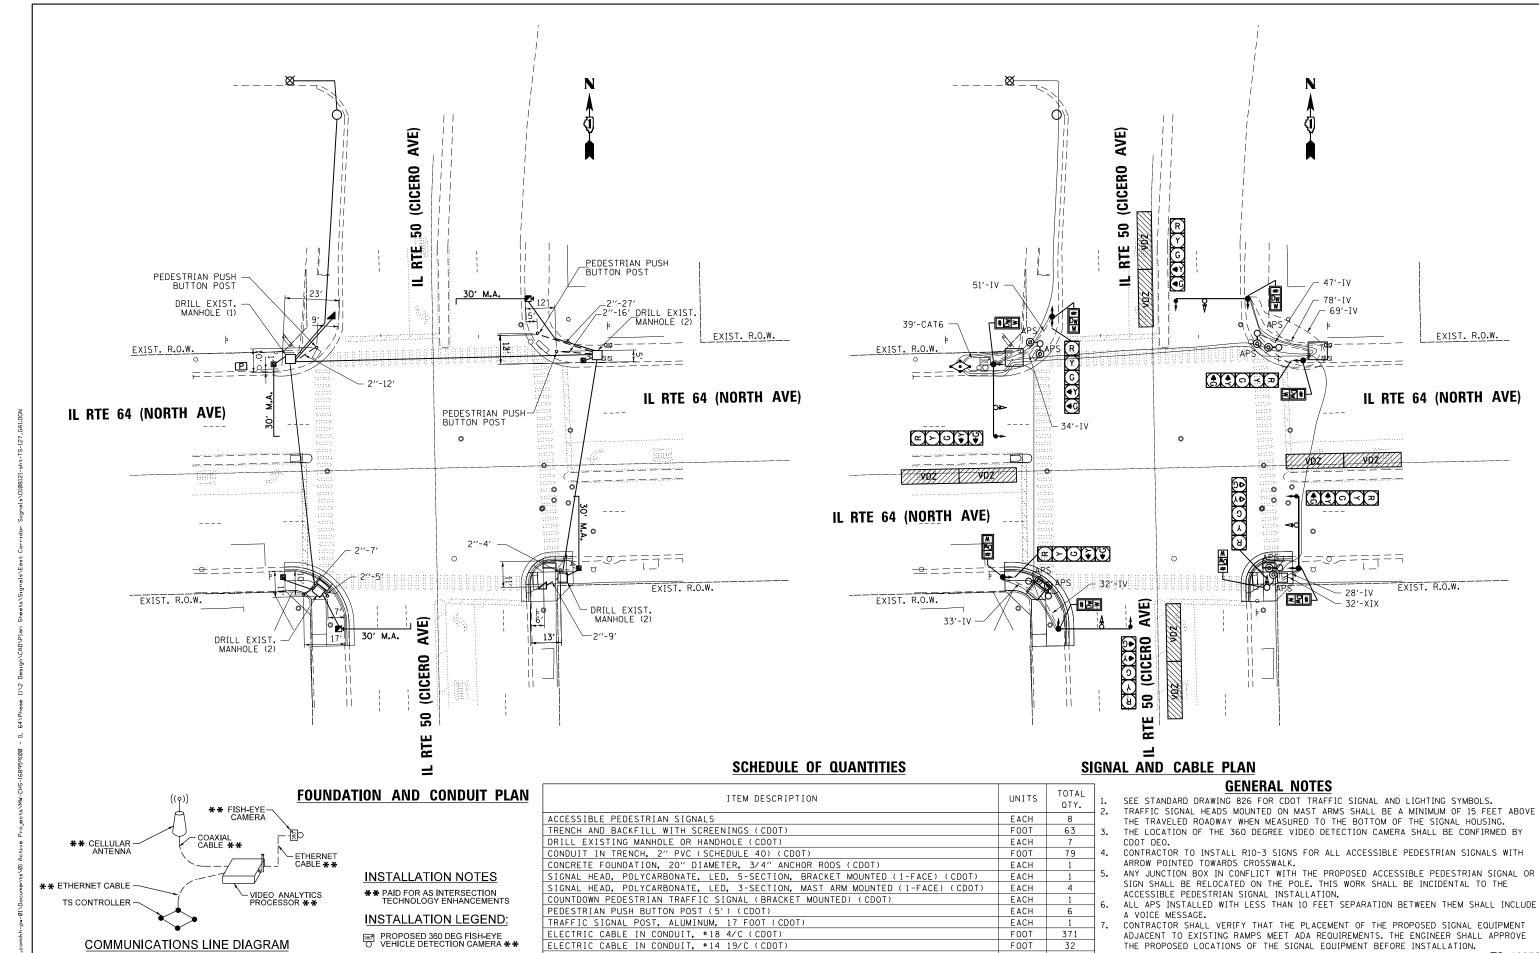

STATE OF ILLINOIS

DEPARTMENT OF TRANSPORTATION

TS 12259

492 294

CONTRACT NO. 62N40

COUNTY

COOK

SECTION

307 2020-263-SUR, SW&TS

TRAFFIC SIGNAL MODERNIZATION PLAN

IL RTE 64 (NORTH AVE) AT IL RTE 50 (CICERO AVE)

SHEET NO. OF SHEETS STA.

INTERSECTION TECHNOLOGY ENHANCEMENTS (CDOT)

DESIGNED - AV, EA

CHECKED - MS

- AV, EA

- 3/22/2024

DRAWN

LOT SCALE = 40.0000 '/ in.

REVISED

REVISED

REVISED

REVISED

FILE NAME =

ENGRERS AND PLANNERS
6035 N. NORTHBEST HIGHBAY
SUITE 306
CHICAGO, ILLINOIS 60631 TELA

TRAFFIC SIGNAL LEGEND (NOT TO SCALE)

| <u>ITEM</u> | | | | | | | | |
|---|------------------------------------|--|--|-----------------|-------------------|--|---|---|
| 11811 | EXISTING | PROPOSED | ITEM | <u>EXISTING</u> | PROPOSED | <u>ITEM</u> | <u>existing</u> | PROPOSED |
| CONTROLLER CABINET | | | HANDHOLE -SQUARE -ROUND | | | SIGNAL HEAD -(P) PROGRAMMABLE SIGNAL HEAD | | R R Y |
| COMMUNICATION CABINET | ECC | CC | HEAVY DUTY HANDHOLE | | - | | | G G 4Y 4Y 4G |
| MASTER CONTROLLER | ЕМС | MC | -SQUARE -ROUND | H (H) | ⊞ ⊕ | | (• G) | G G P |
| MASTER MASTER CONTROLLER | EMMC | ммс | DOUBLE HANDHOLE | | | SIGNAL HEAD WITH BACKPLATE | | RRR |
| UNINTERRUPTABLE POWER SUPPLY | 4 | 4 | JUNCTION BOX | | • | -(P) PROGRAMMABLE SIGNAL HEAD -(RB) RETROREFLECTIVE BACKPLATE | | |
| SERVICE INSTALLATION -(P) POLE MOUNTED | P | - ■ -P | RAILROAD CANTILEVER MAST ARM | XOX X | X OI X | | | G G G 4Y 4Y 4G 4G |
| SERVICE INSTALLATION | G GM | G GM | RAILROAD FLASHING SIGNAL | ∑⊖∑ | X⊕X | | P RB | P RB |
| -(G) GROUND MOUNTED -(GM) GROUND MOUNTED METERED | $\boxtimes^{G}\boxtimes^{GM}$ | ⊠ ^G ⊠ ^{GM} | RAILROAD CROSSING GATE | 202 | X•X | PEDESTRIAN SIGNAL HEAD | () | • |
| TELEPHONE CONNECTION | ET | Т | RAILROAD CROSSBUCK | ★ | * | AT RAILROAD INTERSECTIONS | | ♥ ※ |
| STEEL MAST ARM ASSEMBLY AND POLE | O | •—— | RAILROAD CONTROLLER CABINET | ⊠ | ₽∢ | PEDESTRIAN SIGNAL HEAD WITH COUNTDOWN TIMER | () C () D | ₽ C ★ D |
| ALUMINUM MAST ARM ASSEMBLY AND POLE | | | UNDERGROUND CONDUIT (UC), GALVANIZED STEEL | | | | | |
| STEEL COMBINATION MAST ARM ASSEMBLY AND POLE WITH LUMINAIRE | 0 - X | •* | TEMPORARY SPAN WIRE, TETHER WIRE, AND CABLE | | | ILLUMINATED SIGN "NO LEFT TURN"/"NO RIGHT TURN" | | |
| SIGNAL POST -(BM) BARREL MOUNTED - TEMPORARY | 0 | ● BM | SYSTEM ITEM | S | SP | NUMBER OF CONDUCTORS, ELECTRIC CABLE NO. 14, UNLESS NOTED OTHERWISE. | | |
| WOOD POLE | ⊗ | Θ | INTERSECTION ITEM | I | IP | ALL DETECTOR LOOP CABLE TO BE SHIELDED | | |
| GUY WIRE | | . → | REMOVE ITEM | | R | GROUND CABLE IN CONDUIT, NO. 6 SOLID COPPER (GREEN) | | |
| SIGNAL HEAD | | <i>-</i> ► | RELOCATE ITEM | | RL . | ELECTRIC CABLE IN CONDUIT, TRACER NO. 14 1/C | | |
| SIGNAL HEAD WITH BACKPLATE | #⊳ | +- | ABANDON ITEM CONTROLLER CABINET AND | | Α | COAXIAL CABLE | — <u>c</u> | —c— |
| SIGNAL HEAD OPTICALLY PROGRAMMED | P P P | → P + → P | FOUNDATION TO BE REMOVED | | RCF | COANIAL CABLE | ~~~~~~~~~~~~~~~~~~~~~~~~~~~~~~~~~~~~~~~ | |
| FLASHER INSTALLATION | ot⊳ ^F ot⊳ ^{FS} | •► FS FS | MAST ARM POLE AND FOUNDATION TO BE REMOVED | | RMF | VENDOR CABLE | | |
| -(FS) SOLAR POWERED | DH> ^F DH> ^{FS} | ₽ F ₽FS | SIGNAL POST AND FOUNDATION TO BE REMOVED | | RPF | COPPER INTERCONNECT CABLE, NO. 18, 3 PAIR TWISTED, SHIELDED | 6#18 | <u>—(6#18)</u> |
| PEDESTRIAN SIGNAL HEAD | -0 | -1 | DETECTOR LOOP, TYPE I | | | FIBER OPTIC CABLE -NO. 62.5/125, MM12F | | 12F |
| PEDESTRIAN PUSH BUTTON -(APS) ACCESSIBLE PEDESTRIAN PUSH BUTTON | ⊚ | | PREFORMED DETECTOR LOOP | PP | PP | -NO. 62.5/125, MM12F SM12F -NO. 62.5/125, MM12F SM24F | | |
| RADAR DETECTION SENSOR | LR A | _R ■ | SAMPLING (SYSTEM) DETECTOR | 5 (5) | 5 (5) | | | —(36F)— |
| VIDEO DETECTION CAMERA | | ▽ | INTERSECTION AND SAMPLING (SYSTEM) DETECTOR | IS (IS) | IS (IS) | | | |
| RADAR/VIDEO DETECTION ZONE | | | QUEUE AND SAMPLING (SYSTEM) DETECTOR | os (s) | QS QS | GROUND ROD -(C) CONTROLLER -(M) MAST ARM | <u> </u> | $\stackrel{\cdot}{T}^{C} \stackrel{\cdot}{T}^{M} \stackrel{\cdot}{T}^{P} \stackrel{\cdot}{T}^{S}$ |
| PAN, TILT, ZOOM (PTZ) CAMERA | PTZ | PTZ | WIRELESS DETECTOR SENSOR | (W) | ® | -(P) POST -(S) SERVICE | | |
| EMERGENCY VEHICLE LIGHT DETECTOR | \bowtie | ~ | WIRELESS ACCESS POINT | | - | | | |
| | ○ —□ | ⊢ 4 | | | | | | |
| CONFIMATION BEACON | | The | | | | | | |
| WIRELESS INTERCONNECT | ○1 | • •1 | | | | | | |

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| | DRAWN | • | IP | REVISED | |
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| PLOT DATE = 3/4/2019 | DATE | | 9/29/2016 | REVISED | * |

| STATI | E OF | ILLINOIS |
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| DEPARTMENT | OF | TRANSPORTATION |


SCALE: NONE

| DISTRICT ONE TANDARD TRAFFIC SIGNAL DESIGN DETAILS | | | |
|---|--|------|---|
| | | SHEE | |
| | | 1 | I |


LOOP DETECTOR NOTES

- 1. EACH PAIR OF LOOP WIRES SHALL BE PLACED IN A SEPARATE EMPTY COILABLE NONMETALLIC CONDUIT FROM THE EDGE OF PAVEMENT TO THE HANDHOLE. SPACING BETWEEN THE HOLES DRILLED IN THE PAVEMENT SHALL NOT BE LESS THAN 6" (150 mm). EMPTY COILABLE NONMETALLIC CONDUIT SHALL BE INCLUDED IN THE COST OF THE LOOP WIRE.
- 2. THE NUMBER OF LOOP TURNS SHALL BE AS RECOMMENDED BY THE AMPLIFIER MANUFACTURER. ALL ADJACENT SIDES OF THE LOOPS SHALL BE INSTALLED IN SUCH A WAY THAT THE CURRENT FLOW IS IN THE SAME DIRECTION TO REINFORCE ITS MAGNETIC FIELDS FOR SMALL VEHICLE DETECTION.
- 3. EACH LOOP LEAD-IN SHALL BE IDENTIFIED AND PERMANENTLY TAGGED IN THE HANDHOLE. EACH LEAD-IN CABLE TAG SHALL INDICATE THE LOCATION OF THE LOOP, LOOP ROTATION (CLOCKWISE/COUNTERCLOCKWISE), LOOP LEAD-IN DIRECTION (IN OR OUT), LOOP CABLE NUMBER AND LOCATION IN CABINET, AND NUMBER OF TURNS IN THE DETECTOR LOOPS IN WATER PROOF INK AS INDICATED ON THE DISTRICT 1 STANDARD TRAFFIC SIGNAL DESIGN DETAIL. THE CONTRACTOR SHALL MARK LOOP LOCATIONS ON RECORD DRAWINGS AND PRESENT TO THE ENGINEER AFTER FINAL INSPECTION. LOOPS SHALL BE MARKED BY LANE AND LOOP NUMBER. SEE DETAIL BELOW.
- 4. ALL LOOP CABLE SHALL BE FASTENED WITH PLASTIC TIE WRAP TO THE HANDHOLE HOOKS.
- 5. IN ASPHALT PAVEMENT, LOOPS SHOULD BE PLACED IN THE BINDER AND DIVEHOLES MARKED AT THE CURB WITH A SAW-CUT. THE SAW-CUT SHALL BE CUT IN ACCORDANCE WITH LOCAL AND E,P,A, DUST CONTROL REQUIREMENTS, DETECTOR LOOP(S) SHALL NOT BE INSTALLED IN WET CONDITIONS AND THE SAW-CUTS MUST BE FREE OF DEBRIS AND RESIDUE SUCH AS DUST AND WATER WHICH IS TO BE ACHIEVED BY THE USE OF COMPRESSED AIR, WIRE BRUSHING AND HEAT DRYING ACCORDING TO SEALANT MANUFACTURER REQUIREMENTS. THE DETECTOR WIRE SHALL BE HELD IN PLACE BY THE USE OF FORM WEDGES. WEDGES SHALL BE SPACED NO MORE THAN 18" (450 mm) APART.
- 6. LOOP SPLICES SHALL BE SOLDERED USING A SOLDERING IRON. BLOW TORCHES OR OTHER DEVICES WHICH OXIDIZE COPPER CABLE SHALL NOT BE ALLOWED FOR SOLDERING OPERATIONS. SEE DETAIL BELOW RIGHT.
- 7. PREFORMED DETECTOR LOOPS SHALL BE USED, AS SHOWN ON THE PLANS, WHERE NEW CONCRETE PAVEMENT IS PROPOSED. THE INSTALLATION OF PREFORMED LOOPS SHALL BE IN ACCORDANCE WITH THE DISTRICT 1 SPECIFICATIONS OR AS DIRECTED BY THE ENGINEER.

LOOP LEAD-IN CABLE TAG

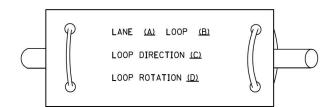



- A. LANE 1 IS THE LANE CLOSEST TO THE CENTERLINE OF THE ROADWAY
- B. LOOP #1 IS THE LOOP IN THE LANE CLOSEST TO THE INTERSECTION.
- C. LABEL LOOP CABLE "IN" OR LOOP CABLE "OUT".
- D. LABEL LOOP CABLE CLOCKWISE OR LOOP CABLE COUNTERCLOCKWISE.

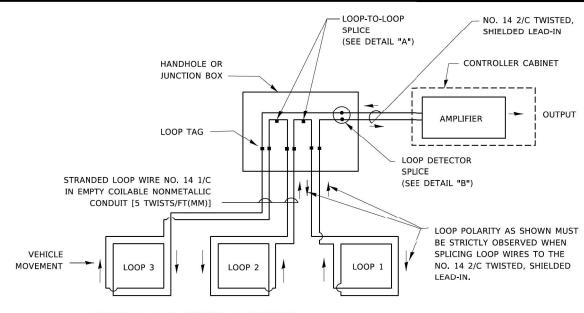

DETECTOR LOOP WIRING SCHEMATIC

- LOOPS SHALL BE SPLICED IN SERIES. SAW-CUTS SHALL BE A MINIMUM WIDTH OF 5/16" (8 mm).
- SAW-CUT DEPTHS SHALL BE 3" (75 mm). IF IN CONCRETE,
- THE SAW-CUT DEPTH SHALL BE TO THE TOP OF THE REINFORCEMENT.
- LOOP CORNERS SHALL BE DRILLED WITH A 2" (50 mm) DIAMETER CORE.

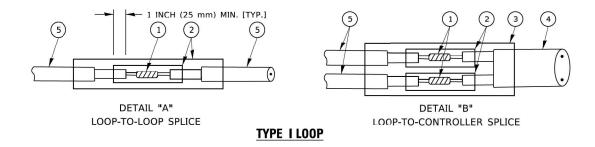

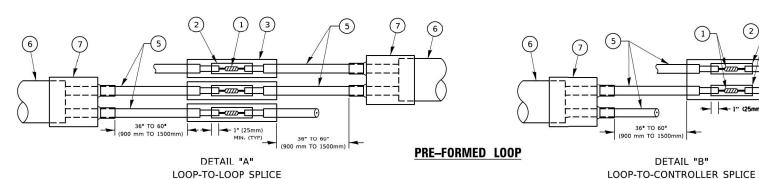

LOOP DETECTOR SPLICE

- (1) WESTERN UNION SPLICE SOLDERED WITH ROSIN CORE FLUX. ALL EXPOSED SURFACES OF THE SOLDER SHALL BE SMOOTH. THE WESTERN UNION SPLICES SHALL BE STAGGERED.
- (2) WCSMW 30/100 HEAT SHRINK TUBE, MINIMUM LENGTH 3" (75 mm), UNDERWATER GRADE.
- (3) WCS 200/750 HEAT SHRINK TUBE, MINIMUM LENGHT 6" (150 mm), UNDERWATER GRADE.
- (4) NO. 14 2/C TWISTED, SHIELDED CABLE.

- 5 LOOP CONDUCTOR WITH FLEXIBLE PLASTIC TUBE. PRE-FORMED LOOP
- (6) XL POLYOLEFIN 2 CONDUCTOR
- (7) BREAKOUT SEALS. TYCO CBR-2 OR APPROVED EQUAL

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| PLOT DATE = 3/4/2019 | DATE - | REVISED - |

STATE OF ILLINOIS **DEPARTMENT OF TRANSPORTATION**

| | | DIST | RICT ON | E | |
|-------------|----------|---------|---------|--------|---------|
| | STANDARD | TRAFFIC | SIGNAL | DESIGN | DETAILS |
| SCALE: NONE | SHEET 2 | OF 7 | SHEETS | STA. | TO STA. |


| | F.A.P. SECTION | | | | COUNTY | TOTAL SHEETS | SHEET NO. |
|--|-----------------------------|------------------------|--|--|-----------|-----------------|--------------|
| | 307 | 307 2020-263-SUR,SW&TS | | | COOK | 492 | 297 |
| | TS-05 ILLINOIS FED. AI | | | | CONTRACT | NO. 62 | N40 |
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1" (25mm) MIN. (TYP)

TRAFFIC SIGNAL MAST ARM AND SIGNAL POST


MAST ARM MOUNTED SIGNALS IN EXISTING, PROPOSED OR FUTURE SIDEWALK/BICYCLE PATH AREA. INTERSECTION SHOWN WITH PEDESTRIAN SIGNALS AND

PEDESTRIAN PUSHBUTTON DETECTORS.

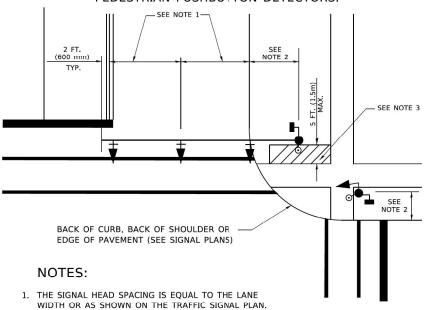


- 2. REFER TO THE TRAFFIC SIGNAL EQUIPMENT OFFSET TABLE.
- PROVIDE A LEVEL ALL-WEATHER SURFACE (CONCRETE SIDEWALK, ASPHALT BICYCLE PATH SURFACE OR MATCHING MATERIAL TO THE ADJACENT SURFACE) UP TO THE MAST ARM SHAFT OR THE SIGNAL POST.
- 4. THE FACE OF THE PEDESTRIAN PUSHBUTTON SHALL BE PARALLEL TO THE CROSSWALK TO BE USED.
- 5. THE LOCATIONS AND INSTALLATION OF PEDESTRIAN SIGNAL HEADS AND PEDESTRIAN PUSHBUTTONS SHALL MEET THE REQUIREMENTS OF THE MUTCD AND INFORMATION FOUND IN THE "AMERICANS WITH DISABILITIES ACT ACCESSIBILITY GUIDELINES FOR BUILDINGS AND FACILITIES."

PEDESTRIAN SIGNAL POST AND PEDESTRIAN PUSH BUTTON POST

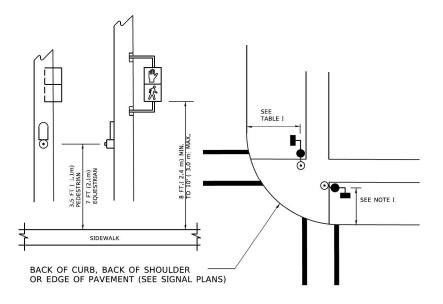

NOTES:

- 1. REFER TO THE TRAFFIC SIGNAL EQUIPMENT OFFSET TABLE.
- PROVIDE A LEVEL ALL-WEATHER SURFACE (CONCRETE SIDEWALK, ASPHALT BICYCLE PATH SURFACE OR MATCHING MATERIAL TO THE ADJACENT SURFACE) UP TO THE PEDESTRIAN SIGNAL POST OR THE PEDESTRIAN PUSH BUTTON POST.
- THE FACE OF THE PEDESTRIAN PUSHBUTTON SHALL BE PARALLEL TO THE CROSSWALK TO BE USED.
- 4. THE LOCATIONS AND INSTALLATION OF PEDESTRIAN SIGNAL HEADS AND PEDESTRIAN PUSHBUTTONS SHALL MEET THE REQUIREMENTS OF THE MUTCD AND INFORMATION FOUND IN THE "AMERICANS WITH DISABILITIES ACT ACCESSIBILITY GUIDELINES FOR BUILDINGS AND FACILITIES."

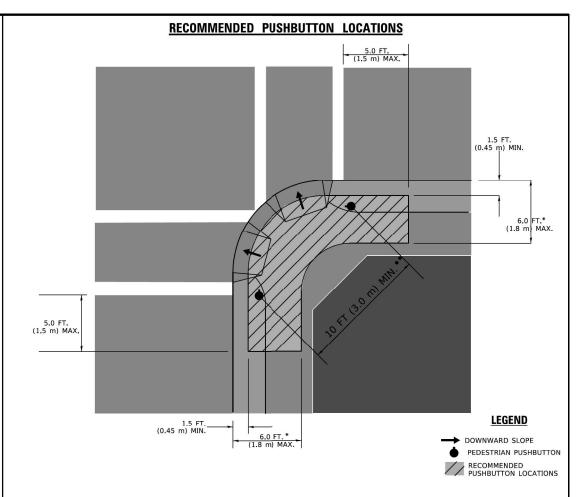

- * WHERE THERE ARE CONSTRAINTS THAT MAKE IT IMPRACTICAL TO PLACE THE PEDESTRIAN PUSHBUTTON BETWEEN 1.5 FT (0.45 m) AND 6 FT (1.8 m) FROM THE EDGE OF THE CURB, SHOULDER, OR PAVEMENT, IT SHOULD NOT BE FURTHER THAN 10 FT (3 m) FROM THE EDGE OF CURB, SHOULDER, OR PAVEMENT.
- ** WHERE THERE ARE CONSTRAINTS ON A PARTICULAR CORNER THAT MAKE IT IMPRACTICAL TO PROVIDE THE 10 FT (3 m) SEPERATION BETWEEN THE TWO PEDESTRIAN PUSHBUTTONS, THE PUSHBUTTONS MAY BE PLACED CLOSER TOGETHER OR ON THE SAME POLE.

NOTES:

- PEDESTRIAN SIGNAL HEADS SHALL BE MOUNTED WITH THE BOTTOM OF THE SIGNAL HOUSING INCLUDING BRACKETS NOT LESS THAN 8 FT (2.4 m) OR MORE THAN 10 FT (3 m) ABOVE SIDEWALK LEVEL, AND SHALL BE POSITIONED AND ADJUSTED TO PROVIDE MAXIMUM VISIBILITY AT THE BEGINNING OF THE CONTROLLED CROSSWALK.
- THE BOTTOM OF THE SIGNAL HOUSING (INCLUDING BRACKETS) OF A VEHICULAR SIGNAL FACE THAT IS NOT LOCATED OVER A HIGHWAY SHALL BE AT LEAST 8 FT (2.4 m) BUT NOT MORE THAN 19 FT (5.8 m) ABOVE THE SIDEWALK OR, IF THERE IS NO SIDEWALK, ABOVE THE PAVEMENT GRADE AT THE CENTER OF THE ROADWAY.
- 3. THE BOTTOM OF THE SIGNAL HOUSING AND ANY RELATED ATTACHMENTS TO A SIGNAL FACE LOCATED OVER ANY PORTION OF A HIGHWAY SHALL BE ACCORDING TO CURRENT STATE STANDARDS 877001, 877002, 877006, 877011 AND 877012 WITH A MINIMUM OF 16 FT (5.0 m) AND A MAXIMUM OF 18 FT. (5.5 m) FROM THE HIGHEST POINT OF PAVEMENT.
- 4. THE BOTTOM OF THE TEMPORARY SPAN WIRE MOUNTED SIGNAL HOUSING AND ANY RELATED ATTACHMENTS TO A SIGNAL FACE LOCATED OVER ANY PORTION OF A HIGHWAY SHALL BE ACCORDING TO CURRENT STATE STANDARD 880001 WITH A MINIMUM OF 17 FT (5.18 m) FROM THE HIGHEST POINT OF PAVEMENT.
- THE TOP OF THE SIGNAL HOUSING OF A SIGNAL FACE LOCATED OVER ANY PORTION OF A HIGHWAY SHALL NOT BE MORE THAN 25.6 FT (7.8 m) ABOVE THE PAVEMENT.

TRAFFIC SIGNAL EQUIPMENT OFFSET

| TRAFFIC SIGNAL EQUIPMENT | COMBINATION CONCRETE CURB AND GUTTER (MINIMUM DISTANCE FROM BACK OF CURB TO CENTERLINE OF FOUNDATION) | SHOULDER/NON-CURBED AREA (MINIMUM DISTANCE FROM EDGE OF PAVEMENT TO CENTERLINE OF FOUNDATION) |
|---------------------------------------|---|---|
| TRAFFIC SIGNAL MAST ARM POLE | 6 FT (1.8m) | SHOULDER WIDTH + 2 FT (0.5m), MINIMUM 10 FT (3.0m) |
| TRAFFIC SIGNAL POST | 4 FT (1.2m) | SHOULDER WIDTH + 2 FT (0.6m), MINIMUM 10 FT (3.0m) |
| PEDESTRIAN SIGNAL POST | 4 FT (1.2m) | SHOULDER WIDTH + 2 FT (0.5m), MINIMUM 10 FT (3.0m) |
| PEDESTRIAN PUSHBUTTON POST | 4 FT (1.2m) | SHOULDER WIDTH + 2 FT (0.6m), MINIMUM 10 FT (3.0m) |
| TEMPORARY WOOD POLE | 6 FT (1.8m) | SHOULDER WIDTH + 2 FT (0.6m), MINIMUM 10 FT (3.0m) |
| CONTROLLER CABINET | 6 FT (1.8m) MINIMUM DISTANCE SEE NOTE 2 | SHOULDER WIDTH + 6 FT (1.8m), MINIMUM 16 FT (4.9m) SEE NOTE 3. |
| SERVICE INSTALLATION, GROUND MOUNT | 6 FT (1.8m) MINIMUM DISTANCE SEE NOTE 2 | SHOULDER WIDTH + 6 FT (1.8m), MINIMUM 16 FT (4.9m) SEE NOTE 3. |

NOTES:

- 1. CONTACT THE "AREA TRAFFIC SIGNAL MAINTENANCE AND OPERATIONS ENGINEER" FOR ASSISTANCE IN LOCATING THE TRAFFIC SIGNAL EQUIPMENT WHEN THERE ARE CONFLICTS WITH DITCHES OR THE MINIMUM OFFSET DISTANCES CANNOT BE MET.
- 2. MINIMUM DISTANCE FROM THE BACK OF CURB TO THE ROADWAY SIDE OF THE FOUNDATION.
- 3. MINIMUM DISTANCE FROM THE EDGE OF PAVEMENT TOTHE ROADWAY SIDE OF THE FOUNDATION.
- 4. ANY CHANGES TO THE OFFSETS OF THE FOUNDATIONS, FROM THE MINIMUM DISTANCES LISTED IN THE "TRAFFIC SIGNAL EQUIPMENT OFFSET" CHART AND THE TRAFFIC SIGNAL INSTALLATION PLAN, COULD EFFECT THE PLACEMENT OF THE SIGNAL HEADS, PEDESTRIAN SIGNAL HEADS AND THE PEDESTRIAN PUSHBUTTONS. THE SIGNAL HEAD PLACEMENT ON THE MAST ARMS SHALL REMAIN AS PER THE TRAFFIC SIGNAL INSTALLATION PLAN AND THE "TRAFFIC SIGNAL MAST ARM AND SIGNAL POST" DETAIL ABOVE. THE PROPOSED MAST ARM LENGTHS MAY NEED TO BE REVISED TO MEET THE ABOVE REQUIREMENTS. THE PEDESTRIAN SIGNAL HEADS AND PEDESTRIAN PUSHBUTTONS MUST MEET THE REQUIREMENTS UNDER THE DETAILS ON THIS SHEET.


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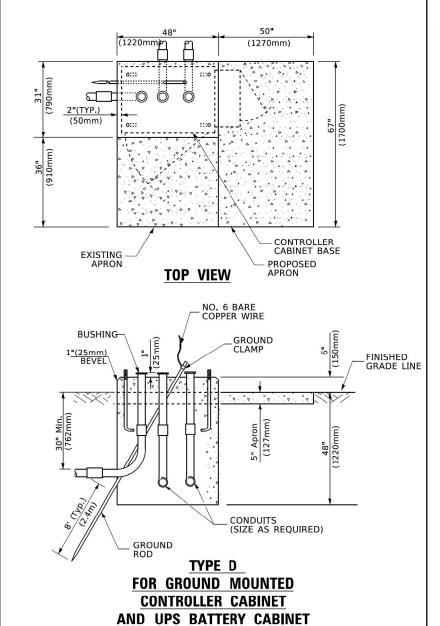
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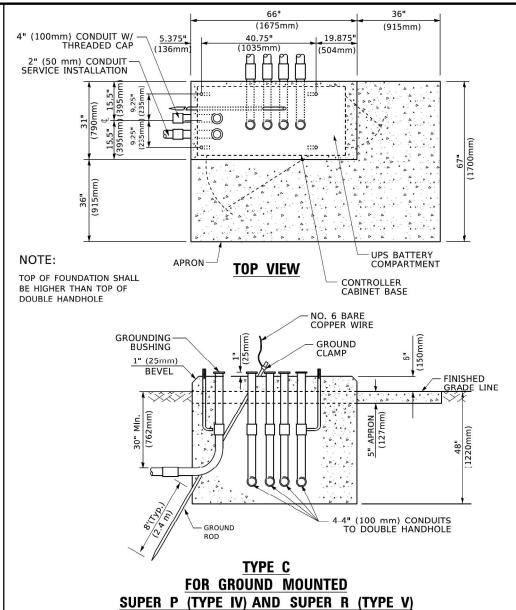
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STATE OF ILLINOIS DEPARTMENT OF TRANSPORTATION

| | DISTRICT ONE | | F.A.P. RTE. | SECTION | COUNTY | TOTAL SHEETS | SHEET NO. | | | |
|--|--------------|---------|----------------|--------------------|--------|-----------------|----------------|-------------|--|--|
| STANDARD TRAFFIC SIGNAL DESIGN DETAILS | | DETAILS | 307 | 2020-263-SUR,SW&TS | COOK | 492 | 298 | | | |
| | | | TS-05 | CONTRACT | NO. 62 | 2N40 | | | | |
| | SHEET 3 | OF 7 | SHEETS | STA | TO STA | | II I INOIC EED | AID PROJECT | | |





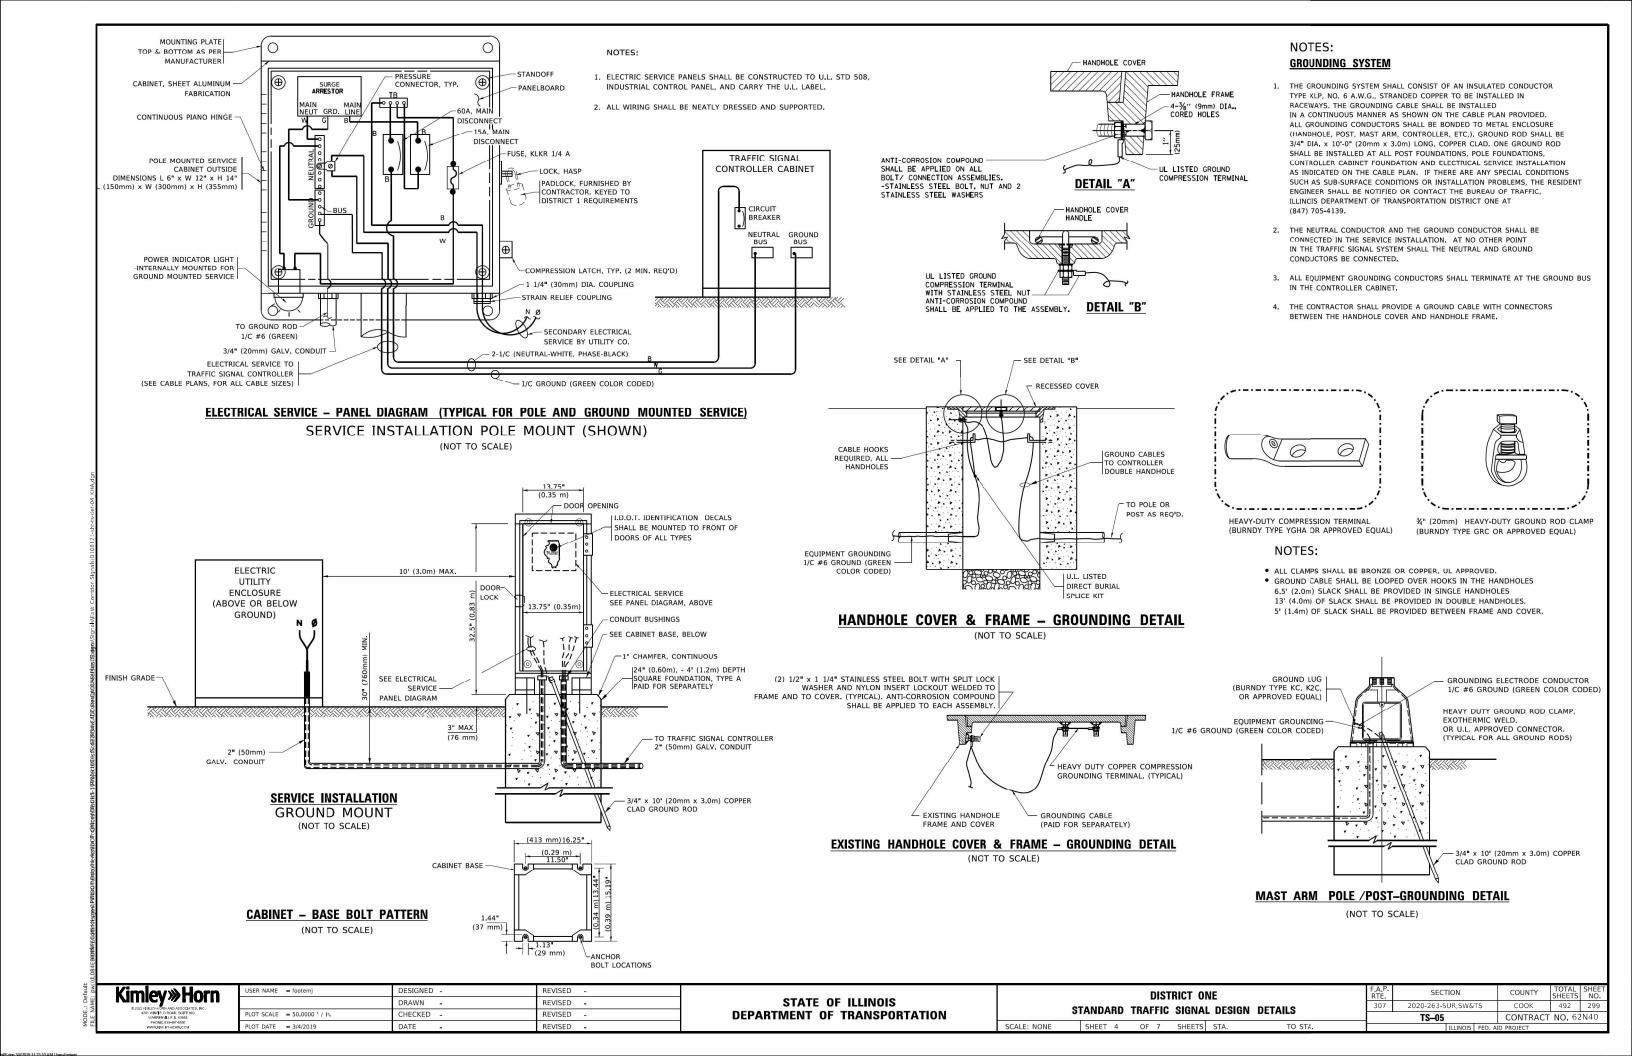

CONTROLLER CABINETS

| FOUNDATION | DEPTH |
|----------------------------|--------------|
| FOUNDATION | DEPIR |
| TYPE A - Signal Post | 4'-0" (1.2m) |
| TYPE C - CONTROLLER W/ UPS | 4'-0" (1.2m) |
| TYPE D - CONTROLLER | 4'-0" (1.2m) |

DEPTH OF FOUNDATION

| Mast Arm Length | Foundation Depth | Foundation Diameter | Spiral Diameter | Quantity of Rebars | Size of Rebars |
|--|--|------------------------|--------------------|-----------------------|-------------------|
| Less than 30′ (9.1 m) | 10'-0" (3.0 m) | 30" (750mm) | 24" (600mm) | 8 | 6(19) |
| Greater than or equal to | 13'-6" (4 ₄ 1 m) | 30" (750mm) | 24" (600mm) | 8 | 6(19) |
| 30' (9.1 m) and less than 40' (12.2 m) | 11'-0" (3.4 m) | 36" (900mm) | 30" (750mm) | 12 | 7(22) |
| Greater than or equal to 40' (12.2 m) and less than 50' (15.2 m) | 13'-0" (4.0 m) | 36" (900mm) | 30" (750mm) | 12 | 7(22) |
| Greater than or equal to 50' (15.2 m) and up to 55' (16.8 m) | 15'-0" (4.6 m) | 36" (900mm) | 30" (750mm) | 12 | 7(22) |
| Greater than or equal to 56' (16.8 m) and less than 65' (19.8 m) | 21'-0" (6.4 m) | 42" (1060mm) | 36" (900mm) | 16 | 8(25) |
| Greater than or equal to 65' (19.8 m) and up to 75' (22.9 m) | 25'-0" (7.6 m) | 42" (1060mm) | 36" (900mm) | 16 | 8(25) |

65" (SEE NOTE 4) (1651mm)

44" 16" (406mm)

2" x 6" (51mm x 152mm) WOOD FRAMING (TYP.)

49" (SEE NOTE 3) (1245mm)

SEE NOTE 5-

TRAFFIC SIGNAL -CONTROLLER CABINET

¾" (19mm) TREATED PHYWOOD DECK

2<u>" x 6" (51mm x 152mm)</u> TREATED WOOD

6" x 6" (152mm x 152mm) NOTES: TREATED WOOD POSTS

 $\ensuremath{\mathfrak{I}}_\bullet$ PLATFORM SIZE FOR CONTROLLER CABINET TYPE IV.

1. BASED ON CONTROLLER CABINET TYPE IV WITH BASE DIMENSIONS OF 26" x 44" (660mm x 1118mm). ADJUST PLATFORM SIZE TO FIT CABINET BASE DIMENSIONS BEING SUPPLIED

4. PLATFORM SIZE FOR CONTROLLER CABINET TYPE IV AND UNINTERRUPTIBLE POWER SUPPLY CABINET.

2. BASED ON UNINTERRUPTIBLE POWER SUPPLY CABINET WITH BASE DIMENSIONS OF 16" x 25" (406mm x 635mm). ADJUST PLATFORM SIZE TO FIT CABINET BASE DIMENSIONS BEING SUPPLIED.

5. DRILLED HOLES THROUGH THE PLATFORM BASE TO MATCH THE CONTROLLER CABINET BOLT TEMPLATE. FASTEN THE CONTROLLER CABINET TO THE PLATFORM WITH CARRIAGE BOLTS, WASHERS AND NUTS.

TEMPORARY SIGNAL CONTROLLER

WOOD SUPPORT PLATFORM

6. FASTEN ALL SUPPORT WOOD FRAMING TO THE WOOD POSTS WITH 2 LAG SCREWS FOR EACH CONNECTION..

- These foundation depths are for sites which have cohesive soils (clayey silt, sandy clay, etc.) along
 the length of the shaft, with an average Unconfined Compressive Strength (Ou) > 1.0 tsf (100 kpa).
 This strength shall be verified by boring data prior to construction or with testing by the Engineer
 during foundation drilling. The Bureau of Bridges & structures should be contacted for a revised
 design if other conditions are encountered.
- 2. Combination mast arm assemblies under 55 feet (16.8 m) shall use 36" (900 mm) diameter foundations.
- 3. Combination mast arm assemblies under 56 feet (16.8 m) through 75 feet (22.9 m) shall use 42" (1060 mm) diameter foundations
- 4. For most arm assemblies with dual arms refer to state standard 878001..

DEPTH OF MAST ARM FOUNDATIONS, TYPE E

| CABLE SLACK LENGTH | FEET | METER |
|---|------|-------|
| HANDHOLE | 6.5 | 2.0 |
| DOUBLE HANDHOLE | 13.0 | 4.0 |
| SIGNAL POST | 2.0 | 0.6 |
| MAST ARM | 2.0 | 0.6 |
| CONTROLLER CABINET | 1.5 | 0.5 |
| FIBER OPTIC AT CABINET | 13.0 | 4.0 |
| ELECTRIC SERVICE AT (CABINET OR SERVICE LOCATION) | 1.5 | 0.5 |
| GROUND CABLE (SIGNAL POST, MAST ARM, CABINET) | 1.5 | 0.5 |
| GROUND CABLE (BETWEEN FRAME AND COVER) | 5.0 | 1.6 |

| FEET 20.0+L | METER 6.0+L |
|-------------|---------------------|
| 20.0+L | 6.0+L |
| | |
| 13.0 | 4.0 |
| 6.0 | 2.0 |
| 13.5 | 4.1 |
| 13.5 | 4.1 |
| 6.0 | 2.0 |
| 3.0 | 1.0 |
| | 13.5 13.5 6.0 |

VERTICAL CABLE LENGTH

CABLE SLACK

| <u> </u> | USER NAME = footemj | DESIGNED - | REVISED - | Т |
|----------|------------------------------|------------|-----------|---|
| | | DRAWN - | REVISED - | |
| | PLOT SCALE = 50.0000 ' / in. | CHECKED - | REVISED - | |
| | PLOT DATE = 3/4/2019 | DATE - | REVISED - | |

STATE OF ILLINOIS **DEPARTMENT OF TRANSPORTATION**

DISTRICT ONE 2020-263-SUR,SW&TS STANDARD TRAFFIC SIGNAL DESIGN DETAILS TS-05 SHEET 5 OF 7 SHEETS STA.

Kimley WHorn

COOK 492 300 CONTRACT NO. 62N40