06-14-2024 LETTING ITEM 052

STATE OF ILLINOIS DEPARTMENT OF TRANSPORTATION

FOR INDEX OF SHEETS, SEE SHEET NO. 2 FOR SUMMARY OF QUANTITIES, SEE SHEET NO. 3

TRAFFIC DATA

FAP 322 (US 51)

0

0

2023 ADT = 10,300 P.U. % 87.4 S.U. % 3.4 M.U. % 9.2

TRAFFIC DATA LOCATIONS

LEG "A" is US 51 from N. First St in Wapella to US 51 Bus North in Clinton

FUNCTIONAL CLASSIFICATION
US 51: Freeway and Expressway

TOWNSHIP CLINTONIA

0 100' 200' 300' 1"= 100' 0 50' 100' 1"= 50' 0 50' 100' 1"= 40' 0 50' 100' 1"= 30' 1"= 20'

FULL SIZE PLANS HAVE BEEN PREPARED USING STANDARD ENGINEERING SCALES. REDUCED SIZED PLANS WILL NOT CONFORM TO STANDARD SCALES. IN MAKING MEASUREMENTS ON REDUCED PLANS, THE ABOVE SCALES MAY BE USED.

J.U.L.I.E.
JOINT UTILITY LOCATION INFORMATION FOR EXCAVATION
1-800-892-0123
OR 811


PROJECT ENGINEER: JASON STULTS
DESIGNER: JEANNIE BLAND
PHONE: (217)465-4181
CONTRACT NO. 70H09

PROPOSED HIGHWAY PLANS

FAP ROUTE 322 (US 51)
SECTION D5 CM PATCHING 2024-5
PROJECT
PATCHING
DEWITT COUNTY

C-95-031-24

N FIRST ST IN WAPELLA TO US 51 BUS N OF CLINTON

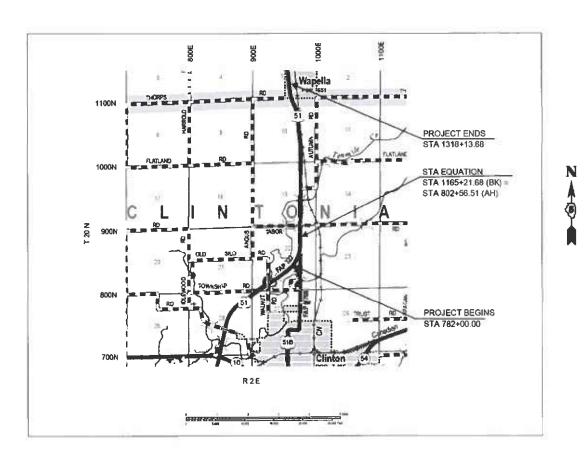

GROSS LENGTH = 17,348.51 FT. = 3.29 MILES
NET LENGTH = 17,348.51 FT. = 3.29 MILES

D-95-012-24



STATE OF ILLINOIS
DEPARTMENT OF TRANSPORTATION

SUBMITTED

12/26
20 2023

**Ensila Marnett swar

REGIONAL ENGINEER

May 10, 2024

ENGINEER OF DESIGN AND ENVIRONMENT

May 10, 2024

State Majada

DIRECTOR OF HIGHWAYS PROJECT IMPLEMENTATION

PRINTED BY THE AUTHORITY OF THE STATE OF ILLINOIS

INDEX-OF-SHEETS

SHEET NO.	DESCRIPIION
1	COVERSHEET
2	INDEX OF SHEETS
2	HIGHWAY STANDARDS
2	GENERAL NOIIES
2	COMMITMENTS
3	SUMMARY OF QUANTILIES
4	TYPICAL CROSS SECTIONS
5	SCHEDULE OF QUANTITIES
6 - 7	DETAIL FOR CLASS A PATCHING (SPL)

UST-OF-HIGHWAY-STANDARDS

STANDARD NO.	DESCRIPIION
000001-08	STANDARDS SYMBOLS, ABBREVIATIONS, & PATTERNS
001001-02	AREAS OF REINFORCEMENT
001006	DECIMAL OF AN INCH AND OF A FOOT
701101-05	OFF-ROAD OPERATIONS, MULTILANE, 15 TO 24" FROM PAVEMENT EDGE
701106-02	OFF-ROAD OPERATIONS, MULTILANE, MORE THAN 15' AWAY
701422-10	LANE CLOSURE, MULTILANE, FOR SPEEDS >/= 45 MPH TO 55 MPH
701901-09	TRAFFIC CONTIROL DEVICES

GENERAL NOTES

G.N.-100A

ELECTRONIC FILES AND/OR ELECTRONIC SURVEY INFORMATION INCLUDING CADD FILES WILL NOT BE AVAILABLE TO THE CONTINACTOR.

COMMITMENTS

THERE ARE NO COMMITMENTS FOR THIS CONTRACT

	t and the second			
	USER NAME = Bridgette. Pierson	DESIGNED -	REVISED -	Г
10		DRAWN -	REVISED -	
	PLOT SCALE = 0.16666667'/in.	CHECKED -	REVISED -	ĺ
	PLOT DATE = 12/12/2023	DATE -	REVISED -	Ĺ

STATE OF ILLINOIS	
DEPARTMENT OF TRANSPORTATION	

I ILLINOIS I FED. A	D PROJECT					
	CONTRAC	ΛT	D . 7	70H()9	
322 5 CM PATCHING 2024-5	VERMILION	1	7	- 1	2	
FAP. I SECTION	COUNTY		OT/		HEE NO	

LOCATION OF WORK:

FAP 322 (US 51) FREEWAY AND EXPRESSWAY

URBAN

STA. 1318+13.68 -STA. 1162+21.68 (BK) STA. 802+56.51 (AH) -STA. 770+00.00 DEWITT 100% STATE

FUNDING BREAKOUT: CONSTRUCTION TYPE CODE:

ATCH REINFORCEMENT AW CUTS	SQ YD FOOT	2,766.0 8,734.0	2,766.0
AW CUTS	FOOT	8.734.0	
4W C015	F001	8.734.0	0.704.0
		٠,٠٠٠	8,734.0
E BARS 3/4"	EACH	3,040.0	3,040.0
OBII IZATION	L SUM	1.0	1.0
RAFFIC CONTROL AND PROTECTION, STANDARD 701422	LSUM	1.0	1.0
RAFFIC CONTROL SURVEILLANCE	CAL DAY	9.0	9.0
HANGEABLE MESSAGE SIGN	CAL DAY	3.0	3.0
LASS A PATCHES, TYPE II, 9" SPECIAL	SQ YD	130.0	130.0
LASS A PATCHES, TYPE III, 9" SPECIAL	SQYD	193.0	193.0
LASS A PATCHES, TYPE IV, 9" SPECIAL	SQYD	2,444.0	2,444.0
DNSTRUCTION LAYOUT	L SUM	1.0	1.0
~	AFFIC CONTROL AND PROTECTION, STANDARD 701422 AFFIC CONTROL SURVEILLANCE HANGEABLE MESSAGE SIGN ASS A PATCHES, TYPE II, 9" SPECIAL ASS A PATCHES, TYPE III, 9" SPECIAL ASS A PATCHES, TYPE IV, 9" SPECIAL	ASS A PATCHES, TYPE II, 9" SPECIAL ASS A PATCHES, TYPE IV, 9" SPECIAL ASS A PATCHES, TYPE IV, 9" SPECIAL SQ YD ASS A PATCHES, TYPE IV, 9" SPECIAL SQ YD	ASS A PATCHES, TYPE II, 9" SPECIAL ASS A PATCHES, TYPE IV, 9" SPECIAL ASS A PATCHES, TYPE IV, 9" SPECIAL SQ YD 1.0 1.0 1.0 1.0 1.0 1.0 1.0 1.

USER NAME = Bridgette.Pierson	DESIGNED -	REVISED -
	DRAWN -	REVISED -
PLOT SCALE = 0.16666667 ' / in.	CHECKED -	REVISED -
PLOT DATE = 2/22/2024	DATE -	REVISED -


STATE OF ILLINOIS DEPARTMENT OF TRANSPORTATION

	F.A.P. RTE	SEC-	FION		COUNTY	TOTAL SHEETS	SHEET NO.
SUMMARY OF QUANTITIES	322	D5 CM PATCHIN	G 2024 - 5		VERMILION	7	3
					CONTRACT	NO. 701	109
SCALE: NONE SHEET 1 OF 1 SHEETS STA. TO STA.			ILLINOIS	FED. AIC	PROJECT		

1) TYPICAL CROSS SECTION


SOUTHBOUND LANES ONLY STATION 770+00.00 TO STATION 802+56.51 BK (STA. EQ.) 1165+21.68 AH (STA. EQU.) TO STATION 1281+03.77 STATION EQUATION 802+56.61 BK = 1165+21.68 AH

NOTE: LIME MODIFIED SUB-GRADE, 12" STA. 1235+20.00 TO 1244+62.56 STA. 1251+32.18 TO 1273+73.85

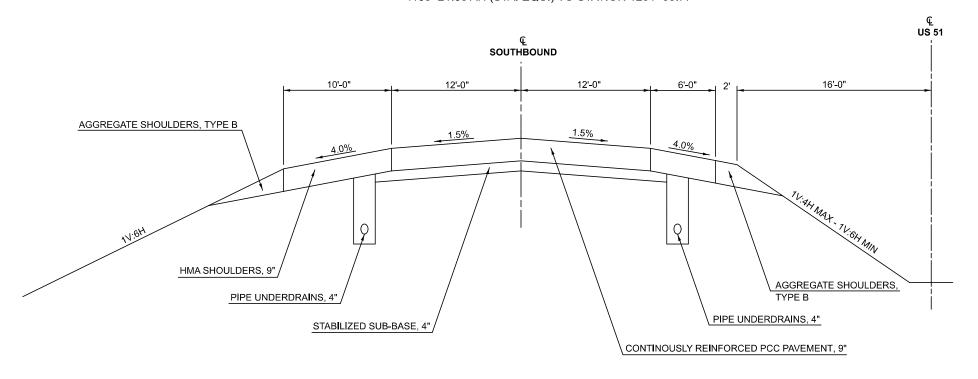

(2) TYPICAL CROSS SECTION

SOUTHBOUND LANES ONLY STATION 1281+03.77 TO STATION 1318+13.69

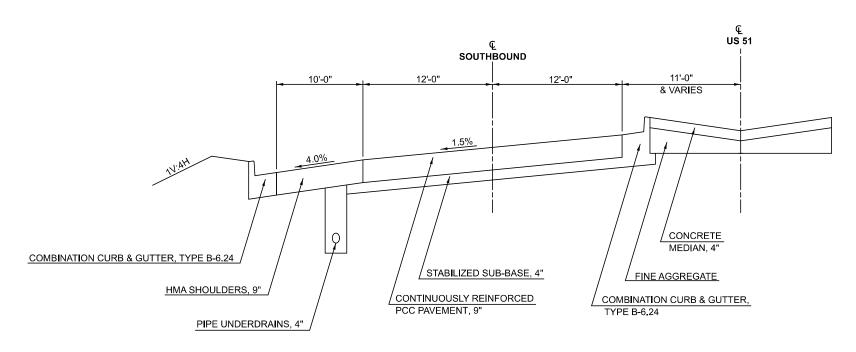

USER NAME = Bridgette.Pierson	DESIGNED -	BBB	REVISED -	RV1
	DRAWN -	CCC	REVISED -	RV2
PLOT SCALE = 0.16666667 ' / in.	CHECKED -	AAA	REVISED -	RV3
PLOT DATE = 2/16/2024	DATE -	XX/XX/XX	REVISED -	RV4

	TY	PICAL C	ROSS S	F.A.P. RTE.	SECTION	COUNTY	TOTAL SHEETS	SHEET NO.		
FAP 322 (US 51)							D5 CM PATCHING 2024-5	DEWITT	7	4
		IAI ·	322 (OO	31)				CONTRACT	NO. 70	H09
SCALE: NONE SHEET 1 OF 1 SHEETS STA. TO STA.							ILLINOIS FED. A	ID PROJECT		


URBAN						CLASS A PATCHES,	CLASS A PATCHES,	CLASS A PATCHES,	PATCH	SAW CUTS	TIE BARS	TIE BARS
US 51 BYPASS						TYPE II, 9 INCH	TYPE III, 9 INCH	TYPE IV, 9 INCH	REINFORCEMENT		3/4"	3/4"
DEWITT COUNTY						SPECIAL	SPECIAL	SPECIAL			(Longitudinal)	(Transverse)
STATION	DIRECTION	LANE	LENGTH	WIDTH	AREA	(SQ YD)	(SQ YD)	(SQ YD)	(SQ YD)	(FT)	(EACH)	(EACH)
			FT	FT	SQYD	X4420545	X4420547	X4420549	44213000	44213200	44213204	44213204
794+66	SB	DL	115.00	6.00	76.67			76.67	76.67	242.00	76.00	10.00
1279+20	SB	DL	525.00	6.00	350.00			350.00	350.00	1,062.00	350.00	10.00
1282+00	SB	DL	82.00	6.00	54.67			54.70	54.70	176.00	54.00	10.00
1283+25	SB	DL	36.00	6.00	24.00		24.00		24.00	84.00	24.00	10.00
1284+85	SB	DL	89.00	6.00	59.33			59.30	59.30	190.00	60.00	10.00
1296+60	SB	DL	120.00	6.00	80.00			80.00	80.00	252.00	80.00	10.00
1311+91	SB	DL	25.00	6.00	16.67		16.67		16.67	62.00	16.00	10.00
	SOUTH	BOUND DRIVING	LANE SUBTOTALS	\$		0.0	40.7	620.7	661.3	2068.0	660.0	70.0
1279+20	SB	PL	586.00	6.00	390.67			390.70	390.70	1,184.00	390.00	10.00
1288+10	SB	PL	259.00	6.00	172.67			172.70	172.70	530.00	172.00	10.00
1296+20	SB	PL	20.00	6.00	13.33	13.30			13.30	52.00	14.00	10.00
1298+15	SB	PL	129.00	6.00	86.00			86.00	86.00	270.00	86.00	10.00
	SOUTHBOUND PASSING LANE SUBTOTALS					13.3	0.0	649.4	662.7	2036.0	662.0	40.0
		SUBTOTA	ALS			13.3	40.7	1,270.1	1,324.0	4,104.0	1,322.0	110.0
		TOTALS I	JSE:			13.0	41.0	1,270.0	1,324.0	4,104.0	1,43	32.0

MODEL: Schedules Sheet FILE NAME: c:\pw work\pwidot\piersonbr\d0932077\D570H09 s


STATE OF ILLINOIS
DEPARTMENT OF TRANSPORTATION

SCALE: NONE


				F.A.P. RTE	SECTION	COUNTY	TOTAL SHEETS	SHEET NO.	
PATCHING SCHEDULE						D5 CM PATCHING 2024-5	DEWITT	7	5
							CONTRACT	NO. 70	H09
SHEET 1 OF 1 SHEETS STA. TO STA.						ILLINOIS FED. A	ID PROJECT		

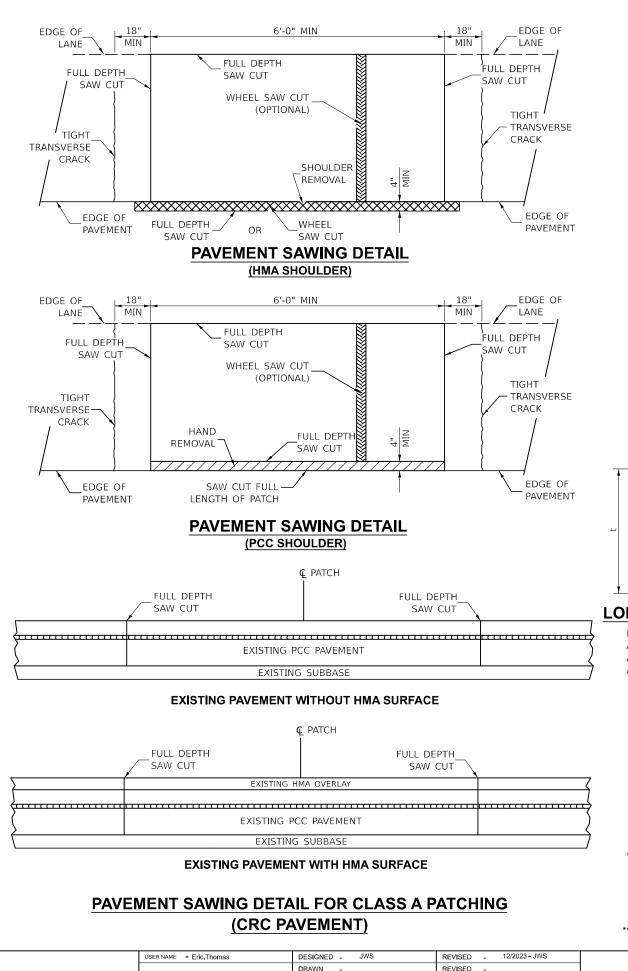


REVISED

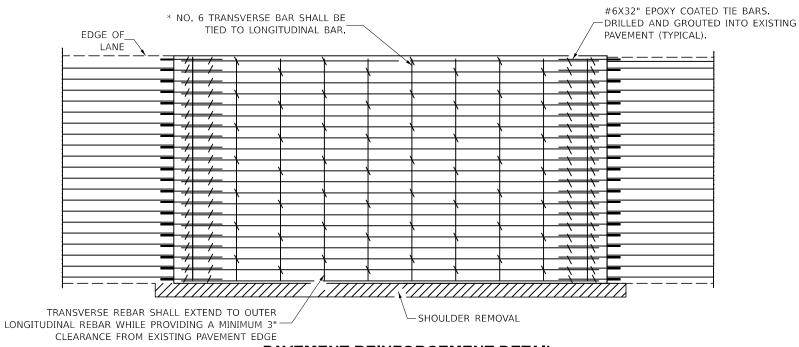

PAVEMENT REINFORCEMENT DETAIL

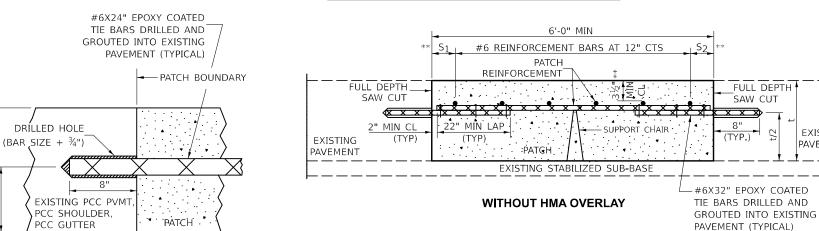

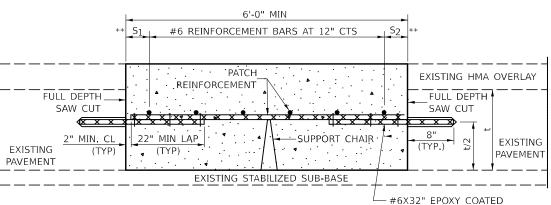

WITH HMA OVERLAY

TIE BARS DRILLED AND GROUTED INTO EXISTING PAVEMENT (TYPICAL)

FULL DEPTH

EXISTING

PAVEMENT

SAW CUT

8"

(TYP.)

PATCHING DETAIL FOR CLASS A PATCHING (CRC PAVEMENT)

Note: All dimensions are in INCHES (millimeters) unless otherwise shown.

DISTRICT 5 DETAIL NO. 44200AAA CLASS A PATCHING (SPECIAL) 322 D5 CM PATCHING 2024-5 VERMILION 7 6 CONTRACT NO. 70H09 SCALE: NONE SHEET 1 OF 2 SHEETS STA.

LONGITUDINAL CONSTRUCTION JOINT

PATCHES MORE THAN 20' IN LENGTH SHALL BE TIED TO ADJACENT PAVEMENT, PCC SHOULDERS OR PCC CURB AND GUTTER WITH #6x24" EPOXY COATED TIE BARS AT 36" CENTERS.

NOTES:

EXISTING LONGITUDINAL REINFORCEMENT SPACING; ±6½".

SPACING OF NEW LONGITUDINAL REINFORCEMENT AND NEW LONGITUDINAL TIE BARS SHALL MATCH SPACING OF EXISTING REINFORCEMENT AND SHALL BE TIED TOGETHER WITH A MINIMUM OF TWO TIES PER BAR.

SUPPORT CHAIRS SHALL BE REQUIRED WHENEVER PATCH LENGTH EXCEEDS 6'-0"


EVERY THIRD INTERSECTION MUST BE TIED. WHEN THE MINIMUM CLEARANCE CANNOT BE OBTAINED WITH THE TRANSVERSE REBAR ON TOP, THEN THE TRANSVERSE REBAR SHALL BE TIED TO THE BOTTOM OF THE LONGITUDINAL REBAR.


** VARIABLES WHERE S AND S ARE $2\frac{1}{2}$ " MIN. AND 12" MAX.


CHECKED -PLOT DATE = 12/7/2022DATE


STATE OF ILLINOIS **DEPARTMENT OF TRANSPORTATION**


CLASS A PATCHING (SPECIAL)

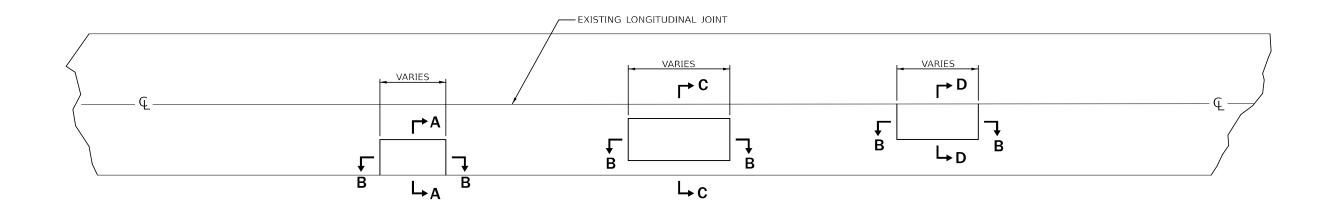

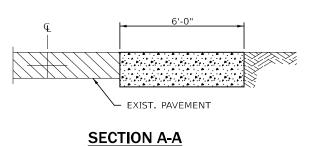

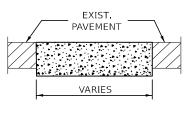

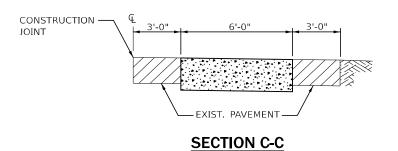

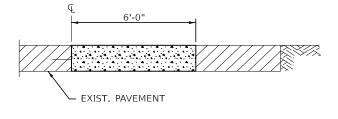

SECTION B-B

SECTION D-D

NOTE: LONGITUDINAL JOINTS SHALL BE AS DETAILED ON STANDARD 420001, EXCEPT TIE BARS ARE NOT REQUIRED FOR PATCHES 20'-0" (6.0 m) OR LESS IN LENGTH.

All dimensions are in INCHES (millimeters) unless otherwise shown.

-	USER NAME = Bridgette.Pierson	DESIGNED -	REVISED -	STATE OF ILLINOIS DEPARTMENT OF TRANSPORTATION							F.A.P.	SECTION	COUNTY	TOTAL	SHEET
		DRAWN -	REVISED -		CLASS A PATCHING (SPECIAL)					322	D5 CM PATCHING 2024-5	VERMILION	7	7	
	PLOT SCALE = 0.16666667 '/in.	CHECKED -	REVISED -		, ,								CONTRACT NO. 70H09		
	PLOT DATE = 12/20/2023	DATE -	REVISED -		SCALE: NONE	SHEET 2	OF 2	SHEETS	STA.	TO STA.		ILLINOIS FED. AI	D PROJECT		