


**FOR INDEX OF SHEETS, SEE SHEET NO. 2
FOR STATE STANDARDS, SEE SHEET NO. 2**

PROPOSED HIGHWAY PLANS

**FAP ROUTE 17 (IL 64)
SECTION D2 PP 2023-02
PROJECT
MILLING AND RESURFACING
OGLE COUNTY**

HIGHWAY CLASSIFICATION
FAP ROUTE 17 (IL 64)
CLASSIFICATION: MINOR ARTERIAL
ADT 4350 (2024)
P.V. 3241 (74.5%)
M.U. 757 (17.4%)
S.U. 352 (8.1%)
DESIGN SPEED 55 MPH
POSTED SPEED 55 MPH

**WHITE ROCK TOWNSHIP: SECTION 24-25
LYNNVILLE TOWNSHIP: SECTIONS 19-25**

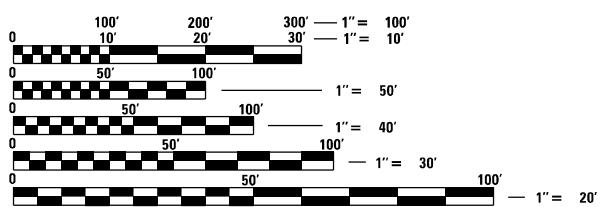

FULL SIZE PLANS HAVE BEEN PREPARED USING STANDARD
ENGINEERING SCALES. REDUCED SIZED PLANS WILL NOT
CONFORM TO STANDARD SCALES. IN MAKING MEASUREMENTS
ON REDUCED PLANS THE ABOVE SCALES MAY BE USED.

**J.U.L.I.E.
JOINT UTILITY LOCATION INFORMATION FOR EXCAVATION
1-800-892-0123
OR 811**

PROJECT ENGINEER: MICHAEL KUEHN 815-284-5503
PROJECT MANAGER: ANDREW DEWEY 815-284-5358
EMAIL: ANDREW.P.DEWEY@ILLINOIS.GOV

GROSS LENGTH = 33277.76 FT. = 6.304 MILE



**PRINTED BY THE AUTHORITY
OF THE STATE OF ILLINOIS**

STATE OF ILLINOIS
DEPARTMENT OF TRANSPORTATION



LOCATION OF SECTION INDICATED THUS: -

INDEX OF SHEETS

1	COVER SHEET
2	INDEX OF SHEETS / HIGHWAY STANDARDS
3	GENERAL NOTES
4 - 9	SUMMARY OF QUANTITIES
10 - 17	SCHEDULES OF QUANTITIES
18 - 21	TYPICAL SECTIONS
22	BUTT JOINT AND TEMPORARY RAMP DETAILS
23 - 34	PLAN SHEETS
35 - 38	WORK ZONE SIGN DETAILS (DS 34.1)
39 - 42	TYPICAL PAVEMENT MARKINGS (DS 41.1)
43	GUARDRAIL AND BARRIER WALL REFLECTORS, TYPE C (SPECIAL) (DS 55.1)
44	GUARDRAIL EROSION CONTROL TREATMENTS (DS 35.2)
	HOT-MIX ASPHALT APPROACHES AND MAILBOX RETURNS FOR TWO LIFTS (3P) RESURFACING PROJECTS (DS 47.2)
45	SAFETY EDGE (3P PROJECTS) (DS 49.2)
	TRAFFIC CONTROL AND PROTECTION AT TURN BAYS (TO REMAIN OPEN TO TRAFFIC) (DS 94.2)
46	HOT-MIX ASPHALT SHOULDER (DS 22.4)
	DELINERATOR AND POST ORIENTATION (DS 37.4)
	SUBGRADE REPLACEMENT (DS 97.4)

HIGHWAY STANDARDS

000001 - 08	STANDARD SYMBOLS ABBREVIATIONS & PATTERNS
001006	DECIMAL OF INCH & FOOT
420001 - 10	PAVEMENT JOINTS
420701 - 03	PAVEMENT WELDED WIRE REINFORCEMENT
442101 - 09	CLASS 3 PATCHES
606001 - 08	CONCRETE CURB TYPE B AND COMBINATION CONCRETE CURB AND GUTTER
606301 - 04	PC CONCRETE ISLANDS AND MEDIANIS
606306 - 04	CORRUGATED PC CONCRETE MEDIANIS
630001 - 13	STEEL PLATE BEAM GUARDRAIL
630201 - 07	PCC/HMA STABILIZATION AT STEEL PLATE BEAM GUARDRAIL
630301 - 09	SHOULDER WIDENING FOR TYPE 1 (SPECIAL) GUARDRAIL TERMINALS
631031 - 18	TRAFFIC BARRIER TERMINAL, TYPE 6
635001 - 02	DELINERATORS
642001 - 03	SHOULDER RUMBLE STRIPS, 16 IN.
701006 - 05	OFF-RD OPERATIONS, 2L, 2W, 15' (4.5 m) TO 24" (600 mm) FROM PAVEMENT EDGE
701011 - 04	OFF-RD MOVING OPERATIONS 2L, 2W, DAY ONLY
701201 - 05	LANE CLOSURE, 2L, 2W, DAY ONLY, FOR SPEEDS ≥ 45 MPH
701301 - 04	LANE CLOSURE, 2L, 2W, SHORT TIME OPERATIONS
701306 - 04	LANE CLOSURE, 2L, 2W, SLOW MOVING OPERATIONS DAY ONLY, FOR SPEEDS ≥ 45 MPH
701311 - 03	LANE CLOSURE 2L, 2W MOVING OPERATIONS - DAY ONLY
701326 - 04	LANE CLOSURE, 2L, 2W, PAVEMENT WIDENING FOR SPEEDS ≥ 45 MPH
701336 - 07	LANE CLOSURE, 2L, 2W, WORK AREAS IN SERIES FOR SPEEDS ≥ 45 MPH
701456 - 05	PARTIAL EXIT RAMP CLOSURE FREEWAY/EXPRESSWAY
701901 - 09	TRAFFIC CONTROL DEVICES
720001 - 01	SIGN PANEL MOUNTING DETAILS
720006 - 04	SIGN PANEL ERECTION DETAILS
725001 - 01	OBJECT AND TERMINAL MARKERS
728001 - 01	TELESCOPING STEEL SIGN SUPPORT
780001 - 05	TYPICAL PAVEMENT MARKINGS
781001 - 04	TYPICAL APPLICATIONS RAISED REFLECTIVE PAVEMENT MARKERS
782006 - 01	GUARDRAIL AND BARRIER WALL REFLECTOR MOUNTING DETAILS
880001 - 01	SPAN WIRE MOUNTED SIGNALS AND FLASHING BEACON INSTALLATION

GENERAL NOTES

1. THE CONTRACTOR SHALL NOTIFY TRAFFIC OPERATIONS A MINIMUM OF 5 WORKING DAYS PRIOR TO PLACING PERMANENT PAVEMENT MARKING OR SIGNING.
2. THE CONTRACTOR SHALL SEED ALL DISTURBED AREAS WITHIN THE PROJECT LIMIT. SEEDING CLASS 4 OR 2A SHALL BE USED, EXCEPT IN FRONT OF PROPERTIES WHERE THE GRASS WILL BE MOWED, THEN USE SEEDING, CLASS 1A. CLASS 2A SHALL BE USED ON FRONT SLOPES AND DITCH BOTTOMS. CLASS 4 SHALL BE USED BEHIND TYPE A GUTTER, ON ALL BACKSLOPES AND AREAS BEHIND THE BACKSLOPE, AND BEYOND THE TOE OF FRONT SLOPE ON FILL SECTIONS WITHOUT DITCHES. THIS WORK WILL BE INCLUDED IN THE COST OF THE GUARDRAIL REPLACEMENT.
3. FERTILIZER SHALL BE APPLIED TO ALL DISTURBED AREAS AND INCORPORATED INTO THE SEEDBED PRIOR TO SEEDING OR PLACEMENT OF SOD AT THE RATE SPECIFIED IN SECTIONS 250 AND 252 OF THE STANDARD SPECIFICATIONS. THIS WORK SHALL BE INCLUDED IN THE COST OF GUARDRAIL REPLACEMENT.
4. MULCH METHOD II SHALL BE APPLIED OVER ALL SEDED AREAS. THIS SHALL BE INCLUDED IN THE COST OF THE GUARDRAIL REPLACEMENT.
5. FERTILIZER NUTRIENTS SHALL BE APPLIED AT THE RATE SPECIFIED IN SECTIONS 250 AND 252 OF THE STANDARD SPECIFICATIONS. THIS SHALL BE INCLUDED IN THE COST OF THE GUARDRAIL REPLACEMENT.
6. EARTH EXCAVATION REQUIRED FOR GUARDRAIL REPLACEMENT SHALL BE INCLUDED IN THE COST OF GUARDRAIL REPLACEMENT.
7. CLOSED EXPANSION JOINTS ON JOINTED PAVEMENTS SHALL BE RE-ESTABLISHED DURING THE PATCHING OPERATIONS. CLASS B PATCHES - WHEN THE PAVEMENT REQUIRES PATCHING AT THE LOCATION OF THE EXPANSION JOINT, A NEW JOINT SHOULD BE ESTABLISHED USING A DOWELLED EXPANSION PATCH AS SHOWN ON HIGHWAY STANDARD 442101. WHEN THE JOINT IS CLOSED, BUT DOES NOT REQUIRE PATCHING, AN EXPANSION JOINT MAY BE FORMED BY SAWING THE PAVEMENT AND FILLING THE SAW CUT WITH A PREFORMED EXPANSION JOINT FILLER MEETING THE REQUIREMENTS OF SECTION 1051 OF THE STANDARD SPECIFICATIONS AS SHOWN ON STANDARD 420001.
8. WHEN LAYING OUT FOR PATCHING, THE MINIMUM DISTANCE BETWEEN NEW PATCHES (SAW CUT TO SAW CUT) SHALL BE 15 FEET. WHEN PATCH SPACING IS LESS THAN 15 FEET, THE PAVEMENT BETWEEN PATCHES SHALL ALSO BE REMOVED AND REPLACED.
9. THE EXISTING HOT-MIX ASPHALT ON PRIVATE AND COMMERCIAL ENTRANCES SHALL BE BLADED OFF OR MILLED AND DISPOSED OF OUTSIDE THE PROJECT LIMITS. THIS COULD BE THE ENTIRE ENTRANCE OR TAPERED AT THE END DEPENDING ON IF THE MAINLINE IS RESURFACED OR MILLED AND RESURFACED. THE COST OF THE BLADING, MILLING, ROLLING, AND DISPOSAL IS INCLUDED IN THE CONTRACT UNIT PRICE FOR INCIDENTAL HOT-MIX ASPHALT SURFACING.
10. THE DROP OFF THAT OCCURS AT ENTRANCE EDGES AS A RESULT OF RESURFACING OF THE ENTRANCE SHALL BE CORRECTED USING AGGREGATE SHOULDER MATERIAL. THIS WORK SHALL BE PAID FOR BY THE TON FOR AGGREGATE SHOULDER OF THE TYPE SPECIFIED IN THE PLANS.
11. QUALITY MANAGEMENT PROGRAM TO BE USED ROW WILL HAVE QC/QA (QUALITY CONTROL/QUALITY ASSURANCE), QCP (HMA QUALITY CONTROL FOR PERFORMANCE), OR PFP (HMA PAY FOR PERFORMANCE USING PERCENT WITHIN LIMITS JOBSITE SAMPLING). WHICH ONE TO USE WILL BE DETERMINED BY MATERIALS. THEY WILL NEED QUANTITIES FOR EACH TYPE OF MIX USED (I.E. SURFACE, BINDER, ETC.). SEE BDE MANUAL CH. 53-4.07 OR CONTACT THE DISTRICT MIXTURES CONTROL ENGINEER FOR MORE INFORMATION.

LOCATIONS AND MIXTURE USE(S):	MAINLINE		SHOULDER
	SURFACE	BINDER	SURFACE
PG:	PG 58-28	PG 58-28	PG 58-28
DESIGN AIR VOIDS:	4.0 @ N50	4.0 @ N50	4.0 @ N50
MIXTURE COMPOSITION:	IL 9.5	IL 9.5	IL 9.5FG
FRiction AGGREGATE:	C	N/A	C
MIXTURE WEIGHT:	112 LB/SY/IN	N/A	112 LB/SY/IN
QUALITY MANAGEMENT PROGRAM:	QCP	QCP	QC/QA
SUBLot SIZE:	1000	1000	N/A
MATERIAL TRANSFER DEVICE:	YES	YES	N/A

12. THE FOLLOWING STRUCTURES CAN BE CROSSED WITH AN EMPTY MATERIAL TRANSFER DEVICE (MTD) WITH THE FOLLOWING MAXIMUM GROSS WEIGHT RESTRICTIONS.

STRUCTURE NO.	MTD MAX. EMPTY GROSS WEIGHT (TONS)	STRUCTURE NO.	MTD MAX. EMPTY GROSS WEIGHT (TONS)
071-1070	22.4	071-1072	40
071-0055	40	071-0091	40
071-0017	40	071-0092	40
071-1071	40		

IF THE SAME MTD IS USED THROUGHOUT THE ENTIRE CONTRACT, THEN THE MTD EMPTY GROSS WEIGHT MUST BE LESS THAN OR EQUAL TO 22.4 TONS.

13. THE CONTRACTOR WILL BE REQUIRED TO FURNISH 5 ½" HIGH BRASS STENCILS AS APPROVED BY THE ENGINEER AND INSTALL STATIONING AT 250' INTERVALS. STATIONING SHALL BE PLACED ON BOTH LANES OF 2 LANE HIGHWAYS AND ON THE OUTSIDE LANES IN BOTH DIRECTIONS ON 4-LANE HIGHWAYS. THE STATIONS SHALL BE PLACED 6" INSIDE THE PAVEMENT MARKING EDGE SO THEY CAN BE READ FROM THE SHOULDER. THIS WORK WILL BE INCLUDED IN THE COST OF THE FINAL PAVEMENT SURFACE.
14. THE AREA TO BE TACKED OR PRIMED SHALL BE LIMITED TO THAT WHICH CAN BE COVERED WITH HMA ON THE NEXT DAY'S PRODUCTION, BUT NO MORE THAN FIVE DAYS IN ADVANCE OF THE PLACEMENT OF THE HMA, UNLESS APPROVED BY THE ENGINEER.
15. THE CONTRACTOR SHALL SUPPLY THE RESIDENT ENGINEER WITH THE MANUFACTURER'S INSTALLATION REQUIREMENTS FOR THE TYPE OF STEEL PLATE BEAM GUARDRAIL TERMINAL TYPE 1 SPECIAL (TANGENT) OR STEEL PLATE BEAM GUARDRAIL TERMINAL TYPE I SPECIAL (FLARED).
16. DELINEATORS SHALL BE INSTALLED AS SHOWN IN STANDARD 635001, EXCEPT THAT THE POST SHALL BE ROTATED 180° AND ONLY METAL-BACKED DELINEATORS SHALL BE PERMITTED. DELINEATORS SHALL BE PLACED AT THE ENDS OF APPROACH GUARDRAIL TERMINAL SECTIONS, AND AT EACH HEADWALL OR END SECTION OF AR CULVERTS. THIS WORK WILL BE PAID FOR AT THE CONTRACT UNIT PRICE EACH FOR DELINEATORS.
17. THE CONTRACTOR SHALL BE RESPONSIBLE FOR COLLECTING AND MAINTAIN AN ELECTRONIC LOG OF ALL STAKEOUT SURVEY THAT IS PERFORMED ON THE JOB, EITHER BY HIM/HER OR ANY SUB-CONTRACTOR PERFORMING THE STAKEOUT. UPON REQUEST, ALL LOGS SHALL BE SUBMITTED TO THE DEPARTMENT. NO ADDITIONAL COMPENSATION WILL BE ALLOWED FOR THIS WORK, BUT SHALL BE CONSIDERED INCLUDED IN THE COST FOR CONSTRUCTION LAYOUT.

CODE NUMBER	PAY ITEM	UNIT	TOTAL QUANTITY	100% STATE
				ROADWAY
30300001	AGGREGATE SUBGRADE IMPROVEMENT	CU YD	34	34
40600290	BITUMINOUS MATERIALS (TACK COAT)	POUND	24,274	24,274
40600295	POLYMERIZED BITUMINOUS MATERIALS (TACK COAT)	POUND	57,490	57,490
40600370	LONGITUDINAL JOINT SEALANT	FOOT	59,384	59,384
40600900	HOT-MIX ASPHALT BINDER COURSE (HAND METHOD), N50	TON	84	84
40600982	HOT-MIX ASPHALT SURFACE REMOVAL - BUTT JOINT	SQ YD	377	377
40600990	TEMPORARY RAMP	SQ YD	563	563
40601005	HOT-MIX ASPHALT REPLACEMENT OVER PATCHES	TON	3,767	3,767
40602978	HOT-MIX ASPHALT BINDER COURSE, IL- 9.5, N50	TON	8,240	8,240
40604000	HOT-MIX ASPHALT SURFACE COURSE IL-9.5FG, MIX "C", N50	TON	6,042	6,042
40604050	HOT-MIX ASPHALT SURFACE COURSE IL-9.5, MIX "C", N50	TON	9,784	9,784
40800050	INCIDENTAL HOT-MIX ASPHALT SURFACING	TON	241	241
42001300	PROTECTIVE COAT	SQ YD	1,077	1,077
44000157	HOT-MIX ASPHALT SURFACE REMOVAL, 2"	SQ YD	53,942	53,942

* SPECIALTY ITEMS

CODE NUMBER	PAY ITEM	UNIT	TOTAL QUANTITY	100% STATE
				ROADWAY
44000164	HOT-MIX ASPHALT SURFACE REMOVAL, 3 3/4"	SQ YD	84,077	84,077
44000500	COMBINATION CURB AND GUTTER REMOVAL	FOOT	24	24
44002232	HOT-MIX ASPHALT REMOVAL OVER PATCHES, 8"	SQ YD	8,408	8,408
44003100	MEDIAN REMOVAL	SQ FT	1,711	1,711
44200050	WELDED WIRE REINFORCEMENT	SQ YD	422	422
44200956	CLASS B PATCHES, TYPE II, 9 INCH	SQ YD	461	461
44200962	CLASS B PATCHES, TYPE III, 9 INCH	SQ YD	201	201
44200964	CLASS B PATCHES, TYPE IV, 9 INCH	SQ YD	222	222
44201298	DOWEL BARS 1 1/4"	EACH	1,540	1,540
44201299	DOWEL BARS 1 1/2"	EACH	78	78
44213200	SAW CUTS	FOOT	2,773	2,773
44213204	TIE BARS 3/4"	EACH	679	679
48102100	AGGREGATE WEDGE SHOULDER, TYPE B	TON	229	229
60608700	COMBINATION CONCRETE CURB AND GUTTER, TYPE M-6.06 (ABUTTING EXISTING PAVEMENT)	FOOT	24	24

* SPECIALTY ITEMS

CODE NUMBER	PAY ITEM	UNIT	TOTAL QUANTITY	100% STATE
				ROADWAY
60619200	CONCRETE MEDIAN, TYPE SB-6.06	SQ FT	1,435	0005 RURAL
60624600	CORRUGATED MEDIAN	SQ FT	276	276
*	63000001 STEEL PLATE BEAM GUARDRAIL, TYPE A, 6 FOOT POSTS	FOOT	3,388	3,388
*	63100085 TRAFFIC BARRIER TERMINAL, TYPE 6	EACH	4	4
*	63100167 TRAFFIC BARRIER TERMINAL, TYPE 1 (SPECIAL) TANGENT	EACH	20	20
63200310	GUARDRAIL REMOVAL	FOOT	4,423	4,423
63500105	DELINEATORS	EACH	20	20
64200116	SHOULDER RUMBLE STRIPS, 16 INCH	FOOT	58,544	58,544
67000400	ENGINEER'S FIELD OFFICE, TYPE A	CAL MO	6	6
67100100	MOBILIZATION	L SUM	1	1
70100450	TRAFFIC CONTROL AND PROTECTION, STANDARD 701201	L SUM	1	1
70100460	TRAFFIC CONTROL AND PROTECTION, STANDARD 701306	L SUM	1	1
70100500	TRAFFIC CONTROL AND PROTECTION, STANDARD 701326	L SUM	1	1
70100600	TRAFFIC CONTROL AND PROTECTION, STANDARD 701336	L SUM	1	1

* SPECIALTY ITEMS

FILE NAME: \$DNAME\$
MODEL: \$DNAME\$



USER NAME = 10017
DESIGNED - CG
DRAWN - MA
PLOT SCALE = 2,000' / In.
PLOT DATE = 02/29/24

REVISED -
REVISED -
REVISED -
REVISED -
DATE - 02/29/2024

STATE OF ILLINOIS
DEPARTMENT OF TRANSPORTATION

SUMMARY OF QUANTITIES

SCALE: NONE SHEET 3 OF 4 SHEETS STA. TO STA.

F.A.P. RTE.	SECTION	COUNTY	TOTAL SHEETS	HEET NO.
17	D2 PP 2023-02	OGLE	46	6
				CONTRACT NO. 64R99

ILLINOIS FED.AID PROJECT

CODE NUMBER	PAY ITEM	UNIT	TOTAL QUANTITY	100% STATE
				ROADWAY
70100825	TRAFFIC CONTROL AND PROTECTION, STANDARD 701456	L SUM	1	1
70107025	CHANGEABLE MESSAGE SIGN	CAL DA	80	80
70300100	SHORT TERM PAVEMENT MARKING	FOOT	14,440	14,440
70300150	SHORT TERM PAVEMENT MARKING REMOVAL	SQ FT	2,888	2,888
70300221	TEMPORARY PAVEMENT MARKING - LINE 4"- PAINT	FOOT	69,167	69,167
70300261	TEMPORARY PAVEMENT MARKING - LINE 12"- PAINT	FOOT	55	55
*	72000100 SIGN PANEL - TYPE 1	SQ FT	465	465
*	72000200 SIGN PANEL - TYPE 2	SQ FT	204	204
*	72400710 RELOCATE SIGN PANEL - TYPE 1	SQ FT	159	159
*	72400720 RELOCATE SIGN PANEL - TYPE 2	SQ FT	31	31
*	72400310 REMOVE SIGN PANEL - TYPE 1	SQ FT	400	400
*	72400320 REMOVE SIGN PANEL - TYPE 2	SQ FT	203	203
*	72501000 TERMINAL MARKER - DIRECT APPLIED	EACH	20	20
*	72800100 TELESCOPING STEEL SIGN SUPPORT	FOOT	336	336

* SPECIALTY ITEMS

CODE NUMBER	PAY ITEM	UNIT	TOTAL QUANTITY	100% STATE
				ROADWAY
* 73000100	WOOD SIGN SUPPORT	FOOT	626	626
* 78000200	THERMOPLASTIC PAVEMENT MARKING - LINE 4"	FOOT	69,167	69,167
* 78000600	THERMOPLASTIC PAVEMENT MARKING - LINE 12"	FOOT	55	55
* 78008300	POLYUREA PAVEMENT MARKING TYPE II - LETTERS AND SYMBOLS	SQ FT	156	156
* 78008310	POLYUREA PAVEMENT MARKING TYPE II - LINE 4"	FOOT	6,334	6,334
* 78008340	POLYUREA PAVEMENT MARKING TYPE II - LINE 8"	FOOT	7,692	7,692
* 78008350	POLYUREA PAVEMENT MARKING TYPE II - LINE 12"	FOOT	540	540
* 78008370	POLYUREA PAVEMENT MARKING TYPE II - LINE 24"	FOOT	64	64
* 78011000	GROOVING FOR RECESSED PAVEMENT MARKING, LETTERS AND SYMBOLS	SQ FT	168	168
* 78011025	GROOVING FOR RECESSED PAVEMENT MARKING 5"	FOOT	74,901	74,901
* 78011045	GROOVING FOR RECESSED PAVEMENT MARKING 9"	FOOT	7,092	7,092
* 78011065	GROOVING FOR RECESSED PAVEMENT MARKING 13"	FOOT	594	594
* 78011125	GROOVING FOR RECESSED PAVEMENT MARKING 25"	FOOT	64	64
* 78100100	RAISED REFLECTIVE PAVEMENT MARKER	EACH	370	370

* SPECIALTY ITEMS

FILE NAME: SP1EFLS
MODEL: \$HODE NAMES



USER NAME = 10017
DESIGNED - CG
DRAWN - MA
REVISED -

REVISED -
DRAWN - MA
REVISED -

REVISED -
CHECKED - CK
REVISED -

REVISED -
DATE - 02/29/2024
REVISED -

STATE OF ILLINOIS
DEPARTMENT OF TRANSPORTATION

SUMMARY OF QUANTITIES

SCALE: NONE SHEET 5 OF 6 SHEETS STA. TO STA.

F.A.P. RTE. 17	SECTION D2 PP 2023-02	COUNTY OGLE	TOTAL SHEETS 46	SHEET NO. 8
CONTRACT NO. 64R99				ILLINOIS FED. AID PROJECT

CODE NUMBER	PAY ITEM	UNIT	TOTAL QUANTITY	100% STATE
				ROADWAY
				0005
				RURAL
78300200	RAISED REFLECTIVE PAVEMENT MARKER REMOVAL	EACH	148	148
78300202	PAVEMENT MARKING REMOVAL - WATER BLASTING	SQ FT	13,819	13,819
*	X0326899 SOLAR-POWERED FLASHING BEACON ASSEMBLY (COMPLETE)	EACH	4	4
*	X7820007 GUARDRAIL REFLECTORS, TYPE C (SPECIAL)	EACH	50	50
Z0001002	GUARDRAIL AGGREGATE EROSION CONTROL	TON	76	76
Z0004542	HOT-MIX ASPHALT REMOVAL (SPECIAL)	SQ YD	3,281	3,281
Z0013798	CONSTRUCTION LAYOUT	L SUM	1	1
Z0028415	GEOTECHNICAL REINFORCEMENT	SQ YD	10,315	10,315
Z0034105	MATERIAL TRANSFER DEVICE	TON	21,791	21,791
Z0040315	PILOT CAR	CAL DA	10	10
Z0077803	REMOVE WOOD POST	EACH	4	4

* SPECIALTY ITEMS

MODEL: \$MODELNAME\$



Stanley Consultants INC.
8501 West Higgins Road, Suite 730, Chicago, Illinois 60631-2801
www.stanleyconsultants.com

USER NAME = 10017	DESIGNED - CG
	DRAWN - MA
PLOT SCALE = 2,000' / In.	CHECKED - CK
PLOT DATE 09/20/01	DATE 09/20/02

**STATE OF ILLINOIS
DEPARTMENT OF TRANSPORTATION**

SUMMARY OF QUANTITIES

F.A.P. RTE.	SECTION	COUNTY	TOTAL SHEETS	HEET NO.
17	D2 PP 2023-02	OGLE	46	9
			CONTRACT NO.	64R99

Short Term Pavement Marking				
Foot	IL-64 Mainline	Offset	Milled - Yellow 4" Centerline	
20	Sta 1776-78 - 1778+15	LT	4' Dash 40' Skip	
20	Sta 1776-78 - 1778+15	RT	4' Dash 40' Skip	
16	Sta 1778+15 - 1780+31	CL	4' Dash 40' Skip	
64	Sta 1780+31 - 1787+00	CL	4' Dash 40' Skip	
140	Sta 1787+00 - 1802+00	CL	4' Dash 40' Skip	
140	Sta 1802+00 - 1817+00	CL	4' Dash 40' Skip	
140	Sta 1817+00 - 1832+00	CL	4' Dash 40' Skip	
140	Sta 1832+00 - 1847+00	CL	4' Dash 40' Skip	
140	Sta 1847+00 - 1862+00	CL	4' Dash 40' Skip	
132	Sta 1862+00 - 1876+50	CL	4' Dash 40' Skip	
8	Sta 1909+43 - 1910+04	CL	4' Dash 40' Skip	
12	Sta 1910+04 - 1911+14	CL	4' Dash 40' Skip	
20	Sta 1911+14 - 1912+98	CL	4' Dash 40' Skip	
56	Sta 1915+01 - 1920+82	CL	4' Dash 40' Skip	
12	Sta 1920+82 - 1922+00	CL	4' Dash 40' Skip	
140	Sta 1922+00 - 1937+00	CL	4' Dash 40' Skip	
140	Sta 1937+00 - 1952+00	CL	4' Dash 40' Skip	
140	Sta 1952+00 - 1967+00	CL	4' Dash 40' Skip	
140	Sta 1967+00 - 1982+00	CL	4' Dash 40' Skip	
140	Sta 1982+00 - 2007+00	CL	4' Dash 40' Skip	
84	Sta 2078+00 - 2087+00	CL	4' Dash 40' Skip	
140	Sta 2087+00 - 2102+00	CL	4' Dash 40' Skip	
4	Sta 2102+00 - 2102+41	CL	4' Dash 40' Skip	
32	Sta 2102+41 - 2105+82	CL	4' Dash 40' Skip	
36	Sta 2105+82 - 2109+55	CL	4' Dash 40' Skip	
2,888				
Foot	IL-64 Mainline	Offset	Tack Coat - Yellow 4" Centerline	
20	Sta 1776-78 - 1778+15	LT	4' Dash 40' Skip	
20	Sta 1776-78 - 1778+15	RT	4' Dash 40' Skip	
16	Sta 1778+15 - 1780+31	CL	4' Dash 40' Skip	
64	Sta 1780+31 - 1787+00	CL	4' Dash 40' Skip	
140	Sta 1787+00 - 1802+00	CL	4' Dash 40' Skip	
140	Sta 1802+00 - 1817+00	CL	4' Dash 40' Skip	
140	Sta 1817+00 - 1832+00	CL	4' Dash 40' Skip	
140	Sta 1832+00 - 1847+00	CL	4' Dash 40' Skip	
140	Sta 1847+00 - 1862+00	CL	4' Dash 40' Skip	
132	Sta 1862+00 - 1876+50	CL	4' Dash 40' Skip	
8	Sta 1909+43 - 1910+04	CL	4' Dash 40' Skip	
12	Sta 1910+04 - 1911+14	CL	4' Dash 40' Skip	
20	Sta 1911+14 - 1912+98	CL	4' Dash 40' Skip	
56	Sta 1915+01 - 1920+82	CL	4' Dash 40' Skip	
12	Sta 1920+82 - 1922+00	CL	4' Dash 40' Skip	
140	Sta 1922+00 - 1937+00	CL	4' Dash 40' Skip	
140	Sta 1937+00 - 1952+00	CL	4' Dash 40' Skip	
140	Sta 1952+00 - 1967+00	CL	4' Dash 40' Skip	
140	Sta 1967+00 - 1982+00	CL	4' Dash 40' Skip	
140	Sta 1982+00 - 1997+00	CL	4' Dash 40' Skip	
140	Sta 1997+00 - 2012+00	CL	4' Dash 40' Skip	
140	Sta 2012+00 - 2027+00	CL	4' Dash 40' Skip	
24	Sta 2027+00 - 2028+22	CL	4' Dash 40' Skip	
108	Sta 2030+45 - 2042+00	CL	4' Dash 40' Skip	
140	Sta 2042+00 - 2057+00	CL	4' Dash 40' Skip	
140	Sta 2057+00 - 2072+00	CL	4' Dash 40' Skip	
140	Sta 2072+00 - 2076+70	CL	4' Dash 40' Skip	
84	Sta 2078+00 - 2087+00	CL	4' Dash 40' Skip	
140	Sta 2087+00 - 2102+00	CL	4' Dash 40' Skip	
4	Sta 2102+00 - 2102+41	CL	4' Dash 40' Skip	
32	Sta 2102+41 - 2105+82	CL	4' Dash 40' Skip	
36	Sta 2105+82 - 2109+55	CL	4' Dash 40' Skip	
2,888				
Foot	IL-64 Mainline	Offset	Binder - Yellow 4" Centerline	
20	Sta 1776-78 - 1778+15	LT	4' Dash 40' Skip	
20	Sta 1776-78 - 1778+15	RT	4' Dash 40' Skip	
16	Sta 1778+15 - 1780+31	CL	4' Dash 40' Skip	
64	Sta 1780+31 - 1787+00	CL	4' Dash 40' Skip	
140	Sta 1787+00 - 1802+00	CL	4' Dash 40' Skip	
140	Sta 1802+00 - 1817+00	CL	4' Dash 40' Skip	
140	Sta 1817+00 - 1832+00	CL	4' Dash 40' Skip	
140	Sta 1832+00 - 1847+00	CL	4' Dash 40' Skip	
140	Sta 1847+00 - 1862+00	CL	4' Dash 40' Skip	
132	Sta 1862+00 - 1876+50	CL	4' Dash 40' Skip	
8	Sta 1909+43 - 1910+04	CL	4' Dash 40' Skip	
12	Sta 1910+04 - 1911+14	CL	4' Dash 40' Skip	
20	Sta 1911+14 - 1912+98	CL	4' Dash 40' Skip	
56	Sta 1915+01 - 1920+82	CL	4' Dash 40' Skip	
12	Sta 1920+82 - 1922+00	CL	4' Dash 40' Skip	
140	Sta 1922+00 - 1937+00	CL	4' Dash 40' Skip	
140	Sta 1937+00 - 1952+00	CL	4' Dash 40' Skip	
140	Sta 1952+00 - 1967+00	CL	4' Dash 40' Skip	
140	Sta 1967+00 - 1982+00	CL	4' Dash 40' Skip	
140	Sta 1982+00 - 1997+00	CL	4' Dash 40' Skip	
140	Sta 1997+00 - 2012+00	CL	4' Dash 40' Skip	
140	Sta 2012+00 - 2027+00	CL	4' Dash 40' Skip	
24	Sta 2027+00 - 2028+22	CL	4' Dash 40' Skip	
108	Sta 2030+45 - 2042+00	CL	4' Dash 40' Skip	
140	Sta 2042+00 - 2057+00	CL	4' Dash 40' Skip	
140	Sta 2057+00 - 2072+00	CL	4' Dash 40' Skip	
140	Sta 2072+00 - 2076+70	CL	4' Dash 40' Skip	
84	Sta 2078+00 - 2087+00	CL	4' Dash 40' Skip	
140	Sta 2087+00 - 2102+00	CL	4' Dash 40' Skip	
4	Sta 2102+00 - 2102+41	CL	4' Dash 40' Skip	
32	Sta 2102+41 - 2105+82	CL	4' Dash 40' Skip	
36	Sta 2105+82 - 2109+55	CL	4' Dash 40' Skip	
2,888				

THERMOPLASTIC PAVEMENT MARKING - LINE 4"				
FOOT	IL-64 MAINLINE	OFFSET	Yellow Centerline	
264	Sta 1776+78 - 1778+09	LT	2 Stripes	
270	Sta 1776+78 - 1778+13	RT	2 Stripes	
47	Sta 1778+09 - 1778+57	CL	1 Stripe	
44	Sta 1778+13 - 1778+57	CL	1 Stripe	
348	Sta 1778+57 - 1780+31	CL	2 Stripes	
168	Sta 1780+31 - 1787+00	CL	10' Dash 30' Skip	
376	Sta 1787+00 - 1802+00	CL	10' Dash 30' Skip	
376	Sta 1802+00 - 1817+00	CL	10' Dash 30' Skip	
376	Sta 1817+00 - 1832+00	CL	10' Dash 30' Skip	
376	Sta 1832+00 - 1847+00	CL	10' Dash 30' Skip	
376	Sta 1847+00 - 1862+00	CL	10' Dash 30' Skip	
364	Sta 1862+00 - 1876+50	CL	10' Dash 30' Skip	
122	Sta 1890+43 - 1910+04	CL	2 Stripes	
219	Sta 1910+04 - 1911+14	CL	2 Stripes	
233	Sta 1911+14 - 1912+98	CL	1 Stripe and 10' Dash 30' Skip	
729	Sta 1915+01 - 1920+82	CL	1 Stripe and 10' Dash 30' Skip	
32	Sta 1920+82 - 1922+00	CL	10' Dash 30' Skip	
376	Sta 1922+00 - 1937+00	CL	10' Dash 30' Skip	
376	Sta 1937+00 - 1952+00	CL	10' Dash 30' Skip	
376	Sta 1952+00 - 1967+00	CL	10' Dash 30' Skip	
376	Sta 1967+00 - 1982+00	CL	10' Dash 30' Skip	
376	Sta 1982+00 - 1997+00	CL	10' Dash 30' Skip	
376	Sta 1997+00 - 2012+00	CL	10' Dash 30' Skip	
376	Sta 2012+00 - 2027+00	CL	10' Dash 30' Skip	
56	Sta 2027+00 - 2029+22	CL	10' Dash 30' Skip	
292	Sta 2030+45 - 2042+00	CL	10' Dash 30' Skip	
376	Sta 2042+00 - 2057+00	CL	10' Dash 30' Skip	
376	Sta 2057+00 - 2072+00	CL	10' Dash 30' Skip	
376	Sta 2072+00 - 2076+70	CL	10' Dash 30' Skip	
228	Sta 2078+00 - 2087+00	CL	10' Dash 30' Skip	
376	Sta 2087+00 - 2102+00	CL	10' Dash 30' Skip	
12	Sta 2102+00 - 2102+41	CL	10' Dash 30' Skip	
430	Sta 2102+41 - 2105+82	CL	1 Stripe and 10' Dash 30' Skip	
747	Sta 2105+82 - 2109+55	CL	2 Stripes	
10,621				
FOOT	IL-64 MAINLINE	OFFSET	White Edge Line	
1,023	Sta 1776+78 - 1787+00	LT	1 Stripe	
1,022	Sta 1776+78 - 1787+00	RT	1 Stripe	
1,500	Sta 1787+00 - 1802+00	LT	1 Stripe	
1,500	Sta 1787+00 - 1802+00	RT	1 Stripe	
1,500	Sta 1802+00 - 1817+00	LT	1 Stripe	
1,500	Sta 1802+00 - 1817+00	RT	1 Stripe	
1,500	Sta 1817+00 - 1832+00	LT	1 Stripe	
1,500	Sta 1817+00 - 1832+00	RT	1 Stripe	
1,105	Sta 1832+00 - 1843+05	LT	1 Stripe	
1,122	Sta 1832+00 - 1843+22	RT	1 Stripe	
323	Sta 1843+77 - 1847+00	RT	1 Stripe	
308	Sta 1843+92 - 1847+00	LT	1 Stripe	
1,500	Sta 1847+00 - 1862+00	LT	1 Stripe	
1,500	Sta 1847+00 - 1862+00	RT	1 Stripe	
771	Sta 1862+00 - 1869+71	RT	1 Stripe	
827	Sta 1862+00 - 1869+95	LT	1 Stripe	
661	Sta 1870+19 - 1876+50	LT	1 Stripe	
611	Sta 1876+39 - 1876+50	RT	1 Stripe	
355	Sta 1909+43 - 1912+98	RT	1 Stripe	
355	Sta 1909+43 - 1912+99	LT	1 Stripe	
699	Sta 1915+01 - 1922+00	RT	1 Stripe	
699	Sta 1915+01 - 1922+00	LT	1 Stripe	
1,500	Sta 1922+00 - 1937+00	LT	1 Stripe	
1,500	Sta 1922+00 - 1937+00	RT	1 Stripe	
1,252	Sta 1937+00 - 1949+52	LT	1 Stripe	
1,272	Sta 1937+00 - 1949+72	RT	1 Stripe	
188	Sta 1950+12 - 1952+00	RT	1 Stripe	
184	Sta 1950+16 - 1952+00	LT	1 Stripe	
1,500	Sta 1952+00 - 1967+00	LT	1 Stripe	
1,500	Sta 1952+00 - 1967+00	RT	1 Stripe	
1,500	Sta 1967+00 - 1982+00	LT	1 Stripe	
1,500	Sta 1967+00 - 1982+00	RT	1 Stripe	
1,500	Sta 1982+00 - 1997+00	LT	1 Stripe	
1,500	Sta 1982+00 - 1997+00	RT	1 Stripe	
594	Sta 1997+00 - 2002+94	LT	1 Stripe	
597	Sta 1997+00 - 2002+97	RT	1 Stripe	
848	Sta 2003+53 - 2012+00	LT	1 Stripe	
835	Sta 2003+66 - 2012+00	RT	1 Stripe	
1,500	Sta 2012+00 - 2027+00	LT	1 Stripe	
1,500	Sta 2012+00 - 2027+00	RT	1 Stripe	
222	Sta 2027+00 - 2029+22	LT	1 Stripe	
222	Sta 2027+00 - 2029+22	RT	1 Stripe	
1,155	Sta 2030+45 - 2042+00	LT	1 Stripe	
1,155	Sta 2030+45 - 2042+00	RT	1 Stripe	
1,402	Sta 2042+00 - 2056+02	LT	1 Stripe	
1,411	Sta 2042+00 - 2056+11	RT	1 Stripe	
47	Sta 2056+58 - 2057+00	LT	1 Stripe	
33	Sta 2056+67 - 2057+00	RT	1 Stripe	
1,500	Sta 2057+00 - 2072+00	LT	1 Stripe	
1,500	Sta 2057+00 - 2072+00	RT	1 Stripe	
462	Sta 2072+00 - 2076+62	LT	1 Stripe	
479	Sta 2072+00 - 2076+79	RT	1 Stripe	
909	Sta 2077+91 - 2087+00	LT	1 Stripe	
892	Sta 2078+08 - 2087+00	RT	1 Stripe	
1,500	Sta 2087+00 - 2102+00	LT	1 Stripe	
1,500	Sta 2087+00 - 2102+00	RT	1 Stripe	
756	Sta 2102+00 - 2109+55	LT	1 Stripe	
754	Sta 2102+00 - 2109+55	RT	1 Stripe	
58,546				

3000600		THERMOPLASTIC PAVEMENT MARKING - LINE 12"		
FOOT	IL-64 MAINLINE	OFFSET	Yellow Median Diagonals	
17	Sta 1776+85 - 1776+97	LT/RT	1 Stripe	
14	Sta 1777+16 - 1777+26	LT/RT	1 Stripe	
11	Sta 1777+47 - 1777+55	LT/RT	1 Stripe	
8	Sta 1777+78 - 1777+84	LT/RT	1 Stripe	
5	Sta 1778+09 - 1778+13	RT	1 Stripe	
55 GRAND TOTAL				
3008300		POLYUREA PAVEMENT MARKING TYPE II - LETTERS AND SYMBOLS		
SQ FT	IL-64 MAINLINE	OFFSET	White	
31	Sta 1886+77 - 1887+04	LT	2 Left Turn Arrows	
47	Sta 1887+76 - 1890+80	LT	3 Left Turn Arrows	
47	Sta 1899+19 - 1901+94	RT	3 Left Turn Arrows	
31	Sta 1902+93 - 1903+22	RT	2 Left Turn Arrows	
156 GRAND TOTAL				
3008310		POLYUREA PAVEMENT MARKING TYPE II - LINE 4"		
FOOT	IL-64 MAINLINE	OFFSET	Yellow	
2,142	Sta 1876+50 - 1887+18	CL	1 Stripe	
2,864	Sta 1887+73 - 1902+01	CL	1 Stripe	
1,328	Sta 1902+81 - 1909+43	CL	1 Stripe	
6,334 GRAND TOTAL				
3008340		POLYUREA PAVEMENT MARKING TYPE II - LINE 8"		
FOOT	IL-64 MAINLINE	OFFSET	White	
1,060	Sta 1876+50 - 1886+86	RT	Edge Line - 1 Stripe	
1,046	Sta 1876+50 - 1886+77	LT	Edge Line - 1 Stripe	
2,106				
FOOT	I-39 SB EXIT RAMP MEDIAN	OFFSET	White	
72	Sta 1886+44 - 1886+93	LT	Edge Line - 1 Stripe	
60	Sta 1886+44 - 1887+04	LT	Edge Line - 1 Stripe	
52	Sta 1886+93 - 1887+04	LT	Edge Line - 1 Stripe	
184				
FOOT	IL-64 MAINLINE	OFFSET	White	
310	Sta 1887+75 - 1890+85	RT	Left Turn Lane Line - 1 Stripe	
1,656	Sta 1887+08 - 1902+90	RT	Edge Line - 1 Stripe	
1,665	Sta 1887+08 - 1902+91	LT	Edge Line - 1 Stripe	
284	Sta 1899+17 - 1902+00	LT	Left Turn Lane Line - 1 Stripe	
3,915				
FOOT	I-39 NB EXIT RAMP MEDIAN	OFFSET	White	
50	Sta 1902+95 - 1903+05	RT	Edge Line - 1 Stripe	
69	Sta 1902+95 - 1903+64	RT	Edge Line - 1 Stripe	
77	Sta 1903+05 - 1903+64	RT	Edge Line - 1 Stripe	
196				
FOOT	IL-64 MAINLINE	OFFSET	White	
641	Sta 1903+20 - 1909+43	RT	Edge Line - 1 Stripe	
650	Sta 1903+15 - 1909+43	RT	Edge Line - 1 Stripe	
1,291				
7,692 GRAND TOTAL				
3008350		POLYUREA PAVEMENT MARKING TYPE II - LINE 12"		
FOOT	I-39 SB EXIT RAMP MEDIAN	OFFSET	White	
249	Sta 1886+44 - 1887+04	LT	Painted Island	
249				
FOOT	I-39 NB EXIT RAMP MEDIAN	OFFSET	White	
290	Sta 1902+95 - 1903+64	RT	Painted Island	
290				
539 GRAND TOTAL				
3008370		POLYUREA PAVEMENT MARKING TYPE II - LINE 24"		
FOOT	I-39 SB EXIT RAMPS	OFFSET	White	
32	Sta 1886+58 - 1887+12	LT	2 Stop Bars	
32	Sta 1902+85 - 1903+53	RT	2 Stop Bars	
64 GRAND TOTAL				
3011000		GROOVING FOR RECESSED PAVEMENT MARKING, LETTERS AND SYMBOLS		
SQ FT	IL-64 MAINLINE	OFFSET	White	
34	Sta 1886+77 - 1887+04	LT	2 Left Turn Arrows	
50	Sta 1887+76 - 1890+80	LT	3 Left Turn Arrows	
50	Sta 1899+19 - 1901+94	RT	3 Left Turn Arrows	
34	Sta 1902+93 - 1903+22	RT	2 Left Turn Arrows	

GROOVING FOR RECESSED PAVEMENT MARKING 5"				
FOOT	IL-64 MAINLINE		OFFSET	Yellow
264	Sta 1776+78	- 1778+09	LT	2 Stripes
270	Sta 1776+78	- 1778+13	RT	2 Stripes
47	Sta 1778+09	- 1778+57	CL	1 Stripe
44	Sta 1778+13	- 1778+57	CL	1 Stripe
348	Sta 1778+57	- 1780+31	CL	2 Stripes
168	Sta 1780+31	- 1787+00	CL	10' Dash 30' Skip
376	Sta 1787+00	- 1802+00	CL	10' Dash 30' Skip
376	Sta 1802+00	- 1817+00	CL	10' Dash 30' Skip
376	Sta 1817+00	- 1832+00	CL	10' Dash 30' Skip
376	Sta 1832+00	- 1847+00	CL	10' Dash 30' Skip
376	Sta 1847+00	- 1862+00	CL	10' Dash 30' Skip
364	Sta 1862+00	- 1876+50	CL	10' Dash 30' Skip
122	Sta 1909+43	- 1910+04	CL	2 Stripes
219	Sta 1910+04	- 1911+14	CL	2 Stripes
233	Sta 1911+14	- 1912+98	CL	1 Stripe and 10' Dash 30' Skip
729	Sta 1915+01	- 1920+82	CL	1 Stripe and 10' Dash 30' Skip
32	Sta 1920+82	- 1922+00	CL	10' Dash 30' Skip
376	Sta 1922+00	- 1937+00	CL	10' Dash 30' Skip
376	Sta 1937+00	- 1952+00	CL	10' Dash 30' Skip
376	Sta 1952+00	- 1967+00	CL	10' Dash 30' Skip
376	Sta 1967+00	- 1982+00	CL	10' Dash 30' Skip
376	Sta 1982+00	- 1997+00	CL	10' Dash 30' Skip
376	Sta 1997+00	- 2012+00	CL	10' Dash 30' Skip
376	Sta 2012+00	- 2027+00	CL	10' Dash 30' Skip
56	Sta 2027+00	- 2029+22	CL	10' Dash 30' Skip
292	Sta 2030+45	- 2042+00	CL	10' Dash 30' Skip
376	Sta 2042+00	- 2057+00	CL	10' Dash 30' Skip
376	Sta 2057+00	- 2072+00	CL	10' Dash 30' Skip
376	Sta 2072+00	- 2076+70	CL	10' Dash 30' Skip
228	Sta 2078+00	- 2087+00	CL	10' Dash 30' Skip
376	Sta 2087+00	- 2102+00	CL	10' Dash 30' Skip
12	Sta 2102+00	- 2102+41	CL	10' Dash 30' Skip
430	Sta 2102+41	- 2105+82	CL	1 Stripe and 10' Dash 30' Skip
747	Sta 2105+82	- 2109+55	CL	2 Stripes
10,621				
FOOT	IL-64 MAINLINE		OFFSET	White
1,023	Sta 1776+78	- 1787+00	LT	1 Stripe
1,022	Sta 1776+78	- 1787+00	RT	1 Stripe
1,500	Sta 1787+00	- 1802+00	LT	1 Stripe
1,500	Sta 1802+00	- 1817+00	LT	1 Stripe
1,500	Sta 1802+00	- 1817+00	RT	1 Stripe
1,500	Sta 1817+00	- 1832+00	LT	1 Stripe
1,500	Sta 1817+00	- 1832+00	RT	1 Stripe
1,105	Sta 1832+00	- 1843+05	LT	1 Stripe
1,122	Sta 1832+00	- 1843+22	RT	1 Stripe
323	Sta 1843+77	- 1847+00	RT	1 Stripe
308	Sta 1843+92	- 1847+00	LT	1 Stripe
1,500	Sta 1847+00	- 1862+00	LT	1 Stripe
1,500	Sta 1847+00	- 1862+00	RT	1 Stripe
771	Sta 1862+00	- 1869+71	RT	1 Stripe
827	Sta 1862+00	- 1869+95	LT	1 Stripe
661	Sta 1870+19	- 1876+50	LT	1 Stripe
611	Sta 1870+39	- 1876+50	RT	1 Stripe
355	Sta 1909+43	- 1912+98	RT	1 Stripe
356	Sta 1909+43	- 1912+99	LT	1 Stripe
699	Sta 1915+01	- 1922+00	RT	1 Stripe
699	Sta 1915+01	- 1922+00	LT	1 Stripe
1,500	Sta 1922+00	- 1937+00	LT	1 Stripe
1,500	Sta 1922+00	- 1937+00	RT	1 Stripe
1,252	Sta 1937+00	- 1949+52	LT	1 Stripe
1,272	Sta 1937+00	- 1949+72	RT	1 Stripe
188	Sta 1950+12	- 1952+00	RT	1 Stripe
184	Sta 1950+16	- 1952+00	LT	1 Stripe
1,500	Sta 1952+00	- 1967+00	LT	1 Stripe
1,500	Sta 1952+00	- 1967+00	RT	1 Stripe
1,500	Sta 1967+00	- 1982+00	LT	1 Stripe
1,500	Sta 1967+00	- 1982+00	RT	1 Stripe
1,500	Sta 1982+00	- 1997+00	LT	1 Stripe
1,500	Sta 1982+00	- 1997+00	RT	1 Stripe
594	Sta 1997+00	- 2002+94	LT	1 Stripe
597	Sta 1997+00	- 2002+97	RT	1 Stripe
848	Sta 2003+53	- 2012+00	LT	1 Stripe
835	Sta 2003+66	- 2012+00	RT	1 Stripe
1,500	Sta 2012+00	- 2027+00	LT	1 Stripe
1,500	Sta 2012+00	- 2027+00	RT	1 Stripe
222	Sta 2027+00	- 2029+22	LT	1 Stripe
222	Sta 2027+00	- 2029+22	RT	1 Stripe
1,155	Sta 2030+45	- 2042+00	LT	1 Stripe
1,155	Sta 2030+45	- 2042+00	RT	1 Stripe
1,402	Sta 2042+00	- 2056+02	LT	1 Stripe
1,411	Sta 2042+00	- 2056+11	RT	1 Stripe
42	Sta 2056+58	- 2057+00	LT	1 Stripe
33	Sta 2056+67	- 2057+00	RT	1 Stripe
1,500	Sta 2057+00	- 2072+00	LT	1 Stripe
1,500	Sta 2057+00	- 2072+00	RT	1 Stripe
462	Sta 2072+00	- 2076+62	LT	1 Stripe
479	Sta 2072+00	- 2076+79	RT	1 Stripe
909	Sta 2077+91	- 2087+00	LT	1 Stripe
892	Sta 2078+08	- 2087+00	RT	1 Stripe
1,500	Sta 2087+00	- 2102+00	LT	1 Stripe
1,500	Sta 2087+00	- 2102+00	RT	1 Stripe
756	Sta 2102+00	- 2109+55	LT	1 Stripe
754	Sta 2102+00	- 2109+55	RT	1 Stripe
58,546				
FOOT	IL-64 MAINLINE MEDIANS		OFFSET	Yellow
2,142	Sta 1875+50	- 1887+18	CL	1 Stripe
2,264	Sta 1887+73	- 1902+01	CL	1 Stripe
1,328	Sta 1902+81	- 1909+43	CL	1 Stripe
5,734				

78011045		GROOVING FOR RECESSED PAVEMENT MARKING 9"				78300202		PAVEMENT MARKING REMOVAL - WATER BLASTING				40600990		TEMPORARY RAMP				LOCATION	63000001	63100167	63100085	72501000	63200310	X7820007	63500105																							
FOOT	IL-04 MAINLINE	OFFSET	White	SQ FT	IL-64 MAINLINE	OFFSET	White	SQ YD	IL-64 MAINLINE WESTBOUND	OFFSET	12' 6" Temp Ramp								STEEL PLATE BEAM	TRAFFIC BARRIER TERMINAL, TYPE 1 (SPECIAL)	TRAFFIC BARRIER TERMINAL, TYPE 6	TERMINAL MARKER - DIRECT APPLIED	GUARDRAIL REMOVAL	GUARDRAIL REFLECTORS, TYPE C (SPECIAL)	LOCATION																							
1,060	Sta 1876+50 - 1886+86	RT	Edge Line - 1 Stripe	31	Sta 1886+77 - 1887+04	LT	2 Left Turn Arrows	27	Sta 1876+78 - 1776+90	LT	12' 6" Temp Ramp	17	Sta 1876+37 - 1876+50	LT	12' 6" Temp Ramp	17	Sta 1909+43 - 1909+56	LT	12' 6" Temp Ramp	17	Sta 1912+88 - 1912+98	LT	12' 6" Temp Ramp	17	Sta 1915+01 - 1915+14	LT	12' 6" Temp Ramp	18	Sta 2029+10 - 2029+22	LT	12' 6" Temp Ramp	18	Sta 2030+45 - 2030+58	LT	12' 6" Temp Ramp	18	Sta 2109+43 - 2109+55	LT	12' 6" Temp Ramp	18	Sta 1791+88.88 - 1796+13.88	325	2	2	429.1	4	LOCATION	DELINEATORS
1,046	Sta 1876+50 - 1886+77	LT	Edge Line - 1 Stripe	47	Sta 1887+76 - 1890+80	LT	3 Left Turn Arrows	17	Sta 1876+37 - 1876+50	LT	12' 6" Temp Ramp	22	Sta 1909+43 - 1909+56	LT	12' 6" Temp Ramp	17	Sta 1912+88 - 1912+98	LT	12' 6" Temp Ramp	17	Sta 1915+01 - 1915+14	LT	12' 6" Temp Ramp	18	Sta 2029+10 - 2029+22	LT	12' 6" Temp Ramp	18	Sta 2030+45 - 2030+58	LT	12' 6" Temp Ramp	18	Sta 2109+43 - 2109+55	LT	12' 6" Temp Ramp	18	Sta 1791+88.88 - 1796+13.88	325	2	2	429.0	4	LOCATION	DELINEATORS				
2,106				47	Sta 1899+19 - 1901+94	RT	3 Left Turn Arrows	17	Sta 1912+88 - 1912+98	LT	12' 6" Temp Ramp	17	Sta 1915+01 - 1915+14	LT	12' 6" Temp Ramp	18	Sta 2029+10 - 2029+22	LT	12' 6" Temp Ramp	18	Sta 2030+45 - 2030+58	LT	12' 6" Temp Ramp	18	Sta 2109+43 - 2109+55	LT	12' 6" Temp Ramp	18	Sta 1791+88.88 - 1796+13.88	325	2	2	429.0	4	LOCATION	DELINEATORS												
				31	Sta 1902+93 - 1903+22	RT	2 Left Turn Arrows	156				17	Sta 1912+88 - 1912+98	LT	12' 6" Temp Ramp	17	Sta 1915+01 - 1915+14	LT	12' 6" Temp Ramp	18	Sta 2029+10 - 2029+22	LT	12' 6" Temp Ramp	18	Sta 2030+45 - 2030+58	LT	12' 6" Temp Ramp	18	Sta 2109+43 - 2109+55	LT	12' 6" Temp Ramp	18	Sta 1791+88.88 - 1796+13.88	325	2	2	429.0	4	LOCATION	DELINEATORS								
				156								17	Sta 1912+88 - 1912+98	LT	12' 6" Temp Ramp	17	Sta 1915+01 - 1915+14	LT	12' 6" Temp Ramp	18	Sta 2029+10 - 2029+22	LT	12' 6" Temp Ramp	18	Sta 2030+45 - 2030+58	LT	12' 6" Temp Ramp	18	Sta 2109+43 - 2109+55	LT	12' 6" Temp Ramp	18	Sta 1791+88.88 - 1796+13.88	325	2	2	429.0	4	LOCATION	DELINEATORS								
												17	Sta 1912+88 - 1912+98	LT	12' 6" Temp Ramp	17	Sta 1915+01 - 1915+14	LT	12' 6" Temp Ramp	18	Sta 2029+10 - 2029+22	LT	12' 6" Temp Ramp	18	Sta 2030+45 - 2030+58	LT	12' 6" Temp Ramp	18	Sta 2109+43 - 2109+55	LT	12' 6" Temp Ramp	18	Sta 1791+88.88 - 1796+13.88	325	2	2	429.0	4	LOCATION	DELINEATORS								
												17	Sta 1912+88 - 1912+98	LT	12' 6" Temp Ramp	17	Sta 1915+01 - 1915+14	LT	12' 6" Temp Ramp	18	Sta 2029+10 - 2029+22	LT	12' 6" Temp Ramp	18	Sta 2030+45 - 2030+58	LT	12' 6" Temp Ramp	18	Sta 2109+43 - 2109+55	LT	12' 6" Temp Ramp	18	Sta 1791+88.88 - 1796+13.88	325	2	2	429.0	4	LOCATION	DELINEATORS								
HMA RESURFACING SCHEDULE

				Shoulder 4060C290	Mainline 40600295 *	Mainline 40600370	Mainline 40602978 **	Shoulder 40604000 **	Mainline 40604050 *	Shoulder 44000157	Mainline 44000164	Shoulder 48102100 ***	Shoulder 64200116	Mainline Z0004542			
Location	MainLine Surface		Shoulder	Aggregate Shoulder	BITUMINOUS MATERIALS (TACK COAT)	POLYMERIZED BITUMINOUS MATERIALS (TACK COAT)	LONGITUDINAL JOINT SEALANT	HOT-MIX ASPHALT BINDER COURSE, IL-9.5, N50 1 3/4"	HOT-MIX ASPHALT SURFACE COURSE, IL-9.5FG, MIX "C", N50, 2"	HOT-MIX ASPHALT SURFACE COURSE, IL-9.5, MIX "C", N50 2"	HOT-MIX ASPHALT SURFACE REMOVAL, 2"	HOT-MIX ASPHALT SURFACE REMOVAL 3 3/4"	AGGREGATE WEDGE SHOULDER, TYPE B	SHOULDER RUMBLE STRIPS, 16 INCH	HOT-MIX ASPHALT REMOVAL (SPECIAL)		
	WIDTH (FT)	SQ YD	SQ YD	FEET	POUND	POUND	FOOT	TON	TON	TON	SQ YD	TON	FOOT	SQ YD			
WESTBOUND																	
Sta 1776 + 78 - 1787 + 00	24-40	1,483.3	879.5	825.0	395.8	1,014.0	2,370.0	145.4	98.5	172.5	879.5	1,483.3	3.3	1,022.7	56.8		
Sta 1787 + 00 - 1802 + 00	24	2,197.4	1,166.9	1,083.0	525.1	1,502.0	3,000.0	215.3	130.7	255.4	1,166.9	2,197.4	4.3	1,499.8	83.3		
Sta 1802 + 00 - 1817 + 00	24	2,064.5	1,283.0	1,257.6	577.4	1,412.3	3,000.0	202.3	143.7	240.6	1,283.0	2,064.5	5.0	1,499.9	83.3		
Sta 1817 + 00 - 1832 + 00	24	2,118.6	1,173.6	1,129.8	528.1	1,448.8	3,000.0	207.6	131.4	246.6	1,173.6	2,118.6	4.5	1,500.0	83.3		
Sta 1832 + 00 - 1847 + 00	24	2,205.1	1,578.6	1,505.1	710.4	1,507.2	3,000.0	216.1	176.8	256.3	1,578.6	2,205.1	6.0	1,428.4	83.3		
Sta 1847 + 00 - 1862 + 00	24	1,958.6	1,443.5	1,500.0	649.6	1,340.8	3,000.0	191.9	161.7	228.7	1,443.5	1,958.6	6.0	1,500.0	83.3		
Sta 1862 + 00 - 1877 + 00	24	2,041.5	1,412.3	1,480.0	635.5	1,396.1	2,899.4	200.1	158.2	237.7	1,412.3	2,041.5	5.9	1,431.8	80.5		
Sta 1877 + 00 - 1892 + 00	-	-	1,274.6	1,109.2	573.6	-	-	-	142.8	-	1,274.6	-	4.4	-	-		
Sta 1892 + 00 - 1907 + 00	24	524.7	445.3	384.3	200.4	358.6	710.9	51.4	49.9	61.0	445.3	524.7	1.5	355.3	19.7		
Sta 1907 + 00 - 1922 + 00	24	1,001.0	1,212.3	356.2	545.5	605.0	1,307.6	98.2	135.8	116.6	1,212.3	1,001.0	1.4	600.3	38.8		
Sta 1922 + 00 - 1937 + 00	24	2,063.4	1,306.8	1,500.0	588.1	1,411.6	3,000.0	202.2	140.4	240.4	1,306.8	2,063.4	6.0	1,500.0	83.3		
Sta 1937 + 00 - 1952 + 00	24	2,144.9	1,337.6	1,516.0	601.9	1,466.6	3,000.0	210.2	149.8	249.6	1,337.6	2,144.9	6.0	1,439.4	83.3		
Sta 1952 + 00 - 1967 + 00	24	1,969.9	1,416.6	1,414.8	637.5	1,348.4	3,000.0	193.1	158.7	230.0	1,416.6	1,969.9	5.6	1,500.0	83.3		
Sta 1967 + 00 - 1982 + 00	24	2,017.2	1,288.7	1,500.0	579.9	1,380.3	3,000.0	197.7	144.3	235.3	1,288.7	2,017.2	6.0	1,500.0	83.3		
Sta 1982 + 00 - 1997 + 00	24	2,055.8	1,312.9	1,280.3	590.8	1,406.4	3,000.0	201.5	147.0	239.6	1,312.9	2,055.8	5.1	1,500.0	83.3		
Sta 1997 + 00 - 2012 + 00	24-26	2,186.6	1,252.9	1,498.0	563.8	1,494.7	3,000.0	214.3	140.3	254.2	1,252.9	2,186.6	6.0	1,441.2	83.3		
Sta 2012 + 00 - 2027 + 00	26	2,166.7	1,166.7	1,500.0	525.0	1,481.3	3,000.0	212.3	130.7	252.0	1,166.7	2,166.7	6.0	1,500.0	83.3		
Sta 2027 + 00 - 2042 + 00	26	1,988.6	1,070.8	1,376.7	481.9	1,359.5	2,753.4	194.9	119.9	231.3	1,070.8	1,988.6	5.5	1,376.7	76.5		
Sta 2042 + 00 - 2057 + 00	26	2,308.0	1,122.4	1,505.0	505.1	1,576.7	3,000.0	226.2	125.7	267.8	1,122.4	2,308.0	6.0	1,444.0	83.3		
Sta 2057 + 00 - 2072 + 00	26	2,166.7	1,166.7	1,500.0	525.0	1,481.2	3,000.0	212.3	130.7	252.0	1,166.7	2,166.7	6.0	1,500.0	83.3		
Sta 2072 + 00 - 2087 + 00	26	1,980.4	1,066.3	1,371.0	479.8	1,353.9	2,742.0	194.1	119.4	230.3	1,066.3	1,980.4	5.5	1,371.0	76.2		
Sta 2087 + 00 - 2102 + 00	26	2,166.7	1,166.7	1,500.0	525.0	1,481.3	3,000.0	212.3	130.7	252.0	1,166.7	2,166.7	6.0	1,500.0	83.3		
Sta 2102 + 00 - 2109 + 55	26	1,091.8	588.6	757.2	264.9	746.4	1,510.5	107.0	65.9	127.0	588.6	1,091.8	3.7	756.4	42.0		
SUB-TOTAL				41,902.3	27,133.3	28,849.2	12,210.1	28,653.1	59,384.0	4,106.4	3,038.9	4,876.8	27,133.3	41,902.3	115.6	29,265.9	1,640.5
EASTBOUND																	
Sta 1776 + 78 - 1787 + 00	24-40	1,666.9	863.4	1,022.4	388.5	1,137.9	-	163.4	96.7	193.1	863.4	1,666.9	4.1	1,022.4	56.8		
Sta 1787 + 00 - 1802 + 00	24	2,130.0	1,199.7	996.2	539.9	1,456.5	-	208.7	134.4	247.9	1,199.7	2,130.0	4.0	1,500.2	83.3		
Sta 1802 + 00 - 1817 + 00	24	2,075.5	1,359.6	1,122.8	611.8	1,419.7	-	203.4	152.3	241.8	1,359.6	2,075.5	4.5	1,500.1	83.3		
Sta 1817 + 00 - 1832 + 00	24	2,057.4	1,216.3	690.9	547.3	1,407.5	-	201.6	136.2	239.8	1,216.3	2,057.4	2.8	1,500.0	83.3		
Sta 1832 + 00 - 1847 + 00	24	2,009.4	1,372.0	1,452.0	617.4	1,375.1	-	196.9	153.7	234.4	1,372.0	2,009.4	5.8	1,429.8	83.3		
Sta 1847 + 00 - 1862 + 00	24	2,004.7	1,393.7	1,500.0	627.2	1,371.9	-	196.5	156.1	233.9	1,393.7	2,004.7	6.0	1,500.0	83.3		
Sta 1862 + 00 - 1877 + 00	24	2,121.1	1,333.6	1,506.0	600.1	1,449.8	-	207.9	149.4	246.6	1,333.6	2,121.1	6.0	1,437.6	80.5		
Sta 1877 + 00 - 1892 + 00	-	-	1,205.0	1,042.9	542.3	-	-	135.0	-	1,205.0	-	4.2					

						72000100	72000200	72400710	72400720	72400310	72400320	72800100	72800100	73000100	Z0077803		
Mile	Side	Common Name of Sign	Sign Code	Size Hor (in)	Size Ver (in)	SIGN PANEL TYPE 1 (SQ FT)	SIGN PANEL TYPE 2 (SQ FT)	RELOCATE SIGN PANEL TYPE I (SQ FT)	RELOCATE SIGN PANEL TYPE 2 (SQ FT)	REMOVE SIGN PANEL Type 1 (SQ FT)	REMOVE SIGN PANEL TYPE 2 (SQ FT)	TELESCOPING STEEL SIGN SUPPORT (FOOT) (2 in)	TELESCOPING STEEL SIGN SUPPORT (FOOT) (2 1/4 in)	WOOD SIGN SUPPORT (FOOT)	REMOVE WOOD POST (EACH)	Notes	
33.62	S	East (White)	M3-2	24	12	2.00						10.0	5.0			150' eas: of IL 251 CL	
		Illinois Route 64	M1-I100	24	24	4.00											
33.63	S	East (White)	M3-2	24	12							2.00				Remove sign and post	
		Illinois Route 64	M1-I100	24	24							4.00					
33.63	N	Illinois Route 251	M1-I100	30	24	5.00						5.00					
		Illinois Route 64	M1-I100	24	24	4.00						4.00					
		Two-headed arrow (white)	M6-4	21	15	2.20						2.20					
		Straight up arrow (white)	M6-3	21	15	2.20						2.20					
33.64	N	<-- Rochelle Rockford -->	D1-2	60	30							12.50				Remove sign and posts	
33.66	S	I-39 US 51 2	D2-2	60	30							12.50				Remove sign and posts	
33.66	S	Speed Limit 55	R2-1	30	36	7.50							10.0	5.0		250 foot sign spacing	
33.67	N	<-- Rochelle Rockford -->	D1-2	60	30		12.50						19.0	10.0		213' east of Rt signing	
33.68	N	Emergency Route	WSPC	24	12							2.00				Remove signs and post	
		Emergency Route	WSPC	24	12							2.00					
		South (Blue)	M3-3	24	12							2.00					
		North (Blue)	M3-1	24	12							2.00					
		I-39	M1-1	24	24							4.00					
		I-39	M1-1	24	24							4.00					
		Left arrow (Blue)	M6-1L	21	15							2.20					
		Right arrow (Blue)	M6-1R	21	15							2.20					
33.71	S	STOP AHEAD	W3-1	36	36	9.00									32.0	650' east of IL 251 stop bar	
		I-39 2	D2-2	60	30		12.50										
33.71	N	STOP AHEAD	W3-1	36	36	9.00									16.0	650' east of IL 251 stop bar	
33.79	N	JCT (white)	M2-1	21	15							2.20				Remove signs and post	
		Illinois 251	M1-I100	30	24							5.00					
33.75	N	Emergency Route	WSPC	24	12	2.00									17.0	200' east of Stop Ahead	
		Emergency Route	WSPC	24	12	2.00											
		South (Blue)	M3-3	24	12	2.00											
		North (Blue)	M3-1	24	12	2.00											
		I-39	M1-1	24	24	4.00											
		I-39	M1-1	24	24	4.00											
		Left arrow (Blue)	M6-1L	21	15	2.20											
		Right arrow (Blue)	M6-1R	21	15	2.20											
33.77	N	STOP AHEAD	W3-1	36	36							9.00				Remove sign and post	
33.77	S	STOP AHEAD	W3-1	36	36							9.00				Remove signs and post	
		Speed Limit 55	R2-1	30	36							7.50					
33.79	N	JCT (white)	M2-1	21	15	2.20									15.0	200' east of the I-39 ER signing	
		Illinois 251	M1-I100	30	24	5.00											
34.79	S	Cross Road	W2-1	36	36							9.00				17.0	Relocate so it is 650' from int.
		Moore Rd	W17-I100	36	9							2.30					
34.91	N	Stop	R1-1	36	36	9.00						9.00					Moore Rd
34.91	S	Stop	R1-1	36	36	9.00						6.30					Moore Rd
34.94	S	Do not drive on shoulder	RSPC	30	30	6.30						6.30		9.0	5.0		
35.03	N	Cross Road	W2-1	36	36	9.00									17.0	650' from int.	
		Moore Rd	W17-I100	36	9	2.30											
35.05	N	Cross Road	W2-1	36	36							9.00				Remove sign and post	
		Moore Rd	W17-I100	36	9							2.30					
35.30	S	Cross Road	W2-1	36	36							9.00				17.0	move west 25' (650' before int)
		Lynnville Rd	W17-I100	36	9							2.30					
35.31	N	Speed Limit 55	R2-1	30	36							7.50					Remove sign and post

						72000100	72000200	72400710	72400720	72400310	72400320	72800100	72800100	73000100	Z0077803	
Mile	Side	Common Name of Sign	Sign Code	Size Hor (in)	Size Ver (in)	SIGN PANEL TYPE 1 (SQ FT)	SIGN PANEL TYPE 2 (SQ FT)	RELOCATE SIGN PANEL TYPE I (SQ FT)	RELOCATE SIGN PANEL TYPE 2 (SQ FT)	REMOVE SIGN PANEL Type 1 (SQ FT)	REMOVE SIGN PANEL TYPE 2 (SQ FT)	TELESCOPING STEEL SIGN SUPPORT (FOOT) (2 in)	TELESCOPING STEEL SIGN SUPPORT (FOOT) (2 1/4 in)	WOOD SIGN SUPPORT (FOOT)	REMOVE WOOD POST (EACH)	Notes
35.36	S	<-- Lindenwood 3	D1-1A	84	18							10.50				Remove sign and posts
35.39	S	<-- Lindenwood 3	D1-1A	84	18		10.50									225' west of int.
35.39	N	West (White)	M3-4	24	12							2.00				Remove sign and post
		Illinois Route 64	M1-I100	24	24							4.00				
35.40	S	West (White)	M3-4	24	12	2.00								10.0	5.0	About 50' east of old location
35.40	S	Illinois Route 64	M1-I100	24	24	4.00										
35.41	N	Stop	R1-1	36	36	9.00						9.00		9.0	5.0	Lynnville Rd
35.41	S	Stop	R1-1	36	36	9.00						6.30		9.0	5.0	Lynnville Rd
35.42	S	East (White)	M3-2	24	12	2.00								10.0	5.0	About 60 feet west of old location
		Illinois Route 64	M1-I100	24	24	4.00										
35.43	S	East (White)	M3-2	24	12							2.00				Remove signs and post
		Illinois Route 64	M1-I100	24	24							4.00				
		Mile post 35.41	M1-I200	18	18							2.30				
		Mile post 35.41	M1-I200	18	18							2.30				
35.46	N	Lindenwood 3 ->	D1-1A	84	18		10.50							20.0	10.0	112' west of old location
		No Passing Zone	W14-3	64	48							10.70				
35.52	N	Cross Road	W2-1	36	36	9.00										
		Lynnville Rd	W17-I100	36	9	2.30										
35.54	S	Divided Highway	W6-1	36	36							9.00				336' feet east of old location
		JCT (blue)	M2-1	21	15	2.20										336' east of old loc (300' sign spacing)
35.60	S	JCT (White)	M2-1	21	15	2.20										
		I-39	M1-1	24	24	4.00										
		US 51	M1-4	24	24	4.00										
35.60	N	IL 251 2	D2-2	48	30							10.00				Relocate at 16' west (200' west of two way traffic sign)
		Oregon 16														Relocate 95' east
35.64	S	North (Blue)	M3-1	24	12							2.00				
		South (Blue)	M3-3	24	12							2.00				
35.64	S	I-39	M1-1	24	24							4.00				
		I-39	M1-1	24	24							4.00				
		Straight up arrow (blue)	M6-3	21	15							2.20				
		Advance right turn arrow (blue)	M5-1R	21	15							2.20				
35.64	S	North (White)	M3-1	24	12							2.00				Relocate 95' east
		South (White)	M3-3	24	12							2.00				
		US 51	M1-4	24	24							4.00				
		US 51	M1-4	24	24							4.00				
		Straight up arrow (white)	M6-3	21	15							2.20				
		Advance right turn arrow (white)	M5-1R	21	15							2.20				
35.67	N	Speed Limit 55	R2-1	30	36	7.50										193' east of two way traffic sign
35.68	N	West (White)	M3-4	24	12							2.00				Remove signs and post
		Illinois Route 64	M1-I100	24	24							4.00				
35.68	N	Emergency Route	WSPC	24	12							2.00				Remove signs and post
		I-39	M1-1	24	24							4.00				
35.70	N	West (White)	M3-4	24	12	2.00										100' east of old location
		Illinois Route 64	M1-I100	24	24	4.00										
		Emergency Route	WSPC	24	12	2.00										
		I-39	M1-1	24	24	4.00										
35.72	N	STOP	R1-1	48	48		16.00						16.00			At I-39 SB ramp
35.72	N	one way (enclosed in right arrow)	R6-1R	54	18	6.80						6.80				Bolt the ends together
35.72	N	one way (enclosed in left arrow)	R6-1L	54	18	6.80						6.80				Install on east side of ramp
35.72	N	STOP	R1-1	48	48		16.00						16.00			West side of ramp
35.72	N	Do Not Enter	R5-1	48	48		16.00						16.00			
		Red strip		2	48	0.70						0.70				
35.72	N	Do Not Enter	R5-1	48	48		16.00						16.00			East side of ramp
		Red strip		2	48	0.70						0.70				


						72000100	72000200	72400710	72400720	72400310	72400320	72800100	72800100	73000100	Z0077803	
Mile	Side	Common Name of Sign	Sign Code	Size Hor (in)	Size Ver (in)	SIGN PANEL TYPE 1 (SQ FT)	SIGN PANEL TYPE 2 (SQ FT)	RELOCATE SIGN PANEL TYPE I (SQ FT)	RELOCATE SIGN PANEL TYPE 2 (SQ FT)	REMOVE SIGN PANEL Type 1 (SQ FT)	REMOVE SIGN PANEL TYPE 2 (SQ FT)	TELESCOPING STEEL SIGN SUPPORT (FOOT) (2 in)	TELESCOPING STEEL SIGN SUPPORT (FOOT) (2 1/4 in)	WOOD SIGN SUPPORT (FOOT)	REMOVE WOOD POST (EACH)	Notes
35.72	Med	No Left Turn Symbol	R3-2	30	30	6.30				6.30				16.0	1.0	Install in same location as existing
		Keep Right	R4-7	24	30	5.00				5.00						
35.73	N	No Right Turn Symbol	R3-1	30	30	6.30				6.30						Banded to I-beam of green interstate sign
		No Left Turn symbol	R3-2	30	30	6.30				6.30						
35.73	S	East (White)	M3-2	24	12	2.00						10.0	5.0			About 75' east of ramps
		Illinois Route 64	M1-I100	24	24	4.00										
35.77	N	Emergency Route	WSPC	24	12					2.00				16.0		
		I-39	M1-1	24	24					4.00						
		Straight up arrow (blue)	M6-1	21	15					2.20						
35.80	S	North (Blue)	M3-1	24	12					2.00						Remove signs and post
		North (White)	M3-1	24	12					2.00						
		I-39	M1-1	24	24					4.00						
		US 51	M1-4	24	24					4.00						
		Advance left turn arrow (blue)	M5-1L	21	15					2.20						
35.84	N	Advance left turn arrow (white)	M5-1L	21	15					2.20						
		South (Blue)	M3-1	24	12	2.00										Just west of the bridge
		South (White)	M3-1	24	12	2.00										
		I-39	M1-1	24	24	4.00										
		US 51	M1-4	24	24	4.00										
35.90	S	Advance left turn arrow (blue)	M5-1L	21	15	2.20										
		Advance left turn arrow (white)	M5-1L	21	15	2.20										
		North (Blue)	M3-1	24	12	2.00								17.0		Just east of the bridge
		North (White)	M3-1	24	12	2.00										
		I-39	M1-1	24	24	4.00										
35.93	N	US 51	M1-4	24	24	4.00										
		Advance left turn arrow (blue)	M5-1L	21	15	2.20										Remove signs and post
		Advance left turn arrow (white)	M5-1L	21	15	2.20										
		South (Blue)	M3-1	24	12					2.00						
		South (White)	M3-1	24	12					2.00						
35.98	N	I-39	M1-1	24	24					4.00						
		US 51	M1-4	24	24					4.00						
		Advance left turn arrow (blue)	M5-1L	21	15					2.20						
		Advance left turn arrow (white)	M5-1L	21	15					2.20						
		West (white)	M3-4	24	12					2.00						
35.98	N	Emergency Route	WSPC	24	12					2.00						
		Illinois 64	M1-I100	24	24					4.00						
		I-39	M1-1	24	24					4.00						
		Straight up arrow (blue)	M6-3	21	15					2.20						
		West (white)	M3-4	24	12	2.00								15.0		about 125' feet east of old location.
35.98	N	Emergency Route	WSPC	24	12	2.00										
		Illinois 64	M1-I100	24	24	4.00										
		I-39	M1-1	24	24	4.00										
		Keep Right	R4-7	24	30	5.00					3.00					
		Hazard Marker	OM3	12	36											
36.01	Med	No Right Turn Symbol	R3-1	30	30	6.30				6.30						Banded to I-beam of green interstate sign
36.01	S	No Left Turn symbol	R3-2	30	30	6.30				6.30						
36.01	S	one way (enclosed in right arrow)	R6-1R	54	18	6.80				6.80						Bolt the ends together
		one way (enclosed in left arrow)	R6-1L	54	18	6.80				6.80						
36.01	S	STOP	R1-1	48	48		16.00				16.00			18.0	1.0	Install on west side of ramp
		Do Not Enter	R5-1	48	48		16.00				16.00					West side of ramp
36.01	S	Red strip		2	48	0.70				0.70						
		Do Not Enter	R5-1	48	48	16.00				16.00						East side of ramp
36.01	S	Red strip		2	48	0.70				0.70						

STATE OF ILLINOIS
DEPARTMENT OF TRANSPORTATION


SCHEDULES OF QUANTITIES

					72000100	72000200	72400710	72400720	72400310	72400320	72800100	72800100	73000100	Z0077803			
Mile	Side	Common Name of Sign	Sign Code	Size Hor (in)	Size Ver (in)	SIGN PANEL TYPE 1 (SQ FT)	SIGN PANEL TYPE 2 (SQ FT)	RELOCATE SIGN PANEL TYPE I (SQ FT)	RELOCATE SIGN PANEL TYPE 2 (SQ FT)	REMOVE SIGN PANEL Type 1 (SQ FT)	REMOVE SIGN PANEL TYPE 2 (SQ FT)	TELESCOPING STEEL SIGN SUPPORT (FOOT) (2 in)	TELESCOPING STEEL SIGN SUPPORT (FOOT) (2 1/4 in)	WOOD SIGN SUPPORT (FOOT)	REMOVE WOOD POST (EACH)	Notes	
36.01	Med	No Left Turn Symbol	R3-2	30	30	6.30				6.30				16.0	1.0	Install in same location as existing	
		Keep Right	R4-7	24	30			5.00									
36.01	N	Freeway Exclusion	R5-I100	48	60		20.00				20.00			16.0			
		East (White)	M3-2	24	12	2.00						11.0	5.0			About 90' east of ramps	
36.03	S	Illinois Route 64	M1-I100	24	24	4.00											
		IL 64 Ogle Mile 36	M1-I200	18	18	2.30				2.30							
36.07	S	East (White)	M3-2	24	12					2.00						Remove signs and post	
		Illinois Route 64	M1-I100	24	24					4.00							
36.07	S	Speed Limit 55	R2-1	30	36	7.50								15.0		200' east of proposed East IL 64	
		South (Blue)	M3-3	24	12			2.00						16.0		Relocate 100' west (300' east of green interstate sign)	
36.08	N	North (Blue)	M3-1	24	12			2.00									
		I-39	M1-1	24	24			4.00									
		I-39	M1-1	24	24			4.00									
		Straight up arrow (blue)	M6-3	21	15			2.20									
		Advance right turn arrow (blue)	M5-1R	21	15			2.20									
36.08	N	South (White)	M3-3	24	12			2.00						16.0		Relocate 100' west	
		North (White)	M3-1	24	12			2.00									
		US 51	M1-4	24	24			4.00									
		US 51	M1-4	24	24			4.00									
		Straight up arrow (white)	M6-3	21	15			2.20									
		Advance right turn arrow (white)	M5-1R	21	15			2.20									
36.10	Med	Keep Right	R4-7	24	30	5.00				5.00		9.0	5.0				
36.10	S	Two-Way Traffic	W6-3	36	36	9.00				9.00				16.0			
36.14	S	Sycamore 17	D2-2	72	30		15.00									about 20' before existing dist. Sign	
		St. Charles 39	D2-2	72	30											300' east of rt markers	
36.14	N	Jct (blue)	M2-1	21	15	2.20											
		Jct (White)	M2-1	21	15	2.20											
		I-39	M1-1	24	24	4.00											
		US 51	M1-4	24	24	4.00											
36.14	S	Sycamore 17	D2-2	72	30						15.00					Remove signs and post	
36.18	N	Divided Highway	W6-1	36	36			9.00						16.0		Relocate to 300' east of Jct sign	
36.23	S	Speed Limit 55	R2-1	30	36					7.50						Remove sign and post	
36.24	S	No Passing Zone	W14-3	64	48				10.70					16.0		Relocate 552' west	
36.78	S	Cross Road	W2-1	36	36			9.00						16.0		Move west 50 feet	
		Mulford Rd	W17-I100	36	9			2.30									
36.93	N	Stop	R1-1	36	36			9.00					9.0	5.0		Mulford Rd	
36.93	S	Stop	R1-1	36	36			9.00					9.0	5.0		Mulford Rd	
37.05	N	Cross Road	W2-1	36	36	9.00								17.0		100' west of current location	
		Mulford Rd	W17-I100	36	9	2.30											
37.07	N	Cross Road	W2-1	36	36					9.00						remove signs and post	
		Mulford Rd	W17-I100	36	9					2.30							
37.82	S	Cross Road	W2-1	36	36	9.00								17.0		150' west of current location	
37.85	S	Chamberlain Rd	W17-I100	36	9	2.30										remove signs and post	
		Cross Road	W2-1	36	36					9.00							
37.85	S	Chamberlain Rd	W17-I100	36	9					2.30							
37.93	N	Stop	R1-1	36	36	9.00				6.30						Chamberlain Rd	
37.93	S	Stop	R1-1	36	36	9.00				6.30						Chamberlain Rd	
38.02	N	Cross Road	W2-1	36	36					9.00						remove signs and post	
		Chamberlain Rd	W17-I100	36	9					2.30							
38.04	N	Cross Road	W2-1	36	36	9.00								17.0		150' east of current location	
		Chamberlain Rd	W17-I100	36	9	2.30											
38.88	S	Creston 5 -->	D1-1A	60	18	7.50				7.50		18.0	10.0				

Mile	Side	Common Name of Sign	Sign Code	Size Hor (in)	Size Ver (in)	72000100 SIGN PANEL TYPE 1 (SQ FT)	72000200 SIGN PANEL TYPE 2 (SQ FT)	72400710 RELOCATE SIGN PANEL TYPE I (SQ FT)	72400720 RELOCATE SIGN PANEL TYPE 2 (SQ FT)	72400310 REMOVE SIGN PANEL Type 1 (SQ FT)	72400320 REMOVE SIGN PANEL TYPE 2 (SQ FT)	72800100 TELESCOPING STEEL SIGN SUPPORT (FOOT) (2 in)	72800100 TELESCOPING STEEL SIGN SUPPORT (FOOT) (2 1/4 in)	73000100 WOOD SIGN SUPPORT (FOOT)	Z0077803 REMOVE WOOD POST (EACH)	Notes
38.93	N	West (white) Illinois Route 64	M3-4 M1-I100	24 24	12 24			2.00						14.0		
38.94	N	Stop	R1-1	36	36	9.00				6.30		9.0	5.0		Woodlawn Rd	
38.95	S	East (white) Illinois Route 64	M3-2 M1-I100	24 24	12 24	2.00								14.0	100' west of current location	
38.97	S	East (white) Illinois Route 64	M3-2 M1-I100	24 24	12 24					2.00						
39.05	N	Cross Road Woodlawn Rd	W2-1 W17-I100	36 36	36 9					4.00		9.00			remove signs and post	
39.07	N	Cross Road Woodlawn Rd	W2-1 W17-I100	36 36	36 9	9.00				2.30				17.0	100' east of current location	
39.80	S	Curve Right	W1-2R	36	36						9.00				Remove sign and post	
39.81	N	No Passing Zone Speed Limit 55	W14-3 R2-1	64 30	48 36		10.70			7.50		10.70				
39.94	N	Ogle County	I1-I104	48	30						10.00				Remove signs and post	
39.93	S	Curve right with perpendicular siderd	W1-10R W17-I100	36 36	36 9	9.00								17.0	Check with Traffic for exact placement	
39.97	N	Ogle County	I1-I104	48	24	8.00								13.0		
		Total				465.60	203.70	158.50	31.40	399.70	203.20	221.00	115.00	626.00	4.00	

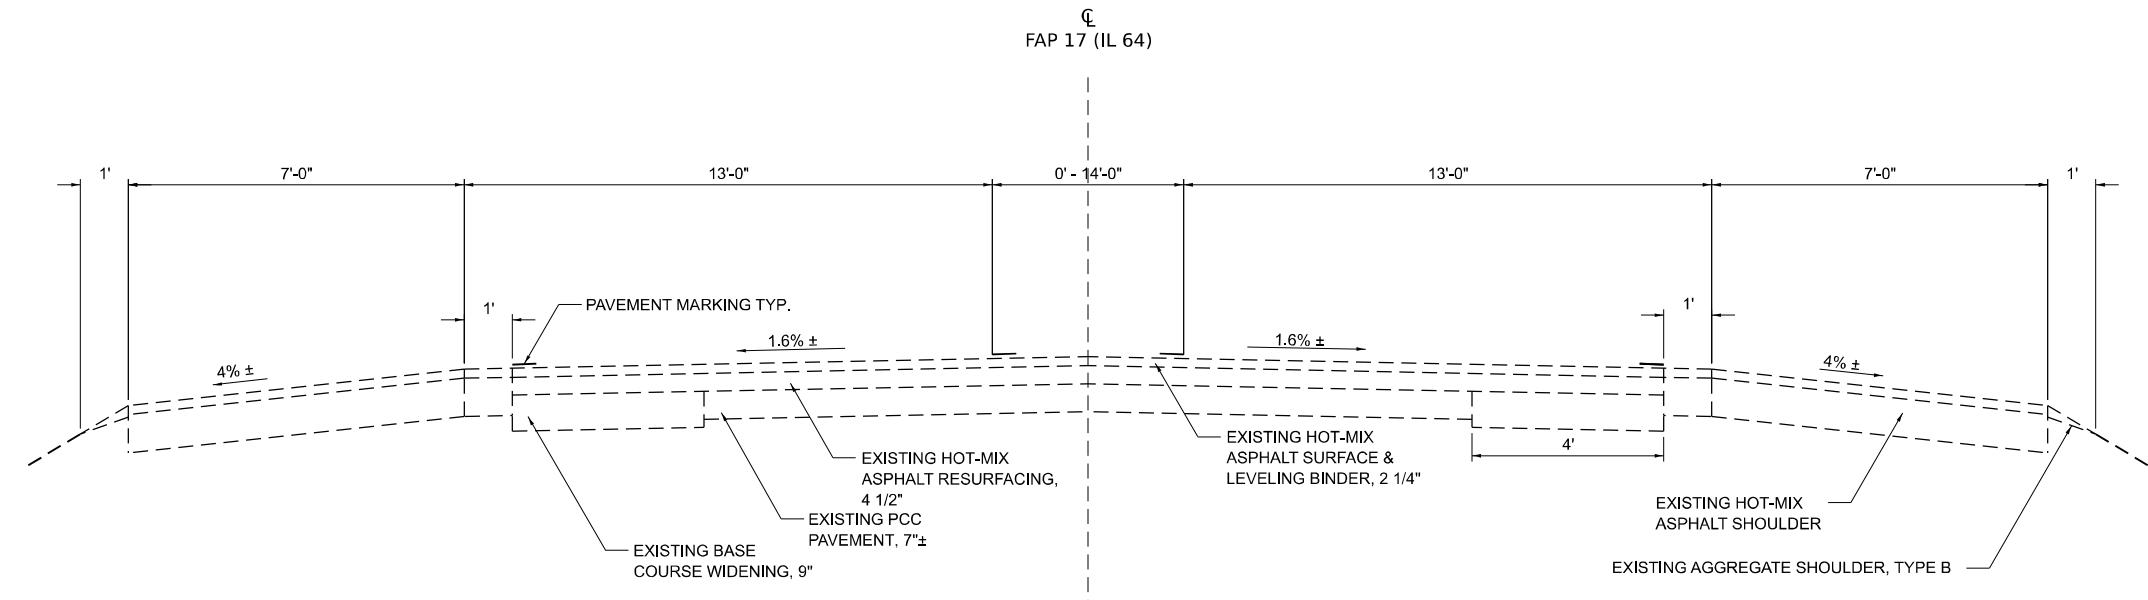

EXISTING TYPICAL SECTION
STA. 1776+77.50 TO STA. 1780+33.15

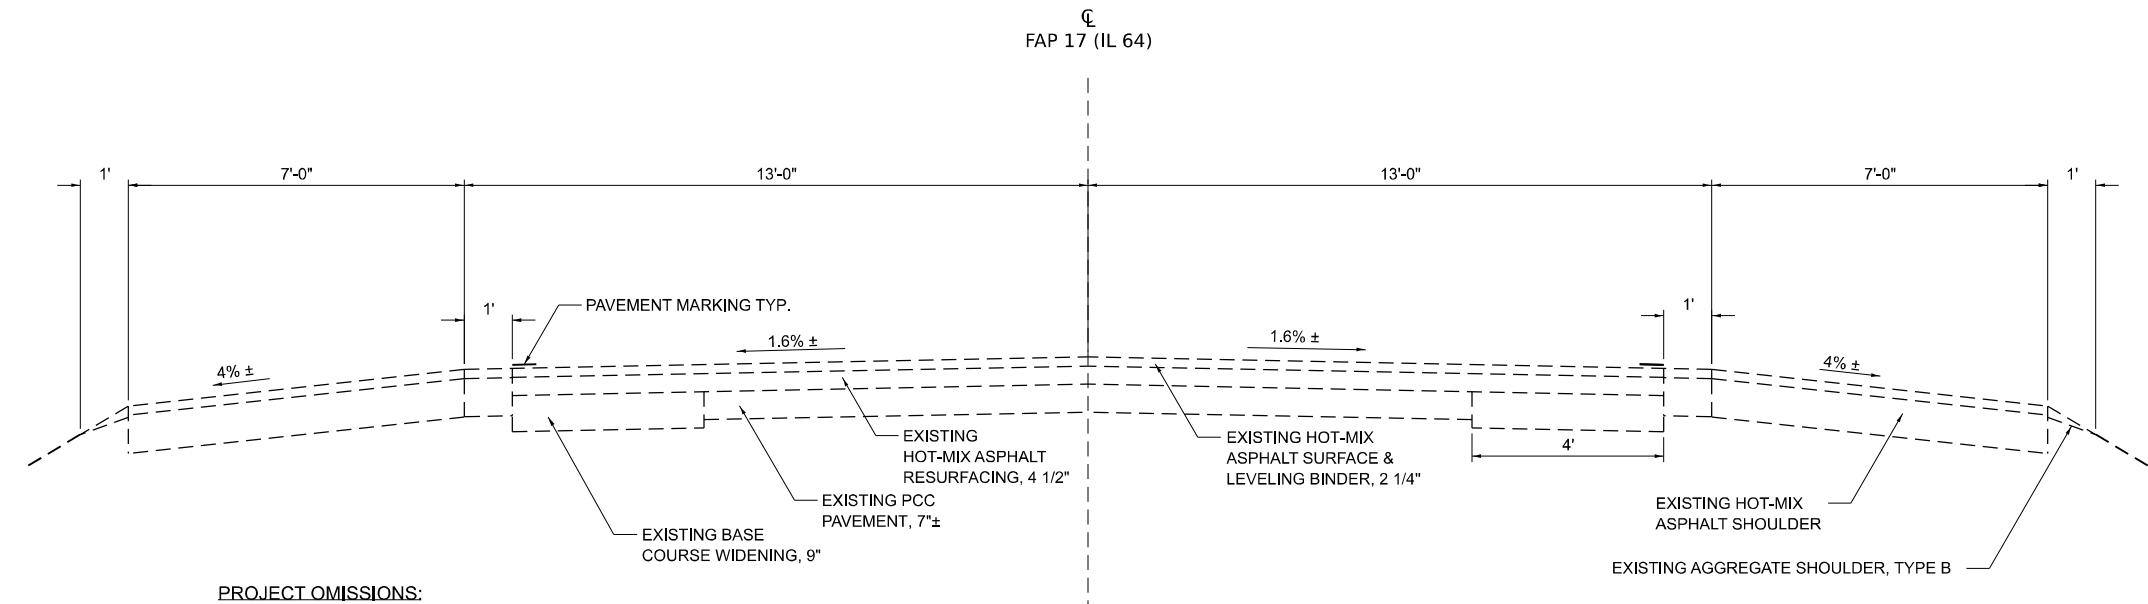

PROJECT OMISSIONS:
STA. 1876+49.68 TO STA. 1909+43.02
STA. 1912+98.70 TO STA. 1915+01.05
STA. 2028+85.55 TO STA. 2030+85.55
STA. 2073+50.55 TO STA. 2081+20.55


EXISTING TYPICAL SECTION
STA. 1780+33.15 TO STA. 1876+49.68
STA. 1915+01.05 TO STA. 2028+85.55
STA. 2030+85.55 TO STA. 2073+50.55
STA. 2081+20.55 TO STA. 2105+90.55

INTERIM NOTES:

- PAVEMENT THICKNESS TO BE VERIFIED AND ADDED TO ACCOUNT FOR PATCHING.


ONCE THE MAINLINE SURFACE AND BINDER HAVE BEEN REMOVED,
THE RESIDENT ENGINEER WILL LAY OUT AREAS OF REPAIR. IN LIEU
OF CLASS D PATCHING, THE CONTRACTOR WILL PERFORM 8"
MILLING WITH 8" HMA REPLACEMENT AT THESE LOCATIONS.

FAP 17 (IL 64)

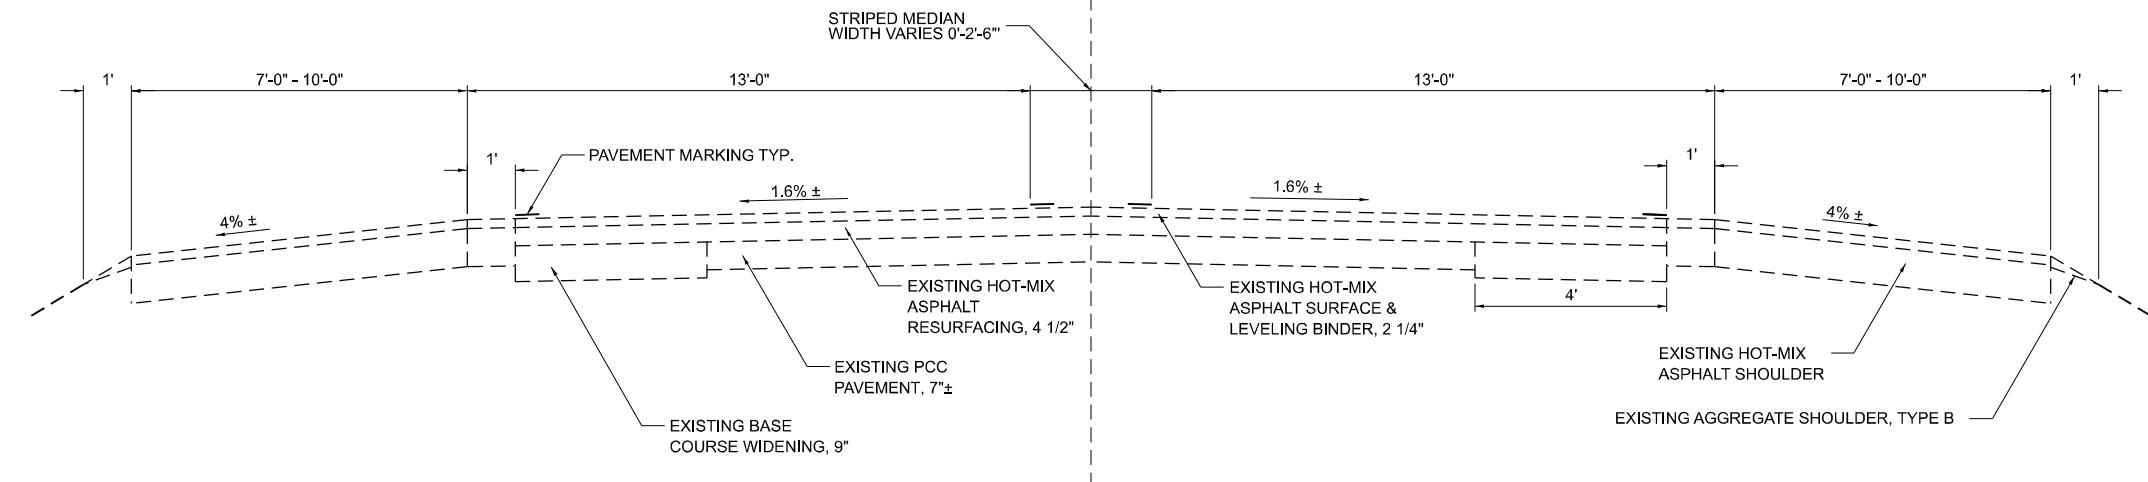

EXISTING TYPICAL SECTION
STA. 1909+43.02 TO STA. 1912+98.70

FAP 17 (IL 64)

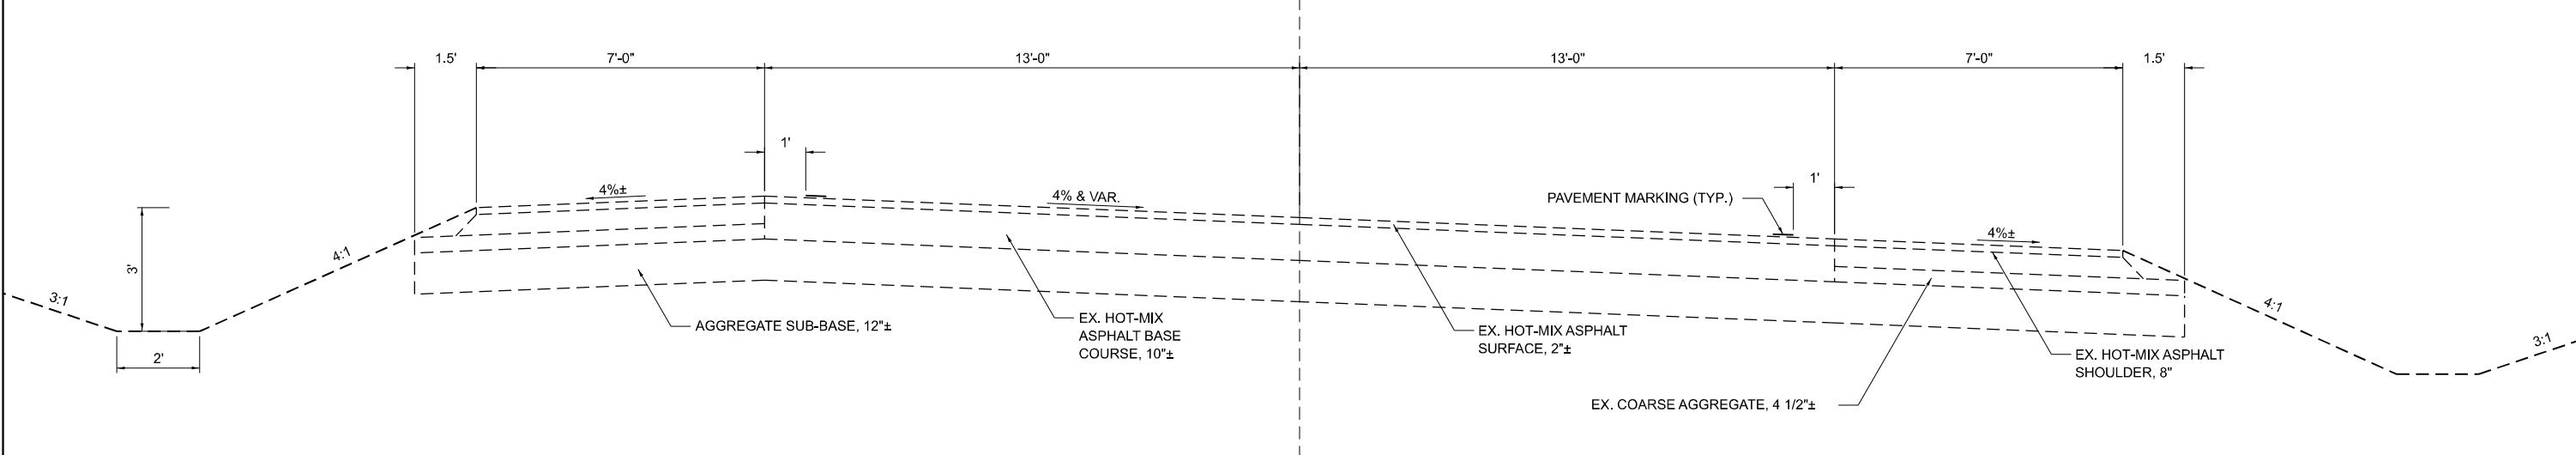


EXISTING TYPICAL SECTION
STA. 2105+90.55 TO STA. 2109+55.26

INTERIM NOTES:

- PAVEMENT THICKNESS TO BE VERIFIED AND ADDED TO ACCOUNT FOR PATCHING.

ONCE THE MAINLINE SURFACE AND BINDER HAVE BEEN REMOVED,
THE RESIDENT ENGINEER WILL LAY OUT AREAS OF REPAIR. IN LIEU
OF CLASS D PATCHING, THE CONTRACTOR WILL PERFORM 8"
MILLING WITH 8" HMA REPLACEMENT AT THESE LOCATIONS.


FAP 17 (IL 64)

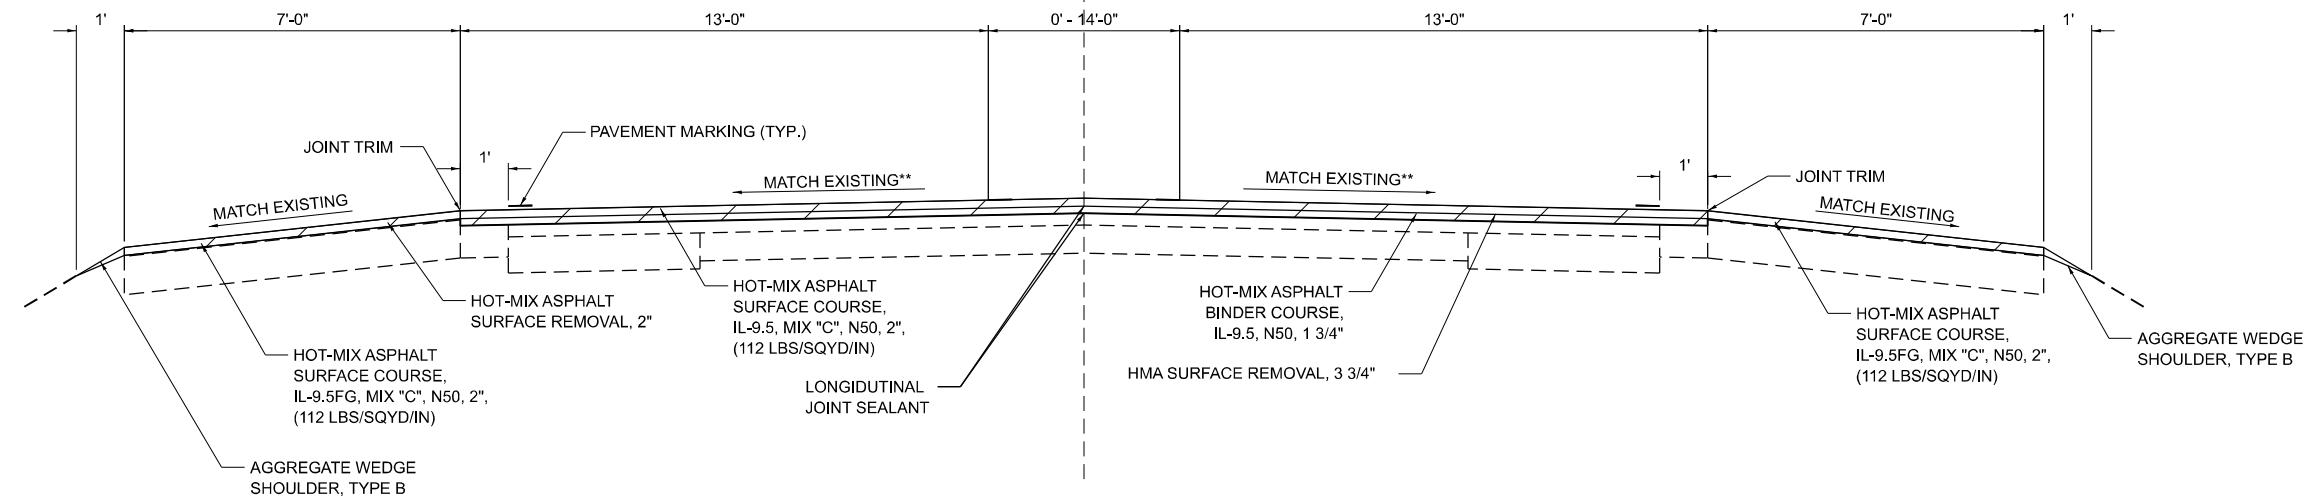

PROPOSED TYPICAL SECTION

STA. 1776+77.50 TO STA. 1780+33.15

FAP 17 (IL 64)

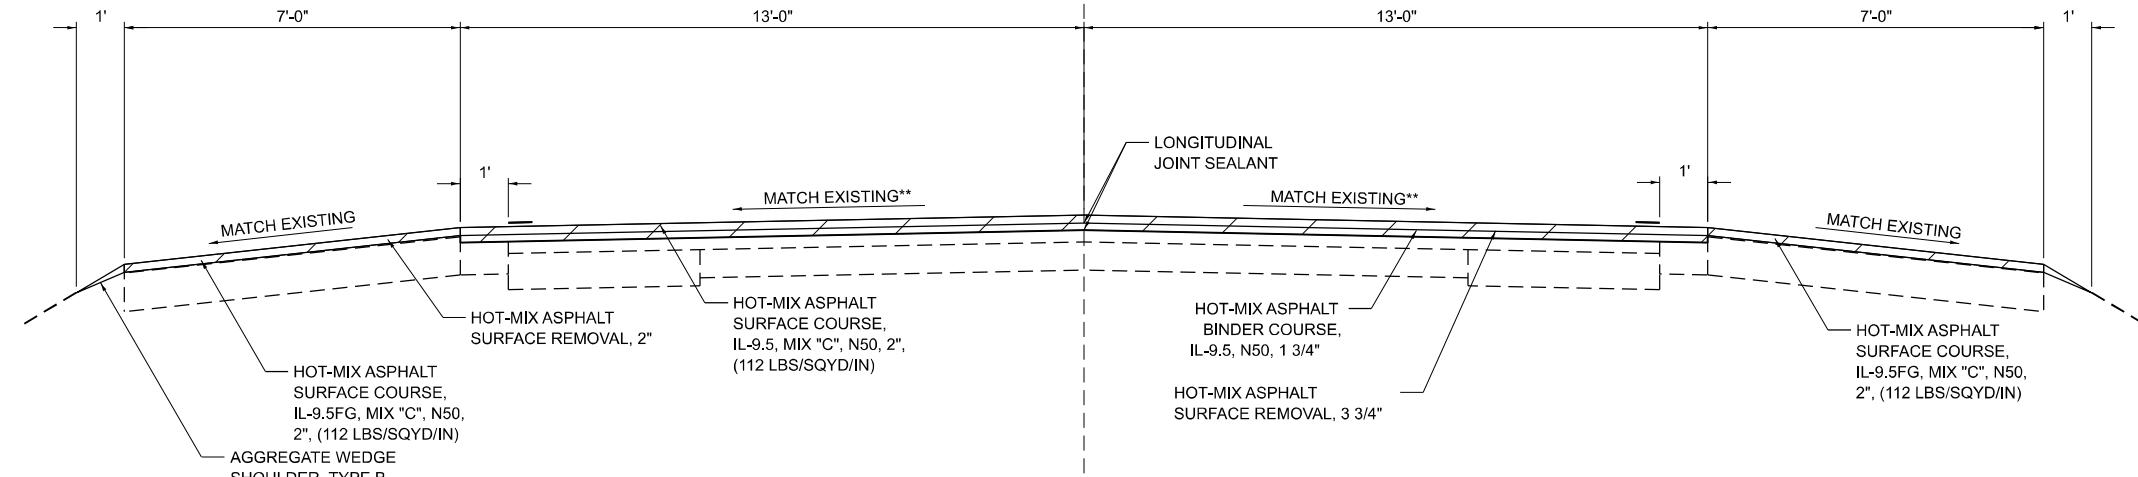

PROPOSED TYPICAL SECTION

STA. 1780+33.15 TO STA. 1876+49.68

MAINLINE PAVEMENT PROJECT OMISSIONS:
STA. 1876+49.68 TO STA. 1909+43.02
STA. 1912+98.49 TO STA. 1915+01.05
STA. 2029+22.07 TO STA. 2030+45.36
STA. 2076+70.00 TO STA. 2078+00.00

ONCE THE MAINLINE SURFACE AND BINDER HAVE BEEN REMOVED,
THE RESIDENT ENGINEER WILL LAY OUT AREAS OF REPAIR. IN LIEU
OF CLASS D PATCHING, THE CONTRACTOR WILL PERFORM 8"
MILLING WITH 8" HMA REPLACEMENT AT THESE LOCATIONS.

**MINIMUM 1/8"/FT CROSS SLOPE

FILE NAME: SP1161
MODEL: \$10017



USER NAME = 10017	DESIGNED - CG	REVISED -
	DRAWN - MA	REVISED -
PLOT SCALE = 0.1666552' / In.	CHECKED - CK	REVISED -
PLOT DATE = 02/29/24	DATE - 02/29/2024	REVISED -

STATE OF ILLINOIS
DEPARTMENT OF TRANSPORTATION



**TYPICAL SECTION
FAP 17 (IL 64)**

SCALE: 1"=5' SHEET 3 OF 4 SHEETS STA. TO STA.

F.A.P. RTE.	SECTION	COUNTY	TOTAL SHEETS	SHEET NO.
17	D2 PP 2023-02	OGLE	46	20


CONTRACT NO. 64R99

ILLINOIS FED. AID PROJECT

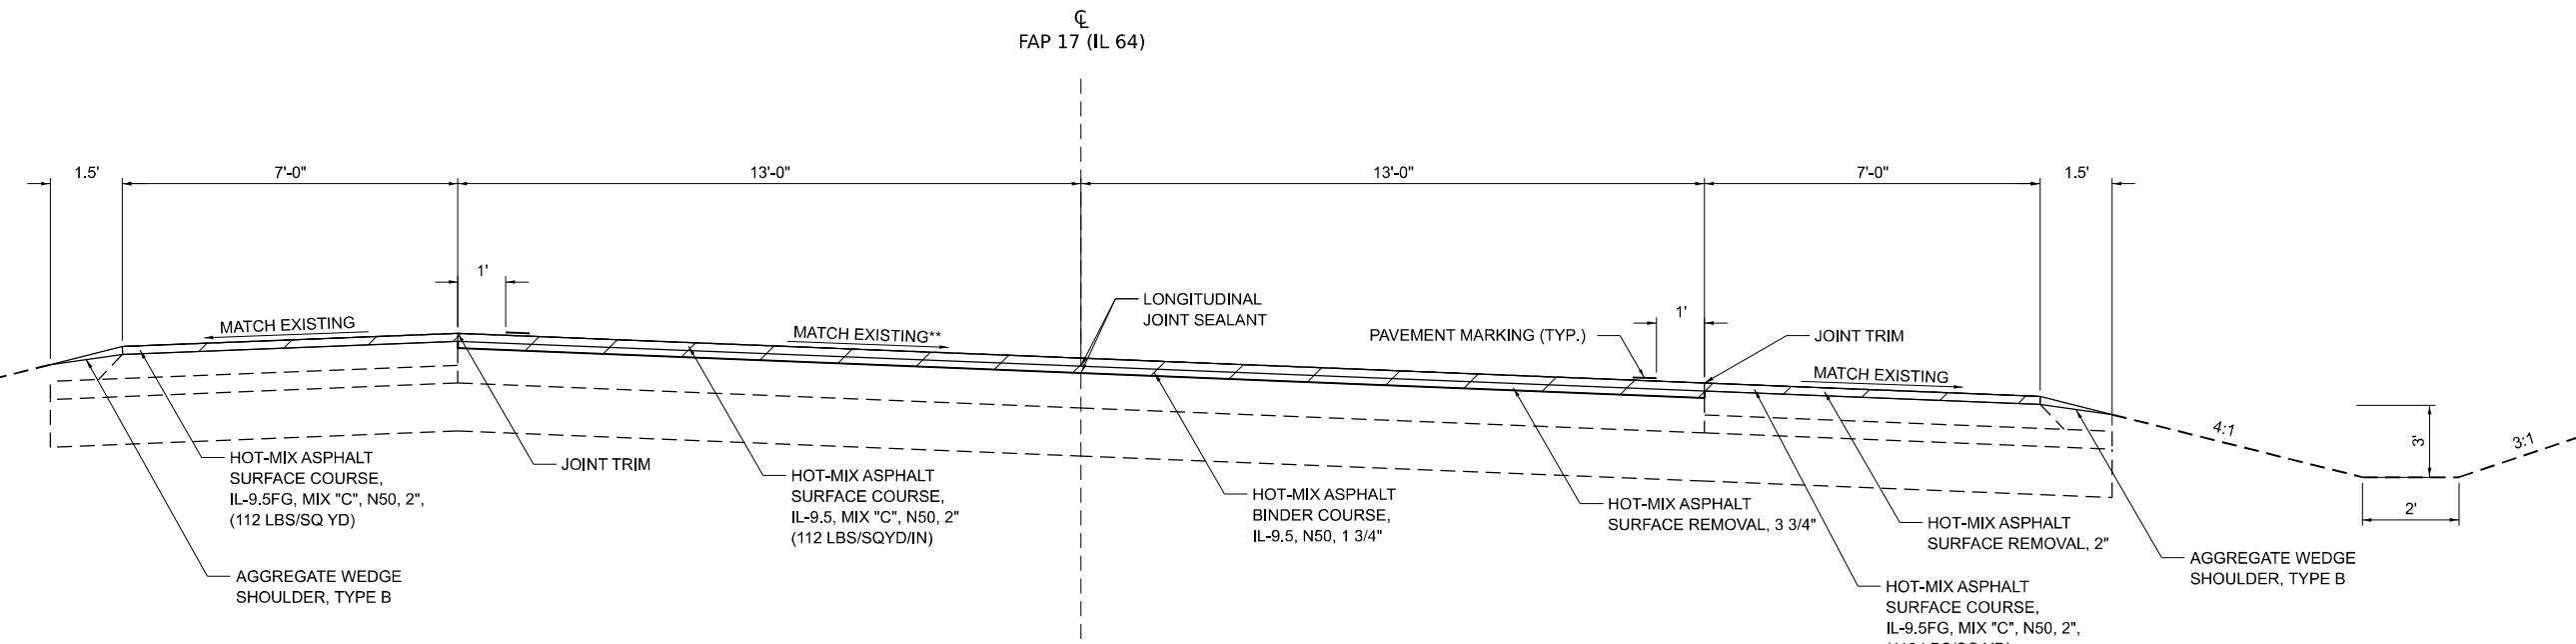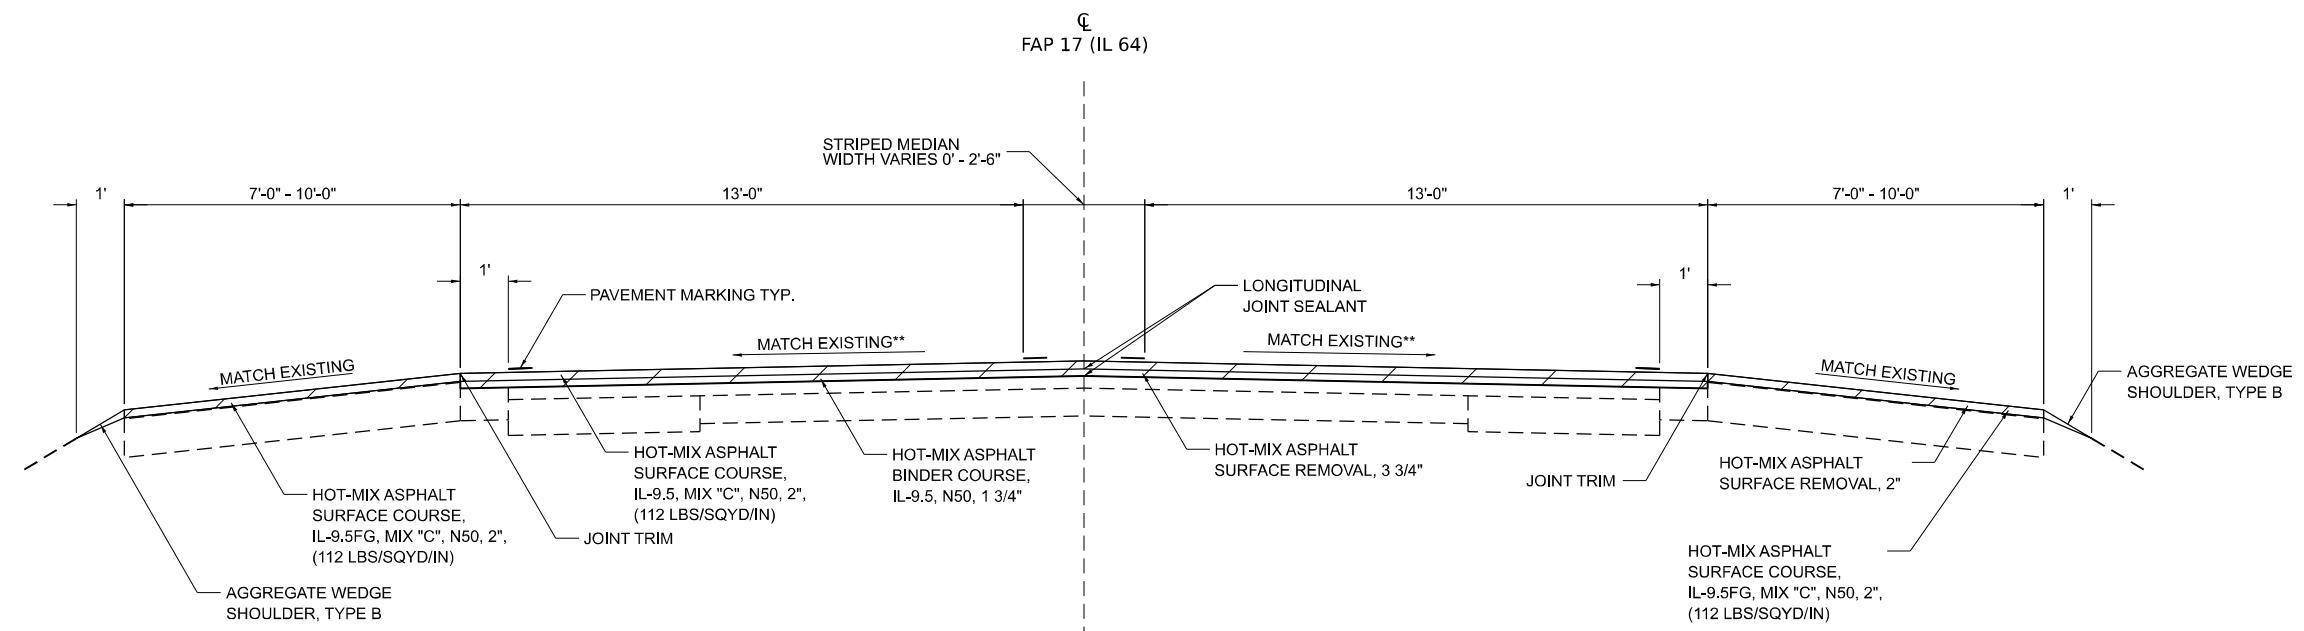


**MINIMUM 1/8"/FT CROSS SLOPE

ONCE THE MAINLINE SURFACE AND BINDER HAVE BEEN REMOVED,
THE RESIDENT ENGINEER WILL LAY OUT AREAS OF REPAIR. IN LIEU
OF CLASS D PATCHING, THE CONTRACTOR WILL PERFORM 8"
MILLING WITH 8" HMA REPLACEMENT AT THESE LOCATIONS.

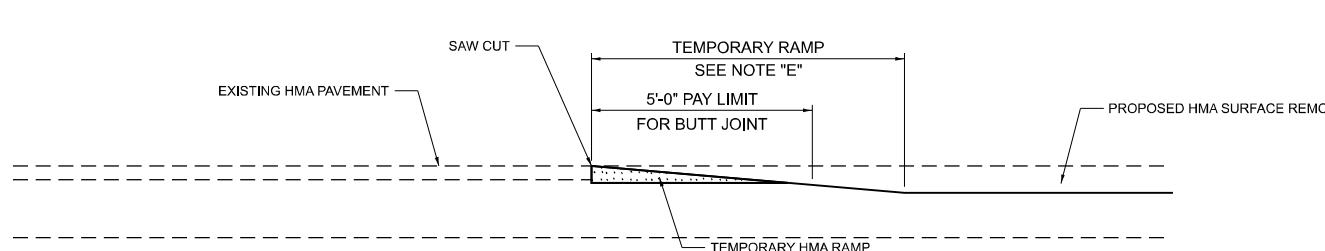

HMA CONSTRUCTED TEMPORARY RAMP

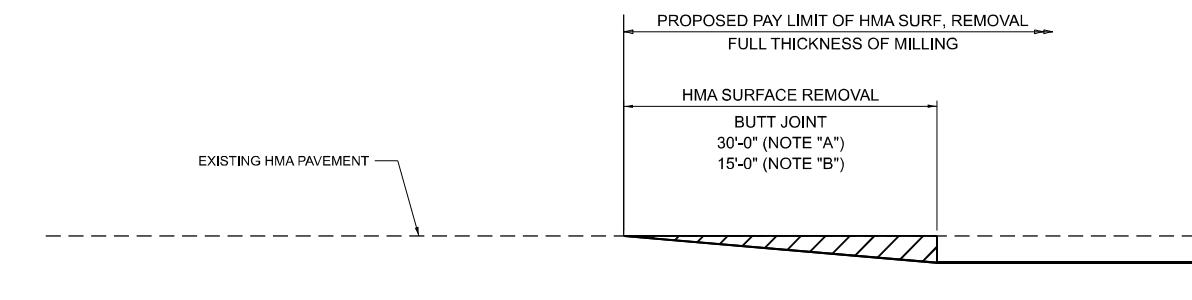

BUTT JOINT DETAIL

- NOTES:
- A. MAINLINE ARTERIAL ROADWAYS
 - B. MINOR SIDE ROADS
 - C. THE TEMP. RAMP SHALL BE CONSTRUCTED IMMEDIATELY UPON REMOVAL OF THE EXISTING HMA SURFACE.
 - D. THE BUTT JOINT SHALL BE CONSTRUCTED IMMEDIATELY PRIOR TO PLACING THE PROPOSED HMA COURSES.
 - E. TAPER THE TEMP. RAMP AT A RATE OF 3-4" PER 1 INCH OF MILLING THICKNESS (SEE TYPICAL SECTIONS FOR MILLING THICKNESS)

MODEL: \$MODELNAME\$
FILE NAME: \$FILE\$



USER NAME = 10017	DESIGNED - CG	REVISED -
	DRAWN - MA	REVISED -
PLOT SCALE = 0.16666633' / In.	CHECKED - CK	REVISED -
PLOT DATE = 02/29/24	DATE - 02/29/2024	REVISED -



STATE OF ILLINOIS
DEPARTMENT OF TRANSPORTATION



BUTT JOINT AND TEMPORARY RAMP DETAILS
FAP 17 (IL 64)



SCALE: 1"=5' SHEET 1 OF 1 SHEETS STA. TO STA.



F.A.P. RTE.	SECTION	COUNTY	TOTAL SHEETS	SHEET NO.
17	D2 PP 2023-02	OGLE	46	22
				CONTRACT NO. 64R99

ILLINOIS FED. AID PROJECT

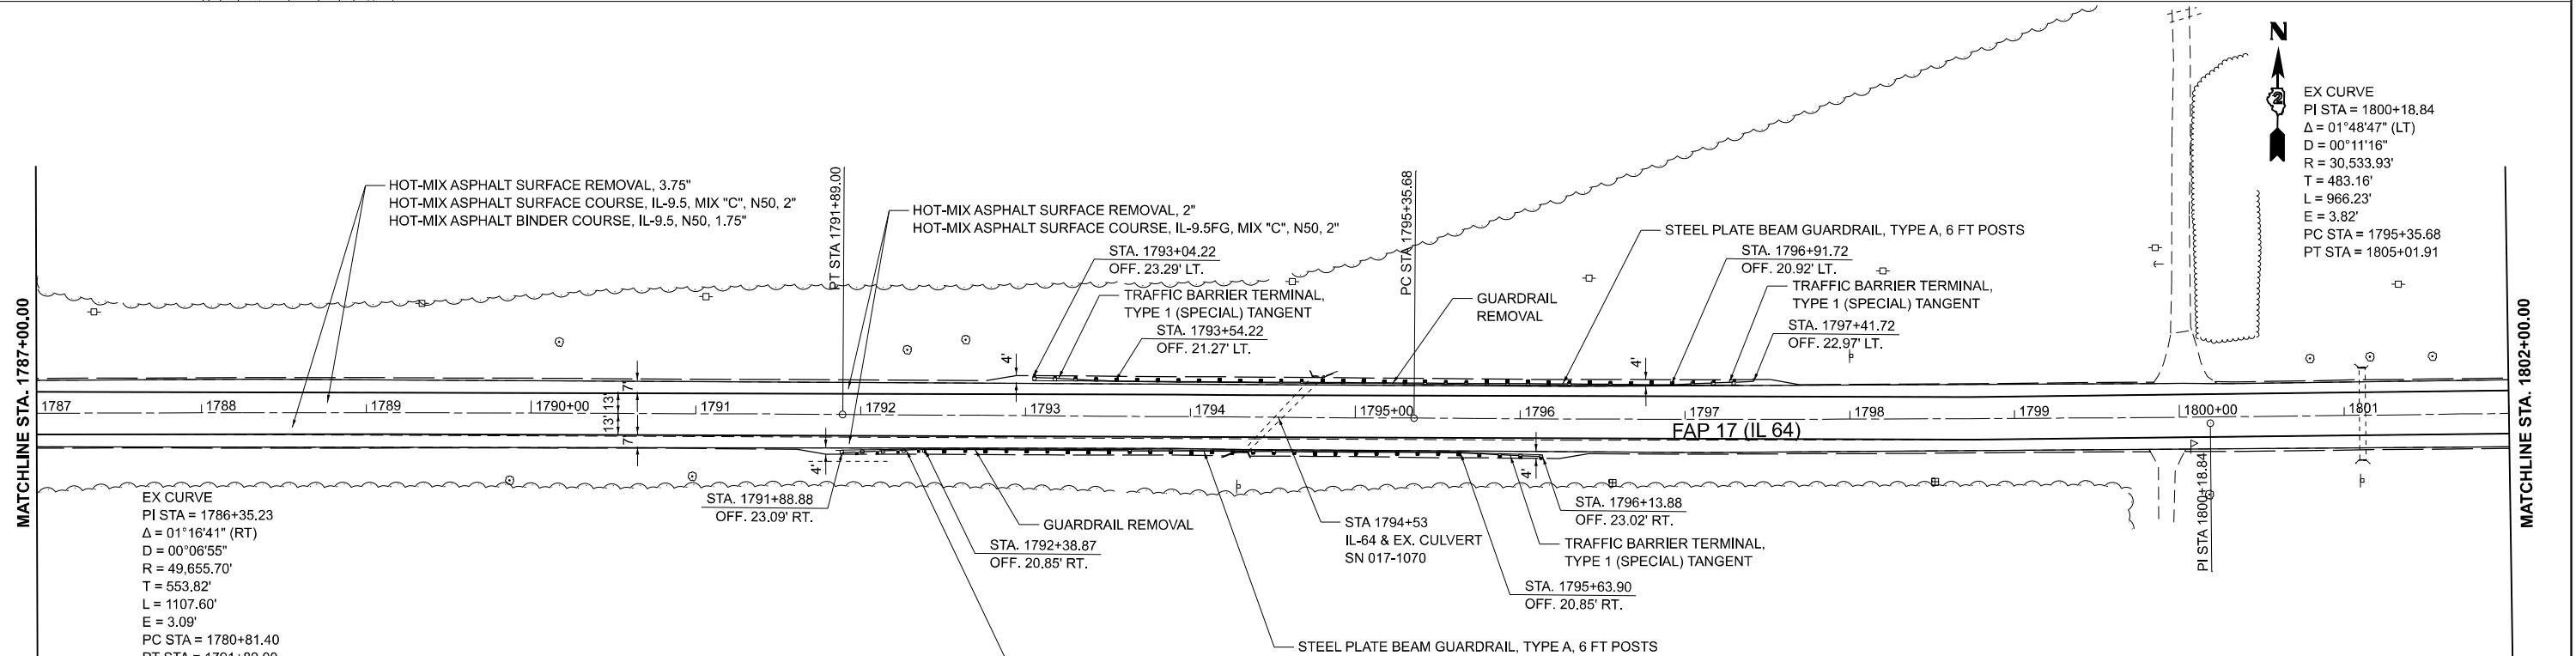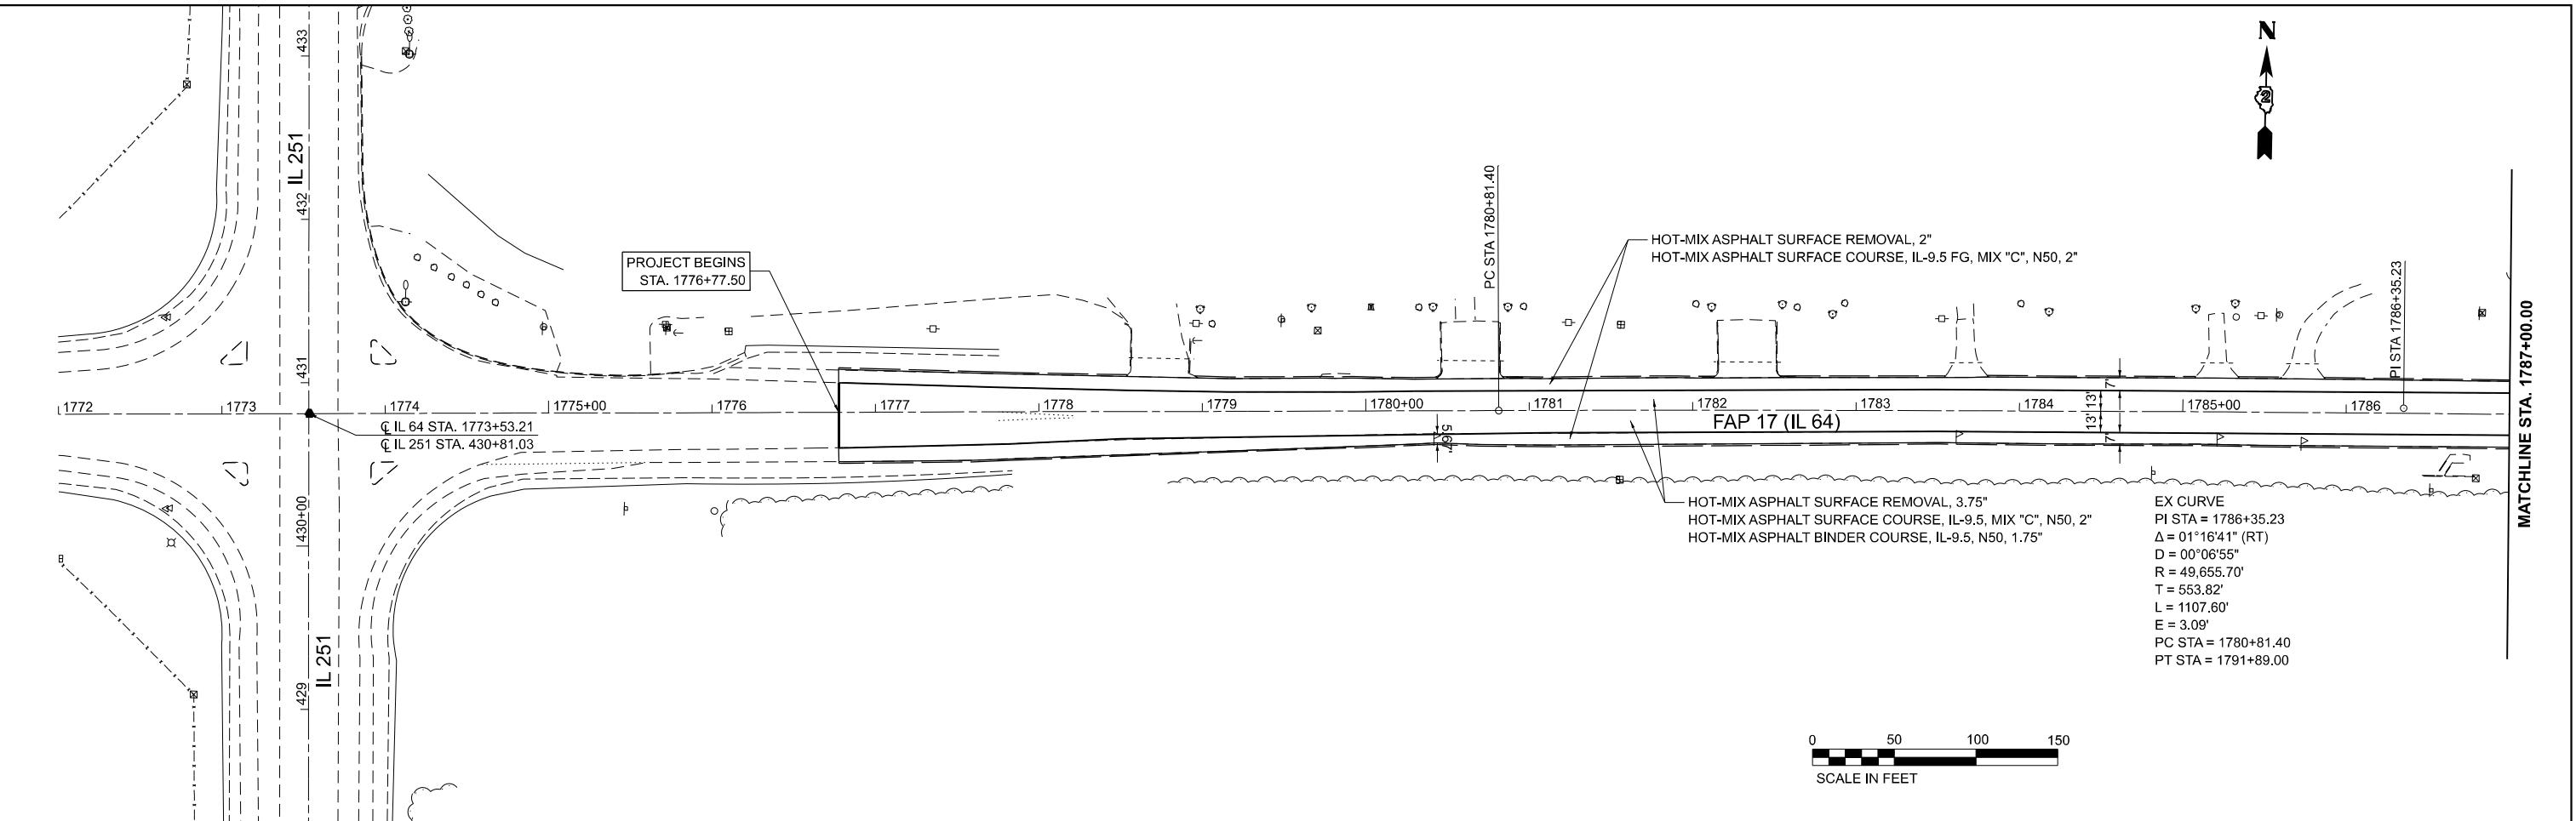

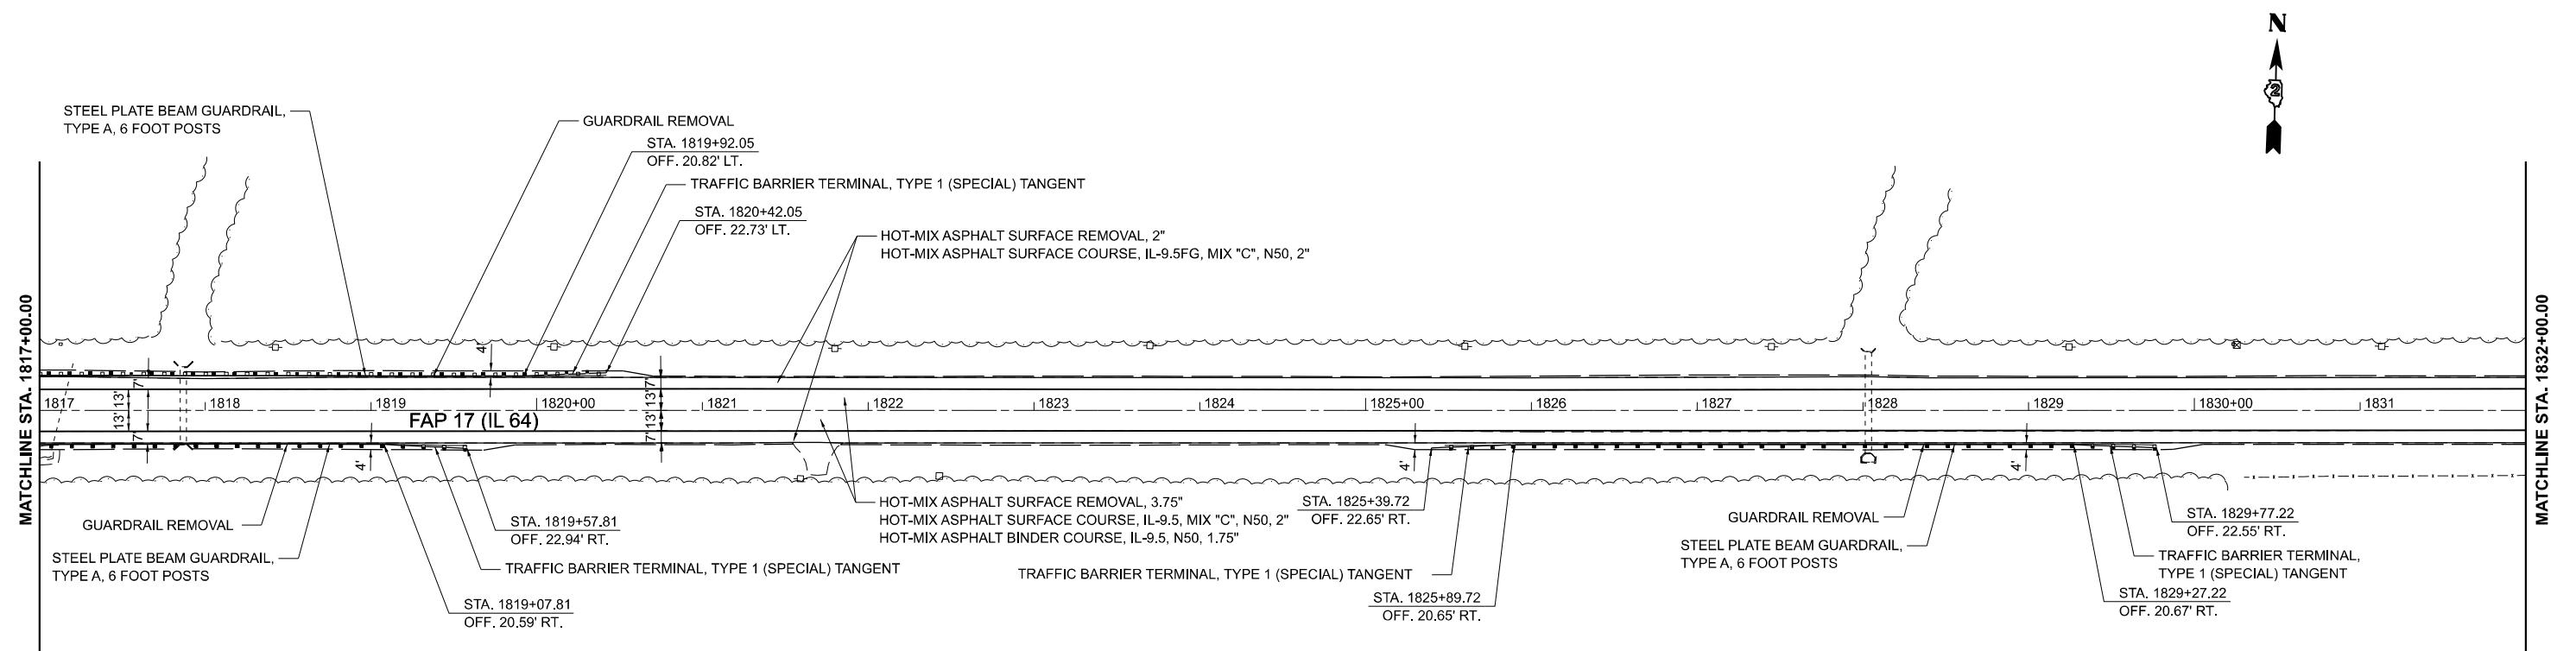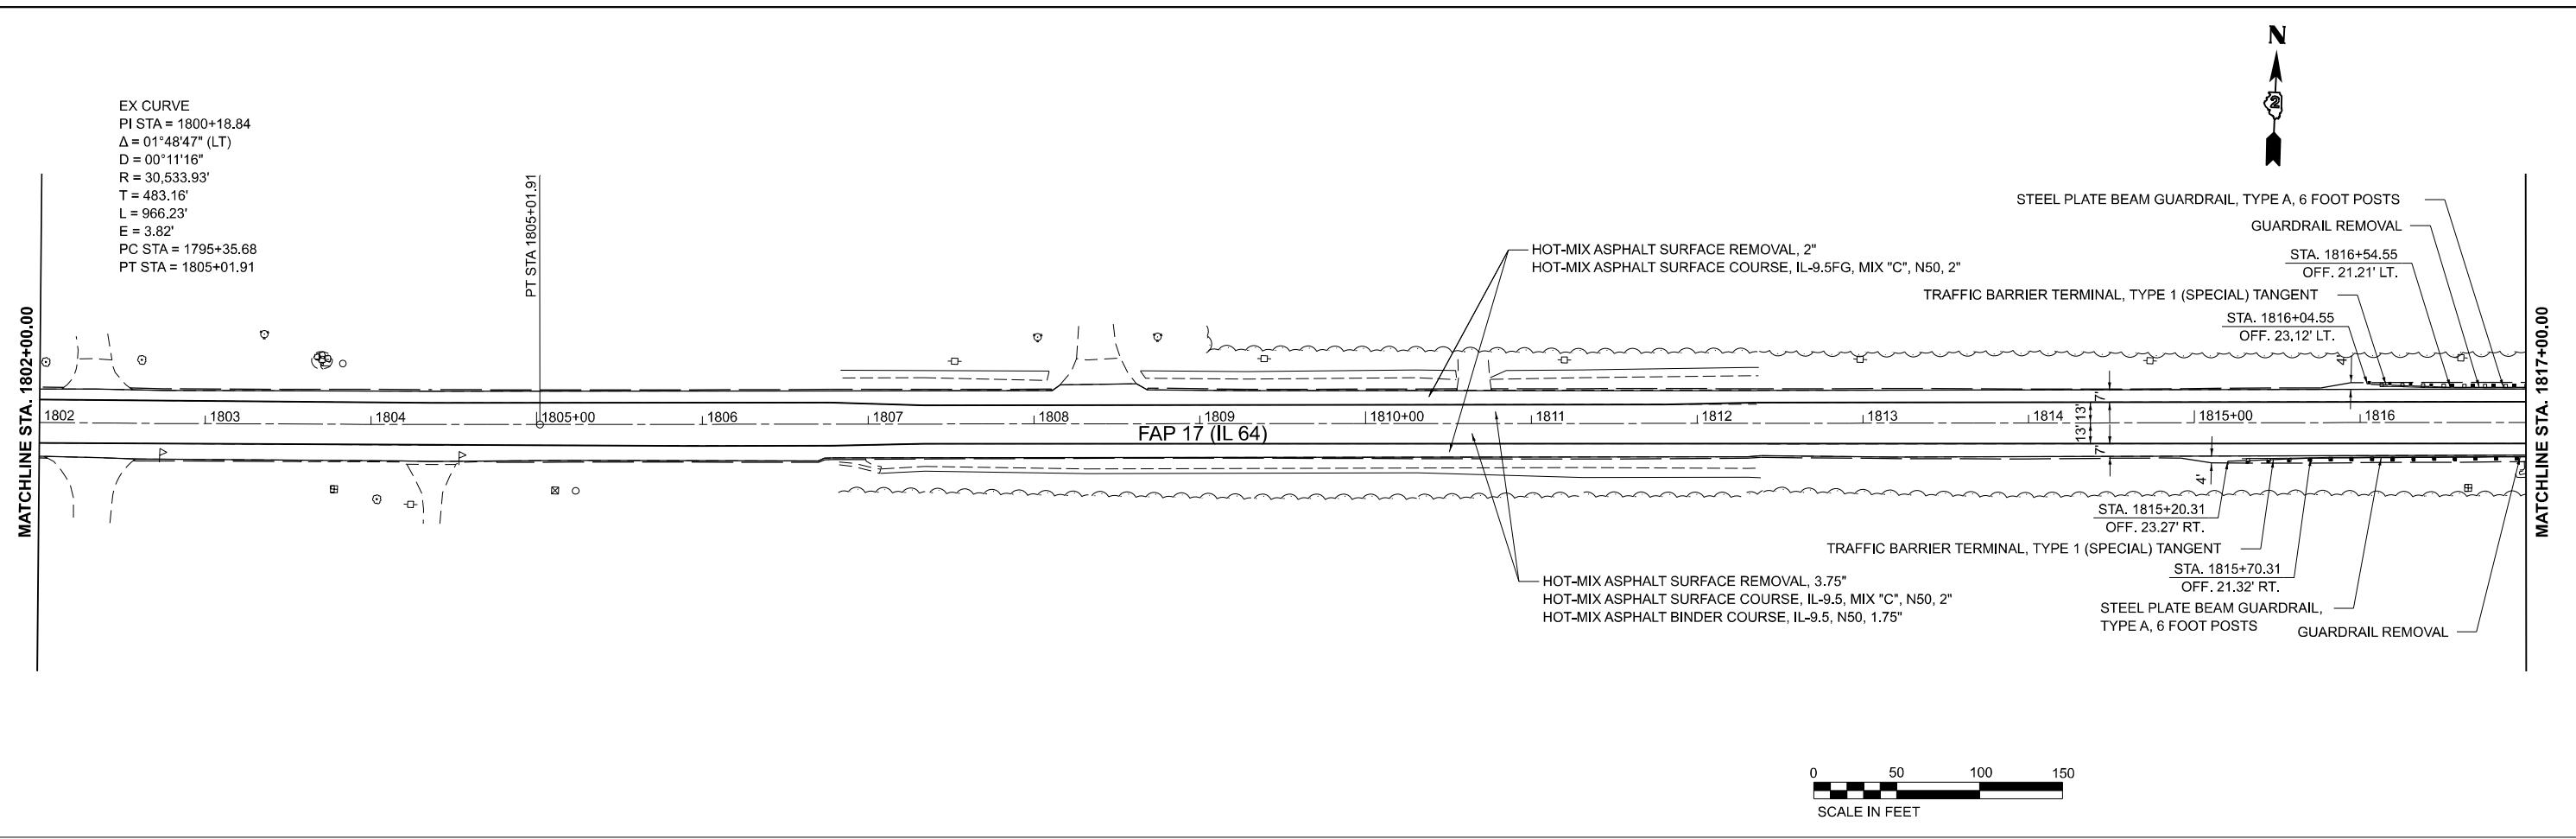

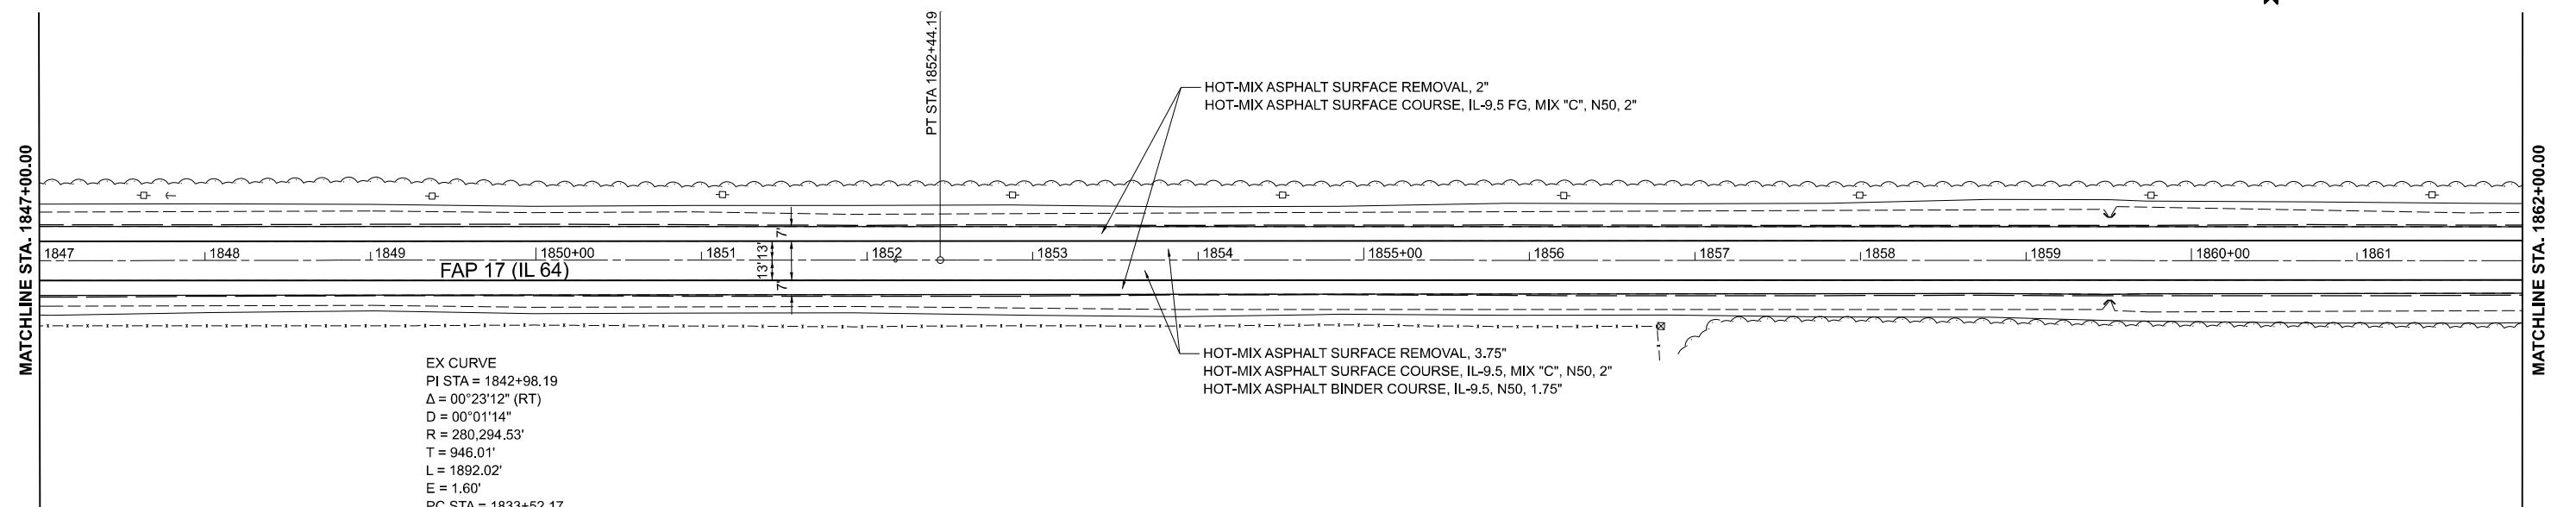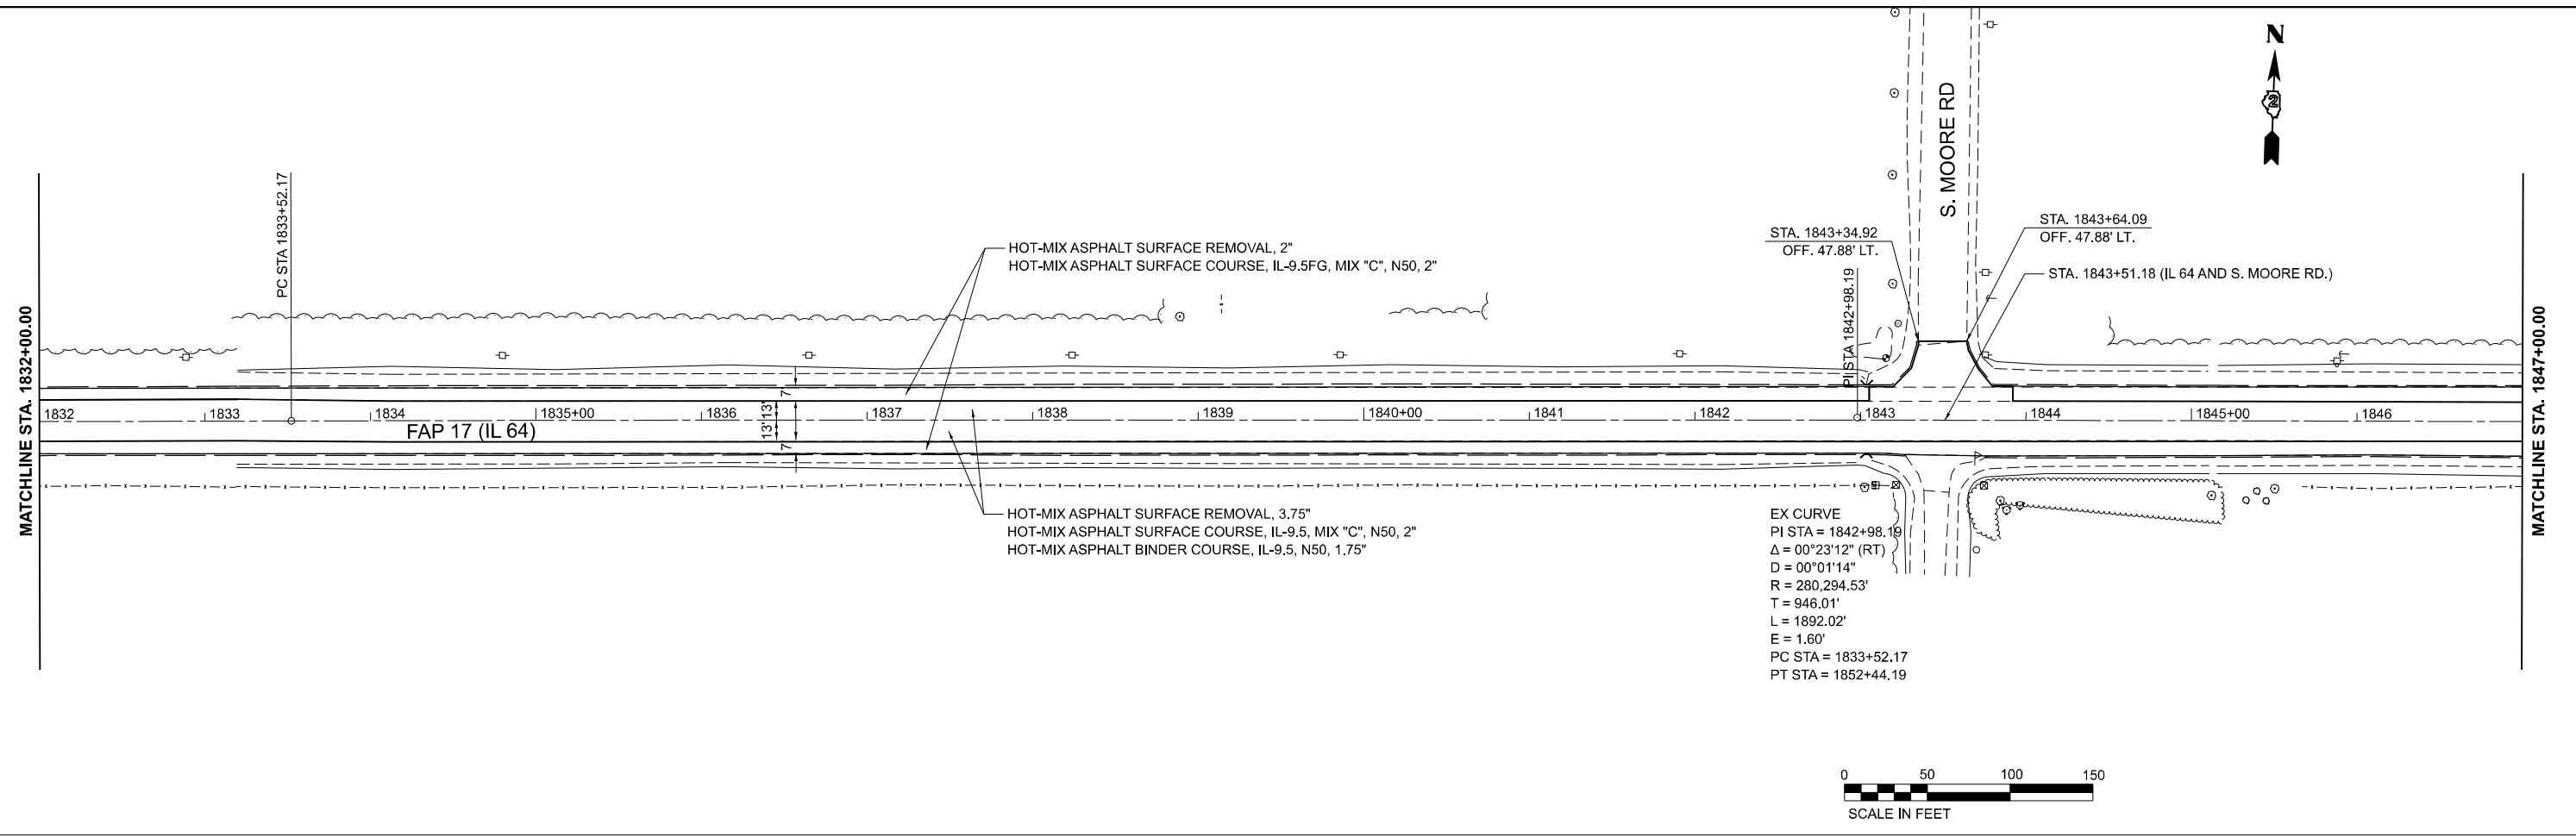

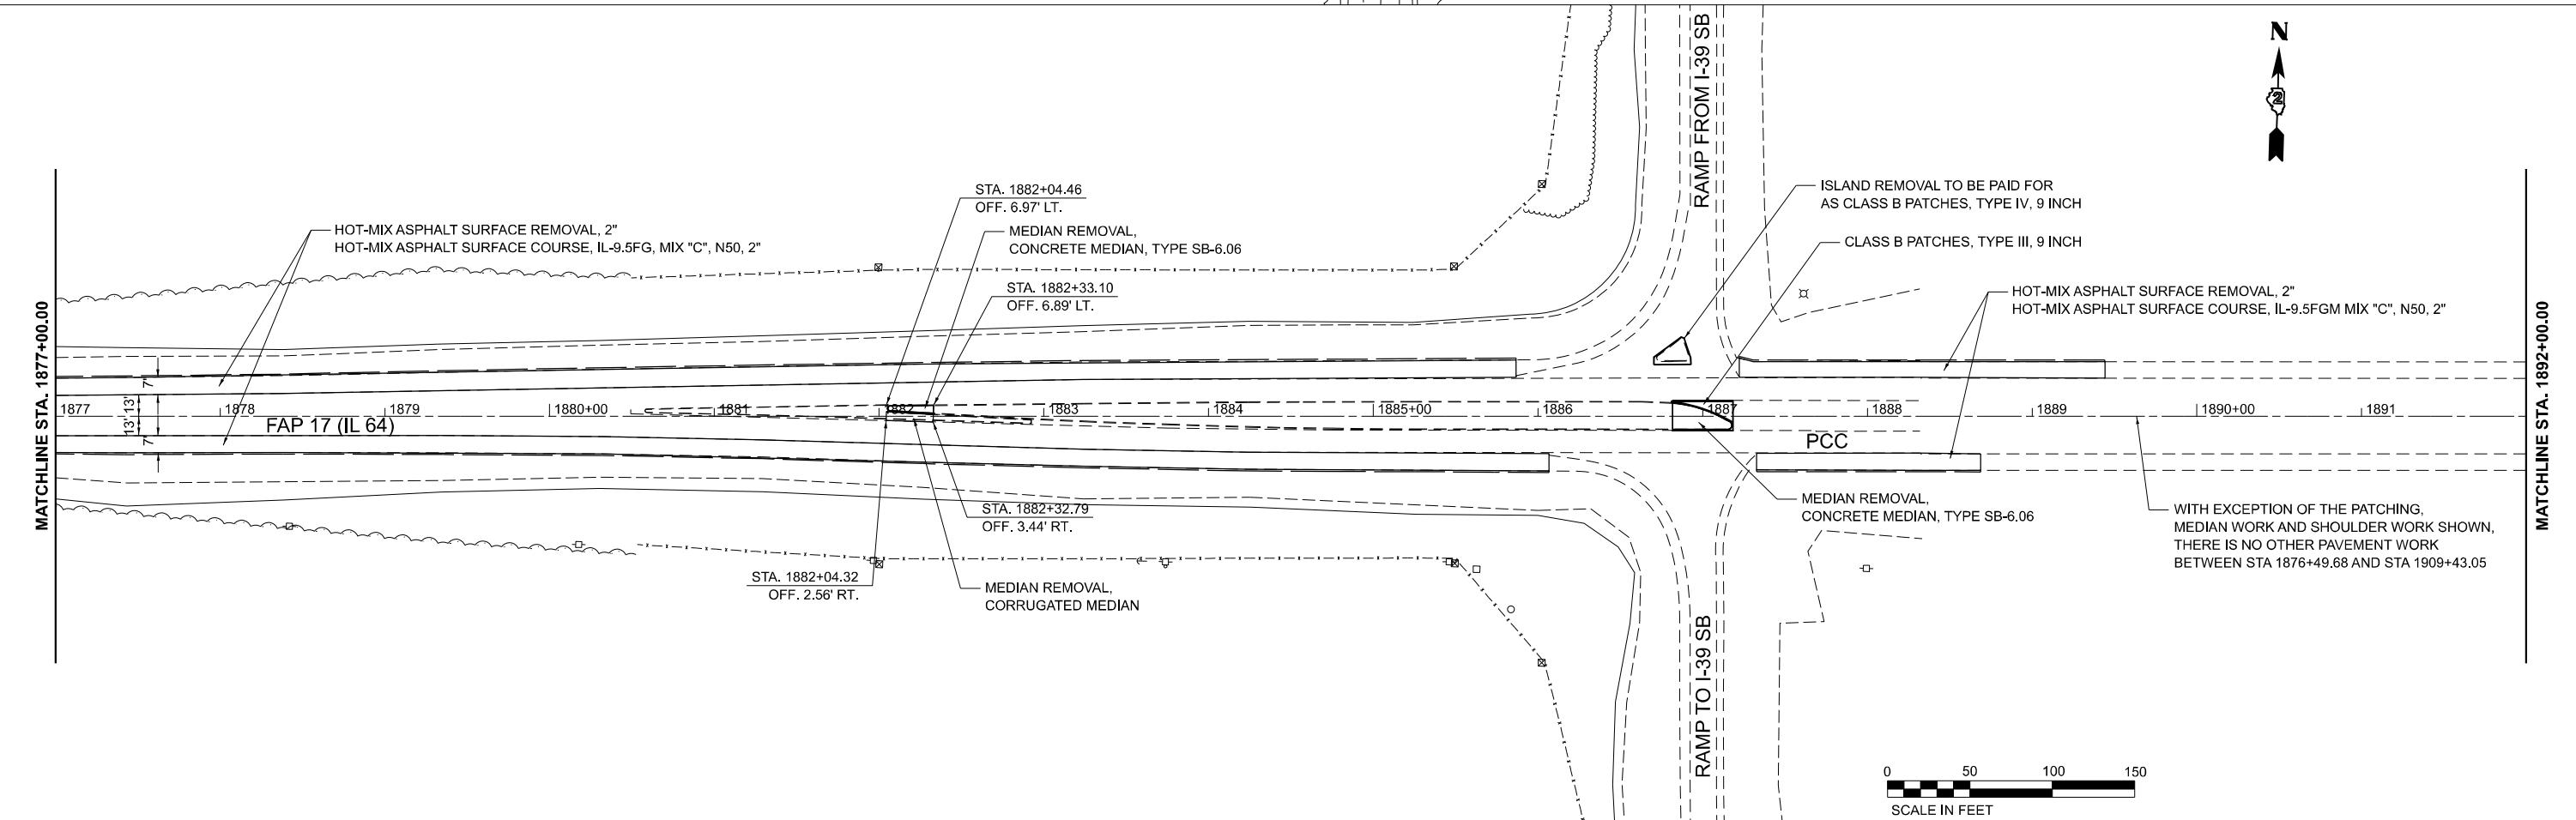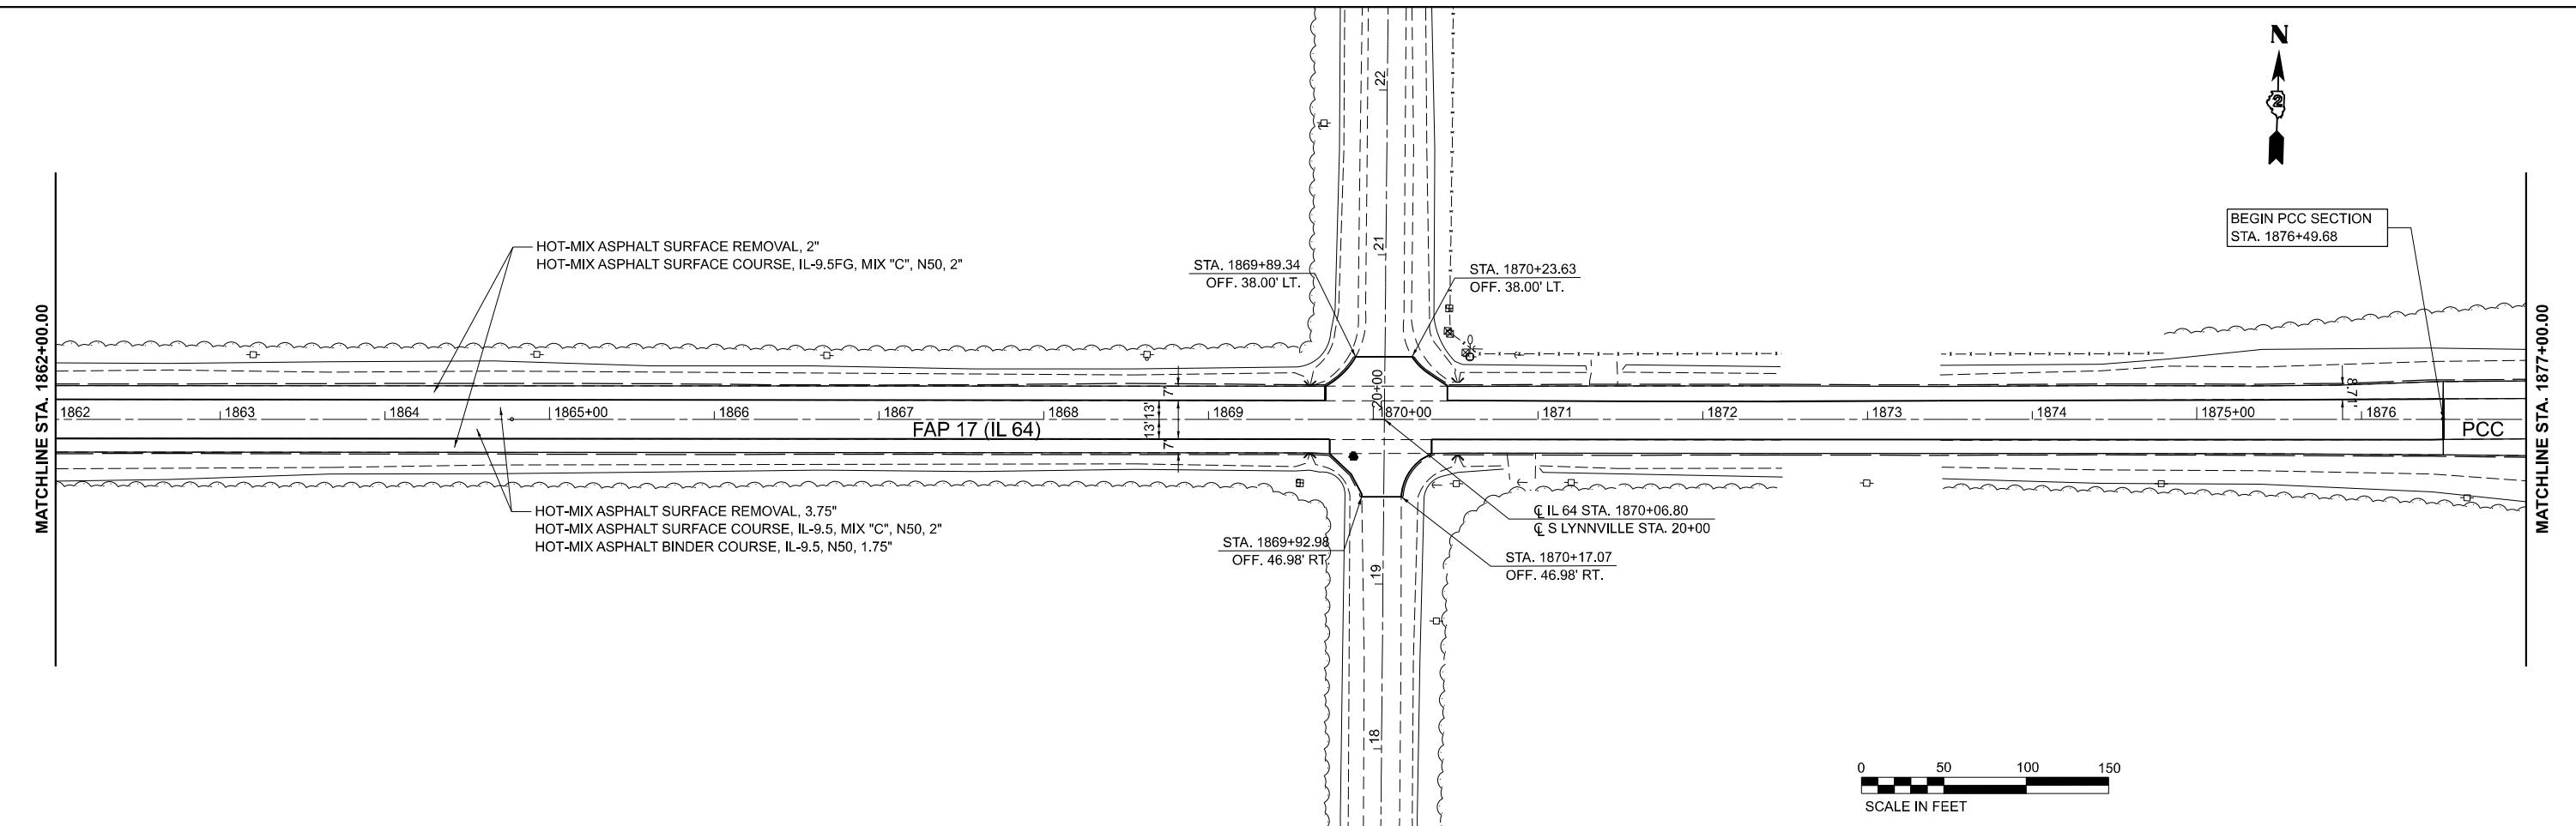

MODEL: \$HODE NAMES
FILE NAME: SPRIELS



USER NAME = 10017	DESIGNED - CG	REVISED -
DRAWN - MA	REVISED -	
PLOT SCALE = 0.16666552' / In.	CHECKED - CK	REVISED -
PLOT DATE = 02/29/24	DATE - 02/29/2024	REVISED -


STATE OF ILLINOIS
DEPARTMENT OF TRANSPORTATION



IL-64 FROM IL-251 TO DEKALB COUNTY LINE
RESURFACING PLAN

SCALE: 1" = 50' SHEET 4 OF 12 SHEETS STA. TO STA.

F.A.P. RTE.	SECTION	COUNTY	TOTAL SHEETS	SHEET NO.
17	D2 PP 2023-02	OGLE	46	26
				CONTRACT NO. 64R99

ILLINOIS FED.AID PROJECT

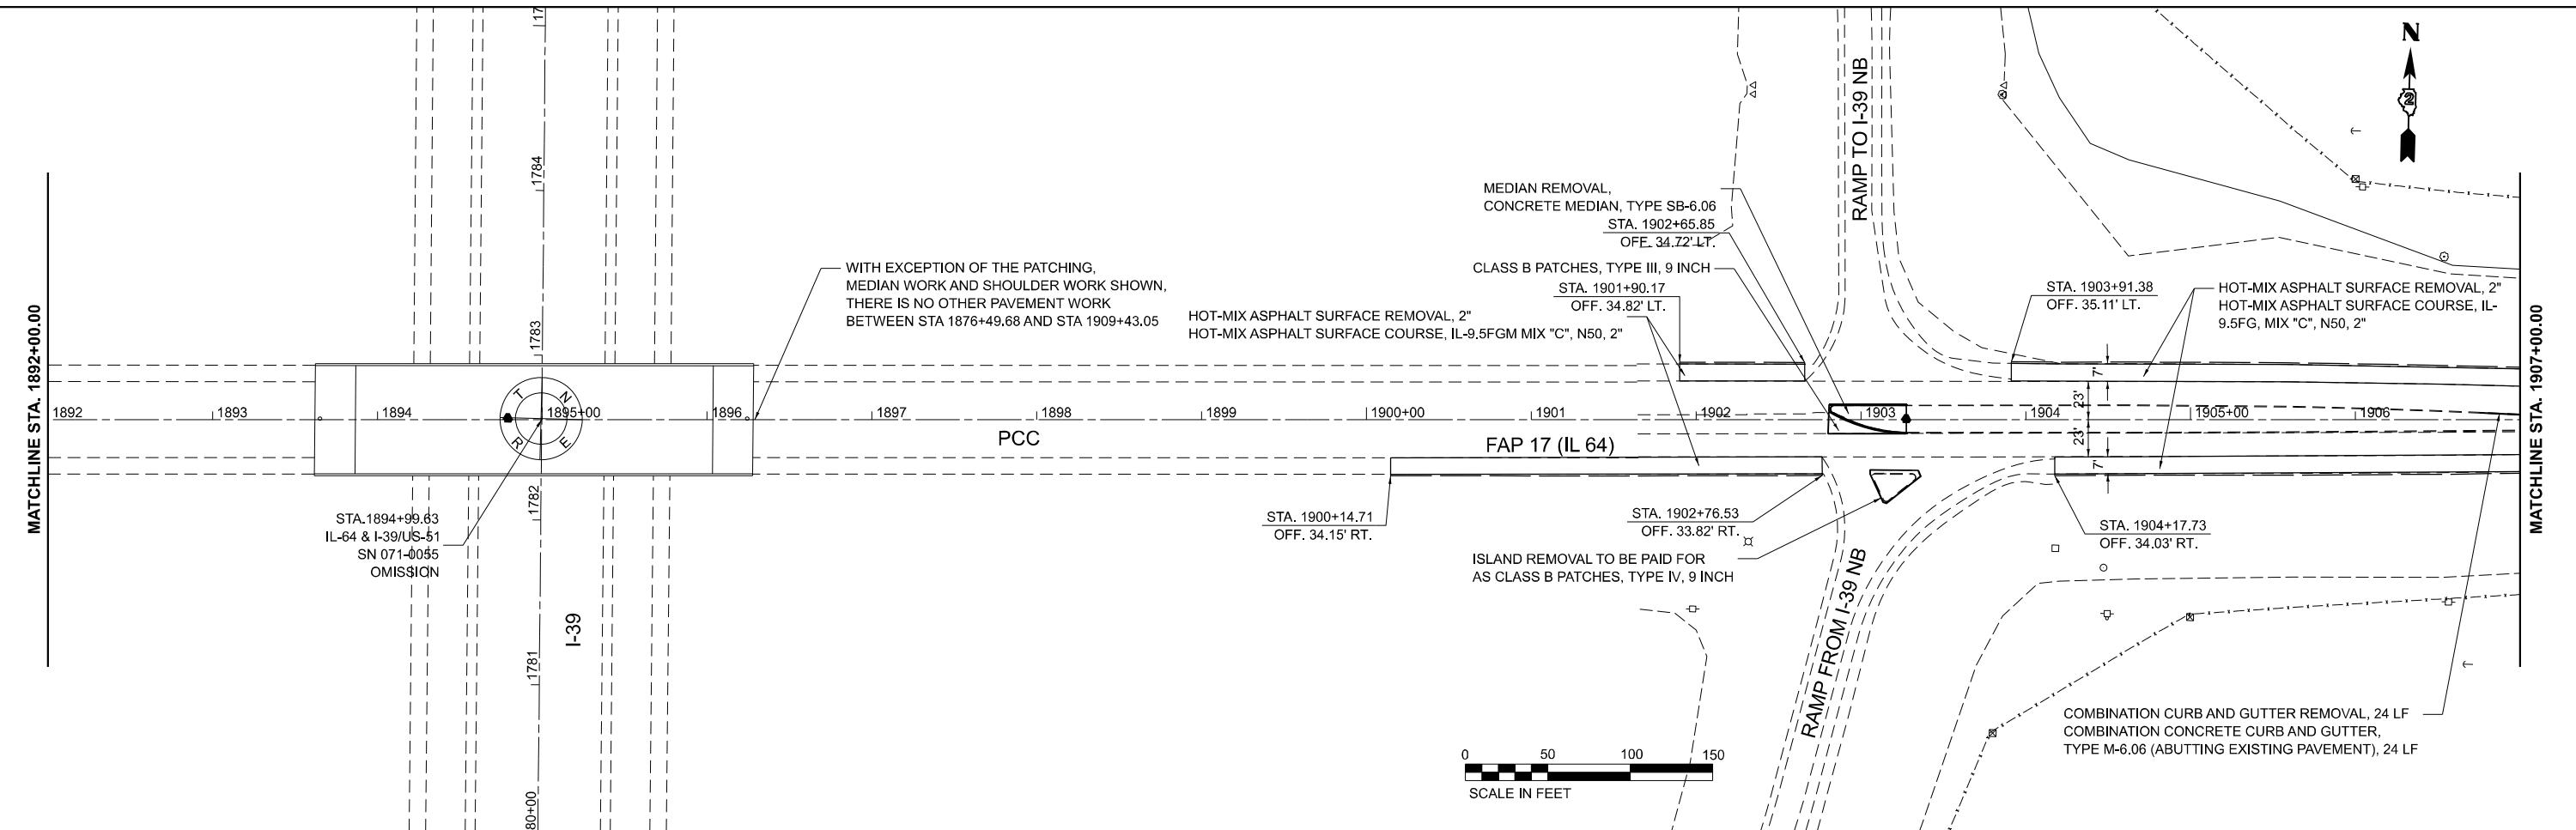

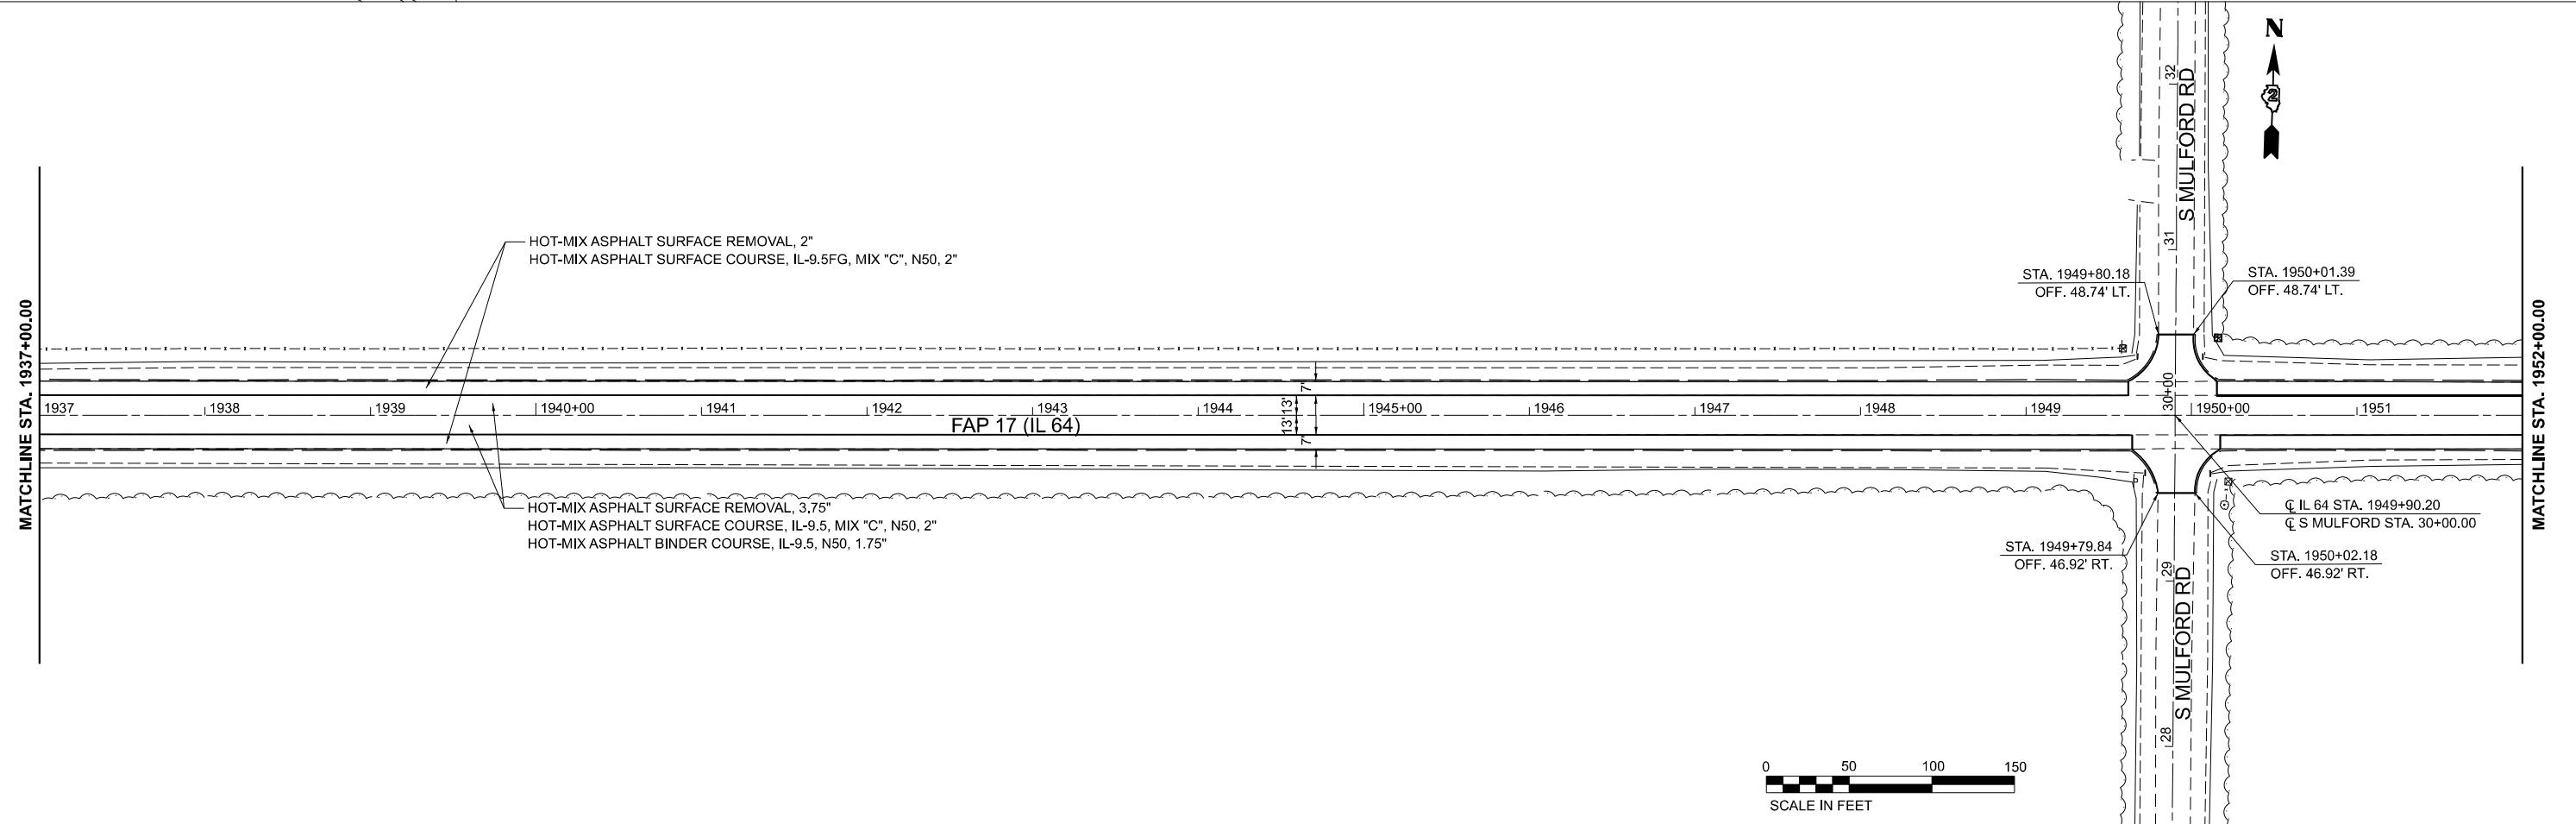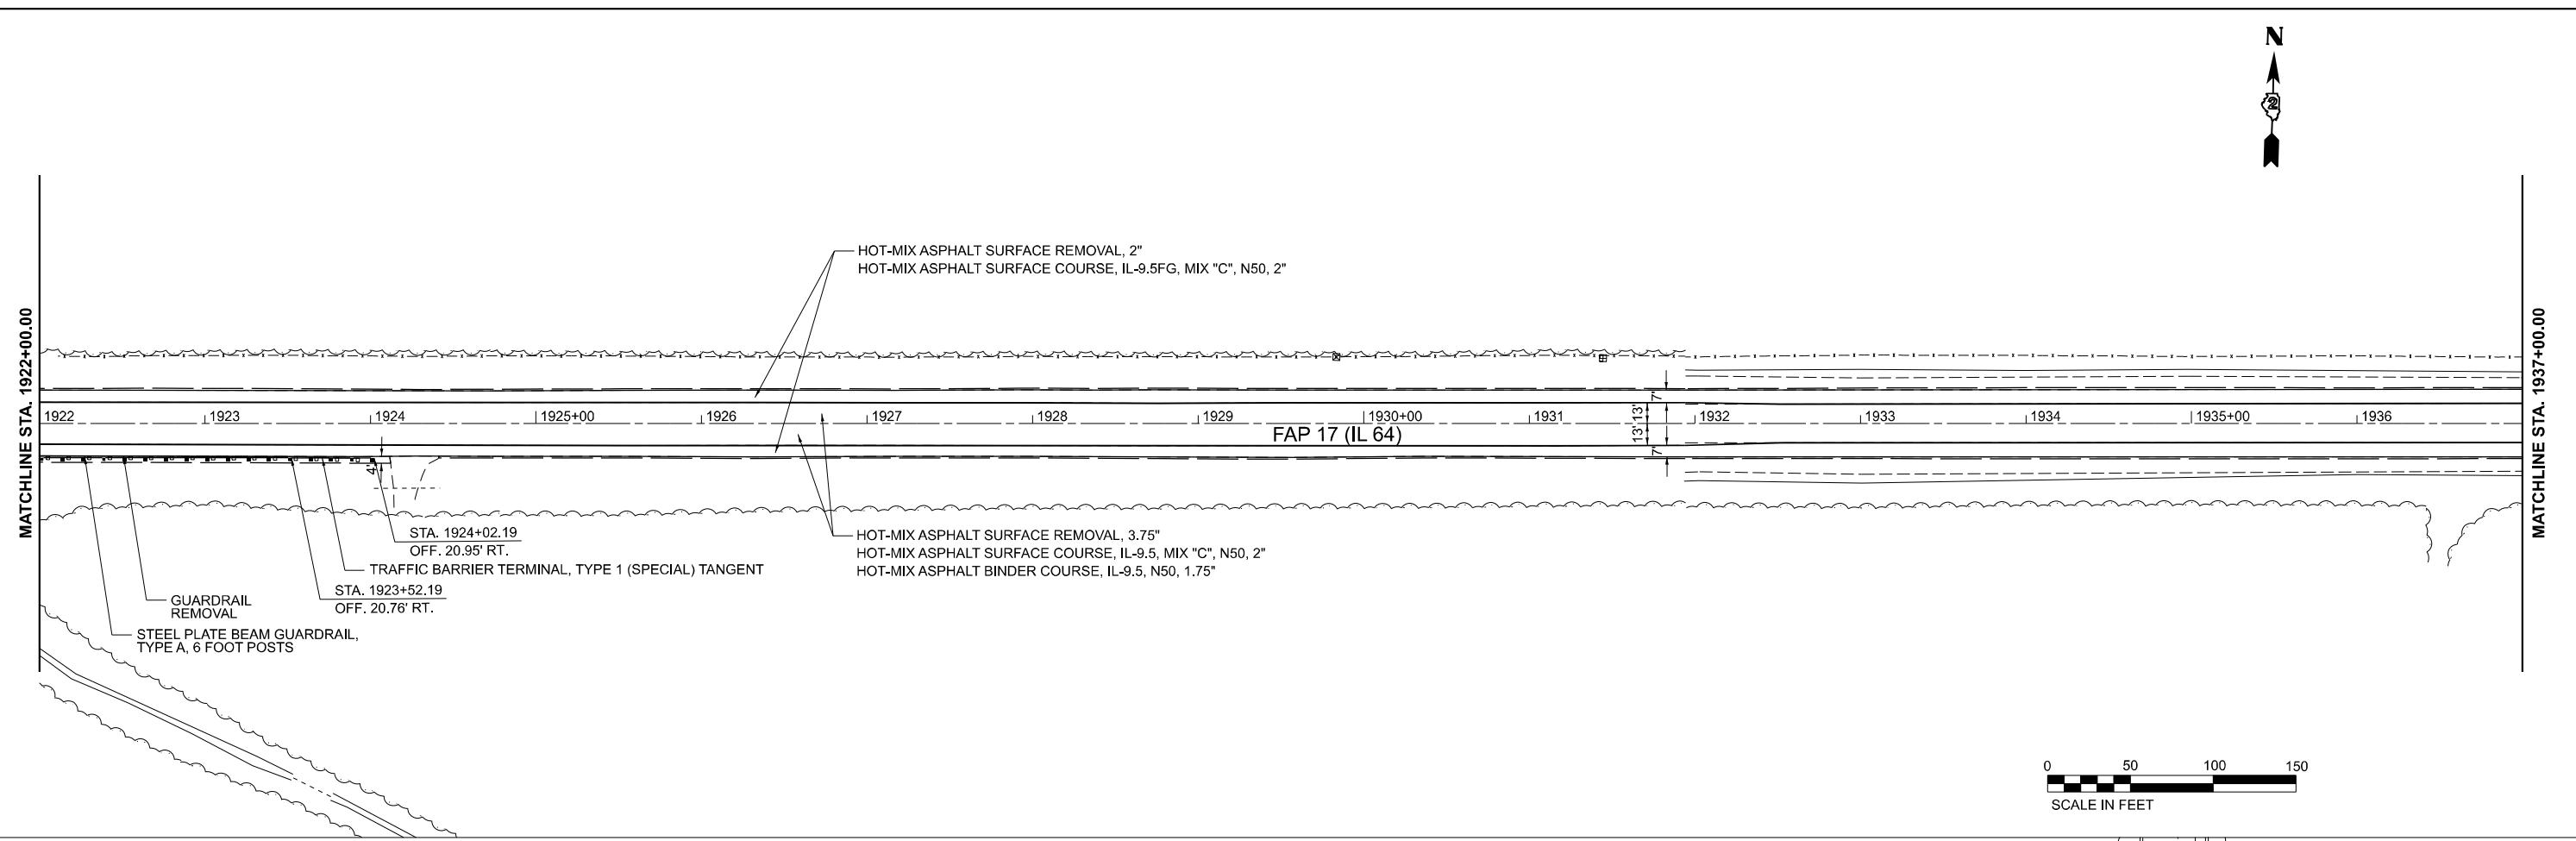

MODEL: \$HODE NAMES
FILE NAME: SPRIELS



USER NAME = 10017	DESIGNED - CG	REVISED -
DRAWN - MA	REVISED -	
PLOT SCALE = 0.16666552' / In.	CHECKED - CK	REVISED -
PLOT DATE = 02/29/24	DATE - 02/29/2024	REVISED -



STATE OF ILLINOIS
DEPARTMENT OF TRANSPORTATION



IL-64 FROM IL-251 TO DEKALB COUNTY LINE
RESURFACING PLAN

SCALE: 1" = 50' SHEET 6 OF 12 SHEETS STA. TO STA.

F.A.P. RTE.	SECTION	COUNTY	TOTAL SHEETS	HEET NO.
17	D2 PP 2023-02	OGLE	46	28
				CONTRACT NO. 64R99

ILLINOIS FED.AID PROJECT

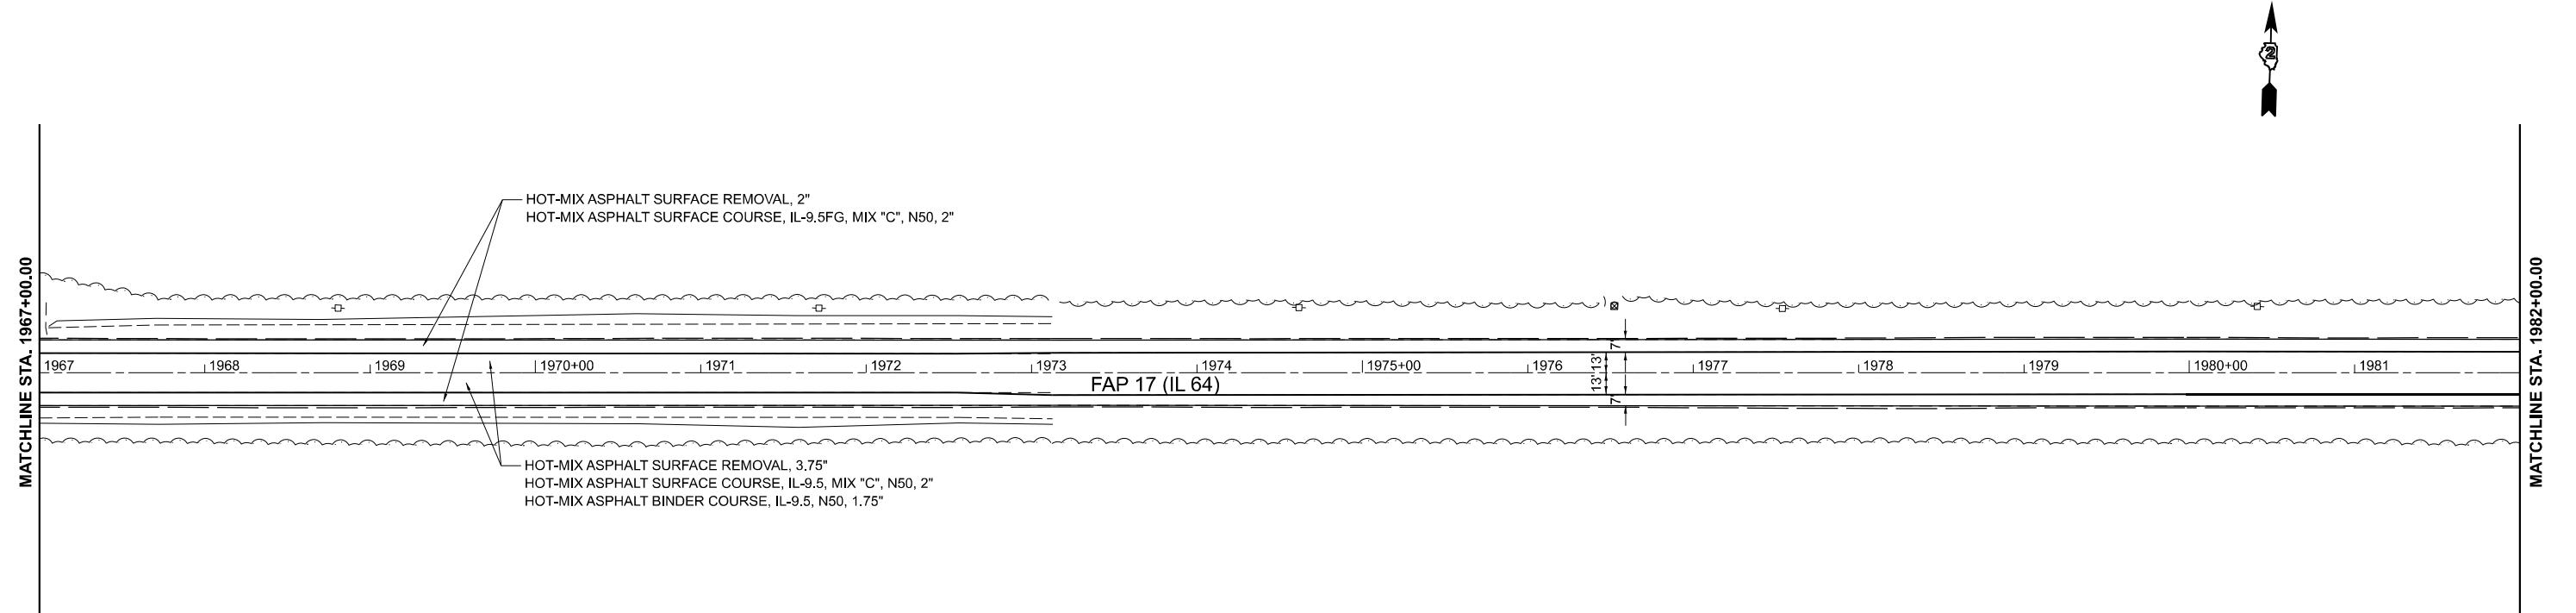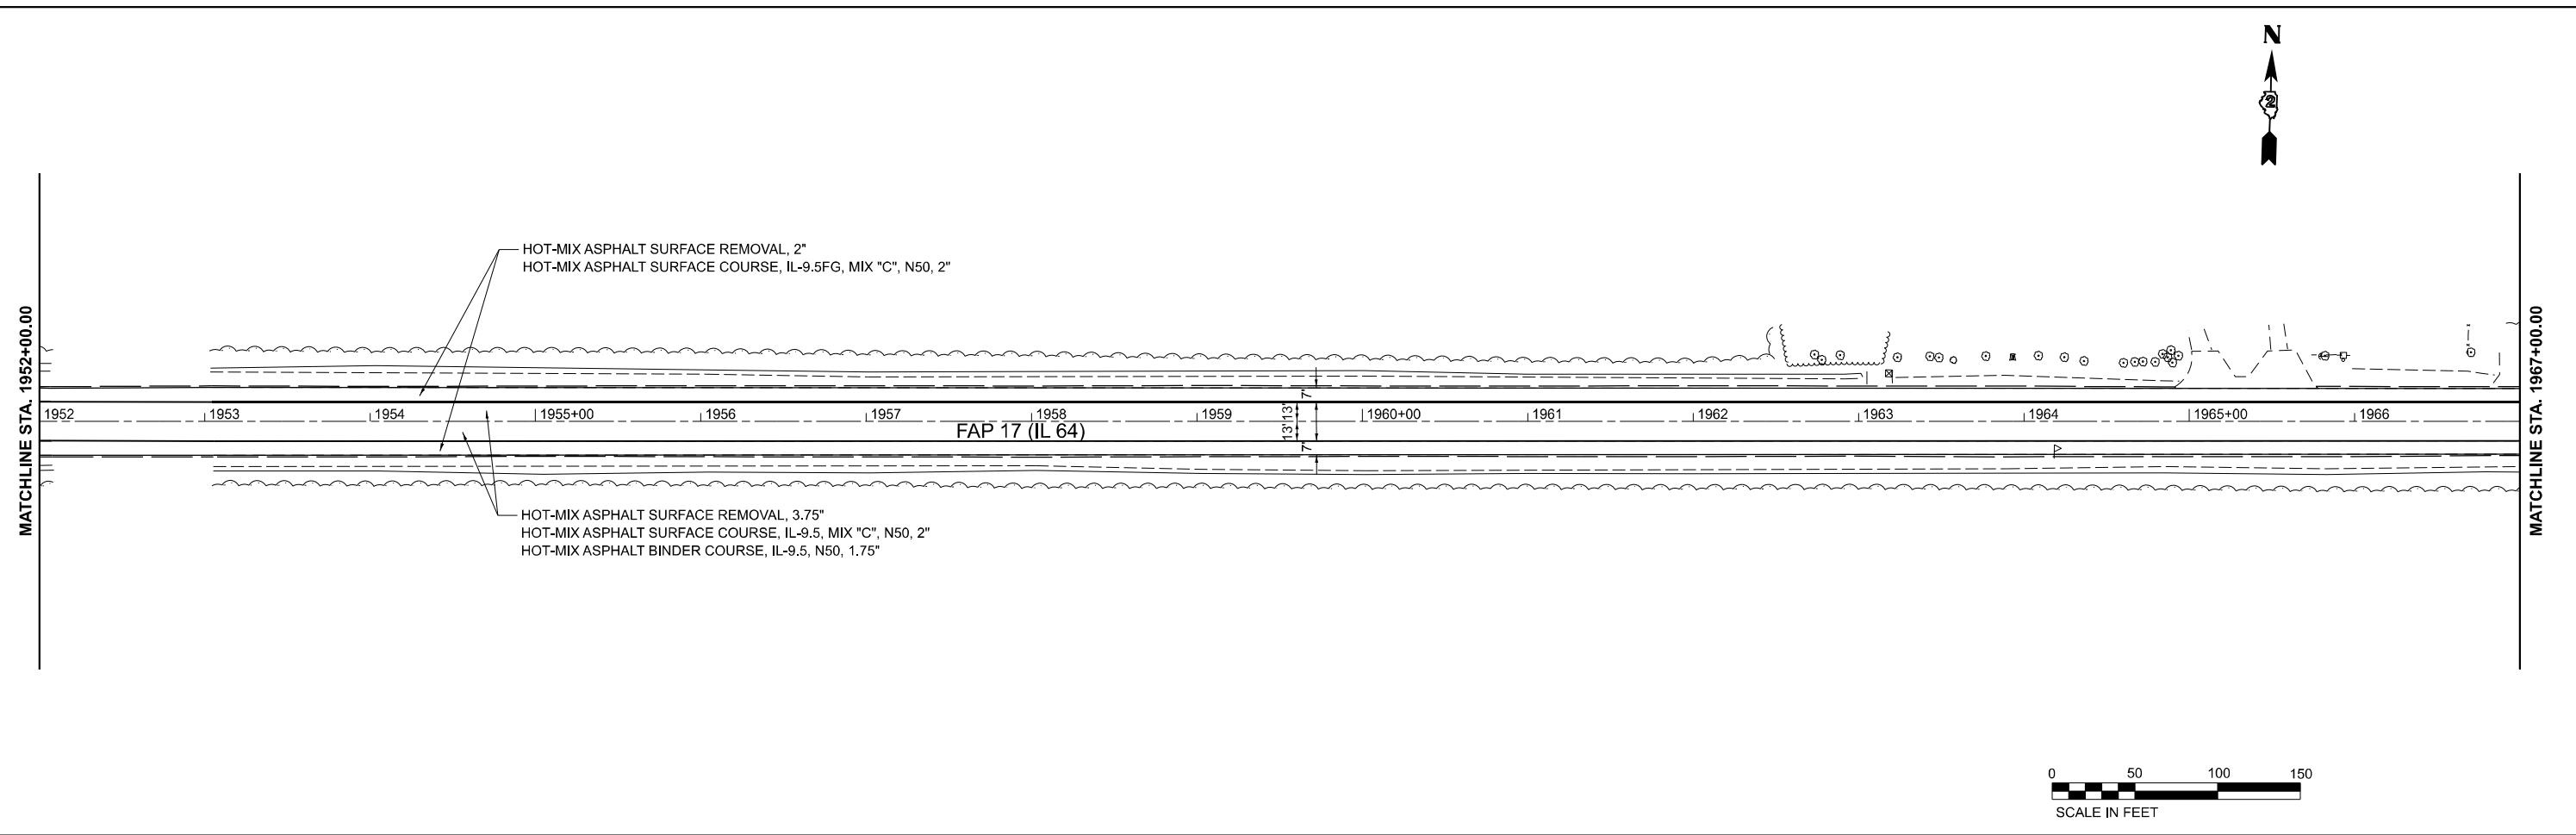

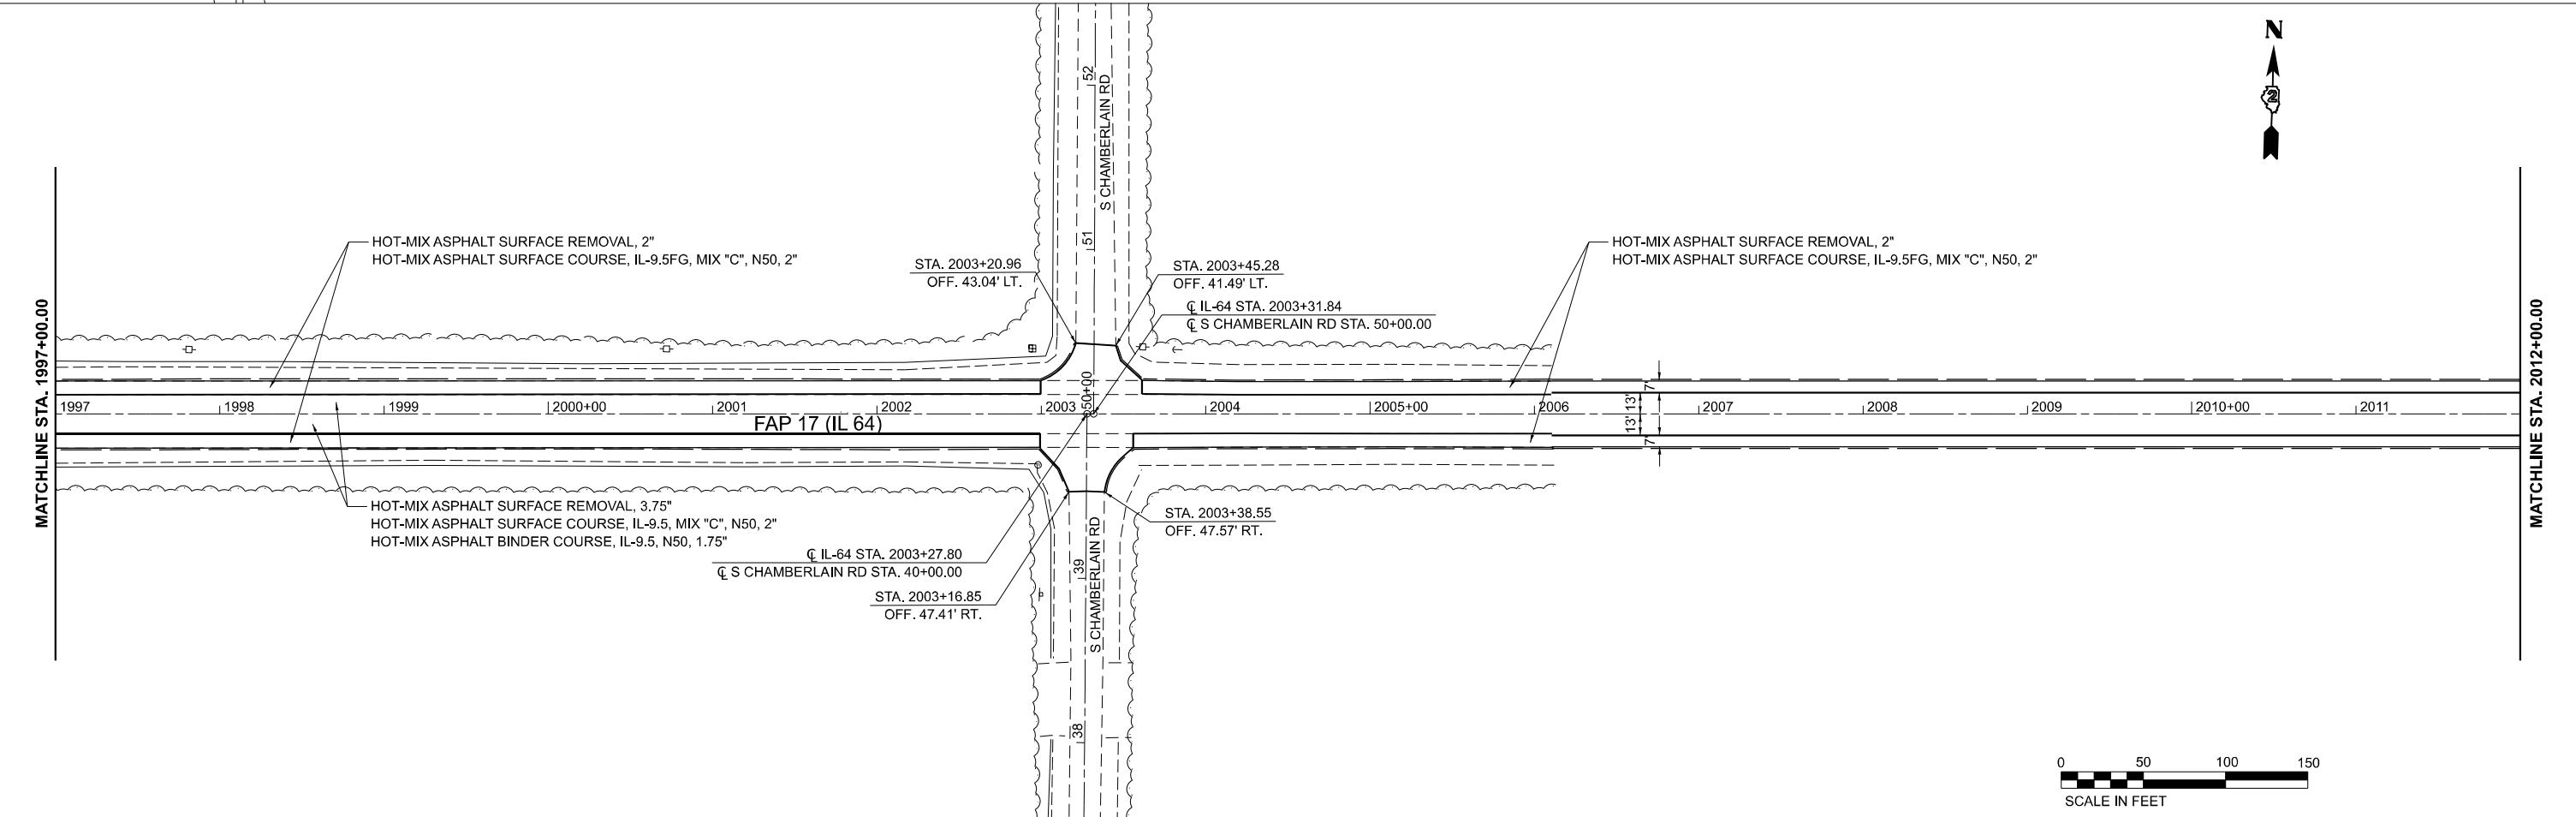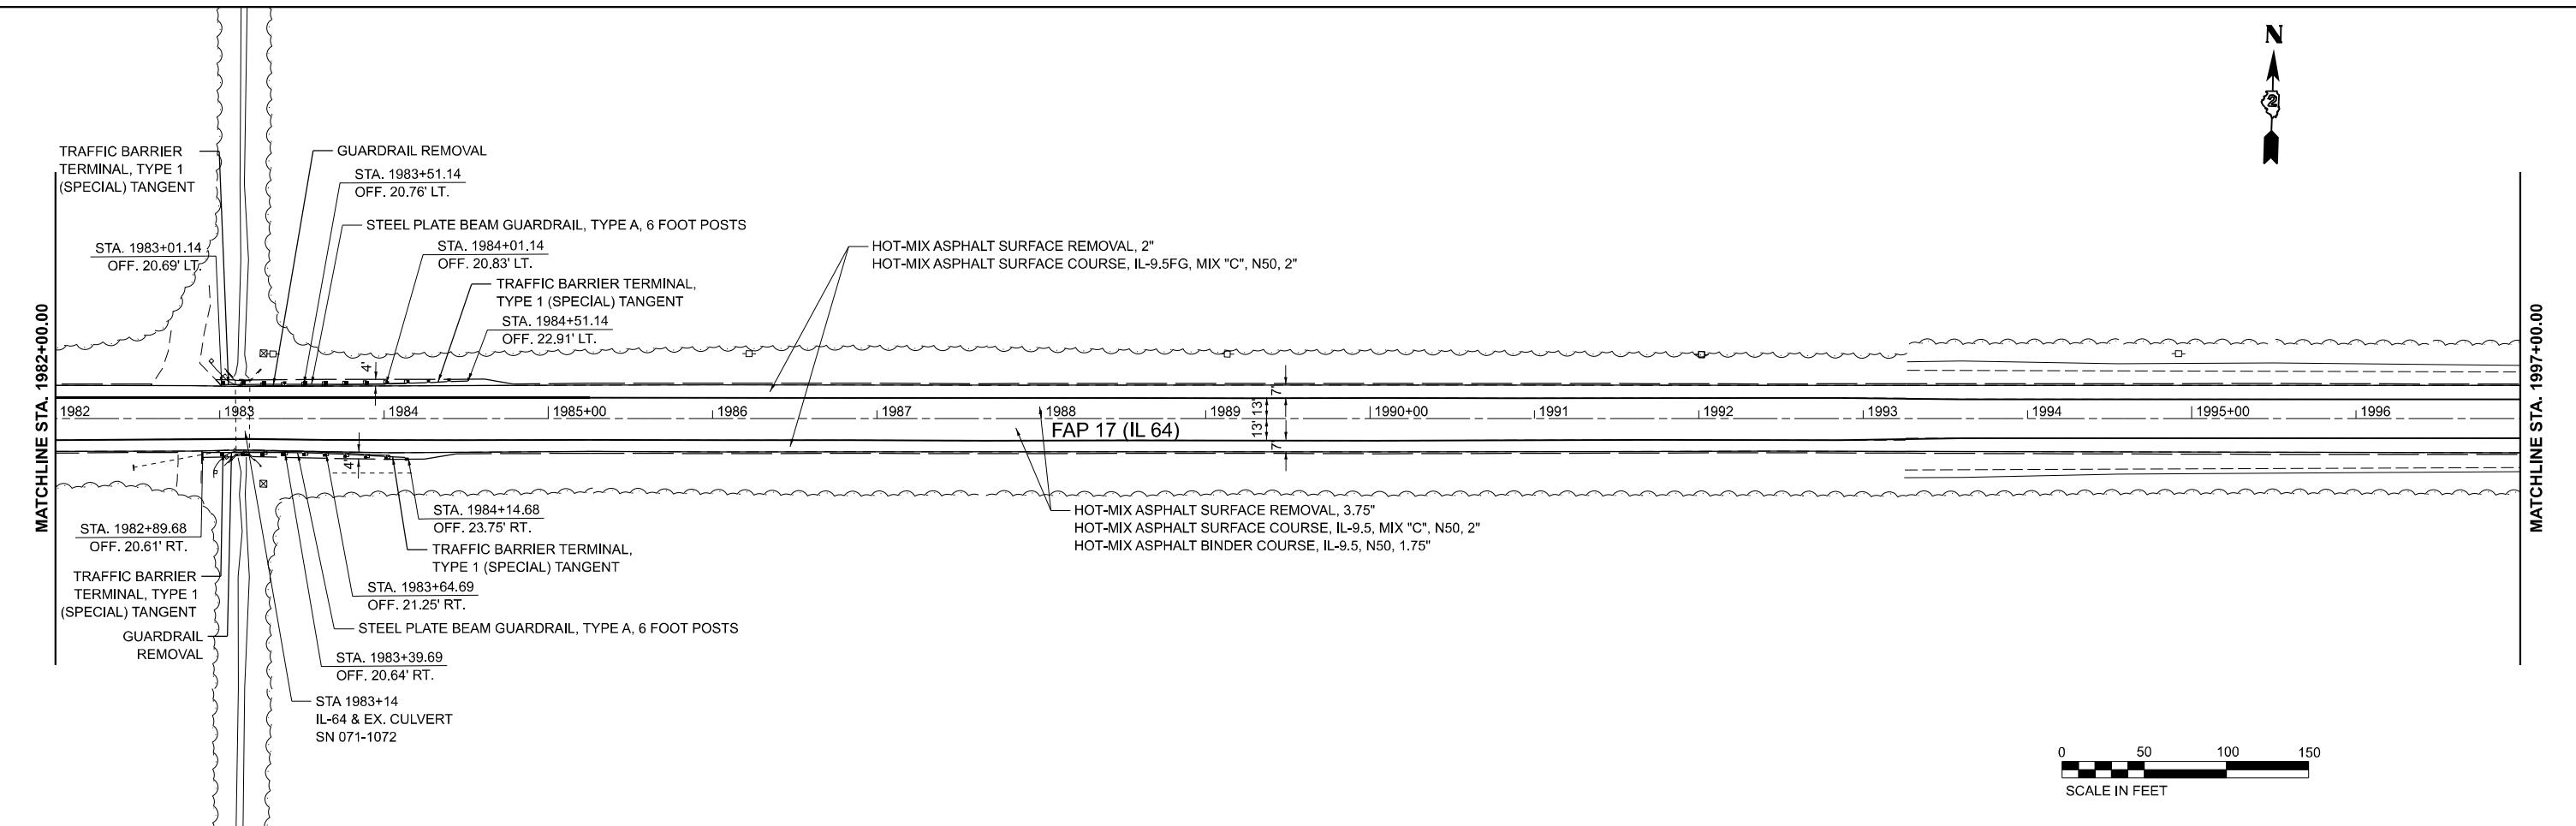

MODEL: \$HODE NAMES
FILE NAME: SPFIELD



USER NAME = 10017
DESIGNED - CG
DRAWN - MA
PLOT SCALE = 0.16666552' / In.
PLOT DATE = 02/29/24

REVISED -
REVISED -
REVISED -
REVISED -

REVISED -
REVISED -
REVISED -
REVISED -

STATE OF ILLINOIS
DEPARTMENT OF TRANSPORTATION



IL-64 FROM IL-251 TO DEKALB COUNTY LINE
RESURFACING PLAN



SCALE: 1" = 50' SHEET 8 OF 12 SHEETS STA. TO STA.



F.A.P. RTE.	SECTION	COUNTY	TOTAL SHEETS	HEET NO.
17	D2 PP 2023-02	OGLE	46	30

CONTRACT NO. 64R99

ILLINOIS FED.AID PROJECT

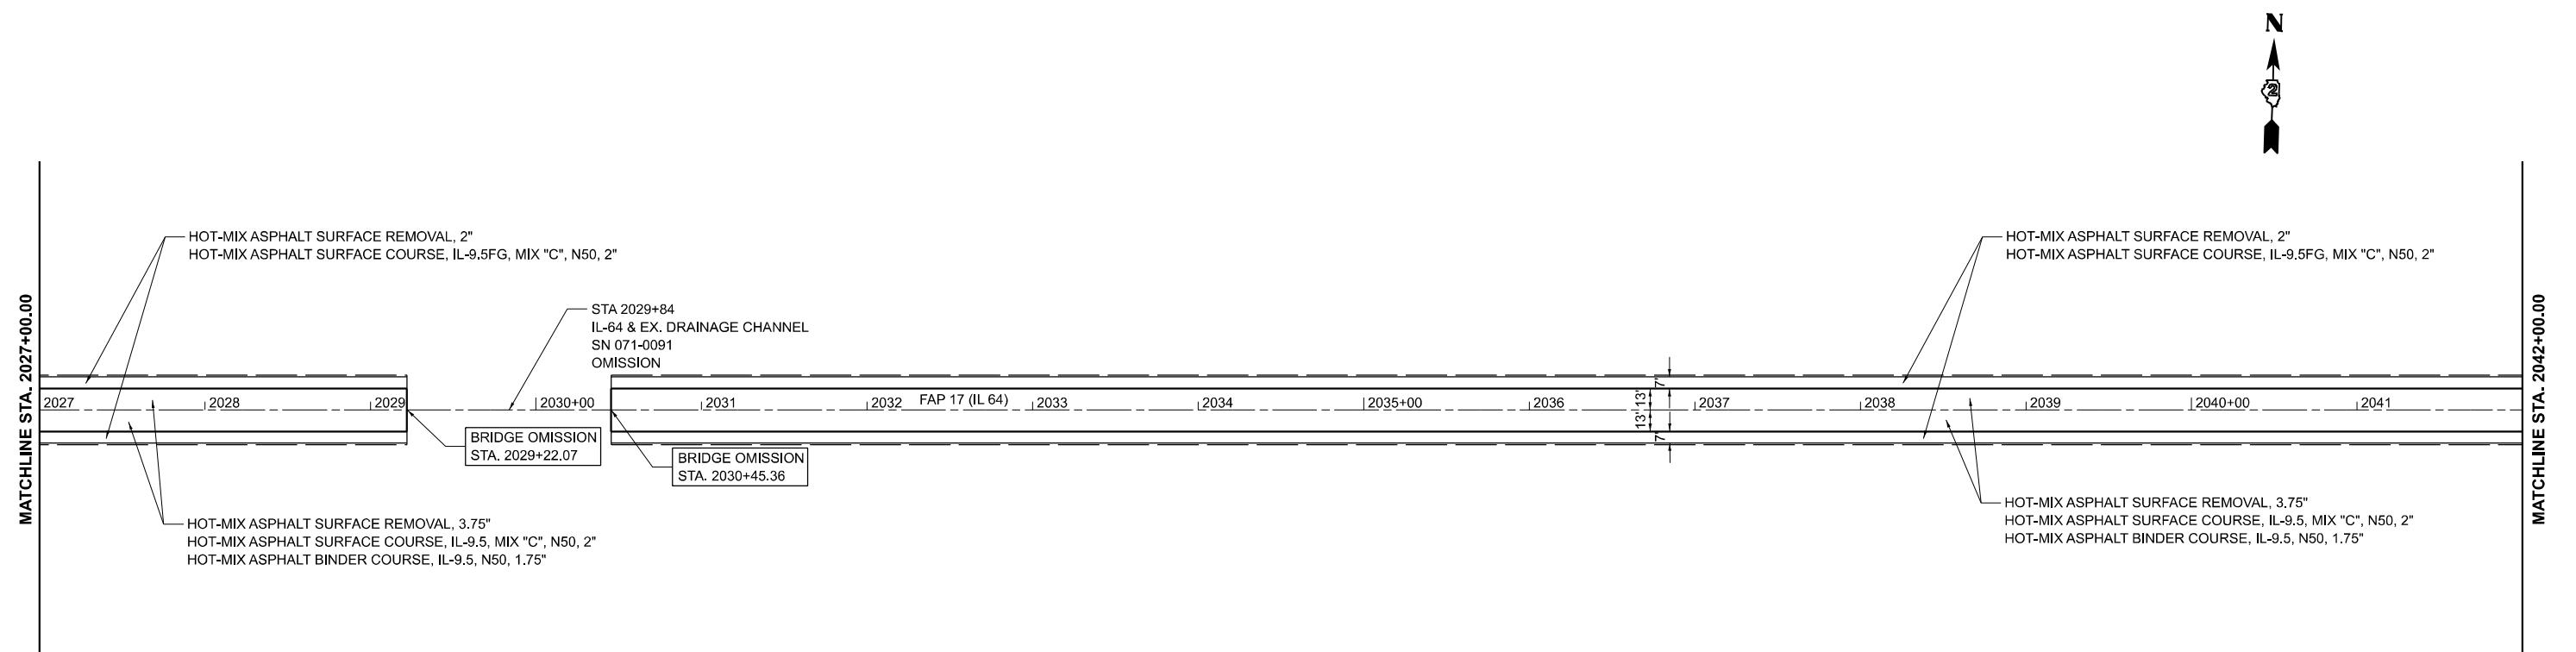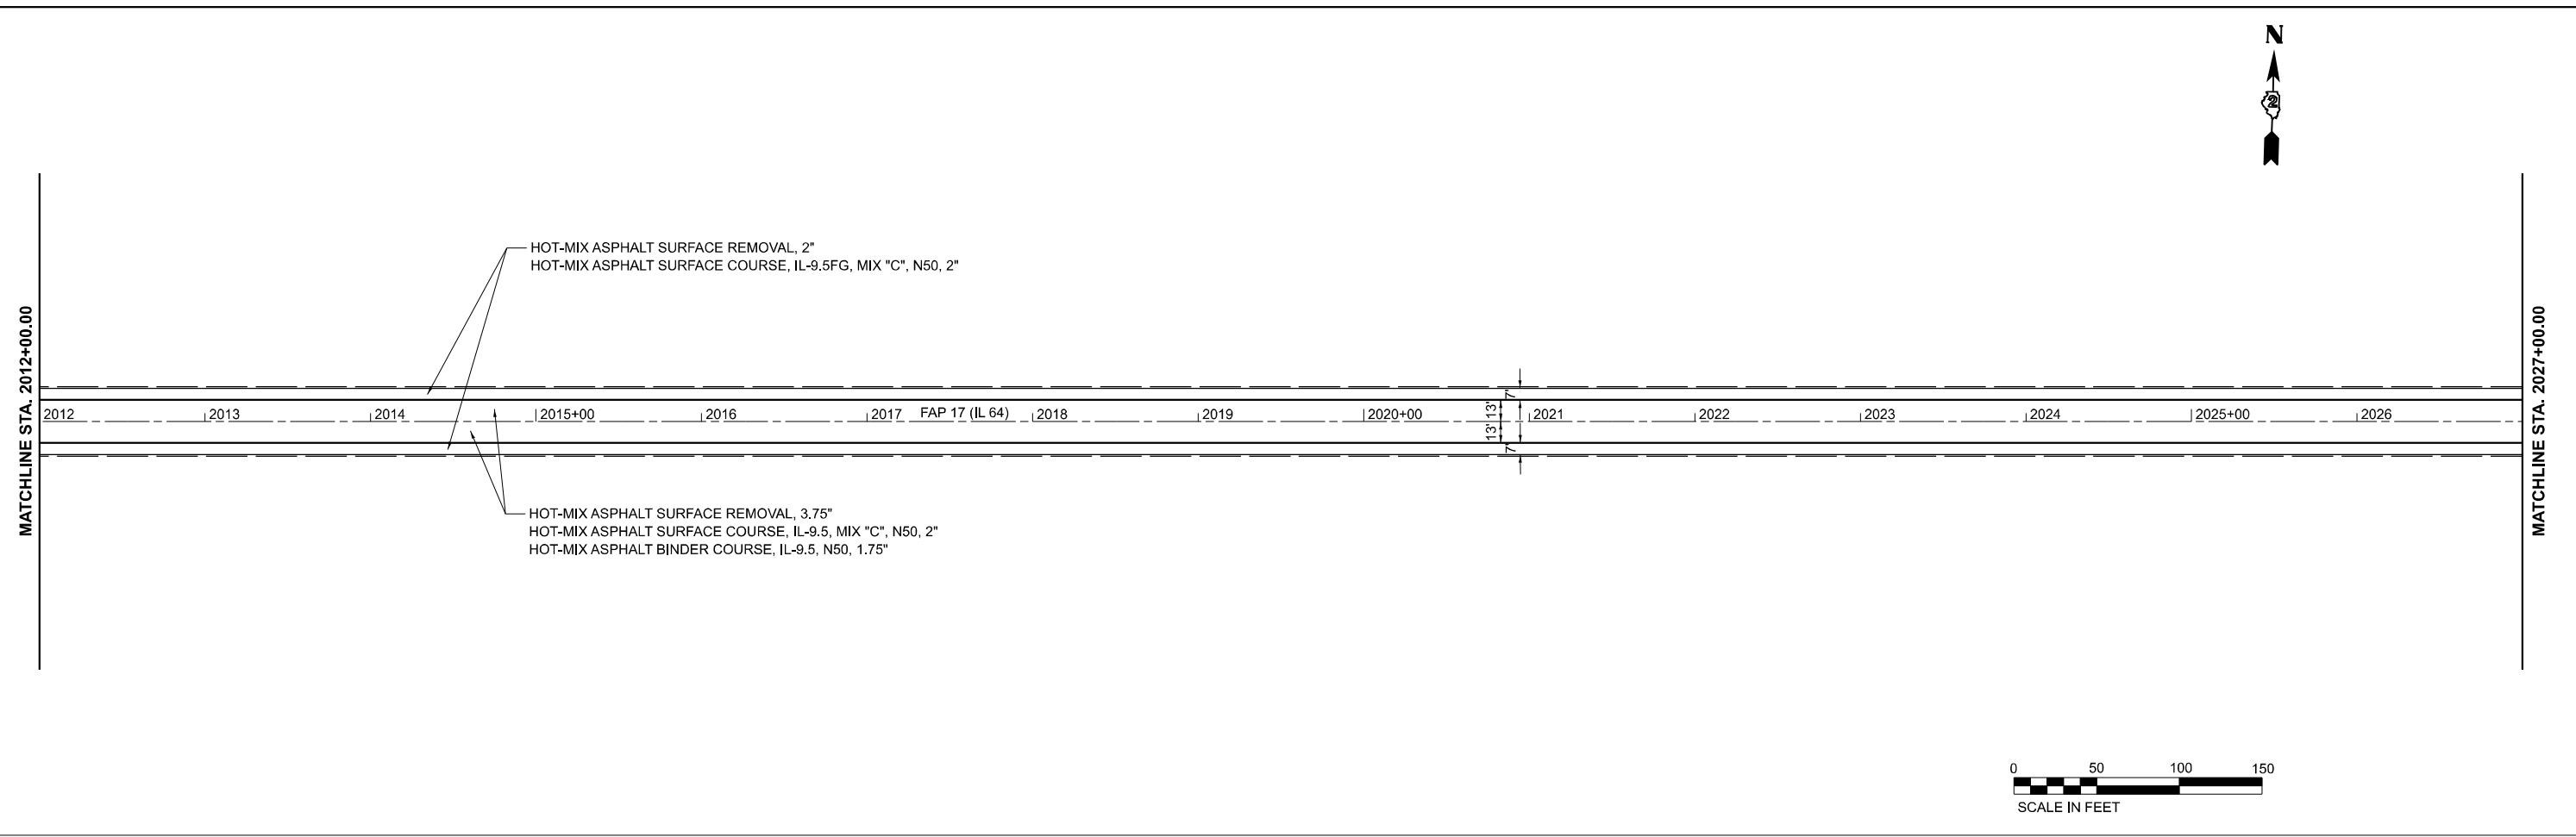

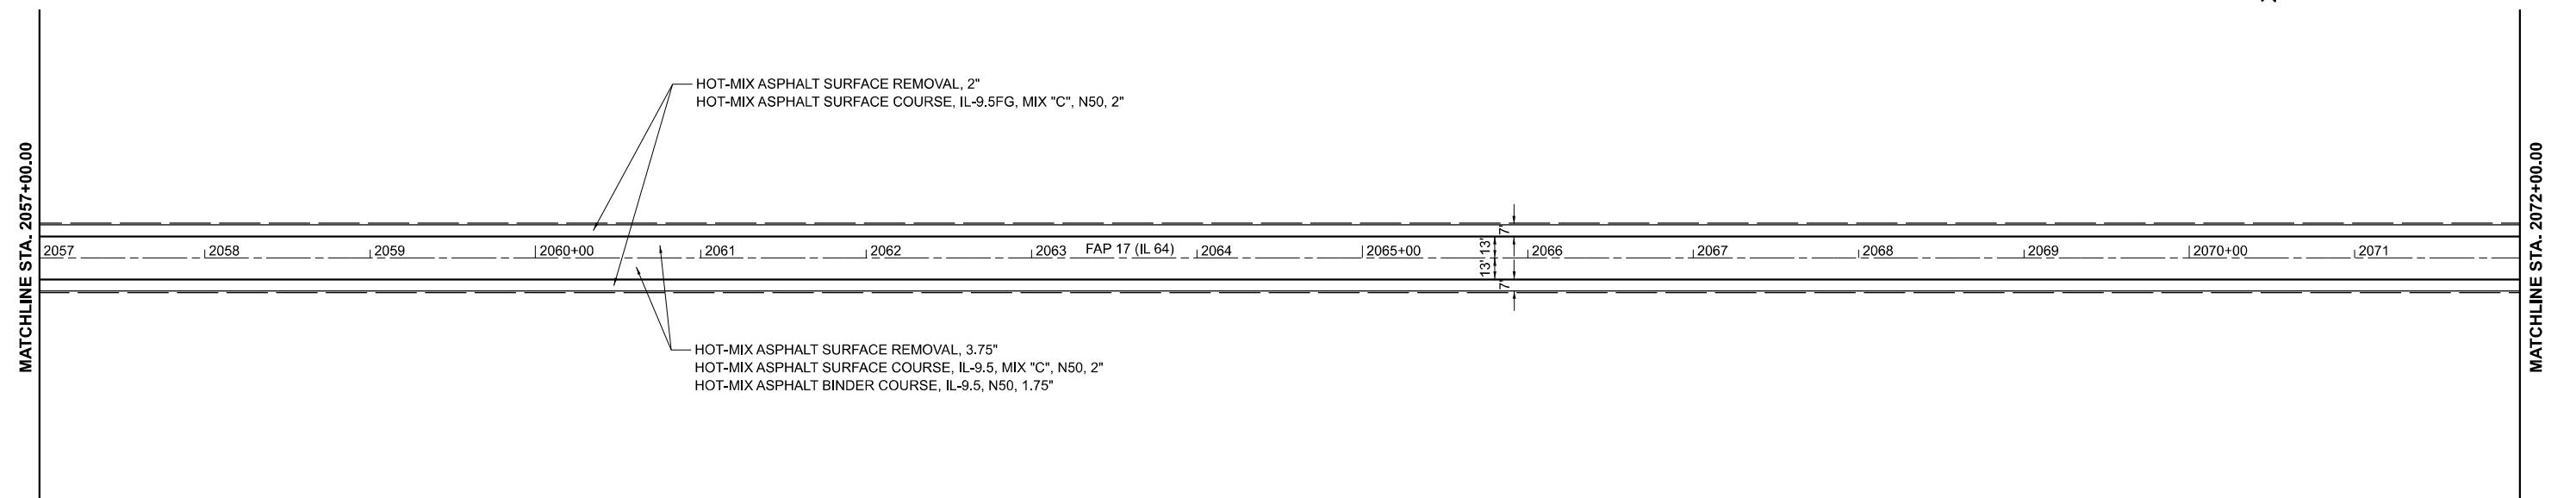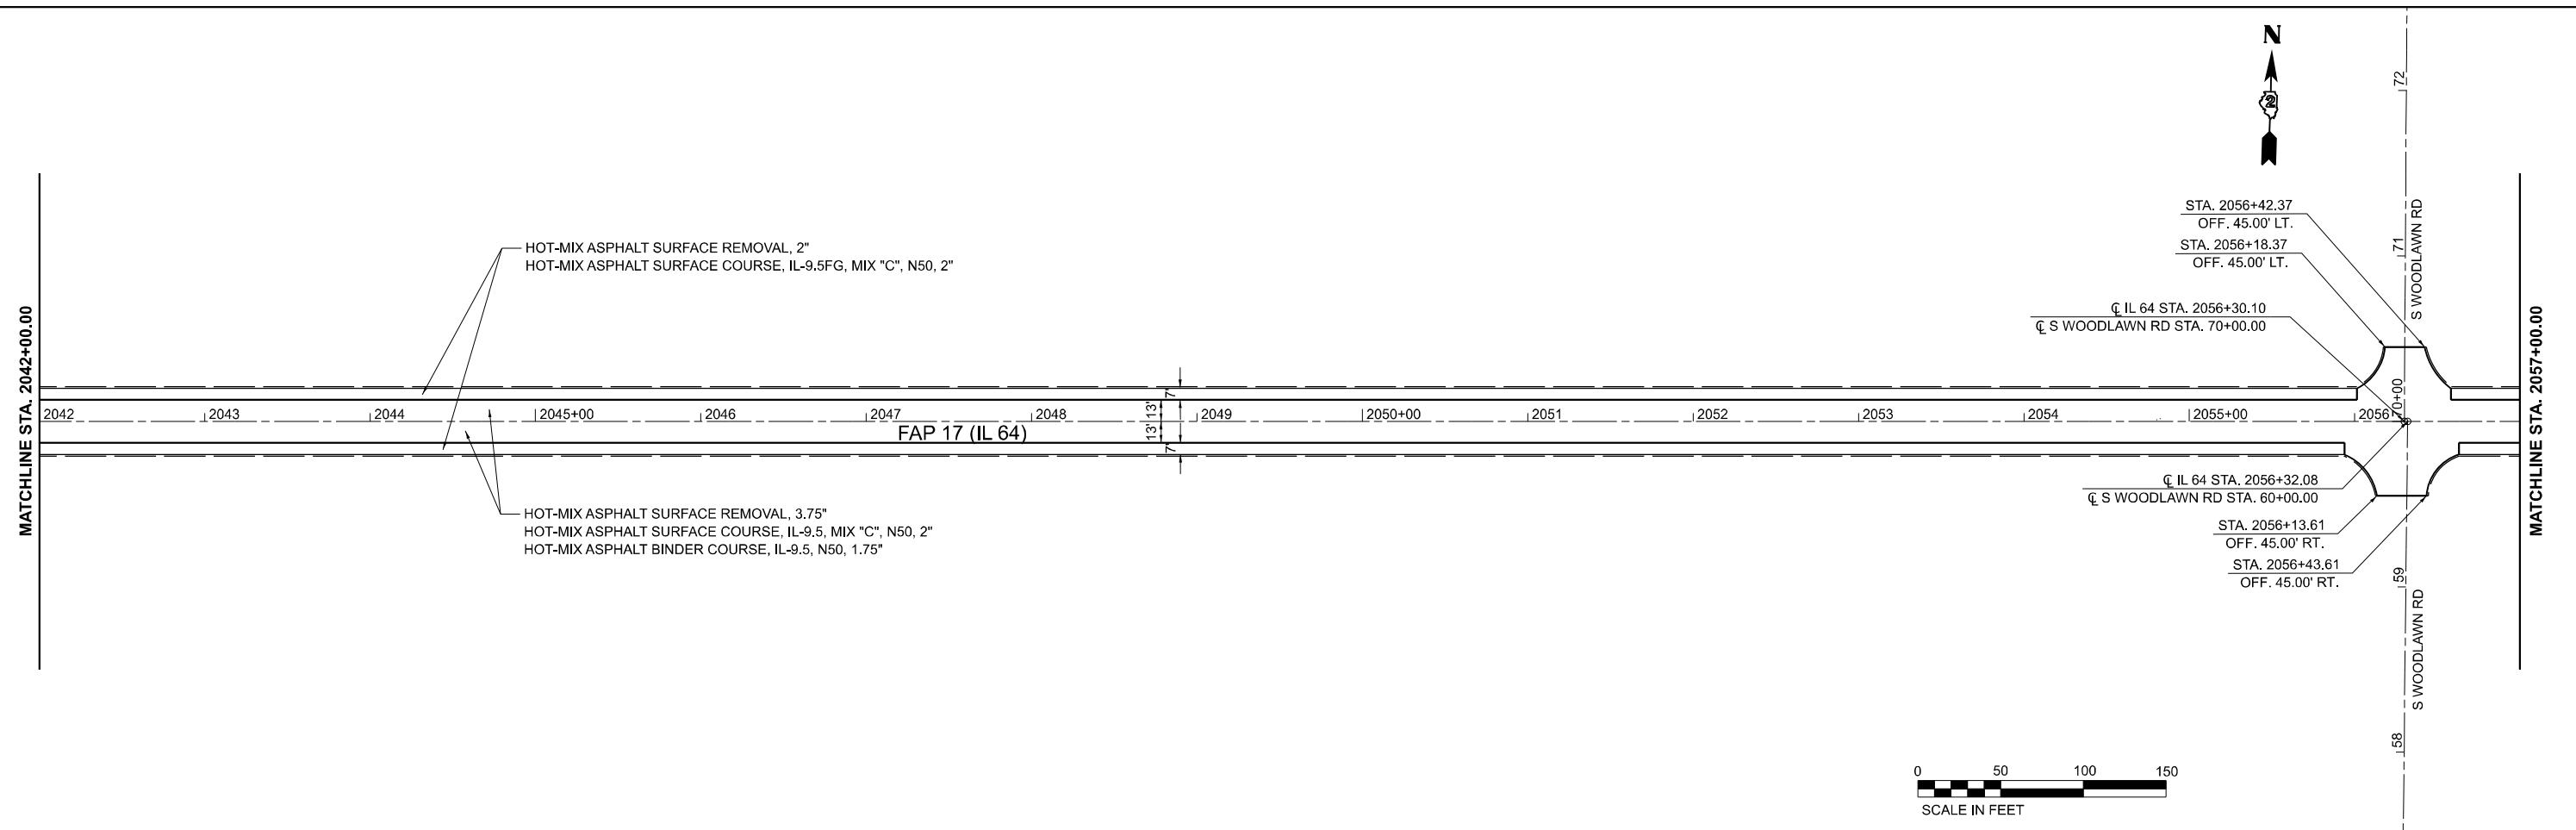

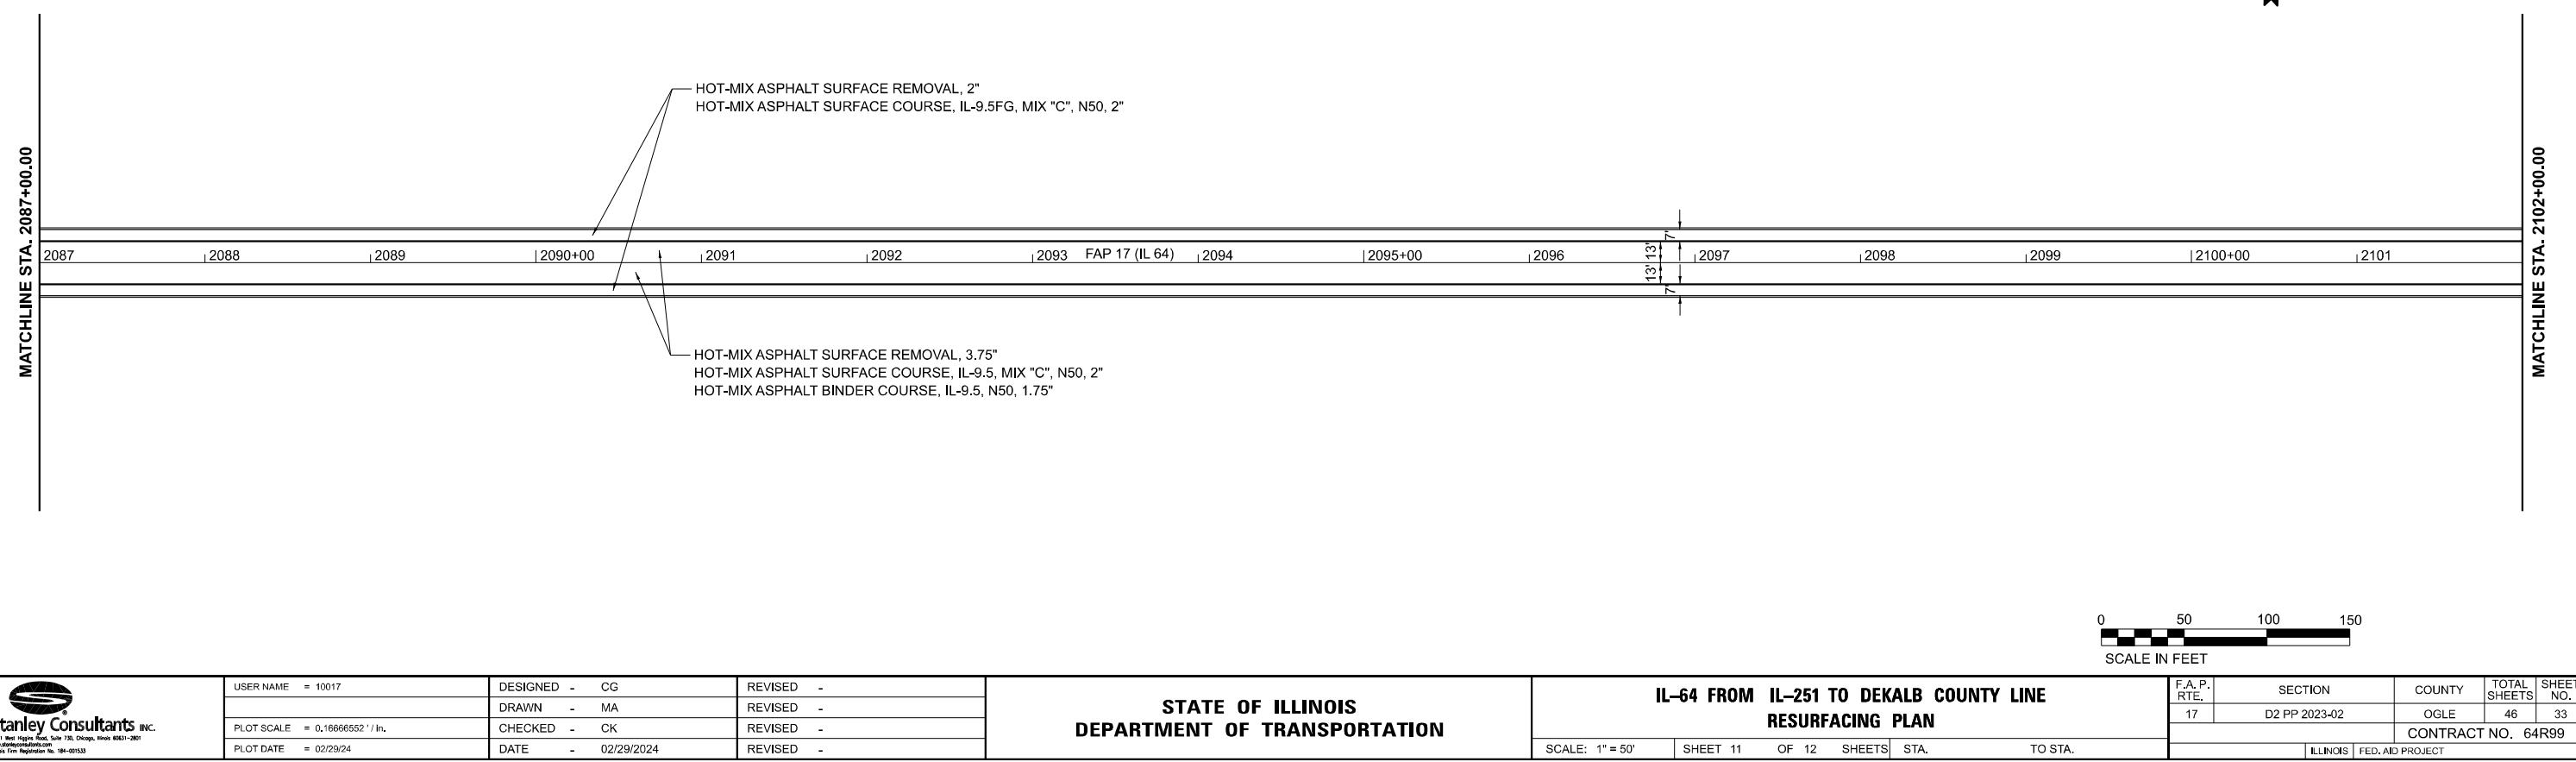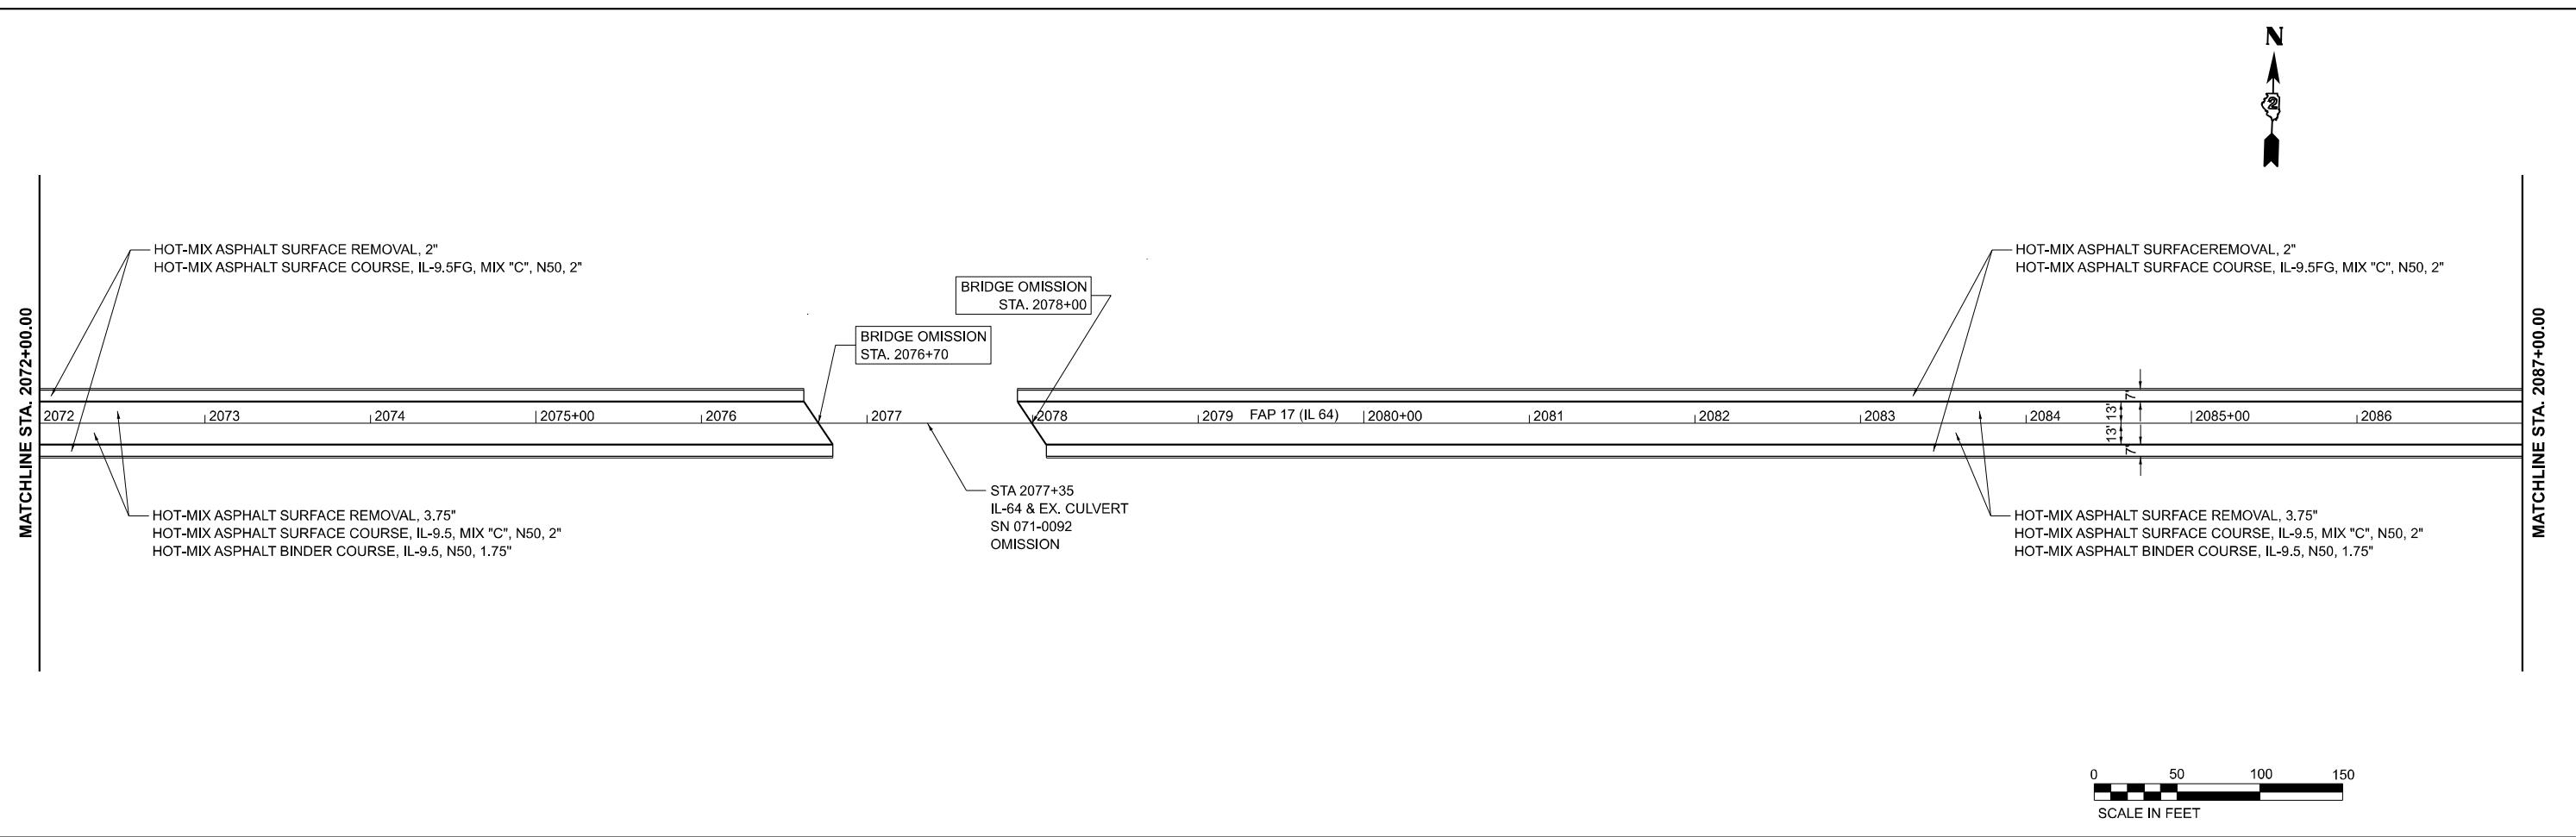



USER NAME = 10017	DESIGNED - CG	REVISED -
	DRAWN - MA	REVISED -
PLOT SCALE = 0.16666552' / In.	CHECKED - CK	REVISED -
PLOT DATE = 02/29/24	DATE - 02/29/2024	REVISED -

STATE OF ILLINOIS
DEPARTMENT OF TRANSPORTATION

IL-64 FROM IL-251 TO DEKALB COUNTY LINE
RESURFACING PLAN

SCALE: 1" = 50' SHEET 12 OF 12 SHEETS STA. TO STA.



0 50 100 150
SCALE IN FEET

MATCHLINE STA. 2102+00.00

HOT-MIX ASPHALT SURFACE REMOVAL, 2"
HOT-MIX ASPHALT SURFACE COURSE, IL-9.5FG, MIX "C", N50, 2"

PC STA 2108+20.82

PI STA 2108+88.09

PT STA 2109+55.26

HOT-MIX ASPHALT SURFACE REMOVAL, 3.75"
HOT-MIX ASPHALT SURFACE COURSE, IL-9.5, MIX "C", N50, 2"
HOT-MIX ASPHALT BINDER COURSE, IL-9.5, N50, 1.75"

EX CURVE
PI STA = 2108+88.09
 $\Delta = 05^{\circ}08'06''$ (RT)
 $D = 03^{\circ}49'11''$
 $R = 1,500.00'$
 $T = 67.26'$
 $L = 134.43'$
 $E = 1.51'$
e = MATCH EXISTING
PC STA = 2108+20.82
PT STA = 2109+55.26

PROJECT ENDS
STA. 2109+55.26

FAP 17 (IL 64)

131131

2102

131131

2103

12104

12105+00

12106

12107

12108


12109

F.A.P. RTE.	SECTION	COUNTY	TOTAL SHEETS	SHEET NO.
17	D2 PP 2023-02	OGLE	46	34
				CONTRACT NO. 64R99

ILLINOIS FED.AID PROJECT

WORK ZONE SIGN DETAILS

ILLINOIS STANDARD G20-I100

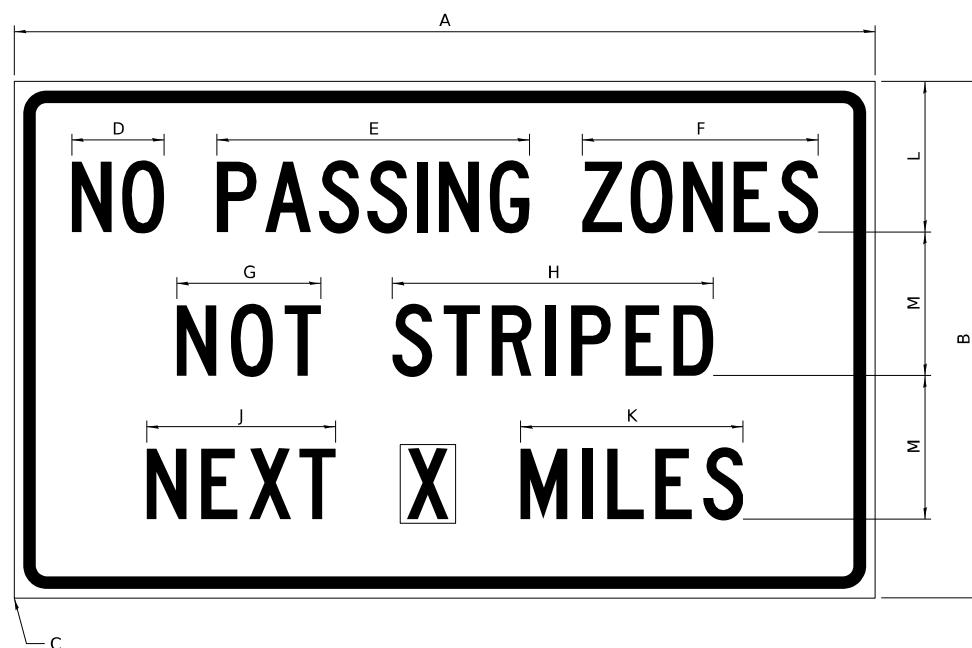

COLOR LEGEND AND BORDER
BACKGROUND BLACK ORANGE NON-REFLECTORIZED
REFLECTORIZED

SIGN SIZE	DIMENSIONS											
	A	B	C	D	E	F	G	H	J	K	L	M
60 x 36	60.00	36.00	2.25	6.4	21.80	16.40	10.00	22.40	13.20	15.50	10.50	10.00

SIGN SIZE	SERIES BY LINE			MARGIN	BORDER
	1	2	3		
60 x 36	5C	5C	5C	0.625	0.875

Sign not to scale

GENERAL NOTES


All work to furnish and install these signs shall be included in the cost of the specified traffic control standards and shall not be paid separately.

All Illinois Standard signs shall conform to the latest edition of the "Illinois Standard Highway Signs Book" in effect on the date of invitation for bids.

Signs shall meet the applicable portions of Sections 701 and 720 of the Standard Specifications.

All dimensions are in inches unless otherwise noted.

ILLINOIS STANDARD W8-I107

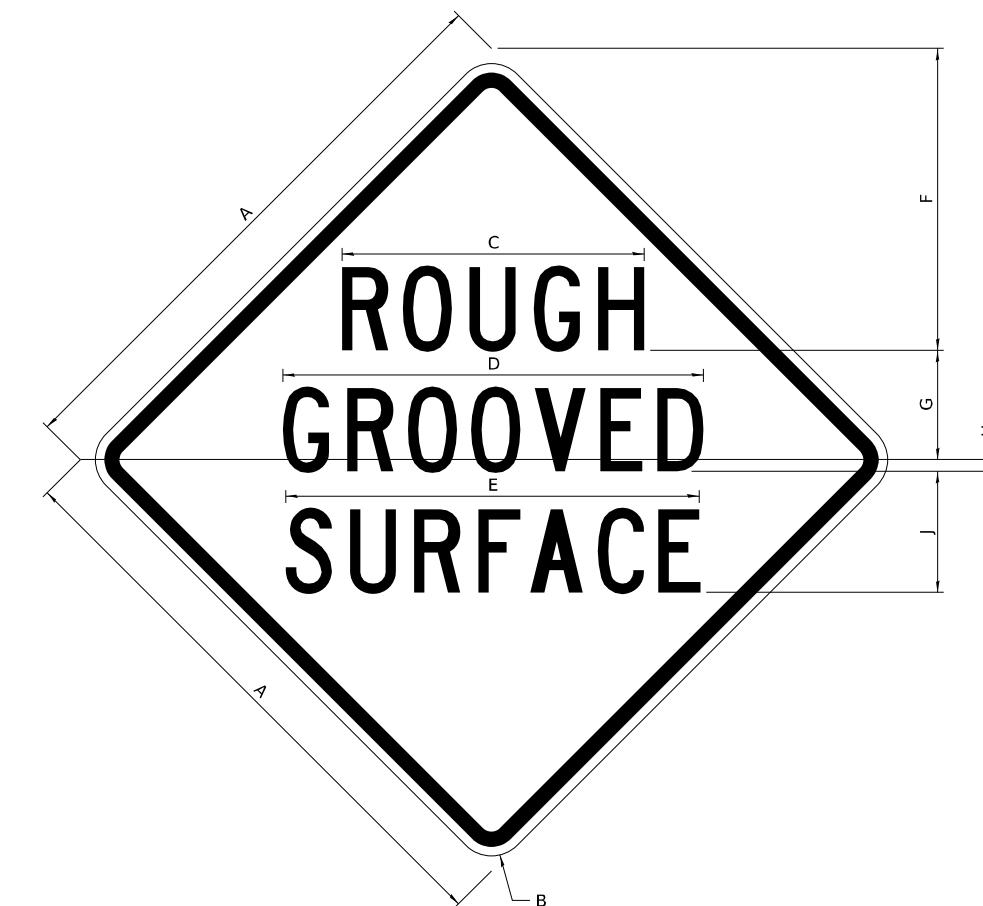

COLOR LEGEND AND BORDER
BACKGROUND BLACK ORANGE NON-REFLECTORIZED
REFLECTORIZED

SIGN SIZE	DIMENSIONS								
	A	B	C	D	E	F	G	H	J
48 x 48	48.00	3.00	25.00	34.80	34.20	24.94	9.00	1.00	10.00

SIGN SIZE	SERIES BY LINE			MARGIN	BORDER
	1	2	3		
48 x 48	7C	7C	7C	1.250	0.750

Sign not to scale

FILE NAME: \$MODEL NAMES
PLOT DATE: = 02/29/24

USER NAME = 10017	DESIGNED -	REVISED -
DRAWN -	REVISED -	
PLOT SCALE = 2,000' / In.	CHECKED -	REVISED -
PLOT DATE = 02/29/24	DATE -	REVISED -

STATE OF ILLINOIS
DEPARTMENT OF TRANSPORTATION

REGION 2 / DISTRICT 2 STANDARD

F.A. RTE.	SECTION	COUNTY	TOTAL SHEETS	SHEET NO.
				CONTRACT NO.

SCALE: SHEET OF SHEETS STA. TO STA.

ILLINOIS FED. AID PROJECT

FILE NAME: \$FIELD

Stanley Consultants Inc.
800 N. Michigan Ave., Suite 1700, Chicago, Illinois 60611-2601
www.stanleyconsultants.com
State Fire Registration No. 104-001533

USER NAME = 10017	DESIGNED -	REVISED -
DRAWN -	REVISED -	
PLOT SCALE = 2,000' / In.	CHECKED -	REVISED -
PLOT DATE = 02/29/24	DATE -	REVISED -

STATE OF ILLINOIS
DEPARTMENT OF TRANSPORTATION

DISTRICT 2 STANDARD DETAILS

F.A.P. RTE.	SECTION	COUNTY	TOTAL SHEETS	SHEET NO.
17	D2 PP 2023-02	OGLE	46	35
				CONTRACT NO. 64R99


SCALE: NONE SHEET 1 OF 12 SHEETS STA. TO STA.

ILLINOIS FED. AID PROJECT

WORK ZONE SIGN DETAILS SHEET 1 OF 4 34.1

WORK ZONE SIGN DETAILS

ILLINOIS STANDARD W12-I102

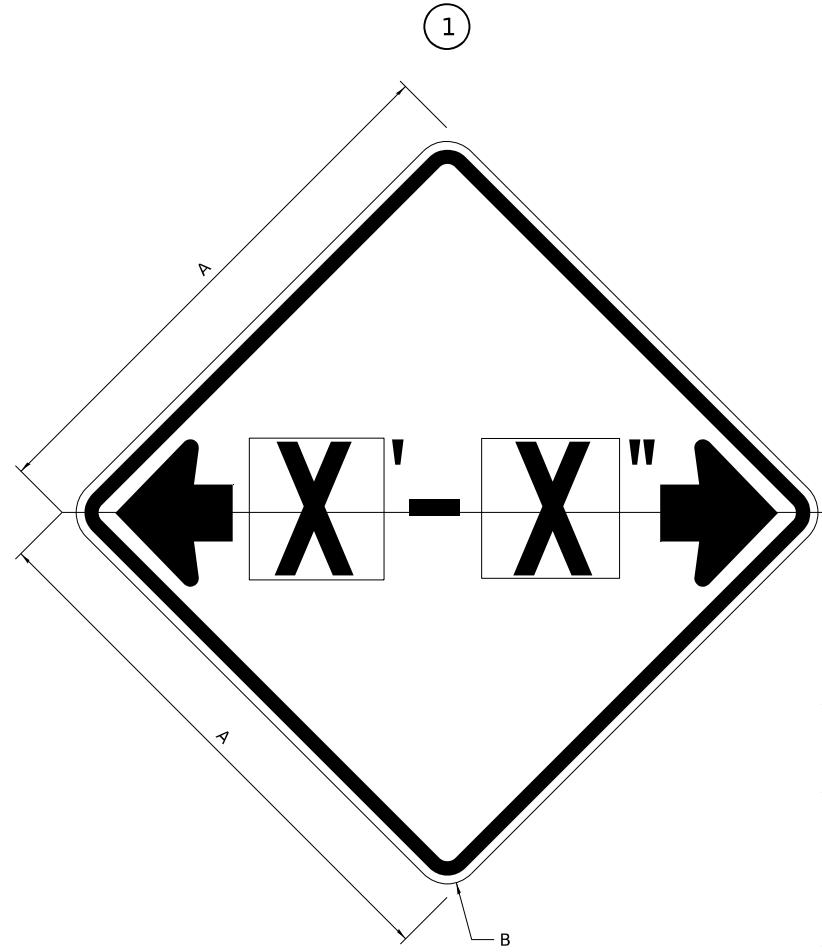

GENERAL NOTES

All work to furnish and install these signs shall be included in the cost of the specified traffic control standards and shall not be paid separately.

All Illinois Standard signs shall conform to the latest edition of the "Illinois Standard Highway Signs Book" in effect on the date of invitation for bids.

Signs shall meet the applicable portions of Sections 701 and 720 of the Standard Specifications.

All dimensions are in inches unless otherwise noted.

COLOR	LEGEND AND BORDER BACKGROUND	BLACK FL ORANGE
-------	---------------------------------	--------------------

NON-REFLECTORIZED

SIGN SIZE	DIMENSIONS	
	A	B
48 x 48	48.00	3.00

(1) Illinois Standard signs W12-I102 and W12-I103 shall be used as described in the special provisions.


SIGN SIZE	SERIES BY LINE	MARGIN	BORDER	DIMENSIONS	
				1	2
48 x 48	12C	0.750	1.250		

Sign not to scale

FILE NAME: \$MODELNAME\$
PLOT DATE: = 02/29/24

STATE OF ILLINOIS
DEPARTMENT OF TRANSPORTATION

ILLINOIS STANDARD W12-I103

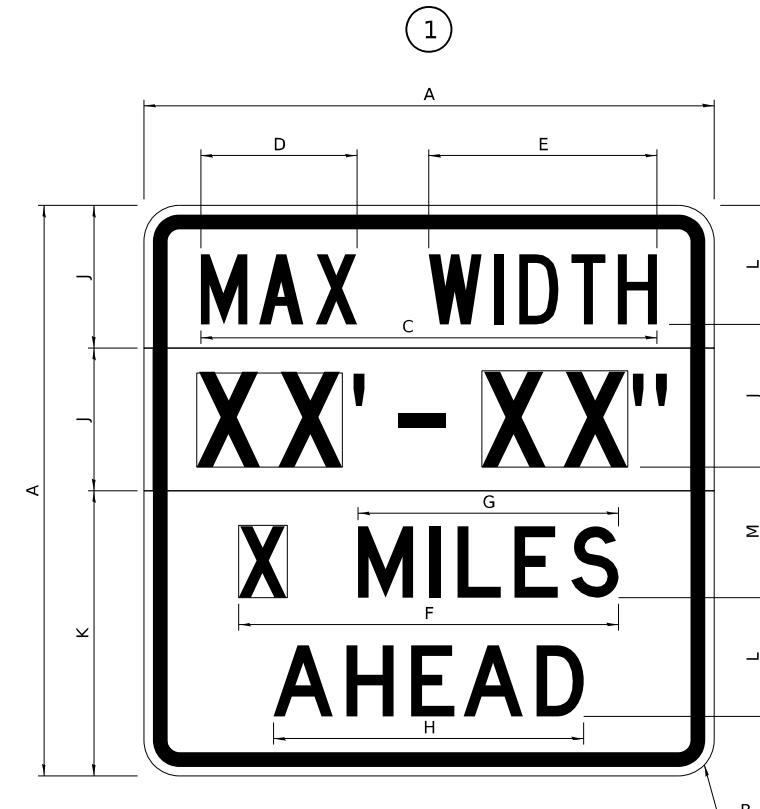

COLOR	LEGEND AND BORDER BACKGROUND	BLACK	NON-REFLECTORIZED
	BACKGROUND (WIDTH)	WHITE FL ORANGE	REFLECTORIZED REFLECTORIZED

SIGN SIZE	DIMENSIONS											
	A	B	C	D	E	F	G	H	J	K	L	M
48 x 48	48.00	3.00	38.40	13.20	19.20	32.00	22.00	26.20	12.00	24.00	10.00	11.00

SIGN SIZE	SERIES BY LINE				MARGIN	BORDER
	1	2	3	4		
48 x 48	6C	8D	6D	6D	0.750	1.250

Sign not to scale

XX'-XX" WIDTH AND X MILES ARE VARIABLE
TOP AND BOTTOM OF BACKGROUND WHITE

F.A. RTE.	SECTION	COUNTY	TOTAL SHEETS	SHEET NO.
				ILLINOIS FED.AID PROJECT

FILE NAME: \$MODELNAME\$
PLOT DATE: = 02/29/24

Stanley Consultants Inc.
800 N. Michigan Ave., Suite 1700, Chicago, Illinois 60611-2601
www.stanleyconsultants.com
State Fire Registration No. 104-001533

USER NAME = 10017	DESIGNED -	REVISED -
DRAWN -	REVISED -	
PLOT SCALE = 2,000' / In.	CHECKED -	REVISED -
PLOT DATE = 02/29/24	DATE -	REVISED -

STATE OF ILLINOIS
DEPARTMENT OF TRANSPORTATION

DISTRICT 2 STANDARD DETAILS

F.A.P. RTE.	SECTION	COUNTY	TOTAL SHEETS	SHEET NO.
17	D2 PP 2023-02	OGLE	46	36


ILLINOIS FED.AID PROJECT

CONTRACT NO. 64R99

WORK ZONE SIGN DETAILS SHEET 2 OF 4 34.1

WORK ZONE SIGN DETAILS

ROAD CLOSED TO OVERSIZED LOADS

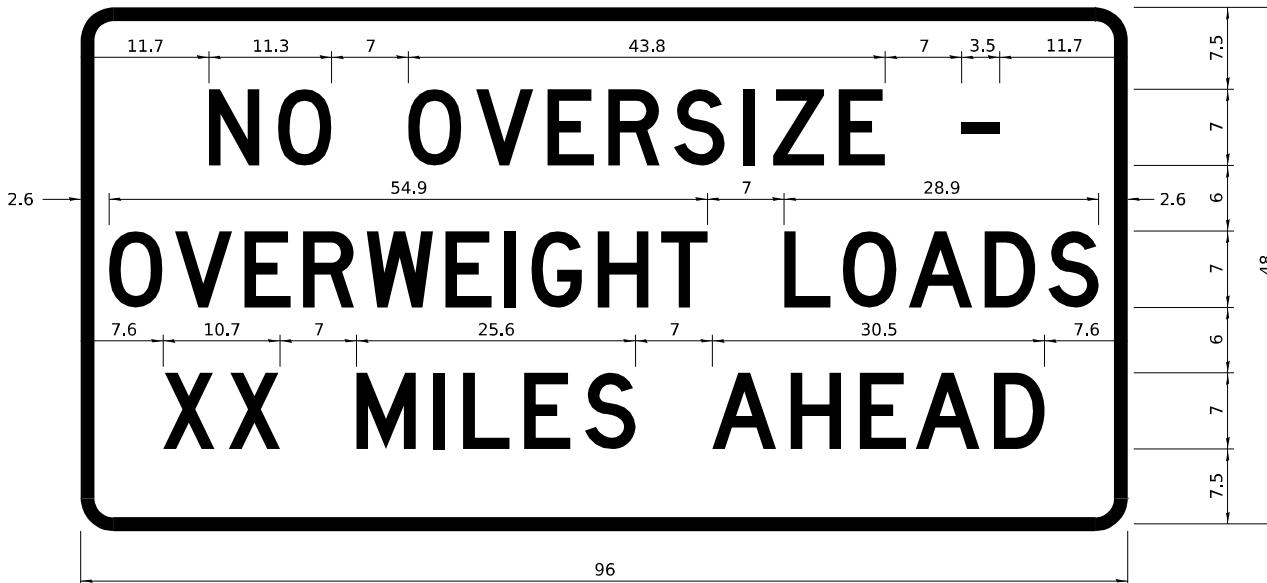

COLOR LEGEND AND BORDER BACKGROUND

BLACK
ORANGE

NON-REFLECTORIZED
REFLECTORIZED

Permit Loads - Loads Over 13 Feet; 3.0" Radius, 1.3" Border;
[NO OVERSIZE -] D; [OVERWEIGHT LOADS] D 85% spacing; [XX MILES AHEAD] D;
Table of letter and object lefts.

N 11.7	O 18.1	O 30.0	V 36.2	E 42.8	R 48.4	S 54.4	I 60.7	Z 63.5	E 69.5	- 80.8
-----------	-----------	-----------	-----------	-----------	-----------	-----------	-----------	-----------	-----------	-----------

O 2.6	V 8.6	E 15.0	R 20.4	W 26.2	E 33.4	I 38.8	G 41.3	H 47.4	T 53.2	L 64.5	O 69.9	A 75.9	D 82.9	S 88.7
----------	----------	-----------	-----------	-----------	-----------	-----------	-----------	-----------	-----------	-----------	-----------	-----------	-----------	-----------

X 7.6	X 13.6	M 25.3	I 32.3	L 35.1	E 40.6	S 46.2	A 57.9	H 65.1	E 71.4	A 76.6	D 83.7
----------	-----------	-----------	-----------	-----------	-----------	-----------	-----------	-----------	-----------	-----------	-----------

Sign not to scale

STOP LINE SIGN FOR TEMPORARY SIGNALS



COLOR LEGEND AND BORDER BACKGROUND BLACK WHITE

NON-REFLECTORIZED REFLECTORIZED

SIGN SIZE	SERIES BY LINE		
	1	2	3
24 x 24	4C	4C	4C

Sign not to scale

GENERAL NOTES

All work to furnish and install these signs shall be included in the cost of the specified traffic control standards and shall not be paid separately.

All Illinois Standard signs shall conform to the latest edition of the "Illinois Standard Highway Signs Book" in effect on the date of invitation for bids.

Signs shall meet the applicable portions of Sections 701 and 720 of the Standard Specifications.

All dimensions are in inches unless otherwise noted.

MODEL: \$002924
FILE NAME: \$002924

USER NAME = 10017	DESIGNED -	REVISED -	3-02-16
DRAWN -	REVISED -		
PLOT SCALE = 2,000' / In.	CHECKED -	REVISED -	
PLOT DATE = 02/29/24	DATE -	REVISED -	

STATE OF ILLINOIS
DEPARTMENT OF TRANSPORTATION

REGION 2 / DISTRICT 2 STANDARD

F.A. RTE.	SECTION	COUNTY	TOTAL SHEETS	SHEET NO.
				CONTRACT NO.

MODEL: \$002924
FILE NAME: \$002924

Stanley Consultants Inc.
800 N. Michigan Ave., Suite 700, Chicago, Illinois 60611-2601
www.stanleyconsultants.com
State Fire Registration No. 104-007533

USER NAME = 10017	DESIGNED -	REVISED -	
DRAWN -	REVISED -		
PLOT SCALE = 2,000' / In.	CHECKED -	REVISED -	
PLOT DATE = 02/29/24	DATE -	REVISED -	

STATE OF ILLINOIS
DEPARTMENT OF TRANSPORTATION

DISTRICT 2 STANDARD DETAILS

F.A.P. RTE.	SECTION	COUNTY	TOTAL SHEETS	SHEET NO.
17	D2 PP 2023-02	OGLE	46	37


ILLINOIS FED. AID PROJECT

WORK ZONE SIGN DETAILS SHEET 3 OF 4 34.1

SCALE: NONE	SHEET 3	OF 12 SHEETS STA.	TO STA.	ILLINOIS FED. AID PROJECT
-------------	---------	-------------------	---------	---------------------------

**ENTRANCE SIGN FOR USE
WITH TEMPORARY SIGNALS**

(2)

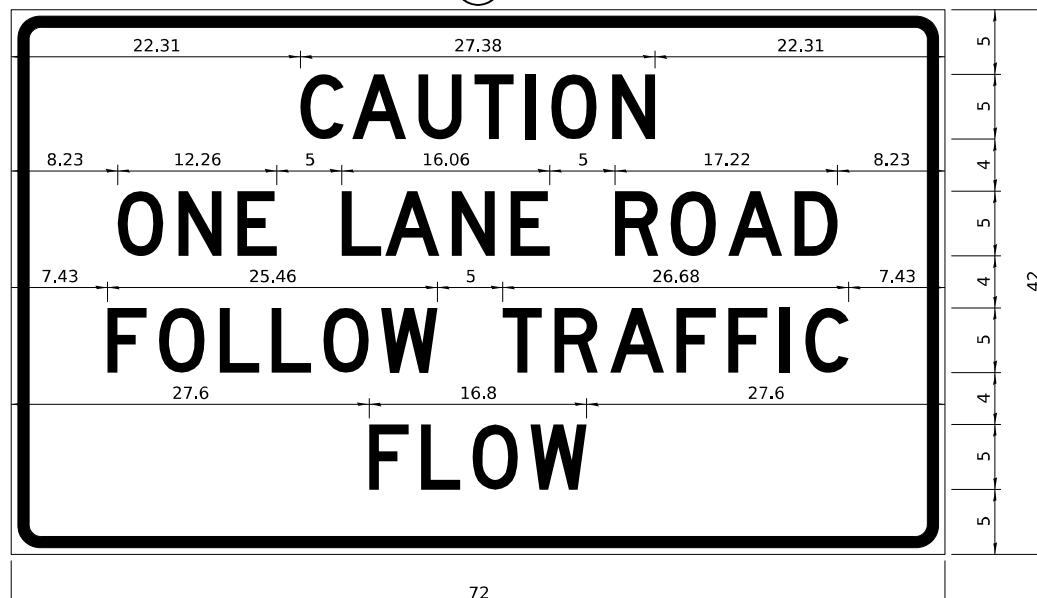

COLOR LEGEND AND BORDER
BACKGROUND BLACK
ORANGE NON-REFLECTORIZED
REFLECTORIZED

2.25" Radius, 0.88" Border, 0.50" IndenT;
[CAUTION] D; [ONE LANE ROAD] D;
[FOLLOW TRAFFIC] D; [FLOW] D

(2) This sign shall be installed at entrances located between
the temporary signals as shown in the staging plans.

Table Of Widths And Spaces

22.31	C	3.36	0.62	A	4.18	0.94	U	3.36	0.94	T	3.04	0.94	I	0.78	1.17	O	3.52	1.17	N	3.36	22.31
-------	---	------	------	---	------	------	---	------	------	---	------	------	---	------	------	---	------	------	---	------	-------

8.23	O	3.51	1.17	N	3.36	1.18	E	3.04
------	---	------	------	---	------	------	---	------

5.00	L	3.05	0.31	A	4.18	0.94	N	3.36	1.17	E	3.05
------	---	------	------	---	------	------	---	------	------	---	------

5.00	R	3.36	0.93	O	3.52	0.94	A	4.18	0.93	D	3.36	8.23
------	---	------	------	---	------	------	---	------	------	---	------	------

7.43	F	3.04	0.94	O	3.52	1.17	L	3.04	0.94	L	3.05	0.94	O	3.51	0.94	W	4.37
------	---	------	------	---	------	------	---	------	------	---	------	------	---	------	------	---	------


5.00	T	3.05	0.94	R	3.36	0.94	A	4.18	0.93	F	3.05	0.94	F	3.04	0.94	I	0.78	1.18	C	3.35	7.43
------	---	------	------	---	------	------	---	------	------	---	------	------	---	------	------	---	------	------	---	------	------

27.60	F	3.05	0.94	L	3.04	0.94	O	3.52	0.93	W	4.38	27.60
-------	---	------	------	---	------	------	---	------	------	---	------	-------

Sign not to scale

WORK ZONE SIGN DETAILS

STAY IN YOUR LANE

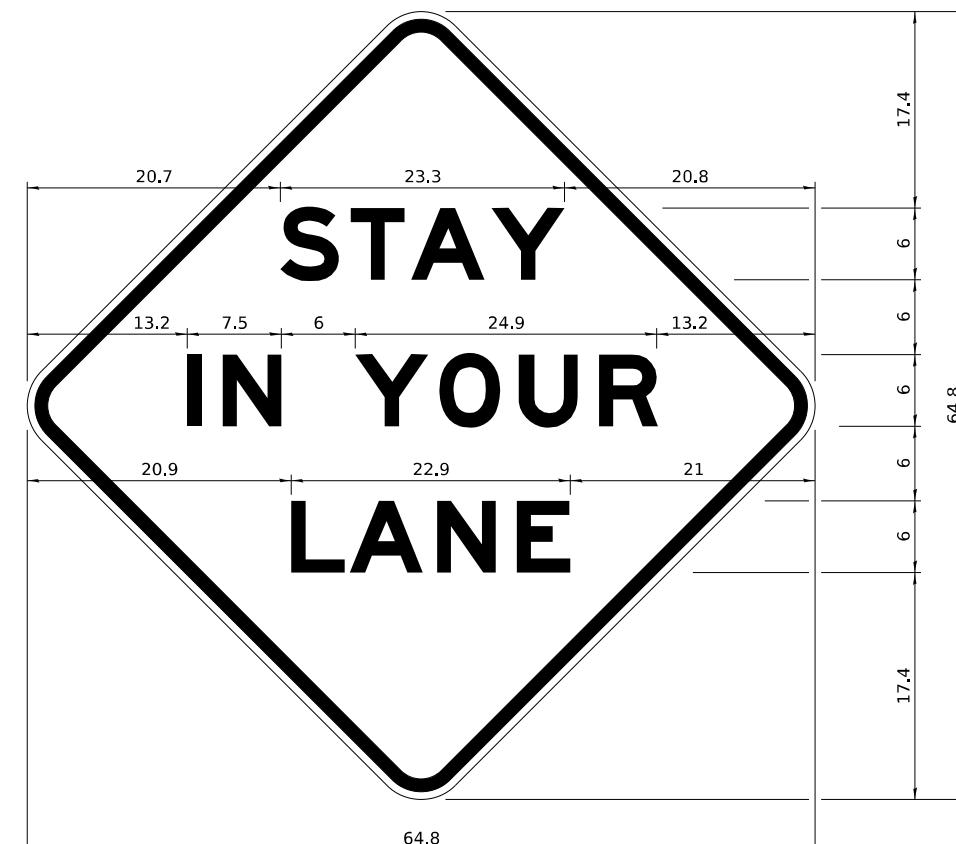

GENERAL NOTES

All work to furnish and install these signs shall be included in the cost of the specified traffic control standards and shall not be paid separately.

All Illinois Standard signs shall conform to the latest edition of the "Illinois Standard Highway Signs Book" in effect on the date of invitation for bids.

Signs shall meet the applicable portions of Sections 701 and 720 of the Standard Specifications.

All dimensions are in inches unless otherwise noted.

COLOR LEGEND AND BORDER
BACKGROUND BLACK
ORANGE NON-REFLECTORIZED
REFLECTORIZED

48.0" across sides 3.8" Radius, 1.0" Border, 0.6" Indent;
"STAY" E Mod; "IN YOUR" E Mod; "LANE" E Mod;

Table of Letter and Object Lefts

S	T	A	Y
20.7	26.8	31.6	38.0

I	N	Y	O	U	R
13.2	15.9	26.7	33.9	40.5	46.8

L	A	N	E
20.9	25.8	33.1	39.4

Sign not to scale

MODEL: \$002924
FILE NAME: \$002924

USER NAME = 10017
DESIGNED -
DRAWN -
PLOT SCALE = 2,000' / In.
PLOT DATE = 02/29/24

REVISED -
REVISED -
REVISED -
REVISED -
DATE -

STATE OF ILLINOIS
DEPARTMENT OF TRANSPORTATION

REGION 2 / DISTRICT 2 STANDARD

FA. RTE.	SECTION	COUNTY	TOTAL SHEETS	SHEET NO.
				CONTRACT NO.
				ILLINOIS FED.AID PROJECT

STATE OF ILLINOIS
DEPARTMENT OF TRANSPORTATION

DISTRICT 2 STANDARD DETAILS

F.A.P. RTE.	SECTION	COUNTY	TOTAL SHEETS	SHEET NO.
17	D2 PP 2023-02	OGLE	46	38
				CONTRACT NO. 64R99
				ILLINOIS FED.AID PROJECT

FILE NAME: \$002924
Stanley Consultants Inc.
800 N Michigan Ave., Suite 2000, Chicago, Illinois 60611-3353
www.stanleyconsultants.com
State Fire Registration No. 104-001753

Stanley Consultants Inc.
800 N Michigan Ave., Suite 2000, Chicago, Illinois 60611-3353
www.stanleyconsultants.com
State Fire Registration No. 104-001753

USER NAME = 10017
DESIGNED -
DRAWN -
PLOT SCALE = 2,000' / In.
PLOT DATE = 02/29/24

REVISED -
REVISED -
REVISED -
REVISED -
DATE - 02/29/2024

STATE OF ILLINOIS
DEPARTMENT OF TRANSPORTATION


SCALE: NONE SHEET 4 OF 12 SHEETS STA. TO STA.

ILLINOIS FED.AID PROJECT


TYPICAL PAVEMENT MARKINGS

TYPICAL PAVEMENT MARKING FOR FLUSH MEDIAN


AT LEFT TURN LANE

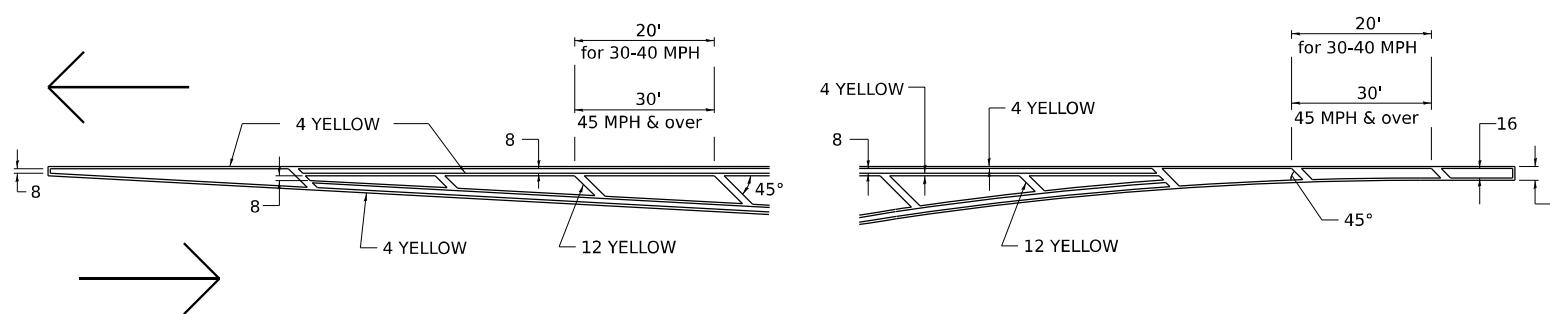


TYPICAL ISLAND OFFSET SHOULDER WIDTH

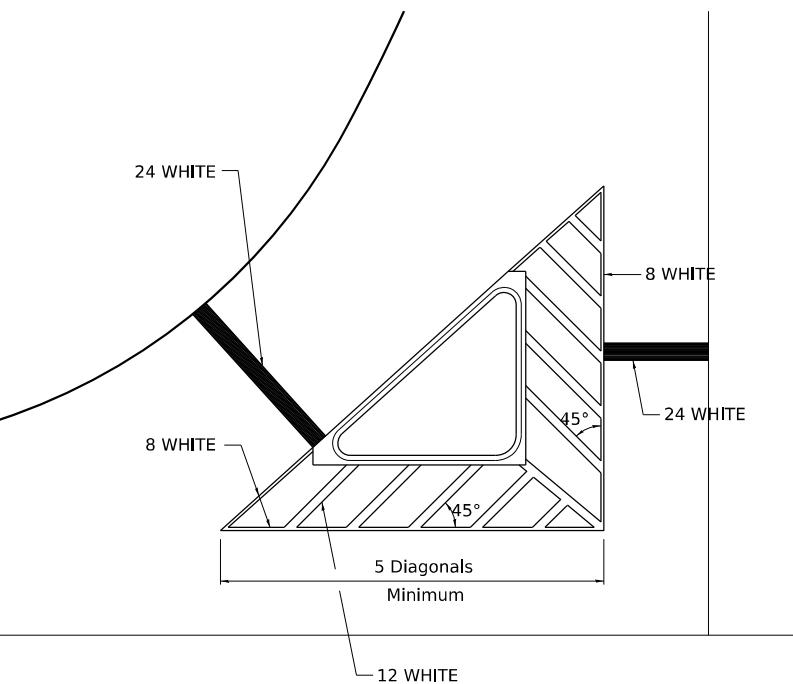

TYPICAL MARKING FOR PAINTED ISLANDS

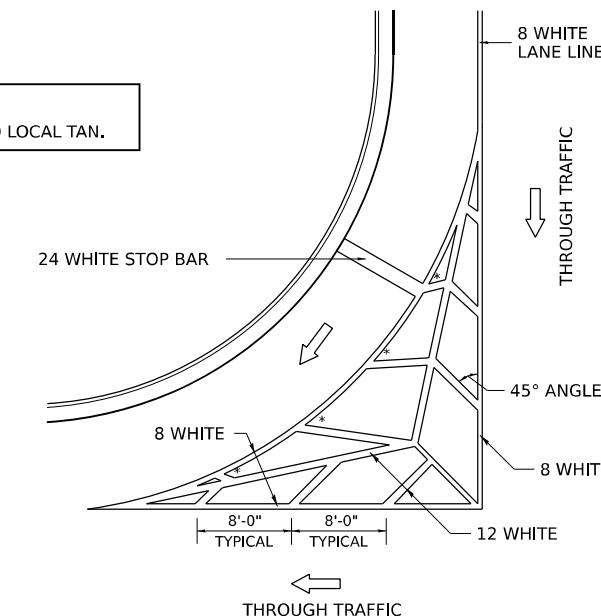


MEDIAN PAVEMENT MARKING

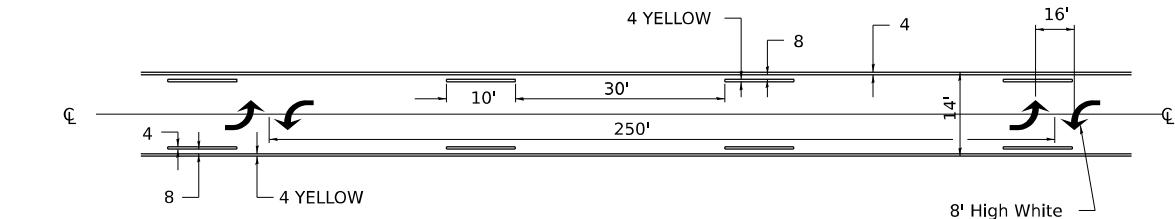

** ALL DIMENSIONS ARE IN INCHES UNLESS OTHERWISE NOTED.

STANDARD CROSSWALK MARKING

See Schedules for Locations

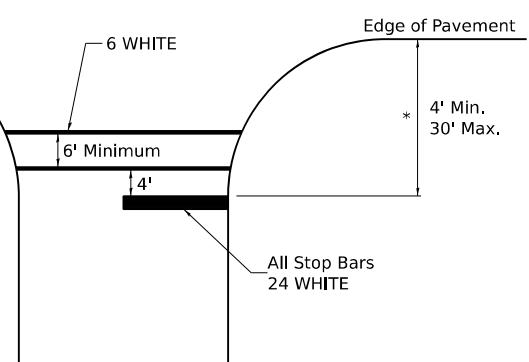

* Distance to the nearest edge of the intersecting roadway in the absence of a marked crosswalk.

FILE NAME: \$MODEL NAMES
PLOT DATE: = 02/29/24

USER NAME = 10017	DESIGNED -	REVISED -
DRAWN -	REVISED -	6-27-14
PLOT SCALE = 2,000' / In.	CHECKED -	3-05-12
PLOT DATE = 02/29/24	DATE -	REVISED -

STATE OF ILLINOIS
DEPARTMENT OF TRANSPORTATION

REGION 2 / DISTRICT 2 STANDARD

FA. RTE.	SECTION	COUNTY	TOTAL SHEETS	SHEET NO.
				CONTRACT NO.

FILE NAME: \$FILE.SL

Stanley Consultants Inc.
800 N. Michigan Ave., Suite 700, Chicago, Illinois 60611-2601
www.stanleyconsultants.com
State Fire Registration No. 104-001533

USER NAME = 10017	DESIGNED -	REVISED -
DRAWN -	REVISED -	-
PLOT SCALE = 2,000' / In.	CHECKED -	REVISED -
PLOT DATE = 02/29/24	DATE -	REVISED -

STATE OF ILLINOIS
DEPARTMENT OF TRANSPORTATION

DISTRICT 2 STANDARD DETAILS

F.A.P. RTE.	SECTION	COUNTY	TOTAL SHEETS	SHEET NO.
17	D2 PP 2023-02	OGLE	46	39

CONTRACT NO. 64R99


TYPICAL PAVEMENT MARKINGS SHEET 1 OF 4 41.1

SCALE: NONE SHEET 5 OF 12 SHEETS STA. TO STA.

ILLINOIS FED.AID PROJECT

TYPICAL PAVEMENT MARKINGS


ARROW LAYOUT

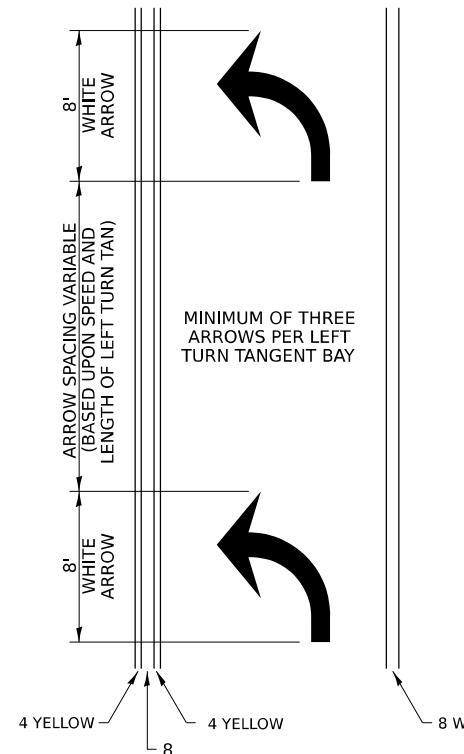


SYMBOLS

- ◀ ONE-WAY AMBER MARKER
- △ ONE-WAY CRYSTAL MARKER
- ◆ TWO-WAY AMBER MARKER

ALL DIMENSIONS ARE IN INCHES
UNLESS OTHERWISE NOTED.

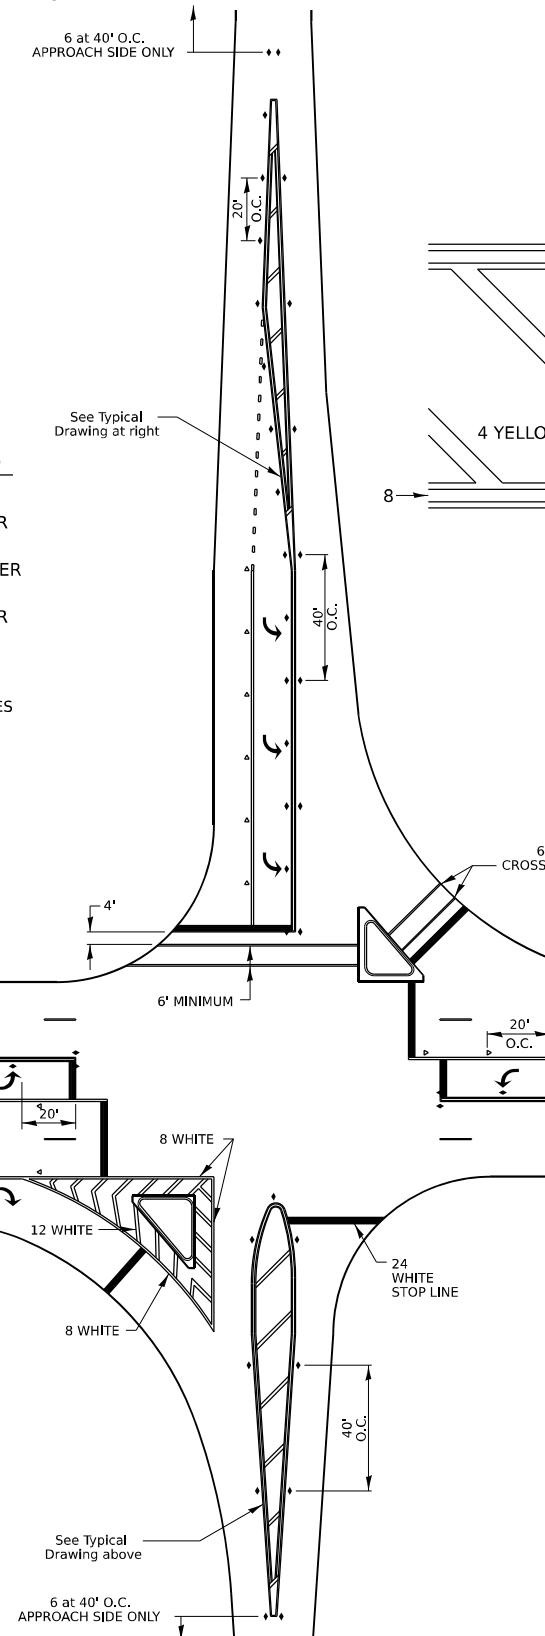


TYPICAL PAVEMENT MARKING FOR FLUSH MEDIAN

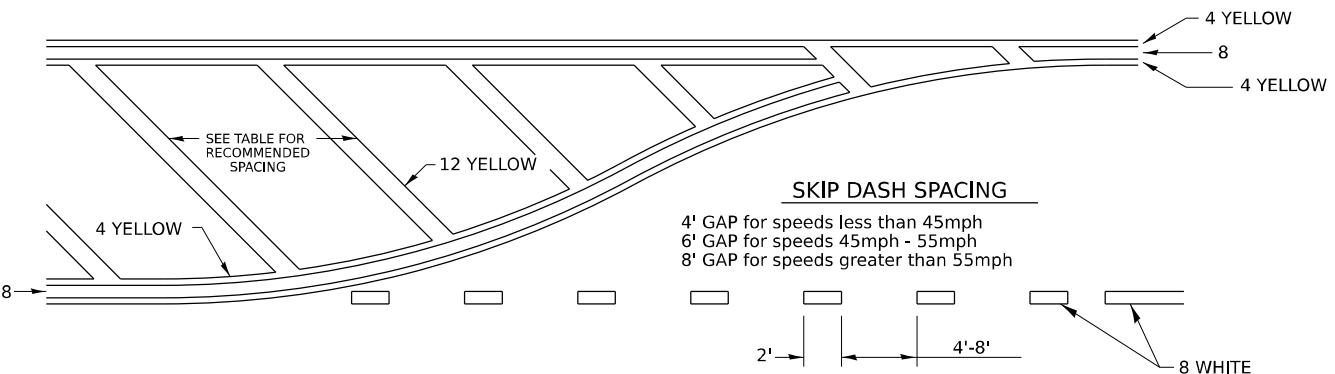

RECOMMENDED SPACING BETWEEN DIAGONALS (IN FEET)

Speed Limit Range	Continuous Median Area	Intersection Channelization	Objects (Islands)
less than 30MPH	50'	15'	10'
30-40MPH	75'	20'	15'
45MPH & over	75'	30'	20'

NOTE: if the spacing recommended in the Table does not permit at least five diagonal lines in the area being marked, the spacing from the next lowest speed range should be used. The recommended spacing is measured parallel to the pavement center line.

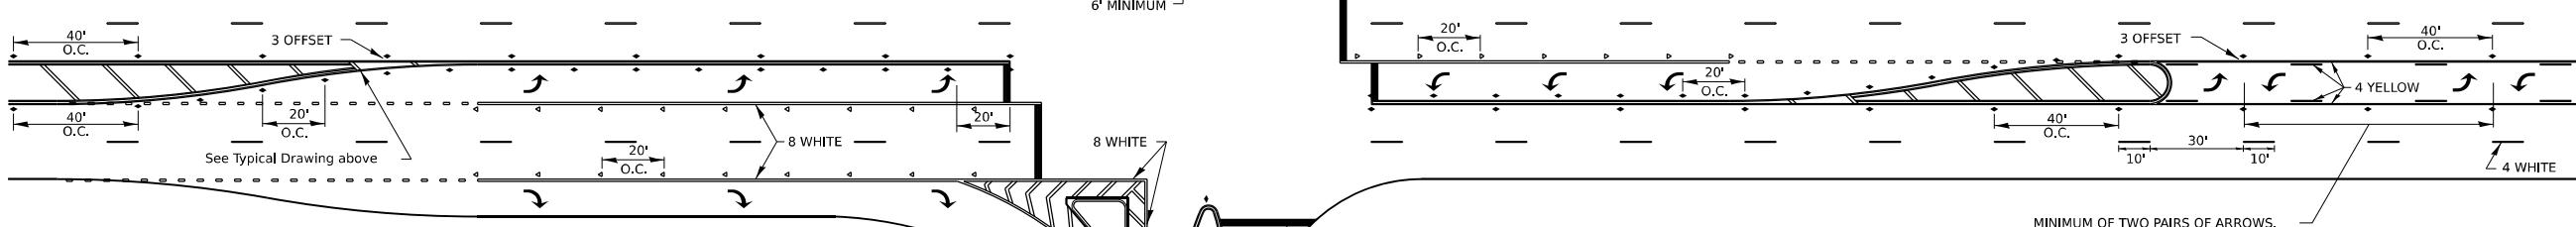

MODEL: \$MODEL NAMES
FILE NAME: \$FILE

PLOT DATE: = 02/29/24

USER NAME = 10017	DESIGNED -	REVISED -
DRAWN -	REVISED -	3-05-12
PLOT SCALE = 2,000' / In.	CHECKED -	REVISED -
PLOT DATE = 02/29/24	DATE -	REVISED -

STATE OF ILLINOIS
DEPARTMENT OF TRANSPORTATION

REGION 2 / DISTRICT 2 STANDARD

F.A. RTE.	SECTION	COUNTY	TOTAL SHEETS	SHEET NO.
				CONTRACT NO.

MODEL: \$MODEL NAMES
FILE NAME: \$FILE

Stanley Consultants Inc.
800 N. Michigan Ave., Suite 700, Chicago, Illinois 60611-2601
www.stanleyconsultants.com
Illinois Registration No. 104-007533

USER NAME = 10017	DESIGNED -	REVISED -
DRAWN -	REVISED -	
PLOT SCALE = 2,000' / In.	CHECKED -	REVISED -
PLOT DATE = 02/29/24	DATE -	REVISED -

STATE OF ILLINOIS
DEPARTMENT OF TRANSPORTATION

DISTRICT 2 STANDARD DETAILS

F.A.P. RTE.	SECTION	COUNTY	TOTAL SHEETS	SHEET NO.
17	D2 PP 2023-02	OGLE	46	40

CONTRACT NO. 64R99


TYPICAL PAVEMENT MARKINGS SHEET 2 OF 4 41.1

SCALE: NONE SHEET 6 OF 12 SHEETS STA. TO STA.


ILLINOIS FED. AID PROJECT

TYPICAL PAVEMENT MARKINGS

TYPICAL PARKING SPACING

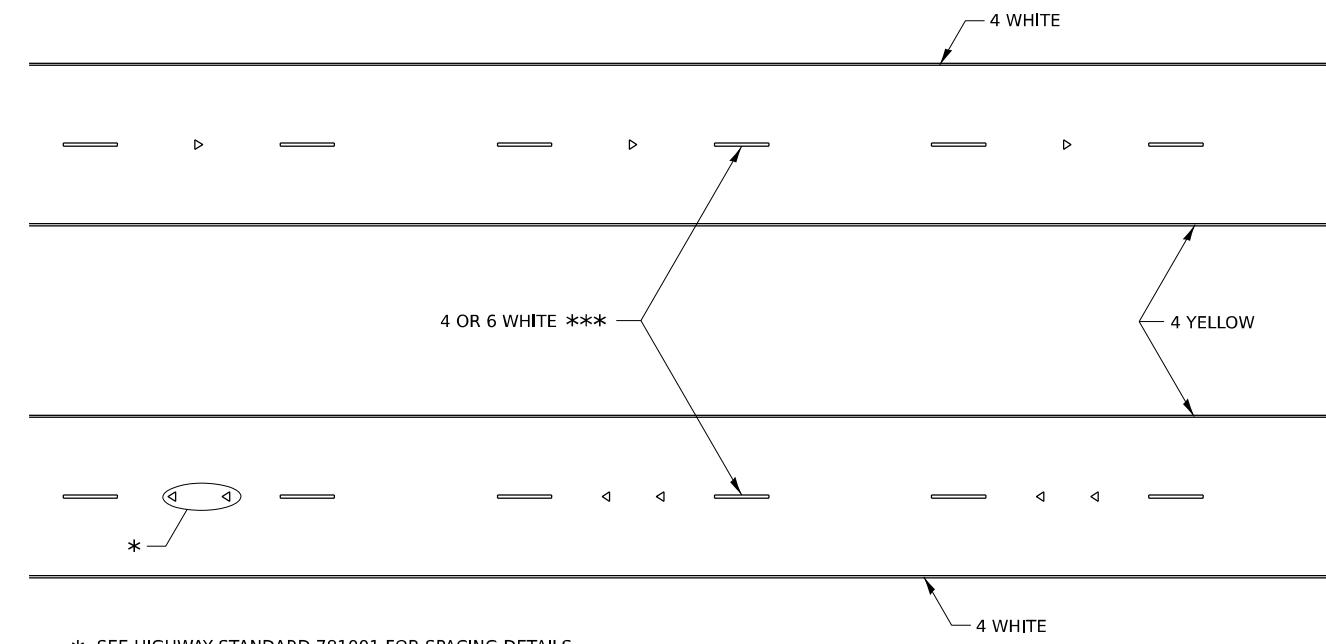


MULTI-LANE / DIVIDED

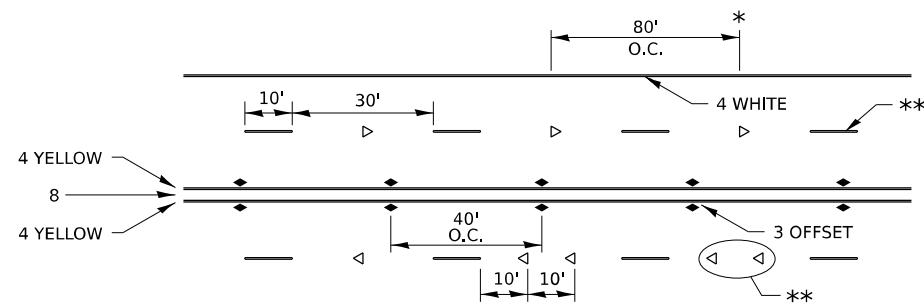


** USE DOUBLE MARKERS WHEN ADT \geq 20,000
*** CENTERLINE SKIP DASH PAVEMENT MARKING SPEED LIMIT LESS THAN 40 MPH USE 4" LINE. SPEED LIMIT 40 MPH AND OVER USE 6" LINE.

MULTI-LANE / UNDIVIDED & ONE WAY

(FOR MULTI-LANE UNDIVIDED HIGHWAYS USE THIS DETAIL NOT HIGHWAY STANDARD 781001)

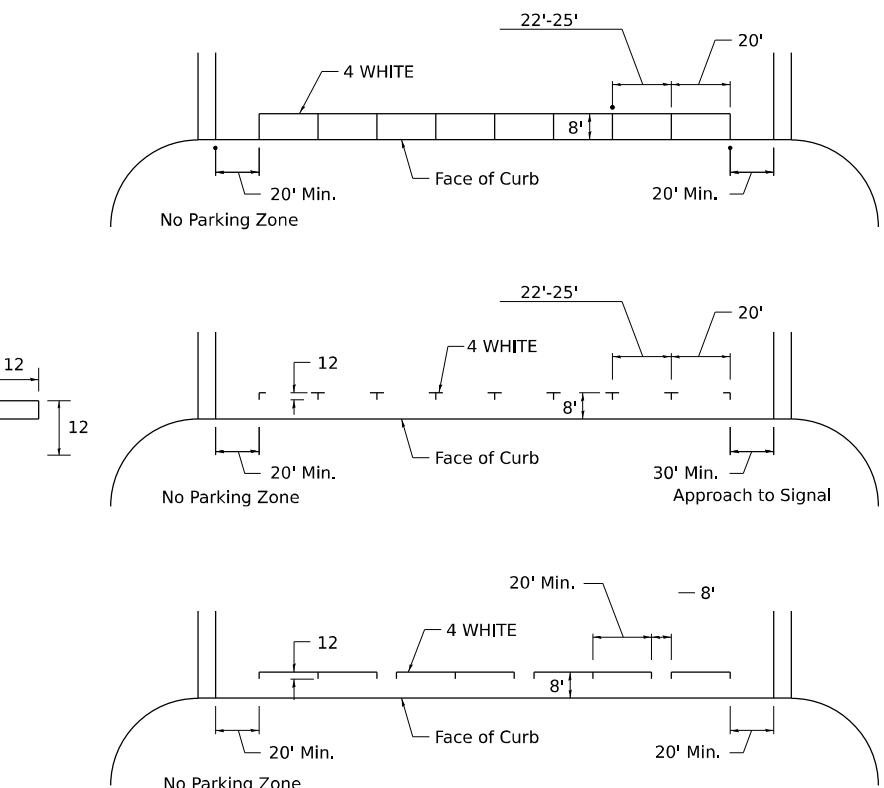

TYPICAL PAVEMENT MARKING FOR TWO LANE SECTION – NO PASSING ZONES

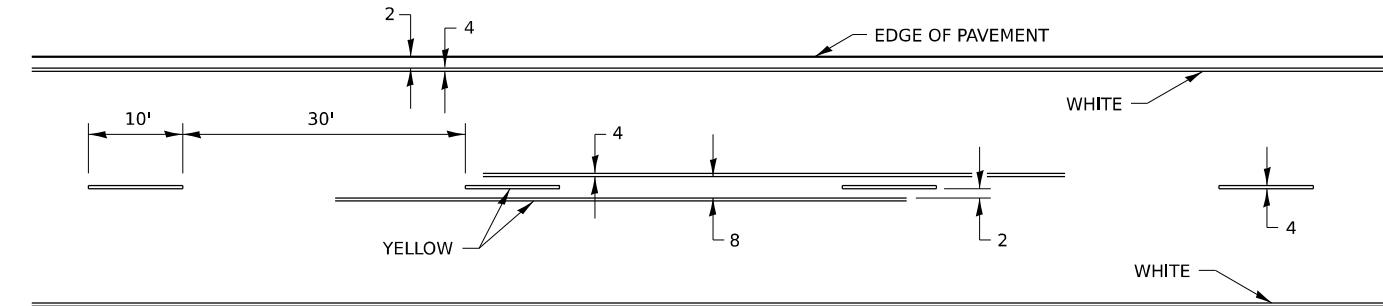

FILE NAME: \$MODELNAME\$
PLOT DATE: = 02/29/24

USER NAME = 10017	DESIGNED -	REVISED -
DRAWN -	REVISED -	6-27-14
PLOT SCALE = 2,000' / In.	CHECKED -	11-28-12
PLOT DATE = 02/29/24	DATE -	REVISED -

STATE OF ILLINOIS
DEPARTMENT OF TRANSPORTATION

REGION 2 / DISTRICT 2 STANDARD

F.A. RTE.	SECTION	COUNTY	TOTAL SHEETS	SHEET NO.
				CONTRACT NO.

STATE OF ILLINOIS
DEPARTMENT OF TRANSPORTATION

DISTRICT 2 STANDARD DETAILS

F.A.P. RTE.	SECTION	COUNTY	TOTAL SHEETS	SHEET NO.
17	D2 PP 2023-02	OGLE	46	41

ILLINOIS FED. AID PROJECT				
				CONTRACT NO. 64R99

STATE OF ILLINOIS
DEPARTMENT OF TRANSPORTATION

DISTRICT 2 STANDARD DETAILS

F.A.P. RTE.	SECTION	COUNTY	TOTAL SHEETS	SHEET NO.
17	D2 PP 2023-02	OGLE	46	41


ILLINOIS FED. AID PROJECT				
				CONTRACT NO. 64R99

TYPICAL PAVEMENT MARKINGS


** 6" WHITE ON INTERSTATES, WHERE THE SPEED LIMIT IS
65 MPH, OR WHEN DIRECTED BY THE ENGINEER.
4" WIDE AT ALL OTHER LOCATIONS.

NOTE: GORE HATCHING PLACED ONLY
WHEN SCHEDULED IN THE PLANS

EXIT RAMP

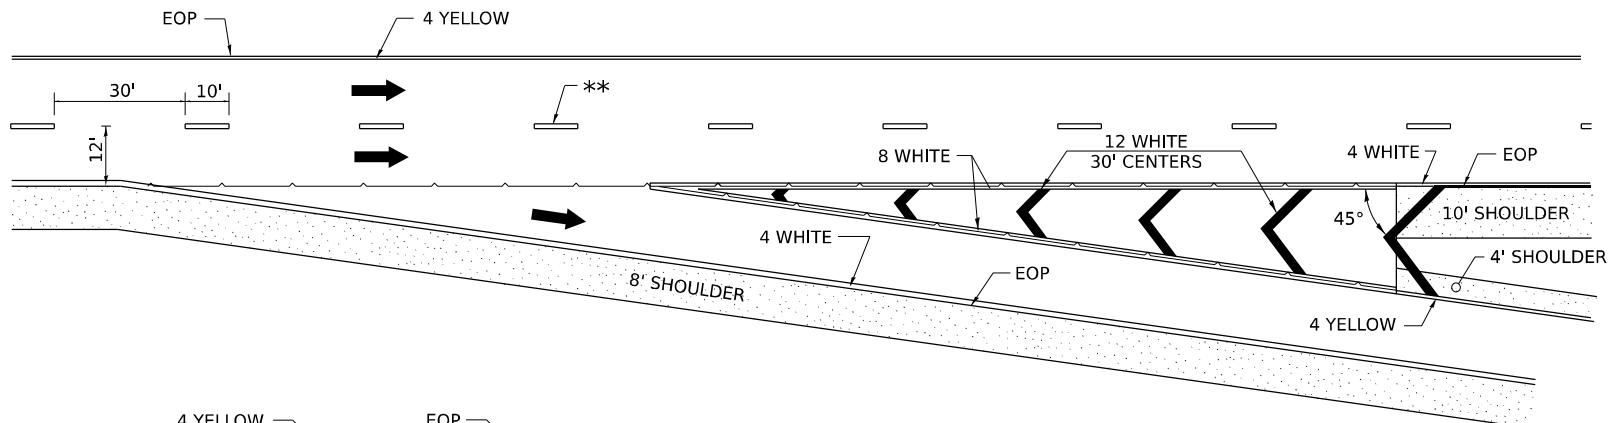


ENTRANCE RAMP

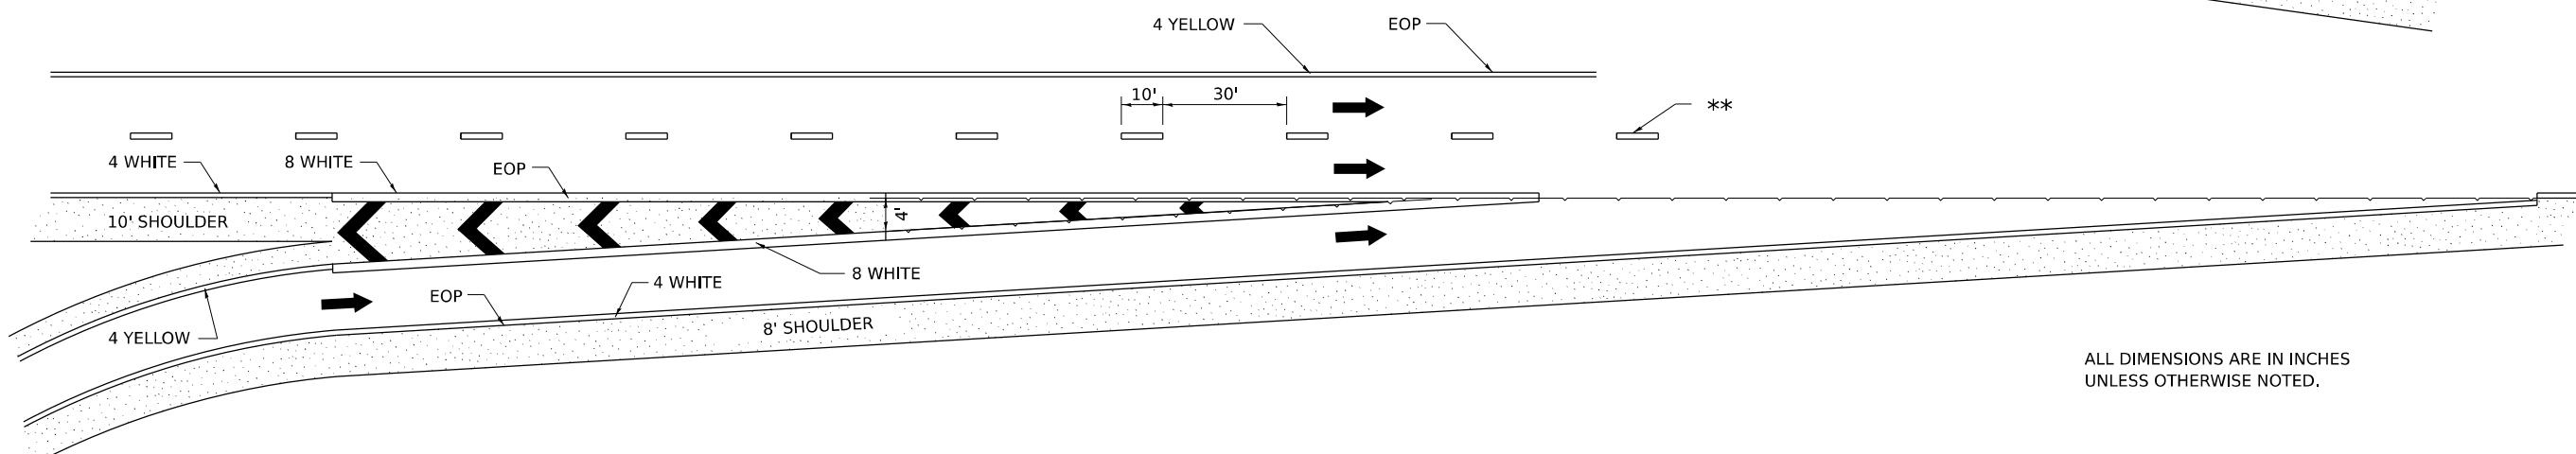

ALL DIMENSIONS ARE IN INCHES
UNLESS OTHERWISE NOTED.

CLOVERLEAF

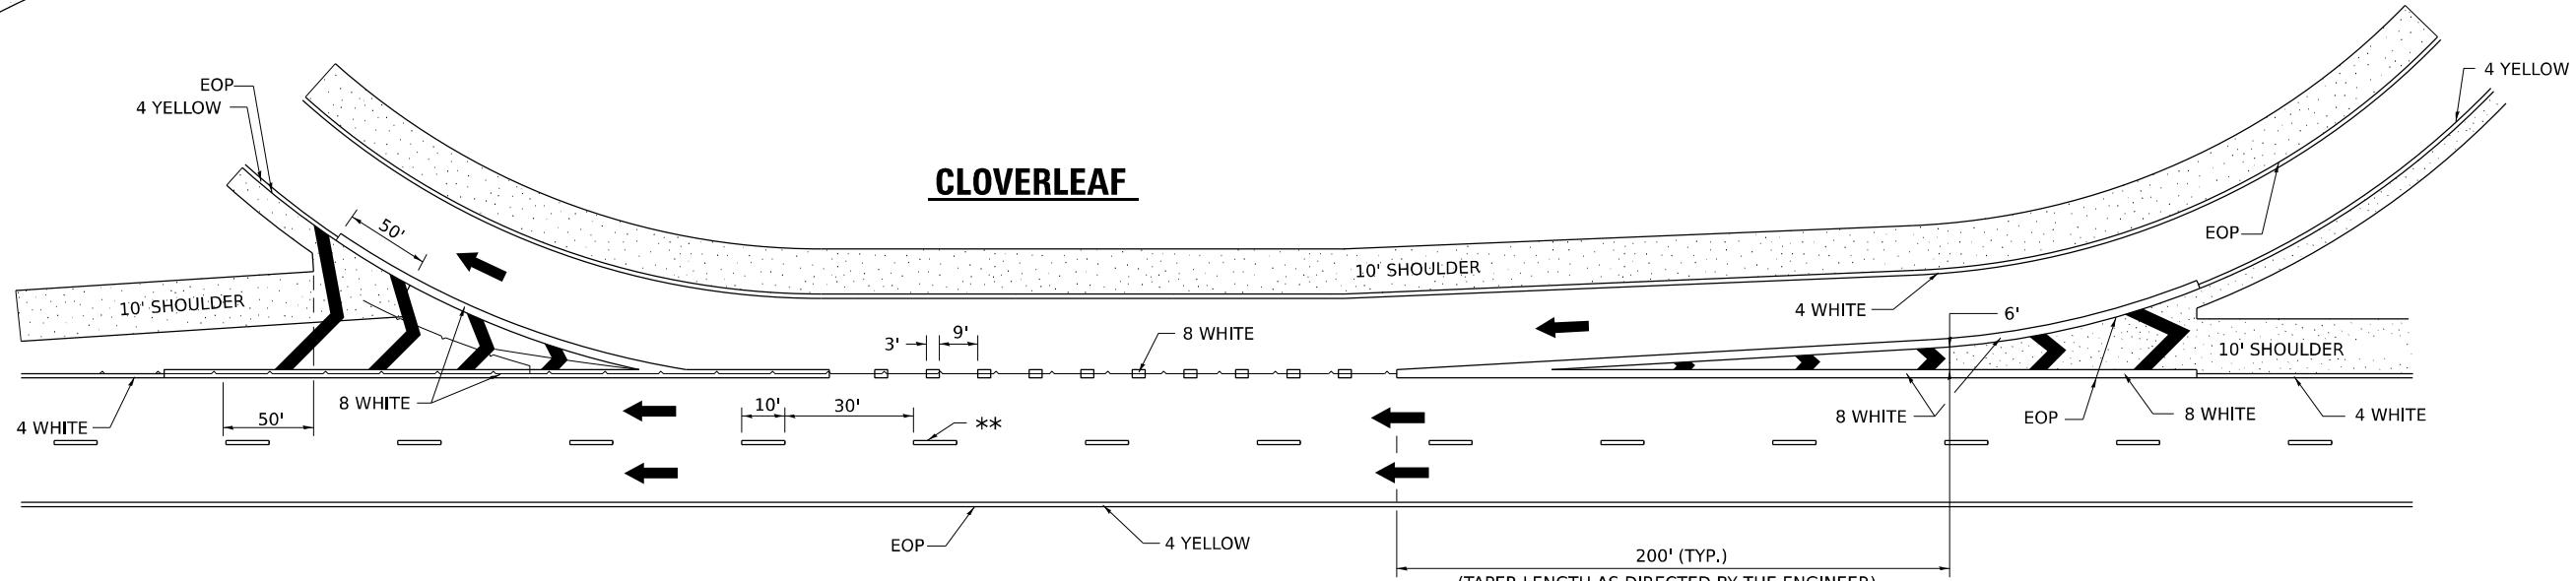

(TAPER LENGTH AS DIRECTED BY THE ENGINEER)

FILE NAME: \$MODELNAME\$
PLOT DATE: 02/29/24

USER NAME = 10017	DESIGNED -	REVISED -
DRAWN -	REVISED -	9-15-23
PLOT SCALE = 2,000' / in.	CHECKED -	8-27-13
PLOT DATE = 02/29/24	DATE -	REVISED -

STATE OF ILLINOIS
DEPARTMENT OF TRANSPORTATION

REGION 2 / DISTRICT 2 STANDARD

F.A. RTE.	SECTION	COUNTY	TOTAL SHEETS	SHEET NO.
				CONTRACT NO.

FILE NAME: \$FILE\$
Stanley Consultants Inc.
800 N. Michigan Ave., Suite 700, Chicago, Illinois 60611-2601
Phone: 312-733-2601 Fax: 312-733-2601
www.stanleyconsultants.com

SCALE: NONE SHEET 8 OF 12 SHEETS STA. TO STA.

TYPICAL PAVEMENT MARKINGS SHEET 4 OF 4 41.1

USER NAME = 10017	DESIGNED -	REVISED -
DRAWN -	REVISED -	10-18-11
PLOT SCALE = 2,000' / in.	CHECKED -	REvised -
PLOT DATE = 02/29/24	DATE -	REVISED -


STATE OF ILLINOIS
DEPARTMENT OF TRANSPORTATION

DISTRICT 2 STANDARD DETAILS

F.A.P. RTE.	SECTION	COUNTY	TOTAL SHEETS	SHEET NO.
17	D2 PP 2023-02	OGLE	46	42


CONTRACT NO. 64R99

GUARDRAIL AND BARRIER WALL REFLECTORS, TYPE C (SPECIAL)

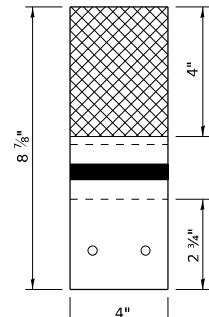


REFLECTORS SHALL BE MOUNTED DIRECTLY TO WOOD OR PLASTIC BLOCK OUTS.

REFLECTORS MOUNTED ON WOODEN OR PLASTIC BLOCK OUT SHALL BE MOUNTED USING TWO 16 DG NAILS AND TWO $\frac{3}{16}$ " WASHERS OR TWO 2 $\frac{1}{2}$ " GALVANIZED SCREWS WITH WASHERS.

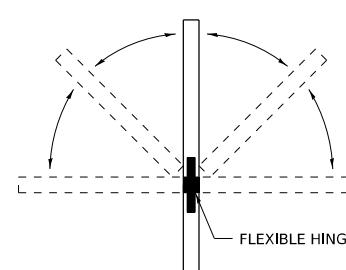


SIDE VIEW

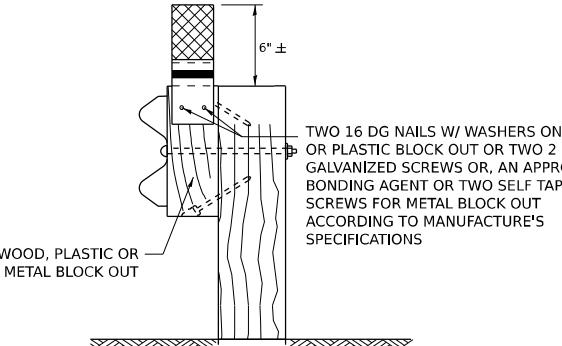


MENTED ON A WOOD OR PASTIC GUARDRAIL BLOCK OUT

TWO 16 DG NAILS W/ WASHERS ON WOOD OR PLASTIC BLOCK OUT OR TWO 2 $\frac{1}{2}$ " GALVANIZED SCREWS OR, AN APPROVED BONDING AGENT OR TWO SELF TAPPING SCREWS FOR METAL BLOCK OUT ACCORDING TO MANUFACTURE'S SPECIFICATIONS

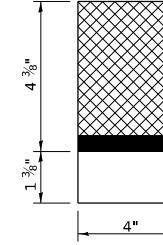


REFLECTORS SHALL BE MOUNTED DIRECTLY TO METAL BLOCK OUT.

REFLECTORS MOUNTED ON METAL BLOCK OUT SHALL BE MOUNTED USING AN APPROVED BONDING AGENT PER THE MANUFACTURE'S SPECIFICATIONS OR TWO SELF TAPPING GALVANIZED SCREWS WITH WASHERS.

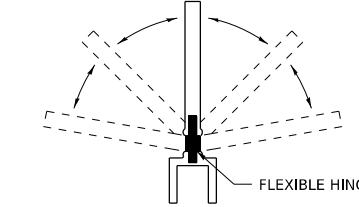


SIDE VIEW

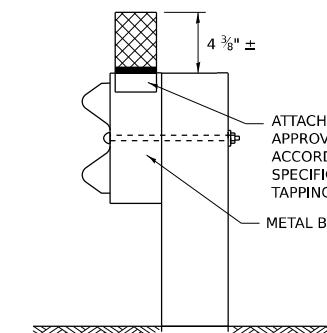

MENTED ON A METAL GUARDRAIL BLOCK OUT

REFLECTORS MOUNTED ON WOOD OR PLASTIC GUARDRAIL BLOCK OUT

STRAIGHT GUARDRAIL / DELINEATOR REFLECTOR

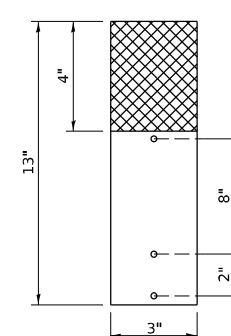


REFLECTORS MAY BE MOUNTED TO DELINEATOR POST USING TWO 10/24 X 1 1/2" BOLTS WITH NUTS AND WASHERS.

ADDITIONAL HOLES SHALL BE DRILLED IN THE REFLECTORS AS SHOWN ABOVE.



SIDE VIEW

ADDITIONAL SHEETING MAY BE ADDED AS NEEDED FOR TURN AROUNDS AS SHOWN IN THE PLANS

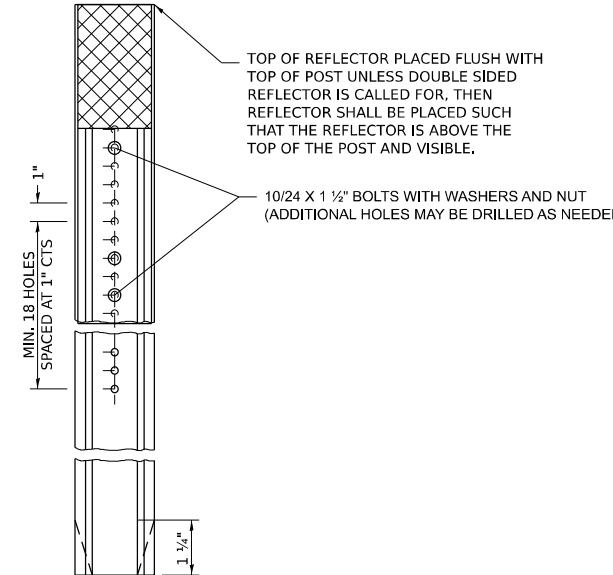

MENTED ON A DELINEATOR POST

DELINATEORS SHALL BE INSTALLED ACCORDING TO STANDARD 635001 EXCEPT THAT THE POST SHALL BE ROTATED 180°. THE POST WILL HAVE THE WIDE SIDE FACING TRAFFIC AND THE REFLECTOR ATTACHECD AS SHOWN ABOVE.

MODEL NAMES
FILE NAME: 002924

USER NAME = 10017	DESIGNED -	REVISED -
DRAWN -	REVISED -	4-27-23
PLOT SCALE = 2,000' / In.	CHECKED -	6-21-21
PLOT DATE = 02/29/24	DATE -	REVISED -

STATE OF ILLINOIS
DEPARTMENT OF TRANSPORTATION

REGION 2 / DISTRICT 2 STANDARD
SCALE: SHEET OF SHEETS STA. TO STA. ILLINOIS FED. AID PROJECT

F.A. RTE.	SECTION	COUNTY	TOTAL SHEETS	SHEET NO.
				CONTRACT NO.

GUARDRAIL AND BARRIER WALL REFLECTORS, TYPE C (SPECIAL) 55.1

STATE OF ILLINOIS
DEPARTMENT OF TRANSPORTATION

DISTRICT 2 STANDARD DETAILS

F.A.P. RTE.	SECTION	COUNTY	TOTAL SHEETS	SHEET NO.
17	D2 PP 2023-02	OGLE	46	43

CONTRACT NO. 64R99

MODEL NAMES
FILE NAME: 002924



Stanley Consultants Inc.
800-333-Help, Post Office Box 730, Chicago, Illinois 60631-2601
www.stanleyconsultants.com
Illinois Fire Registration No. 104-007533

USER NAME = 10017	DESIGNED -	REVISED -
DRAWN -	REVISED -	
PLOT SCALE = 2,000' / In.	CHECKED -	
PLOT DATE = 02/29/24	DATE -	REVISED -


STATE OF ILLINOIS
DEPARTMENT OF TRANSPORTATION

SCALE: NONE SHEET 9 OF 12 SHEETS STA. TO STA. ILLINOIS FED. AID PROJECT


GUARDRAIL EROSION CONTROL TREATMENTS

GENERAL NOTES: EROSION CONTROL CURB

- This work shall consist of grading as needed, installing hardware, 2" x 10" treated timber boards and incidental hot-mix asphalt surfacing in front of steel plate beam guardrail in accordance with plan details.
- Timber shall be treated in accordance with Article 1007.12 Waterborne preservatives "asa" and "cca" shall have a minimum retention of 0.40 lbs./cu.ft.
- This work will be paid for at the contract unit price per foot for EROSION CONTROL CURB (pay code Z0020800).

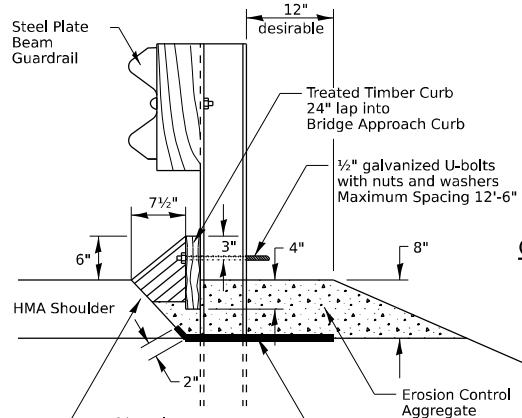

TYPICAL SECTION WITH EROSION CONTROL CURB

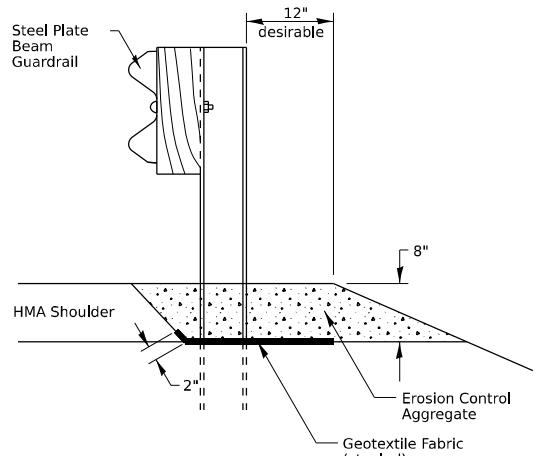

TYPICAL SECTION WITHOUT EROSION CONTROL CURB

- C. The Geotextile Fabric shall be nonwoven fabric in accordance with Article 1080.02 of the Standard Specifications.

7. This work will be paid for at the contract unit price per ton for GUARDRAIL AGGREGATE EROSION CONTROL (pay code Z001002).

MODEL: \$0020800
FILE NAME: FILE15
PLOT DATE: 02/29/24

REGION 2 / DISTRICT 2 STANDARD

F.A. RTE.	SECTION	COUNTY	TOTAL SHEETS	SHEET NO.
		CONTRACT NO.		


REVISED - 1-05-16
REVISED - 10-14-11
REVISED -
REVISED -

SCALE: SHEET OF SHEETS STA. TO STA. ILLINOIS FED. AID PROJECT

GUARDRAIL EROSION CONTROL TREATMENTS

35.2

HOT-MIX ASPHALT APPROACHES & MAILBOX RETURNS FOR TWO LIFT (3P) RESURFACING PROJECTS

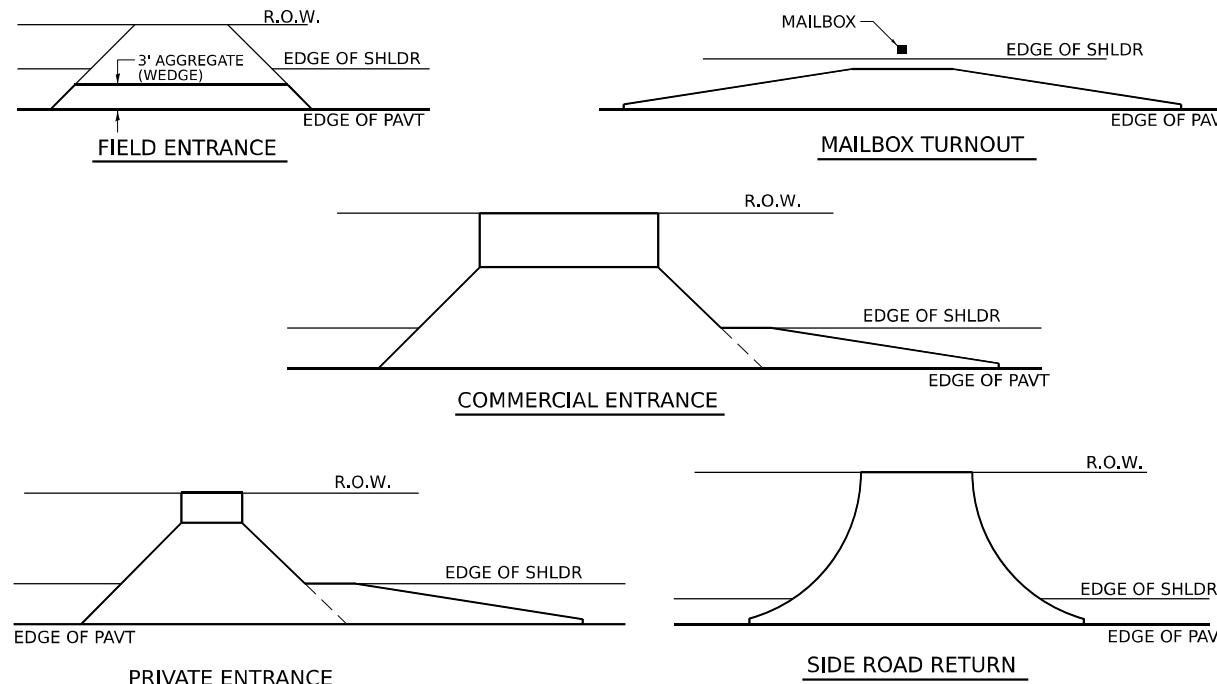


NOTE: EXISTING HMA PE's, CE's, SR's, & MB TURNOUTS
Place 2 1/4" Incidental Hot-Mix Asphalt Surfacing on entrance to conform to the existing configuration.

EXISTING AGG. PE's & CE's
Place 2 1/4" Incidental Hot-Mix Asphalt Surfacing on existing entrance to conform to the present configuration.

EXISTING AGG. SIDEROADS
Place 3" Incidental Hot-Mix Asphalt Surfacing on sideroad to conform to the present configuration.

EXISTING AGG. MAILBOX TURNOUTS
Existing Agg. Mailbox Turnouts shall be constructed as shown below.

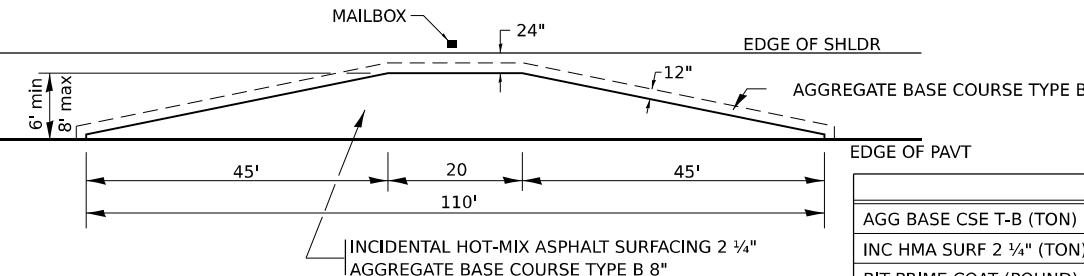

MODEL: \$0020800
FILE NAME: FILE15
PLOT DATE: 02/29/24

REGION 2 / DISTRICT 2 STANDARD

F.A. RTE.	SECTION	COUNTY	TOTAL SHEETS	SHEET NO.
		CONTRACT NO.		

REVISED - 1-05-16
REVISED - 7-21-15
REVISED - 6-27-14
REVISED - 10-21-08

SCALE: SHEET OF SHEETS STA. TO STA. ILLINOIS FED. AID PROJECT

STATE OF ILLINOIS
DEPARTMENT OF TRANSPORTATION


DISTRICT 2 STANDARD DETAILS

F.A.P. RTE.	SECTION	COUNTY	TOTAL SHEETS	SHEET NO.
17	D2 PP 2023-02	OGLE	46	44

CONTRACT NO. 64R99

SCALE: NONE SHEET 10 OF 12 SHEETS STA. TO STA. ILLINOIS FED. AID PROJECT

SAFETY EDGE (3P PROJECTS)

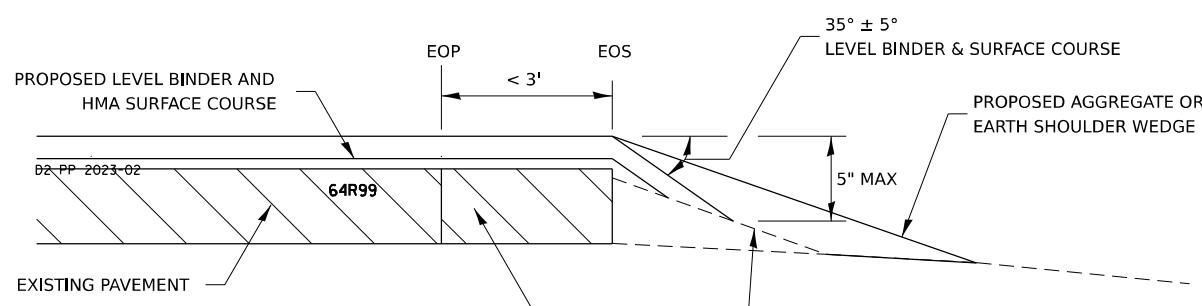

MILLING: WITH ADJACENT SHOULDER FLUSH WITH OR HIGHER THAN MILLED SURFACE

NOTES : THE DEVICE WHICH FORMS THE SAFETY EDGE SHALL BE MOUNTED ON THE PAVER SCREED AGAINST THE END GATE AND SHALL BE REMOVABLE OR BE ABLE TO BE LIFTED WHEN NOT IN USE. THE DEVICE SHALL BE DESIGNED TO MAINTAIN CONTACT WITH SURFACE OF THE SHOULDER AND ALLOW AUTOMATIC TRANSITION TO CROSS ROADS, DRIVEWAYS AND OBSTRUCTIONS. THE DEVICE SHALL ALSO CONSTRAIN THE HMA MATERIAL AND INCREASE THE CONSOLIDATION OF THE EXTRUDED PROFILE. THE USE OF A CONVENTIONAL SINGLE PLATE STRIKE-OFF WILL NOT BE ALLOWED.

ROLLERS WILL NOT BE ALLOWED ON THE SLOPED FACE OF THE SAFETY EDGE.

- ① PRIOR TO THE PLACEMENT OF THE HMA SAFETY EDGE, IF THE ADJACENT AGGREGATE OR EARTH SHOULDER IS HIGHER THAN THE MILLED SURFACE, THE AREA REQUIRED FOR PLACEMENT OF THE SAFETY EDGE SHALL BE BROUGHT FLUSH WITH THE MILLED SURFACE IN A MANNER APPROVED BY THE ENGINEER. THIS WORK SHALL BE CONSIDERED INCLUDED IN THE CONTRACT UNIT PRICE PER TON FOR HOT-MIX ASPHALT SURFACE COURSE OF THE TYPE SPECIFIED.

MODEL: \$002924
FILE NAME: 64R99

REGION 2 / DISTRICT 2 STANDARD

F.A. RTE.	SECTION	COUNTY	TOTAL SHEETS	SHEET NO.
				CONTRACT NO.


SAFETY EDGE (3P PROJECTS) 49.2

MODEL: \$002924
FILE NAME: 64R99



USER NAME = 10017	DESIGNED -	REVISED -
DRAWN -	REVISED -	
SCALE = 2,000' / In.	CHECKED -	REVISED -
PLOT DATE = 02/29/24	DATE = 02/29/2024	REVISED -

TRAFFIC CONTROL AND PROTECTION AT TURN BAYS (TO REMAIN OPEN TO TRAFFIC)

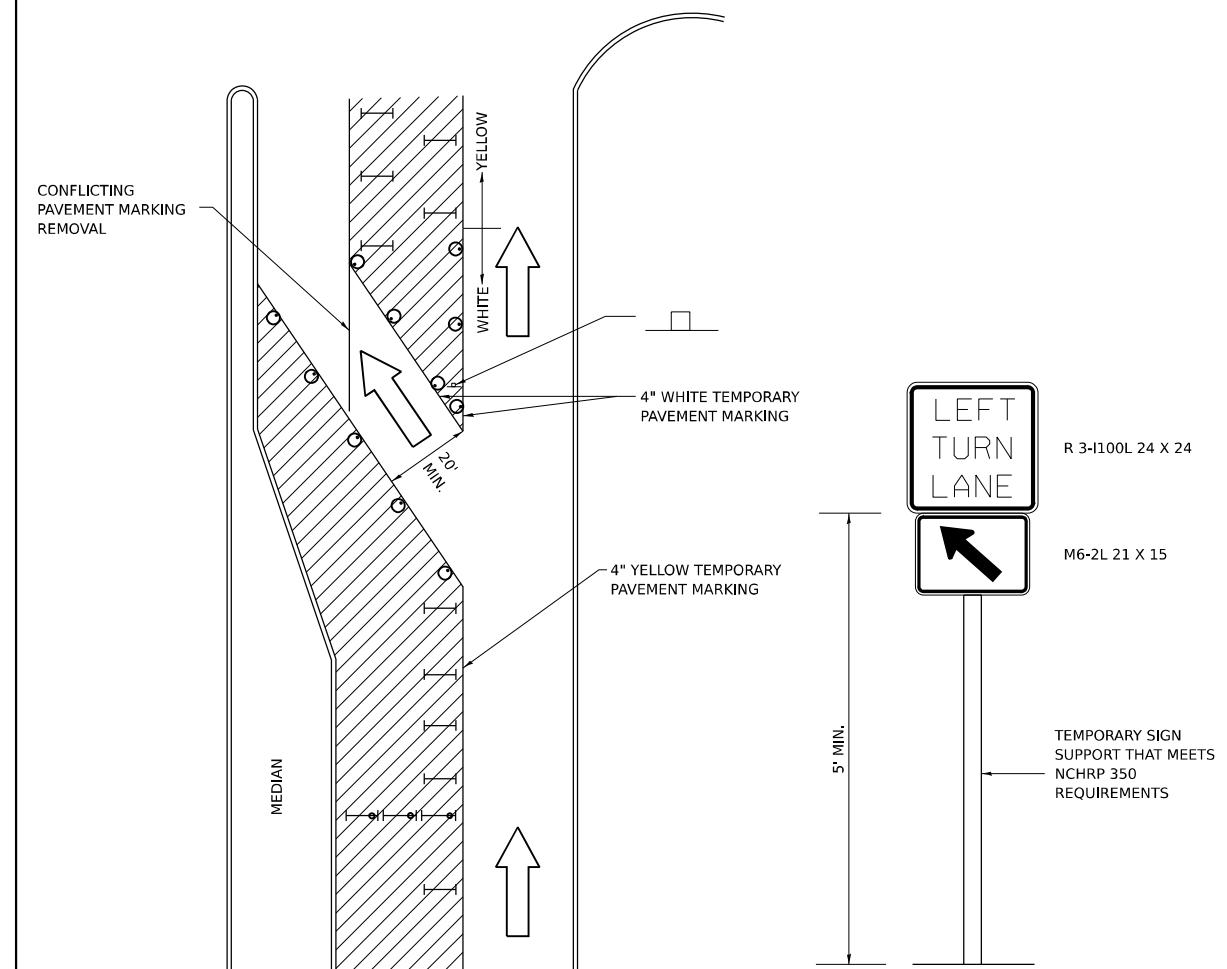

LEGEND

	WORK AREA
	LANE OPEN TO TRAFFIC
	TYPE I OR II BARRICADE OR DRUM WITH FLASHING BURNING LIGHT
	DRUM OR BARRICADE WITH STEADY BURN LIGHT
	SIGN (SEE DETAIL)
	TYPE I OR II CHECK BARRICADE WITH STEADY LIGHT BURN

GENERAL NOTES

CONES MAY BE SUBSTITUTED FOR BARRICADES OR DRUMS AT HALF THE SPACING DURING DAY OPERATIONS. CONES SHALL BE A MINIMUM OF 28 IN HEIGHT.

STEADY BURNING LIGHTS WILL NOT BE REQUIRED ON BARRICADES OR DRUMS FOR DAY OPERATIONS. ALL LIGHTS WILL BE MONODIRECTIONAL.

TEMPORARY PAVEMENT MARKING SHALL BE PLACED THROUGHOUT THE BARRICADED AREA OF EACH BAY WHERE THE CLOSURE TIME IS GREATER THAN FOURTEEN DAYS.

THIS APPLICATION ALSO APPLIES WHEN WORK IS BEING PERFORMED IN THE RIGHT LANE(S) AND THE RIGHT TURN BAY IS TO REMAIN OPEN. UNDER THIS CONDITION, "RIGHT TURN LANE" R3-100 24 X 24 AND M6-2R 21 X 15 SHALL BE USED.

THESE CONTROLS SHALL SUPPLEMENT MAINLINE TRAFFIC CONTROL FOR LANE CLOSURES. LONGITUDINAL DIMENSIONS MAY BE ADJUSTED TO FIT FIELD CONDITIONS.

TRAFFIC CONTROL AND PROTECTION AT TURN BAYS (TO REMAIN OPEN TO TRAFFIC) SHALL BE INCLUDED IN THE COST SPECIFIED TRAFFIC CONTROL STANDARDS OR ITEMS.

ALL DIMENSIONS ARE IN INCHES UNLESS OTHERWISE NOTED.

MODEL: \$002924
FILE NAME: 64R99

REGION 2 / DISTRICT 2 STANDARD

F.A. RTE.	SECTION	COUNTY	TOTAL SHEETS	SHEET NO.
				CONTRACT NO.

F.A.P. RTE.	SECTION	COUNTY	TOTAL SHEETS	SHEET NO.
17	D2 PP 2023-02	OGLE	46	45
				CONTRACT NO. 64R99
		ILLINOIS	FED. AID PROJECT	

SCALE: NONE

SHEET 11

OF 12

SHEETS STA.

TO STA.

STATE OF ILLINOIS
DEPARTMENT OF TRANSPORTATION

DISTRICT 2 STANDARD DETAILS

ILLINOIS	FED. AID PROJECT
----------	------------------

1

2

3

4

5

ILLINOIS

FED. AID PROJECT

1

2

3

4

5

ILLINOIS

FED. AID PROJECT

1

2

3

4

5

ILLINOIS

FED. AID PROJECT

1

2


3

ILLINOIS

FED. AID PROJECT

1</p

HOT-MIX ASPHALT SHOULDER

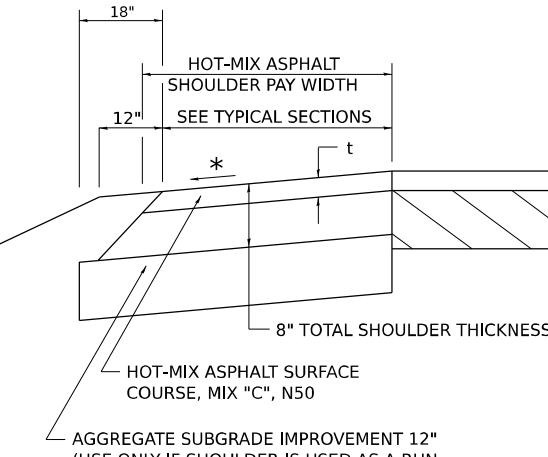

GENERAL NOTES

THE HOT-MIX ASPHALT SHOULDER SHALL BE CONSTRUCTED IN ACCORDANCE WITH SECTION 482 EXCEPT THE TOP LIFT SHALL BE HOT-MIX ASPHALT SURFACE COURSE, MIX "C", N50. THE WORK WILL BE PAID FOR AT THE CONTRACT UNIT PRICE PER TON FOR HOT-MIX ASPHALT SURFACE COURSE, MIX "C", N50 AND SQUARE YARD FOR HOT-MIX ASPHALT SHOULDERS OF THE THICKNESS SPECIFIED.

USE HOT-MIX ASPHALT SURFACE COURSE, MIX "C", N50. WHEN RESURFACING EXISTING HOT-MIX ASPHALT SHOULDERS, THE THICKNESS IS SHOWN ON THE TYPICAL SECTIONS. THIS WORK WILL BE PAID FOR AT THE CONTRACT UNIT PRICE PER TON FOR HOT-MIX ASPHALT SURFACE COURSE, MIX "C", N50.

REMOVAL OF MATERIAL FOR PLACEMENT OF THE HOT-MIX ASPHALT SHOULDER TO BE PAID FOR IN UNITS FOR EXCAVATING AND GRADING EXISTING SHOULDERS OR IN CUBIC YARDS FOR EARTH EXCAVATION OR EARTH EXCAVATION WIDENING.

* 4% WHEN MAINLINE IS ON TANGENT. FOR CROSS SLOPE ON SUPERELEVATION SECTION, SEE HIGHWAY STANDARD 482001 OR 482006.

FILE NAME: \$MODEL\$
PLOT DATE: 02/29/24

REVISED - 1-05-16
REVISED - 3-13-13
REVISED -
REVISED -



REGION 2 / DISTRICT 2 STANDARD

F.A. RTE.	SECTION	COUNTY	TOTAL SHEETS	SHEET NO.

CONTRACT NO.

HOT-MIX ASPHALT SHOULDER 22.4

DELINEATOR AND POST ORIENTATION

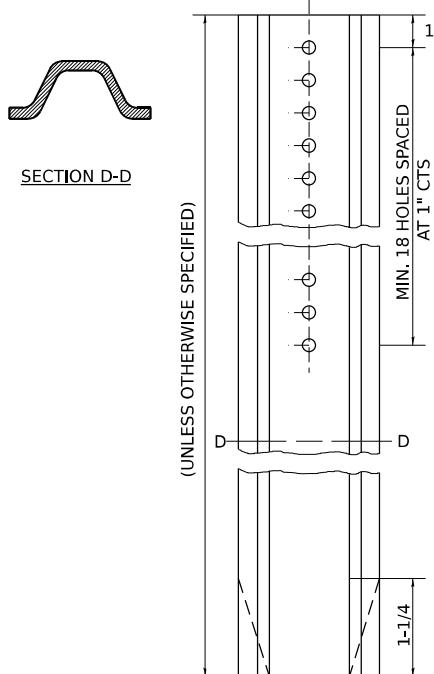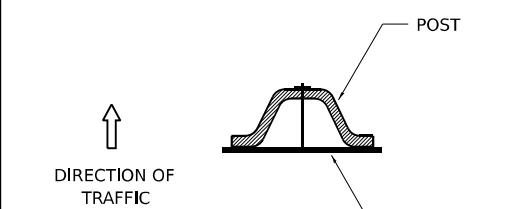

DELINEATORS SHALL BE INSTALLED ACCORDING TO STANDARD 635001 EXCEPT THAT THE POST SHALL BE ROTATED 180°. THE POST WILL HAVE THE WIDE SIDE FACING TRAFFIC AND THE DELINEATOR ATTACHED AS SHOWN ABOVE.

ALL DIMENSIONS ARE IN INCHES UNLESS OTHERWISE NOTED.

FILE NAME: \$MODEL\$
PLOT DATE: 02/29/24

REVISED - 10-03-11
REVISED -
REVISED -
REVISED -


REGION 2 / DISTRICT 2 STANDARD

F.A. RTE.	SECTION	COUNTY	TOTAL SHEETS	SHEET NO.

CONTRACT NO.

DELINEATOR AND POST ORIENTATION 37.4

SUBGRADE REPLACEMENT

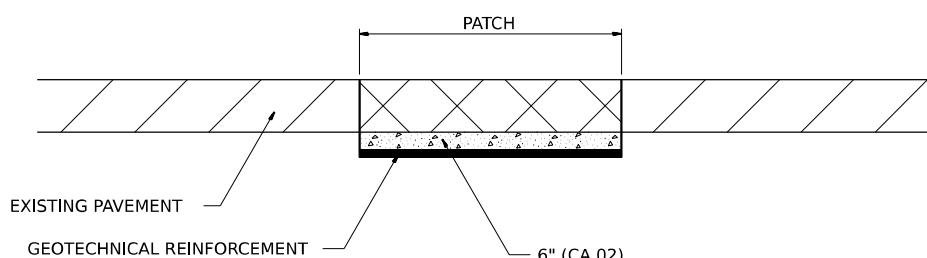

NOTES:

THE CA 02 SHALL BE COMPACTION IN A MANNER APPROVED BY THE ENGINEER. IF THE MOISTURE CONTENT OF THE MATERIAL IS SUCH THAT COMPACTION SATISFACTORY TO THE ENGINEER CANNOT BE OBTAINED, SUFFICIENT WATER SHALL BE ADDED SO THAT SATISFACTORY COMPACTION CAN BE OBTAINED.

THE CA 02 SHALL BE PAID FOR AT THE CONTRACT UNIT PRICE PER CU YD FOR AGGREGATE SUBGRADE IMPROVEMENT WHICH SHALL ALSO INCLUDE ALL EARTH EXCAVATION.

THE GEOTECHNICAL REINFORCEMENT WILL BE PAID FOR AT THE CONTRACT UNIT PRICE PER SQ YD FOR GEOTECHNICAL REINFORCEMENT.

ALL DIMENSIONS ARE IN INCHES UNLESS OTHERWISE NOTED.

FILE NAME: \$MODEL\$
PLOT DATE: 02/29/24

REVISED - 3-13-13
REVISED -
REVISED -
REVISED -

REGION 2 / DISTRICT 2 STANDARD

F.A. RTE.	SECTION	COUNTY	TOTAL SHEETS	SHEET NO.

CONTRACT NO.

SUBGRADE REPLACEMENT 97.4

STATE OF ILLINOIS
DEPARTMENT OF TRANSPORTATION

DISTRICT 2 STANDARD DETAILS

F.A.P. RTE.	SECTION	COUNTY	TOTAL SHEETS	SHEET NO.
17	D2 PP 2023-02	OGLE	46	46

CONTRACT NO. 64R99

FILE NAME: \$MODEL\$
Stanley Consultants Inc.
800-338-Help, Fax: 708-453-2861
www.stanleyconsultants.com
Issue Date: 02/29/24

USER NAME = 10017
DRAWN -
PLOT SCALE = 2,000' / In.
PLOT DATE = 02/29/24

DESIGNED -
REVISED -
CHECKED -
DATE - 02/29/2024

REVISED -
REVISED -
REVISED -
REVISED -

ILLINOIS FED. AID PROJECT

SCALE: NONE SHEET 12 OF 12 SHEETS STA. TO STA.

ILLINOIS FED. AID PROJECT