### **DEPARTMENT OF TRANSPORTATION**

# PROPOSED HIGHWAY PLANS

FAI ROUTE 90 (KENNEDY EXPRESSWAY) 1-90
FROM IL ROUTE 43 TO 1-94
(EDENS EXPRESSWAY)
SECTION 2019-082-RS&T
PROJECT NHPP-35N3(515)
DESIGNED OVERLAY
COOK COUNTY

T. 40 N.

LOCATION MAP
NOT TO SCALE

LIMITS OF IMPROVEMENT
STA 219+00 (I-90 WB)
STA 219+50 (I-90 EB)

STA 219+50 (I-90 EB)

D-91-190-19



EFK+Moen
Civil Engineering Design

STATE OF ILLINOIS
DEPARTMENT OF TRANSPORTATION

SUBMITTED THANKS 14 20 20

LI Canso Expir %: 11/30/2021

ENGINEER OF DESIGN AND ENVIRONMENT

DIRECTOR OF HIGHWAYS PROJECT IMPLEMENTATION

PRINTED BY THE AUTHORITY OF THE STATE OF ILLINOIS

FOR INDEX OF SHEETS, SEE SHEET NO. 2

FOR LIST OF HIGHWAY STANDARDS, SEE SHEET NO. 2

IMPROVEMENT IS LOCATED IN THE CITY OF CHICAGO

### TRAFFIC\_DATA

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FUNCATIONAL CLASSIFICATION: URBAN INTERSTATE 2017 ADT = 179,000 POSTED SPEED = 55 MPH

LIMITS OF IMPROVEMENT
STA 30+25 (I-90 WB)
STA 28+00 (I-90 EB)

STA 28+00 (I-90 EB)

FULL SIZE PLANS HAVE BEEN PREPARED USING STANDARD
ENGINEERING SCALES, REDUCED SIZED PLANS WILL NOT
CONFORM TO STANDARD SCALES, IN MAKING MEASUREMENTS
ON REDUCED PLANS, THE ABOVE SCALES MAY BE USED.

JOINT UTILITY LOCATION INFORMATION FOR EXCAVATORS
1-800-892-0123
OR 811

PROJECT ENGINEER DANIEL WILGREEN, PE (847)705-4240
PROJECT MANAGER FAWAD AQUEEL, PE (847)705-4247

GROSS LENGTH = 18638.40 FT. = 3.53 MILE

NET LENGTH = 18638.40 FT. = 3.53 MILE

1001 0010111 — 10000111

CONTRACT NO. 62J59

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### **HIGHWAY STANDARDS**

STANDARD NO.	DESCRIPTION
000001-07	STANDARD SYMBOLS, ABBREVIATIONS AND PATTERNS
442201-03	CLASS C AND D PATCHES
601001-05	PIPE UNDERDRAINS
602001-02	CATCH BASIN TYPE A
602301-04	INLET TYPE A
602401-06	PRECAST MANHOLE TYPE A 4' DIAMETER
602601-06	PRECAST REINFORCED CONCRETE FLAT SLAB TOP
602701-02	MANHOLE STEPS
604001-05	FRAME AND LIDS TYPE 1
604071-05	FRAME AND GRATE TYPE 20
606001-07	CONCRETE CURB TYPE B AND COMBINATION CONCRETE CURB AND GUTTER
630001-12	STEEL PLATE BEAM GUARDRAIL
630301-09	SHOULDER WIDENING FOR TYPE 1 (SPECIAL) GUARDRAIL TERMINALS
631011-10	TRAFFIC BARRIER TERMINAL, TYPE 2
631046-04	TRAFFIC BARRIER TERMINAL, TYPE 10
635001-02	DELINEATORS
642001-02	SHOULDER RUMBLE STRIPS, 16 IN.
701400-09	APPROACH TO LANE CLOSURE, FREEWAY/EXPRESSWAY
701401-12	LANE CLOSURE, FREEWAY/EXPRESSWAY
701411-09	LANE CLOSURE, MULTILANE, AT ENTRANCE OR EXIT RAMP, FOR SPEEDS > 45 MPH
701427-05	LANE CLOSURE, MULTILANE, INTERMITTENT OR MOVING OPER., FOR SPEEDS $<$ 40 MPH
701428-01	TRAFFIC CONTROL SETUP AND REMOVAL FREEWAY/EXPRESSWAY
701446-10	TWO LANE CLOSURE, FREEWAY/EXPRESSWAY
701501-06	URBAN LANE CLOSURE, 2L, 2W, UNDIVIDED
701601-09	URBAN LANE CLOSURE, MULTILANE, 1W OR 2W WITH NONTRAVERSABLE MEDIAN
701606-10	URBAN SINGLE LANE CLOSURE, MULTILANE, 2W WITH MOUNTABLE MEDIAN
701701-10	URBAN LANE CLOSURE, MULTILANE INTERSECTION
701801-06	SIDEWALK, CORNER OR CROSSWALK CLOSURE
701901-08	TRAFFIC CONTROL DEVICES
704001-08	TEMPORARY CONCRETE BARRIER
720001-01	SIGN PANEL MOUNTING DETAILS
720006-04	SIGN PANEL ERECTION DETAILS
720011-01	METAL POSTS FOR SIGNS, MARKERS & DELINEATORS
725001-01	OBJECT AND TERMINAL MARKERS
729001-01	APPLICATIONS OF TYPES A & B METAL POSTS (FOR SIGNS AND MARKERS)
780001-05	TYPICAL PAVEMENT MARKINGS
782006-01	GUARDRAIL AND BARRIER WALL REFLECTOR MOUNTING DETAILS

STATE OF ILLINOIS
DEPARTMENT OF TRANSPORTATION

### **GENERAL NOTES**

- 1. BEFORE STARTING ANY EXCAVATION, THE CONTRACTOR SHALL CALL "J.U.L.I.E." AT (800) 892-0123 OR 811 FOR FIELD LOCATIONS OF BURIED ELECTRIC, TELEPHONE, AND GAS UTILITIES. 48 HOUR NOTIFICATION IS REQUIRED.
- THE CONTRACTOR SHALL COORDINATE CONSTRUCTION ACTIVITIES WITH UTILITY COMPANIES AND THE CITY OF CHICAGO.
- THE CONTRACTOR WILL NOT BE ALLOWED TO SET UP A YARD OR FIELD OFFICE ON STATE PROPERTY WITHOUT WRITTEN PERMISSION FROM THE DEPARTMENT.
- 4. IT SHALL BE THE CONTRACTOR'S RESPONSIBILITY TO VERIFY ALL DIMENSIONS AND CONDITIONS EXISTING IN THE FIELD PRIOR TO CONSTRUCTION AND ORDERING OF MATERIALS.
- 5. THE CONTRACTOR SHALL CONTACT THE DISTRICT ONE TRAFFIC CONTROL SUPERVISOR AT KALPANA.KANNAN-HOSADURGA@ILLINOIS.GOV MINIMUM OF 72 HOURS IN ADVANCE OF BEGINNING WORK.
- THE RESIDENT ENGINEER SHALL CONTACT THE EXPRESSWAY FIELD ENGINEER AT 847-705-4155 A MINIMUM OF TWO (2) WEEKS PRIOR TO THE PLACEMENT OF PERMANENT PAVEMENT MARKINGS.
- 7. DO NOT SCALE PLANS FOR CONSTRUCTION DIMENSIONS.
- 8. BEFORE BEGINNING ANY WORK, THE CONTRACTOR SHALL RETAIN AND RECORD, FOR FUTURE REFERENCE, ALL EXISTING PAVEMENT MARKING LINES IN ORDER THAT THESE LOCATIONS CAN BE RE-ESTABLISHED FOR STRIPING, EXACT LOCATIONS OF ALL PAVEMENT MARKINGS SHALL BE AS DIRECTED BY THE ENGINEER.
- 9. THE CONTRACTOR SHALL EXCERCISE THE UTMOST PRECAUTIONS WHEN USING ARTIFICIAL LIGHTING DURING NIGHT OPERATIONS TO PREVENT ADVERSE VISIBILITY TO THE MOTORING PUBLIC AND ADJOINING RESIDENTIAL AREAS.
- 10. THE ALIGNMENTS AND SUPPORTING DATA SHOWN IN THE PLANS IS FOR REFERENCE PURPOSES ONLY. THE RELATIVE ACCURACY OF THE INFORMATION IS UNKNOWN AND CANNOT BE GUARANTEED. THE CONTRACTOR MAY BE REQUESTED TO ADJUST LAYOUT TO MATCH ACTUAL FIELD CONDITIONS AND THE INTENT OF THE PLANS.
- 11. NO MATERIAL SHOULD BE LEFT ON OR NEAR THE ROADWAY DURING NON-WORKING HOURS.
- 12. ANY LOOSE MATERIAL DEPOSITED IN THE FLOW LINE OF DRAINAGE STRUCTURES, WHICH OBSTRUCTS THE NATURAL FLOW OF WATER SHALL BE REMOVED AT THE CLOSE OF EACH WORKING DAY. PRIOR TO THE ACCEPTANCE OF THE IMPROVEMENT, ALL DRAINAGE STRUCTURES SHALL BE FREE OF DIRT AND DEBRIS. THIS WORK WILL NOT BE PAID FOR SEPARATELY, BUT SHALL BE INCLUDED IN THE UNIT BID PRICES OF THE CONTRACT.
- 13. MILLING AND RESURFACING OPERATIONS SHALL BE COMPLETED PRIOR TO THE INSTALLATION OF PROPOSED SHOULDER RUMBLE STRIPS.
- 14. SHOULDER RUMBLE STRIPS SHALL BE OMITTED WHEN CROSSING EXISTING DRAINAGE STRUCTURES, EXISITING PAVEMENT MARKINGS, AND LOCATIONS OF EXISTING SHOULDER RUMBLE STRIPS.
- 15. ALL DAMAGE TO EXISTING PAVEMENT MARKINGS OR RAISED REFELECTIVE PAVEMENT MARKERS OUTSIDE THE REMOVAL LINE SHOWN ON THE PLANS SHALL BE REPLACED AT AT NO ADDITIONAL COST TO THE DEPARTMENT.
- 16. RAISED REFLECTIVE PAVEMENT MARKERS SHALL BE IN ACCORDANCE WITH THE DISTRICT ONE DETAIL TC-11 "RAISED REFLECTIVE PAVEMENT MARKERS (SNOW-PLOW RESISTANT)" AND TC-12 "MULTI-LANE FREEWAY PAVEMENT MARKINGS DETAILS".
- 17. ALL PAVEMENT PATCHING LOCATIONS WILL BE AS SHOWN ON THE PLANS AND AS DETERMINED IN THE FIELD BY THE ENGINEER.
- 18. LOCATION OF COMBINATION CONCRETE CURB AND GUTTER REMOVAL AND CONCRETE CURB AND GUTTER REMOVAL AND REPLACEMENT WILL BE AS SHOWN ON THE PLANS AND AS DETERMINED IN THE FIELD BY THE ENGINEER.
- 19. THE THICKNESS OF THE HMA MIXTURE SHOWN ON THE PLANS IS THE NOMINAL THICKNESS. DEVIATIONS FROM THE NOMINAL THICKNESS WILL BE PERMITTED WHEN SUCH DEVIATIONS OCCUR DUE TO IRREGULARITIES IN THE EXISTING SURFACE OR BASE ON WHICH THE HMA MIXTURE IS PLACED.

### **GENERAL NOTES (CONT.)**

- 20. BUTT JOINTS WILL BE INSTALLED AT THE ENDS OF ALL RESURFACING (WHERE RESURFACING MEETS EXISTING PAVEMENT) ACCORDING TO THE DISTRICT ONE DETAIL BD-32 "BUTT JOINTS AND HMA TAPER" INCLUDED IN THE PLANS, UNLESS OTHERWISED SPECIFIED.
- 21. ALL REFERENCES IN THE HIGHWAY STANDARDS AND STANDARD SPECIFICATIONS FOR REINFORCEMENT, DOWEL BARS, AND TIE BARS IN PAVEMENT, SHOULDERS, CURB, GUTTER, COMBINATION CURB AND GUTTER AND MEDIAN, AND CHAIR SUPPORTS FOR CRC PAVEMENT, SHALL BE EPOXY COATED, UNLESS NOTED ON THE PLANS.
- 22. ALL EXCESS MATERIAL (BROKEN CONCRETE, CULVERT PIPE, WASTE ROADWAY EXCAVATION, SURPLUS MATERIAL FROM SEWER TRENCHIES, ETC.) SHALL BE LEGALLY DISPOSED OF OUTSIDE THE LIMITS OF THE RIGHT-OF-WAY. IT SHALL BE THE CONTRACTOR'S RESPONSIBILITY TO SELECT DUMP SITES AND OBTAIN PERMISSION AND ALL NECESSARY PERMITS TO USE SUCH DUMP SITES, PAYMENT FOR THIS WORK SHALL BE INCLUDED IN THE CONTRACT UNIT PRICE FOR EARTH EXCAVATION.
- 23. 10 FOOT TRANSITIONS SHALL BE USED TO MATCH PROPOSED CURB AND GUTTER AND MEDIAN ITEMS OF WORK TO EXISTING CURB AND GUTTER AND MEDIAN ITEMS IN THE FIELD, UNLESS OTHERWISE SHOWN. THE TRANSITIONS SHALL BE PAID FOR AT THE CONTRACT UNIT PRICE FOR THE PROPOSED LARGER ITEM OF SPECIFIED WORK.
- 24. THE CONTRACTOR SHALL USE CARE IN GRADING OR EXCAVATING NEAR ANY AND ALL EXISTING ITEMS THAT WILL NOT BE REMOVED, ANY DAMAGE DONE TO THE EXISTING ITEMS BY THE CONTRACTOR SHALL BE REPAIRED OR REPLACED TO THE SATISFACTION OF THE ENGINEER AT THE CONTRACTOR'S OWN EXPENSE.
- 25. THE CONTRACTOR SHALL REPORT CLEARANCES UNDER BRIDGES BEFORE AND AFTER PROPOSED RESURFACING, AND NOTIFY THE ENGINEER OF ANY CHANGES.

USER NAME = RGall	DESIGNED -	RG	REVISED -
	DRAWN -	CS/JB	REVISED -
PLOT SCALE = 100.0000 / in.	CHECKED -	JH	REVISED -
PLOT DATE = 1/30/2020	DATE -	10/5/19	REVISED -

SCALE: 1"=50"

### DRAINAGE AND UTILITIES GENERAL NOTES:

- . BEFORE ORDERING STORM SEWERS, CATCH BASINS, PIPE CULVERTS, PIPE DRAINS, MANHOLES, INLETS, AND SCUPPERS, THE CONTRACTOR SHALL REVIEW EXISTING FIELD CONDITIONS AND THE DRAINAGE SCHEDULES FOUND IN THE PLANS FOR THE EXACT LENGTH AND QUANTITY REQUIRED.
- 2. THE CONTRACTOR SHALL MAINTAIN THE SURFACE DRAINAGE OF ALL ROADWAYS DURING CONSTRUCTION OF THIS PROJECT. WHEN EXISTING DRAINAGE FACILITIES ARE DISTURBED, THE CONTRACTOR SHALL PROVIDE AND MAINTAIN TEMPORARY OUTLETS AND CONNECTIONS FOR ALL PRIVATE AND PUBLIC DRAINS, SEWERS, INLETS, AND CATCH BASINS. THE CONTRACTOR SHALL PROVIDE FACILITIES TO TAKE IN ALL STORM WATER, WHICH WILL BE RECEIVED BY THESE DRAINS AND SEWERS AND DISCHARGE SAME. THE CONTRACTOR SHALL PROVIDE AND MAINTAIN TEMPORARY OUTLET AND BE PREPARED AT ALL TIMES TO DISPOSE OF THE WATER RECEIVED FROM ALL OF THESE TEMPORARY CONNECTIONSUNTIL INSTALLATION IS COMPLETE. INCLUDING PAVEMENT. THIS WORK SHALL NOT BE PAID FOR DIRECTLY BUT SHALL BE CONSIDERED INCLUDED IN THE CONTRACT. COORDINATION WITH ALL AGENCIES INVOLVED IS REQUIRED.
- 3. ALL EXISTING STORM SEWERS OR DRAINAGE STRUCTURES MARKED FOR REMOVAL ON THE PLANS OR DESIGNATED IN THE FIELD BY THE ENGINER TO BE REMOVED SHALL BE REMOVED AND ANY EXCAVATION SHALL BE BACKFILLED WITH A GRANULAR MATERIAL MEETING THE SPECIFICATIONS FOR FA-1 OR FA-2. THE COST OF ALL LABOR AND MATERIALS REQUIRED TO COMPLETE THIS WORK SHALL BE INCLUDED IN THE CONTRACT UNIT PRICES FOR STORM SEWER OR DRAINAGE STRUCTURE REMOVAL UNLESS PAID FOR AS A SPECIFIC ITEM.
- 4. DRAINAGE STRUCTURE ADJUSTMENT OR RECONSTRUCTION LOCATIONS WILL BE AS SHOWN ON THE PLANS AND AS DETERMINED IN THE FIELD BY THE ENGINEER.
- 5. THE LOCATION AND ELEVATION OF EXISTING UTILITIES ARE APPROXIMATE AND ARE PROVIDED BY THE OWNERS OF THE UTILITIES.
- 6. THE COST OF MAKIING STORM SEWER CONNECTIONS TO EXISTING OR PROPOSED SEWER OR STRUCTURE SHALL BE INCLUDED IN THE CONTRACT UNIT PRICE FOR THE STORM SEWER BEING CONNECTED.
- 7. MANHOLES AND CATCH BASINS SHALL BE CONSTRUCTED WITH FLAT TOPS WHERE THE DIFFERENCE BETWEEN THE RIM ELEVATION AND INVERT ELEVATION IS LESS THAN SIX (6) FEET.
- 8. FOR STORM SEWER CONSTRUCTED UNDER THE ROADWAY, BACKFILLING METHODS, TWO AND THREE AUTHORIZED UNDER THE PROVISIONS OF ARTICLE 555.07 OF THE STANDARD SPECIFICATIONS WILL NOT BE ALLOWED.
- 9. TRENCHES CROSSING TRAFFIC LANES SHALL BE PATCHED WITH CLASS D PATCHES PRIOR TO OPENING THE LANES TO TRAFFIC AT THE END OF ALLOWABLE LANE CLOSURE HOURS.
- 10. ALL ADJUSTMENTS OR RECONSTRUCTION'S SHALL INCLUDE THE REMOVAL AND REPLACEMENT, AT THE CONTRACTOR'S EXPENSE, OF ALL UNSUITABLE ADJUSTING RINGS.
- 11. EXISTING BROKEN FRAMES AND LIDS SHALL BE REMOVED AND DISPOSED OF BY THE CONTRACTOR AND SHALL BE REPLACED AS DIRECTED BY THE ENGINEER. REPLACEMENT FRAMES AND LIDS WILL BE PAID FOR ACCORDING TO ARTICLE 109,04 OF THE STANDARD SPECIFICATIONS UNLESS A SEPARATE PAY ITEM HAS BEEN PROVIDED.
- 12. STORM SEWERS TO BE CLEANED SHALL BE SHOWN ON THE PLANS AND AS DETERMINED IN THE FIELD BY THE ENGINEER.
- 13. THE CONTRACTOR SHALL BE RESPONSIBLE FOR THE PROTECTION OF ALL UNDERGROUND OR SURFACE UTILITIES EVEN THOUGH THEY MAY NOT BE SHOWN ON THE PLANS. ANY UTILITY THAT IS DAMAGED DURING CONSTRUCTION SHALL BE REPAIRED OR REPLACED TO THE SATISFACTION OF THE ENGINEER. THIS WORK SHALL BE AT THE CONTRACTORS EXPENSE.

USER NAME = RGall	DESIGNED -	RG	REVISED -
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PLOT SCALE = 100.0000 ' / in.	CHECKED -	JH	REVISED -
PLOT DATE = 1/30/2020	DATE -	10/5/19	REVISED -

SCALE: 1"=50"

NDEX O	F SHEE	TS, HIGHW	AY STA	NDARDS,	F.A.I RTE	SECTION	COUNTY	TOTAL SHEETS	
	VND	GENERAL	NOTES		90	2019-082-RS&T	соок	119	4
	AND	GENTIAL	IVUILO				CONTRACT	NO. 62	2J59
SHEET	OF	SHEETS	STA.	TO STA.		ILLINOIS FED. A	ID PROJECT		

39.21 IDOT D1 PTB 187-006 WO 21 Kennedy Express/DGN/Design/Prelim/Plotsheets/D162J59-sht-gennote

CONSTRUCTION	ON CODE
90% FED	100%
10% STATE	STATE

				10/0 31A1L	SIAIE		
			URBAN	ROADWAY	ROADWAY		
CODE			TOTAL	0005	0005		
NO.	ITEM	UNIT	QUANTITY				
20200100	EARTH EXCAVATION	CU YD	150	150			
20201200	REMOVAL AND DISPOSAL OF UNSUITABLE MATERIAL	CU YD	115	115			
20800150	TRENCH BACKFILL	CU YD	326	326			
21101615	TOPSOIL FURNISH AND PLACE, 4"	SQ YD	900	900			
21101013	TO SOIL FORMOTTAND FEACE, 4	3415	300				
21301060	EXPLORATION TRENCH 60" DEPTH	FOOT	300	300			
25000210	SEEDING, CLASS 2A	ACRE	0.25	0.25			
25000400	NITROGEN FERTILIZER NUTRIENT	POUND	23	23			
25000500	PHOSPHORUS FERTILIZER NUTRIENT	POUND	23	23			
25000600	POTASSIUM FERTILIZER NUTRIENT	POUND	23	23			
25100630	EROSION CONTROL BLANKET	SQ YD	022	932			
25100630	EROSION CONTROL BLANKET	SQTD	932	932			
28100107	STONE RIPRAP, CLASS A4	SQ YD	52	52			
28200200	FILTER FABRIC	SQ YD	70	70			
40600290	BITUMINOUS MATERIALS (TACK COAT)	POUND	169240	169240			
40600982	HOT-MIX ASPHALT SURFACE REMOVAL - BUTT JOINT	SQ YD	326	326			

\*\* DENOTES SPECIALTY ITEM

REV-SEP

STATE OF ILLINOIS DEPARTMENT OF TRANSPORTATION

		SUMMAR	Y OF QU	ANTITIES	S	F.A.I RTE.	SECT	ION		COUNTY	TOTAL SHEETS	SHEET NO.
		I_90 /II	RTE. 43	_ LQ4\		90	2019-08	2-RS&T		COOK	119	5
		1-30 (IL.	11112. 73	- 1-3-1						CONTRACT	NO. 62	2J59
SCALE: 1"=50"	SHEET	OF	SHEETS	STA.	TO STA.			ILLINOIS	FED. AI	D PROJECT		

CONSTRUCTION CODE					
90% FED	100%				
10% STATE	STATE				

				10% STATE	STATE			
		١,	URBAN	ROADWAY	ROADWAY			
CODE		١,	TOTAL	0005	0005			
NO.	ITEM	UNIT	QUANTITY					
		Ī						
40601005	HOT-MIX ASPHALT REPLACEMENT OVER PATCHES	TON	2495	2495				
40603085	HOT-MIX ASPHALT BINDER COURSE, IL-19.0, N70	TON	4540	4540				
40603200	POLYMERIZED HOT-MIX ASPHALT BINDER COURSE, IL-4.75, N50	TON	1452	1452				
40604062	HOT-MIX ASPHALT SURFACE COURSE, IL-9.5, MIX "D", N70	TON	6690	6690				
40605015	POLYMERIZED HOT-MIX ASPHALT BINDER COURSE, STONE MATRIX ASPHALT	TON	29047	29047				
10000010	12.5, N80	ION	20047	20071				
40605036	POLYMERIZED HOT-MIX ASPHALT SURFACE COURSE, STONE MATRIX ASPHALT, 12.5, MIX "F", N80	TON	20909	20909				
42001300	PROTECTIVE COAT	SOVD	2254	2254				
42001300	PROTECTIVE COAT	SQ YD	2254	2254				
44000100	PAVEMENT REMOVAL	SQ YD	356	356				
44000159	HOT-MIX ASPHALT SURFACE REMOVAL, 2 1/2"	SQ YD	34567	34567				
44000168	HOT-MIX ASPHALT SURFACE REMOVAL, 4 3/4"	SQ YD	216157	216157				
44000500	COMBINATION CURB AND GUTTER REMOVAL	FOOT	1204	1204				
44002210	HOT-MIX ASPHALT REMOVAL OVER PATCHES, 2 1/2"	SQ YD	1383	1383				
				-				
44002219	HOT-MIX ASPHALT REMOVAL OVER PATCHES, 4 3/4"	SQ YD	8646	8646				
44004050	DAVED SHOULDER DEMOVAL	50.772	400	400				
44004250	PAVED SHOULDER REMOVAL	SQ YD	199	199				
L	<u>l</u>	<u> </u>						

\*\* DENOTES SPECIALTY ITEM

REV-SEP

 USER NAME
 = JBerggren
 DESIGNED
 RG
 REVISED

 DRAWN
 CS/JB
 REVISED

 PLOT SCALE
 = 100,0000 ' / in.
 CHECKED
 JH
 REVISED

 PLOT DATE
 = 1/31/2020
 DATE
 10/5/19
 REVISED

STATE OF ILLINOIS
DEPARTMENT OF TRANSPORTATION

		SUMMAR	Y OF QU	ANTITIES		F.A.I RTE	SECT	ION		COUNTY	TOTAL SHEETS	SHEET NO.
		I_90 /II	RTE. 43	_ LQ4\		90	2019-08	2-RS&T		COOK	119	6
		1-30 (IL.	1112. 43	34)						CONTRACT	NO. 62	2J59
SCALE: 1"=50'	SHEET	OF	SHEETS	STA.	TO STA.			ILLINOIS	FED. AI	D PROJECT		

 CONSTRUCTION CODE

 90% FED
 100%

 10% STATE
 STATE

				10/0 31A1L	SIAIE
			URBAN	ROADWAY	ROADWAY
CODE			TOTAL	0005	0005
NO.	ITEM	UNIT	QUANTITY		
44201385	CLASS C PATCHES, TYPE I, 13 INCH	SQ YD	95	95	
44201396	CLASS C PATCHES, TYPE IV, 13 INCH	SQ YD	149	149	
44201761	CLASS D PATCHES, TYPE I, 10 INCH	SQYD	1962	1962	
44201765	CLASS D PATCHES, TYPE II, 10 INCH	SQYD	1980	1980	
44201769	CLASS D PATCHES, TYPE III, 10 INCH	SQ YD	1973	1973	
	1		10.0		
44201771	CLASS D PATCHES, TYPE IV, 10 INCH	SQ YD	2042	2042	
44201798	CLASS D PATCHES, TYPE I, 13 INCH	SQ YD	600	600	
44201803	CLASS D PATCHES, TYPE II, 13 INCH	SQ YD	565	565	
44201807	CLASS D PATCHES, TYPE III, 13 INCH	SQ YD	555	555	
44201809	CLASS D PATCHES, TYPE IV, 13 INCH	SQ YD	679	679	
48101620	AGGREGATE SHOULDERS, TYPE B 10"	SQ YD	253	253	
50600200	PAINTING STEEL RAILING	FOOT	392	392	
52200020	TEMPORARY SOIL RETENTION SYSTEM	SQ FT	1656	1656	
				_	
550A0050	STORM SEWERS, CLASS A, TYPE 1 12"	FOOT	327	327	

\* DENOTES SPECIAL PROVISION REQUIRED

\*\* DENOTES SPECIALTY ITEM

REV-SEP

 USER NAME
 = JBerggren
 DESIGNED
 RG
 REVISED

 DRAWN
 CS/JB
 REVISED

 PLOT SCALE
 = 100,0000 ' / in.
 CHECKED
 JH
 REVISED

 PLOT DATE
 = 1/31/2020
 DATE
 10/5/19
 REVISED

STATE OF ILLINOIS
DEPARTMENT OF TRANSPORTATION

CONSTRUCTION	ON CODE
90% FED	100%
10% STATE	STATE

	•			1070 STATE	STATE
			URBAN	ROADWAY	ROADWAY
CODE			TOTAL	0005	0005
NO.	ITEM	UNIT	QUANTITY		
550A0090	STORM SEWERS, CLASS A, TYPE 1 18"	FOOT	225	225	
550A0120	STORM SEWERS, CLASS A, TYPE 1 24"	FOOT	108	108	
550A0340	STORM SEWERS, CLASS A, TYPE 2 12"	FOOT	119	119	
550A0360	STORM SEWERS, CLASS A, TYPE 2 15"	FOOT	296	296	
55100400	STORM SEWER REMOVAL 10"	FOOT	287	287	
55100700	STORM SEWER REMOVAL 15"	FOOT	58	58	
59200101	BRIDGE WASHING NO. 1	EACH	1	1	
60108204	PIPE UNDERDRAINS, TYPE 2, 4"	FOOT	20	20	
60200105	CATCH BASINS, TYPE A, 4'-DIAMETER, TYPE 1 FRAME, OPEN LID	EACH	4	4	
60218400	MANHOLES, TYPE A, 4'-DIAMETER, TYPE 1 FRAME, CLOSED LID	EACH	2	2	
60237420	INLETS, TYPE A, TYPE 20 FRAME AND GRATE	EACH	18	18	
60250400	CATCH BASINS TO BE ADJUSTED WITH NEW TYPE 1 FRAME, OPEN LID	EACH	20	20	
60251710	CATCH BASINS TO BE ADJUSTED WITH NEW TYPE 20 FRAME AND GRATE	EACH	20	20	
60255800	MANHOLES TO BE ADJUSTED WITH NEW TYPE 1 FRAME, CLOSED LID	EACH	20	20	

\*\* DENOTES SPECIALTY ITEM

REV-SEP

 USER NAME
 = JBerggren
 DESIGNED
 RG
 REVISED

 DRAWN
 CS/JB
 REVISED

 PLOT SCALE
 = 100,0000 ' / in.
 CHECKED
 JH
 REVISED

 PLOT DATE
 = 1/31/2020
 DATE
 10/5/19
 REVISED

STATE OF ILLINOIS
DEPARTMENT OF TRANSPORTATION

	F.A.I RTE	SECT	ION		COUNTY	TOTAL SHEETS	SHEET NO.					
	90	90 2019-082-RS&T C			СООК	119	8					
	I–90 (IL. RTE. 43 − 1–94)									CONTRACT	NO. 62	2J59
CALE: 1"=50'	SHEET	OF	SHEETS	STA.	TO STA.	ILLINOIS FED. AID PROJECT						

 CONSTRUCTION CODE

 90% FED
 100%

 10% STATE
 STATE

CODE			URBAN <b>TOTAL</b>	ROADWAY 0005	ROADWAY 0005
NO.	ITEM	UNIT	QUANTITY		
60260300	INLETS TO BE ADJUSTED WITH NEW TYPE 1 FRAME, OPEN LID	EACH	20	20	
60261510	INLETS TO BE ADJUSTED WITH NEW TYPE 20 FRAME AND GRATE	EACH	20	20	
60500050	REMOVING CATCH BASINS	EACH	1	1	
	The way the state of the state	Z.NO.		<u>'</u>	
63000001	STEEL PLATE BEAM GUARDRAIL, TYPE A, 6 FOOT POSTS	FOOT	137.5	137.5	
63100045	TRAFFIC BARRIER TERMINAL, TYPE 2	EACH	1	1	
63100105	TRAFFIC BARRIER TERMINAL, TYPE 10	EACH	1	1	
63100167	TRAFFIC BARRIER TERMINAL, TYPE 1 (SPECIAL) TANGENT	EACH	1	1	
63200310	GUARDRAIL REMOVAL	FOOT	50	50	
63304000	DEMOVE AND DEEDEST TRAFFIC PARRIED TERMINALS. TYPE 4	FACIL		5	
63301990	REMOVE AND REERECT TRAFFIC BARRIER TERMINALS, TYPE 1	EACH	5	5	
63500105	DELINEATORS	EACH	288	288	
64200116	CHOLL DED BLIMBLE STRIPS 46 INCH	FOOT	59503	59503	
04200116	SHOULDER RUMBLE STRIPS, 16 INCH	1001	59503	59503	
67000400	ENGINEER'S FIELD OFFICE, TYPE A	CAL MO	24	24	
67100100	MOBILIZATION	L SUM	1	1	
		2 30.01	,	'	
66900200	NON-SPECIAL WASTE DISPOSAL	CU YD	100	100	

\* DENOTES SPECIAL PROVISION REQUIRED

\*\* DENOTES SPECIALTY ITEM

REV-SEP

 USER NAME
 = JBerggren
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STATE OF ILLINOIS
DEPARTMENT OF TRANSPORTATION

	F.A.I RTE	SEC <sup>-</sup>	ΠΟN		COUNTY	TOTAL SHEETS	SHEET NO.					
	I–90 (IL. RTE. 43 − 1–94)									соок	119	9
	1-30 (IL. NTC. 43 - 1-34)									CONTRACT	F NO. 6	2J59
SCALE: 1"=50"	SHEET	OF	SHEETS	STA.	TO STA.	ILLINOIS FED. AID PROJECT						

				CONSTRUCT	
				90% FED 10% STATE	100%
		T	URBAN	ROADWAY	ROADWAY
CODE	:		TOTAL	0005	0005
NO.	ITEM	UNIT	QUANTITY		
					1
66900530	SOIL DISPOSAL ANALYSIS	EACH	5	5	
66901001	REGULATED SUBSTANCES PRE-CONSTRUCTION PLAN	L SUM	1	1	
				<u> </u>	71
66901006	REQULATED SUBSTANCES MONITORING	CAL DA	20	20	
66901003		I CUM		4	1 1
66901003	REGULATED SUBSTANCES FINAL CONSTRUCTION REPORT	L SUM	1	1	**
70107025	CHANGEABLE MESSAGE SIGN	CAL DA	360	360	
70300210	TEMPORARY PAVEMENT MARKING LETTERS AND SYMBOLS	SQ FT	454	454	
70300220	TEMPORARY PAVEMENT MARKING - LINE 4"	FOOT	70478	70478	
70300230	TEMPORARY PAVEMENT MARKING - LINE 5"	FOOT	38047	38047	
¥.					E
70300240	TEMPORARY PAVEMENT MARKING - LINE 6"	FOOT	8350	8350	
70300250	TEMPORARY PAVEMENT MARKING - LINE 8"	FOOT	27775	27775	
		1.55			
70300260	TEMPORARY PAVEMENT MARKING - LINE 12"	FOOT	7666	7666	
					1
70300280	TEMPORARY PAVEMENT MARKING - LINE 24"	FOOT	174	174	-
70300900	PAVEMENT MARKING TAPE, TYPE IV - LETTERS AND SYMBOLS	SQ FT	1817	1817	
70300904	PAVEMENT MARKING TAPE, TYPE IV 4"	FOOT	426350	426350	

**★★** DENOTES SPECIALTY ITEM

**REV-SEP** 

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 DATE
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 REVISED

STATE OF ILLINOIS
DEPARTMENT OF TRANSPORTATION

CONSTRUCTION CODE

					CONSTRUCT	ION CODE
					90% FED 10% STATE	100%
		1		LIDDANI		STATE
	CODE			URBAN L	ROADWAY 0005	ROADWAY 0005
	NO.	ITEM	UNIT	QUANTITY	0003	0003
	- 1101		0.11.1	Q07		
				<del>                                     </del>		
•	70300905	PAVEMENT MARKING TAPE, TYPE IV 5"	FOOT	131472	131472	
:	70300908	PAVEMENT MARKING TAPE, TYPE IV 8"	FOOT	137696	137696	
<	70300912	PAVEMENT MARKING TAPE, TYPE IV 12"	FOOT	24736	24736	
	70400100	TEMPORARY CONCRETE BARRIER	FOOT	8350	8350	
	70400200	RELOCATE TEMPORARY CONCRETE BARRIER	FOOT	7125	7125	
	70400200	THE COATE TENT OWNER CONTROL BANNER	1001	7 125	7 123	
		IMPACT ATTENUATORS, TEMPORARY (FULLY REDIRECTIVE, NARROW), TEST				
	70600260	LEVEL 3	EACH	16	16	
	70600290	IMPACT ATTENUATORS, TEMPORARY (SEVERE USE, WIDE), TEST LEVEL 3	EACH	2	2	
	70600332	IMPACT ATTENUATORS, RELOCATE (FULLY REDIRECTIVE, NARROW), TEST LEVEL 3	EACH	16	16	
	72000200	SIGN PANEL - TYPE 2	SQ FT	59	59	
	72400320	REMOVE SIGN PANEL - TYPE 2	SQ FT	32	32	
	1 2 2 2 2 2 2 2 2 2 2 2 2 2 2 2 2 2 2 2		24.1			
	70504000	TERMINAL MARKER, DIRECT APPLIED	FACUL		4	
	72501000	TERMINAL MARKER - DIRECT APPLIED	EACH	1	1	
	72900100	METAL POST - TYPE A	FOOT	162	162	
*	78000100	THERMOPLASTIC PAVEMENT MARKING - LETTERS AND SYMBOLS	SQ FT	454	454	
*	78000200	THERMOPLASTIC PAVEMENT MARKING - LINE 4"	FOOT	70478	70478	

\*\* DENOTES SPECIALTY ITEM

**REV-SEP** 

USER NAME = JBerggren DESIGNED - RG REVISED -DRAWN - CS/JB REVISED -CHECKED - JH PLOT SCALE = 100,0000 ' / in. REVISED -PLOT DATE = 1/31/2020 REVISED -

STATE OF ILLINOIS **DEPARTMENT OF TRANSPORTATION** 

SUMMARY OF QUANTITIES								SEC.	TION		COUNTY	TOTAL SHEETS	SHEET NO.
	I-90 (IL. RTE. 43 - I-94)								32-RS&T		соок	119	11
	1-90 (IL. KIC. 43 - 1-94)										CONTRACT	NO. 63	2J59
SCALE: 1"=5	0'	SHEET	OF	SHEETS	STA.	TO STA.	ILLINOIS FED. AID PROJECT						

					CONSTRUCT	ION CODE
					90% FED 10% STATE	100%
		1	1	LIDDAN	ROADWAY	STATE ROADWAY
	CODE			URBAN L	0005	0005
	NO.	ITEM	UNIT	QUANTITY	0000	0000
**				<del>   </del>		
ጥጥ	78000400	THERMOPLASTIC PAVEMENT MARKING - LINE 6"	FOOT	59	59	
**	78000500	THERMOPLASTIC PAVEMENT MARKING - LINE 8"	FOOT	27775	27775	
				1		
**	78000600	THERMOPLASTIC PAVEMENT MARKING - LINE 12"	FOOT	7666	7666	
**	70000050	THE DWO DIA OTTO DAVENENT MADIVINO. HINE OF	FOOT	174	474	
ጥጥ	78000650	THERMOPLASTIC PAVEMENT MARKING - LINE 24"	FOOT	174	174	
* **	78004354	PREFORMED PLASTIC PAVEMENT MARKING, TYPE D - INLAID - LINE 4"	FOOT	2375	2375	
ጥጥ				1		
*				1		
**	78004355	PREFORMED PLASTIC PAVEMENT MARKING, TYPE D - INLAID - LINE 5"	FOOT	19023	19023	
**	78008210	POLYUREA PAVEMENT MARKING TYPE I - LINE 4"	FOOT	7148	7148	
	70000210	FOLTONEA FAVEIVIENT MARKING TIFET-LINE 4	1 1001	7 140	7 140	
	78100100	RAISED REFLECTIVE PAVEMENT MARKER	EACH	2037	2037	
				1		
				1		
	78200005	GUARDRAIL REFLECTORS, TYPE A	EACH	8	8	
	78200011	BARRIER WALL REFLECTORS, TYPE C	EACH	735	735	
				1		
	78300200	RAISED REFLECTIVE PAVEMENT MARKER REMOVAL	EACH	2037	2037	
			1			
	04000700	LINDEROROUND CONDUIT COULARIE MONIMETALUS CONDUIT (14/1/20)	FOOT	252	250	+
	81028730	UNDERGROUND CONDUIT, COILABLE NONMETALLIC CONDUIT, 1 1/4" DIA.	FOOT	250	250	
*	X0325201	SHOULDER RUMBLE STRIP REMOVAL	SQ YD	238	238	
			+	+ +		
_			1			
*	X0327680	TRENCH DRAIN	FOOT	3048	3048	
		1	1	1		

\*\* DENOTES SPECIALTY ITEM

SUMMARY OF QUANTITIES

I-90 (IL. RTE. 43 - I-94)

TO STA.

SCALE: 1"=50' SHEET OF SHEETS STA.

COUNTY TOTAL SHEET NO.

COOK 119 12

CONTRACT NO. 62J59 SECTION 2019-082-RS&T

**REV-SEP** 

	DATE	10 IE 110	BEN WEED
PLOT SCALE = 100.0000 ' / in.	CHECKED -	JH	REVISED -
	DRAWN -	CS/JB	REVISED -
USER NAME = JBerggren	DESIGNED -	RG	REVISED -

	X0327979	PAVEMENT MARKING REMOVAL - GRINDING	SQ FT	21446	21446	
*	X1400282	POLYETHYLENE DUCT, 1 1/4" DIA	FOOT	2200	2200	
*	X5537700	STORM SEWERS TO BE CLEANED 10"	FOOT	960		960
*	X5537800	STORM SEWERS TO BE CLEANED 12"	FOOT	140		140
*	X5870015	BRIDGE DECK CONCRETE SEALER	SQ FT	122565	122565	
*	X6030310	FRAMES AND LIDS TO BE ADJUSTED (SPECIAL)	EACH	861	861	
*	X7010216	TRAFFIC CONTROL AND PROTECTION, (SPECIAL)	L SUM	1	1	
*	X7011015	TRAFFIC CONTROL AND PROTECTION (EXPRESSWAYS)	L SUM	1	1	
*	X7013820	TRAFFIC CONTROL SURVEILLANCE, EXPRESSWAYS	CAL DA	360	360	
*	X7030005	TEMPORARY PAVEMENT MARKING REMOVAL	SQ FT	198672	198672	
*	X7040125	PINNING TEMPORARY CONCRETE BARRIER	EACH	3714	3714	
*						
**	X7830070	GROOVING FOR RECESSED PAVEMENT MARKING 5"	FOOT	2375	2375	
*						
**	X7830072	GROOVING FOR RECESSED PAVEMENT MARKING 6"	FOOT	19024	19024	
*						
**	X8730312	ELECTRIC CABLE IN CONDUIT, LEAD-IN, NO. 18 4/C, TWISTED, SHIELDED	FOOT	2191	2191	

ITEM

\* DENOTES SPECIAL PROVISION REQUIRED

\*\* DENOTES SPECIALTY ITEM

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 PLOT DATE
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 DATE
 10/5/19
 REVISED

CODE

NO.

STATE OF ILLINOIS DEPARTMENT OF TRANSPORTATION

CONSTRUCTION CODE

STATE

ROADWAY

0005

90% FED 10% STATE

ROADWAY

0005

URBAN **TOTAL** 

UNIT QUANTITY

	SUMMAR	F.A.I RTE	SECTION		COUNTY	TOTAL SHEETS					
	I_90 (II	90	2019-082-RS&T		соок	119	13				
I–90 (IL. RTE. 43 – I–94)									CONTRACT	NO. 62	2J59
SCALE: 1"=50"	SHEET	OF	SHEETS	STA.	TO STA.	ILLINOIS FED. AID PROJECT					

Ø 0042

CODE

NO.

X8850102

Z0004562

Z0018500

Z0030850

Z0033700

Z0034105

Z0038124

Z0048665

Z0076600

Z0076604

Ø

TRAINEES

INDUCTION LOOP

\* \*\*

į	USER NAME = JBerggren	DESIGNED	i k	RG	REVISED	2
		DRAWN	+	CS/JB	REVISED	5
	PLOT SCALE = 100.0000 / in.	CHECKED	16.	JH	REVISED	5
	PLOT DATE = 1/31/2020	DATE	· 20	10/5/19	REVISED	+9

ITEM

COMBINATION CURB AND GUTTER REMOVAL AND REPLACEMENT

DRAINAGE STRUCTURES TO BE CLEANED

TEMPORARY INFORMATION SIGNING

LONGITUDINAL JOINT SEALANT

MATERIAL TRANSFER DEVICE

PORTLAND CEMENT CONCRETE SURFACE REMOVAL 3"

RAILROAD PROTECTIVE LIABILITY INSURANCE

TEMPORARY VEHICLE DETECTION SYSTEM

TRAINEES TRAINING PROGRAM GRADUATE

### STATE OF ILLINOIS **DEPARTMENT OF TRANSPORTATION**

CONSTRUCTION CODE

STATE

**ROADWAY** 

0005

861

90% FED 10% STATE

ROADWAY

0005

5504

156

49956

60

14

1000

1000

URBAN

TOTAL

QUANTITY

5504

861

156

187280

49956

60

14

1000

1000

UNIT

FOOT

FOOT

EACH

SQ FT

FOOT

TON

SQ YD

L SUM

CALMO

HOUR

HOUR

SUMMARY OF QUANTITIES												
	I-90 (IL. RTE. 43 - I-94)											
1"=50'	SHEET	OF	SHEETS	STA.	TO STA.							

SCALE:


COUNTY TOTAL SHEET NO.

COOK 119 14 SECTION COUNTY 2019-082-RS&T CONTRACT NO. 62J59


RED

REV. - MS **REV-SEP** 

*	DENOTES	SPECIAL	PROVISION	REQUIR
**	k DENOTES	SPECIALT	Y ITEM	

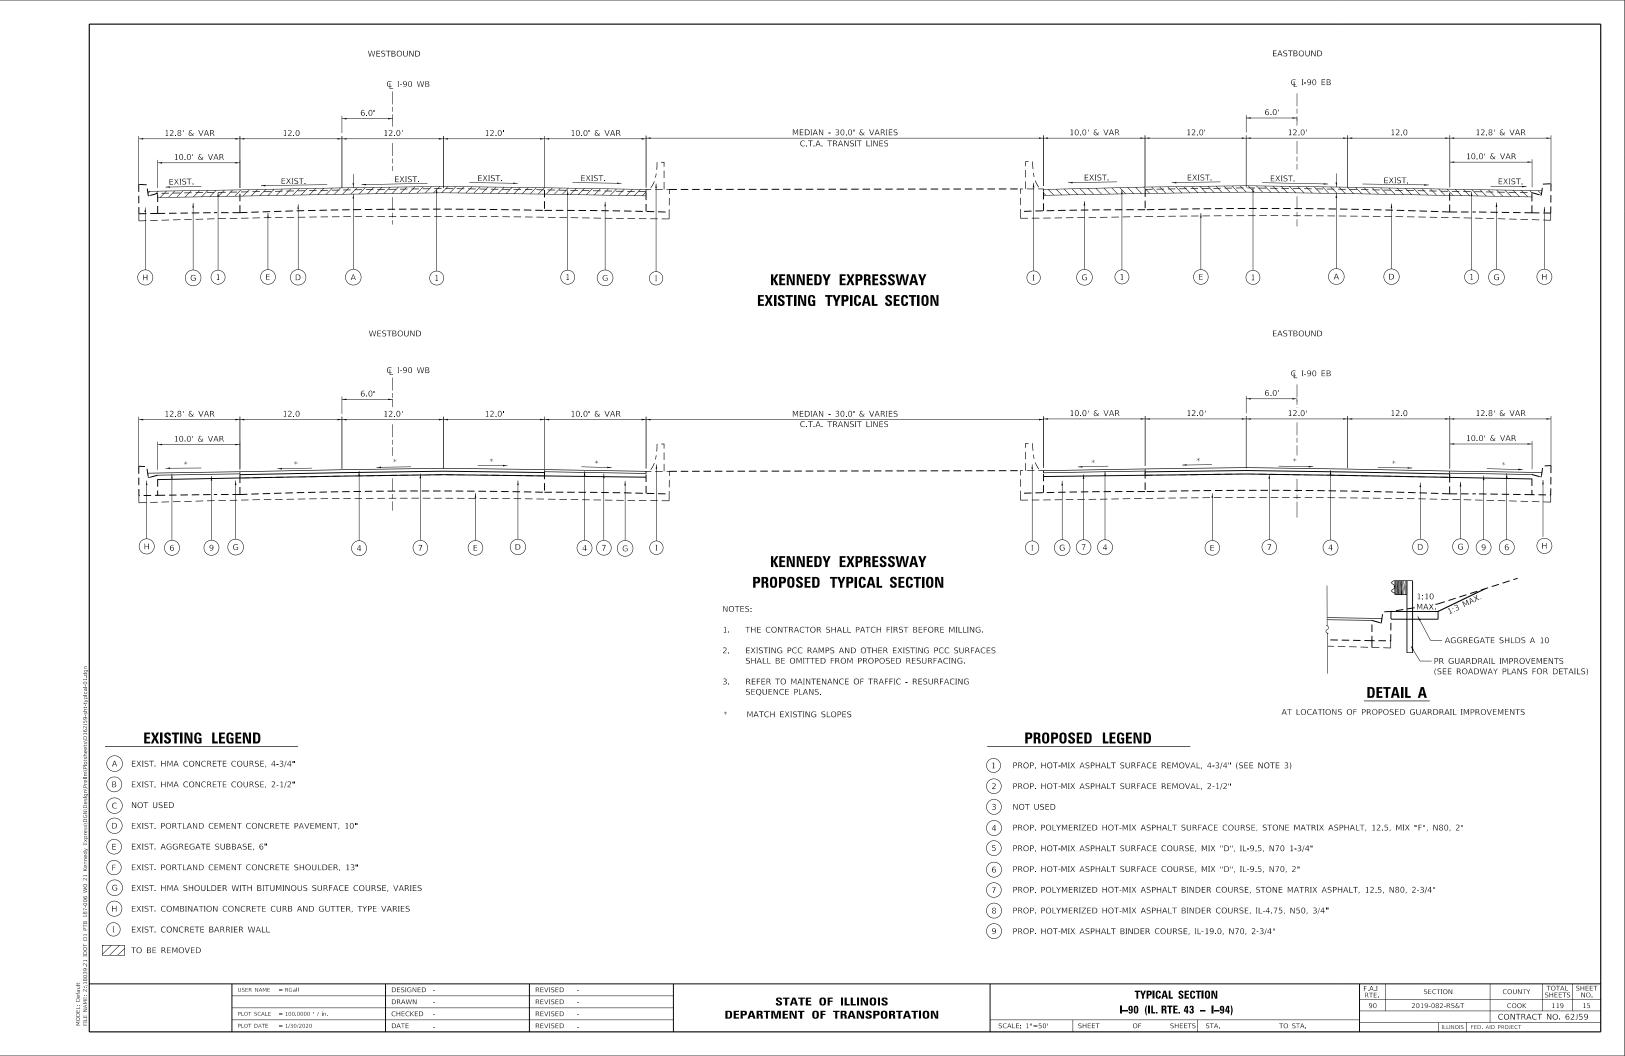


# RAMPS EXISTING TYPICAL SECTION

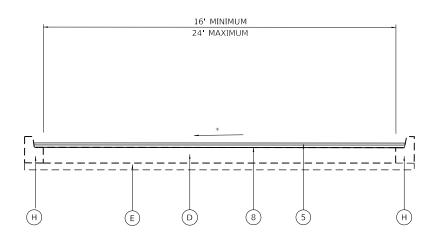


RAMPS
PROPOSED TYPICAL SECTION

### NOTES:

- 1. THE CONTRACTOR SHALL PATCH FIRST BEFORE MILLING.
- . EXISTING PCC RAMPS AND OTHER EXISTING PCC SURFACES SHALL BE OMITTED FROM PROPOSED RESURFACING.
- 3. REFER TO MAINTENANCE OF TRAFIC RESURFACING SEQUENCE PLANS

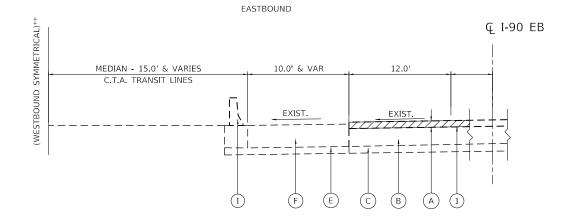

# EXISTING TYPICAL SECTION STA. 183 + 25.83 TO STA. 219 + 50.00 \*\*

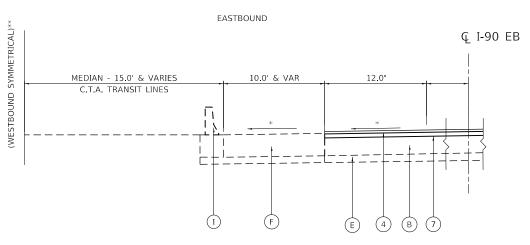

# PROPOSED TYPICAL SECTION STA. 183 + 25.83 TO STA. 218 + 99.66 \*\*

- \* MATCH EXISTING SLOPES
- \*\* WESTBOUND TYPICAL SECTION FROM STA. 30+25.00 TO STA. 183+78.34

### EXISTING LEGEND

- A EXIST. HMA CONCRETE COURSE, 4-3/4"
- B EXIST. HMA CONCRETE COURSE, 2-1/2"
- C NOT USED
- D EXIST. PORTLAND CEMENT CONCRETE PAVEMENT, 10"
- (E) EXIST. AGGREGATE SUBBASE, 6"
- F EXIST PORTLAND CEMENT CONCRETE SHOULDER, 13"
- G EXIST. HMA SHOULDER WITH BITUMINOUS SURFACE COURSE, VARIES
- (H) EXIST. COMBINATION CONCRETE CURB AND GUTTER, TYPE VARIES
- 1 EXIST. CONCRETE BARRIER WALL
- TO BE REMOVED

### PROPOSED LEGEND

- 1 PROP. HOT-MIX ASPHALT SURFACE REMOVAL, 4-3/4" (SEE NOTE 3)
- 2 PROP. HOT-MIX ASPHALT SURFACE REMOVAL, 2-1/2"
- 3 NOT USED
- PROP. POLYMERIZED HOT-MIX ASPHALT SURFACE COURSE, STONE MATRIX ASPHALT, 12.5, MIX "F", N80, 2"
- (5) PROP. HOT-MIX ASPHALT SURFACE COURSE, MIX "D", IL-9.5, N70 1-3/4"
- 6) PROP. HOT-MIX ASPHALT SURFACE COURSE, MIX "D", IL-9.5, N70, 2"
- (7) PROP. POLYMERIZED HOT-MIX ASPHALT BINDER COURSE, STONE MATRIX ASPHALT, 12.5, N80, 2-3/4"
- 8) PROP. POLYMERIZED HOT-MIX ASPHALT BINDER COURSE, IL-4.75, N50, 3/4"
- 9 PROP. HOT-MIX ASPHALT BINDER COURSE, IL-19.0, N70, 2-3/4"

USER NAME = RGall	DESIGNED -	REVISED -	ı
	DRAWN -	REVISED -	ĺ
PLOT SCALE = 100.0000 ' / in.	CHECKED -	REVISED -	ĺ
PLOT DATE = 1/30/2020	DATE -	REVISED -	

STATE OF ILLINOIS	
DEPARTMENT OF TRANSPORTATION	

TYPICAL SEC	F.A.I RTE	SECTION	COUNTY	TOTAL SHEETS	SHEET NO.			
Lon /II RTE //3	_ I_Q/I\		90	2019-082-RS&T	соок	119	16	
F-50 (IL. III L. 43	I–90 (IL. RTE. 43 – I–94)							
SCALE: 1"=50' SHEET OF SHEET		ILLINOIS FED.	AID PROJECT					

### **MIXTURE REQUIREMENTS**

MIXTURE TYPE	AIR VOIDS @ NDES	QMP
RESURFACING ON MAINLINE AND INSIDE SHOULDER		
POLYMERIZED HMA SURFACE COURSE, STONE MATRIX ASPHALT, 12.5, MIX "F", N80, 2"	3.5% @ 80 GYR	PFP
POLYMERIZED HMA BINDER COURSE, STONE MATRIX ASPHALT, 12.5, N80, 2-3/4"	3.5% @ 80 GYR	PFP
RESURFACING ON OUTSIDE SHOULDERS		
HOT-MIX ASPHALT SURFACE COURSE, MIX "D", IL-9.5, N70, 2"	4% @ 70 GYR	QC/QA
HOT-MIX ASPHALT BINDER COURSE, IL-19.0, N70, 2-3/4"	4% @ 70 GYR	QC/QA
RESURFACING ON RAMPS		
HOT-MIX ASPHALT SURFACE COURSE, MIX "D", IL-9.5, N70, 1-3/4"	4% @ 70 GYR	QC/QA
POLYMERIZED HMA BINDER COURSE, IL-4.75, N50, 3/4"	3.5% @ 50 GYR	QC/QA
PATCHING		
CLASS D PATCHES (HMA BINDER IL-19 mm)	4% @ 70 GYR	QC/QA
HMA ASHPALT REPLACEMENT OVER PATCHES (HMA BINDER IL-19mm)	4% @ 70 GYR	QC/QA
OMP DESIGNATION: QUALITY CONTROL/QUALITY ASSURANCE (QC/QA); QUALITY CONTROL FO	R PERFORMANCE	
(QCP); PAY FOR PERFORMANCE (PFP)		

### **NOTES**

- 1. THE UNIT WEIGHT USED TO CALCULATE ALL HOT-MIX ASPHALT SURFACE MIXTURE QUANTITIES IS 112 LB/SY/IN.
- 2. THE "AC TYPE" FOR POLYMERIZED HMA MIXES SHALL BE "SBS/SBR PG 76-22" AND FOR NON-POLYMERIZED HMA THE "AC TYPE" SHALL BE "PG 64-22" UNLESS MODIFIED BY DISTRICT ONE SPECIAL PROVISIONS.
- 3. FOR USE OF RECYCLED MATERIALS SEE SPECIAL PROVISIONS.
- 4. QUALITY MANAGEMENT PROGRAM (QMP) IDENTIFIES THE PARTICULAR QUALITY CONTROL SPECIFICATION THAT APPLIES TO THE HMA MIXTURE.
- 5. LONGITUDINAL JOINT SEALANT SHALL BE PLACED BEFORE AND AFTER THE POLYMERIZED HMA BINDER COURSE, SMA MIXTURE FOR RESURFACING ON MAINLINE AND AFTER THE POLYMERIZED HMA BINDER COURSE, IL-4.75 MIXTURE FOR RESURFACING ON RAMPS

USER NAME = RGall	DESIGNED -	REVISED -
	DRAWN -	REVISED -
PLOT SCALE = 100.0000 ' / in.	CHECKED -	REVISED -
PLOT DATE = 1/30/2020	DATE -	REVISED -

TYPICAL SECTION							SEC <sup>-</sup>	TION	COUNTY	TOTAL SHEETS	
		Lan /II	. RTE. 43	_ I_Q/I\		90	2019-082-RS&T		соок	119	17
		-30 (IL	III L. 73	- I-34)					CONTRAC	T NO. 62	2J59
SCALE: 1"=50' SHEET OF SHEETS STA. TO STA.								ILLINOIS FEE	. AID PROJECT		

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### SCHEDULE OF SAFETY IMPROVEMENTS


	LOCATI	ON		63500105	72000200	72900100	78200011	64200116
	DESIM STA	END CTA	CID.	DELINEATORS	SIGN PANEL - TYPE 2	METAL POST - TYPE A	BARRIER WALL	SHOULDER RUMBLE
ALIGNMENT	BEGIN STA	END STA	SIDE	EACH	SQ FT	FOOT	REFLECTORS, TYPE C EACH	STRIPS, 16 INCH FOOT
I-90 EB	81+11	96+84	RT	5	34,,	, , , ,	27.677	, , , ,
I-90 EB	88+87	110+72	LT				15	
I-90 EB	139+01	143+02	RT	2				
I-90 EB	158+65	167+46	LT				6	
I-90 EB	174+40	178+87	LT				4	
I-90 EB	211+57	217+39	RT	4				
I-90 EB	212+18	218+51	LT				6	
I-90 WB	88+67	110+87	RT	_			15	
I-90 WB	94+39	102+41	LT	6	_			
I-90 WB	94+40		RT		9	27		
I-90 WB	96+00		RT		9	27		
I-90 WB	97+60		RT		9	27		
I-90 WB	99+20		RT		9	27		
I-90 WB I-90 WB	100+80		RT		9	27 27		
I-90 WB	102+40 158+89	165   07	RT RT		9	27	5	
I-90 WB	174+44	165+87 180+50	RT				5	
I-90 WB	174+44	100+30	LT	1			3	
I-90 WB	212+58	218+75	RT	1			6	
I-90 WB	212+58	217+65	LT	1			5	
RAMP 13	212130	21, 103		21				
RAMP 14				21				
RAMP 15				19				
RAMP 16				19				
RAMP 17				19				
RAMP 18				19				
RAMP 19				13				
RAMP 20				12				
RAMP 21				15				
RAMP 22				11				
RAMP 23				4				
RAMP 24				17				
RAMP 25				15				
RAMP 26				10				
RAMP 27				14				
RAMP 28				9				
RAMP 29				15				
RAMP 30				8				
RAMP 31				13				
I-90 EB	27+90	35+81	RT					791
I-90 EB	45+30	46+40	RT					110
I-90 EB	56+11	60+61	RT					450
I-90 EB	70+28	75+25	RT					497
I-90 EB I-90 EB	80+62 110+36	97+00 143+60	RT RT					1638 3324
I-90 EB	150+15	151+59	RT					3324 144
I-90 EB	161+55	178+04	RT					1649
I-90 EB	186+32	197+12	RT					1080
I-90 EB	209+12	218+89	RT					977
I-90 EB	27+90	183+36	LT					15546
I-90 EB	201+24	218+89	LT					1765
I-90 WB	30+20	183+69	RT					15349
I-90 WB	201+16	219+00	RT					1784
I-90 WB	31+12	47+26	LT					1614
I-90 WB	54+16	62+94	LT					878
I-90 WB	68+80	71+80	LT					300
I-90 WB	81+78	104+00	LT					2222
I-90 WB	108+77	126+50	LT					1773
I-90 WB	137+07	148+82	LT					1175
I-90 WB	152+94	157+57	LT					463
I-90 WB	164+78	178+54	LT					1376
I-90 WB	189+30	200+69	LT					1139
I-90 WB	206+16	219+00	LT					1284
	TOTAL			293	54	162	67	57328


2.(18039.2.1 IDOL D1 P1B 187-006 WO 21 Kennedy Express/DGN/Design/Prellm/Plotsheets/D1

STATE OF ILLINOIS
DEPARTMENT OF TRANSPORTATION



- DELINEATORS SHALL BE INSTALLED ALONG ALL RAMPS PROPOSED TO BE RESURFACED AND AT LOCATIONS AS SHOWN ON THE PLANS IN ACCORDANCE TO STANDARD 635001.
- BARRIER WALL MARKERS SHALL BE INSTALLED AT LOCATIONS SHOWN ON THE PLANS ACCORDING TO STANDARD 782006.
- RAISED REFLECTIVE PAVEMENT MARKERS SHALL BE PLACED IN ACCORDANCE WITH THE DISTRICT ONE DETAILS TC-11 "RAISED REFLECTIVE PAVEMENT MARKERS (SNOW-PLOW RESISTANT)" AND TC-12 "MULTI-LANE FREEWAY PAVEMENT MARKING DETAILS".
- RUMBLE STRIPS SHALL BE INSTALLED IN ACCORDANCE WITH STANDARD 642001 AT LOCATIONS AS SHOWN ON THE PLANS.
- SEE DRAINAGE PLANS FOR REMOVAL AND PATCHING ITEMS ASSOCIATED WITH PROPOSED DRAINAGE IMPROVEMENTS.
- A 2 IN. WIDE BY 4 FT LONG REFLECTIVE STRIP SHALL BE INSTALLED ON SIGN POSTS FOR ALL NEW W1-8 SIGNS. THIS WORK SHALL BE PAID FOR AS SIGN PANEL, TYPE 2, IN SQ FT.

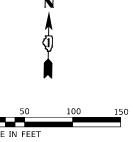

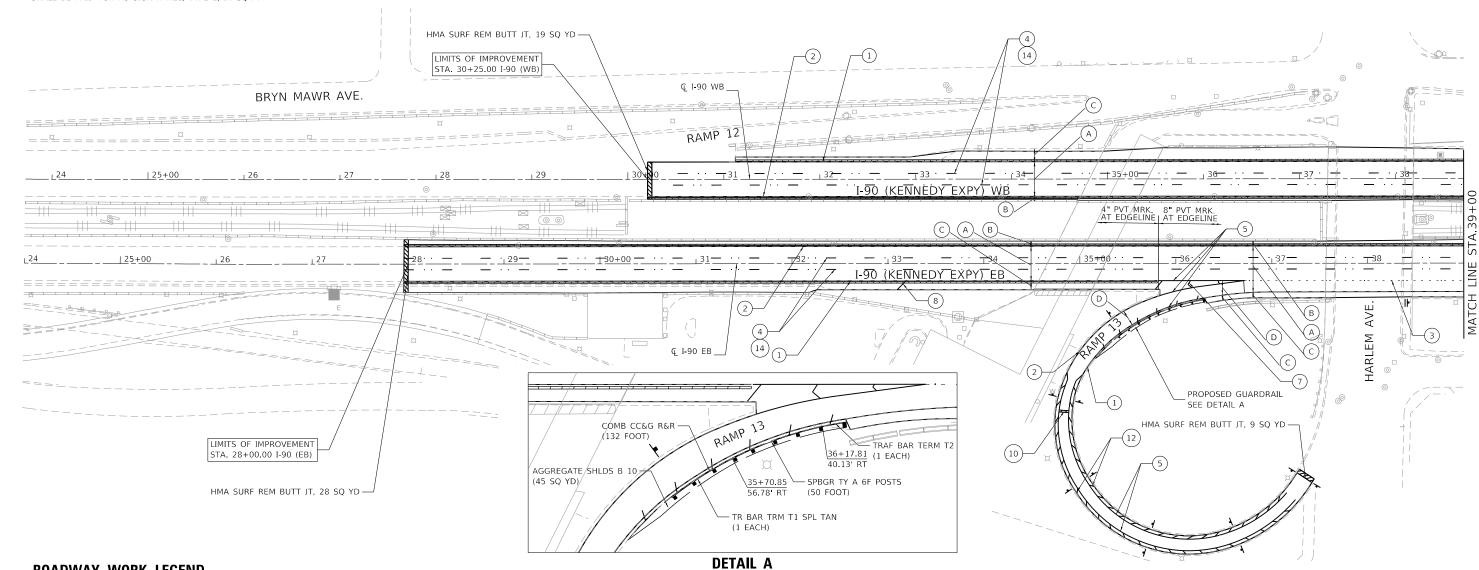

### **ROADWAY WORK LEGEND**

HOT-MIX ASPHALT SURFACE REMOVAL, 4-3/4" POLYMERIZED HMA SURFACE COURSE, SMA, 12.5, MIX "F", N80, 2" POLYMERIZED HMA BINDER COURSE, SMA, 12.5, N80, 2-3/4"

- ON INSIDE SHOULDER:
  I HOT-MIX ASPHALT SURFACE REMOVAL, 4-3/4" (B)- POLYMERIZED HMA SURFACE COURSE, SMA, 12.5, MIX "F", N80, 2" POLYMERIZED HMA BINDER COURSE, SMA, 12.5, N80, 2-3/4"
  - ON OUTSIDE SHOULDER:
- HOT-MIX ASPHALT SURFACE REMOVAL, 4-3/4"

  (C) HOT-MIX ASHPALT SURFACE COURSE, MIX "D", IL-9.5, N70, 2" HMA BINDER COURSE, IL-19.0, N70, 2-3/4"
  - ON RAMPS:
- HOT-MIX ASPHALT SURFACE REMOVAL, 2-1/2" (D) HOT-MIX ASHPALT SURFACE COURSE, MIX "D", IL-9.5, N70, 1-3/4" POLYMERIZED HMA BINDER COURSE, IL-4.75, N50, 3/4"

- PROP. SINGLE DELINEATOR
- IF PROP. DOUBLE DELINEATOR

PROP. RUMBLE STRIP

◆ PROP. BARRIER WALL REFLECTORS, TYPE C

### **PAVEMENT MARKING LEGEND**

- 1) THERMOPLASTIC PAVEMENT MARKING LINE 4" (WHITE)
- 2) THERMOPLASTIC PAVEMENT MARKING LINE 4" (YELLOW)
- (3) PREFORMED PLASTIC PAVEMENT MARKING, TYPE D, INLAID LINE 4" (2' DASH, 6' SKIP, WHITE)
- (4) PREFORMED PLASTIC PAVEMENT MARKING, TYPE D, INLAID LINE 5" (10' DASH, 30' SKIP, WHITE)

SCALE: 1"=50"

- (5) THERMOPLASTIC PAVEMENT MARKING LINE 8" (WHITE)
- THERMOPLASTIC PAVEMENT MARKING LINE 6" (3' DASH, 9' SKIP, WHITE)
- THERMOPLASTIC PAVEMENT MARKING LINE 12" (30' SPACING, CHEVRON, WHITE)
- (8) THERMOPASTIC PAVEMENT MARKING LINE 12" (500' SPACING, 45° DIAGONAL, WHITE)

- THERMOPLASTIC PAVEMENT MARKING LINE 12" (500' - SPACING, 45° DIAGONAL, YELLOW)
- (10) THERMOPLASTIC PAVEMENT MARKING LINE 24" (WHITE)
- (11) THERMOPLASTIC PAVEMENT MARKING LETTERS AND SYMBOLS (WHITE)
- (12) THERMOPLASTIC PAVEMENT MARKING LINE 12" (10' - SPACING, 45° DIAGONAL, WHITE)
- (13) THERMOPLASTIC PAVEMENT MARKING LINE 6" (WHITE)
- RAISED REFLECTIVE PAVEMENT MARKINGS

USER NAME = RGall	DESIGNED -	REVISED -
	DRAWN -	REVISED -
PLOT SCALE = 100.0000 ' / in.	CHECKED -	REVISED -
PLOT DATE = 1/30/2020	DATE -	REVISED -

### STATE OF ILLINOIS **DEPARTMENT OF TRANSPORTATION**

F	ROADWAY AND PAVEMENT MARKING PLAN						F.A.I SECTION COUNTY			SHEET NO.
	1 00 /II DTE 42 1 04\					90	2019-082-RS&T	соок	119	19
	I–90 (IL. RTE. 43 – I–94)							CONTRACT	NO. 62	2J59
	SHEET	OF	SHEETS	STA	TO STA		TILLINOIS SED A	ID DROJECT		

# NOTES: 1. DELINEATORS SHALL BE INSTALLED ALONG ALL RAMPS PROPOSED TO BE RESURFACED AND AT LOCATIONS AS SHOWN ON THE PLANS IN ACCORDANCE TO STANDARD 635001. 2. BARRIER WALL MARKERS SHALL BE INSTALLED AT LOCATIONS SHOWN ON THE PLANS ACCORDING TO STANDARD 782006. 3. RAISED REFLECTIVE PAVEMENT MARKERS SHALL BE PLACED IN ACCORDANCE WITH THE DISTRICT ONE DETAILS TC-11 "RAISED REFLECTIVE PAVEMENT MARKERS (SNOW-PLOW RESISTANT)" AND TC-12 "MULTI-LANE FREEWAY PAVEMENT MARKING DETAILS". 4. RUMBLE STRIPS SHALL BE INSTALLED IN ACCORDANCE WITH STANDARD 642001 AT LOCATIONS AS SHOWN ON THE PLANS. 5. SEE DRAINAGE PLANS FOR REMOVAL AND PATCHING ITEMS ASSOCIATED WITH PROPOSED DRAINAGE IMPROVEMENTS. 6. A 2 IN. WIDE BY 4 FT LONG REFLECTIVE STRIP SHALL BE INSTALLED ON SIGN POSTS FOR ALL NEW W1-8 SIGNS. THIS WORK SHALL BE PAID FOR AS SIGN PANEL, TYPE 2, IN SQ FT. HMA SURF REM BUIT JT, 7 SQ YD (C) (A) (B)

HMA SURF REM BUTT JT, 9 SQ YD

| HOT-MIX ASPHALT SURFACE REMOVAL, 4-3/4"

ON INSIDE SHOULDER: | HOT-MIX ASPHALT SURFACE REMOVAL, 4-3/4"

HOT-MIX ASPHALT SURFACE REMOVAL, 2-1/2"

(A) POLYMERIZED HMA SURFACE COURSE, SMA, 12.5, MIX "F", N80, 2"

POLYMERIZED HMA BINDER COURSE, SMA, 12.5, N80, 2-3/4"

(B)- POLYMERIZED HMA SURFACE COURSE, SMA, 12.5, MIX "F", N80, 2"

POLYMERIZED HMA BINDER COURSE, SMA, 12.5, N80, 2-3/4"

ON OUTSIDE SHOULDER:

HOT-MIX ASPHALT SURFACE REMOVAL, 4-3/4"
HOT-MIX ASHPALT SURFACE COURSE, MIX "D", IL-9.5, N70, 2"
HMA BINDER COURSE, IL-19.0, N70, 2-3/4"

(D) HOT-MIX ASHPALT SURFACE COURSE, MIX "D", IL-9.5, N70, 1-3/4"

POLYMERIZED HMA BINDER COURSE, IL-4.75, N50, 3/4"

**ROADWAY WORK LEGEND** 

ON RAMPS:

# PAVEMENT MARKING LEGEND PAVEMENT MARKING LEGEND THERMOPLASTIC PAVEMENT MARKING - LINE 12\*

RAMP 15

# USER NAME = RGall DESIGNED REVISED DRAWN REVISED PLOT SCALE = 100,0000 ' / in. CHECKED REVISED PLOT DATE = 1/30/2020 DATE REVISED

PROP. SINGLE DELINEATOR

II PROP. DOUBLE DELINEATOR

◆ PROP. BARRIER WALL REFLECTORS, TYPE C

PROP. RUMBLE STRIP

I-90 (KENNEDY EXPY) WB

I-90 (ĶENNEDY EXPY) EB

## STATE OF ILLINOIS DEPARTMENT OF TRANSPORTATION

1) THERMOPLASTIC PAVEMENT MARKING - LINE 4" (WHITE)

(2) THERMOPLASTIC PAVEMENT MARKING - LINE 4" (YELLOW)

(5) THERMOPLASTIC PAVEMENT MARKING - LINE 8" (WHITE)

(6) THERMOPLASTIC PAVEMENT MARKING - LINE 6" (3' - DASH, 9' - SKIP, WHITE)

(7) THERMOPLASTIC PAVEMENT MARKING - LINE 12" (30' - SPACING, CHEVRON, WHITE)

(8) THERMOPASTIC PAVEMENT MARKING - LINE 12" (500' - SPACING, 45° DIAGONAL, WHITE)

(3) PREFORMED PLASTIC PAVEMENT MARKING, TYPE D, INLAID - LINE 4" (2' - DASH, 6' - SKIP, WHITE)

4) PREFORMED PLASTIC PAVEMENT MARKING, TYPE D, INLAID - LINE 5" (10' - DASH, 30' - SKIP, WHITE)

SCALE: 1"=50"

4" PVT MRK. 8" PVT MRK. AT EDGELINE AT EDGELINE

(D)

F	ROADWAY AND PAVEMENT MARKING PLAN						SECTION		COUNTY	TOTAL SHEETS	SHEET NO.
							2019-082-RS&T		COOK	119	20
	I–90 (IL. RTE. 43 – I–94)								CONTRACT	T NO. 63	2J59
	SHEET	OF	SHEETS	STA.	TO STA.		ILLINOIS FE	D. Al	D PROJECT		

(500' - SPACING, 45° DIAGONAL, YELLOW)

12) THERMOPLASTIC PAVEMENT MARKING - LINE 12"

(10' - SPACING, 45° DIAGONAL, WHITE)

(14) RAISED REFLECTIVE PAVEMENT MARKINGS

(10) THERMOPLASTIC PAVEMENT MARKING - LINE 24" (WHITE)

(13) THERMOPLASTIC PAVEMENT MARKING - LINE 6" - (WHITE)

(11) THERMOPLASTIC PAVEMENT MARKING - LETTERS AND SYMBOLS (WHITE)

BRYN MAWR AVE.

(D)


(A)

\_ Q 1-90 WB

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- ON INSIDE SHOULDER:
  HOT-MIX ASPHALT SURFACE REMOVAL, 4-3/4"
  POLYMERIZED HMA SURFACE COURSE, SMA, 12.5, MIX "F", N80, 2" POLYMERIZED HMA BINDER COURSE, SMA, 12.5, N80, 2-3/4"
- ON OUTSIDE SHOULDER:

  HOT-MIX ASPHALT SURFACE REMOVAL, 4-3/4"
  HOT-MIX ASHPALT SURFACE COURSE, MIX "D", IL-9.5, N70, 2"
  HMA BINDER COURSE, IL-19.0, N70, 2-3/4"
- HOT-MIX ASPHALT SURFACE REMOVAL, 2-1/2" (D) HOT-MIX ASHPALT SURFACE COURSE, MIX "D", IL-9.5, N70, 1-3/4" POLYMERIZED HMA BINDER COURSE, IL-4.75, N50, 3/4"

- PROP. SINGLE DELINEATOR
- I PROP. DOUBLE DELINEATOR

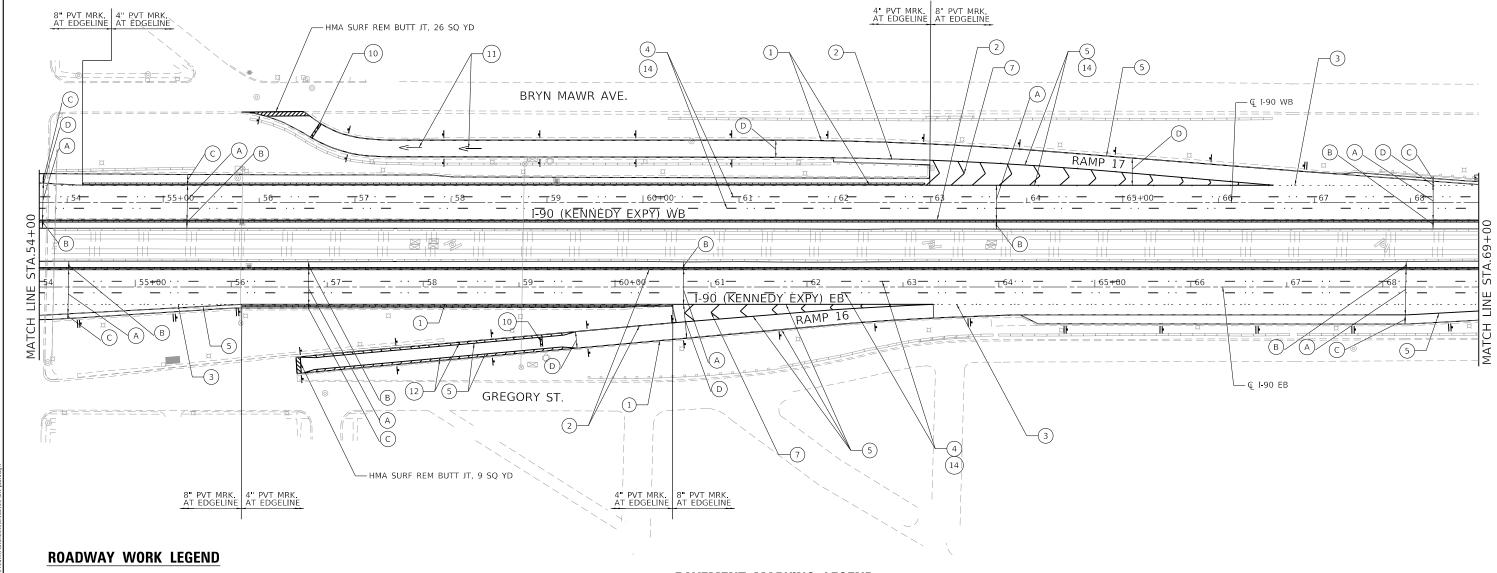PROP. RUMBLE STRIP

◆ PROP. BARRIER WALL REFLECTORS, TYPE C

### **PAVEMENT MARKING LEGEND**

- 1) THERMOPLASTIC PAVEMENT MARKING LINE 4" (WHITE)
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SCALE: 1"=50"

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- (11) THERMOPLASTIC PAVEMENT MARKING LETTERS AND SYMBOLS (WHITE)
- (12) THERMOPLASTIC PAVEMENT MARKING LINE 12" (10' - SPACING, 45° DIAGONAL, WHITE)
- (13) THERMOPLASTIC PAVEMENT MARKING LINE 6" (WHITE)
- (14) RAISED REFLECTIVE PAVEMENT MARKINGS

USER NAME = RGall	DESIGNED -	REVISED -
	DRAWN -	REVISED -
PLOT SCALE = 100.0000 / in.	CHECKED -	REVISED -
PLOT DATE = 1/30/2020	DATE -	REVISED -


STATE OF ILLINOIS **DEPARTMENT OF TRANSPORTATION**  **ROADWAY AND PAVEMENT MARKING PLAN** I-90 (IL. RTE. 43 - I-94)


2019-082-RS&T COOK 119 21 CONTRACT NO. 62J59

### NOTES:

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### **ROADWAY WORK LEGEND**

HOT-MIX ASPHALT SURFACE REMOVAL, 4-3/4" (A) POLYMERIZED HMA SURFACE COURSE, SMA, 12.5, MIX "F", N80, 2" POLYMERIZED HMA BINDER COURSE, SMA, 12.5, N80, 2-3/4"

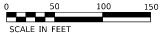- ON INSIDE SHOULDER:
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  POLYMERIZED HMA SURFACE COURSE, SMA, 12.5, MIX "F", N80, 2" POLYMERIZED HMA BINDER COURSE, SMA, 12.5, N80, 2-3/4"
- ON OUTSIDE SHOULDER:

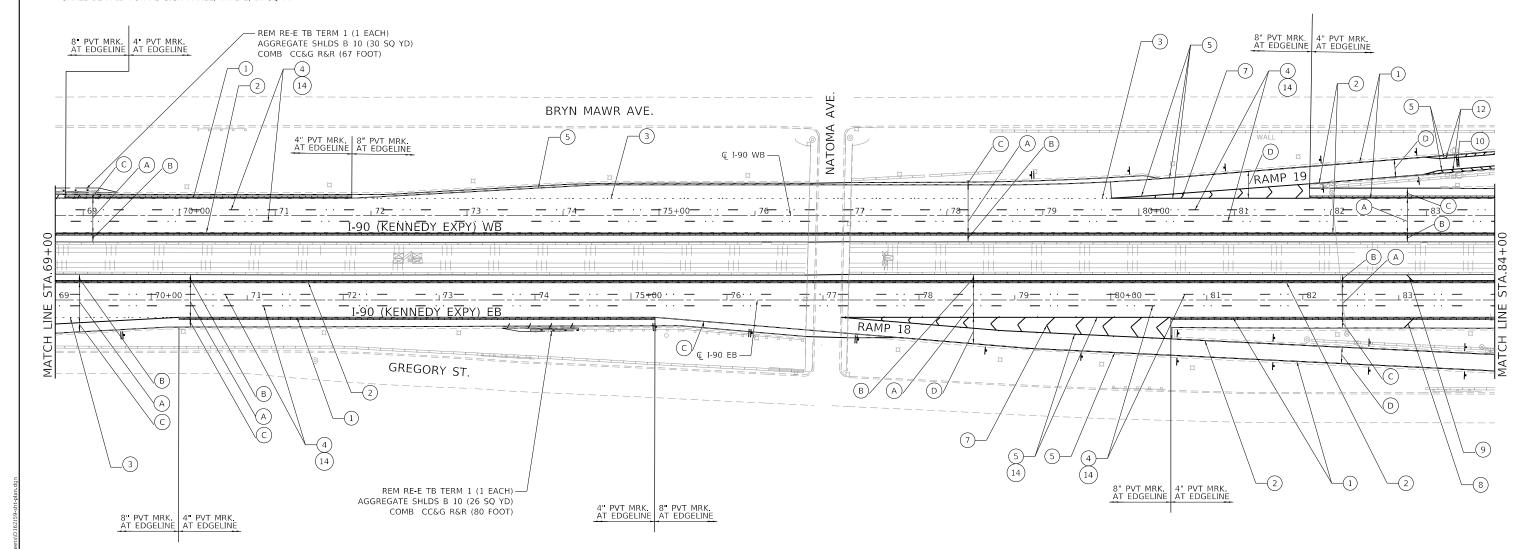  HOT-MIX ASPHALT SURFACE REMOVAL, 4-3/4"
  HOT-MIX ASHPALT SURFACE COURSE, MIX "D", IL-9.5, N70, 2"
  HMA BINDER COURSE, IL-19.0, N70, 2-3/4"
  - ON RAMPS:
- HOT-MIX ASPHALT SURFACE REMOVAL, 2-1/2" (D) HOT-MIX ASHPALT SURFACE COURSE, MIX "D", IL-9.5, N70, 1-3/4" POLYMERIZED HMA BINDER COURSE, IL-4.75, N50, 3/4"

- PROP. SINGLE DELINEATOR
- I PROP. DOUBLE DELINEATOR

PROP. RUMBLE STRIP

◆ PROP. BARRIER WALL REFLECTORS, TYPE C

### **PAVEMENT MARKING LEGEND**

- (1) THERMOPLASTIC PAVEMENT MARKING LINE 4" (WHITE)
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SCALE: 1"=50"

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- 9 THERMOPLASTIC PAVEMENT MARKING LINE 12" (500' - SPACING, 45° DIAGONAL, YELLOW)
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- (13) THERMOPLASTIC PAVEMENT MARKING LINE 6" (WHITE)
- (14) RAISED REFLECTIVE PAVEMENT MARKINGS


USER NAME = RGall	DESIGNED -	REVISED -
	DRAWN -	REVISED -
PLOT SCALE = 100.0000 ' / in.	CHECKED -	REVISED -
PLOT DATE = 1/30/2020	DATE -	REVISED -

STATE OF ILLINOIS **DEPARTMENT OF TRANSPORTATION**  **ROADWAY AND PAVEMENT MARKING PLAN** I-90 (IL. RTE. 43 - I-94)

SECTION 2019-082-RS&T COOK 119 22 CONTRACT NO. 62J59

### NOTES:

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HOT-MIX ASPHALT SURFACE REMOVAL, 4-3/4" (A) POLYMERIZED HMA SURFACE COURSE, SMA, 12.5, MIX "F", N80, 2" POLYMERIZED HMA BINDER COURSE, SMA, 12.5, N80, 2-3/4"

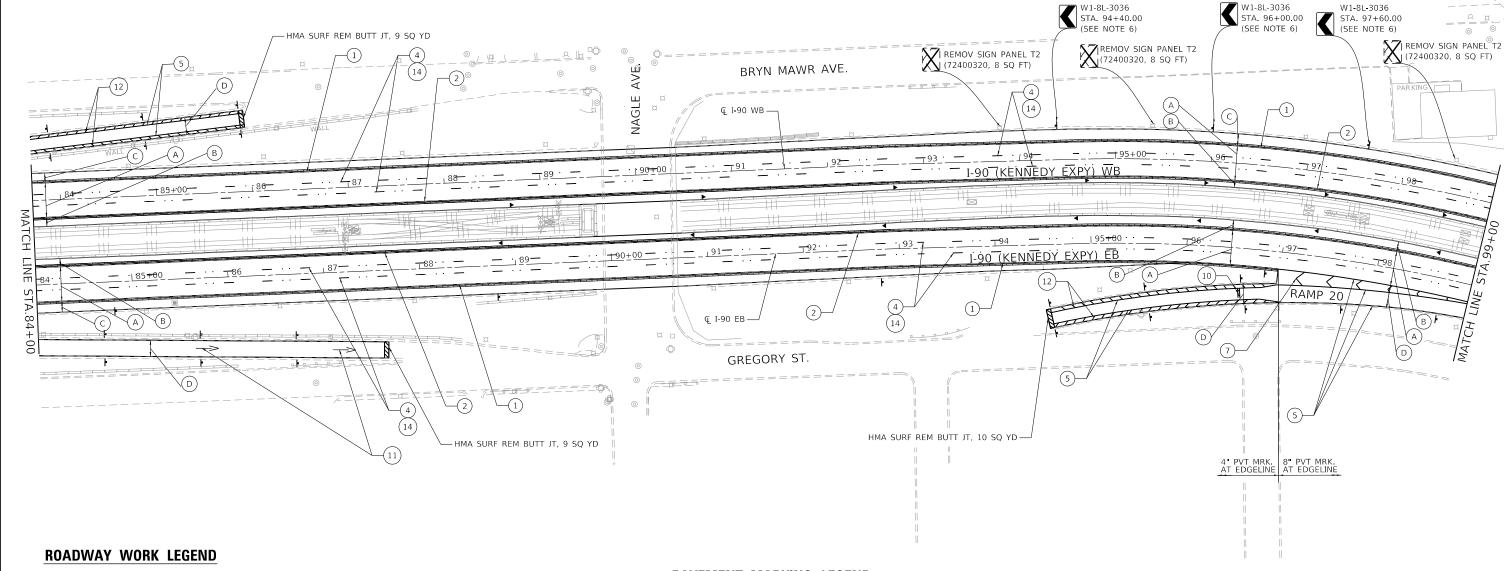- ON INSIDE SHOULDER:
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  POLYMERIZED HMA SURFACE COURSE, SMA, 12.5, MIX "F", N80, 2" POLYMERIZED HMA BINDER COURSE, SMA, 12.5, N80, 2-3/4"
- ON OUTSIDE SHOULDER:

  HOT-MIX ASPHALT SURFACE REMOVAL, 4-3/4"
  HOT-MIX ASHPALT SURFACE COURSE, MIX "D", IL-9.5, N70, 2"
  HMA BINDER COURSE, IL-19.0, N70, 2-3/4"
  - ON RAMPS:
- HOT-MIX ASPHALT SURFACE REMOVAL, 2-1/2" (D) HOT-MIX ASHPALT SURFACE COURSE, MIX "D", IL-9.5, N70, 1-3/4" POLYMERIZED HMA BINDER COURSE, IL-4.75, N50, 3/4"

- PROP. SINGLE DELINEATOR
- II PROP. DOUBLE DELINEATOR

PROP. RUMBLE STRIP

◆ PROP. BARRIER WALL REFLECTORS, TYPE C

### **PAVEMENT MARKING LEGEND**

- (1) THERMOPLASTIC PAVEMENT MARKING LINE 4" (WHITE)
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SCALE: 1"=50"


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- (14) RAISED REFLECTIVE PAVEMENT MARKINGS

DESIGNED REVISED DRAWN REVISED HECKED REVISED

STATE OF ILLINOIS **DEPARTMENT OF TRANSPORTATION**  **ROADWAY AND PAVEMENT MARKING PLAN** I-90 (IL. RTE. 43 - I-94)

SECTION 2019-082-RS&T COOK 119 23 CONTRACT NO. 62J59

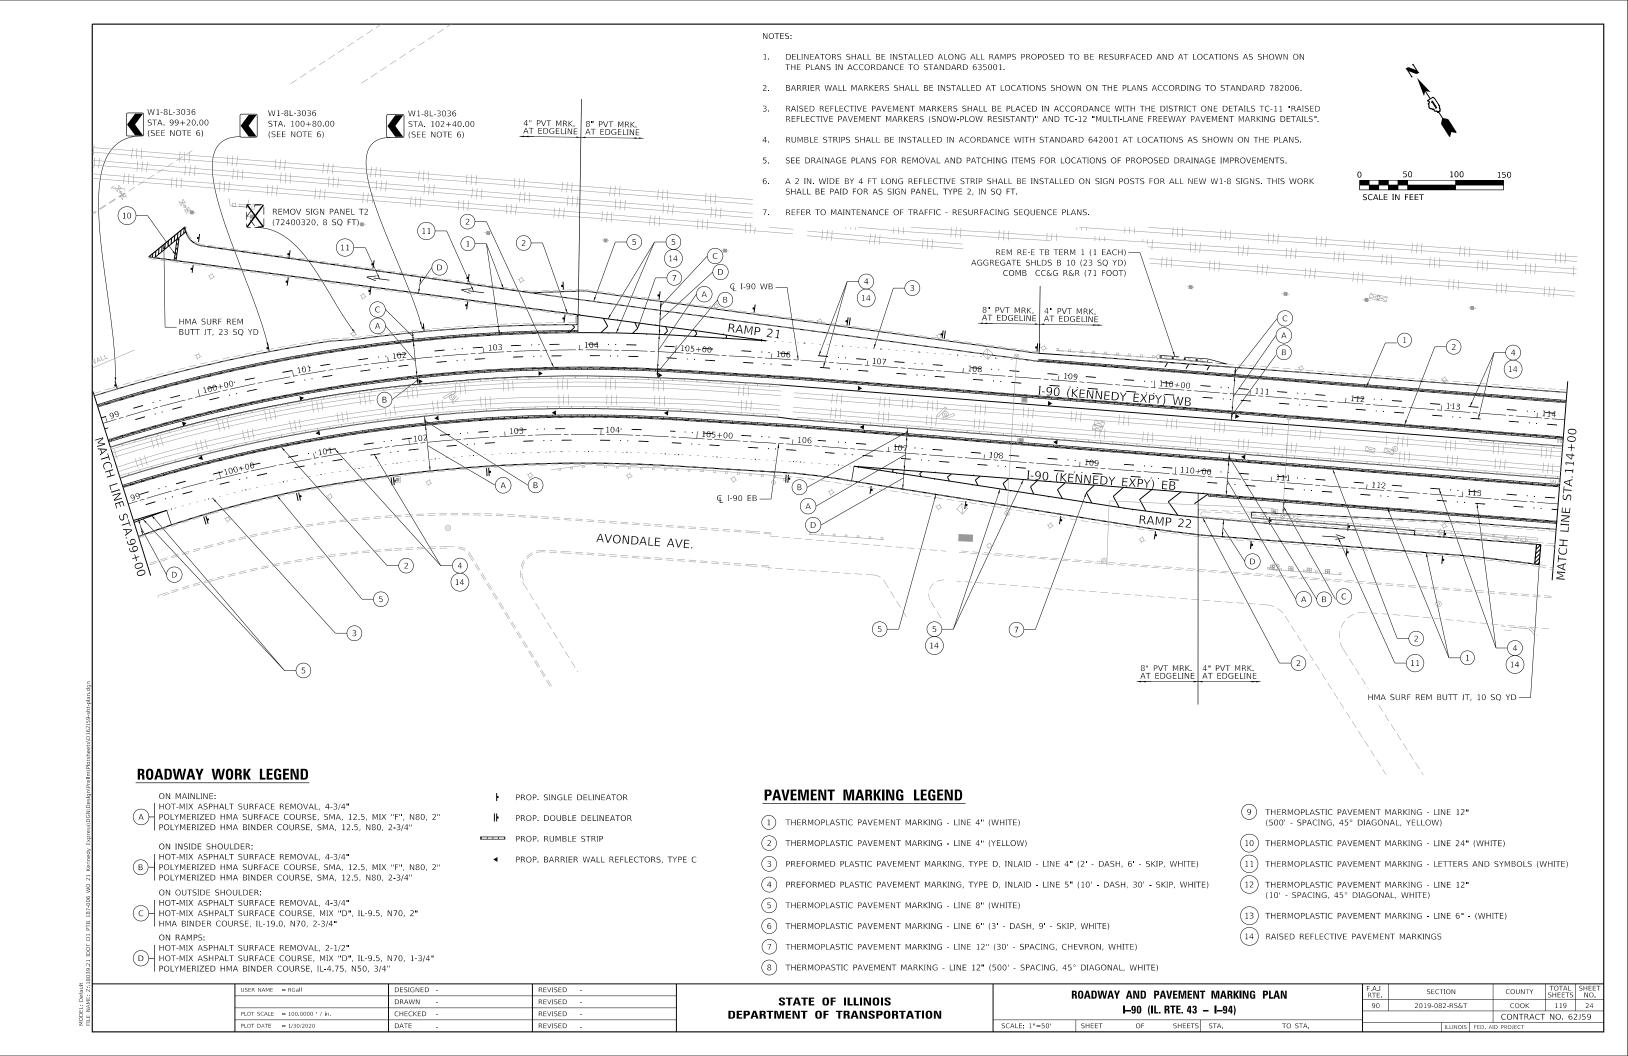

# DELINEATORS SHALL BE INSTALLED ALONG ALL RAMPS PROPOSED TO BE RESURFACED AND AT LOCATIONS AS SHOWN ON THE PLANS IN ACCORDANCE TO STANDARD 635001. BARRIER WALL MARKERS SHALL BE INSTALLED AT LOCATIONS SHOWN ON THE PLANS ACCORDING TO STANDARD 782006. RAISED REFLECTIVE PAVEMENT MARKERS SHALL BE PLACED IN ACCORDANCE WITH THE DISTRICT ONE DETAILS TC-11 "RAISED REFLECTIVE PAVEMENT MARKERS (SNOW-PLOW RESISTANT)" AND TC-12 "MULTI-LANE FREEWAY PAVEMENT MARKING DETAILS". RUMBLE STRIPS SHALL BE INSTALLED IN ACCORDANCE WITH STANDARD 642001 AT LOCATIONS AS SHOWN ON THE PLANS. SEE DRAINAGE PLANS FOR REMOVAL AND PATCHING ITEMS ASSOCIATED WITH PROPOSED DRAINAGE IMPROVEMENTS. A 2 IN. WIDE BY 4 FT LONG REFLECTIVE STRIP SHALL BE INSTALLED ON SIGN POSTS FOR ALL NEW W1-8 SIGNS. THIS WORK SHALL BE PAID FOR AS SIGN PANEL, TYPE 2, IN SQ FT.

MATCH

ON RAMPS:

**ROADWAY WORK LEGEND** 

| HOT-MIX ASPHALT SURFACE REMOVAL, 4-3/4"

HOT-MIX ASPHALT SURFACE REMOVAL, 2-1/2"

(A) POLYMERIZED HMA SURFACE COURSE, SMA, 12.5, MIX "F", N80, 2"

POLYMERIZED HMA BINDER COURSE, SMA, 12.5, N80, 2-3/4"

ON INSIDE SHOULDER:
HOT-MIX ASPHALT SURFACE REMOVAL, 4-3/4"
POLYMERIZED HMA SURFACE COURSE, SMA, 12.5, MIX "F", N80, 2"


POLYMERIZED HMA BINDER COURSE, SMA, 12.5, N80, 2-3/4"

ON OUTSIDE SHOULDER:

HOT-MIX ASPHALT SURFACE REMOVAL, 4-3/4"
HOT-MIX ASHPALT SURFACE COURSE, MIX "D", IL-9.5, N70, 2"
HMA BINDER COURSE, IL-19.0, N70, 2-3/4"

(D) HOT-MIX ASHPALT SURFACE COURSE, MIX "D", IL-9.5, N70, 1-3/4"

POLYMERIZED HMA BINDER COURSE, IL-4.75, N50, 3/4"

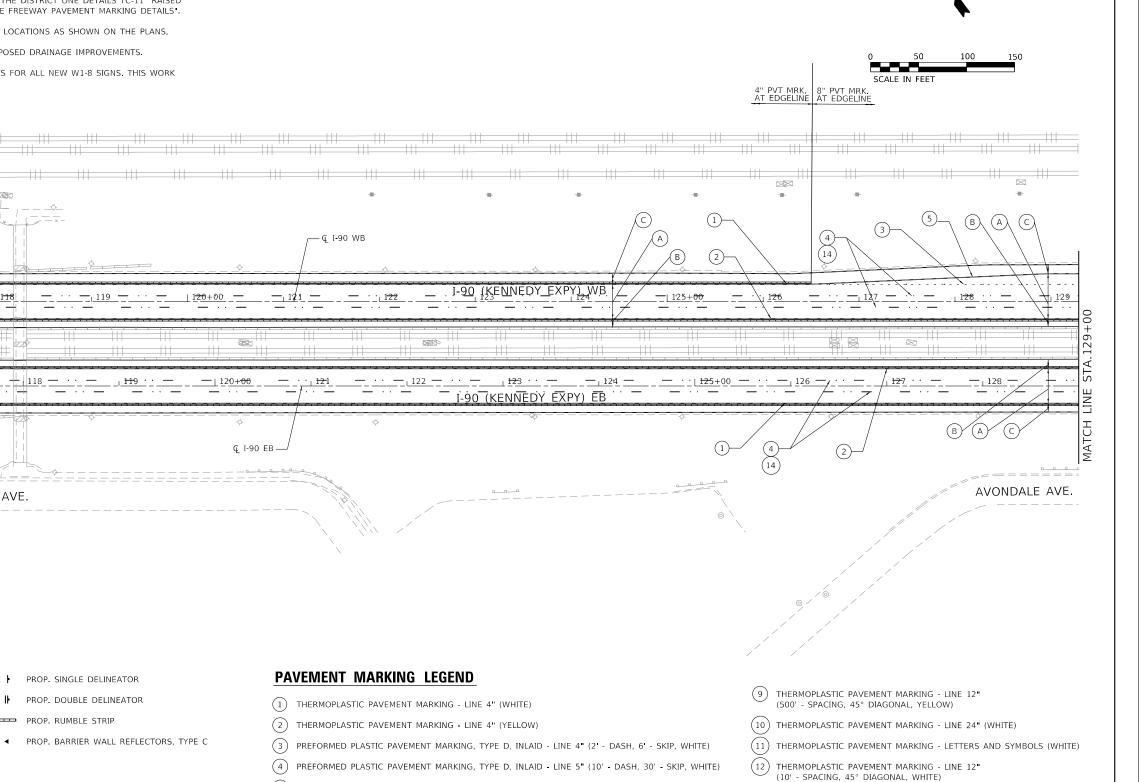

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AVONDALE AVE.

PROP. SINGLE DELINEATOR

I PROP. DOUBLE DELINEATOR

PROP. RUMBLE STRIP

STATE OF ILLINOIS **DEPARTMENT OF TRANSPORTATION** 

5) THERMOPLASTIC PAVEMENT MARKING - LINE 8" (WHITE)

(6) THERMOPLASTIC PAVEMENT MARKING - LINE 6" (3' - DASH, 9' - SKIP, WHITE)

(7) THERMOPLASTIC PAVEMENT MARKING - LINE 12" (30' - SPACING, CHEVRON, WHITE)

(8) THERMOPASTIC PAVEMENT MARKING - LINE 12" (500' - SPACING, 45° DIAGONAL, WHITE)


SCALE: 1"=50"

SECTION **ROADWAY AND PAVEMENT MARKING PLAN** 2019-082-RS&T COOK 119 25 H-90 (IL. RTE. 43 - I-94) CONTRACT NO. 62J59

(14) RAISED REFLECTIVE PAVEMENT MARKINGS

(13) THERMOPLASTIC PAVEMENT MARKING - LINE 6" - (WHITE)

- DELINEATORS SHALL BE INSTALLED ALONG ALL RAMPS PROPOSED TO BE RESURFACED AND AT LOCATIONS AS SHOWN ON THE PLANS IN ACCORDANCE TO STANDARD 635001.
- BARRIER WALL MARKERS SHALL BE INSTALLED AT LOCATIONS SHOWN ON THE PLANS ACCORDING TO STANDARD 782006.
- RAISED REFLECTIVE PAVEMENT MARKERS SHALL BE PLACED IN ACCORDANCE WITH THE DISTRICT ONE DETAILS TC-11 "RAISED REFLECTIVE PAVEMENT MARKERS (SNOW-PLOW RESISTANT)" AND TC-12 "MULTI-LANE FREEWAY PAVEMENT MARKING DETAILS".
- RUMBLE STRIPS SHALL BE INSTALLED IN ACCORDANCE WITH STANDARD 642001 AT LOCATIONS AS SHOWN ON THE PLANS.
- SEE DRAINAGE PLANS FOR REMOVAL AND PATCHING ITEMS ASSOCIATED WITH PROPOSED DRAINAGE IMPROVEMENTS.
- A 2 IN. WIDE BY 4 FT LONG REFLECTIVE STRIP SHALL BE INSTALLED ON SIGN POSTS FOR ALL NEW W1-8 SIGNS. THIS WORK SHALL BE PAID FOR AS SIGN PANEL, TYPE 2, IN SQ FT.

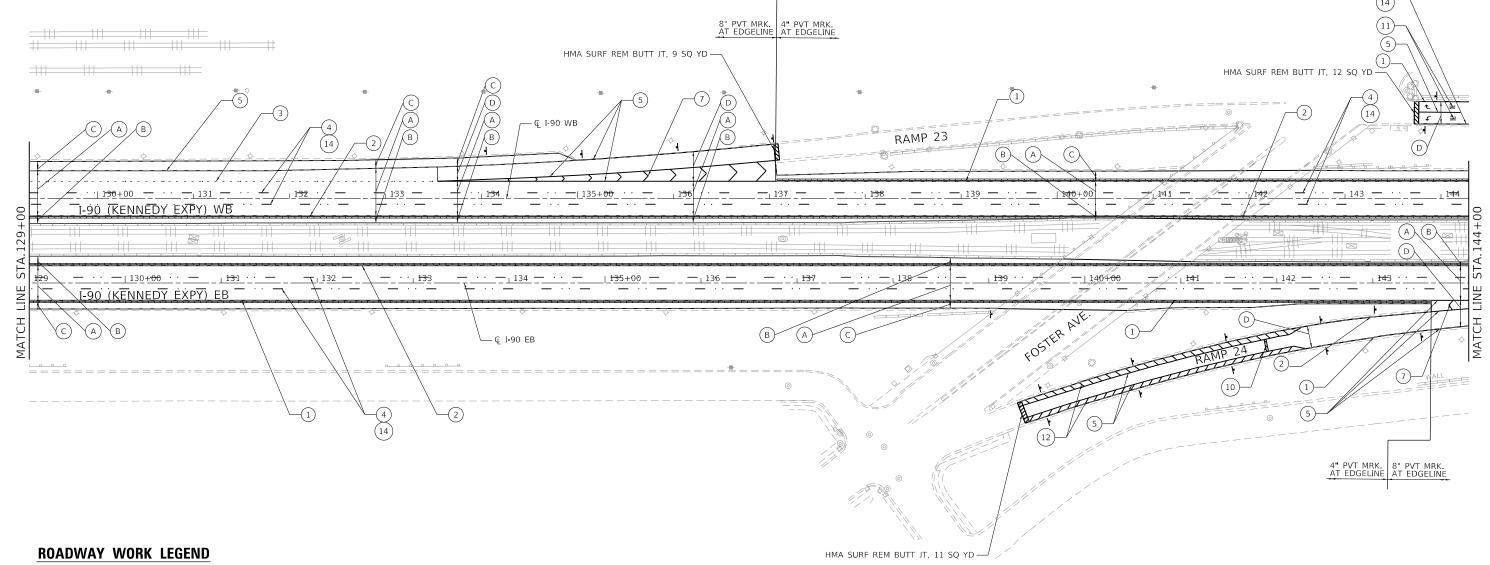

HOT-MIX ASPHALT SURFACE REMOVAL, 4-3/4" (A) POLYMERIZED HMA SURFACE COURSE, SMA, 12.5, MIX "F", N80, 2" POLYMERIZED HMA BINDER COURSE, SMA, 12.5, N80, 2-3/4"

- ON INSIDE SHOULDER:
  HOT-MIX ASPHALT SURFACE REMOVAL, 4-3/4"
  POLYMERIZED HMA SURFACE COURSE, SMA, 12.5, MIX "F", N80, 2" POLYMERIZED HMA BINDER COURSE, SMA, 12.5, N80, 2-3/4"
- ON OUTSIDE SHOULDER:

  HOT-MIX ASPHALT SURFACE REMOVAL, 4-3/4"
  HOT-MIX ASHPALT SURFACE COURSE, MIX "D", IL-9.5, N70, 2"
  HMA BINDER COURSE, IL-19.0, N70, 2-3/4"
- HOT-MIX ASPHALT SURFACE REMOVAL, 2-1/2" (D) HOT-MIX ASHPALT SURFACE COURSE, MIX "D", IL-9.5, N70, 1-3/4" POLYMERIZED HMA BINDER COURSE, IL-4.75, N50, 3/4"

- PROP. SINGLE DELINEATOR
- I PROP. DOUBLE DELINEATOR

PROP. RUMBLE STRIP

◆ PROP. BARRIER WALL REFLECTORS, TYPE C

### **PAVEMENT MARKING LEGEND**

- 1) THERMOPLASTIC PAVEMENT MARKING LINE 4" (WHITE)
- (2) THERMOPLASTIC PAVEMENT MARKING LINE 4" (YELLOW)
- (3) PREFORMED PLASTIC PAVEMENT MARKING, TYPE D, INLAID LINE 4" (2' DASH, 6' SKIP, WHITE)
- 4 PREFORMED PLASTIC PAVEMENT MARKING, TYPE D, INLAID LINE 5" (10' DASH, 30' SKIP, WHITE)

SCALE: 1"=50"

- (5) THERMOPLASTIC PAVEMENT MARKING LINE 8" (WHITE)
- (6) THERMOPLASTIC PAVEMENT MARKING LINE 6" (3' DASH, 9' SKIP, WHITE)
- (7) THERMOPLASTIC PAVEMENT MARKING LINE 12" (30' SPACING, CHEVRON, WHITE)
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- 9 THERMOPLASTIC PAVEMENT MARKING LINE 12" (500' - SPACING, 45° DIAGONAL, YELLOW)
- (10) THERMOPLASTIC PAVEMENT MARKING LINE 24" (WHITE)
- (11) THERMOPLASTIC PAVEMENT MARKING LETTERS AND SYMBOLS (WHITE)

119 26

- 12) THERMOPLASTIC PAVEMENT MARKING LINE 12" (10' - SPACING, 45° DIAGONAL, WHITE)
- (13) THERMOPLASTIC PAVEMENT MARKING LINE 6" (WHITE)
- (14) RAISED REFLECTIVE PAVEMENT MARKINGS


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PLOT SCALE = 100.0000 ' / in.	CHECKED -	REVISED -
PLOT DATE = 1/30/2020	DATE -	REVISED -

STATE OF ILLINOIS **DEPARTMENT OF TRANSPORTATION** 

SECTION **ROADWAY AND PAVEMENT MARKING PLAN** 2019-082-RS&T COOK I-90 (IL. RTE. 43 - I-94) CONTRACT NO. 62J59

### NOTES:

- DELINEATORS SHALL BE INSTALLED ALONG ALL RAMPS PROPOSED TO BE RESURFACED AND AT LOCATIONS AS SHOWN ON THE PLANS IN ACCORDANCE TO STANDARD 635001.
- BARRIER WALL MARKERS SHALL BE INSTALLED AT LOCATIONS SHOWN ON THE PLANS ACCORDING TO STANDARD 782006.
- RAISED REFLECTIVE PAVEMENT MARKERS SHALL BE PLACED IN ACCORDANCE WITH THE DISTRICT ONE DETAILS TC-11 "RAISED REFLECTIVE PAVEMENT MARKERS (SNOW-PLOW RESISTANT)" AND TC-12 "MULTI-LANE FREEWAY PAVEMENT MARKING DETAILS".

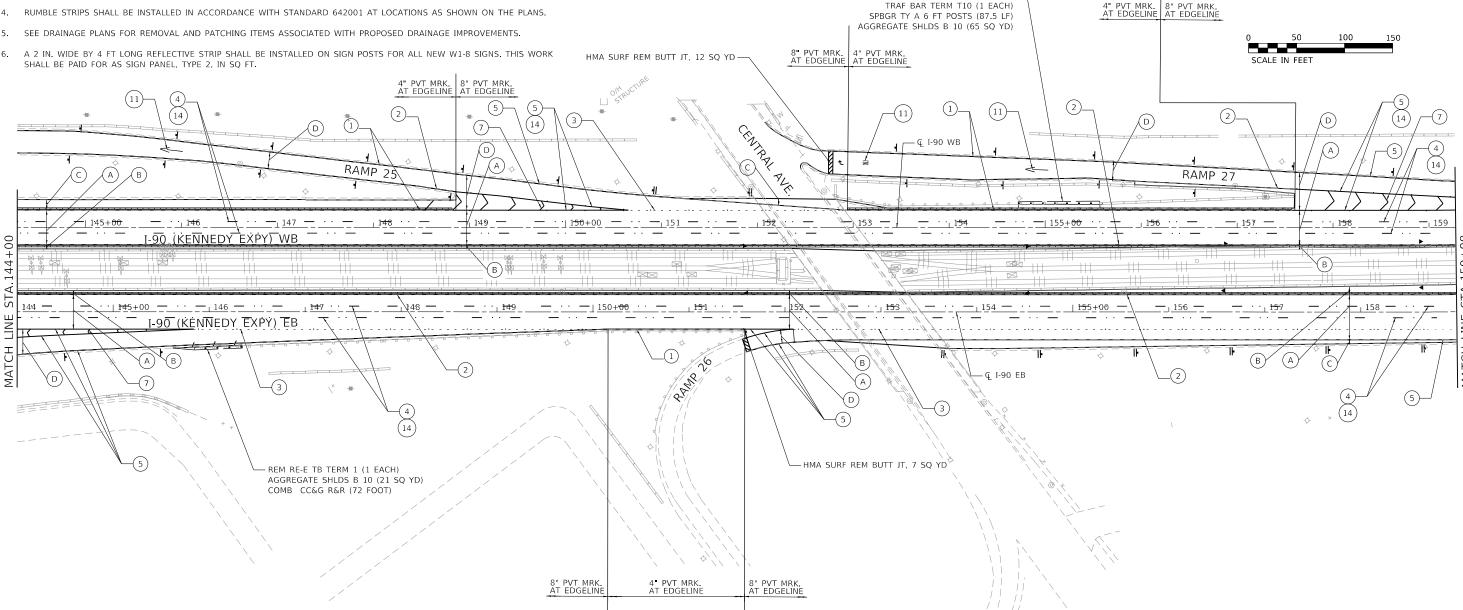

### **ROADWAY WORK LEGEND**

HOT-MIX ASPHALT SURFACE REMOVAL, 4-3/4" (A) POLYMERIZED HMA SURFACE COURSE, SMA, 12.5, MIX "F", N80, 2" POLYMERIZED HMA BINDER COURSE, SMA, 12.5, N80, 2-3/4"

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  HOT-MIX ASPHALT SURFACE REMOVAL, 4-3/4"
  HOT-MIX ASHPALT SURFACE COURSE, MIX "D", IL-9.5, N70, 2"
  HMA BINDER COURSE, IL-19.0, N70, 2-3/4"
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  - POLYMERIZED HMA BINDER COURSE, IL-4.75, N50, 3/4"

- PROP. SINGLE DELINEATOR
- I PROP. DOUBLE DELINEATOR

PROP. RUMBLE STRIP

◆ PROP. BARRIER WALL REFLECTORS, TYPE C

### **PAVEMENT MARKING LEGEND**

- (1) THERMOPLASTIC PAVEMENT MARKING LINE 4" (WHITE)
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- (4) PREFORMED PLASTIC PAVEMENT MARKING, TYPE D, INLAID LINE 5" (10' DASH, 30' SKIP, WHITE)

SCALE: 1"=50"

GUARDRAIL REMOV (50 FT) —


- (5) THERMOPLASTIC PAVEMENT MARKING LINE 8" (WHITE)
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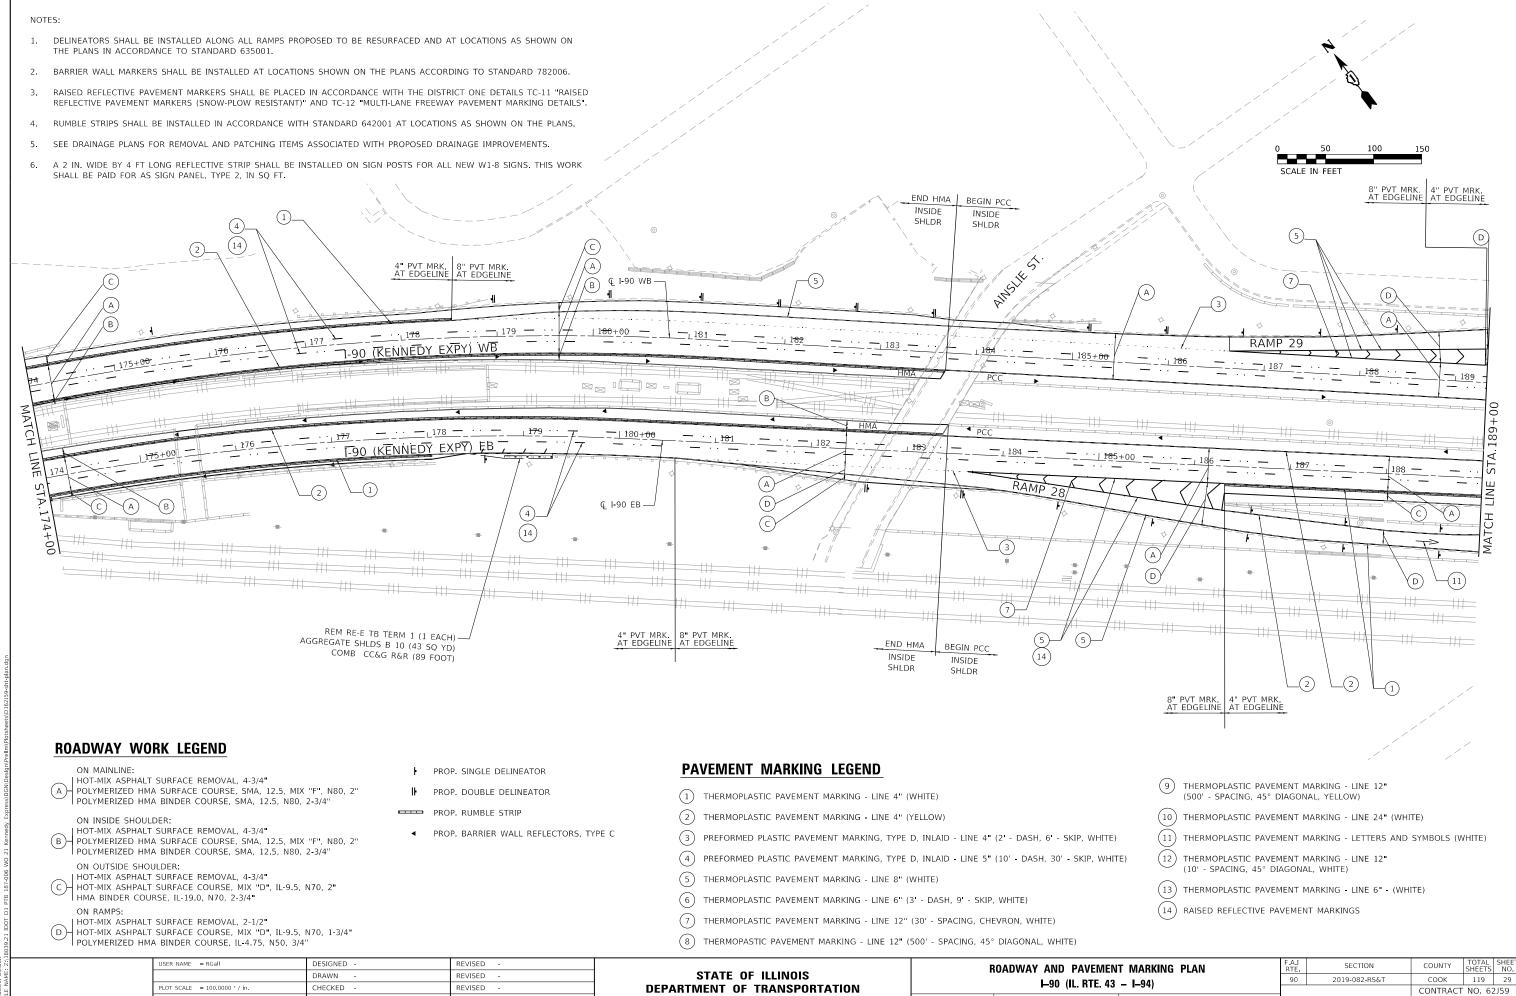
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- (14) RAISED REFLECTIVE PAVEMENT MARKINGS

USER NAME = RGall	DESIGNED -	REVISED -
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PLOT SCALE = 100.0000 / in.	CHECKED -	REVISED -
PLOT DATE = 1/30/2020	DATE -	REVISED -

### STATE OF ILLINOIS **DEPARTMENT OF TRANSPORTATION**

F	ROADWAY AND PAVEMENT MARKING PLAN I–90 (IL. RTE. 43 – I–94)						SECTION	COUNTY	TOTAL SHEETS	SHEET NO.
							2019-082-RS&T	соок	119	27
								CONTRACT	NO. 62	2J59
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SCALE: 1"=50"


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- A 2 IN. WIDE BY 4 FT LONG REFLECTIVE STRIP SHALL BE INSTALLED ON SIGN POSTS FOR ALL NEW W1-8 SIGNS. THIS WORK

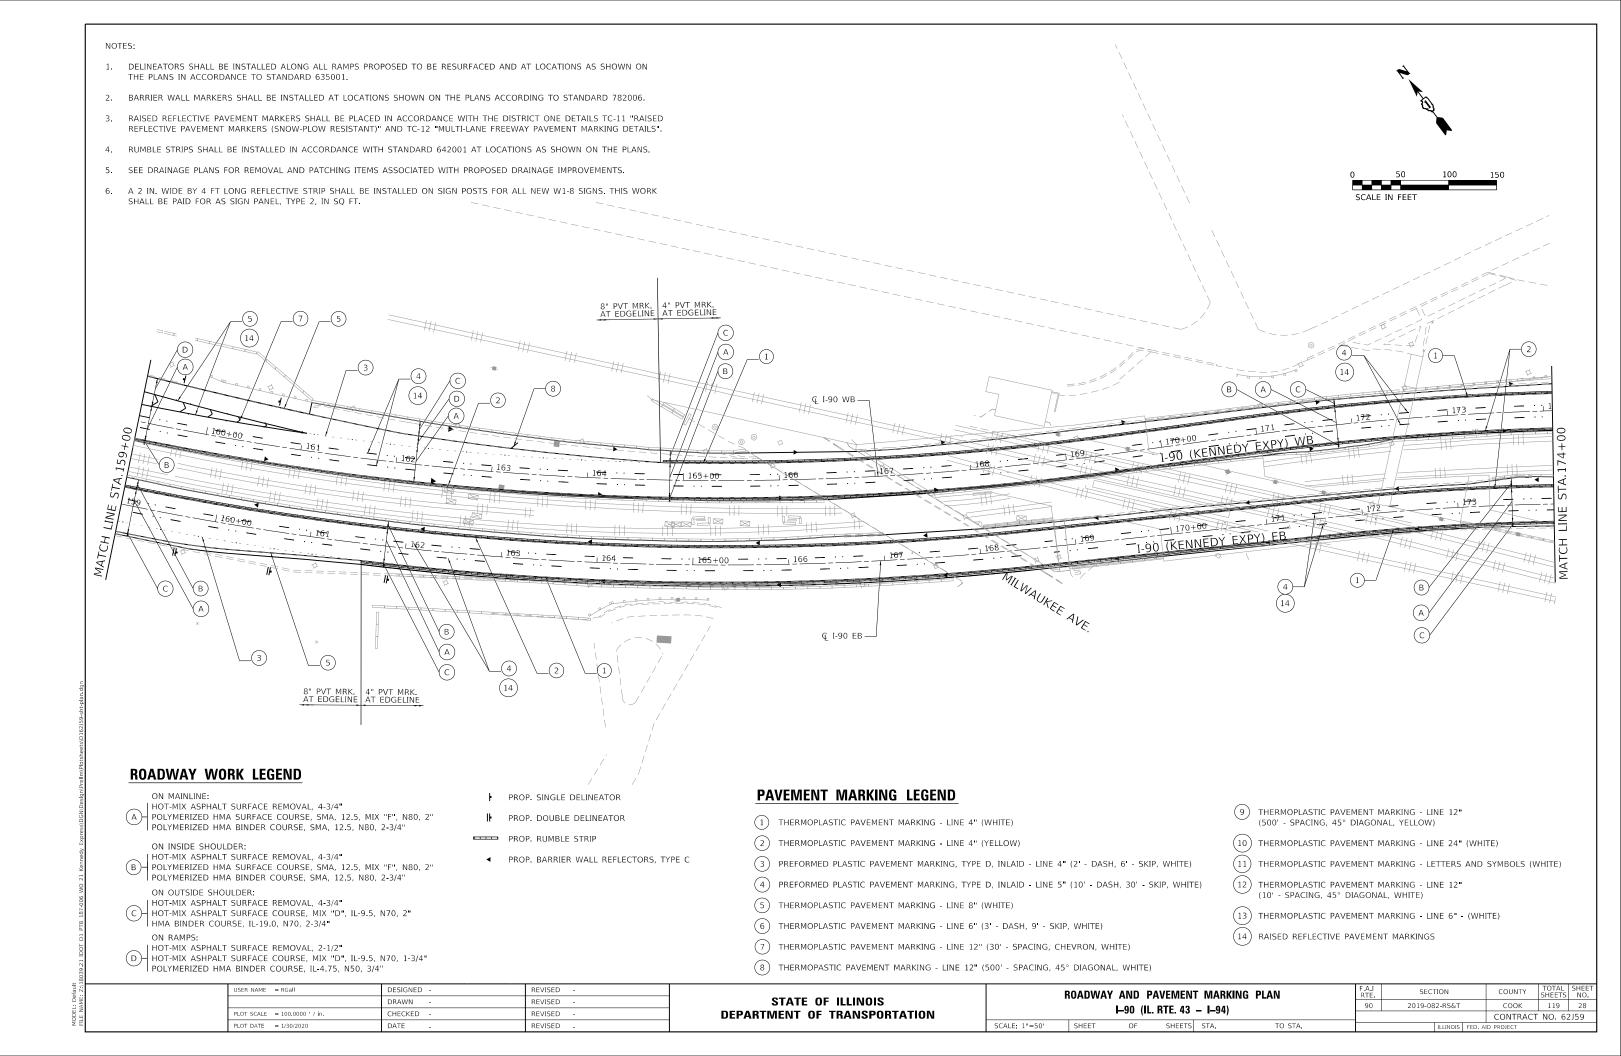





### **ROADWAY WORK LEGEND**
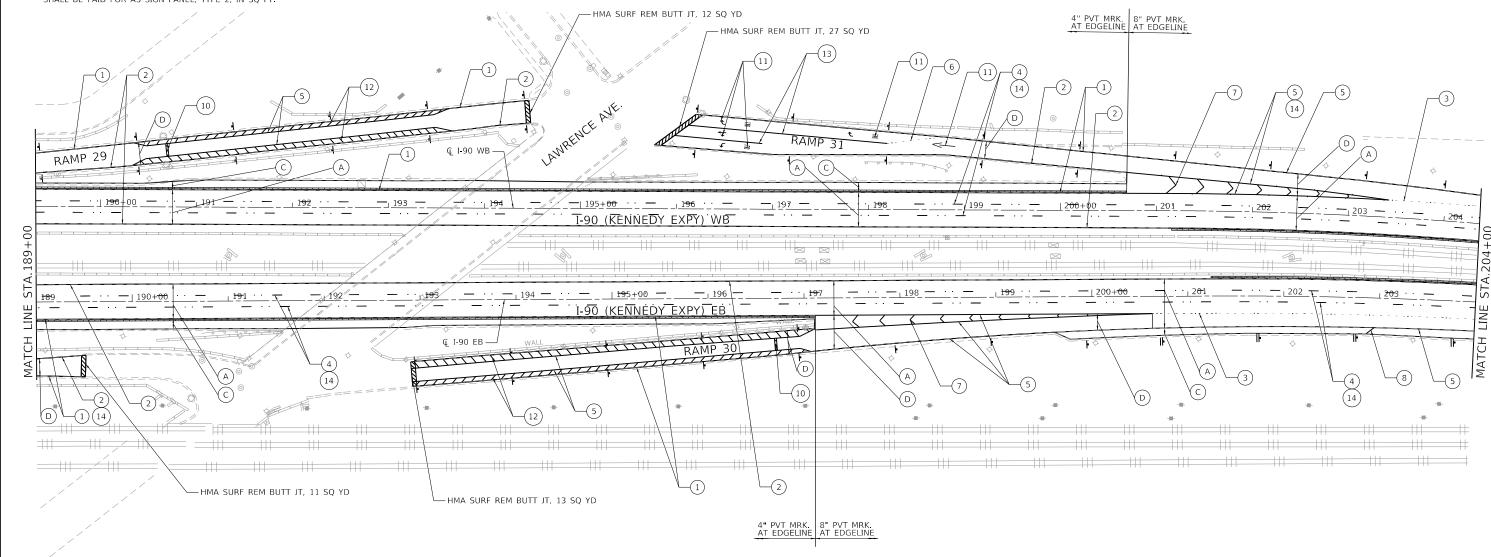
| HOT-MIX ASPHALT SURFACE REMOVAL, 4-3/4" (A) POLYMERIZED HMA SURFACE COURSE, SMA, 12.5, MIX "F", N80, 2" POLYMERIZED HMA BINDER COURSE, SMA, 12.5, N80, 2-3/4"

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  HOT-MIX ASPHALT SURFACE REMOVAL, 4-3/4"

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  HMA BINDER COURSE, IL-19.0, N70, 2-3/4"
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- PROP. SINGLE DELINEATOR
- I PROP. DOUBLE DELINEATOR

PROP. RUMBLE STRIP

◆ PROP. BARRIER WALL REFLECTORS, TYPE C

### **PAVEMENT MARKING LEGEND**

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SCALE: 1"=50"

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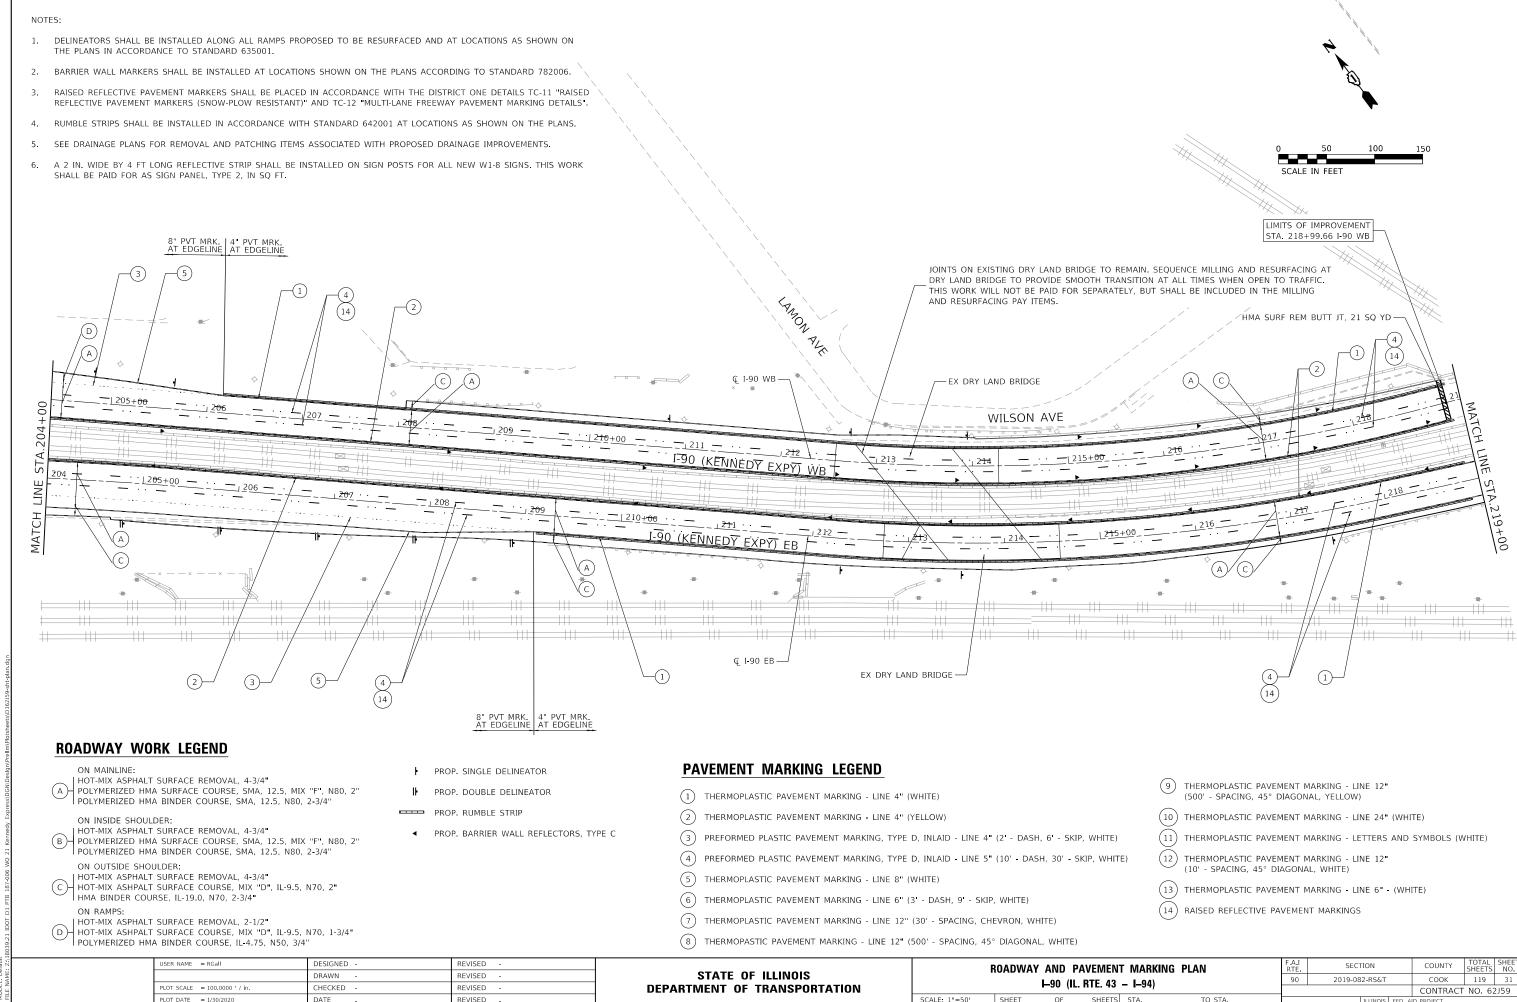
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USER NAME = RGall	DESIGNED -	REVISED -
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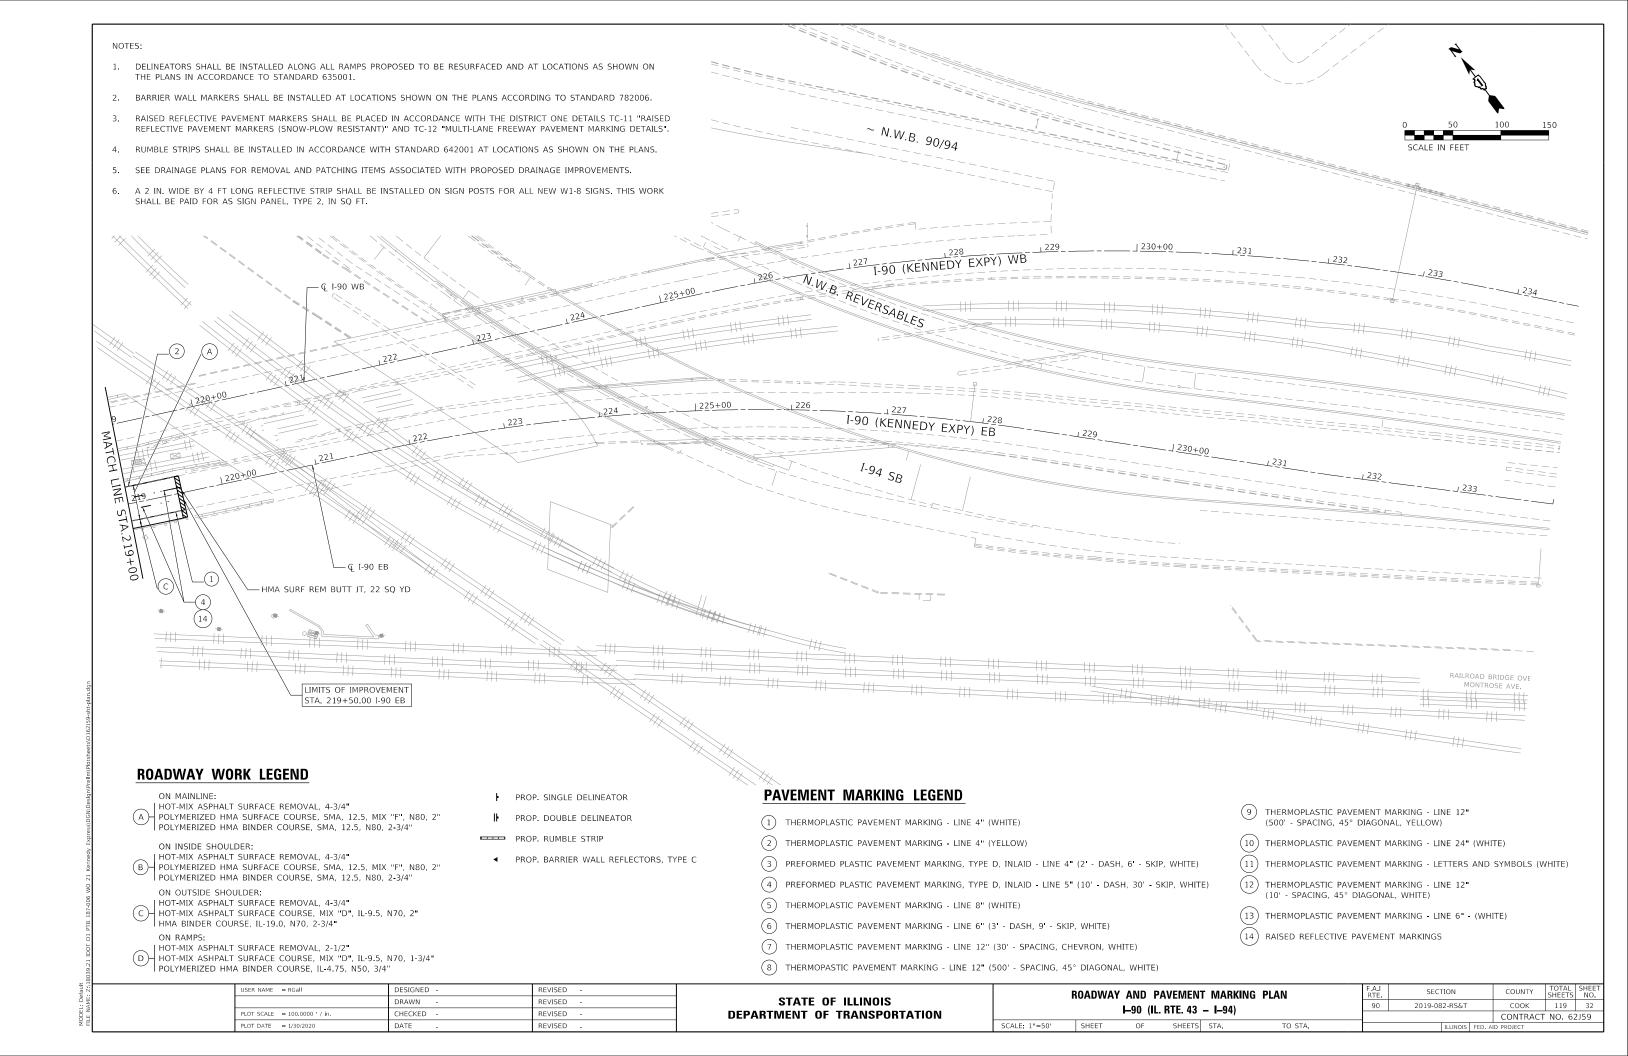
STATE OF ILLINOIS **DEPARTMENT OF TRANSPORTATION** 


SECTION **ROADWAY AND PAVEMENT MARKING PLAN** I-90 (IL. RTE. 43 - I-94)


2019-082-RS&T COOK 119 30 CONTRACT NO. 62J59



# Sport I adom



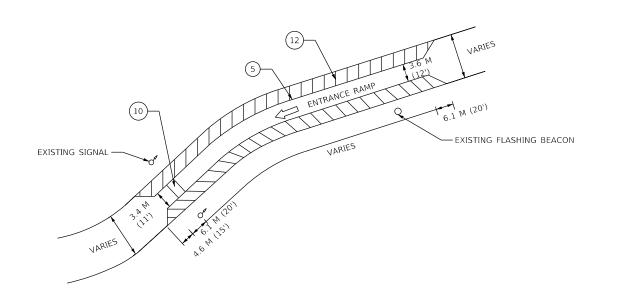

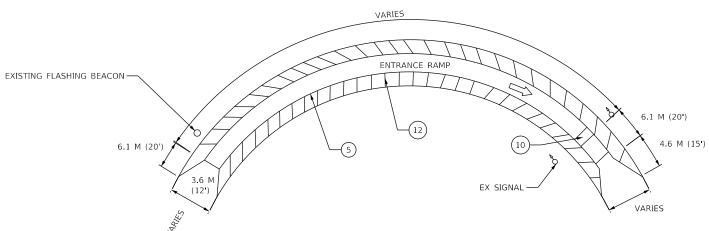

EXISTING SIGNAL

10

5

12

3.6 M (12')

ENTRANCE RAMP

12.2 M (40')

VARIES

(11')

VARIES

(11')

1.6 M (15')

EXISTING FLASHING BEACON

FRONTAGE ROAD

### **PAVEMENT MARKING LEGEND**

- 1) THERMOPLASTIC PAVEMENT MARKING LINE 4" (WHITE)
- 2 THERMOPLASTIC PAVEMENT MARKING LINE 4" (YELLOW)
- 3) PREFORMED PLASTIC PAVEMENT MARKING, TYPE D, INLAID LINE 4" (2' DASH, 6' SKIP, WHITE)
- 4 PREFORMED PLASTIC PAVEMENT MARKING, TYPE D, INLAID LINE 5" (10' DASH, 30' SKIP, WHITE)

SCALE: 1"=50' SHEET

- 5 THERMOPLASTIC PAVEMENT MARKING LINE 8" (WHITE)
- (6) THERMOPLASTIC PAVEMENT MARKING LINE 6" (3' DASH, 9' SKIP, WHITE)
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- (14) RAISED REFLECTIVE PAVEMENT MARKINGS

USER NAME = RGall	DESIGNED -	RG	REVISED -
	DRAWN -	CS/JB	REVISED -
PLOT SCALE = 100.0000 ' / in.	CHECKED -	JH	REVISED -
PLOT DATE = 1/30/2020	DATE -	10/5/19	REVISED -

STATE OF ILLINOIS
DEPARTMENT OF TRANSPORTATION

TYPICAL RAMP METERING STRIPING					SECTION	COUNTY	TOTAL SHEETS	SHEET NO.
					2019-082-RS&T	соок	119	33
IVILIL	JIIING STI	III IIVO				CONTRACT	NO 62	2J59
OF	CHEETC	CTA	TO CT4			-		

FILE NAME: Z:\18039.21 IDOT D1 PTB 187-006

### MAINTENANCE OF TRAFFIC — GENERAL NOTES

- TRAFFIC CONDITIONS, CRASHES, AND OTHER UNFORESEEN EMERGENCY CONDITIONS MAY REQUIRE THE ENGINEER TO RESTRICT, MODIFY, OR REMOVE LANE CLOSURES OR CHANNELIZATIONS SHOWN ON THE PLANS. THE CONTRACTOR SHALL MAKE THE NECESSARY ADJUSTMENTS AS DIRECTED BY THE ENGINEER WITHOUT DELAY. COMPLIANCE WITH THIS REQUIREMENT SHALL BE CONSIDERED INCLUDED IN THE CONTRACT UNIT PRICE OF "TRAFFIC CONTROL AND PROTECTION (EXPRESSWAYS)" (X7011015). NO ADDITIONAL COMPENSATION WILL BE ALLOWED.
- THE MAINTENANCE OF TRAFFIC PLANS SHALL SERVE AS A GUIDE FOR THE SAFE DIVERSION OF TRAFFIC DURING EXECUTION OF THE CONTRACT. THE CONTRACTOR MAY MODIFY THE MAINTENANCE OF TRAFFIC PLANS TO MEET CONSTRUCTION NEEDS, BUT NOT AT THE EXPENSE OF PUBLIC SAFETY OR CONVENIENCE. ANY CHANGES TO THE TRAFFIC CONTROL SHALL BE SUBMITTED TO THE ENGINEER FOR REVIEW AND APPROVAL
- 3. THE CONTRACTOR SHALL REMOVE ALL TEMPORARY OR EXISTING PAVEMENT MARKINGS THAT CONFLICT WITH THE STAGING. REMOVAL OF PAVEMENT MARKING TAPE WILL BE PAID FOR AS "TEMPORARY PAVEMENT MARKING REMOVAL" (X7030005). REMOVAL OF PAVEMENT MARKINGS ON PERMANENT PAVEMENT WILL BE PAID FOR AS PAVEMENT MARKING REMOVAL-WATERBLASTING (X0327980).
- 4. ALL TRAFFIC CONTROL DEVICES INCLUDING, BUT NOT LIMITED TO DRUMS, VERTICAL PANELS, AND BARRICADES IMMEDIATELY ADJACENT TO THE EDGE OF TRAVELED WAY SHALL BE EQUIPPED WITH MONO-DIRECTIONAL STEADY BURNING LIGHTS.
- 5. THE CONTRACTOR SHALL REMOVE OR COVER ALL EXISTING SIGNS THAT CONFLICT WITH OR DO NOT APPLY TO THE REVISED TRAFFIC PATTERNS AND SHALL RESTORE THE SIGNS AT THE END OF CONSTRUCTION AS DIRECTED BY THE ENGINEER.
- 6. THE CONTRACTOR SHALL PROVIDE 48 HOURS ADVANCE NOTICE TO THE ENGINEER OF ANY CONTRUCTION WORK.
- 7. ANY RAISED REFLECTIVE PAVEMENT MARKERS THAT CONFLICT WITH THE TEMPORARY TRAFFIC LANES MUST HAVE THE REFLECTIVE LENSES REMOVED AS DIRECTED BY THE ENGINEER.
- 8. TEMPORARY PAVEMENT MARKINGS ON MILLED SURFACES SHALL BE PAINT. TEMPORARY PAVEMENT MARKINGS APPLIED TO PROPOSED HMA LIFTS INCLUDING THE FINAL WEARING SURFACE SHALL BE PAVEMENT MARKING TAPE, TYPE IV. TEMPORARY PAVEMENT MARKING IS NOT REQUIRED FOR SHORT TERM CLOSURES.
- 9. ALL TEMPORARY PAVEMENT MARKINGS SHOWING DETERIORATION AFTER 7 DAYS OF SERVICE SHALL BE REPLACED BY THE CONTRACTOR AS DIRECTED BY THE ENGINEER, SUFFICIENT QUANTITIES FOR 2 APPLICATIONS OF TEMPORARY PAVEMENT MARKINGS HAVE BEEN PROVIDED FOR EACH STAGE.
- 10. AT THE END OF EACH WORK DAY THE CONTRACTOR SHALL BACKFILL OR COVER ALL EXPOSED TRENCHES AND OPEN EXCAVATION HOLES NOT PROTECTED BY THE TEMPORARY CONCRETE BARRIER IN ORDER TO PROVIDE SAFE CONDITIONS FOR THE TRAVELING PUBLIC.
- 11. DURING CONSTRUCTION ACTIVITIES, THE CONTRACTOR SHALL TAKE NECESSARY PRE-CAUTIONS TO AVOID ANY CONSTRUCTION DEBRIS FROM ENCROACHING INTO THE ADJACENT THROUGH LANES.
- 12. TEMPORARY CONCRETE BARRIERS SHALL BE EQUIPPED WITH BARRIER WALL REFLECTORS, IN ACCORDANCE WITH TRAFFIC CONTROL HIGHWAY STANDARD 704001-08 AT 25' CENTERS.
- 13. LOCATIONS OF CHANGEABLE MESSAGE SIGN (70107025) SHALL BE DETERMINED BY THE ENGINEER.
- 14. THE CONTRACTOR SHALL REQUEST AND GAIN THE APPROVAL FROM THE ILLINOIS DEPARTMENT OF TRANSPORTATION'S EXPRESSWAY TRAFFIC OPERATIONS ENGINEER AT WWW.IDOTLCS.COM TWENTY-FOUR (24) HOURS IN ADVANCE OF ALL DAILY LANE, RAMP AND SHOULDER CLOSURES. SEE KEEPING THE EXPRESSWAY OPEN TO TRAFFIC SPECIAL PROVISION FOR MORE INFORMATION.
- 15. ALL STAGE CHANGES REQUIRING THE STOPPING AND/OR THE PACING OF TRAFFIC SHALL TAKE PLACE DURING THE ALLOWABLE HOURS FOR FULL EXPRESSWAY CLOSURES AND SHALL BE APPROVED BY THE DEPARTMENT. THE CONTRACTOR SHALL NOTIFY THE DISTRICT ONE EXPRESSWAY TRAFFIC CONTROL SUPERVISOR AT LEAST 3 WORKING DAYS (WEEKENDS AND HOLIDAYS DO NOT COUNT INTO THIS 72 HOURS NOTIFICATION) IN ADVANCE OF ANY PROPOSED STAGE CHANGE.
- 16. A MAINTENANCE OF TRAFFIC PLAN SHALL BE SUBMITTED TO THE DIRSTRCT ONE EXPRESSWAY TRAFFIC CONTROL SUPERVISOR 14 DAYS IN ADVANCE OF ANY STAGE CHANGES OR FULL EXPRESSWAY CLOSURES. THE MAINTENACE OF TRAFFIC PLAN SHALL INCLUDE, BUT NOT BE LIMITED TO: LANE AND RAMP CLOSURES, EXISTING GEOMETRICS, AND EQUIPMENT AND MATERIAL LOCATIONS.
- 7. AT LOCATIONS WHERE TRAFFIC IS SHIFTED ONTO THE EXISTING SHOULDERS THE EXISTING RUMBLE STRIPS SHALL BE REMOVED.

### SUGGESTED STAGING NOTES

THE FOLLOWING STAGES SHALL BE USED FOR EASTBOUND AND WESTBOUND. EASTBOUOND SHALL BE CONSTRUCTED IN THE FIRST YEAR. WESTBOUND SHALL BE CONSTRUCTED IN THE SECOND YEAR. STAGES 1A, 1B, 1C, AND 1D MAY BE COMPLETED IN ANY ORDER. DRAINAGE IMPROVEMENTS MUST BE COMPLETED PRIOR TO THE START OF STAGE 2 - RESURFACING

### STAGE 1 A - DRAINAGE IMPROVEMENTS RAMPS, RAMP GORES, AND OUTSIDE SHOULDERS

### TRAFFIC

- 1. REDUCE LANES UTILIZING DISTRICT STANDARD TC-08 TO PROVIDE THREE 11-FOOT LANES, AS SHOWN ON THE PLANS.
- 2. CLOSE RAMPS UTILIZING DISTRICT STANDARD TC-08. RAMPS MAY BE CLOSED ONLY DURING ALLOWABLE TIMES. CONSECUTIVE RAMP CLOSURES AT THE SAME TIME ARE NOT PERMITTED.
- 3. ADDITIONAL LANE CLOSURES ARE ALLOWED DURING ALLOWABLE HOURS.

### CONSTRUCTION

- PLACE TEMPORARY CONCRETE BARRIER ALONG MAINLINE.
- 2. PLACE TEMPORARY PAVEMENT MARKING TAPE, TYPE IV.
- 3. CONSTRUCT TRENCH DRAINS IN RAMPS, RAMP GORES, AND OUTSIDE SHOULDERS.

### STAGE 1 B - DRAINAGE IMPROVEMENTS INSIDE SHOULDERS

### TRAFFIC

- 1. REDUCE LANES UTILIZING DISTRICT STANDARD TC-08 TO PROVIDE THREE 11-FOOT LANES, AS SHOWN ON THE PLANS
- 2. ADDITIONAL LANE CLOSURES ARE ALLOWED DURING ALLOWABLE HOURS.

### CONSTRUCTION

- 1. PLACE TEMPORARY CONCRETE BARRIER ALONG MAINLINE.
- 2. PLACE TEMPORARY PAVEMENT MARKING TAPE, TYPE IV.
- 3. CONSTRUCT TRENCH DRAINS IN INSIDE SHOULDERS.

### STAGE 1 C - DRAINAGE IMPROVEMENTS ACROSS MAINLINE LANES

### TRAFFIC

- 1. CLOSE LANES 2 AND 3 DURING ALLOWABLE TIMES UTILIZING STANDARDS 701400, 701411, 701446, AND TC-09.
- 2. PROVIDE ONE 11-FOOT LANE SHIFTING TRAFFIC TO LANE 1.
- . CLOSE RAMPS UTILIZING STANDARDS TC-08. RAMPS MAY BE CLOSED ONLY DURING ALLOWABLE TIMES. CONSECUTIVE RAMP CLOSURES AT THE SAME TIME ARE NOT PERMITTED.
- 4. ALL LANES OF TRAFFIC MUST BE OPENED TO TRAFFIC AFTER ALLOWABLE LANE CLOSURE HOURS.

### CONSTRUCTION

- 1. CONSTRUCT STORM SEWER FROM OUTSIDE SHOULDER TO MIDDLE OF LANE 2.
- 2. AT THE END OF EACH NIGHTLY SHIFT, THE CONTRACTOR SHALL BACKFILL TRENCHES, PLACE HMA PATCH, MATCH TO EXISTING GRADE, SWEEP THE PAVEMENT SURFACE CLEAN, PLACE TEMPORARY PAVEMENT MARKINGS, AND REMOVE TRAFFIC CONTROL BEFORE OPENING THE LANES TO TRAFFIC.

### STAGE 1 D DRAINAGE IMPROVEMENTS ACROSS MAINLINE LANES

### TRAFFIC

- 1. CLOSE LANES 1 AND 2 DURING ALLOWABLE TIMES UTILIZING STANDARDS 701400, 701411, 701446, AND TC-09.
- 2. PROVIDE ONE 11-FOOT LANE SHIFTING TRAFFIC TO LANE 3
- CLOSE RAMPS UTILIZING STANDARDS TC-08. RAMPS MAY BE CLOSED ONLY DURING ALLOWABLE TIMES. CONSECUTIVE RAMP CLOSURES AT THE SAME TIME ARE NOT PERMITTED.
- 4. ALL LANES OF TRAFFIC MUST BE OPENED TO TRAFFIC AFTER ALLOWABLE LANE CLOSURE HOURS.

### CONSTRUCTION

- 1. CONSTRUCT STORM SEWER FROM MIDDLE OF LANE 2 TO THE MEDIAN.
- 2. AT THE END OF EACH NIGHTLY SHIFT, THE CONTRACTOR SHALL BACKFILL TRENCHES, PLACE HMA PATCH, MATCH TO EXISTING GRADE, SWEEP THE PAVEMENT SURFACE CLEAN, PLACE TEMPORARY PAVEMENT MARKINGS, AND REMOVE TRAFFIC CONTROL BEFORE OPENING THE LANES TO TRAFFIC.

### STAGE 2 RESURFACING

### TRAFFIC

- 1. CLOSE LANES DURING ALLOWABLE HOURS UTILIZING STANDARDS 701400, 701401, 701411, 701446, AND TC-09.
- 2. CLOSE RAMPS UTILIZING STANDARDS TC-08. RAMPS MAY BE CLOSED ONLY DURING ALLOWABLE TIMES. CONSECUTIVE RAMP CLOSURES AT THE SAME TIME ARE NOT PERMITTED.
- 3. ALL LANES MUST BE OPEN TO TRAFFIC AFTER ALLOWABLE LANE CLOSURE HOURS

### CONSTRUCTION

- 1. MILL AND RESURFACE AS SHOWN IN RESURFACING SEQUENCE.
- MILL AND RESURFACE RAMPS.
- 3. DRUMS SHALL NOT BE PLACED IN THE LANE WHICH IS OPEN TO TRAFFIC. THE CONTRACTOR SHALL USE ONE FOOT WIDE VERTICAL BARRICADES WITH STEADY BURN MONO-DIRECTIONAL LIGHTS ALONG THE MILLING AND PAVING OPERATIONS. DRUMS OR TYPE II BARRICADES SHALL BE USED TO DELINEATE ALL OPEN RAMPS THROUGH THE WORK ZONE.
- 4. MILLING OPERATIONS SHALL BE PERFORMED SUCH THAT A VERTICAL MILLED FACE NO GREATER THAN 1-1/2" INCHES EXISTS BETWEEN ADJACENT OPEN LANES OF TRAFFIC AT ANY TIME. THIS MAY BE ACCOMPLISHED BY PLACING A TEMPORARY WEDGE OR MILLING TO PROVIDE A MINIMUM 1:3 SLOPE. OTHER METHODS MAY BE USED IF APPROVED BY THE ENGINEER PRIOR TO IMPLEMENTING THE PROCEDURE. THIS WORK SHALL BE INCLUDED IN THE COST OF HMA SURFACE REMOVAL. OF THE THICKNESS SPECIFIED.
- 5. AT THE END OF EACH NIGHTLY SHIFT, THE CONTRACTOR SHALL SWEEP THE PAVEMENT SURFACE CLEAN, PLACE TEMPORARY PAVEMENT MARKINGS, AND REMOVE TRAFFIC CONTROL.

SCALE: 1"=50"

SHEET

### 

	MAINTENANCE OF TRAFFIC SUGGESTED STAGING NOTES					F.A.I RTE	SECTION		COUNTY	TOTAL SHEETS	SHEET NO.
c						90	2019-082-RS&T		COOK	119	34
									CONTRAC	T NO. 62	2J59
т	OF	SHEETS	STA	TO STA			TILLINOIS	EED AI	D DDOIECT		

### **SUGGESTED STAGING NOTES (CONT)**

THE FOLLOWING STAGES SHALL BE USED FOR APPLICATION OF PROTECTIVE COAT TO BRIDGE DECKS AS SHOWN IN THE PLANS.

### STAGE 3 - PROTECTIVE COAT TO BE APPLIED TO STRUCTURES

- 1. CLOSE LANES ALONG BRIDGES UTILIZING STANDARDS AS SHOWN IN THE TABLE BELOW FOR EACH LOCATION.
- 2. ONE LANE CLOSURES WILL ONLY BE ALLOWED BETWEEN THE HOURS OF 8:00 PM TO 6:00 AM.
- 3. IF RAMP CLOSURES ARE REQUIRED, CLOSE RAMP UTILIZING DISTRICT STANDARDS TC-08. RAMPS MAY BE CLOSED ONLY DURING ALLOWABLE TIMES. CONSECUTIVE RAMP CLOSURES AT THE SAME TIME ARE NOT PERMITTED.

1. APPLY PROTECTIVE COAT TO BRIDGE DECK, SIDEWALK, MEDIAN, FACE OF PARAPET, AND TOP OF PARAPET.

### TRAFFIC CONTROL AND PROTECTION FOR STRUCTURES

STRUCTURE NUMBER	FACILITY CARRIED	FEATURE CROSSED	701501 URBAN LANE CLOSURE, 2L, 2W, UNDIVIDED	701601 URBAN LANE CLOSURE, MULTILANE, 1W OR 2W WITH NONTRAVERSABLE MEDIAN	701606 URBAN SINGLE LANE CLOSURE, MULTILANE, 2W WITH MOUNTABLE MEDIAN	701701 URBAN LANE CLOSURE MULTILANE INTERSECTION	701801 SIDEWALK, CORNER OR CROSSWALK CLOSURE
016-0836	LAWRENCE AVE	I-90			X	X	X
016-1105	AINSLIE ST	I-90	X				X
016-1107	MILWAUKEE AVE	I-90		X			Χ
016-0659	CENTRAL AVE	I-90		X			X
016-0708	NAGLE AVE	I-90			X	X	X
016-1106	NATOMA AVE	I-90	X				X
016-1104	SAYRE AVE	I-90			X		X
016-0309	IL 43 (HARLEM AVE)	I-90		X		X	X


### NOTES:


IN=0.75"

WHEN APPLICABLE, STANDARD 701427 MAY BE USED IF SEALER DRIES IN LESS THAN 1 HOUR.

### ADVANCED SIGNING FOR VEHICLE WIDTH RESTRICTIONS DETAILS

### **ENTRANCE RAMP** 100' MIN. 100 MIN SEE SIGN DETAIL BELOW MAX WIDTH (PAID FOR AS TEMPORARY ROAD XX'-XX" INFORMATION SIGNING) ONSTRUCTION W20-I103(O)-48 90 M6-1(O)-2115 ( A ) RAMP ENTRANCE M6-1(O)-2115

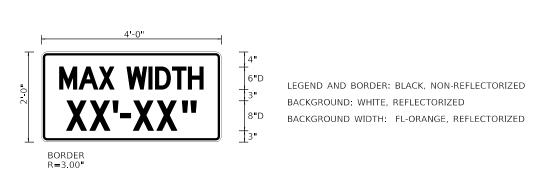

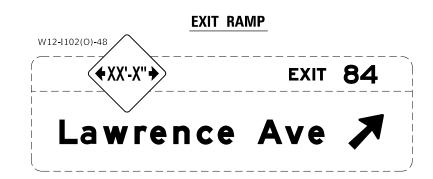


- 1. FOR ENTRANCE RAMPS, ADVANCED SIGNING SHALL BE PLACED AS SHOWN IN THE DETAIL ALONG THE SIDE STREET PRIOR TO THE ENTRANCE OF THE RAMP AND AS SHOWN ON THE PLANS.
- 2. FOR EXIT RAMPS, SIGN W12-I102 SHALL BE PLACED ABOVE THE EXISTING OVERHEAD SIGN PANELS FOR THE CORRESPONDING RAMP AND AS SHOWN ON THE PLANS.

OSEK NAME = KGall	DESIGNED - KG		KENIZED	-	
	DRAWN - CS/JB		REVISED	=	
PLOT SCALE = 100.0000 ' / in.	CHECKED - JH		REVISED	=	
PLOT DATE = 3/10/2020	DATE - 10/5/1	9	REVISED	-	

STATE OF ILLINOIS	
<b>DEPARTMENT OF TRANSPORTATION</b>	

	N	IAINTEN	ANCE OF	TRAFFIC		F.A.I RTE	SECTION	COUNTY	TOTAL SHEETS	SHEET NO.
	cı	ICCESTEI	O STACII	NG NOTES		90	2019-082-RS&T	соок	119	35
		JUULSTEI	JUNUII	NO NOILS				CONTRACT	T NO. 62	2J59
SCALE: 1"=50"	SHEET	OF	SHEETS	STA. TO STA.   ILLINOIS FED. AID PROJECT						

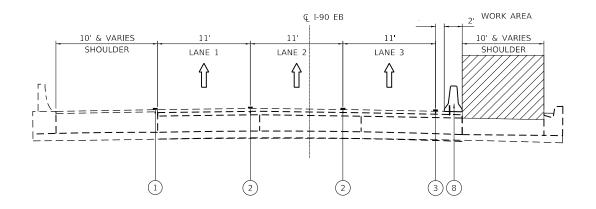

# WORK AREA \* 2' 10' & VARIES SHOULDER LANE 1 LANE 2 LANE 3 SHOULDER 8 4 2 2 1 10' & VARIES 1 10' & VARIES 1 10' & VARIES 1 10' & VARIES 2 1 10' & VARIES 3 10' & VARIES 4 2 2 2 1


### DRAINAGE IMPROVEMENTS AT OUTSIDE SHOULDER

EASTBOUND (WESTBOUND SYMMETRICAL)

### DRAINAGE IMPROVEMENTS AT INSIDE SHOULDER

EASTBOUND (WESTBOUND SYMMETRICAL)

AN 8' MINIMUM WORK ZONE SHALL BE PROVIDED BEHIND THE TEMPORARY CONCRETE BARRIER WALL. FOR LOCATIONS WHERE LESS THAN 8' MINIMUM IS PROVIDED, TRAFFIC SHALL BE SHIFTED ONTO THE OUTSIDE SHOULDER AS SHOWN ON THE PLANS. THE EXISTING OUTSIDE SHOULDER RUMBLE STRIPS SHALL BE REMOVED AT THESE LOCATIONS.

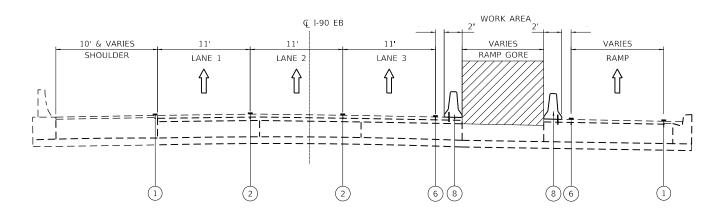

### DRAINAGE IMPROVEMENTS AT RAMP GORE

EASTBOUND (WESTBOUND SYMMETRICAL)

### **LEGEND**

- 1 EX. PAVEMENT MARKING
- 2 PAVEMENT MARKING TAPE TYPE IV LINE 5" (10' DASH 30' SKIP WHITE)
- (3) PAVEMENT MARKING TAPE TYPE IV LINE 4" (SOLID WHITE)
- (4) PAVEMENT MARKING TAPE TYPE IV LINE 4" (SOLID YELLOW)
- (5) PAVEMENT MARKING TAPE TYPE IV LINE 4" (2' DASH 6' SKIP WHITE)
- 6 PAVEMENT MARKING TAPE TYPE IV LINE 8" (WHITE)
- (7) PAVEMENT MARKING TAPE TYPE IV LINE 12" (WHITE)
- 8 TEMPORARY CONCRETE BARRIER WALL W/ BARRIER WALL REFLECTORS, TYPE C CONTINOUSLY PINNED
- 9) TEMPORARY CONCRETE BARRIER WALL W/ BARRIER WALL REFLECTORS, TYPE C



WORK AREA



TEMPORARY CONCRETE BARRIER W/ BARRIER WALL REFLECTORS, TYPE C, PINNING TEMPORARY CONCRETE BARRIER



TYPE II BARRICADE OR DRUM WITH MONO-DIRECTIONAL STEADY BURNING LIGHTS

USER NAME = RGall	DESIGNED -	RG	REVISED -
	DRAWN -	CS/JB	REVISED -
PLOT SCALE = 100.0000 / in.	CHECKED -	JH	REVISED -
PLOT DATE = 1/30/2020	DATE -	10/5/19	REVISED -


STATE OF	FILLINOIS
DEPARTMENT OF	TRANSPORTATION

MAINTENANCE OF TRAFFIC TYPICAL SECTION						F.A.I RTE	SECTION	COUNTY	TOTAL SHEETS	SHEET NO.
		TVDIC	'AI SECT	90	2019-082-RS&T	соок	119	36		
		HIFIC	ML SLUI	CONTRACT NO. 62J5				2J59		
SCALE: 1"=50	SHEET	OF	SHEETS	STA.	TO STA.	ILLINOIS FED. AID PROJECT				

# DRAINAGE IMPROVEMENTS STAGE 1C

EASTBOUND (WESTBOUND SYMMETRICAL)

\* AT THE END OF EACH NIGHTLY SHIFT ALL TRAFFIC CONTROL DEVICES MUST BE REMOVED AND ALL LANES MUST BE OPENED TO TRAFFIC

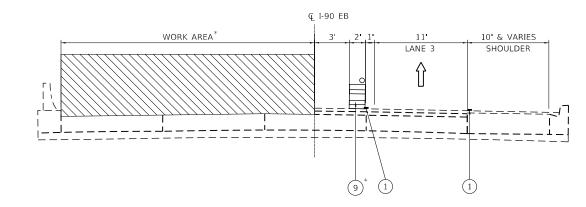

# DRAINAGE IMPROVEMENTS STAGE 1D

EASTBOUND (WESTBOUND SYMMETRICAL)

\* AT THE END OF EACH NIGHTLY SHIFT ALL TRAFFIC CONTROL DEVICES MUST BE REMOVED AND ALL LANES MUST BE OPENED TO TRAFFIC

# **LEGEND**

- 1 EX. PAVEMENT MARKING
- 2 PAVEMENT MARKING TAPE TYPE IV LINE 5" (10' DASH 30' SKIP WHITE)
- 3 PAVEMENT MARKING TAPE TYPE IV LINE 4" (SOLID WHITE)
- (4) PAVEMENT MARKING TAPE TYPE IV LINE 4" (SOLID YELLOW)
- 5 PAVEMENT MARKING TAPE TYPE IV LINE 4" (2' DASH 6' SKIP WHITE)
- (6) PAVEMENT MARKING TAPE TYPE IV LINE 8" (WHITE)
- 7) PAVEMENT MARKING TAPE TYPE IV LINE 12" (WHITE)
- 8 TEMPORARY CONCRETE BARRIER WALL W/ BARRIER WALL REFLECTORS, TYPE C CONTINOUSLY PINNED
- 9 TYPE II DRUM WITH MONO-DIRECTIONAL STEADY BURNING LIGHTS



WORK AREA

PAVEMENT MARKING



TYPE II DRUM WITH MONO-DIRECTIONAL STEADY BURNING LIGHTS





TYPE II BARRICADE OR DRUM WITH MONO-DIRECTIONAL STEADY BURNING LIGHTS


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	DRAWN -	CS/JB	REVISED -
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PLOT DATE = 3/10/2020	DATE -	10/5/19	REVISED -

STATE OF ILLINOIS
DEPARTMENT OF TRANSPORTATION

	N	IAINTEN	ANCE OF	F.A.I RTE	SECTION	COUNTY	TOTAL SHEETS	SHEET NO.		
		TVD	ICAL SECT	TION		90	2019-082-RS&T	соок	119	37
			ICAL SECT			CONTRAC	T NO. 6	2J59		
SCALE: 1"=50'	SHEET	OF	SHEETS	STA.	TO STA.		ILLINOIS FED.	AID PROJECT		

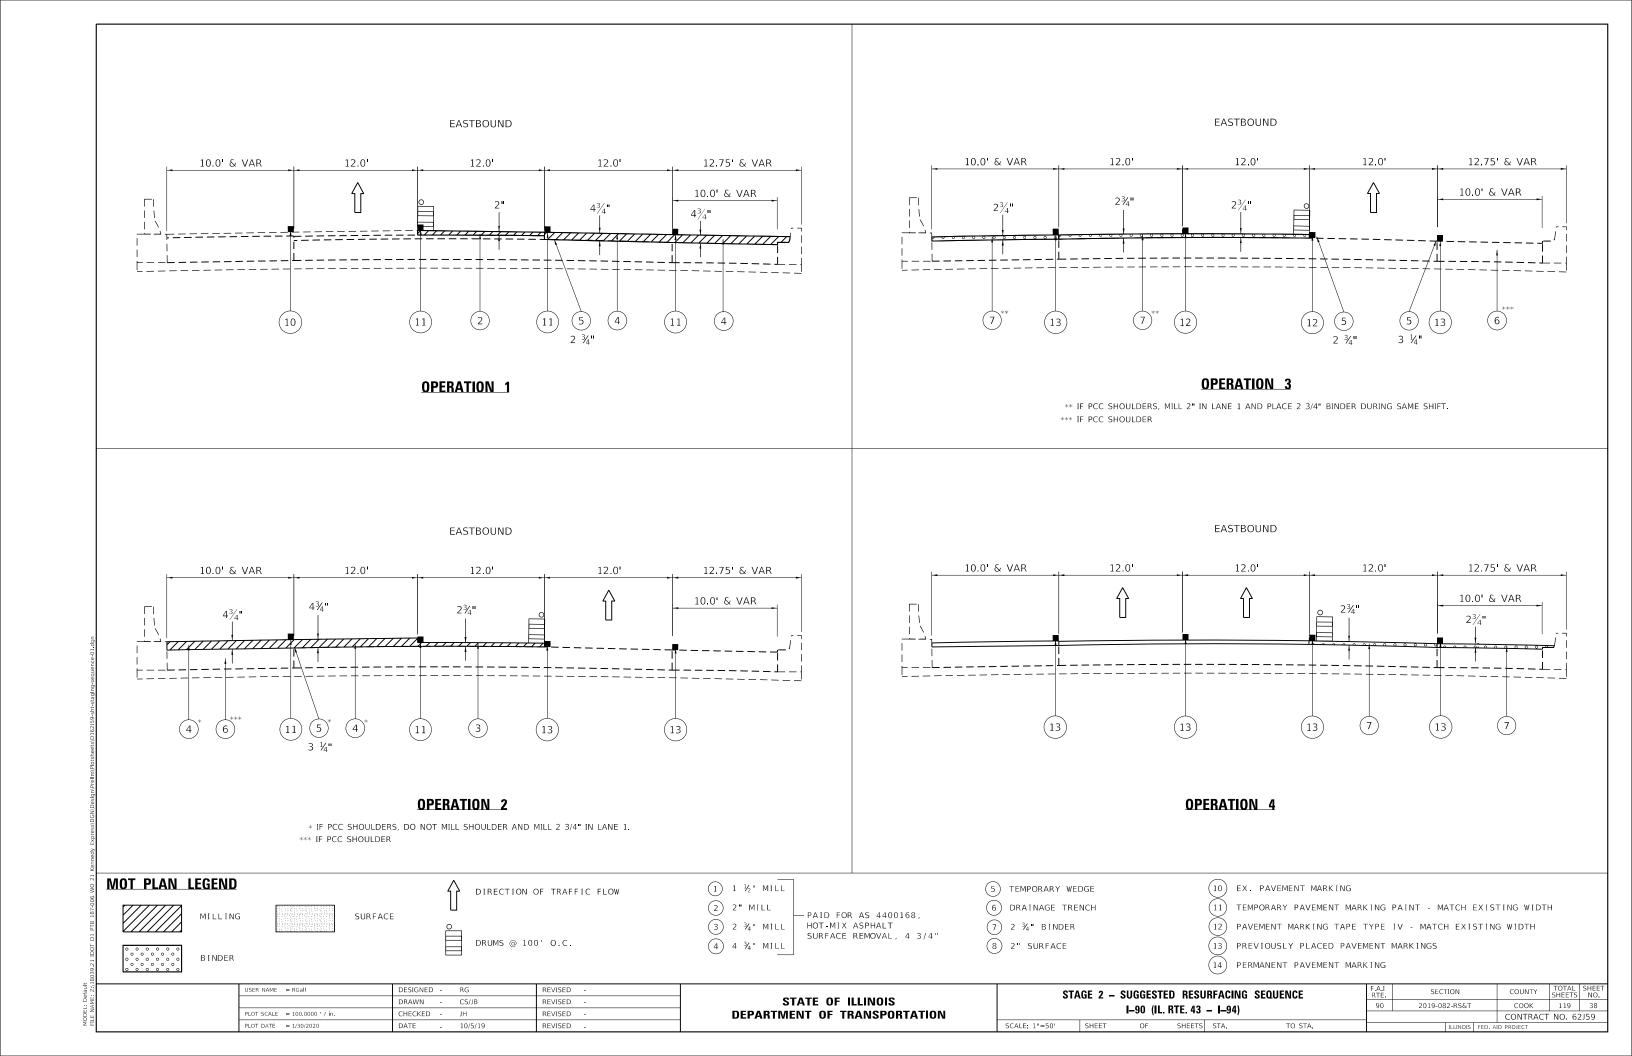

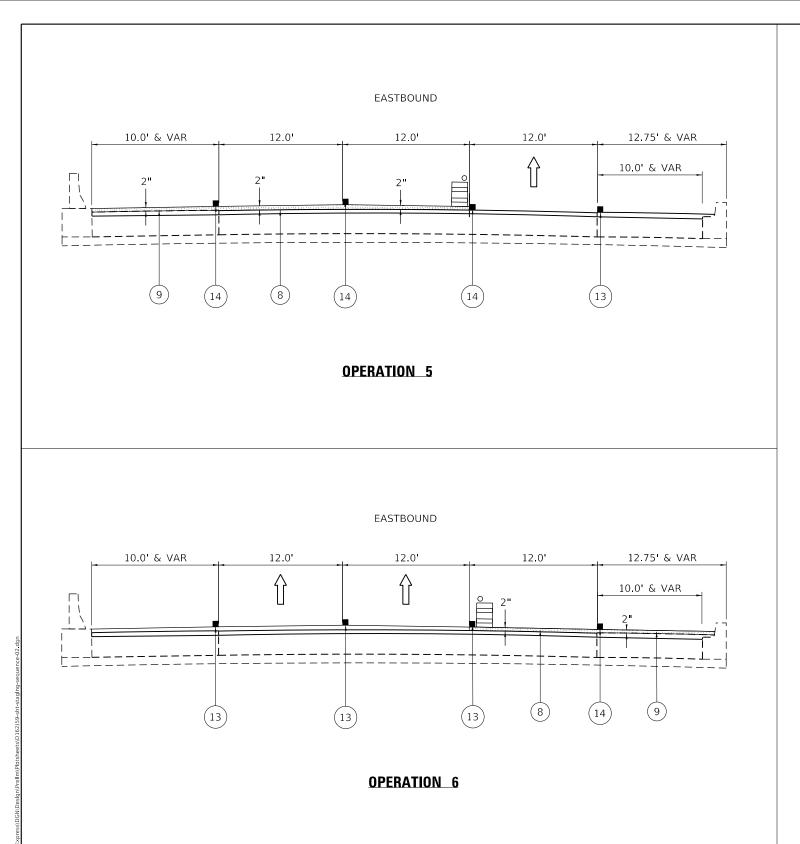

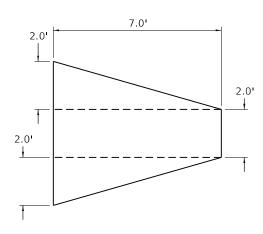

# **DRAINAGE TRENCH DETAIL**

PCC SHOULDER LOCATIONS

### NOTES:

- 1. DRAINAGE TRENCHES TO BE INSTALLED AT SAGS AND 500' INTERVALS AT LOCATIONS APPROVED BY THE ENGINEER.
- 2. PRIOR TO MILLING MAINLINE, CUT DRAINAGE TRENCH TO ALLOW WATER TO RUN OFF MAINLINE PAVEMENT (DEPTH VARIES 0"TO 3 ½"). PAID AS PCC SURFACE REMOVAL 3", Z0038124 (3 SQ. YD EACH LOCATION)
- 3. AFTER MAINLINE HAS BEEN RESURFACED:
  - A. REMOVE FULL DEPTH PCC SHOULDER IN TRENCH AREA AND PATCH. PAID AS CLASS C PATCHES, TYPE I, 13 INCH, 44201385 (3 SQ. YD EACH LOCATION)





MILLING

BINDER



SURFACE



DRUMS @ 100' O.C.

1 ½" MILL 2 2" MILL

3 2 ¾" MILL

4 3/4" MILL


- -PAID FOR AS 4400168, HOT-MIX ASPHALT SURFACE REMOVAL, 4 3/4"
- 5 TEMPORARY WEDGE
- 6 DRAINAGE TRENCH
- 7) 2 ¾" BINDER
- 8 2" SURFACE


- (10) EX. PAVEMENT MARKING
- TEMPORARY PAVEMENT MARKING PAINT MATCH EXISTING WIDTH
- (12) PAVEMENT MARKING TAPE TYPE IV MATCH EXISTING WIDTH
- (13) PREVIOUSLY PLACED PAVEMENT MARKINGS
- (14) PERMANENT PAVEMENT MARKING


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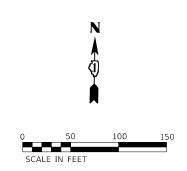
STATE OF ILLINOIS **DEPARTMENT OF TRANSPORTATION** 


SECTION STAGE 2 - SUGGESTED RESURFACING SEQUENCE 2019-082-RS&T COOK 119 39 I-90 (IL. RTE. 43 - I-94) CONTRACT NO. 62J59 SCALE: 1"=50' SHEET OF SHEETS STA.



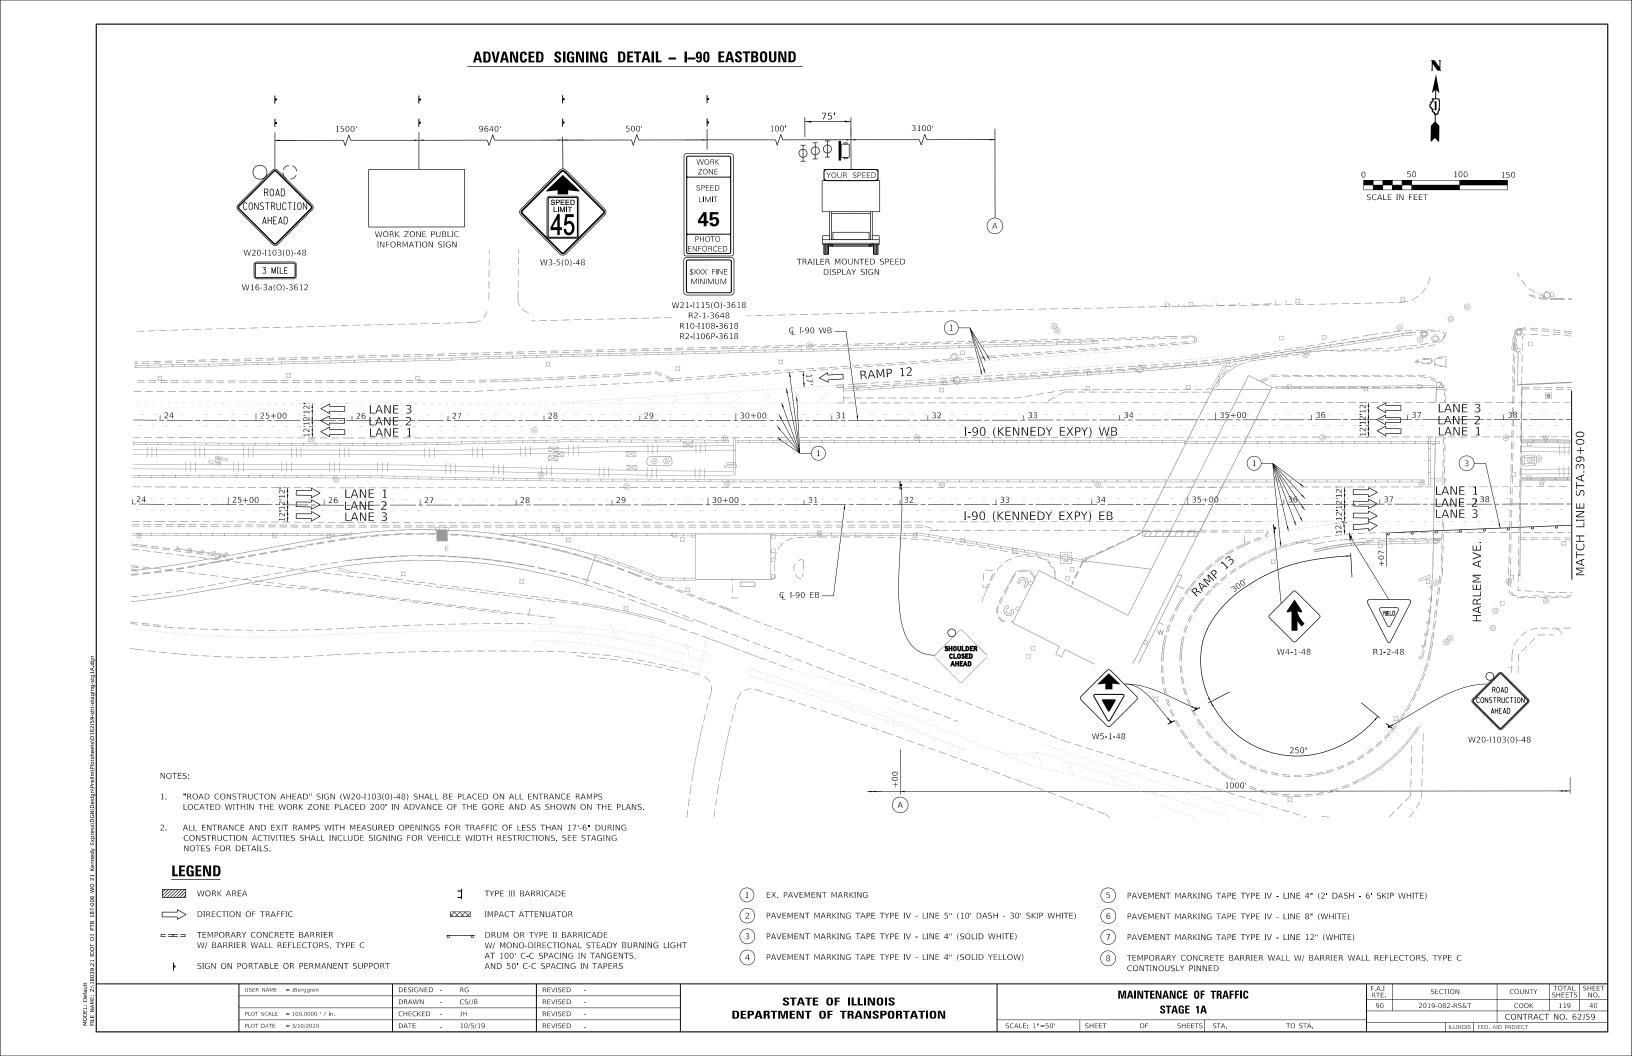

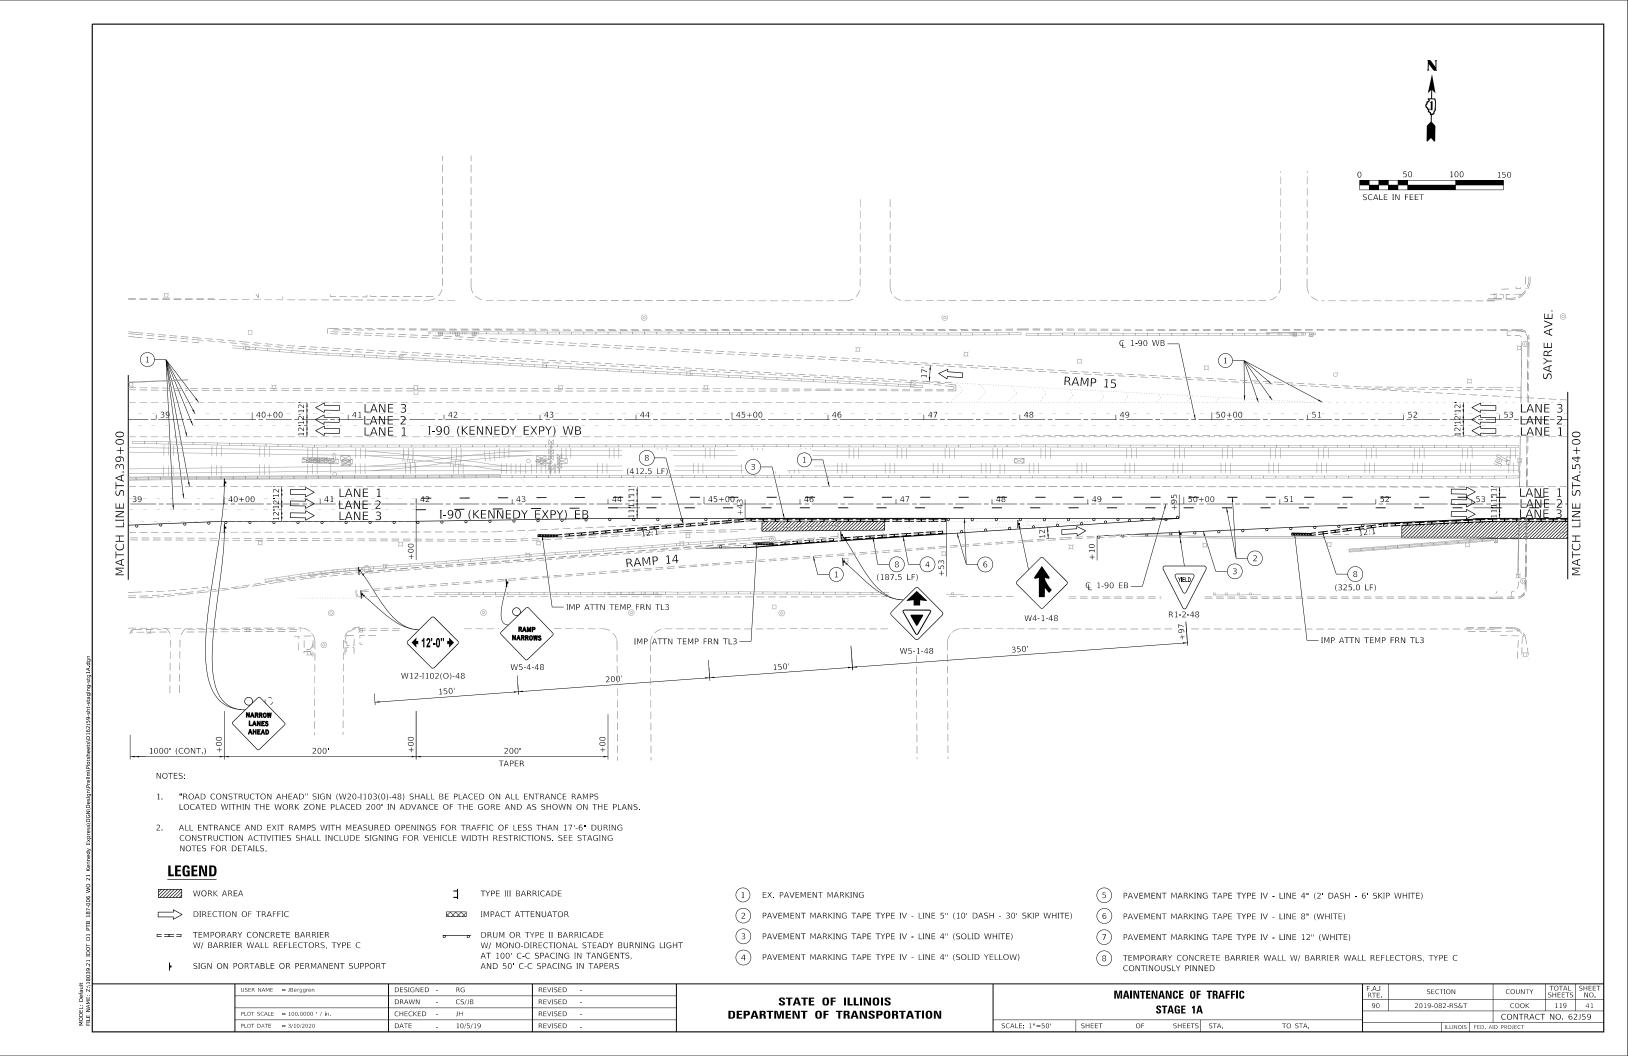

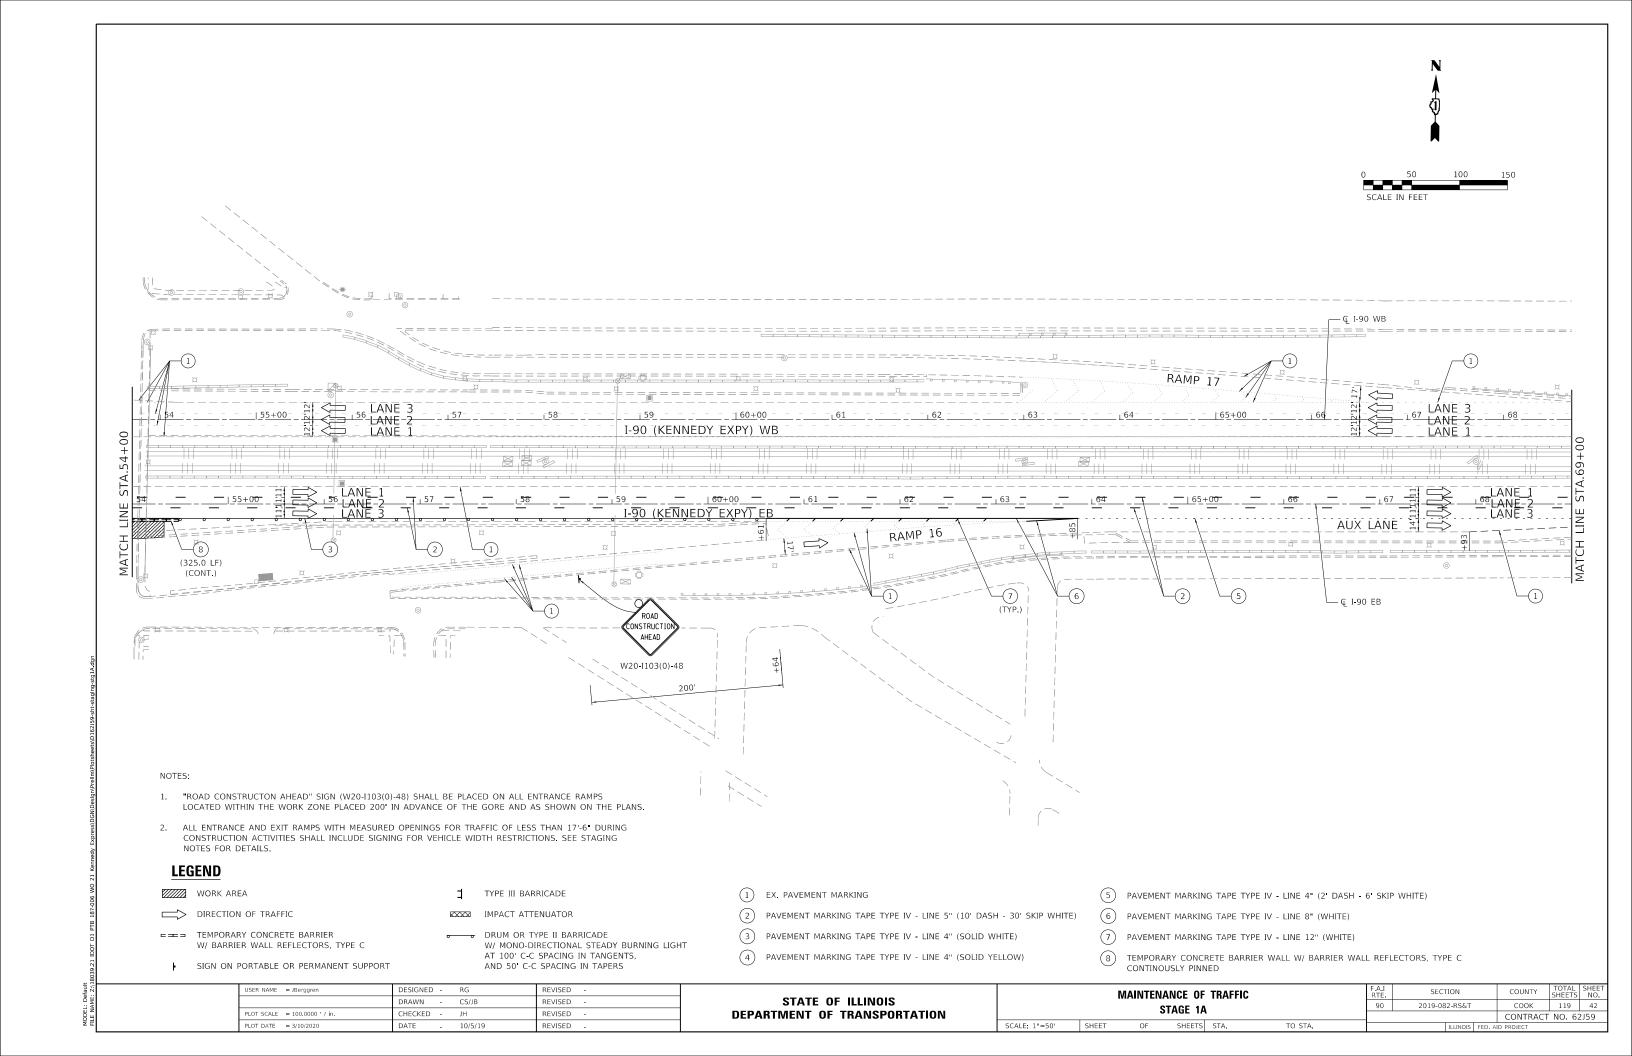

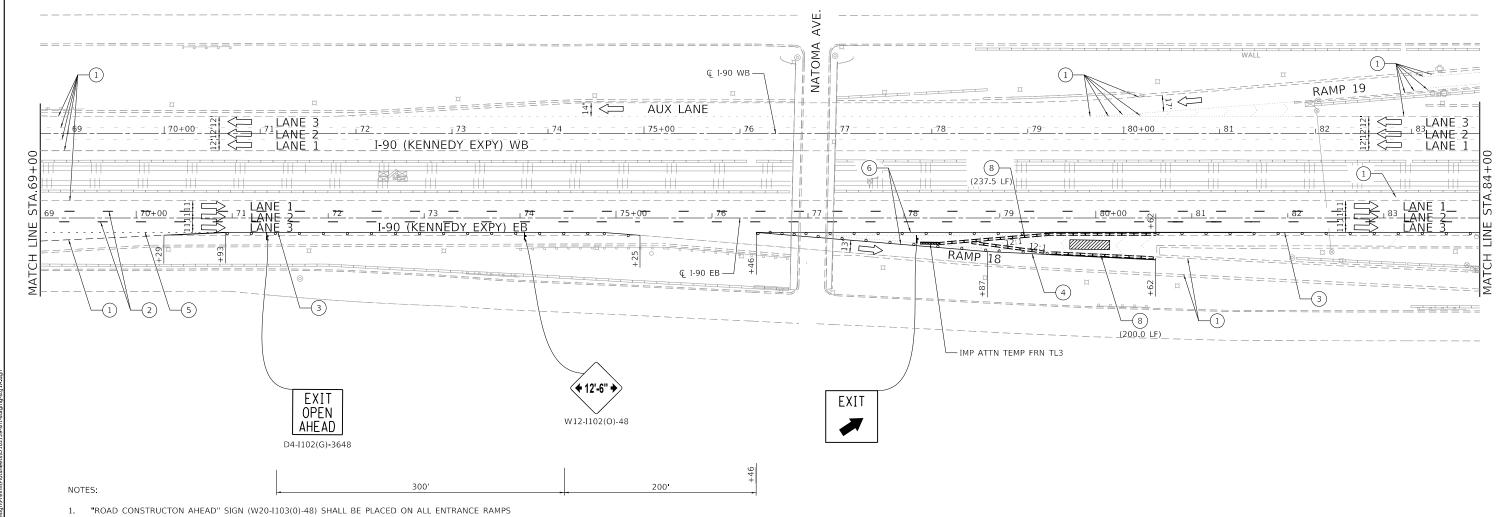

- LOCATED WITHIN THE WORK ZONE PLACED 200' IN ADVANCE OF THE GORE AND AS SHOWN ON THE PLANS.
- 2. ALL ENTRANCE AND EXIT RAMPS WITH MEASURED OPENINGS FOR TRAFFIC OF LESS THAN 17-6 DURING CONSTRUCTION ACTIVITIES SHALL INCLUDE SIGNING FOR VEHICLE WIDTH RESTRICTIONS. SEE STAGING NOTES FOR DETAILS.

# **LEGEND**

WORK AREA

DIRECTION OF TRAFFIC

TEMPORARY CONCRETE BARRIER
W/ BARRIER WALL REFLECTORS, TYPE C

SIGN ON PORTABLE OR PERMANENT SUPPORT

TYPE III BARRICADE

IMPACT ATTENUATOR

DRUM OR TYPE II BARRICADE W/ MONO-DIRECTIONAL STEADY BURNING LIGHT AT 100' C-C SPACING IN TANGENTS, AND 50' C-C SPACING IN TAPERS

- 1 EX. PAVEMENT MARKING
- 2 PAVEMENT MARKING TAPE TYPE IV LINE 5" (10' DASH 30' SKIP WHITE)


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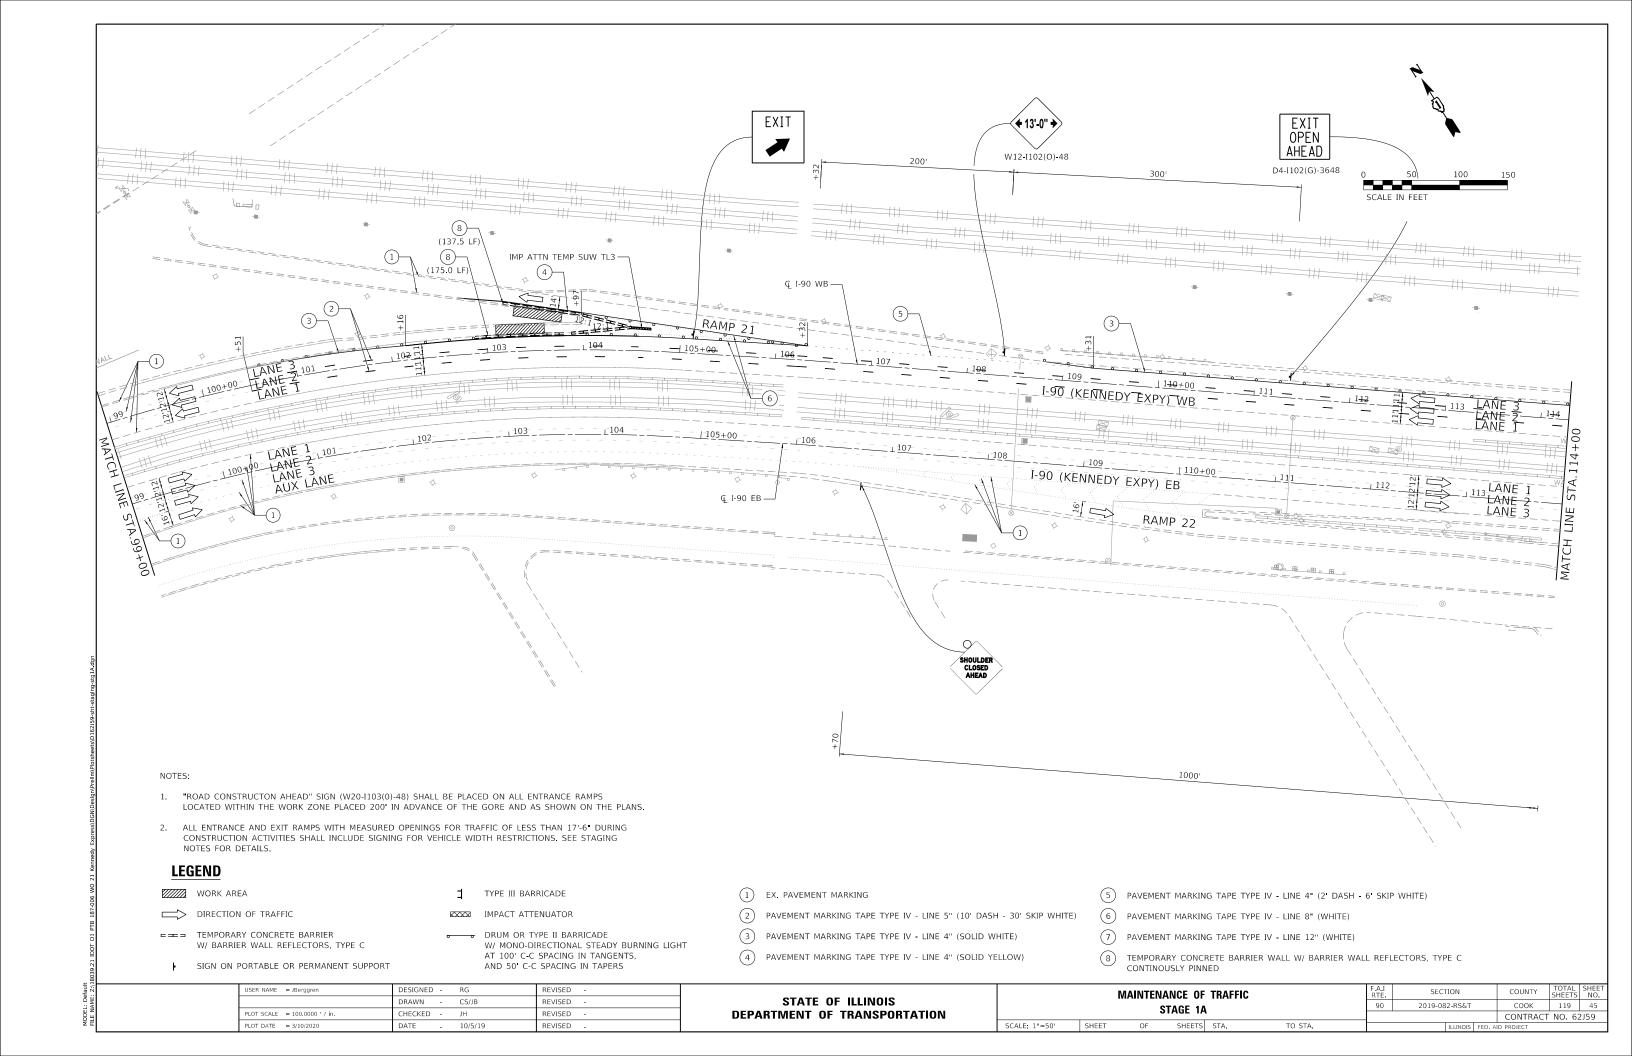
- 3 PAVEMENT MARKING TAPE TYPE IV LINE 4" (SOLID WHITE)
- (4) PAVEMENT MARKING TAPE TYPE IV LINE 4" (SOLID YELLOW)
- (5) PAVEMENT MARKING TAPE TYPE IV LINE 4" (2' DASH 6' SKIP WHITE)
- 6 PAVEMENT MARKING TAPE TYPE IV LINE 8" (WHITE)
- 7 PAVEMENT MARKING TAPE TYPE IV LINE 12" (WHITE)
- (8) TEMPORARY CONCRETE BARRIER WALL W/ BARRIER WALL REFLECTORS, TYPE C CONTINOUSLY PINNED


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PLOT DATE = 3/10/2020	DATE -	10/5/19	REVISED -


STATE OF ILLINOIS
DEPARTMENT OF TRANSPORTATION

	MAINTENANCE OF TRAFFIC STAGE 1A									
	ı	MAINTEN	NANCE OF	TRAFFI	C	F.A.I RTE	SECTION	COUNTY	TOTAL SHEETS	SHEET NO.
			STAGE 1A			90	2019-082-RS&T	COOK	119	43
STAGE IA								CONTRACT	NO. 62	2J59
	CHEET	0.5	CHEETC	CTA	TO CT4					



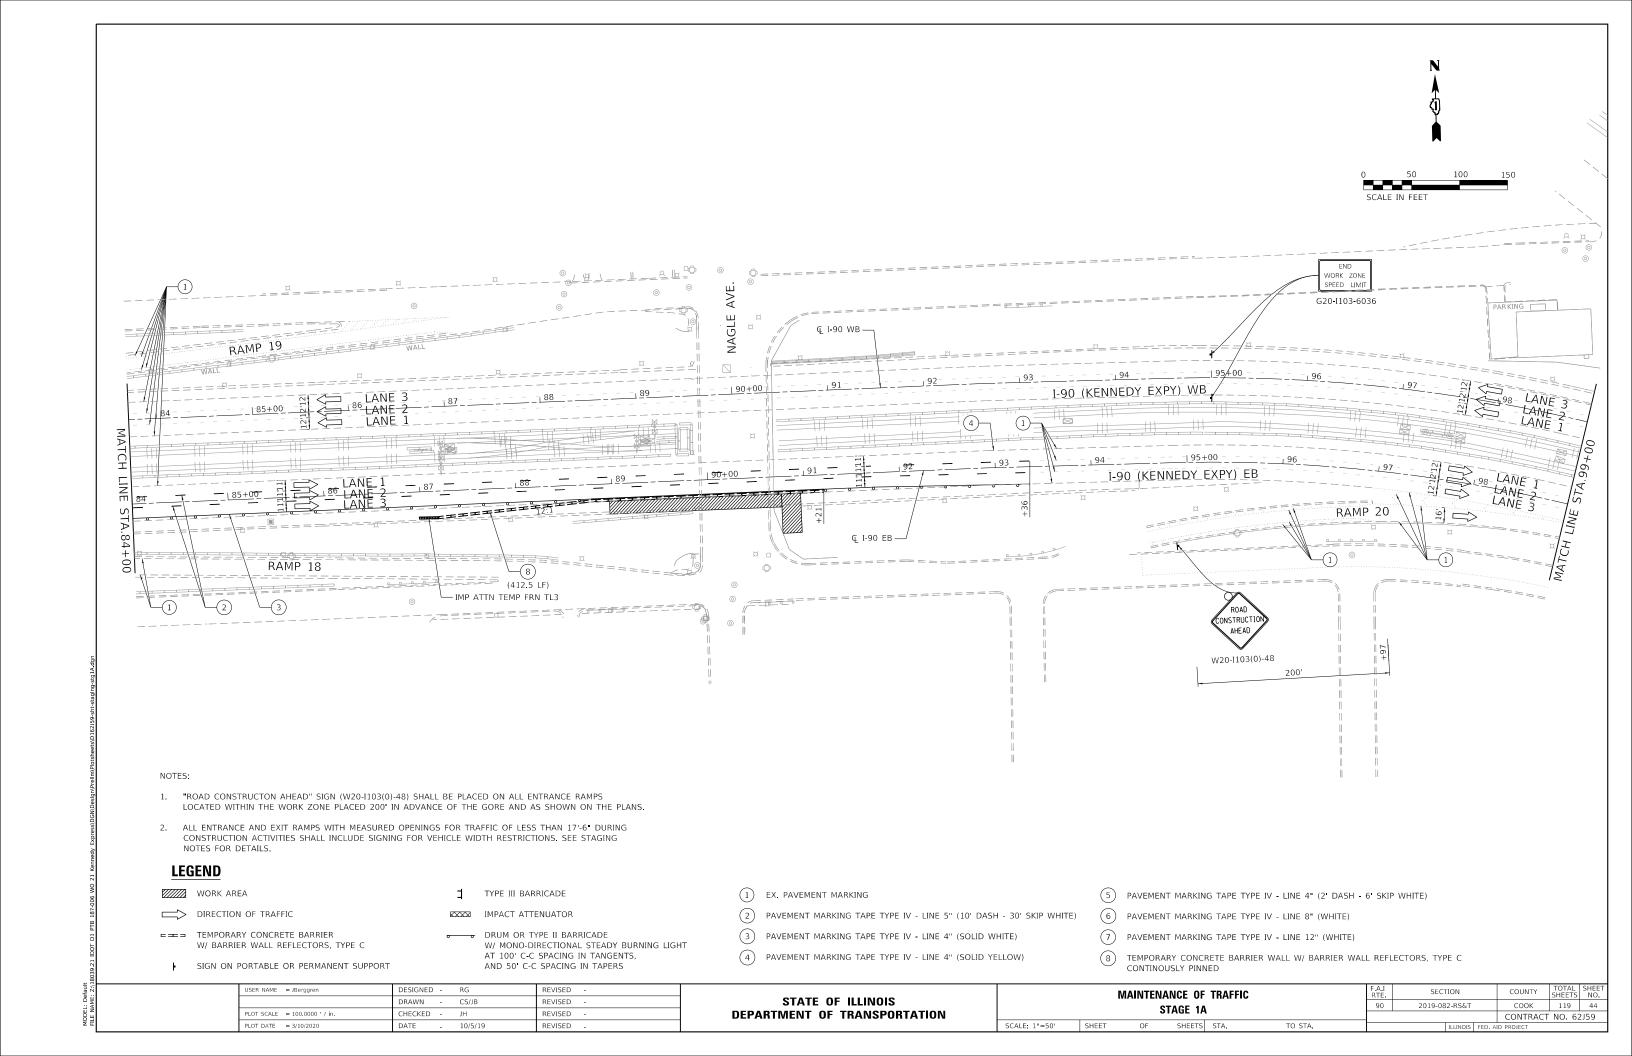

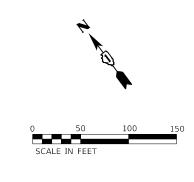

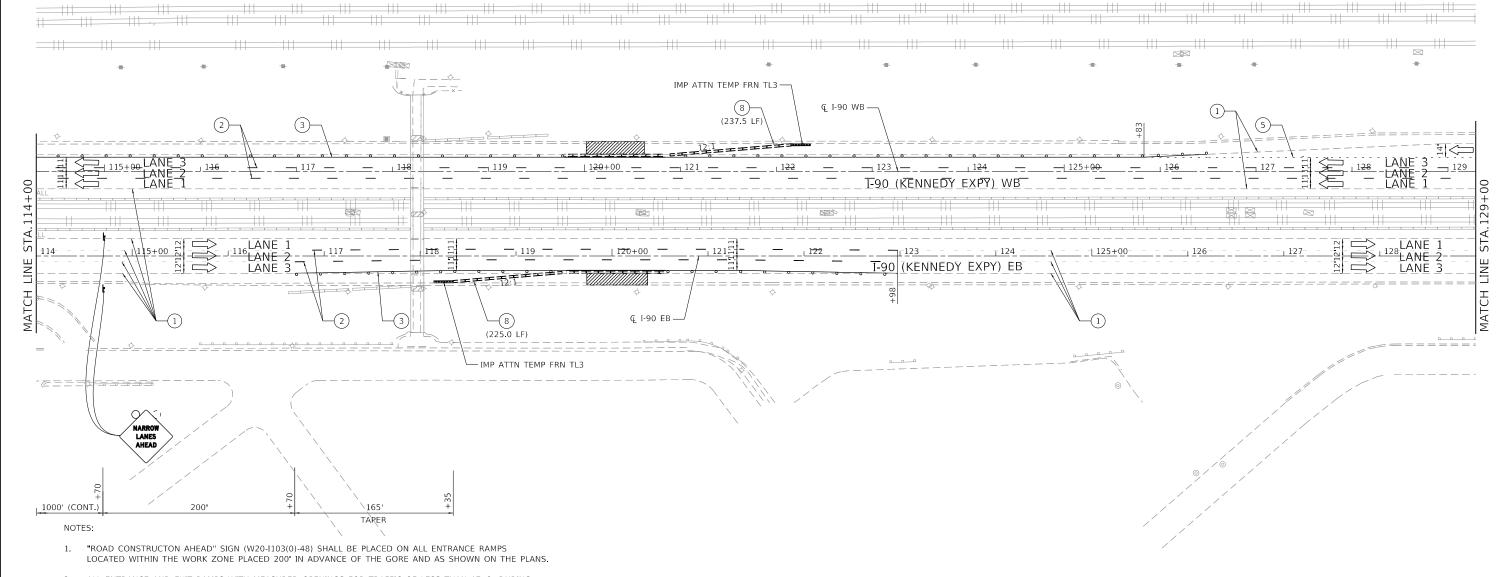

2. ALL ENTRANCE AND EXIT RAMPS WITH MEASURED OPENINGS FOR TRAFFIC OF LESS THAN 17'-6' DURING CONSTRUCTION ACTIVITIES SHALL INCLUDE SIGNING FOR VEHICLE WIDTH RESTRICTIONS. SEE STAGING NOTES FOR DETAILS.

# **LEGEND**

WORK AREA

DIRECTION OF TRAFFIC

TEMPORARY CONCRETE BARRIER
W/ BARRIER WALL REFLECTORS, TYPE C

- SIGN ON PORTABLE OR PERMANENT SUPPORT
- TYPE III BARRICADE

IMPACT ATTENUATOR

DRUM OR TYPE II BARRICADE
W/ MONO-DIRECTIONAL STEADY BURNING LIGHT
AT 100' C-C SPACING IN TANGENTS,
AND 50' C-C SPACING IN TAPERS

- 1 EX. PAVEMENT MARKING
- 2 PAVEMENT MARKING TAPE TYPE IV LINE 5" (10' DASH 30' SKIP WHITE)


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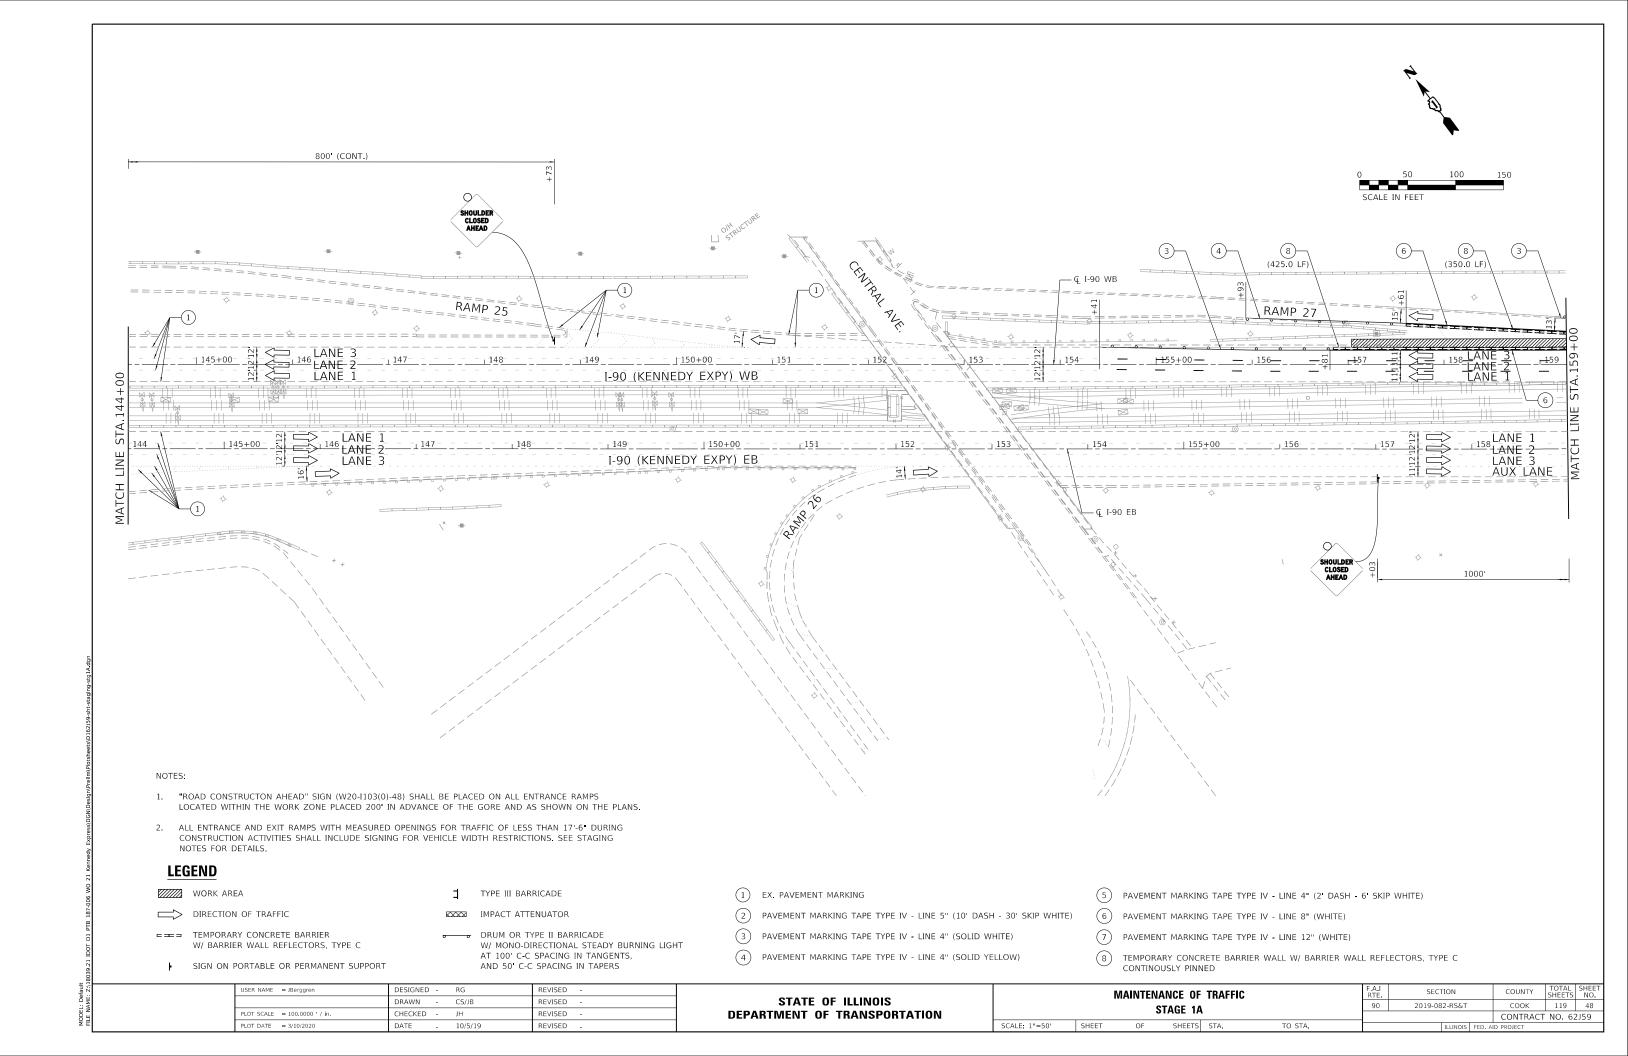
- 3 PAVEMENT MARKING TAPE TYPE IV LINE 4" (SOLID WHITE)
- (4) PAVEMENT MARKING TAPE TYPE IV LINE 4" (SOLID YELLOW)
- (5) PAVEMENT MARKING TAPE TYPE IV LINE 4" (2' DASH 6' SKIP WHITE)
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- 7) PAVEMENT MARKING TAPE TYPE IV LINE 12" (WHITE)
- 8 TEMPORARY CONCRETE BARRIER WALL W/ BARRIER WALL REFLECTORS, TYPE C CONTINOUSLY PINNED


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PLOT DATE = 3/10/2020	DATE -	10/5/19	REVISED -	


STATE OF ILLINOIS
DEPARTMENT OF TRANSPORTATION


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		c	TAGE 1A			90	2019-082-RS&T	соок	119	46
			IAGE IA					CONTRACT	NO. 62	2J59
SHEET OF SHEETS STA.				STA.	TO STA.		TILLINOIS FED A	ID PROJECT		




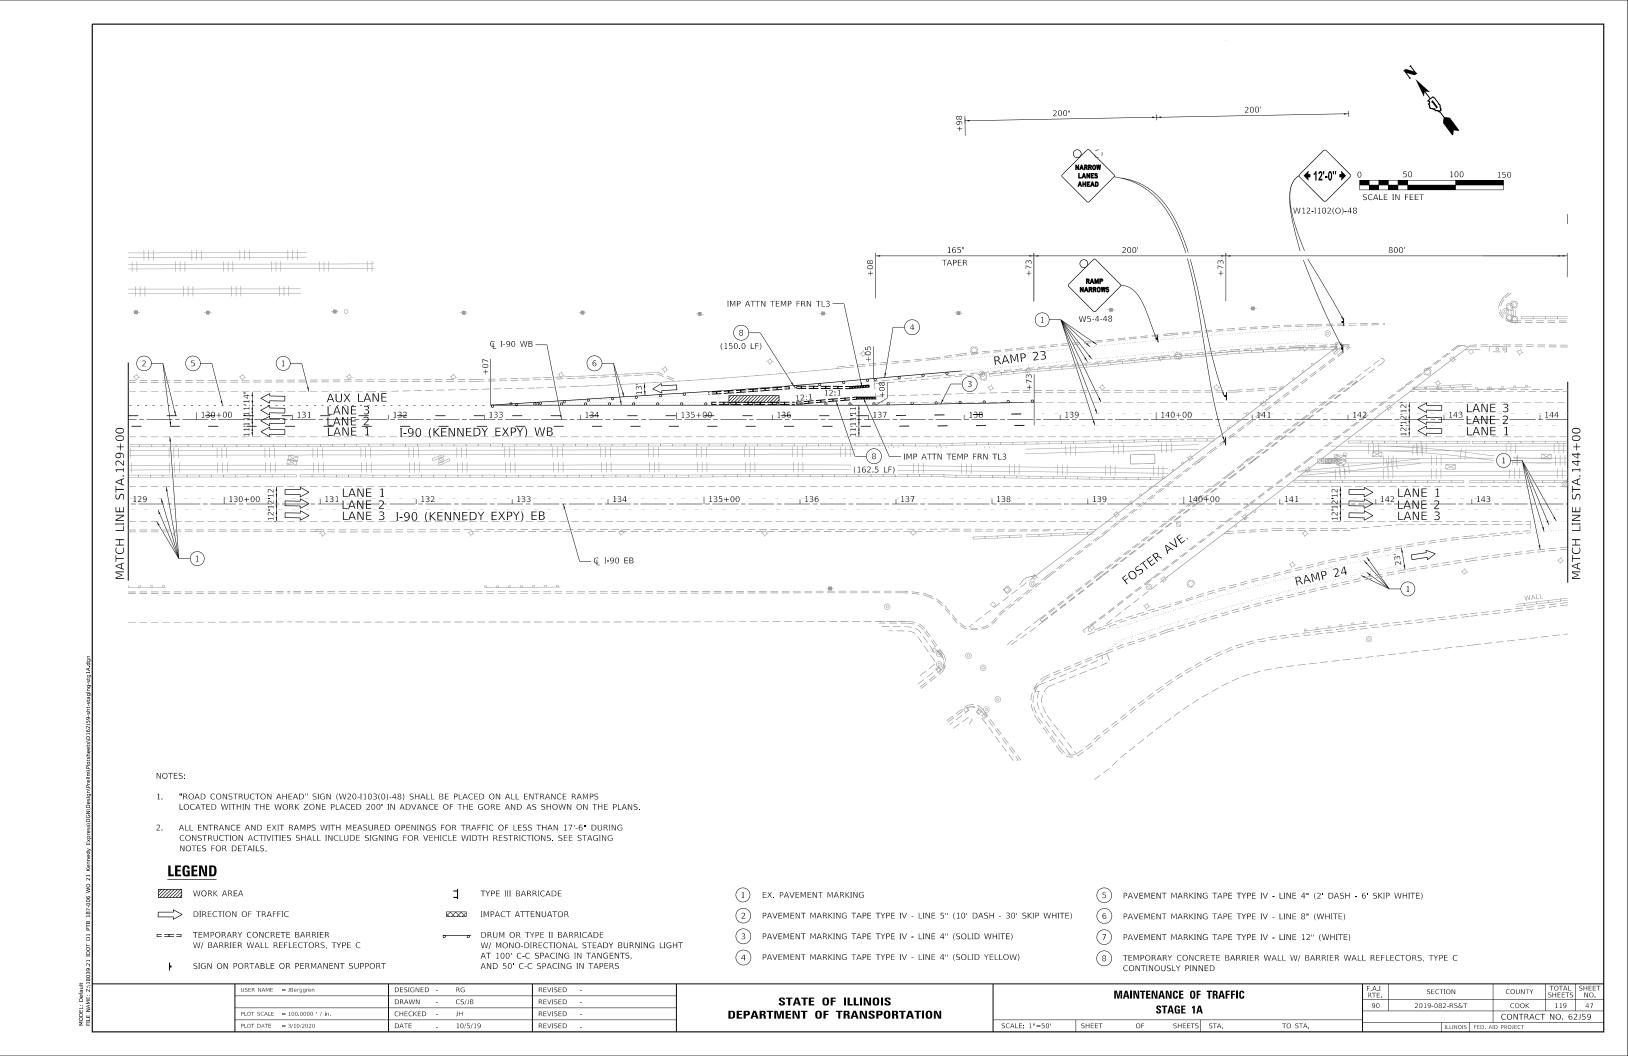


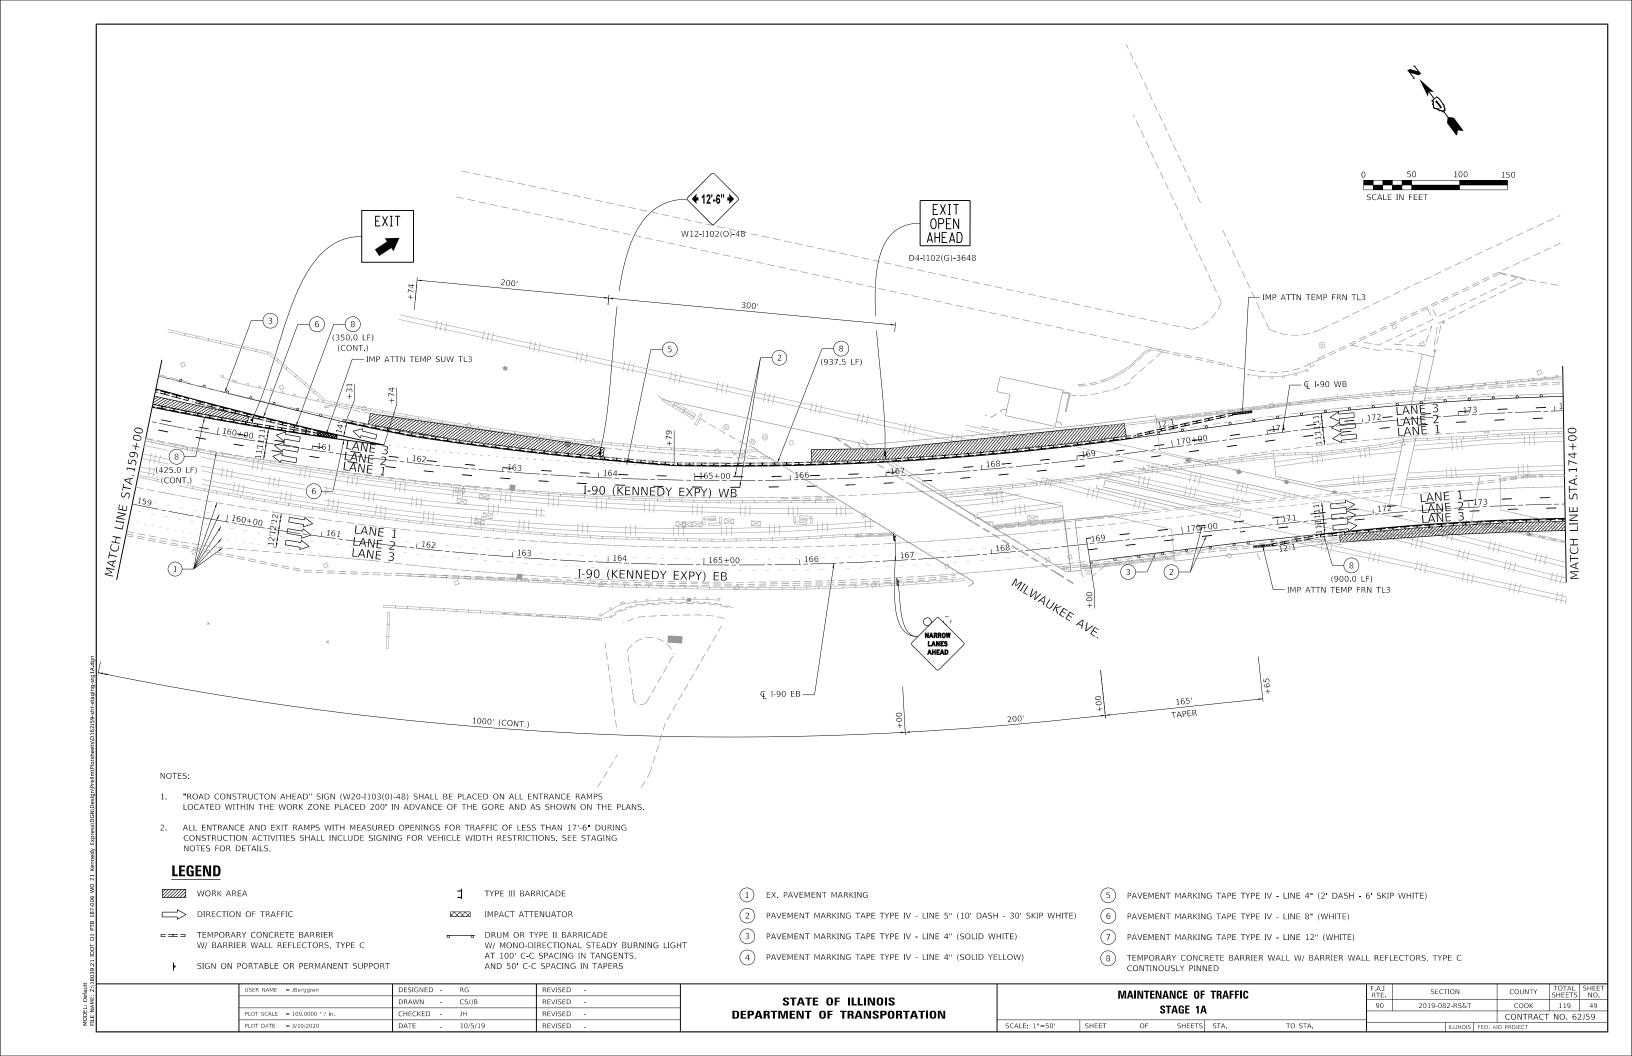


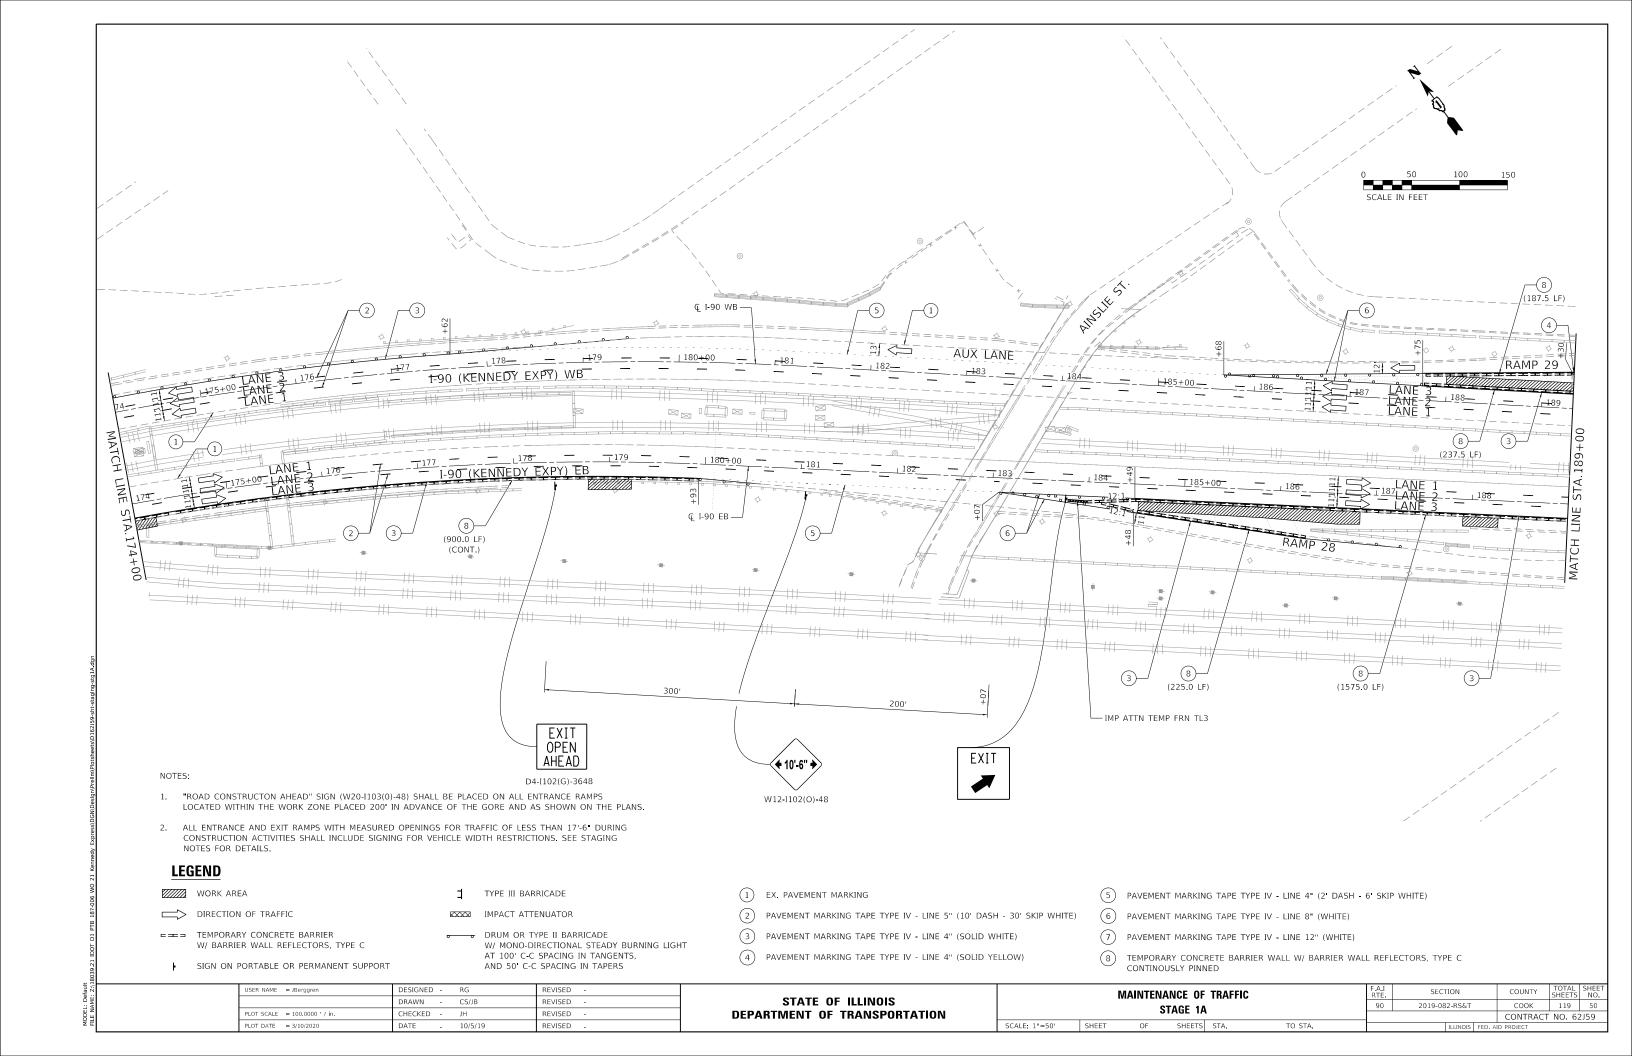


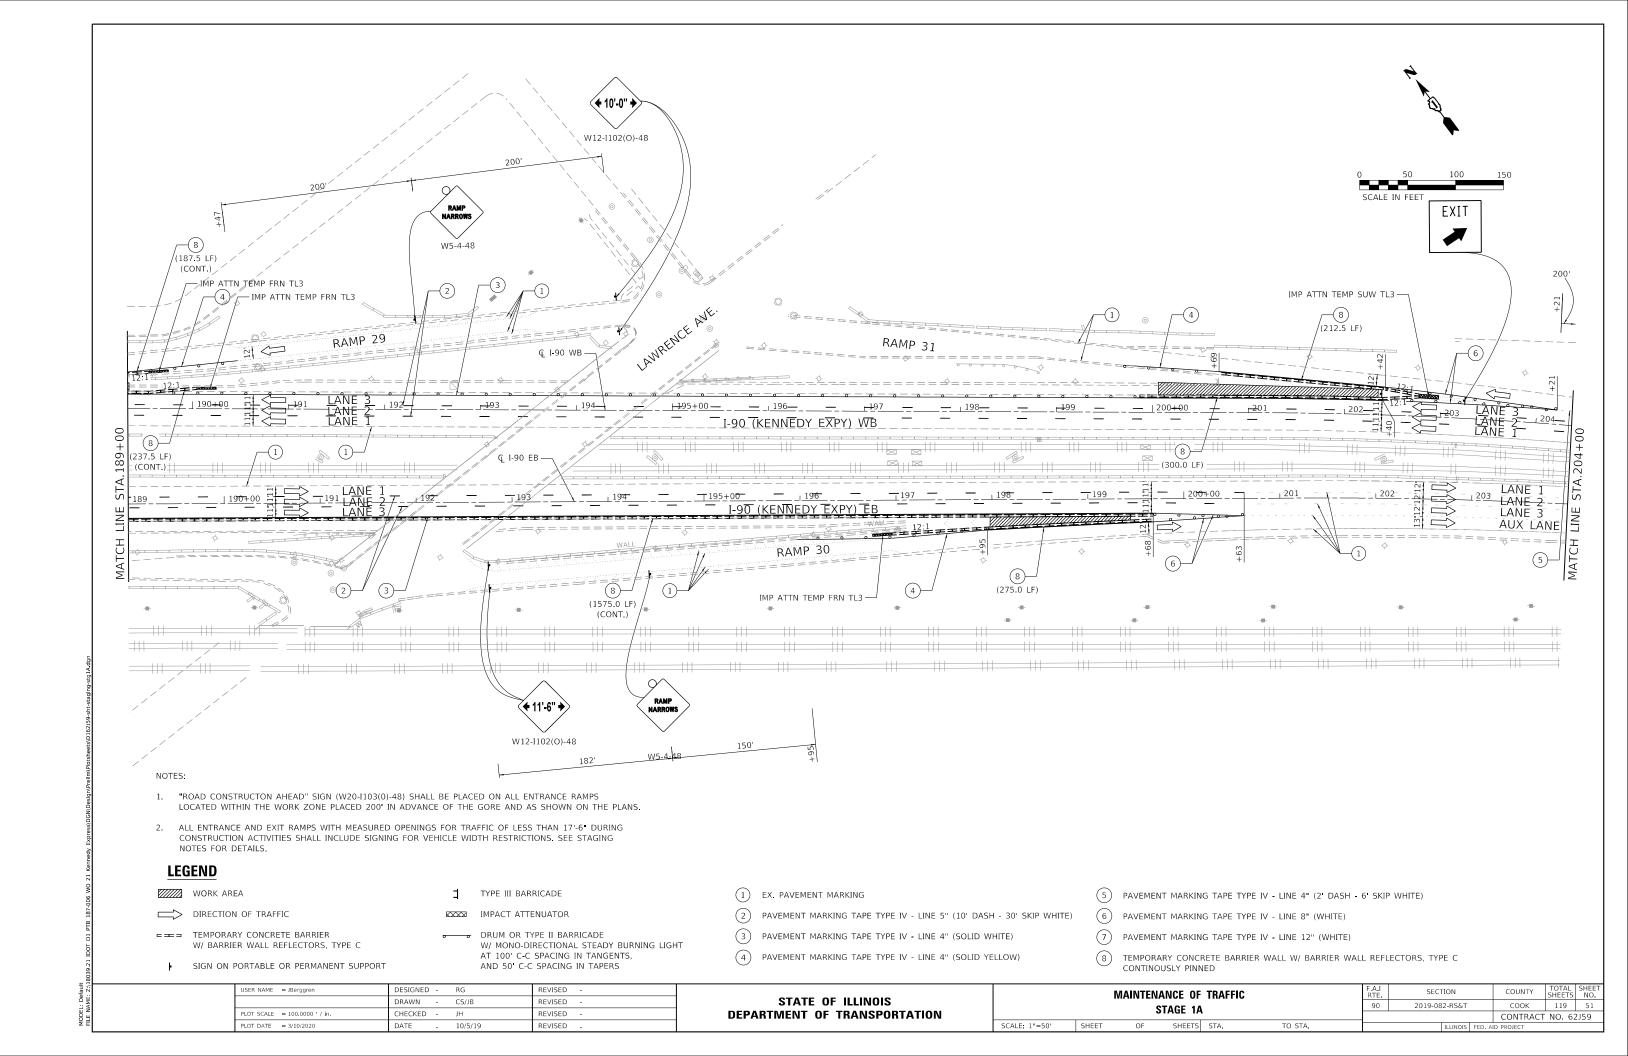


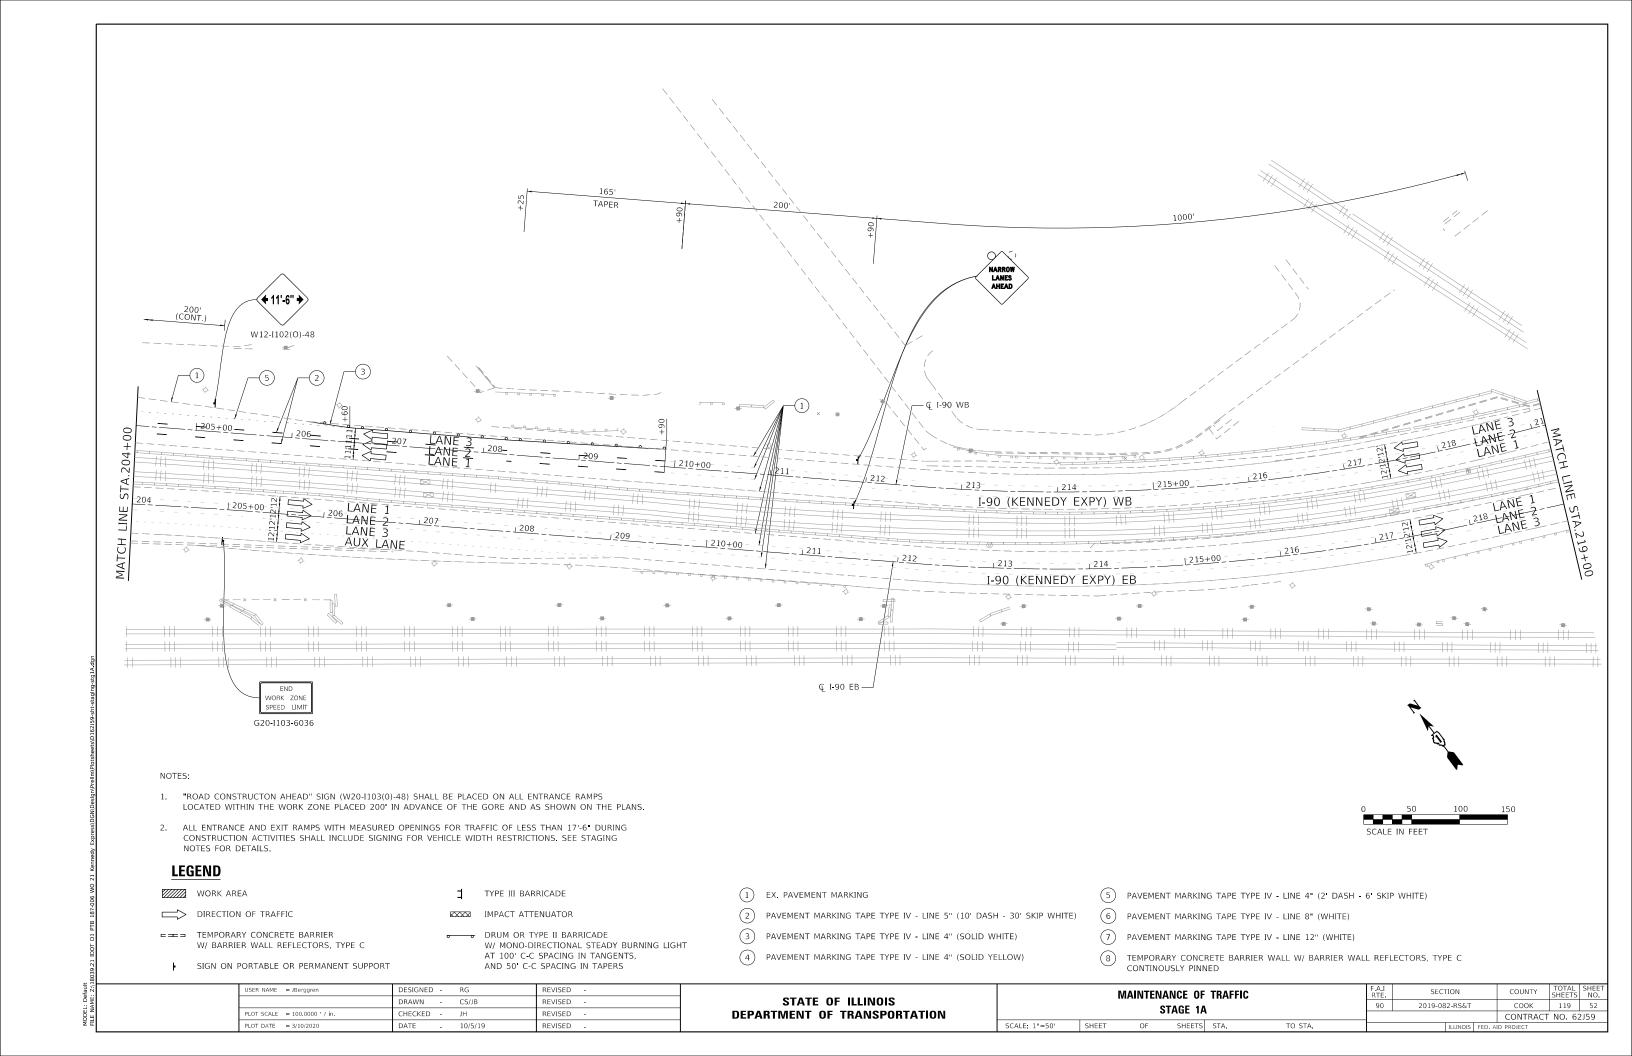


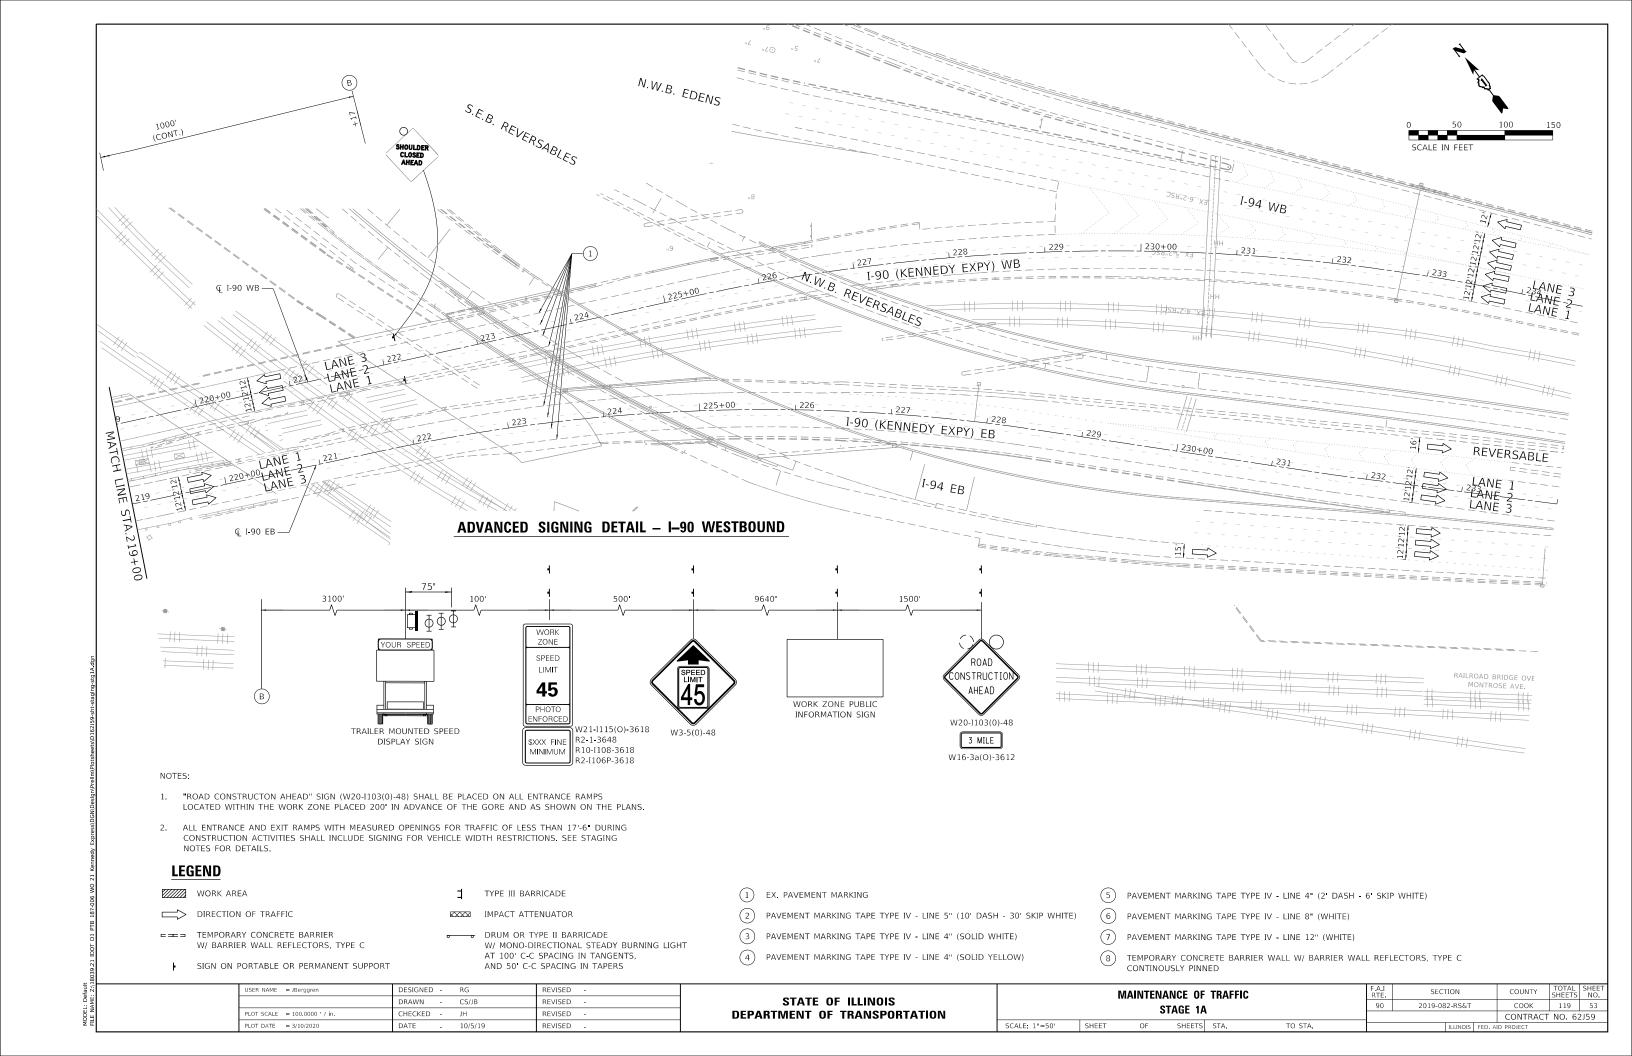


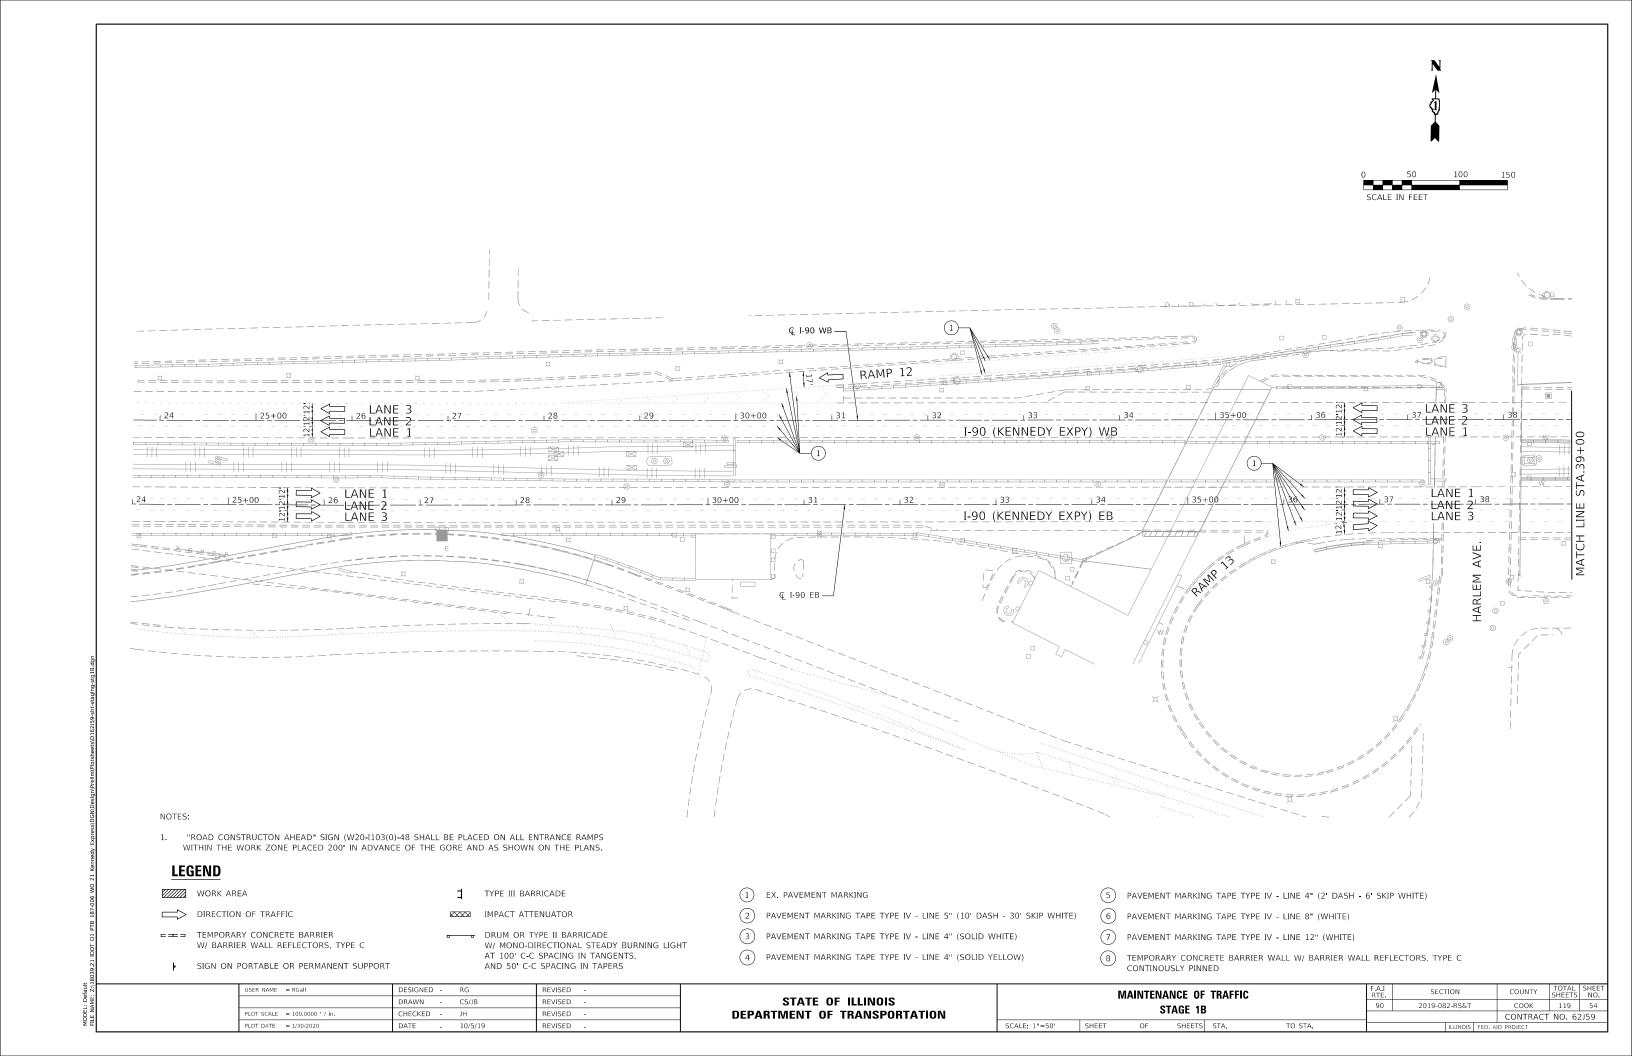

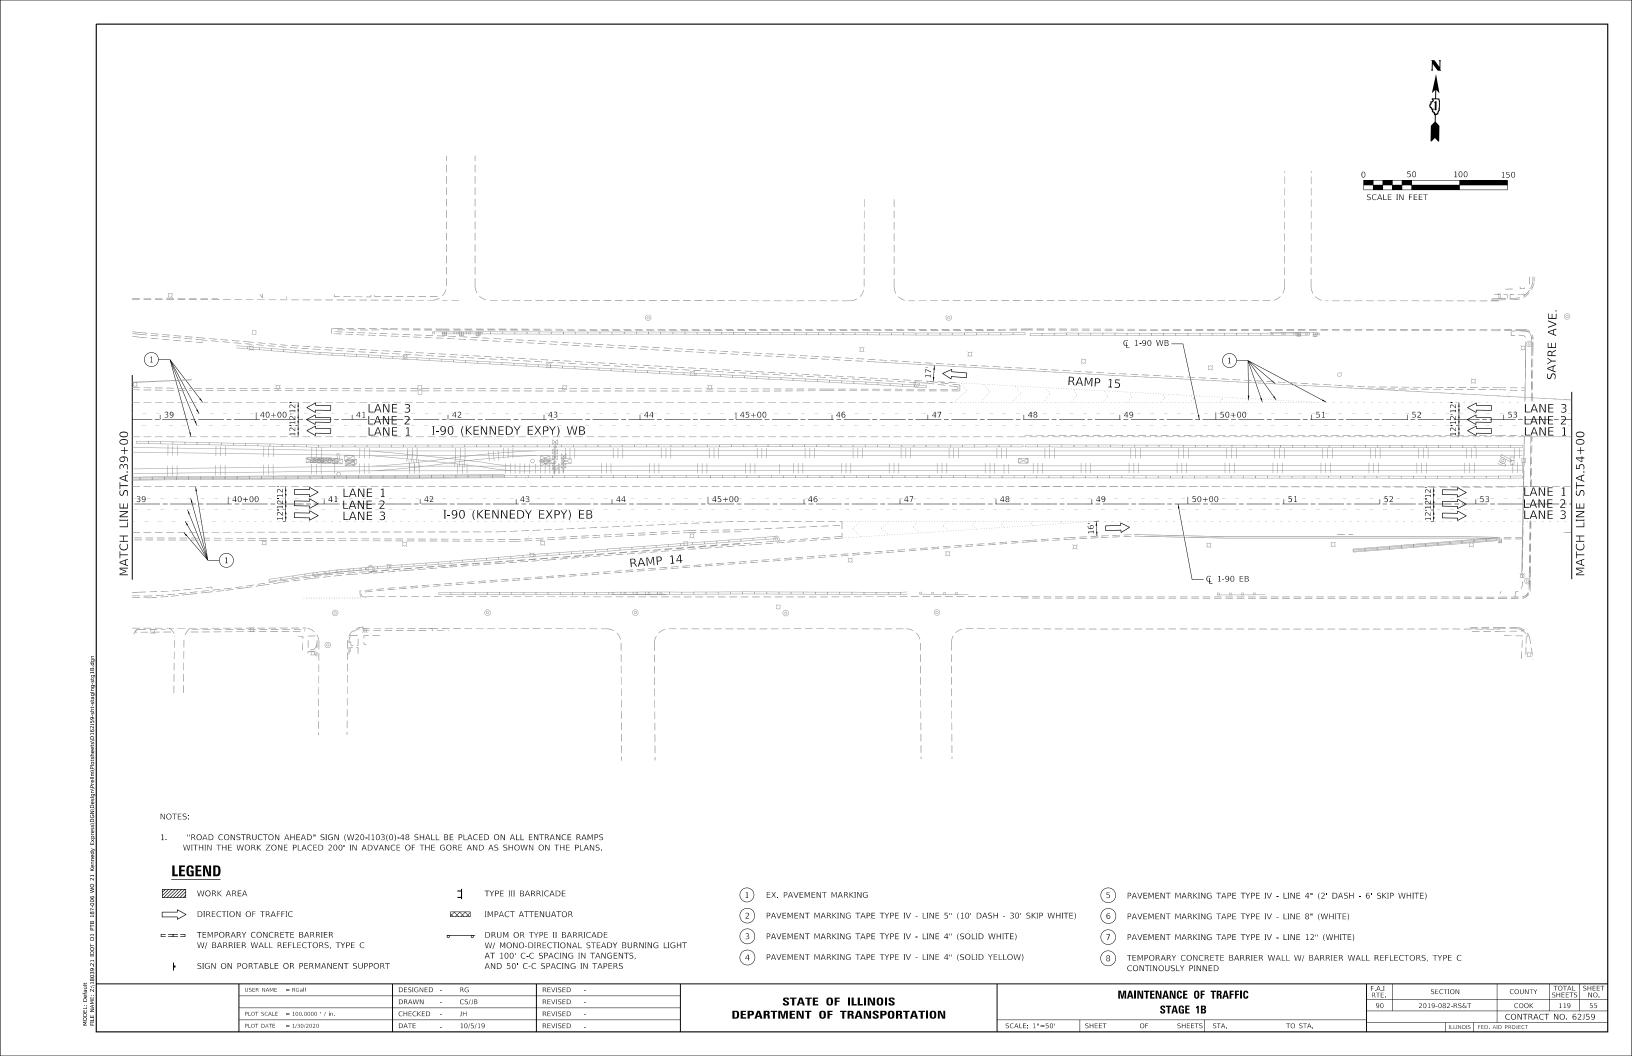

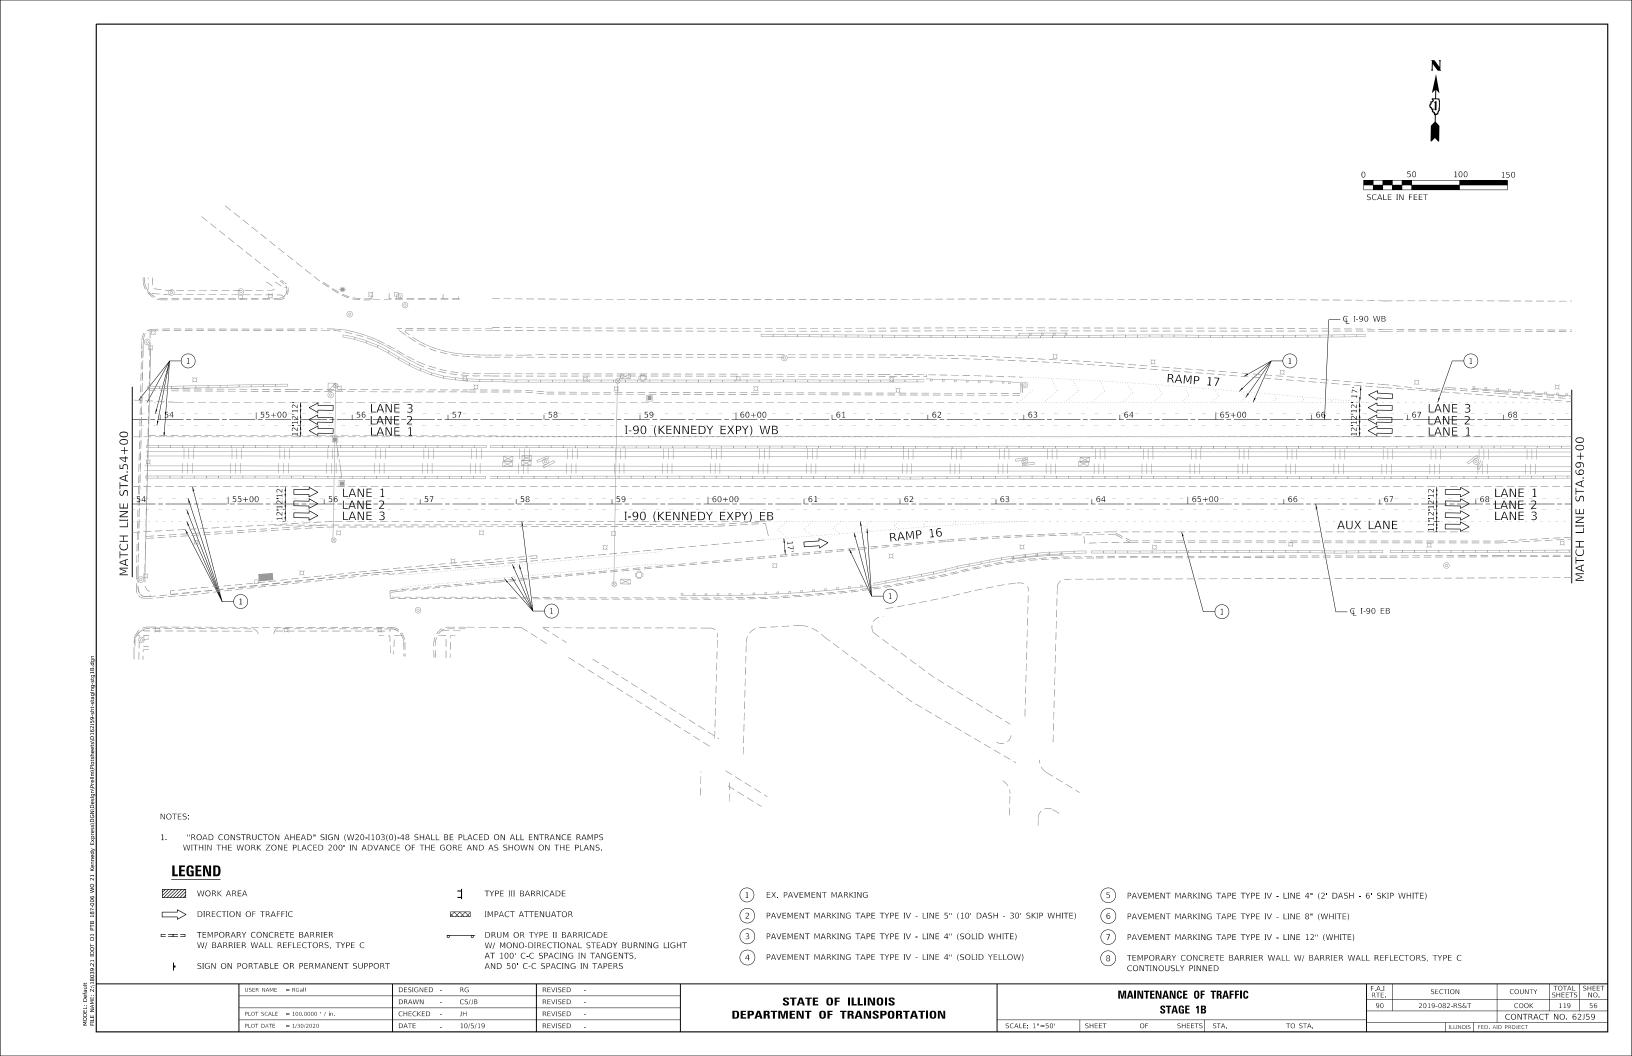

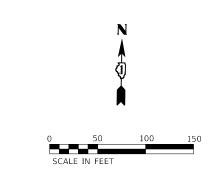

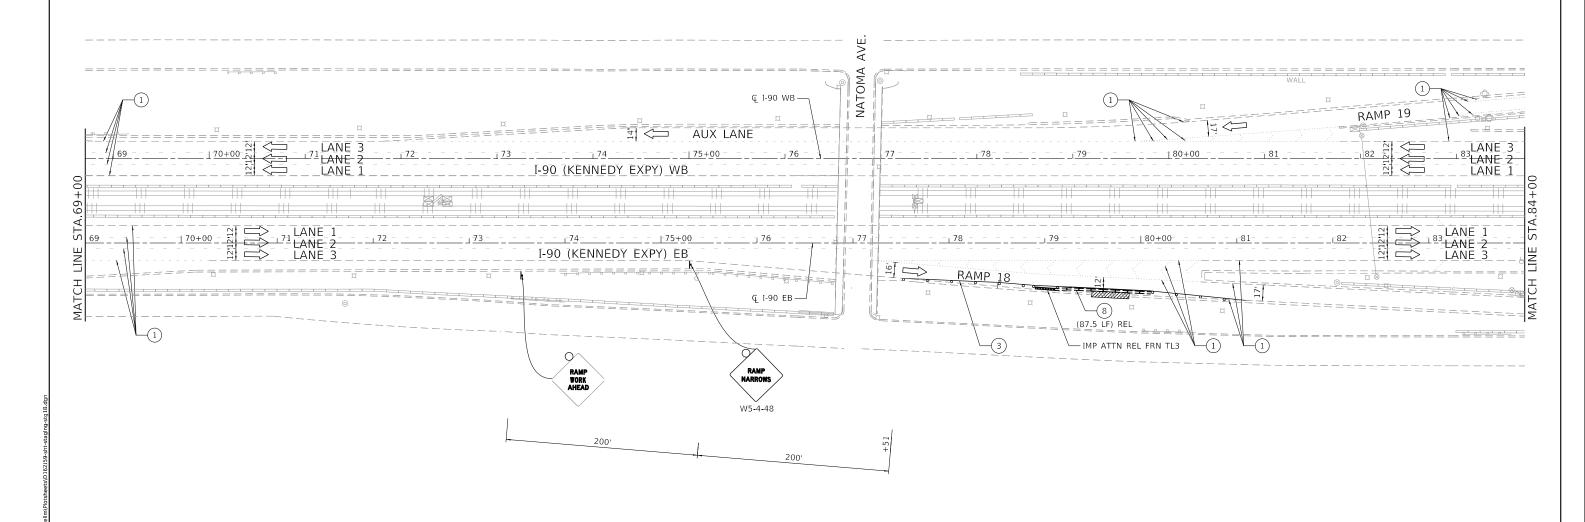

### NOTES

1. "ROAD CONSTRUCTON AHEAD" SIGN (W20-I103(0)-48 SHALL BE PLACED ON ALL ENTRANCE RAMPS WITHIN THE WORK ZONE PLACED 200' IN ADVANCE OF THE GORE AND AS SHOWN ON THE PLANS.

## LEGEND

WORK AREA

DIRECTION OF TRAFFIC

TEMPORARY CONCRETE BARRIER
W/ BARRIER WALL REFLECTORS, TYPE C

F SIGN ON PORTABLE OR PERMANENT SUPPORT

TYPE III BARRICADE


IMPACT ATTENUATOR


DRUM OR TYPE II BARRICADE
W/ MONO-DIRECTIONAL STEADY BURNING LIGHT
AT 100' C-C SPACING IN TANGENTS,
AND 50' C-C SPACING IN TAPERS


- 1 EX. PAVEMENT MARKING
- 2 PAVEMENT MARKING TAPE TYPE IV LINE 5" (10' DASH 30' SKIP WHITE)
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- (4) PAVEMENT MARKING TAPE TYPE IV LINE 4" (SOLID YELLOW)
- 5 PAVEMENT MARKING TAPE TYPE IV LINE 4" (2' DASH 6' SKIP WHITE)
- 6 PAVEMENT MARKING TAPE TYPE IV LINE 8" (WHITE)
- 7) PAVEMENT MARKING TAPE TYPE IV LINE 12" (WHITE)
- B TEMPORARY CONCRETE BARRIER WALL W/ BARRIER WALL REFLECTORS, TYPE C CONTINOUSLY PINNED


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	DRAWN -	CS/JB	REVISED -	STATE OF ILLINOIS
PLOT SCALE = 100.0000 ' / in.	CHECKED -	JH	REVISED -	DEPARTMENT OF TRANSPORTATION
PLOT DATE = 1/30/2020	DATE -	10/5/19	REVISED -	


	M	IAINTEN	ANCE OF	TRAFFIC		F.A.I RTE	SECTION		COUNTY	TOTAL SHEETS	SHEET NO.
		•	TAGE 1B			90	2019-082-RS&T		COOK	119	57
			INGL ID						CONTRACT	NO. 62	2J59
SCALE: 1"=50"	SHEET	OF	SHEETS	STA.	TO STA.		ILLINOIS	FED. AI	D PROJECT		

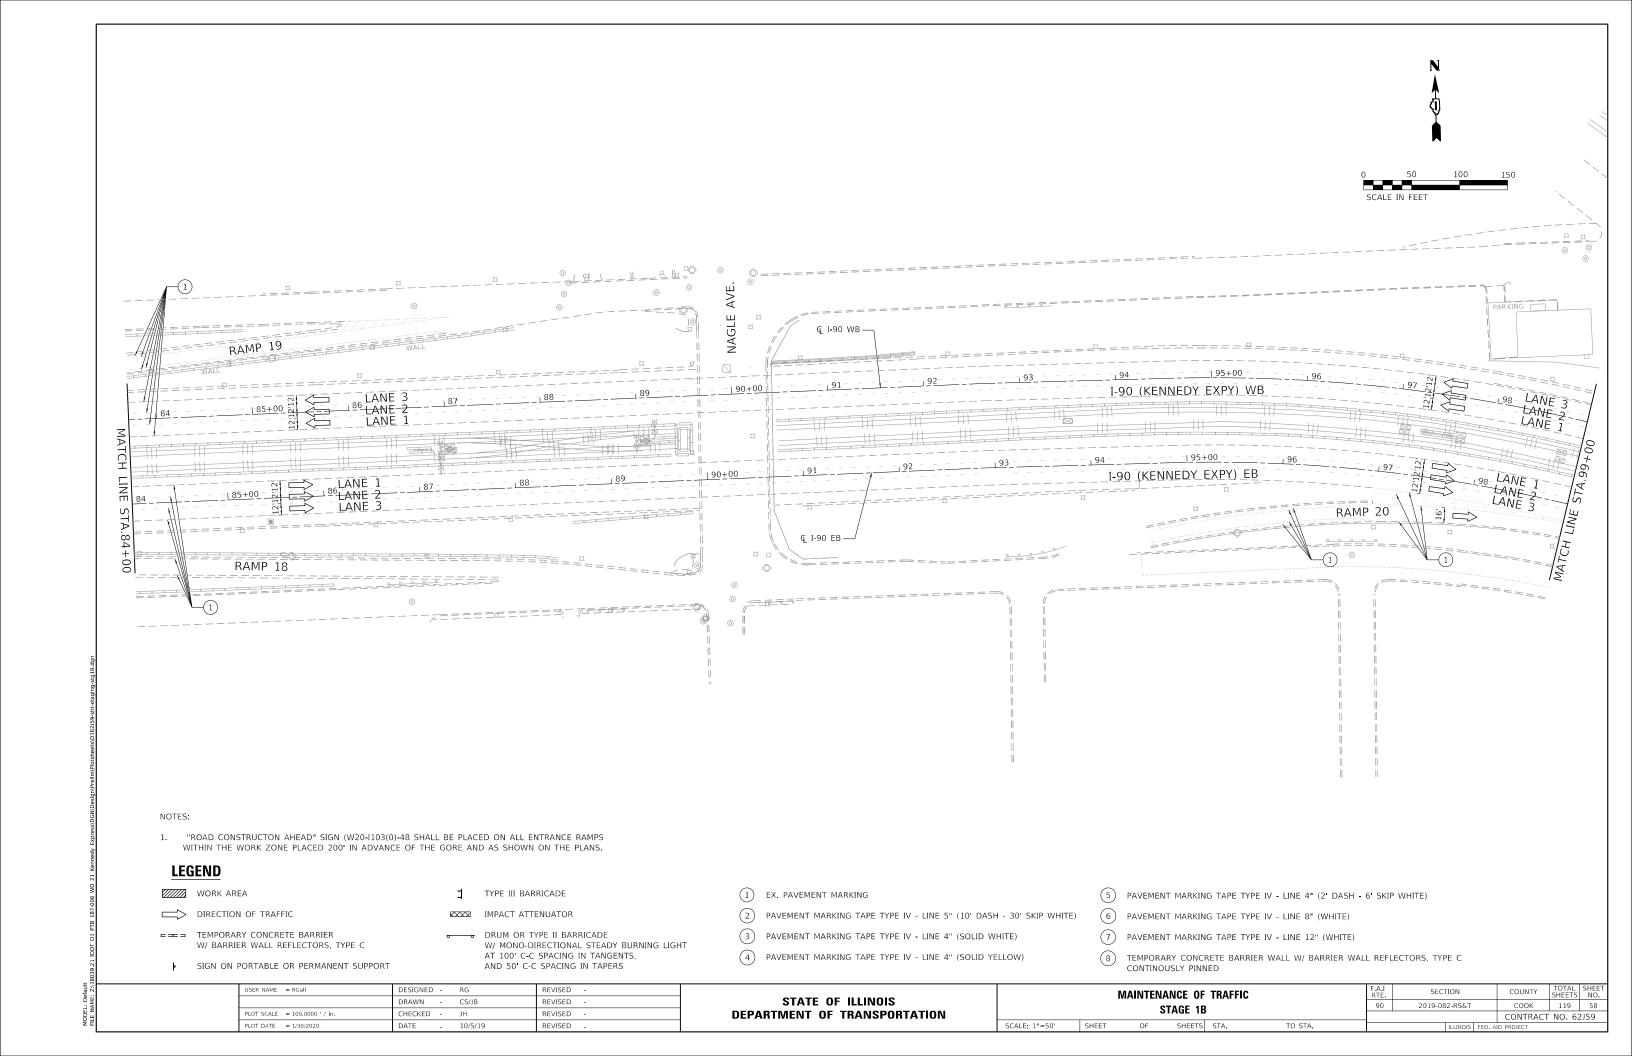

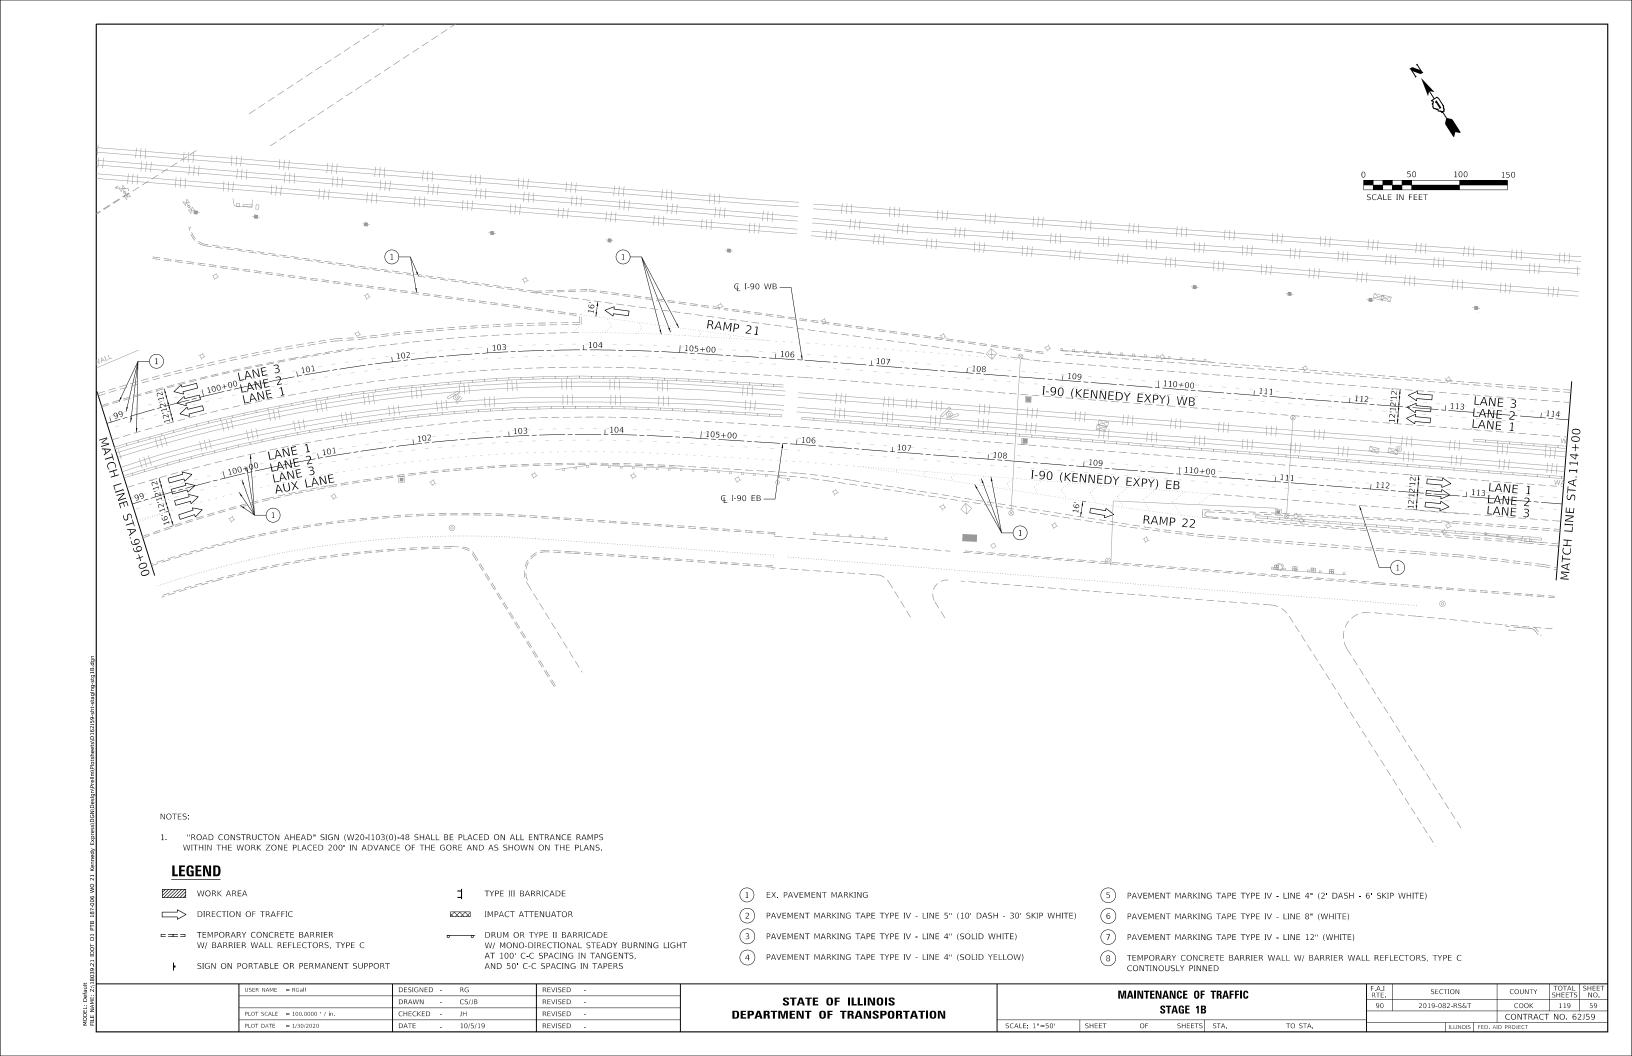

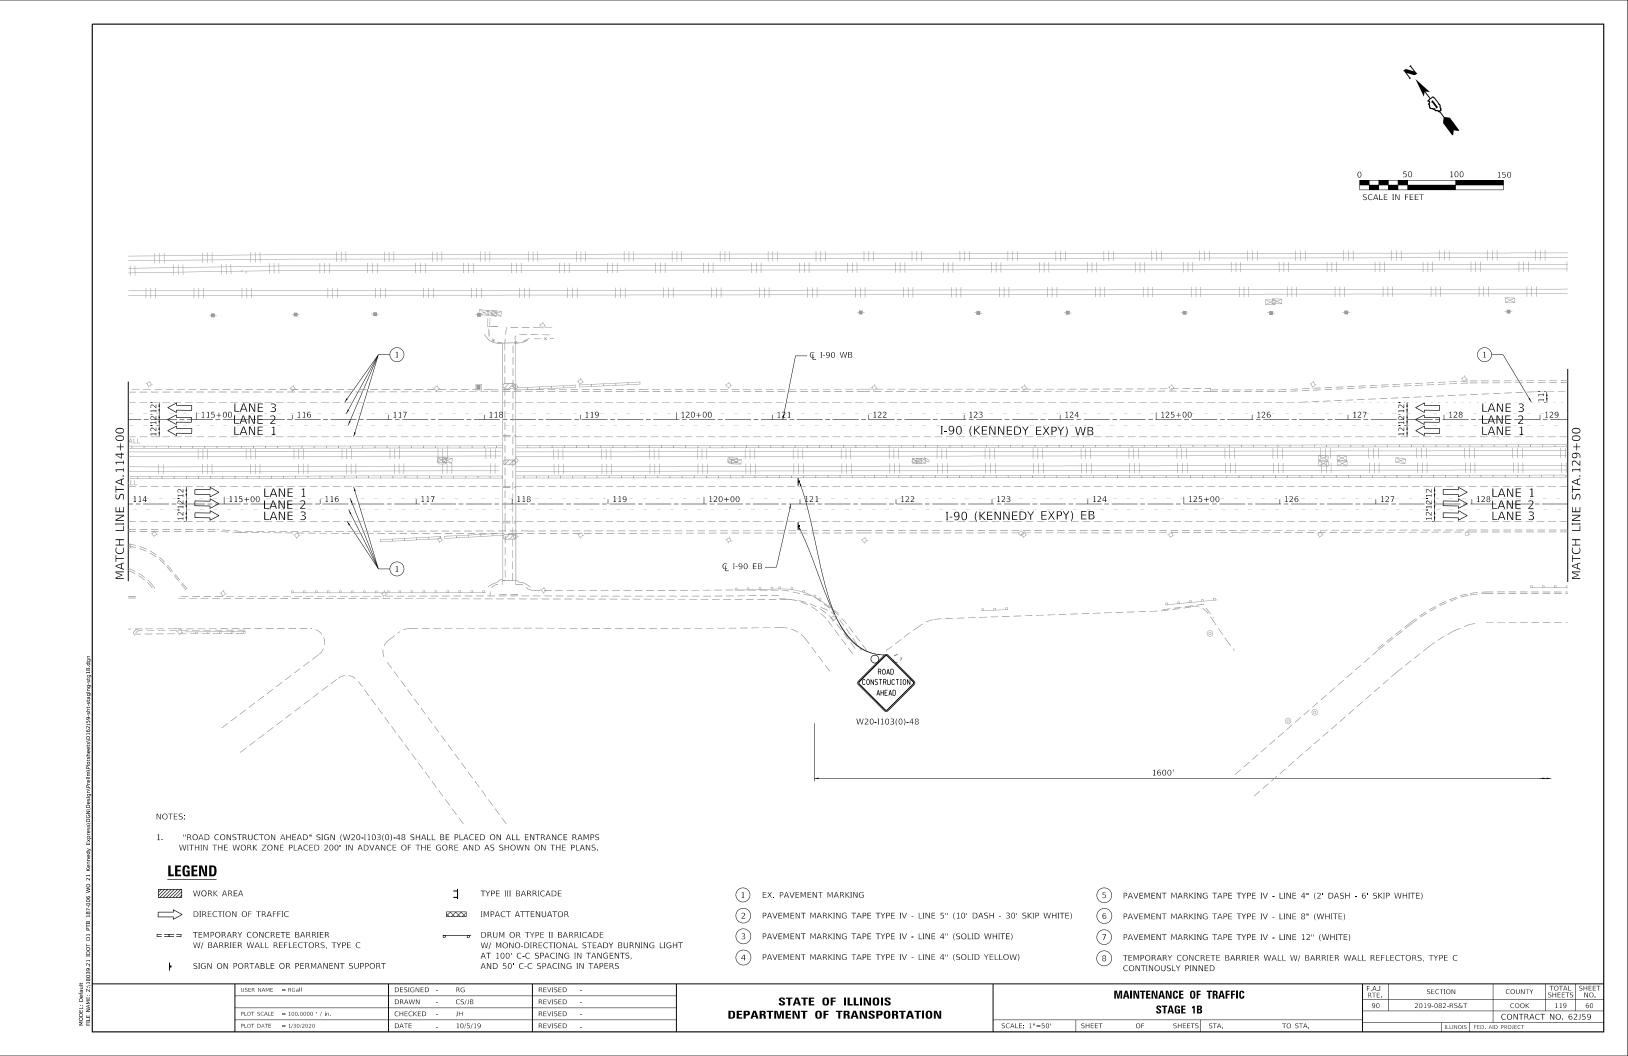

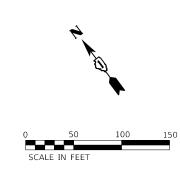

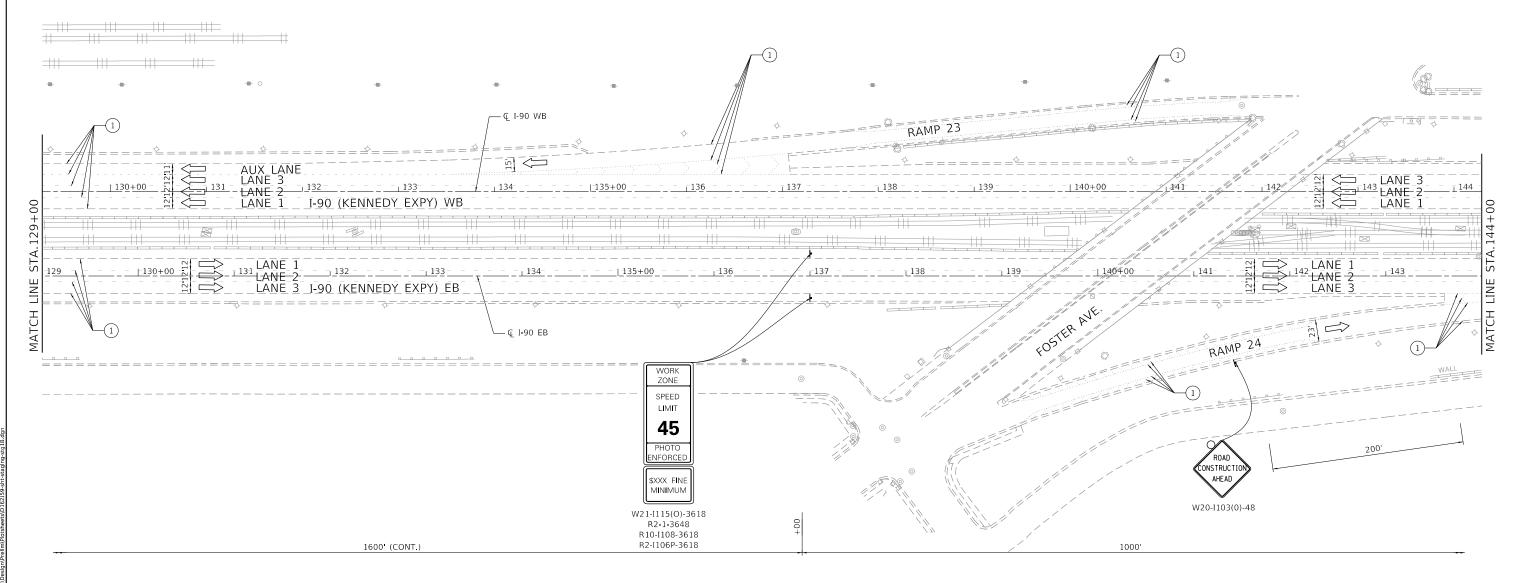

### NOTES:

1. "ROAD CONSTRUCTON AHEAD" SIGN (W20-I103(0)-48 SHALL BE PLACED ON ALL ENTRANCE RAMPS WITHIN THE WORK ZONE PLACED 200' IN ADVANCE OF THE GORE AND AS SHOWN ON THE PLANS.

# **LEGEND**

WORK AREA

DIRECTION OF TRAFFIC

TEMPORARY CONCRETE BARRIER
W/ BARRIER WALL REFLECTORS, TYPE C

SIGN ON PORTABLE OR PERMANENT SUPPORT


TYPE III BARRICADE


IMPACT ATTENUATOR


DRUM OR TYPE II BARRICADE
W/ MONO-DIRECTIONAL STEADY BURNING LIGHT
AT 100' C-C SPACING IN TANGENTS,
AND 50' C-C SPACING IN TAPERS


- 1 EX. PAVEMENT MARKING
- 2 PAVEMENT MARKING TAPE TYPE IV LINE 5" (10' DASH 30' SKIP WHITE)
- 3 PAVEMENT MARKING TAPE TYPE IV LINE 4" (SOLID WHITE)
- (4) PAVEMENT MARKING TAPE TYPE IV LINE 4" (SOLID YELLOW)
- 5 PAVEMENT MARKING TAPE TYPE IV LINE 4" (2' DASH 6' SKIP WHITE)
- 6 PAVEMENT MARKING TAPE TYPE IV LINE 8" (WHITE)
- 7) PAVEMENT MARKING TAPE TYPE IV LINE 12" (WHITE)
- (8) TEMPORARY CONCRETE BARRIER WALL W/ BARRIER WALL REFLECTORS, TYPE C CONTINOUSLY PINNED


USER NAME = RGall	DESIGNED -	RG	REVISED -				MΔINTEN	ANCE O	TRAFFIC		F.A.I RTF	SECTION	COUNTY	TOTA
	DRAWN -	CS/JB	REVISED -	STATE OF ILLINOIS		•					90	2019-082-RS&T	соок	119
PLOT SCALE = 100.0000 ' / in.	CHECKED -	JH	REVISED -	DEPARTMENT OF TRANSPORTATION			•	STAGE 1	5				CONTRACT	T NO.
PLOT DATE = 1/30/2020	DATE -	10/5/19	REVISED -		SCALE: 1"=50'	SHEET	OF	SHEETS	STA.	TO STA.		ILLINOIS FED. A	ID PROJECT	

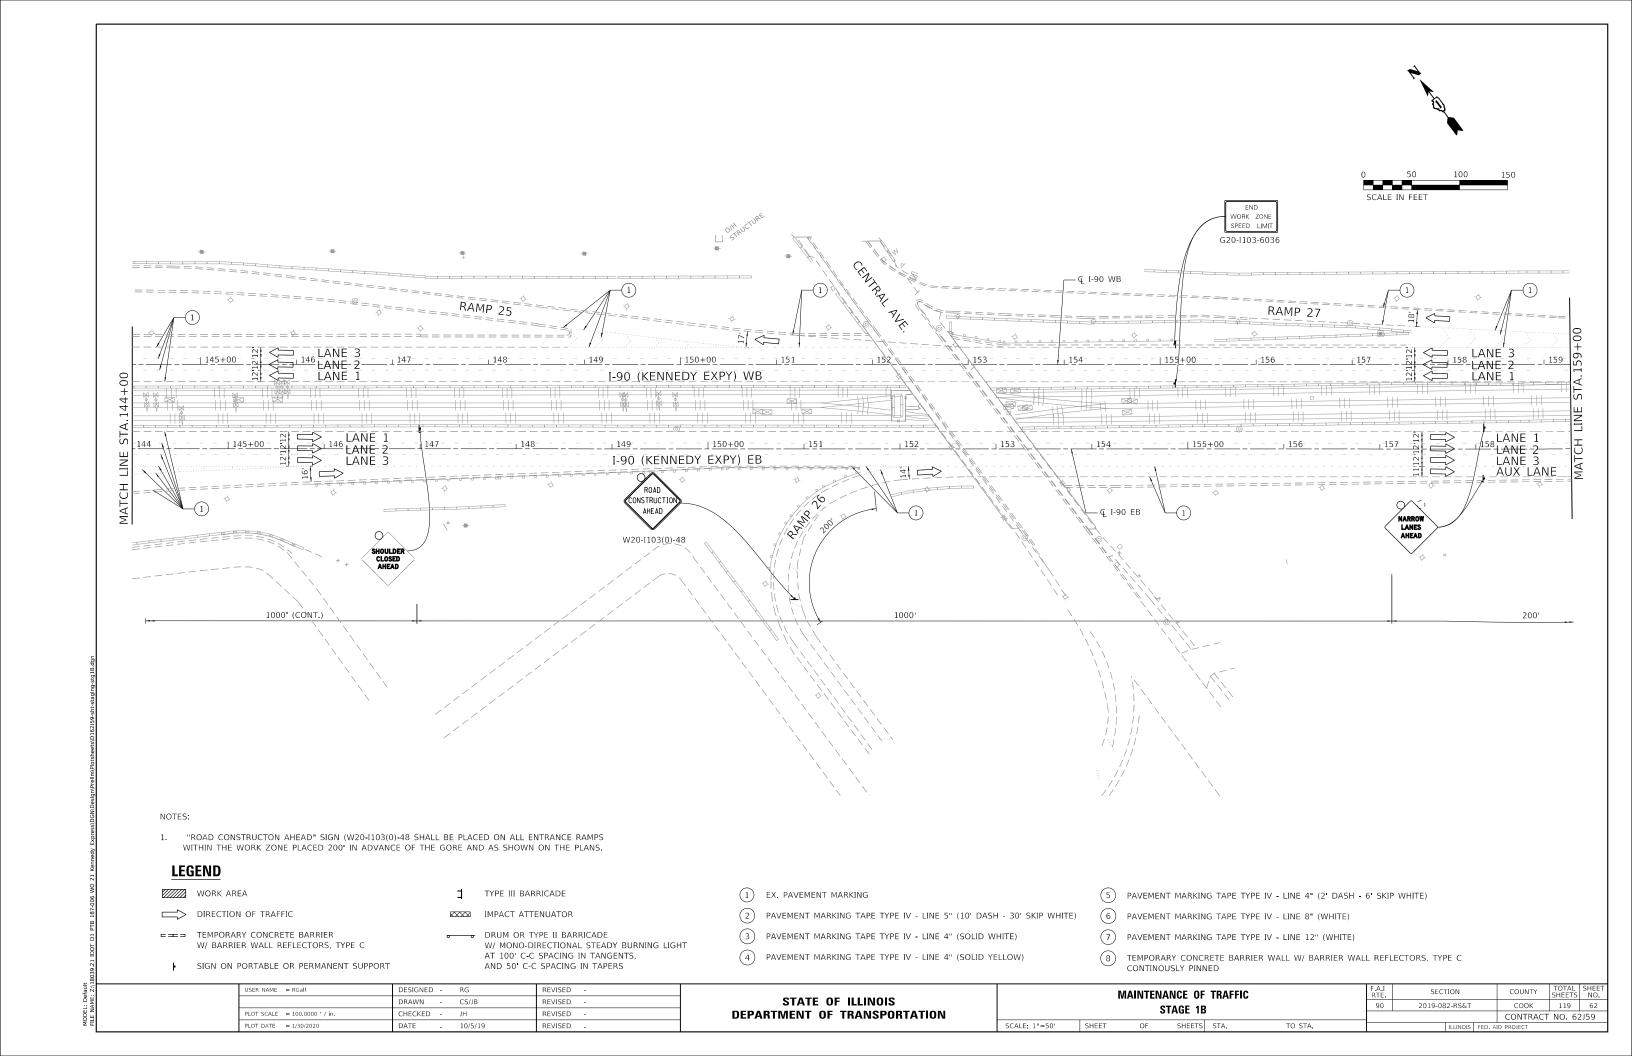


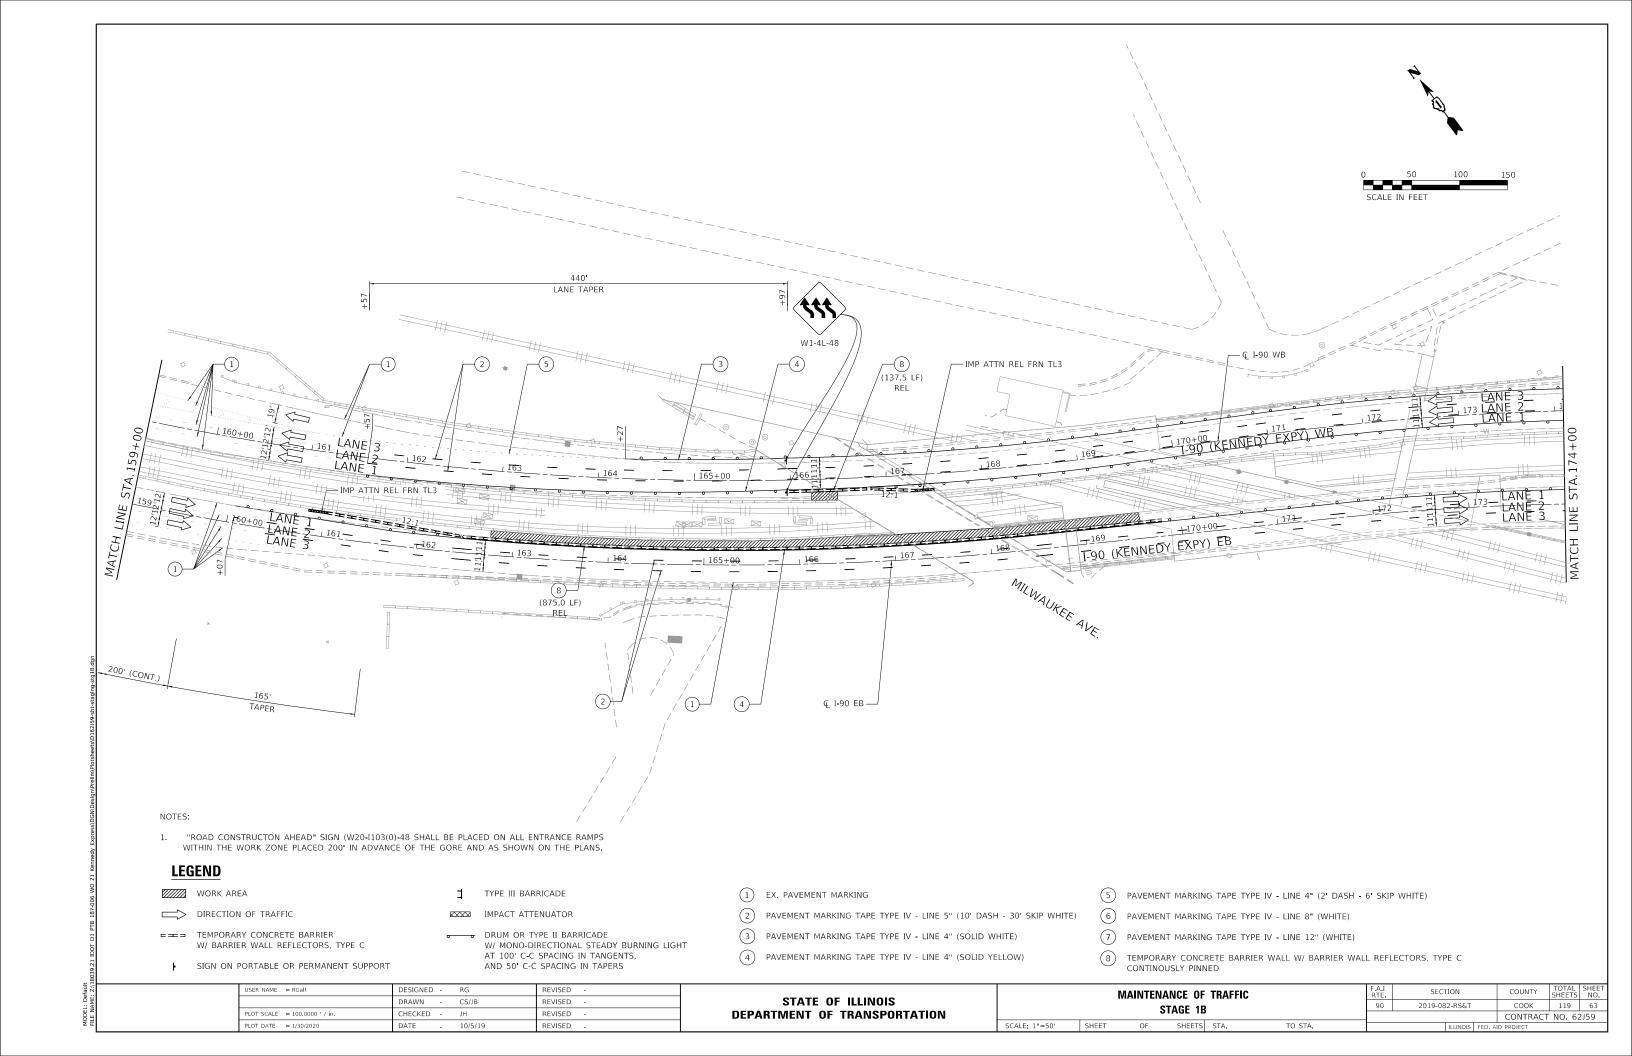

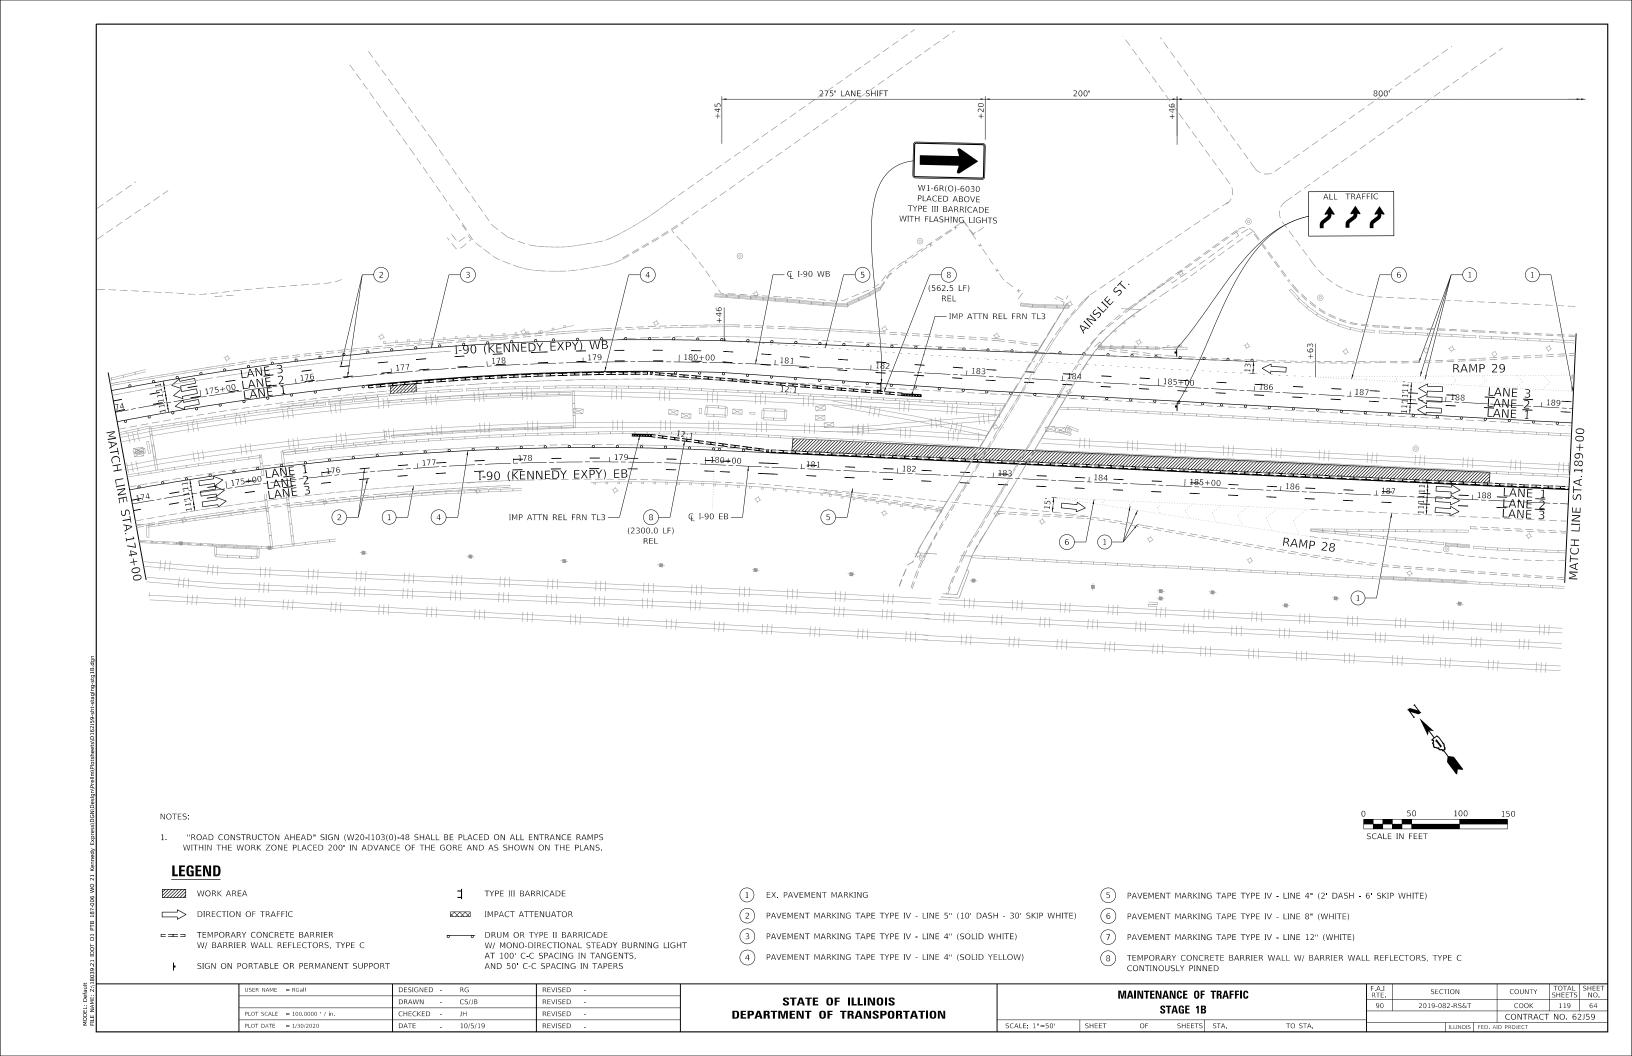

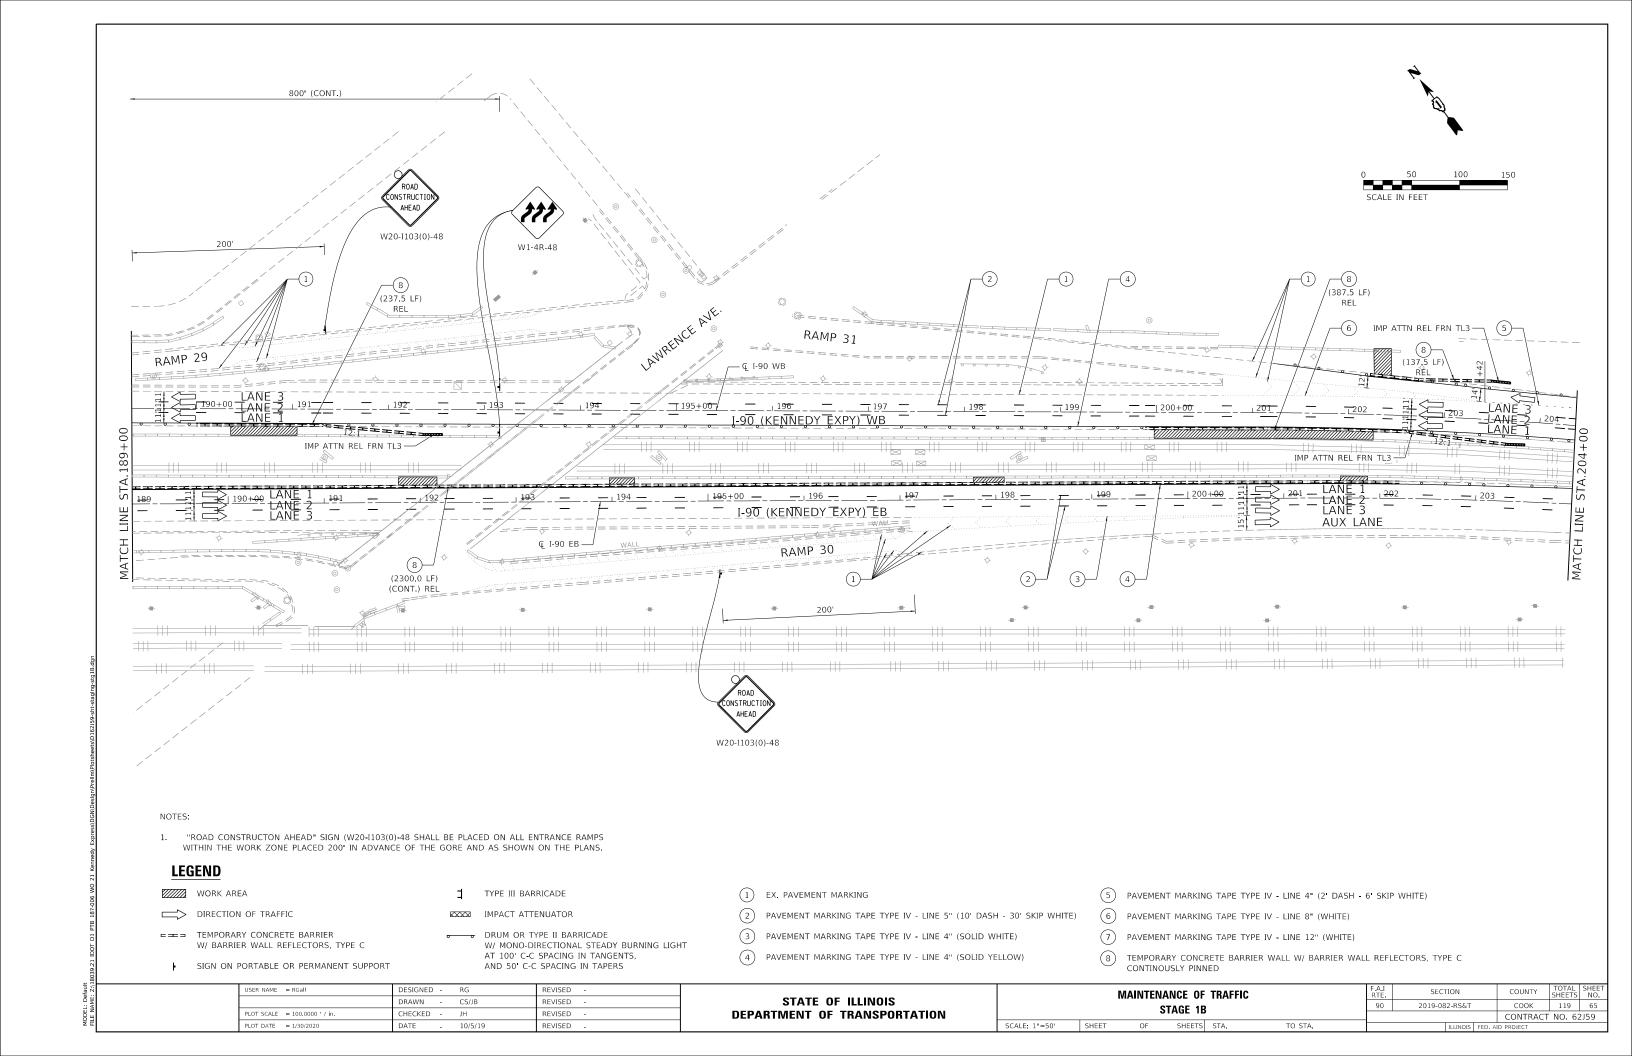

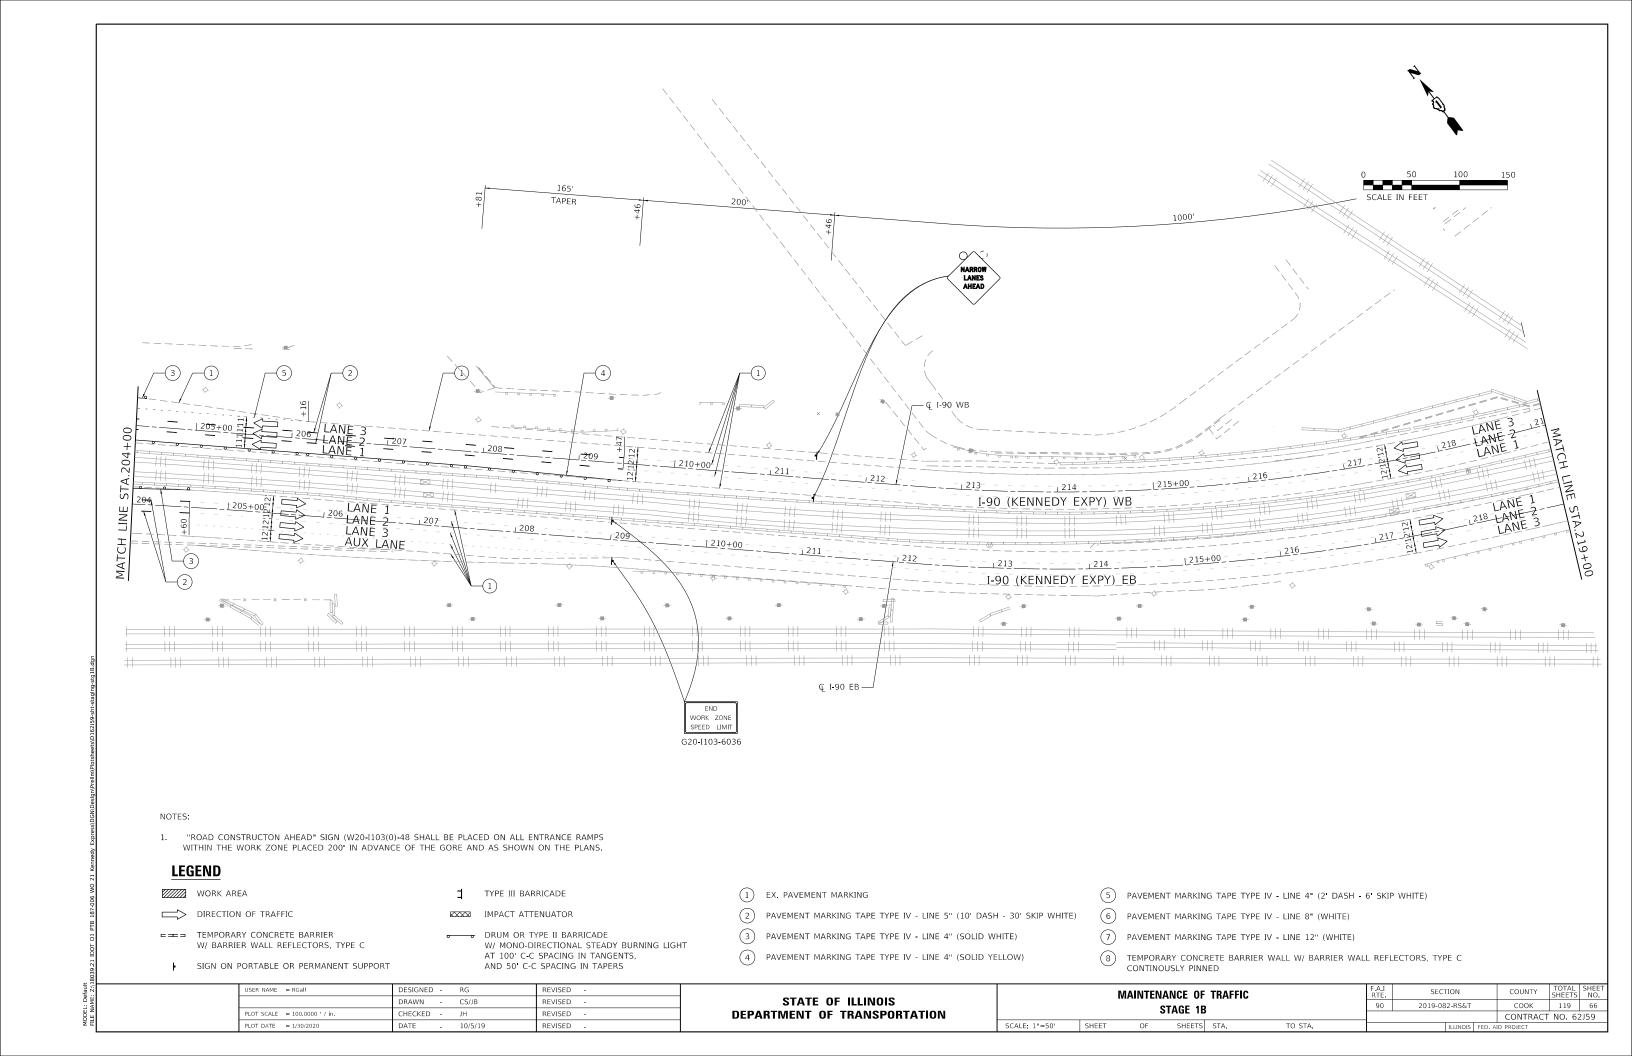

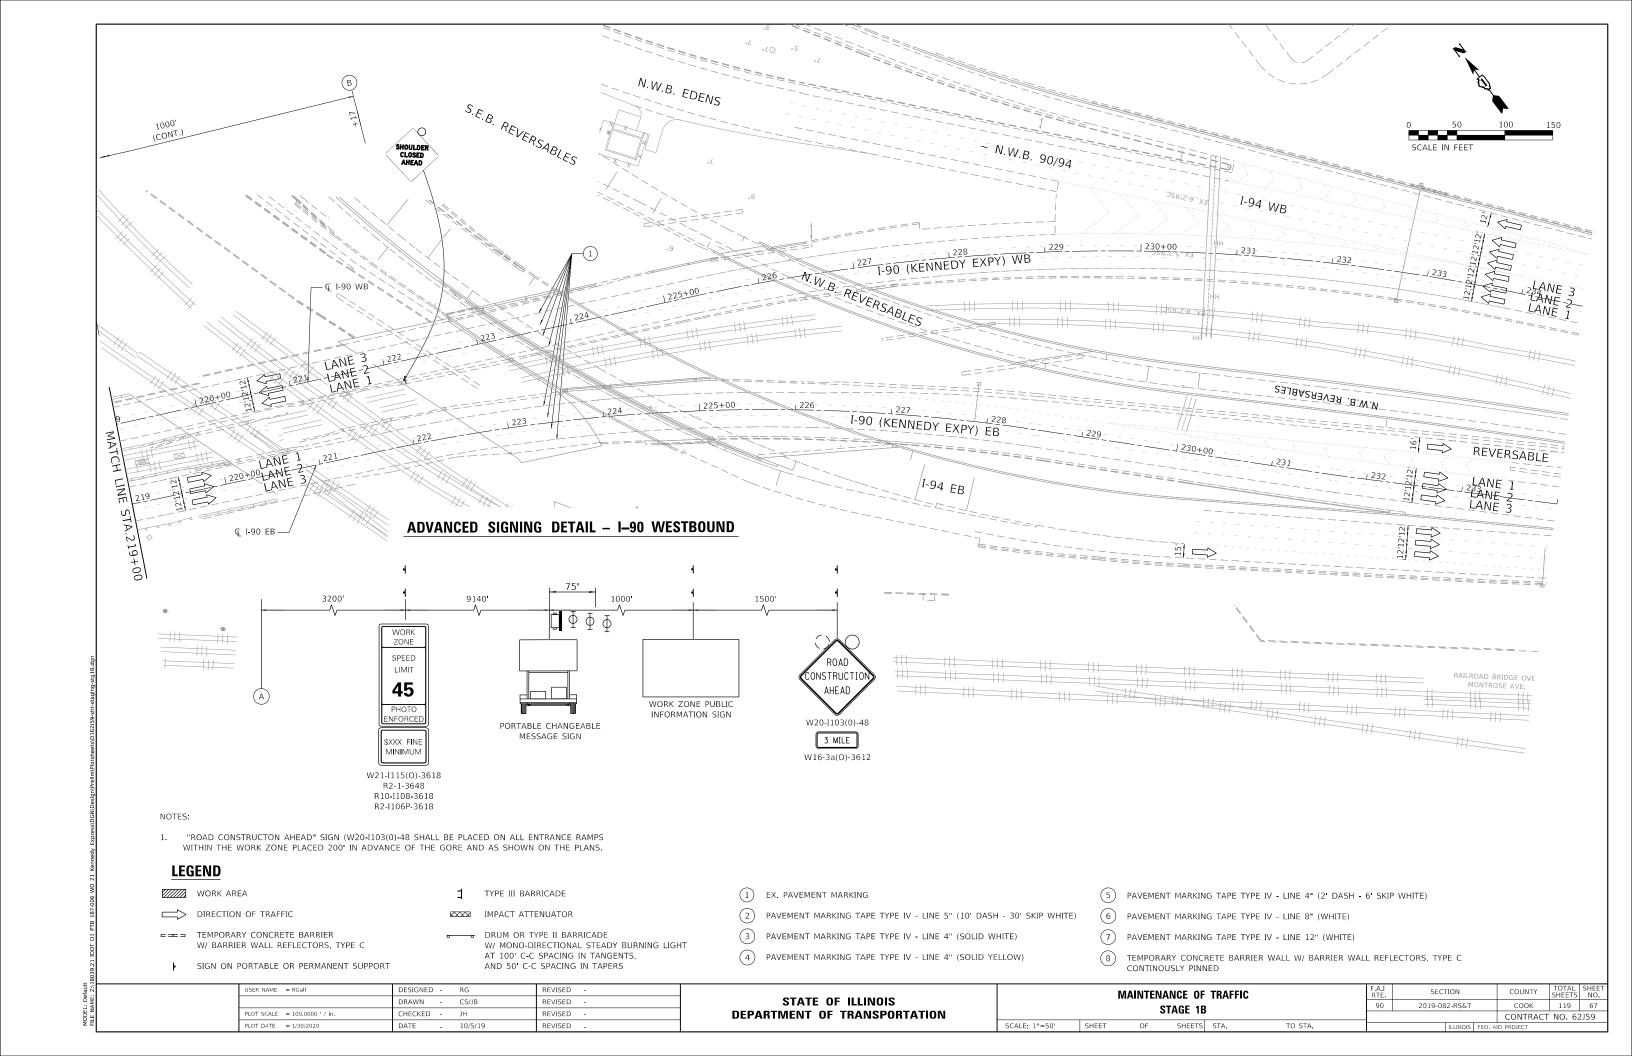

# STORM SEWER SCHEDULE

		FR	OM	Т	0	550A0050	550A0090	550A0120	550A0340	550A0360	20800150	44201385	44201396	44201761	44201765	44201769	44201771	44201798	44201803	44201809	
					-	STORM	STORM	STORM	STO RM	STO RM											
	SLOPE					SEW ER,	SEW ER,	SEW ER,	SEW ER,	SEW ER,		CLASS C	CLASS C	CLASS D	CLASS D	CLASS D	CLASS D	CLASS D	CLASS D	CLASS D	
D 10 5	SLOFE					CLASS A,	CLASS A,	CLASS A,	CLASS A,	CLASS A,		PATCHES,						PATCHES,	PATCHES,	PATCHES,	
PIPE NO		STRUC	****	STRUC	n	TYPE 1 -	TYPE 1 -	TYPE 1 -	TY PE 2 -	TY PE 2 -		TY PE I, 13	· · · · · · · · · · · · · · · · · · ·	· ·	TY PE II, 10	TY PE III, 10	TYPE N,	TY PE I, 13	,	TYPE N,	DEM ABIG
100		NO	INVERT	NO	INVERT	12'	18"	24"	12"	15'	BACKFILL	INCH	13 INCH	INCH	INCH	INCH	10 INCH	INCH	INCH	13 INCH	REMARKS
	%																				
						LF	LF	LF	LF	LF	CUYD	SQ Y D	SQ Y D	SQ Y D	SQ Y D	SQ Y D	SQ Y D	SQYD	SQ Y D	SQ Y D	
1	0.005	2	588.88	3	588.30		115				24									63	
2	0.005	3	588.30	4	587.75		110				29									61	
3	0.005	4	587.75	5	587.50			50			21						31				STRUC NO 5 IS EX MH
4	0.125	8	588.70	9	586.20	20					5								10		
5	0.011	9	586.20	10	585.50				66		44						32				
6	0.007	12	586.70	11	586.30			58			16		36								USE TEMPORARY SOIL RETENTION SYSTEM
7	0.025	16	602.50	13	597.10					218	77		113								USE TEMPORARY SOIL RETENTION SYSTEM
8	0.009	14	602.00	15	601.50				53		16						26				
9	0.018	17	603.20	16	602.50	40					8				13						
10	0.015	18	603.43	17	603.20	15					2			5							
11	0.006	19	603.50	18	603.43	12					2			4							
12	0.05	20	592.14	EXIST	591.39	15					4							5			L1 - SEE PRO PO SED DRAINAGE STRUCTURE AND STORM SEW ER DETAIL
13	0.05	21	591.94	EXIST	591.19	15					4							5			L2 - SEE PRO PO SED DRAINAGE STRUCTURE AND STORM SEW ER DETAIL
14	0.05	22	591.53	EXIST	590.78	15					4							5			L3 - SEE PRO PO SED DRAINAGE STRUCTURE AND STORM SEW ER DETAIL
15	0.05	23	591.02	EXIST	590.27	15					4							5			L4 - SEE PRO PO SED DRAINAGE STRUCTURE AND STORM SEW ER DETAIL
16	0.05	24	593.39	EXIST	592.64	15					4							5			L5 - SEE PRO PO SED DRAINAGE STRUCTURE AND STORM SEW ER DETAIL
17	0.05	25	591.80	EXIST	591.05	15					4							5			L6 - SEE PROPOSED DRAINAGE STRUCTURE AND STORM SEWER DETAIL
18	0.05	26	593.32	EXIST	592.57	15					4							5			L7 - SEE PROPOSED DRAINAGE STRUCTURE AND STORM SEWER DETAIL
19	0.05	27	591.65	EXIST	590.90	15					4							5			L8 - SEE PROPOSED DRAINAGE STRUCTURE AND STORM SEWER DETAIL
20	0.05	28	590.22	EXIST	589.47	15					4							5			L9 - SEE PRO PO SED DRAINAGE STRUCTURE AND STORM SEW ER DETAIL
21	0.05	29	587.15	EXIST	586.40	15					4	5									L10 - SEE PROPOSED DRAINAGE STRUCTURE AND STORM SEWER DETAIL
22	0.05	30	587.58	EXIST	586.83	15					4	5									L11 - SEE PROPOSED DRAINAGE STRUCTURE AND STORM SEWER DETAIL
23	0.05	31	587.40	EXIST	586.65	15					4	5									L12 - SEE PROPOSED DRAINAGE STRUCTURE AND STORM SEWER DETAIL
24	0.05	32	589.70	EXIST	588.95	15					4	5									L13 - SEE PROPOSED DRAINAGE STRUCTURE AND STORM SEWER DETAIL
25	0.05	33	590.58	EXIST	589.83	15					4	5									L14 - SEE PROPOSED DRAINAGE STRUCTURE AND STORM SEWER DETAIL
26	0.05	34	596.68	EXIST	595.93	15					4	5						<u> </u>			L15 - SEE PROPOSED DRAINAGE STRUCTURE AND STORM SEWER DETAIL
27	0.05	35	608.56	EXIST	607.81	15					4	5									L16 - SEE PROPOSED DRAINAGE STRUCTURE AND STORM SEWER DETAIL
28	0.015	36	594.15	37	593.59	15				38	9					20					210 SEE SEED DIVININGE STRUCTURE THE STORM SEW ER DETAIL
29	0.013	38	596.53	39	596.12					40	9				14	20					
29	0.01		) 590.55 ) TALS	Ja	J30.12	327	225	100	119	296	326	35	149	9	27	20	89	45	10	124	
		7 (	JIALS			321	225	108	119	290	320	33	149	9	21	20	89	45	10	124	

### NOTES

- 1. STATIONS, OFFSETS, AND ELEVATIONS ARE BASED ON RECORD DRAWINGS. ADJUST LOCATION AND ELEVATIONS TO MATCH FIELD CONDITIONS.
- 2. STATIONS AND OFFSETS ARE MEASURED TO THE CENTER OF THE STRUCTURE UNLESS NOTED OTHERWISE.
- 3. LENGTH FOR STORM SEWERS TO BE CLEANED SHALL BE THE LENGTH OF EXISTING STORM SEWER FROM THE STRUCTURE INDICATED.

USER NAME = RGall	DESIGNED -	RG	REVISED -
	DRAWN -	CS/JB	REVISED -
PLOT SCALE = 100.0000 / in.	CHECKED -	JH	REVISED -
PLOT DATE = 1/30/2020	DATE -	10/5/19	REVISED -

SCALE: 1"=50'

DRAINAGE SCHEDULE							SECTION	COUNTY	TOTAL SHEETS	SHEET NO.
	1−90 (IL. RTE. 43 − 1−94)						2019-082-RS&T	соок	119	68
								CONTRACT	NO. 62	2J59
	SHEET	OF	SHEETS	STA.	TO STA.		ILLINOIS FED. A	ID PROJECT		

# TRENCH DRAIN SCHEDULE

	STATION LOCATION					X03276080	44000100	44004250	44000500
ALIGNMENT	FROM	ТО	IN GORE	ADJACENT TO GUTTER	IN GUTTER	TRENCH DRAIN	PAVEMENT REMOVAL	PAVED SHOULDER REMOVAL	REMOVAL
						LF	SQ YD	SQ YD	LF
I-90 EB	45+67.76	46+77.73	Χ			110	33		
I-90 EB	52+32.12	52+57.12		X		25		8	
I-90 EB	52+62.11	54+23.17		Χ		162		48	
I-90 EB	79+50.30	79+65.29			X	15			15
I-90 EB	79+70.27	79+85.26			X	15			15
I-90 EB	79+76.26	79+91.26	Χ			15	5		
I-90 EB	79+96.26	80+11.26	Χ			15	5		
I-90 EB	89+02.76	89+22.76		X		20		6	
I-90 EB	89+27.75	89+47.75		X		20		6	
I-90 WB	103+12.56	103+32.26		X		20		6	
I-90 WB	103+31.78	103+50.97			Х	20			20
I-90 WB	103+37.08	103+56.78		Χ		20		6	
I-90 WB	103+55.71	103+75.00			Х	20			20
I-90 EB	119+77.25	120+02.25		Х		25		8	
I-90 EB	120+07.26	120+32.26		X		25		8	
I-90 WB	120+04.27	120+29.27		X		25		8	
I-90 WB	120+34.27	120+59.27		Х		25		8	
I-90 WB	134+75.73	135+65.65			Х	92			92
I-90 WB	135+58.55	135+98.56	Χ			40	12		
I-90 WB	157+22.16	158+09.03	Χ			87	26		
I-90 WB	158+14.03	160+23.00	Χ			209	62		
I-90 EB	166+68.36	167+56.88			Х	88			88
I-90 EB	167+62.00	168+45.00			Х	83			83
I-90 EB	168+50.04	169+48.52			Х	99			99
I-90 WB	166+84.16	167+23.50			Х	40			40
I-90 WB	167+33.64	168+21.32			Х	87			87
I-90 WB	168+26.43	172+25.13			Х	400			400
I-90 EB	171+65.42	172+73.50			Х	108			108
I-90 EB	172+78.54				Х	137			137
I-90 EB	184+58.52		Χ			222	66		
I-90 EB	185+16.90			Х		150		45	
I-90 EB	186+70.87	188+09.75		X		139		42	
I-90 WB	188+05.33		Χ			125	38		
I-90 EB	197+99.28		X			144	43		
I-90 WB	200+08.67	202+28.40	X			221	66		
			TOTALS			3048	356	199	1204

# SCHEDULE OF STORM SEWER CLEANING

	LOC AT I	ON		X5537700	X5537800
			EXIST	STORM SEWERS TO	STORM SEWERS TO BE
ALIGNMENT	STA	OFFSET	STR	BE CLEANED 10"	CLEANED 12"
			TYPE	F00T	F00T
I-90 WB	34+87	30' LT	INLET	40	
I-90 WB	38+73	30' LT	INLET	50	
I-90 WB	40+93	31' LT	INLET	40	
I-90 WB	42+95	31' LT	INLET	40	
I-90 WB	44+93	24' RT	INLET	15	
I-90 WB	44+99	18' RT	CB		50
I-90 WB	45+90	30' LT	INLET	50	
I-90 WB	51+42	35' LT	INLET	65	
I-90 WB	53+09	24' RT	CB		
I-90 WB	39+85	21' RT	CB		
I-90 WB	35+91	20' RT	INLET		
I-90 WB	55+49	25' RT	INLET	15	
I-90 WB	64+51	25' RT	INLET	15	
I-90 WB	73+98	34' LT	INLET	65	
I-90 WB	79+65	20' RT	CB		10
I-90 WB	86+97	30' LT	INLET	40	
I-90 WB	94+99	30' LT	INLET		45
I-90 WB	95+05	24' RT	INLET	15	
I-90 WB	97+00	24' RT	INLET		20
I-90 WB	108+95	25' RT	INLET	15	
I-90 WB	109+81	33' LT	CB	15	
I-90 WB	109+82	30' LT	INLET	40	
I-90 WB	110+98	25' RT	INLET	15	
I-90 WB	112+73	29' LT	INLET	40	
I-90 WB	118+37	25' RT	INLET	15	
I-90 WB	118+44	30' LT	INLET		15
I-90 WB	122+84	23' RT	CB	15	
I-90 WB	135+99	24' RT	INLET	15	
I-90 WB	136+87	23' RT	CB	70	
I-90 WB	143+72	20' LT	INLET	40	
I-90 WB	165+85	20' RT	СВ	15	
I-90 EB	42+16	25' LT	INLET		
I-90 EB	55+81	26' LT	INLET	15	
I-90 EB	56+28	23' RT	INLET	45	
I-90 EB	65+74	26' LT	INLET	15	
I-90 EB	77+52	38' RT	INLET	55	
I-90 EB	102+95	25' LT	INLET	15	
I-90 EB	148+49	25' RT	INLET	70	
	TOTAL		-	960	140


### NOTES:


- STATIONS, OFFSETS, AND ELEVATIONS ARE BASED ON RECORD DRAWINGS. ADJUST LOCATION AND ELEVATIONS TO MATCH FIELD CONDITIONS.
- 2. STATIONS AND OFFSETS ARE MEASURED TO THE CENTER OF THE STRUCTURE UNLESS NOTED OTHERWISE.
- 3. LENGTH FOR STORM SEWERS TO BE CLEANED SHALL BE THE LENGTH OF EXISTING STORM SEWER FROM THE STRUCTURE INDICATED.
- 4. ALL DRAINAGE STRUCTURES THAT ARE ADJUSTED SHALL BE CLEANED.


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	DRAWN -	CS/JB	REVISED -
PLOT SCALE = 100.0000 ' / in.	CHECKED -	JH	REVISED -
PLOT DATE = 1/30/2020	DATE -	10/5/19	REVISED -


STATE	OF.	ILLINOIS	
DEPARTMENT	OF '	TRANSPORTATION	

							F.A.I RTE.				COUNTY	TOTAL SHEETS	SHEET NO.
	⊢90 (IL. RTE. 43 − I–94)						90 2019-082-RS&T		соок	119	69		
	H9U (IL. KTC. 43 - 1-94)										CONTRACT	NO. 62	2J59
SCALE: 1"=50"		SHEET	OF	SHEETS	STA.	TO STA.	ILLINOIS FED. AID PROJECT						

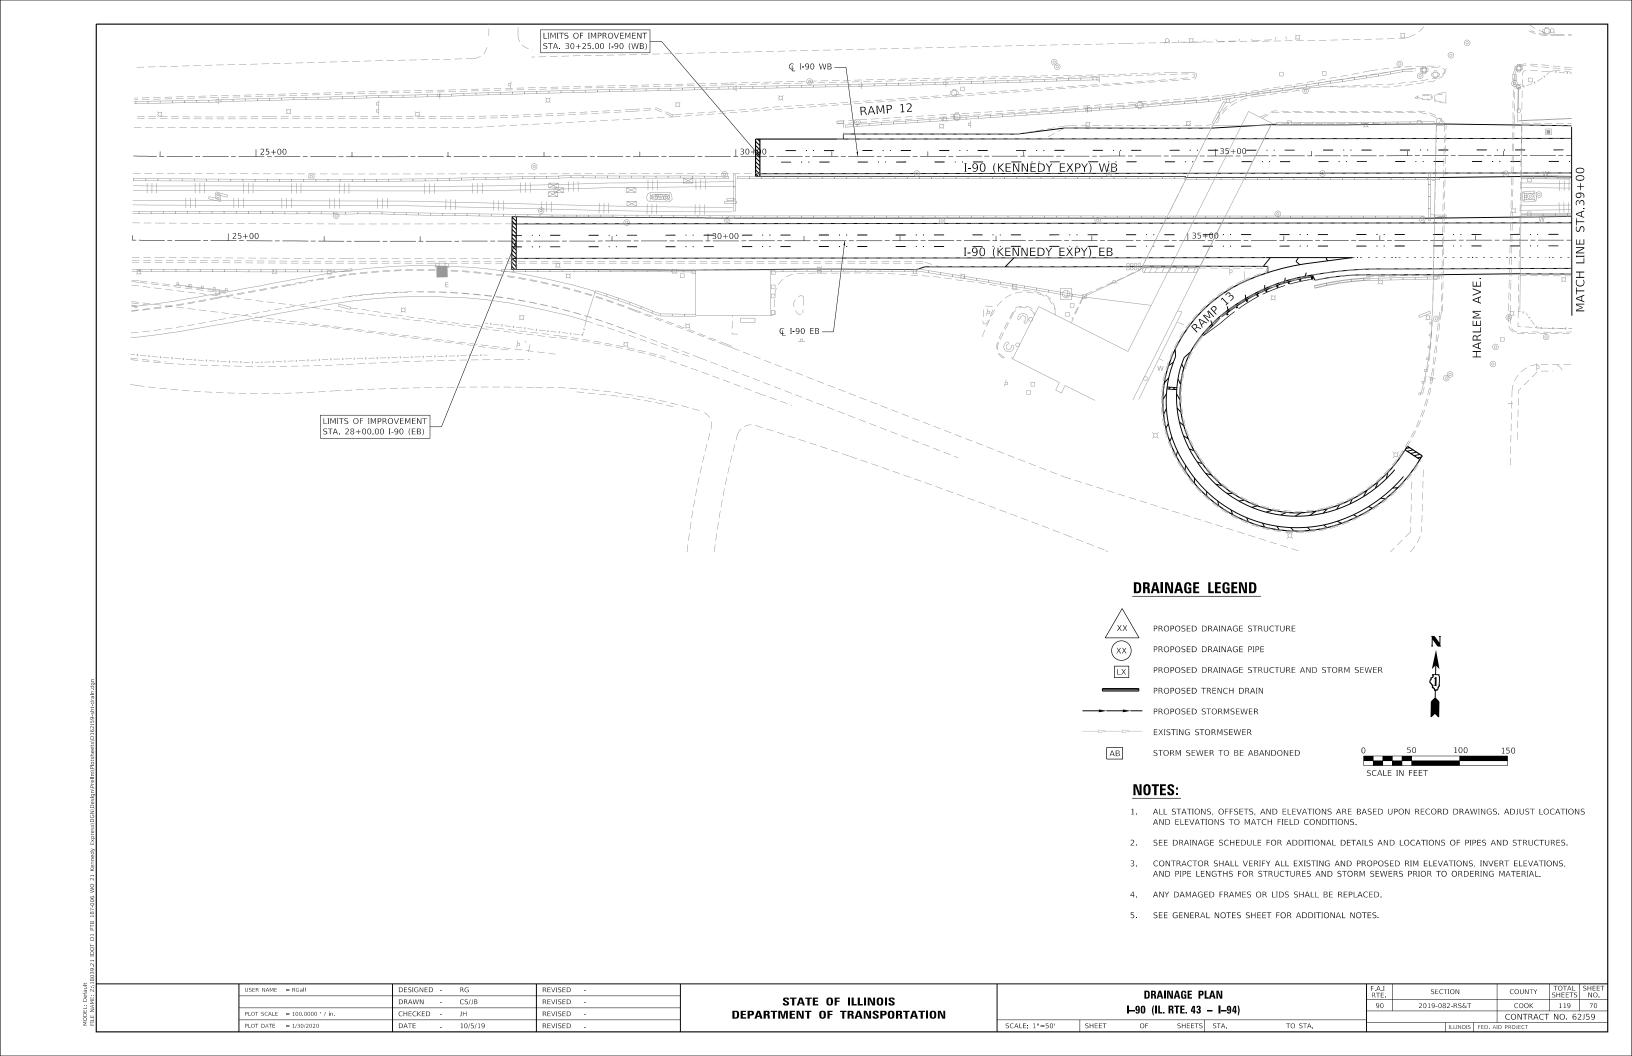

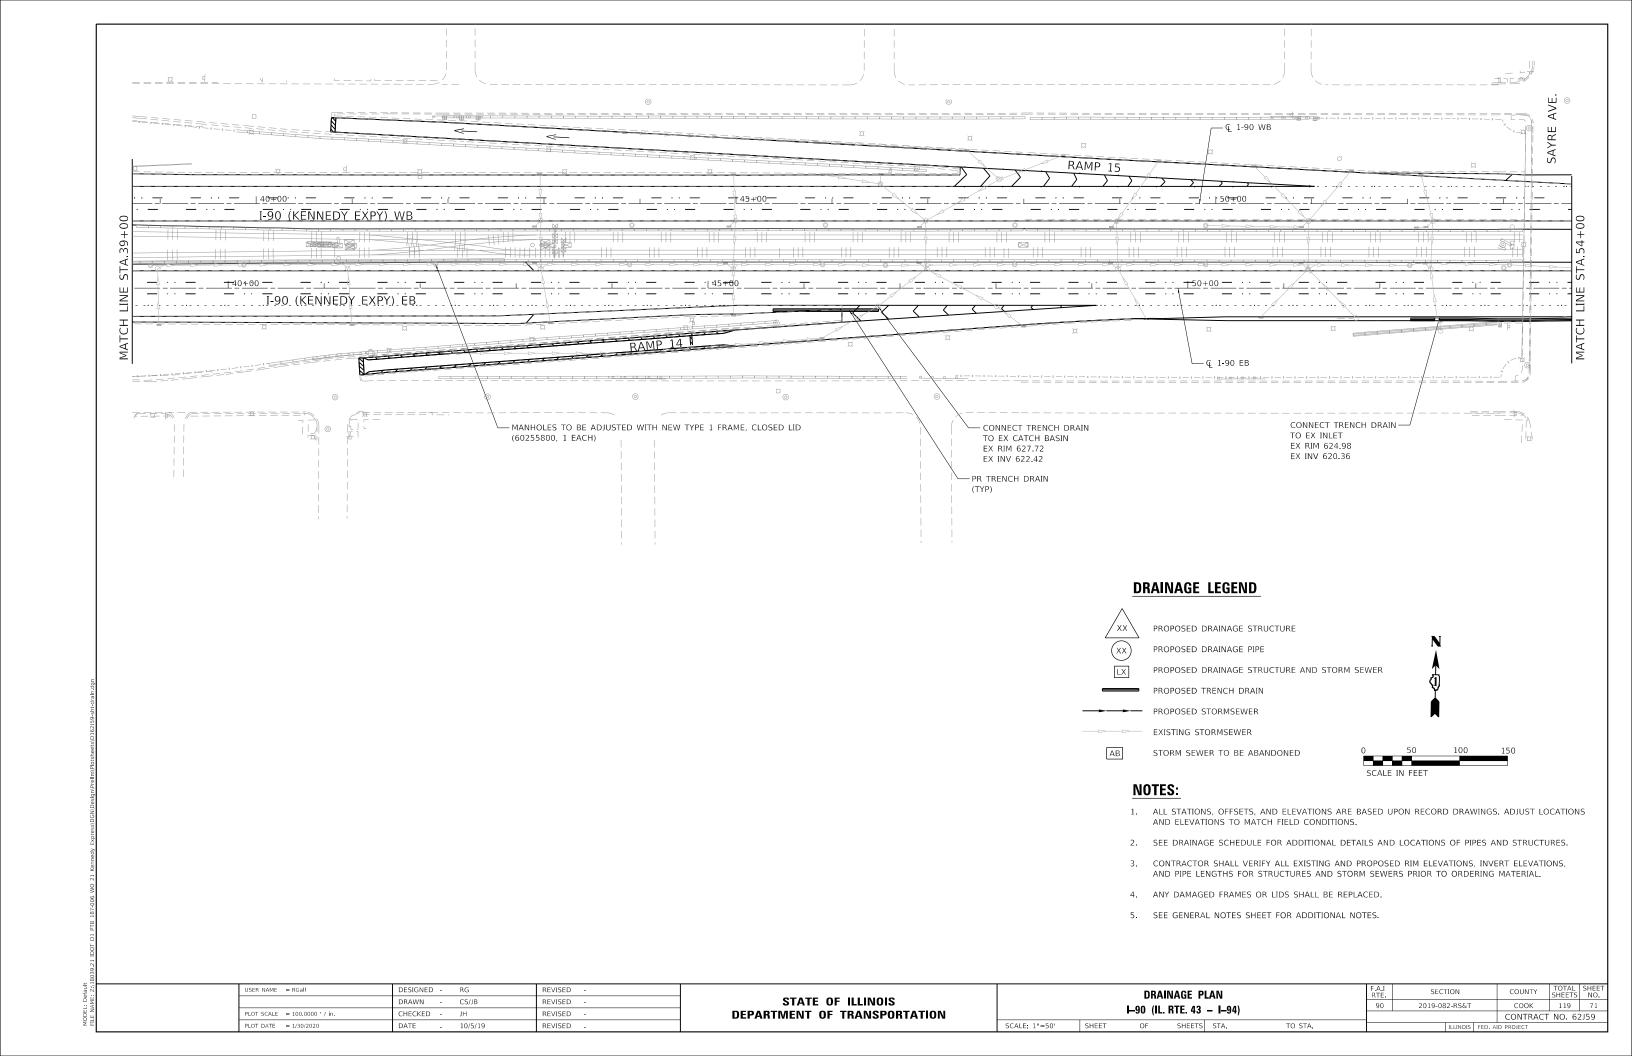

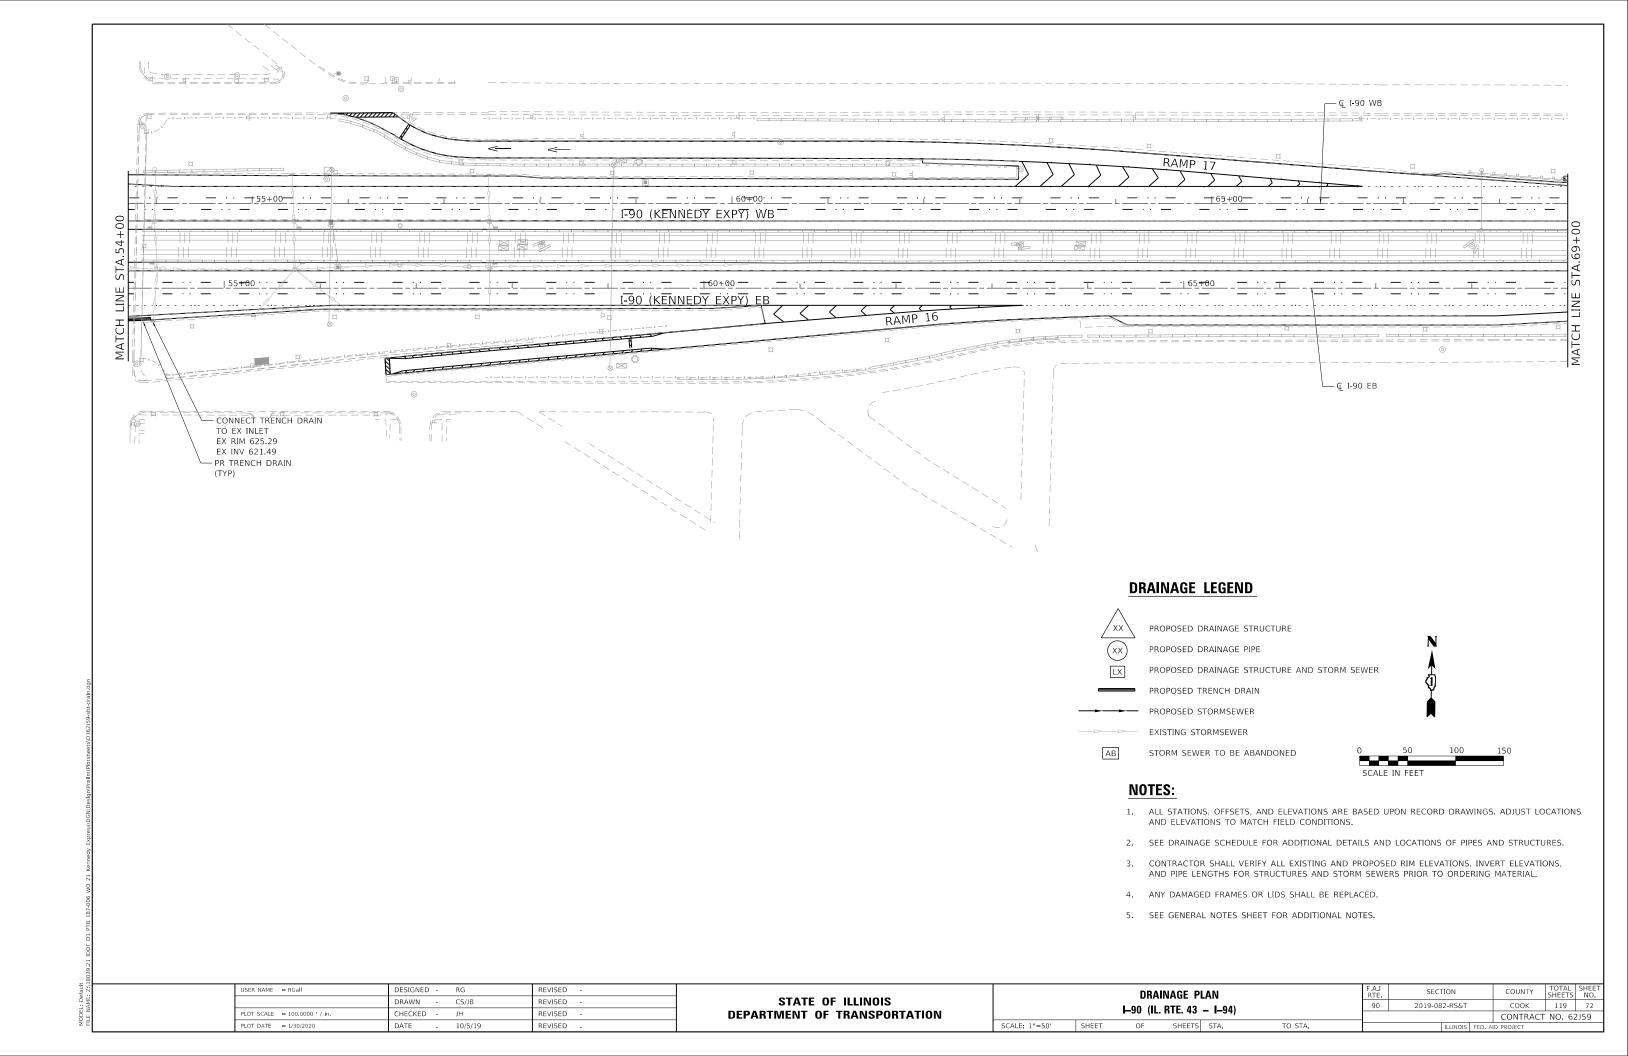


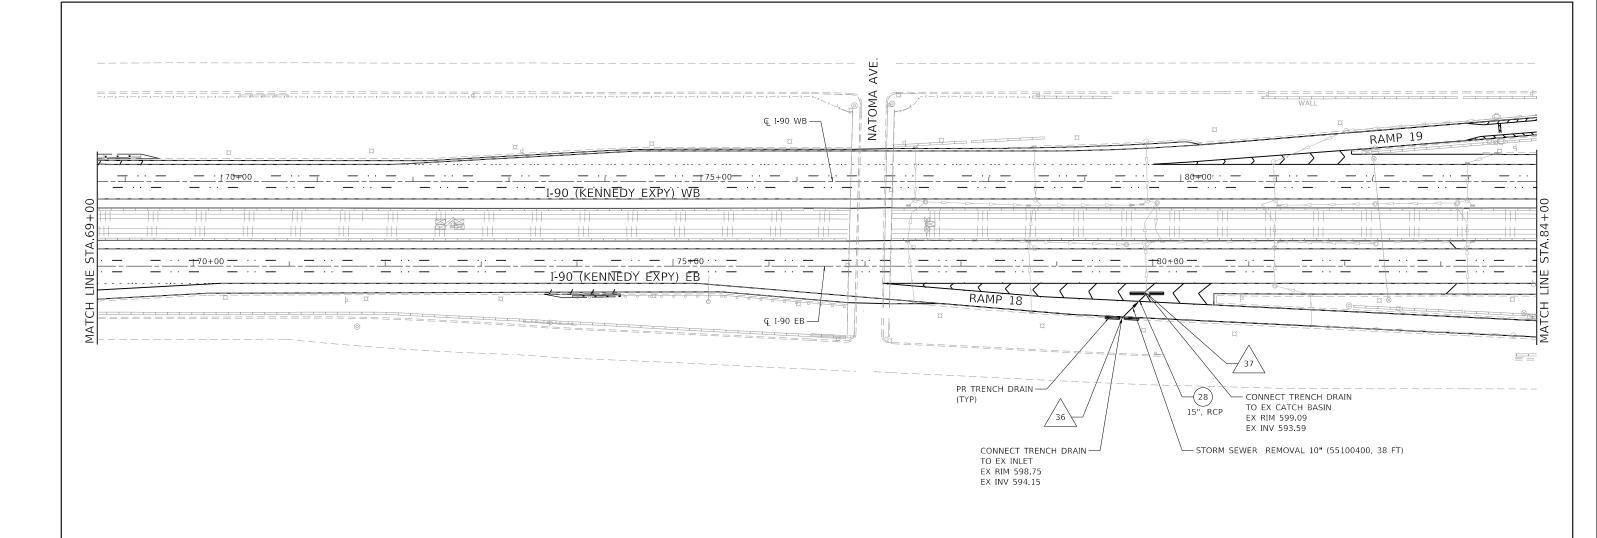

## DRAINAGE STRUCTURE SCHEDULE


										60200105	60218400	60237420	
STRUC						INV	ERTS		EXISTING	CATCH BASIN, TYPE A, 4' DIA,	MANHOLE, TYPE	INLETS. TYPE	
NO	ALIGNMENT	STATION	0FFSET	RIM					STRUCTURE	TYPE 1 F, OPEN	A, 4' DIA, TYPE 1 F, CLOSED LID	A, TYPE 20 F&G	
										LID	.,		
					N	S	Ε	W		EA	EA	EA	
36	I-90 EB	79+67.70	54.29 RT	598.75	594.15				1				ADJUST RIM AND INVERTS TO MATCH EXISTING CONDITIONS
37	I-90 EB	79+93.76	28.49 RT	599.09		593.59			1				ADJUST RIM AND INVERTS TO MATCH EXISTING CONDITIONS


## DRAINAGE LEGEND

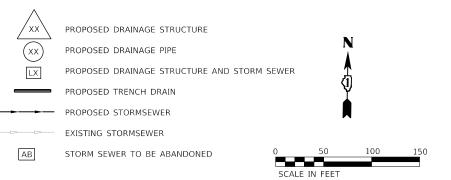



- 1. ALL STATIONS, OFFSETS, AND ELEVATIONS ARE BASED UPON RECORD DRAWINGS. ADJUST LOCATIONS AND ELEVATIONS TO MATCH FIELD CONDITIONS.
- 2. SEE DRAINAGE SCHEDULE FOR ADDITIONAL DETAILS AND LOCATIONS OF PIPES AND STRUCTURES.
- 3. CONTRACTOR SHALL VERIFY ALL EXISTING AND PROPOSED RIM ELEVATIONS, INVERT ELEVATIONS, AND PIPE LENGTHS FOR STRUCTURES AND STORM SEWERS PRIOR TO ORDERING MATERIAL.
- 4. ANY DAMAGED FRAMES OR LIDS SHALL BE REPLACED.
- 5. SEE GENERAL NOTES SHEET FOR ADDITIONAL NOTES.


USER NAME = RGall	DESIGNED -	RG	REVISED -				DR	ΔΙΝΔΩ	E PLAN		F.A.I RTF	SECTION	COUNTY	TOTAL SHEE
	DRAWN -	CS/JB	REVISED -	STATE OF ILLINOIS							90	2019-082-RS&T	соок	119 73
PLOT SCALE = 100.0000 ' / in.	CHECKED -	JH	REVISED -	DEPARTMENT OF TRANSPORTATION			<b>⊢</b> 90 (I	IL. KIE.	43 – I–94)				CONTRAC	T NO. 62J59
PLOT DATE = 1/30/2020	DATE -	10/5/19	REVISED -		SCALE: 1"=50"	SHEET	OF	SH	EETS STA.	TO STA.		ILLINOIS FED.	AID PROJECT	

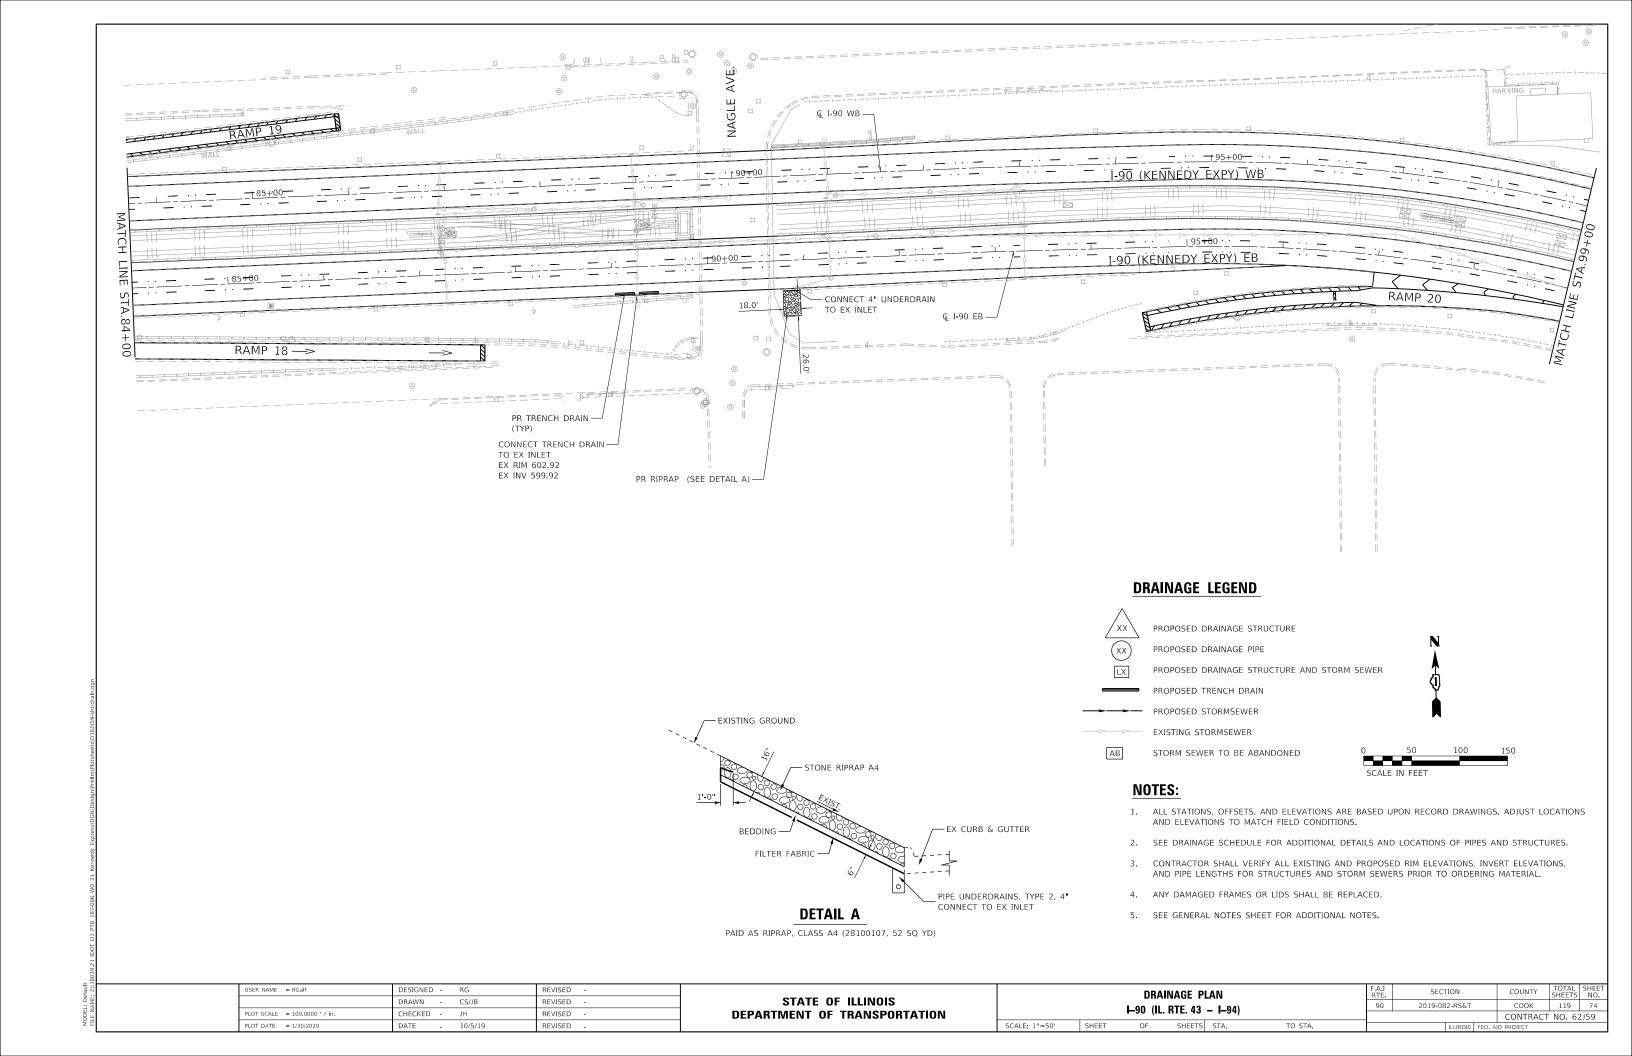


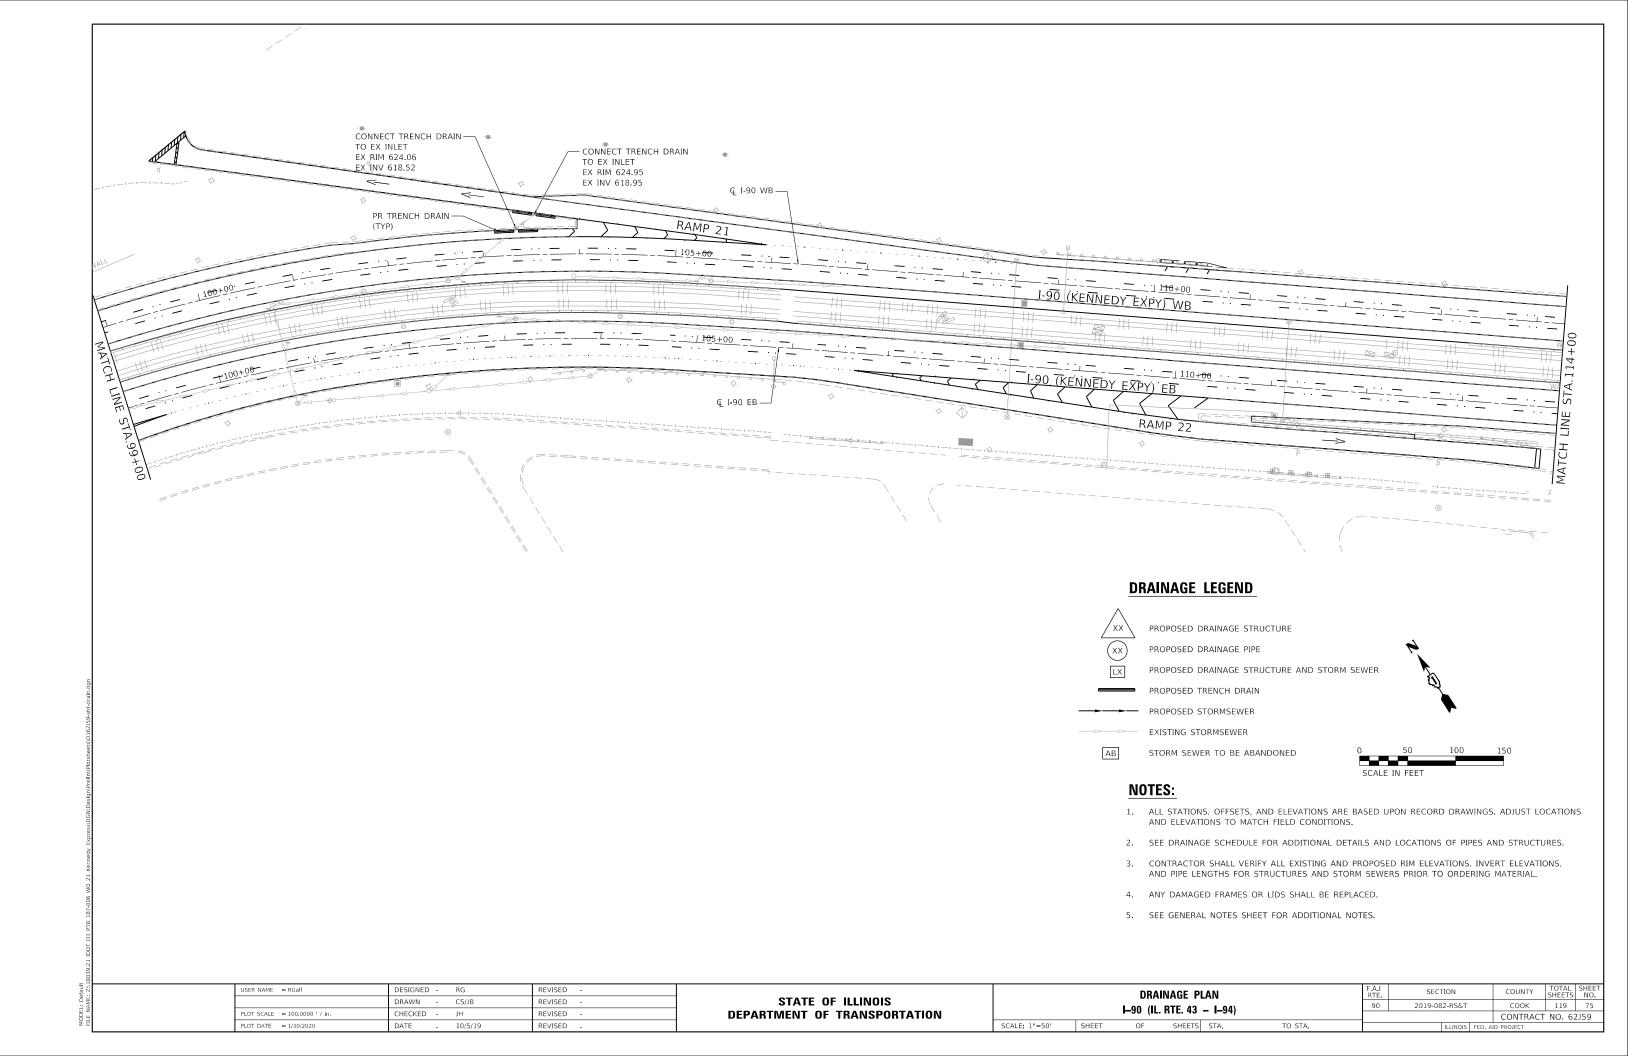

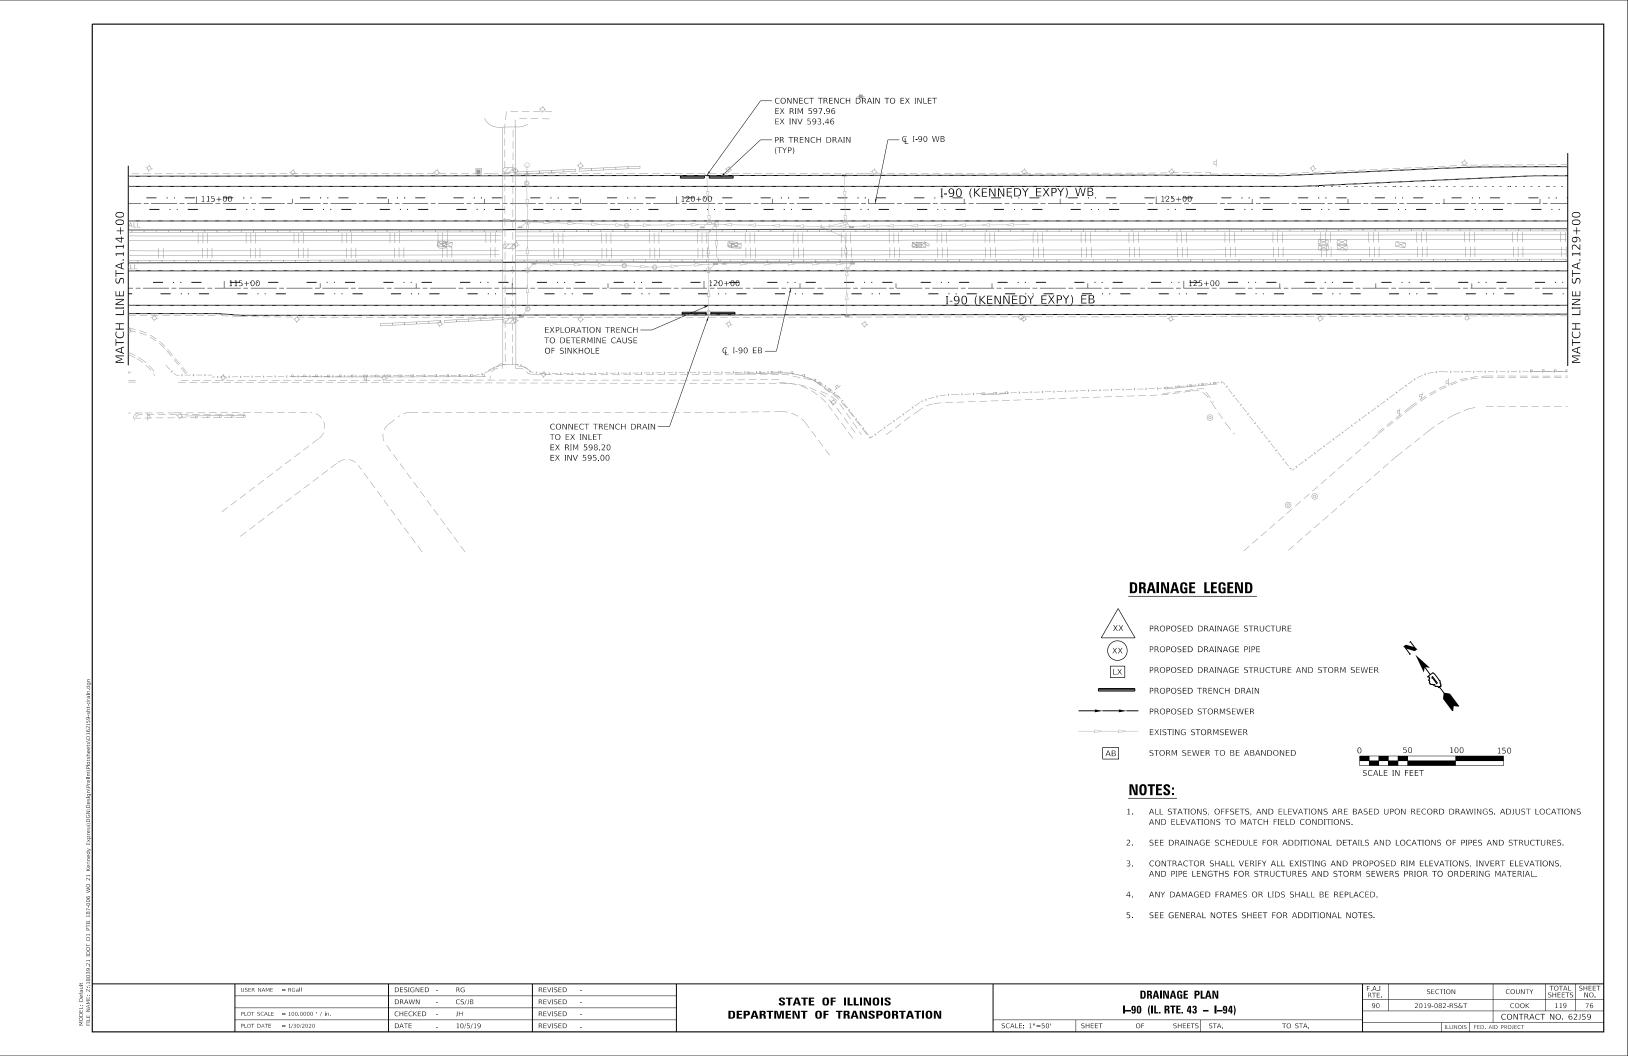


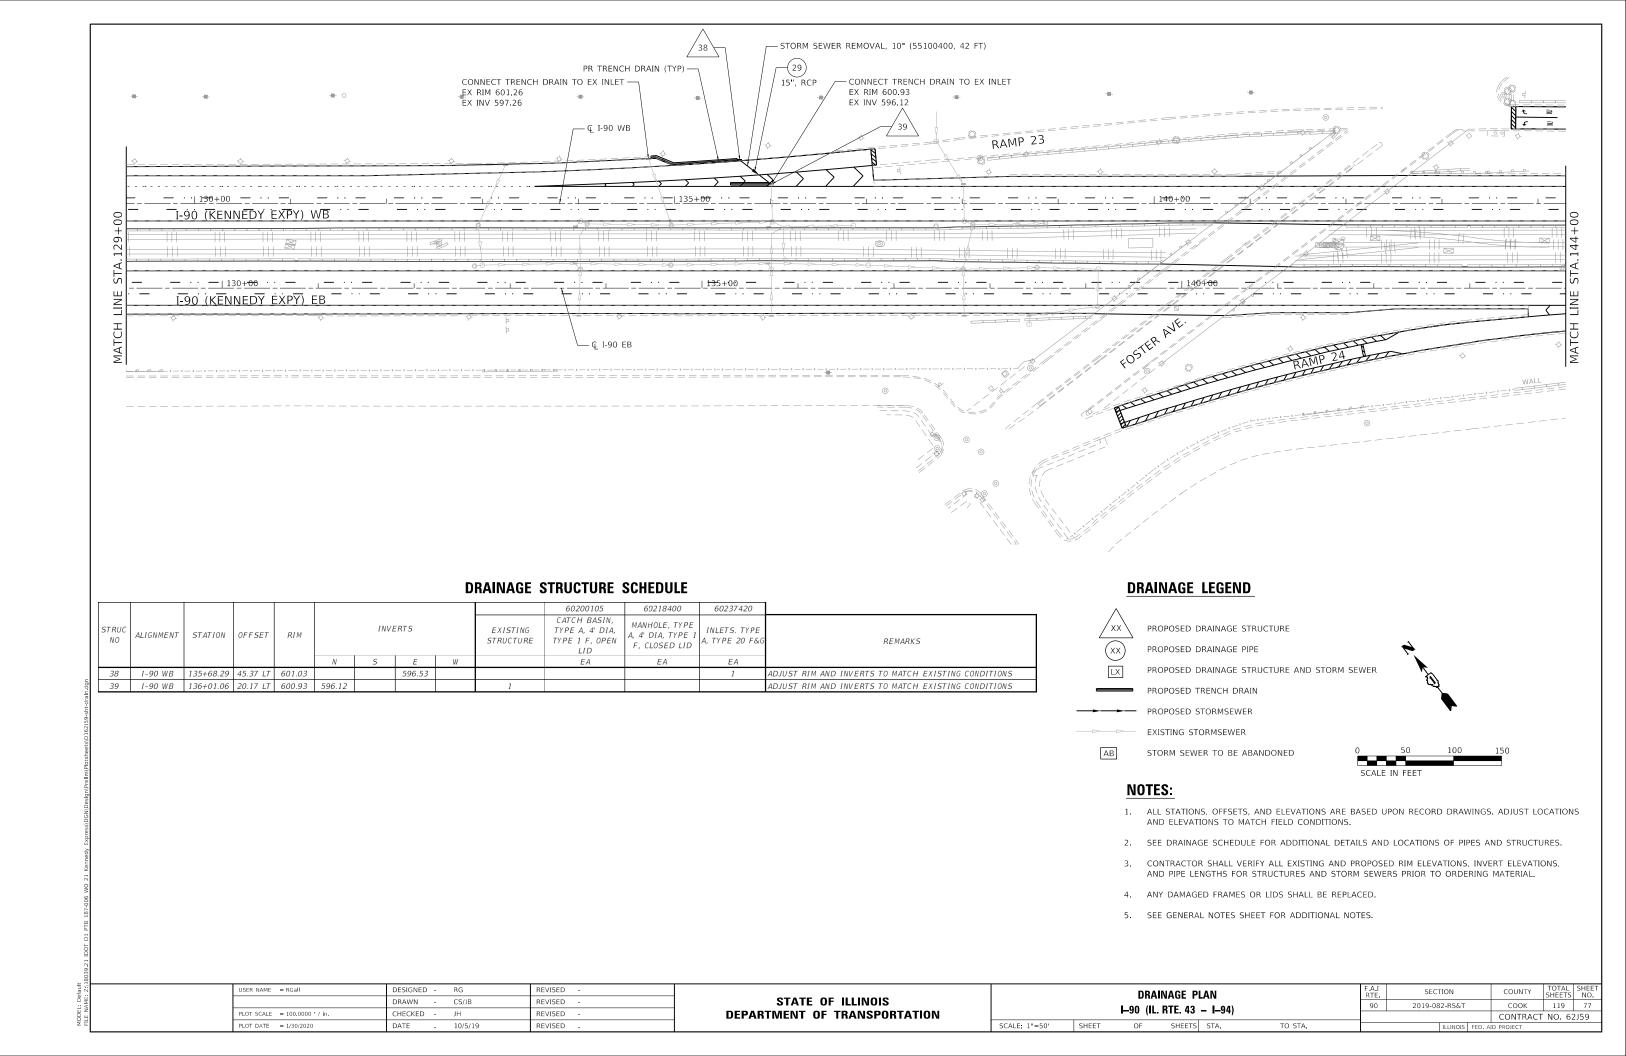

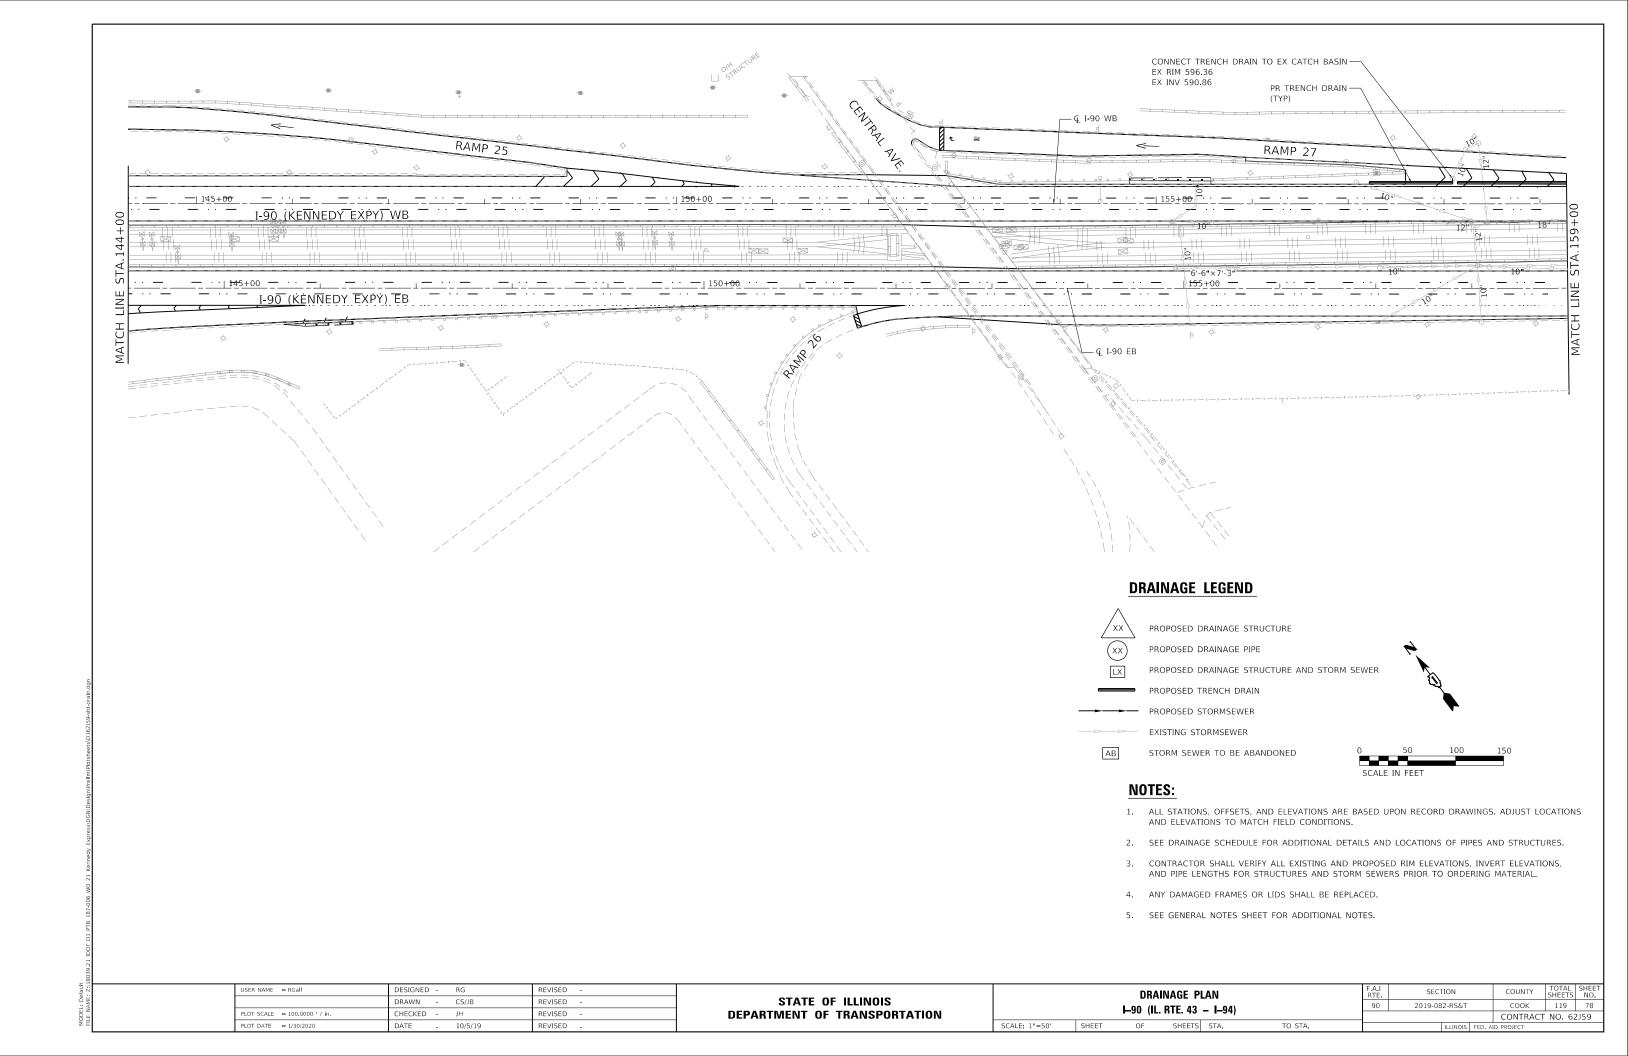

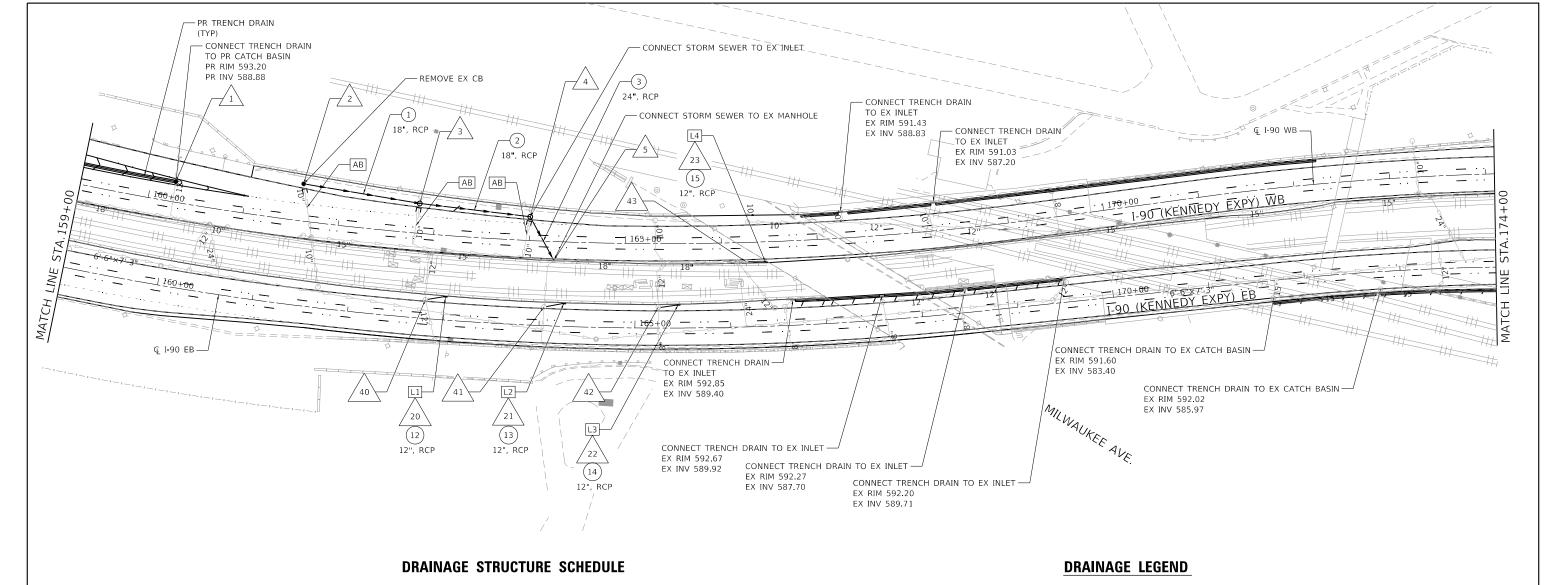


П											60200105	60218400	60237420	
	STRUC NO	ALIGNMENT	STATION	OFFSET	RIM		INVE	ERTS		EXISTING STRUCTURE	CATCH BASIN, TYPE A, 4' DIA, TYPE 1 F, OPEN LID	MANHOLE, TYPE A, 4' DIA, TYPE 1 F, CLOSED LID	INLETS. TYPE A, TYPE 20 F&G	REMARKS
П						Ν	5	Ε	W		EA	EA	EA	
	1	I-90 WB	160+25.00	21.29 LT	FIELD VERIFY	589.00	589.00				1			BUILD ON EXISTING SEWER, MATCH EXISTING INVERTS
П	2	I-90 WB	161+59.03	38.68 LT	592.89	590.79		588.88			1			CONNECT EXISTING INLET
П	3	I-90 WB	162+82.88	31.07 LT	592.69	590.49		588.30	588.30			1		CONNECT EXISTING INLET
П	4	I-90 WB	164+00.00	24.77 LT	592.63	589.85	587.75		587.75			1		CONNECT EXISTING INLET
П	5	I-90 WB	164+26.18	19.66 RT	594.06	587.50	587.24	587.16	587.16	1				ADJUST RIM AND INVERTS TO MATCH EXISTING CONDITIONS
П	6													NOT USED
П	20	I-90 EB	163+00.32	24.34 LT	594.91				591.91				1	L1 - SEE DRAINAGE STRUCTURE AND STORM SEWER DETAIL
П	21	I-90 EB	164+25.03	23.86 LT	594.44				591.44				1	L2 - SEE DRAINAGE STRUCTURE AND STORM SEWER DETAIL
П	22	I-90 EB	165+45.08	24.04 LT	594.03				591.03				1	L3 - SEE DRAINAGE STRUCTURE AND STORM SEWER DETAIL
	23	I-90 WB	166+45.18	20.94 RT	593.52				590.52				1	L4 - SEE DRAINAGE STRUCTURE AND STORM SEWER DETAIL
П	40	I-90 EB	162+79.91	19.58 LT	594.82	590.13	590.21	591.83		1				ADJUST RIM AND INVERTS TO MATCH EXISTING CONDITIONS
П	41	I-90 EB	164+04.51	19.61 LT	594.29	588.09	588.79	591.36	589.39	1				ADJUST RIM AND INVERTS TO MATCH EXISTING CONDITIONS
	42	I-90 EB	165+24.42	21.74 LT	593.96	587.36	588.11	590.95		1				ADJUST RIM AND INVERTS TO MATCH EXISTING CONDITIONS
П	43	I-90 WB	166+25.01	19.96 RT	593.52	587.20	586.10	590.44		1				ADJUST RIM AND INVERTS TO MATCH EXISTING CONDITIONS

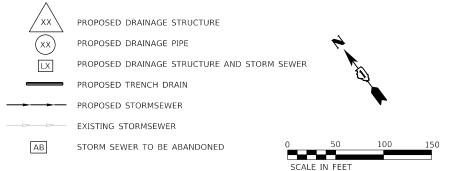

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- 2. SEE DRAINAGE SCHEDULE FOR ADDITIONAL DETAILS AND LOCATIONS OF PIPES AND STRUCTURES.
- . CONTRACTOR SHALL VERIFY ALL EXISTING AND PROPOSED RIM ELEVATIONS, INVERT ELEVATIONS, AND PIPE LENGTHS FOR STRUCTURES AND STORM SEWERS PRIOR TO ORDERING MATERIAL.
- 4. ANY DAMAGED FRAMES OR LIDS SHALL BE REPLACED.
- 5. SEE GENERAL NOTES SHEET FOR ADDITIONAL NOTES.


USER NAME = RGall	DESIGNED -	RG	REVISED -				DE	RAINAGE	ΡΙΔΝ	N		F.A.I RTE	SECTION	COUNTY	TOTAL	SHEET
	DRAWN -	CS/JB	REVISED -	STATE OF ILLINOIS			Lan (	IL. RTE. 4		I–94)		90	2019-082-RS&T	соок	119	79
PLOT SCALE = 100.0000 ' / in.	CHECKED -	JH	REVISED -	DEPARTMENT OF TRANSPORTATION			<b>⊢</b> 90 (	IL. NIC. 4	13 –	1-94)				CONTRAC	T NO. 6	2J59
PLOT DATE = 1/30/2020	DATE -	10/5/19	REVISED -		SCALE: 1"=50'	SHEET	OF	SHEE:	TS ST	TA.	TO STA.		ILLINOIS FED. A	AID PROJECT		

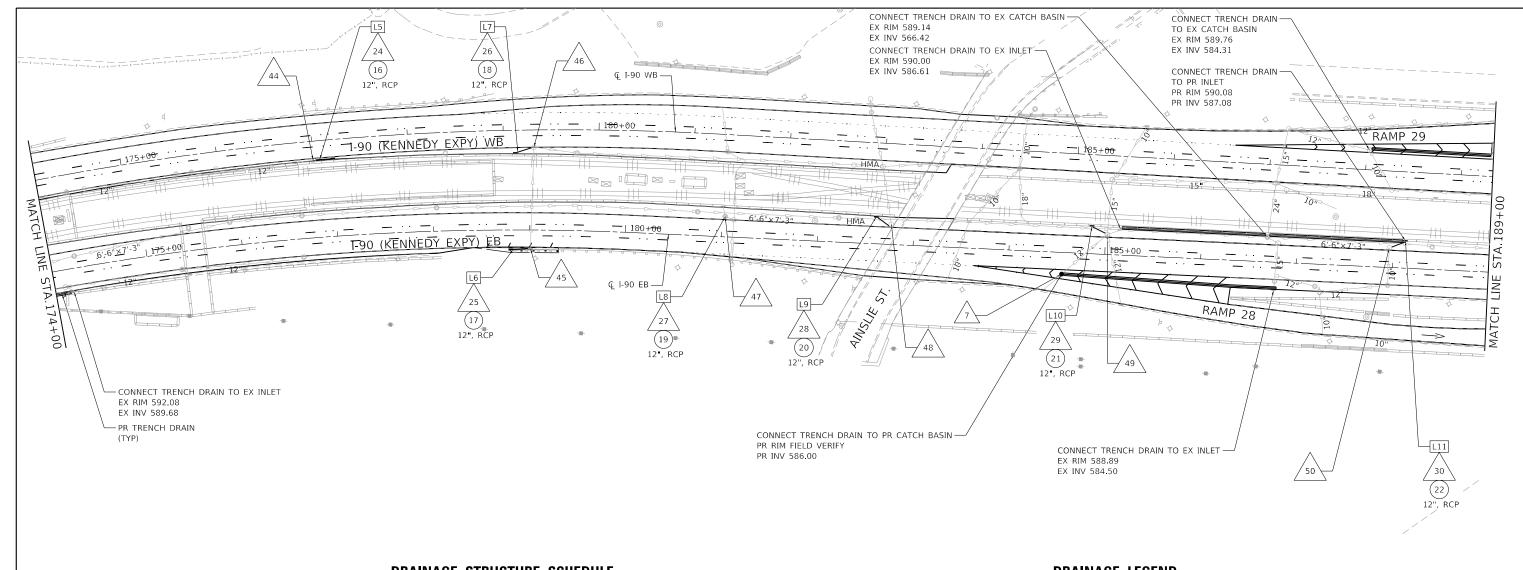

## DRAINAGE STRUCTURE SCHEDULE


										60200105	60218400	60237420	
STF	- ALIGNMENT	STATION	OFFSET	RIM		INVE	ERTS		EXISTING STRUCTURE	CATCH BASIN, TYPE A, 4' DIA, TYPE 1 F, OPEN LID	MANHOLE, TYPE A, 4' DIA, TYPE 1 F, CLOSED LID	INLETS. TYPE A, TYPE 20 F&G	REMARKS
					N	S	Ε	W		EA	EA	EA	
, 7	I-90 EB	184+55.00	22.57 RT	FIELD VERIFY			586.00	586.00		1			BUILD ON EXISTING SEWER, MATCH EXISTING INVERTS
2	I-90 WB	177+06.82	19.68 RT	595.89				592.89				1	L5 - SEE DRAINAGE STRUCTURE AND STORM SEWER DETAIL
2	I-90 EB	179+01.04	19.16 RT	594.30				591.30				1	L6 - SEE DRAINAGE STRUCTURE AND STORM SEWER DETAIL
2	I-90 WB	179+32.90	24.09 RT	595.82				592.82				1	L7 - SEE DRAINAGE STRUCTURE AND STORM SEWER DETAIL
2	' I-90 EB	181+03.05	21.18 LT	594.15				591.15				1	L8 - SEE DRAINAGE STRUCTURE AND STORM SEWER DETAIL
2	I-90 EB	182+60.49	28.19 LT	592.72		589.72						1	L9 - SEE DRAINAGE STRUCTURE AND STORM SEWER DETAIL
2	I-90 EB	184+85.38	28.88 LT	589.76				587.30				1	L10 - SEE DRAINAGE STRUCTURE AND STORM SEWER DETAIL
3	I-90 EB	188+12.25	28.41 LT	589.76	586.76							1	L11 - SEE DRAINAGE STRUCTURE AND STORM SEWER DETAIL
4	I-90 WB	176+99.90	19.97 RT	595.84		592.81	591.33	590.52	1				ADJUST RIM AND INVERTS TO MATCH EXISTING CONDITIONS
4	I-90 EB	179+01.04	19.16 RT	593.93	591.22			591.22	1				ADJUST RIM AND INVERTS TO MATCH EXISTING CONDITIONS
4	I-90 WB	179+31.92	18.00 RT	595.83	588.38	588.43		595.74	1				ADJUST RIM AND INVERTS TO MATCH EXISTING CONDITIONS
4	I-90 EB	181+03.05	21.18 LT	593.84		598.04	588.92		1				ADJUST RIM AND INVERTS TO MATCH EXISTING CONDITIONS
4	I-90 EB	182+76.35	21.05 LT	592.61	587.16			589.64	1				ADJUST RIM AND INVERTS TO MATCH EXISTING CONDITIONS
4	I-90 EB	185+01.73	20.90 LT	590.40	586.57	584.00	584.21	583.91	1				ADJUST RIM AND INVERTS TO MATCH EXISTING CONDITIONS
5	I-90 EB	187+95.85	20.05 RT	589.86		585.76	587.48		1				ADJUST RIM AND INVERTS TO MATCH EXISTING CONDITIONS

## **DRAINAGE LEGEND**

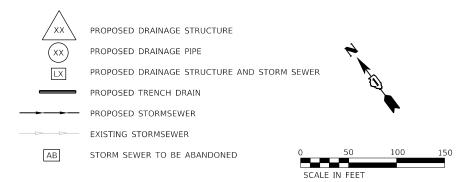

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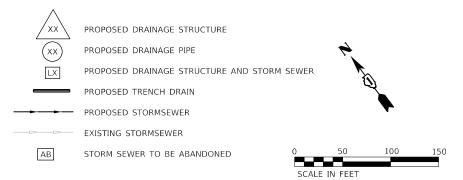
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	DRAWN -	CS/JB	REVISED -	STATE OF ILLINOIS							90	2019-082-RS&T	соок	119 80
PLOT SCALE = 100.0000 / in.	CHECKED -	JH	REVISED -	DEPARTMENT OF TRANSPORTATION			11. He He	. RTE. 43	- I-94)					NO. 62J59
PLOT DATE = 1/30/2020	DATE -	10/5/19	REVISED -		SCALE: 1"=50'	SHEET	OF	SHEETS	STA.	TO STA.		ILLINOIS FED.	AID PROJECT	

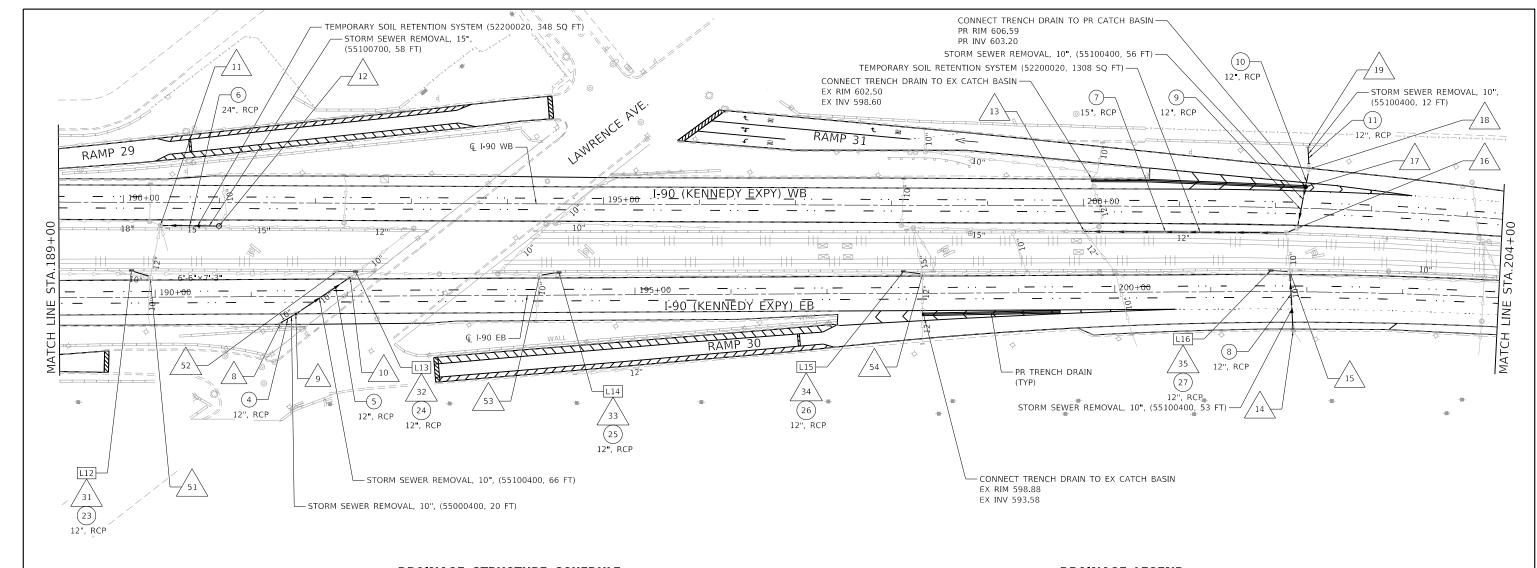

## DRAINAGE STRUCTURE SCHEDULE


										60200105	60218400	60237420	
STRUC NO	ALIGNMENT	STATION	OFFSET	RIM		INVE	ERTS		EXISTING STRUCTURE	CATCH BASIN, TYPE A, 4' DIA, TYPE 1 F, OPEN LID	MANHOLE, TYPE A, 4' DIA, TYPE 1 F, CLOSED LID	INLETS. TYPE A, TYPE 20 F&G	REMARKS
					N	5	Е	W		EA	EA	EA	
8	I-90 EB	191+30.44	28.10 RT	591.70			588.70	588.70	1				ADJUST RIM AND INVERTS TO MATCH EXISTING CONDITIONS
9	I-90 EB	191+46.41	18.31 RT	592.20			586.20	586.20	1				ADJUST RIM AND INVERTS TO MATCH EXISTING CONDITIONS
10	I-90 EB	192+03.31	19.66 LT	591.69	586.77		586.27	586.29					ADJUST RIM AND INVERTS TO MATCH EXISTING CONDITIONS
11	I-90 WB	190+38.57	23.84 RT	590.95	585.77	588.40	586.00	585.75	1				ADJUST RIM AND INVERTS TO MATCH EXISTING CONDITIONS
12	I-90 WB	191+00.00	24.34 RT	591.70	586.70		586.70	586.70	1				ADJUST RIM AND INVERTS TO MATCH EXISTING CONDITIONS
13	I-90 WB	200+00.00	26.55 RT	602.52	595.22	595.33	594.87	594.72	1				BUILD ON EXISTING SEWER, MATCH EXISTING INVERTS
14	I-90 EB	201+86.10	40.88 RT	606.34	602.94							1	ADJUST RIM AND INVERTS TO MATCH EXISTING CONDITIONS
15	I-90 EB	201+82.18	20.91 LT	606.82	600.64	600.92	601.85	602.72	1				
16	I-90 WB	202+23.22	20.93 RT	606.95	600.71	603.44	602.80	600.45	1				
17	I-90 WB	202+30.89	22.27 LT	606.59	603.20	603.20				1			ADJUST RIM AND INVERTS TO MATCH EXISTING CONDITIONS
18	I-90 WB	202+34.00	41.09 LT	606.34	603.14	603.43			1				
19	I-90 WB	202+32.19	63.68 LT	606.16		603.56			1				
31	I-90 EB	189+75.35	27.73 LT	589.90	586.90							1	L12 - SEE DRAINAGE STRUCTURE AND STORM SEWER DETAIL
32	I-90 EB	192+08.87	25.84 LT	592.20				589.20				1	L13 - SEE DRAINAGE STRUCTURE AND STORM SEWER DETAIL
33	I-90 EB	194+20.85	23.77 LT	593.08				590.08				1	L14 - SEE DRAINAGE STRUCTURE AND STORM SEWER DETAIL
34	I-90 EB	197+79.83	22.66 LT	599.18			596.18					1	L15 - SEE DRAINAGE STRUCTURE AND STORM SEWER DETAIL
35	I-90 EB	201+62.43	22.04 LT	611.06			608.06					1	L16 - SEE DRAINAGE STRUCTURE AND STORM SEWER DETAIL
51	I-90 EB	189+94.95	20.05 RT	590.82	586.17	586.23	586.62	585.97	1				ADJUST RIM AND INVERTS TO MATCH EXISTING CONDITIONS
52	1-90 EB	191+88.41	26.01 LT	591.40	588.40	587.08		588.10	1				ADJUST RIM AND INVERTS TO MATCH EXISTING CONDITIONS
53	I-90 EB	194+00.71	20.65 LT	592.78	587.88	587.88	588.40	588.63	1				ADJUST RIM AND INVERTS TO MATCH EXISTING CONDITIONS
54	I-90 EB	197+99.61	19.67 LT	599.18				596.10	1				ADJUST RIM AND INVERTS TO MATCH EXISTING CONDITIONS


## **DRAINAGE LEGEND**




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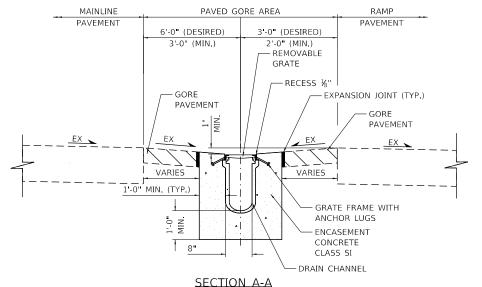
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	DRAWN - CS/JB	REVISED -	STATE OF ILLINOIS			Lan /II	. RTE. 43 – I–94)		90	2019-082-RS&T	соок	119 81
PLOT SCALE = 100.0000 ' / in.	CHECKED - JH	REVISED -	DEPARTMENT OF TRANSPORTATION			1-30 (IL.	: 1112: 45 - 1-54)				CONTRACT	f NO. 62J59
PLOT DATE = 1/30/2020	DATE - 10/5/19	REVISED -		SCALE: 1"=50'	SHEET	OF	SHEETS STA.	TO STA.		ILLINOIS FED.	AID PROJECT	



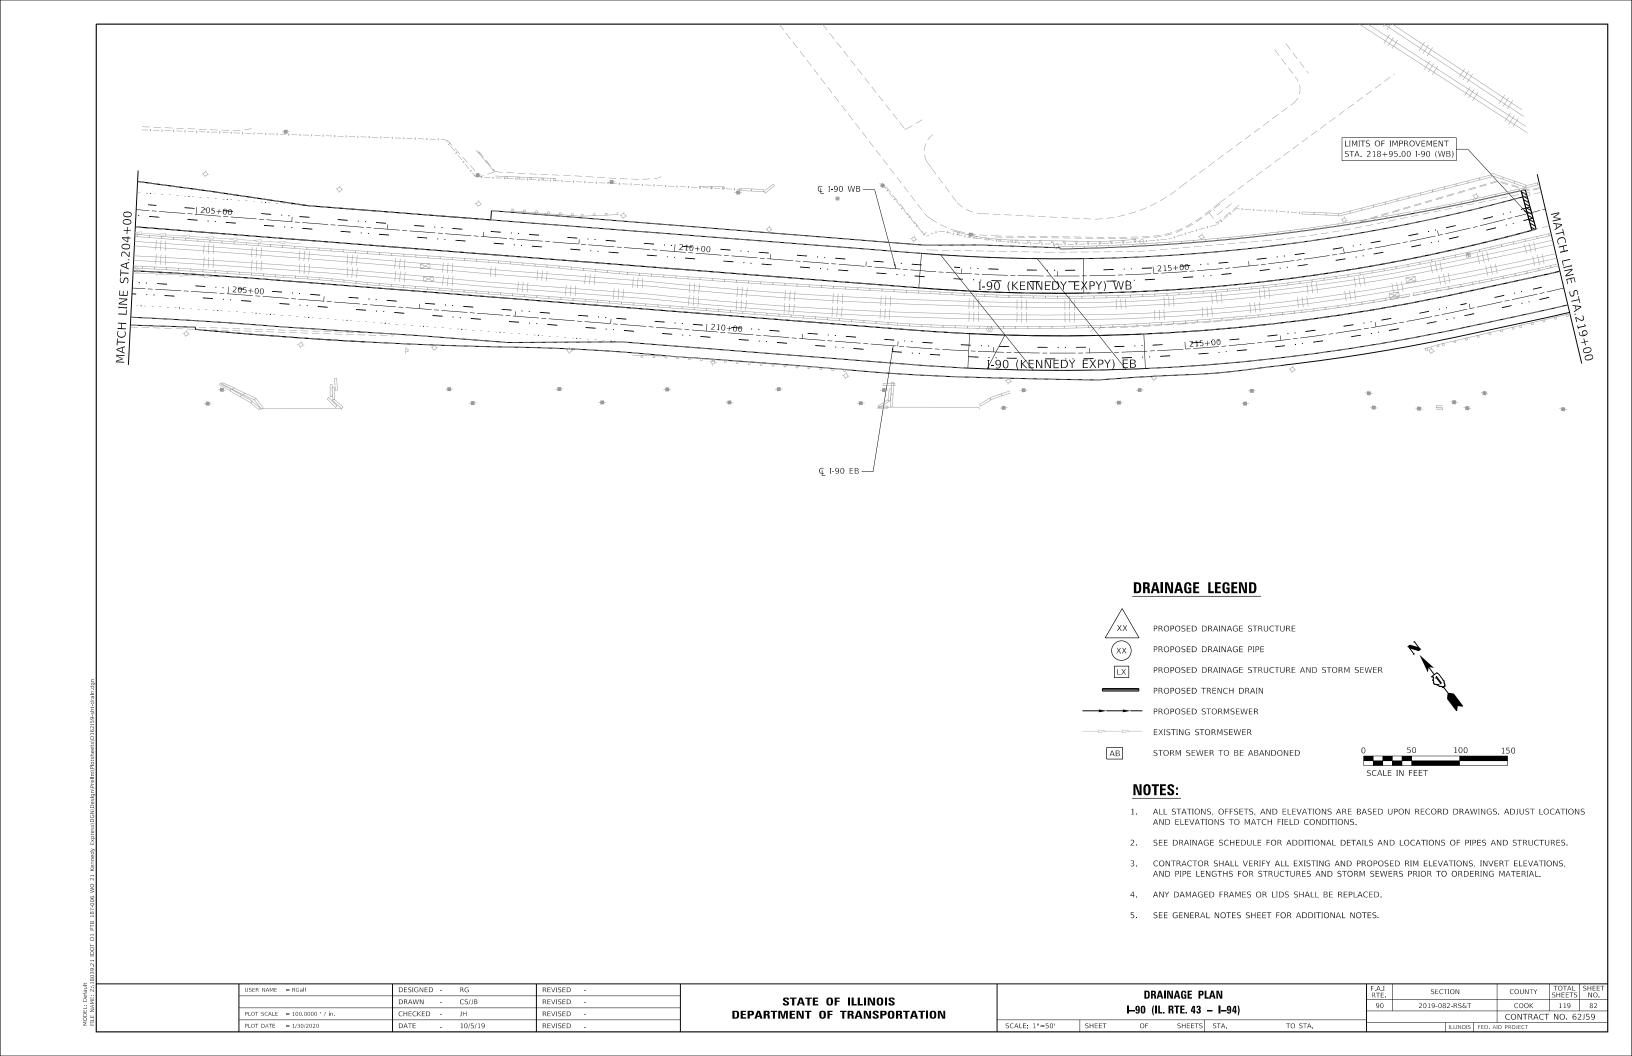


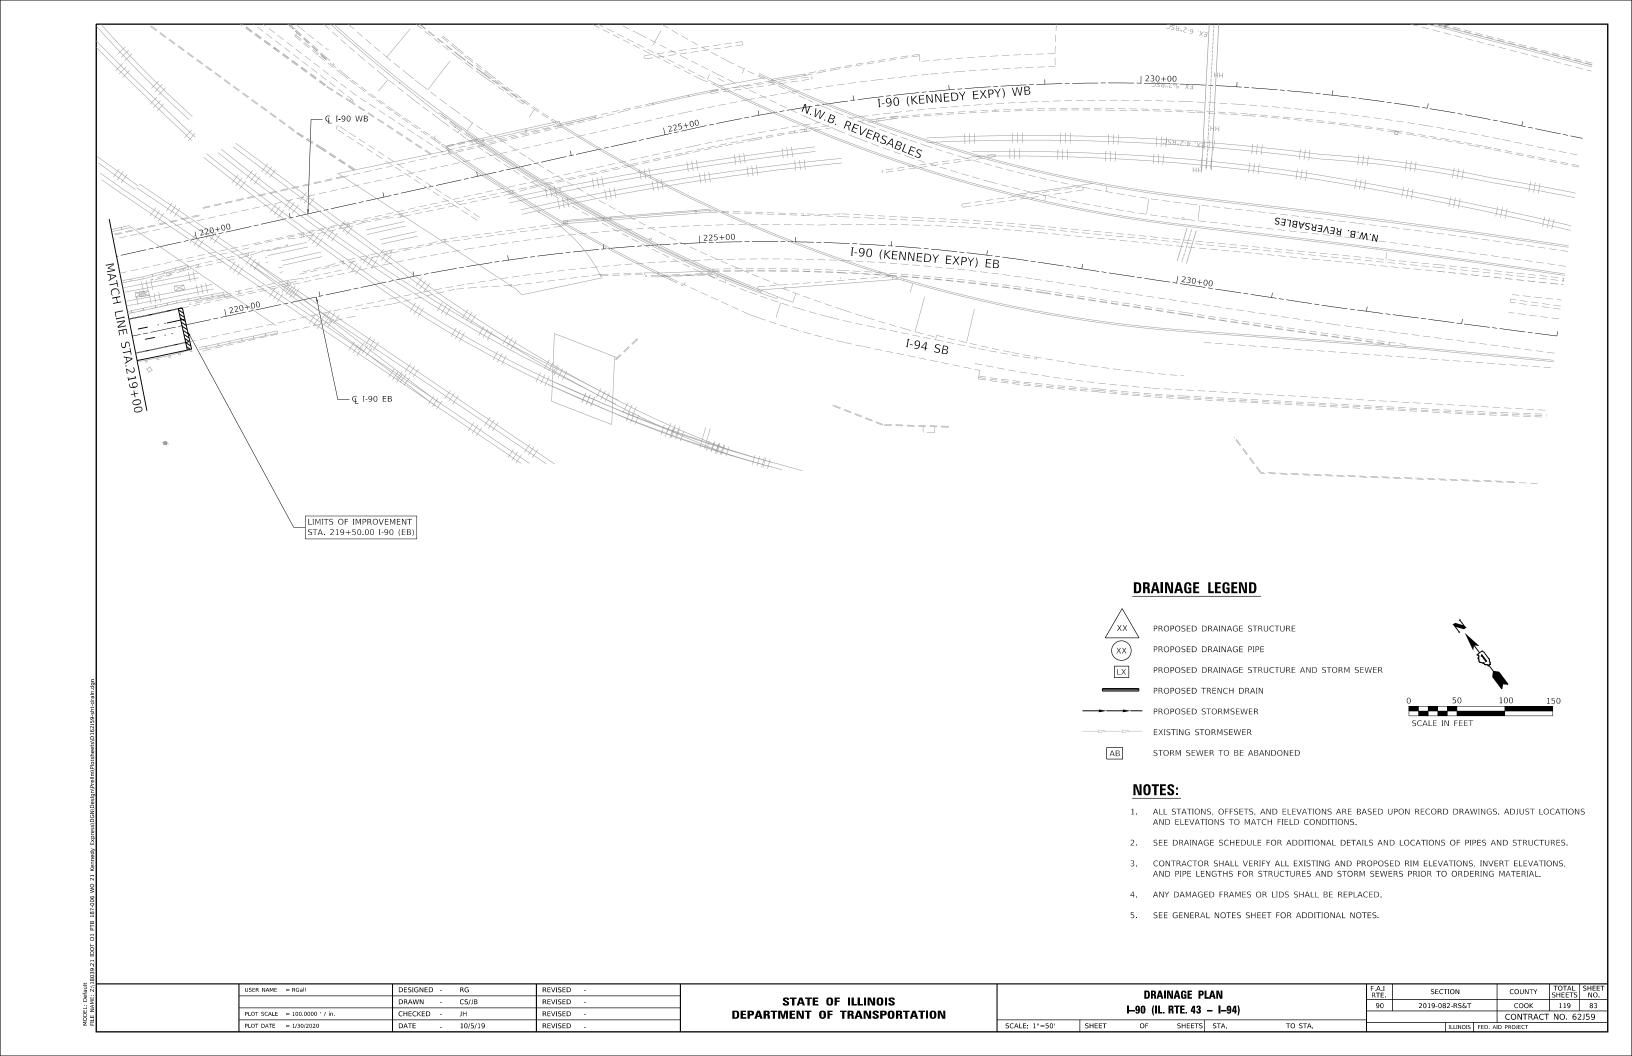

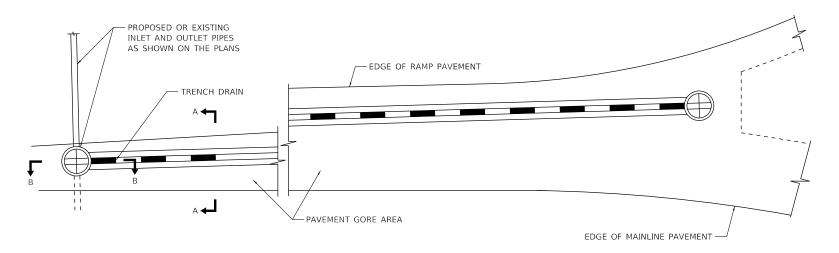PLAN



TRENCH DRAIN INSTALLATION IN GORE

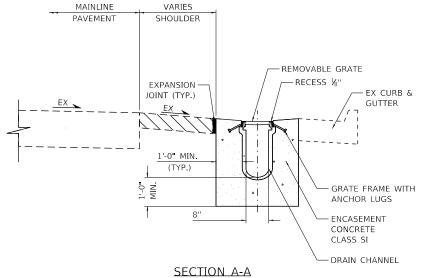

TRENCH DRAIN INSTALLATION ADJACENT TO CURB AND GUTTER

DESIGNED -

DRAWN -

HECKED -

DATE

CS/IB

10/5/19

REVISED


REVISED

REVISED


REVISED

JSER NAME = RGall

PLOT DATE = 1/30/2020

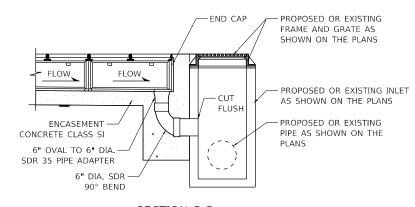


SECTION B-B
PIPE OUTLET TO DRAINAGE STRUCTURE

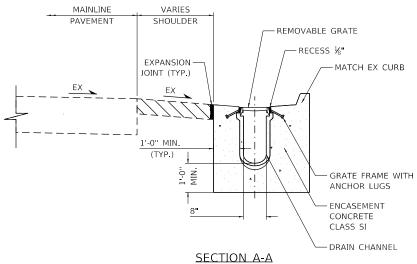


TRENCH DRAIN INSTALLATION REPLACING EXISTING COMBINATION CURB AND GUTTER

STATE OF ILLINOIS DEPARTMENT OF TRANSPORTATION

- 1. OUTLET PIPES AND PREFORMED CHANNEL INVERTS SHALL BE SLOPED AT 0.6% OR STEEPER TOWARD OUTLET REGARDLESS OF THE SURFACE SLOPE.
- 2. MINIMUM TRENCH DRAIN DEPTH IS 1'-0".
- TRENCH DRAINS SHALL BE CONNECTED TO EXISTING OR PROPOSED DRAINAGE STRUCTURES. CONNECTION IS INCLUDED IN COST OF TRENCH DRAIN.
- TRENCH EXCAVATION MUST ALLOW FOR A MINIMUM OF 12 INCHES OF CONCRETE TO BE PLACED UNDER AND ALONGSIDE THE TRENCH DRAIN CHANNEL SYSTEM.
- 5. THE FINISHED LEVEL OF CONCRETE SHALL BE APPROXIMATELY 1/8" ABOVE THE TOP OF THE DRAIN CHANNEL.
- 6. TRENCH DRAINS SHALL BE IN ACCORDANCE WITH THE MANUFACTURERS DETAILS AND SPECIFICATIONS.
- 7. PROVIDE 1" EXPANSION JOINT WITH PREFORMED JOINT FILLER BETWEEN PAVED SHOULDER AND TRENCH DRAIN ENCASEMENT.

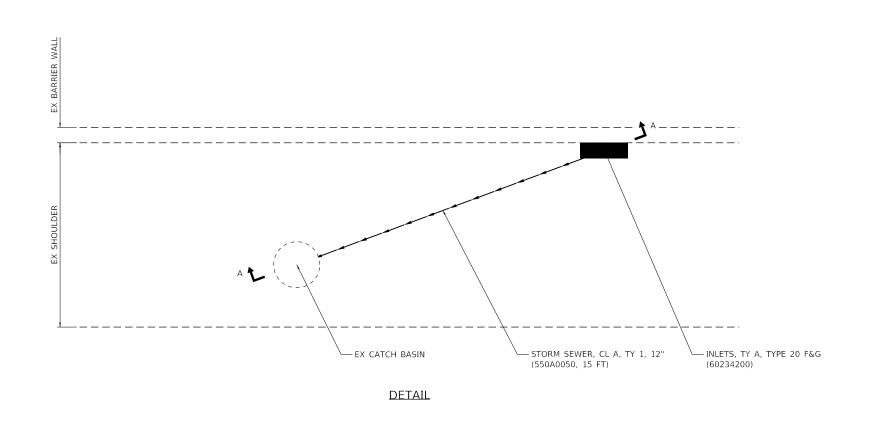

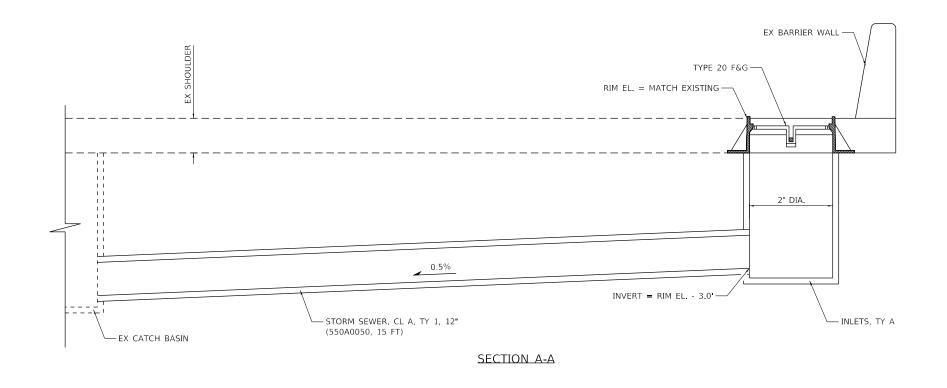


## NOTES:

- 1. THIS DETAIL APPLIES TO LOCATIONS L1 THROUGH L16. SEE DRAINAGE PLANS FOR LOCATION.
- 2. LOCATION IS BASED UPON RECORD DRAWINGS. ADJUST LOCATION BASED UPON FIELD CONDITIONS.
- 3. RIM AND INVERT ELEVATIONS ARE BASED UPON RECORD DRAWINGS. ADJUST ELEVATIONS BASED UPON FIELD CONDITIONS.

USER NAME = RGall	DESIGNED -	RG	REVISED -
	DRAWN -	CS/JB	REVISED -
PLOT SCALE = 100.0000 / in.	CHECKED -	JH	REVISED -
PLOT DATE = 1/30/2020	DATE -	10/5/19	REVISED -

STATE OF ILLINOIS
DEPARTMENT OF TRANSPORTATION

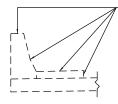

– APPLY PROTECTIVE COAT TO FACE AND TOP OF PARAPET AND SIDEWALK

NOTE:


IN CASES OF A SHORTER PARAPET WITH ATTACHED RAIL, THE ABOVE APPLICATION METHOD WILL STILL APPLY.


			STRUC	TURE SCHEDU	LE					
STRUCTURE NUMBER	FACILITY CARRIED	FEATURE CROSSED	BRIDGE DECK LENGTH	BRIDGE DECK WIDTH	BRIDGE DECK AREA	BRIDGE SIDEWALK AREA	BRIDGE PARAPET AREA	X5870015 BRIDGE DECK CONCRETE SEALER	50600200 PAINTING STEEL RAILING	59200101 BRIDGE WASHING NO. 1
			FOOT	FOOT	SQ FT	SQ FT	SQ FT	SQ FT	F00T	EACH
016-0836	Lawrence Ave	I-90	356.4	59.0	21018.1	<i>2733.3</i>	1247.3	24999		
016-1105	Ainslie St	I-90	299.6	35.7	10699.1	2298.0	1048.6	14046		1
016-1107	Milwaukee Ave	I-90	259.8	46.0	11956.5	1992.7	909.3	14859		
016-0659	Central Ave	I-90	253.9	50.7	12865.1	1947.0	888.5	15701		
016-0708	Nagle Ave	I-90	154.4	75.3	11620.9	1184.5	540.5	13346		
016-1106	Natoma Ave	I-90	234.6	28.4	6658.9	1799.0	820.9	9279		
016-1104	Sayre Ave	I-90	232.4	48.4	11259.4	1782.8	813.5	13856		
016-0309	IL 43 (Harlem Ave)	I-90	195.2	73.3	14298.2	1497.0	683.1	16479	392	
	_	_					TOTAL	122565	392	1


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	DRAWN -	REVISED -	
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PLOT DATE = 1/30/2020	DATE -	REVISED -	


STATE C	F ILLINOIS
DEPARTMENT OF	TRANSPORTATION

							F.A.I RTE	SECT	ΓΙΟΝ	С	OUNTY	TOTAL SHEETS	SHEET NO.
	TYPICAL BRIDGE DECK SECTION							2019-08		соок	119	86	
									CC	ONTRACT	NO. 62	2J59	
	SCALE: 1"=50'	SHEET	OF	SHEETS	STA.	TO STA.		ILLINOIS FED. AI			DJECT		

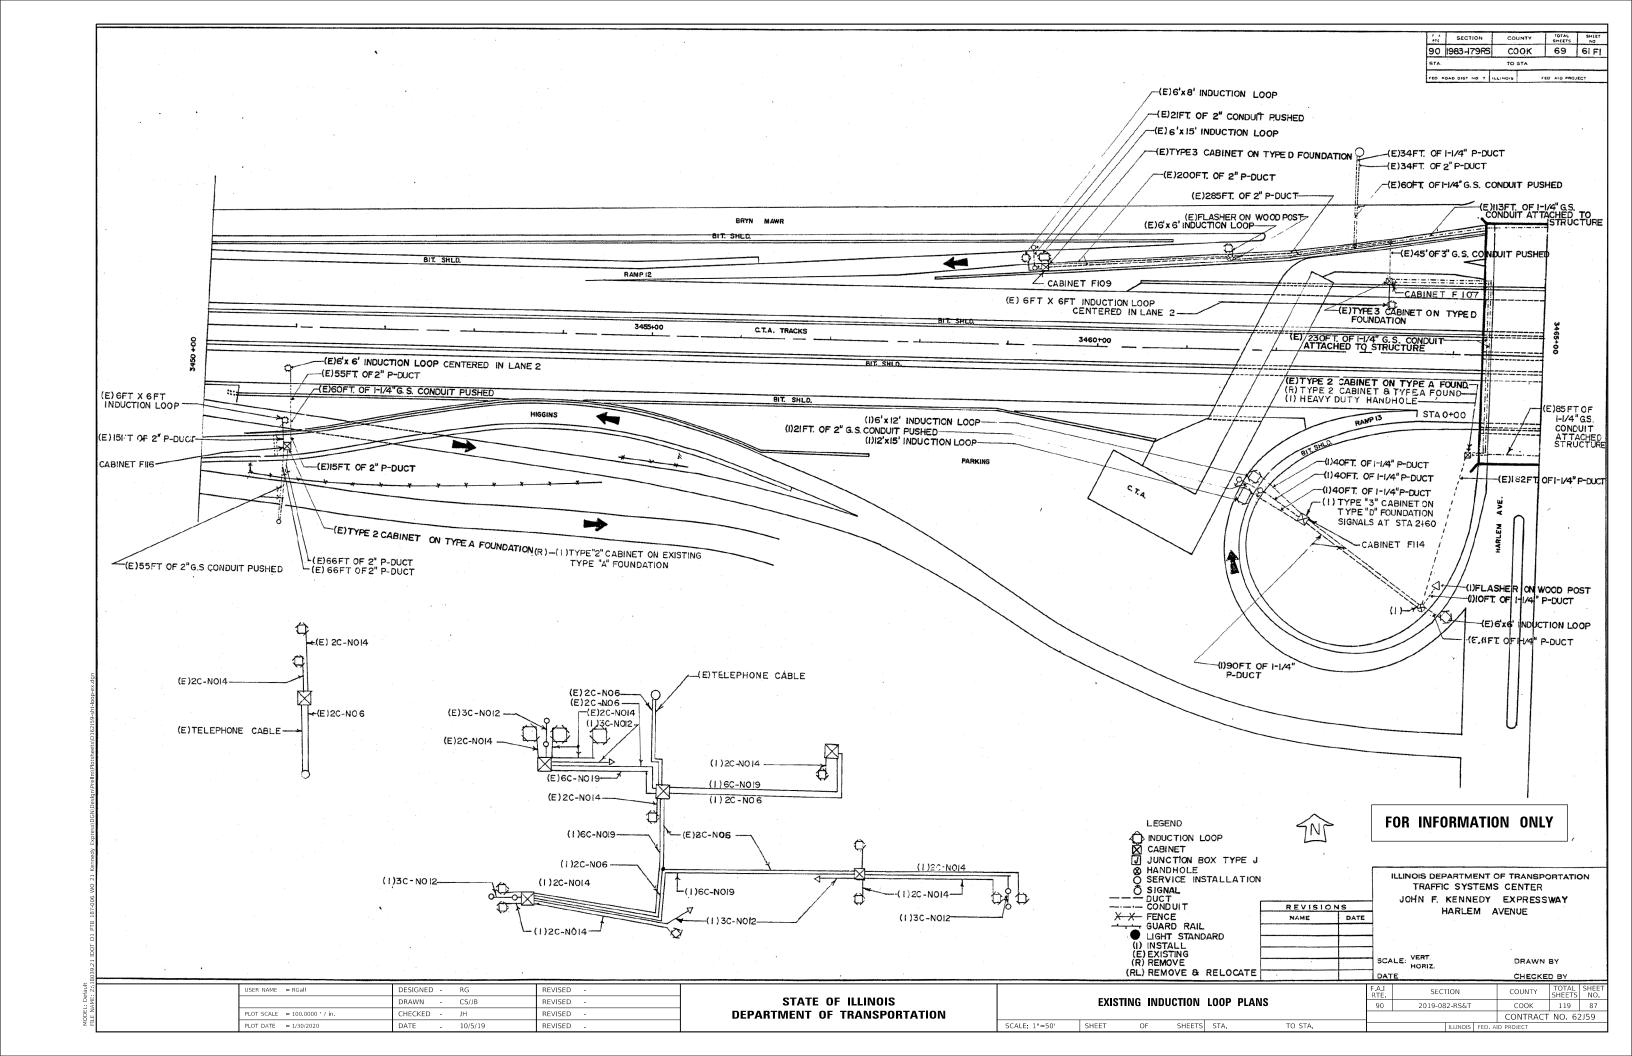

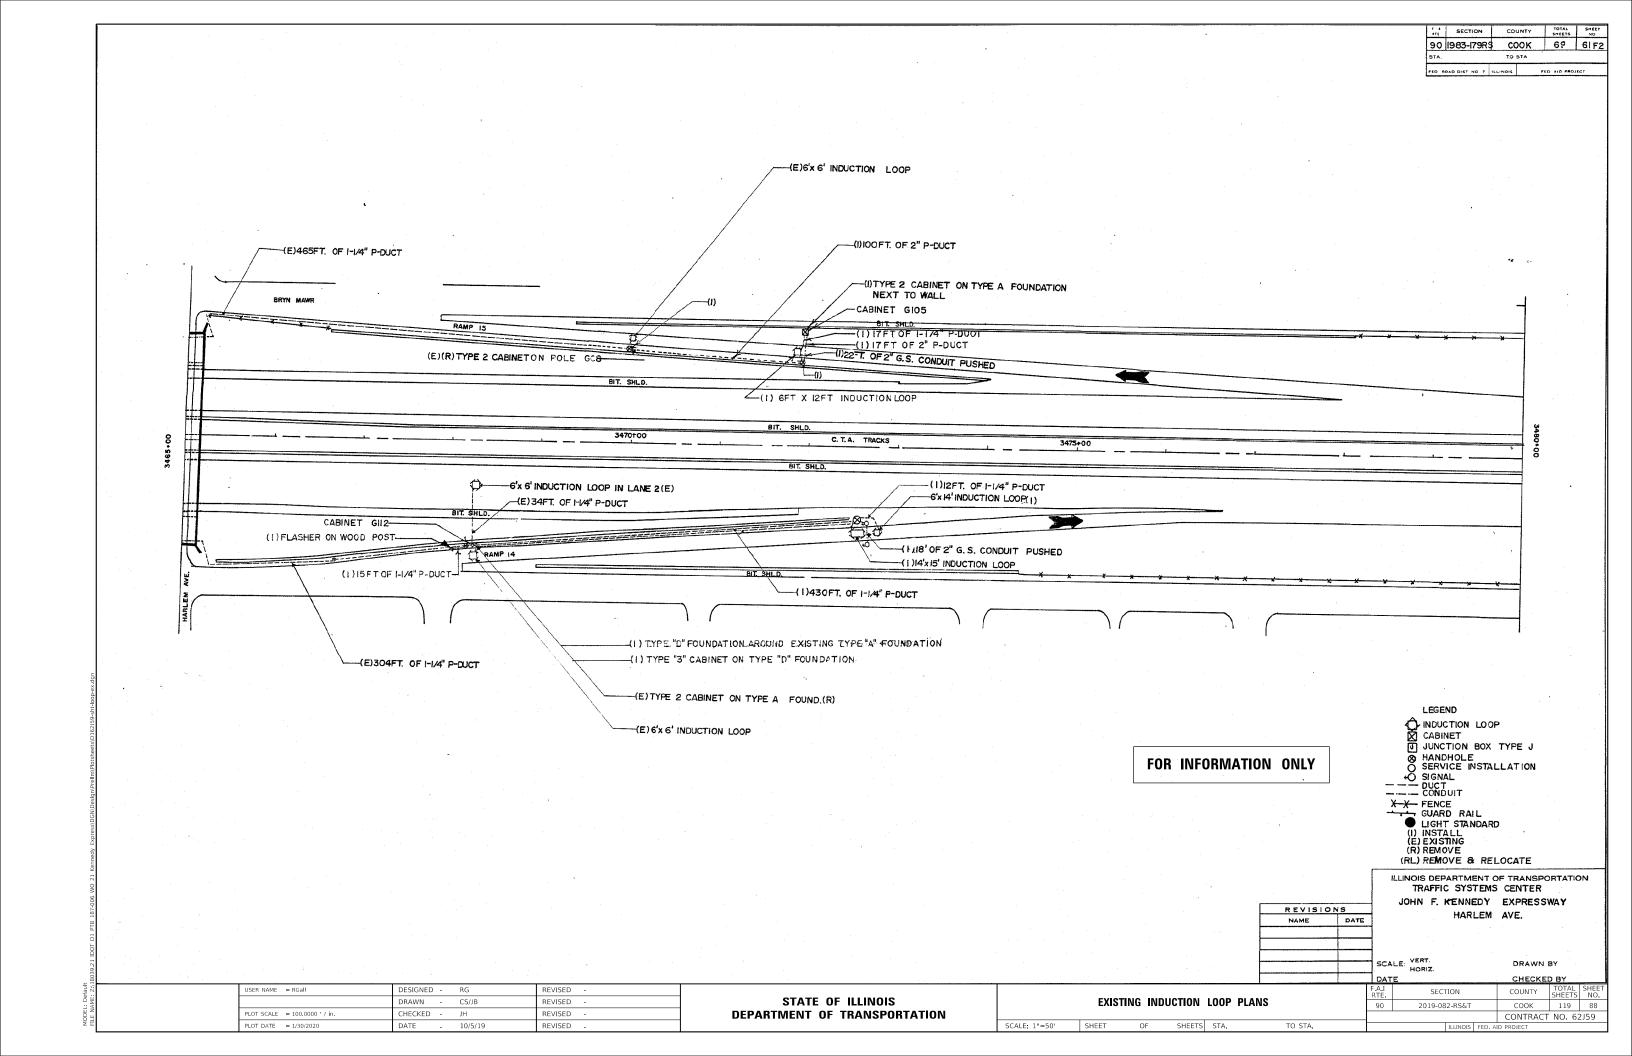

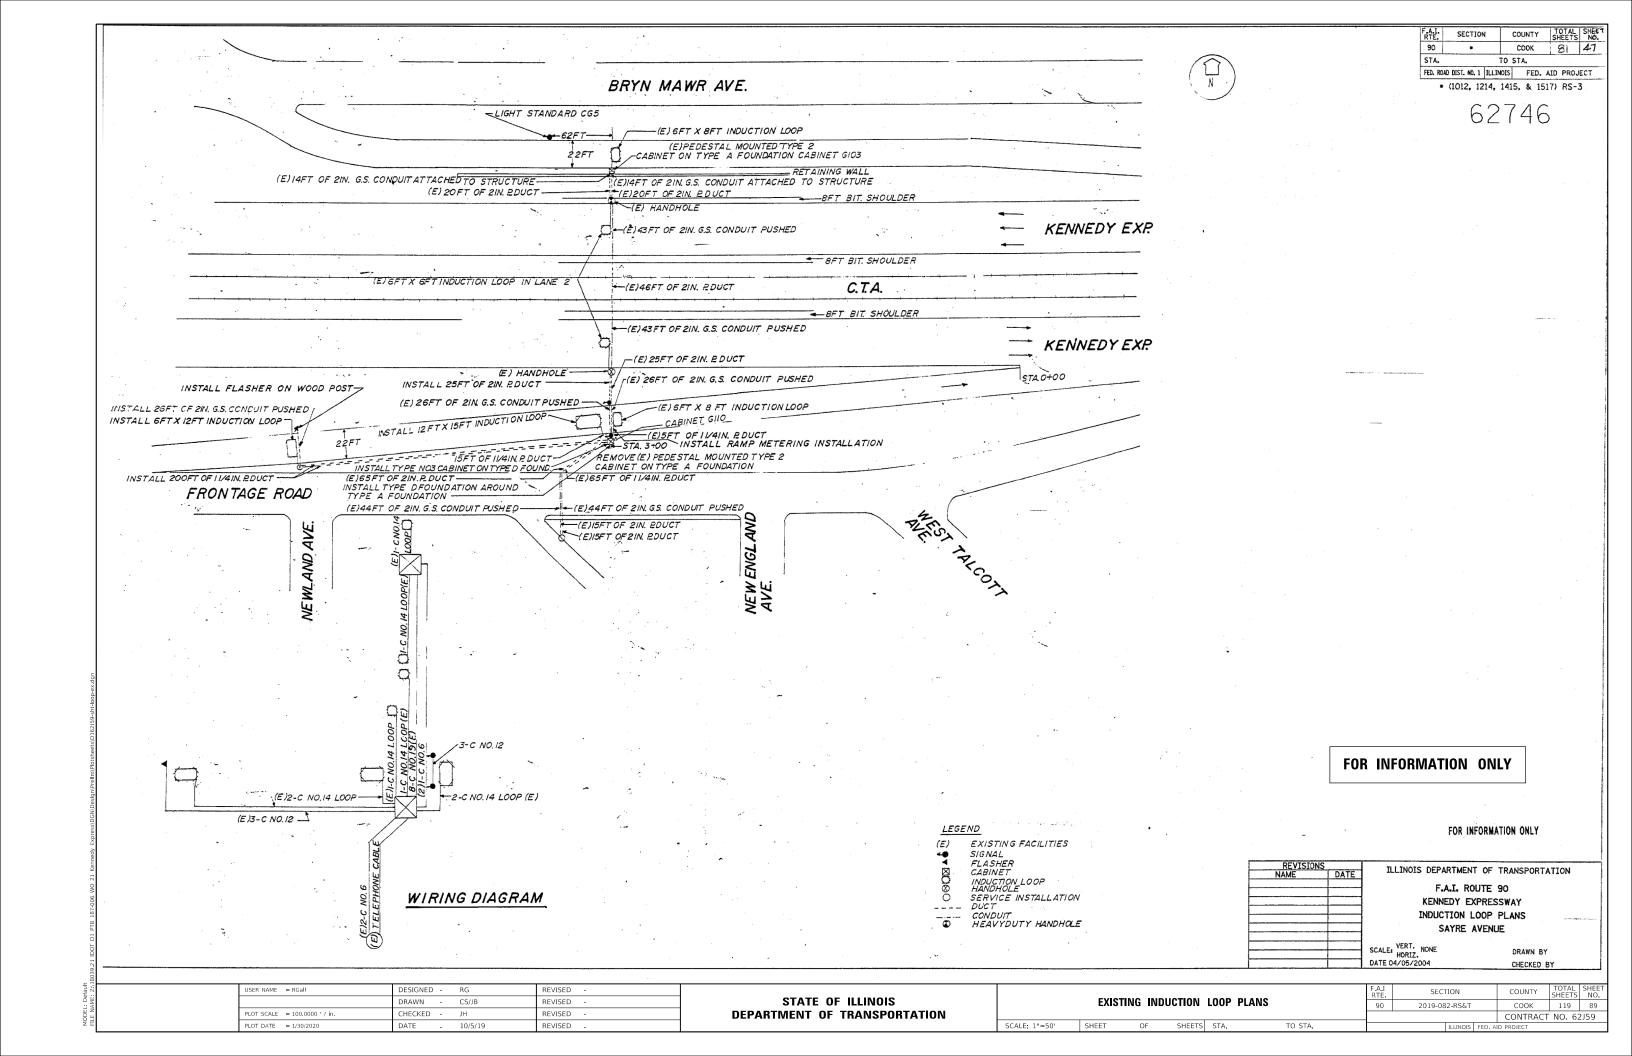

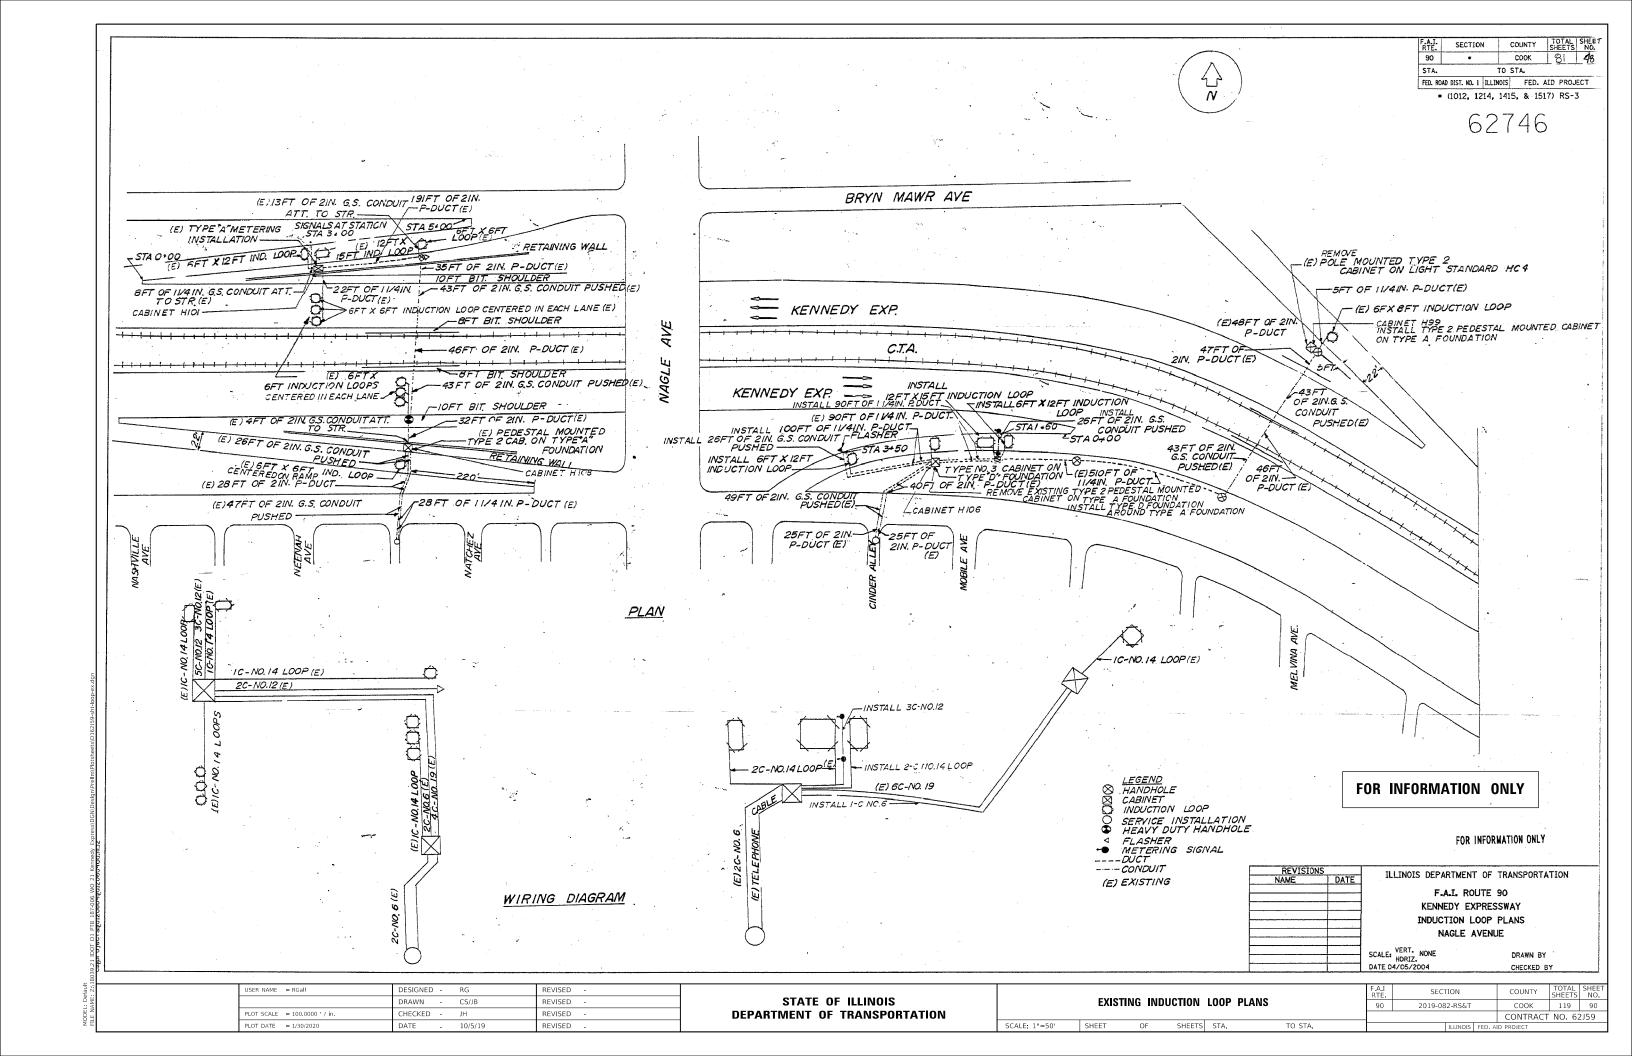

SECTION 90 TO STA. FED. ROAD DIST. NO. 1 ILLINOIS FED. AID PROJECT \* (1012, 1214, 1415, & 1517) RS-3 62746 KENNEDY EXPRESSWAY GFT X GFT INDUCTION LOOP CENTERED IN LANE 2 -BFT BIT. SHOULDER C.T.A. 48FT OF 2IN, P-DUCT (E) AFT BIT SHOULDER 43FT OF 2IN GS. CONDUIT PUSHED (E) 6FT X 6FT INDUCTION
LOOP CENTERED—
IN LANE 2 (E)  $\Rightarrow$  $\Longrightarrow$ KENNEDY EXPRESSWAY (E) 26FT OF 2IN. P-DUCT-GFT X GFT INDUCTION LOOP CENTERED, ON RAMP (E) - 20FT OF 1 1/4 IN. P-DUCT (E) 19 FT OF 2IN. G.S. CONDUIT PUSHED (E) (E) ISFT OF IVAIN P-DUCT\_ (E) 160FT OF 21N. P-DUCT-(E) 160 FT OF 11/41N. P-DUCT--45FT OF 2IN. GS. CONDUIT PUSHED FRONTAGE ROAD MEADE (E) IC-NO. 14 LOOP. 6C -NO.19 (E) <u>LEGEND</u> LEGEND

INDUCTION LOOP


CABINET


SERVICE INSTALLATION


CONDUIT


FENCE


(E) EXISTING FOR INFORMATION ONLY FOR INFORMATION ONLY ILLINOIS DEPARTMENT OF TRANSPORTATION F.A.I. ROUTE 90 KENNEDY EXPRESSWAY WIRING DIAGRAM INDUCTION LOOP PLANS MEADE AVENUE SCALE: VERT. NONE HORIZ. DATE 04/05/2004 DRAWN BY CHECKED BY JSER NAME = RGall DESIGNED - RG REVISED STATE OF ILLINOIS DRAWN - CS/JB **EXISTING INDUCTION LOOP PLANS** REVISED 2019-082-RS&T COOK 119 91 LOT SCALE = 100.0000 ' / in. REVISED **DEPARTMENT OF TRANSPORTATION** CONTRACT NO. 62J59 OF SHEETS STA.

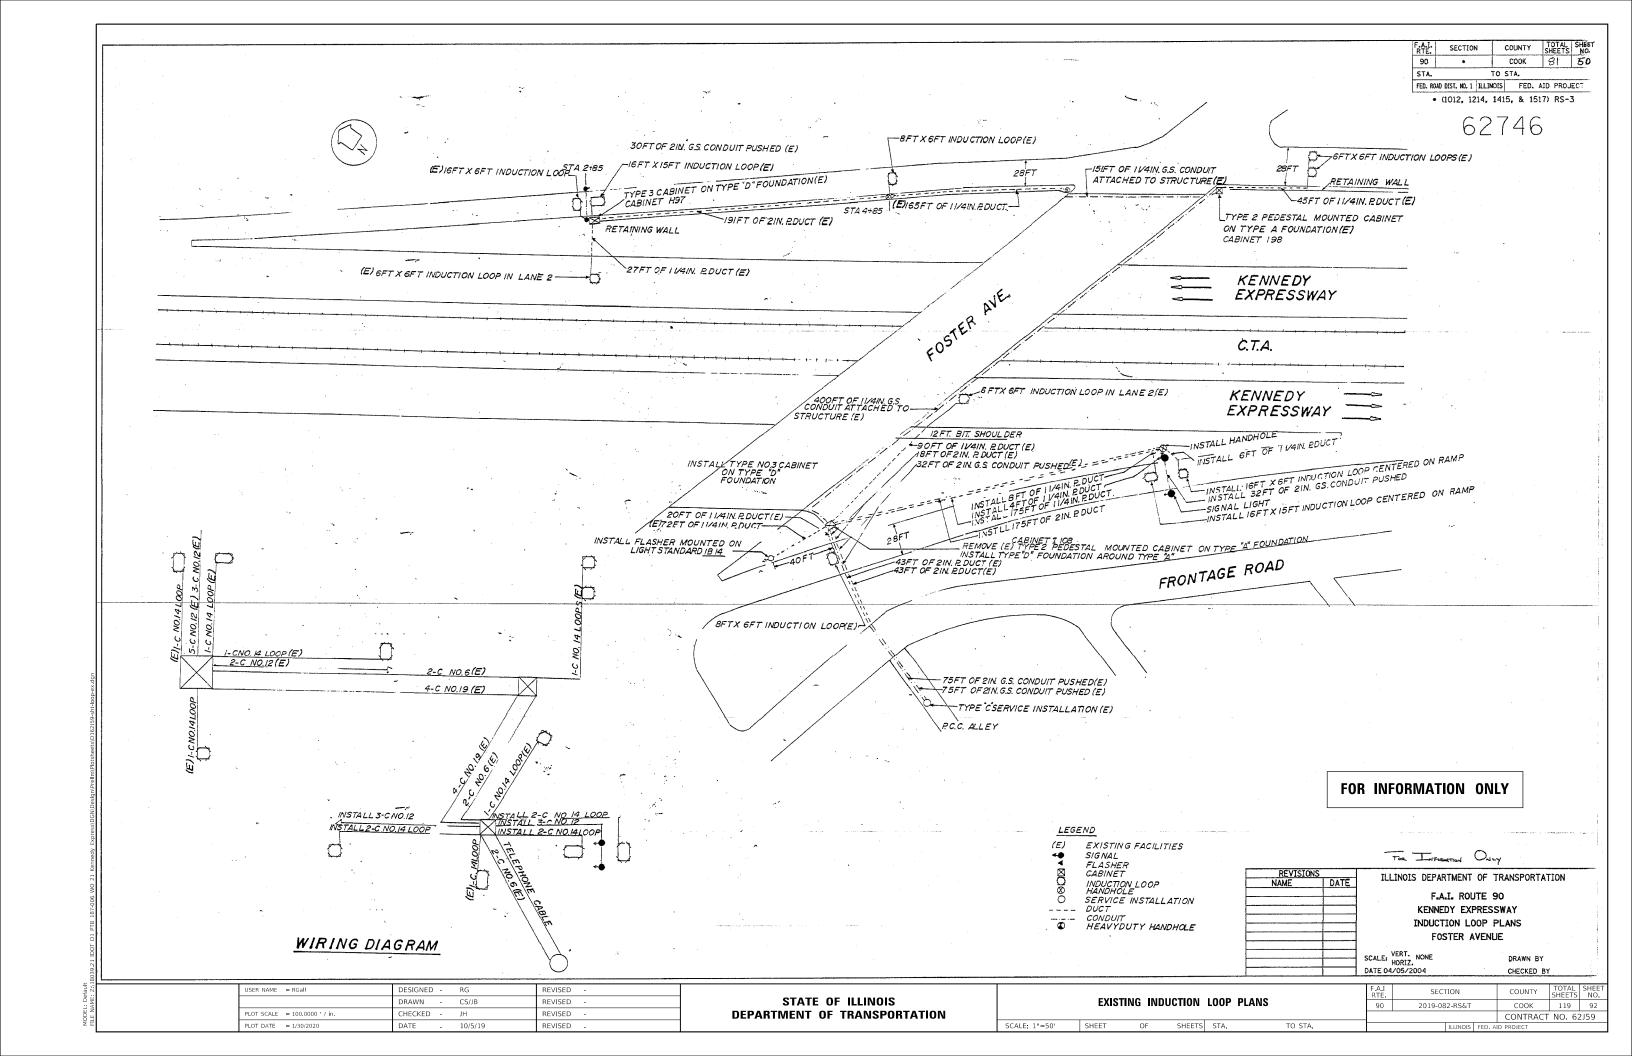

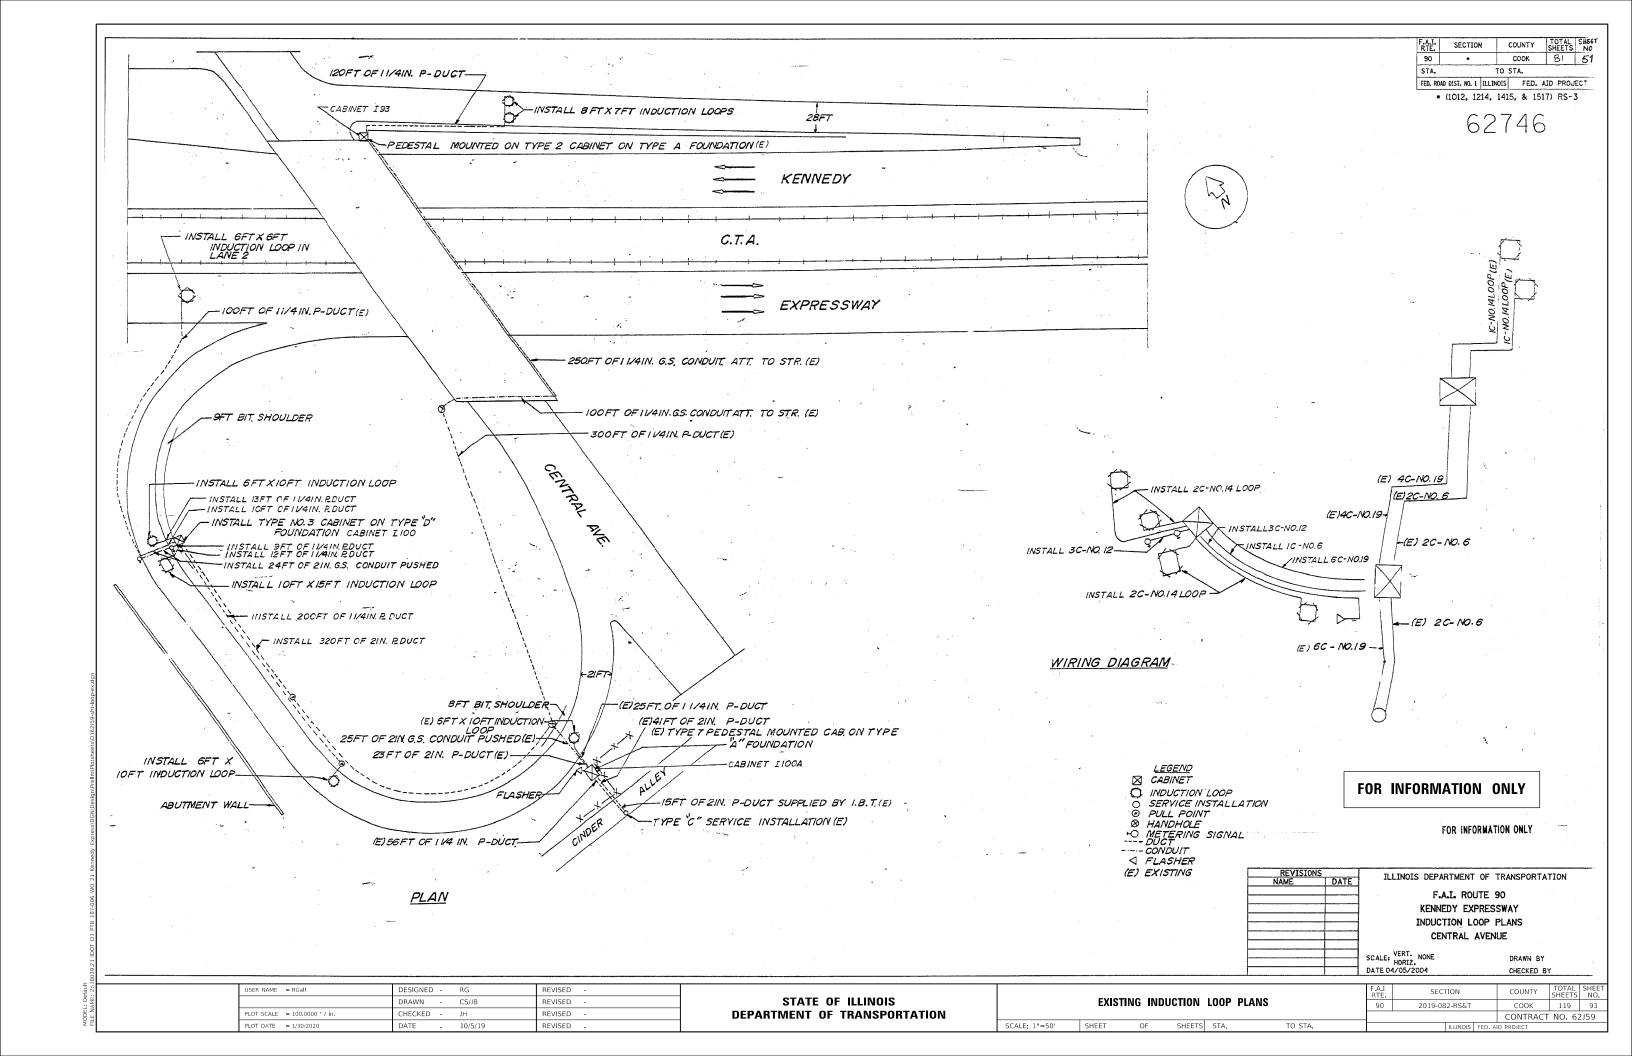

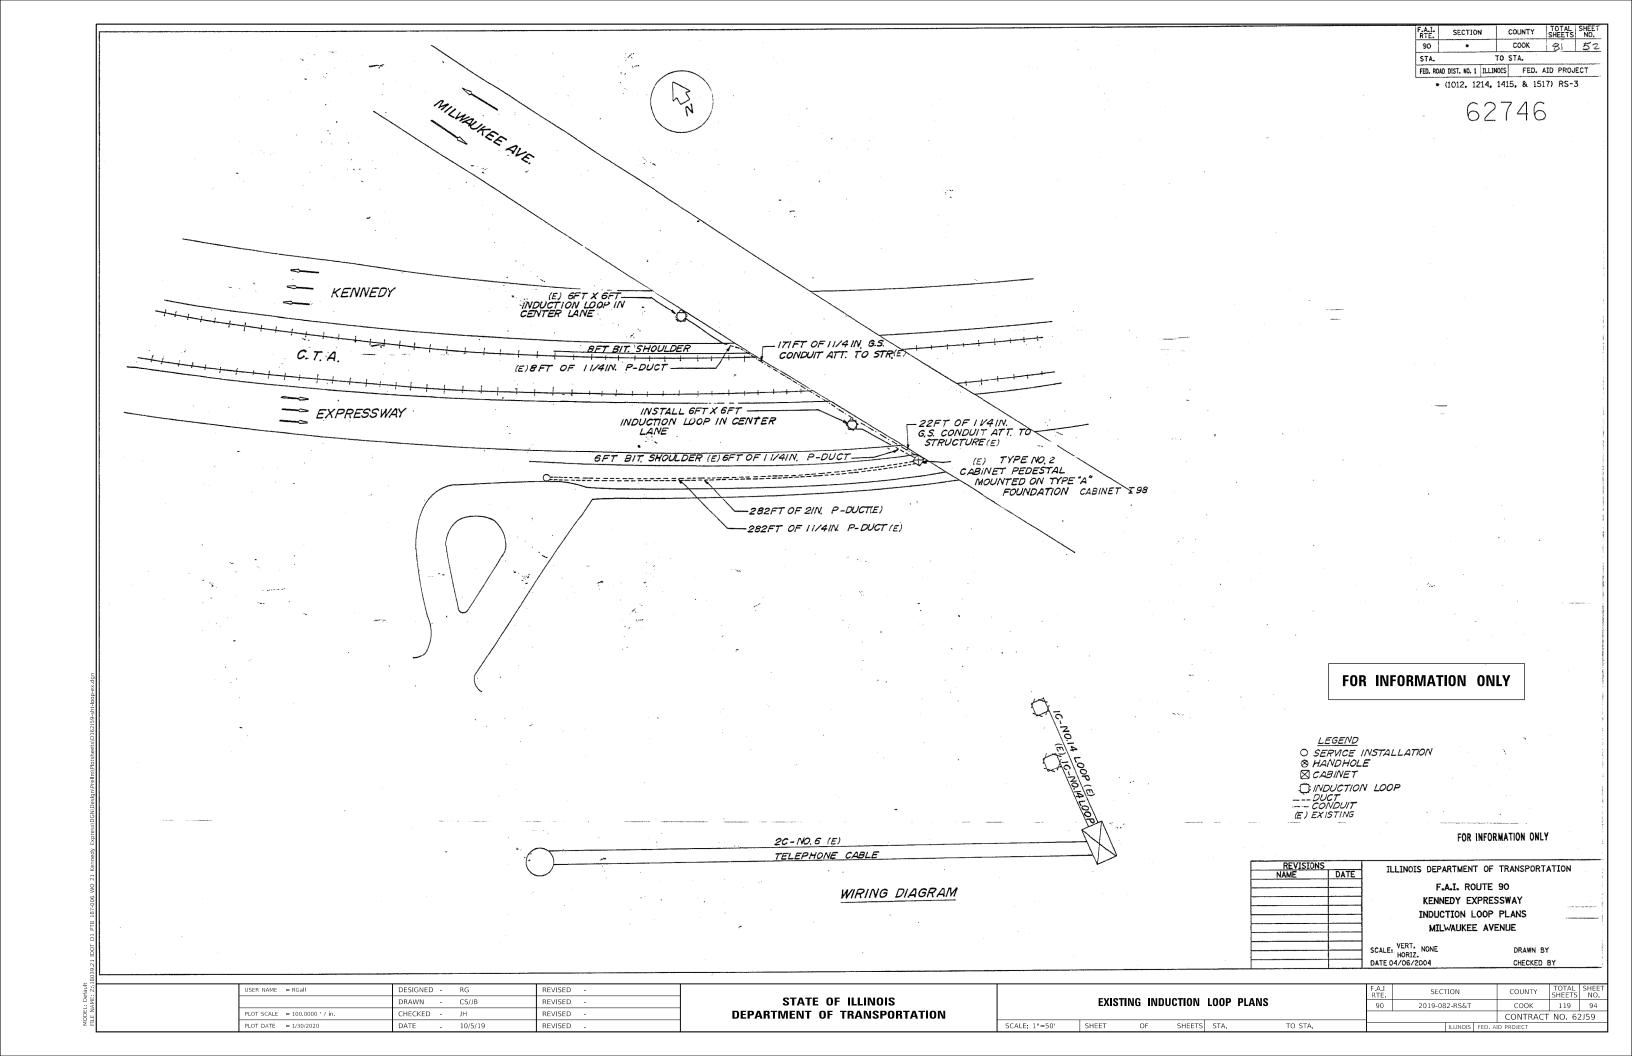

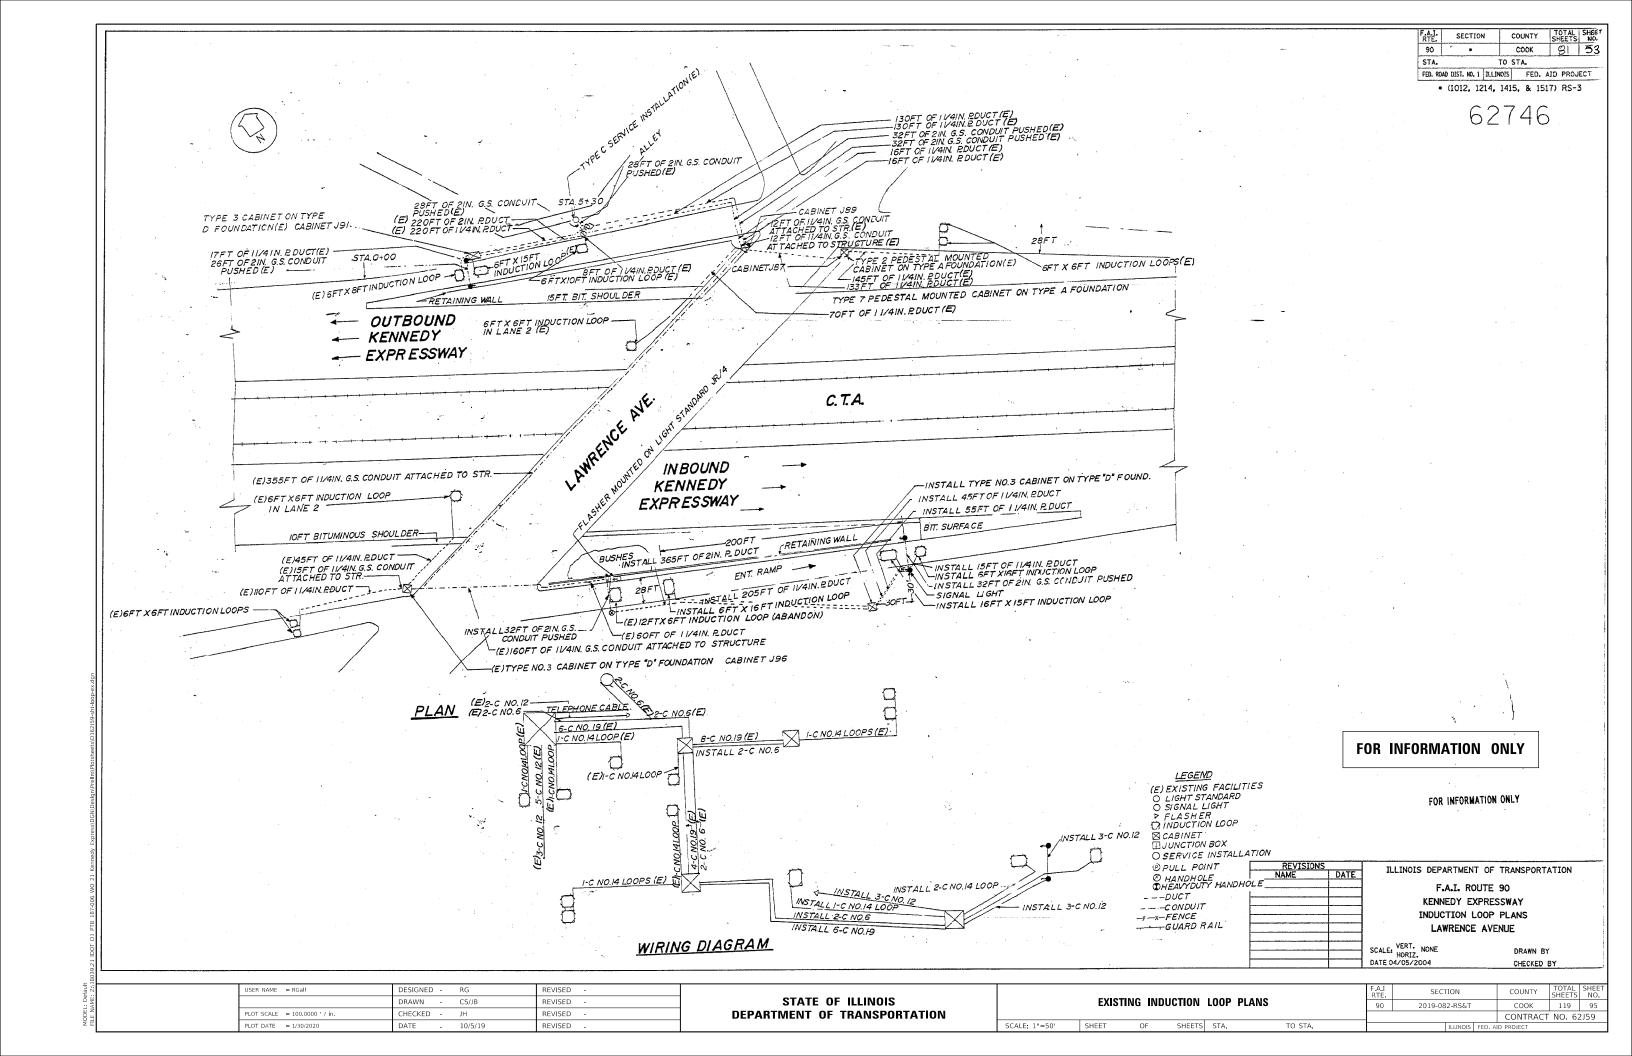

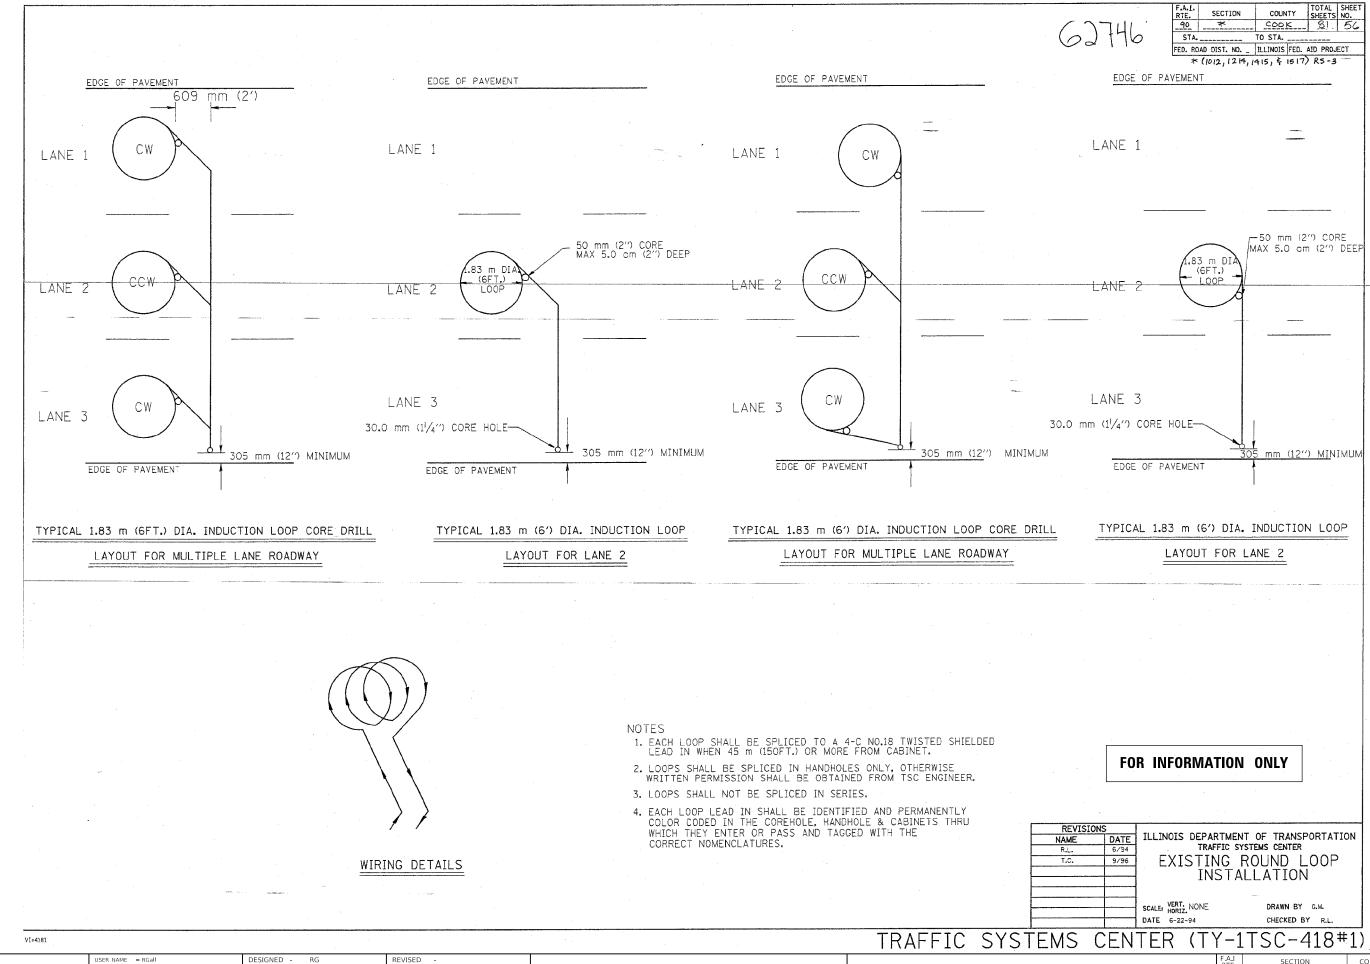

MODEL: Default

DRAWN

HECKED -

LOT SCALE = 100.0000 ' / in.

PLOT DATE = 1/30/2020

CS/JB

REVISED

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REVISED

STATE OF ILLINOIS
DEPARTMENT OF TRANSPORTATION


EXISTING INDUCTION LOOP PLANS

SCALE: 1"=50" SHEET OF SHEETS STA. TO STA.


 
 FALL RTE.
 SECTION
 COUNTY SHEETS
 TOTAL NO.
 SHEETS NO.

 90
 2019-082-RS&T
 COOK
 119
 96

 CONTRACT NO. 62J59

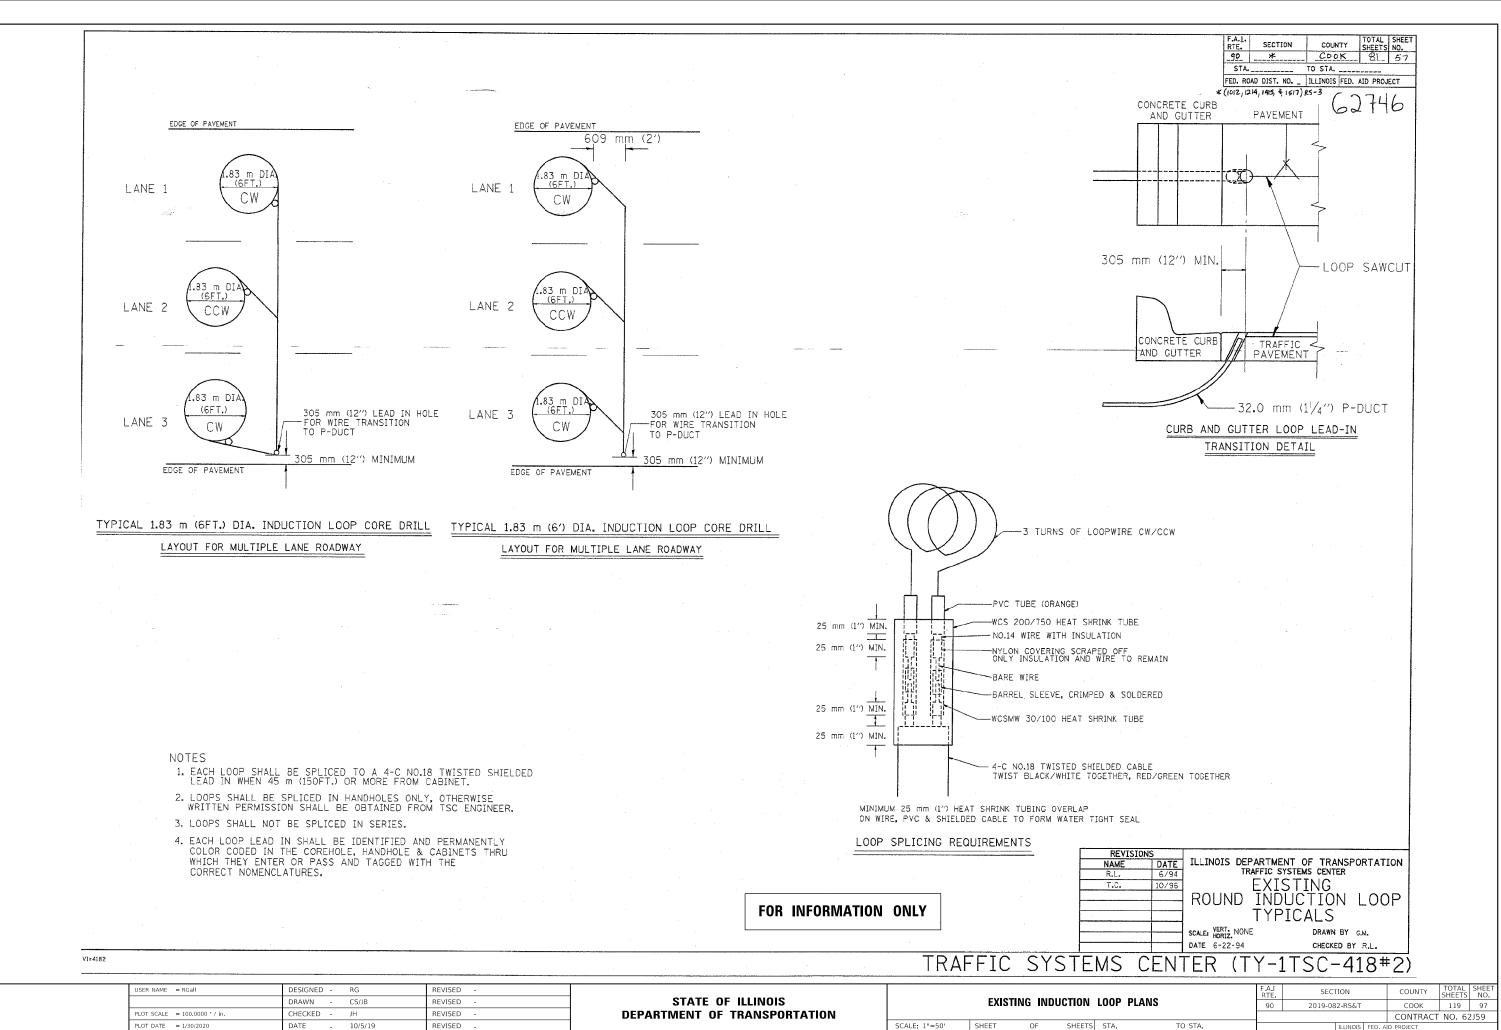


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**DEPARTMENT OF TRANSPORTATION** 

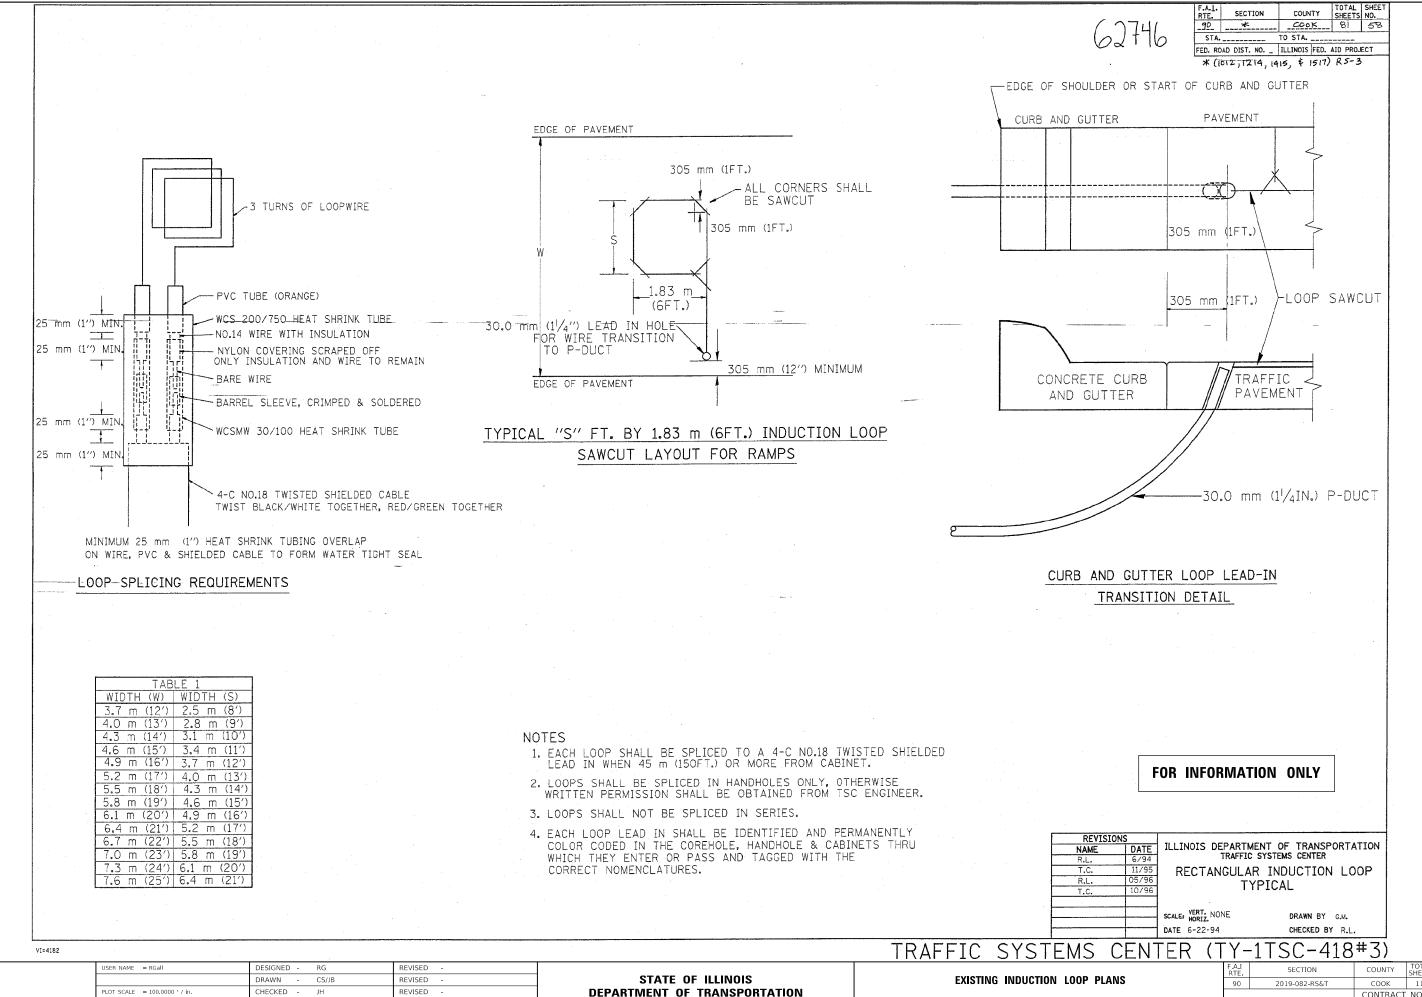SCALE: 1"=50' SHEET OF SHEETS STA.

COOK 119 98 CONTRACT NO. 62J59




**DEPARTMENT OF TRANSPORTATION** 

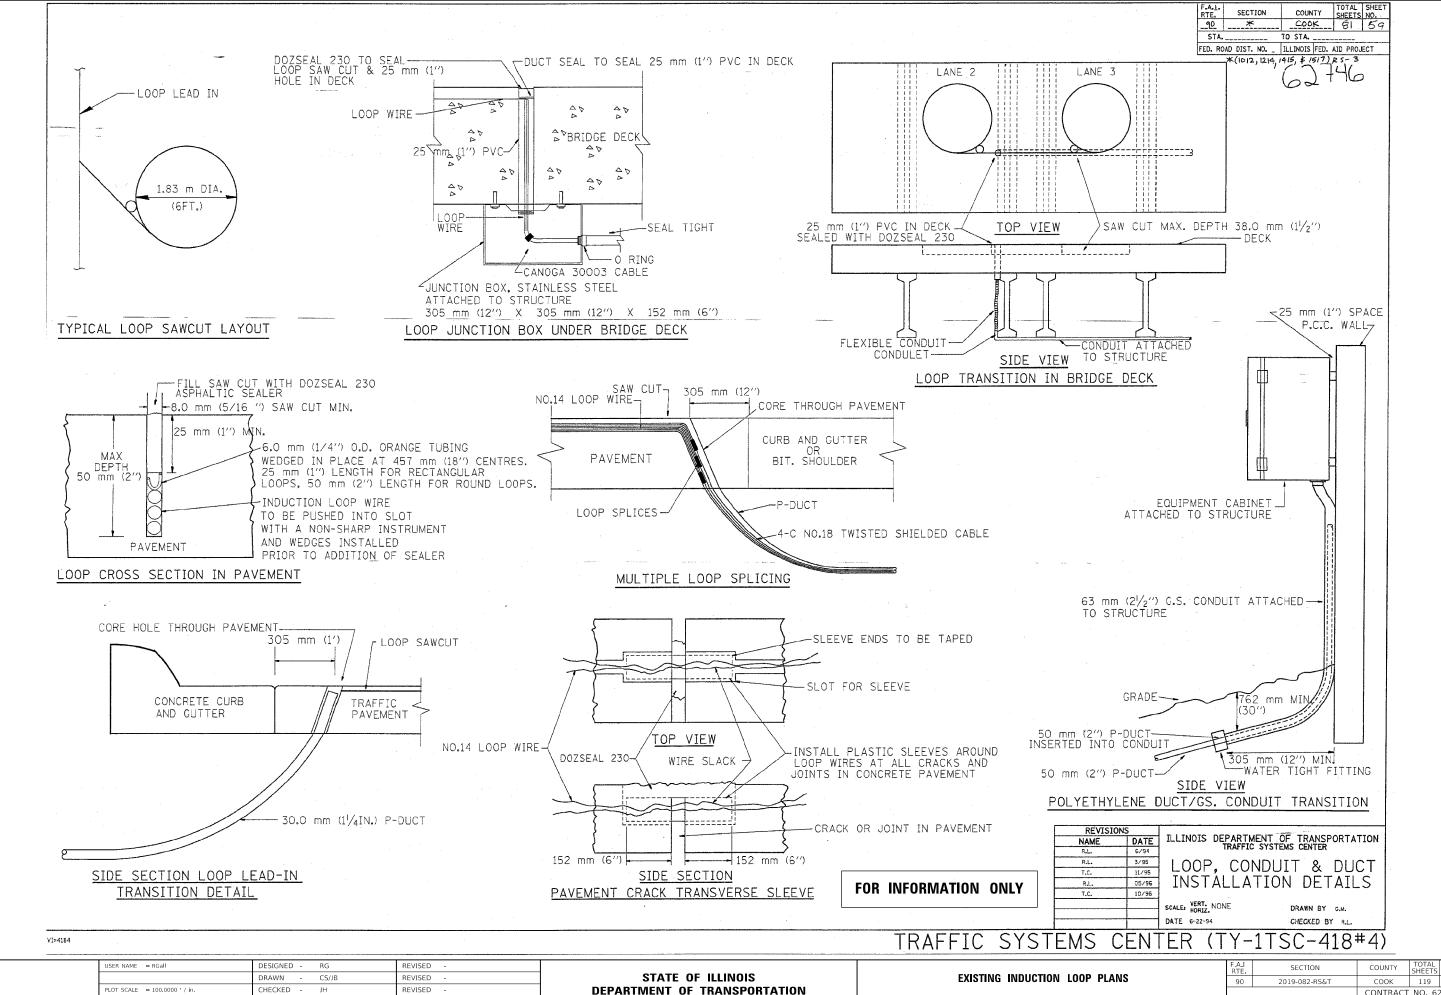
SHEETS STA.

SCALE: 1"=50"

COOK 119 99 CONTRACT NO. 62J59

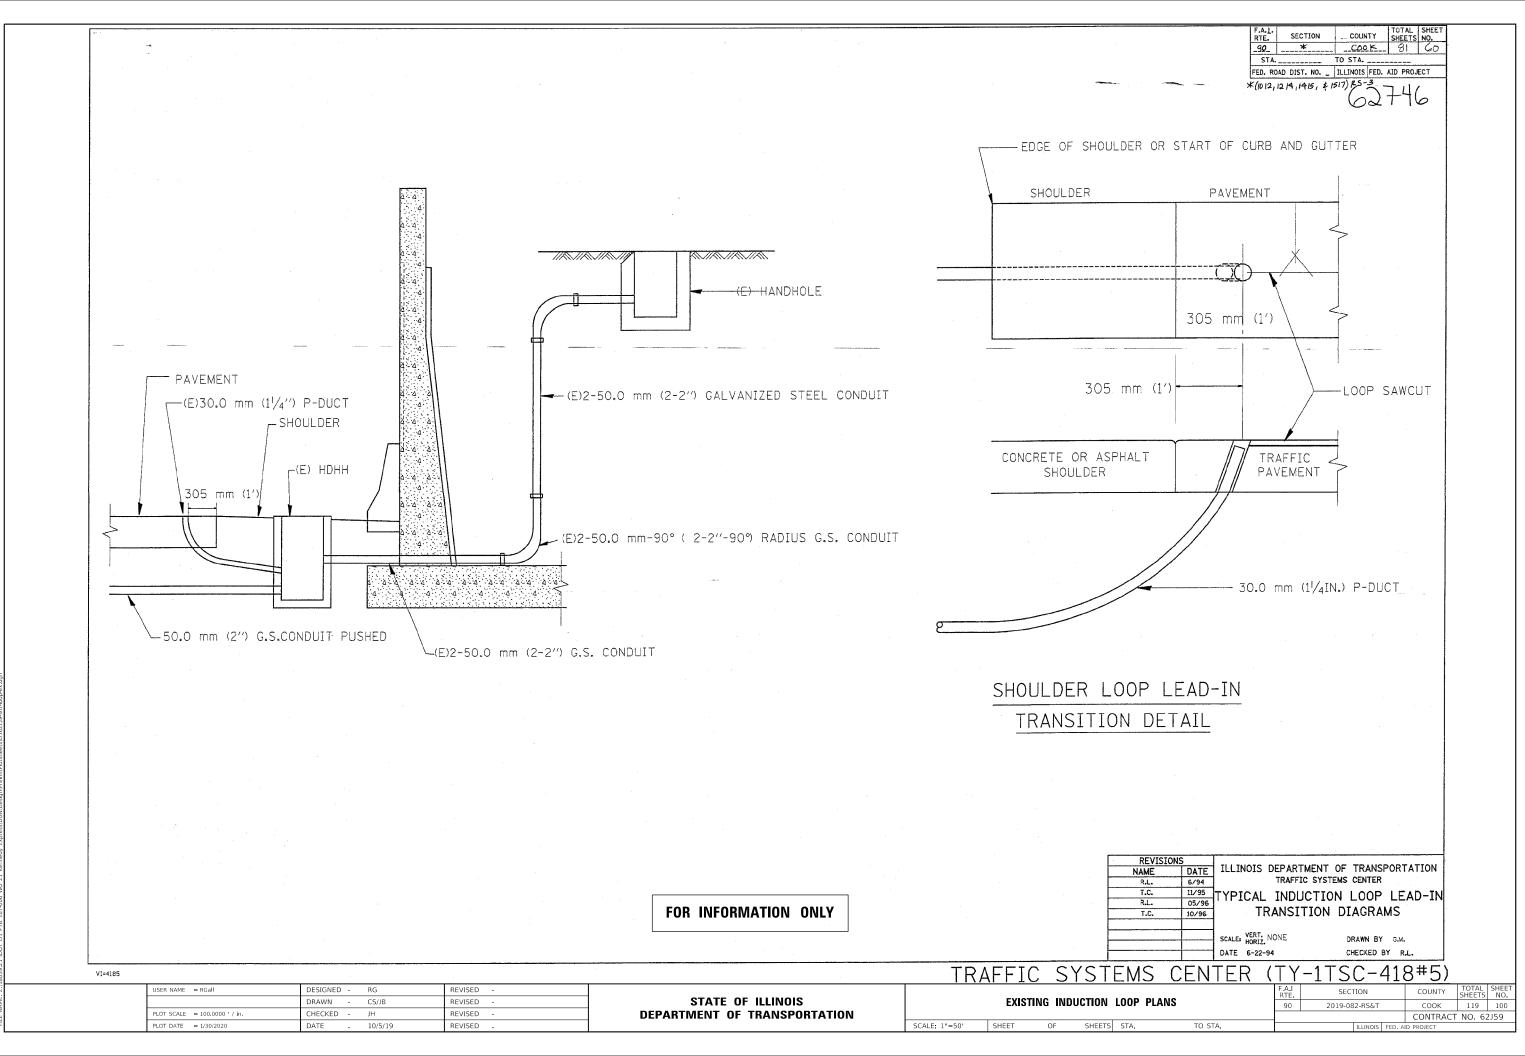

MODEL: Default

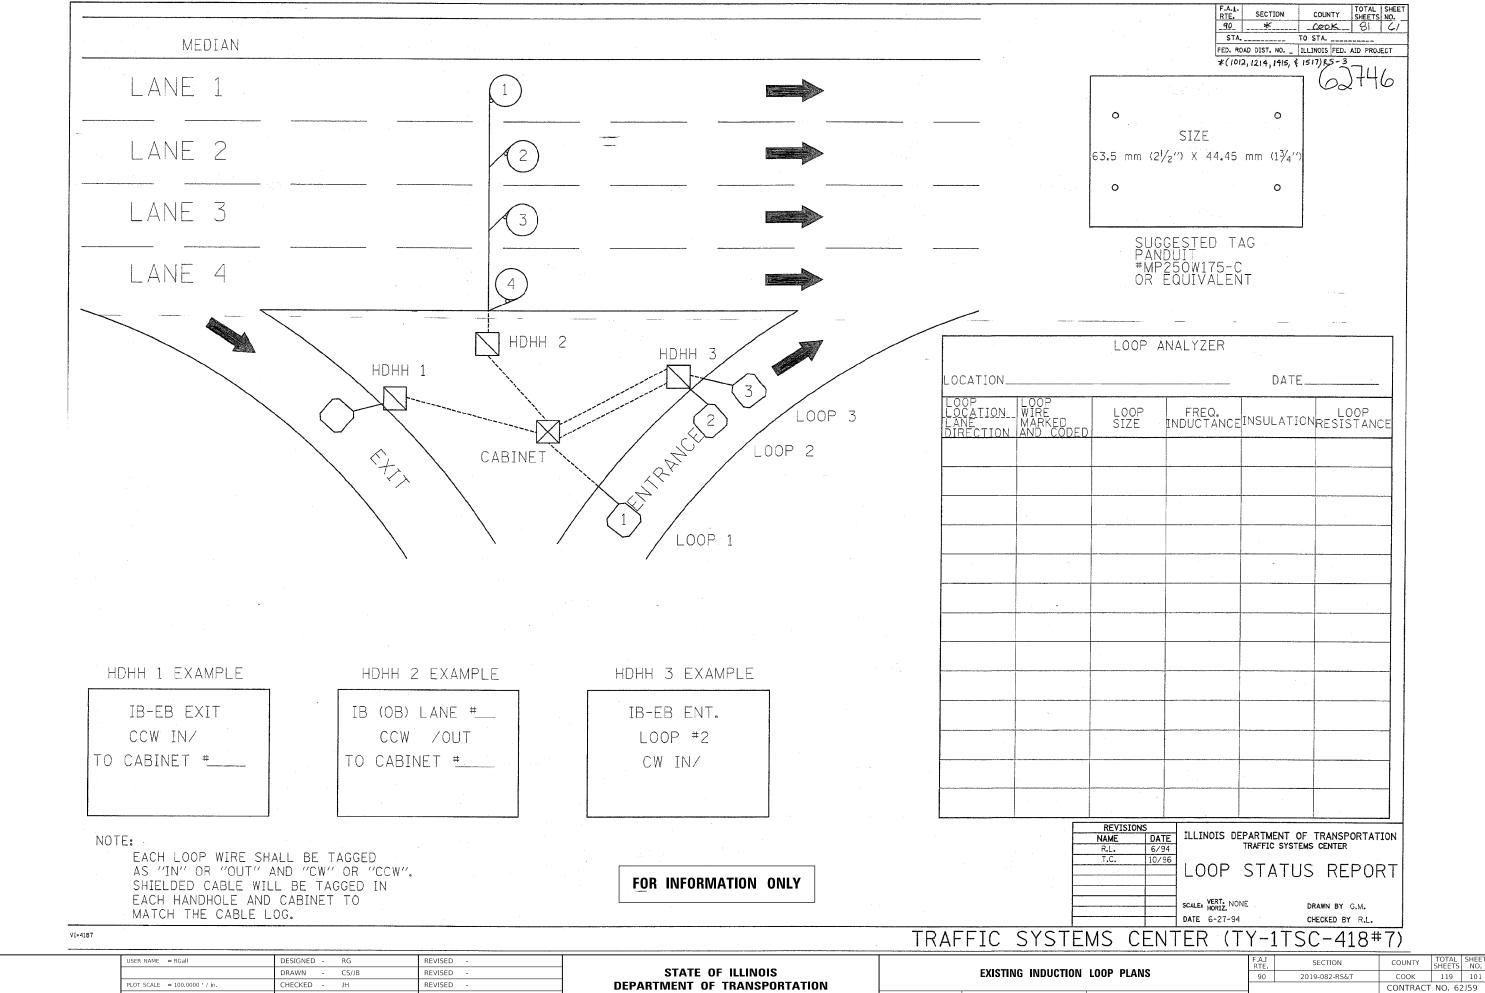



PLOT DATE = 1/30/2020


REVISED


**DEPARTMENT OF TRANSPORTATION** 

SCALE: 1"=50' SHEET OF SHEETS STA. TO STA.

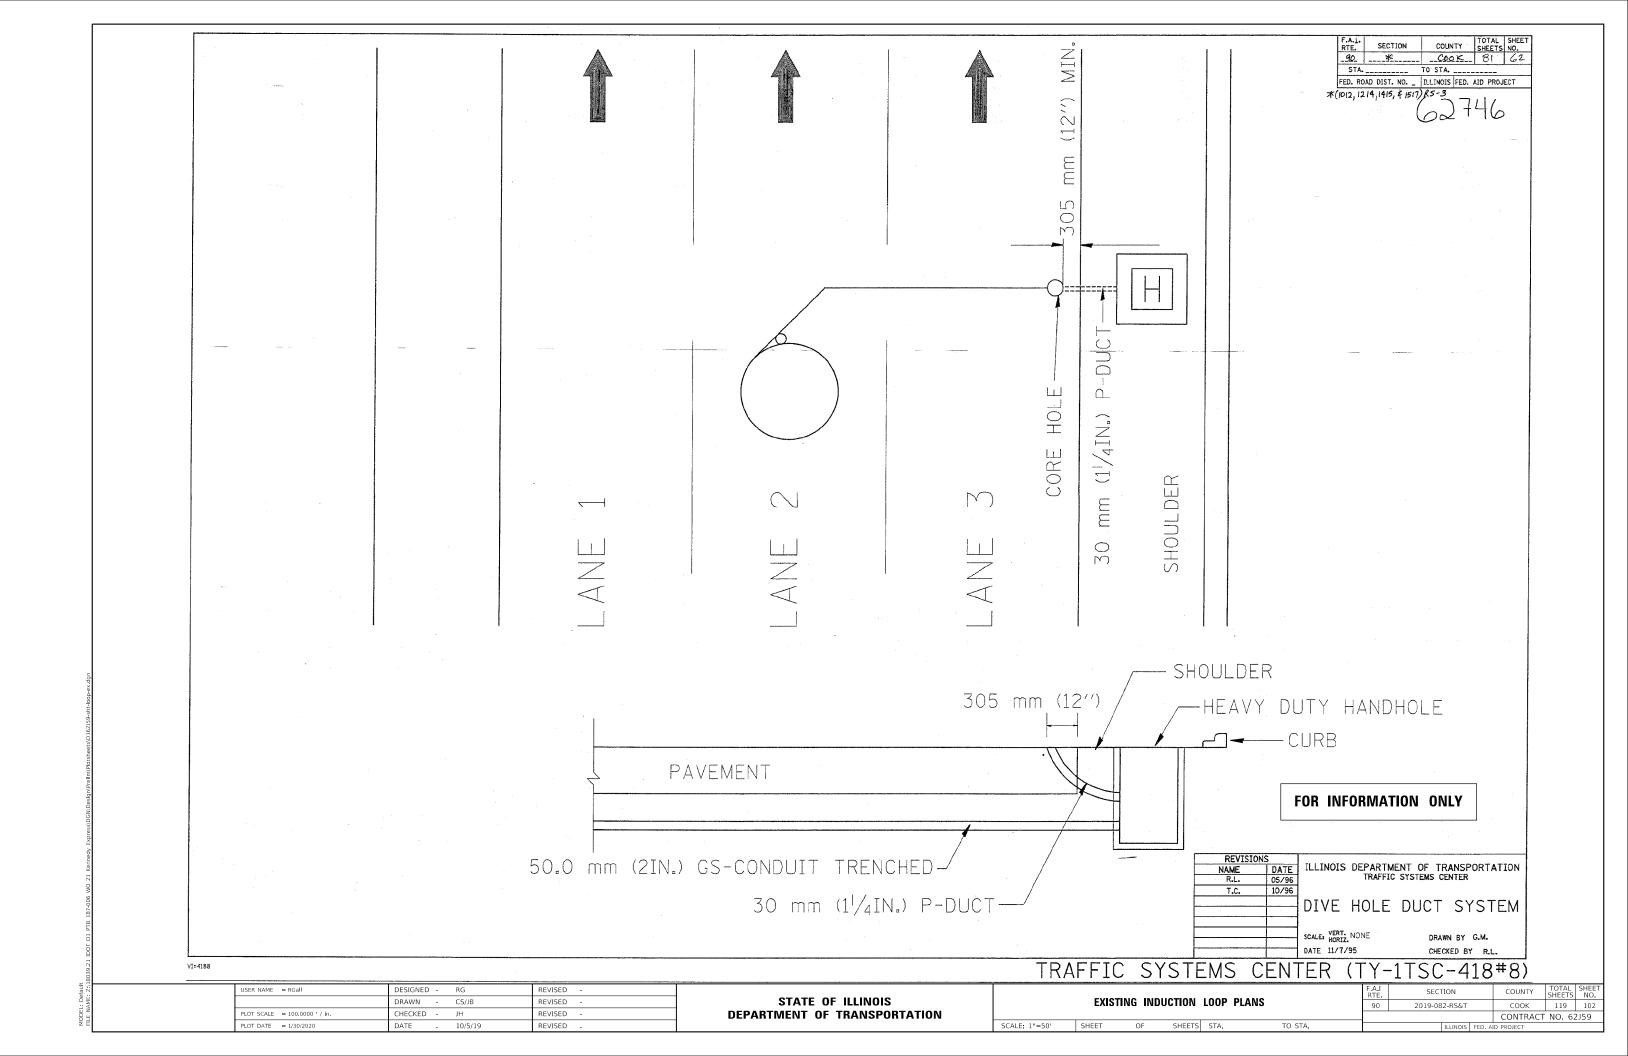

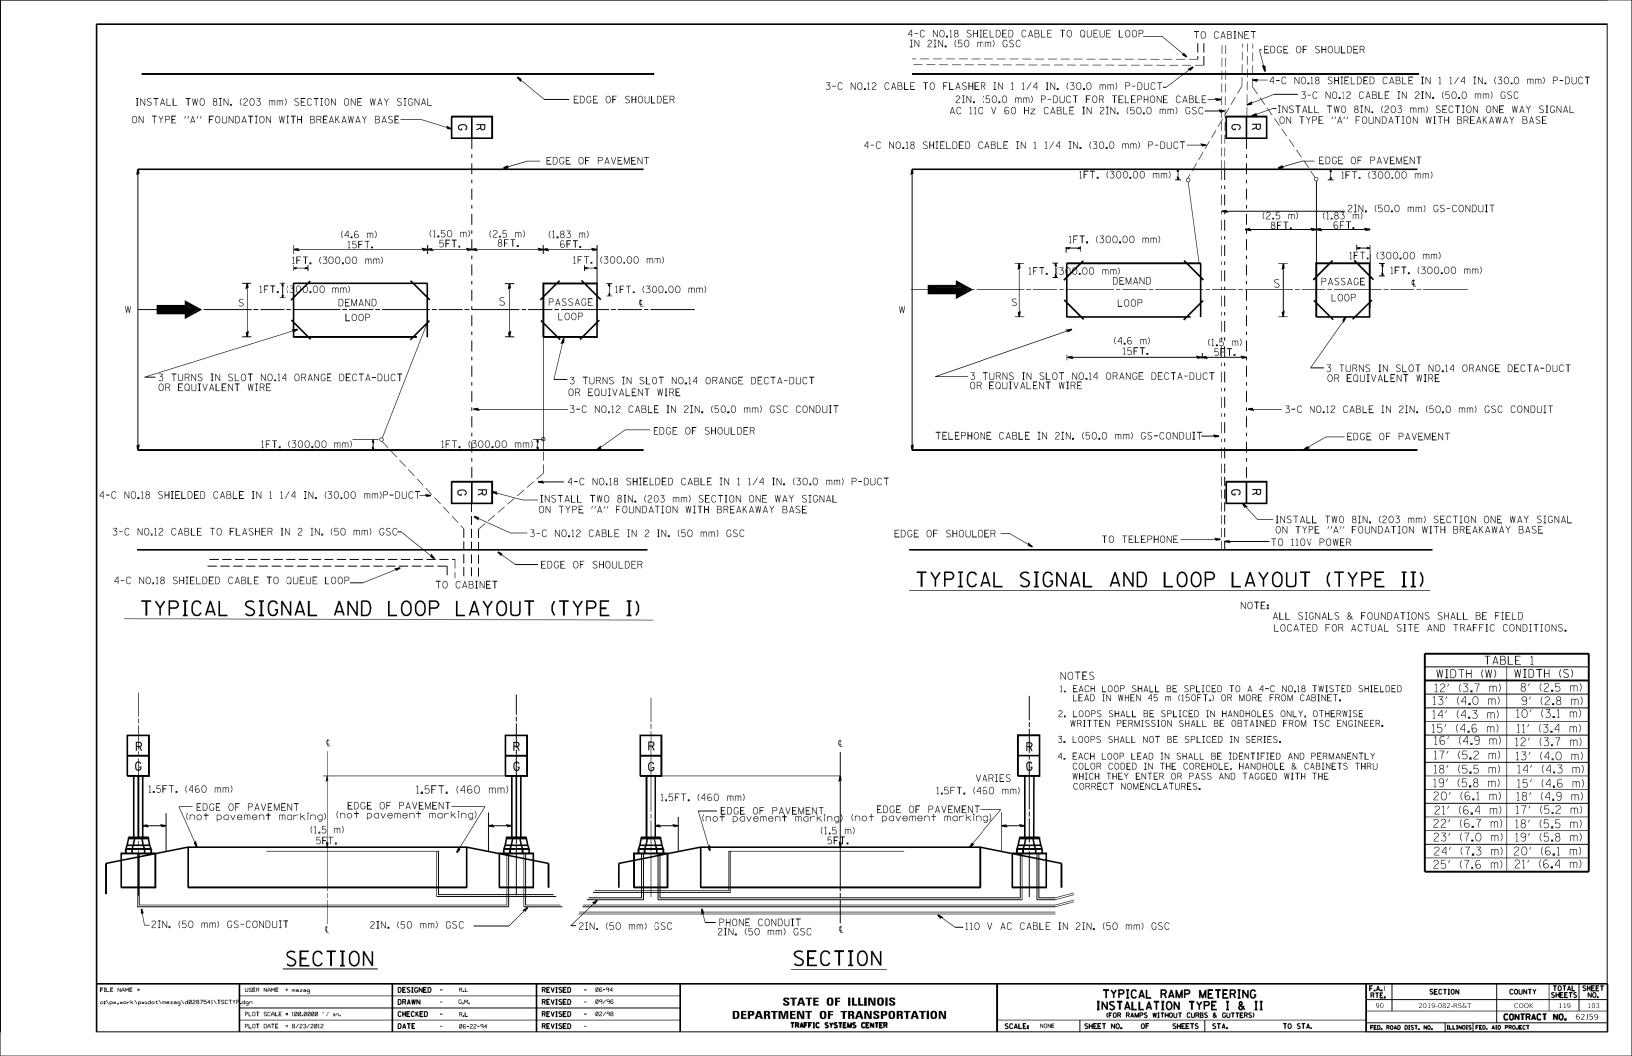

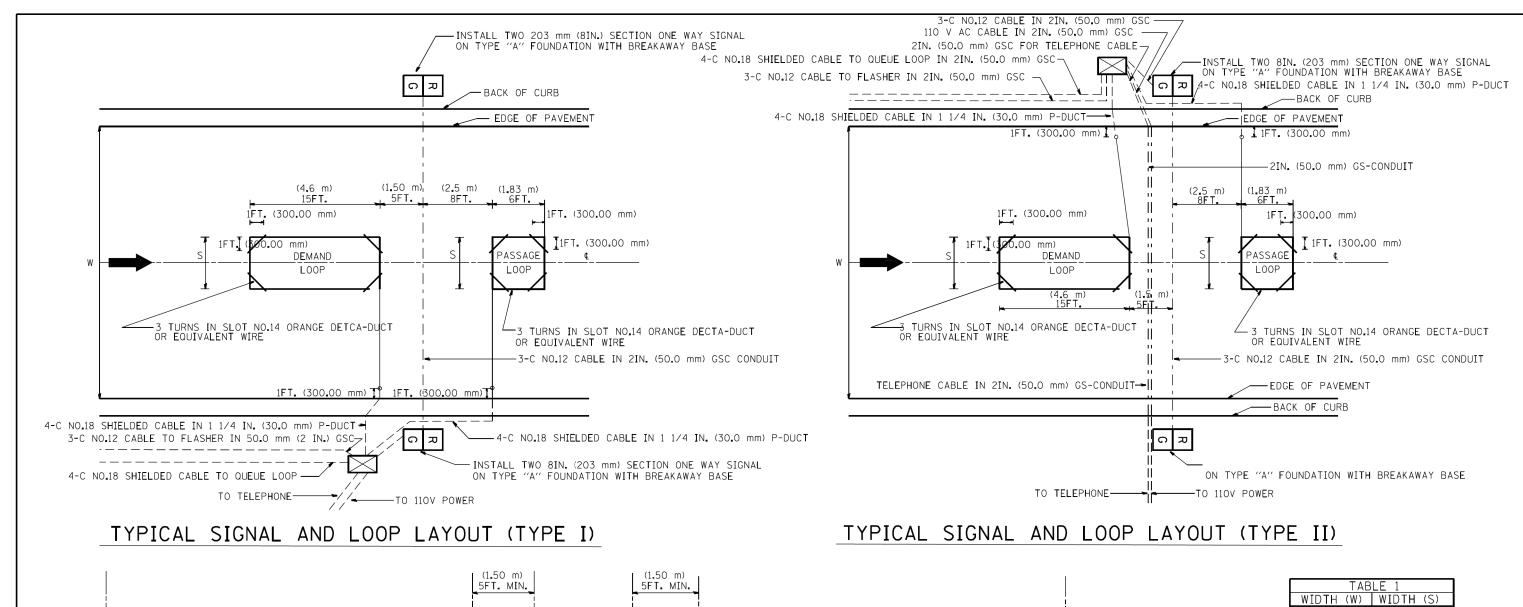

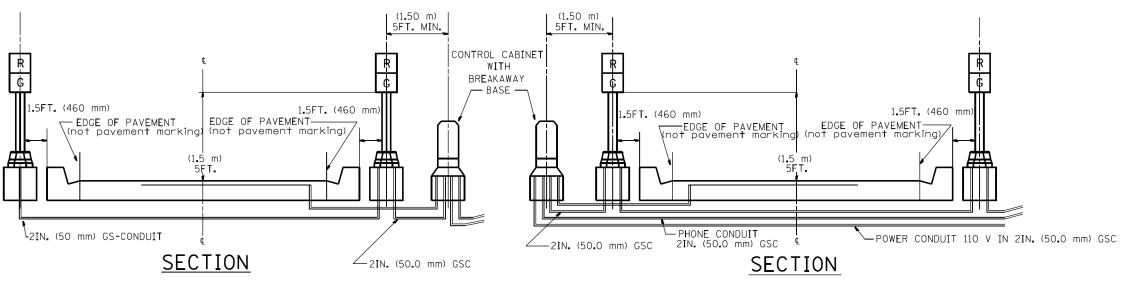


TΔ	RIF 1
WIDTH (W)	TWIDTH (S)
12′ (3 <b>.</b> 7 m)	8' (2.5 m)
13′ (4 <b>.</b> 0 m)	9′ (2 <b>.</b> 8 m)
14' (4.3 m)	10′ (3 <b>.</b> 1 m)
15' (4 <b>.</b> 6 m)	11′ (3.4 m)
16′ (4 <b>.</b> 9 m)	12′ (3.7 m)
17′ (5.2 m)	13′ (4 <b>.</b> 0 m)
18′ (5 <b>.</b> 5 m)	14′ (4.3 m)
19′ (5 <b>.</b> 8 m)	15′ (4 <b>.</b> 6 m)
20′ (6 <b>.</b> 1 m)	18′ (4 <b>.</b> 9 m)
21′ (6.4 m)	17′ (5.2 m)
22′ (6 <b>.</b> 7 m	) 18′ (5 <b>.</b> 5 m)
23′ (7 <b>.</b> 0 m	) 19′ (5 <b>.</b> 8 m)
24′ (7.3 m	) 20′ (6 <b>.</b> 1 m)
25′ (7 <b>.</b> 6 m	) 21′ (6.4 m)


- 1. EACH LOOP SHALL BE SPLICED TO A 4-C NO.18 TWISTED SHIELDED LEAD IN WHEN 150FT. (45 m) OR MORE FROM CABINET.
- 2. LOOPS SHALL BE SPLICED IN HANDHOLES ONLY, OTHERWISE WRITTEN PERMISSION SHALL BE OBTAINED FROM TSC ENGINEER.
- 3. LOOPS SHALL NOT BE SPLICED IN SERIES.
- 4. EACH LOOP LEAD IN SHALL BE IDENTIFIED AND PERMANENTLY COLOR CODED IN THE COREHOLE, HANDHOLE & CABINETS THRU WHICH THEY ENTER OR PASS AND TAGGED WITH THE CORRECT NOMENCLATURES.

FILE NAME =	USER NAME = mezag	DESIGNED	-	R.L.	REVISED	-	06/94	
c:\pw_work\pwidot\mezag\d0287541\TSCTYF	.dgn	DRAWN	-	G.M.	REVISED	-	09/96	
	PLOT SCALE = 100.00000 '/ in.	CHECKED	-	R.L.	REVISED	-	02/98	
	PLOT DATE = 8/23/2012	DATE	-		REVISED	-		

STATE OF ILLINOIS
DEPARTMENT OF TRANSPORTATION
TRAFFIC SYSTEMS CENTER


TYPICAL RAMP METERING	F.A.I RTE.	SECTION	COUNTY	TOTAL SHEETS	SHEET NO.
INSTALLATION TYPE I & II (WITH CURB & GUTTER)	90	2019-082-RS&T	COOK CONTRACT	119 <b>NO.</b> 6	104 52J59
SCALE: NONE SHEET NO. OF SHEETS STA. TO STA.	FED. ROAD DIST. NO.   ILLINOIS FED. AID PROJECT				

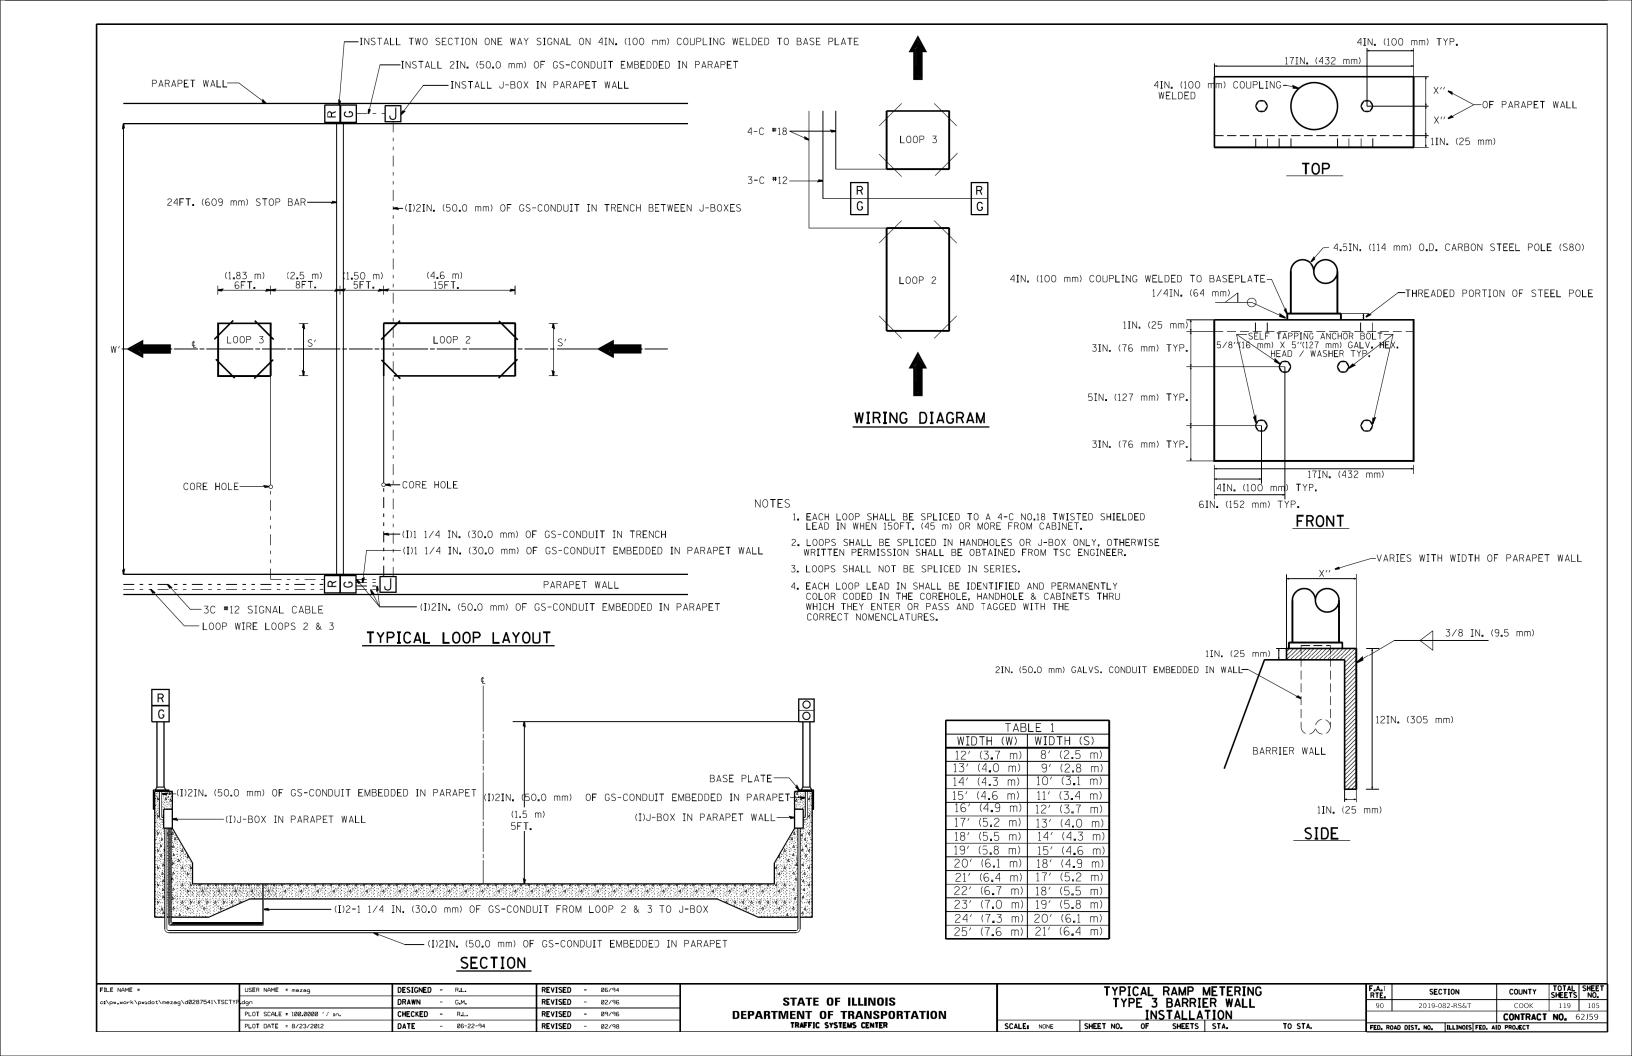

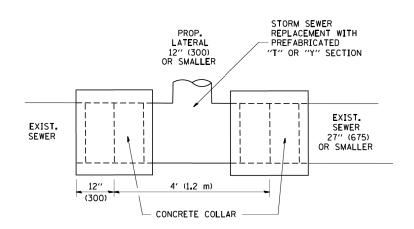


#### DETAIL "A"

LATERAL CONNECTION TO EXISTING SEWER
OF 27" (675) OR SMALLER

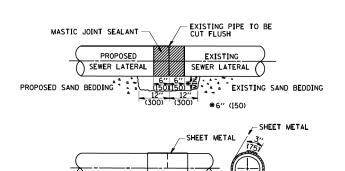

9" 9" (225)

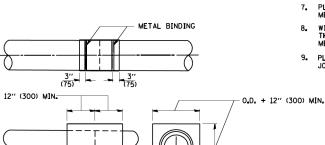


-CLASS SI CONCRETE-

/∠STORM SEWER -MASTIC JOINT SEALANT

<u>DETAIL "B"</u> CLASS SI CONCRETE COLLAR

#### CONSTRUCTION SEQUENCE

- CUI THE EXISTING END OF THE PIPE SO AS TO PRESENT A FLUSH BUTT JOINT, BRUSH AND CLEAN ALL PIPES.
- 2. APPLY THE MASTIC JOINT SEALANT TO THE FIRST 6" (150) OF EACH PIPE.
- 3. BUTT THE PIPES TOGETHER LEAVING A MINIMUM OF 12' × 6' (300 × 150) DEEP EXCAVATION UNDER AND AROUND EACH PIPE END.
- 4. CUT A PIECE OF SHEET METAL GAGE NO. 19 1.1 (0.0418) 18" (450) WIDE BY THE OUTSIDE CIRCUMFERANCE OF THE PIPE PLUS 3" (75) LONG.
- WRAP THE SHEET METAL AROUND THE PIPES, 9" (225) ON EACH SIDE OF THE JOINT, STARTING AT THE TOP OF THE PIPE.
- 6. LAP THE SHEET METAL AT LEAST 3" (75) AT THE TOP OF THE PIPE AND PLACE THE MASTIC JOINT SEALANT BETWEEN THE LAP.
- 7. PLACE TWO METAL BANDS AROUND THE SHEET METAL AND TIGHTEN.
- 8. WIPE OFF ANY EXCESS MASTIC JOINT SEALANT THAT OOZES OUT FROM BETWEEN THE SHEET METAL AND THE PIPES.
- 9. PLACE CLASS SI CONCRETE AROUND THE JOINT.

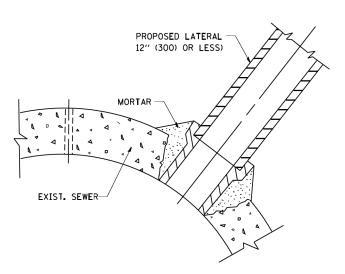

#### DETAIL "C"

PROPOSED LATERAL
CONNECTION TO EXISTING SEWER
OF 30" (750) OR LARGER

#### **NOTES**

#### MATERIAL

MATERIAL USED FOR THE TEE OR WYE SECTION SHALL BE COMPATIBLE WITH THE EXISTING STORM SEWER OR THE PROPOSED STORM SEWER,

#### CONSTRUCTION METHODS

- THIS WORK SHALL BE CONSTRUCTED IN CONFORMANCE WITH THE APPLICABLE PORTIONS OF SECTION 550 OF THE STANDARD SPECIFICATIONS.
- II. CONNECTION TO AN EXISTING STORM SEWER SHALL BE BY EITHER OF THE FOLLOWING METHODS:

  A) PROPOSED STORM SEWER CONNECTION TO EXISTING SEWER OF 27" (675) OR SMALLER SEE DETAIL "A" AND "B".
  - B) PROPOSED STORM SEWER CONNECTION TO EXISTING SEWER OF 30" (750) OR LARGER SEE DETAIL "C".

IF THE EXISTING SEWER PIPE IS CRACKED, BROKEN OR OTHERWISE DAMAGED BY THE CONTRACTOR IN MAKING THE CIRCULAR OPENING, THE CONTRACTOR SHALL REPLACE THAT SECTION OF PIPE WITH PIPE EQUAL AND SIMILAR IN ALL RESPECTS TO THE PIPE IN THE EXISTING SEWER, IN A CAREFUL WORKMANLIKE MANNER, WITHOUT EXTRA COMPENSATION.

#### GENERAL

CARE MUST BE TAKEN TO PREVENT DEBRIS FROM ENTERING THE SEWER. ALL DEBRIS WHICH ENTERS THE SEWER MUST BE REMOVED. THE SEWER MUST BE LEFT CLEAN AND UNOBSTRUCTED UPON COMPLETION OF THE CONTRACT.

CARE MUST BE TAKEN TO PREVENT ANY PART OF THE NEW PIPE CONNECTION FROM PROJECTING INTO THE EXISTING SEWER.

#### BASIS OF PAYMENT

TEE OR WYE CONNECTIONS SHALL BE PAID FOR AT THE CONTRACT UNIT PRICE EACH FOR STORM SEWER TEE OR WYE OF THE TYPE AND SIZE SPECIFIED IN THE PLANS, THIS PRICE SHALL INCLUDE ALL EXCAVATION OF THE TRENCH, REMOVAL OF THE EXISTING STORM SEWER, FURNISHING AND INSTALLING THE SPECIFIED TEE OR WYE SECTION, FURNISHING AND INSTALLING THE REQUIRED CONCRETE COLLAR, AND ALL OTHER MATERIAL NECESSARY TO COMPLETE THIS WORK AS SHOWN AND SPECIFIED.


REMOVAL AND REINSTALLATION OF EXISTING STORM SEWER ADJACENT TO THE PROPOSED TEE OR WYE SECTION, FOR THE PURPOSE OF FACILITATING THE INSTALLATION OF THE TEE OR WYE SECTION, WILL NOT BE PAID FOR SEPARATELY BUT SHALL BE INCLUDED IN THE UNIT PRICE BID FOR THE WORK.


TRENCH BACKFILL, EXCAVATION IN ROCK AND REMOVAL AND REPLACEMENT OF UNSUITABLE MATERIAL BELOW PLAN BEDDING GRADE WILL BE PAID FOR SEPARATELY.

CONCRETE COLLAR FOR CONNECTING A PROPOSED STORM SEWER TO AN EXISTING STORM SEWER WILL NOT BE PAID PAID FOR SEPARATELY BUT SHALL BE INCLUDED IN THE COST OF THE PROPOSED STORM SEWER.

ALL DIMENSIONS ARE IN INCHES (MILLIMETERS) UNLESS OTHERWISE SHOWN.

FILE NAME =	USER NAME = gaglianobt	DESIGNED - M. DE YONG	REVISED - M. DE YONG 05-08-92			DETAIL OF STORM SEWER		F.A.I.	SECTION	COUNTY	TOTAL SHEETS	SHEET NO.
W:\diststd\22x34\bd07.dgn		DRAWN -	REVISED - R. SHAH 09-09-94	STATE OF ILLINOIS			_	90	2019-082-RS&T	соок	119	106
	PLOT SCALE = 50.000 ' / IN.	CHECKED -	REVISED - R. SHAH 10-25-94	DEPARTMENT OF TRANSPORTATION		CONNECTION TO EXISTING SEWEI	K		BD500-01 (BD-7)	CONTRACT	T NO. 62	J59
	PLOT DATE = 1/4/2008	DATE - 07-25-90	REVISED - R. SHAH 06-12-96		SCALE: NONE	SHEET NO. 1 OF 1 SHEETS STA.	TO STA.	FED. RO	AD DIST. NO. 1 ILLINOIS FED.	AID PROJECT		

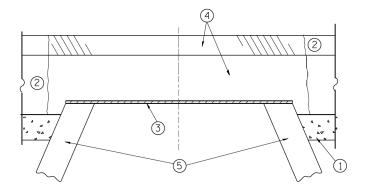

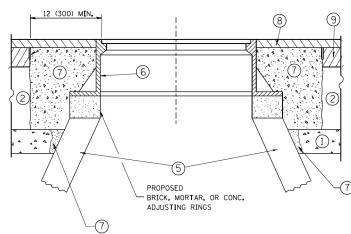

EXISTING BROKEN FRAMES AND LIDS SHALL BE REMOVED AND DISPOSED OF BY THE CONTRACTOR AND SHALL BE REPLACED AS DIRECTED BY THE ENGINEER. REPLACEMENT FRAMES AND LIDS WILL BE PAID FOR IN ACCORDANCE WITH ARTICLE 109,04 OF THE STANDARD SPECIFICATIONS UNLESS A SEPARATE PAY ITEM HAS BEEN PROVIDED.

IF THE EXISTING LIDS ARE OPEN, THE FRAME WILL BE ADJUSTED TO THE ELEVATION OF THE MILLED PAVEMENT SURFACE PRIOR TO THE MILLING OPERATION. THE FRAME WILL NOT BE REMOVED AND COVERED BY THE METAL PLATE.

CITY OF CHICAGO CASTINGS ARE THE PROPERTY OF THE CITY AND THE CONTRACTOR SHALL NOTIFY THE CITY FOR REMOVAL AND DISPOSITION OF THE CASTINGS.

THE METAL PLATE USED TO COVER THE STRUCTURE SHALL REMAIN THE PROPERTY OF THE CONTRACTOR.

WHEN STRUCTURES ARE TO BE ADJUSTED OR RECONSTRUCTED, THE LOWERING AND RAISING OF THE FRAMES AND LIDS WILL NOT BE PAID FOR SEPARATELY BUT WILL BE INCLUDED IN THE COST OF THE CORRESPONDING PAY ITEM.

SCALE: NONE

#### CONSTRUCTION PROCEDURES

#### STAGE 1 (BEFORE PAVEMENT MILLING)

- A) REMOVE A MINIMUM OF 12 (300) OF THE PAVEMENT FROM
- AROUND THE STRUCTURE.

  B) REMOVE THE EXISTING FRAME AND LID FROM THE STRUCTURE.
- C) COVER THE STRUCTURE OPENING WITH A 36 (900) DIAMETER METAL PLATE.

  D) BACKFILL WITH CRUSHED STONE AND A MINIMUM  $1\frac{1}{2}$  (40)
- THICK HMA SURFACE MIX APPROVED BY THE ENGINEER.

#### STAGE 2 (AFTER PAVEMENT MILLING)

- A) REMOVE THE HMA SURFACE MIX AND CRUSHED STONE.
- B) INSTALL THE FRAME AND LID; ADJUST THE FRAME TO ITS FINAL SURFACE ELEVATION.
- C) THE SURROUNDING SPACE SHALL BE FILLED WITH CLASS PP-1\* CONCRETE TO THE ELEVATION OF THE SURFACE OF THE EXISTING BASE COURSE OR THE BINDER COURSE.
- \* UNLESS OTHERWISE SPECIFIED IN THE PLANS.

THE PROCEDURE EXPLAINED ABOVE SHALL CONFORM TO THE APPLICABLE PORTIONS OF SECTIONS 353, 406, 602. AND 603 OF THE STANDARD SPECIFICATIONS EXCEPT THAT "THE CONTRACTOR SHALL ADJUST THE STRUCTURES TO THE FINISHED PAVEMENT ELEVATION NO MORE THAN 5 CALENDAR DAYS PRIOR TO PLACEMENT OF THE FINAL LIFT OF SURFACE UNLESS APPROVED BY THE

#### LEGEND

- 1 SUB-BASE GRANULAR MATERIAL
- (6) FRAME AND LID (SEE NOTES)
- 2 EXISTING PAVEMENT
- (7) CLASS PP-1\* CONCRETE
- 3 36 (900) DIAMETER METAL PLATE
- PROPOSED CRUSHED STONE AND HMA SURFACE MIX
- (8) PROPOSED HMA SURFACE COURSE
- (5) EXISTING STRUCTURE
- 9 PROPOSED HMA BINDER COURSE

#### LOCATION OF STRUCTURES:

THE CONTRACTOR WILL BE REQUIRED TO KEEP A RECORD OF THE LOCATIONS OF THE BURIED STRUCTURES ACCORDING TO THE STATION AND DISTANCE LEFT OR RIGHT OF THE CENTERLINE OF PAVEMENT. UPON COMPLETION OF THE WORK, THE CONTRACTOR WILL DELIVER THE RECORD TO THE ENGINEER.

#### BASIS OF PAYMENT:

REMOVING FRAMES AND LIDS ON DRAINAGE AND UTILITY STRUCTURES IN THE PAVEMENT PRIOR TO MILLING, AND ADJUSTING TO FINAL GRADE PRIOR TO PLACING THE SURFACE COURSE, WILL BE PAID FOR AT THE CONTRACT UNIT PRICE EACH FOR "FRAMES AND LIDS TO BE ADJUSTED

THIS WORK WILL NOT BE PAID FOR WHEN DRAINAGE AND UTILITY STRUCTURES ARE SPECIFIED FOR PAYMENT AS STRUCTURE RECONSTRUCTION.

NEW FRAMES AND LIDS, WHEN SPECIFIED, WILL BE PAID FOR SEPARATELY.

## DETAILS FOR FRAMES AND LIDS ADJUSTMENT WITH MILLING


ALL DIMENSIONS ARE IN INCHES (MILLIMETERS) UNLESS OTHERWISE SHOWN

119

DESIGNED - R. SHAH FILE NAME = USER NAME = bauerdl REVISED - R. WIEDEMAN 05-14-04 DRAWN REVISED - R. BORO 01-01-07 REVISED - R. BORO 03-09-11 PLOT SCALE = 1968.5000 '/ m CHECKED REVISED - R. BORO 12-06-11 PLOT DATE = 12/6/2011 DATE 10-25-94

STATE OF ILLINOIS **DEPARTMENT OF TRANSPORTATION** 

COUNTY **DETAILS FOR** 2019-082-RS&T COOK FRAMES AND LIDS ADJUSTMENT WITH MILLING BD600-03 (BD-8) CONTRACT NO. 62J59 SHEET NO. 1 OF 1 SHEETS STA. ID PROJECT

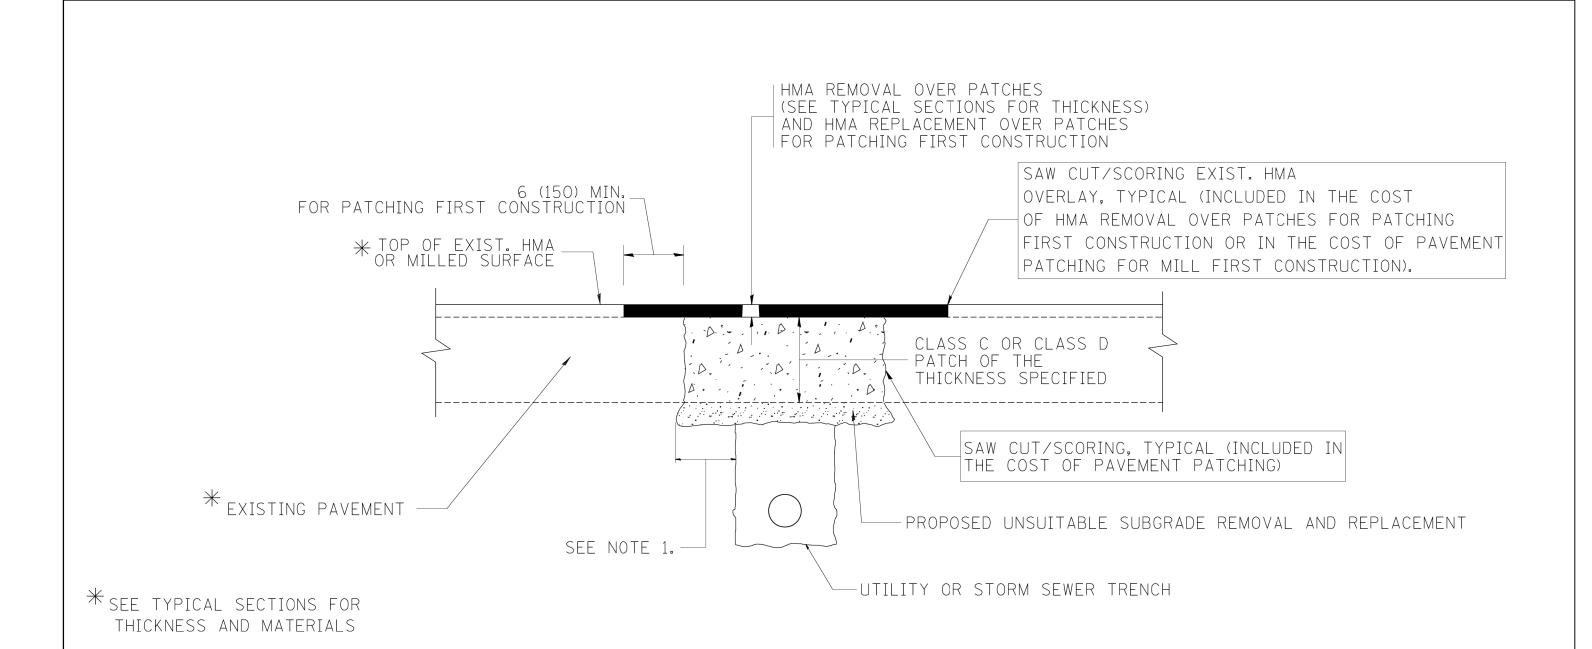

## NOTES:

- 1. THE WIDTH OF THE FULL DEPTH PATCH OVER A TRENCH SHALL BE 12 (300) WIDER ON EACH SIDE OF THE TRENCH.
- 2. FOR METHOD OF MEASUREMENT AND BASIS OF PAYMENT, SEE RECURRING SPECIAL PROVISION "PATCHING WITH HOT-MIX ASPHALT OVERLAY REMOVAL".

## SEQUENCE OF CONSTRUCTION (PATCHING FIRST)


- 1. REMOVE THE EXISTING HMA MATERIAL OVER THE AREA TO BE PATCHED.
- 2. REMOVE AND REPLACE WITH CLASS C OR D PATCH.
- 3. REPLACE HMA MATERIAL OVER THE AREA TO BE PATCHED.

#### SEQUENCE OF CONSTRUCTION (MILLING FIRST)

- 1. MILL HMA FIRST IF THERE IS AT LEAST 41/2 INCHES OR MORE OF HMA MATERIAL ON TOP OF THE EXISTING PAVEMENT OR IF THE PAVEMENT IS FULL DEPTH HMA. A MINIMUM OF 2 INCHES OF HMA MATERIAL SHALL BE IN PLACE AFTER MILLING.
- 2. REMOVE AND REPLACE WITH FULL DEPTH CLASS D PATCHES TO TOP OF MILLED SURFACE.

ALL DIMENSIONS ARE IN INCHES (MILLIMETERS) UNLESS OTHERWISE SHOWN.

FILE NAME =	USER NAME = bauerdl	DESIGNED - R. SHAH	REVISED - A. ABBAS 04-27-98			PAVEMENT PATCHING FOR		RTF.	SECTION	COUNTY	SHEETS NO.
c:\projects\diststd22x34\bd22.dgn		DRAWN -	REVISED - R. BORO 01-01-07	STATE OF ILLINOIS				90	2019-082-RS&T	COOK	119 108
	PLOT SCALE = 50.000 ' / IN.	CHECKED -	REVISED - R. BORO 09-04-07	DEPARTMENT OF TRANSPORTATION		HMA SURFACED PAVEMENT		BD	1400-04 (BD-22)	CONTRACT	NO. 62J59
	PLOT DATE = 10/27/2008	DATE - 10-25-94	REVISED - K. ENG 10-27-08		SCALE: NONE	SHEET NO. 1 OF 1 SHEETS STA.	TO STA	FED. ROAD	DIST. NO. 1 ILLINOIS FED. A	AID PROJECT	

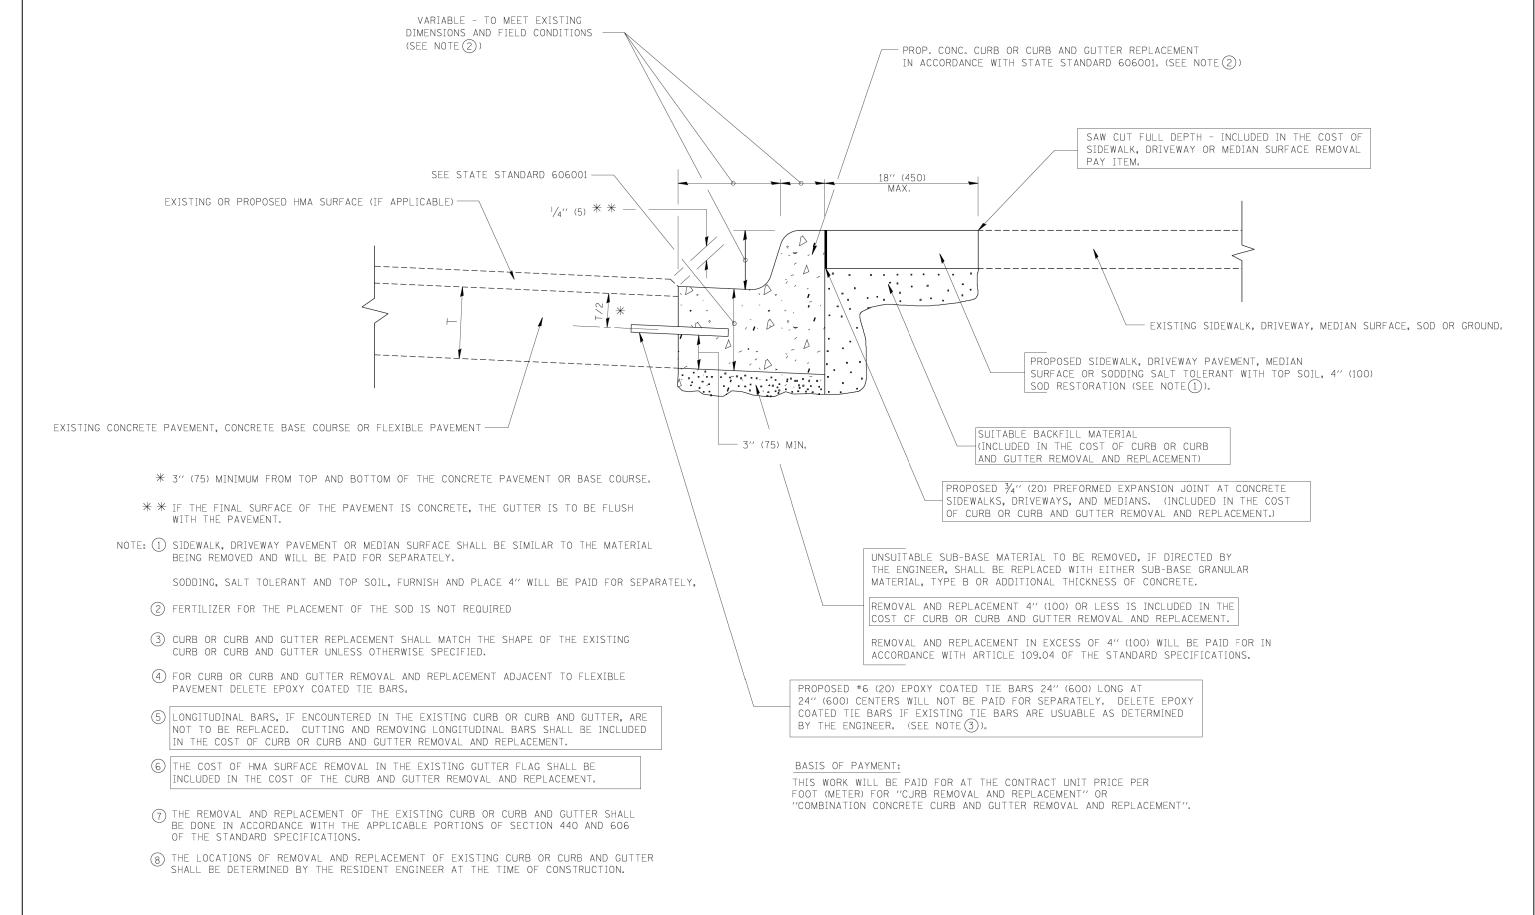

## CURB OR CURB AND GUTTER REMOVAL AND REPLACEMENT

ALL DIMENSIONS ARE IN INCHES (MILLIMETERS) UNLESS OTHERWISE SHOWN.

COOK

CONTRACT NO. 62J59

119 109

2019-082-RS&T

BD600-06 (BD-24)

TO STA.


	FILE NAME =	USER NAME = drivakosgn	DESIGNED - A. HOUSEH	KEA12ED - K' 2HWH IO-02-30			CURB OR CURB AND	CUTTER
	c:\pw_work\pwidot\drivakosgn\d0108315\bd	24.dgn	DRAWN -	REVISED - A. ABBAS 03-21-97	STATE OF ILLINOIS			
		PLOT SCALE = 50.000 '/ IN.	CHECKED -	REVISED - M. GOMEZ 01-22-01	DEPARTMENT OF TRANSPORTATION		REMOVAL AND REPLA	ACEMENT
		PLOT DATE = 12/15/2009	DATE - 03-11-94	REVISED - R. BORO 12-15-09		SCALE: NONE	SHEET NO. 1 OF 1 SHEETS	STA.
-								

REVISED - R. SHAH 10-03-96


USER NAME = drivakosan

FILE NAME =

DESIGNED - A. HOUSEH

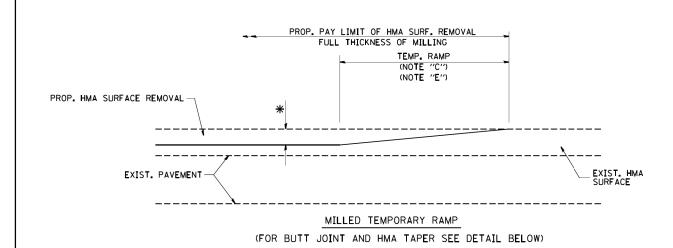


#### OPTION 1

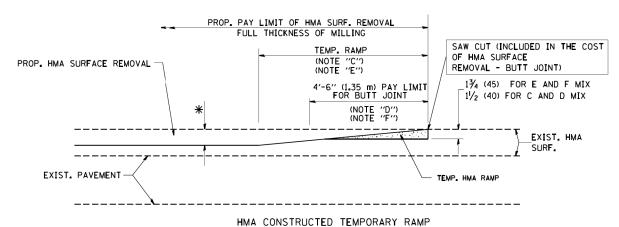

(FOR BUTT JOINT AND HMA TAPER SEE DETAIL BELOW)

## OPTION 2


### TYPICAL TEMPORARY RAMP

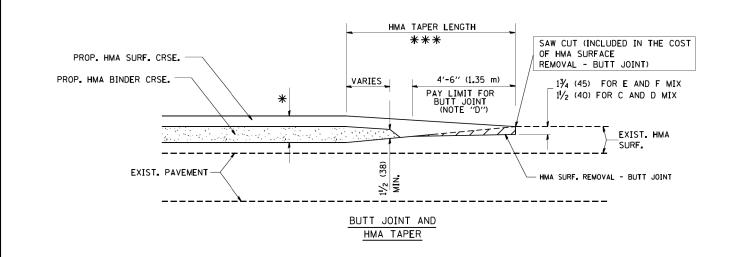


# TYPICAL BUTT JOINT AND HMA TAPER FOR MILLING AND RESURFACING

FILE NAME = DESIGNED - M. DE YONG R. SHAH 10-25-94 USER NAME = gaglianobt REVISED W:\diststd\22x34\bd32.dgn DRAWN REVISED A. ABBAS 03-21-97 CHECKED REVISED M. GOMEZ 04-06-01 LOT SCALE = 50.0000 '/ IN. DATE 06-13-90 REVISED R. BORO 01-01-07

STATE OF ILLINOIS

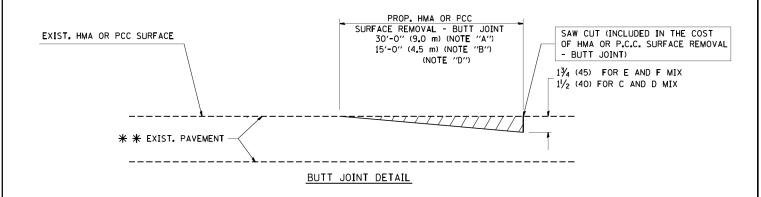

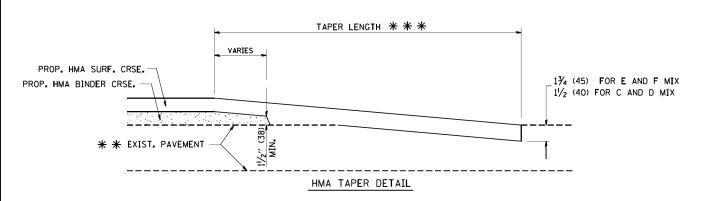

# TYPICAL BUTT JOINT AND HMA TAPER FOR RESURFACING ONLY

\* \* PC CONCRETE, HMA OR HMA RESURFACED PAVEMENT.

#### NOTES

A: MAINLINE ROADWAYS AND MAJOR SIDE ROADS.

B: MINOR SIDE ROADS.

C: THE TEMP. RAMP SHALL BE CONSTRUCTED IMMEDIATELY UPON REMOVAL OF THE EXISTING HMA SURFACE.

D: THE BUTT JOINT SHALL BE CONSTRUCTED IMMEDIATELY PRIOR TO PLACING THE PROPOSED HMA COURSES.

E: TAPER THE TEMP. RAMP AT A RATE OF 3'-0" (900 mm) PER 1 INCH (25 mm) OF MILLING THICKNESS.

F: INSTALLATION AND REMOVAL OF THE 4'-6" (1.35 m) TEMP. RAMP IS INCLUDED IN COST OF HMA SURFACE REMOVAL - BUTT JOINT

G: SEE ARTICLE 406.08 AND 406.14 OF THE STANDARD SPECIFICATIONS FOR "HMA AND/OR PCC SURFACE REMOVAL, BUTT JOINT".

\* SEE TYPICAL SECTIONS FOR MILLING THICKNESS.

\*\* \* 20'-0" (6.1 m) PER 1 (25) RESURFACING (NOTE "A") 10'-0" (3.0 m) PER 1 (25) RESURFACING (NOTE "B")


#### BASIS OF PAYMENT:

**DEPARTMENT OF TRANSPORTATION** 

THE BUTT JOINT WILL BE PAID FOR AT THE CONTRACT UNIT PRICE PER SQUARE YARD (SQUARE METER) FOR "HOT-MIX ASPHALT SURFACE REMOVAL - BUTT JOINT" OR FOR "PORTLAND CEMENT CONCRETE SURFACE REMOVAL- BUTT JOINT".

SCALE: NONE


ALL DIMENSIONS ARE IN INCHES (MILLIMETERS) UNLESS OTHERWISE SHOWN.

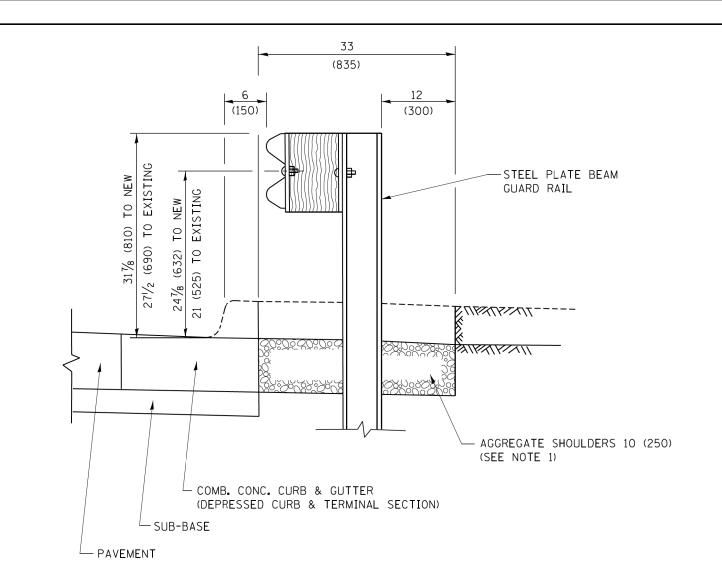

## SECTION A-A

- NOTES: 1. THE AGGREGATE SHOULDER, 10 (250) OR HMA SHOULDER, 6 (150) (IF REQUIRED) SHALL EXTEND UNDER THE TRAFFIC BARRIER TERMINAL.
  - 2. "EXISTING" GUARDRAIL REFERS TO CONNECTING TERMINAL SECTION TO GUARD RAILING PRIOR TO THE MIDWEST GUARDRAIL SYSTEM.
  - 3. THE CONTRACTOR SHALL VERIFY THE TYPE/HEIGHT OF GUARDRAIL IN-PLACE BEFORE ORDERING THE NEW TERMINAL SECTION. COST INCLUDED WITH THE COST OF THE TERMINAL. THE TERMINAL SECTION HEIGHT TO BE PLACED MUST MATCH THE HEIGHT OF THE IN-PLACE GUARDRAIL.

DETAILS FOR STEEL PLATE BEAM GUARD RAIL ADJACENT TO CURB AND GUTTER [FOR ROADWAY SPEED 35 MPH (60 kmh) TO 45 MPH (70 kmh)]

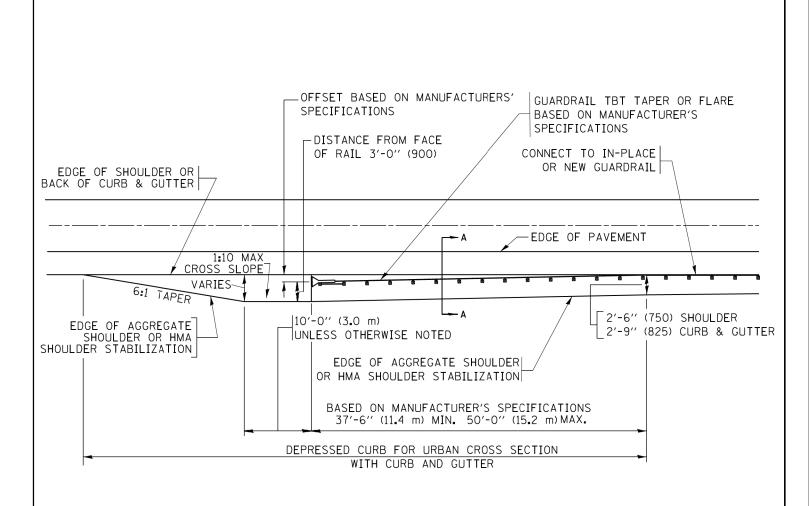

## DEPRESSED CURB AND GUTTER AND SHOULDER TREATMENT AT TBT TY. 1 SPL.

AGGREGATE SHOULDER, 10 (250) WILL BE PAID ACCORDING TO SECTION 481.

HMA SHOULDERS 6 (150) (IF REQUIRED) WILL BE PAID ACCORDING TO SECTION 482.

COMB. CONC. C&G, STEEL PLATE BEAM GUARD RAIL AND TRAFFIC BARRIER TERMINAL, OF THE TYPE SPECIFIED WILL BE PAID FOR SEPARATELY.


> TBT = TRAFFIC BARRIER TERMINAL ALL DIMENSIONS ARE IN INCHES (MILLIMETERS) UNLESS OTHERWISE SHOWN.


FILE NAME =	USER NAME = drivakosgn	DESIGNED - M. DE YONG	REVISED	-	R. BORO 12-08-2008
pw:\\ILØ84EBIDINTEG.:ll:no:s.gov:PWIDOT\Do	cuments\IDOT Offices\District 1\Projects\Dist	St <b>ORAWM</b> \CADD <del>o</del> to\CADsheets\bd34.dgn	REVISED	-	R. BORO 09-14-2009
	PLOT SCALE = 50.0000 '/ in.	CHECKED -	REVISED	-	R. BORO 08-06-2012
Default	PLOT DATE = 12/21/2015	DATE - 09-22-90	REVISED	_	R. BORO 05-08-2015

**STATE OF ILLINOIS** DEPARTMENT OF TRANSPORTATION

	DETAILS FOR	DEPRESSED CURB &	<b>GUTTER AND</b>		
SHOULDER TREATMENT AT TBT TY.1 SPL.					
SCALE: NONE	SHEET 1	OF 1 SHEETS STA.	TO STA		


F.A.I RTE.	SECTION	COUNTY	TOTAL SHEETS	SHEET NO.
90	2019-082-RS&T	соок	119	111
	BD600-10 (BD 34)	CONTRACT	NO. 62	2J59
	ILLINOIS FED. A	D PROJECT		

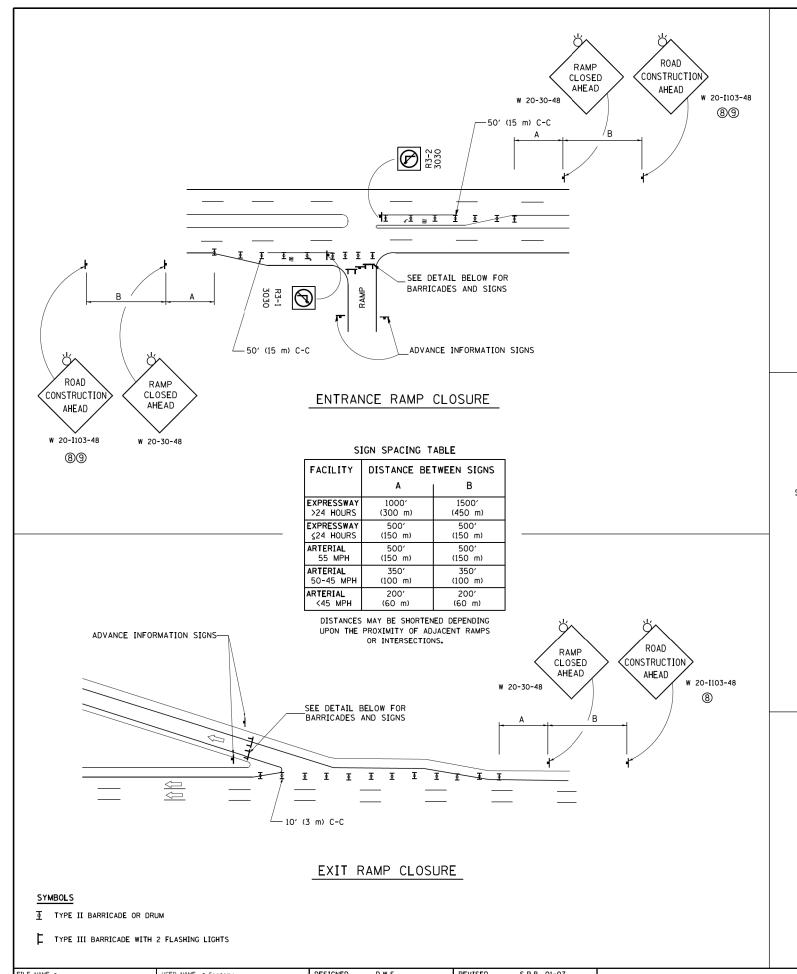

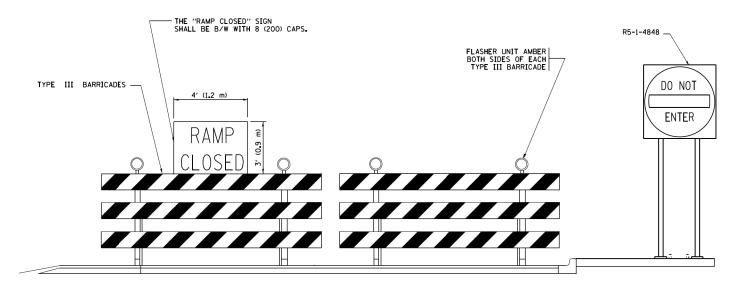

DETAIL FOR REQUIRED BARRICADES & SIGNS


#### RAMP CLOSURE ADVANCE INFORMATION SIGN

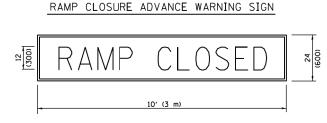

BACKGROUND MOUNTED
DIAGONALLY
E MOD FONT
1 (25 BORDER
SIGNS ARE REQUIRED ON ALL THE EXIT

THESE SIGNS ARE REQUIRED ON ALL THE EXIT
GUIDE SIGNS FOR EXIT RAMPS THAT WILL BE
CLOSED FOR MORE THAN FOUR (4) CONSECUTIVE DAYS.

BLACK LEGEND ON ORANGE

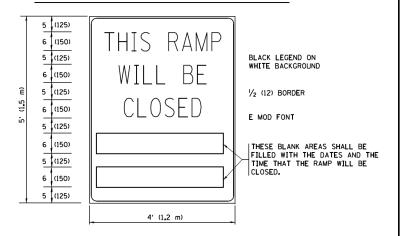

THESE SIGNS ARE REQUIRED ON BOTH SIDES OF THE RAMP, MINIMUM OF 1 WEEK IN ADVANCE OF THE CLOSURE.

THESE SIGNS SHALL BE FABRICATED AND PAID FOR ACCORDING TO THE TEMPORARY INFORMATION SIGNING SPECIAL PROVISION


### GENERAL NOTES:


- ① CONES MAY BE SUBSTITUTED FOR DRUMS OR TYPE II BARRICADES DURING DAY OPERATIONS. CONES SHALL BE A MINIMUM OF 28 (700) HIGH.
- 2 VERTICAL BARRICADES SHALL NOT BE USED FOR RAMP CLOSURES.
- 3 A FLAGGER SHALL BE POSITIONED AT EACH CLOSED RAMP THAT IS OPEN TO CONSTRUCTION VEHICLES, PRECEEDED BY A W20-7 FLAGGER WARNING SIGN.
- (4) ALL ROUTE MARKERS AND TRAILBLAZER ASSEMBLIES WHICH DIRECT MOTORISTS TO A CLOSED ENTRANCE RAMP SHALL BE COVERED WHEN THE RAMP IS CLOSED FOR MORE THAN FOUR (4) DAYS.
- (5) THE SIGNING AND BARRICADING WHICH IS REQUIRED BY THIS DETAIL SHALL BE INCLUDED IN THE COST OF TRAFFIC CONTROL AND PROTECTION (EXPRESSWAYS).

- 6 AUTHORIZATION FROM THE DISTRICT'S BUREAU OF TRAFFIC IS REQUIRED FOR ALL RAMP CLOSURES.
- (7) THE RAMP CLOSURE ADVANCE INFORMATION SIGNS SHALL BE ERECTED IF THE CLOSURE TIME EXCEEDS TWENTY-FOUR (24) HOURS, ADDITIONAL ADVANCE WARNING SIGNS ON EXIT GUIDE SIGNING WILL BE REQUIRED FOR EXIT RAMP CLOSURES THAT EXCEED FOUR (4) DAYS IN LENGTH
- (8) ROAD CONSTRUCTION AHEAD SIGNS MAY BE OMITTED WHEN THIS DETAIL IS USED IN CONJUNCTION WITH OTHER TRAFFIC CONTROL THAT ALREADY INCLUDES A ROAD CONSTRUCTION AHEAD SIGN.
- (3) ARTERIAL ROAD CONSTRUCTION AHEAD SIGNS SHALL BE INSTALLED ON THE LEFT SIDE OF TRAFFIC IF THE MEDIAN IS MORE THAN 10 FT WIDE.

ALL DIMENSIONS ARE IN INCHES (MILLIMETERS)
UNLESS OTHERWISE SHOWN.


FILE NAME =	USER NAME = footemj	DESIGNED - D.W.S.	REVISED - S.P.B. 01-07		ENTRANCE AND EXIT RAMP	F.A.I	SECTION	COUNTY	TOTAL SH	ET
pw:\\IL084EBIDINTEG.ıllınoıs.gov:PWIDOT\Do	cuments\IDOT Offices\District 1\Projects\Dis	t5 <b>:DRAWM</b> \CADD <del>a</del> ta\CADsheets\tc08 <b>.</b> dgn	REVISED - S.P.B. 12-09	STATE OF ILLINOIS	CLOSURE DETAILS	90	2019-082-RS&T	соок	119 1	12
	PLOT SCALE = 50.000 ' / in.	CHECKED -	REVISED - M.D. 06-13	DEPARTMENT OF TRANSPORTATION	GLUSUNE DETAILS		TC-08	CONTRACT	NO. 62J5	<del>)</del>
Default	PLOT DATE = 11/27/2017	DATE - 02-83	REVISED - M.D. 01-18		SCALE NONE SHEET 1 OF 1 SHEETS STA. TO STA.		THE INOTE FED. A	ID BBO ECT		

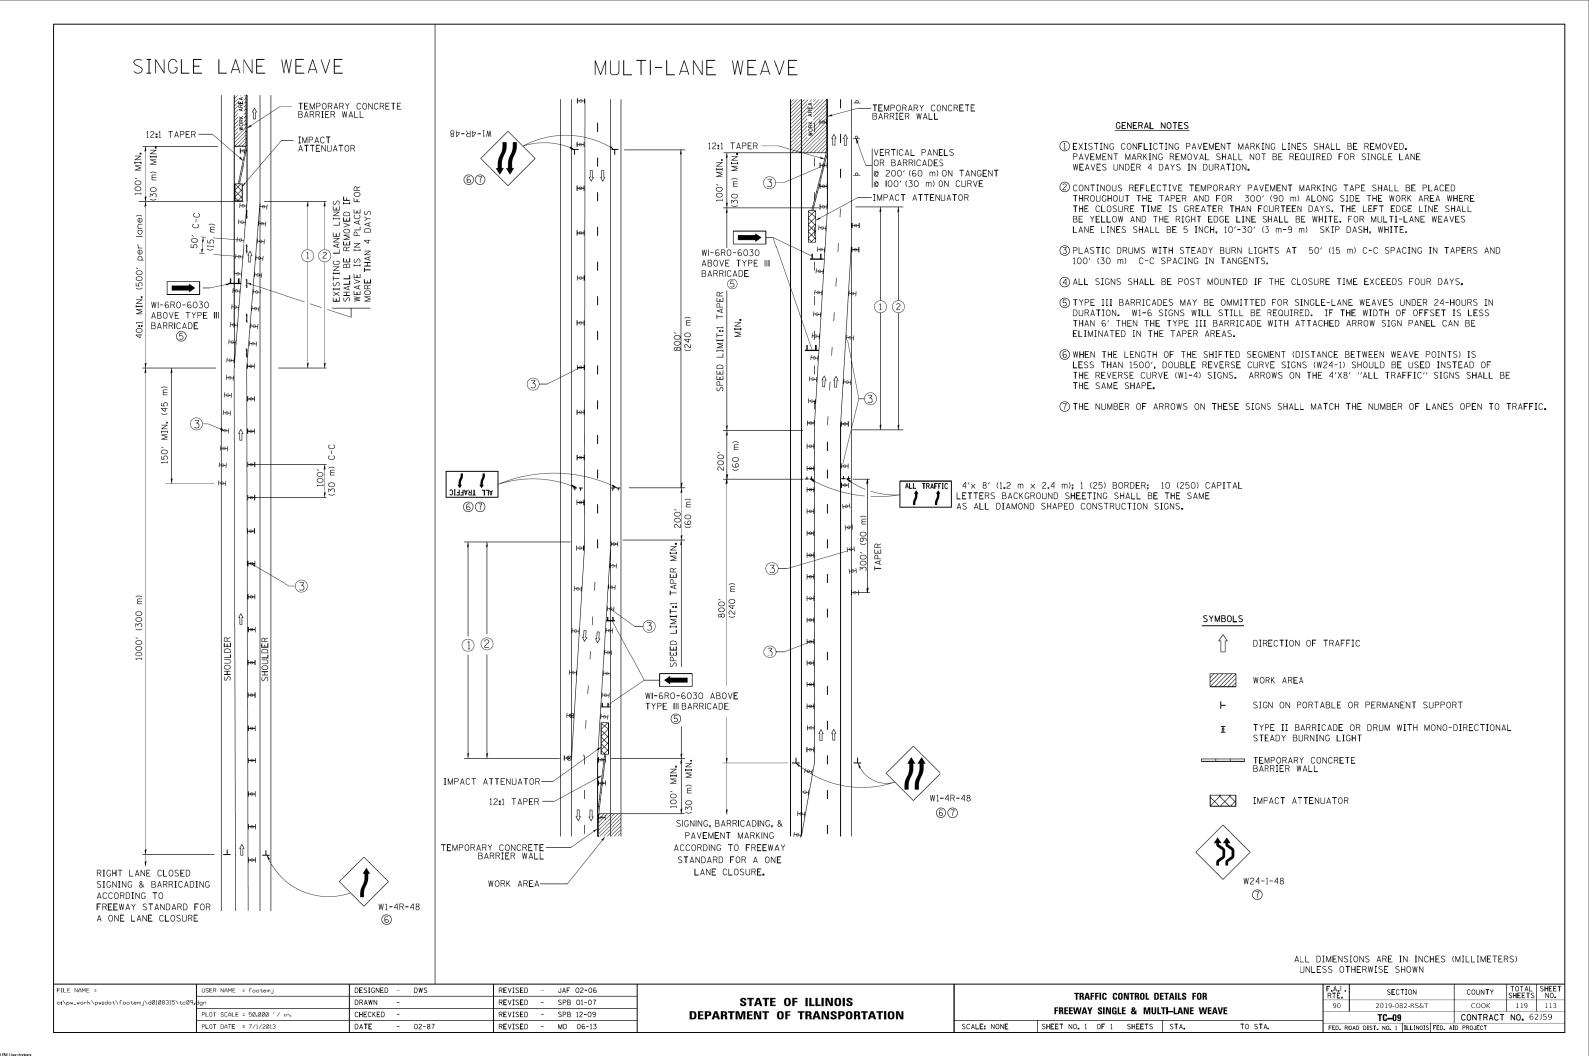


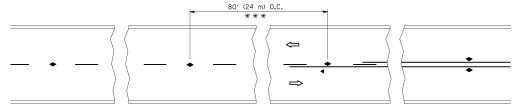


\*\*\* REDUCE TO 40' (12 m) O.C. ON CURVES WITH POSTED OR ADVISORY SPEED 45 M.P.H. (70 km/h) OR LESS.

#### TWO-LANE/TWO-WAY

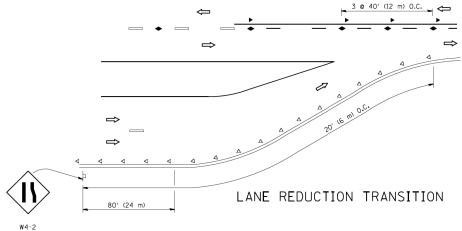


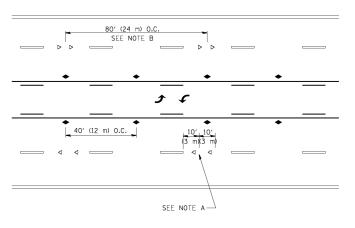

TWO-WAY LEFT TURN

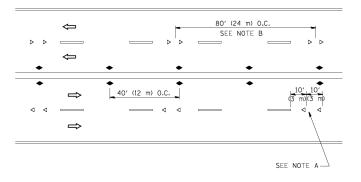

MULTI-LANE/UNDIVIDED

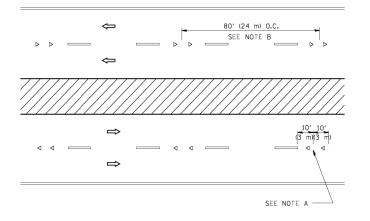

MULTI-LANE/DIVIDED

#### GENERAL NOTES

- 1. MARKERS USED WITH DASHED LINES SHALL BE CENTERED IN THE GAP BETWEEN SEGMENTS.
- 2. MARKERS USED ADJACENT TO SOLID LINES SHALL BE OFFSET 2 TO 3 (50 TO 75) TOWARD TRAFFIC AS SHOWN.
- 3. MARKERS THROUGH TANGENTS LESS THAN 500' (150 m) IN LENGTH BETWEEN CURVES SHALL BE INSTALLED AT THE LESSER OF THE TWO CURVE SPACINGS.

#### LANE MARKER NOTES

A. USE DOUBLE LANE LINE MARKERS SPACED AS SHOWN.

B. REDUCE TO 40' (12 m) O.C. ON CURVES WHERE ADVISORY SPEEDS ARE 10 M.P.H (20 km/h) LOWER THAN POSTED SPEEDS.

### SYMBOLS

---- YELLOW STRIPE

── WHITE STRIP

- ONE-WAY AMBER MARKER
- ONE-WAY CRYSTAL MARKER (₩/O)
- ◆ TWO-WAY AMBER MARKER

#### DESIGN NOTES


- 1. DOUBLE LANE LINE MARKERS SHALL BE USED UNLESS SPECIFIED OTHERWISE.
- EXCEPT AS SHOWN ON THE LANE REDUCTION TRANSITION AND FREEWAY EXIT RAMP DETAIL, MARKERS ARE NOT TO BE SPECIFIED ON RIGHT EDGE LINES.
- 3. THE EXACT MARKER LIMITS, SPACING, AND COLOR SHALL BE INCLUDED IN THE PLANS WHEN STANDARD SPECIFICATIONS ARE NOT BEING USED.
- 4. MARKERS SHOULD NOT BE USED ALONGSIDE CURBS EXCEPT FOR EXTREMELY SHORT SECTIONS OF CURBS WHERE NOT MORE THAN TWO MARKERS WOULD BE INVOLVED.


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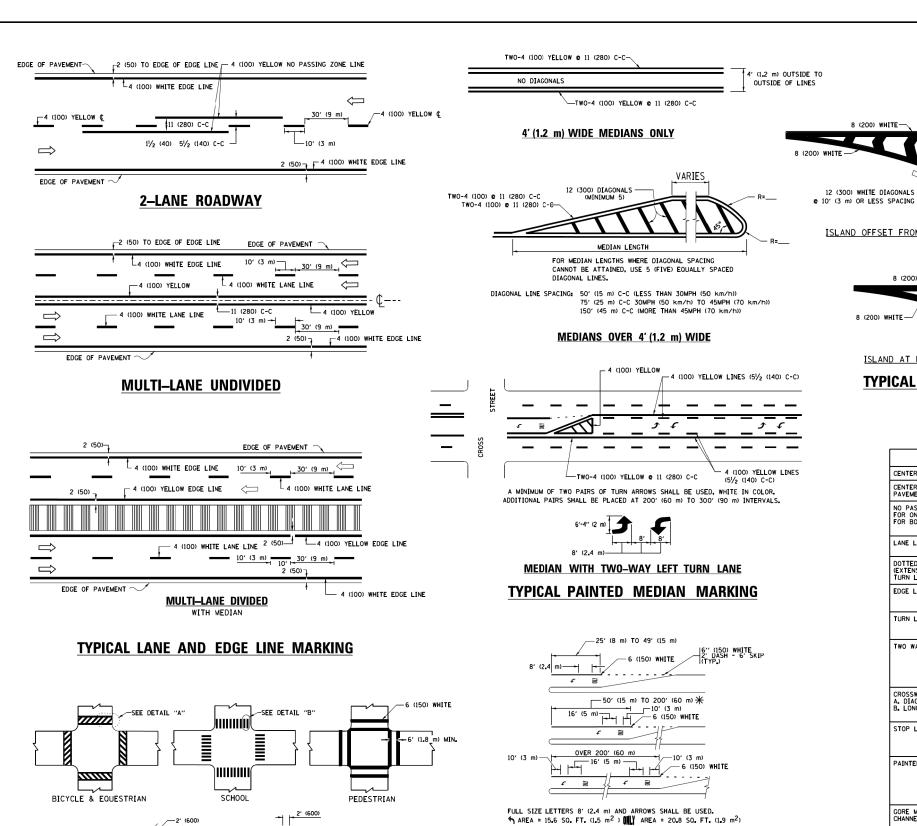
LEFT TURN


All dimensions are in inches (millimeters) unless otherwise shown.

FILE NAME =	USER NAME = leysa	DESIGNED -	REVISED - T. RAMMACHER 09-19-94			TYPICAL APPLICATIONS		RTF.	SECTION	COUNTY	SHEETS NO.	
c:\pw_work\pwidot\leysa\dØ108315\tc11.dgn		DRAWN -	REVISED -T. RAMMACHER 03-12-99	STATE OF ILLINOIS				90	2019-082-RS&T	соок	119 114	1
	PLOT SCALE = 50.000 '/ IN.	CHECKED -	REVISED -T. RAMMACHER 01-06-00	DEPARTMENT OF TRANSPORTATION	RAISED REFLECTIVE PAVEMENT MARKERS (SNOW-PLOW RESISTANT)			TC-11		CONTRACT NO. 62J59		1
	PLOT DATE = 3/2/2011	DATE -	REVISED - C. JUCIUS 09-09-09		SCALE: NONE	SHEET NO. 1 OF 1 SHEETS STA.	TO STA.	FED. ROAD D	IST. NO. 1   ILLINOIS   FED. A	ID PROJECT		



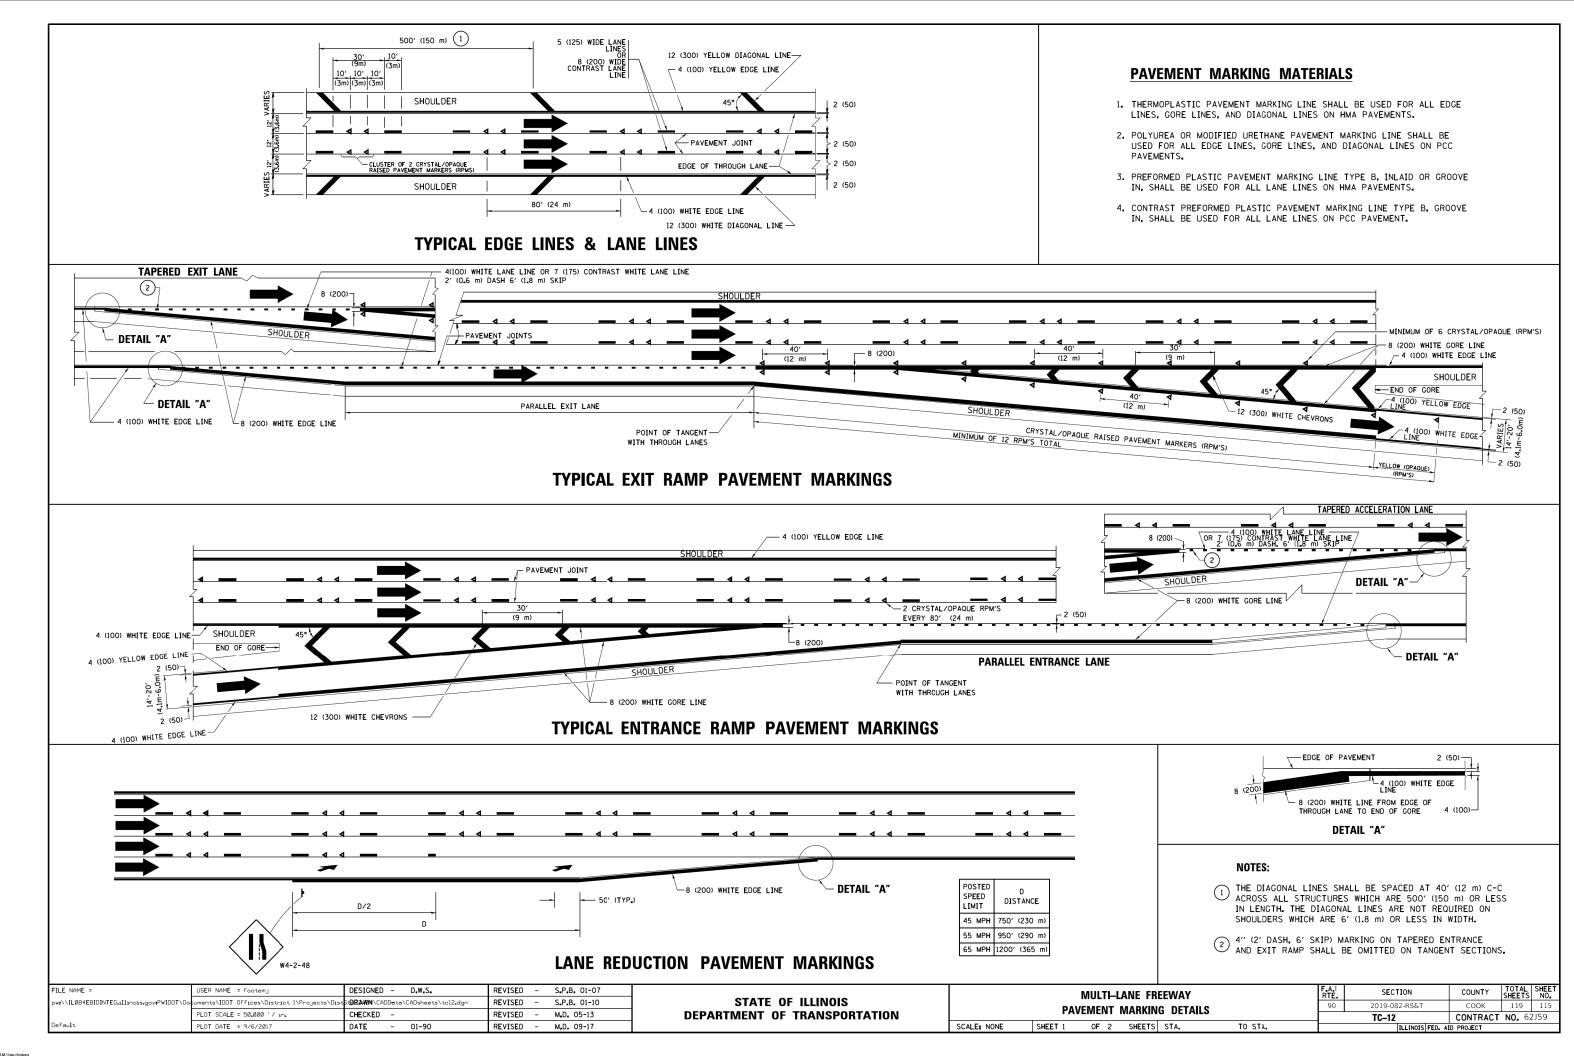

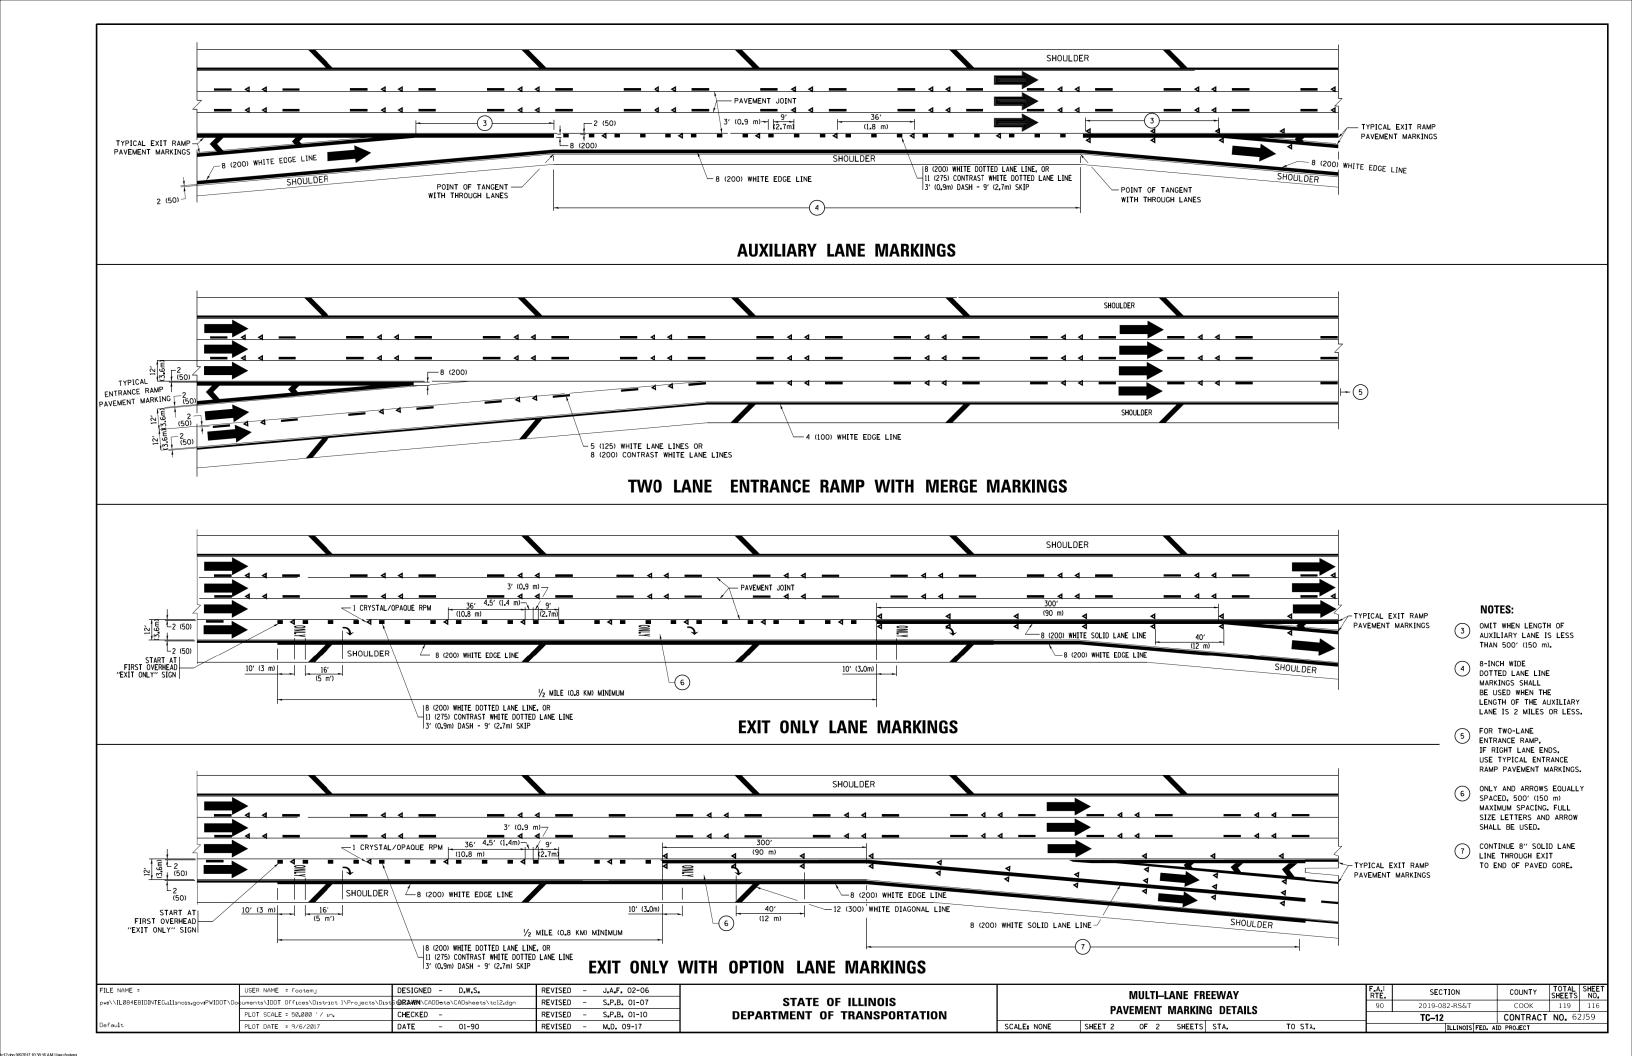

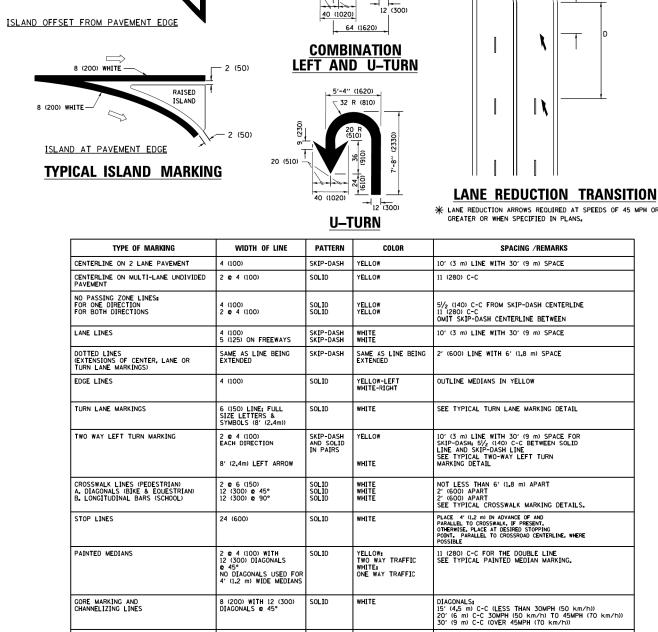

24 (600) TRANSVERSE LINES; "RR" IS 6' (1.8 LETTERS; 16 (400) LINE FOR "X"

12 (300) @ 45°

SEE DETAIL

SOLID

SOLID

SOL TO

WHITE

WHITE

WHITE - RIGHT YELLOW - LEFT

RAILROAD CROSSING

U TURN ARROW

SCALE: NONE

2 ARROW COMBINATION LEFT AND U TURN

SHOULDER DIAGONALS (REQUIRED FOR SHOULDERS  $\geq$  8')

FOR FURTHER DETAILS ON PAVEMENT MARKING REFER TO STANDARD SPECIFICATIONS FOR ROAD AND BRIDGE CONSTRUCTION AND STATE STANDARD 780001.

6'-4" (1930)

(1020)

D(FT)

500

580

665

750

**-20**′

SPEED LIMIT

50

55

FILE NAME = USER NAME = leysa DESIGNED - EVERS REVISED - C. JUCIUS 09-09-09 \diststd\22x34\tc13.dgn DRAWN REVISED -C. JUCIUS 07-01-13 REVISED -CHECKED C. JUCIUS 12-21-15 PLOT SCALE = 50.000 '/ in. PLOT DATE = 6/23/2017 DATE 03-19-90 REVISED -C. JUCTUS 04-12-16

TYPICAL CROSSWALK MARKING

 $oldsymbol{st}$  markings shall be installed parallel to the centerline of

-12 (300) WHITE

DETAIL "B"

- 6 (150) WHITE

THE ROAD WHICH IT CROSSES

DETAIL "A"

STATE OF ILLINOIS
DEPARTMENT OF TRANSPORTATION

\* TURN LANES IN EXCESS OF 400' (120 m) IN LENGTH MAY HAVE AN ADDITIONAL

TYPICAL LEFT (OR RIGHT) TURN LANE

TYPICAL TURN LANE MARKING


SET OF ARROW - "ONLY" INSTALLED MIDWAY BETWEEN THE OTHER TWO SETS OF

SEE STATE STANDARD 780001 AREA OF: "R"=3.6 SO. FT. (0.33 m²) EACH "X"=54.0 SO. FT. (5.0 m²)

unless otherwise shown.


30.4 SF

50' (15 m) C-C (LESS THAN 30MPH (50 km/h)) 75' (25 m) C-C (30 MPH (50 km/h) TO 45MPH (70 km/h) 150' (45 m) C-C (0VER 45MPH (70 km/h))

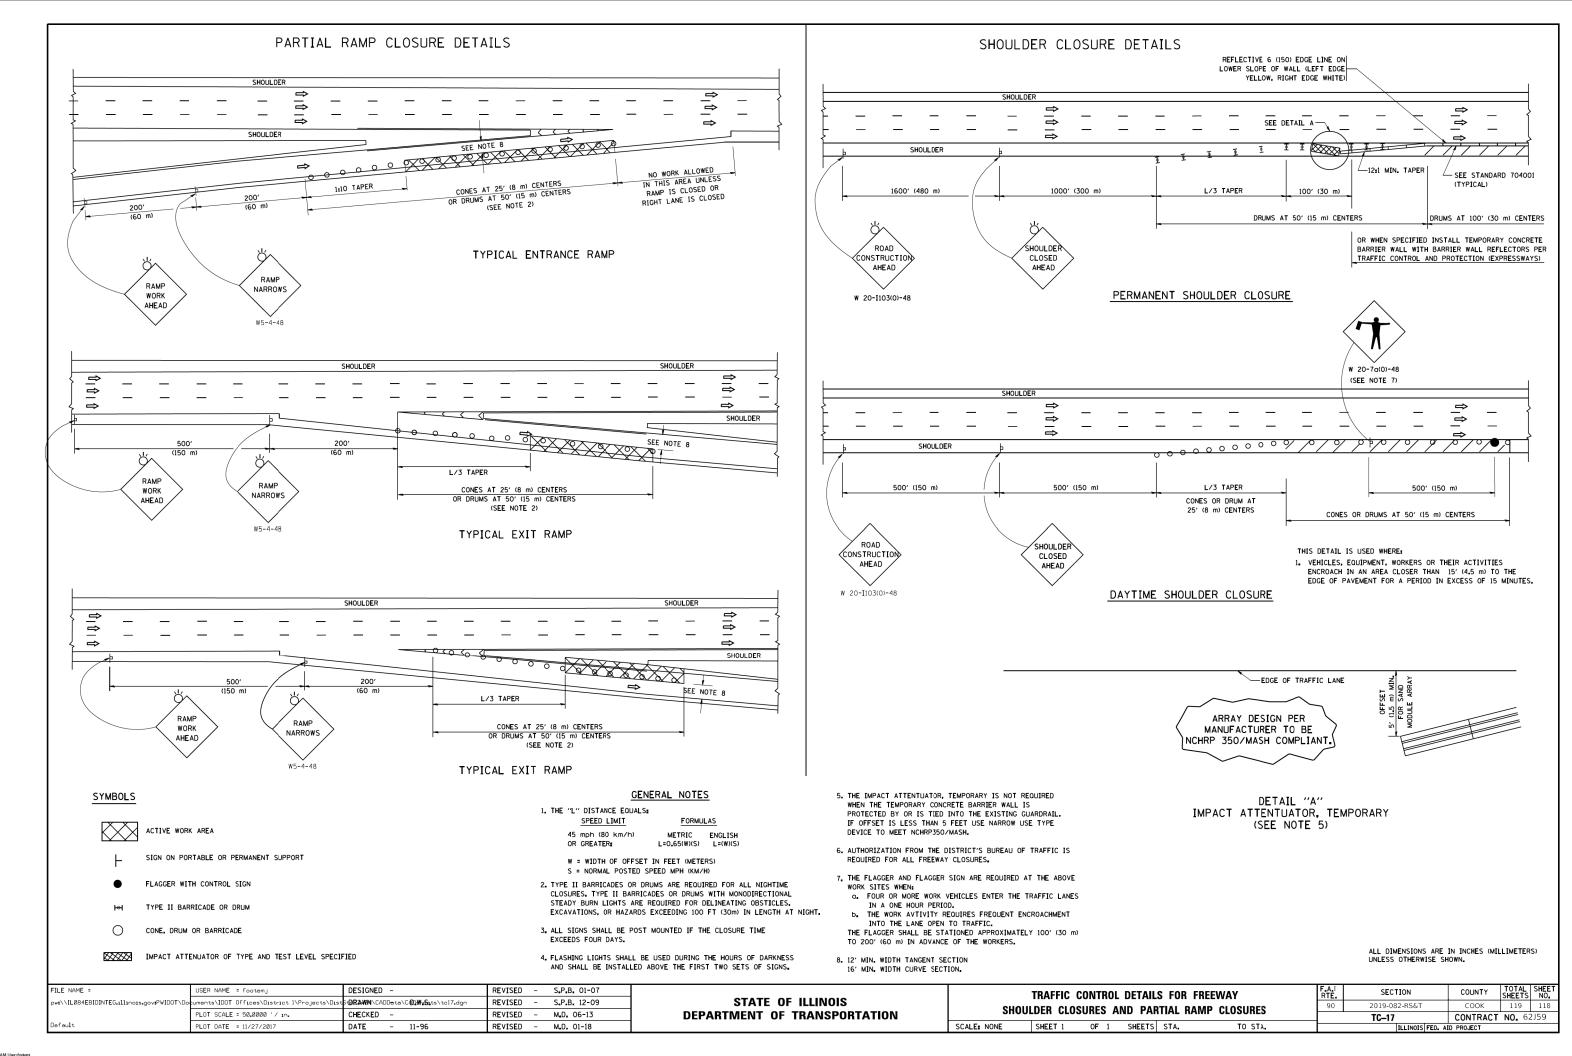


#### SIGNING FOR FLAGGING OPERATIONS AT WORK ZONE OPENINGS

#### WORK ZONE EXIT OPENING

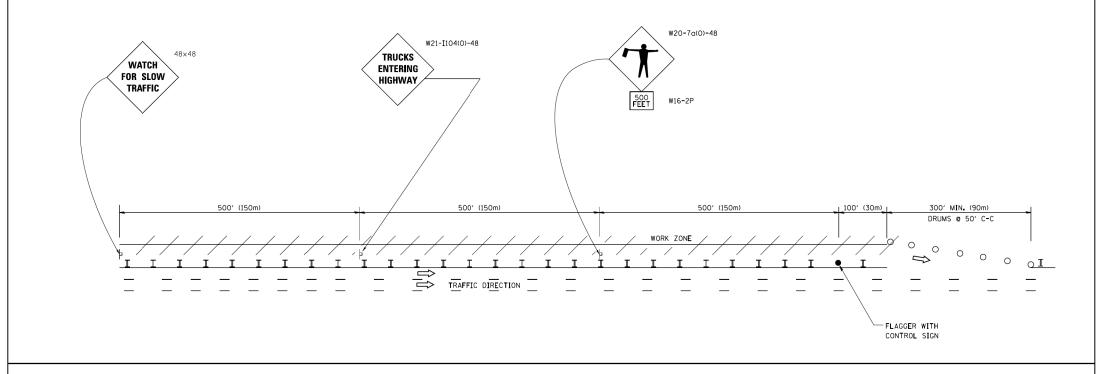

## WORK ZONE ENTRY OPENING

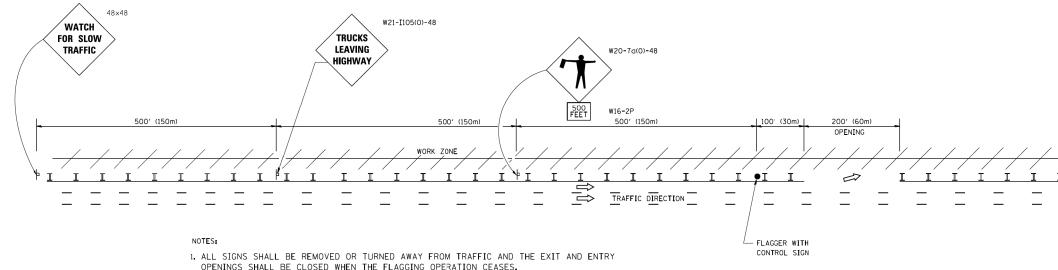

# 1. ALL SIGNS SHALL BE REMOVED OR TURNED AWAY FROM TRAFFIC AND THE EXIT AND ENTRY OPENINGS SHALL BE CLOSED WHEN THE FLAGGING OPERATION CEASES. NON OPERATING EQUIPMENT SHALL COMPLY WITH ARTICLE 701.11

- 2. WORK ZONE OPENINGS SHALL BE A MINIMUM OF ONE HALF MILE APART AND A MINIMUM OF ONE QUARTER MILE FROM ALL ENTRANCE AND EXIT RAMPS.
- 3. EXITING THE WORK ZONE AT ANY PLACE OTHER THAN AT A WORK ZONE EXIT OPENING WILL BE PROHIBITED.
- 4. ALL VEHICLES SHALL ENTER THE WORK ZONE AT ENTRY OPENINGS, USING THEIR TURN SIGNALS TO WARN MOTORISTS
- 5. FLAGGERS SHALL NOT STOP TRAFFIC OR DIRECT TRAFFIC INTO AN ADJACENT LANE.

ALL DIMENSIONS ARE IN INCHES (MILLIMETERS) UNLESS OTHERWISE SHOWN

FILE NAME =	USER NAME = footemj	DESIGNED -	REVISED - J.A.F. 02-06		FREEWAY/EXPRESSWAY SIGNING FOR FLAGGING OPERATIONS	RTE.	SECTION	COUNTY SHEE	ETS NO.	
c:\pw_work\pwidot\footemj\d0108315\tc18.c	lgn	DRAWN -	REVISED - S.P.B. 01-07	STATE OF ILLINOIS		90	2019-082-RS&T	COOK 11	9 119	
	PLOT SCALE = 50.000 ' / in.	CHECKED -	REVISED - S.P.B. 12-09	DEPARTMENT OF TRANSPORTATION	AT WORK ZONE OPENINGS ON FREEWAYS/EXPRESSWAYS		TC-18	CONTRACT NO		
	PLOT DATE = 7/8/2013	DATE -	REVISED - M.D. 06-13		SCALE: NONE SHEET NO. 1 OF 1 SHEETS STA. TO STA.	FED. ROA		AID PROJECT		