
06-14-2019 LETTING ITEM 192


HIGHWAY STANDARDS

STANDARDS SYMBOLS, ABBREVIATIONS AND PATTERNS 000001-07 280001-07 TEMPORARY EROSION CONTROL SYSTEMS 420001-09 PAVEMENT JOINTS 424016-05 MID-BLOCK CURB RAMPS FOR SIDEWALKS 483001-05 PCC SHOULDER 542301-03 PRECAST REINFORCED CONCRETE FLARED END SECTION 601101-02 CONCRETE HEADWALL FOR PIPE UNDERDRAINS 606001-07 CONCRETE CURB TYPE B AND COMBINATION CONCRETE CURB AND GUTTER PC CONCRETE ISLANDS AND MEDIANS 606301-04 OFF-RD OPERATIONS, 2L, 2W, MORE THAN 15" (4.5M) AWAY 701001-02 OFF-RD OPERATIONS, 2L, 2W, 15' (4.5M) TO 24" (600MM) FROM PAVEMENT EDGE 701006-05 OFF-RD OPERATIONS, MULTILANE, 15' (4.5M) TO 24" (600MM) FROM PAVEMENT EDGE 701101-05 OFF-RD OPERATIONS, MULTILANE, MORE THAN 15' (4.5M) AWAY 701106-02 701311-03 LANE CLOSURE 2L, 2W MOVING OPERATIONS DAY ONLY LANE CLOSURE, MULTILANE, AT ENTRANCE OR EXIT RAMP, FOR SPEEDS > 45 MPH 701411-09 701427-05 LANE CLOSURE, MULTILANE, INTERMITTENT OR MOVING OPER, FOR SPEEDS < 40 MPH 701451-05 RAMP CLOSURE FREEWAY/EXPRESSWAY PARTIAL EXIT RAMP CLOSURE FREEWAY/EXPRESSWAY 701456-05 URBAN LANE CLOSURE, MULTILANE, 1W OR 2W WITH NONTRAVERSABLE MEDIAN 701601-09 URBAN LANE CLOSURE, MULTILANE INTERSECTION 701701-10 SIDEWALK, CORNER OR CROSSWALK CLOSURE 701801-06 TRAFFIC CONTROL DEVICES 701901-08 TEMPORARY CONCRETE BARRIER 704001-08 SIGN PANEL MOUNTING DETAILS 720001-01 SIGN PANEL ERECTION DETAILS 720006-04 TELESCOPING STEEL SIGN SUPPORT 728001-01 780001-05 TYPICAL PAVEMENT MARKINGS 814006-02 DOUBLE HANDHOLES STANDARD PHASE DESIGNATION DIAGRAMS AND PHASE SEQUENCES 857001-01 873001-02 TRAFFIC SIGNAL GROUNDING & BONDING

SPAN WIRE MOUNTED SIGNALS AND FLASHING BEACON INSTALLATION

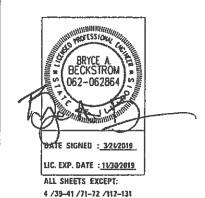

878001-10

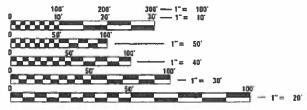

CONCRETE FOUNDATION DETAILS

FULL SIZE PLANS HAVE BEEN PREPARED USING STANDARD ENGINEERING SCALES, REDUCED SIZED PLANS WILL NOT CONFORM TO STANDARD SCALES. IN MAKING MEASUREMENTS ON REDUCED PLANS, THE ABOVE SCALES MAY BE USED.

JOINT UTILITY LOCATION INFORMATION FOR EXCAVATION 1-800-892-0123

PROJECT ENGINEER: RICH DOTSON (309-671-3455) PROJECT MANAGER: KEVIN HORST (309-671-3472) CATALOG NO. 035323-02D

CONTRACT NO. 68E71


STATE OF ILLINOIS DEPARTMENT OF TRANSPORTATION

PROPOSED HIGHWAY PLANS

FAP ROUTE 404 (IL 40) SECTION D4 IL 40 DETOUR RTE PREP 2020 PROJECT NHPP-JSKJ(375) **ROADWAY IMPROVEMENTS** PEORIA /TAZEWELL COUNTY

C-94-009-19


RANGE 4W /8E

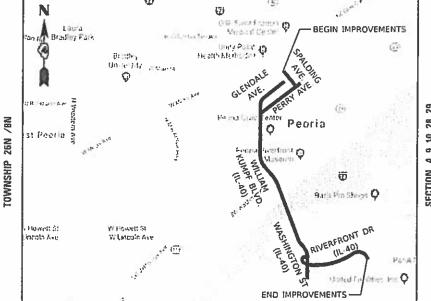


AADT (2020) = 14,600, SU=6.2%, MU=3.2% FUNCTIONAL CLASSIFICATION: URBAN OTHER PRINCIPLE ARTERIAL

GROSS LENGTH = 13,600,00 FT. = 2.576 MILE NET LENGTH = 13,609.00 FT. = 2.576 MILE

404 D4 IL 40 DETOUR PREP 2020 PEORIA 160 1 ILLINOIS CONTRACT NO. 68E71

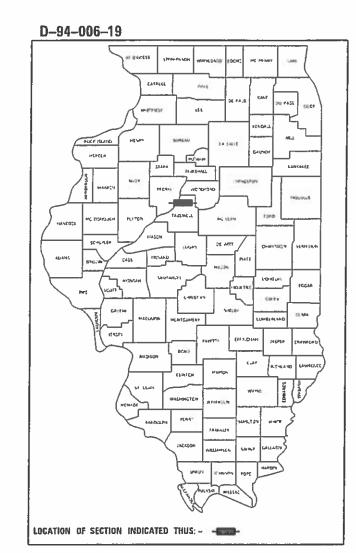

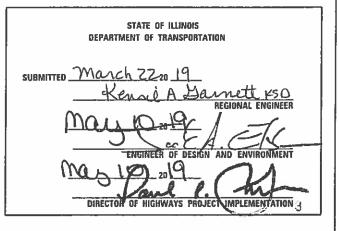

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INDEX OF SHEETS AND LEGEND

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LEGEND

EXISTING MANHOLE ----- SANITARY SEWER

CONTROL POINT

 \blacksquare EXISTING TELEPHONE PEDESTAL TELEPHONE

EXISTING GUY CABLE TELEVISION _____ CTV _____ CTV ____

 $-\Box$ EXISTING POWER POLE FIBER OPTIC

Ø LIGHT POLE WATER

EXISTING SIGN OVERHEAD ELECTRIC

 \odot EXISTING TREE PROPOSED STORM SEWER

 \boxtimes EXISTING R.O.W. MARKER EXISTING STORM SEWER

EXISTING MAILBOX FENCE

PROPOSED INLET PROPOSED R.O.W.

 \odot PROPOSED MANHOLE EXISTING R.O.W.

PROPOSED SIGN TEMPORARY EASEMENT

2	
3	Copyright Hanson Professional Services Inc. 2019
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USER NAME = Ander00846	DESIGNED -	BAB	REVISED -
	DRAWN -	JEO	REVISED -
PLOT SCALE = 2.00 / In	CHECKED -	MGD	REVISED -
PLOT DATE = 3/20/2019	DATE -	3/21/2019	REVISED -

STATE OF ILLINOIS **DEPARTMENT OF TRANSPORTATION**

IL ROUTE 40 DETOUR ROUTE PREP 2020 INDEX OF SHEETS AND LEGEND SHEET OF SHEETS STA. TO STA.					
SHEET	OF	SHEETS	STA.	TO STA.	

F.A.P. RTE	SECT	ΓΙΟΝ		COUNTY	TOTAL SHEETS	SHEET NO.
404	D4 IL 40 DETO	UR PREF	2020	PEORIA TAZEWELL	160	2
				CONTRACT	NO. 6	58E71
		TELIMOIS	EED AT	ID BROJECT		

SCALE:

OF SHEETS STA. TO STA.

GENERAL NOTES:

PLAN ELEVATIONS - U.S.G.S. MEAN SEA LEVEL DATUM
ALL ELEVATIONS SHOWN REFER TO U.S.G.S. DATUM AT MEAN SEA LEVEL UNLESS
OTHERWISE NOTED.

ENVIRONMENTAL REVIEWS

PRIOR TO THE USE OF ANY PROPOSED BORROW AREAS, USE AREAS (TEMPORARY ACCESS ROADS, DETOURS, RUN-AROUNDS, ETC.) AND/OR WASTE AREAS, THE CONTRACTOR SHALL FILE THE REQUIRED ENVIRONMENTAL RESOURCE REQUEST SURVEYS ACCORDING TO SECTION 107.22 OF THE STANDARD SPECIFICATIONS. THESE SURVEYS ARE REQUIRED IN ORDER FOR THE DEPARTMENT TO CONDUCT CULTURAL AND BIOLOGICAL RESOURCE SURVEYS FOR THE PROPOSED SITE.

THE REQUIRED ENVIRONMENTAL RESOURCE DOCUMENTATION SHALL INCLUDE THE FOLLOWING:

- BDE FORM 2289 (CULTURAL AND NATURAL RESOURCES REVIEW OF BORROW AREAS)
- BDE FORM 2290 (WASTE/USE AREA REVIEW)
- A LOCATION MAP SHOWING THE SIZE LIMITS AND LOCATION OF THE USE AREA
- COLOR PHOTOGRAPHS DEPICTING THE USE AREA
- BORROW AREA ENTRY AGREEMENT FORM D4 PI0101

PRIOR TO ANY WASTE MATERIALS BEING REMOVED FROM THE CONSTRUCTION SITE THE REQUIRED ENVIRONMENTAL RESOURCE SURVEYS SHALL BE OBTAINED AND FILED BY THE CONTRACTOR. EXCESS WASTE PRODUCTS REMOVED FROM THE CONSTRUCTION SITE SHALL BE DISPOSED OF AS REQUIRED IN SECTION 202.03 OF THE STANDARD SPECIFICATIONS.

ANY PROTRUDING METAL BARS SHALL BE REMOVED PRIOR TO THE DISPOSAL OF BROKEN CONCRETE AT APPROVED DISPOSAL SITES.

PLEASE NOTE THAT A MINIMUM OF FOUR WEEKS SHALL BE ALLOWED FOR THE DISTRICT TO OBTAIN THE REQUIRED WASTE SITE ENVIRONMENTAL CLEARANCES AND SIX WEEKS FOR THE REQUIRED BORROW SITE ENVIRONMENTAL CLEARANCES.

TRANSITION PAYMENT METHOD - NEW/OLD CONSTRUCTION

TEN FEET (10 FT.) (3 M) TRANSITIONS SHALL BE USED TO MATCH PROPOSED ITEMS OF WORK TO EXISTING ITEMS IN THE FIELD UNLESS OTHERWISE SHOWN. THE TRANSITION SHALL BE PAID FOR AT THE CONTRACT UNIT PRICE FOR THE PROPOSED ITEM OF WORK SPECIFIED.

ADDITIONAL SUPPLEMENTAL TRAFFIC CONTROL

THE DEPARTMENT RESERVE THE RIGHT AT ANY TIME TO ADD ADDITIONAL TRAFFIC CONTROL SYSTEMS OR DEVICES WITHIN THE ACTIVE CONTRACT LIMITS, BY MEANS OF AN ADDITIONAL CONTRACT. ALL TERMS OF ARTICLE 105.08 OF THE STANDARD SPECIFICATIONS SHALL BE FOLLOWED BY EACH CONTRACTOR.

SIGNING

SIGN LOCATIONS MAY VARY FROM THE STATIONS SHOWN ON THE PLANS IN ACCORDANCE WITH DIRECTIONS FROM THE ENGINEER AT THE TIME OF CONSTRUCTION. SIGN LOCATIONS MAY BE ADJUSTED IN THE FIELD TO AVOID ANY FOUND UTILITIES.

ALL WOOD POST LOCATIONS SHALL BE VERIFIED WITH THE BUREAU OF OPERATIONS, TRAFFIC SECTION, BEFORE INSTALLATION.

ORDERING LENGTH CONFIRMATION - DRAINAGE ITEMS

THE CONTRACTOR SHALL CONSULT WITH THE ENGINEER IN REGARD TO THE EXACT LENGTH OF THE BOX/PIPE CULVERTS, STORM SEWERS, AND/OR PIPE DRAINS REQUIRED PRIOR TO ORDERING THESE ITEMS.

EXISTING DRAINAGE PIPES CONNECTED TO NEW STRUCTURES

IN ACCORDANCE WITH SECTION 602 OF THE STANDARD SPECIFICATIONS, THE CONNECTING OF EXISTING DRAIN TILES, PIPE CULVERTS, OR STORM SEWERS TO THE PROPOSED DRAINAGE SYSTEM STRUCTURES WILL NOT BE PAID FOR SEPARATELY BUT SHALL BE CONSIDERED AS INCLUDED IN THE PAY ITEMS PROVIDED.

MEDIAN AND ISLAND NOSES

WHEN CONSTRUCTING MEDIAN AND ISLAND NOSES THE FOLLOWING CRITERIA SHOULD BE

•BARRIER CURB SHALL BE USED TO CONSTRUCT NOSES WHEN THE MEDIAN OR ISLAND SURROUNDS A MAST ARM OR OTHER NON-BREAKAWAY FOUNDATION.

•RAMPED NOSES SHALL BE USED ON MEDIANS OR ISLANDS WITH BREAKAWAY POSTS

REE REMOVAL

THE DISTRICT FOUR TREE COMMITTEE SHOULD BE CONTACTED AND PRIOR APPROVAL OBTAINED FOR ANY TREE REMOVAL BEYOND THE LIMITS/LOCATIONS INCLUDED IN THE PLANS.

COMMITMENTS

NO COMMITMENTS HAVE BEEN MADE ON THIS PROJECT.

GENERAL NOTES (CONTINUED):

HOT-MIX ASPHALT MIXTURE REQUIREMENTS:

	THE FOLLOWING MIX	KTURE REQUIREMENTS TURE REQUIREMENTS FOR THIS PROJECT:					
MIXTURE USE(S): INCIDENTAL HOT-MIX ASPHALT SURFACING TEMPORARY PAVEMENT/ SHOULDER (HMA OPTION) LOWER LIFTS TEMPORARY PAVEMENT/ SHOULDER (HMA OPTION) 1 1/2" SURFACE LIFT							
AC/PG:	SBS OR SBR 76-22	PG 64-22	PG 64-22				
DESIGN AIR VOIDS:	4.0% @ N-50	4.0% @ N-70	4.0% @ N-70				
MIXTURE COMPOSITION: (GRADATION MIXTURE)	IL 4.75	IL 19.0	IL 9.5				
FRICTION AGGREGATE:	N/A	N/A	MIX D				
QUALITY MANAGEMENT:	QC/QA	QC/QA	QC/QA				

NOTES:

- INDIVIDUAL LIFT THICKNESS OF EACH MIX TYPE WILL BE NO LESS THAN 3 TIMES NOMINAL MAXIMUM AGGREGATE SIZE AND NO MORE THAN 6 TIMES NOMINAL MAXIMUM.
- 2. FOR DESIGN PURPOSES, MIXTURE WEIGHT FOR ALL MIXES IS DETERMINED TO BE 112.0 LB / S.Y. / IN., UNLESS OTHERWISE NOTED.
- 3. RESIDUAL RATE FOR POLYMERIZED BITUMINOUS MATERIALS (TACK COAT) SHALL BE 0.08 LB / S.F.

AVAILABILITY OF ELECTRONIC FILES

MICROSTATION AND GEOPAK FILES OF THIS PROJECT WILL BE MADE AVAILABLE TO THE CONTRACTOR AFTER CONTRACT AWARD. IF THERE IS A CONFLICT BETWEEN THE ELECTRONIC FILES AND THE PRINTED CONTRACT PLANS AND DOCUMENTS, THE PRINTED CONTRACT PLANS AND DOCUMENTS, THE PRINTED CONTRACT PLANS AND DOCUMENTS SHALL TAKE PRECEDENCE OVER THE ELECTRONIC FILES. THE CONTRACTOR SHALL ACCEPT ALL RISK ASSOCIATED WITH USING THE ELECTRONIC FILES AND SHALL HOLD THE DEPARTMENT HARMLESS FOR ANY ERRORS OR OMISSIONS IN THE ELECTRONIC FILES AND THE DATA CONTAINED THEREIN. ERRORS OR DELAYS RESULTING FROM THE USE OF THE ELECTRONIC FILES BY THE CONTRACTOR SHALL NOT RESULT IN AN EXTENSION OF TIME FOR ANY INTERIM OR FINAL COMPLETION DATE OR SHALL NOT BE CONSIDERED CAUSE FOR ADDITIONAL COMPENSATION. THE CONTRACTOR SHALL NOT USE, SHARE, OR DISTRIBUTE THESE ELECTRONIC FILES EXCEPT FOR THE PURPOSE OF CONSTRUCTING THIS CONTRACT. ANY CLAIMS BY THIRD PARTIES DUE TO USE OR ERRORS SHALL BE THE SOLE RESPONSIBILITY OF THE CONTRACTOR. THE CONTRACTOR SHALL INCLUDE THIS DISCLAIMER WITH THE TRANSFER OF THESE ELECTRONIC FILES TO ANY OTHER PARTIES AND SHALL INCLUDE APPROPRIATE LANGUAGE BINDING THEM TO SIMILAR RESPONSIBILITIES.

SIGN POST HOLES

VERTICAL HOLES SHALL BE CONSTRUCTED IN THE ISLAND PAVEMENT AND/OR CONCRETE MEDIAN OF THE TYPE SPECIFIED OR CONCRETE MEDIAN SURFACE 4 INCHES (100 MM). THE HOLES SHALL BE 24 INCHES (600 MM) SQUARE AND THEY SHALL BE FREE OF ANY OBSTRUCTION, EXCEPT EARTH, FOR A DEPTH OF 5 FEET (1.5 M) AT THE LOCATIONS SHOWN ON THE PLANS OR AS DIRECTED BY THE ENGINEER. ANY HOLES NOT USED FOR THE PLACEMENT OF SIGNS SHALL BE FILLED AND COMPACTED FLUSH WITH THE TOP OF THE ISLAND PAVEMENT, CONCRETE MEDIAN OF THE TYPES SPECIFIED, OR CONCRETE MEDIAN SURFACE 4 INCHES (100 MM). THE TOP 3 INCHES (75 MM) OF SAID COMPACTED FILL SHALL CONSIST OF A HOT-MIX ASPHALT MIXTURE. ALL HOLES IN WHICH THE SIGN POSTS ARE INSTALLED AT THE TIME OF THIS CONTRACT SHALL BE SIMILARLY FILLED.

THIS WORK, INCLUDING ANY REQUIRED PAVEMENT REMOVAL NECESSARY TO CONSTRUCT THE SIGN POST HOLES, WILL NOT BE PAID FOR SEPARATELY BUT SHALL BE INCLUDED IN THE CONTRACT UNIT PRICE PER SQUARE FOOT (SQUARE METER) FOR ISLAND PAVEMENT AND/OR CONCRETE MEDIAN OF THE TYPE SPECIFIED, OR CONCRETE MEDIAN SURFACE, 4 INCHES (100 MM).

PROJECT NOTES:

DRAINAGE

PRIOR TO COMMENCEMENT OF ANY STORM SEWER WORK, THE CONTRACTOR SHALL FIELD VERIFY ALL LOCATIONS, DIMENSIONS, AND CONDITIONS OF EXISTING FACILITIES. IF A DISCREPANCY OCCURS BETWEEN ACTUAL FIELD CONDITIONS AND THE PLANS, STANDARD SPECIFICATIONS, AND/OR DETAILS, THE CONTRACTOR SHALL NOTIFY THE ENGINEER AND SECURE INSTRUCTION FROM THE ENGINEER PRIOR TO PROCEEDING WITH ANY PART OF THE AFFECTED WORK

UTILITY NOTE: THE LOCATIONS OF EXISTING UTILITIES, AS SHOWN ON THE PLANS ARE BASED ON COORDINATION WITH THE UTILITY COMPANIES AND AVAILABLE EXISTING PLANS. THE LOCATION OF THESE FEATURES ARE SHOWN AS APPROXIMATE AND MAY NOT BE ALL INCLUSIVE. IT SHALL BE THE RESPONSIBILITY OF THE CONTRACTOR TO DETERMINE THEIR EXACT LOCATIONS FROM THE UTILITY COMPANIES. ALL EXISTING UTILITIES WHICH ARE TO REMAIN IN SERVICE SHALL BE FULLY PROTECTED BY THE CONTRACTOR AND ANY DAMAGE CAUSED BY THE CONSTRUCTION OPERATIONS SHALL BE IMMEDIATELY REPAIRED OR REPLACED UNDER THE UTILITY OWNER'S DIRECTION AT NO ADDITIONAL COST TO IDOT.

DELINEATORS

THE CONTRACTOR SHALL MAINTAIN DELINEATORS ON RIVERFRONT DR., AT THE INTERSECTION OF KUMPF BLVD. AND JEFFERSON ST., AND AT THE INTERSECTION OF KUMPF BLVD. AND ADAMS ST. THE INITIAL INSTALLATION OF THE DELINEATORS IS DONE BY OTHERS. THIS WORK WILL BE PAID FOR IN ACCORDANCE WITH ARTICLE 109.04 OF THE STANDARD SPECIFICATIONS. MAINTENANCE OF THE DELINEATORS WILL BE DONE BY OTHERS WHEN THE DETOUR IS IN OPERATION.

UTILITY NOTE

THE LOCATIONS OF THOSE BURIED AND ABOVEGROUND UTILITIES SHOWN ARE APPROXIMATE, ARE SHOWN FOR CONTRACTOR INFORMATIONAL USE ONLY, AND ARE NOT TO BE REFERENCED FOR CONSTRUCTION PURPOSES. THE IMPLIED PRESENCE OR ABSENCE OF UTILITIES IS NOT TO BE CONSTRUED BY THE OWNER, ENGINEER, CONTRACTOR, OR SUBCONTRACTORS TO BE AN ACCURATE AND COMPLETE REPRESENTATION OF UTILITIES THAT MAY OR MAY NOT EXIST ON THE CONSTRUCTION SITE. BURIED AND ABOVEGROUND UTILITY LOCATION, IDENTIFICATION, AND MARKING ARE THE SOLE RESPONSIBILITY OF THE CONTRACTOR. REROUTING, DISCONNECTION, PROTECTION, ETC. OF ANY UTILITIES MUST BE COORDINATED AMONG THE CONTRACTOR, UTILITY COMPANY, AND OWNER, SITE SAFETY, INCLUDING THE AVOIDANCE OF HAZARDS, ASSOCIATED WITH BURIED AND ABOVEGROUND UTILITIES REMAIN THE SOLE RESPONSIBILITY OF THE CONTRACTOR.



USER NAME = Ander00846	DESIGNED -	BAB	REVISED -
	DRAWN -	JEO	REVISED -
PLOT SCALE = 2.00 / In	CHECKED -	MGD	REVISED -
PLOT DATE = 3/20/2019	DATE -	3/21/2019	REVISED -



Status of Utilities

Ameren

Route IL 40 Section County

D4 IL 40 Detour Rte Prep 2020

Tazewell

Contract No.

68E71 (formerly 68C89)

035323-00D Catalog No.

Route	Offset	Location	Type of Utility	Type of Conflict	Disposition
I74 EB & WB ramps	None	Sta. 58 & 60	Aerial Electric	Barrier Wall Construction	Caution

NOTE: Please check all your facilities within the construction limits of this project.



Status of Utilities

AT&T

Route Section County IL 40 D4 IL 40 Detour Rte Prep 2020

Tazewell

68E71 (formerly 68C89)

Contract No. Catalog No.

035323-00D

Route	Offset	Location	Type of Utility	Type of Conflict	Disposition
EB Riverfront Drive ramp	40-50' RT	Sta. 44 & 50	Fiber optic	Ditch Cut	Caution

NOTE: Please check all your facilities within the construction limits of this project.

ISER NAME = \$USER\$ DESIGNED -REVISED DRAWN REVISED LOT SCALE = \$SCALE\$ CHECKED REVISED LOT DATE = \$DATE\$ DATE

STATE OF ILLINOIS DEPARTMENT OF TRANSPORTATION

STATUS OF UTILITIES SHEET OF SHEETS STA.

TO STA.



				00	004		0021
CODE NO.	ITEM	UNIT	TOTAL QUANTITY	PEORIA COUNTY URBAN-ROADWAY 80% FEDERAL 20% TDC	TAZEWELL COUNTY URBAN-ROADWAY 80% FEDERAL 20% TDC	PEORIA COUNTY URBAN-SIGNALS/IT 80% FEDERAL 20% TDC	TAZEWELL COUNTY S URBAN-SIGNALS/ITS 80% FEDERAL 20% TDC
20200100	EARTH EXCAVATION	CU YD	2,115		2,115		
20400800	FURNISHED EXCAVATION	CU YD	2,302		2,302		
21101615	TOPSOIL FURNISH AND PLACE, 4"	SQ YD	4,835		4,835		
25000210	SEEDING, CLASS 2A	ACRE	1.00		1.00		
25000400	NITROGEN FERTILIZER NUTRIENT	POUND	90		90		
23000400	NTIROGEN FERTILIZER NOTRIENT	FOUND	90		90		
25000500	PHOSPHORUS FERTILIZER NUTRIENT	POUND	90		90		
25000600	POTASSIUM FERTILIZER NUTRIENT	POUND	90		90		
25100115	MULCH, METHOD 2	ACRE	1.25		1.25		
25100630	EROSION CONTROL BLANKET	SQ YD	2,813		2,813		
28000250	TEMPORARY EROSION CONTROL SEEDING	POUND	68		68		
28000305	TEMPORARY DITCH CHECKS	FOOT	550		550		
28000400	PERIMETER EROSION BARRIER	FOOT	188		188		
28000500	INLET AND PIPE PROTECTION	EACH	2		2		
28000510	INLET FILTERS	EACH	7		7		

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STATE OF ILLINOIS
DEPARTMENT OF TRANSPORTATION

SCALE:

IL ROUTE 40 DETOUR ROUTE PREP 2020

SUMMARY OF QUANTITIES

SHEET OF SHEETS STA. TO STA.

CONSTRUCTION TYPE CODE



					204			24
			1		004		00	
CODE NO.	ITEM	UNIT	TOTAL QUANTITY	PEORIA COUNTY URBAN-ROADWAY 80% FEDERAL 20% TDC	TAZEWELL COUNTY URBAN-ROADWAY 80% FEDERAL 20% TDC	_	PEORIA COUNTY URBAN-SIGNALS/ITS 80% FEDERAL 20% TDC	TAZEWELL COUNTY URBAN-SIGNALS/ITS 80% FEDERAL 20% TDC
28100207	STONE RIPRAP, CLASS A4	TON	10		10			
28200200	FILTER FABRIC	SQ YD	11		11			
30300106	AGGREGATE SUBGRADE IMPROVEMENT 6"	SQ YD	398		398			
35101400	AGGREGATE BASE COURSE, TYPE B	TON	142		142			
40600295	POLYMERIZED BITUMINOUS MATERIALS (TACK COAT)	POUND	82		82			
40000293	TOLIMENTED BITOMINOUS MATERIALS (TACK COAT)	TOOND	02		02			
40800050	INCIDENTAL HOT-MIX ASPHALT SURFACING	TON	6		6			
42000501	PORTLAND CEMENT CONCRETE PAVEMENT 10" (JOINTED)	SQ YD	209		209			
42001300	PROTECTIVE COAT	SQ YD	1,529	43	1,486			
42400100	PORTLAND CEMENT CONCRETE SIDEWALK 4 INCH	SQ FT	1,046	254	780		12	
		50.57						
42400800	DETECTABLE WARNINGS	SQ FT	284	254	30			
44000100	PAVEMENT REMOVAL	SQ YD	3,828	23	3,805			
		· ·						
44000500	COMBINATION CURB AND GUTTER REMOVAL	FOOT	735	16	719			
44000600	SIDEWALK REMOVAL	SQ FT	826	254	572			
44003100	MEDIAN REMOVAL	SQ FT	881	127	754			

CONSTRUCTION TYPE CODE

DRAWN JEO 2/20/2019

REVIEWED MGD 3/20/2019



on Professional Services Inc, 2019	USER NAME = Ander00846	DESIGNED - BAB DRAWN - JEO	REVISED -	\dashv	STATE OF II	LLINOIS	IL IL	ROUTE 40 DETOUR ROL		F.A.P. SECTI 404 D4 IL 40 DETOL
SPECIALTY I		DESIGNED BAR	REVISED -					-		FAPÍ
CDECIALTY :	LTEMC									
60255500	MANHOLES TO BE ADJUSTE	D		EACH	1		1			
60100060	CONCRETE HEADWALLS FOR	PIPE DRAINS		EACH	1		1			
59300100	CONTROLLED LOW-STRENGT	H MATERIAL		CU YD	14		14			
55100500	STORM SEWER REMOVAL 1	2 "		FOOT	65		65			
550A0050	STORM SEWERS, CLASS A,	TYPE 1 12"		FOOT	58		58			
542A1069	PIPE CULVERTS, CLASS A	A, TYPE 2 24"		FOOT	30		30			
54213669	PRECAST REINFORCED CON	ICRETE FLARED END SECTION	ONS 24"	EACH	1		1			
52000340	NEOPRENE EXPANSION JOI	NT 4"		FOOT	4.5		4.5			
52000320	NEOPRENE EXPANSION JOI	NT 2"		FOOT	12.5		12.5			
							12.5			
50800205	REINFORCEMENT BARS, EP	OXY COATED		POUND	6,830		6830			
							6000			
50300300	PROTECTIVE COAT			SQ YD	267		267			
50300255	CONCRETE SUPERSTRUCTUR	E		CU YD	41.1		41.1			
50102400	CONCRETE REMOVAL			CU YD	7.5		7.5			
48300500	PORTLAND CEMENT CONCRE	TE SHOULDERS 10"		SQ YD	788		788			
NO.		ITEM		UNIT	QUANTITY	80% FEDERAL 20% TDC	80% FEDERAL 20% TDC	_	80% FEDERAL 20% TDC	80% FEDERAL 20% TDC
CODE		ITEM		LINIT	TOTAL	PEORIA COUNTY URBAN-ROADWAY	TAZEWELL COUNTY URBAN-ROADWAY		PEORIA COUNTY URBAN-SIGNALS/ITS	TAZEWELL COUNT URBAN-SIGNALS/IT
						00	004		00	21

DEPARTMENT OF TRANSPORTATION

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THANSON

Hanson Professional Services Inc.

CHECKED - MGD

DATE - 3/21/2019

PLOT DATE = 3/21/2019

REVISED -

REVISED -

REV. 4/30/19

CONSTRUCTION TYPE CODE

SUMMARY OF QUANTITIES

OF SHEETS STA.

TO STA.

SCALE:

SHEET



				000)4	00)21
CODE NO.	ITEM	UNIT	TOTAL QUANTITY		TAZEWELL COUNTY URBAN-ROADWAY 80% FEDERAL 20% TDC	PEORIA COUNTY URBAN-SIGNALS/ITS 80% FEDERAL 20% TDC	TAZEWELL COUNTY URBAN-SIGNALS/ITS 80% FEDERAL 20% TDC
60500060	REMOVING INLETS	EACH	2		2		
60603800	COMBINATION CONCRETE CURB AND GUTTER, TYPE B-6.12	FOOT	124		124		
60604400	COMBINATION CONCRETE CURB AND GUTTER, TYPE B-6.18	FOOT	40		40		
60605000	COMBINATION CONCRETE CURB AND GUTTER, TYPE B-6.24	FOOT	475	16	459		
60605900	COMBINATION CONCRETE CURB AND GUTTER, TYPE B-9.12	FOOT	175		175		
60618300	CONCRETE MEDIAN SURFACE, 4 INCH	SQ FT	2,088		2,088		
60619200	CONCRETE MEDIAN, TYPE SB-6.06	SQ FT	338	338			
60620000	CONCRETE MEDIAN, TYPE SB-6.24	SQ FT	75		75		
60620800	CONCRETE MEDIAN, TYPE SB-9.12	SQ FT	45		45		
67000400	ENGINEER'S FIELD OFFICE, TYPE A	CAL MO	6		6		
67100100	MOBILIZATION	L SUM	1		1		
0103815	TRAFFIC CONTROL SURVEILLANCE	CAL DA	10		10		
0107025	CHANGEABLE MESSAGE SIGN	CAL DA	98		98		

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STATE OF ILLINOIS
DEPARTMENT OF TRANSPORTATION

IL ROUTE 40 DETOUR ROUTE PREP 2020

SUMMARY OF QUANTITIES

SHEET OF SHEETS STA. TO STA.

SCALE:

CONSTRUCTION TYPE CODE



					CONSTRUC	CTION TYPE CODE	
				00	004	00	21
CODE NO.	ITEM	UNIT	TOTAL QUANTITY	PEORIA COUNTY URBAN-ROADWAY 80% FEDERAL 20% TDC	TAZEWELL COUNTY URBAN-ROADWAY 80% FEDERAL 20% TDC	PEORIA COUNTY URBAN-SIGNALS/ITS 80% FEDERAL 20% TDC	TAZEWELL COUNT URBAN-SIGNALS/IT 80% FEDERAL 20% TDC
70400100	TEMPORARY CONCRETE BARRIER	FOOT	1,625.0		1,625.0		
70400200	RELOCATE TEMPORARY CONCRETE BARRIER	FOOT	137.5		137.5		
70600241	IMPACT ATTENUATORS, TEMPORARY (NON- REDIRECTIVE, NARROW), TEST LEVEL 2	EACH	2		2		
72000100	SIGN PANEL - TYPE 1	SQ FT	101.5	32.5	69.0		
72000200	SIGN PANEL - TYPE 2	SQ FT	42.0	10.0	32.0		
72400100	REMOVE SIGN PANEL ASSEMBLY - TYPE A	EACH	14	5	9		
72400320	REMOVE SIGN PANEL - TYPE 2	SQ FT	30	30			
72800100	TELESCOPING STEEL SIGN SUPPORT	FOOT	173		173		
78009000	MODIFIED URETHANE PAVEMENT MARKING - LETTERS AND SYMBOLS	SQ FT	348	258	90		
78009004	MODIFIED URETHANE PAVEMENT MARKING - LINE 4"	FOOT	24,919	777	24,142		
78009008	MODIFIED URETHANE PAVEMENT MARKING - LINE 8"	FOOT	8,857	3,460	5,397		
78009012	MODIFIED URETHANE PAVEMENT MARKING - LINE 12"	FOOT	3,471	734	2,737		
78009024	MODIFIED URETHANE PAVEMENT MARKING - LINE 24"	FOOT	101	83	18		
	UNDERGROUND CONDUIT, PVC, 3" DIA.	FOOT	30			30	

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** SPECIALTY IT

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Hanson Professional Services Inc.

 USER NAME
 = Ander00846
 DESIGNED
 BAB
 REVISED

 DRAWN
 JEO
 REVISED

 PLOT SCALE
 = 2.00 '/ in.
 CHECKED
 MGD
 REVISED

 PLOT DATE
 = 3/21/2019
 REVISED

STATE OF ILLINOIS DEPARTMENT OF TRANSPORTATION

IL ROUTE 40 DETOUR ROUTE PREP 2020
SUMMARY OF QUANTITIES

SHEET OF SHEETS STA. TO STA.



							СО	NSTRUCTION TYPE CODE	
						00	004	00	021
CODE NO.		ITEM		UNIT	TOTAL QUANTITY	PEORIA COUNTY URBAN-ROADWAY 80% FEDERAL 20% TDC	TAZEWELL COUNTY URBAN-ROADWAY 80% FEDERAL 20% TDC	PEORIA COUNTY URBAN-SIGNALS/ITS 80% FEDERAL 20% TDC	TAZEWELL COUNTY URBAN-SIGNALS/ITS 80% FEDERAL 20% TDC
* 87301245	ELECTRIC CABLE IN CON	IDUIT, SIGNAL NO. 14	SC .	FOOT	2,270.5			2,270.5	
* 87301255	ELECTRIC CABLE IN CON	IDUIT, SIGNAL NO. 14	7C	FOOT	1,147.5			1,147.5	
* 87301804	ELECTRIC CABLE IN CON	IDUIT, SERVICE NO. 6 10		FOOT	559			559	
* 87301900	ELECTRIC CABLE IN CON	DUIT, EQUIPMENT GROUND	NG CONDUCTOR, NO. 6	1C FOOT	34			34	
* 87800200	CONCRETE FOUNDATION,	TYPE D		FOOT	3.5			3.5	
* 88700090	CONFIRMATION BEACON			EACH	2			2	
88700200	LIGHT DETECTOR			EACH	2			2	
88700300	LIGHT DETECTOR AMPLIF	IER		EACH	1			1	
89000100	TEMPORARY TRAFFIC SIG	SNAL INSTALLATION		EACH	2			1	1
89502220	MODIFY EXISTING CONCR	ETE FOUNDATION		EACH	1			1	
89502500	REMOVE TEMPORARY TRAF	FIC SIGNAL INSTALLATION	1	EACH	1			1	
89502385	REMOVE EXISTING CONCR	ETE FOUNDATION		EACH	1			1	
X0322281	WIDE AREA VIDEO DETEC	CTION SYSTEM COMPLETE		EACH	1				1
* SPECIALTY I	TEMS								
t Hanson Professional Services Inc. 2019	USER NAME = Ander00846	DESIGNED - BAB DRAWN - JEO	REVISED -		STATE OF II		IL ROUTE 40	DETOUR ROUTE PREP 2020	F.A.P. SECTI

TOPM OPERATION OF THE PROPERTY OF THE PROPERTY

REVISED - STATE OF ILLINOIS
REVISED - DEPARTMENT OF TRANSPORTATION
REVISED -

DRAWN -

CHECKED -

DATE -

PLOT SCALE = 2.00 ' / in.

PLOT DATE = 3/21/2019

JEO

MGD

3/21/2019

IL ROUTE 40 DETOUR ROUTE PREP 2020
SUMMARY OF QUANTITIES

SHEET OF SHEETS STA. TO STA.



ITEM MOVE EXISTING FLARED END SECTION RCUIT BREAKER, 1-POLE, 20 AMP, 120V IN EXISTING TSC CABINET T 5 ETHERNET CABLE BER OPTIC SPLICE-LATERAL /EMENT MARKING REMOVAL - WATER BLASTING	UNIT EACH FOOT EACH	TOTAL QUANTITY 1 1 449		TAZEWELL COUNTY URBAN-ROADWAY 80% FEDERAL 20% TDC	PEORIA COUNTY URBAN-SIGNALS/ITS 80% FEDERAL 20% TDC	TAZEWELL COUNTY
MOVE EXISTING FLARED END SECTION RCUIT BREAKER, 1-POLE, 20 AMP, 120V IN EXISTING TSC CABINET T 5 ETHERNET CABLE BER OPTIC SPLICE-LATERAL	EACH FOOT	QUANTITY 1 1 449	URBAN-ROADWAY 80% FEDERAL	URBAN-ROADWAY 80% FEDERAL 20% TDC	URBAN-SIGNALS/ITS 80% FEDERAL 20% TDC	URBAN-SIGNALS/ITS 80% FEDERAL 20% TDC
RCUIT BREAKER, 1-POLE, 20 AMP, 120V IN EXISTING TSC CABINET T 5 ETHERNET CABLE BER OPTIC SPLICE-LATERAL	FOOT	1 449			449	1
SER OPTIC SPLICE-LATERAL	FOOT	449			449	1
BER OPTIC SPLICE-LATERAL					449	
	EACH	1			I	
/EMENT MARKING REMOVAL - WATER BLASTING					1	
	SQ FT	25,090	7,068	18,022		
DSED CIRCUIT TELEVISION DOME CAMERA, HD	EACH	8			6	2
COVERABLE DELINEATORS	EACH	14		14		
T-MIX ASPHALT SURFACE REMOVAL, VARIABLE DEPTH	SQ YD	113		113		
MPORARY SHOULDERS	SQ YD	648		648		
PE DRAINS 6" (SPECIAL)	FOOT	106		106		
MOVE CONCRETE HEADWALLS FOR PIPE DRAINS	EACH	1		1		
ETS, TYPE G-1, SPECIAL	EACH	1		1		
.ETS TO BE ADJUSTED WITH NEW FRAME AND GRATE (SPECIAL)	EACH	3		3		
INEATOR REMOVAL	EACH	95	31	64		
/O	DRAINS 6" (SPECIAL) VE CONCRETE HEADWALLS FOR PIPE DRAINS TS, TYPE G-1, SPECIAL TS TO BE ADJUSTED WITH NEW FRAME AND GRATE (SPECIAL)	DRAINS 6" (SPECIAL) FOOT WE CONCRETE HEADWALLS FOR PIPE DRAINS EACH TS, TYPE G-1, SPECIAL EACH TS TO BE ADJUSTED WITH NEW FRAME AND GRATE (SPECIAL) EACH	DRAINS 6" (SPECIAL) FOOT 106 VE CONCRETE HEADWALLS FOR PIPE DRAINS EACH 1 TS, TYPE G-1, SPECIAL EACH 1 TS TO BE ADJUSTED WITH NEW FRAME AND GRATE (SPECIAL) EACH 3	DRAINS 6" (SPECIAL) FOOT 106 VE CONCRETE HEADWALLS FOR PIPE DRAINS EACH 1 TS, TYPE G-1, SPECIAL EACH 1 TS TO BE ADJUSTED WITH NEW FRAME AND GRATE (SPECIAL) EACH 3	DRAINS 6" (SPECIAL) FOOT 106 VE CONCRETE HEADWALLS FOR PIPE DRAINS EACH 1 1 TS, TYPE G-1, SPECIAL EACH 1 1 TS TO BE ADJUSTED WITH NEW FRAME AND GRATE (SPECIAL) EACH 3 3	DRAINS 6" (SPECIAL) FOOT 106 106 VE CONCRETE HEADWALLS FOR PIPE DRAINS EACH 1 1 1 TS, TYPE G-1, SPECIAL EACH 1 1 1 TS TO BE ADJUSTED WITH NEW FRAME AND GRATE (SPECIAL) EACH 3 3 3

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STATE OF ILLINOIS
DEPARTMENT OF TRANSPORTATION

IL ROUTE 40 DETOUR ROUTE PREP 2020
SUMMARY OF QUANTITIES

SHEET OF SHEETS STA. TO STA.

					C	CONSTRUCTION TYPE CODE	
				00	04	00)21
CODE NO.	ITEM	UNIT	TOTAL QUANTITY	PEORIA COUNTY URBAN-ROADWAY 80% FEDERAL 20% STATE	TAZEWELL COUNTY URBAN-ROADWAY 80% FEDERAL 20% STATE		TAZEWELL COUNTY URBAN-SIGNALS/ITS 80% FEDERAL 20% STATE
X7010216	TRAFFIC CONTROL AND PROTECTION, (SPECIAL)	L SUM	1		1		
X8140220	DOUBLE HANDHOLE (SPECIAL)	EACH	1			1	
X8570215	FULL-ACTUATED CONTROLLER IN EXISTING CABINET	EACH	9			9	
X8570226	FULL-ACTUATED CONTROLLER AND TYPE IV CABINET, SPECIAL	EACH	3			3	
X8730320	ELECTRIC CABLE IN CONDUIT, SIGNAL, NO. 20 3/C, TWISTED, SHIELDED	FOOT	376.5			376.5	
X8900008	TEMPORARY TRAFFIC SIGNAL INSTALLATION (SPECIAL)	EACH	1				1
Z0013798	CONSTRUCTION LAYOUT	L SUM	1		1		
Z0043900	PREFORMED JOINT FILLER	FOOT	18.6		18.6		
Z0062456	TEMPORARY PAVEMENT	SQ YD	2,003		2,003		
Z0076600	TRAINEES	HOUR	1000	1000			
Z0076604	TRAINEES TRAINING PROGRAM GRADUATE	HOUR	1000	1000			
SPECIALTY I on Professional Services Inc. 2019	TEMS USER NAME = Ander00846 DESIGNED - BAB REVISED -					O DETOUR ROUTE PREP 2020	F.A.P. SECTI

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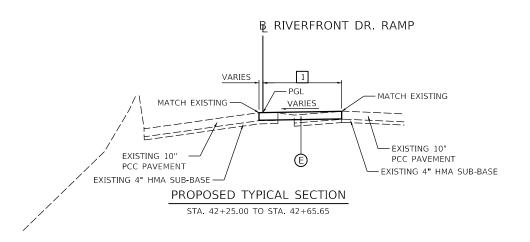
STATE OF ILLINOIS
DEPARTMENT OF TRANSPORTATION


IL ROUTE 40 DETOUR ROUTE PREP 2020

SUMMARY OF QUANTITIES

SHEET OF SHEETS STA. TO STA.







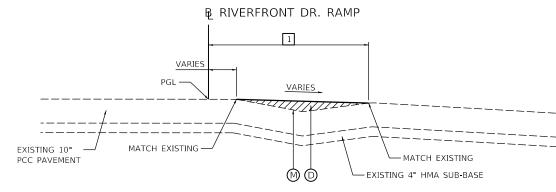


PROPOSED TYPICAL SECTION

STA. 51+58.34 TO STA. 52+76.48

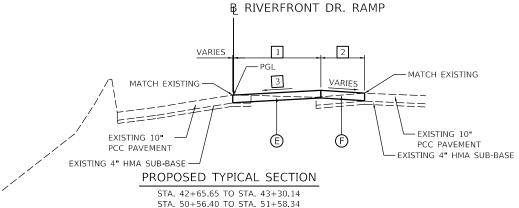

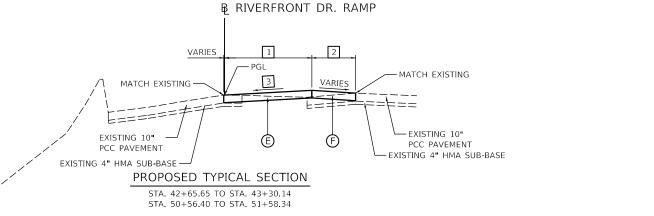

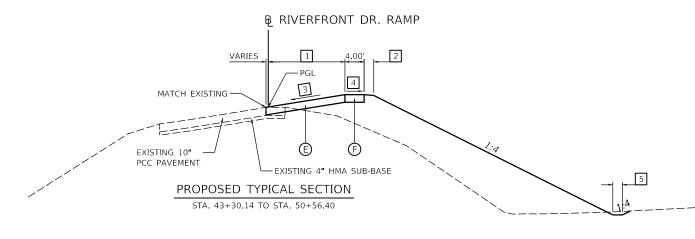

1 PAVEMENT WIDTH STA. 42+25.00 TO STA. 42+65.65 = TRANSITION FROM 12.38' TO 19.44' STA. 42+65.65 TO STA. 43+77.15 = TRANSITION FROM 19.44 TO 16.00 STA. 43+77.15 TO STA. 47+81.79 = 16.00 STA. 47+81.79 TO STA. 51+58.34 = TRANSITION FROM 16.00' TO 12.44' STA. 51+58.34 TO STA. 52+76.48 = TRANSITION FROM 13.36' TO 8.17'

2 SHOULDER WIDTH STA. 42+65.65 TO STA. 43+26.56 = TRANSITION FROM 0.00' TO 17.13' STA. 43+26.56 TO STA. 43+30.14 = TRANSITION FROM 17.13' TO 4.00' STA. 50+56.40 TO STA. 50+57.21 = TRANSITION FROM 4.00' TO 9.92' STA. 50+57.21 TO STA. 51+58.34 = TRANSITION FROM 9.92' TO 0.92'

3 PAVEMENT SLOPE STA. 42+65.00 TO STA. 44+05.00 = TRANSITION FROM 0.97% TO 8.00% STA. 44+05.00 TO STA. 47+17.00 = 8.00% STA. 47+17.00 TO STA. 48+92.00 = TRANSITION FROM 8.00% TO 1.00% STA. 48+92.00 TO STA. 51+00.00 = 1.00%STA. 51+00.00 TO STA. 51+58.45 = TRANSITION FROM 1.00% TO -0.95%

4 SHOULDER SLOPE STA. 43+25.36 TO STA. 44+05.00 = TRANSITION FROM -2.34% TO 0.00% STA. 44+05.00 TO STA. 47+17.00 = 0.00%STA. 47+17.00 TO STA. 48+17.00 = TRANSITION FROM 0.00% TO -4.00%STA. 48+17.00 TO STA. 50+00.00 = -4.00%STA. 50+00.00 TO STA. 50+56.40 = TRANSITION FROM -4.00% TO -0.60%

5 DITCH BOTTOM WIDTH

STA. 43+30.14 TO STA. 44+00.00 = TRANSITION FROM 0.00' TO 2.00'

STA. 44+00.00 TO STA. 49+50.00 = 2.00' STA. 49+50.00 TO STA. 50+20.00 = TRANSITION FROM 2.00' TO 0.00'

LEGEND

A AGGREGATE SUBGRADE IMPROVEMENT 6"

(B) PORTLAND CEMENT CONCRETE PAVEMENT, 10" (JOINTED)

O PORTLAND CEMENT CONCRETE SHOULDERS, 10"

(D) INCIDENTAL HOT-MIX ASPHALT SURFACING

(E) TEMPORARY PAVEMENT

F TEMPORARY SHOULDERS

G TOPSOIL FURNISH AND PLACE, 4"

(H) PORTLAND CEMENT CONCRETE SIDEWALK, 4 INCH

(I) COMBINATION CONCRETE CURB AND GUTTER, TYPE B-6.12

() COMBINATION CONCRETE CURB AND GUTTER, TYPE B-6.24

(K) COMBINATION CONCRETE CURB AND GUTTER, TYPE B-9.12

CONCRETE MEDIAN SURFACE, 4 INCH

(M) POLYMERIZED BITUMINOUS MATERIALS (TACK COAT)

(N) LONGITUDINAL JOINT (SEE JOINTING PLANS)

HANSON

USER NAME = Ander00846	DESIGNED -	BAB	REVISED -
	DRAWN -	RLA	REVISED -
PLOT SCALE = 20.00 ' / In.	CHECKED -	MGD	REVISED -
PLOT DATE = 4/29/2019	DATE -	3/21/2019	REVISED -

DEPARTMENT OF TRANSPORTATION

		UTE 40 DETO				R7
TYPICAL SECTIO	NS – I	RIVERFRONT	DR. RA	MP	TEMP. WIDENING (STAGE 1)	40
SCALE:	SHEET	OF	SHEETS	STA.	TO STA.	\top

P. E			SI	ECTI	ION	1		COUNTY	TOTAL SHEETS	SHEET NO.
4	D4 I	L 40	DE	TOL	JR	PREP	2020	PEORIA TAZEWELL	160	13
							CONTRACT	NO.	68E71	
	ILLINOIS FED. AID					NOIS	ID PROJECT			


NOTES:

1. SEE GRADING DETAILS FOR ADDITIONAL INFORMATION.

PROPOSED TRANSVERSE PAVEMENT JOINTS SHALL MATCH THE EXISTING ADJACENT PAVEMENT JOINTS, IF PCC IS USED FOR THE TEMPORARY PAVEMENT.

NO TIE BARS OR DOWEL BARS SHALL BE USED IN THE TEMPORARY PAVEMENT AND TEMPORARY SHOULDERS.

STATE OF ILLINOIS

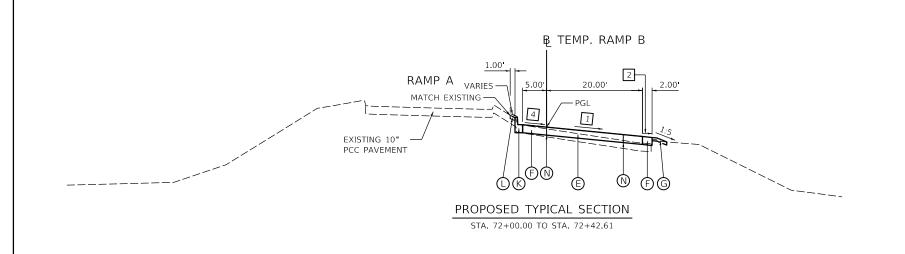



NOTES:

- 1. SEE GRADING DETAILS FOR ADDITIONAL INFORMATION.
- PROPOSED TRANSVERSE PAVEMENT JOINTS SHALL MATCH THE EXISTING ADJACENT PAVEMENT JOINTS, IF PCC IS USED FOR THE TEMPORARY PAVEMENT.
- NO TIE BARS OR DOWEL BARS SHALL BE USED IN THE TEMPORARY PAVEMENT AND TEMPORARY SHOULDERS.

LEGEND

- A AGGREGATE SUBGRADE IMPROVEMENT 6"
- B PORTLAND CEMENT CONCRETE PAVEMENT, 10" (JOINTED)
- O PORTLAND CEMENT CONCRETE SHOULDERS, 10"
- E TEMPORARY PAVEMENT
- (F) TEMPORARY SHOULDERS
- G TOPSOIL FURNISH AND PLACE, 4"
- H PORTLAND CEMENT CONCRETE SIDEWALK, 4 INCH
- (I) COMBINATION CONCRETE CURB AND GUTTER, TYPE B-6.12
- () COMBINATION CONCRETE CURB AND GUTTER, TYPE B-6.24
- (K) COMBINATION CONCRETE CURB AND GUTTER, TYPE B-9.12
- CONCRETE MEDIAN SURFACE, 4 INCH
- M POLYMERIZED BITUMINOUS MATERIALS (TACK COAT)
- N LONGITUDINAL JOINT (SEE JOINTING PLANS)

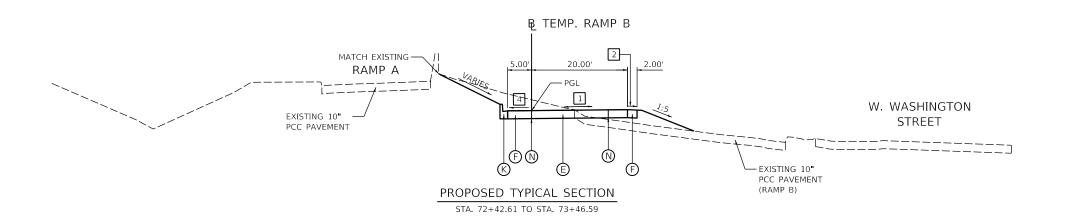

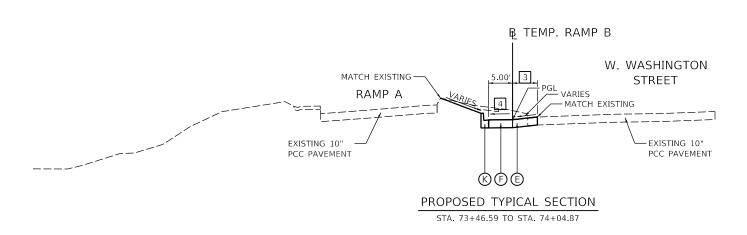

- 1 PAVEMENT SLOPE STA. 72+00.00 TO STA. 72+76.85 = TRANSITION FROM -7.50% TO 0.50% STA. 72+76.85 TO STA. 73+46.59 = 0.50%
- 2 SHOULDER SLOPE RIGHT STA. 72+00.00 TO STA. 72+52.53 = TRANSITION FROM -7.50% TO -2.00% STA. 72+52.53 TO STA. 73+46.59 = -2.00%
- STA. 73+46.59 TO STA. 74+04.87 = TRANSITION FROM 20.00' TO 0.00'
- 4 SHOULDER SLOPE LEFT
 STA. 72+00.00 TO STA. 72+76.85 = TRANSITION FROM -7.50% TO 0.50%
 TO 200% STA. 72+76.85 TO STA. 72+89.00 = TRANSITION FROM 0.50% TO 2.00% STA. 72+89.00 TO STA. 73+00.00 = TRANSITION FROM 2.00% TO 0.50%
 - STA. 72+89.00 TO STA. 73+75.00 = 0.50%STA. 73+75.00 TO STA. 73+85.00 = TRANSITION FROM 0.50% TO 0.00%STA. 73+85.00 TO STA. 74+00.00 = TRANSITION FROM 0.00% TO -5.60%

JSER NAME = Ander00846 DESIGNED -REVISED DRAWN -RLA REVISED CHECKED MGD REVISED PLOT DATE = 3/20/2019 3/21/2019

STATE OF ILLINOIS **DEPARTMENT OF TRANSPORTATION**

IL ROUTE 40 DETOUR ROUTE PREP 2020 TYPICAL SECTIONS - TEMP. RAMP B (STAGE 1 AND 2)

COUNTY 404 D4 IL 40 DETOUR PREP 2020 PEORIA TAZEWELL 160 14 CONTRACT NO. 68E71

HANSON


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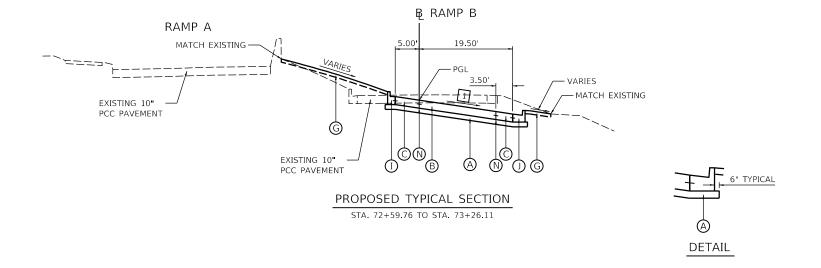



HANSON

JSER NAME = Ander00846

PLOT DATE = 3/20/2019



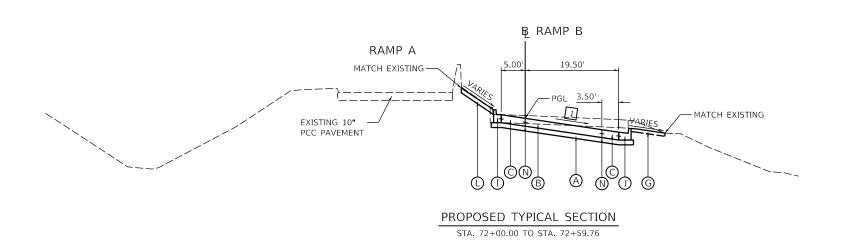

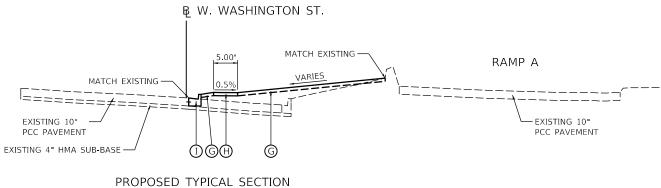

REVISED

REVISED

REVISED

REVISED

STA. 15+72.70 TO STA. 16+59.20

DESIGNED -

DRAWN -

CHECKED

RLA

MGD

3/21/2019

1. SEE GRADING DETAILS FOR ADDITIONAL INFORMATION.

LEGEND

(A) AGGREGATE SUBGRADE IMPROVEMENT 6"

B PORTLAND CEMENT CONCRETE PAVEMENT, 10" (JOINTED)

O PORTLAND CEMENT CONCRETE SHOULDERS, 10"

D INCIDENTAL HOT-MIX ASPHALT SURFACING

E TEMPORARY PAVEMENT

F TEMPORARY SHOULDERS

G TOPSOIL FURNISH AND PLACE, 4"

H PORTLAND CEMENT CONCRETE SIDEWALK, 4 INCH

(I) COMBINATION CONCRETE CURB AND GUTTER, TYPE B-6.12

OMBINATION CONCRETE CURB AND GUTTER, TYPE B-6.24

(K) COMBINATION CONCRETE CURB AND GUTTER, TYPE B-9.12

SECTION

404 D4 IL 40 DETOUR PREP 2020 PEORIA TAZEWELL

160 15

CONTRACT NO. 68E71

CONCRETE MEDIAN SURFACE, 4 INCH

M POLYMERIZED BITUMINOUS MATERIALS (TACK COAT)

N LONGITUDINAL JOINT (SEE JOINTING PLANS)


1 PAVEMENT SLOPE STA. 72+00.00 TO STA. 73+00.00 = -7.40% STA. 73+00.00 TO STA. 73+26.11 = TRANSITION FROM -7.40% TO -6.20%

IL ROUTE 40 DETOUR ROUTE PREP 2020 TYPICAL SECTIONS - RAMP B RESTORATION (STAGE 3)




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B RIVERFRONT DR. RAMP

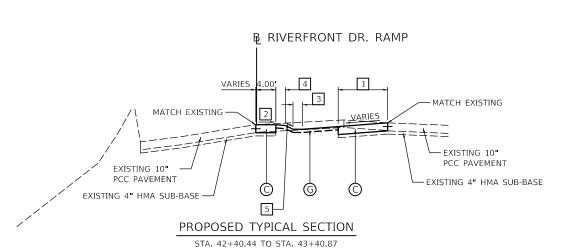


STA. 50+36.60 TO STA. 51+58.46

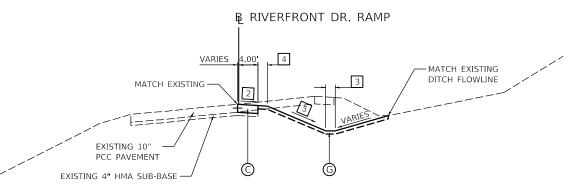

PROPOSED TYPICAL SECTION

STA, 43+40.87 TO STA, 44+25.00 STA, 47+27.00 TO STA, 50+36.60

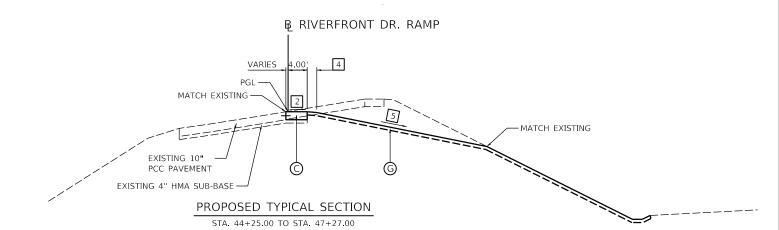

1 SHOULDER WIDTH STA. 42+25.00 TO STA. 42+40.44 = TRANSITION FROM 13.53 TO 15.77 STA. 42+40.44 TO STA. 43+40.87 = 10.00STA. 50+36.60 TO STA. 51+58.46 = 6.00

2 SHOULDER SLOPE STA. 42+40.44 TO STA. 47+30.00 = 0.00%STA. 47+30.00 TO STA. 48+30.00 = TRANSITION FROM 0.00% TO -4.00%STA. 48+30.00 TO STA. 51+25.00 = -4.00%STA. 51+25.00 TO STA. 51+58.46 = TRANSITION FROM -4.00% TO -0.75%

STA. 42+40.44 TO STA. 42+75.00 = TRANSITION FROM 0.00' TO 2.00' STA. 42+75.00 TO STA. 50+50.00 = 2.00STA. 50+50.00 TO STA. 51+58.46= TRANSITION FROM 2.00' TO 0.00'

4 TURF SHOULDER WIDTH STA. 42+40.44 TO STA. 42+75.00 = TRANSITION FROM 0.00' TO 2.00' STA. 42+75.00 TO STA. 50+50.00 = 2.00STA. 50+50.00 TO STA. 51+58.46= TRANSITION FROM 2.00' TO 0.00'

5 DITCH FORESLOPE STA. 42+40.44 TO STA. 43+00.00 = 1:4 STA. 43+00.00 TO STA. 44+25.00 = TRANSITION FROM 1:4 TO 1:10 STA. 44+25.00 TO STA. 45+50.00 = 1:10 STA. 45+50.00 TO STA. 46+12.00 = TRANSITION FROM 1:10 TO 1:4.5 STA. 46+12.00 TO STA. 46+75.00 = TRANSITION FROM 1:4.5 TO 1:10 STA. 46+75.00 TO STA. 48+25.00 = TRANSITION FROM 1:10 TO 1:4 STA. 48+25.00 TO STA. 51+58.46 = 1:4

NOTES:

- SEE GRADING DETAILS FOR ADDITIONAL INFORMATION.
- 2. PROPOSED TRANSVERSE PAVEMENT JOINTS SHALL MATCH THE EXISTING ADJACENT PAVEMENT JOINTS.

LEGEND

- (A) AGGREGATE SUBGRADE IMPROVEMENT 6"
- (B) PORTLAND CEMENT CONCRETE PAVEMENT, 10" (JOINTED)
- (C) PORTLAND CEMENT CONCRETE SHOULDERS, 10"
- (D) INCIDENTAL HOT-MIX ASPHALT SURFACING
- (E) TEMPORARY PAVEMENT
- F TEMPORARY SHOULDERS
- G TOPSOIL FURNISH AND PLACE, 4"
- (H) PORTLAND CEMENT CONCRETE SIDEWALK, 4 INCH
- () COMBINATION CONCRETE CURB AND GUTTER, TYPE B-6.12
- () COMBINATION CONCRETE CURB AND GUTTER, TYPE B-6.24
- (K) COMBINATION CONCRETE CURB AND GUTTER, TYPE B-9.12
- CONCRETE MEDIAN SURFACE, 4 INCH
- M POLYMERIZED BITUMINOUS MATERIALS (TACK COAT)
- (N) LONGITUDINAL JOINT (SEE JOINTING PLANS)

HANSON

SER NAME = Ander00846 DESIGNED -REVISED DRAWN RLA REVISED HECKED MGD REVISED PLOT DATE = 4/29/2019 REVISED DATE 3/21/2019

STATE OF ILLINOIS **DEPARTMENT OF TRANSPORTATION**

IL ROUTE 40 DETOUR ROUTE PREP 2020 TYPICAL SECTIONS - RIVERFRONT DR. RAMP RESTORATION (STAGE 4)

COUNTY 160 16 CONTRACT NO. 68E71



i contract of the contract of		∟ ∧	RTHWORK SUMMARY	,		
		20200100	THINORK SOMMAKI			20400800
		20200100	EXCAVATION TO BE		EARTHWORK	20400600
LOCA-	TION	EARTH	USED IN EMBANKMENT		BALANCE	FURNISHED
LOCA	IION	EXCAVATION	ADJUSTED FOR	EMBANKMENT	WASTE (+) OR	EXCAVATION
		EXCAVATION	25% SHRINKAGE		SHORTAGE (-)	EXCAVATION
BEGIN STATION	END STATION	CUYD	CU YD	CU YD	CU YD	CUYD
BEGIN STATION	END STATION	COTD	COTD	COTD	COTD	COTD
STAG	SF 1					
RIVERFRONT						
42+25.00	48+00.00	60	45	2115	-2070	
48+00.00	52+76.46	40	30	315	-285	
40.00.00	02.70.40	10		010	200	
RAM	P B					
73+13.06	74+07.14	145	109	0	109	
STAGE 1	I TOTAL	245	184	2430	-2246	2246
STAG	GE 2					
RAM	PВ					
72+00.00	73+13.06	75	56	95	-39	
STAGE 2	2 TOTAL	75	56	95	-39	39
STAG						
RAM						
72+00.00	73+54.04	185	139	60	79	
14/ 14/4 61 11	10701107					
W. WASHIN				100		
15+72.70	16+59.20	5	4	100	-96	
074.05.0	TOTAL	190	110	100	47	17
STAGE 3	BIOTAL	190	143	160	-17	17
STAG	2E 1					
RIVERFRONT		-				
42+25.00	48+00.00	1340	1005	5	1000	
48+00.00	52+76.46	265	199	5	194	
40 1 00.00	32170.40	200	100		107	
STAGE 4	LTOTAL	1605	1204	10	1194	
3,7,02 4		1000	1201		1101	
тот	ĀL	2115	1587	2695		2302
			1			

5	STRUCTURE REMOVAL AND ADJUSTMENT SCHEDULE							
		60255500	60500060	X6024503				
LO	CATION	MANHOLES TO BE ADJUSTED	REMOVING INLETS	INLETS TO BE ADJUSTED WITH NEW FRAME AND GRATE (SPECIAL)				
STATION	OFFSET	EACH	EACH	EACH				
ST	TAGE 1							
R/	AMP B							
72+73.34	40.74' LT			1				
72+88.52	51.55' RT			1				
ST	AGE 1							
R/	AMP B							
72+89.00	5.33' LT		1					
ST	AGE 4							
W. WASHING	STON ST MEDIAN	1	1	1				
Т	OTAL	1	2	3				

STORM SEV	VER REMOVAL	SCHEDULE	
	55100500		
LOCA	STORM SEWER		
	REMOVAL 12"		
BEGIN STATION	FOOT		
STAC	GE 3		
RAM	IP B		
72+00.00	73+54.04	58	
STAC	GE 4		
W. WASHINGTO	7		
TOT	ΓAL	65	

		DA\/E	MENT REMOVAL SO	PHEDIII E		
		44000100	44000500	44000600	44003100	X4401198
LOCA	ATION	PAVEMENT REMOVAL	COMBINATION CURB AND GUTTER REMOVAL	SIDEWALK REMOVAL	MEDIAN REMOVAL	HOT-MIX ASPHALT SURFACE REMOVAL VARIABLE DEPTH
BEGIN STATION	END STATION	SQ YD	FOOT	SQ FT	SQ FT	SQ YD
TAZEWEL	L COUNTY					
STAG	GE 1					
RIVERFRONT	DRIVE RAMP					
42+25.00	48+00.00	398				
48+00.00	52+76.46	237				113
RAM	IP B					
73+13.06	74+07.14		96	474	222	
STA						
RAM						
72+00.00	73+13.06	320	164		198	
STAG	GE 3					
RAM	1P B					
72+00.00	73+54.04	533	269	98	334	
STAC	GE 4					
RIVERFRONT	DRIVE RAMP					
42+25.00	48+00.00	1,401				
48+00.00	52+76.46	717				
W. WASHINGTO	ON ST MEDIAN	199	190			
PEORIA	COUNTY					
IL RTE 40 / JEF	FERSON AVE	23	16	254	127	
TO	TAL	3,828	735	826	881	113

		REMOVAL	SCHEDULE		
		72400100	72400320	X0322936	X6015000
LOCATION		REMOVE SIGN PANEL ASSEMBLY - TYPE A	REMOVE SIGN PANEL - TYPE 2	REMOVE EXISTING FLARED END SECTION	REMOVE CONCRETE HEADWALLS FOR PIPE DRAINS
STATION	OFFSET	EACH	SQ FT	EACH	EACH
TAZEV	VELL COUNTY				
5	STAGE 1				
RIVERFRONT DRIVE RAMP					
43+12.74	11.98' RT	1			
43+95.61	26.97' RT				1
45+73.64	44.42' RT			1	
50+26.25	14.43' RT	1			
	STAGE 3				
RIVERFRONT DRIVE RAMP					
48+00.00	21.02' RT	1			
48+00.00	31.51' LT	1			
	RAMP B				
73+05.70	3.94' RT	1			
73+17.59	23.10' LT	1			
73+19.75	52.94' LT	1			
STAGE 4					
RIVERFRONT DRIVE RAMP					
43+73.22	30.02' RT	1			
49+50.24	27.60' RT	1			
PEOI	RIA COUNTY				
IL RTE 40 / JEFFERSON AVE		3	10		
MATCHLINE D	END JEFFERSON AVE		20		
MATCHLINE K	MATCHLINE M	2			
	TOTAL	14	30	1	1

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PLOT SCALE = 2.00 ' /). CHECKED	_	MGD	REVISED	-
					-
c. PLOT DATE = 3/21/201	DATE	-	3/21/2019	REVISED	=

IL ROU	IL ROUTE 40 DETOUR ROUTE PREP 2020				F.A.P. RTE	SEC.	ΓΙΟΝ		COUNTY	TOTAL SHEETS	SHEE NO.
SCHEDULE OF QUANTITIES					404	D4 IL 40 DETO	UR PRE	P 2020	PEORIA TAZEWELL	160	17
SCHEDOLE OF QUANTITIES								CONTRACT	NO.	68E71	
SHEET	OF	SHEETS	STA.	TO STA.			ILLINOIS	FED. A	ID PROJECT		



GNED	BAB	2/20/2019
WN)EO	2/20/2019
/IEWED	MGD	3/20/2019
DEL: Default	efault	

			COMBINATION CON	CRETE CURB & GUT	TER AND CONCRETE	MEDIAN SCHEDUL	E		
		60603800	60604400	60605000	60605900	60618300	60619200	60620000	60620800
LOCA	ATION	COMBINATION CONCRETE CURB AND GUTTER. TYPE B-6.12	COMBINATION CONCRETE CURB AND GUTTER, TYPE B-6.18	COMBINATION CONCRETE CURB AND GUTTER, TYPE B-6.24	COMBINATION CONCRETE CURB AND GUTTER, TYPE B-9.12	CONCRETE MEDIAN SURFACE, 4 INCH	CONCRETE MEDIAN, TYPE SB-6.06	CONCRETE MEDIAN, TYPE SB-6.24	CONCRETE MEDIAN TYPE SB-9.12
BEGIN STATION	END STATION	FOOT	FOOT	FOOT	FOOT	SQ FT	SQ FT	SQ FT	SQ FT
TAZEWEL	L COUNTY								
STA	GE 1								
RIVERFRONT	DRIVE RAMP								
42+25.00	48+00.00								
48+00.00	52+76.46								
RAM	иР В								
73+13.06	74+07.14				75				45
STA	GE 2								
RAM	ИР B								
72+00.00	73+13.06				100	44			
STA	GE 3								
RAM	ИР B								
72+00.00	73+54.04	124	40	214		179		75	
STA	GE 4								
RIVERFRONT	DRIVE RAMP								
42+25.00	48+00.00								
48+00.00	52+76.46								
W. WASHINGT	ON ST MEDIAN			245		1,865			
PEORIA	COUNTY								
IL RTE 40 / JEF	FFERSON AVE			16			338		
TO	TAL	124	40	475	175	2,088	338	75	45

				PAVEM	ENT SCHEDULE					
		30300106	35101400	40600295	40800050	42000501	42001300	48300500	X4810100	Z0062456
LOC	ATION	AGGREGATE SUBGRADE IMPROVEMENT 6"	AGGREGATE BASE COURSE, TYPE B	POLYMERIZED BITUMINOUS MATERIALS (TACK COAT)	INCIDENTAL HOT-MIX ASPHALT SURFACING	PORTLAND CEMENT CONCRETE PAVEMENT 10" (JOINTED)	PROTECTIVE COAT	PORTLAND CEMENT CONCRETE SHOULDERS 10"	TEMPORARY SHOULDERS	TEMPORARY PAVEMENT
BEGIN STATION	END STATION	SQ YD	TON	POUND	TON	SQ YD	SQ YD	SQ YD	SQ YD	SQ YD
TAZEWEL	L COUNTY									
STA	GE 1									
RIVERFRONT	DRIVE RAMP									
42+25.00	48+00.00								316	1,085
48+00.00	52+76.46			82	6				183	534
RAN	MP B									
73+13.06	74+07.14						24		61	132
STA	GE 2									
	MP B									
72+00.00	73+13.06						31		88	252
STA	GE 3									
	MP B	+								
72+00.00	73+54.04	398				205	458	111		
STA	GE 4									
	DRIVE RAMP									
42+25.00	48+00.00						432	432		
48+00.00	52+76.46						245	245		
W. WASHINGT	TON ST MEDIAN		142			4	296			
PEORIA	COUNTY									
	FFERSON AVE						43			
TO	OTAL .	398	142	82	6	209	1,529	788	648	2,003

	SIDEWAL	K SCHEDULE	
		42400100	42400800
LOCA	TION	PORTLAND CEMENT CONCRETE SIDEWALK 4 INCH	DETECTABLE WARNINGS
BEGIN STATION	END STATION	SQ FT	SQ FT
STAC	GE 3		
RAM	IP B		
72+00.00	73+54.04	780	30
STAC	GE 4		
IL RTE 40 / JEF	FERSON AVE	254	254
FROM TRAFFIC	SIGNAL PLANS	12	
TOT	TAL	1,046	284

28200200 FILTER FABRIC
FILTER FABRIC
COVD
SQ YD
11
11

RECOVERABLE DELINEATORS						
X260000						
LO	RECOVERABLE					
		DELINEATORS				
STATION	OFFSET	EACH				
ST						
RIVERFRO	NT DRIVE RAMP					
44+00.00	24.00' RT	1				
44+30.52	24.00' RT	1				
44+61.03	24.00' RT	1				
44+91.55	24.00' RT	1				
45+22.07	24.00' RT	1				
45+52.59	24.00' RT	1				
45+83.10	24.00' RT	1				
46+13.62	24.00' RT	1				
46+44.14	24.00' RT	1				
46+74.66	24.00' RT	1				
47+05.17	24.00' RT	1				
47+35.69	24.00' RT	1				
47+66.21	24.00' RT	1				
47+97.94	23.85' RT	1				
	OTAL	14				

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USER NAME = Ander00846	DESIGNED	-	BAB	REVISED	-
	DRAWN	-	JEO	REVISED	E .
PLOT SCALE = 2.00 / In	CHECKED	-	MGD	REVISED	E .
PLOT DATE = 3/21/2019	DATE	-	3/21/2019	REVISED	=

IL ROUT	IL ROUTE 40 DETOUR ROUTE PREP 2020						SECTION		COUNTY	TOTAL SHEETS	SHEET NO.	
SCHEDULE OF QUANTITIES					404	D4	D4 IL 40 DETOUR PREP 2020		PEORIA TAZEWELL	160	18	
										CONTRACT	NO.	58E71
SHEET	OF	SHEETS	STA.	TO STA.				ILLINOIS	FED. Al	ID PROJECT		



MGD 3/20/2019	BAB 2/20/2019

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				TOPSOIL,	SEEDING, & F	ERILIZER NUT	RIENTS		<u> </u>	<u> </u>
		21101615	25000210	25000400	25000500	25000600	25100115	25100630	28000250	28000400
LOCATION	TOPSOIL	SEEDING.	NITROGEN	PHOSPHORUS	POTASSIUM	MULCH,	EROSION CONTROL	TEMPORARY	PERIMETER	
LOCA	ATION	FURNISH AND	CLASS 2A	FERTILIZER	FERTILIZER	FERTILIZER	· · · · · · · · · · · · · · · · · · ·		EROSION CONTROL	EROSION
		PLACE, 4"	CLASS ZA	NUTRIENT	NUTRIENT	NUTRIENT	METHOD 2	BLANKET	SEEDING	BARRIER
BEGIN STATION	END STATION	SQYD	ACRE	POUND	POUND	POUND	ACRE	SQ YD	POUND	FOOT
AT.S	GE 1									
	DRIVE RAMP									
42+25.00	48+00.00						0.44	549	50	
48+00.00	52+76.46						0.05	201	8	
48+00.00	32+70.40						0.03	201	0	
RAN	ИР В									
73+13.06	74+07.14							184	4	
ATS.	GE 2									
	MP B									
72+00.00	73+13.06							280	6	87
72+00.00	75+15.00							200	0	67
STA	GE 3									
RAMP B										
72+00.00	73+54.04	595	0.12	11	11	11		595		101
ATS.	GE 4									
	DRIVE RAMP									
42+25.00	48+00.00	3.366	0.70	63	63	63	0.64	651		
48+00.00	52+76.46	874	0.18	16	16	16	0.12	353		
	32 . 3 3				1		2	1 222		
W. WASHINGT	ON ST MEDIAN									
ТО	TAL	4,835	1.00	90	90	90	1.25	2,813	68	188

INLE	T AND PIPE PI	ROTECTION SCH	IEDULE
		28000500	28000510
LO	INLET AND PIPE PE LOCATION STATION OFFSET STAGE 1 RIVERFRONT DRIVE RAMP 45+72.00 74.38' RT RAMP B 72+89.00 5.33' LT 72+88.92 51.32' RT STAGE 2 RAMP B 73+12.77 74.38' RT 73+16.86 37.42' RT STAGE 3 RAMP B 73+25.26 20.76' RT 73+25.39 24.25' LT 73+55.83 17.37' LT STAGE 4 RIVERFRONT DRIVE RAMP 45+72.00 74.38' RT	INLET AND PIPE PROTECTION	INLET FILTERS
STATION	OFFSET	EACH	EACH
ST	AGE 1		
RIVERFRON			
45+72.00	74.38' RT	1	
R/	AMP B		
72+89.00	5.33' LT		1
72+88.92	51.32' RT		1
ST	AGE 2		
R/	AMP B		
73+12.77	74.38' RT		1
73+16.86 37.42' RT			1
ST	AGE 3		
	AMP B		
73+25.26	20.76' RT		1
73+25.39	24.25' LT		1
73+55.83	17.37' LT		1
ST	AGE 4		
RIVERFRON	IT DRIVE RAMP		
45+72.00	74.38' RT	1	
Т	OTAL	2	7

STATION DEFINITION DEFINI			END SECTION SCHEDULE			
FLARED END SECTIONS 24" FOR PIPE DRAINS	LOCATION		54213669	60100060		
STATION OFFSET EACH STAGE 1 RIVERFRONT DRIVE RAMP 44+83.81 59.16' RT 1			PRECAST REINFORCED CONCRETE	CONCRETE HEADWALLS		
STAGE 1 RIVERFRONT DRIVE RAMP 44+83.81 59.16' RT 1			FLARED END SECTIONS 24"	FOR PIPE DRAINS		
RIVERFRONT DRIVE RAMP 44+83.81 59.16' RT 1	STATION	OFFSET	EACH	EACH		
RIVERFRONT DRIVE RAMP 44+83.81 59.16' RT 1						
44+83.81 59.16' RT 1	STAGE 1					
1. 22.2	RIVERFRONT DRIVE RAMP					
45+72.00 74.38' RT 1	44+83.81	59.16' RT		1		
	45+72.00	74.38' RT	1			
		_				
TOTAL 1 1	Т	TOTAL	1	1		

C	ULVERT AND PIPI	E DRAINS SCHEDULE		
		542A1069	X6011705	
LOC	ATION	PIPE CULVERTS, CLASS	PIPE DRAINS	
		A, TYPE 2 24"	6" (SPECIAL)	
BEGIN STATION	END STATION	FOOT	FOOT	
STA	GE 1			
RIVERFRON'	T DRIVE RAMP			
42+25.00	48+00.00	30	106	
TC	DTAL	30	106	

OFFSET 1 RIVE RAMP 28.70' RT 32.50' RT 33.250' RT 33.634' RT 39.88' RT 43.05' RT 49.69' RT 53.03' RT 56.37' RT 66.64' RT 70.13' RT 70.13' RT 73.48' RT 73.48' RT 73.48' RT 73.48' RT 73.13' RT 64.92' RT 60.92' RT 57.00' RT 53.13' RT 49.37' RT 41.87' RT 43.81' RT 47.51' RT 48.95' RT	28000305 TEMPORARY DITCH CHECKS FOOT 10 10 10 10 10 10 10 10 10 10 10 10 10
OFFSET 1 RIVE RAMP 28.70' RT 32.50' RT 36.34' RT 43.05' RT 49.69' RT 553.03' RT 56.37' RT 59.73' RT 66.64' RT 70.13' RT 73.48' RT 73.09' RT 69.01' RT 64.92' RT 60.92' RT 57.00' RT 53.13' RT 49.37' RT 49.37' RT 49.37' RT 45.68' RT 41.87' RT 33.18' RT 33.18' RT 23.95' RT 20.67' RT	DITCH CHECKS FOOT 10 10 10 10 10 10 10 10 10 10 10 10 10
1 RIVE RAMP 28.70' RT 32.50' RT 36.34' RT 49.35' RT 49.69' RT 553.03' RT 56.37' RT 65.17' RT 66.64' RT 70.13' RT 73.48' RT 73.09' RT 69.01' RT 64.92' RT 65.31' RT 57.00' RT 57.00' RT 53.13' RT 49.37' RT 45.68' RT 41.87' RT 33.18' RT 37.51' RT 33.18' RT 23.95' RT 20.67' RT 44.37' RT 45.68' RT 41.87' RT 33.18' RT 45.68' RT 41.87' RT 37.51' RT 33.18' RT 23.95' RT 40.67' RT 40.	10 10 10 10 10 10 10 10 10 10 10 10 10 1
1 RIVE RAMP 28.70' RT 32.50' RT 36.34' RT 49.35' RT 49.69' RT 553.03' RT 56.37' RT 65.17' RT 66.64' RT 70.13' RT 73.48' RT 73.09' RT 69.01' RT 64.92' RT 65.31' RT 57.00' RT 57.00' RT 53.13' RT 49.37' RT 45.68' RT 41.87' RT 33.18' RT 37.51' RT 33.18' RT 23.95' RT 20.67' RT 44.37' RT 45.68' RT 41.87' RT 33.18' RT 45.68' RT 41.87' RT 37.51' RT 33.18' RT 23.95' RT 40.67' RT 40.	10 10 10 10 10 10 10 10 10 10 10 10 10 1
RIVE RAMP 28.70' RT 32.50' RT 36.34' RT 39.88' RT 43.05' RT 46.35' RT 49.69' RT 53.03' RT 56.37' RT 66.64' RT 70.13' RT 73.48' RT 73.09' RT 64.92' RT 60.92' RT 57.00' RT 53.13' RT 49.37' RT 49.37' RT 49.37' RT 49.37' RT 45.68' RT 41.87' RT 33.18' RT 23.95' RT 20.67' RT	10 10 10 10 10 10 10 10 10 10 10 10 10 1
RIVE RAMP 28.70' RT 32.50' RT 36.34' RT 39.88' RT 43.05' RT 46.35' RT 49.69' RT 53.03' RT 56.37' RT 66.64' RT 70.13' RT 73.48' RT 73.09' RT 64.92' RT 60.92' RT 57.00' RT 53.13' RT 49.37' RT 49.37' RT 49.37' RT 49.37' RT 45.68' RT 41.87' RT 33.18' RT 23.95' RT 20.67' RT	10 10 10 10 10 10 10 10 10 10 10 10 10 1
28. 70' RT 32. 50' RT 36. 34' RT 39. 88' RT 43. 05' RT 46. 35' RT 49. 69' RT 53. 03' RT 56. 37' RT 66. 64' RT 70. 13' RT 73. 48' RT 73. 09' RT 64. 92' RT 60. 92' RT 57. 00' RT 53. 13' RT 49. 37' RT 49. 37' RT 45. 68' RT 41. 87' RT 33. 18' RT 23. 95' RT 20. 67' RT	10 10 10 10 10 10 10 10 10 10 10 10 10 1
32.50' RT 36.34' RT 39.88' RT 43.05' RT 46.35' RT 49.69' RT 53.03' RT 56.37' RT 66.31' RT 66.64' RT 70.13' RT 73.48' RT 73.09' RT 69.01' RT 64.92' RT 57.00' RT 53.13' RT 49.37' RT 49.37' RT 49.37' RT 45.68' RT 41.87' RT 33.18' RT 23.95' RT	10 10 10 10 10 10 10 10 10 10 10 10 10 1
36. 34' RT 39. 88' RT 43. 05' RT 46. 35' RT 49. 69' RT 53. 03' RT 59. 73' RT 63. 17' RT 63. 17' RT 63. 18' RT 73. 48' RT 73. 09' RT 64. 92' RT 60. 92' RT 57. 00' RT 53. 13' RT 49. 37' RT 45. 68' RT 41. 87' RT 33. 18' RT 23. 95' RT 23. 95' RT	10 10 10 10 10 10 10 10 10 10 10 10 10 1
39.88' RT 43.05' RT 46.35' RT 49.69' RT 53.03' RT 59.73' RT 63.17' RT 63.17' RT 63.17' RT 60.13' RT 73.48' RT 73.09' RT 64.92' RT 60.92' RT 57.00' RT 53.13' RT 49.37' RT 41.87' RT 33.18' RT 42.37' RT	10 10 10 10 10 10 10 10 10 10 10 10 10 1
43.05' RT 46.35' RT 49.69' RT 53.03' RT 56.37' RT 59.73' RT 63.17' RT 66.64' RT 73.48' RT 73.09' RT 64.92' RT 60.92' RT 57.00' RT 57.00' RT 57.00' RT 57.00' RT 41.87' RT 44.87' RT 33.18' RT 23.95' RT 20.67' RT	10 10 10 10 10 10 10 10 10 10 10 10 10 1
46.35' RT 49.69' RT 53.03' RT 56.37' RT 59.73' RT 63.17' RT 66.64' RT 70.13' RT 73.48' RT 69.01' RT 60.92' RT 57.09' RT 57.09' RT 57.09' RT 57.31' RT 49.37' RT 45.68' RT 41.87' RT 33.18' RT 23.95' RT 20.67' RT	10 10 10 10 10 10 10 10 10 10 10 10 10 1
49.69' RT 53.03' RT 56.37' RT 59.73' RT 63.17' RT 66.64' RT 70.13' RT 73.48' RT 69.01' RT 60.92' RT 57.00' RT 53.13' RT 45.68' RT 41.87' RT 33.18' RT 33.18' RT 23.95' RT 20.67' RT	10 10 10 10 10 10 10 10 10 10 10 10 10 1
53.03' RT 56.37' RT 59.73' RT 63.17' RT 66.64' RT 70.13' RT 73.48' RT 73.09' RT 69.01' RT 64.92' RT 60.92' RT 57.00' RT 53.13' RT 49.37' RT 449.37' RT 441.87' RT 33.18' RT 23.95' RT 20.67' RT	10 10 10 10 10 10 10 10 10 10 10 10 10 1
56. 37' RT 59. 73' RT 63. 17' RT 66. 64' RT 70. 13' RT 73. 48' RT 73. 09' RT 69. 01' RT 64. 92' RT 60. 92' RT 57. 00' RT 53. 13' RT 49. 37' RT 49. 37' RT 41. 87' RT 33. 18' RT 23. 95' RT 20. 67' RT	10 10 10 10 10 10 10 10 10 10 10 10 10 1
59,73' RT 63,17' RT 66,64' RT 70,13' RT 73,48' RT 73,09' RT 69,01' RT 64,92' RT 60,92' RT 57,00' RT 53,13' RT 49,37' RT 44,87' RT 41,87' RT 33,18' RT 23,95' RT 20,67' RT	10 10 10 10 10 10 10 10 10 10 10 10 10 1
63.17' RT 66.64' RT 70.13' RT 73.48' RT 73.09' RT 69.01' RT 64.92' RT 60.92' RT 57.00' RT 53.13' RT 49.37' RT 45.68' RT 41.87' RT 33.18' RT 23.95' RT	10 10 10 10 10 10 10 10 10 10 10 10 10 1
66.64' RT 70.13' RT 73.48' RT 73.09' RT 69.01' RT 64.92' RT 57.00' RT 53.13' RT 49.37' RT 45.68' RT 41.87' RT 33.18' RT 23.95' RT	10 10 10 10 10 10 10 10 10 10 10 10 10 1
70.13' RT 73.48' RT 73.09' RT 69.01' RT 64.92' RT 57.00' RT 53.13' RT 45.68' RT 45.68' RT 41.87' RT 33.18' RT 23.95' RT	10 10 10 10 10 10 10 10 10 10 10 10 10 1
73.48' RT 73.09' RT 69.01' RT 64.92' RT 57.00' RT 53.13' RT 49.37' RT 45.68' RT 41.87' RT 33.18' RT 23.95' RT	10 10 10 10 10 10 10 10 10 10 10 10 10
73.09' RT 69.01' RT 64.92' RT 60.92' RT 57.00' RT 53.13' RT 49.37' RT 45.68' RT 41.87' RT 33.18' RT 23.95' RT	10 10 10 10 10 10 10 10 10 10 10 10
69.01' RT 64.92' RT 60.92' RT 57.00' RT 53.13' RT 49.37' RT 45.68' RT 41.87' RT 37.51' RT 33.18' RT 23.95' RT	10 10 10 10 10 10 10 10 10 10 10
64.92' RT 60.92' RT 57.00' RT 53.13' RT 49.37' RT 45.68' RT 41.87' RT 37.51' RT 33.18' RT 23.95' RT 4	10 10 10 10 10 10 10 10 10 10
60.92' RT 57.00' RT 53.13' RT 49.37' RT 45.68' RT 41.87' RT 37.51' RT 33.18' RT 23.95' RT 20.67' RT	10 10 10 10 10 10 10 10 10
57.00' RT 53.13' RT 49.37' RT 45.68' RT 41.87' RT 37.51' RT 33.18' RT 23.95' RT 20.67' RT	10 10 10 10 10 10 10 10 10
53.13' RT 49.37' RT 45.68' RT 41.87' RT 37.51' RT 33.18' RT 23.95' RT 20.67' RT	10 10 10 10 10 10 10
49.37' RT 45.68' RT 41.87' RT 37.51' RT 33.18' RT 23.95' RT 20.67' RT	10 10 10 10 10 10
45.68' RT 41.87' RT 37.51' RT 33.18' RT 23.95' RT 20.67' RT	10 10 10 10 10
41.87' RT 37.51' RT 33.18' RT 23.95' RT 20.67' RT	10 10 10 10
37.51' RT 33.18' RT 23.95' RT 20.67' RT	10 10 10
33.18' RT 23.95' RT 20.67' RT	10 10
23.95' RT 20.67' RT	10
20.67' RT 4	
4	10
8.59' RT	10
11.89' RT	10
16.22' RT	10
22.46' RT	10
31.05' RT	10
44.05' RT	10
46.35' RT	10
49.69' RT	10
53.03' RT	10
56.37' RT	10
59.73' RT	10
63.17' RT	10
	10
	10
13 7/I' DT	10
13.74' RT	10
12.32' RT	10 10
	10 10
12.32' RT	

nson Professional Services Inc. 2019 USER NAME = Ander 00846	DESIGNED - BAB	REVISED -
HANGON	DRAWN - JEO	REVISED -
HANSON PLOT SCALE = 2.00 / In.	CHECKED - MGD	REVISED -
essional Services Inc. PLOT DATE = 3/21/2019	DATE - 3/21/20	019 REVISED -

STATE	E OF	ILLINOIS
DEPARTMENT	OF	TRANSPORTATION

	IL ROUTE 40 DETOUR ROUTE PREP 2020 SCHEDULE OF QUANTITIES					F.A.P. RTE	SECTION		COUNTY	TOTAL SHEETS	SHEET NO.	
						404	D4 IL 40 DETO	UR PREF	2020	PEORIA TAZEWELL	160	19
	SCHEDOLL OF QUANTITIES									CONTRACT	NO.	58E71
	SHEET	OF	SHEETS	STA.	TO STA.			ILLINOIS	FED. AI	D PROJECT		



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						l l				1		
TAZEWE	LL COUNTY	,									-	
ST	AGE 1											_
BEGIN S1	44-	+00.00			889		138		101			
44+00.00	57-	+00.00			1,063	3	1,018	Į	556			
57+00.00	END RIVE	RFRONT DR			305		585					
W. WAS	HINGTON ST	-			175							
	R ROAD						169					
ST	AGE 3											
BEGIN S3	46	+50.00			436			- 2	241			
46+50.00	61·	+00.00			3,557	7	1,237	(969			
61+00.00	67·	+00.00			2,527	7	571	2	255			
23+00.00	MATO	HLINE B			333				30			
MATCHLINE B	MATO	CHLINE C			6,326	6	90		127			_
MATCHLINE C	MATO	HLINE D			2,746	6	297		169			_
MATCHLINE D	EI	ND S3	9	0	952		592		59	18		
	'											
ST	AGE 4											
BEGIN S4	46	+50.00			259							_
46+50.00	61·	+00.00			1,708	8	700	2	230			_
61+00.00	67·	+00.00			690							_
67+00.00	MATO	CHLINE C			881							
MATCHLINE C	14-	+94.00			116							
IL RTE 40 /	RIVER ROA	VD			1,179	9						
CONT	INGENCY											
PEORI	A COUNTY									+		
IL RTE 40	/ ADAMS S	Т			113		272		7	11		
IL RTE 40 / JE	EFFERSON	AVE	6	4	110		1.431		384	+	-	
MATCHLINE D	END JEFF	ERSON AVE	1′	16	97		790		306			_
MATCHLINE H	MATO	CHLINE J					65			12		
MATCHLINE I	MATO	HLINE K			33		132		15			
MATCHLINE J	MATO	CHLINE L			120		267			23		_
			5	2	196		132		22	+		_
MATCHLINE L	EI	ND S4			19					13	-	
MATCHLINE M		ND S4	2	6	89		371			24		_
	•											
T	OTAL		34	18	24,91	9	8,857	3,	471	101		
MATCHLINE M	MATC E1	CHLINE L CHLINE M ND S4 ND S4		2	52 26 348	52 196 19 26 89	52 196 19 26 89	52 196 132 19 26 89 371	52 196 132 19 19 19 19 19 19 19 19 19 19 19 19 19	52 196 132 22 19 26 89 371	52 196 132 22 19 13 26 89 371 24	52 196 132 22 19 13 26 89 371 24
	Т	EMPORARYO	CONCRE	TE BARRIER S	SCHEDI	ULE						
		7040010	0	70400200	,		70600241					
LOCATON		TEMBODA	DV	RELOCAT	E	IMPA	ACT ATTENUATORS,					
LOCATION		TEMPORA	rt	TEMPORAF	RY	TEMPORA	TEMPORARY (NON- REDIRECTIVE					

PAVEMENT MARKING SCHEDULE 78009004

MODIFIED

URETHANE

PAVEMENT

MARKING - LINE 4"

FOOT

78009000 MODIFIED URETHANE

PAVEMENT MARKING -

LETTERS AND

SYMBOLS

SQ FT

LOCATION

END STATION

BEGIN STATION

78009008

MODIFIED

URETHANE

FOOT

78009012

MODIFIED

URETHANE

PAVEMENT PAVEMENT PAVEMENT
MARKING - LINE 8" MARKING - LINE 12" MARKING - LINE 24"

FOOT

78009024

MODIFIED

URETHANE

FOOT

X6350120

DELINEATOR

REMOVAL

EACH

LOCATION		70400400		TEMPORARY CONCRETE BARRIER SCHEDULE								
1.00AT/		70400100	70400200	70600241								
	ON	TEMPORARY	RELOCATE	IMPACT ATTENUATORS,								
LOCATIO	ON	CONCRETE BARRIER	TEMPORARY	TEMPORARY (NON- REDIRECTIVE,								
		CONCRETE BARRIER	CONCRETE BARRIER	NARROW), TEST LEVEL 2								
STATION	OFFSET	FOOT	FOOT	EACH								
· ·												
STAGE	2											
RIVERFRONT	T DRIVE	687.5		1								
STAGE	3											
RIVERFRONT DRIVE		1175.0	137.5	1								
TOTAL	L	1862.5	137.5	2								

TEMPORAR'	Y PAVEMENT MARK	ING AND REMOVA	AL SCHEDULE
		70300220	X0327980
100	ATION	TEMPORARY	PAVEMENT MARKING
LOCA	AΠON	PAVEMENT	REMOVAL - WATER
		MARKING - LINE 4"	BLASTING
BEGIN STATION	END STATION	FOOT	SQ FT
TAZEWEL	L COUNTY		
STA	GE 1		
RIVERFRONT	DRIVE RAMP		
BEGIN S1	44+00.00	2,255	752
44+00.00	57+00.00	3,715	1,238
57+00.00	END RIVERFRONT DR	2,375	792
RAN	ИР В	900	300
RIVER	ROAD	225	75
STAC	GE 1A		
RAN	MP B	63	21
STA	GE 2		
RIVERFRONT	DRIVE RAMP	1,962	654
RAI	ИР B	1,125	375
RIVER	ROAD	225	75
STAC	GE 2A		
RAN	ИР B	63	21
STA	GE 3		
RIVERFRONT	DRIVE RAMP	2,554	851
RAI	ИР B	1,125	375
RIVER	ROAD	225	75
STAC	GE 3A		
RAN	ИР В	63	21
STA	GE 4		
BEGIN S4	44+00.00	2,255	752
44+00.00	57+00.00	3,715	1,238
57+00.00	END RIVERFRONT DR	2,375	792
W. WASHINGT	ON ST MEDIAN	2,440	813
PEORIA	COUNTY		
IL RTE 40 / JEI	FFERSON AVE	984	328
ТО	TAL	28,644	9,548

ř	
3	Copyright Hanson Professional Services Inc. 2019
NAME:	
ΝĀ	CST HANSON
빌	
ш	Hanson Professional Services Inc.

USER NAME = Ander00846	DESIGNED -	BAB	REVISED -
	DRAWN -	JEO	REVISED -
PLOT SCALE = 2.00 / In	CHECKED -	MGD	REVISED -
PLOT DATE = 4/29/2019	DATE -	3/21/2019	REVISED -

	IL ROUTI	E 40 DET	OUR RO	UTE PREF	2020	F.A.P. RTE		SEC	TION		COUNTY	TOTAL SHEETS	SHEET NO.
	SCHEDULE OF QUANTITIES					404	D4 IL	40 DETO	UR PRE	P 2020	PEORIA TAZEWELL	160	20
											CONTRACT	NO.	68E71
	SHEET	OF	SHEETS	STA.	TO STA.				ILLINOIS	FED. A	ID PROJECT		



6107/07/7	2/20/2019	3/20/2019
BAB	OEI	MGD

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A LLANGON	
CON HANSON	Р
Hanson Professional Services Inc.	Р

	PAVEMENT MA	ARKING REMOVAL SCHEDULE								
		X0327980 PAVEMENT MARKING REMOVAL - WATER BLASTING								
LOCA	ATION	PAVEMEN	IT MARKING			ER BLAST	NG			
	I	LETTERS AND		SQ FT						
BEGIN STATION	END STATION	SYMBOLS	4"	6"	8"	12"	24"			
TA75\A/51	LCOUNTY									
	L COUNTY GE 1									
BEGIN S1	44+00.00		296		92	101				
44+00.00	57+00.00		354		679	556				
	END RIVERFRONT DR		102		390					
	NGTON ST		58							
RIVER	ROAD				113					
STA	GE 2									
	RONT DR		14		593	109				
	INGTON ST		68		112					
RIVER	ROAD				1					
OT4	OE 2									
	GE 3									
BEGIN S3 46+50.00	46+50.00 61+00.00		841		454	90				
61+00.00	67+00.00		829		30	19				
23+00.00	MATCHLINE B		29		- 30	19				
MATCHLINE B	MATCHLINE C		710							
MATCHLINE C	MATCHLINE D	432	513		132					
MATCHLINE D	END S3		147		112					
I-74 WB / WA	SHINGTON ST						132			
	COUNTY									
	ADAMS ST	288								
	FERSON AVE									
	WYNN JR AVE	288								
	MONROE ST PERRY ST	144 144								
	/ MAIN ST	144								
	AMILTON AVE									
	AYETTE AVE	288								
	TE AVE	432								
	TBOUND	432								
STA	GE 4									
	L COUNTY									
BEGIN S4	46+50.00									
46+50.00										
IL RTE 40 / F	RIVER ROAD		393		302					
DEODLA	COLINITY				-					
	ADAMS ST		23		266	121				
	FERSON AVE	146	118		764	339				
	END JEFFERSON AVE	73	110		792	130				
IL RTE 40	31			64	72	23				
IL RTE 40 / H/	52		70	754	540					
IL RTE 40 / F	26		26	166	75	53				
FROM TEMP PVMT N	MARKING SCHEDULE		9,548							
SUBT	TOTAL	2,776	14,043	96	5,815	2,152	208			
	TA !			05.000						
10	TAL			25,090	1					

			SIGN SCHE	DULE	
			72000100	72000200	72800100
LOCATION			SIGN PANEL -	SIGN PANEL -	TELESCOPING STEEL
			TYPE 1	TYPE 2	SIGN SUPPORT
STATION	OFFSET	SIGN	SQ FT	SQ FT	FOOT
TAZEV	VELL COU	NTY			
	STAGE 1				
RIVERFRONT DRIVE					
43+72.16	RT	W4-3		16	17
49+49.10	RT	W12-1	9		16
5	STAGE 2				
	RAMP B				
72+92.36	RT	W1-8R	3		15
73+14.79	RT	W1-8R	3		15
73+37.23	RT	W1-8R	3		15
·					
5	STAGE 3				
	RAMP B				
16+01.52	RT	W1-8R	3		15
16+14.59	RT	W1-8R	3		15
73+27.79	RT	R1-2	9		16
73+27.79	RT	R5-1	9		
73+30.33	LT	R1-2	9		16
73+30.33	LT	R5-1	9		
·		•			
	STAGE 4				
RIVER	FRONT DE	RIVE			
43+20.00	RT	W4-3		16	17
50+19.73	RT	W12-1	9		16
PEO	RIA COUN	TY			
IL 40 / AI	DAMS	R10-11C	8.75		
IL 40 / AI	DAMS	R10-11C	8.75		
IL 40 / JEFF	FERSON	R3-8A		10	
IL 40 / JEFF	FERSON	R3-5R	7.5		
IL 40 / JEFF	ERSON	R3-5L	7.5		
	TOTAL		101.5	42	173

USER NAME = Ander00846	DESIGNED -	BAB	REVISED -
	DRAWN -	JEO	REVISED -
PLOT SCALE = 2.00 / In	CHECKED -	MGD	REVISED -
PLOT DATE = 3/21/2019	DATE -	3/21/2019	REVISED -

STATE OF ILLINOIS DEPARTMENT OF TRANSPORTATION

						F.A.P. RTE	SECTION		COUNTY	TOTAL SHEETS	SHEET NO.
						404	D4 IL 40 DETOUR PREF	2020	PEORIA TAZEWELL	160	21
	SCHEDULE OF QUANTITIES								CONTRACT	NO.	68E71
	SHEET	OF	SHEETS	STA.	TO STA.		ILLINOIS	FED. A	ID PROJECT		

DEPARTMENT OF TRANSPORTATION

CHECKED -

DATE

MGD

3/21/2019


REVISED

404 D4 IL 40 DETOUR PREP 2020 PEORIA TAZEWELL

ALIGNMENT, BENCHMARKS AND TIES

160 22

CONTRACT NO. 68E71

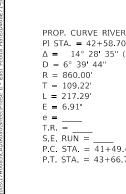


PLOT DATE = 3/20/2019

DATE

- 3/21/2019

REVISED -

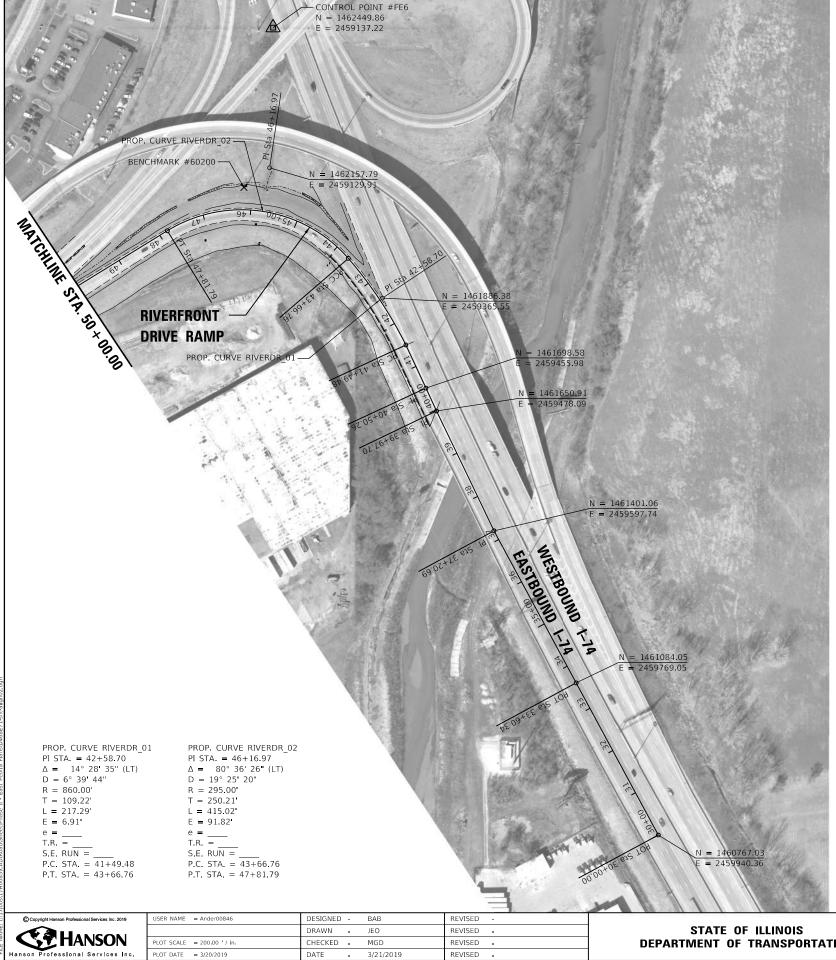

BENCHMARKS AND TIES

BM #43060 FOUND DISK ON TOP OF SOUTH PARAPET WALL ABOVE PLAQUE I-74 EASTBOUND AND NORTHBOUND RAMPS AND CAMP STREET EXIT. STR# 090-0044 ELEV. = 484.59


BM #50886 FOUND DISK IN SOUTHWEST WINGWALL WEST SIDE OF ROUTE 40 JUST SOUTH OF 1-74 EASTBOUND AND WESTBOUND RAMP STR# 090-0120


ELEV. = 465.30

BM #60200 CHISELED "" ON SOUTHWEST CORNER OF MISC. CONCRETE PAD NEAR LIGHTPOLE

FOUNDATION.


ELEV. = 455.16

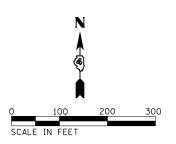

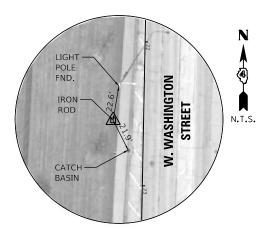


CONTROL POINT #FE100

SET IRON PIN WITH CAP STA. 22+54.94, 21.14 RT. N = 1461259.52E = 2456938.95

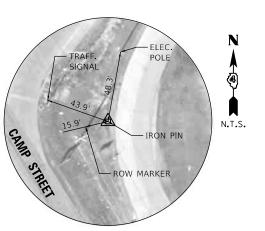

CONTROL POINT #FE101

SET IRON PIN WITH CAP STA. 57+01.04, 543.52' LT. N = 1461083.59 E = 2458246.47

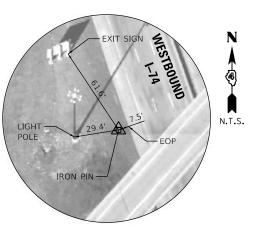


CONTROL POINT #FE6


SET IRON PIN WITH CAP STA. 45+90.31, 382.66 RT. N = 1462449.86E = 2459137.22


			TOUR RO		
SCALE:	SHEET	OF	SHEETS	STA.	1


F.A.P. RTE	SECT	COUNTY	TOTAL SHEETS	SHEE NO.		
404	D4 IL 40 DETO	UR PREF	2020	PEORIA TAZEWELL	160	23
				CONTRACT	NO.	68E71
		TELIMOIS	FED AL	ID PROJECT		

STATE OF ILLINOIS					
DEPARTMENT OF TRANSPORTATION					

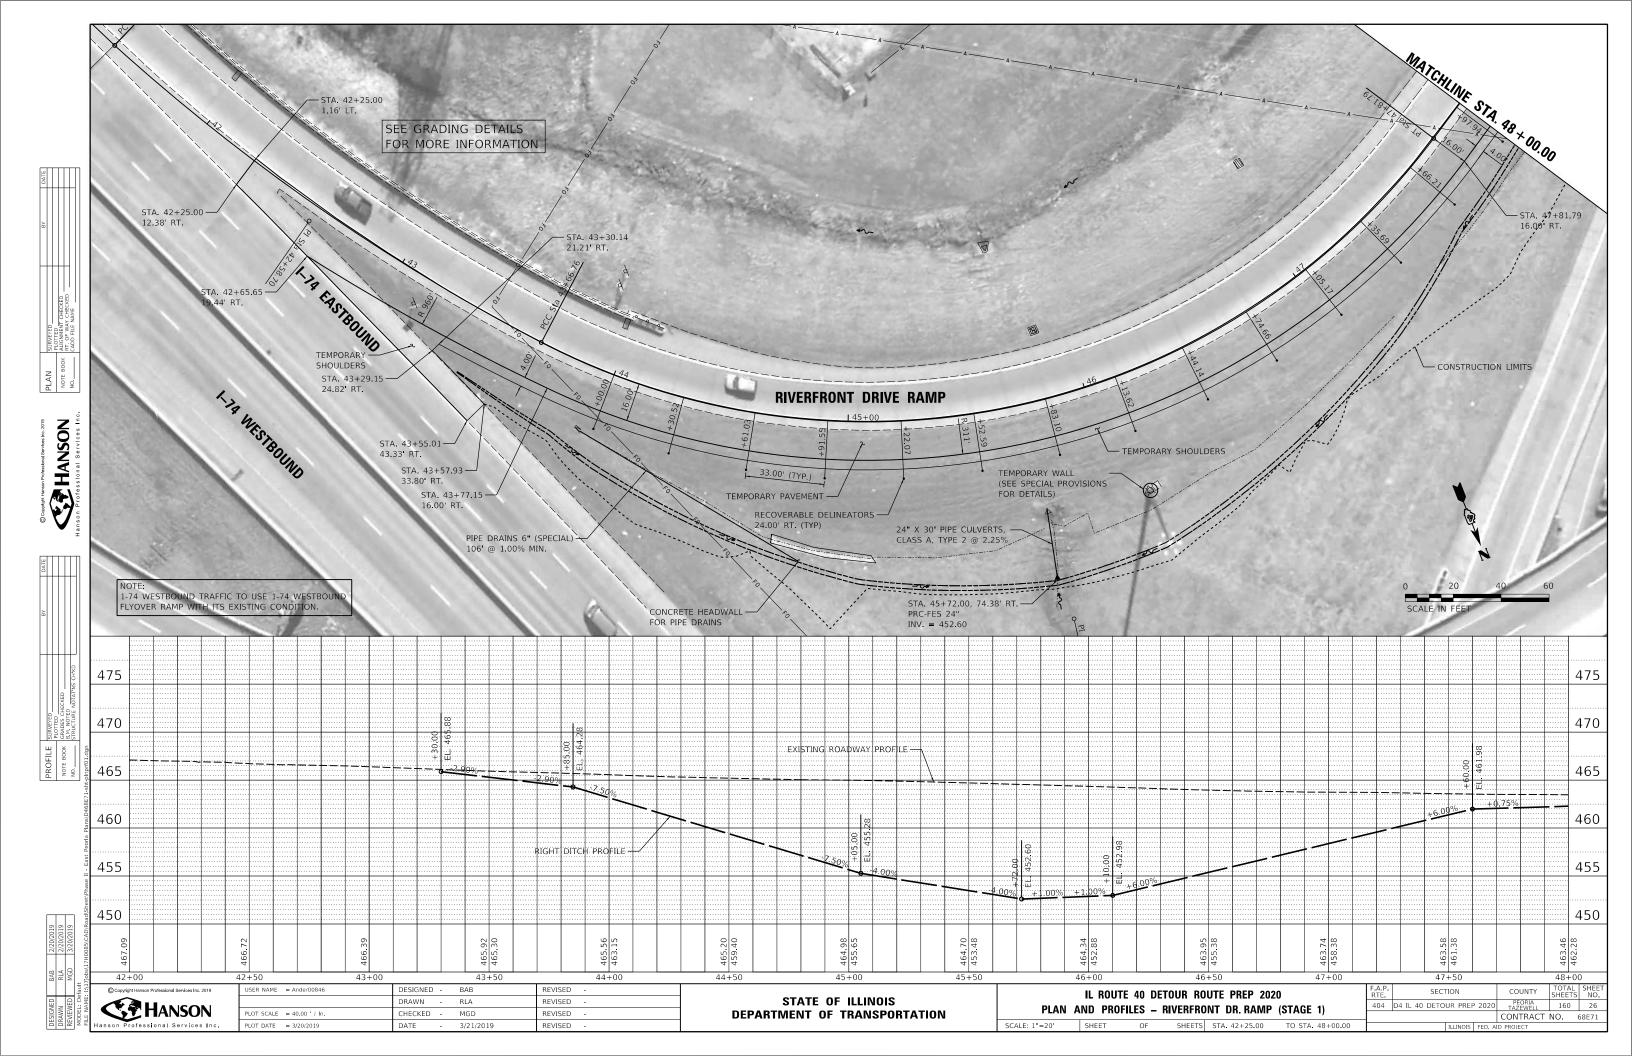


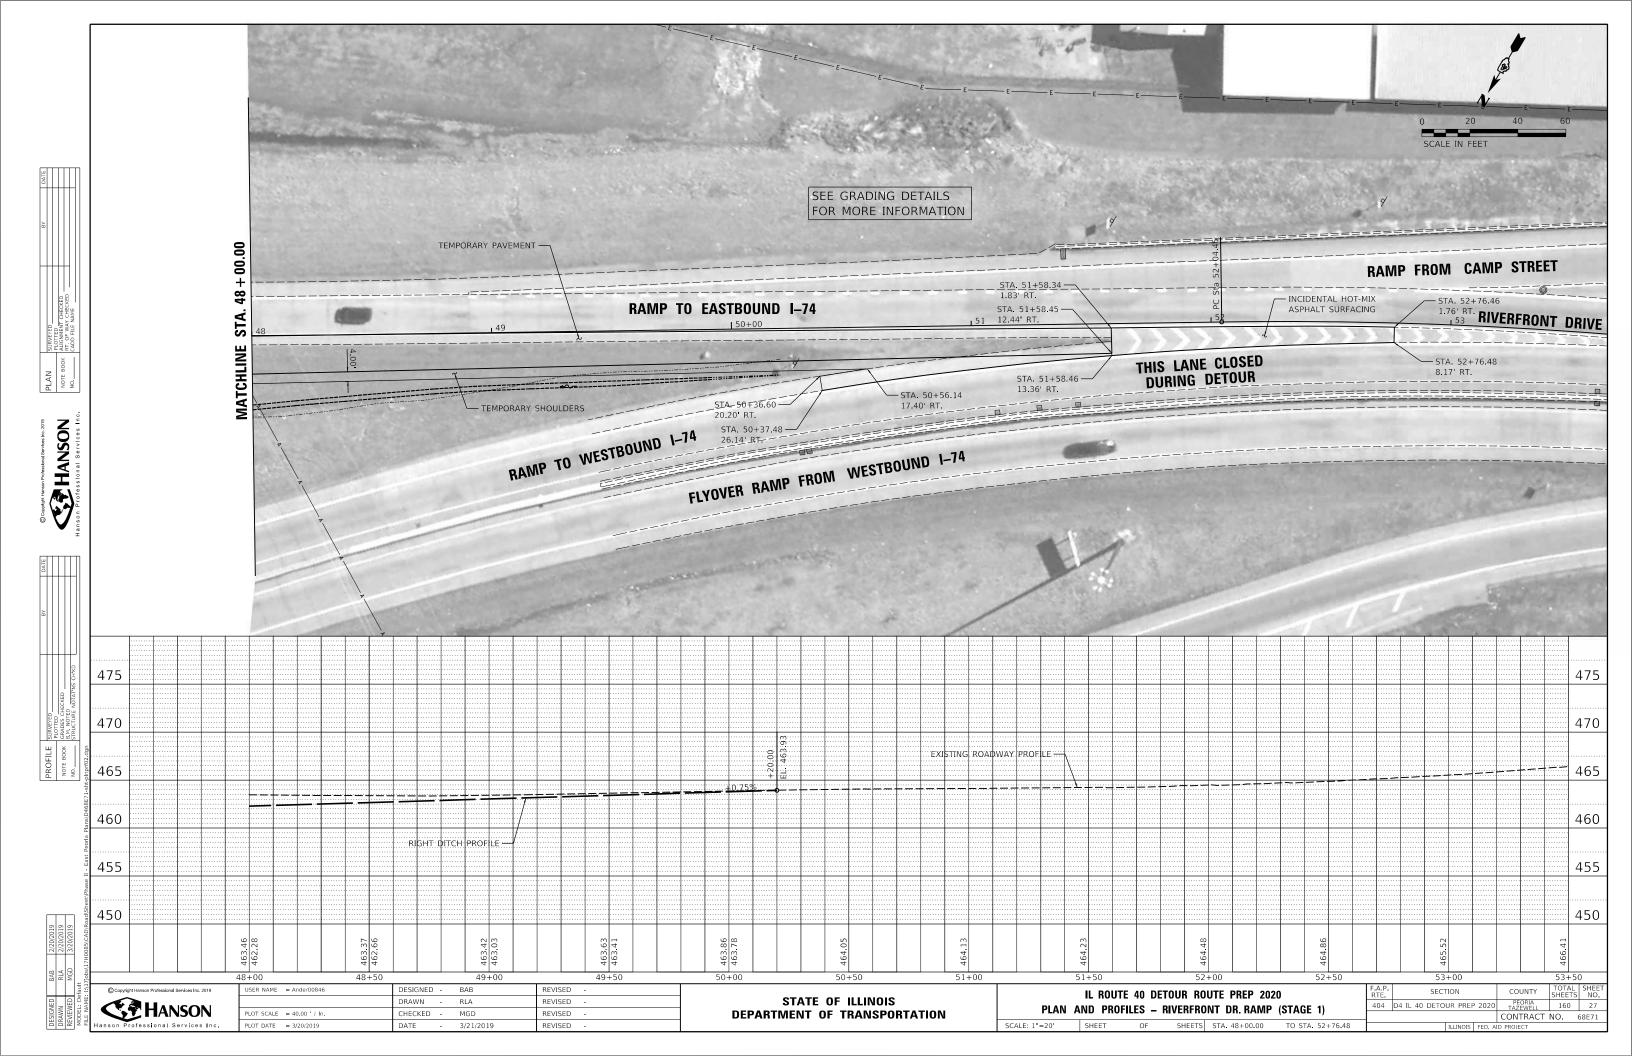


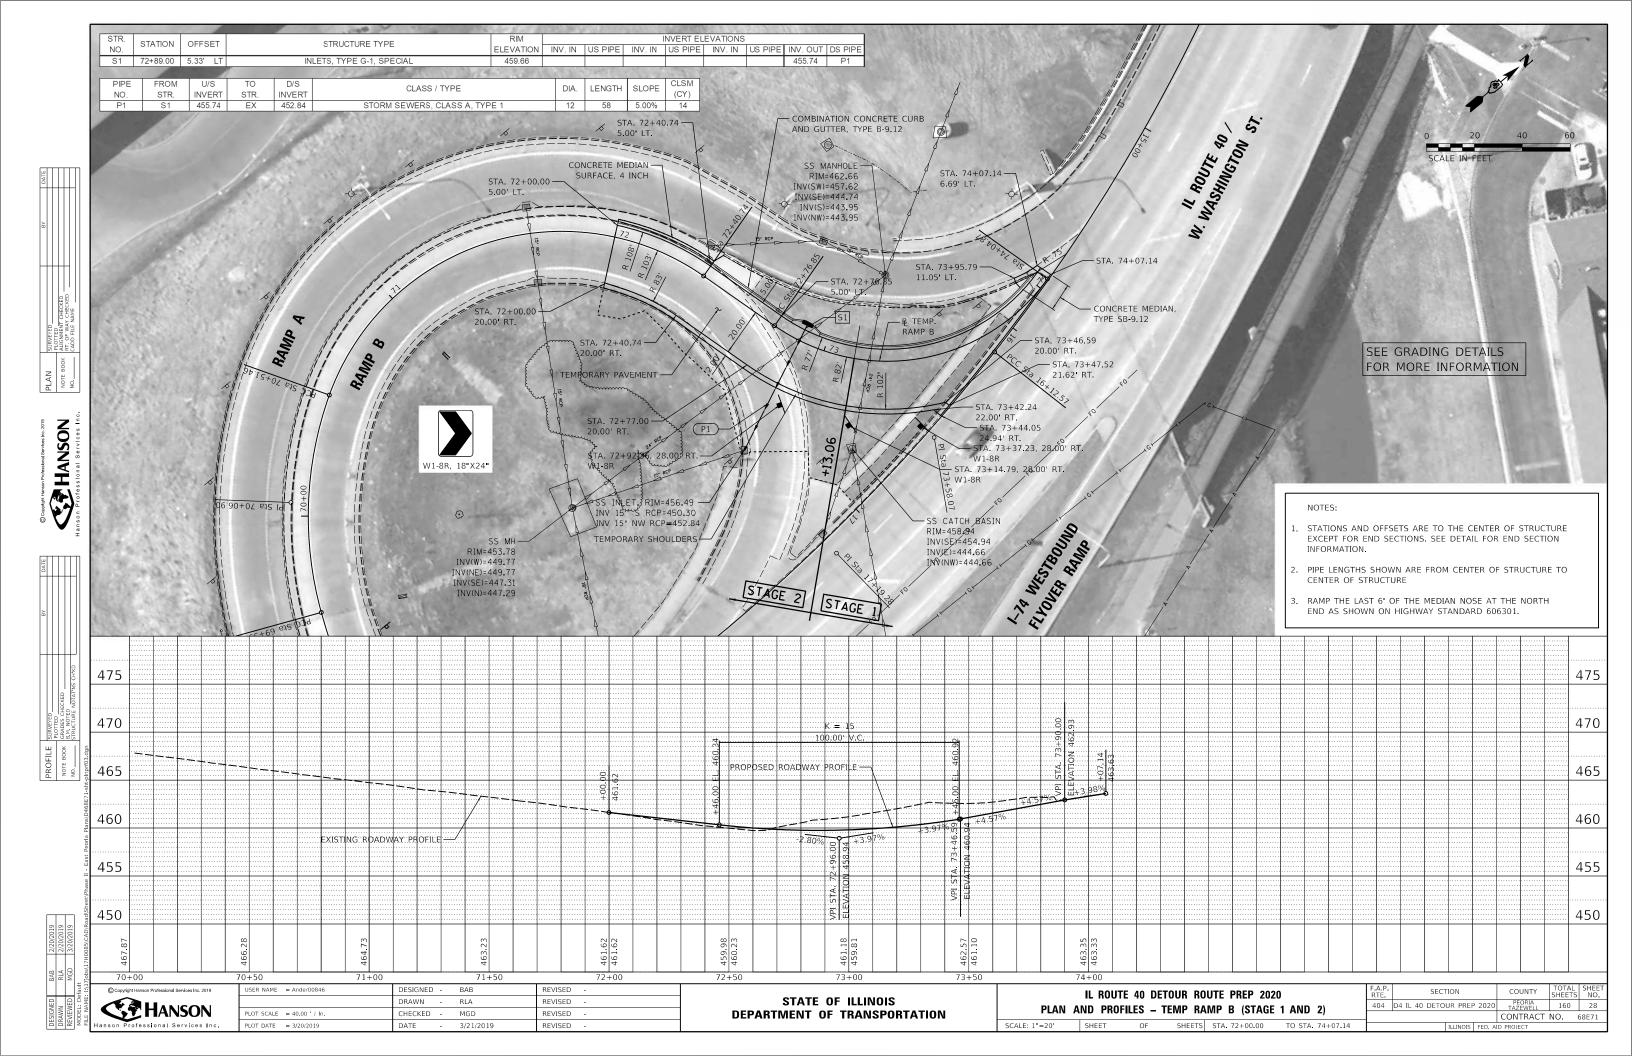


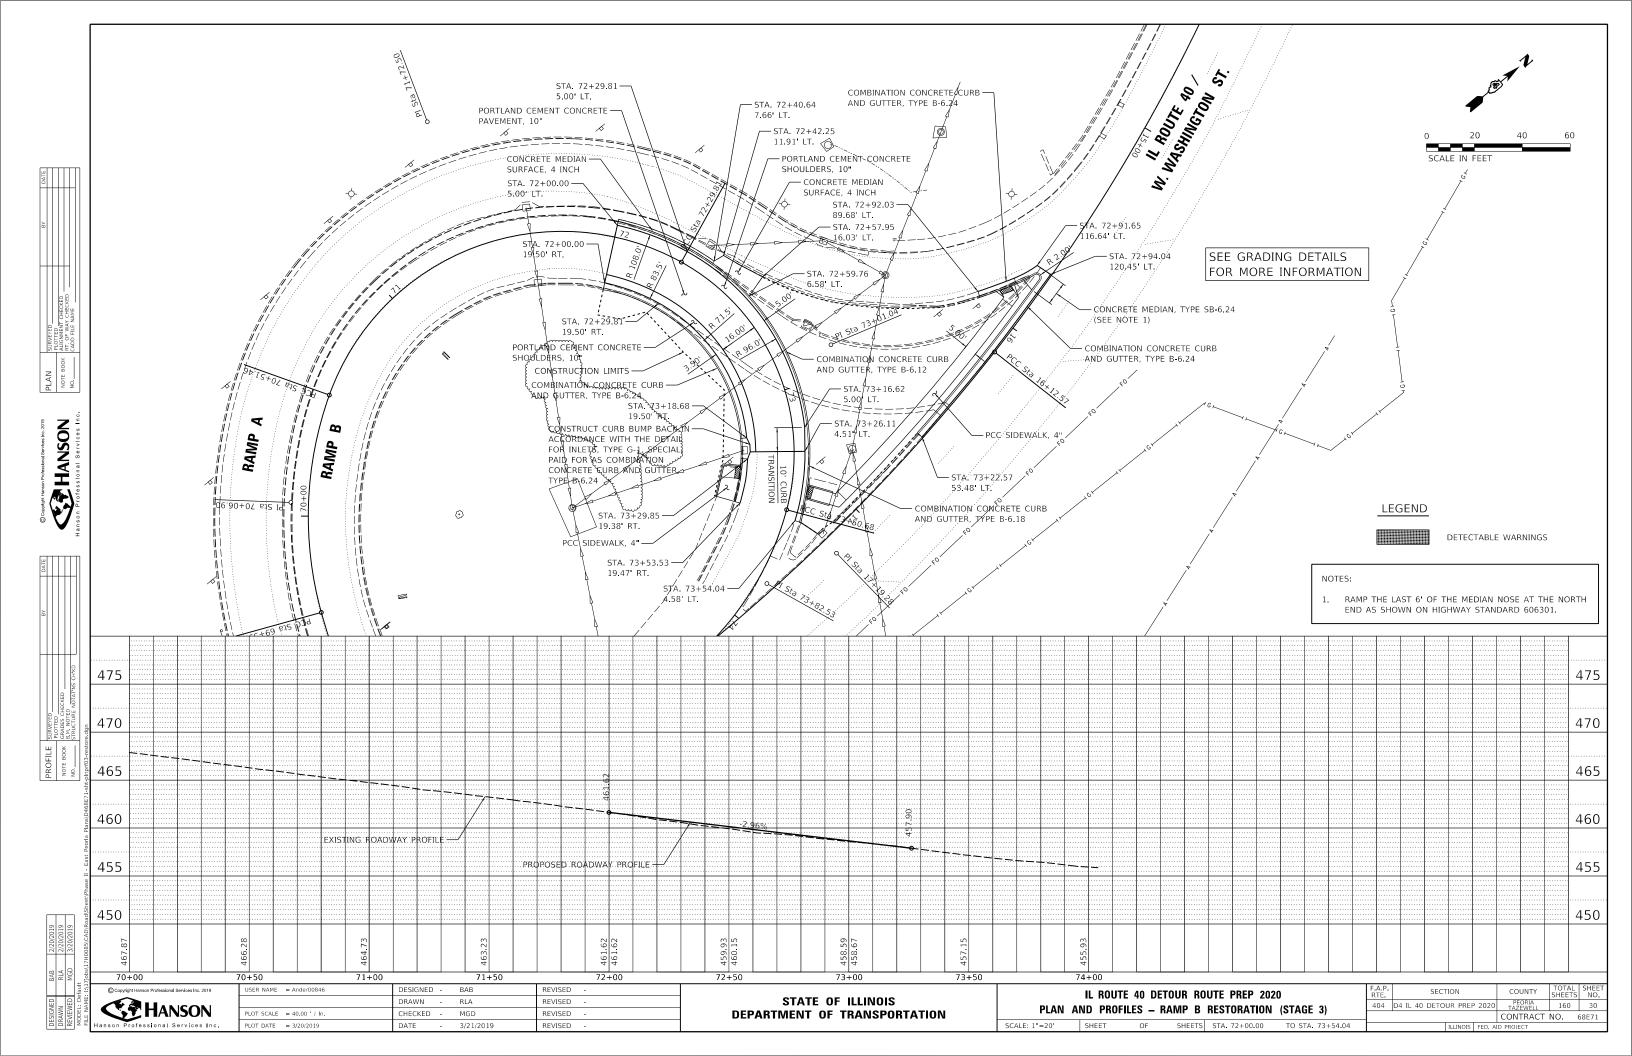





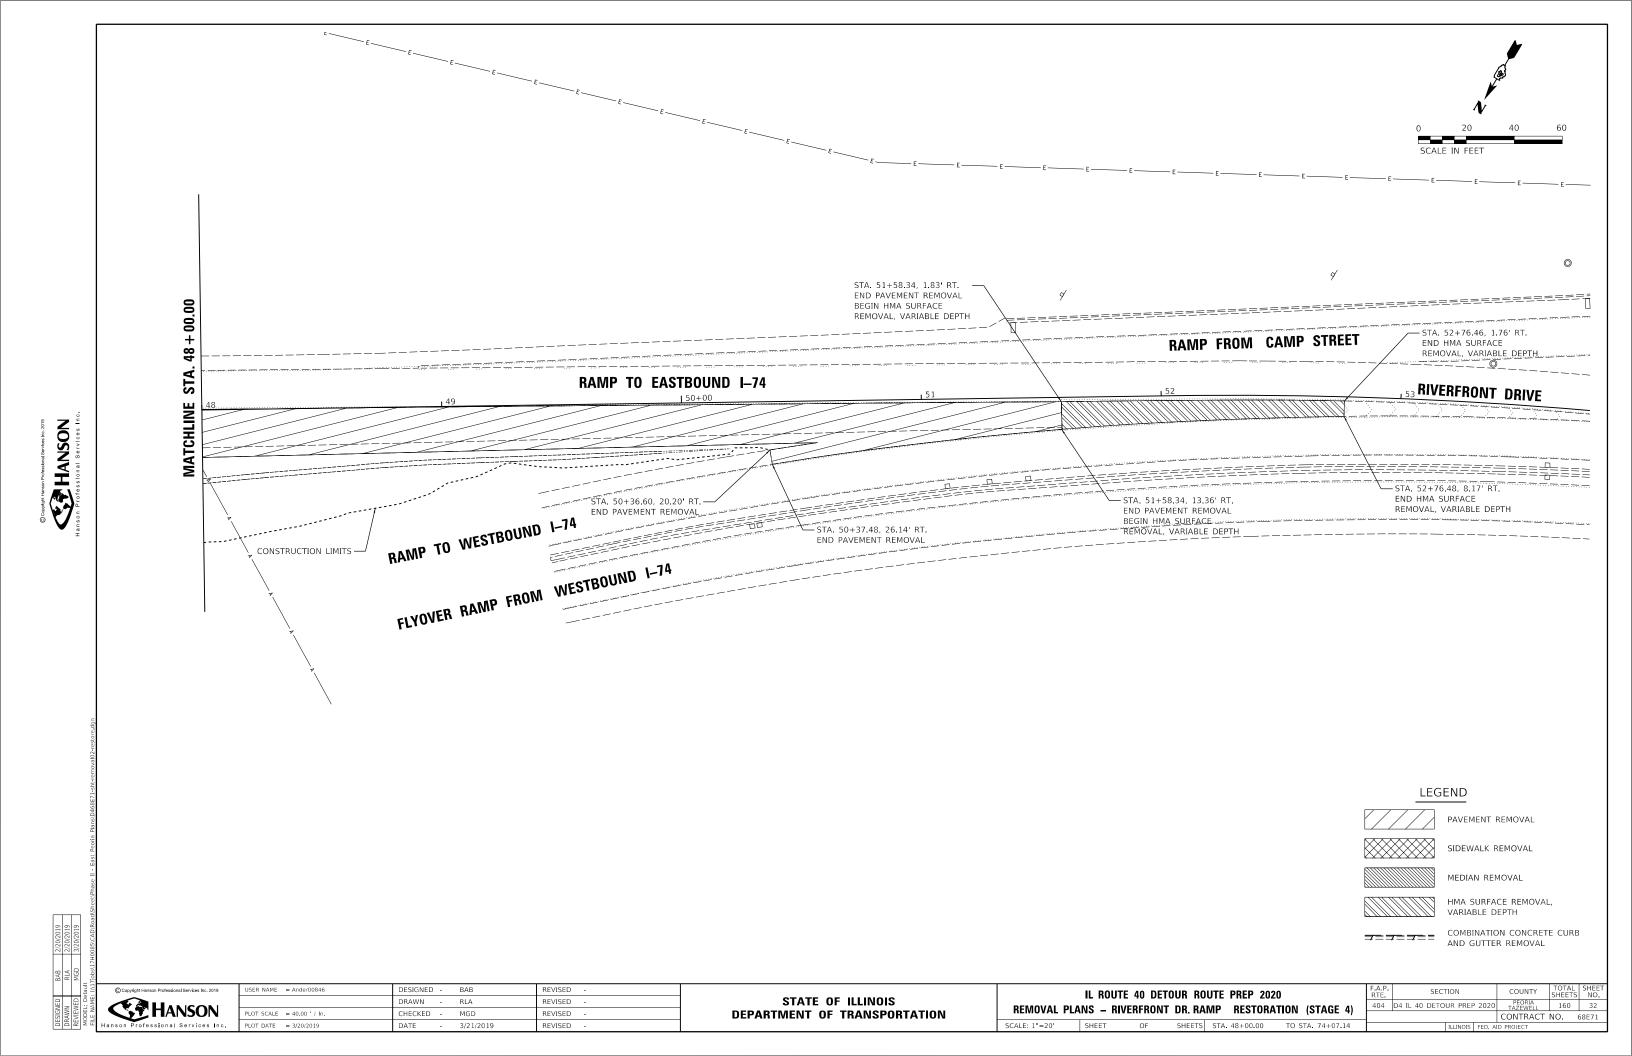


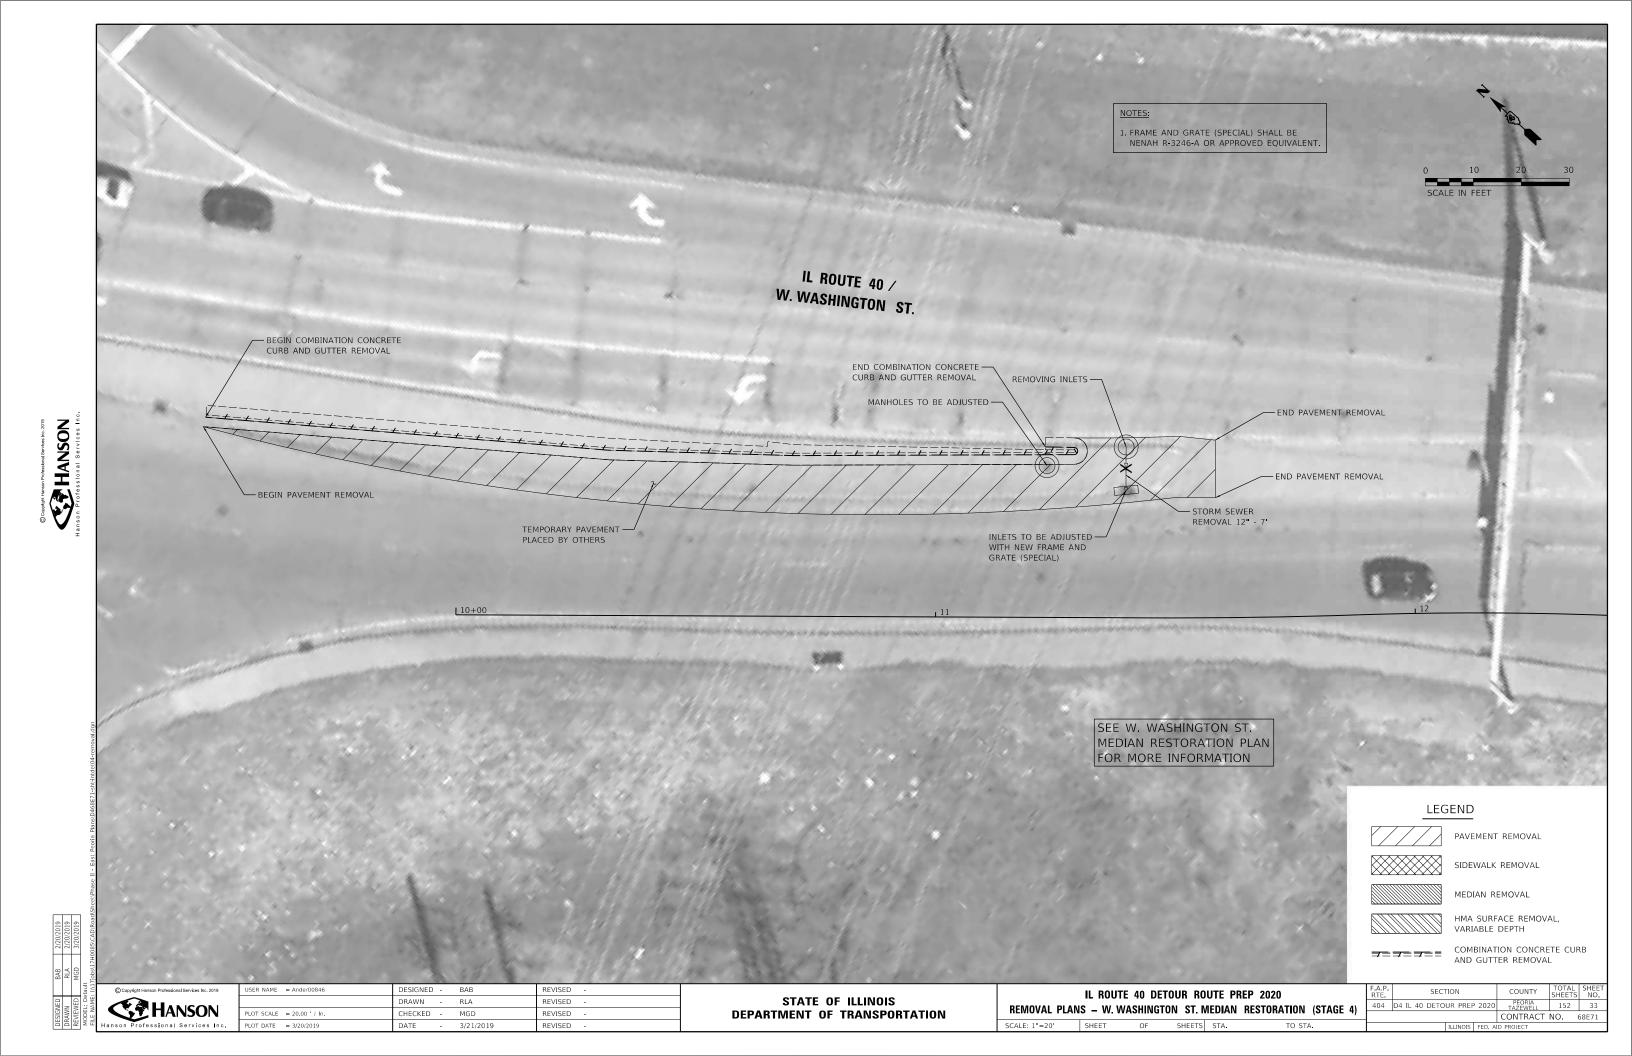

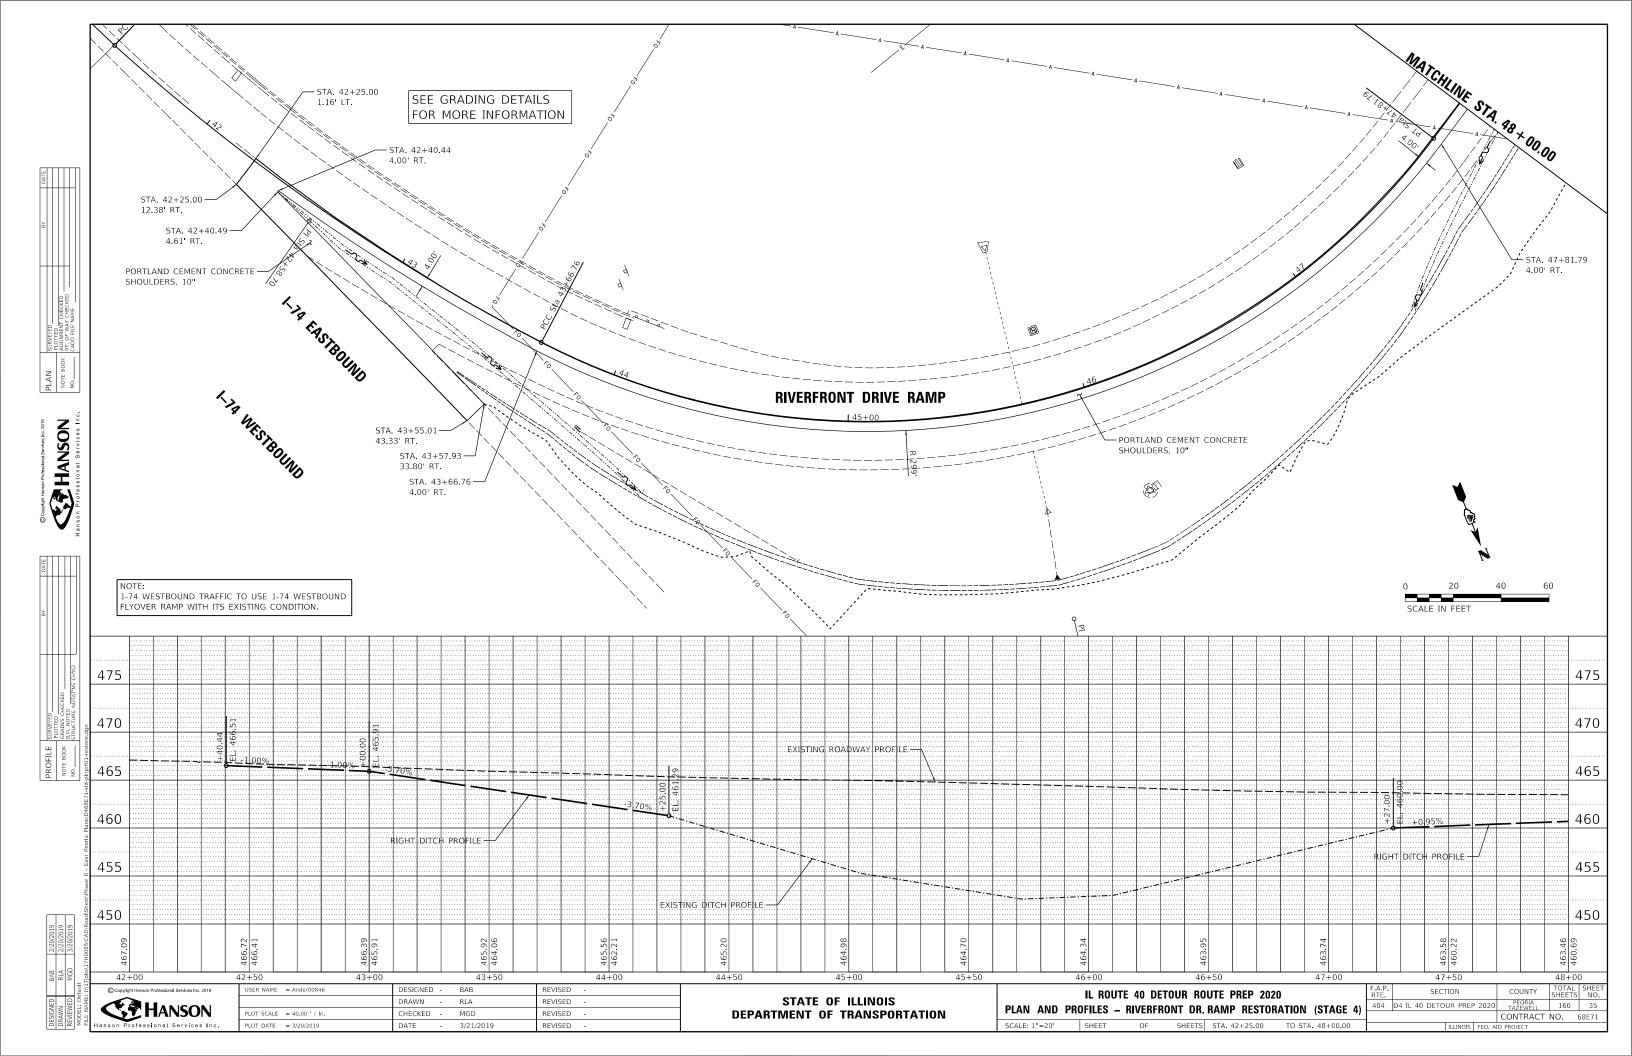

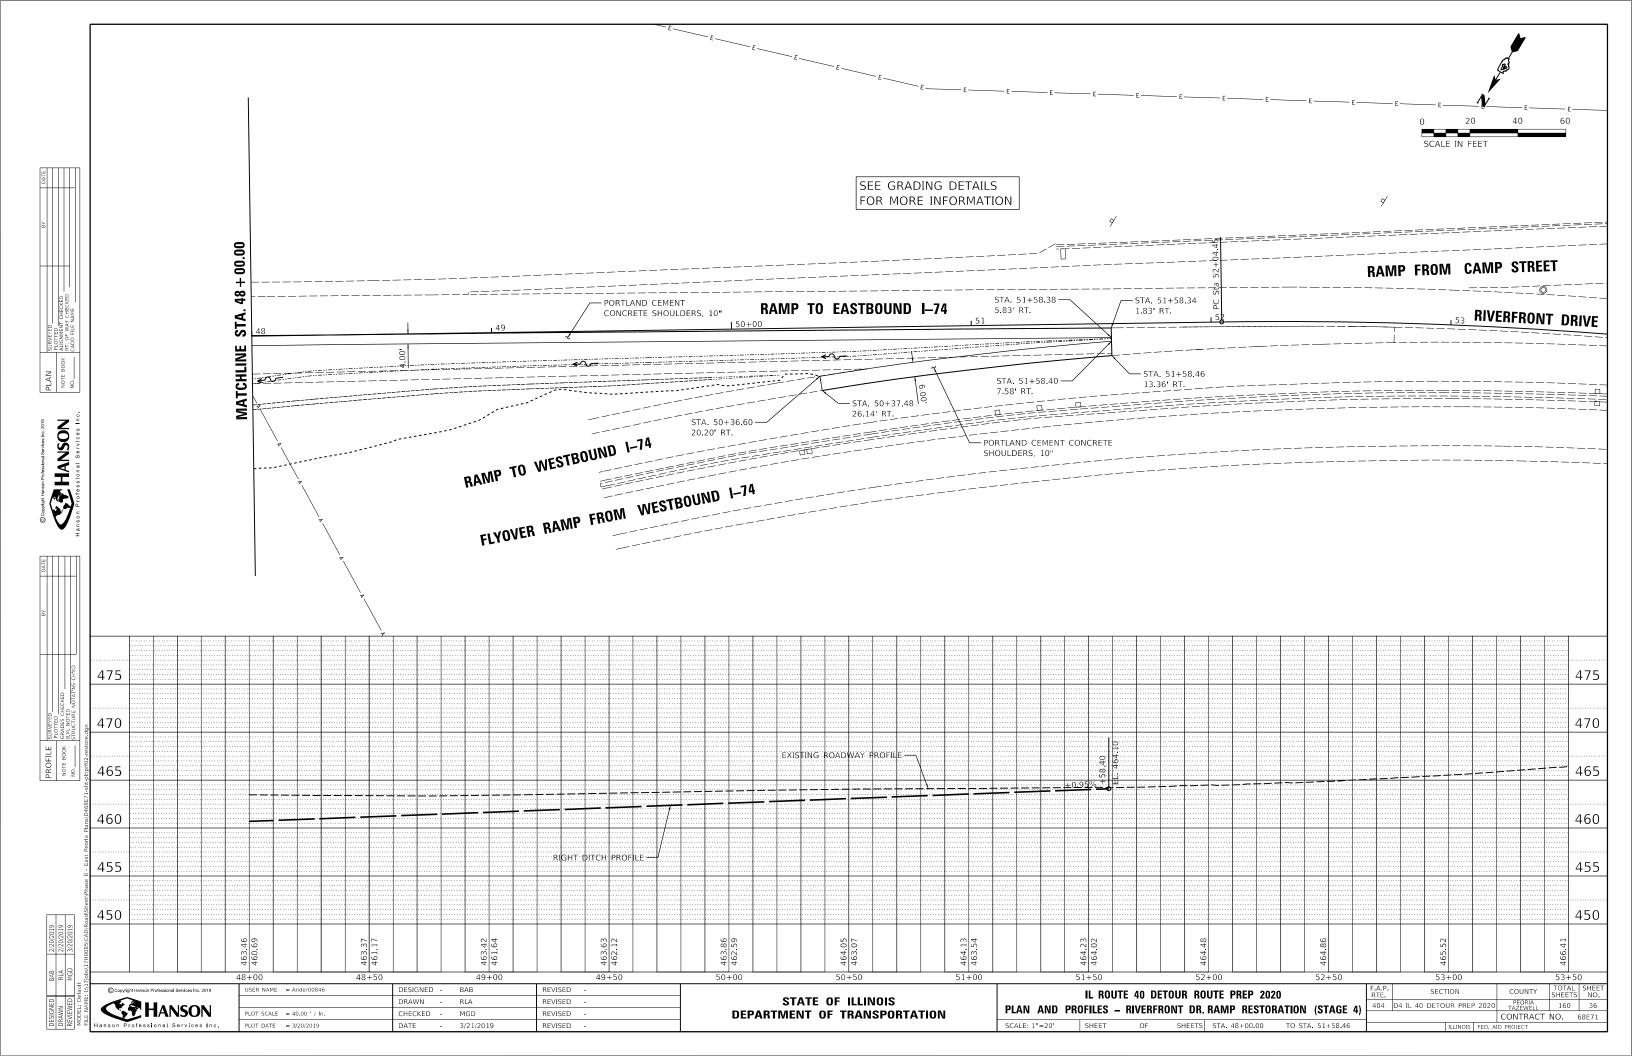

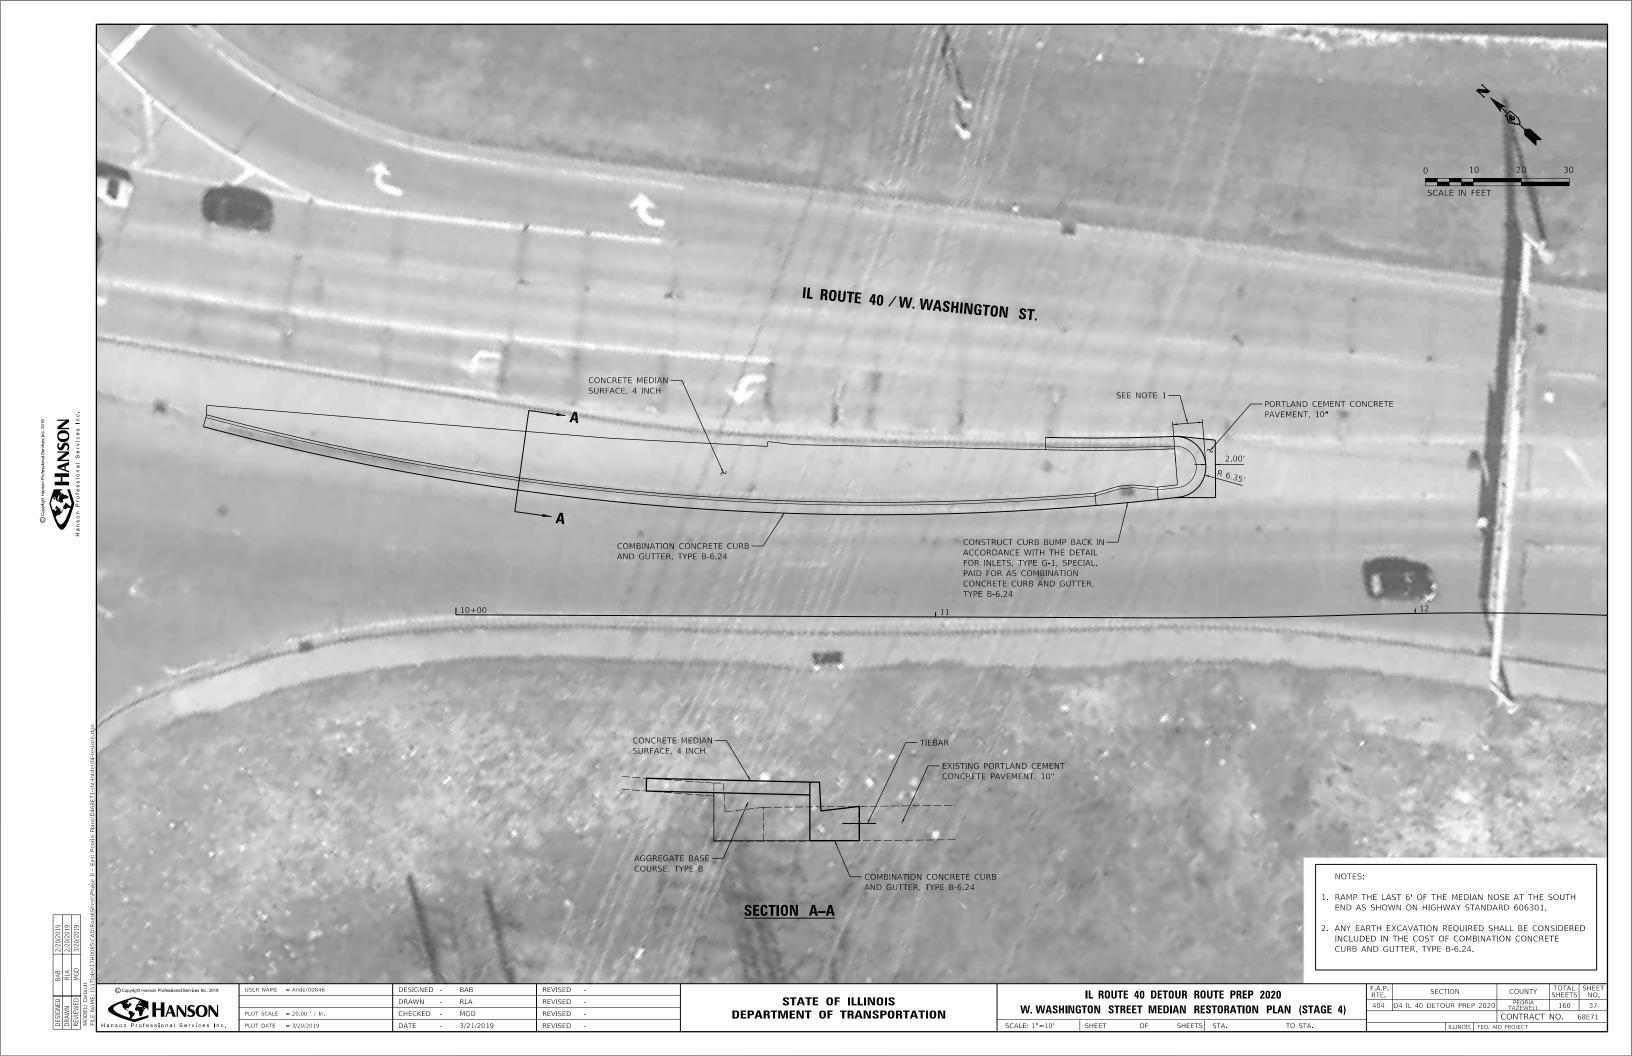

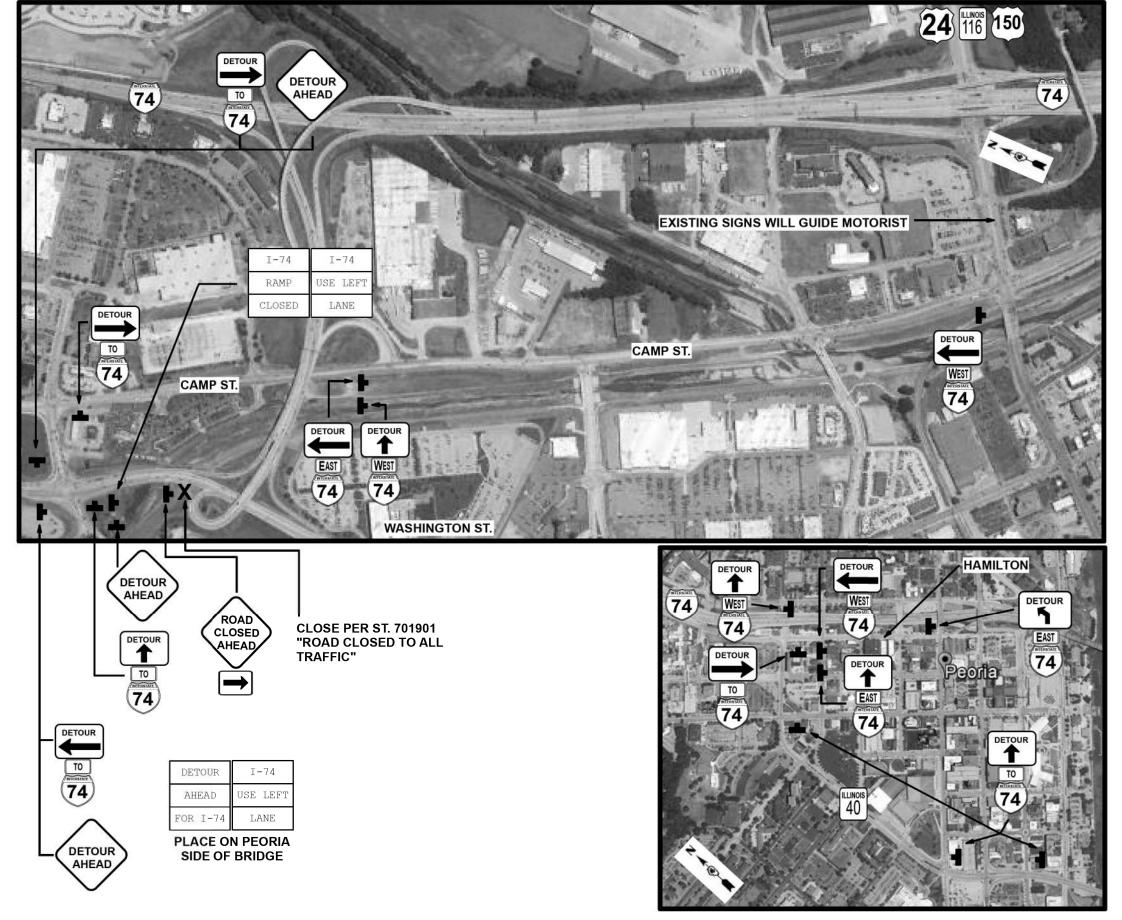

STATE OF ILLINOIS

DEPARTMENT OF TRANSPORTATION

DETOUR/CLOSURE NOTES

- 1) ONE PORTABLE CHANGEABLE MESSAGE SIGN SHALL BE IN PLACE FOR FIVE DAYS TO ADVANCE WARN THE PUBLIC OF THE RAMP CLOSURE.
- 2) SIGNS SHALL BE STAND MOUNTED IN AREAS WHERE POST MOUNTING IS NOT PRACTICAL. THE RESIDENT ENGINEER SHALL APPROVE SUCH LOCATIONS.
- 3) DIRECTION ARROW SIGNS SHALL BE BLACK ON WHITE. DETOUR SIGNS SHALL BE BLACK ON ORANGE. EAST, WEST, AND TO SIGNS SHALL BE WHITE ON BLUE.
- 4) SIGN LOCATIONS SHALL BE DISCUSSED AT THE PRE-CONSTRUCTION MEETING.

SER NAME = SUSERS

DESIGNED


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DRAWN

REVISED

REVISED


REVISED

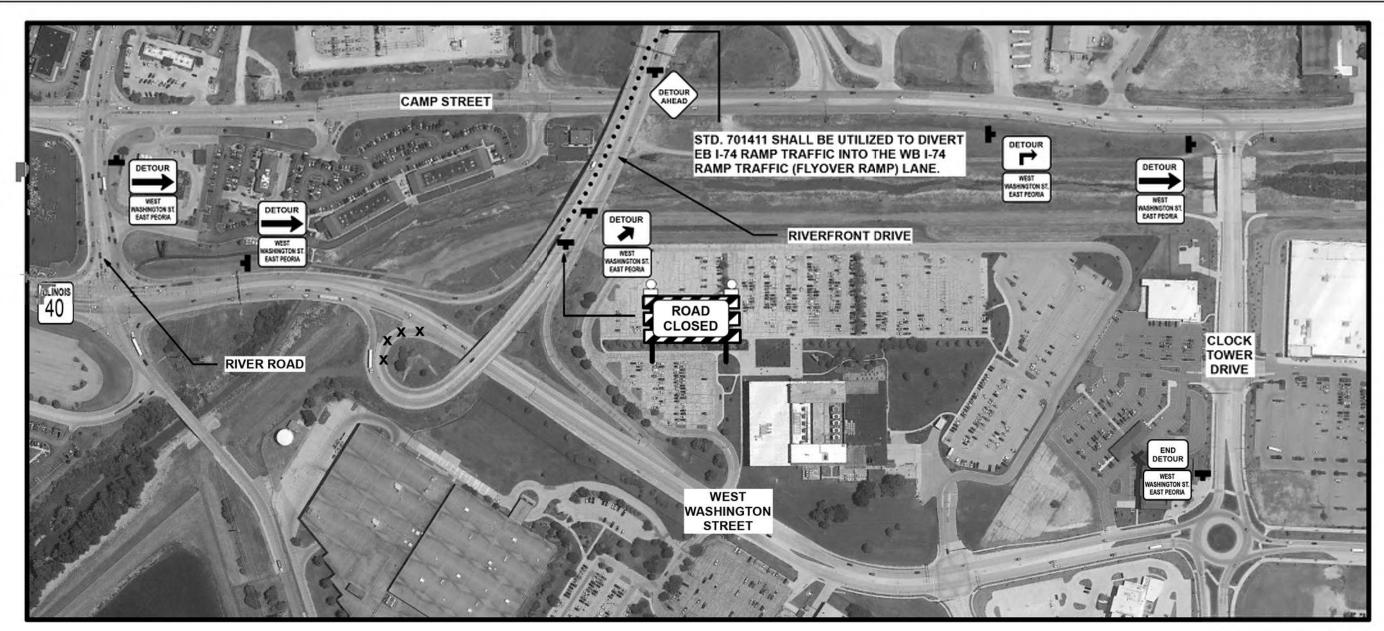

DETOUR/CLOSURE NOTES

- 1) ONE PORTABLE CHANGEABLE MESSAGE SIGN SHALL BE IN PLACE FOR FIVE DAYS TO ADVANCE WARN THE PUBLIC OF THE RAMP CLOSURE.
- 2) SIGNS SHALL BE STAND MOUNTED IN AREAS WHERE POST MOUNTING IS NOT PRACTICAL. THE RESIDENT ENGINEER SHALL APPROVE SUCH LOCATIONS.
- 3) STREET SIGNS SHALL BE BLACK ON WHITE. DETOUR SIGNS SHALL BE BLACK ON ORANGE.
- 4) SIGN LOCATIONS SHALL BE DISCUSSED AT THE PRE-CONSTRUCTION MEETING.

USER NAME = SUSERS	DESIGNED -	REVISED -	STATE OF ILLINOIS DEPARTMENT OF TRANSPORTATION	500 E					F.A.P. RTF	SECTION	COUNTY	TOTAL	SHEET	
	DRAWN -	REVISED -		RIVERFRONT DRIVE RAMP DETOUR DETAIL				404 D	4 IL 40 DETOUR PREP 2020		160	40		
PLOT SCALE = \$SCALE\$	CHECKED -	REVISED -								-		CONTRACT	F NO. 68	E71
PLOT DATE = \$DATE\$	DATE -	REVISED -		SCALE:	SHEET	OF	SHEETS	STA.	TO STA.		ILLINGIS FED.	AID PROJECT		

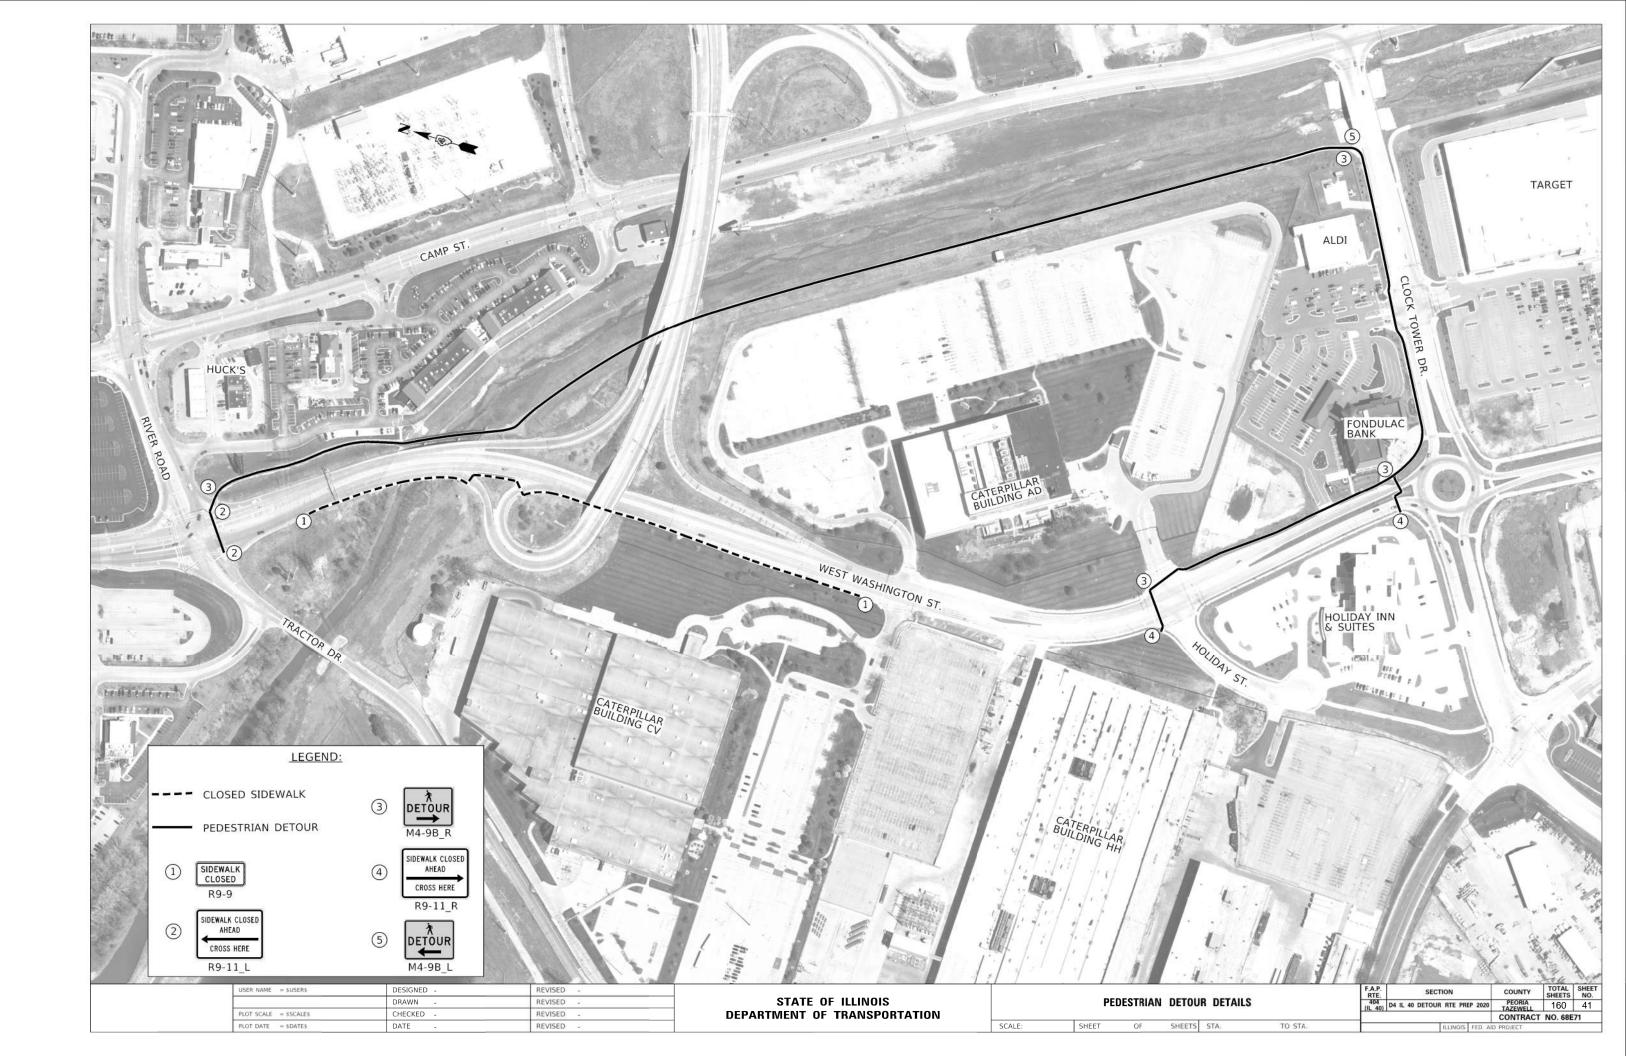

THE FOLLOWING IDOT HIGHWAY TRAFFIC CONTROL STANDARDS ARE THE MINIMUM REQUIREMENTS FOR THE TRAFFIC CONTROL FOR THIS PROJECT:

701311, 701411, 701427, 701451, 701456, 701601, 701701, 701801, 701901, 704001

- THE FURNISHING, INSTALLATION AND RELOCATION OF ALL TEMPORARY TRAFFIC CONTROL DEVICES SHALL BE IN ACCORDANCE WITH THE MANUAL ON UNIFORM TRAFFIC CONTROL DEVICES AND THE STATE STANDARD SPECIFICATIONS.
- TRAFFIC CONTROL ITEMS SHALL BE PAID FOR BY LUMP SUM TRAFFIC CONTROL AND PROTECTION, (SPECIAL). SEE HIGHWAY STANDARDS AND SPECIAL PROVISIONS FOR ADDITIONAL
- 5. EXISTING PAVEMENT MARKINGS IN CONFLICT WITH TEMPORARY PAVEMENT MARKINGS SHALL BE WATER BLASTED AND RESTORED TO THE ORIGINAL CONDITION AT THE END OF EACH STAGE.
- ALL ADVANCED WARNING SIGNS AND TEMPORARY PAVEMENT MARKINGS SHALL BE IN PLACE AND APPROVED BY THE ENGINEER PRIOR TO THE COMMENCEMENT OF ANY STAGE OF CONSTRUCTION.

SEQUENCE OF CONSTRUCTION

STAGE 1 (FALL 2019, NOVEMBER 15, 2019 COMPLETION DATE)

EAST PEORIA

ESTABLISH TEMPORARY EROSION CONTROL

WIDENING OF EASTBOUND I-74 ON-RAMP FROM RIVERFRONT DRIVE (IL 40)

CLOSE SIDEWALK ON WASHINGTON ST. AND SIGN THE PEDESTRIAN DETOUR W. WASHINGTON STREET (IL 40) LOOP RAMP REVERSAL (STAGE 1 PORTION)

INSTALL TEMPORARY TRAFFIC SIGNALS AT WESTBOUND I-74 EXIT RAMP 96/WASHINGTON ST. INTERSECTION (SIGNAL NOT ACTIVATED UNTIL STAGE 2)

PEORIA

TEMPORARY SIGNAL WORK ON ADAMS ST. AT KUMPF BLVD. (SIGNALS NOT ACTIVATED UNTIL STAGE 2)

STAGE 2 - PRESTAGE (WINTER/SPRING 2020, MARCH 20, 2020 COMPLETION DATE) EAST PEORIA

W. WASHINGTON ST. (IL 40) LOOP RAMP REVERSAL (COMPLETE WORK)

ACTIVATE TEMPORARY SIGNALS AND INSTALL PAVEMENT MARKINGS AT WESTBOUND I-74 EXIT RAMP 96/WASHINGTON ST. INTERSECTION

INSTALL TEMPORARY TRAFFIC SIGNALS AT WASHINGTON ST. (IL 40) AND TRACTOR DR. / RIVER RD. THE CLOSURE OF THE DUAL LEFT TURN FROM SOUTHBOUND WASHINGTON ST. (IL 40) AND THE PARTIAL CLOSURE OF EASTBOUND RIVER RD. SHALL BE COMPLETE ON MARCH 22, 2020 AND SHALL BE COORDINATED WITH THE CONTRACTORS ON CONTRACT #68C89.

PLACE TEMPORARY PAVEMENT MARKING FOR INTERSTATE CLOSURE (BY OTHERS)

PEORIA

ACTIVATE TEMPORARY SIGNALS ON ADAMS ST. AND KUMPF BLVD.

PLACE TEMPORARY PAVEMENT MARKING FOR INTERSTATE CLOSURE (BY OTHERS)

STAGE 2 (SPRING-FALL 2020)

I-74 CLOSURE AND MURRAY BAKER BRIDGE WORK (BY OTHERS) - MARCH 29, 2020 TO OCTOBER 31, 2020

STAGE 3 (FALL 2020, DECEMBER 6, 2020 COMPLETION DATE; ALL LANES ON WASHINGTON ST. (IL 40) SHALL BE OPENED TO TRAFFIC ON OR BEFORE NOVEMBER 22, 2020)

AFTER COMPLETION OF BRIDGE WORK AND I-74 IS REOPENED

RESTORE TRAFFIC SIGNALS AT WASHINGTON ST. (IL 40) AND TRACTOR DR. / RIVER RD. COORDINATE WITH THE CONTRACTORS ON CONTRACT #68C89.

SCALE: 1"=1'

RESTORE WASHINGTON ST (IL 40) LOOP RAMP

ESTABLISH PERMANENT EROSION CONTROL

REMOVE TEMPORARY EROSION CONTROL

RESTORE MARKINGS ON RIVER ROAD AND WASHINGTON STREET

RESTORE (PARTIAL) PAVEMENT MARKINGS ALONG RIVERFRONT DRIVE TO REESTABLISH NORMAL TRAFFIC REMOVE TEMPORARY SIGNALS/MARKINGS AT WESTBOUND I-74 EXIT RAMP 96/WASHINGTON ST. INTERSECTION

RESTORE MEDIAN ON RIVERFRONT DRIVE BRIDGE OVER CAMP STREET

RESTORE I-74 MAINLINE AND RAMP MARKINGS (BY OTHERS)

REMOVE I-74 SHIELDS AND "EAST" AND "WEST" PAVEMENT MARKINGS

RESTORE I-74 MAINLINE AND RAMP MARKINGS (BY OTHERS)

STAGE 4 (SPRING 2021, JUNE 15, 2021 COMPLETION DATE)

EAST PEORIA

RESTORE W WASHINGTON STREET MEDIAN

RESTORE RAMP FROM EASTBOUND RIVERFRONT DR. TO EASTBOUND I-74 RESTORE PAVEMENT MARKINGS ON EASTBOUND I-74 ON-RAMP FROM RIVERFRONT DR. (IL 40)

PEORIA

RESTORE TRAFFIC SIGNALS AND SIDEWALK AT THE INTERSECTION OF JEFFERSON ST. AND KUMPF BLVD.

RESTORE MEDIAN ON SOUTH LEG OF KUMPF BLVD./JEFFERSON AVE. INTERSECTION

REMOVE TEMPORARY TRAFFIC SIGNALS ON ADAMS ST. AT KUMPF BLVD.

RESTORE PAVEMENT MARKINGS

PROPOSED CHANGEABLE MESSAGE SIGN (CMS) LOCATIONS



NOTE: CHANGEABLE MESSAGE SIGN (CMS) LOCATIONS AND MESSAGES TO BE APPROVED BY THE ENGINEER



HANSON HANSON

USER NAME = Ander00846	DESIGNED -	MGD	REVISED -
	DRAWN -	MQC	REVISED -
PLOT SCALE = 2.00 ' / In.	CHECKED -	MGD	REVISED -
PLOT DATE = 4/29/2019	DATE -	3/21/2019	REVISED -

A.P. TE.	SECTION	COUNTY	TOTAL SHEETS	SHE
04	D4 IL 40 DETOUR PREP 2020	PEORIA TAZEWELL	160	42
		CONTRACT	NO.	58E7





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Hanson Professional Services Inc.

JSER NAME = Ander00846 DESIGNED - MGD REVISED -DRAWN -MOC REVISED -PLOT SCALE = 20.00 / In. CHECKED -MGD REVISED -PLOT DATE = 3/20/2019 DATE 3/21/2019 REVISED

STATE OF ILLINOIS **DEPARTMENT OF TRANSPORTATION**


IL ROUTE 40 DETOUR ROUTE PREP 2020 STAGING TYPICAL SECTIONS SCALE: 1"=10' SHEET OF SHEETS STA. TO STA.

SECTION COUNTY 404 D4 IL 40 DETOUR PREP 2020 PEORIA TAZEWELL 160 43 CONTRACT NO. 68E71

10.00 STRIPED MEDIAN VARIES 0.00'-11.00' VARIES 11.00'-0.00' WORKZONE ┌ SIDEWALK 11.00 11.00 DRUMS WITH STEADY BURN WARNING LIGHTS YELLOW-TEMPORARY PAVEMENT MARKING LINE 4" WHITE-TEMPORARY
PAVEMENT MARKING
LINE 4"

MAINTENANCE OF TRAFFIC

TYPICAL SECTION - STAGES 1, 2, 3 WASHINGTON STREET (IL 40) LOOKING SOUTH

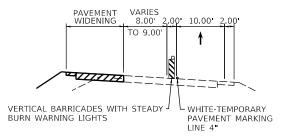


MAINTENANCE OF TRAFFIC

TYPICAL SECTION - STAGE 1 & 4
RIVERFRONT DR. (IL 40)
TO EASTBOUND I-74





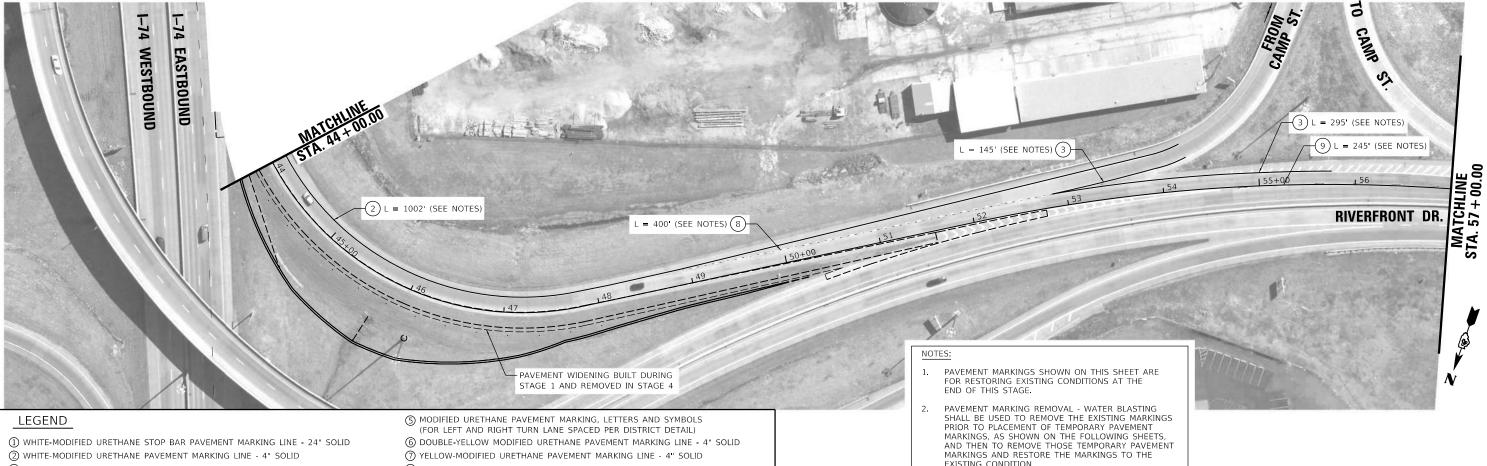

- ① WHITE-MODIFIED URETHANE STOP BAR PAVEMENT MARKING LINE 24" SOLID
- ② WHITE-MODIFIED URETHANE PAVEMENT MARKING LINE 4" SOLID
- ③ WHITE-MODIFIED URETHANE PAVEMENT MARKING LINE 8" SOLID
- 4 WHITE-MODIFIED URETHANE PAVEMENT MARKING LINE 12" (ON 45° ANGLE, 20' CTC)
- 6 DOUBLE-YELLOW MODIFIED URETHANE PAVEMENT MARKING LINE 4" SOLID
- 7 YELLOW-MODIFIED URETHANE PAVEMENT MARKING LINE 4" SOLID
- (8) WHITE-MODIFIED URETHANE PAVEMENT MARKING LINE 2' LONG, 6' GAP 8"
- 9 WHITE-MODIFIED URETHANE PAVEMENT MARKING LINE 10' LONG, 30' GAP 4"

IL ROUTE 40 DETOUR ROUTE PREP 2020 STAGE 1 PAVEMENT MARKING REMOVAL / RESTORATION FOR STAGING

LENGTHS PROVIDED ARE APPROXIMATE.

160 44 CONTRACT NO. 68E71

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DRAWN -MOC REVISED REVISED







NOTES:

1. SEE STANDARD DETAILS 701411 AND 701456
FOR ADDITIONAL DETAILS.

2. PROVIDE TRUCK MOUNTED ATTENUATOR DURING
WORK IN GORE AREAS TO PROTECT WORKERS.
COST INCLUDED IN TRAFFIC CONTROL &
PROTECTION, (SPECIAL).

PROVIDE TRUCK MOUNTED ATTENUATOR DURING PLACEMENT OF TRAFFIC CONTROL ON 1-74. COST INCLUDED IN TRAFFIC CONTROL & PROTECTION, (SPECIAL).

STAGING LEGEND

CONSTRUCTION AREA

→ TRAFFIC FLOW ARROW TYPE III BARRICADE WITH FLASHING LIGHTS

++ **←** ARROW BOARD MOT SIGN

STATE OF ILLINOIS **DEPARTMENT OF TRANSPORTATION**

TEMPORARY MARKINGS

YELLOW - TEMPORARY PAVEMENT MARKING - LINE 4"

(A) WHITE - TEMPORARY PAVEMENT MARKING - LINE 4"
(B) YELLOW - TEMPORARY PAVEMENT MARKING - LINE 4"
(C) WHITE - TEMPORARY PAVEMENT MARKING - LINE 4" WHITE - TEMPORARY PAVEMENT MARKING - LINE 4" (2'LONG, 6' GAP)


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	-6					
SCALE	IN F	EET				
					TOTAL	г

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DRAWN MOC REVISED MGD REVISED

IL ROUTE 40 DETOUR ROUTE PREP 2020 STAGE 1/4 RIVERFRONT DR. WIDENING/RESTORATION SCALE: 1"=50"

F.A.P. RTE	SECTION		COUNTY	TOTAL SHEETS	SHEE NO.
404	D4 IL 40 DETOUR PREP	2020	PEORIA TAZEWELL	160	45
			CONTRACT	NO.	68E71
	ILLINOIS	FED. AI	ID PROJECT		

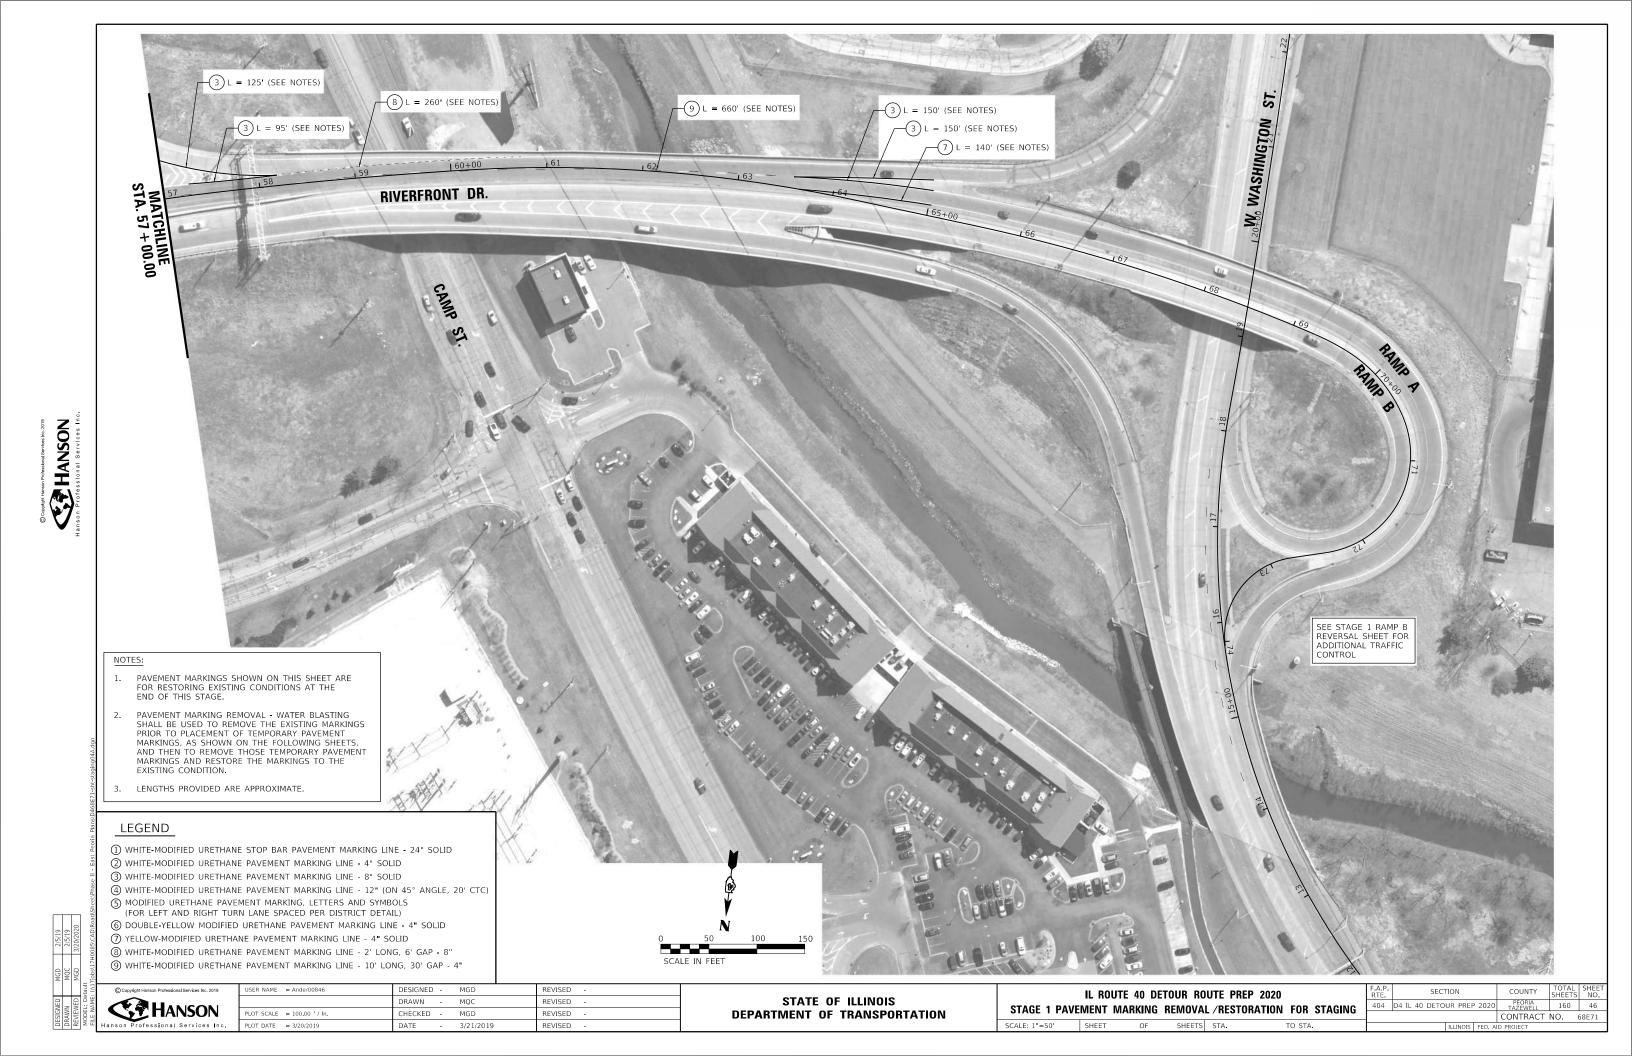

SCALE: 1"=50'

OF SHEETS STA.

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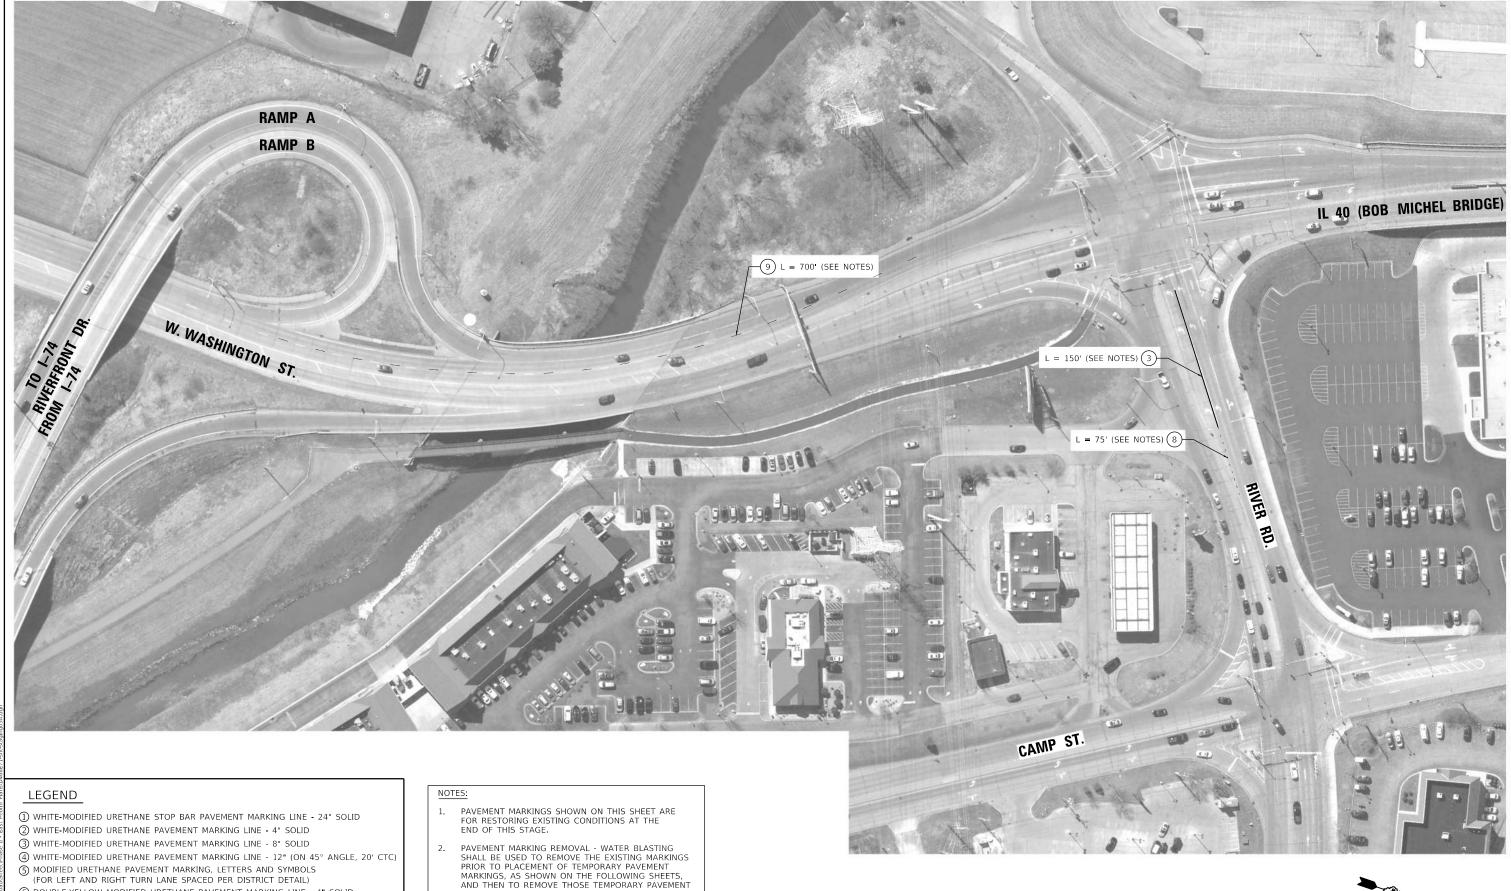
PLOT DATE = 4/29/2019

DATE


3/21/2019

REVISED





- 6 DOUBLE-YELLOW MODIFIED URETHANE PAVEMENT MARKING LINE 4" SOLID
- 7 YELLOW-MODIFIED URETHANE PAVEMENT MARKING LINE 4" SOLID
- 9 WHITE-MODIFIED URETHANE PAVEMENT MARKING LINE 10' LONG, 30' GAP 4"
- (8) WHITE-MODIFIED URETHANE PAVEMENT MARKING LINE 2' LONG, 6' GAP 8"
- PAVEMENT MARKING REMOVAL WATER BLASTING SHALL BE USED TO REMOVE THE EXISTING MARKINGS PRIOR TO PLACEMENT OF TEMPORARY PAVEMENT MARKINGS, AS SHOWN ON THE FOLLOWING SHEETS, AND THEN TO REMOVE THOSE TEMPORARY PAVEMENT MARKINGS AND RESTORE THE MARKINGS TO THE EXISTING CONDITION.
- 3. LENGTHS PROVIDED ARE APPROXIMATE.

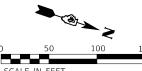


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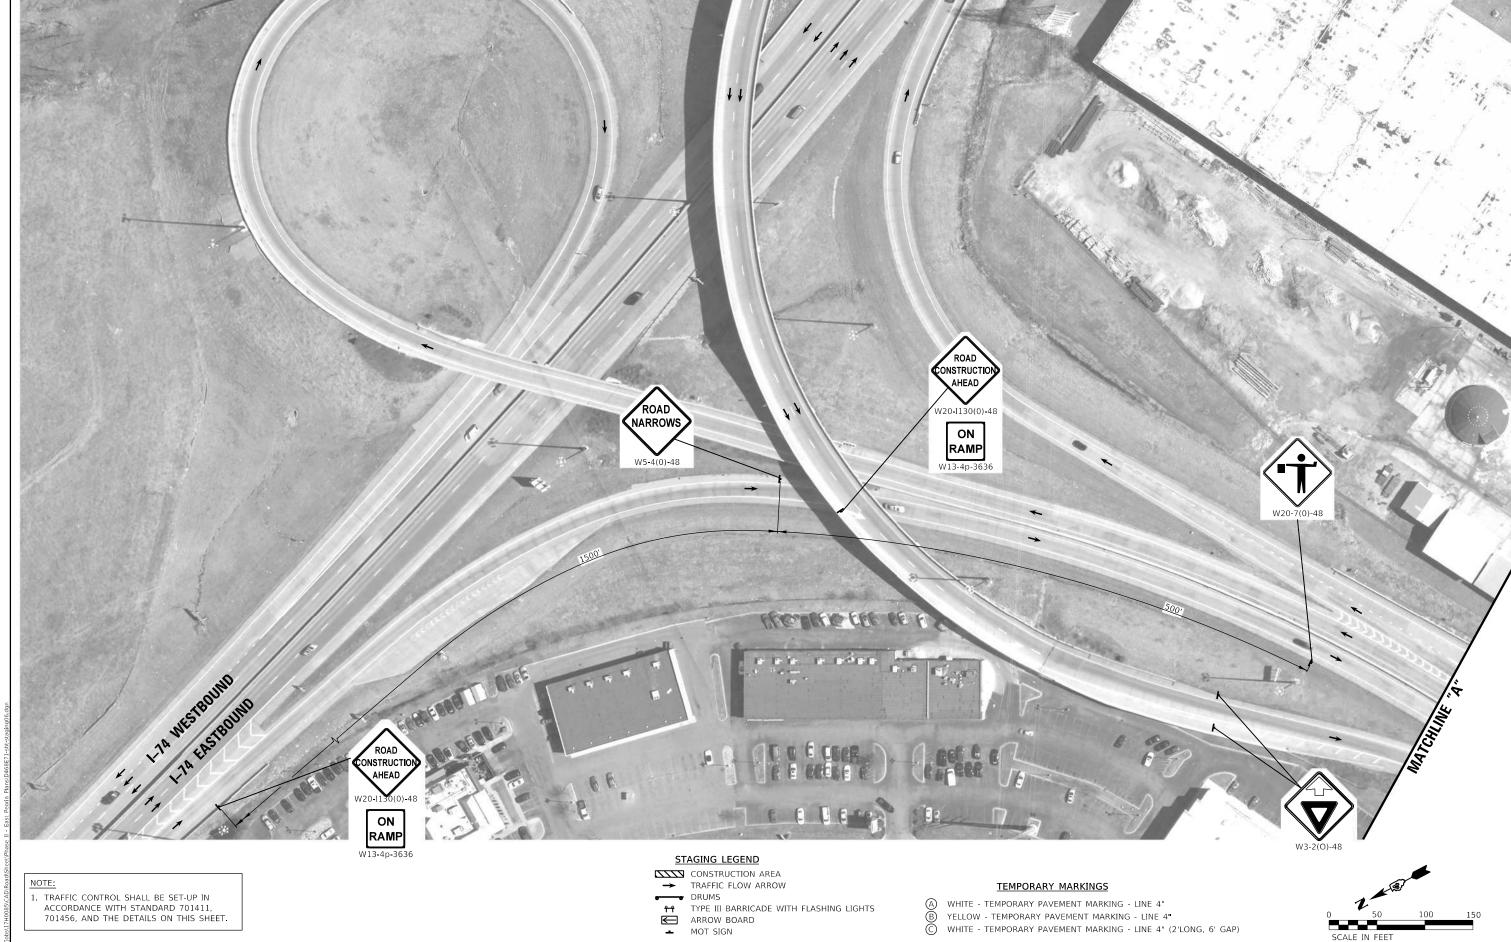
USER NAME = Ander00846	DESIGNED -	MGD	REVISED -
	DRAWN -	MQC	REVISED -
PLOT SCALE = 100.00 '/ In.	CHECKED -	MGD	REVISED -
PLOT DATE = 3/20/2019	DATE -	3/21/2019	REVISED -

	IL RO	UTE 40 DE	TOUR RO	UTE PF	REP 2020	L
STAGE 1 PAVE	MENT	MARKING	REMOVA	L /REST	ORATION FOR STAGING	F
ALE: 1"-50"	SHEET	OF	SHEETS	STA	TO STA	₽

A.P.	SECT	TION		COUNTY	TOTAL SHEETS	SHEET NO.		
404	D4 IL 40 DETO	UR PREF	2020	PEORIA TAZEWELL	160	48		
			CONTRACT	NO.	68E71			
	ILLINOIS FED. AID PROJECT							



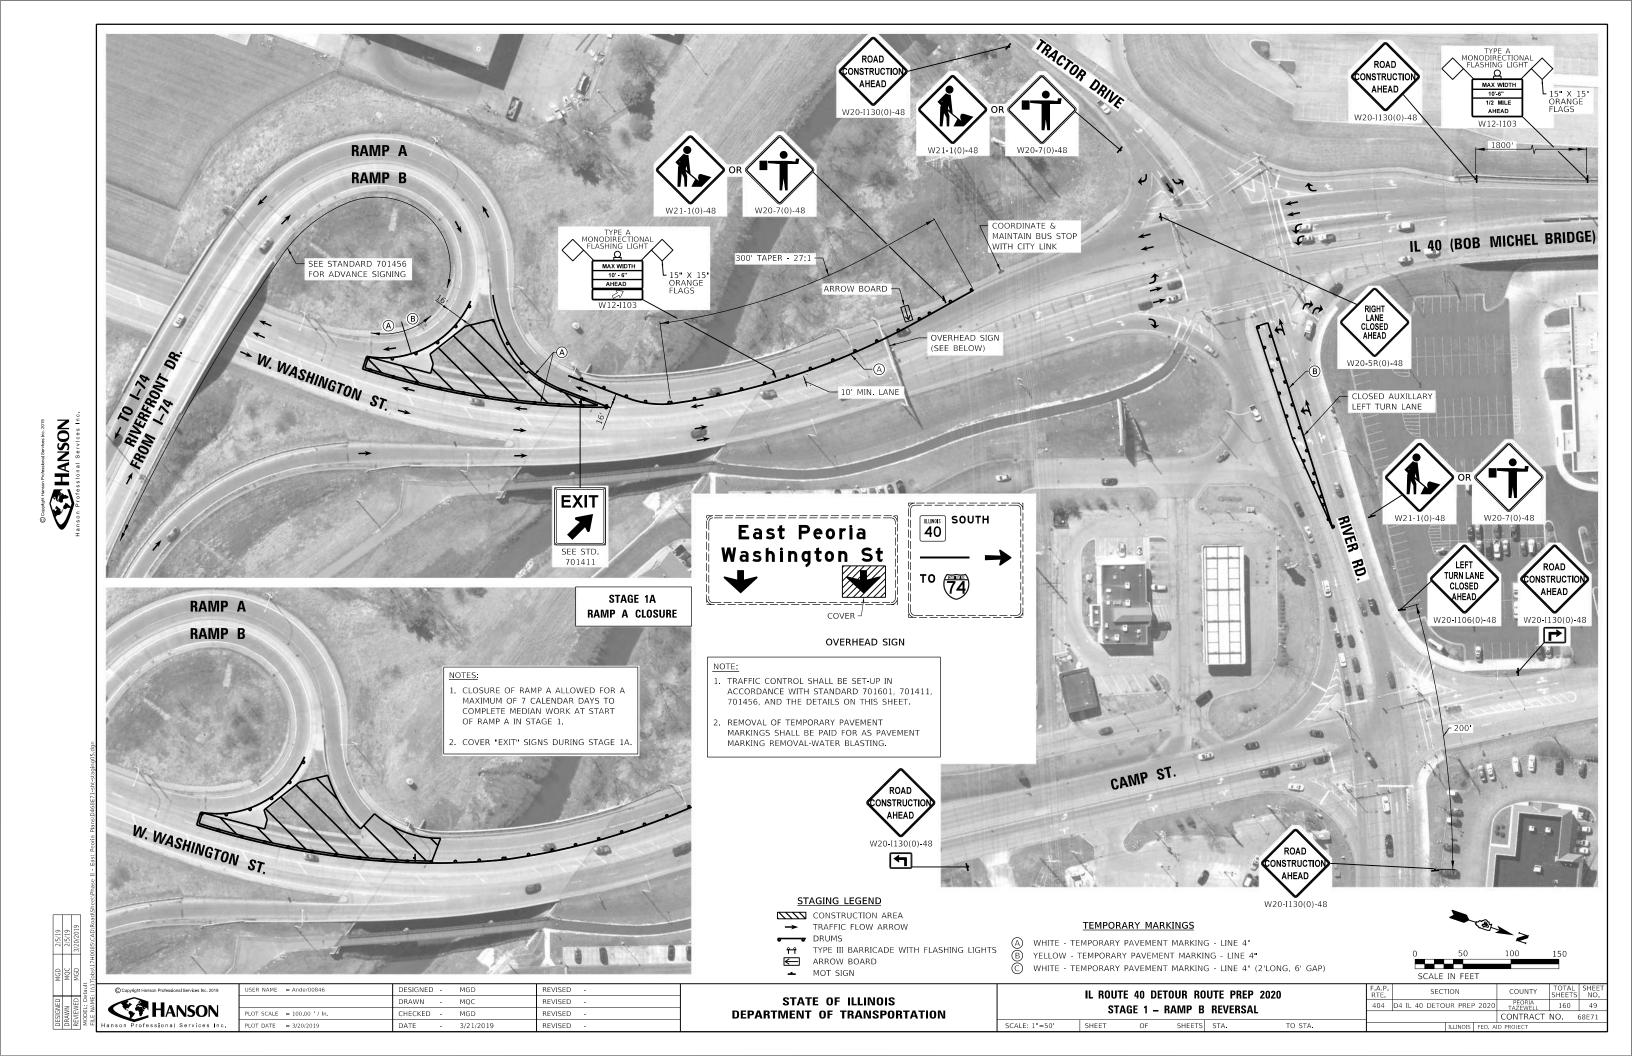



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DRAWN -REVISED -MOC LOT SCALE = 100.00 / In. REVISED

	IL ROUT	E 40 DE	TOUR RO	UTE PI	REP 2020
	STAGE 2/3	B RAMP	B REVER	SAL/RE	STORATION
SCALE: 1"=50'	SHEET	OF	SHEETS	STA.	TO STA.

	JCALL	114 1 1 1	. 1			
A.P. TE.	SECT	TION		COUNTY	TOTAL SHEETS	SHEET NO.
04	D4 IL 40 DETO	UR PREF	2020	PEORIA TAZEWELL	160	50
			CONTRACT	NO. 6	58E71	
		TELIMOTE	EED A	ID BROJECT		





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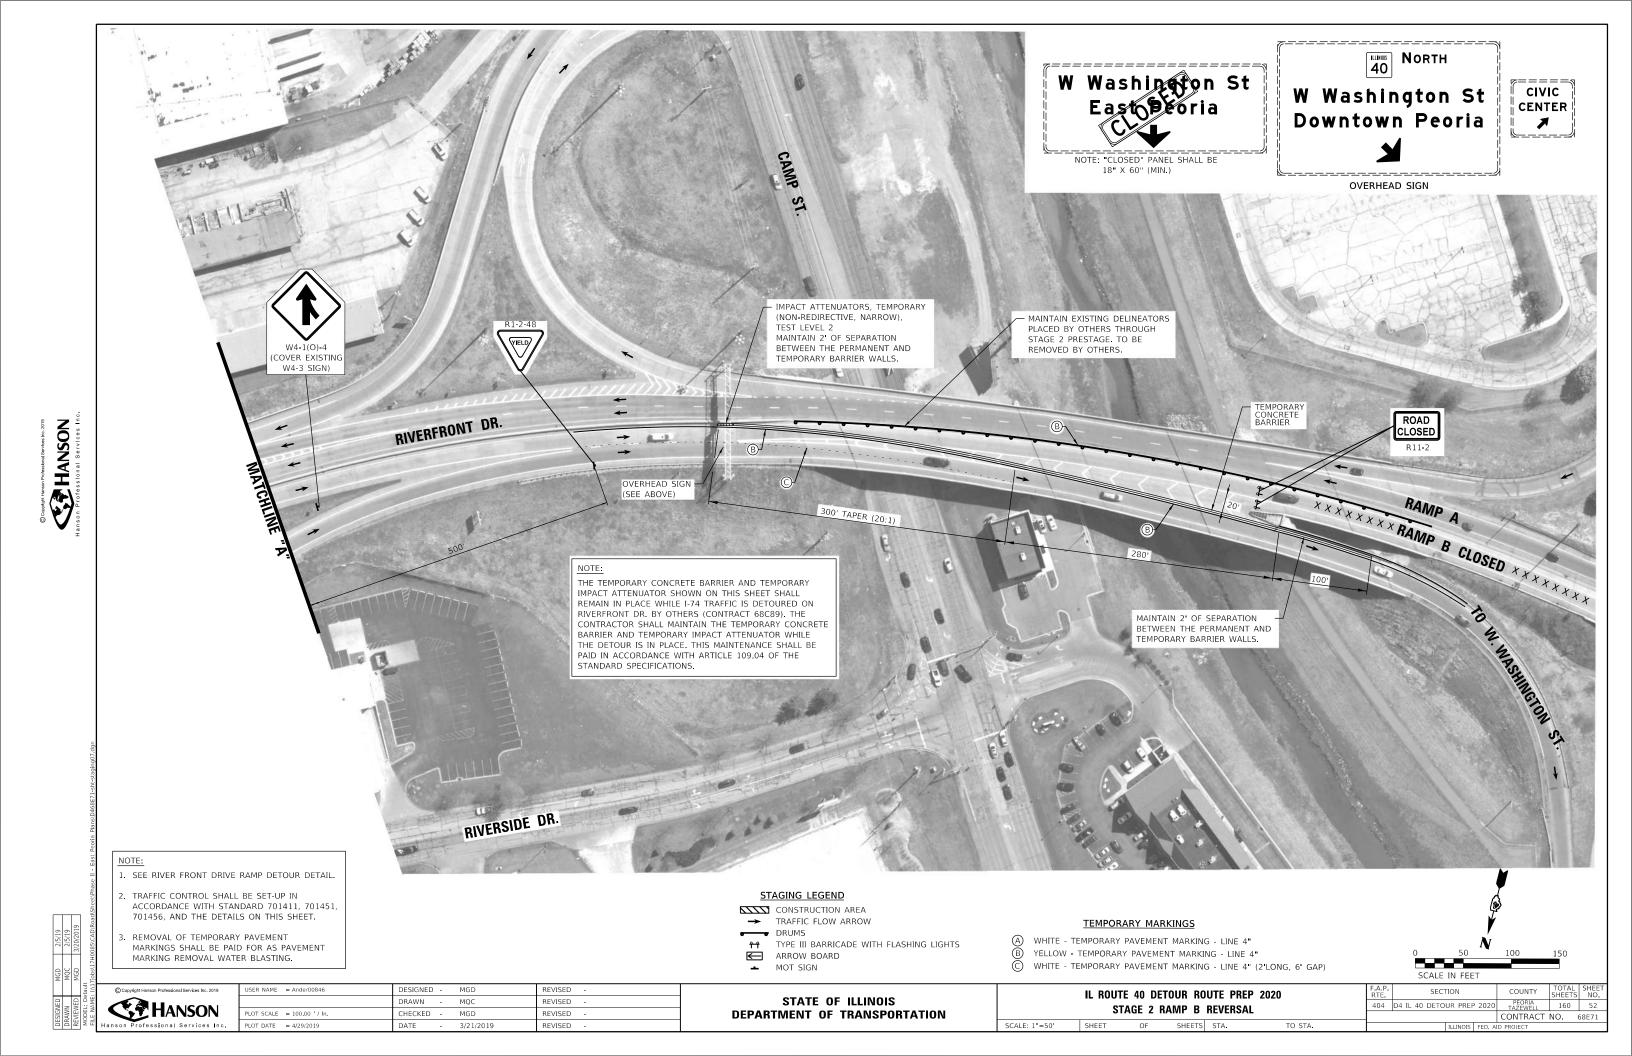
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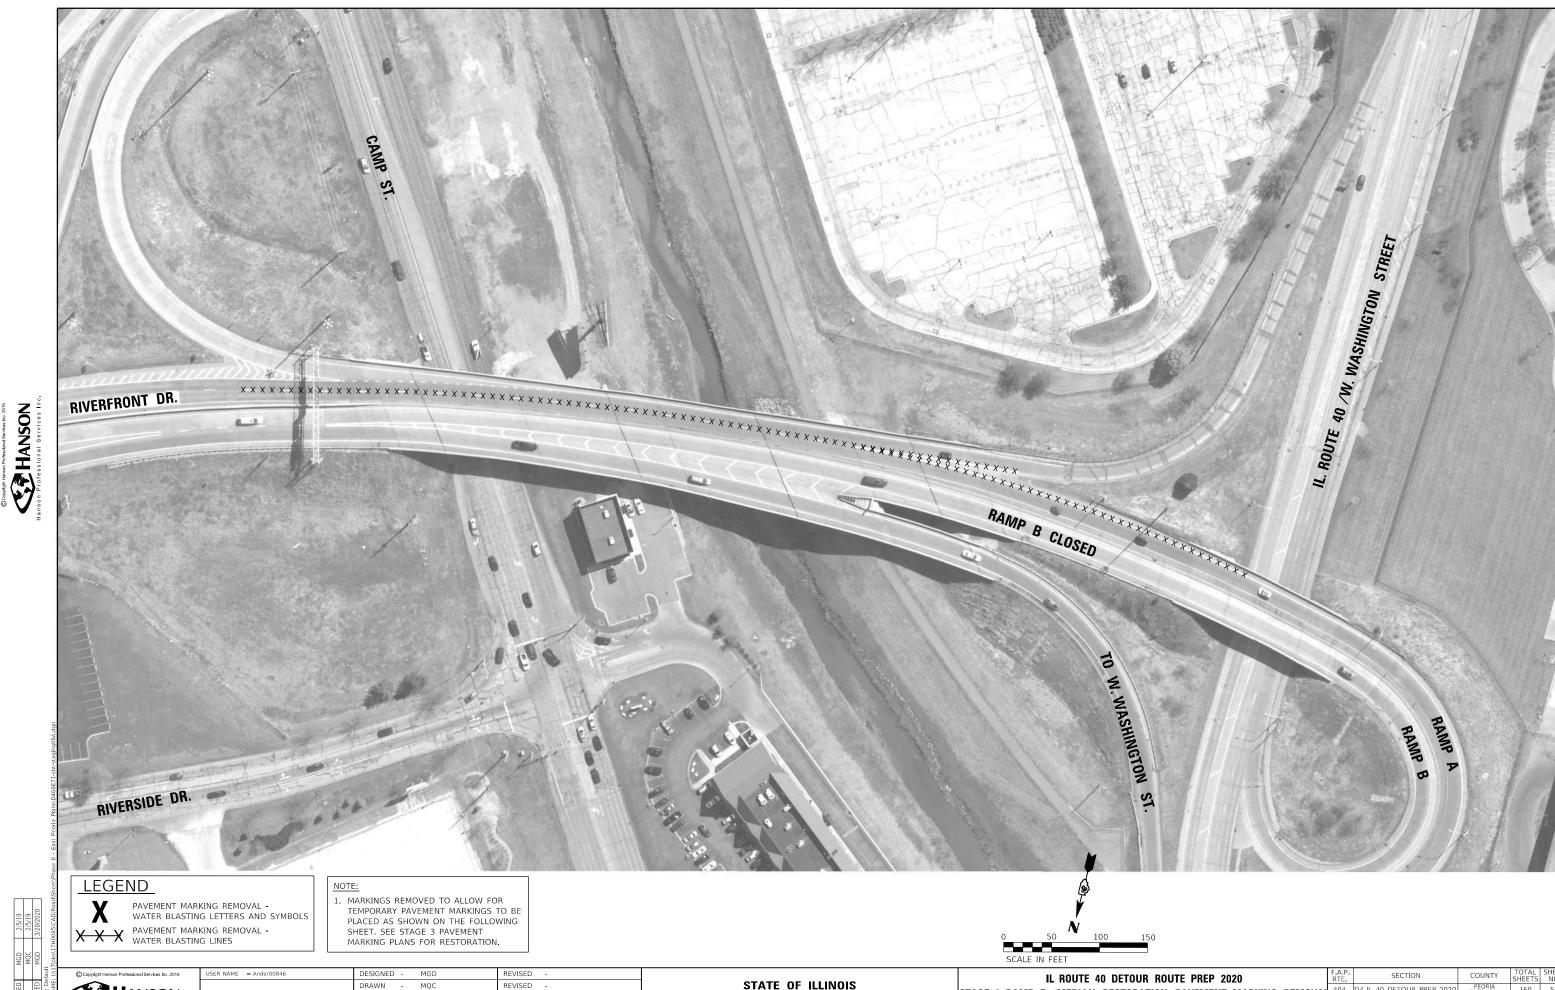
DRAWN -MQC REVISED -PLOT SCALE = 100.00 ' / In.

PLOT DATE = 3/20/2019 MGD REVISED

STATE OF ILLINOIS DEPARTMENT OF TRANSPORTATION

IL ROUTE 40 DETOUR ROUTE PREP 2020 STAGE 2 RAMP B REVERSAL /PAVEMENT MARKING REMOVAL CONTRACT NO. 68E71





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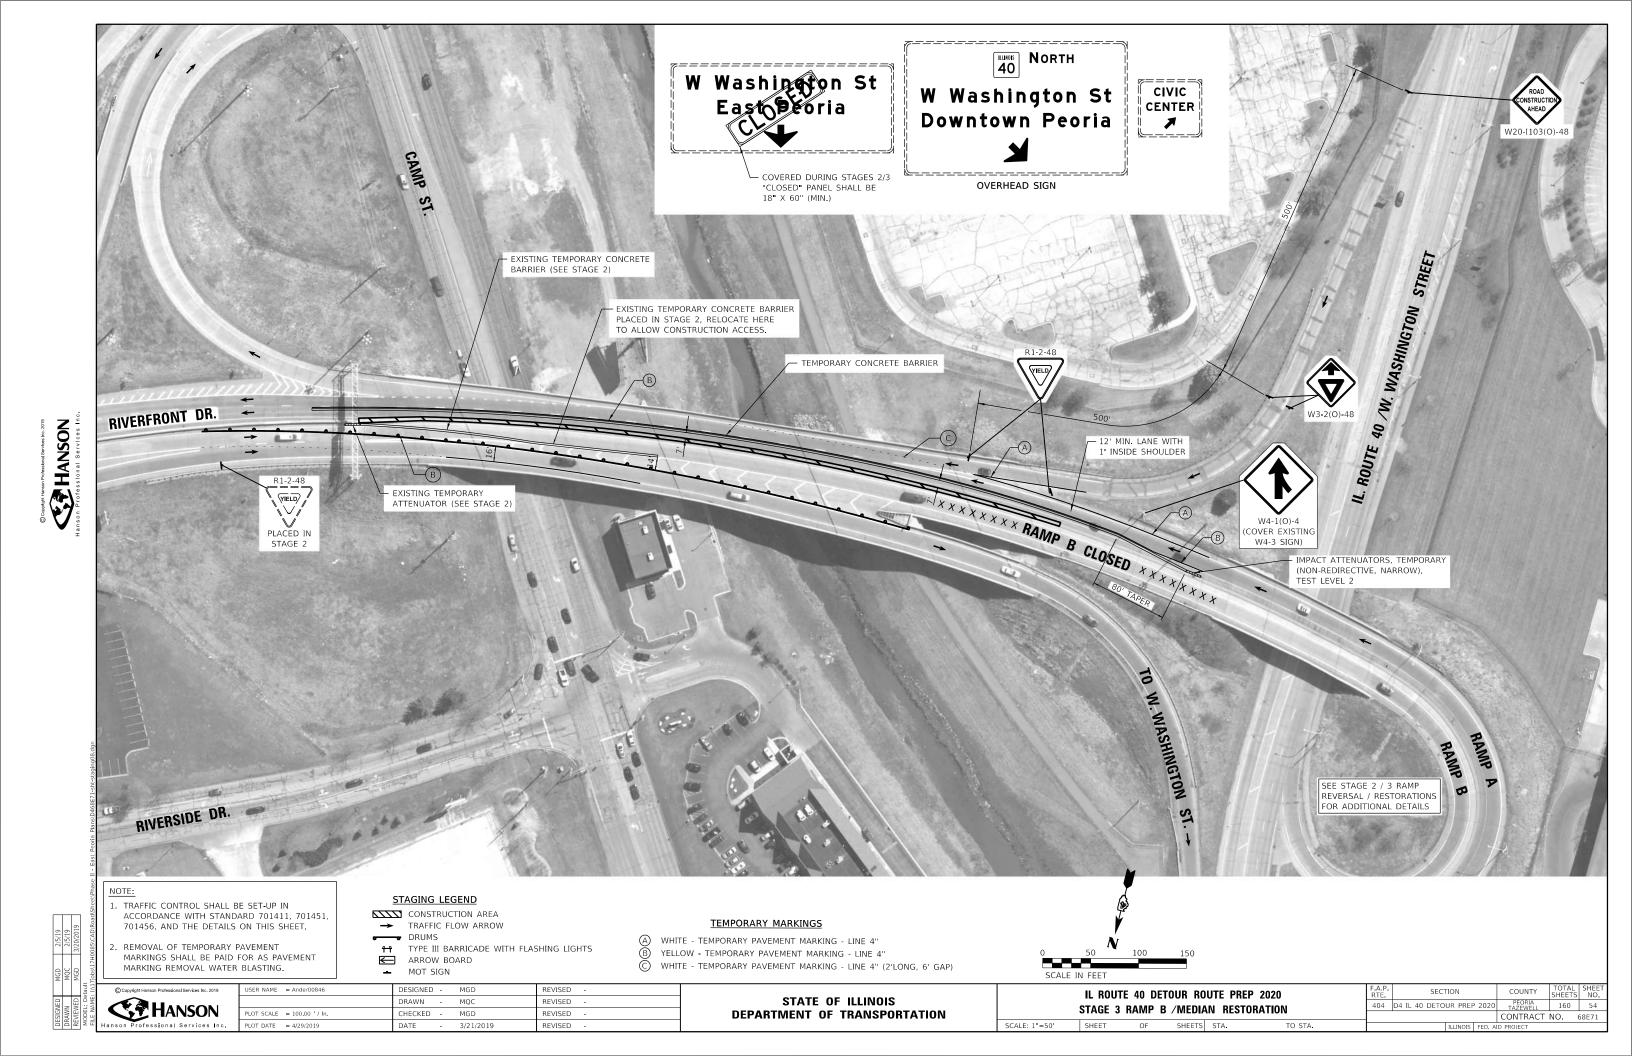
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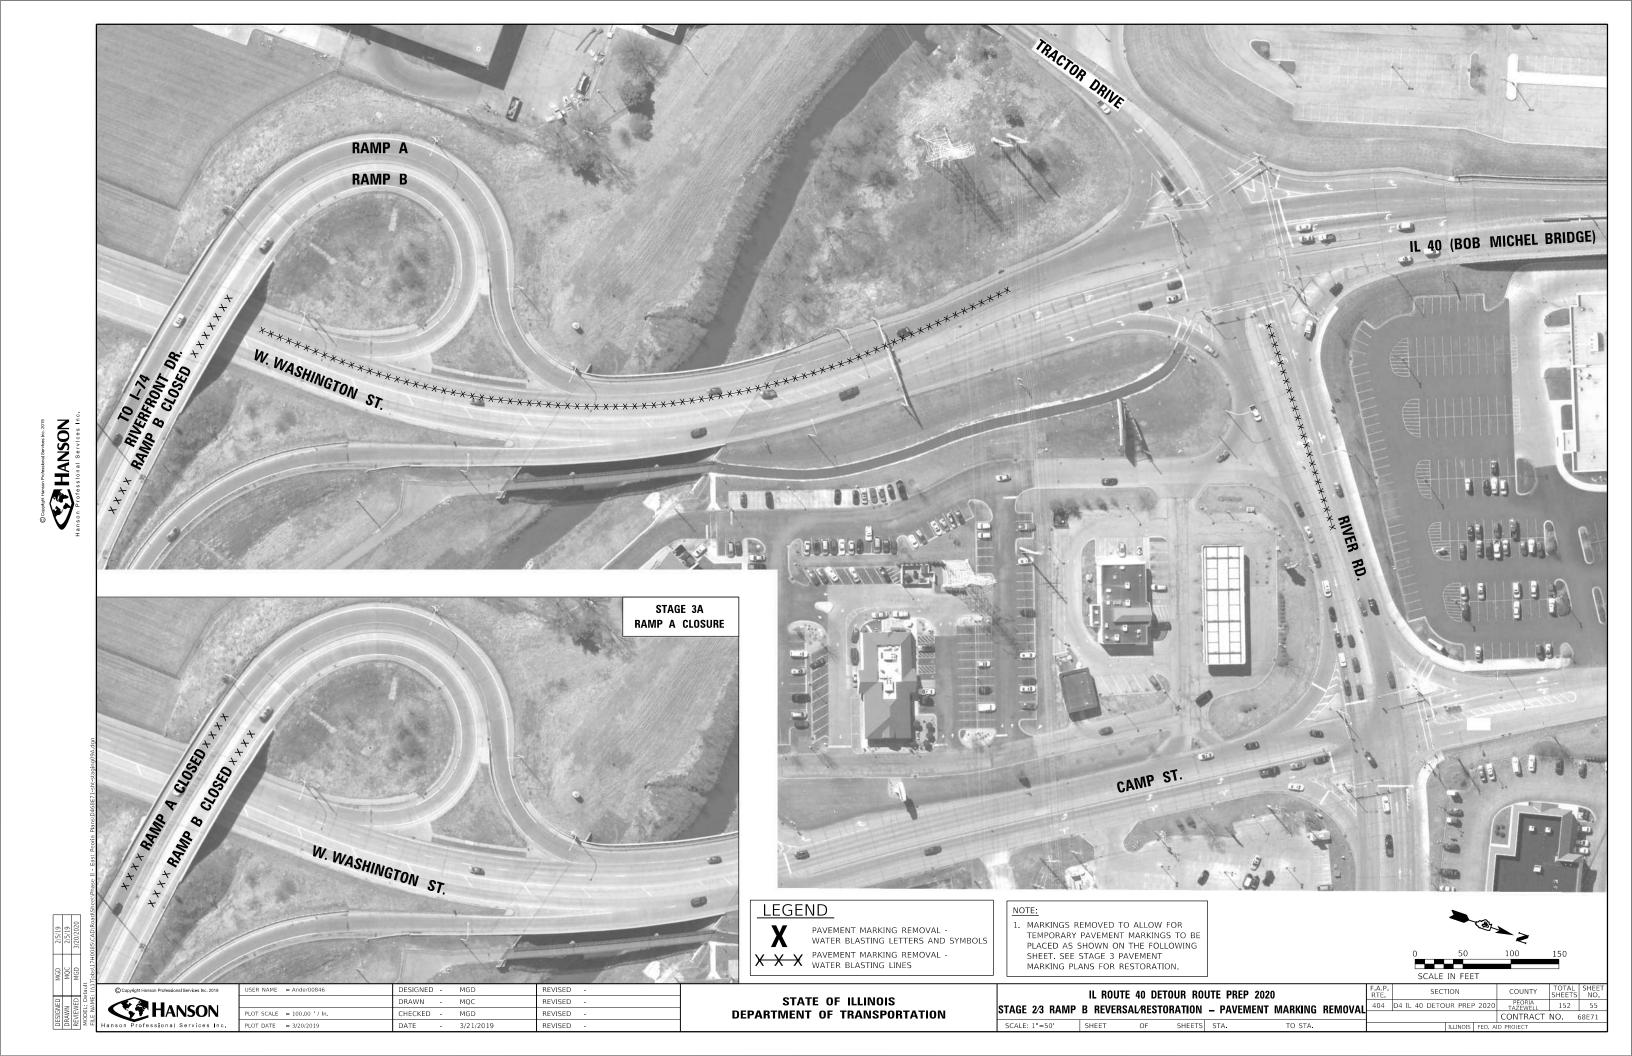
PLOT DATE = 3/20/2019 MGD REVISED


STATE OF ILLINOIS DEPARTMENT OF TRANSPORTATION


STAGE 3 RAMP B / MEDIAN RESTORATION PAVEMENT MARKING REMOVAL 40 D4 IL 40 DETOUR PREP 2020 PEOPLE AND A D4 IL 40 DETOUR PREP 2020 PEOPLE

CONTRACT NO. 68E71





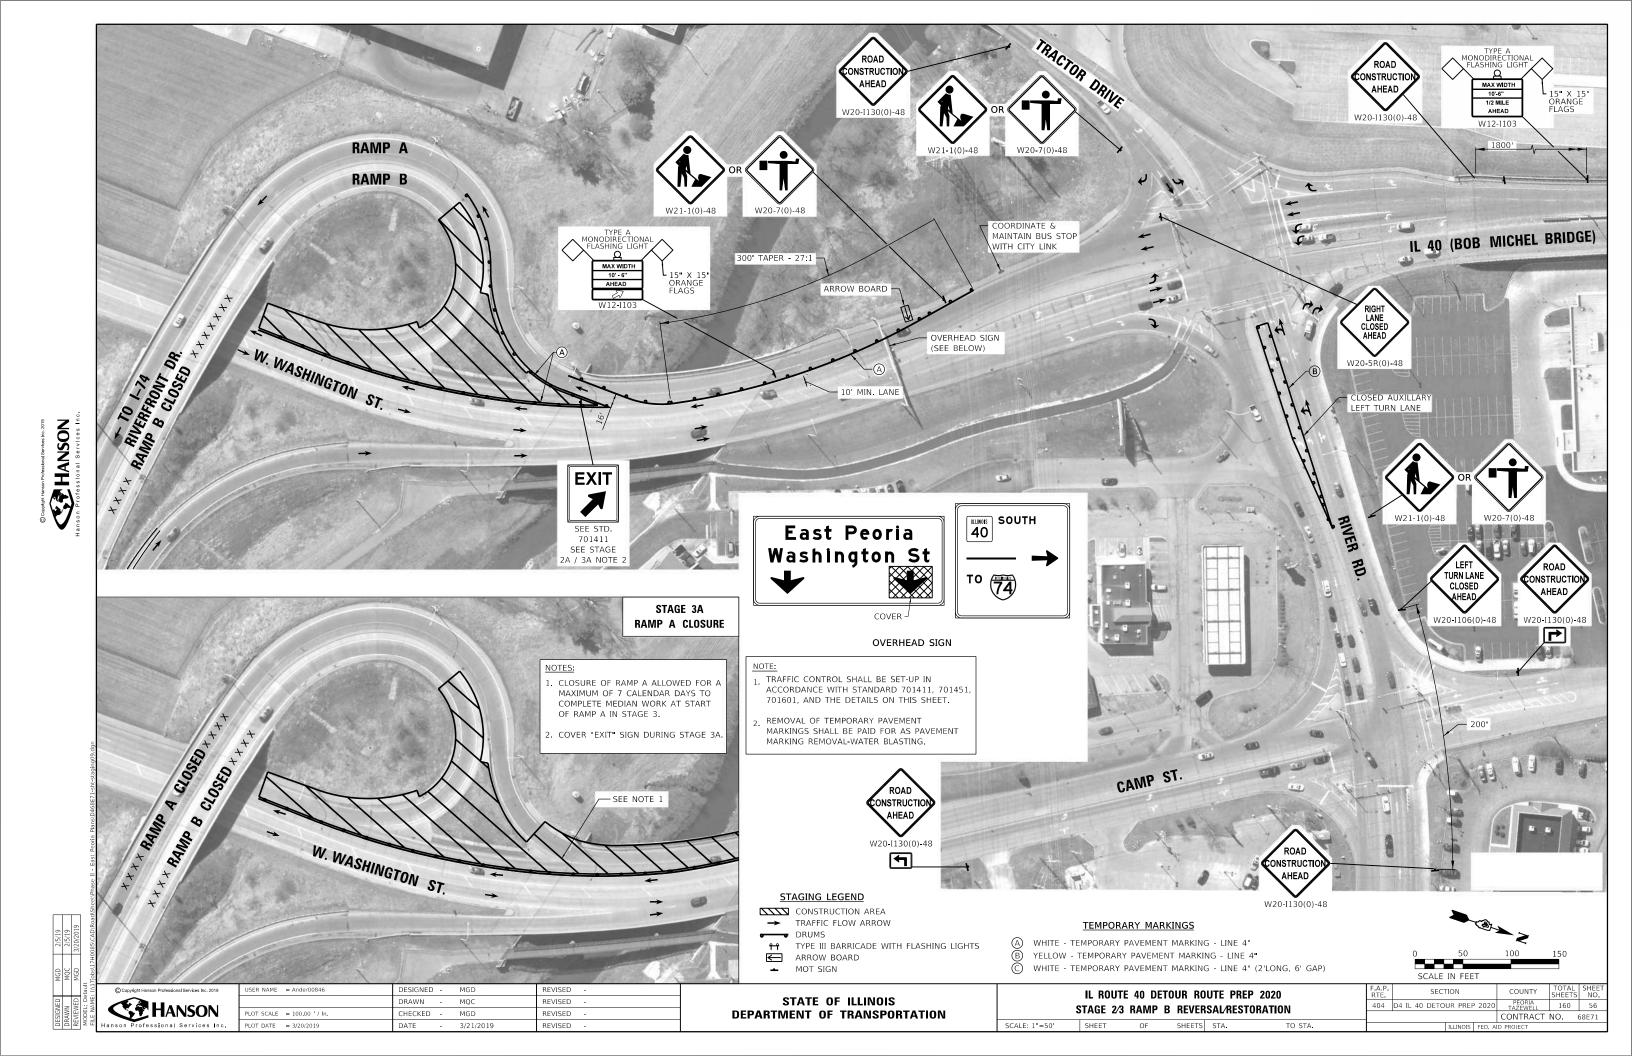

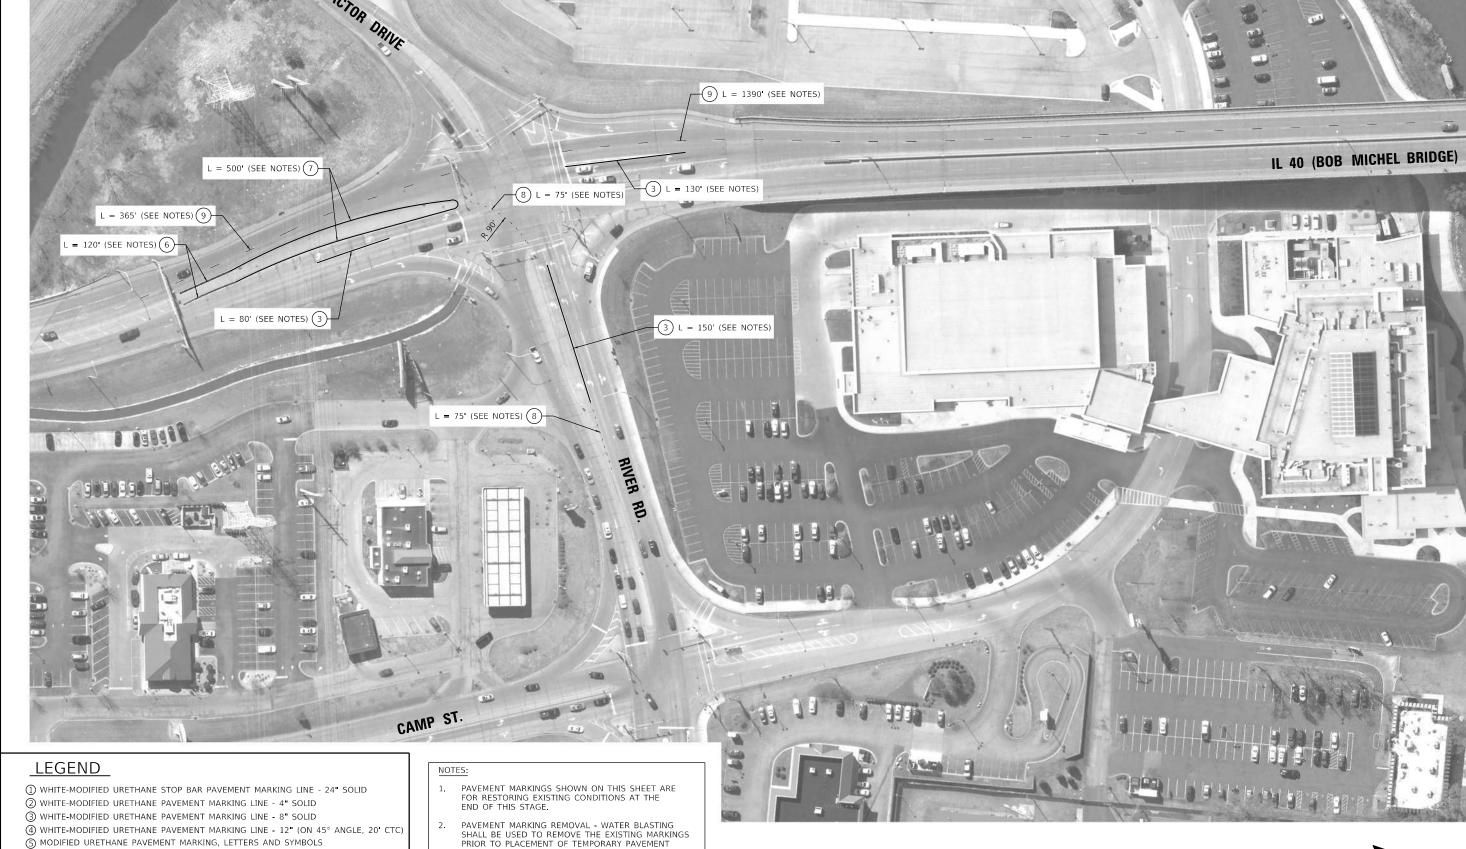

STATE OF ILLINOIS

DEPARTMENT OF TRANSPORTATION

1 PAVEMENT MARKING REMOVAL - WATER BLASTING HANSON

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DESIGNED -DRAWN MOC LOT SCALE = 100.00 ' / In.

(FOR LEFT AND RIGHT TURN LANE SPACED PER DISTRICT DETAIL) 6 DOUBLE-YELLOW MODIFIED URETHANE PAVEMENT MARKING LINE - 4" SOLID 7 YELLOW-MODIFIED URETHANE PAVEMENT MARKING LINE - 4" SOLID ® WHITE-MODIFIED URETHANE PAVEMENT MARKING LINE - 2' LONG, 6' GAP - 8"

9 WHITE-MODIFIED URETHANE PAVEMENT MARKING LINE - 10' LONG, 30' GAP - 4"


- PAVEMENT MARKING REMOVAL WATER BLASTING SHALL BE USED TO REMOVE THE EXISTING MARKINGS PRIOR TO PLACEMENT OF TEMPORARY PAVEMENT MARKINGS, AS SHOWN ON THE FOLLOWING SHEETS, AND THEN TO REMOVE THOSE TEMPORARY PAVEMENT MARKINGS AND RESTORE THE MARKINGS TO THE EXISTING CONDITION.
- LENGTHS PROVIDED ARE APPROXIMATE.

REVISED

REVISED

IL ROUTE 40 DETOUR ROUTE PREP 2020 STAGE 4 W. WASHINGTON ST. PAVEMENT MARKING REMOVAL CONTRACT NO. 68E71



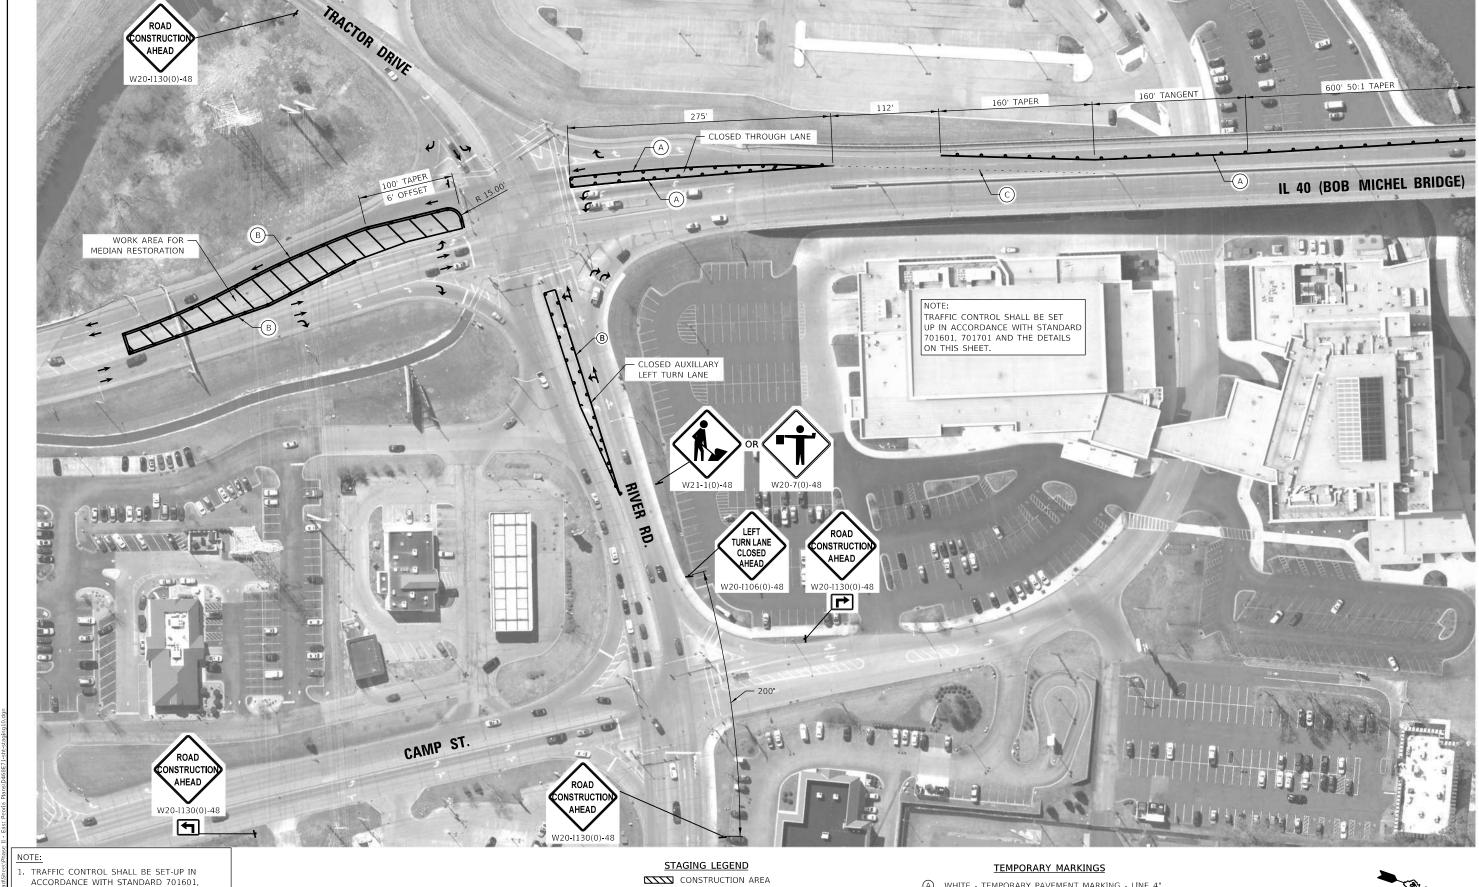

ACCORDANCE WITH STANDARD 701601, 701701, AND THE DETAILS ON THIS SHEET.

REMOVAL OF TEMPORARY PAVEMENT MARKINGS SHALL BE PAID FOR AS PAVEMENT MARKING REMOVAL WATER BLASTING.

CONSTRUCTION AREA
TRAFFIC FLOW ARROW


→ DRUMS TYPE III BARRICADE WITH FLASHING LIGHTS
ARROW BOARD

MOT SIGN

STATE OF ILLINOIS **DEPARTMENT OF TRANSPORTATION**

(A) WHITE - TEMPORARY PAVEMENT MARKING - LINE 4"
(B) YELLOW - TEMPORARY PAVEMENT MARKING - LINE 4" YELLOW - TEMPORARY PAVEMENT MARKING - LINE 4"

WHITE - TEMPORARY PAVEMENT MARKING - LINE 4" (2'LONG, 6' GAP)

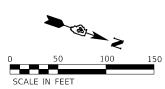

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DESIGNED -REVISED DRAWN -MOC REVISED PLOT SCALE = 100.00 ' / In. REVISED

IL ROUTE 40 DETOUR ROUTE PREP 2020 STAGE 4 W. WASHINGTON ST. MEDIAN RESTORATION

F.A.P. RTE				COUNTY	TOTAL SHEETS	SHEET NO.	
404				PEORIA TAZEWELL	160	58	
			CONTRACT NO. 68E71				
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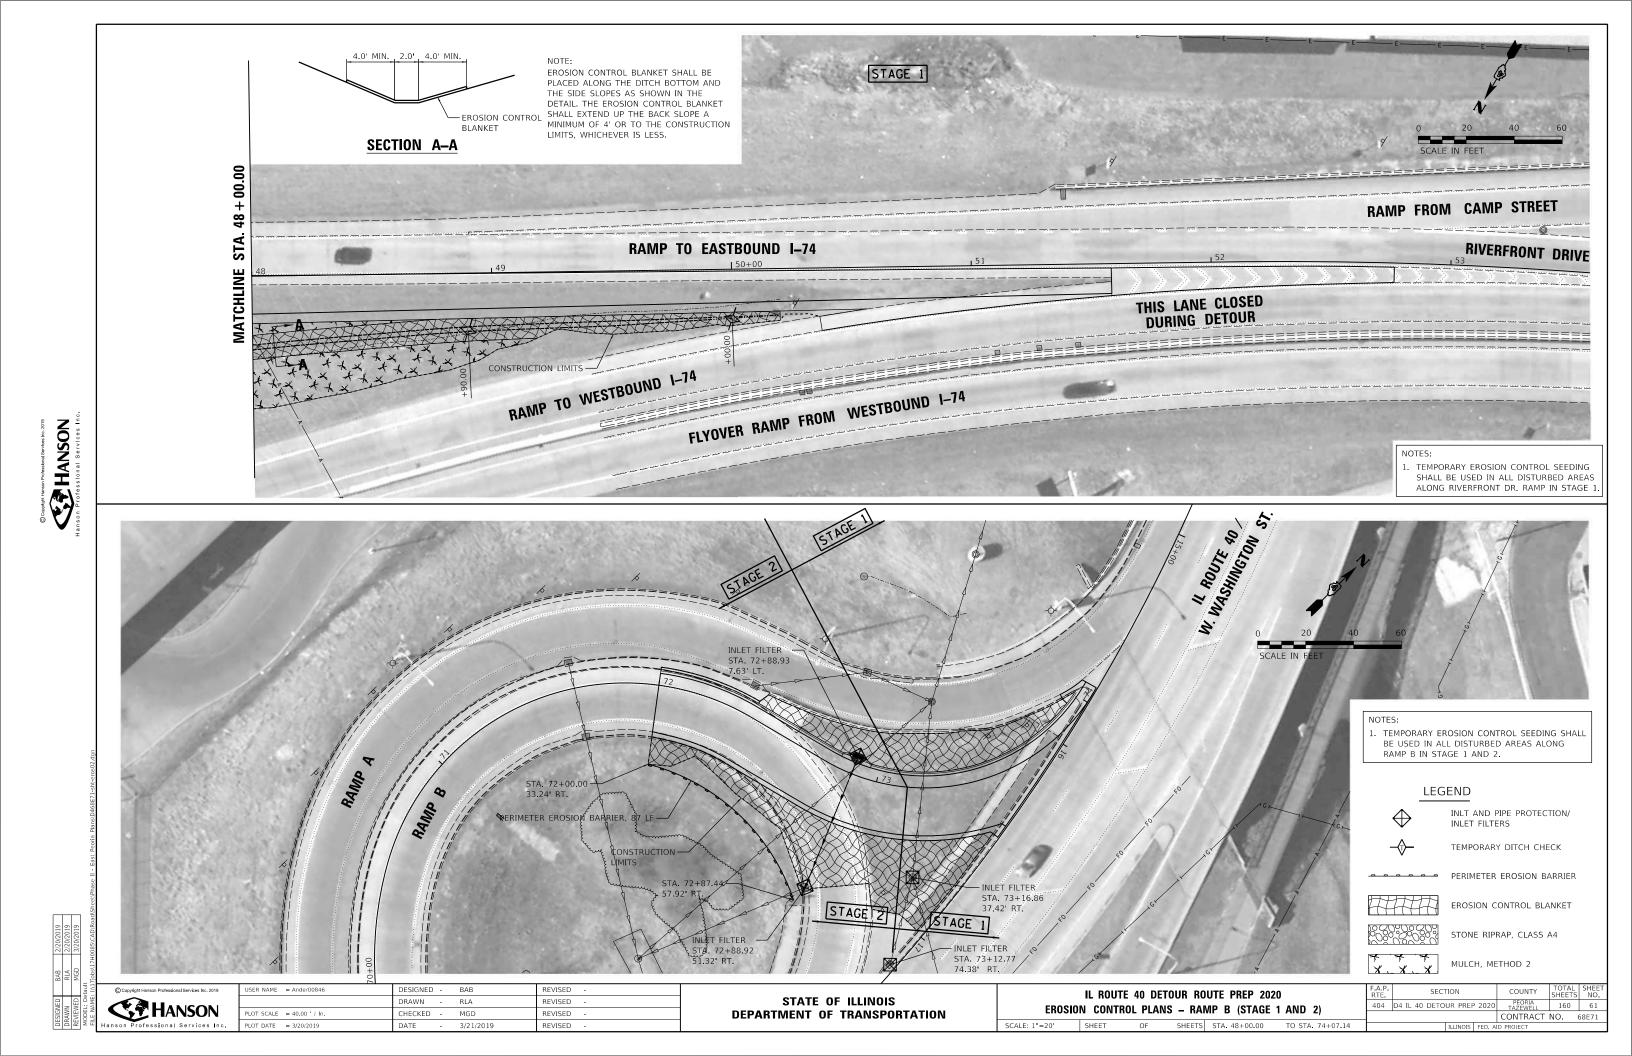
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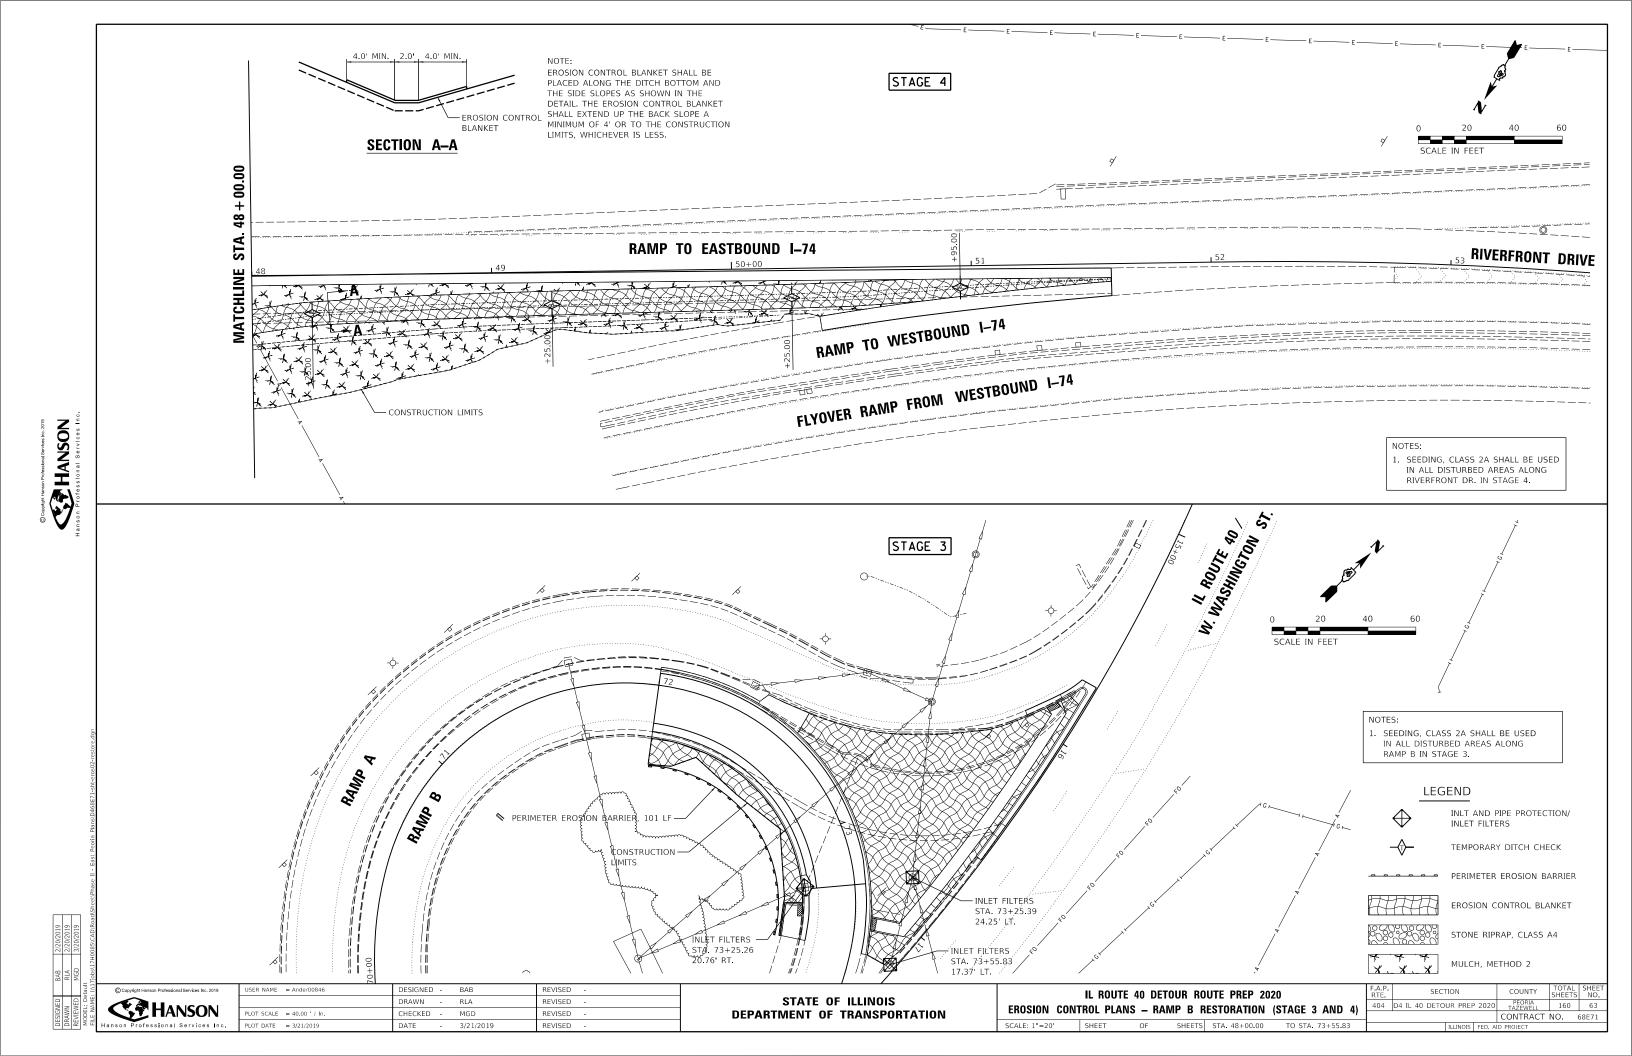
HANSON


Hanson Professional Services Inc.

	2020				
STAGE 4	W. WILLIA	M KUM	PF BLV[). MEDIAN	RESTORATION
SCALE: 1"=50'	SHEET	OF	SHEETS	STA.	TO STA.


F.A.P. RTE	SECTION			COUNTY	TOTAL SHEETS	SHEET NO.
404	D4 IL 40 DETOUR PREP 2020			PEORIA TAZEWELL	160	59
				CONTRACT	NO.	58E71
ILLINOIS EED AT				ID PROJECT		





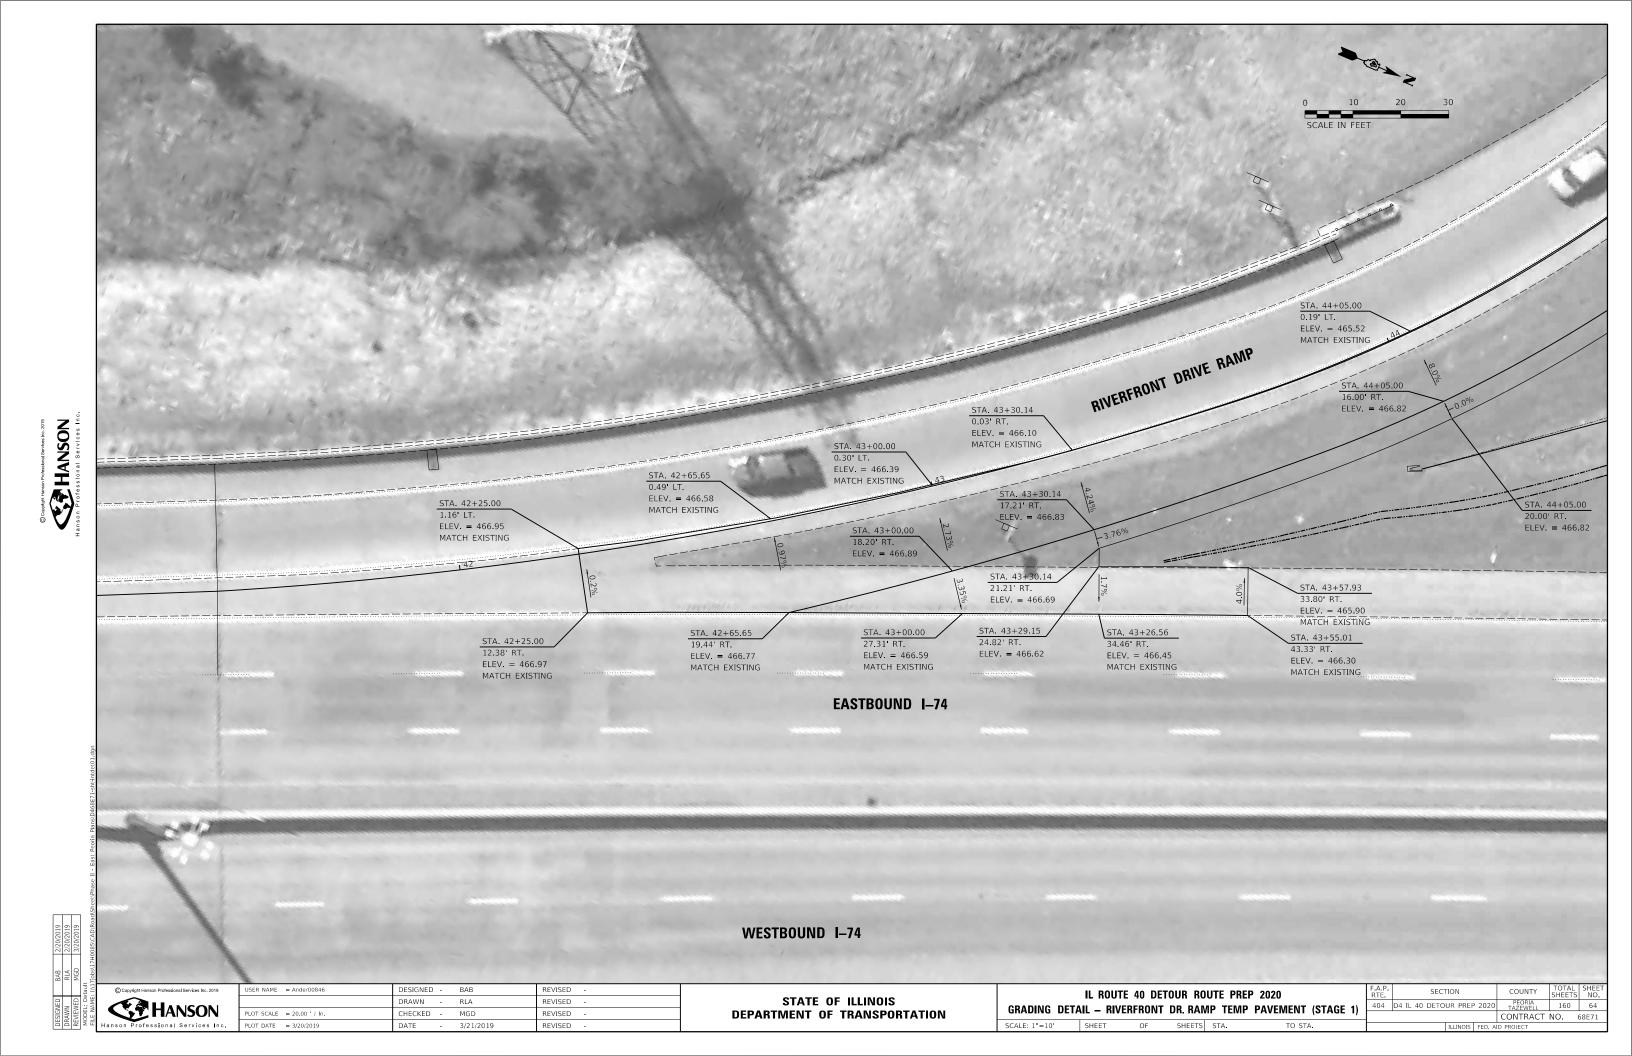



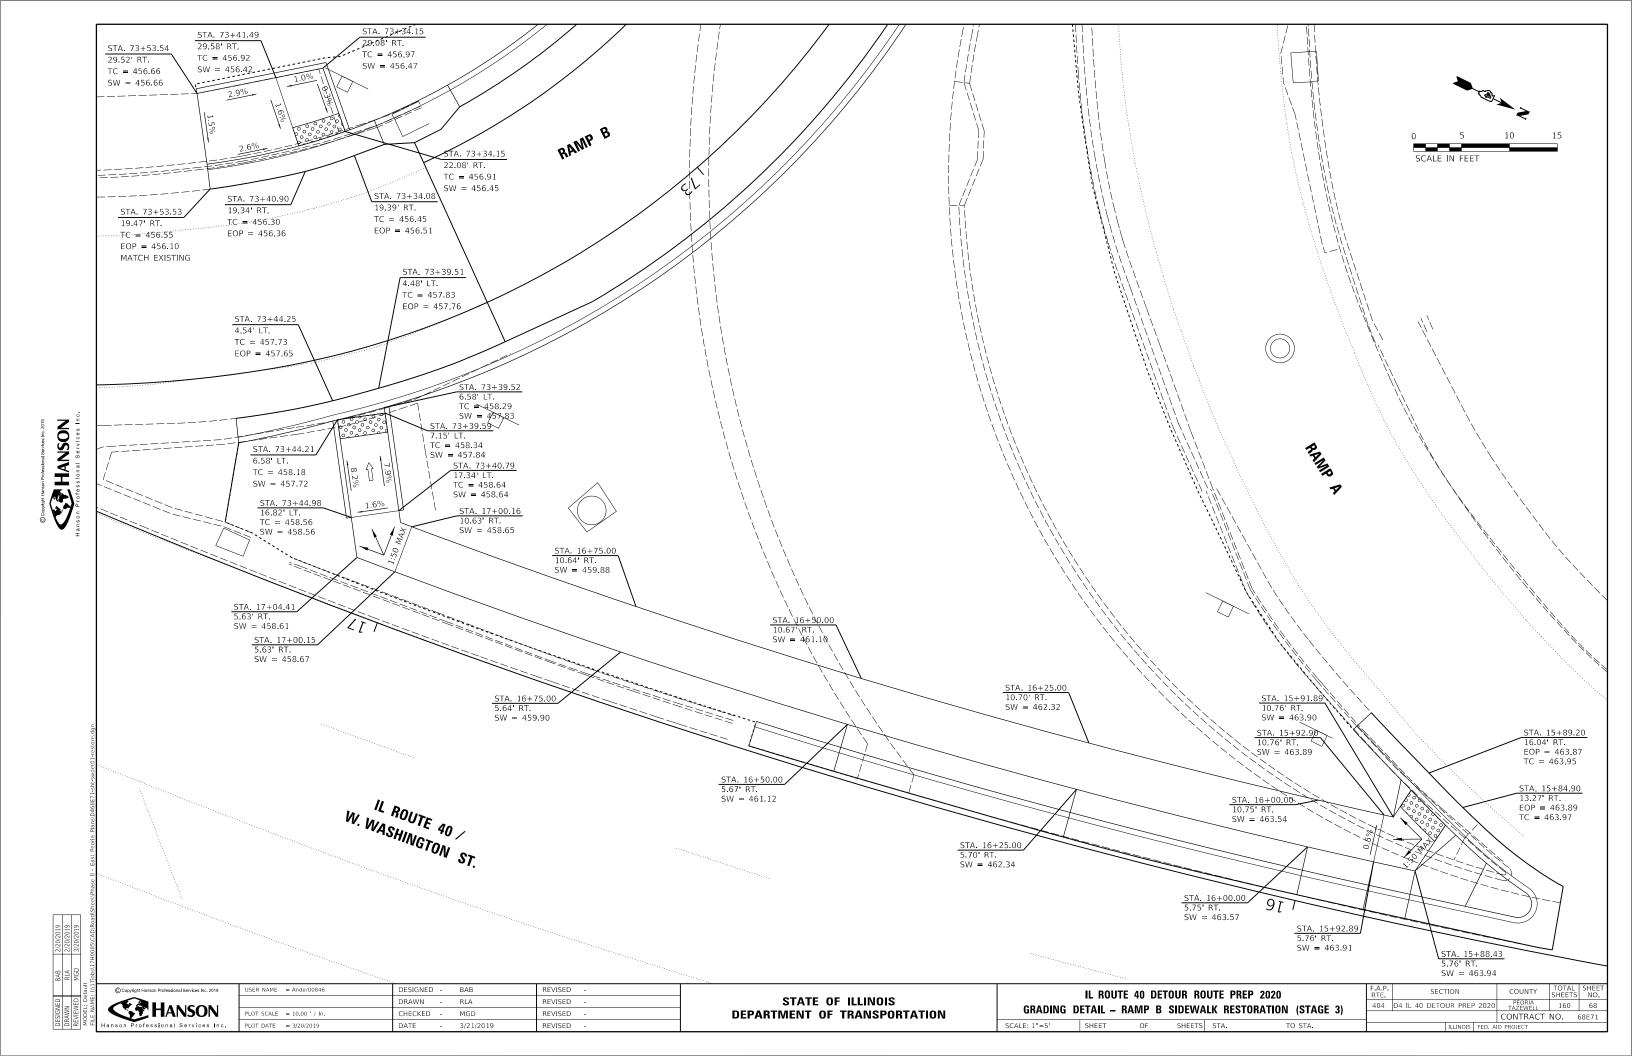


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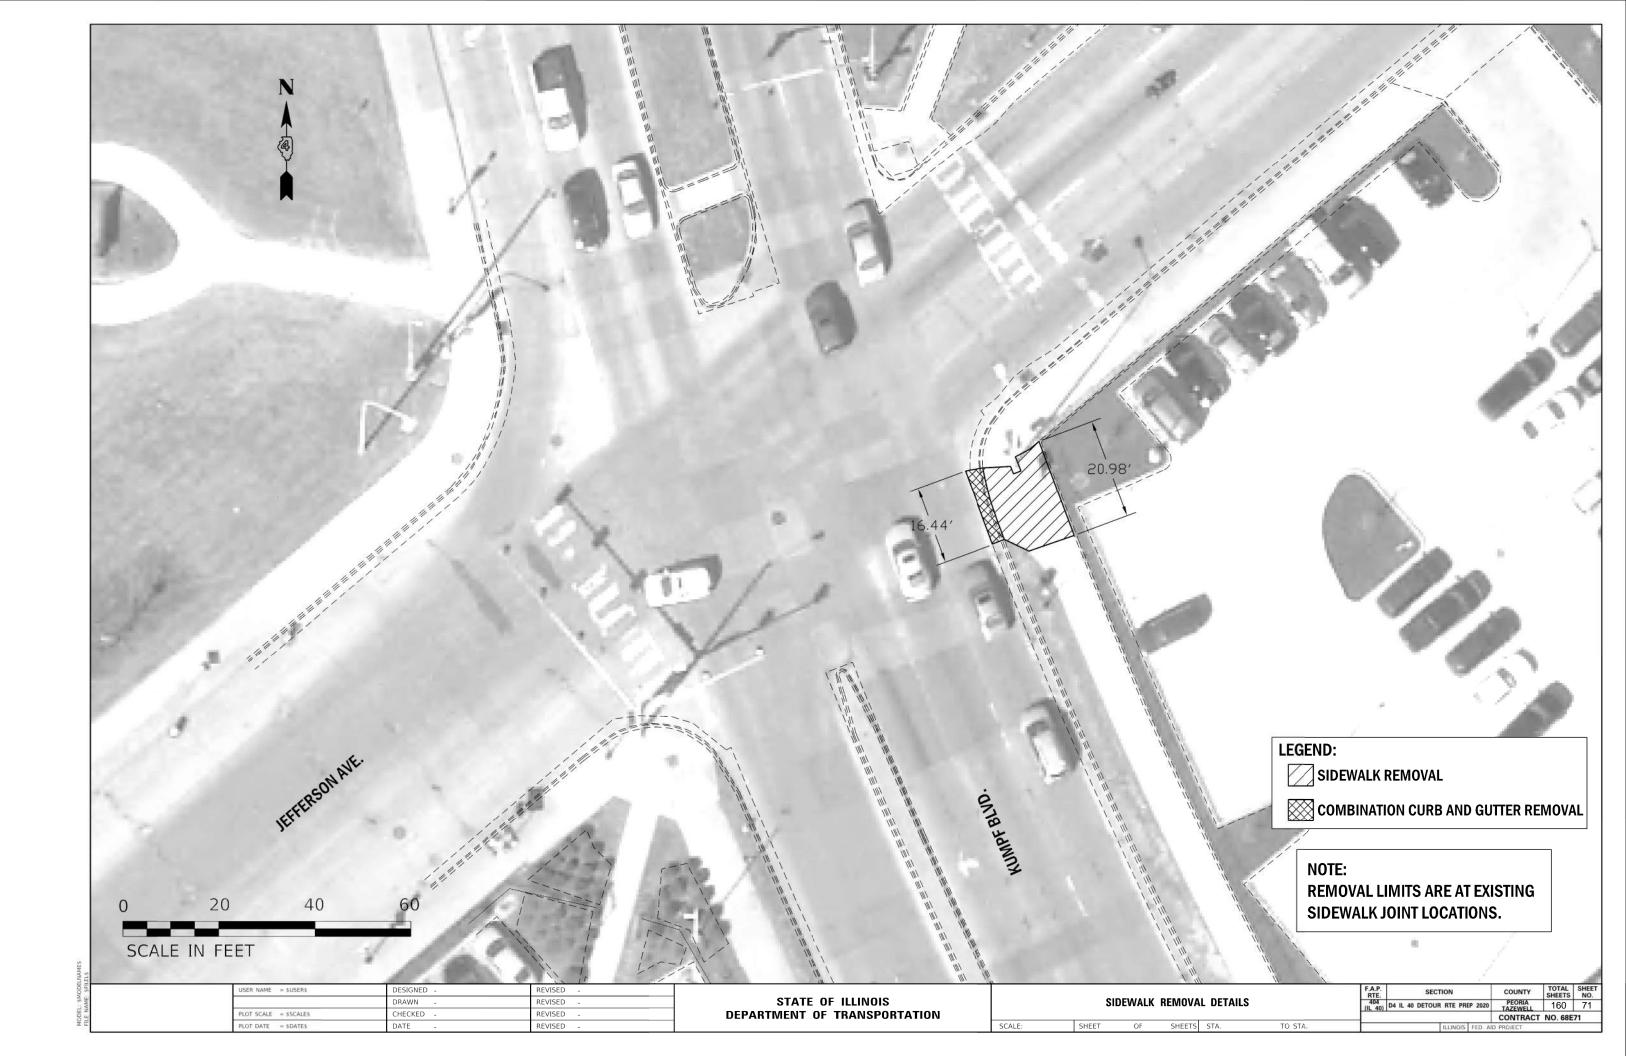
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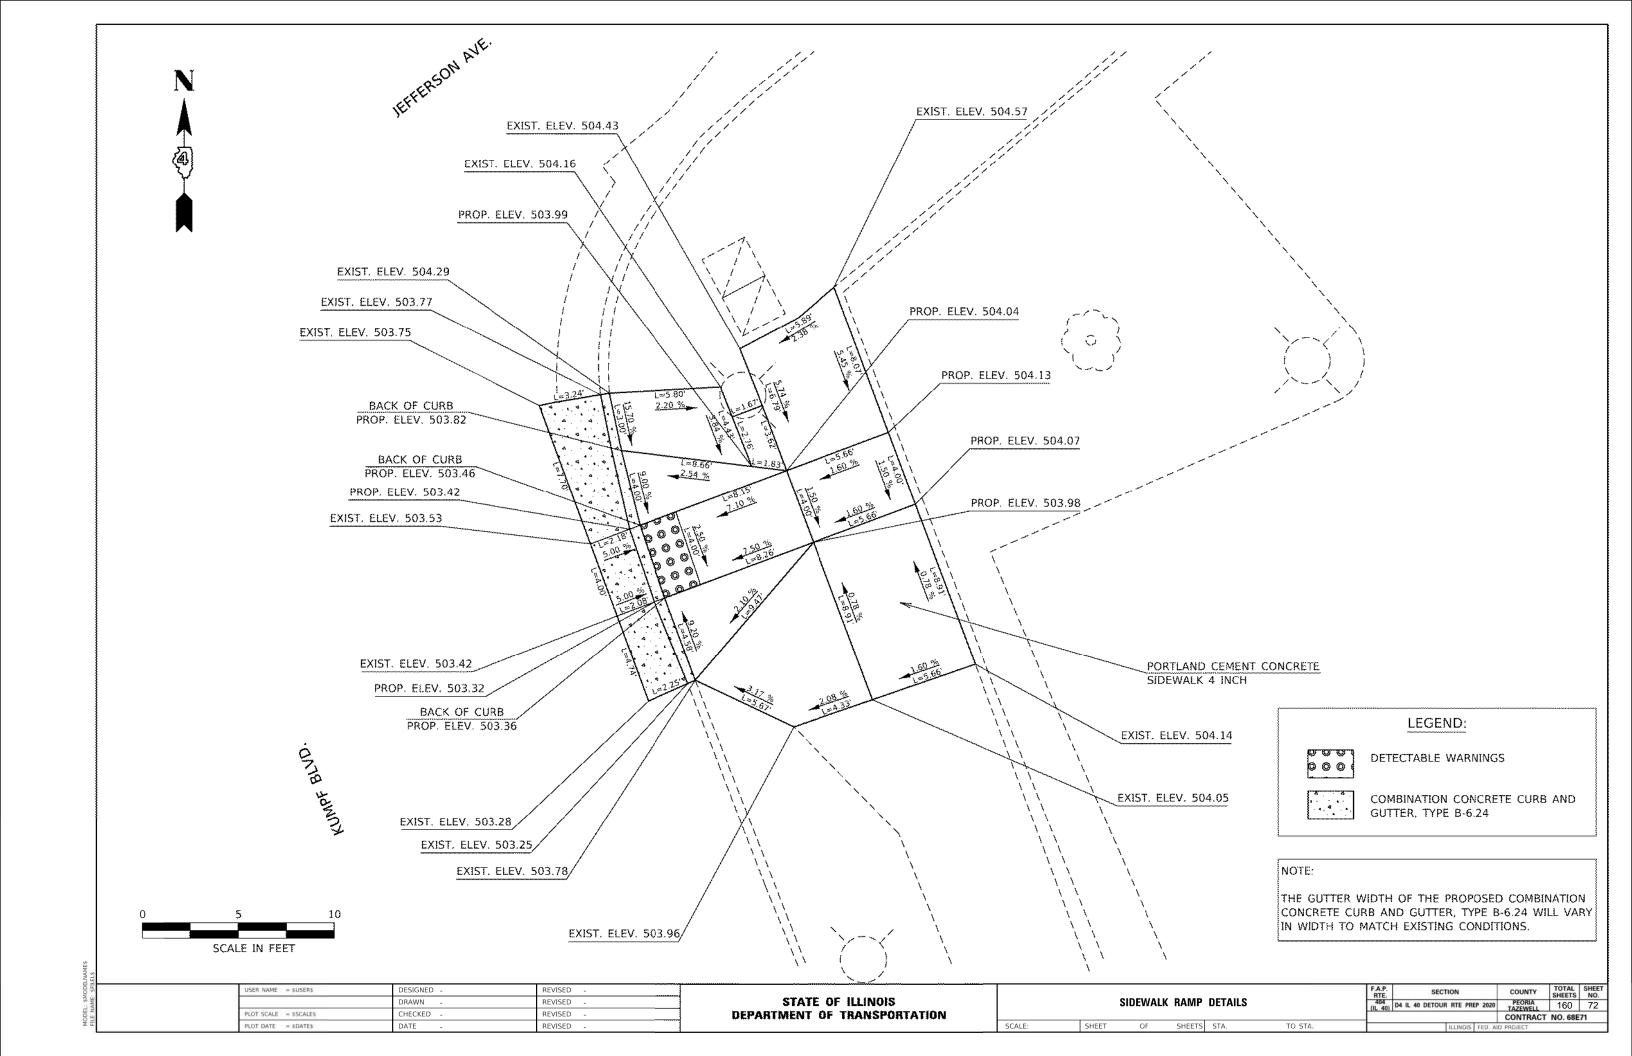
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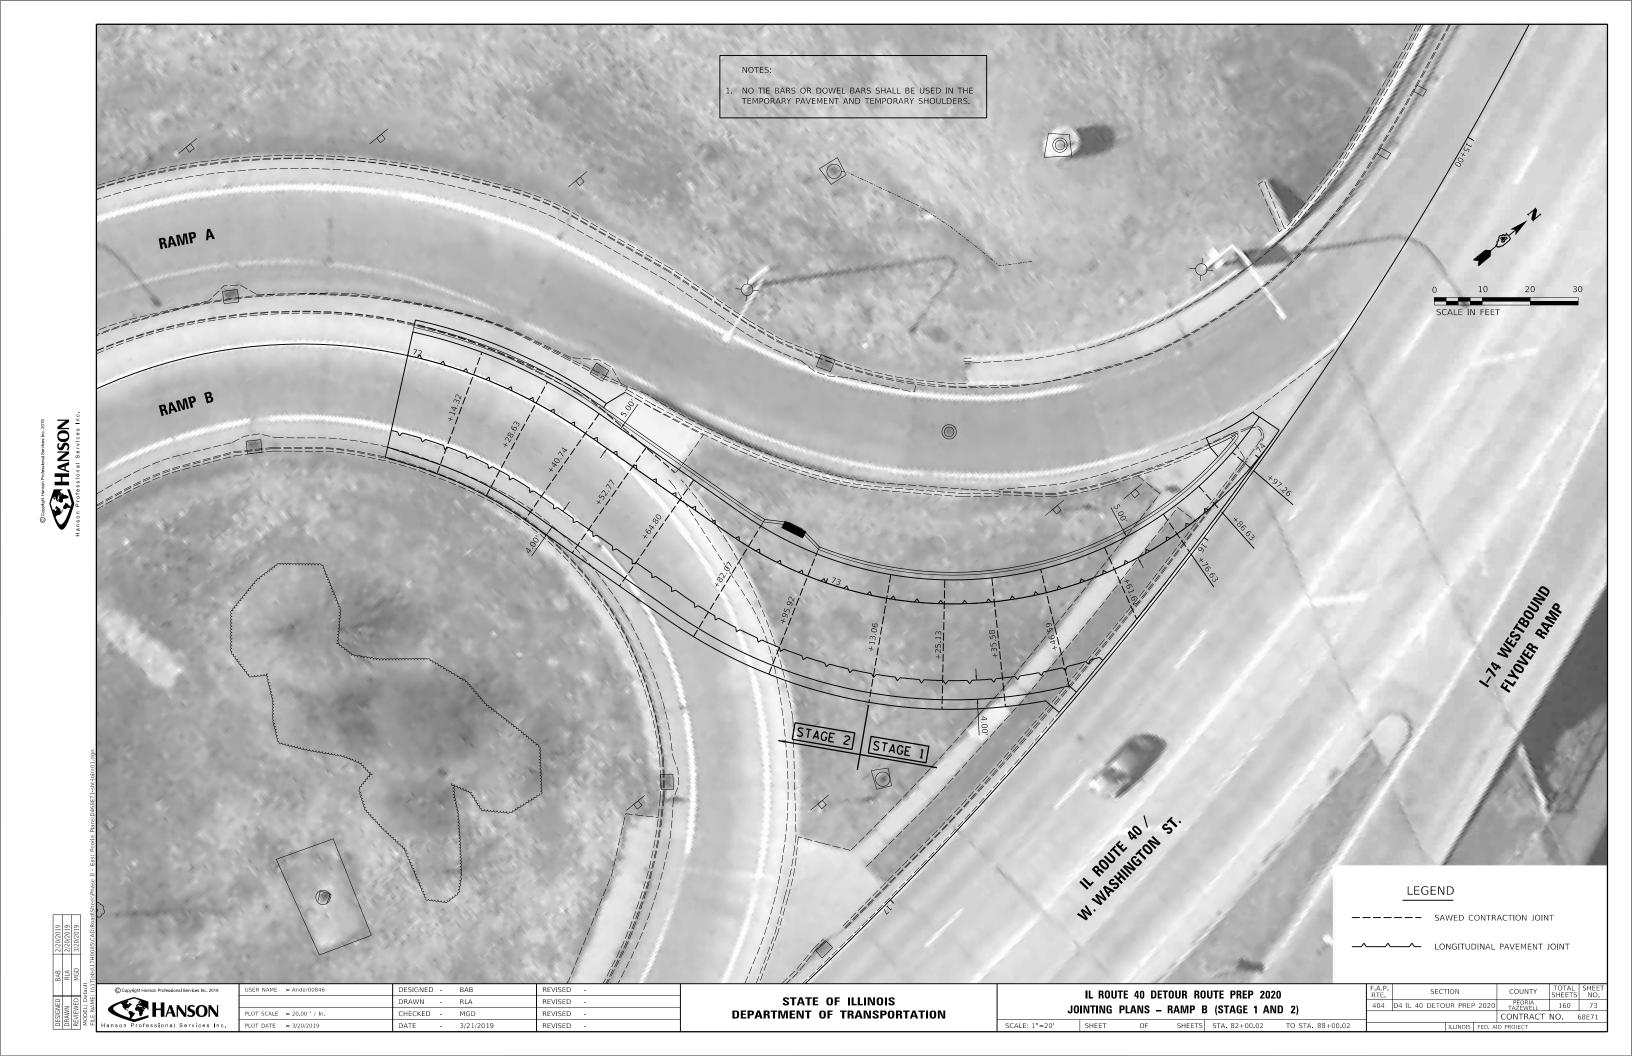
STATE OF ILLINOIS
DEPARTMENT OF TRANSPORTATION


GRADING DETAIL - RIVERFRONT DR. RAMP RESTORATION (STAGE 4)









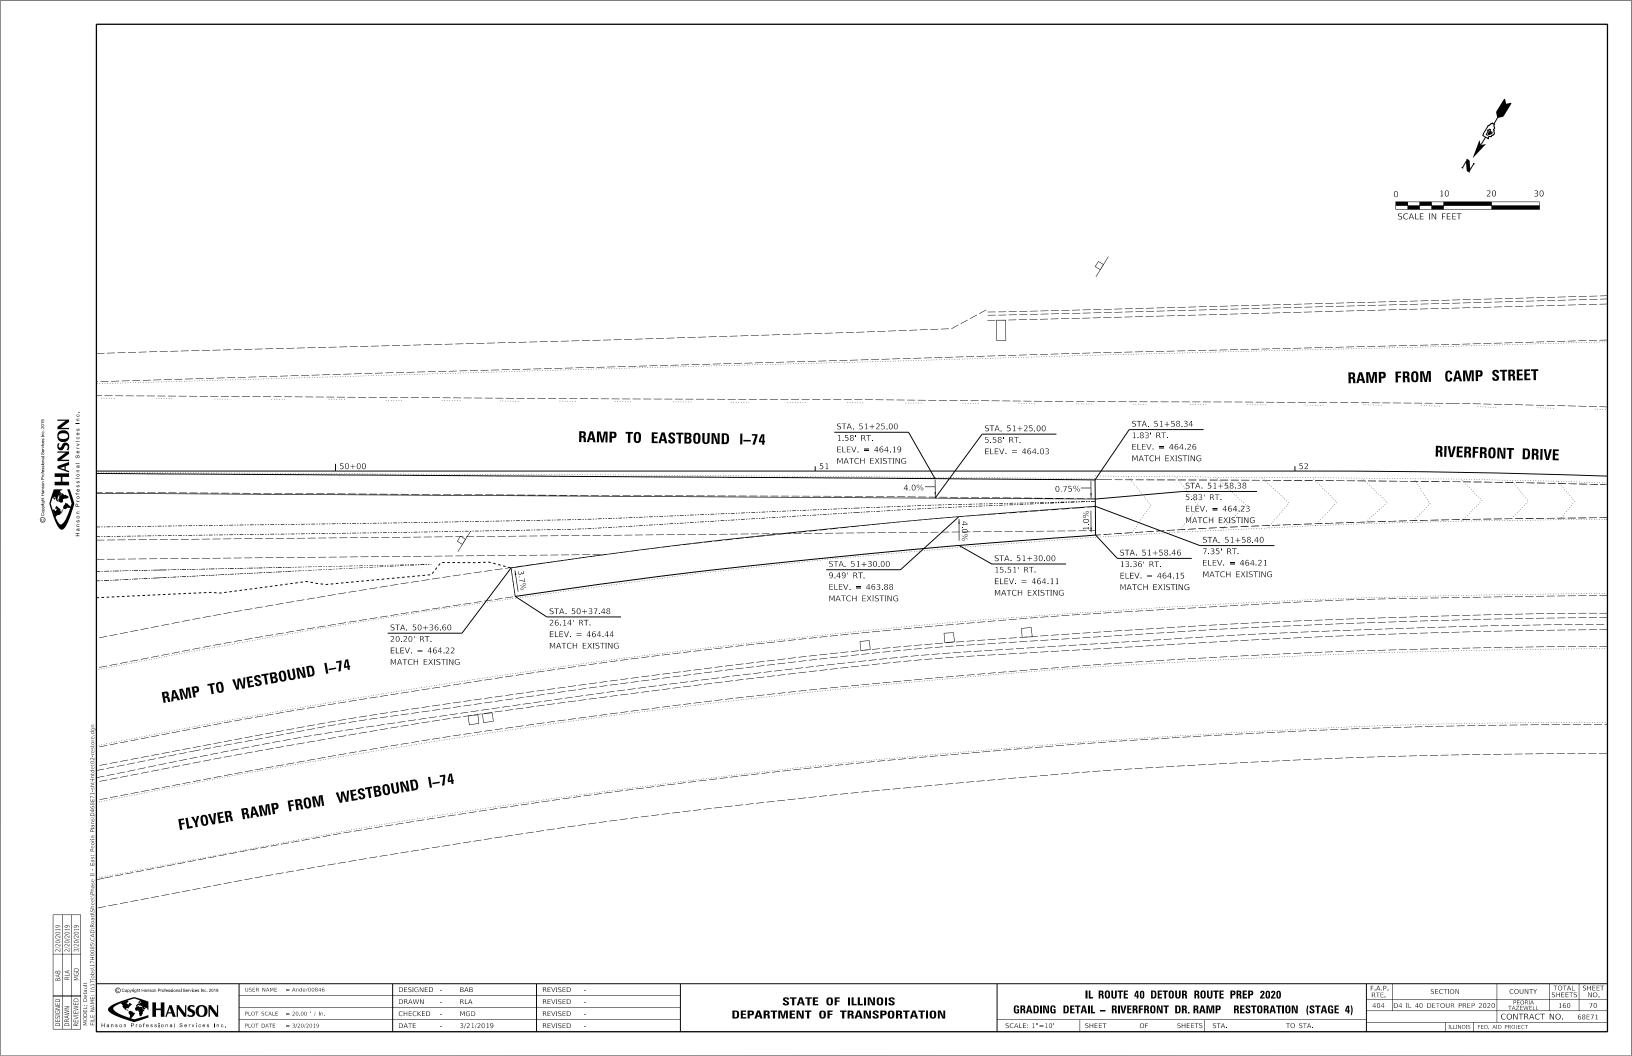

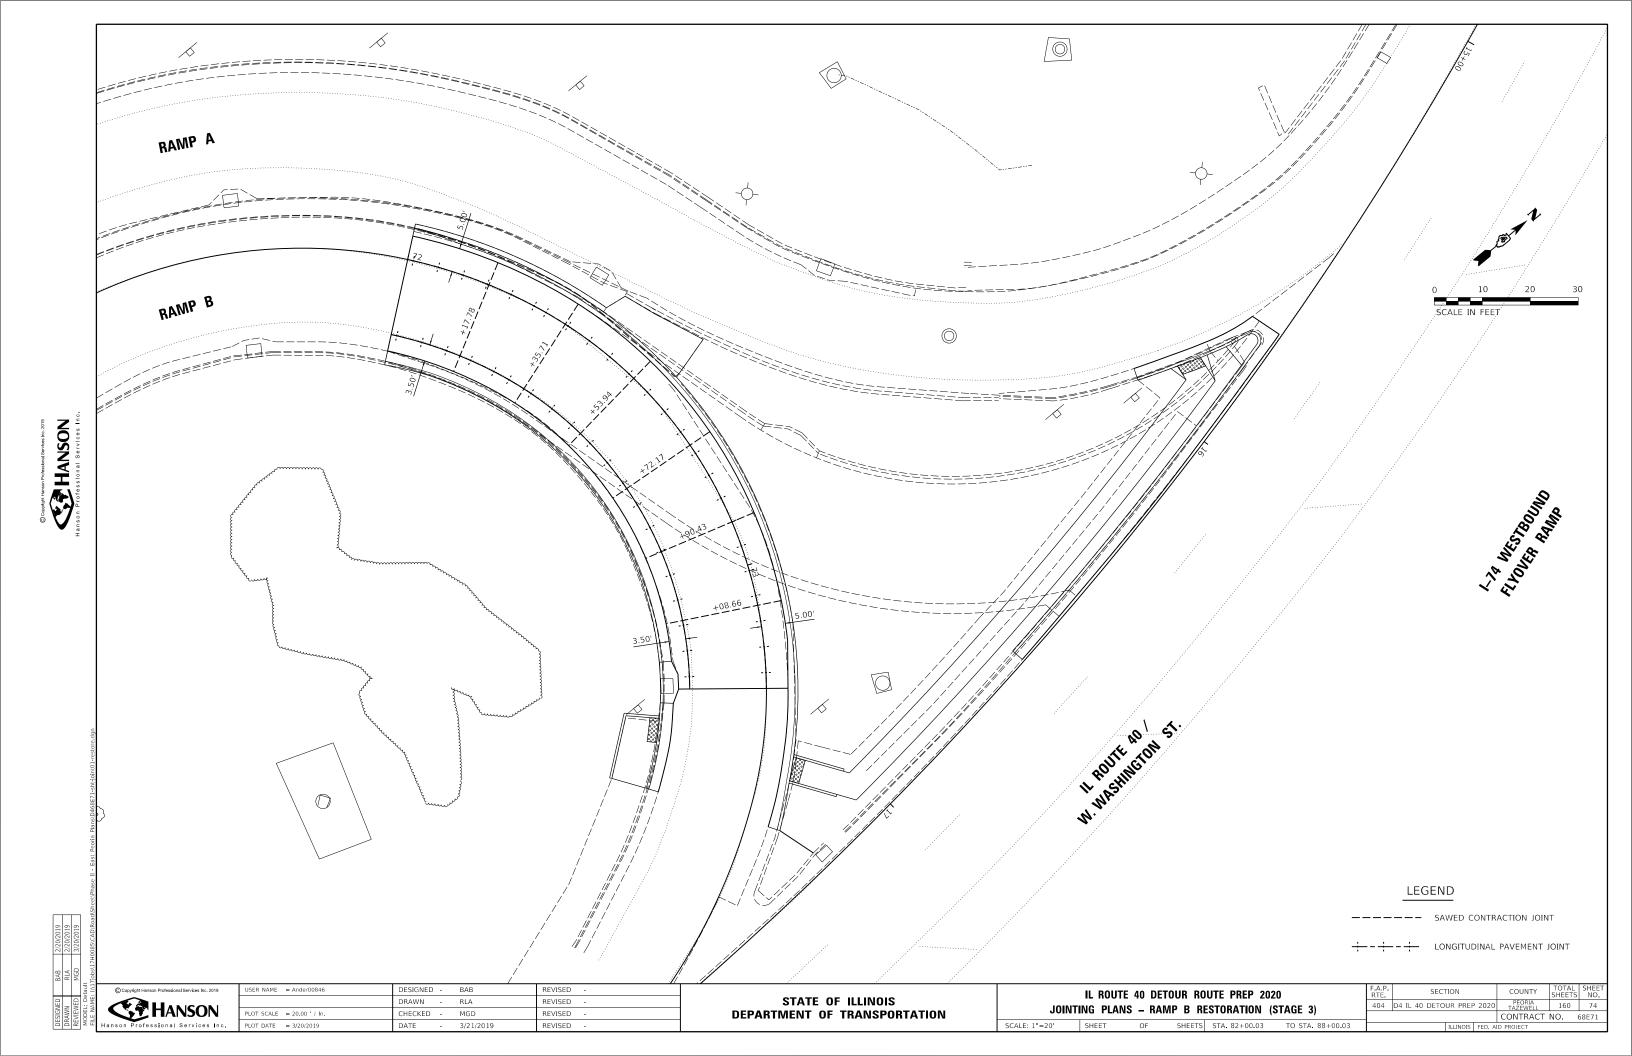



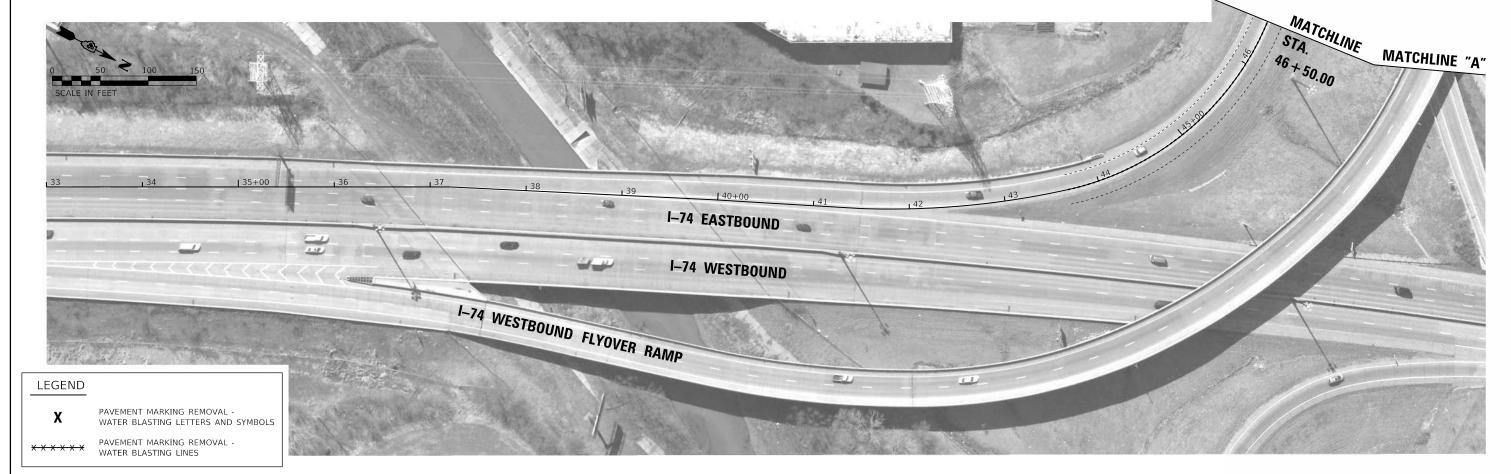

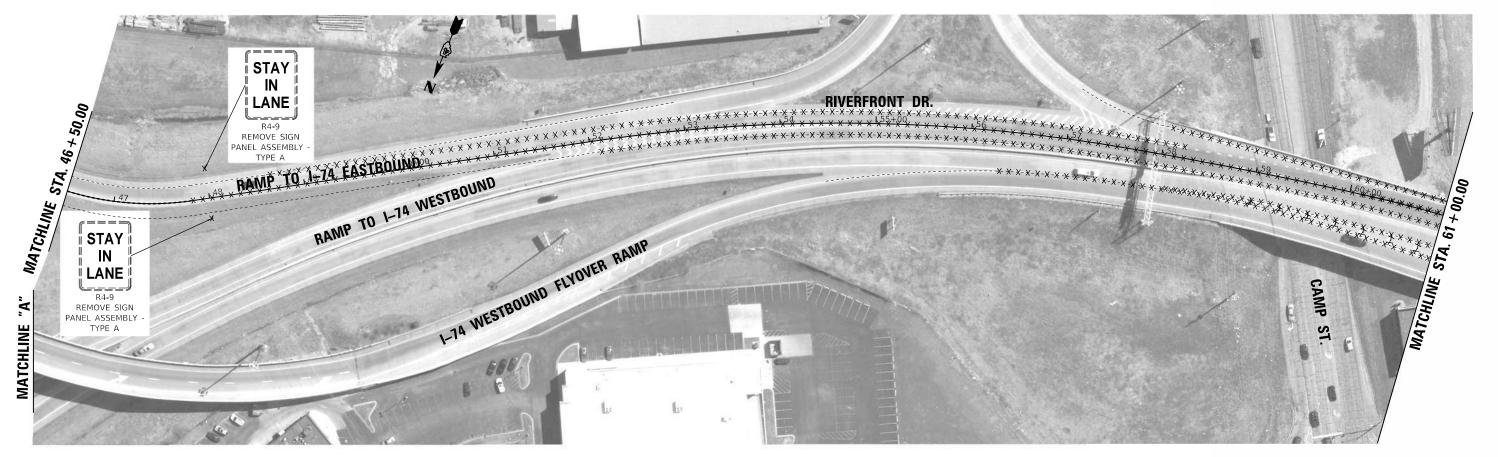

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USER NAME = Ander00846

PLOT SCALE = 100.00 ' / In.

PLOT DATE = 3/20/2019

DESIGNED -

DRAWN -

CHECKED -

RDH

MGD

REVISED -

REVISED

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DEPARTMENT OF TRANSPORTATION

PAVEMENT MARKING REMOVAL PLANS – RESTORATION (STAGE 3)

ALE: 1"=50' SHEET OF SHEETS STA. TO STA.


F.A.P. SECTION COUNTY TOTAL SHEETS NO.

404 D4 IL 40 DETOUR PREP 2020 PEORIAL 160 76

CONTRACT NO. 68E71





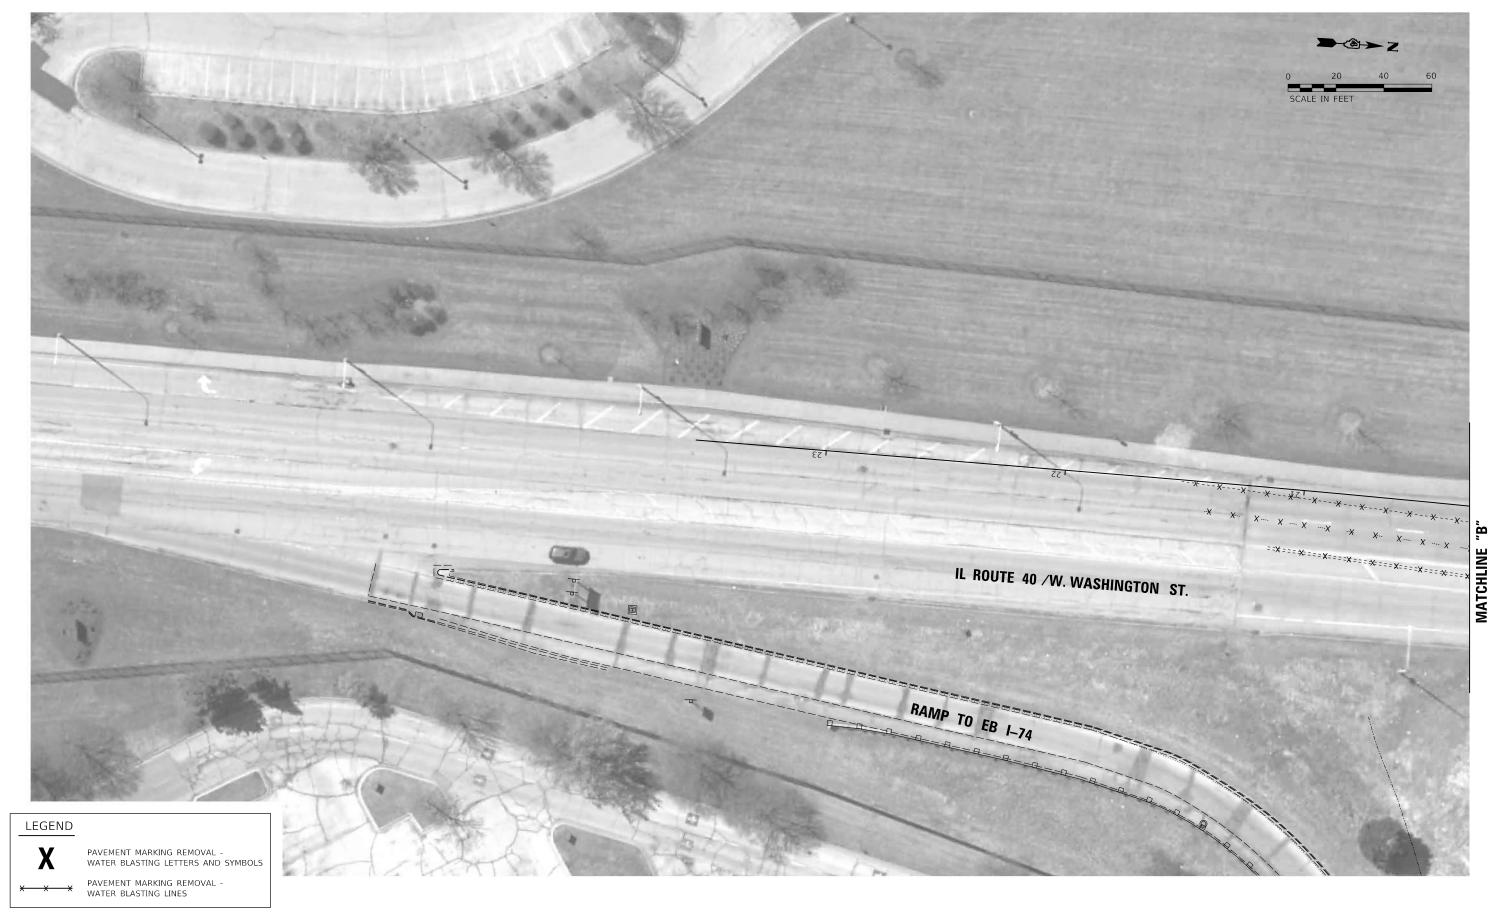

N WED 7/20/2019
N M RDH 2/20/2019
MGD 3/20/2019
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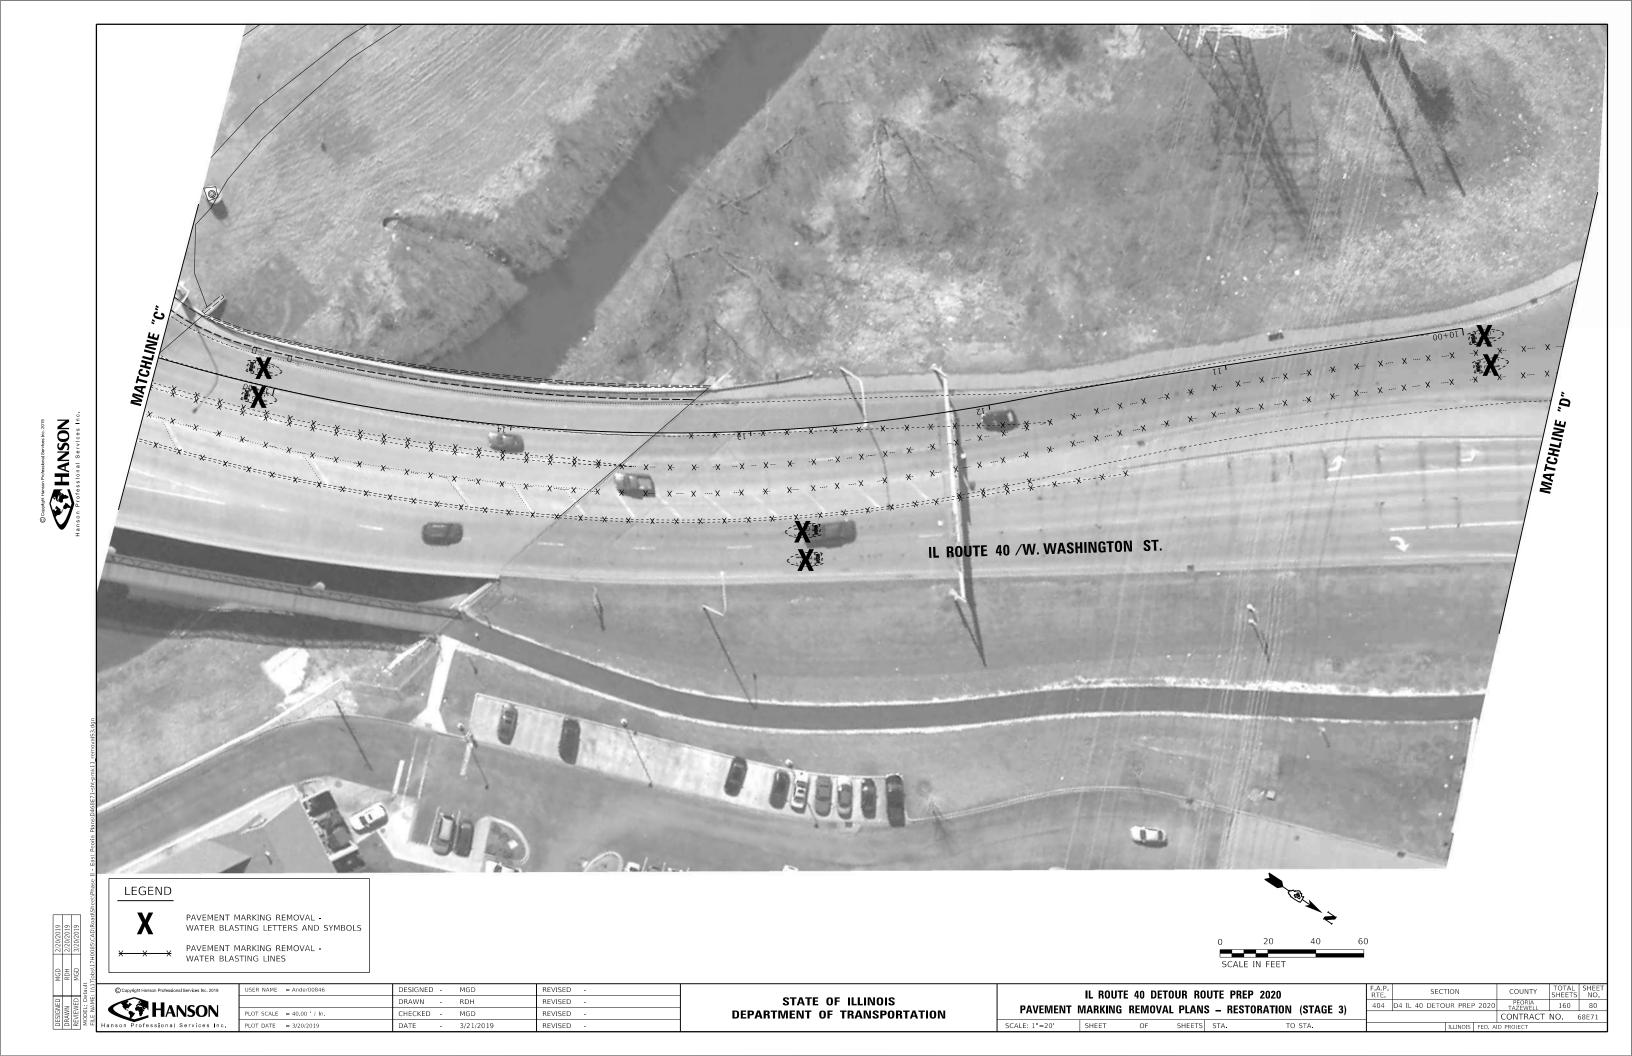
| DRAWN - RDH REVISED - | PLOT SCALE = 40,00 ' / In, | CHECKED - MGD REVISED - | PLOT DATE = 3/20/2019 | DATE - 3/21/2019 | REVISED - | |

STATE OF ILLINOIS DEPARTMENT OF TRANSPORTATION


PAVEMENT MARKING REMOVAL PLANS – RESTORATION (STAGE 3)

ALE: 1"=20' SHEET OF SHEETS STA. TO STA.







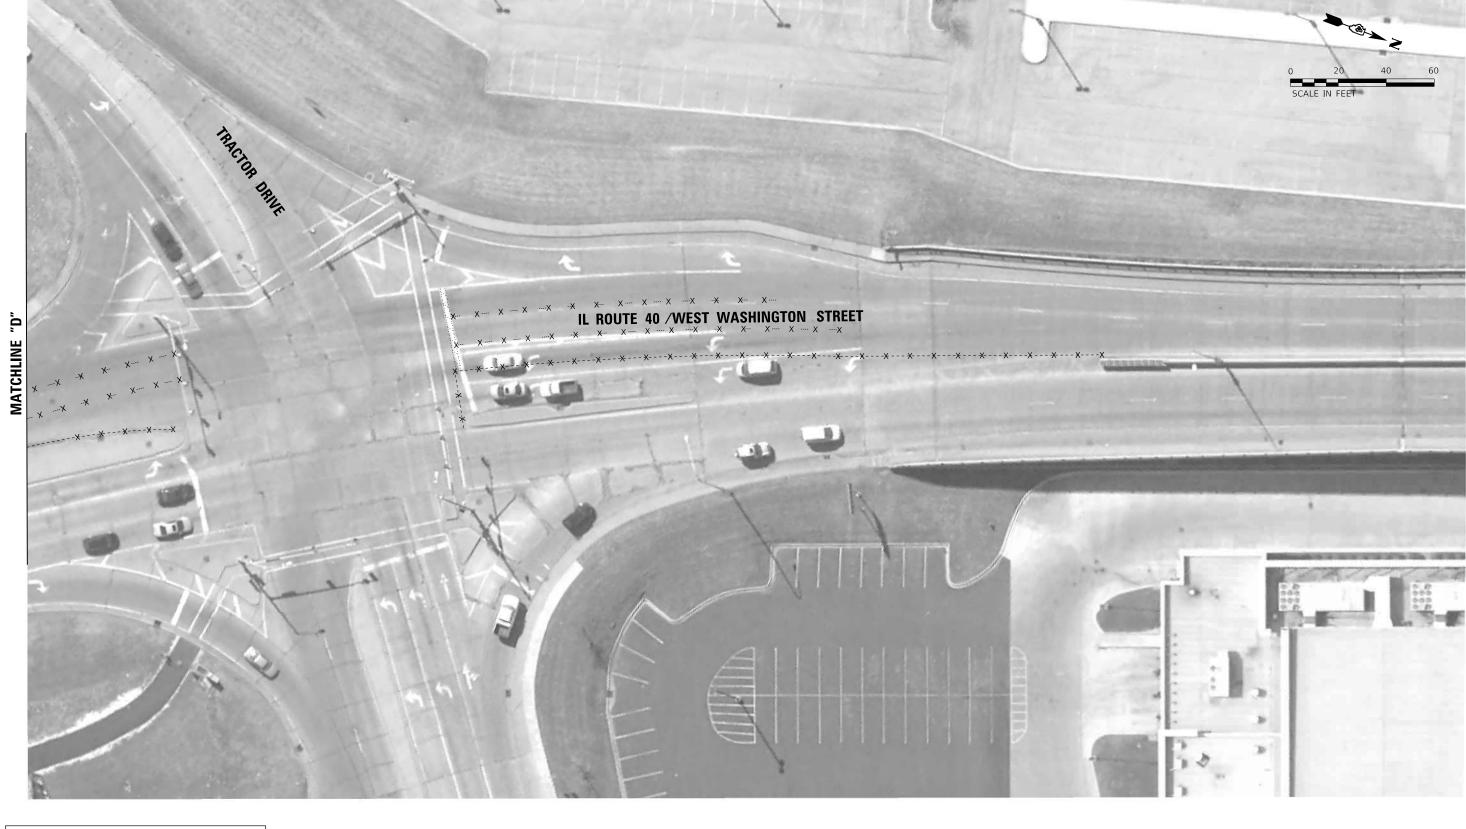

LEGEND

X

PAVEMENT MARKING REMOVAL -WATER BLASTING LETTERS AND SYMBOLS

PAVEMENT MARKING REMOVAL -WATER BLASTING LINES

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USER NAME = Ander00846	DESIGNED -	MGD	REVISED	-
	DRAWN -	RDH	REVISED	-
PLOT SCALE = 40.00 / In	CHECKED -	MGD	REVISED	-
PLOT DATE = 3/20/2019	DATE -	3/21/2019	REVISED	-
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STATE OF ILLINOIS DEPARTMENT OF TRANSPORTATION

	IL ROUTE	40 DETO	UR RO	UTE PR	EP 2020	
PAVEMENT I	MARKING	REMOVAL	PLANS	S – RES	TORATION (STAGE 3)	
SCALE: 1"=20'	SHEET	OF	SHEETS	STA.	TO STA.	

A.P. RTE.	SE	CTION		COUNTY	TOTAL SHEETS	SHEET NO.
404	D4 IL 40 DET	OUR PRE	2020	PEORIA TAZEWELL	160	81
				CONTRACT	NO.	58E71
ILLINOIS FED. AID PROJECT						




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LOT SCALE = 40.00 / In MGD REVISED

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DEPARTMENT OF TRANSPORTATION

PAVEMENT MARKING REMOVAL PLANS - RESTORATION (STAGE 3)



REVISED -

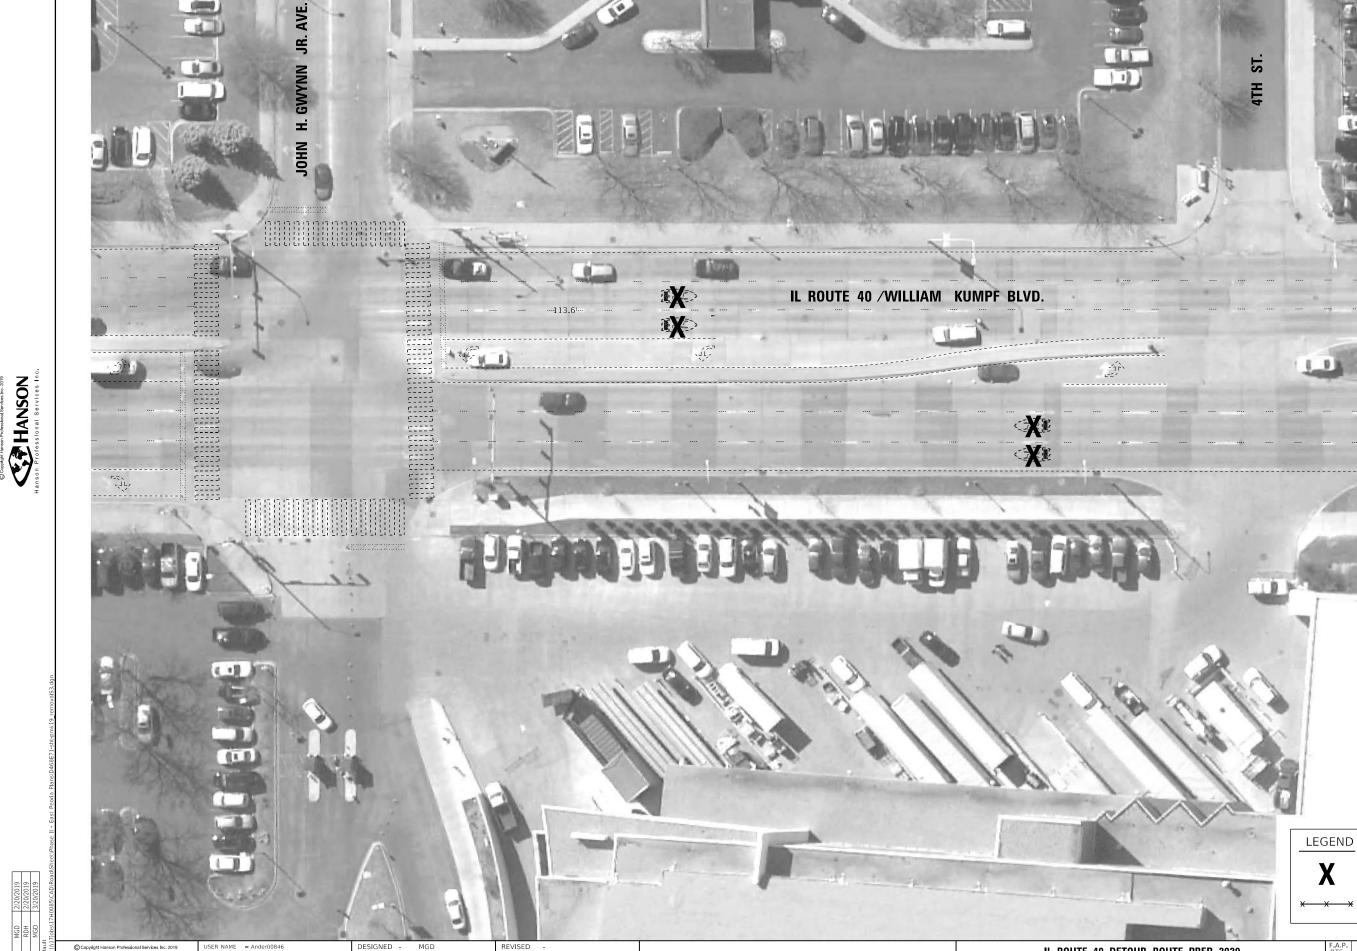REVISED

DRAWN

DATE

CHECKED -

RDH

MGD

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LOT SCALE = 40.00 / In

STATE OF ILLINOIS
DEPARTMENT OF TRANSPORTATION

IL ROUTE 40 DETOUR ROUTE PREP 2020 PAVEMENT MARKING REMOVAL PLANS - RESTORATION (STAGE 3) 0 PEORIA 160 83

CONTRACT NO. 68E71

AID PROJECT

PAVEMENT MARKING REMOVAL WATER BLASTING LINES

PAVEMENT MARKING REMOVAL - WATER BLASTING LETTERS AND SYMBOLS

SCALE IN FEET



HANSON Professional Services Inc

TAZEWELL 160 84 CONTRACT NO. 68E71



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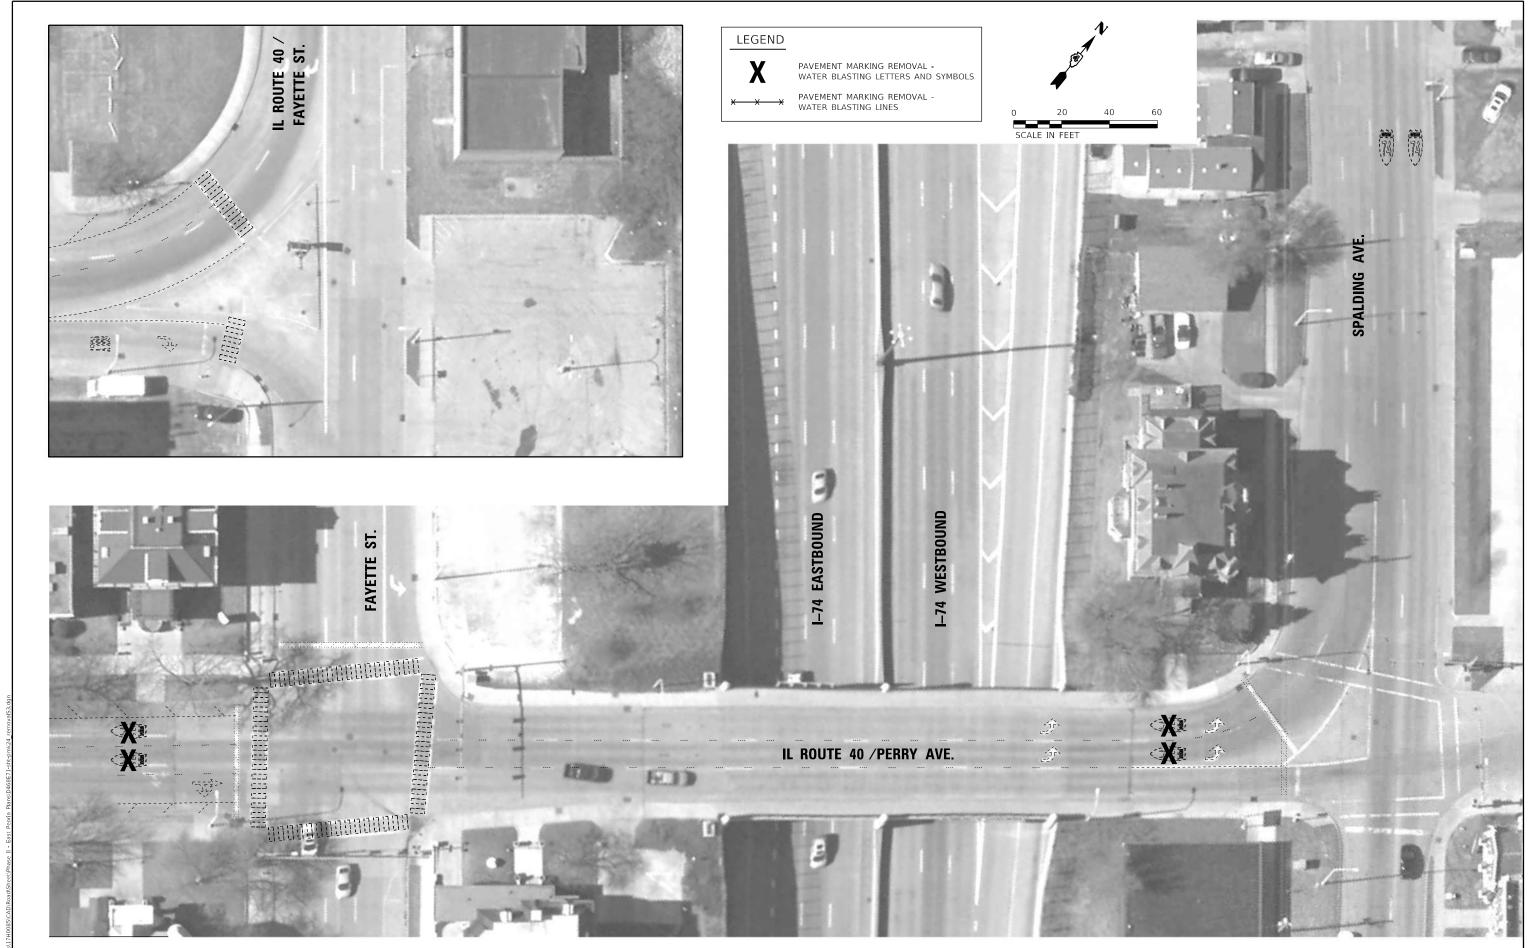
Janson Professional Services Inc.

PLOT SCALE = 40,00 ' / In.

PLOT DATE = 3/20/2019 REVISED

D PEORIA 160 85
CONTRACT NO. 68E71





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 USER NAME
 = Ander00846
 DESIGNED
 MGD
 REVISED

 DRAWN
 RDH
 REVISED

 PLOT SCALE
 = 40.00 \(^1\) In.
 CHECKED
 MGD
 REVISED

 PLOT DATE
 = 3/20/2019
 DATE
 3/21/2019
 REVISED

STATE OF ILLINOIS
DEPARTMENT OF TRANSPORTATION

IL ROUTE 40 DETOUR ROUTE PREP 2020

PAVEMENT MARKING REMOVAL PLANS – RESTORATION (STAGE 3)

ALE: 1"=20' SHEET OF SHEETS STA. TO STA.

F.A.P. SECTION COUNTY TOTAL SHEETS NO.

404 | D4 | L 40 | DETOUR PREP 2020 PEORIA TAZEWELL 160 86

| LLINOIS | FED. AID PROJECT NO. 68E71




LOT SCALE = 100.00 / In.

MGD

REVISED





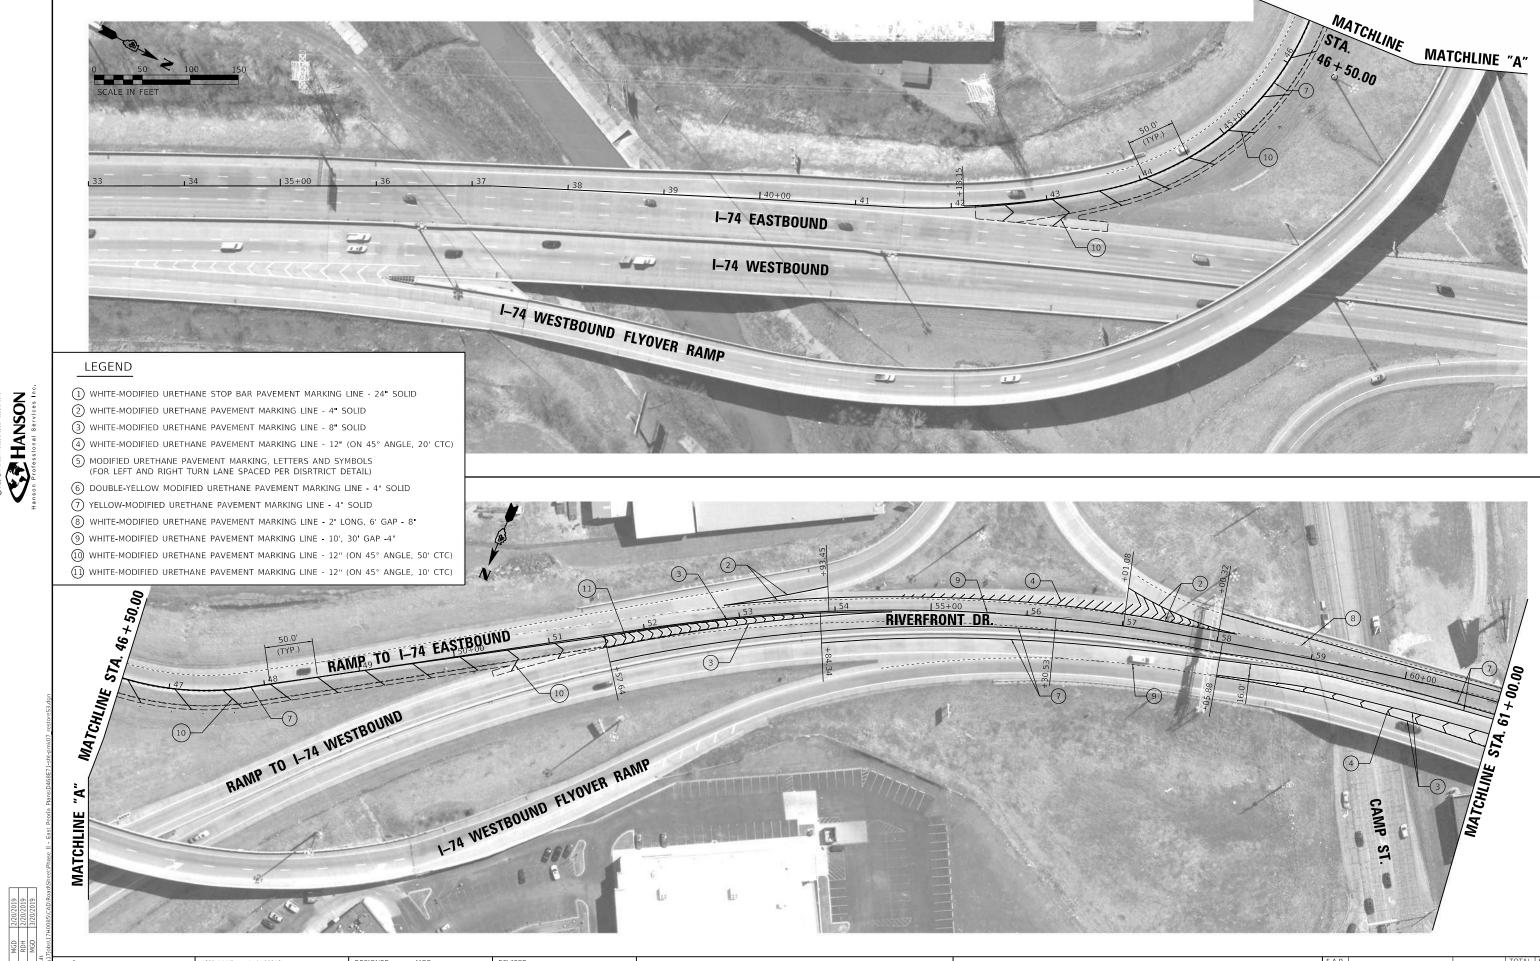



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DESIGNED -DRAWN RDH REVISED OT SCALE = 100.00 / In. REVISED


STATE OF ILLINOIS **DEPARTMENT OF TRANSPORTATION**

IL ROUTE 40 DETOUR ROUTE PREP 2020 PAVEMENT MARKING PLANS - RESTORATION (STAGE 3)



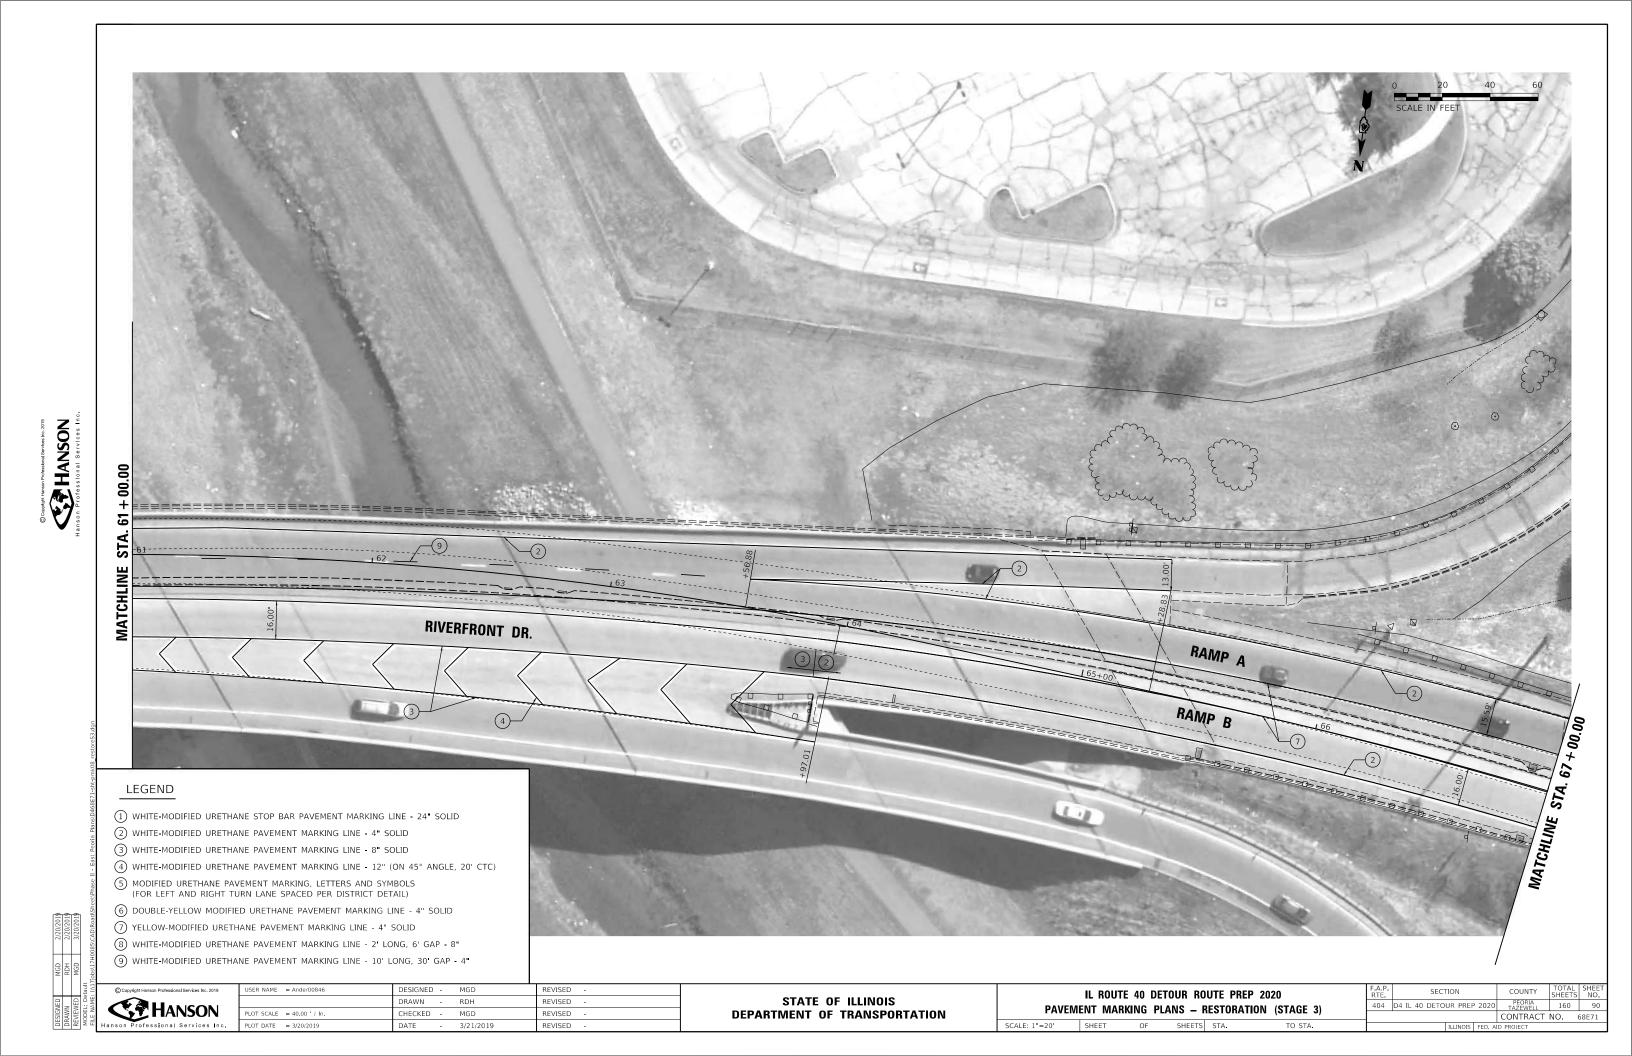


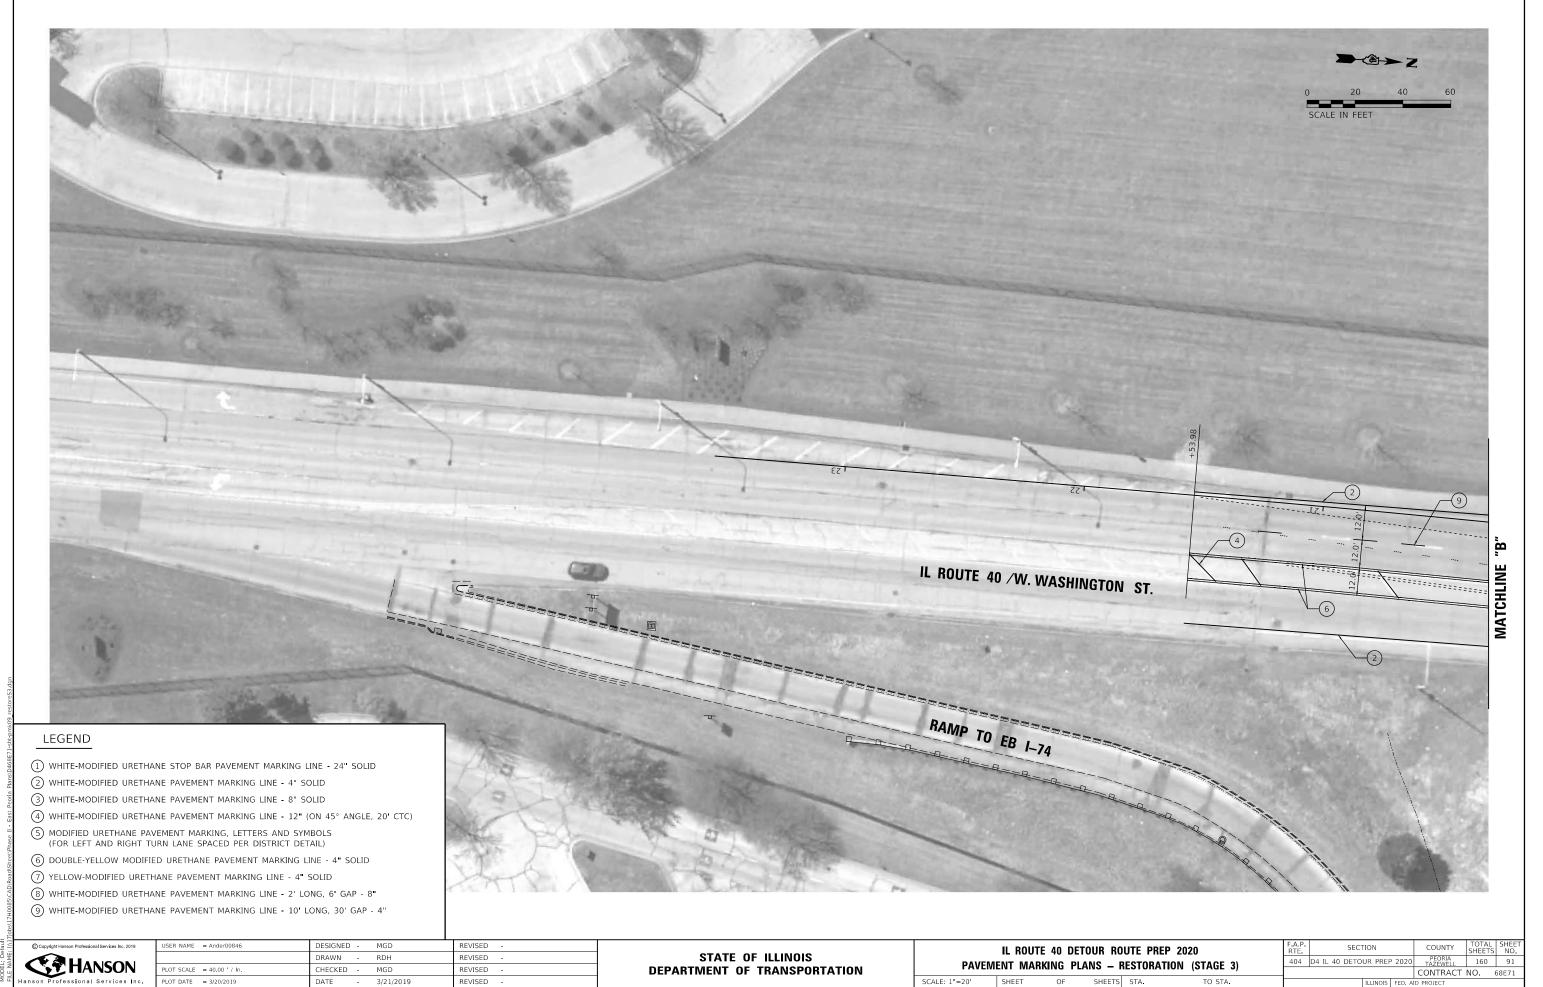

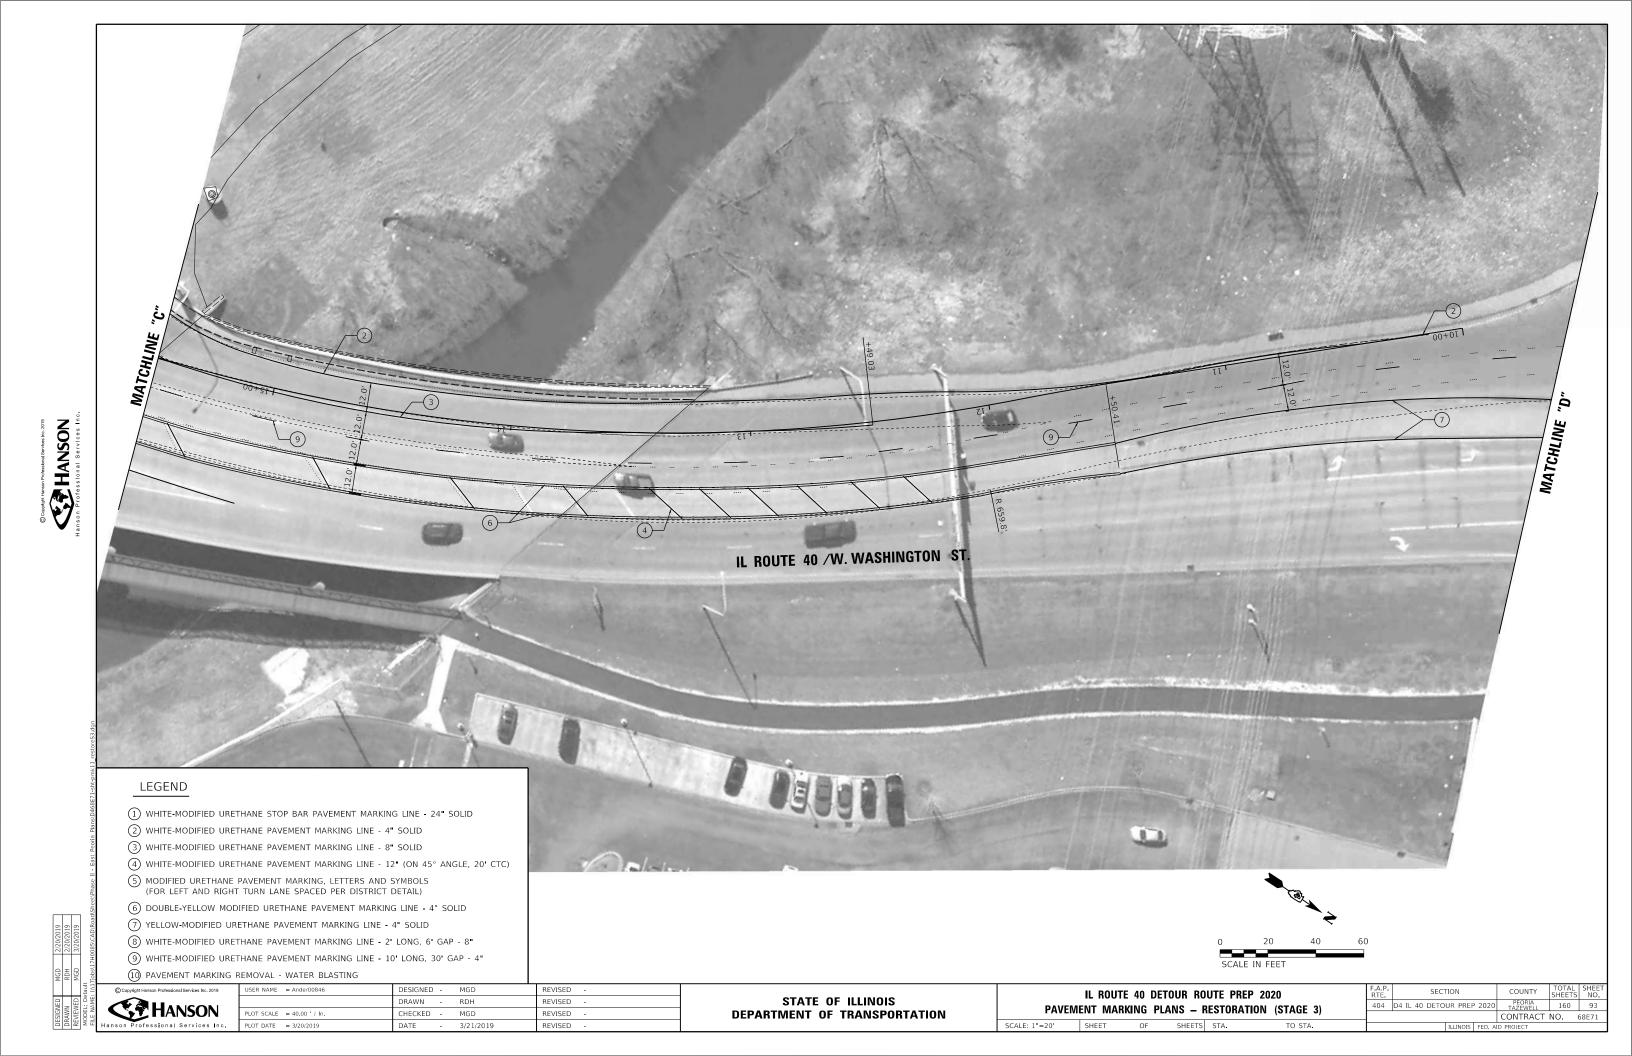



LOT SCALE = 40.00 / In

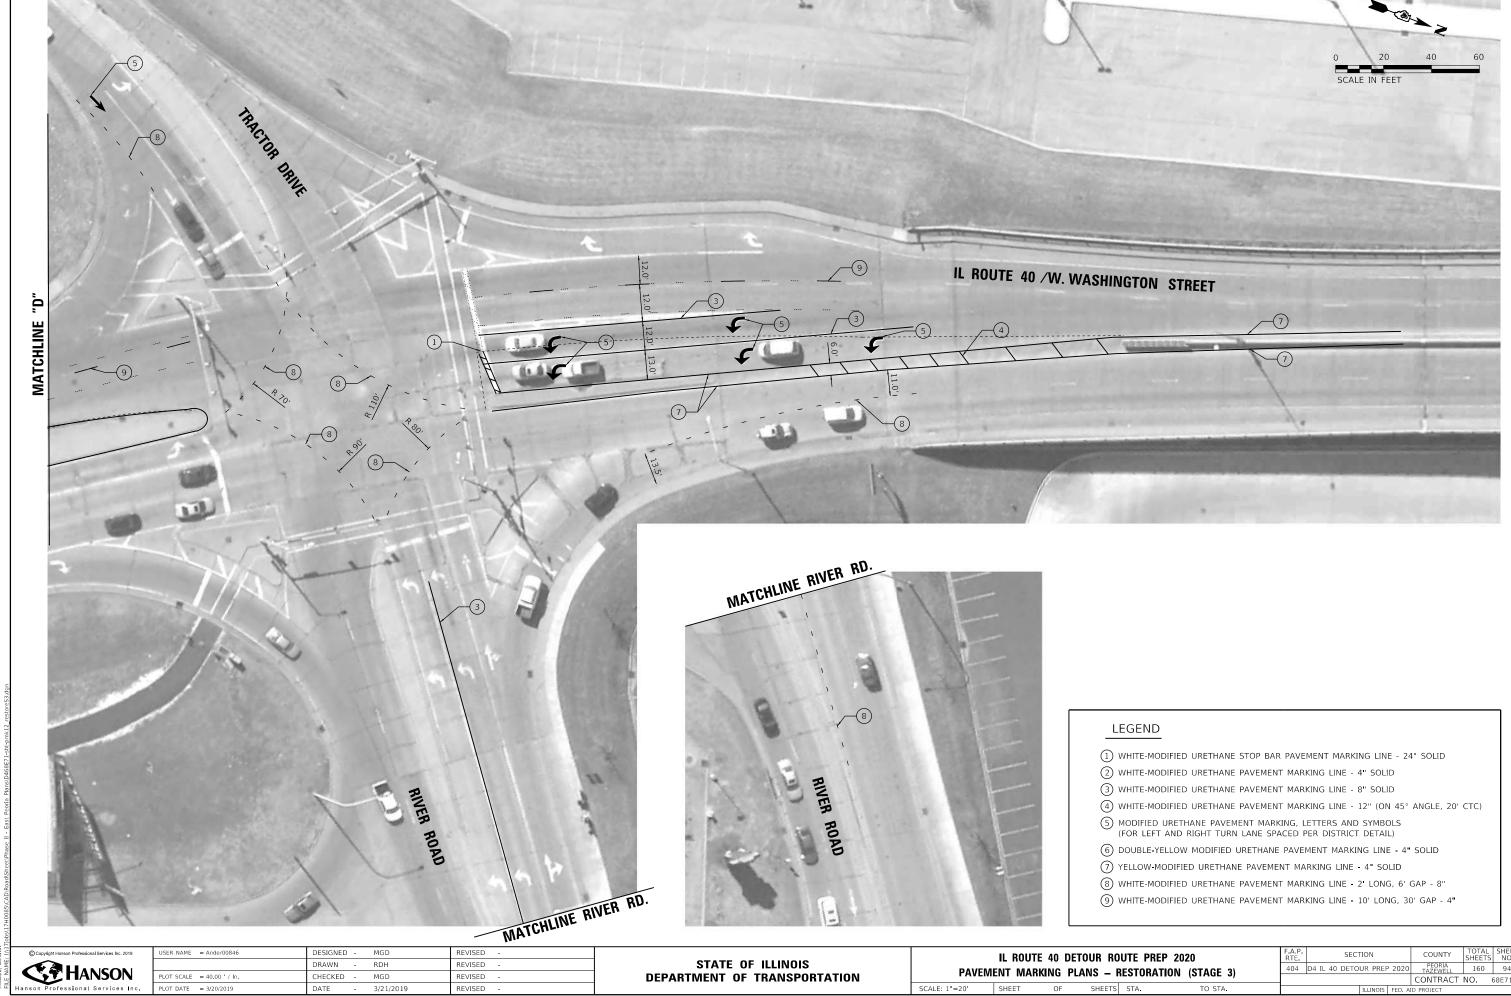


CONTRACT NO. 68E71


OF SHEETS STA.



HANSON
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LOT SCALE = 100.00 / In.



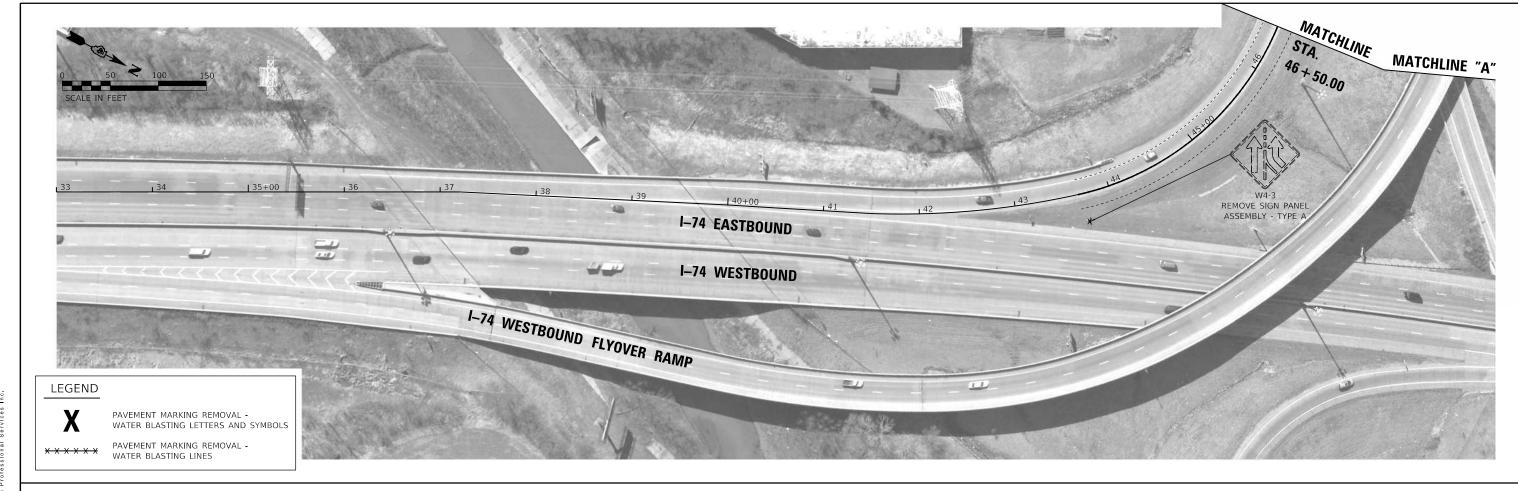

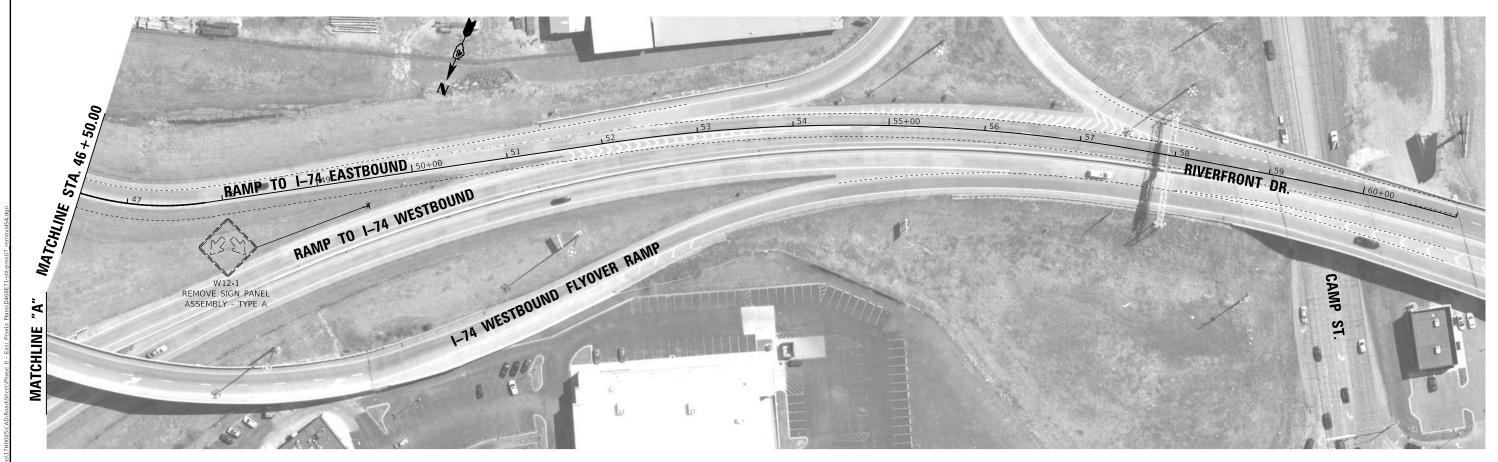STATE OF ILLINOIS DEPARTMENT OF TRANSPORTATION

SECTION

CONTRACT NO. 68E71

IL ROUTE 40 DETOUR ROUTE PREP 2020

PAVEMENT MARKING REMOVAL PLANS - RESTORATION (STAGE 4)

DESIGNED -

RDH

MGD

REVISED -

REVISED

DRAWN





INED MGD 2/20/2019
IN RDH 2/20/2019
WED MGD 3/20/2019

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HANSON
tanson Professional Services Inc.

 USER NAME
 = Ander00846
 DESIGNED
 MGD
 REVISED

 DRAWN
 RDH
 REVISED

 PLOT SCALE
 = 40,00 ' / in,
 CHECKED
 MGD
 REVISED

 PLOT DATE
 = 3/20/2019
 DATE
 3/21/2019
 REVISED

STATE OF ILLINOIS
DEPARTMENT OF TRANSPORTATION

IL ROUTE 40 DETOUR ROUTE PREP 2020

PAVEMENT MARKING REMOVAL PLANS – RESTORATION (STAGE 4)


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F.A.P. SECTION COUNTY STATE NO.

404 D4 IL 40 DETOUR PREP 2020 PEORIA TAEEWELL 160 96


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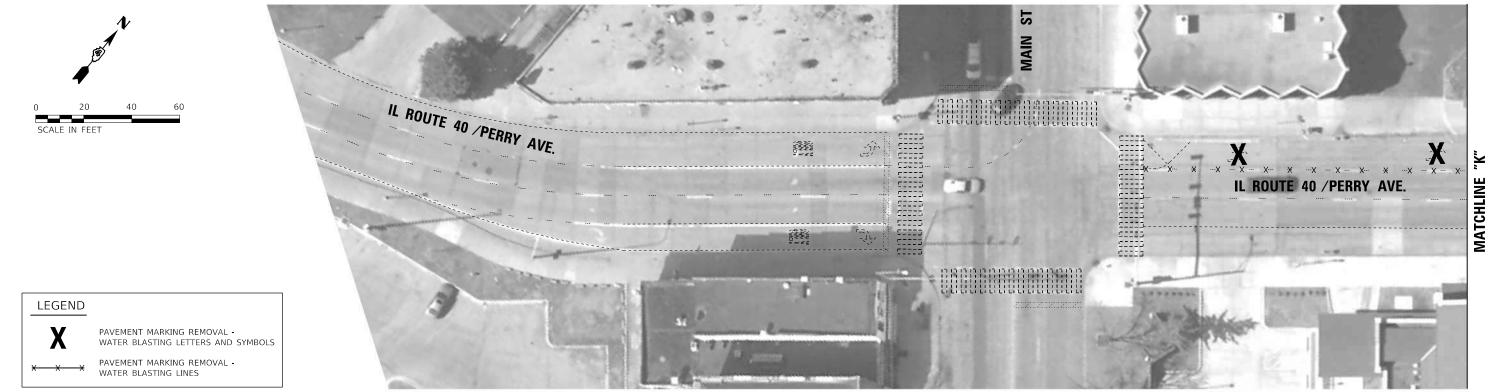
ILLINOIS FED. AID PROJECT



Hanson Professional Services Inc.

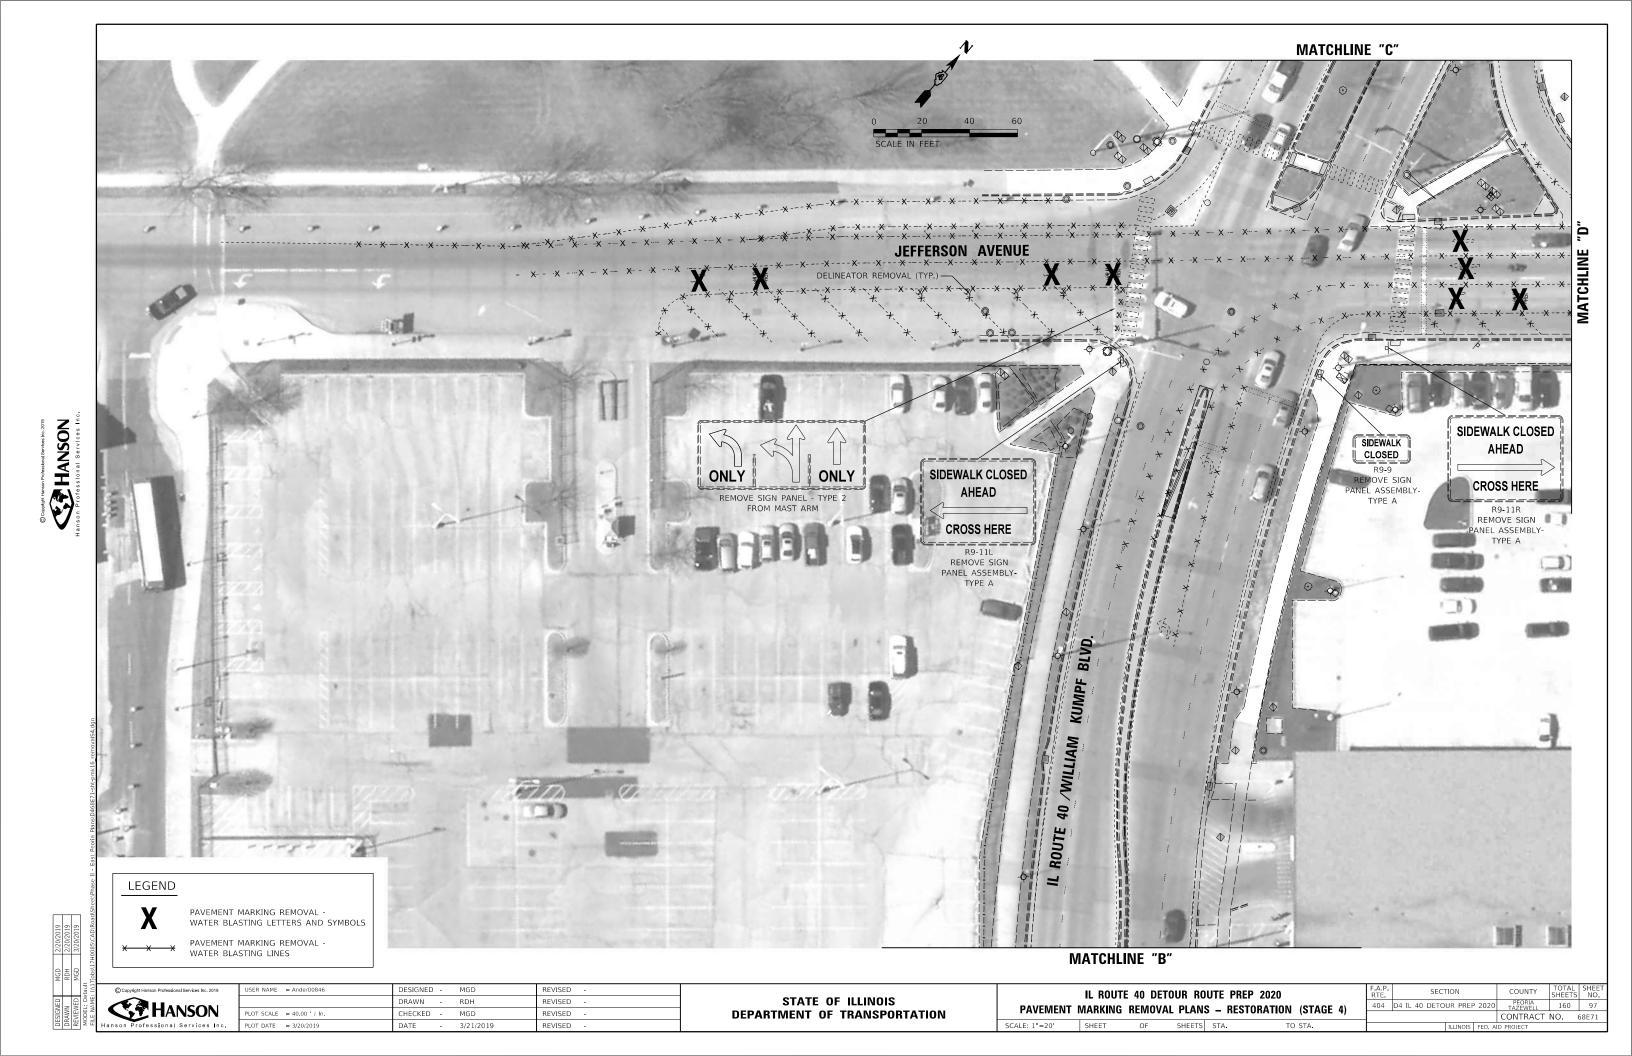



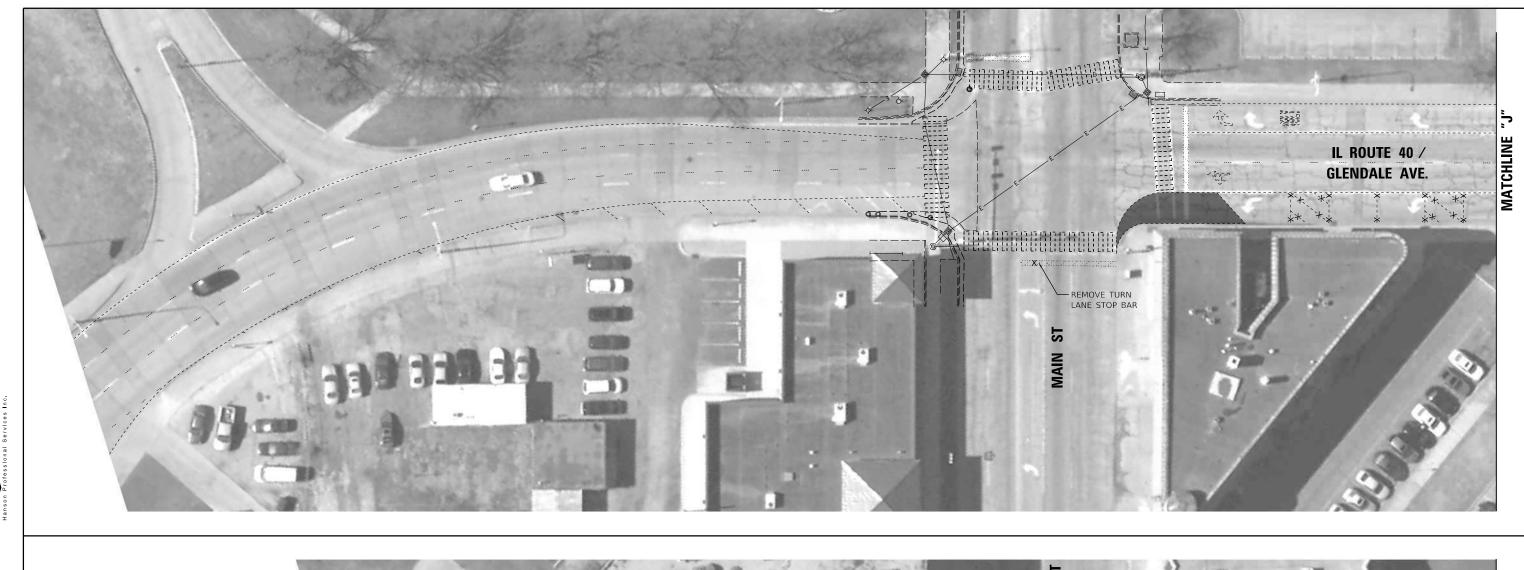

STATE OF ILLINOIS
DEPARTMENT OF TRANSPORTATION

IL ROUTE 40 DETOUR ROUTE PREP 2020
PAVEMENT MARKING REMOVAL PLANS – RESTORATION (STAGE 4)

ALE: 1"=20' SHEET OF SHEETS STA. TO STA.

F.A.P. SECTION COUNTY SHEETS NO.

404 D4 IL 40 DETOUR PREP 2020 PEORIA TAZEWELL 160 99

[ILLINOIS FED. ALD PROJECT NO. 68E71]



HANSON

Hanson Professional Services Inc.

OT SCALE = 40.00 / In.


DRAWN -


RDH

MGD

REVISED -

REVISED -

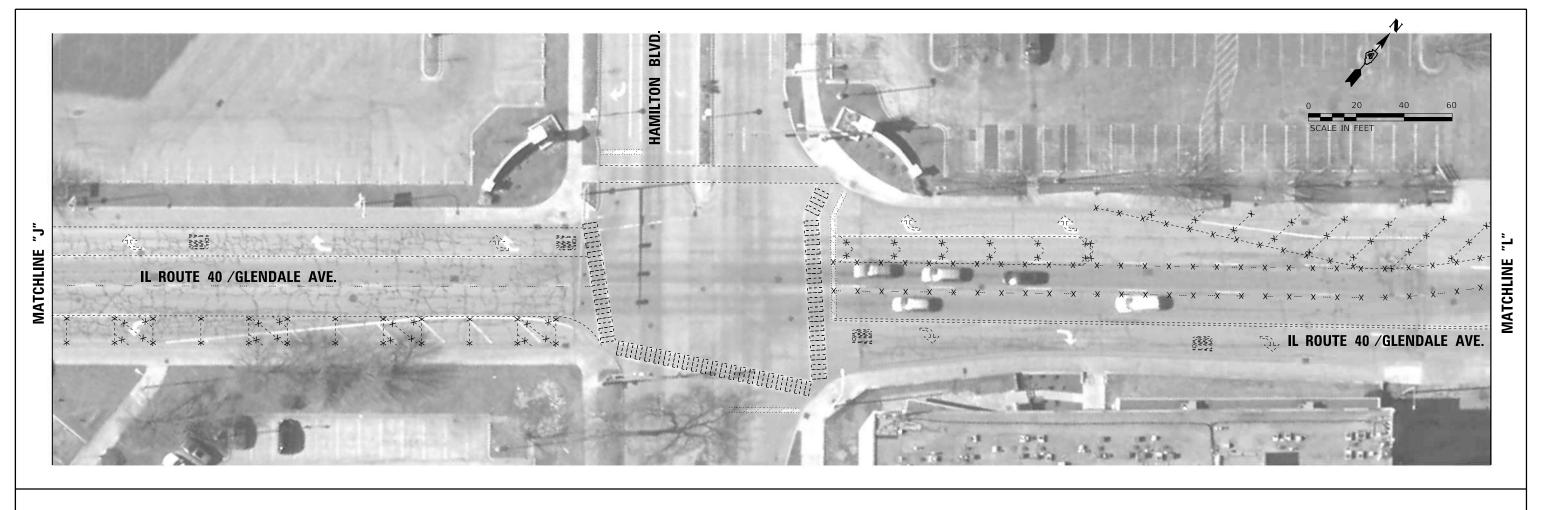

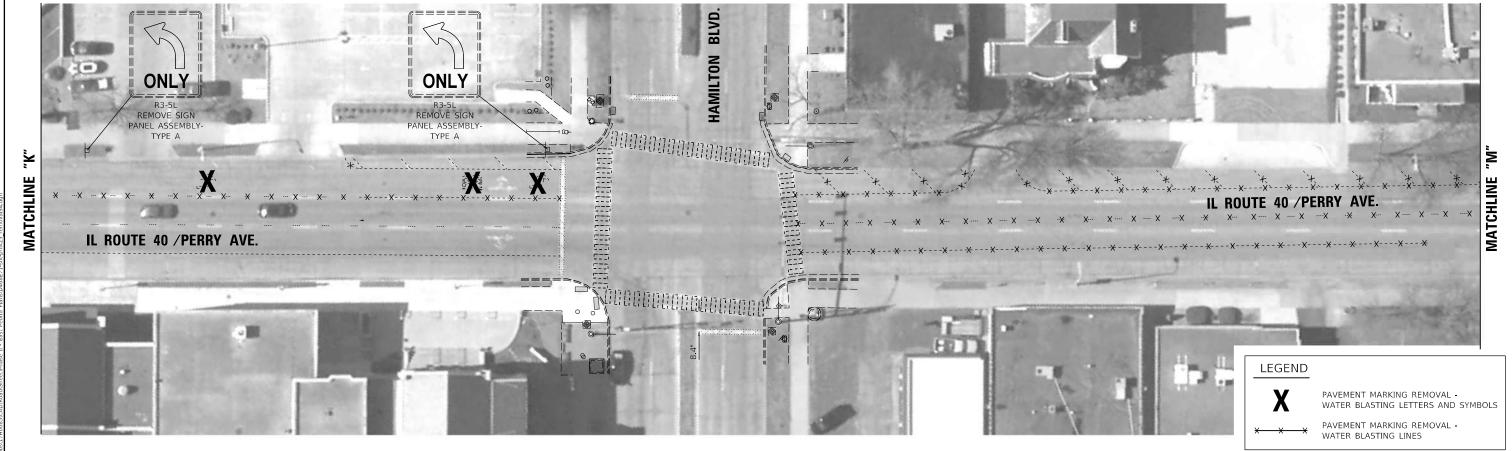

STATE OF ILLINOIS DEPARTMENT OF TRANSPORTATION

IL ROUTE 40 DETOUR ROUTE PREP 2020

PAVEMENT MARKING REMOVAL PLANS - RESTORATION (STAGE 4)