# STATE OF ILLINOIS **DEPARTMENT OF TRANSPORTATION**

2018-033-DR



D-91-027-19



STATE OF ILLINOIS

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FOR INDEX OF SHEETS, SEE SHEET NO. 2

THIS PROJECT IS LOCATED IN THE VILLAGES OF BELLWOOD, HOMEWOOD, LAKE BLUFF, PALATINE, AND ROSELLE

**PROPOSED HIGHWAY PLANS** 

**VARIOUS ROUTES VARIOUS LOCATIONS SECTION: 2018-083-DR** DRAINAGE VARIOUS COUNTIES (COOK, DUPAGE, AND LAKE COUNTIES)

C-91-226-19

FOR GENERAL LOCATION MAPS, SEE SHEET NO. 6 AND 7

ENGINEERING SCALES. REDUCED SIZED PLANS WILL NOT CONFORM TO STANDARD SCALES. IN MAKING MEASUREMENTS ON REDUCED PLANS, THE ABOVE SCALES MAY BE USED.

JOINT UTILITY LOCATION INFORMATION FOR EXCAVATORS 1-800-892-0123 OR 811

PROJECT ENGINEER: DAN WILGREEN (847) 705-4240 PROJECT MANAGER: FAWAD AQUEEL (847) 705-4247

CONTRACT NO. 62H33

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### INDEX OF SHEETS HIGHWAY STANDARDS CONT.

SHEET NO.	DESCRIPTION	STANDARD NO.	DESCRIPTION
1	COVER SHEET	642001-02	SHOULDER RUMBLE STRIPS, 16 in.
2	INDEX OF SHEETS, HIGHWAY STANDARDS, AND GENERAL NOTES	643001-02	SAND MODULE IMPACT ATTENUATORS
3-5	SUMMARY OF QUANTITIES	701001-02	OFF-RD OPERATIONS, 2L, 2W, MORE THAN 15' (4.5 m) AWAY
6-7	GENERAL LOCATION MAPS	701006-05	OFF-RD OPERATIONS, 2L, 2W, 15' (4.5 m) TO 24" (600 mm) FROM PAVEMENT EDGE
8	LOCATION 1: SCRANTON AVE. DRAINAGE PLAN	701011-04	OFF-RD MOVING OPERATIONS 2L, 2W, DAY ONLY
9-16	LOCATION 2: I-290 MOT AND DRAINAGE PLANS	701101-05	OFF-RD OPERATIONS, MULTILANE, 15' (4.5 m) TO 24" (600 mm) FROM PAVEMENT EDGE
17	LOCATION 3: IL 19 DRAINAGE PLAN AND PROFILE	701106-02	OFF-RD OPERATIONS, MULTILANE, MORE THAN 15' (4.5 m) AWAY
18-20	LOCATION 4: US 14 EROSION CONTROL AND DRAINAGE PLANS	701301-04	LANE CLOSURE 2L, 2W, SHORT TIME OPERATIONS
21-22	LOCATION 5: RIDGE RD. (CENTER AVE. TO HALSTED ST.) DRAINAGE PLANS	701311-03	LANE CLOSURE 2L, 2W, MOVING OPERATIONS DAY ONLY
23	DRIVEWAY DETAILS - DISTANCE BETWEEN R.O.W. AND FACE	701400-09	APPROACH TO LANE CLOSURE, FREEWAY/EXPRESSWAY
24	OF CURB < 15' (4.5 m) (BD-02)  PAVEMENT PATCHING FOR HMA SURFACED PAVEMENT (BD-22)	701401-12	LANE CLOSURE, FREEWAY/EXPRESSWAY
25	CURB OR CURB AND GUTTER REMOVAL AND REPLACEMENT (BD-24)	701411-09	LANE CLOSURE, MULTILANE, AT ENTRANCE OR EXIT RAMP, FOR SPEEDS >= 45 MPH
25		701426-09	LANE CLOSURE, MULTILANE, INTERMITTENT OR MOVING OPER., FOR SPEEDS >= 45 MPH
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27	TRAFFIC CONTROL AND PROTECTION FOR SIDE ROADS, INTERSECTIONS, AND DRIVEWAYS (TC-10)	701428-01	TRAFFIC CONTROL SETUP AND REMOVAL FREEWAY/EXPRESSWAY
	TYPICAL APPLICATIONS - RAISED REFLECTIVE PAVEMENT MARKERS	701446-09	TWO LANE CLOSURE, FREEWAY/EXPRESSWAY
28	(SNOW-PLOW RESISTANT) (TC-11)	701501-06	URBAN LANE CLOSURE, 2L, 2W, UNDIVIDED
29-30	MULTI-LANE FREEWAY PAVEMENT MARKING DETAILS (TC-12)	701606-10	URBAN LANE CLOSURE, MULTILANE, 2W WITH MOUNTABLE MEDIAN
31	DISTRICT ONE TYPICAL PAVEMENT MARKINGS (TC-13)	701701-10	URBAN LANE CLOSURE, MULTILANE INTERSECTION
32	TRAFFIC CONTROL DETAILS FOR FREEWAY SHOULDER CLOSURES AND PARTIAL RAMP CLOSURES (TC-17)	701801-06	SIDEWALK, CORNER OR CROSSWALK CLOSURE
77	FREEWAYS/EXPRESSWAYS SIGNING FOR FLAGGING OPERATIONS	701901-08	TRAFFIC CONTROL DEVICES
33	AT WORK ZONE OPENINGS ON FREEWAYS/EXPRESSWAYS (TC-18)	704001-08	TEMPORARY CONCRETE BARRIER
34	ARTERIAL ROAD INFORMATION SIGN (TC-22)	780001-05	TYPICAL PAVEMENT MARKINGS
35	TRAFFIC CONTROL DETAILS FOR FREEWAY CENTER LANE CLOSURE SHOULDER LANE (TC-25)	782006	GUARDRAIL AND BARRIER WALL REFLECTOR MOUNTING DETAILS

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STANDARD NO.	DESCRIPTION
000001-07	STANDARD SYMBOLS, ABBREVIATIONS AND PATTERNS
280001-07	TEMPORARY EROSION CONTROL SYSTEMS
442201-03	CLASS C AND D PATCHES
482001-02	HMA SHOULDER ADJACENT TO FLEXIBLE PAVEMENT
602001-02	CATCH BASIN TYPE A
602011-02	CATCH BASIN TYPE C
602301-04	INLET-TYPE A
602402-02	PRECAST MANHOLE TYPE A 5' (1.52 m) DIAMETER
602411-08	PRECAST MANHOLE TYPE A 7' (2.13 m) DIAMETER
602601-06	PRECAST REINFORCED CONCRETE FLAT TOP SLAB
602701-02	MANHOLE STEPS
604001-04	FRAME AND LIDS, TYPE 1
604006-05	FRAME AND GRATE TYPE 3
604031-03	GRATE TYPE 7
606001-07	CONCRETE CURB TYPE B AND COMBINATION CONCRETE CURB AND GUTTER
635001-02	DELINEATORS

MIXTURE USES	MIXTURE TYPE	AIR VOIDS @ Ndes	QUALITY MANAGEMENT PROGRAM (QMP)
SHOULDER RECONSTRUCTION	HMA SURFACE COURSE, MIX "D", N70, (IL 9.5 mm); 2"	4% @ 70 GYR.	QC/QA
(HMA SHOULDERS, 8")	HMA BINDER COURSE, IL-19.0, N70, 6"	4% @ 70 GYR.	QC/QA
DDIVEWAYC	HMA SURFACE COURSE, MIX "D", N50, (IL-9.5 mm); 2"	4% @ 50 GYR.	QC/QA
DRIVEWAYS	HMA BASE COURSE, (HMA BINDER IL-19 mm); PE - 6"	4% @ 50 GYR.	QC/QA
PATCHING	CLASS D PATCHES (HMA BINDER IL-19.0 mm)	4% @ 70 GYR	QC/QA

NOTE 1: THE UNIT WEIGHT USED TO CALCULATE ALL HMA SURFACE MIXTURE QUANTITIES IS 112 LBS/SQ YD/IN.

NOTE 2: THE "AC TYPE" FOR POLYMERIZED HMA MIXES SHALL BE "SBS/SBR PG 76 -22" AND FOR NON-POLYMERIZED HMA

THE "ACTIYPE" FOR POLYMERIZED HMA MIXES SHALL BE "SBS/SBR PG (6 -22" AND FOR NON-POLYMERIZED THE "ACTIYPE" SHALL BE "PG 64 -22" UNLESS MODIFIED BY DISTRICT ONE SPECIAL PROVISIONS.

FOR USE OF RECYCLED MATERIALS SEE DISTRICT ONE SPECIAL PROVISIONS.

QUALITY MANAGEMENT PROGRAM (QMP) IDENTIFIES THE PARTICULAR QUALITY CONTROL SPECIFICATION THAT APPLIES TO THE HMA MIXTURE.

#### **GENERAL NOTES**

- 1. BEFORE STARTING ANY EXCAVATION, THE CONTRACTOR SHALL CALL "JULIE" AT (800) 892-0123 OR 811 FOR FIELD LOCATIONS OF BURIED ELECTRIC, TELEPHONE, AND GAS FACILITIES (48 HOUR NOTIFICATION REQUIRED). THE CONTRACTOR SHALL ALSO CALL E.M.C. (DISTRICT 1 ELECTRICAL MAINTENANCE CONTRACTOR) AT (708) 524-2145 FOR FIELD LOCATIONS OF DISTRICT 1 ELECTRICAL CABLES.
- 2. THE CONTRACTOR SHALL COORDINATE CONSTRUCTION ACTIVITIES WITH UTILITY COMPANIES AND THE VILLAGES OF BELLWOOD, HOMEWOOD, LAKE BLUFF, PALATINE, AND ROSELLE.
- 3. THE CONTRACTOR WILL NOT BE ALLOWED TO SET UP A YARD OR FIELD OFFICE ON STATE PROPERTY WITHOUT THE WRITTEN PERMISSION OF THE DEPARTMENT.
- 4. BEFORE BEGINNING ANY WORK, THE CONTRACTOR SHALL RETAIN AND RECORD FOR FUTURE REFERENCE, ALL EXISTING PAVEMENT MARKING LINES IN ORDER THAT THESE LOCATIONS CAN BE RE-ESTABLISHED FOR STRIPING. EXACT LOCATIONS OF ALL PAVEMENT MARKINGS SHALL BE AS DIRECTED BY THE ENGINEER.
- 5. IT SHALL BE THE CONTRACTOR'S RESPONSIBILITY TO VERIFY ALL DIMENSIONS AND CONDITIONS EXISTING IN THE FIELD PRIOR TO CONSTRUCTION AND ORDERING OF MATERIALS.
- 6. ALL DAMAGE TO EXISTING PAVEMENT MARKINGS OR RAISED REFLECTIVE PAVEMENT MARKERS OUTSIDE THE REMOVAL LINE SHOWN ON THE PLANS SHALL BE REPLACED AT THE CONTRACTOR'S EXPENSE.
- 7. ALL PAVEMENT PATCHING AND CURB AND GUTTER REMOVAL AND REPLACEMENT LOCATIONS WILL BE DETERMINED IN THE FIELD BY THE ENGINEER.
- 8. THE CONTRACTOR SHALL BE REQUIRED TO PROVIDE ACCESS TO ABUTTING PROPERTY AT ALL TIMES DURING THE CONSTRUCTION OF THIS PROJECT.
- 9. DO NOT SCALE PLANS FOR CONSTRUCTION DIMENSIONS.
- 10. TEN (10) FOOT TRANSITIONS SHALL BE USED TO MATCH PROPOSED CURB AND GUTTER AND MEDIAN ITEMS OF WORK TO EXISTING CURBS AND GUTTER AND MEDIANS IN THE FIELD, UNLESS OTHERWISE SHOWN. THE TRANSITIONS SHALL BE PAID FOR AT THE CONTRACT UNIT PRICE FOR THE PROPOSED ITEMS OF WORK SPECIFIED.
- 11. THE CONTRACTOR SHALL CONTACT THE DISTRICT ONE TRAFFIC CONTROL SUPERVISOR AT KALPANA.KANNAN-HOSADURGA@ILLINOIS.GOV A MINIMUM OF 72 HOURS IN ADVANCE OF BEGINNING WORK ON ARTERIALS.
- 12. THE ENGINEER SHALL CONTACT DON CHIARUGI, ARTERIAL TRAFFIC FIELD ENGINEER, AT DON.CHIARUGI@ILLINOIS.GOV FOR A MINIMUM OF TWO (2) WEEKS PRIOR TO THE PLACEMENT OF PERMANENT PAVEMENT MARKINGS.
- 13. THE CONTRACTOR SHALL CONTACT THE DISTRICT ONE TRAFFIC CONTROL SUPERVISOR AT (847) 705-4155 A MINIMUM OF 72 HOURS IN ADVANCE OF BEGINNING WORK ON EXPRESSWAYS.
- 14. THE ENGINEER SHALL CONTACT THE EXPRESSWAY FIELD ENGINEER AT (847) 705-4153 A MINIMUM OF 72 HOURS PRIOR TO PLACEMENT OF PERMANENT PAVEMENT MARKINGS.
- 5. DOUBLE LANE MARKERS ARE TO BE USED AS SHOWN ON THE DISTRICT ONE DETAIL "TYPICAL APPLICATIONS RAISED REFLECTIVE PAVEMENT MARKERS (SNOW-PLOW RESISTANT)" SHOWN IN THE PLANS.
- 16. TOP OF GRATE ELEVATIONS GIVEN ON THE PLANS ARE ONLY TO ASSIST THE CONTRACTOR IN DETERMINING THE APPROXIMATE OVERALL HEIGHT OF EACH STRUCTURE. FRAMES/GRATES ON ALL NEW STRUCTURES SHALL BE ADJUSTED TO THE FINAL ELEVATIONS OF THE AREAS IN WHICH THEY ARE LOCATED, AS PART OF THE STRUCTURE COST.
- 17. UNLESS OTHER CONDITIONS WARRANT EXTENDED LANE CLOSURE AS DETERMINED AND APPROVED IN WRITING BY THE ENGINEER OR AS PROVIDED FOR IN THE CONTRACT SPECIFICATIONS, OVERNIGHT CLOSURES SHALL NOT BE ALLOWED FOR REHABILITATION PROJECTS INVOLVING DAYTIME MILLING AND RESURFACING OPERATIONS AND CLASS DEATCHING.
- 18. EXISTING BROKEN FRAMES AND LIDS SHALL BE REMOVED AND DISPOSED OF BY THE CONTRACTOR AND SHALL BE REPLACED AS DIRECTED BY THE ENGINEER. REPLACEMENT FRAMES AND LIDS WILL BE PAID FOR ACCORDING TO ARTICLE 109.04 OF THE STANDARD SPECIFICATIONS UNLESS A SEPARATE PAY ITEM HAS BEEN PROVIDED.
- 9. SOIL DISTURBANCE SHALL BE CONDUCTED IN SUCH A MANNER AS TO MINIMIZE EROSION.
- 20. PROPERTIES AND CHANNELS ADJOINING THE SITE SHALL BE PROTECTED FROM EROSION AND SEDIMENTATION.
- 21. SOIL EROSION AND SEDIMENT CONTROL FEATURES SHALL BE CONSTRUCTED PRIOR TO THE COMMENCEMENT OF HYDROLOGIC DISTURBANCE OF HIPLAND AREAS.
- 22. DISTURBED AREAS SHALL BE STABILIZED WITH TEMPORARY OR PERMANENT MEASURES WITHIN ONE (1) CALENDAR DAY FOLLOWING THE END OF ACTIVE HYDROLOGIC DISTURBANCE.
- 23. ALL TEMPORARY AND PERMANENT EROSION AND SEDIMENT CONTROL MEASURES SHALL BE MAINTAINED IN IN EFFECTIVE WORKING CONDITION.
- 24. ALL ESC MEASURES WILL BE MAINTAINED IN ACCORDANCE WITH THE IDOT EROSION AND SEDIMENT CONTROL FIELD GUIDE FOR CONSTRUCTION INSPECTION AND IDOT'S BEST MANAGEMENT PRACTICES-MAINTENANCE GUIDE: (http://www.idot.illinois.gov/TRANSPORTATION-SYSTEM/ENVIRONMENT/EROSION-AND-SEDIMENT-CONTROL).

\* COOK, DUPAGE, & LAKE

STATE OF ILLINOIS
DEPARTMENT OF TRANSPORTATION

INDEX

SCALE:

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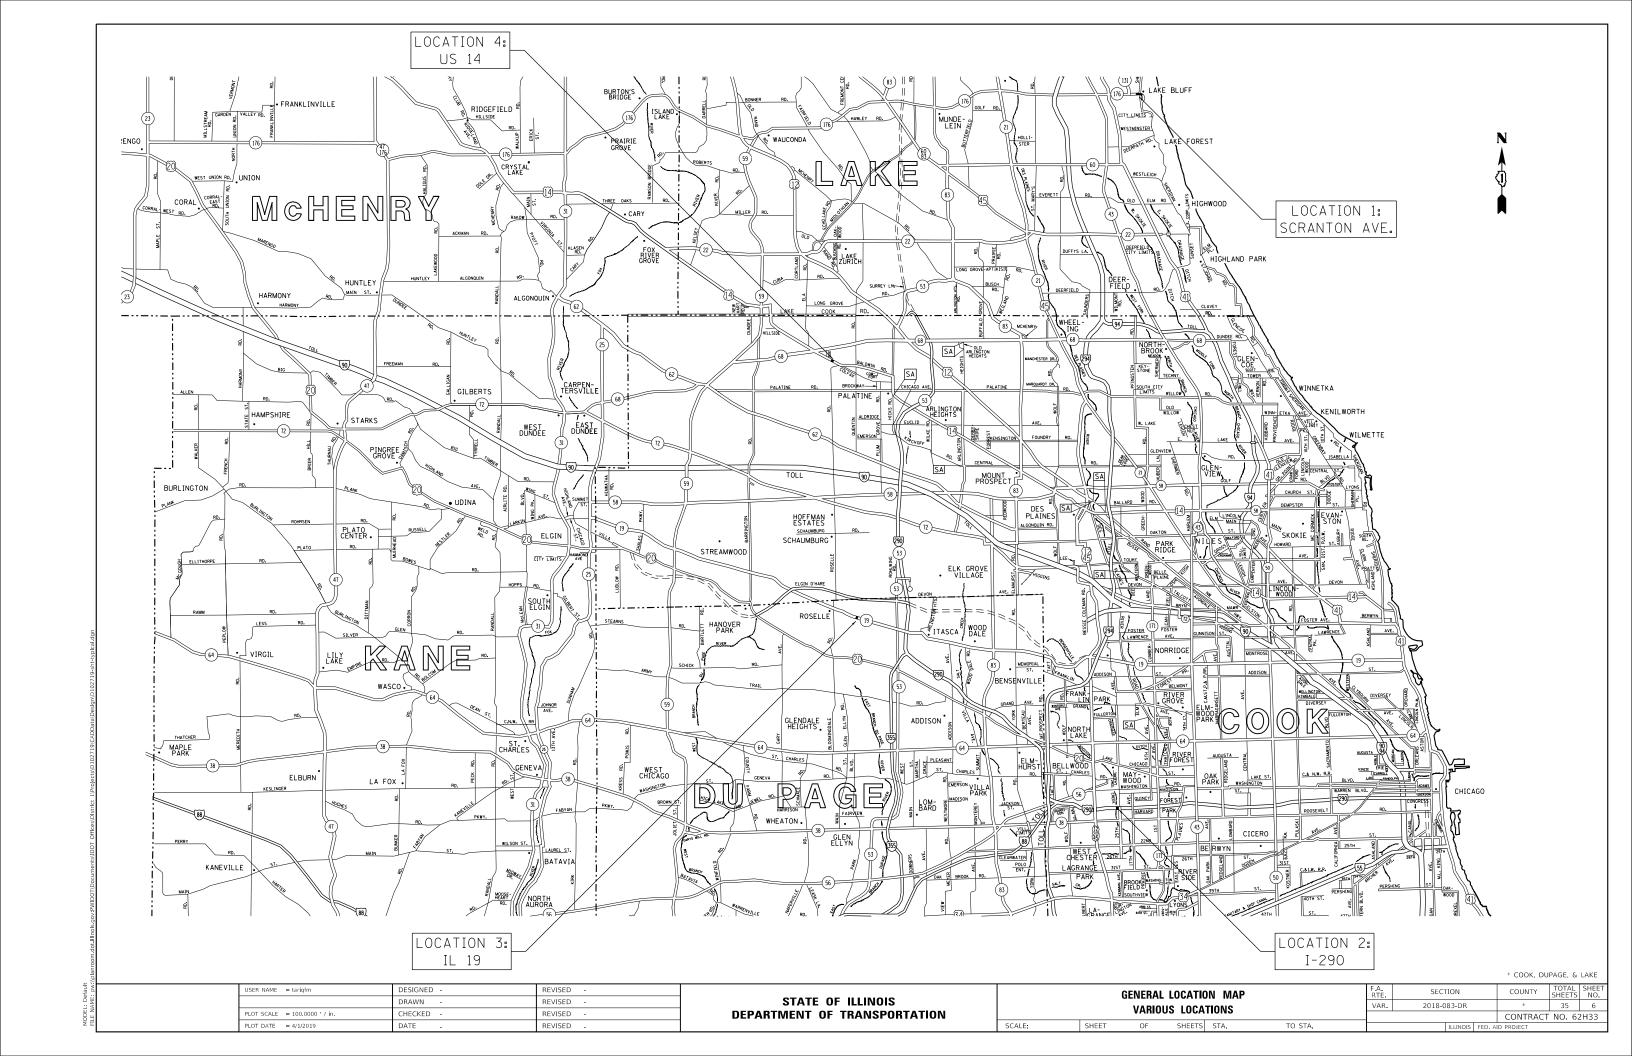
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1995   1995	20200100	EARTH EXCAVAT	ION	CU YD	7				7	42001300	PROTECTIVE C	OAT	SO YD	33			3		30
100-1525   100-1525	20800150	TRENCH BACKFI	LL	CU YD	199		7	13	179	42400200	PORTLAND CEM	ENT CONCRETE SIDEWALK 5 INCH	SO FT	5					5
100-1525   100-1525																			
Section   CLASS 24   CAPE   O.1	21101615	TOPSOIL FURNI	SH AND PLACE, 4"	SQ YD	128			2	126	44000100	PAVEMENT REM	OVAL	SO YD	13					13
2000000 NETWINDER FERTILIZER NUTRITION POUND 11 9 2 4420170 CLASS & PATCHES, TYPE 111, 60 INCH 50 70 22 22 22 12 12 12 12 12 12 12 12 12 12	21101625	TOPSOIL FURNI	SH AND PLACE, 6"	SQ YD	250			250	)	44000200	DRIVEWAY PAV	EMENT REMOVAL	SO YD	19					19
2000000 NETWINDER FERTILIZER NUTRITION POUND 11 9 2 4420170 CLASS & PATCHES, TYPE 111, 60 INCH 50 70 22 22 22 12 12 12 12 12 12 12 12 12 12	25000210	SEEDING CLAS	5 24	ACRE	0.1				1	44000600	SIDEWALK PEN	IOVAL	SO ET	5					5
1000000   PROSPRIGHES FERTILIZER NUTRIENT   POIND   11   9 2   44201187   CLASS D PATCHES, TYPE   11, 10 INCH   50 TO   16   16   17   17   17   17   17   18   18   18	23000210	JELDING, CLAS	<u> </u>	ACRE	0.1					1700000	SIDEWALK REM	WYNL	Ju Fi						
2005600 POTASSIAN FERTILIZER MURRIENT POUND 11 9 2 4420181 CLASS D PATCHES, TYPE 1, 14 INCH 50 YO 7 7 7 7 7 7 7 1 1 1 1 1 1 1 1 1 1 1 1	25000400	NITROGEN FERT	ILIZER NUTRIENT	POUND	11			9	2	44201721	CLASS D PATC	HES, TYPE III, 6 INCH	SO YD	22		22			
STORE   STOR	25000500	PHOSPHORUS FE	RTILIZER NUTRIENT	POUND	11			9	) 2	44201769	CLASS D PATC	HES, TYPE III, 10 INCH	SO YD	16	16				
STORE   STOR	25000500	DOTACCIUM FED	TILIZED MUTDIEMT	DOUND	11					44201811	CLASS D DATO	THE TYPE I 14 INCH	50. VD	7					7
\$20110 \$0001NG, \$ALT TOLERANT \$0 YO 128 \$2 126 48101600 AGGREGATE SHOULDERS, TYPE B 8" \$0 YO 40 40 40 40 40 40 40 40 40 40 40 40 40	23000600	FOTASSIUM FER	TILIZEN NOTRIENT	FOUND	11					14201011	CLASS D FAIC	nes, tire i, 14 inch	30 10	'					'
145   145	25100630	EROSION CONTR	OL BLANKET	SQ YD	250			250		44201815	CLASS D PATC	HES, TYPE II, 14 INCH	SO YD	25			25		
SOURCE   SUBGRADE   IMPROVEMENT   12"   SO YD   22   22	25200110	SODDING, SALT	TOLERANT	SQ YD	128			2	126	48101600	AGGREGATE SH	OULDERS, TYPE B 8"	SO YD	40			40		
SOURCE   SUBGRADE   IMPROVEMENT   12"   SO YD   22   22																			
5501308 HOT-MIX ASPHALT BASE COURSE, 6" SO YD 19 19 19 19 550A0050 STORM SEWERS, CLASS A, TYPE 1 12" FOOT 175 175 175 175 175 175 175 175 175 175	28000400	PERIMETER ERO	SION BARRIER	FOOT	145			145	5	48203029	HOT-MIX ASPH	ALT SHOULDERS, 8"	SO YD	13					13
10603335   HOT-MIX ASPHALT SURFACE COURSE, MIX   TON   3   3   550A0070   STORM SEWERS, CLASS A, TYPE 1   15"   FOOT   4   4   4   5   5   5   5   5   5   5	30300112	AGGREGATE SUB	GRADE IMPROVEMENT 12"	SQ YD	22		22			54248510	CONCRETE COL	LAR	CU YD	0.5		0.5			
"D", N50	35501308	HOT-MIX ASPHA	LT BASE COURSE, 6"	SQ YD	19				19	550A0050	STORM SEWERS	. CLASS A. TYPE 1 12"	FOOT	175					175
"D", N50	40603335	HOT MAY ASSU	T SUPERACE COURSE MAY	TO:-	-					FF0/0070	CTODA CEMEN	CLASS A TURE 1 15"	5007						4
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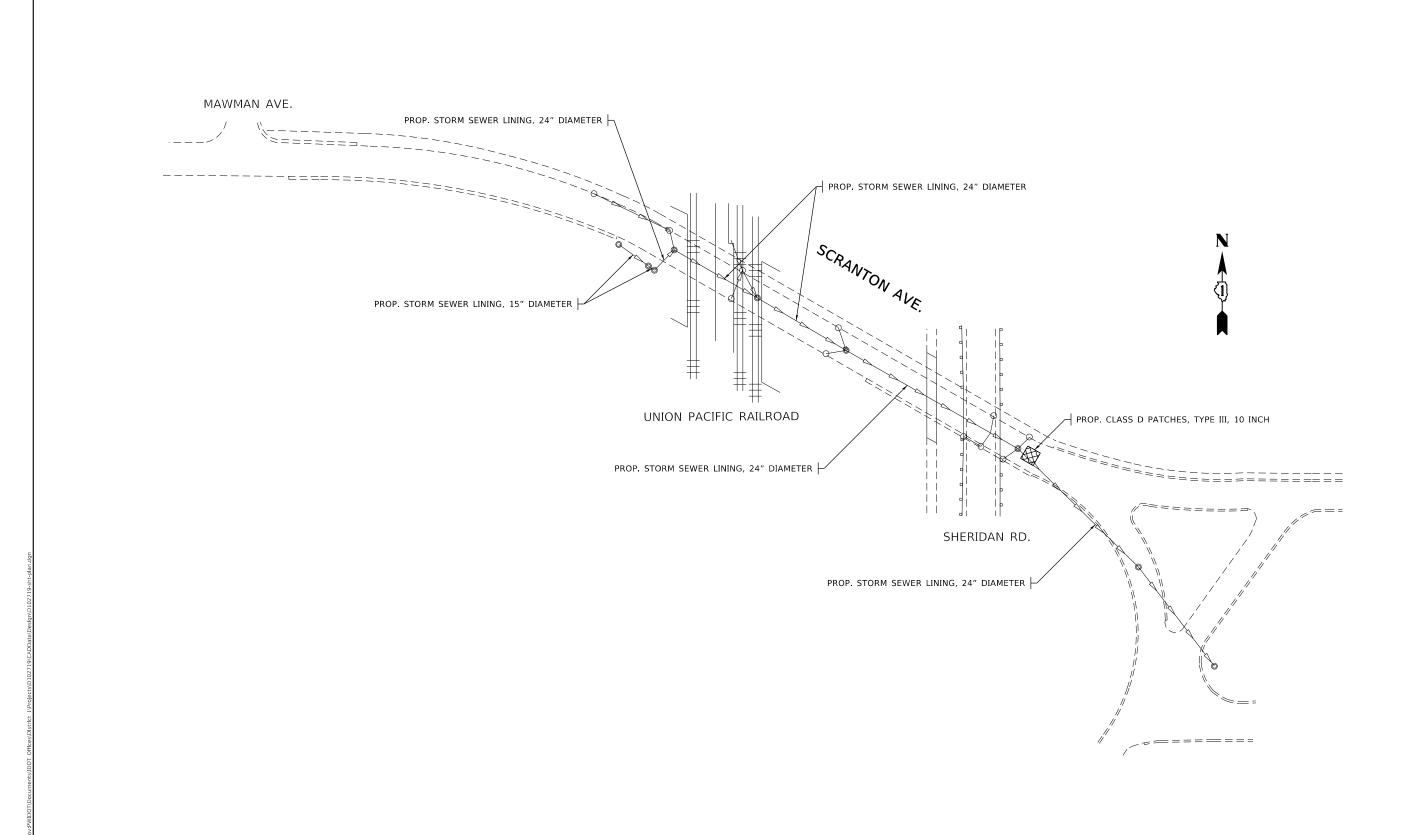
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CODE NO	ITEM	UNIT	TOTAL QUANTITIES URBAN	0004 SCRANTON AVE.	0004 I-290 (LOCATION =2)	0004 IL 19 (LOCATION =3)	0004 US 14 (LOCATION =4)	0004  RIDGE RD. (LOCATION =5)		CODE NO	ITEM	UNIT	TOTAL QUANTITIES URBAN	SCRANTON AVE.	0004 I-290 (LOCATION =2)	0004 IL 19 (LOCATION =3)	0004 US 14 (LOCATION =4)	0004  RIDGE RD. (LOCATION =5)	
550A0360	STORM SEWERS, CLASS A, TYPE 2 15"	FOOT	32		20			12	*	66900530	SOIL DISPOSAL ANALYSIS	EACH	4		1	1	1	1	
550A0420	STORM SEWERS, CLASS A, TYPE 2 27"	FOOT	16				16		*	66901001	REGULATED SUBSTANCES PRE-CONSTRUCTION	LSUM	1		0. 25	0. 25	0. 25	0.25	
												1							
55100700	STORM SEWER REMOVAL 15"	FOOT	20		20						PLAN								
									*	66901002	ON-SITE MONITORING OF REGULATED	CAL DA	15		3	3	3	6	
55101300	STORM SEWER REMOVAL 27"	FOOT	16				16				SUBSTANCES								
60200105	CATCH BASINS, TYPE A, 4'-DIAMETER, TYPE	EACH	4			1		3	*	66901003	REGULATED SUBSTANCES FINAL CONSTRUCTION	LSUM	1		0. 25	0. 25	0. 25	0.25	
	1 FRAME, OPEN LID					•					REPORT		-				0.20		
60200305	CATCH BASINS, TYPE A, 4'-DIAMETER, TYPE	EACH	1			1				67000400	ENGINEER'S FIELD OFFICE, TYPE A	CAL MO	6	1. 2	1. 2	1. 2	1. 2	1. 2	
	3 FRAME AND GRATE																		<u> </u>
										67100100	MOBILIZATION	L SUM	1	0. 2	0.2	0.2	0.2	0.2	
60206905	CATCH BASINS, TYPE C, TYPE 1 FRAME,	EACH	1					1											
	OPEN LID						1			70102625	TRAFFIC CONTROL AND PROTECTION.	L SUM	1			0.4	0.3	0.3	<u> </u>
											STANDARD 701606								<u> </u>
60221100	MANHOLES, TYPE A, 5'-DIAMETER, TYPE 1	EACH	2					2											
	FRAME, CLOSED LID									70102630	TRAFFIC CONTROL AND PROTECTION, STANDARD 701601	L SUM	1			0.4	0.3	0.3	
60234200	INLETS, TYPE A, TYPE 1 FRAME, OPEN LID	EACH	1			1					STANDARD TOTOUT								<u> </u> 
										70102632	TRAFFIC CONTROL AND PROTECTION,	L SUM	1			0.4	0. 3	0. 3	
60402110	GRATES, TYPE 7	EACH	1				1				STANDARD 701602								
50500050	DEMOVING IN ETC	FACU	<u> </u>			1				70102675	TRAFFIC CONTROL AND PROTECTION	1 51114	1	1					
60500060	REMOVING INLETS	EACH	1			1				70102635	TRAFFIC CONTROL AND PROTECTION, STANDARD 701701	L SUM	1	1					
64200116	SHOULDER RUMBLE STRIPS, 16 INCH	FOOT	390		390														
										70107025	CHANGEABLE MESSAGE SIGN	CAL DA	42		42				
* 66900200	NON-SPECIAL WASTE DISPOSAL	CU YD	386		49	26	24	287		70300004	PAVEMENT MARKING TAPE, TYPE IV 4"	FOOT	4000		4000				
							* SPFO	IALTY I	TFMS	70300904	PAVEMENT MARKING TAPE, TYPE IV 4"	F00T	1280		4096 1280		_		 ∀ MS
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	SUMMARY OF QUANTITIES				COI	NSTRUCTIO	N TYPE CO	DDE			SUMMAR	RY OF QUANTITIES				CO	NSTRUCTIO	N TYPE C	DDE	
CODE NO	ITEM	UNIT	TOTAL QUANTITIES URBAN		0004 I-290 (LOCATION =2)	0004 IL 19 (LOCATION =3)	0004 US 14 (LOCATION =4)	0004 RIDGE RD. (LOCATION =5)		CODE NO		ITEM	UNIT	TOTAL QUANTITIES URBAN	0004 SCRANTON AVE.	0004 I-290 (LOCATION =2)	0004 IL 19 (LOCATION =3)	0004 US 14 (LOCATION =4)	0004 RIDGE RD. (LOCATION =5)	
70300908	PAVEMENT MARKING TAPE, TYPE IV 8"	FOOT	2399		2399					x5538300	STORM SEWERS	TO BE CLEANED 27"	FOOT	362				362		
70300912	PAVEMENT MARKING TAPE, TYPE IV 12"	F00T	109		109					x6020090	MANHOLES, WI	TH RESTRICTOR PLATE	EACH	1				1		
70400100	TEMPORARY CONCRETE BARRIER	F00T	675		675					X6061700		CONCRETE CURB AND GUTTER,	FOOT	150					150	
70600260	IMPACT ATTENUATORS, TEMPORARY (FULLY	EACH	2		2						TYPE B (SPEC	IAL)								
10800280	REDIRECTIVE, NARROW), TEST LEVEL 3	EACH	2		2					X7011015	TRAFFIC CONTI	ROL AND PROTECTION	L SUM	1		1				
	NEDITECTIVE, NAMON, 1231 ELVE 3									***************************************	(EXPRESSWAYS)		2 30#	<u> </u>		•				
* 78000200	THERMOPLASTIC PAVEMENT MARKING - LINE 4"	FOOT	1410		1330	20		60												
										X7013820	TRAFFIC CONT	ROL SURVEILLANCE,	CAL DA	21		21				
* 78000500	THERMOPLASTIC PAVEMENT MARKING - LINE 8"	F00T	1014		1014						EXPRESSWAYS									
* 78000600	THERMOPLASTIC PAVEMENT MARKING - LINE 12"	F00T	695		695					x7030005	TEMPORARY PAY	VEMENT MARKING REMOVAL	SQ FT	3611		3611				
* 78004220	PREFORMED PLASTIC PAVEMENT MARKING,	F00T	538		538					X7040125	PINNING TEMP	DRARY CONCRETE BARRIER	EACH	36		36				
	TYPE B - INLAID - LINE 5"									Z0004562	COMBINATION	CONCRETE CURB AND GUTTER	FOOT	10			10			
* 78100100	RAISED REFLECTIVE PAVEMENT MARKER	EACH	226		222	4					REMOVAL AND F									
78200011	BARRIER WALL REFLECTORS, TYPE C	EACH	56		56					Z0013798	CONSTRUCTION	LAYOUT	L SUM	1		0. 25	0. 25	0. 25	0.25	
78300200	RAISED REFLECTIVE PAVEMENT MARKER	EACH	226		222	4				Z0030850	TEMPODADY INI	FORMATION SIGNING	SO FT	179. 9	51.4		51.4	25. 7	51.4	
78300200	REMOVAL	EACH	220		222	7				20030830	TEMPORARI IN	TOWN TION STUNING	30 F1	113.3	512 7		J1. 7	2321	51.7	
	··									Z0073400	TEMPORARY SUF	PPORT SYSTEM	EACH	1		1				
x0327649	SOIL RETENTION SYSTEM	SO FT	312		312															
										X1200222	STORM SEWER I	LINING, 15" DIAMETER	FOOT	36	36					
x0327980	PAVEMENT MARKING REMOVAL - WATER	SO FT	3808		3808															
	BLASTING									X1200223	STORM SEWER I	LINING, 24" DIAMETER	FOOT	493	493					
x5537900	STORM SEWERS TO BE CLEANED 15"	FOOT	113		113		6555	TAL TY 5	TEV.C										REV	′ MS
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#### MAINTENANCE OF TRAFFIC GENERAL NOTES

- 1. THE MAINTENANCE OF TRAFFIC CONTROL PLANS SHALL PROVIDE THE CONTRACTOR AN ACCEPTED METHOD OF TEMPORARY TRAFFIC CONFIGURATION DURING THE LENGTH OF THIS CONTRACT. IN THE CASE THE CONTRACTOR MAY REQUIRE A MODIFICATION TO THE SUGGESTED MAINTENANCE OF TRAFFIC PLANS, THE CONTRACTOR SHALL PROVIDE DETAILED PLANS AND/OR REVISIONS 48 HOURS IN ADVANCE OF ANY CONSTRUCTION ACTIVITIES. ANY MODIFICATIONS SHALL NOT INCONVENIENCE THE TRAVELING PUBLIC WITH SIGNIFICANT DELAYS OR LANE CLOSURES.
- 2. THE CONTRACTOR SHALL MAKE ANY MODIFICATIONS TO THE SUGGESTED MAINTENANCE OF TRAFFIC PLANS IN THE CASE THE TRAFFIC CONDITIONS, WEATHER, VEHICULAR ACCIDENTS, OR ANY OTHER UNFORESEEN CONDITIONS REQUIRE ON -SITE ACTIONS FOR THE TRAVELING PUBLIC. THE CONTRACTOR SHALL RESPOND WITHIN 30 MINUTES OF NOTIFICATION BY THE ENGINEER.
- 3. THE CONTRACTOR SHALL REMOVE ANY EXISTING CONFLICTING PAVEMENT MARKINGS THAT ARE TO BE REPLACED WITH TEMPORARY PAVEMENT MARKINGS AS SHOWN ON THE SUGGESTED MAINTENANCE OF TRAFFIC PLANS. THE REMOVAL OF EXISTING PAVEMENT MARKINGS SHALL BE PAID FOR AS (X0327980) PAVEMENT MARKING REMOVAL - WATER BLASTING.
- 4. ALL TRAFFIC CONTROL DEVICES USED FOR THE MAINTENANCE OF TRAFFIC, AS DETAILED ON PLANS, SHALL BE REFLECTORIZED PRIOR TO INSTALLATION AND CLEANED AS SPECIFIED IN SECTION 701 OF THE SPECIFICATIONS, AS DIRECTED BY THE ENGINEER, AND BE VISIBLE TO THE TRAVELING PUBLIC AT ALL TIMES.
- 5. ALL DRUMS, VERTICAL PANELS, AND BARRICADES IMMEDIATELY ADJACENT TO THE EDGE OF TRAVELED WAY SHALL BE EQUIPPED WITH STEADY MONO-DIRECTIONAL LIGHTS. DRUMS, VERTICAL PANELS, AND BARRICADES SHALL BE PLACED TO ASSURE THE MONO-DIRECTIONAL LIGHTS ARE PLACED ON THE SIDE OF THE TRAVELING PUBLIC.
- 6. AT THE END OF EACH WORK DAY THE CONTRACTOR SHALL BACKFILL OR COVER ALL EXPOSED TRENCHES AND OPEN EXCAVATION HOLES NOT PROTECTED BY THE TEMPORARY CONCRETE BARRIER IN ORDER TO PROVIDE SAFE CONDITIONS FOR THE TRAVELING PUBLIC.
- 7. DURING CONSTRUCTION ACTIVITIES, THE CONTRACTOR SHALL TAKE NECESSARY PRE-CAUTIONS TO AVOID ANY CONSTRUCTION DEBRIS FROM ENCROACHING INTO THE ADJACENT THROUGH
- 8. TEMPORARY CONCRETE BARRIER SHALL BE EQUIPPED WITH (78200011) BARRIER WALL REFLECTORS, TYPE C, IN ACCORDANCE WITH HIGHWAY STANDARD 782006 AT 25' CENTERS.
- 9. THE ENDS OF TEMPORARY CONCRETE BARRIERS AS SHOWN ON THE PLANS SHALL BE ANCHORED TO THE PAVEMENT AS PER IDOT SUPPLEMENTAL SPECIFICATION SECTION 704 REQUIREMENTS AND SHALL BE PAID FOR AS (X7040125) PINNING TEMPORARY CONCRETE BARRIER.
- 10. LOCATIONS OF CHANGEABLE MESSAGE SIGN (70107025) SHALL BE DETERMINED BY THE FNGINFFR.
- 11. THE CONTRACTOR SHALL PROVIDE, INSTALL, MAINTAIN, AND REMOVE ALL SIGNS AND SIGN SUPPORTS REQUIRED FOR TRAFFIC CONTROL AND PROTECTION. THIS WORK SHALL NOT BE PAID FOR SEPARATELY, BUT SHALL BE INCLUDED IN THE CONTRACT UNIT PRICE PER LUMP SUM FOR (X7011015) TRAFFIC CONTROL AND PROTECTION (EXPRESSWAYS).
- 12. ALL "ROAD CONSTRUCTION AHEAD" WARNING SIGNS SHALL BE EQUIPPED WITH HIGH INTENSITY
- 13. REMOVAL OF TEMPORARY TAPE PAVEMENT MARKINGS SHALL BE PAID FOR AS (X7011015) TEMPORARY PAVEMENT MARKING REMOVAL.
- 14. THE CONTRACTOR SHALL REQUEST AND GAIN THE APPROVAL FROM THE ILLINOIS DEPARTMENT OF TRANSPORTATION'S EXPRESSWAY TRAFFIC OPERATIONS ENGINEER AT <u>www.idotlcs.com</u> TWENTY-FOUR (24) HOURS IN ADVANCE OF ALL DAILY LANE, RAMP AND SHOULDER CLOSURES. PLEASE SEE KEEPING THE EXPRESSWAY OPEN TO TRAFFIC SPECIAL PROVISION FOR MORE INFORMATION.
- 15. THE CONTRACTOR SHALL PROVIDE AND MAINTAIN THREE (3) WESTBOUND AND THREE (3) EASTBOUND LANES ALONG I-290. IN ADDITION, THE WESTBOUND ENTRANCE AND THE EASTBOUND EXIT RAMPS AT THE 25TH AVENUE INTERCHANGE SHALL BE MAINTAINED AS SHOWN ON THE PLANS. THE MINIMUM 1-290 MAINLINE LANE WIDTHS SHALL BE 11'-0".

TAPER LENGTH FOR TRAFFIC CONTROL DEVICES IS DEFINED AS FOLLOWS:


 $L = (W) \times (S)$ 

L = TAPER LENGTH (FEET)

W = WIDTH OF OFFSET (FEET)


S = POSTED SPEED (MPH)

#### MAINTENANCE OF TRAFFIC TYPICAL SECTIONS

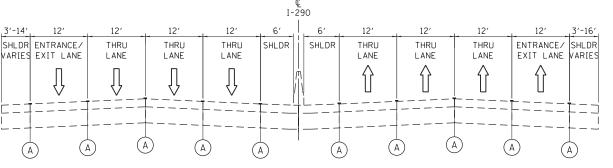

#### **EXISTING TYPICAL SECTION**

NOT TO SCALE

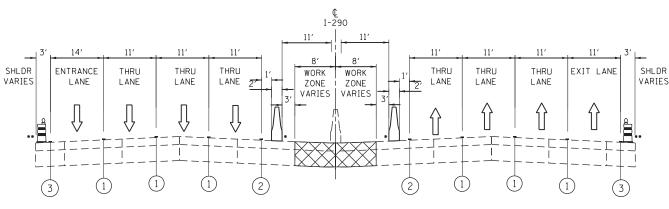

#### STAGE 1 TYPICAL SECTION

NOT TO SCALE

\* TEMPORARY CONCRETE BARRIER SHALL BE PINNED AT THE LOCATIONS AS SHOWN ON THE MOT PLAN AND PER NOTE 9 REQUIREMENTS AND/OR AS DIRECTED BY THE ENGINEER.

\*\* PROVIDE AT THE LANE SHIFT LOCATIONS

#### PRE-STAGE CONSTRUCTION & TRAFFIC

- PLANS OR/AND DIRECTED BY THE ENGINEER.
- SHOWN ON THE SUGGESTED MAINTENANCE OF TRAFFIC PLANS PER IDOT STANDARD DRAWINGS.
- SHIFT THE THREE LANES OF THROUGH TRAFFIC ALONG I-290 IN BOTH THE WEST AND EAST DIRECTIONS AS SHOWN IN THE SUGGESTED MAINTENANCE OF TRAFFIC PLANS. CONTINUE TO MAINTAIN THE WESTBOUND ENTRANCE LANE AND THE EASTBOUND EXIT LANE AT THE 25TH AVENUE INTERCHANGE.
- -INSTALL TEMPORARY CONCRETE BARRIER AS SHOWN IN PLANS. PIN DOWN BOTH ENDS OF TEMPORARY CONCRETE BARRIER AS SHOWN ON THE PLANS OR DIRECTED BY THE ENGINEER AND INSTALL REFLECTIVE MARKERS AT 25' CENTERS.
- MAINTAIN THREE LANES OF THROUGH TRAFFIC ALONG I-290 IN BOTH THE WEST AND EAST DIRECTIONS. MAINTAIN THE WESTBOUND ENTRANCE LANE AND THE EASTBOUND EXIT LANE AT THE 25TH AVENUE INTERCHANGE.

#### STAGE 1 CONSTRUCTION & TRAFFIC

IMPROVEMENTS AS SHOWN ON THE CONTRACT PLANS.

### **MOT TYPICAL LEGEND**

CONSTRUCTION WORK ZONE



DIRECTION OF TRAFFIC



TEMPORARY CONCRETE BARRIER (70400100)



TYPE II BARRICADES OR DRUMS WITH STEADY BURNING LIGHT

- EXISTING PAVEMENT MARKINGS
- PAVEMENT MARKING TAPE. TYPE IV - LINE 4" (SOLID, WHITE) (70300904)
- PAVEMENT MARKING TAPE, TYPE IV - LINE 4" (SOLID, YELLOW) (70300904)
- PAVEMENT MARKING TAPE. TYPE IV - LINE 8" (SOLID, WHITE) (70300908)

#### SUGGESTED CONSTRUCTION SEQUENCING

- ERECT ALL TEMPORARY SIGNING REQUIRED DURING STAGED CONSTRUCTION AS SHOWN ON THE
- REMOVE EXISTING PAVEMENT MARKINGS AND INSTALL TEMPORARY PAVEMENT MARKINGS AS

- SAW-CUT EXISTING PAVEMENT AND COMPLETE PROPOSED ROADWAY AND DRAINAGE

POST STAGE CONSTRUCTION & TRAFFIC

- REMOVE TEMPORARY CONCRETE BARRIERS, ATTENUATORS, TEMPORARY PAVEMENT MARKINGS AND TEMPORARY SIGNS.
- SHIFT THE THREE LANES OF THROUGH TRAFFIC ALONG I-290 IN BOTH THE WEST AND EAST DIRECTIONS BACK TO THE EXISTING CONDITIONS WITH THE ORIGINAL LANE WIDTHS.
- INSTALL PERMANENT PAVEMENT MARKINGS AND RUMBLE STRIPS

DESIGNED REVISED - 4/25/2019 USER NAME = \$USER\$ efault ORAWN RO REVISED LOT SCALE = \$SCALES HECKED REVISED PLOT DATE = 4/25/2019 DATE REVISED 3/1/2019

STATE OF ILLINOIS **DEPARTMENT OF TRANSPORTATION** 


I-290 - MAINTENANCE OF TRAFFIC TYPICAL SECTIONS **VARIOUS LOCATIONS** SCALE: N.T.S SHEET 1 OF 3 SHEETS STA. TO STA.


. COOK. DUPAGE. & LAKE COUNTY 35 9 CONTRACT NO. 62H33


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SECTION


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#### **EXISTING PLAN**

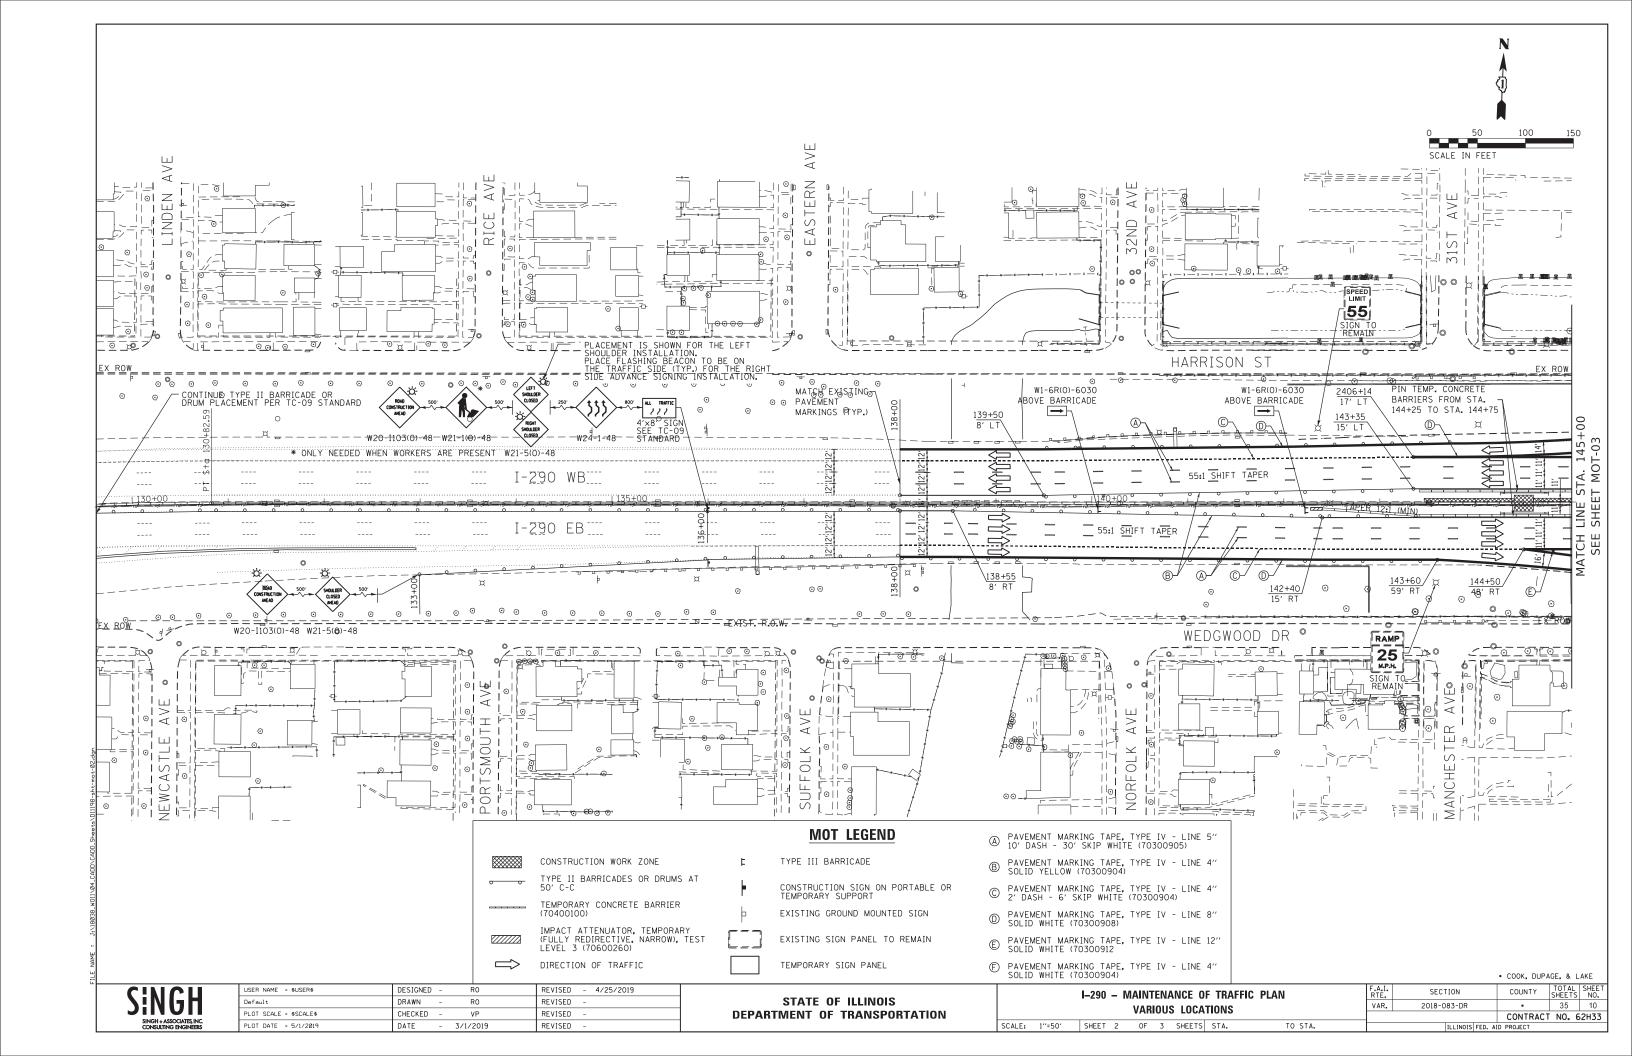

#### **NOTES:**

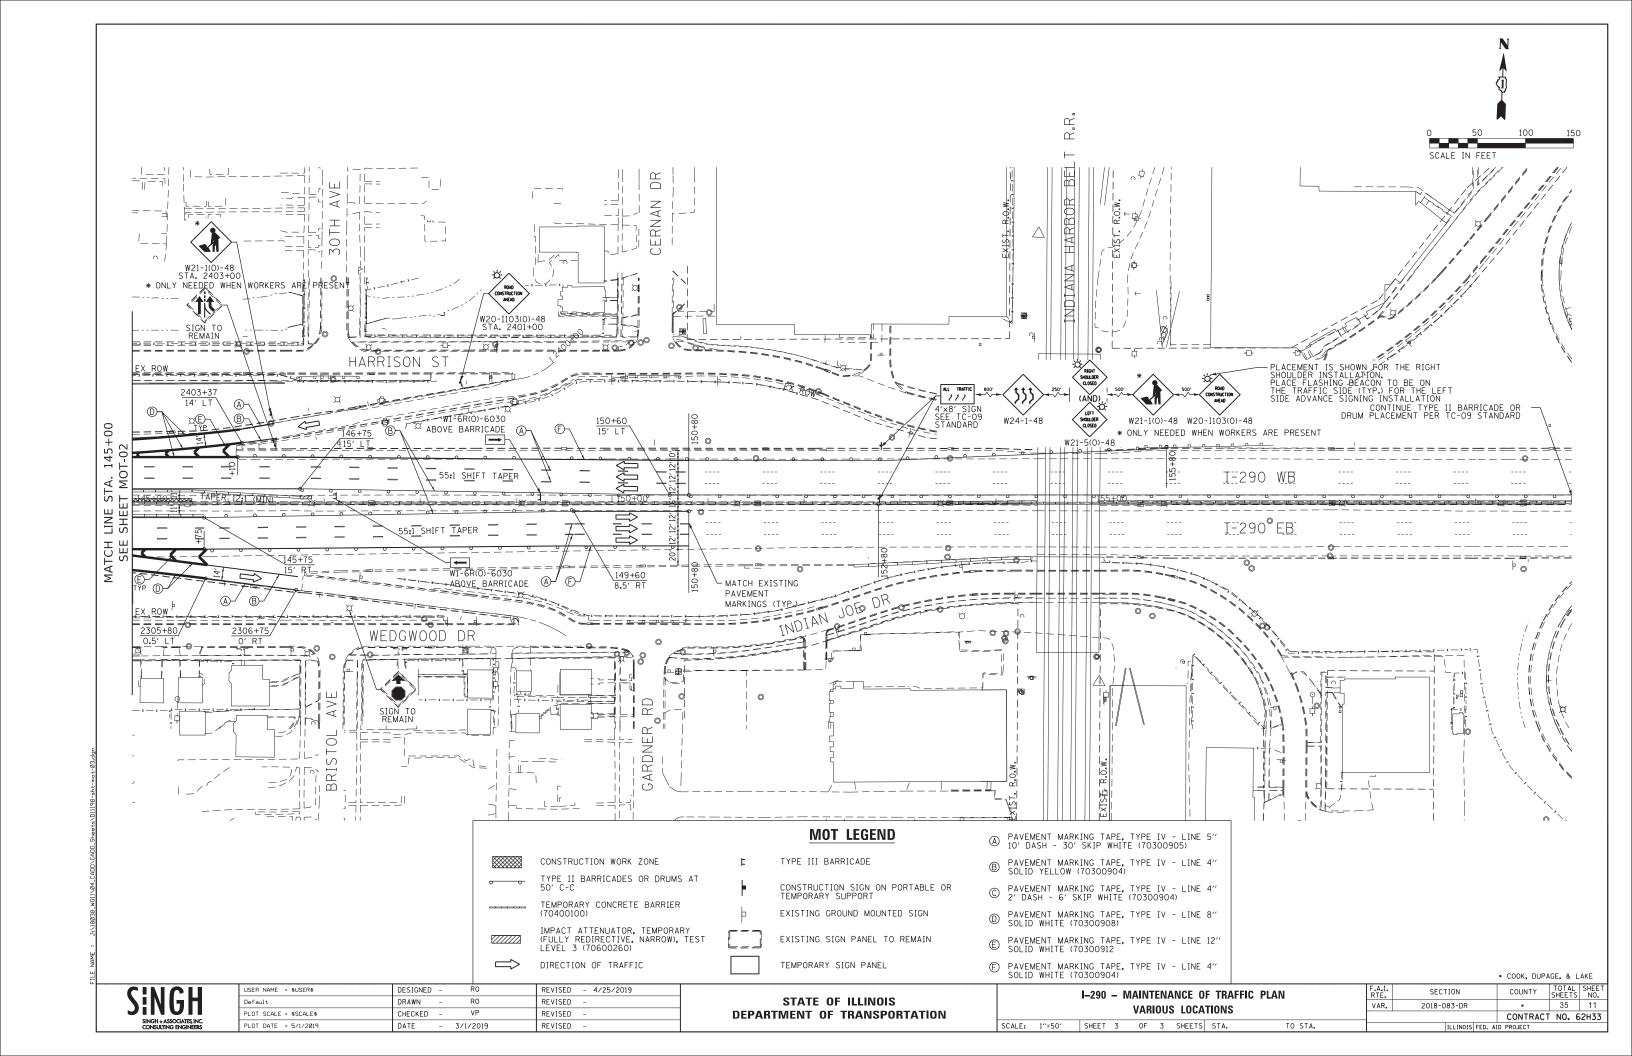LEGEND

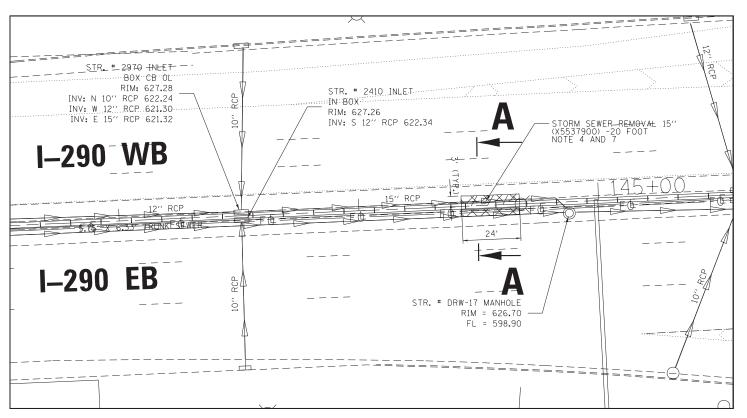XXX

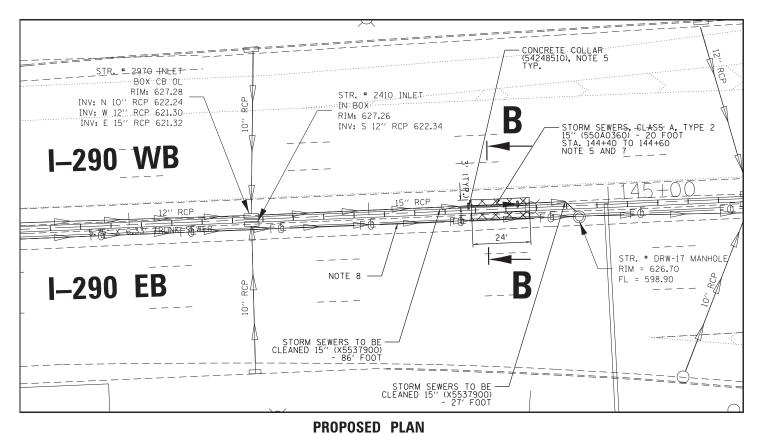XXX

- SAW CUT AND REMOVE EXISTING ASPHALT PAVEMENT ON BOTH SIDES OF THE MEDIAN BARRIER. COST OF ASPHALT PAVEMENT REMOVAL IS INCLUDED IN THE COST OF CLASS D PATCHES, TYPE III, 6 INCH (44201721) AND WILL NOT BE PAID FOR SEPARATELY.
- 2. EXCAVATE AROUND THE 15" SEWER PIPE SEGMENT TO BE REPLACED AND INSTALL SOIL RETENTION SYSTEM TO STABILIZE THE PERIMETER OF THE EXCAVATED AREA.
- INSTALL TEMPORARY SUPPORT SYSTEM TO SUPPORT EXISTING CONCRETE MEDIAN JERSEY WALL, LIGHT POLE AND LIGHT POLE FOUNDATION DURING THE SINKHOLE WORK REPAIR DURATION.
- REMOVE EXISTING 15" RCP DAMAGED PIPE SEGMENT AND CLEAN EXISTING 15" RCP SEWER UPSTREAM AND DOWNSTREAM UP TO THE NEAREST DRAINAGE STRUCTURE.
- INSTALL THE NEW 15" RCP PIPE SEGMENT. CONNECT PROPOSED SEWER TO THE EXISTING EXPOSED SEWER PIPE ENDS BY CONSTRUCTING CONCRETE COLLARS. SEE COLLAR DETAIL ON ROADWAY AND DRAINAGE PLAN SHEET 2 OF 2. MATCH EXISTING INVERT ELEVATIONS, WHILE MAINTAINING POSITIVE DRAINAGE SLOPE.
- 6. BACK FILL THE TRENCH AND INSTALL AGGREGATE SUBGRADE.
  RE-USE THE EXCAVATED TRENCH MATERIAL AS MUCH AS POSSIBLE
  BY CONSULTING WITH THE ENGINEER.
- 7. SOIL RETENTION, STORM SEWER, SHOULDER AND OTHER WORK ITEM EXACT REMOVAL AND INSTALLATION LIMITS AND THE CORRESPONDING QUANTITIES REQUIRED FOR THE SINKHOLE REPAIR WORK TO BE DETERMINED IN THE FIELD BY ASSESSING CURRENT SINKHOLE CONDITION AND AS DIRECTED BY THE ENGINEER.

ASPHALT REMOVAL

6 INCH (44201721)


STORM SEWER REMOVAL

EXISTING STORM SEWER

PROPOSED STORM SEWER

CLASS D PATCHES, TYPE III,

8. DEEP STORM SEWER TRUNK LINE IS NOT SHOWN IN THE SECTION VIEW AND SHOULD NOT BE IMPACTED BY THE CONSTRUCTION ACTIVITIES.

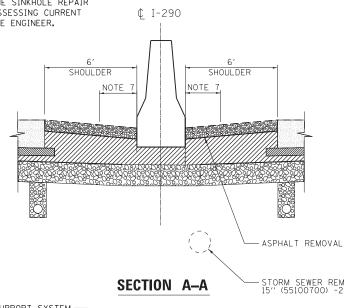

SE	STORM SEWER REMOVAL 15" (55100700) -20 FOOT
TEMPORARY SUPPORT SYSTEM (Z0073400) FOR MEDIAN JERSEY WALL	Ů I-290
AGGREGATE SUBGRADE IMPROVEMENT 12"  4'	SOIL RETENTION SYSTEM (X0327649) (TYP,) NOTE 7  CLASS D PATCHES, TYPE III, 6 INCH (44201721) - 2 PATCH (TYP,) NOTE 7
	STORM SEWERS, CLASS A, TYPE 2 15" (550A0360) -

SECTION B-B

. COOK, DUPAGE, & LAKE

SINGH


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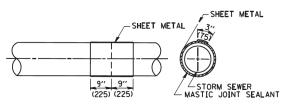
STATE OF ILLINOIS **DEPARTMENT OF TRANSPORTATION** 


I-290 - ROADWAY AND DRAINAGE PLAN **VARIOUS LOCATIONS** SCALE: 1"-20" SHEET 1 OF 2 SHEETS STA. TO STA.

SECTION COUNTY 2018-083-DR 35 12 CONTRACT NO. 62H33

20 40 60 SCALE IN FEET



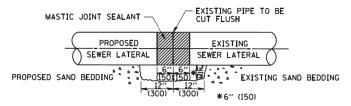

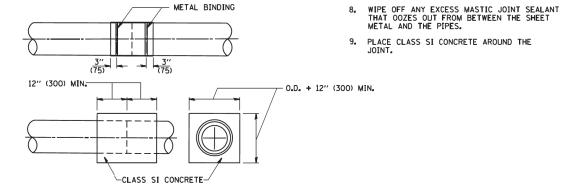

DETAIL "B" CLASS SI CONCRETE COLLAR

CONSTRUCTION SEQUENCE

CUT THE EXISTING END OF THE PIPE SO AS TO PRESENT A FLUSH BUTT JOINT. BRUSH AND CLEAN

2. APPLY THE MASTIC JOINT SEALANT TO THE FIRST 6" (150) OF EACH PIPE.

3. BUTT THE PIPES TOGETHER LEAVING A MINIMUM OF 12' × 6' (300 × 150) DEEP EXCAVATION UNDER AND AROUND EACH PIPE END.

5. WRAP THE SHEET METAL AROUND THE PIPES, 9" (225) ON EACH SIDE OF THE JOINT, STARTING AT THE TOP OF THE PIPE.

6. LAP THE SHEET METAL AT LEAST 3" (75) AT THE TOP OF THE PIPE AND PLACE THE MASTIC JOINT SEALANT BETWEEN THE LAP.

7. PLACE TWO METAL BANDS AROUND THE SHEET METAL AND TIGHTEN.

4. CUT A PIECE OF SHEET METAL GAGE NO. 19 1.1 (0.0418)
18" (450) WIDE BY THE OUTSIDE CIRCUMFERANCE
OF THE PIPE PLUS 3" (75) LONG.

#### NOTES

#### **GENERAL**

CARE MUST BE TAKEN TO PREVENT DEBRIS FROM ENTERING THE SEWER. ALL DEBRIS WHICH ENTERS THE SEWER MUST BE REMOVED. THE SEWER MUST BE LEFT CLEAN AND UNOBSTRUCTED UPON COMPLETION OF THE CONTRACT.

CARE MUST BE TAKEN TO PREVENT ANY PART OF THE NEW PIPE CONNECTION FROM PROJECTING INTO THE EXISTING SEWER.

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Default	DRAWN	-	VP	REVISED	-
PLOT SCALE = \$SCALE\$	CHECKED	-	EC	REVISED	=
PLOT DATE = 3/26/2019	DATE	-	3/1/2019	REVISED	-

• COOK, DUPAGE, & LAKE TOTAL SHEET NO. 35 13 SECTION COUNTY I-290 - ROADWAY AND DRAINAGE PLAN STATE OF ILLINOIS VAR. 2018-083-DR VARIOUS LOCATIONS **DEPARTMENT OF TRANSPORTATION** CONTRACT NO. 62H33 SCALE: NTS SHEET 2 OF 2 SHEETS STA. TO STA.


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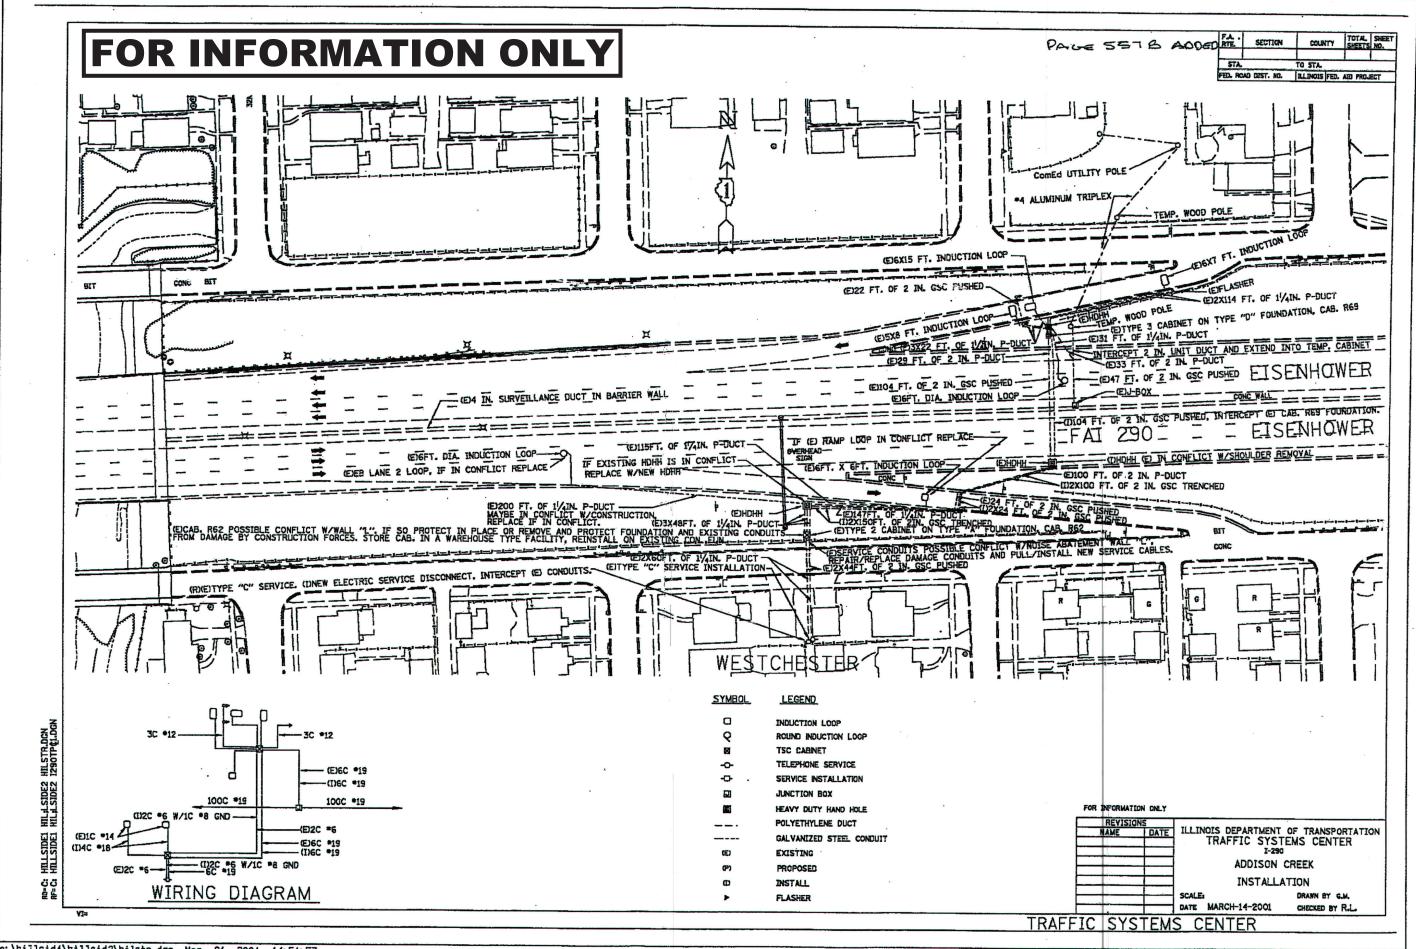
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LIMITED SCOPE OF WORK FOR SECTION 1984-007-R SHALL CONSIST OF:	PED 8040	s-e* ub 7	*******	re	- AC	

- 1. PERFORM ALL WORK INDICATED IN THE MEDIAN.
- 2. PUSH RIGID STEEL CONDUIT UNDER EXISTING MAINLINE ROADWAY.
- 3. NO CABLE-DUCT SHALL BE INSTALLED FROM THE MEDIAN TO THE RAMPS.
- 4. NO WORK SHALL BE PERFORMED ON THE RAMPS.
- 5. REMOVE EXISTING LIGHTING UNITS FROM MAINLINE
- 6. INSTALL 3-1/C NO. 4 AERIAL CABLES TO ENERGIZE EXISTING RAMP LIGHTING. COST INCIDENTAL TO REMOVAL OF EXISTING LIGHTING UNIT.




#### LEGEND




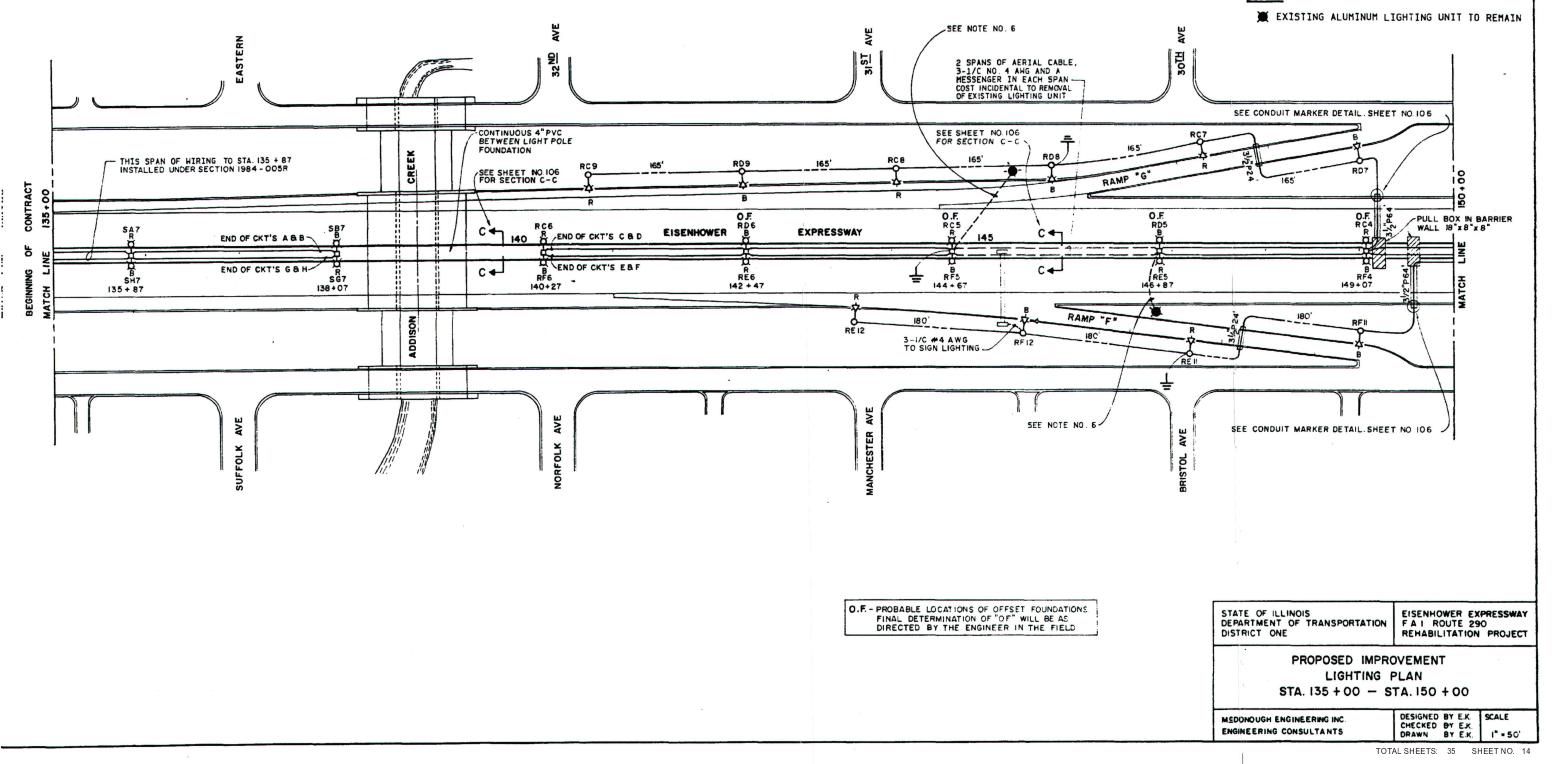


# FOR INFORMATION ONLY

F.A.I. 1984 -290 007-R COOK 152 106

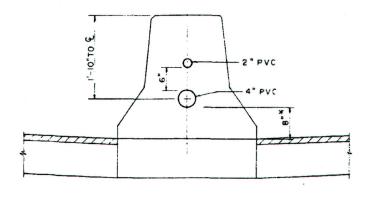

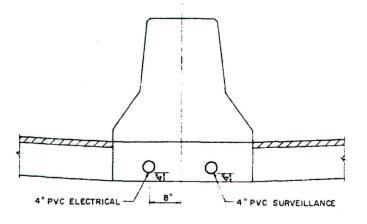

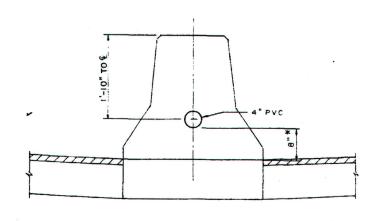

SECTION A-A


SECTION B-B

SECTION C-C


\* ABOVE PGL.

FINAL SHOULDER LIFT ( BY OTHERS )

NOTE: FOR SURVEILLANCE DUCT NOT SHOWN IN SECTION A-A AND C-C, REFER TO BARRIER WALL DETAILS

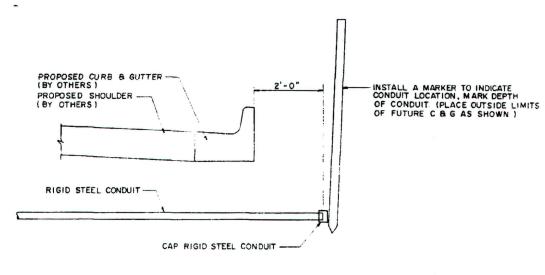

CONDUIT MARKER DETAIL

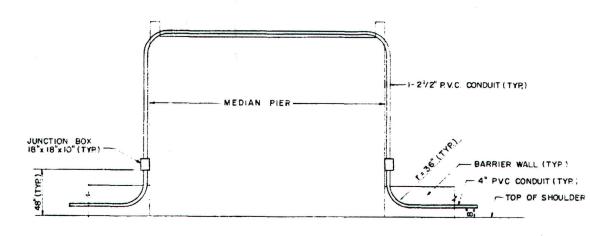

#### CONDUIT CROSSING AT MEDIAN PIER


TYPICAL FOR: 5 TH AVE. BRIDGE 17 TH AVE. BRIDGE


25 TH AVE. BRIDGE I.H.B. R.R. BRIDGE STATE OF ILLINOIS DEPARTMENT OF TRANSPORTATION DISTRICT ONE


EISENHOWER EXPRESSWAY F A I. ROUTE 290 REHABILITATION PROJECT


LIGHTING DETAILS


ME DONOUGH ENGINEERING INC. ENGINEERING CONSULTANTS DESIGNED BY NJL SCALE
CHECKED BY NJL NO SCALE
DRAWN BY JTE NO SCALE

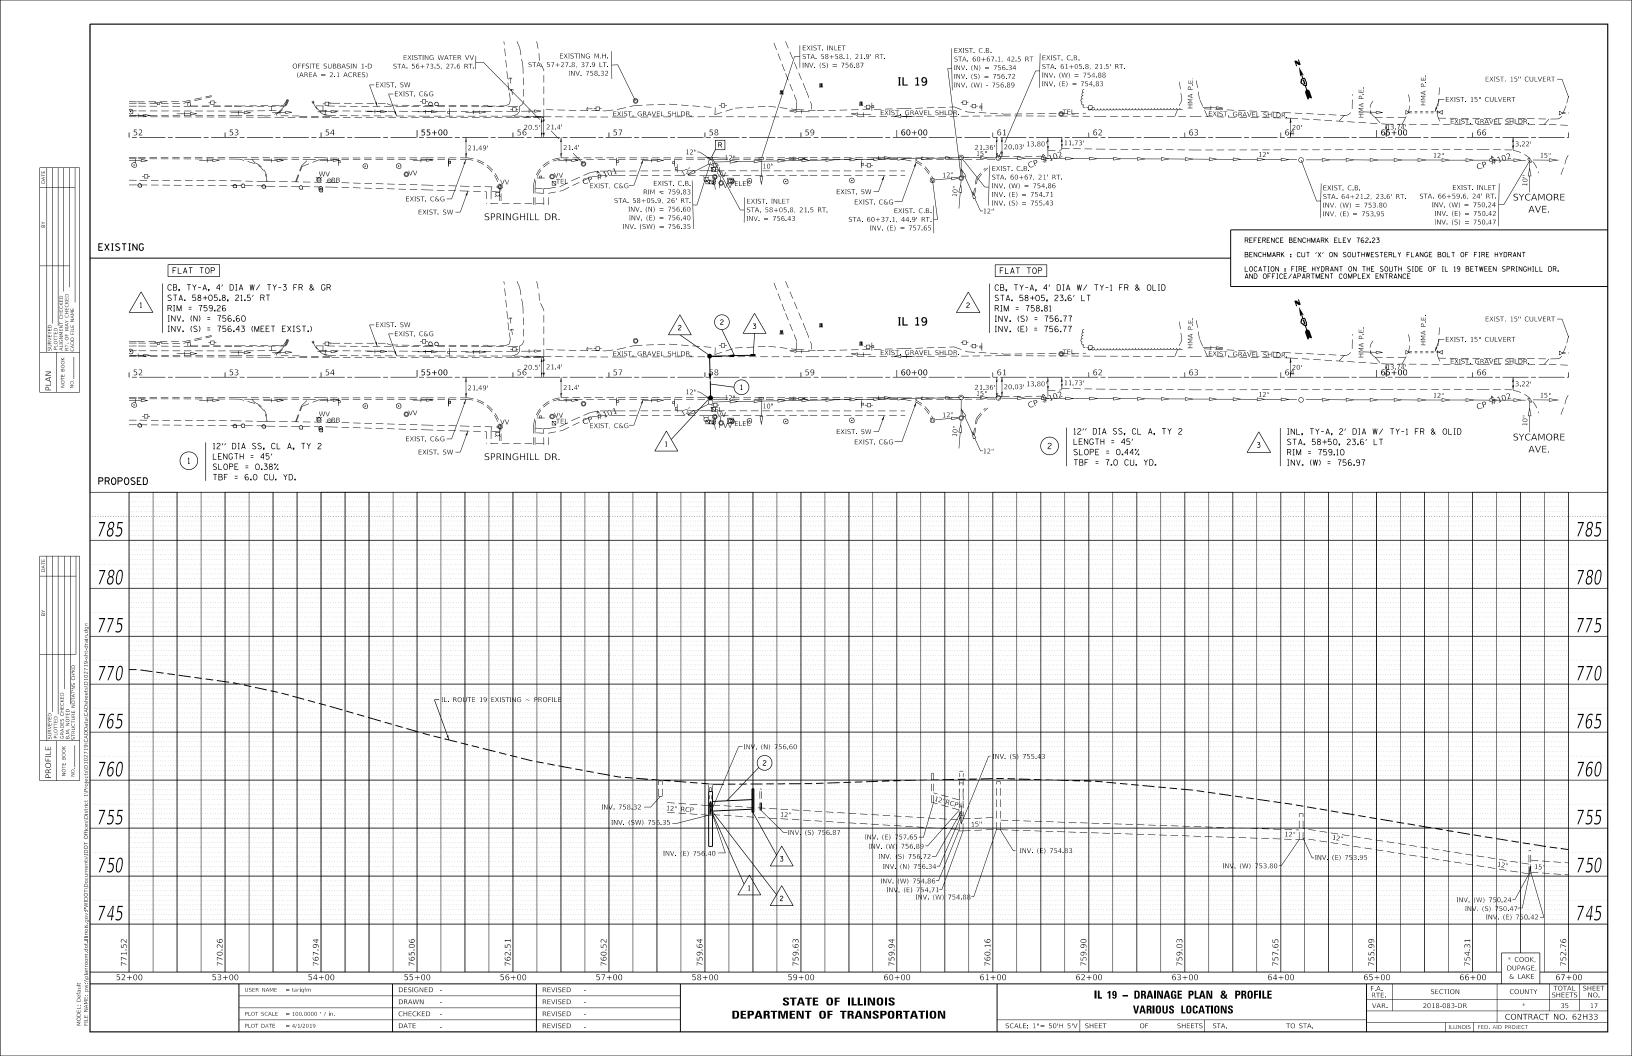


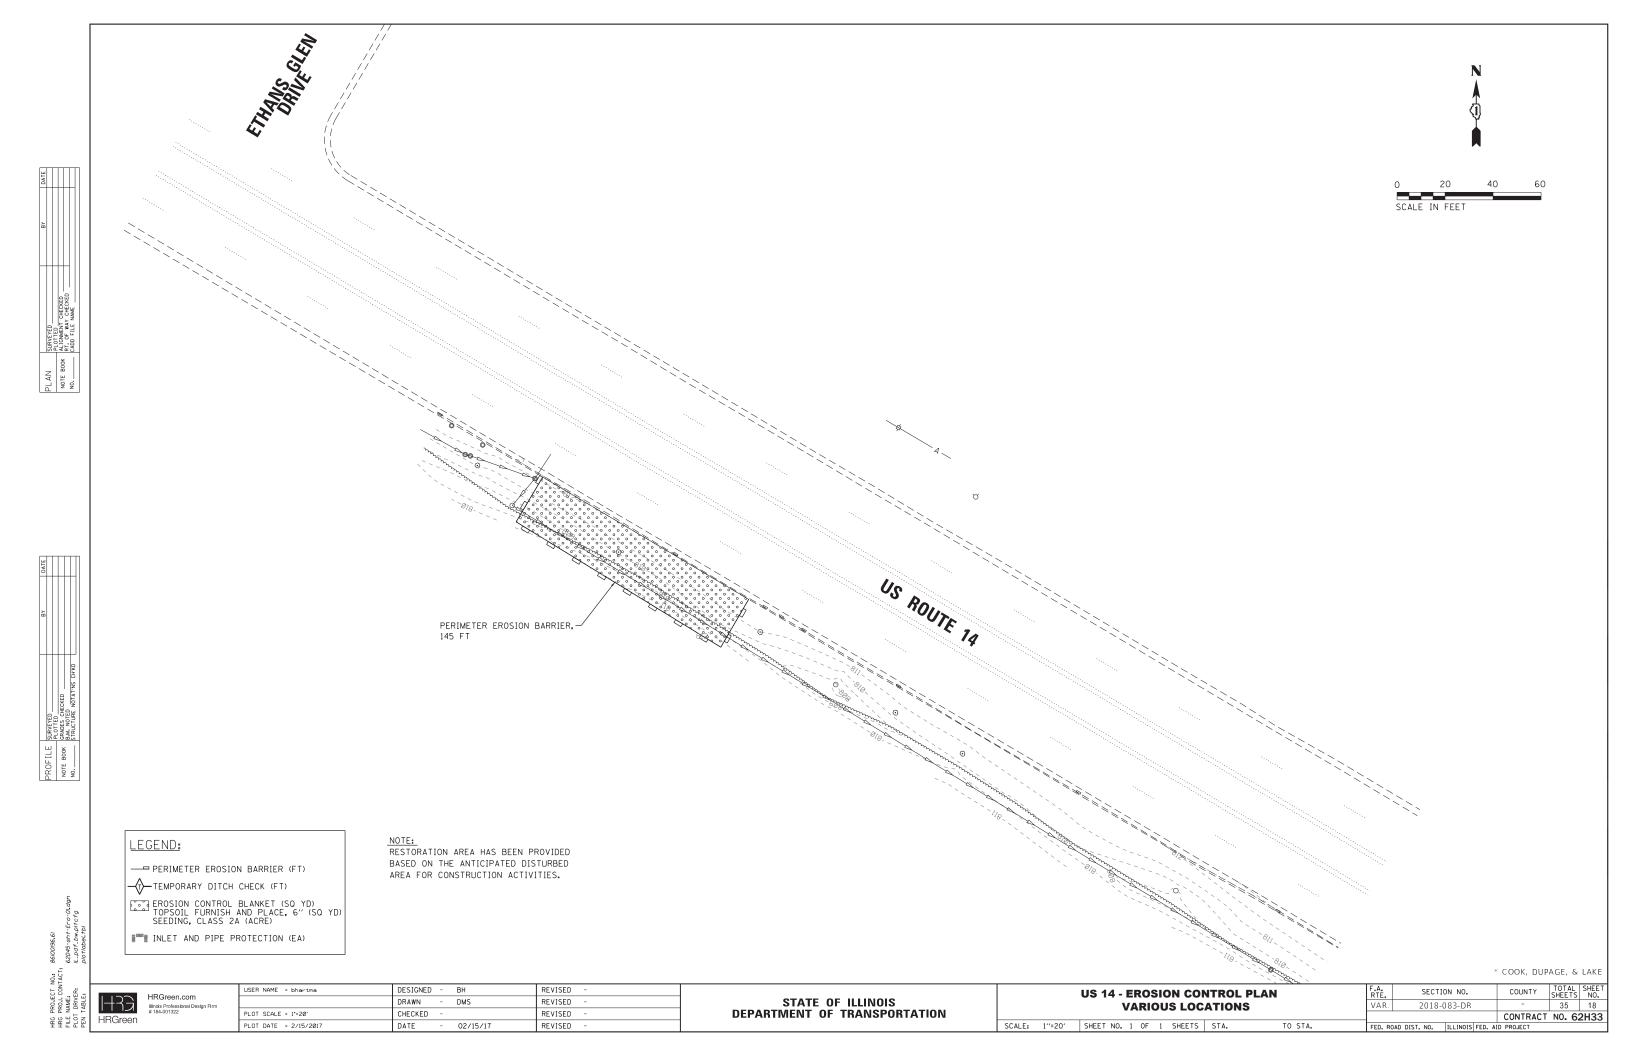

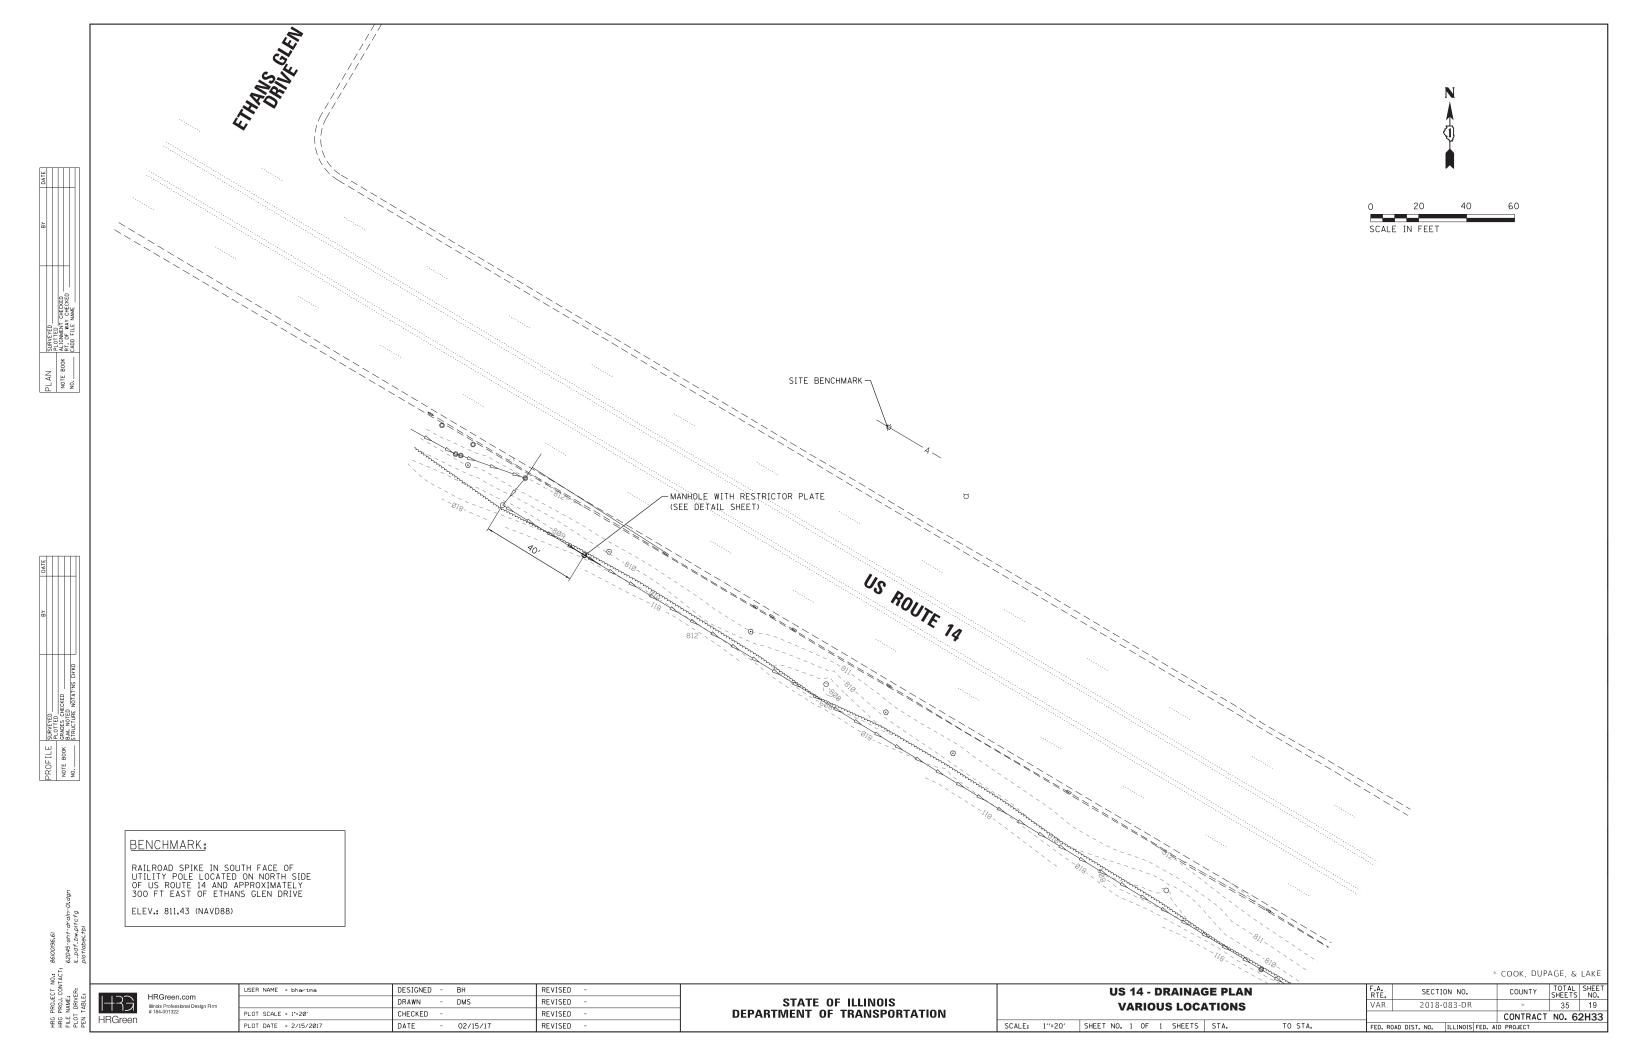

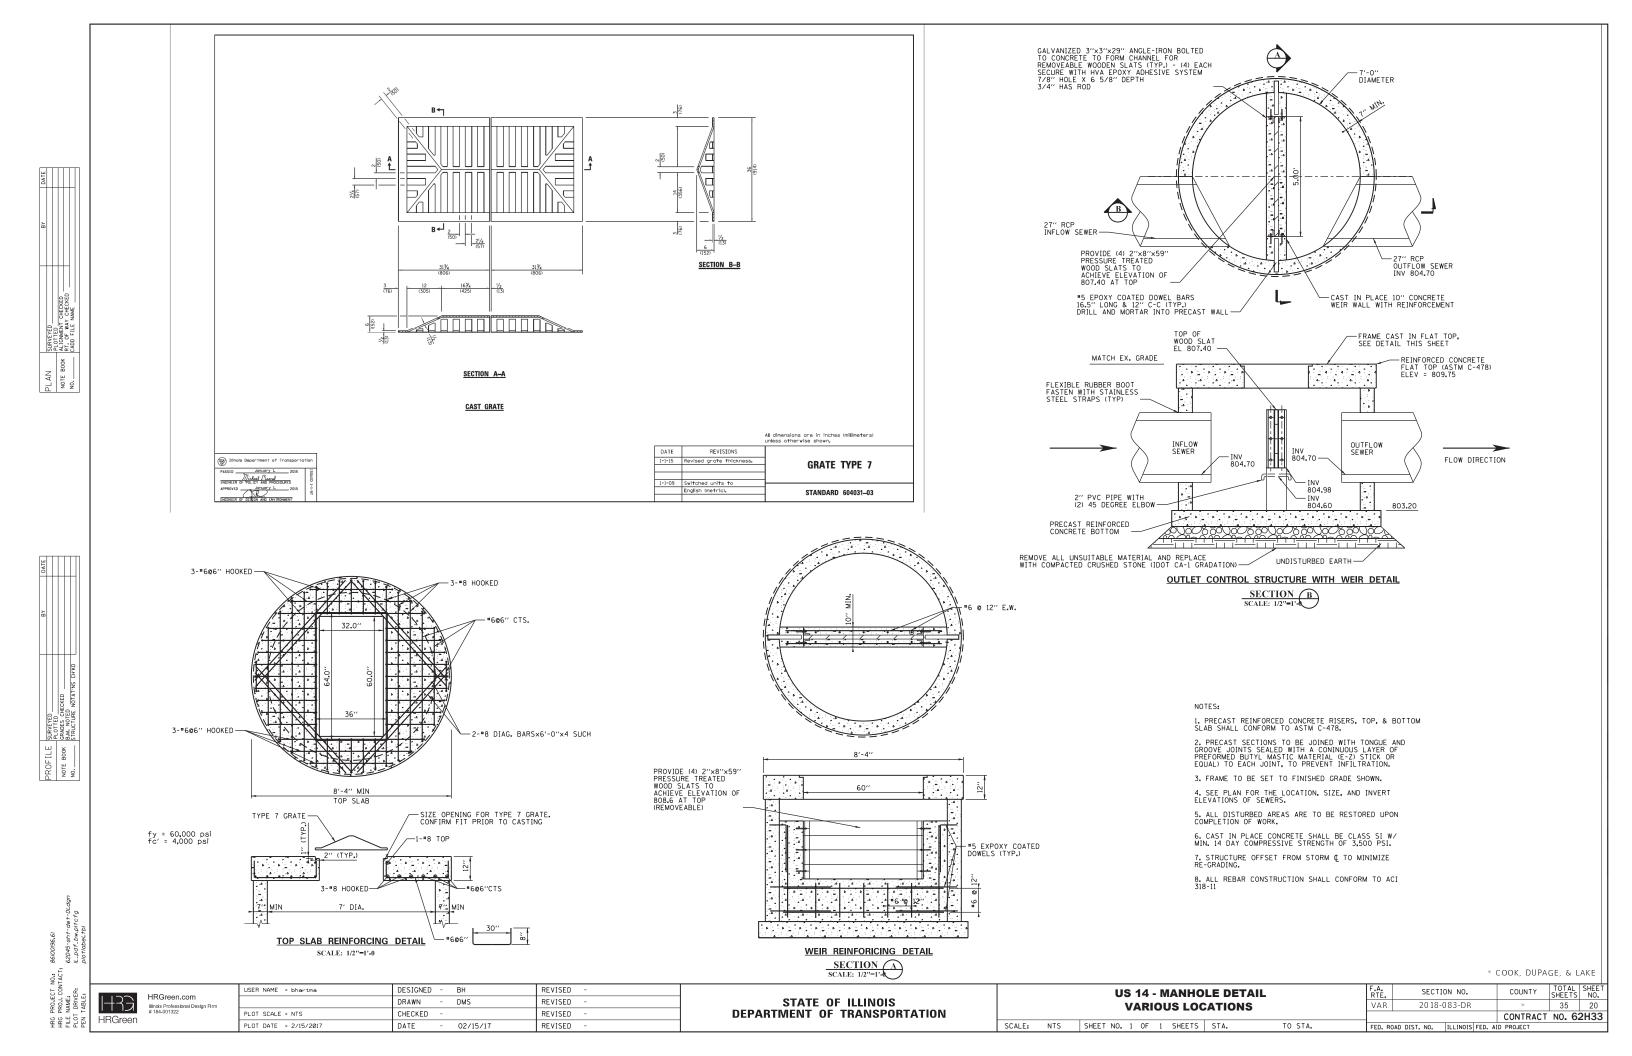

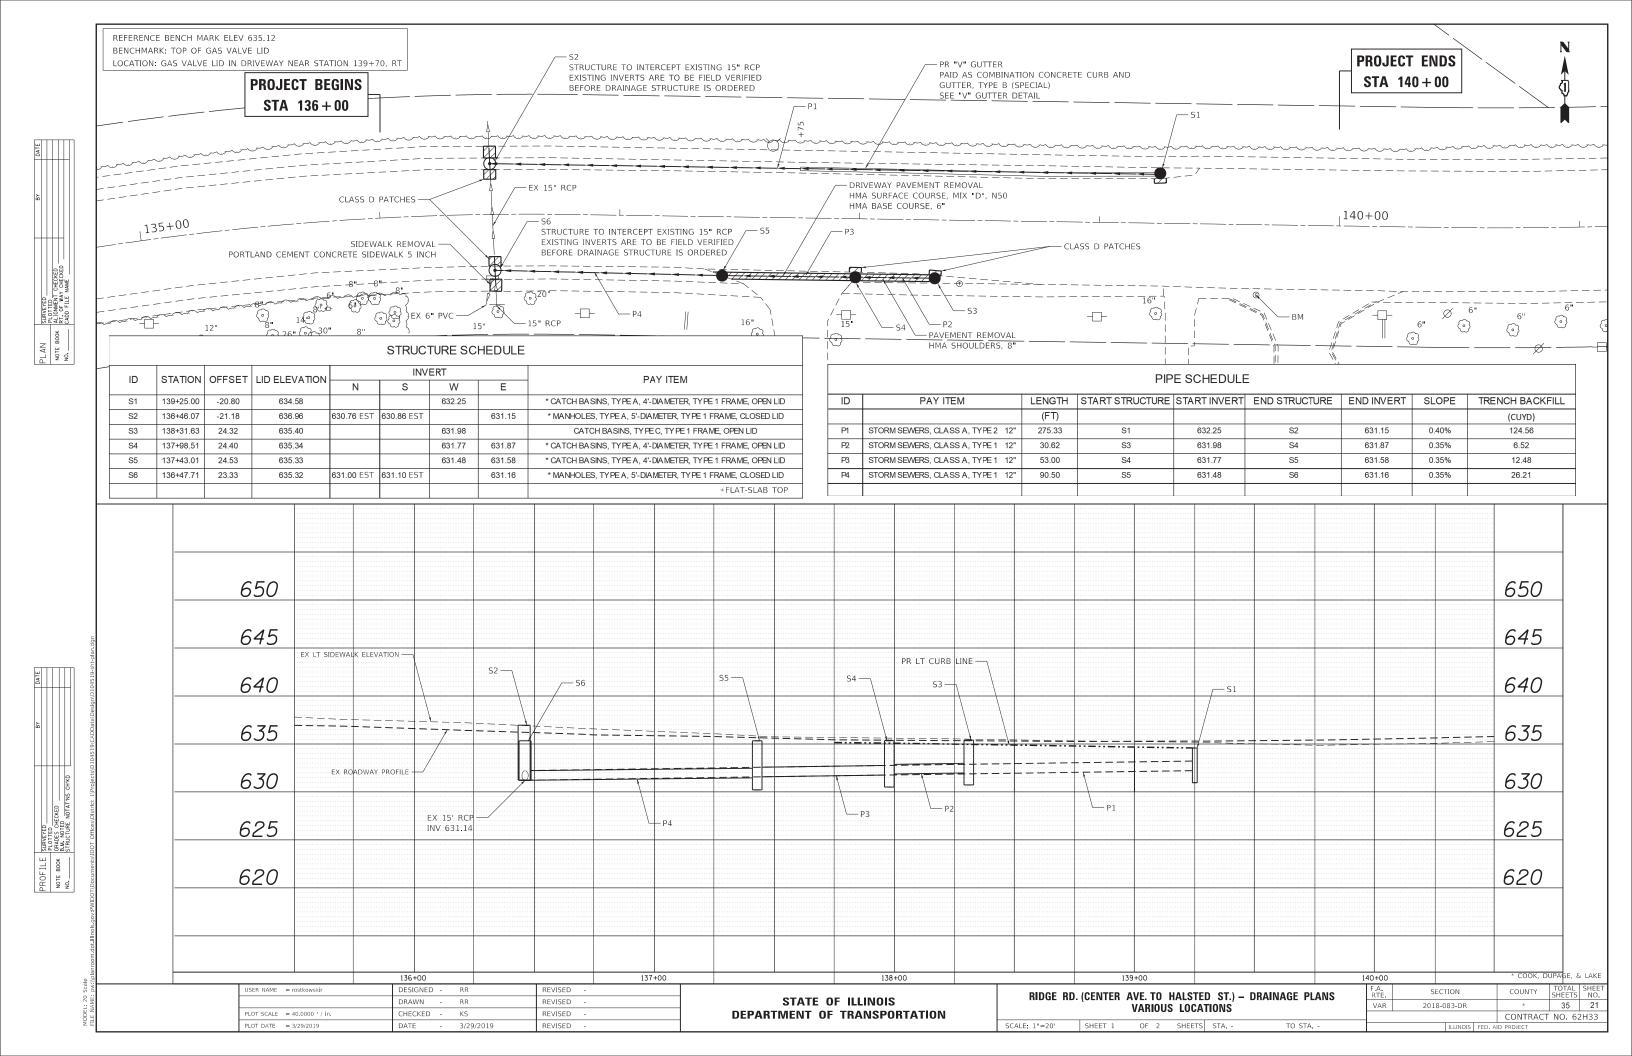

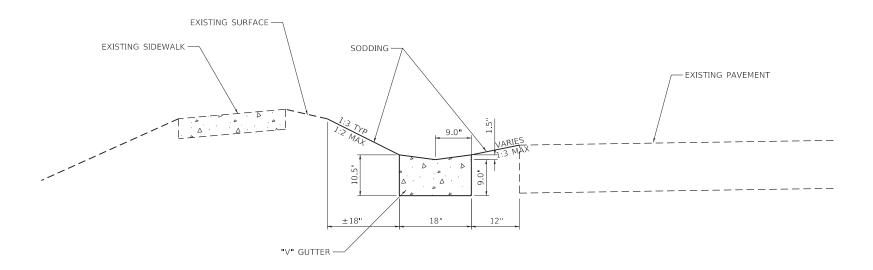

#### **"V" GUTTER DETAIL**


(PAID AS COMBINATION CONCRETE CURB AND GUTTER, TYPE B (SPECIAL))


JSER NAME = rostkowskir DESIGNED - RR REVISED -DRAWN - RR REVISED REVISED PLOT SCALE = 40.0000 ' / in. CHECKED -PLOT DATE = 3/29/2019 DATE - 3/29/2019 REVISED

STATE OF ILLINOIS **DEPARTMENT OF TRANSPORTATION** 

SECTION RIDGE RD. (CENTER AVE. TO HALSTED ST.) – DRAINAGE PLANS VARIOUS LOCATIONS 2018-083-DR CONTRACT NO. 62H33 SCALE: NONE SHEET 2 OF 2 SHEETS STA. -TO STA. -

\* COOK, DUPAGE, & LAKE SHEETS NO.

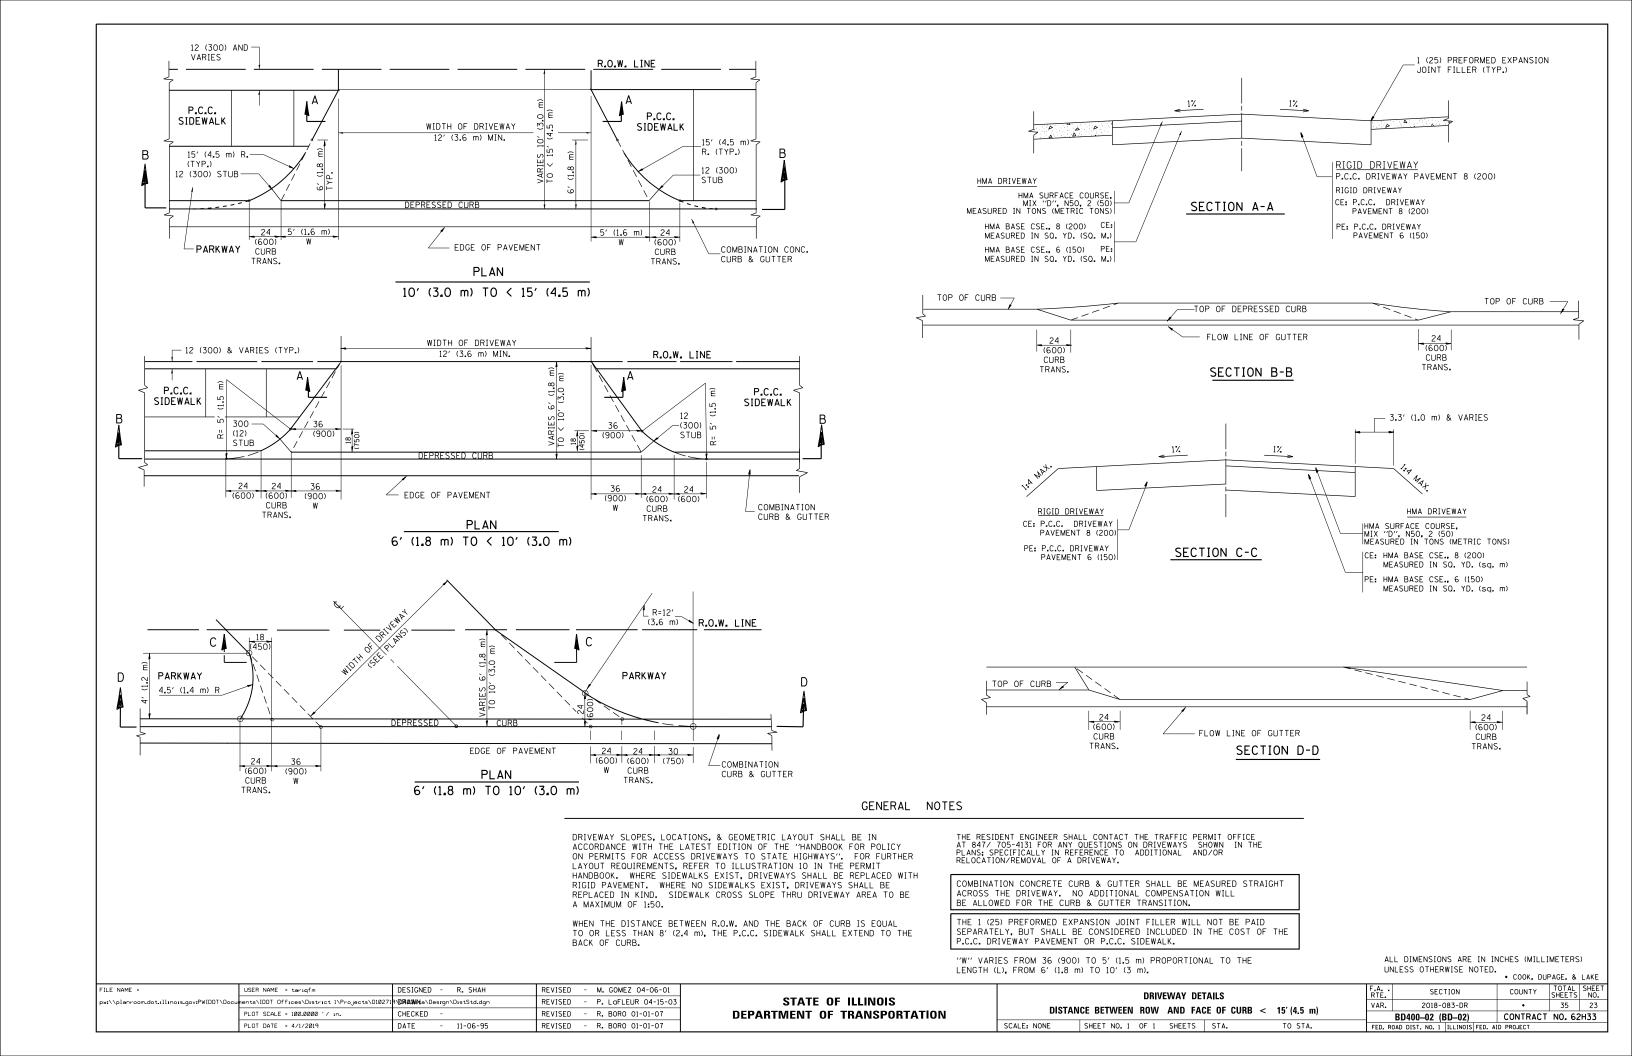

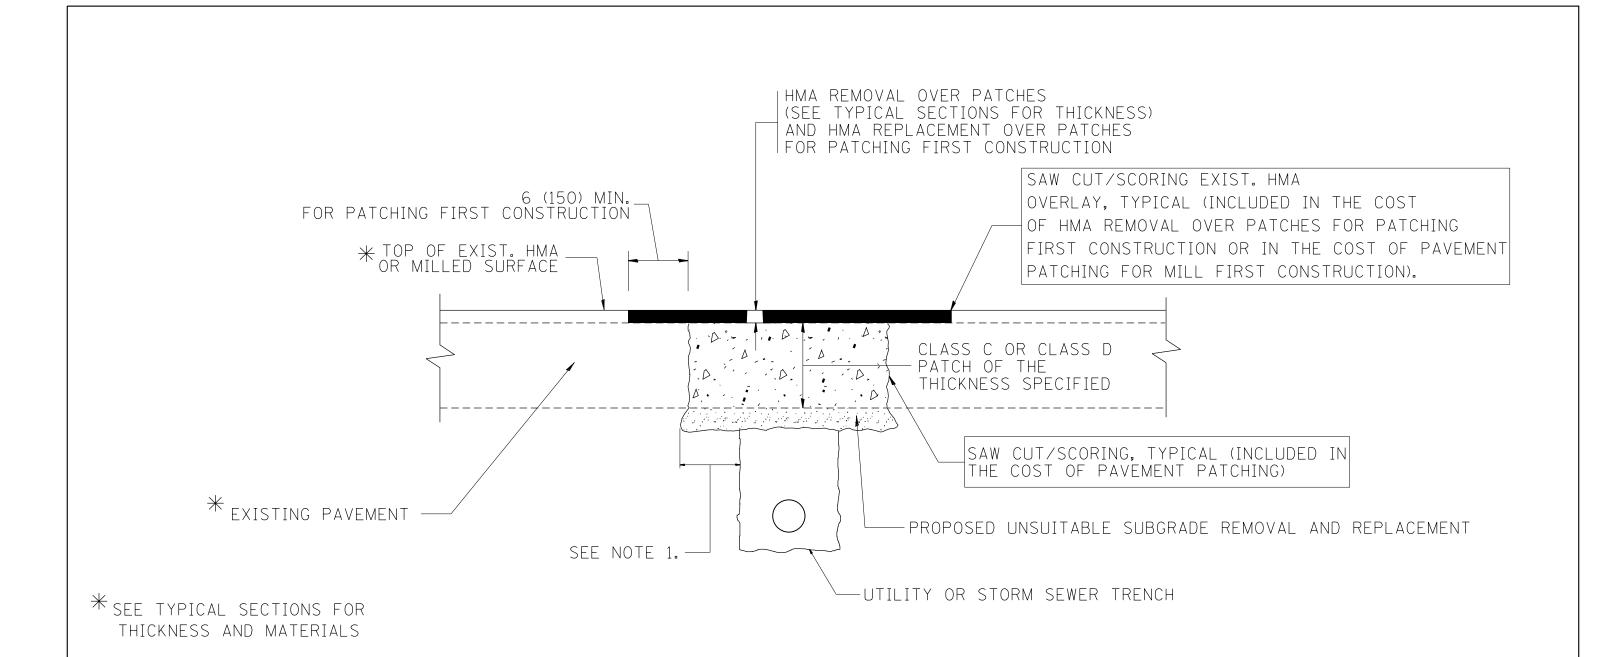

#### NOTES:

- 1. THE WIDTH OF THE FULL DEPTH PATCH OVER A TRENCH SHALL BE 12 (300) WIDER ON EACH SIDE OF THE TRENCH.
- 2. FOR METHOD OF MEASUREMENT AND BASIS OF PAYMENT, SEE RECURRING SPECIAL PROVISION "PATCHING WITH HOT-MIX ASPHALT OVERLAY REMOVAL".

#### SEQUENCE OF CONSTRUCTION (PATCHING FIRST)

- 1. REMOVE THE EXISTING HMA MATERIAL OVER THE AREA TO BE PATCHED.
- 2. REMOVE AND REPLACE WITH CLASS C OR D PATCH.
- 3. REPLACE HMA MATERIAL OVER THE AREA TO BE PATCHED.


#### SEQUENCE OF CONSTRUCTION (MILLING FIRST)

- 1. MILL HMA FIRST IF THERE IS AT LEAST 41/2 INCHES OR MORE OF HMA MATERIAL ON TOP OF THE EXISTING PAVEMENT OR IF THE PAVEMENT IS FULL DEPTH HMA. A MINIMUM OF 2 INCHES OF HMA MATERIAL SHALL BE IN PLACE AFTER MILLING.
- 2. REMOVE AND REPLACE WITH FULL DEPTH CLASS D PATCHES TO TOP OF MILLED SURFACE.

ALL DIMENSIONS ARE IN INCHES (MILLIMETERS) UNLESS

• COOK, DUPAGE, & LAKE

- 1	FILE NAME =	USER NAME = tariqfm	DESIGNED - R. SHAH	REVISED -	A. ABBAS 04-27-98			PAVEMENT PATCHII	NG FOR		RTF.	SECTION	COUNTY	SHEETS	SHEET
	pw:\\planroom.dot.illinois.gov:PWIDOT\Docu	ents\IDOT Offices\District 1\Projects\D10271	R <b>OMANN</b> a\Design\DistStd.dgn	REVISED -	R. BORO 01-01-07	STATE OF ILLINOIS					VAR.	2018-083-DR	<del>-</del>	35	24
		PLOT SCALE = 100.0000 '/ in.	CHECKED -	REVISED -	R. BORO 09-04-07	DEPARTMENT OF TRANSPORTATION	HMA SURFACED PAVEMENT			.,	BD400-04 (BD-22)	CONTRACT	T NO. 62	H33	
L		PLOT DATE = 4/1/2019	DATE - 10-25-94	REVISED -	K. ENG 10-27-08		SCALE: NONE	SHEET NO. 1 OF 1 SHEETS	STA.	TO STA.		AD DIST. NO. 1   ILLINOIS FED.			-55

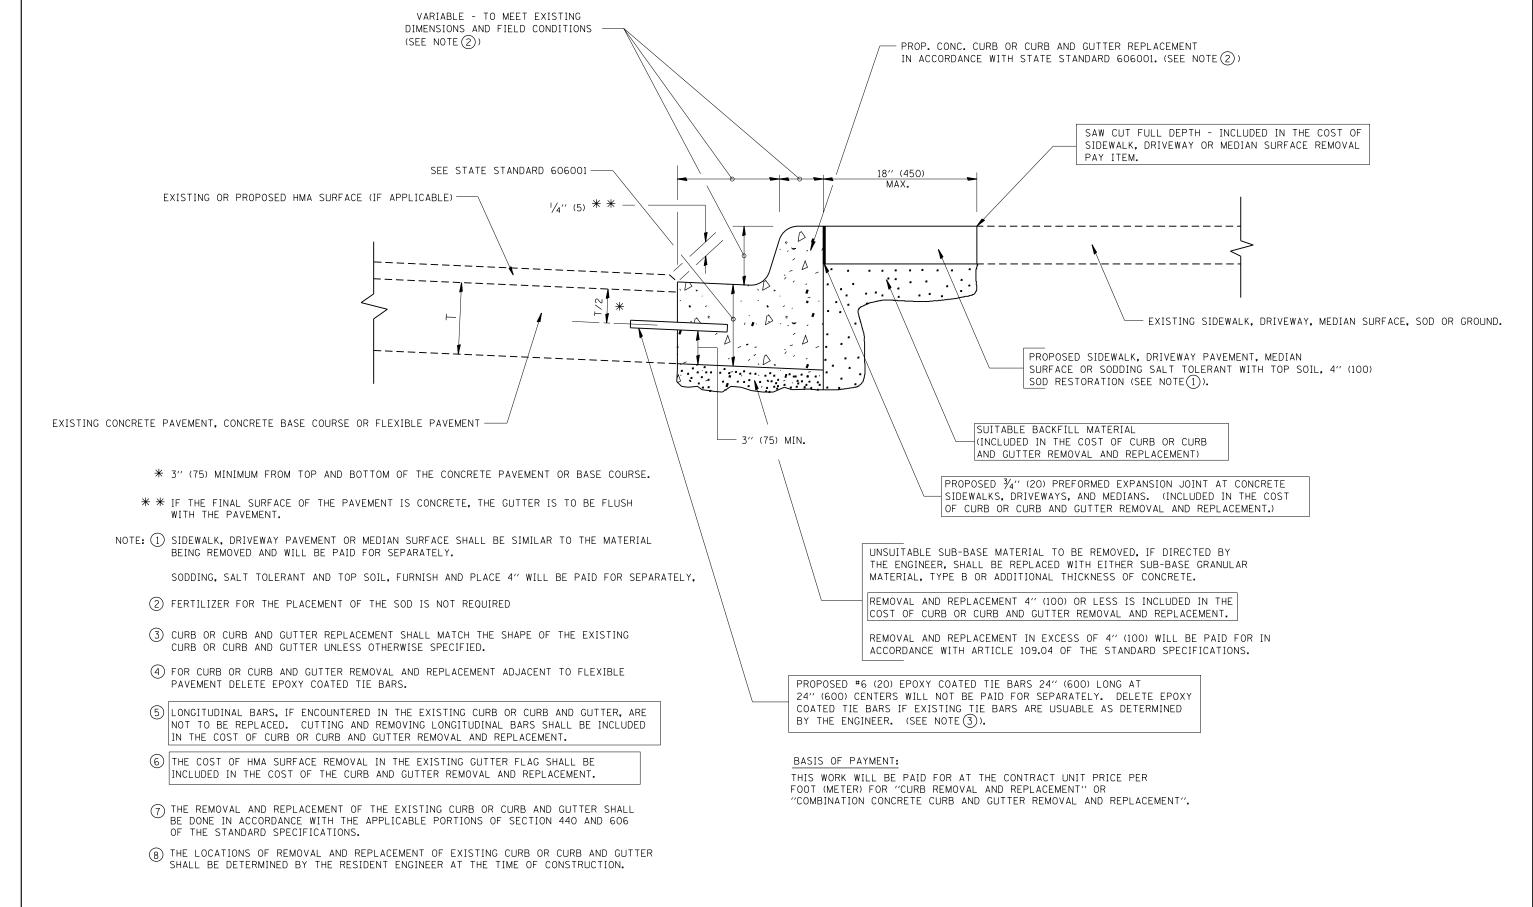



## CURB OR CURB AND GUTTER REMOVAL AND REPLACEMENT

ALL DIMENSIONS ARE IN INCHES (MILLIMETERS)
UNLESS OTHERWISE SHOWN.

• COOK, DUPAGE, & LAKE

FILE NAME =	USER NAME = tariqfm	DESIGNED - A. HOUSEH	REVISED - R. SHAH 10-03-96			CURB OR CURB AND GUTTER	F.A.	SECTION	COUNTY	SHEET	S SHEET
pw:\\planroom.dot.ıllınoıs.gov:PWIDOT\Docu	ments\IDOT Offices\District 1\Projects\D10271	7 ORANNA Design\DistStd.dgn	REVISED - A. ABBAS 03-21-97	STATE OF ILLINOIS			VAR.	2018-083-DR	•	35	25
	PLOT SCALE = 100.0000 '/ in.	CHECKED -	REVISED - M. GOMEZ 01-22-01	DEPARTMENT OF TRANSPORTATION	REMOVAL AND REPLACEMENT			BD600-06 (BD-24)	CONTRAC	T NO. 6	2H33ء
	PLOT DATE = 4/1/2019	DATE - 03-11-94	REVISED - R. BORO 12-15-09		SCALE: NONE	SHEET NO. 1 OF 1 SHEETS STA. TO STA.	FED. F	ROAD DIST. NO. 1   ILLINOIS FE	D. AID PROJECT		

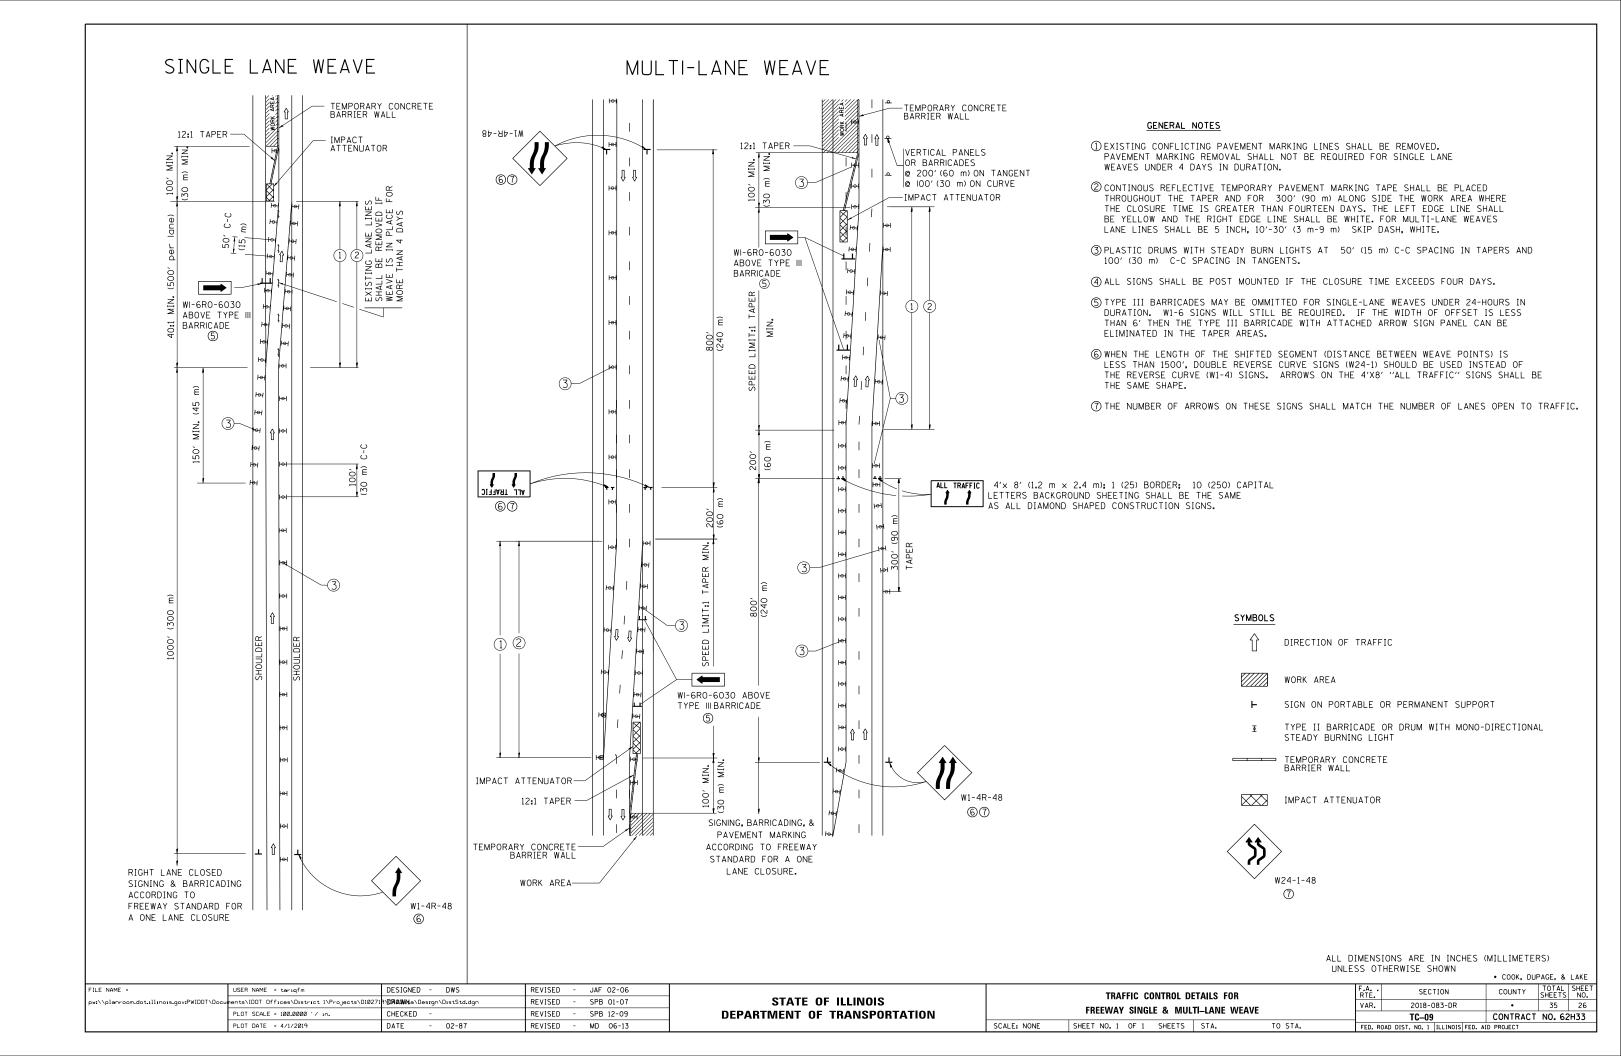

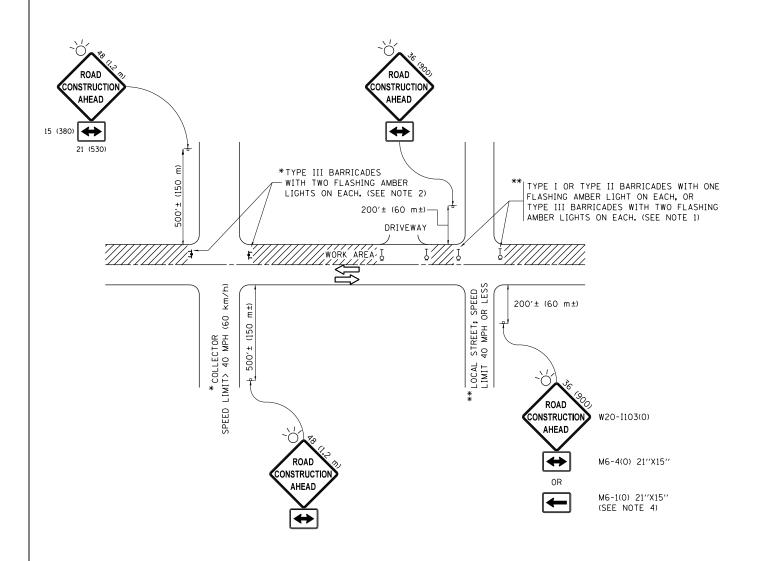

#### **NOTES:**


- 1. SIDE ROAD WITH A SPEED LIMIT OF 40 MPH (60 km/h) OR LESS AS SHOWN ON THE DRAWING AND AS DIRECTED BY THE ENGINEER:
  - a) ONE "ROAD CONSTRUCTION AHEAD" SIGN 36 x 36 (900x900) WITH A FLASHER MOUNTED ON IT APPROXIMATELY 200' (60 m) IN ADVANCE OF THE MAIN ROUTE.
  - b) THE CLOSED PORTION OF THE MAIN ROUTE SHALL BE PROTECTED BY BLOCKING WITH TYPE I, TYPE II OR TYPE III BARRICADES, 1/3 OF THE CROSS SECTION OF THE CLOSED PORTION.
- 2. SIDE ROAD WITH A SPEED LIMIT GREATER THAN 40 MPH (60 km/h) AS SHOWN ON THE DRAWING AND AS DIRECTED BY THE ENGINEER:
  - a) ONE "ROAD CONSTRUCTION AHEAD" SIGN 48  $\times$  48 (1.2 m  $\times$  1.2 m) WITH A FLASHER MOUNTED ON IT APPROXIMATELY 500" (150 m) IN ADVANCE OF THE MAIN ROUTE.
  - b) THE CLOSED PORTION OF THE MAIN ROUTE SHALL BE PROTECTED BY BLOCKING WITH TYPE III BARRICADES, 1/2 OF THE CROSS SECTION OF THE CLOSED PORTION.
- 3. CONES MAY BE SUBSTITUTED FOR BARRICADES OR DRUMS AT HALF THE SPACING DURING DAY OPERATIONS. CONES SHALL BE A MINIMUM OF 28 (710) IN HEIGHT
- 4. WHEN THE SIDE ROAD LIES BETWEEN THE BEGINNING OF THE MAINLINE SIGNING AND THE WORK ZONE, A SINGLE HEADED ARROW (M6-1) SHALL BE USED IN LIEU OF THE DOUBLE HEADED ARROW (M6-4).

SCALE: NONE

- 5. WHEN WORK IS BEING PERFORMED ON A SIDE ROAD OR DRIVEWAY, FOLLOW THE APPLICABLE STANDARD(S). THE DIRECTIONAL ARROW (M6-1 OR M6-4) SHALL BE COVERED OR REMOVED WHEN NO LONGER CONSISTENT WITH THE TRAFFIC CONTROL SET-UP.
- 6. ADVANCE WARNING SIGNS ARE TO BE OMITTED ON DRIVEWAYS UNLESS OTHERWISE SPECIFIED IN THE PLANS OR BY THE ENGINEER
- 7. THE TRAFFIC CONTROL AND PROTECTION FOR SIDE ROADS, INTERSECTIONS, AND DRIVEWAYS SHALL BE INCLUDED IN THE COST OF SPECIFIED TRAFFIC CONTROL STANDARDS OR ITEMS.


All dimensions are in inches (millimeters)
unless otherwise shown.
• COOK, DUPAGE, & LAKE


STATE OF ILLINOIS
DEPARTMENT OF TRANSPORTATION

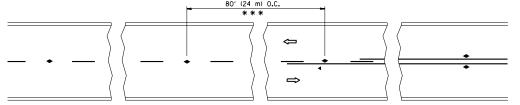


\*\*\* REDUCE TO 40' (12 m) O.C. ON CURVES WITH POSTED OR ADVISORY SPEED 45 M.P.H. (70 km/h) OR LESS.

TWO-LANE/TWO-WAY

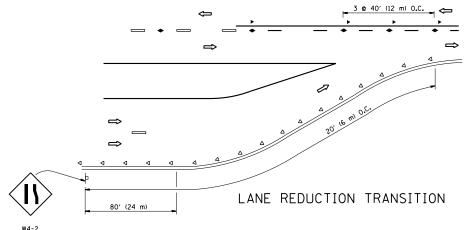


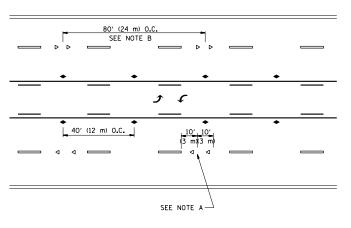

TWO-WAY LEFT TURN

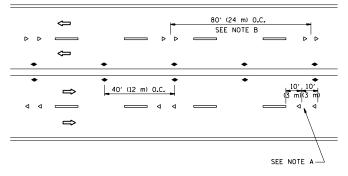

MULTI-LANE/UNDIVIDED

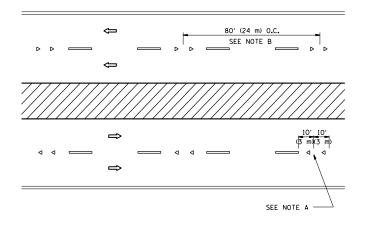

MULTI-LANE/DIVIDED

#### GENERAL NOTES

- MARKERS USED WITH DASHED LINES SHALL BE CENTERED IN THE GAP BETWEEN SEGMENTS.
- 2. MARKERS USED ADJACENT TO SOLID LINES SHALL BE OFFSET 2 TO 3 (50 TO 75) TOWARD TRAFFIC AS SHOWN.
- 3. MARKERS THROUGH TANGENTS LESS THAN 500' (150 m) IN LENGTH BETWEEN CURVES SHALL BE INSTALLED AT THE LESSER OF THE TWO CURVE SPACINGS.

#### LANE MARKER NOTES

A. USE DOUBLE LANE LINE MARKERS SPACED AS SHOWN.

B. REDUCE TO 40' (12 m) O.C. ON CURVES WHERE ADVISORY SPEEDS ARE 10 M.P.H (20 km/h) LOWER THAN POSTED SPEEDS.

#### SYMBOLS

---- YELLOW STRIPE

WHITE STRIPE

- ONE-WAY AMBER MARKER
- ONE-WAY CRYSTAL MARKER (W/O)
- ◆ TWO-WAY AMBER MARKER

#### DESIGN NOTES

- 1. DOUBLE LANE LINE MARKERS SHALL BE USED UNLESS SPECIFIED OTHERWISE.
- 2. EXCEPT AS SHOWN ON THE LANE REDUCTION TRANSITION AND FREEWAY EXIT RAMP DETAIL, MARKERS ARE NOT TO BE SPECIFIED ON RIGHT EDGE LINES.
- 3. THE EXACT MARKER LIMITS, SPACING, AND COLOR SHALL BE INCLUDED IN THE PLANS WHEN STANDARD SPECIFICATIONS ARE NOT BEING USED.
- 4. MARKERS SHOULD NOT BE USED ALONGSIDE CURBS EXCEPT FOR EXTREMELY SHORT SECTIONS OF CURBS WHERE NOT MORE THAN TWO MARKERS WOULD BE

3 e 80' (24 m) 0.C 3 e 40' (12 m) '0		MINIMUM OF 3 W EQUALLY SPACED	E * 3 e 40′ (12 m) - 3 e 80′ (24 m) 0.C.
* 0.c.	40' (12 m) 0.C.	40' (12 m) 0.c.	0.C. *
	0.C. 4  40. (15 w)	40' (12 m) 0.C.	<b>⇒</b>
		* SEE TWO-LANE/TWO-WAY WHERE MARK!  * * WHERE THE MEDIAN WIDTH IS 6' (2 m. USE TWO-WAY MARKERS.	

LEFT TURN

All dimensions are in inches (millimeters) unless otherwise shown.

• COOK, DUPAGE, & LAKE

STATE OF ILLINOIS
DEPARTMENT OF TRANSPORTATION

TYPICAL APPLICATIONS

RAISED REFLECTIVE PAVEMENT MARKERS (SNOW-PLOW RESISTANT)


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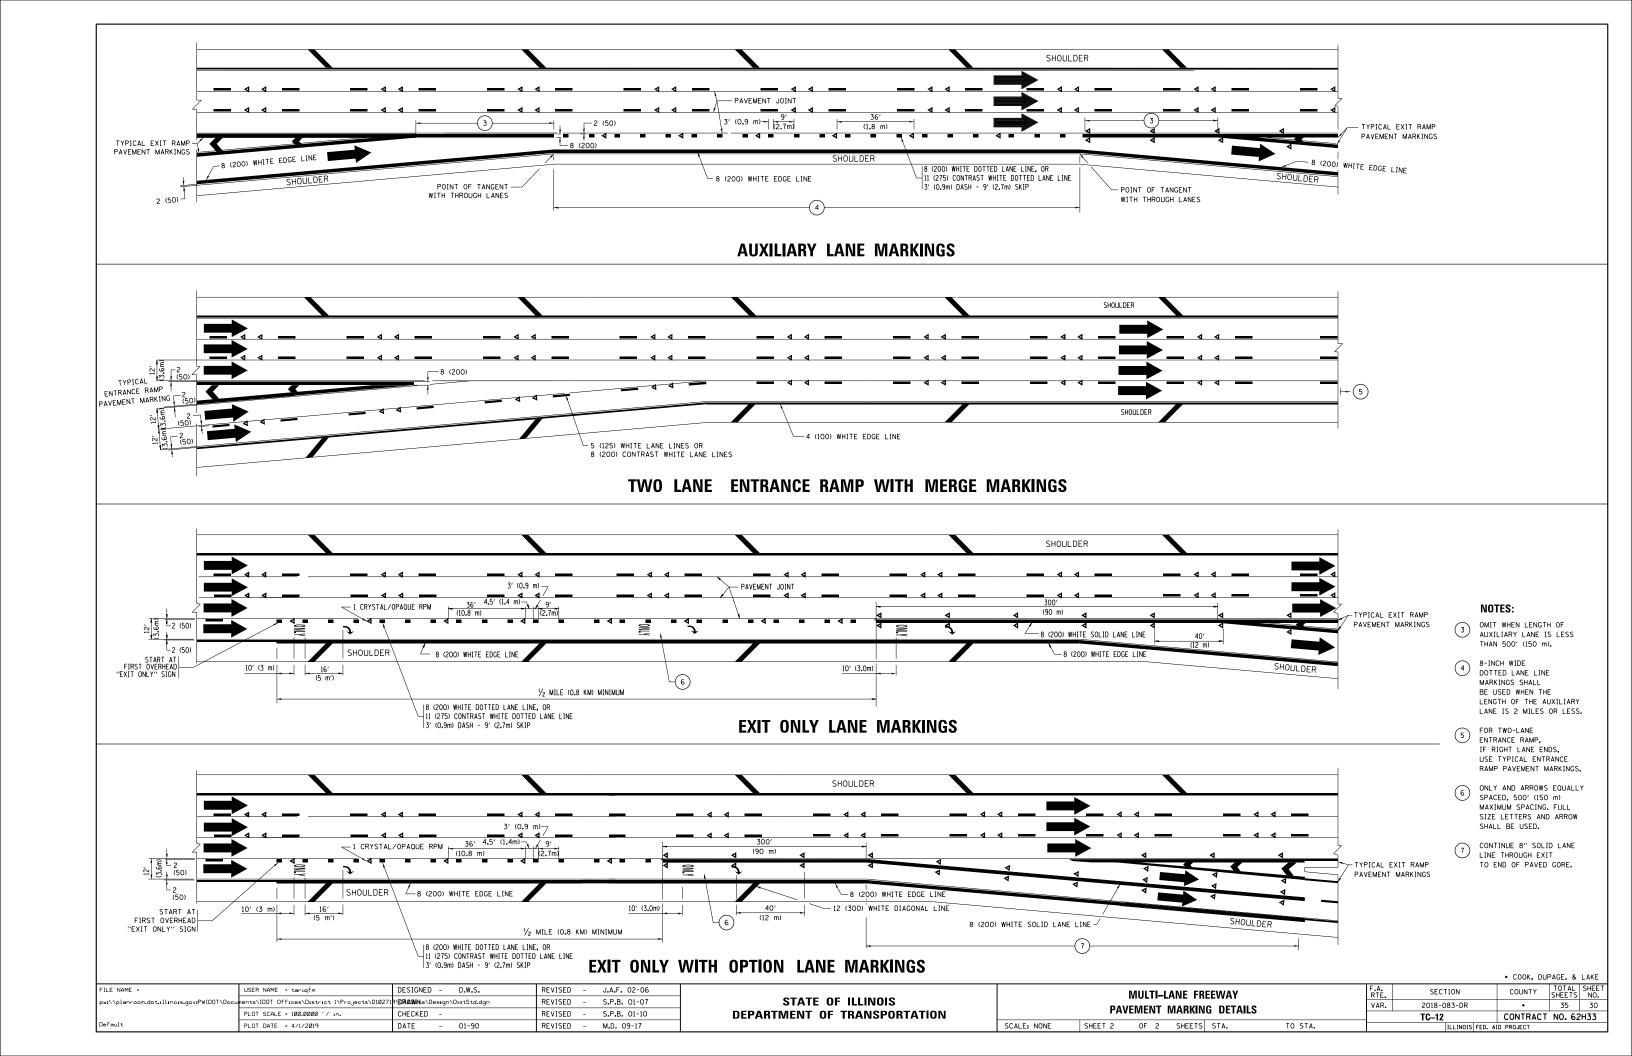
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 COUNTY SHEET SNC.
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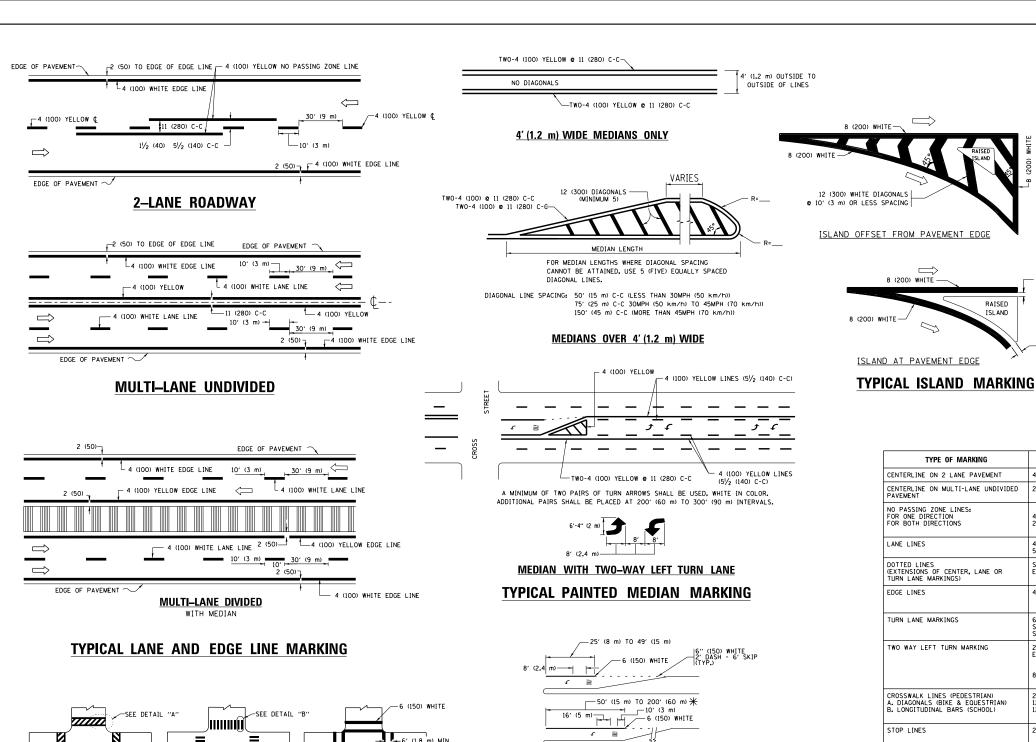
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 TC-11
 CONTRACT NO. 62H33

 FED. ROAD DIST. NO. 1 | ILLINOIS FED. AID PROJECT





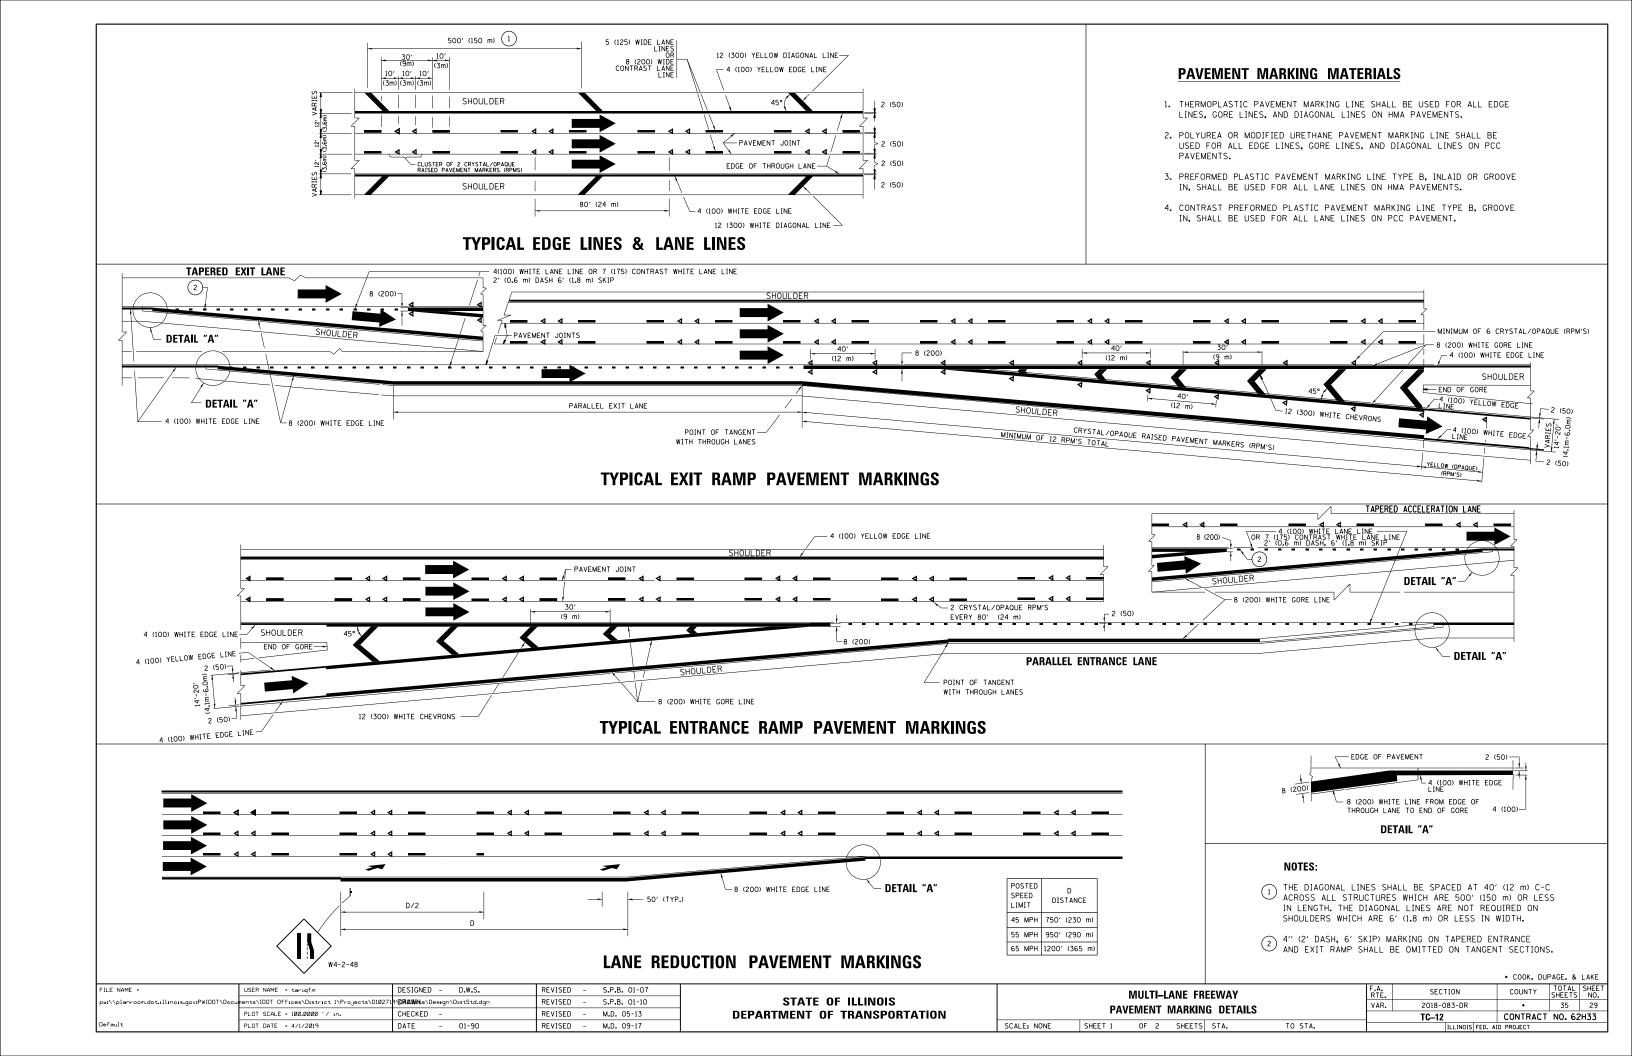

# OVER 200' (60 m) \_\_\_\_ 6 (150) WHITE

FULL SIZE LETTERS 8' (2.4 m) AND ARROWS SHALL BE USED. AREA = 15.6 SO. FT. (1.5 m2 ) ONLY AREA = 20.8 SO. FT. (1.9 m2)

\* TURN LANES IN EXCESS OF 400' (120 m) IN LENGTH MAY HAVE AN ADDITIONAL SET OF ARROW - "ONLY" INSTALLED MIDWAY BETWEEN THE OTHER TWO SETS OF

TYPICAL LEFT (OR RIGHT) TURN LANE

TYPICAL TURN LANE MARKING

TYPICAL CROSSWALK MARKING \* MARKINGS SHALL BE INSTALLED PARALLEL TO THE CENTERLINE OF THE ROAD WHICH IT CROSSES FILE NAME = DESIGNED - EVERS USER NAME = tariqfm REVISED - C. JUCIUS 09-09-09 ents\IDOT Offices\District I\Projects\D10271P\**ORAGH\**a\Des<del>i</del>gn\DistStd.dgn REVISED -C. JUCIUS 07-01-13 CHECKED REVISED -C. JUCIUS 12-21-15 PLOT DATE = 4/1/2019 DATE REVISED -C. JUCIUS 04-12-16

2' (600)

DETAIL "B"

12 (300) WHITE

PEDESTRIAN

-6 (150) WHITE

DETAIL "A"

BICYCLE & EQUESTRIAN

STATE OF ILLINOIS **DEPARTMENT OF TRANSPORTATION** 

500 580 45 665 50 750 55 **−20**′ 40 (1020) COMBINATION LEFT AND U-TURN 5'-4" (1620) √ 32 R (810) LANE REDUCTION TRANSITION \* LANE REDUCTION ARROWS REQUIRED AT SPEEDS OF 45 MPH OR GREATER OR WHEN SPECIFIED IN PLANS. **U\_TURN** 

D(FT)

345

425

SPEED LIMIT

TYPE OF MARKING	WIDTH OF LINE	PATTERN	COLOR	SPACING /REMARKS
CENTERLINE ON 2 LANE PAVEMENT	4 (100)	SKIP-DASH	YELLOW	10' (3 m) LINE WITH 30' (9 m) SPACE
CENTERLINE ON MULTI-LANE UNDIVIDED PAVEMENT	2 @ 4 (100)	SOLID	YELLOW	11 (280) C-C
NO PASSING ZONE LINES: FOR ONE DIRECTION FOR BOTH DIRECTIONS	4 (100) 2 @ 4 (100)	SOLID SOLID	YELLOW YELLOW	5½ (140) C-C FROM SKIP-DASH CENTERLINE 11 (280) C-C OMIT SKIP-DASH CENTERLINE BETWEEN
LANE LINES	4 (100) 5 (125) ON FREEWAYS	SKIP-DASH SKIP-DASH	WHITE WHITE	10' (3 m) LINE WITH 30' (9 m) SPACE
DOTTED LINES (EXTENSIONS OF CENTER, LANE OR TURN LANE MARKINGS)	SAME AS LINE BEING EXTENDED	SKIP-DASH	SAME AS LINE BEING EXTENDED	2' (600) LINE WITH 6' (1.8 m) SPACE
EDGE LINES	4 (100)	SOLID	YELLOW-LEFT WHITE-RIGHT	OUTLINE MEDIANS IN YELLOW
TURN LANE MARKINGS	6 (150) LINE: FULL SIZE LETTERS & SYMBOLS (8' (2.4m))	SOLID	WHITE	SEE TYPICAL TURN LANE MARKING DETAIL
TWO WAY LEFT TURN MARKING	2 @ 4 (100) EACH DIRECTION 8' (2.4m) LEFT ARROW	SKIP-DASH AND SOLID IN PAIRS	YELLOW WHITE	10' (3 m) LINE WITH 30' (9 m) SPACE FOR SKIP-DASH; 5½ (140) C-C BETWEEN SOLID LINE AND SKIP-DASH LINE SEE TYPICAL TWO-WAY LEFT TURN MARKING DETAIL
CROSSWALK LINES (PEDESTRIAN) A. DIAGONALS (BIKE & EOUESTRIAN) B. LONGITUDINAL BARS (SCHOOL)	2 @ 6 (150) 12 (300) @ 45° 12 (300) @ 90°	SOLID SOLID SOLID	WHITE WHITE WHITE	NOT LESS THAN 6' (1.8 m) APART 2' (600) APART 2' (600) APART 5EE TYPICAL CROSSWALK MARKING DETAILS.
STOP LINES	24 (600)	SOLID	WHITE	PLACE 4' (1,2 m) IN ADVANCE OF AND PARALLEL TO CROSSMALK, IF PRESENT. OTHERWISE, PLACE AT DESIRED STOPPING POINT. PARALLEL TO CROSSROAD CENTERLINE, WHERE POSSIBLE
PAINTED MEDIANS	2 @ 4 (100) WITH 12 (300) DIAGONALS @ 45° NO DIAGONALS USED FOR 4' (1.2 m) WIDE MEDIANS	SOLID	YELLOW: TWO WAY TRAFFIC WHITE: ONE WAY TRAFFIC	11 (280) C-C FOR THE DOUBLE LINE SEE TYPICAL PAINTED MEDIAN MARKING.
GORE MARKING AND CHANNELIZING LINES	8 (200) WITH 12 (300) DIAGONALS @ 45°	SOLID	WHITE	DIACONALS: 15' (4,5 m) C-C (LESS THAN 30MPH (50 km/h)) 20' (6 m) C-C 30MPH (50 km/h) TO 45MPH (70 km/h)) 30' (9 m) C-C (OVER 45MPH (70 km/h))
RAILROAD CROSSING	24 (600) TRANSVERSE LINES; "RR" IS 6' (1.8 m) LETTERS; 16 (400) LINE FOR "X"	SOLID	WHITE	SEE STATE STANDARD 780001 AREA OF: "R"=3.6 SO. FT. (0.33 m²) EACH "X"=54.0 SO. FT. (5.0 m²)
SHOULDER DIAGONALS (REQUIRED FOR SHOULDERS > 8')	12 (300) <b>©</b> 45°	SOLID	WHITE - RIGHT YELLOW - LEFT	50' (15 m) C-C (LESS THAN 30MPH (50 km/h)) 75' (25 m) C-C (30 MPH (50 km/h) TO 45MPH (70 km/h 150' (45 m) C-C (0VER 45MPH (70 km/h))
U TURN ARROW	SEE DETAIL	SOLID	WHITE	16.3 SF
2 ARROW COMBINATION LEFT AND U TURN	SEE DETAIL	SOLID	WHITE	30.4 SF

6'-4" (1930)

— 2 (50)

2 (50)

RAISED


ISLAND

8 (200) WHITE -

FOR FURTHER DETAILS ON PAVEMENT MARKING REFER TO STANDARD SPECIFICATIONS FOR ROAD AND BRIDGE CONSTRUCTION AND STATE STANDARD 780001.


• COOK, DUPAGE, & LAKE

DISTRICT ONE							SECTION	COUNTY	TOTAL SHEETS	SHEET NO.
	TYPICAL PAVEMENT MARKINGS							•	35	31
								CONTRACT NO. 62H33		
SCALE: NONE	SHEET 1	OF 1	SHEETS	STA.	TO STA.	ILLINOIS FED. AID PROJECT				

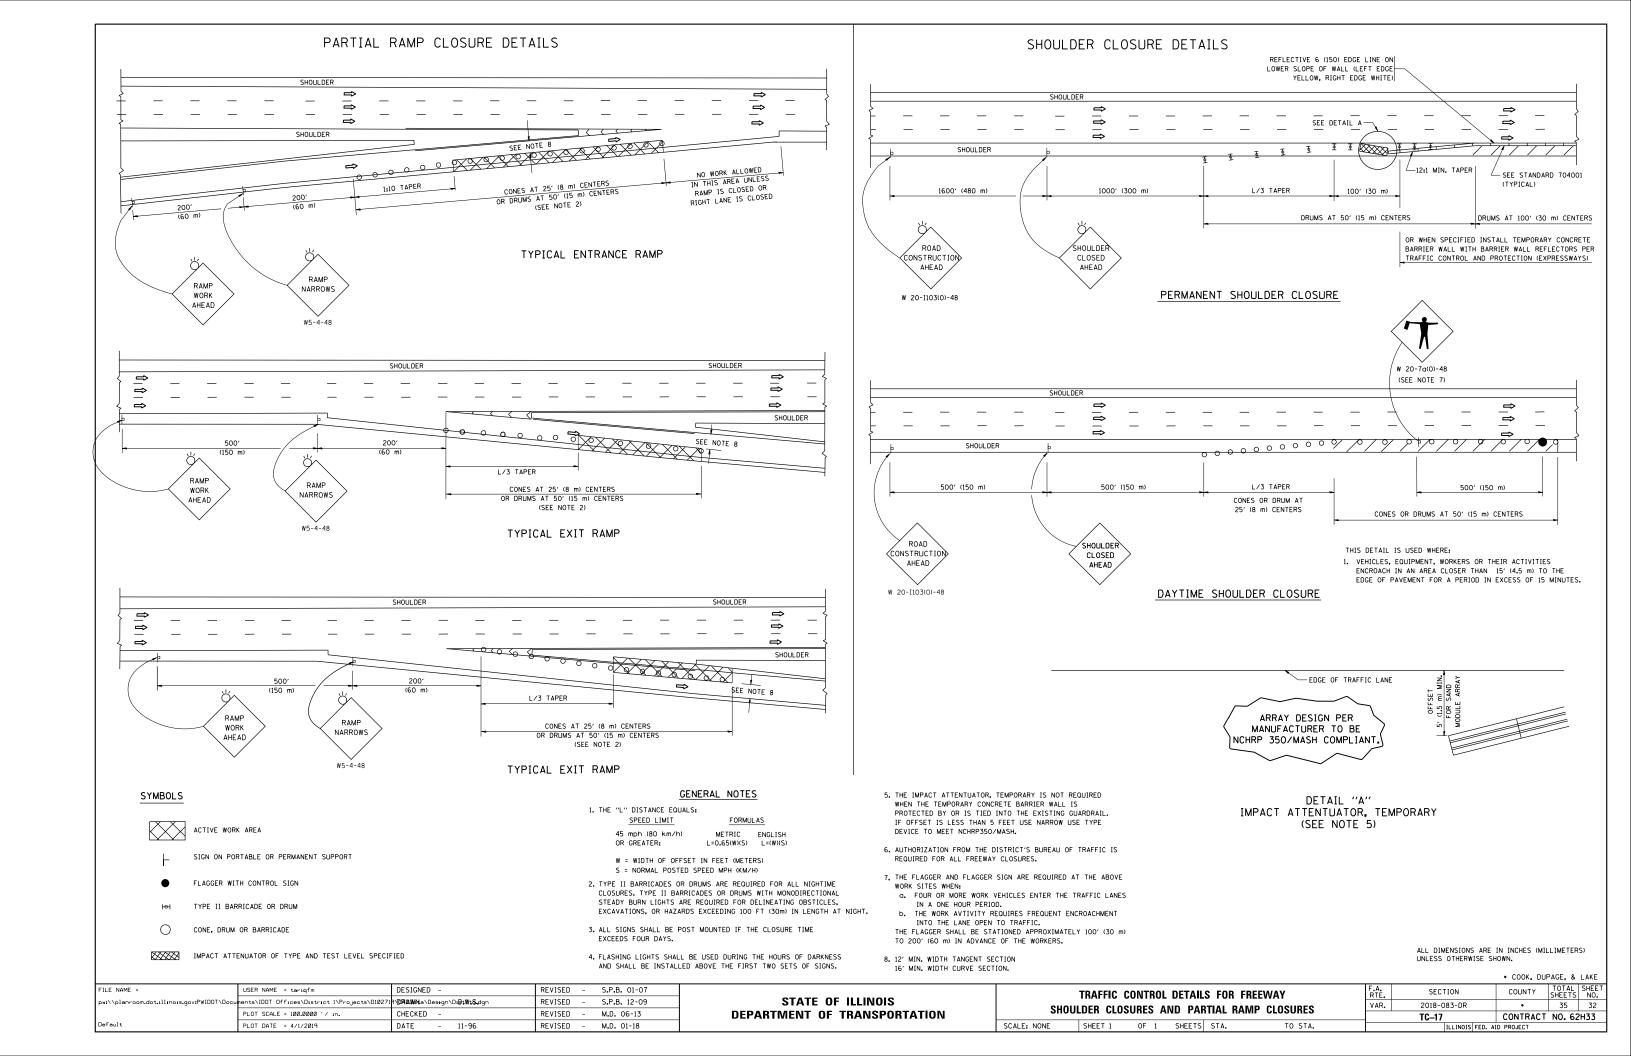


#### SIGNING FOR FLAGGING OPERATIONS AT WORK ZONE OPENINGS

#### WORK ZONE EXIT OPENING

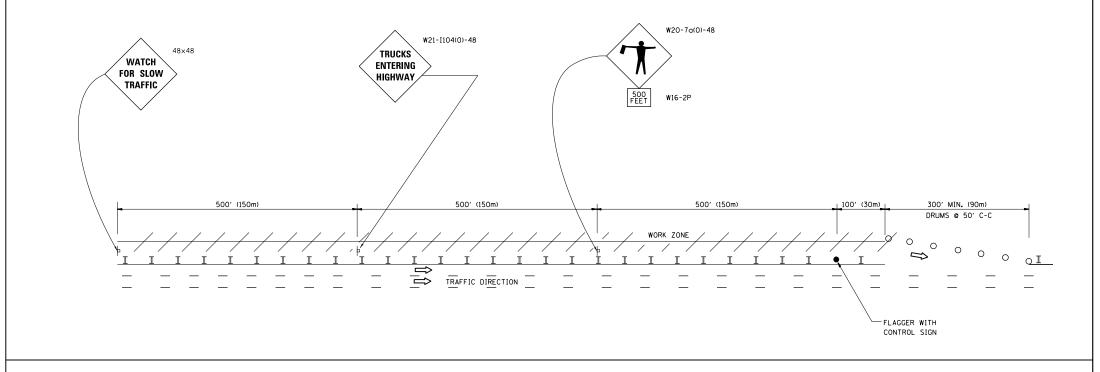

#### WORK ZONE ENTRY OPENING

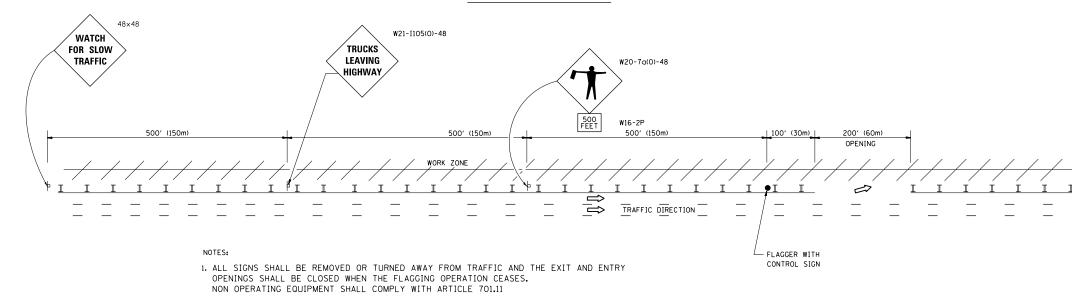


- 2. WORK ZONE OPENINGS SHALL BE A MINIMUM OF ONE HALF MILE APART AND A MINIMUM OF ONE QUARTER MILE FROM ALL ENTRANCE AND EXIT RAMPS.
- 3. EXITING THE WORK ZONE AT ANY PLACE OTHER THAN AT A WORK ZONE EXIT OPENING WILL BE PROHIBITED.
- 4. ALL VEHICLES SHALL ENTER THE WORK ZONE AT ENTRY OPENINGS, USING THEIR TURN SIGNALS TO WARN MOTORISTS
- 5. FLAGGERS SHALL NOT STOP TRAFFIC OR DIRECT TRAFFIC INTO AN ADJACENT LANE.

• COOK, DUPAGE, & LAKE

ALL DIMENSIONS ARE IN INCHES (MILLIMETERS)
UNLESS OTHERWISE SHOWN

FILE NAME =	USER NAME = tariqfm	DESIGNED -	REVISED -	J.A.F. 02-06		FREE	·WAVÆYPRESSI	NAV SIGNI	NG FOR	FI AGGING	OPERATIONS	F.A	SECTION	COUNTY	TOTAL	SHEE	.₸
pw://planroom.dot.illinois.gov:PWIDOT/Docu	nents\IDOT Offices\District 1\Projects\D1027:	13/QRANHYa\Design\DistStd.dgn	REVISED -	S.P.B. 01-07	STATE OF ILLINOIS		WORK ZONE					VAR.	2018-083-DR	•	35	33	Т
	PLOT SCALE = 100.00000 '/ in.	CHECKED -	REVISED -	S.P.B. 12-09	DEPARTMENT OF TRANSPORTATION	Ai	WURK ZUINE	UPENINGS	UN FRE	ENNAL PARY			TC-18	CONTRACT	F NO. 67	2H33	$\neg$
	PLOT DATE = 4/1/2019	DATE -	REVISED -	M.D. 06-13		SCALE: NONE	SHEET NO. 1	OF 1 SH	EETS	STA.	TO STA.	FED. ROAD	DIST. NO. 1 ILLINOIS FED. A	ID PROJECT			$\neg$

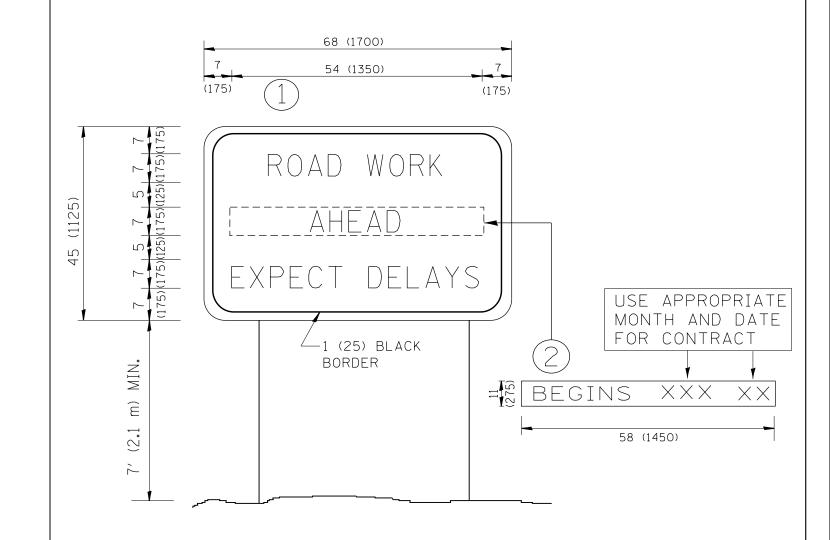

## NOTES:

1. USE BLACK LETTERING ON ORANGE BACKGROUND.

SCALE: NONE

- 2. ERECT SIGNS IN ADVANCE OF THE LOCATION FOR THE "ROAD CONSTRUCTION AHEAD" SIGN AT LOCATIONS AS DIRECTED BY THE ENGINEER.
- 3. ERECT SIGN (1) WITH INSTALLED PANEL (2) ONE WEEK PRIOR TO THE START OF CONSTRUCTION.
- 4. REMOVE PANEL (2) SOON AFTER THE START OF CONSTRUCTION.
- 5. SEE SPECIAL PROVISION FOR "TEMPORARY INFORMATION SIGNING" FOR ADDITIONAL INFORMATION.
- 6. ONE SIGN ASSEMBLY EQUALS 25.70 SQ. FT. (2.3 SQ. M.)
- 7. SHALL BE PAID FOR AS TEMPORARY INFORMATION SIGNING.

ALL DIMENSIONS ARE IN INCHES (MILLIMETERS) UNLESS OTHERWISE SHOWN.

• COOK, DUPAGE, & LAKE

FILE NAME =	USER NAME = tariqfm	DESIGNED -	REVISED	-	R. MIRS 09-15-97
pw:\\planroom.dot.illinois.gov:PWIDOT\Docu	ments\IDOT Offices\District 1\Projects\D10271	N <b>ORANN</b> a\Design\DistStd.dgn	REVISED	-	R. MIRS 12-11-97
	PLOT SCALE = 100.0000 '/ in.	CHECKED -	REVISED	- T.	RAMMACHER 02-02-99
	PLOT DATE = 4/1/2019	DATE -	REVISED	_	C. JUCIUS 01-31-07

					AD Sign		
SHEET	NO.	1	OF	1	SHEETS	STA.	TO STA.

F.A. SECTION COUNTY TOTAL SHEET NO.


VAR. 2018-083-DR • 35 34


TC-22 CONTRACT NO. 62H33


## CENTER LANE CLOSURE TYPE I CHECK BARRICADES DRUMS AT 50' (15 m) CENTERS AT 100' (30 m) CENTERS MIN m) (90 ARROW BOARD DISPLAYING-DOUBLE ARROW PATTERN CENTER LANE CLOSE W9-3-48 \* ₩9-3a-48 SIGNING & BARRICADING ACCORDING TO FREEWAY STANDARD FOR A ONE LANE CLOSURE INSTALLATION SEQUENCE 1. CLOSE LANES 1&2 ACTIVE NOTES WORK AREA 1. DRUMS WITH STEADY BURN LIGHTS SHALL BE USED AT 50' (15 m) CENTERS ON ALL TAPERS AND TANGENTS IN 2. ERECT INSIDE LANE 2 TAPER ADVANCE OF WORK AREA. 2. CLOSURE SHALL BE USED ONLY FOR OPERATIONS LASTING 72 HOURS OR LESS. 3. OPEN LANE 2 BY RELOCATING FIRST TAPER 3. CENTER LANE CLOSURE CONFIGURATION NON-ACTIVE IS NOT TO BE USED WITH WORKERS WORK AREA PRESENT. 4. REMOVE CLOSURE IN REVERSE ORDER

## SHOULDER LANE

NOTE: CLOSURE SHALL BE USED ONLY FOR OPERATIONS LASTING 72 HOURS OR LESS.

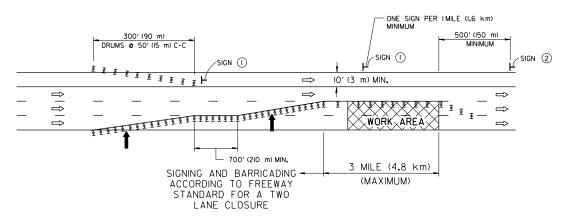

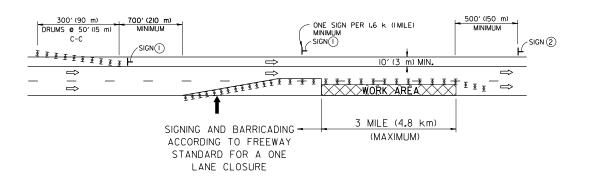

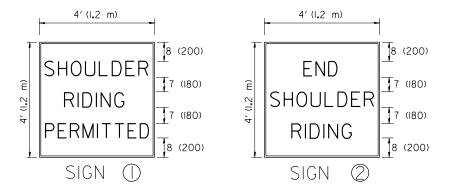

6 (150) SERIES "C" LEGEND BLACK LEGEND WHITE REFLECT. BACKGROUND 1(25) BORDER

#### SYMBOLS

DIRECTION OF TRAFFIC

**■** ARROWBOARD

ACTIVE WORK AREA

- ► SIGN ON PORTABLE OR PERMANENT SUPPORT \*
- TYPE II BARRICADE, OR DRUM WITH MONO-DIRECTIONAL STEADY BURN LIGHT

ALL DIMENSIONS ARE IN INCHES (MILLIMETERS)
UNLESS OTHERWISE SHOWN

 $\mbox{\#}$  ALL SIGNS SHALL BE MOUNTED AT A MINIMUM HEIGHT OF 5' (1.5 m).

• COOK, DUPAGE, & LAKE

FILE NAME = USER NAME = tariqfm DESIGNED REVISED - J.A.F. 04-03 COUNTY SECTION TRAFFIC CONTROL DETAILS FOR FREEWAY STATE OF ILLINOIS S.P.B. 01-07 ents\IDOT Offices\District 1\Projects\D10271**p\@AQWY.**a\Design\DistStd.dgn REVISED 2018-083-DR 35 35 VAR. CENTER LANE CLOSURE SHOULDER LANE PLOT SCALE = 100.0000 '/ in. CHECKED REVISED S.P.B. 12-09 **DEPARTMENT OF TRANSPORTATION** CONTRACT NO. 62H33 TC-25 SCALE: NONE SHEET NO. 1 OF 1 SHEETS STA. TO STA. PLOT DATE = 4/1/2019 DATE REVISED FED. ROAD DIST, NO. 1 ILLINOIS FED. AID PROJECT