06-13-2025 LETTING ITEM 235

FOR INDEX OF SHEETS, SEE SHEET NO. 2

TRAFFIC DATA

0

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0

0

INTERSTATE 80	2023 ADT 83,600	POSTED SPEED 55 MPH
MOLINE EXPY (WESTBOUND)	2023 ADT 5400	POSTED SPEED 45 MPH
MOLINE EXPY (EASTBOUND)	2023 ADT 83,600	POSTED SPEED 45 MPH
LAGRANGE ROAD (NORTHBOUND)	2023_ADT 42,400	POSTED SPEED 45 MPH
LAGRANGE ROAD (SOUTHBOUND)	2023 ADT 44,300	POSTED SPEED 45 MPH

HIGHWAY FUNCTIONAL CLASSIFICATION

INTERSTATE 80


INTERSTATE

LAGRANGE ROAD

ARTERIAL

PROJECT IS LOCATED IN:

VILLAGE OF MOKENA VILLAGE OF ORLAND PARK **VILLAGE OF TINLEY PARK**

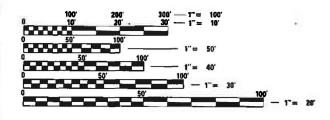

EULL SIZE PLANS HAVE BEEN PREPARED USING STANDARD ENGINEERING SCALES, REDUCED SIZED PLANS WILL NOT CONFIRM TO STANDARD SCALES IN MAKING MEASUREMENTS ON FROUCED PLANS, THE ABOVE SCALES MAY BE USED.

JOINT UTILITY LOCATION INFORMATION FOR EXCAVATORS 1-800-892-0123 OR 811 MEADE ELECTRIC CO. DISTRICT ONE ELECTRICAL MAINTENANCE CONTRACTOR LOCATES IDOT ELECTRICAL EQUIPMENT AND UNDERGROUND CABLES 773-287-7672

PROJECT MANAGER: TONY GODINHO (847) 705-4442 PROJECT ENGINEER: TONY GODINHO (847) 705-4442

CONTRACT NO. 62W15

STATE OF ILLINOIS

DEPARTMENT OF TRANSPORTATION


PROPOSED HIGHWAY PLANS

FAI ROUTE I-80 AND **US ROUTE 45 (LAGRANGE RD)**

SECTION FAI 80 23 LIGHTING PROJECT CR-GAUQ(946) **CARBON REDUCTION FUNDING PROJECT**

HIGH MAST LIGHTING REPLACEMENT

WILL COUNTY

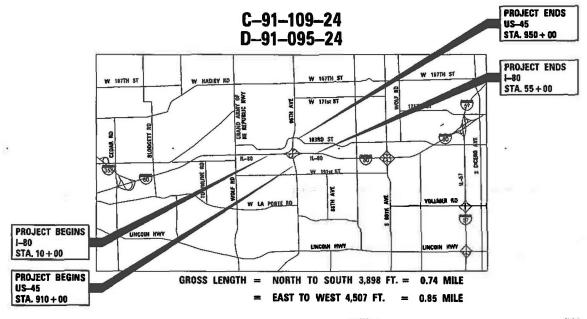

NET LENGTH = 1.59 MILE 062-06461

RASHESHKUMAR D. PATEL, P.E. EXPIRES: 11-30-2025 SHEETS: 3, 7-11, 43-49 SHEETS: 1-2, 4-6, 12-42

HOTHY & HEISER


03/20/2025 TIMOTHY B. HEUER, P.E

LICENSE NO.: 062-069545 EXPIRES: 11-30-2025

FAI 80 23 LIGHTING



230 WEST MONROE STREET (312) 629-0240 ILLINOIS PROFESSIONAL DESIGN FIRM REGISTRATION NO. 184001139-002

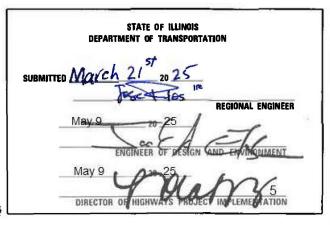

PRINTED BY THE AUTHORITY OF THE STATE OF ILLINOIS

REV-SEP

INDEX OF SHEETS

SHEET NUMBERS	DRAWING NUMBERS	DESCRIPTION
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4	SOQ-01	SUMMARY OF QUANTITIES
5	SOQ-02	SUMMARY OF QUANTITIES
6	SOQ-03	SUMMARY OF QUANTITIES
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12	LT-01	LIGHTING LEGEND AND GENERAL NOTES
13 - 17	LT-02 TO LT-06	LIGHTING REMOVAL PLAN HIGH MAST LIGHTING IMPROVEMENTS AT I-80 AND US 45
18 - 22	LT-07 TO LT-11	LIGHTING PROPOSED PLAN HIGH MAST LIGHTING IMPROVEMENTS AT I-80 AND US 45
23	LT-12	LIGHTING UNDERPASS REMOVAL PLAN I-80 AND US 45
24	LT-13	LIGHTING UNDERPASS PROPOSED AND INSTALLATION PLAN 1-80 AND US 45
25	LT-14	LIGHTING CONTROLLER "F" WIRING DIAGRAM
26 - 32	LT-15 TO LT-21	IDOT CONTRACT 82462 RECORD DRAWINGS
33 - 42	SD-01 TO SD-10	IDOT D1-BUREAU OF ELECTRICAL STANDARD DETAIL
43 - 49	SD-11 TO SD-17	IDOT D1-TRAFFIC CONTROL STANDARDS

IDOT DISTRICT ONE STANDARD DETAILS

STANDARD NO.	TITLE
BE-206	LIGHTING CONTROLLER, BASE MOUNTED. 480VOLT, 200AMP (DUAL) RADIO SCADA - FIBER OPTIC PROVISION
BE-220	ELECTRIC SERVICE INSTALLATION AERIAL, REMOTE DISCONNECT
BE-305	LIGHT POLE FOUNDATION, METAL
BE-400	ALUMINUM LIGHT POLE 47'-6" (14.478 m) MOUNTING HEIGHT
BE-701	LUMINAIRE SAFETY CABLE ASSEMBLY
BE-702	MISC. ELECTRICAL DETAILS SHEET A
BE-901	SUSPENDED MOUNT LED UNDERPASS LUMINAIRE INSTALLATION DETAILS
TC-08	ENTRANCE AND EXIT RAMP CLOSURE DETAILS
TC-09	TRAFFIC CONTROL DETAILS FOR FREEWAY SINGLE & MULTI-LANE WEAVE
TC-10	TRAFFIC CONTROL AND PROTECTION FOR SIDE ROADS, INTERSECTIONS, AND DRIVEWAYS
TC-12	MULTI-LANE FREEWAY PAVEMENT MARKING DETAILS
TC-17	TRAFFIC CONTROL DETAILS FOR FREEWAY SHOULDER CLOSURES AND PARTIAL RAMP CLOSURES
TC-22	ARTERIAL ROAD INFORMATION SIGN

GENERAL NOTES

- 1. SEVENTY-TWO (72) HOURS BEFORE STARTING EXCAVATION, THE CONTRACTOR SHALL CALL JULIE AT 1-800-892-0123 TO HAVE THE LOCATION OF EXISTING UNDERGROUND UTILITIES MARKED IN THE FIELD.
- 2. THE CONTRACTOR SHALL CONTACT THE DISTRICT ONE TRAFFIC CONTROL SUPERVISOR AT KALPANA.KANNAN-HOSADURGA@ILLINOIS.GOV A MINIMUM OF 72 HOURS IN ADVANCE OF BEGINNING WORK.
- 3. THE CONTRACTOR IS RESPONSIBLE FOR OBTAINING ALL NECESSARY PERMITS TO PERFORM WORK.
- 4. THE CONTRACTOR SHALL BE RESPONSIBLE FOR THE PROTECTION OF ALL UNDERGROUND OR SURFACE UTILITIES EVEN THOUGH THEY MAY NOT BE SHOWN IN THE PLANS. ANY UTILITY THAT IS DAMAGED DURING CONSTRUCTION SHALL BE REPAIRED OR REPLACED TO THE SATISFACTION OF THE ENGINEER. THIS WORK WILL BE AT THE CONTRACTOR'S EXPENSE.
- 5. THE CONTRACTOR SHALL COORDINATE WORK WITH UTILITIES IN ADVANCE OF WORKING IN THE VICINITY OF THEIR FACILITIES, AND ALLOW SUFFICIENT TIME FOR THEM TO PERFORM ADJUSTMENTS TO THEIR FACILITIES IN ACCORDANCE WITH THE CONTRACTOR'S SCHEDULE, COORDINATION EFFORTS SHALL BE INCLUDED IN THE COST OF THE CONTRACT BID PRICE.
- 6. THE CONTRACTOR MUST CALL THE IDOT ELECTRICAL MAINTENANCE CONTRACTOR TO LOCATE IDOT FACILITY CABLES.
- 7. IT SHALL BE THE CONTRACTOR'S RESPONSIBILITY TO VERIFY ALL DIMENSIONS AND CONDITIONS EXISTING IN THE FIELD PRIOR TO ORDERING MATERIALS AND BEGINNING CONSTRUCTION.
- 8. THE CONTRACTOR WILL NOT BE ALLOWED TO SET UP A YARD OR FIELD OFFICE ON STATE PROPERTY WITHOUT WRITTEN PERMISSION FROM THE DEPARTMENT INCLUDING THE ROADSIDE DEVELOPMENT UNIT
- 9. BARRICADES: TYPE II, AND TYPE III BARRICADES SHALL BE WEIGHTED IN A MANNER APPROVED BY THE MANUFACTURER SO THEY ARE NOT MOVED BY TRAFFIC.
- 10. THE DEPARTMENT HAS NOT OBTAINED ANY PERMITS FOR OFFSITE BORROW, WASTE, USE (BWU) AREAS. PRIOR TO WORKING IN BWU AREAS, IF THE CONTRACTOR CHOOSES TO USE ACTIVITIES REQUIRING PERMITS IT IS THE CONTRACTOR'S RESPONSIBILITY TO SECURE THE PROPER PERMITS, IN ADDITION TO THE BORROW REVIEW (BDE 2289) AND USE/WASTE REVIEW (BDE 2290) SUBMITTALS, THE CONTRACTOR SHALL SUBMIT AN EROSION AND SEDIMENT CONTROL (ESC) PLAN FOR EVERY BWU SITE TO THE DEPARTMENT FOR ACCEPTANCE. GUIDELINES FOR ACCEPTABLE BWU PRACTICES CAN BE FOUND IN SECTION 11.0.1 AND 1 OF THE SWPPP. THE COST OF ALL MATERIALS AND LABOR NECESSARY TO COMPLY WITH THE ABOVE PROVISIONS TO PREPARE AND IMPLEMENT ESC PLANS WILL NOT BE PAID FOR SEPARATELY, BUT SHALL BE CONSIDERED AS INCLUDED IN THE UNIT BID PRICES OF THE CONTRACT AND NO ADDITIONAL COMPENSATION WILL BE ALLOWED.
- 11. THE CONTRACTOR SHALL REQUEST AND GAIN APPROVAL FROM THE ILLINOIS DEPARTMENT OF TRANSPORTATION'S EXPRESSWAY TRAFFIC OPERATIONS ENGINEER AT WWW.IDOTLCS.COM TWENTY-FOUR (24) HOURS IN ADVANCE OF ALL DAILY LANE, RAMP, AND SHOULDER CLOSURES AND 7 DAYS IN ADVANCE OF ALL PERMANENT AND WEEKEND CLOSURES ON ALL FREEWAYS AND/OR EXPRESSWAYS IN DISTRICT ONE. THE ADVANCE NOTIFICATION IS CALCULATED BASED ON WORKWEEK OF MONDAY THROUGH FRIDAY AND SHALL NOT INCLUDE WEEKENDS OR HOLIDAYS.
- 12. THE CONTRACTOR SHALL TAKE EXTRA CARE IN GRADING AND EXCAVATING NEAR EXISTING TREES AS NOT TO CAUSE INJURY TO THE TRUNK, BRANCHES, OR ROOT SYSTEM. ANY DAMAGE DONE TO EXISTING ITEMS BY THE CONTRACTOR SHALL BE REPAIRED AND/OR REPLACED BY THE CONTRACTOR AT THE CONTRACTOR'S OWN EXPENSE.
- 13. CAREFULLY MAINTAIN PRESENT GRADE WITHIN DRIPLINE OF ALL EXISTING TREES. PREVENT EXISTING TREES AGAINST UNNECESSARY CUTTING, BREAKING, OR SKINNING OF ROOTS, BRUISING, SKINNING, OR DAMAGING OF BARK OR SMOTHERING OF TREES AND ITS ROOTS. DRIVING, PARKING, DUMPING, STOCKPILING, AND/OR STORAGE OF VEHICLES, EQUIPMENT, SUPPLIES, MATERIAL, OR DEBRIS ON TOP OF THE ROOT ZONES AND/OR DRIPLINE OF EXISTING TREES OR OTHER PLANT MATERIAL IS STRICTLY PROHIBITED. ANY DAMAGE DONE TO EXISTING ITEMS BY THE CONTRACTOR SHALL BE REPAIRED AND/OR REPLACED BY THE CONTRACTOR AT THE CONTRACTOR'S OWN EXPENSE.
- 14. THE CONTRACTOR SHALL ATTACH AN ALUMINUM SIGN WITH THE FOLLOWING TEXT: PROTECTED WETLAND NO INTRUSION. THE SIGN(S) SHALL BE ATTACHED TO THE STAKES BY A METHOD APPROVED BY THE ENGINEER. THE SIGN(S) WILL BE PROVIDED BY THE DEPARTMENT AND SHALL BE PICKED UP BY THE CONTACTOR FROM THE DISTRICT ONE ROADSIDE DEVELOPEMENT ARCHITECT IN SCHAUMBURG, ILLINOIS, SCHEDULING THE PICKUP OF THE SIGNS CAN BE ARRANGED BY CONTACTING THE DISTRICT ONE ROADSIDE DEVELOPMENT UNIT AT (847)705-4171. WHEN WORK HAS BEEN COMPLETED, THE SIGN SHALL BE INCLUDED IN THE CONTRACT UNIT PRICE FOR PERIMETER EROSION BARRIER.
- 5. THE CONTRACTOR SHALL CONTACT KALPANA KANNAN-HOSADURGA, THE DISTRICT ONE TRAFFIC CONTROL SUPERVISOR AT KALPANA.KANNAN-HOSADURGA@LLLINOIS.GOV A MINIMUM OF 72 HOURS IN ADVANCE OF BEGINNING WORK.
- 16. WHEN WORKING ADJACENT TO THE ROAD AND UTILIZING DAILY LANE CLOSURES, DROP-OFFS ADJACENT TO THE TRAVEL LANES SHALL BE KEPT TO A MINIMUM. DROP-OFFS GREATER THAN (OR GREATER THAN OR EQUAL TO) 12" WILL NOT BE ALLOWED AT LOCATIONS WHERE THE DROP-OFF IS LOCATED WITHIN 8 FT OF THE EDGE OF THE TRAVEL LANE. THE CONTRACTOR WILL BE REQUIRED TO PERFORM THE EXCAVATION REQUIRED FOR THE CONSTRUCTION DURING THE TIME THAT THE ADJACENT LANE IS CLOSED. AS NOTED ABOVE, PRIOR TO REOPENING THE LANE TO TRAFFIC THE CONTRACTOR SHALL PLACE SUFFICIENT MATERIAL TO REDUCE THE DROP-OFF TO LESS THAN 12". THE CONTRACTOR SHALL BE RESPONSIBLE TO DETERMINE THE AMOUNT OF WORK THAT CAN BE COMPLETED WITHIN THE TIME OF THE DAILY LANE CLOSURE. NO ADDITIONAL COMPENSATION SHALL BE ALLOWED TO COMPLY WITH THIS REQUIREMENT.

IDOT HIGHWAY STANDARDS

SCALE:

STANDARD NO.	TITLE
280001-07	STANDARD SYMBOLS, ABBREVIATIONS, AND PATTERNS
701101-05	OFF-RD OPERATIONS, MULTILANE, 15' TO 24" FROM PAVEMENT EDGE
701106-02	OFF-RD OPERATIONS, MULTILANE, MORE THAN 15' AWAY
701400-12	APPROACH TO LANE CLOSURE, FREEWAY/EXPRESSWAY
701401-13	LANE CLOSURE, FREEWAY/EXPRESSWAY
701411-09	LANE CLOSURE, MULTILANE, AT ENTRANCE OR EXIT RAMP, FOR SPEEDS >= 45 MPH
701421-08	LANE CLOSURE, MULTILANE, DAY OPERATIONS ONLY, FOR SPEEDS >= 45 MPH TO 55 MPH
701428-01	TRAFFIC CONTROL, SETUP AND REMOVAL, FREEWAY/EXPRESSWAY
701601-09	URBAN LANE CLOSURE, MULTILANE, 1W OR 2W WITH NON TRAVERSABLE MEDIAN
701901-10	TRAFFIC CONTROL DEVICES





 USER NAME
 = mgarvida
 DESIGNED
 - MG
 REVISED

 DRAWN
 - VN
 REVISED

 PLOT SCALE
 = 2,0000 '/ in.
 CHECKED
 - RP/VG
 REVISED

 PLOT DATE
 = 5/2/2025
 DATE
 - 03/14/2025
 REVISED

STATE OF ILLINOIS
DEPARTMENT OF TRANSPORTATION

WILL | 49 | 2

COUNTY

MAINTENANCE OF TRAFFIC GENERAL NOTES

1. THE RECOMMENDED WORK ZONE STRATEGY DURING CONSTRUCTION CONSISTS OF THE FOLLOWING STANDARDS FOR WORK ON I-80 AND THE US 45 INTERCHANGE RAMPS:

IDOT STD. 701106 - OFF-RD OPERATIONS, MULTILANE, MORE THAN 15' AWAY

IDOT STD. 701400 - APPROACH TO LANE CLOSURE, FREEWAY / EXPRESSWAY

IDOT STD. 701401 - LANE CLOSURE, FREEWAY/EXPRESSWAY

IDOT STD. 701411 - MULTI-LANE, TRAFFIC CONTROL AT ENTRANCE OR EXIT RAMPS

IDOT STD. 701428 - TRAFFIC CONTROL SETUP AND REMOVAL FREEWAY / EXPRESSWAY

IDOT STD. 701901 - TRAFFIC CONTROL DEVICES

IDOT D1 STD. 8 - ENTRANCE AND EXIT RAMP CLOSURE DETAILS IDOT D1 STD. 9 - SINGLE LANE WEAVE AND MULTI-LANE WEAVE

IDOT D1 STD. 12 - MULTI-LANE FREEWAY PAVEMENT MARKING DETAIL

IDOT D1 STD. 17 - TRAFFIC CONTROL DETAILS FOR FREEWAY SHOULDER CLOSURES AND

PARTIAL RAMP CLOSURES

2. THE RECOMMENDED WORK ZONE STRATEGY DURING CONSTRUCTION CONSISTS OF THE FOLLOWING STANDARDS FOR WORK ON US 45:

IDOT STD. 701101 - 15' TO 24" OFF-RD OPERATIONS, MULTILANE FROM PAVEMENT EDGE

IDOT STD. 701106 - OFF-RD OPERATIONS, MULTILANE, MORE THAN 15' AWAY

IDOT STD. 701411 - MULTI-LANE, TRAFFIC CONTROL AT ENTRANCE OR EXIT RAMPS

IDOT STD. 701421 - LANE CLOSURE, MULTILANE, DAY OPERATIONS ONLY, FOR SPEEDS 45 MPH TO 55 MPH

IDOT STD. 701601 - URBAN LANE CLOSURE, MULTILANE, 1W OR 2W WITH NONTRAVERSABLE MEDIAN

3. THE SPEED LIMIT IN THE WORK ZONE OF I-80 SHALL BE REDUCED FROM 65 MPH TO 55 MPH DURING CONSTRUCTION ACTIVITIES.

SHOULDER AND RAMP CLOSURES

- 4. TYPE II BARRICADES OR DRUMS ARE REQUIRED FOR ALL NIGHTTIME CLOSURES. TYPE II BARRICADES OR DRUMS WITH MONODIRECTIONAL STEADY BURN LIGHTS ARE REQUIRED FOR DELINEATING OBSTICLES EXCAVATIONS, OR HAZARDS EXCEEDING 100 FT IN LENGTH AT
- 5. ALL SIGNS SHALL BE POST MOUNTED IF THE CLOSURE TIME EXCEEDS FOUR DAYS
- 6. FLASHING LIGHTS SHALL BE USED DURING THE HOURS OF DARKENESS AND SHALL BE INSTALLED ABOVE THE FIRST TWO SETS OF SIGNS.
- 7. THE FLAGGER AND FLAGGER SIGN ARE REQUIRED WHEN:
 - -FOUR OR MORE WORK VEHICLES ENTER THE TRAFFIC LANES IN A ONE HOUR PERIOD -THE WORK ACTIVITY REQUIRES FREQUENT ENCROACHMENT INTO THE LANE OPEN TO TRAFFIC

THE FLAGGER SHALL BE STATIONED APPROXIMATELY 100' TO 200' IN ADVANCE OF THE

FREEWAY / EXPRESSWAY SIGNING FOR FLAGGING OPERATIONS

- 8. ALL SIGNS SHALL BE REMOVED OR TURNED AWAY FROM TRAFFIC AND THE EXIT AND ENTRY OPENINGS SHALL BE CLOSED WHEN THE FLAGGING OPERATION CEASES. NON OPERATING EQUIPMENT SHALL COMPLY WITH ARTICLE 701.12
- 9. EXITING THE WORK ZONE AT ANY PLACE OTHER THAN THE WORK ZONE EXIT OPENING WILL BE
- 10. ALL VEHICLES SHALL ENTER THE WORK ZONE AT ENTRY OPENINGS, USING THEIR TURN SIGNALS TO WARN MOTORISTS.
- 11. FLAGGERS SHALL NOT STOP TRAFFIC OR DIRECT TRAFFIC INTO AN ADJACENT LANE.

Cìorba Group
8725 W. Higgins Rd, Ste 600, Chicago, IL 60631
P 773.775.4009 www.ciorba.com

USER NAME = Roadway	DESIGNED - AMS	REVISED -	
	DRAWN - AMS	REVISED -	
PLOT SCALE = 2.000 / in.	CHECKED - TBH	REVISED -	
PLOT DATE = 4/22/2025	DATE - 4/22/2025	REVISED -	

STATE OF ILLINOIS **DEPARTMENT OF TRANSPORTATION**

SCALE: N.T.S.

MAINTENANCE OF TRAFFIC GENERAL NOTES	F.A. P. RTE	SECTION	COUNTY	TOTAL SHEETS	SHEET NO.
	342	2018-100-BR	WILL	49	3
			CONTRACT	NO. 62	2W15
SHEET 1 OF 1 SHEETS STA. TO STA.		TILLINOIS FED A	D PROJECT		

MOT-01

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	Ö	NSULTII	SSOCIAT NG ENG	NÉE

USER NAME = vnunez	DESIGNED - MG	REVISED -
	DRAWN - VN	REVISED -
PLOT SCALE = 2'/in.	CHECKED - RP/VG	REVISED -
PLOT DATE = 3/19/2025	DATE = 03/14/2025	REVISED _

CODE

NO.

20200100

20400800

21101505

21101625

25000210

25000400

25000500

25000600

28000250

28000305

67100100

66900200

EARTH EXCAVATION

SEEDING, CLASS 2A

FURNISHED EXCAVATION

TOPSOIL EXCAVATION AND PLACEMENT

TOPSOIL FURNISH AND PLACE, 6"

NITROGEN FERTILIZER NUTRIENT

PHOSPHORUS FERTILIZER NUTRIENT

POTASSIUM FERTILIZER NUTRIENT

TEMPORARY DITCH CHECKS

NON-SPECIAL WASTE DISPOSAL

MOBILIZATION

TEMPORARY EROSION CONTROL SEEDING

DEPARTMENT OF TRANSPORTATION

	011545445	, 05 011			F.A. I. RTE.	SECTION	(
	SUMMARY	r uf uu	ANTITES	ĺ	80	FAI 80 23 LIGHTING	
							C
SHEET	OF	SHEETS	STA.	TO STA.] ILLINOIS] FED. A	D PRO

CONSTRUCTION CODE

10% STATE

LIGHTING

0021

90% FED 10% STATE

ROADWAY

0004

178

57

200

0.75

46

46

300

200

135

TOTAL

QUANTITY

178

57

407

200

0.75

46

46

46

300

200

1

135

UNIT

CU YD

CU YD

CU YD

SQ YD

ACRE

POUND

POUND

POUND

POUND

FOOT

L SUM

CU YD

SCALE:

F.A. I. RTE.	SECTION	COUNTY	SHEETS	SHEE NO.
80	FAI 80 23 LIGHTING	WILL	49	4
		CONTRACT	NO. 62	2W15
	ILLINOIS FED. A	D PROJECT		

SOQ-01

GH	DESIGNED - MG REVISED - DRAWN - VN REVISED -			STATE OF ILLINOIS	SI	SUMMARY OF QUANTITES			
	USER NAME = ynunez		DESIGNED - MG	REVISED -					F.A. RTI
		70103815	TRAFFIC CONTROL SURV	/EILLANCE		CAL DA	180	180	-
		70102630	TRAFFIC CONTROL AND	PROTECTION, STANDARD 701601		L SUM	1	1	-
		70100420	TRAFFIC CONTROL AND	PROTECTION, STANDARD 701411		EACH	6	6	-
		70100310	TRAFFIC CONTROL AND	PROTECTION, STANDARD 701421		L SUM	1	1	-
	*	66901006	REGULATED SUBSTANCE	ES MONITORING		CAL DA	20	20	-
	*	66901003	REGULATED SUBSTANCE	ES FINAL CONSTRUCTION REPOR	रा	LSUM	1	1	-
	* 66901001 REGULATED SUBSTANCES PRE-CONSTRUCTION PLAN					LSUM	1	1	-
	* 66900530 SOIL DISPOSAL ANALYSIS					EACH	4	4	-

ITEM

				CONSTRUC	TION CODE
				90% FED 10% STATE	90% FED 10% STATE
CODE			TOTAL	ROADWAY	LIGHTING
NO.	ITEM	UNIT	QUANTITY	0004	0021
80400100	ELECTRIC SERVICE INSTALLATION	EACH	1	-	1
80400200	ELECTRIC UTILITY SERVICE CONNECTION	L SUM	1	_	1
81028240	UNDERGROUND CONDUIT, GALVANIZED STEEL, 4" DIA.	FOOT	520	-	520
81100320	CONDUIT ATTACHED TO STRUCTURE, 1" DIA., PVC COATED GALVANIZED STEEL	FOOT	560	_	560
	CONDENT AND THE CONTROL OF THE CONTR	1001	000		000
81300220	JUNCTION BOX, STAINLESS STEEL, ATTACHED TO STRUCTURE, 6" X 6" X 4"	EACH	12	-	12
81300530	JUNCTION BOX, STAINLESS STEEL, ATTACHED TO STRUCTURE, 12" X 10" X 6"	EACH	6	_	6
01000000	JUNCTION BOX, STAINLESS STEEL, ATTACHED TO STRUCTURE, 12 X 10 X 0	EACH	0	-	0
81603081	UNIT DUCT, 600V, 3-1C NO.2, 1/C NO.4 GROUND, (XLP-TYPE USE), 1 1/2" DIA. POLYETHYLENE	FOOT	8,507	-	8,507
81702110	ELECTRIC CABLE IN CONDUIT, 600V (XLP-TYPE USE) 1/C NO. 10	FOOT	1,310	-	1,310
81702220	ELECTRIC CABLE IN CONDUIT, 600V (XLP-TYPE USE) 1/C 350MCM	FOOT	1,200	-	1,200
82110008	LUMINAIRE, LED, ROADWAY, OUTPUT DESIGNATION H	EACH	23	-	23
82110009	LUMINAIRE, LED, ROADWAY, OUTPUT DESIGNATION I	EACH	15	-	15
82110027	LUMINAIRE, LED, UNDERPASS, SUSPENDED, OUTPUT DESIGNATION E	EACH	12	-	12
83050810	LIGHT POLE, ALUMINUM, 47.5 FT. M.H., 15 FT. MAST ARM	EACH	38	-	38
83600365	LIGHT POLE FOUNDATION, METAL, 15" BOLT CIRCLE, 10" X 8'	EACH	38	-	38
83800205	BREAKAWAY DEVICE, TRANSFORMER BASE, 15 INCH BOLT CIRCLE	EACH	38	-	38
84500110	REMOVAL OF LIGHTING CONTROLLER	EACH	1	-	1
84500120	REMOVAL OF ELECTRIC SERVICE INSTALLATION	EACH	1	_	1
87900200	DRILL EXISTING HANDHOLE	EACH	4	-	4

SOQ-02

SINGH ASSOCIATE, INC.

USER NAME = vnunez	DESIGNED - MG	REVISED -
_	DRAWN - VN	REVISED -
PLOT SCALE = 2'/in.	CHECKED - RP/VG	REVISED -
PLOT DATE = 3/19/2025	DATE = 03/14/2025	REVISED -

STATE OF ILLINOIS
DEPARTMENT OF TRANSPORTATION

										•	JUU-	-UZ
l I R						F.A. I. SECTION			COUNTY	TOTAL	SHEET NO.	
SUMMARY OF QUANTITES							FAI 80 23 LIGHTING			WILL	49	5
										CONTRACT	FNO. 62	2W15
SCALE:	SHEET	OF	SHEETS	STA.	TO STA.			ILLINOIS	FED. A	D PROJECT		
					•			·				

CONSTRUCTION CODE

				10% STATE	10% STATE
CODE			TOTAL	ROADWAY	LIGHTING
NO.	ITEM	UNIT	QUANTITY	0004	0021
X1400190	REMOVAL OF HIGH MAST LUMINAIRES, SALVAGE	EACH	54	-	54
X1400341	REMOVAL OF LUMINAIRE, SALVAGE	EACH	91		91
X1400402	LIGHTING CONTROLLER, BASE MOUNTED, 480VOLT, 200AMP (DUAL), RADIO SCADA, FIBER OPTIC	EACH	1	-	1
X2511630	EROSION CONTROL BLANKET (SPECIAL)	SQ YD	2,103	2,103	-
X6700407	ENGINEER'S FIELD OFFICE, TYPE A (D1)	CAL MO	18	18	-
X8210007	LUMINAIRE, LED, ROADWAY, REPLACEMENT, OUTPUT DESIGNATION H	EACH	90	-	90
X8420111	REMOVAL OF UNDERPASS LIGHTING UNIT, NO SALVAGE	EACH	12	-	12
X8420502	REMOVAL OF LIGHT TOWER, NO SALVAGE	EACH	13	-	13
X8420510	REMOVAL OF TOWER FOUNDATION	EACH	13	-	13
Z0013798	CONSTRUCTION LAYOUT	L SUM	1	1	-
X7200061	TEMPORARY INFORMATION SIGNING	SQ FT	206	206	-
Z0033020	LUMINAIRE SAFETY CABLE ASSEMBLY	EACH	128	-	128
X8000003	MAINTENANCE OF LIGHTING SYSTEM	CAL MO	12	-	12

USER NAME = vnunez	DESIGNED - MG	REVISED -
	DRAWN - VN	REVISED -
PLOT SCALE = 2'/in.	CHECKED - RP/VG	REVISED -
PLOT DATE = 3/19/2025	DATE = 03/14/2025	REVISED -

STATE OF ILLINOIS DEPARTMENT OF TRANSPORTATION


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SUMMARY OF QUANTITES									
SCALE:	SHEET	OF	SHEETS	STA.	TO STA.				


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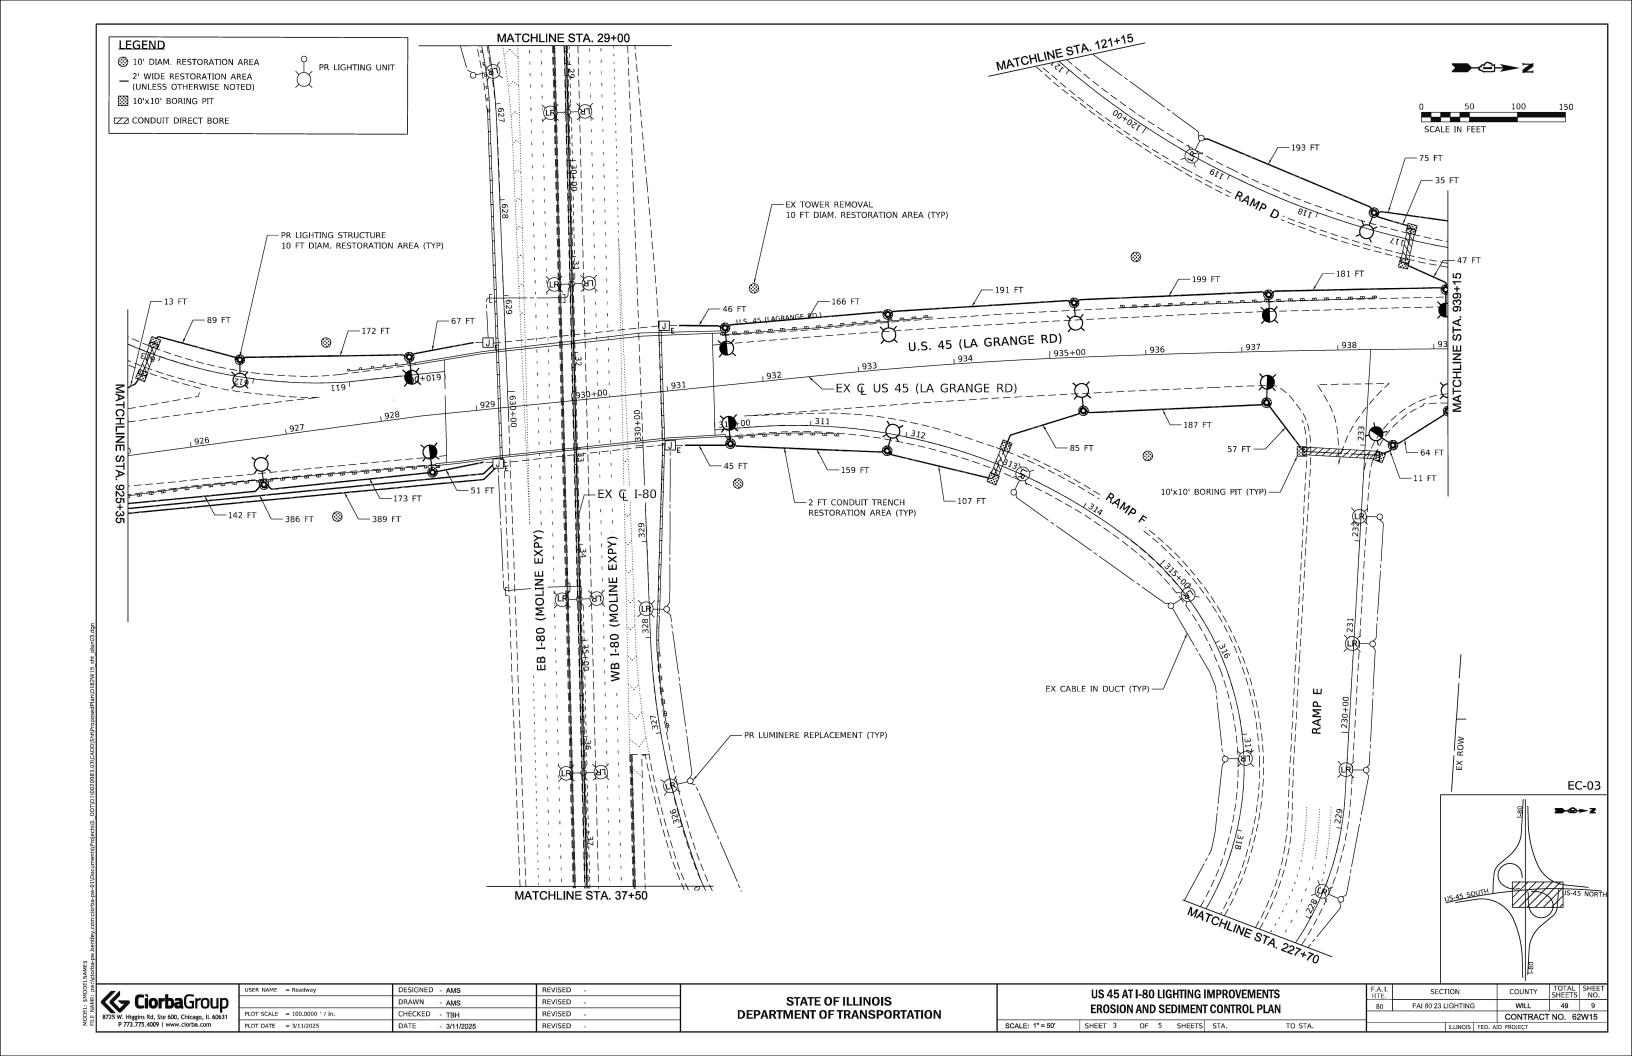
90% FED

90% FED

SOQ-03



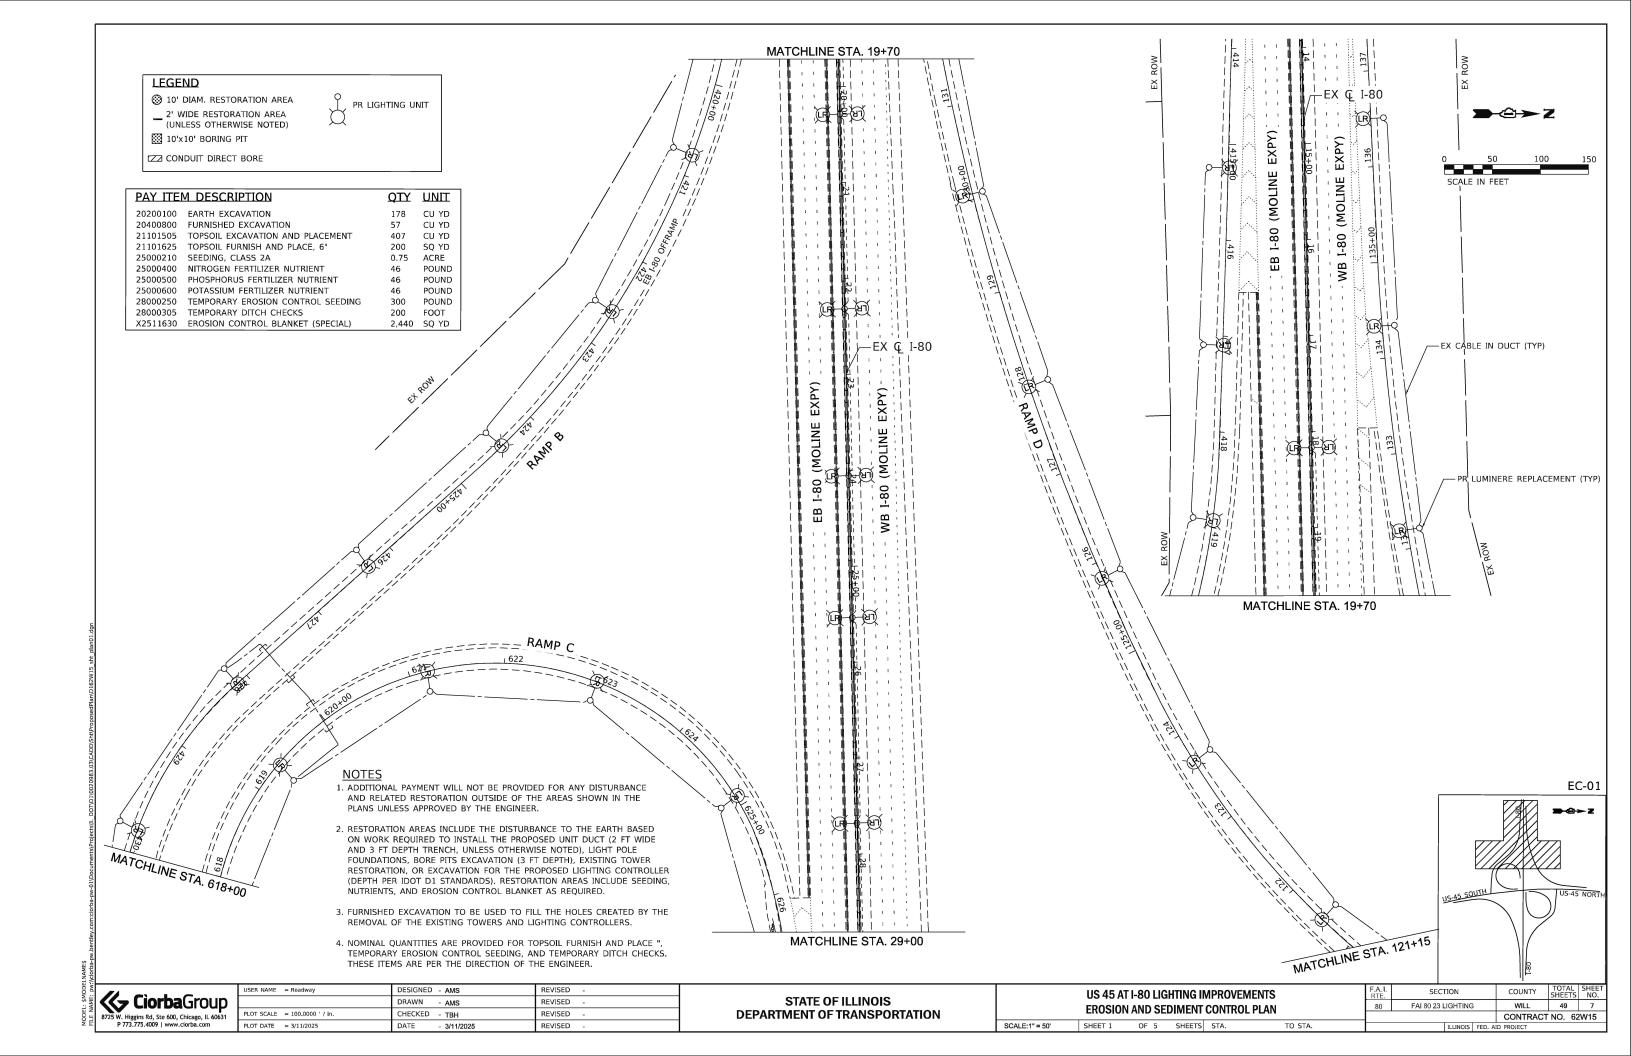

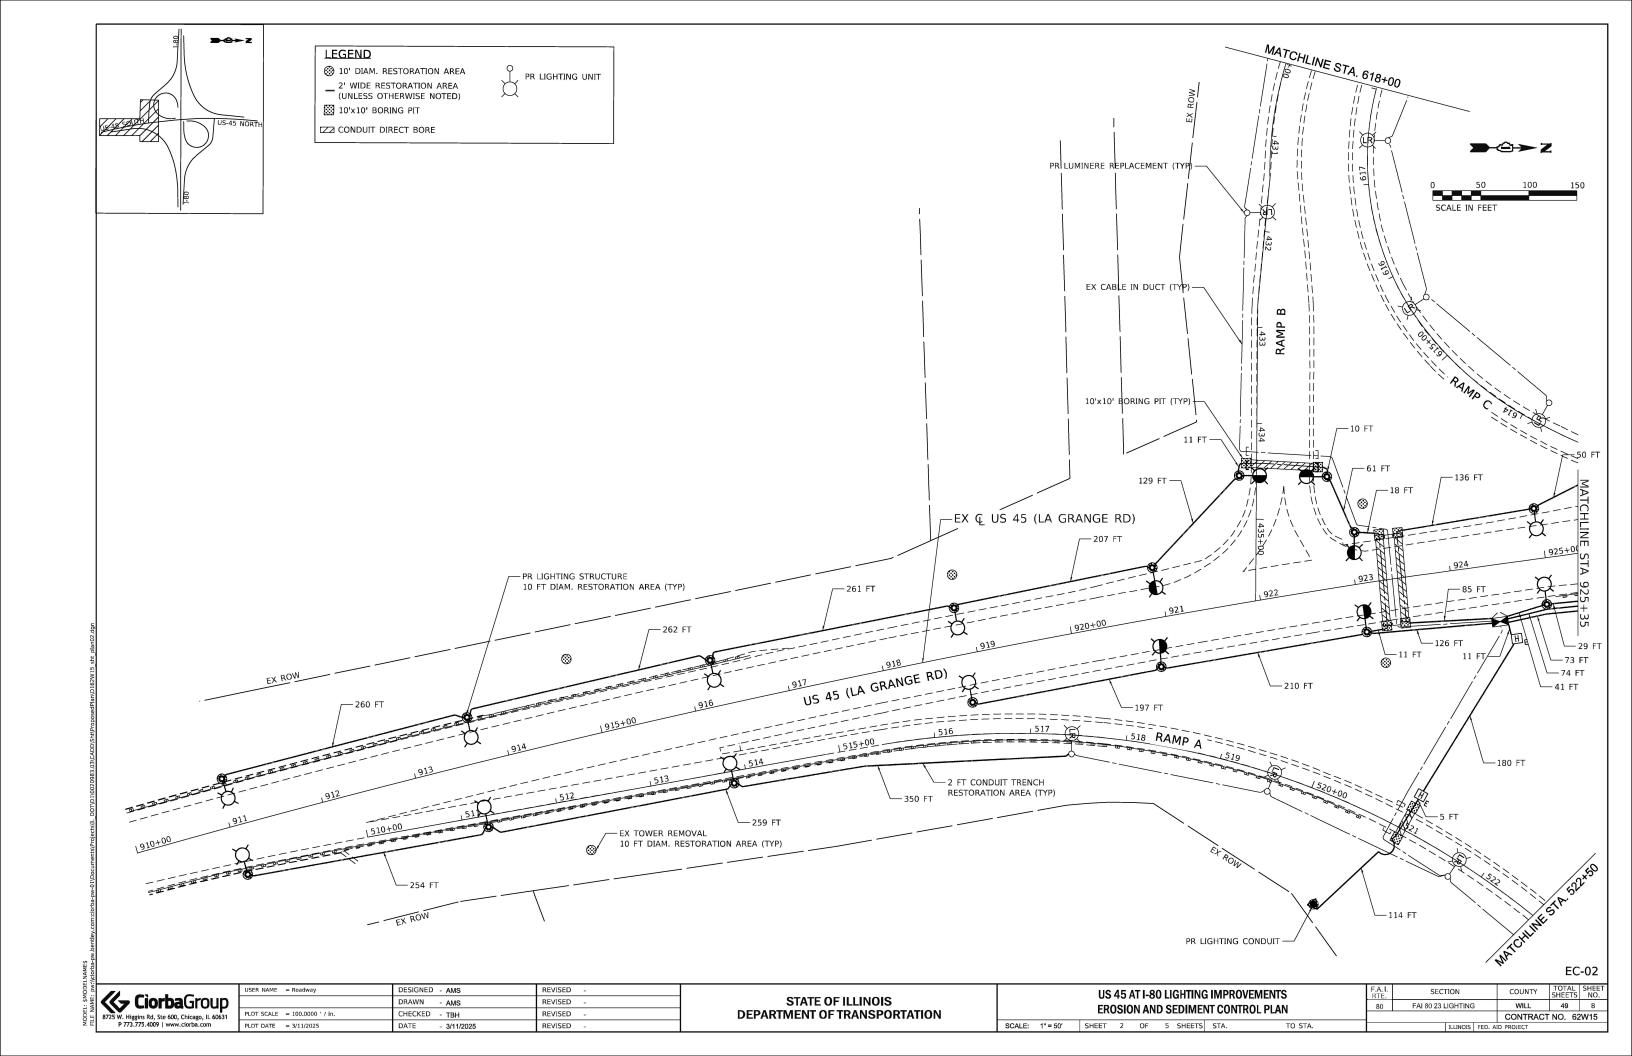


LEGEND

 ⊕ 10' DIAM. RESTORATION AREA __ 2' WIDE RESTORATION AREA (UNLESS OTHERWISE NOTED)

PR LIGHTING UNIT

₩ 10'x10' BORING PIT

ZZ CONDUIT DIRECT BORE

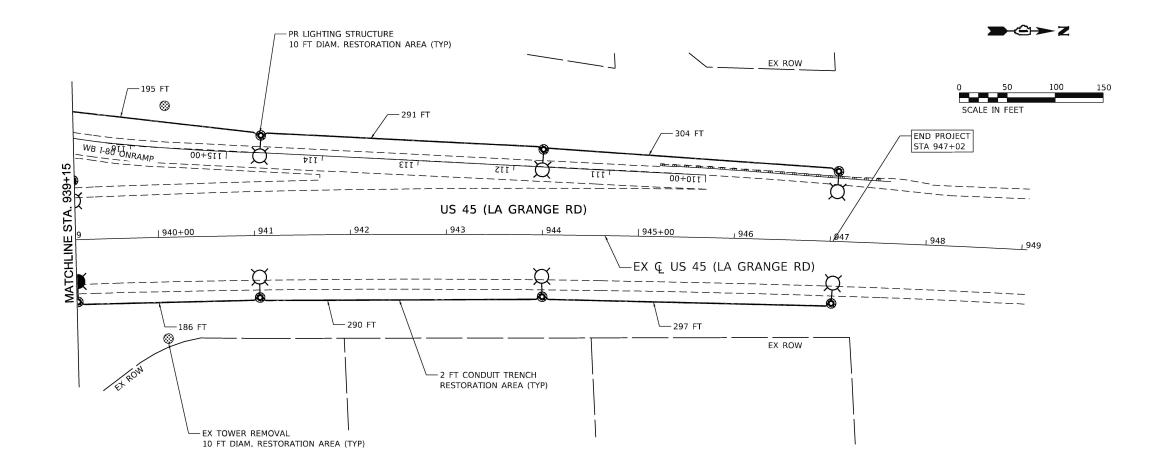

EC-04


á	
AME: pw	Cìorba Group
Z	
븶	8725 W. Higgins Rd, Ste 600, Chicago, IL 60631
ш	P 773.775.4009 www.ciorba.com

USER NAME = Roadway	DESIGNED - AMS	REVISED -
	DRAWN - AMS	REVISED -
PLOT SCALE = 100.0000 ' / in.	CHECKED - TBH	REVISED -
PLOT DATE = 3/11/2025	DATE - 3/11/2025	REVISED -


SCALE: 1" = 50'

SHEET

										4		
US 45 AT I-80 LIGHTING IMPROVEMENTS					F.A.I. RTE.	SECTION		COUNTY	TOTAL SHEETS	SHEET NO.		
EROSION AND SEDIMENT CONTROL PLAN				80	FAI 80 23 LIGHTING		è	WILL	49	10		
LINGGIGI	TAIL	, OL	DIMENT	OOMING	JET EAN					CONTRAC	T NO. 62	2W15
SHEET 4	OF	5	SHEETS	STA	TO STA			II I IMOIC	EED A	ID BROIECT		

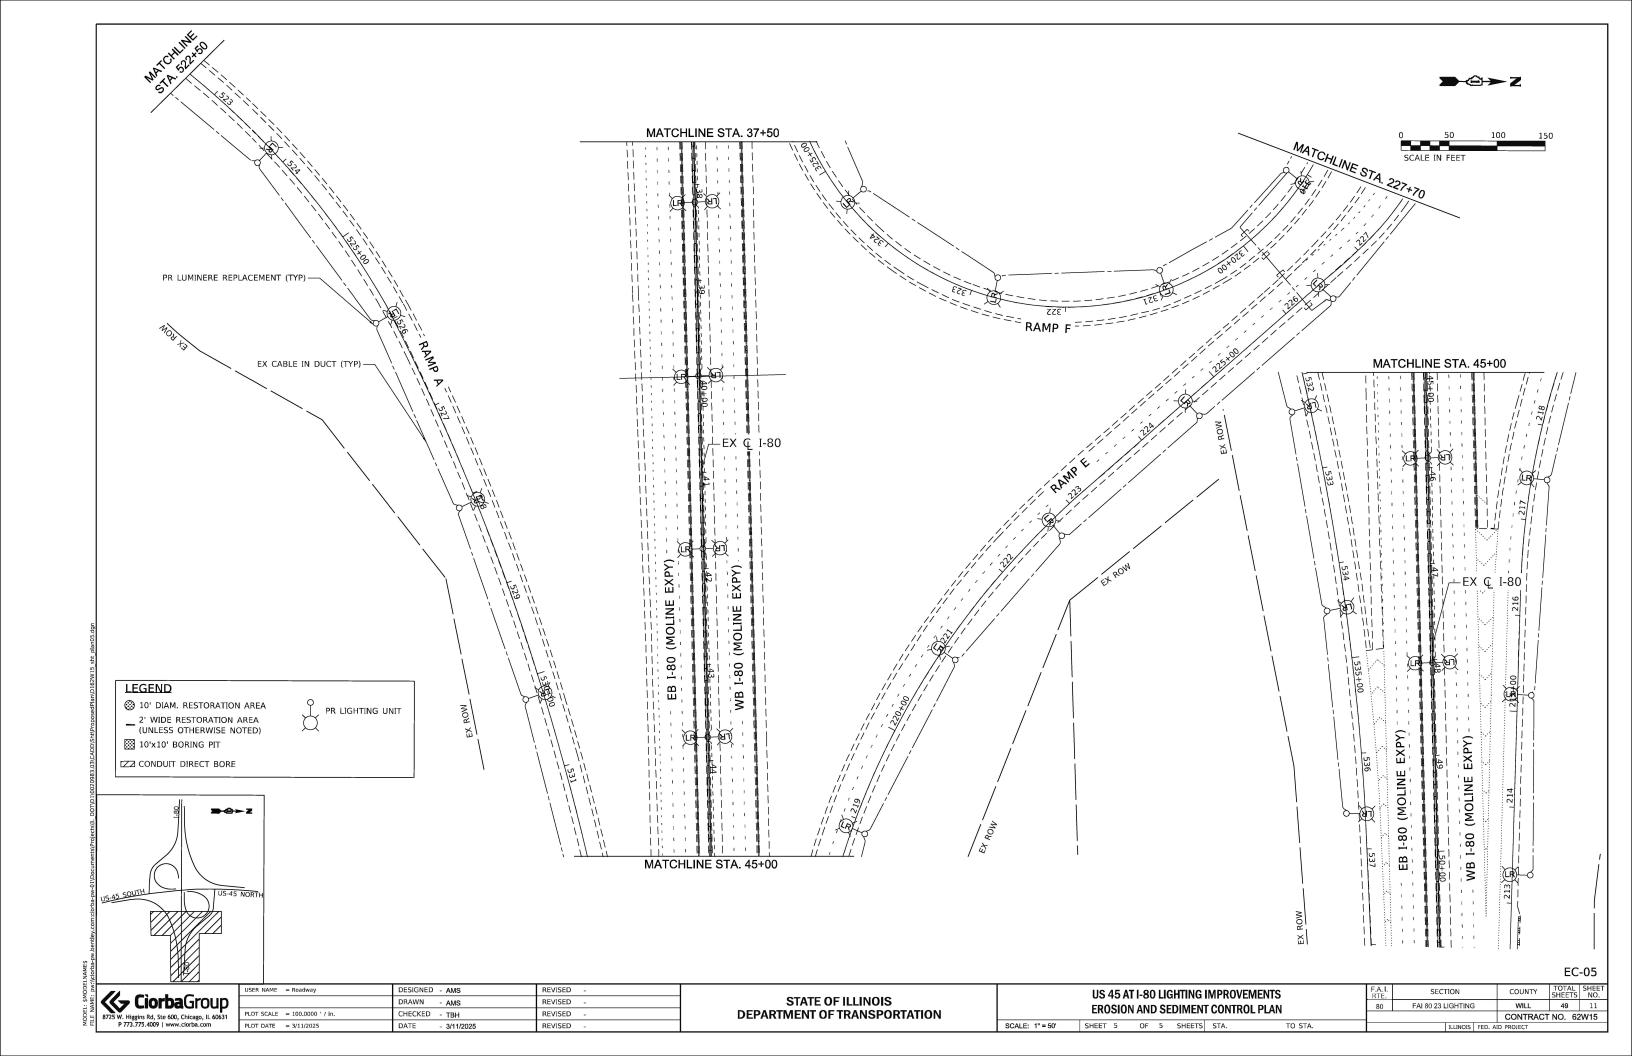

LIGHTING AND ELECTRICAL LEGEND							
SYMBOL	DESCRIPTION						
R R	EXISTING IDOT HIGH MAST LIGHTING TOWER AND FOUNDATION TO BE REMOVED, NO SALVAGE. LUMINAIRES REMOVED, SALVAGE						
○—(E)	EXISTING IDOT LIGHTING UNIT TO REMAIN						
⊶¤	PROPOSED IDOT LIGHTING UNIT MOUNTED ON BREAKAWAY DEVICE METAL FOUNDATION, 15" BOLT CIRCLE, 10" X 8', 47.5 FT M.H., 15 FT MAST ARM, LUMINAIRE TO BE LED, HORIZONTAL MOUNT, OUTPUT DESIGNATION H, 27K LUMENS MINIMUM (240 VAC)						
⊶	PROPOSED IDOT LIGHTING UNIT MOUNTED ON BREAKAWAY DEVICE METAL FOUNDATION, 15" BOLT CIRCLE, 10" X 8', 47.5 FT M.H., 15 FT MAST ARM, LUMINAIRE TO BE LED, HORIZONTAL MOUNT, OUTPUT DESIGNATION I, 36K LUMENS MINIMUM (240 VAC)						
- - <u></u> @	REMOVE EXISTING LUMINAIRE, SALVAGE. INSTALL LUMINAIRE SAFETY CABLE AND LED LUMINAIRE (HORIZONTAL MOUNT, OUTPUT DESIGNATION H, 27K LUMENS MINIMUM) ON EXISTING IDOT GROUND MOUNTED LIGHT POLE AND MAST ARM, REPLACE THE EXISTING POLE WIRES, ADD GROUND WIRE AND REPLACE FUSEHOLDERS AND FUSES PER LED LUMINAIRE REPLACEMENT PAY ITEM						
○ R	EXISTING UNDERPASS LUMINAIRE TO BE REMOVED, NO SALVAGE						
	PROPOSED UNDERPASS LED LUMINAIRE, SUSPENDED MOUNTED, OUTPUT DESIGNATION E, 13.5K LUMENS MINIMUM						
J _R	EXISTING JUNCTION BOX TO BE REMOVED						
J _E	EXISTING JUNCTION BOX TO BE REMAIN						
J	PROPOSED JUNCTION BOX, SIZE AND TYPE AS NOTED						
H _R	EXISTING HANDHOLE TO BE REMOVED						
\bowtie	EXISTING IDOT LIGHTING CONTROLLER TO BE REMOVED						
\bowtie	PROPOSED IDOT LIGHTING CONTROLLER						
\triangle	EXISTING ELECTRIC UTILITY SERVICE TO BE REMOVED						
	PROPOSED ELECTRIC UTILITY SERVICE						
	EXISTING CABLE IN CONDUIT CONDUIT EMBEDDED IN STRUCTURE TO REMAIN						
	EXISTING CONDUIT ATTACHED TO STRUCTURE TO REMAIN						
	PROPOSED ELECTRIC CABLE IN CONDUIT, SIZE AND TYPE AS NOTED						
	PROPOSED UNIT DUCT, SIZE AND TYPE AS NOTED						
	PROPOSED UNIT DUCT IN UNDERGROUND CONDUIT, SIZE AND TYPE AS NOTED						
	EXISTING UNIT DUCT TO REMAIN						
—— E ——	EXISTING UNDERGROUND UNIT DUCT TO BE ABANDONED IN PLACE						

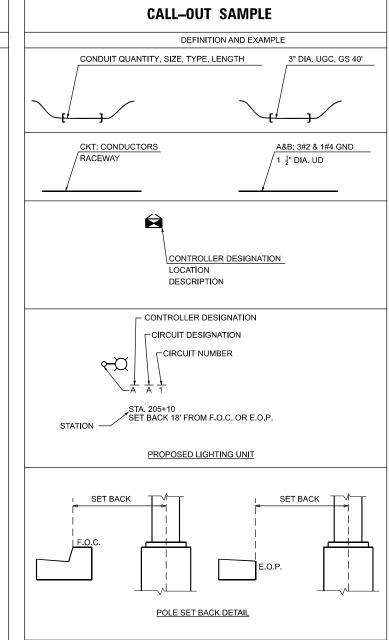

SCALE:

GENERAL NOTES

- THE ELECTRICAL WORK SHALL BE PERFORMED IN ACCORDANCE WITH THE LATEST CODES, STANDARDS AND THE IDOT STANDARD SPECIFICATIONS FOR ROAD AND BRIDGE CONSTRUCTION ADOPTED JANUARY 1, 2024, AND SUPPLEMENTAL SPECIFICATIONS AND RECURRING SPECIAL PROVISIONS.
- 2. THE CONTRACTOR SHALL CONTACT MEADE ELECTRIC CO. DISTRICT ONE ELECTRICAL MAINTENANCE CONTRACTOR TO LOCATE IDOT ELECTRICAL EQUIPMENT AND UNDERGROUND CABLES 773-287-7672.

<u>IDOT-D1 STANDARDS</u>:

STANDARD	NO.	TITLE

BE-206 LIGHTING CONTROLLER, BASE MOUNTED, 480VOLT, 200AMP (DUAL)

RADIO SACDA - FIBER OPTIC PROVISION

BE-220 ELECTRIC SERVICE INSTALLATION, REMOTE DISCONNECT

BE-305 LIGHT POLE FOUNDATION, METAL

BE-400 ALUMINUM LIGHT POLE 47'-6" (14.478 m) MOUNTING HEIGHT

BE-701 LUMINAIRE SAFETY CABLE ASSEMBLY

BE-702 MISC. ELECTRICAL DETAILS SHEET A

BE-901 SUSPENDED MOUNT LED UNDERPASS LUMINAIRE INSTALLATION DETAILS

SINGH SINGH+ASSOCIATES, INC.


ISER NAME = mgonzalez	DESIGNED - MG	REVISED -
	DRAWN - VN	REVISED -
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LOT DATE = 5/1/2025	DATE - 03/14/2025	REVISED -


LIGHTIN	0.15051	ID AND O	ENIEDAL I	NOTES	F.A.I. RTE	SECTION
LIGHTIN	G LEGE	ND AND G	ENERALI	NOTES	80	FAI 80 23 LIGHTING
SHEET	OF	SHEETS	STA.	TO STA.		ILLINOIS


 COUNTY
 TOTAL SHEETS NO.


 WILL
 49
 12

 CONTRACT NO.
 62W15

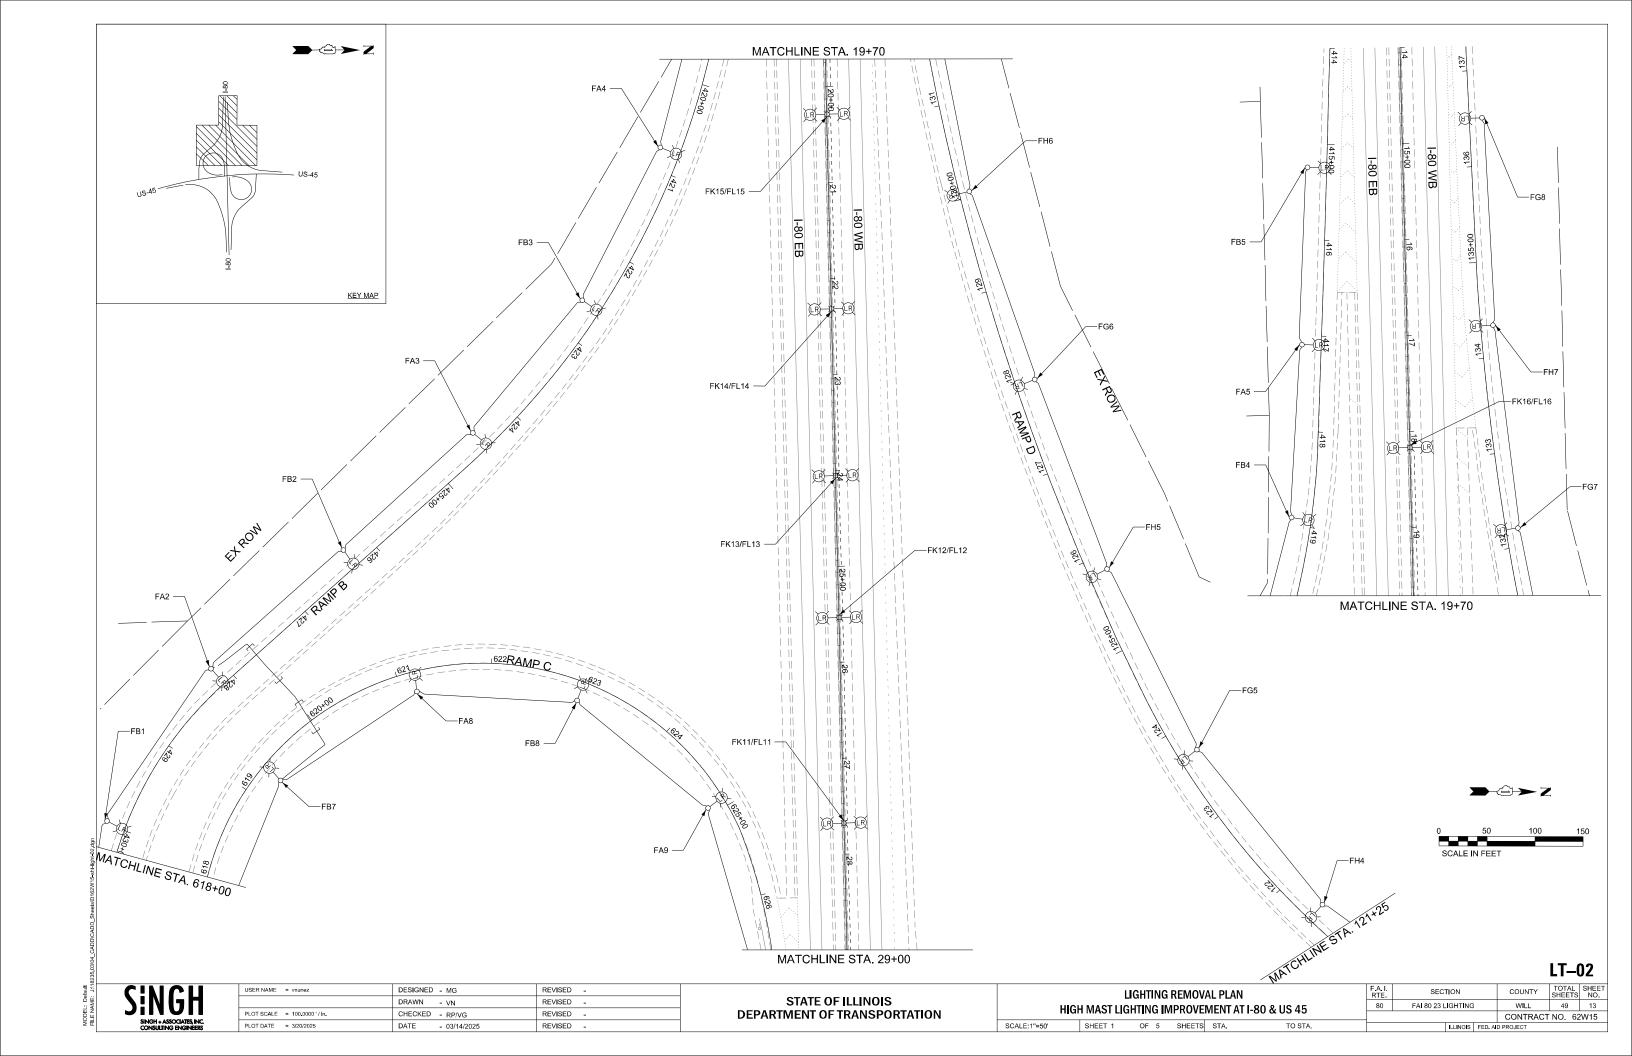

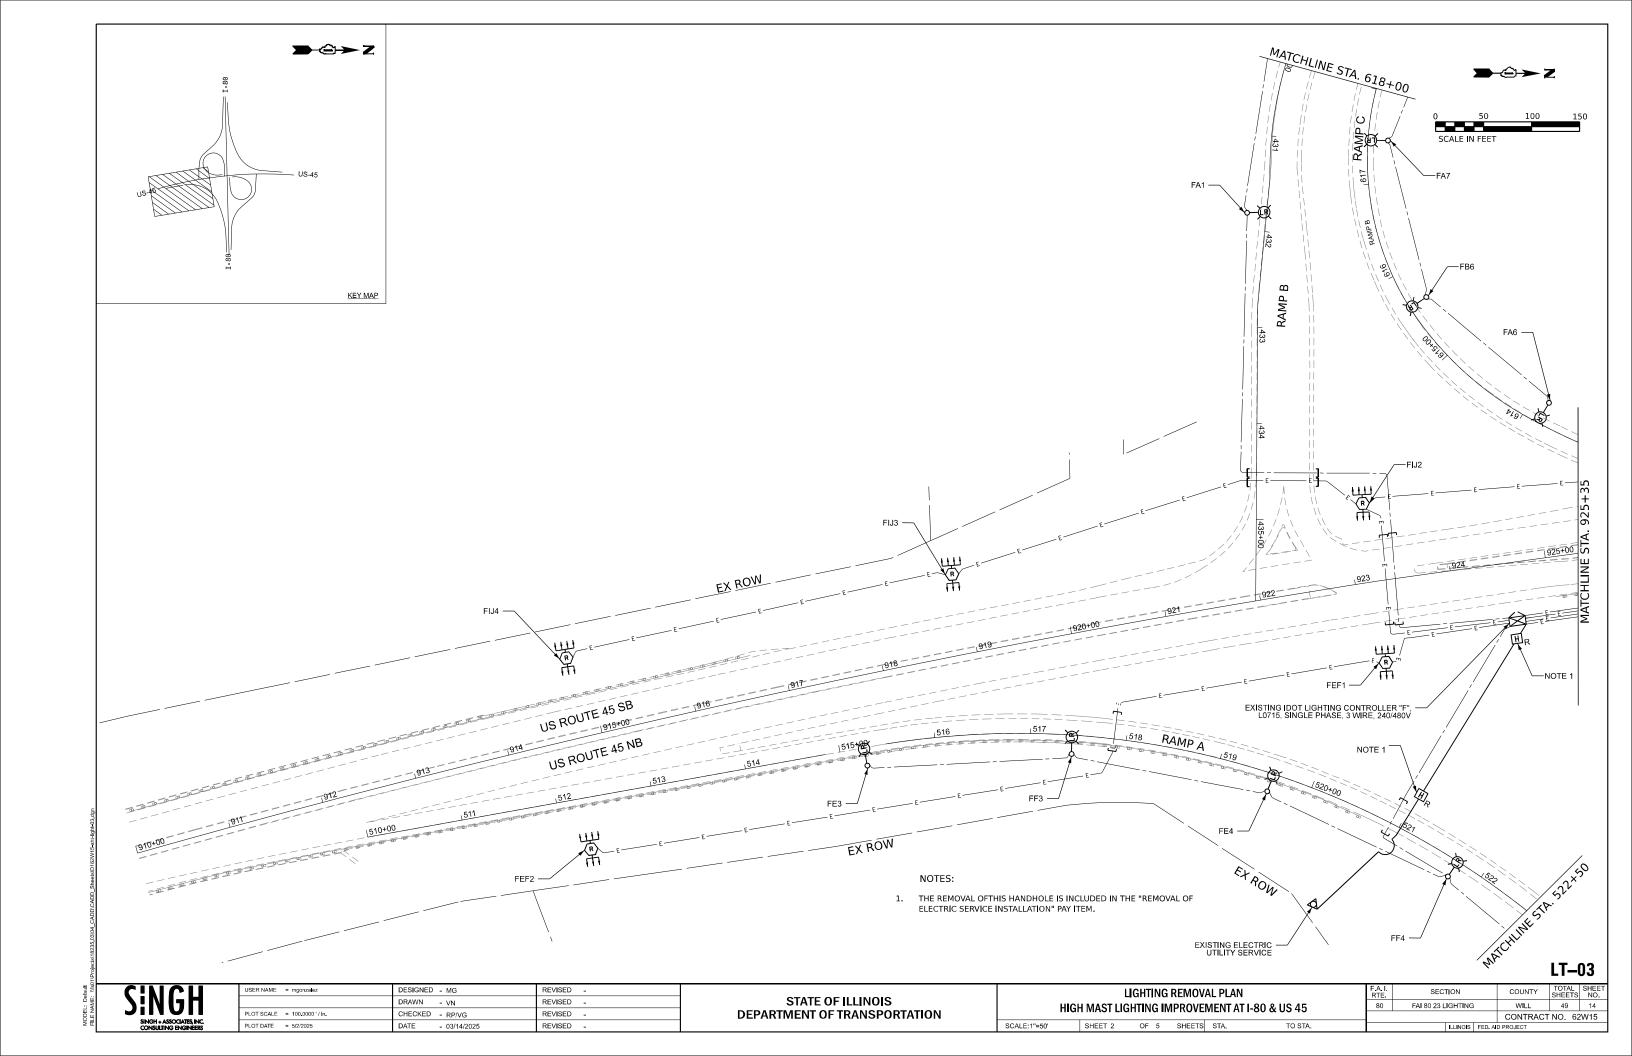

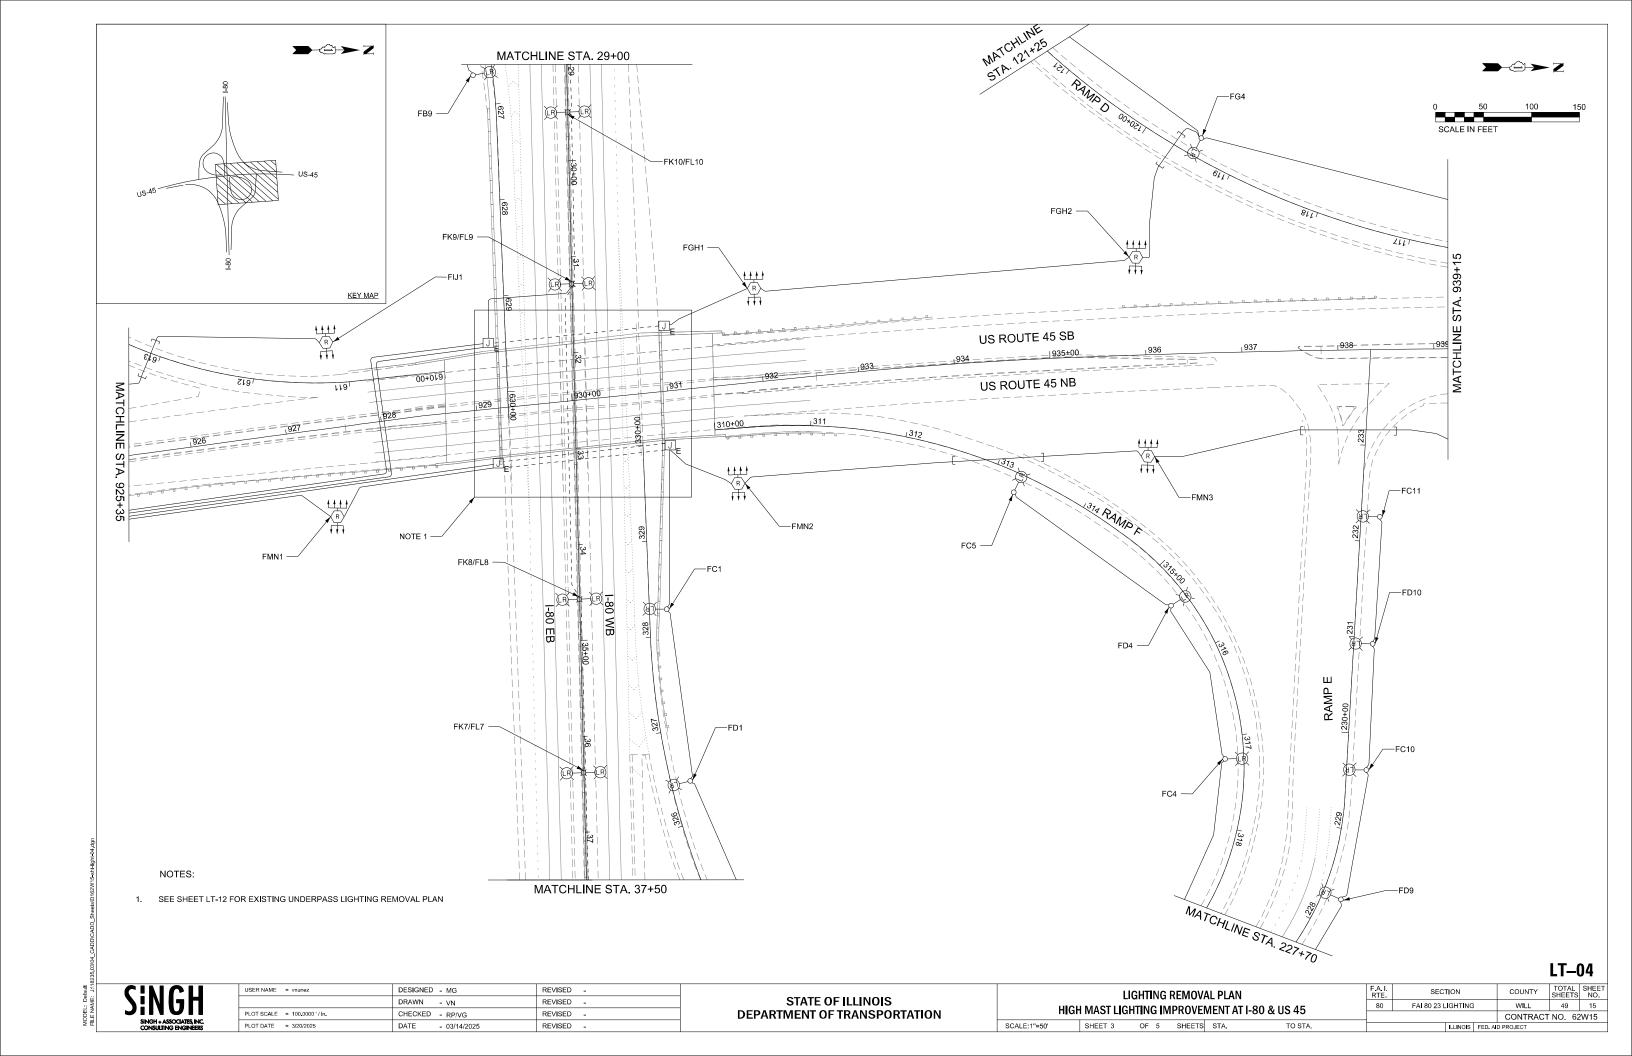

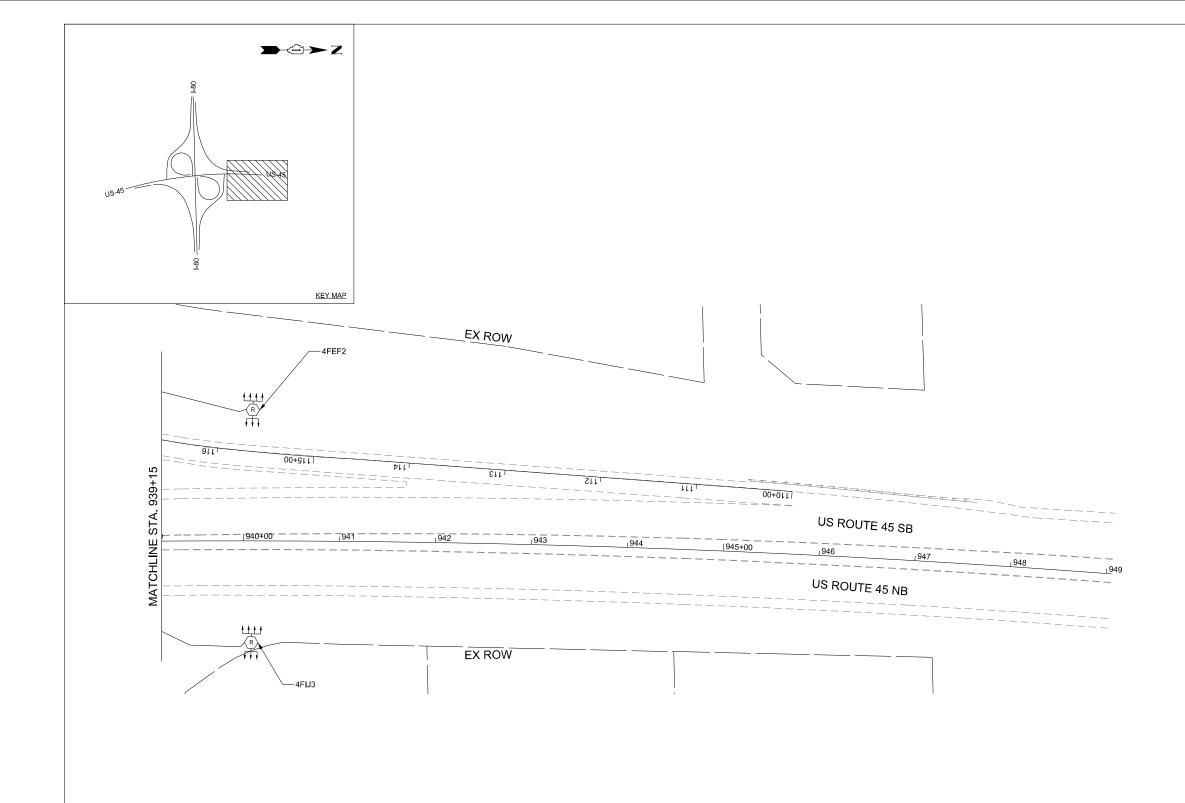

LT-05


| TOTAL SHEET | NO. | 49 | 16 | NO. | 62W45





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	DRAWN - VN	REVISED -	
PLOT SCALE = 100.0000 ' / in.	CHECKED - RP/VG	REVISED -	
PLOT DATE = 3/20/2025	DATE - 03/14/2025	REVISED -	


STATE OF ILLINOIS	
DEPARTMENT OF TRANSPORTATION	


	Ll	IGHTING	REMOV	AL PLAN		F.A.I. RTE	SECTION	COUNTY	TOTAL SHEETS	SHEET NO.
HIGH	MASTIIG	HTING IM	IDRAVE	MENT AT	I-80 & US 45	80	FAI 80 23 LIGHTING	WILL	49	16
Hijai	I WIASI LIG	i i i ji va jiv	II KOVLI	VILIVI AI	1-00 & 03 +3			CONTRACT	NO. 62	2W15
SCALE:1"=50'	SHEET 4	OF 5	SHEETS	STA.	TO STA.		ILLINOIS FE	D. AID PROJECT		

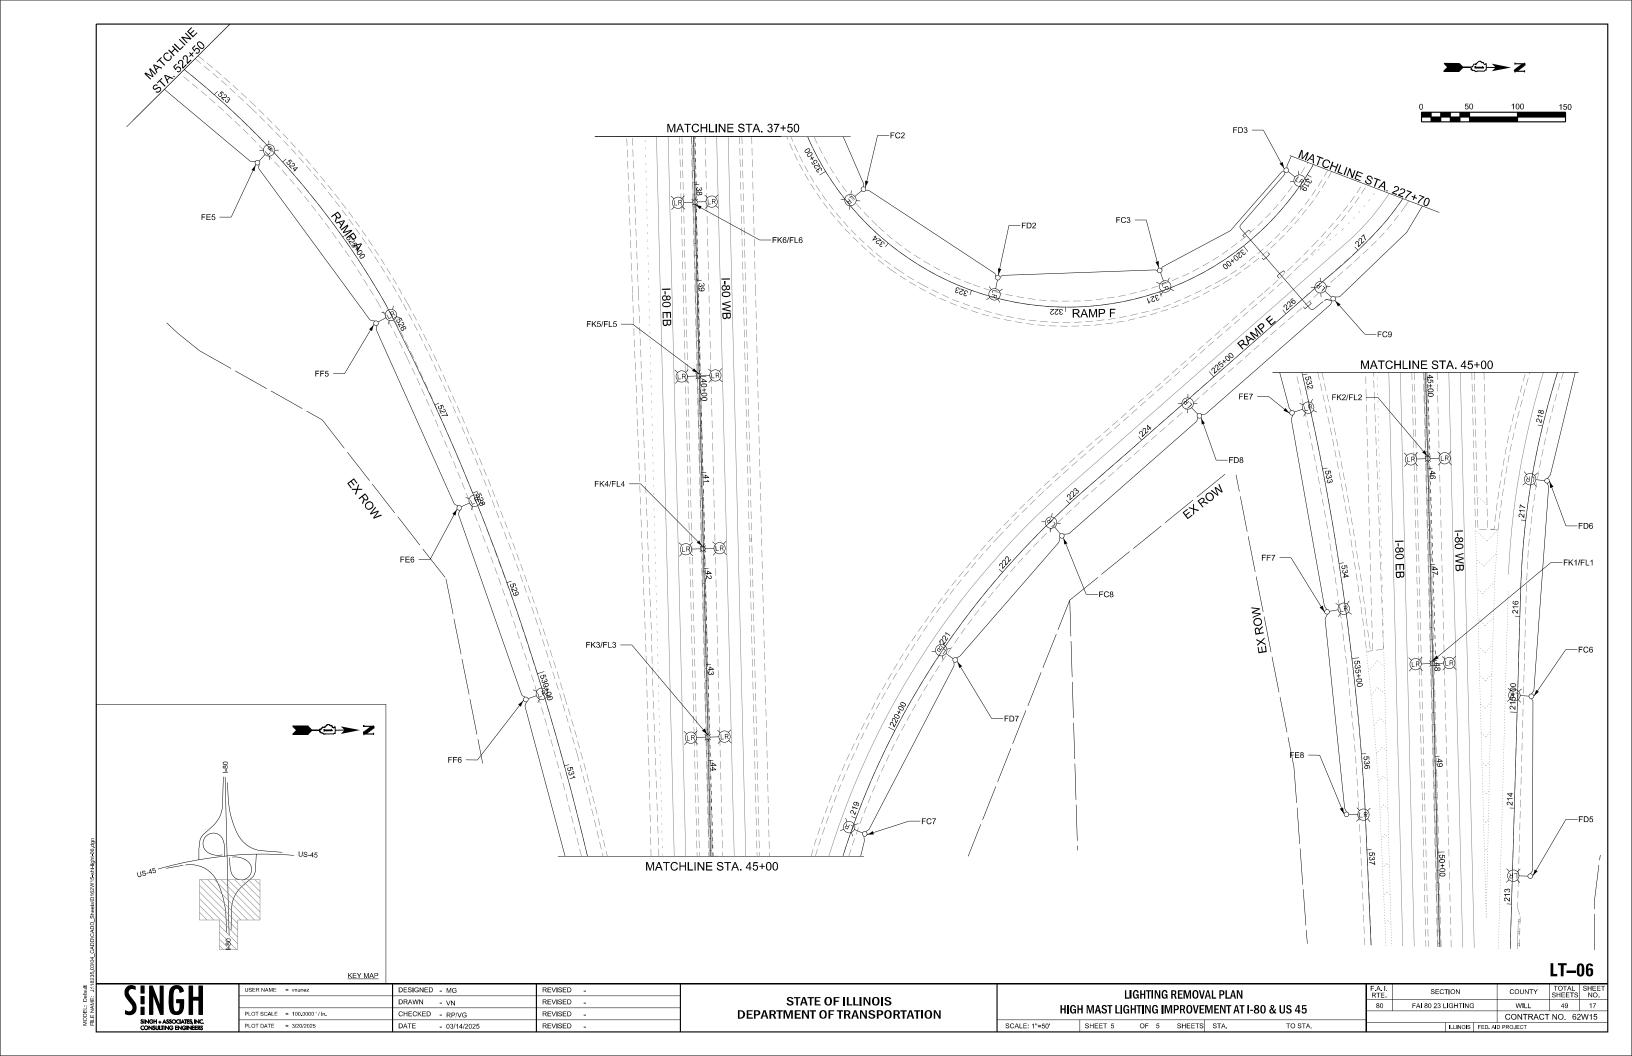

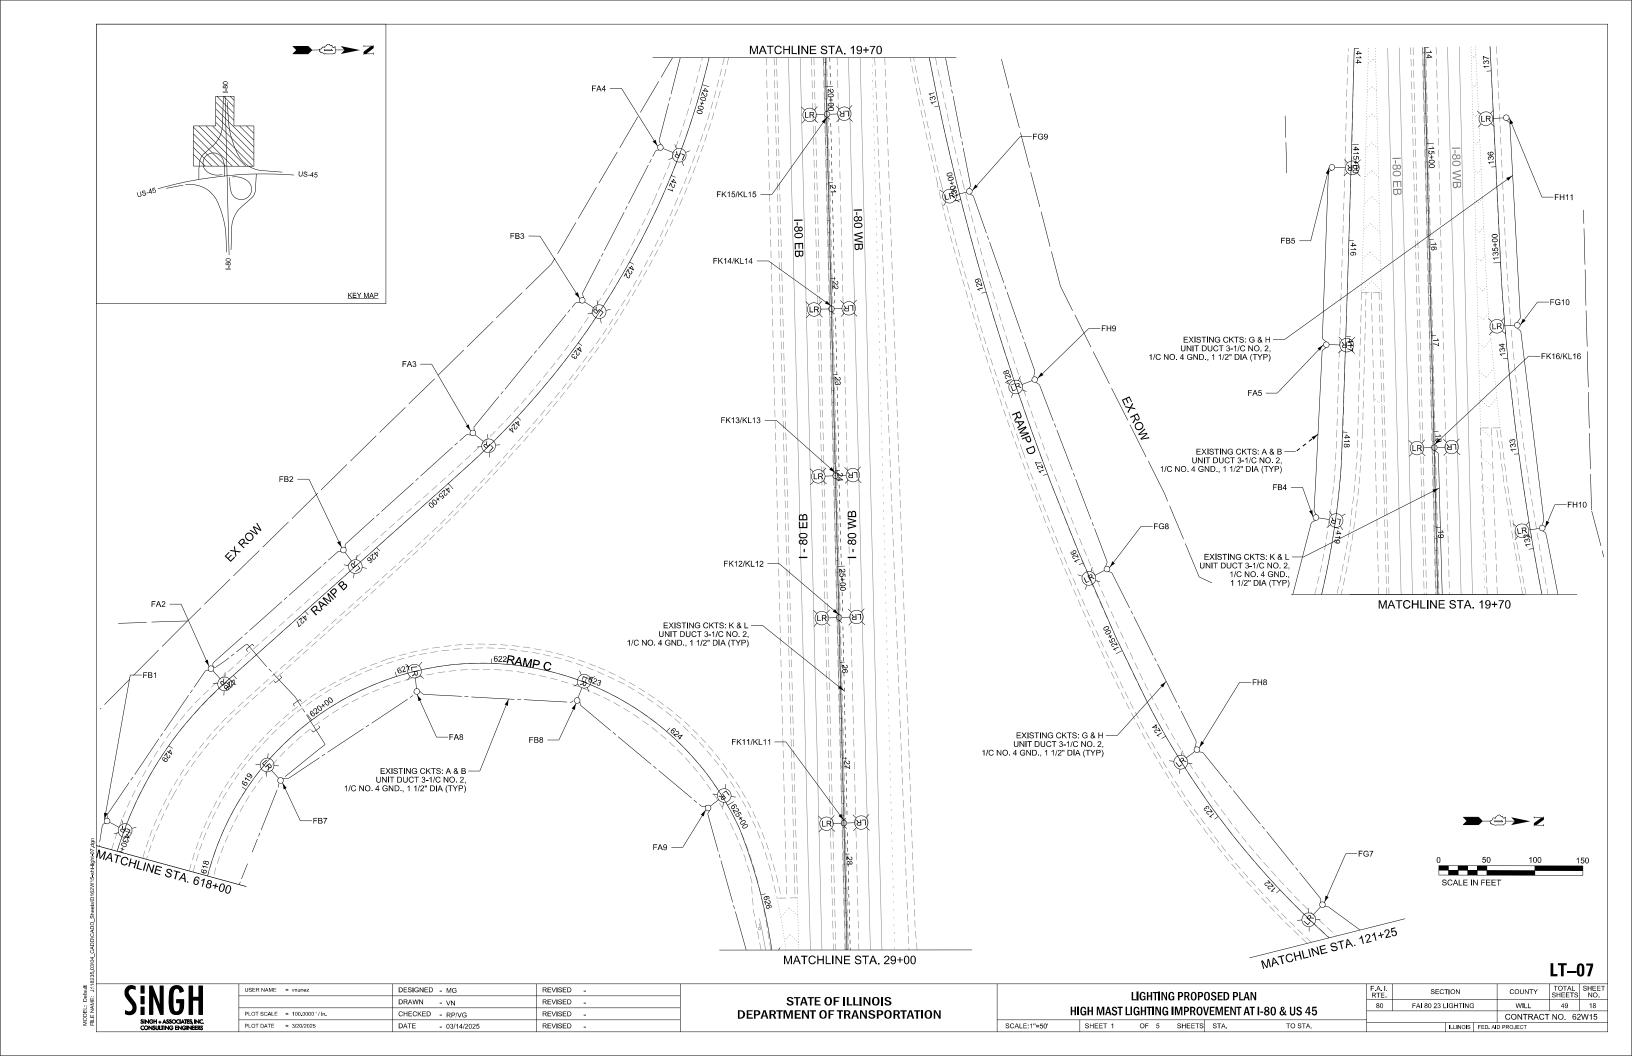

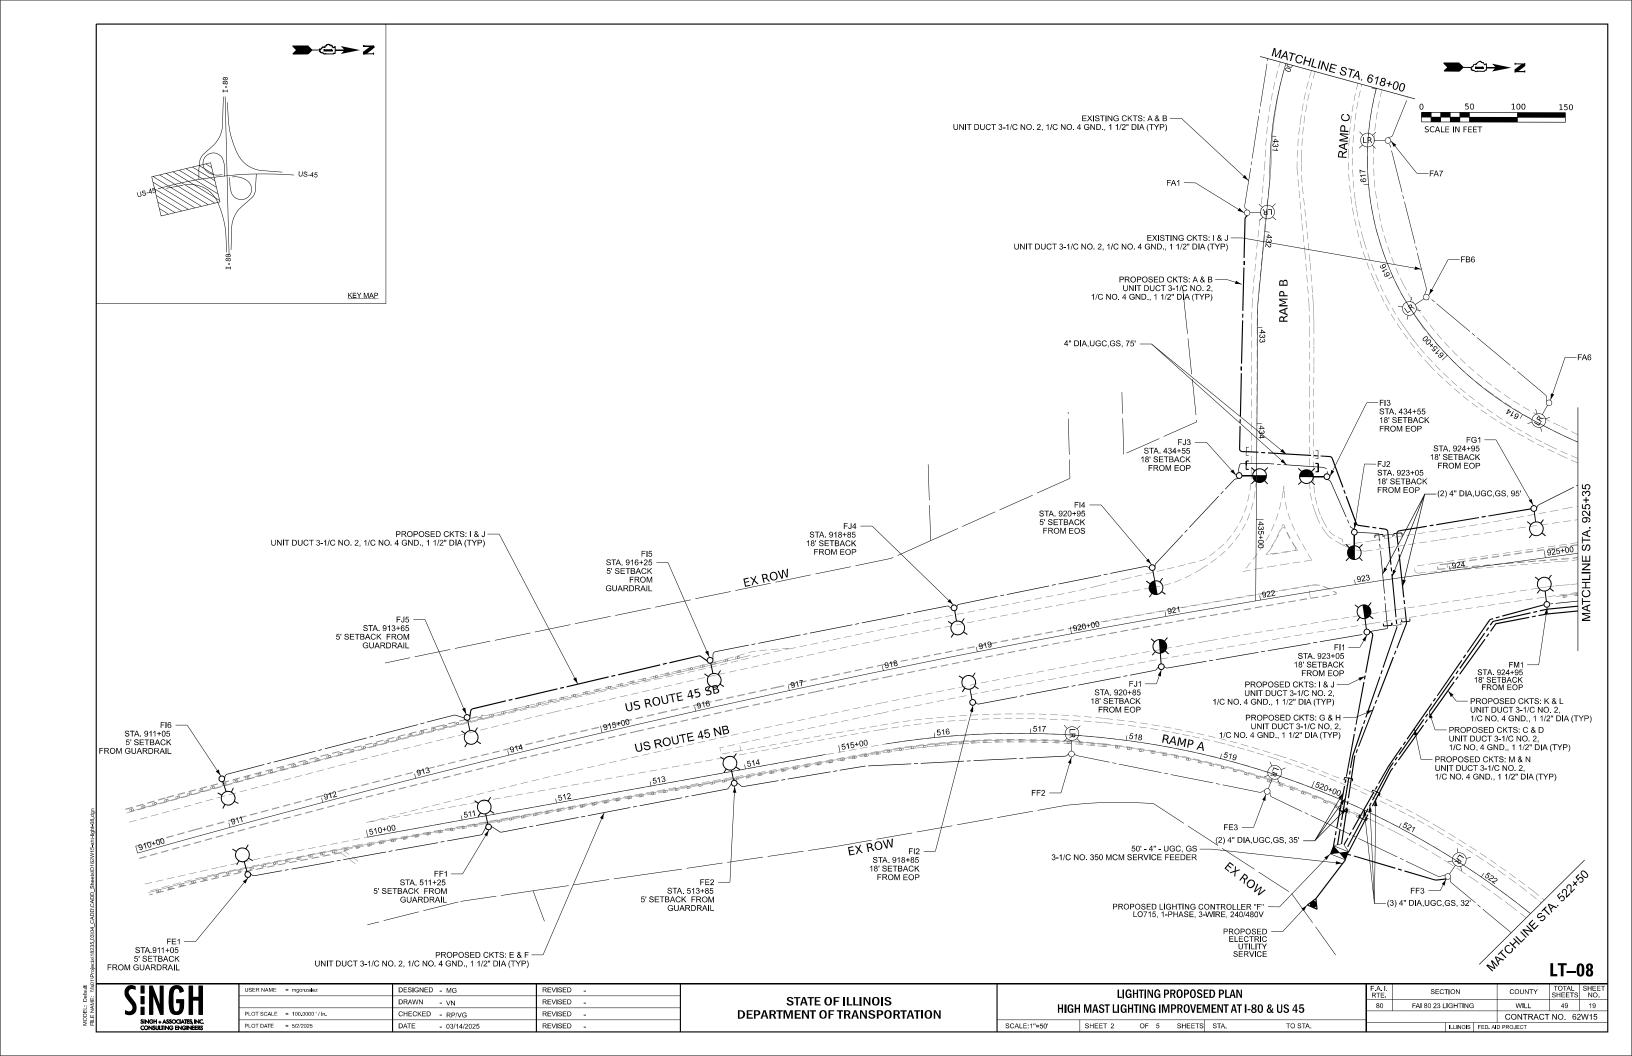

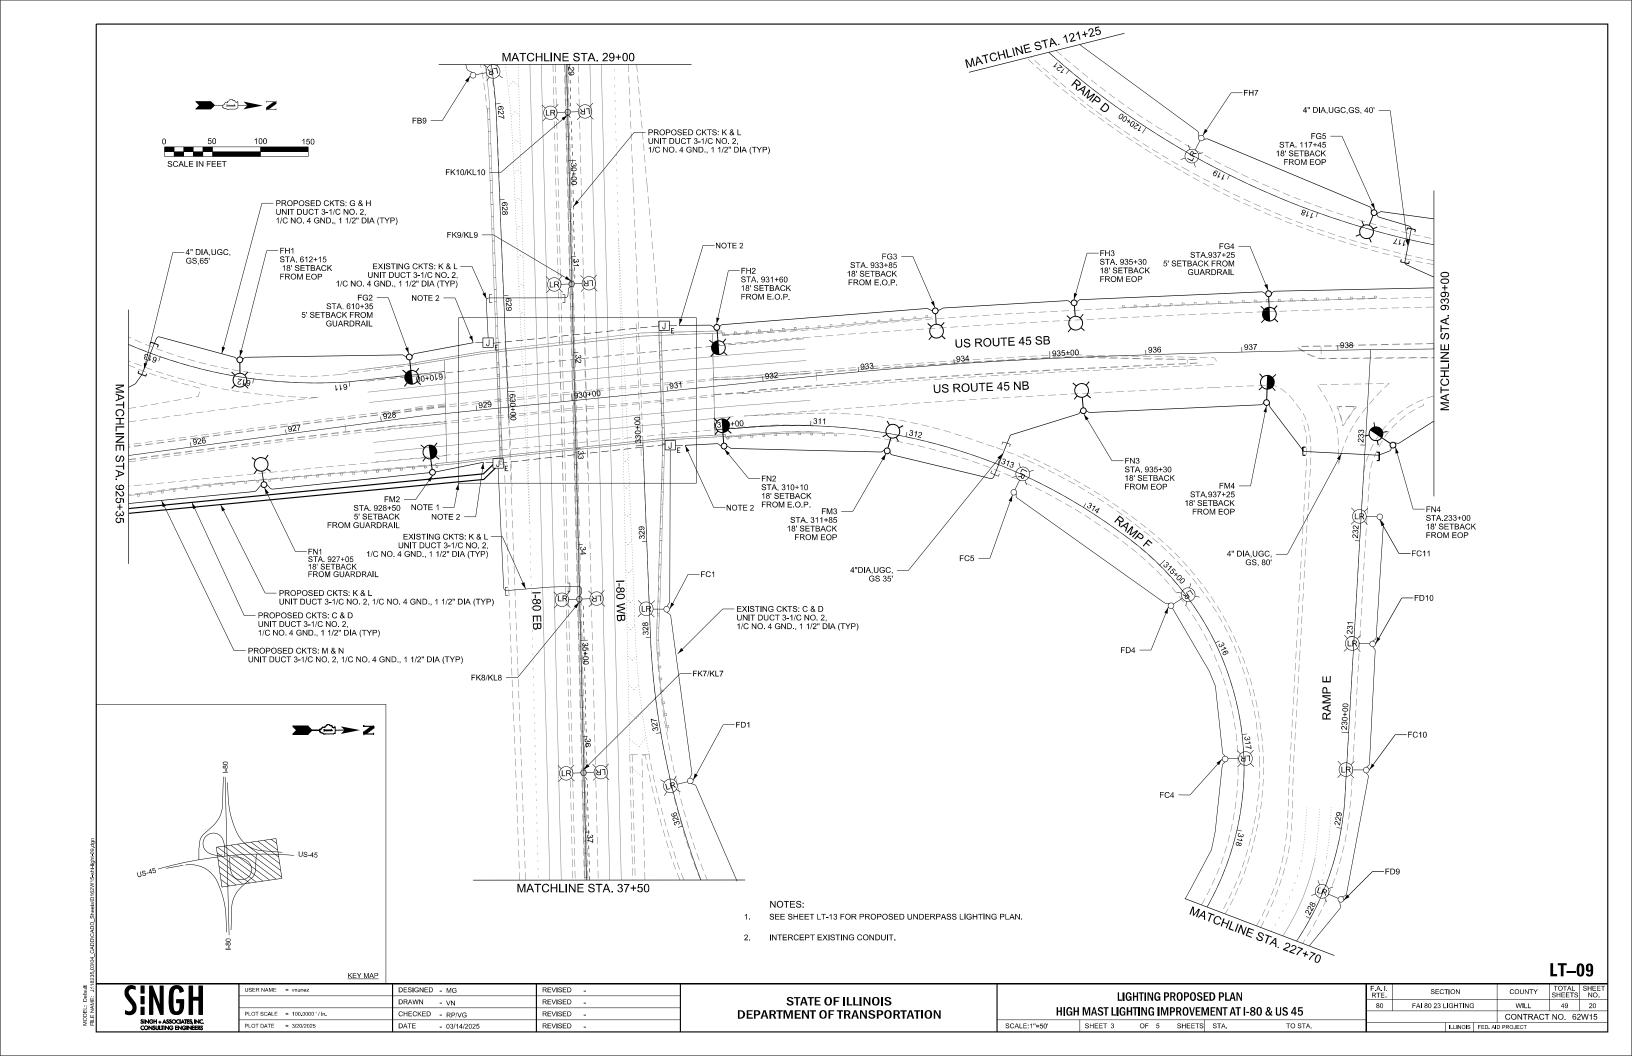

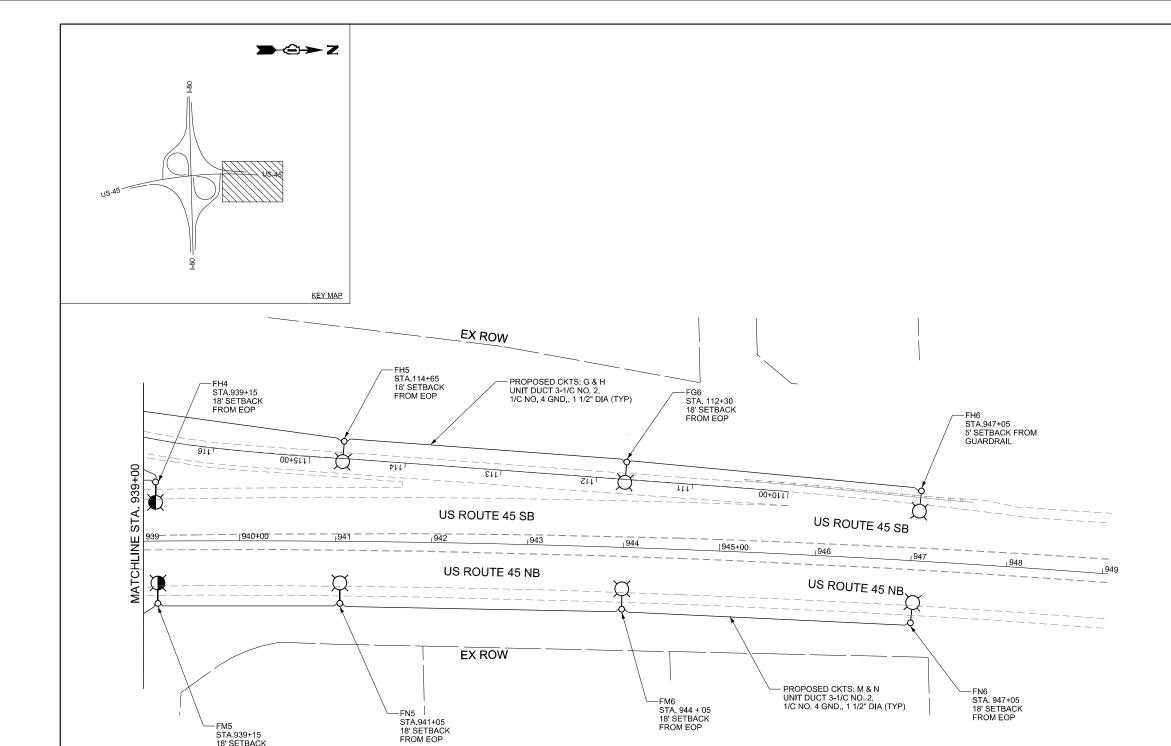





LT-10 COUNTY TOTAL SHEET NO.
WILL 49 21

COUNTY

S	N	G	H
		ASSOCIATING ENG	


—FM5 STA.939+15 18' SETBACK FROM EOP


ı	USER NAME = vnunez	DESIGNED - MG	REVISED -	
ı		DRAWN - VN	REVISED -	
ı	PLOT SCALE = 100.0000 ' / in.	CHECKED - RP/VG	REVISED -	
	PLOT DATE = 3/20/2025	DATE - 03/14/2025	REVISED -	

SCALE:1"=50'

SECTION

FAI 80 23 LIGHTING

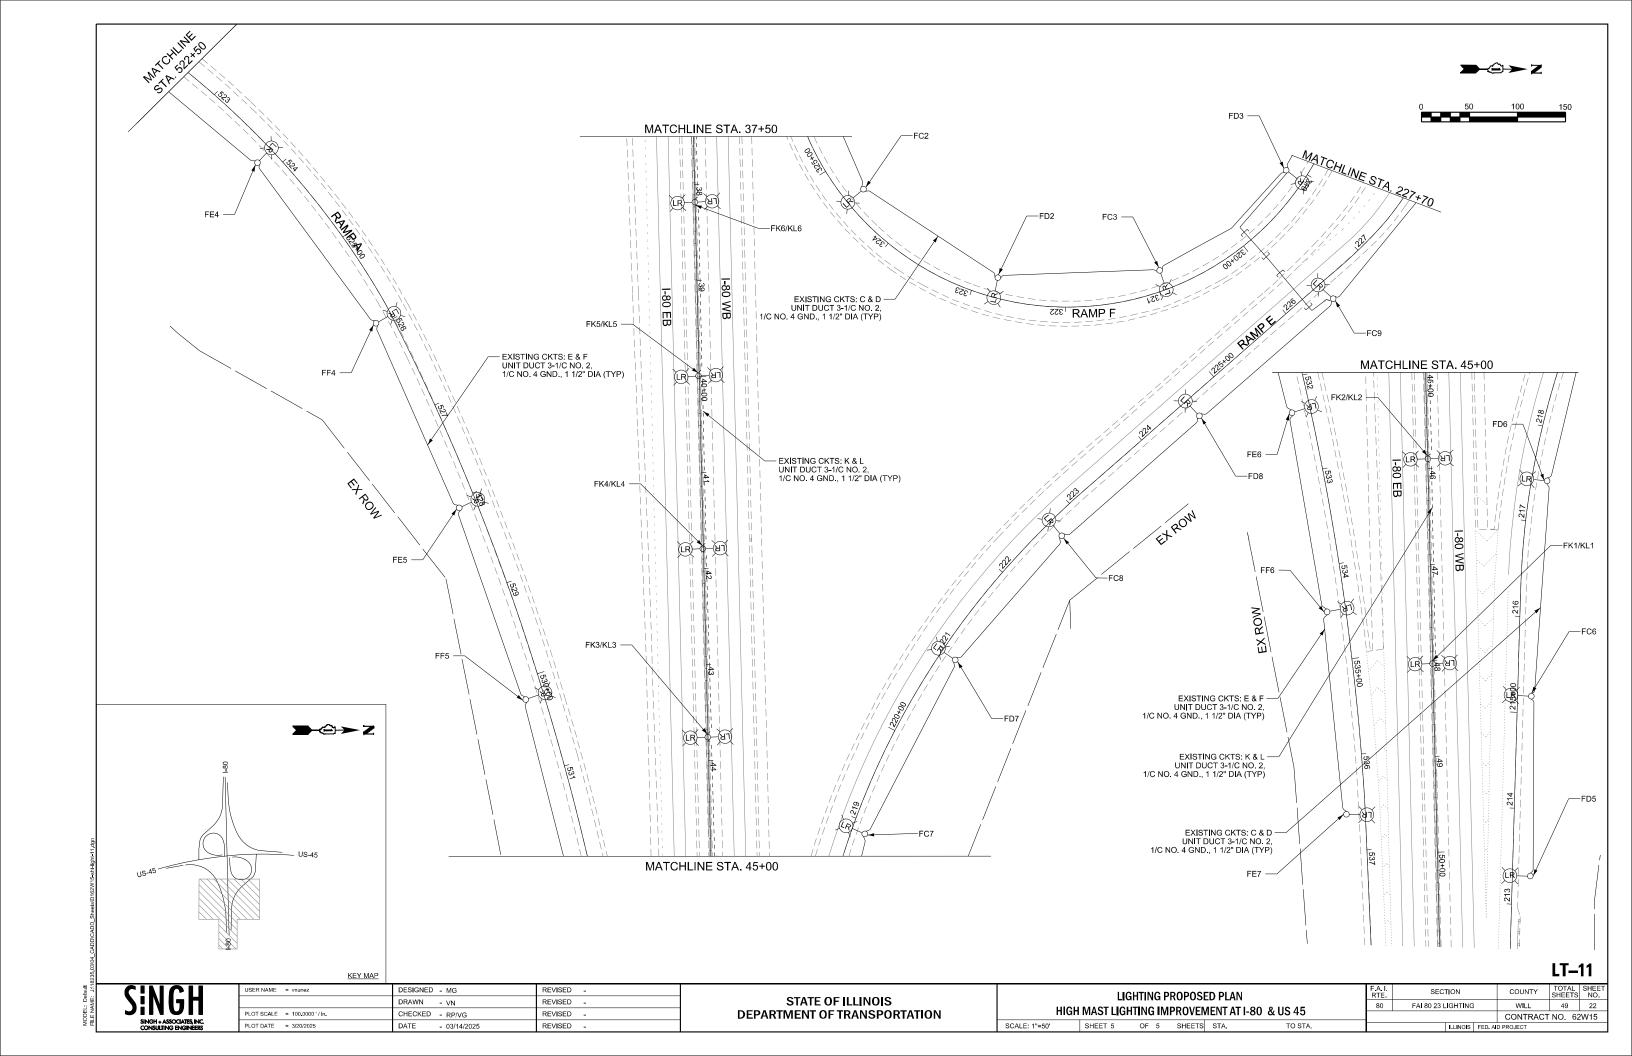

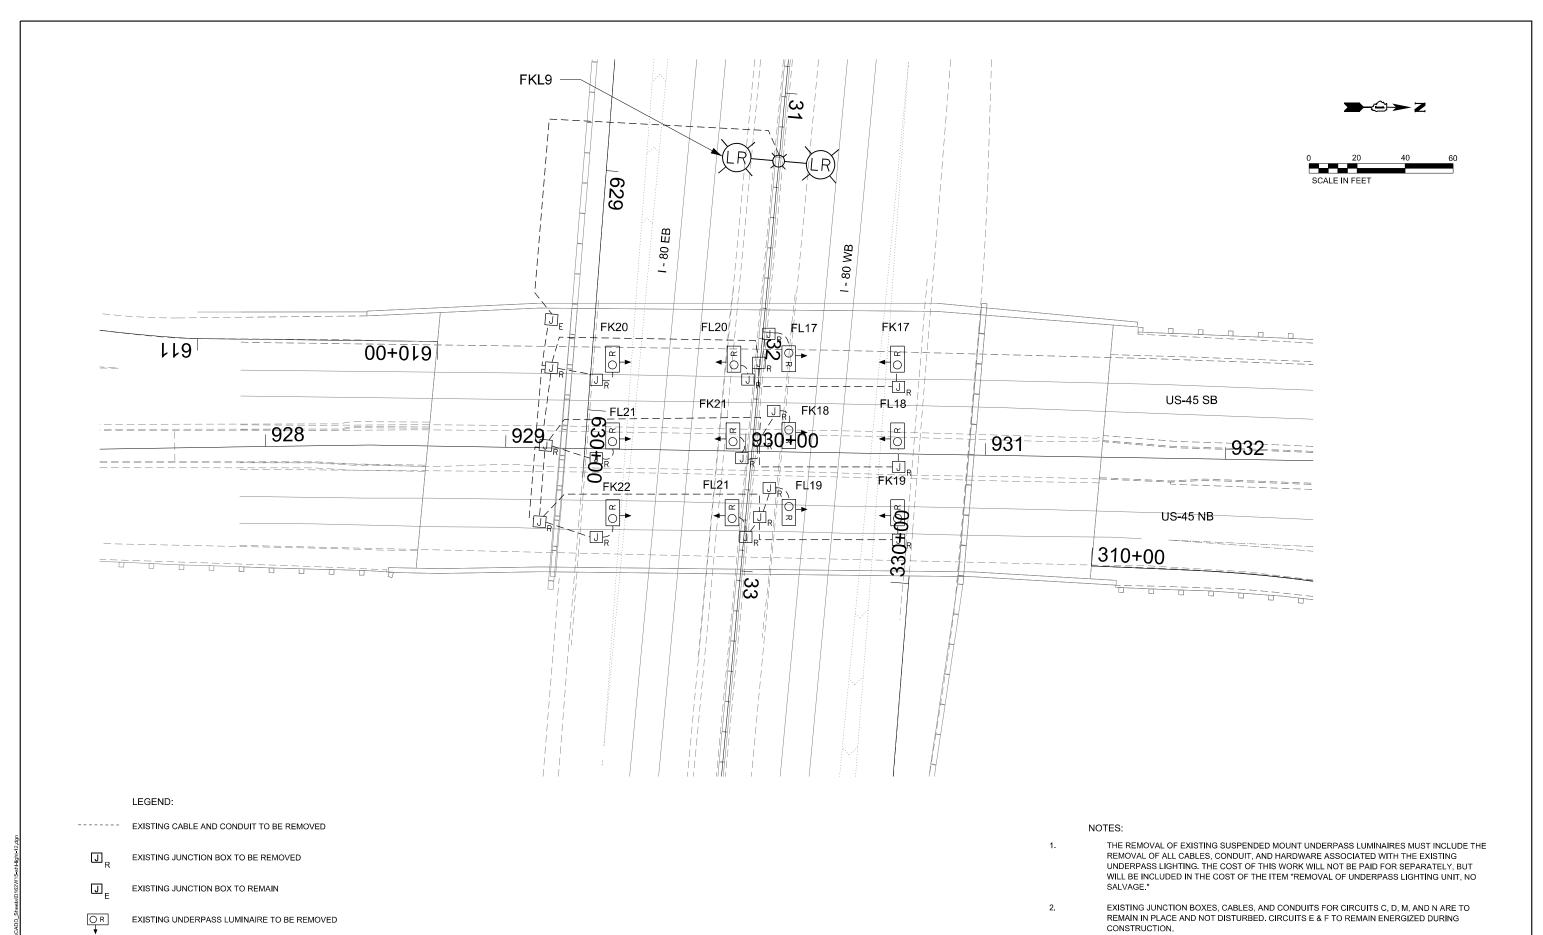

ITV

LT-12

SINGH

 USER NAME
 = vnunez
 DESIGNED
 - MG
 REVISED

 DRAWN
 - VN
 REVISED

 PLOT SCALE
 = 40,0000*/ in.
 CHECKED
 - RP/VG
 REVISED

 PLOT DATE
 = 3/20/2025
 DATE
 - 03/14/2025
 REVISED

STATE OF ILLINOIS DEPARTMENT OF TRANSPORTATION EXISTING UNDERPASS LIGHTING REMOVAL PLAN

I - 80 AT US - 45

SCALE: 1:20 SHEET 1 OF 1 SHEETS STA. TO STA.


 F.A.I. RTE.
 SECTION
 COUNTY
 TOTAL SHEETS
 NO.

 80
 FAI 80 23 LIGHTING
 WILL
 49
 23

 CONTRACT NO. 62W15

LEGEND

- A 3-1/C NO.10 AND 1/C NO.10 GND IN 1" PVCC RGC
- B 2-1/C NO.10 AND 1/C NO.10 GND IN 1"PVCC RGC
- $\langle C \rangle$ 2-1/C NO.10 AND 1-1/C NO.10 GND IN 3/4" LIQUID-TIGHT FLEXIBLE CONDUIT
- $\Big\langle \, \mathsf{D} \Big\rangle \,$ UNIT DUCT, 600V, 3-1/C NO. 2 1/C NO. 4, GND 1 1/2" DIA. (TYP)
- LUMINAIRE, LED, UNDERPASS, SUSPENDED, OUTPUT DESIGNATION E (14.5-FT M.H.)
- JUNCTION BOX, STAINLESS STEEL, ATTACHED TO STRUCTURE, 6"X6"X4"
- JUNCTION BOX, STAINLESS STEEL, ATTACHED TO STRUCTURE, 12" X 10" X 6"
- EXISTING JUNCTION BOX TO REMAIN

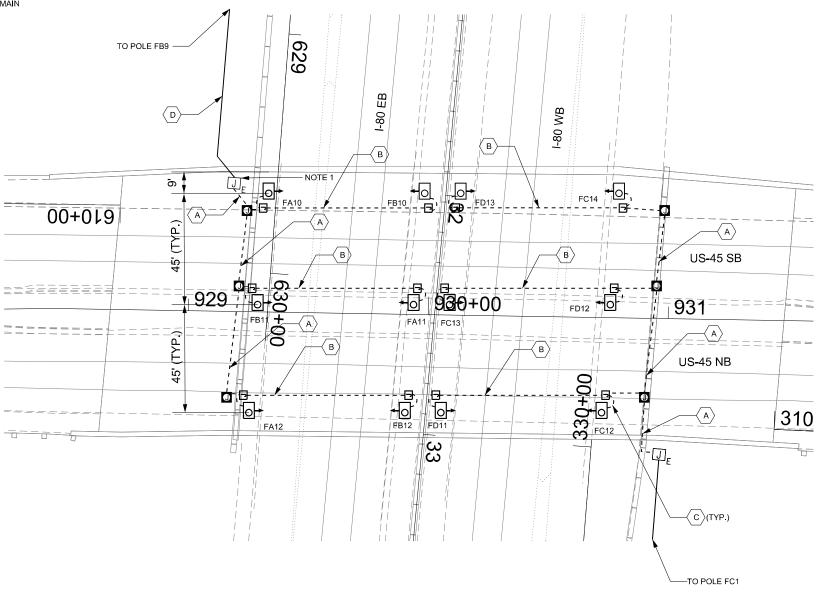


NOTES

- 1. INSTALL FUSEHOLDER WITH 30 AMP FUSES AND NEUTRAL SLUG INSIDE THE JUNCTION BOX.
- 2. PROPOSED UNDERPASS LUMINAIRES SHALL BE SETBACK 6' FROM EDGE OF PAVEMENT.

LT-13



USER NAME = vnunez	DESIGNED - MG	REVISED -
	DRAWN - VN	REVISED -
PLOT SCALE = 40.0000 / in.	CHECKED - RP/VG	REVISED -
PLOT DATE = 3/20/2025	DATE - 03/14/2025	REVISED -

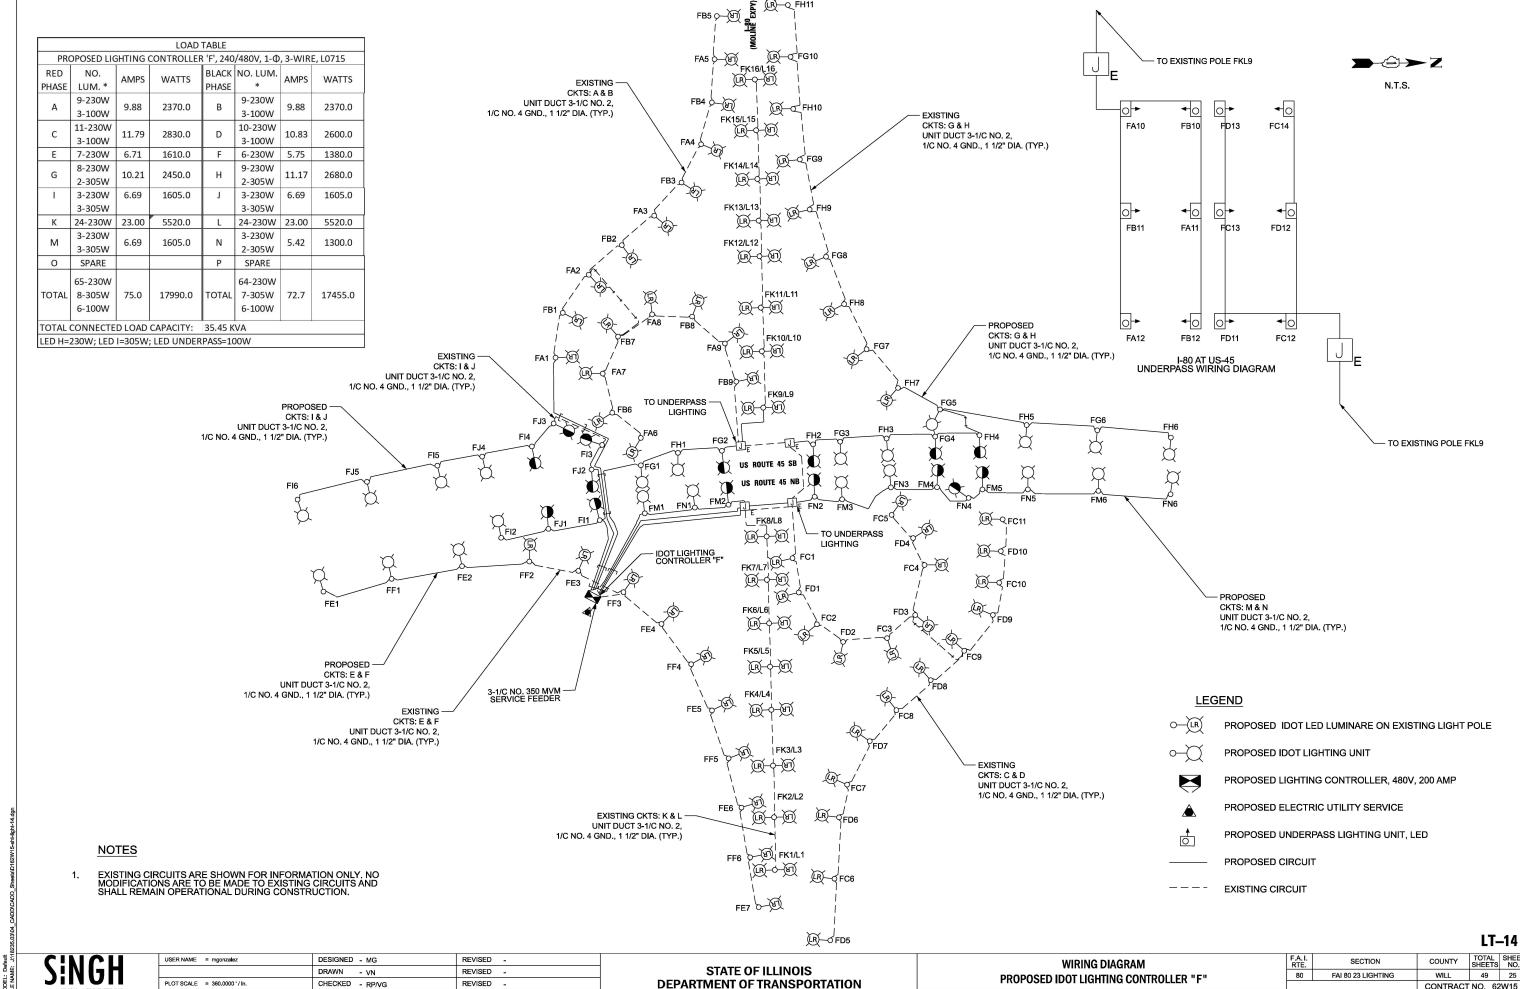

SCALE: N.T.S.

OF 1 SHEETS STA.

CONTRACT NO. 62W15


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PLOT DATE = 5/1/2025

CHECKED - RP/VG

- 03/14/2025

REVISED

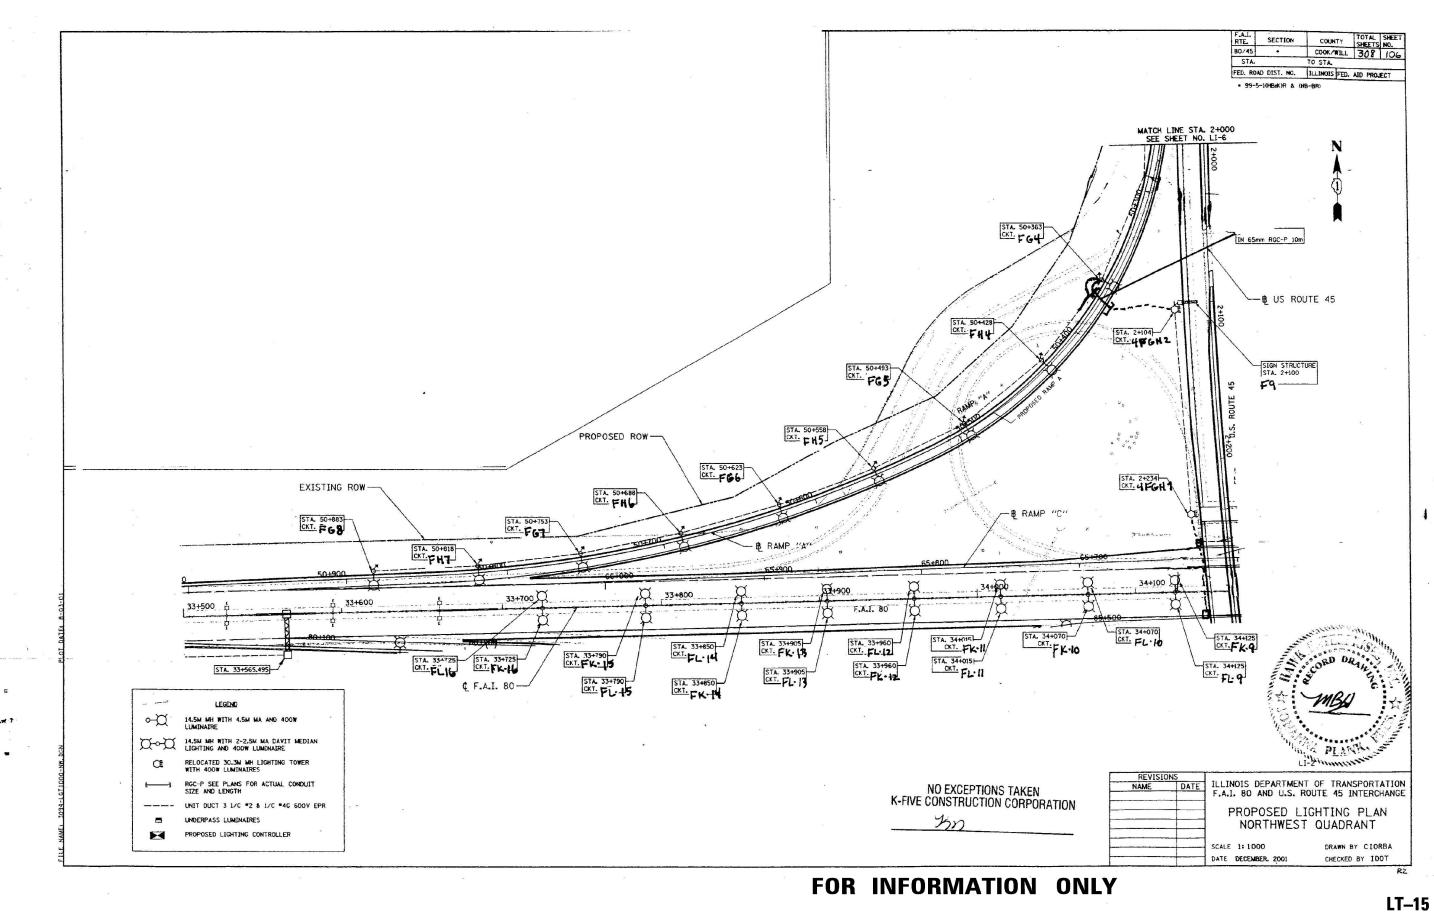


JSER NAME = vnunez

DESIGNED - MG DRAWN - VN REVISED -PLOT SCALE = 2,0000 ' / In. CHECKED - RP/VG REVISED -- 03/14/2025 REVISED .

REVISED -

STATE OF ILLINOIS **DEPARTMENT OF TRANSPORTATION** **IDOT CONTRACT 82462 RECORD DRAWINGS** OF SHEETS STA.

TOTAL SHEET NO. SECTION COUNTY FAI 80 23 LIGHTING WILL CONTRACT NO. 62W15

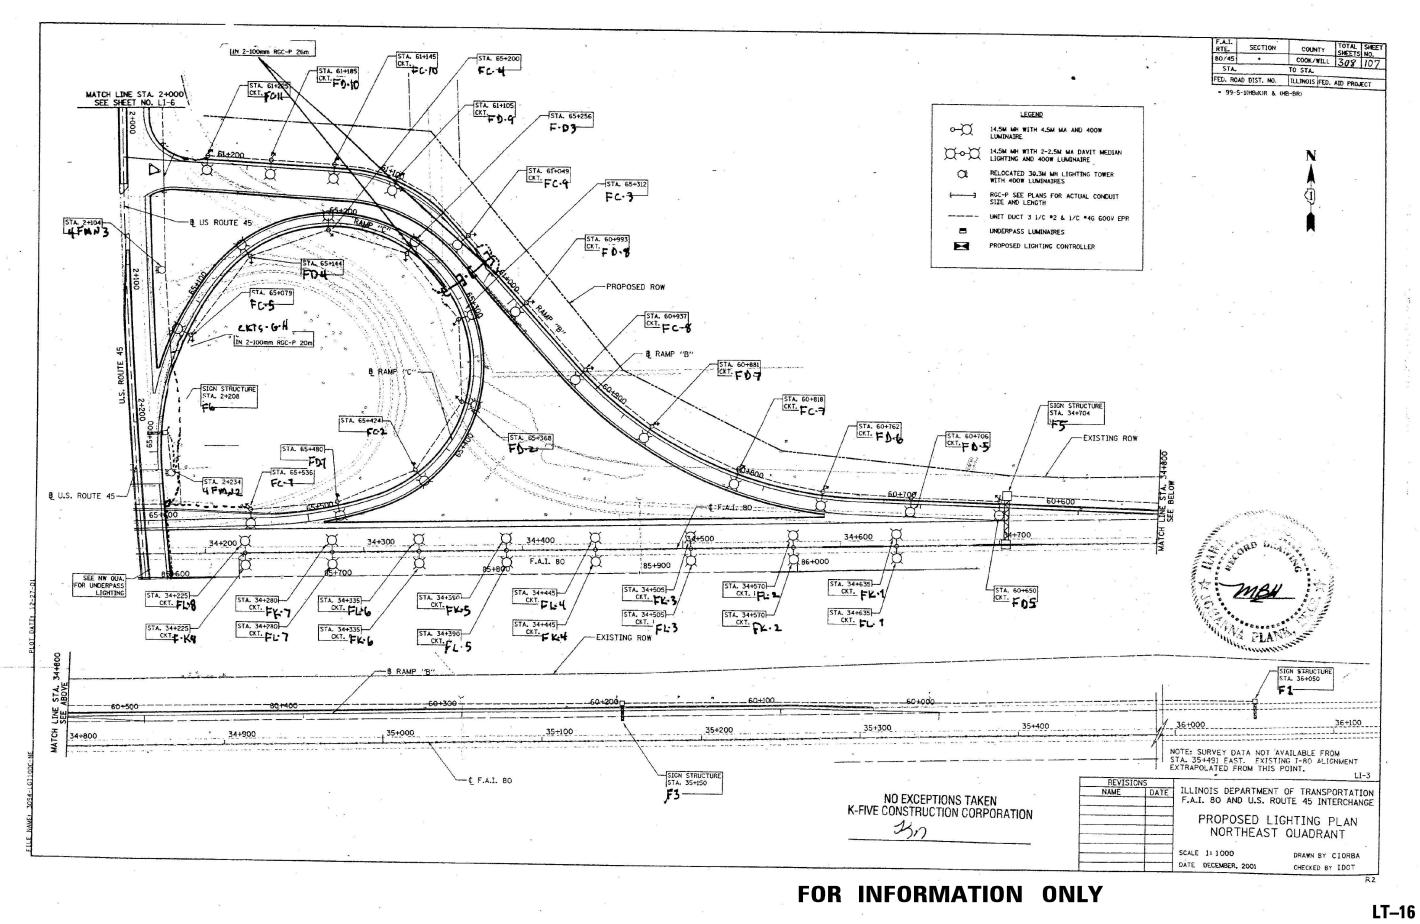


JSER NAME = vnunez

DESIGNED - MG DRAWN - VN REVISED PLOT SCALE = 2,0000 ' / In. CHECKED - RP/VG REVISED -- 03/14/2025 REVISED

REVISED -

STATE OF ILLINOIS **DEPARTMENT OF TRANSPORTATION** **IDOT CONTRACT 82462 RECORD DRAWINGS** SHEETS STA.

TOTAL SHEET NO. SECTION COUNTY FAI 80 23 LIGHTING WILL CONTRACT NO. 62W15

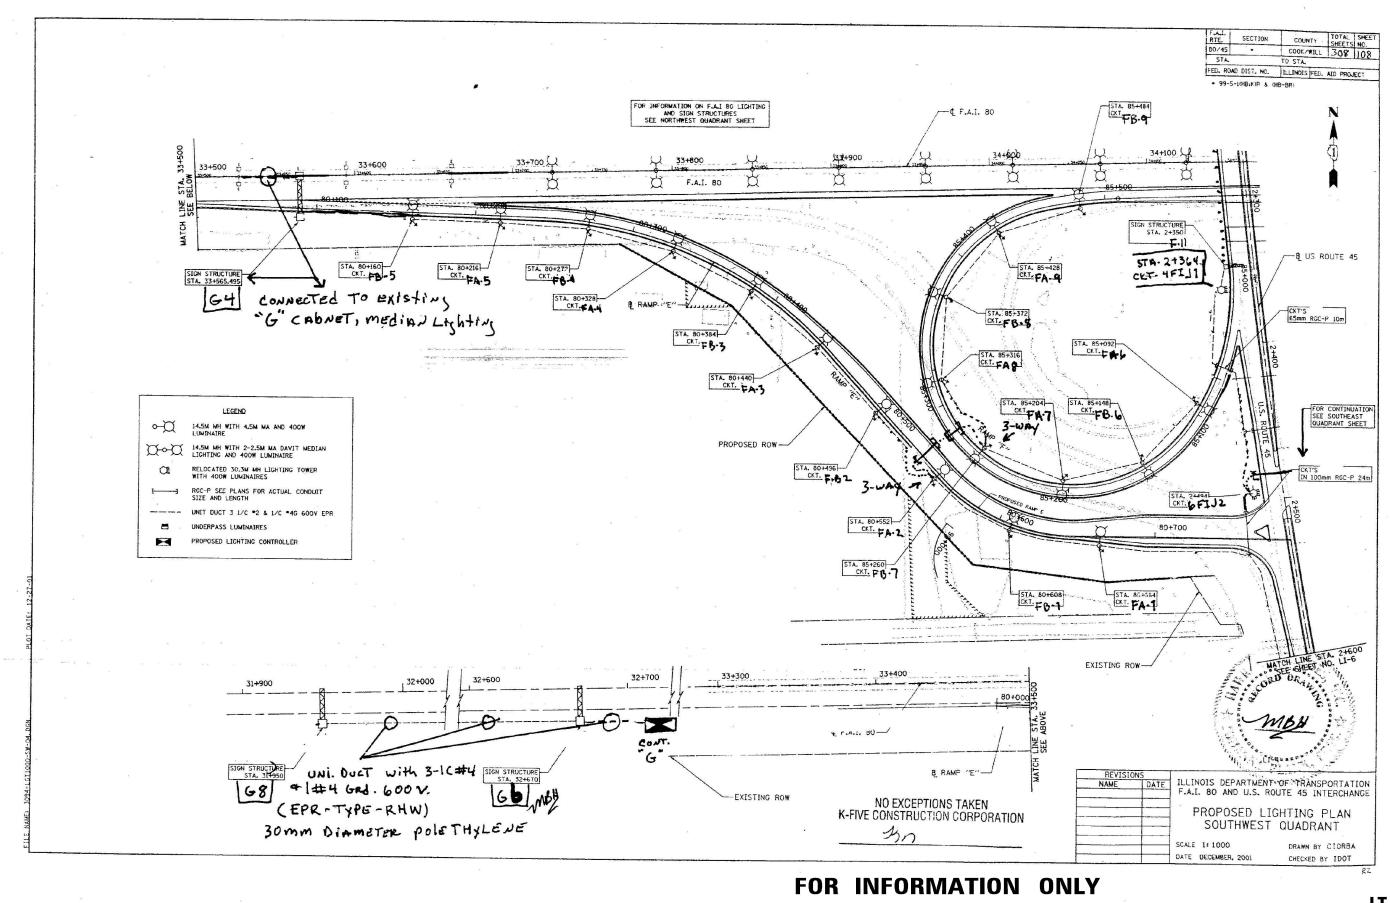

LT-17

SINGH ASSOCIATES INC.

USER NAME = vnunez	DESIGNED - MG	REVISED -
	DRAWN - VN	REVISED -
PLOT SCALE = 2,0000 '/ In.	CHECKED - RP/VG	REVISED -
PLOT DATE = 3/20/2025	DATE - 03/14/2025	REVISED -

STATE OF ILLINOIS
DEPARTMENT OF TRANSPORTATION


IDOT CONTRACT 82462 RECORD DRAWINGS

SCALE: SHEET OF SHEETS STA. TO STA.

A.I. SECTION COUNTY TOTAL SHEET NO.

80 FAI 80 23 LIGHTING WILL 49 28

CONTRACT NO. 62W15

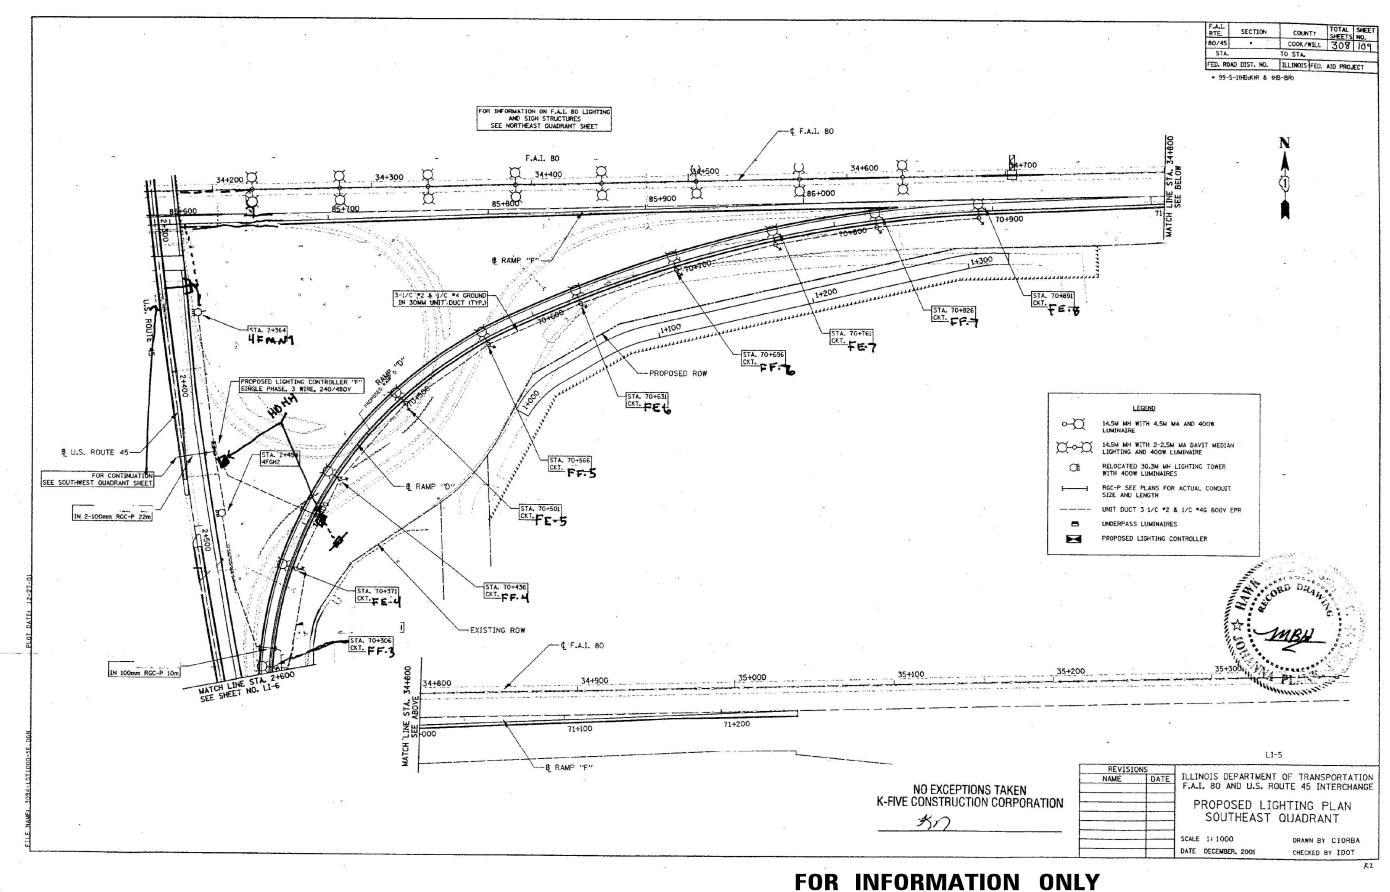


LT-18

JSER NAME = vnunez DESIGNED - MG REVISED -DRAWN - VN REVISED -PLOT SCALE = 2,0000 ' / In. CHECKED - RP/VG REVISED -- 03/14/2025 REVISED

STATE OF ILLINOIS
DEPARTMENT OF TRANSPORTATION

IDOT CONTRACT 82462 RECORD DRAWINGS OF SHEETS STA.

TOTAL SHEET NO.
49 29 SECTION FAI 80 23 LIGHTING WILL CONTRACT NO. 62W15

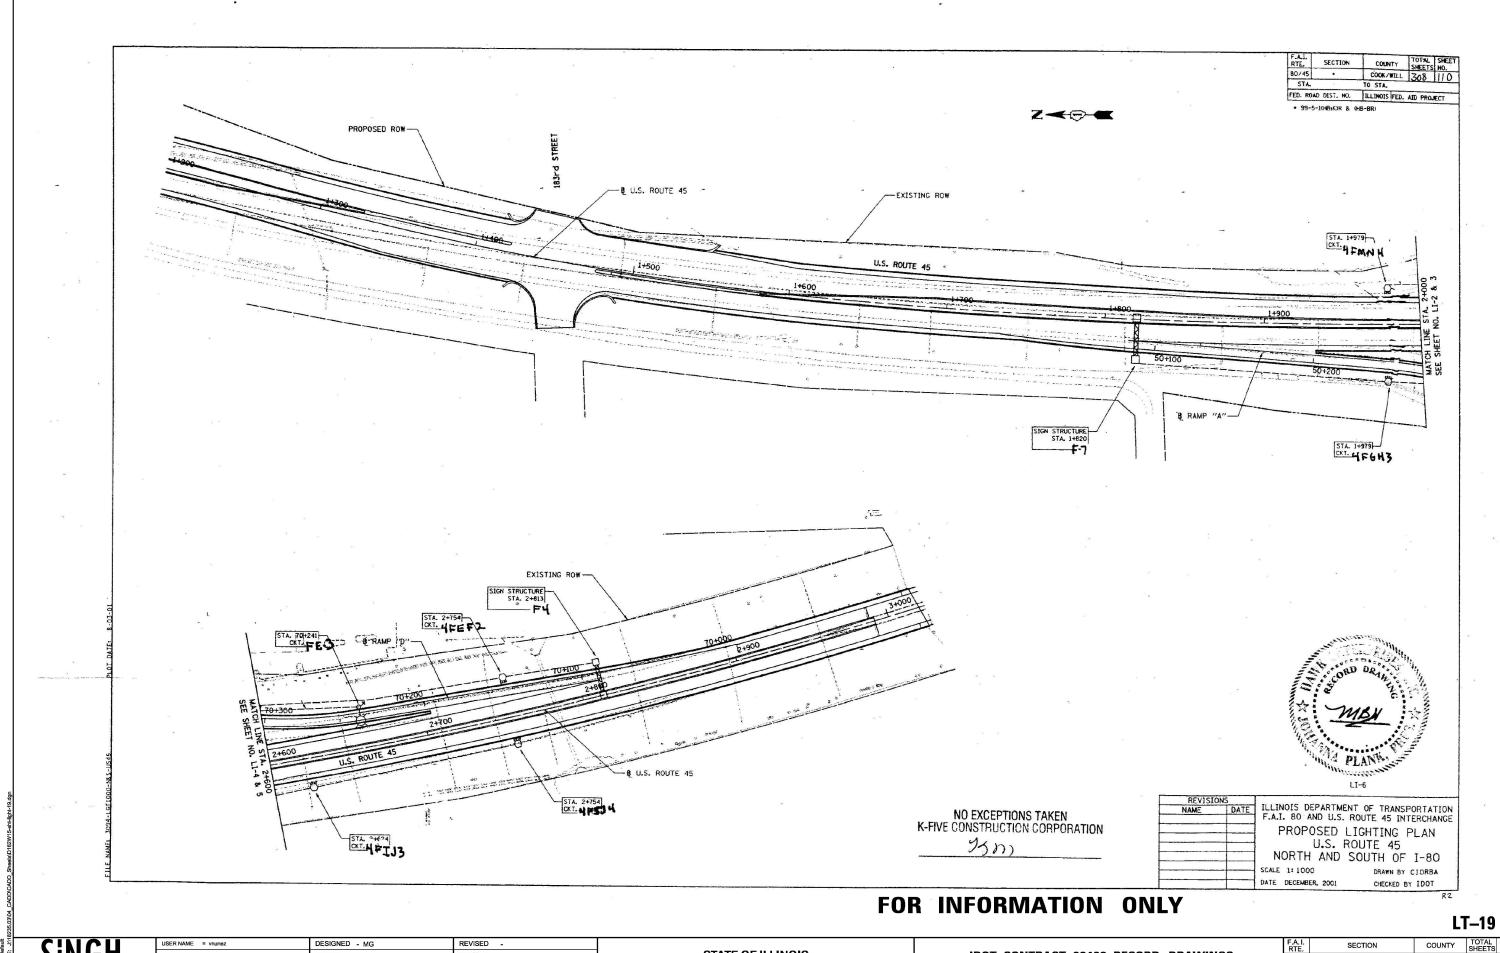

DRAWN - VN REVISED -CHECKED - RP/VG PLOT SCALE = 2,0000 '/ In. REVISED -- 03/14/2025

STATE OF ILLINOIS
DEPARTMENT OF TRANSPORTATION


IDOT CONTRACT 82462 RECORD DRAWINGS OF SHEETS STA.

FAI 80 23 LIGHTING

 COUNTY
 TOTAL SHEETS NO.

 WILL
 49
 30

 CONTRACT NO.
 62W15

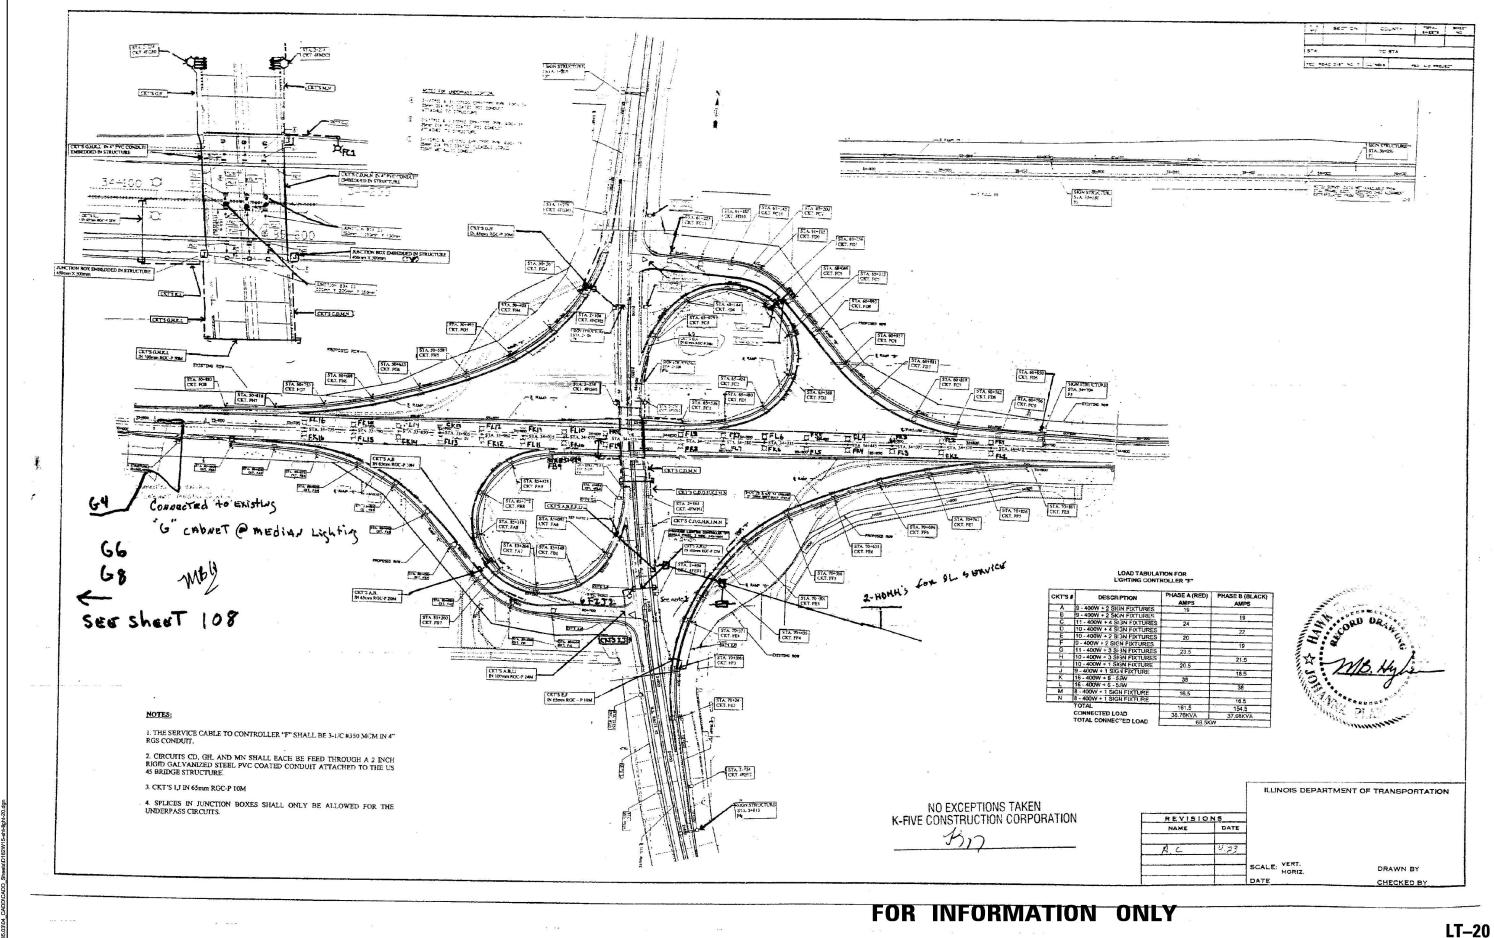


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	DRAWN - VN	REVISED -
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PLOT DATE = 3/20/2025	DATE - 03/14/2025	REVISED -

STATE OF ILLINOIS **DEPARTMENT OF TRANSPORTATION**


	IDOT	CONTI	RACT	82462	RE	CORD	DRAWINGS	
SCALE:		SHEET	OF	SHEE	TS	STA.	TO STA.	


TOTAL SHEET NO. SECTION COUNTY FAI 80 23 LIGHTING WILL CONTRACT NO. 62W15

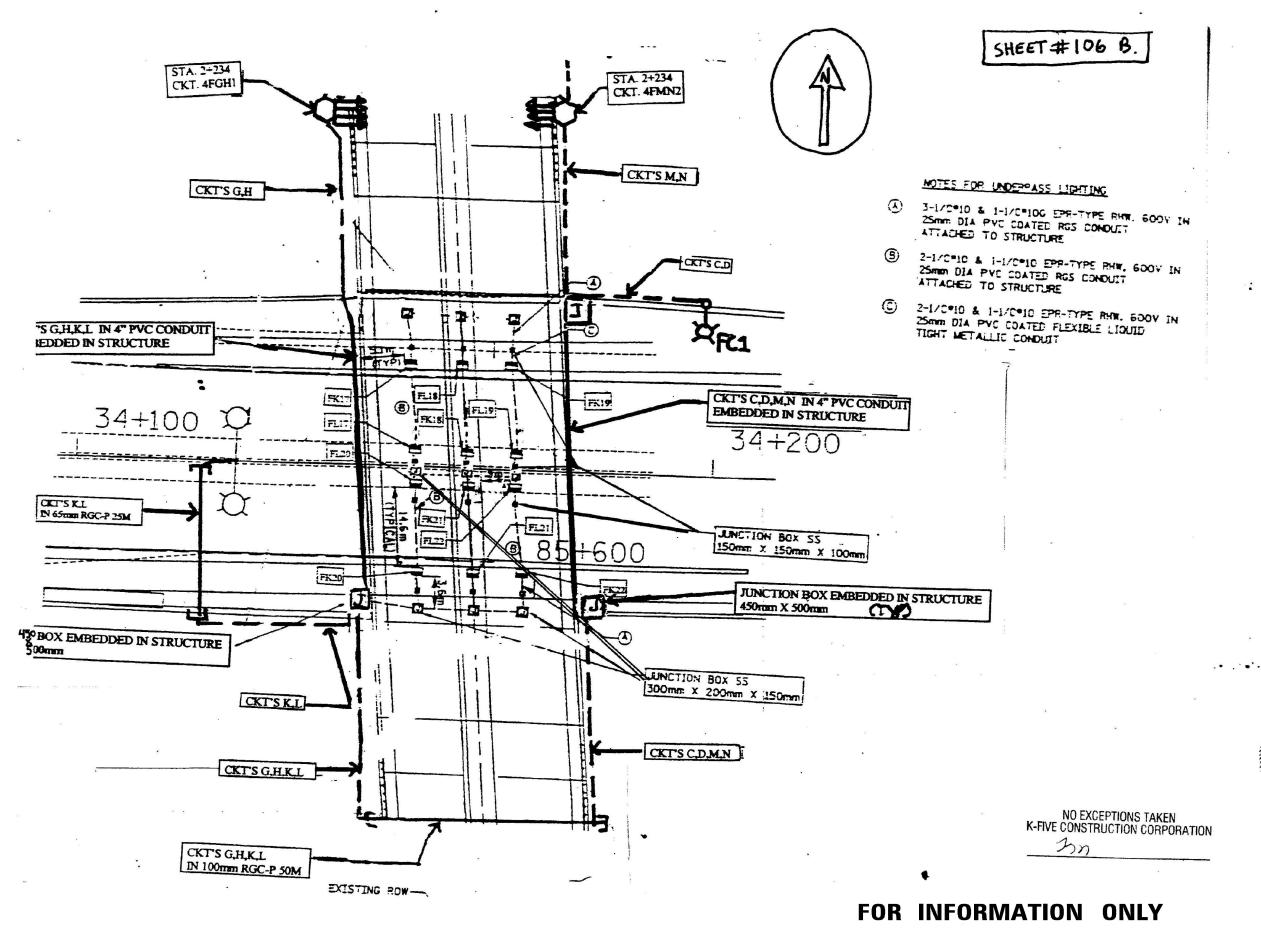

LT-21

TOTAL SHEET NO.
49 32 DESIGNED - MG JSER NAME = vnunez REVISED -SECTION COUNTY STATE OF ILLINOIS DRAWN - VN REVISED -**IDOT CONTRACT 82462 RECORD DRAWINGS** FAI 80 23 LIGHTING WILL PLOT SCALE = 2,0000 ' / In. CHECKED - RP/VG REVISED -**DEPARTMENT OF TRANSPORTATION** CONTRACT NO. 62W15 PLOT DATE = 3/20/2025 SHEET OF SHEETS STA. - 03/14/2025 REVISED .

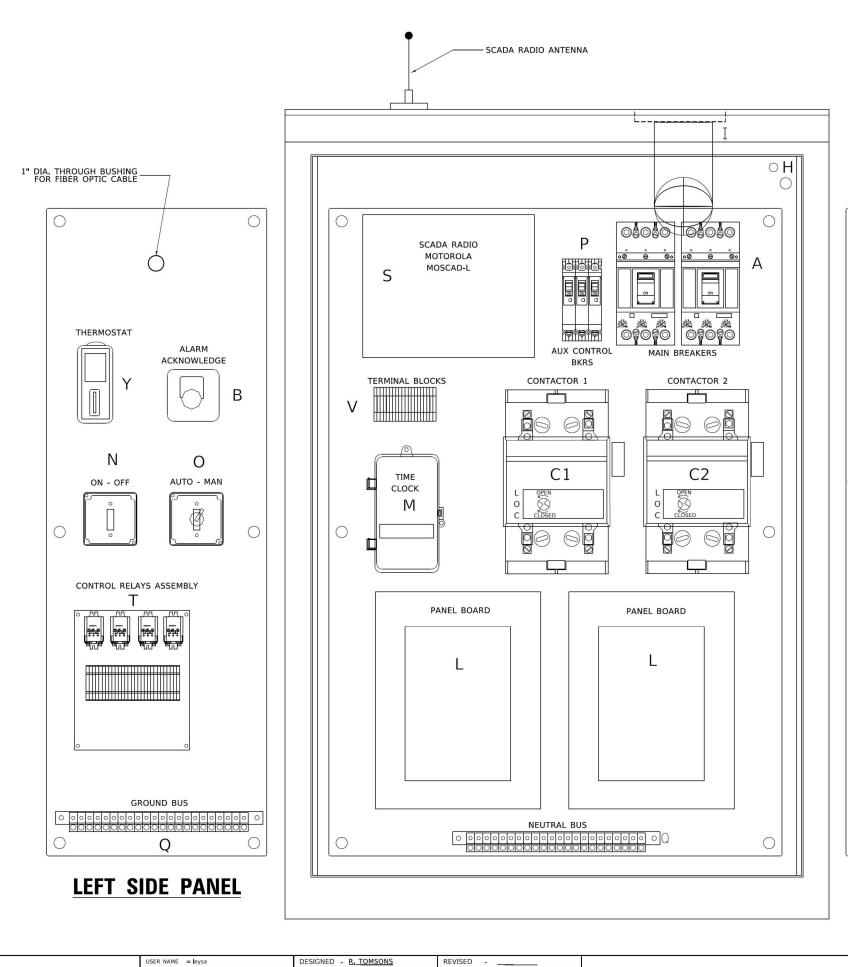

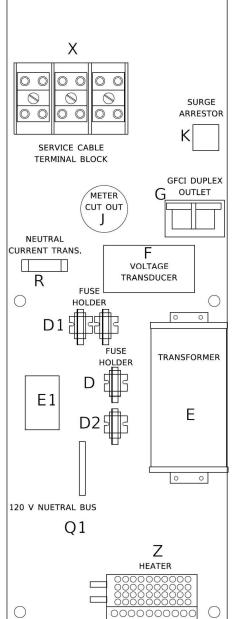

RIGHT SIDE PANEL

BILL OF MATERIALS						
ITEM	ITEM QTY DESCRIPTION					
А	2	MAIN CIRCUIT BREAKERS 2 POLE 200 AMP WITH AUX CONTACT				
В	1	ACKNOWLEDGE SWITCH, PUSH BUTTON WITH YELLOW INSERT				
C1, C2*	2	CONTACTOR 2 POLE 200 AMP 240V COIL WITH AUX CONTACTS				
D	1	FINGERSAFE FUSE HOLDER WITH KTK - 20A FUSE				
D1	2	FINGERSAFE FUSE HOLDER WITH KTK - ½ A FUSE				
D2	1	FINGERSAFE FUSE HOLDER WITH KTK - 2A FUSE				
Е	1	2.0 KVA 277V-240/120 TRANSFORMER				
E1	1	0.25 KVA240/ 120 - 24 VAC TRANSFORMER				
F	1	VOLTAGE TRANSDUCER WITH COVER TERMINALS				
G	1	20 AMP GFCI DUPLEX OUTLET W/COVER				
Н	2	DOOR SWITCH				
I	1	LIGHT FIXTURE				
J	1	METER FITTING 1 PHASE 3 WIRE 200 AMP				
K	1	SURGE ARRESTER				
L	2	PANEL BOARD 480/ 240V 1 PHASE, 250 AMP COPPER BUS				
М	1	2 CHANNEL DIGITAL TIME CLOCK				
N	1	MOMENTARY SWITCH ON - OFF				
0	1	SQUARE D, 9001KS11BH13, 2 POSITION SWITCH IN 9001KY1 ENCLOSURE OR APPROVED EQUAL				
Р	2	BREAKER 1P 15A				
Q	2	COPPER GROUND AND NEUTRAL BUS 1 X 16 X 1/4				
Q1	1	COPPER NEUTRAL BUS WITH 1 #6 AND 8 #12 CONDUCTOR POINTS				
R	1	CURRENT TRANSDUCER				
S	1	MOTOROLA MOSCAD-L RADIO, 240 V				
т*	1	CONTROL RELAY ASSEMBLY 240V COILS WITH 4 - 3PDT 25A RELAYS (W389ACX-15) (R1, R2, R3, R4). QTY 32 TERMINAL BLOCKS				
٧	20	TERMINAL BLOCKS				
х*	1	620 AMP SPLICE BLOCK				
Y	1	40-80 DEGREE THERMOSTAT				
Z	1	375 WATT HEATER				

* TERMINALS SHALL BE COVERED WITH CLEAR PLEXIGLASS SHEET

SD-01

LIGHTING CONTROLLER, BASE MOUNTED, 480VOLT, 200AMP (DUAL) RADIO SCADA - FIBER OPTIC PROVISION SCALE; NONE SHEET 1 OF 4 SHEETS STA.

 COUNTY
 TOTAL SHEETS NO.

 WILL
 49
 33


 CONTRACT NO.
 62W15
 SECTION FAI 80 23 LIGHTING BE-206 CONTRA


STATE OF ILLINOIS **DEPARTMENT OF TRANSPORTATION**

PLOT SCALE = 50,0000 ' / in. CHECKED -REVISED -PLOT DATE = 1/15/2020 DATE - <u>01-15-2020</u>

REVISED - ___

DRAWN

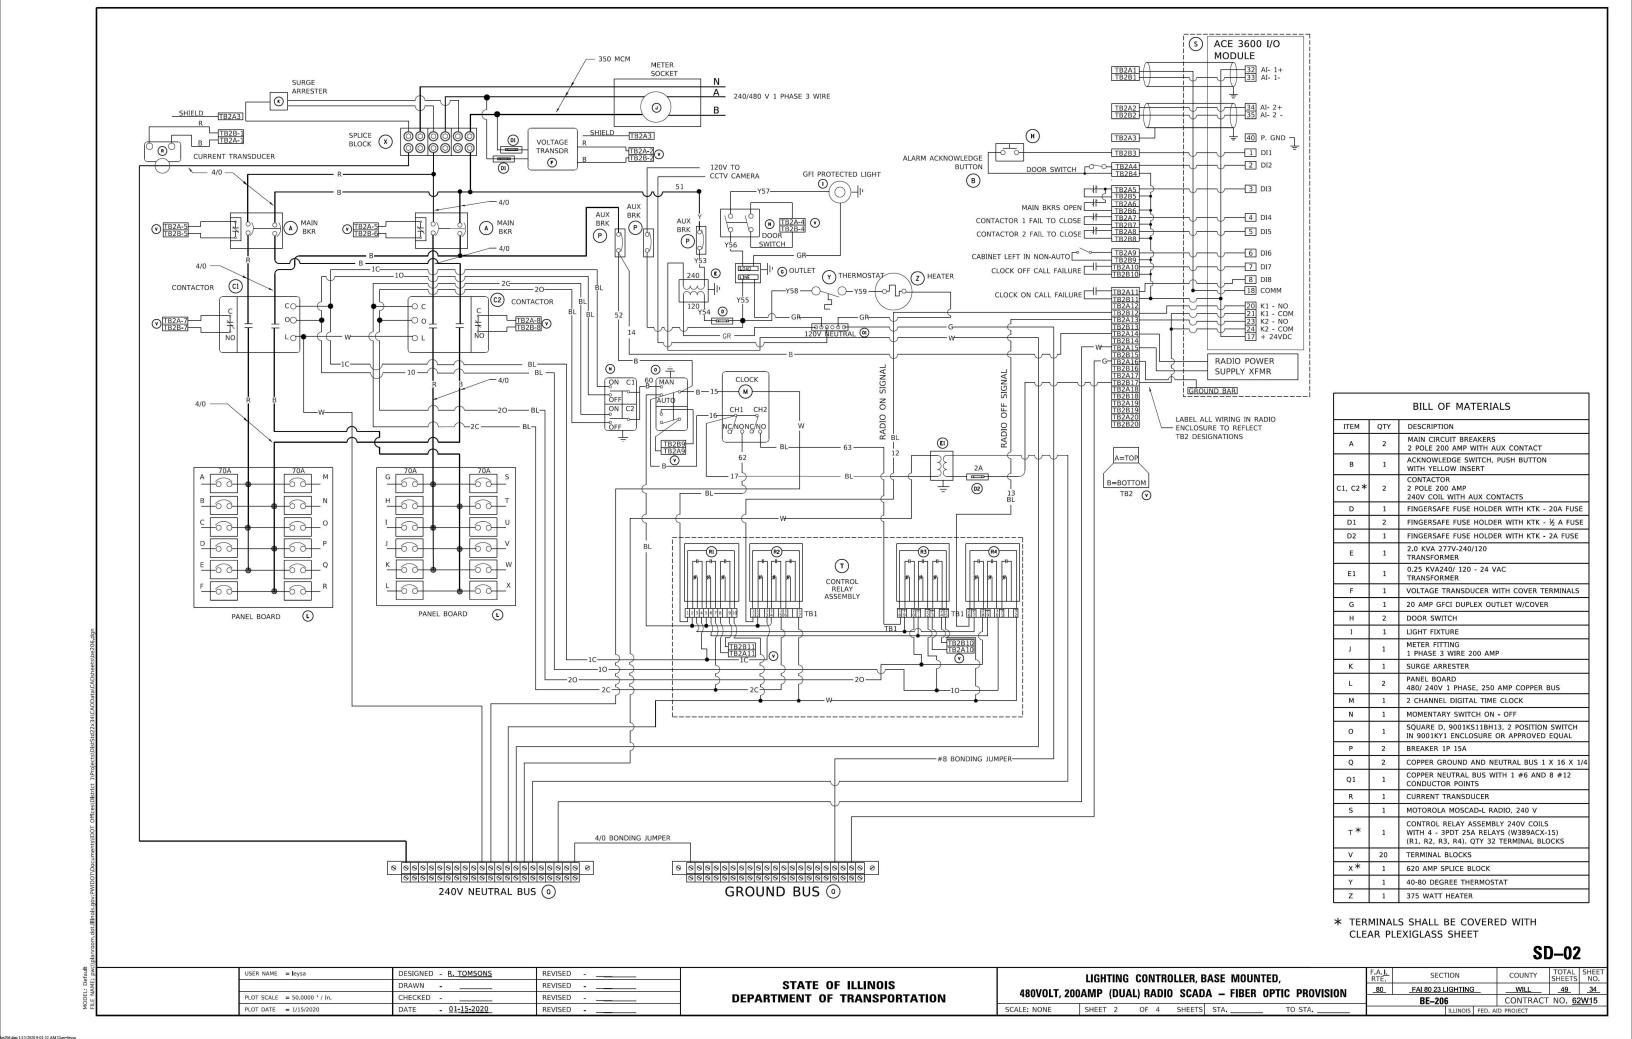

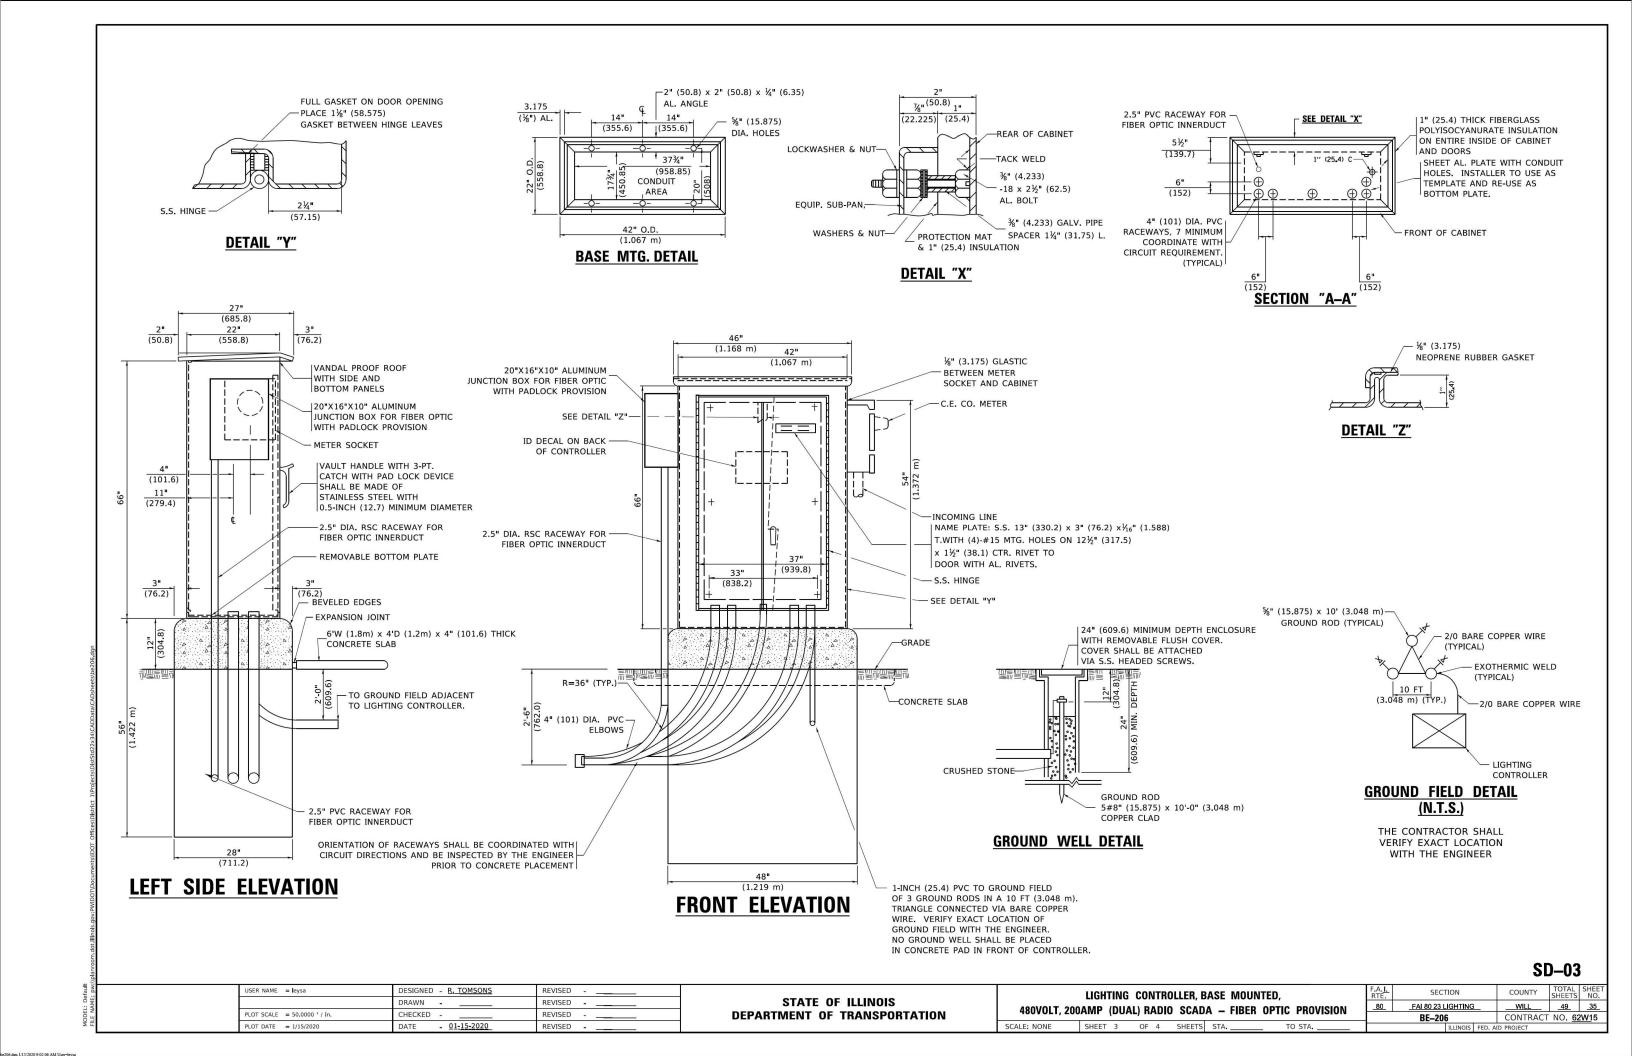


NOTES

- CABINET SHALL BE FABRICATED FROM 0.125-INCH (3.175) SHEET ALUMINUM #3003H14, FORMED AND ARC WELDED.
- ALL SCREWS AND HARDWARE SHALL BE PLATED, GALVANIZED, OR MADE OF BRASS, ALUMINUM OR STAINLESS STEEL, UNLESS OTHERWISE NOTED.
- NAME PLATE SHALL HAVE ENGRAVED 0.75-INCH (19.05) HIGH LETTERS FILLED IN BLACK: "STATE OF ILLINOIS LIGHTING CONTROLS" UNLESS OTHERWISE SPECIFIED.
- ONE INCH THICK POLYISOCYANURATE INSULATION SHALL BE INSTALL AND PERMANENTLY CEMENTED ON ALL SIDES OF THE CABINET AND DOORS.
- 5. CABINET SHALL BE PRIMED AND PAINTED AS SPECIFIED.
- ELECTRIC UTILITY METER BOX SHALL BE MOUNTED ON THE SIDE OF CONTROL CABINET AS SHOWN ON THE PANEL LAYOUT DIAGRAM.
- THE COMPLETED CONTROLLER SHALL BE U.L. LISTED AS AN INDUSTRIAL CONTROL PANEL UNDER UL508.
- METAL MOUNTING PANEL SHALL BE FABRICATED FROM THE SAME MATERIAL AS THE CABINET AND SHALL BE FLANGED BACK 0.75-INCHES I.D. ON 4 SIDES.
- CIRCUIT BREAKERS AND CONTACTORS AND OTHER COMPONENTS SHALL BE MOUNTED ON 0.125-INCH (3.175) THICK GLASTIC INSULATION BACK PANEL.
- 10. ALL DEVICES SHALL BE FRONT REMOVABLE.
- 11. TIME CLOCK CHANNEL 1 N.O. CONTACT IS CLOSED NIGHT AND OPEN DAY (LIGHTS ON).
- 12. SET LATITUDE TO 42 DEGREES. SET CH.1 TO 23 MINUTES AFTER ASTRONOMICAL SUNSET, 50 MINUTES BEFORE ASTRONOMICAL SUNRISE. SET CH.2 TO 60 MINUTES AFTER ASTRONOMICAL SUNRISE (WITH A SIGNAL LENGTH OF 1 SECOND), +28 MINUTES AFTER ASTRONOMICAL SUNRISE (WITH A SIGNAL LENGTH OF 7 SECONDS.)
- 13. BUS BAR SHALL HAVE 22 LUG TERMINALS SIZED TO ACCOMMODATE REQUIRED WIRE SIZES. 240V NEUTRAL BUS SHALL BE PAINTED WHITE, GROUND BUS SHALL BE PAINTED GREEN, AND THE 120V NEUTRAL BUS SHALL BE PAINTED GREY.
- 14. ALL LUGS SHALL BE OF COPPER SCREWS AND CONNECTORS, SPRING HELD.
- 15. ALL WIRING TERMINATIONS SHALL BE RATED NOT LESS THAN 75 DEGREE CENTIGRADE.
- 16. ALL CONTROL WIRING SHALL BE 600V #12 TYPE MTW, SCADA WIRING SHALL BE #18.
- 17. ALL POWER WIRING SHALL BE 600V TYPE RHH/RHW.
- 18. ALL WIRING WITHIN THE CABINET SHALL BE COLOR CODED AS INDICATED:

R = RED Y = YELLOW B = BLACK W = WHITE BL = BLUE G = GREEN G = GREY

- 19. MOSCAD I/O WIRING SHALL BE:
 DIGITAL INPUT (DI) WIRING SHALL BE #18 MTW PURPLE.
 ANALOG INPUT (AI) WIRING SHALL BE #18, 2/C SHIELDED.
 AI AND DI WIRING MAY BE BUNDLED TOGETHER, BUT SHALL NOT BE BUNDLED WITH OTHER WIRING.
- 20. ALL DIMENSIONS ARE IN INCHES (MILLIMETERS) UNLESS OTHERWISE INDICATED.
- 21. SCHEMATIC SHOWN WITH BREAKER OPEN, CONTACTOR OPEN, CABINET DOOR CLOSED, CLOCK NOT ACTIVE (DE-ENERGIZED STATE).
- 22. A LAMINATED COPY OF THE CIRCUIT SCHEMATIC AND SCADA I/O DIAGRAM (NO SMALLER THAN 11"x17" EACH) SHALL BE ATTACHED TO THE INSIDE OF THE CONTROLLER WITH STAINLESS STEEL SCREWS.

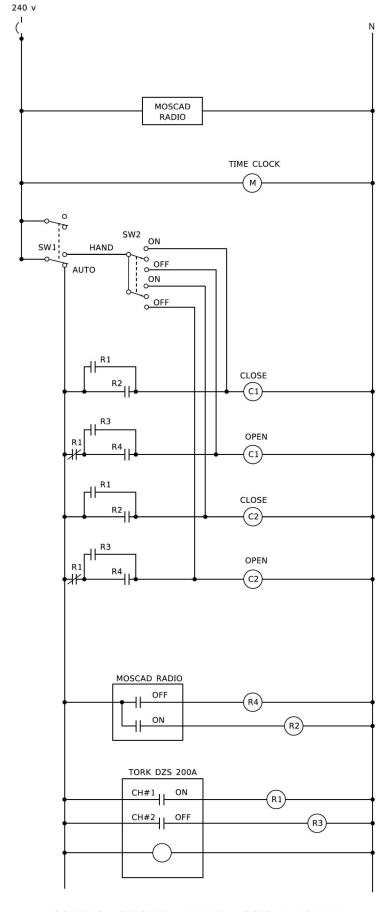

MOSCAD I/O ASSIGNMENTS		
ΓERM	MOSCAD DESTINATION	DESCRIPTION OF INPUT
1	DIGITAL INPUT 1	ALARM KNOWLEDGE
2	DIGITAL INPUT 2	DOOR OPEN
3	DIGITAL INPUT 3	MAIN(S) BREAKER OPEN
4	DIGITAL INPUT 4	CONTACTOR 1 OPEN
5	DIGITAL INPUT 5	CONTACTOR 2 OPEN
6	DIGITAL INPUT 6	CABINET IN NON-AUTO
7	DIGITAL INPUT 7	BACK-UP CLOCK OFF CALL
8	DIGITAL INPUT 8	BACK-UP CLOCK ON CALL
17	24 V+	24+VDC
18	DI COMMON	COMMON
21	K1 C	K1 COMMON
22	K1 NO	LIGHTS ON CALL
24	K2 C	K2 COMMON
25	K2 NO	LIGHTS OFF CALL
32	ANALOG INPUT 1 (+)	CABINET NEUTRAL CURRENT
33	ANALOG INPUT 1 (-)	CABINET NEUTRAL CURRENT
34	ANALOG INPUT 2 (+)	CABINET SERVICE VOLTAGE
35	ANALOG INPUT 2 (-)	CABINET SERVICE VOLTAGE
40	P. GROUND	GROUND

ALL ANALOG INPUTS WILL BE 4-20 MA ONLY. DIGITAL OUTPUT RELAYS WILL BE ELECTRICALLY ENERGIZED AND MOMENTARILY HELD

MIXED I/O MODULE MODEL NUMBER V436

CONTROL CIRCUIT LADDER LOGIC DIAGRAM


SD-04

STATE OF ILLINOIS
DEPARTMENT OF TRANSPORTATION

LIGHTING CONTROLLER, BASE MOUNTED,

480VOLT, 200AMP (DUAL) RADIO SCADA – FIBER OPTIC PROVISION

ALE: NONE SHEET 4 OF 4 SHEETS STA. _____ TO STA. _____

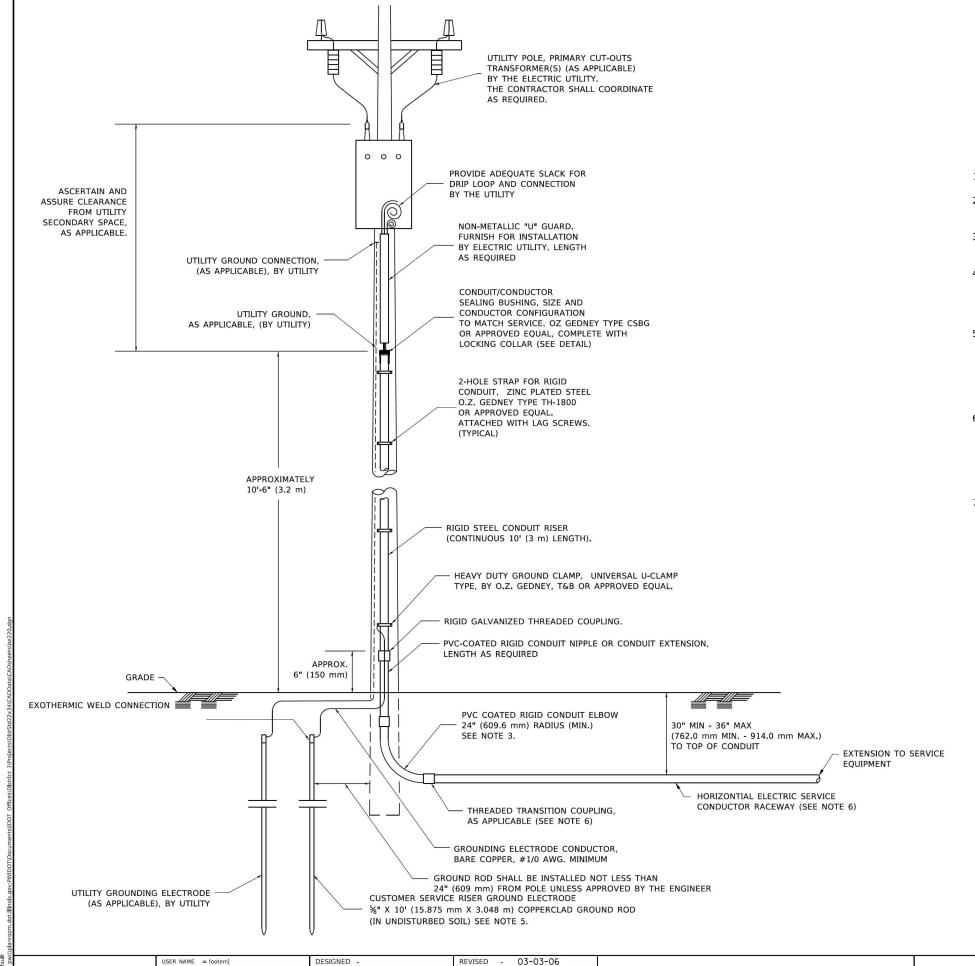

REVISED -

REVISED

REVISED

STATE OF ILLINOIS

DEPARTMENT OF TRANSPORTATION

DRAWN -

PLOT SCALE = 50,0000 ' / in.

PLOT DATE = 4/19/2019


CHECKED - MEA

APPLICATION

THIS DETAIL APPLIES FOR LOW VOLTAGE ELECTRIC SERVICE (660 V OR LESS) FROM AN OVERHEAD UTILITY SUPPLY TO SEPERATLY-MOUNTED SERVICE EQUIPMENT.

NOTES

- 1. SERVICE VOLTAGE SHALL BE AS INDICATED ELSEWHERE IN THE DRAWINGS.
- 2. UNLESS OTHERWISE INDICATED, ITEMS AND WORK SHALL BE INCLUDED AND PAID AS PART OF THE ELECTRIC UTILITY SERVICE INSTALLATION PAY ITEM.
- 3. CONDUIT AND CONNECTOR DIAMETER SHALL MATCH THE DIAMETER OF THE SERVICE CONDUCTOR RACEWAY AS INDICATED ON THE PLANS.
- 4. PVC COATED RACEWAYS AND ACCESSORIES SHALL BE CAREFULLY INSTALLED WITH MFR RECOMMENDED TOOLS AND PROCEDURES TO AVOID DAMAGE. ANY DAMAGE SHALL BE REPAIRED WITH COMPATIBLE PVC TOUCH-UP MATERIAL TO THE SATISFACTION OF THE ENGINEER OR THE DAMAGED MATERIAL SHALL BE REPLACED AT NO ADDITIONAL COST.
- 5. THE CONTRACTOR SHALL OBTAIN INSPECTION AND APPROVAL BY THE ENGINEER OF SERVICE RISER GROUND ELECTRODE, RISER ELBOW, NIPPLE AND CONNECTION TO SERVICE CONDUCTOR RACEWAY EXTENSION BEFORE BACKFILL AND SHALL ALSO OBTAIN INSPECTION OF SERVICE RISER AND SEALING BUSHING BEFORE UTILITY "U" GUARD INSTALLATION AND SERVICE CONNECTION.
- 6. THE HORIZONTAL ELECTRIC SERVICE CONDUCTOR RACEWAY SHALL BE AS INDICATED AND SHALL BE MEASURED SEPARATELY FOR PAYMENT. WHEN THE RACEWAY IS PVC-COATED RIGID GALVANIZED STEEL, THE COUPLING SHALL BE THE SAME. WHEN THE RACEWAY IS PVC CONDUIT (IN CONCRETE), THE COUPLING SHALL BE A METALIC TO NON METALIC ADAPTER. WHEN THE RACEWAY IS ENCASED IN CONCRETE, THE CONCRETE SHALL EXTEND TO COVER THE COUPLING.
- 7. PLANS AND DETAILS INDICATE THE GENERAL NATURE AND REQUIREMENTS. THEY DO NOT SHOW EVERY ACCESSORY AND ATTACHMENT, AND THEY DO NOT RELIEVE THE CONTRACTOR OF THE REQUIREMENTS OF THE SPECIFICATIONS AND SPECIAL PROVISIONS TO ASCERTAIN UTILITY REQUIREMENTS AND TO COORDINATE ACCORDINGLY, FURNISHING ALL ITEMS AND WORK NOT PROVIDED BY THE UTILITY, BUT NECESSARY FOR A COMPLETE SERVICE INSTALLATION IS REQUIRED AND SHALL BE INCLUDED IN THE ELECTRIC UTILITY SERVICE INSTALLATION PAY ITEM.

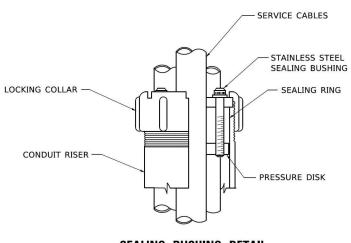


SEALING BUSHING DETAIL


SD-05

ELECTRIC SERVICE INSTALLATION AERIAL, REMOTE DISCONNECT										
AERIAL, REMUTE DISCUNNECT										
SCALE: NONE	SHEET	1 (OF	1	SHEET	S STA.	TO STA.			

| SECTION | COUNTY | STATE | SHEE | SOLOTION | SHEET | SOLOTION | SHEET | SOLOTION | SHEET | SHEET | SOLOTION | SHEET | SHEET

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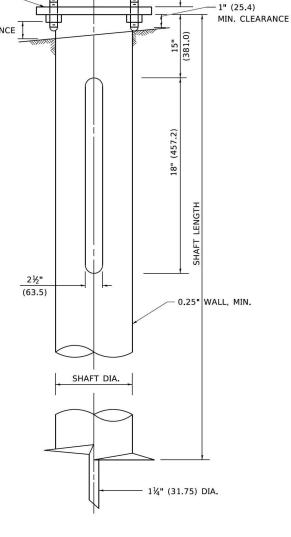


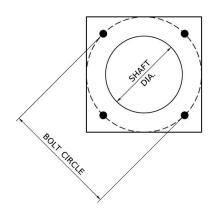HELIX FOUNDATION SIZE

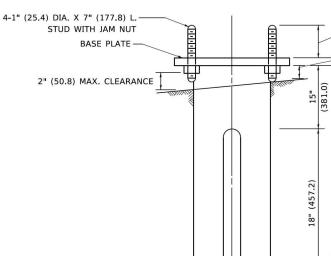POLE MOUNTING HEIGHT	BOLT CIRCLE	SHAFT DIAMETER	SHAFT LENGTH	BASEPLATE
30 FT.	11½"	8%"	6 FT.	12"x12"x1"
31 FT35 FT.	11½"	8%"	6 FT.	12"x12"x1"
36 FT40FT.	15"	8%"	6 FT.	15"x15"x1¼"
41 FT45 FT.	15"	8%"	6 FT.	15"x15"x1¼"
46 FT50 FT.	15"	10"	8 FT.	15"x15"x1¼"

METAL HELIX FOUNDATION MATERIALS

ITEM	MATERIAL REQUIREMENT
BASEPLATE	AASHTO M 270M, GRADE 36 (M270M, GRADE 250)
SHAFT	ASTM A 252, GRADE 2 (PHOSPHOROUS 0.04% MAXIMUM, SULFUR 0.05% MAXIMUM)
HELIX SCREW	AASHTO M 183 (ASTM A 635)
PILOT POINT	AASHTO M 270 (ASTM A 575)
ANCHOR RODS/STUDS	AASHTO M 314 (ASTM F 1554)
HEXAGON NUTS	AASHTO M 291M (ASTM A 563) GRADE DH, OR AASHTO M 292 (ASTM A 194) GRADE 2H
WASHERS	AASHTO M 293 (ASTM F 436)




NOTES

- 1. ALL DIMENSION IN INCHES (MILLIMETERS) UNLESS OTHERWISE SHOWN.
- 2. ALL MATERIAL SHALL BE GALVINIZED ACCORDING TO AASHTO M111, UNLESS OTHERWISE SPECIFIED.
- 3. ALL WELDS SHALL BE CONTINUOUS AND NOT LESS THAN 1#4" (6.35 mm) FILLET WELDS. THE WELDED FOUNDATION SHALL BE CAPABLE OF WITHSTANDING 10,000 FT/LBS (13558.18 n.m) OF INSTALLATION TORQUE APPLIED ABOUT THE AXIS OF THE FOUNDATION.
- 4. THE HELIX FOUNDATION SHAFT SHALL BE INSTALLED VERTICAL AND THE BASE PLATE SHALL BE IN LEVEL. THE BREAKAWAY COUPLINGS AND HARDWARE SHALL NOT BE USED TO ALIGN THE POLE INSTALLATION.
- 5. THE CABLE TRENCH SHALL BE BACKFILLED AND FIRMLY COMPACTED BEFORE THE INSTALLATION OF THE LIGHT POLE.
- 6. THE CONTRACTOR SHALL COORDINATE EXTENSION OF ANCHOR BOLTS ABOVE TOP OF THE BASE PLATE WITH THE BREAKAWAY DEVICE MANUFACTURER'S REQUIREMENTS.
- 7. ANY VOIDS WITHIN THE METAL FOUNDATION SHALL BE FILLED WITH FINE AGGREGATE.
- 8. METAL FOUNDATIONS SHALL BE INSTALLED IN UNDISTURBED SOIL. PREDRILLING A PILOT HOLE AND/OR BACKFILLING AROUND THE FOUNDTION IS NOT ALLOWED.
- 9. THE METAL FOUNDATION SHALL NOT BE INSTALLED TO A TORQUE WHICH EXCEEDS THE MANUFACTURER'S MAXIMUM TORQUE RATING NOR SHALL IT BE INSTALLED TO AN INSTALLATION TORQUE VALUE OF LESS THAN 3,500 FT LB (4,750 KNM). METAL FOUNDATIONS THAT ARE NOT INSTALLED TO FULL INSTALLATION DEPTH OR DO NOT ACHIEVE THE MINIMUM INSTALLATION TORQUE SHALL BE REMOVED AND REPLACED WITH A CONCRETE FOUNDATION AT NO ADDITIONAL COST.
- 10. THE BASEPLATE SHALL BE PERPENDICULAR TO THE SHAFT AXIS (\pm 1 $^{\circ}$) AND THE HOLE CENTERLINE SHALL BE CONCENTRIC (\pm 0.188) TO THE SHAFT AXIS.
- 11. THE PILOT POINT AND SHAFT AXIS SHALL BE CONCENTRIC (± 0.125) AND IN LINE (± 2°).
- 12. THE BASEPLATE SHALL BE STAMPED WITH THE MANUFACTURERS NAME AND DATE OF MANUFACTURE.

SD-06

USER NAME = footemj	DESIGNED -	REVISED -					F.A.I.	SECTION	COUNTY	SHEETS	SHEET
	DRAWN - DLB	REVISED -	STATE OF ILLINOIS		LIGHT POLE FOUNDATION, METAL		80	FAI 80 23 LIGHTING	WILL	49	38
PLOT SCALE = 50,0000 ' / in.	CHECKED -	REVISED -	DEPARTMENT OF TRANSPORTATION					BE-305	CONTRACT	NO. 62V	W15
PLOT DATE = 4/19/2019	DATE - 02-27-07	REVISED -		SCALE: NONE	SHEET 1 OF 1 SHEETS STA.	TO STA.		ILLINOIS FED. A	ID PROJECT		

SEE NOTE NO. 6

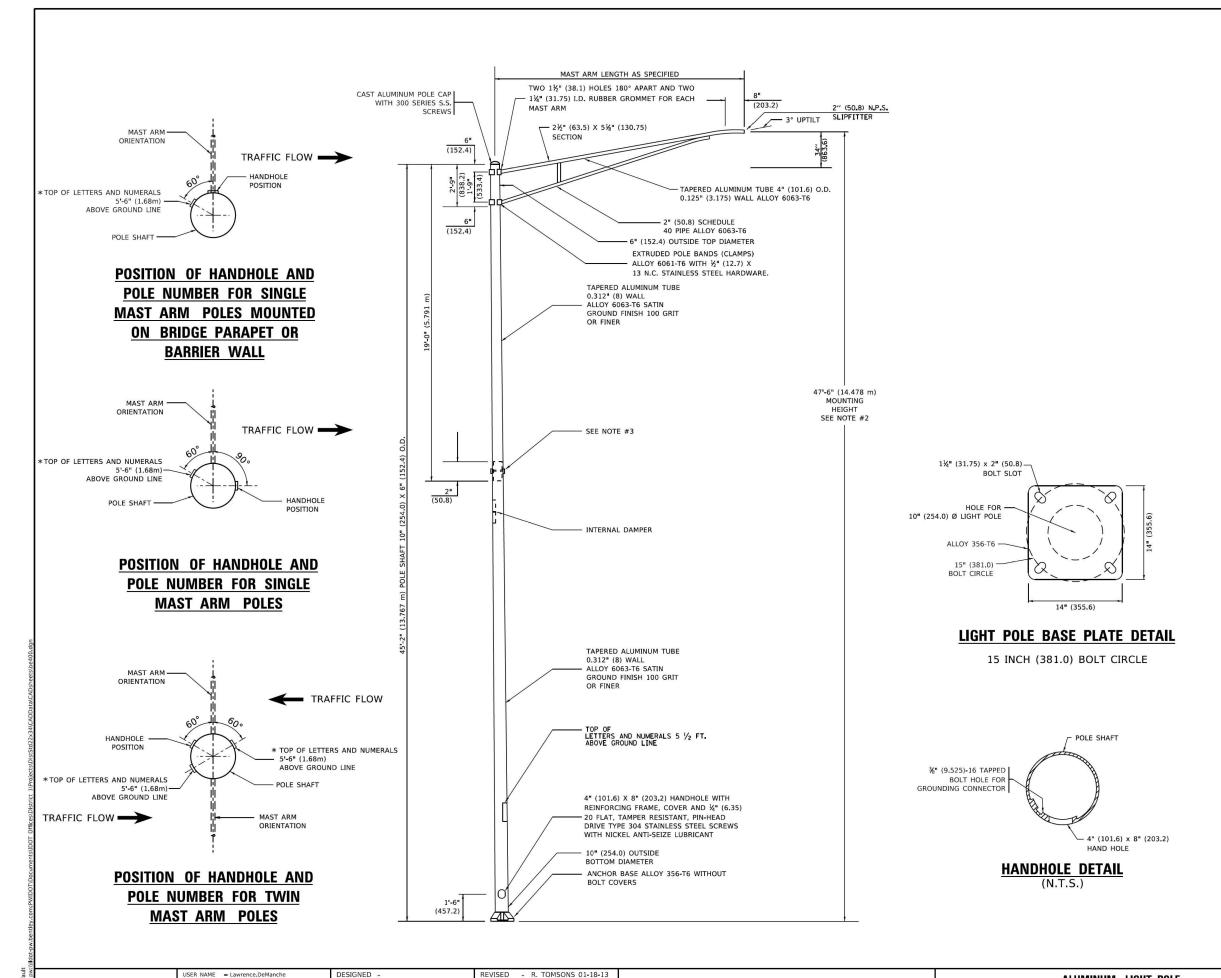

DRAWN

CHECKED

DATE

PLOT SCALE = 100.0000 ' / in.


PLOT DATE = 12/19/2023

NOTES


- 1. ALL DIMENSIONS ARE IN INCHES (MILLIMETERS) UNLESS OTHERWISE SHOWN.
- MOUNTING HEIGHT IS DEFINED AS THE DISTANCE FROM THE CENTERLINE OF THE TENON TO THE BOTTOM OF THE ANCHOR BASE.
- TWO PIECE SHAFT WILL BE MATCHED MARKED AND INTERCHANGEABLE BETWEEN DIFFERENT UNITS. FIELD DRILLING OF THE HOLES WILL NOT BE ALLOWED.
- 4. THE LIGHT POLE WILL MEET AASHTO DESIGN CRITERIA AS SPECIFIED.
- 5 THE INSTALLING CONTRACTOR WILL PROVIDE A UL LISTED GROUNDING CONNECTOR. BURNDY K2C23. T&B SP4DL OR APPROVED EQUAL.
- LIGHT POLES WILL NOT BE INSTALLED WITHOUT MAST ARMS AND LUMINAIRES.
- LIGHT POLES WILL BE SET PLUMB ON THE FOUNDATION WITHOUT THE USE OF LEVELING NUTS, WASHERS OR SHIMS.
- 8. LIGHTING UNIT IDENTIFICATION NUMBERS SHALL BE INSTALLED BEFORE THE LIGHTING UNIT IS ENERGIZED.

SD-07

SECTION COUNTY ALUMINUM LIGHT POLE REVISED - R. TOMSONS 03-18-15 STATE OF ILLINOIS FAI 80 23 LIGHTING WILL 49 39 47'-6" (14.478 m) MOUNTING HEIGHT **DEPARTMENT OF TRANSPORTATION** REVISED - TG 06-13-22 CONTRACT NO. 62W15 BE-400 SHEET 1 OF 1 SHEETS STA. SCALE: NONE REVISED - R TOMSONS 12-19-23

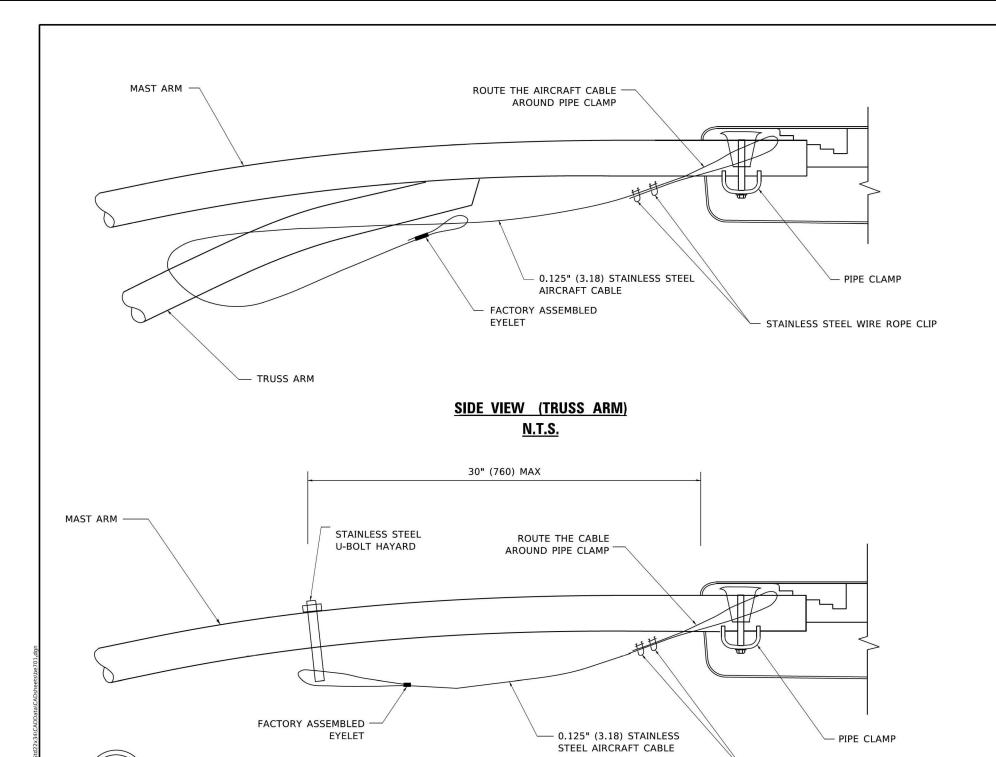

SIDE VIEW (SINGLE MEMBER OR DAVIT ARM)
N.T.S.

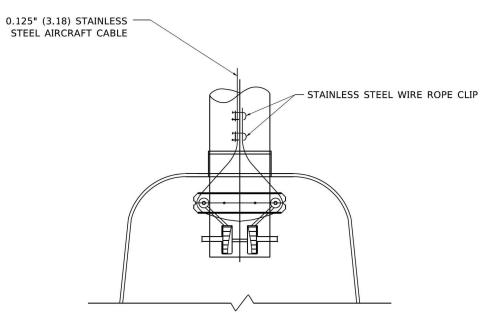

BOTTOM VIEW N.T.S.

NOTES:

- 1. ALL DIMENSIONS ARE IN MILLIMETERS (INCHES) UNLESS OTHERWISE SHOWN.
- 2. CONTRACTOR SHALL ADJUST THE WIRE CLIP TO ELIMINATE ANY SLACK FROM THE WIRE ROPE.
- 3. THE 0.125" (3.18) STAINLESS STEEL AIRCRAFT CABLE SHALL REMAIN VISIBLE FROM THE GROUND LEVEL.
- 4. THE BREAKING STRENGTH OF THE CABLE SHALL BE 1700 LBS. MIN.

SD-08

USER NAME = footemj	DESIGNED -	REVISED - 08-08-03							RTE	SECTION	COUNTY	SHEETS	NO.
	DRAWN -	REVISED -	STATE OF ILLINOIS	LUM	INAIRE SAFE	TY CAB	LE ASSEMB	LY	80	FAI 80 23 LIGHTIN	G WILL	49	40
PLOT SCALE = 50.0000 ' / in.	CHECKED -	REVISED -	DEPARTMENT OF TRANSPORTATION						,	BE-701	CONTRA	CT NO. 6	32W15
PLOT DATE = 4/19/2019	DATE -	REVISED -		SCALE: NONE SHEET	1 OF 1	SHEETS	STA.	TO STA.		ILLINOIS	FED. AID PROJECT		

STAINLESS STEEL

WIRE ROPE CLIP


MAST ARM


S.S. NUT &

STAINLESS STEEL

U-BOLT HAYARD

LOCK WASHER

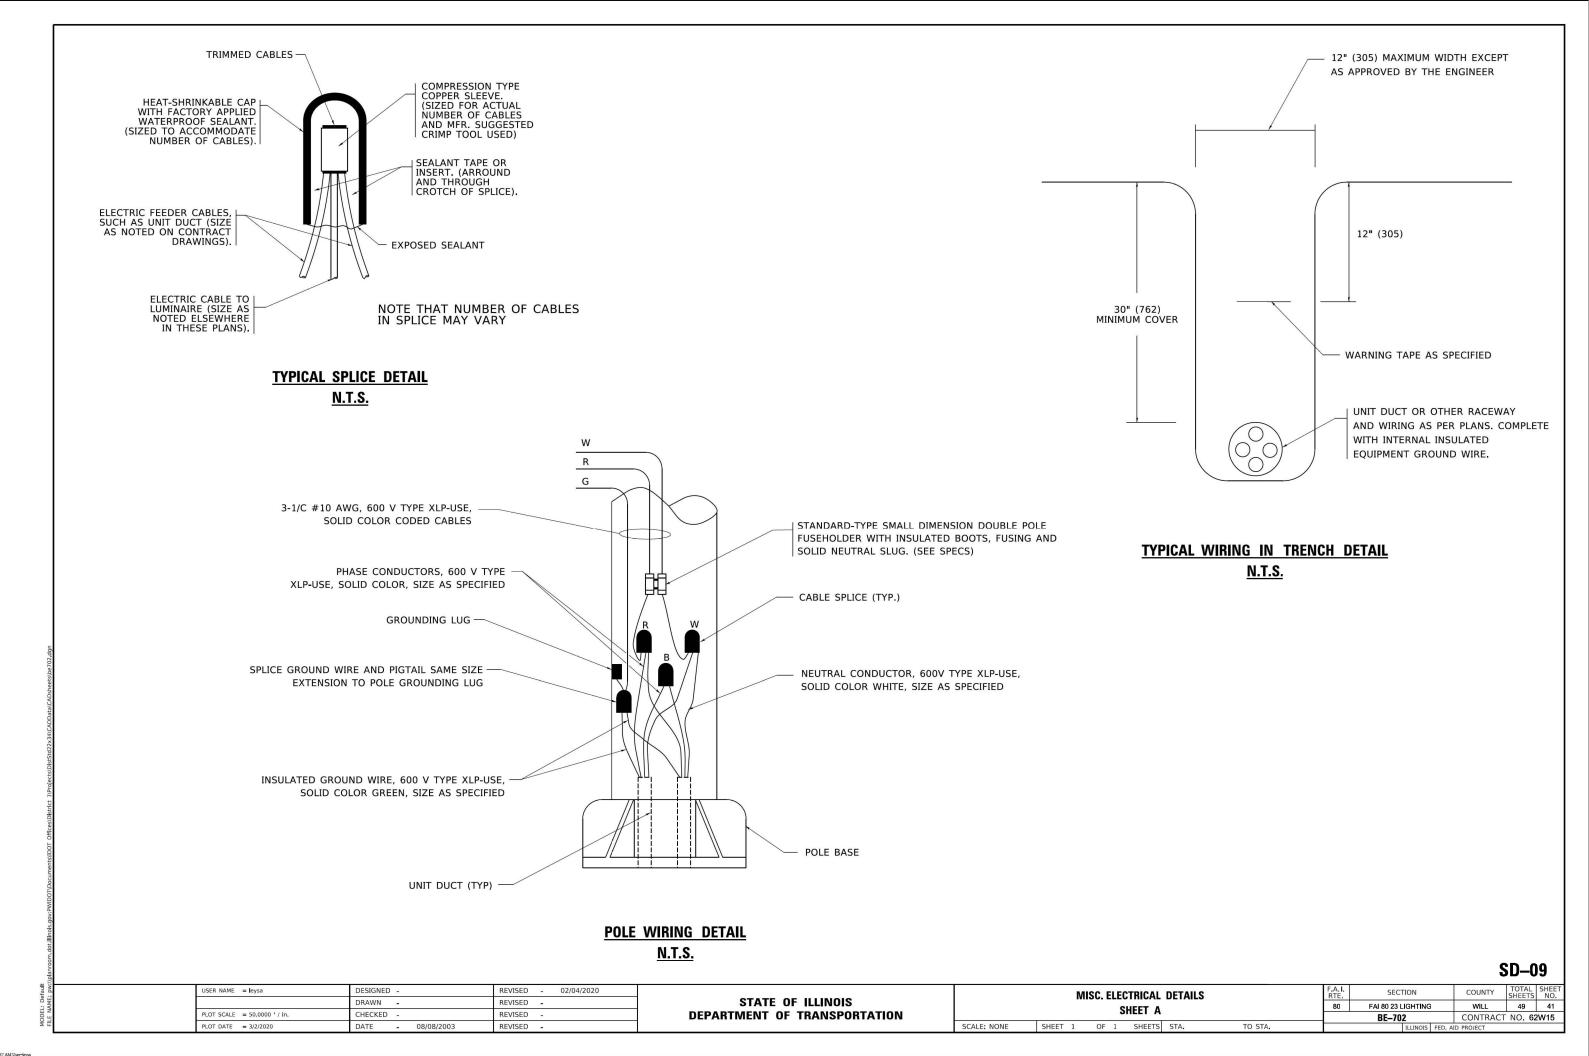

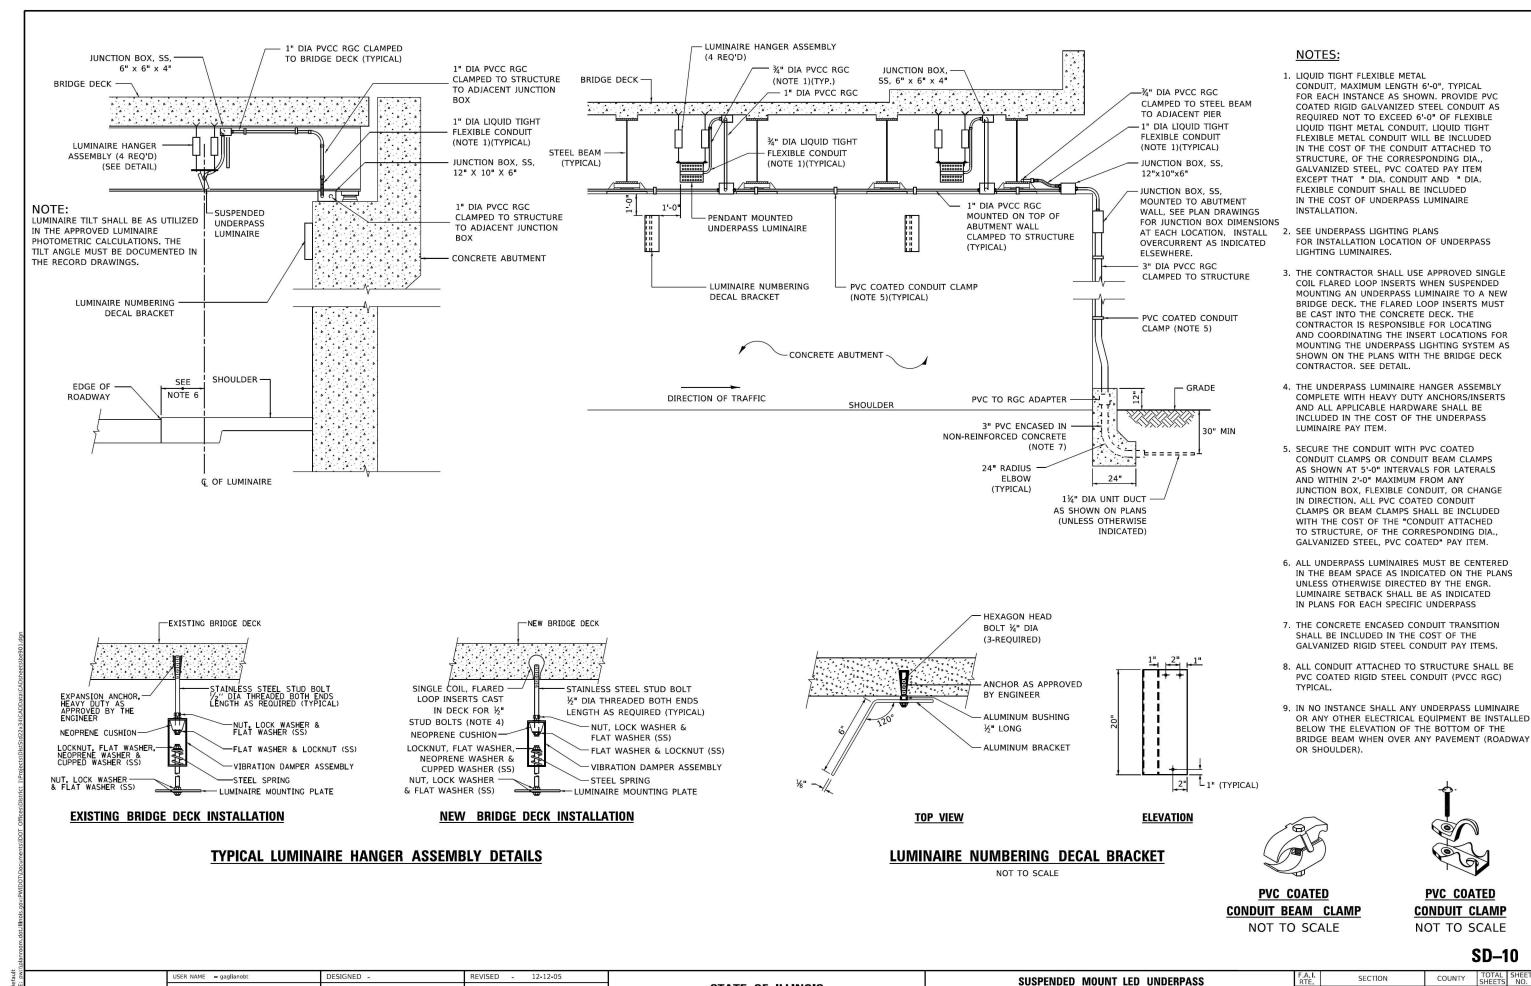

STATE OF ILLINOIS

DEPARTMENT OF TRANSPORTATION

DRAWN

DATE

PLOT SCALE = 100.0000 ' / in.

CHECKED

REVISED -

REVISED

REVISED

SD-10 COUNTY

CONTRACT NO. 62W15

49 42

WILL

80

TO STA.


LUMINAIRE INSTALLATION DETAILS


SHEET 1 OF 1 SHEETS STA.

SCALE: NONE

FAI 80 23 LIGHTING

BE-901

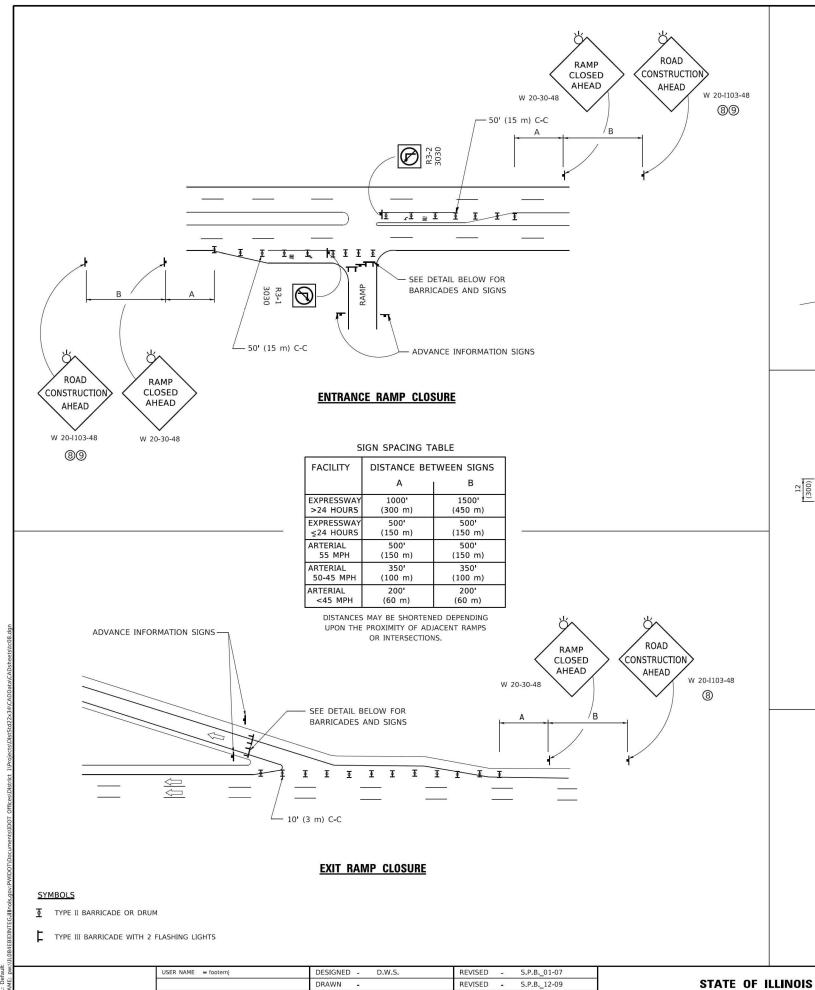


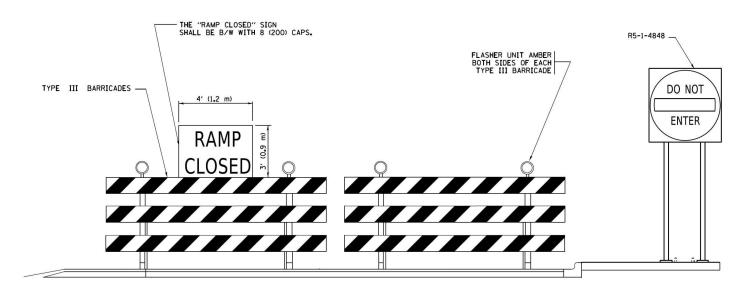

DETAIL FOR REQUIRED BARRICADES & SIGNS

RAMP CLOSURE ADVANCE INFORMATION SIGN


RAMP CLOSURE ADVANCE WARNING SIGN

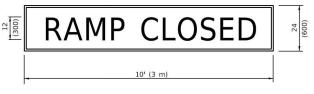

BLACK LEGEND ON ORANGE

BACKGROUND MOUNTED
DIAGONALLY
E MOD FONT
1 (25) BORDER
SIGNS ARE REQUIRED ON ALL THE EXIT

1 (25) BORDER
THESE SIGNS ARE REQUIRED ON ALL THE EXIT
GUIDE SIGNS FOR EXIT RAMPS THAT WILL BE
CLOSED FOR MORE THAN FOUR (4) CONSECUTIVE DAYS.

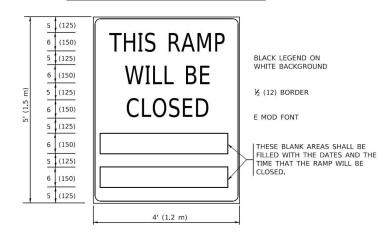

THESE SIGNS ARE REQUIRED ON BOTH SIDES OF THE RAMP, MINIMUM OF 1 WEEK IN ADVANCE OF THE CLOSURE.

THESE SIGNS SHALL BE FABRICATED AND PAID FOR ACCORDING TO THE TEMPORARY INFORMATION SIGNING SPECIAL PROVISION

GENERAL NOTES:

- ① CONES MAY BE SUBSTITUTED FOR DRUMS OR TYPE II BARRICADES DURING DAY OPERATIONS. CONES SHALL BE A MINIMUM OF 28 (700) HIGH.
- (2) VERTICAL BARRICADES SHALL NOT BE USED FOR RAMP CLOSURES.
- A FLAGGER SHALL BE POSITIONED AT EACH CLOSED RAMP THAT IS OPEN TO CONSTRUCTION VEHICLES, PRECEEDED BY A W20-7 FLAGGER WARNING SIGN.
- 4 ALL ROUTE MARKERS AND TRAILBLAZER ASSEMBLIES WHICH DIRECT MOTORISTS TO A CLOSED ENTRANCE RAMP SHALL BE COVERED WHEN THE RAMP IS CLOSED FOR MORE THAN FOUR (4) DAYS.
- (5) THE SIGNING AND BARRICADING WHICH IS REQUIRED BY THIS DETAIL SHALL BE INCLUDED IN THE COST OF TRAFFIC CONTROL AND PROTECTION (EXPRESSWAYS).

SCALE: NONE

- (6) AUTHORIZATION FROM THE DISTRICT'S BUREAU OF TRAFFIC IS REQUIRED FOR ALL RAMP CLOSURES.
- THE RAMP CLOSURE ADVANCE INFORMATION SIGNS SHALL BE ERECTED IF THE CLOSURE TIME EXCEEDS TWENTY-FOUR (24) HOURS. ADDITIONAL ADVANCE WARNING SIGNS ON EXIT GUIDE SIGNING WILL BE REQUIRED FOR EXIT RAMP CLOSURES THAT EXCEED FOUR (4) DAYS IN LENGTH
- (3) ROAD CONSTRUCTION AHEAD SIGNS MAY BE OMITTED WHEN THIS DETAIL IS USED IN CONJUNCTION WITH OTHER TRAFFIC CONTROL THAT ALREADY INCLUDES A ROAD CONSTRUCTION AHEAD SIGN.
- ARTERIAL ROAD CONSTRUCTION AHEAD SIGNS SHALL BE INSTALLED
 ON THE LEFT SIDE OF TRAFFIC IF THE MEDIAN IS MORE THAN 10 FT WIDE.

ALL DIMENSIONS ARE IN INCHES (MILLIMETERS) **SD—11**


STATE OF ILLINOIS
DEPARTMENT OF TRANSPORTATION


ENTRANCE_AND_EXIT_RAMP Closure_details										
SHEET	1	OF	1	SHEETS	STA.	TO STA.				

F.A.I. SECTION COUNTY TOTAL SHEETS NO.

80 FAI 80 23 LIGHTING WILL 49 43

TC-08 CONTRACT NO. 62W15

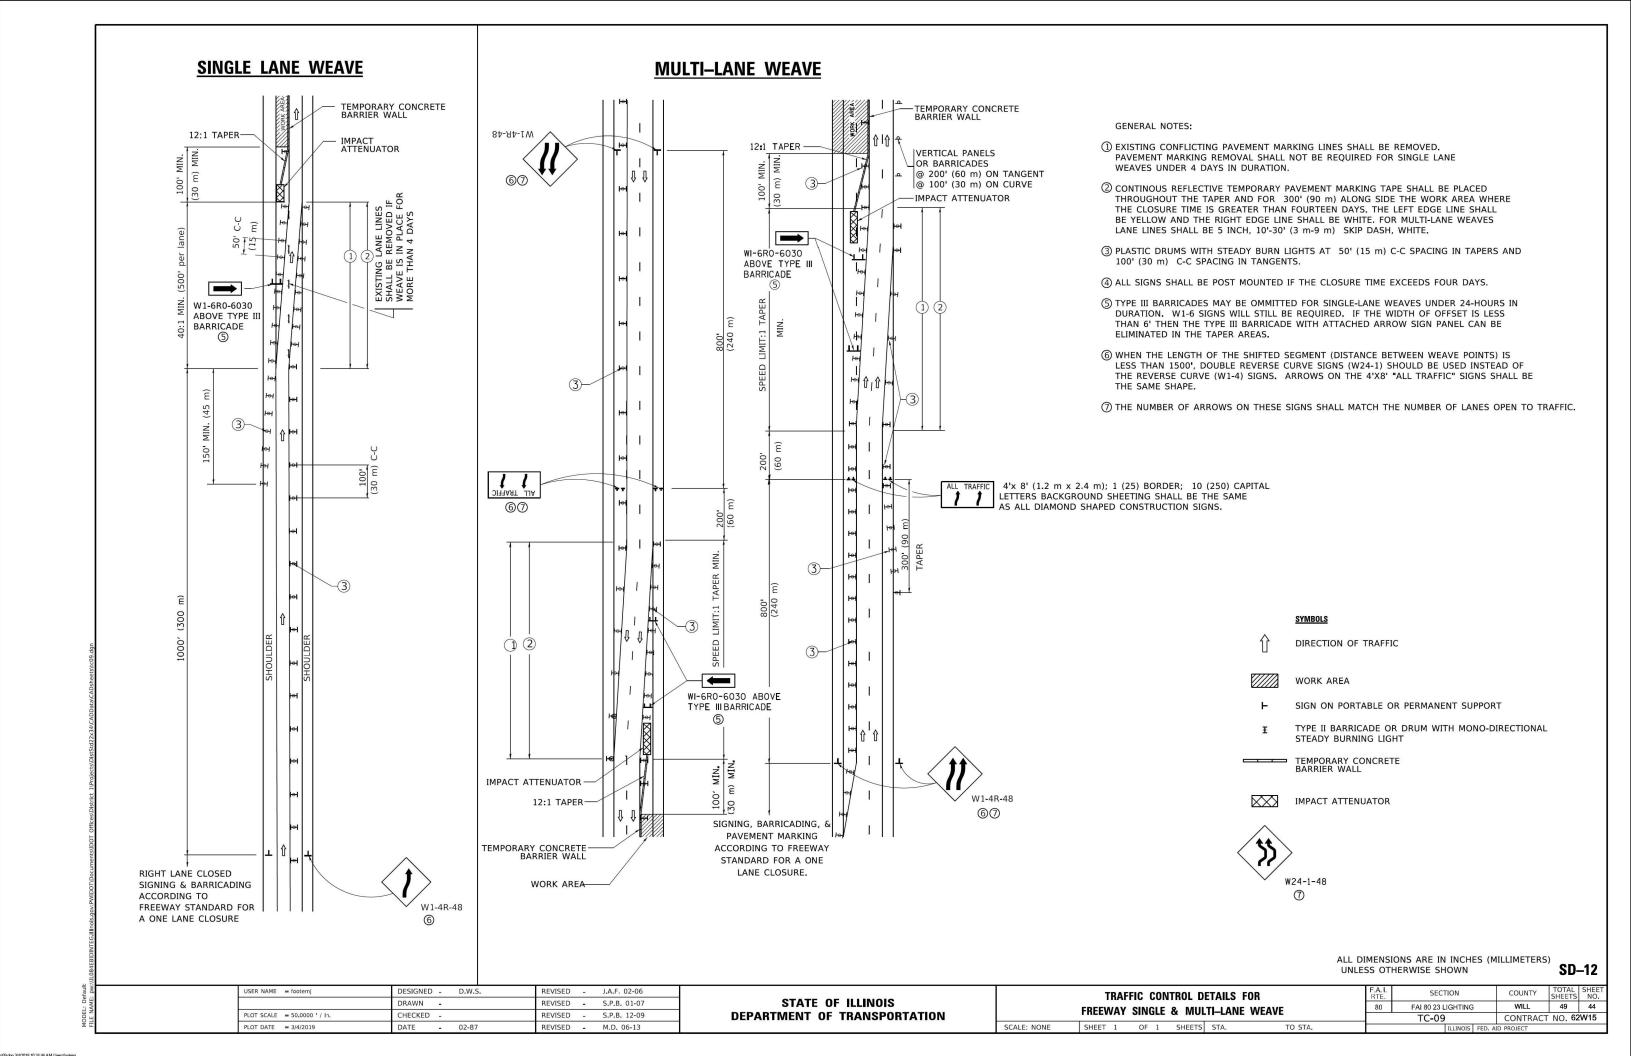

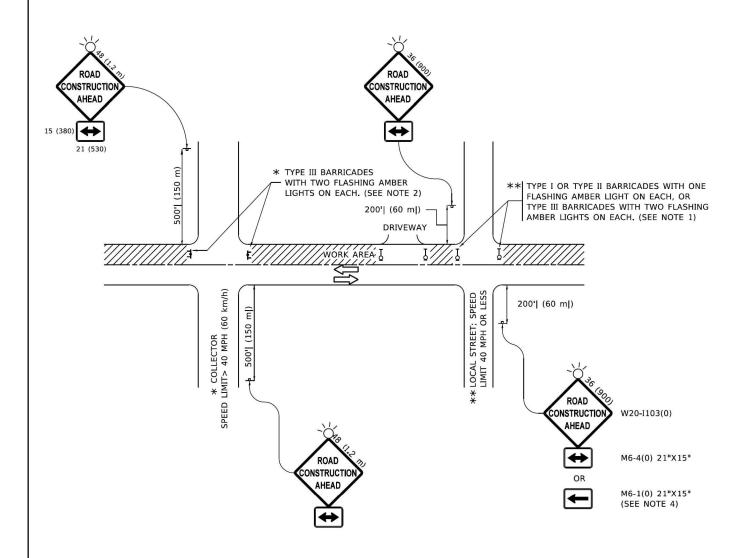

NOTES:

- 1. SIDE ROAD WITH A SPEED LIMIT OF 40 MPH (60 km/h) OR LESS AS SHOWN ON THE DRAWING AND AS DIRECTED BY THE ENGINEER:
- a) ONE "ROAD CONSTRUCTION AHEAD" SIGN 36 x 36 (900x900) WITH A FLASHER MOUNTED ON IT APPROXIMATELY 200' (60 m) IN ADVANCE OF THE MAIN ROUTE.
- b) THE CLOSED PORTION OF THE MAIN ROUTE SHALL BE PROTECTED BY BLOCKING WITH TYPE I, TYPE II OR TYPE III BARRICADES, 1/3 OF THE CROSS SECTION OF THE CLOSED PORTION.
- SIDE ROAD WITH A SPEED LIMIT GREATER THAN 40 MPH (60 km/h) AS SHOWN ON THE DRAWING AND AS DIRECTED BY THE ENGINEER:
- a) ONE "ROAD CONSTRUCTION AHEAD" SIGN 48 x 48 (1.2 m x 1.2 m) WITH A FLASHER MOUNTED ON IT APPROXIMATELY 500' (150 m) IN ADVANCE OF THE MAIN ROUTE.
- THE CLOSED PORTION OF THE MAIN ROUTE SHALL BE PROTECTED BY
 b) BLOCKING WITH TYPE III BARRICADES, 1/2 OF THE CROSS SECTION
 OF THE CLOSED PORTION.
- 3. CONES MAY BE SUBSTITUTED FOR BARRICADES OR DRUMS AT HALF THE SPACING DURING DAY OPERATIONS. CONES SHALL BE A MINIMUM OF 28 (710)
- WHEN THE SIDE ROAD LIES BETWEEN THE BEGINNING OF THE MAINLINE
 4. SIGNING AND THE WORK ZONE, A SINGLE HEADED ARROW (M6-1) SHALL
 BE USED IN LIEU OF THE DOUBLE HEADED ARROW (M6-4).

SCALE: NONE


- 5. WHEN WORK IS BEING PERFORMED ON A SIDE ROAD OR DRIVEWAY, FOLLOW THE APPLICABLE STANDARD(S). THE DIRECTIONAL ARROW (M6-1 OR M6-4) SHALL BE COVERED OR REMOVED WHEN NO LONGER CONSISTENT WITH THE TRAFFIC CONTROL SET-UP.
- 6. ADVANCE WARNING SIGNS ARE TO BE OMITTED ON DRIVEWAYS UNLESS OTHERWISE SPECIFIED IN THE PLANS OR BY THE ENGINEER
- 7. THE TRAFFIC CONTROL AND PROTECTION FOR SIDE ROADS, INTERSECTIONS, AND DRIVEWAYS SHALL BE INCLUDED IN THE COST OF SPECIFIED TRAFFIC CONTROL STANDARDS OR ITEMS.


All dimensions are in inches (millimeters) unless otherwise shown.


USER NAME = Lawrence.DeManche	DESIGNED - L.H.A.	REVISED - T. RAMMACHER 01-06-00
	DRAWN -	REVISED - A. SCHUETZE 07-01-13
PLOT SCALE = 100.0000 ' / in.	CHECKED -	REVISED - A. SCHUETZE 09-15-16
PLOT DATE = 5/3/2024	DATE - 06-89	REVISED - D. SENDERAK 05-03-24


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1 61	ICCT		0.5	•	CHEET	C CTA		TO	CTA

F.A. I. RTE.	SECTION	COUNTY	TOTAL SHEETS	SHEE NO.	
80	FAI 80 23 LIGHTING	WILL	49	45	
	TC-10	CONTRACT	NO. 62	W15	
	TLUMOIS	EED A	ID PROJECT		

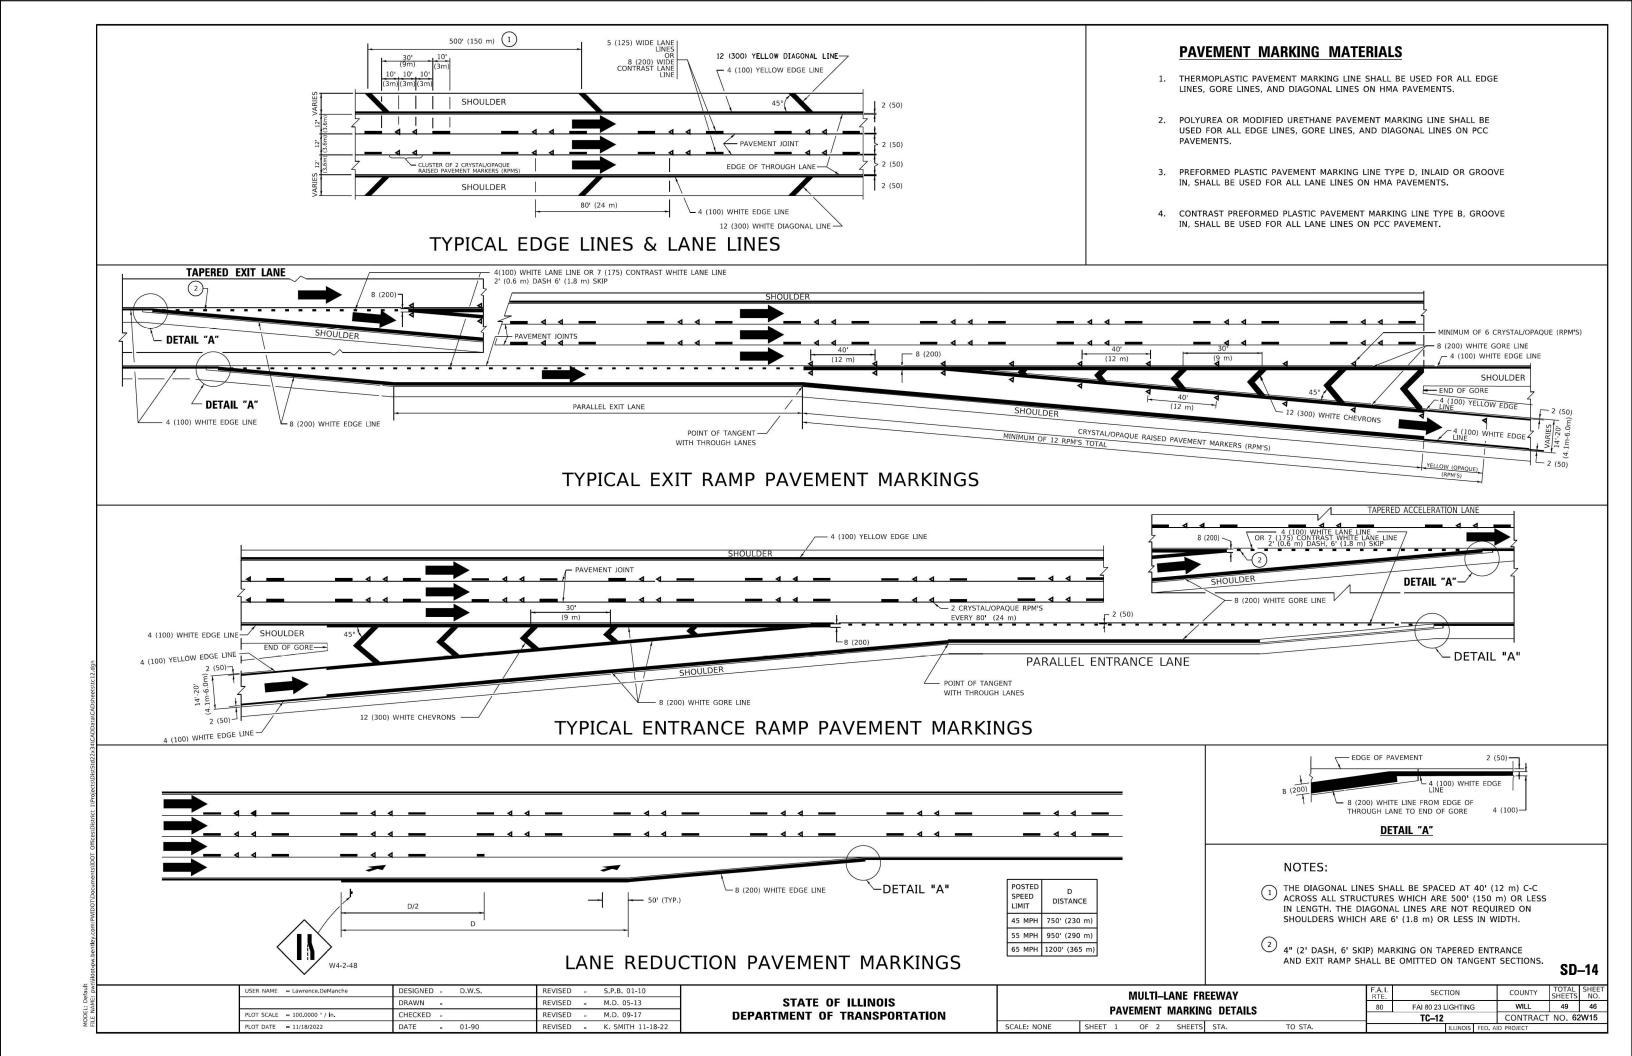

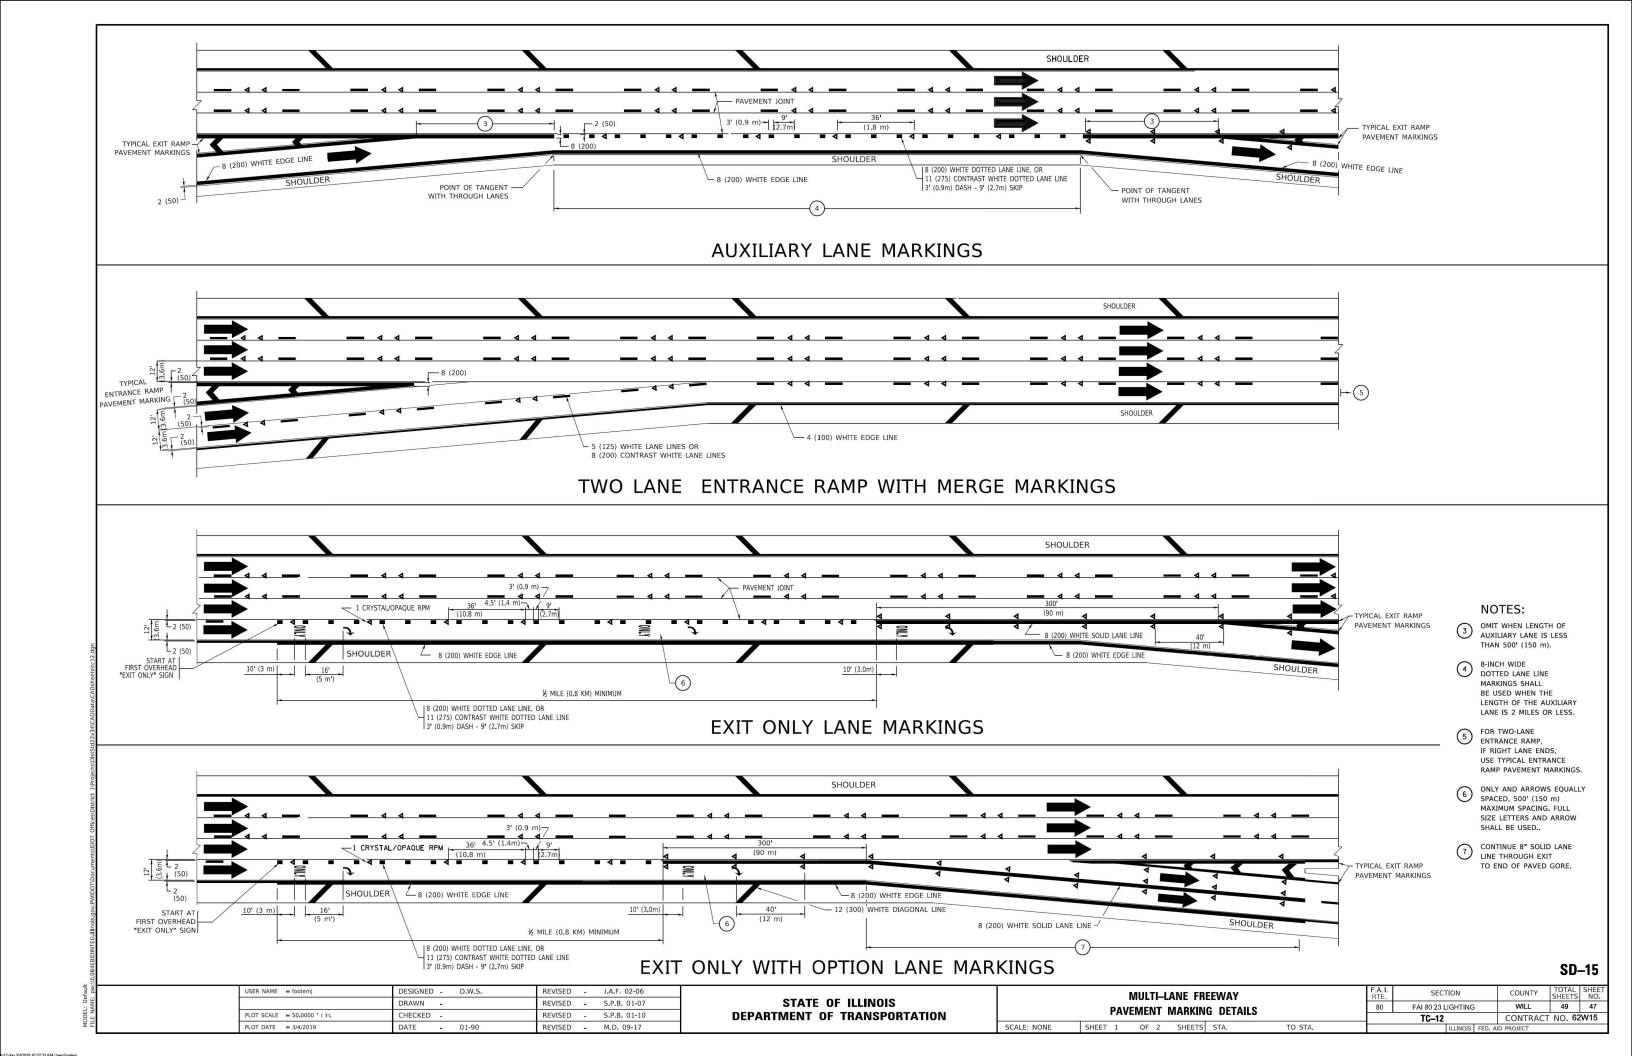

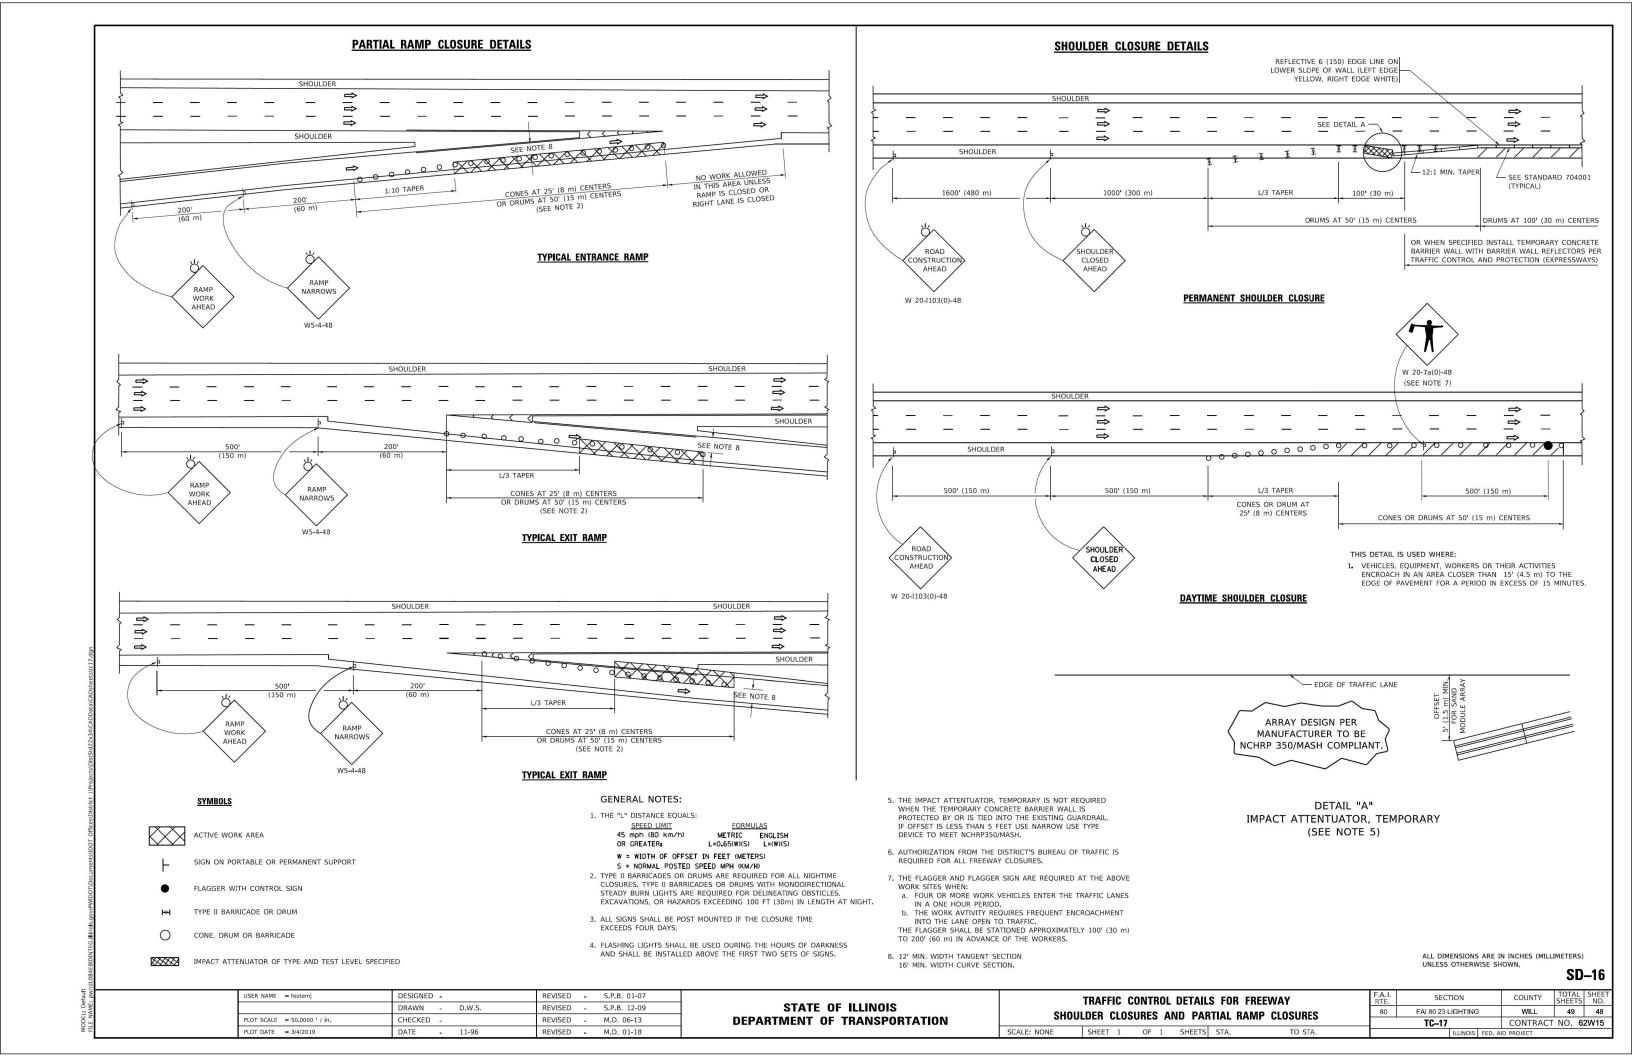

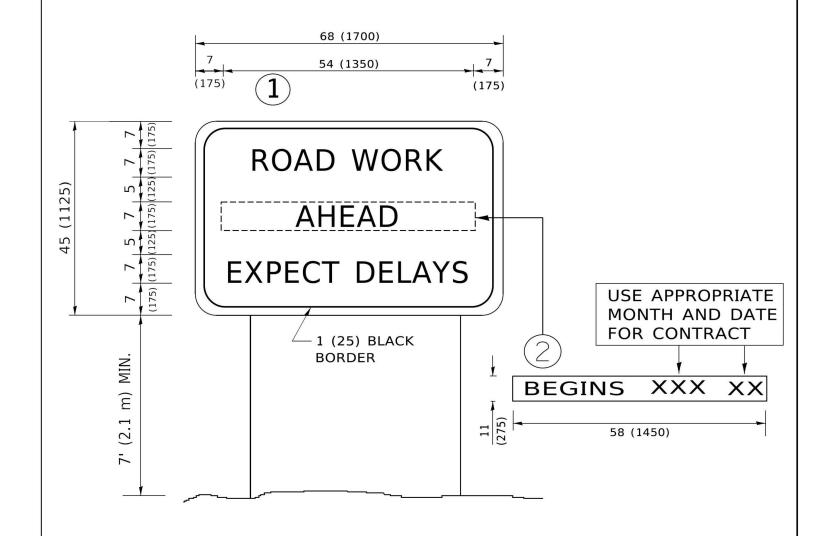

NOTES:

- 1. USE BLACK LETTERING ON ORANGE BACKGROUND.
- 2. ERECT SIGNS IN ADVANCE OF THE LOCATION FOR THE "ROAD CONSTRUCTION AHEAD" SIGN AT LOCATIONS AS DIRECTED BY THE ENGINEER.
- 3. ERECT SIGN 1 WITH INSTALLED PANEL 2 ONE WEEK PRIOR TO THE START OF CONSTRUCTION.
- 4. REMOVE PANEL 2 SOON AFTER THE START OF CONSTRUCTION.
- 5. SEE SPECIAL PROVISION FOR "TEMPORARY INFORMATION SIGNING" FOR ADDITIONAL INFORMATION.
- 6. ONE SIGN ASSEMBLY EQUALS 25.70 SQ. FT. (2.3 SQ. M.)
- 7. SHALL BE PAID FOR AS TEMPORARY INFORMATION SIGNING.

ALL DIMENSIONS ARE IN INCHES (MILLIMETERS) UNLESS OTHERWISE SHOWN.

SD-17

OSER NAME = TOOLETIIJ	DESIGNED -	KEVISED	-5	K. MIKS 09-13-97
	DRAWN -	REVISED	-	R. MIRS 12-11-97
PLOT SCALE = 50.0000 ' / in.	CHECKED -	REVISED	- T.	RAMMACHER 02-02-
PLOT DATE = 3/4/2019	DATE -	REVISED	-	C. JUCIUS 01-31-07

STATI	E OI	F ILLINOIS
DEPARTMENT	OF	TRANSPORTATION

			INF	ORI	MATION	SIGN	
NE	SHEET	1	OF	1	SHEETS	STA.	TO S

LI. SECTION COUNTY TOTAL SHEET NO.

10 FAI 80 23 LIGHTING WILL 49 49

TC-22 CONTRACT NO. 62W15