FOR INDEX OF SHEETS SEE SHEET NO. 2

TRAFFIC DATA

BUTTERFIELD ROAD 2012 ADT = 12,500 ST. CHARLES ROAD 2010 ADT = 18,000 25th AVENUE 2010 ADT = 19,000 LOCAL STREETS 2014 ADT = 300 POSTED SPEED LIMIT: 20 MPH DESIGN SPEED LIMIT: 30 MPH

DESIGN DESIGNATION = LOCAL STREET

PROJECT LOCATED IN THE VILLAGE OF BELLWOOD

JEFFERSON ELEMENTARY SCHOOL

SCALE: 1" = 10' SCALE: 1" = 50' SCALE: 1" = 40'

FULL SIZE PLANS HAVE BEEN PREPARED USING STANDARD ENGINEERING SCALES. REDUCED SIZED PLANS WILL NOT CONFORM TO STANDARD SCALES. IN MAKING MEASUREMENTS ON REDUCED PLANS, THE ABOVE SCALES MAY BE USED.

> Call Before You Dig ILLINOIS **ONE-CALL SYSTEM**

CONTRACT NO. 61A49

STATE OF ILLINOIS **DEPARTMENT OF TRANSPORTATION DIVISION OF HIGHWAYS PLANS FOR PROPOSED FEDERAL AID HIGHWAY VARIOUS ROUTES (VARIOUS LIMITS) CURB AND GUTTER, SIDEWALK, PAVEMENT MARKINGS, & SIGNAGE SECTION 12-00143-00-SW PROJECT SRTS-4009(192)** VILLAGE OF BELLWOOD **COOK COUNTY**

C-91-565-12 **RANGE 12 EAST** 3RD PM (NOT TO SCALE) ELEMETARY SCHOOL ROOSEVELT MIDDLE



LOCATION OF SECTION **INDICATED THUS:**

STATE OF ILLINOIS ILLINOIS DEPARTMENT OF TRANSPORTATION **DIVISION OF HIGHWAYS** 0 3/2///4
VILLAGE OF BELLWOOD, PRESIDENT

PRINTED BY THE AUTHORITY OF THE STATE OF ILLINOIS



EDWIN HANCOCK ENGINEERING COMPANY 9933 ROOSEVELT ROAD PHONE: (708)865-0300 WESTCHESTER, ILLINOIS 60154



LIVING WORLD CHRISTIAN ACADEMY

> LINCOLN **ELEMETARY** SCHOOL

> > **PROVISO TOWNSHIP**

- AREA OF IMPROVEMENT

GROSS LENGTH OF IMPROVEMENT = 6,501 FT = 1.288 MI NET LENGTH OF IMPROVEMENT = 6,501 FT = 1,288 MI

ENGINEERING + Established 1911

E.H.E. NO. 080-13-07902

IN	IDEX OF SHEETS
SHEET NO.	DESCRIPTION
1	TITLE SHEET, LOCATION MAP
2	INDEX OF SHEETS, LEGEND, HIGHWAY STANDARDS
3	GENERAL NOTES
4	SUMMARY OF QUANTITIES
5-11	SCHOOL IMPROVEMENT PLANS
12	SIGNING LEGEND
13-14	DETAILS
15	TRAFFIC CONTROL AND PROTECTION FOR SIDE ROADS, INTERSECTIONS, AND DRIVEWAYS (TC-10)
16	DISTRICT ONE TYPICAL PAVEMENT MARKINGS (TC-13)

I.D.O.T. STANDARD DRAWINGS

STANDARD NO.	TITLE OR DESCRIPTION
000001-06	STANDARD SYMBOLS, ABBREVIATIONS AND PATTERNS
280001-07	TEMPORARY EROSION CONTROL SYSTEMS
420001-07	PAVEMENT JOINTS
424001-07	PERPENDICULAR CURB RAMPS FOR SIDEWALKS
424021-02	DEPRESSED CORNER FOR SIDEWALKS
424026-01	ENTRANCE/ALLEY PEDESTRIAN CROSSING
701006-05	OFF-RD OPERATIONS, 2L, 2W, 15' (4.5m) TO 24" (600mm) FROM PAVEMENT EDGE
701101-04	OFF-RD OPERATIONS, MULTILANE, 15' (4.5m) TO 24" (600mm) FROM PAVEMENT EDGE
701301-04	LANE CLOSURE, 2L, 2W, SHORT TIME OPERATIONS
701427-02	LANE CLOSURE, MULTILANE, INTERMITTENT OR MOVING OPER. FOR SPEEDS < 40MPH
701501-06	URBAN LANE CLOSURE, 2L, 2W, UNDIVIDED
701701-09	URBAN LANE CLOSURE, MULTILANE INTERSECTION
701801-05	SIDEWALK, CORNER OR CROSSWALK CLOSURE
701901-03	TRAFFIC CONTROL DEVICES
780001-04	TYPICAL PAVEMENT MARKINGS

EXISTING	PROPOSED	DESCRIPTION	EXISTING	PROPOSED	DESCRIPTION
Ø		POWER POLE	\longrightarrow		STORM SEWER PIPE
Δ		GAS VALVE			COMBINATION SEWER PIPE
-000		STREET LIGHT			SANITARY SEWER PIPE
· ·		WATER MAIN BUFFALO BOX	——-E		ELECTRIC LINE
\otimes		WATER MAIN VALVE BOX	G		GAS LINE
(\$)		SPRINKLER	T		TELEPHONE LINE
		WATER MAIN VALVE VAULT			WATER MAIN PIPE
0		STORM SEWER MANHOLE			CURB AND GUTTER
0		STORM CATCH BASIN		~~~	DIRECTION OF FLOW
		STORM INLET		-\$-	DRAINAGE SUMMIT
Ω		FIRE HYDRANT	XXX		WATER MAIN VALVE VAULT RIM AND TOP OF PIPE ELEVATION
X		TREE TO BE REMOVED	XXX		COMBINATION MANHOLE RIM AND INVERT ELEVATION
		TREE	XXX		STORM SEWER MANHOLE/CATCHBASIN RIM AND INVERT ELEVATION
		EXISTING CURB AND GUTTER TO BE REMOVED		Α	STRUCTURE TO BE ADJUSTED
		EXISTING CONCRETE AREA TO BE REMOVED		1C	TYPE 1 FRAME & CLOSED LID
		HOT-MIX ASPHALT SURFACE REMOVAL		1P	TYPE 1 FRAME & OPEN LID
		COMBINATION SEWER PIPE TO BE REMOVED		RC	RECONSTRUCT EXISTING STRUCTURE
-///		STORM SEWER PIPE TO BE REMOVED	× ^{643.90}	× ^{632.25}	GROUND ELEVATIONS
-/-/		SANITARY SEWER PIPE TO BE ABANDONED			
		WATER MAIN TO BE REMOVED			
)¥ (e)			
				*1	



	DESIGNED -	JGG	REVISED -	
780	DRAWN -	MK	REVISED -	
340	CHECKED -	JGG	REVISED -	
	DATE -	03-21-14	REVISED -	

STATE OF ILLINOIS **DEPARTMENT OF TRANSPORTATION**

INI					END OF	SYMBOLS,
SCALE: NONE	SHEET NO.	1 (OF 1	SHEETS	STA.	TO STA.

UNDERGROUND UTILITIES

THE LOCATIONS OF THE UNDERGROUND UTILITIES AS SHOWN ON THE PLANS HAVE BEEN OBTAINED BY FIELD SURVEYS AND SEARCHES OF AVAILABLE RECORDS. IT IS BELIEVED THAT THE DATA IS ESSENTIALLY CORRECT, BUT THE VILLAGE OF BELLWOOD AND THE ILLINOIS DEPARTMENT OF TRANSPORTATION AND/OR OTHER OFFICES AND AGENCIES ASSOCIATED WITH THE DEVELOPMENT OF THESE PLANS DO NOT GUARANTEE THEIR ACCURACY OR COMPLETENESS. THE CONTRACTOR WILL BE REQUIRED TO VERIFY THE LOCATION OF EACH FACILITY WITH THE UTILITY COMPANY, AND SHALL TAKE DUE CARE IN ALL PHASES OF THE CONSTRUCTION TO PROTECT ANY SUCH FACILITIES WHICH MAY BE AFFECTED BY THE WORK. ANY DAMAGE TO EXISTING UTILITIES SHALL BE REPAIRED IN **ACCORDANCE WITH ARTICLE LR 105**

ADJUSTMENTS REQUIRED BY UTILITY COMPANIES WILL BE PERFORMED BY THE COMPANY INVOLVED OR ITS CONTRACTOR, BUT WILL BE COORDINATED BY GENERAL CONTRACTOR.

COORDINATION OF ALL UTILITY WORK INVOLVED IN THE CONSTRUCTION AREA WILL BE DISCUSSED AT A PRE-CONSTRUCTION CONFERENCE.

THE CONTRACTOR SHALL USE EXTREME CAUTION IN THE REMOVAL OF ABANDONED EXISTING GAS LINES SINCE RESIDUAL MATERIALS CONTAINED THEREIN ARE HIGHLY EXPLOSIVE, FLAMMABLE, AND TOXIC. ONCE THE MAINS ARE ABANDONED BY THE OWNER, THE CONTRACTOR SHALL ASSUME ALL RESPONSIBILITY FOR ANY DAMAGE AND/OR INJURY OCCURRING ON THE PROJECT DUE TO HIS OPERATIONS NEXT TO THE MAINS AND/OR THE METHOD OF REMOVAL OF THE ABANDONED MAINS.

FRAMES AND GRATES

THE TYPE OF FRAMES AND GRATES REQUIRED FOR ALL CATCH BASINS AND MANHOLES LISTED IN THE SUMMARY OF QUANTITIES MAY BE FOUND ON THE PLANS AT THEIR RESPECTIVE LOCATIONS. WHERE LIDS ARE CALLED FOR ON THE PLANS, THEY SHALL BE IN ACCORDANCE WITH ARTICLE 604.01 OF THE STANDARD SPECIFICATIONS AND THE TERM LID IS USED IN LIEU OF GRATE.

ON ALL IMPROVEMENTS, THE FRAMES AND LIDS OF EXISTING CATCH BASINS, INLETS, MANHOLES, AND VALVE VAULTS WHICH ARE TO BE ABANDONED DUE TO CONSTRUCTION OF THIS IMPROVEMENT ARE TO REMAIN THE PROPERTY OF THE VILLAGE AND BE SALVAGED. THE CONTRACTOR IS TO DELIVER FRAMES AND LIDS TO THE VILLAGE'S PUBLIC WORKS YARD. BELLWOOD'S DEPARTMENT OF PUBLIC WORKS IS LOCATED AT 203 30TH AVENUE, BELLWOOD, ILLINOIS, PHONE NUMBER IS (708) 547-3540.

FORMS FOR CONCRETE SIDEWALKS, DRIVEWAYS, **PAVEMENT, AND GUTTER FLAGS**

A 2" X 6" BOARD WILL BE USED AS A FORM FOR ALL SIDEWALKS TO BE INSTALLED FIVE INCHES (5") IN THICKNESS. A 2" X 8" BOARD WILL BE USED AS A FORM FOR ALL DRIVEWAYS TO BE INSTALLED SEVEN INCHES (7") IN THICKNESS. A 2" X 10" BOARD WILL BE USED AS THE FORM FOR ALL PAVEMENTS TO BE INSTALLED EIGHT INCHES (8") IN THICKNESS. A 2" X 12" BOARD WILL BE USED AS THE FORM FOR THE FACE OF THE GUTTER FLAGS TO BE INSTALLED TEN INCHES (10") IN THICKNESS. ALL FORMS MUST BE OF A MINIMUM HEIGHT OF THE PROPOSED THICKNESS OF THE RESPECTIVE CONCRETE ITEMS TO BE INSTALLED. METAL FORMS WILL NOT BE ALLOWED ON THIS PROJECT.

OPEN EXCAVATION

LEAVING OF ANY EXCAVATION NECESSARY FOR STORM SEWERS OPEN OVERNIGHT WILL NOT BE ALLOWED ON THIS PROJECT. THE CONTRACTOR WILL BE RESPONSIBLE FOR COMPLETELY BACKFILLING OR PLATING OVER OF ALL EXCAVATIONS AT THE END OF EACH DAY, IF THE EXCAVATIONS ARE BACKFILLED THEY SHALL BE FILLED WITH AN AGGREGATE MEETING THE GRADATION OF CA-6. THE MATERIAL WILL BE COMPACTED SUFFICIENTLY TO PREVENT RUTTING OR SETTLEMENT OF MATERIAL UNDER TRAFFIC LOADS. IF PLATES ARE USED THEY SHALL BE OF SUFFICIENT THICKNESS TO SUPPORT VEHICULAR LOADS. ADDITIONALLY THEY SHALL EXTEND A MINIMUM OF NINE INCHES (9") BEYOND THE LIMITS OF THE EXCAVATION ON ALL SIDES. IF THE PLATES ARE TO BE LEFT OVER THE WEEKEND, THE EDGES OF THE PLATES SHALL BE CUSHIONED WITH A BITUMINOUS MIXTURE IN AREAS WHERE VEHICULAR TRAFFIC WILL CROSS THE PLATES.

THE COSTS FOR PROVIDING THE AGGREGATE, PLATES AND BITUMINOUS MIXTURE WILL NOT BE PAID FOR DIRECTLY BUT SHALL BE INCLUDED IN THE VARIOUS CONTRACT ITEMS.

MAINTENANCE OF SEWER FLOWS

THE CONTRACTOR SHALL CONDUCT HIS OPERATIONS SO AS TO MAINTAIN AT ALL TIMES FLOWS THROUGH EXISTING STORM AND COMBINED SEWER SYSTEMS. HE SHALL ALSO PROVIDE AND MAINTAIN AN EFFICIENT PUMPING PLANT IF NECESSARY AND A TEMPORARY OUTLIET AND BE PREPARED AT ALL TIMES TO DISPOSE OF THE WATER COLLECTED IN A SAFE MANNER WITHOUT DAMAGE OF ANY KIND TO ADJACENT PROPERTIES. THE ENDS OF EXISTING DRAINAGE LINES WHICH ARE NOT TO BE INCORPORATED INTO THE PROJECT ARE TO BE SEALED AS SPECIFIED IN THE SPECIAL PROVISIONS. THE COST OF ALL THE PREVIOUSLY MENTIONED WORK SHALL BE INCLUDED IN THE RESPECTIVE SEWER PAY ITEMS. ALL ACCUMULATION OF MATERIAL IN THE STRUCTURE DUE TO CONSTRUCTION OPERATIONS AS WELL AS MATERIAL EXISTING BEFORE CONSTRUCTION, SHALL BE REMOVED BY THE CONTRACTOR AT HIS EXPENSE.

EXISTING STRUCTURE MODIFICATIONS

ALL KNOWN EXISTING STRUCTURES IN THE PAVEMENT OR ADJACENT AREAS WHICH ARE INVOLVED IN THE CONSTRUCTION HAVE BEEN SHOWN ON THE PLANS AND NOTED AS TO BE REMOVED, FILLED, RECONSTRUCTED, OR ADJUSTED BY THE CONTRACTOR EXCEPT THOSE OF AMERITECH, COMED, AND THE NICOR GAS COMPANY, WHICH ARE TO BE ADJUSTED BY THE APPROPRIATE UTILITY FORCE. WHERE EXISTING STRUCTURES ARE TO BE REMOVED OR FILLED, OR THE EXISTING CASTING REPLACED, THE CASTINGS REMOVED FROM THE STRUCTURE ARE TO REMAIN THE PROPERTY OF THE VILLAGE AND BE SALVAGED. THE CONTRACTOR IS TO DELIVER FRAMES AND LIDS TO THE VILLAGE'S

MAINTENANCE OF EXISTING DRAINAGE STRUCTURES

WHEN DURING THE CONSTRUCTION OPERATIONS, ANY LOOSE MATERIAL IS DEPOSITED IN THE FLOW LINE OF ANY GUTTERS OR DRAINAGE STRUCTURE SO THAT THE NATURAL FLOW OF WATER IS OBSTRUCTED, IT SHALL BE REMOVED AT THE CLOSE OF EACH WORKING DAY. AT THE CONCLUSION OF THE CONSTRUCTION OPERATIONS, ALL DRAINAGE FACILITIES SHALL BE CLEAN AND FREE OF ALL OBSTRUCTIONS. THE COST OF THIS WORK SHALL BE INCLUDED IN THE RESPECTIVE SEWER PAY ITEMS.

SAW CUTTING

THE CONTRACTOR SHALL SAW CUT ASPHALT PAVEMENT AND CONCRETE PAVEMENT AS INDICATED ON THE PLANS OR AS DIRECTED BY THE ENGINEER, TO SEPARATE THE EXISTING PAVEMENT TO BE REMOVED BY MEANS OF AN APPROVED CONCRETE SAW TO A DEPTH AS DIRECTED BY THE ENGINEER. SUITABLE GUIDELINES OR DEVICES SHALL BE USED TO ASSURE CUTTING A NEAT, STRAIGHT LINE AS SHOWN ON THE PLANS. CARE SHALL BE TAKEN BY THE CONTRACTOR SO AS NOT TO DAMAGE THE REMAINING PAVEMENT DIRECTLY ADJACENT TO THE PAVEMENT TO BE REMOVED. ANY DAMAGE TO THE EXISTING PAVEMENT RESULTING FROM PAVEMENT REMOVAL OPERATIONS SHALL BE REPAIRED AT THE CONTRACTOR'S EXPENSE. THE PRICE OF SAW CUTTING, AS NOTED ABOVE, SHALL BE INCLUDED IN THE PARTICULAR PAY ITEMS.

PROPOSED STRUCTURES

THE CONTRACTOR SHALL NOT ORDER PROPOSED STRUCTURES UNTIL A JULIE REQUEST HAS BEEN EXECUTED AND THE ENGINEER HAS BEEN NOTIFIED BY THE CONTRACTOR OF ANY CONFLICTS.

ITEMS TO BE SALVAGED

WHERE SPECIFIED ON THE PLANS OR AS DIRECTED BY THE ENGINEER, EXISTING SEWER FRAMES AND LIDS, VALVE BOXES, DOMESTIC WATER SERVICE BOXES, FIRE HYDRANTS AND OTHER CASTINGS ARE TO BE REMOVED BY THE CONTRACTOR. ADDITIONALLY, ALL EXISTING SIGNAGE SCHEDULED FOR REMOVAL WILL ALSO BE APPROPRIATED BY THE CONTRACTOR. THESE ITEMS WILL REMAIN THE PROPERTY OF THE VILLAGE, AND SHALL BE DELIVERED TO THE OWNER AT ITS PUBLIC WORKS FACILITY AT 203 30TH AVENUE, BELLWOOD, IL 60104.

BITUMINOUS MATERIALS (PRIME COAT)

THE PLACEMENT OF BITHMINOUS MATERIALS (PRIME COAT) WILL NOT BE PAID FOR SEPARATELY BUT SHALL BE INCLUDED IN THE COST OF HOT-MIX ASPHALT SURFACE COURSE, MIX D. N50.

TRAFFIC PROTECTION

CONTRACTOR'S ATTENTION IS DIRECTED TO THE FACT THAT WHEN WORK COMMENCES, THE CONTRACTOR SHALL ASSUME THE MAINTENANCE OF ANY PAVEMENT, SHOULDERS, DRAINAGE FACILITIES, TRAFFIC CONTROL, SIGNS, PAVEMENT MARKINGS, AND OTHER APPURTENANCES ON ROADWAYS WITHIN THE LIMITS OF THE CONTRACT WHICH ARE TO BE USED BY THE PUBLIC DURING CONSTRUCTION AND TO RETAIN THIS MAINTENANCE RESPONSIBILITY UNTIL PROJECT COMPLETION. NEED FOR SNOW AND ICE CONTROL DURING THE CONSTRUCTION PERIOD SHALL BE ACCOMMODATED FOR BY OTHERS.

STORM SEWER STRUCTURES

PRE-CAST REINFORCED CONCRETE SECTIONS FABRICATED IN ACCORDANCE WITH ASTM C-478 WILL BE USED ON ALL STRUCTURES AND RECONSTRUCTED STRUCTURES. FINAL ADJUSTMENT SHALL BE MADE USING PRE-CAST ADJUSTING RINGS. A MAXIMUM OF 6" OF ADJUSTING RINGS WILL BE PERMITTED. THE WORK DESCRIBED WITHIN THE SPECIAL PROVISION FOR FRAMES AND LIDS TO BE ADJUSTED (SPECIAL) SHALL BE PERFORMED WHEN INSTALLING A NEW STORM SEWER STRUCTURE. THIS ITEM WILL NOT BE PAID FOR SEPARATELY BUT WILL BE INCLUDED IN THE UNIT PRICE FOR THE VARIOUS PROPOSED STORM SEWER STRUCTURES IN THE CONTRACT.

MANHOLE OR VALVE VAULT COVERS

THE WORD "WATER", "SANITARY", OR "STORM" SHALL BE CAST INTO THE LID OF EACH RESPECTIVE MANHOLE OR VALVE VAULT.

EXISTING SIGN AND POST REMOVAL

ALL EXISTING SCHOOL CROSSING RELATED SIGNS SHOWN ON THE PLANS SHALL BE REMOVED AND DISPOSED OF BY THE CONTRACTOR. THE COST OF THIS WORK WILL NOT BE PAID FOR SEPARATELY BUT SHALL BE INCLUDED IN COST OF SIGN AND POST ITEMS.

DESIGNED - JGG REVISED -DRAWN -MK REVISED CHECKED . JGG REVISED 03-21-14 REVISED

STATE OF ILLINOIS **DEPARTMENT OF TRANSPORTATION** SCALE: NONE

GENERAL NOTES

SHEET NO. 1 OF 1 SHEETS STA.

SECTION COUNTY SHEETS 12-00143-00-SW COOK 16 3 FIELD BOOK NO.: ---CONTRACT NO. 61A49 FED. ROAD DIST. NO. 1 | ILLINOIS | FED. AID PROJECT

	CODE	PAY ITEM DESCRIPTION	UNIT	TOTAL QUANTITY	CONST. TYPE CODE	
	CODE	PAT HEIN DESCRIPTION	UNII	TOTAL QUANTITY	100% FEDERAL	
	21101615	TOPSOIL FURNISH AND PLACE, 4"	SQ YD	430	430	
	25200100	SODDING	SQ YD	430	430	
	40603335	HOT-MIX ASPHALT SURFACE COURSE, MIX D, N50	TON	30	30	
	42300300	PORTLAND CEMENT CONCRETE DRIVEWAY PAVEMENT, 7 INCH	SQ YD	5	5	
	42400200	PORTLAND CEMENT CONCRETE SIDEWALK 5 INCH	SQ FT	6,500	6,500	
L	42400800	DETECTABLE WARNINGS	SQ FT	840	840	
	44000100	PAVEMENT REMOVAL	SQ YD	60	60	
	44000157	HOT-MIX ASHPALT SURFACE REMOVAL, 2"	SQ YD	265	265	
	44000200	DRIVEWAY PAVEMENT REMOVAL	SQ YD	5	5	
	44000500	COMBINATION CURB AND GUTTER REMOVAL	FOOT	1,140	1,140	
	44000600	SIDEWALK REMOVAL	SQ FT	8,250	8,250	
	60300305	FRAMES AND LIDS TO BE ADJUSTED	EACH	15	15	
	60604100	COMBINATION CONCRETE CURB AND GUTTER, TYPE B-6.12 (MODIFIED)	FOOT	1,140	1,140	
	67100100	MOBILIZATION	LSUM	1	1	
	70102620	TRAFFIC CONTROL AND PROTECTION, STANDARD 701501	LSUM	1	1	
	70102635	TRAFFIC CONTROL AND PROTECTION, STANDARD 701701	LSUM	1	1	
	70102640	TRAFFIC CONTROL AND PROTECTION, STANDARD 701801	LSUM	1	1	
	72000100	SIGN PANEL - TYPE 1	SQ FT	200	200	
	72900100	METAL POST - TYPE A	FOOT	300	300	
*	78000600	THERMOPLASTIC PAVEMENT MARKING - LINE 12"	FOOT	2,000	2,000	
*	78000650	THERMOPLASTIC PAVEMENT MARKING - LINE 24"	FOOT	600	600	
	78300100	PAVEMENT MARKING REMOVAL	SQ FT	2,100	2,100	

- * DENOTES SPECIALTY ITEM
- ~ DENOTES THAT A SPECIAL PROVISION HAS BEEN PROVIDED

HANCOCK	 ♣ Civil Engineers ♠ Municipal Consultants
L ENGINEERING	♦ Established 1911

DESIGNED - JGG REVISED -DRAWN -REVISED -CHECKED -JGG REVISED -REVISED -


STATE OF ILLINOIS **DEPARTMENT OF TRANSPORTATION**


SUMMARY OF QUANTITIES SHEET NO. 1 OF 1 SHEETS STA.

SCALE: NONE


COUNTY TOTAL SHEET NO.

COOK 16 4 SECTION FIELD BOOK NO. : --CONTRACT NO. 61A49 FED. ROAD DIST. NO. 1 | ILLINOIS | FED. AID PROJECT E.H.E. PROJECT NO. 080-13-07902

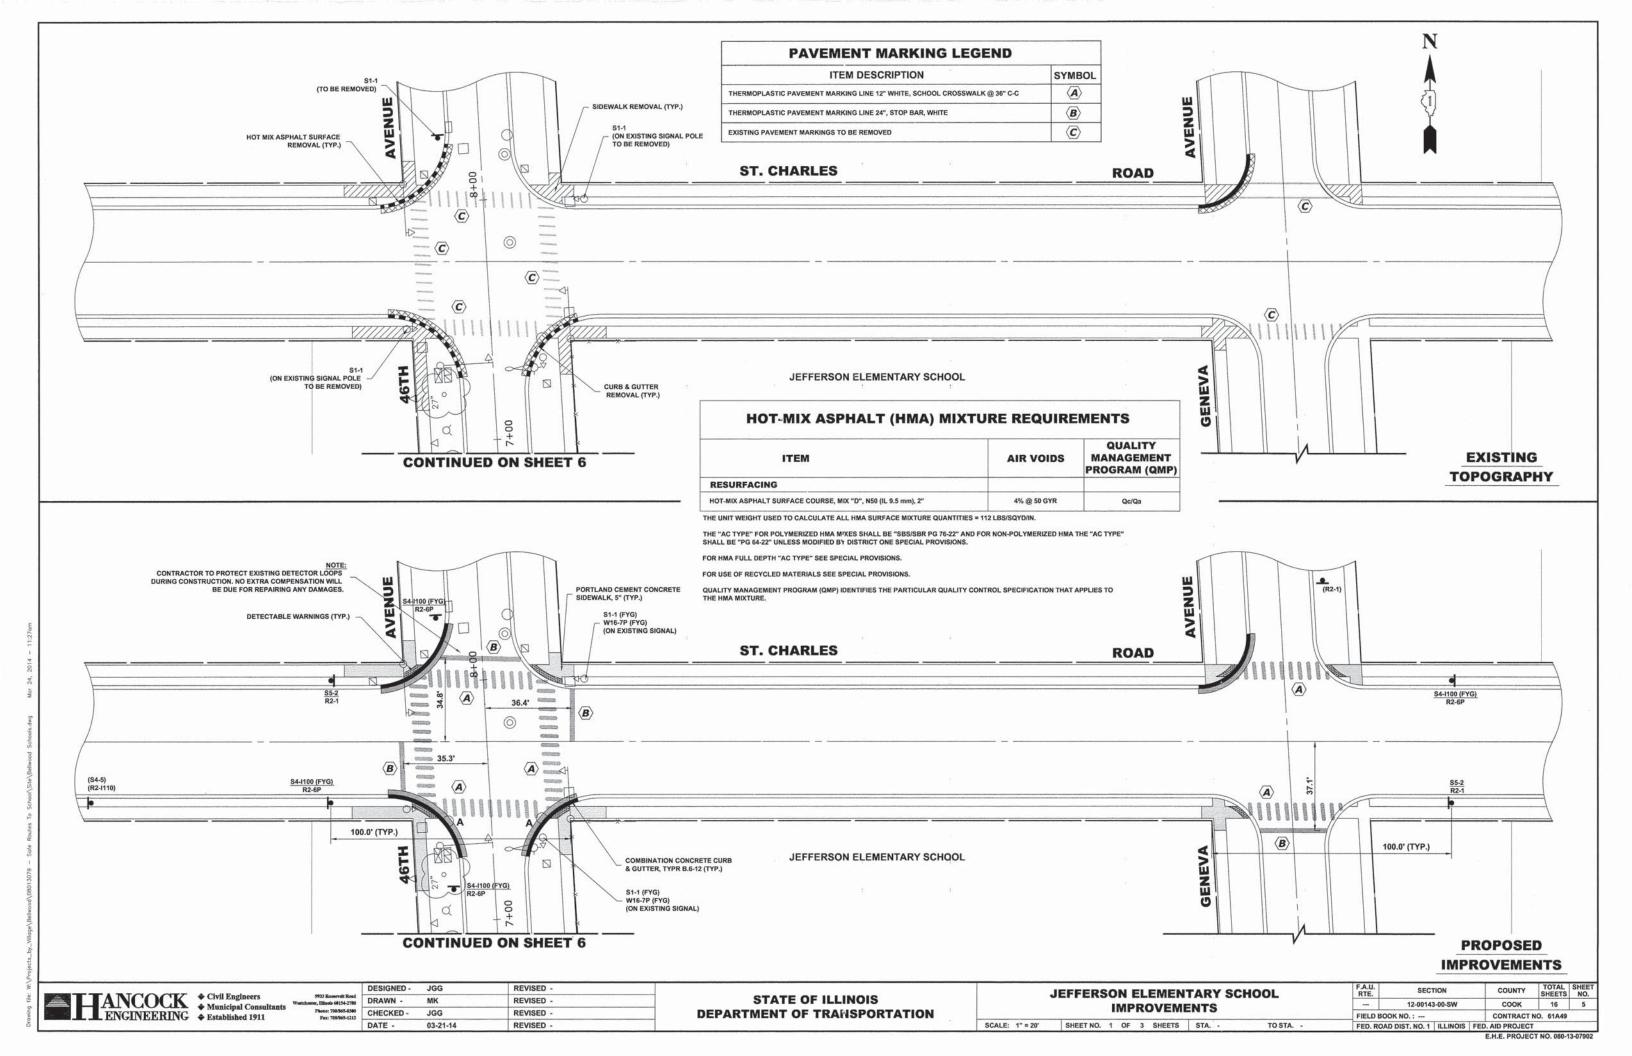

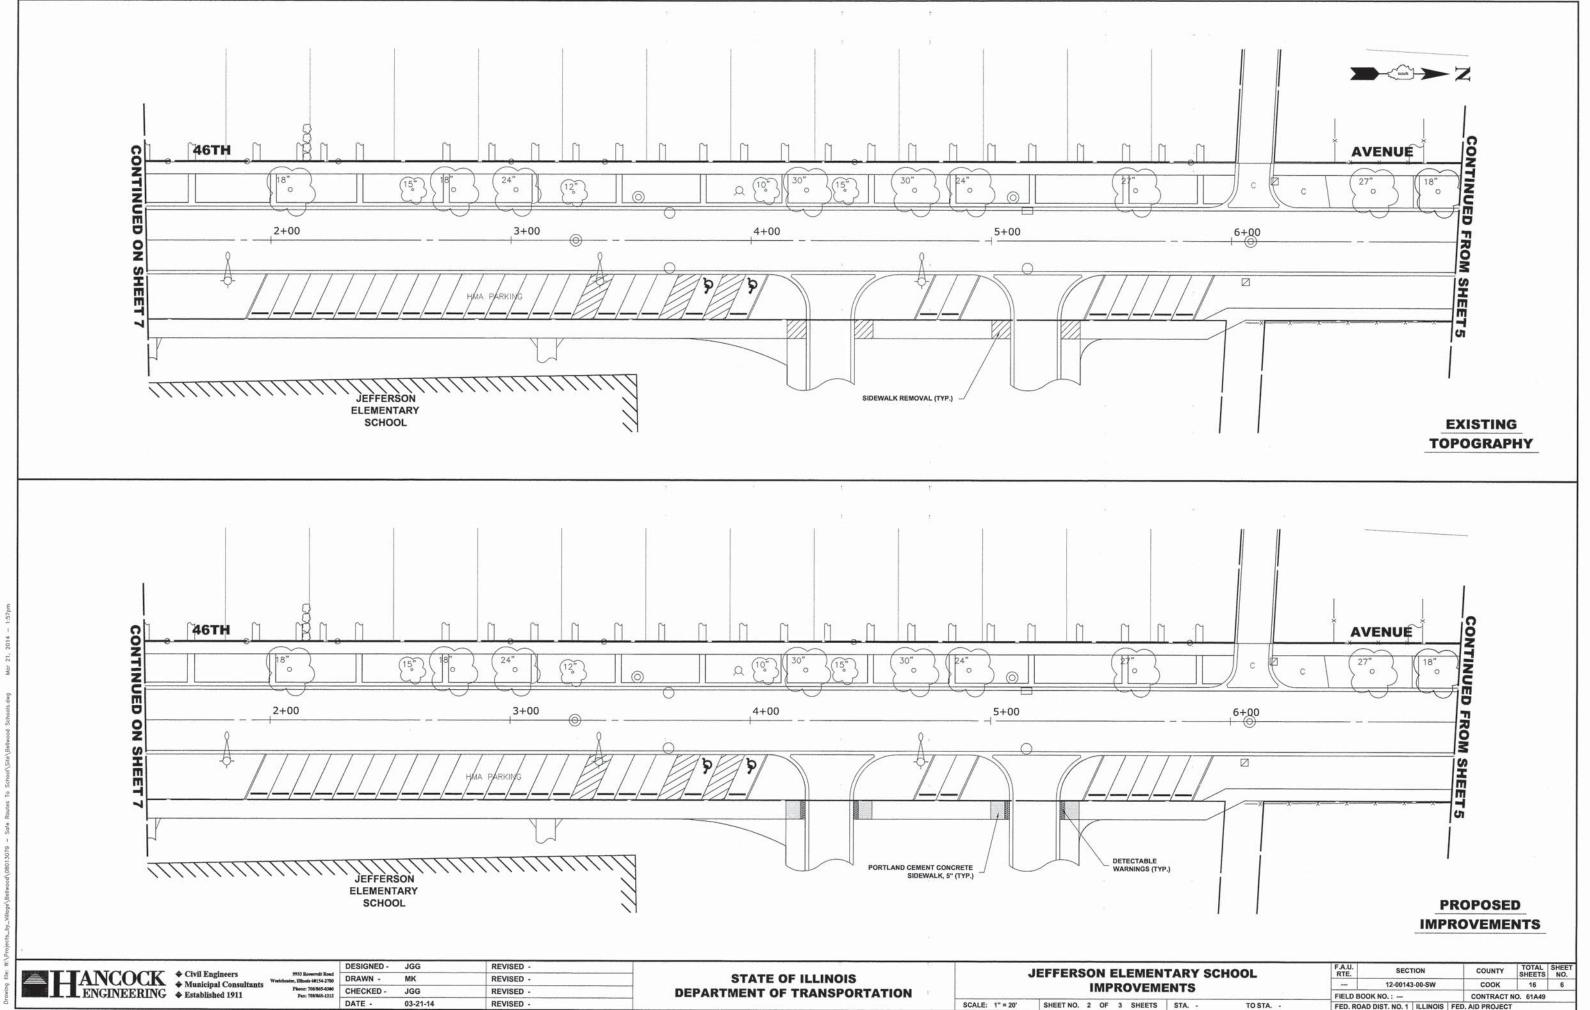

E.H.E. PROJECT NO. 080-13-07902

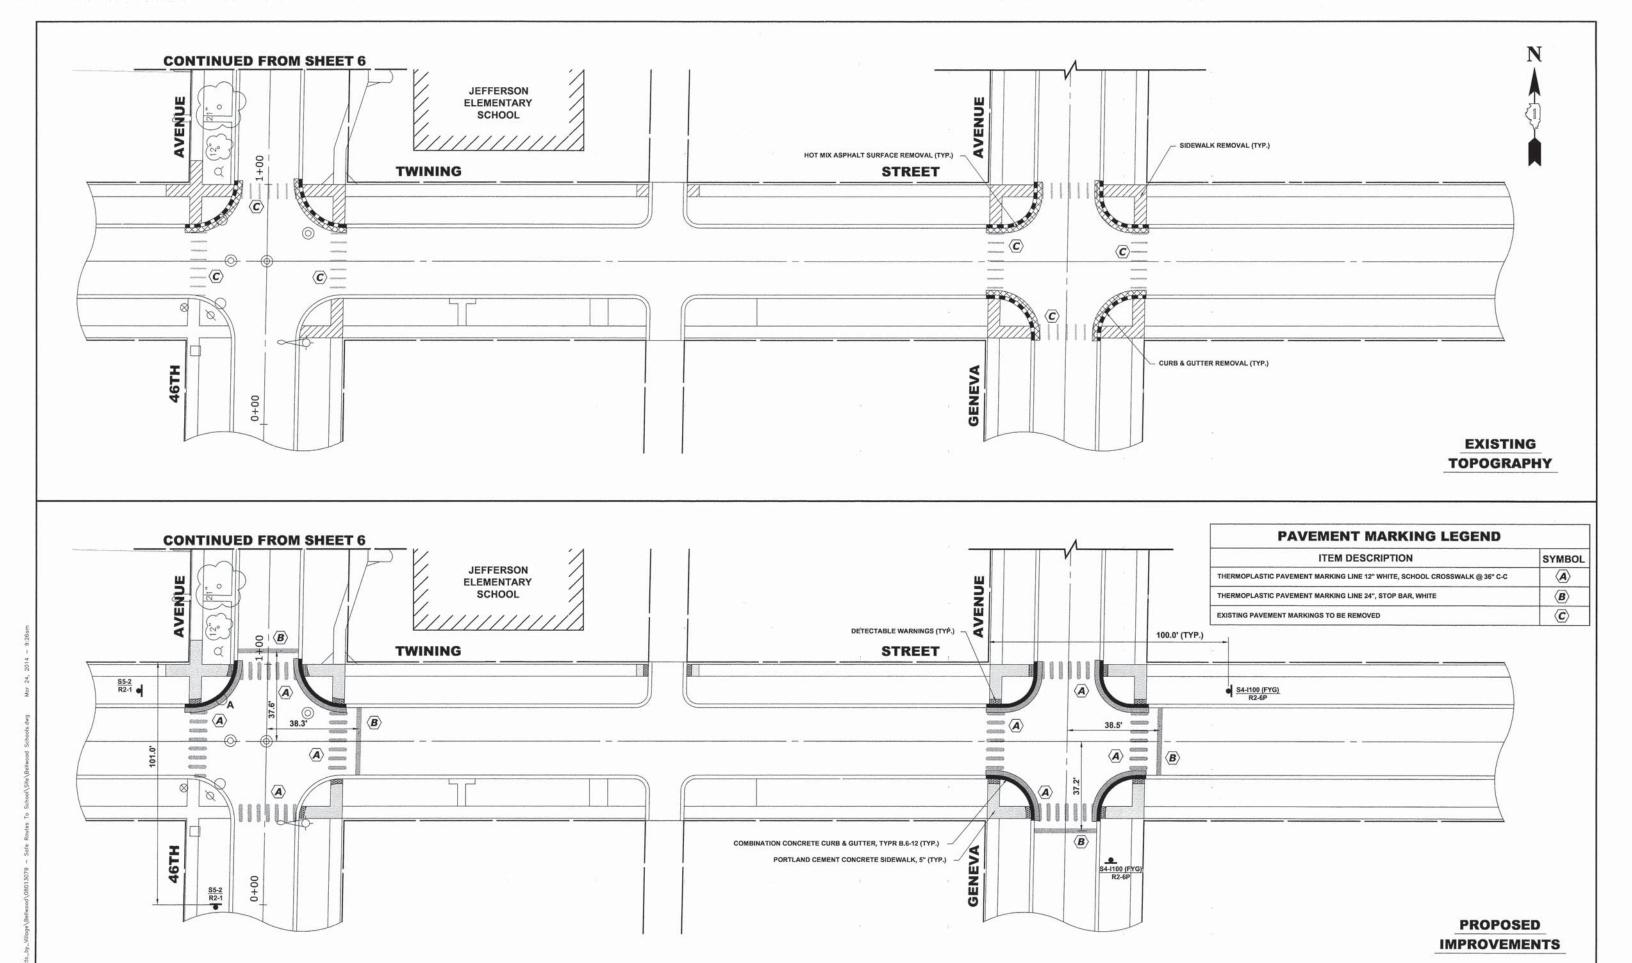



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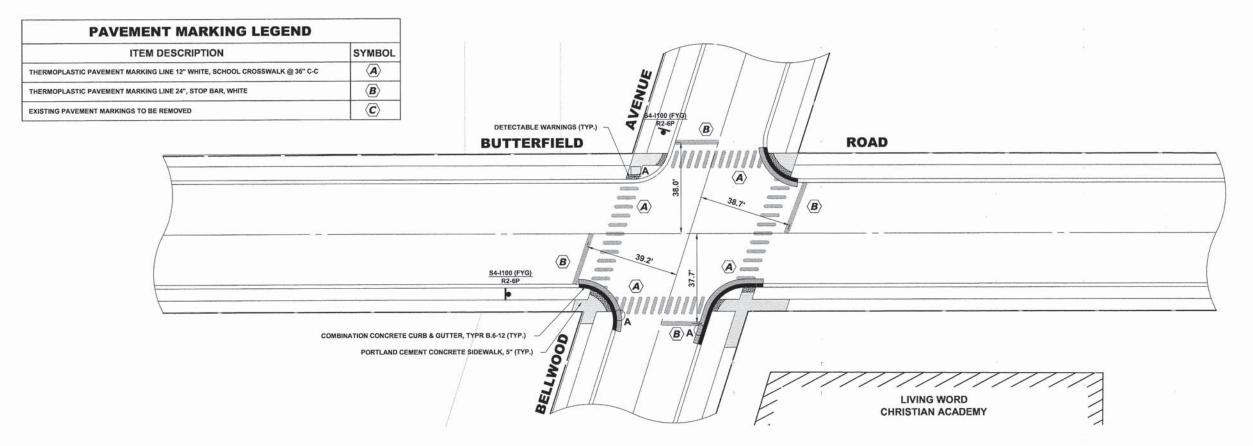
STATE OF ILLINOIS **DEPARTMENT OF TRANSPORTATION**

JEFFERSON ELEMENTARY SCHOOL IMPROVEMENTS SCALE: 1" = 20' SHEET NO. 3 OF 3 SHEETS STA. -TO STA. -

12-00143-00-SW COOK 16 7 CONTRACT NO. 61A49 FIELD BOOK NO. : --FED. ROAD DIST. NO. 1 | ILLINOIS | FED. AID PROJECT



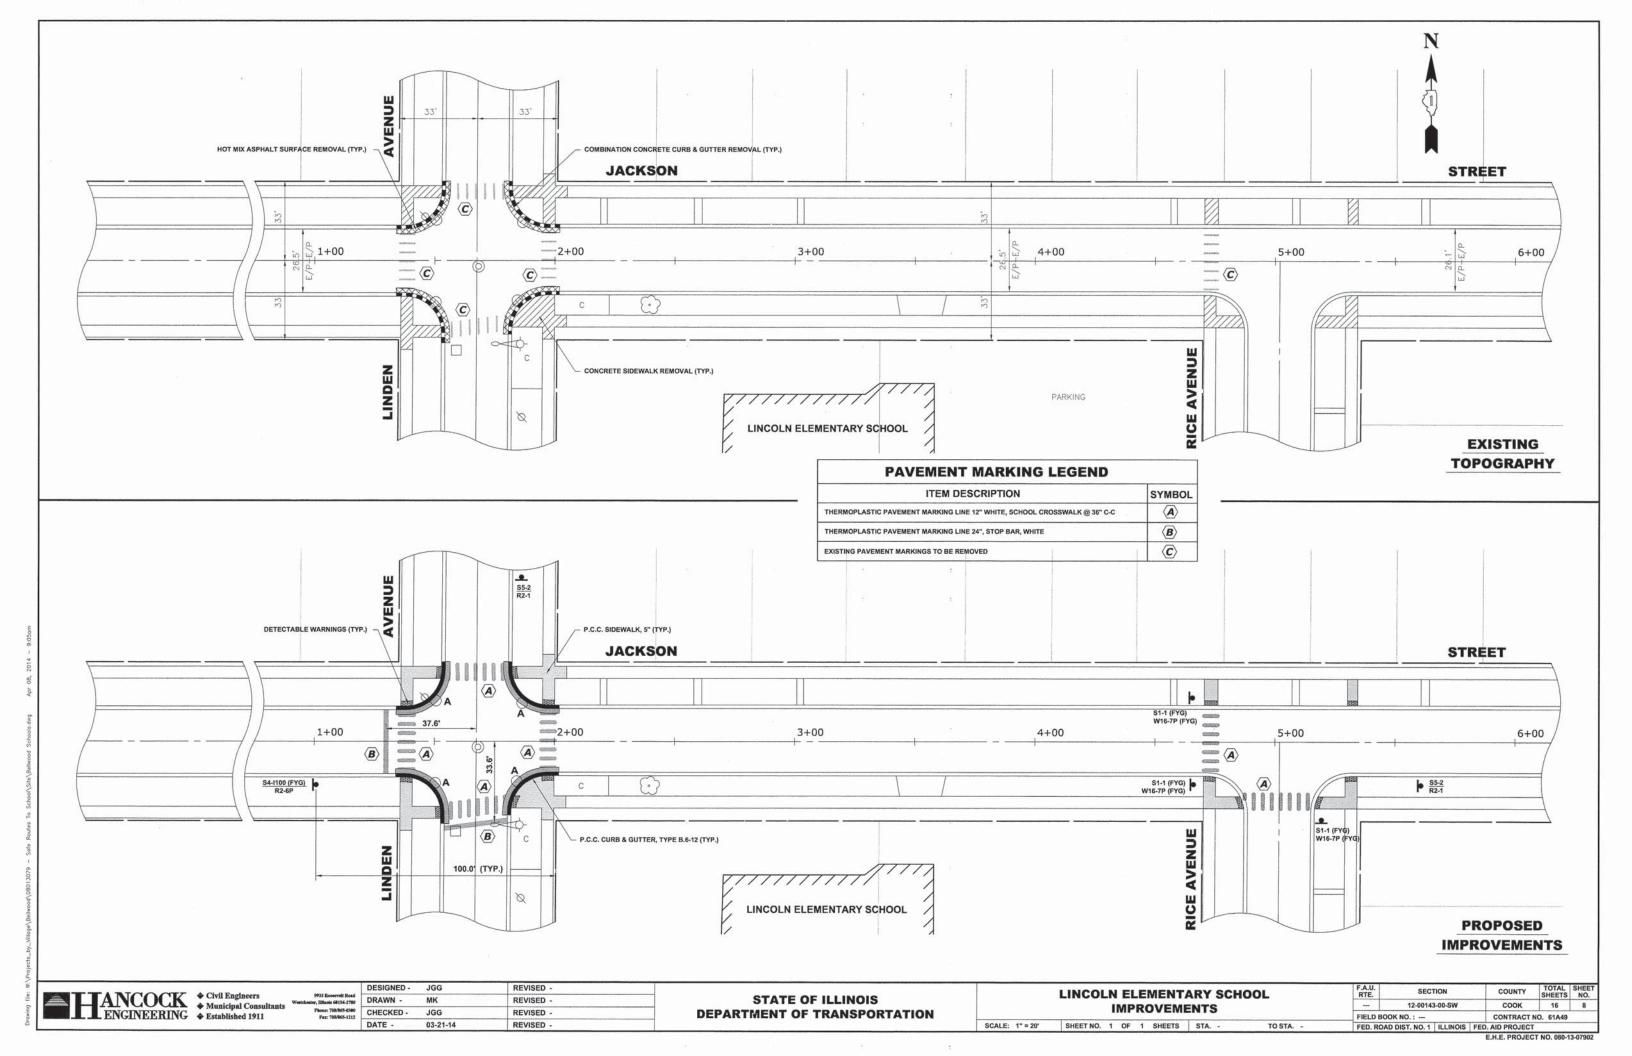

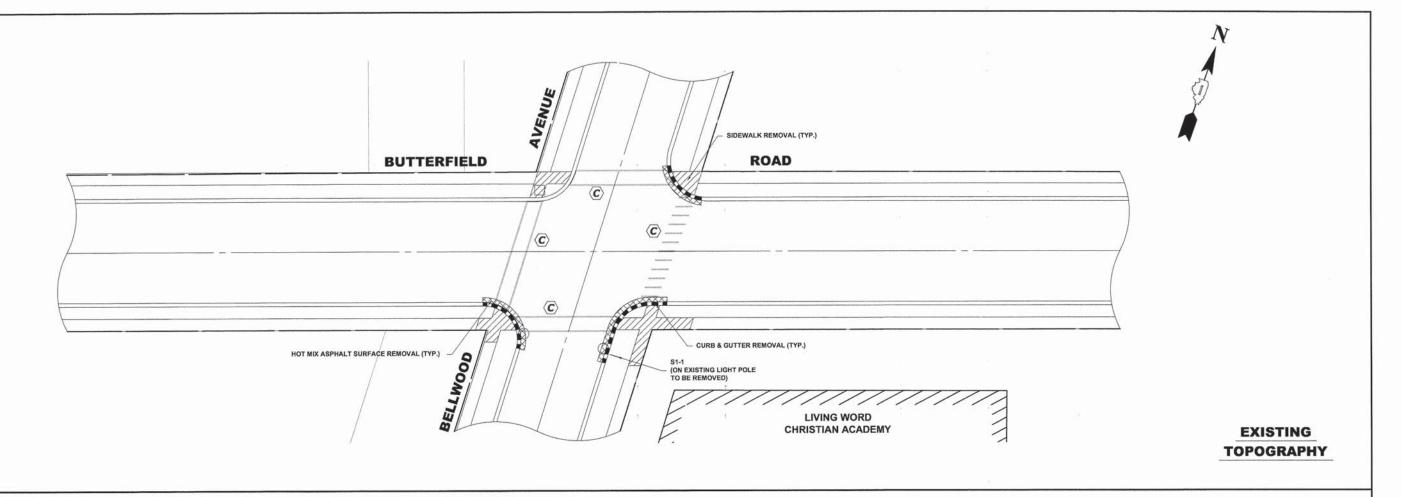

PROPOSED IMPROVEMENTS

DESIGNED - JGG DRAWN -CHECKED -JGG


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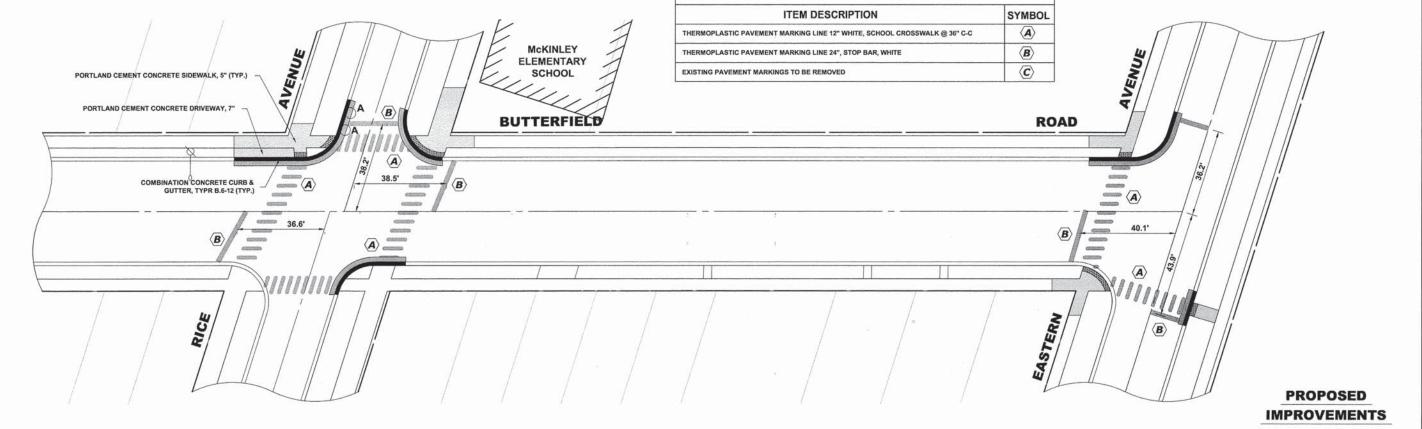
STATE OF ILLINOIS **DEPARTMENT OF TRANSPORTATION**

LIVING WORD CHRISTIAN ACADEMY **IMPROVEMENTS** SCALE: 1" = 20' SHEET NO. 1 OF 1 SHEETS STA. -TO STA. -

COUNTY TOTAL SHEETS NO.

COOK 16 9 F.A.U. RTE. SECTION COUNTY 12-00143-00-SW FIELD BOOK NO. : --CONTRACT NO. 61A49 FED. ROAD DIST. NO. 1 | ILLINOIS | FED. AID PROJECT



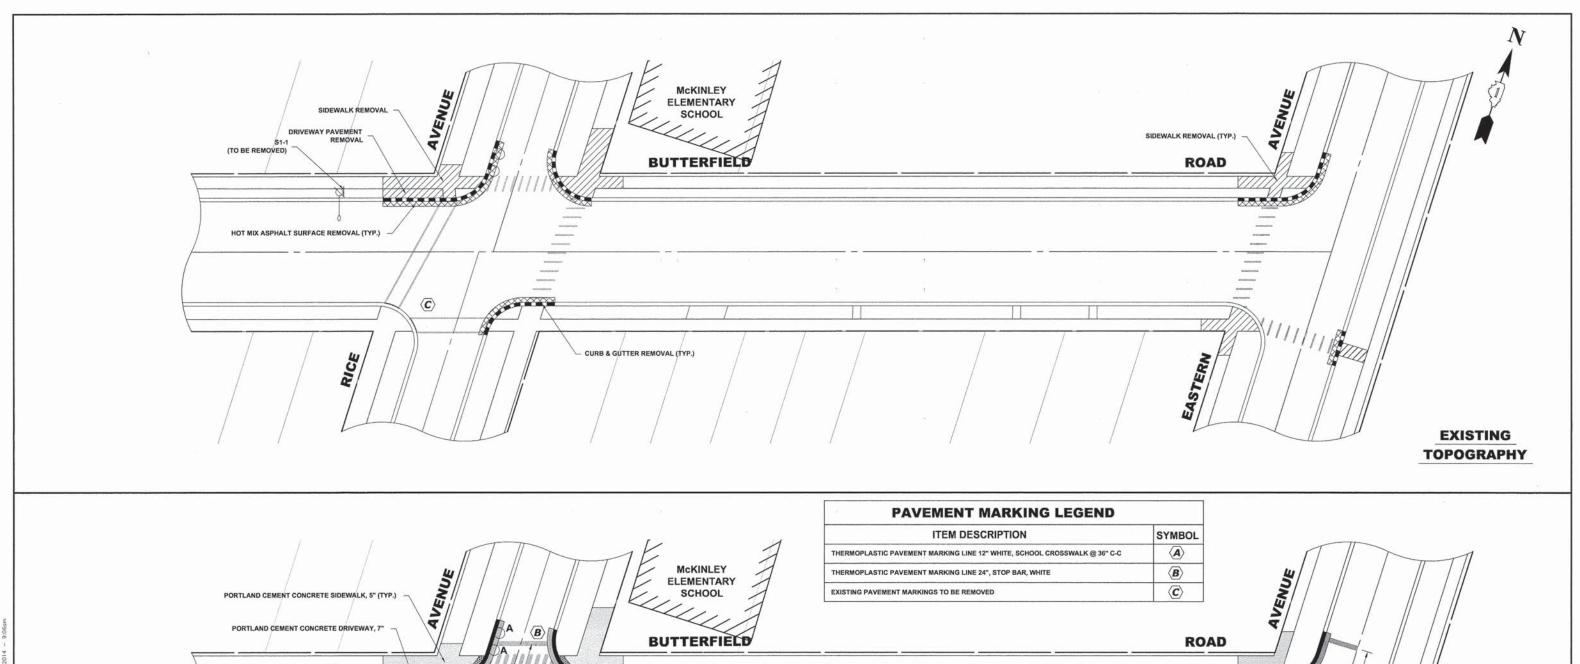


DESIGNED - JGG REVISED -DRAWN -REVISED -JGG CHECKED -REVISED -DATE -03-21-14 REVISED -

STATE OF ILLINOIS **DEPARTMENT OF TRANSPORTATION**

McKINLEY ELEMENTARY SCHOOL **IMPROVEMENTS** SCALE: 1" = 20' SHEET NO. 1 OF 1 SHEETS STA. -TO STA. -

FIELD BOOK NO.: --CONTRACT NO. 61A49 FED. ROAD DIST. NO. 1 | ILLINOIS | FED. AID PROJECT

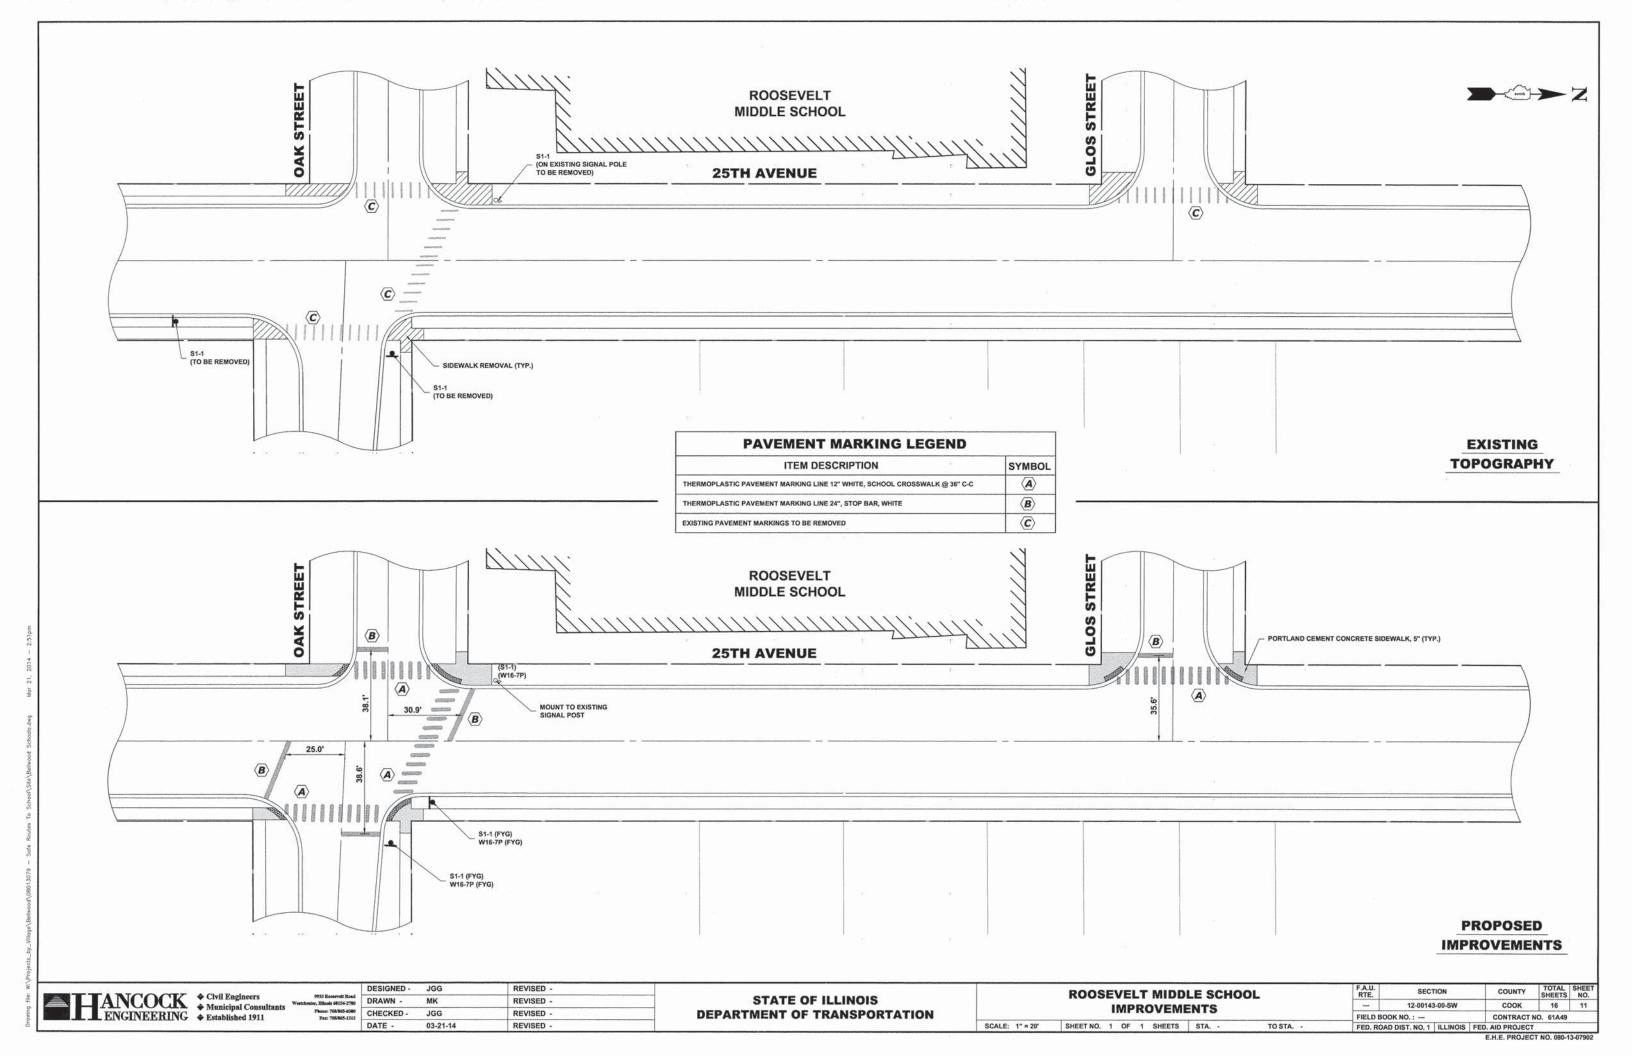

NOTE: FYG - FLUORESCENT YELLOW GREEN

TANCOCK

+ Civil Engineers

Municipal Consultants

Municipal Consultants

Plener 700865-001

Fig. 700865-0112

DESIGNED - JGG REVISED -DRAWN -REVISED -CHECKED -JGG REVISED -DATE -

STATE OF ILLINOIS **DEPARTMENT OF TRANSPORTATION**

SIGNING LEGEND SCALE: NTS SHEET NO. 1 OF 1 SHEETS STA. -


TO STA. -

COUNTY TOTAL SHEET NO.


COOK 16 12 SECTION -- 12-00143-00-SW FIELD BOOK NO. : ---CONTRACT NO. 61A49 FED. ROAD DIST. NO. 1 | ILLINOIS | FED. AID PROJECT

E.H.E. PROJECT NO. 080-13-07902

TYPICAL CURB AND GUTTER EXPANSION JOINT

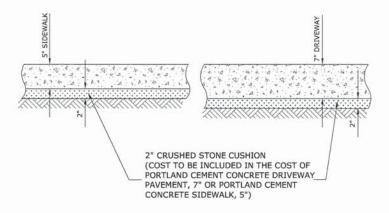

TYPICAL P.C.C. SIDEWALK, DRIVEWAY

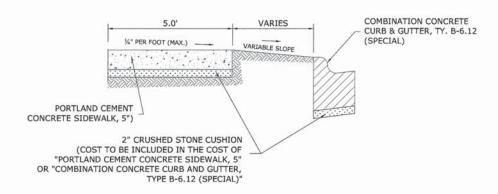

PROPOSED P.C.C. SIDEWALK **AND GRASS PARKWAY**

GENERAL NOTES

DEPRESSED CURBS - THE TOP OF CURBS SHALL BE DEPRESSED WHERE THE CURB AND GUTTER IS CONSTRUCTED AT HANDICAP ACCESSIBLE SIDEWALK RAMPS AT ALLEY RETURNS AND STREET INTERSECTIONS, AND FOR PRIVATE AND COMMERCIAL DRIVES AND AS DIRECTED BY THE ENGINEER

DRAINAGE OPENINGS - AT ALL LOCATIONS WHERE CASTINGS ARE TO BE INCORPORATED IN THE CURB AND GUTTER, A 3/4" EXPANSION JOINT SHALL BE INSTALLED IN THE CURB AND GUTTER A DISTANCE OF 5 FT. FROM EACH SIDE OF THE CASTING. 2-NO. 4 RE-BARS, 9' IN LENGTH, SHALL BE INCORPORATED IN THE CONTINUOUS PORTION OF CONCRETE CURB BEHIND THE CASTING.

DETECTABLE WARNINGS - DETECTABLE WARNINGS SHALL BE INSTALLED AT HANDICAP ACCESSIBLE SIDEWALK RAMPS, AT ALLEY RETURNS, AND STREET INTERSECTIONS. THESE SHALL BE CONSTRUCTED IN ACCORDANCE WITH THE APPLICABLE IDOT STANDARDS.

DEPRESSED CURB HEIGHT - THE HEIGHT OF THE DEPRESSED CURB SHALL BE 1-1/2" AT DRIVEWAYS. SEE IDOT STANDARD 424001-07 FOR HEIGHT AT SIDEWALK RAMP.


BITUMINOUS EXPANSION JOINTS - THREE QUARTER INCH (3/4") BITUMINOUS PREMOLDED INORGANIC FIBER EXPANSION JOINTS SHALL BE INSTALLED WHERE NEW SIDEWALK OR CURB AND GUTTER OR DRIVEWAY PAVEMENT ABUTS AN EXISTING CONCRETE WALK, DRIVE, OR CURB WHICH IS TO REMAIN IN PLACE, AND AT NOT LESS THAN NINETY FOOT (90') INTERVALS AT LOCATIONS WHERE CURB REPLACEMENT IS IN EXCESS OF NINETY FEET (90'); AT RADIUS POINTS, AT BOTH SIDES OF FRAMES AND GRATES WHICH FALL IN THE CURB; AND AS DIRECTED BY THE ENGINEER.

ALL EXPANSION JOINTS LOCATED IN THE CURB AND GUTTER SHALL HAVE TWO (2) THREE QUARTER INCH (3/4") DIAMETER, SMOOTH, ROUND, EPOXY COATED DOWEL BARS, EIGHTEEN INCHES (18") IN LENGTH, WITH GREASED PLASTIC END CAPS INSERTED TO ALLOW THE CURB AND GUTTER TO EXPAND AND CONTRACT LATERALLY. CONTRACTION JOINTS SHALL BE TOOLED INTO THE CURB AND GUTTER AT INTERVALS NOT TO EXCEED FIFTEEN FEET (15'). THESE CONTRACTION JOINTS SHALL BE SAW CUT TO A DEPTH OF TWO INCHES (2") WITHIN TWENTY-FOUR (24) HOURS OF CONCRETE PLACEMENT. THE COST OF THE ABOVE WORK SHALL BE INCLUDED IN THE RESPECTIVE ITEMS FOR CONCRETE INSTALLATION.

THE COSTS FOR REMOVAL OF ANY ASPHALT OVERLAY THAT EXTENDS INTO THE GUTTER PORTION OF THE CURB AND GUTTER WILL BE INCLUDED IN THE PRICE FOR COMBINATION CURB AND GUTTER REMOVAL

THE EDWIN HANCOCK ENGINEERING COMPANY AND THE VILLAGE PUBLIC WORKS DEPARTMENT SHALL BE NOTIFIED AT LEAST TWO (2) WORKING DAYS PRIOR TO ANY CONSTRUCTION ACTIVITY. CONTACT INFORMATION IS AS FOLLOWS:

EDWIN HANCOCK ENGINEERING COMPANY: 708-865-0300 BELLWOOD DEPARTMENT OF PUBLIC WORKS: 708-547-3540

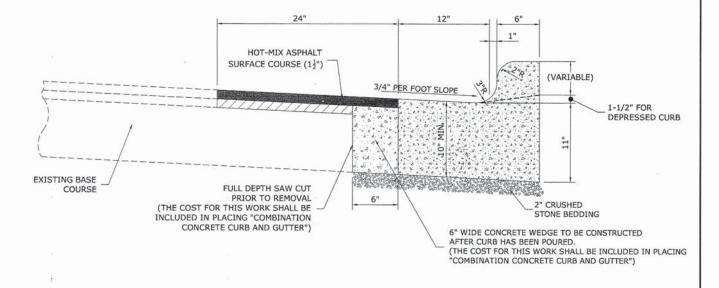

COMBINATION CONCRETE CURB & GUTTER TYPE B-6.12 (MODIFIED)



DESIGNED -JGG REVISED -DRAWN . MK REVISED CHECKED -JGG REVISED DATE -03-21-14 REVISED

STATE OF ILLINOIS DEPARTMENT OF TRANSPORTATION

SCALE: NONE


ROADWAY DETAILS 12-00143-00-SW FIELD BOOK NO. : --SHEET NO. 1 OF 2 SHEETS STA. FED. ROAD DIST, NO. 1 ILLINOIS FED. AID PROJECT

E.H.E. PROJECT NO. 080-13-07902

COOK 16 13

TOTAL SHEETS NO.

CONTRACT NO. 61A49

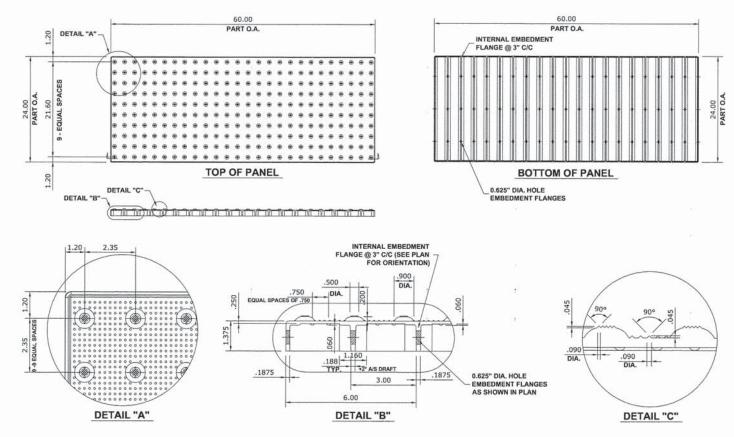

CAST-IN-PLACE COMPOSITE PAVER TILE FOR DETECTABLE WARNING

ANCOCK

Output

Outp

DATE -

DESIGNED - JGG REVISED -DRAWN -MK REVISED -CHECKED -JGG REVISED -03-21-14 REVISED -

STATE OF ILLINOIS **DEPARTMENT OF TRANSPORTATION**

SCALE: NONE

ROADWAY DETAILS SHEET NO. 2 OF 2 SHEETS STA. TO STA.

F.A.U. RTE. SECTION 12-00143-00-SW COOK 16 14 CONTRACT NO. 61A49 FIELD BOOK NO. : --FED. ROAD DIST. NO. 1 | ILLINOIS | FED. AID PROJECT

E.H.E. PROJECT NO. 080-13-07902

TRAFFIC CONTROL AND PROTECTION FOR SIDE ROADS, INTERSECTIONS, AND DRIVEWAYS

NOTES:

- A. FOR NO LANE RESTRICTION ON THE SIDE ROAD OR DRIVEWAYS
- 1. SIDE ROAD WITH A SPEED LIMIT OF 40 MPH (60 km/h) OR LESS AS SHOWN ON THE DRAWING AND AS DIRECTED BY THE ENGINEER:
- a) DNE ROAD CONSTRUCTION AHEATSIGN 36 x 36 (900x900) WITH A FLASHER AND FLAG MOUNTED ON IT APPROXIMATELY 200' (60 m) IN ADVANCE
- b)THE CLOSED PORTION OF THE MAIN ROUTE SHALL BE PROTECTED BY BLOCKING WITH TYPE I, TYPE II OR TYPE III BARRICADES, 1/3 OF THE CROSS SECTION OF THE CLOSED PORTION.
- 2. SIDE ROAD WITH A SPEED LIMIT GREATER THAN 40 MPH (60 km/h) AS SHOWN ON THE DRAWING AND AS DIRECTED BY THE ENGINEER:
- o) DNE RDAD CONSTRUCTION AHEABIGN 48 x 48 (1.2 m x 1.2 m) WITH A FLASHER MOUNTED ON IT APPROXIMATELY 500' (150 m) IN ADVANCE OF THE MAIN ROUTE.
- b)THE CLOSED PORTION OF THE MAIN ROUTE SHALL BE PROTECTED BY BLOCKING WITH TYPE III BARRICADES, 1/2 OF THE CROSS SECTION OF THE CLOSED PORTION.
- 3, WHEN THE SIDE ROAD LIES BETWEEN THE BEGINNING OF THE MAINLINE SIGNING AND THE, WORK ZONE, A SINGLE HEADED ARROW (MG-1) SHALL BE USED IN LIEU OF THE DOUBLE HEADED ARROW (M6-4).

SCALE: NONE

- B. FOR A LANE CLOSURE ON A SIDE ROAD OR DRIVEWAY:
- USE APPLICABLE PORTIONS OF THE TYPICAL APPLICATION OF TRAFFIC CONTROL DEVICES (STD. 701501, STD. 701606 OR THE APPROPRIATE STANDARD). THE SPACING OF SIGNS AND BARRICADES SHALL BE ADJUSTED FOR FIELD CONDITIONS AS DIRECTED BY THE ENGINEER. THE DIRECTIONAL ARROW SHALL BE COVERED OR REMOVED WHEN NO LONGER CONSISTENT WITH THE SIDE ROAD LANE CLOSURE.
- C. ADVANCE WARNING SIGNS ARE TO BE OMITTED ON DRIVEWAY UNLESS DTHERWISE NOTED.
- D. THE TRAFFIC CONTROL AND PROTECTION FOR SIDE ROADS, INTERSECTIONS, AND DRIVEWAYS SHALL BE INCIDENTAL TO THE COST OF SPECIFIED TRAFFIC CONTROL STANDARDS OR ITEMS.

All dimensions are in millimeters (inches) unless otherwise shown.


USER NAME = DESIGNED - LHA REVISED - J. OBERLE 10-18-95 DRAWN REVISED - A. HOUSEH 03-06-96 PLOT SCALE = CHECKED DATE - 06-89 REVISED - T. RAMMACHER 01-06-00


STATE OF ILLINOIS **DEPARTMENT OF TRANSPORTATION**


TRAFFIC CONTROL AND PROTECTION FOR SIDE ROADS, INTERSECTIONS, AND DRIVEWAYS SHEET NO. 1 OF 1 SHEETS STA.

SECTION COUNTY 12-00143-00-SW COOK 16 15 CONTRACT NO. 61A49 TC-10

FED. ROAD DIST. NO. 1 ILLINOIS FED. AID PROJECT E.H.E. PROJECT NO. 082-13-07902

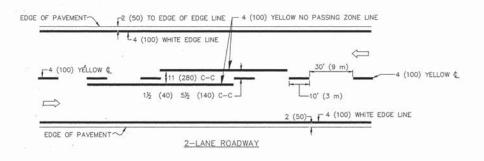


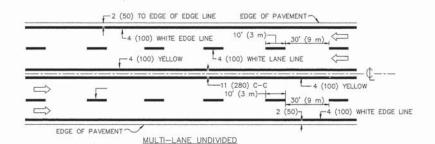

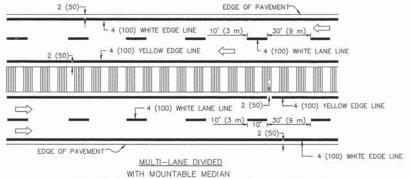


NOTE: MEDIANS WITH BARRIER CURB DO NOT REQUIRE AN EDGE LINE


TYPICAL LANE AND EDGE LINE MARKING

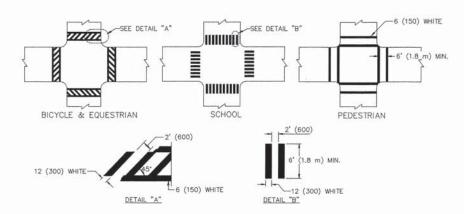

TYPICAL CROSSWALK MARKING

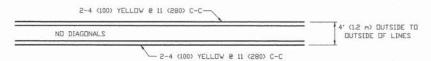


4' (1.2 m) WIDE MEDIANS DNLY

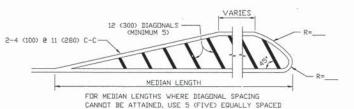

DIAGONAL LINE SPACING 50' (15 m) C-C (LESS THAN 30MPH (50 km/h))
75' (25 m) C-C 30MPH (50 km/h) TO 45MPH (70 km/h))
150' (45 m) C-C (MORE THAN 45MPH (70 km/h))


MEDIANS OVER 4' (1.2 m) WIDE

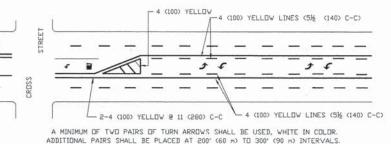



MEDIAN WITH TWO-WAY LEFT TURN LANE

TYPICAL PAINTED MEDIAN MARKING

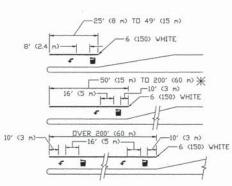


FULL SIZE LETTERS 8' (2.4 m) AND ARROWS SHALL BE USED. \P AREA = 15.6 SQ. FT. (1.5 m²) MLY AREA = 20.8 SQ. FT. (1.9 m²)

* TURN LAMES IN EXCESS OF 400' (120 m) IN LENGTH MAY HAVE AN ADDITIONAL SET OF ARROW - 'ONLY' INSTALLED MIDWAY BETWEEN THE OTHER TWO SETS OF ARROW - 'ONLY'.

TYPICAL LEFT (OR RIGHT) TURN LANE

TYPICAL TURN LANE MARKING

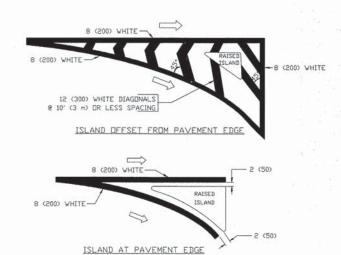

TYPICAL ISLAND MARKING

TYPE OF MARKING	WIDTH OF LINE	PATTERN	COLOR	SPACING / REMARKS
CENTERLINE ON 2 LANE PAVEMENT	4 (100)	SKIP-DASH	YELLOW	10' (3 m) LINE WITH 30' (9 m) SPACE
CENTERLINE ON MULTI-LANE UNDIVIDED PAVEMENT	2 @ 4 (100)	SOLID	YELLOW	11 (280) C-C
NO PASSING ZONE LINES: FOR DNE DIRECTION FOR BOTH DIRECTIONS	4 (100) 2 @ 4 (100)	SOLID SOLID	YELLOW	5 1/2 (140) C-C FROM SKIP-DASH CENTERLINE 11 (280) C-C DMIT SKIP-DASH CENTERLINE BETWEEN
LANE LINES	5 (125) ON FREEWAYS	SKIP-DASH SKIP-DASH	WHITE WHITE	10' (3 m) LINE WITH 30' (9 m) SPACE
DOTTED LINES (EXTENSIONS OF CENTER, LANE OR TURN LANE MARKINGS)	SAME AS LINE BEING EXTENDED	SKIP-DASH	SAME AS LINE BEING EXTENDED	2' (600) LINE WITH 6' (1.8 m) SPACE
EDGE LINES	4 (100)	SOLID	YELLOW-LEFT WHITE-RIGHT	DUTLINE MOUNTABLE MEDIANS IN YELLOW; EDGE LINES ARE NOT USED NEXT TO BARRIER CURB
TURN LANE MARKINGS	6 (150) LINE; FULL SIZE LETTERS & SYMBOLS (8' (2.4m))	SOLID	WHITE	SEE TYPICAL TURN LANE MARKING DETAIL
TWO WAY LEFT TURN MARKING	2 € 4 (100) EACH DIRECTION	SKIP-DASH AND SOLID	YELLOW	10' (3 m) LINE WITH 30' (9 m) SPACE FOR SKIP-DASH; 5 1/2 (140) C-C BETWEEN SOLID LINE AND SKIP-DASH LINE
	8' (2.4m) LEFT ARROW	IN PAIRS	WHITE	SEE TYPICAL TWO-WAY LEFT TURN MARKING DETAIL
CROSSWALK LINES (PEDESTRIAN) A. DIAGONALS (BIKE & EQUESTRIAN) B. LONGITUDINAL BARS (SCHOOL)	2 @ 6 (150) 12 (300) @ 45* 12 (300) @ 90*	SOLID SOLID	WHITE WHITE WHITE	NOT LESS THAN 6' (1.8 m) APART 2' (600) APART 2' (600) APART SEE TYPICAL CROSSWALK MARKING DETAILS.
STOP LINES	24 (600)	SULID	WHITE	PLACE 4' (12 m) IN ADVANCE OF AND PARALLEL TO CROSSWALK, IF PRESENT. UTHERWISE, PLACE AT DESIRED STOPPING POINT. PARALLEL TO CROSSROAD CENTERLINE, WHERE POSSIBLE
PAINTED MEDIANS	2 @ 4 (100) WITH 12 (300) DIAGONALS @ 45* NO DIAGONALS USED FOR 4' (1.2 m) WIDE MEDIANS	SOLID	YELLOW: TWO WAY TRAFFIC WHITE: ONE WAY TRAFFIC	11 (280) C-C FOR THE DOUBLE LINE SEE TYPICAL PAINTED MEDIAN MARKING.
GORE MARKING AND CHANNELIZING LINES	8 (200) WITH 12 (300) DIAGONALS @ 45*	SOLID	WHITE	DIAGUNALS: 15' (4.5 m) C-C (LESS THAN 30MPH (50 km/h)) 20' (6 m) C-C 30MPH (50 km/h) TD 45MPH (70 km/h)) 30' (9 m) C-C (DVER 45MPH (70 km/h))
RAILROAD CROSSING	24 (600) TRANSVERSE LINES; 'RR' IS 6' (1.8 m) LETTERS; 16 (400) LINE FOR 'X'	SOLID	WHITE	SEE STATE STANDARD 780001 AREA DF: "X"=3.6 SQ, FT. (0.33 m²) EACH "X"=54.0 SQ, FT. (5.0 m²)
SHOULDER DIAGONALS	12 (300) € 45°	SOLID	WHITE - RIGHT YELLOW - LEFT	50' (15 m) C-C (LESS THAN 30MPH (50 km/h)) 75' (25 m) C-C (30 MPH (50 km/h) TU 45MPH (70 km/h) 150' (45 m) C-C (UVER 45MPH (70 km/h))

FOR FURTHER DETAILS ON PAVEMENT MARKING REFER TO STANDARD SPECIFICATIONS FOR ROAD AND BRIDGE CONSTRUCTION AND STATE STANDARD 780001.

SCALE:

All dimensions are in inches (millimeters) unless otherwise shown.

USER NAME =	DESIGNED - EVERS	REVISED - T.RAMMACHER 10-27-94
	DRAWN -	REVISED - C. JUCIUS 09-09-09
PLOT SCALE =	CHECKED -	REVISED -
PLOT DATE =	DATE - 03-19-90	REVISED -

STATE OF ILLINOIS
DEPARTMENT OF TRANSPORTATION

DISTRICT ONE TYPICAL PAVEMENT MARKINGS					F.A.U. RTE.	SECTION	COUNTY	TOTAL	SHEET NO.
						12-00143-00-SW	соок	16	16
						TC-13	CONTRAC	T NO.	61A49
NONE	SHEET NO. 1 OF 1	SHEETS	STA.	TO STA.	FED. ROAD	DIST. NO. 1 ILLINOIS FED	. AID PROJECT		