06-13-14 LETTING ITEM 202

COVER SHEET, INDEX OF SHEETS & STATE STANDARDS SUMMARY OF QUANTITIES & GENERAL NOTES

STATE OF ILLINOIS DEPARTMENT OF TRANSPORTATION **DIVISION OF HIGHWAYS**

PLANS FOR PROPOSED FEDERAL AID HIGHWAY

FAU 1708 (OKETO AVENUE) FAU 1558 (87TH STREET) TO FAU 1537 (71ST STREET)

RESURFACING

SECTION NO.: 14-00064-00-RS PROJECT NO.: M-4003(320)

VILLAGE of BRIDGEVIEW

COOK COUNTY

JOB NO. C-91-292-14

NOT TO SCALE

HIGHWAY STANDARDS

STANDARD SYMBOLS, ABBREVIATIONS AND PATTERNS

INDEX OF SHEETS

IDOT DISTRICT 1 STANDARD DETAILS

TYPICAL CROSS SECTIONS

PAVEMENT PLAN STRIPING PLAN

4.-6. 7.-9.

CURB RAMPS FOR SIDEWALKS CLASS C AND D PATCHES 442201-03 CONCRETE CURB TYPE B AND COMBINATION CONCRETE CURB AND GUTTER 606001-05 LANE CLOSURE, 2L, 2W, SHORT TIME OPERATIONS URBAN LANE CLOSURE, 2L, 2W, UNDIVIDED LANE CLOSURE, MULTILANE 1W OR 2W CROSSWALK OR SIDEWALK CLOSURE 701801-05

TRAFFIC CONTROL DEVICES 701901-03 780001-04 TYPICAL PAVEMENT MARKINGS DETECTOR LOOP INSTALLATIONS TYPICAL LAYOUTS FOR DETECTION LOOPS

> **OKETO AVENUE** ADT = 6,200 (2009) =6,300 (2040) DESIGN SPEED=25 MPH POSTED SPEED LIMIT=20 MPH DESIGN DESIGNATION=LOCAL STREET


REGIN IMPROVEMENT PROFILE HORIZ. - 1"=50" PROFILE VERT. - 1"=5" CROSS SECTIONS - 1"=10" FULL SIZE PLANS HAVE BEEN PREPARED USING STANDARD ENGINEERING SCALES. REDUCED SIZED PLANS WILL NOT CONFORM TO STANDARD SCALES, IN MAKING MEASUREMENTS ON REDUCED PLANS, THE ABOVE SCALES MAY BE USED.

J. U. L. I. E. JOINT UTILITY LOCATION INFORMATION FOR EXCAVATION 1 - 800 - 892 - 0123 or 811

CONTRACT NO. 61A45

GROSS LENGTH=10,429.27 FEET (1.98 MILES) NET LENGTH=6,371.79 FEET (1.21 MILES)

BEGIN PROJECT OMISSION STA 29+59.60

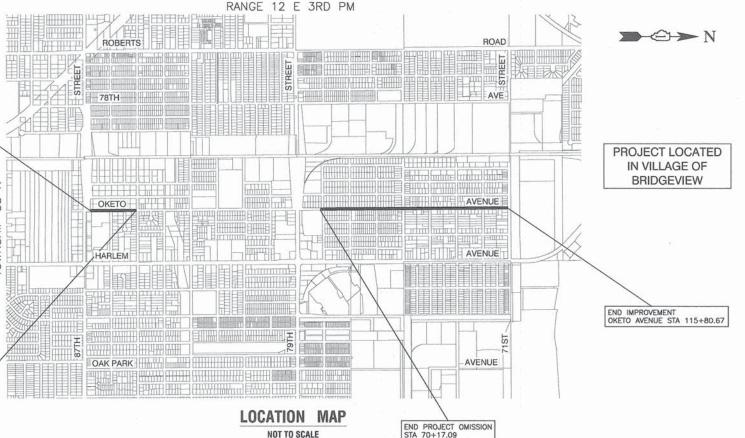

1708 14-00064-00-RS COOK FED. ROAD DIST. NO. [| ILLINOIS | FED. NO PROJECT M-4003(320)

CONTRACT #61A45



STATE OF ILLINOIS DEPARTMENT OF TRANSPORTATION DIVISION OF HIGHWAYS
a. 3/20/2014
Stro Ella
President, Village of Bridgeview
APRIL 7, 2014
CHUT CHRISTOSHER LOCT
District 1 Engineer of Local Roads & Streets
2 . 1
Apr. 17 2014
John tertmann son
Deputy Director of Highways, Region 1 Engineer

PRINTED BY THE AUTHORITY OF THE STATE OF ILLINOIS

DIRECT SUPERVISION OF



		SUMMARY OF QUANTITIES	T		CONSTRUCTION OF COD
I. COD	DE NO.	PAY ITEM	UNIT	QUAN	0005
211	101615	TOPSOIL, FURNISH AND PLACE, 4"	SQ YD	700	700
252	200200	SUPPLEMENTAL WATERING	UNIT	5	5
280	000510	INLET FILTERS	EACH	30	30
406	600400	MIXTURE FOR CRACKS, JOINTS, AND FLANGEWAYS	TON	10	10
406	600827	POLYMERIZED LEVELING BINDER (MACHINE METHOD), IL-4.75, N50	TON	1200	1200
406	600982	HOT-MIX ASPHALT SURFACE REMOVAL - BUTT JOINT	SQ YD	274	274
406	603335	HOT-MIX ASPHALT SURFACE COURSE, MIX "D", N50	TON	1825	1825
423	300300	PORTLAND CEMENT CONCRETE DRIVEWAY PAVEMENT, 7 INCH	SQ YD	115	115
424	400200	PORTLAND CEMENT CONCRETE SIDEWALK 5 INCH	SQ FT	1170	1170
424	400800	DETECTABLE WARNINGS	SQ FT	312	312
440	000158	HOT-MIX ASPHALT SURFACE REMOVAL 2 1/4"	SQ YD	20955	20955
440	000200	DRIVEWAY PAVEMENT REMOVAL	SQ YD	255	255
440	000600	SIDEWALK REMOVAL	SQ FT	1170	1170
442	201725	CLASS D PATCHES, TYPE I, 7 INCH	SQ YD	30	30
442	201729	CLASS D PATCHES, TYPE II, 7 INCH	SQ YD	250	250
442	201733	CLASS D PATCHES, TYPE III, 7 INCH	SQ YD	250	250
442	201735	CLASS D PATCHES, TYPE IV, 7 INCH	SQ YD	600	600
602	250200	CATCH BASINS TO BE ADJUSTED	EACH	27	27
602	252800	CATCH BASINS TO BE RECONSTRUCTED	EACH	1	
602	255500	MANHOLES TO BE ADJUSTED	EACH	5	
602	260100	INLETS TO BE ADJUSTED	EACH	1	
602	265700	VALVE VAULTS TO BE ADJUSTED	EACH	4	4
602	266600	VALVE BOXES TO BE ADJUSTED	EACH	1	
671	00100	MOBILIZATION	L SUM	1	
701	102620	TRAFFIC CONTROL AND PROTECTION, STANDARD 701501	L SUM	1	

* - INDICATES SPECIALTY ITEMS

FILE NAME = 10193-QUAN-01 - IDOT P01	USER NAME =	DESIGNED — JH	REVISED —
		CHECKED — PKB	REVISED —
	PLOT SCALE =	DRAWN — RG	REVISED —
The Supplier to the property of the con-	PLOT DATE = 01-16-14	CHECKED — AG	REVISED —

	70102640	TRAFFIC CONTROL AND PROTECTION, STANDARD 701801	L SUM	1	1
	70300100	SHORT-TERM PAVEMENT MARKING	FOOT	2000	2000
	70301000	WORK ZONE PAVEMENT MARKING REMOVAL	SQ FT	670	670
	72000100	SIGN PANEL - TYPE 1	SQ FT	100	100
	72400310	REMOVE SIGN PANEL - TYPE 1	SQ FT	100	100
	78000200	THERMOPLASTIC PAVEMENT MARKING - LINE 4"	FOOT	1500	1500
	78000400	THERMOPLASTIC PAVEMENT MARKING — LINE 6"	FOOT	1075	1075
	78000650	THERMOPLASTIC PAVEMENT MARKING - LINE 24"	FOOT	450	450
	Z0004514	HOT-MIX ASPHALT DRIVEWAY PAVEMENT, 4"	SQ YD	140	140
T	Z0004562	COMBINATION CURB AND GUTTER REMOVAL AND REPLACEMENT	FOOT	3200	3200
10 200	Z0013798	CONSTRUCTION LAYOUT	L SUM	1	1
	X2520700	SODDING, SPECIAL	SQ YD	700	700
1	X4060110	BITUMINOUS MATERIALS (PRIME COAT)	POUND	14145	14145
, 100 m	X6030310	FRAMES AND LIDS TO BE ADJUSTED (SPECIAL)	EACH	29	29
		COMMITMENTS	GEN	IERAL NO	TES

NO PAVEMENT PATCHING WILL BE PERMITED AFTER FRIDAY AT 3:00PM OF EACH WEEK.

SCALE: NA

SUMMARY OF QUANTITIES

PAY ITEM

S.I. CODE NO.

BEFORE STARTING ANY EXCAVATION THE CONTRACTOR SHALL CALL "J.U.L.I.E." AT (800) 892-0123 AND (312) 744-7000 FOR FIELD LOCATIONS OF BURIED ELECTRIC, TELEPHONE AND GAS UTILITIES. (48 HOUR NOTIFICATION REQUIRED)

CONSTRUCTION TYPE CODE

0005

UNIT

QUAN


- UTILITIES INDICATED ON THE PLANS ARE PROVIDED FOR THE CONTRACTORS USE AND ARE BASED UPON INFORMATION AVAILABLE AT THE TIME OF THE ADVERTISEMENT FOR BIDS. THE OWNER AND ENGINEER DO NOT GUARANTEE THE ACCURACY OF UTILITY INFORMATION.
- 3. IT SHALL BE THE CONTRACTOR'S RESPONSIBILITY TO VERIFY ALL DIMENSIONS AND CONDITIONS EXISTING IN THE FIELD PRIOR TO CONSTRUCTION AND ORDERING OF MATERIALS.
- SCHEDULES INCLUDED IN THE PLANS HAVE BEEN PREPARED FROM FIELD NOTES. EXACT LOCATIONS FOR PATCHING SHALL BE DETERMINED IN THE FIELD BY THE ENGINEER.
- 5. THE THICKNESS OF HMA MIXTURE STATED IN THE SPECIFICATIONS IS THE NOMINAL THICKNESS. DEVIATIONS FROM THE NOMINAL THICKNESS WILL BE PERMITTED WHEN SUCH DEVIATIONS OCCUR DUE TO IRREGULARITIES IN THE EXISTING SURFACE OR BASE ON WHICH THE HMA SURFACE IS PLACED.
- ACCESS TO DRIVEWAYS SHALL BE MAINTAINED AT ALL TIMES BY LIMITING CURB AND GUTTER REPAIR TO ONE—HALF THE DRIVEWAY WIDTH AT ONE TIME AS WELL AS TEMPORARY AGGREGATE. THE COST OF TEMPORARY AGGREGATE SHALL BE CONSIDERED INCLUDED IN THE COST OF DRIVEWAY ITEMS.
- 7. THE REMOVAL AND/OR REPLACEMENT OF ANY DRIVEWAYS, PAVEMENT, CURB, SIDEWALK, ECT. SHALL BE ACCOMPLISHED BY MEANS OF A SAW CUT JOINT, AT THE DIRECTION OF THE ENGINEER. THIS WORK WILL NOT BE PAID FOR SEPARATELY, BUT SHALL BE INCLUDED IN THE UNIT PRICE FOR THE VARIOUS ITEMS BEING REMOVED.
- ANY LOOSE MATERIAL DEPOSITED IN THE FLOW LINE OF DITCHES, GUTTERS OR OTHER DRAINAGE STRUCTURES SHALL BE REMOVED BY THE END OF EACH DAY BY THE CONTRACTOR AT THEIR EXPENSE.
- EROSION CONTROL ITEMS HAVE BEEN ADDED FOR USE AT THE DIRECTION OF THE ENGINEER.


STATE OF ILLINOIS DEPARTMENT OF TRANSPORTATION

OKETO AVENUE RESURFACING 87TH STREET TO 71ST STREET SUMMARY OF QUANTITIES AND GENERAL NOTES

SHEET NO. 2 OF 14 SHEETS STA.

TOTAL SHEET NO. SECTION COUNTY COOK 14 2 14-00064-00-RS CONTRACT NO. 61A45 FED. ROAD DIST, NO. 1 ILLINOIS FED. AID PROJECT M-4003(320)

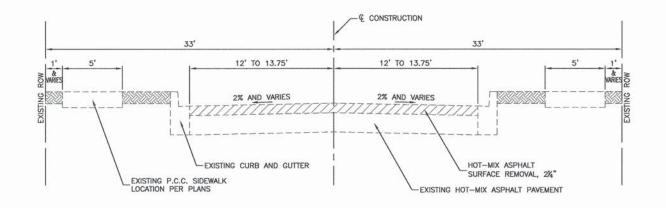

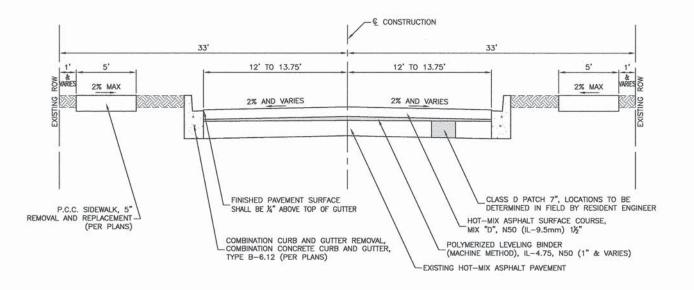

EXISTING TYPICAL SECTION

OKETO AVENUE
87TH STREET TO 71ST STREET
STA 11+51.40 TO STA 115+80.67
(OMISSION 84TH STREET TO 78TH STREET,
STA 29+59.60 TO STA 70+17.09)

NOTE: CONTRACTOR SHALL MILL BEFORE PATCHING

PROPOSED TYPICAL SECTION


OKETO AVENUE
87TH STREET TO 71ST STREET
STA 11+51.40 TO STA 115+80.67
(OMISSION 84TH STREET TO 78TH STREET,
STA 29+59.60 TO STA 70+17.09)

HOT-MIX ASPHALT MIXTURE REQUIREMENTS


MIXTURE TYPE	AIR VOIDS @ Ndes	QUALITY MANAGEMENT PROGRAM (QMP)
RESURFACING		
HOT MIX ASPHALT SURFACE COURSE, MIX "D", N50(IL-9.5mm), 1 1/2"	4% @ 50 Gyr.	QCP
POLYMERIZED LEVELING BINDER (MACHINE METHOD), IL-4.75, N50, 1"	3.5% @ 50 Gyr.	QCP
DRIVEWAYS		
HOT MIX ASPHALT SURFACE COURSE, MIX "D", N50 (IL-9.5mm); 1 3/4"	4% @ 50 Gyr.	QCP
HOT MIX ASPHALT BASE COURSE, (HMA BINDER IL-19.0mm); 2 1/4"	4% @ 50 Gyr.	QCP
PATCHING		
CLASS D PATCHES, TYPE I, II, III, IV (HMA BINDER IL-19.0mm), 7" (IN 3 LIFTS)	4% ⊚ 70 Gyr.	QCP
HOT-MIX ASPHALT - CURB PATCHING		
HOT MIX ASPHALT PATCH HMA BINDER; IL-19.0mm, 7" (IN 3 LIFTS)	4% @ 70 Gyr.	QCP
QMP OPTIONS: QUALITY CONTROL/QUALITY ASSURANCE (QC/QA); QUALITY CONTROL FOR PERFORM	ANCE (QCP), PAY FOR PERFORM	ANCE (PFP)

- 1. THE UNIT WEIGHT USED TO CALCULATE ALL HOT-MIX ASPHALT SURFACE MIXTURE QUANTITIES IS 112 LBS/SQ YD/IN.
- 2. THE "AC TYPE" FOR POLYMERIZED HMA MIXES SHALL BE "SBS/SBR PG 76-22" AND FOR NON-POLYMERIZED HMA THE "AC" TYPE" SHALL BE "PG 64-22" UNLESS MODIFIED BY DISTRICT ONE SPECIAL PROVISIONS.
- 3. FOR HMA FULL DEPTH "AC TYPE" SEE SPECIAL PROVISIONS.
- 4. FOR USE OF RECYCLED MATERIALS SEE SPECIAL PROVISIONS.
- 5. QUALITY MANAGEMENT PROGRAM (QMP) IDENTIFIES THE PARTICULAR QUALITY CONTROL SPECIFICATION THAT APPLIES TO THE HMA MIXTURE.

FILE NAME = 10193-TYPX-01 - IDOT P01	USER NAME =	DESIGNED — JH	REVISED — REL - 03-31-11			OKETO AVENUE RESURI	FACING	F.A.U.	SECTION	COUNTY	TOTAL	SHEET NO.					
1			REVISED —	STATE OF ILLINOIS		87TH STREET TO 71ST S	STREET	1708	14-00064-00-RS	СООК	14	3					
	PLOT SCALE =			PLOT SCALE =	PLOT SCALE =	PLOT SCALE =	DRAWN — RG	REVISED —	DEPARTMENT OF TRANSPORTATION	TYPICAL CROSS SECTIONS			-	14-00064-00-03		CT NO. 61A45	5
LYSP whith Mr. Villegers 196 b Fers. 40 GTT (2004 SMATH-OF DOWNS SMATS)	PLOT DATE = 01-16-14	PLOT DATE = 01-16-14 CHECKED - AG REVISED -			SCALE: NA	SCALE: NA SHEET NO. 3 OF 14 SHEETS STA. TO		FED. ROAL	DIST. NO. 1 ILLINOIS FE		-4003(320)						

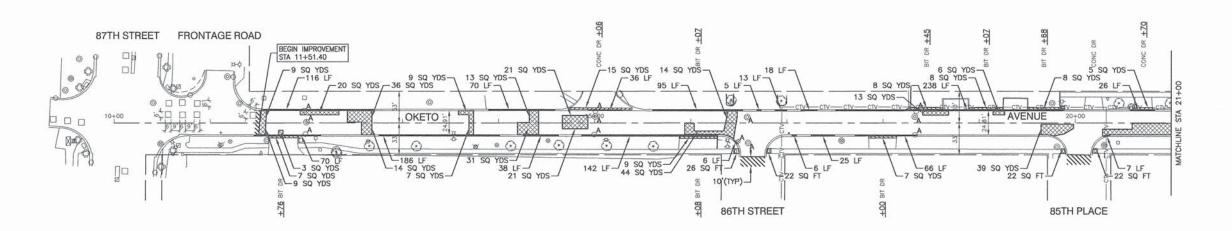



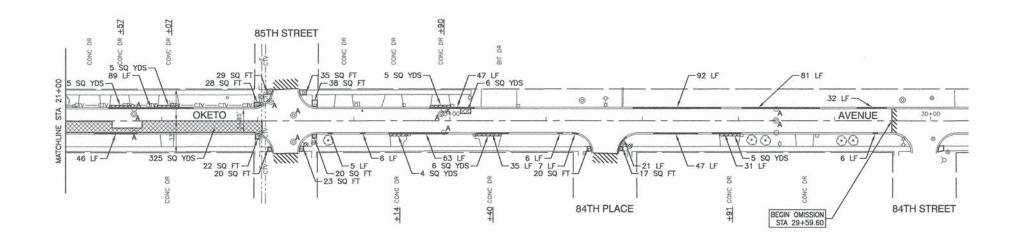

- DETECTABLE WARNINGS ARE TO BE INSTALLED AT LOCATIONS OF SIDEWALK REMOVAL AND REPLACEMENT. CONTRACTOR TO POSITION AND PLACE DETECTABLE WARNINGS AT THE DIRECTION OF THE ENGINEER IN ACCORDANCE WITH ADA REQUIREMENTS.
- LIMIT OF CONSTRUCTION ON ALL SIDE STREETS IS THE RADIUS RETURN PLUS 10' BUTT JOINT OR ROW AS NOTED.
- ACCESS TO ALL DRIVEWAYS SHALL BE MAINTAINED UPON COMPLETION OF EACH WORKDAY. RESIDENTS SHALL BE NOTIFIED 24 HOURS IN ADVANCE OF WHEN DRIVEWAY REPLACEMENT WILL TAKE PLACE.

LEGEND

CLASS D PATCHES, 7"

HMA DRIVEWAY REMOVAL AND REPLACEMENT

CONCRETE DRIVEWAY REMOVAL AND REPLACEMENT


CONCRETE SIDEWALK REMOVAL AND REPLACEMENT

BUTT JOINTS


CURB & GUTTER REMOVAL AND REPLACEMENT
CATCH BASIN TO BE ADJUSTED,
MANHOLE TO BE ADJUSTED,
VALVE BOX TO BE ADJUSTED,
FRAME & LID TO BE ADJUSTED (SPECIAL)

DETECTABLE WARNINGS

FILE NAME = 10193-PLAN-01 - IDOT P01	USER NAME =	DESIGNED — JH	REVISED —		OKETO AVENUE RESURFACING	F.A.U.	SECTION	COUNTY	TOTAL SHEET
		CHECKED — PKB	REVISED —	STATE OF ILLINOIS	87TH STREET TO 71ST STREET	1708	14-00064-00-RS	соок	14 4
	PLOT SCALE = PLOT DATE = 01-16-14	DRAWN — RG	REVISED —	DEPARTMENT OF TRANSPORTATION	PAVEMENT PLAN	1100	14-00004-00110	CONTRACT	T NO 61445
I FIRE E SHOW HAVE SHE RANGE THE BUILD HE TO POOR HEAT HAS BEEN ENGINEERING ON BUILDING		PLOT DATE = 01-16-14	CHECKED AG	REVISED —		SCALE: 1*=50' SHEET NO. 4 OF 14 SHEETS STA, 11+51,40 TO STA, 33+00	FED. ROAD	DIST, NO. 1 ILLINOIS FED.	, AID PROJECT M-40

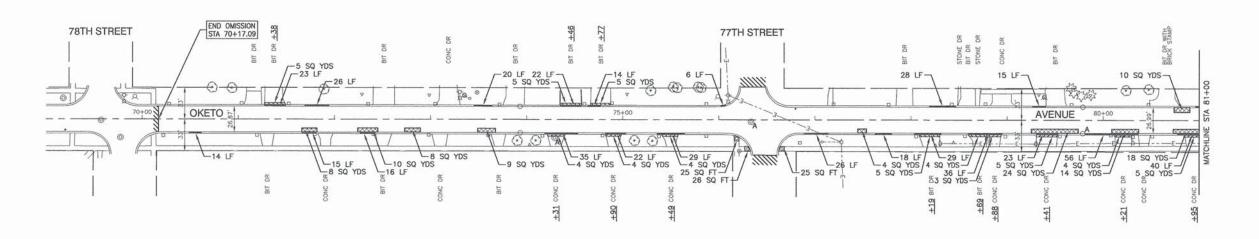



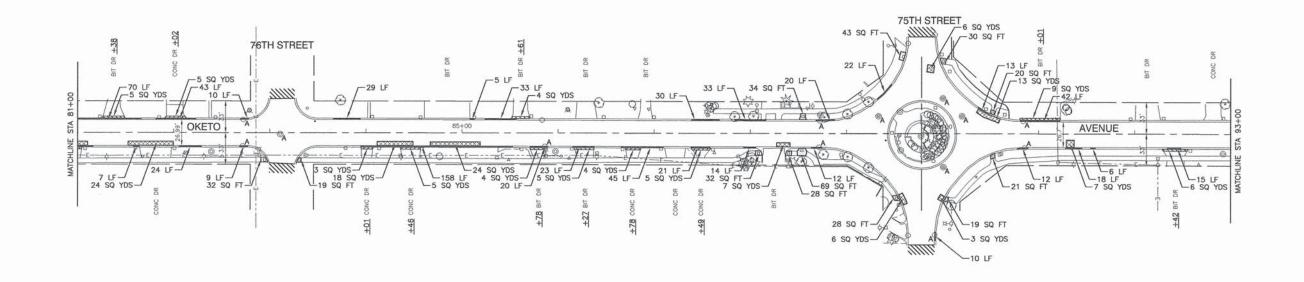

- DETECTABLE WARNINGS ARE TO BE INSTALLED AT LOCATIONS OF SIDEWALK REMOVAL AND REPLACEMENT. CONTRACTOR TO POSITION AND PLACE DETECTABLE WARNINGS AT THE DIRECTION OF THE ENGINEER IN ACCORDANCE WITH ADA REQUIREMENTS.
- LIMIT OF CONSTRUCTION ON ALL SIDE STREETS IS THE RADIUS RETURN PLUS 10' BUTT JOINT OR ROW AS NOTED.
- ACCESS TO ALL DRIVEWAYS SHALL BE MAINTAINED UPON COMPLETION OF EACH WORKDAY. RESIDENTS SHALL BE NOTIFIED 24 HOURS IN ADVANCE OF WHEN DRIVEWAY REPLACEMENT WILL TAKE PLACE.

LEGEND

CLASS D PATCHES, 7"

HMA DRIVEWAY REMOVAL AND REPLACEMENT

CONCRETE DRIVEWAY REMOVAL AND REPLACEMENT

CONCRETE SIDEWALK REMOVAL AND REPLACEMENT

BUTT JOINTS


CURB REMOVAL

CATCH BASIN TO


CATCH BASIN TO BE ADJUSTED, MANHOLE TO BE ADJUSTED, VALVE BOX TO BE ADJUSTED, FRAME & LID TO BE ADJUSTED (SPECIAL)

DETECTABLE WARNINGS

FILE NAME = 10193-PLAN-01 - IDOT P03 (2)	USER NAME =	DESIGNED — JH	REVISED —		1000	OKETO AVENUE RESURFACING	F,	A.U.	SECTION	COUNTY	TOTAL SH
		CHECKED — PKB REVISED —		STATE OF ILLINOIS		87TH STREET TO 71ST STREET	11	1708 14-000	00064-00-RS	соок	SHEETS IN
	PLOT SCALE =	DRAWN — RG	REVISED —	DEPARTMENT OF TRANSPORTATION		PAVEMENT PLAN	-	144	0000-00-110		T NO. 61A45
Little Most April (stopped sider arter). VCDT Health (sext High Polyther (sext high side).	PLOT DATE = 01-16-14	CHECKED — AG	REVISED —		SCALE: 1"=50"	SHEET NO. 5 OF 14 SHEETS STA. 57+00 TO STA. 81	+00 FE	D. ROAD DIST. NO.	1 ILLINOIS FED.	AID PROJECT M-40	

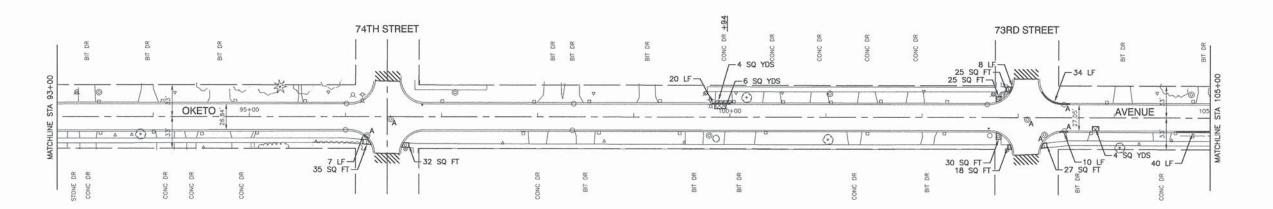



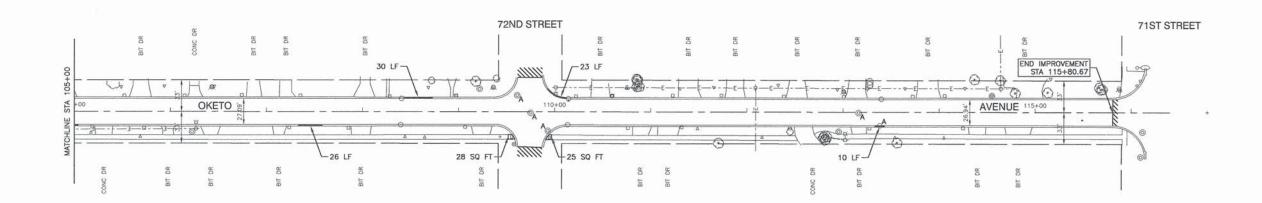

- DETECTABLE WARNINGS ARE TO BE INSTALLED AT LOCATIONS OF SIDEWALK REMOVAL AND REPLACEMENT. CONTRACTOR TO POSITION AND PLACE DETECTABLE WARNINGS AT THE DIRECTION OF THE ENGINEER IN ACCORDANCE WITH ADA REQUIREMENTS.
- 2. LIMIT OF CONSTRUCTION ON ALL SIDE STREETS IS THE RADIUS RETURN PLUS 10' BUTT JOINT OR ROW AS NOTED.
- ACCESS TO ALL DRIVEWAYS SHALL BE MAINTAINED UPON COMPLETION OF EACH WORKDAY. RESIDENTS SHALL BE NOTIFIED 24 HOURS IN ADVANCE OF WHEN DRIVEWAY REPLACEMENT WILL TAKE PLACE.

LEGEND

CLASS D PATCHES, 7"

HMA DRIVEWAY REMOVAL AND REPLACEMENT CONCRETE DRIVEWAY REMOVAL AND REPLACEMENT

CONCRETE SIDEWALK REMOVAL AND REPLACEMENT

BUTT JOINTS


CURB REMOVAL


CATCH BASIN TO BE ADJUSTED, MANHOLE TO BE ADJUSTED, VALVE BOX TO BE ADJUSTED, FRAME & LID TO BE ADJUSTED (SPECIAL)

DETECTABLE WARNINGS

				r								
FILE NAME = 10193-PLAN-01 - IDOT P04	USER NAME =	DESIGNED — JH	REVISED —			OKETO AVENUE RESU	F.A.U.	SECTION	COUNTY	TOTAL	SHEET	
		CHECKED — PKB	REVISED —	STATE OF ILLINOIS		87TH STREET TO 71S		HIE.		соок	SHEETS	NO.
-	PLOT SCALE =	ALE = DRAWN — RG REVISED —		DEPARTMENT OF TRANSPORTATION		PAVEMENT PL	1700	14-00064-00-RS	CONTRACT NO.		0	
USC Sevenior IS elected this bright PLO PLO	PLOT DATE = 01-16-14	CHECKED — AG REVISED —			SCALE: 1"=50"	FED, ROAD DIS	T. NO. 1 TILLINGIS	S FED. AID PROJECT M-	-4003(320)	0		



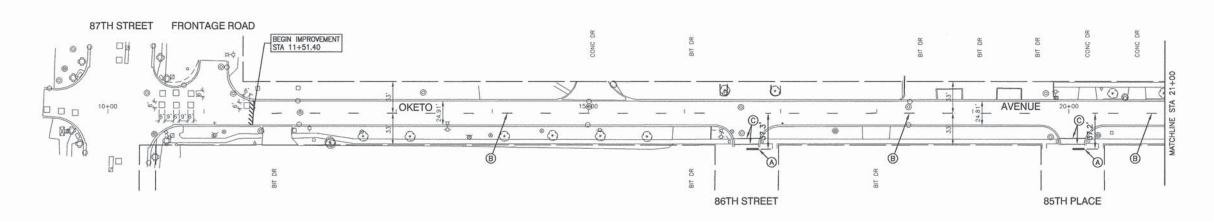


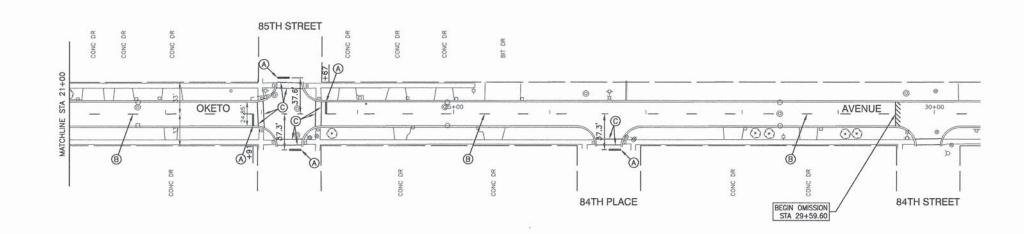


LEGEND

- A THERMOPLASTIC PAVEMENT MARKING WHITE, 24"
- B THERMOPLASTIC PAVEMENT MARKING YELLOW, LINE, 4", SKIP DASH (10' LINE-30' SPACE)
- © THERMOPLASTIC PAVEMENT MARKING WHITE, LINE, 6"

FILE NAME = 10193-PLAN-01 - PVMK01					OKETO AVENUE RESURF	ACING	F.A.U.	SECTION	COUNTY	TOTAL	SHEET	
		CHECKED — PKB	REVISED —	STATE OF ILLINOIS		87TH STREET TO 71ST ST	TREET	1708	14-00064-00-RS	СООК	14	7
	PLOT SCALE =	DRAWN — RG	REVISED —	DEPARTMENT OF TRANSPORTATION		STRIPING PLAN		1100	14-00004-00110	CONTRAC	TNO 61A	15
A DOT HARMON CONTRACTOR MANAGEMENT AND	PLOT DATE = 01-16-14	CHECKED — AG	REVISED —		SCALE: 1"=50"	SHEET NO. 7 OF 14 SHEETS STA	. 11+51.40 TO STA. 33+00	FED BOAD	DIST NO 1 JULINOIS SEE	AID PROJECT M-4		

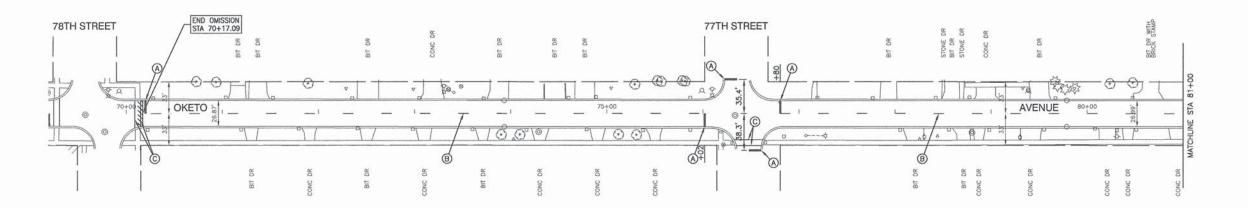




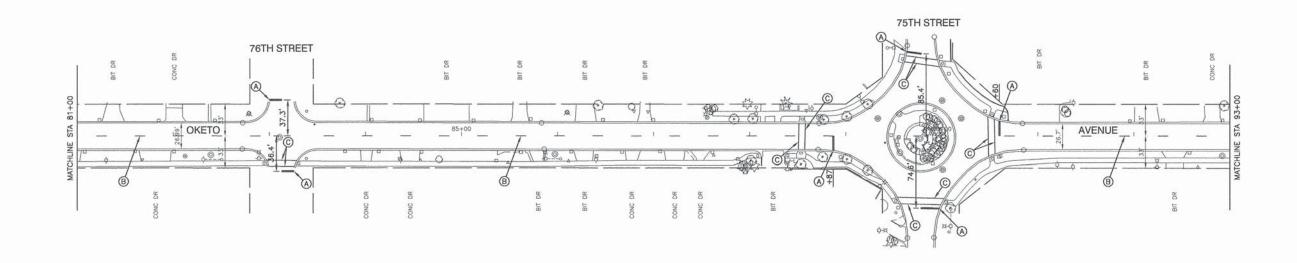

LEGEND

- A THERMOPLASTIC PAVEMENT MARKING WHITE, 24"
- B YELLOW, LINE, 4", SKIP DASH (10' LINE-30' SPACE
- © THERMOPLASTIC PAVEMENT MARKING WHITE, LINE, 6"

FILE NAME = 10193-PLAN-01 - PVMK03	USER NAME =	DESIGNED - JH	REVISED —		OKETO AVENUE RESURFACING	F.A.	U. S	SECTION	COUNTY	TOTAL	SHEET
		CHECKED — PKB	REVISED —	STATE OF ILLINOIS	87TH STREET TO 71ST STREET	170	8 14-0	-00064-00-RS	COOK	14	8
	PLOT SCALE =	DRAWN — RG	REVISED —	DEPARTMENT OF TRANSPORTATION	STRIPING PLAN				CONTRACT	NO. 61A	45
CALM SAME RECOVERED ON WARRED ON THE RECOVERED ON THE REC	PLOT DATE = 01-16-14	16-14 CHECKED — AG REVISED —			SCALE: 1"=50' SHEET NO. 8 OF 14 SHEETS STA. 57+00 TO STA. 8	+00 FED	FED. ROAD DIST. NO. 1 ILLINOIS FED. AID PROJECT M-4003(32				

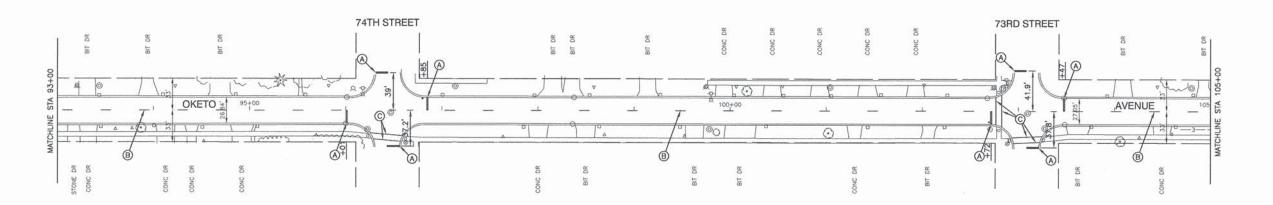




			S				72ND 5	STREET								7187	STREET
		F DR	ONC	F 08	T DR	T OR			T 08	T DR	80	DR T	7 DR	± DR	T DR		
IE STA 105+00	+00		OKETO	227.09 G		7 -		110+00		-	- 1 7	~	- 0 -	v ,	END IMPROSTA 115	VEMENT 5+80.67	
MATCHLIN	80	8	8 6 / 8		, /º	80	Ø+1	4	no T	<u> </u>	① / °	8	S I ho	٥	* * *		
	CONC	TIB	E B		TIR.	E B	B	ŀ	HB	EIT		CONC	TI8		TIB TIB	l,	

LEGEND


- THERMOPLASTIC PAVEMENT MARKING WHITE, 24**
- B THERMOPLASTIC PAVEMENT MARKING YELLOW, LINE, 4", SKIP DASH (10' LINE-30' SPACE)
- © THERMOPLASTIC PAVEMENT MARKING WHITE, LINE, 6"

FILE NAME = 10193-PLAN-01 - PVMK04	USER NAME =	DESIGNED — JH	REVISED		OKETO AVENUE RESURFACING		SECTION	COUNTY	TOTAL SHEE
DATE DESCRIPTION OF THE PROPERTY OF THE STATE OF THE STAT	PLOT SCALE =	CHECKED — PKB	REVISED —	STATE OF ILLINOIS	87TH STREET TO 71ST STREET	1708	14-00064-00-RS	соок	14 9
		PLOT SCALE = DRAWN RG REVISED		DEPARTMENT OF TRANSPORTATION	STRIPING PLAN	1100	11000010010	CONTRACT NO. 61A45	
	PLOT DATE = 01-16-14	CHECKED AG	REVISED —		SCALE: 1"=50" SHEET NO. 9 OF 14 SHEETS STA. 81+00 TO STA. 105+00	FFD BOAD	DIST NO. 1 TILLINOIS FE	D AID PROJECT M-4	

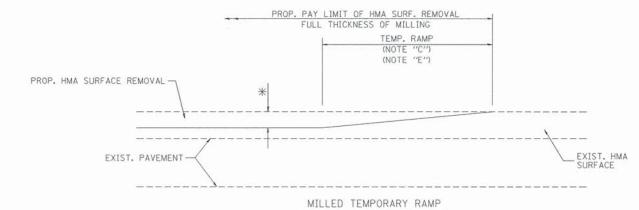

(FOR BUTT JOINT AND HMA TAPER SEE DETAIL BELOW)


OPTION 1

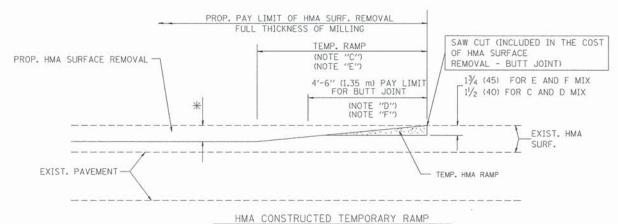


(FOR BUTT JOINT AND HMA TAPER SEE DETAIL BELOW)


OPTION 2

TYPICAL TEMPORARY RAMP

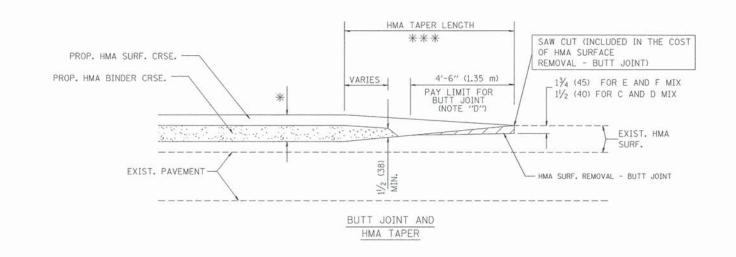

TYPICAL BUTT JOINT AND HMA TAPER FOR MILLING AND RESURFACING

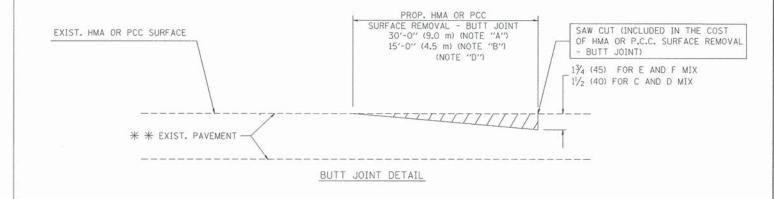

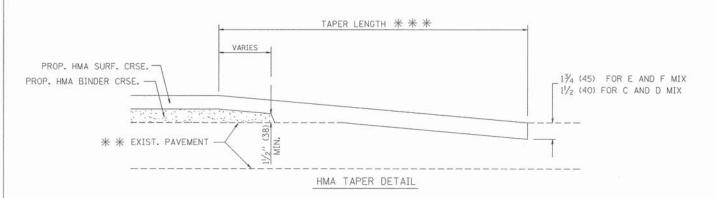

TYPICAL BUTT JOINT AND HMA TAPER FOR RESURFACING ONLY

PC CONCRETE, HMA OR HMA RESURFACED PAVEMENT.

NOTES

- A: MAINLINE ROADWAYS AND MAJOR SIDE ROADS.
- B: MINOR SIDE ROADS.
- C: THE TEMP. RAMP SHALL BE CONSTRUCTED IMMEDIATELY UPON REMOVAL OF THE EXISTING HMA SURFACE.
- D: THE BUTT JOINT SHALL BE CONSTRUCTED IMMEDIATELY PRIOR TO PLACING THE PROPOSED HMA COURSES.
- E: TAPER THE TEMP, RAMP AT A RATE OF 3'-0" (900 mm) PER 1 INCH (25 mm) OF MILLING THICKNESS.
- F: INSTALLATION AND REMOVAL OF THE 4'-6" (1.35 m) TEMP, RAMP IS INCLUDED IN COST OF HMA SURFACE REMOVAL BUTT JOINT
- G: SEE ARTICLE 406.08 AND 406.14 OF THE STANDARD SPECIFICATIONS FOR "HMA AND/OR PCC SURFACE REMOVAL, BUTT JOINT".
- * SEE TYPICAL SECTIONS FOR MILLING THICKNESS.

BASIS OF PAYMENT:


THE BUTT JOINT WILL BE PAID FOR AT THE CONTRACT UNIT PRICE PER SOUARE YARD (SOUARE METER)
FOR "HOT-MIX ASPHALT SURFACE REMOVAL - BUTT JOINT" OR FOR "PORTLAND CEMENT CONCRETE SURFACE REMOVAL- BUTT JOINT".

ALL DIMENSIONS ARE IN INCHES (MILLIMETERS) UNLESS OTHERWISE SHOWN.

FILE NAME = 10193-DTLS-01-BD32 - BD-32	USER NAME = gaglianobt	DESIGNED - M. DE YONG	REVISED — R. SHAH 10-25-94
		CHECKED —	REVISED — A. ABBAS 03-21-97
	PLOT SCALE = 50.0000 ' / IN.	DRAWN —	REVISED - M. GOMEZ 04-06-01
	PLOT DATE = 1/4/2008	CHECKED - 06-13-90	REVISED - R. BORO 01-01-07

STATE OF ILLINOIS DEPARTMENT OF TRANSPORTATION

	BUTT JOINT	AND	F.A.U. RTE, SECTION		COUNTY	TOTAL	SHEET NO.
	UMA TARER D	1708	1708 14-00064-00-RS		14	10	
HMA TAPER DETAILS			B	D400-05 BD32	CONTRACT	NO. 61A	45
	SHEET NO. 10 OF 14 SHEETS	STA. TO STA.	FED BOAD	DIST. NO. 1 ILLINOIS FED	AID PROJECT M-40	03/390)	

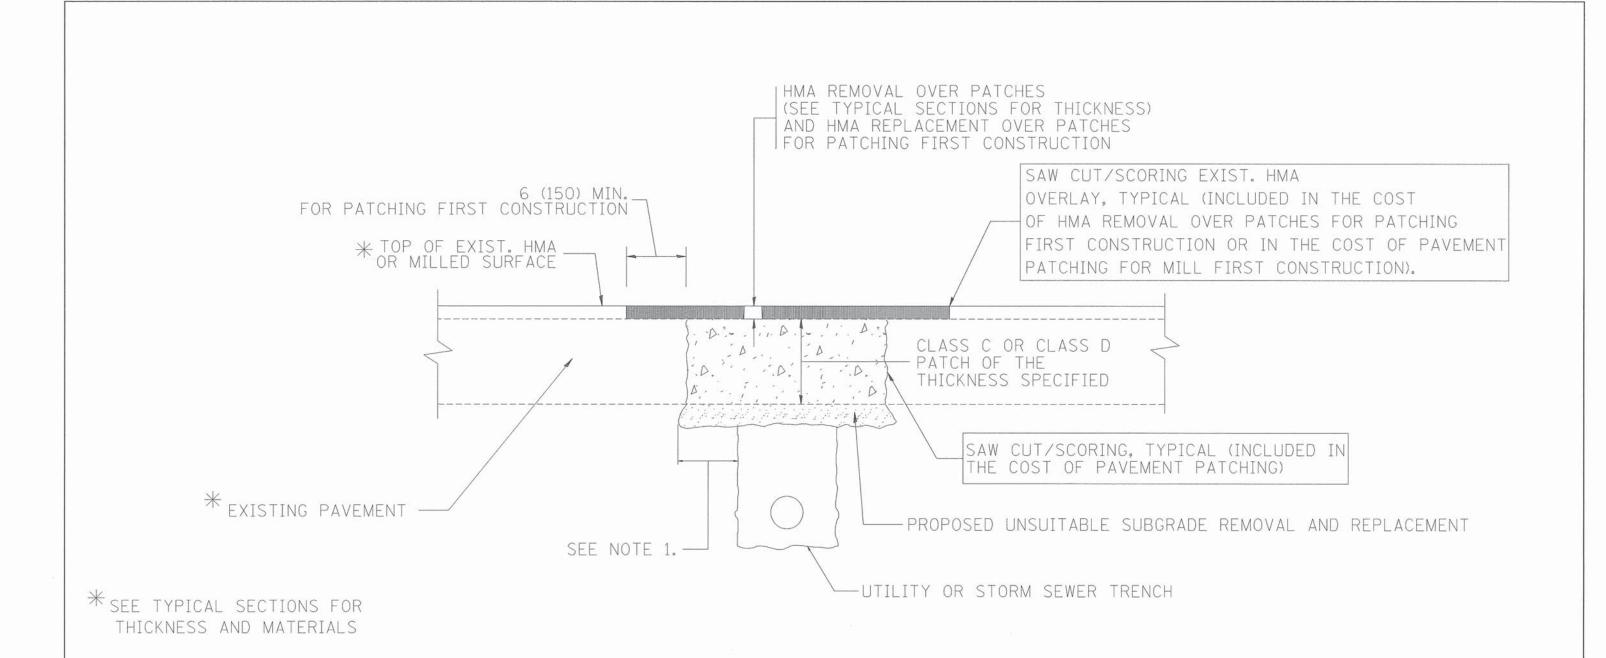

- 1. THE WIDTH OF THE FULL DEPTH PATCH OVER A TRENCH SHALL BE 12 (300) WIDER ON EACH SIDE OF THE TRENCH.
- 2. FOR METHOD OF MEASUREMENT AND BASIS OF PAYMENT, SEE RECURRING SPECIAL PROVISION "PATCHING WITH HOT-MIX ASPHALT OVERLAY REMOVAL".

SEQUENCE OF CONSTRUCTION (PATCHING FIRST)


- 1. REMOVE THE EXISTING HMA MATERIAL OVER THE AREA TO BE PATCHED.
- 2. REMOVE AND REPLACE WITH CLASS C OR D PATCH.
- 3. REPLACE HMA MATERIAL OVER THE AREA TO BE PATCHED.


SEQUENCE OF CONSTRUCTION (MILLING FIRST)

- 1. MILL HMA FIRST IF THERE IS AT LEAST 41/2 INCHES OR MORE OF HMA MATERIAL ON TOP OF THE EXISTING PAVEMENT OR IF THE PAVEMENT IS FULL DEPTH HMA. A MINIMUM OF 2 INCHES OF HMA MATERIAL SHALL BE IN PLACE AFTER MILLING.
- 2. REMOVE AND REPLACE WITH FULL DEPTH CLASS D PATCHES TO TOP OF MILLED SURFACE.

ALL DIMENSIONS ARE IN INCHES (MILLIMETERS) UNLESS OTHERWISE SHOWN.

FILE NAME = 10193-DTLS-02-BD22 - BD-22	USER NAME = bouerdl	DESIGNED — R. SHAH	REVISED — A. ABBAS 04-27-98			DAVEMENT DATCHIN	IC FOR		F.A.U.	SECTION	COUNTY	TOTAL	SHEET
		CHECKED —	REVISED - R. BORO 01-01-07	STATE OF ILLINOIS	PAVEMENT PATCHING FOR HMA SURFACED PAVEMENT		1708	14-00064-00-RS	соок	14	11		
	PLOT SCALE = 50.000 ' / IN.	DRAWN —	REVISED — R. BORO 09-04-07	DEPARTMENT OF TRANSPORTATION			R	D400-04 (BD-22)	CONTRACT		5		
	PLOT DATE = 10/27/2008	CHECKED — 10-25-94	REVISED — K. ENG 10-27-08		SCALE:	SHEET NO. 11 OF 14 SHEETS	STA.	TO STA.	FED. ROA		D. AID PROJECT M-40		

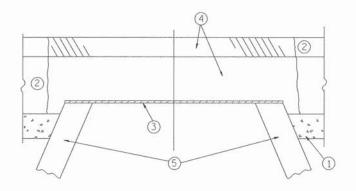

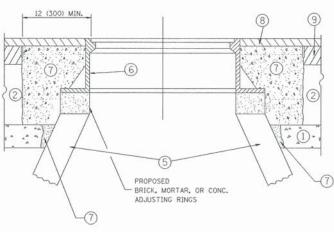

EXISTING BROKEN FRAMES AND LIDS SHALL BE REMOVED AND DISPOSED OF BY THE CONTRACTOR AND SHALL BE REPLACED AS DIRECTED BY THE ENGINEER. REPLACEMENT FRAMES AND LIDS WILL BE PAID FOR IN ACCORDANCE WITH ARTICLE 109.04 OF THE STANDARD SPECIFICATIONS UNLESS A SEPARATE PAY ITEM HAS BEEN PROVIDED.

IF THE EXISTING LIDS ARE OPEN, THE FRAME WILL BE ADJUSTED TO THE ELEVATION OF THE MILLED PAVEMENT SURFACE PRIOR TO THE MILLING OPERATION. THE FRAME WILL NOT BE REMOVED AND COVERED BY THE METAL PLATE.

CITY OF CHICAGO CASTINGS ARE THE PROPERTY OF THE CITY AND THE CONTRACTOR SHALL NOTIFY THE CITY FOR REMOVAL AND DISPOSITION OF THE CASTINGS.

THE METAL PLATE USED TO COVER THE STRUCTURE SHALL REMAIN THE PROPERTY OF THE CONTRACTOR.

WHEN STRUCTURES ARE TO BE ADJUSTED OR RECONSTRUCTED, THE LOWERING AND RAISING OF THE FRAMES AND LIDS WILL NOT BE PAID FOR SEPARATELY BUT WILL BE INCLUDED IN THE COST OF THE CORRESPONDING PAY ITEM.

CONSTRUCTION PROCEDURES

STAGE 1 (BEFORE PAVEMENT MILLING)

- A) REMOVE A MINIMUM OF 12 (300) OF THE PAVEMENT FROM AROUND THE STRUCTURE.
- B) REMOVE THE EXISTING FRAME AND LID FROM THE STRUCTURE.
- C) COVER THE STRUCTURE OPENING WITH A 36 (900) DIAMETER
- METAL PLATE.

 D) BACKFILL WITH CRUSHED STONE AND A MINIMUM 11/2 (40)
- THICK HMA SURFACE MIX APPROVED BY THE ENGINEER.

STAGE 2 (AFTER PAVEMENT MILLING)

- A) REMOVE THE HMA SURFACE MIX AND CRUSHED STONE.
- B) INSTALL THE FRAME AND LID; ADJUST THE FRAME TO ITS FINAL SURFACE ELEVATION.
- C) THE SURROUNDING SPACE SHALL BE FILLED WITH CLASS PP-1*
 CONCRETE TO THE ELEVATION OF THE SURFACE OF THE EXISTING BASE COURSE OR THE BINDER COURSE.
- * UNLESS OTHERWISE SPECIFIED IN THE PLANS.

THE PROCEDURE EXPLAINED ABOVE SHALL CONFORM TO THE APPLICABLE PORTIONS OF SECTIONS 353, 406. 602, AND 603 OF THE STANDARD SPECIFICATIONS.

- 1 SUB-BASE GRANULAR MATERIAL
- (6) FRAME AND LID (SEE NOTES)
- 2 EXISTING PAVEMENT
- (7) CLASS PP-1* CONCRETE
- 3 36 (900) DIAMETER METAL PLATE
- 8 PROPOSED HMA SURFACE COURSE
- 4 PROPOSED CRUSHED STONE AND HMA SURFACE MIX
- (9) PROPOSED HMA BINDER COURSE

LOCATION OF STRUCTURES:

(5) EXISTING STRUCTURE

THE CONTRACTOR WILL BE REQUIRED TO KEEP A RECORD OF THE LOCATIONS OF THE BURIED STRUCTURES ACCORDING TO THE STATION AND DISTANCE LEFT OR RIGHT OF THE CENTERLINE OF PAVEMENT. UPON COMPLETION OF THE WORK. THE CONTRACTOR WILL DELIVER THE RECORD TO THE ENGINEER.

BASIS OF PAYMENT: THIS WORK WILL BE PAID FOR AT THE CONTRACT UNIT PRICE PER EACH FOR "FRAMES AND LIDS TO BE ADJUSTED, SPECIAL" NEW FRAMES AND LIDS, WHEN SPECIFIED, WILL BE PAID FOR SEPARATELY.

DETAILS FOR FRAMES AND LIDS ADJUSTMENT WITH MILLING

SCALE:

ALL DIMENSIONS ARE IN INCHES (MILLIMETERS) UNLESS OTHERWISE SHOWN

FED. ROAD DIST. NO. 1 ILLINOIS FED. AID PROJECT M-4003(320


TOTAL SHEET NO.

14 12

FILE NAME = 10193-DTLS-03-BD08 - BD-08 REVISED -A. ABBAS 03-21-97 USER NAME = gaglianobt DESIGNED - R. SHAH CHECKED REVISED -R. WIEDEMAN 05-14-04 PLOT SCALE = 50.0000 ' / IN. REVISED -R. BORO 01-01-07 DRAWN PLOT DATE = 1/4/2008 CHECKED REVISED

STATE OF ILLINOIS **DEPARTMENT OF TRANSPORTATION**

COUNTY SECTION DETAILS FOR 14-00064-00-RS COOK FRAMES AND LIDS ADJUSTMENT WITH MILLING BD600-03 (BD-8) CONTRACT NO. 61A45 SHEET NO. 12 OF 14 SHEETS STA.

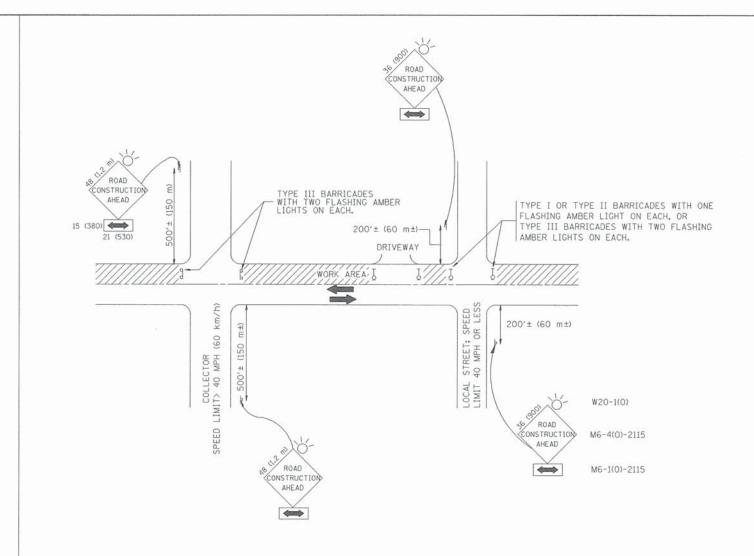

TRAFFIC CONTROL AND PROTECTION FOR SIDE ROADS, INTERSECTIONS, AND DRIVEWAYS

NOTES:

- A. FOR NO LANE RESTRICTION ON THE SIDE ROAD OR DRIVEWAYS
- SIDE ROAD WITH A SPEED LIMIT OF 40 MPH (60 km/h) OR LESS AS SHOWN ON THE DRAWING AND AS DIRECTED BY THE ENGINEER:
- O) ONE ROAD CONSTRUCTION AHEAD SIGN 36 × 36 (900×900) WITH A FLASHER AND FLAG MOUNTED ON IT APPROXIMATELY 200' (60 m) IN ADVANCE OF THE MAIN ROUTE.
- b) THE CLOSED PORTION OF THE MAIN ROUTE SHALL BE PROTECTED BY BLOCKING WITH TYPE I, TYPE II OR TYPE III BARRICADES, 1/3 OF THE CROSS SECTION OF THE CLOSED PORTION.
- 2. SIDE ROAD WITH A SPEED LIMIT GREATER THAN 40 MPH (60 km/h) AS SHOWN ON THE DRAWING AND AS DIRECTED BY THE ENGINEER:
- O) ONE ROAD CONSTRUCTION AHEAD SIGN 48 × 48 (1.2 m × 1.2 m) WITH A FLASHER MOUNTED ON IT APPROXIMATELY 500' (150 m) IN ADVANCE OF THE MAIN ROUTE.
- b) THE CLOSED PORTION OF THE MAIN ROUTE SHALL BE PROTECTED BY BLOCKING WITH TYPE III BARRICADES, 1/2 OF THE CROSS SECTION OF THE CLOSED PORTION.
- 3. WHEN THE SIDE ROAD LIES BETWEEN THE BEGINNING OF THE MAINLINE SIGNING AND THE WORK ZONE, A SINGLE HEADED ARROW (MG-1) SHALL BE USED IN LIEU OF THE DOUBLE HEADED ARROW (MG-4).

SCALE:

B. FOR A LANE CLOSURE ON A SIDE ROAD OR DRIVEWAY:

- USE APPLICABLE PORTIONS OF THE TYPICAL APPLICATION OF TRAFFIC CONTROL DEVICES (STD. 701501, STD. 701606 OR THE APPROPRIATE STANDARD). THE SPACING OF SIGNS AND BARRICADES SHALL BE ADJUSTED FOR FIELD CONDITIONS AS DIRECTED BY THE ENGINEER. THE DIRECTIONAL ARROW SHALL BE COVERED OR REMOVED WHEN NO LONGER CONSISTENT WITH THE SIDE ROAD LANE CLOSURE.
- C. ADVANCE WARNING SIGNS ARE TO BE OMITTED ON DRIVEWAY UNLESS OTHERWISE NOTED.
- D. THE TRAFFIC CONTROL AND PROTECTION FOR SIDE ROADS, INTERSECTIONS, AND DRIVEWAYS SHALL BE INCIDENTAL TO THE COST OF SPECIFIED TRAFFIC CONTROL STANDARDS OR ITEMS.

All dimensions are in millimeters (inches) unless otherwise shown.

FILE NAME = 10183-DTLS-05-TC10 - TC-10

USER NAME = 9eglianobt

DESIGNED - LHA

REVISED - J. OBERLE 10-18-95

CHECKED - REVISED - A. HOUSEH 03-06-96

PLOT SCALE = 50.000 '/ IN.

DRAWN - REVISED - A. HOUSEH 10-15-96

PLOT DATE = 1/4/2008


CHECKED - 06-89

REVISED - T. RAMMACHER 01-06-00

STATE OF ILLINOIS DEPARTMENT OF TRANSPORTATION

	TRAFFIC	CONTRO	L AND	PROTEC	TION FOR
	SIDE ROAD	S, INTER	SECTION	VS, AND	DRIVEWAYS
1	SHEET NO. 13	OF 14	SHEETS	STA.	TO STA.

	F.A.U. RTE.	SE	CTION	-118.9	COUNTY	TOTAL	SHEET NO.				
	1708	14-00	064-00-RS		соок	14	13				
_		TC-10				CONTRACT NO. 61A45					
	FED. ROAD D	IST. NO. 1	ILLINOIS	FED, A	ID PROJECT M-40	03(320)	3.15				

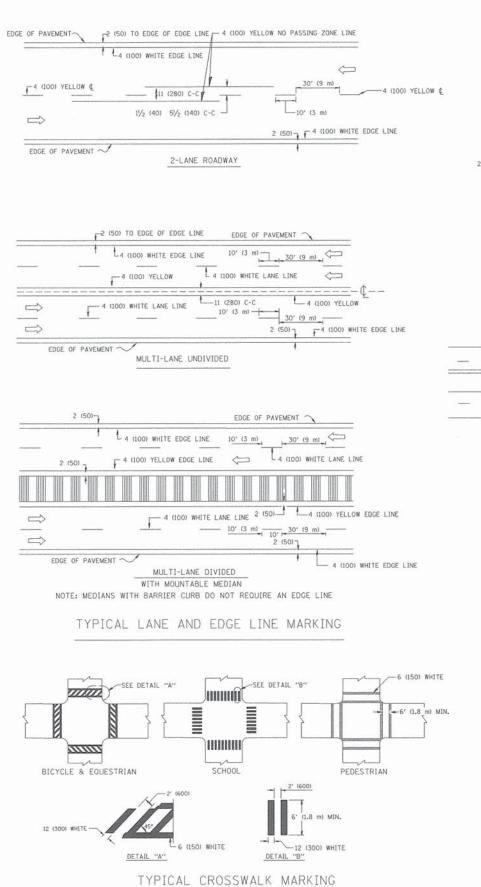


2-4 (100) YELLOW @ 11 (280) C-C

NO DIAGONALS

4' (1,2 m) OUTSIDE TO OUTSIDE OF LINES


2-4 (100) YELLOW @ 11 (280) C-C

4' (1.2 m) WIDE MEDIANS ONLY

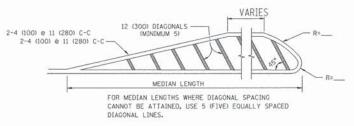

DIAGONAL LINE SPACING: 50' (15 m) C-C (LESS THAN 30MPH (50 km/h))
75' (25 m) C-C 30MPH (50 km/h) TO 45MPH (70 km/h))
150' (45 m) C-C (MORE THAN 45MPH (70 km/h))

MEDIANS OVER 4' (1.2 m) WIDE

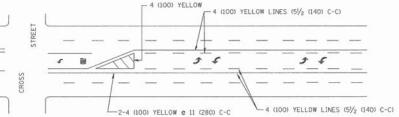


A MINIMUM OF TWO PAIRS OF TURN ARROWS SHALL BE USED, WHITE IN COLOR, ADDITIONAL PAIRS SHALL BE PLACED AT 200' (60 m) TO 300' (90 m) INTERVALS.



MEDIAN WITH TWO-WAY LEFT TURN LANE


TYPICAL PAINTED MEDIAN MARKING

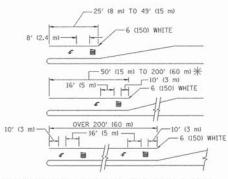

* TURN LANES IN EXCESS OF 400' (120 m) IN LENGTH MAY HAVE AN ADDITIONAL SET OF ARROW - "ONLY" INSTALLED MIDWAY BETWEEN THE OTHER TWO SETS OF ARROW - "ONLY".

TYPICAL LEFT (OR RIGHT) TURN LANE

TYPICAL TURN LANE MARKING

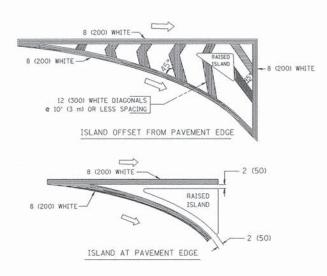

TYPICAL ISLAND MARKING

TYPE OF MARKING	WIDTH OF LINE	PATTERN	COLOR	SPACING / REMARKS
CENTERLINE ON 2 LANE PAVEMENT	4 (100)	SKIP-DASH	YELLOW	10' (3 m) LINE WITH 30' (9 m) SPACE
CENTERLINE ON MULTI-LANE UNDIVIDED PAVEMENT	2 @ 4 (100)	SOLID	YELLOW	11 (280) C-C
NO PASSING ZONE LINES: FOR ONE DIRECTION FOR BOTH DIRECTIONS	4 (100) 2 @ 4 (100)	SOLID SOLID	YELLOW YELLOW	5½ (140) C-C FROM SKIP-DASH CENTERLINE 11 (280) C-C OMIT SKIP-DASH CENTERLINE BETWEEN
LANE LINES	4 (100) 5 (125) ON FREEWAYS	SKIP-DASH SKIP-DASH	WHITE WHITE	10' (3 m) LINE WITH 30' (9 m) SPACE
DOTTED LINES (EXTENSIONS OF CENTER, LANE OR TURN LANE MARKINGS)	SAME AS LINE BEING EXTENDED	SKIP-DASH	SAME AS LINE BEING EXTENDED	2' (600) LINE WITH 6' (1.8 m) SPACE
EDGE LINES	4 (100)	SOLID	YELLOW-LEFT WHITE-RIGHT	OUTLINE MOUNTABLE MEDIANS IN YELLOW: EDGE LINES ARE NOT USED NEXT TO BARRIER CURB
TURN LANE MARKINGS	6 (150) LINE: FULL SIZE LETTERS & SYMBOLS (8' (2.4m))	SOLID	WHITE	SEE TYPICAL TURN LANE MARKING DETAIL
TWO WAY LEFT TURN MARKING	2 @ 4 (100) EACH DIRECTION	SKIP-DASH AND SOLID	YELLOW	10' (3 m) LINE WITH 30' (9 m) SPACE FOR SKIP-DASH; 5½ (140) C-C BETWEEN SOLID LINE AND SKIP-DASH LINE
	8' (2.4m) LEFT ARROW	IN PAIRS	WHITE	SEE TYPICAL TWO-WAY LEFT TURN MARKING DETAIL
CROSSWALK LINES (PEDESTRIAN) A. DIAGONALS (BIKE & EQUESTRIAN) B. LONGITUDINAL BARS (SCHOOL)	2 e 6 (150) 12 (300) e 45° 12 (300) e 90°	SOLID SOLID SOLID	WHITE WHITE WHITE	NOT LESS THAN 6' (1.8 m) APART 2' (600) APART 2' (600) APART SEE TYPICAL CROSSWALK MARKING DETAILS.
STOP LINES	24 (600)	SOLID	WHITE	PLACE 4' (1.2 m) IN ADVANCE OF AND PARALLEL TO CROSSWALK, IF PRESENT. OTHERWISE, PLACE AT DESIRED STOPPING POINT. PARALLEL TO CROSSROAD CENTERLINE, WHERE POSSIBLE
PAINTED MEDIANS	2 & 4 (100) WITH 12 (300) DIAGONALS & 45° NO DIAGONALS USED FOR 4' (1.2 m) WIDE MEDIANS	SOLID	YELLOW: TWO WAY TRAFFIC WHITE: ONE WAY TRAFFIC	11 (280) C-C FOR THE DOUBLE LINE SEE TYPICAL PAINTED MEDIAN MARKING.
GORE MARKING AND CHANNELIZING LINES	8 (200) WITH 12 (300) DIAGONALS @ 45°	SOLID	WHITE	DIAGONALS: 15' (4,5 m) C-C (LESS THAN 30MPH (50 km/h)) 20' (6 m) C-C 30MPH (50 km/h) TO 45MPH (70 km/h)) 30' (9 m) C-C (OVER 45MPH (70 km/h))
RAILROAD CROSSING	24 (600) TRANSVERSE LINES; "RR" IS 6' (1.8 m) LETTERS; 16 (400) LINE FOR "X"	SOLID	WHITE	SEE STATE STANDARD 780001 AREA OF: "R""3.6 SO. FT. (0.33 m ²) EACH "X"=54,0 SO. FT. (5.0 m ²)
SHOULDER DIAGONALS	12 (300) e 45°	SOLID	WHITE - RIGHT YELLOW - LEFT	50' (15 m) C-C (LESS THAN 30MPH (50 km/h)) 75' (25 m) C-C (30 MPH (50 km/h) T0 45MPH (70 km/h) 150' (45 m) C-C (0VER 45MPH (70 km/h))

FOR FURTHER DETAILS ON PAVEMENT MARKING REFER TO STANDARD SPECIFICATIONS FOR ROAD AND BRIDGE CONSTRUCTION AND STATE STANDARD 780001.

All dimensions are in inches (millimeters) unless otherwise shown.

FILE NAME = 10193-DTLS-06-TC13 - TC-13	USER NAME = drivakosgn	DESIGNED — EVERS	REVISED —T. RAMMACHER 10-27-
		CHECKED —	REVISED —C. JUCIUS 09-09-0
	PLOT SCALE = 50.000 ' / IN.	DRAWN —	REVISED —
	PLOT DATE = 9/9/2009	CHECKED — 03-19-90	REVISED —

STATE OF ILLINOIS
DEPARTMENT OF TRANSPORTATION

				F.A.U. RTE. SECTION				COUNTY TOT		SHEET NO.
			1708	14-0006	4-00-RS		COOK	14	14	
TYPICAL PAVEMENT MARKINGS				TC-13			CONTRACT NO. 61A45		15	
SCALE:	SHEET NO. 14 OF 14 SHEETS	STA.	TO STA.		FED. ROAD DIST. NO. 1 ILLINOIS FED. AID PROJECT M-4003(320)					