STATE OF ILLINOIS DEPARTMENT OF TRANSPORTATION

D-91-176-19

PROPOSED HIGHWAY PLANS

FAU ROUTE 1602 (147TH STREET)

OVER TRIBUTARY C OF THE CAL—SAG CHANNEL

(1.2 MI WEST OF IL 50 AT MENARD AVE)

SECTION 2019—051—T

CULVERT REPLACEMENT COOK COUNTY

C-91-396-19

R13E



LOCATION MAP
NOT TO SCALE



The seal shown above is valid for Sheets 1-18, 27-32, 37-45

Signed: Olex C Bengy Date: 3/5/2020

License Expires: 11/30/2020
The seal shown above is valid for Sheets 33-35

SAME STAND S

EFK Moen
Civil Engineering Design

STATE OF ILLINOIS
DEPARTMENT OF TRANSPORTATION

SUBMITTED

May 8, 2020

ENGINEER OF DESIGN AND ENVIRONMENT

May 8, 2020

DIRECTOR OF HIGHWAYS PROJECT IMPLEMENTATION 13

PRINTED BY THE AUTHORITY OF THE STATE OF ILLINOIS

FOR LIST OF HIGHWAY STANDARDS, SEE SHEET NO. 2

IMPROVEMENT IS LOCATED IN THE CITY OF OAK FOREST AND THE FOREST PRESERVES DISTRICT OF COOK COUNTY.

FOR INDEX OF SHEETS, SEE SHEET NO. 2

TRAFFIC DATA

FUNCTIONAL CLASSIFICATION: SUBURBAN MINOR ARTERIAL

2018 ADT = 11100

POSTED SPEED = 45 MPH

DESIGN SPEED = 45 MPH

END IMPROVEMENT
STA 520 + 90

CULVERT REPLACEMENT
STA 520 + 75

EXIST SN: N/A

PROP SN: 016-2272

0 10' 20' 30' 1"= 10'
0 50' 100' 1"= 50'
0 50' 100' 1"= 40'
0 50' 100' 1"= 30'
FULL SIZE PLANS HAVE BEEN PREPARED USING STANDARD

FULL SIZE PLANS HAVE BEEN PREPARED USING STANDARD ENGINEERING SCALES. REDUCED SIZED PLANS WILL NOT CONFORM TO STANDARD SCALES. IN MAKING MEASUREMENTS ON REDUCED PLANS, THE ABOVE SCALES MAY BE USED.

J.U.L.I.E.
JOINT UTILITY LOCATION INFORMATION FOR EXCAVATORS
1-800-892-0123

PROJECT ENGINEER: PRAVEEN KAINI, PE (847)705-4237 PROJECT MANAGER: FAWAD AQUEEL, PE (847)705-4247 L36N

BEGIN IMPROVEMENT STA 520+60

GROSS LENGTH = 351 FT. = 0.07 MILE

BREMEN TOWNSHIP

NET LENGTH = 351 FT. = 0.07 MILE

CONTRACT NO. 62J28

OR 811

REV-SEP

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niunvvai	STANDANDS
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GENERAL NOTES

- BEFORE STARTING ANY EXCAVATION, THE CONTRACTOR SHALL CALL "J.U.L.I.E." AT (800) 892-0123 OR 811 FOR FIELD LOCATIONS OF BURIED ELECTRIC, TELEPHONE AND GAS UTILITIES. (48 HOUR NOTIFICATION IS REQUIRED
- 2. THE CONTRACTOR SHALL COORDINATE CONSTRUCTION ACTIVITIES WITH UTILITY COMPANIES, THE CITY OF OAK FOREST. AND THE FOREST PRESERVE OF COOK COUNTY
- 3. THE CONTRACTOR SHALL INFORM THE COOK COUNTY DEPARTMENT OF TRANSPORTATION AND HIGHWAYS DESIGN ENGINEER AT (312) 603-1730 PRIOR TO THE START OF ANY WORK ON THE CONTRACT. A MINIMUM OF FIVE (5) WORKING DAYS ADVANCED NOTICE IS REQUIRED.
- THE CONTRACTOR WILL NOT BE ALLOWED TO SET UP A YARD OR FIELD OFFICE ON STATE PROPERTY WITHOUT WRITTEN PERMISSION FROM THE DEPARTMENT
- ALL DAMAGE TO EXISTING PAVEMENT MARKINGS OR RAISED REFLECTIVE PAVEMENT MARKERS OUTSIDE THE REMOVAL LINE SHOWN ON THE PLANS SHALL BE REPLACED AT NO ADDITIONAL COST TO THE DEPARTMENT
- BEFORE BEGINNING ANY WORK, THE CONTRACTOR SHALL RETAIN AND RECORD FOR FUTURE REFERENCE, ALL EXISTING PAVEMENT MARKING LINES (AND RAISED REFLECTIVE PAVEMENT MARKERS) IN ORDER THAT THESE LOCATIONS CAN BE RE-ESTABLISHED FOR STRIPING. EXACT LOCATIONS OF ALL PAVEMENT MARKINGS SHALL BE AS DIRECTED BY THE RESIDENT ENGINEER
- 7. IT SHALL BE THE CONTRACTOR'S RESPONSIBILITY TO VERIFY ALL DIMENSIONS AND CONDITIONS EXISTING IN THE FIELD PRIOR TO CONSTRUCTION AND ORDERING OF MATERIALS
- 8. THE CONTRACTOR SHALL CONTACT THE DISTRICT ONE TRAFFIC CONTROL SUPERVISOR AT KALPANA.KANNAN-HOSADURGA@ILLINOIS.GOV A MINIMUM OF 72 HOURS IN ADVANCE OF
- THE RESIDENT ENGINEER SHALL CONTACT PATRICE HARRIS, AREA TRAFFIC FIELD TECHNICIAN, AT PATRICE.HARRIS@ILLINOIS.GOV A MINIMUM OF TWO (2) WEEKS PRIOR TO THE PLACEMENT OF PERMANENT PAVEMENT MARKINGS.
- 10. DO NOT SCALE PLANS FOR CONSTRUCTION DIMENSIONS.
- 11. THIS PROJECT REQUIRES A U.S. ARMY CORPS OF ENGINEERS (USACE) 404 PERMIT THAT WILL BE SECURED BY THE DEPARTMENT. AS A CONDITION OF THIS PERMIT, THE CONTACTOR WILL NEED TO SUBMIT AN IN-STREAM WORK PLAN TO THE DEPARTMENT FOR APPROVAL. GUIDELINES ON ACCEPTABLE IN-STREAM WORK TECHNIQUES CAN BE FOUND ON THE USACE WEBSITE. THE USACE DEFINES AND DETERMINES IN-STREAM WORK. THE COST OF ALL MATERIALS AND LABOR NECESSARY TO COMPLY WITH THE ABOVE PROVISIONS TO PREPARE AND IMPLEMENT AN IN-STREAM WORK PLAN WILL NOT BE PAID FOR SEPARATELY, BUT SHALL BE CONSIDERED AS INCLUDED IN THE UNIT BID PRICES OF THE CONTRACT AND NO ADDITIONAL COMPENSATION WILL BE ALLOWED WITH THE EXCEPTION OF COFFERDAMS WHICH WILL PAID FOR AS COFFERDMAN (TYPE 1) (IN-STREAM/WETLAND WORK) WITH A BASIS OF PAYMENT OF EACH.
- ALL UTILITIES, SCHOOL DISTRICTS, LOCAL POLICE, AND FIRE DEPARTMENTS SHALL BE NOTIFIED BY THE CONTRACTOR PRIOR TO THE START OF CONSTRUCTION
- 13. THE CONTRACTOR SHALL USE CARE IN GRADING OR EXCAVATING NEAR ANY AND ALL EXISTING ITEMS THAT WILL NOT BE REMOVED INCLUDING PREVIOUSLY SEEDED AREAS. ANY DAMAGE DONE TO EXISTING ITEMS BY THE CONTRACTOR SHALL BE REPAIRED AT THE CONTRACTOR'S OWN EXPENSE TO THE SATISFACTION OF THE ENIGINEER.
- COMED COMPANY WIRES ARE NOT INSULATED AND EXTRA CAUTION AND VIGILANCE MUST BE ADHERED TO WHEN WORKING AROUND THEM. CONTRACTORS SHOULD ALWAYS USE CAUTION IN OPERATING CRANES AND OR OTHER EQUIPMENT NEAR OVERHEAD ELECTRICAL FACILITIES. THE OCCUPATIONAL HEALTH AND SAFETY ORGANIZATION (OSHA) RULES REQUIRE THAT WORKERS AND EQUIPMENT SHALL NOT APPROACH WITHIN TEN (10) FEET AWAY OF OVERHEAD ELECTRICAL EQUIPMENT WITHOUT APPROPRIATE SUPPLEMENTAL PROTECTION. PLEASE BE CERTAIN THAT ALL WORKERS ON THIS PROJECT HAVE BEEN FULLY TRAINED AND CONFORM TO OSHA RULES AND OTHER APPLICABLE GUIDELINES REGARDING WORKING SAFELY AROUND ELECTRICAL POWER LINES.

DRAINAGE AND UTILITIES GENERAL NOTES

- 1. THE CONTRACTOR SHALL MAINTAIN THE SURFACE DRAINAGE OF ALL ROADWAYS DURING CONSTRUCTION OF THIS PROJECT. WHEN EXISTING DRAINAGE FACILITIES ARE DISTURBED, THE CONTRACTOR SHALL PROVIDE AND MAINTAIN TEMPORARY OUTLETS AND CONNECTIONS FOR ALL PRIVATE OR PUBLIC DRAINS, SEWERS, INLETS, AND CATCH BASINS. THE CONTRACTOR SHALL PROVIDE FACILITIES TO TAKE IN ALL STORM WATER, WHICH WILL BE RECEIVED BY THESE DRAINS AND SEWERS AND DISCHARGE SAME. THE CONTRACTOR SHALL PROVIDE AND MAINTAIN A TEMPORARY OUTLET AND BE PREPARED AT ALL TIMES TO DISPOSE OF THE WATER RECEIVED FROM ALL THESE TEMPORARY CONNECTIONS UNTIL INSTALLATION IS COMPLETE, INCLUDING PAVEMENT. THIS WORK SHALL NOT BE PAID FOR DIRECTLY BUT SHALL BE CONSIDERED INCLUDED IN THE CONTRACT. COORDINATION WITH ALL AGENCIES INVOLVED IS REQUIRED.
- 2 THE LOCATION AND ELEVATION OF EXISTING LITHLITIES ARE APPROXIMATE AND ARE PROVIDED BY THE OWNERS. THE EXACT LOCATIONS AND ELEVATIONS ARE TO BE VERIFIED BY THE CONTACTOR THROUGH THE OWNERS OF THE UTILITIES.
- 3. THE COST OF MAKING STORM SEWER CONNECTIONS TO EXISTING SEWER SHALL BE INCLUDED IN THE CONTRACT UNIT PRICE FOR THE STORM SEWER BEING CONNECTED.
- 4. THE RESIDENT ENGINEER SHALL CONTACT THE VILLAGE OF OAK LAWN A MINIMUM OF 48 HOURS
- A MINIMUM OF TWO (2) FEET OF COVER SHALL BE MAINTAINED ABOVE THE EXISTING WATERMAIN

EROSION CONTROL AND LANDSCAPING GENERAL NOTES

- 1. THE CONTRACTOR SHALL INSTALL PERIMETER EROSION BARRIER PRIOR TO STRIPPING OF VEGETATION.
- 2. RUNOFF FROM EXCAVATED AREAS SHALL LEAVE THE SITE THROUGH SEDIMENT CONTROL DEVICES SHOWN IN IDOT STD 280001, AND/OR NRCS DETAILS FROM THE MOST RECENT VERSION OF THE ILLINOIS URBAN MANUAL
- THE CONTRACTOR SHALL SURROUND ANY NECESSARY EARTH STOCKPILES WITH PERIMETER **EROSION BARRIER**
- ALL EROSION CONTROL MEASURES SHOULD BE CHECKED WEEKLY AND AFTER EACH RAINFALL 0.5 Inches or greater. Additionally during winter months, all measures should be
- 5. STABILIZATION OF DISTURBED AREAS MUST BE INITIATED WITHIN ONE (1) WORKING DAY OF THE TEMPORARY OR PERMANENT CESSATION OF EARTH DISTURBING ACTIVITIES AND SHALL BE COMPLETED AS SOON AS POSSIBLE BUT NO LATER THAN 14 DAYS FROM THE INITIATION OF STABILIZATION OF WORK IN AN AREA.
- 6. ALL WASTE GENERATED AS A RESULT OF THE PROJECT INCLUDING DISCARDED BUILDING MATERIALS, CONCRETE TRUCK WASHOUT, CHEMICALS, LITTER, SANITARY WASTE, OR ANY OTHER WASTE SHALL BE PROPERLY DISPOSED OF AND BE PREVENTED FROM BEING CARRIED OFF THE SITE BY EITHER WIND OR WATER.
- 7. ALL EXPOSED IDLE EARTH, INCLUDING EARTH STOCKPILES, WILL BE SEEDED WITH TEMPORARY EROSION CONTROL SEEDING. THE APPLICATION RATE FOR TEMPORARY EROSION CONTROL SEEDING IS 100 POUNDS PER ACRE FOR THREE APPLICATIONS.
- 8. ALL TEMPORARY EROSION AND SEDIMENT CONTROL MEASURES SHALL BE REMOVED WITHIN 30 DAYS OF ACHIEVING PERMANENT SOIL STABILIZATION. TRAPPED SEDIMENT AND OTHER DISTURBED SOILS RESULTING FROM TEMPORARY MEASURES SHALL BE PROPERLY DISPOSED OF AND THE AREA PERMANENTLY STABILIZED
- 9. ALL ESC MEASURES WILL BE MAINTAINED IN ACCORDANCE WITH THE IDOT EROSION AND SEDIMENT CONTROL FIELD GUIDE FOR CONSTRUCTION INSPECTION FOUND ON THE CONSTRUCTION TAB AT (HTTP://WWW.IDOT.ILLINOIS.GOV/TRANSPORTATION-SYSTEM/ENVIRONMENT/EROSION-AND-SEDIMENT-CONTROL).
- 10. THE CONTRACTOR WILL ASSUME RESPONSIBILITY FOR MAINTENANCE OF ALL SOIL EROSION CONTROL DURING CONSTRUCTION
- 11. ANY LOOSE MATERIAL DESPOSITED IN THE FLOW LINE OF DRAINAGE STRUCTURES, WHICH OBSTRUCTS THE NATURAL FLOW OF WATER, SHALL BE REMOVED AT THE CLOSE OF EACH WORKING DAY. PRIOR TO ACCEPTANCE OF THE IMPROVEMENT, ALL DRAINAGE STRUCTURES SHALL BE FREE OF DIRT AND DEBRIS. THIS WORK WILL NOT BE PAID FOR SEPARATELY BUT SHALL BE CONSIDERED AS INCIDENTAL.
- 12. THE CONTRACTOR SHOULD PROVIDE TO THE RE A PLAN TO ENSURE THAT A STABILIZED FLOW LINE WILL BE PROVIDED DURING STORM SEWER CONSTRUCTION. THE USE OF A STABILIZED FLOW LINE BETWEEN INSTALLED STORM SEWER AND OPEN DISTURBANCE WILL REDUCE THE POTENTIAL FOR THE OFFSITE DISCHARGE OF SEDIMENT-BEARING WATERS, ESPECIALLY WHEN RAIN IS FORECASTED, SO THAT FLOW WILL NOT ERODE. LACK OF APPROVED PLAN OR FAILURE TO COMPLY WILL RESULT IN AN ESC DEFICIENCY DEDUCTION.
- 13. UNDER NO CIRCUMSTANCES SHALL THE CONTRACTOR PROLONG FINAL GRADING AND SHAPING SO THAT THE ENTIRE PROJECT CAN BE PERMANENTLY SEEDED AT ONE TIME.
- 14. EROSION CONTROL ITEMS ARE CONSIDERED TO BE A HIGH PRIORITY ON THE CONTRACT. THE CONTRACTOR IS RESPONSIBLE FOR INSTALLATION OF ANY ADDITIONAL EROSION CONTROL MEASURES NECESSARY TO PREVENT EROSION AND SEDIMENTATION AS DETERMINED BY THE RE.
- 15. "WETLANDS NO INTRUSION" SIGNAGE SHOULD ALSO BE PROVIDED AT THE BOUNDARY OF ALL UN-IMPACTED WETLANDS AND/OR WOUS. THE CONTRACTOR CAN BORROW THE SIGNS FROM THE BUREAU OF MAINTENANCE. INCLUDE TEMPORARY FENCING AND WETLAND SIGNAGE WITHIN THE EROSION AND SEDIMENT CONTROL STRATEGY

COMMITMENTS

NONE

REV-SEP

DESIGNED -REVISED USER NAME = RGall STATE OF ILLINOIS DRAWN CS REVISED PLOT SCALE = 100.0000 ' / in. CHECKED REVISED **DEPARTMENT OF TRANSPORTATION** SHEETS STA. REVISED SCALE: OF PLOT DATE = 3/17/2020 DATE 11/8/19

SECTION COUNTY 147TH ST OVER TRIBUTARY C TO CAL-SAG CHANNEL 1602 2019-051-T COOK | 45 | 2 **INDEX, GENERAL NOTES, STANDARDS** CONTRACT NO. 62J28 TO STA.

CONSTR. CODE 100% STATE

	T		STATE	
			URBAN	BOX CULVERT
CODE	17514		TOTAL	0010
NO.	ITEM	UNIT	QUANTITY	S.N. 016-2272
20100110	TREE REMOVAL (6 TO 15 UNITS DIAMETER)	UNIT	486	486
20100210	TREE REMOVAL (OVER 15 UNITS DIAMETER)	UNIT	124	124
20101000	TEMPORARY FENCE	FOOT	458	458
20200100	EARTH EXCAVATION	CU YD	455	455
20201200	REMOVAL AND DISPOSAL OF UNSUITABLE MATERIAL	CU YD	235	235
20700220	POROUS GRANULAR EMBANKMENT	CU YD	44	44
20700220	I GROOD GIVENDERK EMBERHANIERT	00.15	1	
21101615	TOPSOIL FURNISH AND PLACE, 4"	SQYD	1118	1118
25000210	SEEDING, CLASS 2A	ACRE	0.25	0.25
25000314	SEEDING, CLASS 4B	ACRE	0.25	0.25
25000324	SEEDING, CLASS 5B	ACRE	0.25	0.25
25000400	NITROGEN FERTILIZER NUTRIENT	POUND	23	23
20000400	INTROCENT ENTERENT MENT	1 00110	20	20
25000500	PHOSPHORUS FERTILIZER NUTRIENT	POUND	23	23
25000600	POTASSIUM FERTILIZER NUTRIENT	POUND	23	23
25003310	INTERSEEDING, CLASS 4	ACRE	0.50	0.50

* DENOTES SPECIAL PROVISION REQUIRED

** DENOTES SPECIALTY ITEM

REV-SEP

USER NAME = RGall DESIGNED - RAG REVISED -STATE OF ILLINOIS DRAWN - CS REVISED -REVISED -**DEPARTMENT OF TRANSPORTATION** PLOT SCALE = 100.0000 ' / in. CHECKED - JH PLOT DATE = 3/17/2020 REVISED -

147TH ST OVER TRIBUTARY C TO CAL-SAG CHANNEL SUMMARY OF QUANTITIES

SCALE:

COUNTY TOTAL SHEET NO.

COOK 45 3 SECTION 1602 2019-051-T CONTRACT NO. 62J28 SHEET OF SHEETS STA. TO STA.

URBAN 2005 STATE

BOX CULVERT

TOTAL 0010

QUANTITY S.N. 016-2272

				BOX CULVERT	
CODE			TOTAL	0010	
NO.	ITEM	UNIT	QUANTITY	S.N. 016-2272	
28000250	TEMPORARY EROSION CONTROL SEEDING	POUND	113	113	
28000305	TEMPORARY DITCH CHECKS	FOOT	240	240	
28000400	PERIMETER EROSION BARRIER	FOOT	110	110	
28000510	INLET FILTERS	EACH	1	1	
30300112	AGGREGATE SUBGRADE IMPROVEMENT 12"	SQ YD	64	64	
40600275	BITUMINOUS MATERIALS (PRIME COAT)	POUND	144	144	
40600290	BITUMINOUS MATERIALS (TACK COAT)	POUND	86	86	
40603085	HOT-MIX ASPHALT BINDER COURSE, IL-19.0, N70	TON	65	65	
40604062	HOT-MIX ASPHALT SURFACE COURSE, IL-9.5, MIX "D", N70	TON	9	9	
44000100	PAVEMENT REMOVAL	SQ YD	80	80	
48101200	AGGREGATE SHOULDERS, TYPE B	TON	5	5	
48101600	AGGREGATE SHOULDERS, TYPE B 8"	SQ YD	302	302	
50100100	REMOVAL OF EXISTING STRUCTURES	EACH	1	1	
50104400	CONCRETE HEADWALL REMOVAL	EACH	1	1	
	•	<u> </u>			

* DENOTES SPECIAL PROVISION REQUIRED

** DENOTES SPECIALTY ITEM

REV-SEP

STATE OF ILLINOIS
DEPARTMENT OF TRANSPORTATION

SCALE:

147TH ST OVER TRIBUTARY C TO CAL—SAG CHANNEL SUMMARY OF QUANTITIES

SHEET OF SHEETS STA. TO STA.

CONSTR. CODE 80% FED 20% STATE URBAN

				BOX CULVERT
CODE			TOTAL	0010
NO.	ITEM	UNIT	QUANTITY	S.N. 016-2272
50800105	REINFORCEMENT BARS	POUND	4140	4140
51500100	NAME PLATES	EACH	1	1
54003000	CONCRETE BOX CULVERTS	CU YD	20.4	20.4
54010603	PRECAST CONCRETE BOX CULVERTS 6' X 3'	FOOT	36	36
54213660	PRECAST REINFORCED CONCRETE FLARED END SECTIONS 15"	EACH	1	1
550A0360	STORM SEWERS, CLASS A, TYPE 2 15"	FOOT	108	108
55100700	STORM SEWER REMOVAL 15"	FOOT	117	117
59100100	GEOCOMPOSITE WALL DRAIN	SQ YD	51	51
63200310	GUARDRAIL REMOVAL	FOOT	383	383
67000400	ENGINEER'S FIELD OFFICE, TYPE A	CAL MO	6	6
67100100	MOBILIZATION	L SUM	1	1
	4			
78000200	THERMOPLASTIC PAVEMENT MARKING - LINE 4"	FOOT	100	100
70405 **	1			
78100100	RAISED REFLECTIVE PAVEMENT MARKER	EACH	4	4
7920000	PAIGED BEELFOTY PAYEMENT MARKET THE PAYEMENT MARKET	F10::		4
78300200	RAISED REFLECTIVE PAVEMENT MARKER REMOVAL	EACH	4	4

* DENOTES SPECIAL PROVISION REQUIRED

** DENOTES SPECIALTY ITEM

USER NAME = RGall DESIGNED - RAG REVISED -DRAWN - CS REVISED -REVISED -PLOT SCALE = 100.0000 ' / in. CHECKED - JH PLOT DATE = 3/17/2020 DATE - 11/8/19 REVISED -

STATE OF ILLINOIS **DEPARTMENT OF TRANSPORTATION**

SCALE:

147TH ST OVER TRIBUTARY C TO CAL-SAG CHANNEL SUMMARY OF QUANTITIES SHEET OF SHEETS STA. TO STA.

REV-SEP

COUNTY TOTAL SHEET NO.

COOK 45 5 SECTION 1602 2019-051-T CONTRACT NO. 62J28

80% FED 20% STATE

		T			20/0 31A1L
				URBAN	BOX CULVERT
	CODE			TOTAL	0010
	NO.	ITEM	UNIT	QUANTITY	S.N. 016-2272
**	A2000216	TREE, ACER X FREEMANII MARMO (MARMO FREEMAN MAPLE), 2" CALIPER, BALLED AND BURLAPPED	EACH	3	3
**	A2002916	TREE, CELTIS OCCIDENTALIS (COMMON HACKBERRY), 2" CALIPER, BALLED AND BURLAPPED	EACH	4	4
**	A2C022G3	TREE, CARYA ILLINOENSIS (PECAN), CONTAINER GROWN, 3-GALLON	EACH	10	10
		TREE, CELTIS OCCIDENTALIS (COMMON HACKBERRY), CONTAINER GROWN,			
**	A2C026G3	3-GALLON	EACH	10	10
		TREE, PLATANUS OCCIDENTALIS (SYCAMORE), CONTAINER GROWN, 3-			
**	A2C040G3	GALLON	EACH	10	10
		TREE, QUERCUS MACROCARPA (BURR OAK), CONTAINER GROWN, 3-			
**	A2C056G3	GALLON	EACH	10	10
**	A2C060G3	TREE, QUERCUS PALUSTRIS (PIN OAK), CONTAINER GROWN, 3-GALLON	EACH	10	10
		TREE, AMELANCHIER CANADENSIS (SHADBLOW SERVICEBERRY), 5'			
**	B2000564	HEIGHT, SHRUB FORM, BALLED AND BURLAPPED	EACH	15	15
**	D0004004	TREE, BETULA NIGRA LITTLE KING (FOX VALLEY RIVER BIRCH), 5' HEIGHT,	F4011	45	45
	B2001064	CLUMP FORM, BALLED AND BURLAPPED	EACH	15	15
**	C2002736	SHRUB, EUONYMUS ATROPURPUREA (EASTERN WAHOO), 3' HEIGHT,	EACH	10	10
	02002700	BALLED AND BURLAPPED	27.011	10	10
*	K0029614	WEED CONTROL, AQUATIC	GALLON	1	1
**					
*	K0029634	WEED CONTROL, PRE-EMERGENT GRANULAR HERBICIDE	POUND	5	5
*	X0326806	WASHOUT BASIN	L SUM	1	1
*	X0900064	MEMBRANE WATERPROOFING SYSTEM FOR BURIED STRUCTURES	SQ YD	51	51
		·			

* DENOTES SPECIAL PROVISION REQUIRED

** DENOTES SPECIALTY ITEM

REV-SEP

STATE OF ILLINOIS
DEPARTMENT OF TRANSPORTATION

147TH ST OVER TRIBUTARY C TO CAL—SAG CHANNEL SUMMARY OF QUANTITIES

SHEET OF SHEETS STA. TO STA.

 F.A.U. RTE.
 SECTION
 COUNTY
 TOTAL SHEETS
 SHEETS NO.

 1602
 2019-051-T
 COOK
 45
 6

 CONTRACT
 NO.
 62J28

Deravit ME: Z.\17002.22 IDOT D1 PTB 181-04 WO22 147th CulvertIDGN/Design/Prellm/Plotsheets/D162/28-sht-9 CODE

NO.

X0900075

X2503110

X2511630

X7010216

Z0005300

Z0013798

Z0030850

Z0064800

Z0073510

66900200

66900530

66901001

66901003

66901006

*

ITEM

COFFERDAM (TYPE 1) (IN-STREAM/WETLAND WORK)

EROSION CONTROL BLANKET (SPECIAL)

BOX CULVERTS TO BE CLEANED

TEMPORARY INFORMATION SIGNING

TEMPORARY TRAFFIC SIGNAL TIMING

REGULATED SUBSTANCES PRE-CONSTRUCTION PLAN

REGULATED SUBSTANCES FINAL CONSTRUCTION REPORT

REGULATED SUBSTANCES MONITORING

NON-SPECIAL WASTE DISPOSAL

SOIL DISPOSAL ANALYSIS

CONSTRUCTION LAYOUT

SELECTIVE CLEARING

TRAFFIC CONTROL AND PROTECTION, (SPECIAL)

MOWING (SPECIAL)

STATE OF ILLINOIS DEPARTMENT OF TRANSPORTATION

80% FED 20% STATE

0010

0.50

3615

1

1

1

51.4

20

160

2

1

10

URBAN BOX CULVERT

QUANTITY S.N. 016-2272

TOTAL

0.50

3615

51.4

20

160

2

1

10

UNIT

EACH

ACRE

SQ YD

L SUM

EACH

L SUM

SQ FT

UNIT

CUYD

EACH

LSUM

LSUM

DAYS

	147TH	ST O	/ER TRIBUT/	ARY C	TO CAL-	SAG CHANNEL	
SUMMARY OF QUANTITIES							
SCALE:		SHEET	OF	SHEETS	STA.	TO STA.	


DLINO	TES STECTALTT IT		REV-	-SEP				
F.A.U. RTE.	SECTION	COUNTY	TOTAL SHEETS	SHEET NO.				
1602	2019-051-T	соок	45	7				
		CONTRACT	NO. 62	2J28				
	ILLINOIS FED. AID PROJECT							

NON-P	AKI.	100%	SIAI	E	

* DENOTES SPECIAL PROVISION REQUIRED


** DENOTES SPECIALTY ITEM

DENOTES STECTAL TROVISION REQUIRE

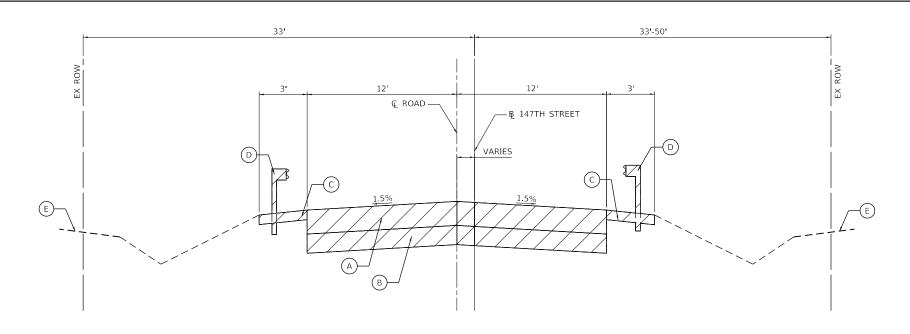

EXISTING TYPICAL SECTION 147TH STREET

STA. 520+60.00 TO STA. 520+90.00

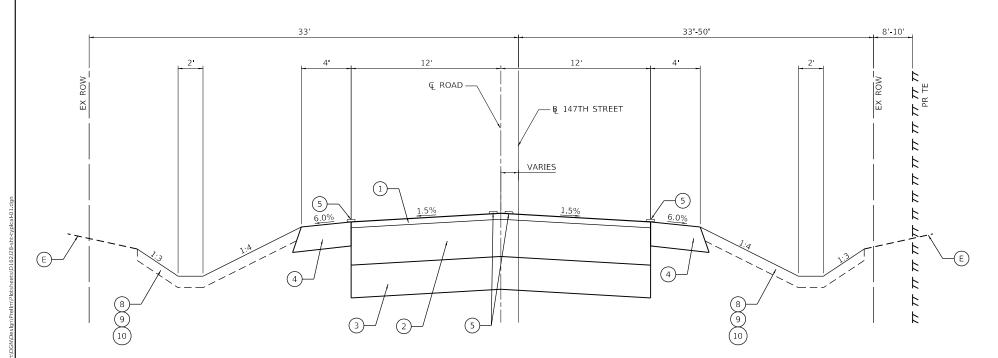

PROPOSED TYPICAL SECTION 147TH STREET

STA. 520+60.00 TO STA. 520+71.42 STA. 520+78.58 TO STA. 520+90.00

STATE OF ILLINOIS DEPARTMENT OF TRANSPORTATION

SCALE:

147TH ST OVER TRIBUTARY C TO CAL—SAG CHANNEL TYPICAL SECTIONS SHEET OF SHEETS STA. TO STA.

EXISTING LEGEND

- (A) EXISTING HMA PAVEMENT, 8 1/2" *
- B EXISTING CONCRETE BASE COURSE, 4" *
- (C) EXISTING AGGREGATE SHOULDER
- D EXISTING GUARDRAIL
- E EXISTING GROUND

DENOTES REMOVAL ITEM

PROPOSED LEGEND

- 1) HOT-MIX ASPHALT SURFACE COURSE, MIX "D", IL-9.5, N70, 2"
- (2) HOT-MIX ASPHALT BINDER COURSE, IL-19.0, N70 **
- 3) AGGREGATE SUBGRADE IMPROVEMENT 12" ***
- 4) AGGREGATE SHOULDERS TYPE B, 8" ****
- (5) THERMOPLASTIC PAVEMENT MARKING LINE 4"
- (6) PROPOSED HEADWALL (SEE STRUCTURAL PLANS FOR CULVERT)
- 7) PROPOSED CULVERT (SEE STRUCTURAL PLANS FOR CULVERT)
- 8 EROSION CONTROL BLANKET (SPECIAL)
- (9) SEEDING CLASS 2A
- (10) TOPSOIL FURNISH AND PLACE, 4"
- (11) SEEDING CLASS 4B
- 12) SEEDING CLASS 5B

MIXTURE REQUIREMENTS


MIXTURE TYPE	AIR VOIDS @ NDES	QMP				
PROPOSED PAVEMENT						
HOT-MIX ASPHALT SURFACE COURSE, MIX "D", IL-9.5, N70, 2"	4% @ 70 GYR	QC/QA				
HOT-MIX ASPHALT BINDER COURSE, IL-19.0, N70, 16 1/4" (VARIES) **	4% @ 70 GYR	QC/QA				
ONE DESCRIPTION OF THE CONTROL OF TH						


QMP DESIGNATION: QUALITY CONTROL/QUALITY ASSURANCE (QC/QA); QUALITY CONTROL FOR PERFORMANCE (QCP); PAY FOR PERFORMANCE (PFP)

NOTES

- THE UNIT WEIGHT USED TO CALCULATE ALL HOT-MIX ASPHALT SURFACE MIXTURE QUANTITIES IS 112 LB/SY/IN.
- 2. THE "AC TYPE" FOR POLYMERIZED HMA MIXES SHALL BE "SBS/SBR PG 76-22" AND FOR NON-POLYMERIZED HMA THE "AC TYPE" SHALL BE "PG 64-22" UNLESS MODIFIED BY DISTRICT ONE SPECIAL PROVISIONS.
- 3. FOR USE OF RECYCLED MATERIALS SEE SPECIAL PROVISIONS.
- QUALITY MANAGEMENT PROGRAM (QMP) IDENTIFIES THE PARTICULAR QUALITY CONTROL SPECIFICATION THAT APPLIES TO THE HMA MIXTURE.
- * SEE SOIL BORING LOGS FOR EXISTING PAVEMENT THICKNESS.
- ** DEPTH OF HMA BINDER COURSE PLACED OVER CULVERT VARIES FROM 6" MAX. AT CENTER OF CULVERT TO 4" MIN. AT EDGE OF PAVEMENT. DEPTH OF HMA BINDER COURSE AT ALL OTHER LOCATIONS SHALL BE 16 1/4".
- *** AGGREGATE SUBGRADE IMPROVEMENT 12" NOT PLACED OVER CULVERT.
- AGGREGATE SHOULDER OVER CULVERT VARIES FROM 6" MAX. AT EDGE OF PAVEMENT TO 5" MIN. AT EDGE OF SHOULDER. DEPTH OF AGGREGATE SHOULDER AT ALL OTHER LOCATIONS SHALL BE 8".

10DEL: Default

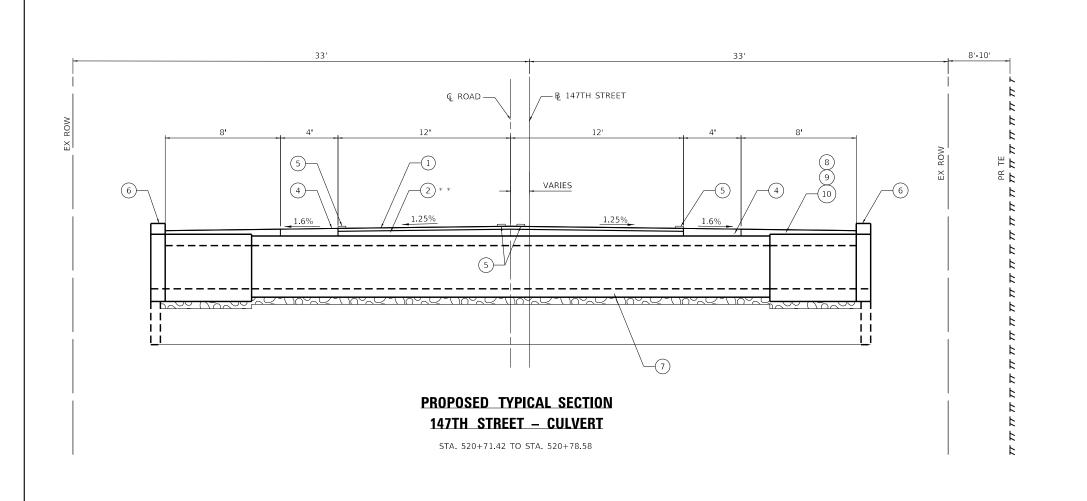

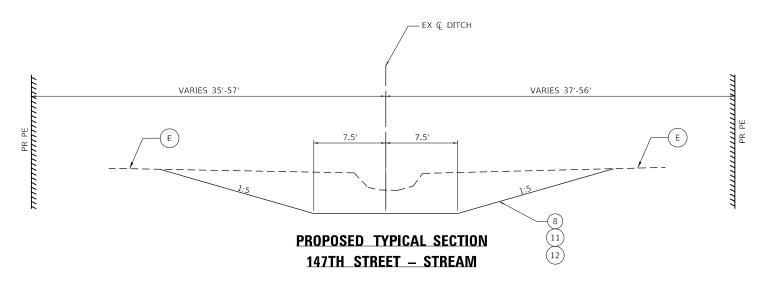

(LOOKING NORTH) STA. 10+26.50 TO STA. 12+02.79

EXISTING LEGEND

- (A) EXISTING HMA PAVEMENT, 8 1/2" *
- (B) EXISTING CONCRETE BASE COURSE, 4" *
- (C) EXISTING AGGREGATE SHOULDER
- (D) EXISTING GUARDRAIL
- (E) EXISTING GROUND

DENOTES REMOVAL ITEM

PROPOSED LEGEND

- 1) HOT-MIX ASPHALT SURFACE COURSE, MIX "D", IL-9.5, N70, 2"
- (2) HOT-MIX ASPHALT BINDER COURSE, IL-19.0, N70 **
- 3) AGGREGATE SUBGRADE IMPROVEMENT 12" ***
- 4 AGGREGATE SHOULDERS TYPE B ****
- 5 THERMOPLASTIC PAVEMENT MARKING LINE 4"
- (6) PROPOSED HEADWALL (SEE STRUCTURAL PLANS FOR CULVERT)
- 7) PROPOSED CULVERT (SEE STRUCTURAL PLANS FOR CULVERT)
- 8 EROSION CONTROL BLANKET (SPECIAL)
- 9) SEEDING CLASS 2A
- 0) TOPSOIL FURNISH AND PLACE, 4"
- 11) SEEDING CLASS 4B
- (12) SEEDING CLASS 5B
- * SEE SOIL BORING LOGS FOR EXISTING PAVEMENT THICKNESS.
- ** DEPTH OF HMA BINDER COURSE PLACED OVER CULVERT VARIES FROM 6* MAX. AT CENTER OF CULVERT TO 4" MIN. AT EDGE OF PAVEMENT. DEPTH OF HMA BINDER COURSE AT ALL OTHER LOCATIONS SHALL BE 16 1/4".
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USER NAME = RGall	DESIGNED	-	RAG	REVISED -
	DRAWN	-	CS	REVISED -
PLOT SCALE = 100.0000 ' / in.	CHECKED	-	JH	REVISED -
PLOT DATE = 3/17/2020	DATE	_	11/8/19	REVISED -

STATE OF ILLINOIS
DEPARTMENT OF TRANSPORTATION

SCALE:

147TH ST OVER TRIBUTARY C TO CAL-SAG CHANNEL
TYPICAL SECTIONS

SHEET OF SHEETS STA. TO STA.

TREE REMOVAL SCHEDULE									
ROUTE	STATION	OFFSET	MS DIAMETER (INCH)	20100110 TREE REMOVAL (6 TO 15 UNITS DIAMETER) (UNIT)	20100210 TREE REMOVAL (OVER 15 UNITS DIAMETER) (UNIT)				
147TH ST	519+29.04	18.89' RT	· · · · · · · · · · · · · · · · · · ·	12					
147TH ST	519+30.35	24.37' LT	MS(10, 9.5, 7, 6.5, 6.5)	39					
147th ST	519+48.80	23.52' RT	MS (17, 13)	13	17				
147th ST	519+60.06	17.40' RT	MS (15, 9, 3, 3)	30					
147th ST	519+62.06	23.45' LT	MS(12, 8.5, 8, 7, 6.5, 5)	42					
147th ST	519+83.58	15.11' RT	MS (7, 6, 5)	18					
147th ST	520+19.12	174.53' LT	MS(6, 5, 4, 3)						
147th ST	520+21.93	17.08' RT	MS (12, 6, 5)	23					
147th ST	520+29.37	165.76' LT	(, -, -,	11					
147th ST	520+31.89	17.81' RT	MS (12, 9, 6, 4)	31					
147th ST	520+33.25	14.83' RT	(, -, -, -,	8					
147th ST	520+37.61	21.94' RT	MS (8, 8, 7, 4, 3)	23					
147th ST	520+37.97	151.00' LT	(5, 5, 1, 1, 5,	12					
147th ST	520+39.82	155.33' LT	MS(7, 6)	13					
147th ST	520+40.77	168.64' LT	(., -,	9					
147th ST	520+42.56	149.75' LT		7					
147th ST	520+48.43	18.13' RT	MS (6, 4)	6					
147th ST	520+49.00	16.71' RT	MS(18, 7)	7	18				
147th ST	520+52.47	166.19' LT	(==, -,	6					
147th ST	520+58.67	21.95' RT	MS(8, 4)	8					
147th ST	520+59.90	13.31' RT	(-) (-)	6					
147th ST	520+61.68	42.55' LT	MS(19, 6)	6	19				
147th ST	520+62.42	46.44' LT	MS(7.5, 5.5)	13					
147th ST	520+62.45	16.02' RT	MS(11, 4)	15					
147th ST	520+62.74	92.16' LT	. , ,						
147th ST	520+62.90	21.42' RT		9					
147th ST	520+63.19	32.23' LT	MS(8, 7)	15					
147th ST	520+64.74	135.09' LT	MS(6, 5)	6					
147th ST	520+70.18	24.54' RT		11					
147th ST	520+71.16	129.44' LT		12					
147th ST	520+75.40	124.19' LT		10					
147th ST	520+75.99	34.44' LT		15					
147th ST	520+76.70	140.69' LT		8					
147th ST	520+77.78	31.76' RT	MS(11, 10)	21					
147th ST	520+79.06	75.12' LT	, , ,		20				
147th ST	520+79.45	33.97' LT			16				
147th ST	520+79.45	88.47' LT			18				
147th ST	520+86.99	33.04' RT	MS(16, 14, 7)	21	16				
147th ST			. , , ,						
147th ST									
147th ST									
147th ST									
147th ST									
147th ST									
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PLOT SCALE = 100.0000 ' / in.	CHECKED - JH	REVISED -	
PLOT DATE = 3/17/2020	DATE - 11/8/19	REVISED -	

EARTHWORK SCHEDULE							
ROUTE	EARTH EXCAVATION (CU YD)	UNSUITABLE MATERIAL (CU YD)	EXCAVATION TO BE USED IN EMBANKMENT (15% SHRINKAGE) (CU YD)	EMBANKMENT (CU YD)	EARTHWORK BALANCE WASTE (+) OR SHORTAGE (-) (CU YD)		
147TH	150	130	128	110	18		
DITCH	305	105	260	0	260		
TOTAL	455	235	388	110	278		

A 147TH ST OVER TRIBUTARY C TO CAL—SAG CHANNEL

STATE OF ILLINOIS

DEPARTMENT OF TRANSPORTATION

147TH ST OVER TRIBUTARY C TO CAL—SAG CHANNEL

SCHEDULE OF QUANTITIES


SCHEDULE OF QUANTITIES

SCALE: SHEET OF SHEETS STA. TO STA. TO STA. SECTION COUNTY TOTAL SHEETS NO.


1602 2019-051-T COOK 45 10


CONTRACT NO. 25 11

CONTRACT N

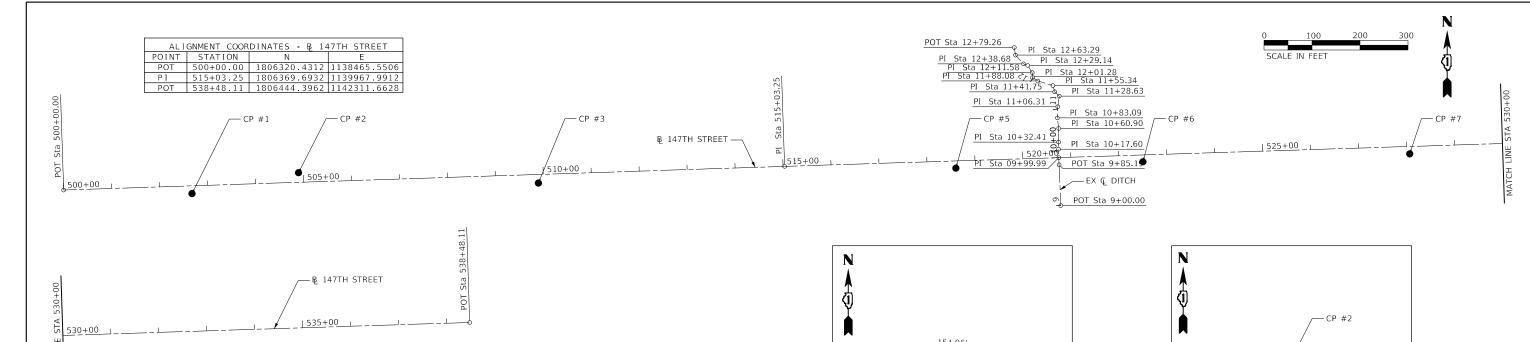

AL I	GNMENT COOR	DINATES - Q DI	ITCH
POINT	STATION	N	E
POT	9+00.00	1806287.9996	1140543.4339
POT	9+85.19	1806373.1226	1140540.0617
PΙ	9+99.99	1806387.9089	1140539.4759
PΙ	10+17.60	1806405.5011	1140538.7175
PΙ	10+32.41	1806420.3120	1140538.8756
PΙ	10+60.90	1806448.8022	1140539.1299
PΙ	10+83.09	1806470.8150	1140536.3302
PΙ	11+06.31	1806494.0208	1140537.2692
PΙ	11+28.63	1806516.1035	1140540.4572
PΙ	11+41.75	1806525.0322	1140530.8442
PΙ	11+55.34	1806538.0764	1140526.9997
PΙ	11+88.08	1806547.6561	1140495.6983
PΙ	12+01.28	1806554.8196	1140484.6083
PΙ	12+11.58	1806565.0875	1140483.8511
PΙ	12+29.14	1806580.0050	1140474.5905
PΙ	12+38.68	1806583.4346	1140465.6880
PΙ	12+63.29	1806601.6258	1140449.0999
POT	12+79.26	1806617.3959	1140446.6175

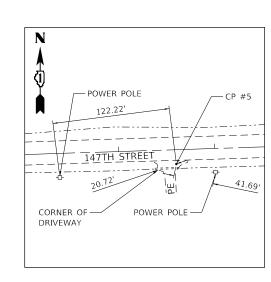

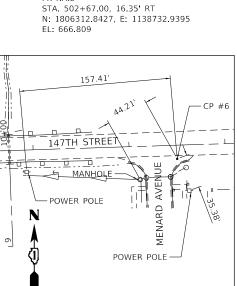


147TH STREET

POWER POLE -

CONTROL POINT #1

- END OF FENCE END OF FENCE

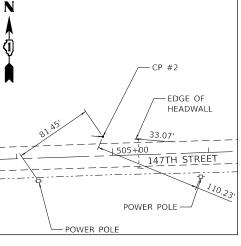

CONTROL POINT #2 IRON ROD W/ CAP STA. 504+90.42, 19.98' LT N: 1806356.4707, E: 1138955.0475 EL: 663.723

147TH STREET MANHOLE CORNER OF SIDEWALK POWER POLE -

CONTROL POINT #3

ADVERTISING SIGN -

LIGHT POLE

_| <u>51</u>0<u>+00</u>

147TH, STREET

POWER POLE

PK NAII STA. 509+89.21, 17.88' RT N: 1806334.9738, E: 1139454.8203 EL: 666.105

CONTROL POINT #5

PK NAII STA. 518+59.71, 14.94 RT N: 1806366.1142, E: 1140324.7493 EL: 662.606

CONTROL POINT #6

STA. 522+49.82, 14.24' RT N: 1806379.2430, E: 1140714.6350 EL: 661.664

SCALE:

147TH


CONTROL POINT #7


PK NAIL STA. 528+06.09, 15.31' RT N: 1806395.8991, E: 1141270.6608 EL: 665.577


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PLOT DATE = 3/17/2020	DATE -	11/8/19	REVISED -


STATE OF ILLINOIS **DEPARTMENT OF TRANSPORTATION**

1	ST OVER TRIBUTARY C TO CAL-SAG CHANNEL		F.A.U. RTE	SECT	ION		COUNTY	TOTAL SHEETS	SHEET NO.			
	ALIGNMENT, TIES, AND BENCHMARK				1602	2019-0)51-T		COOK	45	11	
	ALIGINIVILIVI, IILS, AND BLIVEINMANK							CONTRAC	T NO. 62	2J28		
	SHEET	OF	SHEETS	STA.	TO STA.			ILLINOIS	FED. AI	ID PROJECT		

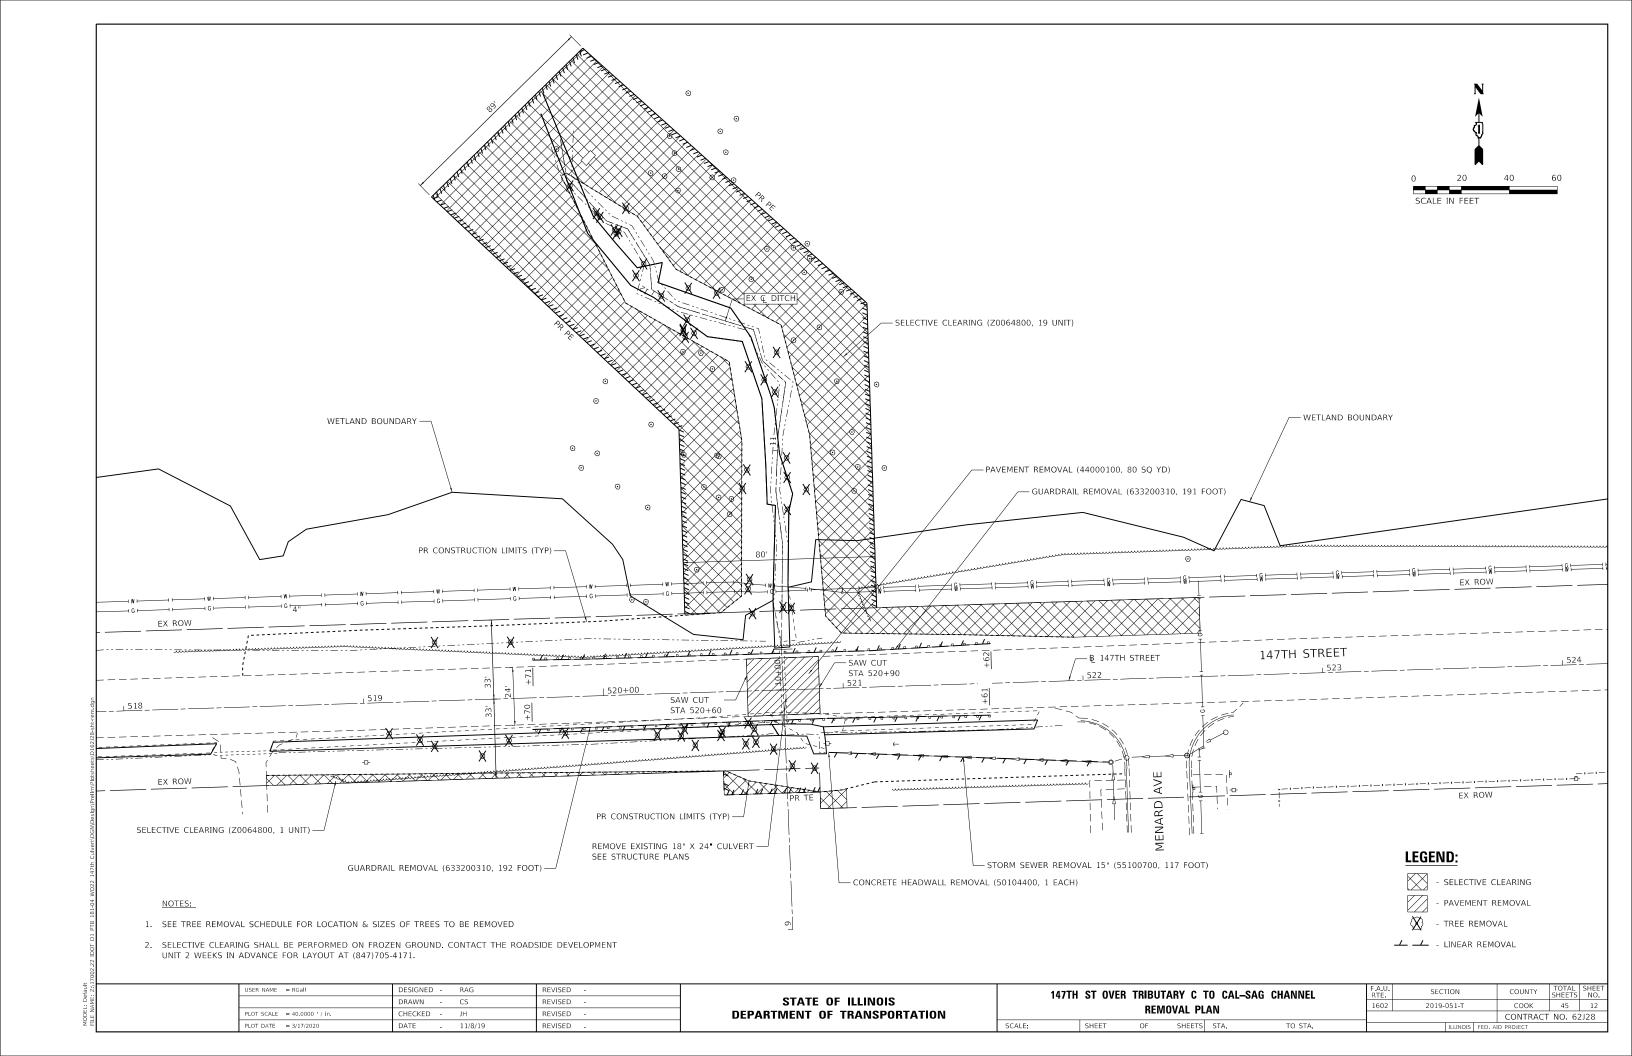

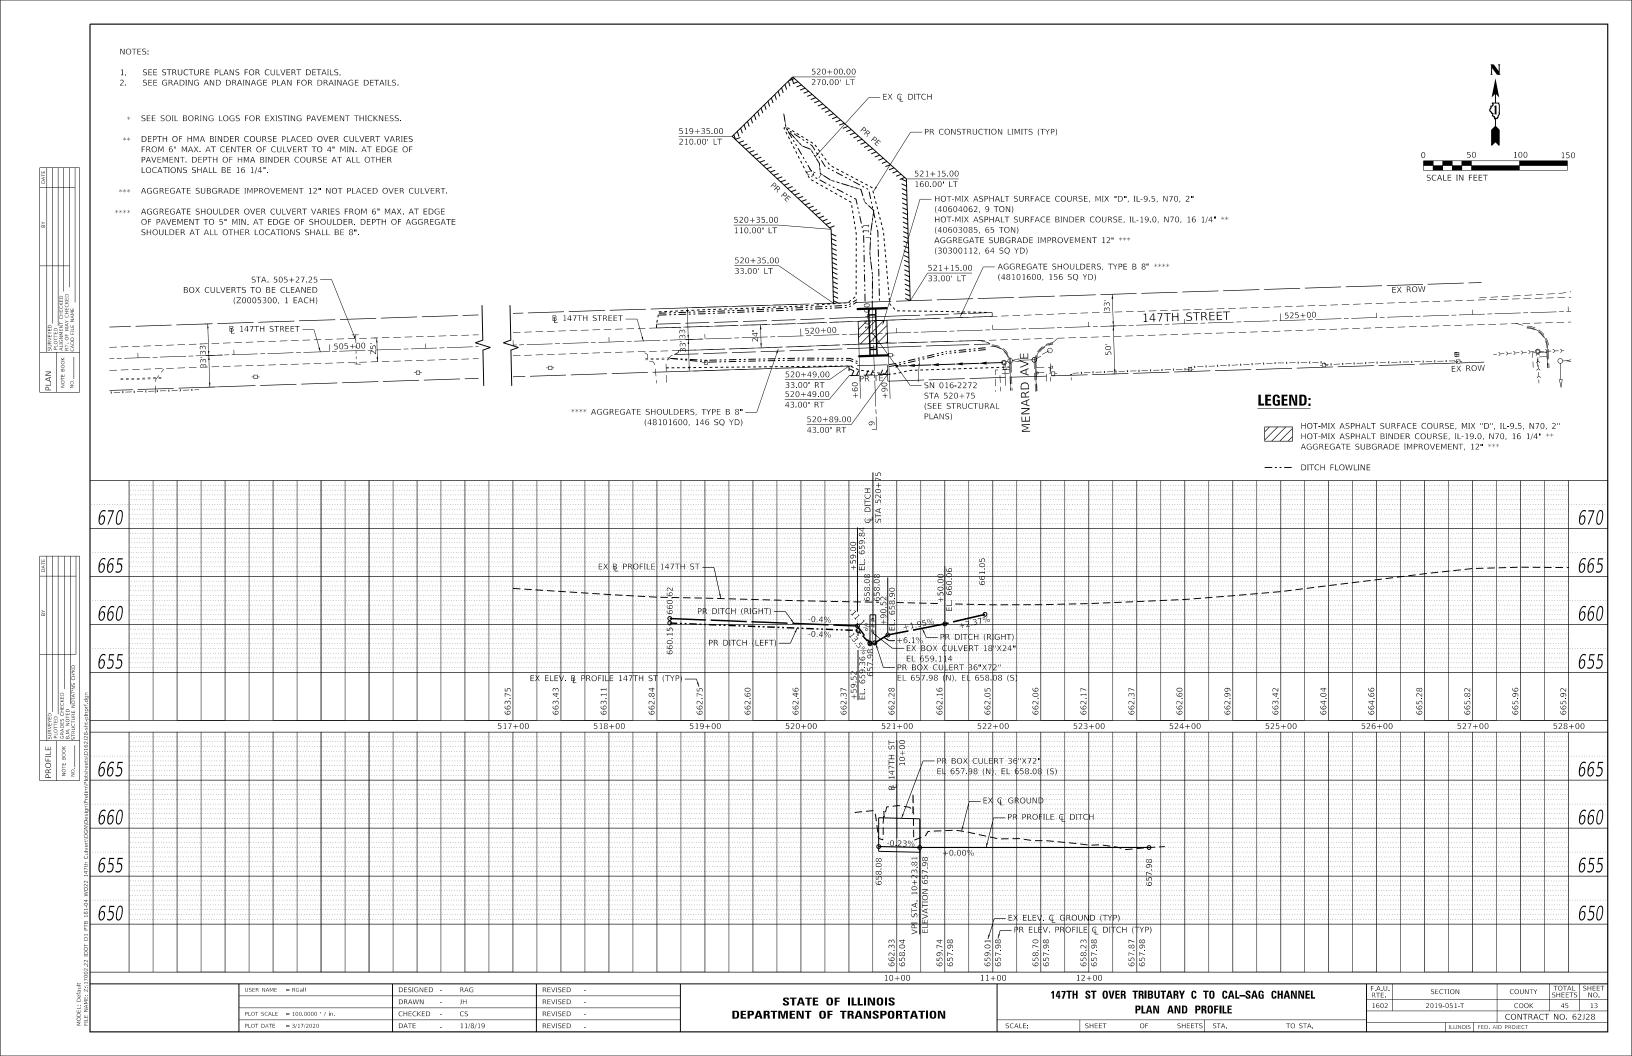

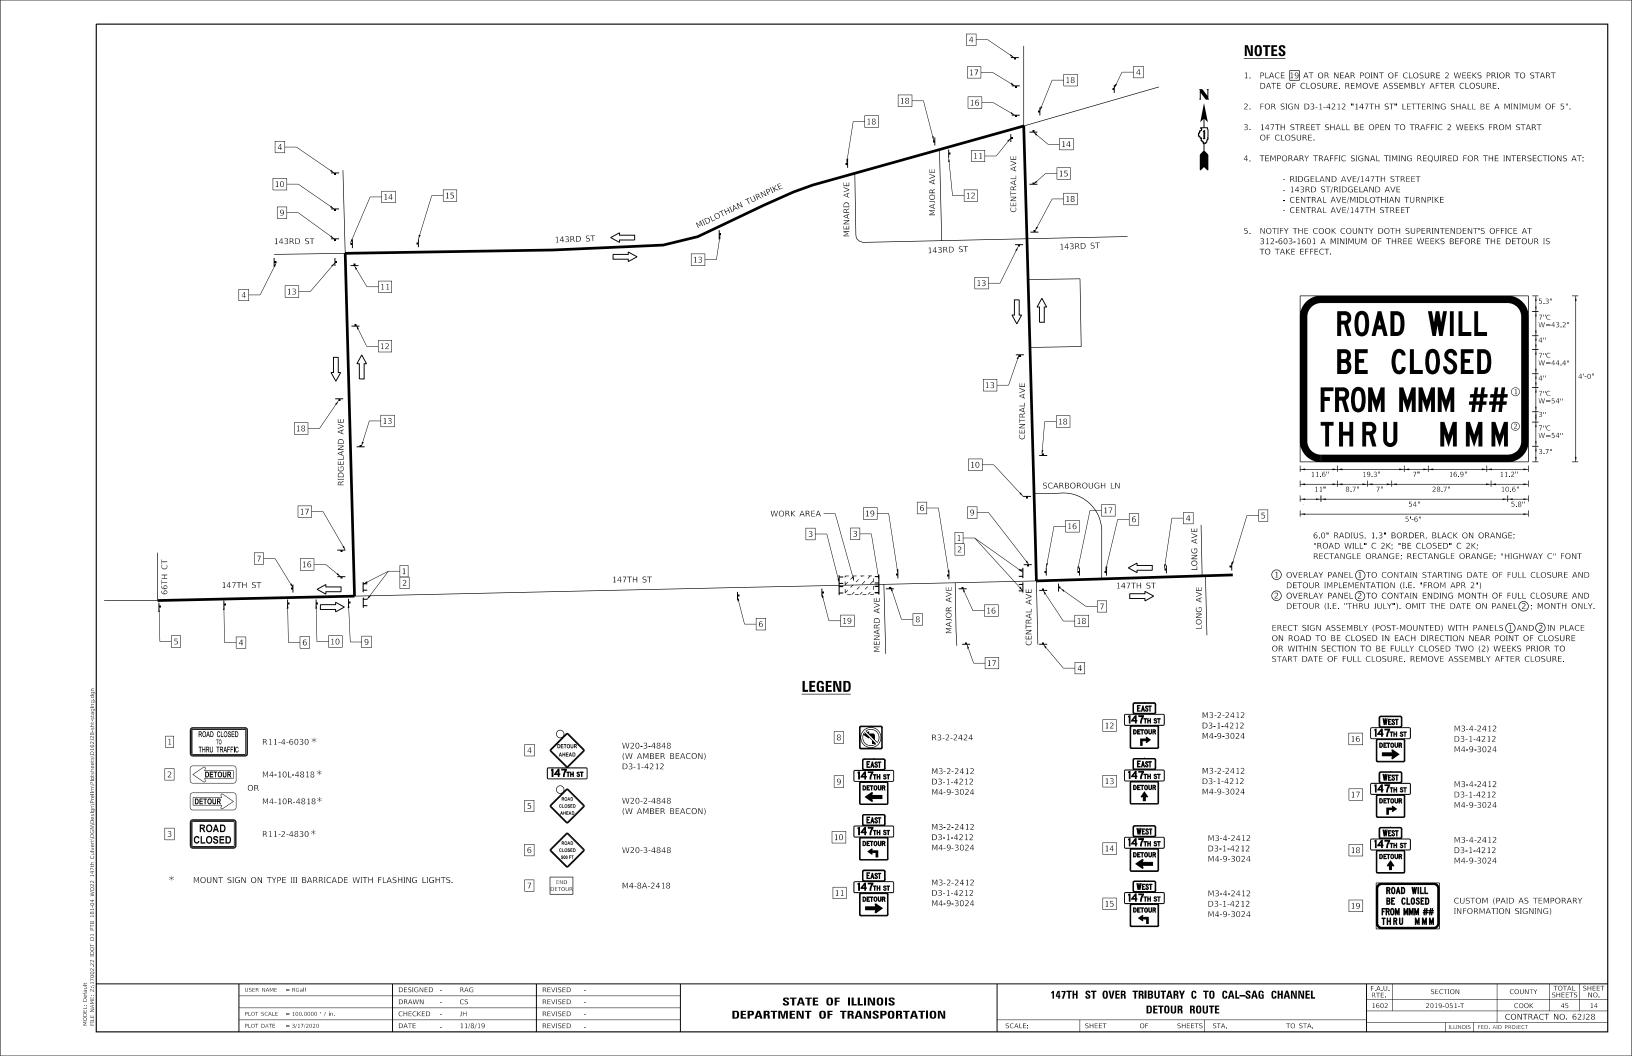

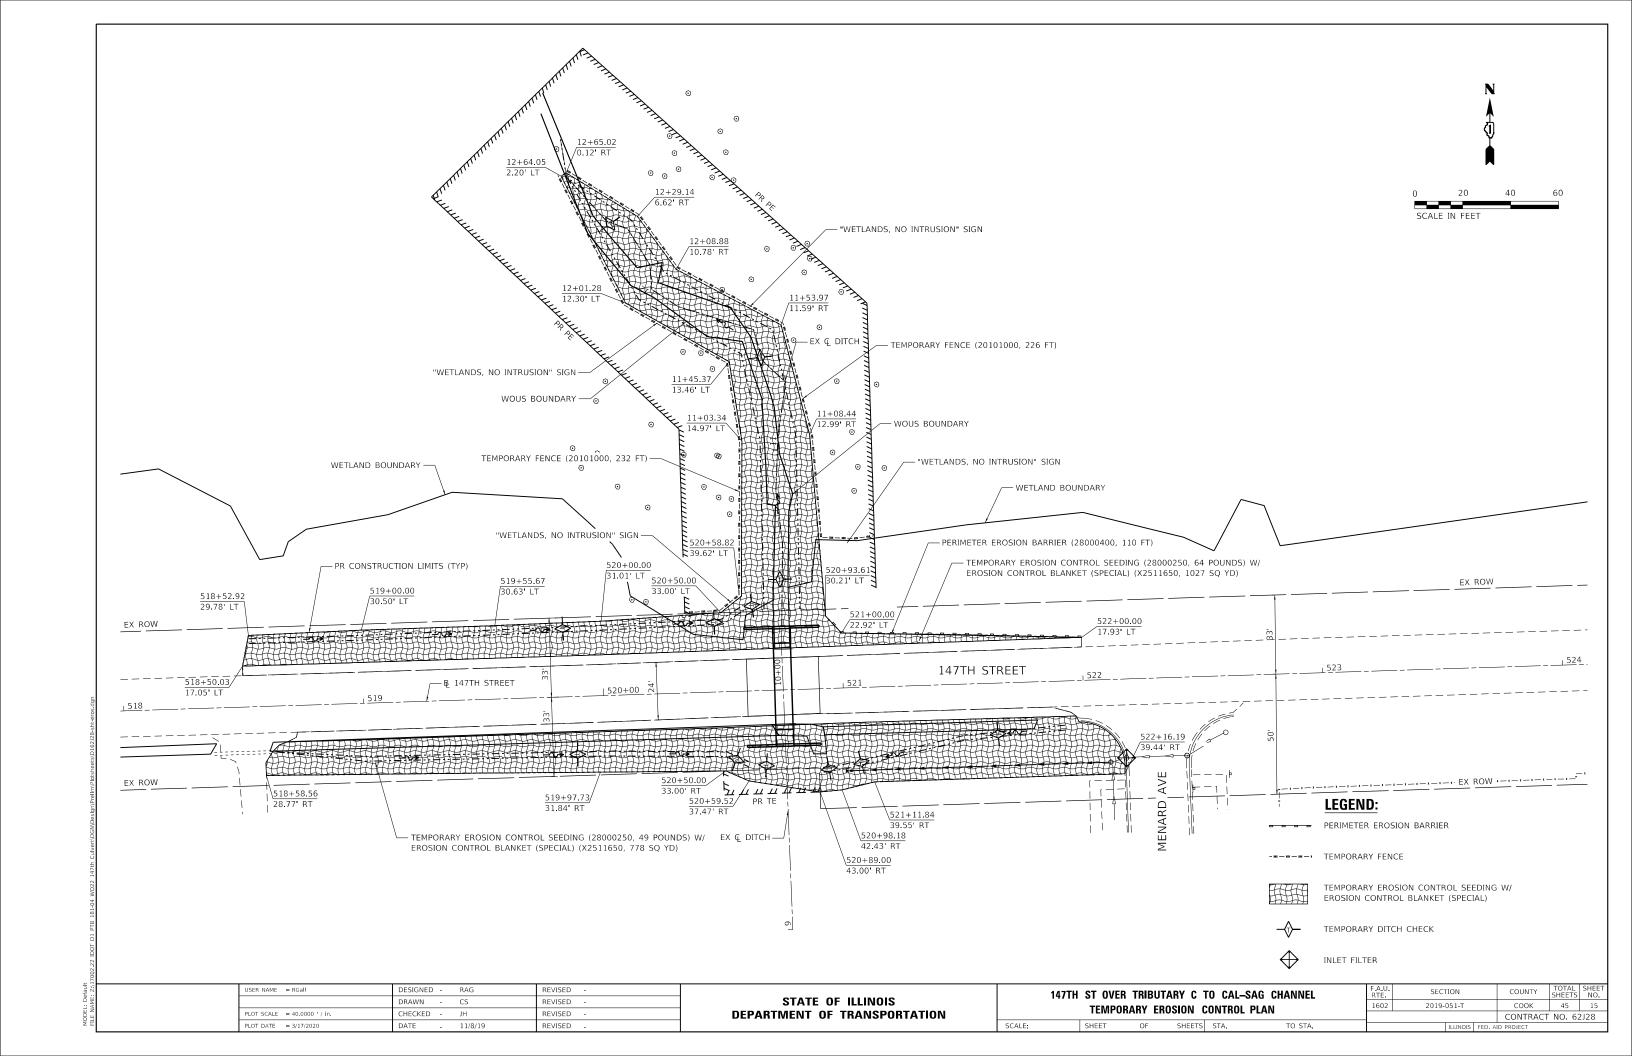


ROLLED EROSION CONTROL PRODUCTS

STAKING PATTERN GUIDE STRAW WATTLE OR ROLLED EXCELSION—IN 3" DEEP TRENCH STAKE WITHIN 2" OF-THE END OF WATTLE -WOOD STAKE OR LESS) Soil Soil

- NOTES:
 1. OVERLAP MINIMUM IS THE DIAMETER OF THE ROLL.
 2. 4' SPACING FOR WATTLES.
 3. 2' SPACING FOR ROLLED EXCELSIOR.

- 4. OR SPACE ACCORDING TO MANUFACTURER'S SPECIFICATIONS.

STAKE DETAIL

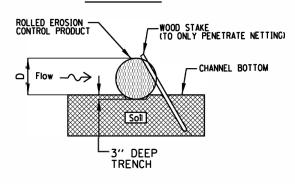


- NOTES:
 1. DRAWINGS ARE NOT TO SCALE.
 2. ENDS OF WATTLES OR ROLLED EXCELSIOR SHALL BE TURNED AT LEAST 6" UPSLOPE.
 3. RECOMMENDED STAKES ARE 1 1/8" WIDE × 1 1/8" THICK × 30" LONG.
 4. STAKES SHALL NOT EXTEND ABOVE THE STRAW WATTLE MORE THAN 2".
 5. SPACING: THE TOE OF THE UPSTREAM DITCH CHECK SHALL CREATE A HORIZONTAL LINE WITH THE TOP OF THE DOWNSTREAM DITCH CHECK.

REFERENCE	
Project	
Designed Dat	:e
Checked Dat	:e
Approved Dat	:e



STANDARD DWG. NO.

IUM-514 SHEET 1 OF 1 DATE 08-2-2019

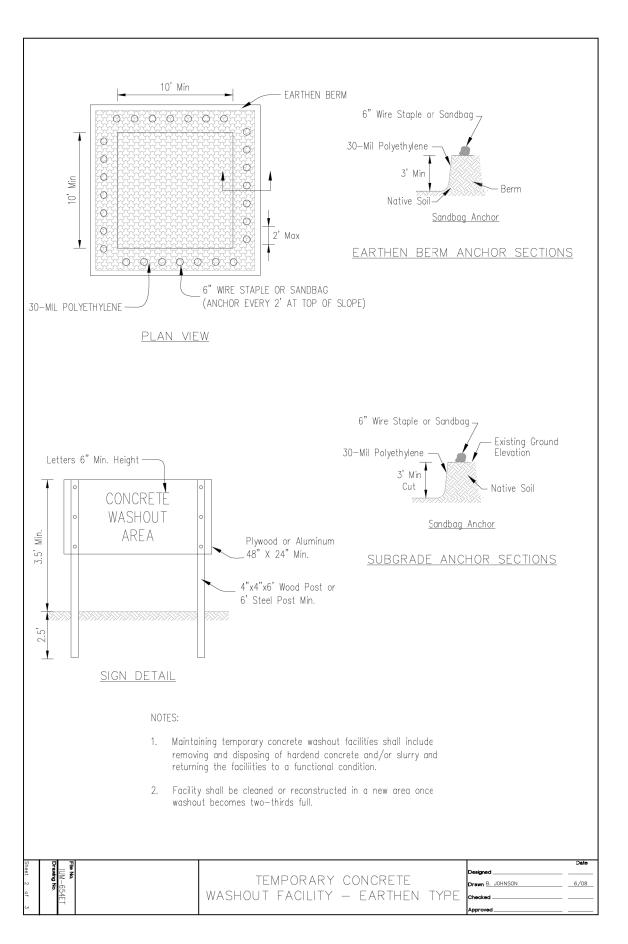


USER NAME = RGall	DESIGNED - RAG	REVISED -
	DRAWN - CS	REVISED -
PLOT SCALE = 100.0000 ' / in.	CHECKED - JH	REVISED -
PLOT DATE = 3/17/2020	DATE - 11/8/19	REVISED -

STATE OF ILLINOIS **DEPARTMENT OF TRANSPORTATION**

SCALE:

SECTION COUNTY 147TH ST OVER TRIBUTARY C TO CAL-SAG CHANNEL 1602 2019-051-T COOK 45 16 **EROSION CONTROL DETAILS** CONTRACT NO. 62J28 SHEETS STA. TO STA.

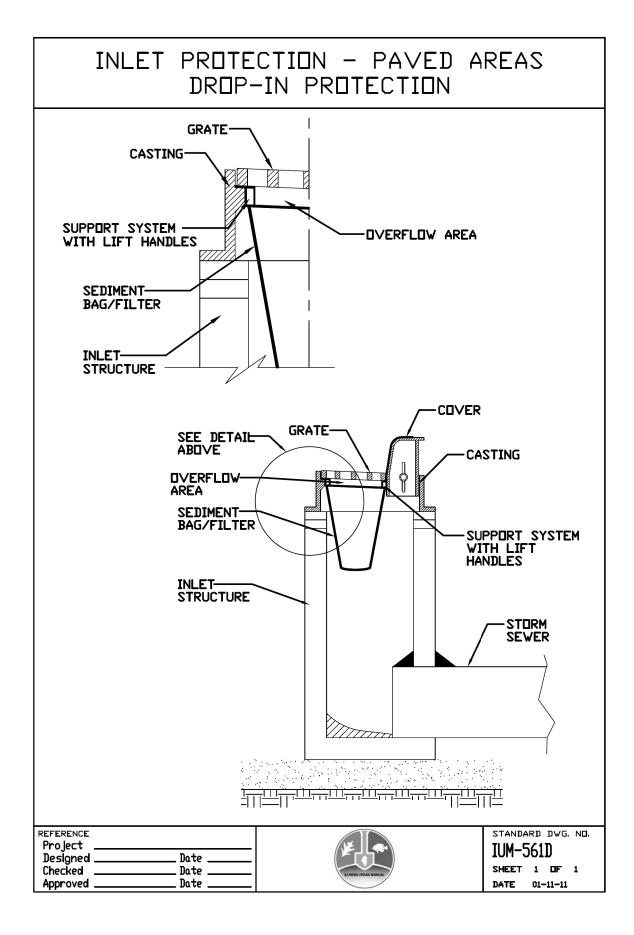

USER NAME = RGall	DESIGNED	-	RAG	REVISED -
	DRAWN	-	CS	REVISED -
PLOT SCALE = 100.0000 / in.	CHECKED	-	JH	REVISED -
PLOT DATE = 3/17/2020	DATE	-	11/8/19	REVISED -

STATE OF ILLINOIS
DEPARTMENT OF TRANSPORTATION


 147TH ST OVER TRIBUTARY C TO CAL—SAG CHANNEL
 FA.U. RTE.
 SECTION
 COUNTY SHEETS NO.
 SHEETS NO.

 EROSION CONTROL DETAILS
 1602
 2019-051-T
 COOK
 45
 17

 SHEET OF SHEETS STA.
 TO STA.
 ILLINOIS FED. ALID PROJECT

OT D1 PTB 181-04 WO22 147th Culvert\DGN\Deslgn\Prellm\Plotsheets

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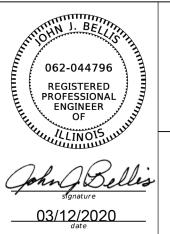


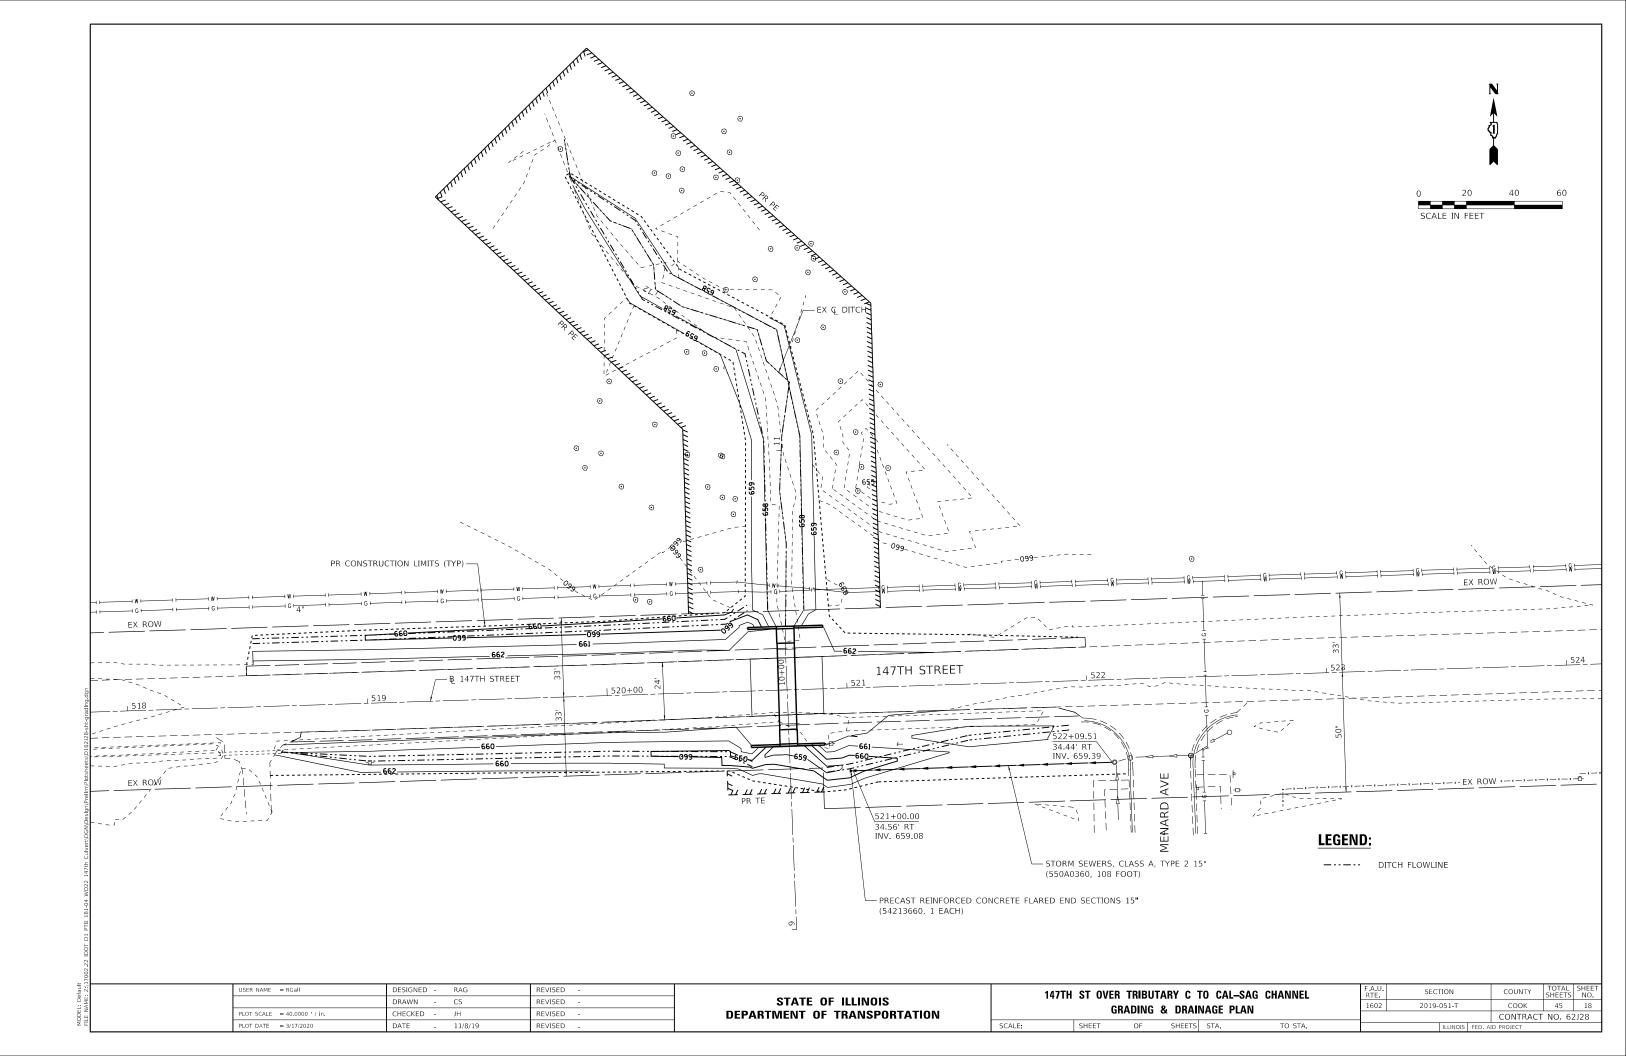THIS INFORMATION TO QUALITY LEVEL D INFORMATION.

INFORMATION DERIVED FROM EXISITNG RECORDS OR ORAL RECOLLECTIONS.

IDOT W.O. 226

ASCE STANDARDS OF DEPICTION **GENERAL NOTES:** UTILITY LEGEND: OF SUBSURFACE UTILITIES QUALITY LEVEL A (QLA) WGI INC. HAS EXERCISED ITS BEST PROFESSIONAL EXPERTISE AND GEOPHYSICAL — △ ——— - AERIAL PROSPECTING TECHNIQUES TO DEVELOP THIS MAPPING OF SUBSURFACE UTILITIES PRECISE HORIZONTAL AND VERTICAL LOCATION OF UTILITIES OBTAINED BY THE ACTUAL EXPOSURE (OR VERIFICATION OF PREVIOUSLY EXPOSED AND - UNKNOWN UTILITY WITHIN THE PROJECT LIMITS. SURVEYED UTILITIES) USING MINIMALLY INTRUSIVE EXCAVATION EQUIPMENT → ○ **├** - *OIL* TO MINIMIZE POTENTIAL FOR UTILITY DAMAGE, AND SUBSEQUENT MEASURMENT WGI INC. DOES NOT GUARANTEE THAT UTILITIES SHOWN COMPRISE ALL CTV --- - CABLE TV OF THE SUBSURFACE UTILITIES WITH OTHER UTILITY ATTRIBUTES SUCH AS UTILITIES WITHIN THE PROJECT AREA. TYPE, SIZE & MATERIAL OF UTILITY. - T ----- - TELEPHONE WGI's FIELD INVESTIGATION WAS PERFORMED ON 02/28/2020. CHANGES TO UTILITIES AFTER 02/28/2020 MAY HAVE BEEN MADE AND THEREFORE MAY RESULT IN VARIANCES FROM THIS PLAN IF DEEMED ADVISABLE PRIOR TO FINAL - GAS QUALITY LEVEL B (QLB) INFORMATION OBTAINED THROUGH THE APPLICATION OF APPROPRIATE — E ——— - ELECTRIC SURFACE GEOPHYSICAL METHODS TO DETERMINE THE EXISTENCE AND APPROXIMATE HORIZONTAL POSITION OF SUBSURFACE UTILTIES. - F - - TRAFFIC SIGNAL/LIGHTING QUALITY LEVEL B DATA SHOULD BE REPRODUCIBLE BY SURFACE GEOPHYSICS AT ANY POINT OF THEIR DEPICTION. THIS INFORMATION IS SURVEYED TO FIELD LOCATED UTILITIES MEET THE FEDERAL HIGHWAY ADMINISTRATION ─ W F - WATER DEFINITION FOR "QUALITY LEVEL B" (QLB) STANDARDS. APPLICABLE TOLERANCES DEFINED BY THE PROJECT AND REDUCED ONTO PLAN DOCUMENTS. -)--)--)--)--)-- - FORCE MAIN UTILITY SIZE AND INFORMATION IS BASED ON BEST AVAILABLE FIELD AND — FO — - FIBER OPTIC QUALITY LEVEL C (QLC) RECORD INFORMATION. - TEST HOLE INFORMATION OBTAINED BY SURVEYING AND PLOTTING VISIBLE ABOVE-GROUND UTLITY FEATURES AND BY USING PROFESSIONAL JUDGEMENT IN CORRELATING SEOI - END OF INFORMATION



license expires 11/30/2021



MENARD



2001 Butterfield Road, Suite 410 Downers Grove, IL 60515 Phone No. (630) 307-3800 Fax No. (630) 307-7030

USER NAME = Erick Maleza	DESIGNED -	REVISED -
	DRAWN - EM	REVISED -
PLOT SCALE = 20,0000 ' / in.	CHECKED - EG	REVISED -
PLOT DATE = 3/12/2020	DATE -	REVISED -

STATE OF ILLINOIS **DEPARTMENT OF TRANSPORTATION**

ED

- ELECTRONIC DEPTH

SCALE:

147th ST. OVER TRIBUTARY C TO CAL-SAG CHANNEL OAK FOREST, ILLINOIS SHEET 1 OF 1 SHEETS STA.

F.A.U. RTE.	SECT	ΓΙΟΝ		COUNTY	TOTAL SHEETS	SHEET NO.
1602	2019-	2019-051-T			45	19
				CONTRACT NO	. 62J28	
		II I INIOIC		ID DOOLECT		


STATE OF ILLINOIS DEPARTMENT OF TRANSPORTATION DIVISION OF HIGHWAYS

PARCEL NUMBER SHEE" PROPERTY ACQUIRED BY CLROBOUSPE OF COOK COUNTY 3, 6, 7 1918 2, 460 96 OLRODOITE HAIHER NARIIN WINTERS 3 18 L 050137

PLAT OF HIGHWAYS

ROUTE: 147TH STREET SECTION COUNTY: COOK LIMITS: TRIBUTARY C CAL—SAG JOB NO.: R—90—018—17



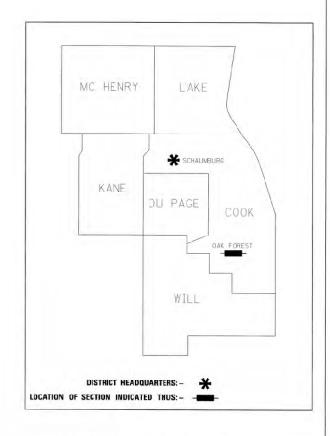

PRINTED BY THE AUTHORITY OF THE STATE OF ILLINOIS

LOCATION MAP


GROSS LENGTH = x.xx FT. = x.xxx MILE NET LENGTH = x.xx FT. = x.xxx MILE IDOT USE ONLY

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	DRAWN - CS	REVISED -	
PLOT SCALE = 2.0000 / in.	CHECKED - JH	REVISED -	
PLOT DATE = 3/17/2020	DATE - 11/8/19	REVISED -	

STATE OF ILLINOIS	
DEPARTMENT OF TRANSPORTATION	

147TH	ST OVER		TARY C TO THE STATE OF HIGH		-SAG CHANNEL
	SHEET	OF	SHEETS	STA.	TO STA.

A.U. RTE	SECTION	COUNTY	TOTAL SHEETS	SHEET NO.					
602	2019-051-T	СООК	45 20						
			CONTRACT NO. 62J28						
ILLINOIS FED AID PROJECT									

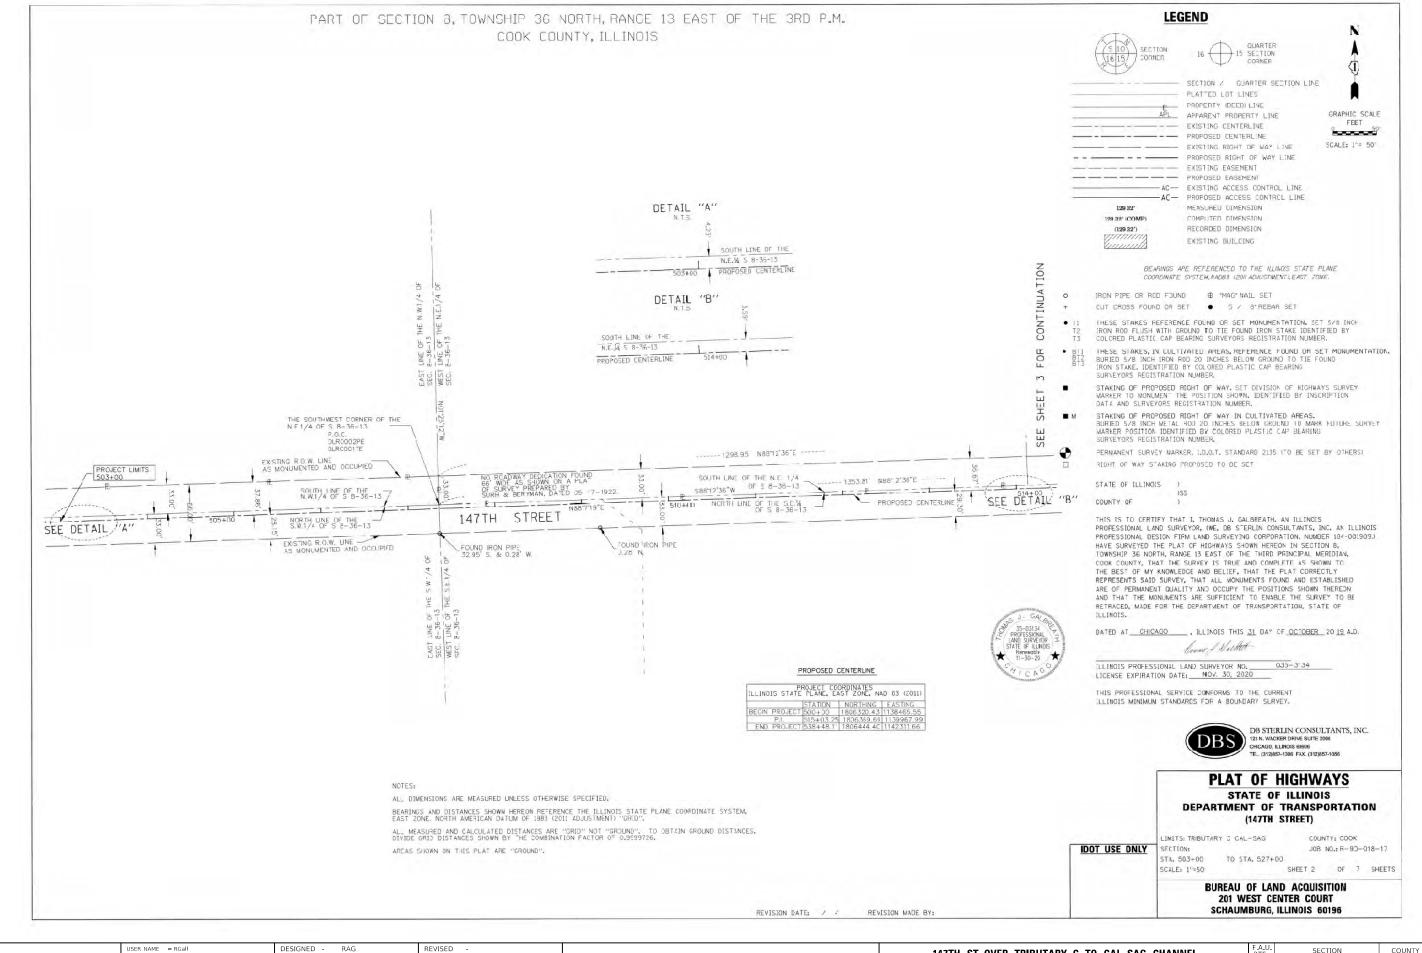

STATE OF ILLINOIS
DEPARTMENT OF TRANSPORTATION


147TH ST OVER TRIBUTARY C TO CAL-SAG CHANNEL
PLAT OF HIGHWAYS

SHEET OF SHEETS STA. TO STA.

 F.A.U. RTE.
 SECTION
 COUNTY
 TOTAL SHEETS
 SHEET NO.

 1602
 2019-051-T
 COOK
 45
 21

 CONTRACT NO. 62J28

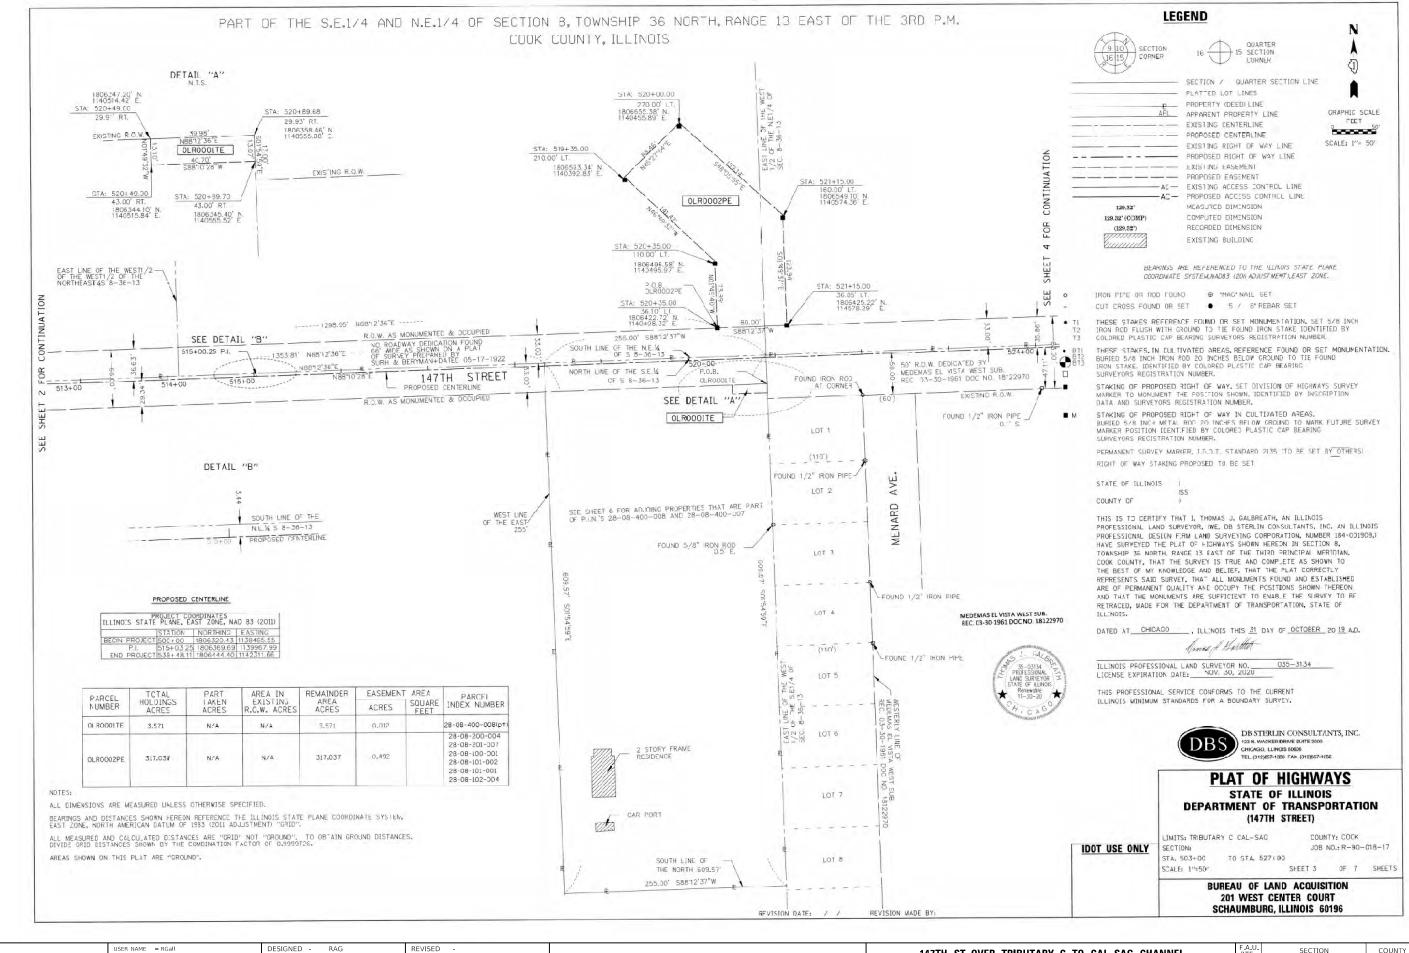

DRAWN - CS REVISED
ALE = 2.0000 ' / in. CHECKED - JH REVISED
TE = 3/17/2020 DATE - 11/8/19 REVISED -


STATE OF ILLINOIS
DEPARTMENT OF TRANSPORTATION

147TH ST OVER TRIBUTARY C TO CAL—SAG CHANNEL PLAT OF HIGHWAYS

 F.A.U. RTE.
 SECTION
 COUNTY
 TOTAL SHEETS NO.

 1602
 2019-051-T
 COOK
 45
 22

 CONTRACT NO. 62J28

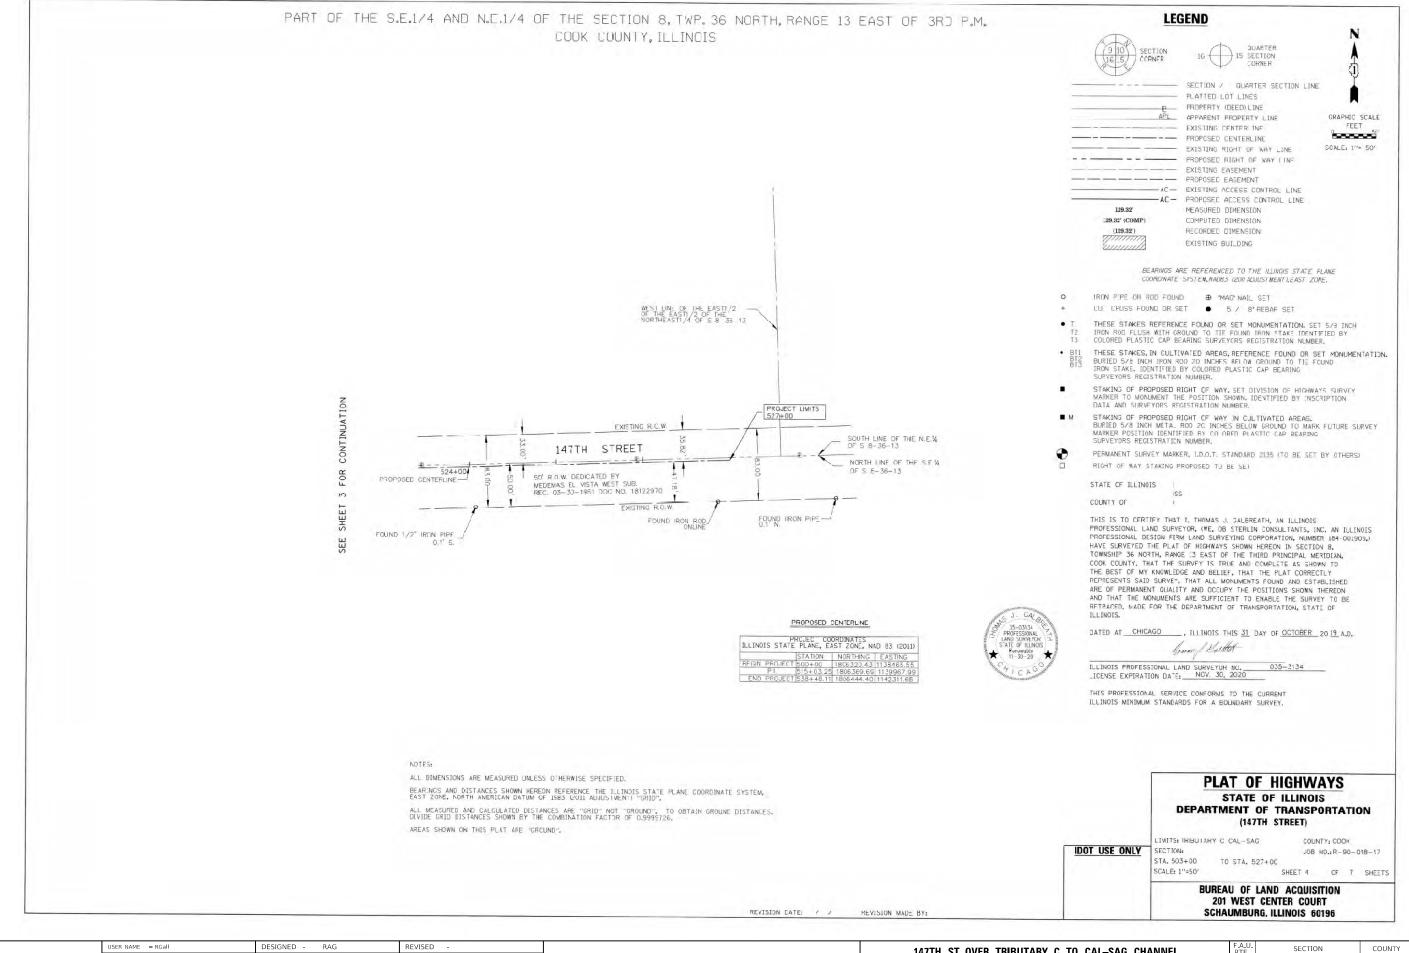

MODEL: Default


| DESIGNED - RAG REVISED - | DRAWN - CS REVISED - | DATE | 3/17/2020 | DATE | 11/8/19 REVISED - | DATE | DATE

STATE OF ILLINOIS
DEPARTMENT OF TRANSPORTATION

147	TH ST OVE		TARY C T OF HIGHV		SAG CHANNEL
	CHEET	0.5	CHEETC	CT.	TO 574
	SHEET	OF	SHEETS	SIA.	TO STA.

SCALE:

F.A.U. RTE	SECT	ΓΙΟΝ		COUNTY	TOTAL SHEETS	SHEET NO.			
1602	2019-	051-T		COOK 45 23					
RTE. SECTION 1602 2019-05				CONTRACT NO. 62J28					
		TI LINIOTE							

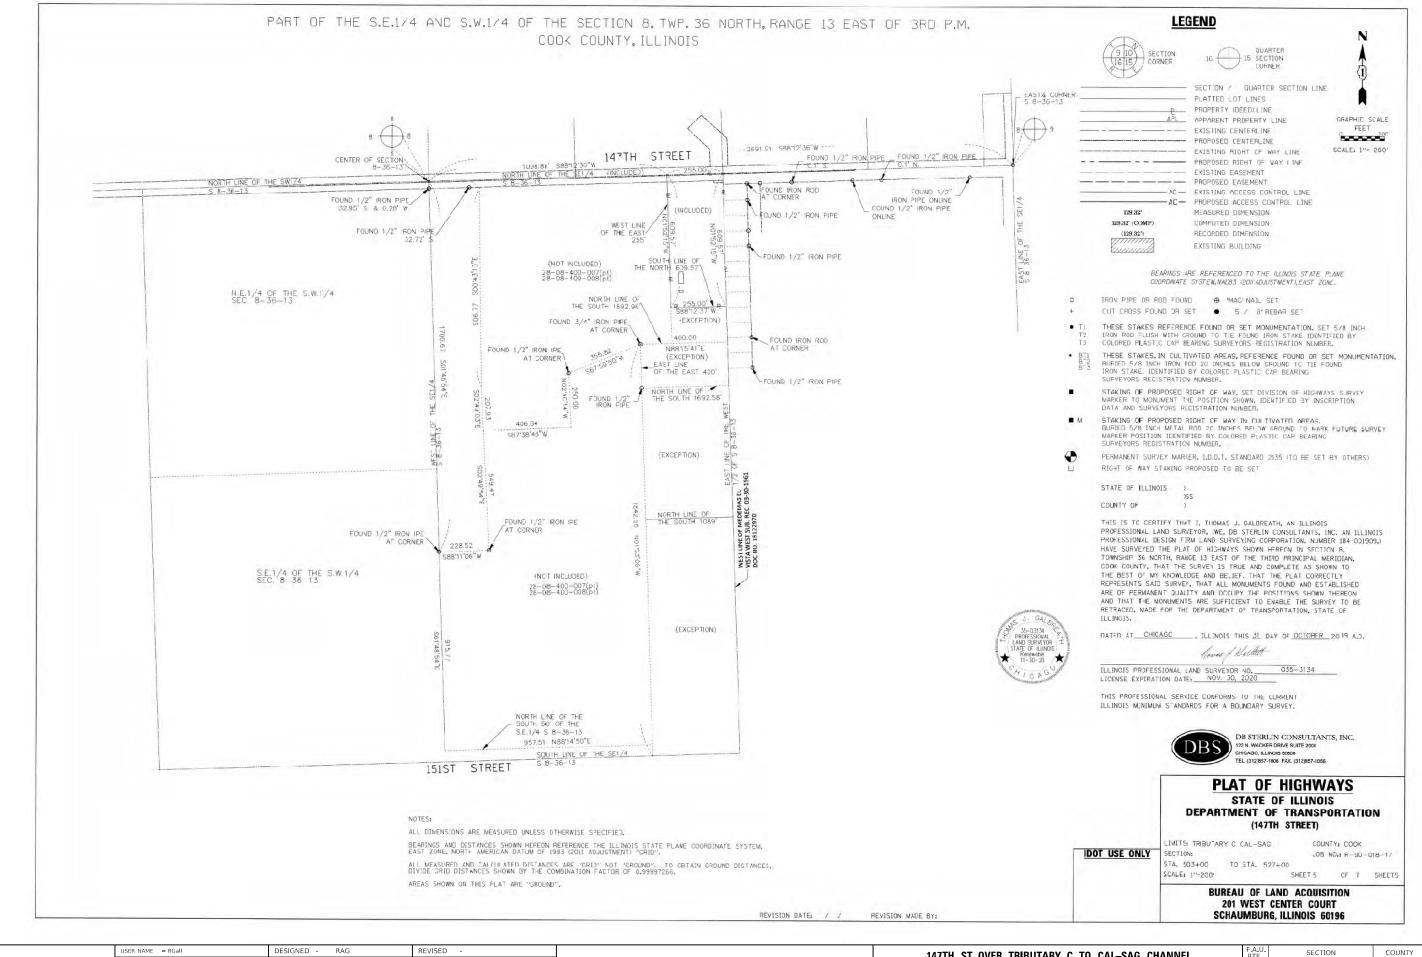

STATE OF ILLINOIS
DEPARTMENT OF TRANSPORTATION

SCALE:


147TH ST OVER TRIBUTARY C TO CAL-SAG CHANNEL
PLAT OF HIGHWAYS

SHEET OF SHEETS STA. TO STA.

 F.A.U. RTE.
 SECTION
 COUNTY SHEETS NO.
 TOTAL SHEETS NO.
 SHEETS NO.

 1602
 2019-051-T
 COOK
 45
 24

 CONTRACT NO. 62J28

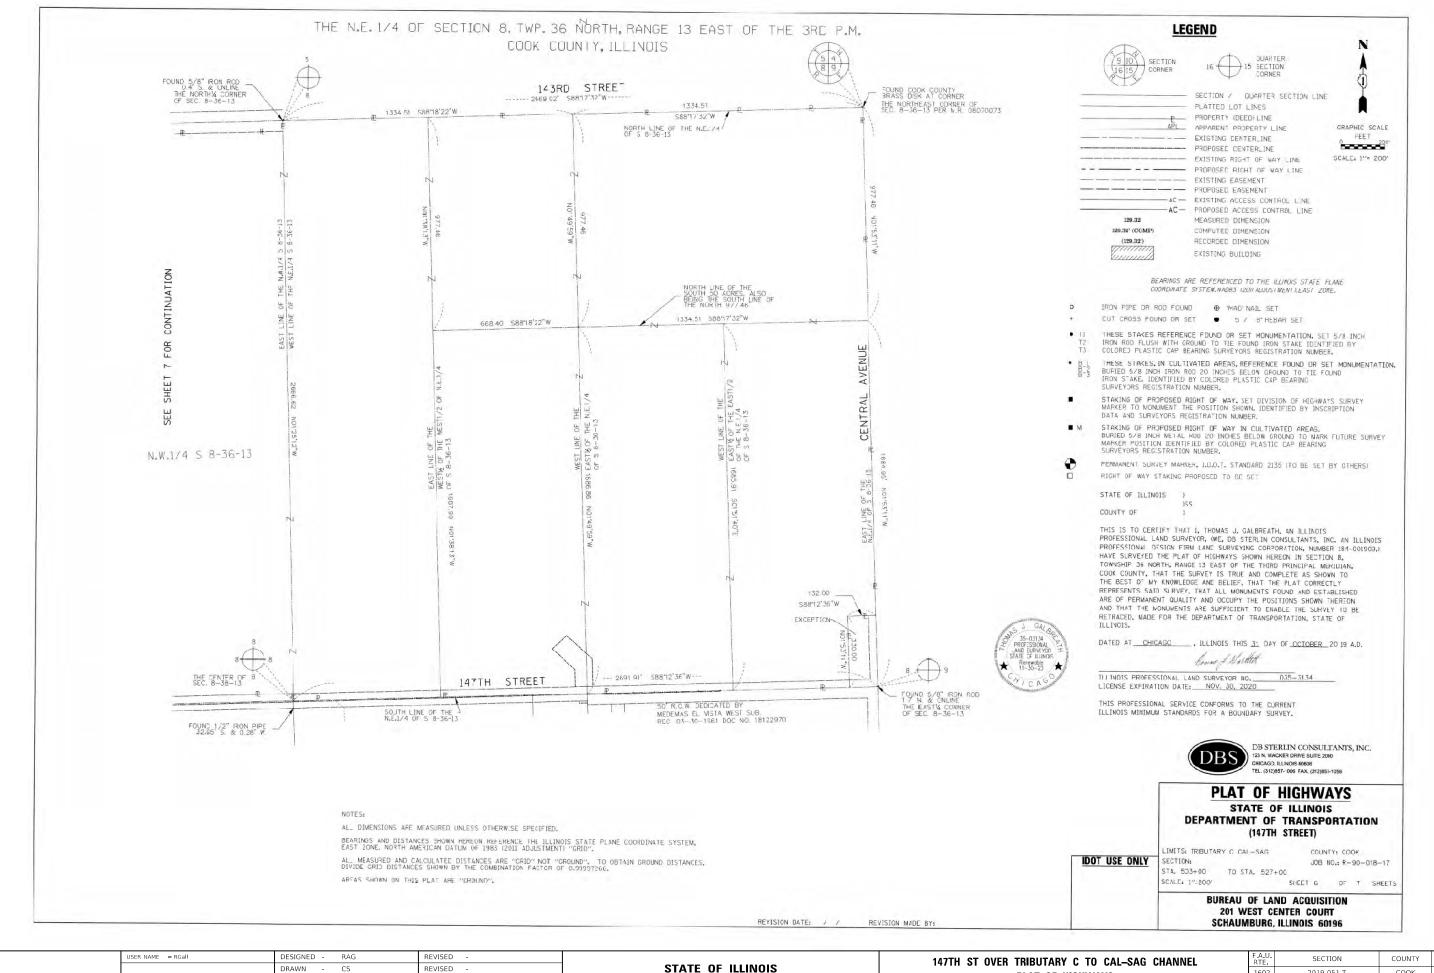

PLOT DATE = 3/17/2020

HECKED -

DATE

REVISED


REVISED

STATE OF ILLINOIS DEPARTMENT OF TRANSPORTATION 147TH ST OVER TRIBUTARY C TO CAL—SAG CHANNEL
PLAT OF HIGHWAYS

SHEET OF SHEETS STA. TO STA.

SCALE:

F.A.U. RTE	SECTION		COUNTY	TOTAL SHEETS	SHEET NO.		
1602	2019-051-T		соок	COOK 45			
			CONTRACT	NO. 62	2J28		
	ILLINOIS	FED. A	ID PROJECT				

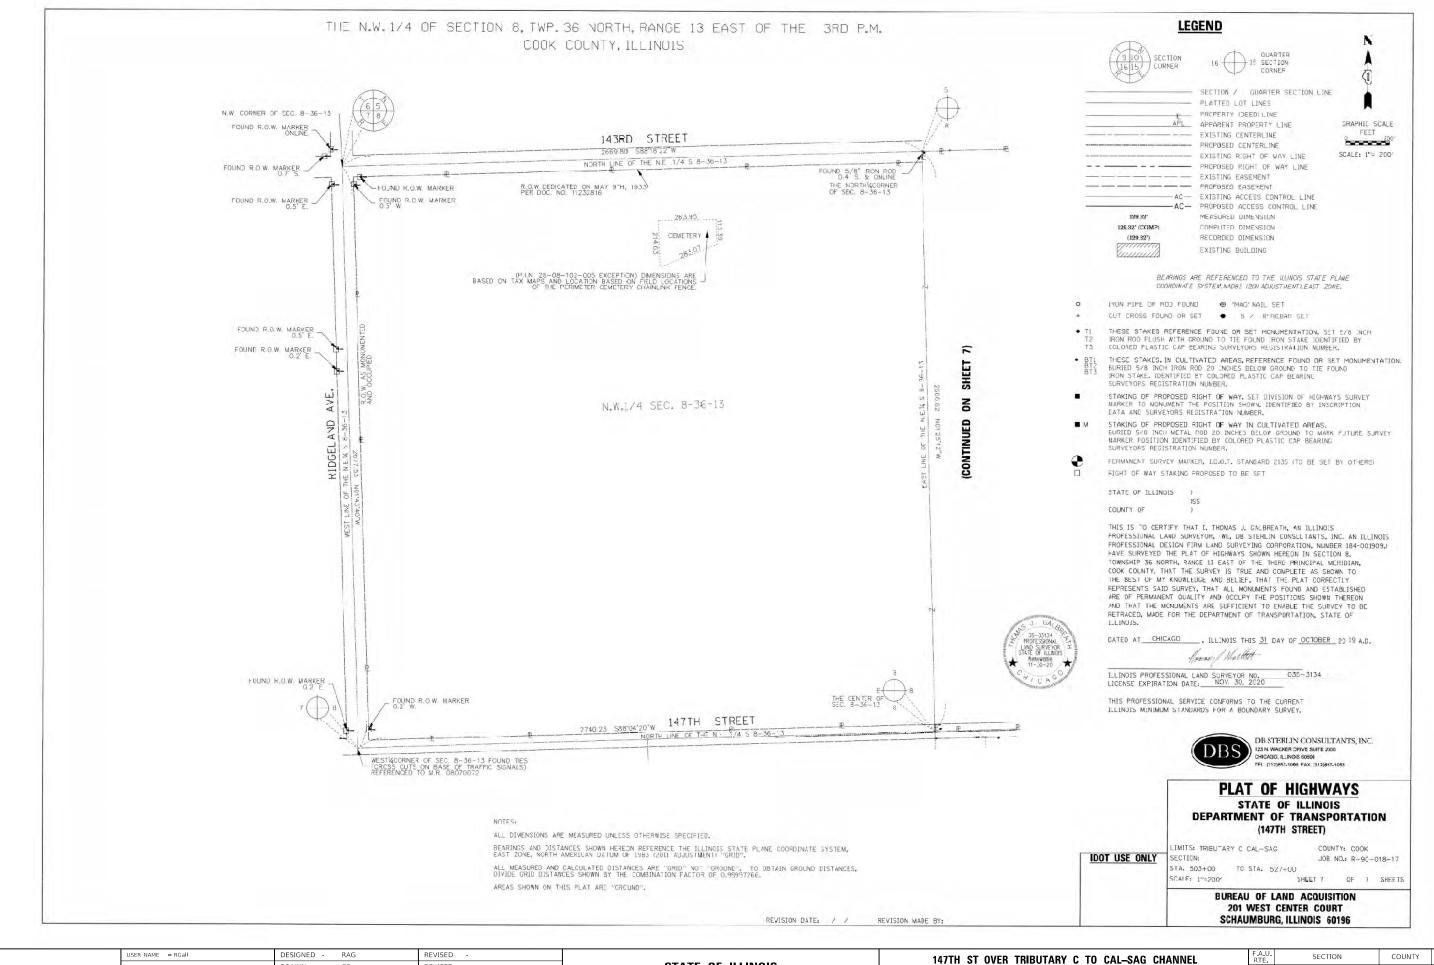

| DRAWN - CS REVISED - | PLOT SCALE | = 2.0000 ' / in. | CHECKED - JH REVISED - | PLOT DATE | = 3/17/2020 | DATE - 11/8/19 | REVISED - |

STATE OF ILLINOIS
DEPARTMENT OF TRANSPORTATION

SCALE:


TOTH ST OVER TRIBUTARY C TO CAL-SAG CHANNEL
PLAT OF HIGHWAYS


SHEET OF SHEETS STA. TO STA.


 F.A.U. RTE.
 SECTION
 COUNTY
 TOTAL SHEETS
 SHEET NO.

 1602
 2019-051-T
 COOK
 45
 26

 CONTRACT NO. 62J28

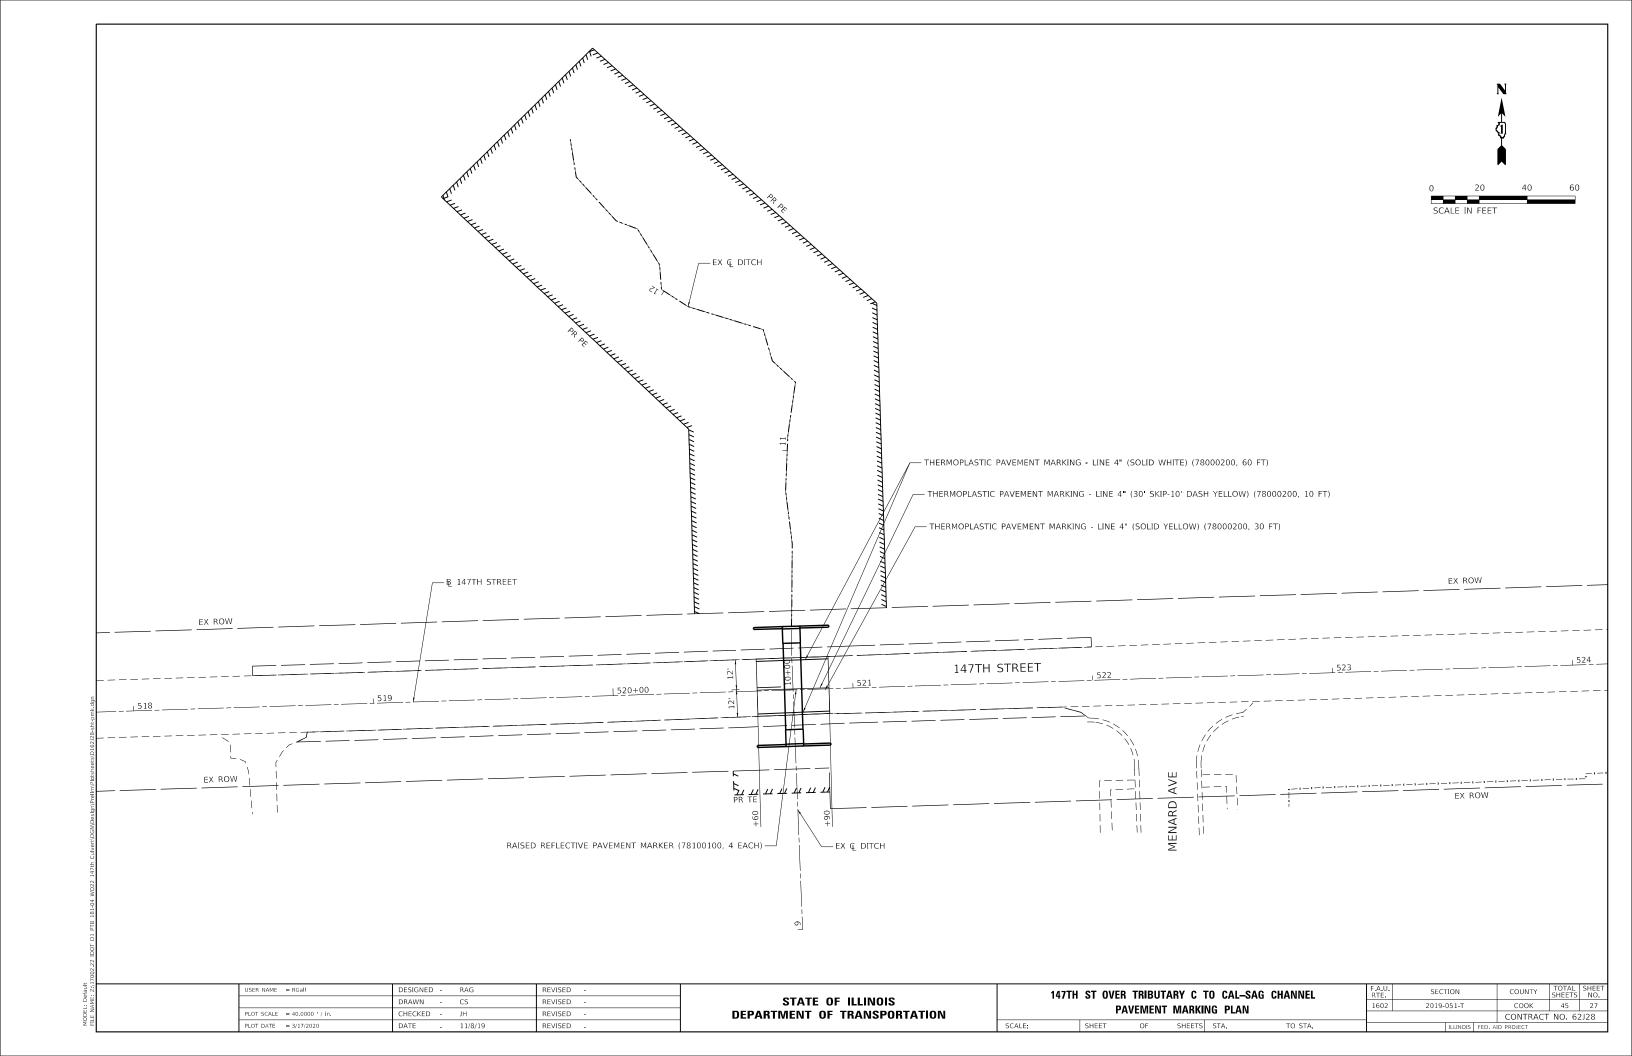

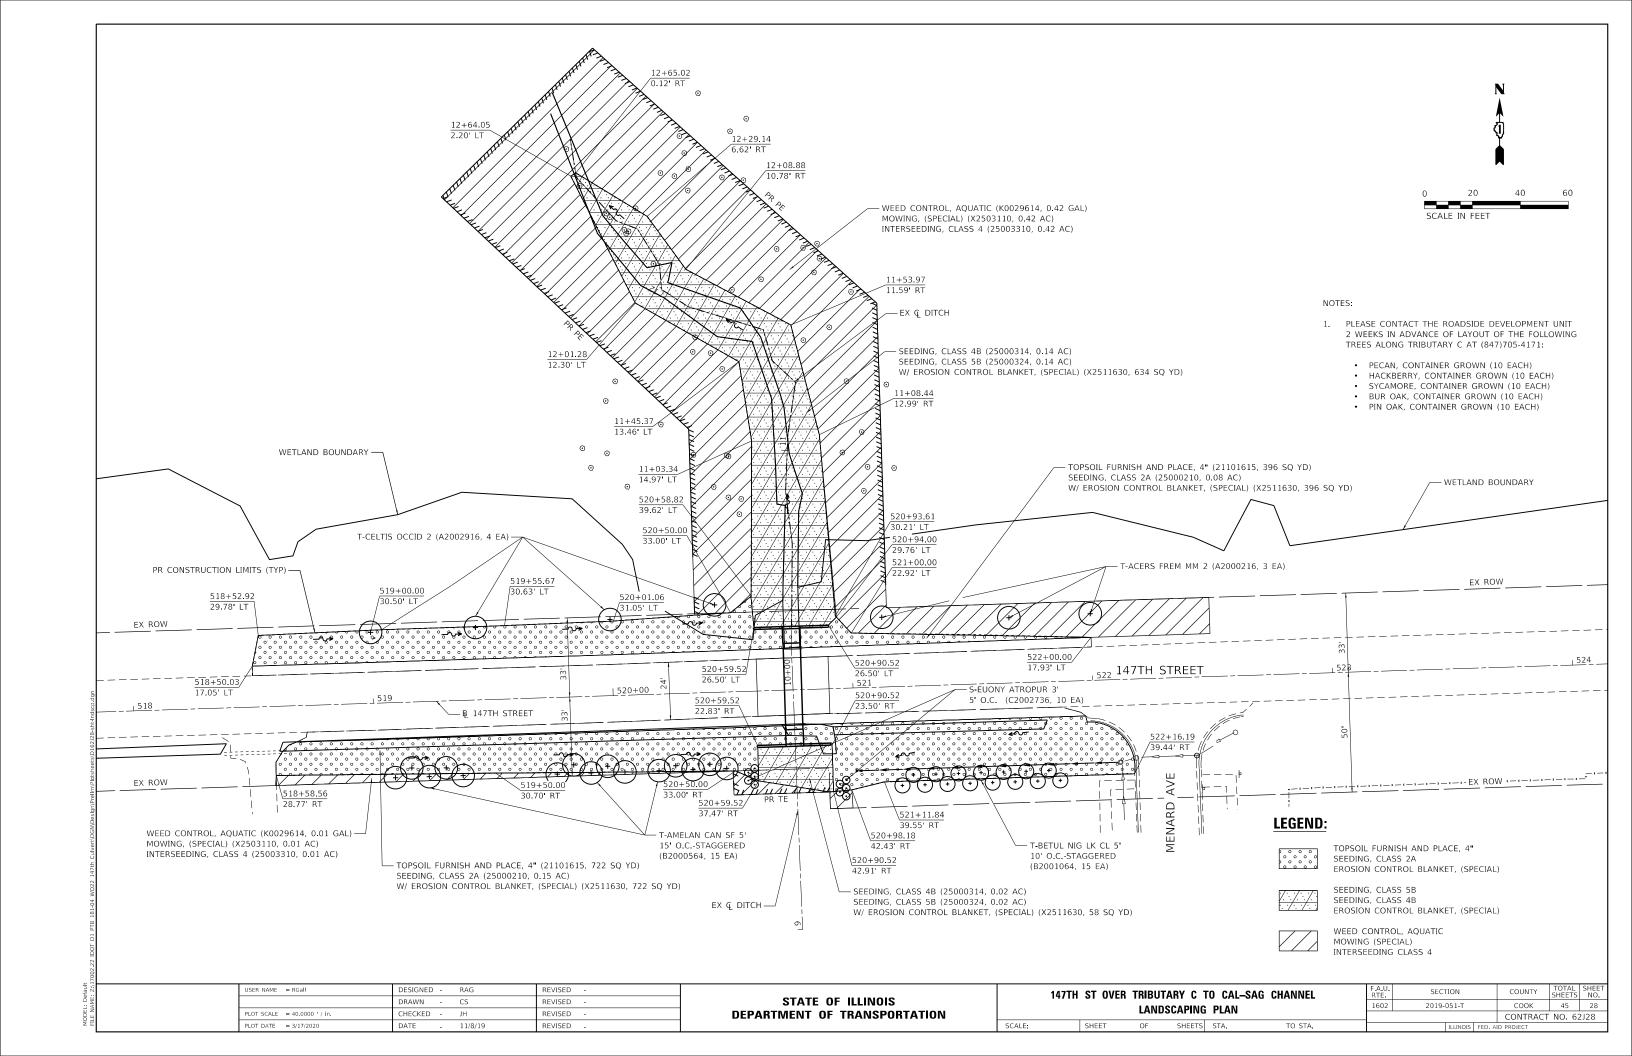

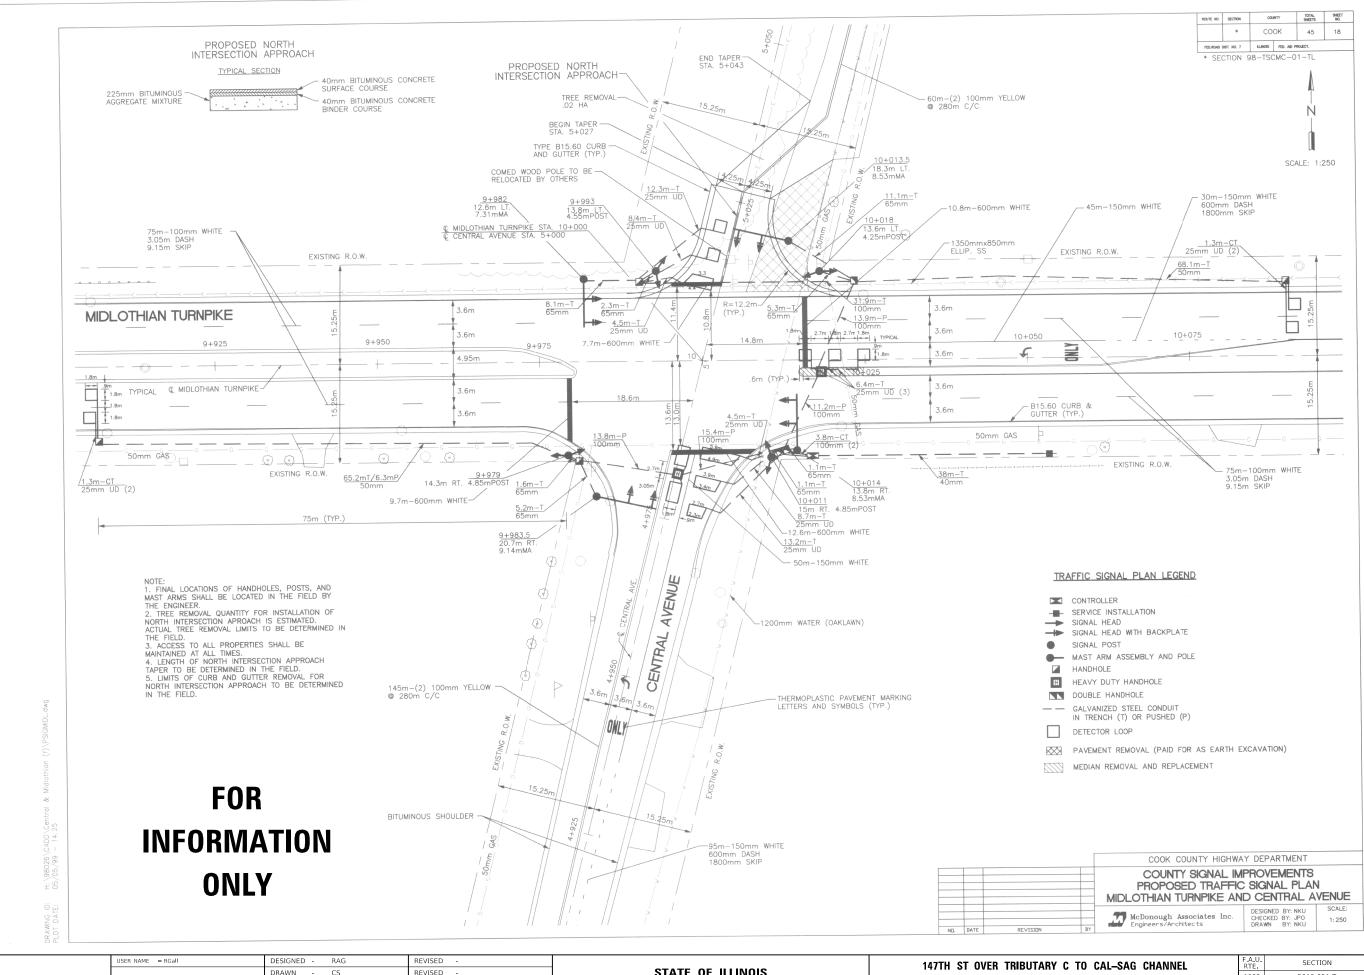

STATE OF ILLINOIS **DEPARTMENT OF TRANSPORTATION** **EXISTING TRAFFIC SIGNAL PLANS** SHEETS STA.


COOK 45 29 1602 2019-051-T CONTRACT NO. 62J28

LOT SCALE = 2.0000 ' / in.

HECKED -

REVISED

REVISED

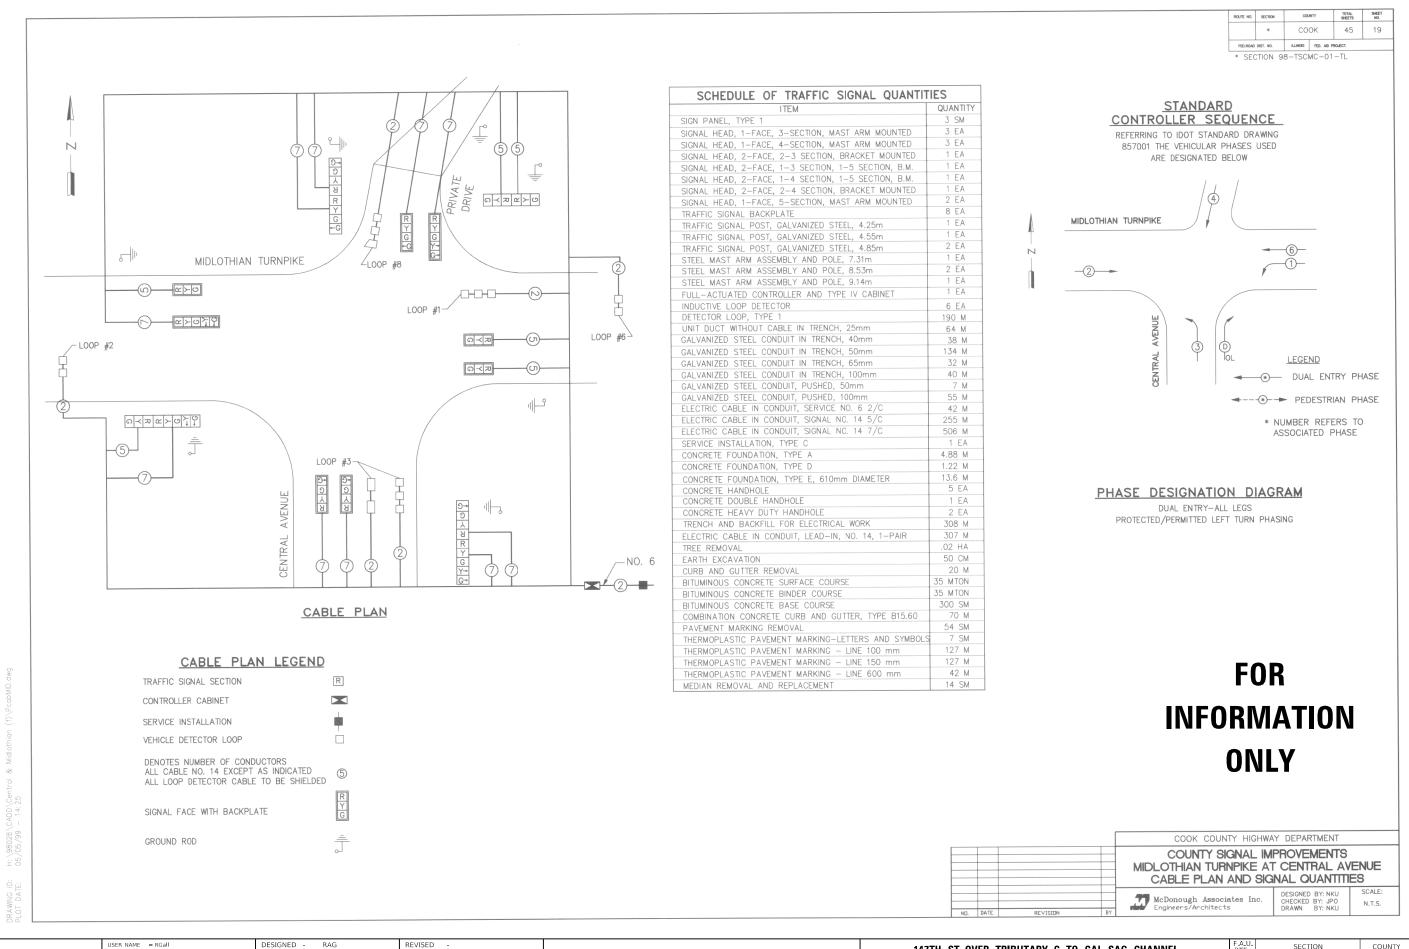

STATE OF ILLINOIS

DEPARTMENT OF TRANSPORTATION

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DATE

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PLOT DATE = 3/17/2020

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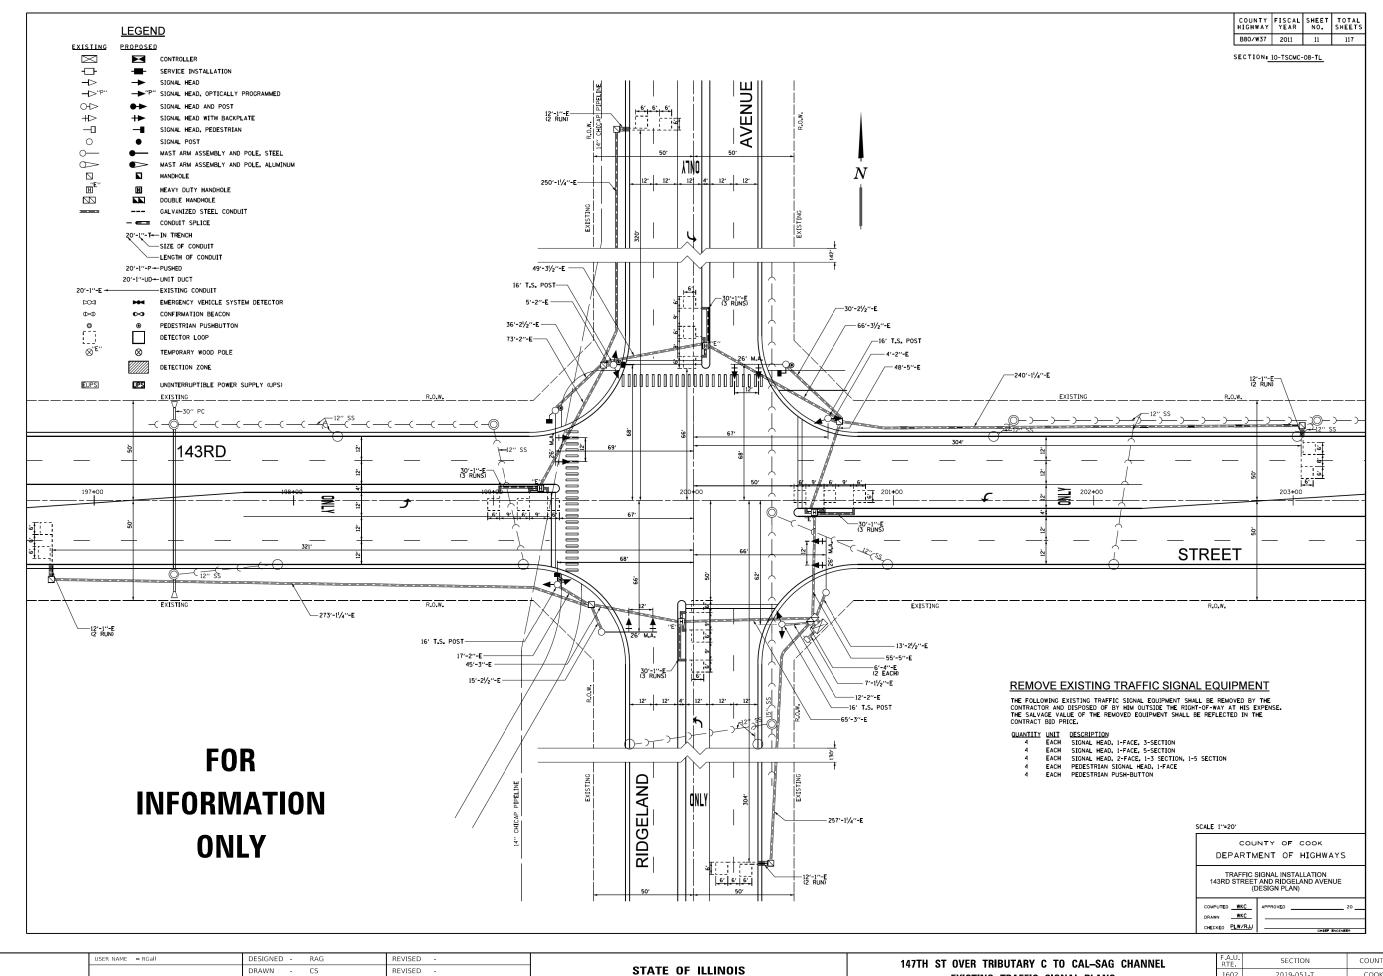
REVISED

REVISED

147TH ST OVER TRIBUTARY C TO CAL-SAG CHANNEL **EXISTING TRAFFIC SIGNAL PLANS** SHEETS STA. TO STA.

SCALE:

SECTION COUNTY 1602 2019-051-T COOK 45 30 CONTRACT NO. 62J28




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DEPARTMENT OF TRANSPORTATION

EXISTING TRAFFIC SIGNAL PLANS

COUNTY COOK 45 31 1602 2019-051-T CONTRACT NO. 62J28

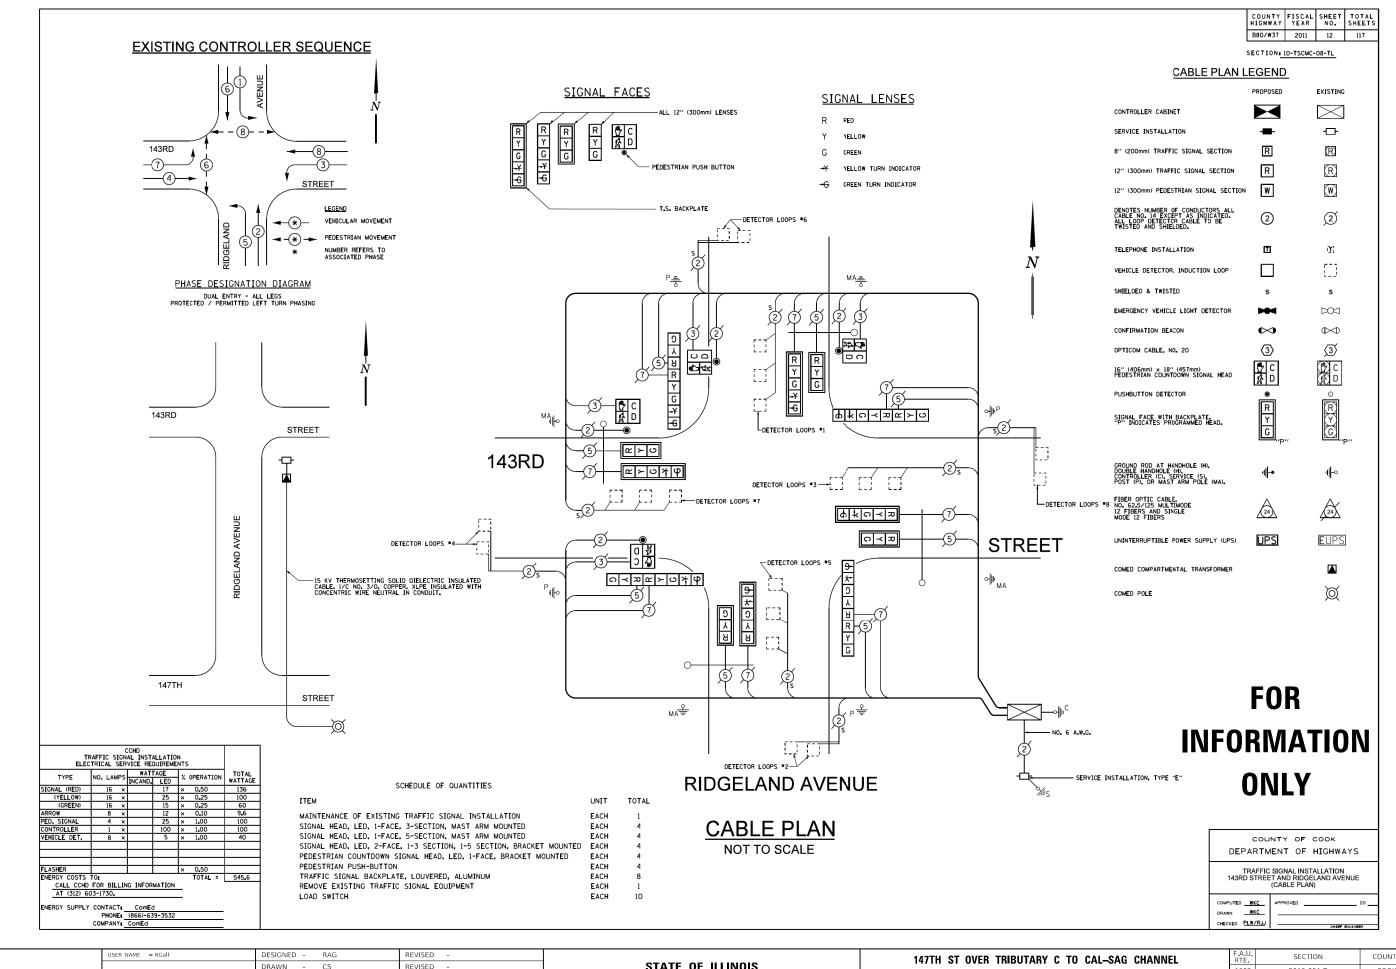

MODEL: Default

LOT SCALE = 2.0000 ' / in.

PLOT DATE = 3/17/2020

HECKED -

DATE

REVISED


REVISED

STATE OF ILLINOIS DEPARTMENT OF TRANSPORTATION

147TH ST OVER TRIBUTARY C TO CAL-SAG CHANNEL
EXISTING TRAFFIC SIGNAL PLANS

SHEET OF SHEETS STA. TO STA.

SCALE:

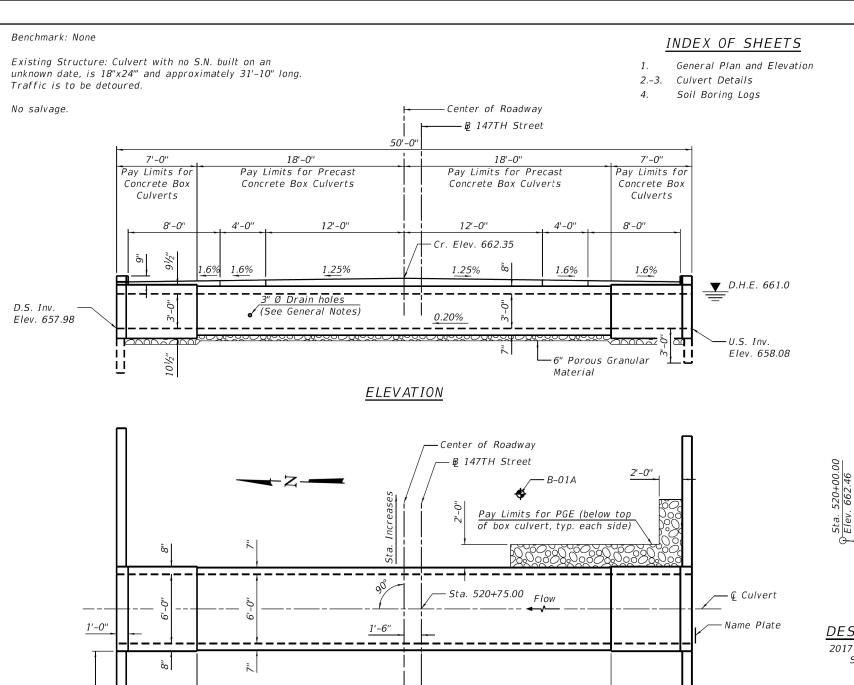

16'-6"

25'-0"

GENERAL NOTES


The design fill height for this box is 1.0 ft. The precast box culvert sections shall conform to the requirements of ASTM C 1577.

Drain holes shall be provided on exterior culvert walls for each precast box segment with a clear rise greater than 3 ft. The drain hole shall be located within 1/3 of the clear rise of the box culvert, shall not intercept the haunch, and shall conform to the requirements of Article 503.11 of the Standard Specification.

The 6 in. thick layer of porous granular material required for the precast concrete box culvert per Art. 540.06 of the Standard Specifications shall also apply to the end sections. Cost of the porous granular material will not be paid for separately but shall be included in the unit price of the work for which it is required.

Nonwoven geotextile fabric shall conform to the requirements of Art. 1080.01 of the Standard Specifications. The minimum weight of the fabric shall be 6 ounces per square yard.

Precast concrete box culverts and concrete box culverts shall be backfilled with Porous Granular Embankment below the top of the box culvert extending to a vertical plane 2 ft from the exterior sides of the culvert, 2 ft from the back face of the end sections, and not closer than 2 ft from the face of embankment.

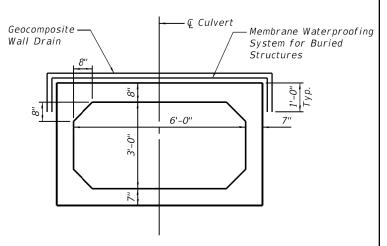

SECTION THRU BARREL

WATERWAY INFORMATION

Drainage Area = 0.08 sq. mi. Low Grade Elev. = 662.05 ft @ Sta. 522+00										
Flood	Freq.	Q	Opening	Sq. Ft.	Nat.	Head	- Ft.	Headwater El.		
F1000	Yr.	C.F.5.	Exist.	Prop.	H.W.E.	Exist.	Prop.	Exist.	Prop.	
	10	15.4	3.0	15.0		0.8	0.5	661.5	659.6	
Design	50	62.7	3.0	15.0		1.2	1.0	662.3	660.9	
Base	100	129.7	3.0	15.0		1.2	1.2	662.3	661.3	
Overtopping		20.0	3.0	15.0		0.9	0.5	662.2	659.7	
Max. Calc.	500									

10 year existing velocity = 5.1 fps 10 year proposed velocity = 3.2 fps

2-vear peak flow = 8.6 c.f.s. 2-year peak elevation = 658.9 ft 2-year peak bypass opening = 3 sq. ft.

TOTAL BILL OF MATERIAL

ITEM	UNIT	TOTAL
Porous Granular Embankment	Cu. Yd.	44
Removal of Existing Structures	Each	1
Reinforcement Bars	Pound	4,140
Name Plates	Each	1
Concrete Box Culverts	Cu. Yd.	20.4
Precast Concrete Box Culverts, 6'x3'	Foot	36
Geocomposite Wall Drain	Sq. Yd.	51
Membrane Waterproofing System for Buried Structures	Sq. Yd.	51
Cofferdam (Type 1) (In-Stream/ Wetland Work)	Each	1

GENERAL PLAN AND ELEVATION 147TH STREET OVER TRIBUTARY C OF THE CAL-SAG CHANNEL F.A.U. RTE. 1602 SEC. 2019-051-T COOK COUNTY STATION 520+75

S.N. 016-2272

Structure Location PROFILE GRADE

(Along & 147th Street)

DESIGN SPECIFICATIONS

2017 AASHTO LRFD Bridge Design Specifications, 8th Edition

LOADING HL-93

Allow 50#/sq. ft. for future wearing surface.

DESIGN STRESSES

PRECAST UNITS

f'c = 5,000 psi

fy = 65,000 psi (Welded Wire Reinforcement)


FIELD UNITS

 $f'c = 3,500 \ psi$

fy = 60,000 psi (Reinforcement)

STATION 520+75 BUILT STATE OF ILLINOIS F.A.U. RT. 1602 SEC. 2019-051-T LOADING HL-93 STR. NO. 016-2272

> NAME PLATE See Std. 515001

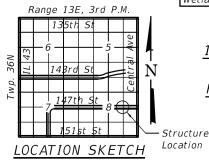

GENERAL PLAN AND ELEVATION STRUCTURE NO. 016-2272 SHEET 1 OF 4 SHEETS

SECTION COUNTY COOK 45 33 1602 2019-051-T CONTRACT NO. 62J28

EFK•Moen

7'-0"

USER NAME = acb DESIGNED - KAB REVISED -CHECKED - ACB REVISED -DRAWN -REVISED -PLOT DATE = 4/10/2020 CHECKED - ACB REVISED -

36'-0" Out to Out of Precast Culvert

50'-0" Out to Out of Headwalls


PLAN


19'-6"


25'-0"

STATE OF ILLINOIS DEPARTMENT OF TRANSPORTATION

7'-0"

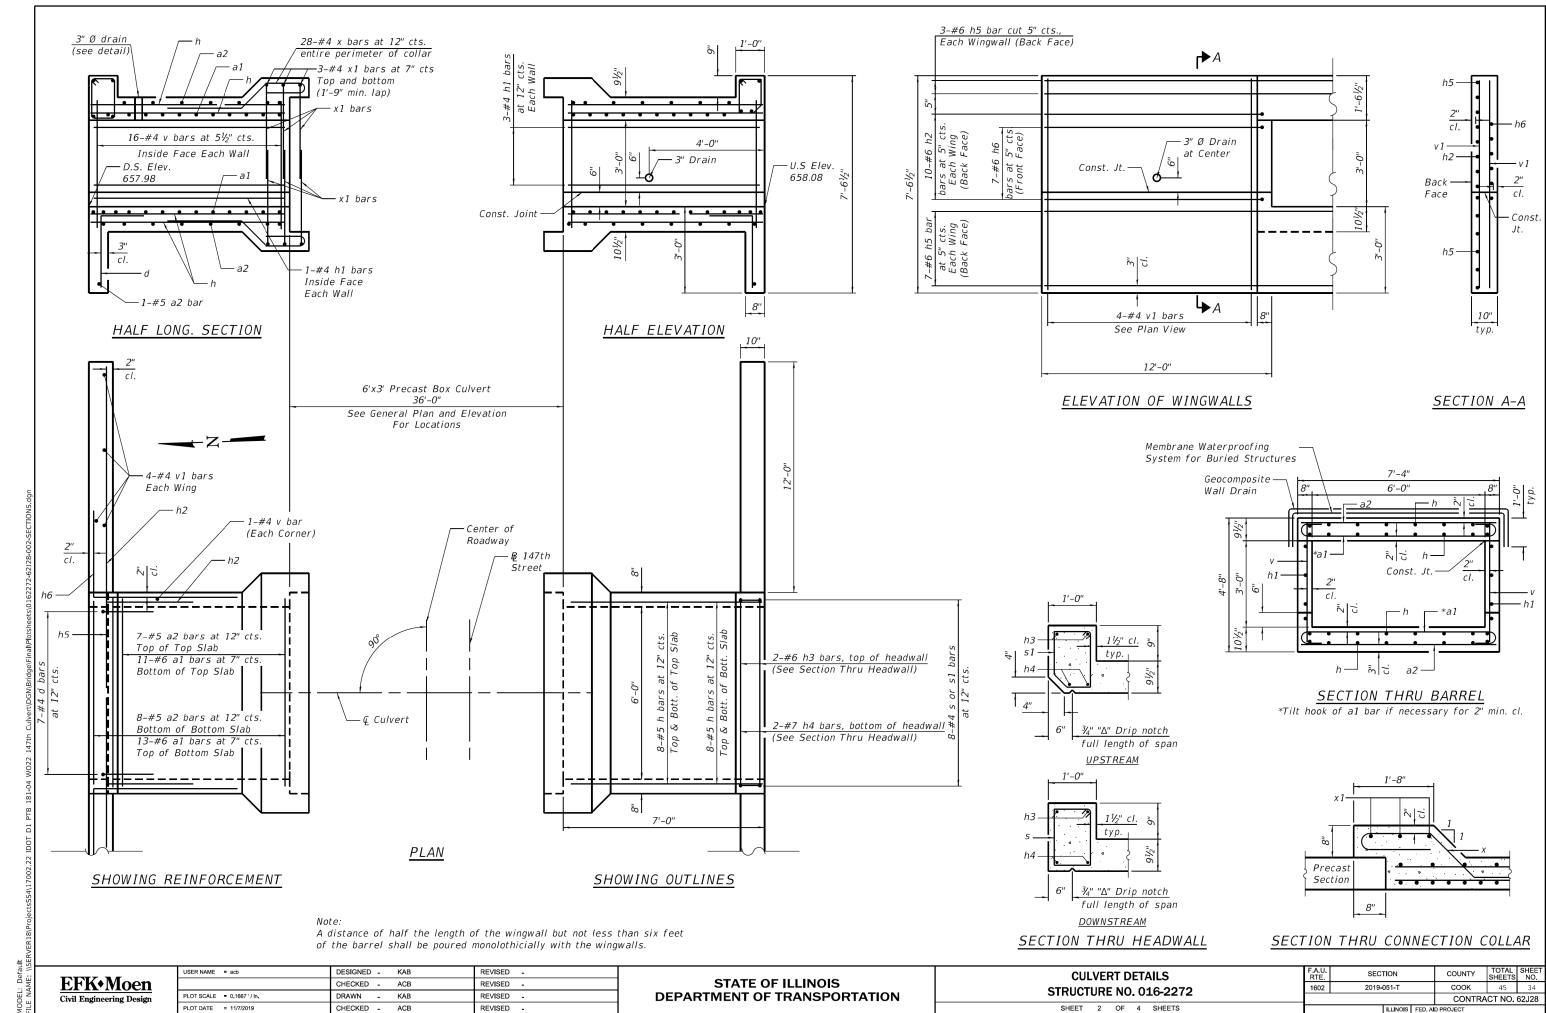

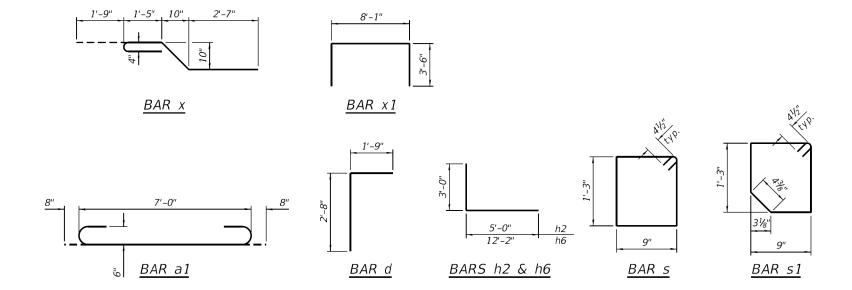

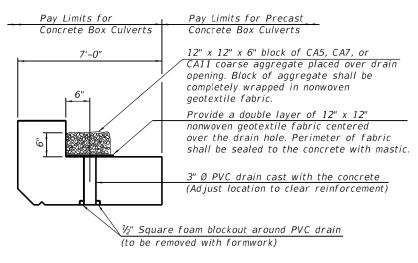

DRAIN DETAIL

(All costs associated with furnishing and constructing the above drain detail will not be measured for payment but shall be included in the contract unit price for the associated work.)

BILL OF MATERIAL

Bar	No.	Size	Length	Shape
a1	48	#6	8'-4"	J
a2	32	#5	7'-0"	
d	14	#4	4'-5"	
h	64	#5	6'-8"	
h1	16	#4	6'-8"	
h2	40	#6	8'-0"	
h3	4	#6	7'-0"	
h4	4	#7	7'-0"	
h5	40	#6	15'-2"	
h6	24	#6	15'-2"]
S	8	#4	4'-9"	
s1	8	#4	4'-8"	כ
V	68	#4	4'-5"	
v 1	16	#4	7'-3"	
X	56	#4	7'-0"	/
x 1	12	#4	15'-1"	Г
		Culverts	Cu. Yd.	20.4
Reinfo	rcemen	t Bars	Pound	4,140

EF	K•Moen
Civil	Engineering Design

USER NAME = acb	DESIGNED - KAB	REVISED -
	CHECKED - ACB	REVISED -
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STATE OF ILLINOIS DEPARTMENT OF TRANSPORTATION

CULVERT DETAILS
STRUCTURE NO. 016-2272

SHEET 3 OF 4 SHEETS

8. Brojects SS417002.22 IDOT D1 PTB 181-04 WO22 147th Culvert DGN Bridge Vina NPlotsheets (0.162272-62128-003-DETALLS. d



GSI Job No. <u>16131-B</u>

SOIL BORING LOG

Page <u>1</u> of <u>1</u>

Date 6/13/19 LOGGED BY RT

	ROUTE	147th Street	DES	SCRIP	TION	l		IDOT PTB 181-004 WO# 22	LC	OGG	ED BY	F	RT
	SECTION			_ LC	CAT	ION _	NW 1/	4, SEC. 8, TWP. T36N, RNG. R13E,	3 rd PM				
	COUNTY	Cook DF	RILLING	METI	HOD		Hol	low Stem Auger HAMMER	TYPE	(OME A	utoma	tic
	Station BORING NO Station Offset	B-01A 520+85 8.60ft Right ce Elev. 662.20		D E P T H	B L O W S	U C S Qu (tsf)	M O I S T	Surface Water Elev. Stream Bed Elev. Groundwater Elev.: First Encounter 656.2 Upon Completion After Hrs.	_ft _ft <u>▼</u>	D E P T H	B L O W S	U C S Qu (tsf)	M O I S T
		, 4.0" CONCRETE	"	(,	,,,	(10.)	(70)	Drillers Observation: Weathered	_ 11	(,	(, ,	(10.)	(70)
	011 737 01 437 11		661.20					Rock (continued)	641.20		F0 (0)		
	SILTY CLAY-bl	ack-stiff		+	2	1.2	22	Auger Refusal @ -21.0'. End Of Boring. Boring backfilled with		_	50/0"		NR
					2	В		cuttings.					
	hecoming brow	n & gray @ -3.0'											
	becoming brow	ii a giay @ -0.0		_	3					_			
					3	1.2	31						
			656.70	-5	2	В				-25			
	SANDY LOAM	-brown-loose		V									
5/19				+	1		38			_			
7/1					3								
36.6F	CHTVLOAMA		654.20										
-B -C	SILTY LOANI I	D LOAM-gray-loose		-	3					_			
LOGS/16131-B LOG.GPJ 7/15/19					3		19						
rogs			054.70	-10	3					-30			
RING	CLAY LOAM-g	ray-stiff	651.70							_			
-B BO					3	4.7	04						
16131				_	4 7	1.7 B	21						
PTB 181-004, WO #22\16131-B BORING													
W. W				_	4					_			
181-00					4	1.0	18						
PTB				-15	7	Р				-35			
MOEN.	FRACTURED I	ROCK-gray-very	646.70 646.20	-						_			
EFK N			540.20	5	50/2"								
Z:\PROJECTS\2016\16131-B EFK	Rock	ation: Weathered		_			8						
16/161				+						_			
TS\20;				\Box	0.00								
DJECT				- 5	50/0"		NR						
Z:\PR(-20						-40			

The Unconfined Compressive Strength (UCS) Failure Mode is indicated by (B-Bulge, S-Shear, P-Penetrometer) The SPT (N value) is the sum of the last two blow values in each sampling zone (AASHTO T206)

BBS, from 137 (Rev. 8-99)



GSI Job No. <u>16131-B</u>

SOIL BORING LOG

Page <u>1</u> of <u>1</u>

Date 6/13/19

ROUTE	147th Street	DES	SCRI	PTION	١		IDOT PTB 181-004 WO# 22	L(OGG	ED BY	F	RT
SECTIO	N		_ ι	OCAT	ION _	NW 1	4, SEC. 8, TWP. T36N, RNG. R13E,	3 rd PM				
COUNT	Y Cook D	RILLING	ME	THOD		Но	llow Stem Auger HAMMER	TYPE	(OME A	utoma	tic
Station	T. NO D B NO B-02A		D E P T	B L O W	U C S	M O I S	Surface Water Elev. Stream Bed Elev. Groundwater Elev.:		D E P T	B L O W	U C S	M O I S
Station	520+61 16.80ft Left		Н	S	Qu	Т	First Encounter 655.6		Н	S	Qu	Т
Offset	16.80ft Left d Surface Elev. 661.60	ft	(ft)	(/6")	(tsf)	(%)	Upon Completion After Hrs.	_ ft _ ft	(ft)	(/6")	(tsf)	(%)
	PHALT, 4.0" CONCRETE	1	()	(, ,	(/	(10)	Drillers Observation: Weathered	_ 10	(,	(/	()	(70)
0.0 7101	TIMET, 1.5 GONGRETE	660.56	_				Rock (continued)		_			
	CLAY-black-stiff to very	000.50		4						50/2"		
stiff				3	2.7	21						16
			_	3	В				_			
becomin	ng brown & gray @ -3.0'											
Boooniii	ig bronn a gray @ o.o		_	3					_	50/1"		
				3	1.2	28						NR
			-5	3	В				-25			
0.41101/		656.10	_									
SANDY	LOAM-brown-very loose		Y	1						50/0"		
5/19			_	1		23	Auger Refusal @ -26.5'. End Of	635.10	-	30/0		NR
17/				1			Boring. Boring backfilled with					
9.GP		653.60					cuttings.					
SILTY L	OAM-gray-very loose											
131-8				2		19						
S/16:				_		19			_			
90		651.10	-10				-		30			
SILTY C	CLAY-dark gray-very stiff	001.10	_									
8				2								
131-				3	2.5	16						
22/16			_	6	Р		-		_			
\$ CLAYI	OAM-gray-stiff	648.60		-								
7,40	er un gray eun		_	3					_			
181-0				4	1.4	18						
PTB			-15	7	В				-35			
OEN,			_	-					_			
ZAPPROJECTS/2016/16/131-B EFK MOEN, PTB 181-004, WO #22/16/131-B BORING LOGS/16/131-B LOG GPJ 7/16/19 ZAPPROJECTS/2016/16/131-B EFK MOEN, PTB 181-004, WO #22/16/131-B BORING LOGS/16/131-B LOG GPJ 7/16/19 ZAPPROJECTS/2016/16/131-B EFK MOEN, PTB 181-004, WO #22/16/131-B BORING LOGS/16/131-B LOG GPJ 7/16/19 ZAPPROJECTS/2016/131-B EFK MOEN, PTB 181-004, WO #22/16/131-B BORING LOGS/16/131-B LOG GPJ 7/16/19 ZAPPROJECTS/2016/131-B EFK MOEN, PTB 181-004, WO #22/16/131-B BORING LOGS/16/131-B LOG GPJ 7/16/19 ZAPPROJECTS/2016/131-B EFK MOEN, PTB 181-004, WO #22/16/131-B BORING LOGS/16/131-B LOG GPJ 7/16/19 ZAPPROJECTS/2016/131-B EFK MOEN, PTB 181-004, WO #22/16/131-B BORING LOGS/16/131-B LOG GPJ 7/16/19 ZAPPROJECTS/2016/131-B LOG GPJ 7/16/19 ZAPPROJECTS/2016/19 ZAPPROJECTS/2016/131-B LOG GPJ 7/16/19 ZAPPROJECTS/2016/19 ZAPPROJECTS/2016/19 ZAPPROJECTS/2016/19 ZAPPROJECTS/2	CLAY LOAM with	645.60		50/5"								
Fracture	ed Rock-gray-very dense	645.10	_	30/0		19	-		_			
Drillers	Observation: Weathered	-										
Rock												
18/20				F0.:2::								
) TEC.				50/2"		33	-					
PRC			-			33						
ii L			-20						-40			

The Unconfined Compressive Strength (UCS) Failure Mode is indicated by (B-Bulge, S-Shear, P-Penetrometer) The SPT (N value) is the sum of the last two blow values in each sampling zone (AASHTO T206)

BBS, from 137 (Rev. 8-99)

EFK•Moen


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STATE OF ILLINOIS DEPARTMENT OF TRANSPORTATION

SOIL BORING LOGS STRUCTURE NO. 016-2272 SHEET 4 OF 4 SHEETS

COUNTY TOTAL SHEET NO.

COOK 45 36 SECTION 2019-051-T 1602 CONTRACT NO. 62J28

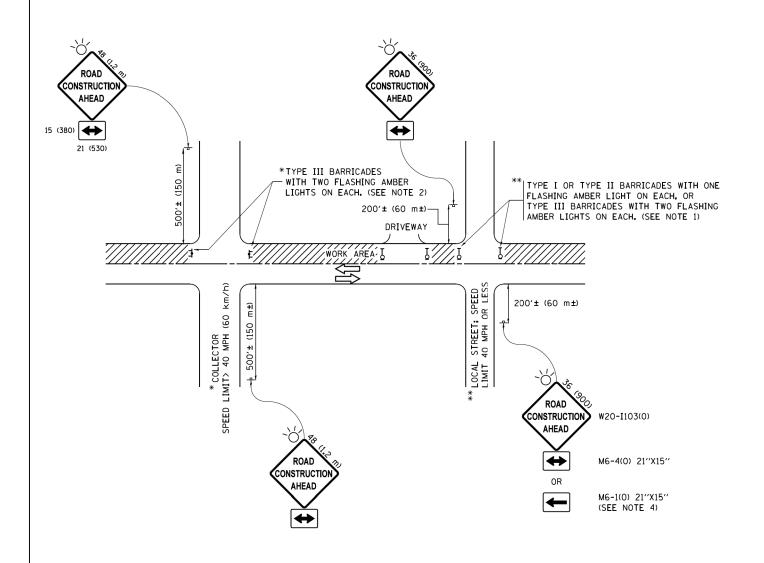

NOTES:

- 1. SIDE ROAD WITH A SPEED LIMIT OF 40 MPH (60 km/h) OR LESS AS SHOWN ON THE DRAWING AND AS DIRECTED BY THE ENGINEER:
 - a) ONE "ROAD CONSTRUCTION AHEAD" SIGN 36 x 36 (900x900) WITH A FLASHER MOUNTED ON IT APPROXIMATELY 200" (60 m) IN ADVANCE OF THE MAIN ROUTE.
 - b) THE CLOSED PORTION OF THE MAIN ROUTE SHALL BE PROTECTED BY BLOCKING WITH TYPE I, TYPE II OR TYPE III BARRICADES, 1/3 OF THE CROSS SECTION OF THE CLOSED PORTION.
- 2. SIDE ROAD WITH A SPEED LIMIT GREATER THAN 40 MPH (60 km/h) AS SHOWN ON THE DRAWING AND AS DIRECTED BY THE ENGINEER:
 - a) ONE "ROAD CONSTRUCTION AHEAD" SIGN 48 \times 48 (1.2 m \times 1.2 m) WITH A FLASHER MOUNTED ON IT APPROXIMATELY 500' (150 m) IN ADVANCE OF THE MAIN ROUTE.
 - b) THE CLOSED PORTION OF THE MAIN ROUTE SHALL BE PROTECTED BY BLOCKING WITH TYPE III BARRICADES, 1/2 OF THE CROSS SECTION OF THE CLOSED PORTION.
- 3. CONES MAY BE SUBSTITUTED FOR BARRICADES OR DRUMS AT HALF THE SPACING DURING DAY OPERATIONS. CONES SHALL BE A MINIMUM OF 28 (710)
- 4. WHEN THE SIDE ROAD LIES BETWEEN THE BEGINNING OF THE MAINLINE SIGNING AND THE WORK ZONE, A SINGLE HEADED ARROW (M6-1) SHALL BE USED IN LIEU OF THE DOUBLE HEADED ARROW (M6-4).

SCALE: NONE

- 5. WHEN WORK IS BEING PERFORMED ON A SIDE ROAD OR DRIVEWAY, FOLLOW THE APPLICABLE STANDARD(S). THE DIRECTIONAL ARROW (M6-1 OR M6-4) SHALL BE COVERED OR REMOVED WHEN NO LONGER CONSISTENT WITH THE TRAFFIC CONTROL SET-UP.
- 6. ADVANCE WARNING SIGNS ARE TO BE OMITTED ON DRIVEWAYS UNLESS OTHERWISE SPECIFIED IN THE PLANS OR BY THE
- 7. THE TRAFFIC CONTROL AND PROTECTION FOR SIDE ROADS, INTERSECTIONS, AND DRIVEWAYS SHALL BE INCLUDED IN THE COST OF SPECIFIED TRAFFIC CONTROL STANDARDS OR ITEMS.

All dimensions are in inches (millimeters) unless otherwise shown.


COOK 45 37

CONTRACT NO. 62J28

FILE NAME =	USER NAME = footemj	DESIGNED - L.H.A.	REVISED	- A. HOUSEH 10-15-96
pw:\\IL084EBIDINTEG.:ll1no1s.gov:PWIDOT\Do	cuments\IDOT Offices\District 1\Projects\Dist	St ORAWM \CADD o to\CADsheets\tc10.dgn	REVISED	-T. RAMMACHER 01-06-00
	PLOT SCALE = 50.000 '/ in.	CHECKED -	REVISED	- A. SCHUETZE 07-01-13
Default	PLOT DATE = 9/15/2016	DATE - 06-89	REVISED	- A. SCHUETZE 09-15-16


STATI	E OF	ILLINOIS
DEPARTMENT	OF	TRANSPORTATION


	TRAFFIC (CONTROL	AND P	TRAFFIC CONTROL AND PROTECTION FOR						
cı	SIDE ROADS, INTERSECTIONS, AND DRIVEWAYS					1602	2019-051-T			
31	DE HOADS	, INTLIN	LUTIONS	, AND	DIIIVLVVAIS		TC-10			
	SHEET 1	OF 1	SHEETS	STA.	TO STA.		ILLINOIS FE			

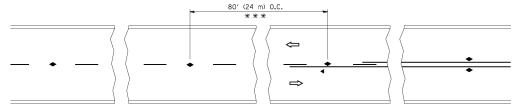


*** REDUCE TO 40' (12 m) O.C. ON CURVES WITH POSTED OR ADVISORY SPEED 45 M.P.H. (70 km/h) OR LESS.

TWO-LANE/TWO-WAY

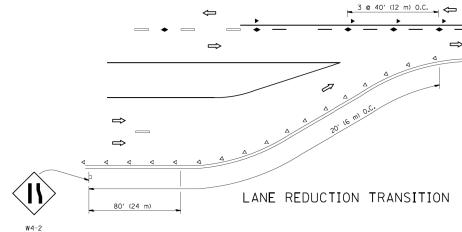


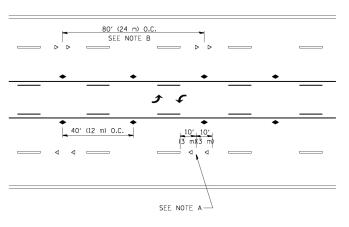

TWO-WAY LEFT TURN

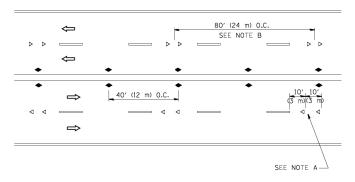

MULTI-LANE/UNDIVIDED

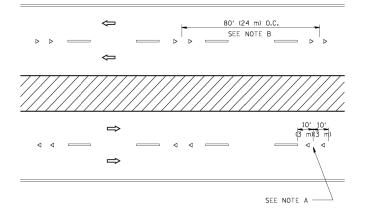

MULTI-LANE/DIVIDED

GENERAL NOTES

- 1. MARKERS USED WITH DASHED LINES SHALL BE CENTERED IN THE GAP BETWEEN SEGMENTS.
- 2. MARKERS USED ADJACENT TO SOLID LINES SHALL BE OFFSET 2 TO 3 (50 TO 75) TOWARD TRAFFIC AS SHOWN.
- 3. MARKERS THROUGH TANGENTS LESS THAN 500' (150 m) IN LENGTH BETWEEN CURVES SHALL BE INSTALLED AT THE LESSER OF THE TWO CURVE SPACINGS.

LANE MARKER NOTES

A. USE DOUBLE LANE LINE MARKERS SPACED AS SHOWN.

B. REDUCE TO 40' (12 m) O.C. ON CURVES WHERE ADVISORY SPEEDS ARE 10 M.P.H (20 km/h) LOWER THAN POSTED SPEEDS.

SYMBOLS

---- YELLOW STRIPE

── WHITE STRIF

- ONE-WAY AMBER MARKER
- ONE-WAY CRYSTAL MARKER (W/O)
- ◆ TWO-WAY AMBER MARKER


DESIGN NOTES

- 1. DOUBLE LANE LINE MARKERS SHALL BE USED UNLESS SPECIFIED OTHERWISE.
- EXCEPT AS SHOWN ON THE LANE REDUCTION TRANSITION AND FREEWAY EXIT RAMP DETAIL, MARKERS ARE NOT TO BE SPECIFIED ON RIGHT EDGE LINES.
- 3. THE EXACT MARKER LIMITS, SPACING, AND COLOR SHALL BE INCLUDED IN THE PLANS WHEN STANDARD SPECIFICATIONS ARE NOT BEING USED.
- 4, MARKERS SHOULD NOT BE USED ALONGSIDE CURBS EXCEPT FOR EXTREMELY SHORT SECTIONS OF CURBS WHERE NOT MORE THAN TWO MARKERS WOULD BE INVOLVED.

LEFT TURN

All dimensions are in inches (millimeters) unless otherwise shown.

	FILE NAME =	USER NAME = leysa	DESIGNED -	REVISED -T. RAMMACHER 09-19-94			TYPICAL APPLICATIONS	F.A.U	SECTION	COUNTY	SHEETS	SHEET NO.
	c:\pw_work\pwidot\leysa\d0108315\tc11.dgn		DRAWN -	REVISED -T. RAMMACHER 03-12-99	STATE OF ILLINOIS			1602	2 2019-051-T	соок	45	38
		PLOT SCALE = 50.000 '/ IN.	CHECKED -	REVISED -T. RAMMACHER 01-06-00	DEPARTMENT OF TRANSPORTATION	RAISED REFLECTIVE PAVEMENT MARKERS (SNOW-PLOW RESISTANT)			TC-11	CONTRACT	NO. 62J	J28
L		PLOT DATE = 3/2/2011	DATE -	REVISED - C. JUCIUS 09-09-09		SCALE: NONE	SHEET NO. 1 OF 1 SHEETS STA. TO STA.	FED.	ROAD DIST. NO. 1 ILLINOIS FED. A	AID PROJECT		

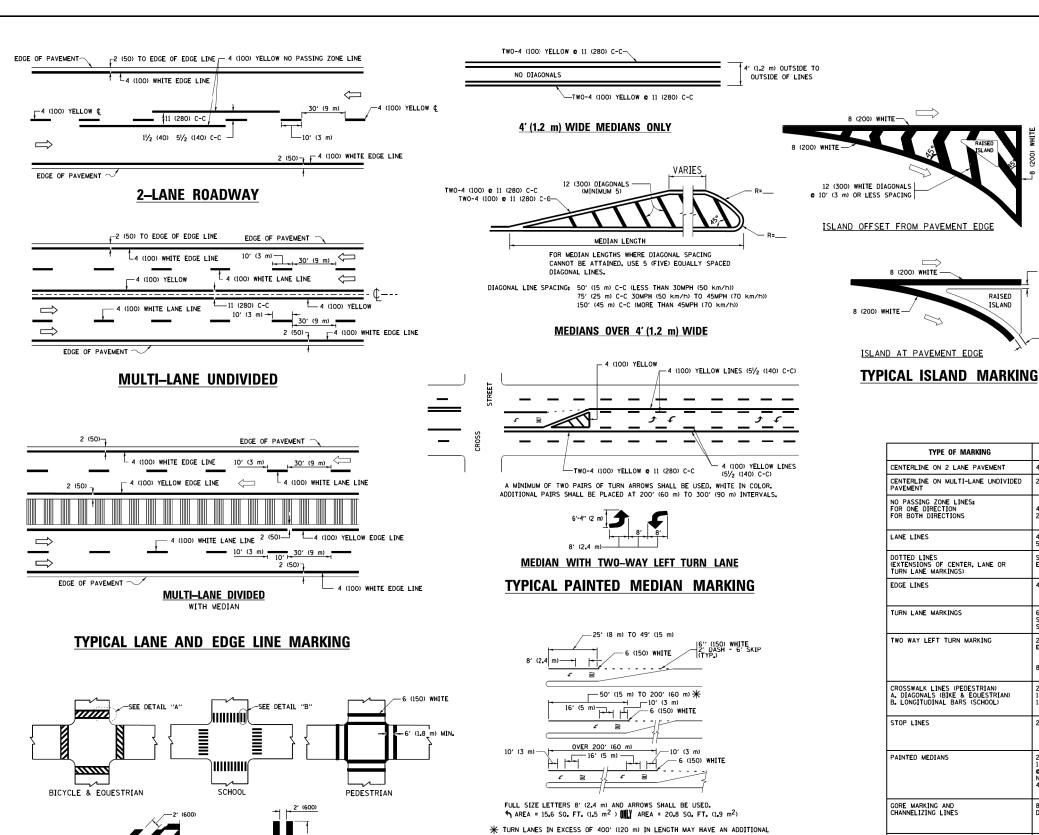

DOTTED LINES (EXTENSIONS OF CENTER, LANE OR TURN LANE MARKINGS) EDGE LINES 4 (100) SOLID YELLOW-LEFT WHITE-RIGHT OUTLINE MEDIANS IN YELLOW TURN LANE MARKINGS 6 (150) LINE; FULL SIZE LETTERS & SYMBOLS (8' (2.4m)) SEE TYPICAL TURN LANE MARKING DETAIL SOLID WHITE 10' (3 m) LINE WITH 30' (9 m) SPACE FOR SKIP-DASH; 5½ (140) C-C BETWEEN SOLID LINE AND SKIP-DASH LINE SEE TYPICAL TWO-WAY LEFT TURN MARKING DETAIL TWO WAY LEFT TURN MARKING YELLOW (2.4m) LEFT ARROW WHITE CROSSWALK LINES (PEDESTRIAN)
A. DIAGONALS (BIKE & EQUESTRIAN)
B. LONGITUDINAL BARS (SCHOOL) NOT LESS THAN 6' (1.8 m) APART 2' (600) APART 2' (600) APART SEE TYPICAL CROSSWALK MARKING DETAILS. PLACE 4' (1.2 m) IN ADVANCE OF AND PARALLEL TO CROSSHALK, IF PRESENT, OTHERWISE, PLACE AT DESIRED STOPPING POINT, PARALLEL TO CROSSROAD CENTERLINE, WHERE POSSIBLE STOP LINES 24 (600) SOLID WHITE 2 @ 4 (100) WITH 12 (300) DIAGONALS PAINTED MEDIANS SOLID II (280) C-C FOR THE DOUBLE LINE SEE TYPICAL PAINTED MEDIAN MARKING. YELLOW: TWO WAY TRAFFIC WHITE: ONE WAY TRAFFIC NO DIAGONALS USED FOR 4' (1.2 m) WIDE MEDIANS 8 (200) WITH 12 (300) DIAGONALS @ 45° GORE MARKING AND CHANNELIZING LINES SOLID)IACONALS: 15' (4,5 m) C-C (LESS THAN 30MPH (50 km/h)) 20' (6 m) C-C 30MPH (50 km/h) TO 45MPH (70 km/h)) 30' (9 m) C-C (OVER 45MPH (70 km/h)) 24 (600) TRANSVERSE LINES; "RR" IS 6' (1.8 LETTERS; 16 (400) LINE FOR "X" SEE STATE STANDARD 780001 AREA OF: "R"=3.6 SO. FT. (0.33 m²) EACH "X"=54.0 SO. FT. (5.0 m²) SET OF ARROW - "ONLY" INSTALLED MIDWAY BETWEEN THE OTHER TWO SETS OF RAILROAD CROSSING SOLID WHITE 50' (15 m) C-C (LESS THAN 30MPH (50 km/h)) 75' (25 m) C-C (30 MPH (50 km/h) TO 45MPH (70 km/h) 150' (45 m) C-C (0VER 45MPH (70 km/h)) TYPICAL LEFT (OR RIGHT) TURN LANE SHOULDER DIAGONALS (REQUIRED FOR SHOULDERS \geq 8') WHITE - RIGHT YELLOW - LEFT 12 (300) @ 45° SOLID U TURN ARROW SEE DETAIL SOL TO WHITE TYPICAL TURN LANE MARKING

FOR FURTHER DETAILS ON PAVEMENT MARKING REFER TO STANDARD SPECIFICATIONS FOR ROAD AND BRIDGE CONSTRUCTION AND STATE STANDARD 780001.

2 ARROW COMBINATION LEFT AND U TURN

SCALE: NONE

unless otherwise shown.

FILE NAME =	USER NAME = leysa	DESIGNED - EVERS	REVISED -	C. JUCIUS 09-09-09
W:\diststd\22x34\tc13.dgn		DRAWN -	REVISED -	C. JUCIUS 07-01-13
	PLOT SCALE = 50.000 ' / in.	CHECKED -	REVISED -	C. JUCIUS 12-21-15
Default	PLOT DATE = 6/23/2017	DATE - 03-19-90	REVISED -	C. JUCTUS 04-12-16

TYPICAL CROSSWALK MARKING

 $oldsymbol{st}$ markings shall be installed parallel to the centerline of

-12 (300) WHITE

DETAIL "B"

- 6 (150) WHITE

THE ROAD WHICH IT CROSSES

DETAIL "A"

STATE OF ILLINOIS **DEPARTMENT OF TRANSPORTATION**

		DIS	TRICT OF	NE		F.A.∪. RTE.	SECTION	COUNTY	TOTAL SHEETS	SHEET NO.	
	TVDI	CAI DAV	/EMENT	MARKING	:e	1602	2019-051-T	COOK	45	39	
TYPICAL PAVEMENT MARKINGS					TC-13	CONTRACT	NO. 62	2J28			
	SHEET 1	OF 1	SHEETS	STA.	TO STA.	ILLINOIS FED. AID PROJECT					

30.4 SF

6'-4" (1930)

40 (1020)

__ 2 (50)

2 (50)

WIDTH OF LINE

4 (100) 5 (125) ON FREEWAYS

SAME AS LINE BEING EXTENDED

4 (100) 2 **c** 4 (100)

RAISED

ISL AND

TYPE OF MARKING

CENTERLINE ON MULTI-LANE UNDIVIDED PAVEMENT

CENTERLINE ON 2 LANE PAVEMENT

NO PASSING ZONE LINES: FOR ONE DIRECTION FOR BOTH DIRECTIONS

LANE LINES

8 (200) WHITE -

COMBINATION

LEFT AND U-TURN

5'-4" (1620)

√ 32 R (810)

U_TURN

YELLOW

SAME AS LINE BEING EXTENDED

12 (300)

40 (1020)

PATTERN

SKIP-DASH

SKIP-DASH SKIP-DASH

SKIP-DASH

SOLID

WHITE

SOLID

(1020)

D(FT)

500

580

665

750

-20′

LANE REDUCTION TRANSITION

* LANE REDUCTION ARROWS REQUIRED AT SPEEDS OF 45 MPH OF GREATER OR WHEN SPECIFIED IN PLANS.

SPACING /REMARKS

10' (3 m) LINE WITH 30' (9 m) SPACE

10' (3 m) LINE WITH 30' (9 m) SPACE


2' (600) LINE WITH 6' (1.8 m) SPACE


51/₂ (140) C-C FROM SKIP-DASH CENTERLINE 11 (280) C-C OMIT SKIP-DASH CENTERLINE BETWEEN

SPEED LIMIT

50

55

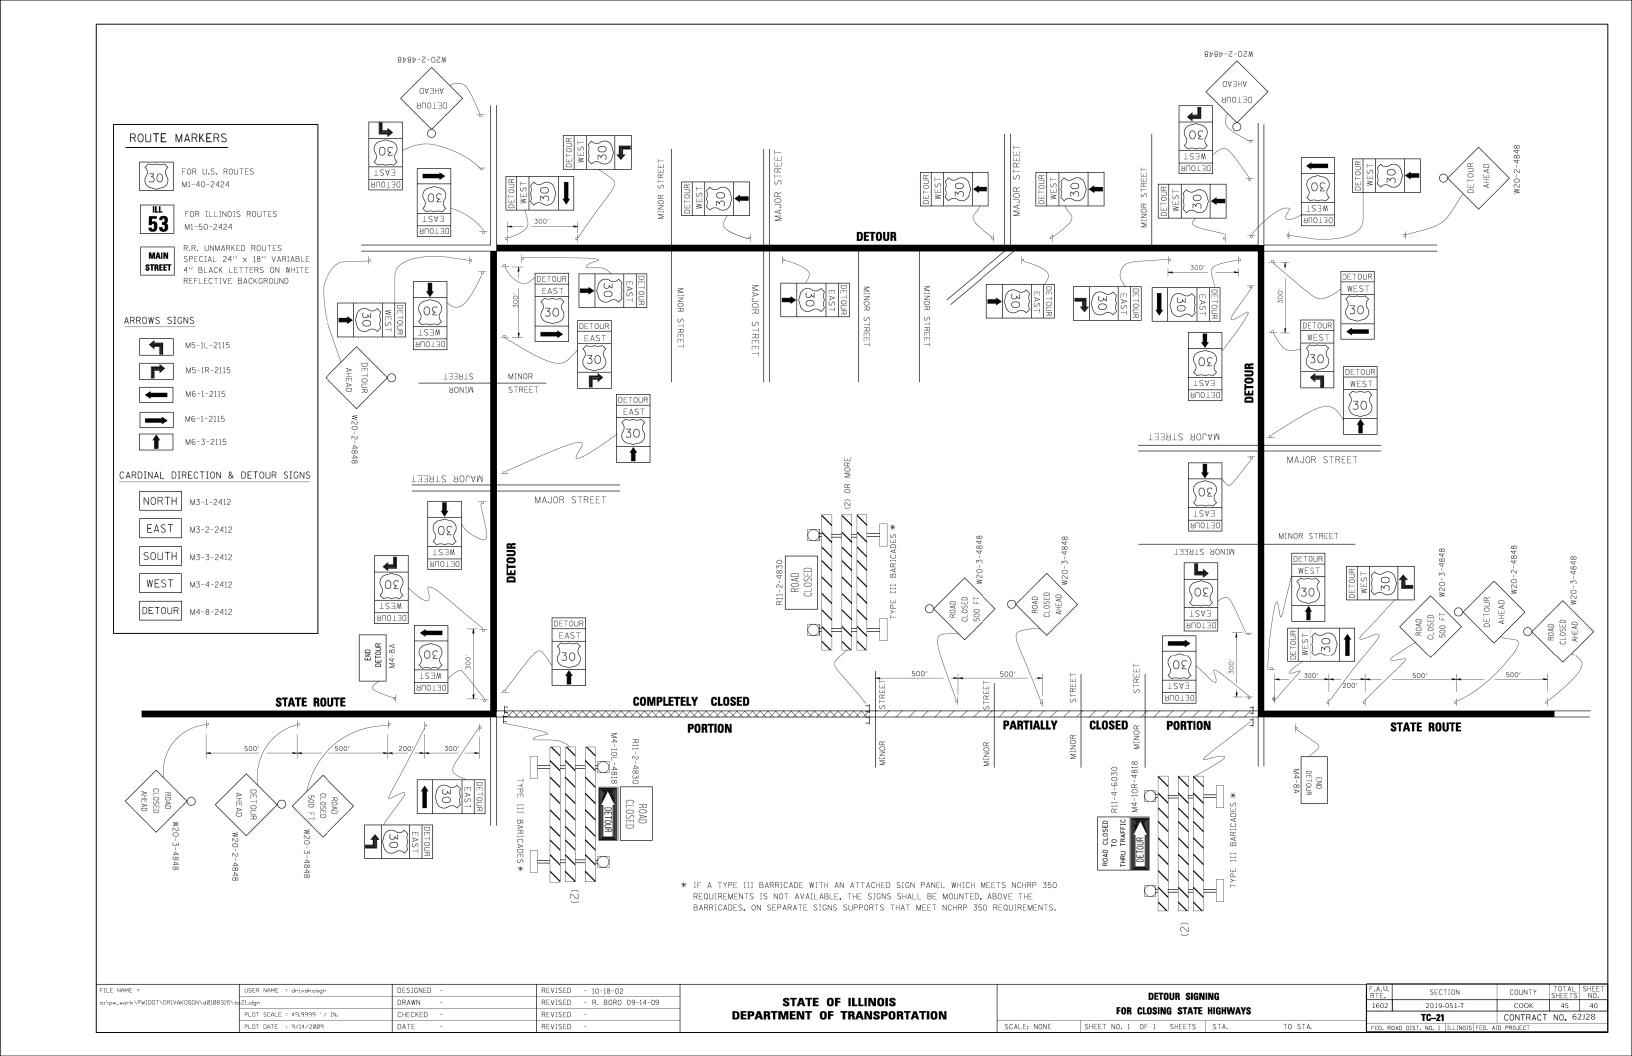

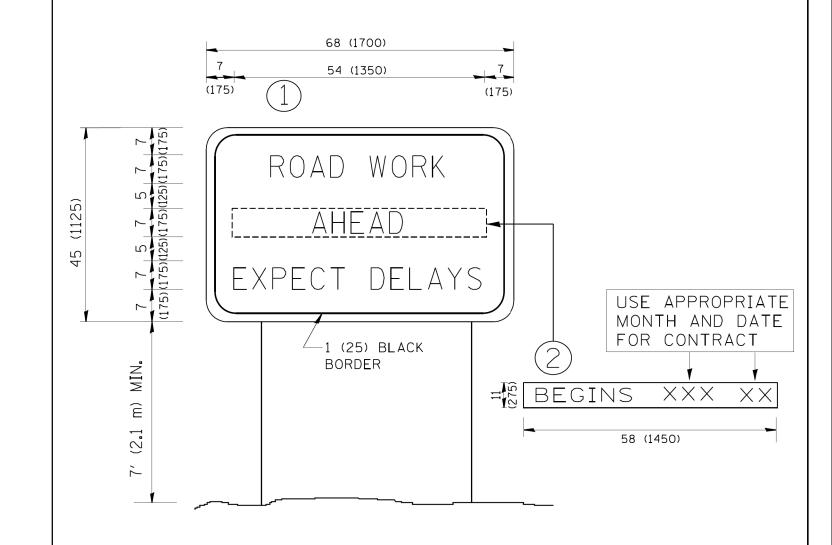

NOTES:

- 1. USE BLACK LETTERING ON ORANGE BACKGROUND.
- 2. ERECT SIGNS IN ADVANCE OF THE LOCATION FOR THE "ROAD CONSTRUCTION AHEAD" SIGN AT LOCATIONS AS DIRECTED BY THE ENGINEER.
- 3. ERECT SIGN () WITH INSTALLED PANEL (2) ONE WEEK PRIOR TO THE START OF CONSTRUCTION.
- 4. REMOVE PANEL (2) SOON AFTER THE START OF CONSTRUCTION.
- 5. SEE SPECIAL PROVISION FOR "TEMPORARY INFORMATION SIGNING" FOR ADDITIONAL INFORMATION.
- 6. ONE SIGN ASSEMBLY EQUALS 25.70 SQ. FT. (2.3 SQ. M.)
- 7. SHALL BE PAID FOR AS TEMPORARY INFORMATION SIGNING.

ALL DIMENSIONS ARE IN INCHES (MILLIMETERS) UNLESS OTHERWISE SHOWN.

l l	FILE NAME =	USER NAME = gaglianobt	DESIGNED -	REVISED - R. MIRS 09-15-97			ADTEDIAL DO	AD		F.A.U.	SECTION	COUNTY	TOTAL SHEET SHEETS NO.
	W:\diststd\22x34\tc22.dgn		DRAWN -	REVISED - R. MIRS 12-11-97	STATE OF ILLINOIS	ARTERIAL ROAD INFORMATION SIGN		1602	2019-051-T	соок	45 41		
		PLOT SCALE = 50.000 '/ IN.	CHECKED -	REVISED -T. RAMMACHER 02-02-99	DEPARTMENT OF TRANSPORTATION		INFORMATION	SIGN		TC-22			NO. 62J28
		PLOT DATE = 1/4/2008	DATE -	REVISED - C. JUCIUS 01-31-07		SCALE: NONE SHEET NO. 1 OF 1 SHEETS STA. TO STA.		TO STA.	FED. ROAD DIST. NO. 1 ILLINOIS F				

