06-12-2020 LETTING ITEM 166

STATE OF ILLINOIS DEPARTMENT OF TRANSPORTATION 19-00070-00-SW MCHENRY 18 1 CONTRACT NO. 61G63

FOR INDEX OF SHEETS, SEE SHEET NO. 2

FOR INDEX OF HIGHWAY STANDARDS, SEE SHEET NO. 2

PLANS FOR PROPOSED FEDERAL AID HIGHWAY

FAU 4056 (W MAIN STREET) FROM FAU 4052 (CARY-ALGONQUIN ROAD) TO MUN 2110 (WULFF STREET) **SECTION: 19-00070-00-SW**

PROJECT: LIPR(748)

SIDEWALK INSTALLATION **VILLAGE OF CARY, ILLINOIS McHENRY COUNTY**

C-91-189-20

STA 58+46 IMPROVEMENTS BEGIN

BEGIN OMISSION

END OMISSION STA 61+98

IMPROVEMENTS END

STA 63+17

STA 50+30

ENGINEERING SCALES. REDUCED SIZED PLANS WILL NOT CONFORM TO STANDARD SCALES. IN MAKING MEASUREMENTS ON REDUCED PLANS, THE ABOVE SCALES MAY BE USED.


J.U.L.I.E. DESIGN STAGE REQUEST DIG. No. _X3520987



CONTACT JULIE AT 811 OR 800-892-0123

CITY-TWNSHP. = CARY - ALGONOUIN
SEC. & 1/4 SEC. NO. = NW 1/4 S13 T43N RBE
ONE CALL SYSTEM
48 HOURS (2 working days) BEFORE YOU DIG

CONTRACT NO. 61G63

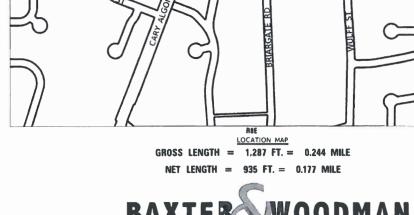







PRINTED BY THE AUTHORITY OF THE STATE OF ILLINOIS

B&W PROJECT NO.: 181149

GENERAL NOTES

- 1. ALL CONSTRUCTION SHALL BE DONE IN ACCORDANCE WITH THE DETAILS IN THE PLANS, THE SPECIAL PROVISIONS INCLUDED IN THE CONTRACT DOCUMENTS, AND THE FOLLOWING STATE OF ILLINOIS SPECIFICATIONS: "THE STANDARD SPECIFICATIONS FOR ROAD AND BRIDGE CONSTRUCTION APRIL 2016" (REFERRED TO AS THE "STANDARD SPECIFICATIONS"), THE "SUPPLEMENTAL SPECIFICATIONS AND RECURRING SPECIAL PROVISIONS JANUARY 2020", THE "MANUAL ON UNIFORM TRAFFIC CONTROL DEVICES FOR STREETS AND HIGHWAYS", THE "MANUAL OF TEST PROCEDURES FOR MATERIALS" AND THE "STANDARD SPECIFICATIONS FOR WATER AND SEWER MAIN CONSTRUCTION IN ILLINOIS".
- THE LOCATIONS OF PUBLIC UTILITIES SHOWN ON THE PLANS REPRESENTS ONLY THE OPINION
 OF THE ENGINEER AND IS ONLY INCLUDED FOR THE CONVENIENCE OF THE BIDDER AND THE
 ACCURACY IS NOT GUARANTEED. THE CONTRACTOR SHALL BE RESPONSIBLE FOR THE PROTECTION OF ALL UNDERGROUND OR SURFACE UTILITIES, INCLUDING SPRINKLER SYSTEMS, EVEN THOUGH THEY MAY NOT BE SHOWN ON THE PLANS.
- 3. THE CONTRACTOR SHALL NOTIFY THE VILLAGE ENGINEER AT 847-639-0003 AT LEAST 48 HOURS IN ADVANCE OF BEGINNING WORK TO OBTAIN VILLAGE UTILITY LOCATIONS.
- THE CONTRACTOR MAY OBTAIN MUNICIPAL WATER IN BULK, AT NO CHARGE, AS LONG AS THERE IS NOT A "WATERING BAN" IN EFFECT. THE INDISCRIMINATE USE OF FIRE HYDRANTS IS STRICTLY PROHIBITED. WATER FOR CONSTRUCTION SHALL BE METERED OR OTHERWISE ACCOUNTED FOR AND A DAILY LOG MAINTAINED. THE CONTRACTOR SHALL PROVIDE THE WATER TRUCK AND DRIVER REQUIRED TO OBTAIN AND TRANSPORT THIS WATER. THE VILLAGE RESERVES THE RIGHT TO RESTRICT OR REFUSE THE USE OF VILLAGE WATER IF DEEMED NECESSARY.
- 5. ACCESS TO PRIVATE DRIVEWAYS SHALL BE PROVIDED AT ALL TIMES EXCEPT DURING ACTUAL CONSTRUCTION ADJACENT THERE TO.
- 6. DURING CONSTRUCTION, THE CONTRACTOR WILL BE PERMITTED TO LIMIT ON-STREET PARKING IN ORDER TO COMPLETE CONSTRUCTION OPERATIONS. THE CONTRACTOR WILL BE REQUIRED TO COORDINATE WITH THE MUNICIPALITY A MINIMUM OF 48 HOURS IN ADVANCE. IT WILL BE THE RESPONSIBILITY OF THE CONTRACTOR TO PLACE ADVANCE SIGNS TO ALERT RESIDENTS AND COMMUTERS OF THE CONSTRUCTION WORK. THE PLACEMENT OF THESE SIGNS SHALL TAKE PLACE 48 HOURS IN ADVANCE IN ORDER TO ALLOW SUFFICIENT TIME FOR RESIDENTS AND GENERAL PUBLIC TO REVISE THEIR PARKING PATTERNS.
- 7. GEOTECHNICAL FABRIC FOR GROUND STABILIZATION AND/OR AGGREGATE SUBGRADE IMPROVEMENT (CU YD) HAVE BEEN PROVIDED FOR USE AT THE LOCATIONS INDICATED FOR SOILS THAT TEND TO BE UNSTABLE AND/OR UNSUITABLE. THE ACTUAL NEED FOR REMOVAL AND REPLACEMENT WITH ABOVE ITEM WILL BE DETERMINED IN THE FIELD AT THE TIME OF CONSTRUCTION BY THE GEOTECHNICAL ENGINEER. ALL POTENTIALLY UNSTABLE SOILS SHOULD BE TESTED WITH A STATIC OR DYNAMIC CONE PENETROMETER AND TREATED IN ACCORDANCE WITH ARTICLE 301.04 OF THE SSRBC AND IDOT SUBGRADE STABILITY MANUAL. IF UNSTABLE AND/OR UNSUITABLE SOILS ARE NOT ENCOUNTERED, THEN THE QUANTITY SHALL BE DEDUCTED AND NO ADDITIONAL COMPENSATION WILL BE DUE TO THE CONTRACTOR.
- ANY AGGREGATE SUBGRADE IMPROVEMENT CONTAMINATED AND/OR DAMAGED BY THE CONTRACTOR'S VEHICLES AND/OR EQUIPMENTS IS TO BE REMOVED AND REPLACED AS DIRECTED BY THE ENGINEER AT CONTRACTOR EXPENSE.

HIGHWAY STANDARDS

000001-07	STANDARD SYMBOLS, ABBREVIATIONS AND PATTERNS		
424001-11	PERPENDICULAR CURB RAMPS FOR SIDEWALKS	1	COVER
424031-02	MEDIAN PEDESTRIAN CROSSINGS		CENERAL NOTES LUCIDIVAY STANDARDS
606001-07	CONCRETE CURB TYPE B AND COMBINATION CONCRETE CURB AND GUTTER	2	GENERAL NOTES, HIGHWAY STANDARDS, BENCHMARKS, AND INDEX OF SHEETS
606301-04	PC CONCRETE ISLANDS AND MEDIANS		DENCHMANO, AND INDEX OF SHEETS
701006-05	OFF-RD OPERATIONS, 2L, 2W, 15' (4.5 m) TO 24" (600 mm) FROM PAVEMENT EDGE	3	SUMMARY OF QUANTITIES
701301-04	LANE CLOSURE, 2L, 2W, SHORT TIME OPERATIONS		TYPICAL SECTIONS AND HOT-MIX ASPHALT
701501-06	URBAN LANE CLOSURE, 2L, 2W, UNDIVIDED	4	MIXTURE REQUIREMENTS
701502-09 701801-06	URBAN LANE CLOSURE, 2L, 2W, WITH BIDIRECTIONAL LEFT TURN LANE		Thirtone negotierens
701801-08	SIDEWALK, CORNER OR CROSSWALK CLOSURE TRAFFIC CONTROL DEVICES	5 - 6	PLAN AND PROFILE
720001-01	SIGN PANEL MOUNTING DETAILS	7	PLAN
720001-01	SIGN PANEL ERECTION DETAILS	,	FEAT
878001-10	CONCRETE FOUNDATION DETAILS	8	EROSION CONTROL PLAN
		9 - 11	ADA DETAILS
		J 11	NOT DE ITALES
		12	MISCELLANEOUS DETAILS
			CURB OR CURB AND GUTTER REMOVAL AND
		13	REPLACEMENT
		14	DISTRICT ONE TYPICAL PAVEMENT MARKINGS
		*-	DISTRICT ONE THICKE PAVENERY MARKINGS
		15 - 18	CROSS SECTIONS

BENCHMARKS

(NAVD88)

NORTHEAST ARROW BOLT ON FIRE HYDRANT ON NORTH SIDE OF MAIN STREET AT ADDRESS 664 ELEV = 867.414

NORTHEAST ARROW BOLT ON FIRE HYDRANT ON NORTH SIDE OF MAIN STREET AT ADDRESS 628 ELEV = 847.732

SCALE: N.T.S.

USER NAME = 642jdm	DESIGNED - JRNEW	REVISED -
	DRAWN - KAR	REVISED -
PLOT SCALE = 20,0000 ' / in.	CHECKED - JJF	REVISED -
PLOT DATE = 3/27/2020	DATE - 3-27-20	FILE - 181149-SHT-GenNotes dan

INDEX OF SHEETS

	20101000	TEMPORARY FENCE	FOOT	500	500
¥	20101200	TREE ROOT PRUNING	EACH	8	8
*	20101350	TREE PRUNING (OVER 10 INCH DIAMETER)	EACH	8	8
	20200100	EARTH EXCAVATION	CUYD	167	167
					,
	20201200	REMOVAL AND DISPOSAL OF UNSUITABLE MATERIAL	CUYD	214	214
	21001000	GEOTECHNICAL FABRIC FOR GROUND STABILIZATION	SQYD	1,413	1,413
	21101615	TOPSOIL FURNISH AND PLACE, 4"	SQYD	930	930
	25000110	SEEDING, CLASS 1A	ACRE	0.3	0.3
	~******************************				
	25000400	NITROGEN FERTILIZER NUTRIENT	POUND	27	27
	91291121011117JUST				
	25000500	PHOSPHORUS FERTILIZER NUTRIENT	POUND	27	27
	25000600	POTASSIUM FERTILIZER NUTRIENT	POUND	27	27
	25100630	EROSION CONTROL BLANKET	SQYD	930	930
-	28000250	TEMPORARY EROSION CONTROL SEEDING	POUND	30	30
	28000400	PERIMETER EROSION BARRIER	FOOT	150	150
***************************************	28000510	INLET FILTERS	EACH	7	7
	W16248 / 2007 2				
		PECIALTY ITEM PECIAL PROVISION			

ITEM

				CONSTRUCTION CODE
				SRTS 100%
CODE			TOTAL	SIDEWALK
NO.	ПЕМ	UNIT	QUANTITY	0021 URBAN
30300001	AGGREGATE SUBGRADE MPROVEMENT	CUYD	58	S8
35101600	AGGREGATE BASE COURSE, TYPE B 4"	SQYD	683	683
40800050	INCIDENTAL HOT-MIX ASPHALT SURFACING	том	4	4
42001300	PROTECTIVE COAT	SQYD	760	760
42400200	PORTLAND CEMENT CONCRETE SIDEWALK 5 INCH	SQFT	5,840	5,840
42400800	DETECTABLE WARNINGS	SQFT	136	136
44000100	PAVEMENT REMOVAL	\$QYD	46	40
44000600	SIDEWALK REMOVAL	SQFT	425	425
60600605	CONCRETE CURB, TYPE B	FOOT	310	310
60603800	COMBINATION CONCRETE CURB AND GUTTER, TYPE B-5.12	FOOT	95	95
60618300	CONCRETE MEDIAN SURFACE, 4 INCH	SQFT	150	150
67100100	MOBILIZATION	LSUM	1.00	1.00
70102620	TRAFFIC CONTROL AND PROTECTION, STANDARD 701501	LSUM	1.00	1.00
70102622	TRAFFIC CONTROL AND PROTECTION, STANDARD 701502	LSUM	1.90	1.00
70102640	TRAFFIC CONTROL AND PROTECTION, STANDARD 701801	L SUM	1.00	1,00

					CONSTRUCTION CODE SRTS 100%
r			т п		
	CODE	*****	UNIT	TOTAL	SIDEWALK
	NO.	TEM	UNIT	QUANTITY	0021
-			 		URBAN
-	72000100	SIGN PANEL - TYPE 1	SQFT	46	46
-	72400500	RELOCATE SIGN PANEL ASSEMBLY - TYPE A	EACH	2	2
-					
	72800100	TELESCOPING STEEL SIGN SUPPORT	FOOT	60	60
	78000600	THERMOPLASTIC PAVEMENT MARKING - LINE 12"	FOOT	184	184
	78000650	THERMOPLASTIC PAVEMENT MARKING - LINE 24"	FOOT	24	24
	89501510	RELOCATE EXISTING FLASHING BEACON	EACH	2	2
-		RECORD ENGINEERING CONTROL			<u></u>
ŀ	Z0004562	COMBINATION CONCRETE CURB AND GUTTER REMOVAL AND REPLACEMENT	FOOT	165	165
	Z0013798	CONSTRUCTION LAYOUT	LSUM	1.00	1.00
	Z0017400	DRAMAGE & UTILITY STRUCTURES TO BE ADJUSTED	EACH	3	3
-	Z0033058	POST MOUNTED FLASHING BEACON INSTALLATION (SPECIAL)	EACH	2	2
	X0327980	PAVEMENT MARKING REMOVAL - WATER BLASTING	SQFT	128	128
				**************************************	***************************************

-					

CODE NO.

· INDICATES SPECIALTYITEM
INDICATES SPECIAL PROVISION

CONSTRUCTION CODE SRTS 100% SIDEWALK

0021 URBAN

TOTAL QUANTITY


INDICATES SPECIAL PROVISION


BAXTER WOODMAN


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Γ		DRAWN	-	KAR	REVISED -
Γ	PLOT SCALE = 20.0000 ' / in.	CHECKED	-	IJF	REVISED -
Γ	PLOT DATE = 3/27/2020	DATE	-	3-27-20	FILE - 181149-SHT-SOQ.dgn

STAT	E OF	ILLINOIS
DEPARTMENT	OF	TRANSPORTATION

SUMMARY OF QUANTITIES							F.A.U. RTE.	SECTION	COUNTY	SHEETS	NO.	ĺ
							4056	19-00070-00-SW	McHENRY	18	3	ĺ
									CONTRAC	T NO. 61	G63	ĺ
CALE: N.T.S.	SHEET 1	OF	1	SHEETS	STA.	TO STA.	ILLINOIS FED. AID PROJECT LIPR(748)				ĺ	

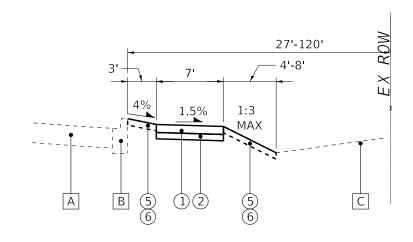

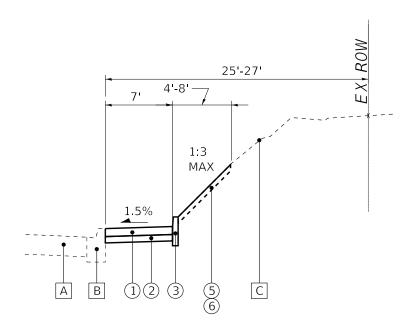

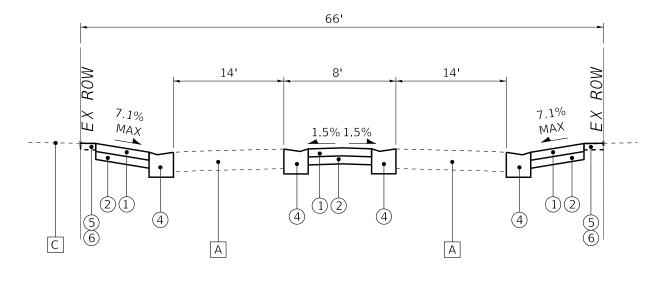

TYPICAL SECTION

W MAIN STREET STA 50+30 TO STA 54+40

TYPICAL SECTION

W MAIN STREET STA 54+40 TO STA 57+73

TYPICAL SECTION

W MAIN STREET AT WULFF ROAD

LEGEND

EXISTING PAVEMENT

В EXISTING CURB AND GUTTER

C EXISTING GROUND

1 PORTLAND CEMENT CONCRETE SIDEWALK - 5"

2 AGGREGATE BASE COURSE, TYPE B - 4"

3 CONCRETE CURB, TYPE B - 6"

4 COMBINATION CONCRETE CURB AND GUTTER TYPE B-6.12

(5) SEEDING, CLASS 1A

TOPSOIL FURNISH AND PLACE, 4"

HOT-MIX ASPHALT MIXTURE REQUIREMENTS

MIXTURE TYPE	AIR VOIDS @ Ndes		
INCIDENTAL HOT-MIX ASPHALT SURFACING			
HOT-MIX ASPHALT SURFACE COURSE, MIX "D", N50; 2" (IL-9.5mm)	4% @ 50 Gyr.		
NOTES:	•		

SCALE: N.T.S.

1. THE UNIT WEIGHT USED TO CALCULATE ALL HMA SURFACE MIXTURE QUANTITIES IS 112 LBS/SQ YD/IN.
2. THE "AC TYPE" FOR POLYMERIZED HMA MIXES SHALL BE "SBS/SBR PG 76 -22" AND FOR NON-POLYMERIZED HMA THE "AC TYPE" SHALL BE "PG 64 -22" UNLESS MODIFIED BY DISTRICT ONE SPECIAL PROVISIONS.

3. FOR USE OF RECYCLED MATERIALS SEE SPECIAL PROVISIONS.

BAXTER WOODMAN Consulting Engineers

USER NAME = 642jdm	DESIGNED - JRNEW	REVISED -
	DRAWN - KAR	REVISED -
PLOT SCALE = 20.0000 ' / in.	CHECKED - JJF	REVISED -
PLOT DATE = 3/27/2020	DATE - 3-27-20	FILE - 181149-SHT-TypSec.dgn

STATE OF ILLINOIS **DEPARTMENT OF TRANSPORTATION**

	1	ΥPI	CA	SECTI	ONS AI	ND	F.A.U. RTE	SECTION
но	Τ_ΜΙΧ Δ	SPH	ΔΙΊ	міхті	RF RF	QUIREMENTS	4056	19-00070-00-SW
110	I WIIA A	<i>7</i> 1 11	AL	WIIN	INE INE	SOUVEINIENIO		
SI	HEET 1	OF	1	SHEETS	STA	TO STA		II LIMOIC

STATE OF ILLNOIS - PROFESSIONAL DESIGN FIRM_DOLDGY_DOTG-BW_D6FQUH_DIT 14-00112] - EXPRES 4.2027]XLOXDOPPOLSVBURGE-BPH ILPON-TID 52772020 as 328229 AM FLCTYSTOLLOGG (XRYV)RIGHS-SORD

McHENRY 18 4 CONTRACT NO. 61G63

MAIN ST BEGIN IMPROVEMENT W MAIN STREET SIDEWALK 19-13-103-020 19-13-103-017 19-13-103-018 19-13-103-019 19-13-103-021 19-13-103-022 - INCIDENTAL HOT-MIX STA 50+30 ASPHALT SURFACING CARY_ALGONQUIN ROAD STA 54+40 STA 14+92 PGL - COMB CONC CURB AND GUTTER REMOVAL AND REPLACEMENT RELOCATE SIGN PANEL ASSEMBLY, TYPE A -STA 51+15 STA 54+15 -STA 11+67 PGL STA 51+60 STA 12+12 PGL STA 12+19 PGL 25′ [©]12′′ — STA 51+92 STA 12+44 PGL 25′ 6′′ (STA 11+00 PGL) 2' WEDGE TO BACK OF CURB RELOÇATE SIGN PANEL ASSEMBLY, TYPE A PCC SIDEWALK, 5 INCH (TYP) PEDESTAL AND GUY WIRE PCC SIDEWALK, 5 INCH (TYP) PROFILE GRADE LINE (PGL) TO BE RELOCATED (BY OTHERS) POWER POLE TO REMAIN 19-13-152-002 SIDEWALK REMOVAL CONCRETE CURB, TYPE B 60 870 870 ROPOSED PGL PROFILE EXISTING::PGL::PROFILE: 865 865 860 860 855 855 850 850 PR PGL 845 845 863.43 864.34 864.30 864.65 864.69 USER NAME = 642jdm DESIGNED -REVISED PLAN & PROFILE SECTION COUNTY BAXTER WOODMAN Consulting Engineers STATE OF ILLINOIS DRAWN KAR REVISED 18 5 4056 19-00070-00-SW McHENRY W MAIN ST LOT SCALE = 20.0000 ' / in. CHECKED -REVISED **DEPARTMENT OF TRANSPORTATION** CONTRACT NO. 61G63 SCALE: 1" = 20' SHEET SHEETS STA. 50+00 TO STA. 55+00 FILE - 181149-SHT-PP1-WMain.dgn

PLOT DATE = 3/27/2020 FILE - 181149-SHT-Plan1-WMain.dgn


BAXTER WOODMAN Consulting Engineers

LOT SCALE = 5.0000 ' / in. REVISED

DEPARTMENT OF TRANSPORTATION

MAIN STREET AND CARY-ALGONQUIN ROAD

McHENRY 18 9 CONTRACT NO. 61G63 19-00070-00-SW

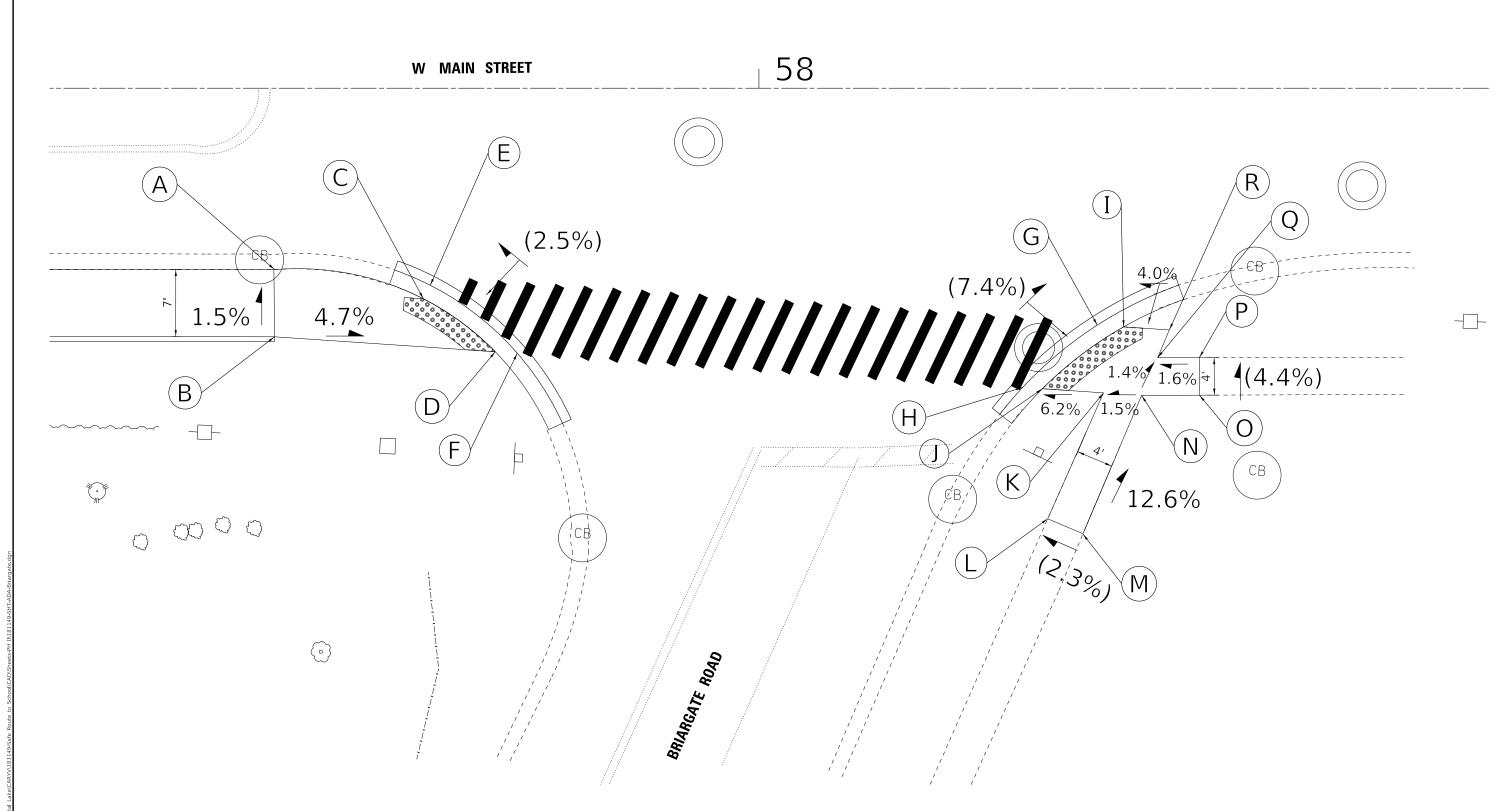


STATE DF ILLINDIS - PROFESSIONAL DESIGN FIRM.Not-dr-v.pdf-BW.lbefoult.pit LICENSE NO. - 184-001121 - EXPIRES 4/38021\CADVPlots\N8149.FH ILPen.tbl 642jdm 3/21/2020 8:28:47 AM IS/Crystall.dke/CARTYVI8149-Safe Route to School\CAD\Sheets-PH


BAXTER WOODMAN Consulting Engineers

STATE OF ILLINOIS
DEPARTMENT OF TRANSPORTATION

SIDEWALK DETAILS
MAIN STREET AND BRIARGATE ROAD

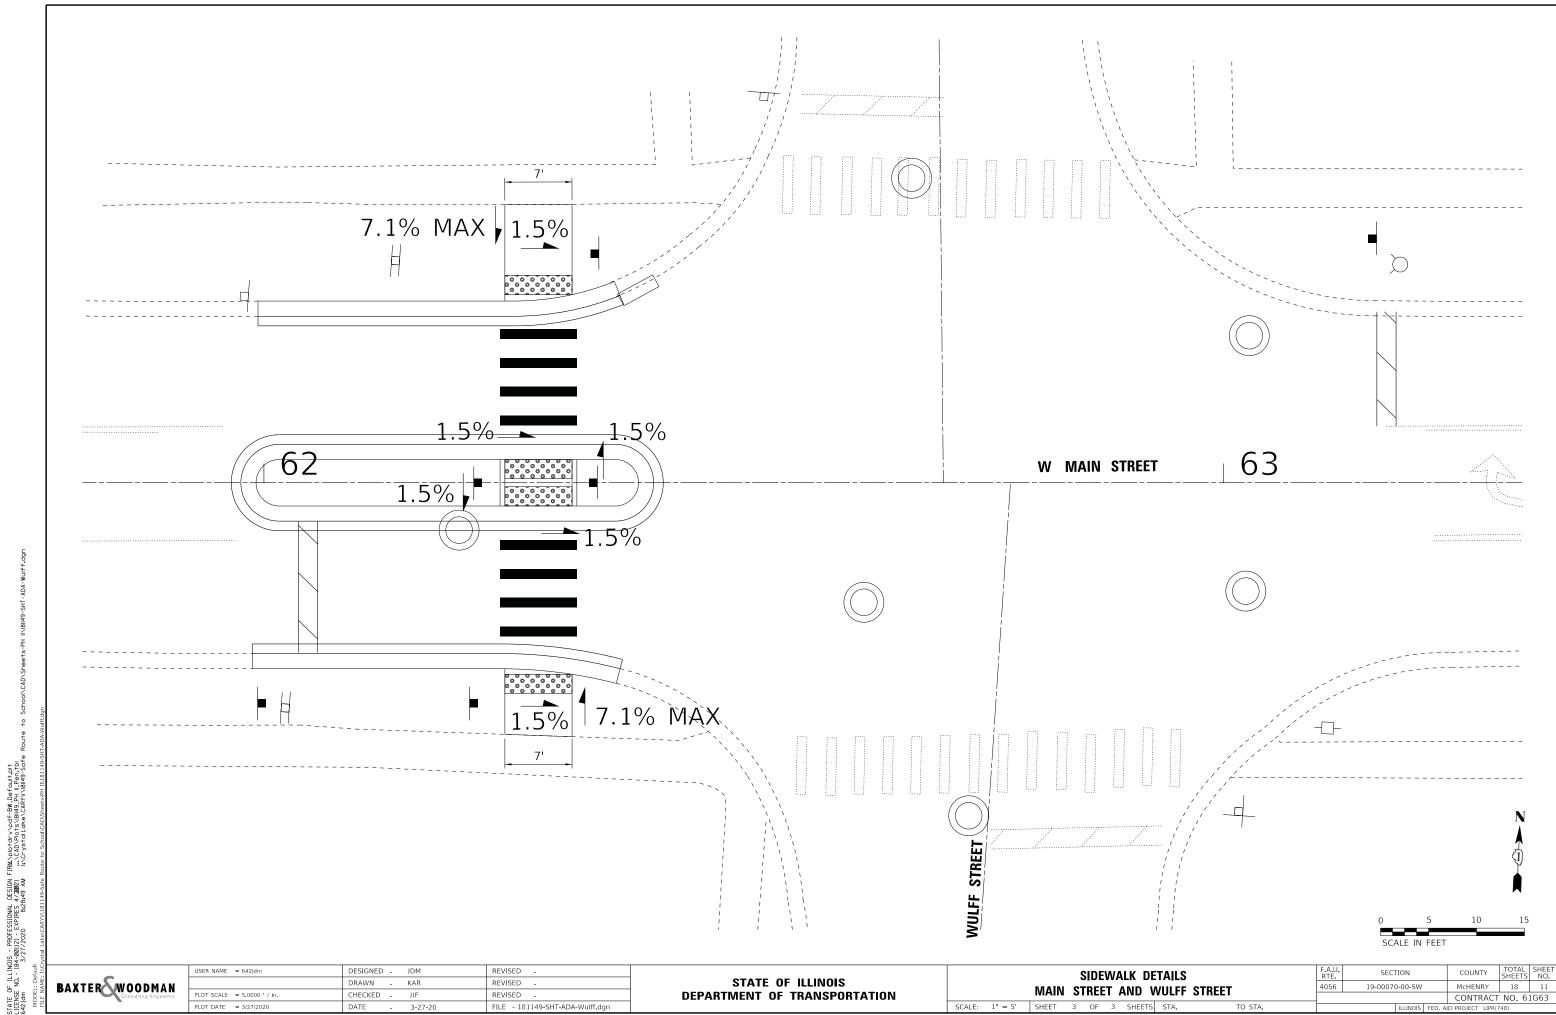

BAXTER WOODMAN

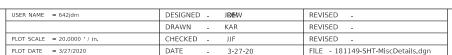

RELOCATED FLASHING BEACON ASSEMBLY

BOLT PATTERN SET INTO FOUNDATIONS

TO MATCH EXISTING BASE PLATE

- CONCRETE FOUNDATION, TYPE A

24" DIA X 48" DEPTH (OR MATCH EXISTING)

RELOCATE EXISTING FLASHING BEACON FOUNDATION DETAIL

NO SCALE

STEEL MESH REPLACEABLE -FILTER BAG _PLAN GENERAL NOTES:

<u>SECTION</u>

FRAME: TOP RING CONSTRUCTED FROM 1 1/4" x 1 1/4" x 1/8" ANGLE.

BASE RING CONSTRUCTED OF 1 1/2" x 1/2" x 1/8" CHANNEL.

HANDLES & SUSPENSION BRACKETS CONSTRUCTED FROM 1/4" x 1

1/4" FLAT. ALL STEEL CONFORMING TO ASTM—ASA.


12"-30"'

REPLACEABLE BAG: CONSTRUCTED FROM 4 OZ./SQ. YD. NON-WOVEN POLYPROPYLENE GEOTEXTILE REINFORCED WITH POLYESTER MESH. CONNECTED TO BASE RING WITH STAINLESS STEEL STRAP & LOCK.


SCALE: N.T.S.

STEEL MESH: REMOVABLE STAINLESS STEEL MESH STRAINER BASKET. 1/4" DIA. HOLE SIZE, 58% OPEN AREA.

INLET PROTECTION FILTER NO SCALE

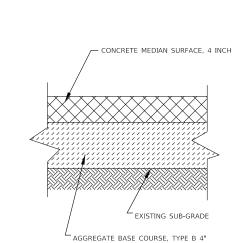



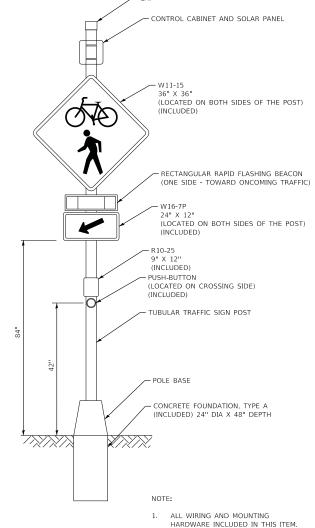


- - 2. APPLICABLE SIGNAGE AND BEACON LOCATED ON BOTH SIDES OF POST.

POST MOUNTED FLASHING BEACON INSTALLATION (SPECIAL) DETAIL

STATE OF ILLINOIS	
DEPARTMENT OF TRANSPORTATION	

MISCELLANEOUS DETAILS							SECTION			COUNTY	TOTAL SHEETS	SHEE'
							19-00070-00-SW			McHENRY	18	12
										CONTRACT	NO. 6	1G63
	SHEET 1	OF 1	SHEETS	STA.	TO STA.			ILLINOIS	FED. Al	ID PROJECT LIPR(7	748)	

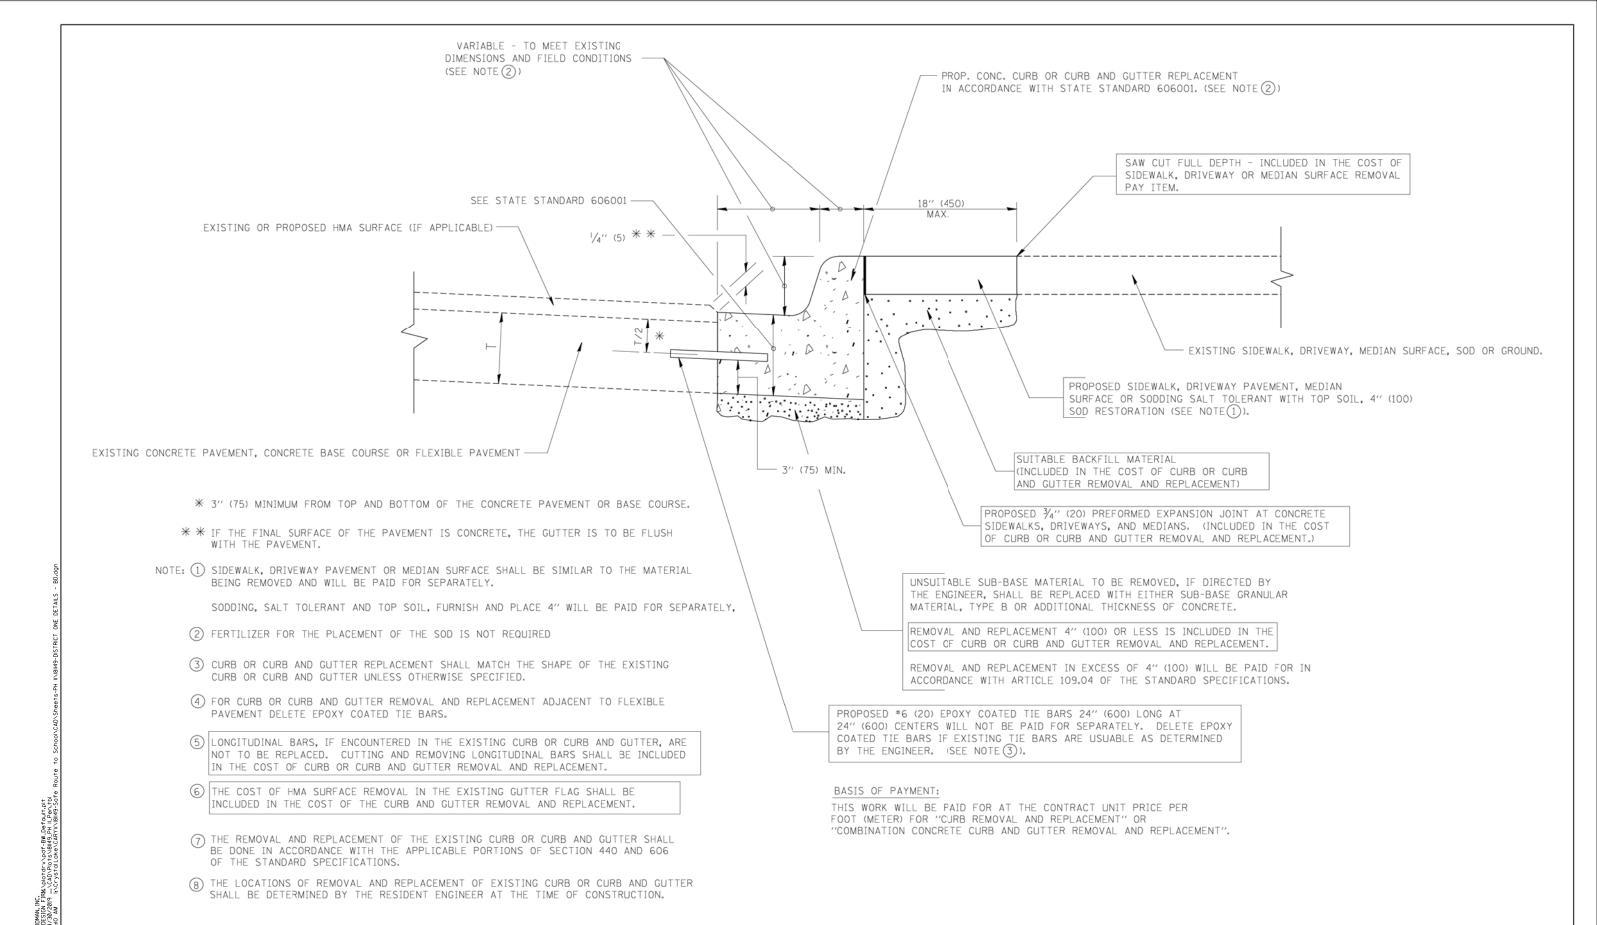

CURB OR CURB AND GUTTER REMOVAL AND REPLACEMENT


SCALE: NONE


ALL DIMENSIONS ARE IN INCHES (MILLIMETERS) UNLESS OTHERWISE SHOWN.

FILE NAME =	USER NAME = drivakosgn	DESIGNED -	A. HOUSEH	REVISED	-	R. SHAH 10-03-96
c:\pw_work\pwidot\drivakosgn\d0108315\bd	24.dgn	DRAWN -		REVISED	-	A. ABBAS 03-21-97
	PLOT SCALE = 50.000 '/ IN.	CHECKED -		REVISED	-	M. GOMEZ 01-22-01
	PLOT DATE = 12/15/2009	DATE -	03-11-94	REVISED	-	R. BORO 12-15-09

STATE OF ILLINOIS
DEPARTMENT OF TRANSPORTATION

CURB OR CURB A	ND GUTTER	ł	F.A RTE.	SECTION	COUNTY	TOTAL	SHEE NO.	
REMOVAL AND RE	DI ACEMENT		4056	19-00070-00-SW	McHENRY	18	13	
NEWIOVAL AND NE	PLACEMIEN		BD600-06 (BD-24) CONTRACT NO. 61G6					
SHEET NO. 1 OF 1 SHEETS	STA.	TO STA.	FED. R	OAD DIST, NO. 1 ILLINOIS FED. A	D PROJECT LIP	R(748)		

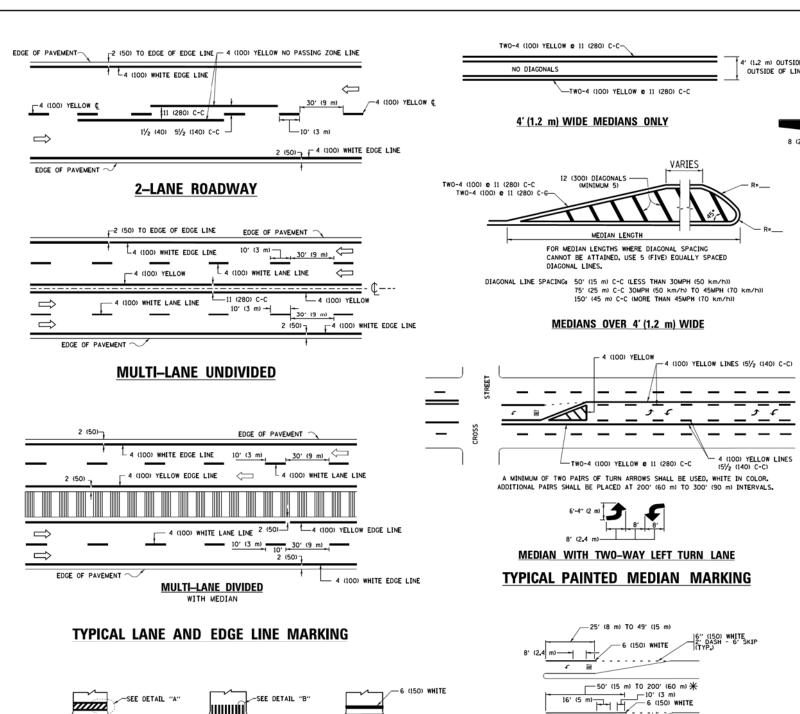

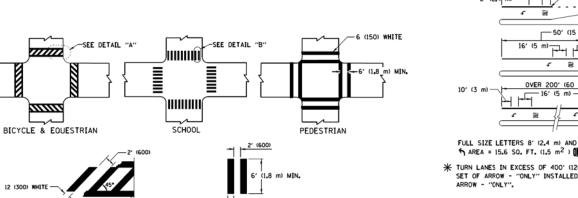

-12 (300) WHITE


DETAIL "B"

TYPICAL CROSSWALK MARKING

 \divideontimes MARKINGS SHALL BE INSTALLED PARALLEL TO THE CENTERLINE OF THE ROAD WHICH IT CROSSES

DETAIL "A"

4' (1.2 m) OUTSIDE TO OUTSIDE OF LINES 12 (300) WHITE DIAGONALS e 10' (3 m) OR LESS SPACING ISLAND OFFSET FROM PAVEMENT EDGE

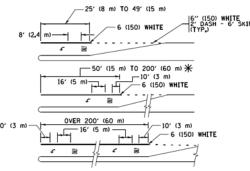


FULL SIZE LETTERS 8' (2.4 m) AND ARROWS SHALL BE USED.

* TURN LANES IN EXCESS OF 400' (120 m) IN LENGTH MAY HAVE AN ADDITIONAL SET OF ARROW - "ONLY" INSTALLED MIDWAY BETWEEN THE OTHER TWO SETS OF

TYPICAL LEFT (OR RIGHT) TURN LANE

TYPICAL TURN LANE MARKING

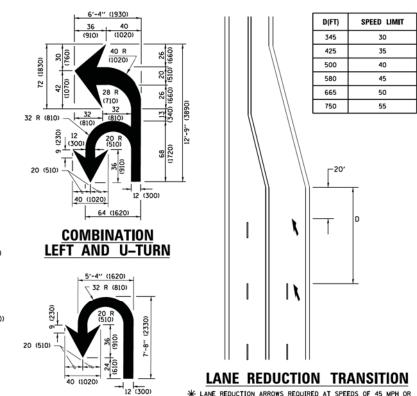

* LANE REDUCTION ARROWS REQUIRED AT SPEEDS OF 45 MPH OR GREATER OR WHEN SPECIFIED IN PLANS.

TYPE OF MARKING	WIDTH OF LINE	PATTERN	COLOR	SPACING /REMARKS
CENTERLINE ON 2 LANE PAVEMENT	4 (100)	SKIP-DASH	YELLOW	10' (3 m) LINE WITH 30' (9 m) SPACE
CENTERLINE ON MULTI-LANE UNDIVIDED PAVEMENT	2 @ 4 (100)	SOLID	YELLOW	11 (280) C-C
NO PASSING ZONE LINES: FOR ONE DIRECTION FOR BOTH DIRECTIONS	4 (100) 2 0 4 (100)	SOLID SOLID	YELLOW	5½ (140) C-C FROM SKIP-DASH CENTERLINE 11 1280) C-C OMIT SKIP-DASH CENTERLINE BETWEEN
LANE LINES	4 (100) 5 (125) ON FREEWAYS	SKIP-DASH SKIP-DASH	WHITE WHITE	10' (3 m) LINE WITH 30' (9 m) SPACE
DOTTED LINES (EXTENSIONS OF CENTER, LANE OR TURN LANE MARKINGS)	SAME AS LINE BEING EXTENDED	SKIP-DASH	SAME AS LINE BEING EXTENDED	2' (600) LINE WITH 6' (1,8 m) SPACE
EDGE LINES	4 (100)	SOLID	YELLOW-LEFT WHITE-RIGHT	OUTLINE MEDIANS IN YELLOW
TURN LANE MARKINGS	6 (150) LINE; FULL SIZE LETTERS & SYMBOLS (8' (2,4m))	SOLID	WHITE	SEE TYPICAL TURN LANE MARKING DETAIL
TWO WAY LEFT TURN MARKING	2 © 4 (100) EACH DIRECTION 8' (2.4m) LEFT ARROW	SKIP-DASH AND SOLID IN PAIRS	WHITE	10' (3 m) LINE WITH 30' (9 m) SPACE FOR SKIP-DASH, 5½ (140) C-C BETWEEN SOLID LINE AND SKIP-DASH LINE SEE TYPICAL TWO-WAY LEFT TURN MARKING DETAIL
CROSSWALK LINES (PEDESTRIAN) A. DIAGONALS (BIKE & EOUESTRIAN) B. LONGITUDINAL BARS (SCHOOL)	2 @ 6 (150) 12 (300) @ 45° 12 (300) @ 90°	SOLID SOLID SOLID	WHITE WHITE WHITE	NOT LESS THAN 6' (1.8 m) APART 2' (600) APART 2' (600) APART SEE TYPICAL CROSSWALK MARKING DETAILS.
STOP LINES	24 (600)	SOLID	WHITE	PLACE 4' (1,2 m) IN ADVANCE OF AND PARALLEL TO CROSSMALK, IF PRESENT, OTHERNISE, PLACE AT DESIRED STOPPING POINT. PARALLEL TO CROSSROAD CENTERLINE, WHERE POSSIBLE
PAINTED MEDIANS	2 © 4 (100) WITH 12 (300) DIAGONALS © 45° NO DIAGONALS USED FOR 4' (1,2 m) WIDE MEDIANS	SOLID	YELLOW: TWO WAY TRAFFIC WHITE: ONE WAY TRAFFIC	11 (280) C-C FOR THE DOUBLE LINE SEE TYPICAL PAINTED MEDIAN MARKING.
GORE MARKING AND CHANNELIZING LINES	8 (200) WITH 12 (300) DIAGONALS @ 45°	SOLID	WHITE	DIAGONALS: 15' (4.5 m) C-C (LESS THAN 30MPH (50 km/h)) 20' (6 m) C-C 30MPH (50 km/h) TO 45MPH (70 km/h) 30' (9 m) C-C (OVER 45MPH (70 km/h))
RAILROAD CROSSING	24 (600) TRANSVERSE LINES; "RR" IS 6' (1,8 m) LETTERS; 16 (400) LINE FOR "X"	SOLID	WHITE	SEE STATE STANDARD 780001 AREA OF: "R"=3.6 SO. FT. (0.33 m²) EACH "X"=54,0 SO. FT. (5,0 m²)
SHOULDER DIAGONALS (REQUIRED FOR SHOULDERS ≥ 8')	12 (300) e 45°	SOLID	WHITE - RIGHT YELLOW - LEFT	50' (15 m) C-C (LESS THAN 30MPH (50 km/h)) 75' (25 m) C-C (30 MPH (50 km/h) TO 45MPH (70 km/ 150' (45 m) C-C (OVER 45MPH (70 km/h))
U TURN ARROW	SEE DETAIL	SOLID	WHITE	16.3 SF
2 ARROW COMBINATION LEFT AND U TURN	SEE DETAIL	SOLID	WHITE	30.4 SF

U-TURN

FOR FURTHER DETAILS ON PAVEMENT MARKING REFER TO STANDARD SPECIFICATIONS FOR ROAD AND BRIDGE CONSTRUCTION AND STATE STANDARD 780001.

SCALE: NONE

8 (200) WHITE

ISLAND AT PAVEMENT EDGE

TYPICAL ISLAND MARKING

8 (200) WHITE ---

RAISED

All dimensions are in inches (millimeters) unless otherwise shown.

DISTRICT ONE TYPICAL PAVEMENT MARKINGS CONTRACT NO. 61G63 TC-13 SHEET 1 OF 1 SHEETS STA. TO STA. ILLINOIS FED. AID PROJECT | IPR(748

DESIGNED - EVERS REVISED -FILE NAME = USER NAME = leusa C. JUCIUS 09-09-09 DRAWN C. JUCIUS 07-01-13 PLOT SCALE = 50.000 '/ in. CHECKED REVISED -C. JUCIUS 12-21-15 DATE 03-19-90 REVISED -C. JUCIUS 04-12-16

STATE OF ILLINOIS **DEPARTMENT OF TRANSPORTATION**