



WATER MAINS CROSSING OVER

SEWERS & HOUSE DRAINS

PROFILE THROUGH SEWER/DRAIN

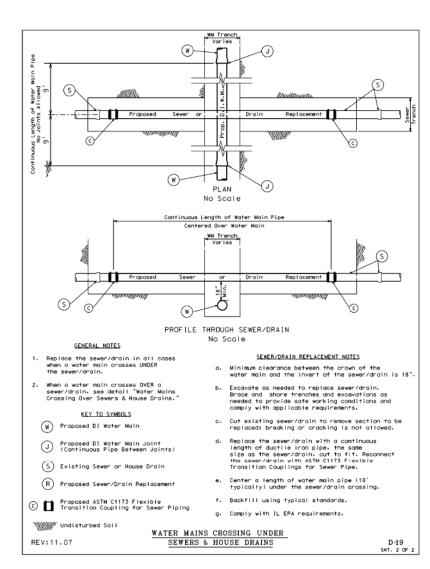

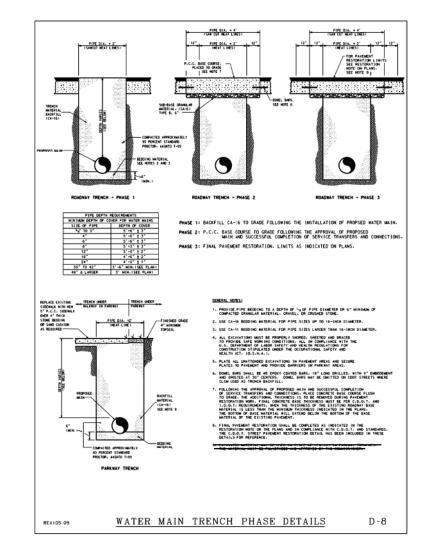



Rev:11.07

D162A75-SHT-WM-DET-02.dgn	DESIGNED	-	RBB	REVISED	-
USER NAME   dishevez	DRAWN	-	AFC .	REVISED	-
PLOT SCALE = 40.0008 '/ in-	CHECKED	-	MJE	REVISED	-
PLOT DATE = 3/20/2017	DATE	-	03/21/2017	REVISED	-

 f. Except where bentonite seals are shown, backfill using typical standards.

 Comply with IL EPA requirements (modified and approved by IL EPA November 13, 2007).

> STATE OF ILLINOIS DEPARTMENT OF TRANSPORTATION

> > SCALE: NONE

SCALE:	SHEET 2	0F	4	SHEETS	STA.	TO STA.		ELENOIS FED. AL	D PROJECT		
									CONTRAC	NO. 6	2A75
		WAII	EK I	MAIN [	ETAILS		90/94/290	2015-021-[	COOK	153	60
							RTE	SECTION	COUNTY	SHEETS	NO.

Tran Systems


 D168/X94-SHT-WATERMAIN-08.dgn
 DESIGNED
 REVISED

 USER NAME
 = Vljanachione
 DRAWN
 NLD
 REVISED

 PLOT SCALE
 = 180.0000 ' / in.
 CHECKED
 JMG
 REVISED

 PLOT DATE
 = 3/6/2020
 DATE
 3-13-2020
 REVISED


STATE OF ILLINOIS
DEPARTMENT OF TRANSPORTATION

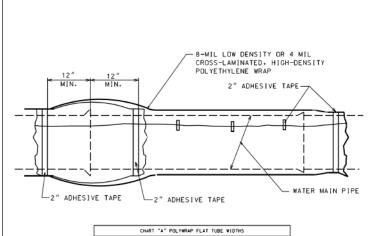

c	HART "A" POLYWRAP FLAT	TUBE WIDTHS		
PIPE DIAMETER	D. [.P. WITH PUSH-ON JOINTS (IN.)	D.I.P. WITH MECHANICAL JOINTS (IN.		
4	14	16		
6	17	20		
8	21	24		
12	29	30		
16	37	37		
24	53	53		

- USE ONE LENGTH OF POLYETHYLENE TUBE WRAP FOR EACH LENGTH OF PIPE, OVERLAPPED AT PIPE JOINTS AND FOLD EXCESS OVER TOP OF TUBE FOR SLACK REDUCTION.
- 2. USE CHART "A" TO SELECT SIZE OF WRAP.

WATER MAIN
POLYETHYLENE WRAP DETAIL REV:04.09

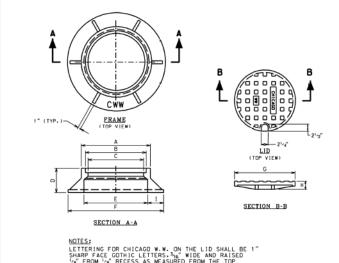

LETTERING FOR C.W.W. ON THE FRAME SHALL BE LOCATED ON THE TOP SURFACE OF THE MORIZONTAL FLANGE AND SHALL BE 1" SHARP FACE GOTHIC."," "NIDE AND RAISED"," AS MEASURED FROM THE FLANGE SURFACE. LOCATION OF LETTERING SHALL BE AS INDICATED ON DRAWING.


F	RAME AND LID	DIMENSIONS		
	FRAME	AND LID TYPES		
	STANDARD	36" SPECIAL F&L		
DIMENSION	INCHES	INCHES		
A	26	-		
В	23	36		
С	21	34		
D	9	81/2		
E	24	36		
F	36	45		
G	223/4	36		
н	3	11/2		
I	6	41/2		

STANDARD   36" SPECIAL F&L		FRAME	AND LID TYPES
LID 152 -		STANDARD	36" SPECIAL F&L
		LBS	LBS
FRAME 395 -	LID	152	-
	FRAME	395	-
TOTAL 547 720	TOTAL	547	720

D-15

SCALE: NONE

FRAME & LID REV:04.07

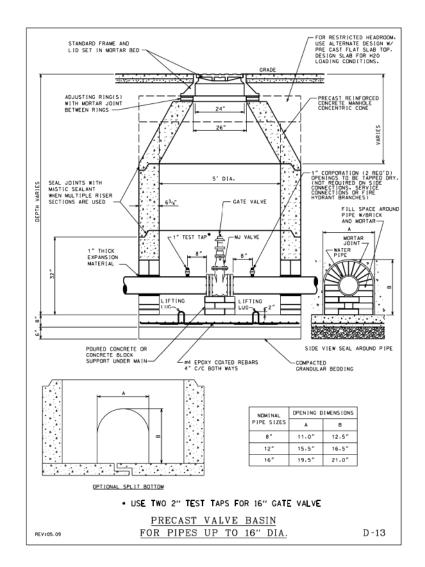

303 EAST WACKER DRIVE, SUITE 1400 CHICAGO, E. 60601-5276 PROMI (312) 373-7700 PAN (312) 373-6800

0162A75-SHT-WM-DET-83.dgn	DESIGNED - RBB	REVISED -
USER NAME = dishevez	DRAWN - AFC	REVISED -
PLOT SCALE - 48,8898 '/ Lo.	CHECKED - MJE	REVISED -
PLOT DATE - 3/20/2017	DATE - 03/21/2017	REVISED -

D-10


STATE OF ILLINOIS DEPARTMENT OF TRANSPORTATION

WATER MAIN DETAILS							RTE.	SECTION	COUNTY	TOTAL SHEETS	SHEET
		WAI	ĿК	MAIN D	ETAILS		90/94/290	2015-021- <b>[</b>	COOK	153	61
									CONTRACT	NO. (	62A75
SCALE	SHEET 3	OF	4	SHEETS	STA.	TO STA.		JULINOIS FED. AL	D PROJECT		



DI60X94-SHT-WATERMAIN-09.dgn	DESIGNED -	REVISED -
USER NAME = vljanachione	DRAWN - NLD	REVISED -
PLOT SCALE = 100.0000 ' / in.	CHECKED - JMG	REVISED -
PLOT DATE = 3/6/2020	DATE - 3-13-2020	REVISED -

										_
	EXISTING WATER MAIN PLANS					F.A.I. RTE.	SECTION	COUNTY	TOTAL SHEETS	SHEE NO.
JACKSON BOULEVARD				90/94/290	2014-015R&B-R	COOK	825	202		
		JAUKSUI	1 DOOL	LVAIID				CONTRACT	NO. 6	0X94
	SHEET 9	OF 17	SHEETS	STA.	TO STA.		ILLINOIS FED. A	ID PROJECT		

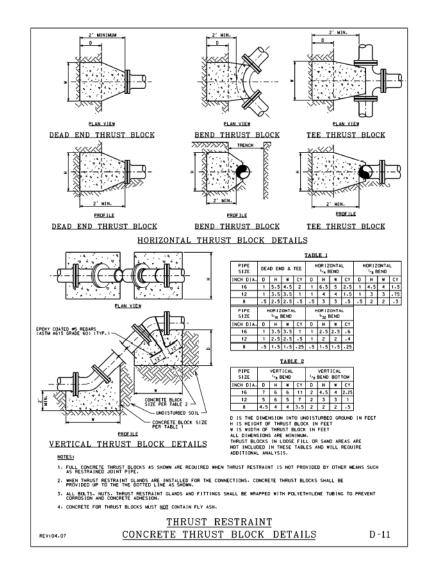

 PAYMENT FOR DWM STANDARD THRUST BLOCKS TO BE CONSTRUCTED PER DETAIL DRAWING D-11 IS INCLUDED IN THE COST OF DUCTILE IRON WATER MAIN, MECHANICAL JOINT 16". SEE SPECIAL PROVISIONS.

AECOM
303 EAST WHOLEY DRIVE, SECTI MOD
cide.060, D. 666001-5276
PRINT, 1322 3737-7700 FAM, 1332 373-6400

 DISCAPS-SHT-MM-DET-64.dgg
 DESIGNED
 RBB
 REVISED

 USER NAME
 data-weez
 DRAWN
 AFC
 REVISED

 PLOT SCALE
 48,8888 '/ un
 CHECKED
 MJE
 REVISED

 PLOT DATE
 3/28/2817
 DATE
 03/21/2017
 REVISED


STATE OF ILLINOIS
DEPARTMENT OF TRANSPORTATION


SCALE: NONE

Tran Systems

D160X94-SHT-WATERMAIN-10.dgn	DESIGNED -	REVISED -
USER NAME = vljanachione	DRAWN - NLD	REVISED -
PLOT SCALE = 100.0000 ' / in.	CHECKED - JMG	REVISED -
DLOT DATE - 2/C/2020	DATE 7 17 2020	DEVICED

EXIS	TING WA	TER M	AIN PLAI	VS	F.A.I. RTE.	SECTION	COUNTY	TOTAL SHEETS	SHEET NO.
JACKSON BOULEVARD				90/94/290	2014-015R&B-R	COOK	825	203	
	UNUNUUN						CONTRACT	NO. 6	0X94
SHEET 10	OF 17	SHEETS	STA.	TO STA.		ILLINOIS FED. A	D PROJECT		

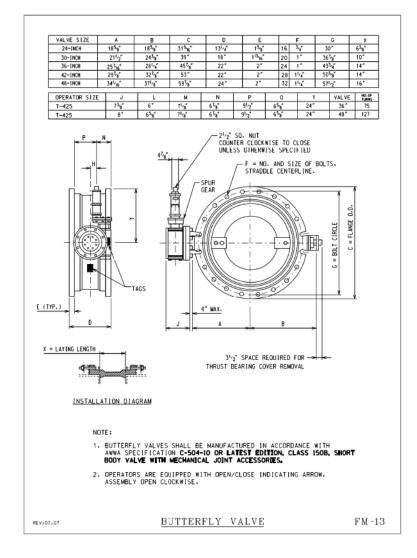

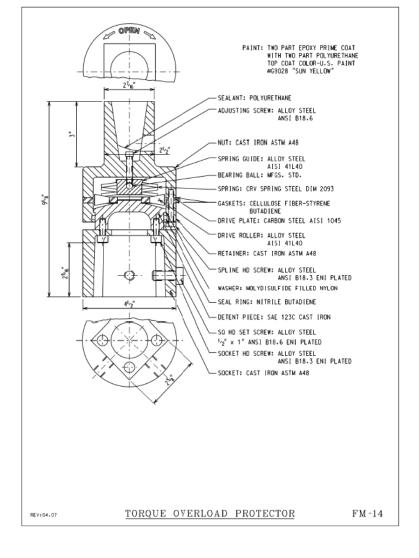

 WATER MAIN CONTROL VALVE-48 INCH BUTTERFLY VALVE SHALL BE AN ADVANCE PROCUREMENT FOR CONTRACT 62A74. SEE SPECIAL PROVISIONS FOR ADDITIONAL INFORMATION.

AECOM

303 EAST WACHE DRIVE, SUCTI 1400

ORIGADO, D. GOSCH-SE75

PROBE 3122 737-7000 CARA (3122 375-4000


STATE OF ILLINOIS DEPARTMENT OF TRANSPORTATION

SCALE: NONE



D160X94-SHT-WATERMAIN-11.dgn	DESIGNED -	REVISED -
USER NAME = vljanachione	DRAWN - NLD	REVISED -
PLOT SCALE = 100.0000 ' / in.	CHECKED - JMG	REVISED -
DI OT DATE - 246 (2022	DATE 7 17 2020	DEVICED

EXISTING WATER MAIN PLANS						F.A.I. RTE.	SECTION	COUNTY	TOTAL SHEETS	SHEET NO.
JACKSON BOULEVARD							2014-015R&B-R	COOK	825	204
	UAUI	.001	DOOL	LVAIID				CONTRACT	NO. 6	0X94
SHEET 11	OF	17	SHEETS	STA.	TO STA.		ILLINOIS FED. A	ID PROJECT		

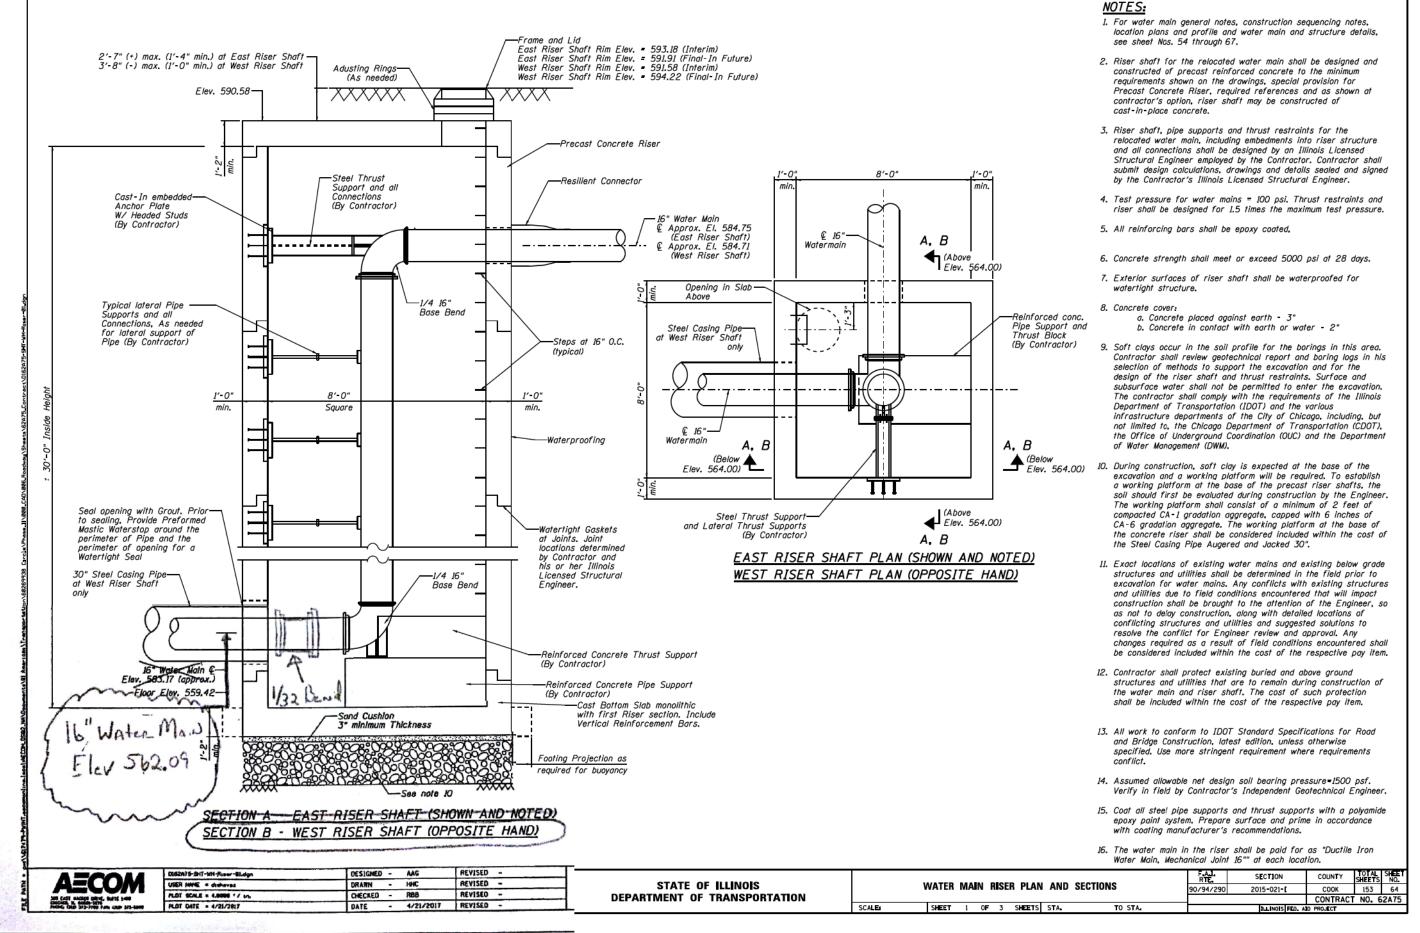

Tran Systems

STATE OF ILLINOIS
DEPARTMENT OF TRANSPORTATION

EXISTING WATER MAIN PLANS
JACKSON BOULEVARD


SHEET 12 OF 17 SHEETS STA.

TO STA.


SCALE: NONE


F.A.I. SECTION COUNTY TOTAL SHEETS NO. 90/94/290 2014-015R&B-R COOK 825 205

CONTRACT NO. 60X94

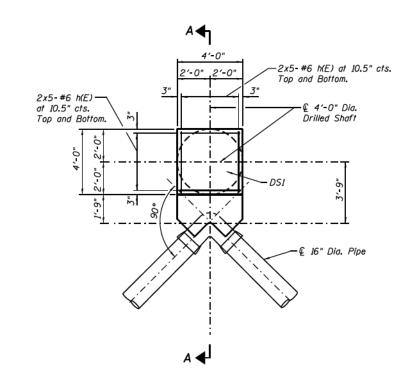



PLAN DETAIL
THRUST RESTRAINT - TYPE 1 (1 THUS)

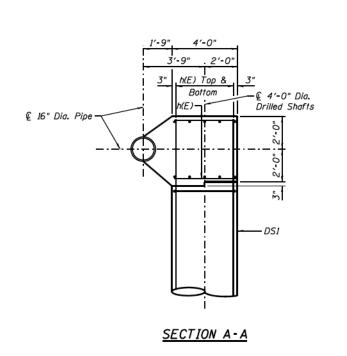

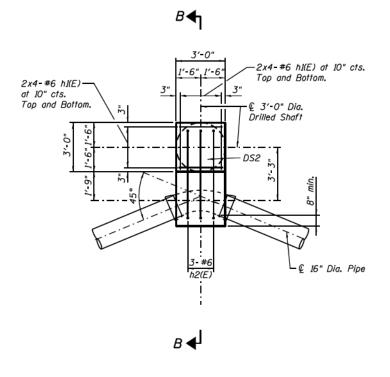


PLAN DETAIL
THRUST RESTRAINT - TYPE 2 (2 THUS)

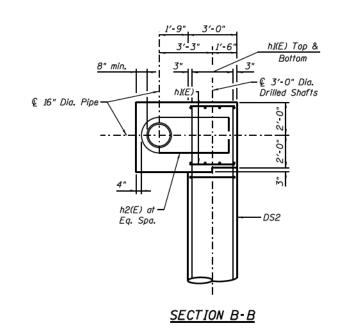

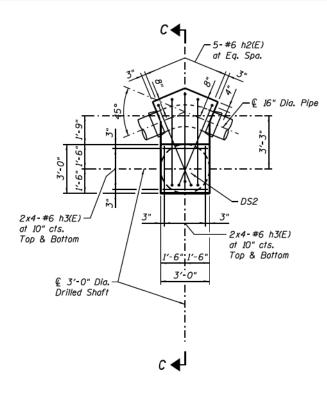

PLAN DETAIL
THRUST RESTRAINT - TYPE 3 (1 THUS)

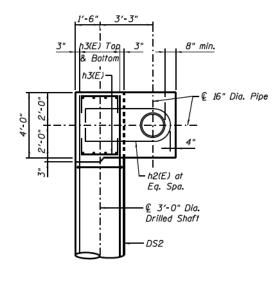

SECTION C-C

1. Work this sheet with Sheet No. 66.



						_
DI62A75-SHT-WM-Thrust-Detail-01.dgn	DESIGNED	-	AAG	REVISED	-	Г
USER NAME = floresg	DRAWN	-	GF	REVISED	-	ı
PLOT SCALE = 200 Y / 10.	CHECKED	-	KWH/AAG	REVISED	-	ı
PLOT DATE = 3/17/2017	DATE	-	03/21/2017	REVISED	-	

STATE OI	F ILLINOIS
DEPARTMENT OF	TRANSPORTATION

WATER I	MAIN	THRUS	T	RES	TRAINT	DETAILS	AND SECTIONS	
SCALE:	SHEET	2 (	)F	3	SHEETS	STA.	TO STA.	

RTE.	SECT]ON		COUNTY	TOTAL SHEETS	SHEET NO.
90/94/290	2015-021-		COOK	153	65
			CONTRACT	NO 6	2A75
	1LLIN0IS	FED. AJO	PROJECT		




DI60X94-SHT-WATERMAIN-13.dgn	DESIGNED -	REVISED -
USER NAME = vljanachione	DRAWN - NLD	REVISED -
PLOT SCALE = 100.0000 ' / in.	CHECKED - JMG	REVISED -
PLOT DATE = 3/6/2020	DATE - 3-13-2020	REVISED -

				ATER M N BOUL	AIN PLANS EVARD	
SCALE: NONE	SHEET 13	OF	17	SHEETS	STA.	TO STA.


F.A.I. RTE.	SECTION	COUNTY	TOTAL SHEETS	SHEET NO.
90/94/290	2014-015R&B-R	COOK	825	206
		CONTRACT	NO. 6	0X94
	ILLINOIS FED. A	ID PROJECT		

# 16 - #10 v(E) at DS1 #4 s(E) at 18" cts. SECTION E-E

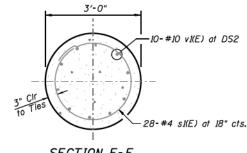

# - Bonded Joint See Specifications Top of Shaft Elev. See Schedule 3" CIr to Ties Minimum Diameter See Schedule /ert. Reinf. Bars See Schedule - Min. Net Allowable E or F E or F Soil Bearing Capacity Required = 2000 PSF in very stiff silty clay to silty clay loam fill. See Note 10. Note: For Shaft Construction, See Notes 9 and 10. Bottom of Shaft -Elevation - See

TYPICAL DRILLED SHAFT DETAIL

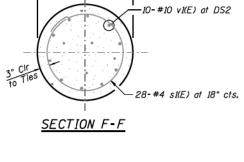

II" typ.

4'-3"

BAR h2(E)


# NOTES:

- For water main general notes, location plans, profiles, details and thrust restraint locations and types see Sheet Nos. 54 through 62. For existing water main reference drawings, see Sheet Nos. 55, 68 and 69.
- 2. Exact locations of existing water mains, existing concrete thrust blocks and existing below grade structures and utilities shall be determined in the field prior to excavation for water mains and drilling shafts for new reinforced concrete thrust restraints and pipe supports. Any conflicts with existing structures and utilities due to field conditions encountered that will impact construction shall be brought to the attention of the Engineer, so as not to delay construction, along with detailed locations of conflicting structures and utilities and suggested solutions to resolve the conflict for Engineer review and approval.
- Contractor shall protect existing buried and above ground structures and utilities that are to remain during construction of the water main and thrust restraints. The cost of such protection shall be considered included within the cost of the respective pay item.
- New permanent concrete thrust restraints shall have been in place for a minimum of 28 days and shall have achieved a minimum 28 day compressive strength of 4000 psi prior to pressure testing pipe with water.
- 5. Maximum test pressure for water mains = 100 psi.

BAR h3(E)

SCALE: NONE

- Fitting bends shall not be encased in concrete unless otherwise noted on the drawings. Minor adjustments to concrete dimensions and reinforcing bars shown may be required in the field and shall be considered included within the cost of the respective pay item.
- 7. Trench excavation and backfill for thrust restraint shall be considered included within the cost of the Ductile Iron Water Main, Mechanical Joint,
- 8. Mechanical reinforcing bar splices, where shown or required, shall be considered included within the cost of Reinforcement Bars, Epoxy Coated.
- 9. Contractor shall review Geotechnical Report and boring logs in his selection of methods to support the excavation in the various stages of shaft drilling, cleaning and concrete placement dependent on the boring logs and site conditions encountered. Surface water shall not be permitted to enter the hole. The Contractor shall comply with the requirements of the Illinois Department of Transportation (IDOT) and the various infrastructure departments of the City of Chicago. including, but not limited to, the Chicago Department of Transportation (CDOT), the Office of Underground Coordination (OUC) and the Department of Water Management (DWM).
- 10. Shafts must be drilled into very stiff silty clay to silty clay loam with a minimum net allowable soil bearing capacity of 2000 PSF, however, the drilled shaft shall not be less than 50 feet in length for DSI & 41 feet in length for DS2
- 11. Concrete Cover:
  - a. Concrete placed against earth 3"
  - b. Concrete in contact with earth 2"
- 12. All work to conform to IDOT Standard Specifications for Road and Bridge Construction, latest edition.
- 13. Work this sheet with Sheet No. 65.

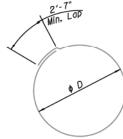

BAR	φD
s(E)	3'-6"
s1(E)	2′-6"

TIES

# THRUST RESTRAINTS BILL OF MATERIAL

Bar	No.	Size	Length	Shape
h(E)	20	#6	3′-6"	
h1(E)	32	#6	2'-6"	
h2(E)	11	#6	13′-6"	
h3(E)	E) 16 #6		4'-6"	
v(E)	16	#10	53′-6"	
v1(E)	30	#10	44'-6"	
s(E)	34	#4	13'-8"	0
sI(E)	84	#4	10'-6"	0
It	em		Unit	Quantity
Concrete S			Cu. Yd.	12
Reinforcem		Pound	10.890	
Epoxy Coat	ed	7 00/10	10,030	
Drilled Sha	ft In So	oil	Cu. Yd.	56

	SCHEDULE FOR DRILLED SHAFTS IN SOIL											
MARK	TOTAL QUANTITY	ELEV. © WATERMAIN (FEET)	ELEV. TOP OF DRILLED SHAFT (FEET)	ELEV. BOTTOM OF DRILLED SHAFT (FEET)	MINIMUM DRILLED SHAFT LENGTH (FEET)	MINIMUM DRILLED SHAFT DIAMETER (FEET)	VERTICAL REINFORCEMENT BARS AT EACH SHAFT	CIRCULAR TIES AT EACH SHAFT	SECTION	THRUST RESTRAIN TYPE		
DS1	1	587.37	585.37	535.37	50′	4'-0"	16-#10 v(E)	34-#4 s(E) at 18"	Ε	1		
DS2	3	587.47	585.47	544.47	41'	3'-0"	10-#10 v(E)	28-#4 s1(E) at 18"	F	2, 3		

Schedule

D162A75-SHT-WM-Thrust-Detail-82.dgn	DES1GNED	-	AAG	REVISED	-
USER NAME   dishevez	DRAWN	-	GF	REVISED	-
PLOT SCALE = 2:0 1/ / m.	CHECKED	-	KWH/AAG	REVISED	-
PLOT DATE • 3/28/2017	DATE	-	03/21/2017	REVISED	-

STATE OF ILLINOIS **DEPARTMENT OF TRANSPORTATION** 

	WATER	MAIN	THRU	JST	RES	TRAINT	DETAILS	AND	SECTIONS	
ALE:		SHEET	3	0F	3	SHEETS	STA.		TO STA.	

LEGEND DS - Drilled Shaft


RTE	SECTION	COUNTY	SHEETS	NO.
90/94/290	2015-021 <b>-1</b>	COOK	153	66
		CONTRACT	NO. 6	2A7
	ILLINOIS FED. A	D PROJECT		



DI60X94-SHT-WATERMAIN-14.dgn	DESIGNED -	REVISED -
USER NAME = vljanachione	DRAWN - NLD	REVISED -
PLOT SCALE = 100.0000 ' / in.	CHECKED - JMG	REVISED -
PLOT DATE = 3/6/2020	DATE - 3-13-2020	REVISED -

			ATER M. N BOUL	AIN PLANS EVARD	
SHEET 14	OF	17	SHEETS	STA.	TO STA.

					- 1
F.A.I. RTE.	SECTION		COUNTY	TOTAL SHEETS	SHEI NO
90/94/290	2014-015R&E	3-R	COOK	825	20
			CONTRACT	NO. 6	0X9
	ILLINOIS	FED. AI	D PROJECT		

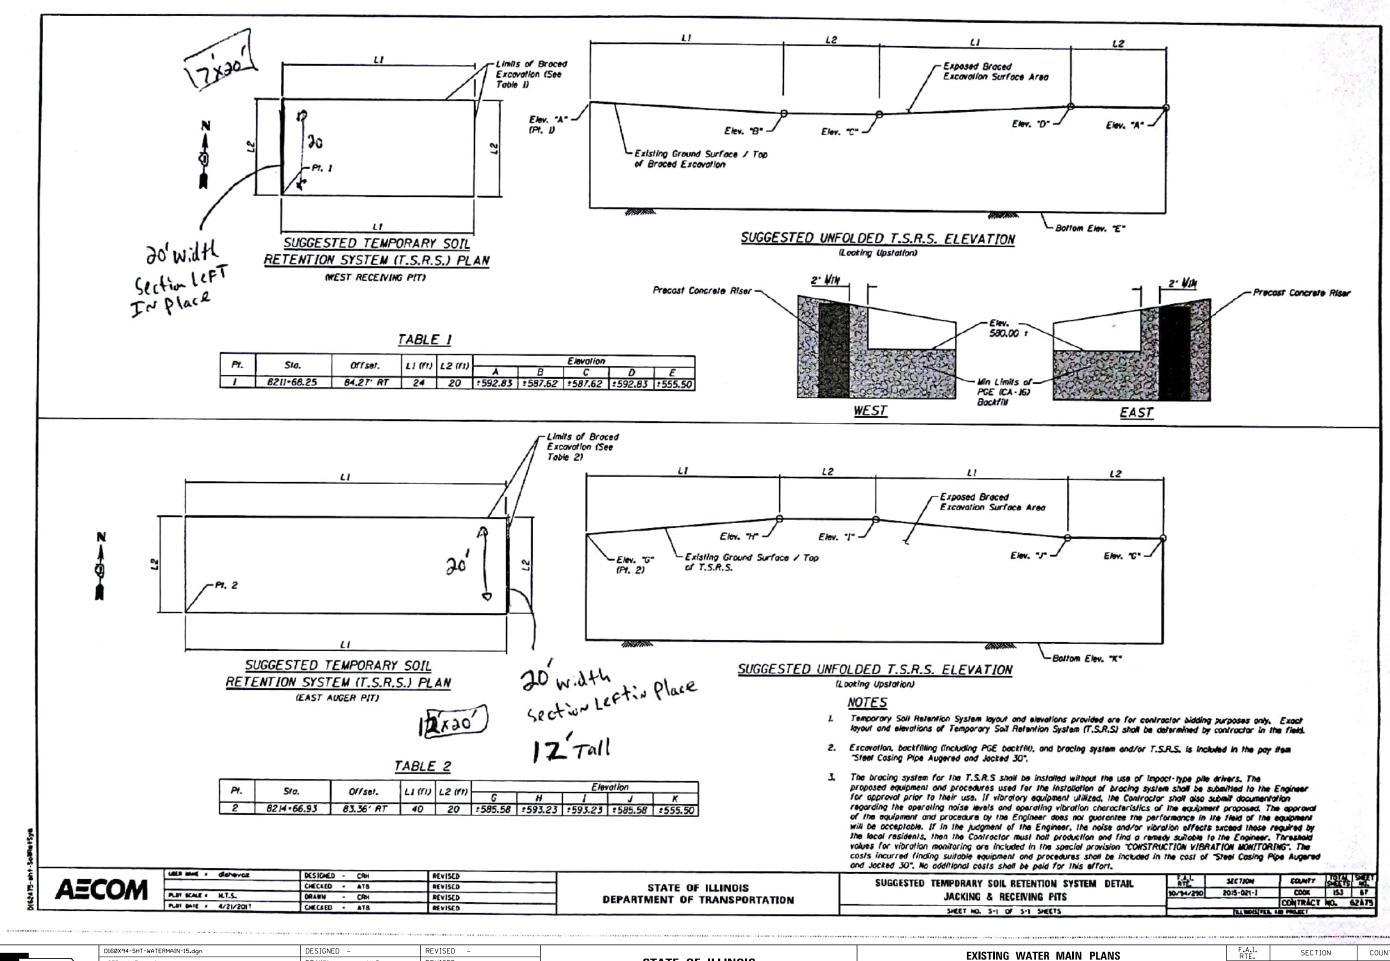

Tran Systems

 DIESTONED
 REVISED

 USER NAME = vljanachione
 DRAWN
 NLD
 REVISED

 PLOT SCALE = 100.0000 '/ in.
 CHECKED
 JMG
 REVISED

 PLOT DATE = 3/6/2020
 DATE
 3-13-2020
 REVISED

STATE OF ILLINOIS
DEPARTMENT OF TRANSPORTATION

EXISTING WATER MAIN PLANS

JACKSON BOULEVARD

SHEET 15 OF 17 SHEETS STA.

TO STA.


SCALE: NONE

F.A.I. RTE. SECTION COUNTY TOTAL SHEETS NO.

90/94/290 2014-015R&B-R COOK 825 208

CONTRACT NO. 60X94

# FOR INFORMATION ONLY

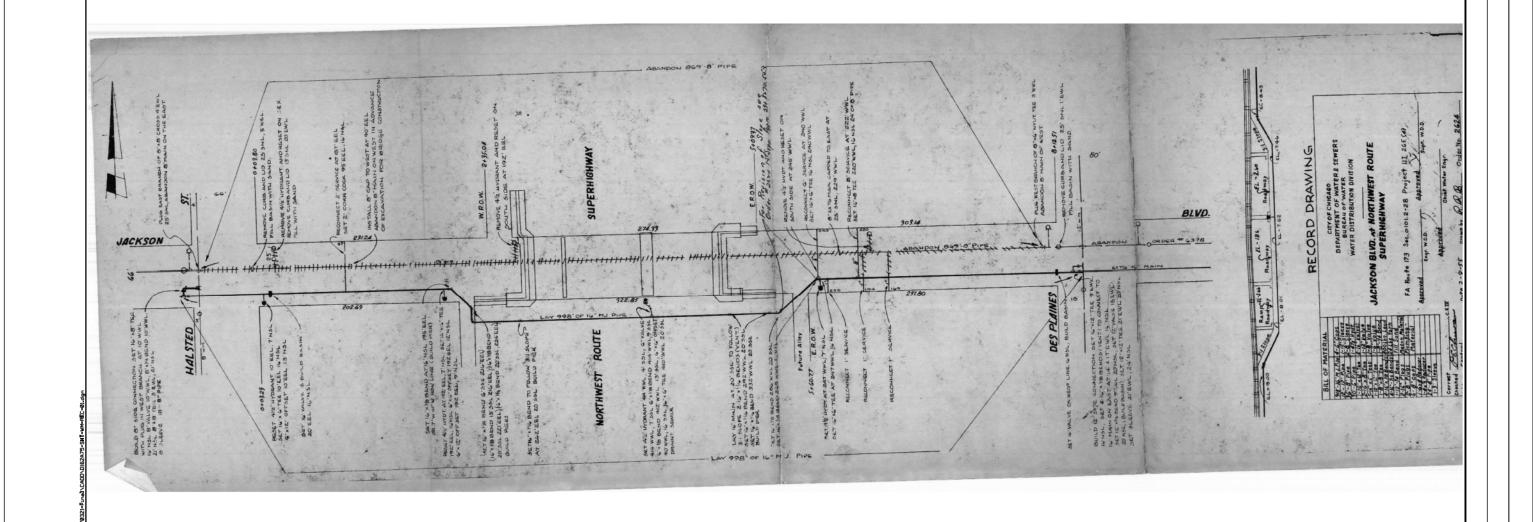

**AECOM**303 BAST WADER ORING SUCTI 1400
046250, D. 60601-5276 SUCTI 1400
1407 PRING 0313 737-7700 PAIR (332) 373-6400

STATE OF ILLINOIS DEPARTMENT OF TRANSPORTATION

SCALE: NONE



D160X94-SHT-WATERMAIN-16.dgn	DESIGNED -	REVISED -
USER NAME = vljanachione	DRAWN - NLD	REVISED -
PLOT SCALE = 100.0000 ' / in.	CHECKED - JMG	REVISED -
PLOT DATE = 3/6/2020	DATE - 3-13-2020	REVISED -

STATE OF ILLINOIS
DEPARTMENT OF TRANSPORTATION


EXIS	TING WA	TER M	AIN PL	ANS	F.A.I. RTE.	SECTION
JACKSON BOULEVARD						2014-015R&F
	OAGROUI	. DOOL	LVAIID			
SHEET 16	OF 17	SHEETS	STA.	TO STA.		ILLINOIS

COUNTY TOTAL SHEET NO.

COOK 825 209

CONTRACT NO. 60X94

# FOR INFORMATION ONLY

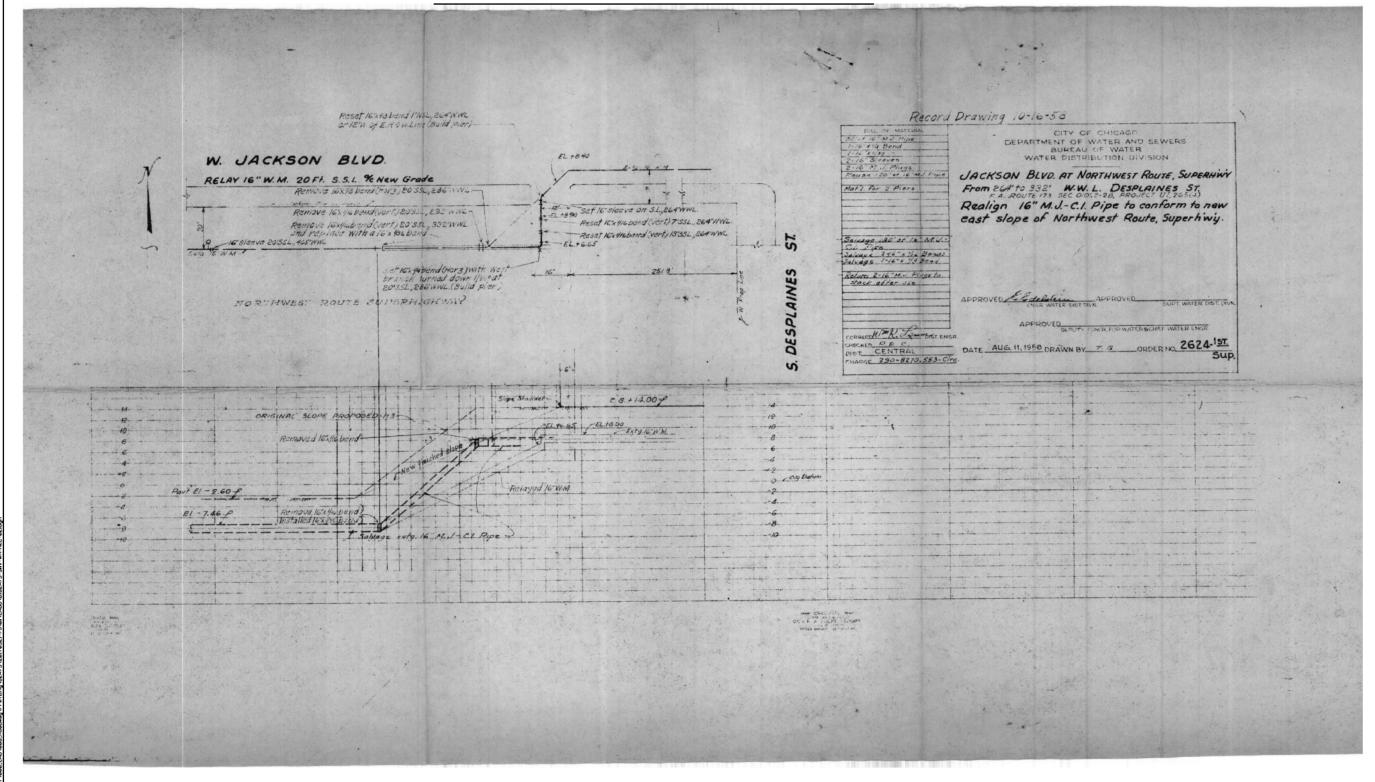

<b>AECOM</b>	
303 EAST WACKER DRIVE, SUCTE 1400 CHECAGO, D. 60601-5276 PHONE (312) 373-7700 FAX: (312) 373-6800	

D162A75-SHT-WM-REC-02,dgn	DESIGNED	-		REVISED	-	
USER NAME   dishevez	DRAWN	-		REVISED		
PLOT SCALE = 40.0800 '/ Lo.	CHECKED	-		REVISED	-	
PLOT DATE • 3/28/2017	DATE	-	03/21/2017	REV1SED	-	

STATI	E 01	F ILLINOIS
DEPARTMENT	OF	TRANSPORTATION

						INFORMATION:		F.A.L RTE.	SECTION	COUNTY	TOTAL SHEETS	SHEET NO,
	WATE	:K I	MA	IN	KECOKD	INFORMATION		90/94/290	2015-021 <b>-1</b>	COOK	153	69
										CONTRACT	T NO. 6	2A75
SCALE:	SHEET	2	0F	2	SHEETS	STA.	TO STA.		ILLINOIS FED. A	D PROJECT		




D160X94-SHT-WATERMAIN-17.dgn	DESIGNED -	REVISED -
USER NAME = vljanachione	DRAWN - NLD	REVISED -
PLOT SCALE = 100.0000 ' / in.	CHECKED - JMG	REVISED -
PLOT DATE = 3/6/2020	DATE - 3-13-2020	REVISED -


STATE OF ILLINOIS **DEPARTMENT OF TRANSPORTATION** 


EXIS	TING	W	ATER MA	AIN PLAN	S
	JAC	(SOI	N BOUL	EVARD	
HEET 17	OF	17	SHEETS	STA.	TO ST


SCALE: NONE


		ILL INOIS	EED	AID	PROJECT	NO. C	0 1 3-
				Т	CONTRACT	NO. 6	N Y 9 Z
90/94/290	2014-015R&B-R				COOK	825	210
RTE.	SECTION				COUNTY	SHEETS	SHEE NO.

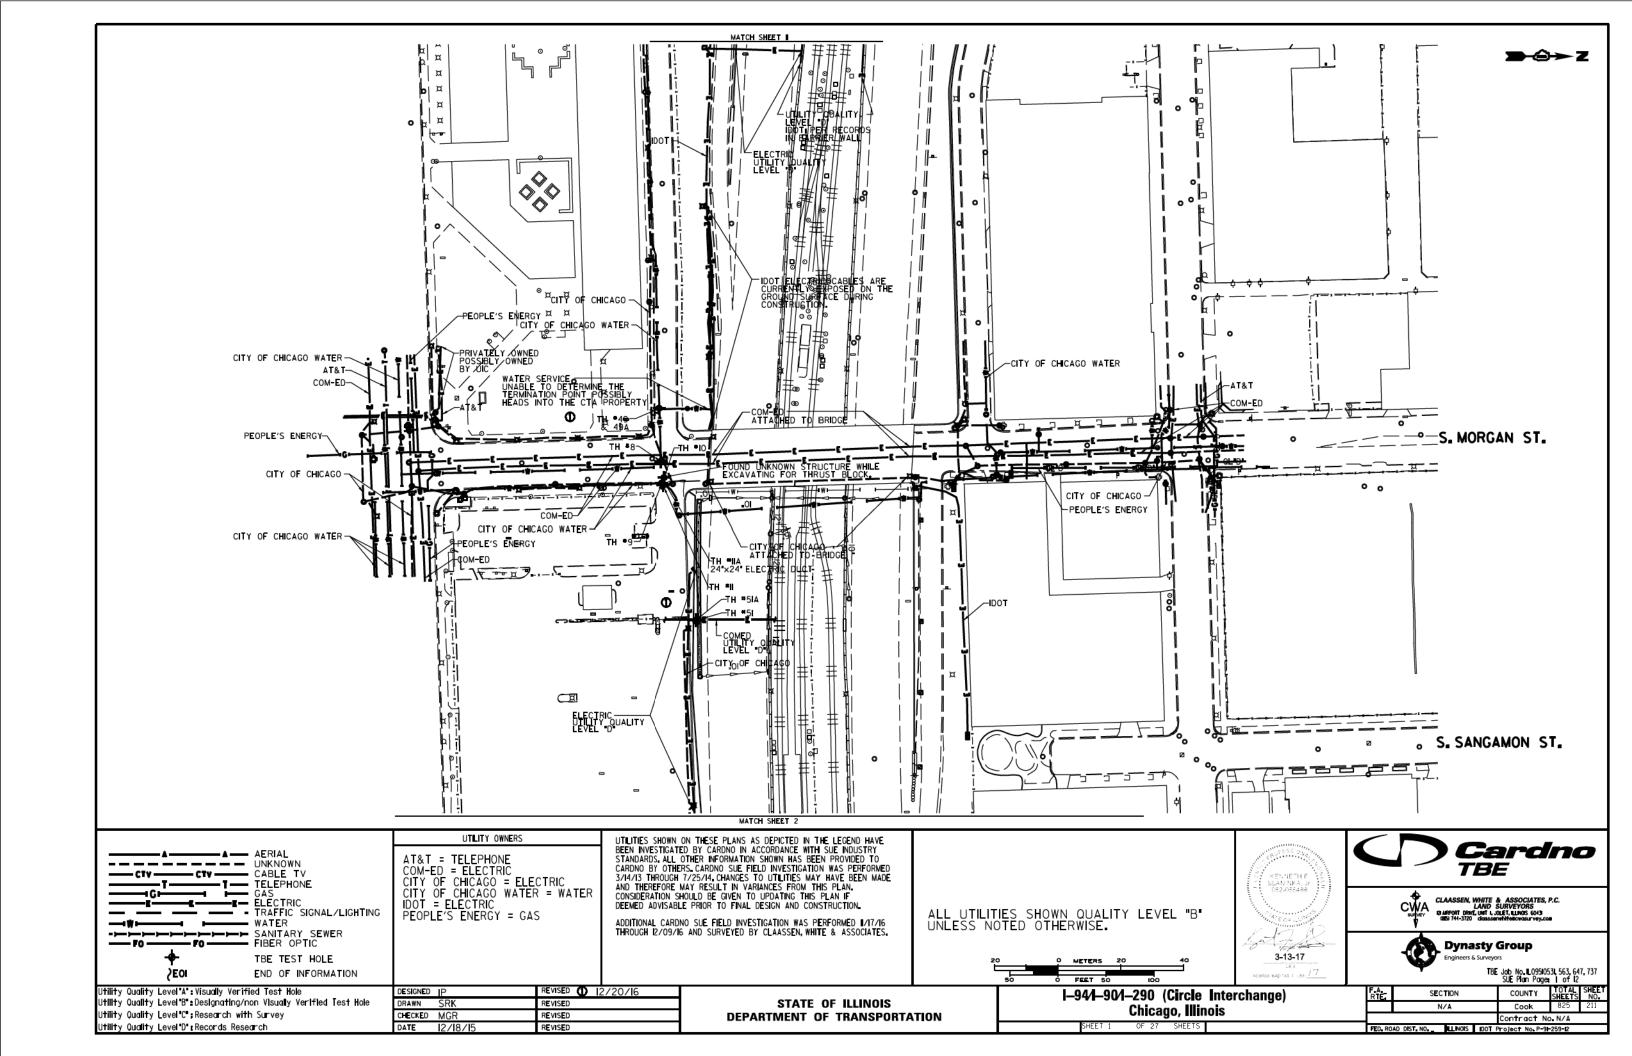


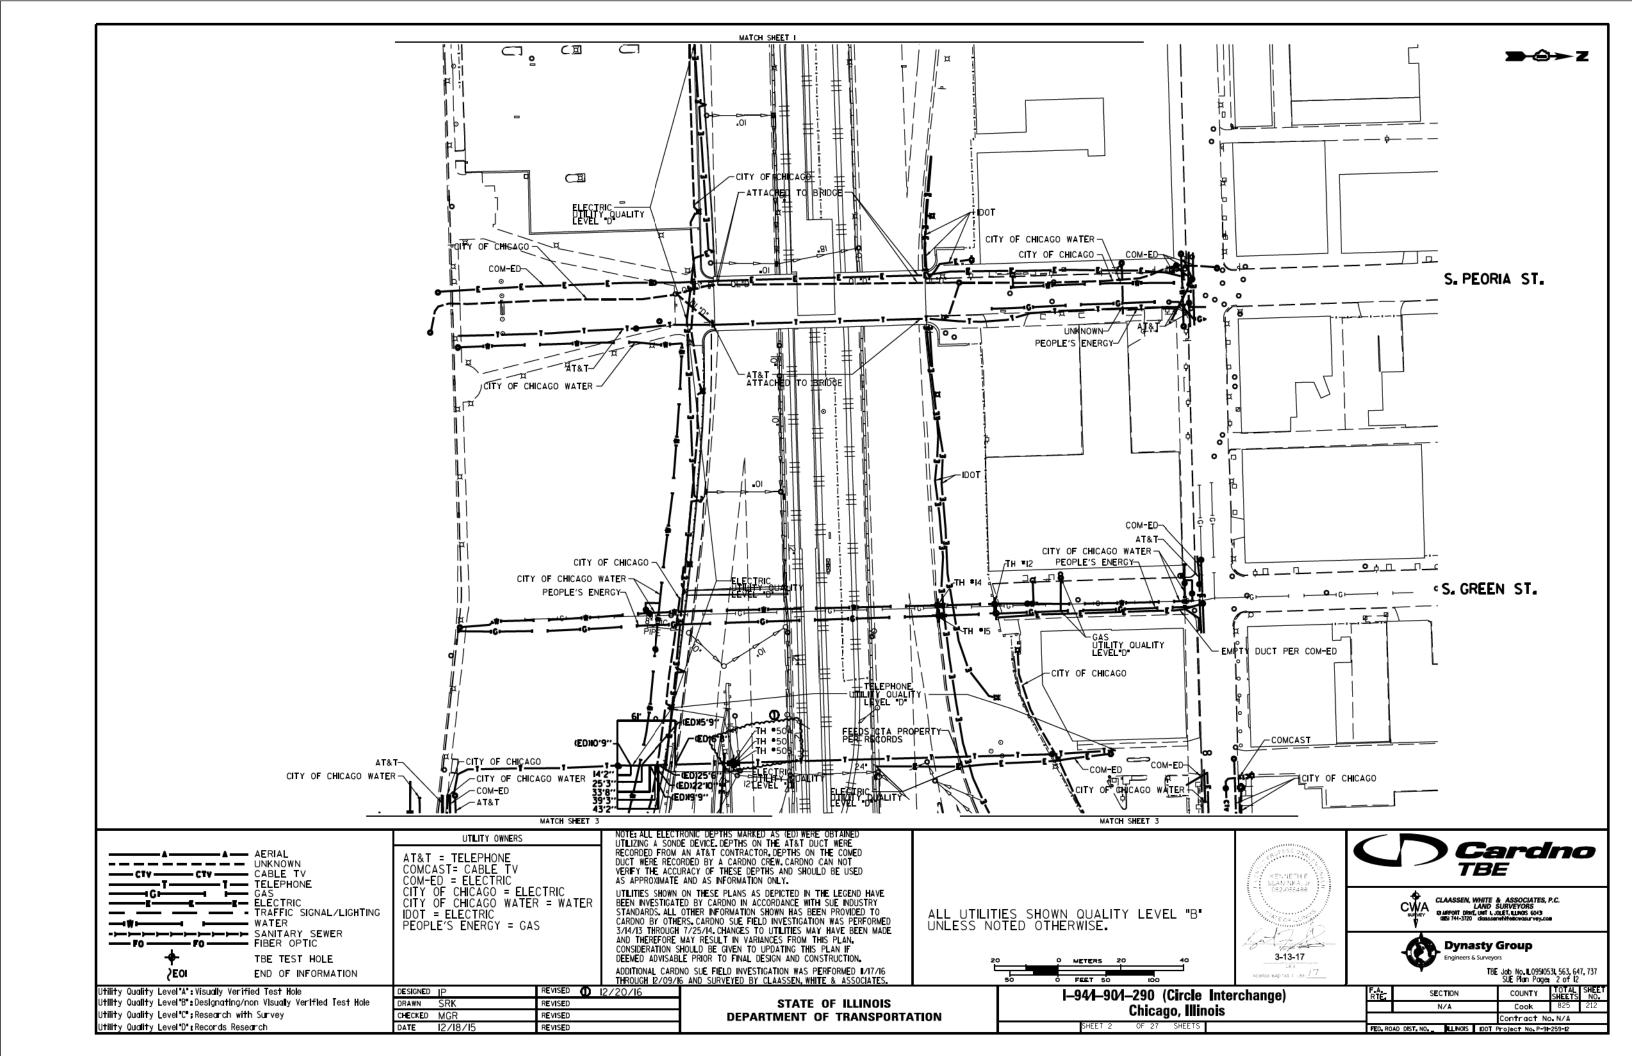

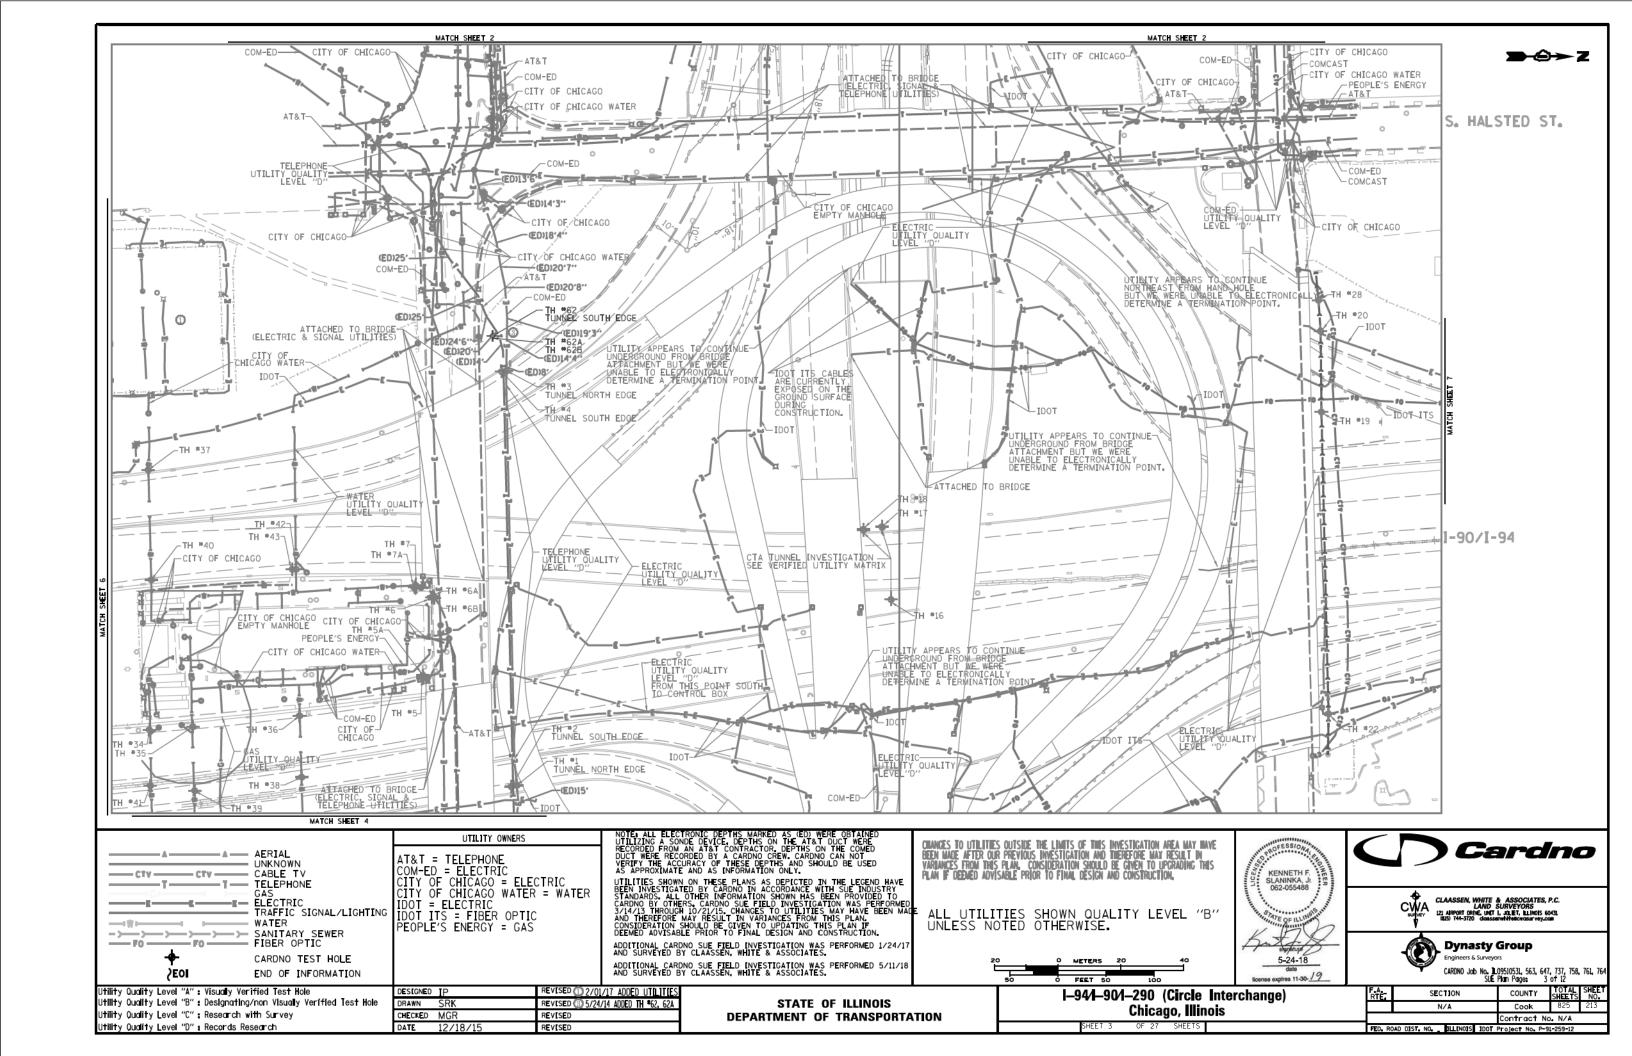

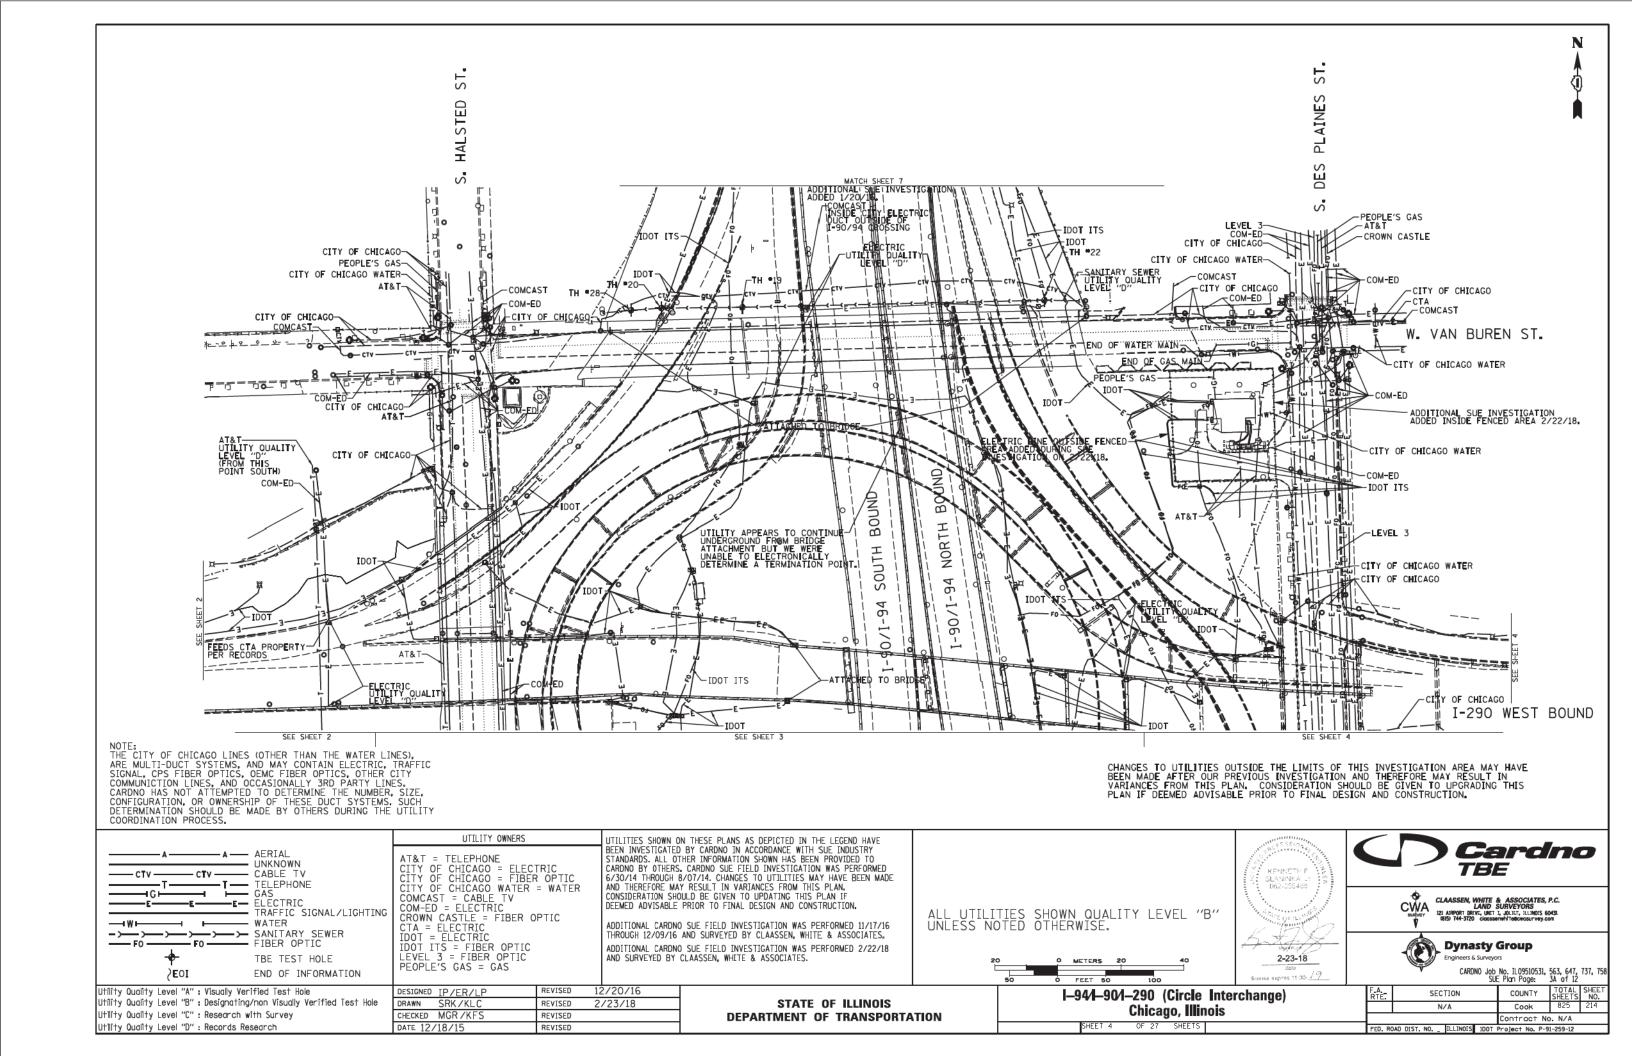

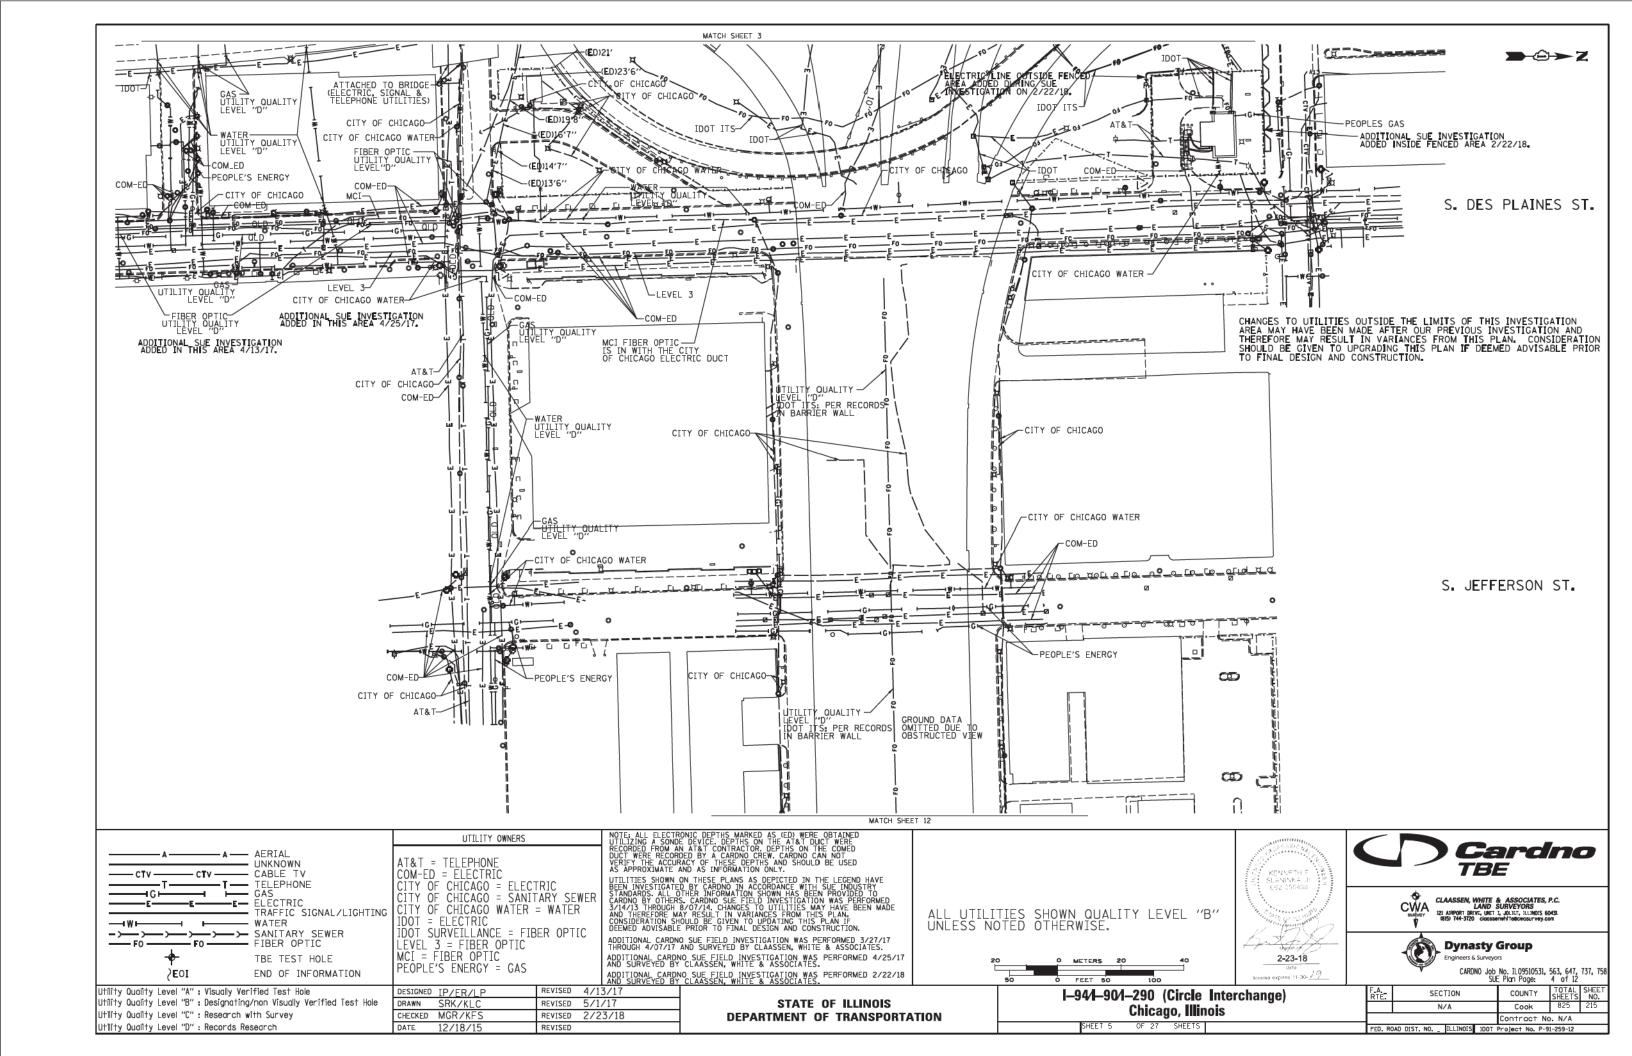

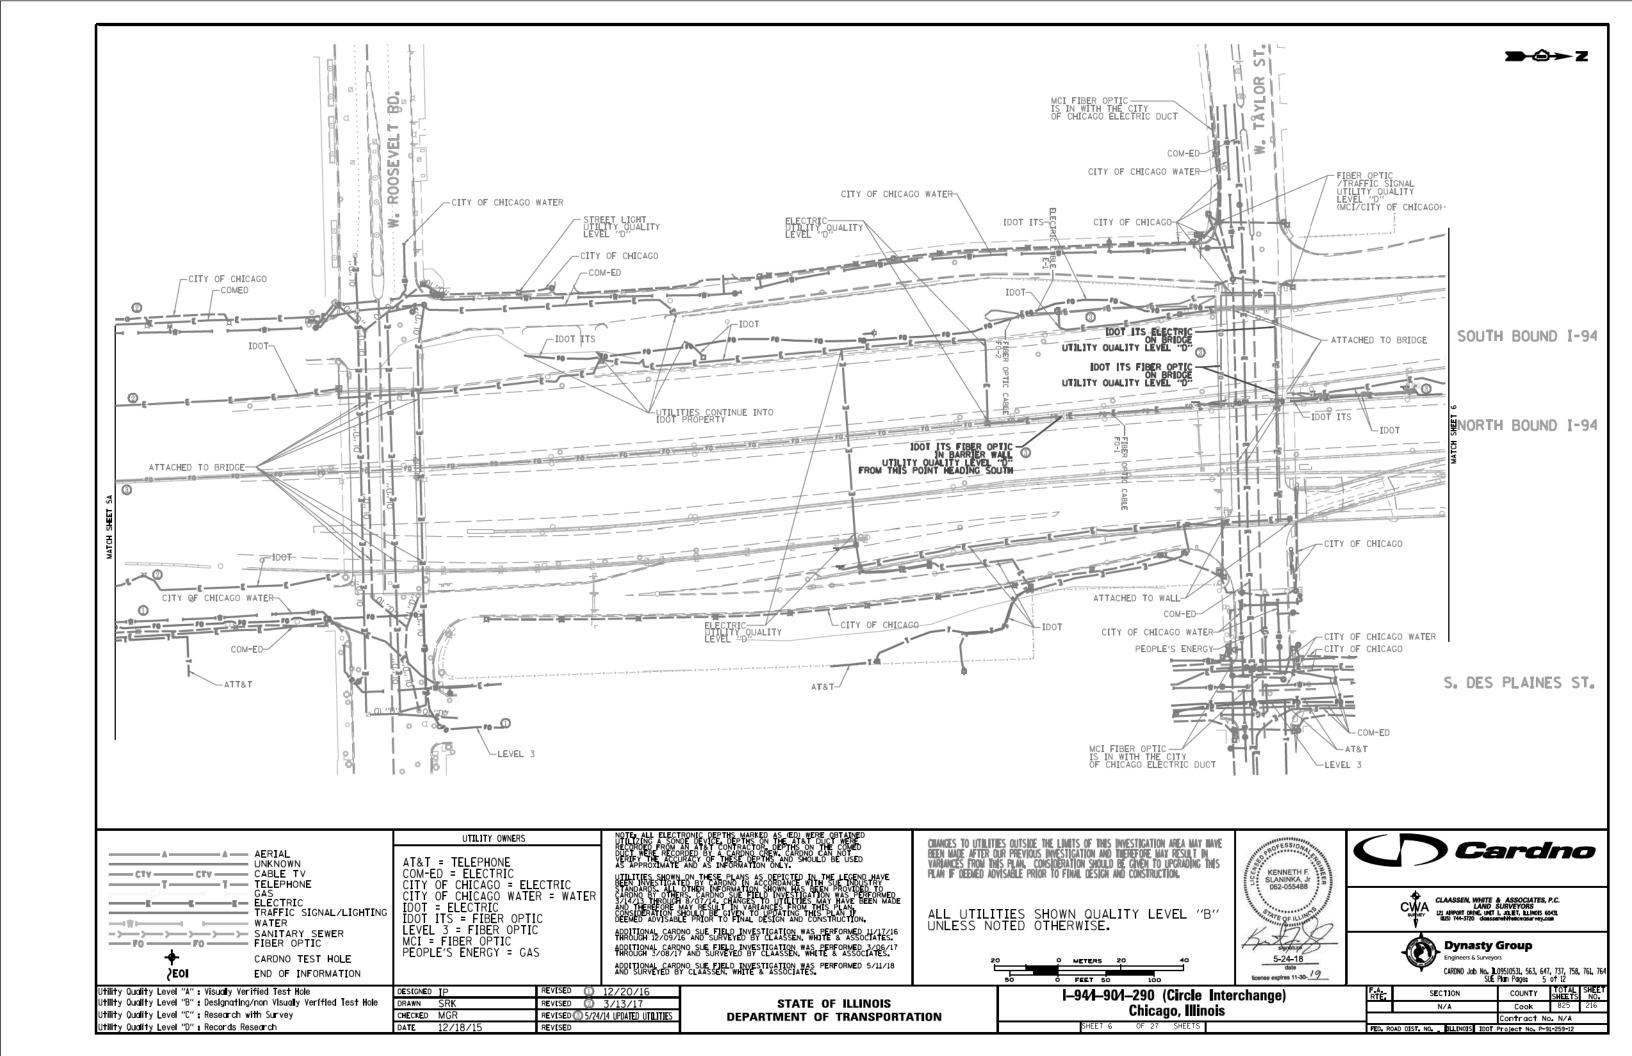


TEAET ..D., NITTILX ONVEIL. -IDOL \_\_\_\_\_\_ -UTILITY QUALITY LEVEL "D" -UTILITY QUALITY LEVEL "D" YAWSSARAY EXPRESSWAY LEVEL "D" CITY OF CHICAGO WATER LEVEL 3 CITY OF CHICAGO -ATT&T -PEOPLES GAS UTILITIES SHOWN ON THESE PLANS AS DEPICTED IN THE LEGEND HAVE BEEN INVESTIGATED BY CARDNO IN ACCORDANCE WITH SUE INDUSTRY STANDARDS, ALL OTHER INFORMATION SHOWN HAS BEEN PROVIDED TO CARDNO BY OTHERS, CARDNO SUE FIELD INVESTIGATION WAS PERFORMED 11/17/16 THROUGH 12/09/16, CHANGES TO UTILITIES MAY HAVE BEEN MADE AND THEREFORE MAY RESULT IN VARIANCES FROM THIS PLAN. CONSIDERATION SHOULD BE GIVEN TO UPDATING THIS PLAN IF DEEMED ADVISABLE PRIOR TO FINAL DESIGN AND CONSTRUCTION. UTILITY OWNERS CHANGES TO UTILITIES OUTSIDE THE LIMITS OF THIS INVESTIGATION AREA MAY MAVE BEEN MADE AFTER OUR PREVIOUS INVESTIGATION AND THEREFORE MAY RESULT IN VARIANCES FROM THIS PLAN. CONSIDERATION SHOULD BE GIVEN TO UPGRADING THIS PLAN OF DEEMED ADVISABLE PRIOR TO FINAL DESIGN AND CONSTRUCTION. Cardno AT&T = TELEPHONE
COM-ED = ELECTRIC
CITY OF CHICAGO = ELECTRIC
CITY OF CHICAGO WATER = WATER
IDOT = ELECTRIC
IDOT ITS = FIBER OPTIC
LEVEL 3 = FIBER OPTIC
PEOPLE'S ENERGY = GAS AERIAL UNKNOWN CABLE TV - CTV - CTV TELEPHONE GAS ELECTRIC CLAASSEN, WHITE & ASSOCIATES, P.C. LAND SURVEYORS
121 AIRPORT DRIVE, UNCT 1, JULET, BLI HOIS 60431
1815) 744-5720 doasserwhiteGovgour vey.com ALL UTILITIES SHOWN QUALITY LEVEL "B" UNLESS NOTED OTHERWISE. TRAFFIC SIGNAL/LIGHTING ADDITIONAL CARDNO SUE FIELD INVESTIGATION WAS PERFORMED 3/06/17 THROUGH 3/08/17 AND SURVEYED BY CLAASSEN, WHITE & ASSOCIATES. WATER SANITARY SEWER FIBER OPTIC ADDITIONAL CARDNO SUE FIELD INVESTIGATION WAS PERFORMED 5/11/18 AND SURVEYED BY CLAASSEN, WHITE & ASSOCIATES. CARDNO TEST HOLE 5-24-18 date CARDNO Job No. 1L09510531, 563, 647, 737, 758, 761, 76 SUE Plan Page: 5A of 12 }E0I END OF INFORMATION Utility Ouality Level "A" : Visually Verified Test Hole Utility Ouality Level "B" : Designating/non Visually Verified Test Hole REVISED 3/13/17 I–94/I–90/I–290 (Circle Interchange) DESIGNED IP SECT10N COUNTY DRAWN SRK REVISED 3 5/24/14 UPDATED UTILITIES STATE OF ILLINOIS Chicago, Illinois
OF 27 SHEETS Cook 825 Utility Quality Level "C"; Research with Survey CHECKED MGR REVISED **DEPARTMENT OF TRANSPORTATION** Contract No. N/A Utility Quality Level "D" : Records Research DATE 12/20/1 REV[SED


CITY OF CHICAGO WATER


- COMED


CITY OF CHICAGO

COMED :

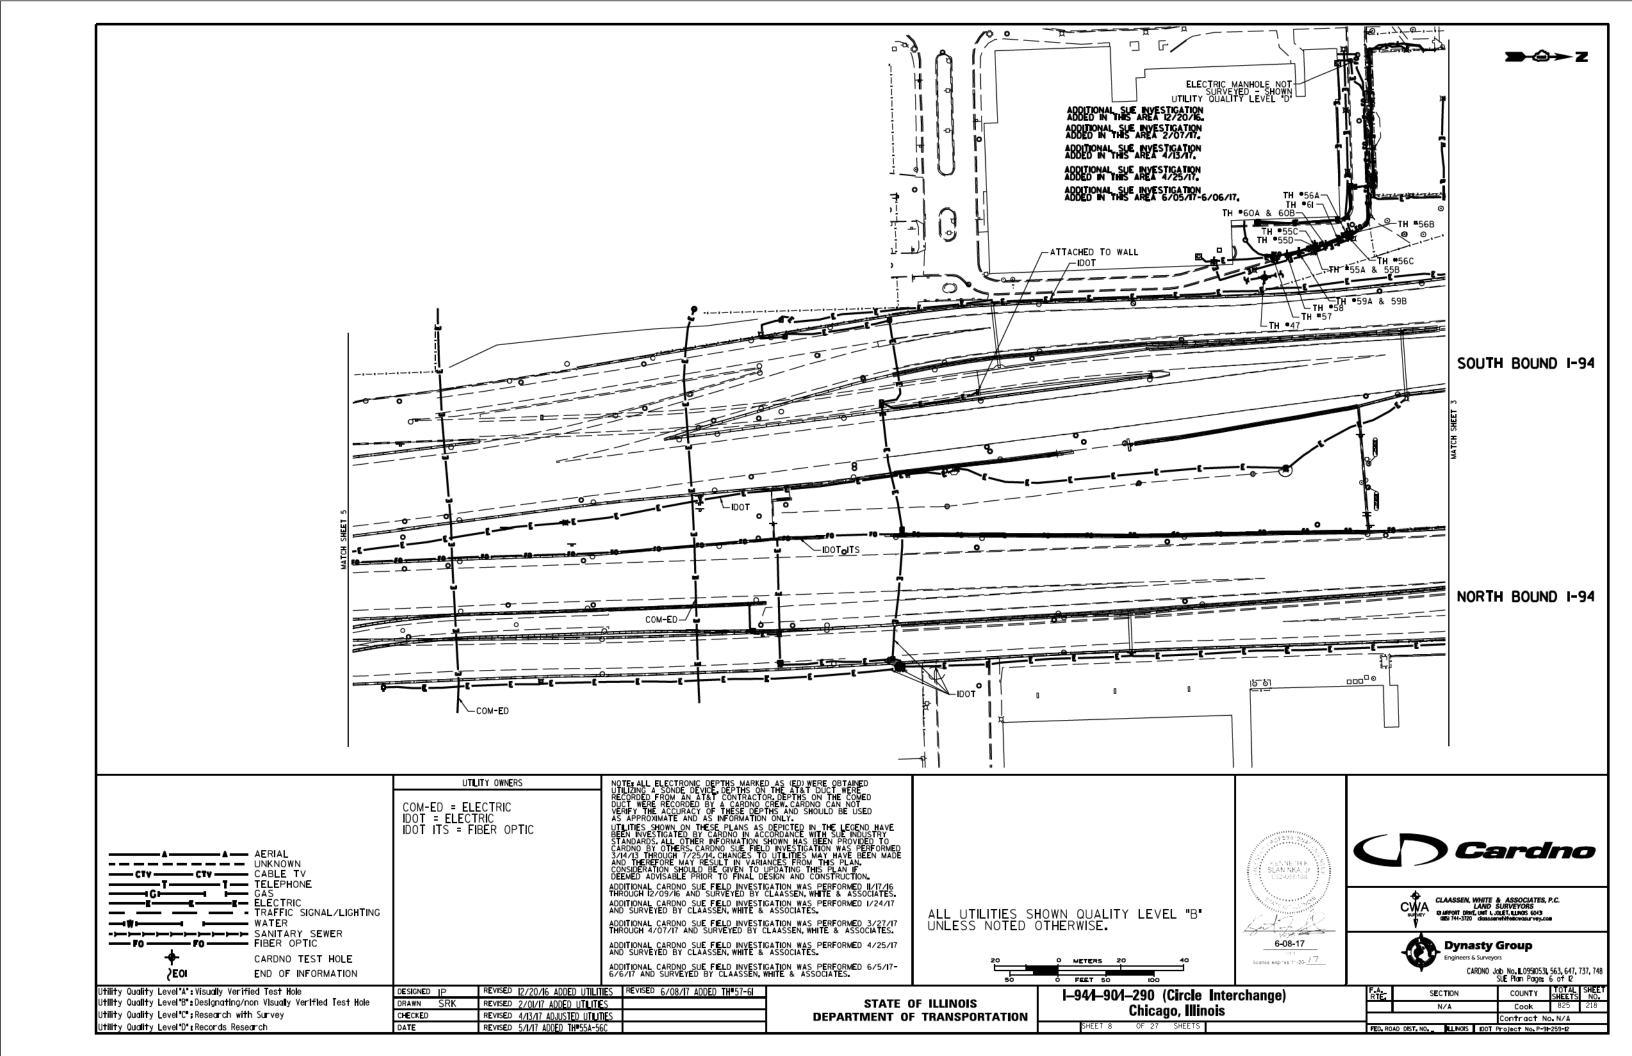

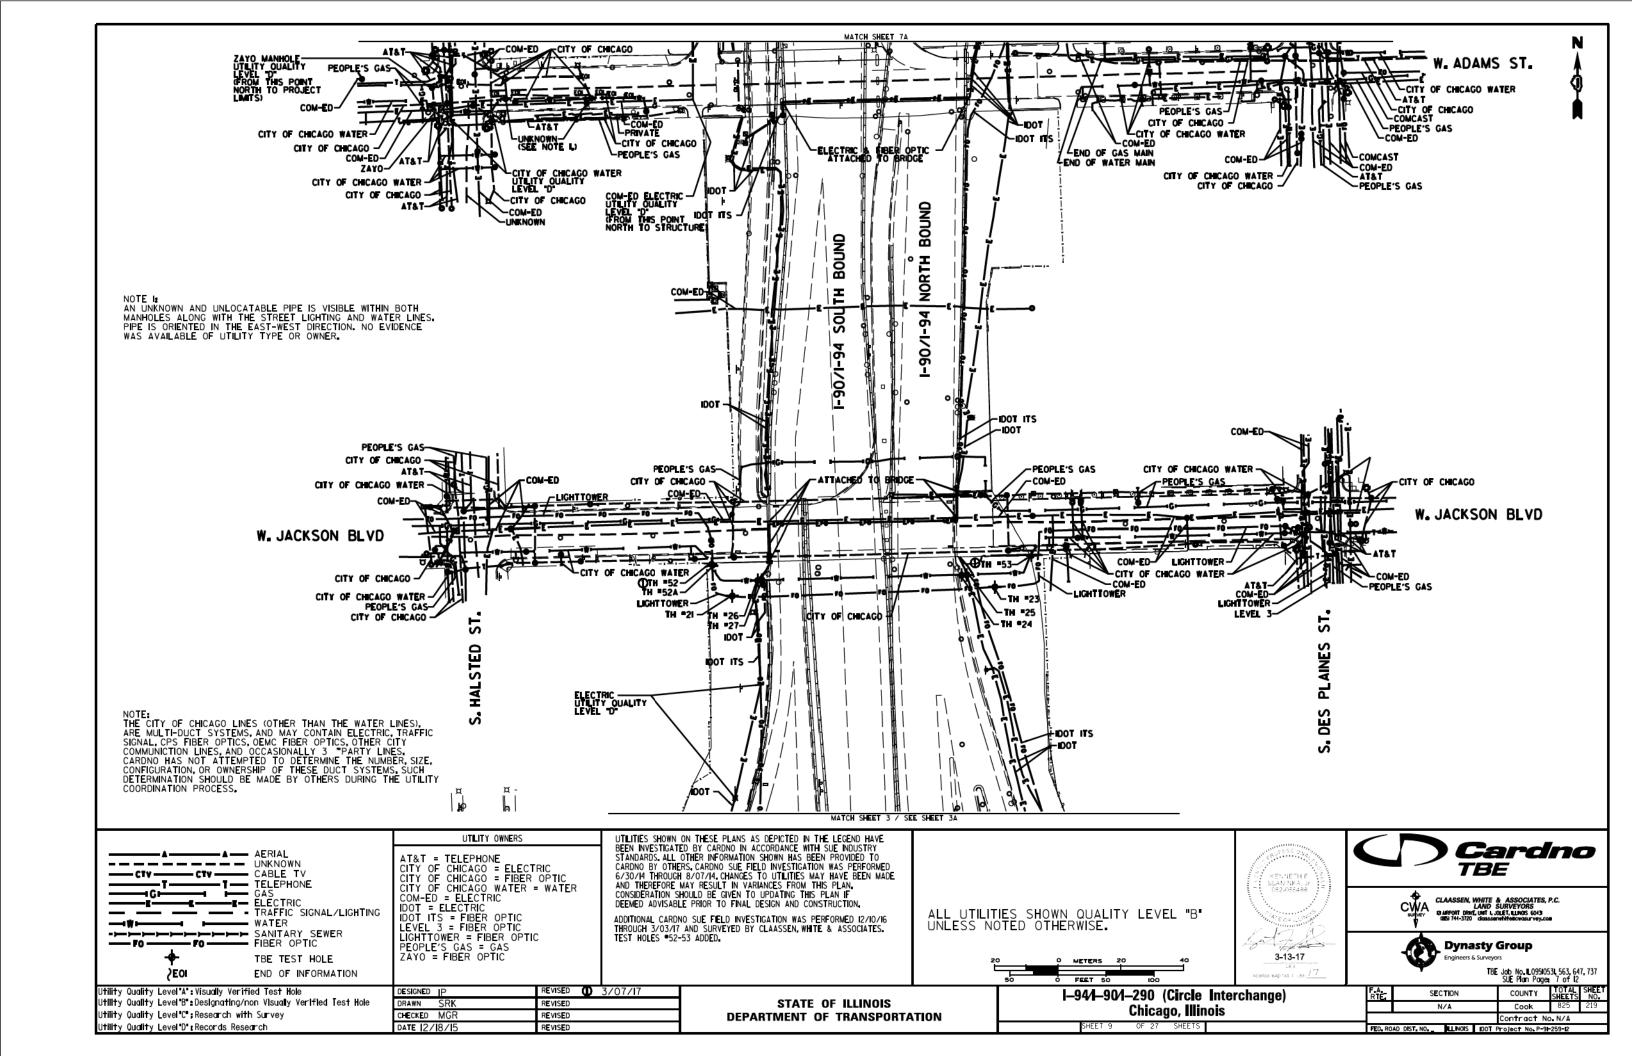

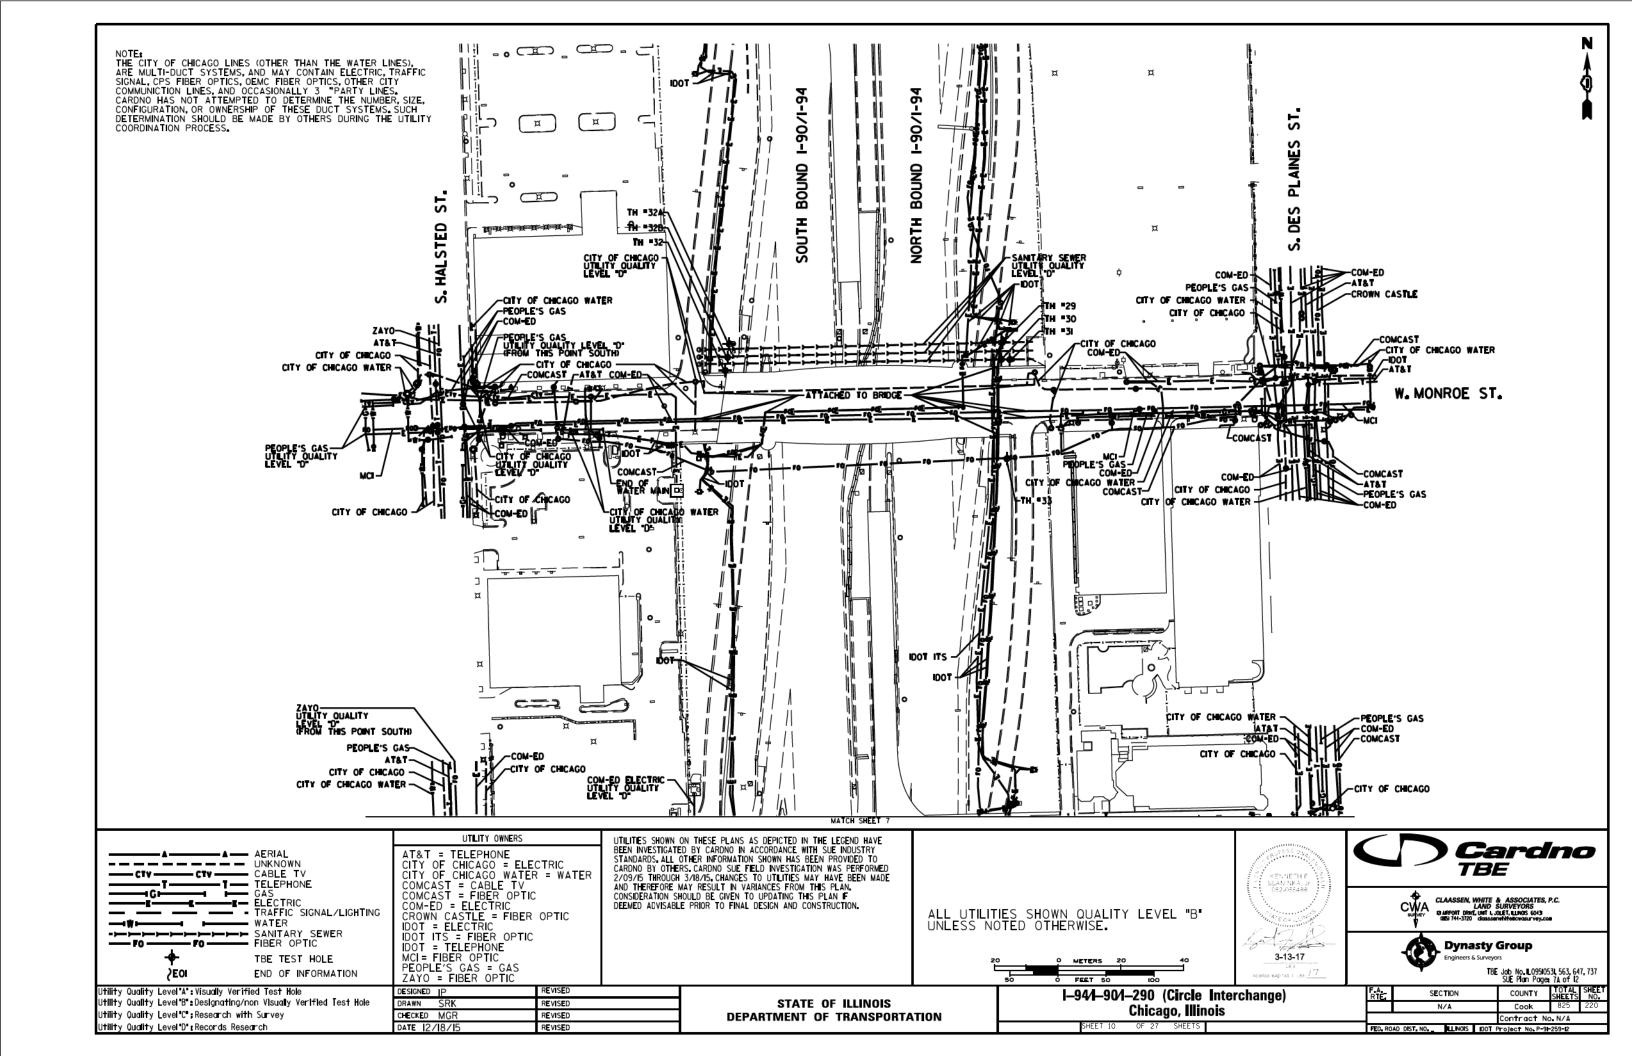

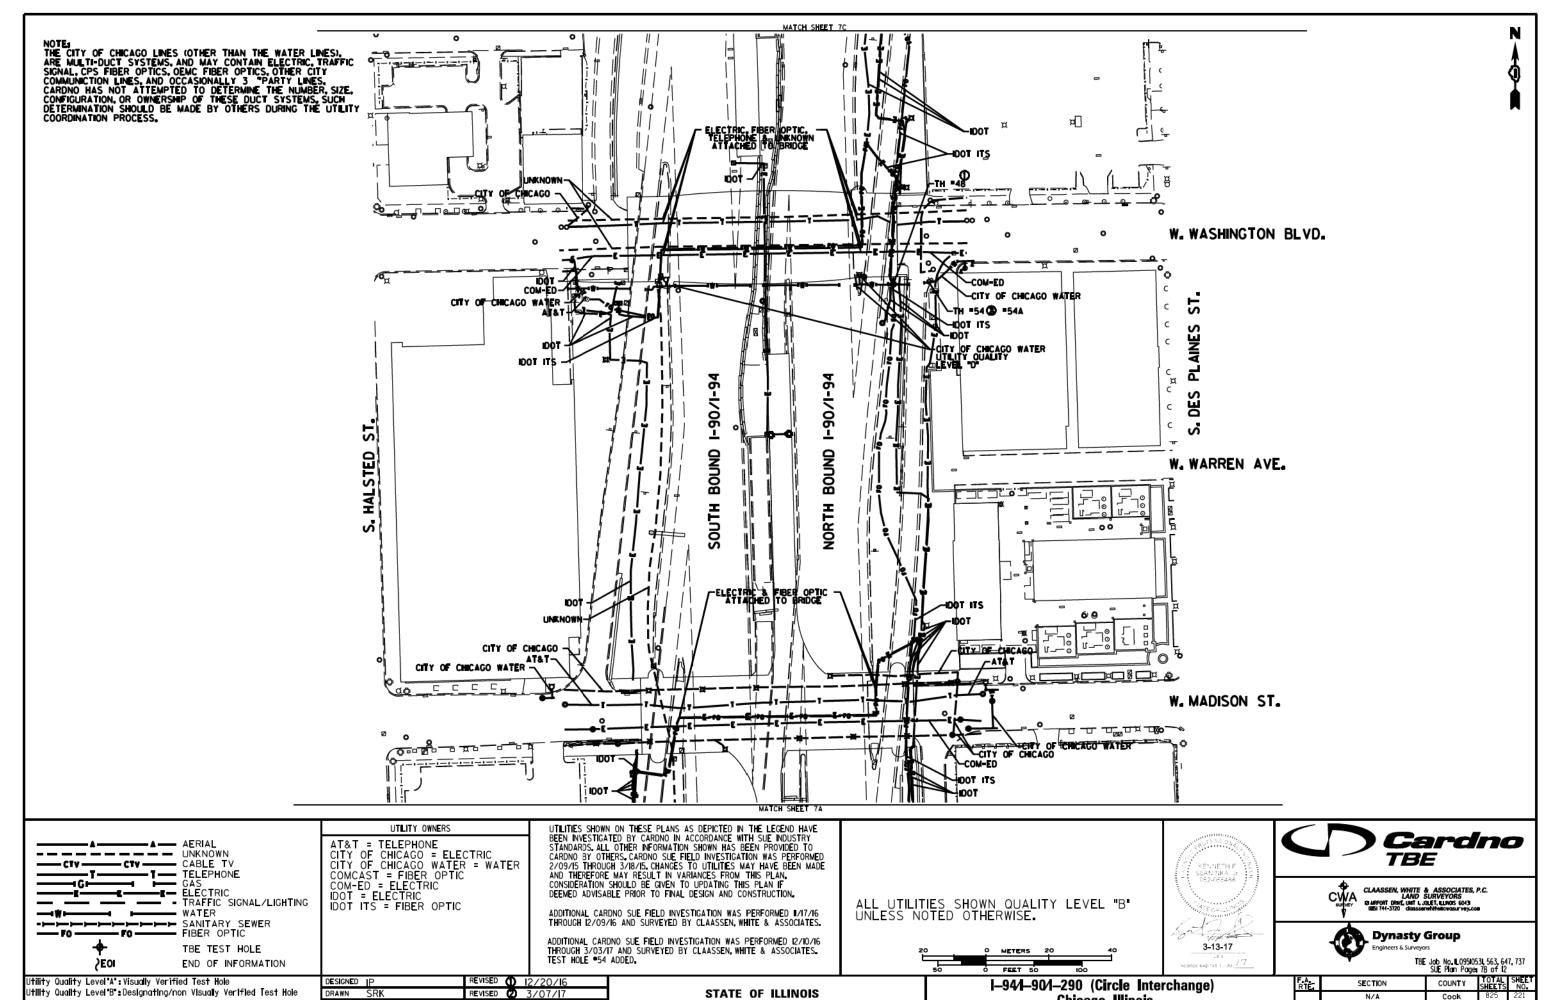

SECTION COUNTY Cook Contract No. N/A

STATE OF ILLINOIS **DEPARTMENT OF TRANSPORTATION** 

Utility Quality Level "B" : Designating/non Visually Verified Test Hole

CHECKED MGR

DATE |2/18/15


REVISED


REVISED


Utility Quality Level C : Research with Survey


Utility Quality Level D' Records Research


I-94/I-90/I-290 (Circle Interchange) Chicago, Illinois OF 27 SHEETS

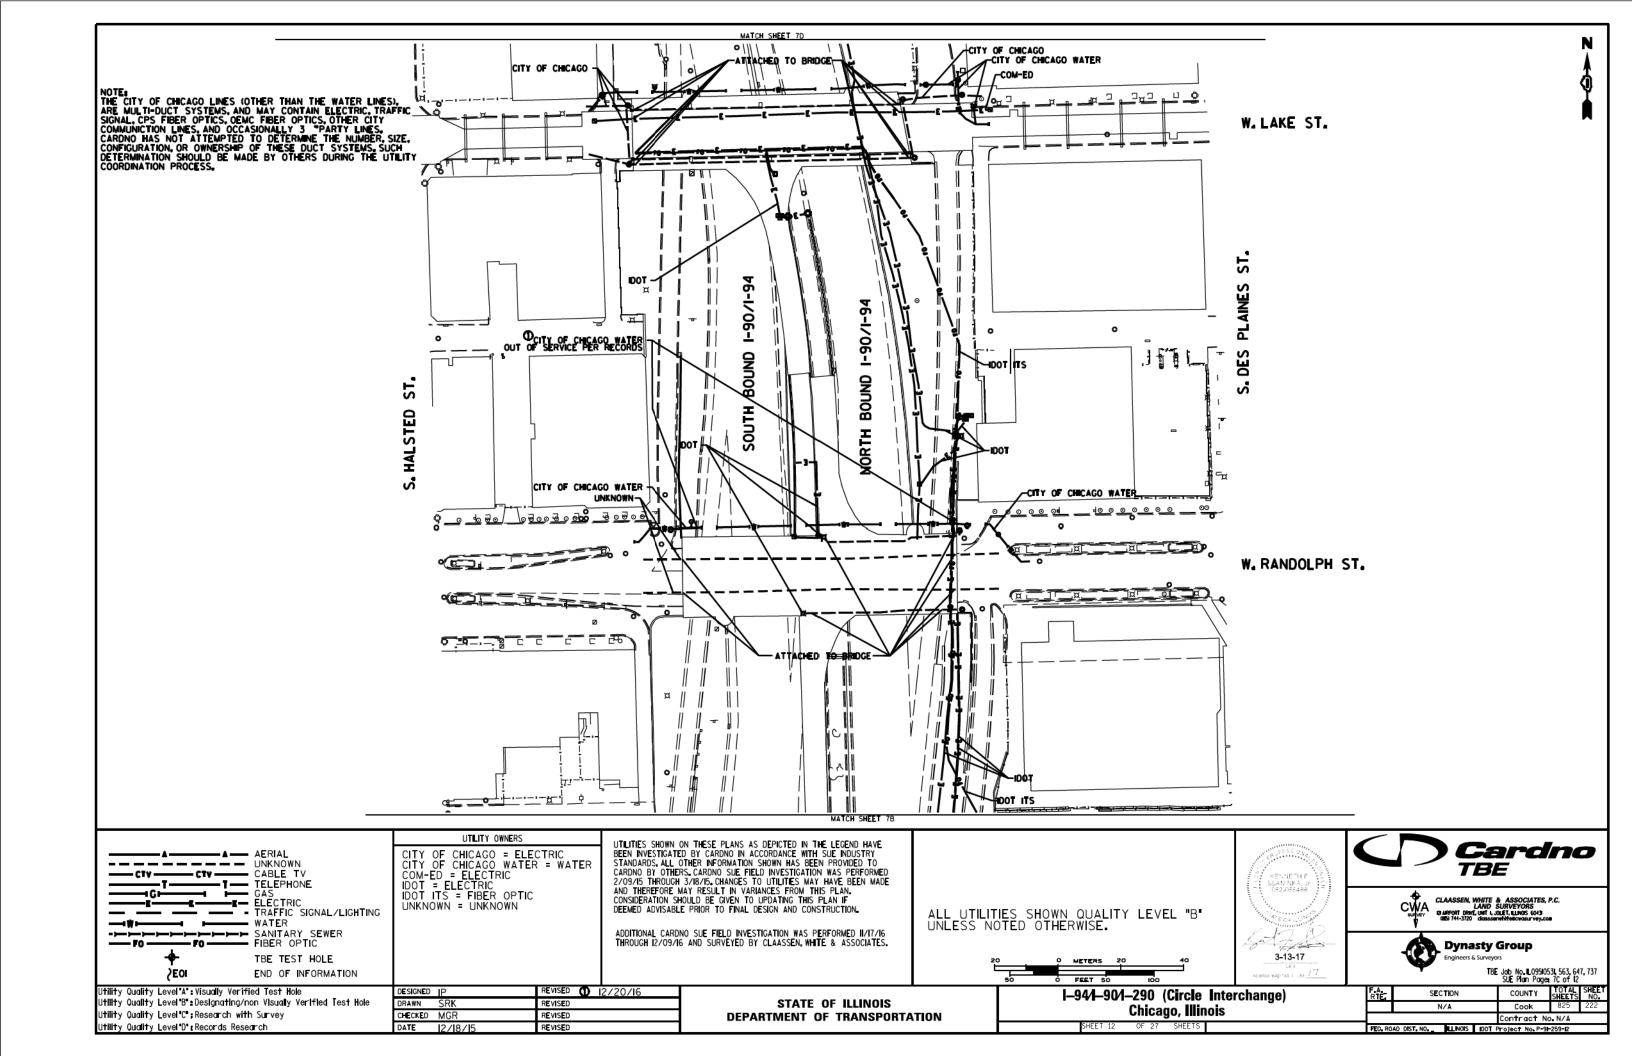


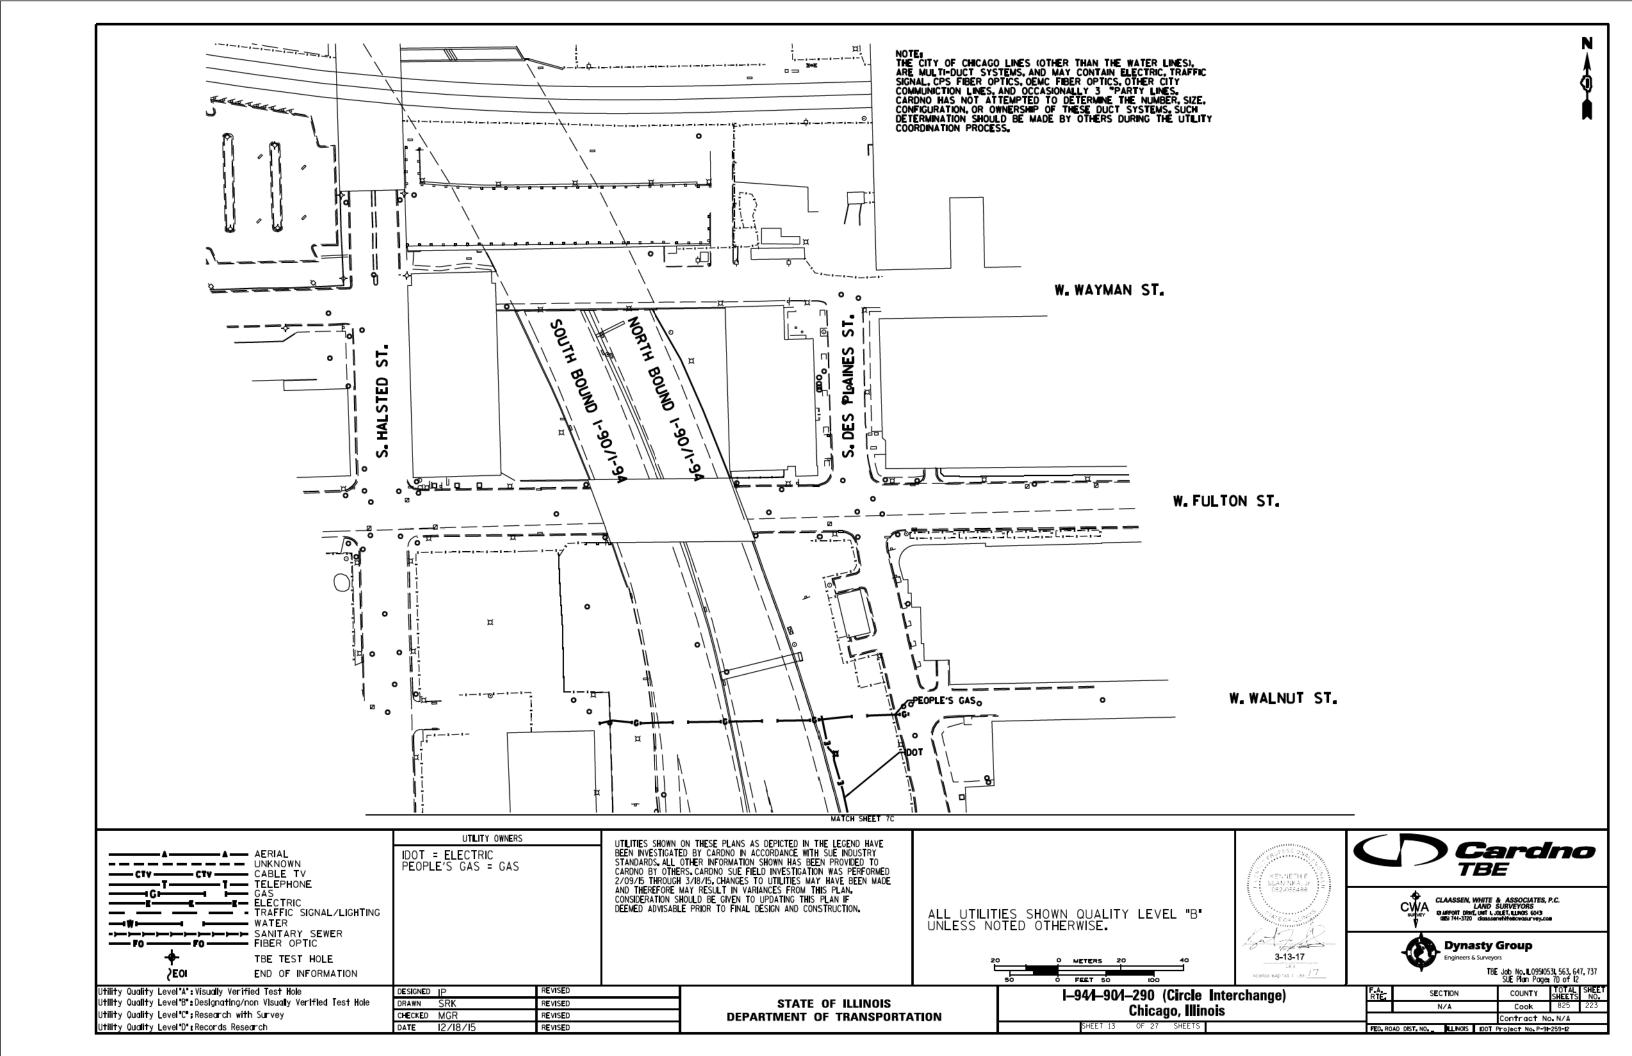


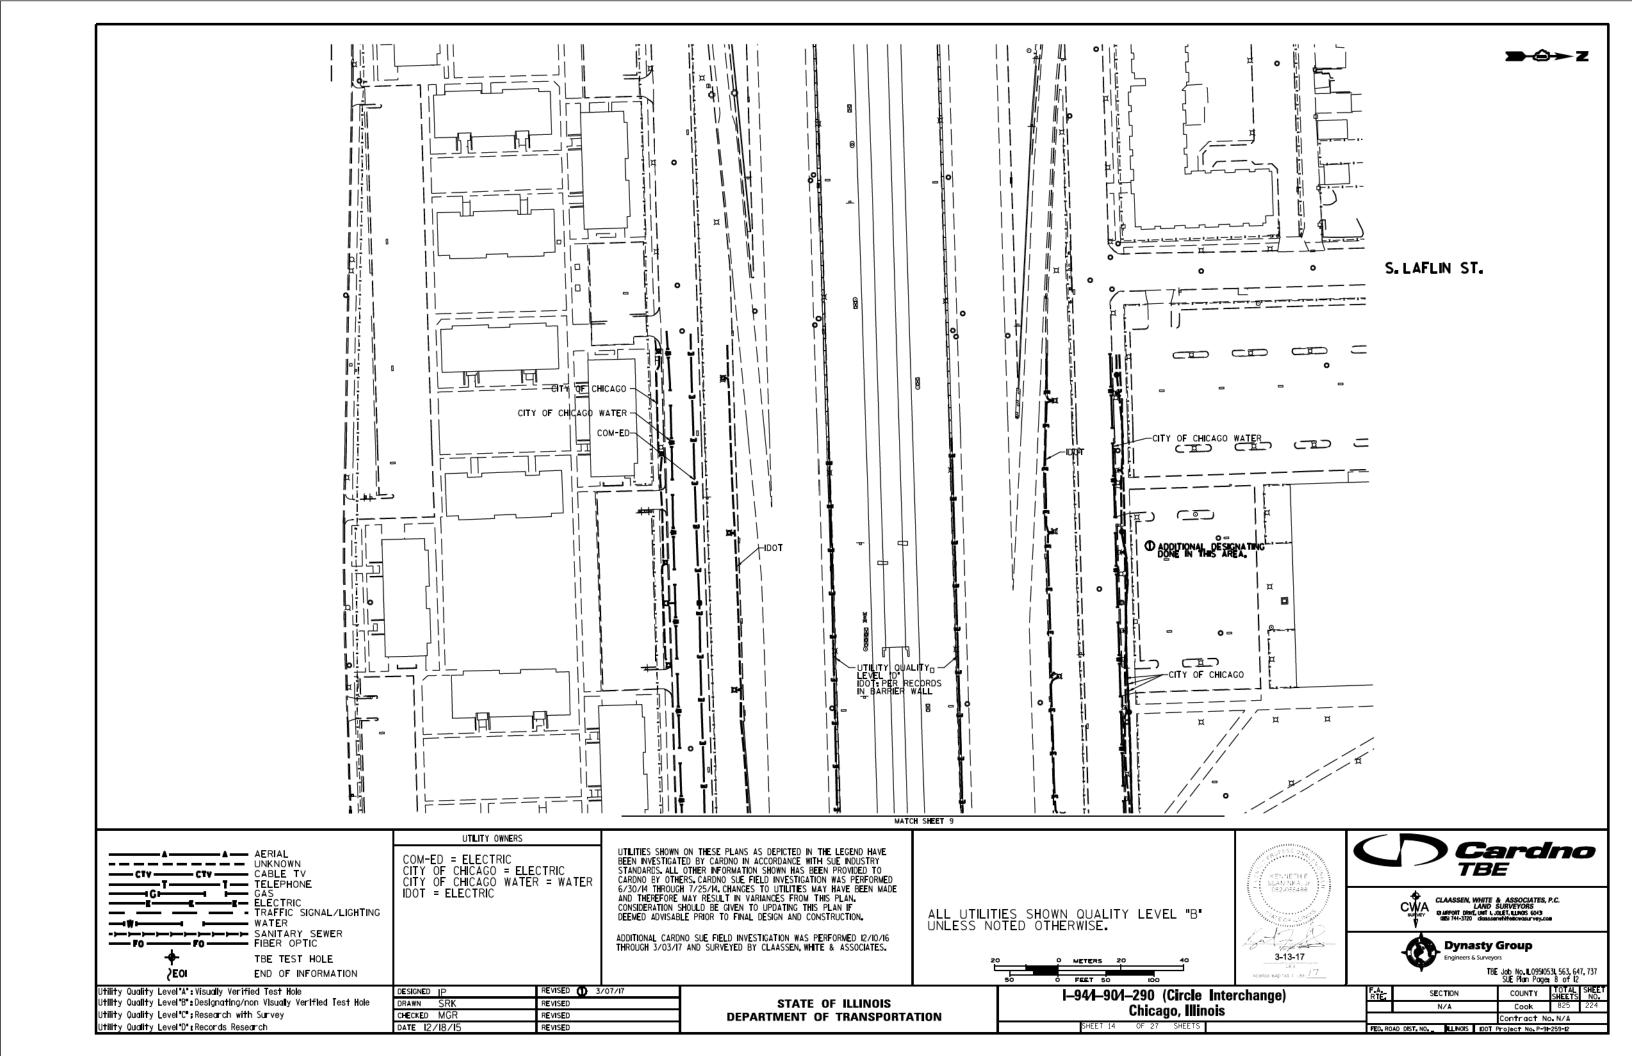

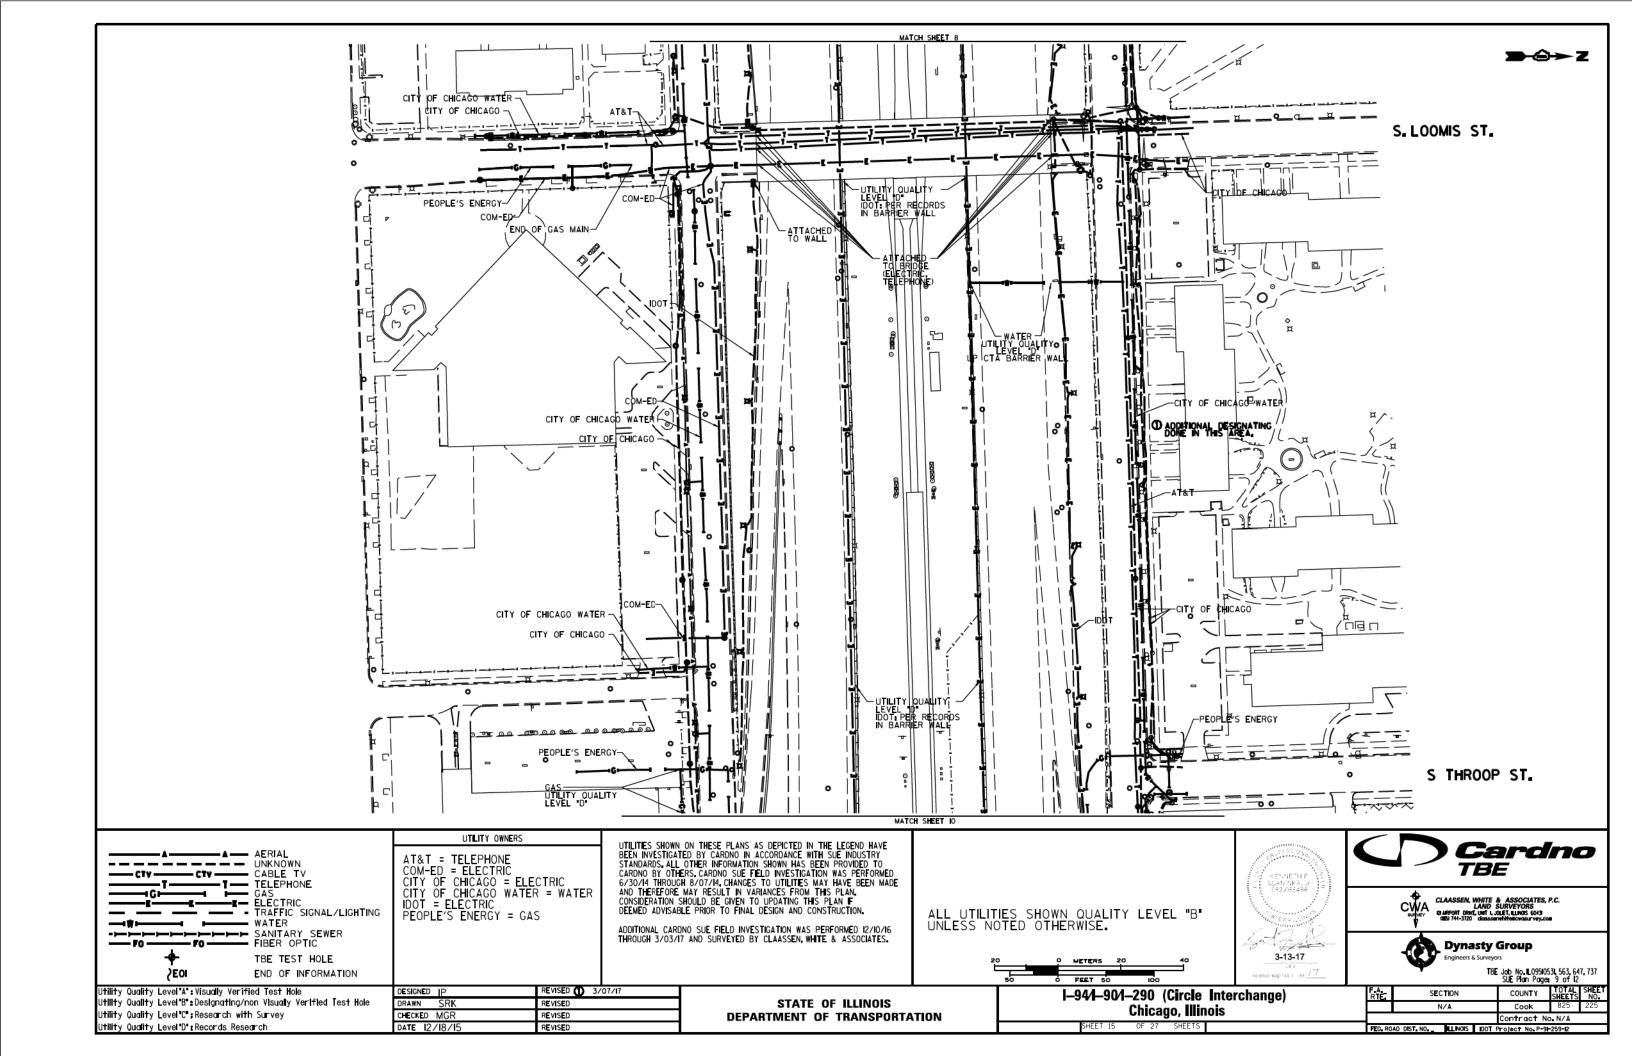

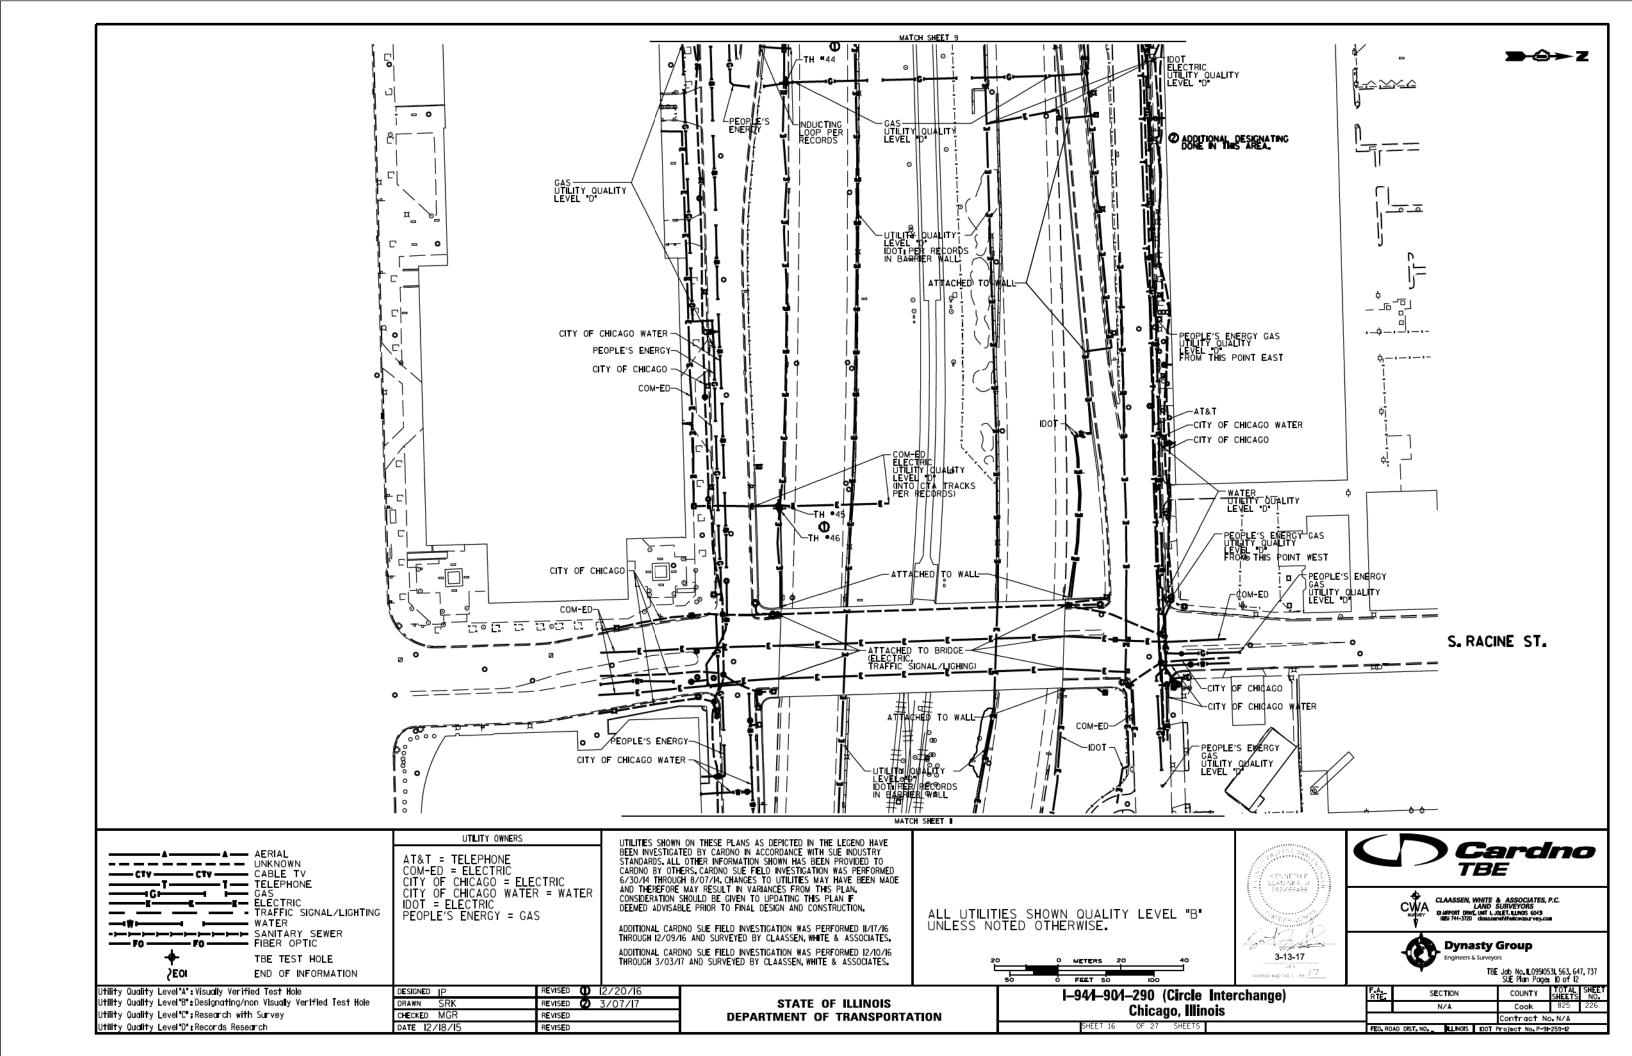

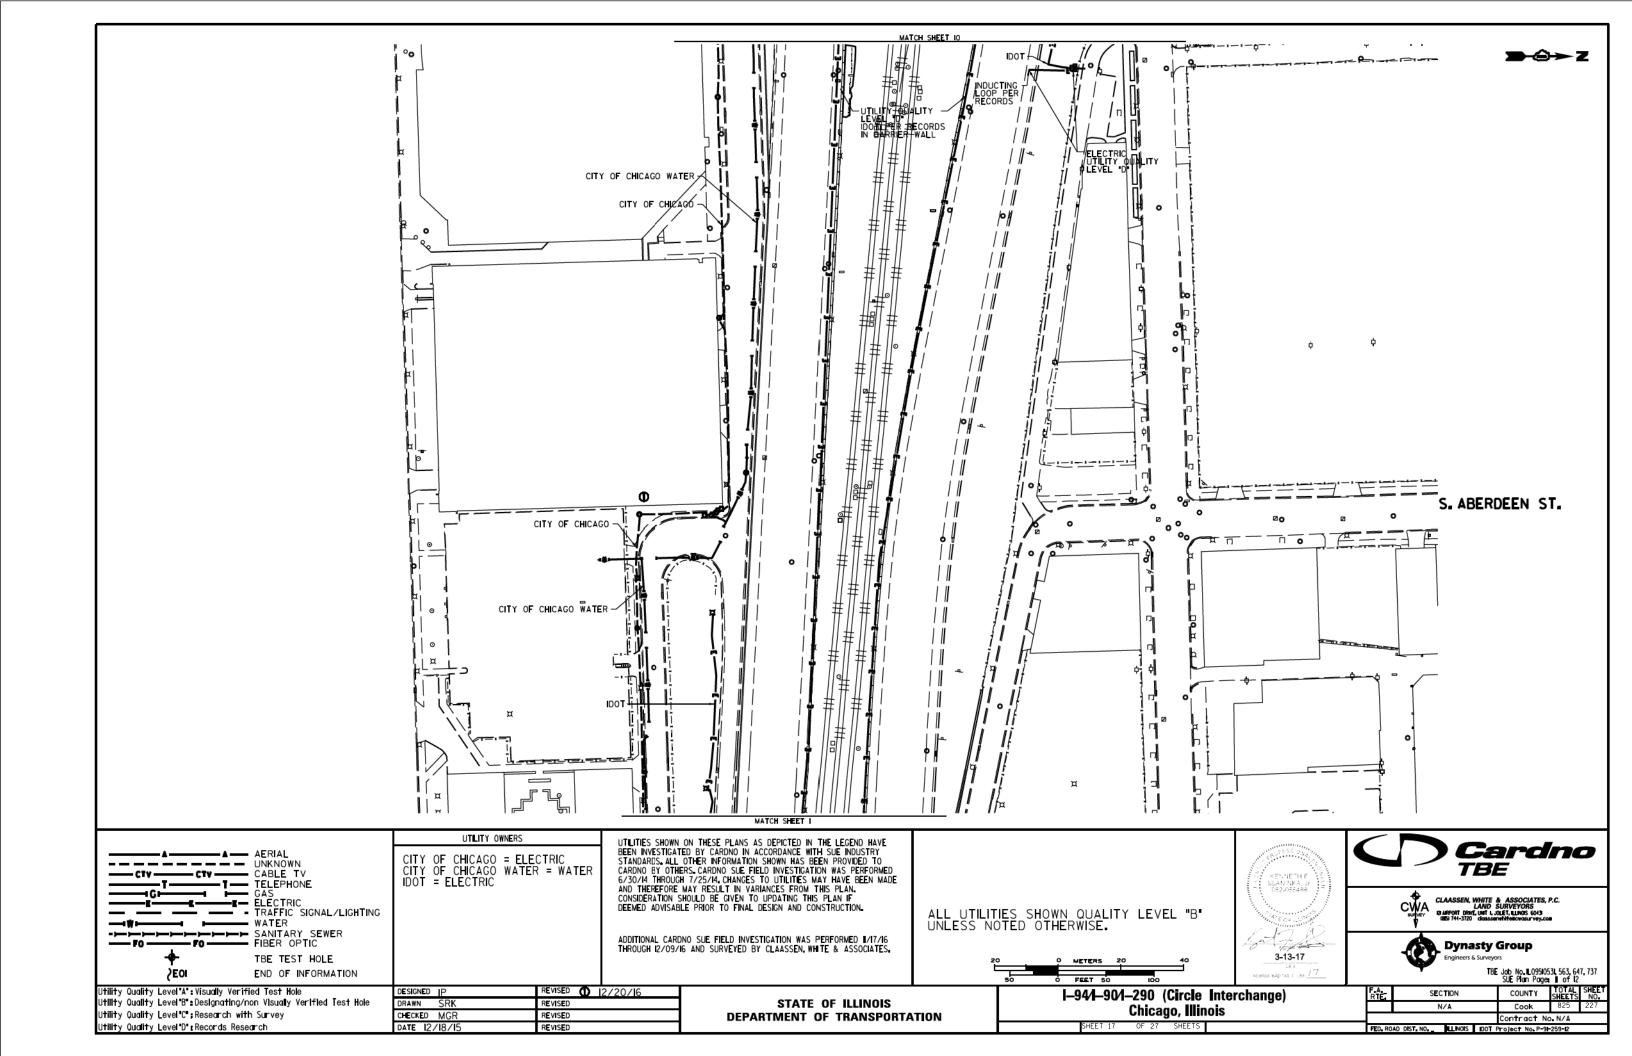

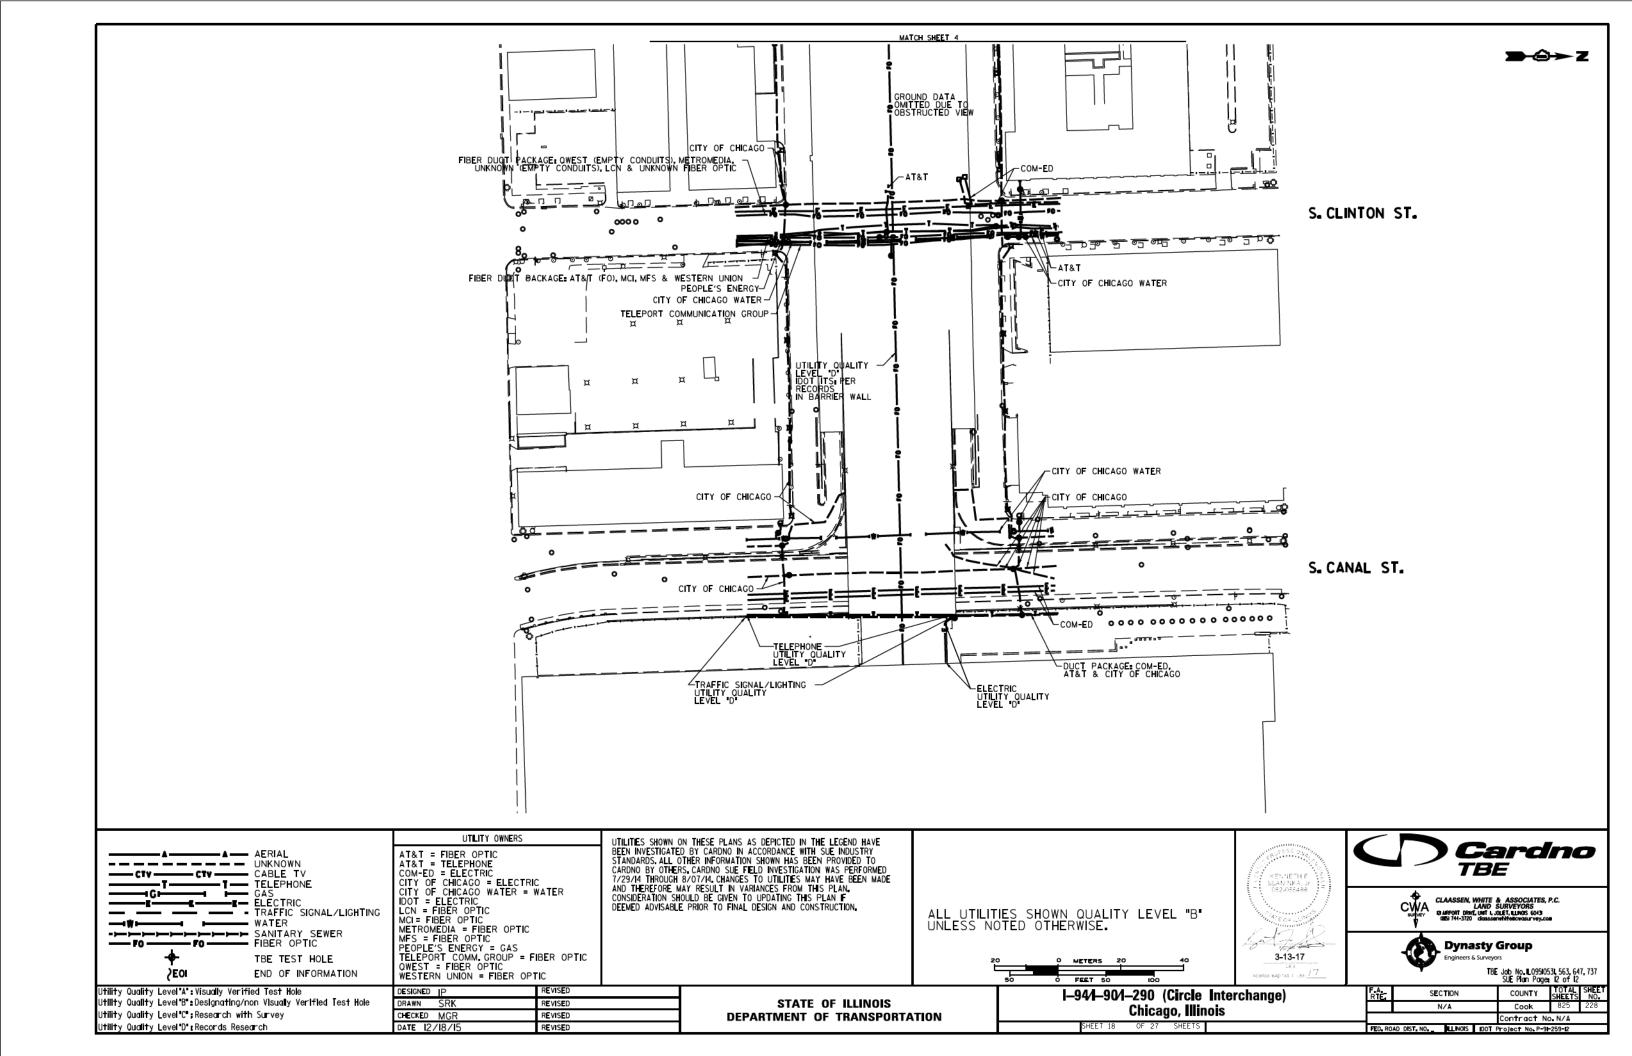

		V	ERIFIED U	TILITY INFOR	RMATION			
TEST HOLE #	SIZE & TYPE	NORTHING	EASTING	EXISTING TOP ELEVATION	EXISTING CUT	REFERENCE ELEVATION	SUE QUALITY LEVEL	COMMENTS
<u> </u>	N/A TUNNEL	1897611.31	1171790.60	573.30′	7.17′	580.47′	А	NORTH EDGE
2	N/A TUNNEL	1897605.50	1171792.00	573.36′	6.92′	580.28′	А	SOUTH EDGE
3	N/A TUNNEL	1897600.91	1171359.65	573.15′	3,86′	577.01	А	NORTH EDGE
4	N/A TUNNEL	1897595.46	1171360.49	573.09′	3.90′	576.99′	Α	SOUTH EDGE
5	N/A . THRUST BLOCK	1897513.66	1171678.90	589.72′	6,56′	596.28′	А	
5A	N/A THRUST BLOCK	1897513.63	1171676.05	589.64′	7.20′	596.84′	А	
6	N/A THRUST BLOCK	1897522.75	1171594.74	589.37′	6,68′	596.05′	А	
6.4	N/A THRUST BLOCK	1897524.90	1171593.77	589.37′	6.76′	596.13′	A	
6B	N/A THRUST BLOCK	1897525.17	1171595.71	589.38′	6.73′	596.11′	А	
7	N/A THRUST BLOCK	1897506.19	1171582.40	589,21′	6.36′	595.57′	А	
7A	N/A THRUST BLOCK	1897505.10	1171584,54	589,201	6.42′	595.62'	A	
8	8" WATER	1897811.64	1169853.98	586.86′	7.31′	594.17′	А	
9	N/A THRUST BLOCK	1897812.80	1169876.49	588.42′	4.88′	593.30′	А	
10	N/A THRUST BLOCK	1897815.06	1169870.75	588.64′	5.09'	593.73′	. А	
	SEE NOTE WATER	1897813.75	1169879.18	588.06′	5.49'	593.55′	А	
IIA	24"×24" ELECTRIC	1897814.13	1169877.49	591.41′	2.03'	593.44′	А	
12	16" WATER	1898158.45	1170801.96	586.95′	6.60′	593.55′	А	
13	24" GAS	1898159.98	1170811.42	590.55′	3.22′	593.77′	Α .	
14	I6" WATER	1898098.96	1170803.32	570.59′	5.30′	575.89′	А	
15	20" GAS	1898100.29	1170814.06	569.38′	6.45′	575,83′	А	
16	N/A TUNNEL	1898000.74	1171597.17	569.79′	8.10′	577.89′	А	
17	N/A TUNNEL	1897991.35	1171521.95	572.07′	4.11′	576.18′	А	
18	N/A TUNNEL	1897921.01	1171524.66	572.02′	3.99′	576.01′	. А	
19	60" SIPHON	1898449,22	1171402.46	572.68′	7.88′	580.56′	А	
20	60" SIPHON	1898448.41	1171318.35	572.62′	6.12′	578.74′	В	
21	2-(4") FIBER OPTIC	1898798.52	1171364.87	581.80′	6.04′	587.84′	А	
22	60" SIPHON	1898456.60	1171716.09	571.31′	11.07′	582.38′	A	
23	2-(4") FIBER OPTIC	1898807.90	1171637.47	574.87′	9.02'	583.89′	Α	
	SEE NOTE WATER	1898820.21	1171602.72	571.87′	4.71′	576.58′	А	
25	SEE NOTE WATER	1898820.37	1171608.33	571.65′	5.80′	577.45′	В	

- TH \*I- Found North edge of what appears to be a 6' wide wooden frame around utility tunnel. Frame has appearance of wooden railroad ties.
- TH \*2 Found South edge of what appears to be a 6" wide wooden frame around utility tunnel Frame has appearance of wooden raliroad ties.
- TH \*3 Found North edge of what appears to be a 6'wide wooden frame around utility tunnel Frame has appearance of wooden railroad ties. Wooden frame is 5" thick, TH #4 - Found South edge of what appears to be a 6' wide wooden frame cround utility tunnel Frame has appearance of wooden railroad ties.
- TH \*5 Found North edge of Thrust Block.
- TH #5A Found North edge of Thrust Block.Reference point placed on east curb of driveway.
- TH #6 Found West edge of Thrust Block.
- TH #6A Found a 90 degree bend on Thrust Block.Reference point placed in line with bend. TH #6B - Found North edge of Thrust Block.
- TH #7 Found North edge of Thrust Block.
- TH #7A Found North edge of Thrust Block.
- TH #9 Found what is believed to be the southern edge of thrust block.
- TH \*10 Found what is believed to be the southern edge of thrust block. Also found a vertical concrete structure that the thrust block seemed to go around. Reference point was placed
- where edge of thrust block met this structure.
- TH #N Found the east edge of water main at the bend. Water main was directly under City of Chicago electric duct and could not verify a size. Records show that this main is a 30". Reference point was place directly in line with the eastern edge of pipe at the center of bend.
- TH \*IIA Found a 24x24 concrete electric duct while excavating for water main.
- TH \*13 Exposed fitting connecting steelgas main to cast iron gas main.(Per Joe People's Energy Inspector)
- TH \*14 Did not find bend. Water main was still on slight downward slope.
- TH \*15 Cas main was still on slight downward slope. Exposed pipe at a weld but could not determine if this was part of the bend.
- TH \*16 Exposed Northern edge of CTA Tunnel.

REVISED

REVISED

REVISED

REVISED

- TH #17 Top of CTA Tunnel.
- TH =18 Top of CTA Tunnel.

DESIGNED EG

DRAWN SRK

CHECKED MGR

DATE 12/18/15

- TH =19 Exposed what we believe to be the crown of the concrete pipe. Records indicate the Utility size to be 60".
- TH \*20 Unable to visually verify utility due to back fill inflitrating the test hole. However, by utilizing the air lance we were able to feel what is believed to be the edges and top of the pipe. Records indicate utility to be a 60" pipe.
- TH #22 Exposed what we believe to be the crown of the concrete pipe. Records indicate the utility to be a 60" pipe.
- TH =24 Briefly had a visual of the utility until sand and ground water inflitrated the test hole. By utilizing the air lance we were able to feel what is believed to be the edges and top of pipe. Records indicate the utility to be a 16" pipe.
- TH #25 Unable to visually verify utility due to back fill inflitrating the test hole. However, by utilizing the air lance we were able to feel what is believed to be the edges and top of the pipe. Records indicate utility to be a 16" pipe.

I-94/1-90/1-290 (Circle Interchange) STATE OF ILLINOIS Chicago, Illinois DEPARTMENT OF TRANSPORTATION SHEET NO. 19F 27 SHEETS STA. TO STA.

ALL INFORMATION SHOWN WAS OBTAINED FROM A LOCATION SURVEY.



CIVIL ENGINEERING TRANSPORTATION ENVIRONMENTAL PLANNING STRUCTURE PLANNING STRUCTURE PROPERTY OF THE PROPERTY

TBE30b, No. L0950531, 563, 647, 731

SHEET 10F 3

COUNTY TOTAL SHEET SHEETS NO.

Cook 825 229

SECTION Contract No. N/A FED. ROAD DIST. NO. ILLINOIS Job No.1 P-91-259-12

TEST HOLE #	SIZE	& TYPE	NORTHING	EASTING	EXISTING TOP ELEVATION	EXISTING CUT	REFERENCE ELEVATION	SUE QUALITY LEVEL	COMMENTS
26	N/A	WATER	1898814.654	1171391.251	572.75′	7.50′	580.25′	В	
27	N/A	WATER	1898814.915	1171395.719	571.67′	7.16′	578.83′	В	
28	NZA	SIPHON	1898446.146	1171286.067	572,68′	13.38′	586,06′	В	
29	N/A	SIPHON	1899863.107	1171643.779	572.74′	7.90′	580.64′	В	
30	N/A	SIPHON	1899845.426	1171642.747	572.90′	7.06′	579.96′	Α	
31	N/A	SIPHON	1899845.311	1171651.515	575.42	6.42′	581.84′	А	
32	N/A	SIPHON	1899833.821	1171355.929	576.15′	3.62′	579.77′	А	
327	N/A	SIPHON	1899861.396	1171360,162	574.89′	4.07′	579.07′	Α	
32B	N/A_	SIPHON	1899847.605	1171358.462	575.20′	4.18′	579.38	A	
33	N/A_	FIBER OPTIC	1899742.060	1171648.471	N/A	SEE NOTE	585.56′	С	
34	48"	WATER	1897228.575	1171732.883	576.44′	5.14′	581.58′	Α .	
35	48"	WATER	1897273,960	1171729.504	576.92	4.46′	581,38′	Α	
36	<u> </u>	WATER	1897385.054	1171718.156	578.38′	2.22′	580.60′	Α Α	
37	54"	WATER	1897227.364	1171462.933	576.33′	6.03"	582.36′	A	
38	N/A	WATER	1897387,290	1171782.047	576,60′	5.46′	582.06′	A	
39	N/A	WATER	1897275.870	1171796.286	57.7-47'	5.97′	583,44′	A	
40	54"	WATER	1897230.523	1171576.646	578.58′	2.80′	581.38′	A	
4!	N/A	WATER	1897229,624	1171730.841	577.55′	6.17′	583.72′	А	
42	46"	WATER	1897381.570	1171565.533	575.29′	4,43'	579.72'	Α	
43	_14"×14"	UNKNOWN	. 1897377,583	1171565.776	577.49'	2.14'	579.63′	Α	
·								·	
		3							1
	4,								
									The second secon
									· · · · · · · · · · · · · · · · · · ·

TH #26 - Unable to visually verity utility due to back fill inflitrating the test hole. However, by utilizing the air lance we were able to feel what is believed to be the edges and top of the pipe. Records indicate utility to be a 16" pipe.

TH #27 - Unable to visually verify utility due to back fill inflitrating the test hole. However, by utilizing the air lance we were able to feel what is believed to be the edges and top of the pipe. Records indicate utility to be a 16" pipe.

TH #28 - Unable to visually verify utility due to back flitand ground water infiltrating the test hole. However, by utilizing the air lance we were able to feel what is believed to be the crown of pipa.Records indicate utility to be a 60" pipa. TH #29 - Unable to visually verify utility due to sand and ground water inflitrating the test hole. However, by utilizing the dir lance we were able to feel what is believed to be the crown of

pipe. Records indicate utility to be a 60" pipe. TH \*30 - Exposed what we believe to be the crown of the concrete pipe. Records indicate the utility to be a 108" pipe.

TH #31- Exposed what we believe to be the crown of the concrete pipe. Records indicate the utility to be a 108" pipe. Found what we believe to be the Siphon Outlet Chamber.

TH #32 - Found a flat formed concrete structure.Reference point placed in line with southern edge of concrete structure.

TH #32A - Found a flat formed concrete structure.Reference point placed in line with Northern edge of concrete structure.

TH \*328 - Found a flat formed concrete structure. Reference point placed in line with center of concrete structure. TH #33 - Were only able to excavated to a depth of 10' and did not find utility. Electronic depths indicate utility to 27' +/- deep.

TH \*35 - Depth tuken from top of pipe joint.

TH \*38 - Were only able to see the top crown of pipe Records indicate pipe size to be 36".

TH \*39 - Were only able to see the top crown of pipe. Records indicate pipe size to be 48".

TH  $^st 40$  - Pipe appears to be on a slight upward angle towards the retaining wall.

TH #41- Were only able to see the top crown of pipe. Records indicate pipe size to be 48".

TH #42 - Depth taken from top of pipe joint.

TH #43 - Found unknown concrete 14'x14' structure that appears to be a duct.

ALL INFORMATION SHOWN WAS OBTAINED FROM, A LOCATION SURVEY.



CIVIL ENGINEERING TRANSPORTATION ENVIRONMENTAL PLANNING OF THE PLANNING OF T

TBE Job No. IL09510531, 563, 647, 737 SHEET 2 OF 3

DESIGNED EG REVISED DRAWN SRK REVISED CHECKED MCR REVISED DATE 12/18/15

STATE OF ILLINOIS DEPARTMENT OF TRANSPORTATION I-94/1-90/1-290 (Circle Interchange) Chicago, Illinois

SHEET NO. 20 OF 27 SHEETS STA. TO STA.

COUNTY Cook Contract No. N/A

Job No.1 P-91-259-12

			V	ERIFIED U	TILITY INFOR	RMATION			
TEST HOLE #	SIZE & TYP	È.	NORTHING	EASTING	EXISTING TOP ELEVATION	EXISTING CUT	REFERENCE ELEVATION	SUE QUALITY LEVEL	COMMENTS
44	SEE NOTE GA	S	189794I <b>.</b> 863	1167859.669	572.26′	8.14′	580.40′	В	
45	18"×4" ELEC	TRIC	1897934.185	1168300.312	574.30′	5.26′	579.56′	А	
46	6" UNKO		1897935.218	II68302.972	577 <b>.</b> I5′	2.31′	579.46′	А	
47	60" SANIT		1897000.917	II7I469 <b>.</b> 596	582.85′	9.84′	592.69′	Д	
48	SEE NOTE WAT		1900713.310	1171605,295	57 <b>1.</b> 30′	8 <b>.</b> 18′	579.48′	В	
49	2" WAT		1897809.914	II69798.544	588.83′	4.92′	593 <b>.</b> 75′	А	
49A	8" WAT	ER	1897809.914	II69798.544	587.83′	5.92′	593 <b>.</b> 75′	А	
50	42" TELEP		1897887.300	1170967.618	568.18′	7.04′	575.22′	Α	
50A	2" TELEP	HONE	1897887.267	II70965 <b>.</b> 824	570.40′	4.81′	575,21′	А	
50B	42" TELEP		1897887.404	II70969 <b>.</b> 38I	568.18′	7.04′	575.22′	Δ	
5I	(2) 4" ELEC		1897848.317	1170019.373	573.62′	3.71′	577.33′	А	
5IA	(2) 4" ELEC		1897848.348	1170018.630	573 <b>.</b> 73′	3,63′	577.36′	Α	
52	I6" WAT		1898832 <b>.</b> IIO	1171343,510	587.38′	5.02′	592,40′	А	
52A	(2) 4" FIBER		1898829.974	1171344.221	589 <b>.</b> 65′	2.92′	592.57′	Δ	
53	I6" WAT		1898840.107	1171675.502	587 <b>.</b> 67′	5.08′	592 <b>.</b> 75′	А	
54	I2" WAT		1900715.908	1171642.460	586 <b>.</b> 55′	7.00′	593 <b>.</b> 55′	Α	
54A	I2" WAT		1900715,908	1900715.908	570.95′	22.60′	593.55′	А	
55A	40"XI8" ELEC/FIBE		1897053.710	1171439,938	590.22′	2.69′	592.91′	Δ	
55B	40"XI8" ELEC/FIBE		1897053.710	1171439.938	588 <b>.</b> 72′	4 <b>.</b> 19′	592.91′	А	
55C	40"XI8" ELEC/FIBE	R OPTIC	1897053 <b>.</b> 661	1171436.669	590.23′	2.38′	592.61′	А	
55D	(2) I.5" UNKN		1897054.054	1171438.116	590.37′	2 <b>.</b> I2′	592.49′	А	
56A	40" ELEC/FIBE	R OPTIC	1897086.682	1171423.877	588 <b>.</b> 8ľ	3.92′	592,73′	Δ	
56B	(2) I.5" UNKN	OWN	1897087.277	1171425,482	589.26′	3.45′	592.71′	Δ	
56C	40" ELEC/FIBE	R OPTIC	1897087.963	1171426.847	588.63′	4.03′	592.66′	А	
								+	

TH #44 - Unable to visually verify utility due to back fillinfiltrating the test hole. However, by utilizing the air lance we were able to feel what is believed to be the edges and top of the pipe. Records indicate utility to be a 18" pipe.

TH #48 - Unable to visually verify utility due to back fillinfiltrating the test hole. However, by utilizing the air lance we were able to feel what is believed to be the edges and top of the pipe. Records indicate utility to be a 12" pipe.

TH #51- Found (2) 4" conduits side by side. Reference placed in the center of Eastern pipe.

TH #5IA - Found (2) 4 conduits side by side Reference placed in the center of Western pipe.

TH #52A - Found (2) 4 conduits side by side Reference placed in the center of the two pipes.

TH #54 - Claassen, White & Associates obtained an elevation of 586.55 on the 90 degree bend on the water main inside the manhole. The approximate manual depth of 7' was also obtained by Claassen, White & Associates.

TH #54A - Claassen, White & Associates obtained an elevation of 570.95 on the water main near the bottom of the manhole as it heads West.

The approximate manual depth of 22.6' was also obtained by Claassen, White & Associates,

TH #55A - Exposed the top Eastern edge of the concrete duct.

TH #55B - Exposed the bottom Eastern edge of the concrete duct.

TH #55C - Exposed the top Western edge of the concrete duct.

TH #55D - Exposed (2) L5" unknown direct buried cables laying on top of the concrete duct in approximately the center of the duct.

TH #56A - Exposed the top Western edge of the concrete duct.

TH #56B - Exposed (2) 1.5" unknown direct buried cables laying on top of the concrete duct in approximately the center of the duct.

TH #56C - Exposed the bottom eastern edge of the concrete duct. Also attempted to expose the bottom eastern edge of the duct but we were unable, due to the gravelfill infiltrating the test hole.

ALL INFORMATION SHOWN WAS OBTAINED FROM A LOCATION SURVEY.





CIVIL ENGINEERING \* TRANSPORTATION \* ENVIRONMENTAL \* PLANNING \* UTILITY ENGINEERING/LOCATING

Checked By: \_\_\_\_\_\_\_\_ TBE Job No. L099053L 563, 647.

DESIGNED EJ	REVISED 3/07/I7 ADDED THP52-54		I-94/I-90/I-290 (Circle Interchange)	F.A. SECTION	COUNTY SHEET
DRAWN KLC	REVISED 3/13/17 ADDED TH*54A	STATE OF ILLINOIS		N/A	Cook 825 231
CHECKED KS	REVISED 5/01/17 ADDED THP55A - 56C	DEPARTMENT OF TRANSPORTATION	Chicago, Illinois		Contract No. N/A
DATE 12/20/16	REVISED		SHEET 240. OF 27 SHEETS STA. TO STA.	FED. ROAD DIST. NO. LLINOIS	Job No. P-91-259-12

	VERIFIED UTILITY INFORMATION								
TEST HOLE *	SIZE	& TYPE	NORTHING	EASTING	EXISTING TOP ELEVATION	EXISTING CUT	REFERENCE ELEVATION	SUE QUALITY LEVEL	COMMENTS
57	SEE NOTE	ELEC/FIBER OPTIC	1897009.098	1171448.371	588.19′	4.12′	592.31′	А	
58	SEE NOTE	ELEC/FIBER OPTIC	1897024.271	1171446.227	588.36′	3.96′	592.32′	Α	
59A	SEE NOTE	ELEC/FIBER OPTIC	1897036.487	1171443.974	587.23′	5.08′	592.31′	А	
59B	SEE NOTE	ELEC/FIBER OPTIC	1897036.487	1171443.974	589.00′	3.31′	592.31′	А	
60A	SEE NOTE	ELEC/FIBER OPTIC	1897064.630	1171436.240	590.08′	2.99′	593.07′	А	
60B	SEE NOTE	ELEC/FIBER OPTIC	1897064.630	1171436.240	588 <b>.</b> 58′	4.49′	593.07′	А	
61	SEE NOTE	ELEC/FIBER OPTIC	1897078.362	1171430.925	589,45′	3.29′	592,74′	А	
62	SEE NOTE	TELEPHONE	1897586.227	1171323.180	573.12′	7.75′	580.87′	А	
62A	SEE NOTE	SEE NOTE	1897585.995	1171323.301	571 <b>.</b> 77′	9.07′	580.84′	А	
62B	SEE NOTE	SEE NOTE	1897585.995	1171323.301	566.27′	14.57′	580.84′	А	

TH #57 – Only exposed the top of the eastern edge of the concrete duct. Measured the thickness of the duct to be approximately  $14^{\prime\prime}$ .

TH #58 - Only exposed the top of the eastern edge of the concrete duct. Unable to determine the thickness of the duct due to bricks and big rocks inside the hole.

DESIGNED EJ

DRAWN KLC

CHECKED KFS

TH #59A - Manual depth obtained from the bottom of the eastern edge of the concrete duct. Same reference point used in the field for the top and bottom measurements.

TH #59B - Manual depth obtained from the top of the eastern edge of the concrete duct. Same reference point used in the field for the top and bottom measurements.

TH \*60A - Manual depth obtained from the top of the eastern edge of the concrete duct. Same reference point used in the field for the top and bottom measurements.

TH #60B - Manual depth obtained from the bottom of the eastern edge of the concrete duct. Same reference point used in the field for the top and bottom measurements.

TH \*61 - Only exposed the the top of the eastern edge of the duct. Attempted to expose the bottom of the eastern edge of the duct but was unable to accurately do so due to the curb and gutter.

TH #62 - Only exposed the top of the eastern edge of the duct. Attempted to expose the bottom of the eastern edge of the duct but was unable to accurately do so due to the curb and gutter.

TH #62A - Depth was recorded from from we believe to be a some type of wooden support for the AT&T tunnel.

TH #62B - Depth was recorded from what we believe to be a some type of wooden support for the AT&T tunnel, Unable to determine if this support was located at the bottom of the AT&T tunnel due to water was infiltrating the hole. Used the same reference point from test hole 62A.

REVISED 5/24/18 ADDED TH 462 - 62B REVISED STATE OF ILLINOIS REVISED **DEPARTMENT OF TRANSPORTATION** DATE 6/08/17 REVISED

ALL INFORMATION SHOWN WAS OBTAINED FROM A LOCATION SURVEY.









CIVIL ENGINEERING \* TRANSPORTATION \* ENVIRONMENTAL \* PLANNING \* UTILITY ENGINEERING/LOCATING

CARDNO Job No. IL09510531, 563, 647, 737, 748, 761

				JI.	ELI TUFT			í
I-94/I-90/I-290 (Circle Inter	change)	F.A. RTE	S <b>E</b> (	TJON	COUNTY	TOTAL SHEETS	SHEET NO.	
Chicago, Illinois			N/A		Cook	825	232	
Gilleagu, Illilluis					Contrac	No. N	I/A	ĺ
SHEET NO. 22 OF 27 SHEETS STA.	TO STA.	FED. RO	DAD DIST. NO.	ILLINOIS	Job No.∎ P	91-259-12		ĺ

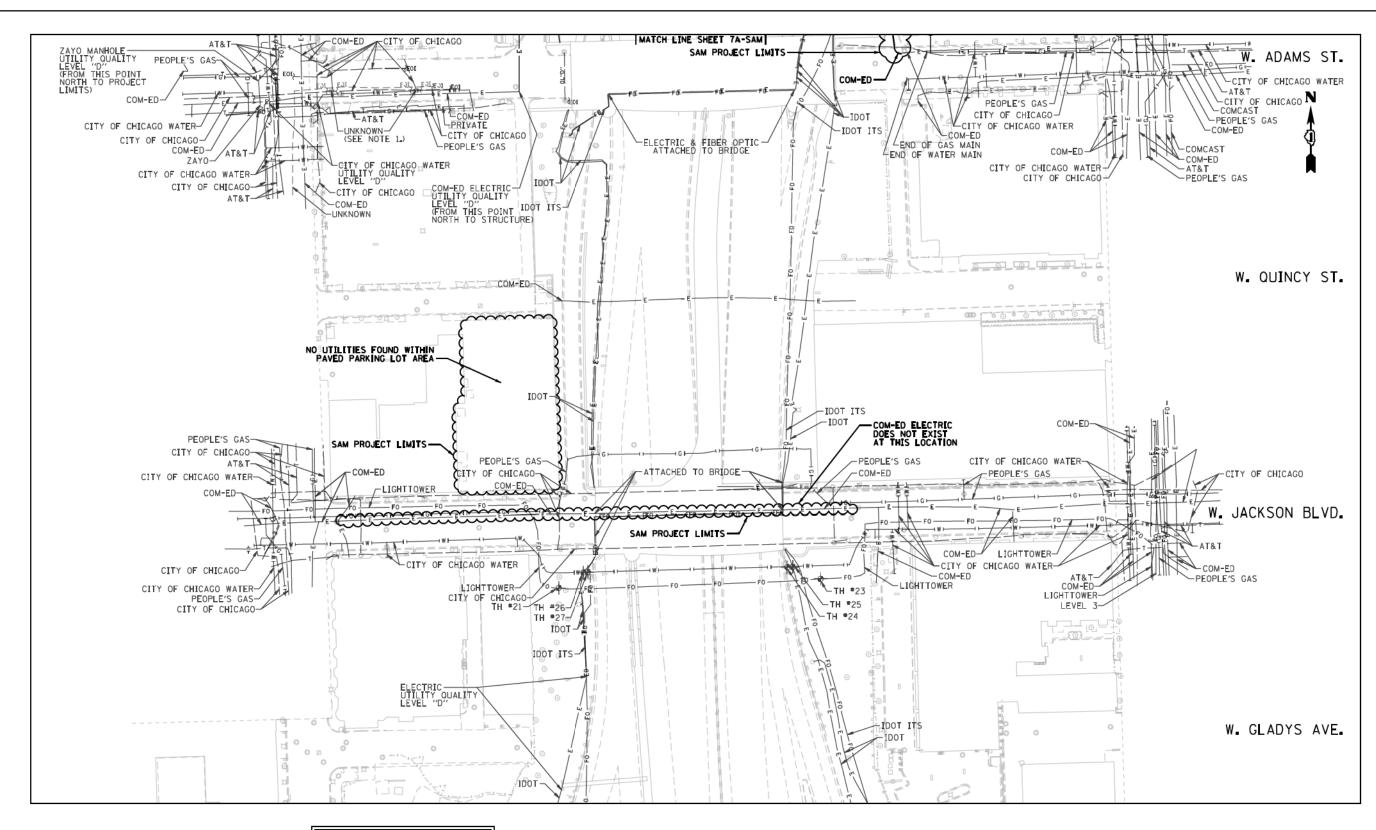

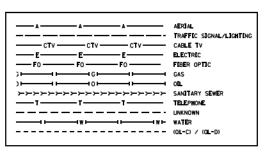



I. SCOTT A. WECHTER, CERTIFY TO THE
ILLINOIS DEPARTMENT OF TRANSPORTATION
THAT TO THE BEST OF MY KNOWLEDGE,
INFORMATION, AND BELIEF, THE UTILITY
INFORMATION DEPICTED BY SAM, LLC.
ON THIS PLAN SHEET WAS OBTAINED AND
COMPILED UNDER MY DIRECT SUPERVISION
USING ACCEPTED PRACTICES AND PROCEDURES.

SCOTT A. WECHTER
PROJECT MANAGER SAM, LLC

BRIT Carille Moran, Managemen Vo. 2011 Oil: TOURISMONE For TELESCO, 1921 For (STANK) WINNERSON  WIN						
D162A77_SUE_DGN			P <b>.</b>			
Scales 1"=50"	Drafted By P.	В.				
Sheet: 7-SAM	Checked By: S.	W.				
Da <b>te:</b> 04-29-2019	1018047098	IDOT-1 W	1.0. 120			


SCALE IN FEET


 $7 - S \land M$ 

NOTES:

UTILITIES DESIGNATED BY SAM, LLC. ARE SHOWN AS THICK LINES.
 UTILITIES DESIGNATED BY CARDNO ARE SHOWN AS THIN LINES.

TOTAL SHEETS	SHEET NO.
825	233

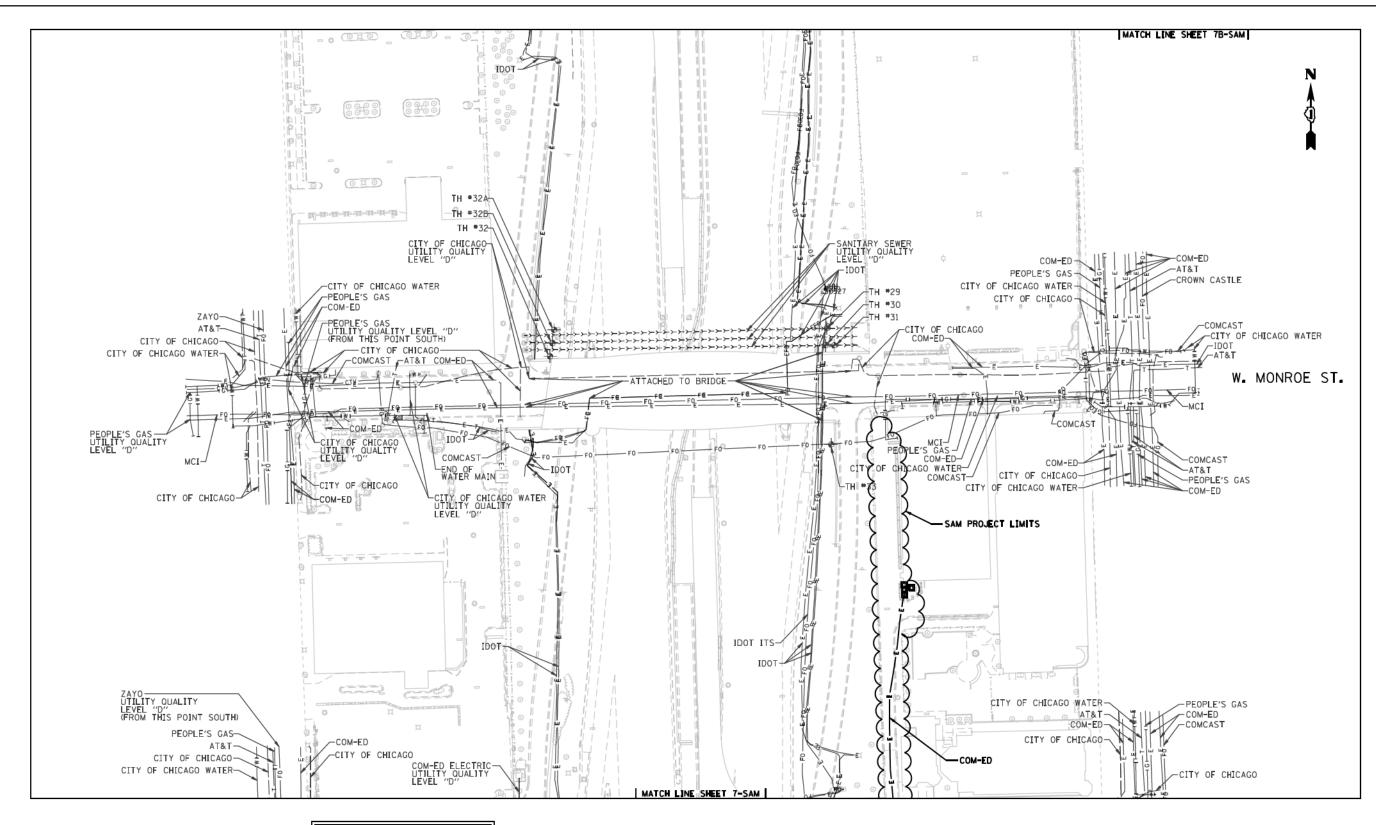

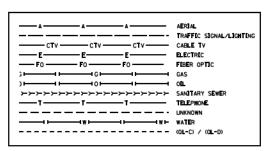



I, SCOTT A, WECHTER, CERTIFY TO THE
ILLINOIS DEPARTMENT OF TRANSPORTATION
THAT TO THE BEST OF MY KNOWLEDGE,
INFORMATION, AND BELIEF, THE UTILITY
INFORMATION DEPICTED BY SAM, LLC.
ON THIS PLAN SHEET WAS OBTAINED AND
COMPILED UNDER MY DIRECT SUPERVISION
USING ACCEPTED PRACTICES AND PROCEDURES.

SCOTT A. WECHTER
PROJECT MANAGER SAM, LLC

SCALA STATE CONTROL CONTROL TO A STATE OF THE STATE OF TH						
D162A77_SUE_DCNIDesignated www.mabb						
Scale: 1"=50"	Drafted By P.					
Sheet: 7A-SAM	Checked By: S	.W.				
Da <b>te:</b> 04-29-2019	1018047098	IDOT-1	W.O.	120		


SCALE IN FEET


 $7 \land - S \land M$ 

NOTES:

UTILITIES DESIGNATED BY SAM, LLC. ARE SHOWN AS THICK LINES.
 UTILITIES DESIGNATED BY CARDNO ARE SHOWN AS THIN LINES.

TOTAL SHEETS	SHEET NO.
825	234

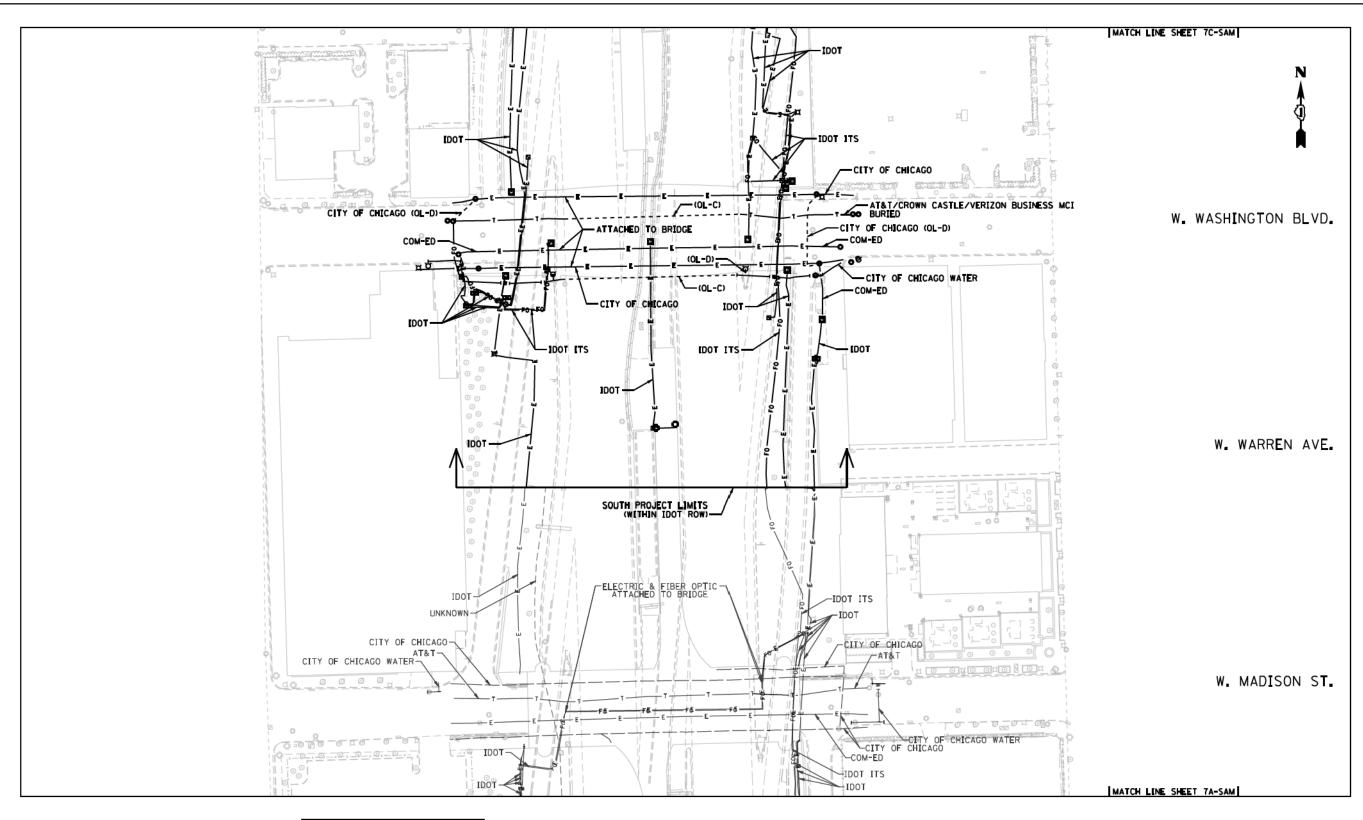

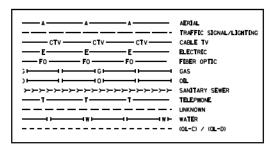



I, SCOTT A. WECHTER, CERTIFY TO THE
ILLINOIS DEPARTMENT OF TRANSPORTATION
THAT TO THE BEST OF MY KNOWLEDGE,
INFORMATION. AND BELIFF. THE UTILITY
INFORMATION DEPICTED BY SAM, LLC.
ON THIS PLAN SHEET WAS OBTAINED AND
COMPILED UNDER MY DIRECT SUPERVISION
USING ACCEPTED PRACTICES AND PROCEDURES.


15 Apr.	DATE	04-29-2019
SCOTT A. WECHTER		
PROJECT MANAGER SAM, LLC	;	


SALVA SALVANA AMERICAN 5377 Eurik Ammu, Marassus, VA. 20111 Ok. POJANI ADOS. Fra 721,267,2931 Friedjanski wenningalik					
D162A77_SUE_DGN			L.P.		
Scales 1"=50"	Drafted By P.	B.			
Sheet: 7B-SAM	Checked By: S.	W.			
Da <b>te:</b> 04-29-2019	1018047098	IDOT-1	W.O.	120	

NOTES:

UTILITIES DESIGNATED BY SAM, LLC. ARE SHOWN AS THICK LINES.
 UTILITIES DESIGNATED BY CARDNO ARE SHOWN AS THIN LINES.

TOTAL SHEETS	SHEET NO.
825	235

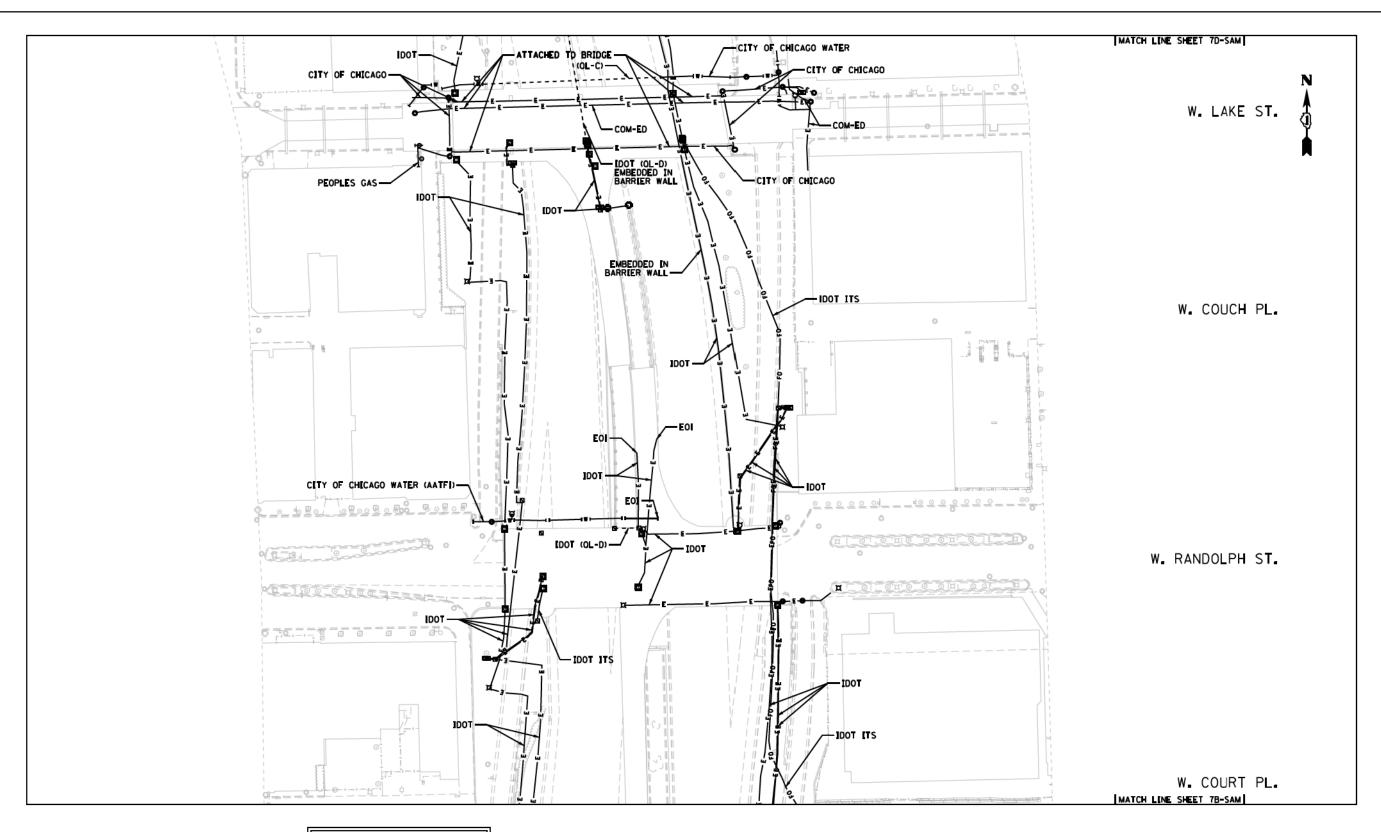

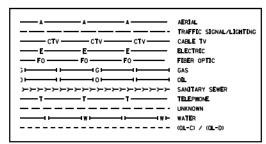



I, SCOTT A. WECHTER, CERTIFY TO THE
ILLINOIS DEPARTMENT OF TRANSPORTATION
THAT TO THE BEST OF MY KNOWLEDGE,
INFORMATION, AND BELIEF, THE UTILITY
INFORMATION DEPICTED BY SAM, LLC.
ON THIS PLAN SHEET WAS OBTAINED AND
COMPILED UNDER MY DIRECT SUPERVISION
USING ACCEPTED PRACTICES AND PROCEDURES.

SCOTT A, WECHTER
PROJECT MANAGER SAM, LLC

# D162A77\_SUE\_DGN Designated By: B.J. E.F. L.P. Scale: 1'=50' Drafted By: P.B. Sheet: 7C-SAM Checked By: S.W. Date: 04-29-2019 1018047098 IDOT-1 W.O. 120


0 50 100 150 SCALE IN FEET

# NOTES:

- 1. UTILITIES DESIGNATED BY SAM, LLC. ARE SHOWN AS THICK LINES. UTILITIES DESIGNATED BY CARDNO ARE SHOWN AS THIN LINES.
- 2. RECORDS FROM CDOT INDICATE FREIGHT TUNNELS UNDER FULTON STREET, LYDIA STREET, AND LAKE STREET.

TOTAL SHEET NO. 825 236



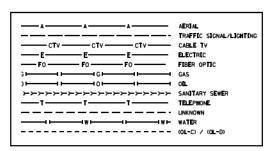



I. SCOTT A. WECHTER, CERTIFY TO THE
ILLINOIS DEPARTMENT OF TRANSPORTATION
THAT TO THE BEST OF MY KNOWLEGGE,
INFORMATION, AND BELIEF, THE UTILITY
INFORMATION DEPICTED BY SAM, LLC.
ON THIS PLAN SHEET WAS OBTAINED AND
COMPILED UNDER MY DIRECT SUPERVISION
USING ACCEPTED PRACTICES AND PROCEDURES.

SCOTT A, WECHTER
PROJECT MANAGER SAM, LLC

7 Euclid Avenue, Manassas, VA fo 703,361,6005 Fax 701,361 Info@sam.htz www.som.bt	.7587			
	_			
gnated B	y: B.J.	E.F.	L.P.	
fted By	P.B.			
cked By:	S.W.			
804709	8 IDO	T-1	W.O.	120
	fted By:	fted By P.B. cked By S.W.	fted By: P.B. cked By: S.W.	


50 100 150

## 70-SAM

#### NOTES:

- 1. UTILITIES DESIGNATED BY SAM, LLC. ARE SHOWN AS THICK LINES. UTILITIES DESIGNATED BY CARDNO ARE SHOWN AS THIN LINES.
- RECORDS FROM CDOT INDICATE FREIGHT TUNNELS UNDER FULTON STREET, LYDIA STREET, AND LAKE STREET.

TOTAL SHEET NO. 825 237

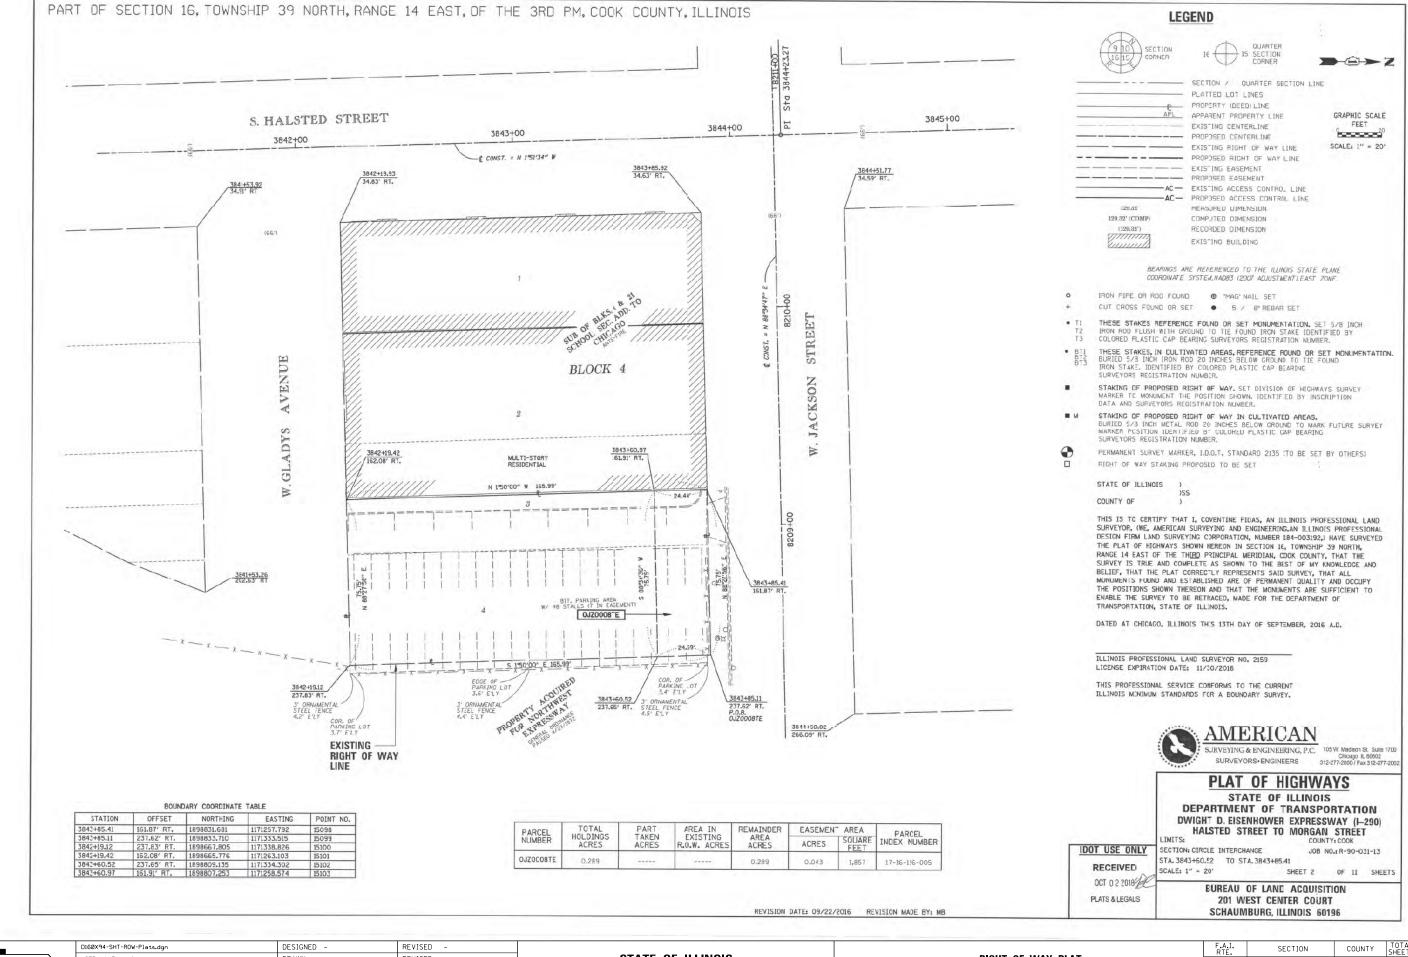


JSER NAME = vlianachione DRAWN REVISED CHECKED REVISED PLOT DATE = 3/6/2020 DATE REVISED

STATE OF ILLINOIS **DEPARTMENT OF TRANSPORTATION**  RIGHT OF WAY PLAT

TO STA.

90/94/290 2014-015R&B-R COOK 825 238 CONTRACT NO. 60X94

SCALE: NONE SHEET 1 OF 6 SHEETS STA.

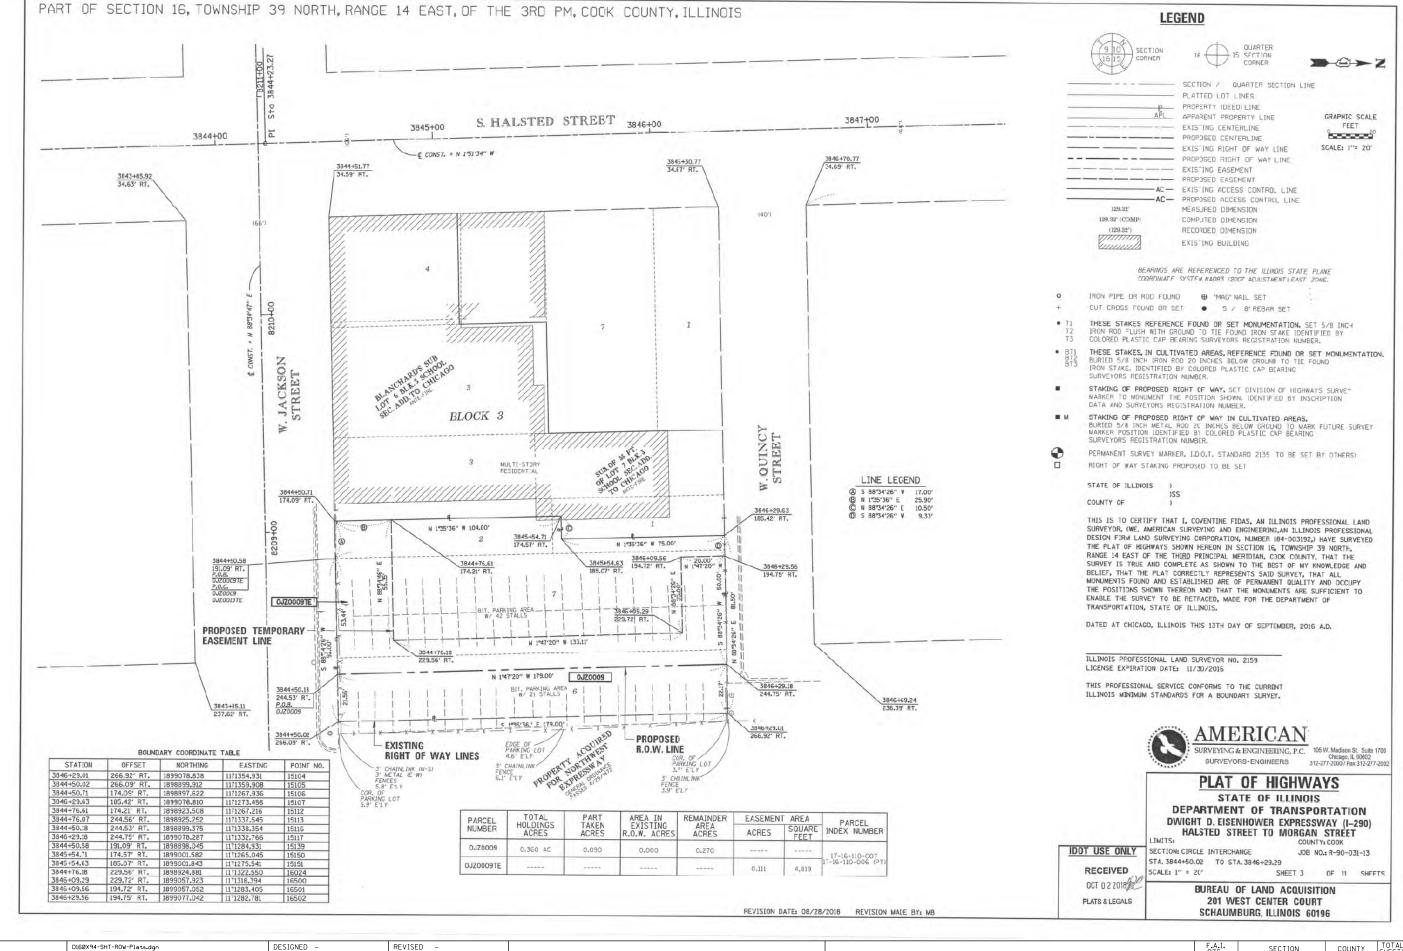

STATE OF ILLINOIS DEPARTMENT OF TRANSPORTATION


RIGHT OF WAY PLAT

TO STA.

SCALE: NONE

F.A.I. SECTION COUNTY TOTAL SHEETS NO. 90/94/290 2014-015R&B-R COOK 825 239


CONTRACT NO. 60X94

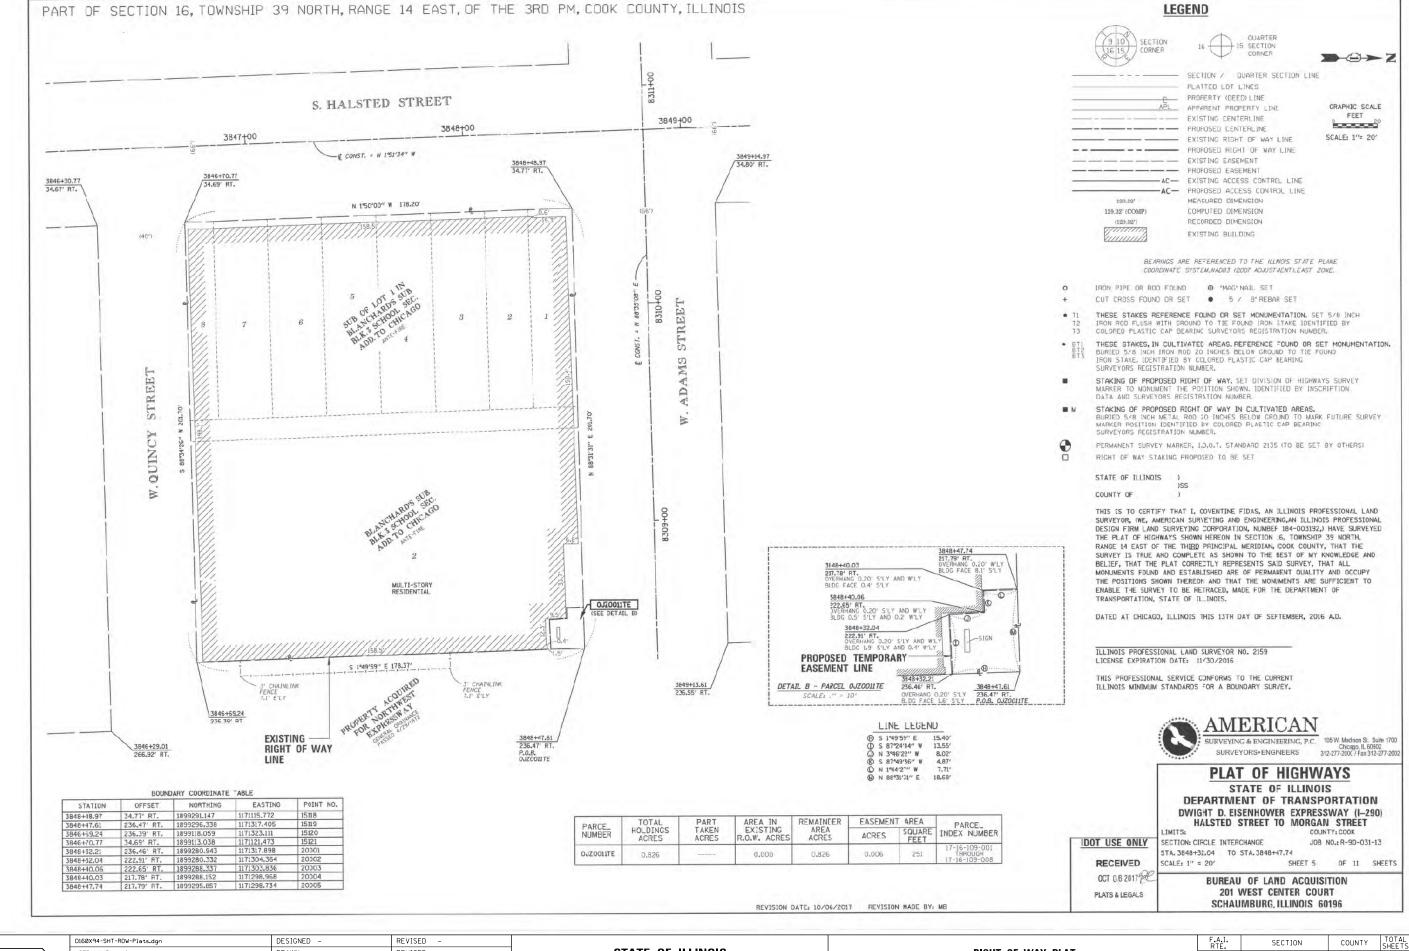

STATE OF ILLINOIS
DEPARTMENT OF TRANSPORTATION

RIGHT OF WAY PLAT

SCALE: NONE SHEET 3 OF 6 SHEETS STA. TO STA.

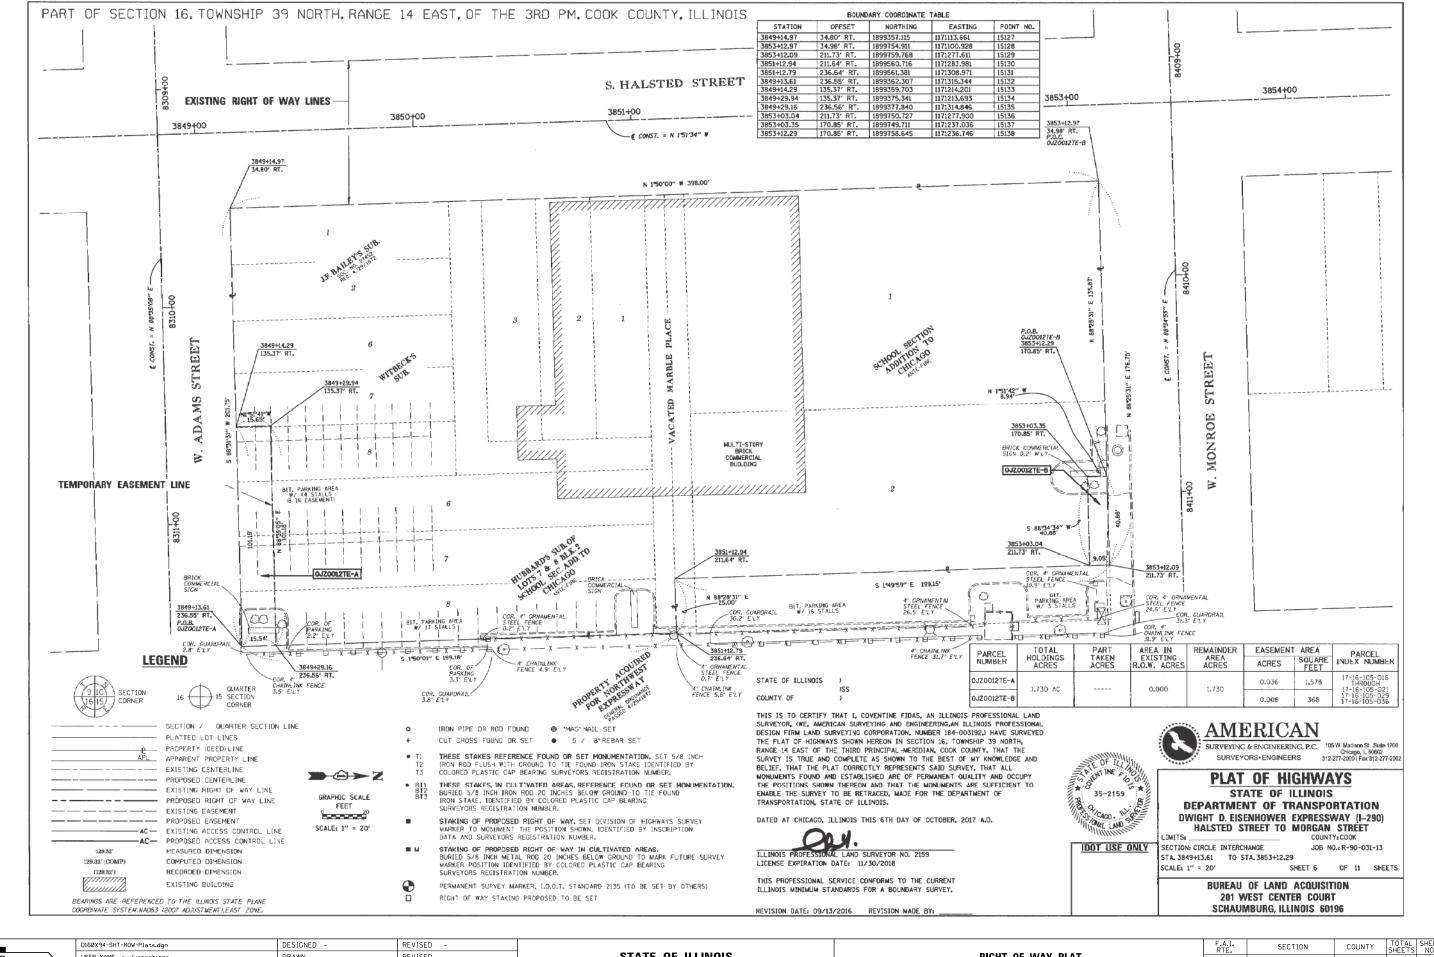


DIBUX94-5HI-KUW-Plats.dgn	DESIGNED -	KENIZED -
USER NAME = vljanachione	DRAWN -	REVISED -
PLOT SCALE = 2.0000 '/ in.	CHECKED -	REVISED -
PLOT DATE = 3/6/2020	DATE - 3-13-2020	REVISED -

STATE OF ILLINOIS
DEPARTMENT OF TRANSPORTATION

SCALE: NONE

SHEET 4

				F.A.I. RTE.	SECTI
RIGHT	OF WA	Y PLAT		90/94/290	2014-015
OF 6	SHEETS	STA.	TO STA.		TLLIN

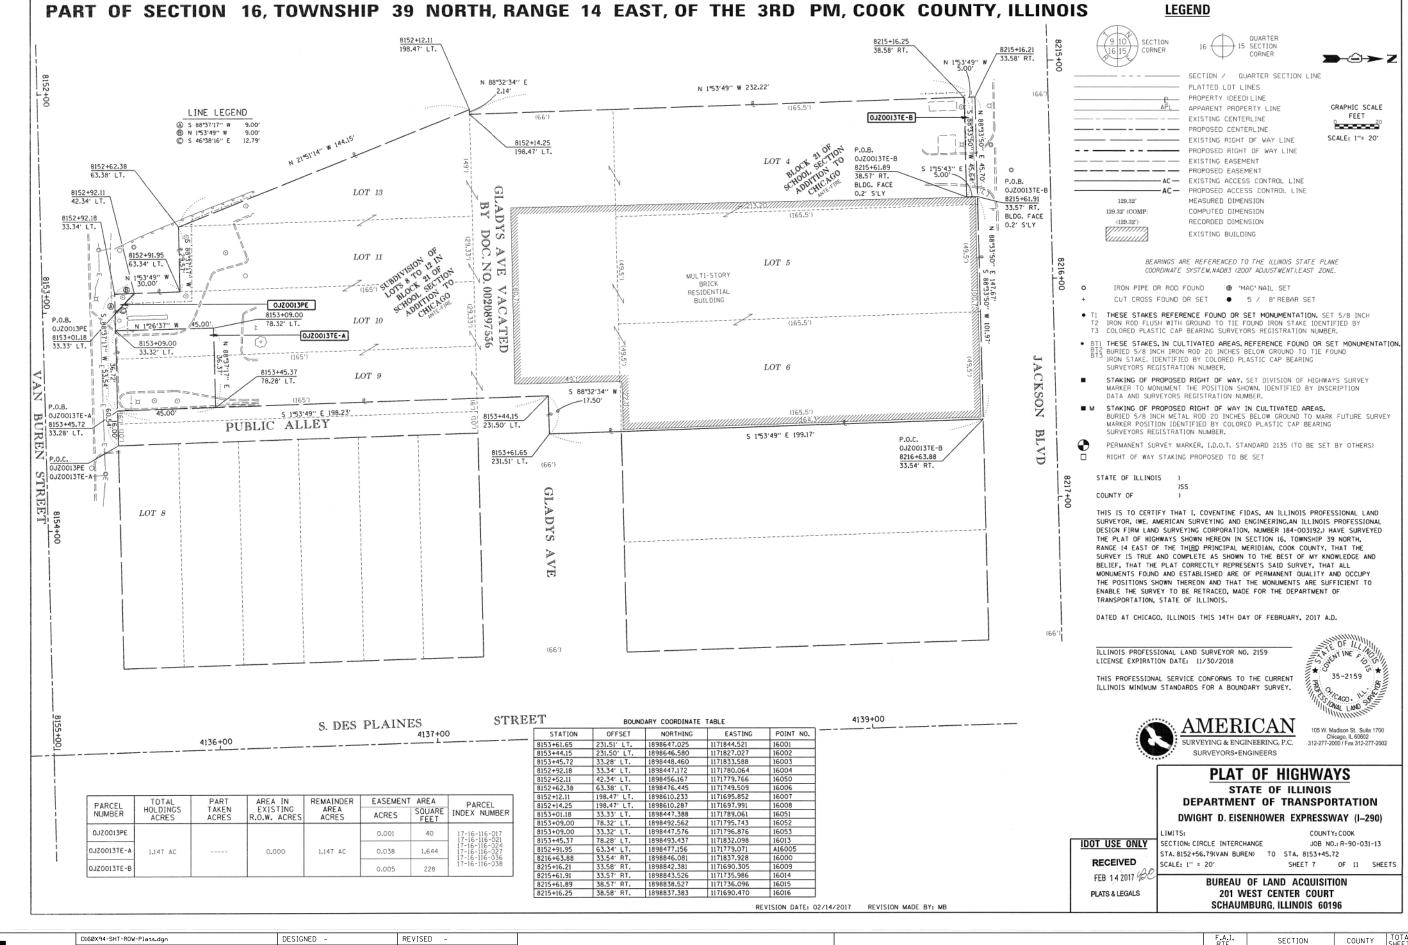

 USER NAME = vlyanachione
 DRAWN
 REVISED

 PLOT SCALE = 2,0000 '/ In.
 CHECKED
 REVISED

 PLOT DATE = 3/6/2020
 DATE
 3-13-2020
 REVISED


STATE OF ILLINOIS DEPARTMENT OF TRANSPORTATION

RIGHT OF WAY PLAT

| SHEET 5 OF 6 SHEETS STA.

TO STA.

SCALE: NONE

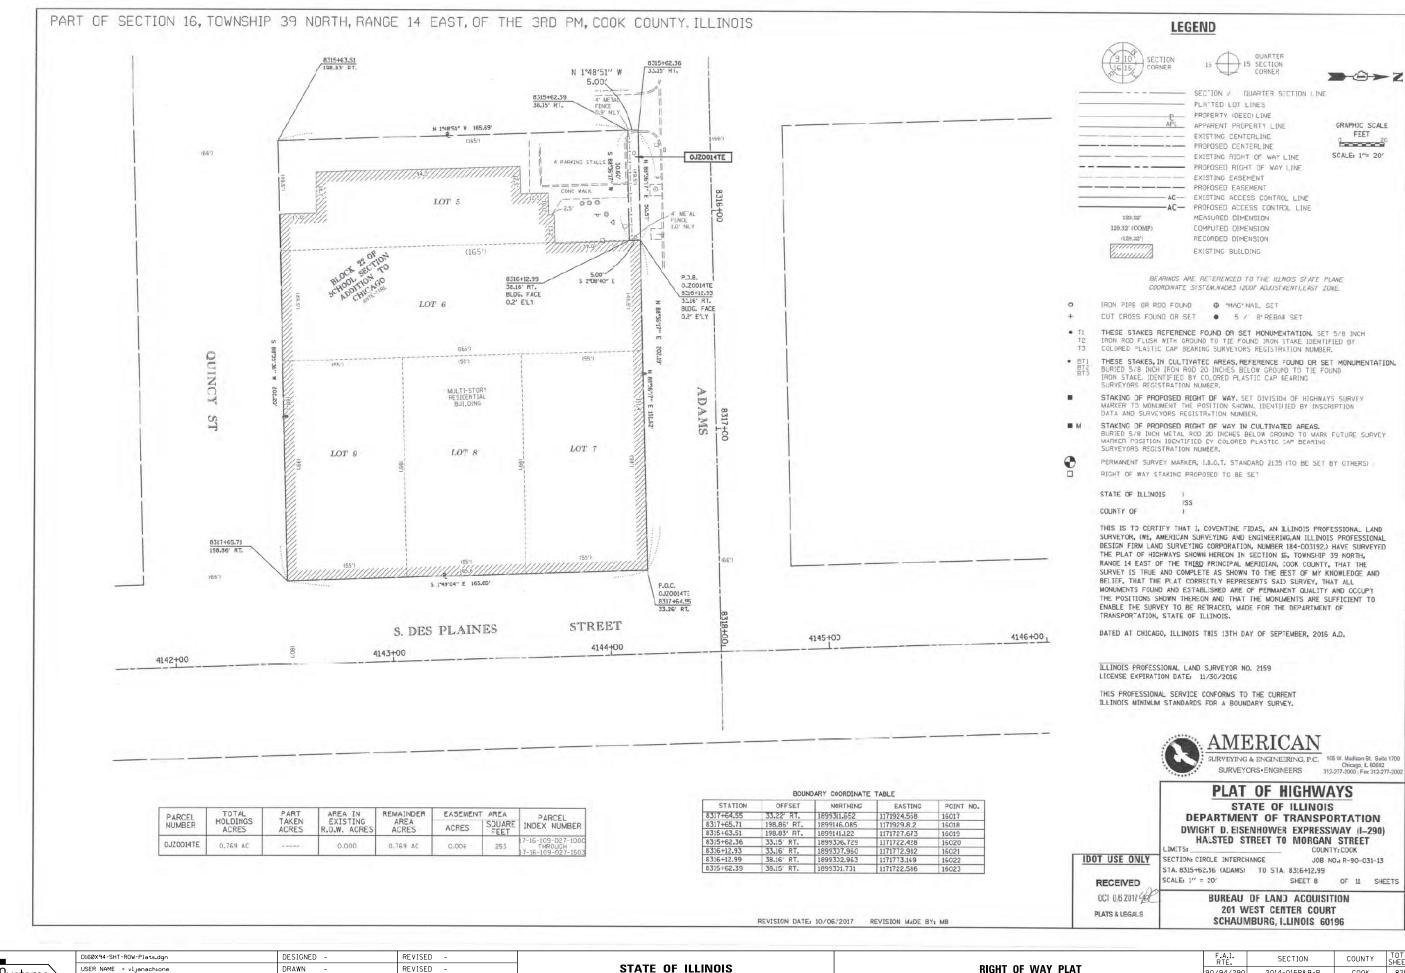



CHECKED REVISED PLOT DATE = 3/6/2020 DATE REVISED

**DEPARTMENT OF TRANSPORTATION** 

**RIGHT OF WAY PLAT** 

90/94/290 2014-015R&B-R COOK

SCALE: NONE SHEET 6 OF 6 SHEETS STA. TO STA.

825 243 CONTRACT NO. 60X94


#### **PAVEMENT MARKING SCHEDULE**

	THERMOPLASTIC PAVEMENT MARKING - LETTERS AND SYMBOLS	THERMOPLASTIC PAVEMENT MARKING - LINE 4"	THERMOPLASTIC PAVEMENT MARKING - LINE 6"	THERMOPLASTIC PAVEMENT MARKING - LINE 24"	PAINT PAVEMENT MARKING - LETTERS AND SYMBOLS	PAINT PAVEMENT MARKING - LINE 4"	PAINT PAVEMENT MARKING - LINE 6"	PREFORMED THERMOPLASTIC PAVEMENT MARKING - LETTERS AND SYMBOLS	POLYUREA PAVEMENT MARKING TYPE I - LINE 4"	POLYUREA PAVEMENT MARKING TYPE I - LINE 6"	POLYUREA PAVEMENT MARKING TYPE I - LINE 8"	POLYUREA PAVEMENT MARKING TYPE I - LINE 12"	POLYUREA PAVEMENT MARKING TYPE I - LINE 24"	MODIFIED URETHANE PAVEMENT MARKING - LINE 8"	MODIFIED URETHANE PAVEMENT MARKING - LINE 12"	MODIFIED URETHANE PAVEMENT MARKING - LINE 24"	PAVEMENT MARKING REMOVAL - GRINDING	PREFORMED PLASTIC PAVEMENT MARKING, TYPE D - LETTERS AND SYMBOLS	GROOVING FOR RECESSED PAVEMENT MARKING, LETTERS AND SYMBOLS
LOCATION	SQ FT	FOOT	FOOT	FOOT	SQ FT	FOOT	FOOT	SQ FT	FOOT	FOOT	FOOT	FOOT	FOOT	FOOT	FOOT	FOOT	SQ FT	SQ FT	SQ FT
PMK SHEET 1 - I-90/94 NORTH OF 6149+00	37	278	-	300	-	-	29	-	770	65	124	275	136	1,217	793	12	631	61	68
PMK SHEET 2 - I-90/94 SOUTH OF 6149+00	-	124	2,682	328	24	1,100	60	24	78	1,065	35	407	88	1,052	629	12	1,602	61	68
TOTAL	37	402	2,682	628	24	1,100	89	24	848	1,130	159	682	224	2,269	1,422	24	2,233	122	136

• Tran Systems

D160X94-sht-PMK-Schedule.dgn	DESIGNED - \$PMS-01-DE	REVISED -
USER NAME = vljanachione	DRAWN - \$PMS-01-DR	REVISED -
PLOT SCALE = 20.0000 '/ in.	CHECKED - \$PMS-01-CH	REVISED -
PLOT DATE = 3/11/2020	DATE - 3-13-2020	REVISED -

						F.A.I. RTE.	SECTION	COUNTY	TOTAL SHEETS	SHEET NO.
	PAVE	MENT	WARKING	SCHEDULE		90/94/290	2014-015R&B-R	COOK	825	244
								CONTRACT	NO. 6	0X94
SCALE: NONE	SHEET 1	OF 1	SHEETS	STA.	TO STA.		ILLINOIS FED. AI	D PROJECT		

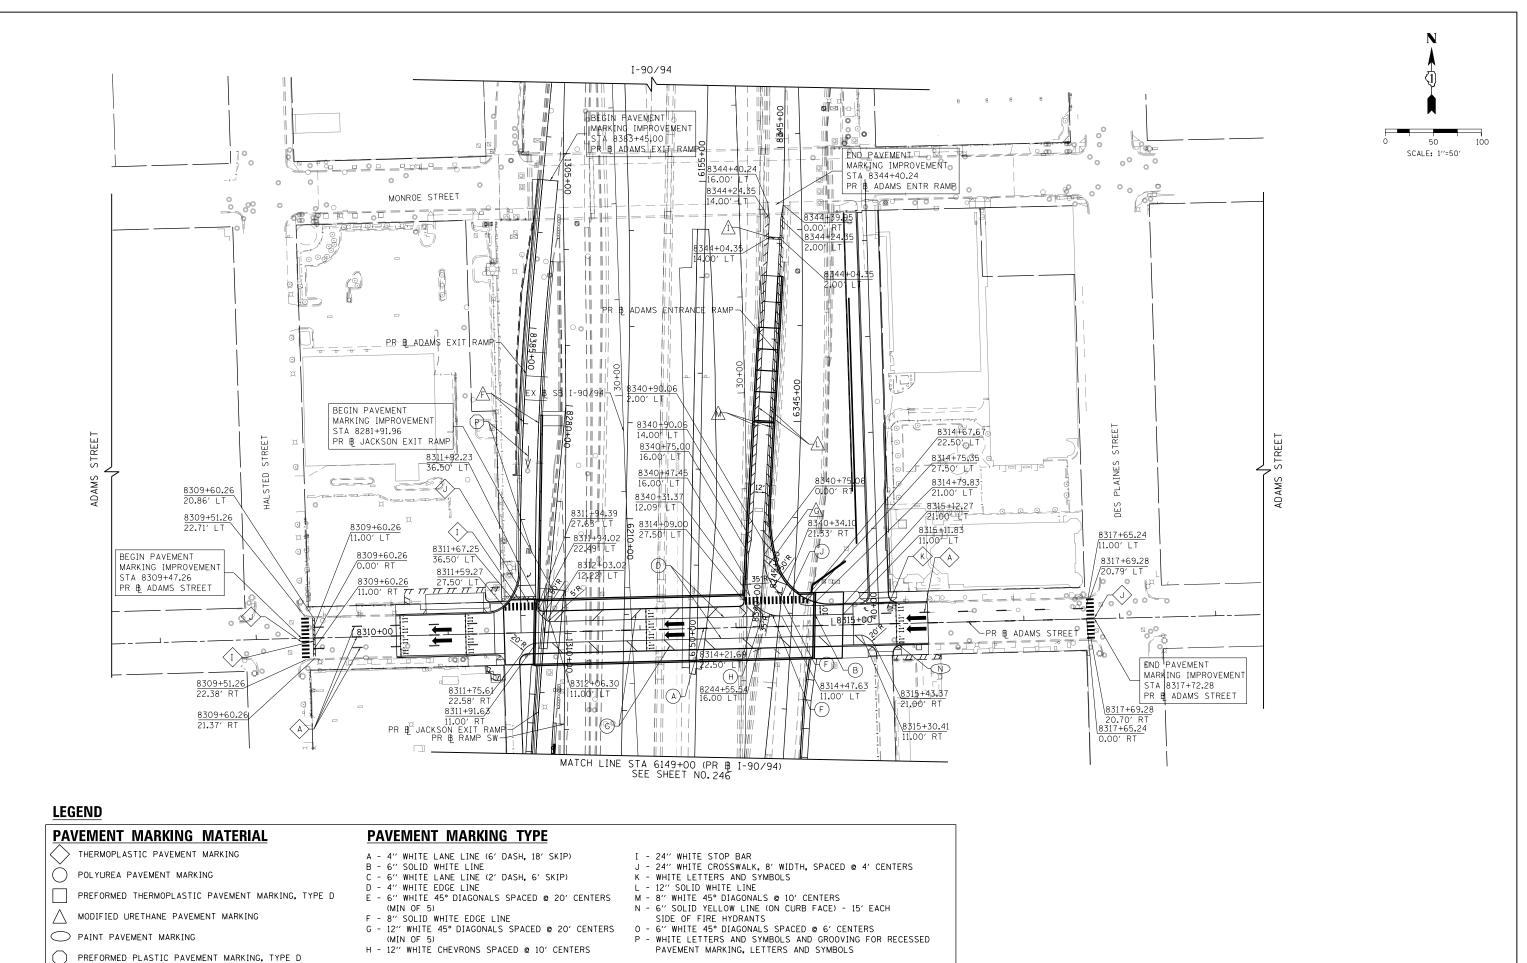

STATE OF ILLINOIS

**DEPARTMENT OF TRANSPORTATION** 

SECTION

2014-015R&B-R

90/94/290

TO STA, 8319+50

PAVEMENT MARKING PLAN

**ADAMS STREET** 

OF 2 SHEETS STA.8307+50

SCALE: 1"=50"

SHEET 1

COUNTY

COOK

825 245

CONTRACT NO. 60X94

Tran Systems

D160X94-Sht-PMK-01.dgn

USER NAME = vljanachione

PLOT DATE = 3/11/2020

DESIGNED - MJL

DRAWN - JM

DATE

CHECKED - JMG


- 3-13-2020

REVISED -

REVISED

REVISED

REVISED

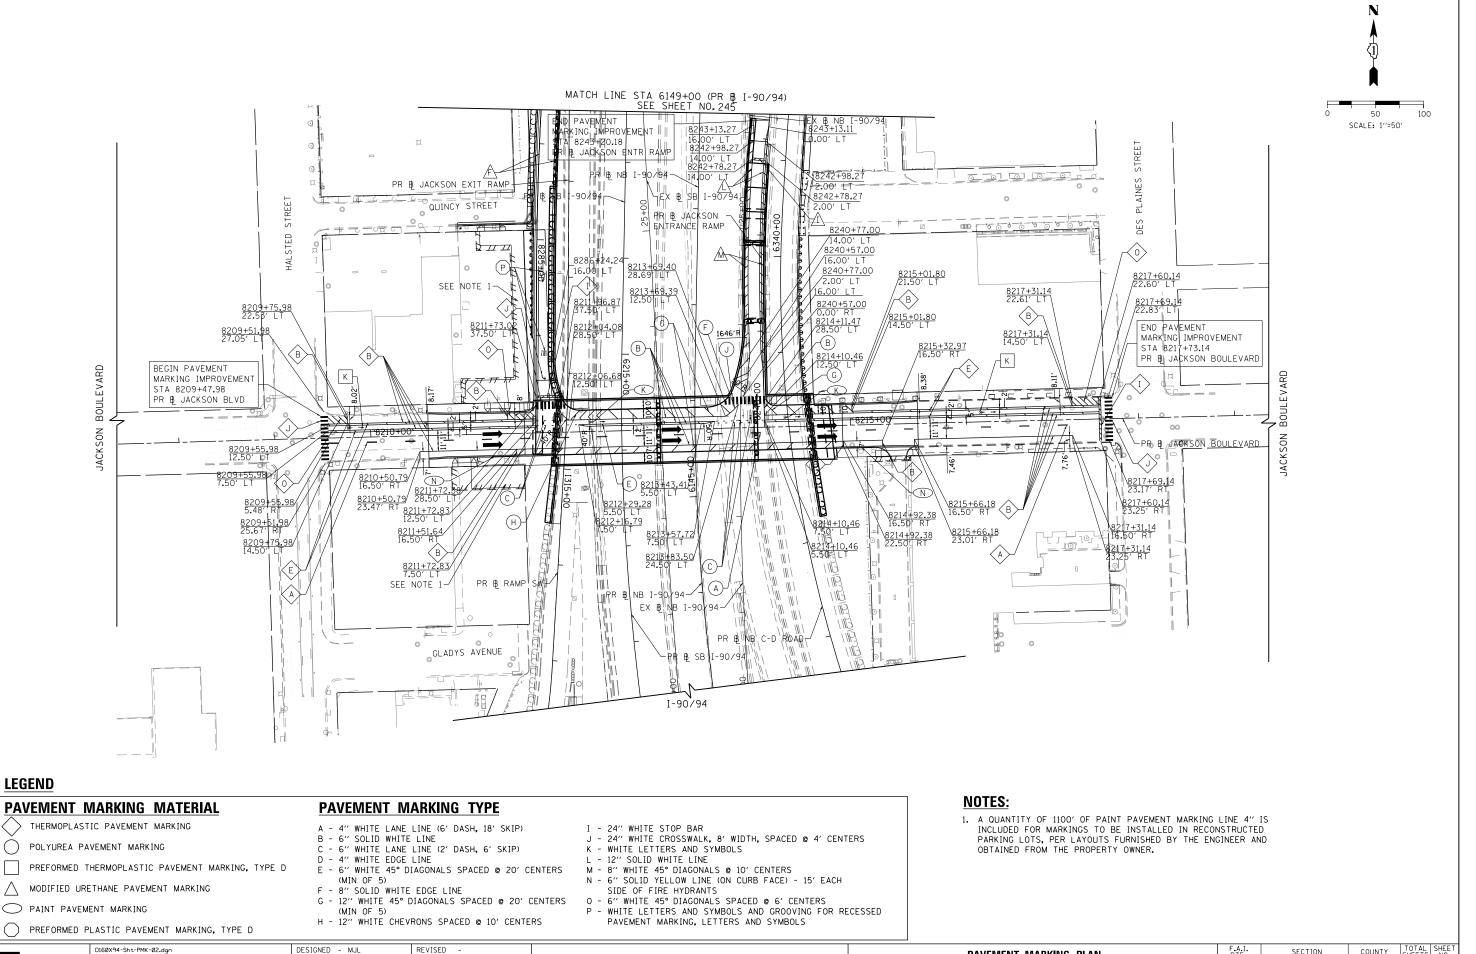

STATE OF ILLINOIS

**DEPARTMENT OF TRANSPORTATION** 

COUNTY

COOK

825 246

CONTRACT NO. 60X94

90/94/290

TO STA. 8219+36

2014-015R&B-R

PAVEMENT MARKING PLAN

JACKSON BOULEVARD

SCALE: 1"=50" SHEET 2 OF 2 SHEETS STA. 8207+35

**Tran** Systems

D160X94-Sht-PMK-02.dgr

USER NAME = vljanachione

DRAWN - JM

CHECKED - JMG

- 3-13-2020

DATE

REVISED

REVISED

REVISED

#### SIGNING SCHEDULE

LOCATION	SIGN NO.	LEGEND / DESCRIPTION	CODE	ACTION	LOCATION (STA	T	SET)	EXISITINI PANEL IMENSION	NS [	PROPOSED PANEL DIMENSIONS		SIGN PANEL - TYPE 1	SIGN PANEL - TYPE 2	REMOVE SIGN PANEL - TYPE 1	RELOCATE SIGN PANEL - TYPE 1	REMOVE SIGN PANEL - TYPE 2	REMOVE SIGN PANEL - TYPE 3	TELESCOPING STEEL SIGN SUPPORT	METAL POST - TYPE A	METAL POST - TYPE B	BASE FOR TELESCOPING STEEL SIGN SUPPORT	REMOVE CONCRETE FOUNDATION - GROUND SUPPORT
					EXISITING	PROP				FT) (FT)		(SQ FT)	(SQ FT)	(SQ FT)	(SQ FT)	(SQ FT)	(SQ FT)	(FT)	(FT)	(FT)	(EA)	(EA)
	ADM-01-ST	BUS STOP 126 JACKSON	CTA	EXISTING SIGN TO REMAIN	8309+71.89 23.64' LT		1.		00		-										<u> </u>	
	ADM-02-ST	NO PARKING TOW ZONE	R7-201-4	EXISTING SIGN TO REMAIN	8309+78.31 23.71' LT		1.	50 1.5	50		-										<u> </u>	
	ADM-03-ST	NO PARKING TOW ZONE LA	R7-201-3	EXISTING SIGN TO REMAIN	8310+07.69 24.41' LT		1.	50 1.5	50		-											
		NO PARKING 7AM-9AM 4PM-6PM, M-F	R7-2-24	EXISTING SIGN TO REMAIN	8310+44.76 23.93′ LT				50		-											
		DO NOT ENTER	R5-1	REMOVE AND REPLACE SIGN						.00 4.00	_		16		16							
	ADM-06-ST		R1-1-2	REMOVE AND REPLACE SIGN	8311+62.87 37.62' LT	8387+80.63				.00 3.00		9		7						32		
		NO LEFT TURN ARROW	R3-2	REMOVE AND REPLACE SIGN						.00 2.00		4		4								
		DO NOT ENTER	R5-1	REMOVE AND REPLACE SIGN			l —		_	.00 4.00	_		16		16						」 '	
	ADM-09-PP		R1-1-2	REMOVE AND REPLACE SIGN	8387+84.76 18.23′ LT	8387+80.36	_		_	.00 3.00	_	9		7				9			1 '	
		NO LEFT TURN ARROW	R3-2	REMOVE AND REPLACE SIGN			2.	00 2.0	00 2.	.00 2.00		4		4								
	ADM-11-ST																					
	ADM-12-ST		M1-1	REMOVE AND REPLACE SIGN			I —		_	.00 2.00	_	4		4							ן '	
	ADM-13-ST		M1-1	REMOVE AND REPLACE SIGN	8313+53.37 32.04' LT	8315+14.45	125 00′ 1 1 1 1 1 1 1 1 1 1 1 1 1 1 1 1 1 1			.00 2.00	_	4		4				14			-l '	
	ADM-14-ST		M3-4	REMOVE AND REPLACE SIGN		0010 1110	2.		_	.00 1.00	_	2		2								
		RIGHT ARROW	M6-1	REMOVE AND REPLACE SIGN					$\overline{}$	.75 1.25		3		3							'	
		USE PROHIBITED BY MOTOR DRIVEN CYCLES •	R5-I100	REMOVE AND REPLACE SIGN	8313+56.82 41.15′ LT					.00 5.00			20			20		9			1 1	
		NO PARKING	R7-1-4	REMOVE AND REPLACE SIGN	8313+17.54 22.53' LT	8313+17.00				.50 1.50	1	3		2				9			1	
		SPEED LIMIT 30	R2-1	REMOVE SIGN	8315+75.96 24.20' LT				50		-			5								
		NO PARKING TOW ZONE SCHOOL DAYS 7AM-6PM RA	R7-9-1	REMOVE AND REPLACE SIGN	0313 113230 2 1220 21	8315+75.96	24.75' LT 1.			.50 1.50	_	3		3				9			1	
		NO PARKING TOW ZONE WHEN SNOW IS OVER 2 INCHES	R7-210-1	EXISTING SIGN TO REMAIN	8316+88.69 24.32' LT				50		-											
		NO PARKING TOW ZONE SCHOOL DAYS 7AM-6PM	R7-9-4	EXISTING SIGN TO REMAIN	0310 100103 2 1132 2 1				50		-											
	ADM-22-ST	NO PARKING TOW ZONE RA	R7-201-1	EXISTING SIGN TO REMAIN	8317+35.80 24.30' LT		1.	50 1.5	50		-											
	ADM-23-ST	NO PARKING TOW ZONE SCHOOL DAYS 7AM-6PM LA	R7-9-3	EXISTING SIGN TO REMAIN	0311133.00 24.30 E1		1.	50 1.5	50		-										<u> </u>	
	ADM-24-SP	HISTORIC US ROUTE 66	XM-21	EXISTING SIGN TO REMAIN			2.	00 2.5	50		-											
	ADM-25-SP	UP ARROW	CUSTOM	EXISTING SIGN TO REMAIN	8317+62.34 25.16' LT		1.	34 1.6	67		-											
ADAMS	ADM-26-SA	N/S DES PLAINES ST 640-W	D3-2	EXISTING SIGN TO REMAIN	0311 +02.34 23.16 E1		5.	00 1.5	50		-											
STREET	ADM-27-SP	ONE WAY RA	R6-2R	EXISTING SIGN TO REMAIN			1.	50 2.0	00		-											
	ADM-28-LP	DO NOT ENTER	R5-1	EXISTING SIGN TO REMAIN	9319   34 15 36 937   1		2.	50 2.5	50		-										'	
	ADM-28A-LP	ONE WAY LA	R6-2L	EXISTING SIGN TO REMAIN	8318+34.15 36.92' LT		1.	50 2.0	00		-										'	
	ADM-29-SP	ONE WAY LA	R6-2L	EXISTING SIGN TO REMAIN	8318+45.77 24.74' RT		1.	50 2.0	00		-											
	ADM-30-SP	ONE WAY RA	R6-2R	EXISTING SIGN TO REMAIN	0717170 07 76 40/ 07		1.	50 2.0	00		-											
	ADM-31-SA	W ADAMS ST 200 S	D3-2	EXISTING SIGN TO REMAIN	8317+78.07 36.48' RT		5.	00 1.5	50		-											
	ADM-32-ST	PAY AT PARK, PARK CHICAGO	CUSTOM	EXISTING SIGN TO REMAIN	8317+35.73 23.99' RT		2.	00 1.5	50		-											
	ADM-33-ST	PAY AT PARK, PARK CHICAGO	CUSTOM	EXISTING SIGN TO REMAIN			2.	00 1.5	50		-											
	ADM-33A-ST	PAY AT PARK, PARK CHICAGO	CUSTOM	EXISTING SIGN TO REMAIN	0716 +60 05 24 25′ 57		2.	00 1.5	50		-											
	ADM-33B-ST	7 DAY PAID PARKING	CUSTOM	EXISTING SIGN TO REMAIN	8316+69.95 24.25' RT		2.	00 0.	50		-											
1	ADM-33C-ST	7 DAY PAID PARKING	CUSTOM	EXISTING SIGN TO REMAIN			2.	00 0.	50		-											
	ADM-34-LP	NO PARKING TOW ZONE WHEN SNOW IS OVER 2 INCHES	R7-210-1	EXISTING SIGN TO REMAIN	8316+50.49 24.20' RT		1.	50 1.5	50		-											
	ADM-35-ST	PAY AT PARK, PARK CHICAGO	CUSTOM	RELOCATE SIGN PANEL	8315+84.72 24.55' RT	8315+84.72	24.75' RT 1.	50 2.0	00 1.	.50 2.00	1				3			9			1	
	ADM-36-ST	NO PARKING	R7-1-4	REMOVE AND REPLACE SIGN	8314+99.98 24.85' RT	8314+99.98	24.00' RT 1.	00 1.5	50 1.	.50 1.50	1	3		2				9			1	
		NO PARKING	R7-1-4	REMOVE AND REPLACE SIGN	8313+17.35 23.73' RT			00 1.5	50 1.	.50 1.50	1	3		2				9			1	
	ADM-38-ST	NO LEFT TURN ARROW	R3-2	REMOVE AND REPLACE SIGN			2.	00 2.0	00 2.	.00 2.00		4		4								
	ADM-39-ST	ONE WAY RA	R6-2R	REMOVE AND REPLACE SIGN	8311+80.47 23.94' RT	8311+80.47	24.28' RT 1.	50 2.0	00 1.	.50 2.00	1	3		3				11			1 1	
	ADM-39A-ST	ONE WAY LA	R6-2L	REMOVE AND REPLACE SIGN			1.	50 2.0	00 1.	.50 2.00		3		3				1			1 '	
		GREEKTOWN RA	CUSTOM	REMOVE AND REPLACE SIGN	8311+51.66 25.89' RT	8311+51.66	25.89' RT 4.			.00 3.00	-		12			12						
	ADM-41-ST	15 MINUTE LOADING ZONE USE FLASHING LIGHTS RA	SPECIAL (NOTE 2)	REMOVE AND REPLACE SIGN	8311+38.32 24.18' RT	8311+38.32	24.75' RT 1.	50 1.5	50 1.	.50 1.50	1	3		3				9			1	
		15 MINUTE LOADING ZONE USE FLASHING LIGHTS LA		REMOVE AND REPLACE SIGN	8311+18.05 24.58' RT					.50 1.50		3		3				9			1	
		ONE WAY RA	R6-2R	EXISTING SIGN TO REMAIN					00		-										T	
		ONE WAY LA	R6-2L	EXISTING SIGN TO REMAIN			1.		00		-											
		NO LEFT TURN ARROW	R3-2	EXISTING SIGN TO REMAIN	8309+47.46 39.59' RT				00		-											
		NO RIGHT TURN ARROW	R3-1	EXISTING SIGN TO REMAIN				00 2.0			-										<u> </u>	
		HONORARY P.K.7 KOGEONES ST	D3-3	EXISTING SIGN TO REMAIN				50 0.			-											
			<u> </u>				1		- 1				1	1	1				1	1		



REFLECTIVE: YES MOUNT: CENTER

(48''×48'')

ADM-05-ST ADM-08-PP ADM-06-ST



R1-1-2 REFLECTIVE: YES MOUNT: CENTER

(36''x36'')

ADM-09-PP







(24''x24'')

ADM-07-ST ADM-10-PP

ADM-38-ST





REFLECTIVE: YES MOUNT: CENTER

(18''×24'')

ADM-39A-ST



(18''×24'')

ADM-39-ST



M1-1 REFLECTIVE: YES MOUNT: CENTER

(24''×24'')

ADM-12-ST ADM-13-ST



M3-4 REFLECTIVE: YES MOUNT: CENTER

(24''x12'')

ADM-14-ST



(21"×15")

ADM-15-ST



ADM-16-PP

PROHIBITED





SEE NOTE 1
REFLECTIVE: NO
MOUNT: CENTER
(18"'×18")

ADM-17-ST ADM-36-ST ADM-37-ST

#### SIGN NUMBERING CODE - EXAMPLE

#### **NOTES**

- FOR CDOT SIGN PANEL DETAILS SEE THE MOST CURRENT EDITION OF "THE FIELD MANUAL FOR SIGN INSTALLATION GUIDE" AND "SIGN FABRICATION AND INSTALLATIONS" MANUALS AND THE DETAILS IN THESE PLANS.
- 2. SIGN PANEL DETAILS FOR LOADING ZONES SHALL FOLLOW THE R7-201-X DETAILS.
- PER MUTCD 2A.21 PARAGRAPH 4. 3" RED REFLECTIVE STRIPS SHALL BE INSTALLED ON STOP, WRONG WAY, AND DO NOT ENTER SIGN POSTS. THE COST SHALL BE INCLUDED IN THE COST OF THE POST.



SEE NOTE 1 REFLECTIVE: NO MOUNT: CENTER (18"×18")

ADM-19-ST

#### DIRECTION OF TRAFFIC

ADM - ADAMS STREET ASX - ADAMS SOUTH EXIT RAMP ANT - ADAMS NORTH ENTRANCE RAMP

JAC - JACKSON BOULEVARD JSX - JACKSON SOUTH EXIT RAMP

JNT - JACKSON NORTH ENTRANCE RAMP

SIGN PANEL NUMBER

FM - FENCE MOUNTED GM - GROUND MOUNTED BM - BRIDGE MOUNTED BS - BREAKAWAY STEEL WP - WOOD POST OH - OVERHEAD

LP - LIGHT POLE BANDING ST - STEEL POST

SA - SIGNAL POLE MAST ARM

MOUNTING TYPE

SP - SIGNAL POLE BANDING PP - PARAPET MOUNTED

	Trank	- Svstems >
8		Jy Otorrio /

D160X94-sht-Sign-Schedule-01.dgn	DESIGNED - MKW	REVISED -
USER NAME = vljanachione	DRAWN - CAT	REVISED -
PLOT SCALE = 20.0000 '/ in.	CHECKED - JMG	REVISED -
PLOT DATE = 3/6/2020	DATE - 3-13-2020	REVISED -

STATE OF ILLINOIS **DEPARTMENT OF TRANSPORTATION** 

		SI	IGNING			F.A.I. RTE.	SECTION	COUNTY	TOTAL SHEETS	SHEET NO.
		S.C	HEDULE	:		90/94/290	2014-015R&B-R	COOK	825	247
		30	IILDULL	•				CONTRACT	NO. 6	0X94
SCALE NONE	SHEET 1	OF 4	SHEETS	STA	TO STA		THE INDIC CED. AT	D DDO IECT		

#### SIGNING SCHEDULE

LOCATION	SIGN NO.	LEGEND / DESCRIPTION	CODE	ACTION	LOCA	TION (ST	ATION / OFF	SET)	DIME	SITING ANEL NSIONS	DIME	POSED ANEL NSIONS	NUMBER OF POSTS	SIGN PANEL - TYPE 1	SIGN PANEL - TYPE 2	REMOVE SIGN ANEL - TYPE 1	RELOCATE SIGN VANEL - TYPE 1	REMOVE SIGN ANEL - TYPE 2	REMOVE SIGN ANEL - TYPE 3	TELESCOPING STEEL SIGN SUPPORT	METAL POST - TYPE A	METAL POST - TYPE B	BASE FOR TELESCOPING STEEL SIGN SUPPORT	REMOVE CONCRETE FOUNDATION - GROUND SUPPORT
					EXISI	TING	PR0P	OSED		HEIGHT (FT)				(SO ET)	(SQ FT)	(SO ET)	(SO ET)	(SO ET)	(SO ET)	(FT)	(FT)	(FT)	(EA)	(EA)
	ADM-48-SA	NO LEFT TURN ARROW	R3-2	EXISTING SIGN TO REMAIN						2.00	-	-	-	130 117	130 117	130 1 17	130 117	130 117	134 117	1 17	\\ \ \ \ \ \ \ \ \ \ \ \ \ \ \ \ \ \ \ \		- CEAY	1.27/
	ADM-49-SA	W ADAMS ST 200 S	D3-2	EXISTING SIGN TO REMAIN	8308+96.96	35.32' R	т		5.00	1.50	-	-	-											
	ADM-50-SP	HONORARY TED G. SPYROPOULOS	D3-3	EXISTING SIGN TO REMAIN					2.50	0.56	-	-	-											
	ADM-51-SP	STOP AHEAD	W3-1	EXISTING SIGN TO REMAIN	0700 105 50	22.654.1	_		2.50	2.50	-	-	-											
	ADM-52-SA	S HALSTED ST 800 W	D3-2	EXISTING SIGN TO REMAIN	8308+85.58	22.65 L			5.00	1.50	-	-	-											
	ADM-53-SP	ONE WAY LA	R6-2L	EXISTING SIGN TO REMAIN					1.50	2.00	-	-	-											
	ADM-54-SP	ONE WAY RA	R6-2R	EXISTING SIGN TO REMAIN	8308+96.73	43.59' L	Т		1.50	2.00	-	-	-											
	ADM-55-SP	HONORARY P.K.7 KOGEONES ST	D3-3	EXISTING SIGN TO REMAIN					2.50	0,56	-	-	-											
40.046	ADM-56-SP	BIKE NORTH TO DEPAUL	D11-1c	EXISTING SIGN TO REMAIN					2.00	1.50	-	-	-											
ADAMS STREET	ADM-57-SA	NO RIGHT TURN ARROW	R3-1	EXISTING SIGN TO REMAIN	8309+47.07	37.76' L	Т		2.00	2.00	-	-	-											
JINEE	ADM-58-SA	W ADAMS ST 200 S	D3-2	EXISTING SIGN TO REMAIN					5.00	1.50	-	-	-											
	ADM-59-ST	PARK 1	CUSTOM	EXISTING SIGN TO REMAIN	8310+61.94	35.35′ L	Т		8.00	3.00	-	-	-											
	ADM-60-LP	UNITED CENTER BIKE DESTINATION SIGN	D1-1b	EXISTING SIGN TO REMAIN					3.00	0.50	-	-	-											
	ADM-61-LP	UIC DISTANCE BIKE DESTINATION SIGN	D1-1b	EXISTING SIGN TO REMAIN	8310+44.76	23.93′ L	Т		3.00		-	-	-											
	ADM-62-LP	DEPAUL DISTANCE BIKE DESTINATION SIGN	D1-1c	EXISTING SIGN TO REMAIN					3.00	0.50	-	-	-											
	ADM-63-GM	WALGREENS	CUSTOM	EXISTING SIGN TO REMAIN	8311+50.99	35.95′ L	Т		9.08	2.25	-	-	-											
	ADM-64-ST	NO PARKING TOW ZONE	R7-201-4	PROPOSED			8312+01.22	24.75′ LT	-	-	1.50	1.50	1	3						9			1	
	ADM-65-ST	NO RIGHT TURN ARROW	R3-1	REMOVE AND REPLACE SIGN			8312+24.50	25.00' LT	2.00	2.00	2.00	2.00	1	4		4				9			1	
	ADM-66-ST	NO PARKING TOW ZONE	R7-201-4	REMOVE					1.50	1.50	-	-	1			3								
ADAMS		WRONG WAY	R5-1a	REMOVE AND REPLACE SIGN			8386+58.85				3.50		2	9		9					26			
EXIT RAMP	ASX-02-PP	WRONG WAY	R5-1a	REMOVE AND REPLACE SIGN	8386+39.67	18.27' L	8386+58.85	20.28' LT	3.50	2.50	3.50	2.50	1	9		9				6			1	
	ANT-01-SP	RAMP METER AHEAD	W3-7	REMOVE AND REPLACE SIGN	8340+90.45	75.85′ L	T 8341+36.28	19.60' LT	3.00	3.00	3.00	3.00	-	9		9								
ADAMS ENTRANCE	ANT-02-ST		R1-2	REMOVE SIGN	8341+84.09				3.00	3.00	-	-	-			9								
RAMP		STOP HERE ON RED	R10-6aR	REMOVE AND REPLACE SIGN			8344+04.35				2.00		-	5		5								
	ANT-04-SP	STOP HERE ON RED	R10-6aL	REMOVE AND REPLACE SIGN	8342+57.48	71.15′ L	8344+04.35	3.80' RT	2.00	2.50	2.00	2.50	-	5		5								



- FOR CDOT SIGN PANEL DETAILS SEE THE MOST CURRENT EDITION OF "THE FIELD MANUAL FOR SIGN INSTALLATION GUIDE" AND "SIGN FABRICATION AND INSTALLATIONS" MANUALS AND THE DETAILS IN THESE PLANS.
- 2. SIGN PANEL DETAILS FOR LOADING ZONES SHALL FOLLOW THE R7-201-X DETAILS.
- PER MUTCD 2A.21 PARAGRAPH 4, 3" RED REFLECTIVE STRIPS SHALL BE INSTALLED ON STOP, WRONG WAY, AND DO NOT ENTER SIGN POSTS. THE COST SHALL BE INCLUDED IN THE COST OF THE POST.



R5-1a REFLECTIVE: YES MOUNT: CENTER (42''×30'')

ASX-01-ST ASX-02-PP



W3-7 REFLECTIVE: YES MOUNT: CENTER (36"×36")

ANT-01-SP



R10-6aR/R10-6aL REFLECTIVE: YES MOUNT: CENTER (24''×30'')

ANT-03-SP ANT-04-SP



R7-201-4 SEE NOTE 1 REFLECTIVE: NO MOUNT: CENTER (18''×18'')

ADM-64-ST



R3-1 REFLECTIVE: YES MOUNT: CENTER (24''x24'')

ADM-65-ST

#### SIGN NUMBERING CODE - EXAMPLE

MOUNTING TYPE

LP - LIGHT POLE BANDING ST - STEEL POST

DIRECTION OF TRAFFIC ADM - ADAMS STREET

ASX - ADAMS SOUTH EXIT RAMP ANT - ADAMS NORTH ENTRANCE RAMP JAC - JACKSON BOULEVARD

JSX - JACKSON SOUTH EXIT RAMP JNT - JACKSON NORTH ENTRANCE RAMP

SA - SIECL FUSI FM - FENCE MOUNTED GM - GROUND MOUNTED BM - BRIDGE MOUNTED BS - BREAKAWAY STEEL WP - WOOD POST

SIGN PANEL NUMBER

OH - OVERHEAD SP - SIGNAL POLE BANDING

	8	Tran Systems
--	---	--------------

D160X94-sht-Sign-Schedule-02.dgn DESIGNED - MKW REVISED -DRAWN - CAT USER NAME = vljanachione REVISED -CHECKED - JMG REVISED PLOT DATE = 3/6/2020 DATE REVISED - 3-13-2020

STATE OF ILLINOIS **DEPARTMENT OF TRANSPORTATION** 

PP - PARAPET MOUNTED SECTION COUNTY SIGNING COOK 825 248 90/94/290 2014-015R&B-R **SCHEDULE** CONTRACT NO. 60X94 SCALE: NONE SHEET 2 OF 4 SHEETS STA. TO STA.

#### SIGNING SCHEDULE

							FVI	ITING	DDO	OSED			-	SIGN TYPE 1	SIGN PE 1	SIGN TYPE 2	SIGN TYPE 3	OPING SIGN ORT	, E	- -	~ S S C	ш Z
LOCATION	SIGN NO.	LEGEND / DESCRIPTION	CODE	ACTION	LOCATION (STATION / O	FFSET)	P.A	NEL NSIONS	PA		NUMBER OF POSTS	SIGN PANE TYPE 1	IGN PANEL TYPE 2	REMOVE S: ANEL - TY	RELOCATE SIGN PANEL - TYPE	REMOVE S. ANEL - TY	REMOVE S.	TELESCOPI STEEL SI SUPPORI	ETAL POST TYPE A	ETAL POST TYPE B	BASE FOR TELESCOPING STEEL SIGN SUPPORT	REMOVE CONCRETE SUNDATION GROUND SUPPORT
					EXISITING PR	OPOSED	WIDTH (FT)	HEIGHT (FT)		HEIGHT (FT)			(SO ET)	(SQ FT)		_ 4			(FT)	(FT)	(EA)	(EA)
	JAC-01-ST	NO PARKING TOW ZONE LA	R7-201-3	EXISTING SIGN TO REMAIN			1.50	1.50	-	-	-	130 1 17	130 117	130 117	(30 1 17	130 117	130 117	XI 17	VI 17	VI 17	T CA	(LA)
	JAC-02-ST	7 DAY PAID PARKING, PAY AT PAY BOX, PARK CHICAGO	CUSTOM	EXISTING SIGN TO REMAIN	8209+75.29 26.05′ LT		1.50	2.00	-	-	-											
	JAC-03-ST	PAY TO PARK, PARK CHICAGO	CUSTOM	EXISTING SIGN TO REMAIN			2.00	1.50	-	-	-											
		PAY TO PARK, PARK CHICAGO	CUSTOM	EXISTING SIGN TO REMAIN	8210+26.71 25.58' LT		2.00	1.50	-	-	-											
		7 DAY PAID PARKING	CUSTOM	EXISTING SIGN TO REMAIN	0210 120:11 23:30 E1		2.00	0.50	-	-	-											
		7 DAY PAID PARKING	CUSTOM	EXISTING SIGN TO REMAIN			2.00	0.50	-	-	-											
		BIKE LANE	SPECIAL	EXISTING SIGN TO REMAIN	8210+52.27 26.57′ LT		2.50	2.00	-	-	-											
		7 DAY PAID PARKING, PAY AT PAY BOX, PARK CHICAGO	CUSTOM	RELOCATE SIGN PANEL	8211+36.71 25.33' LT 8211+43.	51 25,25	LT 1.50	2.00	1.50		1				3			9			- 1	
		NO PARKING TOW ZONE RA	R7-201-1	REMOVE AND REPLACE SIGN			1.50	1.50	1.50	1.50		3	10	3		10						
		DO NOT ENTER	R5-1	REMOVE AND REPLACE SIGN			4.00	4.00	4.00	4.00			16	-		16						
	JAC-08-ST		R1-1-2	REMOVE AND REPLACE SIGN	8286+60.79 24.93' LT 8211+69.	52 37 <b>.</b> 50′	LT 2.50 2.00	2.50	3.00 2.00	3.00 2.00	2	4		4						34		
		NO RIGHT TURN ARROW ONE WAY LA	R3-1 R6-1L	REMOVE AND REPLACE SIGN REMOVE AND REPLACE SIGN			3,00	1.00	3.00	1,00		3		3								
		DO NOT ENTER	R5-1	REMOVE AND REPLACE SIGN			4.00	4.00	4.00	4.00		16		J							+	$\overline{}$
	JAC-12-PP		R1-1-2	REMOVE AND REPLACE SIGN	8286+60.79 50.51' LT 8286+62.	06 26.45	2.50	2.50	3.00	3.00	1	9						8			- 1	
		USE PROHIBITED BY MOTOR DRIVEN CYCLES *	R5-I100	PROPOSED	8213+71	40 33.25		-	4.00		1	,	20					9			1	<del>                                     </del>
	JAC-14-ST		M3-4	PROPOSED	02131111	10 33.23	-	-	2.00	1.00	-	2	20								+	
		I-90	M1-1	PROPOSED			-	-	2.00	2.00		4						-			1	
	JAC-16-ST		M1-1	PROPOSED	8213+41.	30 25.67	LT -	-	2.00	2.00	1	4						14			- 1	
		LEFT ARROW	M6-1	PROPOSED			-	-	1.75	1.25		3						1			1	
		NO PARKING TOW ZONE LEFT ARROW	R7-201-3	REMOVE AND REPLACE SIGN	0044.67.65.05.04.17.0045.04.	70 05 054	1.50	1.50				3		3								
		7 DAY PAID PARKING, PAY AT PAY BOX, PARK CHICAGO	CUSTOM	RELOCATE SIGN PANEL	8214+67.66 26.04' LT 8215+01.	70 25.25	1.50	2.00	1.50	2.00	1				3			9			1 1	
	JAC-20-ST	7 DAY PAID PARKING, PAY AT PAY BOX, PARK CHICAGO	CUSTOM	RELOCATE SIGN PANEL	0015 + 70 00 00 04 + 7 0015 + 70	00 05 004	1.50	2.00	1.50	2.00					3			9				
	JAC-21-ST	15 MINUTE LOADING ZONE USE FLASHERS RA	SPECIAL (NOTE 2)	REMOVE AND REPLACE SIGN	8215+39.69 26.04' LT 8215+39.	03 22.26	1.50	1.50	1.50	1.50	1	3		3				] "			1 1	
	JAC-22-ST	7 DAY PAID PARKING, PAY AT PAY BOX, PARK CHICAGO	CUSTOM	RELOCATE SIGN PANEL	8215+58.09 25.57' LT 8215+58.	09 27 00'	1.50	2.00	1.50	2.00	1				3			9			1	
	JAC-23-ST	15 MINUTE LOADING ZONE USE FLASHERS LA	SPECIAL	RELOCATE SIGN PANEL	0213+30:09 23:31 E1 0213+30:	03 21.00	1.50	1.50	1.50	1.50	1				3			3			1	
JACKSON		NO PARKING WHEN SNOW IS OVER 2 INCHES	R7-210-1	EXISTING SIGN TO REMAIN	8215+90.76 25.70' LT		1.50	1.50	-	-	-											
BLVD		PAY TO PARK, PARK CHICAGO	CUSTOM	EXISTING SIGN TO REMAIN			2.00	1.50	-	-	-											
		PAY TO PARK, PARK CHICAGO	CUSTOM	EXISTING SIGN TO REMAIN	8216+14.62 25.55′ LT		2.00	1.50	-	-	-											
		7 DAY PAID PARKING	CUSTOM	EXISTING SIGN TO REMAIN			2.00	0.50	-	-	-											
		7 DAY PAID PARKING	CUSTOM	EXISTING SIGN TO REMAIN			2.00	0.50	-	-	-											
		7 DAY PAID PARKING, PAY AT PAY BOX, PARK CHICAGO	CUSTOM	RELOCATE SIGN PANEL	8217+49.32 25.27' LT 8217+31.8	36 25.45	LT 1.50	2.00	1.50	2.00	1				3			9			- 1	
		NO PARKING TOW ZONE RA	R7-201-1	RELOCATE SIGN PANEL	0017 - 74 05 45 704 - 7		1.50	1.50	1.50	1.50					3							
		ONE WAY LA	R6-2L	EXISTING SIGN TO REMAIN	8217+74.85 45.32′ LT		1.50	2.00	-	-	-											
		DO NOT ENTER ONE WAY LA	R5-1 R6-2L	EXISTING SIGN TO REMAIN EXISTING SIGN TO REMAIN	8218+34.43 42.73′ LT	+	2.50 1.50	2.50								-				-	+	
		S DES PLAINES ST 640 W	D3-2	EXISTING SIGN TO REMAIN	8218+46.36 27.29' RT		5.00	1.50	-	-	-									-	+	
	JAC-31-SA JAC-32-SP		D3 2	EXTOTING STOR TO REMAIN		+	3.00	1.30												<del>                                     </del>	+	<del></del>
		NO TURN ON RED	R10-11B	EXISTING SIGN TO REMAIN	8217+65.25 26.73' RT		2.00	2.00	-	-	-										+	
		W JACKSON BLVD 300 S	D3-2	EXISTING SIGN TO REMAIN		_	5.00	1.50	-	-	-											
		ONE WAY RA	R6-2R	EXISTING SIGN TO REMAIN	8217+77.01 34.69' RT		1.50	2.00	-	-	-											
		7 DAY PAID PARKING, PAY AT PAY BOX, PARK CHICAGO	CUSTOM	RELOCATE SIGN PANEL			1.50	2.00	1.50	2.00												
		NO PARKING TOW ZONE LA	R7-201-3	RELOCATE SIGN PANEL	8217+47.35 25.37' RT 8217+31.	14 27.01	1.50	1.50	1.50	1.50	1							9			1 1	
		NO PARKING WHEN SNOW IS OVER 2 INCHES	R7-210-1	EXISTING SIGN TO REMAIN	921C   7C 71 27 17/ DT		1.50	1.50	-	-	-										1	
1	JAC-38-ST	MAXWELL SUNDAY MARKET	CUSTOM	EXISTING SIGN TO REMAIN	8216+76.31 27.17' RT		2.00	2.00	-	-	-											
	JAC-39-ST	PAY TO PARK, PARK CHICAGO	CUSTOM	EXISTING SIGN TO REMAIN			2.00	1.50	-	-	-											
1		7 DAY PAID PARKING	CUSTOM	EXISTING SIGN TO REMAIN	8216+63.28 26.42' RT		2.00	0.50	-	-	-											
		PAY TO PARK, PARK CHICAGO	CUSTOM	EXISTING SIGN TO REMAIN	0210+03•20   20•42   K1		2.00	1.50	-	-	-											
		7 DAY PAID PARKING	CUSTOM	EXISTING SIGN TO REMAIN			2.00	0.50	-	-	-											
		7 DAY PAID PARKING, PAY AT PAY BOX, PARK CHICAGO	CUSTOM	RELOCATE SIGN PANEL	8215+67.71 26.60' RT 8215+67.	71 26.68′	_	2.00	1.50	2.00	1				3			9			1	
1		WARNING * (PRIVATE SIGN)	CUSTOM	EXISTING SIGN TO REMAIN	8215+37.68 39.52′ RT		3.00	2.00	-	-	-											
		NO PARKING TOW ZONE RA	R7-201-1	PROPOSED	8214+92.	38 26.25′	RT -	-	1.50	1.50		3						9			1	
	JAC-44-ST																					
	JAC-45-LP	NOT USED																				



REFLECTIVE: YES MOUNT: CENTER



REFLECTIVE: YES MOUNT: CENTER (36"×36")














M1-1





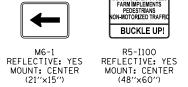



PROHIBITED



REFLECTIVE: YES MOUNT: CENTER



R7-201-1

SEE NOTE 1 REFLECTIVE: NO MOUNT: FLAG



R7-201-3

SEE NOTE 1 REFLECTIVE: NO MOUNT: FLAG

(18''×18'')

JAC-07-ST JAC-11-PP JAC-08-ST JAC-12-PP

REFLECTIVE: YES MOUNT: CENTER (24"×24") JAC-09-ST

REFLECTIVE: YES MOUNT: CENTER (24"×24")

JAC-15-ST JAC-16-ST

JAC-14-ST

JAC-17-ST

(48''×60'') JAC-13-PP

(36"×12") JAC-10-ST

(18''×18'') JAC-06-ST JAC-43-ST

JAC-18-ST

SIGN NUMBERING CODE - EXAMPLE

DIRECTION OF TRAFFIC

ADM - ADAMS STREET ASX - ADAMS SOUTH EXIT RAMP ANT - ADAMS NORTH ENTRANCE RAMP

JAC - JACKSON BOULEVARD JSX - JACKSON SOUTH EXIT RAMP

JNT - JACKSON NORTH ENTRANCE RAMP

SIGN PANEL NUMBER

LP - LIGHT POLE BANDING ST - STEEL POST SA - SIGNAL POLE MAST ARM

MOUNTING TYPE

FM - FENCE MOUNTED GM - GROUND MOUNTED

BM - BRIDGE MOUNTED BS - BREAKAWAY STEEL WP - WOOD POST

OH - OVERHEAD SP - SIGNAL POLE BANDING

PP - PARAPET MOUNTED

**NOTES** 

FOR CDOT SIGN PANEL DETAILS SEE THE MOST CURRENT EDITION OF "THE FIELD MANUAL FOR SIGN INSTALLATION GUIDE" AND "SIGN FABRICATION AND INSTALLATIONS" MANUALS AND THE DETAILS IN THESE PLANS.

2. SIGN PANEL DETAILS FOR LOADING ZONES SHALL FOLLOW THE R7-201-X DETAILS.

PER MUTCD 2A.21 PARAGRAPH 4, 3" RED REFLECTIVE STRIPS SHALL BE INSTALLED ON STOP, WRONG WAY, AND DO NOT ENTER SIGN POSTS. THE COST SHALL BE INCLUDED IN THE COST OF THE POST.



D160X94-sht-Sign-Schedule-03.dgn	DESIGNED - MKW	REVISED -
USER NAME = vljanachione	DRAWN - CAT	REVISED -
PLOT SCALE = 20.0000 '/ in.	CHECKED - JMG	REVISED -
PLOT DATE = 3/6/2020	DATE - 3-13-2020	REVISED -

STATE OF ILLINOIS **DEPARTMENT OF TRANSPORTATION** 

			SIGNING			F.A.I. RTE.	SECTION	COUNTY	TOTAL SHEETS	SHEET NO.
		9	CHEDULE			90/94/290	2014-015R&B-R	СООК	825	249
			OHLDOLL	1				CONTRACT	NO. 6	0X94
SCALE: NONE	SHEET 3	OF 4	SHEETS	STA.	TO STA.		ILL INOIS FED. A	ID PROJECT		

LOCATION	SIGN NO.	LEGEND / DESCRIPTION	CODE	ACTION	LOCATIO	DN (STATIO	ON / OFFSE	ET)	EXISI PAN DIMEN	IEL	PAI	POSED NEL NSIONS	NUMBER OF POSTS	SIGN PANEL - TYPE 1	SIGN PANEL - TYPE 2	REMOVE SIGN ANEL - TYPE 1	RELOCATE SIGN ANEL - TYPE 1	REMOVE SIGN ANEL - TYPE 2	REMOVE SIGN ANEL - TYPE 3	TELESCOPING STEEL SIGN SUPPORT	METAL POST - TYPE A	METAL POST - TYPE B	BASE FOR TELESCOPING STEEL SIGN SUPPORT	REMOVE CONCRETE FOUNDATION - GROUND SUPPORT
					EXISITIN	IG	PROPOS	SED	WIDTH (FT)	HEIGHT (FT)	WIDTH (FT)			(SQ FT)		(SQ FT)	ш. С.	۵.		(FT)	(FT)	(FT)	(EA)	(EA)
	JAC-46-LP	NO PARKING TOW ZONE LA	R7-201-3	PROPOSED					-	-	1.50		-	3	130 117	130 117	150 1 17	(30 1 17	150 1 17	31 17	VI 17	0.17		(,,,,,,,,,,,,,,,,,,,,,,,,,,,,,,,,,,,,,,
		NO PARKING LOADING ZONE TOW ZONE RA	R7-601-1	PROPOSED		82	211+09.00 2	27.07′ RT	-	-		1.50		3										
	JAC-48-ST																							
		NO PARKING PRIVATE TOW ZONE	R7-201-4	EXISTING SIGN TO REMAIN					1.50	1.50	-	-												
		ILLEGALLY PARKED AND UNAUTHORIZED VEHICLES *	CUSTOM	EXISTING SIGN TO REMAIN	8210+97.27 34.	.03′ RT				2.00	-	-	-											
		NO PARKING TOW ZONE BUS STOP RA	R7-207-1	EXISTING SIGN TO REMAIN					1.50	1.50	-	-	-											
		NO PARKING TOW ZONE LOADING ZONE 10 AM - 3 AM LA	R7-601-93	EXISTING SIGN TO REMAIN	8210+49.55 26.	.61' RT			1.50	1.50	-	-	-											
		BUS STOP 126 JACKSON	СТА	EXISTING SIGN TO REMAIN	8210+35.44 26	.31' RT				2.00	-	-												
		S HALSTED ST 800 W	D3-2	EXISTING SIGN TO REMAIN	8209+57.43 27.				5.00	1.50	-	-	_											
		HONORARY P.K.7 KOGEONES ST	D3-3	EXISTING SIGN TO REMAIN					2.50	0.56	-	-												
		ONE WAY RA	R6-2R	EXISTING SIGN TO REMAIN	8209+48.85 35.	-67' RT				2.00	-	-	_											
		ONE WAY LA	R6-2L	EXISTING SIGN TO REMAIN	-				1.50	2.00	-	-	_											
		W JACKSON BLVD 300 S	D3-2	EXISTING SIGN TO REMAIN					5.00	1.50	-	-	_											
		NO RIGHT TURN ARROW	R3-1	EXISTING SIGN TO REMAIN	8208+96.89 38.	.74' RT			2.00	2.00	-	-	_											
		RIGHT TURN ONLY EXCEPT BIKE	SPECIAL	EXISTING SIGN TO REMAIN	8208+87.74 26.	28' RT			2.00	2.50	-	-	_											
	JAC-61-LP	HONORARY DR. CHRIS NIKOLAS BLVD	D3-3	EXISTING SIGN TO REMAIN					2.50	0.56	-	-												
		HONORARY P.K.7 KOGEONES ST	D3-3	EXISTING SIGN TO REMAIN	<del> </del> 8208+84 <b>.</b> 36 27.	.62′ LT├			2.50	0.56	-	-	_											
JACKSON		NO LEFT TURN ARROW	R3-2	EXISTING SIGN TO REMAIN		02.00.104.30 Z1.02 L1				2.00	-	-												
BLVD		NO RIGHT TURN ARROW	R3-1	EXISTING SIGN TO REMAIN					2.00	2.00	-	-	_											
		ONE WAY RA	R6-2R	EXISTING SIGN TO REMAIN	<del>    8208+97.73</del> 44.	.43' LT				2.00	-	-												
		ONE WAY LA	R6-2L	EXISTING SIGN TO REMAIN	_				1.50	2.00	-	-	_											
		NO LEFT TURN ARROW	R3-1	EXISTING SIGN TO REMAIN					3.00	3.00	-	-												
		W JACKSON BLVD 300 S	D3-2	EXISTING SIGN TO REMAIN	<del> </del> 8209+48.31 41.	.63′ LT ├─			5.00	1.50	_	_												
	JAC-69-ST		CUSTOM	REMOVE (RETURN TO PROPERTY OWNER)					8.00	3.00	_	_							24					
	JAC-69A-ST		CUSTOM	REMOVE (RETURN TO PROPERTY OWNER)	8211+34.09 36.	.63′ LT├─				3.75	_	_						10	27					1 1
		NO PARKING PRIVATE TOW ZONE	R7-201-4	EXISTING SIGN TO REMAIN					1.50	1.50	-	-						10						
		ILLEGALLY PARKED AND UNAUTHORIZED VEHICLES •	CUSTOM	EXISTING SIGN TO REMAIN	<del>    8210+90.60   34</del> .	.23′ RT				2.00	-	-											$\overline{}$	
		PAY TO PARK, PARK CHICAGO	CUSTOM	EXISTING SIGN TO REMAIN					2.00	1.50	_	_												
		PAY TO PARK, PARK CHICAGO	CUSTOM	EXISTING SIGN TO REMAIN	-	_			2.00	1.50	-	-	_										$\overline{}$	
		7 DAY PAID PARKING	CUSTOM	EXISTING SIGN TO REMAIN	<del> </del> 8210+95 <b>.</b> 14 216	5.03′ LT—			2.00	0.50	-	-	-											
		7 DAY PAID PARKING	CUSTOM	EXISTING SIGN TO REMAIN	-				2.00	0.50	_	_												
		PAY TO PARK, PARK CHICAGO	CUSTOM	RELOCATE SIGN PANEL	8211+41.17 216	3.45' IT 8	211+41 17 2	16 45′ I T		2.00	1.50	2.00	1				3			9			1	
		STEEL POST NO SIGN (ASSUMED AS CITY PARKING RESTRICTION)		REMOVE	8211+23.47 33.		2111-1111 2	10.73 L1	1.50	1.50	-	-				3	,			J				
		NO PARKING TOW ZONE	R7-201-4	PROPOSED	0211123.41 33.		212+78.02 2	24.50′ LT		-	1.50		1	3						9			1	
		NO PARKING TOW ZONE	R7-201-4	PROPOSED			212+74.57 2				1.50	1.50	1	3						9			1	
		WRONG WAY	R5-1a	REMOVE AND REPLACE SIGN	8285+34.10 24.					2.50	3.50	2.50	2	9		9				,	26			
	JSX-01-31 JSX-02-PP	WRONG WAY	R5-1d	REMOVE AND REPLACE SIGN	8285+33.75 54.					2.50	3.50	2.50	1	9	1	9			1	6	20		1	$\overline{}$
JACKSON	JSX-02-FF JSX-03-PP	BICYCLE SYMBOL	W11-1	REMOVE AND REPLACE SIGN	0203733,13 34.	.CJ L1 04	200713.13 1	10.13 L1	3.00		3.00		1	9	+	9				0			-	$\overline{}$
EXIT RAMP	JSX-03-PP JSX-04-PP	200 FT	W16-2aP	REMOVE AND REPLACE SIGN	8284+77.81 26.	.83' LT 82	284+74.94 1	18.79' LT	2.00		2.00	1.00	1	2	+	2				9			1	$\overline{}$
		NO DOGS ALLOWED	CUSTOM	REMOVE (RETURN TO PROPERTY OWNER)	8284+80.23 0.	16' PT			1.00	1.50	2.00	- 1.00			+	2							$\overline{}$	$\overline{}$
1400000	JNT-01-SP	RAMP METER AHEAD	W3-7	PROPOSED	0204100.23 0.		324116.91 1	18 79' I T	-		3.00	3.00		9	+					<del>                                     </del>				$\overline{}$
JACKSON ENTRANCE		STOP HERE ON RED	R10-6aR	PROPOSED	<del>                                     </del>		242+78.27 1		_ +		2.00	2.50		5	+	1				<del>                                     </del>			$\longrightarrow$	
RAMP		STOP HERE ON RED	R10-6aL	PROPOSED			242+78.27			-	2.00	2.50		5	+					<del>                                     </del>				$\overline{}$
	0141 03 35	1 STOT HERE ON NED	paro ouc	i noi oseb		02	. 12 1 10 . 2 1	C. 17 111			2.00	TOTAL		237	100	175	62	58	24	275	52	66	30	1
												TOTAL		201	100	1113	02	70		1 213	JL	1 00	, 30	





JSX-01-ST JSX-02-ST



REFLECTIVE: YES MOUNT: CENTER (36"×36")

JSX-03-ST

FOR CDOT SIGN PANEL DETAILS SEE THE MOST CURRENT EDITION OF "THE FIELD

PER MUTCD 2A.21 PARAGRAPH 4, 3" RED REFLECTIVE STRIPS SHALL BE INSTALLED ON STOP, WRONG WAY, AND DO NOT ENTER SIGN POSTS. THE COST SHALL BE INCLUDED IN THE COST OF THE POST.

MANUAL FOR SIGN INSTALLATION GUIDE" AND "SIGN FABRICATION AND INSTALLATIONS" MANUALS AND THE DETAILS IN THESE PLANS.

2. SIGN PANEL DETAILS FOR LOADING ZONES SHALL FOLLOW THE R7-201-X DETAILS.



W16-2aP REFLECTIVE: YES MOUNT: CENTER (24"×12")

JSX-04-ST

XXX FT

JNT



W3-7 REFLECTIVE: YES MOUNT: CENTER (36"×36")

JNT-01-SP



R10-6aR/610-6aL REFLECTIVE: YES MOUNT: CENTER (24"×30")

JNT-02-SP JNT-03-SP



R7-201-3 SEE NOTE 1 REFLECTIVE: NO MOUNT: CENTER (18"×18")

JAC-46-LP



R7-601-1 SEE NOTE 1 REFLECTIVE: NO MOUNT: CENTER (18"×18")

JAC-47-LP

JAC-75-ST JAC-76-ST

R7-201-4 SEE NOTE 1 REFLECTIVE: NO MOUNT: CENTER

#### SIGN NUMBERING CODE - EXAMPLE

DIRECTION OF TRAFFIC

ADM - ADAMS STREET
ASX - ADAMS SOUTH EXIT RAMP
ANT - ADAMS NORTH ENTRANCE RAMP

JAC - JACKSON BOULEVARD
JSX - JACKSON SOUTH EXIT RAMP

JNT - JACKSON NORTH ENTRANCE RAMP

SIGN PANEL NUMBER

MOUNTING TYPE

LP - LIGHT POLE BANDING
ST - STEEL POST

SA - SIGNAL POLE MAST ARM

FM - FENCE MOUNTED GM - GROUND MOUNTED BM - BRIDGE MOUNTED BS - BREAKAWAY STEEL

BS - BREAKAWAY STEEL WP - WOOD POST OH - OVERHEAD


SP - SIGNAL POLE BANDING PP - PARAPET MOUNTED

**Tran** Systems

**NOTES** 

D160X94-sht-Sign-Schedule-04.dgn	DESIGNED - MKW	REVISED -
USER NAME = vljanachione	DRAWN - CAT	REVISED -
PLOT SCALE = 20.0000 '/ in.	CHECKED - JMG	REVISED -
PLOT DATE = 3/6/2020	DATE - 3-13-2020	REVISED -

				F.A.I. RTE.	SECTION	COUNTY	TOTAL SHEETS	SHEET NO.			
				CHEDULE	90/94/290	2014-015R&B-R	COOK	825	250		
ļ				CIILDOLI			CONTRACT	NO. 6	0X94		
	SCALE: NONE	SHEET 4	OF 4	SHEETS	STA.	TO STA.		ILLINOIS FED. AI	D PROJECT		

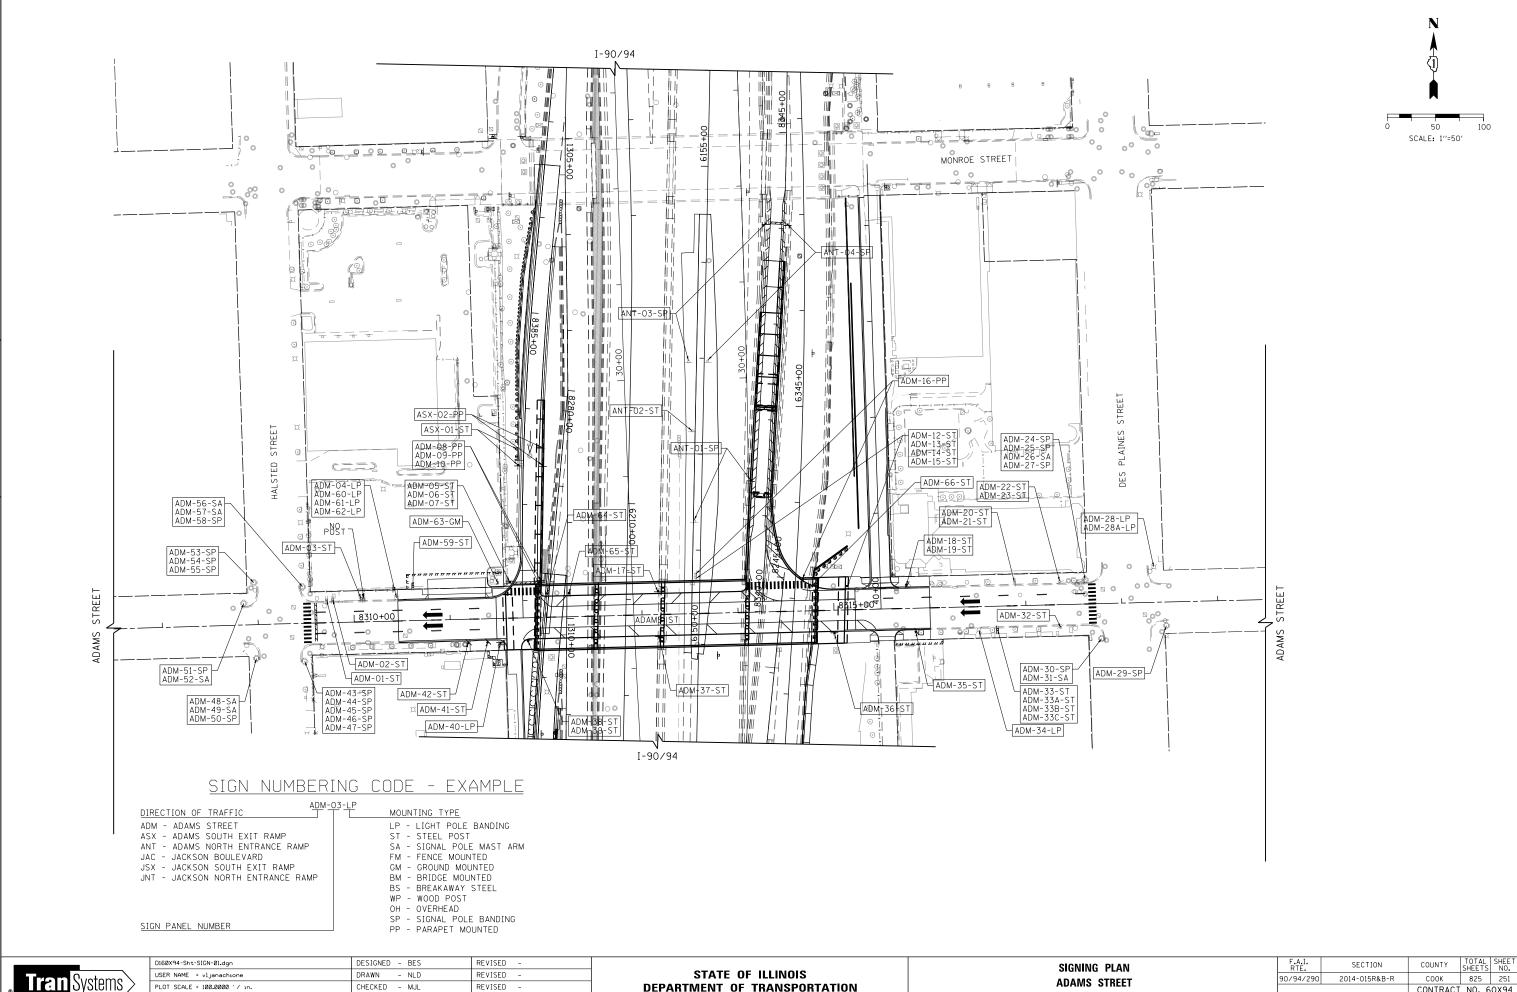




PLOT DATE = 3/6/2020

REVISED DATE - 3-13-2020 REVISED

**DEPARTMENT OF TRANSPORTATION** 

SCALE: 1"=50" SHEET 1 OF 2 SHEETS STA.8307+50 TO STA. 8319+50

CONTRACT NO. 60X94

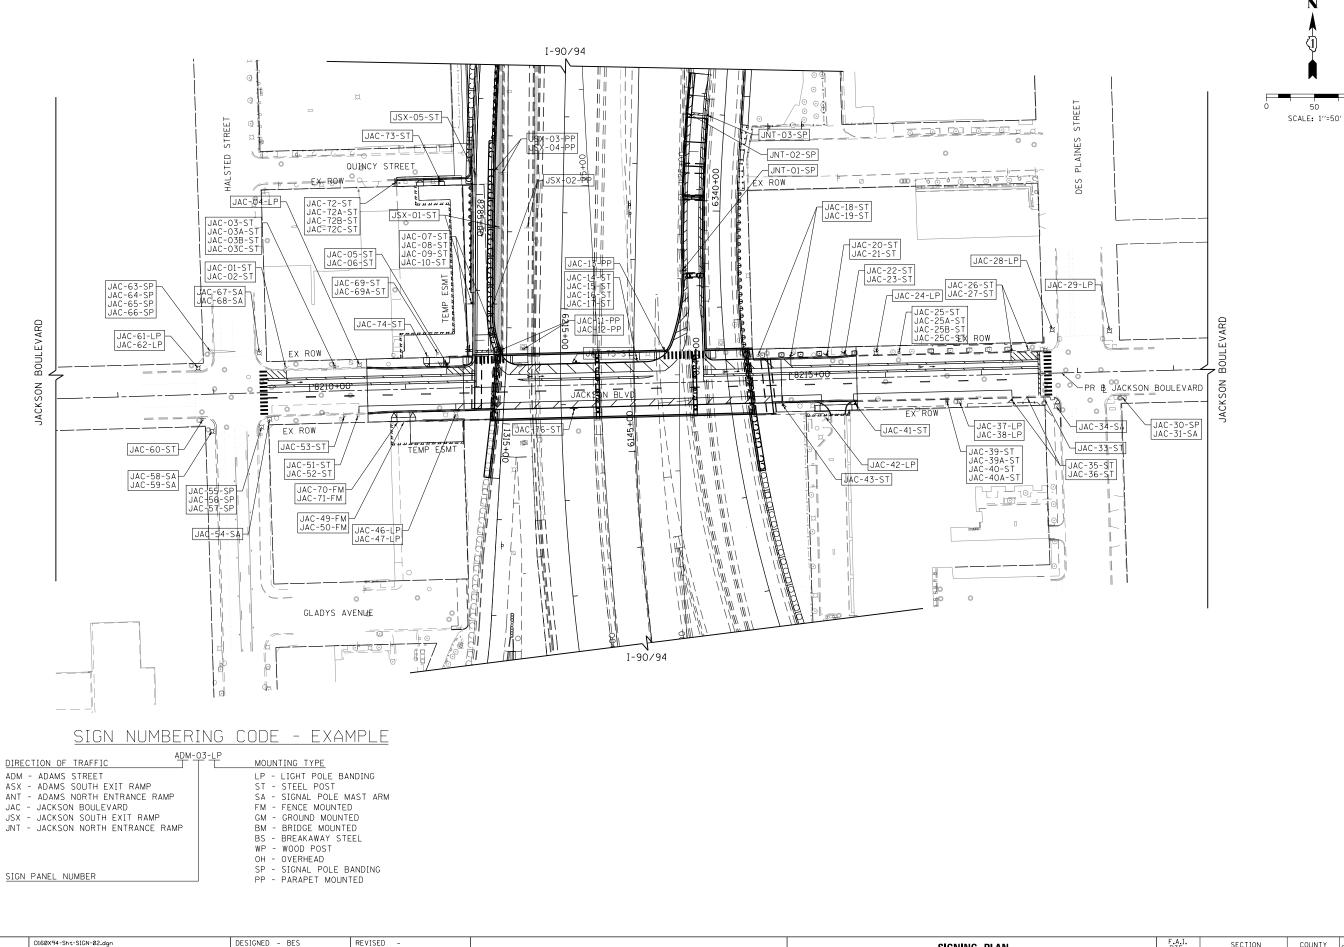





USER NAME = vljanachione DRAWN - NID REVISED CHECKED - MJL REVISED PLOT DATE = 3/6/2020 DATE - 3-13-2020 REVISED

STATE OF ILLINOIS **DEPARTMENT OF TRANSPORTATION** 


SECTION SIGNING PLAN 90/94/290 2014-015R&B-R JACKSON BOULEVARD SCALE: 1"=50" SHEET 2 OF 2 SHEETS STA.8207+35 TO STA.8219+36

COUNTY COOK 825 252 CONTRACT NO. 60X94

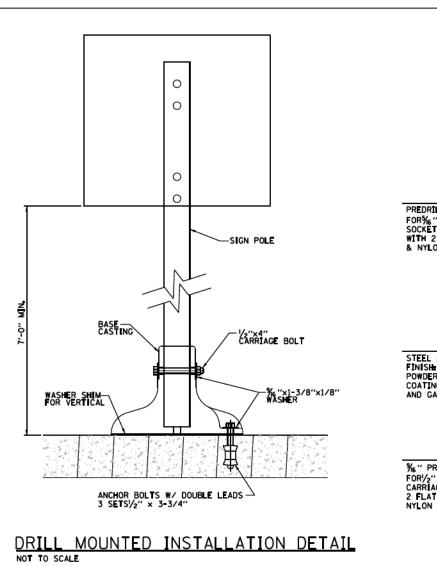


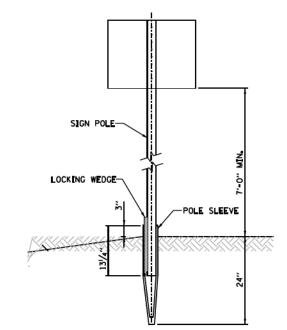

GROUND DIG INSTALLATION DETAIL NOT TO SCALE

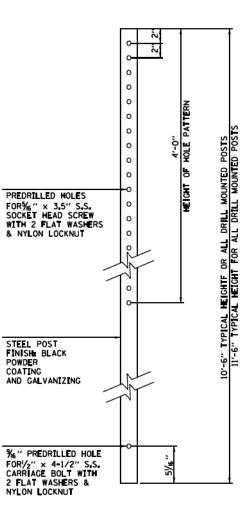

DELEVATION: DRILLED SIGN POST

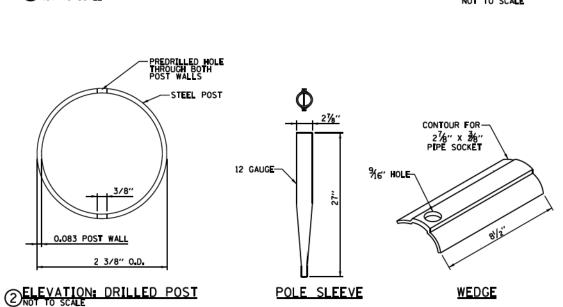

SIGN POLE DETAIL
NOT TO SCALE

PIPE SOCKET AND WEDGE DETAIL NOT TO SCALE

上" LETTERS-(EMBOSSED)

HOLES (CORE) -


THE WELL SHALL BE CAPABLE— OF RECEIVING A STANDARD 2" GALVANIZED PIPE FREELY

TOP VIEW

3%6″ DIA.

12" DIA

FRONT VIEW

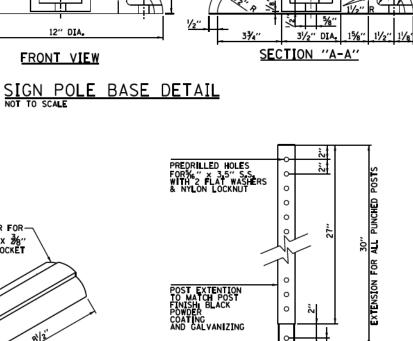

**BOTTOM VIEW** APPROXIMATE WT: 82,75 POUNDS

-%" SOUARE HOLE (CORE)

- 5/8" DIA. HOLE CORE

SECTION: DRILLED POST EXTENSION NOT TO SCALE


TOTAL SHEET NO. 825 253



D160X94-sht-Sign-Det-01.dgn	DESIGNED - JDT	REVISED -
USER NAME = vljanachione	DRAWN - BAW	REVISED -
PLOT SCALE = 20.0000 '/ in.	CHECKED - JMG	REVISED -
PLOT DATE = 3/6/2020	DATE - 3-13-2020	REVISED -

STATE OF ILLINOIS **DEPARTMENT OF TRANSPORTATION** 


						F.A.I. RTE.	SECTION	COUNTY	TOTAL SHEETS	SHEET NO.
		SIGNIN	G DETA	ILS		90/94/290	2014-15R&B-R	COOK	825	253
								CONTRACT	NO. 6	0X94
SCALE: NONE	SHEET 1	OF 3	SHEETS	STA.	TO STA.		ILLINOIS FED. A	ID PROJECT		

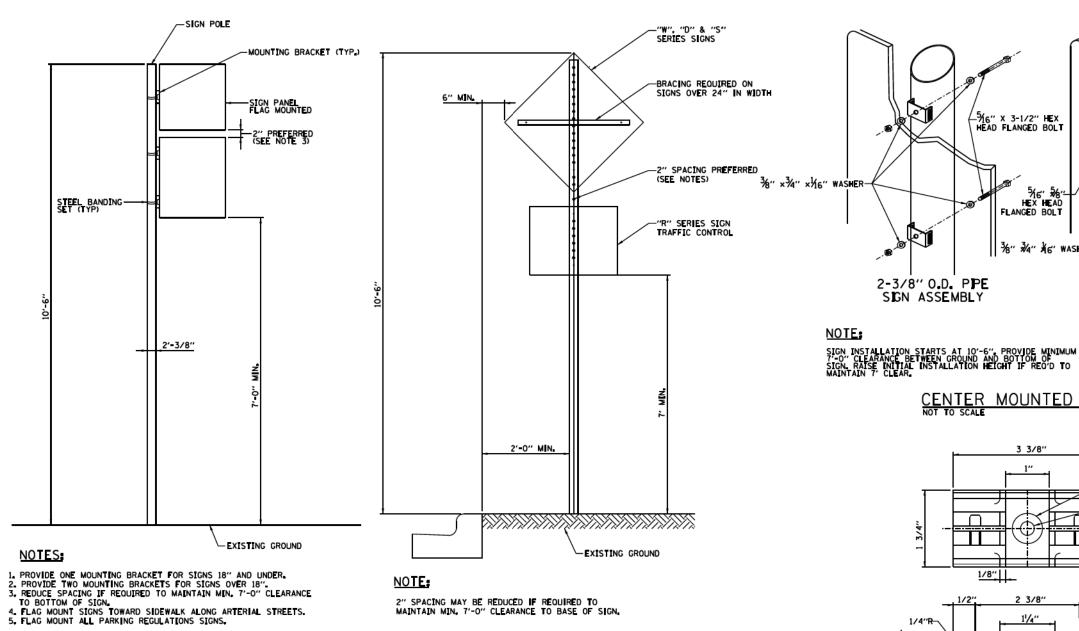

2" SPACING MAY BE REDUCED IF REQUIRED TO MAINTAIN MIN. 7'-O" CLEARANCE TO BASE OF SIGN.

## FLAG MOUNTED SIGN INSTALLATION DETAIL NOT TO SCALE

### CENTER MOUNTED SIGN INSTALLATION NOT TO SCALE

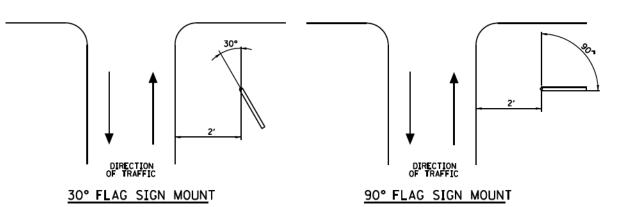

## SIGN MOUNTING DETAILS



D160X94-sht-Sign-Det-02.dgn	DESIGNED - JDT	REVISED -
USER NAME = vljanachione	DRAWN - BAW	REVISED -
PLOT SCALE = 20.0000 '/ in.	CHECKED - JMG	REVISED -
PLOT DATE = 3/6/2020	DATE - 3-13-2020	REVISED -

#### STATE OF ILLINOIS **DEPARTMENT OF TRANSPORTATION**

								F.A.I. RTE.	SECTION	COUNTY	TOTAL SHEETS	SHEET NO.
			SIG	NIN	G DETA	ILS		90/94/290	2014-15R&B-R	СООК	825	254
										CONTRACT	NO. 6	50X94
SCALE: NONE	SHEET	2	OF	3	SHEETS	STA.	TO STA.		ILLINOIS FED. A	ID PROJECT		

1/8" 3/32"

-SIGN BRACKET 1/2" x /4"


−¾" x dia 20" Banding set

LIGHT STANDARD ASSEMBLY

REUIREMENT

-DRILL 11/32" AND

•2 BANDS PER SIGN UNDER 6' •3 BANDS PER SIGN OVER 6'

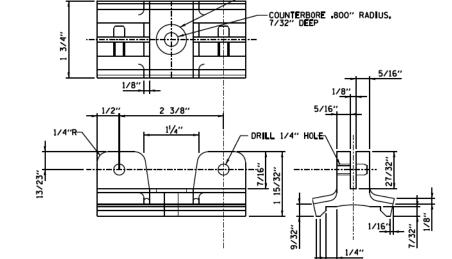

-5/16" X 3-1/2" HEX HEAD FLANGED BOLT

5/6' 5/8"-HEX HEAD FLANGED BOLT

2-3/8" O.D. PPE SIGN ASSEMBLY

36" 34" ¥6" WASHER-


CENTER MOUNTED SIGN ASSEMBLY

3 3/8"

SIGN MOUNTING MATERIALI ALUMINUM-ZINC ALLOY TENZALOY


SIGN MOUNTING BRACKET DETAIL NOT TO SCALE (VERSION 2A)

## REGULATORY TRAFFIC SIGNS (CHICAGO STYLE)

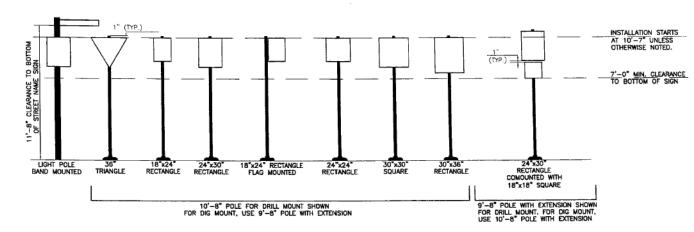

TYPICAL LAYOUT

## REGULATORY PARKING SIGNS (CHICAGO STYLE)

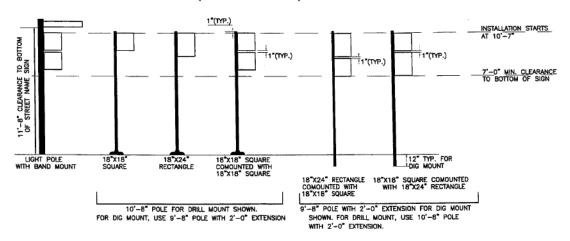


TYPICAL LAYOUT

8	Tran	Systems
18		10,0100

DI60X94-sht-Sign-Det-03.dgn	DESIGNED - JDT	REVISED -
USER NAME = vljanachione	DRAWN - BAW	REVISED -
PLOT SCALE = 20.0000 '/ in.	CHECKED - JMG	REVISED -
PLOT DATE = 3/6/2020	DATE - 3-13-2020	REVISED -

I	CIONINO DETAILO						F.A.I. RTE.	SECTION	COUNTY	TOTAL SHEETS	SHEET NO.
l	SIGNING DETAILS					90/94/290	2014-15R&B-R	COOK	825	255	
ŀ								CONTRAC	T NO. 6	50X94	
	SCALE: NONE	SHEET 3	OF 3	SHEETS	STA.	TO STA.		ILLINOIS FED. A	ID PROJECT		

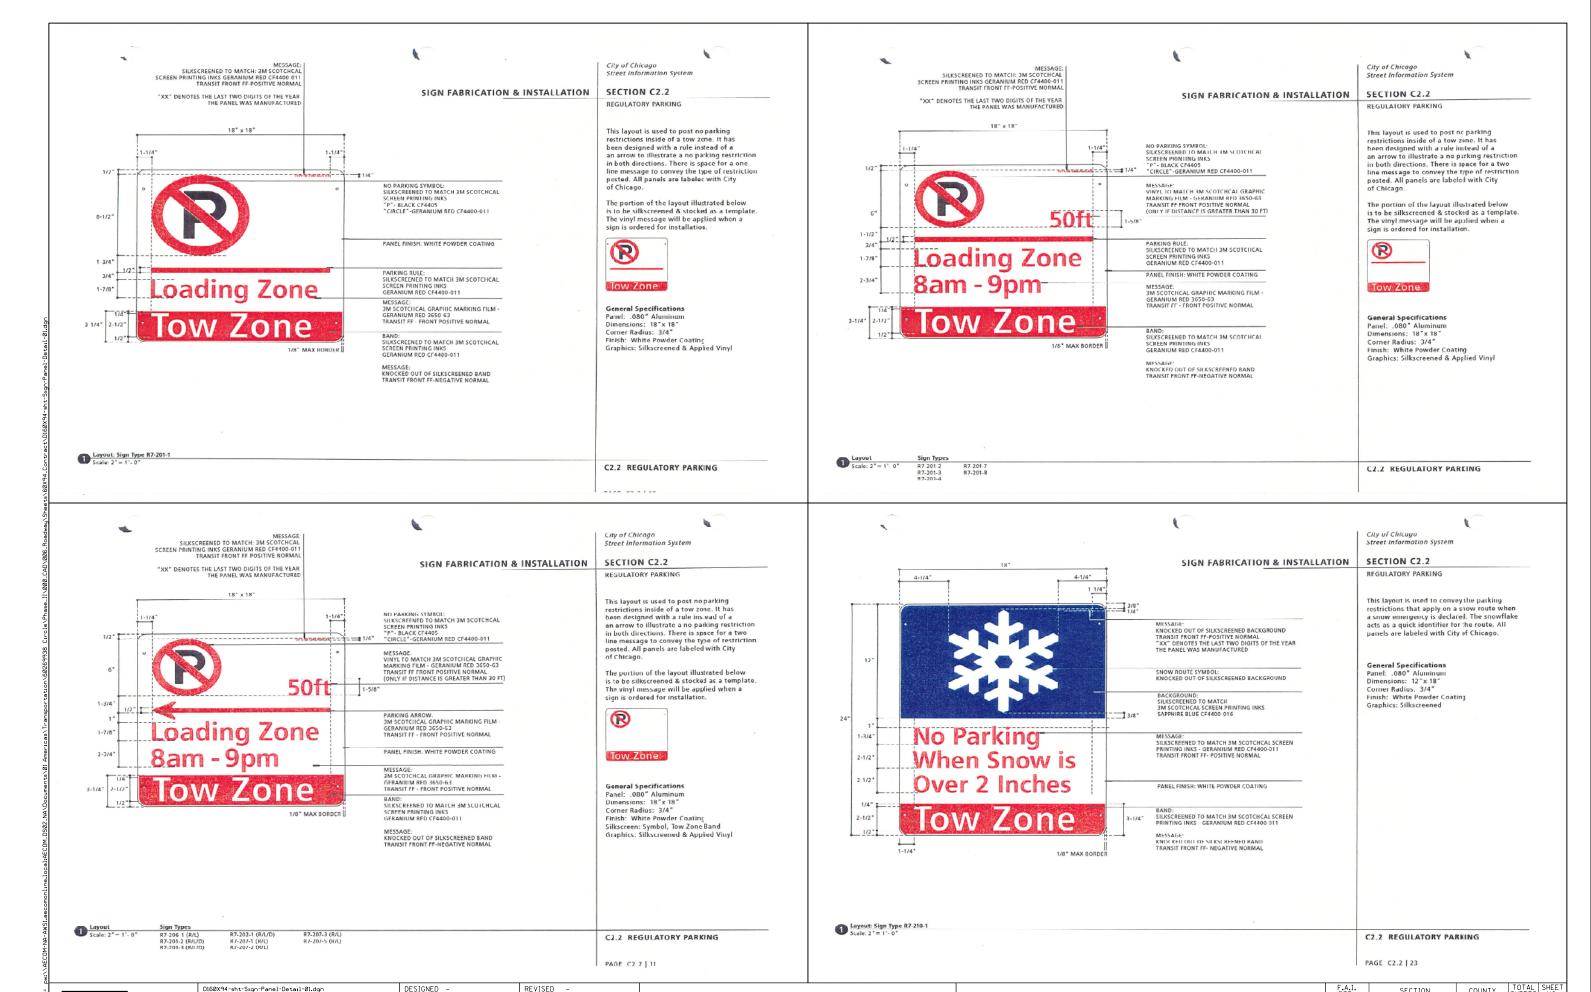

USER NAME = vljanachione DRAWN REVISED CHECKED REVISED DATE REVISED PLOT DATE = 3/9/2020


**Tran** Systems

STATE OF ILLINOIS **DEPARTMENT OF TRANSPORTATION** 

SCALE: NONE

COUNTY SIGN PANEL DETAILS 90/94/290 2014-015R&B-R COOK CONTRACT NO. 60X94 SHEET 1 OF 2 SHEETS STA. TO STA.

825 256

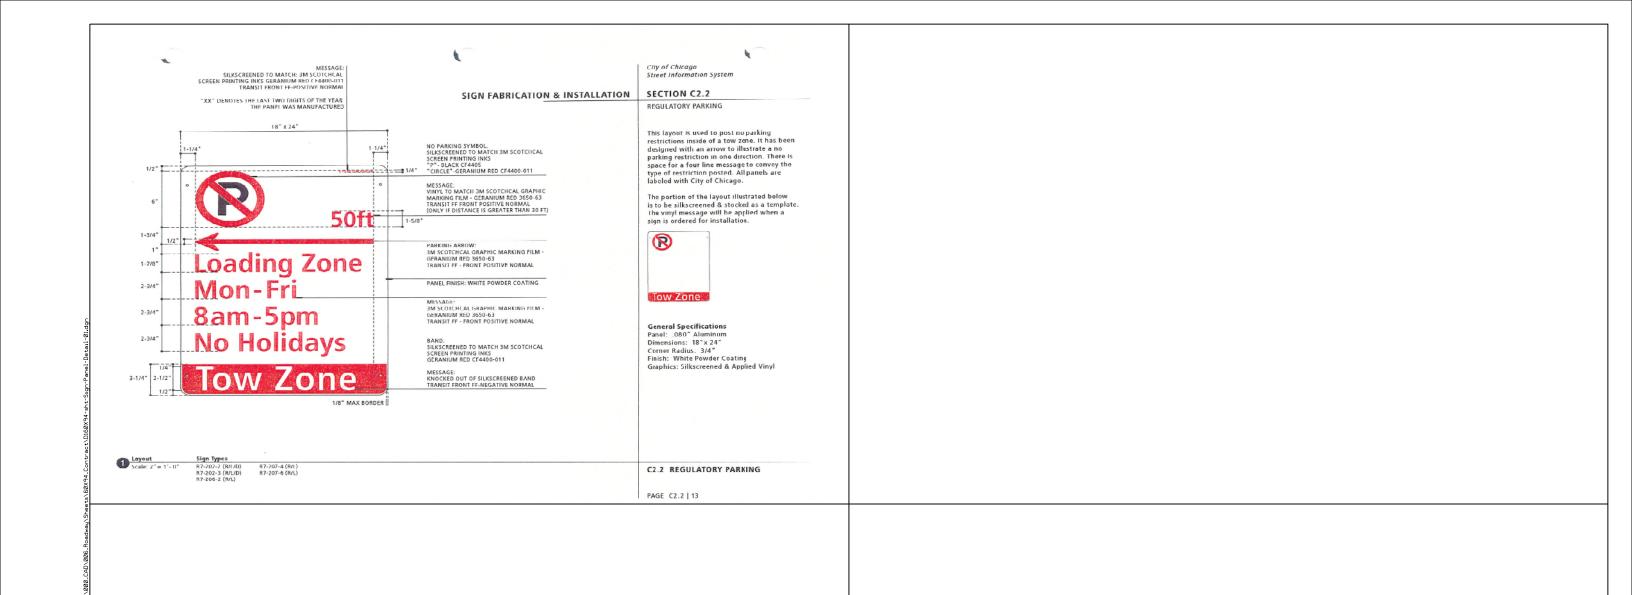

<b>Tran</b> Systems	
---------------------	--

D160X94-sht-Sign-Panel-Detail-01.dgn	DESIGNED -	REVISED -
USER NAME = vljanachione	DRAWN -	REVISED -
PLOT SCALE = 20.0000 '/ in.	CHECKED -	REVISED -
PLOT DATE = 3/9/2020	DATE - 3-13-2020	REVISED -

STATE	OF	ILLINOIS
DEPARTMENT	0F	TRANSPORTATION

CIONI DANIEL DETAILO						F.A.I. RTE.	SECTION	COUNTY	TOTAL SHEETS	SHEET NO.
	SIGN PANEL DETAILS					90/94/290	2014-015R&B-R	COOK	825	257
						_		CONTRAC	T NO. 6	50X94
SCALE: NONE	SHEET 2	OF 2	SHEETS	STA.	TO STA.		ILLINOIS FED.	AID PROJECT		

PROPOSED	D PRESENT	PROPOS <b>E</b> D	PRESENT			
↔	→ SIGNAL, TRAFFIC 3 SECTION 1-WAY ADJUSTABLE, 12" OR AS NOTED	<u></u>		MANHOLE, 3'X4'X4' 24" F & C (DWG,#730) (A) 30" F & C (DWG#729) (	B)C.M.H. LUM	MINAIRES
40≯	SIGNAL, TRAFFIC 3 SECTION 2-WAY ADJUSTABLE, 12" OR AS NOTED			MANHOLE, 4'X6'X6' 24" F & C (DWG,#732) (C) 30" F & C (DWG#733) (	D) PROPOSED	PRESENT
*	* SIGNAL OPTICALLY PROGRAMMED	(H)	(F)	HANDHOLE, HEAVY DUTY, 36" I.D. (DWG.#866) 24" F & C (E). (DWG#871) 30" F	& C (F)	
≠ Dw W	₩ ₩ SIGNAL, PEDESTRIAN, COUNTDOWN	()	0	HANDHOLE, CIRCULAR WITH 24"FRAME & COVER, 30"I.D. (#867) (G)		<ul> <li>☐ LUMINAIRE, C.M.H. 315W LAMP, 240V</li> <li>① LUMINAIRE, C.M.H. 315W LAMP, 240V, (FLOOD)</li> </ul>
	<u>w</u>	Δ	<b>4</b>	FOUNDATION, CONTROLLER OR PEDESTAL, 13" B.C., 20"X5' (DWG. #709)		
Dw W	SIGNAL, PEDESTRIAN, DON'T WALK/WALK	=1		FOUNDATION, TRAFFIC CONTROLLER DWG, #854, F.A. TERMINAL FND, DWG, #11972	Ø	
<b>→</b>	→ SIGNAL FACE ARROW, 12" COLOR AS NOTED	ŒΙ	Œ	FOUNDATION, TRAFFIC TYPE "P", BASE MOUNT, (DWG, #888)	<i>⊗</i>	▲ LUMINAIRE, C.M.H. 140W LAMP, 120V, (ALLEY)
	$oxtimes_{\mathbb{G}}^{I}$ SIGNAL FACE, 1 SECTION YELLOW/GREEN ARROW DUAL INDICATION		0	FOUNDATION, CONTROLLER STREET LIGHT, SPECIAL, 100A & 200A, (DWG.#876 & # 8		D LUMINAIRE, C.M.H. 90W LAMP, 120V, (ALLET)
	PUSH BUTTON, PEDESTRIAN			FOUNDATION, TRANSCLOSURE; TRANSCLOSURE HOUSING, (DWG.# 583 & #891)	D	₩ LUMINAIRE, C.M.H. 90W LAMP, 240V (ACORN)
Z Z Z	SIGN, ILLUMINATED, WITH MESSAGE OR SYMBOL AS INDICATED	$\boxtimes$	<u> </u>	CONTROLLER, UNDERPASS LIGHTING 120V. & 240V. (DWG. #860 & #861)	D	₩ LUMINAIRE, C.M.H. 60W LAMP, 240V (ACORN)
	H MAST ARM, MONOTUBE, STEEL. SIZE AS INDICATED (SEE DWG. #870)		E	MANHOLE, UTILITY, E=COMMONWEALTH EDISON; T=ILL.BELL TEL.; G=PEOPLES GAS;		, , , , , , , , , , , , , , , , , , , ,
	MAST ARM, TRUSS, ALUMINUM, SIZE AS INDICATED		ഥ	W=CITY WATER; P=CHGO PARK DISTRICT; CTA=C.T.A; S= SEWER		RNAMENTAL LUMINAIRES
<b>~</b>	CONTROLLER, TRAFFIC SIGNAL. PEDESTAL OR BASE MOUNTED AS INDICATED	<b>(</b>	Ø	JUNCTION BOX, IN PAVEMENT (DWG. #815)	PROPOSED	PRESENT
$\boxtimes$	■ CONTROLLER, STREET LIGHTING, PEDESTAL OR BASE MOUNTED. (DWG. 876 or 880)			DETECTOR LOOP IN PAVEMENT	♦	♦ 310W PENDANT (240V)
$\bowtie$	CONTROLLER, STREET LIGHTING. POLE MOUNTED (DWG, #11940)		Ш оп	CONDUIT or P.V.C., NUMBER, SIZE & TYPE. (AS NOTED)	•	♦ 400W PENDANT (240V)
Ü		<del>早 2D</del>	<del>早 2D</del>	CONDUIT or P.V.C. ENCASED IN CONCRETE. (SECTION or NUMBER OF CONDUIT INDI	CATED 🛭	♦ 250W PENDANT (240V)
	■ POLE, CITY STEEL, ANCHOR BASE, 34'6", 7 GA. 10" DI A. AND 15"B.C.	igorphi		LUMINAIRE, H.P.S.V. 400W LAMP, 240V, SEMI-CUTOFF	$\Leftrightarrow$	→ 150W ACORN (120V)
	24"X7' FND. W/ $1\frac{1}{4}$ " ANCHOR RODS DRG. #818.		<del></del>	LUMINAIRE, H.P.S.V. 400W LAMP, 240V, CUTOFF	♡	150W ACORN (240V)
⊞	■H POLE, CITY STEEL, ANCHOR BASE, 34'-6", 3 GA. 10" DIA. AND 15" B.C.	8	⊗	LUMINAIRE, H.P.S.V. 310W LAMP, 240V	$\otimes$	★ 50W ACORN (240V)
	24"X9' FND. W/ 1 <sup>1</sup> 4" ANCHOR RODS DRG. #818 (16',20'or 26'M.A.)	-⊗-	-&- <b>Ω</b>	LUMINAIRE, H.P.S.V. 310W LAMP 240V, CUTOFF LUMINAIRE, H.P.S.V. 150W LAMP, 240V	•	■ 100W ACORN (240V)
ZH	▼H POLE, CITY STEEL, ANCHOR BASE, 34"-6", 3GA., 11" DIA. AND 17 ¼" B.C.	$\Theta$	<b>O</b>	LUMINAIRE, H.P.S.V. 150W LAMP, 120V	$\nabla$	<b>▼</b> 150W GLOBE (240V)
	30"X9' FND. W/ 114" ANCHOR RODS DRG. #816. (30' M.A.)	<b>⊘</b>	<u> </u>	LUMINAIRE, H.P.S.V. 250W LAMP, 120V, (ALLEY LIGHT)		■ 100W GLOBE (240V)
⊗ı	NOTE: POLE, CITY STEEL, ANCHOR BASE 34'-6", 3 GA. 12 ½" DIA. AND 16½" B.C.	<del>-</del>	•	LUMINAIRE, H.P.S.V. 250W LAMP, 120V	$\overline{\otimes}$	<b>❤</b> 50W GLOBE (240V)
	30"X11' FND. W/ 1½" ANCHOR RODS DRG.#817. (35',40'or 44' M.A.)	$\triangle$		LUMINAIRE, H.P.S.V. 400W LAMP, 240V, (FLOOD LIGHT)		
ŒΗ	POLE, CITY STEEL, ANCHOR BASE, 32'-6", 3 GA. 10" DIA., WITH 3 GA. BAL.	$\bigcirc$	Œ	TERMINAL, CABINET F.A. & P.C.	L.E.D. LUM	MINAIRES
	HSG. BASE AND 1714" B.C. ON 30"X9' FND. W/ 114" ANCHOR RODS DRG. #816.	(E)	È	FIRE ALARM BOX, MOUNTED	PROPOSED	PRESENT
0	D POLE, CITY STEEL, ANCHOR BASE, 20',27'-6",29'-6", 7 GA. WITH STEEL BAL.	Ð	Œ	FIRE ALARM BOX, POLE MOUNTED		(400W HPSV EQUIVALENT), 240V
	HSG. BASE AND FND. W/ 10" D. B.C. AND 1" ANCHOR RODS DRG. #716.	PR_	PR	CABLE, TRAFFIC SIGNAL, COMMUNICATION, 1-PAIR #14 SHIELDED, IN CONDUIT	0	(100W HPSV EQUIVALENT), 240V, ACORN
ΦH	DH POLE, CITY STEEL, ANCHOR BASE, 20',27'-6",29'-6", 3 GA., WITH STEEL BAL.	<del>2</del>		CABLE, TRAFFIC SIGNAL, COMMONICATION, 1-FAIR #14 SHIELDED, IN CONDUIT	$\square$	
	HSG. BASE AND FND. W/ 10" D. B.C. AND 1" ANCHOR RODS DWG.#719.				0	(100/150W HPSV EQUIVALENT), 240V ACORN
Φ	● POLE, CITY STEEL, ANCHOR BASE, 20',27'-6", 29'-6" 7 GA., AND ALUMINUM			CABLE, TRAFFIC SIGNAL POWER SUPPLY, 2 1/C-#2 or #1/0 600V. EPR IN CONDUIT CABLE, TRAFFIC SIGNAL POWER SUPPLY, 2/C-#10 or #6, 600V NSRI, IN CONDUIT	$\blacksquare$	(250W HPSV EQUIVALENT), 240V
	RESIDENTIAL DAVIT,AND FND. WITH 10" B.C. AND 1" ANCHOR RODS DWG#565 (CONCRETE) OR DWG.#936 (HELIX).	<del></del>	<del></del>			■ (50W HPSV EQUIVALENT), 240V, ACORN
	(CONCRETE) OR DWG.#950 (NEEDA).	<del>X</del>	<del>- VII-</del>			<del>                                     </del>
ФН	•,		<del></del>	CABLE, TRAFFIC SIGNAL, 10/C-#12 600V, EPR IN CONDUIT		E OL OO AA ARRED LED LUMINAARES A MEH
	10" B.C. AND 1" ANCHOR RODS DWG. #565 (CONCRETE) OR DWG.#936 (HELIX).	<del>-XIX-</del>	-XIX			F 01-08-14 ADDED LED LUMINAIRES A.VIEU E 09-19-13 ADDED CMH LUMINAIRES A.VIEU
0	POLE , CITY STEEL, ANCHOR BASE, 32'-6", 7 GA., AND FND. WITH 11 1/2" B.C. AND	<del>2N</del>				E 09-19-13 ADDED CMH LUMINAIRES A.VIEU  D 02-06-04 REVISED/REDRAW R.POOL/B.I.
	1" ANCHOR RODS DWG. #753.	<del>-2NC-</del>	<del>2N</del>			c 04-01-02 REVISED/REDRAW R.POOL/B.I.
Ø4			<del>-2NC-</del>	CABLE, STREET LIGHT, 2 1/C-#6, 600V, RINS IN CONDUIT		B 12-4-01 ADDED ORNAMENTAL SYMBOLS
	1" ANCHOR RODS DWG. #753.	<del>-3TC-</del>	<del>-3TC-</del>	CABLE, STREET LIGHT, 2 1/C-#6 EPRN 600V. & 1 1/C-#8 GREEN, TRIPLEXED. IN CONDUIT		A 8-6-96 REDRAWN
Ø	■ POLE, CITY STEEL, ANCHOR BASE, 32'-6" 7 GA., ALUM. BHB AND FND. WITH 15" B.C24"X7' WITH 1" ANCHOR RODS DRG. #691.	<del>-3NC-</del>	<del>-3NC-</del>	CABLE, STREET LIGHT, 3 1/C-#1/0, or #2/0, or #4, 600V. EPR		DATE REVISION
	· · · · · · · · · · · · · · · · · · ·			IN CONDUIT		SUPERSEDES DWG. •
⊠+	NH POLE, CITY STEEL, ANCHOR BASE, 32'−6", 3 GA., ALUM. BHB AND FND. WITH  15" B.C. 24"X 7' WITH 1" ANCHOR RODS DWG. #691.	<del>-2W-</del>	<del>-2W-</del>	WIRE, STREET LIGHT, 2 1/C-#6, HDNS, AERIAL		
	,	<del>-3W-</del>	<del>-3W-</del>	WIRE, STREET LIGHT, 2 1/C-#6 & 1 1/C #8, HDNS. AERIAL		WORK ORDER NO DATE COST ALLOCATION ACCOUNT
0	POLE, CITY ALUMINUM, WITH ROUND BAL. HSG. BASE, 25', 28', or 30' ON FND. WITH 14" B.C., ACQUIRED FROM CHICAGO PARK DISTRICT.	-111	111	CABLE. STREET LIGHT AERIAL. 3 1/C-#4 or #2 SELF SUPPORTING.		APPROPRIATION ACCOUNT { MATERIAL
		wFA	FA	600V EPR WIRE, F.A. & P.C. AERIAL, 1/C-#10, NUMERAL DENOTES QUANTITY		
•	● POLE, CITY STEEL, EMBEDDED, 4"X 9"X 35' 7 GA., TAPERED TUBULAR. (DWG. #658)		-W			STANDARD CODE
<b>⊙</b> H	POLE, CITY STEEL, EMBEDDED, 4"X 9"X 35' 3 GA., TAPERED TUBULAR. (DWG. #658)	/ / PR	<del>/ / /</del>	CABLE, F.A. & P.C. AERIAL, W/ MESSENGER #19-(NUMBER OF PAIRS AS INDICATED)		FOR
	▼ POLE, CITY STEEL, EMBEDDED. (ACQUIRED FROM CTA)	PR	-6 PR			TRAFFIC SIGNALS/
	⊠ COLUMN,ELEVATED STRUCTURE	<del>0 0</del>	<del></del>	PAIRS AS INDICATED)		STREET LIGHTING
Ø	■ POLE, WOOD, (SIZE AS NOTED)	<u>37 PR</u>	<u>37 PR</u>	CABLE, F.A. & P.C., IN CONDUIT, #19-(NUMBER OF PAIRS AS		CITY OF CHICAGO
ď	● POLE, FOUNDATION WITH ELBOWS AS INDICATED.(SIZE AS NOTED)		_	INDICATED)		DEPT. OF TRANSPORTATION DIVISION OF ENGINEERING ELECTRICAL SECTION
0	POLE, ORNAMENTAL OR OTHER, AS INDICATED ON THE PLANS		<b>★</b>	DOWNLIGHT ASSEMBLY. (DWG. #850)		DRAFTSMAN: CHIEF DRAFTSMAN: ENGINEER: R, IVY R. CARTER R. POOL/R.C/W.T.
$\Diamond$	RESIDENTIAL STREET LIGHTING CONTROLLER		**	LIGHT, TRAFFIC SAFETY ISLAND		SUPERVISING ENGINEERS ELEC. DESIGN ENGR.  DWG. NO.
$\bigotimes$	RESIDENTIAL STREET LIGHTING CONTROLLER	$\Diamond$	•	FLASHING BEACON & DOWNLIGHT		ENGINEER OF ELECTRICITY
						GEN'L SUPT. OF CONSTRUCTION:
						DEPUTY COMMISSIONER:
						SIZE: 22" 36" SCALE: NONE DATE: 09-19-13

TranSmart/EJM
411 South Welk Street Suite 1000
Chicago, Illinois 60607

D160X94-Sht-Light-15A.dgn	DESIGNED - NRJ	REVISED -
USER NAME = njones	DRAWN - NRJ	REVISED -
PLOT SCALE = 40.0000 ' / in.	CHECKED - MKR	REVISED -
PLOT DATE = 3/5/2020	DATE - 3-13-2020	REVISED -
	USER NAME = njones PLOT SCALE = 40.0000 '/ in.	USER NAME = njones

STATE OF ILLINOIS						
DEPARTMENT	0F	TRANSPORTATION				

						F.A.I. RTE.	SECTION	COUNTY	TOTAL SHEETS	SHEET NO.	
CDOT ELECTRICAL SYMBOLS					90/94/290	2014-15R&B-R	COOK	825	258		
									CONTRACT	NO. (	60X94
SCALE: N.T.S.	SHEET 1	OF	16	SHEETS	STA.	TO STA.		ILLINOIS FED. A	D PROJECT		


- INTERCEPT EXISTING CONDUIT AND INSTALL 3'X4'X4' MANHOLE WITH 30" FRAME AND COVER.
- INTERCEPT EXISTING CONDUIT AND INSTALL
  7' HELIX FOUNDATION, 3' OFF FACE OF CURB
  (SEE SHEET LTC-14 FOR DETAIL).
- 3. INSTALL EXPANSION/DEFLECTION COUPLING.
- 4. INSTALL 3'X4'X4' MANHOLE WITH 30" FRAME AND COVER.
- 5. SEE SHEET E-14 FOR CONDUIT HANGER DETAILS.

#### **LEGEND:**

(PR NO. 2

STA 8313+00 SEE SHEET I

MATCH

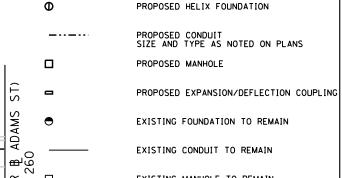

# EXISTING CONDUIT TO REMAIN EXISTING MANHOLE TO REMAIN

## **FOUNDATION AND CONDUIT PLAN**

PR TEMPORARY EASEMENT

<u>| 8310+00</u>

BEGIN CONSTRUCTION ADAMS STREET


B ADAMS STREET -

STA 8310+46.00

STREET

HALSTED

8309

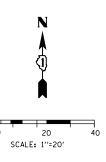

LTC-02

TranSmart/EJM"

STREET

ADAMS

D160X94-Sht-Light-15B.dgn	DESIGNED - NRJ	REVISED -
USER NAME = njones	DRAWN - NRJ	REVISED -
PLOT SCALE = 40.0000 '/ in.	CHECKED - MKR	REVISED -
PLOT DATE = 3/5/2020	DATE - 3-13-2020	REVISED -

STATE OF ILLINOIS **DEPARTMENT OF TRANSPORTATION** 

PR & ADAMS EXIT RAMP

SEE NOTE 3-

(4) CONDUIT ATTACHED TO STRUCTURE,

4" DIA., PVCC RGS-350' (SEE NOTE 5)

188

ADAMS STREET

(4) 4"-40" (SCH. 80)-

SEE NOTE 1-

SEE NOTE 2-

PR TEMPORARY EASEMENT-

(4) 4"-20' (SCH. 80)-

SEE NOTE 4-

**ROADWAY LIGHTING PLAN ADAMS STREET** SCALE: 1"=20" SHEET 2 OF 16 SHEETS STA. 8308+00 TO STA. 8313+00

BŁ JACKS∳N

-PR BERAMPPSW∥∏

1 11

1 113/11 1 T III

PR ADAMS | STREET BRIDGE SN |016-1701 | SEE STRUCTURAL PLANS

i ii di i

|PR| 8 |SB| I-90/94-EX B I-90/94

EXIT RAMP

SECTION COUNTY 90/94/290 2014-15R&B-R COOK 825 259

CONTRACT NO. 60X94

- 1. INTERCEPT EXISTING CONDUIT AND INSTALL 3'X4'X4' MANHOLE WITH 30" FRAME AND COVER.
- INTERCEPT EXISTING CONDUIT AND INSTALL
  7' HELIX FOUNDATION, 3' OFF FACE OF CURB
  (SEE SHEET LTC-14 FOR DETAIL).
- 3. INSTALL EXPANSION/DEFLECTION COUPLING.
- 4. SEE SHEET E-14 FOR CONDUIT HANGER DETAILS.


#### **LEGEND:**

Φ PROPOSED HELIX FOUNDATION PROPOSED CONDUIT SIZE AND TYPE AS NOTED ON PLANS PROPOSED MANHOLE PROPOSED EXPANSION/DEFLECTION COUPLING EXISTING FOUNDATION TO REMAIN EXISTING CONDUIT TO REMAIN

EXISTING MANHOLE TO REMAIN

#### 11111 1111 (4) CONDUIT ATTACHED TO -SEE NOTE 2-11111 STRUCTURE, 4" DIA., PVCC 11111 RGS-350' (SEE NOTE 4) 2"-10" (SCH. 80)-SEE NOTE 3-END CONSTRUCTION PR & ADAMS INTERNET PROPERTY AND PROPERTY AN (4) 4"-10" (SCH. 80) ADAMS STREET SEE NOTE 1 STA 8316+00.00 -B ADAMS STREET EX ROW DES PLAINE 18′ ADAMS STREE S j [1] 1111 STREET 1111 $\bigcirc$ 1 [1] 1111 1111 1111 1111 <u> Ничипппиу</u> 1111 1111 1111 1117 1 11/1 1111 1111 1 14/ -i-i// IIIIШ └-PR TEMPORARY EASEMENT IIII

## **FOUNDATION AND CONDUIT PLAN**

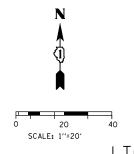

LTC-03

TranSmart/EJM"

| PR | B NB I-90/94

PR ADAMS STREET BRIDGE

\$N | φ16-1701

SEE STRUCTURAL PLANS

 $\Pi$ 

 $\Pi$ 

 $\Pi$ 

160X94-Sht-Light-16.dgn	DESIGNED - NRJ	REVISED -
SER NAME = njones	DRAWN - NRJ	REVISED -
LOT SCALE = 40.0000 '/ in.	CHECKED - MKR	REVISED -
LOT DATE = 3/5/2020	DATE - 3-13-2020	REVISED -

STATE OF ILLINOIS **DEPARTMENT OF TRANSPORTATION** 

**ROADWAY LIGHTING PLAN** ADAMS STREET SCALE: 1"=20' SHEET 3 OF 16 SHEETS STA. 8313+00 TO STA. 8318+00

F.A.I. RTE. SECTION COUNTY 90/94/290 2014-15R&B-R COOK 825 260

CONTRACT NO. 60X94

- 1. INTERCEPT EXISTING CONDUITS AND INSTALL 3'X4'X4' MANHOLE WITH 30" FRAME AND COVER.
- 2. INSTALL 7' HELIX FOUNDATION, 3' OFF FACE OF CURB (SEE SHEET LTC-14 FOR DETAIL).
- 3. INSTALL EXPANSION/DEFLECTION COUPLING.
- 4. ADJUST FRAME AND LID TO GRADE.
- 5. SEE SHEET E-14 FOR CONDUIT HANGER DETAILS.

#### **LEGEND**:


PROPOSED CONDUIT SIZE AND TYPE AS NOTED ON PLANS PROPOSED MANHOLE PROPOSED EXPANSION/DEFLECTION COUPLING

PROPOSED HELIX FOUNDATION


EXISTING CONDUIT TO REMAIN

EXISTING FOUNDATION TO REMAIN

EXISTING MANHOLE TO REMAIN

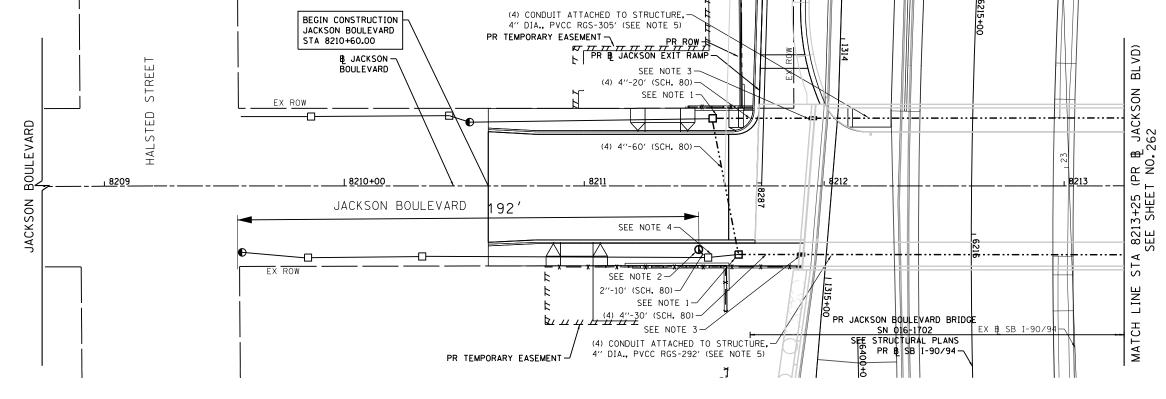

## FOUNDATION AND CONDUIT PLAN

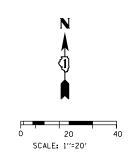

LTC-04

TranSmart/EJM\* Chicago, Illinois 60607

D162A78-Sht-Light-11.dgn	DESIGNED - NRJ	REVISED -
USER NAME = njones	DRAWN - NRJ	REVISED -
PLOT SCALE = 40.0000 ' / in.	CHECKED - MKR	REVISED -
PLOT DATE = 3/5/2020	DATE - 3-13-2020	REVISED -

STATE OF ILLINOIS **DEPARTMENT OF TRANSPORTATION** 

**ROADWAY LIGHTING PLAN** JACKSON BOULEVARD SCALE: 1"=20" SHEET 4 OF 16 SHEETS STA. 8308+00 TO STA. 8313+00

F.A.I. RTE. SECTION COUNTY 90/94/290 2014-15R&B-R COOK 825 261 CONTRACT NO. 60X94

- INTERCEPT EXISTING CONDUITS AND INSTALL 3'X4'X4' MANHOLE WITH 30" FRAME AND COVER.
- 2. INSTALL EXPANSION/DEFLECTION COUPLING.
- 3. SEE SHEET E-14 FOR CONDUIT HANGER DETAILS.

#### **LEGEND**

PROPOSED CONDUIT SIZE AND TYPE AS NOTED ON PLANS


PROPOSED MANHOLE

PROPOSED EXPANSION/DEFLECTION COUPLING


EXISTING FOUNDATION TO REMAIN

EXISTING CONDUIT TO REMAIN

EXISTING MANHOLE TO REMAIN

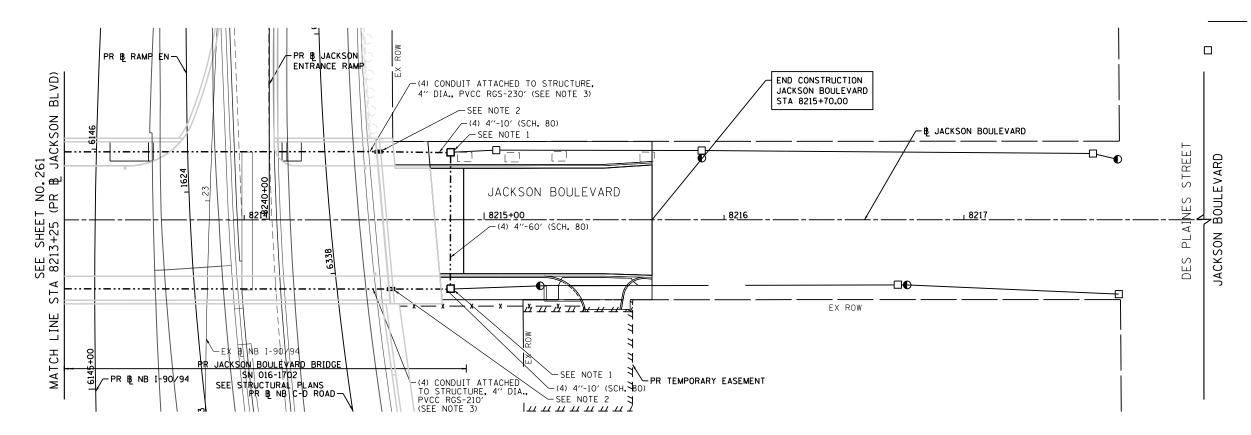

## **FOUNDATION AND CONDUIT PLAN**

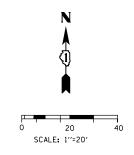

LTC-05

TranSmart/EJM"

D162A78-Sht-Light-12.dgn	DESIGNED - NRJ	REVISED -
USER NAME = njones	DRAWN - NRJ	REVISED -
PLOT SCALE = 40.0000 '/ in.	CHECKED - MKR	REVISED -
PLOT DATE = 3/5/2020	DATE - 3-13-2020	REVISED -

STATE OF ILLINOIS **DEPARTMENT OF TRANSPORTATION** 

	ROADWAY LIGHTING PLAN								
JACKSON BOULEVARD									
SCALE: 1"=20"	SHEET 5	OF 16	SHEETS	STA. 8213+25	TO STA. 8217+75				

F.A.I. RTE. SECTION COUNTY COOK 825 262 90/94/290 2014-15R&B-R CONTRACT NO. 60X94

1. INSTALL 7' HELIX FOUNDATION, 3' OFF FACE OF CURB (SEE SHEET LTC-14 FOR DETAIL).

#### **LEGEND**:


Φ PROPOSED HELIX FOUNDATION

Ø EXISTING EMBEDDED POLE


EXISTING FOUNDATION TO REMAIN

EXISTING CONDUIT TO REMAIN

EXISTING MANHOLE TO REMAIN

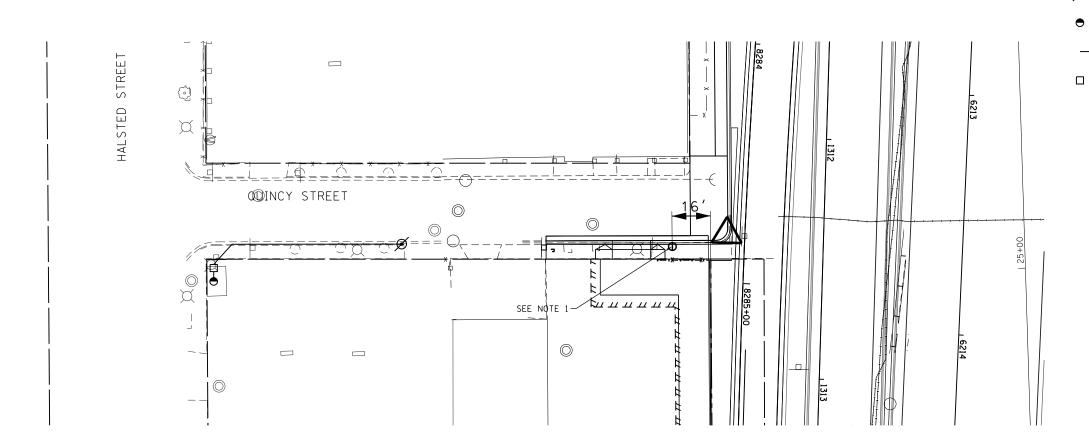

## **FOUNDATION AND CONDUIT PLAN**

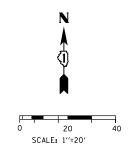

LTC-06


TranSmart/EJM\*\*


162A78-Sht-Light-13.dgn	DESIGNED - NRJ	REVISED -
SER NAME = njones	DRAWN - NRJ	REVISED -
OT SCALE = 40.0000 '/ in.	CHECKED - MKR	REVISED -
OT DATE = 3/5/2020	DATE - 3-13-2020	REVISED -


STATE OF ILLINOIS **DEPARTMENT OF TRANSPORTATION** 

ROADWAY LIGHTING PLAN QUINCY STREET  SCALE: 1":20' SHEET 6 OF 16 SHEETS STA, 8308+00 TO STA,										
SCALE: 1"=20"	SHEET 6	OF 1	6 SHEETS	STA. 8308+00	TO STA. 83					

F.A.I. RTE.	SECTION	COUNTY	TOTAL SHEETS	SHEET NO.					
90/94/290	2014-15R&B-R	соок	825	263					
		CONTRACT	NO. 6	0X94					
THE INDICE FED. AND DROUGET									

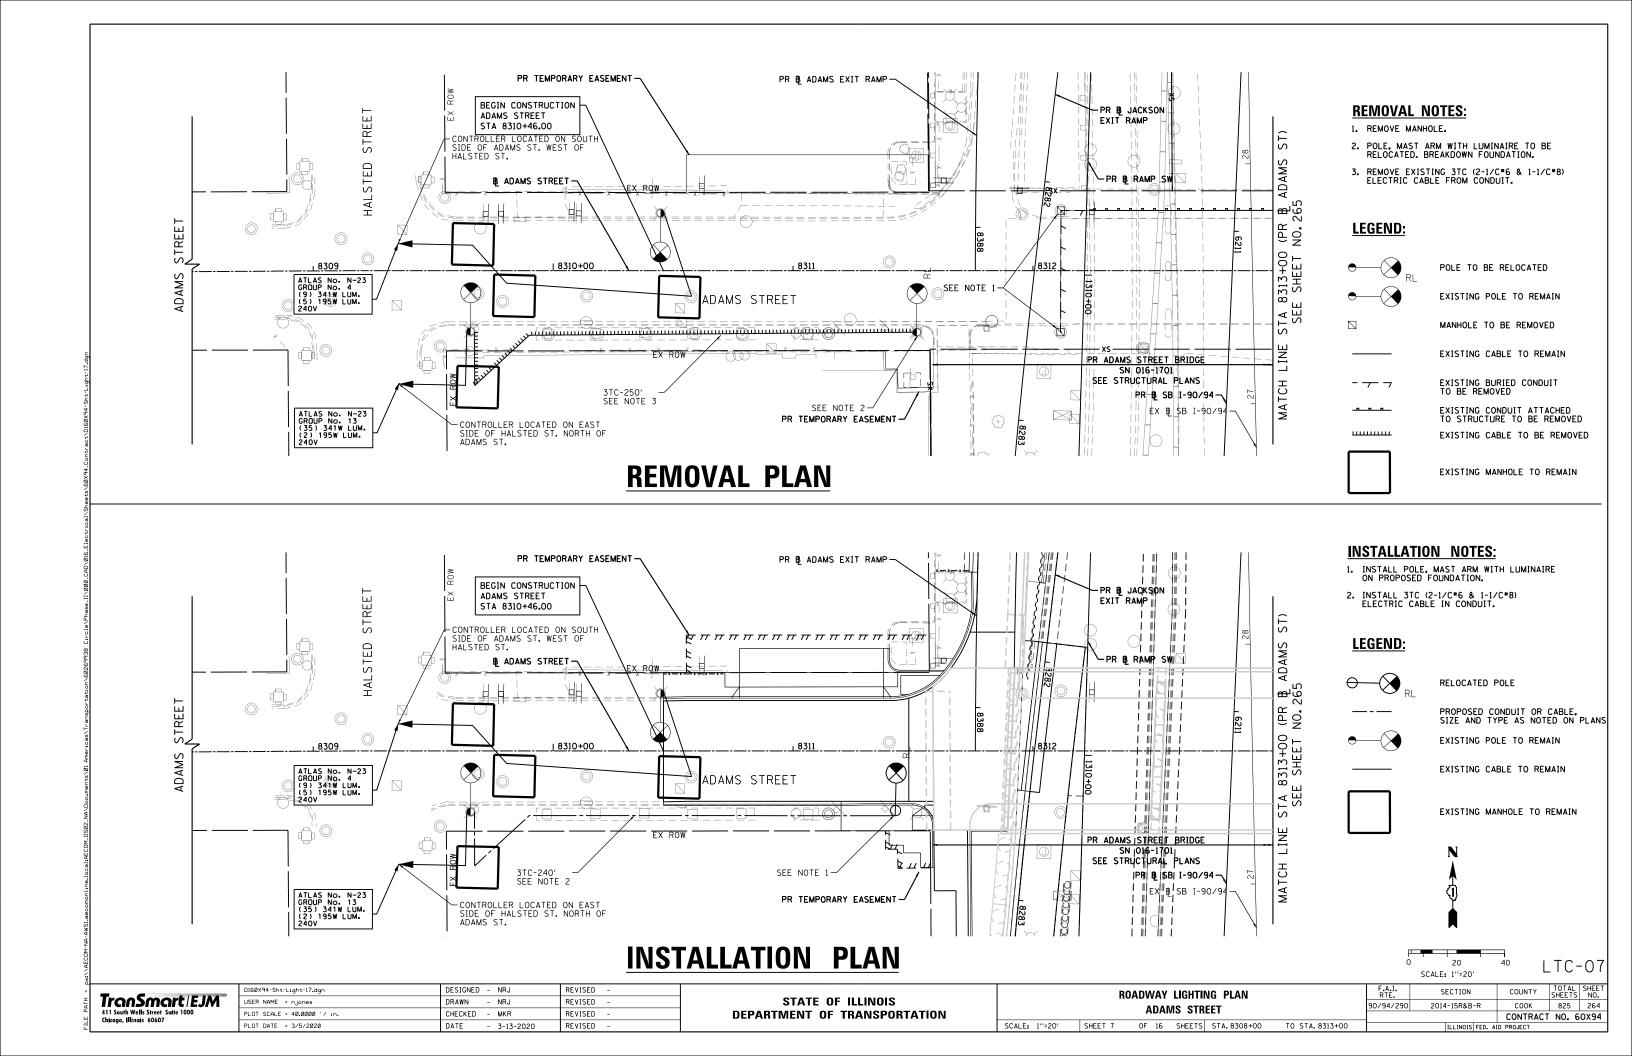

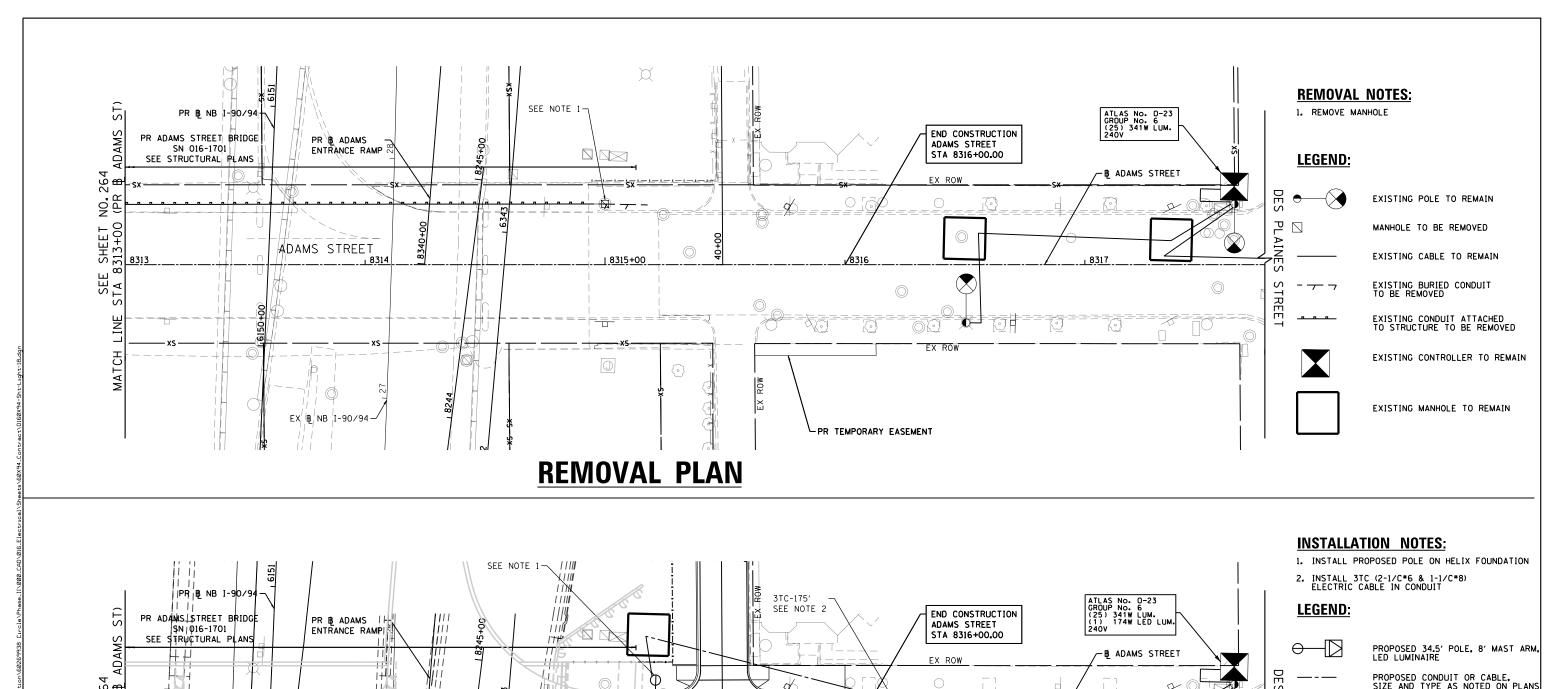

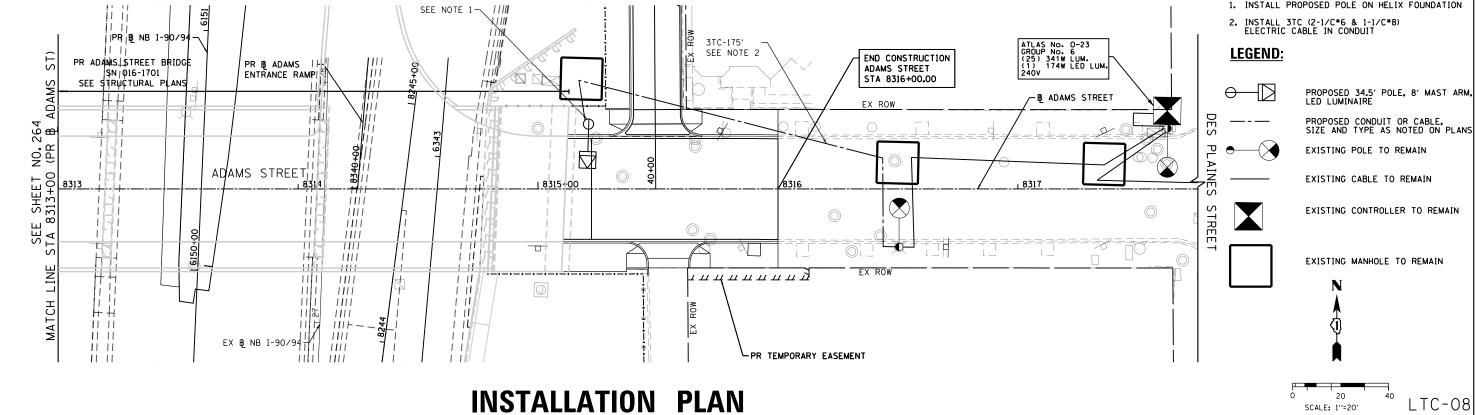

TranSmart/EJM

411 South Wells Street Suite 1000
Chicago, Illinois 60607


D16ØX94-Sht-Light-18.dgn	DESIGNED - NRJ	REVISED -
USER NAME = njones	DRAWN - NRJ	REVISED -
PLOT SCALE = 40.0000 ' / in.	CHECKED - MKR	REVISED -
PLOT DATE = 3/5/2020	DATE - 3-13-2020	REVISED -


STATE OF ILLINOIS DEPARTMENT OF TRANSPORTATION


R	OADW A				
SHEET 8	OF	16	SHEETS	STA. 8313+00	TO STA. 8318+00


SCALE: 1"=20"


F.A.I. RTE.	SECTION		COUNTY	TOTAL SHEETS	SHEE NO.
90/94/290	2014-15R&B-R	014-15R&B-R		825	265
			CONTRACT	NO. 6	0X9
	ILLINOIS FE	D. AI	D PROJECT		

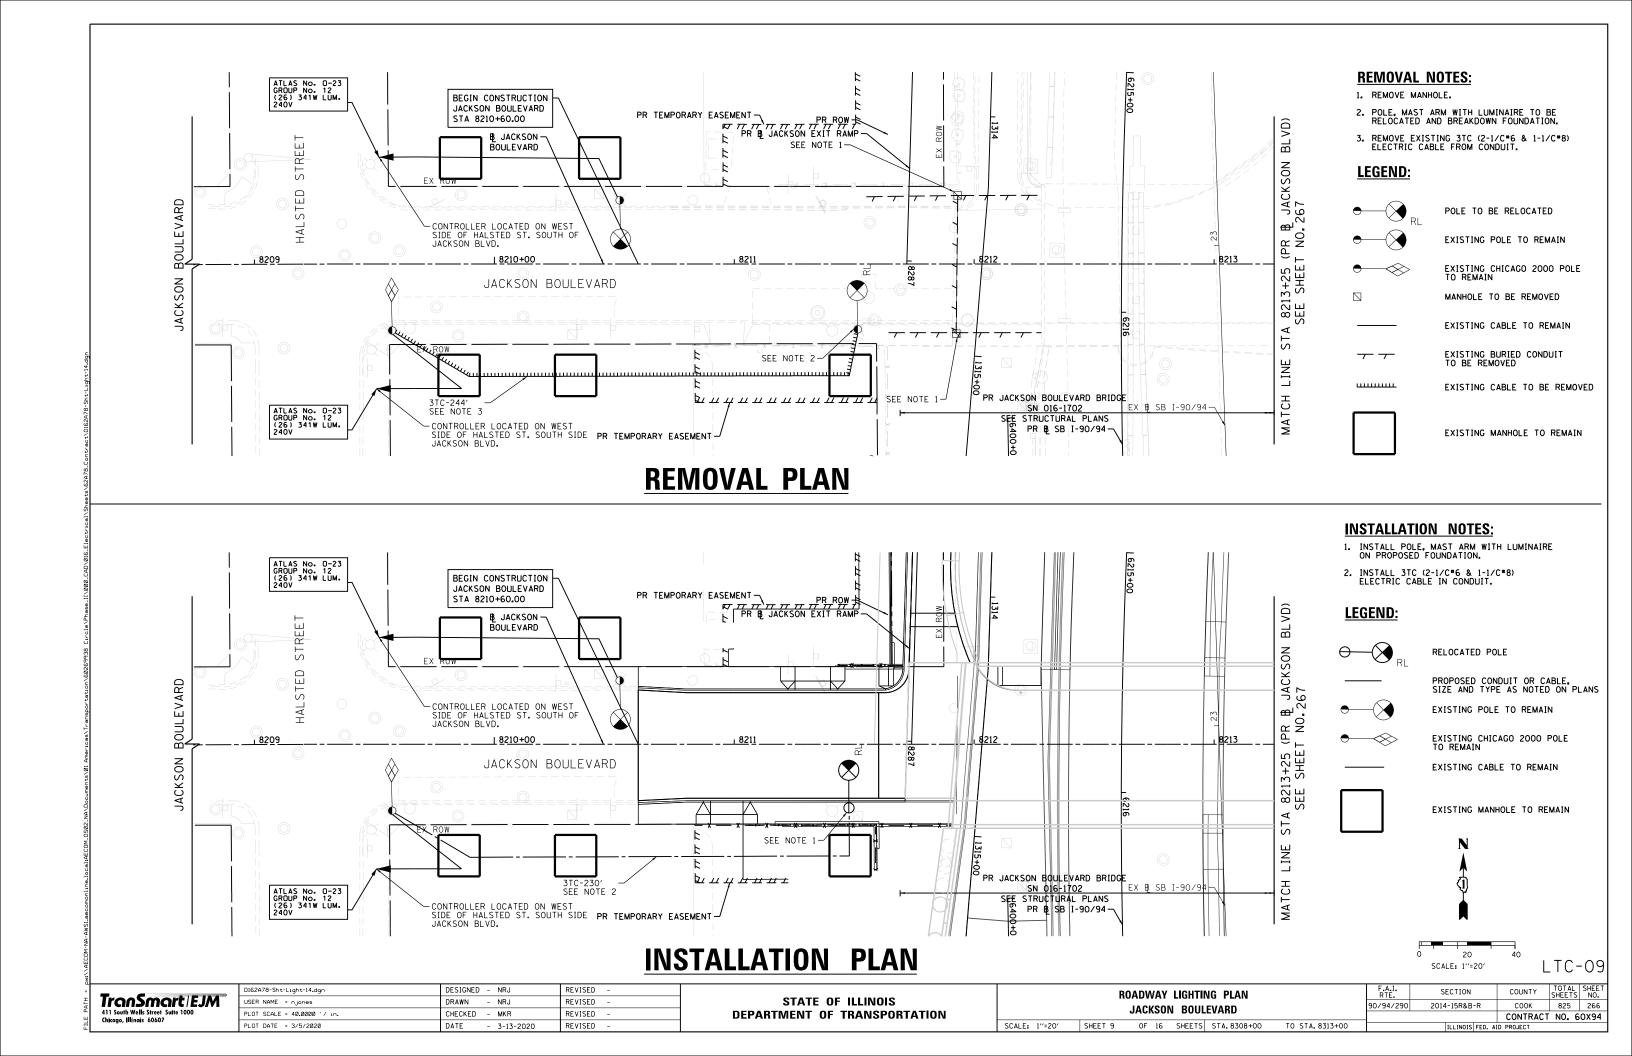

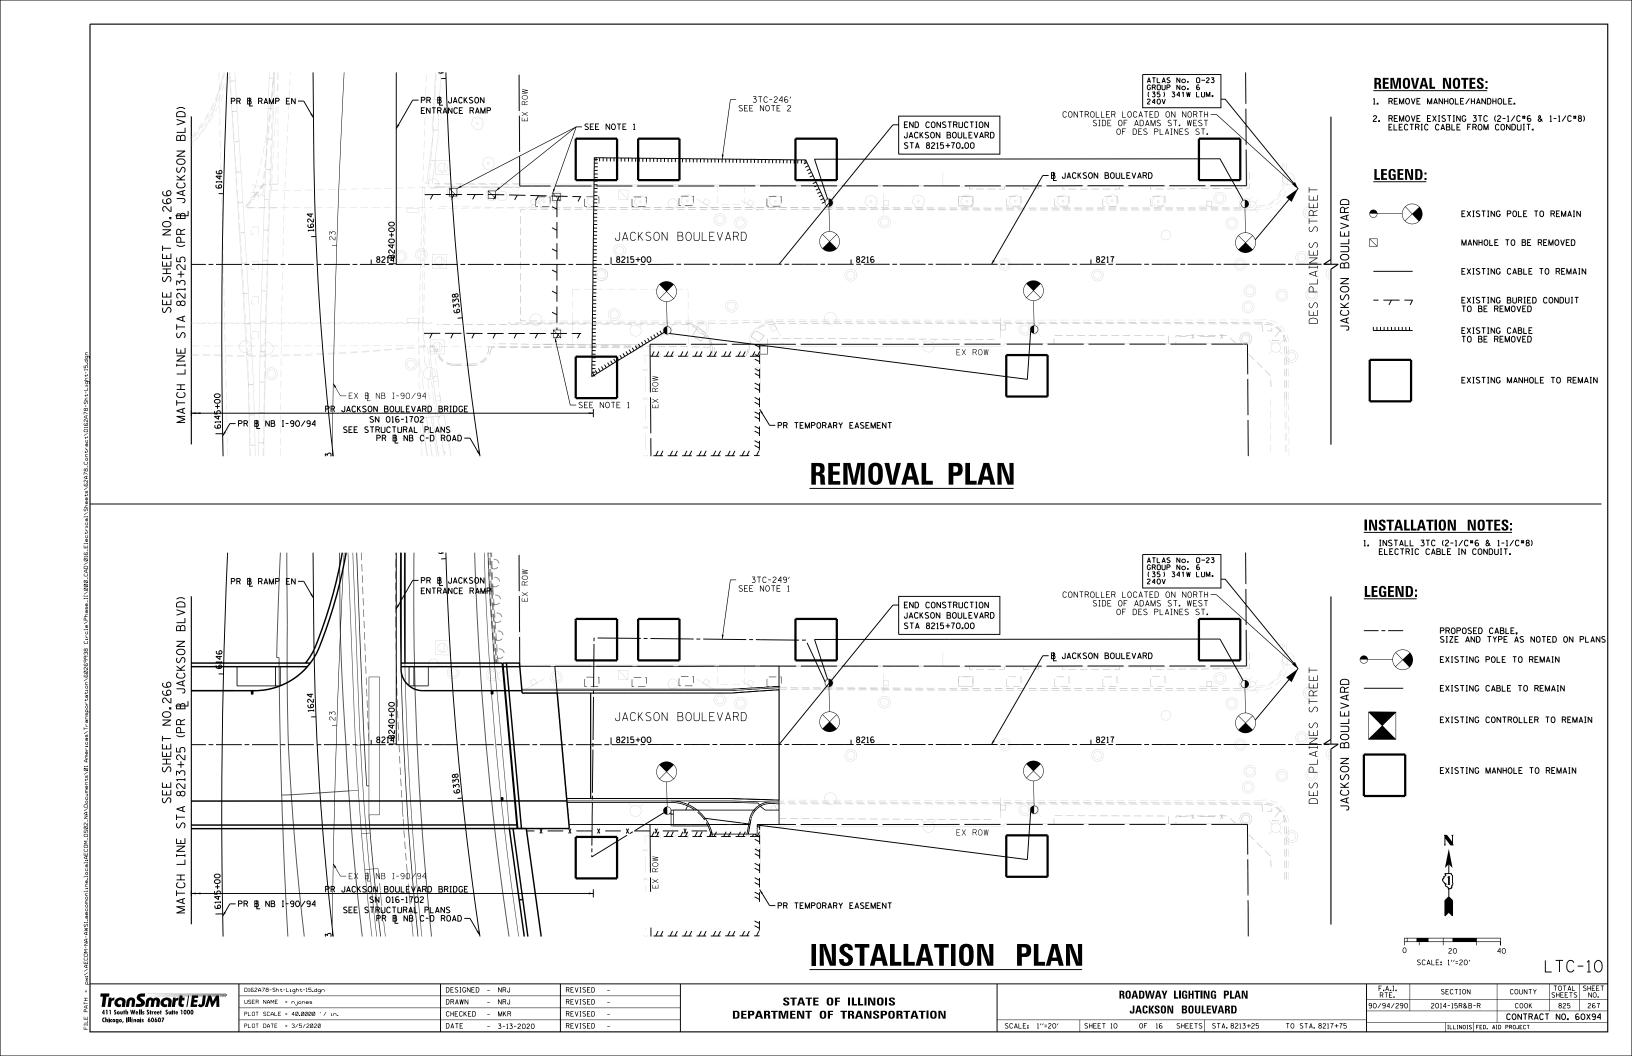

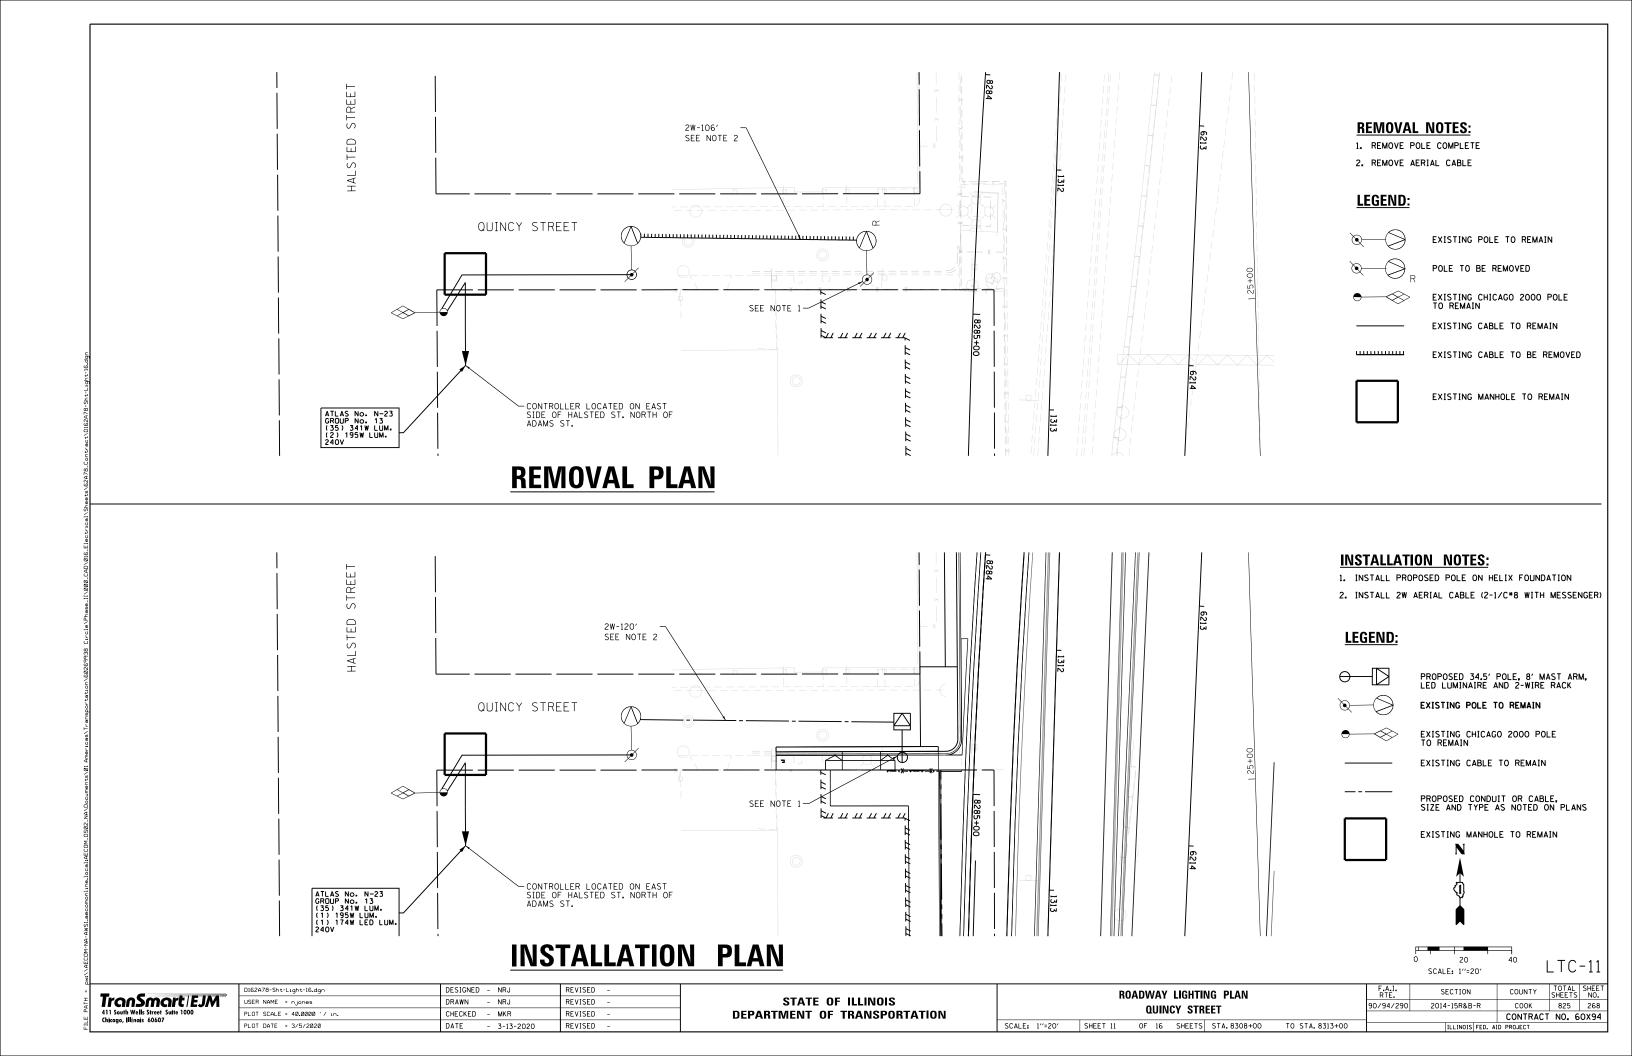

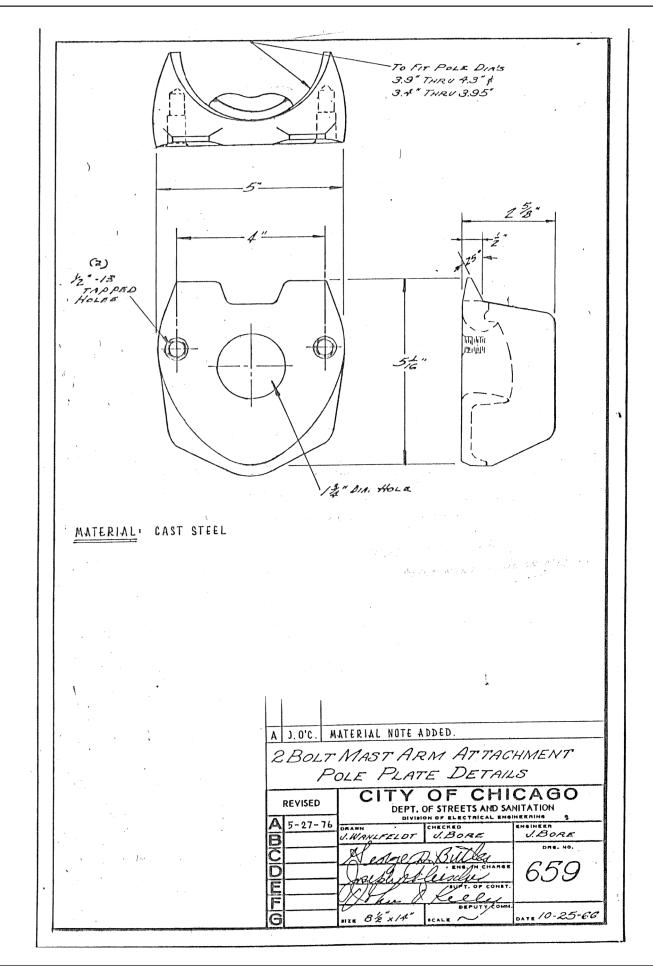

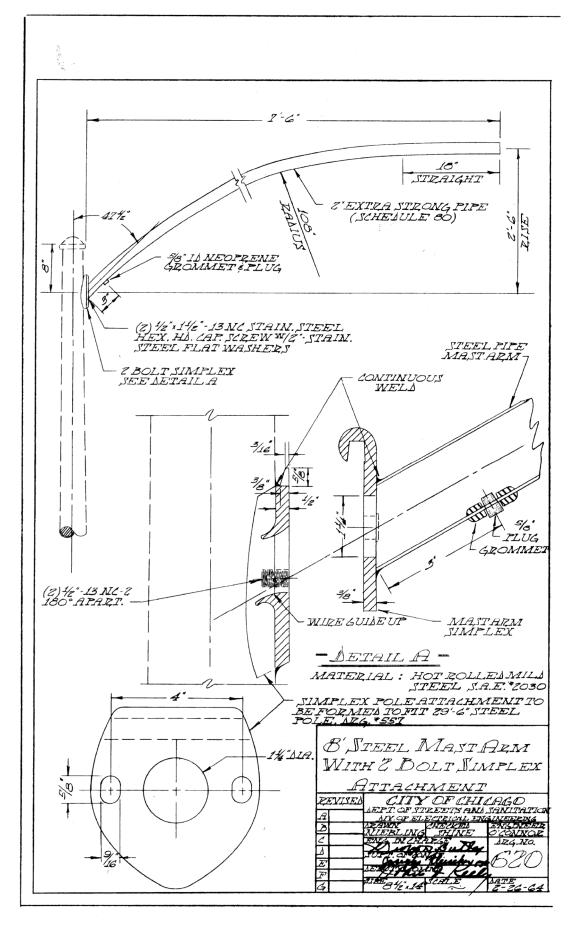



TranSmart/EJM\*\*
411 South Wells Street Suite 1000
Chicago, Illinois 60607

D160X94-Sht-Light-19.dgn	DESIGNED - NRJ	REVISED -
USER NAME = njones	DRAWN - NRJ	REVISED -
PLOT SCALE = 40.0000 '/ in.	CHECKED - MKR	REVISED -
PLOT DATE = 3/5/2020	DATE - 3-13-2020	REVISED -

STATE OF ILLINOIS
DEPARTMENT OF TRANSPORTATION

Ī							F.A.I. RTE.	SECTION	COUNTY	TOTAL SHEETS	SHEET NO.
l	ELECTRICAL DETAILS				90/94/290	2014-15R&B-R	COOK	825	269		
							CONTRACT	NO. 6	0X94		
l	SCALE: N.T.S.	SHEET 12	0F 16	SHEETS	STA.	TO STA.		ILLINOIS FED. AID PROJECT			

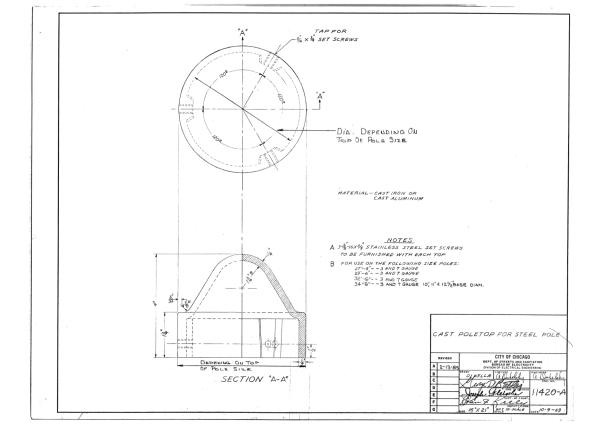


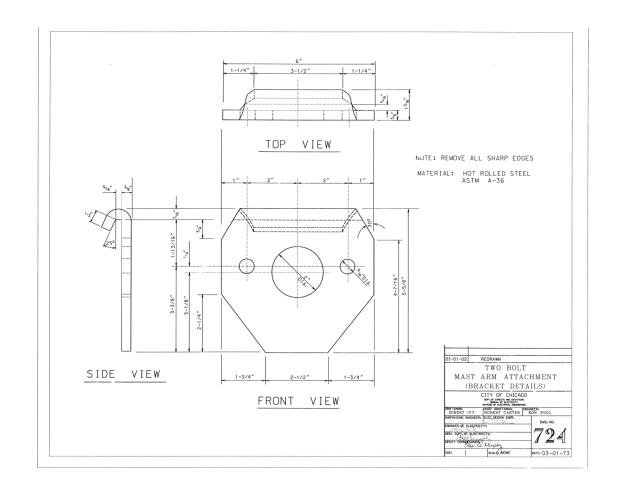


Transmart/EJM\*\*
411 South Wells Street Suite 1000
Chicago, Illinois 60607

D160X94-Sh	t-Light-20.dgn	DESIGNED -	- NRJ	REVISED -	
USER NAME	= njones	DRAWN	- NRJ	REVISED -	1
PLOT SCALE	= 40.0000 ' / in.	CHECKED	- MKR	REVISED -	1
PLOT DATE	= 3/5/2020	DATE	- 3-13-2020	REVISED -	


STATE OF ILLINOIS DEPARTMENT OF TRANSPORTATION

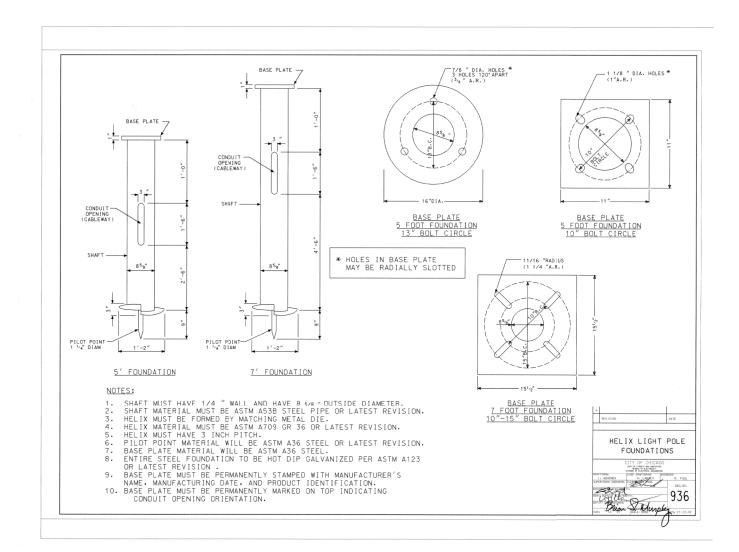


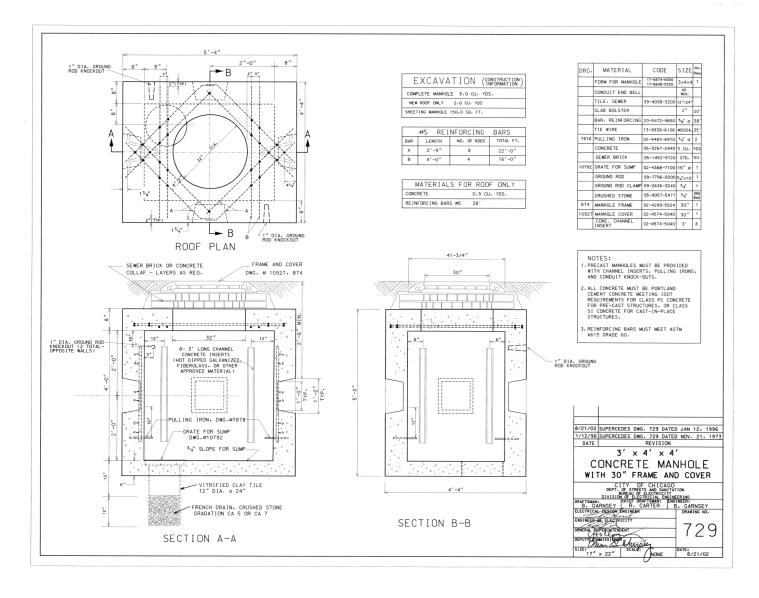

TronSmart/EJM\*\*
411 South Wells Street Suite 1000
Chicago, Illinois 60607

D160X94-Sht-Light-21.dgn	DESIGNED - NRJ	REVISED -					F.A.I.	SECTION	COUNTY	TOTAL SHEETS	SHEET
USER NAME = njones	DRAWN - NRJ	REVISED -	STATE OF ILLINOIS		ELECTRICAL DETAILS		90/94/290	2014-15R&B-R	соок	825	271
PLOT SCALE = 40.0000 ' / in.	CHECKED - MKR	REVISED -	DEPARTMENT OF TRANSPORTATION						CONTRAC		0X94
PLOT DATE = 3/5/2020	DATE - 3-13-2020	REVISED -		SCALE: N.T.S.	SHEET 14 OF 16 SHEETS STA.	TO STA.		ILLINOIS FED. A	ID PROJECT		

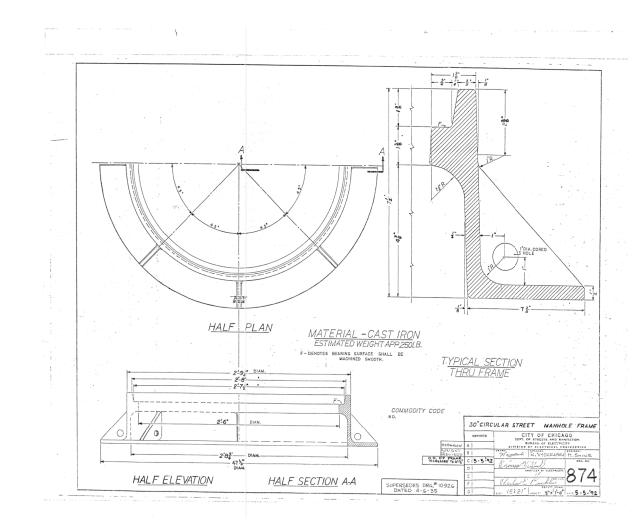


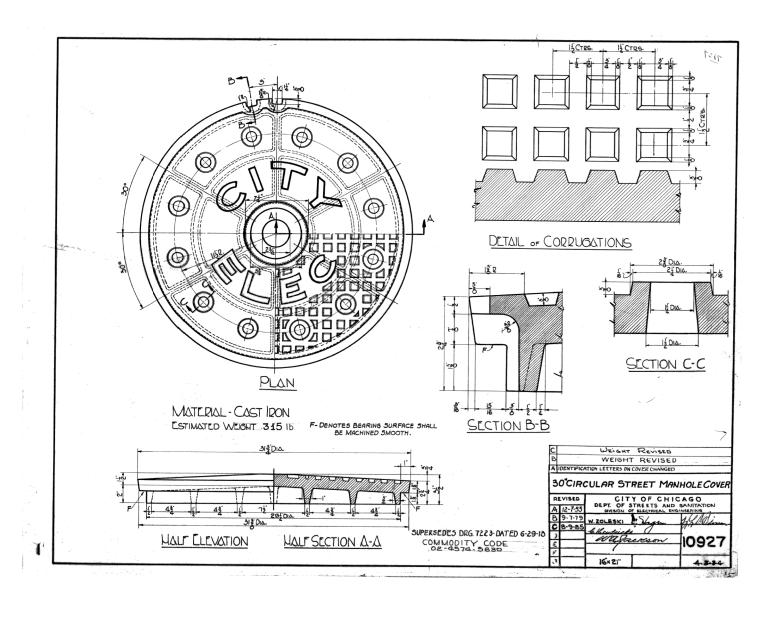

LTC-15

TranSmart/EJM\*\*\*
411 South Wells Street Suite 1000
Chicago, Illinois 60607

DI60X94-Sht-Light-22.dgn	DESIGNED - NRJ	REVISED -
USER NAME = njones	DRAWN - NRJ	REVISED -
PLOT SCALE = 40.0000 ' / in.	CHECKED - MKR	REVISED -
PLOT DATE = 3/5/2020	DATE - 3-13-2020	REVISED -

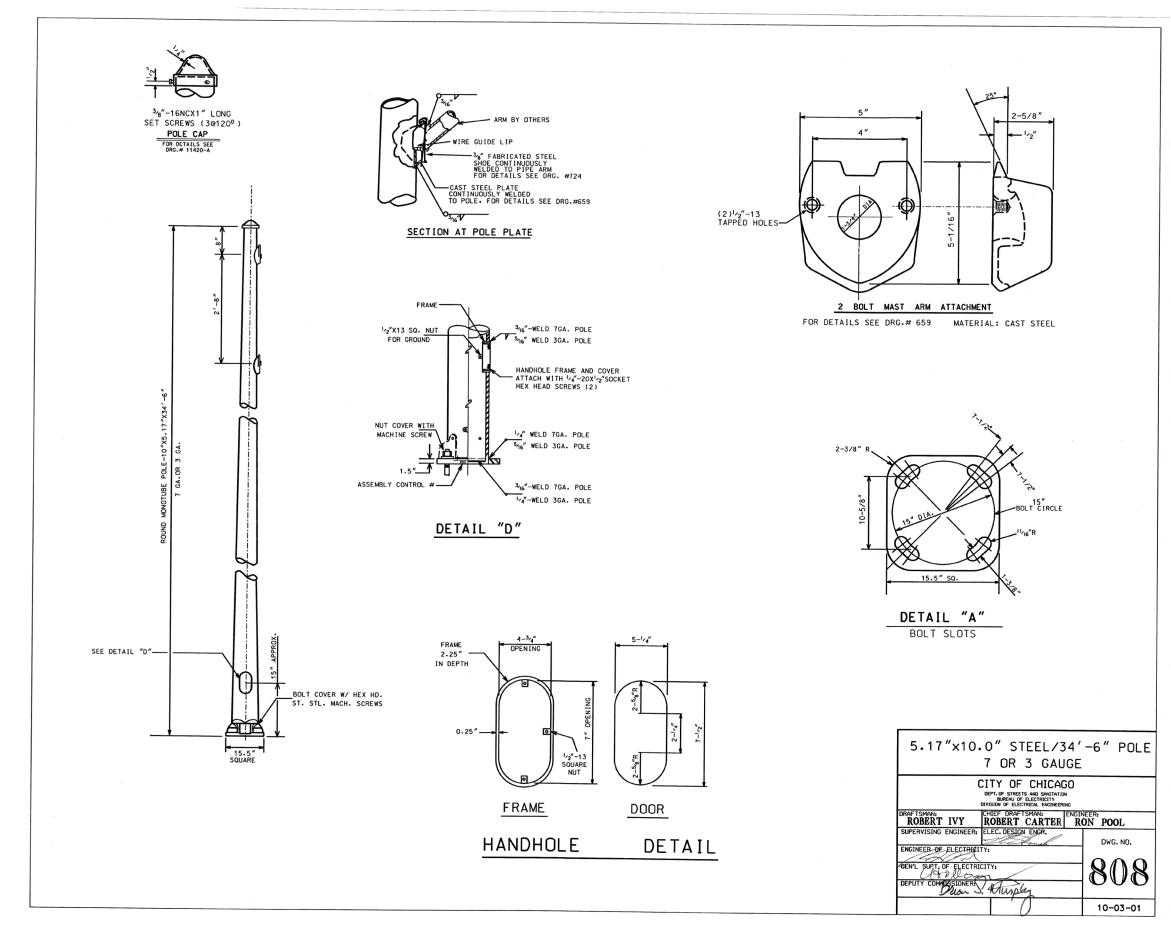

LTC-16

TranSmart/EJM
411 South Wells Street Suite 1000
Chicago, Illinois 60607

STATE OF ILLINOIS
DEPARTMENT OF TRANSPORTATION

SCALE: N.T.S. SHEET 16 OF 16 SHEETS STA. TO STA.

F.A.I. SECTION COUNTY TOTAL SHEETS NO.
90/94/290 2014-15R&B-R COOK 825 273

CONTRACT NO. 60X94

| ILLINOIS | FED. AID PROJECT



DATE

- 3-13-2020

REVISED

PLOT DATE = 3/6/2020


**DEPARTMENT OF TRANSPORTATION** 

SHEET 1 OF 15 SHEETS STA.

TO STA.


SCALE: N.T.S.

CONTRACT NO. 60X94

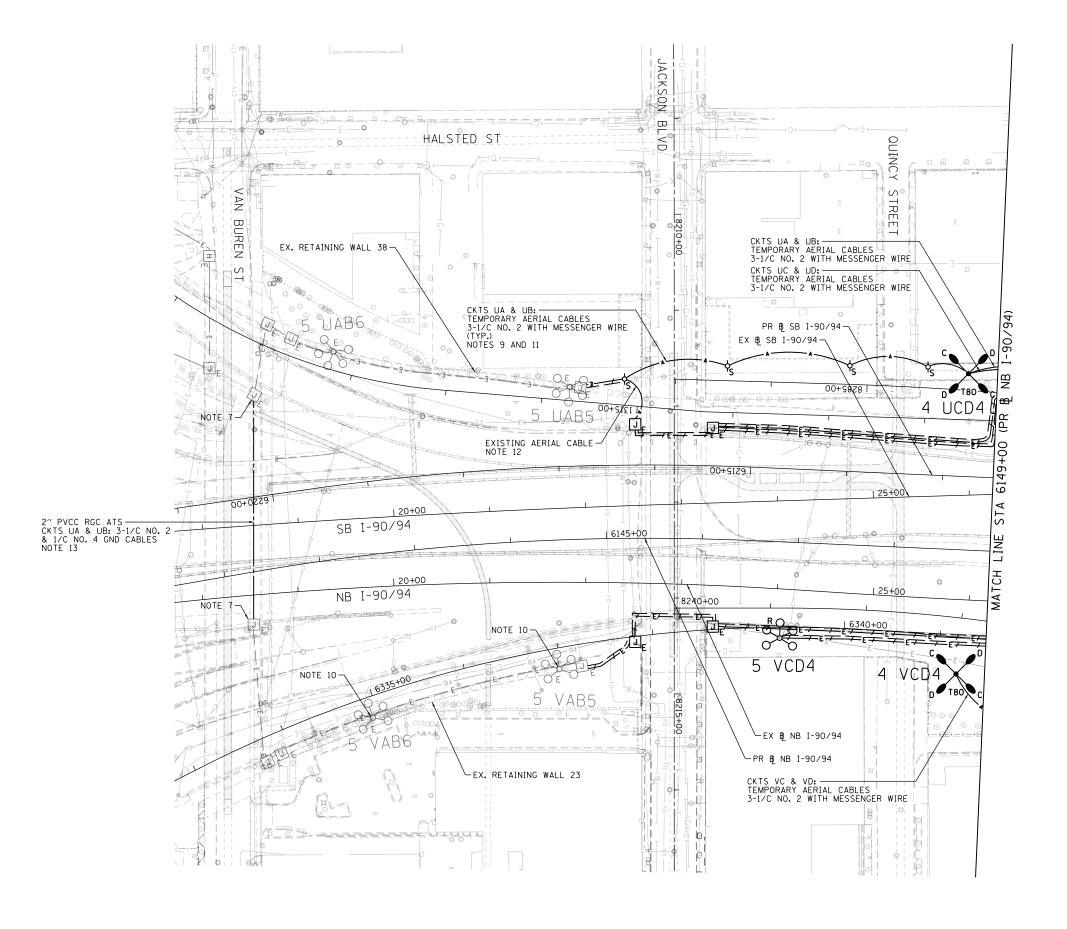

- 1. SEE DRAWING E-01 FOR IDOT ELECTRICAL SYMBOLS AND ABBREVIATIONS.
- 2. LOCATIONS OF EXISTING ELECTRICAL EQUIPMENT SHOWN ON THIS DRAWING ARE APPROXIMATIONS AND MUST BE VERIFIED IN THE FIELD BY THE CONTRACTOR.
- CONTRACTOR.

  3. THE EXISTING ELECTRICAL SYSTEMS, AS DEPICTED ON THE PLANS, ARE INTENDED TO INDICATE THE GENERAL EQUIPMENT INSTALLATIONS INVOLVED AND SHALL NOT BE CONSTRUED AS AN EXACT REPRESENTATION OF THE FIELD CONDITIONS. IT IS THE CONTRACTOR'S RESPONSIBILITY TO CONFIRM AND ASCERTAIN THE EXACT CONDITION, SIZE, TYPE, QUANTITY AND LOCATION OF THE EXISTING ELECTRICAL EQUIPMENT. ANY DISCREPANCIES BETWEEN THE ACTUAL EXISTING ELECTRICAL EOUIPMENT IN THE FIELD AND THE DEPICTION OF THE EXISTING ELECTRICAL EQUIPMENT SHOWN ON THE PLANS SHALL IMMEDIATELY BE BROUGHT TO THE ATTENTION OF THE RESIDENT ENGINEER FOR RESOLUTION, FAILURE TO VERIFY THE CONDITIONS, DIMENSIONS AND DETAILS OF THE EXISTING ELECTRICAL EQUIPMENT TO CONFIRM THAT THE NEW EQUIPMENT IS COMPATIBLE WITH THE EXISTING EOUIPMENT AND CAN BE PROPERLY INSTALLED AND CONNECTED AS SHOWN ON THE PLANS WILL NOT RELIEVE THE CONTRACTOR OF THEIR RESPONSIBILITY FOR PROVIDING A SAFE, COMPLETE AND FULLY FUNCTIONAL ELECTRICAL SYSTEM. AND FULLY FUNCTIONAL ELECTRICAL SYSTEM.
- 4. ALL WORK SHOWN ON THIS DRAWING MUST BE COORDINATED WITH THIS CONTRACT'S CONSTRUCTION WORK AND STAGING.
- 5. IDOT CONTRACTS 62A77, 62A76 AND 60Y00 WILL BE ONGOING SIMULTANEOUSLY WITH THIS CONTRACT. THE CONTRACTOR IS RESPONSIBLE FOR COORDINATING ALL ELECTRICAL WORK FOR THIS CONTRACT WITH THE WORK IN THOSE CONTRACTS. THIS COORDINATION WORK SHALL BE INCLUDED AT NO ADDITIONAL COST TO THIS CONTRACT.
- 6. ALL OF THE EXISTING LIGHTING UNITS AND
  LIGHTING CIRCUITS CURRENTLY FED FROM EXISTING
  IDOT LIGHTING CONTROLLERS SHALL REMAIN
  ENERGIZED DURING NIGHTIME HOURS FOR THE
  DURATION OF THE CONTRACT. ANY TEMPORARY
  POWER REQUIRED TO KEEP THE LIGHTING SYSTEM
  ENERGIZED WILL BE PROVIDED BY THE CONTRACTOR
  AT NO ADDITIONAL COST TO THE CONTRACT AT NO ADDITIONAL COST TO THE CONTRACT.
- 7. DRILL THE EXISTING JUNCTION BOX ATTACHED TO THE VAN BUREN PIER STRUCTURE AND ROUTE THE PROPOSED CONDUIT AND LIGHTING CIRCUIT FEDS INTO THE JUNCTION BOX, CONNECT THE PROPOSED LIGHTING CIRCUIT CABLES TO THE EXISTING LIGHTING CIRCUIT CABLES.
- 8. ALL EXISTING LIGHT TOWERS SHOWN TO BE REMOVED SHALL BE DISPOSED OF PROPERLY OFFSITE.
- 9. ATTACH THE TEMPORARY AERIAL LIGHTING CIRCUIT CABLES TO THE EXISTING WOOD POLES USED FOR THE TEMPORARY ITS FEEDS. PROVIDE 50 FEET OF SLACK CABLE AT EACH WOOD POLE TO ALLOW FOR RELOCATION OF AERIAL CABLES DURING THE DIFFERENT STAGES OF CONSTRUCTION.
- 10. DURING TEMPORARY CONDITIONS LIGHT TOWERS 5 VAB5, 5 VAB6, AND THE UNDERPASS LIGHTING SYSTEM ON THE EAST SIDE OF VAN BUREN SHALL BE FED FROM CIRCUITS A AND B FROM EXISTING IDOT LIGHTING CONTROLLER U.
- 11. THE TEMPORARY AERIAL LIGHTING CIRCUIT CABLES ATTACHED TO THE ITS WOOD POLES SHALL BE REMOVED ONCE THE PERMANENT LIGHTING FEEDS SHOWN ON DRAWING E-04 HAVE BEEN INSTALLED, ENERGIZED, TESTED, AND APPROVED BY IDOT. THE REMOVAL OF THESE TEMPORARY AERIAL CABLES SHALL BE PAID FOR BY THE "REMOVE AERIAL CABLE" PAY ITEM.
- 12. REMOVE THE EXISTING AERIAL CABLES FROM THE JUNCTION BOX ATTACHED TO THE WEST ABUTMENT OF THE JACKSON STREET BRIDGE PRIOR TO THE ABUTMENT BEING REMOVED.
- 13. DISCONNECT AND REMOVE THE TEMPORARY LIGHTING CIRCUIT CABLES ONCE THE PERMANENT FEEDS FOR LIGHT TOWERS 5 VAB6 AND 5 VAB5, SHOWN ON DRAWING E-04, HAVE BEEN INSTALLED, ENERGIZED, TESTED, AND APPROVED BY IDOT.

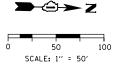

E-02


**AECOM** 

DESIGNED - TJL REVISED D160X94-sht-Light-02 USER NAME = myersc DRAWN - CAM REVISED PLOT SCALE = 100.0000 '/ in. CHECKED - WDS REVISED PLOT DATE = 3/6/2020 DATE REVISED - 3-13-2020

STATE OF ILLINOIS **DEPARTMENT OF TRANSPORTATION**  **EXISTING LIGHTING PLAN JACKSON BOULEVARD** 

F.A.I. RTE. SECTION COUNTY 90/94/290 2014-015R&B-R COOK 825 275 CONTRACT NO. 60X94

SCALE: 1"=50" SHEET 2 OF 15 SHEETS STA TO STA, 6213+00

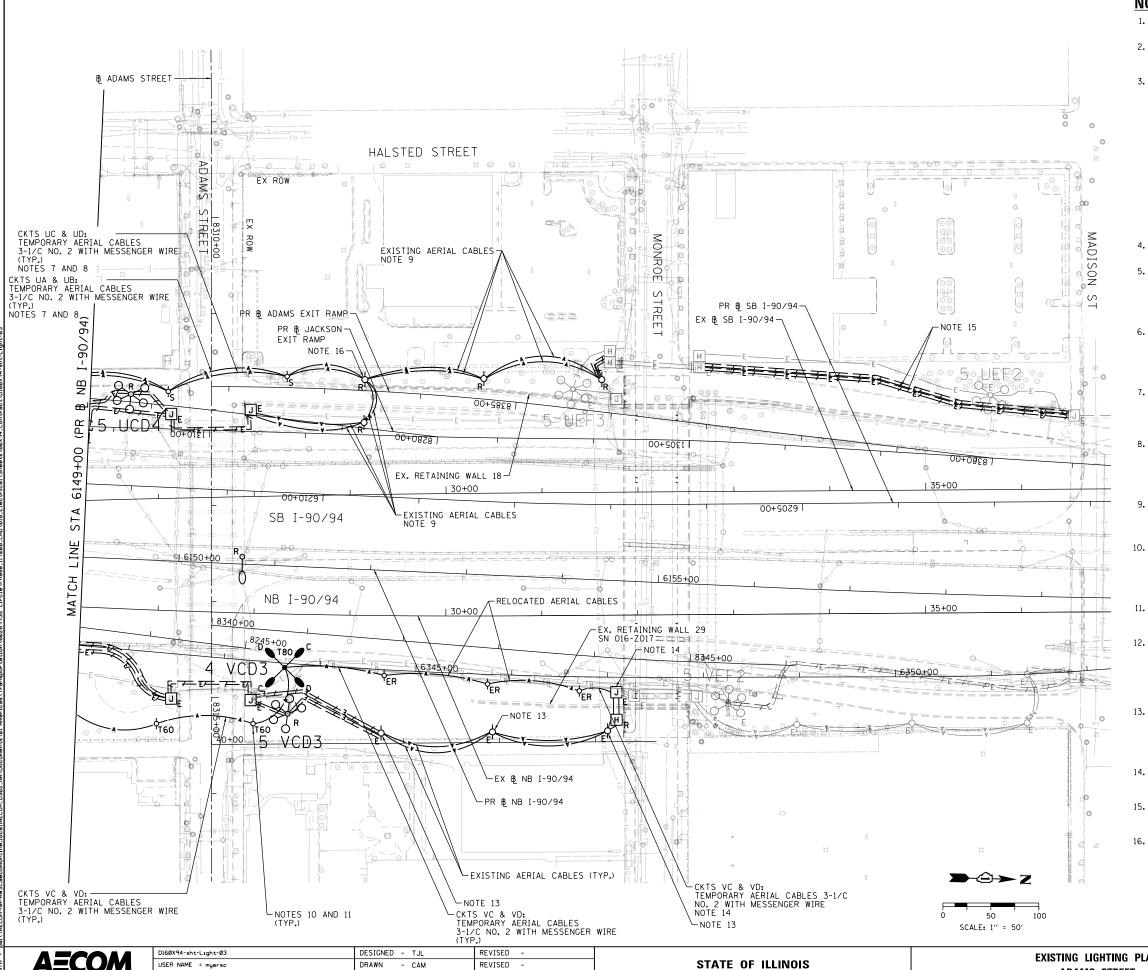

- 1. SEE DRAWING E-01 FOR IDOT ELECTRICAL SYMBOLS AND
- 2. LOCATIONS OF EXISTING ELECTRICAL EQUIPMENT SHOWN ON THIS DRAWING ARE APPROXIMATIONS AND MUST BE VERIFIED IN THE FIELD BY THE CONTRACTOR.
- 3. THE EXISTING ELECTRICAL SYSTEMS, AS DEPICTED ON THE PLANS, ARE INTENDED TO INDICATE THE GENERAL EQUIPMENT INSTALLATIONS INVOLVED AND SHALL NOT BE CONSTRUED AS AN EXACT REPRESENTATION OF THE FIELD CONDITIONS. IT IS THE CONTRACTOR'S RESPONSIBILITY TO CONFIRM AND ASCERTAIN THE EXACT CONDITION, SIZE, TYPE, QUANTITY AND LOCATION OF THE EXISTING ELECTRICAL EQUIPMENT, ANY DISCREPANCIES BETWEEN THE ACTUAL EXISTING ELECTRICAL EQUIPMENT IN THE FIELD AND THE DEPICTION OF THE EXISTING ELECTRICAL EQUIPMENT SHOWN ON THE PLANS SHALL IMMEDIATELY BE BROUGHT TO THE ATTENTION OF THE RESIDENT ENGINEER FOR RESOLUTION, FAILURE TO VERIFY THE CONDITIONS, DIMENSIONS AND DETAILS OF THE EXISTING ELECTRICAL EQUIPMENT TO CONFIRM THAT THE NEW EQUIPMENT IS COMPATIBLE WITH THE EXISTING EQUIPMENT AND CAN BE PROPERLY INSTALLED AND CONNECTED AS SHOWN ON THE PLANS WILL NOT RELIEVE THE CONTRACTOR OF THEIR RESPONSIBILITY FOR PROVIDING A SAFE, COMPLETE AND FULLY FUNCTIONAL ELECTRICAL SYSTEM.
- 4. ALL WORK SHOWN ON THIS DRAWING MUST BE COORDINATED WITH THIS CONTRACT'S CONSTRUCTION WORK AND STAGING.
- 5. IDOT CONTRACTS 62A77, 62A76 AND 60YOO WILL BE ONGOING SIMULTANEOUSLY WITH THIS CONTRACT. THE CONTRACTOR IS RESPONSIBLE FOR COORDINATING ALL ELECTRICAL WORK FOR THIS CONTRACT WITH THE WORK IN THOSE CONTRACTS. THIS COORDINATION WORK SHALL BE INCLUDED AT NO ADDITIONAL COST TO THIS CONTRACT. TO THIS CONTRACT.
- 6. ALL OF THE EXISTING LIGHTING UNITS AND LIGHTING CIRCUITS CURRENTLY FED FROM EXISTING IDOT LIGHTING CONTROLLERS SHALL REMAIN ENERGIZED DURING NIGHTTIME HOURS FOR THE DURATION OF THE CONTRACT. ANY TEMPORARY POWER REQUIRED TO KEEP THE LIGHTING SYSTEM ENERGIZED WILL BE PROVIDED BY THE CONTRACTOR AT NO ADDITIONAL COST TO THE CONTRACT.
- 7. ATTACH THE TEMPORARY AERIAL LIGHTING CIRCUIT CABLES TO THE EXISTING WOOD POLES USED FOR THE TEMPORARY ITS FEEDS. PROVIDE 50 FEET OF SLACK CABLE AT EACH WOOD POLE TO ALLOW FOR RELOCATION OF AERIAL CABLES DURING THE DISE DIFFERENT STAGES OF CONSTRUCTION.
- 8. THE TEMPORARY AERIAL LIGHTING CIRCUIT CABLES ATTACHED TO THE ITS WOOD POLES SHALL BE REMOVED ONCE THE PERMANENT LIGHTING FEEDS SHOWN ON DRAWING E-O5 HAVE BEEN INSTALLED, ENERGIZED, TESTED, AND APPROVED BY IDOT. THE REMOVAL OF THESE TEMPORARY AERIAL CABLES SHALL BE PAID FOR BY THE "REMOVE AERIAL CABLE" PAY ITEM.
- REMOVAL OF THE AERIAL CABLES ATTACHED TO THE TEMPORARY WOOD POLES TO BE REMOVED WILL NOT BE PAID FOR SEPARATELY AND SHALL BE INCLUDED IN THE COST OF THE "REMOVE TEMPORARY WOOD POLE" PAY ITEM.
- 10. THE LOCATIONS OF THE WOOD POLES SHOWN ARE APPROXIMATIONS. THE FINAL INSTALLATION LOCATION OF THE POLE SHALL BE STAKED IN THE FIELD AND APPROVED BY THE ENGINEER PRIOR TO INSTALLATION TO IDENTIFY ANY CONFLICTS WITH EXISTING/PROPOSED UTILITIES AND WORK TO BE PERFORMED BY OTHER DISCIPLINES.
- 11. PROVIDE 50 FEET OF SLACK CABLE AT EACH TEMPORARY WOOD POLE TO ALLOW FOR RELOCATION OF AERIAL CABLES DURING THE DIFFERENT STAGES OF CONSTRUCTION.
- 12. THE TEMPORARY WOOD POLES, TEMPORARY LIGHTING UNITS, AND ASSOCIATED AERIAL CABLES ALONG THE EAST SIDE OF NB I-90/94 SHALL BE REMOVED ONCE THE PERMANENT FEEDS SHOWN ON DRAWING E-05 HAVE BEEN INSTALLED, ENERGIZED, TESTED, AND APPROVED BY IDOT. ALL UNDERGROUND FEEDS SHALL BE DISCONNECTED AND ABANDONED IN PLACE UNLESS OTHERWISE NATED.
- 13. RELOCATE THE EXISTING WOOD POLES AND AERIAL CABLES FOR CIRCUITS VC AND VD WEST TO THE NEW LOCATIONS SHOWN TO AVOID CONFLICT WITH CONSTRUCTION OF RW 51. THE EXISTING AERIAL CABLES FOR CIRCUITS VA AND VB SHALL BE REMOVED AND PROPERLY DISPOSED OF. THIS WORK SHALL BE INCLUDED IN THE COST OF THE "RELOCATE EXISTING WOOD POLES" PAY ITEM.
- 14. DRILL THE EXISTING JUNCTION BOX ON THE FRONT OF EXISTING RW 29 AND CONNECT THE TEMPORARY AERIAL CABLES TO THE EXISTING LIGHTING CIRCUIT CABLES WITHIN THE JUNCTION BOX.
- 15. THE EXISTING UNDERGROUND LIGHTING CIRCUITS UA, UB, UC AND UD SHALL REMAIN ACTIVE UNTIL THE PROPOSED INFRASTRUCTURE HAS BEEN INSTALLED.
- 16. SPLICE THE PROPOSED TEMPORARY AERIAL CABLES TO THE EXISTING AERIAL CABLES.

E-03


A*ECOM* 

PLOT SCALE = 100.0000 '/ in. CHECKED - WDS REVISED PLOT DATE = 3/6/2020 DATE REVISED - 3-13-2020

**DEPARTMENT OF TRANSPORTATION** 

**EXISTING LIGHTING PLAN ADAMS STREET** SCALE: 1"=50" SHEET 3 OF 15 SHEETS STA. 6149+00 TO STA.

F.A.I. RTE. SECTION COUNTY 90/94/290 2014-015R&B-R COOK 825 276 CONTRACT NO. 60X94

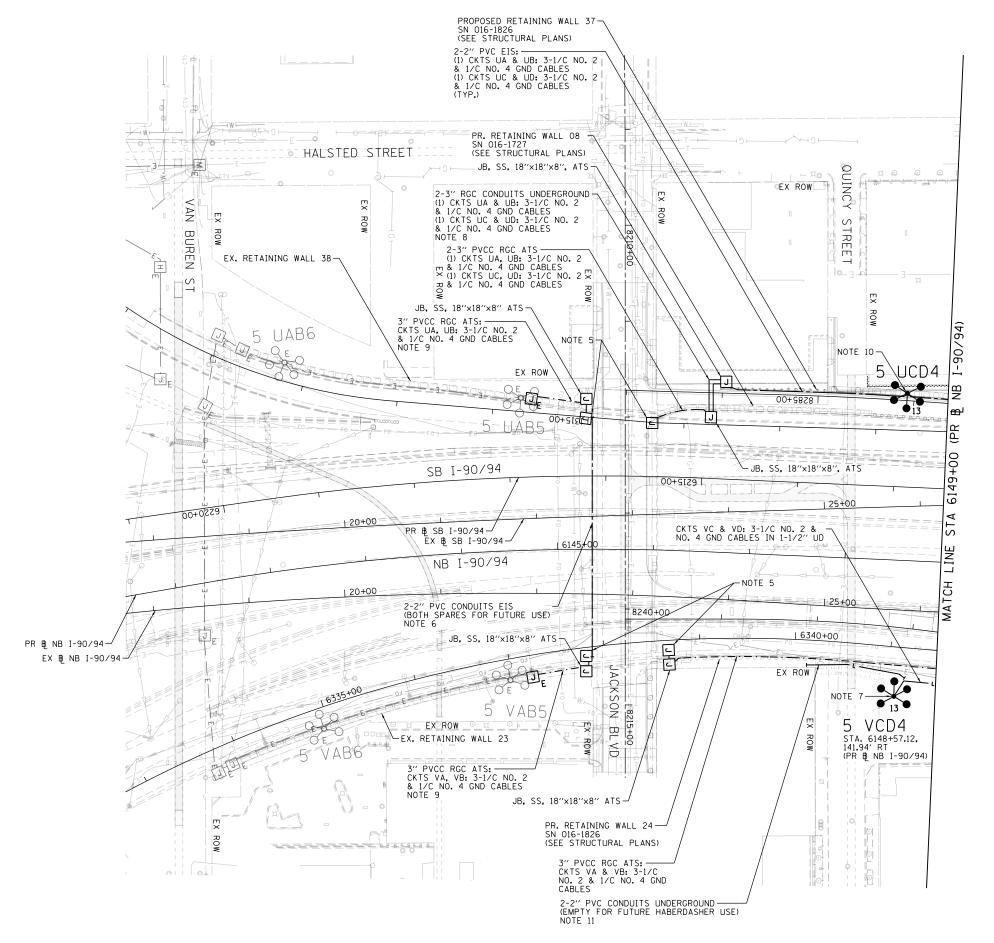

- SEE DRAWING E-01 FOR IDOT ELECTRICAL SYMBOLS AND ABBREVIATIONS.
- 2. ALL WORK SHOWN ON THIS DRAWING MUST BE COORDINATED WITH THIS CONTRACTS CONSTRUCTION WORK AND STAGING.
- 3. IDOT CONTRACTS 62A77, 62A76 AND 60Y00 WILL BE ONGOING SIMULTANEOUSLY WITH THIS CONTRACT. THE CONTRACTOR IS RESPONSIBLE FOR COORDINATING ALL ELECTRICAL WORK FOR THIS CONTRACT WITH THE WORK IN THOSE CONTRACTS. THIS COORDINATION WORK SHALL BE INCLUDED AT NO ADDITIONAL COST TO THIS CONTRACT.
- 4. LOCATIONS OF EXISTING ELECTRICAL EQUIPMENT SHOWN ON THIS DRAWING ARE APPROXIMATIONS AND MUST BE VERIFIED IN THE FIELD BY THE CONTRACTOR.
- 5. SEE DRAWING E-O7 FOR CONTINUATION OF LIGHTING CIRCUITS.
- 6. THE PROPOSED CONDUITS EMBEDDED IN THE BRIDGE PARAPET SHALL BE STUBBED OUT 6 INCHES BELOW THE BRIDGE DECK OVER THE SHOULDERS AND CAPPED AT EACH END FOR FUTURE USE. SEE "CONDUIT ROUTING DETAIL" ON DRAWING E-10 FOR ADDITIONAL INFORMATION.
- 7. SEE DRAWING E-15 FOR PROPOSED BOLLARDS TO BE INSTALLED AROUND THE LIGHT TOWER SERVICE PAD.
- 8. THE PROPOSED RGC CONDUITS SHALL BE INSTALLED UNDER THE PROPOSED JACKSON EXIT RAMP. ROUTED THROUGH THE CONDUIT SLEEVES INSTALLED IN PROPOSED RETAINING WALL 08, AND TERMINATE INSIDE THE JUNCTION BOX ATTACHED TO THE FRONT FACE OF THE PROPOSED RETAINING WALL.
- 9. DRILL THE EXISTING JUNCTION BOX AND CONNECT THE PROPOSED LIGHTING CIRCUIT CABLES TO THE EXISTING LIGHTING CIRCUIT CABLES INSIDE THE JUNCTION BOX.
- 10. SEE THE STRUCTURAL DRAWINGS FOR ADDITIONAL INFORMATION REGARDING THE LIGHT TOWER FOUNDATION INTEGRAL TO PROPOSED RETAINING WALL 37.
- 11. ROUTE TWO 2-INCH PVC CONDUITS (EMPTY) FROM THE WEST SIDE OF THE HABERDASHER BUILDING BETWEEN THE EXISTING RETAINING WALL AT THE END OF QUINCY STREET AND PROPOSED RETAINING WALL NO. 24 TO THE GRASS AREA AS SHOWN. PROVIDE PULL CORDS AND CAP BOTH ENDS OF THE CONDUIT FOR FUTURE USE BY HABERDASHER. INSTALL THESE CONDUITS AFTER THE RETAINING WALL NO. 24 WORK HAS BEEN COMPLETED.

0 50 100 SCALE: 1" = 50'

E-04




DI60X94-sht-Light-04	DESIGNED - TJL	REVISED -
USER NAME = myersc	DRAWN - CAM	REVISED -
PLOT SCALE = 100.0000 ' / in.	CHECKED - WDS	REVISED -
PLOT DATE = 3/6/2020	DATE - 3-13-2020	REVISED -


STATE OF ILLINOIS
DEPARTMENT OF TRANSPORTATION

					LIGHTIN N BOULE	G PLAN VARD	
SCALE: 1"=50"	SHEET	4	OF	15	SHEETS	STA.	


F.A.I. SECTION COUNTY TOTAL SHEET NO. 90/94/290 2014-015R&B-R COOK 825 277

TO STA, 6149+00 IILLINOIS|FED. AID PROJECT

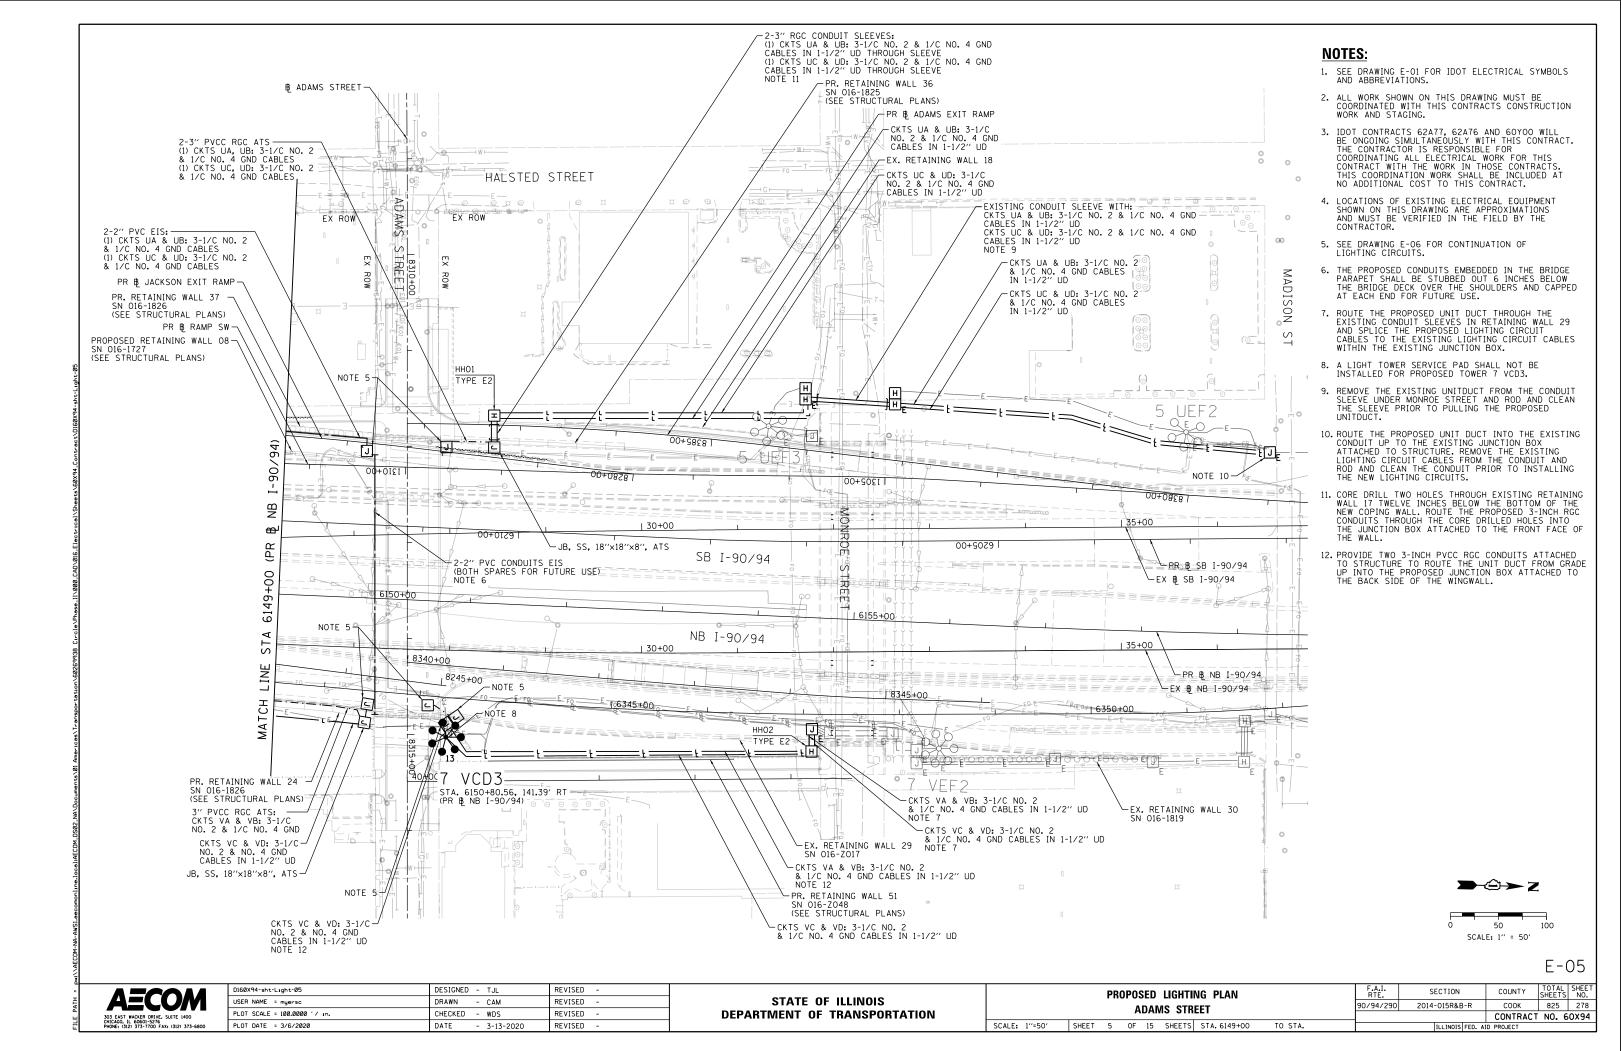

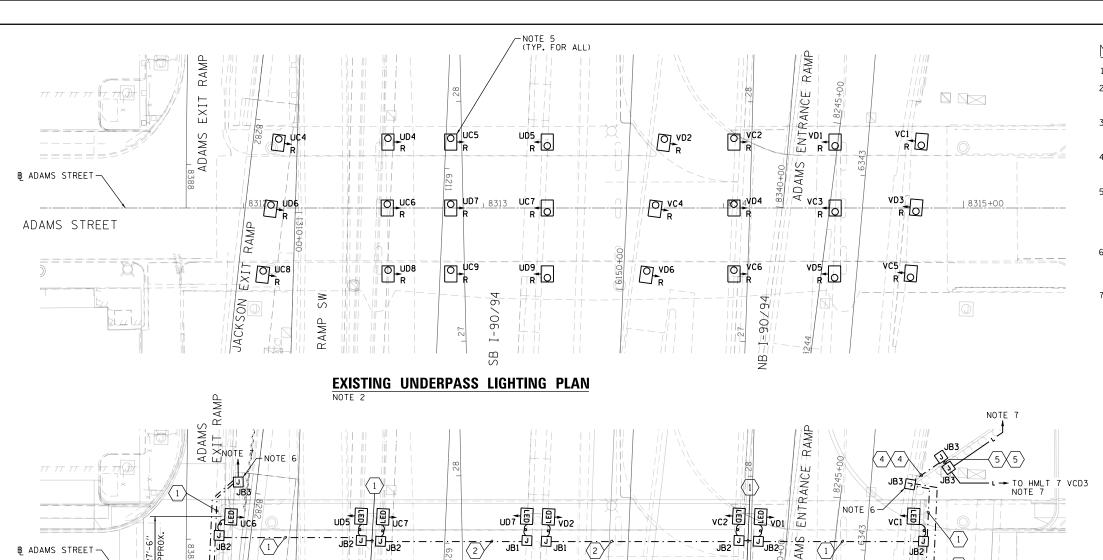

- 1. SEE DRAWING E-01 FOR IDOT ELECTRICAL SYMBOLS.
- 2. LOCATIONS OF EXISTING ELECTRICAL EQUIPMENT SHOWN ON THIS DRAWING ARE APPROXIMATIONS AND MUST BE VERIFIED IN THE FIELD BY THE CONTRACTOR.
- 3. SEE IDOT STANDARD DRAWING BE-903 FOR ADDITIONAL INSTALLATION DETAILS FOR THE PROPOSED PIER/ABUTMENT WALL MOUNTED UNDERPASS LUMINAIRES.
- 4. ALL PROPOSED UNDERPASS LIGHTING UNITS SHOWN ON THIS DRAWING WILL BE FED FROM EXISTING IDOT LIGHTING CONTROLLERS "U" AND
- 5. THE REMOVAL OF EXISTING UNDERPASS LUMINAIRES MUST INCLUDE THE REMOVAL OF ALL CABLES, CONDUIT, JUNCTION BOXES, AND HARDWARE ASSOCIATED WITH THE EXISTING UNDERPASS LIGHTING. COST FOR THIS WORK WILL NOT BE PAID FOR SEPARATELY BUT WILL BE INCLUDED AS PART OF THE "REMOVAL OF LIGHTING UNIT, NO SALVAGE" PAY ITEM.
- 6. PROVIDE TERMINAL BLOCKS AND 30A FUSES IN THE JUNCTION BOX FOR SPLICING THE NO. 10 UNDERPASS LIGHTING WIRES TO THE NO. 2 LIGHTING CIRCUITS WIRES. SEE DRAWING E-10 FOR TYPICAL UNDERPASS LIGHTING UNIT WIRING DIAGRAM.
- 7. SEE DRAWING E-05 FOR CONTINUATION OF THE LIGHTING CIRCUIT ROUTING.

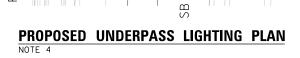

UCB UD9

. 185 <u>1</u>195-

11 B 8317

₩c10 SON

JACK EXIT

JB2

JB3

NOTE

JUNCTION BOX SCHEDULE					
SIZE	SIZE DESCRIPTION				
6"X6"X	6"X6"X4" STAINLESS STEEL, ATTACHED TO STRUCTURE, UNDERPASS LIGHTING				
12′′X10′′	STAINLESS STEEL, ATTACHED TO STRUCTURE, UNDERPASS LIGHTING				
18''X18''X	STAINLESS STEEL, ATTACHED TO STRUCTURE, UNDERPASS LIGHTING				

JB1

I-90/94

UC9 E VC4

ND11 A 181

			CABLE / CONDUIT SCHEDULE							
ACHED 'ASS			3-1/C*10, 1-1/C*10 GND IN 1" DIA PVCC RGC ATTACHED TO STRUCTURE (CKTS AS INDICATED ON THIS DRAWING)							
		2	2-1/C#10, 1-1/C#10 GND IN 1" DIA PVCC RGC ATTACHED TO STRUCTURE (CKTS AS INDICATED ON THIS DRAWING)							
ACHED 'ASS		3	2-1/C*10, 1-1/C*10 GND IN 3/4" DIA LIOUID TIGHT FLEXIBLE CONDUIT (CKTS AS INDICATED ON THIS DRAWING)							
ACHED 'ASS		4	3-1/C*2, 1-1/C*4 GND IN 3" DIA PVCC RGC ATTACHED TO STRUCTURE (CKTS AS INDICATED ON THIS DRAWING)							
		5	3-1/C#2, 1-1/C#4 GND IN 3" DIA PVC EMBEDDED IN STRUCTURE (CKTS AS INDICATED ON THIS DRAWING)							

VD4 B VC3

-- JB2 6 3 JB2 VC6 B V05

JB2

J<sub>B2</sub>+

90794


LED LED UNDERPASS LUMINAIRE TYPE D

JB2 g

VC5 E

NOTE 7

TYPICAL(3)

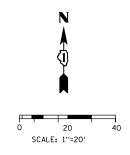

COUNTY

E-06

COOK 825 279 CONTRACT NO. 60X94

<b>AECOM</b>	
303 EAST WACKER DRIVE, SUITE 1400 CHICAGO, IL 60601-5276 PHONE: (312) 373-7700 FAX: (312) 373-6800	


B ADAMS STREET

ADAMS STREET

DI60X94-sht-Light-06	DESIGNED - TJL	REVISED -
USER NAME = myersc	DRAWN - CAM	REVISED -
PLOT SCALE = 40.0000 ' / in.	CHECKED - WDS	REVISED -
PLOT DATE = 3/6/2020	DATE - 3-13-2020	REVISED -

STATE OF ILLINOIS	
DEPARTMENT OF TRANSPORTATION	

	UNDERPASS LIGHTING PLAN ADAMS STREET							F.A.I. RTE.	SECTION	
								90/94/290	2014-015R&B-R	
					DAI				l	
	SCALE: 1"=20"	SHEET	6	OF	15	SHEETS	STA.	TO STA.		ILLINOIS FE

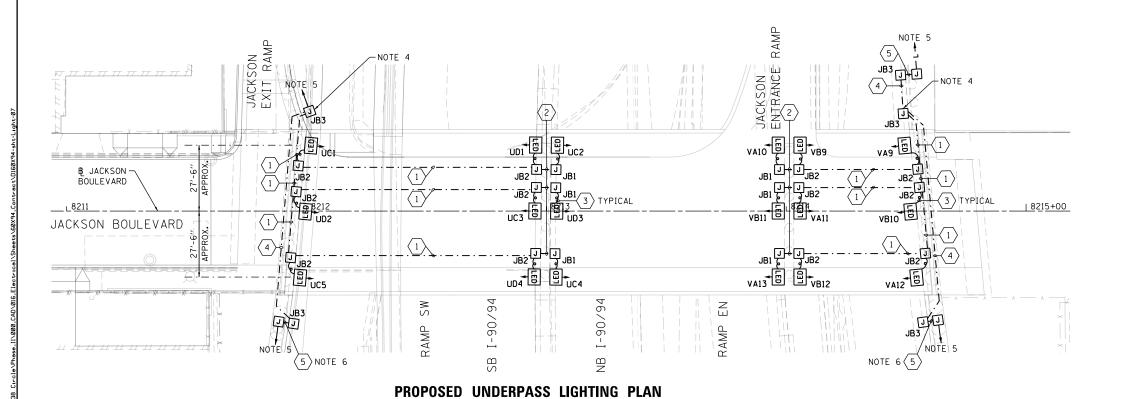

## LED LED UNDERPASS LUMINAIRE TYPE D

		JUNCTION BOX SCHEDULE					
$\overline{\ }$		DESCRIPTION	SIZE	NO.			
$\langle 1 \rangle$		STAINLESS STEEL, ATTACHED TO STRUCTURE, UNDERPASS	6′′X6′′X4′′	JB1			
(2)		LIGHTING	JBI 6"X6"X4"				
		STAINLESS STEEL. ATTACHED					
3		TO STRUCTURE, UNDERPASS LIGHTING	12''X10''X6''	JB2			
4		STAINLESS STEEL, ATTACHED TO STRUCTURE, UNDERPASS LIGHTING	18''X18''X8''	JB3			
(5)	J						

			CABLE / CONDUIT SCHEDULE						
_			3-1/C*10, 1-1/C*10 GND IN 1" DIA PVCC RGC ATTACHED TO STRUCTURE (CKTS AS INDICATED ON THIS DRAWING)						
_		2	2-1/C*10, 1-1/C*10 GND IN 1" DIA PVCC RGC ATTACHED TO STRUCTURE (CKTS AS INDICATED ON THIS DRAWING)						
,		3	2-1/C*10, 1-1/C*10 GND IN 3/4" DIA LIQUID TIGHT FLEXIBLE CONDUIT (CKTS AS INDICATED ON THIS DRAWING)						
)		4	3-1/C*2, 1-1/C*4 GND IN 3" DIA PVCC RGC ATTACHED TO STRUCTURE (CKTS AS INDICATED ON THIS DRAWING)						
	1	5	3-1/C*2, 1-1/C*4 GND IN 3" DIA PVC EMBEDDED IN STRUCTURE (CKTS AS INDICATED ON THIS DRAWING)						

	N (1)		
0	-		7
-	20 SCALE: 1'' =	201	40
•	SCALE: I -	20	

E-07

AECOM
303 EAST WACKER ORIVE. SUITE 1400
CNICACO, II. 60601-5276
PHONE: 1312 373-7700 FAX: (3121 373-6800

D160X94-sht-L1ght-07	DESIGNED - TJL	REVISED -	
USER NAME = myersc	DRAWN - CAM	REVISED -	
PLOT SCALE = 40.0000 '/ in.	CHECKED - WDS	REVISED -	
PLOT DATE = 3/6/2020	DATE - 3-13-2020	REVISED -	

STATE OF ILLINOIS
DEPARTMENT OF TRANSPORTATION

		UND	ERP	ASS	LIGHT	ING PLAN	
		J	JACK	(SOI	N BOUL	.EVARD	
SCALE: 1"=20"	SHEET	7	0F	15	SHEETS	STA.	TO STA.

NOTES:

1. SEE DRAWING E-01 FOR IDOT ELECTRICAL SYMBOLS.

2. SEE IDOT STANDARD DRAWING BE-903 FOR ADDITIONAL INSTALLATION DETAILS FOR THE PROPOSED PIER/ABUTMENT WALL MOUNTED UNDERPASS LUMINAIRES.


3. ALL PROPOSED UNDERPASS LIGHTING UNITS SHOWN ON THIS DRAWING WILL BE FED FROM EXISTING IDOT LIGHTING CONTROLLERS "U" AND

4. PROVIDE TERMINAL BLOCKS AND 30A FUSES IN THE JUNCTION BOX FOR SPLICING THE NO. 10 UNDERPASS LIGHTING WIRES TO THE NO. 2 LIGHTING CIRCUITS WIRES. SEE DRAWING E-10 FOR TYPICAL UNDERPASS LIGHTING UNIT WIRING DIAGRAM.

5. SEE DRAWING E-04 FOR CONTINUATION OF THE LIGHTING CIRCUIT ROUTING.

6. SEE DRAWING E-10 FOR THE CONDUIT ROUTING THROUGH JACKSON WINGWALL DETAIL.

	ILL INOIS	FFD. AT	D PROJECT		
			CONTRACT	NO. 6	OXS
/94/290	2014-015R&B	-R	соок	825	28
F.A.I. RTE.	SECTION		COUNTY	TOTAL SHEETS	SHE

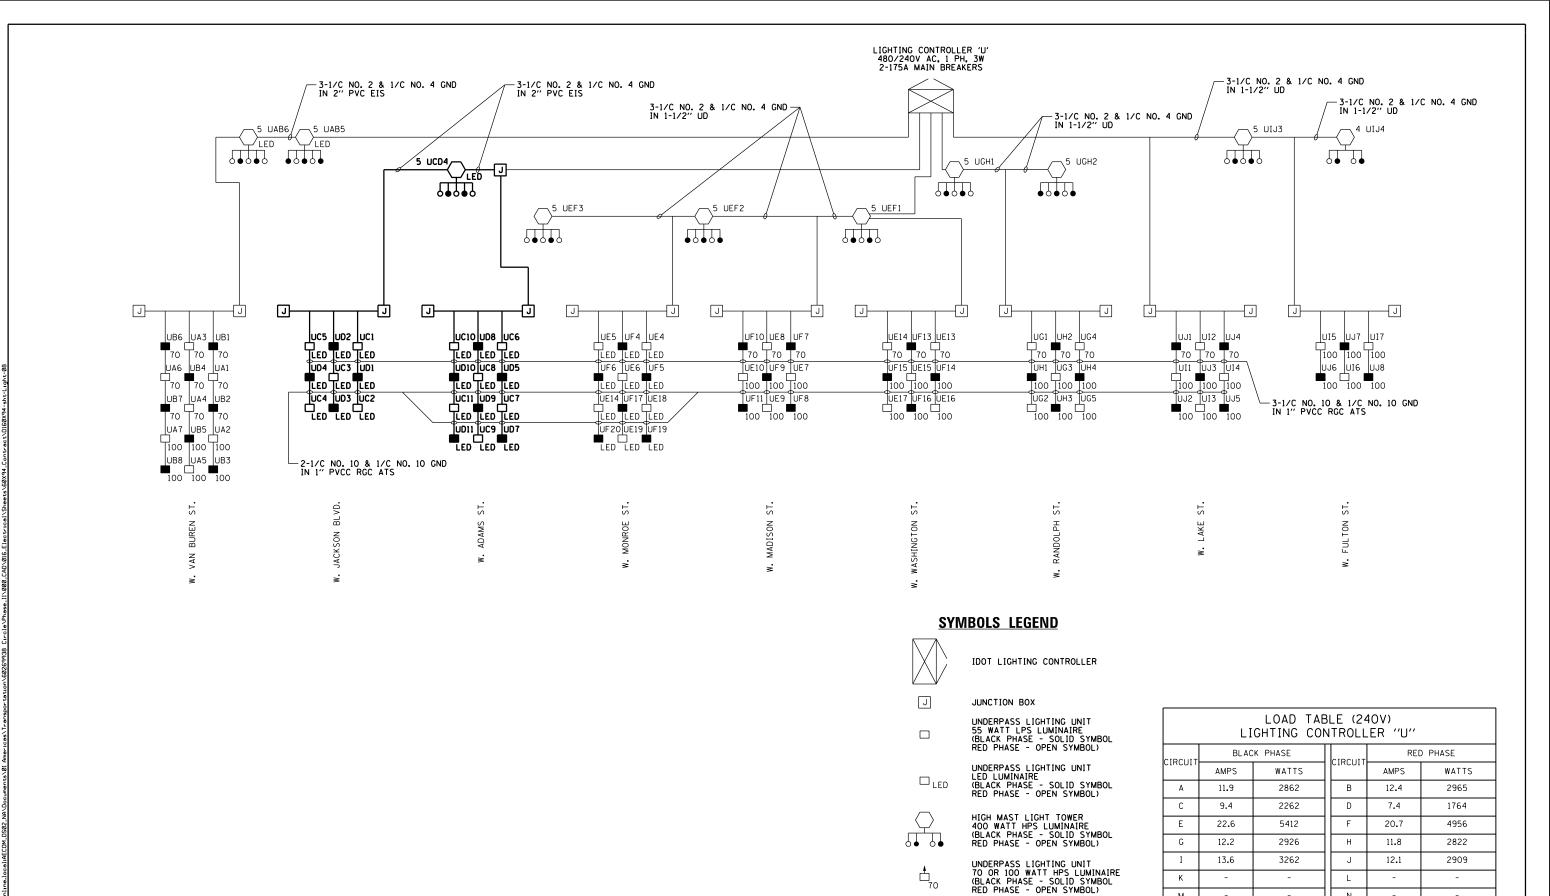

<b>AECOM</b>
303 EAST WACKER DRIVE, SUITE 1400 CHICAGO, IL 60601-5276

D160X94-sht-Light-08 DESIGNED - TJL REVISED -USER NAME = myersc DRAWN - CAM REVISED -PLOT SCALE = 40.0000 ' / 10. CHECKED - WDS REVISED -PLOT DATE = 3/6/2020 DATE REVISED - 3-13-2020

STATE OF ILLINOIS **DEPARTMENT OF TRANSPORTATION** 

IDOT LIGHTING CONTROLLER 'U' WIRING DIAGRAM SCALE: N.T.S. SHEET 8 OF 15 SHEETS STA.

HIGH MAST LIGHT TOWER

LED LUMINAIRE
(BLACK PHASE - SOLID SYMBOL)
RED PHASE - OPEN SYMBOL)

М

0

TOTAL

69.7

TO STA.

16723

F.A.I. RTE. SECTION COUNTY 90/94/290 2014-015R&B-R

64.2

N

TOTAL


**→**②→ Z

E-08

-

15416

COOK 825 281 CONTRACT NO. 60X94

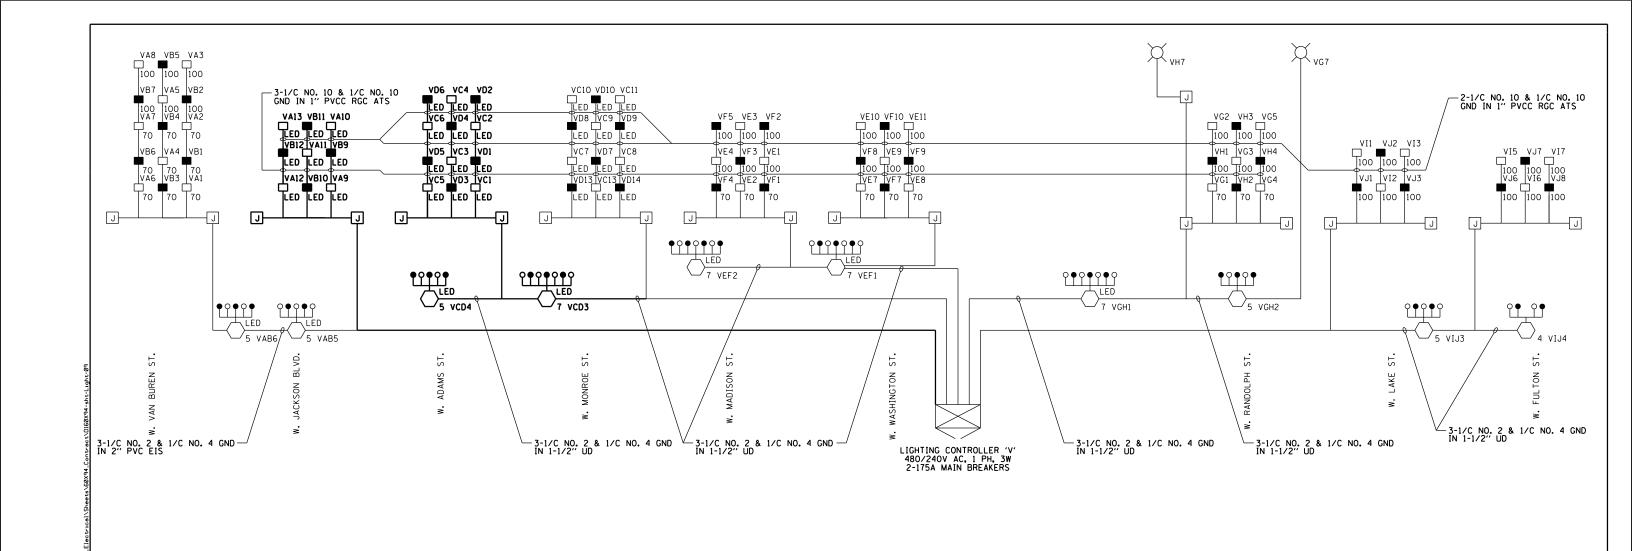

### SYMBOLS LEGEND

 $\Box_{\mathsf{LED}}$ 

IDOT LIGHTING CONTROLLER

J JUNCTION BOX

UNDERPASS LIGHTING UNIT 55 WATT LPS LUMINAIRE (BLACK PHASE - SOLID SYMBOL RED PHASE - OPEN SYMBOL)

UNDERPASS LIGHTING UNIT LED LUMINAIRE (BLACK PHASE - SOLID SYMBOL RED PHASE - OPEN SYMBOL)

HIGH MAST LIGHT TOWER 400 WATT HPS LUMINAIRE (BLACK PHASE - SOLID SYMBOL RED PHASE - OPEN SYMBOL)

UNDERPASS LIGHTING UNIT 70 OR 100 WATT HPS LUMINAIRE (BLACK PHASE - SOLID SYMBOL RED PHASE - OPEN SYMBOL)

HIGH MAST LIGHT TOWER LED LUMINAIRE (BLACK PHASE - SOLID SYMBOL RED PHASE - OPEN SYMBOL)

LOAD TABLE (240V) LIGHTING CONTROLLER "V"									
CIDCUIT	BLACK PHASE			RED	) PHASE				
CIRCUIT	AMPS	WATTS	CIRCUIT	AMPS	WATTS				
Α	15.1	3613	В	16.4	3930				
С	18.8	4500	D	17.7	4248				
E	20.6	4938	F	20.6	4938				
G	16.9	4046	Н	16.7	3997				
I	16.0	3839	J	14.1	3383				
K	-	-	L	-	-				
М	-	-	N	-	-				
0	-	-	Р	-	-				
TOTAL	87.2	20936	TOTAL	85.4	20496				



TO STA.

E-09




D160X94-sht-L1ght-09 DESIGNED - TJL REVISED -USER NAME = myersc DRAWN - CAM REVISED -PLOT SCALE = 40.0000 '/ in. CHECKED - WDS REVISED -PLOT DATE = 3/6/2020 DATE - 3-13-2020 REVISED -


STATE OF ILLINOIS **DEPARTMENT OF TRANSPORTATION** 

IDOT LIGHTING CONTROLLER 'V' WIRING DIAGRAM SCALE: N.T.S. SHEET 9 OF 15 SHEETS STA.

F.A.I. RTE. COUNTY SECTION 2014-015R&B-R COOK 825 282 90/94/290 CONTRACT NO. 60X94

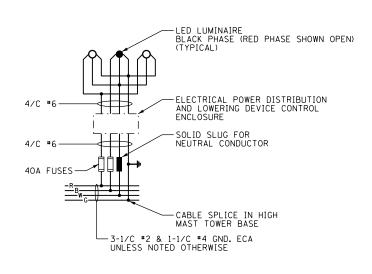


LED UNDERPASS LUMINAIRE BLACK PHASE (RED PHASE SHOWN OPEN) -1/C #10 (TYPICAL) **30A FUSES** NOTE 2 - JUNCTION BOX MOUNTED ON ABUTMENT WALL -SOLID SLUG FOR NEUTRAL CONDUCTOR NOTE 2 -CABLE SPLICE IN JUNCTION BOX MOUNTED ON ABUTMENT WALL -3-1/C #2 & 1-1/C #4 GND. ECA UNLESS NOTED OTHERWISE

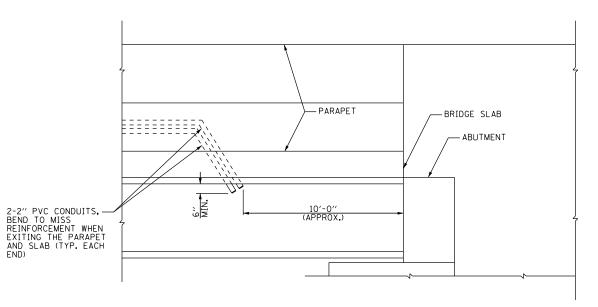


TYPICAL HIGH MAST LIGHT TOWER WIRING DIAGRAM NOT TO SCALE

TYPICAL UNDERPASS LIGHTING UNIT WIRING DIAGRAM NOT TO SCALE

CONDUIT ROUTING DETAIL NOT TO SCALE

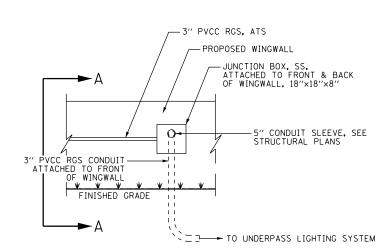

CONDUIT ROUTING THROUGH JACKSON WINGWALL DETAIL NOT TO SCALE

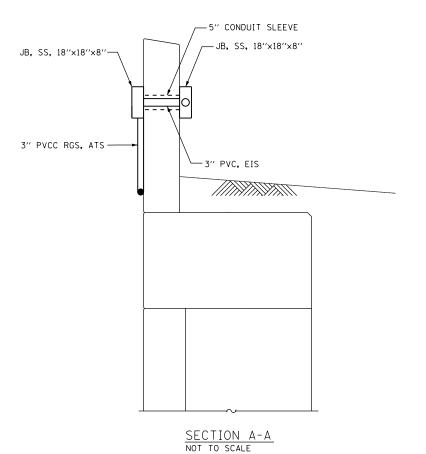


- 1. SEE DRAWING E-01 FOR IDOT ELECTRICAL SYMBOLS.
- 2. THE FUSES, FUSE HOLDERS, AND SOLID SLUGS SHALL BE PROVIDED ACCORDING TO ARTICLE 1065.01 OF THE IDOT STANDARDS. THE COST OF PROVIDING THE FUSES, FUSE HOLDERS, AND SOLID SLUGS IN THE JUNCTION BOX WILL NOT BE PAID FOR SEPARATELY AND WILL BE INCLUDED IN THE COST OF THE JUNCTION BOX IN WHICH THEY ARE INSTALLED.
- 3. SEE IDOT STANDARDS BE-506 AND BE-511 FOR LIGHT TOWER FOUNDATION DETAILS.
- 4. THE SCHEDULE ON THIS DRAWING REPLACES THE "SHAFT LENGTH (D) TABLE" SHOWN ON IDOT STANDARDS BE-506 AND BE-511.


D160X94-sht-L1ght-10 DESIGNED - TJL REVISED USER NAME = myersc DRAWN - CAM REVISED PLOT SCALE = 40.0000 ' / 10. CHECKED - WDS REVISED PLOT DATE = 3/6/2020 DATE REVISED - 3-13-2020

STATE OF ILLINOIS **DEPARTMENT OF TRANSPORTATION** 

**ELECTRICAL DETAILS** 90/94/290 2014-015R&B-R SCALE: N.T.S. SHEET 10 OF 15 SHEETS STA. TO STA.

SECTION COUNTY COOK 825 283 CONTRACT NO. 60X94

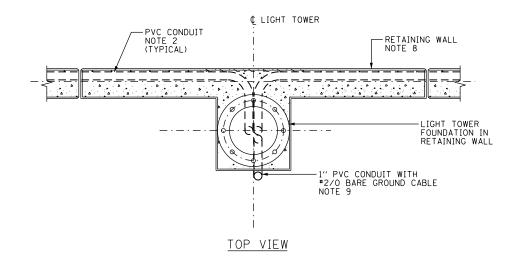

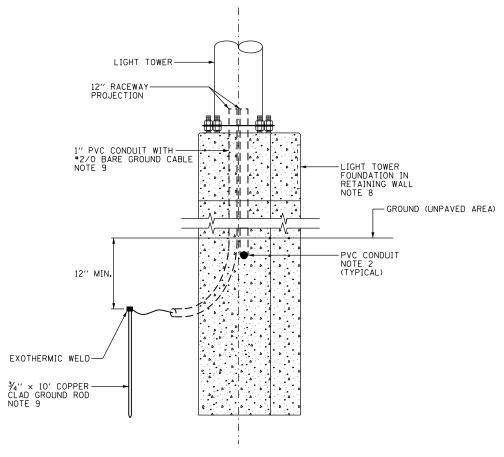


SIDE ELEVATION VIEW


CONDUIT INSTALLATION DETAIL

FOR HIGH MAST LIGHT TOWER FOUNDATION

IN RETAINING WALL

NOT TO SCALE

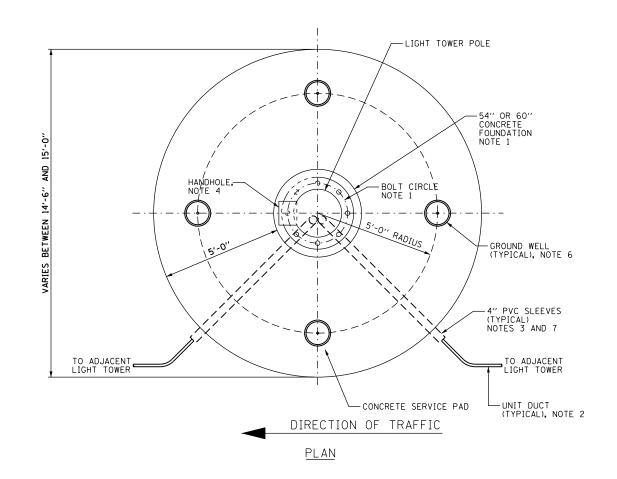

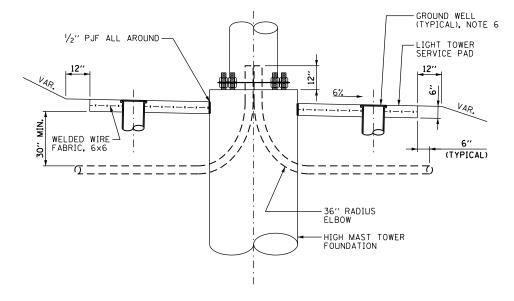

ELEVATION - SHOWN WITHOUT CURB

GROUND MOUNTED HIGH MAST TOWER SERVICE PAD,
GROUNDING AND CONDUIT INSTALLATION DETAILS
NOT TO SCALE

### NOTES:

- 1. SEE IDOT STANDARD DRAWING BE-506 AND BE-511 FOR ADDITIONAL HIGH MAST LIGHT TOWER FOUNDATION AND GROUND WELL DETAILS.
- SEE ELECTRICAL PLAN DRAWINGS FOR QUANTITY, SIZE, AND TYPE OF RACEWAY AND LIGHTING CIRCUITS ROUTED TO EACH HIGH MAST LIGHT TOWER FOUNDATION.
- 3. PVC SLEEVES MUST BE EXTENDED 6 INCHES BEYOND THE EDGE OF THE CONCRETE PAD.
- 4. THE HANDHOLE FOR THE HIGH MAST LIGHTING UNIT MUST BE ORIENTED SUCH THAT IT IS MOUNTED ON THE SIDE OF THE POLE THAT IS OPPOSITE THE DIRECTION OF TRAFFIC.
- 5. ALL EMPTY SLEEVES MUST BE CAPPED UNLESS NOTED OTHERWISE ON THE PLANS.
- 6. INSTALL GROUND WELLS 5'-O" AS MEASURED FROM THE CENTER LINE OF THE HIGH MAST TOWER TO THE CENTER LINE OF THE WELL.
- 7. PVC CONDUIT SLEEVES SHALL BE INCLUDED IN THE COST OF THE LIGHT TOWER FOUNDATION AND SHALL NOT BE PAID FOR SEPARATELY.
- 8. SEE STRUCTURAL PLANS FOR THE FOUNDATION INSTALLATION DESIGN DETAILS.
- 9. ALL NECESSARY WORK AND MATERIALS FOR GROUNDING SHALL BE INCLUDED IN THE COST OF THE RETAINING WALL.

AECOM

303 EAST WACER DRIVE, SUITE 1400

WILDON IN GERON 6572E

 DI68X94-sht-Light-II
 DESIGNED
 - TJL
 REVISED

 USER NAME = myersc
 DRAWN
 - CAM
 REVISED

 PLOT SCALE = 2.0000 ' / in.
 CHECKED
 - WDS
 REVISED

 PLOT DATE
 = 3/6/2020
 DATE
 - 3-13-2020
 REVISED


STATE OF ILLINOIS
DEPARTMENT OF TRANSPORTATION


LIGHT TOWER SERVICE PAD AND CONDUIT DETAILS

SCALE: N.T.S. | SHEET | 11 OF 15 SHEETS | STA. TO STA.


F.A.I. SECTION COUNTY TOTAL SHEETS NO. 90/94/290 2014-015R&B-R COOK 825 284

CONTRACT NO. 60X94

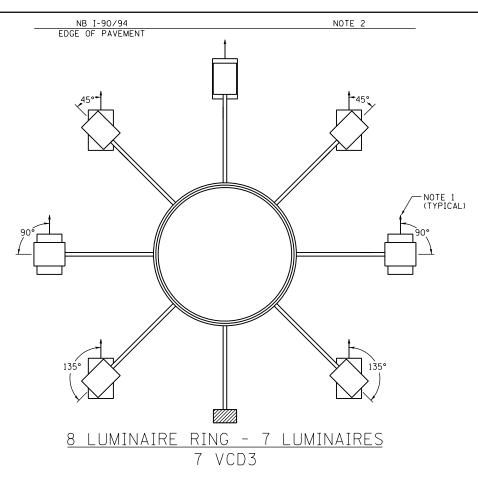

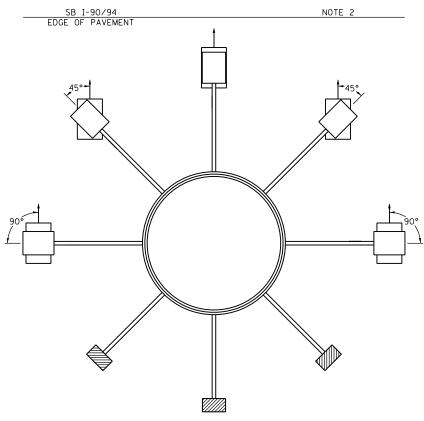

8 LUMINAIRE RING - 5 LUMINAIRES 5 UCD4

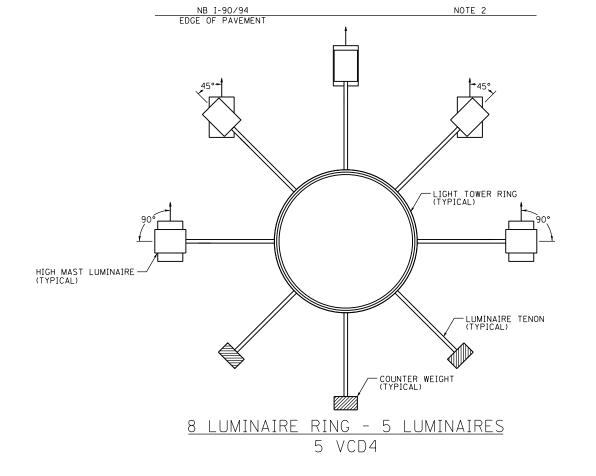

### NOTES:

- 1. LUMINAIRE DISTRIBUTION PATTERN DIRECTION AS INDICATED BY ARROW.
- 2. ROTATE THE LUMINAIRES TOWARDS THE ROADWAY AS SHOWN.

VIEW LOOKING FROM TOP OF LIGHT TOWERS


E-12

D160X94-sht-L1ght-12 DESIGNED - TJL REVISED -USER NAME = myersc DRAWN - CAM REVISED -PLOT SCALE = 40.0000 ' / in. CHECKED - WDS REVISED -PLOT DATE = 3/6/2020 DATE - 3-13-2020 REVISED -

STATE OF ILLINOIS **DEPARTMENT OF TRANSPORTATION** 


HIGH MAST LIGHT TOWER LUMINAIRE ORIENTATION SCALE: N.T.S. SHEET 12 OF 15 SHEETS STA.

COUNTY | TOTAL | SHEET | NO. | COOK | 825 | 285 | CONTRACT | NO. | 60X94 SECTION 2014-015R&B-R 90/94/290

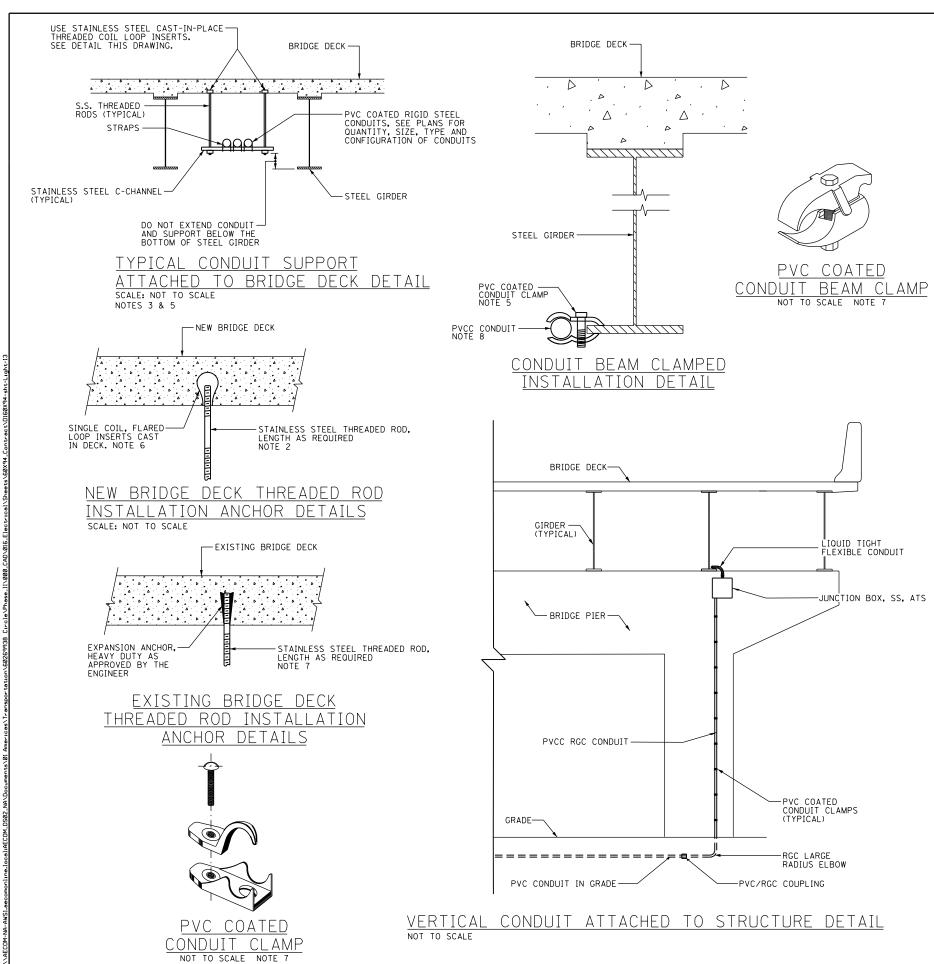


- 1. THE CONTRACTOR IS RESPONSIBLE FOR DETERMINING THE MEANS AND METHODS FOR ATTACHING CONDUITS AND JUNCTION BOXES TO A STRUCTURE. ALL WORK REQUIRED TO ATTACH CONDUIT TO STRUCTURES MUST COMPLY WITH SECTION 811 OF THE STANDARD SPECIFICATIONS AND ALL MATERIALS MUST COMPLY WITH SECTION 1088 OF THE STANDARD SPECIFICATIONS.
- THE CONTRACTOR MUST COORDINATE THREADED ROD END SIZES WITH THE C-CHANNEL AND FLARED LOOP INSERT MANUFACTURERS.
- 3. THE CONDUIT SUPPORT SYSTEM ATTACHED TO THE BRIDGE STRUCTURE, INCLUDING THE CONCRETE INSERTS AND MOUNTING HARDWARE, WILL NOT BE PAID FOR SEPARATELY, AND SHALL BE INCLUDED IN THE COST FOR THE "CONDUIT ATTACHED TO STRUCTURE" PAY
- 4. SEE PLAN DRAWINGS FOR THE PROPOSED CONDUIT ROUTING.
- ALL MOUNTING HARDWARE FOR THE PVCC RGC CONDUIT MUST BE PVC COATED.

- THE CONTRACTOR MUST USE APPROVED SINGLE COIL FLARED LOOP INSERTS WHEN PENDANT MOUNTING THREADED RODS TO A NEW BRIDGE DECK. THE FLARED LOOP INSERTS MUST BE CAST INTO THE CONCRETE DECK. THE CONTRACTOR IS RESPONSIBLE FOR LOCATING THE INSERT LOCATIONS IN THE FIELD AND COORDINATING ALL WORK WITH THE BRIDGE DECK CONSTRUCTION.
- 7. SECURE THE CONDUIT WITH PVC COATED CONDUIT CLAMPS OR CONDUIT BEAM CLAMPS AS SHOWN AT 5'-0" INTERVALS FOR LATERALS AND WITHIN 2'-0" MAXIMUM FROM ANY JUNCTION BOX, FLEXIBLE CONDUIT, OR CHANGE IN DIRECTION. ALL PVC COATED CONDUIT CLAMPS OR BEAM CLAMPS WILL BE INCLUDED WITH THE COST OF THE "CONDUIT ATTACHED TO STRUCTURE" PAY ITEM.
- 8. ALL CONDUIT ATTACHED TO STRUCTURE SHALL BE PVC COATED RIGID STEEL CONDUIT (PVCC RGC) TYPICAL.

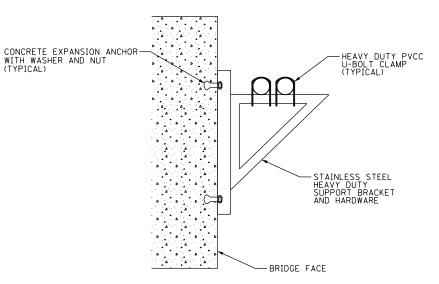

MOUNTING BRACKET FOR MULTIPLE CONDUITS NOT TO SCALE

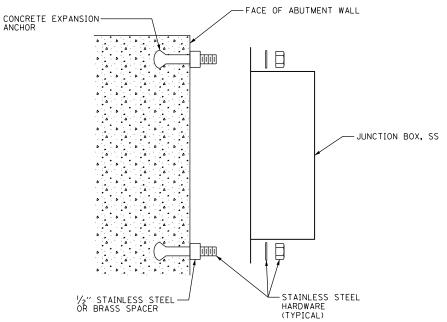

JUNCTION BOX MOUNTED TO STRUCTURE NOT TO SCALE


A*ECOM* 

DESIGNED - TJL REVISED DRAWN - CAM REVISED CHECKED - WDS REVISED DATE - 3-13-2020 REVISED


F.A.I. RTE. SECTION COUNTY 90/94/290 2014-015R&B-R COOK 825 286 CONTRACT NO. 60X94

E-13


1160X94-sht-Light-13 STATE OF ILLINOIS USER NAME = myersc MISCELLANEOUS ELECTRICAL DETAILS PLOT SCALE = 40.0000 ' / In. **DEPARTMENT OF TRANSPORTATION** SCALE: N.T.S. SHEET 13 OF 15 SHEETS STA. TO STA. PLOT DATE = 3/6/2020

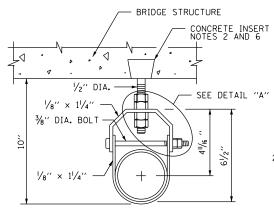



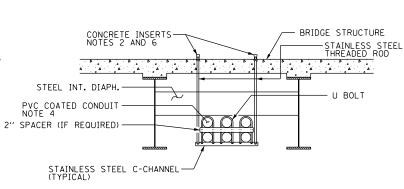



CONDUIT SUPPORT ATTACHED TO BRIDGE WITH DIAPHRAGM DETAIL NOTES 2 AND 3

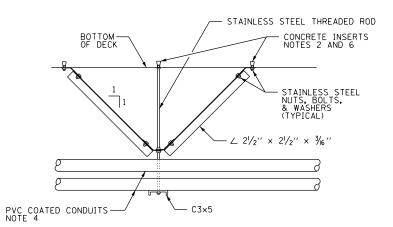


### CENTERING DEVICE DETAIL - SIDE VIEW

(LOCATED ONLY ON A HANGER ADJACENT TO PIER)

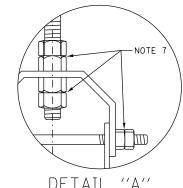


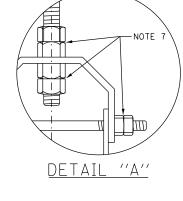

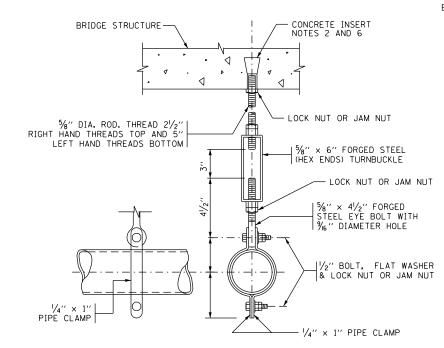


# HANGER ASSEMBLY

EACH HANGER ASSEMBLY SHALL CONSIST OF CONCRETE INSERT, STAINLESS STEEL ROD, PIPE CLAMPS, NUTS, BOLTS, WASHERS, TURNBUCKLE AND EYE BOLT

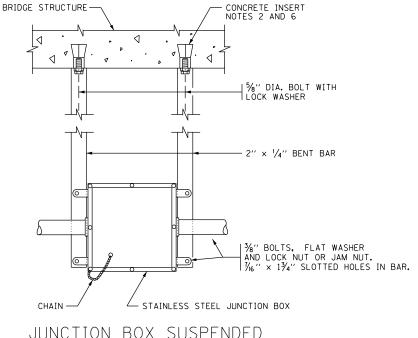

JUNCTION BOX SUSPENDED STRUCTURE DETAILS NOTE 5

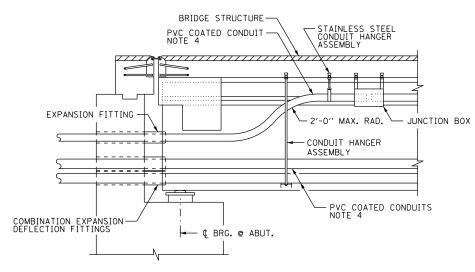

### LONGITUDINAL SECTION

- 1. THE CONTRACTOR IS RESPONSIBLE FOR DETERMINING THE MEANS AND METHODS FOR ATTACHING CONDUITS AND JUNCTION BOXES TO A STRUCTURE. ALL WORK REQUIRED TO ATTACH CONDUIT TO STRUCTURES MUST COMPLY WITH SECTION 811 OF THE STANDARD SPECIFICATIONS AND ALL MATERIALS MUST COMPLY WITH SECTION 1088 OF THE STANDARD SPECIFICATIONS.
- 2. SEE DRAWING E-13 FOR ADDITIONAL CONDUIT MOUNTING DETAILS AND FOR DETAILS REGARDING THE INSTALLATION OF CONCRETE INSERTS.
- 3. THE CONDUIT SUPPORT SYSTEM ATTACHED TO THE BRIDGE STRUCTURE, INCLUDING THE CONCRETE INSERTS AND MOUNTING HARDWARE, WILL NOT BE PAID FOR SEPARATELY, AND SHALL BE INCLUDED IN THE COST FOR THE "CONDUIT ATTACHED TO STRUCTURE" PAY ITEM.
- 4. SEE THE PLAN DRAWINGS FOR THE PROPOSED CONDUIT ROUTING.
- 5. THE JUNCTION BOX SUPPORT SYSTEM ATTACHED TO THE BRIDGE STRUCTURE, INCLUDING THE CONCRETE INSERTS AND ALL MOUNTING HARDWARE, WILL NOT BE PAID FOR SEPARATELY, AND SHALL BE INCLUDED IN THE COST FOR THE "JUNCTION BOX, STAINLESS STEEL, ATTACHED TO STRUCTURE" PAY ITEM.
- 6. SPACE INSERTS AT 10 FOOT (MAXIMUM) CENTERS.
- 7. PROVIDE STAINLESS STEEL DOUBLE NUTS, JAM NUTS OR LOCK NUTS FOR THIS INSTALLATION.
- 8. PROVIDE CONDUIT SLEEVES IN THE BRIDGE ABUTMENT AS REQUIRED TO ROUTE THE CONDUITS THROUGH THE STRUCTURE AS SHOWN. THE DIAMETER OF THE SLEEVES SHALL BE A MINIMUM OF 2 INCHES LARGER IN DIAMETER THAN THE DIAMETER OF THE CONDUIT. PROVIDE WATERPROOF SEALANT IN THE INTERSTITIAL SPACE BETWEEN THE SLEEVE AND THE CONDUIT.

DI60X94-sht-Light-14	DESIGNED - TJL	REVISED -
USER NAME = myersc	DRAWN - CAM	REVISED -
PLOT SCALE = 40.0000 ' / in.	CHECKED - WDS	REVISED -
PLOT DATE = 3/6/2020	DATE - 3-13-2020	REVISED -


STATE OF ILLINOIS **DEPARTMENT OF TRANSPORTATION** 

	MISCI	ELLA	NEO	JS I	ELECTRIC	CAL DETAILS	
SCALE: N.T.S.	SHEET	14	OF	15	SHEETS	STA.	TO STA.


F.A.I. RTE.	SE	CTION		соι	JNTY	TOTAL SHEETS	SHEE NO.
90/94/290	2014-	·015R&E	8-R	C	ок	825	287
				CON	ITRACT	NO.	60X94
		ILLINOIS	FED. A	ID PROJE	CT		

- NOTES:

  1. SEE DRAWING E-11 FOR ADDITIONAL LIGHT TOWER SERVICE PAD DETAILS.
- 2. THE CONTRACTOR SHALL STAKE THE FINAL LOCATIONS OF THE BOLLARDS IN THE FIELD FOR THE ENGINEER'S REVIEW AND APPROVAL PRIOR TO STARTING ANY WORK.
- 3. THE BOLLARDS SHALL BE PAINTED. COLOR SHALL BE SAFETY YELLOW.
- 4. COORDINATE THE LOCATION OF THE CONDUIT SLEEVES AND BOLLARDS TO AVOID CONFLICT.

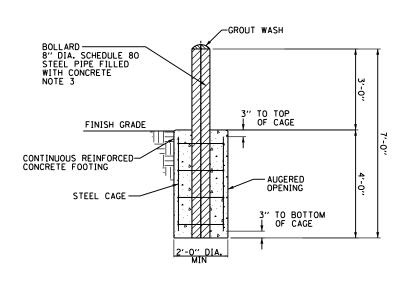

### BOLLARD DETAIL (NOT TO SCALE)

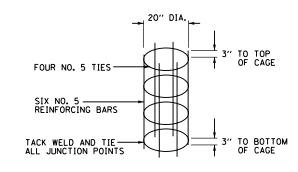

ISOMETRIC VIEW OF STEEL CAGE (NOT TO SCALE)

# BOLLARD INSTALLATION AT SERVICE PAD DETAIL FOR LIGHT TOWER 5 VCD4 ONLY NOT TO SCALE

**ELEVATION** 

<u>PL AN</u>

-LIGHT TOWER 5 VCD4

-CONDUIT SLEEVE (TYP.) NOTE 4

LIGHT TOWER SERVICE PAD NOTE 1

2'-0" TYP.

-CONCRETE SERVICE PAD FOR LIGHT TOWER 5 VCD4 NOTE 1

HIGH MAST TOWER FOUNDATION

BOLLARD AND CONCRETE FOUNDATION (TYPICAL)

-BOLLARD AND CONCRETE FOUNDATION (8 TOTAL) NOTE 2

-LIGHTWEIGHT CONCRETE FILL (TYPICAL)



CONDUIT SLEEVE-

D160X94-sht-L1ght-15	DESIGNED - TJL	REVISED -
USER NAME = myersc	DRAWN - CAM	REVISED -
PLOT SCALE = 40.0000 '/ in.	CHECKED - WDS	REVISED -
PLOT DATE = 3/6/2020	DATE - 3-13-2020	REVISED -

STATE OF ILLINOIS **DEPARTMENT OF TRANSPORTATION** 

LIGH	T TOWI	ER	SERVI	CE	PAD A	AND COM	IDUIT DETAILS
SCALE: N.T.S.	SHEET	15	OF	15	SHEETS	S STA.	TO STA.

F.A.I. RTE. COUNTY SECTION 2014-015R&B-R COOK 825 288 90/94/290 CONTRACT NO. 60X94

### **SEQUENCING NOTES:**

- 1. IMPLEMENTATION OF INTELLIGENT TRANSPORTATION SYSTEMS (ITS) TO BE PERFORMED IN COORDINATION WITH CONCURRENT CONTRACTS 60X79, 60X93, 62J31, 60Y00, 62A76, AND 62A77, THESE CONTRACTS REMOVE EXISTING ITS ELEMENTS AND INSTALL CONDUIT, HANDHOLES/JUNCTION BOXES, ITS CABINETS, CABLING, ITS DEVICE STRUCTURES, AND OTHER INFRASTRUCTURE THAT MUST BE COORDINATED WITH WORK DESCRIBED HEREIN. STAGES REFERENCED IN THESE PLANS CORRELATES TO STAGES OF CONSTRUCTION FROM THE CONCURRENT CONTRACTS.
- 2. IN GENERAL, ITS EQUIPMENT IDENTIFIED FOR REMOVAL OR SALVAGING TO BE REMOVED/SALVAGED IN THE CONSTRUCTION STAGE THAT INCLUDES WORK AROUND THE ITS SITE. LIKEWISE, ITS INFRASTRUCTURE INSTALLATION TO TAKE PLACE IN THE CONSTRUCTION STAGE THAT INCLUDES WORK AROUND THE
- 3. WORK THAT IMPACTS THE NORMAL OPERATION OF THE TRAFFIC MANAGEMENT OR COMMUNICATIONS SYSTEMS SHALL ONLY BE EXECUTED ON WEEKENDS FROM 10 PM FRIDAY EVENING TO 4 AM MONDAY MORNING. HOLIDAYS AND SPECIAL EVENT WEEKENDS SHALL BE EXCLUDED. THE CONTRACTOR SHALL COORDINATE AND RECEIVE PRIOR APPROVAL FROM THE ENGINEER FOR ALL WORK THAT COULD DEGRADE OR IMPAIR THE OPERATIONAL SYSTEMS. REQUESTS FOR APPROVAL SHALL BE MADE TO THE ENGINEER A MINIMUM OF 72 HOURS PRIOR TO THE ACTUAL COMMENCEMENT OF THE WORK.

### **GENERAL NOTES:**

- 1. EXISTING/TEMPORARY ITS PLAN SHEETS DEPICT EXISTING CONDITIONS AND WORK TO BE PERFORMED TO MAINTAIN, REMOVE, SALVAGE, OR ABANDON EXISTING ITS INFRASTRUCTURE, PROPOSED ITS PLAN SHEETS DEPICT NEW ITS INFRASTRUCTURE TO BE INSTALLED, PROPOSED ITS SHEETS ALSO SHOW ITS INFRASTRUCTURE INSTALLED BY OTHERS IN CONCURRENT CONTRACTS AS EXISTING, WITH THE APPLICABLE CONTRACT NUMBER NOTED.
- 2. NOTATION FOR THE EXISTING/TEMPORARY ITS SHEETS IS AS FOLLOWS: - MAINTAINED = ITS INFRASTRUCTURE AND ITS OPERATION TO BE MAINTAINED THROUGH THE CONTRACT PERIOD (UNLESS OTHERWISE NOTED). THIS WORK IS TO BE PERFORMED UNDER THE "MAINTAINING ITS DURING CONSTRUCTION" PAY ITEM.

REMOVED = ITS INFRASTRUCTURE AND ITS OPERATION TO BE MAINTAINED UNTIL NO LONGER FEASIBLE DUE TO OTHER WORK IN THIS OR ANOTHER CONTRACT. ITEM(S) TO BE REMOVED AND DISPOSED OF. THIS WORK WILL NOT BE PAID FOR SEPARATELY AND WILL BE INCLUDED IN THE COST OF THE "REMOVE EXISTING SURVEILLANCE EQUIPMENT" PAY ITEM.

- SALVAGED = ITS INFRASTRUCTURE AND ITS OPERATION TO BE MAINTAINED UNTIL NO LONGER FEASIBLE DUE TO OTHER WORK IN THIS OR ANOTHER CONTRACT. ITEM(S) TO BE REMOVED AND TURNED OVER TO IDOT DISTRICT 1. THIS WORK WILL NOT BE PAID FOR SEPARATELY AND WILL BE INCLUDED IN THE COST OF THE "REMOVE EXISTING SURVEILLANCE

- ABANDONED = ITS INFRASTRUCTURE AND ITS OPERATION TO BE MAINTAINED UNTIL NO LONGER FEASIBLE DUE TO OTHER WORK IN THIS OR ANOTHER CONTRACT.

- 3. THE EXISTING ITS INFRASTRUCTURE, AS DEPICTED ON THE PLANS, IS INTENDED TO INDICATE THE GENERAL EQUIPMENT INSTALLATIONS INVOLVED AND SHALL NOT BE CONSTRUED AS AN EXACT REPRESENTATION OF THE FIELD AND SHALL NOT BE CONSTRUED AS AN EXACT REPRESENTATION OF THE FIELD CONDITIONS. IT IS THE CONTRACTOR'S RESPONSIBILITY TO CONFIRM ASCERTAIN THE EXACT CONDITION, SIZE, TYPE, QUANTITY, AND LOCATION OF THE EXISTING ITS EQUIPMENT IN THE FIELD. ANY DISCREPANCIES BETWEEN THE ACTUAL EXISTING ITS EQUIPMENT IN THE FIELD AND THE EXISTING ITS EQUIPMENT AS DEPICTED ON THE PLANS SHALL IMMEDIATELY BE BROUGHT TO THE ATTENTION OF THE RESIDENT ENGINEER FOR RESOLUTION. FAILURE TO VERIFY THE CONDITIONS, DIMENSIONS, AND DETAILS OF THE EXISTING ITS EQUIPMENT TO CONFIRM THAT THE NEW EQUIPMENT IS COMPATIBLE WITH THE EXISTING EQUIPMENT CAN BE PROPERLY INSTALLED AND CONNECTED AS SHOWN ON THE PLANS SHALL NOT RELIEVE THE CONTRACTOR OF THEIR RESPONSIBILITY FOR PROVIDING SAFE, COMPLETE, AND FULLY FUNCTIONAL ITS INFRASTRUCTURE.
- 4. LOCATIONS SHOWN FOR PROPOSED ITS INFRASTRUCTURE ARE DIAGRAMMATIC ONLY, UNLESS STATIONING AND OFFSET VALUES ARE PROVIDED. FINAL LOCATIONS FOR PROPOSED ITS ITEMS SHALL BE AS APPROVED BY THE

### ABBREVIATIONS:

ATTACHED TO STRUCTURE CCTV CLOSED-CIRCUIT TELEVISION DIA DIAMETER

EMBEDDED IN STRUCTURE

EIS ENC ENCASED IN CONCRETE, REINFORCED

ΕX EXISTING

GS HDHH GALVANIZED STEEL HEAVY-DUTY HANDHOLE

ITS INTELLIGENT TRANSPORTATION SYSTEM

JUNCTION BOX POLYVINYL CHLORIDE

JB PVC PVCC GS PVC COATED GALVANIZED STEEL RADAR VEHICLE SENSING DEVICE

RVDS SINGLE MODE FIBER

SS STAINLESS STEEL

LINDERGROUND

UG WVDS WIRELESS VEHICLE DETECTION SYSTEM




D160X94-SHT-ITS-01	DESIGNED - PTJ	REVISED -
USER NAME = myersc	DRAWN - CAM	REVISED -
PLOT SCALE = 100.0000 ' / in.	CHECKED - MJL	REVISED -
PLOT DATE = 3/6/2020	DATE - 3-13-2020	REVISED -


STATE OF ILLINOIS **DEPARTMENT OF TRANSPORTATION** 


	SUGGES				ED ITS IG AND	PLAN GENERA	L NOTES
SCALE: N.T.S	SHEET	1	OF	14	SHEETS	STA.	TO STA.


F.A.I. RTE.	SECTION	COUNTY	TOTAL SHEETS	SHEET NO.
/94/290	2014-015R&B-R	соок	825	289
		CONTRACT	NO. 6	0X94
	ILLINOIS FED. AI	D PROJECT		


ITS-01

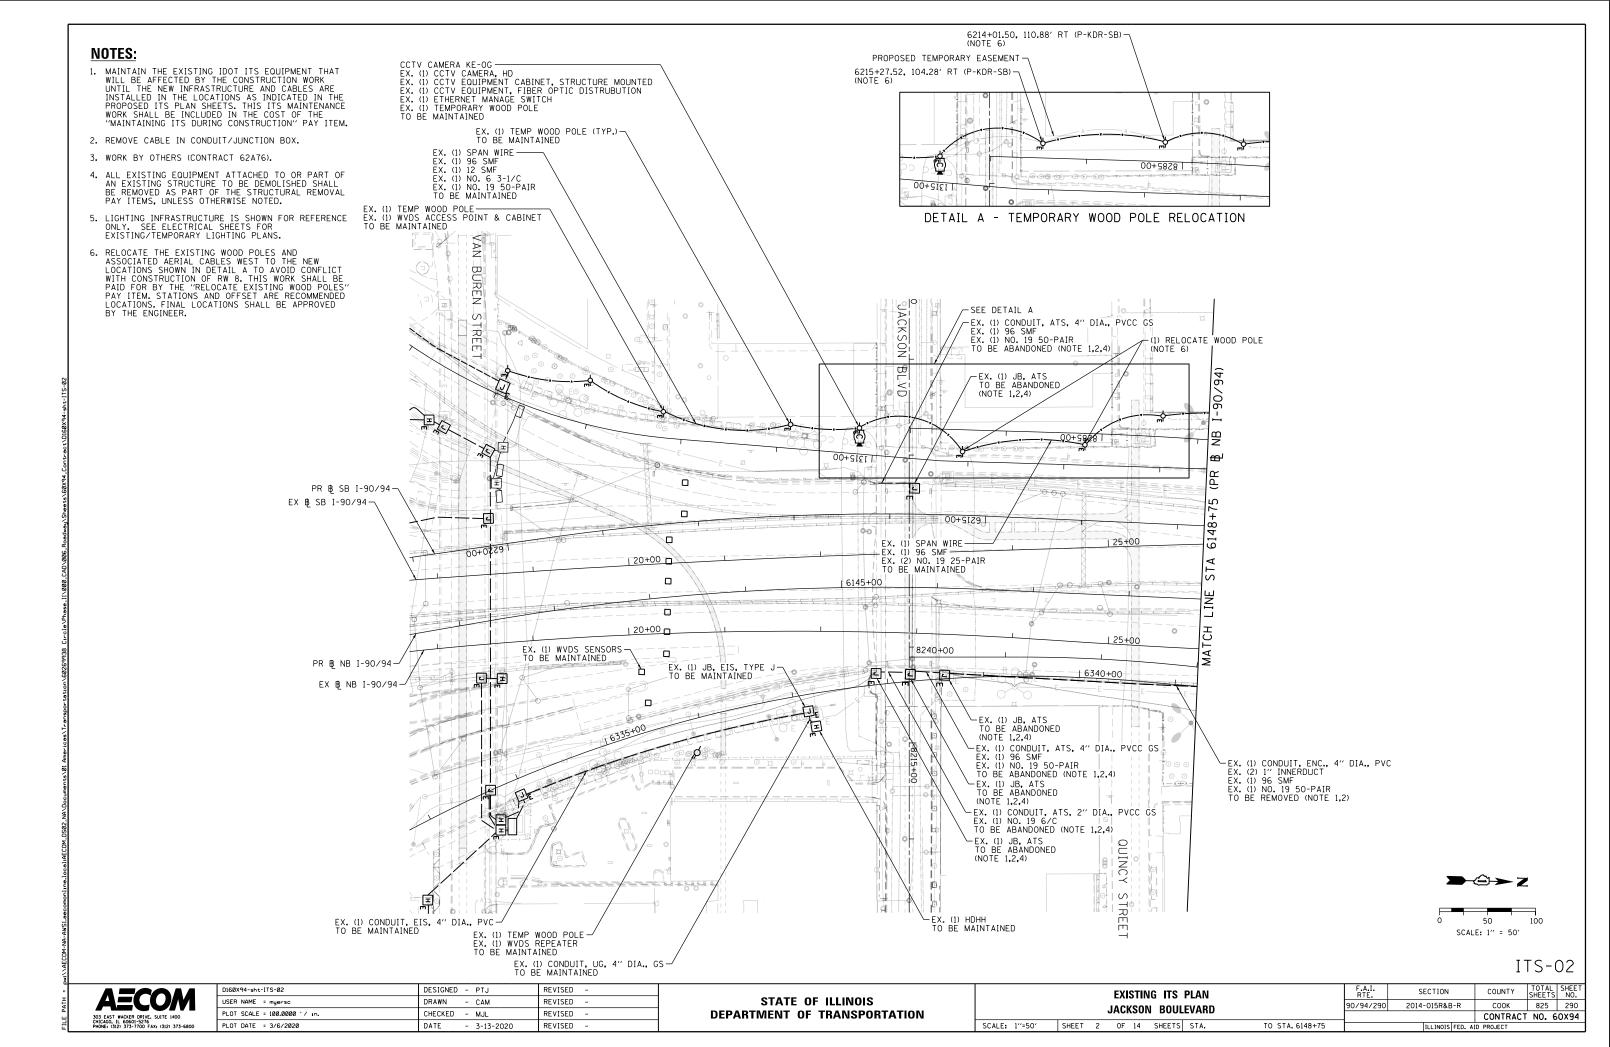

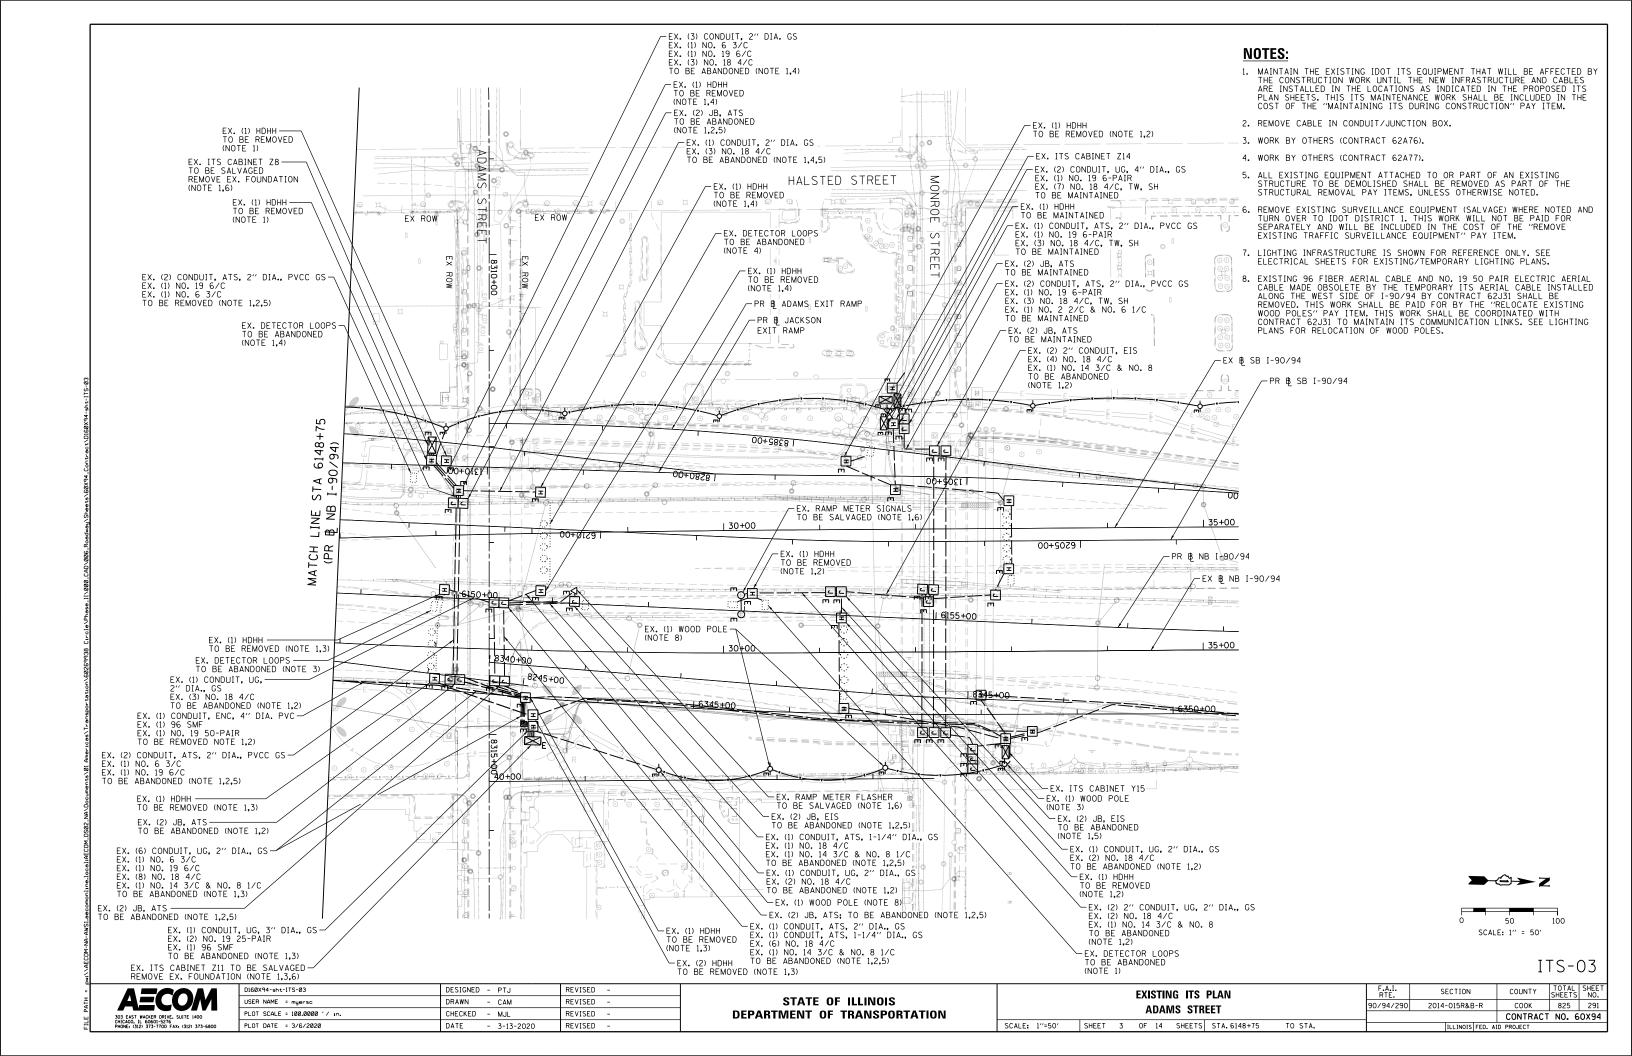


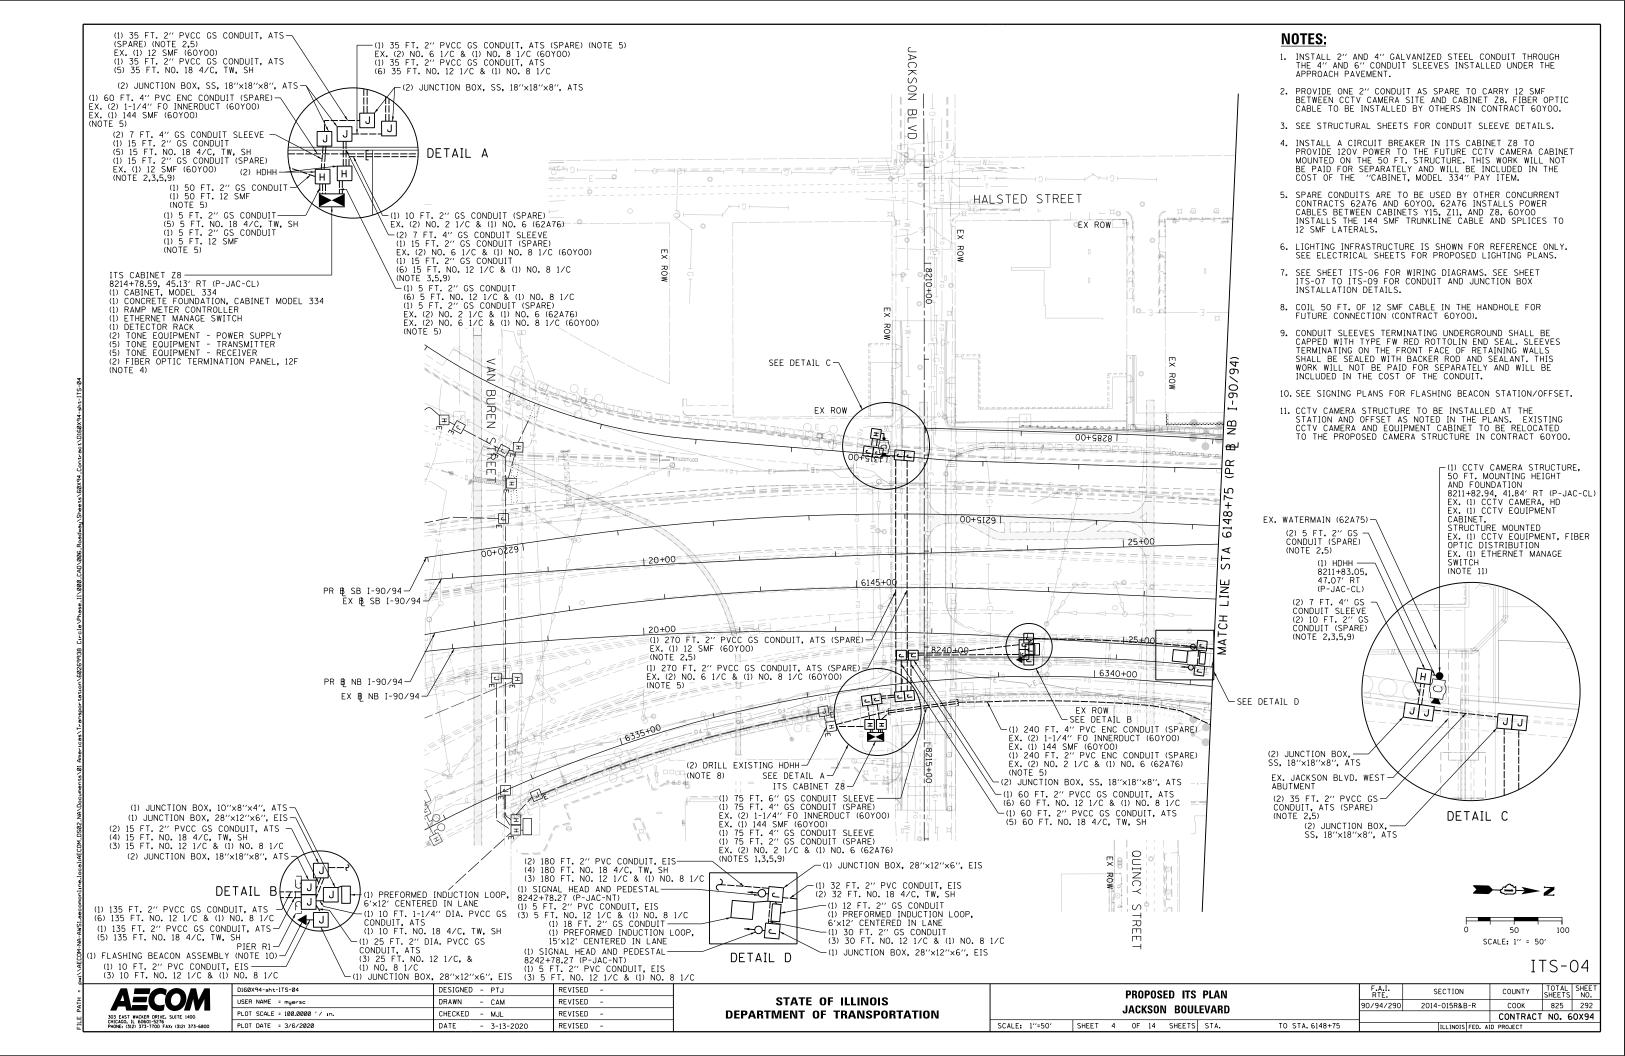

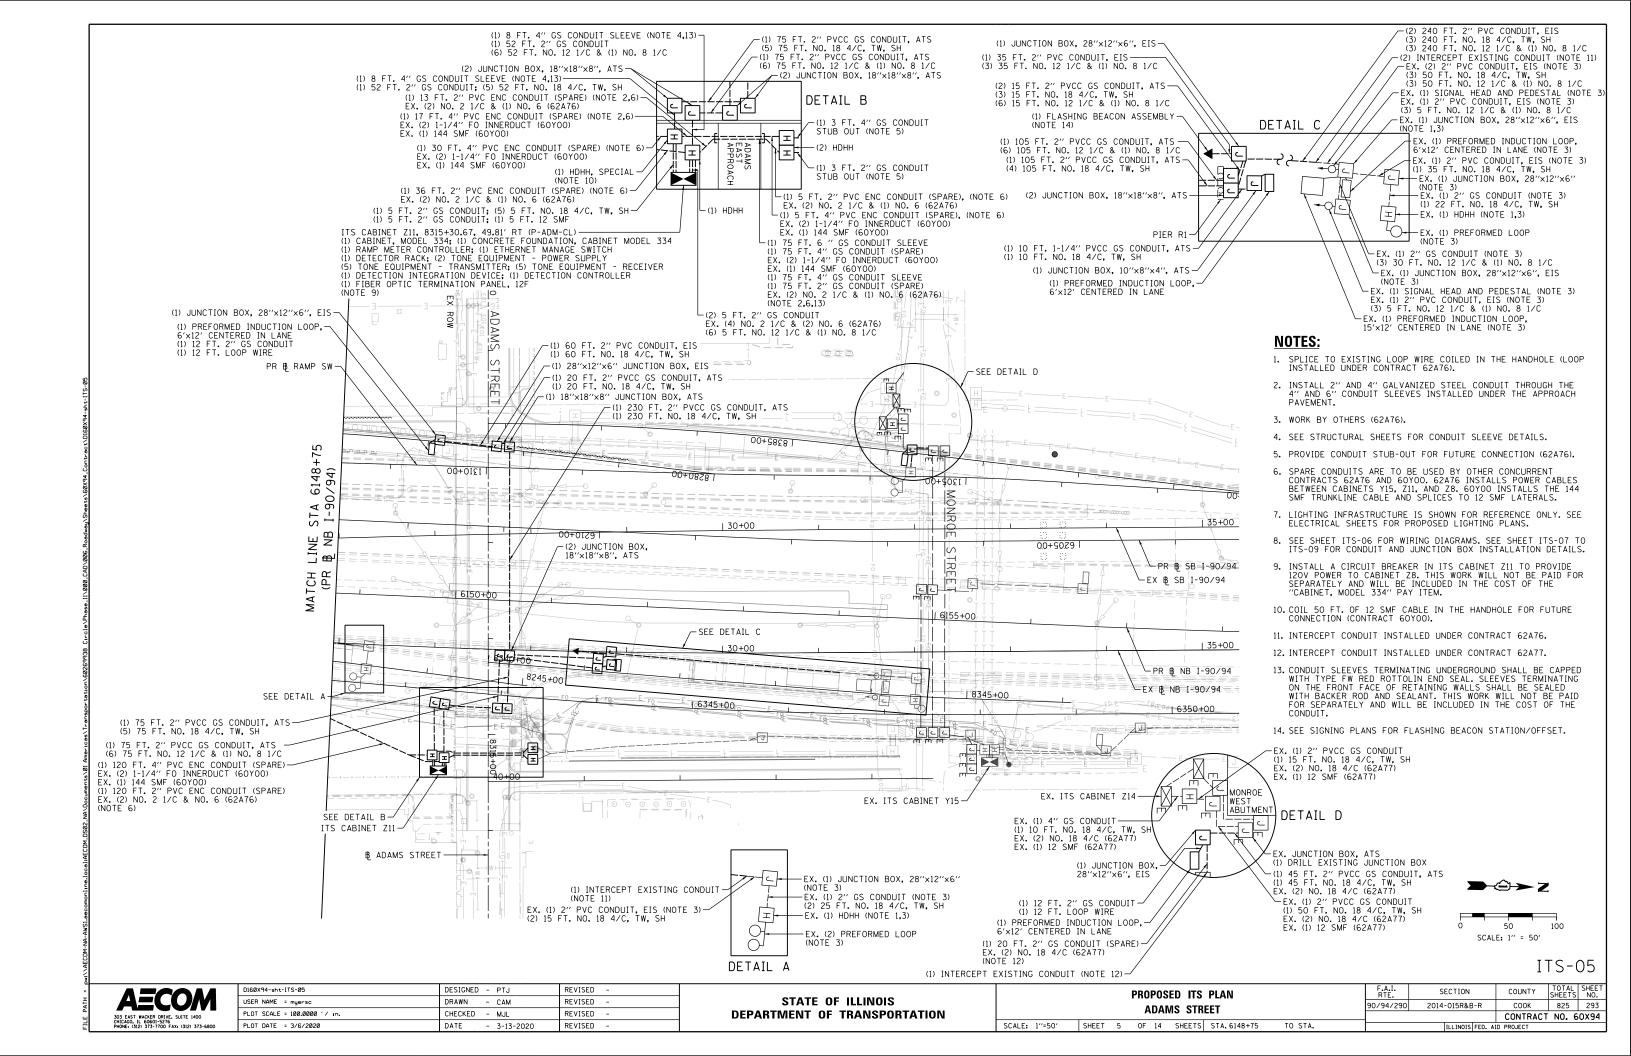


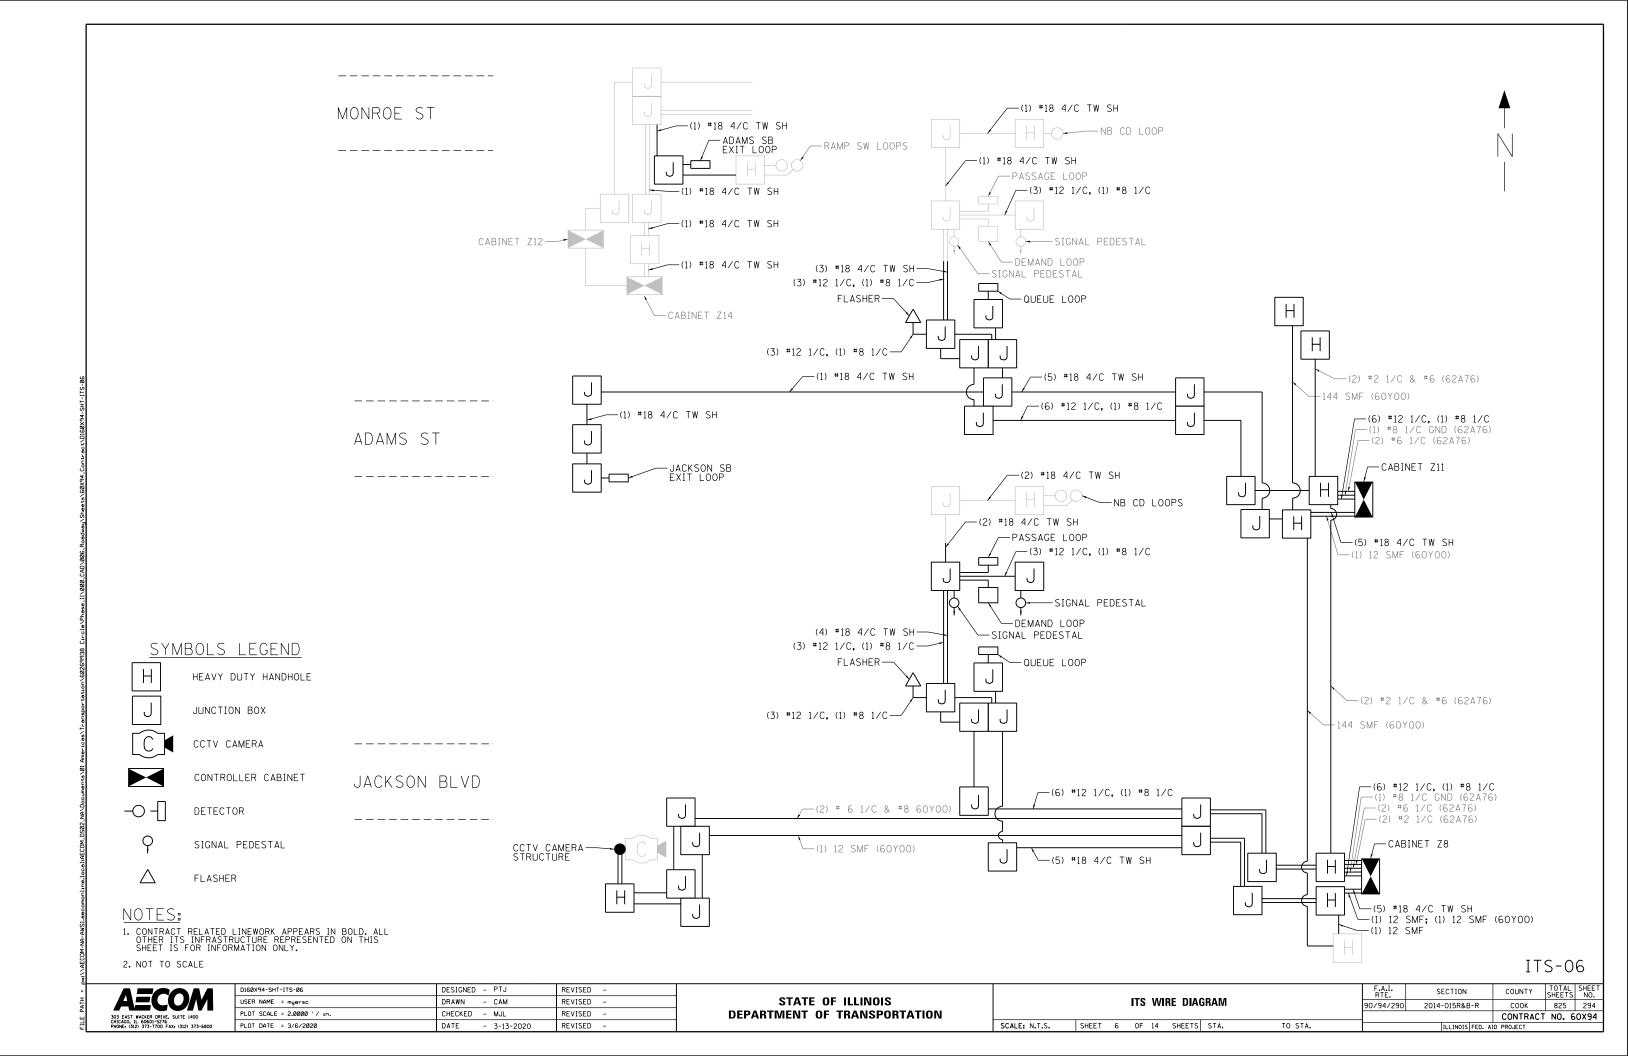

### EXPANSION/DEFLECTION CONDUIT COUPLING DETAIL NOTES 1 AND 6

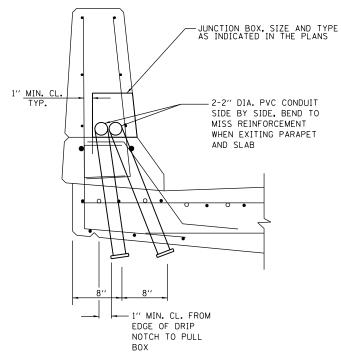

CONDUIT DROP-OUT AT PIER

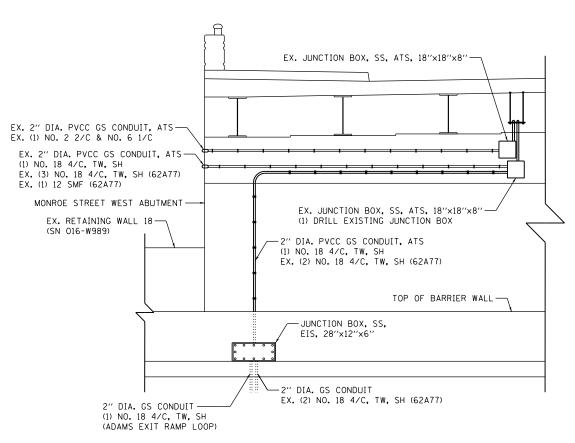

### MONROE STREET - WEST ABUTMENT (LOOKING WEST)

### NOTES:


- 1. THE CONTRACTOR SHALL INSTALL A CONDUIT EXPANSION/DEFLECTION COUPLING AT THE JOINT LOCATIONS IN THE CONCRETE PARAPET ON THE BRIDGE CAPABLE OF ACCEPTING THE LONGITUDINAL MOVEMENT. ALL METALLIC PARTS OF THE COUPLING SHALL BE MADE OF STAINLESS STEEL OR AS APPROVED BY THE ENGINERR. ANY NON-STAINLESS METAL SHALL BE HOT DIP GALVANIZED AND COATED TO PREVENT REACTION WITH THE CONCRETE. THE COST OF THE COUPLING SHALL BE PART OF AND INCIDENTAL TO THE CONDUIT SYSTEM.
- 2. THE BARREL IN THE EXPANSION FITTING SHALL BE IN THE CONCRETE ON ONE SIDE OF THE EXPANSION JOINT. ONE HALF THE LENGTH OF THE DEFLECTION FITTING SHALL BE EMBEDDED IN THE CONCRETE ON THE OTHER SIDE OF THE COUPLING.
- 3. A CAVITY OPENING 3" LARGER IN DIAMETER THAN THE DEFLECTION FITTING SHALL BE PROVIDED IN THE CONCRETE TO ENSURE PROPER PERFORMANCE OF THE COUPLING.
- 4. CAREFUL ATTENTION TO JOINT MOVEMENT OVER A RANGE OF OF TEMPERATURES SHALL BE COORDINATED WITH THE SELECTION AND INSTALLATION OF THE COUPLING TO ENSURE THE RANGE OF MOVEMENT OF THE COUPLING IS NOT EXEEDED AT TEMPERATURE EXTREMES.
- 5. ALL MANUFACTURER'S INSTALLATION INSTRUCTIONS SHALL BE CAREFULLY FOLLOWED TO ENSURE OPTIMUM PERFORMANCE OF THE EXPANSION/DEFLECTION COUPLING.
- 6. THE CONTRACTOR SHALL INSTALL COUPLINGS AT ALL BRIDGE EXPANSION JOINTS AND SHALL BE RESPONSIBLE TO DETERMINE THE PROPER NUMBER OF COUPLINGS REQUIRED. SEE STRUCTURAL DRAWINGS FOR THE EXPANSION JOINT LOCATIONS.
- 7. WITH THE APPROVAL OF THE ENGINEER, THE CONTRACTOR MAY SUBSTITUTE TWO (2) STAINLESS STEEL JUNCTION BOXES ATTACHED TO THE BACK OF THE WALL AND CONNECTED BY A HIGH GRADE OF FLEXIBLE METAL CONDUIT FOR ALL EXPANSION JOINTS. THIS SUBSTITUTION SHALL BE MADE AT NO ADDITIONAL COST TO THE DEPARTMENT.
- 8. EXPANSION/DEFLECTION COUPLINGS ARE INCIDENTAL TO THE COST OF THE CONDUIT.
- 9. CONDUIT DROP-OUTS AT PIERS ARE INCIDENTAL TO THE COST OF THE EMBEDDED JUNCTION BOX.


D160X94-SHT-ITS-07	DESIGNED - PTJ	REVISED -	Т
USER NAME = myersc	DRAWN - CAM	REVISED -	
PLOT SCALE = 2.0000 ' / in.	CHECKED - MJL	REVISED -	
PLOT DATE = 3/6/2020	DATE - 3-13-2020	REVISED -	

STATE OF ILLINOIS **DEPARTMENT OF TRANSPORTATION** 

						F.A.I. RTE.	SE	ECTION	COUNTY	TOTAL SHEETS	SHEET NO.		
ITS DETAILS					90/94/290	2014-	-015R&B-R	COOK	825	295			
											CONTRACT	NO. 6	0X94
CALE: N.T.S.	SHEET	7	OF 14	4	SHEETS	STA.	TO STA.			ILLINOIS FED. AT	D PROJECT		

ITS-07

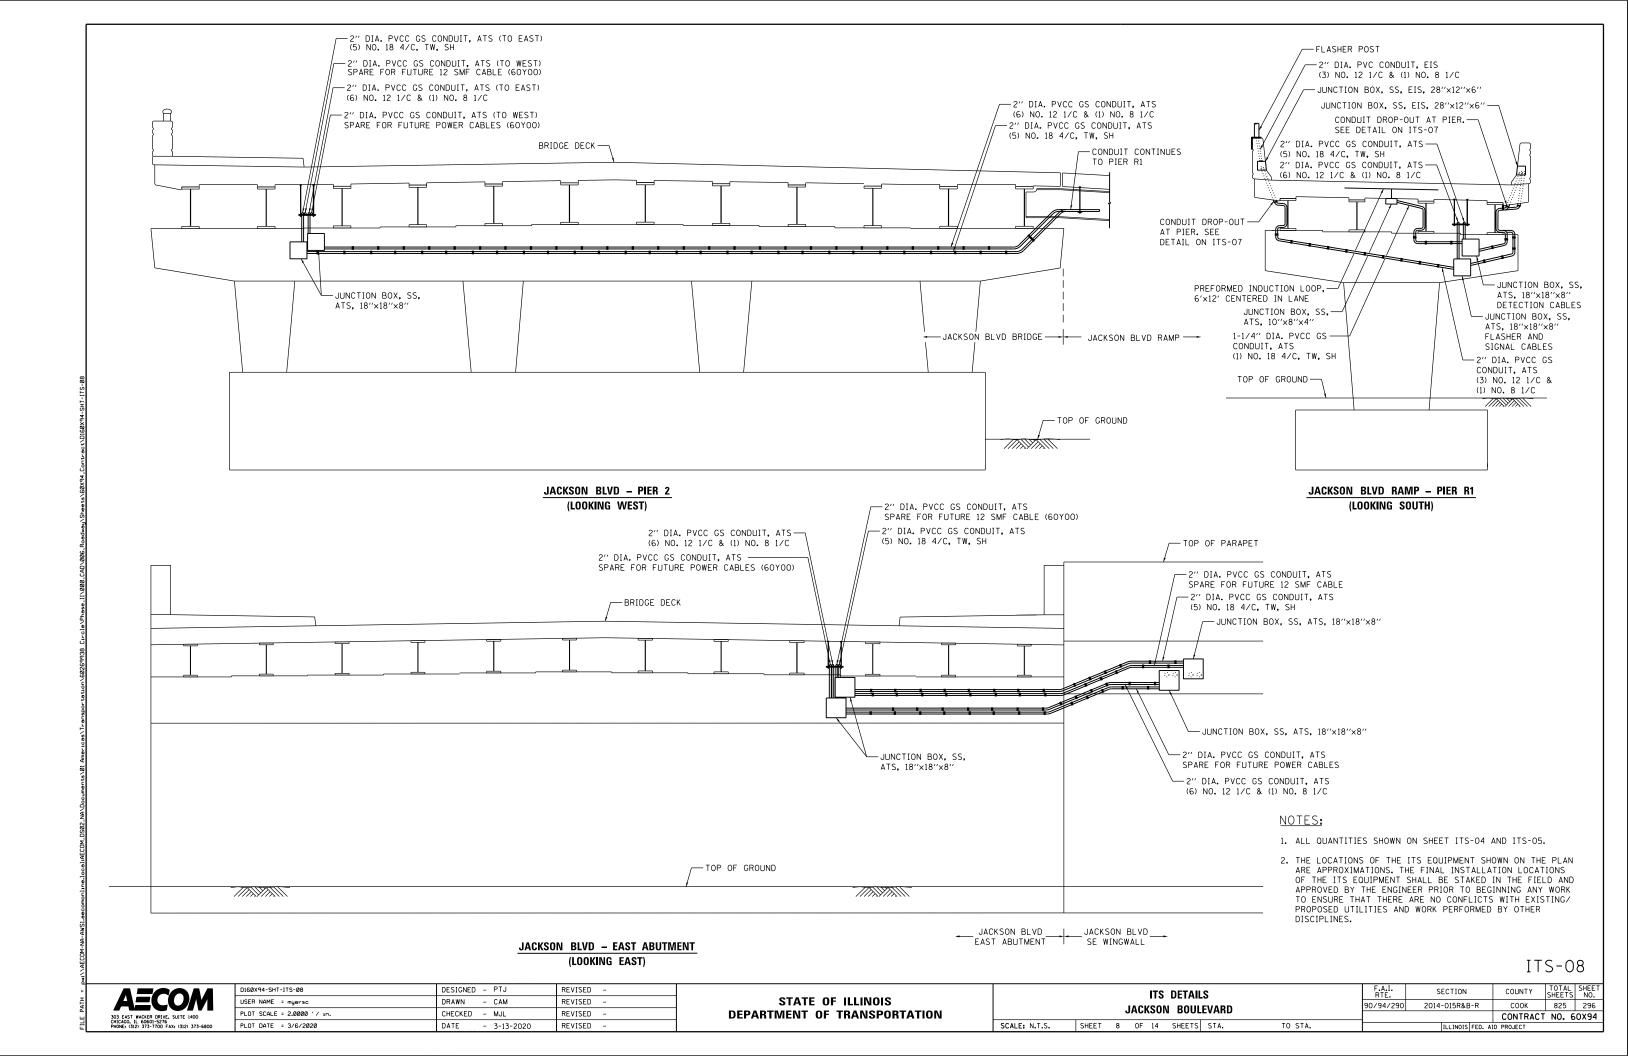

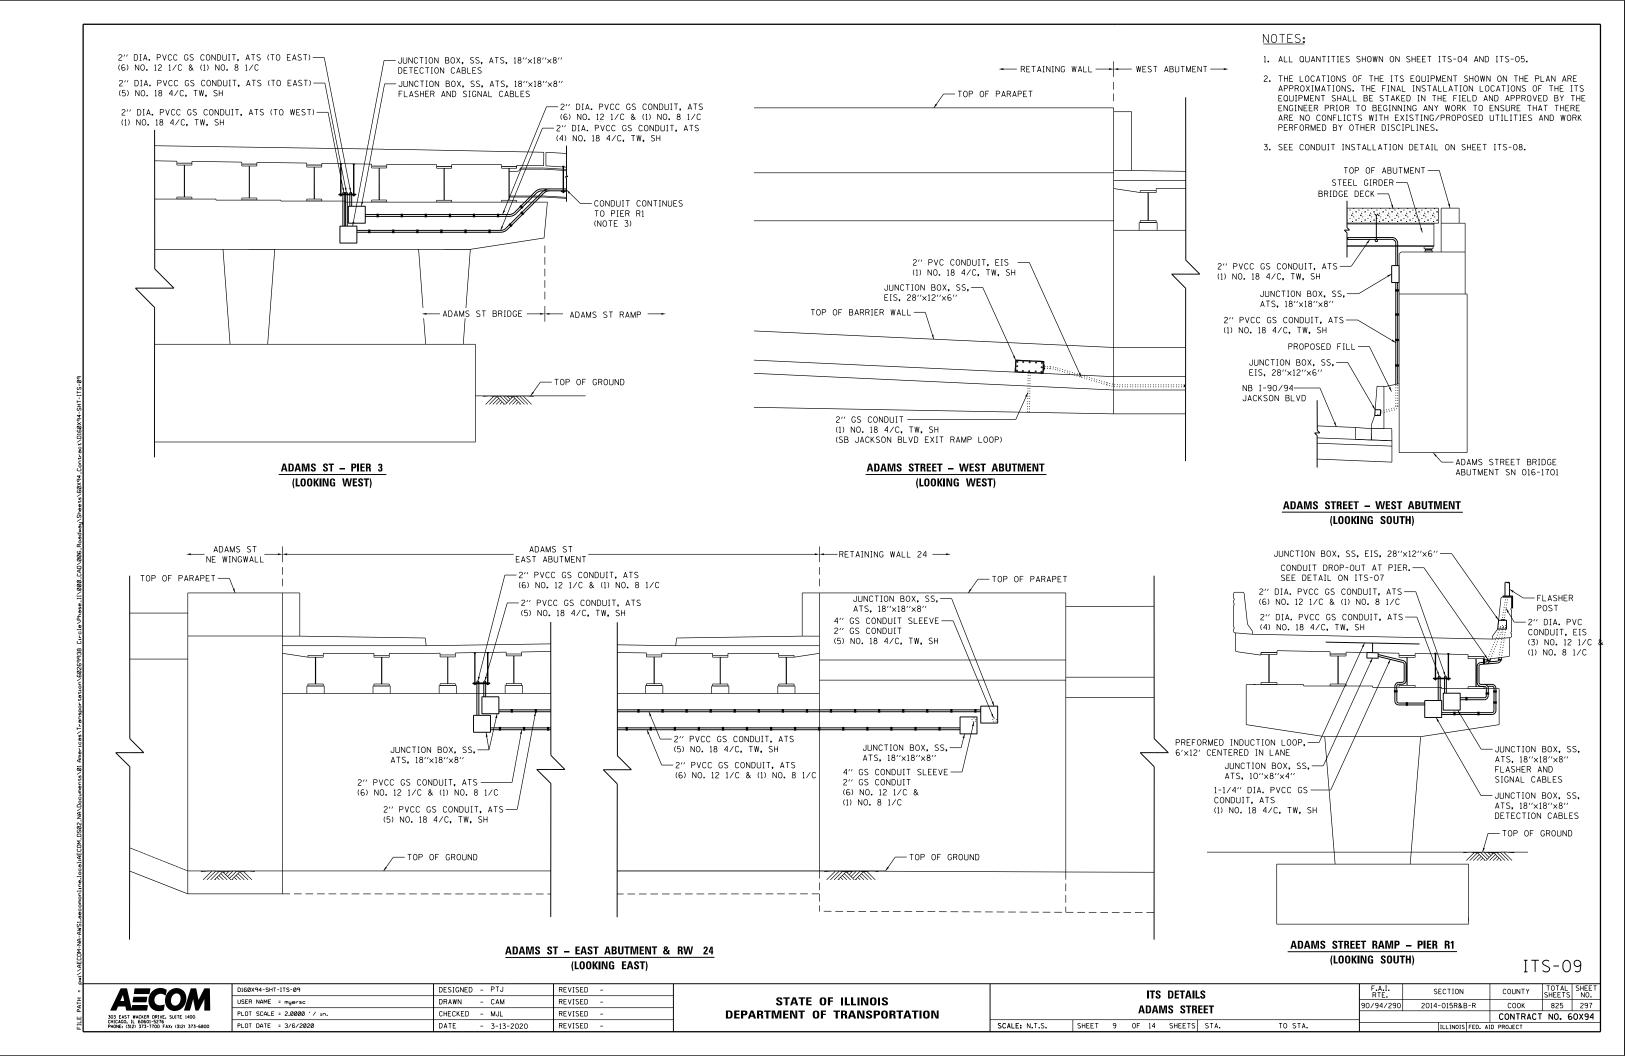

# TYPICAL DETAIL CONCRETE BASE, CONTROLLER CABINET

# CABINET DETAIL CONCRETE BASE MOUNTED (MODEL 334)

# NOTES:

- 1. INSTALL FOUR 3\*4 INCH DIAMETER X 12 INCH MINIMUM LENGTH APPROVED J-BOLTS TO ANCHOR THE CABINET BASES. THE ANCHOR BOLTS SHALL BE GALVANIZED STEEL AND LOCATED AS DIRECTED BY THE ENGINEER TO PROPERLY ANCHOR THE CONTROL CABINET TO THE BASE.
- CONTROL CABINET BASE TOP SURFACES SHALL BE TROWEL FINISHED AND LEVEL, PRIOR TO CABINET INSTALLATION. LEVELING OF TOP SURFACES AFTER CONCRETE BASE HAS CURED SHALL ONLY BE ACCOMPLISHED BY GRINDING.
- 3. MAINTENANCE PLATFORMS ARE NOT REQUIRED WHEN THE SURROUNDING AREA IS PAVED.
- 4. CONCRETE FORM DEPTH BELOW FINISHED GRADE SHALL BE 6" MAXIMUM. CONCRETE FORMS SHALL BE REMOVED AFTER CONCRETE HAS SET.
- 5. CONCRETE MAINTENANCE PLATFORM AND CABINET FOUNDATION FOR CABINET SHALL BE MONOLITHIC POUR.
- 6. WHEN REQUIRED TO CONNECT NONMETALLIC CONDUIT TO METALLIC CONDUIT, ONLY ADAPTER FITTINGS, U.L. LISTED FOR ELECTRICAL USE, SHALL BE USED.
- 7. CONDUIT HEIGHT ABOVE THE CONCRETE BASE SHALL BE 3 INCH.
- 8. MINIMUM BENDING RADIUS OF CONDUIT = 6 X THE DIAMETER.
- 9. ALL METALLIC CONDUIT ENDS SHALL BE REAMED AND THREADED.
- 10. CAP ALL BELOW GRADE METALLIC CONDUIT ENDS IN WHICH WIRE OR CABLE IS NOT BEING INSTALLED.

- 11. PLUG ALL BELOW GRADE NONMETALLIC CONDUIT ENDS IN WHICH WIRE OR CABLE IS NOT BEING INSTALLED.
- 12. ALL CONDUIT ENDS AT THE TOP OF CONCRETE BASES SHALL BE CAPPED IF METALLIC OR PLUGGED IF NONMETALLIC IMMEDIATELY AFTER PLACEMENT AND BEFORE CONCRETE IS POURED. CONDUITS IN WHICH WIRE OR CABLE IS NOT BEING INSTALLED SHALL REMAIN CAPPED OR PLUGGED.
- 13. ALL METALLIC CONDUIT ENDS AT TOP OF CONCRETE BASES SHALL HAVE BUSHINGS AND ALL NON METALLIC CONDUIT ENDS AT TOP OF CONCRETE BASES SHALL HAVE END BELLS.
- 14. REFER TO SPECIAL PROVISIONS FOR CABINET DETAILS AND ADDITIONAL REQUIREMENTS.
- 15. CABINET ENTRIES INCLUDE VERTICAL ARRANGEMENT FOR MAJOR EQUIPMENT ITEMS ONLY.
- 16. INSTALL ADDITIONAL ITEMS ON SIDE AND BACK PANELS PER THE SPECIAL PROVISIONS.
- 17. THE CONTRACTOR SHALL INSTALL INSULATED BUSHINGS AND DUCT SEALANT AT ALL CONDUIT BEND TERMINATIONS IN FOUNDATIONS.
- 18. CONCRETE BASE TO BE FORMED AT LEAST 6" ABOVE THE GROUND SURFACE.
- 19. ALL WORK INDICATED SHALL BE PAID FOR UNDER ITEM CABINET, MODEL 334 EXCLUSIVE OF THE CONCRETE FOUNDATION.
- 20. CABINET BOTTOM CONFIGURATION SHALL BE AS DIRECTED BY THE ENGINEER.

SCALE: N.T.S.

TOTAL SHEET NO.

COOK 825 298

CONTRACT NO. 60X94


COUNTY



0160X94-sht-ITS-10	DESIGNED - PTJ	REVISED -
JSER NAME = myersc	DRAWN - CAM	REVISED -
PLOT SCALE = 40.0000 '/ in.	CHECKED - MJL	REVISED -
PLOT DATE = 3/6/2020	DATE - 3-13-2020	REVISED -

CABINET, MODEL 334 FOUNDATION DETAIL					F.A.I. RTE.	SECTION			
					FOUND	DATION	DETAIL	90/94/290	2014-015R&B-R
	SHEET	10	OF	14	SHEETS	STA.	TO STA.		ILL INOIS FED



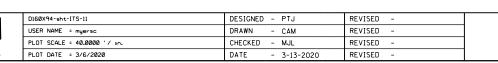

5′ 6-7/8′′ [1698**.**6]

STATE OF ILLINOIS **DEPARTMENT OF TRANSPORTATION** 

-LIFTEYE @ 2 LIFT CABINET WITH CHAINS AT 90° TO AVOID DAMAGE TO LIFTEYES

-LOCK PER PROJECT REQUIREMENTS (TYPICAL FRONT AND REAR DOOR)

- REUSABLE 12" X 16" FILTER FOR FRESH AIR INTAKE (TYPICAL FRONT AND REAR DOOR)

RAMP METER CONTROLLER

DETECTOR RACK

PULLOUT DRAWER

DETECTION— INTEGRATION DEVICE

DIN RELAY

FIBER OPTIC PATCH PANEL

CIRCUIT BREAKERS -

SURGE SUPPRESSOR-500W CABINET HEATER-

- 2' 1/4'' [616] -

**FRONT VIEW** 

CABINET, MODEL 334 EQUIPMENT, RAMP METER DETAIL

COUNTY SECTION COOK 825 299 90/94/290 2014-015R&B-R CONTRACT NO. 60X94 SCALE: N.T.S. SHEET 11 OF 14 SHEETS STA.

TRAFFIC CABINET NOTES:

-LIGHT AND DOOR DETECTION SWITCH

-DETECTION CONTROLLER

POWER DISTRIBUTION ASSEMBLY (PDA)
4-OUTLET POWER STRIPS

-DUPLEX 3-PRONG GFI OUTLET

-ETHERNET SWITCH AND POWER SUPPLY

TERMINAL BLOCKS

-GROUND BUSBARS

**COMMUNICATIONS COMPARTMENT** 

(NO DOORS SHOWN)

1. CABINET SPECIFICATIONS:

-ALL DIMENSIONS IN FEET & INCHES [MM], UNLESS OTHERWISE SPECIFIED

-0.125" MILL FINISH ALUMINUM 5052-H32 CONSTRUCTION

WITH CONTINUOUSLY WELDED EXTERNAL SEAMS

-THREE POINT LATCH WITH SST HANDLE

-DOUBLE FLANGED DOOR SEAL WITH 1/2" X 2" CLOSED

CELL NEOPRENE GASKET

-FULL LENGTH EIA GAGE FOR 19" EQUIPMENT

-NEMA 3R ENCLOSURE

-ALL STAINLESS STEEL HARDWARE WITH FULL LENGTH

STAINLESS STEEL HINGE.
-DOOR OPENING: 56.750" X 21.750"

2. ALL MODIFICATIONS TO CABINET MUST MAINTAIN NEMA 3R RATING.

ITS-11

