

PLOT SCALE = 40.0000 '/ in.

PLOT DATE = 2/13/2020

CHECKED -

DATE

DWB

02/13/2020

REVISED


REVISED


WILMETTE AVENUE WILMETTE AVENUE AVENUE AVENUE AVENUE CENTRAL HHMM 1475 EAST WOODFIELD ROAD, SUITE 600 SCHAUMBURG, ILLINOIS 60173 (847) 605-9600 WILMETTE AVENUE WILMETTE AVENUE STAGE III STAGE IV SCALE IN FEET TOTAL SHEET NO. 318 201 F.A.U. RTE. 1296 DESIGNED - GR REVISED USER NAME = Mlbeening SECTION COUNTY CENTRAL AVENUE AND WILMETTE AVENUE TEMPORARY TRAFFIC SIGNAL STAGING PLAN AND (SHEET 2 OF 2) TSØ114-MOT Stage STATE OF ILLINOIS - BTW DRAWN REVISED COOK 16-00199-00-RS


**DEPARTMENT OF TRANSPORTATION** 

SHEET 14 OF 33 SHEETS STA.

CONTRACT NO. 61G42

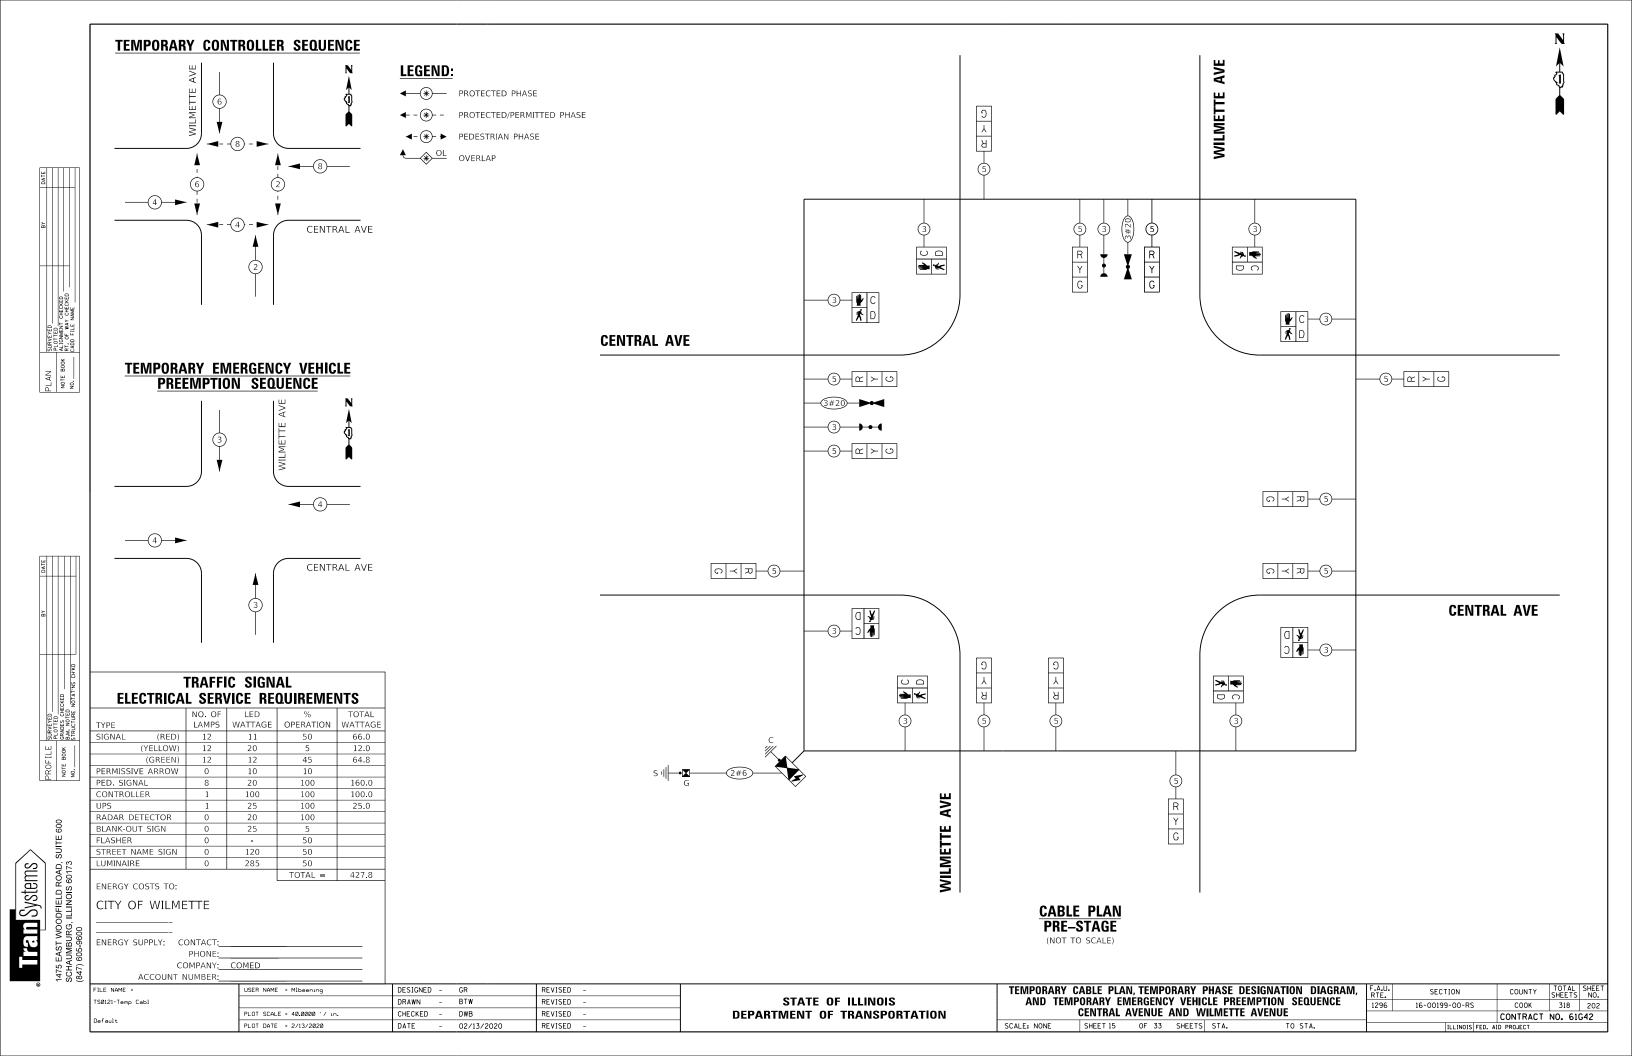

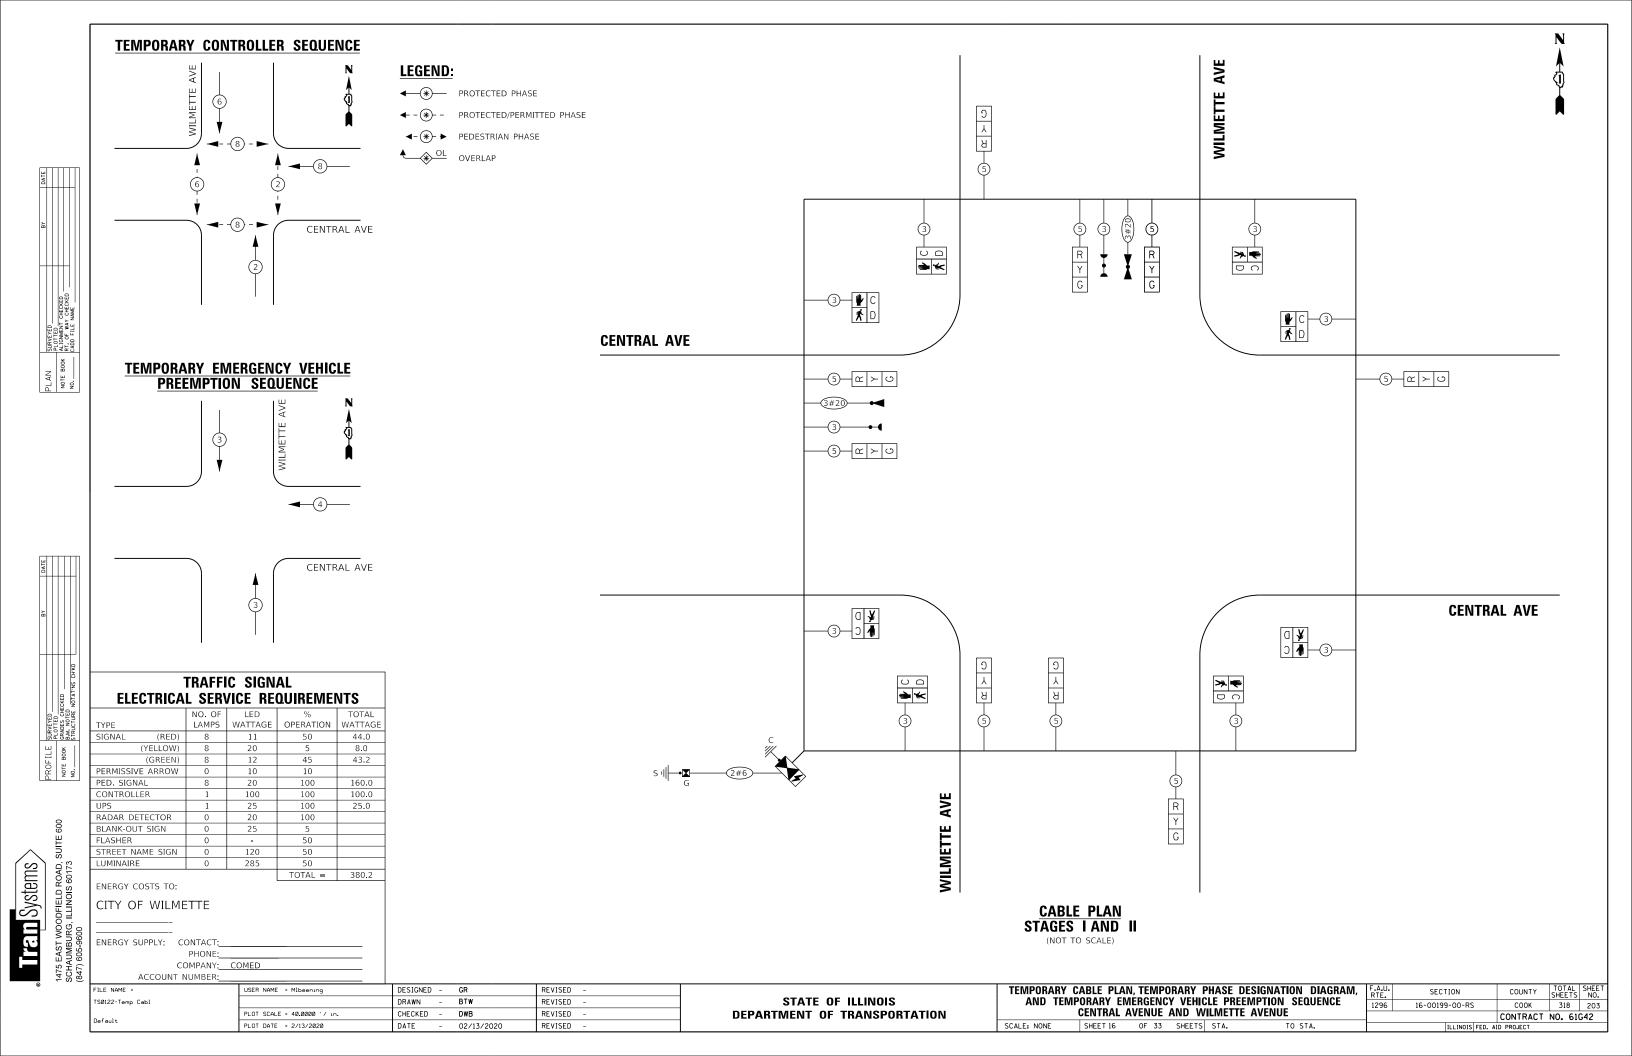

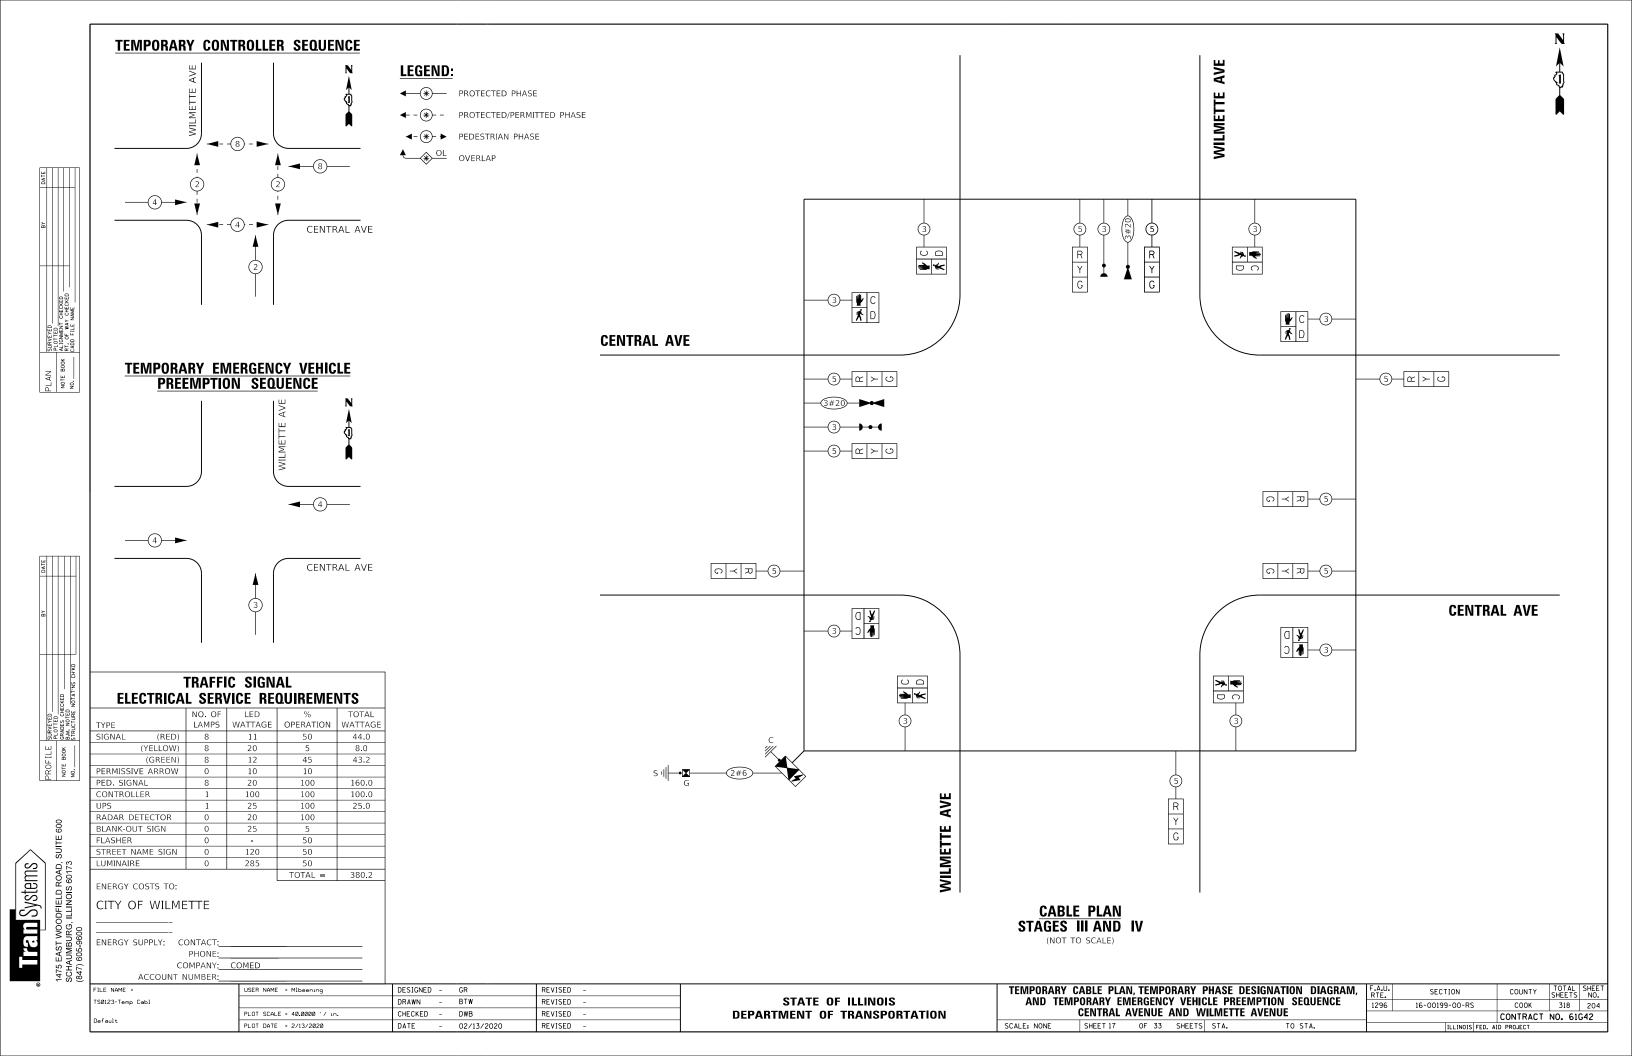


#### NOTES: THE TRAFFIC SIGNAL INSTALLATION SHALL OPERATE UNDER PRE-TIMED SIGNAL CONTROL. TRAFFIC SIGNAL EQUIPMENT SHALL BE PAINTED BLACK. WILMETTE AVENUE 83 -UC-4" -SCALE IN FEET PS-4 -16' POST APPROX STA 106+95.3, 29.7'LT 18'-UC-3" — 14'-UC-3" · — 6'-UC-3" MA-4 – 20' MA - 30" DIA FDN (10' DEPTH) APPROX STA 106+66.6, 18.6 LT 80'-UC-2-4" — - MA-1 28' MA - 30" DIA FDN (10' DEPTH) APPROX STA 107+60.8, 35.7'LT PS-3-16' POST APPROX STA 106+42.3, 25.7'RT TYPE IV CABINET -CENTRAL AVE PS-1 16' POST APPROX STA 107+70.5, 25.4'LT EX ROW EX ROW AVENUE AVENUE CENTRAL CENTRAL EX ROW CENTRAL AVE 5'-UC-4" -W/ THREADED CAP - MA-2 22' MA - 30" DIA FDN (10' DEPTH) APPROX STA 107+53.6, 19.6'RT 5'-UC-4-4" — ── 38'-UC-3" 26'-UC-3" -─-9'-UC-3" 41'-UC-2" 31 -UC-3 -— PS-2 16' POST APPROX STA 107+11.9, 35.0'RT MA-3— 34' MA - 36" DIA FDN (11' DEPTH) APPROX STA 106+47.6, 33.1'RT └─ 104'-UC-4" WILMETTE AVENUE

FILE NAME :	1475 EAST WOOD SCHAUMBURG, II (847) 605-9600	
		FILE NAME :


. Train Systems

FILE NAME =	USER NAME = Mlbeening	DESIGNED - GR	REVISED -			CENTRAL AVENUE AND WHENETTE AVENUE	F.A.U.	SECTION	COUNTY	TOTAL	SHEET
TSØ151-Pr Traffı		DRAWN - BTW	REVISED -	STATE OF ILLINOIS		CENTRAL AVENUE AND WILMETTE AVENUE TRAFFIC SIGNAL INSTALLATION PLAN	1296	16-00199-00-RS	СООК	318	205
D 5 1.	PLOT SCALE = 40.0000 '/ in.	CHECKED - DWB	REVISED -	DEPARTMENT OF TRANSPORTATION		MAINO SIGNAL INSTALLATION TEAN			CONTRACT	F NO. 61	1G42
Default	PLOT DATE = 2/13/2020	DATE - 02/13/2020	REVISED -		SCALE: 1"=20"	SHEET 18 OF 33 SHEETS STA. TO STA.		ILLINOIS FED.	AID PROJECT		

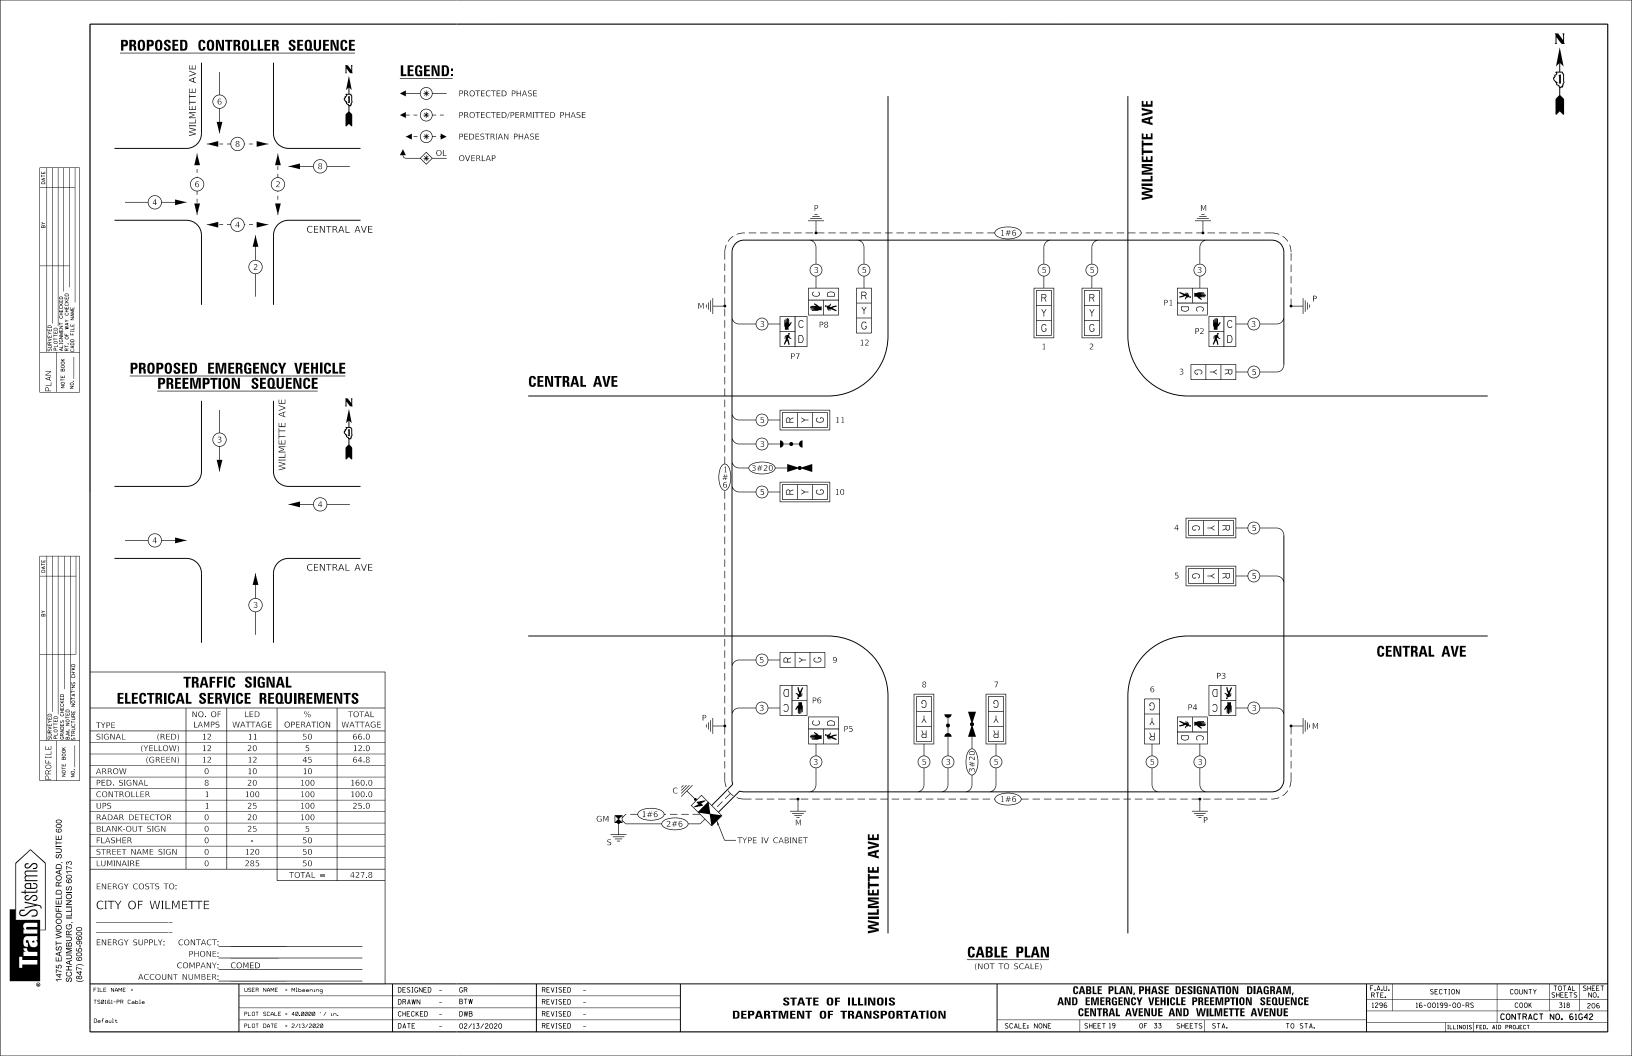


#### SIGN PANEL – TYPE 1 OR TYPE 2

ALL DIMENSIONS ARE IN INCHES UNLESS NOTED OTHERSWISE

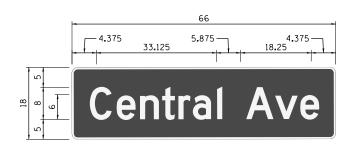

DESIGN	AREA	SIGN PANEL	SHEETING	QTY.
SERIES	(SQ FT)	TYPE	TYPE	REQUIRED
D	8.25	1	ZZ	2

SIGNS SHALL BE DOUBLE-SIDED

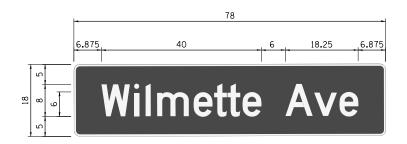

DESIGN	AREA	SIGN PANEL	SHEETING	QTY.
SERIES	(SQ FT)	TYPE	TYPE	REQUIRED
D	9.75	2	ZZ	2

SIGNS SHALL BE DOUBLE-SIDED






#### SCHEDULE OF QUANTITIES

PAY ITEM NAME	UNIT	QUANTIT
SIGN PANEL - TYPE 1	SQ FT	16.50
SIGN PANEL - TYPE 2	SQ FT	19.50
ELECTRIC UTILITY SERVICE CONNECTION	L SUM	1
UNDERGROUND CONDUIT, GALVANIZED STEEL, 2" DIA.	FOOT	41
UNDERGROUND CONDUIT, GALVANIZED STEEL, 3" DIA.	FOOT	120
UNDERGROUND CONDUIT, GALVANIZED STEEL, 4" DIA.	FOOT	801
HANDHOLE	EACH	2
DOUBLE HANDHOLE	EACH	2
MAINTENANCE OF EXISTING TRAFFIC SIGNAL INSTALLATION	EACH	2
PAINT NEW TRAFFIC SIGNAL POST	EACH	4
PAINT NEW MAST ARM AND POLE, UNDER 40 FOOT	EACH	4
ELECTRIC CABLE IN CONDUIT, SIGNAL NO. 14 3C	FOOT	1,310
ELECTRIC CABLE IN CONDUIT, SIGNAL NO. 14 5C	FOOT	1,835
ELECTRIC CABLE IN CONDUIT, SERVICE, NO. 6 2 C	FOOT	56
ELECTRIC CABLE IN CONDUIT, EQUIPMENT GROUNDING CONDUCTOR, NO. 6 1C	FOOT	464
TRAFFIC SIGNAL POST, GALVANIZED STEEL 16 FT.	EACH	4
STEEL MAST ARM ASSEMBLY AND POLE, 20 FT.	EACH	1
STEEL MAST ARM ASSEMBLY AND POLE, 22 FT.	EACH	1
STEEL MAST ARM ASSEMBLY AND POLE, 28 FT.	EACH	1
STEEL MAST ARM ASSEMBLY AND POLE, 34 FT.	EACH	1
CONCRETE FOUNDATION, TYPE A	FOOT	20
CONCRETE FOUNDATION, TYPE C	FOOT	4
CONCRETE FOUNDATION, TYPE E 30-INCH DIAMETER	FOOT	30
CONCRETE FOUNDATION, TYPE E 36-INCH DIAMETER	FOOT	11
SIGNAL HEAD, LED, 1-FACE, 3-SECTION, MAST-ARM MOUNTED	EACH	8
SIGNAL HEAD, LED, 1-FACE, 3-SECTION, BRACKET MOUNTED	EACH	4
PEDESTRIAN SIGNAL HEAD, LED, 1-FACE, BRACKET MOUNTED WITH COUNTDOWN TIMER	EACH	8
TRAFFIC SIGNAL BACKPLATE, LOUVERED, FORMED PLASTIC	EACH	8
LIGHT DETECTOR	EACH	2
LIGHT DETECTOR AMPLIFIER	EACH	1
TEMPORARY TRAFFIC SIGNAL INSTALLATION	EACH	1
REMOVE EXISTING TRAFFIC SIGNAL EQUIPMENT	EACH	1
REMOVE EXISTING HANDHOLE	EACH	4
REMOVE EXISTING CONCRETE FOUNDATION	EACH	9
EMERGENCY VEHICLE PRIORITY SYSTEM LINE SENSOR CABLE, NO. 20 3/C	FOOT	232
SIGNAL TIMING	L SUM	1
SERVICE INSTALLATION, GROUND MOUNTED, METERED	EACH	1
FULL-ACTUATED CONTROLLER AND TYPE IV CABINET, SPECIAL	EACH	1
UNINTERRUPTABLE POWER SUPPLY, SPECIAL	EACH	1
TEMPORARY TRAFFIC SIGNAL TIMING	EACH	3

#### NOTES:

 FOR ADDITIONAL DESIGN AND INSTALLATION INFORMATION PLEASE SEE DISTRICT ONE MAST ARM MOUNTED STREET NAME SIGNS DETAIL.

FILE NAME =	USER NAME = Mlbeening	DESIGNED - GR	REVISED -		MAST ARM MOUNTED STREET NAME SIGNS	F.A.U. SECTION	COUNTY TOTAL SHEET
TSØ171-PR Signag		DRAWN - BTW	REVISED -	STATE OF ILLINOIS	AND SCHEDULE OF QUANTITIES	1296 16-00199-00-RS	COOK 318 207
	PLOT SCALE = 40.0000 '/ in.	CHECKED - DWB	REVISED -	DEPARTMENT OF TRANSPORTATION	CENTRAL AVENUE AND WILMETTE AVENUE		CONTRACT NO. 61G42
Default	PLOT DATE = 2/13/2020	DATE - 02/13/2020	REVISED -		SCALE: NONE ' SMEET 20 OF 33 SHEETS STA. TO STA.	ILLINOIS FED. AI	ID PROJECT

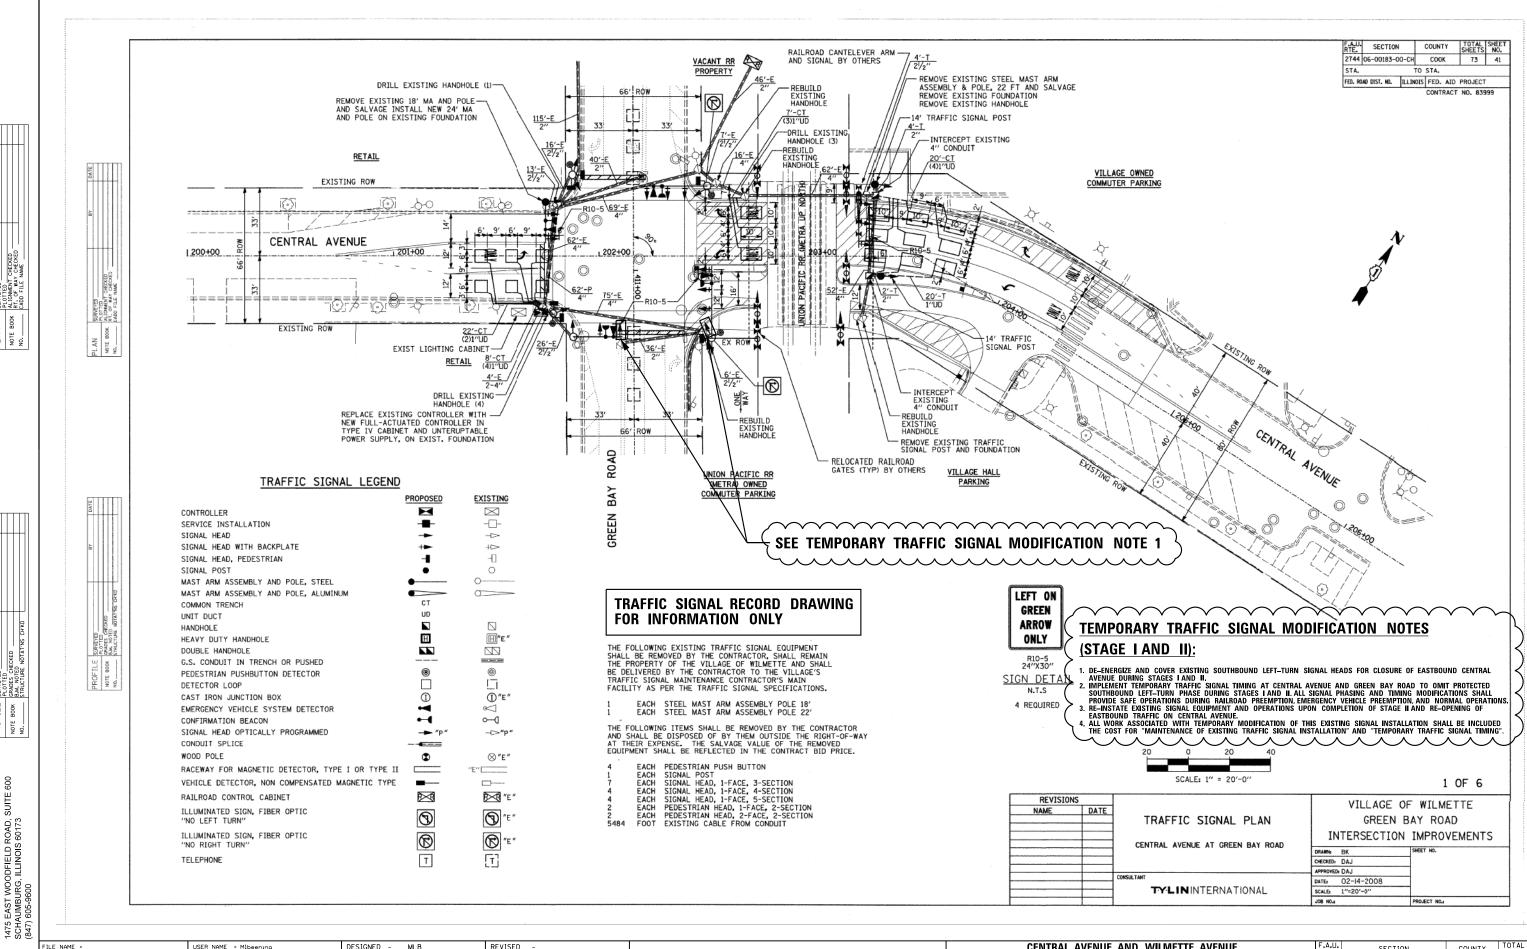

Ten Systems

DESIGNED -REVISED USER NAME = Mlbeening MLB SØ181-Ex TS Gre ORAWN MLB REVISED LOT SCALE = 40.0000 '/ in. CHECKED DWB REVISED PLOT DATE = 2/13/2020 DATE 02/13/2020 REVISED

STATE OF ILLINOIS
DEPARTMENT OF TRANSPORTATION


SCALE: NONE

CENTRAL AVENUE AND WILMETTE AVENUE
EXISTING TRAFFIC SIGNAL PLANS
GREEN BAY ROAD AND CENTRAL AVENUE

SHEET 21 OF 33 SHEET STA. TO STA.

F.A.U. RTE. SECTION COUNTY SHEET NO. 1296 16-00199-00-RS COOK 318 208

CONTRACT NO. 61G42

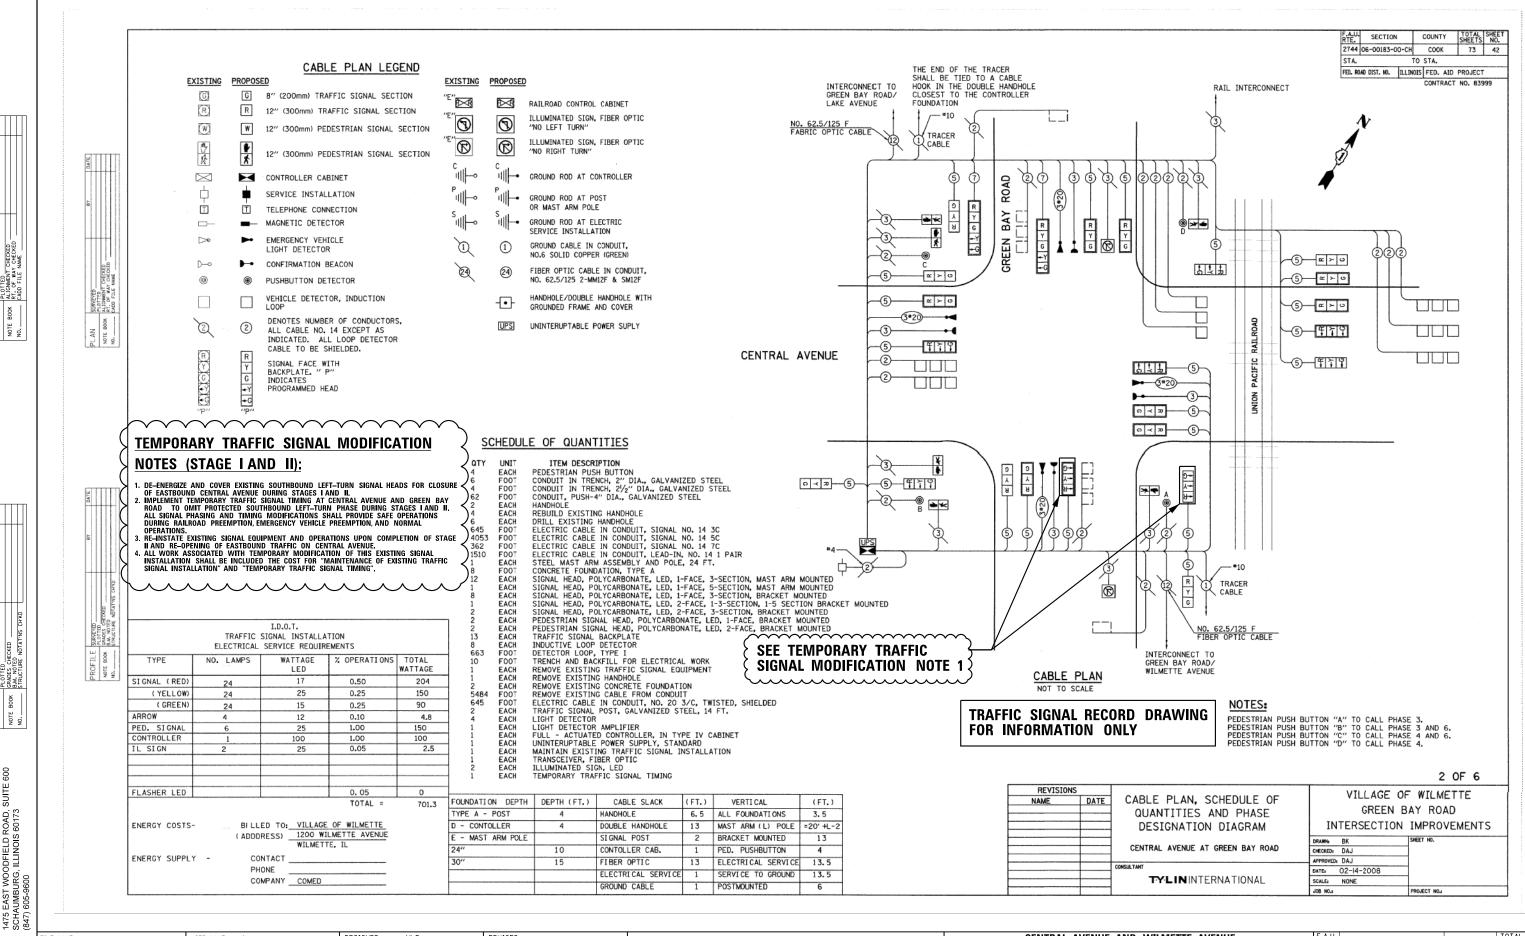

**Trem** Systems

FILE NAME = FSØ182-Ex Cable Default

STATE OF ILLINOIS
DEPARTMENT OF TRANSPORTATION

CENTRAL AVENUE AND WILMETTE AVENUE
EXISTING TRAFFIC SIGNAL CABLE PLANS
GREEN BAY ROAD AND CENTRAL AVENUE

SHEFT 22 OF 33 SHEFTS STA. TO S

SCALE: NONE

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TSØ183-Ex Phasin

USER NAME = Mlbeening

PLOT DATE = 2/13/2020

PLOT SCALE = 40.0000 '/ in.

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	CHANGE TO			1+6	1	2+5	2+ 3+ 3+ 4+ 4+	-7 -8 -7	$^{\circ}/^{\circ}$		1+5 2+5 3+7 3+8 4+7 4+8		2+6			3+7 3+8 4+7 4+8		2+6		/	3+	16 17 18 17		3+8			4+7			4	1+8		/	9/		4+8		•			4+8					1+5 1+6 2+5 2+6 3+7	6 5 6		3+8		4	4+7		
PLAN SURFERD OUTED NOTE OF WAS CHEED NOT OF WAS CHEED NOT OUT OF WAY CHEED NOT OUT OUT OUT OUT OUT OUT OUT OUT OUT O		OAD NEAR RIGHT AND FAR RIGHT MAST N/B	R	R R	R	R	R	R	R	R	R F	R	R	G	Y	R	G	G	G	G	Υ	R	R	R	R F	F	R	R	SLRVEYED PLOTTED ALIGNAEN CADD FILE	AND FAR LEF		R <del>◀⊕</del> ◀	R <del>IY</del> R	R <b>∢</b> G		R <del>◀Y</del>	R	R	R	R I	R R	R	G <b>◆</b> e		R	G <b>◆</b> ¥	_ G	G	G	Υ	R	R	R	R R	F	R	R	AN TE BOOK		OAD NEAR RIGHT AND FAR RIGHT MAST S/B	R	RR	R	R	R	R	G	G	Y F	G	G	R	R	R	R	R	G	G	Υ	R	R	R	RF	F	R	R	R	R	R	R	R	R	R	R	R	R	R	R	R	R	R	R	R	R	R	R	R R	R	R	R	R	R
교일	GREEN BAY R AND FAR LEF	OAD LEFT MAST ARM T SIGNALS S/B	<b>4</b> 0− 4	<del>16</del> <del>46</del>	- <b>4</b> ¥	■R	<b>4</b> ¥	<b>∢</b> R	<del>46</del> ◆	16-	+ 4	₽ 4	¥ <b>4</b> f	+ ◆1	₹- <b>4</b> R	₹R	<b>◆</b> R	- <b>∢</b> R	<del>∢</del> R	<b>∢</b> R	◆R	₹R	<b>4</b> ₽ •	<b>4</b> ₽ •	<del></del>	+ 41	R- 41	<b>←</b> 4-R	- <b>∢</b> R	<b>◆</b> R	<b>∢</b> R	<b>∢</b> R	<del>4₽</del>	<b>4</b> R	<del>◆R</del> -	<b>4</b> R−	<del>▼R</del>	<b>4</b> R	₩-	<del></del>	<del></del>	<del>4R-</del>	<b>4</b> R−	<del>∢R</del>	<del>4</del> R-	<b>∢</b> R	<b>∢</b> R-	<b>∢</b> R-	<del>+R</del> ◆	R- <b>◆</b> F	R- <b>∢</b> R-	<b>∢</b> R ·	<b>∢</b> R •	<b>∢</b> R
		NUE FAR RIGHT AND ARM SIGNALS W/B	R	R R	R	R	R	R	R	R	R	RF	R	R	R	R	R	R	R	R	R	R	R	R	R	R	R	R	R	R	R	R	G	G	G	G	G	G	R	R	R	R	G	G	G	G	Y	R	G	3 G	G	Y	R	R
	CENTRAL AVE FAR LEFT SIG	NUE LEFT MAST ARM AN GNALS W/B	<sup>ID</sup> ◀R-	<del>4R</del> <del>∢</del> R	+ <del></del>	<b>∢</b> R	<b>∢</b> R	<b>∢</b> R-	<b>∢</b> R- <b>∢</b>	<del>+R-</del> ◀	R 4	₽ 4	R- ◀R	- 4	<b>←</b>   <b>∢</b> R	₹R	- R	◆R	<b>∢</b> R-	<b>∢</b> R-	<b>∢</b> R-	<b>▼</b> R-	<b>4</b> 6	<b>4</b> 6-	16-	3- 40	3- <b> </b> ◆ Y	- <del> </del>	<b>- </b>	- ◆6	<b>◆</b> ¥	<b>◆</b> R	<del>4</del> 6-	<del>4</del> 6−	<b>◆</b> 6-	<b>4</b> 6−	<b>∢</b> ¥-	<b>4</b> R−	ŧR- ◀	HR-	₽R-	<b>4</b> R−	◆R	<b>∢</b> R-	<b>∢</b> R	<b>∢</b> R-	₹R	<b>4</b> R- <b>4</b>	<b>4</b> R <b>4</b> 1	R- <b>◆</b> F	R- ◀R-	<b>∢</b> R	<b>4</b> ₽ •	<b>∢</b> R
	CENTRAL AVE LEFT CANTIL MEDIAN SIGNA	NUE (EAST OF TRACKS) EVER AND FAR LEFT ALS W/B	<b>◆</b> R·	◆R ◆R	+ <b>4</b> R	◆R	<b>◆</b> R	<b>∢</b> R	<b>4</b> ₽ <b>4</b>	ŧR- ◀	IR ◀	R	R- ◀R	+ +	₹	- <b>  ∢</b> R	- <b> </b>	− dR	<b>∢</b> R	<del>∢R</del>	<del>▼R</del>	◆R	<b>4</b> 6-	<b>4</b> 0 •	16	<del>Y-</del>	R- <b>◆</b> f	₹- <b>4</b> R	- <b>◆</b> ¥	₽R	<b>∢</b> R	<b>∢</b> R	<b>4</b> 6−	<b>4</b> 6−	<b>◆</b> ¥-	<b>∢</b> R-	<del>∢R</del>	<del>4R</del> -	ŧR- ◀	<del>IR</del> •	<del>•R</del> •	<b>∢</b> R-	<b>◆</b> R-	<b>∢</b> R-	<b>∢</b> R	<b>∢</b> R	<b>∢</b> R-	<del>∢R</del> ◆	4R ◆1	R- ◆F	- <b>∢</b> R-	<b>∢</b> R	<b>4</b> ₽ •	<del>∢</del> R
		NUE (EAST OF TRACKS) ND CENTER CANTILEVER W/B	R	R R	R	R	R	R	R	R I	R	R F	R	R	R	R	R	R	R	R	R	R	R	R	R F	R	R	R	R	R	R	R	G	G	G	G	G	G	R	R	R	R	G	С	Υ	R	R	R	G f	3 Y	y R	R	R	R
DATE.		NUE NEAR RIGHT CENTER HT MAST ARM SIGNALS E/B	R	R R	R	R	R	R	R	R	R	R F	R	R	R	R	R	R	R	R	R	R	R	R	R R	R	R	R	R	R	R	R	R	R	R	R	R	R	G	G	G	G	G	G	G	G	Υ	R	Υ 1	R G	G G	G	G	R
A S	CENTRAL AVE AND FAR LEF	NUE LEFT MAST ARM	<b>4</b> R- <b>4</b>	◆R- ◆R	+ <del></del> R	<b>◆</b> R-	◆R	<b>◆</b> R-	<b>←</b> R-	<del></del>	+R- ◀	<del>R</del> ◀	R- ◀R	- <b>4</b> €	<del>\</del> <b>∢</b> R	- <del> </del> R-	− <b>∢</b> R	- <b>∢</b> R	₹R	<b>∢</b> R	◆R	<b>∢</b> R	<b>4</b> 6 ·	<b>∢</b>	+R- <b>◆</b> €	- 40	3-   4€	<b>- 4</b> €	- ◆6	- 46-	<b>▲</b> ¥	<b>◆</b> R	<b>◆</b> R	<b>∢</b> R	<b>∢</b> R-	<b>∢</b> R	<b>∢</b> R	<b>4</b> R−	<del>1</del> 6− <b>&lt;</b>	10-	<b>←</b> ·	<b>∢</b> R	<b>∢</b> R	◆R	<b>∢</b> R	<del>∢R</del>	<del>∢R</del>	<b>∢</b> R ·	+	R- 4f	R- ◀R-	<b>◆</b> R	<b>∢</b> R •	◆R
	GREEN BAY F	SIGNALS CROSSING ROAD ON SOUTH SIDE AVENUE (S. LEG)	н	н	н	н	н	н	н	н	н	н	,	, ,	н н	н	н	н	н	н	Н	Н	н	н	н	1 1	4 н	н	Н	Н	н	н	н	н	Н	н	н			ŧ * FH	н	н	* P	* * FH	н	н	н	н	н	Н	н	н	н	D A R
CKED NOTATING CHKID	GREEN BAY F	SIGNALS CROSSING ROAD ON NORTH SIDE AVENUE (N. LEG)	н	н	н	н	н	н	н	н	н	н н	і н	,	н	н	н	н	н	н	н	н	н	н	н	,	н н	н	н	н	н	н		* * FH	H.	н	Р	Р	н	н	н	- 1		* * FH	н	н	н	н	н н	+ Н	н	н	H A	D A R
PROFILE STREETED (AUTO) NOTE BOOK (BALKE) GEGETS NO. STREETINGS (GEGETS) NO.	PEDESTRIAN CENTRAL AVE OF GREEN BA	SIGNALS CROSSING ENUE ON WEST SIDE LY ROAD (W. LEG)	н	н	н	н	н	н	* * P F		н	н	н	Н	н	н	н	н	* P	* * FH	н	н	н	н	н	·   +	1 н	н	н	Н	н	н	н	н	н	н	н	н	н	н	н	н	н	н	Н	н	н	н	н	н	Н	н	Н	D A R
PROF NOTE	FH = ILL H = ILL * TO	.UMINATED PERSON .UMINATED FLASHIN .UMINATED SOLID H APPEAR ONLY UPON SHING	G HAND AND = PUSHBL	DON'T	WALK ACTUA	TI ON			0	±	THIS MAY F THROU NOT S	INISH IGH MO SUFFIC VINTE	OR OR TIM DVEME CIENT ERVAL	FLAS ING I NT IF TO 0	SHING IN THE THE COMPLE	BI-I	IN DIRE ARR	TERVA CTION OW TI	L AL ST ME IS LASHI	RAI GI	11													TR.	AFFI R IN	C S	SIGI RM	IAL ATI(	RE(	COF ON	RD LY	DR	AW	'ING	i		Pi Pi Ci	HASE ?	2 AND 6 ON REG NATED S	5 SHAL CALL F SYSTEM	_L BE FOR			
	// OF	THE PEDESTRIAN IN AND FLASHING	TERVAL	L CLEA	RANCE BE S	ET ON!	_Y ON	PHAS	GES WHI	ERE ERATI	ON.						,																		REVIS		DATI		CEN	NTRAL	. AVE	NUE A	AT GR		ATION BAY RO		CH AP DA	DRAWN: CHECKEDs APPROVEDs	GF FERSE 02-14-20	REEN	OF WIND BAY	WILME ' ROA	AD ·	Ξ

CENTRAL AVENUE AND WILMETTE AVENUE EXISTING SEQUENCE OF OPERATIONS GREEN BAY ROAD AND CENTRAL AVENUE F.A.U. RTE. 1296 COUNTY TOTAL SHEET NO.

COOK 318 210 SECTION STATE OF ILLINOIS 16-00199-00-RS CONTRACT NO. 61G42

ILLINOIS FED. AID PROJECT **DEPARTMENT OF TRANSPORTATION** SCALE: NONE SHEET 23 OF 33 SHEETS STA.

F.A.U RTE.	SECTION	COUNT	Y TOTAL SHEETS	SHEET NO.
2744	06-00183-00-	-сн соо	K 73	44
STA.		TO STA.		
FED. F	OAD DIST. NO. IL	LINOIS FED.	AID PROJECT	Г
		CONT	RACT NO. 839	999

#### PROPOSED EMERGENCY VEHICLE PREEMPTION SEQUENCE OF OPERATIONS

																				PREEMPTOR NUMBER 3	PREEMPTOR NUMBER 4	PREEMPTOR NUMBER 5	PREEMPTOR NUMBER 6	
CHANGE FROM NORMAL SEQUENCE OF OPERATION INTERVAL NUMBER		1		1	1			5		5	9	9	)		12			12						CLEAR TO
EMERGENCY VEHICLE PREEMPTION SEQUENCE OF OPERATION INTERVAL NUMBER	1A	1B	10	1D	1E	1F	1G	1H	<b>1</b> J	1K	1L	1M	1N	1P	10	1R	15	1T	10	2	3	4	5	NORMAL SEQUENCE
CHANGE TO EMERGENCY VEHICLE PREEMPTION SEQUENCE OF OPERATION INTERVAL NUMBER	18	2	1D	3	1F	4 OR 5	1H	1J	2, 4 OR 5	3	2	1N	3, 4 OR 5	10	1R	2	1T	10	3, 4 OR 5					<b>♦</b>
GREEN BAY ROAD NEAR RIGHT AND CENTER AND FAR RIGHT MAST ARM SIGNALS N/B	R	R	R	R	R	R	R	R	R	R	G	Υ	R	G	G	G	G	Y	R	G	R	R	R	•
GREEN BAY ROAD LEFT MAST ARM AND FAR LEFT SIGNALS N/B	R <b>46</b> -	R <b>∢6</b>	R <b>∢</b> Y	R	R <b>∢</b> Y	R	R	R	R	R	G <b>∢</b> 6-	Υ	R	G	G	G	G	Y	R	G <b>∢</b> 6	R	R	R	•
GREEN BAY ROAD NEAR RIGHT AND CENTER AND FAR RIGHT MAST ARM SIGNALS 5/B	R	R	R	R	R	R	G	Υ	R	G	R	R	R	G	Υ	R	G	Υ	R	R	G	R	R	<b>♦</b>
GREEN BAY ROAD LEFT MAST AFM AND FAR LEFT SIGNALS S/B	<b>◆</b> ¥-	<del>∢R</del> -	<del>4</del> 0-	<del>4</del> 8-	<b>◆</b> ¥	<del>∢R-</del>	<b>4</b> 6-	<b>◆</b> ¥	<del>◆R-</del>	<del>4</del> 6-	<del>∢R</del> -	<b>◆</b> R-	<b>∢</b> R-	<b>◆</b> R-	<b>◆</b> R-	<b>∢</b> R-	<b>◆</b> R-	<b>∢</b> R	<del>∢R-</del>	<b>∢</b> R-	<del>40</del>	<b>∢</b> R−	<b>∢</b> R−	•
CENTRAL AVENUE FAR RIGHT AND CENTER MAST ARM SIGNALS W/B	R	R	R	R	R	R	R	R	R	R	R	R	R	R	R	R	R	R	R	R	R	G	R	•
CENTRAL AVENUE LEFT MAST ARM AND FAR LEFT SIGNALS W/B	<b>4</b> R-	<b>4</b> R−	<b>∢</b> R	<b>∢</b> R-	<b>∢</b> R-	<b>4</b> ₽	<b>∢</b> R-	<b>∢</b> R−	<b>∢</b> R	<b>∢</b> R-	<b>∢</b> R-	<b>∢</b> R−	<b>◆</b> R-	<b>∢</b> R-	<b>∢</b> R-	<b>∢</b> R−	<b>∢</b> R-	<b>∢</b> R-	<b>∢</b> R−	<b>∢</b> R	<b>∢</b> R	<b>4</b> 6-	<b>∢</b> R−	<b>♦</b>
CENTRAL AVENUE (EAST OF TRACKS) LEFT CANTILEVER AND FAR LEFT MEDIAN SIGNALS W/B	<b>◆</b> R-	<b>◆</b> R-	<del>∢R</del>	◆R	<b>◆</b> R-	<b>4</b> ₽-	<b>∢</b> R−	<del>4₽</del> -	◆R	<b>◆</b> R-	<b>∢</b> R−	◆R	<b>∢</b> R	<b>∢</b> R	<b>∢</b> R-	<b>∢</b> R-	∢R−	<b>∢</b> R−	◆R	<b>∢</b> R-	∢R	<b>4</b> 6-	<b>∢</b> R−	•
CENTRAL AVENUE (EAST OF TRACKS) FAR RIGHT AND CENTER CANTILEVER SIGNALS W/B	R	R	R	R	R	R	R	R	R	R	R	R	R	R	R	R	R	R	R	R	R	G	R	•
CENTRAL AVENUE NEAR RIGHT CENTER AND FAR RIGHT MAST ARM SIGNALS E/B	R	R	R	R	R	R	R	R	R	R	R	R	R	R	Ř	R	R	R	R	R	R	R	G	<b>♦</b>
CENTRAL AVENUE LEFT MAST AFM AND FAR LEFT SIGNALS E/B	<b>◆</b> R	<b>∢</b> R-	<b>◆</b> R-	<b>◆</b> R-	<b>◆</b> R	<b>◆</b> R-	<b>◆</b> R−	<b>∢</b> R−	◆R-	<b>◆</b> R−	<b>◆</b> R-	◆R	<b>◆</b> R-	<b>∢</b> R	<b>∢</b> R_	<b>∢</b> R-	<b>∢</b> R−	<b>∢</b> R−	◆R−	<b>∢</b> R-	· <del>◆R</del> -	<b>∢</b> R-	<b>4</b> 6-	•
PEDESTRIAN SIGNALS CROSSING GREEN BAY ROAD ON SOUTH SIDE OF CENTRAL AVENUE (S. LEG)	Н	Н	Н	Н	Н	н	Н	Н	н	Н	Н	н	Н	н	Н	н	Н	н	н	н	Н	н	н	<b>*</b>
PEDESTRIAN SIGNALS CROSSING GREEN BAY ROAD ON NORTH SIDE OF CENTRAL AVENUE (N. LEG)	Н	н	Н	Н	н	Н	Н	Ħ	Н	н	Н	н	н	Н	н	Н	Н	н	Н	Н	н	н	н	•
PEDESTRIAN SIGNALS CROSSING CENTRAL AVENUE ON WEST SIDE OF GREEN BAY ROAD (W. LEG)	н	н	н	Н	н	н	FH	Н	н	FH	н	н	Н	FH	н	н	FH	н	н	н	Н	н	н	<b>♦</b>

P = ILLUMINATED PERSON = WALK

FH = ILLUMINATED FLASHING HAND = FLASHING DON'T WALK

H = ILLUMINATED SOLID HAND = DON'T WALK

◆= EMERGENCY VEHICLE SEQUENCE SHALL PROVIDE THE PROPER CLEARANCE INTERVAL TO RESUME THE NORMAL OPERATION OR PROPER CLEARANCE INTERVAL TO DISPLAY A DIFFERENT EMERGENCY VEHICLE INTERVAL AFTER EMERGENCY VEHICLE INTERVAL 2 OR 3 IS TERMINATED.

### TRAFFIC SIGNAL RECORD DRAWING FOR INFORMATION ONLY

4 OF 6

ENERGENOV VEHTOLE PRESIDENCE	VILLAGE OF	WILMETTE
EMERGENCY VEHICLE PREEMPTION	VILLAGE OF	WILIVILIIL
SEQUENCE OF OPERATIONS	GREEN B	AY ROAD
SHEET 1 OF 2	INTERSECTION	IMPROVEMENTS
CENTRAL AVENUE AT GREEN BAY ROAD	DRAWNs	SHEET NO.
	CHECKEDs	
	APPROVED	
	DATE: 02-14-2008	
TY:LININTERNATIONAL	SCALE: NONE	
	J0B N0.s	PROJECT NO.:
	SEQUENCE OF OPERATIONS SHEET 1 OF 2	SHEET 1 OF 2  CENTRAL AVENUE AT GREEN BAY ROAD  CONSULTANT  TYLININTERNATIONAL  INTERSECTION  DRAWN  CHICKNED  APPROVED  DATE: 02-14-2008  SCALE: NONE

1475 EAST WOODFIELD ROAD, SUITE 600 SCHAUMBURG, ILLINOIS 60173 (847) 605-9600

Train Systems

PLAN SIRVEYED ROLL BOOK RIT, OF WAY CHECKED NO. CADO FILE NAME

PROFILE SURVEYED

NOTE BOOK GROSS OFFICED

NO. STRUCTURE NOTATION

NAME =	USER NAME = Mlbeening	DESIGNED -	MLB	REVISED -	
84-Ex Emerge		DRAWN -	MLB	REVISED -	
	PLOT SCALE = 40.0000 '/ in.	CHECKED -	DWB	REVISED -	
ult	PLOT DATE = 2/13/2020	DATE -	02/13/2020	REVISED -	
					Ξ

STATE OF ILLINOIS	
DEPARTMENT OF TRANSPORTATION	

CLIVITIAL AVENUE AND WILIVIETE AVENUE	F.A.U. RTE.	SECTION	COUNTY	TOTAL SHEETS	SHEET NO.
EXISTING EMERGENCY VEHICLE PREEMPTION SEQUENCE OF OPERATIONS	1296	16-00199-00-RS	соок	318	211
GREEN BAY ROAD AND CENTRAL AVENUE			CONTRACT	NO. 610	G42
SCALE: NONE   SHEET 24 OF 33 SHEETS   STA. TO STA.		ILLINOIS FED. A	ID PROJECT		

F.A.U. RTE.	SECTION		COUNT	Υ	TOTAL	SHEET NO.
2744	06-00183-0	о-сн	C00	K	73	45
STA.		7	O STA.			
FED. RO	AD DIST. NO.	ILLIN	OIS FED.	AID	PROJECT	
			CONT	RACT	NO. 839	999

#### PROPOSED EMERGENCY VEHICLE PREEMPTION SEQUENCE OF OPERATIONS

																																		PREEMPTOR NUMBER 3		PREEMPTOR NUMBER 5		
CHANGE FROM NORMAL SEQUENCE OF OPERATION INTERVAL NUMBER		1	15			5		1	5				1	9		19		2	2	22			2	25			2	25			2	25						CLEAR TO
EMERGENCY VEHICLE PREEMPTION SEQUENCE OF OPERATION INTERVAL NUMBER	1V	1W	1X	1Y	1Z	1AA	1BB	100	1DD	1EE	1FF	1GG	1HH	1JJ	1KK	1LL	1MM	1NN	1PP	100	1RR	155	1TT	100	177	1WW	1XX	1YY	1ZZ	1AAA	1BBB	1CCC	1DDD	2	3	4	5	NORMAL SEQUENCE
CHANGE TO EMERGENCY VEHICLE PREEMPTION SEQUENCE OF OPERATION INTERVAL NUMBER	1W	1X	1Y	2 OR 3	1AA	4	100	1DD	1EE	5	1GG	1HH	1JJ	1KK	2, 3 OR 5	4	1NN	1PP	2, 3 OR 4	5	155	177	100	177	2 OR 3	1XX	1YY	4	1AAA	18B8	1CCC	1DDD	5					<b>♦</b>
GREEN BAY ROAD NEAR RIGHT AND CENTER AND FAR RIGHT MAST ARM SIGNALS N/B	R	R	R	R	R	R	R	R	R	R	R	R	R	R	R	R	R	R	R	R	R	R	R	R	R	R	R	R	R	R	R	R	R	G	R	R	R	<b>♦</b>
GREEN BAY ROAD LEFT MAST ARM AND FAR LEFT SIGNALS N/B	R	R	R	R	R	R	R	R	R	R	R	R	R	R	R	R	R	R	R	R	R	R	R	R	R	R	R	R	R	R	R	R	R	G <b>∢</b> 6	R	R	R	•
GREEN BAY ROAD NEAR RIGHT AND CENTER AND FAR RIGHT MAST ARM SIGNALS S/B	R	R	R	R	R	R	R	R	R	R	R	R	R	R	R	R	R	R	R	R	R	R	R	R	R	R	R	R	R	R	R	R	R	R	G	R	R	<b>♦</b>
GREEN BAY ROAD LEFT MAST ARM AND FAR LEFT SIGNALS S/B	<b>∢</b> R-	<b>∢</b> R-	<b>∢</b> R-	<b>∢</b> R	<b>∢</b> R	<del>∢R</del> -	<b>∢</b> R-	<b>∢</b> R	<b>∢</b> R-	<b>∢</b> R-	<b>∢</b> R-	<b>∢</b> R	<b>∢</b> R	<b>∢</b> R	<b>∢</b> R-	<b>◆</b> R	<b>∢</b> R-	<b>∢</b> R-	<b>∢</b> R	<b>∢</b> R−	<b>∢</b> R	<b>∢</b> R	<b>∢</b> R	<b>∢</b> R-	<b>∢</b> R-	◆R	<b>∢</b> R−	<b>∢</b> R-	<b>∢</b> R−	<b>∢</b> R−	<b>∢</b> R−	<b>∢</b> R	<b>◆</b> R-	<b>◆</b> R	<del>40</del>	<b>∢</b> R−	<b>∢</b> R-	•
CENTRAL AVENUE FAR RIGHT AND CENTER MAST ARM SIGNALS W/B	R	R	R	R	R	R	R	R	R	R	G	G	G	Y	R	G	R	R	R	R	G	G	G	Y	R	G	G	G	G	G	G	Y	R	R	R	G	R	<b>♦</b>
CENTRAL AVENUE LEFT MAST ARM AND FAR LEFT SIGNALS W/B	<b>4</b> 6−	<b>4</b> 6-	<b>◆</b> ¥	◆R	<b>4</b> 6−	<b>4</b> 6−	<b>4</b> 6−	<b>4</b> 6−	<b>∢</b> Υ	<b>∢</b> R-	<del>4</del> 0-	<b>4</b> 6−	<del>46</del> -	<b>◆</b> ¥-	<b>◆R</b> -	<b>4</b> 6	<b>∢</b> R-	<b>∢</b> R-	<b>∢</b> R−	<b>∢</b> R−	<b>◆</b> R-	<b>∢</b> R−	<b>◆</b> R-	<b>∢</b> R−	<b>∢</b> R−	◆R	<b>∢</b> R−	<b>∢</b> R	<b>∢</b> R−	<b>∢</b> R−	<b>∢</b> R−	<b>∢</b> R	<b>∢</b> R	<b>∢</b> R-	. ◆R-	<b>4</b> 6-	◆R	<b>♦</b>
CENTRAL AVENUE (EAST OF TRACKS) LEFT CANTILEVER AND FAR LEFT MEDIAN SIGNALS W/B	<del>∢</del> Y	• <del></del> R-	<b>∢</b> R-	<b>∢</b> R	<b>4</b> 6-	<b>4</b> 6	<b>◆</b> ¥-	<b>◆</b> R-	<b>∢</b> R	<b>4</b> R−	<b>4</b> 6−	<b>◆</b> ¥-	<b>∢</b> R	<b>∢</b> R-	<b>∢</b> R-	<b>4</b> 6-	<b>∢</b> R-	◆R	<b>∢</b> R−	<b>∢</b> R−	<b>4</b> R−	<del>∢R</del>	<b>∢</b> R	<b>∢</b> R-	<b>∢</b> R	<b>∢</b> R	<b>∢</b> R-	<del>∢R</del>	<b>∢</b> R-	<b>∢</b> R−	<b>∢</b> R	<b>∢</b> R-	<b>◆</b> R-	<del>∢R</del>	₹R	<del>4</del> 6-	<b>∢</b> R-	<b>♦</b>
CENTRAL AVENUE (EAST OF TRACKS) FAR RIGHT AND CENTER CANTILEVER SIGNALS W/B	R	R	R	R	R	R	R	R	R	R	G	Y	R	R	R	G	R	R	R	R	G	Υ	R	R	R	G	G	G	G	Y	R	R	R	R	R	G	R	•
CENTRAL AVENUE NEAR RIGHT CENTER AND FAR RIGHT MAST ARM SIGNALS E/B	R	R	R	R	R	R	R	R	R	R	R	R	R	R	R	R	G	Υ	R	G	G	G	G	Y	R	G	Y	R	G	G	G	G	G	R	R	R	G	<b>♦</b>
CENTRAL AVENUE LEFT MAST ARM AND FAR LEFT SIGNALS E/B	<del>4</del> 6-	<b>4</b> 6	<b>∢</b> ¥-	<b>∢</b> R	<b>∢</b> ¥	<b>◆R</b> -	<b>4</b> 6-	<b>4</b> 6−	<del>46</del> -	<del>4</del> 6−	<b>∢</b> R−	<b>4</b> R−	<b>∢</b> R−	<b>◆</b> R-	<b>∢</b> R-	<b>∢</b> R-	<b>4</b> 6−	<b>◆</b> ¥	<b>∢</b> R-	<b>4</b> 6-	<b>∢</b> R-	<b>∢</b> R-	<b>∢</b> R	<b>∢</b> R-	<b>◆R</b> -	<b>◆</b> R-	<b>∢</b> R-	<b>∢</b> R	<b>∢</b> R-	<b>◆</b> R-	<b>∢</b> R-	<b>∢</b> R−	<b>◆</b> R	<b>∢</b> R-	<b>◆</b> R-	<del>∢R</del> -	<del>∢</del> 6-	<b>♦</b>
PEDESTRIAN SIGNALS CROSSING GREEN BAY ROAD ON SOUTH SIDE OF CENTRAL AVENUE (S. LEG)	н	н	н	н	н	н	н	н	н	н	н	н	н	н	н	н	FH	Н	н	FH	FH	Н	н	н	н	FH	н	н	FH	н	Н	н	н	н	н	н	Н	•
PEDESTRIAN SIGNALS CROSSING GREEN BAY ROAD ON NORTH SIDE OF CENTRAL AVENUE (N. LEG)	н	н	н	н	н	н	н	н	н	н	FH	н	н	н	н	FH	н	н	н	Н	FH	Н	н	Н	Н	FH	Н	H	FH	н	н	Н	н	Н	н	н	Н	<b>♦</b>
PEDESTRIAN SIGNALS CROSSING CENTRAL AVENUE ON WEST SIDE OF GREEN BAY ROAD (W. LEG)	н	н	н	н	Н	н	н	н	н	н	Н	н	н	н	н	Н	Н	н	н	н	н	Н	н	Н	н	н	н	н	Н	н	Н	Н	н	н	н	н	н	<b>♦</b>

STATE OF ILLINOIS

**DEPARTMENT OF TRANSPORTATION** 

P = ILLUMINATED PERSON = WALK

FH = ILLUMINATED FLASHING HAND = FLASHING DON'T WALK

H = ILLUMINATED SOLID HAND = DON'T WALK

◆= EMERGENCY VEHICLE SEQUENCE SHALL PROVIDE THE PROPER CLEARANCE INTERVAL TO RESUME THE NORMAL OPERATION OR PROPER CLEARANCE INTERVAL TO DISPLAY A DIFFERENT EMERGENCY VEHICLE INTERVAL AFTER EMERGENCY VEHICLE INTERVAL 2 OR 3 IS TERMINATED.

### TRAFFIC SIGNAL RECORD DRAWING FOR INFORMATION ONLY

5 OF 6

[	REVISIONS		SUSSICIONAL VIEW SUSSICIONAL S	VILLAGE OF	WILMETTE
	NAME	DATE	EMERGENCY VEHICLE PREEMPTION SEQUENCE OF OPERATIONS		AY ROAD
			SHEET 2 OF 2	INTERSECTION	IMPROVEMENTS
			CENTRAL AVENUE AT GREEN BAY ROAD	DRAWN:	SHEET NO.
				CHECKED:	
			CONSILITANT	APPROVEDs	
- 1			***************************************	DATE: 02-14-2008	
			TYLININTERNATIONAL	SCALE: NONE	
				JOB NO.s	PROJECT NO.2

FILE NAME = MIbeening DESIGNED - MLB REVISED TS0185-Ex Emerge DRAWN - MLB REVISED 
PLOT SCALE = 40.0000 '/ in. CHECKED - DWB REVISED 
PLOT DATE = 2/13/2020 DATE - 02/13/2020 REVISED -

CENTRAL AVENUE AND WILMETTE AVENUE
EXISTING EMERGENCY VEHICLE PREEMPTION SEQUENCE OF OPERATIONS
GREEN BAY ROAD AND CENTRAL AVENUE

SCALE: NONE SHEET 25 OF 33 SHEETS STA. TO STA.

PROFILE SIGNACED PROFICE SIGNACED PLOTED PLO

PLAN SURMEYED OF OTED NOTE BOOK ALGENED NO. CADO FILE NAME.

PROFILE NOTE BOOK

TEID Systems

1475 EAST WOODFIELD ROAD, SUITE 600
SCHAUMBURG, ILLINOIS 60173
(847) 605-9600

3 AB	SURVEYED	PLOTTED	NOTE BOOK GRADES CHECKED	NOTED	CIURE NOTATINS CHIKD	
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Tran Systems

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TSØ186-Ex Railro

F.A.U. SECTION 2744 06-00183-00-CH TO STA. FED. ROAD DIST. NO. ILLINOIS FED. AID PROJECT PROPOSED RAILROAD PREEMPTION SEQUENCE OF OPERATIONS CONTRACT NO. 83999

																		MPTOR BER 3		MPTOR SER 4		MPTOR BER 4		MPTOR BER 5	PREEMPTOR NUMBER 2				
CHANGE FROM NORMAL SEQUENCE OF OPERATION INTERVAL NUMBER		1		5		9	1	2	1	5	1	19	2	22	2	!5													
CHANGE FROM EMERGENCY VEHICLE PREEMPTION SEQUENCE OF OPERATION INTERVAL NUMBER																		2		3		4	į	5					CLEAR TO NORMAL SEQUENCE
RAILROAD PREEMPTION SEQUENCE OF OPERATION INTERVAL NUMBER	1A	1B	1C	1D	1E	1F	1G	1H	1J	1K	1L	1M	1N	1P	10	1R:	15	1T	1U	1٧	1W	1X	1Y	1Z	2	3	4	5	
CHANGE TO RAILROAD PREEMPTION SEQUENCE OF OPERATION INTERVAL NUMBER	1B	2	1D	2	1F	2	1H	2	2	2	1M	2	1P	2	1R	2	1T	2	1٧	2	1X	2	1Z	2	3	4	5		
GREEN BAY ROAD NEAR RIGHT AND CENTER AND FAR RIGHT MAST ARM SIGNALS N/B	R	R	R	R	Y	R	Υ	R	R	R	R	R	R	R	R	R	Υ	R	R	R	R	R	R	R	R	R	R	G	
GREEN BAY ROAD LEFT MAST ARM AND FAR LEFT SIGNALS N/B	R <b>∢</b> Y	R	R	R	Υ	R	Υ	R	R	R	R	R	R	R	R	R	Υ	R	R	R	R	R	R	R	R	R	R	G	
GREEN BAY ROAD NEAR RIGHT AND CENTER AND FAR RIGHT MAST ARM SIGNALS S/B	R	R	Υ	R	R	R	Υ	R	R	R	R	R	R	R	R	R	R	R	Υ	R	R	R	R	R	R	R	R	G	
GREEN BAY ROAD LEFT MAST ARM AND FAR LEFT SIGNALS S/B	<b>◆</b> ¥	<b>◆</b> R	<b>◆</b> ¥	<b>◆</b> R-	<b>◆</b> R	<b>∢</b> R	<b>◆</b> R	<b>◆</b> R-	<b>◆</b> R-	<b>∢</b> R	<b>∢</b> R⊢	<b>◆</b> R-	<b>◆</b> R-	<b>∢</b> R-	<b>◆</b> R	<b>∢</b> R−	<b>∢</b> R	<b>∢</b> R-	<b>◆</b> ¥	<b>∢</b> R	<b>∢</b> R	◆R	<b>∢</b> R	<b>∢</b> R-	<b>◆</b> R-	<b>∢</b> R-	<b>◆</b> R-	<b>◆</b> R	
CENTRAL AVENUE FAR RIGHT AND CENTER MAST ARM SIGNALS W/B	R	R	R	R	R	R	R	R	R	R	G	G	R	R	G	G	R	R	R	G	G	G	R	R	G	Υ	R	R	
CENTRAL AVENUE LEFT MAST ARM AND FAR LEFT SIGNALS W/B	<b>∢</b> R	<b>∢</b> R	<b>◆</b> R-	<b>∢</b> R-	<b>∢</b> R	<b>∢</b> R-	<del>∢R</del> -	<b>∢</b> R	<del>46</del> -	<b>4</b> 6-	<b>4</b> 6−	<del>4</del> 6-	◆R	<b>◆</b> R-	<b>∢</b> R	<b>◆</b> R	<b>∢</b> R	<b>∢</b> R	<b>◆</b> R-	◆R	<b>4</b> 6−	<b>4</b> 6-	<b>◆</b> R	<b>∢</b> R	<del>46</del> -	<b>◆</b> ¥	<b>◆</b> R-	<b>◆</b> R	
CENTRAL AVENUE (EAST OF TRACKS) LEFT CANTILEVER AND FAR LEFT MEDIAN SIGNALS W/B	<b>∢</b> R-	<b>∢</b> R	<b>◆</b> R-	<b>◆</b> R-	<b>◆</b> R-	<b>◆</b> R-	<b>∢</b> R	<b>◆</b> R-	<b>◆</b> ¥	<b>◆</b> R-	<b>4</b> ¥	<b>◆</b> R-	<b>◆</b> R	◆R	<b>∢</b> R	<b>∢</b> R−	<b>∢</b> R	<b>∢</b> R-	<b>∢</b> R-	<b>∢</b> R-	<b>4</b> ¥	<b>∢</b> R-	<b>∢</b> R	◆R	<b>∢</b> R-	<b>∢</b> R-	<b>◆</b> R-	<b>∢</b> R-	<b>A</b>
CENTRAL AVENUE (EAST OF TRACKS) FAR RIGHT AND CENTER CANTILEVER SIGNALS W/B	R	R	R	R	R	R	R	R	R	R	Υ	R	R	R	Υ	R	R	R	R	R	Y	R	R	R	R	R	R	R	
CENTRAL AVENUE NEAR RIGHT CENTER AND FAR RIGHT MAST ARM SIGNALS E/B	R	R	R	R	R	R	R	R	R	R	R	R	Y	R	Υ	R	R	R	R	R	R	R	Υ	R	R	R	R	R	
CENTRAL AVENUE LEFT MAST ARM AND FAR LEFT SIGNALS E/B	<b>◆</b> R	<b>◆</b> R-	<b>◆</b> R-	<b>◆</b> R-	<b>∢</b> R	<b>∢</b> R	<b>∢</b> R	<b>∢</b> R−	<b>◆</b> ¥	<b>◆</b> R-	<del>◆R</del>	<b>◆</b> R	<b>◆</b> ¥	<b>∢</b> R	<b>◆</b> R	<b>∢</b> R	<b>◆</b> R-	<b>∢</b> R-	<b>∢</b> R-	<b>◆</b> R	<b>◆</b> R-	◆R-	<b>◆</b> ¥	<b>◆</b> R-	<del>∢</del> R-	◆R	◆R	<b>∢</b> R	
PEDESTRIAN SIGNALS CROSSING GREEN BAY ROAD ON SOUTH SIDE OF CENTRAL AVENUE (S. LEG)	н	Н	Н	Н	Н	н	Н	Н	н	Н	Н	н	FH	Н	FH	Н	Н	н	Н	н	н	н	н	н	Н	Н	Н	Н	
PEDESTRIAN SIGNALS CROSSING GREEN BAY ROAD ON NORTH SIDE OF CENTRAL AVENUE (N. LEG)	н	Н	н	н	Н	Н	Н	н	Н	Н	FH	Н	Н	Н	н	н	Н	н	Н	н	Н	н	Н	Н	Н	Н	н	Н	
PEDESTRIAN SIGNALS CROSSING CENTRAL AVENUE ON WEST SIDE OF GREEN BAY ROAD (W. LEG)	н	Н	FH	Н	Н	Н	FH	н	н	Н	Н	н	н	Н	Н	Н	Н	Н	Н	Н	н	H	н	Н	н	н	н	Н	
INTERNALLY ILLUMINATED NRT SIGNS - GREEN BAY ROAD	NRT	NRT	NRT	NRT	NRT	NRT	NRT	NRT	NRT	NRT	NRT	NRT	NRT	NRT	NRT	NRT	NRT	NRT	NRT	NRT	NRT	NRT	NRT	NRT	NRT	NRT	NRT	NRT	
						,														•	•					•	•	HOLD	

RAILROAD PREEMPTION SEQUENCE SHALL PROVIDE THE PROPER CLEARANCE INTERVAL TO RESUME THE NORMAL SEQUENCE OF OPERATION OR PROPER CLEARANCE INTERVAL TO DISPLAY AN EMERGENCY VEHICLE INTERVAL 2, 3 OR 4 (IF APPLICABLE) AFTER RAILROAD PREEMPTION INTERVAL 5 IS TERMINATED.

P = ILLUMINATED PERSON = WALK

FH = ILLUMINATED FLASHING HAND = FLASHING DON'T WALK

H = ILLUMINATED SOLID HAND = DON'T WALK

### TRAFFIC SIGNAL RECORD DRAWING FOR INFORMATION ONLY

6 OF 6


COOK

REVISIONS			VILLAGE OF	- WILMETTE
NAME	DATE	RAILROAD PREEMPTION		
			GREEN B	AY ROAD
		SEQUENCE OF OPERATIONS	INTERSECTION	IMPROVEMENTS
			TIVIENSECTION	IMP KOAFMENIS
		CENTRAL AVENUE AT GREEN BAY ROAD	DRAWN:	SHEET NO.
			CHECKEDs	
		CONSULTANT	APPROVED:	
			DATE: 02-14-2008	
		TY-LININTERNATIONAL	SCALE: NONE	
			JOB NO.s	PROJECT NO.:

USER NAME = Mlbeening	DESIGNED -	MLB	REVISED -	
	DRAWN -	MLB	REVISED -	STATE OF ILLINOIS
PLOT SCALE = 40.0000 ' / in.	CHECKED -	DWB	REVISED -	DEPARTMENT OF TRANSPORTATION
DI OT DATE - 2/12/2020	DATE	02/13/2020	DEVISED	

	EXISTING	CENTRAL AV RAILROAD GREEN BAY	PREEMP	TION	SEQUENC	E OF OPERATIONS
ĺ	SCALE: NONE	SHEET 26	OF 33	SHEETS	STA.	TO STA.

F.A.U. RTE.	SECTION	COUNTY	TOTAL SHEETS	SHEE
1296	16-00199-00-RS	COOK	318	213
		CONTRACT	NO. 61	G42
	ILLINOIS FED. A	ID PROJECT		

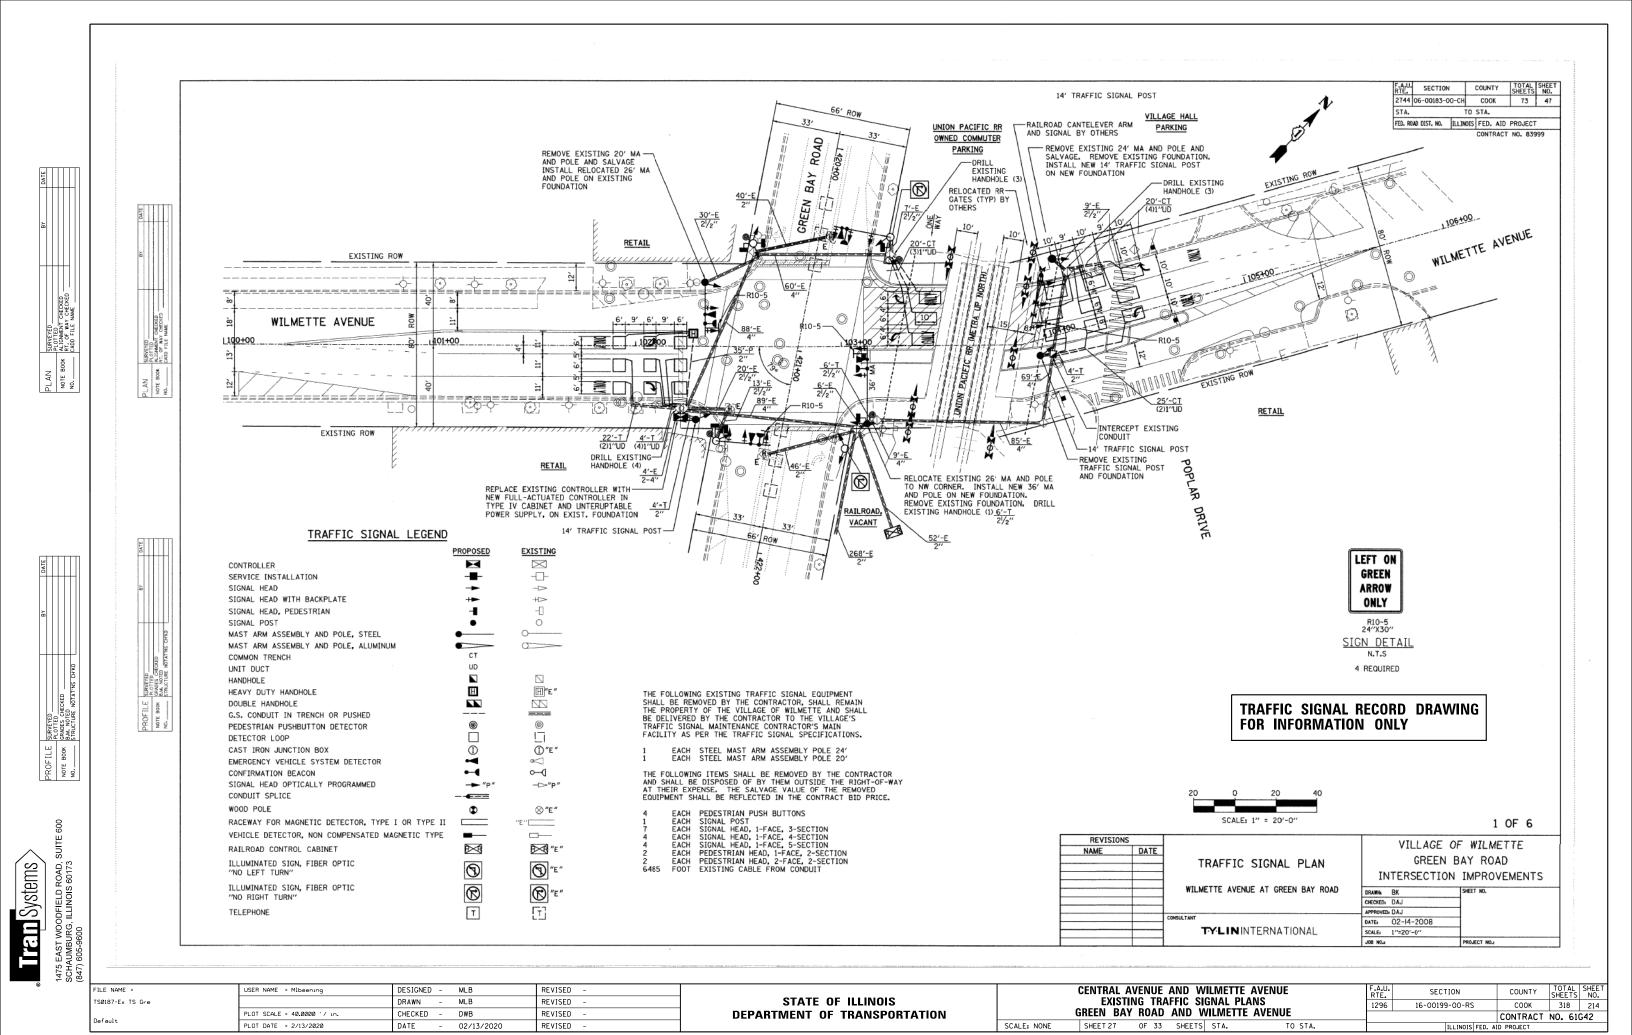

2744 06-00183-00-CH COOK 73 48 INTERCONNECT TO GREEN BAY ROAD/ INTERCONNECTION DETECTOR CENTRAL AVENUE FED. ROAD DIST. NO. ILLINOIS FED. AID PROJECT NO. 62.5/125 F FIBER OPTIC CABLE CABLE PLAN LEGEND TRACER EXISTING EXISTING PROPOSED PROPOSED (C) 8" (200mm) TRAFFIC SIGNAL SECTION ″E‴**⊵**⊠€ **₹** RAILROAD CONTROL CABINET  $\mathbb{R}$ 12" (300mm) TRAFFIC SIGNAL SECTION ILLUMINATED SIGN, FIBER OPTIC W "NO LEFT TURN" 12" (300mm) PEDESTRIAN SIGNAL SECTION ILLUMINATED SIGN, FIBER OPTIC **B** "NO RIGHT TURN" BAY 12" (300mm) PEDESTRIAN SIGNAL SECTION **9** ∭⊸  $\bowtie$ GROUND ROD AT CONTROLLER -ড্র-CONTROLLER CABINET  $\operatorname{const}(\mathcal{A}) = \operatorname{const}(\mathcal{A})$  $\Box$ SERVICE INSTALLATION -⊚ C GROUND ROD AT POST -(5)--(E'>'0' TELEPHONE CONNECTION - E > O 222 CHECKED GROUND ROD AT ELECTRIC MAGNETIC DETECTOR SERVICE INSTALLATION -(5)-EMERGENCY VEHICLE -(5)---(a > 0 Œ GROUND CABLE IN CONDUIT LIGHT DETECTOR 3\*20-NO.6 SOLID COPPER (GREEN) CONFIRMATION BEACON 2 -S--FITT FIBER OPTIC CABLE IN CONDUIT, NO. 62.5/125 2-MM12F & SM12F PUSHBUTTON DETECTOR PACIFIC B00K -S-FIT VEHICLE DETECTOR, INDUCTION LOOP HANDHOLE/DOUBLE HANDHOLE WITH GROUNDED FRAME AND COVER <del>-</del>2-하시죠 DENOTES NUMBER OF CONDUCTORS. Q UNINTERUPTABLE POWER SUPLY **3#20**-ALL CABLE NO. 14 EXCEPT AS -2)-WILMETTE AVENUE INDICATED. ALL LOOP DETECTOR <del>-</del>(3)-CABLE TO BE SHIELDED. ର ≺ ଅ – **(1)** SIGNAL FACE WITH BACKPLATE. " P" INDICATES PROGRAMMED HEAD റ ≺ ¤ – -(5)o ≺ z -5-**5 FITT** · · SCHEDULE OF QUANTITIES <u>.</u> >> = A ITEM DESCRIPTION EACH FOOT FOOT FOOT PEDESTRIAN PUSH BUTTON CONCRETE FOUNDATION, TYPE A, 30 INCH DIAMETER CONDUIT IN TRENCH, 2" DIA., GALVANIZED STEEL CONDUIT PUSHED, 2" DIA., GALVANIZED STEEL (5) (5) HANDHOLE
HANDHOLE
HEAVY DUTY HANDHOLE
DRILL EXISTING HANDHOLE
DRILL EXISTING HANDHOLE
IT ELECTRIC CABLE IN CONDUIT, SIGNAL NO. 14 3C
ELECTRIC CABLE IN CONDUIT, SIGNAL NO. 14 7C
ELECTRIC CABLE IN CONDUIT, SIGNAL NO. 14 7C
ELECTRIC CABLE IN CONDUIT, LEAD-IN, NO. 14 1 PAIR
FIBER OPTIC CABLE
HAST ARM ASSEMBLY AND POLE, 36 FT.
RELOCATE EXISTING MAST ARM ASSEMBLY AND POLE
SIGNAL HEAD, POLYCARBONATE, LED, 1-FACE, 3-SECTION, MAST ARM MOUNTED
SIGNAL HEAD, POLYCARBONATE, LED, 1-FACE, 3-SECTION, BRACKET MOUNTED
SIGNAL HEAD, POLYCARBONATE, LED, 1-FACE, 3-SECTION, BRACKET MOUNTED
SIGNAL HEAD, POLYCARBONATE, LED, 2-FACE, 1-3 SECTION, BRACKET MOUNTED
SIGNAL HEAD, POLYCARBONATE, LED, 2-FACE, 3-SECTION, BRACKET MOUNTED
SIGNAL HEAD, POLYCARBONATE, LED, 2-FACE, 3-SECTION, BRACKET MOUNTED
TOUR SIGNAL HEAD, POLYCARBONATE, LED, 2-FACE, BRACKET MOUNTED
TRAFFIC SIGNAL BACKPLATE
INDUCTIVE LOOP DETECTOR
TRAFFIC SIGNAL BACKPLATE
INDUCTIVE LOOP TYPE I
LIGHT DETECTOR, AMPLIFIER
TRENCH AND BACKFILL FOR ELECTRICAL WORK
TREMOVE EXISTING TRAFFIC SIGNAL EQUIPMENT
TO ELECTRIC CABLE IN CONDUIT, NO. 20 3/C, TWISTED, SHIELDED
TRAFFIC SIGNAL POST, GALVANIZED STEEL, 14 FT.
TREMOVE EXISTING CONCRETE FOUNDATION
HERMOVE EXISTING CONCRETE FOUNDATION
HERMOVE EXISTING CONCRETE FOUNDATION
HERMOVE EXISTING CONCRETE FOUNDATION
HIT REMOVE EXISTING CONCRETE FOUNDATION
HERMOVE EXISTING CONCRETE FOUNDATION
HER HEAVY DUTY HANDHOLE EACH EACH FOOT FOOT FOOT NO. 62.5/125 F FIBER OPTIC CABLE RAIL INTERCONNECT TRACER CABLE SYSTEM AND ----I.D.O.T. EACH EACH EACH EACH FOOT EACH TRAFFIC SIGNAL INSTALLATION PEDESTRIAN PUSH BUTTON "A" TO CALL PHASE 3. PEDESTRIAN PUSH BUTTON "B" TO CALL PHASE 3 AND 6. PEDESTRIAN PUSH BUTTON "C" TO CALL PHASE 4 AND 6. PEDESTRIAN PUSH BUTTON "D" TO CALL PHASE 4. DETECTOR ELECTRICAL SERVICE REQUIREMENTS % OPERATIONS TOTAL WATTAGE LED CABLE PLAN SIGNAL (RED) 204 NOT TO SCALE 150 (YELLOW) 25 0.25 FOOT EACH FOOT ( GREEN) 0.25 90 24 0.10 4.8 6485 150 TRAFFIC SIGNAL RECORD DRAWING 1.00 EACH EACH EACH 1.00 100 100 FOR INFORMATION ONLY IL SIGN 0.05 2.5 ILLUMINATED SIGN, LED
TEMPORARY TRAFFIC SIGNAL TIMING 2 OF 6 MAINTAIN EXISTING TRAFFIC SIGNAL INSTALLATION REVISIONS FLASHER LED 0.05 VILLAGE OF WILMETTE CABLE PLAN, SCHEDULE OF FOUNDATION DEPTH DEPTH (FT.) VERTI CAL NAME CABLE SLACK (FT.) DATE TOTAL = 701.3 Systems GREEN BAY ROAD QUANTITIES AND PHASE YPE A - POST HANDHOLE 6.5 ALL FOUNDATIONS 3.5 1475 EAST WOODFIELD ROAD, SCHAUMBURG, ILLINOIS 60173 BILLED TO: VILLAGE OF WILMETTE DESIGNATION DIAGRAM INTERSECTION IMPROVEMENTS - CONTOLLER DOUBLE HANDHOLE 13 MAST ARM (L) POLE =20' +L-2 ( ADDDRESS) 1200 WILMETTE AVENUE MAST ARM POLE ST GNAL POST 2 BRACKET MOUNTED 13 WILMETTE, IL WILMETTE AVENUE AT GREEN BAY ROAD PED. PUSHBUTTON CONTOLLER CAB CHECKED: DAJ ENERGY SUPPLY -CONTACT FIBER OPTIC ELECTRICAL SERVICE 13.5 PHONE DATE: 02-14-2008 Tran ELECTRICAL SERVICE 1 SERVICE TO GROUND 13.5 TY:LININTERNATIONAL COMPANY COMED SCALE: NONE GROUND CABLE 1 POSTMOUNTED JOB NO. **CENTRAL AVENUE AND WILMETTE AVENUE** DESIGNED -REVISED USER NAME = Mlbeening MLB SECTION COUNTY

STATE OF ILLINOIS

**DEPARTMENT OF TRANSPORTATION** 

SØ188-E× Cable

ORAWN

DATE

PLOT DATE = 2/13/2020

CHECKED

MLB

DWB

02/13/2020

REVISED

REVISED

REVISED

EXISTING TRAFFIC SIGNAL CABLE PLANS

**GREEN BAY ROAD AND WILMETTE AVENUE** 

SHEET 28 OF 33 SHEETS STA.

1296

16-00199-00-RS

COOK

CONTRACT NO. 61G42

318 215

Train Systems 1475 EAST WOODFIELD ROAI SCHAUMBURG, ILLINOIS 6017 847) 605-9600

TSØ189-Ex Phasis

DESIGNED -

CHECKED -

DRAWN

DATE

USER NAME = Mlbeening

PLOT DATE = 2/13/2020

PLOT SCALE = 40.0000 '/ in.

MLB

MLB

DWB

02/13/2020

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<u> </u>						П	
DA							
Вү							
	SURVEYED	PLOTTED	OK GRADES CHECKED	B.M. NOTED	STRUCTURE NOTATINS CHIKD		
1	PROFILE S		NOTE BOOK		NO.		
		COULTE COO	D, SUITE BOO				

CHECKED Y CHECKED NAME

PROPOSED NORMAL SEQUENCE OF OPERATIONS MOVEMENT 3 8 **4**7₃ PHASE 1+5 2+5 2+6 3+7 3+8 4+8 INTERVAL 2A 2B 3A 3B 4A 4B 5 6 7A 7B 8A 8B 9 10A 10B 11A 11B 12 13 144 14B 15 16A 16B 17A 17B 17C 17D 18A 18B 18C 18D 19 20 21A 21B 21C 21D 22 23 24A 24B 25 26 27A 27B 27C 27D 28A 28B 29A 29B 29C 29D 2+6 3+7 3+8 4+7 4+8 CHANGE TO 1+6 2+5 1+6 2+5 2+6 3+7 3+8 3+8 4+7 4+8 GREEN BAY ROAD NEAR RIGHT AND CENTER AND FAR RIGHT MAST SURVEYED PLOTTED ALIGNMENT RT, OF NAY RT, OF NAY GREEN BAY ROAD LEFT MAST ARM GREEN BAY ROAD NEAR RIGHT AND PLAN NOTE BOOK NO. CENTER AND FAR RIGHT MAST ARM SIGNALS GREEN BAY ROAD LEFT MAST ARM 48 48 4Y 4R AND FAR LEFT SIGNALS WILMETTE AVENUE FAR RIGHT AND CENTER MAST ARM SIGNALS W/B WILMETTE AVENUE LEFT MAST ARM AND FAR LEFT SIGNALS W/E WILMETTE AVENUE (EAST OF TRACKS) LEFT CANTILEVER AND FAR LEFT MEDIAN SIGNALS W/B WILMETTE AVENUE (EAST OF TRACKS) FAR RIGHT AND CENTER CANTILEVER SIGNALS W/B AND FAR RIGHT MAST ARM SIGNALS WILMETTE AVENUE LEFT MAST ARM AND FAR LEFT SIGNALS E/B PEDESTRIAN SIGNALS CROSSING GREEN BAY ROAD ON SOUTH SIDE OF WILMETTE AVENUE (S. LEG) PEDESTRIAN SIGNALS CROSSING GREEN BAY ROAD ON NORTH SIDE OF WILMETTE AVENUE (N. LEG) SURVEYED PLOTTED GRADES CHE B.M. NOTED STRUCTURE PEDESTRIAN SIGNALS CROSSING WILMETTE AVENUE ON WEST SIDE OF GREEN BAY ROAD (W. LEG) PROFILE NOTE BOOK NO. = THIS "A" OR FLASHING "INTERVAL MAY FINISH TIMING IN THE BI-DIRECTIONAL STRAIGHT THROUGH MOVEMENT IF THE LEFT ARROW TIME IS NOT SUFFICIENT TO COMPLETE "OR FLASHING" OR FLASHING" PHASE 2 AND 6 SHALL BE PLACED ON RECALL FOR COORDINATED SYSTEM P = ILLUMINATED PERSON = WALK FH = ILLUMINATED FLASHING HAND = FLASHING DON'T WALK TRAFFIC SIGNAL RECORD DRAWING H = ILLUMINATED SOLID HAND = DON'T WALK FOR INFORMATION ONLY \* TO APPEAR ONLY UPON PUSHBUTTON ACTUATION \*\*FLASHING OF THE PEDESTRIAN INTERVAL CLEARANCE. REVISIONS AND FLASHING TIMINGS TO BE SET ONLY ON PHASES WHERE VILLAGE OF WILMETTE NAME DATE GREEN BAY ROAD SEQUENCE OF OPERATIONS "AND FLASHING" ARE INDICATED IN THE SEQUENCE OF OPERATION. INTERSECTION IMPROVEMENTS

> **CENTRAL AVENUE AND WILMETTE AVENUE** EXISTING SEQUENCE OF OPERATIONS STATE OF ILLINOIS 1296 GREEN BAY ROAD AND WILMETTE AVENUE **DEPARTMENT OF TRANSPORTATION** SCALE: NONE SHEET 29 OF 33 SHEETS STA.

WILMETTE AVENUE AT GREEN BAY ROAD

TY-LININTERNATIONAL

2744 06-00183-00-CH

COOK

TO STA. FED. ROAD DIST. NO. ILLINOIS FED. AID PROJECT

73 49

3 OF 6

COUNTY

COOK

CONTRACT NO. 61G42

318 216

DATE: 02-14-2008

SECTION

16-00199-00-RS

SCALE: NONE JOB NO.s

F.A.U. RTE.	SECTION	N	COUNT	Y	SHEETS	SHEET NO.
2744	06-00183-0	00-CH	COO	K	73	50
STA.			TO STA.		•	
FED. RO	AD DIST. NO.	ILLIN	OIS FED.	AID	PROJEC	r
			CONT	RACT	NO. 83	999

#### PROPOSED EMERGENCY VEHICLE PREEMPTION SEQUENCE OF OPERATIONS

																				PREEMPTOR NUMBER 3	PREEMPTOR NUMBER 4	PREEMPTOR NUMBER 5	PREEMPTOR NUMBER 6	
CHANGE FROM NORMAL SEQUENCE OF OPERATION INTERVAL NUMBER		1		1		ı		5		5	9	9	9		12			12						CLEAR TO
EMERGENCY VEHICLE PREEMPTION SEQUENCE OF OPERATION INTERVAL NUMBER	1A	1B	10	1D	1E	1F	1G	1H	1J	1K	1L	1M	1N	1P	10	1R	15	17	10	2	3	4	5	NORMAL SEQUENCI
CHANGE TO EMERGENCY VEHICLE PREEMPTION SEQUENCE OF OPERATION INTERVAL NUMBER	18	2	1D	3	1F	4 OR 5	1H	1J	2, 4 OR 5	3	2	1N	3, 4 OR 5	10	1R	2	1T	1U	3, 4 OR 5					<b>♦</b>
GREEN BAY ROAD NEAR RIGHT AND CENTER AND FAR RIGHT MAST ARM SIGNALS N/B	R	R	R	R	R	R	R	R	R	R	G	Υ	R	G	G	G	G	Y	R	G	R	R	R	•
GREEN BAY ROAD LEFT MAST ARM AND FAR LEFT SIGNALS N/B	R <b>∢6</b>	R <b>∢6</b> -	R <b>∢</b> Y	R	R <b>∢</b> Y	R	R	R	R	R	G <b>◆</b> 6	Y	R	G	G	G	G	Y	R	G <b>∢</b> 6	R	R	R	<b>♦</b>
GREEN BAY ROAD NEAR RIGHT AND CENTER AND FAR RIGHT MAST ARM SIGNALS 5/B	R	R	R	R	R	R	G	Y	R	G	R	R	R	G	Y	R	G	Υ	R	R	G	R	R	<b>♦</b>
GREEN BAY ROAD LEFT MAST AFM AND FAR LEFT SIGNALS S/B	<b>◆</b> ¥	<del>◆R</del>	<del>4</del> 0-	<b>4</b> 6-	<b>◆</b> ¥	<del>∢R-</del>	<del>4</del> 6-	<b>◆</b> ¥-	<del>◆R</del> -	<del>46</del>	<b>∢</b> R−	<b>◆</b> R	<b>◆</b> R-	<b>◆</b> R-	<b>∢</b> R−	<b>∢</b> R−	<b>◆</b> R−	<b>∢</b> R−	<b>◆</b> R−	<del>◆R-</del>	<del>4</del> 6-	<del>∢R-</del>	<del>∢R</del> -	<b>♦</b>
WILMETTE AVENUE FAR RIGHT AND CENTER MAST ARM SIGNALS W/B	R	R	R	R	R	R	R	R	R	R	R	R	R	R	R	R	R	R	R	R	R	G	R	•
WILMETTE AVENUE LEFT MAST ARW AND FAR LEFT SIGNALS W/B	<b>∢</b> R-	<b>∢</b> R-	<b>∢</b> R-	<b>◆</b> R-	<b>∢</b> R−	<b>∢</b> R-	<b>∢</b> R-	<b>∢</b> R-	<b>∢</b> R-	<b>∢</b> R	<b>∢</b> R-	<b>∢</b> R-	<b>∢</b> R-	<b>◆</b> R-	<b>∢</b> R-	<b>∢</b> R−	<b>◆</b> R-	<b>∢</b> R	<b>∢</b> R−	<b>∢</b> R	<b>∢</b> R	<del>4</del> 8-	<b>∢</b> R-	<b>♦</b>
WILMETTE AVENUE (EAST OF TRACKS) LEFT CANTILEVER AND FAR LEFT MEDIAN SIGNALS W/B	<b>◆</b> R-	<b>◆</b> R-	<b>◆</b> R-	<b>4</b> ₽	<b>◆</b> R-	<b>4</b> R−	<b>4</b> R−	<b>◆</b> R-	<b>4</b> ₽	<b>4</b> ₽	<b>4</b> ₽	<b>4</b> R−	<b>4</b> R−	<b>4</b> R−	<b>4</b> R−	<b>∢</b> R-	<b>4</b> R−	<b>4</b> R−	<b>4</b> ₽-	<b>4</b> R-	∢R	<b>4</b> 6-	<b>∢</b> R-	<b>♦</b>
WILMETTE AVENUE (EAST OF TRACKS) FAR RIGHT AND CENTER CANTILEVER SIGNALS W/B	R	R	R	R	R	R	R	R	R	R	R	R	R	R	R	R	R	R	R	R	R	G	R	•
WILMETTE AVENUE NEAR RIGHT CENTER AND FAR RIGHT MAST ARM SIGNALS E/B	R	R	R	R	R	R	R	R	R	R	R	R	R	R	R	R	R	R	R	R	R	R	G	<b>♦</b>
WILMETTE AVENUE LEFT MAST ARM AND FAR LEFT SIGNALS E/B	<b>∢</b> R-	<b>∢</b> R−	<b>∢</b> R−	◆R	<b>∢</b> R−	<b>◆</b> R−	<b>◆</b> R-	<b>∢</b> R−	◆R−	<b>∢</b> R−	<b>◆</b> R−	◆R−	<b>∢</b> R-	<b>∢</b> R-	<b>∢</b> R	<b>∢</b> R-	<b>∢</b> R-	<b>4</b> R−	<b>∢</b> R−	<del>∢R</del>	<b>∢</b> R- ∵	◆R	<del>4</del> 6-	•
PEDESTRIAN SIGNALS CROSSING GREEN BAY ROAD ON SOUTH SIDE OF WILMETTE AVENUE (S. LEG)	Н	н	н	Н	н	н	Н	Н	Н	Н	Н	Н	Н	н	н	Н	Н	н	н	Н	Н	н	Н	<b>♦</b>
PEDESTRIAN SIGNALS CROSSING GREEN BAY ROAD ON NORTH SIDE OF WILMETTE AVENUE (N. LEG)	Н	Н	н	н	н	н	н	н	н	н	Н	Н	н	н	Н	н	н	Н	н	н	н	н	н	•
PEDESTRIAN SIGNALS CROSSING WILMETTE AVENUE ON WEST SIDE OF GREEN BAY ROAD (W. LEG)	н	н	н	н	н	Н	FH	Н	н	FH	н	Н	Н	FH	н	н	FH	н	Н	Н	н	Н	Н	<b>♦</b>

P = ILLUMINATED PERSON = WALK

PLAN SIRWEYED
PLOTTER BOOK ALLOWER'S DECKED
NOTE BOOK PILE NAME
NO. CAUD FILE NAME

PROFILE SURVEYED PROFILE BOOK GARCKED - NOTE BOOK BAN HOTED - NO.

FH = ILLUMINATED FLASHING HAND = FLASHING DON'T WALK

H = ILLUMINATED SOLID HAND = DON'T WALK

◆= EMERGENCY VEHICLE SEQUENCE SHALL PROVIDE THE PROPER CLEARANCE INTERVAL TO RESUME THE NORMAL OPERATION OR PROPER CLEARANCE INTERVAL TO DISPLAY A DIFFERENT EMERGENCY VEHICLE INTERVAL AFTER EMERGENCY VEHICLE INTERVAL 2 OR 3 IS TERMINATED.

### TRAFFIC SIGNAL RECORD DRAWING FOR INFORMATION ONLY

4 OF 6

REVISIONS		ENEDOCHON NELLOLE DECEMBERON	VILLAGE OF	WILMETTE
NAME	DATE	EMERGENCY VEHICLE PREEMPTION	TILLAGE OF	WILIMETTE
		SEQUENCE OF OPERATIONS	GREEN B	AY ROAD
		SHEET 1 OF 2	INTERSECTION	IMPROVEMENTS
		WILMETTE AVENUE AT GREEN BAY ROAD	DRAWN:	SHEET NO.
			CHECKEDs	
			APPROVED:	
		CONSULTANT	DATE: 02-14-2008	1
		TY:LININTERNATIONAL	SCALE: NONE	
			JOB NO.s	PROJECT NO.

Systems

1475 EAST WOODFIELD ROAD, SUITE 600
SCHAUMBURG, ILLINOIS 60173
(847) 605-9600

TS0190-Ex Emerge

USER NAME = Mlbeening	DESIGNED	-	MLB	REVISED -	
	DRAWN	-	MLB	REVISED -	
PLOT SCALE = 40.0000 '/ in.	CHECKED	-	DWB	REVISED -	
PLOT DATE = 2/13/2020	DATE	-	02/13/2020	REVISED -	

STATE OF ILLINOIS DEPARTMENT OF TRANSPORTATION

			AND WILMETT		F.A. RTE
				QUENCE OF OPERATION	129
	GREEN BAY	KUAD	AND WILMET	IE AVENUE	
SCALE: NONE	SHEET 30	OF 33	SHEETS STA.	TO STA.	

F.A.U. RTE.	SECTION		COUNTY	TOTAL SHEETS	SHEET NO.
1296	16-00199-00-RS		COOK	318	217
			CONTRACT	NO. 610	G42
	ILLINOIS	FED. A	D PROJECT		
				•	

F.A.U. RTE.	SECTION		COUNT	Υ	TOTAL SHEETS	SHEET NO.
2744	06-00183-00	-CH	C00	K	73	51
STA.		TO	STA.			
FED. RO	AD DIST. NO.	ILLINO	S FED.	AID	PROJECT	
			CONT	RACT	NO. 839	999

#### PROPOSED EMERGENCY VEHICLE PREEMPTION SEQUENCE OF OPERATIONS

																																		PREEMPTOR NUMBER 3		PREEMPTOR NUMBER 5		
CHANGE FROM NORMAL SEQUENCE OF OPERATION INTERVAL NUMBER		1	15		1	5		1	5	'			1	9		19		2	2	22			2	25			2	25			2	25						CLEAR TO
EMERGENCY VEHICLE PREEMPTION SEQUENCE OF OPERATION INTERVAL NUMBER	1V	1W	1X	1Y	1Z	1AA	1BB	1CC	1DD	1EE	1FF	1GG	1HH	1JJ	1KK	1LL	1MM	1NN	1PP	100	1RR	155	177	100	177	1WW	1XX	1YY	1ZZ	1AAA	188B	1CCC	1DDD	2	3	4	5	NORMAL SEQUENCE
CHANGE TO EMERGENCY VEHICLE PREEMPTION SEQUENCE OF OPERATION INTERVAL NUMBER	1W	1X	1Y	2 OR 3	1AA	4	1CC	1DD	1EE	5	1GG	1HH	1JJ	1KK	2, 3 0R 5	4	1NN	1PP	2, 3 OR 4	5	155	1TT	100	177	2 OR 3	1XX	1YY	4	1AAA	1BBB	1CCC	1DDD	5					<b>*</b>
GREEN BAY ROAD NEAR RIGHT AND CENTER AND FAR RIGHT MAST ARM SIGNALS N/B	R	R	R	R	R	R	R	R	R	R	R	R	R	R	R	R	R	R	R	R	R	R	R	R	R	R	R	R	R	R	R	R	R	G	R	R	R	<b>*</b>
GREEN BAY ROAD LEFT MAST ARM AND FAR LEFT SIGNALS N/B	R	R	R	R	R	R	R	R	R	R	R	R	R	R	R	R	R	R	R	R	R	R	R	R	R	R	R	R	R	R	R	R	R	G <b>∢</b> 6-	R	R	R	<b>*</b>
GREEN BAY ROAD NEAR RIGHT AND CENTER AND FAR RIGHT MAST ARM SIGNALS S/B	R	R	R	R	R	R	R	R	R	R	R	R	R	R	R	R	R	R	R	R	R	R	R	R	R	R	R	R	R	R	R	R	R	R	G	R	R	<b>*</b>
GREEN BAY ROAD LEFT MAST ARM AND FAR LEFT SIGNALS S/B	₽	<b>◆</b> R-	<b>◆</b> R-	<b>4</b> R−	<b>∢</b> R−	<b>∢</b> R−	<b>∢</b> R−	<b>∢</b> R−	<b>∢</b> R−	<b>∢</b> R−	<b>∢</b> R−	<b>◆</b> R-	<b>∢</b> R	<b>◆</b> R	<b>∢</b> R-	<b>4</b> R-	<b>∢</b> R−	<b>∢</b> R−	<b>◆</b> R-	<b>∢</b> R−	<b>◆</b> R-	<b>∢</b> R−	<b>◆</b> R	<b>∢</b> R−	<b>◆</b> R~	<b>₽</b> ₽	<b>◆</b> R	<b>∢</b> R	<b>◆</b> R	<b>∢</b> R	<b>∢</b> R−	<b>∢</b> R	<b>∢</b> R	<b>◆</b> R	<del>4</del> 6-	<b>4</b> R−	<del>∢R-</del>	<b>*</b>
WILMETTE AVENUE FAR RIGHT AND CENTER MAST ARM SIGNALS W/B	R	R	R	R	R	R	R	R	R	R	G	G	G	Y	R	G	R	R	R	R	G	G	G	Y	R	G	G	G	G	G	G	Y	R	R	R	G	R	<b>♦</b>
WILMETTE AVENUE LEFT MAST ARM AND FAR LEFT SIGNALS W/B	<del>46</del>	<del>46</del> -	<b>◆</b> ¥-	<b>∢</b> R-	<b>4</b> 6-	<b>4</b> 6-	<b>4</b> 6−	<b>4</b> 6-	<b>◆</b> ¥-	<b>∢</b> R−	<b>4</b> 0-	<del>40</del> -	<b>4</b> 6−	<b>◆</b> ¥	<b>◆R</b> -	<b>4</b> 6−	<b>∢</b> R-	<b>∢</b> R-	<b>∢</b> R-	<b>∢</b> R-	<b>∢</b> R−	<b>∢</b> R−	<b>◆</b> R-	<b>∢</b> R	<b>∢</b> R−	<b>∢</b> R−	<b>∢</b> R	<b>∢</b> R−	<b>◆</b> R-	<b>∢</b> R−	◆R-	<b>∢</b> R-	◆R	◆R-	<b>∢</b> R-	<b>4</b> 6-	<b>∢</b> R	<b>♦</b>
WILMETTE AVENUE (EAST OF TRACKS) LEFT CANTILEVER AND FAR LEFT MEDIAN SIGNALS W/B	<b>4</b> ¥	<b>∢</b> R	<b>∢</b> R-	<b>4</b> R−	<del>46</del> -	<b>4</b> 6-	<b>∢</b> ¥-	<b>∢</b> R−	<b>∢</b> R-	<b>∢</b> R-	<del>40</del> -	<b>∢</b> ¥-	<b>∢</b> R-	<b>∢</b> R-	<b>∢</b> R-	<del>46</del>	<b>∢</b> R-	<b>∢</b> R-	<b>∢</b> R-	<b>∢</b> R-	<b>4</b> R−	<b>∢</b> R-	<b>∢</b> R-	<b>∢</b> R	<b>∢</b> R-	<b>∢</b> R	<b>∢</b> R	<b>∢</b> R	<b>∢</b> R-	<b>∢</b> R−	<b>∢</b> R-	<b>∢</b> R-	<b>∢</b> R-	<del>∢R</del>	<b>∢</b> R	<del>4</del> 6-	<del>∢</del> R-	<b>♦</b>
WILMETTE AVENUE (EAST OF TRACKS) FAR RIGHT AND CENTER CANTILEVER SIGNALS W/B	R	R	R	R	R	R	R	R	R	R	G	Y	R	R	R	G	R	R	R	R	G	Y	R	R	R	G	G	G	G	Υ	R	R	R	R	R	G	R	<b>*</b>
WILMETTE AVENUE NEAR RIGHT CENTER AND FAR RIGHT MAST ARM SIGNALS E/B	R	R	R	R	R	R	R	R	R	R	R	R	R	R	R	R	G	Υ	R	G	G	G	G	Y	R	G	Y	R	G	G	G	G	G	R	R	R	G	<b>♦</b>
WILMETTE AVENUE LEFT MAST ARM AND FAR LEFT SIGNALS E/B	<del>4</del> 6−	<b>4</b> 6−	<b>◆</b> ¥-	<b>∢</b> R	<b>◆</b> ¥	◆R	<b>4</b> 6−	<b>4</b> 6−	<b>4</b> 6-	<b>4</b> 6−	<b>◆</b> R−	<b>∢</b> R−	<b>∢</b> R−	<b>◆</b> R-	<b>∢</b> R-	<b>∢</b> R-	<b>4</b> 6-	<b>◆</b> ¥	<b>∢</b> R−	<b>4</b> 6-	<b>◆</b> R	<b>∢</b> R-	<b>∢</b> R	<b>∢</b> R	<b>∢</b> R-	<b>◆</b> R-	<b>∢</b> R	<b>∢</b> R−	<b>∢</b> R−	◆R	<b>∢</b> R	<b>∢</b> R	<b>◆</b> R-	◆R	<b>◆</b> R-	<b>◆</b> R-	<del>46</del>	<b>♦</b>
PEDESTRIAN SIGNALS CROSSING GREEN BAY ROAD ON SOUTH SIDE OF WILMETTE AVENUE (S. LEG)	н	н	Н	н	н	Н	н	н	Н	Н	Н	Н	Н	Н	н	Н	FH	Н	Н	FH	FH	Н	Н	Н	Н	FH	н	н	FH	н	н	н	н	Н	Н	н	н	<b>♦</b>
PEDESTRIAN SIGNALS CROSSING GREEN BAY ROAD ON NORTH SIDE OF WILMETTE AVENUE (N. LEG)	н	н	Н	н	н	н	н	н	н	н,	FH	н	н	н	н	FH	н	н	н	н	FH	н	н	Н	н	FH	н	н	FH	н	н	н	н	Н	н	Н	н	<b>♦</b>
PEDESTRIAN SIGNALS CROSSING WILMETTE AVENUE ON WEST SIDE OF GREEN BAY ROAD (W. LEG)	Н	н	н	Н	н	н	н	н	н	н	н	Н	н	Н	н	Н	Н	Н	н	Н	н	Н	н	Н	н	н	н	н	Н	н	Н	н	н	Н	н	н	н	•

P = ILLUMINATED PERSON = WALK

PLAN SURVEYED PLOTES

NOTE BOOK RT. OF WAY CHECKED

ND. CADS FILE MANE

PROFILE NOTE 800K NO.

FH = ILLUMINATED FLASHING HAND = FLASHING DON'T WALK

H = ILLUMINATED SOLID HAND = DON'T WALK

◆= EMERGENCY VEHICLE SEQUENCE SHALL PROVIDE THE PROPER CLEARANCE INTERVAL TO RESUME THE NORMAL OPERATION OR PROPER CLEARANCE INTERVAL TO DISPLAY A DIFFERENT EMERGENCY VEHICLE INTERVAL AFTER EMERGENCY VEHICLE INTERVAL 2 OR 3 IS TERMINATED.

### TRAFFIC SIGNAL RECORD DRAWING FOR INFORMATION ONLY

5 OF 6

				3 01 0
REVISIONS			VIII A	GE OF WILMETTE
NAME	DATE	EMERGENCY VEHICLE PREEMPTION		
		SEQUENCE OF OPERATIONS	GRE	EEN BAY ROAD
		SHEET 2 OF 2	INTERSEC	TION IMPROVEMENTS
		WILMETTE AVENUE AT GREEN BAY ROAD	DRAWN:	SHEET NO.
			CHECKED:	
			APPROVED:	
		CONSULTANT	DATE: 02-14-2008	В
		TY:LININTERNATIONAL	SCALE: NONE	
			JOB NO.s	PROJECT NO.s

• TED Systems

1475 EAST WOODFIELD ROAD, SUITE 600
SCHAUMBURG, ILLINOIS 60173
(847) 605-9600

TSØ191-E× Emerge

USER NAME = Mlbeening	DESIGNED	-	MLB	REVISED -	
	DRAWN	-	MLB	REVISED -	
PLOT SCALE = 40.0000 '/ in.	CHECKED	-	DWB	REVISED -	
PLOT DATE = 2/13/2020	DATE	-	02/13/2020	REVISED -	

EXISTING EMER	CENTRAL AV GENCY VEH GREEN BAY	ICLE PI	REEMPT	ION SEQ	UENCE OF	OPERATIONS
SCALE: NONE	SHEET 31	OF 33	SHEETS	STA.	TO	STA.

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s	F.A.U. RTE.	SECTION	COUNTY	TOTAL SHEETS	SHEET NO.

DATE

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PROPOSED	RAILROAD	PREEMPTION	SEQUENCE	0F	OPERATIONS

F.A.U. RTE.	SECTION	N	-	COUNTY	TOTAL	SHEET NO.		
2744	06-00183-0	оо-сн	COOK 73 52					
STA.		1	0	STA.				
FED. RO	AD DIST. NO.	ILLIN	OIS	FED. AID	PROJECT	-		
				CONTRACT	NO 839	200		

																		MPTOR BER 3		MPTOR BER 4		MPTOR BER 4		MPTOR BER 5	PREEMPTOR NUMBER 2				
CHANGE FROM NORMAL SEQUENCE OF OPERATION INTERVAL NUMBER		1		5		9	1	2	1	5	1	9	2	22	2	25													0.540.70
CHANGE FROM EMERGENCY VEHICLE PREEMPTION SEQUENCE OF OPERATION INTERVAL NUMBER																		2		3		4	5	5					CLEAR TO NORMAL SEQUENCE
RAILROAD PREEMPTION SEQUENCE OF OPERATION INTERVAL NUMBER	1A	1B	1C	1D	1E	1F	1G	1H	1J	1K	1L	1M	1N	1P	10	1R	15	1T	10	1٧	1W	1X	1Y	1Z	2	3	4	5	
CHANGE TO RAILROAD PREEMPTION SEQUENCE OF OPERATION INTERVAL NUMBER	1B	2	1D	2	1F	2	1H	2	2	2	1M	2	1P	2	1R	2	1T	2	1٧	2	1X	2	1Z	2	3	4	5		<b>A</b>
GREEN BAY ROAD NEAR RIGHT AND CENTER AND FAR RIGHT MAST ARM SIGNALS N/B	R	R	R	R	Υ	R	Y	R	R	R	R	R	R	R	R	R	Υ	R	R	R	R	R	R	R	R	R	R	G	<b>A</b>
GREEN BAY ROAD LEFT MAST ARM AND FAR LEFT SIGNALS N/B	R <b>∢</b> ¥	R	R	R	Y	R	Υ	R	R	R	R	R	R	R	R	R	Υ	R	R	R	R	R	R	R	R	R	R	G	<b>A</b>
GREEN BAY ROAD NEAR RIGHT AND CENTER AND FAR RIGHT MAST ARM SIGNALS S/B	R	R	Υ	R	R	R	Y	R	R	R	R	R	R	R	R	R	R	R	Y	R	R	R	R	R	R	R	R	G	
GREEN BAY ROAD LEFT MAST ARM AND FAR LEFT SIGNALS S/B	<b>◆</b> ¥-	<b>◆</b> R	<b>◆</b> ¥	<b>◆</b> R-	<b>◆</b> R-	<b>◆</b> ₽-	<b>◆</b> ₽	<b>◆</b> R	<b>◆</b> R-	<b>∢</b> R−	<b>◆</b> R	<b>◆</b> R	<b>◆</b> R-	<b>∢</b> R	<b>◆</b> R	· <b>∢</b> R-	<b>∢</b> R-	<b>∢</b> R	4 Y	<b>◆</b> R-	<b>◆</b> R-	◆R	<b>∢</b> R-	<b>◆</b> R-	<b>◆</b> R-	<b>∢</b> R	<b>◆</b> R-	<b>◆</b> R	<b>A</b>
WILMETTE AVENUE FAR RIGHT AND CENTER MAST ARM SIGNALS W/B	R	R	R	R	R	R	R	R	R	R	G	G	R	R	G	G	R	R	R	G	G	G	R	R	G	Υ	R	R	<b>A</b>
WILMETTE AVENUE LEFT MAST ARM AND FAR LEFT SIGNALS W/B	<del>◆R</del>	<b>◆</b> R	<b>∢</b> R-	<b>∢</b> R-	<b>◆</b> R	<b>◆</b> R	<b>∢</b> R	<b>◆</b> R	<del>46</del> -	<del>4</del> 6-	<b>4</b> 6-	<b>4</b> 6-	◆R	<b>◆</b> R-	<b>◆</b> R-	◆R	<b>◆</b> R-	<b>∢</b> R	<b>∢</b> R-	<b>∢</b> R-	<b>4</b> 6−	<b>4</b> 6-	<b>∢</b> R-	<b>∢</b> R-	<b>◆</b> 6-	<b>∢</b> ¥-	<b>∢</b> R-	<b>∢</b> R-	
WILMETTEAVENUE (EAST OF TRACKS) LEFT CANTILEVER AND FAR LEFT MEDIAN SIGNALS W/B	<b>∢</b> R-	<b>◆</b> R	<del>∢R-</del>	<b>∢</b> R-	<b>∢</b> R	<b>∢</b> R	<b>∢</b> R-	<b>∢</b> R-	<b>◆</b> ¥-	<b>∢</b> R	<b>∢</b> ¥	<b>∢</b> R-	<b>∢</b> R-	<b>∢</b> R−	<b>◆</b> R-	<b>∢</b> R	<b>∢</b> R⊢	<b>∢</b> R-	<b>∢</b> R-	<b>∢</b> R	<b>◆</b> ¥	<b>∢</b> R-	<b>∢</b> R	<b>∢</b> R-	<b>∢</b> R-	<b>∢</b> R	<b>∢</b> R−	<b>∢</b> R-	
WILMETTE AVENUE (EAST OF TRACKS) FAR RIGHT AND CENTER CANTILEVER SIGNALS W/B	R	R	R	R	R	R	R	R	R	R	Υ	R	R	R	Υ	R	R	R	R	R	Y	R	R	R	R	R	R	R	
WILMETTE AVENUE NEAR RIGHT CENTER AND FAR RIGHT MAST ARM SIGNALS E/B	R	R	R	R	R	R	R	R	R	R	R	R	Υ	R	Υ	R	R	R	R	R	R	R	Υ	R	R	R	R	R	
WILMETTE AVENUE LEFT MAST ARM AND FAR LEFT SIGNALS E/B	<b>4</b> ₽-	<del>∢R</del>	<del>∢R</del>	<b>∢</b> R-	<b>◆</b> R-	<b>◆</b> R-	<b>∢</b> R	<b>◆</b> R-	<b>◆</b> ¥	<b>◆</b> R-	<del>∢R</del> -	<b>◆</b> R-	<b>◆</b> ¥	<b>∢</b> R-	<b>∢</b> R	<del>∢R</del>	<b>∢</b> R-	<b>∢</b> R-	<b>∢</b> R-	◆R	<b>∢</b> R	<b>◆</b> R-	<b>◆</b> ¥-	<b>◆</b> R-	<b>∢</b> R	<b>∢</b> R	<b>◆</b> R-	<b>◆</b> R-	
PEDESTRIAN SIGNALS CROSSING GREEN BAY ROAD ON SOUTH SIDE OF WILMETTE AVENUE (S. LEG)	н	н	н	н	Н	н	Н	Н	н	Н	Н	Н	FH	Н	FH	н	Н	Н	н	н	н	н	Н	Н	Н	н	Н	н	
PEDESTRIAN SIGNALS CROSSING GREEN BAY ROAD ON NORTH SIDE OF WILMETTE AVENUE (N. LEG)	н	Н	н	н	Н	н	Н	Н	н	Н	FH	Н	Н	Н	Н	Н	Н	н	Н	н	н	н	Н	Н	н	Н	Н	Н	<b>A</b>
PEDESTRIAN SIGNALS CROSSING WILMETTE AVENUE ON WEST SIDE OF GREEN BAY ROAD (W. LEG)	н	Н	FH	н	Н	Н	FH	Н	н	Н	Н	Н	Н	Н	Н	Н	Н	Н	Н	н	Н	Н	н	Н	н	н	н	н	
INTERNALLY ILLUMINATED NRT SIGNS - GREEN BAY ROAD	NRT	NRT	NRT	NRT	NRT	NRT	NRT	NRT	NRT	NRT	NRT	NRT	NRT	NRT	NRT	NRT	NRT	NRT	NRT	NRT	NRT	NRT	NRT	NRT	NRT	NRT	NRT	NRT	
																												HOLD	

RAILROAD PREEMPTION SEQUENCE SHALL PROVIDE THE PROPER CLEARANCE INTERVAL TO RESUME THE NORMAL SEQUENCE OF OPERATION OR PROPER CLEARANCE INTERVAL TO DISPLAY AN EMERGENCY VEHICLE INTERVAL 2, 3 OR 4 (IF APPLICABLE) AFTER RAILROAD PREEMPTION INTERVAL 5 IS TERMINATED.

P = ILLUMINATED PERSON = WALK

FH = ILLUMINATED FLASHING HAND = FLASHING DON'T WALK


H = ILLUMINATED SOLID HAND = DON'T WALK

### TRAFFIC SIGNAL RECORD DRAWING FOR INFORMATION ONLY

6 OF 6

REVISIONS				VILLAGE OF	WILMETTE
NAME D	DATE	DATI DOAD DOCCMOTION		VILLAGE OF	MICINICITE
		RAILROAD PREEMPTION		GREEN B	AY ROAD
		SEQUENCE OF OPERATIONS	T.	TEDEFOTION	THERENIES
			IN	HERSECTION	IMPROVEMENTS
		WILMETTE AVENUE AT GREEN BAY ROAD	DRAWNt		SHEET NO.
			CHECKEDs		
			APPROVED	•	
<u> </u>		CONSULTANT	DATEs	02-14-2008	
		TYLININTERNATIONAL	SCALE	NONE	
			JOB NO.s		PROJECT NO.1

FILE NAME =	USER NAME = Mlbeening	DESIGNED - MLB	REVISED -		CENTRAL AVENUE AND WILMETTE AVENUE	F.A.U. SECTION	COUNTY TOTA	AL SHEET
TSØ192-Ex Railro		DRAWN - MLB	REVISED -	STATE OF ILLINOIS	EXISTING RAILROAD PREEMPTION SEQUENCE OF OPERATIONS	1296 16-00199-00-	RS COOK 318	8 219
Default	PLOT SCALE = 40.0000 '/ in.	CHECKED - DWB	REVISED -	DEPARTMENT OF TRANSPORTATION	GREEN BAY ROAD AND WILMETTE AVENUE		CONTRACT NO. (	61G42
Derault	PLOT DATE = 2/13/2020	DATE - 02/13/2020	REVISED -		SCALE: NONE SHEET 32 OF 33 SHEETS STA. TO STA.	ILLINO	IS FED. AID PROJECT	

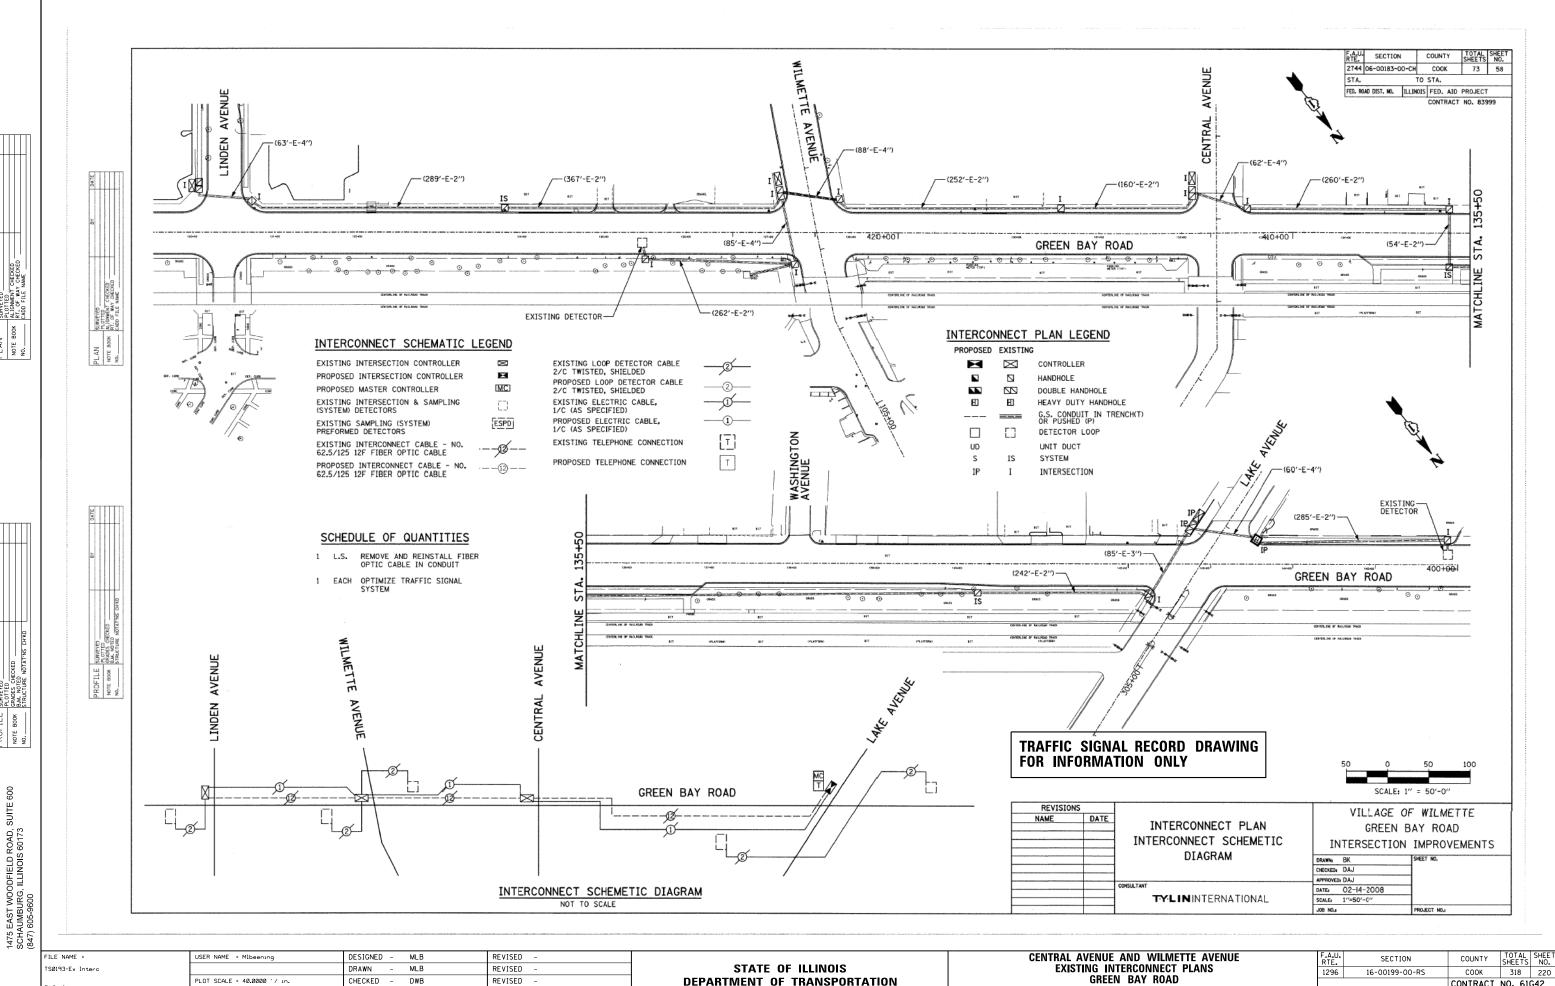

**DEPARTMENT OF TRANSPORTATION** 

SCALE: NONE

SHEET 33

OF 33 SHEETS STA.

TO STA.

CONTRACT NO. 61G42

Train Systems

PLOT SCALE = 40.0000 '/ in.

PLOT DATE = 2/13/2020

CHECKED -


DATE

DWB

02/13/2020

REVISED

REVISED

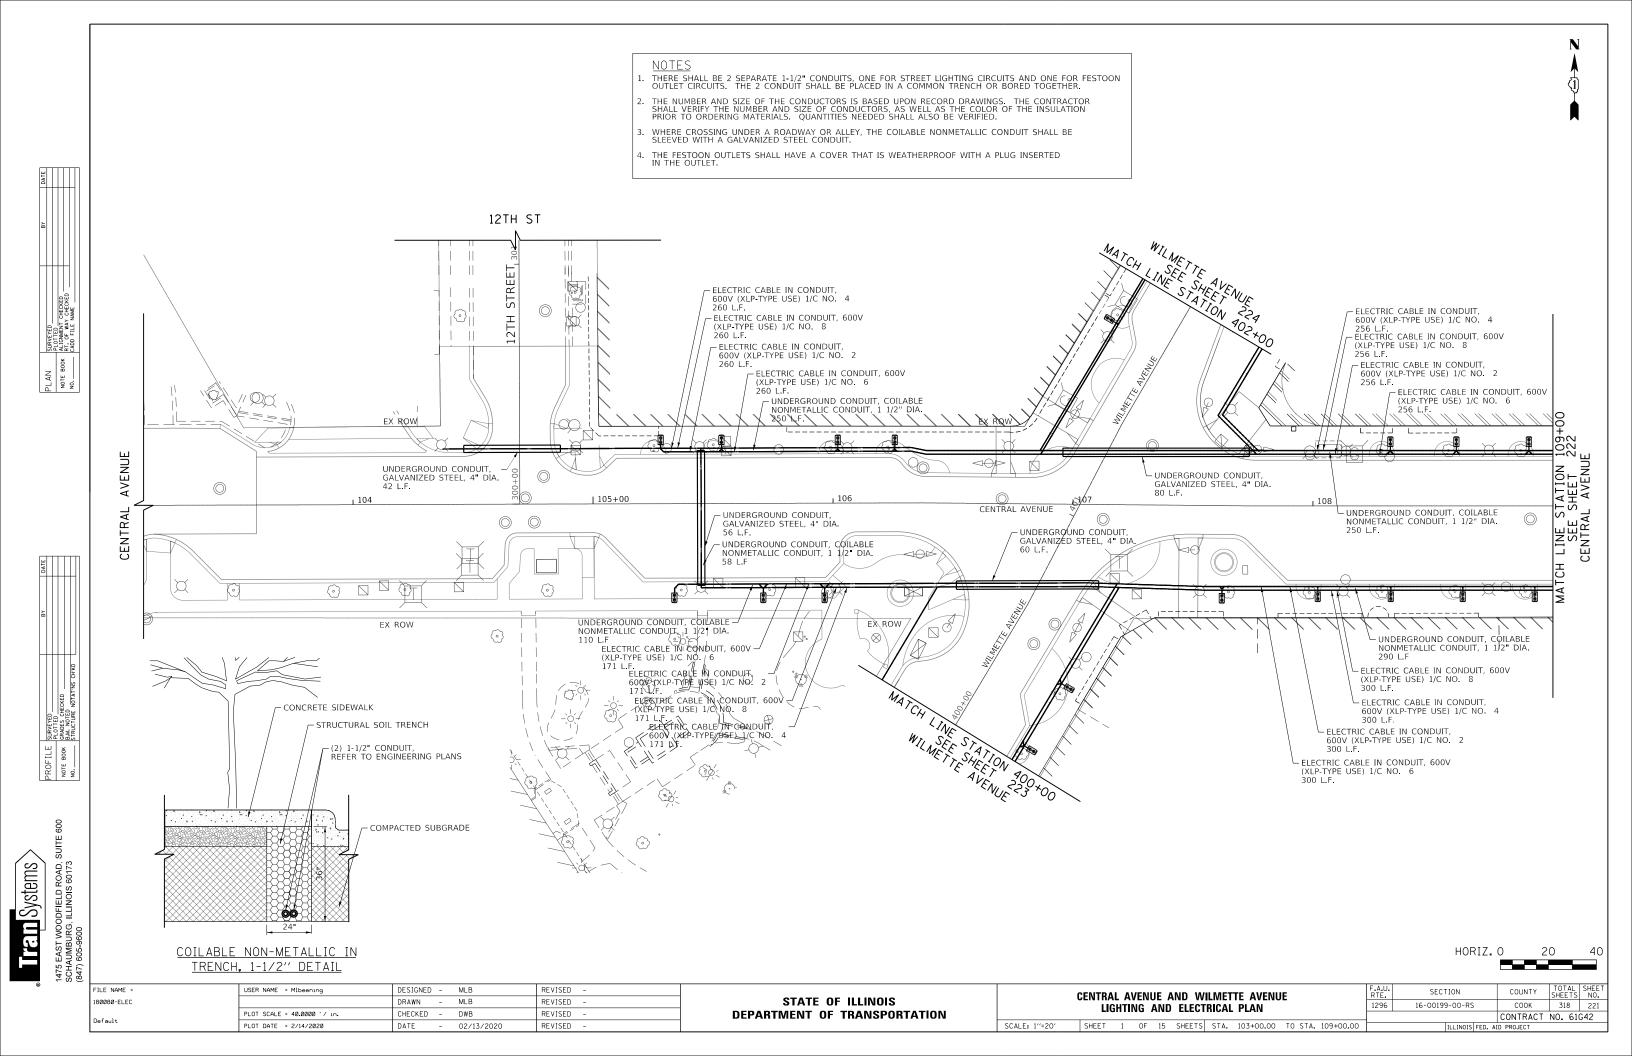

 PLAN
 SURVEYED
 BY
 DATE


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180080-ELEC




DESIGNED - MLB REVISED USER NAME = Mlbeening COUNTY SHEETS NO.

COOK 318 222 SECTION COUNTY CENTRAL AVENUE AND WILMETTE AVENUE STATE OF ILLINOIS DRAWN MLB REVISED 16-00199-00-RS LIGHTING AND ELECTRICAL PLAN PLOT SCALE = 40.0000 '/ 10. CHECKED -DWB REVISED **DEPARTMENT OF TRANSPORTATION** CONTRACT NO. 61G42 SCALE: 1"=20' SHEET 2 OF 15 SHEETS STA. 110+00.00 TO STA. 115+00.00 PLOT DATE = 2/14/2020 DATE 02/13/2020 REVISED

HORIZ. O

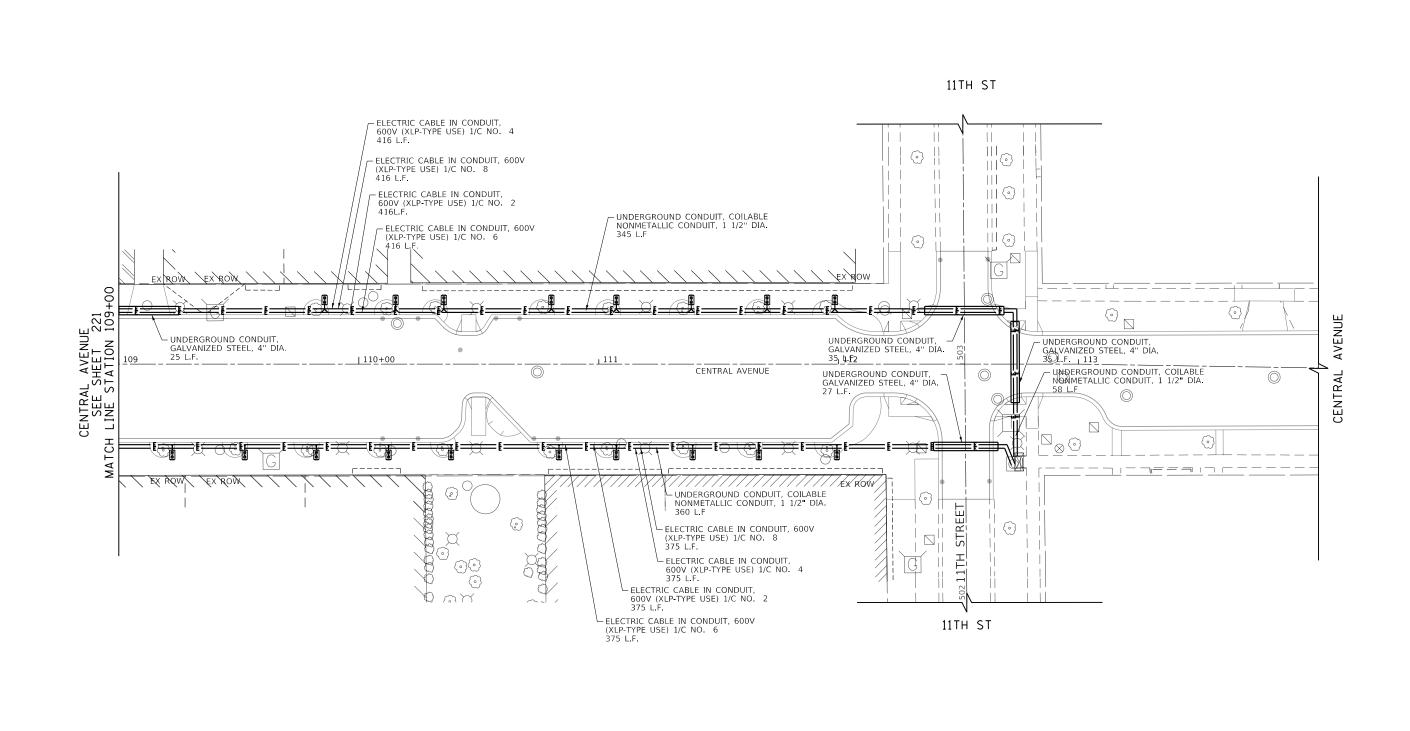20

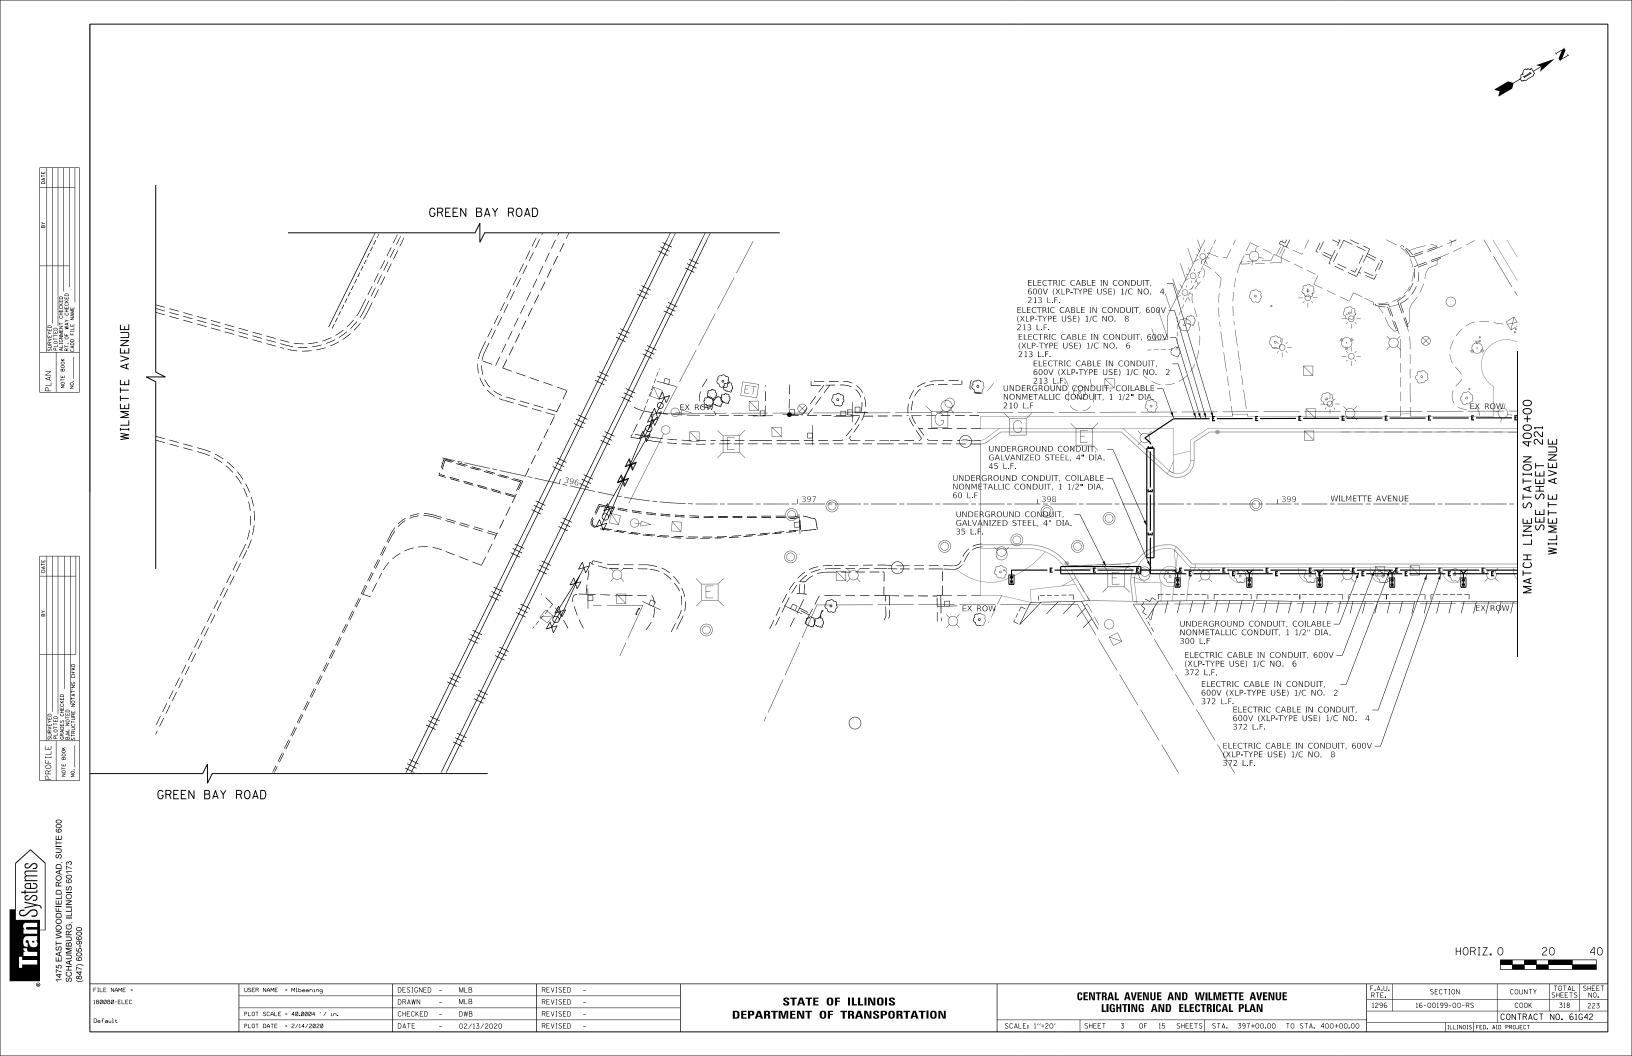

- ELECTRIC CABLE IN CONDUIT, 600V (XLP-TYPE USE) 1/C NO. 4 428 L.F. PLAN SURVEYED
NOTE BOOK ALLOWENT CHECKED
NO. CADD FILE NAME - ELECTRIC CABLE IN CONDUIT, 600V (XLP-TYPE USE) 1/C NO. 8 428 L.F. ELECTRIC CABLE IN CONDUIT, 600V (XLP-TYPE USE) 1/C NO. 6 428 L.F. - ELECTRIC CABLE IN CONDUIT, 600V (XLP-TYPE USE) 1/C NO. 2 428 L.F. - UNDERGROUND CONDUIT, COILABLE NONMETALLIC CONDUIT, 1 1/2" DIA. 410 L.F.  $\odot$ 904 AVENUE WILMETTE AVENUE SEE SHEET 221 H LINE STATION 402 – UNDERGROUND CONDUIT, GALVANIZED STEEL, 4" DIA. 25 L.F. 403 405+00 WILMETTE WILMETTE AVENUE UNDERGROUND CONDUIT, -GALVANIZED STEEL, 4" DIA. 25 L.F.  $\bigcirc$  $\bigcirc$  $\bigcirc$  $\bigcirc$  $\bigcirc$ EX ROW UNDERGROUND CONDUIT, COKABLE | NONMETALLIC CONDUIT, 1 1/2" DIA. | 385 L.F ELECTRIC CABLE IN CONDUIT, 600V –/ (XLP-TYPE USE) 1/C NO. 6 401 L.F. ELECTRIC CABLE IN CONDUIT, 600V (XLP-TYPE USE) 1/C NO. 2
401 L.F. ELECTRIC CABLE IN CONDUIT, 600V (XLP-TYPE USE) 1/C NO. 4
401 L.F. ELECTRIC CABLE IN CONDUIT, 600V — (XLP-TYPE USE) 1/C NO. 8 401 L.F.

Trem Systems	1475 EAST WOODFIELD ROAD, SI SCHAUMBURG, ILLINOIS 60173
	4 S


DESIGNED - MLB REVISED USER NAME = Mlbeening COUNTY SHEETS NO.

COOK 318 224 SECTION COUNTY CENTRAL AVENUE AND WILMETTE AVENUE STATE OF ILLINOIS DRAWN MLB REVISED 16-00199-00-RS LIGHTING AND ELECTRICAL PLAN PLOT SCALE = 40.0000 '/ in. CHECKED -DWB REVISED **DEPARTMENT OF TRANSPORTATION** CONTRACT NO. 61G42 SCALE: 1"=20" SHEET 4 OF 15 SHEETS STA. 402+00.00 TO STA. 407+00.00 REVISED PLOT DATE = 2/14/2020 DATE 02/13/2020

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180080-ELEC



Trap Systems

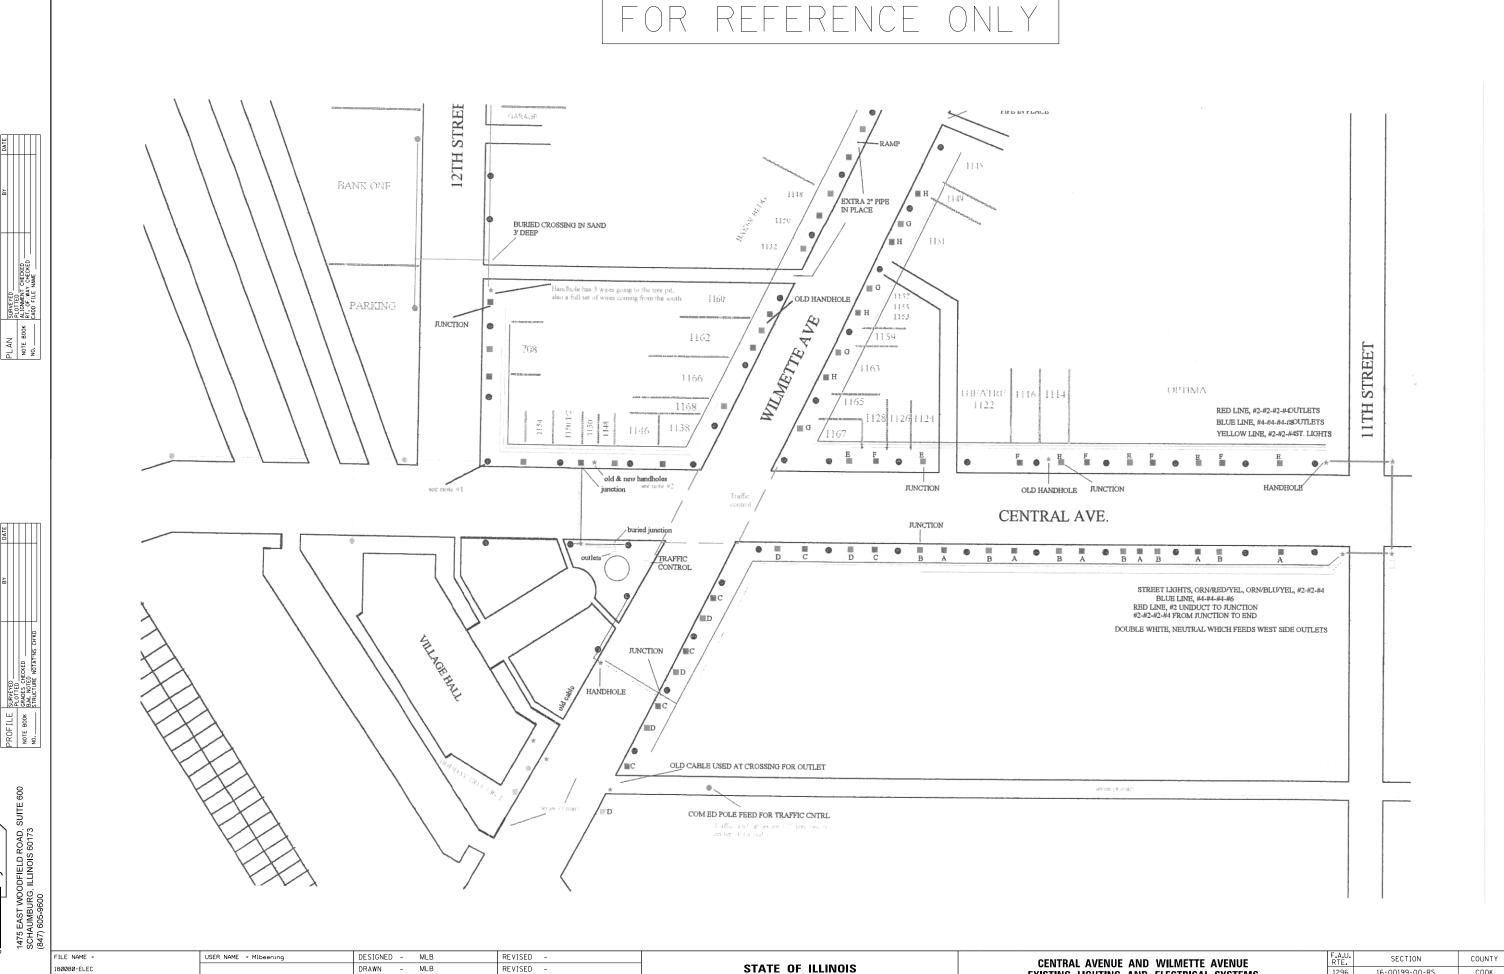180080-ELEC

**DEPARTMENT OF TRANSPORTATION** 

CHECKED -

DATE

PLOT DATE = 2/14/2020

DWB


- 02/13/2020


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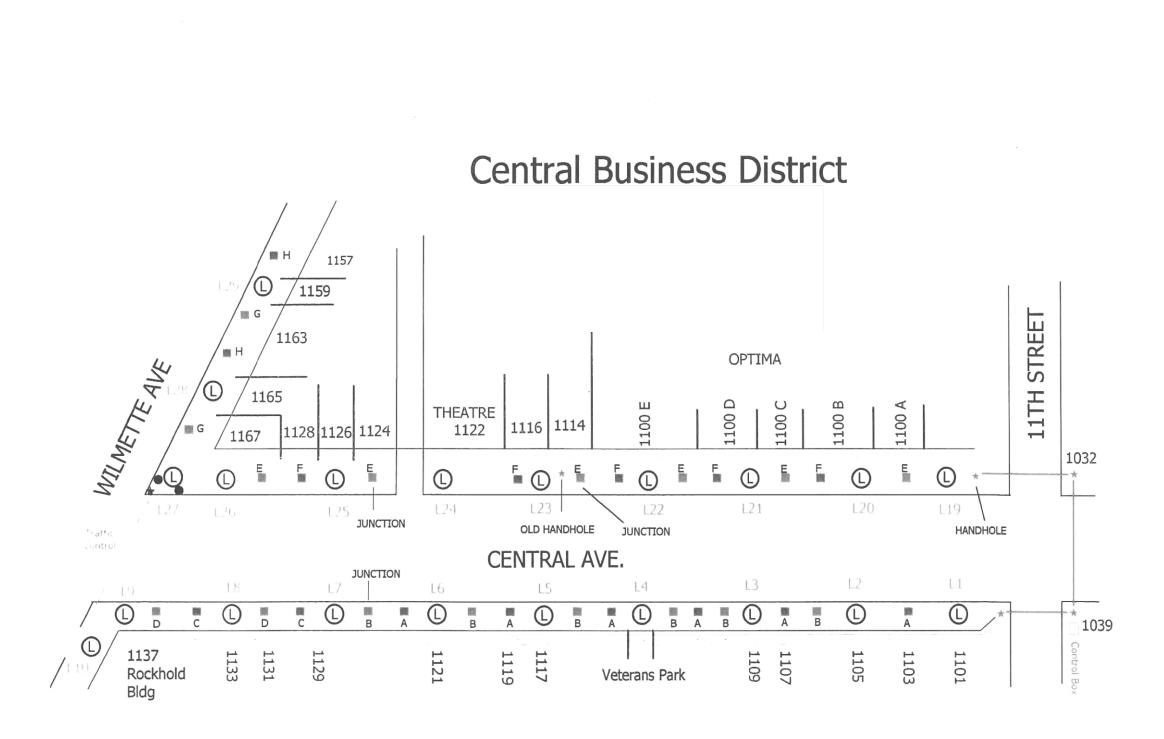
**EXISTING LIGHTING AND ELECTRICAL SYSTEMS** SCALE: NONE SHEET 5 OF 15 SHEETS STA.

COUNTY TOTAL SHEET NO. COOK 318 225 16-00199-00-RS 1296 CONTRACT NO. 61G42



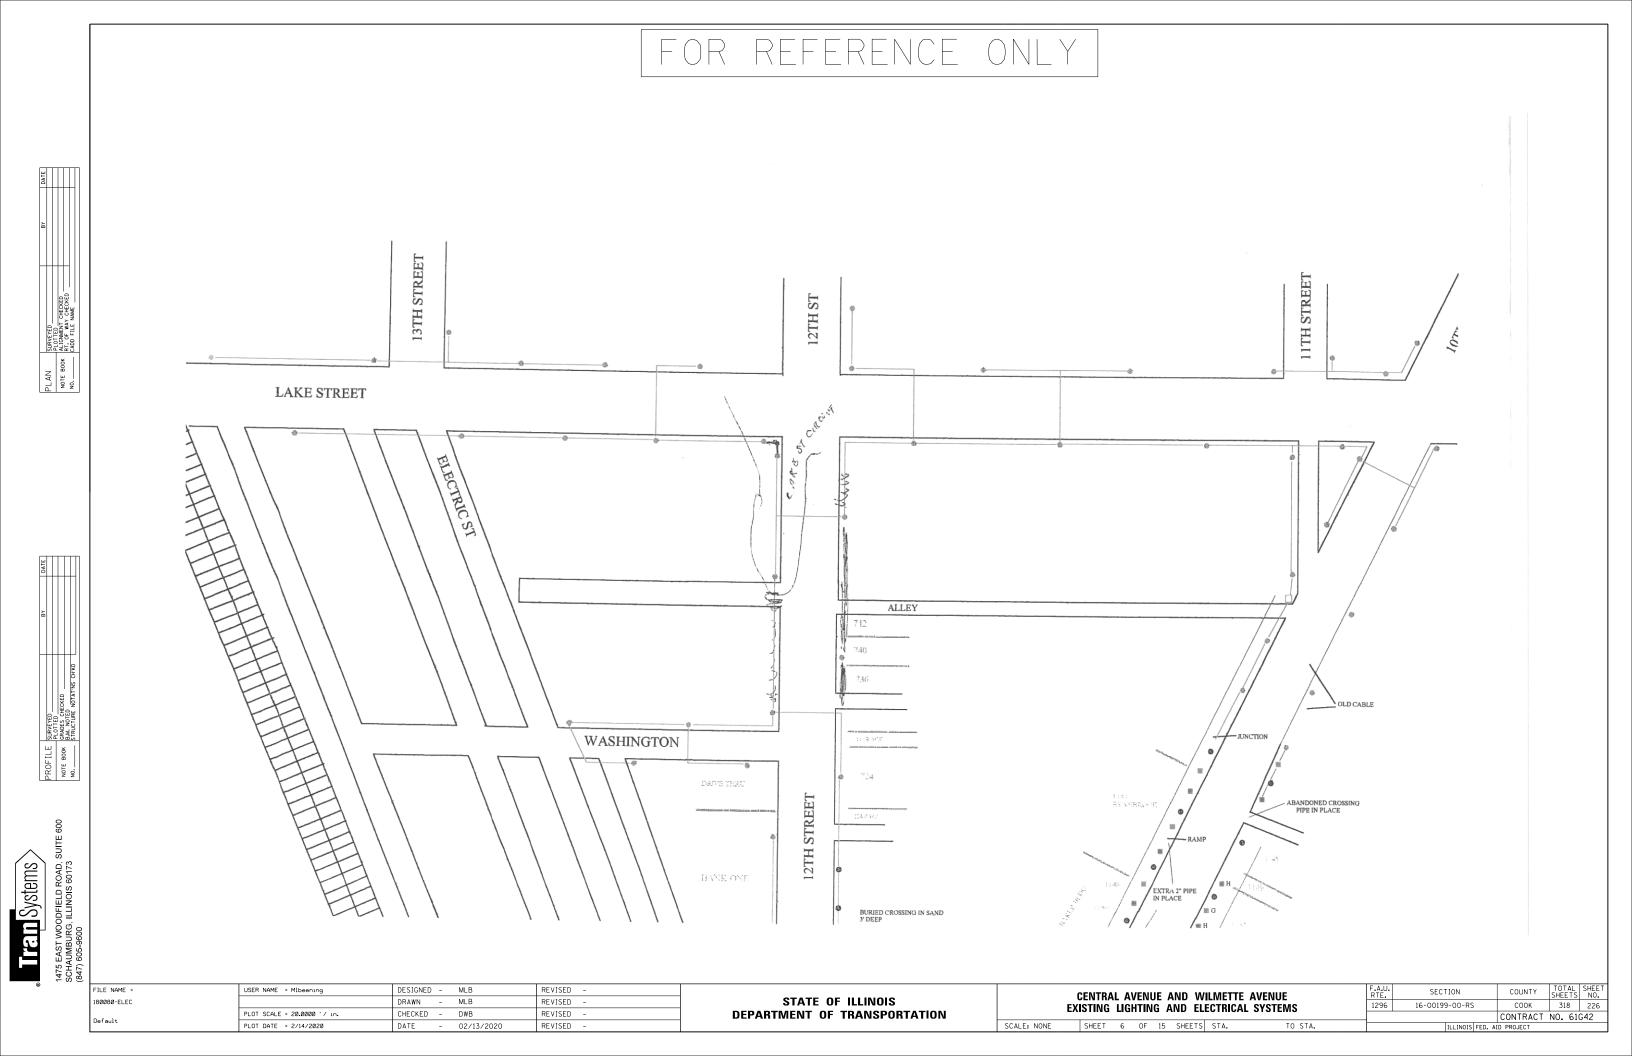

### FOR REFERENCE ONLY

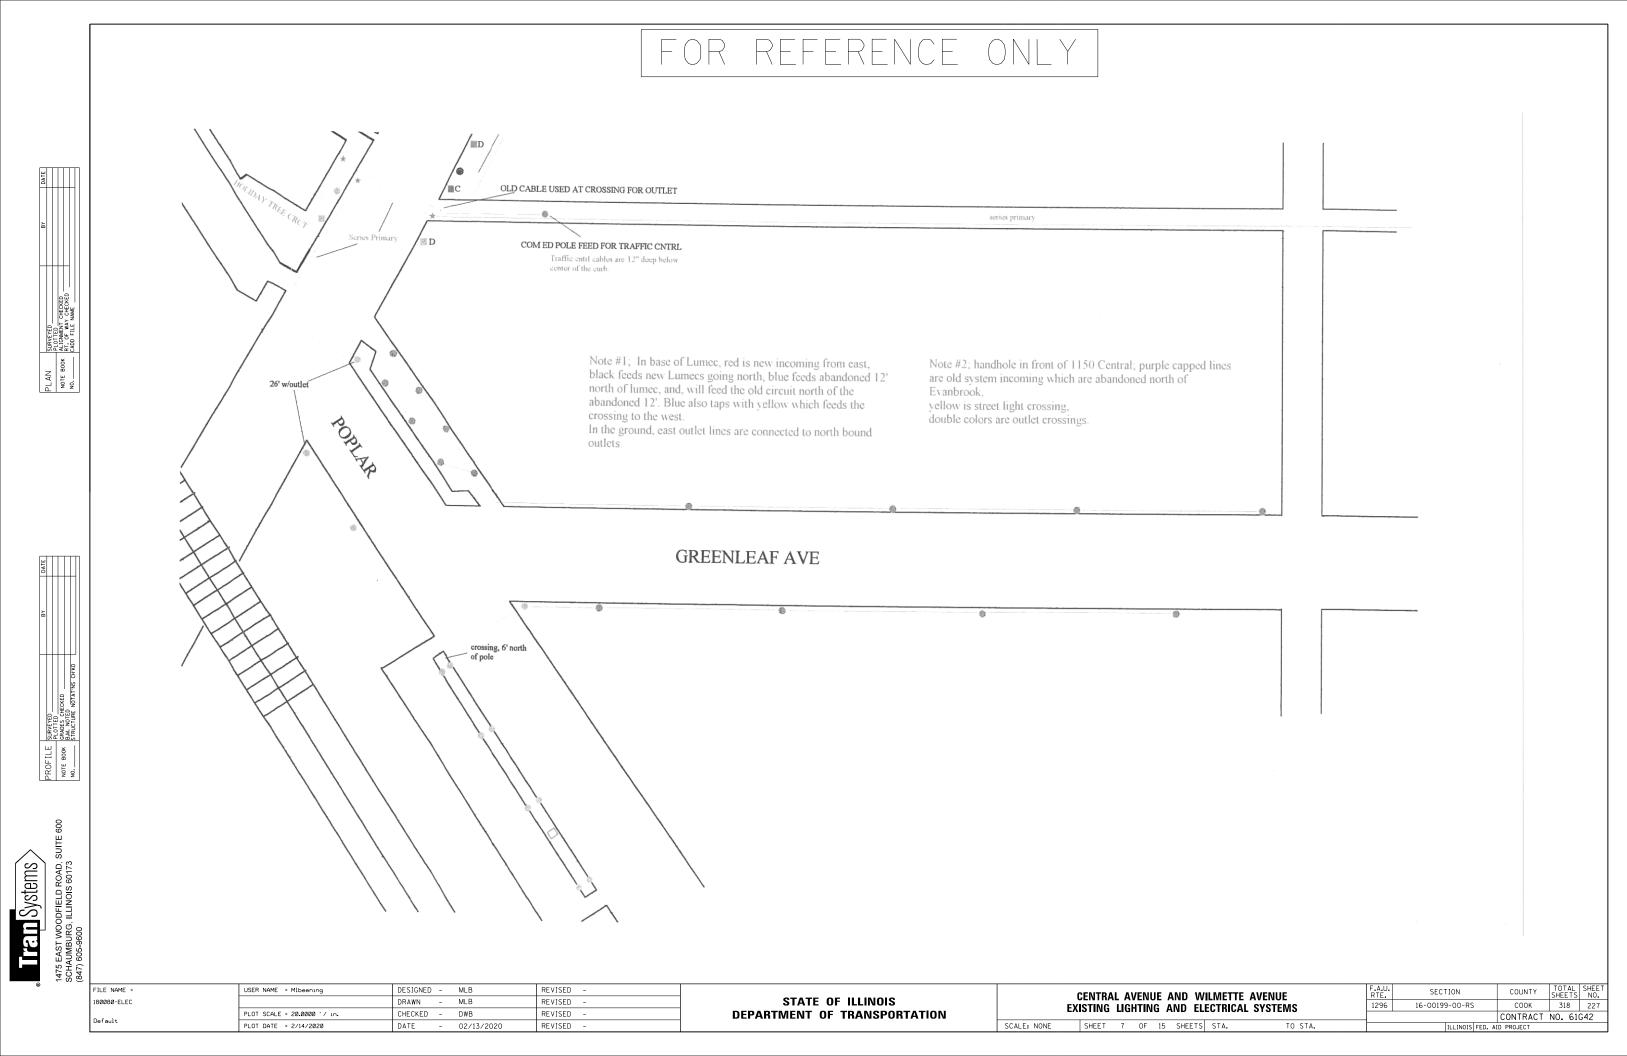

SCHAUMBURG, ILLINOIS 600773

STATE OF ILLINOIS DEPARTMENT OF TRANSPORTATION CENTRAL AVENUE AND WILMETTE AVENUE
EXISTING LIGHTING AND ELECTRICAL SYSTEMS

SHEET 8 OF 15 SHEETS STA. TO STA.


F.A.U. SECTION COUNTY TOTAL SHEETS NO.

1296 16-00199-00-RS COOK 318 228

CONTRACT NO. 61642

# FOR REFERENCE ONLY

#### Central Business District

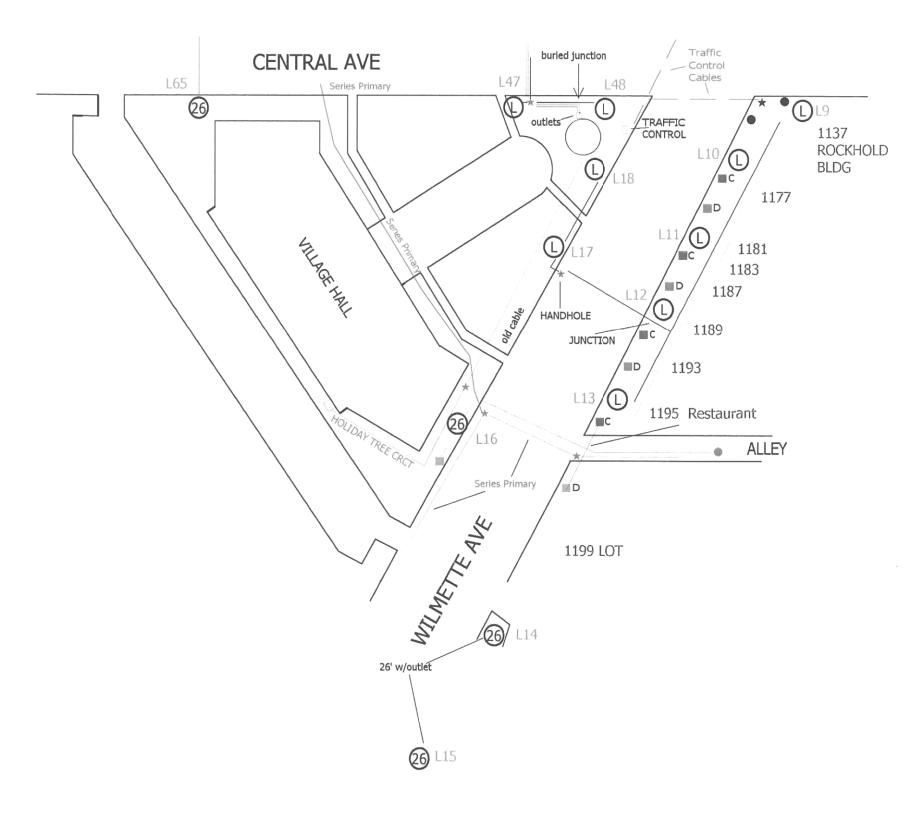



SCHAUMBURG, ILLINOIS 60173 (847) 605-9600

STATE OF ILLINOIS DEPARTMENT OF TRANSPORTATION CENTRAL AVENUE AND WILMETTE AVENUE
EXISTING LIGHTING AND ELECTRICAL SYSTEMS

SHEET 9 OF 15 SHEETS STA. TO STA.

F.A.U. SECTION COUNTY TOTAL SHEETS NO.
1296 16-00199-00-RS COOK 318 229

CONTRACT NO. 61G42



180080-ELEC

USER NAME = Mlbeening

PLOT DATE = 2/14/2020

PLOT SCALE = 20.0000 '/ in.

DESIGNED - MLB

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DWB


02/13/2020

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STATE OF ILLINOIS

**DEPARTMENT OF TRANSPORTATION** 

COUNTY TOTAL SHEETS NO.
COOK 318 230
CONTRACT NO. 61G42

SECTION

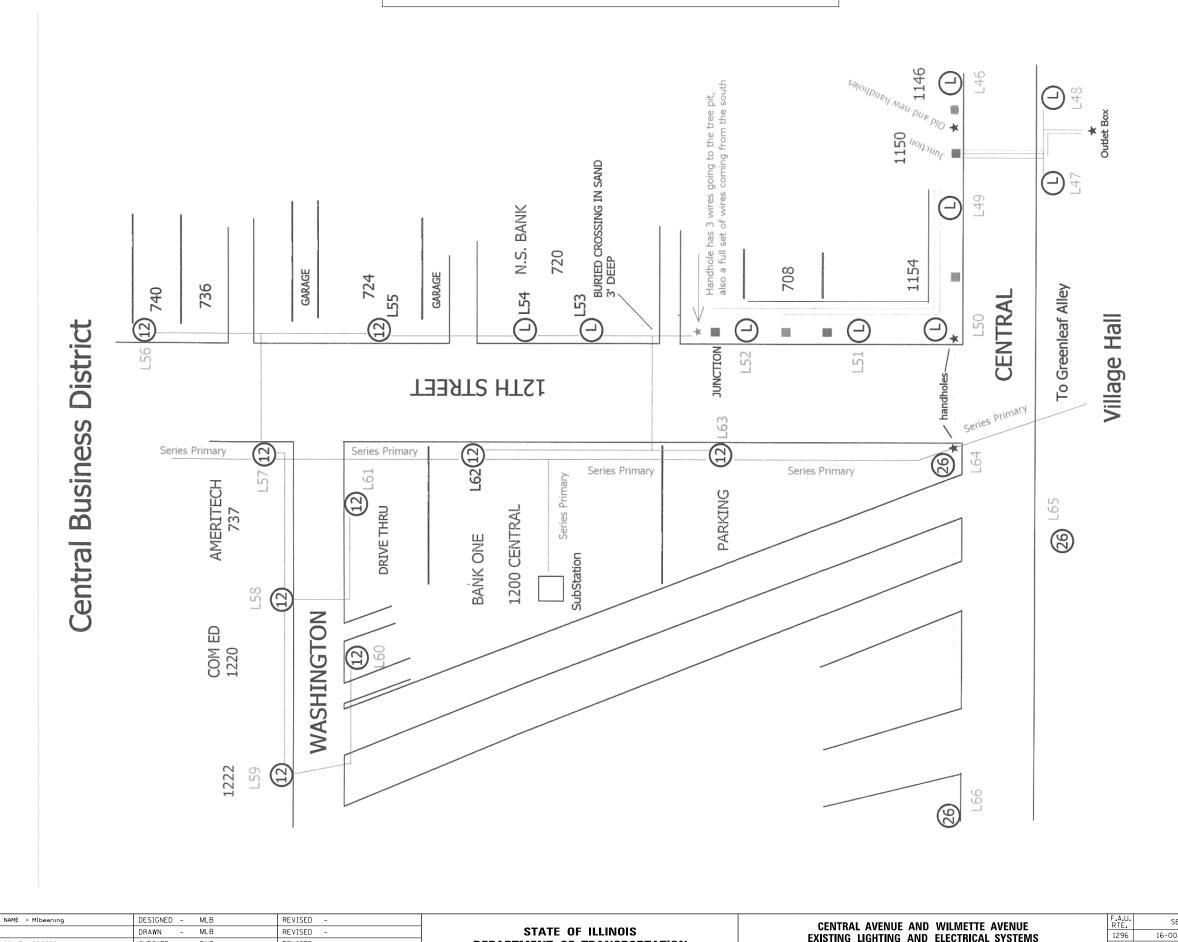16-00199-00-RS

CENTRAL AVENUE AND WILMETTE AVENUE EXISTING LIGHTING AND ELECTRICAL SYSTEMS

SHEET 10 OF 15 SHEETS STA.

OR REFERENCE ONLY




180080-ELEC

USER NAME = Mlbeening

PLOT DATE = 2/14/2020

PLOT SCALE = 20.0000 '/ in.

# 1125 LAKE STREET See Page 20 Mu 1135 1130 St Augustines 1140 0 1144 EVANBROOK Business District Central

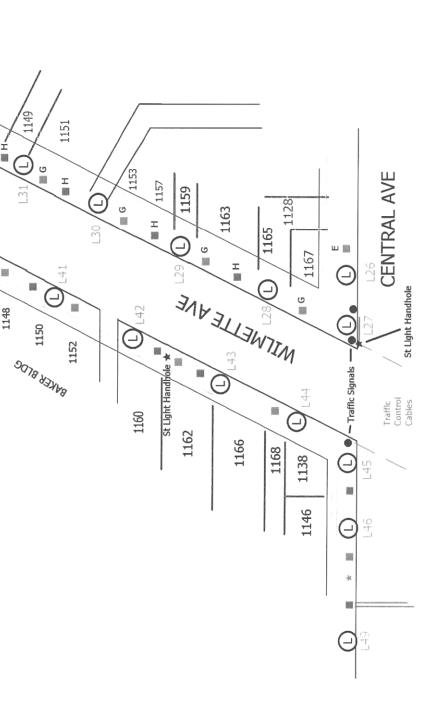



(	CENTRAL AVENUE AND WILMETTE AVENUE						AVENUE	F.A.U. RTE.	SECTION	COUNTY	TOTAL SHEETS	SHEI NO
							L SYSTEMS	1296	16-00199-00-RS	COOK	318	23
										CONTRACT	NO. 610	G42
	SHEET	11	OF	15	SHEETS	STA.	TO STA.		ILLINOIS FED. A	ID PROJECT		


DESIGNED - MLB REVISED STATE OF ILLINOIS
DEPARTMENT OF TRANSPORTATION MLB REVISED DRAWN -CHECKED -DWB REVISED DATE 02/13/2020 REVISED

SCALE: NONE


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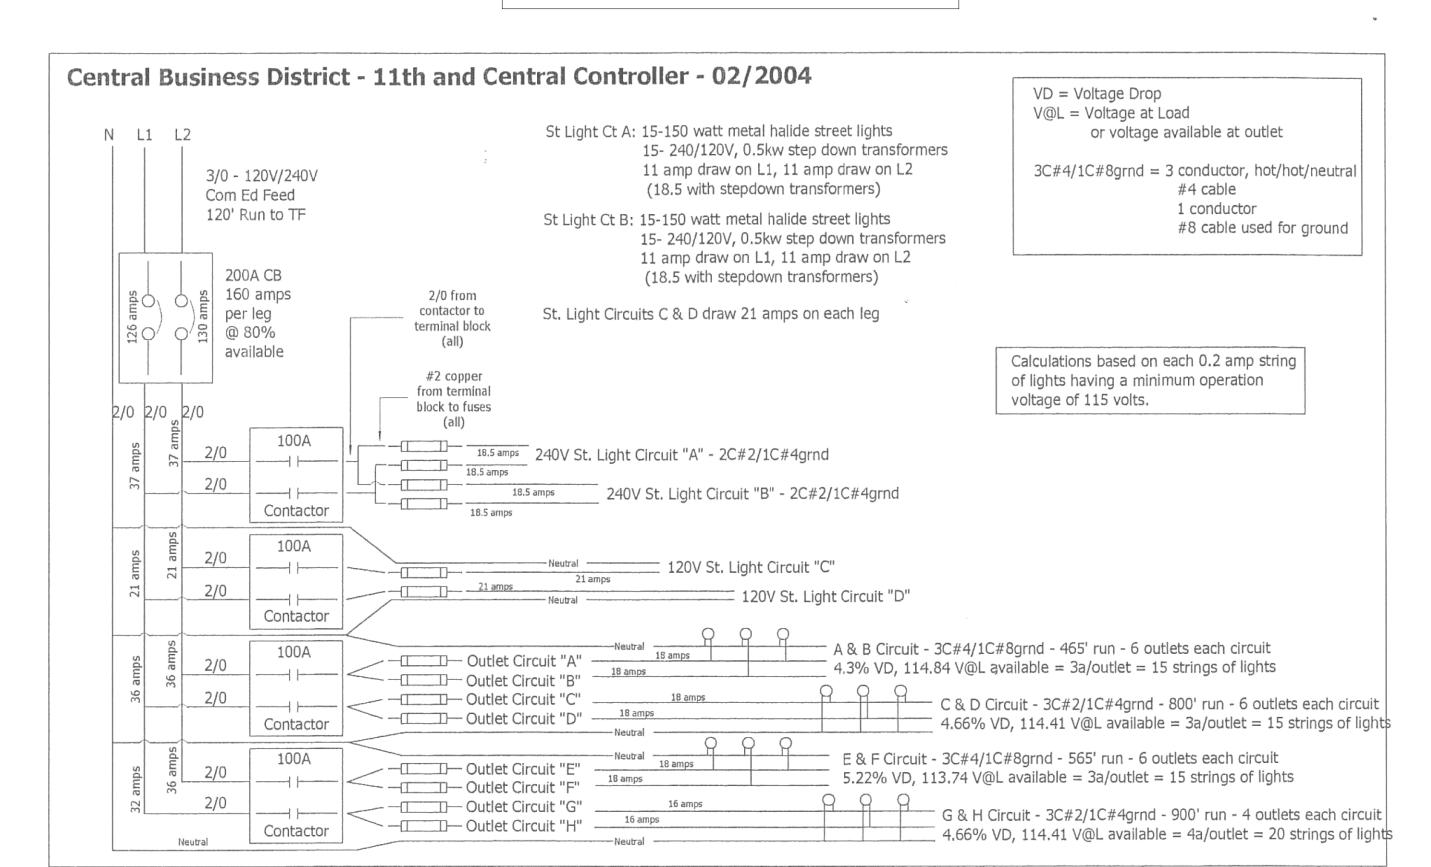
## FOR REFERENCE ONLY

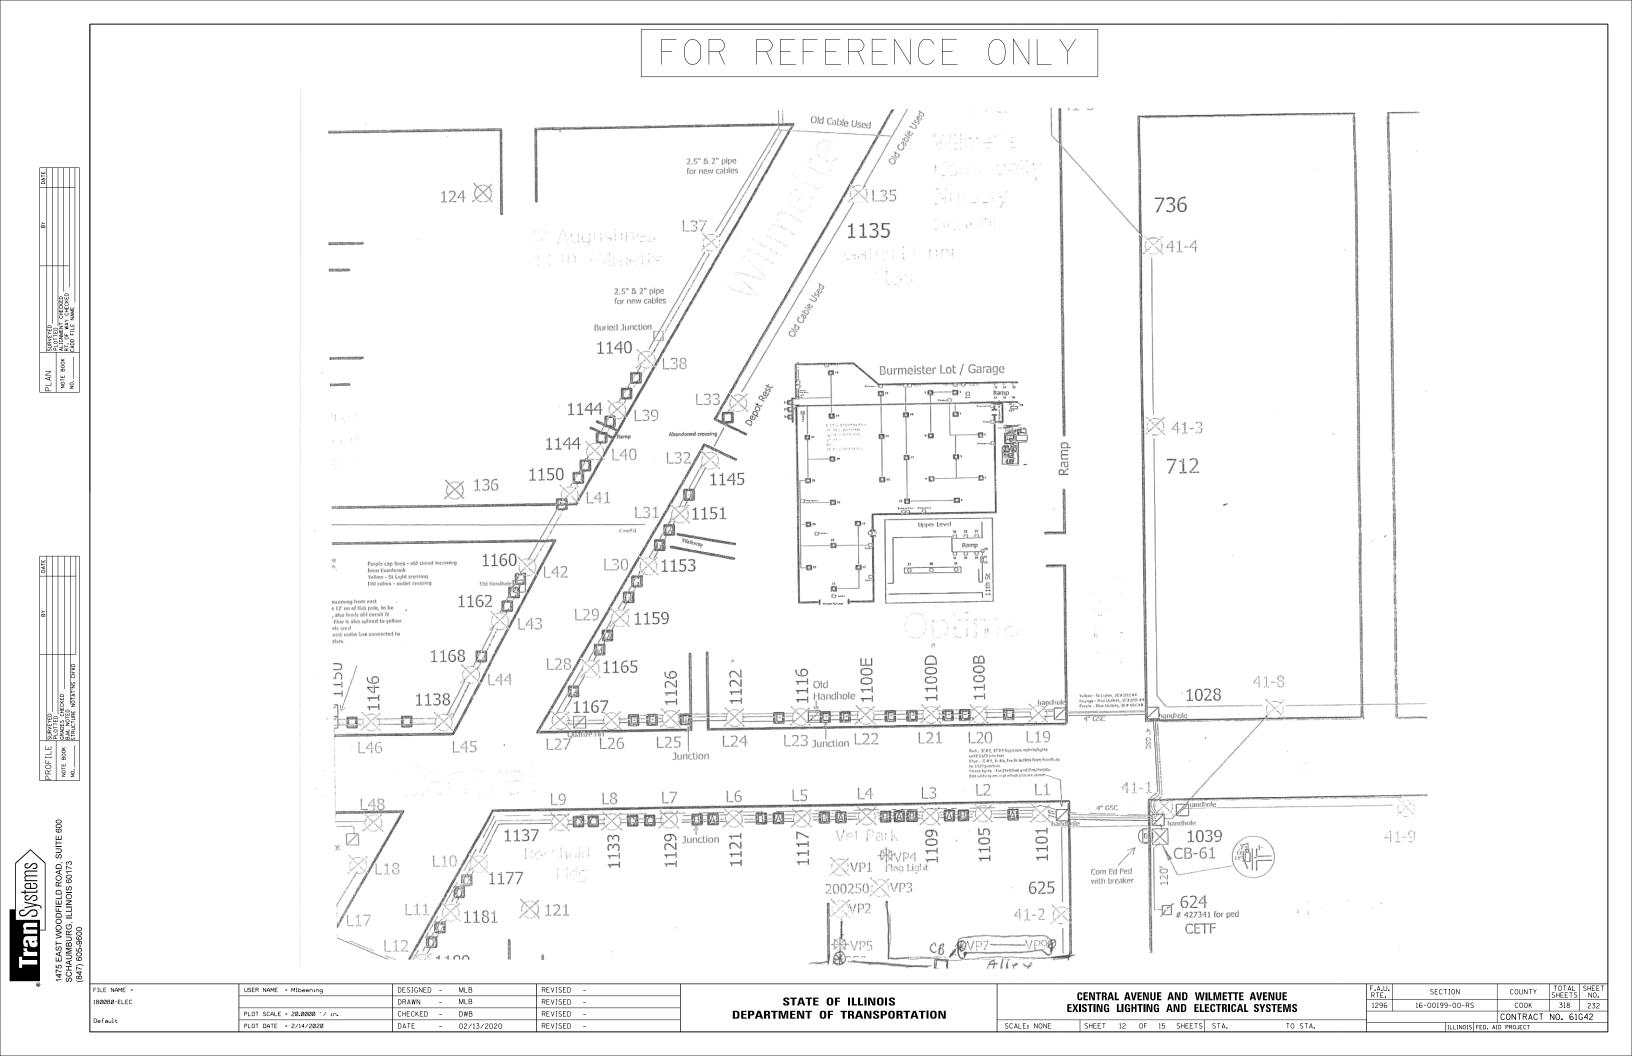

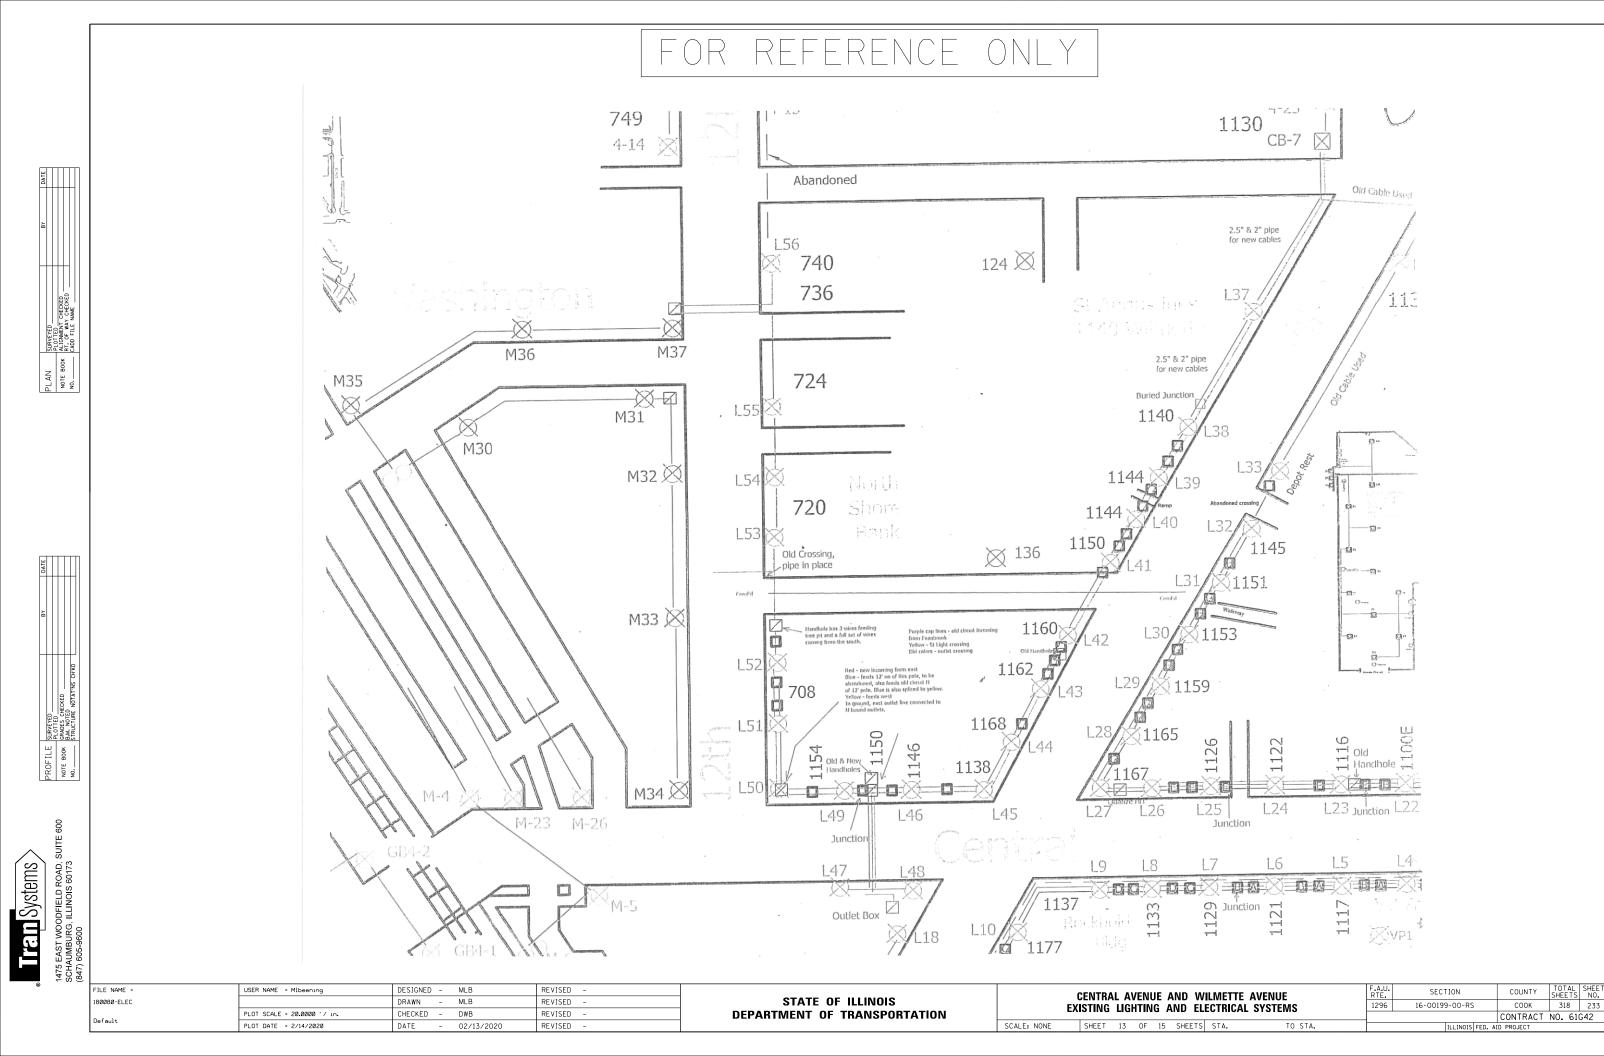

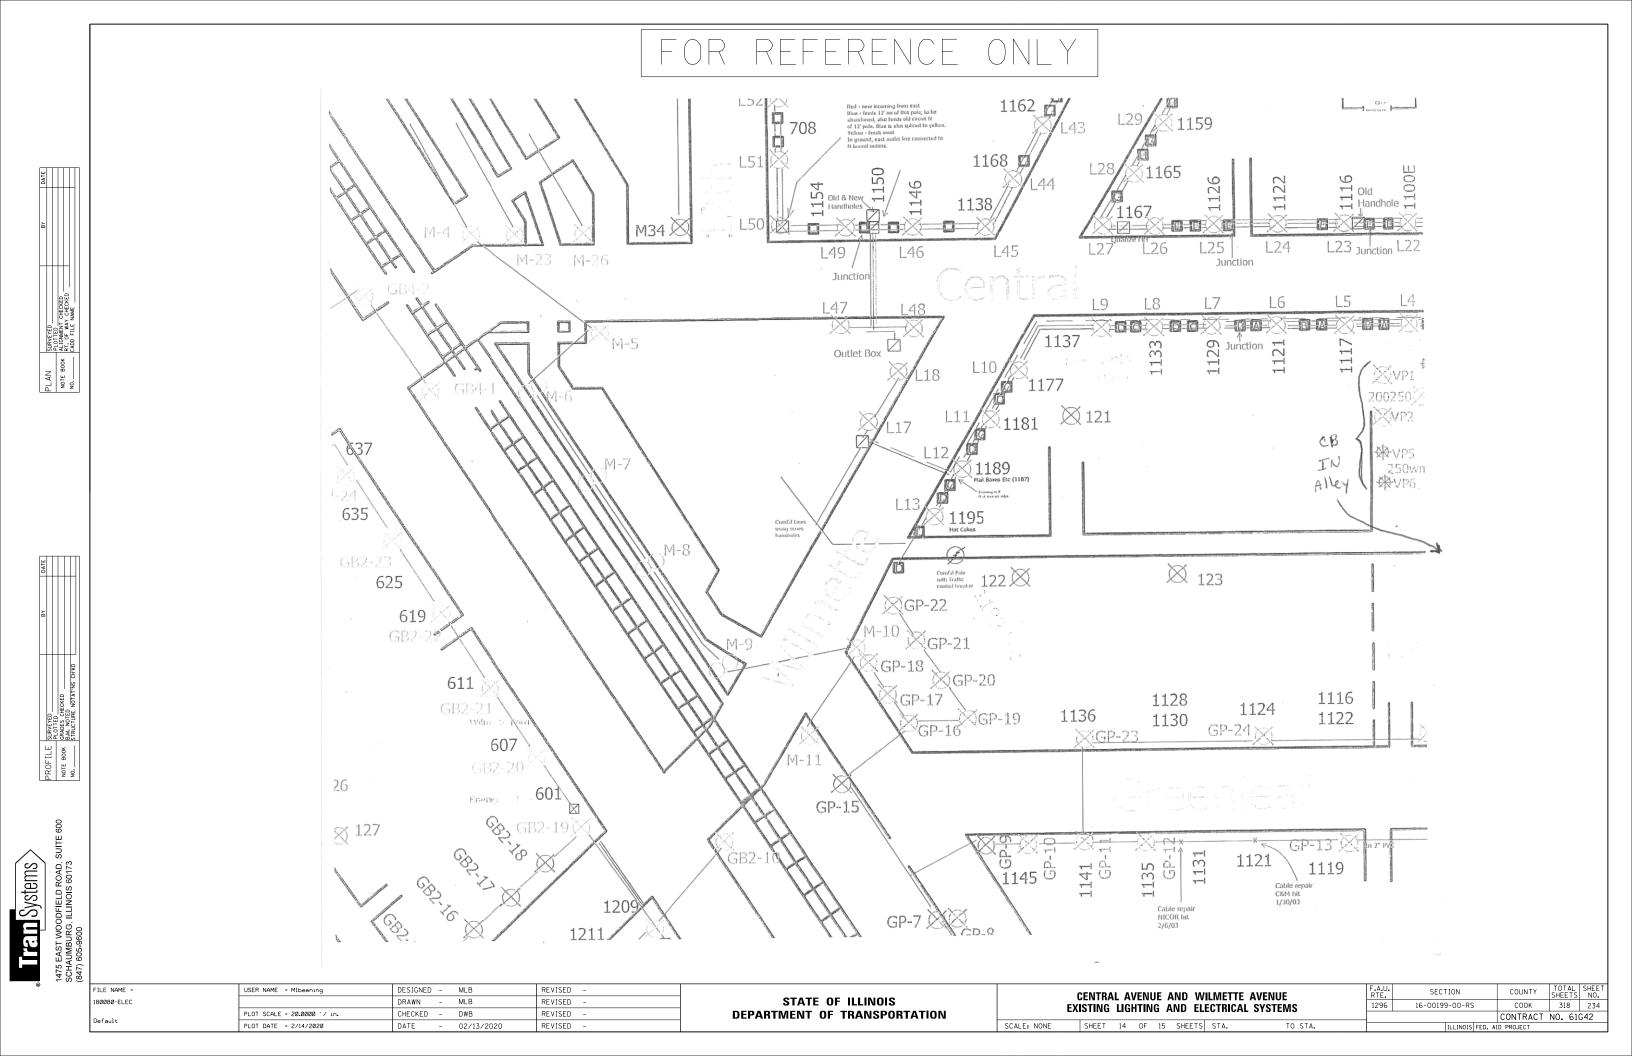

180080-ELEC

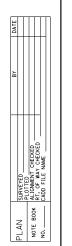

DESIGNED	-	MLB	REVISED	-
DRAWN	-	MLB	REVISED	-
CHECKED	-	DWB	REVISED	-
DATE	_	02/13/2020	REVISED	_

USER NAME = Mlbeening


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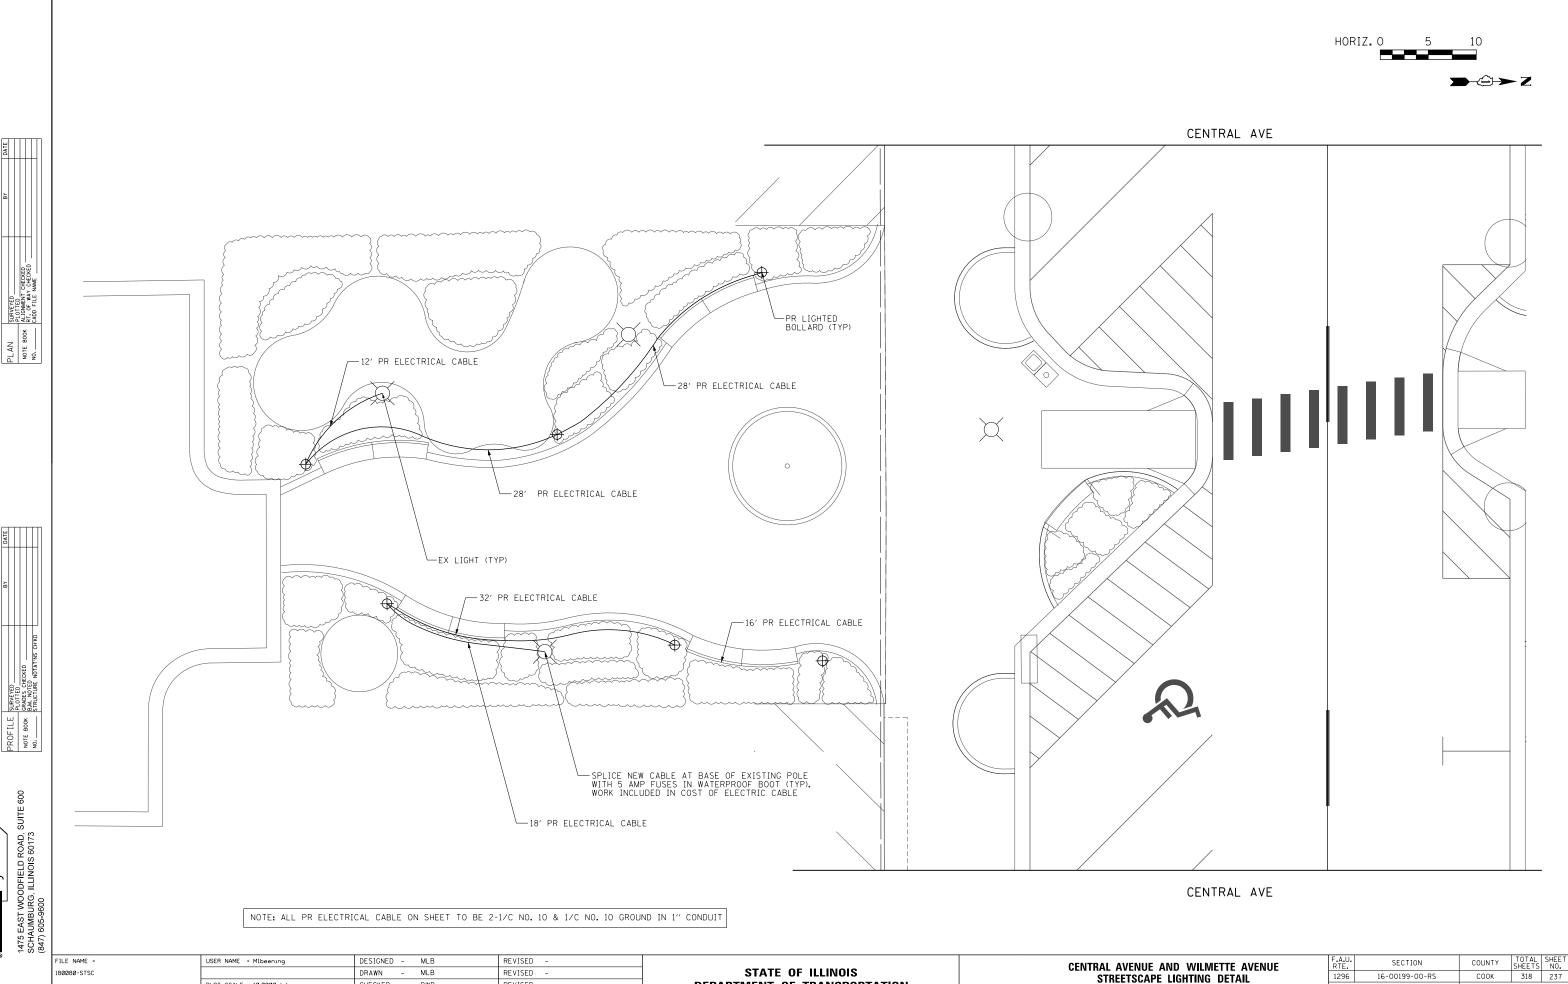
PLOT SCALE = 20.0000 '/ in.

STATE OF ILLINOIS
DEPARTMENT OF TRANSPORTATION

						E AVENUE LL SYSTEMS
CHEET	1.5	OΓ	1.5	CHEETC	CTA	TO CTA

SCALE: NONE



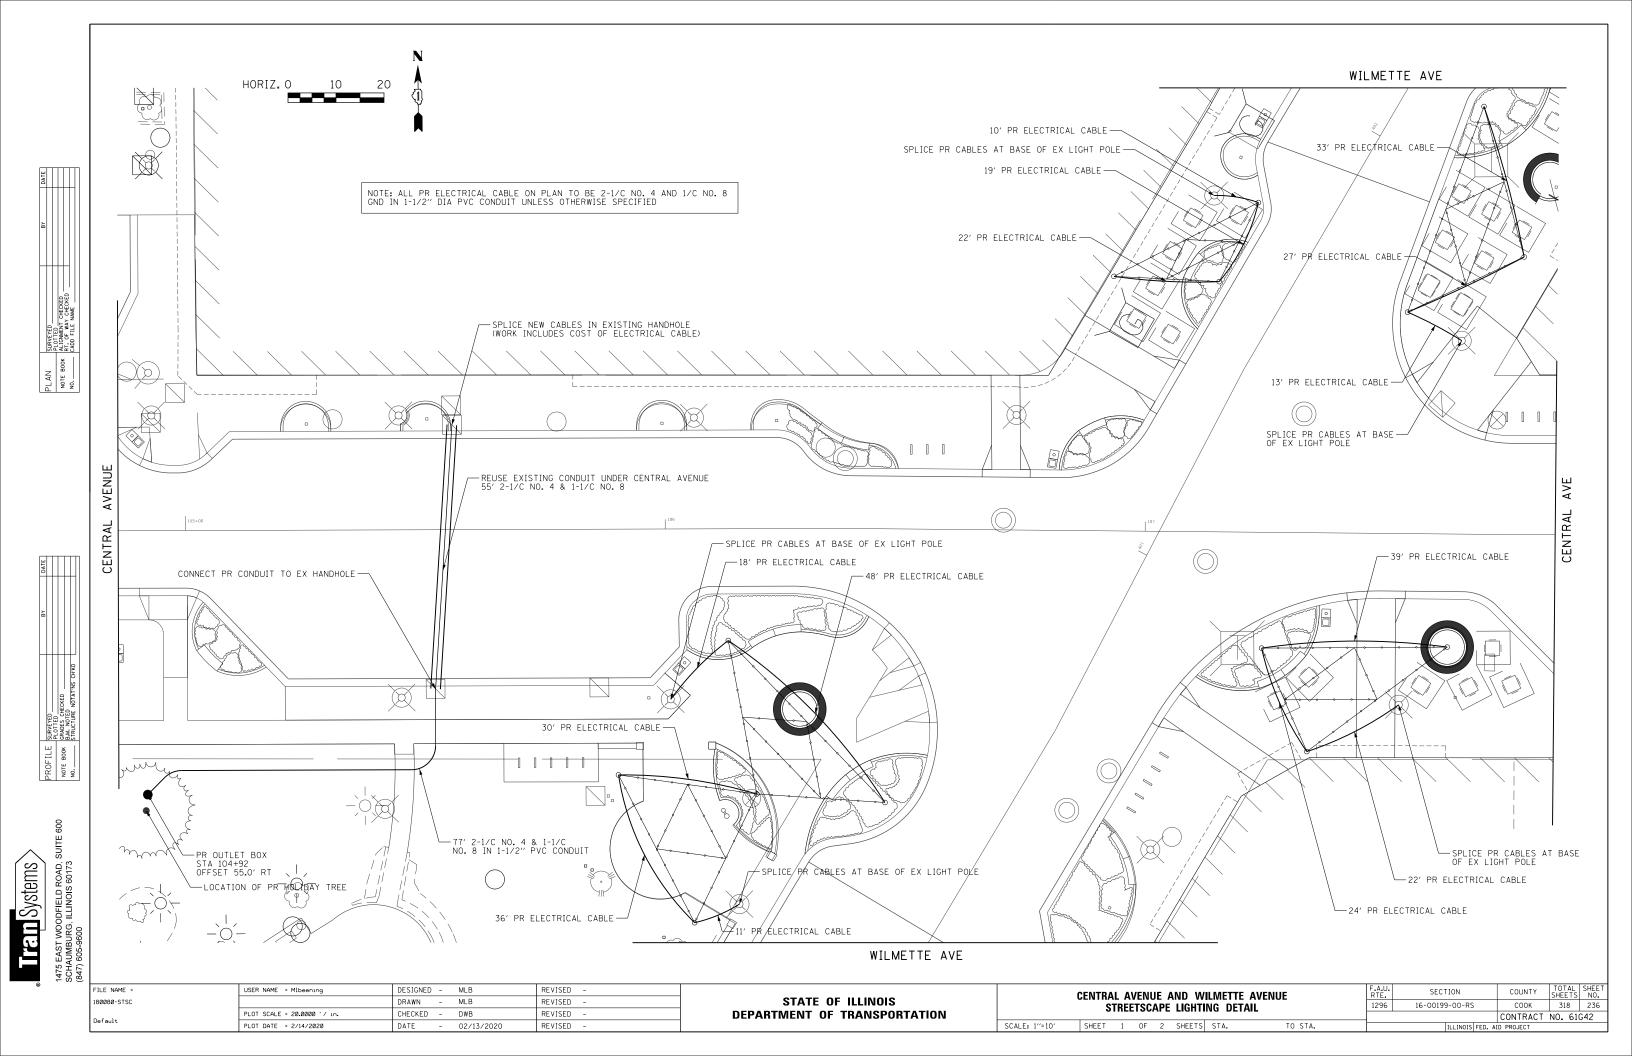


Tran Systems

DRAWN - MLB REVISED PLOT SCALE = 10.0000 '/ in. CHECKED -DWB REVISED PLOT DATE = 2/14/2020 DATE REVISED -- 02/13/2020

STATE OF ILLINOIS **DEPARTMENT OF TRANSPORTATION** 


CENTRAL AVENUE AND WILMETTE AVENUE 16-00199-00-RS STREETSCAPE LIGHTING DETAIL SCALE: 1"=5" SHEET 2 OF \$\$STSSHEETIDE T-STOAL

CONTRACT NO. 61G42

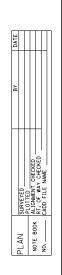






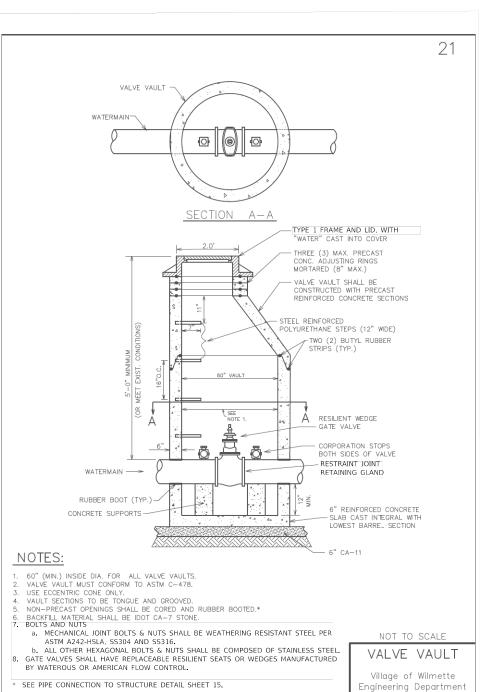

REVISED: 02/12/1

847.853.7660

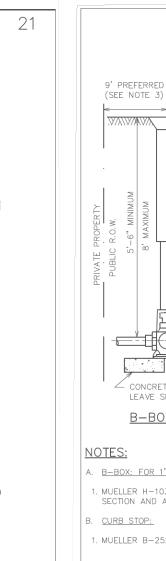

#### NOTES:

A. B-BOX: FOR 1", 11/2", 2" WATER SERVICES:

B-BOX DETAIL

CONCRETE BLOCK SUPPORT,

LEAVE SPACE FOR DRAINAGE

1. MUELLER H-10302 OR H-10386 WITH 1½" I.D. UPPER SECTION AND A 2" MINNEAPOLIS TAPPED BASE.

"WATER" CAST

ONTO COVER GRADE

- CURB STOP

- 1. MUELLER B-25204 OR H-15204 (1", 1½", 2")
- C. CORPORATION STOP:
- 1. MUELLER B25000 PLUS H-15068 QUARTER BEND FLARED COUPLING
- 2. WHERE 1½" TO 2" TAPS ARE REQUIRED, A DOUBLE-STRAP BRONZE SADDLE MUST BE USED FOR THE TAP, MUELLER H16126—H16137, FORD 202B-540 OR A.Y. McDONALD No. 3825 TAP SIZE.

# NOTES:

CORPORATION STOP COUPLING -

> 1. PIPE SIZE CAN VARY, BUT 1½" MINIMUM. OTHER APPURTENANCES SHALL REFLECT SAMF.

SERVICE TAP ON NEW MAIN

- SAME.

  2. COPPER PIPE SHALL BE ONE PIECE BETWEEN TAP AND CURB BOX.

  3. CURB BOX SHALL BE 3' FROM PROPERTY LINE WITHIN CUL-DE-SACS.

  4. MINIMUM OF 3' BETWEEN TAPS AND 3' TO
- NEAREST JOINT.

NEW WATERMAIN AND SFRVICF: NEW B-BOX

Village of Wilmette Engineering Department

18" MIN. By Village of Wilmette By Contractor Contractor Requirements for Indirect Taps for Water Service Connections

1½"COPPER PIPE,

COPPER PIPE, TYPE "K"

- 1. A 1½" tap through a 12" x (pipe diameter) stainless steel sleeve with a 1 ½" outlet is required. The stainless steel sleeve shall be fitted with copper conductivity strips to provide continuity between the water service and the water main.
- 1. A 2" tap through a 12" x (pipe diameter) stainless steel sleeve with a 2" outlet is required. The stainless steel sleeve shall be fitted with copper conductivity strips to provide continuity between the water service and the water main.
- 2. Taps shall be 18" from any pipe flaws, joints or other taps
- 3. The excavation shall be a minimum of 60"x60" from the face of the tapped main
- 4. The main is tapped at the 3:00 position.
- 5. Shoring conforming to OSHA standards is required for excavations deeper than 47".
- 6. Village of Wilmette tapping crews will not work in an undermined excavation. Tapping crews will not work under curbs and the
- 7. There shall be no water in the excavated area where the Village will perform the tap.
- 8. The water main will be exposed for the width of the excavation. The entire circumference of the main shall be cleaned for
- 9. Contractor will be charged the hourly rate for delays or cancellations due to non-compliance with these requirements

NOT TO SCALE

WATER SERVICE INDIRECT TAP (PREFERRED) RESIDENTIAL WORK

25


Village of Wilmette Engineering Department 847.853.7660 REVISED: 10/10/18


REVISED: 01/04/18

847.853.7660


DESIGNED - MLB REVISED FILE NAME USER NAME = Mlbeening SECTION COUNTY **CENTRAL AVENUE AND WILMETTE AVENUE STATE OF ILLINOIS** 180080-WILMETTE DETAI DRAWN MLB REVISED 1296 16-00199-00-RS COOK 318 238 **VILLAGE OF WILMETTE DETAILS DEPARTMENT OF TRANSPORTATION** PLOT SCALE = 100.0000 '/ 10. CHECKED DWB REVISED CONTRACT NO. 61G42 SCALE: NONE SHEET 1 OF 7 SHEETS STA. TO STA. REVISED PLOT DATE = 2/14/2020 DATE 02/13/2020




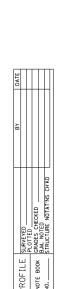

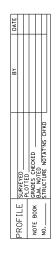




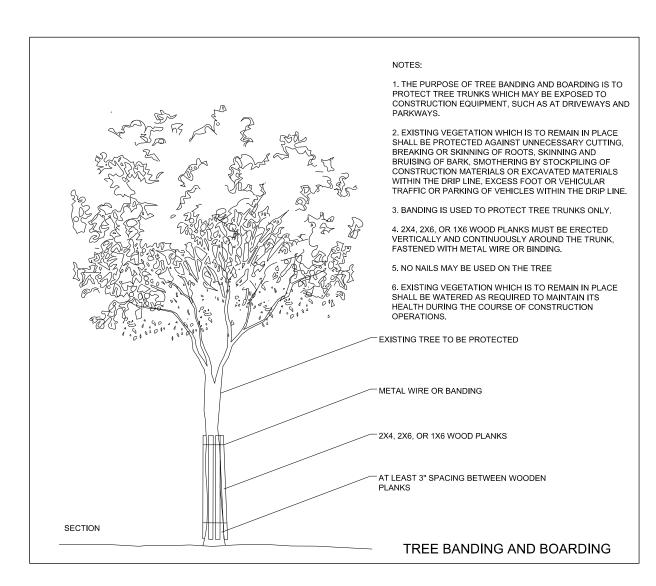

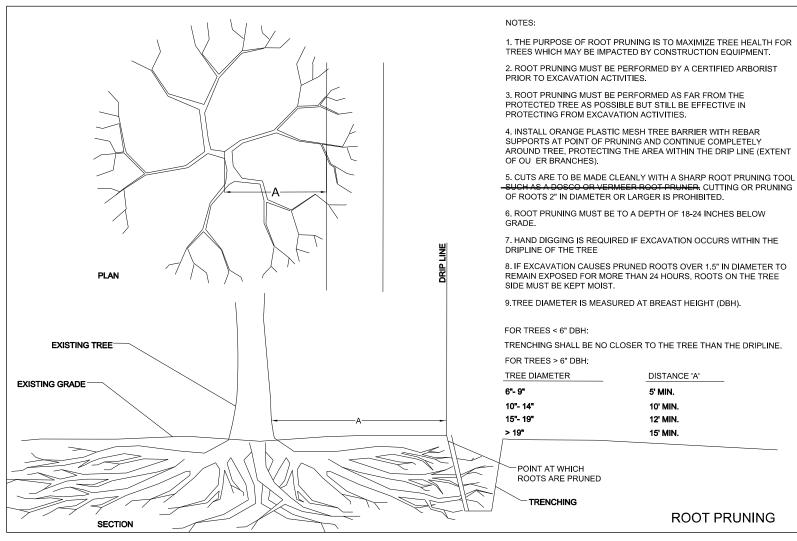

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	FILE NAME =	USER NAME = Mlbeening	DESIGNED - MLB	REVISED -		CENTRAL AVENUE AND WILME	TTE AVENUE	F.A.U.	SECTION	COUNTY TOT	TAL SHEET
	180080-WILMETTE DETAI		DRAWN - MLB	REVISED -	STATE OF ILLINOIS	VILLAGE OF WILMETTE DI		1296	16-00199-00-RS	COOK 31	18 239
	0.5.1.	PLOT SCALE = 100.00000 ' / in.	CHECKED - DWB	REVISED -	DEPARTMENT OF TRANSPORTATION	VILLAGE OF WILIWIETTE DI	VILLAGE OF WILMETTE DETAILS			CONTRACT NO.	61G42
	Default	PLOT DATE = 2/14/2020	DATE - 02/13/2020	REVISED -		SCALE: NONE SHEET 2 OF 7 SHEETS STA.	TO STA.		ILLINOIS FED.	AID PROJECT	

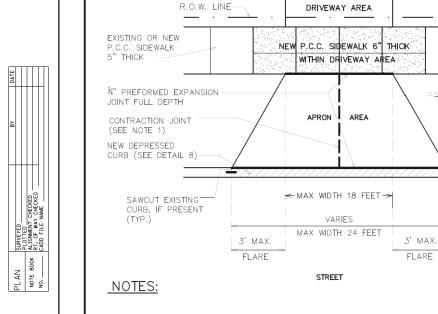

1. FOR CONCRETE APRONS WIDER THAN 16', A CONTRACTION JOINT SHALL BE LOCATED ALONG THE CENTERLINE.

2. P.C.C. CONCRETE DRIVEWAYS:

- a. APRON 6" (SIX INCH) MINIMUM PORTLAND CEMENT CONCRETE AND 4" (FOUR INCH) MINIMUM IDOT CA-6 CRUSHED STONE
- b. DRIVEWAY 4" (FOUR INCH) MINIMUM PORTLAND CEMENT CONCRETE AND 4" (FOUR INCH) MINIMUM IDOT CA-6 CRUSHED STONE
- 3. BITUMINOUS DRIVEWAYS:

Trein Systems

1475 EAST WOODFIELD ROAD, SCHAUMBURG, ILLINOIS 60173 847) 605-9600

- a. APRON -3" (THREE INCH) MINIMUM BITUMINOUS CONCRETE SURFACE COURSE AND 6" (SIX INCH) MINIMUM IDOT CA-6 CRUSHED STONE
- b. DRIVEWAY 3" (THREE INCH) MINIMUM BITUMINOUS CONCRETE SURFACE COURSE AND 4" (FOUR INCH ) MINIMUM IDOT CA-6 CRUSHED STONE BRICK PAVERS AND OTHER ARCHITECTURAL PAVING MATERIALS ARE NOT ALLOWED IN A
- DRIVEWAY APRON AREA WITHOUT A BUILDING PERMIT AND WRITTEN PERMISSION INCLUDING A HOLD HARMLESS AGREEMENT (APPROVED BY VILLAGE ENGINEER).
- MAINTAIN FULL SIDEWALK WIDTH THROUGH DRIVEWAYS UNLESS DIRECTED OTHERWISE BY VILLAGE ENGINEER. CURBING SHALL NOT RUN THROUGH SIDEWALK AREAS IN DRIVEWAYS.
- CURB CUTS/SHAVING ARE NOT PERMITTED.


NOT TO SCALE RESIDENTIAL DRIVEWAY Village of Wilmette Engineering Department REVISED: 01/09/ 847.853.7660


6

PARKWAY WIDTH

SAWCUT EXISTING CURB, IF PRESENT

(VARIES

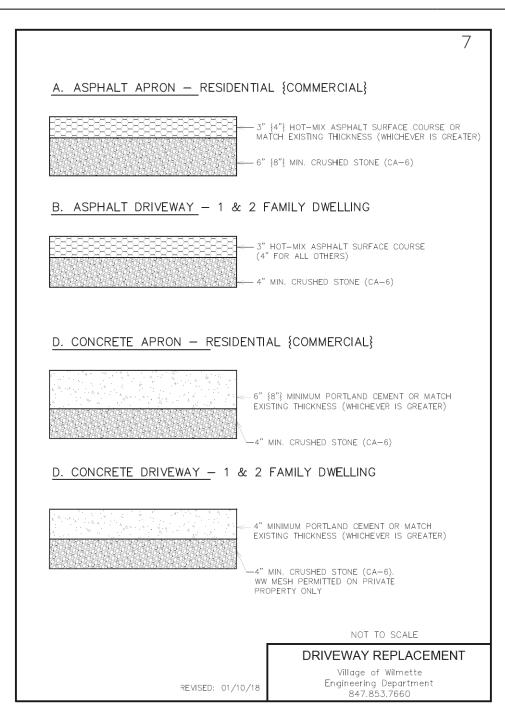

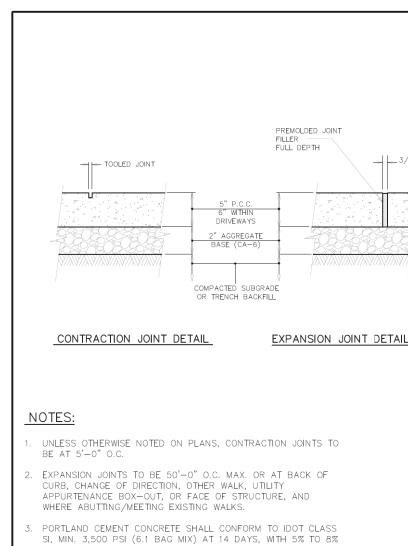

A PROTECTIVE COAT OR CONCRETE SEALER WILL BE APPLIED TO

ALL NEW CONCRETE SIDEWALKS AND CURB AND GUTTERS IN ACCORDANCE WITH SECTION 420 OF THE IDOT STANDARD

AIR ENTRAINMENT.

SPECIFICATIONS.


11

NOT TO SCALE

CONCRETE WALK

JOINT DETAIL

Vilage of Wilmette Engineering Department 847.853.7660

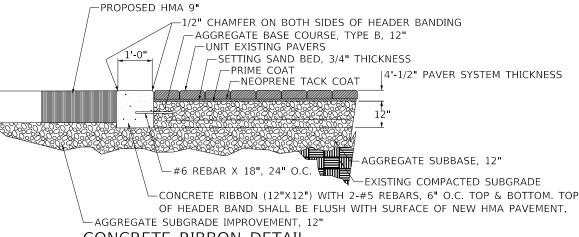

DESIGNED - MLB REVISED FILE NAME USER NAME = Mlbeening 180080-WILMETTE DETAI DRAWN - MLB REVISED PLOT SCALE = 100.0000 '/ in. CHECKED -DWB REVISED DATE REVISED PLOT DATE = 2/14/2020 02/13/2020


STATE OF ILLINOIS **DEPARTMENT OF TRANSPORTATION** 

SCALE: NONE

SECTION COUNTY **CENTRAL AVENUE AND WILMETTE AVENUE** 1296 16-00199-00-RS COOK 318 240 **VILLAGE OF WILMETTE DETAILS** CONTRACT NO. 61G42 SHEET 3 OF 7 SHEETS STA. TO STA.


REVISED: 01/10/1

CONCRETE RIBBON DETAIL

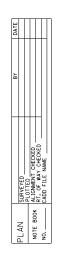





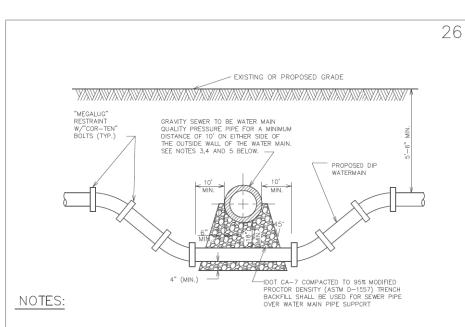



- HORIZONTAL AND VERTICAL SEPARATION BETWEEN WATERMAINS AND SEWERS SHALL COMPLY WITH VILLAGE ENGINEERING STANDARDS MANUAL OR IEPA REQUIREMENTS, WHICHEVER IS MORE STRINGENT.
- 2. CONTRACTOR MAY BEND WATER MAIN PIPE UNIFORMLY UNDER SEWERS WITHOUT USING FITTINGS, PROVIDED THAT JOINT DEFLECTION DOES NOT EXCEED 5 DEGREES PER JOINT FOR PIPE UNDER 14" IN DIAMETER AND 3 DEGREES PER JOINT FOR PIPE 14" AND OVER IN DIAMETER. IF FITTINGS ARE USED, CONTINUOUS STRAPPING WITH RODS, STRAPS, NUTS AND BOLTS BELOW NORMAL WATERMAIN DEPTH ARE REQUIRED, OR RETAINER GLANDS MAY BE USED IN LIEU OF STRAPPING. RETAINER GLANDS TO BE RESTRAINED JOINT RETAINER GLAND WITH WEATHER RESISTANT BOLTS MEETING THE REQUIREMENT OF ASTM A242-HSLA, \$5304 AND \$5316.
- 3. ALL SANITARY SEWER (INCLUDING SERVICE) CROSSINGS WHERE THE WATER MAINS OR WATER SERVICES ARE LESS THAN 18" VERTICALLY ABOVE THE SEWER SHALL BE POLYVINYL CHLORIDE PRESSURE PIPE (SDR 26-160 PSI) AND SHALL CONFORM WITH THE LATEST REVISION OF ASTM D— 2241, JOINTS SHALL CONFORM TO ASTM D—3139 AND ELASTOMERIC GASKETS SHALL CONFORM TO ASTM F-477. THE SAME PIPE AND JOINT MATERIALS SHALL BE USED WHENEVER WATER MAIN CROSSES BELOW THE SEWER.
- 4. ALL STORM SEWER (INCLUDING SERVICE) CROSSINGS WHERE THE WATER MAINS ARE LESS THAN 18" VERTICALLY ABOVE THE SEWER SHALL BE REINFORCED CONCRETE PIPE, ASTM C-361, CLASS D-25,WITH BELL AND SPIGOT JOINTS AND RUBBER GASKETS, OR PVC SDR 26 AS SPECIFIED IN NOTE 3 ABOVE. THE SAME PIPE AND JOINT MATERIAL SHALL BE USED WHENEVER WATER MAIN CROSSES BELOW THE SEWER.
- 5. FOR NEW SEWER INSTALLATIONS CROSSING OVER WATER MAINS, THE ENTIRE RUN OF NEW SEWER SHALL BE WATER MAIN QUALITY PIPE, EXTENDING FROM STRUCTURE TO STRUCTURE ON EACH SIDE OF THE CROSSING.

NOT TO SCALE


WATER MAIN CROSSING Village of Wilmette

Village of Wilmette Engineering Department 847.853.7660

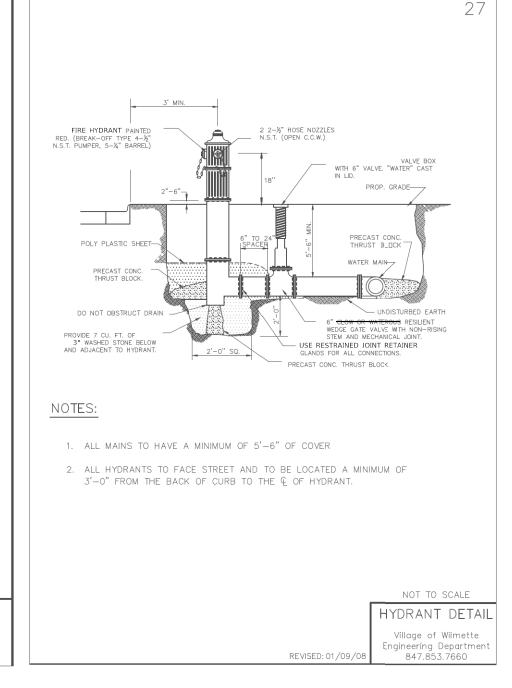

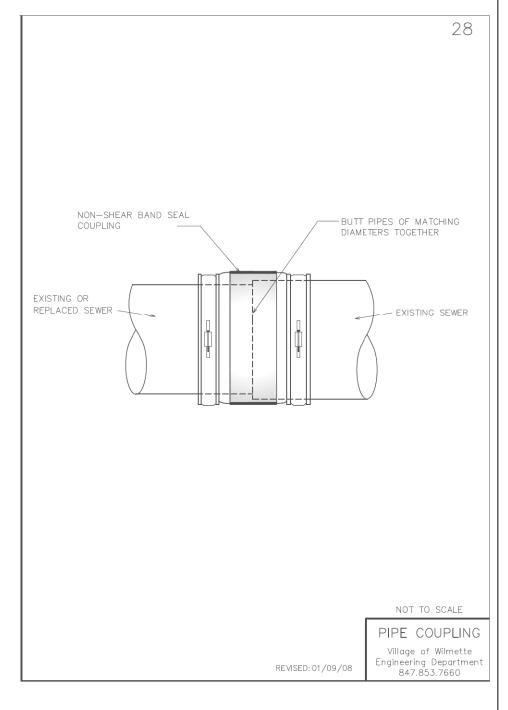


DESIGNED - MLB REVISED **CENTRAL AVENUE** FILE NAME USER NAME = Mlbeening SECTION COUNTY **STATE OF ILLINOIS** 180080-WILMETTE DETAI DRAWN MLB REVISED UNION PACIFIC RAILROAD TO SHERIDAN ROAD 1296 16-00199-00-RS COOK 318 241 PLOT SCALE = 100.0000 ' / 10. CHECKED DWB REVISED **DEPARTMENT OF TRANSPORTATION VILLAGE OF WILMETTE DETAILS** CONTRACT NO. 61G42 SHEET 4 OF 7 SHEETS STA. SCALE: NONE REVISED PLOT DATE = 2/14/2020 DATE 02/13/2020

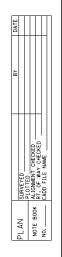







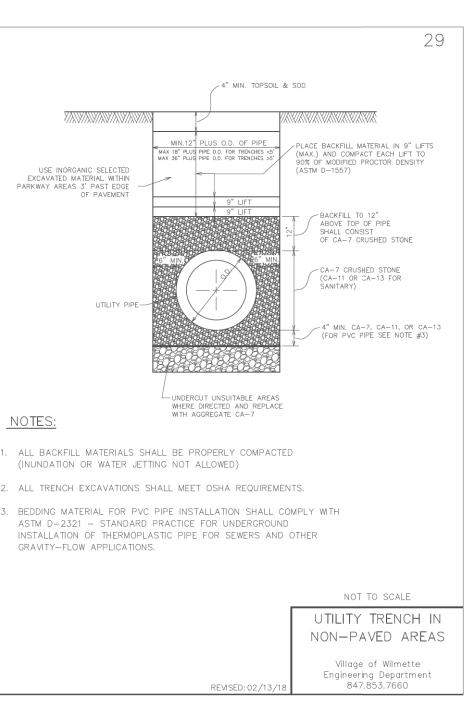



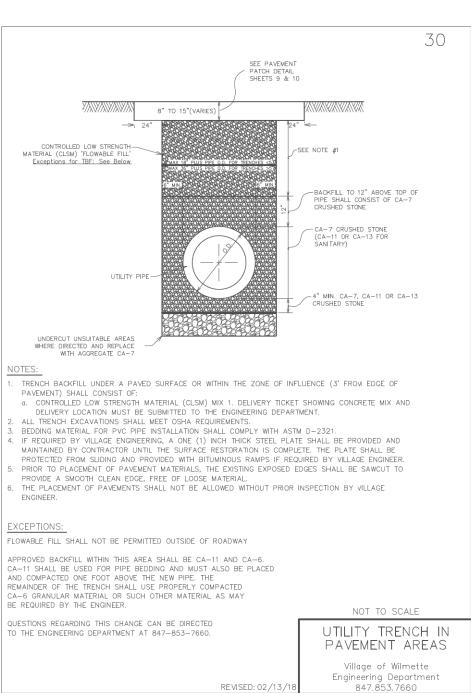

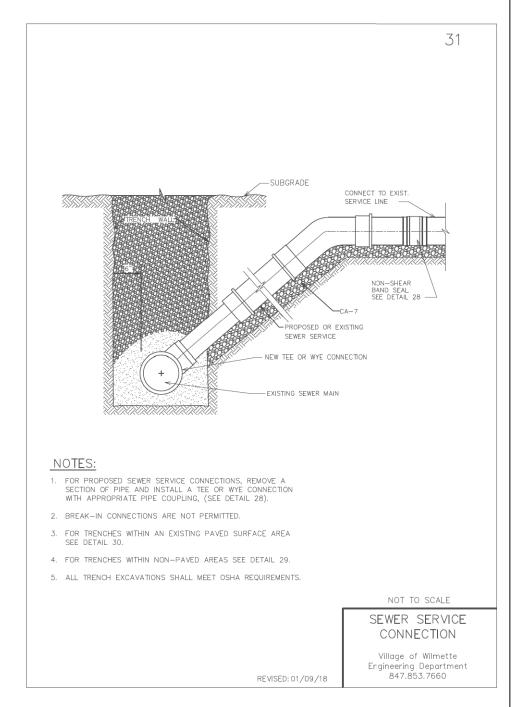


DESIGNED - MLB REVISED FILE NAME USER NAME = Mlbeening 180080-WILMETTE DETAI DRAWN MLB REVISED PLOT SCALE = 100.0000 '/ 10. CHECKED DWB REVISED REVISED PLOT DATE = 2/14/2020 DATE 02/13/2020

**STATE OF ILLINOIS DEPARTMENT OF TRANSPORTATION** 

SCALE: NONE


CENTRAL AVENUE SECTION COUNTY UNION PACIFIC RAILROAD TO SHERIDAN ROAD 1296 16-00199-00-RS COOK 318 242 **VILLAGE OF WILMETTE DETAILS** CONTRACT NO. 61G42 SHEET 5 OF 7 SHEETS STA.

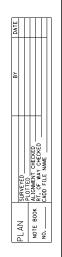






180080

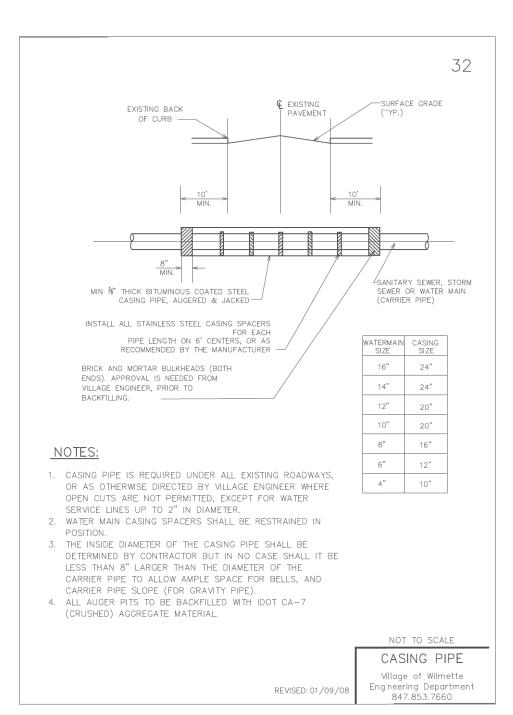

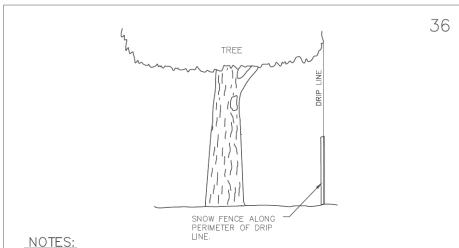

- 1. EXISTING VEGATATION WHICH IS TO REMAIN IN PLACE SHALL BE PROTECTED AGAINST UNNECESSARY CUTTING, BREAKING OR SKINNING OF ROOTS, SKINNING AND BRUISING OF BARK, SMOTHERING BY STOCKPILING OF CONSTRUCTION MATERIALS OR EXCAVATED MATERIALS WITHIN THE DRIP LINE OF THE EXISTING VEGATATION CANOPY, EXCESS FOOT OR VEHICULAR TRAFFIC OR PARKING OF VEHICLES WITHIN THE DRIP LINE OF THE
- 2. ALL TREES TO REMAIN SHALL BE PROTECTED WITH A SNOW FENCE INSTALLED AROUND THE PERIMETER OF THE TREES DRIP LINE, WITH STURDY STEEL POLES SET 3' ON CENTER ALONG THE FENCE. ANY CONSTRUCTION INSIDE THE DRIP LINE OF THE TREE REQUIRES INSPECTION FOR POSSIBLE ROOT PRUNING PRIOR TO THE EXCAVATION. ROOT PRUNING MAY BE NECESSARY IN ORDER TO LESSEN THE IMPACT OF DAMAGE TO THE VEGATATION'S ROOT SYSTEM.
- 3. EXISTING VEGATATION WHICH IS TO REMAIN IN PLACE SHALL BE WATERED A MINIMUM OF 1" OF WATER PER WEEK. WATERING SHALL COVER THE ENTIRE ROOT SYSTEM WITHIN THE TREE'S DRIPLINE EXTENDING OUT TO ITS DRIPLINE. WATERING IS REQUIRED AS TO HELP MAINTAIN ITS HEALTH DURING THE COURSE OF CONSTRUCTION OPERATIONS.
- 4. PROTECTION SHALL BE PROVIDED FOR ROOTS OVER 1-1/2" WHICH ARE CUT DURING CONSTRUCTION OPERATIONS. WHENEVER SUCH A ROOT IS CUT, THE CUT FACES SHALL BE COATED WITH A PRUNE WOOD DRESSING OR OTHER ACCEPTABLE COATING SPECIALLY FORMULATED FOR HOTICULTURAL USE ON DAMAGED OR CUT PLANT TISSUES. ALL EXPOSED ROOTS SHALL BE TEMPORARILY COVERED WITH WET BURLAP TO PREVENT THE ROOTS FROM DRYING OUT. EXPOSED ROOTS SHALL BE PROVIDED WITH SOIL COVER AS
- VEGATATION THAT BECOMES DAMAGED BY CONSTRUCTION OPERATIONS SHALL BE REPAIRED OR REPLACED IN A MANNER ACCEPTABLE TO THE VILLAGE.
- 6. DAMAGED TREES SHALL BE REPAIRED BY AN ISA CERTIFIED ARBORIST. DAMAGED TREES WHICH CANNOT BE REPAIRED AND RESTORED TO FULL GROWTH STATUS, AS DETERMINED BY THE VILLAGE AND/OR THE CERTIFIED ARBORIST, SHALL BE REPLACED WITHIN A TIME PERIOD STATED BY THE VILLAGE.


ALSO SEE SHEET239

REVISED: 01/25/10

TREE PROTECTION

Village of Wilmette Engineering Department 847.853.7660


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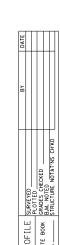

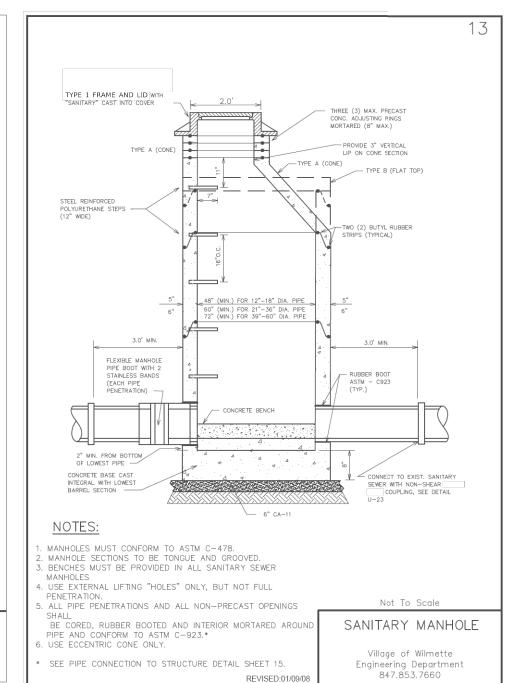
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-WILMETTE DETAI		DRAWN -	MLB	REVISED -
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It	PLOT DATE = 2/14/2020	DATE -	02/13/2020	REVISED -


**STATE OF ILLINOIS DEPARTMENT OF TRANSPORTATION** SCALE: NONE

**CENTRAL AVENUE** SECTION COUNTY UNION PACIFIC RAILROAD TO SHERIDAN ROAD 1296 16-00199-00-RS COOK 318 243 **VILLAGE OF WILMETTE DETAILS** CONTRACT NO. 61G42 SHEFT 6 OF 7 SHEFTS STA.



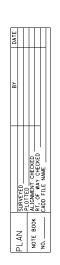




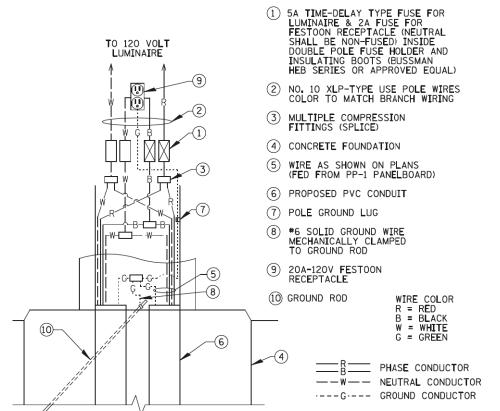

# DECORATIVE FESTOON LIGHT POLE HANDHOLE WIRING DIAGRAM

NOTE:

ALL MATERIALS SHALL BE INCLUDED IN THE COST OF LIGHT POLE, SPECIAL

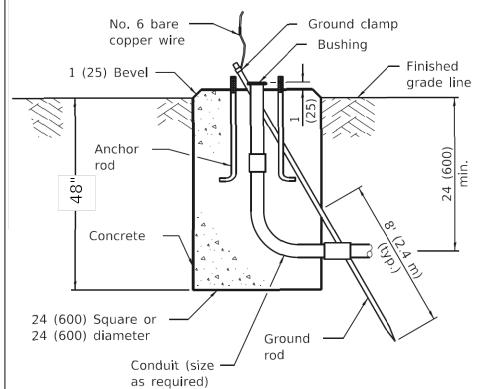


## TYPE A FOUNDATION FOR DECORATIVE FESTOON LIGHT POLE

NOTE:

FOUNDATIONS FOR LIGHT POLE, SPECIAL SHALL BE PAID FOR AS CONCRETE FOUNDATION, TYPE A.

**STATE OF ILLINOIS** 

**DEPARTMENT OF TRANSPORTATION** 

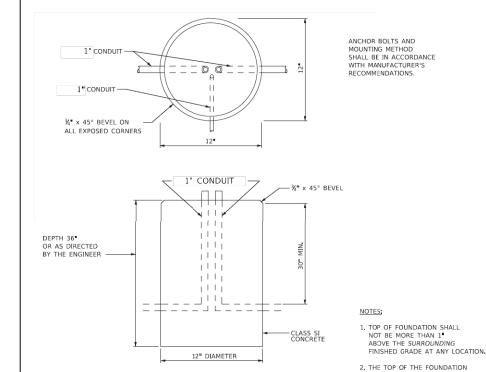

CONCRETE FOUNDATION (SPECIAL)

SHALL LEVEL AND SMOOTH.

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CENTRAL AVENUE
UNION PACIFIC RAILROAD TO SHERIDAN ROAD 1296 **VILLAGE OF WILMETTE DETAILS** 

COUNTY TOTAL SHEET NO.

COOK 318 244 SECTION 16-00199-00-RS CONTRACT NO. 61G42 SHEET 7 OF 7 SHEETS STA.

#### A. REFERENCED SPECIFICATIONS

- 1. ALL CONSTRUCTION SHALL BE IN ACCORDANCE WITH THE APPLICABLE SECTIONS OF THE FOLLOWING,
- ALL CONSTRUCTION SHALL BE IN ACCORDANCE WITH THE APPLICABLE SECTIONS OF THE FOLLOWING, EXCEPT AS MODIFIED HEREIN OR ON THE PLANS:

  \* STANDARD SPECIFICATIONS FOR ROAD AND BRIDGE CONSTRUCTION (LATEST EDITION), BY THE ILLINOIS DEPARTMENT OF TRANSPORTATION (IDOT SS) FOR ALL IMPROVEMENTS EXCEPT SANITARY SEWER AND WATER MAIN CONSTRUCTION;

  \* STANDARD SPECIFICATIONS FOR WATER AND SEWER MAIN CONSTRUCTION IN ILLINOIS, LATEST EDITION (SSWS) FOR SANITARY SEWER AND WATER MAIN CONSTRUCTION;

  \* VILLAGE OF WILMETTE MINITEDIAL CODE:

- EDITION (SSWS) FOR SANITARY SEWER AND WATER MAIN CONSTRUCTION;

  \* VILLAGE OF WILMETTE MUNICIPAL CODE;

  \* THE METROPOLITAN WATER RECLAMATION DISTRICT OF GREATER CHICAGO (MWRD) WATERSHED MANAGEMENT ORDINANCE AND TECHNICAL GUIDANCE MANUAL;

  \* IN CASE OF CONFLICT BETWEEN THE APPLICABLE ORDINANCES NOTED, THE MORE STRINGENT SHALL TAKE PRECEDENCE AND SHALL CONTROL ALL CONSTRUCTION.

#### **B. NOTIFICATIONS**

- 1. THE MWRD LOCAL SEWER SYSTEMS SECTION FIELD OFFICE MUST BE NOTIFIED AT LEAST TWO (2) WORKING DAYS PRIOR TO THE COMMENCEMENT OF ANY WORK (CALL 708-588-4055).
- 2. THE VILLAGE OF WILMETTE ENGINEERING AND PUBLIC WORKS DEPARTMENT MUST BE NOTIFIED AT LEAST 24 HOURS PRIOR TO THE START OF CONSTRUCTION AND PRIOR TO EACH PHASE OF WORK, CONTRACTOR SHALL DETERMINE ITEMS REQUIRING INSPECTION PRIOR TO START OF CONSTRUCTION OR EACH WORK PHASE.
- 3. THE CONTRACTOR SHALL NOTIFY ALL UTILITY COMPANIES PRIOR TO BEGINNING CONSTRUCTION FOR THE EXACT LOCATIONS OF UTILITIES AND FOR THEIR PROTECTION DURING CONSTRUCTION. IF EXISTING UTILITIES ARE ENCOUNTERED THAT CONFLICT IN LOCATION WITH NEW CONSTRUCTION, IMMEDIATELY NOTIFY THE ENGINEER SO THAT THE CONFLICT CAN BE RESOLVED. CALL J.U.L.I.E. AT 1-800-892-0123.

- 1. ALL ELEVATIONS SHOWN ON PLANS REFERENCE THE NATIONAL GEODETIC VERTICAL DATUM OF 1988 (NGVD88).
- 2. MWRD, THE MUNICIPALITY AND THE OWNER OR OWNER'S REPRESENTATIVE SHALL HAVE THE AUTHORITY TO INSPECT, APPROVE, AND REJECT THE CONSTRUCTION IMPROVEMENTS
- 3. THE CONTRACTOR(S) SHALL INDEMNIFY THE OWNER, ENGINEER, MUNICIPALITY, MWRD, AND THEIR AGENTS, ETC., FROM ALL LIABILITY INVOLVED WITH THE CONSTRUCTION, INSTALLATION, OR TESTING OF THIS WORK
- 4. THE PROPOSED IMPROVEMENTS MUST BE CONSTRUCTED IN ACCORDANCE WITH THE ENGINEERING PLANS AS APPROVED BY MWRD AND THE MUNICIPALITY UNLESS CHANGES ARE APPROVED BY MWRD, THE MUNICIPALITY, OR AUTHORIZED AGENT. THE CONSTRUCTION DETAILS, AS PRESENTED ON THE PLANS, MUST BE FOLLOWED. PROPER CONSTRUCTION TECHNIQUES MUST BE FOLLOWED ON THE IMPROVEMENTS
- 5. THE LOCATION OF VARIOUS UNDERGROUND UTILITIES WHICH ARE SHOWN ON THE PLANS ARE FOR INFORMATION ONLY AND REPRESENT THE BEST KNOWLEDGE OF THE ENGINEER. VERIFY LOCATIONS AND
- 6. ANY EXISTING PAVEMENT, SIDEWALK, DRIVEWAY, ETC., DAMAGED DURING CONSTRUCTION OPERATIONS AND NOT CALLED FOR TO BE REMOVED SHALL BE REPLACED AT THE EXPENSE OF THE CONTRACTOR.
- 7. MATERIAL AND COMPACTION TESTING SHALL BE PERFORMED IN ACCORDANCE WITH THE REQUIREMENTS OF THE MUNICIPALITY, MWRD, AND OWNER.
- THE UNDERGROUND CONTRACTOR SHALL MAKE ALL NECESSARY ARRANGEMENTS TO NOTIFY ALL INSPECTION AGENCIES.
- 9. ALL NEW AND EXISTING UTILITY STRUCTURES ON SITE AND IN AREAS DISTURBED DURING CONSTRUCTION SHALL BE ADJUSTED TO FINISH GRADE PRIOR TO FINAL INSPECTION.
- 10. RECORD DRAWINGS SHALL BE KEPT BY THE CONTRACTOR AND SUBMITTED TO THE ENGINEER AS SOON AS UNDERGROUND IMPROVEMENTS ARE COMPLETED. FINAL PAYMENTS TO THE CONTRACTOR SHALL BE HELD UNTIL THEY ARE RECEIVED. ANY CHANGES IN LENGTH, LOCATION OR ALIGNMENT SHALL BE SHOWN IN RED. ALL WYES OR BENDS SHALL BE LOCATED FROM THE DOWNSTREAM MANHOLE. ALL VALVES, B-BOXES, TEES OR BENDS SHALL BE TIED TO A FIRE HYDRANT.

#### D. SANITARY SEWER

- 1. THE CONTRACTOR SHALL TAKE MEASURES TO PREVENT ANY POLLUTED WATER, SUCH AS GROUND AND SURFACE WATER, FROM ENTERING THE EXISTING SANITARY SEWERS.
- 2. A WATER-TIGHT PLUG SHALL BE INSTALLED IN THE DOWNSTREAM SEWER PIPE AT THE POINT OF SEWER CONNECTION PRIOR TO COMMENCING ANY SEWER CONSTRUCTION. THE PLUG SHALL REMAIN IN PLACE UNTIL REMOVAL IS AUTHORIZED BY THE MUNICIPALITY AND/OR MWRD AFTER THE SEWERS HAVE BEEN
- 3. DISCHARGING ANY UNPOLLUTED WATER INTO THE SANITARY SEWER SYSTEM FOR THE PURPOSE OF SEWER FLUSHING OF LINES FOR THE DEFLECTION TEST SHALL BE PROHIBITED WITHOUT PRIOR APPROVAL
- 4. ALL SANITARY SEWER CONSTRUCTION SHALL BE IN ACCORDANCE WITH THE STANDARD SPECIFICATIONS FOR WATER AND SEWER MAIN CONSTRUCTION IN ILLINOIS (LATEST EDITION).
- 5. ALL FLOOR DRAINS SHALL DISCHARGE TO THE SANITARY SEWER SYSTEM.
- 6. ALL DOWNSPOUTS AND FOOTING DRAINS SHALL DISCHARGE TO THE STORM SEWER SYSTEM.
- 7. ALL SANITARY SEWER PIPE MATERIALS AND JOINTS (AND STORM SEWER PIPE MATERIALS AND JOINTS IN A COMBINED SEWER AREA) SHALL CONFORM TO THE FOLLOWING:

PIPE MATERIAL	PIPE SPECIFICATIONS	JOINT SPECIFICATIONS
VITRIFIED CLAY PIPE	ASTM C-700	ASTM C-425
REINFORCED CONCRETE SEWER PIPE	ASTM C-76	ASTM C-443
CAST IRON SOIL PIPE	ASTM A-74	ASTM C-564
DUCTILE IRON PIPE	ANSI A21.51	ANSI A21.11
POLYVINYL CHLORIDE (PVC) PIPE 6-INCH TO 15-INCH DIAMETER SDR 26 18-INCH TO 27-INCH DIAMETER F/DY=46	ASTM D-3034 ASTM F-679	ASTM D-3212 ASTM D-3212
HIGH DENSITY POLYETHYLENE (HDPE)	ASTM D-3350 ASTM D-3035	ASTM D-3261,F-2620 (HEAT FUSION ASTM D-3212,F-477 (GASKETED)
WATER MAIN QUALITY PVC 4-INCH TO 36-INCH 4-INCH TO 12-INCH 14-INCH TO 48-INCH	ASTM D-2241 AWWA C900 AWWA C905	ASTM D-3139 ASTM D-3139 ASTM D-3139 ASTM D-3139

THE FOLLOWING MATERIALS ARE ALLOWED ON A QUALIFIED BASIS SUBJECT TO DISTRICT REVIEW AND APPROVAL PRIOR TO PERMIT ISSUANCE. A SPECIAL CONDITION WILL BE ADDED TO THE PERMIT WHEN THE PIPE MATERIAL BELOW IS USED FOR SEWER CONSTRUCTION OR A CONNECTION IS MADE.

<u>PIPE MATERIAL</u> POLYPROPYLENE (PP) PIPE	PIPE SPECIFICATIONS	JOINT SPECIFICATIONS
12-INCH TO 24-INCH DOUBLE WALL	ASTM F-2736	D-3212, F-477
30-INCH TO 60-INCH TRIPLE WALL	ASTM F-2764	D3212, F-477

- 8. ALL SANITARY SEWER CONSTRUCTION (AND STORM SEWER CONSTRUCTION IN COMBINED SEWER AREAS), REQUIRES STONE BEDDING WITH STONE ¼ "TO 1" IN SIZE, WITH MINIMUM BEDDING THICKNESS EQUAL TO ¼ THE OUTSIDE DIAMETER OF THE SEWER PIPE, BUT NOT LESS THAN FOUR (4) INCHES NOR MORE THAN EIGHT (8) INCHES. MATERIAL SHALL BE CA-7, CA-11 OR CA-13 AND SHALL BE EXTENDED AT LEAST 12" ABOVE THE TÒP OF THE PIPE WHEN USING PVC.
- 9. NON-SHEAR FLEXIBLE-TYPE COUPLINGS SHALL BE USED IN THE CONNECTION OF SEWER PIPES OF DISSIMILAR PIPE MATERIALS.
- 10. ALL MANHOLES SHALL BE PROVIDED WITH BOLTED, WATERTIGHT COVERS, SANITARY LIDS SHALL BE CONSTRUCTED WITH A CONCEALED PICKHOLE AND WATERTIGHT GASKET WITH THE WORD "SANITARY" CAST INTO THE LID.
- 11. WHEN CONNECTING TO AN EXISTING SEWER MAIN BY MEANS OTHER THAN AN EXISTING WYE, TEE, OR AN EXISTING MANHOLE, ONE OF THE FOLLOWING METHODS SHALL BE USED:
  - a) A CIRCULAR SAW-CUT OF SEWER MAIN BY PROPER TOOLS AND PROPER INSTALLATION OF
  - HUBWYE SADDLE OR HUB-TEE SADDLE. b) REMOVE AN ENTIRE SECTION OF PIPE (BREAKING ONLY THE TOP OF ONE BELL) AND REPLACE WITH
  - A WYE OR TEE BRANCH SECTION. c) WITH PIPE CUTTER, NEATLY AND ACCURATELY CUT OUT DESIRED LENGTH OF PIPE FOR INSERTION OF PROPER FITTING, USING "BAND SEAL" OR SIMILAR COUPLINGS TO HOLD IT FIRMLY IN PLACE.
- 12. WHENEVER A SANITARY/COMBINED SEWER CROSSES UNDER A WATERMAIN, THE MINIMUM VERTICAL DISTANCE FROM THE TOP OF THE SEWER TO THE BOTTOM OF THE WATERMAIN SHALL BE 18 INCHES. FURTHERMORE, A MINIMUM HORIZONTAL DISTANCE OF 10 FEET BETWEEN SANITARY/COMBI SEWERS AND WATERMAINS SHALL BE MAINTAINED UNLESS: THE SEWER IS LAID IN A SEPARATE TRENCH, KEEPING A MINIMUM 18" VERTICAL SEPARATION; OR THE SEWER IS LAID IN THE SAM TRENCH WITH THE WATERMAIN LOCATED AT THE OPPOSITE SIDE ON A BENCH OF UNDISTURBED EARTH, KEEPING A MINIMUM 18" VERTICAL SEPARATION. IF EITHER THE VERTICAL OR HORIZONTAL DISTANCES DESCRIBED CANNOT BE MAINTAINED, OR THE SEWER CROSSES ABOVE THE WATER MAIN, THE SEWER SHALL BE CONSTRUCTED TO WATER MAIN STANDARDS OR IT SHALL BE ENCASED WITH A WATER MAIN QUALITY CARRIER PIPE WITH THE ENDS SEALED.
- 13. ALL EXISTING SEPTIC SYSTEMS SHALL BE ABANDONED. ABANDONED TANKS SHALL BE FILLED WITH GRANULAR MATERIAL OR REMOVED.
- 14. ALL SANITARY MANHOLES, (AND STORM MANHOLES IN COMBINED SEWER AREAS), SHALL HAVE A MINIMUM INSIDE DIAMETER OF 48 INCHES, AND SHALL BE CAST IN PLACE OR PRE-CAST REINFORCED
- 15. ALL SANITARY MANHOLES, (AND STORM MANHOLES IN COMBINED SEWER AREAS), SHALL HAVE PRECAST "RUBBER BOOTS" THAT CONFORM TO ASTM C-923 FOR ALL PIPE CONNECTIONS. PRECAST SECTIONS SHALL CONSIST OF MODIFIED GROOVE TONGUE AND RUBBER GASKET TYPE JOINTS.
- 16. ALL ABANDONED SANITARY SEWERS SHALL BE PLUGGED AT BOTH ENDS WITH AT LEAST 2 FEET LONG NON-SHRINK CONCRETE OR MORTAR PLUG.
- 17. EXCEPT FOR FOUNDATION/FOOTING DRAINS PROVIDED TO PROTECT BUILDINGS, OR PERFORATED PIPES ASSOCIATED WITH VOLUME CONTROL FACILITIES, DRAIN TILES/FIELD TILES/UNDERDRAINS/PERFORATED PIPES ARE NOT ALLOWED TO BE CONNECTED TO OR TRIBUTARY TO COMBINED SEWERS, SANITARY SEWERS, OR STORM SEWERS TRIBUTARY TO COMBINED SEWERS IN COMBINED SEWER AREAS. CONSTRUCTION OF NEW FACILITIES OF THIS TYPE IS PROHIBITED; AND ALL EXISTING DRAIN TILES AND PERFORATED PIPES ENCOUNTERED WITHIN THE PROJECT AREA SHALL BE PLUGGED OR REMOVED, AND SHALL NOT BE CONNECTED TO COMBINED SEWERS, SANITARY SEWERS, OR STORM SEWERS TRIBUTARY TO COMBINED SEWERS.
- 18. A BACKFLOW PREVENTER IS REQUIRED FOR ALL DETENTION BASINS TRIBUTARY TO COMBINED SEWERS REQUIRED BACKFLOW PREVENTERS SHALL BE INSPECTED AND EXERCISED ANNUALLY BY THE PROPERTY OWNER TO ENSURE PROPER OPERATION, AND ANY NECESSARY MAINTENANCES SHALL BE PERFORMED TO ENSURE FUNCTIONALITY. IN THE EVENT OF A SEWER SURCHARGE INTO AN OPEN DETENTION BASIN TRIBUTARY TO COMBINED SEWERS, THE PERMITTEE SHALL ENSURE THAT CLEAN UP AND WASH OUT OF SEWAGE TAKES PLACE WITHIN 48 HOURS OF THE STORM EVENT.

SCALE: N.T.S.

#### E. EROSION AND SEDIMENT CONTRO


- THE CONTRACTOR SHALL INSTALL THE EROSION AND SEDIMENT CONTROL DEVICES AS SHOWN ON THE APPROVED EROSION AND SEDIMENT CONTROL PLAN.
- 2. EROSION AND SEDIMENT CONTROL PRACTICES SHALL BE FUNCTIONAL PRIOR TO HYDROLOGIC
- 3. ALL DESIGN CRITERIA, SPECIFICATIONS, AND INSTALLATION OF EROSION AND SEDIMENT CONTROL PRACTICES SHALL BE IN ACCORDANCE WITH THE ILLINOIS URBAN MANUAL
- 4. A COPY OF THE APPROVED EROSION AND SEDIMENT CONTROL PLAN SHALL BE MAINTAINED ON THE
- 5. INSPECTIONS AND DOCUMENTATION SHALL BE PERFORMED, AT A MINIMUM: a) UPON COMPLETION OF INITIAL EROSION AND SEDIMENT CONTROL MEASURES, PRIOR TO ANY SOIL DISTURBANCE.
  - b) ONCE EVERY SEVEN (7) CALENDAR DAYS AND WITHIN 24 HOURS OF THE END OF A STORM EVENT WITH GREATER THAN 0.5 INCH OF RAINFALL OR LIQUID EQUIVALENT PRECIPITATION.
- 6. SOIL DISTURBANCE SHALL BE CONDUCTED IN SUCH A MANNER AS TO MINIMIZE EROSION.
  IF STRIPPING, CLEARING, GRADING, OR LANDSCAPING ARE TO BE DONE IN PHASES, THE CO-PERMITTEE SHALL PLAN FOR APPROPRIATE SOIL EROSION AND SEDIMENT CONTROL MEASURES.
- 7. A STABILIZED MAT OF CRUSHED STONE MEETING THE STANDARDS OF THE ILLINOIS URBAN MANUAL SHALL BE INSTALLED AT ANY POINT WHERE TRAFFIC WILL BE ENTERING OR LEAVING A CONSTRUCTION SITE. SEDIMENT OR SOIL REACHING AN IMPROVED PUBLIC RIGHT-OF-WAY, STREET, ALLEY OR PARKING AREA SHALL BE REMOVED BY SCRAPING OR STREET CLEANING AS ACCUMULATIONS WARRANT AND TRANSPORTED TO A CONTROLLED SEDIMENT DISPOSAL AREA.
- 8. CONCRETE WASHOUT FACILITIES SHALL BE CONSTRUCTED IN ACCORDANCE WITH THE ILLINOIS URBAN MANUAL AND SHALL BE INSTALLED PRIOR TO ANY ON SITE CONSTRUCTION ACTIVITIES INVOLVING
- 9. MORTAR WASHOUT FACILITIES SHALL BE CONSTRUCTED IN ADDITION TO CONCRETE WASHOUT FACILITIES FOR ANY BRICK AND MORTAR BUILDING ENVELOPE CONSTRUCTION ACTIVITIES.
- 10. TEMPORARY DIVERSIONS SHALL BE CONSTRUCTED AS NECESSARY TO DIRECT ALL RUNOFF FROM HYDROLOGICALLY DISTURBED AREAS TO AN APPROPRIATE SEDIMENT TRAP OR BASIN. VOLUME CONTROL FACILITIES SHALL NOT BE USED AS TEMPORARY SEDIMENT BASINS.
- 12. DISTURBED AREAS OF THE SITE WHERE CONSTRUCTION ACTIVITIES HAVE TEMPORARILY OR PERMANENTLY CEASED SHALL BE STABILIZED WITH TEMPORARY OR PERMANENT MEASURES WITHIN
- 13. ALL FLOOD PROTECTION AREAS AND VOLUME CONTROL FACILITIES SHALL, AT A MINIMUM, BE PROTECTED WITH A DOUBLE-ROW OF SILT FENCE (OR EQUIVALENT).
- 14. VOLUME CONTROL FACILITIES SHALL NOT BE CONSTRUCTED UNTIL ALL OF THE CONTRIBUTING DRAINAGE AREA HAS BEEN STABILIZED.
- 15. SOIL STOCKPILES SHALL, AT A MINIMUM, BE PROTECTED WITH PERIMETER SEDIMENT CONTROLS. SOIL STOCKPILES SHALL NOT BE PLACED IN FLOOD PROTECTION AREAS OR THEIR BUFFERS.
- 16. EARTHEN EMBANKMENT SIDE SLOPES SHALL BE STABILIZED WITH APPROPRIATE EROSION CONTROL
- 17. STORM SEWERS THAT ARE OR WILL BE FUNCTIONING DURING CONSTRUCTION SHALL BE PROTECTED BY APPROPRIATE SEDIMENT CONTROL MEASURES.
- 18. THE CONTRACTOR SHALL EITHER REMOVE OR REPLACE ANY EXISTING DRAIN TILES AND INCORPORATE THEM INTO THE DRAINAGE PLAN FOR THE DEVELOPMENT. DRAIN TILES CANNOT BE TRIBUTARY TO A SANITARY OR COMBINED SEWER, DRAIN TILES ALLOWED IN COMBINED SEWER AREA FOR GREEN INFRASTRUCTURE PRACTICES.
- 19. IF DEWATERING SERVICES ARE USED, ADJOINING PROPERTIES AND DISCHARGE LOCATIONS SHALL BE PROTECTED FROM EROSION AND SEDIMENTATION. DEWATERING SYSTEMS SHOULD BE INSPECTED DAILY DURING OPERATIONAL PERIODS. THE SITE INSPECTOR MUST BE PRESENT AT THE COMMENCEMENT OF DEWATERING ACTIVITIES.
- 20. THE CONTRCTOR SHALL BE RESPONSIBLE FOR TRENCH DEWATERING AND EXCAVATION FOR THE INSTALLATION OF SANITARY SEWERS, STORM SEWERS, WATERMAINS AS WELL AS THEIR SERVICES AND OTHER APPURTENANCES. ANY TRENCH DEWATERING, WHICH CONTAINS SEDIMENT SHALL PASS THROUGH A SEDIMENT SETTLING POND OR EQUALLY EFFECTIVE SEDIMENT CONTROL DEVICE.
  ALTERNATIVES MAY INCLUDE DEWATERING INTO A SUMP PIT, FILTER BAG OR EXISTING VEGETATED UPSLOPE AREA. SEDIMENT LADEN WATERS SHALL NOT BE DISCHARGE TO WATERWAYS, FLOOD PROTECTION AREAS OR THE COMBINED SEWER SYSTEM.
- 21. ALL PERMANENT EROSION CONTROL PRACTICES SHALL BE INITIATED WITHIN SEVEN (7) DAYS FOLLOWING THE COMPLETION OF SOIL DISTURBING ACTIVITIES.
- 22. ALL EROSION AND SEDIMENT CONTROL MEASURES SHALL BE MAINTAINED AND REPAIRED AS NEEDED ON A YEAR-ROUND BASIS DURING CONSTRUCTION AND ANY PERIODS OF CONSTRUCTION SHUTDOWN UNTIL PERMANENT STABILIZATION IS ACHIEVED.
- 23. ALL TEMPORARY EROSION AND SEDIMENT CONTROL MEASURES SHALL BE REMOVED WITHIN THIRTY (30) DAYS AFTER PERMANENT SITE STABILIZATION.
- 24. THE EROSION AND SEDIMENT CONTROL MEASURES SHOWN ON THE PLANS ARE THE MINIMUM REQUIREMENTS. ADDITIONAL MEASURES MAY BE REQUIRED, AS DIRECTED BY THE ENGINEER, SITE INSPECTOR, OR MWRD.


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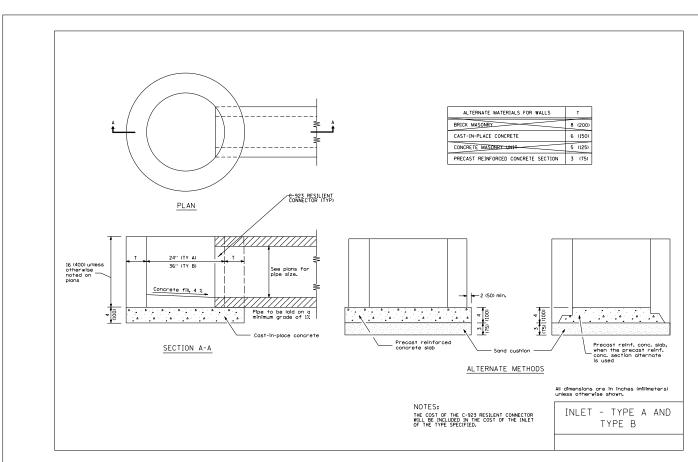


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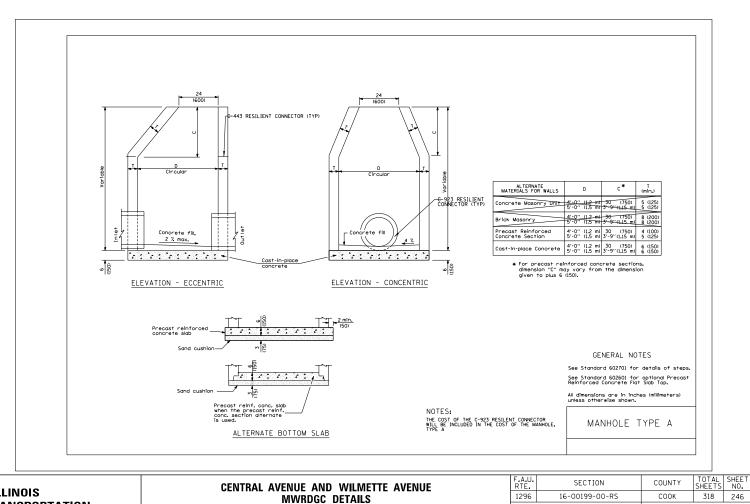
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STATE OF ILLINOIS

**DEPARTMENT OF TRANSPORTATION** 

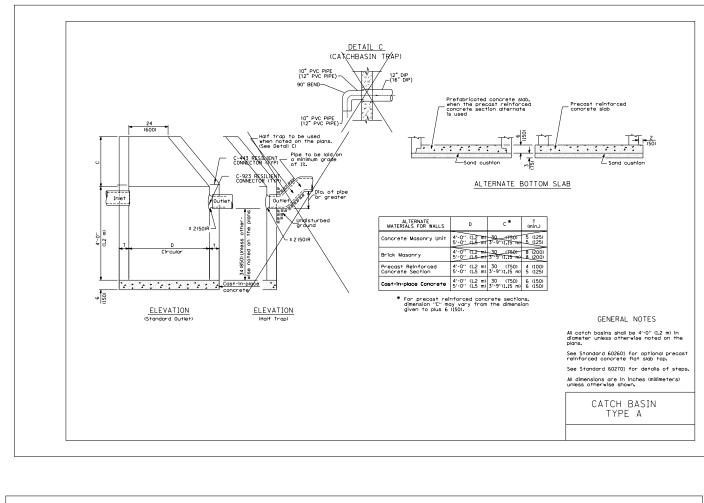

CENTRAL AVENUE AND WILMETTE AVENUE

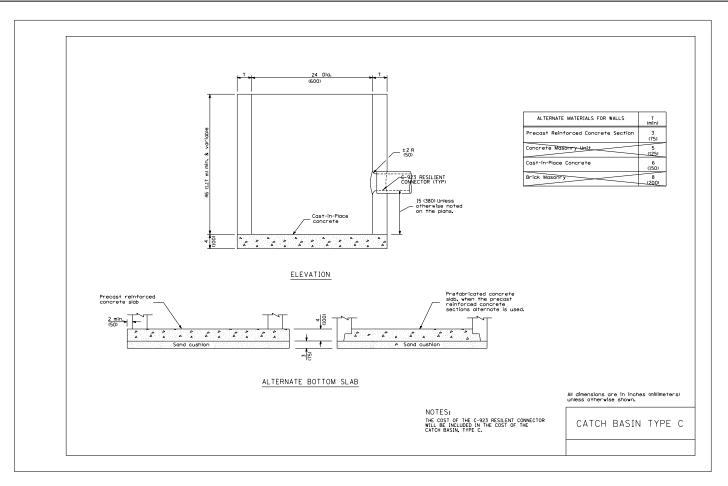MWRDGC DETAILS

SCALE: 1"=50" SHEET 2 OF 2 SHEETS STA.

SECTION

16-00199-00-RS


1296

TO STA.


COUNTY


CONTRACT NO. 61G42




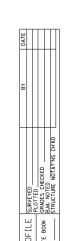





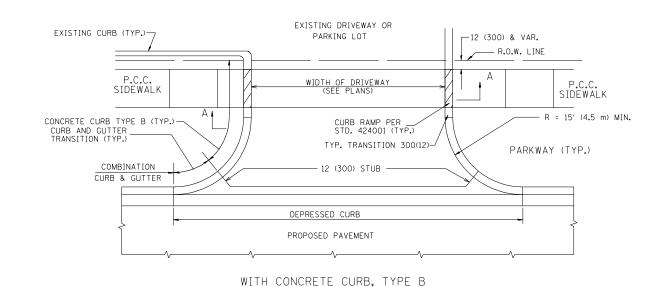

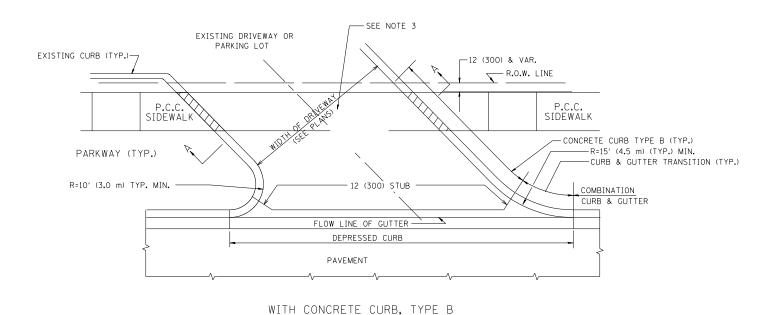

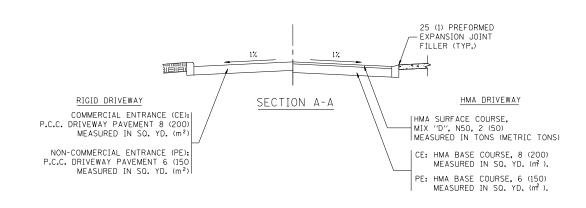

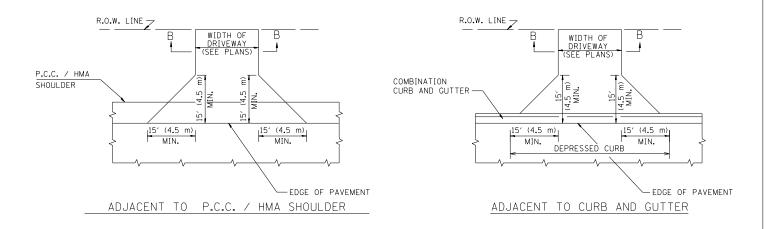

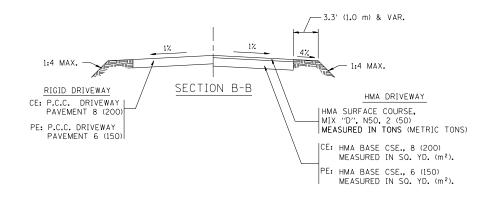

#### RURAL FIELD ENTRANCE (FE)

HMA SURFACE COURSE, MIX "D", N50, 2 (50) MEASURED IN TONS (METRIC TONS)

AGGREGATE BASE CSE., TYPE B, 8 (200) MEASURED IN SO. YD. (m²).

#### GENERAL NOTES:

DRIVEWAY SLOPES, LOCATIONS, & GEOMETRIC LAYOUT SHALL BE IN ACCORDANCE WITH THE LATEST EDITION OF THE "HANDBOOK FOR POLICY ON PERMITS FOR ACCESS DRIVEWAYS TO STATE HIGHWAYS". FOR FURTHER LAYOUT REQUIREMENTS, REFER TO ILLUSTRATIONS IN THE PERMIT HANDBOOK. DRIVEWAYS SHALL BE REPLACED IN KIND, UNLESS OTHERWISE NOTED ON THE PLANS.

COMMERCIAL DRIVEWAYS SHALL BE CONSTRUCTED WITH CONCRETE CURB, TYPE B RETURNS EXCEPT WHEN THE SIDEWALK EDGE IS 4 FEET (1.2 METERS) OR LESS FROM THE BACK OF CURB, CONSTRUCT A FLARE DRIVEWAY WITHOUT CURB.

THE RESIDENT ENGINEER SHALL CONTACT THE TRAFFIC PERMIT OFFICE AT 847/ 705-4131 FOR ANY OUESTIONS ON DRIVEWAYS SHOWN IN THE PLANS; SPECIFICALLY IN REFERENCE TO ADDITIONAL AND/OR RELOCATION/REMOVAL OF A DRIVEWAY.

COMBINATION CONCRETE CURB & GUTTER SHALL BE MEASURED STRAIGHT ACROSS THE DRIVEWAY. NO ADDITIONAL COMPENSATION WILL BE ALLOWED FOR THE CURB & GUTTER TRANSITION.


1 (25) PREFORMED EXPANSION JOINT FILLER WILL NOT BE PAID SEPARATELY, BUT SHALL BE CONSIDERED INCLUDED IN THE COST OF THE P.C.C. DRIVEWAY PAVEMENT OR P.C.C. SIDEWALK.

WHEN THE P.C.C. SIDEWALK EXTENDS THROUGH THE DRIVEWAY, THE THICKNESS OF THE SIDEWALK IN THE DRIVEWAY AREA SHALL BE THE SAME AS THE DRIVEWAY THICKNESS. SIDEWALK WILL BE PAID FOR AS P.C.C. SIDEWALK OF THE THICKNESS SPECIFIED. SIDEWALK CROSS SLOPE THRU DRIVEWAY AREA TO BE A MAXIMUM OF 1:50.

SCALE: NONE

FILE NAME =	USER NAME = leysa	DESIGNED - R. SHAH	REVISED - P. LaFLUER 04-15-03
::\pw_work\pwidot\leysa\d0108315\bd01.dgr		DRAWN -	REVISED - R. BORO 01-01-07
80080-DISTDET-BD01	PLOT SCALE = 50.0000 '/ in.	CHECKED -	REVISED - R. BORO 06-11-08
Default	PLOT DATE = 9/6/2011	DATE - 11-04-95	REVISED - R. BORO 09-06-11

DRIVEWAY DETAILS – DISTANCE BETWEEN R.O.W.	F.A.U. RTE.	SECTION	COUNTY	TOTAL SHEETS	SHEET NO.
AND FACE OF CURB & EDGE OF SHOULDER > = 15' (4.5 m)	1296	16-00199-00-RS	COOK	318	247
AND FACE OF COME OR EDGE OF SHOOLDEN > - 13 (4.5 III)	BD0156-07 (BD-01) CONTRACT NO.				
NE SHEET NO. 1 OF 1 SHEETS STA. TO STA.	FFD. RO	DAD DIST, NO. 1   ILLINOIS FED. AI	D PROJECT		

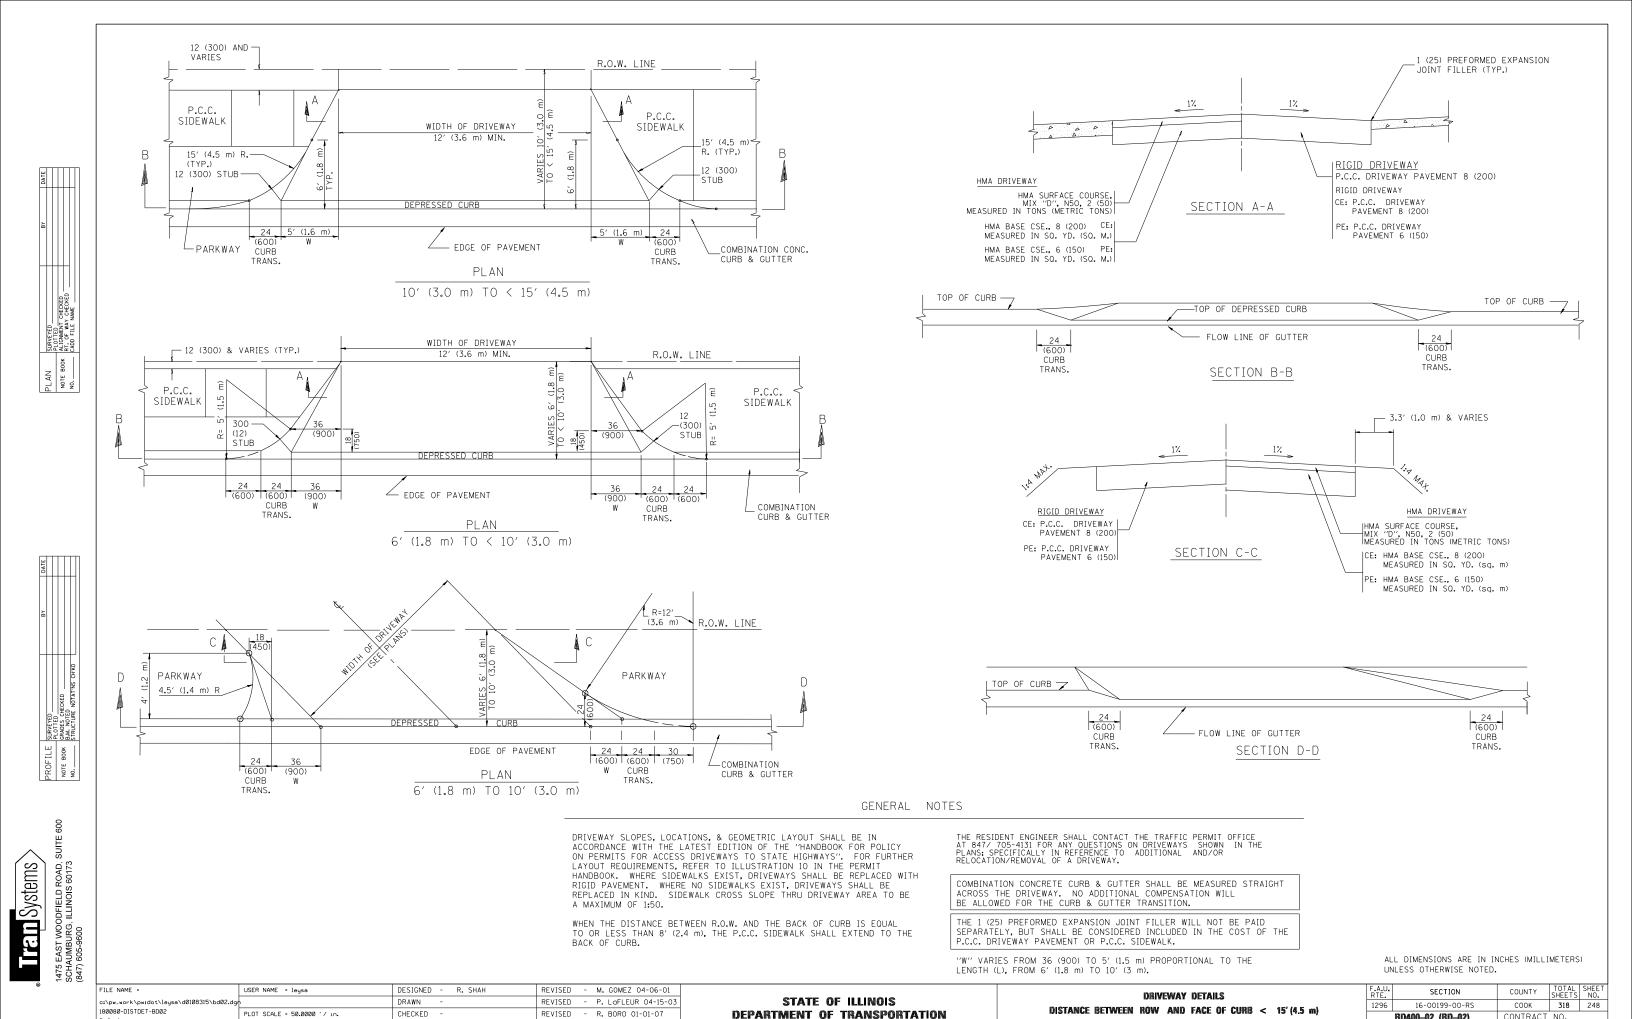

CONTRACT NO.

BD400-02 (BD-02)

SHEET NO. 1 OF 1 SHEETS STA.

PLOT SCALE = 50.0000 ' / 10.

PLOT DATE = 10/28/2011

CHECKED


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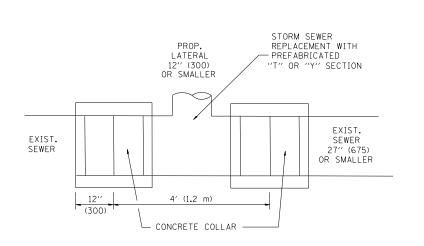
REVISED

- R. BORO 09-06-11









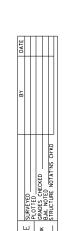


#### DETAIL "A"

LATERAL CONNECTION TO EXISTING SEWER OF 27" (675) OR SMALLER

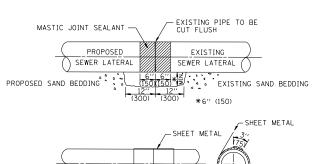

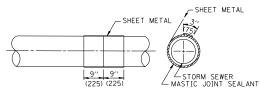

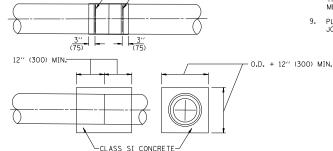


METAL BINDING

DETAIL "B" CLASS SI CONCRETE COLLAR

#### CONSTRUCTION SEQUENCE

- 1. CUT THE EXISTING END OF THE PIPE SO AS TO PRESENT A FLUSH BUTT JOINT. BRUSH AND CLEAN ALL PIPES.
- 2. APPLY THE MASTIC JOINT SEALANT TO THE FIRST  $6^{\prime\prime}$  (150) OF EACH PIPE.
- 3. BUTT THE PIPES TOGETHER LEAVING A MINIMUM OF 12' × 6' (300 × 150) DEEP EXCAVATION UNDER AND AROUND EACH PIPE END.
- 4. CUT A PIECE OF SHEET METAL GAGE NO. 19 1.1 (0.0418) 18" (450) WIDE BY THE OUTSIDE CIRCUMFERANCE OF THE PIPE PLUS 3" (75) LONG.
- WRAP THE SHEET METAL AROUND THE PIPES, 9" (225) ON EACH SIDE OF THE JOINT, STARTING AT THE TOP OF THE PIPE.
- 6. LAP THE SHEET METAL AT LEAST 3" (75) AT THE TOP OF THE PIPE AND PLACE THE MASTIC JOINT SEALANT BETWEEN THE LAP.
- 7. PLACE TWO METAL BANDS AROUND THE SHEET METAL AND TIGHTEN.
- 8. WIPE OFF ANY EXCESS MASTIC JOINT SEALANT THAT OOZES OUT FROM BETWEEN THE SHEET METAL AND THE PIPES.
- 9. PLACE CLASS SI CONCRETE AROUND THE JOINT.

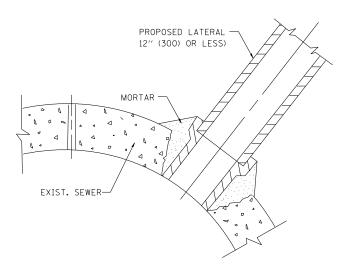

DETAIL "C"

PROPOSED LATERAL CONNECTION TO EXISTING SEWER OF 30" (750) OR LARGER

#### NOTES

#### MATERIAL

MATERIAL USED FOR THE TEE OR WYE SECTION SHALL BE COMPATIBLE WITH THE EXISTING STORM SEWER OR THE PROPOSED STORM SEWER.

- I. THIS WORK SHALL BE CONSTRUCTED IN CONFORMANCE WITH THE APPLICABLE PORTIONS OF SECTION 550 OF THE STANDARD SPECIFICATIONS.
- II. CONNECTION TO AN EXISTING STORM SEWER SHALL BE BY EITHER OF THE FOLLOWING METHODS: A) PROPOSED STORM SEWER CONNECTION TO EXISTING SEWER OF 27" (675) OR SMALLER SEE
  - B) PROPOSED STORM SEWER CONNECTION TO EXISTING SEWER OF 30" (750) OR LARGER SEE

IF THE EXISTING SEWER PIPE IS CRACKED, BROKEN OR OTHERWISE DAMAGED BY THE CONTRACTOR IN MAKING THE CIRCULAR OPENING, THE CONTRACTOR SHALL REPLACE THAT SECTION OF PIPE WITH PIPE EQUAL AND SIMILAR IN ALL RESPECTS TO THE PIPE IN THE EXISTING SEWER, IN A CAREFUL WORKMANLIKE MANNER, WITHOUT EXTRA COMPENSATION.

#### GENERAL

CARE MUST BE TAKEN TO PREVENT DEBRIS FROM ENTERING THE SEWER. ALL DEBRIS WHICH ENTERS THE SEWER MUST BE REMOVED. THE SEWER MUST BE LEFT CLEAN AND UNOBSTRUCTED UPON COMPLETION OF THE CONTRACT.

CARE MUST BE TAKEN TO PREVENT ANY PART OF THE NEW PIPE CONNECTION FROM PROJECTING INTO THE EXISTING SEWER.

#### BASIS OF PAYMENT

TEE OR WYE CONNECTIONS SHALL BE PAID FOR AT THE CONTRACT UNIT PRICE EACH FOR STORM SEWER TEE OR WYE OF THE TYPE AND SIZE SPECIFIED IN THE PLANS, THIS PRICE SHALL INCLUDE ALL EXCAVATION OF THE TRENCH, REMOVAL OF THE EXISTING STORM SEWER, FURNISHING AND INSTALLING THE SPECIFIED TEE OR WYE SECTION, FURNISHING AND INSTALLING THE REQUIRED CONCRETE COLLAR, AND ALL OTHER MATERIAL NECESSARY TO COMPLETE THIS WORK AS SHOWN AND SPECIFIED.


REMOVAL AND REINSTALLATION OF EXISTING STORM SEWER ADJACENT TO THE PROPOSED TEE OR WYE SECTION, FOR THE PURPOSE OF FACILITATING THE INSTALLATION OF THE TEE OR WYE SECTION, WILL NOT BE PAID FOR SEPARATELY BUT SHALL BE INCLUDED IN THE UNIT PRICE BID FOR THE WORK.


TRENCH BACKFILL, EXCAVATION IN ROCK AND REMOVAL AND REPLACEMENT OF UNSUITABLE MATERIAL BELOW PLAN BEDDING GRADE WILL BE PAID FOR SEPARATELY.

CONCRETE COLLAR FOR CONNECTING A PROPOSED STORM SEWER TO AN EXISTING STORM SEWER WILL NOT BE PAID PAID FOR SEPARATELY BUT SHALL BE INCLUDED IN THE COST OF THE PROPOSED


ALL DIMENSIONS ARE IN INCHES (MILLIMETERS) UNLESS OTHERWISE SHOWN.


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W:\diststd\22x34\bd07.dgn		DRAWN -	REVISED - R. SHAH 09-09-94	STATE OF ILLINOIS	DETAIL OF STORM SEWER	1296 16-00199-00-RS	COOK 318 249
180080-DISTDET-BD07	PLOT SCALE = 50.000 '/ IN.	CHECKED -	REVISED - R. SHAH 10-25-94	DEPARTMENT OF TRANSPORTATION	CONNECTION TO EXISTING SEWER	BD500-01 (BD-7)	CONTRACT NO.
Default	PLOT DATE = 1/4/2008	DATE - 07-25-90	ATE - 07-25-90 REVISED - R. SHAH 06-12-96		SCALE: NONE SHEET NO. 1 OF 1 SHEETS STA. TO STA.		ID PROJECT

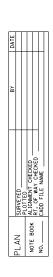

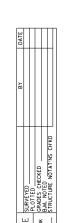



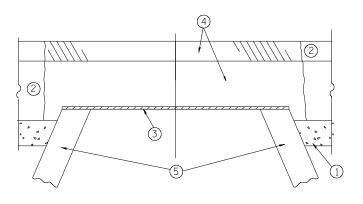

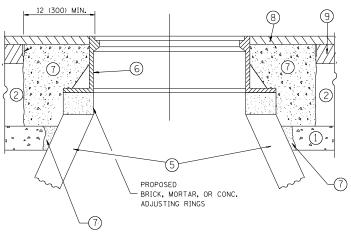

#### NOTES:

EXISTING BROKEN FRAMES AND LIDS SHALL BE REMOVED AND DISPOSED OF BY THE CONTRACTOR AND SHALL BE REPLACED AS DIRECTED BY THE ENGINEER. REPLACEMENT FRAMES AND LIDS WILL BE PAID FOR IN ACCORDANCE WITH ARTICLE 109.04 OF THE STANDARD SPECIFICATIONS UNLESS A SEPARATE PAY ITEM HAS BEEN PROVIDED.

IF THE EXISTING LIDS ARE OPEN, THE FRAME WILL BE ADJUSTED TO THE ELEVATION OF THE MILLED PAVEMENT SURFACE PRIOR TO THE MILLING OPERATION. THE FRAME WILL NOT BE REMOVED AND COVERED BY THE METAL PLATE.

CITY OF CHICAGO CASTINGS ARE THE PROPERTY OF THE CITY AND THE CONTRACTOR SHALL NOTIFY THE CITY FOR REMOVAL AND DISPOSITION OF THE CASTINGS.

THE METAL PLATE USED TO COVER THE STRUCTURE SHALL REMAIN THE PROPERTY OF THE CONTRACTOR.

WHEN STRUCTURES ARE TO BE ADJUSTED OR RECONSTRUCTED, THE LOWERING AND RAISING OF THE FRAMES AND LIDS WILL NOT BE PAID FOR SEPARATELY BUT WILL BE INCLUDED IN THE COST OF THE CORRESPONDING PAY ITEM.

SCALE: NONE

#### CONSTRUCTION PROCEDURES

#### STAGE 1 (BEFORE PAVEMENT MILLING)

- A) REMOVE A MINIMUM OF 12 (300) OF THE PAVEMENT FROM
- AROUND THE STRUCTURE.

  B) REMOVE THE EXISTING FRAME AND LID FROM THE STRUCTURE.
- C) COVER THE STRUCTURE OPENING WITH A 36 (900) DIAMETER
- METAL PLATE.

  D) BACKFILL WITH CRUSHED STONE AND A MINIMUM 1½ (40) THICK HMA SURFACE MIX APPROVED BY THE ENGINEER.

#### STAGE 2 (AFTER PAVEMENT MILLING)

- A) REMOVE THE HMA SURFACE MIX AND CRUSHED STONE.
- B) INSTALL THE FRAME AND LID; ADJUST THE FRAME TO ITS FINAL SURFACE ELEVATION.
- C) THE SURROUNDING SPACE SHALL BE FILLED WITH CLASS PP-1\* CONCRETE TO THE ELEVATION OF THE SURFACE OF THE EXISTING BASE COURSE OR THE BINDER COURSE.
- \* UNLESS OTHERWISE SPECIFIED IN THE PLANS.

THE PROCEDURE EXPLAINED ABOVE SHALL CONFORM TO THE APPLICABLE PORTIONS OF SECTIONS 353, 406, 602, AND 603 OF THE STANDARD SPECIFICATIONS EXCEPT THAT "THE CONTRACTOR SHALL ADJUST THE STRUCTURES TO THE FINISHED PAVEMENT ELEVATION NO MORE THAN 5 CALENDAR DAYS PRIOR TO PLACEMENT OF THE FINAL LIFT OF SURFACE UNLESS APPROVED BY THE

#### LEGEND

- 1 SUB-BASE GRANULAR MATERIAL
- (6) FRAME AND LID (SEE NOTES)
- 2 EXISTING PAVEMENT
- (7) CLASS PP-1\* CONCRETE
- 3 36 (900) DIAMETER METAL PLATE
- PROPOSED CRUSHED STONE AND HMA SURFACE MIX
- (8) PROPOSED HMA SURFACE COURSE
- (5) EXISTING STRUCTURE
- 9 PROPOSED HMA BINDER COURSE

#### LOCATION OF STRUCTURES:

THE CONTRACTOR WILL BE REQUIRED TO KEEP A RECORD OF THE LOCATIONS OF THE BURIED STRUCTURES ACCORDING TO THE STATION AND DISTANCE LEFT OR RIGHT OF THE CENTERLINE OF PAVEMENT. UPON COMPLETION OF THE WORK, THE CONTRACTOR WILL DELIVER THE RECORD TO THE ENGINEER.

#### BASIS OF PAYMENT:

REMOVING FRAMES AND LIDS ON DRAINAGE AND UTILITY STRUCTURES IN THE PAVEMENT PRIOR TO MILLING, AND ADJUSTING TO FINAL GRADE PRIOR TO PLACING THE SURFACE COURSE, WILL BE PAID FOR AT THE CONTRACT UNIT PRICE EACH FOR "FRAMES AND LIDS TO BE ADJUSTED


THIS WORK WILL NOT BE PAID FOR WHEN DRAINAGE AND UTILITY STRUCTURES ARE SPECIFIED FOR PAYMENT AS STRUCTURE RECONSTRUCTION.

NEW FRAMES AND LIDS, WHEN SPECIFIED, WILL BE PAID FOR SEPARATELY.

DETAILS FOR FRAMES AND LIDS ADJUSTMENT WITH MILLING

ALL DIMENSIONS ARE IN INCHES (MILLIMETERS) UNLESS OTHERWISE SHOWN

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c:\pw_work\pwidot\bauerdl\d0108315\bd08.	dgn	DRAWN -	REVISED - R. BORO 01-01-07	
180080-DISTDET-BD08	PLOT SCALE = 1968.5000 '/ m	CHECKED -	REVISED - R. BORO 03-09-11	D
Default	PLOT DATE = 12/6/2011	DATE - 10-25-94	REVISED - R. BORO 12-06-11	

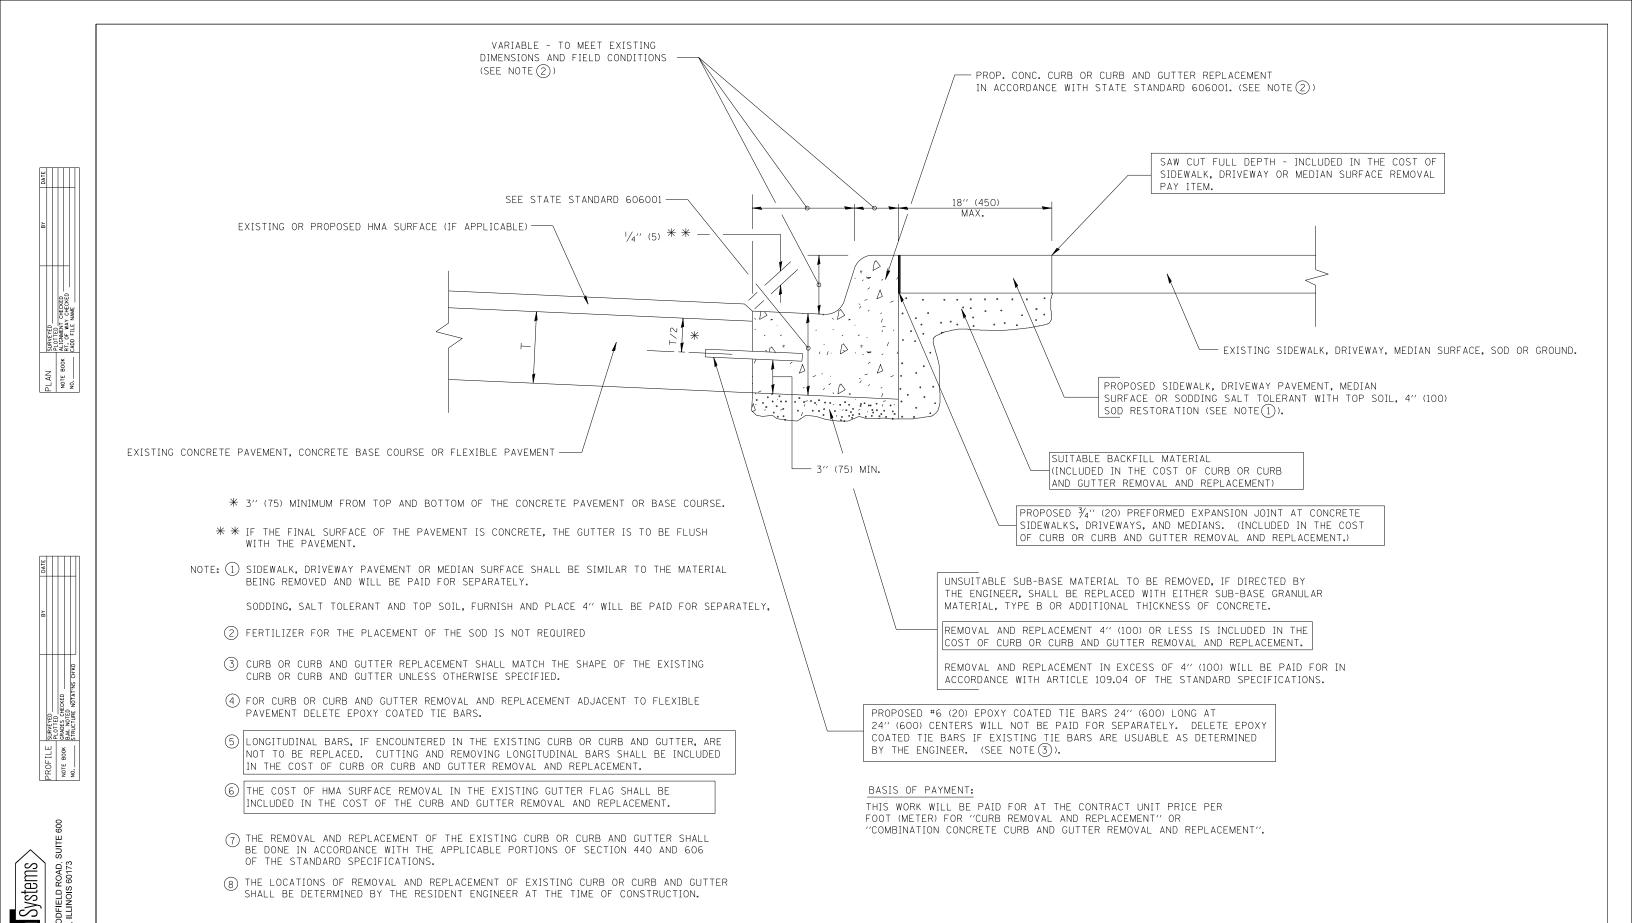


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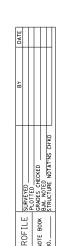
(8) THE LOCATIONS OF REMOVAL AND REPLACEMENT OF EXISTING CURB OR CURB AND GUTTER SHALL BE DETERMINED BY THE RESIDENT ENGINEER AT THE TIME OF CONSTRUCTION.

Tran


ALL DIMENSIONS ARE IN INCHES (MILLIMETERS) UNLESS OTHERWISE SHOWN.


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	FILE NAME =	USER NAME = drivakosgn	DESIGNED - A. HOUSEH	REVISED - R. SHAH 10-03-96			CURB OR CURB AND GUTTER		F.A.U.	SECTION	COUNTY	TOTAL	SHEET
	c:\pw_work\pwidot\drivakosgn\d0108315\bc	24 <b>.</b> dgn	DRAWN -	REVISED - A. ABBAS 03-21-97	STATE OF ILLINOIS				1296	16-00199-00-RS	COOK	318	251
	l =	PLOT SCALE = 50.000 '/ IN.	CHECKED -	REVISED - M. GOMEZ 01-22-01	DEPARTMENT OF TRANSPORTATION	REMOVAL AND REPLACEMENT BD6		600-06 (BD-24)	CONTRACT I	NO.			
	Default	PLOT DATE = 12/15/2009	DATE - 03-11-94	REVISED - R. BORO 12-15-09		SCALE: NONE	SHEET NO. 1 OF 1 SHEETS STA.	TO STA.	FED. ROAD	DIST. NO. 1 ILLINOIS FED. AI	D PROJECT		



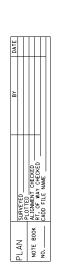




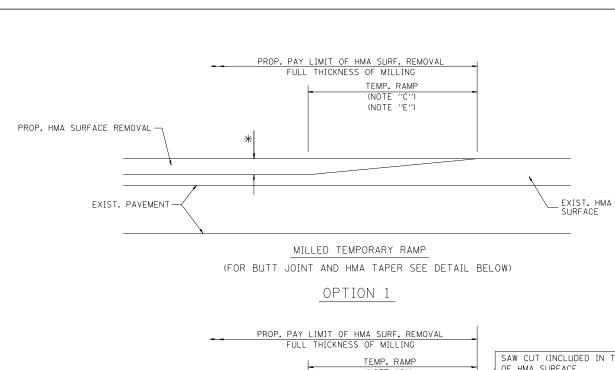

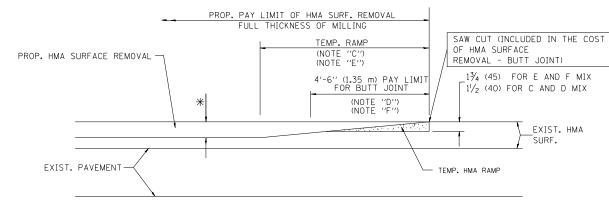

HMA CONSTRUCTED TEMPORARY RAMP (FOR BUTT JOINT AND HMA TAPER SEE DETAIL BELOW)


> OPTION 2 TYPICAL TEMPORARY RAMP

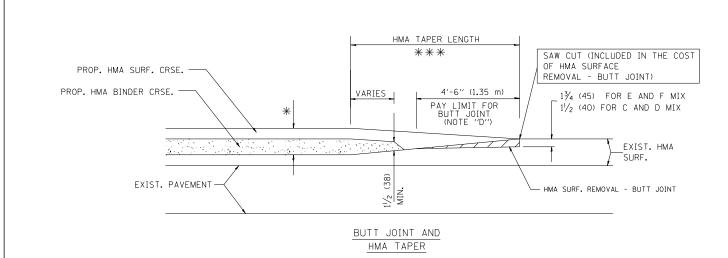

#### TYPICAL BUTT JOINT AND HMA TAPER FOR MILLING AND RESURFACING

DESIGNED - M. DE YONG USER NAME = gaglianobt REVISED - R. SHAH 10-25-94 W:\diststd\22x34\bd32.dgn DRAWN REVISED - A. ABBAS 03-21-97 180080-DISTDET-BD32 CHECKED REVISED M. GOMEZ 04-06-01 PLOT DATE = 1/4/2008 DATE R. BORO 01-01-07 06-13-90 REVISED -

NOTES A: MAINLINE ROADWAYS AND MAJOR SIDE ROADS. B: MINOR SIDE ROADS. C: THE TEMP. RAMP SHALL BE CONSTRUCTED IMMEDIATELY UPON REMOVAL OF THE EXISTING HMA SURFACE. D: THE BUTT JOINT SHALL BE CONSTRUCTED IMMEDIATELY PRIOR TO PLACING THE PROPOSED HMA COURSES.

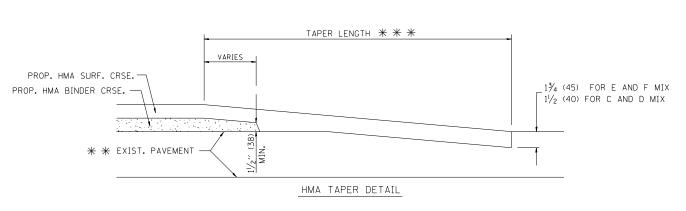

BUTT JOINT DETAIL

PROP. HMA OR PCC

SURFACE REMOVAL - BUTT JOINT

30'-0" (9.0 m) (NOTE "A")

15'-0" (4.5 m) (NOTE "B")

(NOTE "D")

#### TYPICAL BUTT JOINT AND HMA TAPER FOR RESURFACING ONLY

\* \* PC CONCRETE, HMA OR HMA RESURFACED PAVEMENT.

\* \* EXIST. PAVEMENT

EXIST. HMA OR PCC SURFACE

- E: TAPER THE TEMP. RAMP AT A RATE OF 3'-0" (900 mm) PER 1 INCH (25 mm) OF MILLING THICKNESS.
- F: INSTALLATION AND REMOVAL OF THE 4'-6" (1.35 m) TEMP. RAMP IS INCLUDED IN COST OF HMA SURFACE REMOVAL - BUTT JOINT
- G: SEE ARTICLE 406.08 AND 406.14 OF THE STANDARD SPECIFICATIONS FOR "HMA AND/OR PCC SURFACE REMOVAL, BUTT JOINT".
- st SEE TYPICAL SECTIONS FOR MILLING THICKNESS.

#### BASIS OF PAYMENT:

THE BUTT JOINT WILL BE PAID FOR AT THE CONTRACT UNIT PRICE PER SQUARE YARD (SQUARE METER) FOR "HOT-MIX ASPHALT SURFACE REMOVAL - BUTT JOINT" OR FOR "PORTLAND CEMENT CONCRETE SURFACE REMOVAL- BUTT JOINT".

SCALE: NONE

ALL DIMENSIONS ARE IN INCHES (MILLIMETERS) UNLESS OTHERWISE SHOWN.

SAW CUT (INCLUDED IN THE COST

BUTT JOINT)

 $1\frac{3}{4}$  (45) FOR E AND F MIX 1/2 (40) FOR C AND D MIX


OF HMA OR P.C.C. SURFACE REMOVAL

						F.A.U.	TOTAL	SHEET		
	BUTT JOINT AND HMA TAPER DETAILS					RTE.	SECTION	COUNTY SHEETS		NO. 252
						1296	16-00199-00-RS	O-RS COOK 318		
		0 0 0 0 0 0 0 0	I AU EII BE	IMILE		BD400—05 BD32 CONTRACT NO.				
	SHEET NO. 1 OF 1 SHEETS STA. TO STA.					FED. RO	AD DIST. NO. 1   ILLINOIS FED. AI	D PROJECT		







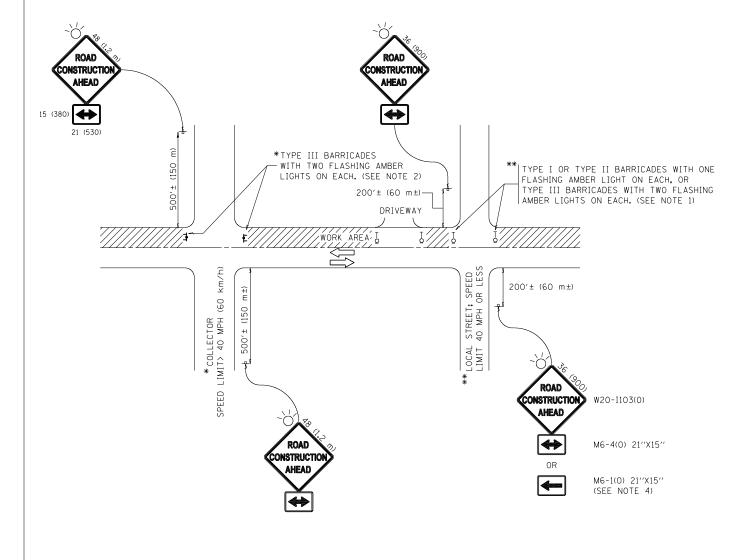

#### NOTES:

- 1. SIDE ROAD WITH A SPEED LIMIT OF 40 MPH (60 km/h) OR LESS AS SHOWN ON THE DRAWING AND AS DIRECTED BY THE ENGINEER:
  - a) ONE "ROAD CONSTRUCTION AHEAD" SIGN 36 x 36 (900x900) WITH A FLASHER MOUNTED ON IT APPROXIMATELY 200' (60 m) IN ADVANCE OF THE MAIN ROUTE.
  - b) THE CLOSED PORTION OF THE MAIN ROUTE SHALL BE PROTECTED BY BLOCKING WITH TYPE I, TYPE II OR TYPE III BARRICADES, 1/3 OF THE CROSS SECTION OF THE CLOSED PORTION.
- 2. SIDE ROAD WITH A SPEED LIMIT GREATER THAN 40 MPH (60 km/h) AS SHOWN ON THE DRAWING AND AS DIRECTED BY THE ENGINEER:
  - a) ONE "ROAD CONSTRUCTION AHEAD" SIGN 48  $\times$  48 (1.2 m  $\times$  1.2 m) WITH A FLASHER MOUNTED ON IT APPROXIMATELY 500' (150 m) IN ADVANCE OF THE MAIN ROUTE.

SIDE

- b) THE CLOSED PORTION OF THE MAIN ROUTE SHALL BE PROTECTED BY BLOCKING WITH TYPE III BARRICADES, 1/2 OF THE CROSS SECTION OF THE CLOSED PORTION.
- 3. CONES MAY BE SUBSTITUTED FOR BARRICADES OR DRUMS AT HALF THE SPACING DURING DAY OPERATIONS. CONES SHALL BE A MINIMUM OF 28 (710)
- 4. WHEN THE SIDE ROAD LIES BETWEEN THE BEGINNING OF THE MAINLINE SIGNING AND THE WORK ZONE, A SINGLE HEADED ARROW (M6-1) SHALL BE USED IN LIEU OF THE DOUBLE HEADED ARROW (M6-4).


SCALE: NONE


- 5. WHEN WORK IS BEING PERFORMED ON A SIDE ROAD OR DRIVEWAY, FOLLOW THE APPLICABLE STANDARD(S). THE DIRECTIONAL ARROW (M6-1 OR M6-4) SHALL BE COVERED OR REMOVED WHEN NO LONGER CONSISTENT WITH THE TRAFFIC CONTROL SET-UP.
- 6. ADVANCE WARNING SIGNS ARE TO BE OMITTED ON DRIVEWAYS UNLESS OTHERWISE SPECIFIED IN THE PLANS OR BY THE
- 7. THE TRAFFIC CONTROL AND PROTECTION FOR SIDE ROADS, INTERSECTIONS, AND DRIVEWAYS SHALL BE INCLUDED IN THE COST OF SPECIFIED TRAFFIC CONTROL STANDARDS OR ITEMS.

All dimensions are in inches (millimeters) unless otherwise shown.


FILE NAME =	USER NAME = footemj	DESIGNED - L.H.A.	REVISED	- A. HOUSEH 10-15-96
pw:\\IL084EBIDINTEG.:ll:no:s.gov:PWIDOT\Do	cuments\IDOT Offices\District 1\Projects\Dist	Star 2008 200 MM CADData CADsheets \tcl0.dgn	REVISED	-T. RAMMACHER 01-06-00
180080-DISTDET-TC10	PLOT SCALE = 50.000 '/ in.	CHECKED -	REVISED	- A. SCHUETZE 07-01-13
Befault	PLOT DATE = 9/15/2016	DATE - 06-89	REVISED	- A. SCHUETZE 09-15-16


	TRAFFIC C	ONTRO	L AND P	ROTEC	TION FOR	F.A.U. RTE.	SECTION	COUNTY	TOTAL SHEETS	SHEE NO.
en	DE BUNDS	IMTERG	ECTIONS	: AMD	DRIVEWAVC	1296	16-00199-00-RS	COOK	318	253
SIDE ROADS, INTERSECTIONS, AND DRIVEWAYS					TC-10	CONTRACT NO.				
	SHEET 1	OF 1	SHEETS	STA.	TO STA.		TILLINOIS FED. A	ID PROJECT		

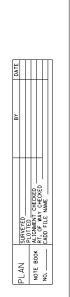

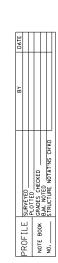




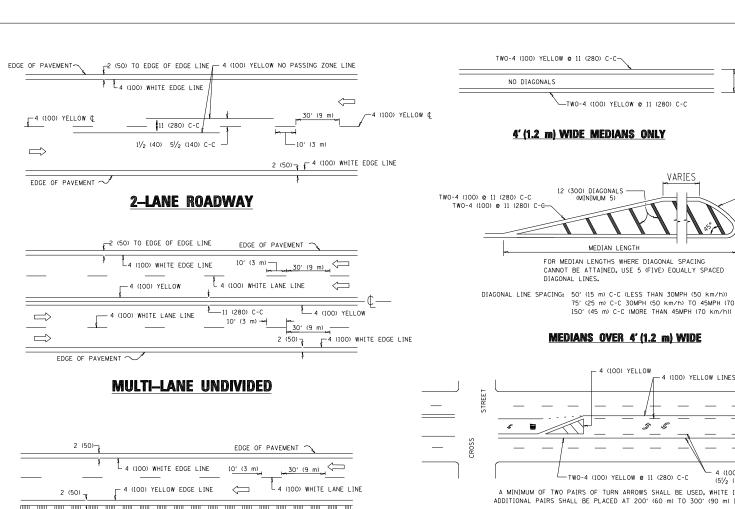

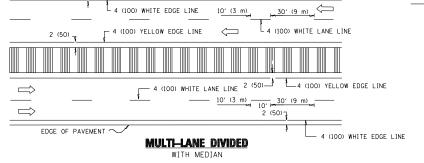


#### TYPICAL LANE AND EDGE LINE MARKING

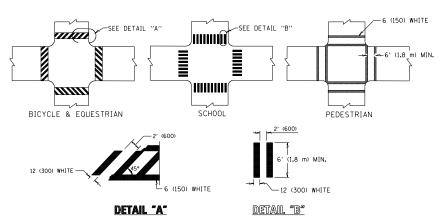


### **TYPICAL CROSSWALK MARKING**

\* MARKINGS SHALL BE INSTALLED PARALLEL TO THE CENTERLINE OF


# 4' (1.2 m) OUTSIDE TO OUTSIDE OF LINES VARIES

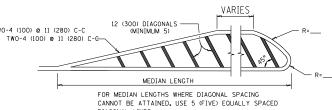


DIAGONAL LINE SPACING: 50' (15 m) C-C (LESS THAN 30MPH (50 km/h))
75' (25 m) C-C 30MPH (50 km/h) TO 45MPH (70 km/h))

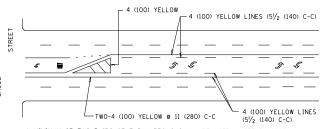

A MINIMUM OF TWO PAIRS OF TURN ARROWS SHALL BE USED, WHITE IN COLOR. ADDITIONAL PAIRS SHALL BE PLACED AT 200' (60 m) TO 300' (90 m) INTERVALS.

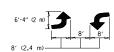

#### MEDIAN WITH TWO-WAY LEFT TURN LANE TYPICAL PAINTED MEDIAN MARKING

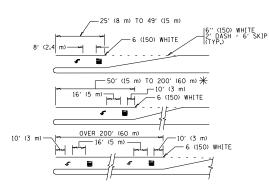



FULL SIZE LETTERS 8' (2.4 m) AND ARROWS SHALL BE USED. AREA = 15.6 SO. FT. (1.5 m<sup>2</sup> ) ONLY AREA = 20.8 SO. FT. (1.9 m<sup>2</sup>)


# TURN LANES IN EXCESS OF 400' (120 m) IN LENGTH MAY HAVE AN ADDITIONAL SET OF ARROW - "ONLY" INSTALLED MIDWAY BETWEEN THE OTHER TWO SETS OF ARROW - "ONLY".

#### TYPICAL LEFT (OR RIGHT) TURN LANE


#### TYPICAL TURN LANE MARKING

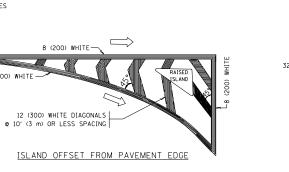


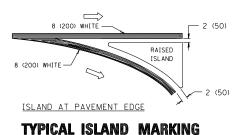

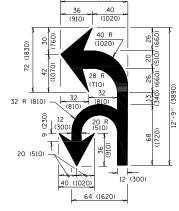

#### **COMBINATION** LEFT AND U-TURN

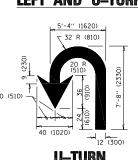

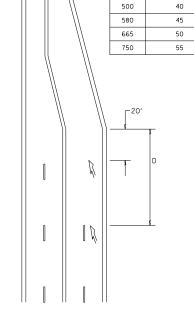

D(FT)

425

speed limit

#### LANE REDUCTION TRANSITION

\* LANE REDUCTION ARROWS REQUIRED AT SPEEDS OF 45 MPH OR GREATER OR WHEN SPECIFIED IN PLANS.


CENTERLINE ON 2 LANE PAVEMENT CENTERLINE ON MULTI-LANE UNDIVIDED CAVEMENT	4 (100)			
		SKIP-DASH	YELLOW	10' (3 m) LINE WITH 30' (9 m) SPACE
	2 @ 4 (100)	SOLID	YELLOW	11 (280) C-C
NO PASSING ZONE LINES: OR ONE DIRECTION FOR BOTH DIRECTIONS	4 (100) 2 @ 4 (100)	SOLID SOLID	YELLOW YELLOW	5½ (140) C-C FROM SKIP-DASH CENTERLINE 11 (280) C-C OMIT SKIP-DASH CENTERLINE BETWEEN
ANE LINES	4 (100) 5 (125) ON FREEWAYS	SKIP-DASH SKIP-DASH	WHITE WHITE	10' (3 m) LINE WITH 30' (9 m) SPACE
OOTTED LINES EXTENSIONS OF CENTER, LANE OR FURN LANE MARKINGS)	SAME AS LINE BEING EXTENDED	SKIP-DASH	SAME AS LINE BEING EXTENDED	2' (600) LINE WITH 6' (1.8 m) SPACE
EDGE LINES	4 (100)	SOLID	YELLOW-LEFT WHITE-RIGHT	OUTLINE MEDIANS IN YELLOW
TURN LANE MARKINGS	6 (150) LINE; FULL SIZE LETTERS & SYMBOLS (8' (2.4m))	SOLID	WHITE	SEE TYPICAL TURN LANE MARKING DETAIL
TWO WAY LEFT TURN MARKING	2 @ 4 (100) EACH DIRECTION 8' (2.4m) LEFT ARROW	SKIP-DASH AND SOLID IN PAIRS	YELLOW	10' (3 m) LINE WITH 30' (9 m) SPACE FOR SKIP-DASH, 5½ (140) C-C BETWEEN SOLID LINE AND SKIP-DASH LINE ESE TYPICAL TWO-WAY LEFT TURN MARKING DETAIL
CROSSWALK LINES (PEDESTRIAN) A. DIAGONALS (BIKE & EQUESTRIAN) B. LONGITUDINAL BARS (SCHOOL)	2 @ 6 (150) 12 (300) @ 45° 12 (300) @ 90°	SOLID SOLID SOLID	WHITE WHITE WHITE	NOT LESS THAN 6' (1.8 m) APART 2' (600) APART 2' (600) APART 5EE TYPICAL CROSSWALK MARKING DETAILS.
STOP LINES	24 (600)	SOLID	WHITE	PLACE 4' (1,2 m) IN ADVANCE OF AND PARALLEL TO CROSSMALK, IF PRESENT. OTHERWISE, PLACE AT DESIRED STOPPING POINT. PARALLEL TO CROSSROAD CENTERLINE, WHERE POSSIBLE
PAINTED MEDIANS	2 @ 4 (100) WITH 12 (300) DIAGONALS @ 45° NO DIAGONALS USED FOR 4' (1.2 m) WIDE MEDIANS	SOLID	YELLOW: TWO WAY TRAFFIC WHITE: ONE WAY TRAFFIC	11 (280) C-C FOR THE DOUBLE LINE SEE TYPICAL PAINTED MEDIAN MARKING.
CORE MARKING AND CHANNELIZING LINES	8 (200) WITH 12 (300) DIAGONALS @ 45°	SOLID	WHITE	DIACONALS: 15' (4,5 m) C-C (LESS THAN 30MPH (50 km/h)) 20' (6 m) C-C 30MPH (50 km/h) TO 45MPH (70 km/h)) 30' (9 m) C-C (OVER 45MPH (70 km/h))
RAILROAD CROSSING	24 (600) TRANSVERSE LINES; "RR" IS 6' (1.8 m. LETTERS; 16 (400) LINE FOR "X"	SOLID	WHITE	SEE STATE STANDARD 780001 AREA OF: "R"=3.6 SO. FT. (0.33 m²) EACH "X"=54.0 SO. FT. (5.0 m²)
SHOULDER DIAGONALS (REQUIRED FOR SHOULDERS > 8')	12 (300) <b>@</b> 45°	SOLID	WHITE - RIGHT YELLOW - LEFT	50' (15 m) C-C (LESS THAN 30MPH (50 km/h)) 75' (25 m) C-C (30 MPH (50 km/h) TO 45MPH (70 km/h 150' (45 m) C-C (0VER 45MPH (70 km/h))
J TURN ARROW	SEE DETAIL	SOLID	WHITE	16.3 SF
ARROW COMBINATION LEFT AND U TURN	SEE DETAIL	SOLID	WHITE	30.4 SF

FOR FURTHER DETAILS ON PAVEMENT MARKING REFER TO STANDARD SPECIFICATIONS FOR ROAD AND BRIDGE CONSTRUCTION AND STATE STANDARD 780001.

All dimensions are in inches (millimeters) unless otherwise shown.


DESIGNED - EVERS USER NAME = leysa REVISED - C. JUCIUS 09-09-09 W:\diststd\22x34\tc13.dgn DRAWN REVISED -C. JUCIUS 07-01-13 180080-DISTDET-TC13 PLOT SCALE = 50.000 '/ in. CHECKED REVISED -C. JUCIUS 12-21-15 Befault PLOT DATE = 6/23/2017 DATE REVISED - C. JUCIUS 04-12-16 03-19-90


	DISTRICT ONE							COUNTY	TOTAL SHEETS	SHEET NO.
	TYPICAL PAVEMENT MARKINGS						16-00199-00-RS	COOK	318	254
		IVAL IA	A CHAICIA I	IAIL THE THE COL			TC-13	CONTRACT	NO.	
SCALE: NONE	SHEET 1	OF 1	SHEETS	STA.	TO STA.		ILLINOIS FED. A	ID PROJECT		$\overline{}$

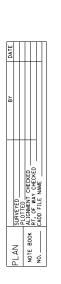






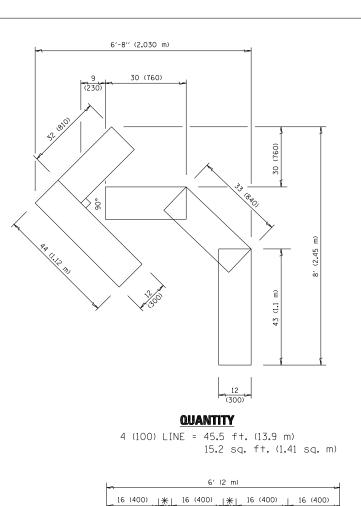

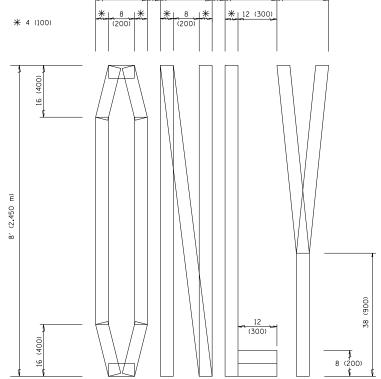

4 (100) LINE = 64.1 ft. (19.5 m) 21.4 sq. ft. (1.99 sq. m)

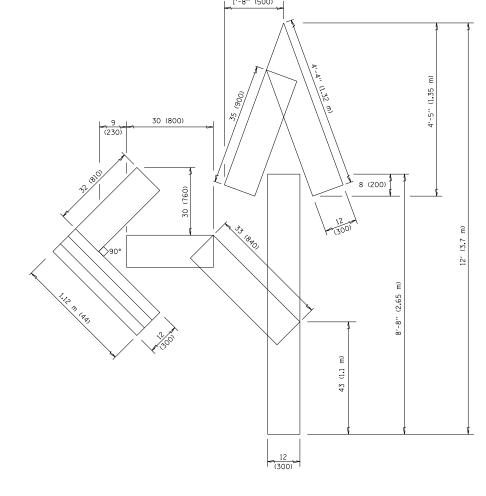


#### QUANTITY

4 (100) LINE = 82.5 ft. (25.1 m) 27.5 sq. ft. (2.53 sq. m)

#### NOTE:

ALL QUANTITIES OF PLACEMENT ARE REPRESENTED IN LINEAR FEET OF 4" LINES TO MATCH THE 4" TEMPORARY TAPE PAY ITEM AND REPRESENTS THE TOTAL QUANTITY OF 4" TAPE REQUIRED.

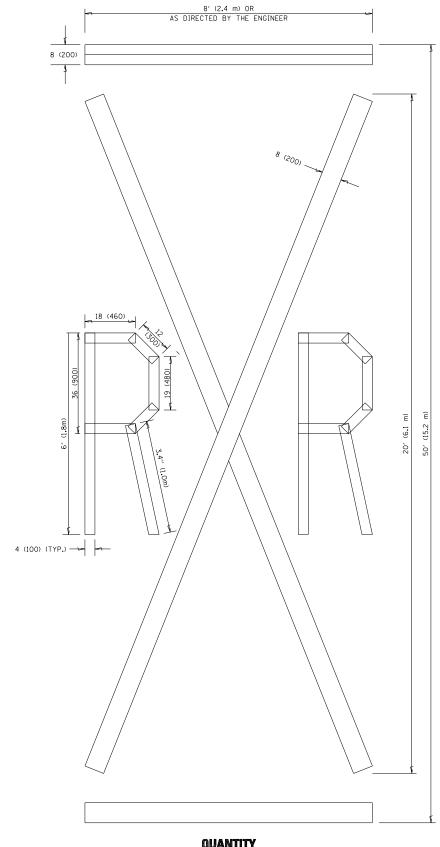

#### QUANTITY

4 (100) LINE = 225.9 ft. (68.9 m) 75.3 sq. ft. (6.99 sq. m)


> All dimensions are in inches (millimeters) unless otherwise shown.

FILE NAME =	USER NAME = footemj	DESIGNED -	REVISED	-T. RAMMACHER 03-02-98	
ow:\\ILØ84EBIDINTEG.:ll:no:s.gov:PWIDOT\Do	cuments\IDOT Offices\District 1\Projects\Dist	Stalkaway\CADData\CADsheets\tc16.dgn	REVISED	-E. GOMEZ 08-28-00	
80080-DISTDET-TC16	PLOT SCALE = 50.0000 '/ in.	CHECKED -	REVISED	-E. GOMEZ 08-28-00	
Default	PLOT DATE = 9/15/2016	DATE - 09-18-94	REVISED	- A. SCHUETZE 09-15-16	

QUANTITY

STATI	e of	f Illinois
DEPARTMENT	0F	TRANSPORTATION

	SHORT TERM PAVEMENT MARKING LETTERS AND SYMBOLS  ALE: NONE   SHEFT NO. 1 OF 1 SHEFTS   STA. TO STA.		F.A.U. RTE.	SECTION	COUNTY	TOTAL SHEETS	SHEET NO.					
SHORT	TERM	PAVEME	NT MA	ARKING	LETTERS A	AND	ZAMBOLZ	1296	16-00199-00-RS	COOK	318	255
									TC-16	CONTRACT	NO.	
SCALE: NONE	SHEET	NO. 1 OF	1 SH	HEETS	STA.		TO STA.	FED. RO	AD DIST. NO. 1 ILLINOIS FED. A	D PROJECT		

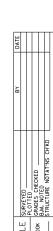



W:\diststd\22x34\tc22.dgr

180080-DISTDET-TC22

USER NAME = gaglianobt

PLOT DATE = 1/4/2008


PLOT SCALE = 50.000 '/ IN.

DESIGNED -

DRAWN

DATE

CHECKED

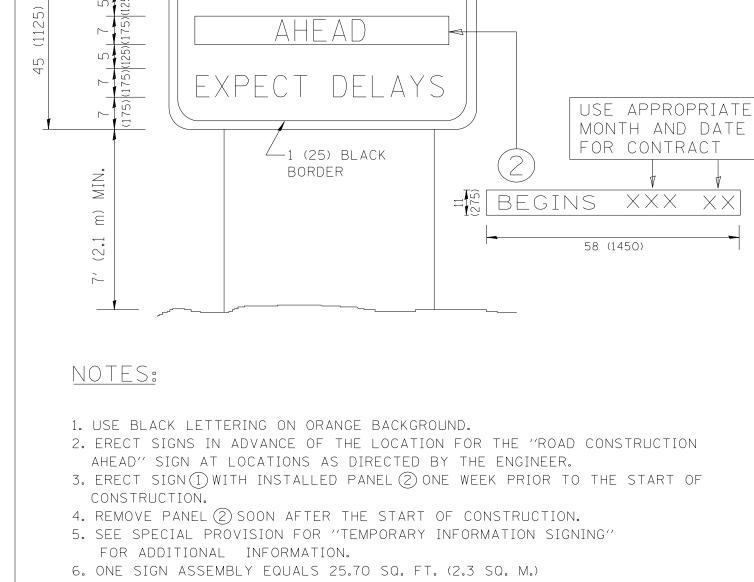

68 (1700)

54 (1350)

ROAD WORK

(175)

(175)

7. SHALL BE PAID FOR AS TEMPORARY INFORMATION SIGNING.

ALL DIMENSIONS ARE IN INCHES (MILLIMETERS) UNLESS OTHERWISE SHOWN.

- R. MI	IRS 12-11-97
-T. RAMM	ACHER 02-02-9
- C II	ICTUS 01-31-07

R. MIRS 09-15-97

REVISED


REVISED


REVISED

REVISED

STATE OF ILLINOIS



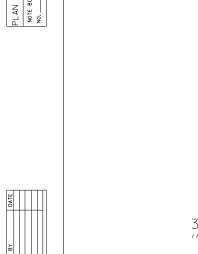

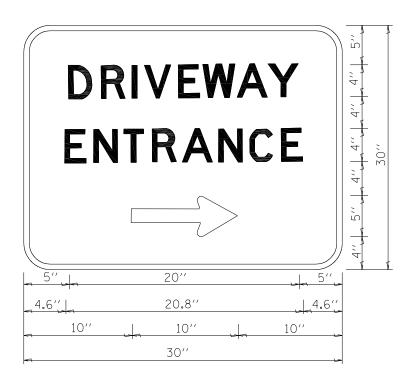

3.0" RADIUS, 0.5" BORDER, WHITE ON GREEN; REFLECTORIZED "DRIVEWAY" D; "ENTRANCE" D; STANDARD ARROW CUSTOM 12.0" x 5.0"

#### NOTES:

- 1. HALF OF THE SIGNS WILL REQUIRE A LEFT HAND FACING ARROW.
- 2. TWO SIGNS SHALL BE USED AT EACH COMMERCIAL ENTRANCE PLACED BACK-TO-BACK: ONE WITH A RIGHT HAND ARROW (SHOWN) SHALL BE PLACED ON THE NEAR RIGHT SIDE THE DRIVEWAY AND ONE WITH A LEFT HAND ARROW SHALL BE PLACED ON THE FAR LEFT SIDE OF THE DRIVEWAY.
- 3. SIGNS TO BE PAID FOR AS ITEM "TEMPORARY INFORMATION SIGNING".



LE NAME =	USER NAME = gaglianobt	DESIGNED -	REVISED - C. JUCI	US 02-15-07
LE NAME = USER NAME = gaglianobt DESIGNED - REVISED - C. JUCIUS 02-1  \( \text{PM_work\pmidot\gaglianobt\d0108315\tc} \) \( \text{Ed.dgn} \)  \( \text{DRAWN} \) - \( \text{CHECKED} \) - \( \text{REVISED} \) - \( \text{CHISED} \) - \( \text{CHISED} \) - \( \text{FeVISED} \) -				
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of ault	PLOT DATE = 12/13/2012	DATE -	REVISED -	
fault	PLOT DATE = 12/13/2012		REVISED -	

STATE	OF	ILLINOIS	
DEPARTMENT (	)F 1	<b>TRANSPORTATION</b>	

	DRIVEWAY ENTRANC	F.A.U. RTE.	SECTION	COUNTY	TOTAL SHEETS	SHEET NO.		
					16-00199-00-RS	соок	318	257
			TC-26	CONTRACT	NO.			
SCALE: NONE	SHEET NO. 1 OF 1 SHEETS	STA.	TO STA.	FED. RO	AD DIST. NO. 1   ILLINOIS   FED. A	ID PROJECT		

