FOR INDEX OF SHEETS SEE SHEET NO. 2

TRAFFIC DATA

LOCAL STREETS 2014 ADT = 300 POSTED SPEED LIMIT: 20 MPH DESIGN SPEED LIMIT: 30 MPH

DESIGN DESIGNATION = LOCAL STREET

SCALE: 1" = 50' SCALE: 1" = 40' SCALE: 1" = 20'


FULL SIZE PLANS HAVE BEEN PREPARED USING STANDARD ENGINEERING SCALES. REDUCED SIZED PLANS WILL NOT CONFORM TO STANDARD SCALES. IN MAKING MEASUREMENTS ON REDUCED PLANS, THE ABOVE SCALES MAY BE USED.

> Call Before You Dig **ONE-CALL SYSTEM**

> > 1-800-892-0123 OR 811

CONTRACT NO. 61B47

STATE OF ILLINOIS **DEPARTMENT OF TRANSPORTATION DIVISION OF HIGHWAYS PLANS FOR PROPOSED FEDERAL AID HIGHWAY VARIOUS ROUTES (VARIOUS LIMITS) CURB AND GUTTER & SIDEWALK SECTION 14-00127-00-SW PROJECT SRTS-4009(321) VILLAGE OF BROOKFIELD COOK COUNTY** 

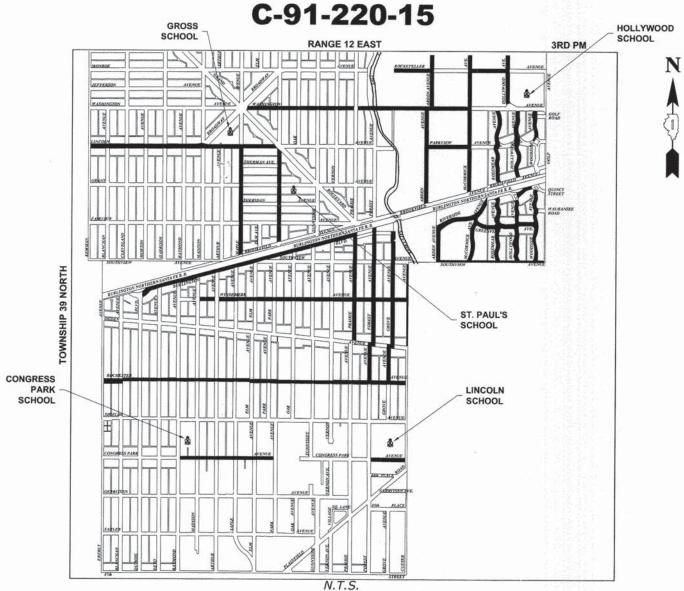


**PROVISO AND LYONS TOWNSHIPS** 

- AREA OF IMPROVEMENT

GROSS LENGTH OF IMPROVEMENT = 5,578 FT = 1.056 MI NET LENGTH OF IMPROVEMENT = 5,578 FT = 1.056 MI

14-00127-00-SW ILLINOIS PROJECT SRTS-4009(321) 14-00127-00-SW CONTRACT NO. 61B47 LOCATION OF SECTION INDICATED THUS: STATE OF ILLINOIS

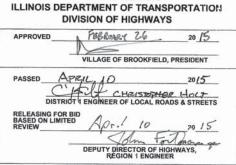

PRINTED BY THE AUTHORITY OF THE STATE OF ILLINOIS



LICENSE EXPIRES : 11/30/15



- Municipal Consultants
- ◆ Established 1911

E.H.E. NO. 125-14-28002

Phone: 708-865-0300

(TO BE USED IN CONJUNCTION WITH I.D.O.T. STANDARD 000001-06)

INDEX OF SHEETS		EXISTING	PROPOSED	DESCRIPTION	EVISTING	PROPOSED	DESCRIPTION
SHEET NO.	DESCRIPTION	EXISTING	PROPOSED	DESCRIPTION	EXISTING	PROPOSED	DESCRIPTION
1	TITLE SHEET, LOCATION MAP	xx		FENCE		11 12 1 1 1 1 1 1 1 1 1 1 1 1 1 1 1 1 1	CURB AND GUTTER
2	INDEX OF SHEETS, LEGEND, HIGHWAY STANDARDS	Ø		POWER POLE			EXISTING CURB AND GUTTER TO BE REMOVED
3	GENERAL NOTES	Δ		GAS VALVE			EXISTING CONCRETE AREA TO BE REMOVED
		-\$>>		STREET LIGHT			HOT-MIX ASPHALT DRIVEWAY REMOVAL
4	SUMMARY OF QUANTITIES	0		WATER MAIN BUFFALO BOX			SIDEWALK REMOVAL, DRIVEWAY REMOVAL
5-6	TYPICAL SECTIONS	⊗ .		WATER MAIN VALVE BOX			PCC SIDEWALK, PCC DRIVEWAY
7-9	CONGRESS PARK AVENUE SIDEWALK IMPROVEMENTS	\$		SPRINKLER		-~-	DIRECTION OF FLOW
10	LOCATIONS OF INTERMITTENT SIDEWALK REPLACEMENT			WATER MAIN VALVE VAULT		-\$-	DRAINAGE SUMMIT
11	DETAILS	0		STORM SEWER MANHOLE	×643.90	× <sup>632.25</sup>	GROUND ELEVATIONS
12	CURB OR CURB AND GUTTER REMOVAL AND REPLACEMENT (BD-24)	0		STORM CATCH BASIN			
12	TRAFFIC CONTROL AND PROTECTION FOR			STORM INLET			
13	SIDE ROADS, INTERSECTIONS, AND DRIVEWAYS (TC-10)	Q		FIRE HYDRANT			
14-16	STATION CROSS SECTIONS	\$	*	BUSH			
				TREE			

## I.D.O.T. STANDARD DRAWINGS

STANDARD NO.	TITLE OR DESCRIPTION
000001-06	STANDARD SYMBOLS, ABBREVIATIONS AND PATTERNS
280001-07	TEMPORARY EROSION CONTROL SYSTEMS
424001-08	PERPENDICULAR CURB RAMPS FOR SIDEWALKS
701006-05	OFF-ROAD OPERATIONS, 2L, 2W, 15' TO 24" FROM PAVEMENT EDGE
701301-04	LANE CLOSURE, 2L, 2W, SHORT TIME OPERATIONS
701501-06	URBAN LANE CLOSURE, 2L, 2W, UNDIVIDED
701801-05	SIDEWALK, CORNER OR CROSSWALK CLOSURE
701901-04	TRAFFIC CONTROL DEVICES

	DESIGNED -	BPS	REVISED -	
180 180	DRAWN -	DMM	REVISED -	
300	CHECKED -		REVISED -	
	DATE -	02/11/15	REVISED -	

INDEX OF SHEETS, LEGEND OF SYMBOLS, HIGHWAY STANDARDS SCALE: NONE SHEET NO. 1 OF 1 SHEETS STA.

CONTRACT NO. 61B47 FIELD BOOK NO. : FED. ROAD DIST. NO. 1 ILLINOIS FED. AID PROJECT

# FORMS FOR CONCRETE SIDEWALKS, DRIVEWAYS, PAVEMENT, AND GUTTER FLAGS

A 2" X 6" BOARD WILL BE USED AS A FORM FOR ALL SIDEWALKS TO BE INSTALLED FIVE INCHES (5") IN THICKNESS. A 2" X 8" BOARD WILL BE USED AS A FORM FOR ALL DRIVEWAYS TO BE INSTALLED SEVEN INCHES (7") IN THICKNESS. A 2" X 12" BOARD WILL BE USED AS THE FORM FOR THE FACE OF THE GUTTER FLAGS TO BE INSTALLED TEN INCHES (10") IN THICKNESS. ALL FORMS MUST BE OF A MINIMUM HEIGHT OF THE PROPOSED THICKNESS OF THE RESPECTIVE CONCRETE ITEMS TO BE INSTALLED. METAL FORMS WILL BE ALLOWED FOR REMOVAL AND REPLACEMENT OPERATIONS ONLY ON THIS PROJECT.

#### **MAINTENANCE OF SEWER FLOWS**

THE CONTRACTOR SHALL CONDUCT HIS OPERATIONS SO AS TO MAINTAIN AT ALL TIMES FLOWS THROUGH EXISTING STORM AND COMBINED SEWER SYSTEMS DRAINAGE STRUCTURES. HE SHALL ALSO PROVIDE AND MAINTAIN AN EFFICIENT PUMPING PLANT IF NECESSARY AND A TEMPORARY OUTLET AND BE PREPARED AT ALL TIMES TO DISPOSE OF THE WATER COLLECTED IN A SAFE MANNER WITHOUT DAMAGE OF ANY KIND TO ADJACENT PROPERTIES. THE ENDS OF EXISTING DRAINAGE LINES WHICH ARE NOT TO BE INCORPORATED INTO THE PROJECT ARE TO BE SEALED AS SPECIFIED IN THE SPECIAL PROVISIONS. THE COST OF ALL THE PREVIOUSLY MENTIONED WORK SHALL BE INCLUDED IN THE PAY ITEMS. ALL ACCUMULATION OF MATERIAL IN THE STRUCTURE DUE TO CONSTRUCTION OPERATIONS AS WELL AS MATERIAL EXISTING BEFORE CONSTRUCTION, SHALL BE REMOVED BY THE CONTRACTOR AT HIS EXPENSE.

#### **STANDARDS**

ANY REFERENCE TO STANDARDS THROUGHOUT THE PLANS OR SPECIAL PROVISIONS SHALL BE INTERPRETED TO BE THE LATEST STANDARD OF THE ILLINOIS DEPARTMENT OF TRANSPORTATION AS SHOWN ON THE INDEX OF SHEETS IN THE PLANS. ALL CONSTRUCTION SHALL BE DONE IN ACCORDANCE WITH THE STANDARD SPECIFICATIONS FOR ROAD AND BRIDGE CONSTRUCTION ADOPTED JANUARY 1, 2012, THE "SUPPLEMENTAL SPECIFICATIONS AND RECURRING SPECIAL PROVISIONS" ADOPTED JANUARY 1, 2015, THE LATEST EDITION OF THE "ILLINOIS MANUAL ON UNIFORM TRAFFIC CONTROL DEVICES FOR STREETS AND HIGHWAYS," "THE STANDARD SPECIFICATIONS FOR WATER AND SEWER MAIN CONSTRUCTION IN ILLINOIS" JULY 2014 7TH EDITION, AND THE "DETAILS" IN THE PLANS AND THE "SPECIAL PROVISIONS" INCLUDED IN THE CONTRACT DOCUMENTS.

#### **EXISTING STRUCTURE MODIFICATIONS**

ALL KNOWN EXISTING STRUCTURES IN THE PAVEMENT OR ADJACENT AREAS WHICH ARE INVOLVED IN THE CONSTRUCTION HAVE BEEN SHOWN ON THE PLANS AND NOTED AS TO BE REMOVED, FILLED, RECONSTRUCTED, OR ADJUSTED BY THE CONTRACTOR EXCEPT THOSE OF AMERITECH, COMED, AND THE NICOR GAS COMPANY, WHICH ARE TO BE ADJUSTED BY THE APPROPRIATE UTILITY FORCE. WHERE EXISTING STRUCTURES ARE TO BE REMOVED OR FILLED, OR THE EXISTING CASTING REPLACED, THE CASTINGS REMOVED FROM THE STRUCTURE ARE TO REMAIN THE PROPERTY OF THE VILLAGE AND BE SALVAGED. THE CONTRACTOR IS TO DELIVER FRAMES AND LIDS TO THE VILLAGE'S PUBLIC WORKS YARD.

#### MAINTENANCE OF EXISTING DRAINAGE STRUCTURES

WHEN DURING THE CONSTRUCTION OPERATIONS, ANY LOOSE MATERIAL IS DEPOSITED IN THE FLOW LINE OF ANY GUTTERS OR DRAINAGE STRUCTURE SO THAT THE NATURAL FLOW OF WATER IS OBSTRUCTED, IT SHALL BE REMOVED AT THE CLOSE OF EACH WORKING DAY. AT THE CONCLUSION OF THE CONSTRUCTION OPERATIONS, ALL DRAINAGE FACILITIES SHALL BE CLEAN AND FREE OF ALL OBSTRUCTIONS. THE COST OF THIS WORK SHALL BE INCLUDED IN THE CONTRACT PAY ITEMS.

#### **SAW CUTTING**

THE CONTRACTOR SHALL SAW CUT ASPHALT PAVEMENT, CONCRETE PAVEMENT, SIDEWALKS, CURBS, AND DRIVEWAYS, AS INDICATED ON THE PLANS OR AS DIRECTED BY THE ENGINEER, TO SEPARATE THE EXISTING PAVEMENT TO BE REMOVED BY MEANS OF AN APPROVED CONCRETE SAW TO A DEPTH AS DIRECTED BY THE ENGINEER. SUITABLE GUIDELINES OR DEVICES SHALL BE USED TO ASSURE CUTTING A NEAT, STRAIGHT LINE AS SHOWN ON THE PLANS. CARE SHALL BE TAKEN BY THE CONTRACTOR SO AS NOT TO DAMAGE THE REMAINING PAVEMENT DIRECTLY ADJACENT TO THE PAVEMENT TO BE REMOVED. ANY DAMAGE TO THE EXISTING PAVEMENT RESULTING FROM PAVEMENT REMOVAL OPERATIONS SHALL BE REPAIRED AT THE CONTRACTOR'S EXPENSE. THE PRICE OF SAW CUTTING, AS NOTED ABOVE, SHALL BE INCLUDED IN THE PARTICULAR PAY ITEMS.

#### **UNCONTAMINATED SOIL CERTIFICATION**

SECTION 22.51 OF THE ENVIRONMENTAL PROTECTION ACT REQUIRES THAT UNCONTAMINATED SOIL, INCLUDING UNCONTAMINATED SOIL MIXED WITH OTHER CLEAN CONSTRUCTION OR DEMOLITION DEBRIS (CCDD) MATERIALS ACCEPTED AT A CCDD LANDFILL FACILITY, MUST BE CERTIFIED TO BE UNCONTAMINATED. DEPENDING ON THE LOCATION OF THE SOIL REMOVAL, THE CERTIFICATION MAY HAVE TO BE MADE BY A LICENSED PROFESSIONAL ENGINEER.

ANY COSTS FOR THE TESTING OF THE UNCONTAMINATED MATERIAL AND HAVING A LICENSED PROFESSIONAL ENGINEER COMPLETE THE REQUIRED PAPERWORK TO CERTIFY THAT THE MATERIAL IS UNCONTAMINATED AND CAN BE PROPERLY DISPOSED AT A CCDD FACILITY SHALL BE INCLUDED IN THE COST OF MOBILIZATION.

IF THE CONTRACTOR CHOOSES TO DISPOSE OF THE EXCAVATED MATERIAL AT MORE THAN ONE CCDD FACILITY, THEN ANY ADDITIONAL COSTS SHALL ALSO BE BORNE BY THE CONTRACTOR. SHOULD ANY CONTAMINATED MATERIAL BE DISCOVERED ON THE PROJECT, THE ADDITIONAL COSTS FOR TESTING AND PROPER DISPOSAL OF THE CONTAMINATED MATERIAL SHALL EITHER BE PAID BY THE VILLAGE UNDER SEPARATE CONTRACT OR AS PART OF THIS CONTRACT AS ADDITIONAL WORK AT A PRICE TO BE AGREED UPON OR ON A TIME AND MATERIAL BASIS.

<b>ETTAN</b>	COCK
LLENG	INEERING

♦ Civil Engineers
 ♦ Municipal Consultants
 ♦ Established 1911

9933 Roo Westchester, Ellinois of Phone: 76 Fax: 76

9933 Roosevelt Road bester, Ellinois 60154-2780 Phone: 708/365-0300 Fax: 708/865-1212

 DESIGNED BPS
 REVISED 

 DRAWN DMM
 REVISED 

 CHECKED -- REVISED 

 DATE 02/11/15
 REVISED

STATE OF ILLINOIS
DEPARTMENT OF TRANSPORTATION

GENERAL NOTES

TO STA.

SHEET NO. 1 OF 1 SHEETS STA.

SCALE: NONE

SP	SI	CODE NO.	ITEM	UNIT	TOTAL QUANTITY	CONS. TYPE CODE 021 80% FEDERAL 20% LOCAL
		20200400				
		20200100	EARTH EXCAVATION	CU YD	135	135
	<del></del>	21101610	TOPSOIL FURNISH AND PLACE, 3"	SQ YD	550	550
	X	25000100	SEEDING, CLASS 1	SQ YD	100	100
	×	25200100	SODDING	SQ YD	450	450
				F1884		
		42001300	PROTECTIVE COAT	SQ YD	925	925
		42300300	PORTLAND CEMENT CONCRETE DRIVEWAY PAVEMENT, 7 INCH	SQ YD	120	120
				1.84		
		42400200	PORTLAND CEMENT CONCRETE SIDEWALK, 5 INCH	SQ FT	21,475	21,475
X		42400800	DETECTABLE WARNINGS	SQ FT	160	160
X		44000200	DRIVEWAY PAVEMENT REMOVAL	SQ YD	150	150
				1 4 5		
Х		44000600	SIDEWALK REMOVAL	SQ FT	21,550	21,550
		67100100	MOBILIZATION	L SUM	1	1
		70102620	TRAFFIC CONTROL AND PROTECTION, STANDARD 701501	L SUM	1	1
		70102640	TRAFFIC CONTROL AND PROTECTION, STANDARD 701801	L SUM	1	1
х		X4240430	PORTLAND CEMENT CONCRETE SIDEWALK, 5 INCH, SPECIAL	SQ FT	6,790	6,790
		Z0004562	COMBINATION CONCRETE CURB AND GUTTER REMOVAL AND REPLACEMENT	FOOT	100	100

SI - DENOTES SPECIALTY ITEM

SP - DENOTES SPECIAL PROVISION HAS BEEN PROVIDED

ATE		02/11/15	REVISED -
HECKED	-		REVISED -
RAWN	•	DMM	REVISED -
ESIGNED	١-	BPS	REVISED -

STATE OF ILLINOIS					
DEPARTMENT	OF	TRANSPORTATION			

	SUMMARY OF QUANTITIES					RTE.	SE	CTIO		
							14-00	127-00		
						FIELD BO	OK NO.:			
	SHEET NO.	1	OF	1	SHEETS	STA.	TO STA.	FED. ROAD D	NST. NO. 1	ILL


CONTRACT NO. 61B47

COUNTY TOTAL SHEET NO.

COOK 16 4


## **EXISTING TYPICAL SECTION**

**CONGRESS PARK AVENUE** STA. 1+64 TO STA. 9+66

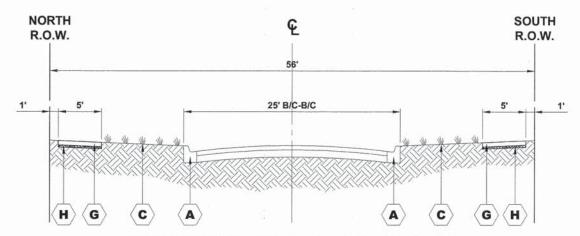


## PROPOSED TYPICAL SECTION

**CONGRESS PARKWAY** STA. 1+64 TO STA. 9+66

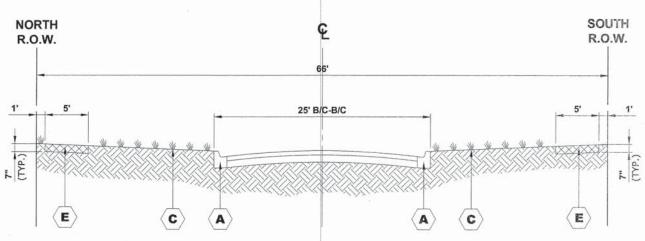

## **EXISTING TYPICAL SECTION**

**CONGRESS PARK AVENUE** STA. 33+46 TO STA. 37+65

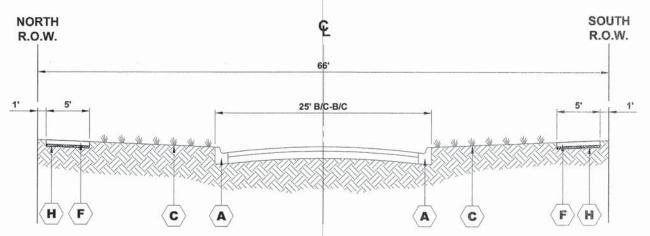

## PROPOSED TYPICAL SECTION

**CONGRESS PARK AVENUE** STA. 33+46 TO STA. 37+65

## **LEGEND OF SYMBOLS**

SYMBOL	DESCRIPTION	SYMBOL	DESCRIPTION
$\langle \mathbf{A} \rangle$	EXISTING COMBINATION CONCRETE CURB AND GUTTER, TYPE B-6.12	E	EARTH EXCAVATION
$\langle \mathbf{B} \rangle$	EXISTING PORTLAND CEMENT CONCRETE SIDEWALK	<b>(F</b> )	INTERMITTENT REPLACEMENT PORTLAND CEMENT CONCRETE SIDEWALK, 5"
$\langle \mathbf{c}  angle$	EXISTING LANDSCAPED PARKWAY	<b>G</b>	PORTLAND CEMENT CONCRETE SIDEWALK, 5 INCH, SPECIAL
$\langle \mathbf{D} \rangle$	INTERMITTENT SIDEWALK REMOVAL	H	SUB-BASE GRANULAR MATERIAL, TYPE B, 2" (INCLUDED IN THE COST OF PCC SIDEWALK, 5" or PCC SIDEWALK, 5", SPECIAL)

DESIGNED -REVISED -DMM REVISED DRAWN -CHECKED -REVISED DATE - 02/11/15 REVISED -

STATE OF ILLINOIS **DEPARTMENT OF TRANSPORTATION** 


TYPICAL SECTIONS SHEET NO. 1 OF 2 SHEETS STA. -

TO STA.

SCALE: NONE

соок CONTRACT NO. 61B47 FIELD BOOK NO. : ILLINOIS FED. AID PROJECT FED. ROAD DIST. NO. 1

## **EXISTING TYPICAL SECTION VARIOUS STREETS**

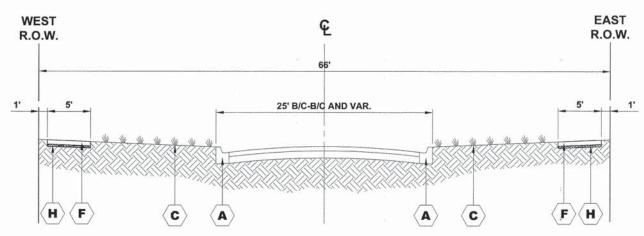

PROPOSED TYPICAL SECTION **VARIOUS STREETS** 

## **LEGEND OF SYMBOLS**

SYMBOL	DESCRIPTION
$\langle \mathbf{A} \rangle$	EXISTING COMBINATION CONCRETE CURB AND GUTTER, TYPE B-6.12
$\langle \mathbf{B} \rangle$	EXISTING PORTLAND CEMENT CONCRETE SIDEWALK
$\langle \mathbf{c} \rangle$	EXISTING LANDSCAPED PARKWAY
$\langle \mathbf{D} \rangle$	INTERMITTENT SIDEWALK REMOVAL
E	EARTH EXCAVATION
<b>(F</b> )	INTERMITTENT REPLACEMENT PORTLAND CEMENT CONCRETE SIDEWALK, 5"
G	PORTLAND CEMENT CONCRETE SIDEWALK, 5 INCH, SPECIAL
$\langle \mathbf{H} \rangle$	SUB-BASE GRANULAR MATERIAL, TYPE B, 2" (INCLUDED IN THE COST OF PCC SIDEWALK, 5" or PCC SIDEWALK, 5", SPECIAL)

EARTHWORK SUMMARY						
LOCATION	EARTH EXCAVATION 20200100	EARTH EXCAVATION ADJUSTED SHRINKAGE (25%)	EMBANKMENT	EARTHWORK BALANCE WASTE (+) OR SHORTAGE (-)		
SECTION	CU YD	CU YD	CU YD	CU YD		
CONGRESS PARK AVE.	135	101.25	0	101.25		
TOTAL	135	101.25	0	101.25		


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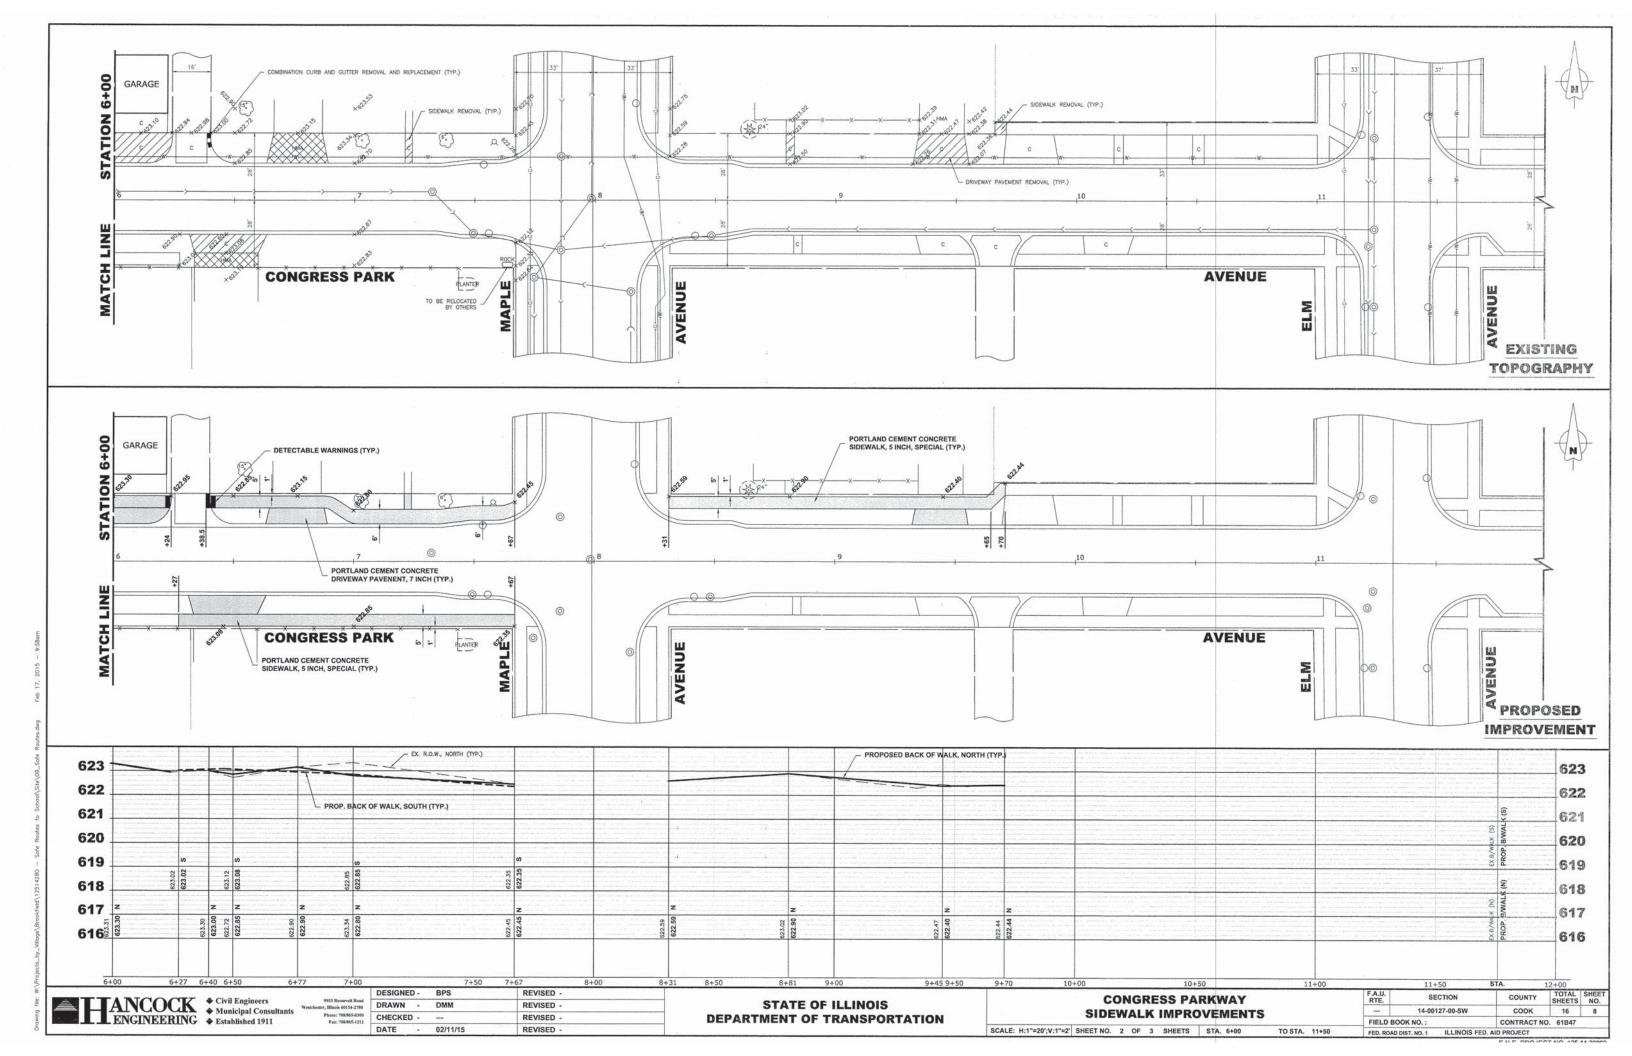
DESIGNED - BPS REVISED -REVISED -REVISED . REVISED -


STATE OF ILLINOIS **DEPARTMENT OF TRANSPORTATION** 


SCALE: NONE

SECTION TYPICAL SECTIONS 14-00127-00-SW соок 16 6 FIELD BOOK NO.: CONTRACT NO. 61B47 SHEET NO. 2 OF 2 SHEETS STA. -FED. ROAD DIST. NO. 1 ILLINOIS FED. AID PROJECT



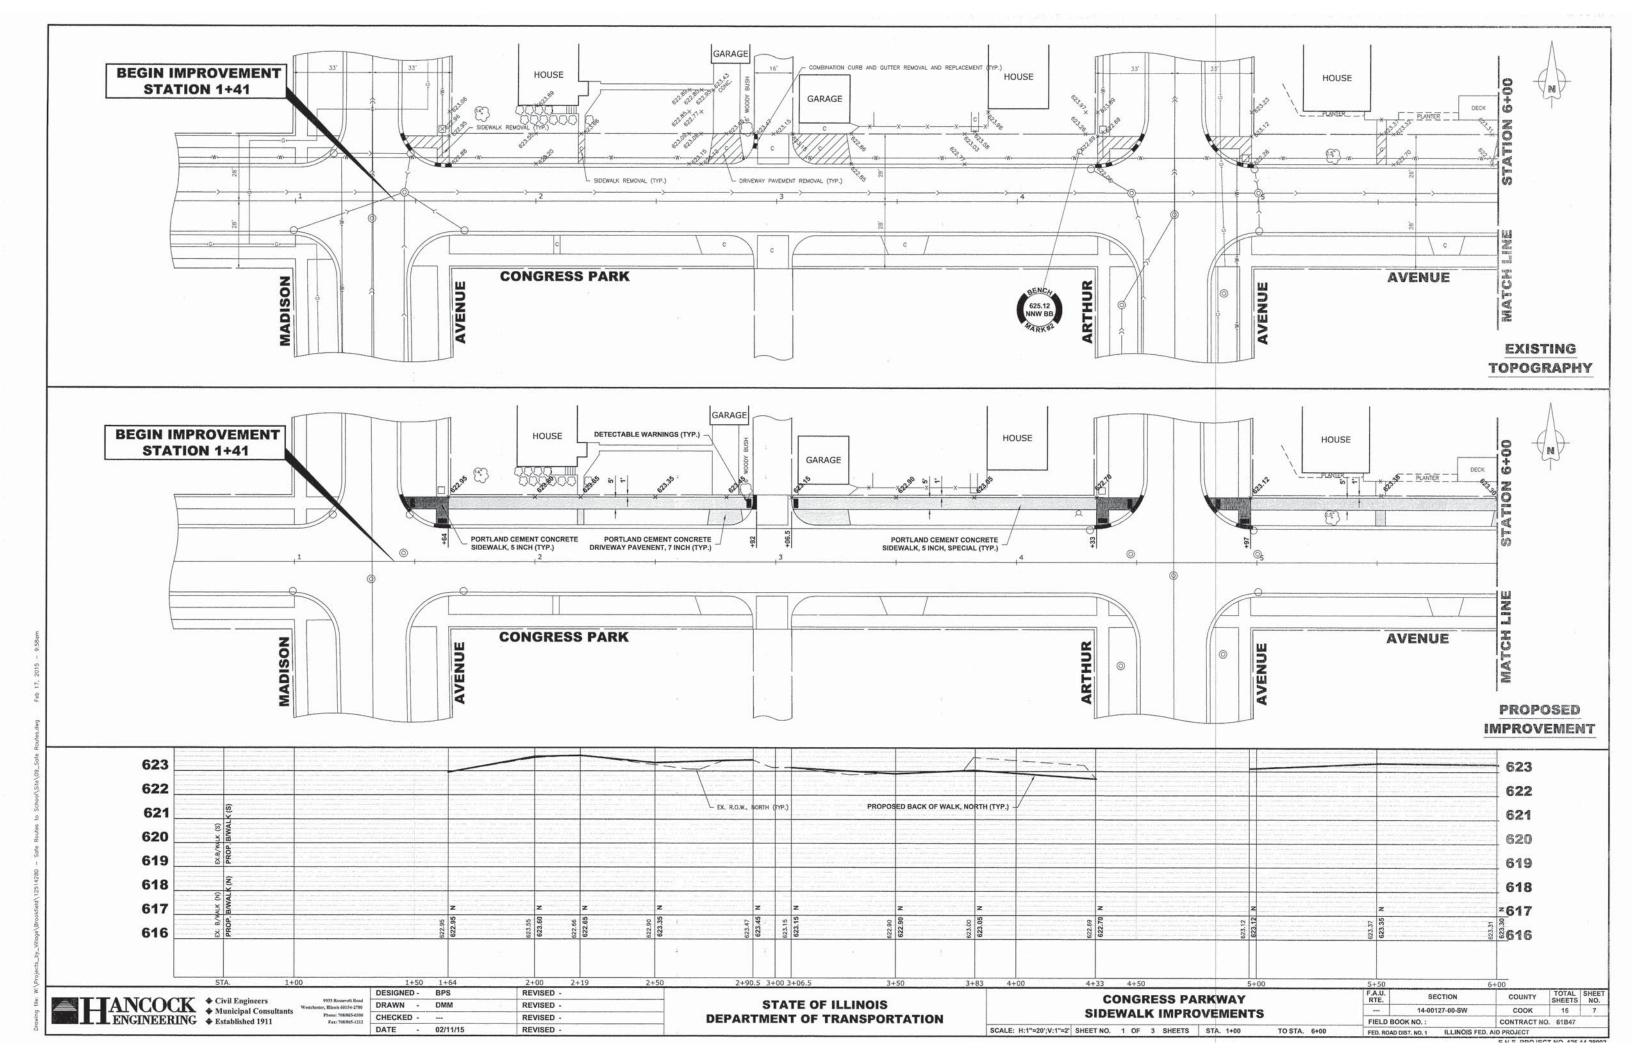

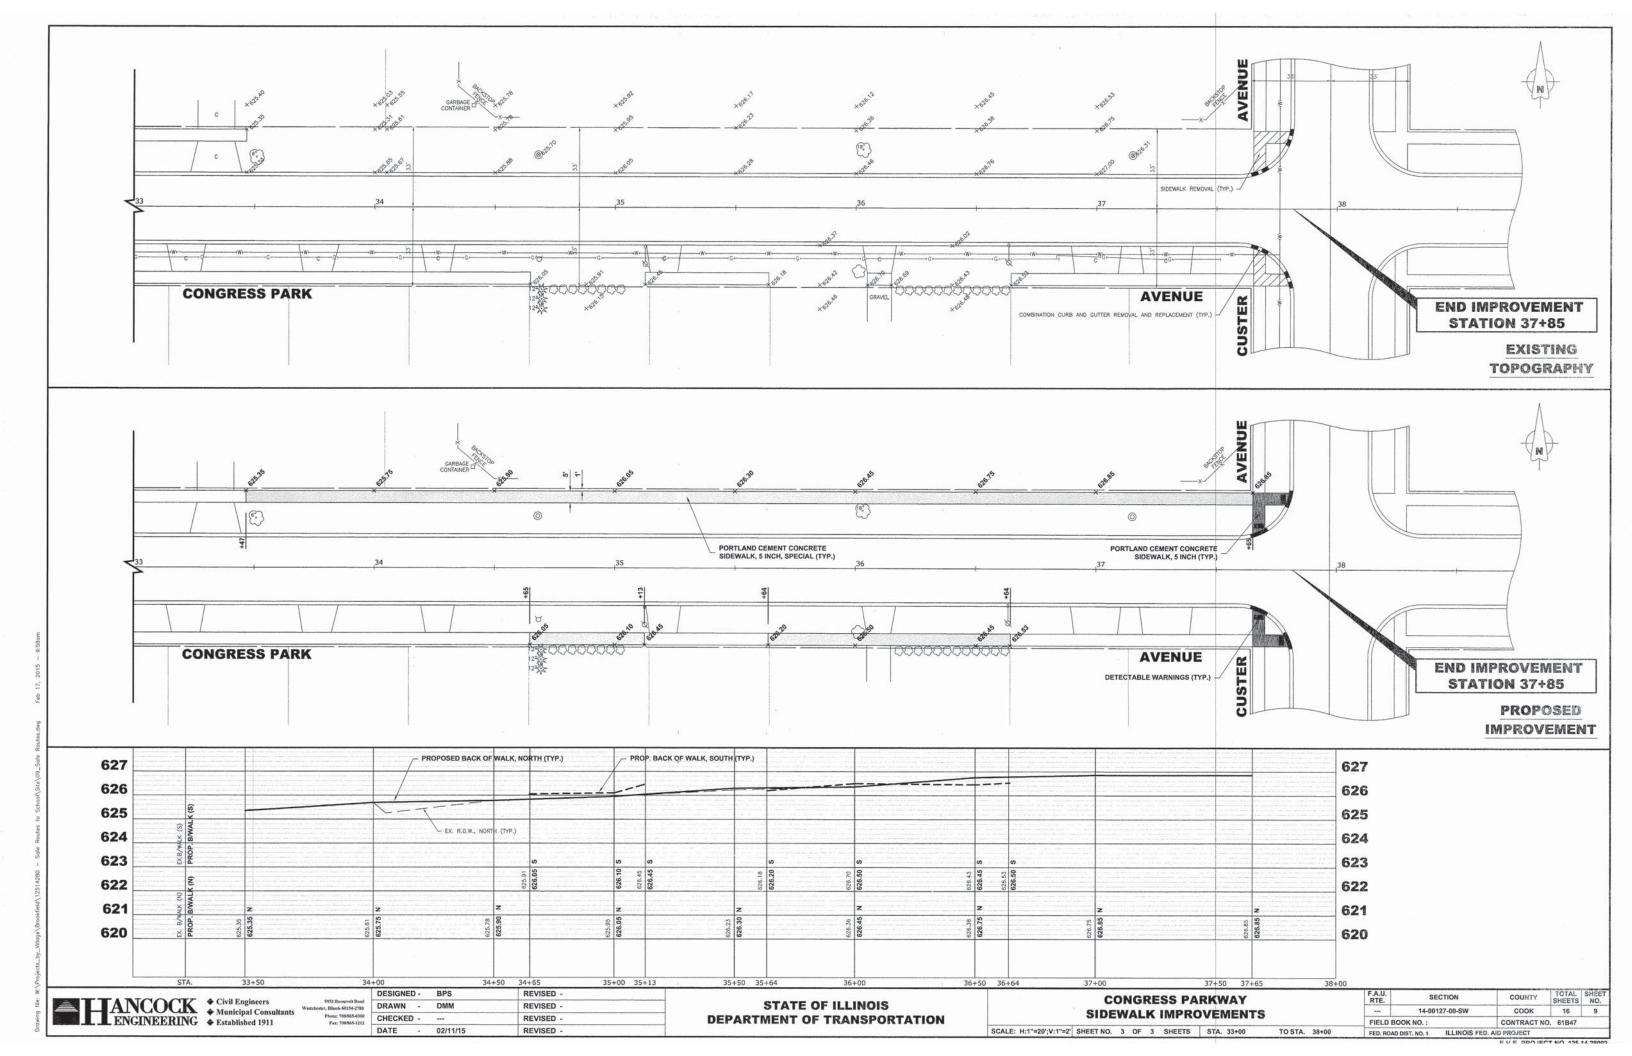

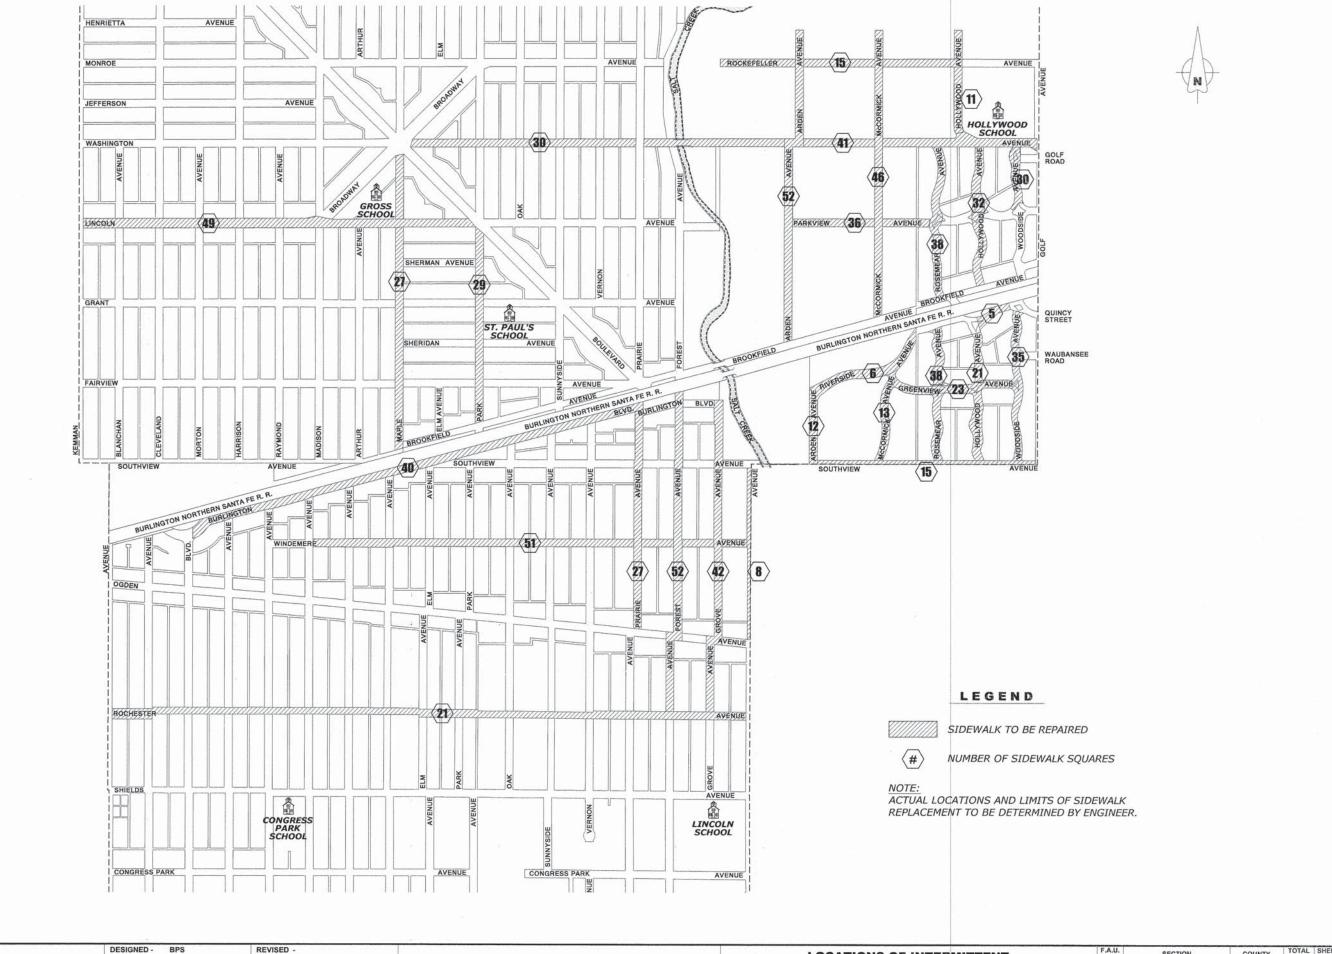

Civil Engineers

Municipal Consultants

ENGINEERING

Civil Engineers

Municipal Consultants

Established 1911


DRAWN - DMM REVISED CHECKED -REVISED DATE - 02/11/15 REVISED

STATE OF ILLINOIS **DEPARTMENT OF TRANSPORTATION** 

LOCATIONS OF INTERMITTENT SIDEWALK REPLACEMENT SCALE: 1" = 400' SHEET NO. 1 OF 1 SHEETS STA.

TOTAL SHEET SHEETS NO. 16 10 CONTRACT NO. 61B47 FIELD BOOK NO. : FED. ROAD DIST. NO. 1 ILLINOIS FED. AID PROJECT

#### **TYPICAL CURB AND GUTTER EXPANSION JOINT**

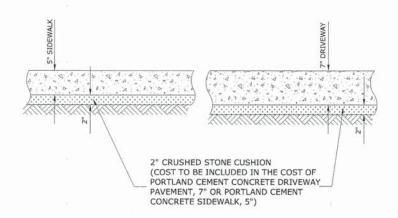

## TYPICAL P.C.C. SIDEWALK, DRIVEWAY

#### **GENERAL NOTES**

DEPRESSED CURBS - THE TOP OF CURBS SHALL BE DEPRESSED WHERE THE CURB AND GUTTER IS CONSTRUCTED AT HANDICAP ACCESSIBLE SIDEWALK RAMPS AT ALLEY RETURNS AND STREET INTERSECTIONS, AND FOR PRIVATE AND COMMERCIAL DRIVES AND AS DIRECTED BY THE ENGINEER

DRAINAGE OPENINGS - AT ALL LOCATIONS WHERE CASTINGS ARE TO BE INCORPORATED IN THE CURB AND GUTTER, A 3/4" EXPANSION JOINT SHALL BE INSTALLED IN THE CURB AND GUTTER A DISTANCE OF 5 FT. FROM EACH SIDE OF THE CASTING. 2-NO. 4 RE-BARS, 9' IN LENGTH, SHALL BE INCORPORATED IN THE CONTINUOUS PORTION OF CONCRETE CURB BEHIND THE CASTING.

DETECTABLE WARNINGS - DETECTABLE WARNINGS SHALL BE INSTALLED AT HANDICAP ACCESSIBLE SIDEWALK RAMPS, AT ALLEY RETURNS, AND STREET INTERSECTIONS. THESE SHALL BE CONSTRUCTED IN ACCORDANCE WITH THE APPLICABLE IDOT STANDARDS.

DEPRESSED CURB HEIGHT - THE HEIGHT OF THE DEPRESSED CURB SHALL BE 1-1/2" AT DRIVEWAYS. SEE IDOT STANDARD 424001-08 FOR HEIGHT AT SIDEWALK RAMP.


BITUMINOUS EXPANSION JOINTS - THREE QUARTER INCH (3/4") BITUMINOUS PREMOLDED INORGANIC FIBER EXPANSION JOINTS SHALL BE INSTALLED WHERE NEW SIDEWALK OR CURB AND GUTTER OR DRIVEWAY PAVEMENT ABUTS AN EXISTING CONCRETE WALK, DRIVE, OR CURB WHICH IS TO REMAIN IN PLACE, AND AT NOT LESS THAN NINETY FOOT (90') INTERVALS AT LOCATIONS WHERE CURB REPLACEMENT IS IN EXCESS OF NINETY FEET (90'); AT RADIUS POINTS, AT BOTH SIDES OF FRAMES AND GRATES WHICH FALL IN THE CURB; AND AS DIRECTED BY THE ENGINEER.


ALL EXPANSION JOINTS LOCATED IN THE CURB AND GUTTER SHALL HAVE TWO (2) THREE QUARTER INCH (3/4") DIAMETER, SMOOTH, ROUND, EPOXY COATED DOWEL BARS, EIGHTEEN INCHES (18") IN LENGTH, WITH GREASED PLASTIC END CAPS INSERTED TO ALLOW THE CURB AND GUTTER TO EXPAND AND CONTRACT LATERALLY. CONTRACTION JOINTS SHALL BE TOOLED INTO THE CURB AND GUTTER AT INTERVALS NOT TO EXCEED FIFTEEN FEET (15'). THESE CONTRACTION JOINTS SHALL BE SAW CUT TO A DEPTH OF TWO INCHES (2") WITHIN TWENTY-FOUR (24) HOURS OF CONCRETE PLACEMENT. THE COST OF THE ABOVE WORK SHALL BE INCLUDED IN THE RESPECTIVE ITEMS FOR CONCRETE INSTALLATION.

THE COSTS FOR REMOVAL OF ANY ASPHALT OVERLAY THAT EXTENDS INTO THE GUTTER PORTION OF THE CURB AND GUTTER WILL BE INCLUDED IN THE PRICE FOR COMBINATION CURB AND GUTTER REMOVAL.


THE EDWIN HANCOCK ENGINEERING COMPANY AND THE VILLAGE PUBLIC WORKS DEPARTMENT SHALL BE NOTIFIED AT LEAST TWO (2) WORKING DAYS PRIOR TO ANY CONSTRUCTION ACTIVITY. CONTACT INFORMATION IS AS FOLLOWS:


FOWIN HANCOCK ENGINEERING COMPANY: 708-865-0300 VILLAGE OF BROOKFIELD PUBLIC WORKS: 708-485-2540

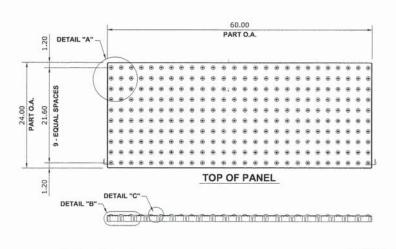


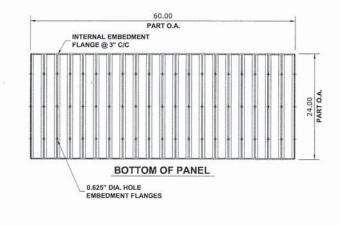

SCALE: NONE

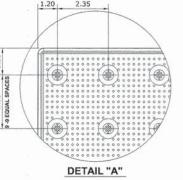

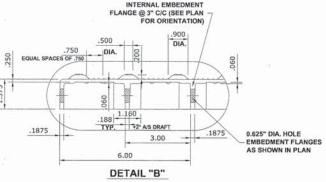

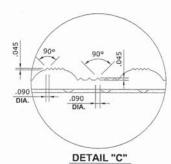

## **CAST-IN-PLACE COMPOSITE PAVER TILE** FOR DETECTABLE WARNING

TANCOCK 

Civil Engineers

Municipal Consultants ENGINEERING Established 1911


DESIGNED -BPS REVISED -DRAWN -REVISED CHECKED -DATE - 02/11/15 REVISED .

STATE OF ILLINOIS **DEPARTMENT OF TRANSPORTATION** 

**ROADWAY DETAILS** SHEET NO. 1 OF 1 SHEETS STA.

TO STA.

TOTAL SHEE SHEETS NO. COUNTY соок CONTRACT NO. 61B47 FIELD BOOK NO.: FED. ROAD DIST. NO. 1 ILLINOIS FED. AID PROJECT

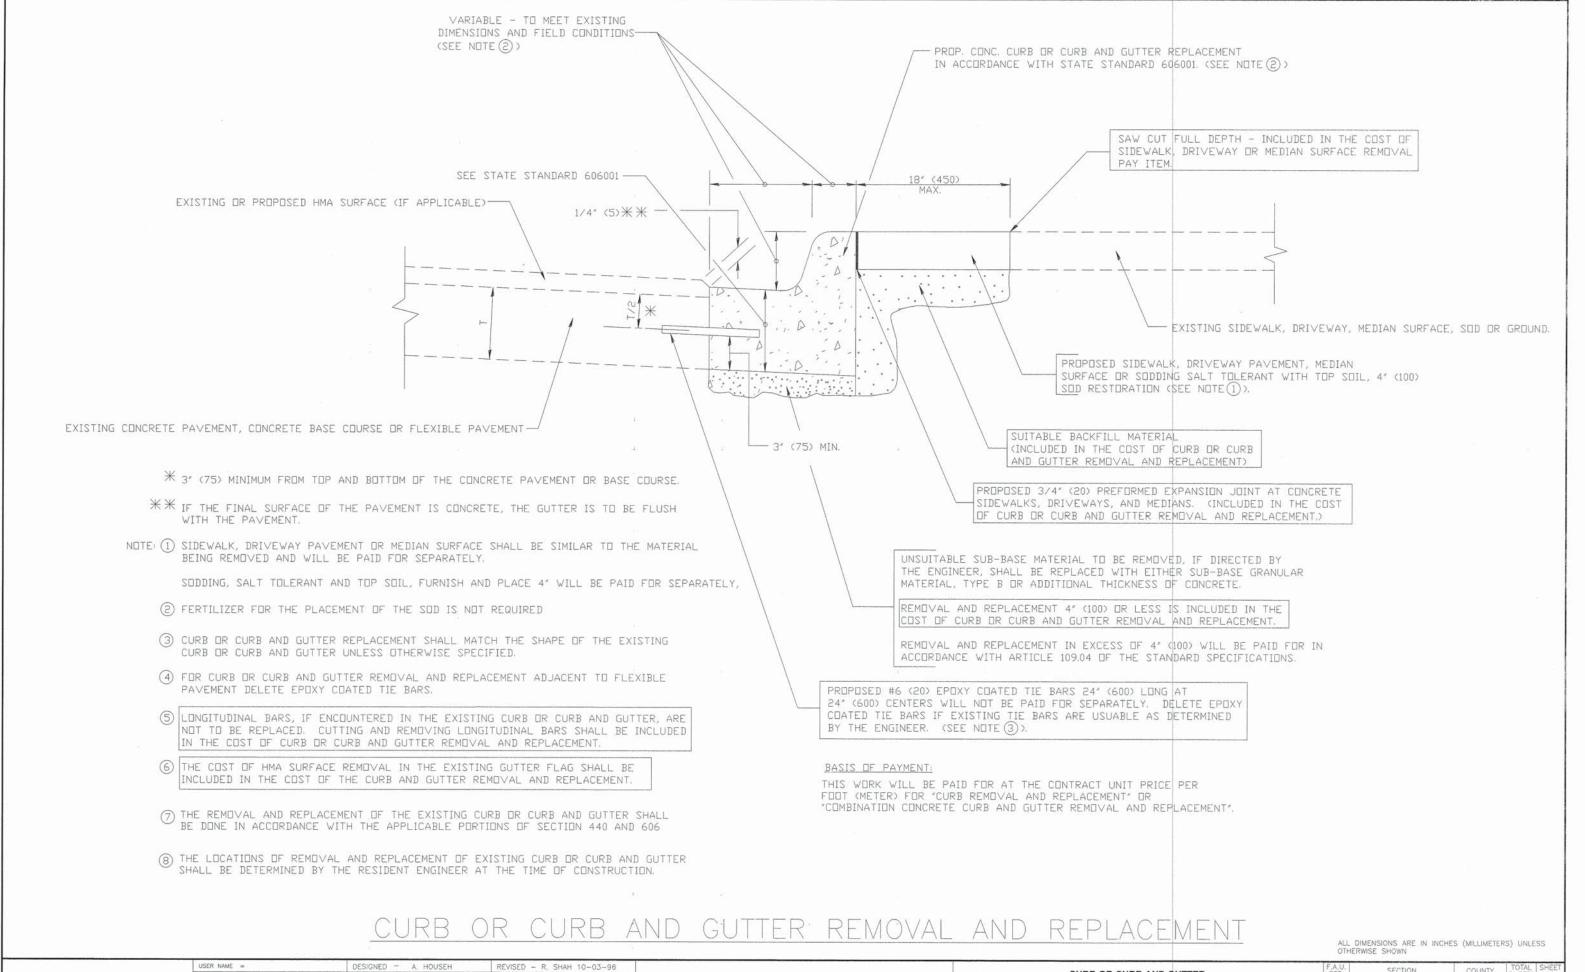

December (2) MA Decises by Ulland Description 1995 1199

PLOT SCALE =

PLOT DATE =

CHECKED

03-11-94

DATE


REVISED - M. GOMEZ 01-22-01

REVISED - R. BORO 12-15-09

STATE OF ILLINOIS
DEPARTMENT OF TRANSPORTATION

CURB OR CURB AND GUTTER
REMOVAL AND REPLACEMENT

SHEET NO. 1 OF 1 SHEETS STA.

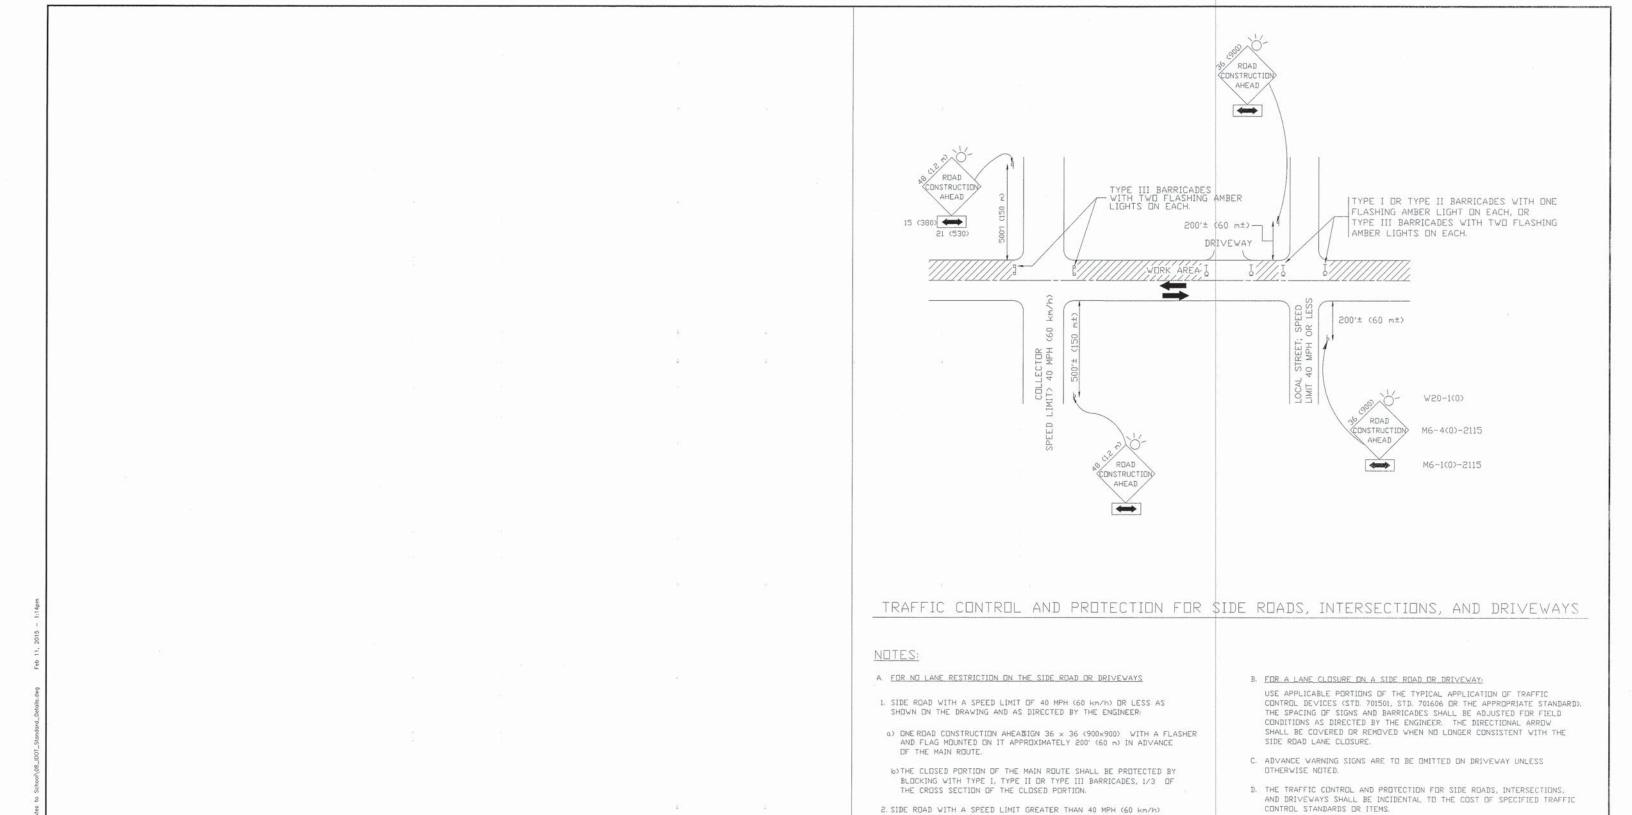

USER NAME =	DESIGNED - LHA	REVISED - J. OBERLE 10-18-95
	DRAWN -	REVISED - A. HOUSEH 03-06-96
PLOT SCALE =	CHECKED -	REVISED - A. HOUSEH 10-15-96
PLOT DATE =	DATE - 06-89	REVISED - T. RAMMACHER 01-06-00

AS SHOWN ON THE DRAWING AND AS DIRECTED BY THE ENGINEER: 0) ONE ROAD CONSTRUCTION AHEABIGN 48  $\times$  48 (1.2 m  $\times$  1.2 m) WITH A FLASHER MOUNTED ON IT APPROXIMATELY 500' (150 m) IN ADVANCE

6) THE CLOSED PORTION OF THE MAIN ROUTE SHALL BE PROTECTED BY BLOCKING WITH TYPE III BARRICADES, 1/2 OF THE CROSS SECTION

3. WHEN THE SIDE ROAD LIES BETWEEN THE BEGINNING OF THE MAINLINE SIGNING AND THE WORK ZONE, A SINGLE HEADED ARROW (M6-1) SHALL

SCALE: NONE

BE USED IN LIEU OF THE DOUBLE HEADED ARROW (M6-4).

OF THE CLOSED PORTION.

-	medd o trief mide drie			
J.	SECTION	COUNTY	TOTAL	SHEET NO.
	14-00127-00-SW	соок	16	13
TC-10		CONTRACT NO. 61B47		

All dimensions are in millimeters (inches)

