06-12-2015 LETTING ITEM 137

STATE OF ILLINOIS


**DEPARTMENT OF TRANSPORTATION** 

**DIVISION OF HIGHWAYS** 

FOR INDEX OF SHEETS, SEE SHEET NO. 2

# PROPOSED HIGHWAY PLANS

FAP ROUTE 678 (IL 4)
SECTION 52-I
PROJECT ACHSIP-0678 (006)
RESURFACING, NEW SHOULDERS
& RUMBLE STRIPS
ST. CLAIR COUNTY

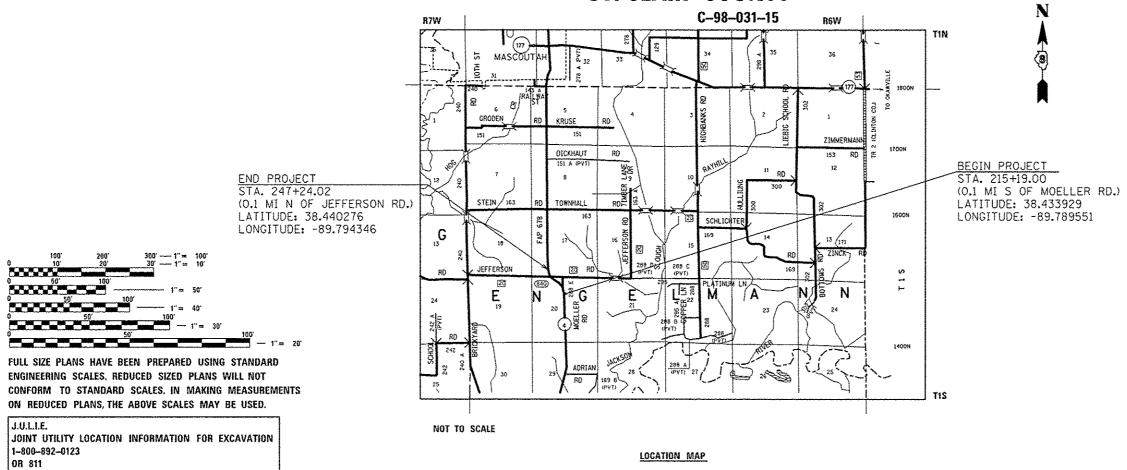

PROJECT ENGINEER: MICHAEL PRITCHETT (618) 346–3180 DESIGNER: ALVIN NIEVES-ROSARIO (618) 346–3454


GROSS LENGTH = 3205.02 FT. = 0.607 MILE NET LENGTH = 3205.02 FT. = 0.607 MILE

ENGELMANN TOWNSHIP

CONTRACT NO. 76H79

0-98-036-15



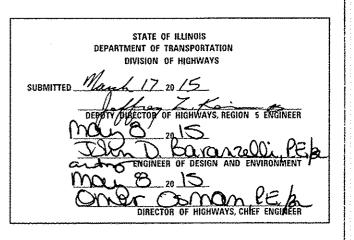

PRINTED BY THE AUTHORITY OF THE STATE OF ILLINOIS

INDEX OF SHEETS

COMMITMENTS NONE

1 COVER SHEET

- 2 INDEX OF SHEETS, GENERAL NOTES, COMMITMENTS & HIGHWAY STANDARDS
- 3-4 SUMMARY OF QUANTITIES
- 5-7 TYPICAL SECTIONS 8 LOCATON MAP
- 9-10 SCHEDULES
- 11-12 DETAIL SHEET

#### GENERAL NOTES

- 1. THE CONTRACTOR AND THE ENGINEER SHALL BE AWARE THAT NO FORMAL SURVEY WAS PERFORMED FOR THIS PROJECT. THE STATIONING AND TOPO SHOWN IN THE PLANS WAS CREATED USING MICROFILM AND FIELD MEASUREMENTS MADE BY DESIGN PERSONNEL. BOTH SHALL BE ASSUMED TO BE APPROXIMATE.
- 2. ILLINOIS STATE LAW REQUIRES A 48-HOUR NOTICE BE GIVEN TO ALL UTILITIES BEFORE DIGGING. FIELD MARKING OF FACILITIES MAY BE OBTAINED BY CONTACTING J.U.L.I.E. OR FOR NON-MEMBERS, THE UTILITY COMPANY DIRECTLY. AGENCIES KNOWN TO HAVE FACILITIES WITHIN THE PROJECT AREA ARE AS FOLLOWS:

\*AMEREN TILINOIS - GAS & ELECTRIC

(AERIAL & BURIED) (AERIAL & BURIED)

\*CLEARWAVE COMMUNICATIONS - COMMUNICATIONS \*CLINTON COUNTY ELECTRIC COOPERATIVE, INC. - ELECTRIC

.VILLAGE OF FAYETTEVILLE - WATER & SANITARY SEWER

(AERIAL & BURIED) (BURIED)

\*FRONTIER NORTH, INC. - COMMUNICATIONS

(AERIAL & BURIED)

\*FSH WATER COMMISION - WATER

(BURIED)

J.U.L.I.E. MEMBERS MUST BE NOTIFIED INDIVIDUALLY.

MEMBERS OF JULLIE, CALL TOLL FREE (800) 892-0123 OR 811 AND ARE INDICATED BY .. NON-JULLIE. MEMBERS MUST BE NOTIFIED INDIVIDUALLY.

- 3. THE CONTRACTOR SHALL VERIFY ALL DIMENSIONS AND CONDITIONS IN THE FIELD PRIOR TO ORDERING OF MATERIALS AND CONSTRUCTION.
- 4. NO OVERNIGHT LANE CLOSURES WILL BE ALLOWED.
- 5. THE THICKNESS OF THE BITUMINOUS MIXTURE SHOWN ON THE PLANS IS THE NOMINAL THICKNESS. DEVIATIONS FROM THE NOMINAL THICKNESS WILL BE PERMITTED WHEN SUCH DEVIATIONS OCCUR DUE TO IRREGULARITIES IN THE EXISTING SURFACE OR BASE ON WHICH THE BITUMINOUS MIXTURE IS PLACED.
- 6. ALL AREAS DISTURBED FOR ANY REASON SHALL BE SEEDED AS DIRECTED BY THE ENGINEER. ALL AREAS DISTURBED BY THE CONTRACTOR OUTSIDE THE PROPOSED CONSTRUCTION LIMITS SHALL BE SEEDED AT THE CONTRACTOR'S EXPENSE.
- 7. THE INTENT OF GRADING AND SHAPING DITCHES IS TO ESTABLISH POSITIVE DRAINAGE BETWEEN THE EDGE OF THE STABILIZED SHOULDER AND THE FLOWLINE OF THE DITCH. AN ESTIMATED 350 CUBIC YARDS OF EXCESS SOIL ARE ANTICIPATED.
- 8. FLAGGERS SHALL BE PRESENT DURING ALL CLOSURE HOURS, INCLUDING LUNCH HOUR, AND NO ADDITIONAL COMPENSATION SHALL BE PAID.
- 9. THE PAVEMENT MARKING SHOWN IN THE SCHEDULES IS APPROXIMATE. THE LOCATION OF THE PROPOSED MARKINGS SHALL MATCH EXISTING LOCATIONS.
- 10. ALL TEMPORARY PAVEMENT MARKINGS SHALL BE PLACED IN SUCH A MANNER SO AS NOT TO INTERFERE WITH THE PLACEMENT OF PERMANENT PAVEMENT MARKINGS.
- 11. SHORT TERM AND TEMPORARY PAVEMENT MARKING REMOVAL FROM FINAL SURFACE SHALL BE PAID FOR AS WORK ZONE PAVEMENT MARKING REMOVAL.
- 12. THE DEPARTMENT STRONGLY ENCOURAGES THE PRIME CONTRACTOR AND THEIR APPROVED SUB-CONTRACTORS TO HIRE MINORITY, WOMEN AND DISADVANTAGED INDIVIDUALS FROM ITS FEDERALLY FUNDED HIGHWAY CONSTRUCTION CAREERS TRAINING PROGRAM (HCCTP) TO HELP MEET WORKFORCE AND TRAINEE GOALS. THIS PROGRAM IS TRAINING MINORITIES, WOMEN AND DISADVANTAGED INDIVIDUALS IN HIGHWAY CONSTRUCTION-RELATED SKILLS, E.G., MATH FOR THE TRADES, JOB READINESS, TECHNICAL SKILLS COURSEWORK (CARPENTRY, CONCRETE FLATWORK, BLUEPRINT READING, SITE PLANS, SITE WORK, TOOLS USE, ETC.) AND OSHA 10 HOUR CERTIFICATION, TO PREPARE THEM FOR A CAREER IN THE HIGHWAY CONSTRUCTION TRADES. GRADUATES ARE WELL-TRAINED AND READY TO BECOME PRODUCTIVE ENTRY-LEVEL CONSTRUCTION WORKERS. CONTACT THE DISTRICT 8 EEO OFFICE AT 618-346-3360 AND/OR THE HCCTP COORDINATOR AT 618-874-6528 TO LEARN MORE ABOUT THE PROGRAM AND FOR ASSISTANCE IN MEETING WORKFORCE AND TRAINEE GOALS.
- 13, ALL EARTHWORK REQUIRED TO COMPLY WITH HICHWAY STANDARD 630301-06 SHALL BE INCLUDED IN THE COST OF TRAFFIC BARRIER TERMINAL, TYPE I (SPECIAL), TANGENT.

- 14. THE INTENT OF THIS CONTRACT IS TO CONSTRUCT A 3' HMA SHOULDER AND A VARIABLE WIDTH AGGREGATE WEDGE SHOULDER WITHIN THE EXISITNG AVAILABLE TOP.
- 15. ALL SAW CUTTING REQUIRED FOR REMOVALS SHALL BE INCLUDED IN THE CONTRACT UNIT PRICE FOR THE REMOVAL ITEM.
- 16. EARTH EXCAVATION SHALL INCLUDE ALL MATERIALS ENCOUNTERED, INCLUDING, BUT NOT LIMITED TO, OIL AND CHIP SIDE ROADS AND HMA ENTRANCES.
- 17. HMA INCIDENTAL SURFACING IS INCLUDED TO PROVIDE A SMOOTH TRANSITION AT HMA ENTRANCES, CONTRACTOR SHALL VERIFY LOCATIONS WHERE THIS IS NECESSARY.

#### MIXTURE REQUIREMENTS

ROUTE	FAP 678 (IL 4)
SECTION	52-1
COUNTY	ST. CLAIR
CONTRACT	76H79

DESCRIPTION:	RESURFACING, SHOULDERS, RUMBLE STRIP PLACEMENT ON CENTERLINE &	*
DESCRIPTION:	SHOULDERS	į

	IL4
ADT (CONSTRUCTION YR.)	3000
MU%:	6
SU%:	3
20 YR. ESAL:	1.07

MIXTURE USE	SURFACING	INCIDENTAL
AC/PG	PG-64-22	PG 64-22
RAP % (MAX)	SEE SPECIAL PROVISION	SEE SPECIAL PROVISION
DESIGN AIR VOIDS	4.0% @ Ndes=70	4.0% @ Ndes=70
MIX COMPOSITION (GRADATION)	IL 9.5	IL 9.5
FRICTIONAGG	MIXTURE "D"	MIXTURE "D"
QUALITY MGMT PROGRAM	QC/QA	QC/QA

MIXTURE USE	SHOULDERS ≥ 2.25"
AC/PG	PG-64-22
RAP% (MAX)	SEE SPECIAL PROVISION
DESIGN AIR VOIDS	4.0% @ Ndes=30
MIX COMPOSITION (GRADATION)	IL 19.0L
FRICTION AGG	
QUALITY MGMT PROGRAM	

PLAN QUANTITIES FOR BITUMINOUS CONCRETE SURFACE COURSE ITEMS ARE CALCULATED USING A UNIT WEIGHT OF 112 LB/SQ YD/IN (59.8 KG/SQ M/25MM THICKNESS).

#### HIGHWAY STANDARDS

000001-06 STANDARD SYMBOLS, ABBREVIATIONS AND PATTERNS DECIMAL OF AN INCH AND OF A FOOT 482001-02 HMA SHOULDER ADJACENT TO FLEXIBLE PAVEMENT STEEL PLATE BEAM GUARDRAIL LONG-SPAN GUARDRAIL OVER CULVERT 630106-01 630301-06 SHOULDER WIDENING FOR TYPE 1 (SPECIAL) GUARDRAIL TERMINALS 635006-03 REFLECTOR AND TERMINAL MARKER PLACEMENT 635011-02 REFLECTOR MARKER AND MOUNTING DETAILS 642006 SHOULDER RUMBLE STRIPS, 8 IN. OFF ROAD OPERATIONS, 2L, 2W, MORE THAN 15' (4.5m) AWAY OFF ROAD OPERATIONS, 2L, 2W, 15' TO 24" FROM PAVEMENT EDGE OFF ROAD MOVING OPERATIONS, 2L. 2W, DAY ONLY LANE CLOSURE, 2L, 2W, DAY ONLY, FOR SPEEDS ≥ 45 MPH 701201-04 LANE CLOSURE, 2L, 2W, SHORT TIME OPERATIONS 701306-03 LANE CLOSURE, 2L, 2W, SLOW MOVING OPERATIONS DAY ONLY, FOR SPEEDS ≥ 45 MPH LANE CLOSURE, 2L. 2W. MOVING OPERATIONS - DAY ONLY

LANE CLOSURE, 2L, 2W, PAVEMENT WIDENING, FOR SPEEDS ≥ 45 MPH

TRAFFIC CONTROL DEVICES TYPICAL PAVEMENT MARKINGS 780001-05

TYPICAL APPLICATIONS RAISED REFLECTIVE PAVEMENT MARKERS 781001-03

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STATE OF ILLINOIS DEPARTMENT OF TRANSPORTATION

						F.A.P RTE.	SECTION	COUNTY	TOTAL SHEETS	SHEET NO.
GENER	al notes, inc	EX 0	F SHEETS	& HIGHWAY	STANDARDS	678	52-1	ST, CLAIR	12	2
								CONTRACT	NO. 7	6H79
SCALE: NTS	SHEET NO.	OF	SHEETS	STA.	TO STA.	FED. RC	AD DIST. NO. ILLINOIS FED. A	D PROJECT		

90% FED	10%	STATE
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CONSTR. CODE

				ROADWAY
CODE	ITEM	UNIT	TOTAL	0005 RURAL
NO.	1 I E M		UUANIIII	NUNAL
20200100	EARTH EXCAVATION	CU YD	280	280
		OCCUPANT AND		
21400100	GRADING AND SHAPING DITCHES	FOOT	2344	2344
5500000	CEEDING CLASS 2	ACDE	0.0	0.0
25000200	SEEDING, CLASS 2	ACRE	0.9	0.9
25000400	NITROGEN FERTILIZER NUTRIENT	POUND	50	50
			-	
25000500	PHOSPHORUS FERTILIZER NUTRIENT	POUND	50	50
		12		~~~~~~~~~~~~~~~~~~~~~~~~~~~~~~~~~~~~~~
25000600	POTASSIUM FERTILIZER NUTRIENT	POUND	50	50
25100630	EROSION CONTROL BLANKET	SQ YD	2448	2448
31101000	SUBBASE GRANULAR MATERIAL, TYPE B	TON	92	92
40600275	BITUMINOUS MATERIALS (PRIME COAT)	POUND	3545	3545
40600982	HOT-MIX ASPHALT SURFACE REMOVAL - BUTT JOINT	SQ YD	57	57
40600990	TEMPORARY RAMP	SQ YD	24.4	24,4
40603340	HOT-MIX ASPHALT SURFACE COURSE, MIX "D", N70	TON	665	665
40800035	DITHUINOUS MATERIALS (ROINE COAT)	DOLIND	27	27
40800025	BITUMINOUS MATERIALS (PRIME COAT)	POUND	27	£ !
40800050	INCIDENTAL HOT-MIX ASPHALT SURFACING	TON	4	4
		****		

90% FED / 10% STATE

	CODE			TOTAL	ROADWAY 0005
-	NO.	ITEM	UNIT	QUANTITY	RURAL
***************************************	44000100	PAVEMENT REMOVAL	SQ YD	31	31
	44000155	HOT-MIX ASPHALT SURFACE REMOVAL, 11/2"	SQ YD	7875	7875
	44004250	PAVED SHOULDER REMOVAL	SO YD	576	576
	48102100	AGGREGATE WEDGE SHOULDER, TYPE B	TON	90	90
	48203029	HOT-MIX ASPHALT SHOULDERS, 8"	SO YD	1733	1733
	63000001	STEEL PLATE BEAM GUARDRAIL, TYPE A. 6 FOOT POSTS	FOOT	162.5	162.5
	63000350	LONG-SPAN GUARDRAIL OVER CULVERT, 12 FT 6 IN SPAN	FOOT	325.0	325.0
*	63100167	TRAFFIC BARRIER TERMINAL, TYPE 1 (SPECIAL) TANGENT	EACH	4	4
***************************************	64200108	SHOULDER RUMBLE STRIPS, 8 INCH	FOOT	5155	5155
ven.meniser.edizer.earnisen.earnisen.	67000400	ENGINEER'S FIELD OFFICE, TYPE A	CAL MO	3	3
THE PERSON NAMED IN COLUMN TWO IS NOT THE OWNER.	67100100	MOBILIZATION	L SUM	1	1
	70100450	TRAFFIC CONTROL AND PROTECTION, STANDARD 701201	L SUM	1	1
The second secon	70100460	TRAFFIC CONTROL AND PROTECTION, STANDARD 701306	L SUM	1	1
**************************************	70100500	TRAFFIC CONTROL AND PROTECTION, STANDARD 701326	. L SUM	1	1
, manual to					

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\* SPECIALTY ITEM

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DEPARTMENT	OF	TRANSPORTATION

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		SUN	AMARY	OF QU	ANTITIES		678	52-1	ST. CLAIR	12	3
									CONTRACT	NO.	76H79
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90% FED / 10% STATE


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				ROADWAY
CODE			TOTAL [	0005
NO.	ITEM	UNIT	QUANTITY	RURAL
70103815	TRAFFIC CONTROL SURVEILLANCE	CAL DA	5	5
			A A A A A A A A A A A A A A A A A A A	
70300100	SHORT TERM PAVEMENT MARKING	FOOT	583	583
70300220	TEMPORARY PAVEMENT MARKING - LINE 4"	FOOT	12146	12146
70301000	WORK ZONE PAVEMENT MARKING REMOVAL	SO FT	4147	4147
78000200	THERMOPLASTIC PAVEMENT MARKING - LINE 4"	FOOT	6412	6412
			THE STATE OF THE S	
78001110	PAINT PAVEMENT MARKING - LINE 4"	FOOT	5734	5734
78100100	RAISED REFLECTIVE PAVEMENT MARKER	EACH	81	81
78200410	GUARDRAIL MARKERS, TYPE A	EACH	12	12
78201000	TERMINAL MARKER - DIRECT APPLIED	EACH	4	4
78300200	RAISED REFLECTIVE PAVEMENT MARKER REMOVAL	EACH	81	81
X0326898	CENTER LINE - RUMBLE STRIP - 16"	FOOT	3208	3208


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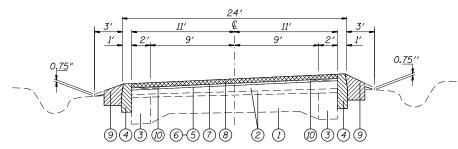
\* SPECIALTY ITEM

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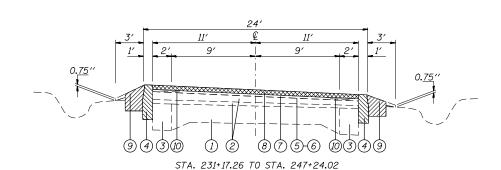


STA. 217+56.37 TO STA. 220+78.00



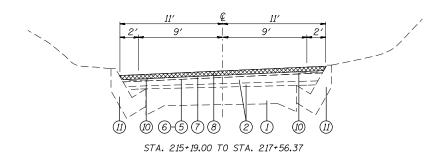

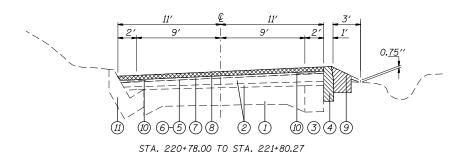
STA. 221+80.27 TO STA. 231+17.26



### LEGEND

- (1) EXISTING 9-6-9 PCC PAVEMENT
- (2) EXISTING BITUMINOUS RESURFACING, 3"
- (3) EXISTING P.C.C BASE COURSE WIDENING
- 4 EXISTING BITUMINOUS SHOULDER, 11"
- EXISTING BITUMINOUS MATERIALS (PRIME COAT)
- 6 EXISTING AGGREGATE (PRIME COAT)
- (7) EXISTING LEVELING BINDER (MACHINE METHOD) TYPE 2, 3/4"
- 8 EXISTING BITUMINOUS CONCRETE SURFACE COURSE, 1 1/2"
- (9) EXISTING AGGREGATE SHOULDER
- (D) EXISTING STRIP REFLECTIVE CRACK CONTROL TREATMENT
- (11) EXISTING CONCRETE GUTTER
- PROPOSED HMA SURFACE COURSE, 1 1/2"
- (3) PROPOSED HMA SHOULDER, 8"
- 14 PROPOSED AGGREGATE WEDGE SHOULDER, TYPE B
- (5) PROPOSED SUBBASE GRANULAR MATERIAL, TYPE B
- (6) PROPOSED BITUMINOUS MATERIALS (PRIME COAT)
- 7 PROPOSED GUARDRAIL



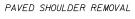




EARTH EXCAVATION




HMA SURFACE REMOVAL, 1 1/2"

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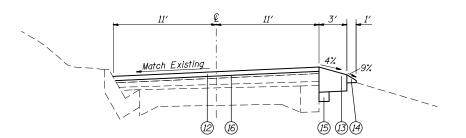
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STA. 215+19.00 TO STA. 217+56.37

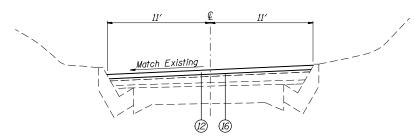

STA. 217+56.37 TO STA. 220+78.00

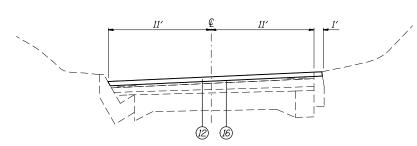

STA. 217+56.37 TO STA. 221+80.27


\*FROM STA 226+27 TO STA 226+77 NO AGGREGATE WEDGE SHOULDER, TYPE B SHOULD BE PLACED.

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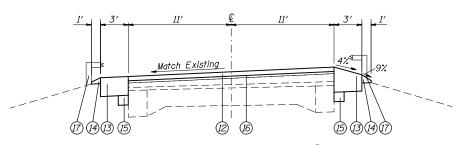
### LEGEND

- 1 EXISTING 9-6-9 PCC PAVEMENT
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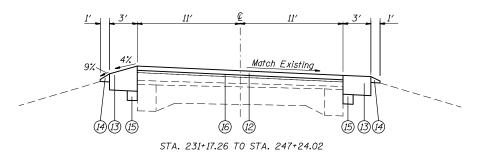
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STA. 228+45.75 TO STA. 231+17.26



STA. 224+58.25 TO STA. 228+45.75\*

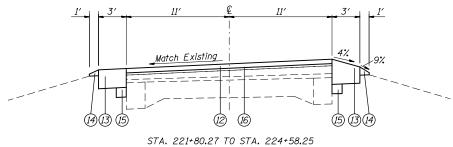

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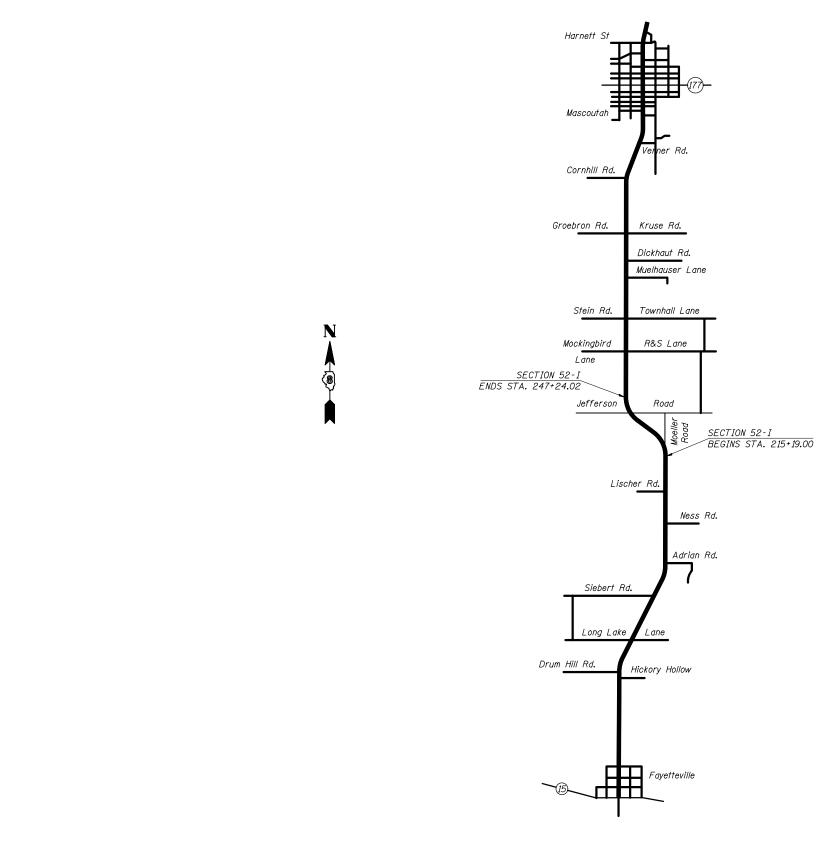
# STATE OF ILLINOIS **DEPARTMENT OF TRANSPORTATION**

						F.A.P RTE.	SEC	TION	COUNTY	TOTAL SHEETS	SHEET NO.
	PROI	POSED	TYPICAL	SECTIONS		678	52	2-I	ST. CLAIR	12	7
									CONTRACT	NO.	76H79
SCALE: NTS	SHEET NO.	0F	SHEETS	STA.	TO STA.	FED. R	OAD DIST. NO.	ILLINOIS FED. AI	D PROJECT		

#### LEGEND

- 1 EXISTING 9-6-9 PCC PAVEMENT
- ② EXISTING BITUMINOUS RESURFACING, 3"
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- (5) PROPOSED SUBBASE GRANULAR MATERIAL, TYPE B
- (6) PROPOSED BITUMINOUS MATERIALS (PRIME COAT)
- (7) PROPOSED GUARDRAIL



LOCATION MAP

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	PLOT DATE = 3/18/2015	DATE -	REVISED -		SCALE: NTS	SHEET NO. OF SHEETS STA. T	O STA.	FED. ROAD DI	ST. NO. ILLINOIS FED. AI		

	PAVEMENT MARKING SCHEDULE														
			NO PASSING	PAINT	LINE 4"	THERMOPLASTIC LINE, 4"	RAISED REFLECTIVE PAVEMENT	REFLECTIVE	TEMPORARY PAVEMENT	SHORT TERM	WORK ZONE PAVEMENT				
STA	ТО	STA	DIRECTION	YEL	LOW	WHITE	MARKERS*	PAVEMENT MARKERS	MARKING LINE	PAVEMENT MARKING	MARKING				
			NB/SB	SOLID	SKIP DASH	SOLID	AMBER	REMOVAL	- 4"		REMOVAL				
				FOOT	FOOT	FOOT	EACH	EACH	FOOT	FOOT	SQ FT				
215+19.00	ТО	238+16.57	вотн	4596		4596	58	58	9192	418	3134				
238+16.57	ТО	247+24.02	SB	908	230	1816	23	23	2954	165	1013				
	SI	JB TOTAL:		5504	230	6412	81	81	12146	583	4147				
		TOTAL:		57	'34	6412	81	81	12146	583	4147				

<sup>\*</sup>RRPM'S SHALL BE SPACED @ 40' CENTERS TO MATCH EXISTING.

						RESURFACI	NG SCHEDUL	_E					
STA.	ТО	STA.	HMA SURFACE COURSE, MIX D, N70, 1 1/2"	BITUMINOUS MATERIAL (PRIME COAT)	HMA SURFACE REMOVAL 1 1/2"	HMA SHOULDERS, 8"	PAVEMENT REMOVAL*	SUBBASE GRANULAR MATERIAL, TYPE B	PAVED SHOULDER REMOVAL	AGGREGATE WEDGE SHOULDER, TYPE B	EARTH EXCAVATION	SHOULDER RUMBLE STRIPS, 8"	CENTERLINE RUMBLE STRIPS, 16"
			TON	POUND	SQ YD	SQ YD	SQ YD	TON	SQ YD	TON	CU YD	FOOT	FOOT
215+19.00	ТО	220+78.00	118	631	1403								559
220+78.00	ТО	221+80.27	21	113	250	35		2	12	2	10	103	103
221+80.27	ТО	226+27.00	92	492	1093	298		16	100	16	50	894	447
226+27.00	ТО	226+77.00	11	55	123	34		2	12		10	100	50
226+77.00	ТО	231+17.26	91	485	1077	294		16	98	16	50	882	441
231+17.26	ТО	238+06.47	142	759	1685	460	9	24	154	24	70	1380	690
238+06.47	ТО	238+26.47	5	22	49	13	13						20
238+26.47	ТО	247+24.02	185	988	2195	599	9	32	200	32	90	1796	898
Т	OTAL	_ 0	665	3545	7875	1733	31	92	576	90	280	5155	3208

NOTE: FROM STA 220+78.00 TO STA. 221+80.27 ALL WORK RELATED TO THE SHOULDERS SHALL ONLY BE PERFORMED ON THE RIGHT SIDE.

\* PAVEMENT REMOVAL AT JEFFERSON RD FROM STA 237+81.47 TO STA 238+51.47. SEE DETAIL.

FILE NAME =	USER NAME = nievesa	DESIGNED -	REVISED -					F.A.P RTF	SECTION	COUNTY	TOTAL SHEET
c:\pw_work\pwidot\nievesa\dØ418617\d876	76-plan.dgn	DRAWN -	REVISED -	STATE OF ILLINOIS	SCHEDULES			678	52-I	ST. CLAIR	12 9
	PLOT SCALE = 100.0000 '/ in.	CHECKED -	REVISED -	DEPARTMENT OF TRANSPORTATION							T NO. 76H79
	PLOT DATE = 3/18/2015	DATE -	REVISED -		SCALE: NTS	SHEET NO. OF SHEETS STA.	TO STA.	FED. ROAD D	IST. NO. ILLINOIS FED. A	ID PROJECT	

	GRADING & EROSION CONTROL SCHEDULE													
STA	ТО	STA	L/R	GRADING & SHAPING DITCHES	EROSION CONTROL BLANKET	SEEDING, CLASS 2	NITROGEN FERTILIZER NUTRIENT	PHOSPHORUS FERTILIZER NUTRIENT	POTASSIUM FERTILIZER NUTRIENT					
				FOOT	SQ YD	ACRE	POUND	POUND	POUND					
221+80	ТО	222+85	R	105	130	0.1	3	3	3					
222+85	TO	230+17	R	732	991	0.2	19	19	19					
230+17	TO	231+17	ВОТН	200	217	0.1	5	5	5					
231+17	ТО	233+02	R	185	128	0.1	3	3	3					
233+02	TO	235+37	ВОТН	470	456	0.1	9	9	9					
235+37	ТО	238+17	R	280	269	0.1	6	6	6					
238+17	ТО	239+82	ВОТН	330	214	0.1	4	4	4					
239+82	ТО	240+24	L	42	43	0.1	1	1	1					
		TOTAL:		2344	2448	0.9	50	50	50					

	GUARDRAIL SCHEDULE													
STA	TA TO STA		L/R	LENGTH	SPBGR, TYPE A	LONG-SPAN GUARDRAIL OVER CULVERT, 12FT GIN SPAN	TRAFFIC BARRIER TERMINAL, TYPE 1 (SPECIAL) TANGENT	TERMINAL MARKERS, DIRECT APPLIED	GUARDRAIL MARKERS, TYPE A					
				FOOT	FOOT	FOOT	EACH	EACH	EACH					
224+58.25	ТО	225+70.75	R	112.5	62.5		1	1	2					
225+70.75	ТО	227+33.25	R	162.5		162.5			3					
227+33.25	TO	228+08.25	R	75.0	25.0		1	1	1					
225+08.25	TO	225+70.75	L	62.5	12.5		1	1	1					
225+70.75	ТО	227+33.25	L	162.5		162.5			3					
227+33.25	TO	228+45.75	L	112.5	62.5		1	1	2					
		ТОТА	L		162.5	325.0	4	4	12					

HMA ENTRANCE SCHEDULE												
STATION	RT/LT	LENGTH	WIDTH	HMA SURFACE REMOVAL - BUTT JOINT	BITUMINOUS MATERIAL (PRIME COAT)	INCIDENTAL HMA SURFACING						
		FT	FΤ	SQ YD	POUND	TON						
231+82.61	RT	7.5	14.5	13	6	1						
241+86.22	LT	7.5	19	16	8	1						
244+50.33	LT	7.5	21	18	8	1						
245+55.97	245+55.97 LT		11.5	10	5	1						
	TOTA	L		57	27	4						


TEMPORARY RAMP SCHEDULE									
INCIDENTAL HMA SURFACING									
SQ YD									
12.2									
12.2									
24.4									

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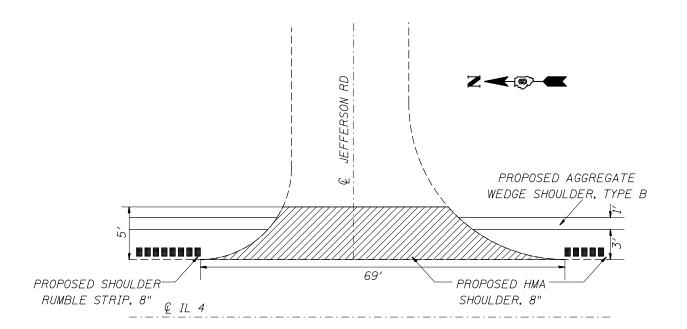
STATE	E 01	F ILLINOIS
DEPARTMENT	0F	TRANSPORTATION


	CONTOUR FO								COUNTY	TOTAL SHEETS	SHEET NO.
	SCHEDULES							!-I	ST. CLAIR	12	10
									CONTRACT	NO. 7	76H79
SCALE: NTS	SHEET NO.	OF	SHEETS	STA.	TO STA.	FED. R	DAD DIST. NO.	ILLINOIS FED. A	ID PROJECT		-

# CENTERLINE RUMBLE STRIP DETAIL

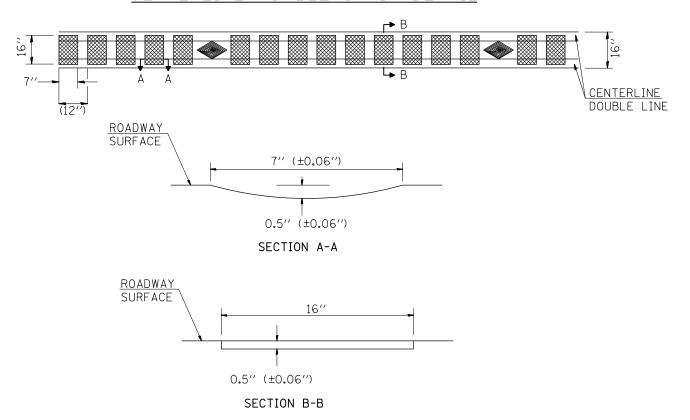

NOTE: THE PROPOSED CENTERLINE PAVEMENT MARKINGS SHALL BE PLACED AFTER THE CONSTRUCTION OF THE RUMBLE STRIP. RUMBLE STRIP IS TO BE SPACED BETWEEN RAISED REFLECTIVE PAVEMENT MARKERS.



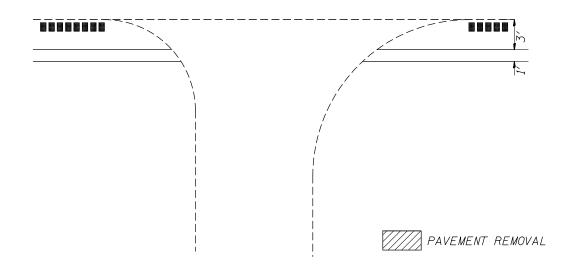


# PAVED SHOULDER DETAIL E OF JEFFERSON RD. STA. 238+16.47


NOTE: PAVEMENT STRUCTURE ON JEFFERSON RD IS UNKNOWN.

## NOT TO SCALE

# NOT TO SCALE

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	:\pw_work\pwidot\nievesa\dØ418617\d876H	76-plan.dgn	DRAWN -	REVISED -	STATE OF ILLINOIS				TAIL SHEET		678	52-I		ST. CLAIR		11
		PLOT SCALE = 100.0000 '/ in.	CHECKED -	REVISED -	DEPARTMENT OF TRANSPORTATION									CONTRACT		6H79
		PLOT DATE = 3/18/2015	DATE -	REVISED -		SCALE: NTS	SHEET NO.	0F	SHEETS STA.	TO STA.	FED. ROA	AD DIST. NO. ILLI	INOIS FED. AID			

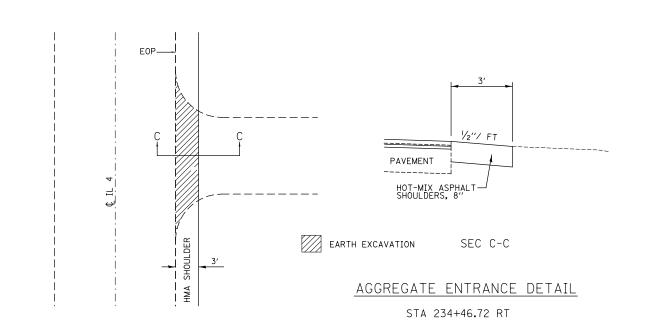

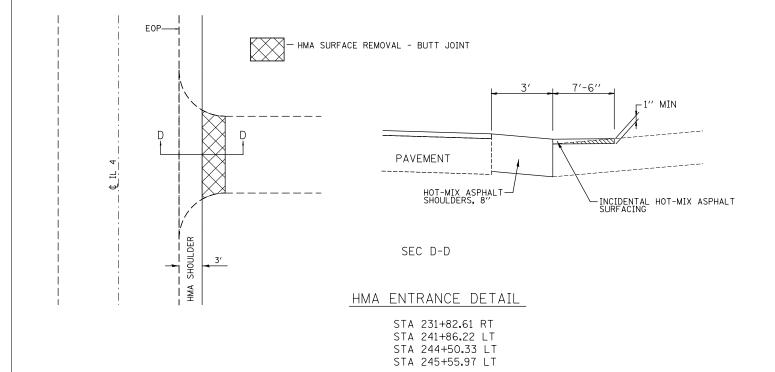

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		PLOT SCALE = 100.00000 '/ in.	CHECKED -	REVISED -	DEPARTMENT OF TRANSPORTATION								92 /	-	CONTRACT	NO. 7	6H79
		PLOT DATE = 3/18/2015	DATE -	REVISED -		SCALE: NTS	SHEET NO.	OF	SHEETS	STA.	TO STA.	FED. RO	DAD DIST. NO. IL	LINOIS FED. AI			