06-12-2015 LETTING ITEM 127

FOR INDEX OF SHEETS, SEE SHEET NO. 2

0

0

0

STATE OF ILLINOIS

DEPARTMENT OF TRANSPORTATION

DIVISION OF HIGHWAYS

PROPOSED HIGHWAY PLANS

VARIOUS ROUTES
SECTION DIST 8 GUARDRAIL 2016-1
SAFETY ITEM REPAIR
VARIOUS COUNTIES

C-98-005-15

100' 200' 300' — 1" = 100'
10' 20' 30' — 1" = 10'

50' 100' 1" = 50'

50' 100' 1" = 40'

50' 100' — 1" = 30'


- 1" = 20'

FULL SIZE PLANS HAVE BEEN PREPARED USING STANDARD ENGINEERING SCALES. REDUCED SIZED PLANS WILL NOT CONFORM TO STANDARD SCALES. IN MAKING MEASUREMENTS ON REDUCED PLANS, THE ABOVE SCALES MAY BE USED.

J.U.L.I.E.
JOINT UTILITY LOCATION INFORMATION FOR EXCAVATION
1-800-892-0123
OR 811

PROJECT ENGINEER: PATTI LeBEAU 618-346-3179
PROJECT DESIGNER: KAREN CHALLANDES 618-346-3329

CONTRACT NO. 76H52

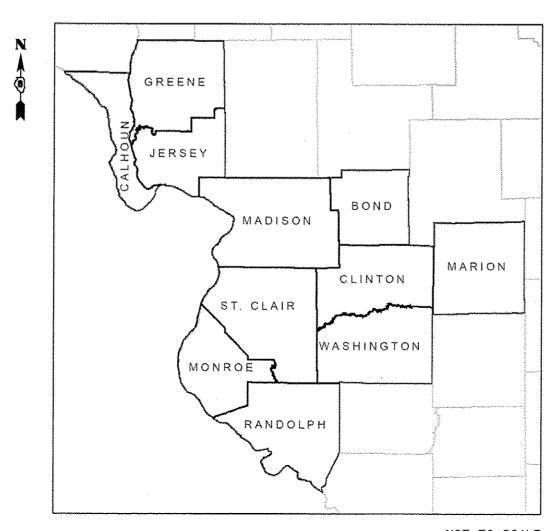

NOT TO SCALE


RTE. SECTION COUNTY TOTAL SHEET NO.

VARIOUS DIST 8 GUARDRAIL 2016-1 VARIOUS 12 1

SILINOIS CONTRACT NO. 76H52

D-98-008-15



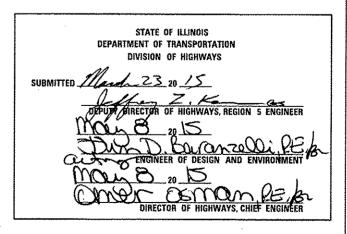

PRINTED BY THE AUTHORITY OF THE STATE OF ILLINOIS

GENERAL NOTES

- 1. BEFORE ORDERING THE IMPACT ATTENUATORS, THE CONTRACTOR MUST CONTACT THE OPERATIONS FIELD ENGINEER AT (618) 346-3279 OR (618) 346-3233 TO RECEIVE APPROVAL OF THE PROPOSED INSTALLATION.
- 2. ALL WORK IS TO BE REPLACED IN KIND OR AS INDICATED ON THE CONTRACT PLANS AND PROVISIONS.
- 3. THE LOCATIONS OF THE REPAIR AREAS SHALL BE DETERMINED BY THE ENGINEER.
- 4. GUARDRAIL WORK WILL INCLUDE ALIGNMENT AS NECESSARY TO RESTORE THE RAIL AND POST TO THE ORIGINAL CONDITIONS.
- 5. NO MATERIAL SHALL BE LEFT ON OR NEAR THE ROADWAY DURING NON-WORKING HOURS.
- 6. ANY NECESSARY TRAFFIC CONTROL WILL BE PROVIDED BY THE CONTRACTOR; APPROPRIATE STANDARDS ARE LISTED IN THE PLANS AND CONTRACT DOCUMENTS.
- 7. THE LIMITS OF THE DAMAGED GUARDRAIL WILL BE MARKED WITH PAINT. THE REPLACEMENT PARTS AND THE QUANTITIES INDICATED ARE WITHIN THESE LIMITS AS MARKED.
- 8. GUARDRAIL MARKERS SHALL NOT BE ATTACHED TO TERMINAL SECTIONS. ALL OTHER MARKERS SHALL BE PLACED AT THE DISCRETION OF THE ENGINEER. COST OF MARKERS TO BE INCLUDED IN THE GUARDRAIL PAY ITEMS.
- 9. ILLINOIS STATE LAW REQUIRES A 48-HOUR NOTICE TO BE GIVEN TO UTILITIES BEFORE DIGGING. FIELD MARKING OF FACILITIES MAY BE OBTAINED BY CONTACTING J.U.L.I.E. (PHONE: 800-892-0123) OR FOR NON-MEMBER, THE UTILITY COMPANY DIRECTLY.
- 10. WHEN NO WORK IS BEING PERFORMED, THE FLAGGERS WILL NOT BE REQUIRED. IF THE FLAGGERS ARE NOT PRESENT, THE FLAGGER SIGNS SHALL BE REMOVED OR COVERED.
- 11. PRIOR TO ORDERING ANY MATERIALS, THE CONTRACTOR SHALL CONFIRM THE TYPES AND SPECIFIC MANUFACTURER FOR THE GUARDRAIL AND CABLE REPAIRS REQUIRED.
- 12. 45 AND 55 MPH SIGNS ARE INCLUDED IN ALL INTERSTATE LANE CLOSURES. IF THE LANE CLOSURE DURATION IS LESS THAN 4 HOURS, THE 45 AND 55 MPH SIGNS ARE NOT REQUIRED.
- 13. ANY WORK ORDER MAY BE CANCELED AT THE ENGINEER'S DISCRETION.
- 14, CORTEN ITEMS SHALL BE PAID FOR THE SAME AS REGULAR ITEMS.
- 15. NO OVERNIGHT LANE CLOSURES WILL BE ALLOWED.
- 16. ARTICLE 701.20 OF THE STANDARD SPECIFICATIONS DISCUSSES AN ADJUSTED UNIT PRICE. NO ADJUSTMENTS SHALL BE MADE TO THE TRAFFIC CONTROL PAY ITEMS FOR THIS CONTRACT.
- 17. THE CONTRACTOR SHALL BE ADVISED THAT THE GUARDRAIL PAY ITEMS INCLUDED IN THE PLANS MAY BE USED TO REPLACE/REPAIR SPBGR AND TRAFFIC BARRIER TERMINALS FOR EITHER THE CURRENT MIDWEST STYLES AS SHOWN IN THE HIGHWAY STANDARDS OR SPBGR AND TRAFFIC BARRIER TERMINALS INSTALLED PRIOR TO JANUARY 1, 2007 AS SHOWN IN THE PLAN DETAILS. NO ADDITIONAL COMPENSATION WILL BE ALLOWED FOR UTILIZING THE CURRENT MIDWEST STANDARDS.
- 18. THE DEPARTMENT STRONGLY ENCOURAGES THE PRIME CONTRACTOR AND THEIR APPROVED SUB-CONTRACTORS TO HIRE MINORITY, WOMEN AND DISADVANTAGED INDIVIDUALS FROM ITS FEDERALLY FUNDED HIGHWAY CONSTRUCTION CAREERS TRAINING PROGRAM (HCCTP) TO HELP MEET WORKFORCE AND TRAINEE GOALS. THIS PROGRAM IS TRAINING MINORITIES, WOMEN AND DISADVANTAGED INDIVIDUALS IN HIGHWAY CONSTRUCTION-RELATED SKILLS, E.G., MATH FOR THE TRADES, JOB READINESS, TECHNICAL SKILLS COURSEWORK (CARPENTRY, CONCRETE FLATWORK, BLUEPRINT READING, SITE PLANS, SITE WORK, TOOLS USE, ETC.) AND OSHA 10 HOUR CERTIFICATION, TO PREPARE THEM FOR A CAREER IN THE HIGHWAY CONSTRUCTION TRADES. GRADUATES ARE WELL-TRAINED AND READY TO BECOME PRODUCTIVE ENTRY-LEVEL CONSTRUCTION WORKERS. CONTACT THE DISTRICT EEO OFFICE AT 618-346-3360 AND/OR THE HCCTP COORDINATOR AT 618-874-6528 TO LEARN MORE ABOUT THE PROGRAM AND FOR ASSISTANCE IN MEETING WORKFORCE AND TRAINEE GOALS.

INDEX OF SHEETS

- COVER SHEET
- 2. GENERAL NOTES, INDEX OF SHEETS STANDARDS. AND COMMITMENTS
- 3.-5. SUMMARY OF QUANTITIES
- HIGH TENSION CABLE LOCATION MAP
- 7.-12. GUARDRAIL DETAILS

COMMITMENTS NONE

STANDARDS

000001-06	701106-02
630001-10	701201-04
630101-09	701301-04
630301-06	701400-08
631006-08	701406-09
631011-09	701421-07
631026-06	701428
631031-13	701456-03
635001-01	701501-06
635006-03	701502-06
636001-02	701601-09
701001-02	701602-07
701006-05	701606-10
701011-04	701701-09
701101-04	701901-04

	FILE NAME =	USER NAME = phallandoska	DESIGNED -	REVISED -
	oz\p=_uprk\psidot\ohallandaska\d8407335	76H52-gennote.dgn	DRAWN ~	REVISED -
-		PLOT SCALE = 100.0000 '/ 17.	CHECKED -	REVISED -
	#MODELNAME#	PLOT DATE = 3/18/2015	DATE -	REVISED -

STATE OF ILLINOIS
DEPARTMENT OF TRANSPORTATION

	GENE	RAL NO	TES, INDE	X OF	SHEETS	
	STA	NDARDS	, AND CO	MMIT	MENTS	
ALE: NONE	SHEET	0F	SHEETS	STA.	1	ř

F.A. RTE.			SECTION		COUNTY	TOTAL SHEETS	SHEET NO.
VARIOUS	DIST	8	GUARDRAIL	2016-1	VARIOUS	12	2
					CONTRACT	NO. 7	6H52
			HLINOIS	FEQ. AND	PROJECT		

				COI	NSTRUCTION (CODE
CODE NO.	ITEM	UNIT	TOTAL OUANTITY	CONT. MAINT. 0021	MCHDF 0021	0021
63000350	LONG-SPAN GUARDRAIL OVER CULVERT, 12 FT 6 IN SPAN	FOOT	162. 5	162.5		Tables of the Control
63100041	TRAFFIC BARRIER TERMINAL, TYPE 18	EACH	2		2	
63100045	TRAFFIC BARRIER TERMINAL, TYPE 2	EACH	7	4	3	
63100070	TRAFFIC BARRIER TERMINAL, TYPE 5	EACH	5	4	1	
63100085	TRAFFIC BARRIER TERMINAL, TYPE 6	EACH	9	8	1	
63100167	TRAFFIC BARRIER TERMINAL, TYPE 1 (SPECIAL) TANGENT	EACH	83	65	18	
63100169	TRAFFIC BARRIER TERMINAL, TYPE 1 (SPECIAL) FLARED	EACH	25	5	20	
64300260	IMPACT ATTENUATORS (FULLY REDIRECTIVE, NARROW). TEST LEVEL 3	EACH	5	3	2	
64300370	IMPACT ATTENUATORS (FULLY REDIRECTIVE, WIDE), TEST LEVEL 3	EACH	5	3	2	
67100100	MOBILIZATION	L SUM	1	0.33	0. 34	0, 33
X0325972	CABLE GUARD POST	EACH	340			340
X0326466	HIGH TENSION CABLE POST REPAIR	EACH	80			80
X0326468	MEDIAN CABLE	FOOT	300			300
X6300210	GUARDRAIL BLOCKS	EACH	785	400	385	
14						

FILE NAME =	USER NAME = challandeaka	DESIGNED ~	REVISED -
a:\p=_vork\pv:dat\shallendeske\d0407335	78H52-S00.dgn	DRAWN -	REVISED -
	PLOT SCALE * 100.0000 ' / in.	CHECKED -	REVISED -
#MODELNAME#	PLOT DATE * 3/19/2015	DATE -	REVISED -

STATE OF ILLINOIS
DEPARTMENT OF TRANSPORTATION

***************************************			SUMM/	ARY OF QUANTITI	ES	F.A. RTE,		SECTION		COUNTY	TOTAL	SHEET NO.
***************************************						VARIOUS	DIST	8 GUARDRAIL	2016-1	VARIOUS	12	3
										CONTRAC	T NO.	76H52
J	SCALE: NONE	SHEET	OF	SHEETS STA.	TO STA.			ILLINOIS	FED. ATC	PROJECT		

				CON	STRUCTION C	ODE
CODE NO.	ITEM	UNIT	TOTAL QUANTITY	CONT. MAINT. 0021	MCHDF 0021	HTMCB 0021
X6300215	RAIL ELEMENT PLATES	EACH	510	200	310	
X6300217	RAIL ELEMENT PLATES (RADIUS)	EACH	50	25	25	
X6300220	EXTRUDER HEAD	EACH	15	10	5	
X6300225	SINGLE END SECTION	EACH	3	2	1	
X6300231	STEEL POST, ATTACHED TO STRUCTURES	EACH	7	3	4	
X6300236	STEEL POSTS 6'	EACH	625	300	325	
X6300239	STEEL POSTS 9'	EACH	250	100	150	
X6331110	STEEL POSTS, SPECIAL	EACH	12	10	2	
X6430210	REMOVE AND REINSTALL IMPACT ATTENUATORS	EACH	85	20	65	
X7010410	SPEED DISPLAY TRAILER	CAL MO	1	1		
X7011834	TRAFFIC CONTROL AND PROTECTION, CALL OUT WORK	EACH	296	176	120	
X7011836	TRAFFIC CONTROL AND PROTECTION, FREEWAY/EXPRESSWAY, CALL OUT WORK	EACH	275	175	100	And a second sec
X8030110	LOCATING UNDERGROUND CABLE, SPECIAL	EACH	7	5	2	
	HIGH TENSION CABLE ROAD GUARDPOST	EACH	825			825

* SPECIALTY ITEM

1	FILE NAME =	USER NAME = ahallandoska	DESIGNED ~	REVISED -	
1	st\pv.work\pvidot\ehallandaska\d84Ø7335	78H52-S0D.dgn	DRAWN ~	REVISED -	
1		PLOT SCALE # 100.0000 ' / 10.	CHECKED -	REVISEO -	
1	#MODELNAME#	PLOT DATE > 3/19/2015	DATE -	REVISED -	

STATE OF ILLINOIS
DEPARTMENT OF TRANSPORTATION

SUMMARY OF QUANTITIES					F.A. RTE.		SECTION		COUNTY	TOTAL	SHEET NO.			
								VARIOUS	IST 8	GUARDRAIL	2016-1	VARIOUS	12	4
	,											CONTRACT		76H52
SCALE: NONE	SHEET	0F	SHEETS	STA.	TO	STA.				ILLINOIS		PROJECT		

CODE NO. 1 TEM UNIT OUNTITY OO21 0021 0021 0021 OO21 0021 0021 OO21 0021 0021 OO21 0021 OO22 0020 OO22 0020 0020 0020 0020 00		•			0011	STRUCTION C	11 0005		
CODE NO. TITEM	*				and the state of t		nder block make		
CODE NO. TITEM					COUT MALUE	Monut	11000		
NO. STEM	0005			T07.1					
70029957 HIGH TENSION CABLE SYSTEM MAINTENANCE EACH 35				f	0021	0021	0021		
14 65 15 16 16 17 18 18 18 18 18 18 18	NO.	ITEM	UNIT	QUANTITY					
14 65 15 16 16 17 18 18 18 18 18 18 18									
14 65	Z0029657	HIGH TENSION CABLE SYSTEM MAINTENANCE	EACH	35	ACT AND		35		
10029662 REPLACE HIGH TENSION CABLE GUARDHOST FOUNDATION EACH 9 9 9 9 9 9 9 9 10029662 REPLACE HIGH TENSION CABLE GUARDHOST FOUNDATION EACH 84 44 40 40 40 40 40 40						***************************************			
0052410 REFAIR TRAFFIC BARRIER TERMINAL, TYPE : SPECIAL (TANGENT) EACH 84 44 40 0 0 0 0 0 0 0 0 0 0 0 0 0 0 0	Z0029658	REPAIR TRAFFIC BARRIER TERMINAL TYPE 1 SPECIAL - POST	EACH	79	14	65			
0052410 REFAIR TRAFFIC BARRIER TERMINAL, TYPE : SPECIAL (TANGENT) EACH 84 44 40 0 0 0 0 0 0 0 0 0 0 0 0 0 0 0			a de la companya de l		ALL AND				
12 10 2 2 2 2 2 2 2 2 2	Z0029662	REPLACE HIGH TENSION CABLE GUARDPOST FOUNDATION	EACH	9	All Harden		9		
12 10 2 2 2 2 2 2 2 2 2					de la companya de la				
CO052600 REPAIR TRAFFIC BARRIER TERMINAL, TYPE 2 EACH 9 5 4 4	Z0052410	REPAIR TRAFFIC BARRIER TERMINAL, TYPE 1 SPECIAL (TANGENT)	EACH	84	44	40			
CO052600 REPAIR TRAFFIC BARRIER TERMINAL, TYPE 2 EACH 9 5 4 4	**************************************								
CO052600 REPAIR TRAFFIC BARRIER TERMINAL, TYPE 2 EACH 9 5 4 4	Z0052415	REPAIR TRAFFIC BARRIER TERMINAL. TYPE 1 SPECIAL (FLARED)	EACH	12	C	2			
CO052800 REPAIR TRAFFIC BARRIER TERMINAL, TYPE 3A EACH 7 5 2 CO053000 REPAIR TRAFFIC BARRIER TERMINAL, TYPE 5 EACH 4 2 2 CO053200 REPAIR TRAFFIC BARRIER TERMINAL, TYPE 6 EACH 7 5 2 CO053200 REPAIR TRAFFIC BARRIER TERMINAL TYPE 1 SPECIAL - RAIL ELEMENT PLATE EACH 27 7 20 CO053660 REPAIR TRAFFIC BARRIER TERMINAL TYPE 1 SPECIAL - RAIL ELEMENT PLATE		·	and the second s			····	<u> </u>		
CO052800 REPAIR TRAFFIC BARRIER TERMINAL, TYPE 3A EACH 7 5 2 CO053000 REPAIR TRAFFIC BARRIER TERMINAL, TYPE 5 EACH 4 2 2 CO053200 REPAIR TRAFFIC BARRIER TERMINAL, TYPE 6 EACH 7 5 2 CO053200 REPAIR TRAFFIC BARRIER TERMINAL TYPE 1 SPECIAL - RAIL ELEMENT PLATE EACH 27 7 20 CO053660 REPAIR TRAFFIC BARRIER TERMINAL TYPE 1 SPECIAL - RAIL ELEMENT PLATE	Z0052600	REPAIR TRAFFIC BARRIER TERMINAL. TYPE 2	EACH	9	5	4			
20053000 REPAIR TRAFFIC BARRIER TERMINAL, TYPE 5 EACH 4 2 2 00053200 REPAIR TRAFFIC BARRIER TERMINAL, TYPE 6 EACH 7 5 2 00053660 REPAIR TRAFFIC BARRIER TERMINAL TYPE 1 SPECIAL - RAIL ELEMENT PLATE EACH 27 7 20									
20053000 REPAIR TRAFFIC BARRIER TERMINAL, TYPE 5 EACH 4 2 2 00053200 REPAIR TRAFFIC BARRIER TERMINAL, TYPE 6 EACH 7 5 2 00053660 REPAIR TRAFFIC BARRIER TERMINAL TYPE 1 SPECIAL - RAIL ELEMENT PLATE EACH 27 7 20	70052800	REPAIR TRAFFIC BARRIER TERMINAL TYPE 34	FACH	7	5	2			
0053200 REPAIR TRAFFIC BARRIER TERMINAL, TYPE 6 EACH 7 5 2 0059660 REPAIR TRAFFIC BARRIER TERMINAL TYPE 1 SPECIAL - RAIL ELEMENT PLATE EACH 27 7 20		THE WAY THAT TO BANTER TERMINAL THE SA		<u> </u>	3				
0053200 REPAIR TRAFFIC BARRIER TERMINAL, TYPE 6 EACH 7 5 2 0059660 REPAIR TRAFFIC BARRIER TERMINAL TYPE 1 SPECIAL - RAIL ELEMENT PLATE EACH 27 7 20	Z0053000	REPAIR TRAFFIC BARRIER TERMINAL. TYPE 5	FACH	4	2	2			
0059660 REPAIR TRAFFIC BARRIER TERMINAL TYPE I SPECIAL - RAIL ELEMENT PLATE EACH 27 7 20	***************************************								
0059660 REPAIR TRAFFIC BARRIER TERMINAL TYPE I SPECIAL - RAIL ELEMENT PLATE EACH 27 7 20	70053200	REPAIR TRAFFIC BARRIER TERMINAL. TYPE 6	FACH	7	т.	2	4		
				-					
	Z0059660	REPAIR TRAFFIC BARRIER TERMINAL TYPE 1 SPECIAL - RAIL ELEMENT PLATE	EACH	27	7	20			
	···········								
			***************************************	· · · · · · · · · · · · · · · · · · ·					
	***************************************		The second secon						
	·		Arminist Company						

					<u></u>				


O'


FILE NAME =	USER NAME = challendaska	DESIGNED -	REVISED -
or\pw,work\pwidot\challandaaka\d0497335	76H52~600.dgn	DRAWN ~	REVISED -
	PLOT SCALE = 186.8808 '/ in.	CHECKED -	REVISED -
MODELNAME	PLOT DATE # 3/19/2015	DATE -	REVISED -


STATE OF ILLINOIS
DEPARTMENT OF TRANSPORTATION

CONSTRUCTION CODE


		SUMMAI	RY OF Q	UANTITI	ES		F.A. RTE.		SECTI)N		COUNTY	TOTAL	SHEET NO.
							VARIOUS	DIST 8	B GUAROF	AIL	2016-1	VARIOUS	12	5
												CONTRACT	NO.	76H52
CALE: NONE	SHEET	0F	SHEETS	STA.	TO	STA.			1LL	NOIS	FED. AT	PROJECT		

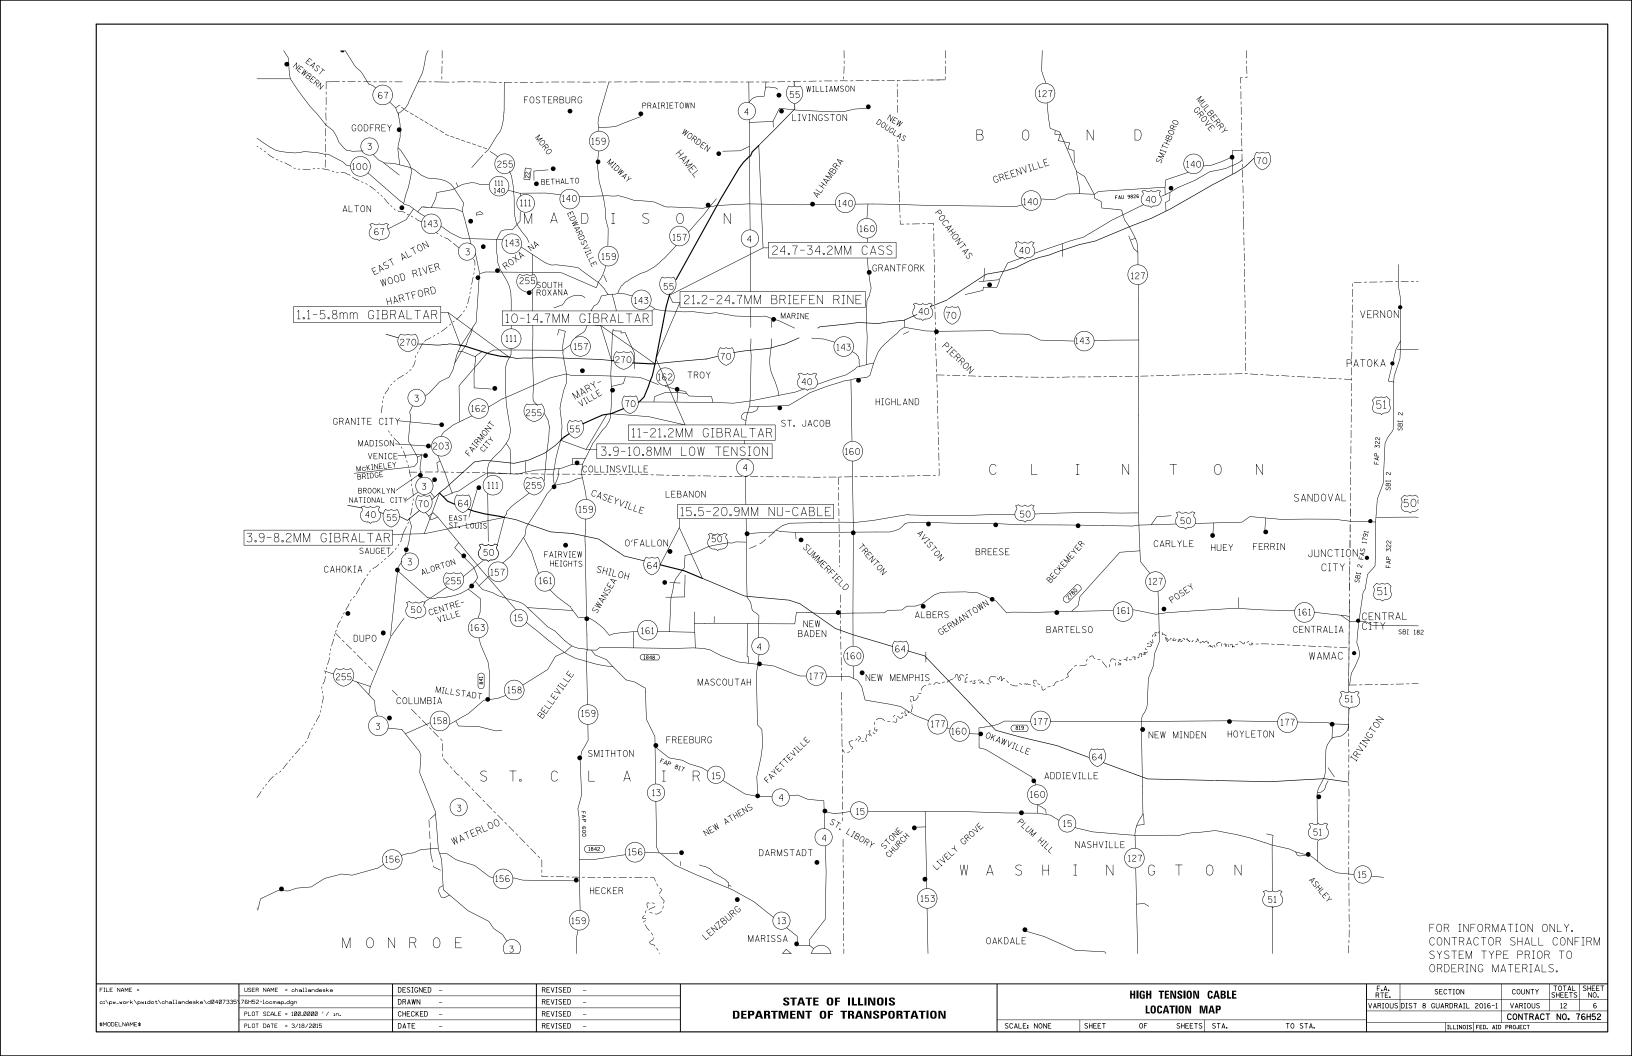


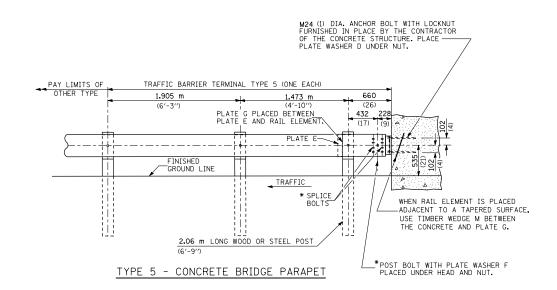

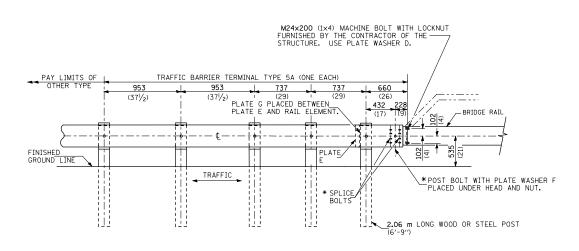

TYPE 5A - STEEL BRIDGE RAIL

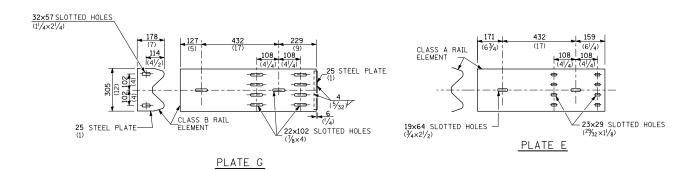

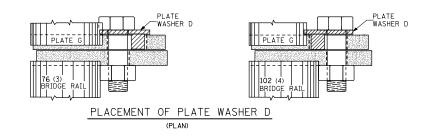



GENERAL NOTES

INSTALL PLATE WASHER D SO THAT THE 25 mm (1") PROJECTION FILLS THE REMAINDER OF THE SLOTTED HOLES IN THE 25 mm (1") END PLATE ON PLATE G AFTER THE M24 (1") DIA. BOLTS ARE IN PLACE.

* BOLTS SHALL BE PROVIDED WITH LOCKNUT OR DOUBLE NUT AND SHALL BE TIGHTENED ONLY TO A POINT THAT WILL ALLOW PLATE G TO BE FREE TO MOVE WHEN AN EXPANSION JOINT EXISTS BELOW THE CONNECTOR.


ALL DIMENSIONS ARE IN MILLIMETERS (INCHES) UNLESS OTHERWISE SHOWN.

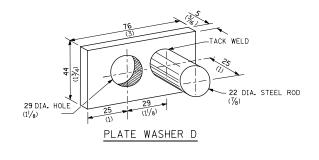

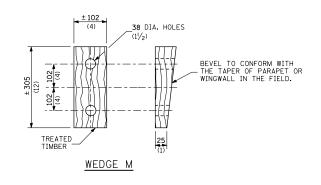


FILE NAME =		USER NAME = challandeske	DESIGNED -	REVISED -			TRAFFIC BARRIER TERMINAL		F.A.	SECTION	COUNTY	TOTAL SHEET
c:\pw_work\pwidot\c	challandeske\dØ4Ø7335	76H52-details.dgn	DRAWN -	REVISED -	STATE OF ILLINOIS				VARIOUS DIST	8 GUARDRAIL 2016-1	VARIOUS	12 7
		PLOT SCALE = 100.0000 '/ in.	CHECKED -	REVISED -	DEPARTMENT OF TRANSPORTATION	TYPE 5 & 5A			CONTRACT NO. 76H			
\$MODELNAME\$		PLOT DATE = 3/18/2015	DATE -	REVISED -		SCALE: NONE	SHEET 1 OF 1 SHEETS STA.	TO STA.		ILLINOIS FED. AID	PROJECT	



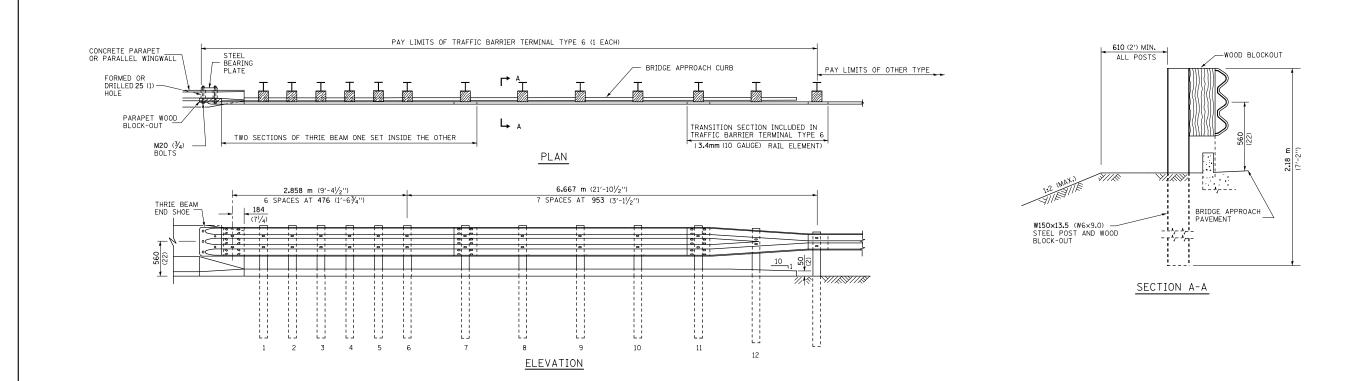

OTHER CONCRETE STRUCTURE

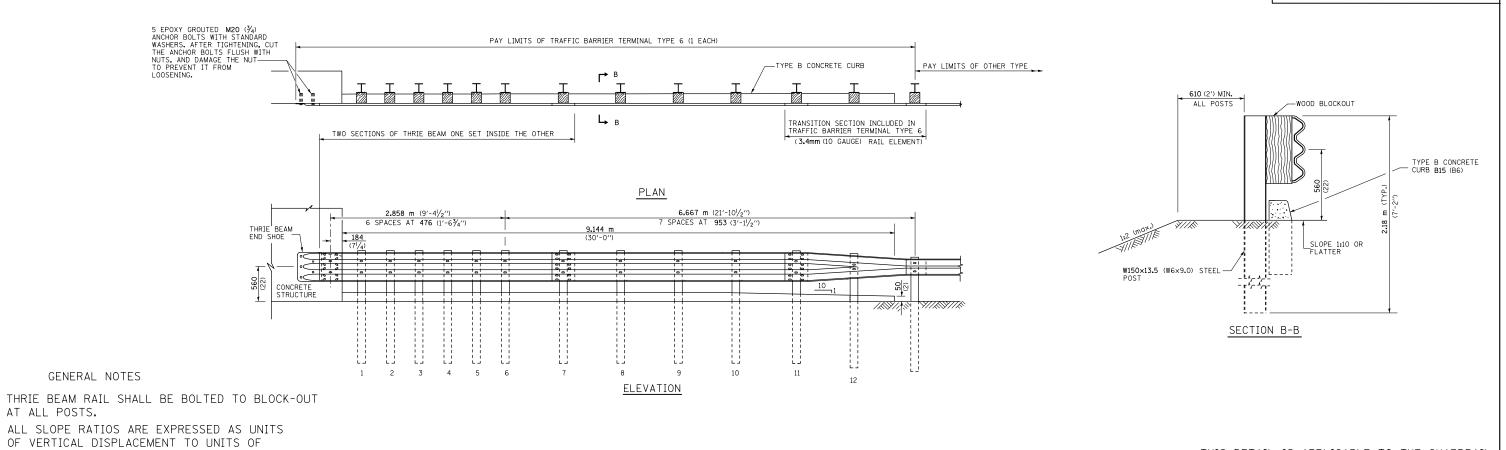


ALL DIMENSIONS ARE IN MILLIMETERS (INCHES)
UNLESS OTHERWISE SHOWN.


FILE NAME = USER NAME = challandeske DESIGNED - REVISED -


HORIZONTAL DISPLACEMENT (V:H).

FILE NAME =	USER NAME = challandeske	DESIGNED -	REVISED -			TRAFFIC BARRIER		RTF.	SECTION	COUNTY SHEETS NO.
c:\pw_work\pwidot\challandeske\d0407335\	.76H52-details.dgn	DRAWN -	REVISED -	STATE OF ILLINOIS				VARIOUS DIST	8 GUARDRATI 2016-1	VARIOUS 12 8
	PLOT SCALE = 100.00000 '/ in.	CHECKED -	REVISED -	DEPARTMENT OF TRANSPORTATION		TERMINAL, TYPE 6		77111200 5101	0 00////01/12 2010 1	CONTRACT NO. 76H52
\$MODELNAME\$	PLOT DATE = 3/18/2015	DATE -	REVISED -		SCALE: NONE	SHEET 1 OF 2 SHEETS STA.	TO STA.		ILLINOIS FED. AID	PROJECT

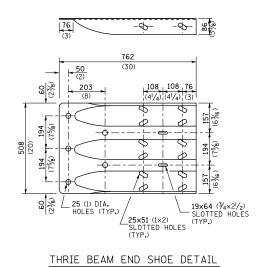

POSTS 1-11 WOOD BLOCKOUT DETAIL

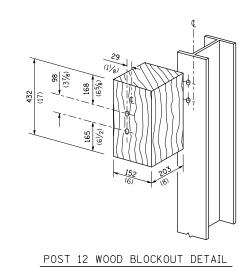

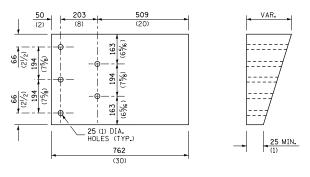


36 (1/2) (2/1) (1/2) (3/1) (1/2) (3/2) (


PARAPET WOOD BLOCK-OUT DETAIL


PARAPET STEEL BEARING PLATE DETAIL


(5 EACH INDIVIDUAL125×125×16 (5×5×5%) STEEL PLATES WITH CENTERED 25 (1) HOLES MAY BE SUBSTITUTED FOR THE PLATE SHOWN.)


FILE NAME =	USER NAME = challandeske	DESIGNED -	REVISED -		TRAFFIC BARRIER			F.A.	SECTION	COUNTY T	TOTAL SHEET
c:\pw_work\pwidot\challandeske\d0407335	76H52-details.dgn	DRAWN -	REVISED -	STATE OF ILLINOIS				VARIOUS DIST 8	GUARDRAIL 2016-1	VARIOUS	12 9
	PLOT SCALE = 100.00000 ' / in.	CHECKED -	REVISED -	DEPARTMENT OF TRANSPORTATION		TERMINAL, TYPE 6			CONTRACT NO. 76H5		
\$MODELNAME\$	PLOT DATE = 3/18/2015	DATE -	REVISED -		SCALE: NONE	SHEET 2 OF 2 SHEETS STA.	TO STA.	ILLINOIS FED. AID PRO			

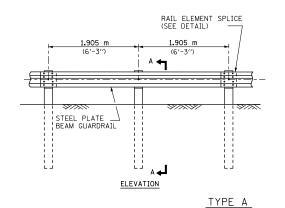

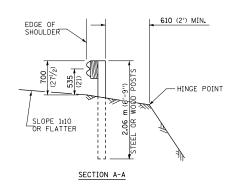


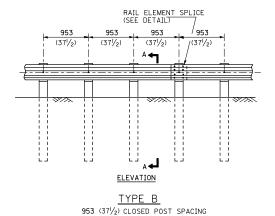


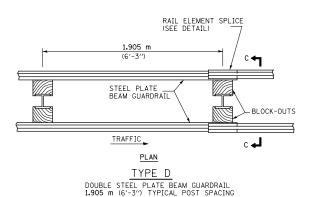


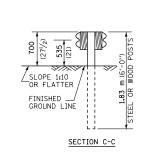



1.905 m (6'-3") TYPICAL POST SPACING

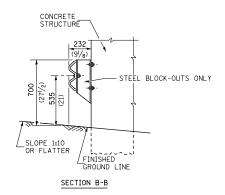

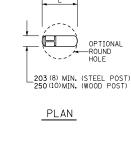

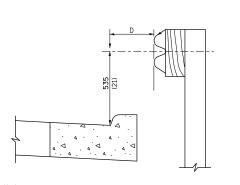

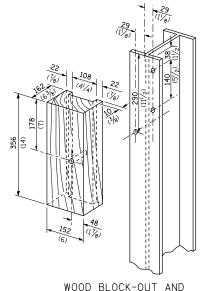

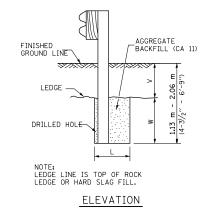

FOOTING FOR POST WHEN IMPERVIOUS
MATERIAL IS ENCOUNTERED

GUARDRAIL PLACED BEHIND CURB

(D = 0 DESIRABLE TO 300 (12) MAXIMUM)

IF IT IS NECESSARY FOR D TO BE MORE THAN 300 (12)AND LESS THAN 3.0 m (10'-0") TYPE M-5 (M-2)CURB AND GUTTER (STD. 606001) SHALL BE USED IN FRONT OF AND IN ADVANCE OF THE GUARDRAIL.

STEEL POST DETAILS


GENERAL NOTES

953 (371/2) BLOCK-OUT SPACING


ALL SLOPE RATIOS ARE EXPRESSED AS UNITS OF VERTICAL DISPLACEMENT TO UNITS OF HORIZONTAL DISPLACEMENT (V:H).

ALL DIMENSIONS ARE IN MILLIMETERS (INCHES) UNLESS OTHERWISE SHOWN.

THE EXISTING STEEL POSTS MAY BE DRILLED TO MATCH THE BOLT PATTERN SHOWN HEREIN FOR THE WOOD BLOCK-OUT, OR A NEW STEEL POST SHALL BE PROVIDED.

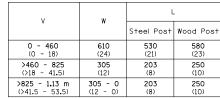




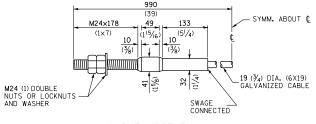



CABLE ASSEMBLY
(18,100 kg (40,000 LBS.) MIN. BREAKING STRENGTH)
TIGHTEN TO TAUT TENSION.

FILE NAME =	USER NAME = challandeske	DESIGNED -	REVISED -		STEEL PLATE BEAM GUARDRAIL	F.A. SECTION C	COUNTY TOTAL SHEET
c:\pw_work\pwidot\challandeske\d0407335	76H52-details.dgn	DRAWN -	REVISED -	STATE OF ILLINOIS	STEEL PEAN GOARDIALE	VARIOUS DIST 8 GUARDRAIL 2016-1 V	ARIOUS 12 10
	PLOT SCALE = 100.0000 '/ in.	CHECKED -	REVISED -	DEPARTMENT OF TRANSPORTATION		CO	NTRACT NO. 76H52
\$MODELNAME\$	PLOT DATE = 3/18/2015	DATE -	REVISED -		SCALE: NONE SHEET 1 OF 2 SHEETS STA. TO STA.	ILLINOIS FED. AID PRO	

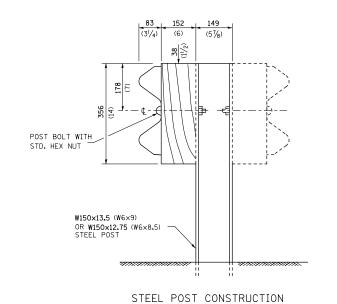

STEEL BLOCK-OUT DETAIL

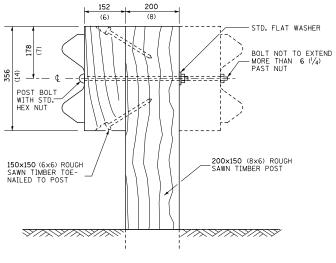

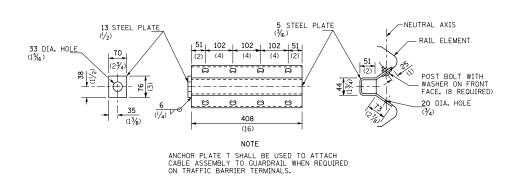

ANCHOR PLATE T DETAILS

WOOD POST CONSTRUCTION





NOTE


19 DIA. HOLE

PLATE A SHALL BE PLACED BETWEEN RAIL ELEMENT AND BLOCK-OUT AT NON-SPLICE MOUNTING POINTS ONLY WHEN STEEL BLOCK-OUTS ARE USED.

PLATE A

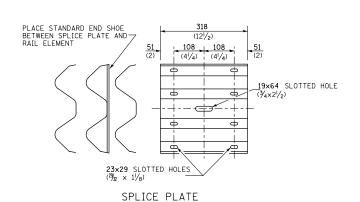

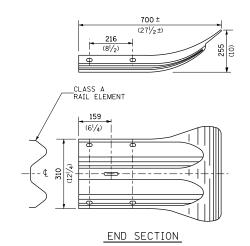

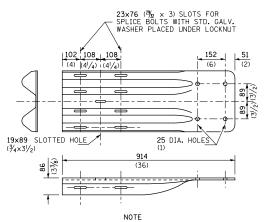


WHEN END SHOE IS ATTACHED TO A BRIDGE PARAPET WHICH HAS AN EXPANSION JOINT, THE BOLTS SHALL BE PROVIDED WITH A LOCKNUT OR DOUBLE NUT AND SHALL BE TIGHTENED ONLY TO A POINT THAT WILL ALLOW GUARDRAIL MOVEMENT.


THE STANDARD END SHOE SHALL BE ATTACHED TO THE CONCRETE WITH PRE-DRILLED OR SELF-DRILLING ANCHOR BOLTS. THE ANCHOR CONE SHALL BE SET FLUSH WITH THE SURFACE OF THE CONCRETE.


EXTERNALLY THREADED STUDS PROTRUDING FROM THE SURFACE OF THE CONCRETE WILL NOT BE PERMITTED.

END SHOE

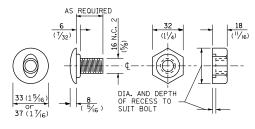


POST OR SPLICE BOLT & NUT

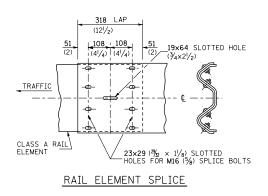


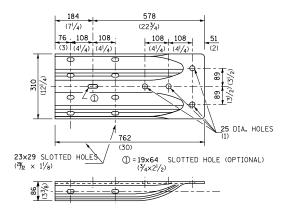



ALTERNATE END SHOE

FILE NAME =	USER NAME = challandeske	DESIGNED -	REVISED -		STEEL PLATE BEAM GUARDRAIL	F.A. SECTION COUNTY TOTAL SHEET
c:\pw_work\pwidot\challa	ndeske\d0407335\76H52-details.dgn	DRAWN -	REVISED -	STATE OF ILLINOIS	OTELL PEAN GOARDIAL	VARIOUS DIST 8 GUARDRAIL 2016-1 VARIOUS 12 11
	PLOT SCALE = 100.0000 '/ in.	CHECKED -	REVISED -	DEPARTMENT OF TRANSPORTATION		CONTRACT NO. 76H52
\$MODELNAME\$	PLOT DATE = 3/18/2015	DATE -	REVISED -	1	SCALE: NONE SHEET 2 OF 2 SHEETS STA. TO STA.	ILLINOIS FED. AID PROJECT

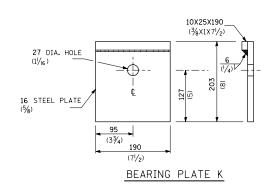

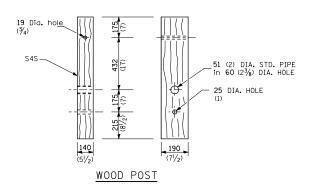

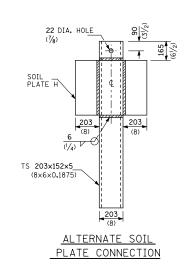

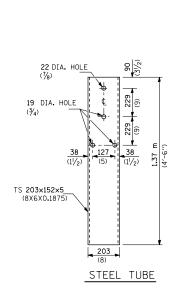


WOOD POST INSERTED IN STEEL TUBE.

> LAP RAIL OVER END SECTION

> > M20 BOLT (3/4)

M16 BOLTS

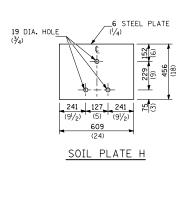

PAY LIMITS OF STEEL PLATE BEAM
GUARDRAIL TYPE A OR TYPE B

LAP THE RAIL ELEMENT IN_ THE DIRECTION OF TRAFFIC.

> _ FINISHED GROUND LINE

> > THIS DETAIL IS APPLICABLE TO THE GUARDRAIL

SYSTEM USED PRIOR TO JANUARY 1, 2007.

FOR DETAILS ON THE MIDWEST GUARDRAIL

SYSTEM, SEE STANDARD 630001.

TRAFFIC FLOW

TRAFFIC BARRIER TERMINAL TYPE 2 (1 EACH)

__CABLE __ASSEMBLY USE PLATE WASHER F

TYPICAL POST SPACING OR CLOSED POST SPACING.
STEEL POSTS SHOWN, WOOD POSTS PERMITTED

PLAN

ELEVATION

GENERAL NOTES

USE PLATE WASHER F AT ALL POSTS.

THE BEARING PLATE K SHALL BE HELD IN POSITION BY (2) TWO EIGHT PENNY NAILS DRIVEN INTO THE POST AND BENT OVER THE TOP OF THE PLATE.

ALL DIMENSIONS ARE IN MILLIMETERS (INCHES)

UNLESS OTHERWISE SHOWN.

FILE NAME =	USER NAME = challandeske	DESIGNED -	REVISED -				TRAFFIC BARRIER		F.A.	T	SECTION		COUNTY	TOTAL	SHEET
c:\pw_work\pwidot\challandeske\d0407335\	76H52-details.dgn	DRAWN -	REVISED -	STATE OF ILLINOIS				VARIOUS	S DIST	8 GUARDRAIL	2016-1	VARIOUS	12	12	
	PLOT SCALE = 100.0000 ' / in.	CHECKED -	REVISED -	DEPARTMENT OF TRANSPORTATION			TERMINAL TYPE 2			11		С	CONTRACT	Γ NO. 7	6H52
\$MODELNAME\$	PLOT DATE = 3/18/2015	DATE -	REVISED -		SCALE: NONE	SHEET 1	OF 1 SHEETS STA.	TO STA.			TLL TNOTS	S FED ATD PR	ROJECT		