06-12-2015 LETTING ITEM 017

FOR INDEX OF SHEETS, SEE SHEET 2

ROADWAY CLASSIFICATION NORTH ARDMORE AVENUE - MAJOR COLLECTOR

TRAFFIC DATA 2008 - 10,400 ADT

POSTED - 25 MPH

ENGINEERING SCALES. REDUCED SIZED PLANS WILL NOT CONFORM TO STANDARD SCALES. IN MAKING MEASUREMENTS ON REDUCED PLANS, THE ABOVE SCALES MAY BE USED.

JOINT UTILITY LOCATION INFORMATION FOR EXCAVATION 1-800-892-0123

OR 811



STATE OF ILLINOIS **DEPARTMENT OF TRANSPORTATION DIVISION OF HIGHWAYS** 

# PLANS FOR PROPOSED FEDERAL AID HIGHWAY FAU ROUTE 2651 (NORTH ARDMORE AVENUE)

UNION PACIFIC RR TO SOUTH OF NORTH AVENUE STREETSCAPE IMPROVEMENTS SECTION NO. 10-00091-00-LS **PROJECT NO. TE-00D1(893) VILLAGE OF VILLA PARK DU PAGE COUNTY** C-91-336-12

R 11 E 3RD PM PROJECT ENDS STA. 229 + 70.17 N ARDMORE AVE EX BRIDGE STA 222+84.93 STA 224+01.88 SN 022-6930 PROJECT BEGINS STA 201 + 49.21 ARDMORE AVE RAILROAD LOCATION MAP YORK TOWNSHIP

GROSS LENGTH = 2,820.96 FT. = 0.53 MILE NET LENGTH = 2,820.96 FT. = 0.53 MILE

PROFESSIONAL ENGINEER'S SIGN AND SEAF


#062-058827 EXP. DATE: 11/30/2015

TIMOTHY KING TIM KING, ASLA, PLA EXP. DATE: 08/31/2015

LANDSCAPE ARCHITECT'S SIGN AND SEAL

SECTION COUNTY DUPAGE 10-00091-00-LS ILLINOIS CONTRACT NO. 61807



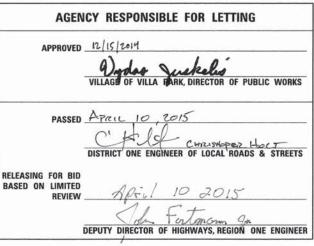

PRINTED BY THE AUTHORITY OF THE STATE OF ILLINOIS

CONTRACT NO. 61B07

(847) 705-4021 SCHAUMBURG AQUEEL, PE, PTOE **ENGINEER: FAWAD PROGRAM** 

0

0

AID

**FEDERAL** 

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### **GENERAL NOTES:**

- 1. ALL CONSTRUCTION SHALL BE DONE IN ACCORDANCE WITH THE DETAILS IN THE PLANS, THE SPECIAL PROVISIONS INCLUDED IN THE CONTRACT DOCUMENTS, AND THE LATEST EDITION OF THE FOLLOWING STATE OF ILLINOIS SPECIFICATIONS: "THE STANDARD SPECIFICATIONS FOR ROAD AND BRIDGE CONSTRUCTION" ADOPTED JANUARY 1, 2012 (REFERRED TO AS THE STANDARD SPECIFICATIONS), THE "MANUAL ON UNIFORM TRAFFIC CONTROL DEVICES FOR STREETS AND HIGHWAYS", THE "MANUAL OF TEST PROCEDURES FOR MATERIALS", AND THE "SUPPLEMENTAL SPECIFICATIONS AND RECURRING SPECIAL PROVISIONS" ADOPTED JANUARY 1, 2015.
- BEFORE STARTING ANY EXCAVATION, THE CONTRACTOR SHALL CALL "JULIE" AT (800) 892-0123 OR 811, DUPAGE COUNTY AND THE VILLAGE OF VILLA PARK FOR FIELD LOCATIONS OF BURIED UTILITIES (48 HOURS NOTIFICATION REQUIRED).
- THE CONTRACTOR WILL NOT BE PERMITTED TO SET UP A YARD OR FIELD OFFICE ON STATE OR VILLAGE PROPERTY WITHOUT PRIOR WRITTEN PERMISSION OF THE DEPARTMENT.
- 4. PRIOR TO NEW WORK, IT SHALL BE THE CONTRACTOR'S RESPONSIBILITY TO FIELD CHECK ALL DIMENSIONS AND ELEVATIONS AND TO VERIFY THE LOCATION AND ELEVATION OF EXISTING UTILITY LINES AND STRUCTURES THAT MAY BE IMPACTED BY THE PROPOSED WORK PRIOR TO ORDERING MATERIAL OR BEGINNING CONSTRUCTION, ANY DISCREPANCIES FROM THE PLANS SHALL BE REPORTED TO THE ENGINEER IMMEDIATELY.
- 5. THE LOCATION AND ELEVATION OF EXISTING UTILITIES ARE APPROXIMATE. THE EXACT LOCATIONS AND ELEVATIONS ARE TO BE VERIFIED BY THE CONTRACTOR. THE CONTRACTOR SHALL COORDINATE CONSTRUCTION ACTIVITIES WITH ALL UTILITY COMPANIES AND GOVERNMENT AGENCIES AFFECTED BY THE WORK.
- 6. ANY EXISTING SIDEWALK, CURB, PAVEMENT, AND/OR OTHER APPURTENANCES TO REMAIN AND IS DAMAGED DUE TO CONSTRUCTION SHALL BE REPLACED PROMPTLY AND IN COMPLIANCE WITH IDOT STANDARD SPECIFICATIONS IN MATERIALS AND WORKMANSHIP BY THE CONTRACTOR AT THE CONTRACTOR'S SOLE EXPENSE.
- 7. WHENEVER, DURING CONSTRUCTION OPERATIONS, LOOSE MATERIAL IS DEPOSITED IN THE FLOW LINE OF GUTTERS, DRAINAGE STRUCTURES, DITCHES ECT., SUCH THAT THE NATURAL FLOW LINE OF WATER IS OBSTRUCTED, THE LOOSE MATERIAL SHALL BE REMOVED AT THE CLOSE OF EACH WORKING DAY. AT THE CONCLUSION OF THE CONSTRUCTION OPERATION, ALL DRAINAGE STRUCTURES AND FLOW LINES SHALL BE FREE FROM DIRT AND DEBRIS. THIS WORK SHALL BE INCLUDED IN THE COST OF THE CONTRACT. THE CONTRACTOR'S FAILURE TO PROVIDE THE ABOVE WILL PRECLUDE ANY POSSIBLE ADDED COMPENSATION REQUESTED DUE TO DELAYS OR UNSUITABLE MATERIAL CREATED AS A RESULT THEREOF.
- ALL DIMENSIONS, INCLUDING RADII, ARE GIVEN TO THE EDGE OF PAVEMENT UNLESS OTHERWISE NOTED.
- 9. FULL-DEPTH OR RESURFACING SAW CUTS SHALL BE USED TO REMOVE EXISTING PAVING AND APPURTENANCES FROM MATERIAL TO REMAIN IN ACCORDANCE WITH SECTION 440 OF THE STANDARD SPECIFICATIONS. THE COST OF THE SAW CUT SHALL BE INCLUDED IN THE COST OF THE ITEM BEING REMOVED.
- 10. WHERE SECTION OR SUBSECTION MONUMENTS ARE ENCOUNTERED, THE ENGINEER SHALL BE NOTIFIED BEFORE SUCH MONUMENTS ARE DISTURBED. THE CONTRACTOR SHALL CAREFULLY PRESERVE ALL PROPERTY MARKERS AND MONUMENTS UNTIL THE OWNER, AN AUTHORIZED SURVEYOR OR AGENT HAS WITNESSED OR OTHERWISE REFERENCED EACH LOCATION.
- 11. ALL AREAS OF PLANNED SUBGRADE TREATMENT SHOULD BE VERIFIED IN THE FIELD AT THE TIME OF CONSTRUCTION BY A QUALIFIED SOILS INSPECTOR. ALL POTENTIALLY UNSTABLE/UNSUITABLE SOILS SHOULD BE TESTED WITH A STATIC CONE PENETROMETER AND TREATED IN ACCORDANCE WITH ARTICLE 301.04 OF THE STANDARD SPECIFICATIONS FOR ROAD AND BRIDGE CONSTRUCTION AND THE UNDERCUT GUIDELINES IN THE IDOT SUBGRADE STABILITY MANUAL (SSM). ANY AGGREGATE SUBGRADE IMPROVEMENTS (CY) AND GEOTECHNICAL FABRIC FOR GROUND STABILIZATION QUANTITIES NOT USED DURING CONSTRUCTION SHOULD BE DELETED FROM THE CONTRACT.
- 12. THE CONTRACTOR SHALL USE ALL NECESSARY PRECAUTIONARY AND PROTECTIVE MEASURES REQUIRED TO MAINTAIN AND PROTECT EXISTING UTILITIES, SEWERS, MAINS AND APPURTENANCES THAT MUST BE KEPT IN OPERATION. IN PARTICULAR, THE CONTRACTOR SHALL TAKE ADEQUATE MEASURES TO PREVENT THE UNDERMINING OF UTILITIES, SEWERS AND MAINS WHICH WILL REMAIN IN SERVICE. THE CONTRACTOR SHALL COORDINATE WITH THE ENGINEER AND UTILITY COMPANY IF IT IS DETERMINED THAT TEMPORARY BRACING OR SUPPORT OF THE UTILITIES IS REQUIRED. THE PROTECTION AND/OR TEMPORARY BRACING OR SUPPORT OF UTILITIES WILL NOT BE PAID FOR SEPARATELY BUT SHALL BE CONSIDERED AS INCLUDED IN THE UNIT BE PRICES OF THE CONTRACT AND NO ADDITIONAL COMPENSATION WILL BE ALLOWED.

## DRAINAGE AND UTILITIES GENERAL NOTES:

- 1. EXISTING MANHOLE / CATCH BASIN RIMS SHALL BE ADJUSTED AS NOTED.
- 2. ALL SEWER AND WATERMAIN CROSSINGS SHALL MEET WITH THE APPLICABLE LOCAL AND STATE GUIDELINES AS DESCRIBED IN THE LATEST EDITION OF THE "STANDARD SPECIFICATIONS FOR WATER AND SEWER MAIN CONSTRUCTION IN ILLINOIS".
- THE CONTRACTOR SHALL COORDINATE THE PROPOSED STORM SEWER CONSTRUCTION WITH ALL OTHER UTILITY ADJUSTMENTS AND INSTALLATIONS AS APPROVED BY THE ENGINEER.
- 4. UNDERGROUND UTILITIES AND DRAINAGE SYSTEMS SHOWN ON THE PLANS ARE BASED ON AVAILABLE SURVEYS AND AS-BUILT INFORMATION. THE LOCATION OF UNDERGROUND FACILITIES ARE APPROXIMATE. PRIOR TO CONSTRUCTION, THE CONTRACTOR IS REQUIRED TO VERIFY ALL UTILITY LOCATION AND DEPTHS.
- DURING CONSTRUCTION, THE CONTRACTOR SHALL MAINTAIN ALL SURFACE DRAINAGE WITHIN THE PROJECT LIMITS. ALL STORM FLOW MUST BE MAINTAINED AT ALL TIMES, UNLESS OTHERWISE DIRECTED BY ENGINEER.
- 6. ANY EXISTING DRAINAGE FACILITIES DISTURBED OR DAMAGED DURING CONSTRUCTION SHALL BE REPAIRED OR REPLACED BY THE CONTRACTOR AT HIS/HER EXPENSE. THIS WORK SHALL BE PERFORMED TO THE SATISFACTION OF THE ENGINEER.
- OFFSETS AND TOP OF FRAME OR LID ELEVATIONS FOR STRUCTURES LOCATED IN THE GUTTER ARE GIVEN AT THE EDGE OF PAVEMENT.
- THE COST OF MAKING STORM SEWER CONNECTIONS TO EXISTING OR PROPOSED SEWER OR DRAINAGE STRUCTURES SHALL BE INCLUDED IN THE COST OF THE STORM SEWER BEING CONNECTED.
- 9. THE EXISTING STORM SEWER TO REMAIN SHALL BE INSPECTED BY THE CONTRACTOR BEFORE CONSTRUCTION STARTS. ANY EXISTING ACCUMULATED MATERIAL SHALL BE DOCUMENTED BY THE CONTRACTOR. ANY UNDOCUMENTED ACCUMULATION OF MATERIAL FOUND IN THE STRUCTURES OR PIPES AFTER CONSTRUCTION IS COMPLETED SHALL BE REMOVED BY THE CONTRACTOR AT HIS EXPENSE.
- 10. THE CONTRACTOR SHALL FURNISH ALL LABOR, EQUIPMENT AND MATERIAL NECESSARY FOR DEWATERING TRENCH EXCAVATIONS AS WELL AS SHORING TRENCH WALLS DURING UTILITY AND STORM SEWER OPERATIONS. THE COST OF COMPLIANCE WITH THE ABOVE, SHALL BE INCLUDED IN THE COST OF THE UTILITY BEING INSTALLED.
- 11. TOP OF FRAME ("RIM") ELEVATIONS GIVEN ON THE PLANS ARE ONLY TO ASSIST THE CONTRACTOR IN DETERMINING THE APPROXIMATE OVERALL HEIGHT OF EACH STRUCTURE. FRAMES ON ALL NEW STRUCTURES SHALL BE ADJUSTED TO THE FINAL ELEVATIONS OF THE AREAS IN WHICH THEY ARE LOCATED, AS PART OF THE STRUCTURE COST.

# **MAINTENANCE OF TRAFFIC GENERAL NOTES:**

- TRAFFIC CONTROL AND PROTECTION SHALL BE PERFORMED IN ACCORDANCE WITH THE MAINTENANCE OF TRAFFIC PLAN AND PROTECTION SECTION 701 OF THE STANDARD SPECIFICATIONS.
- THE COST OF SUPPLYING, ERECTING, AND MAINTAINING TRAFFIC CONTROL DEVICES, LIGHTS, AND SIGNS SHALL BE INCLUDED IN THE CONTRACT LUMP SUM PRICE FOR TRAFFIC CONTROL AND PROTECTION (SPECIAL).
- CONTRACTOR SHALL MAINTAIN ACCESS TO ALL PROPERTIES AND SIDE ROADS TO REMAIN DURING CONSTRUCTION OPERATIONS.
- CONTRACTOR SHALL MAINTAIN DRAINAGE OF THE ROADWAY DURING THROUGHOUT CONSTRUCTION OPERATIONS.
- THE CONTRACTOR SHALL PERFORM ALL WORK BETWEEN THE WEEKDAY HOURS OF 9:00AM AND 3:30PM, UNLESS OTHERWISE ALLOWED BY THE ENGINEER.

## LIST OF ILLINOIS HIGHWAY STANDARDS

000001-06	STANDARD SYMBOLS, ABBREVIATIONS AND PATTERNS
424001-08	PERPENDICULAR CURB RAMPS FOR SIDEWALKS
424021-03	DEPRESSED CORNER FOR SIDEWALKS
602011-02	CATCH BASIN, TYPE C
602401-03	MANHOLE, TYPE A
604001-0 <b>4</b>	FRAME AND LIDS. TYPE 1
604091-03	FRAME AND GRATE, TYPE 24
606001-06	CONCRETE CURB TYPE B AND COMBINATION CONCRETE CURB AND GUTTER
701427-03	LANE CLOSURE, MULTILANE, INTERMITTENT OR MOVING OPERATION.
	FOR SPEEDS < 40 MPH
701701-09	URBAN LANE CLOSURE, MULTILANE INTERSECTION
701801-05	LANE CLOSURE, MULTILANE 1W OR 2W CROSSWALK OR SIDEWALK CLOSURE
701901-04	TRAFFIC CONTROL DEVICES
720001-01	SIGN PANEL MOUNTING DETAILS
720006-04	SIGN PANEL ERECTION DETAILS
720011-01	METAL POSTS FOR SIGNS, MARKERS AND DELINEATORS
729001-01	APPLICATIONS OF TYPES A AND B METAL POSTS (FOR SIGNS & MARKERS
780001-05	TYPICAL PAVEMENT MARKINGS
805001-01	ELECTRICAL SERVICE INSTALLATION DETAILS
814001- 03	HANDHOLES
BLR 18-6	TRAFFIE CONTROL DEVICES-DAY LABOR MAITENANCE

# LIST OF DISTRICT ONE STANDARDS

BD-01	DRIVEWAY DETAILS - DISTANCE BETWEEN ROW AND CURB OR EDGE GREATER THAN OR EQUAL TO 15'
BD-24	CURB OR CURB AND GUTTER REMOVAL AND REPLACEMENT
BE-220	ELECTRIC SERVICE INSTALLATION AERIAL, REMOTE DISCONNECT
TC-10	TRAFFIC CONTROL AND PROTECTION FOR SIDE ROADS, INTERSECTIONS AND DRIVEWAYS
TC-13	DISTRICT ONE TYPICAL PAVEMENT MARKINGS
TC-14	TRAFFIC CONTROL AND PROTECTION AT TURN BAYS (TO REMAIN OPEN TO TRAFFIC)
TC-22	ARTERIAL ROAD INFORMATION SIGN
TC-26	DRIVEWAY ENTRANCE SIGNING

# INDEX OF SHEETS:

HADEN	OI SIILLIS.
1	TITLE SHEET
2	GENERAL NOTES AND HIGHWAY STANDARDS
3-4	SUMMARY OF QUANTITIES
5	TYPICAL SECTIONS
6	ALIGNMENT, TIES, AND BENCHMARKS
7-9	EROSION CONTROL AND REMOVALS PLAN
10-12	ΡΩΔΝΜΑΥ ΡΙΔΝ

10-12	HOADWAT FLAN
13-17	GRADING PLAN
18-22	SIDEWALK PROFILES
23-25	DRAINAGE AND UTILITIES PLAN
26-28	PAVEMENT MARKING AND SIGNAGE PLAN

29-31	PLANTING	PLAIN		
32	PLANTING	MATERIALS, NOTES	AND	DETAILS

33-37	STREETSCAPE DETAILS
38	LIGHTING AND ELECTRICAL GENERAL NOTES
39-41	LIGHTING AND ELECTRICAL PLAN
42	SINGLE LINE WIRING DIAGRAM
43-44	LIGHTING AND ELECTRICAL DETAILS

45	CONSTRUCTION DETAILS
6-53	DISTRICT ONE DETAILS

The same of	V3 Companies
/	7325 Janes Avenue
/ •	Woodridge, IL 60517
•	630.724,9200 phone
\ \ <b>-</b>	630.724.9202 fax
	www.v3co.com

USER NAME = mrechtorik	DESIGNED -	EIH	REVISED -	П
	DRAWN -	DRP	REVISED -	
PLOT SCALE = 1'	CHECKED -	MJR	REVISED -	
PLOT DATE = 4/7/2015	DATE -	04-07-15	REVISED -	

SHEET NO. 1 OF 1 SHEETS

SCALE: N/A

F.A.U. RTE.	SECTION	COUNTY	TOTAL	SHEET NO.
2651	10-00091-00-LS	DUPAGE	53	2
		CONTRAC	T NO. 1	51B07
	ILLINOIS FED.	AID PROJECT		

Ţ	V3 Companies 7325 Janes Avenue Woodridge, IL 605 630.724.9200 pho 630.724.9202 fax www.v3co.com

USER NAME = ehsu	DESIGNED -	EIH	REVISED -	
	DRAWN -	DRP	REVISED -	
PLOT SCALE = 1'	CHECKED -	MJR	REVISED -	
PLOT DATE = 4/8/2015	DATE -	04-07-15	REVISED -	

# STATE OF ILLINOIS DEPARTMENT OF TRANSPORTATION

1 1 1 2 3 7		CUMMANDY OF QUANTITIES	F.A.U. RTE.	SECTION	COUNTY	TOTAL	
	SUMMARY OF QUANTITIES		2651	10-00091-00-LS	DUPAGE	53	3
					CONTRAC	T NO.	61B07
	SCALE: N/A	SHEET NO. 1 OF 2 SHEETS	ILLINOIS FED, AID PROJECT				
_				ILLUIDID I LOS	HID THOUSET		

CODE NO.	ITEM	UNIT	TOTAL QUANTITY	ROADWAY 80% FEDERAL 20% LOCAL 00:31	ROADWAY 0% FEDERAL 100% LOCAL 0031		CODE NO.	110
20101000	TEMPORARY FENCE	FOOT	1,861	1,861			55100900	STORM SEWER REMOVAL 18"
20101100	TREE TRUNK PROTECTION	EACH	32	32			56400100	FIRE HYDRANTS TO BE MOVED
20101200	TREE ROOT PRUNING	EACH	32	32			56500600	DOMESTIC WATER SERVICE BOXES T
20101300	TREE PRUNING (1 TO 10 INCH DIAMETER)	EACH	15	15			60100905	PIPE DRAINS 4"
201013 <b>5</b> 0	TREE PRUNING (OVER 10 INCH DIAMETER)	EACH	26	26			60107600	PIPE UNDERDRAINS 4"
20200100	EARTH EXCAVATION							
		CU YD	1,887	1,725	162		60107700	PIPE UNDERDRAINS 6"
20201200	REMOVAL AND DISPOSAL OF UNSUITABLE MATERIAL	CU YD	130	70	60		60207905	CATCH BASINS, TYPE C, TYPE 11 F
20700220	POROUS GRANULAR EMBANKMENT	CU YD	130		130		60218300	MANHOLES, TYPE A, 4'-DIAMETER, T
20800150	TRENCH BACKFILL	CU YD	10		10		60255500	MANHOLES TO BE ADJUSTED
21001000	GEOTECHNICAL FABRIC FOR GROUND STABILIZATION	SO YD	400		400		60256700	MANHOLES TO BE ADJUSTED WITH N
21101625	TOPSOIL FURNISH AND PLACE, 6"	SQ YD	250	250			60258200	MANHOLES TO BE RECONSTRUCTED I
21101665	TOPSOIL FURNISH AND PLACE, 18"	SQ YD	385	385			60259100	MANHOLES TO BE RECONSTRUCTED
21101685	TOPSOIL FURNISH AND PLACE, 24"	SO YD	250	250			60265700	VALVE VAULTS TO BE ADJUSTED
25000400	NITROGEN FERTILIZER NUTRIENT	POUND						
				30			60404950	FRAMES AND GRATES, TYPE 24
25000500	PHOSPHORUS FERTILIZER NUTRIENT	POUND	30	30			60406100	FRAMES AND LIDS, TYPE 1, CLOSED
25000600	POTASSIUM FERTILIZER NUTRIENTS	POUND	30	30			60600605	CONCRETE CURB, TYPE B
25200110	SODDING, SALT TOLERANT	SO YD	1,160	1,160			60603800	COMBINATION CONCRETE CURB AND
25200200	SUPPLEMENTAL WATERING	UNIT	15	15			60605000	COMBINATION CONCRETE CURB AND
28000510	INLET FILTERS	EACH	41	41			66900200	NON-SPECIAL WASTE DISPOSAL
35101600	AGGREGATE BASE COURSE, TYPE B 4"	SO YD	2,245	2,245			66900450	SPECIAL WASTE PLAN AND REPORTS
35101800	AGGREGATE BASE COURSE, TYPE B 6"	SQ YD	378		378		66900530	SOIL DISPOSAL ANALYSIS
35501316	HOT-MIX ASPHALT BASE COURSE, 8"	SO YD	145	145			67000400	ENGINEER'S FIELD OFFICE, TYPE A
40600275	BITUMINOUS MATERIALS (PRIME COAT)	POUND	1,011	33	978		67100100	MOBILIZATION
40603080	HOT-MIX ASPHALT BINDER COURSE, IL-19.0, N50	TON	85					
					85		72000100	SIGN PANEL - TYPE 1
40603335	HOT-MIX ASPHALT SURFACE COURSE, MIX "D", N50	TON	96	43	53		72300100	INSTALL EXISTING SIGN PANEL
42300400	PORTLAND CEMENT CONCRETE DRIVEWAY PAVEMENT, 8 INCH	SQ YD	108	108			72400100	REMOVE SIGN PANEL ASSEMBLY - T
42400200	PORTLAND CEMENT CONCRETE SIDEWALK, 5 INCH	SO FT	15,087	15,087			72400200	REMOVE SIGN PANEL ASSEMBLY - T
42400410	PORTLAND CEMENT CONCRETE SIDEWALK, 8 INCH	SQ FT	564	564			72900100	METAL POST - TYPE A
42400800	DETECTABLE WARNINGS	SQ FT	190	190			78000100	THERMOPLASTIC PAVEMENT MARKING
44000100	PAVEMENT REMOVAL	SO YD	19	19			78000200	THERMOPLASTIC PAVEMENT MARKING
44000157	HOT-MIX ASPHALT SURFACE REMOVAL, 2"	SO YD	321	227	94		78300100	PAVEMENT MARKING REMOVAL
44000200	DRIVEWAY PAVEMENT REMOVAL	SO YO	604	243	361		80400100	ELECTRIC SERVICE INSTALLATION
44000300	CURB REMOVAL	FOOT	73		73		80400200	
44000500				007				ELECTRIC UTILITY SERVICE CONNEC
	COMBINATION CURB AND GUTTER REMOVAL	FOOT	1,426	993	433		81028220	UNDERGROUND CONDUIT, GALVANIZED
44000600	SIDEWALK REMOVAL	SQ FT	8,149	8,149		ė	81028240	UNDERGROUND CONDUIT, GALVANIZED
550A0050	STORM SEWERS, CLASS A, TYPE 1 12"	FOOT	14		14	•	81028260	UNDERGROUND CONDUIT, GALVANIZED
55080090	STORM SEWERS, CLASS B, TYPE 1 18"	FOOT	20		20		81028740	UNDERGROUND CONDUIT, COILABLE N
SPECIALTY ITEM	ws .							

				CONSTRUC	TION CODE
CODE NO.	ITEM	UNIT	TOTAL	ROADWAY 80% FEDERAL 20% LOCAL 00.31	ROADWAY 0% FEDERAL 100% LOCAL 00 31
55100900	STORM SEWER REMOVAL 18"	FOOT	20	0021	20
56400100	FIRE HYDRANTS TO BE MOVED	EACH	4	4	
56500600	DOMESTIC WATER SERVICE BOXES TO BE ADJUSTED	EACH	5	5	
60100905	PIPE DRAINS 4"	FOOT	23	23	
60107600	PIPE UNDERDRAINS 4"	FOOT	214	214	
60107700	PIPE UNDERDRAINS 6"	FOOT	138	138	
60207905	CATCH BASINS, TYPE C, TYPE 11 FRAME AND GRATE	EACH		.30	2
60218300			2		2
	MANHOLES, TYPE A, 4'-DIAMETER, TYPE 1 FRAME, OPEN LID	EACH	1		1
60255500	MANHOLES TO BE ADJUSTED	EACH	1	1	
60256700	MANHOLES TO BE ADJUSTED WITH NEW TYPE 11 FRAME AND GRATE	EACH	1		1
60258200	MANHOLES TO BE RECONSTRUCTED WITH NEW TYPE 1 FRAME, CLOSED LID	EACH	2		2
60259100	MANHOLES TO BE RECONSTRUCTED WITH NEW TYPE 11 FRAME AND GRATE	EACH	1		11
60265700	VALVE VAULTS TO BE ADJUSTED	EACH	2	2	
60404950	FRAMES AND GRATES, TYPE 24	EACH	14	10	4
60406100	FRAMES AND LIDS, TYPE 1, CLOSED LID	EACH	1	1	
60600605	CONCRETE CURB, TYPE B	FOOT	149	149	
60603800	COMBINATION CONCRETE CURB AND GUTTER, TYPE B-6.12	FOOT	615	190	425
60605000	COMBINATION CONCRETE CURB AND GUTTER, TYPE B-6,24	FOOT	1,228	806	422
66900200	NON-SPECIAL WASTE DISPOSAL				
		CU YD		1,030	162
66900450	SPECIAL WASTE PLAN AND REPORTS	LSUM	1.00	0.60	0.40
66900530	SOIL DISPOSAL ANALYSIS	EACH	1.0	0.6	0.4
67000400	ENGINEER'S FIELD OFFICE, TYPE A	CAL MO	4	3	1
67100100	MOBILIZATION	LSUM	1.00	0.75	0.25
72000100	SIGN PANEL - TYPE 1	SQ FT	11		11
72300100	INSTALL EXISTING SIGN PANEL	SO FT	42	26	16
72400100	REMOVE SIGN PANEL ASSEMBLY - TYPE A	EACH	13	9	4
72400200	REMOVE SIGN PANEL ASSEMBLY - TYPE B	EACH	1	1	
72900100	METAL POST - TYPE A	FOOT	60		60
78000100	THERMOPLASTIC PAVEMENT MARKING - LETTERS AND SYMBOLS	SO FT	18		18
78000200	THERMOPLASTIC PAVEMENT MARKING - LINE 4"	FOOT	280		280
78300100	PAVEMENT MARKING REMOVAL			747	200
		SO FT	747	747	
80400100	ELECTRIC SERVICE INSTALLATION	EACH	1	1	
80400200	ELECTRIC UTILITY SERVICE CONNECTION	LSUM	1	1	
81028220	UNDERGROUND CONDUIT, CALVANIZED STEEL, 3" DIA.	FOOT	995	995	
81028240	UNDERGROUND CONDUIT, GALVANIZED STEEL, 4" DIA.	FOOT	47	47	
81028260	UNDERGROUND CONDUIT, GALVANIZED STEEL, 6" DIA.	FOOT	47	47	
81028740	UNDERGROUND CONDUIT, COILABLE NONMETALLIC CONDUIT, 1 1/2" DIA.	FOOT	989	989	

CODE NO.	ITEM	UNIT	TOTAL QUANTITY	CONSTRUCT ROADWAY 80% FEDERAL 20% LOCAL 00:31	ROADWAY 0% FEDERAI 100% LOCAI 0031
81400100	HANDHOLE	EACH	2	2	
81500120	GULFBOX JUNCTION, COMPOSITE CONCRETE	EACH	8	8	
81603010	UNIT DUCT, 600V, 2-1C NO.10, 1/C NO.10 GROUND, (XLP-TYPE USE), 3/4" DIA. POLYETHYLENE	FOOT	336	336	
81603047	UNIT DUCT, 600V, 3-1C NO.6, 1/C NO.6 GROUND, (XLP-TYPE USE), 1 1/4" DIA. POLYETHYLENE	FOOT	2,539	2,539	
81603070	UNIT DUCT, 600V, 2-1C NO.2, 1/C NO.4 GROUND, (XLP-TYPE USE), 1 1/4" DIA. POLYETHYLENE	FOOT	4,556	4,556	
81603081					
	UNIT DUCT, 600V, 3-1C NO.2, 1/C NO.4 GROUND, (XLP-TYPE USE), 1 1/2" DIA, POLYETHYLENE	FOOT	3,019	3,019	
81603085	UNIT DUCT, 600V, 3-1C NO.4, 1/C NO.4 GROUND, (XLP-TYPE USE), 1 1/4" DIA. POLYETHYLENE	FOOT	3,585	3,585	
81603156	UNIT DUCT, 600V, 5-1C NO.2, 1/C NO.4 GROUND, (XLP-TYPE USE), 2" DIA, POLYETHYLENE	FOOT	61	61	
81702140	ELECTRIC CABLE IN CONDUIT, 600V (XLP-TYPE USE) 1/C NO. 4	FOOT	1,188	1,188	
81702220	ELECTRIC CABLE IN CONDUIT, 600V (XLP-TYPE USE) 1/C 350MCM	FOOT	597	597	
A2000118	TREE, ACER X FREEMANII AUTUMN BLAZE (AUTUMN BLAZE FREEMAN MAPLE), 3" CALIPER, BALLED AND BURLAPPED	EACH	7	7	
A2002924	TREE, CELTIS OCCIDENTALIS (COMMON HACKBERRY), 3" CALIPER, BALLED AND BURLAPPED	EACH	3	3	
A2004424	TREE, GINKGO BILOBA (GINKGO), 3" CALIPER, BALLED AND BURLAPPED	EACH	8	8	
A2004824	TREE, GLEDITSIA TRIACANTHOS INERMIS SKYLINE (SKYLINE THORNLESS COMMON HONEYLOCUST), 3" CALIPER, BALLED AND BURLAPPED				
		EACH	7	7	
A2008517	TREE, ULMUS JAPONICA X WILSONIANA MORTON (ACCOLADE ELM), 2-1/2" CALIPER, BALLED AND BURLAPPED	EACH	4	4	
C2005812	SHRUB, RHUS AROMATICA GRO-LOW (GRO-LOW FRAGRANT SUMAC), 2' HEIGHT, BALLED AND BURLAPPED	EACH	13	13	
C2C03424	SHRUB, HYDRANGEA ARBORESCENS ANNABELLE (ANNABELLE SMOOTH HYDRANGEA), 2' HEIGHT CONTAINER	EACH	69	69	
C2C07005	SHRUB, ROSA RADTKOPINK (PINK DOUBLE KNOCKOUT ROSE), 18" HEIGHT, CONTAINER	EACH	81	81	
D2015401	EVERGREEN, JUNIPERUS CHINENSIS KALLAYS COMPACTA, (KALLAY COMPACT JUNIPER), 24" WIDTH, BALLED AND BURLAPPED	EACH	20	20	
K0012990	PERENNIAL PLANTS, ORNAMENTAL TYPE, GALLON POT	UNIT	12.20	12.20	
K0029634	WEED CONTROL, PRE-EMERGENT GRANULAR HERBICIDE	POUND	30	30	
X0322917	PROPOSED STORM SEWER CONNECTION TO EXISTING MANHOLE	EACH	5		5
x0325970	SOIL CONDITIONER 3"	SQ YD		705	
			795	795	
X0326864	BRICK SIDEWALK REMOVAL	SO FT	94	94	
X0327018	DECORATIVE SIGN POST	EACH	11	11	
X2130010	EXPLORATION TRENCH, SPECIAL	FOOT	1,600	1,200	400
X5030400	SIDEWALK FLOOR DRAINS	EACH	5	5	
X7010216	TRAFFIC CONTROL AND PROTECTION (SPECIAL)	LSUM	1.00	0.75	0.25
X8250500	LIGHTING UNIT COMPLETE, SPECIAL	EACH	61	61	
X8250505	LIGHTING CONTROLLER, SPECIAL	EACH	1	1	
X8360120	LIGHT POLE FOUNDATION, SPECIAL	FOOT	382	382	
XX000959	TRASH RECEPTACLES	EACH	6	6	
XX005735	PLANTER CURB	FOOT	578	578	
XX005972	STAMPED ASPHALT CROSSWALK	SO YD	376	376	
XX007297	MASONRY COLUMN, LARGE	EACH	2	2	
YY007300	MASONRY COLUMN, SMALL	EACH	2	2	
XX007298					


	V3 Companies
/	7325 Janes Avenue
	Woodridge, IL 6051
	630.724.9200 phor
\ \-	630.724.9202 fax
5	www.v3co.com

USER NAME = ensu	DESIGNED - FIN	KEAIZED -
	DRAWN - DRP	REVISED -
PLOT SCALE = 1'	CHECKED - MJR	REVISED -
PLOT DATE = 4/7/2015	DATE - 04-07-15	REVISED -

# STATE OF ILLINOIS DEPARTMENT OF TRANSPORTATION

CUMMARY OF QUANTITIES		F.A.U. RTE.	SECTION	COUNTY	TOTAL	SHEE NO.
100	SUMMARY OF QUANTITIES	2651	10-00091-00-LS	DUPAGE	53	4
				CONTRACT	NO. 6	51B07
SCALE: N/A	SHEET NO. 2 OF 2 SHEETS	ILLINOIS FED, AID PROJECT				

CODE NO. XX008257 XX008269 Z0003850 Z0003855 Z0013798 Z0048665 Z0048665	STAMPED COLORED PORTLAND CEMENT CONCRETE SIDEWALK, 5 INCH WAYFINDING SIGN BENCHES BICYCLE RACKS CONSTRUCTION LAYOUT RAILROAD PROTECTIVE LIABILITY INSURANCE	EACH  EACH  LSUM	TOTAL QUANTITY 4,256 6 10	ROADWAY 80% FEDERAL 20% LOCAL 00.31 4,256	0% FEDERAL 100% LOCAL 00 31
XX008269 Z0003850 Z0003855 Z0013798 Z0048665	WAYFINDING SIGN  BENCHES  BICYCLE RACKS  CONSTRUCTION LAYOUT	EACH EACH	6	6	
Z0003855 Z0003855 Z0013798 Z0048665	BENCHES BICYCLE RACKS CONSTRUCTION LAYOUT	EACH	10		
z0003855 z0013798 z0048665	BENCHES BICYCLE RACKS CONSTRUCTION LAYOUT	EACH	10		
z0003855 z0013798 z0048665	BICYCLE RACKS  CONSTRUCTION LAYOUT	EACH		10	
Z0013798 Z0048665	CONSTRUCTION LAYOUT		2	3-1-1-73-77	10000
Z0013798 Z0048665	CONSTRUCTION LAYOUT		2	2	
Z0048665 31G0 3171		LSUM		2	
81603171	RAILROAD PROTECTIVE LIABILITY INSURANCE		1.00	0.75	0.25
81603171	RAILROAD PROTECTIVE LIABILITY INSURANCE				
		LSUM	1	1	
	UNIT DUCT, 600V, 6-1C NO.2, 1/C NO.4 GROUND, (XLP-TYPE USE),	FOOT	746	746	
1603810	2" DIA. POLYETHYLENE				S. 24 - 14 - 17 - 17 - 17 - 17 - 17 - 17 - 1
1603810					
Committee of the Commit	UNIT DUCT, 600V, 8-IC NO.2, 1/C NO.4 GROUND, (XLP-TYPE USE), 2 1/2" DIA, POLYETHYLENE	FOOT	61	61	
1000	Z 1/2 DIA FOLIEITIENE				
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					J. Villian

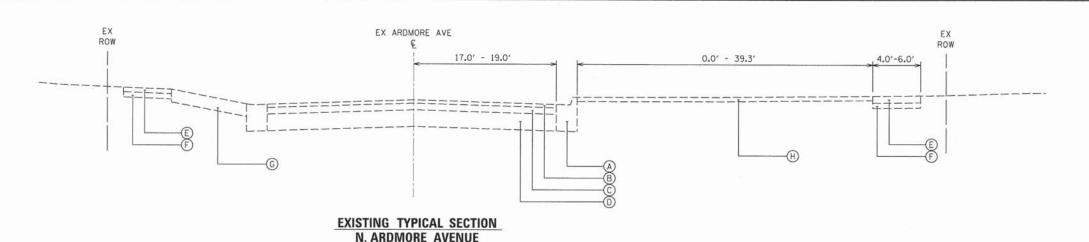


STA 201+49.21 TO STA 229+70.17

#### - LIGHTPOLE LOCATED IN PARKWAY. SEE LIGHTING PLANS FOR LOCATIONS. EX EX ARDMORE AVE 8.5 EX ROW ROW 2.5' 0'-13' 14.7'-20.7' VARIES SAWCUT SAWCUT (1.0%)-(1.8%) VARIES VARIES (0.0%)-(1.5%) -4.8%)-(3.3%) - MILL & RESURFACE MILL & RESURFACE 0.5% - 2.0% 4.8%)-(0.4%)

# PROPOSED TYPICAL SECTION N. ARDMORE AVENUE

STA 201+49.21 TO STA 206+30.79

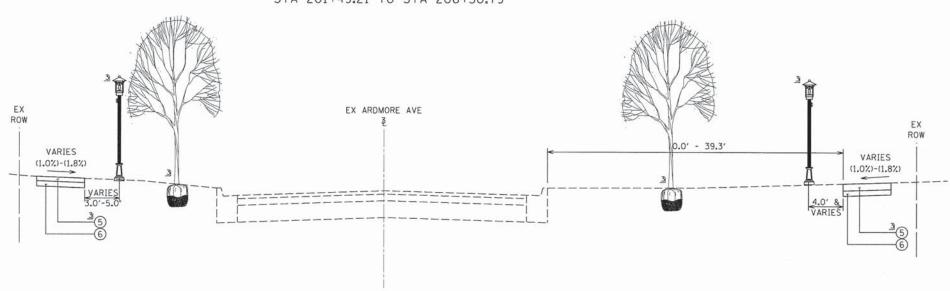

# PROPOSED TYPICAL SECTION N. ARDMORE AVENUE


STA 206+30.79 TO STA 229+70.17

#### LEGE

- (A) EXIST. COMB. CONC. CURB AND GUTTER, B-6.24
- B EXIST. HMA SURFACE COURSE, 2" ±
- © EXIST. HMA BINDER COURSE, 4" ±
- D EXIST. AGGREGATE BASE COURSE, 6" ±
- E EXIST. PCC SIDEWALK, 5"
- F EXIST. AGGREGATE BASE COURSE, 4"
- G EXIST. DRIVEWAY
- (H) EXIST. PARKWAY

#### LEGEND

- 1 PROP. COMB. CONC. CURB AND GUTTER, B-6.24
- (2) PROP. HMA SURFACE COURSE, MIX "D", N50, 2"
- 3 PROP. HMA BINDER COURSE, IL-19.0, N50, 4"
- 4 PROP. AGGREGATE BASE COURSE, TYPE B. 6"
- (5) PROP. PCC SIDEWALK, 5"
- 6 PROP. AGGREGATE BASE COURSE, TYPE B, 4"
- 7 PROP. COMMERCIAL DRIVEWAY
- (8) PROP. TOPSOIL AND SODDING, SALT TOLERANT
- 9 PROP. COMB. CONC. CURB AND GUTTER, B-6.12

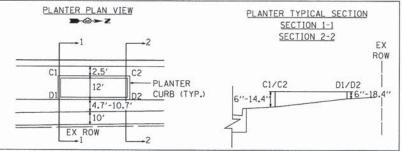

#### PLANTER TYPICAL SECTION DETAIL

#### NOTES

- 1. SEE PLANS FOR LOCATION OF PLANTERS.
- 2. SEE PLANTER DETAIL ABOVE FOR PLANTER TYPICAL SECTION.
- 3. SEE PLANS FOR LOCATIONS OF PROPOSED SIDEWALK, TREES, AND LIGHT POLES.

### **HOT-MIX ASPHALT MIXTURE REQUIREMENTS**

MIXTURE TYPE	AIR VOIDS @ Ndes			
PAVEMENT RESURFACING/STAMPED ASPHALT CROSSWALK				
HOT-MIX ASPHALT SURFACE COURSE, MIX "D", N50, 2"	4% @ 50 Gyr.			
PAVEMENT WIDENING				
HOT-MIX ASPHALT SURFACE COURSE, MIX "D", N50, 2" HOT-MIX BINDER COURSE, IL-19.0, N50, 4"	4% © 50 Gyr. 4% © 50 Gyr.			
COMMERCIAL DRIVEWAYS				
HOT-MIX ASPHALT SURFACE COURSE, MIX "D", N50, 2" HOT-MIX ASPHALT BASE COURSE (HMA BINDER IL-19.0, N50); 8" (2 LIFTS)	4% @ 50 Gyr. 4% @ 50 Gyr.			

TOTAL SHEETS NO.

CONTRACT NO. 61B07

COUNTY

DUPAGE


- THE UNIT WEIGHT USED TO CALCULATE ALL HMA SURFACE MIXTURE QUANTITIES IS 112 LBS/SY/IN.
- 2. THE "AC TYPE" SHALL BE "PG 64-22" UNLESS MODIFIED BY DISTRICT ONE SPECIAL PROVISIONS. FOR "PERCENT OF RAP" SEE SPECIAL PROVISIONS.



USER NAME = \$USER\$	DESIGNED - EIH	REVISED -	
	DRAWN - DRP	REVISED -	
PLOT SCALE = \$SCALE\$	CHECKED - MJR	REVISED -	
PLOT DATE = SDATES	DATE - 04-07-15	REVISED -	

STATE OF ILLINOIS
DEPARTMENT OF TRANSPORTATION

	TVDICAL OF	F.A.U. RTE.	SECTION	
TYPICAL SECTIONS				10-00091-00-LS
SCALE: N/A	SHEET NO. 1 OF 1 SHEETS	STA, 201+70.32 TO STA, 205+75.59	_	ILLINOIS FED. AI

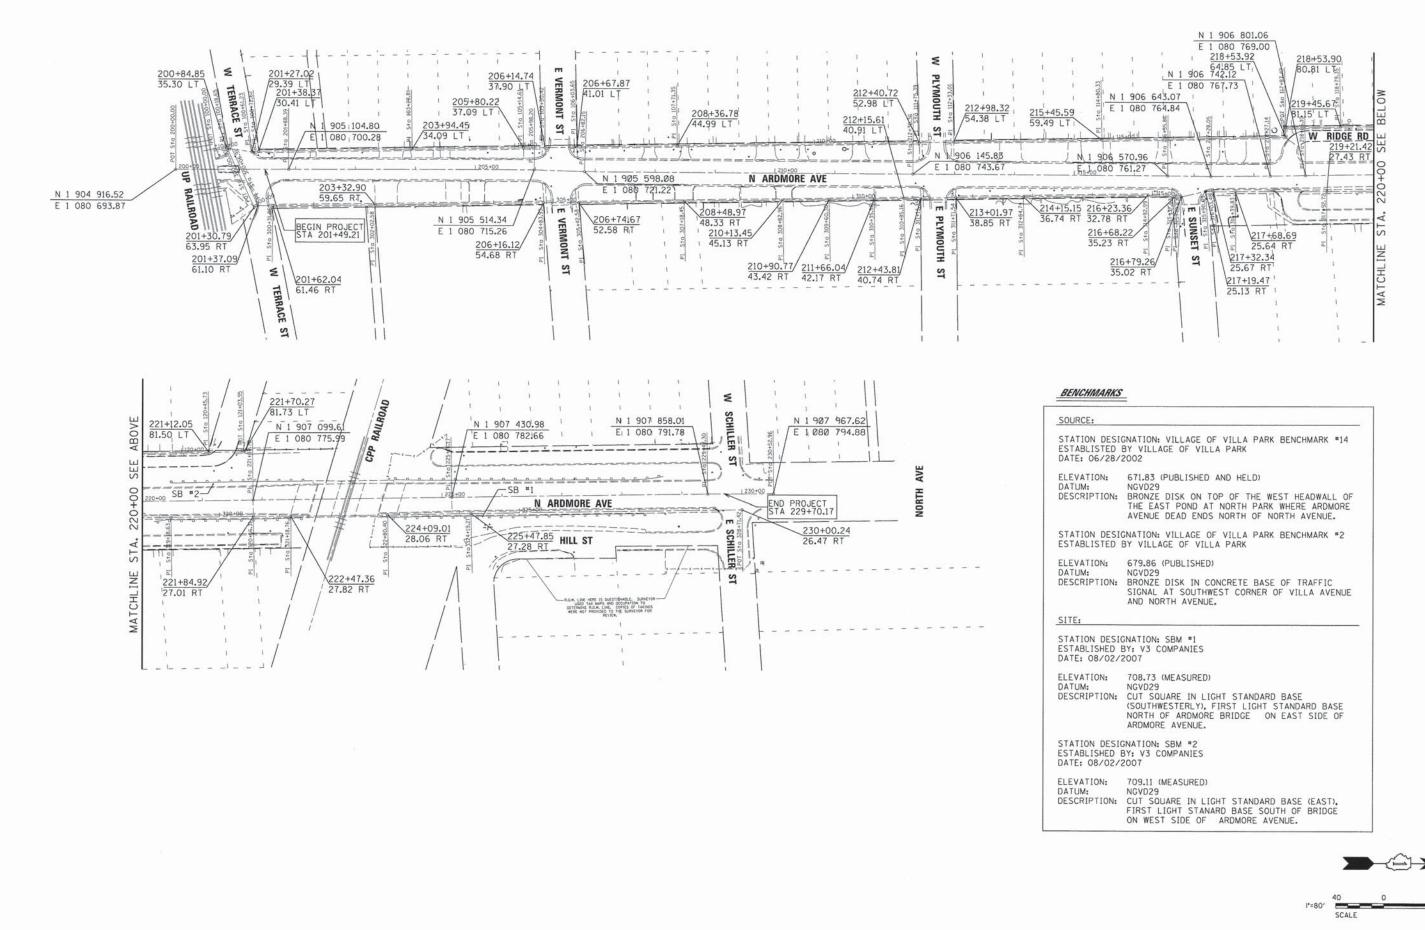




USER NAME = mrechtorik	DESIGNED	*	EIH	REVISED		
	DRAWN	-	DRP	REVISED	*	
PLOT SCALE = 80°	CHECKED	-	MJR	REVISED		7
PLOT DATE = 4/7/2015	DATE	-	04-07-15	REVISED	*	1
						_


STATI	E OI	F ILLINOIS
DEPARTMENT	OF	TRANSPORTATION


	ALIGNMENT, TIES, AND BENCHMARKS
SCALE: 1" = 80"	SHEET NO. 1 OF 1 SHEETS STA. 200+00.00 TO STA. 220+52.96


E.	SECTION	COUNTY	TOTAL	SHEE NO.	
51	10-00091-00-LS	DUPAGE	53	6	
		CONTRAC	T NO. 6	1B0	
	ILLINOIS FED. A	ID PROJECT			


FEET

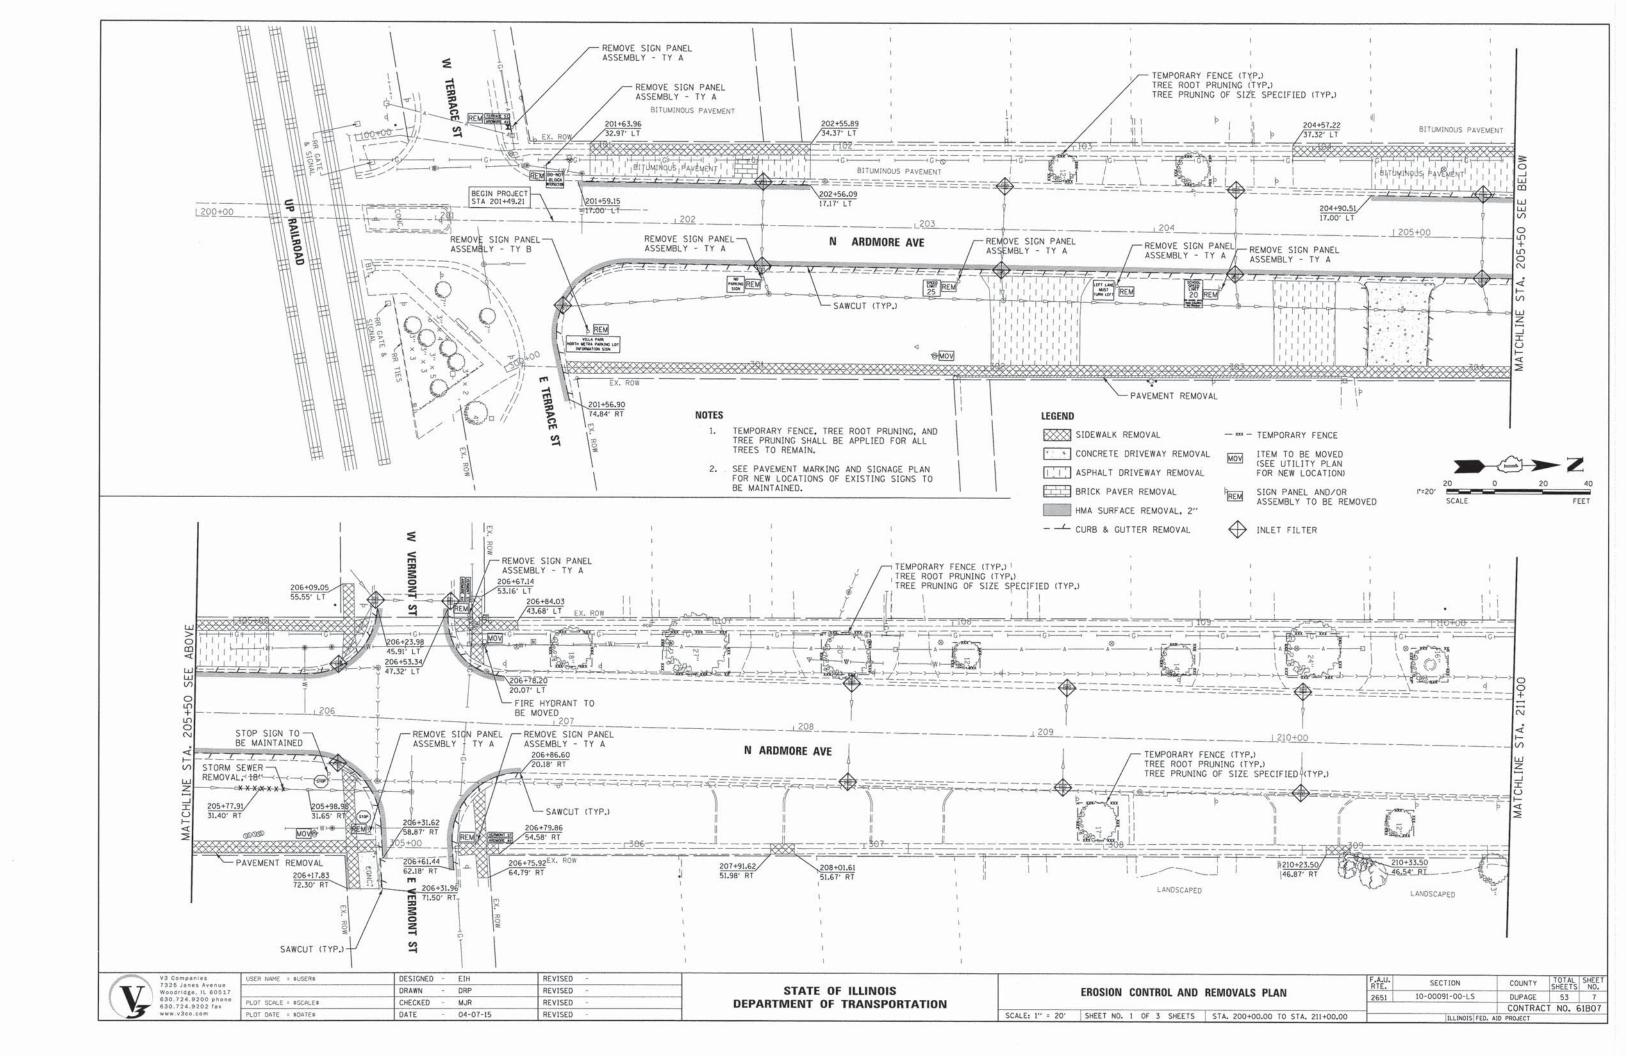


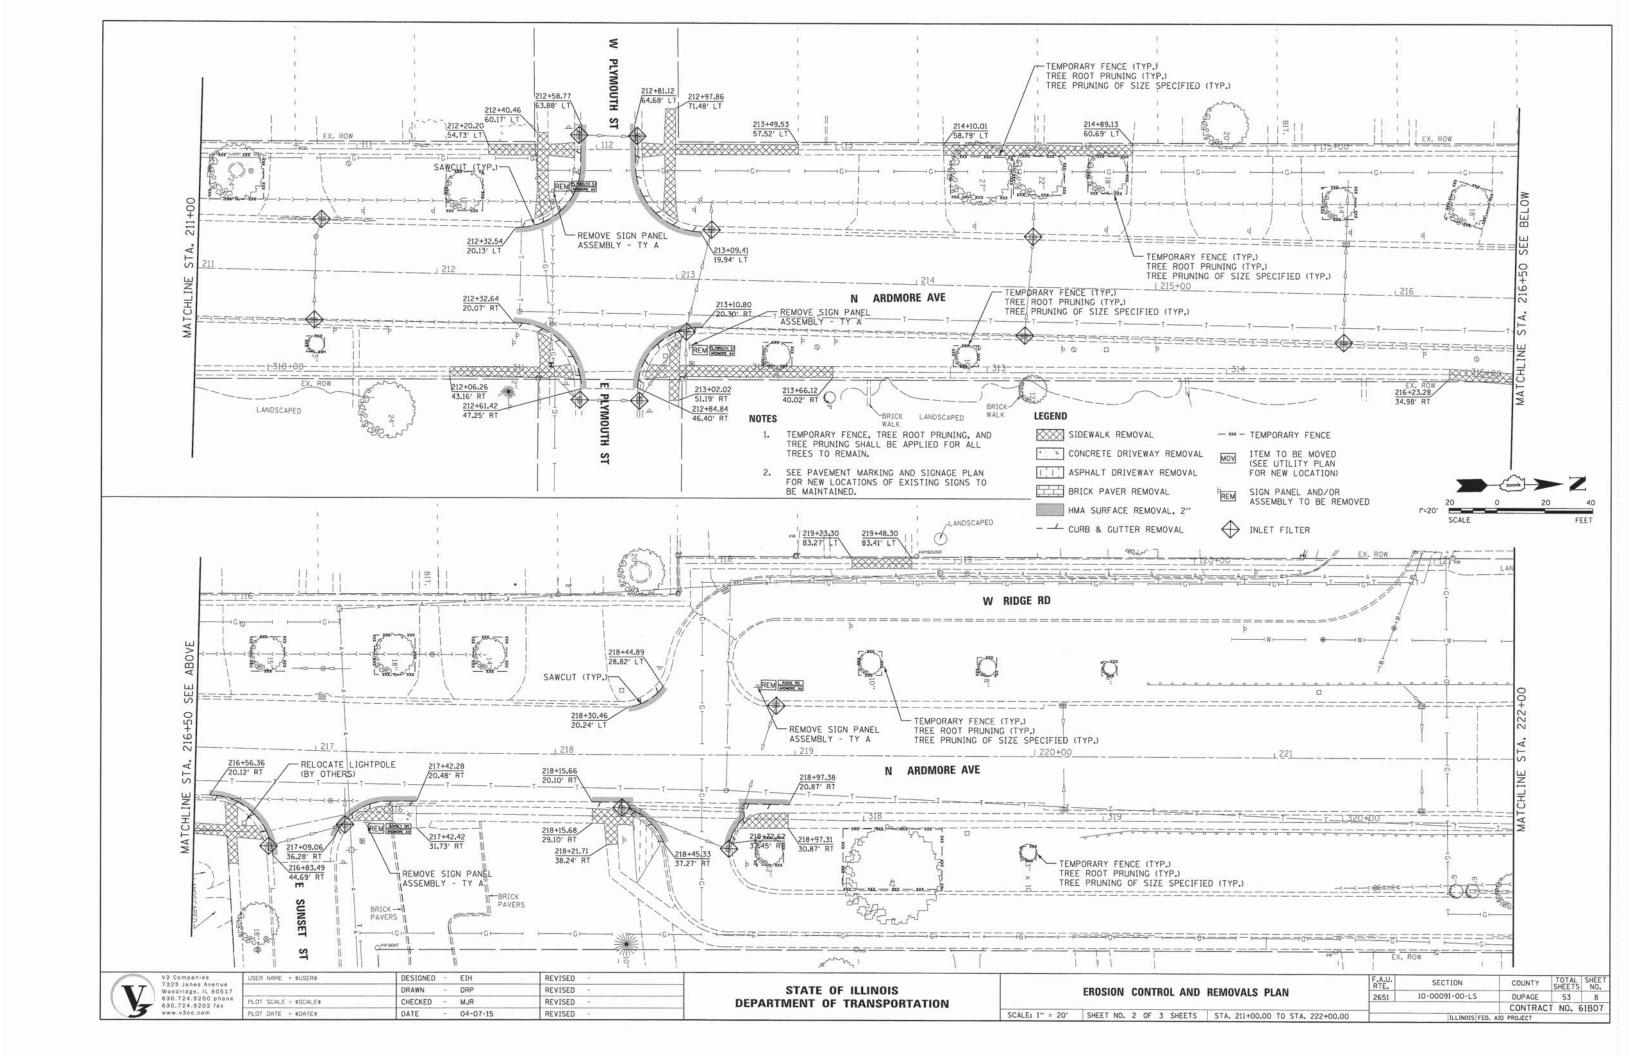


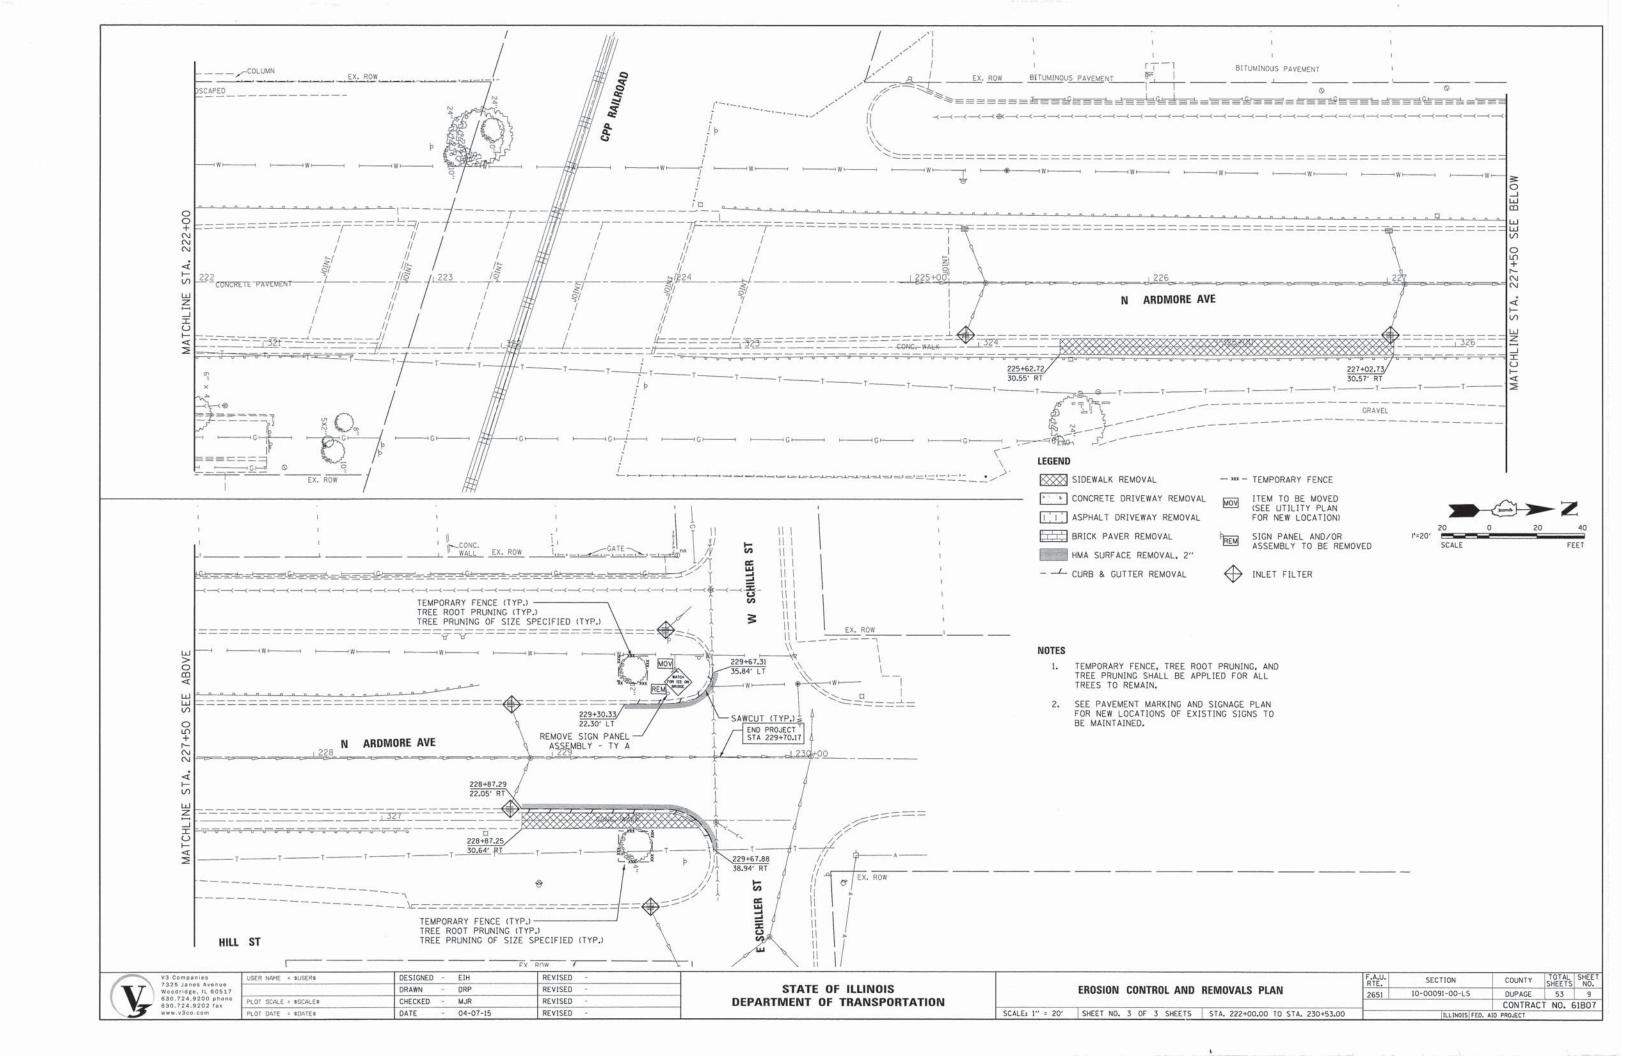


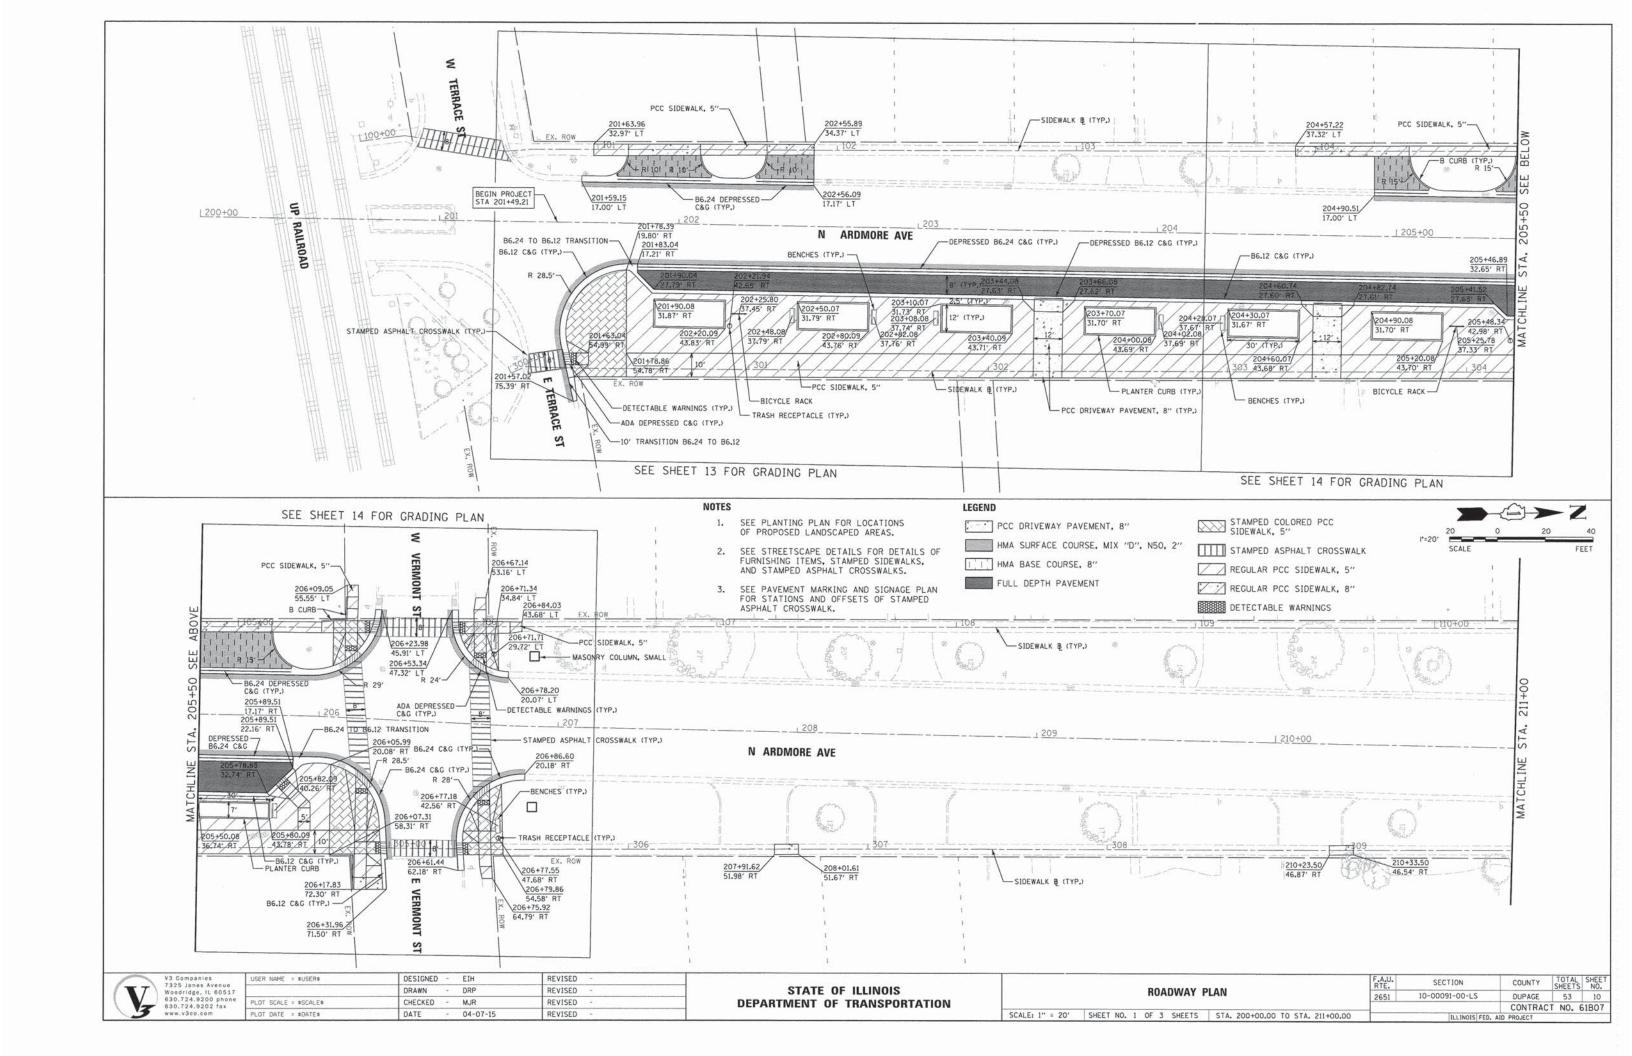


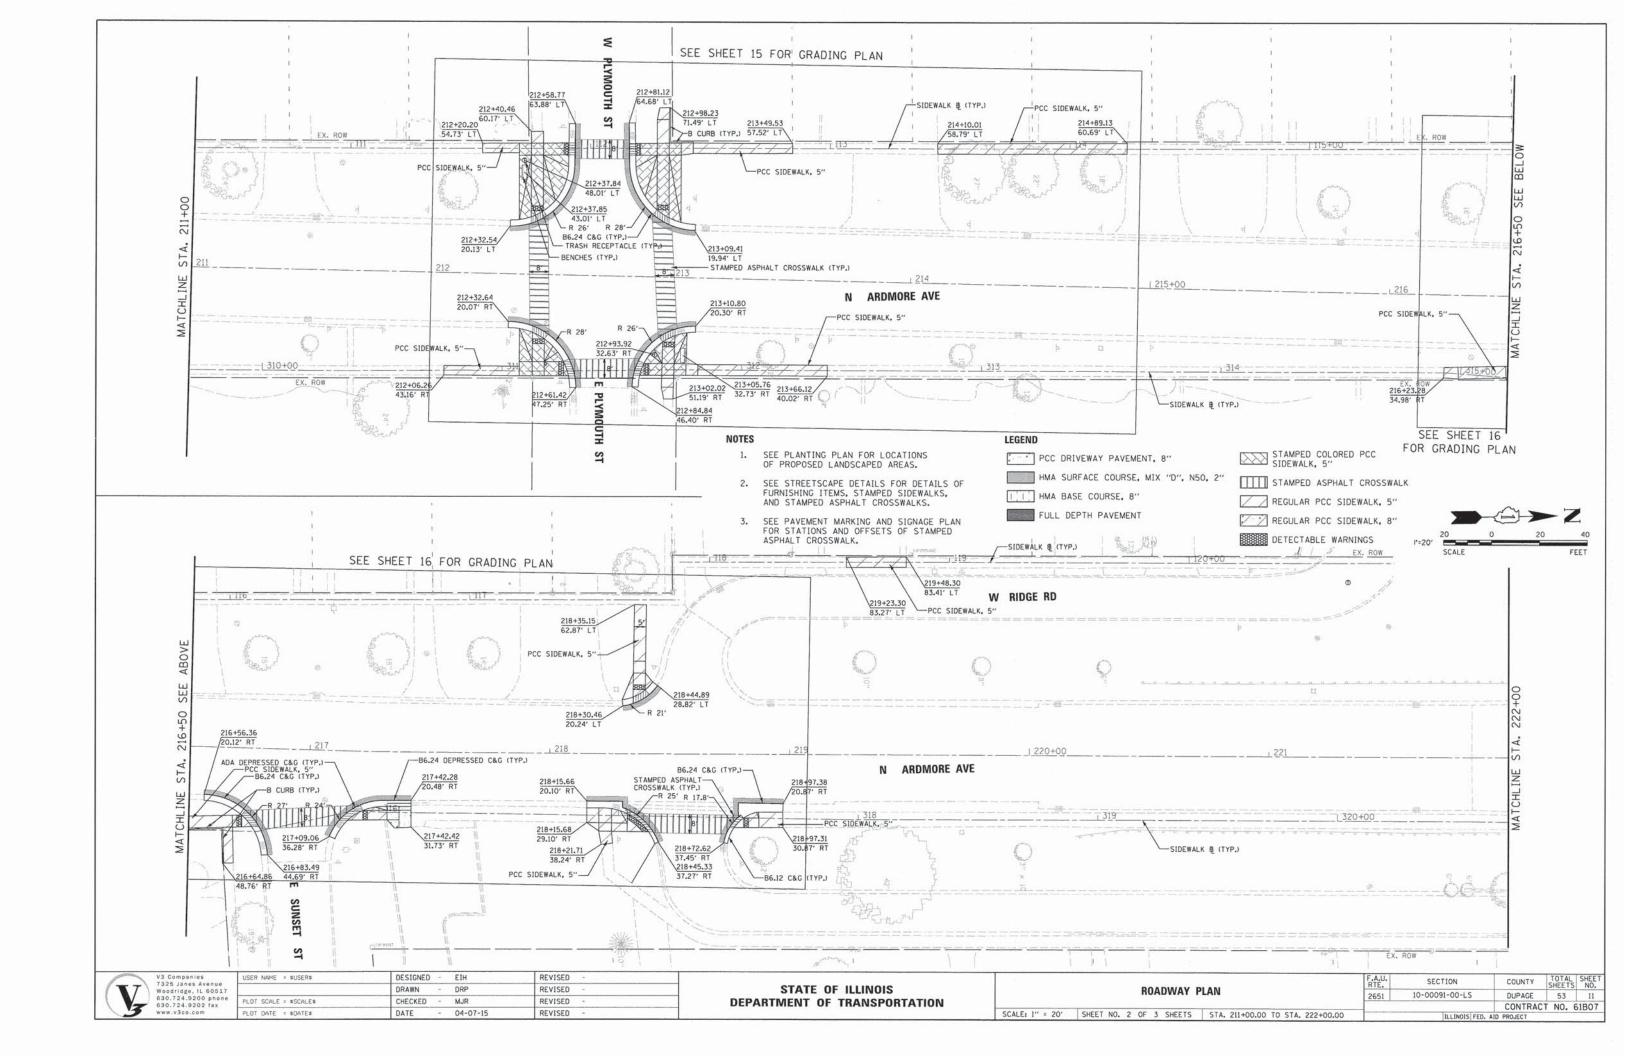


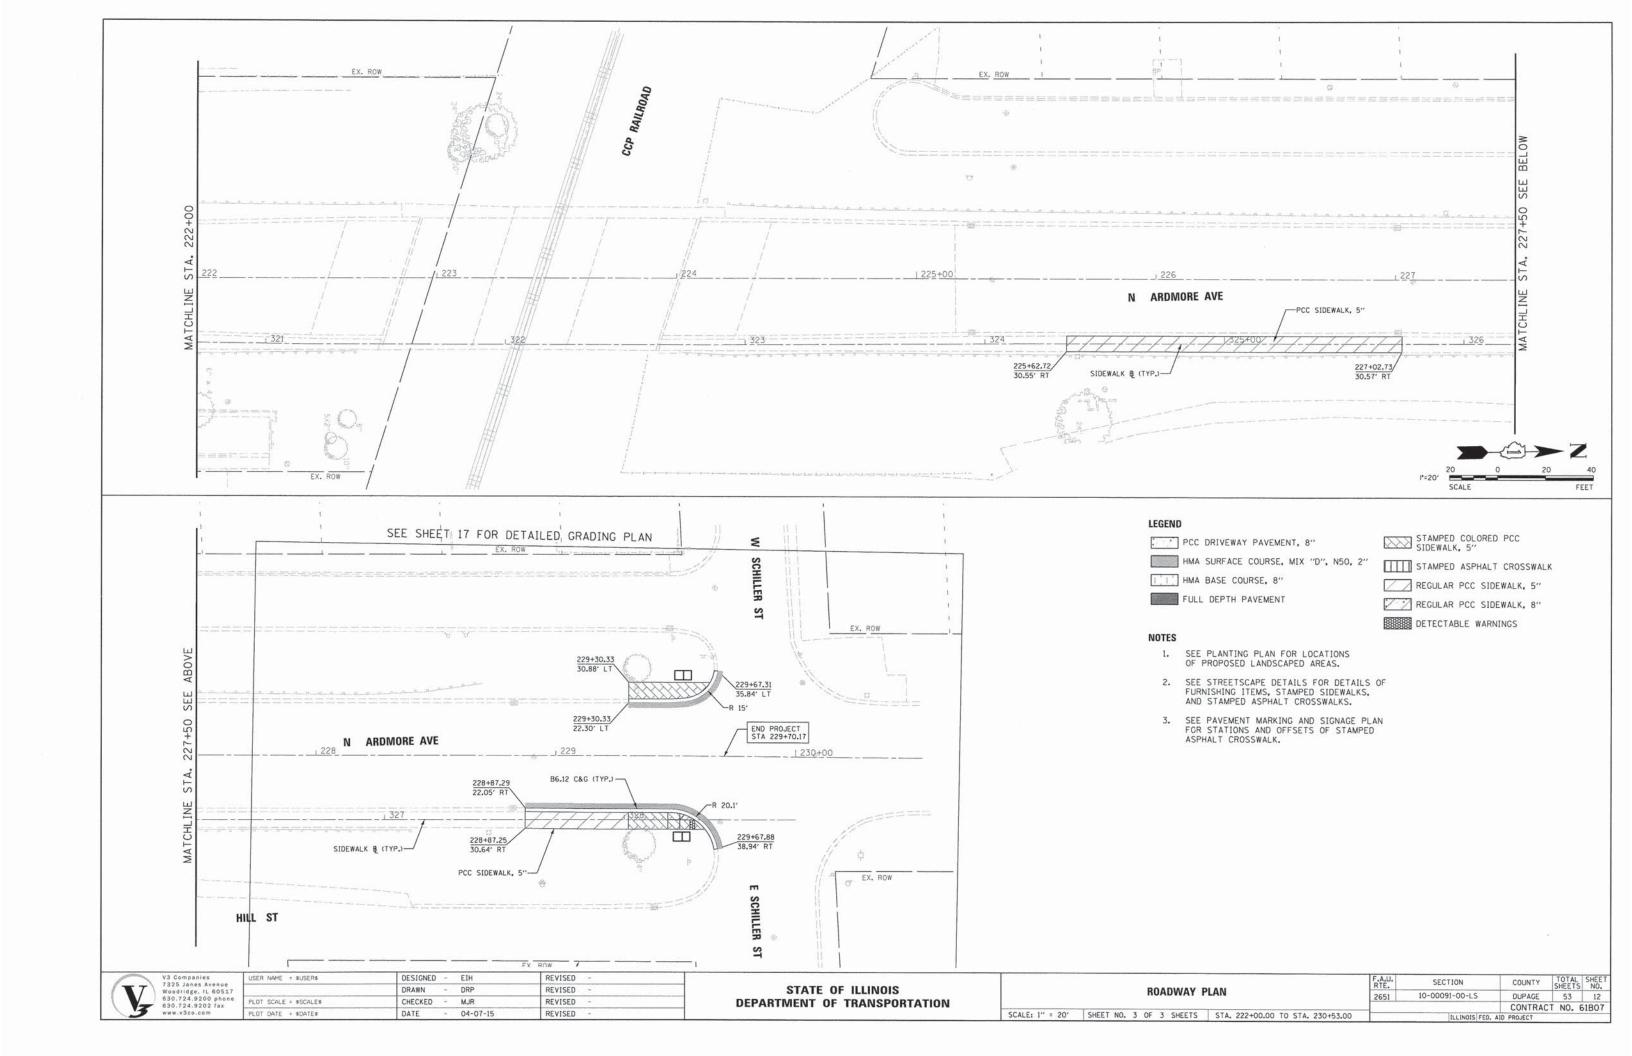


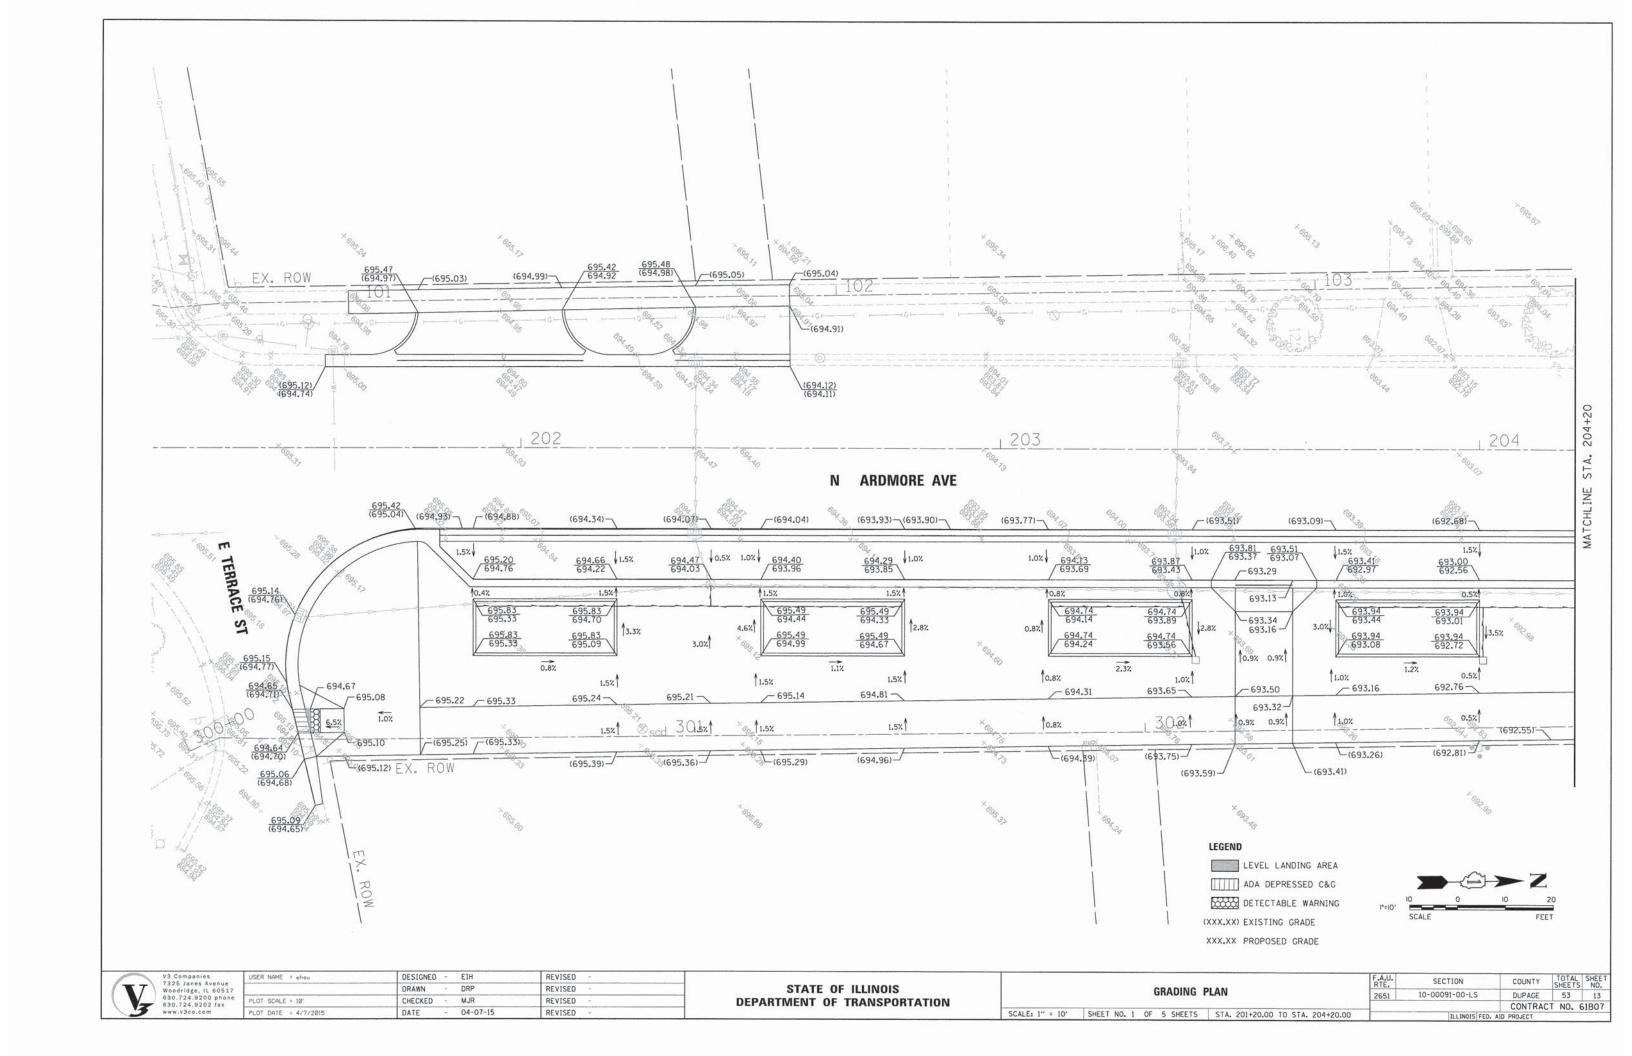


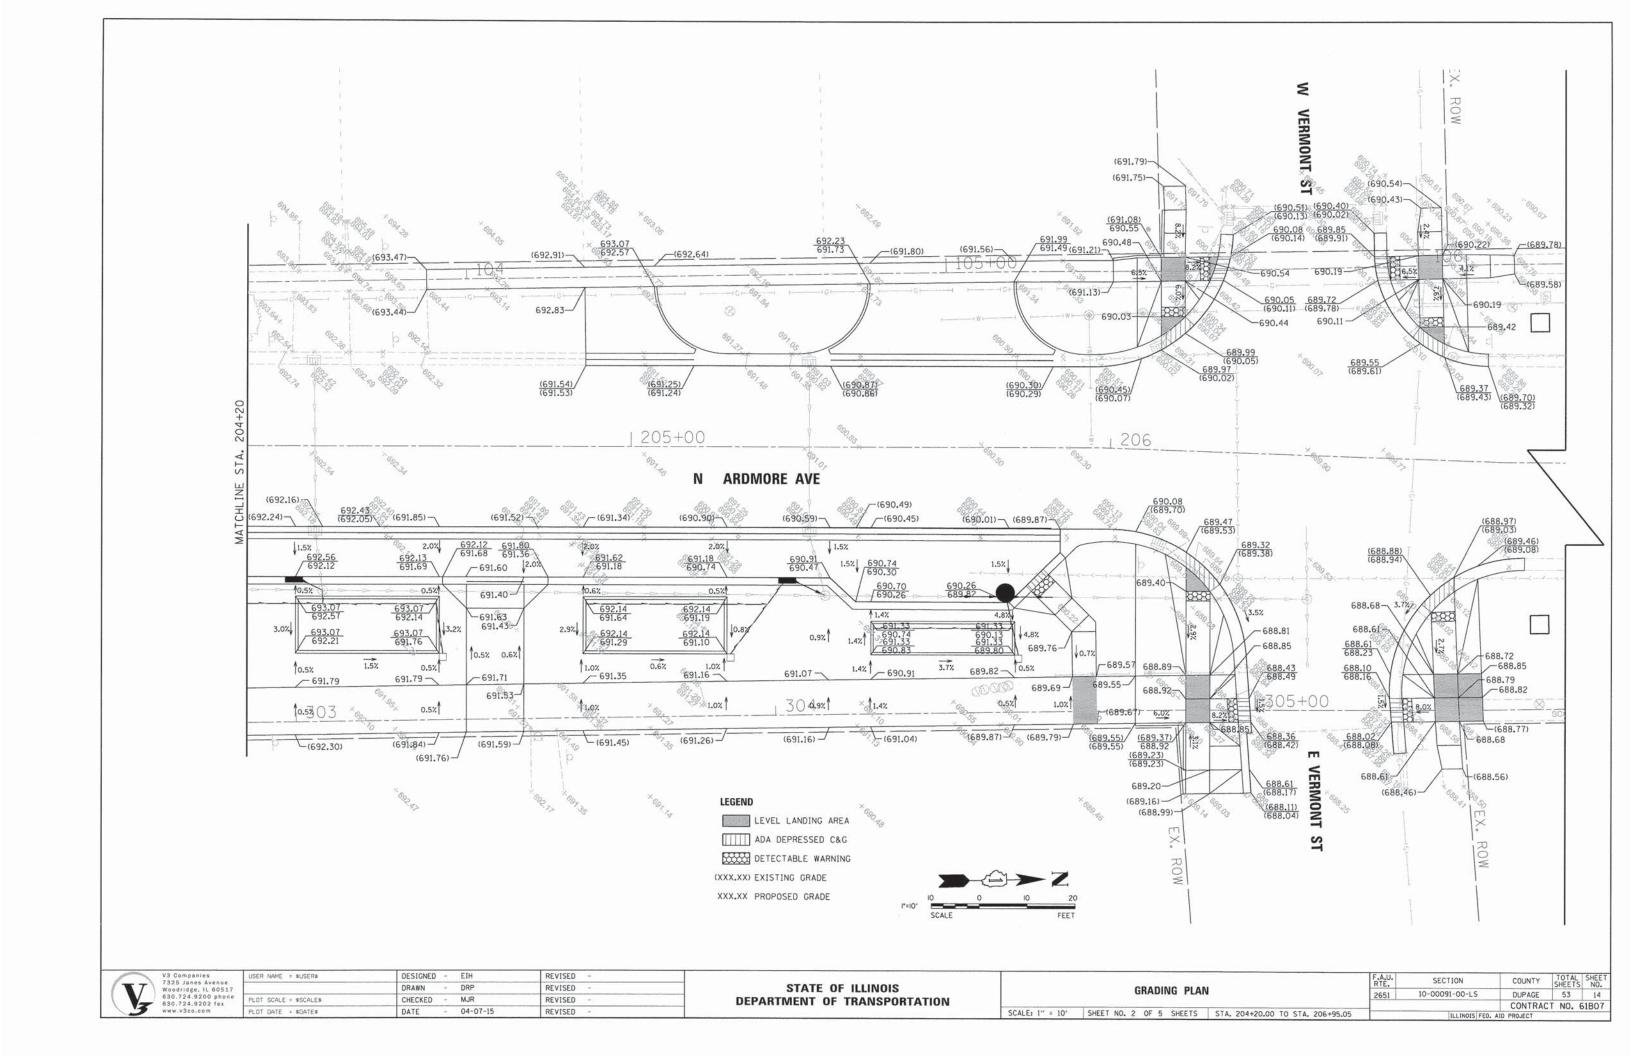


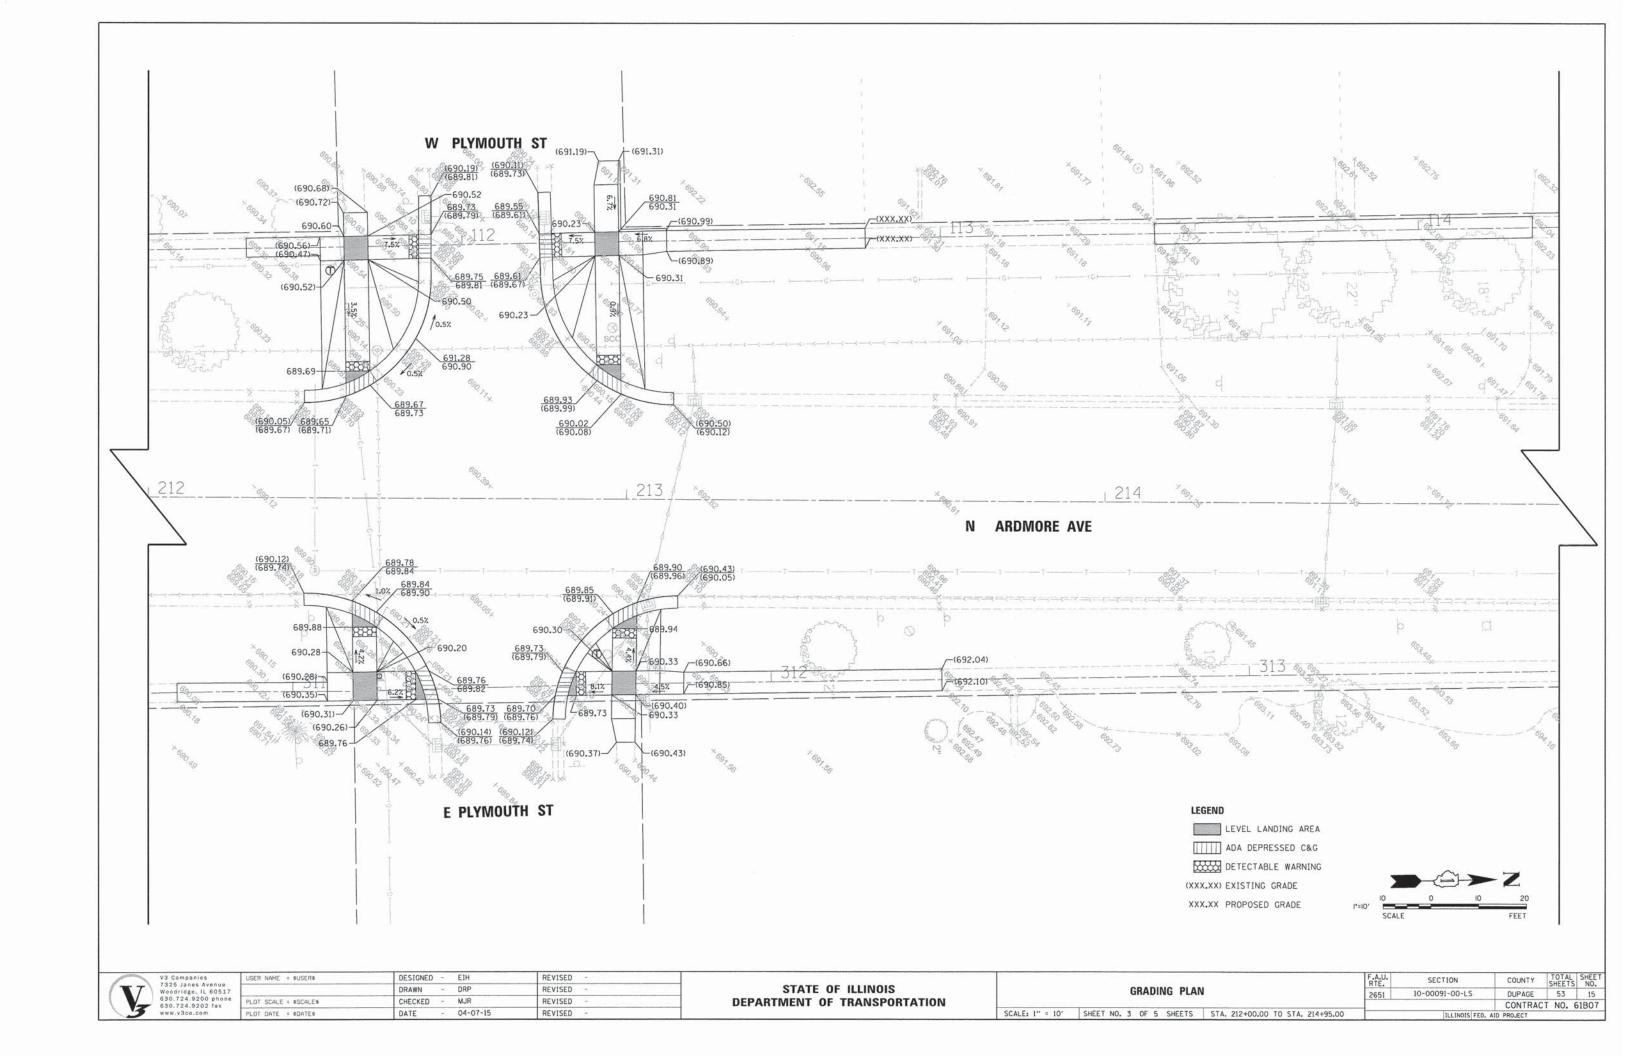


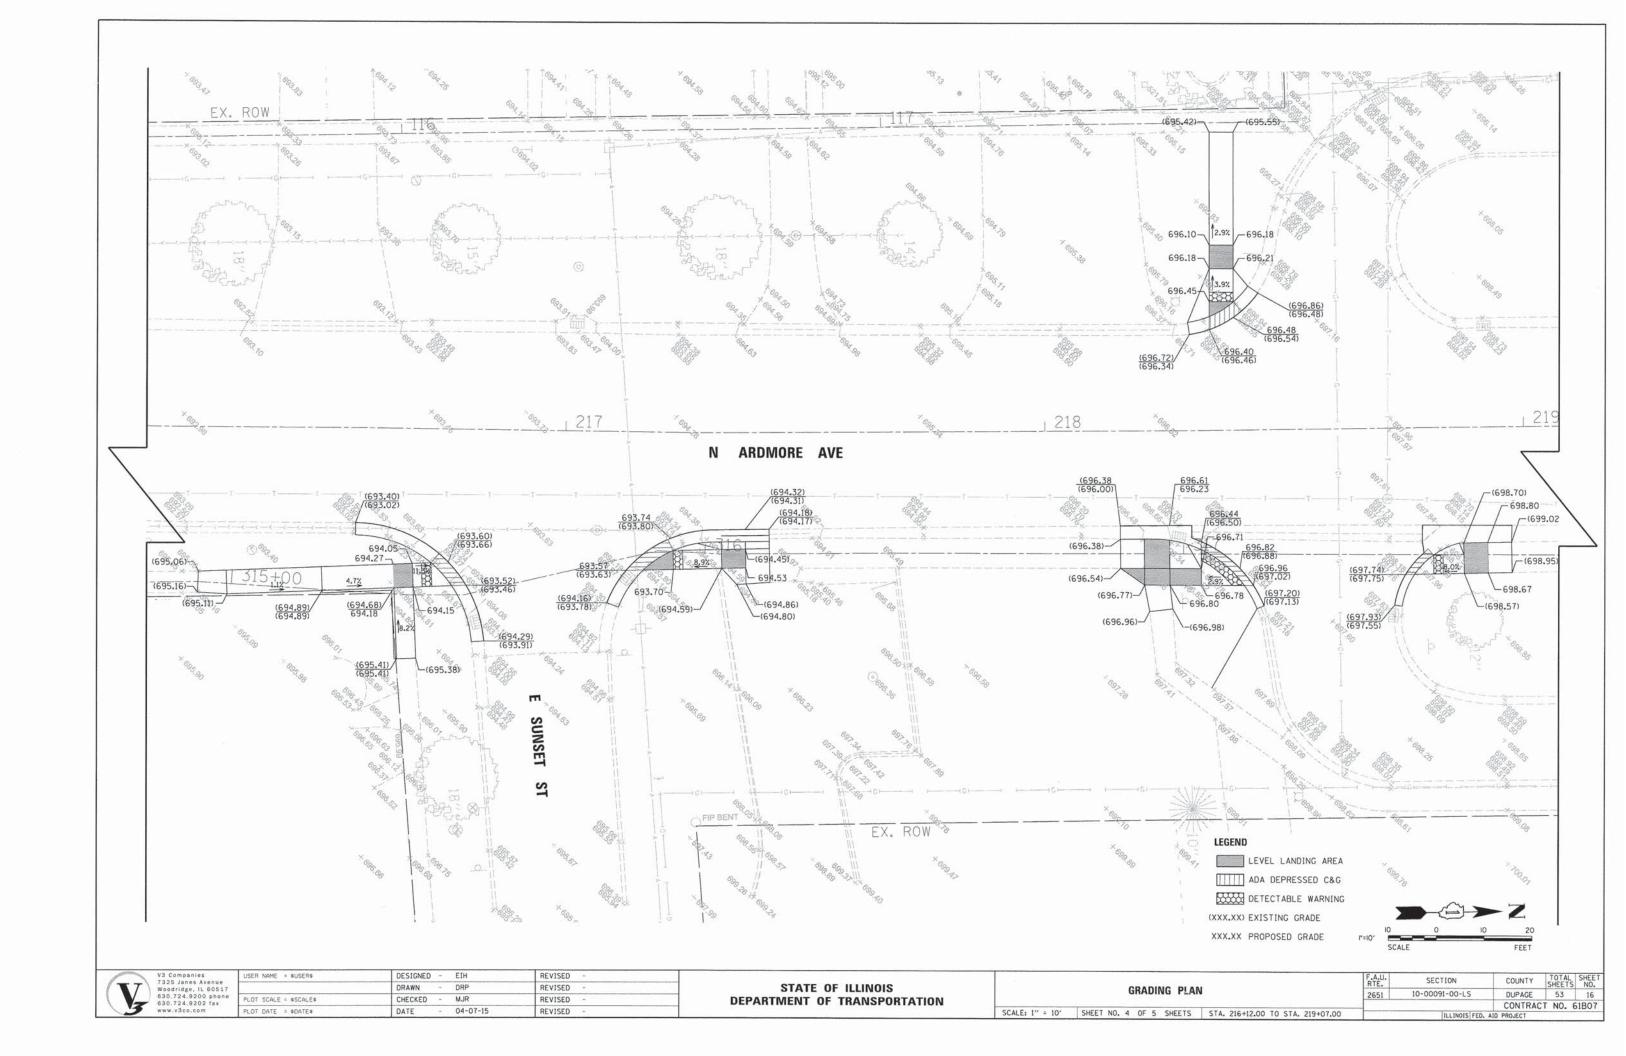


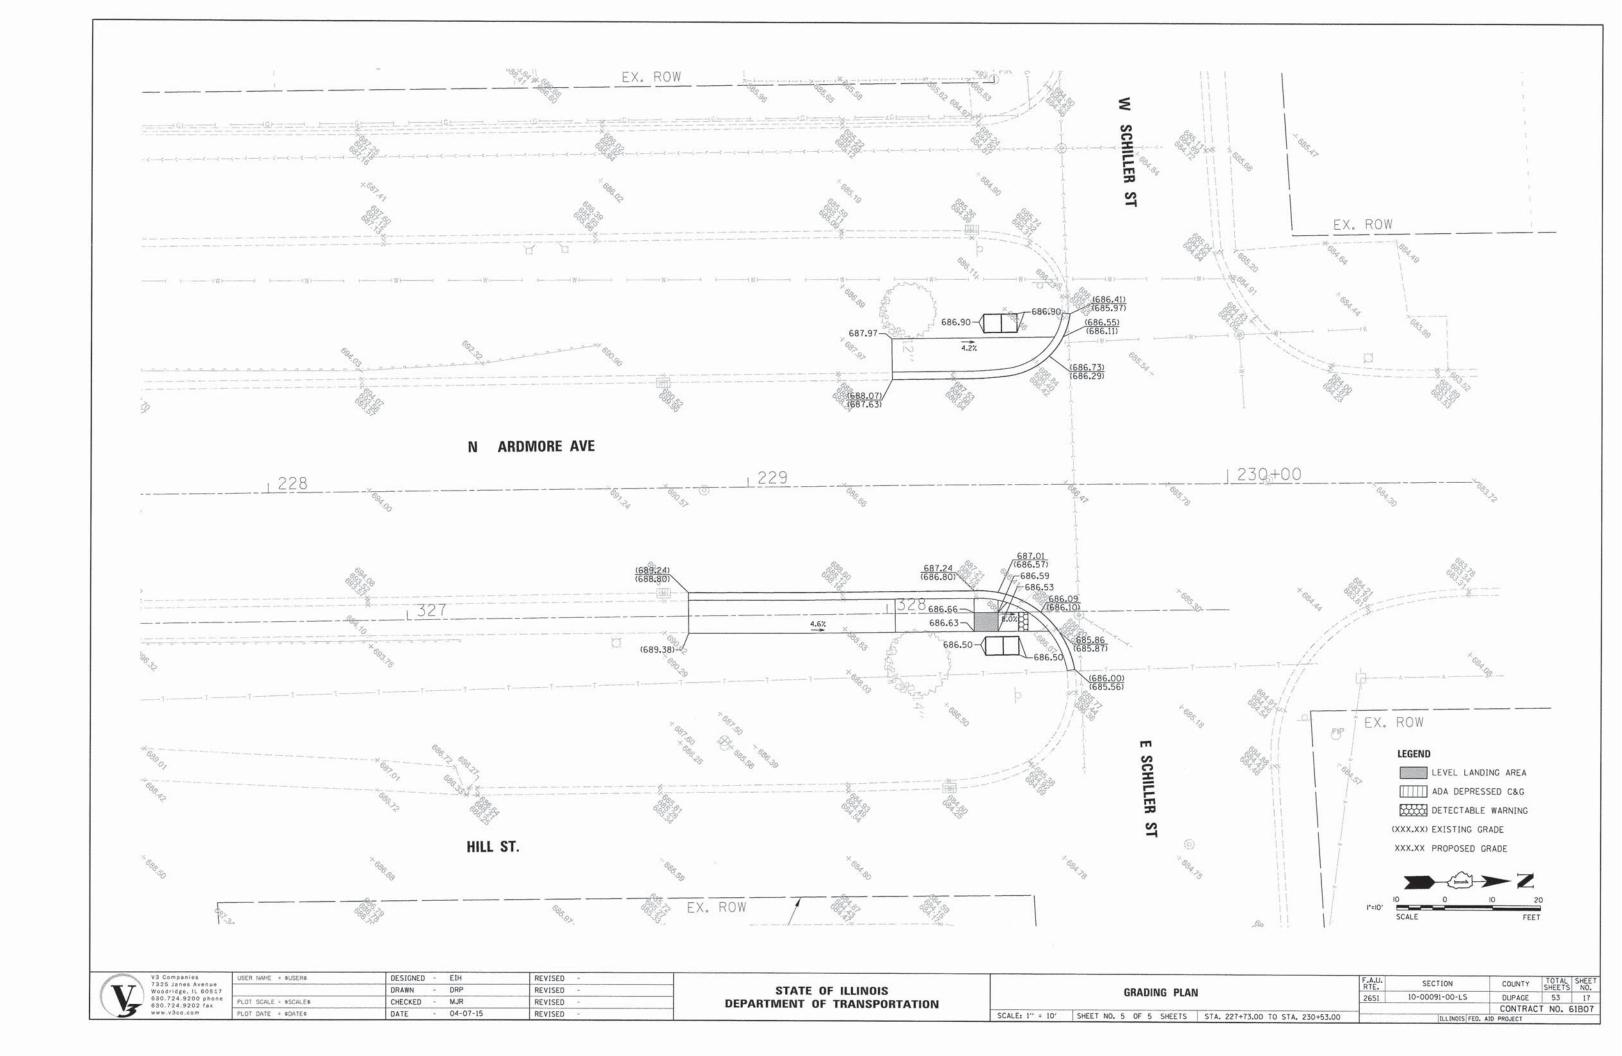


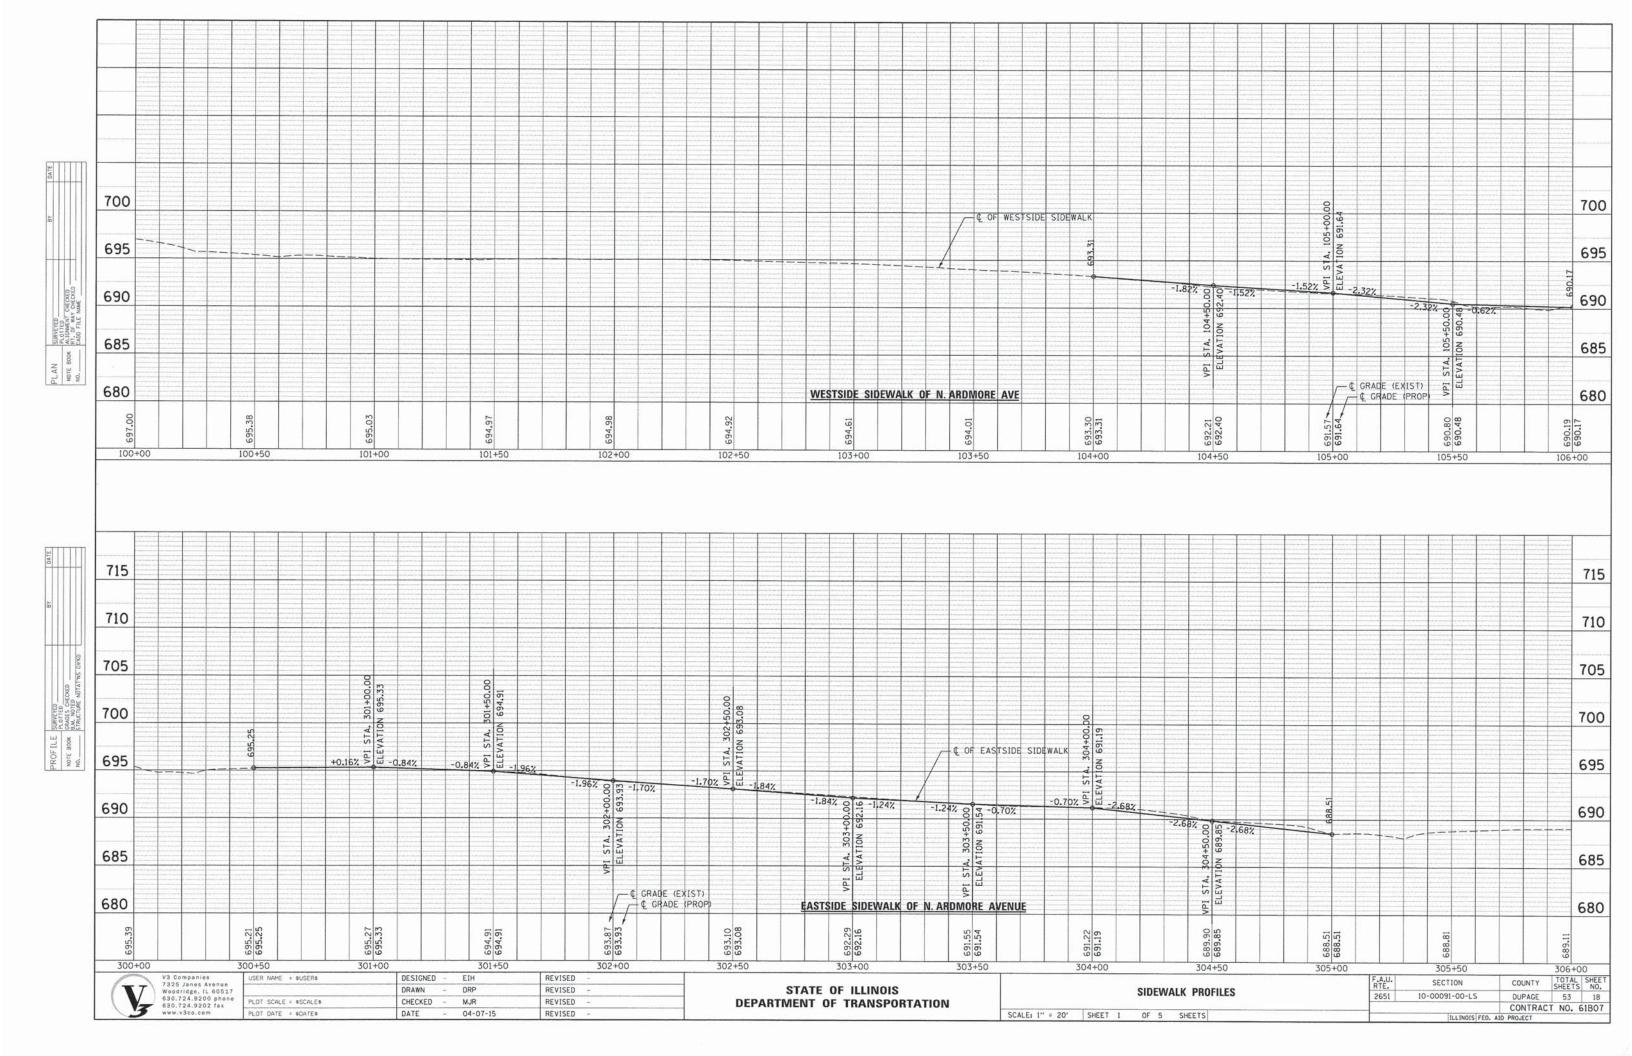


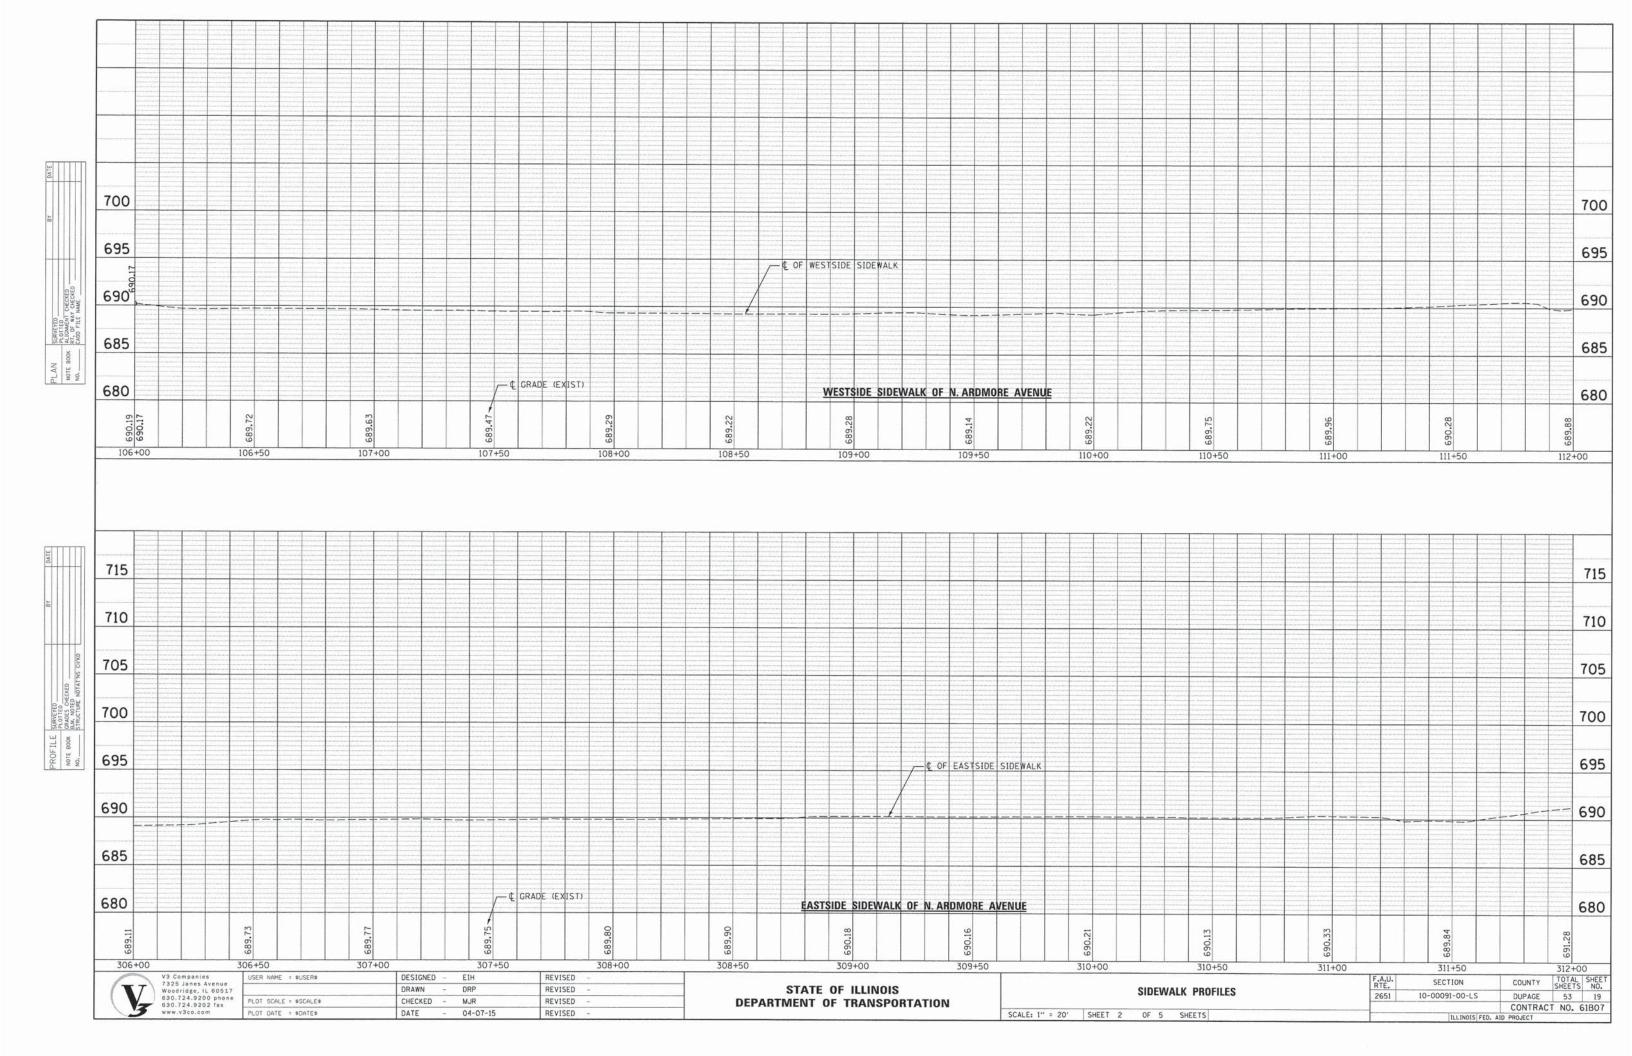


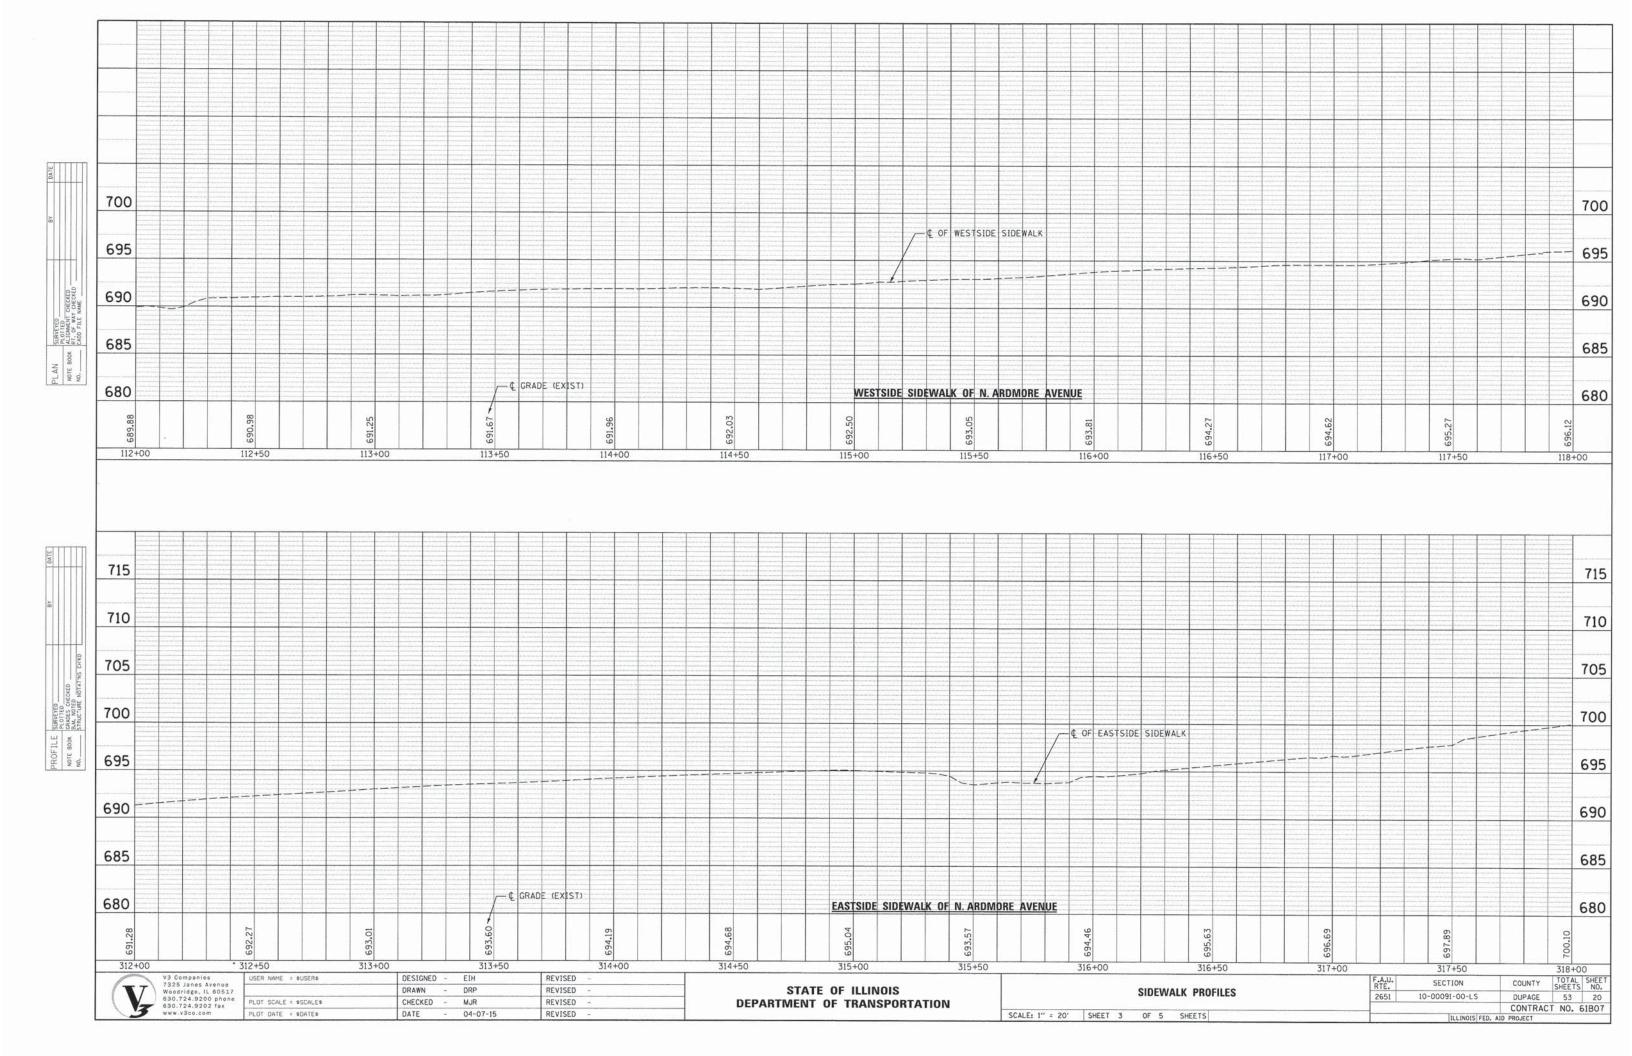


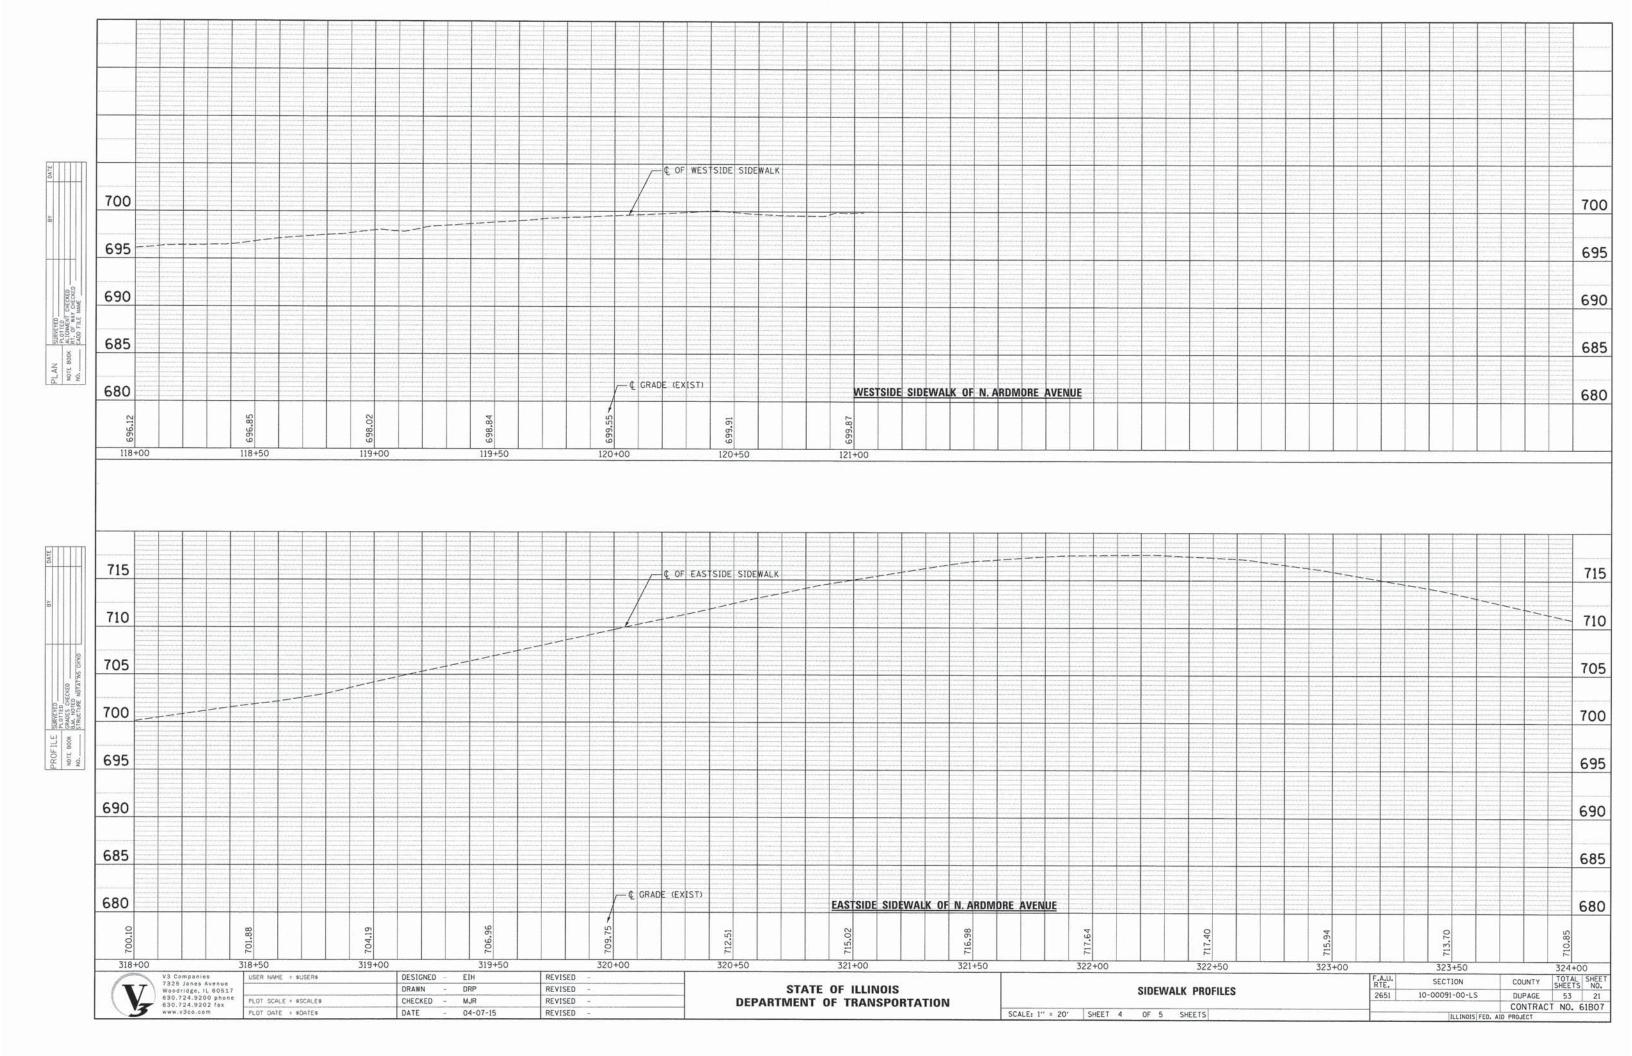


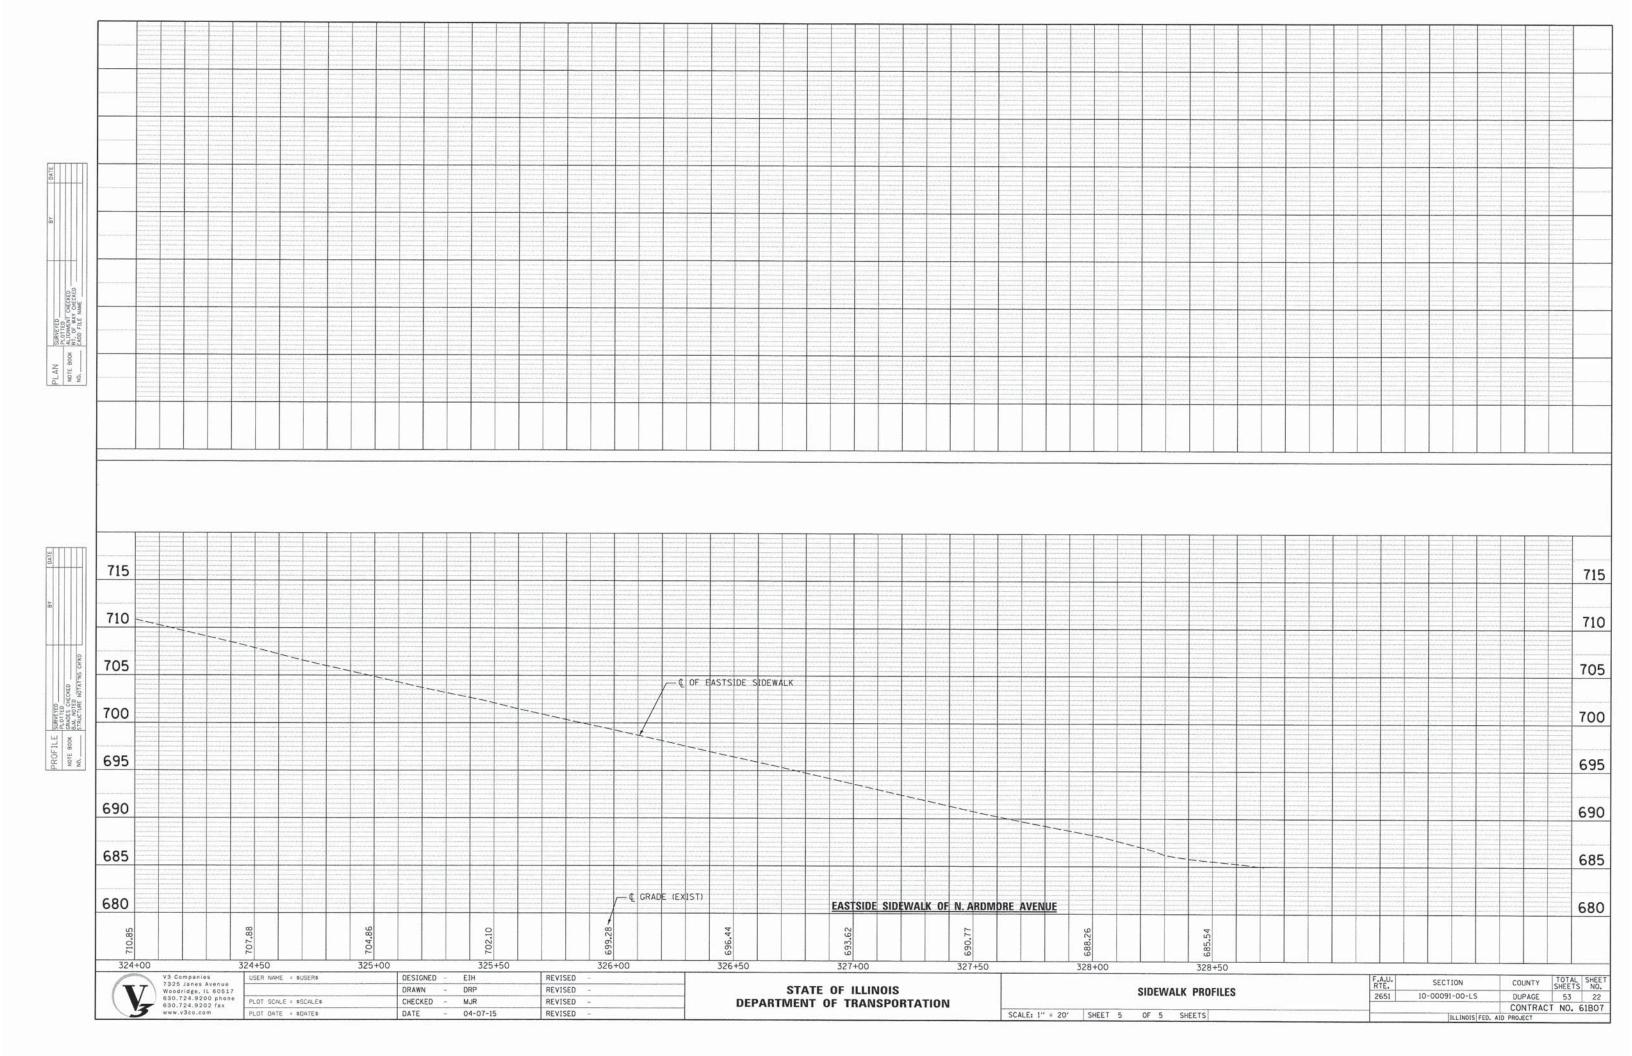


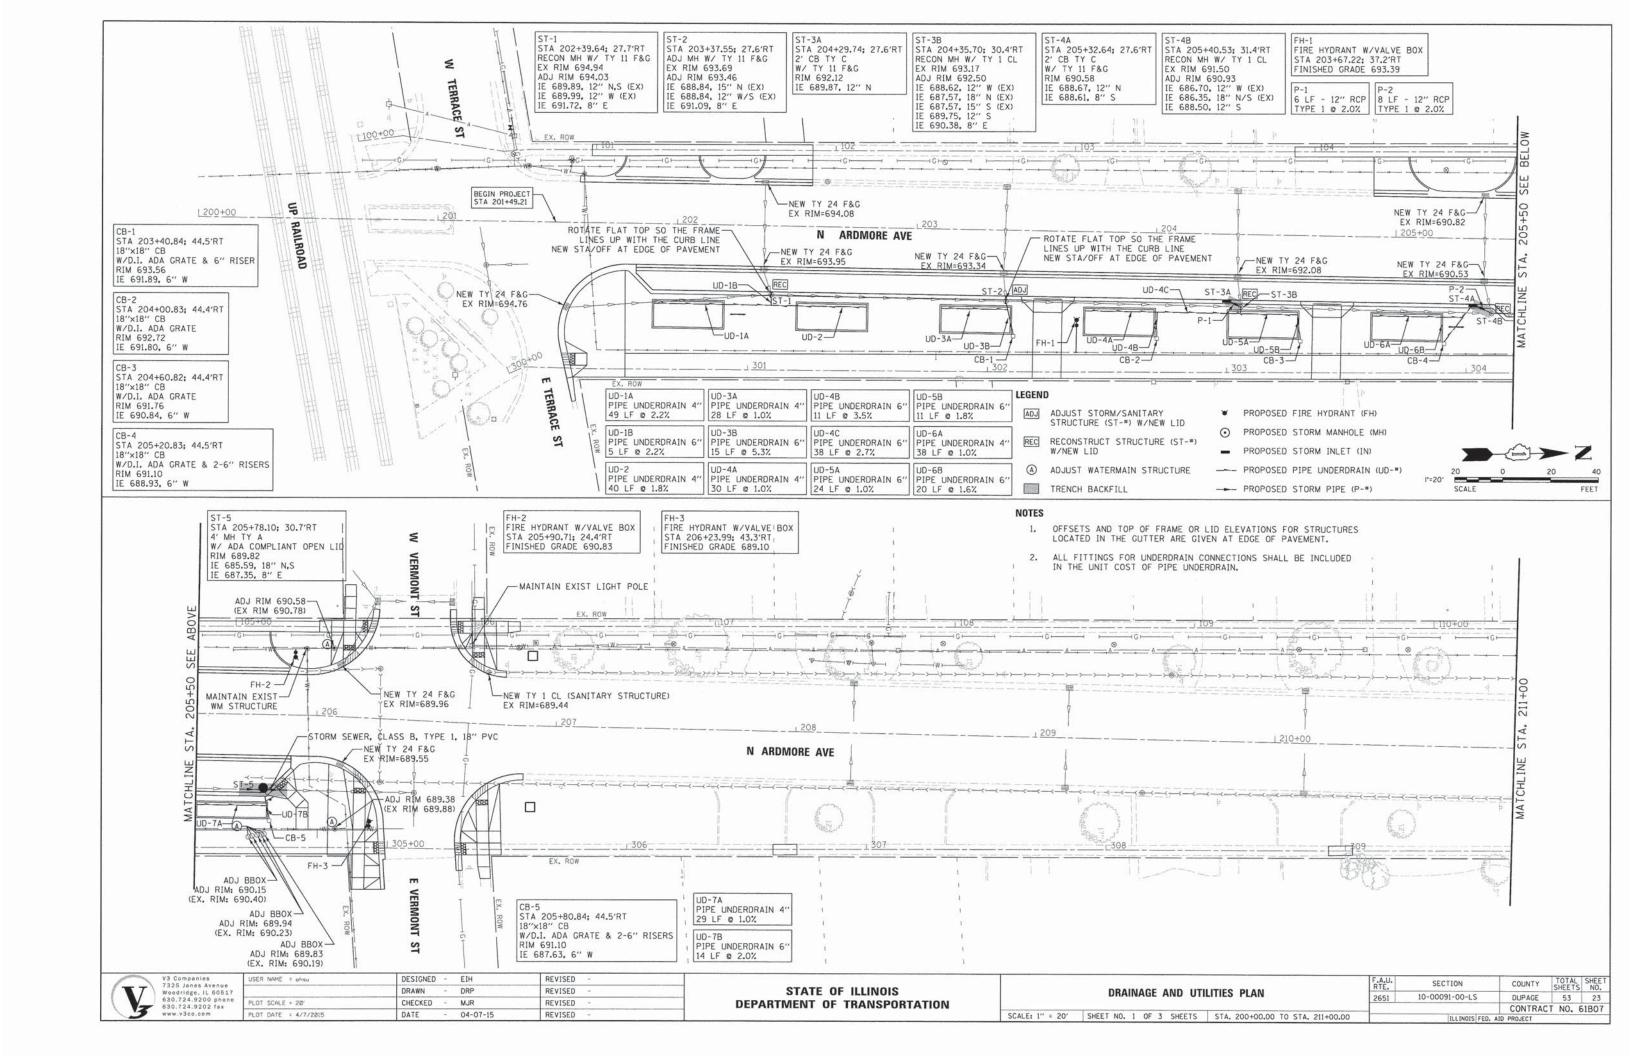


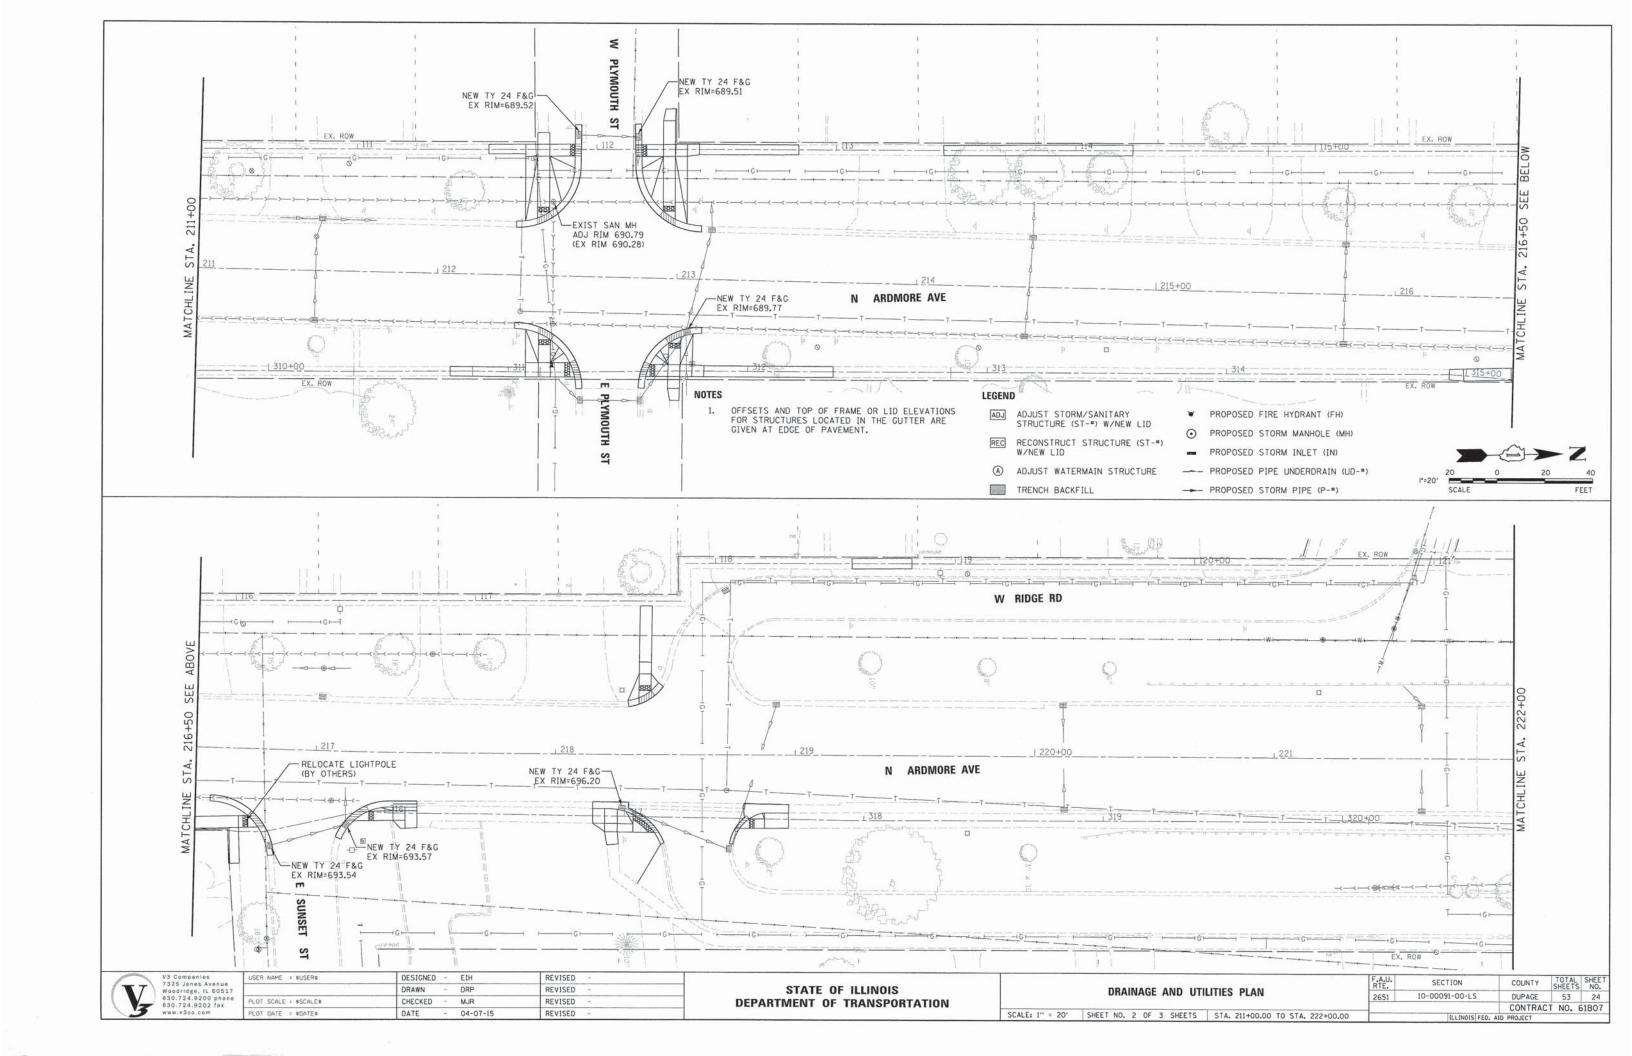


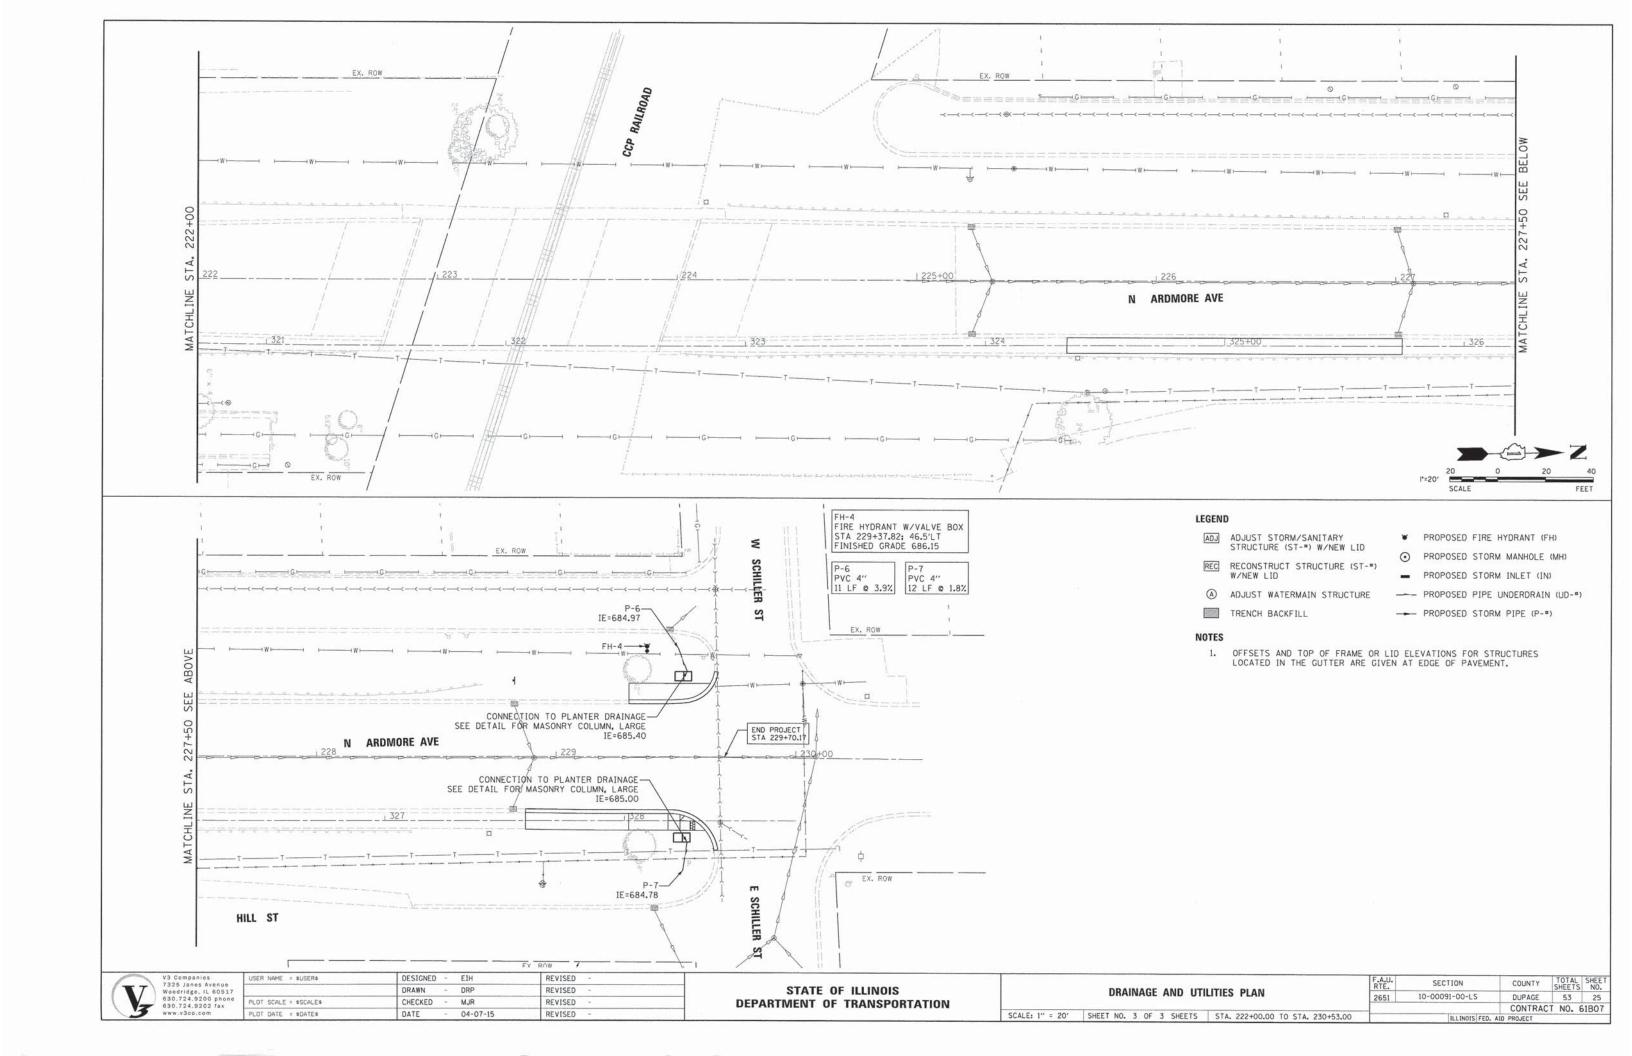


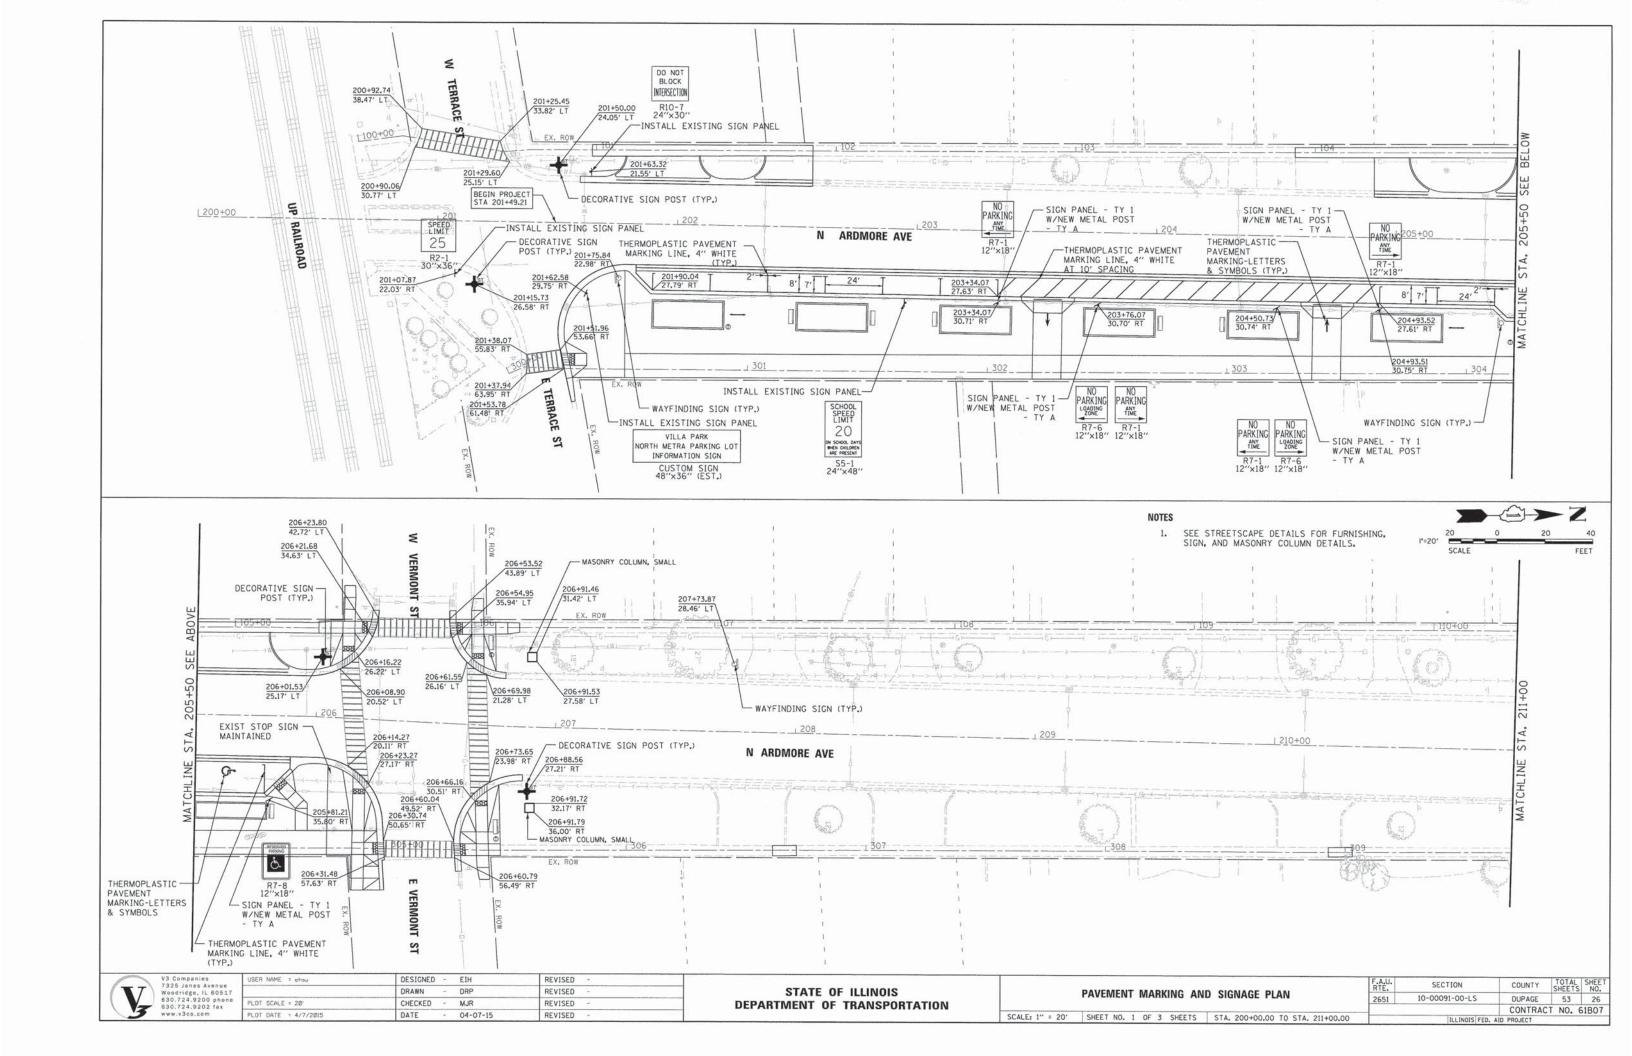


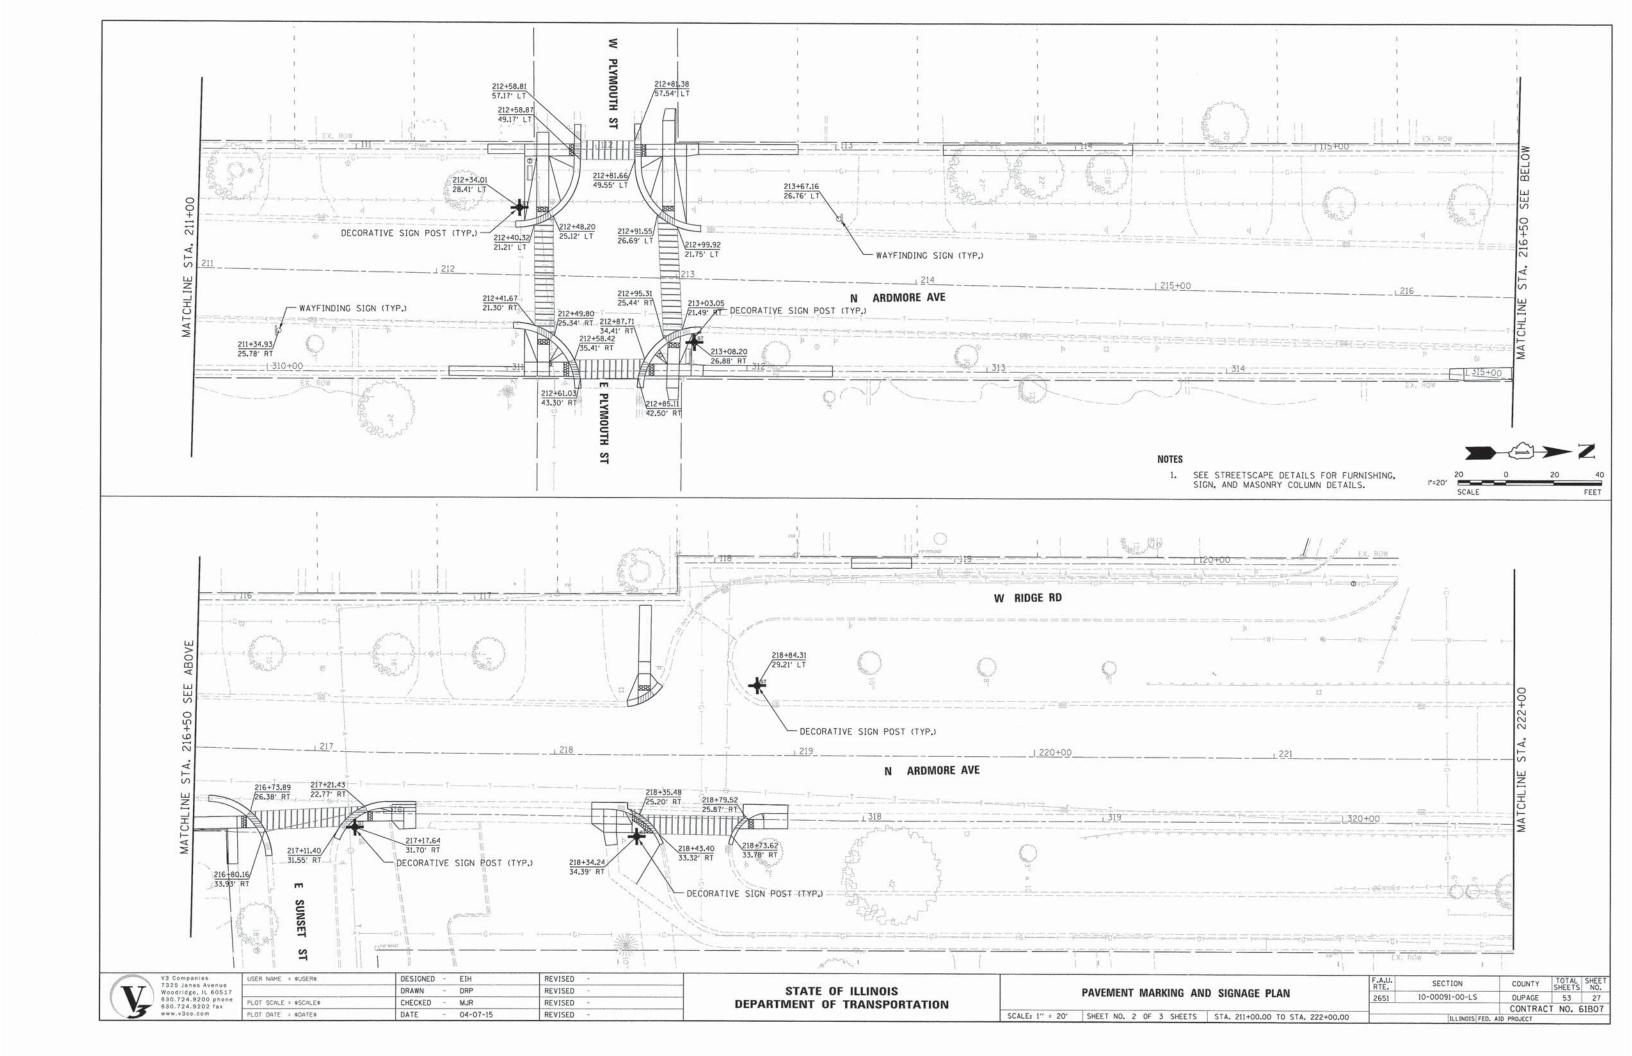


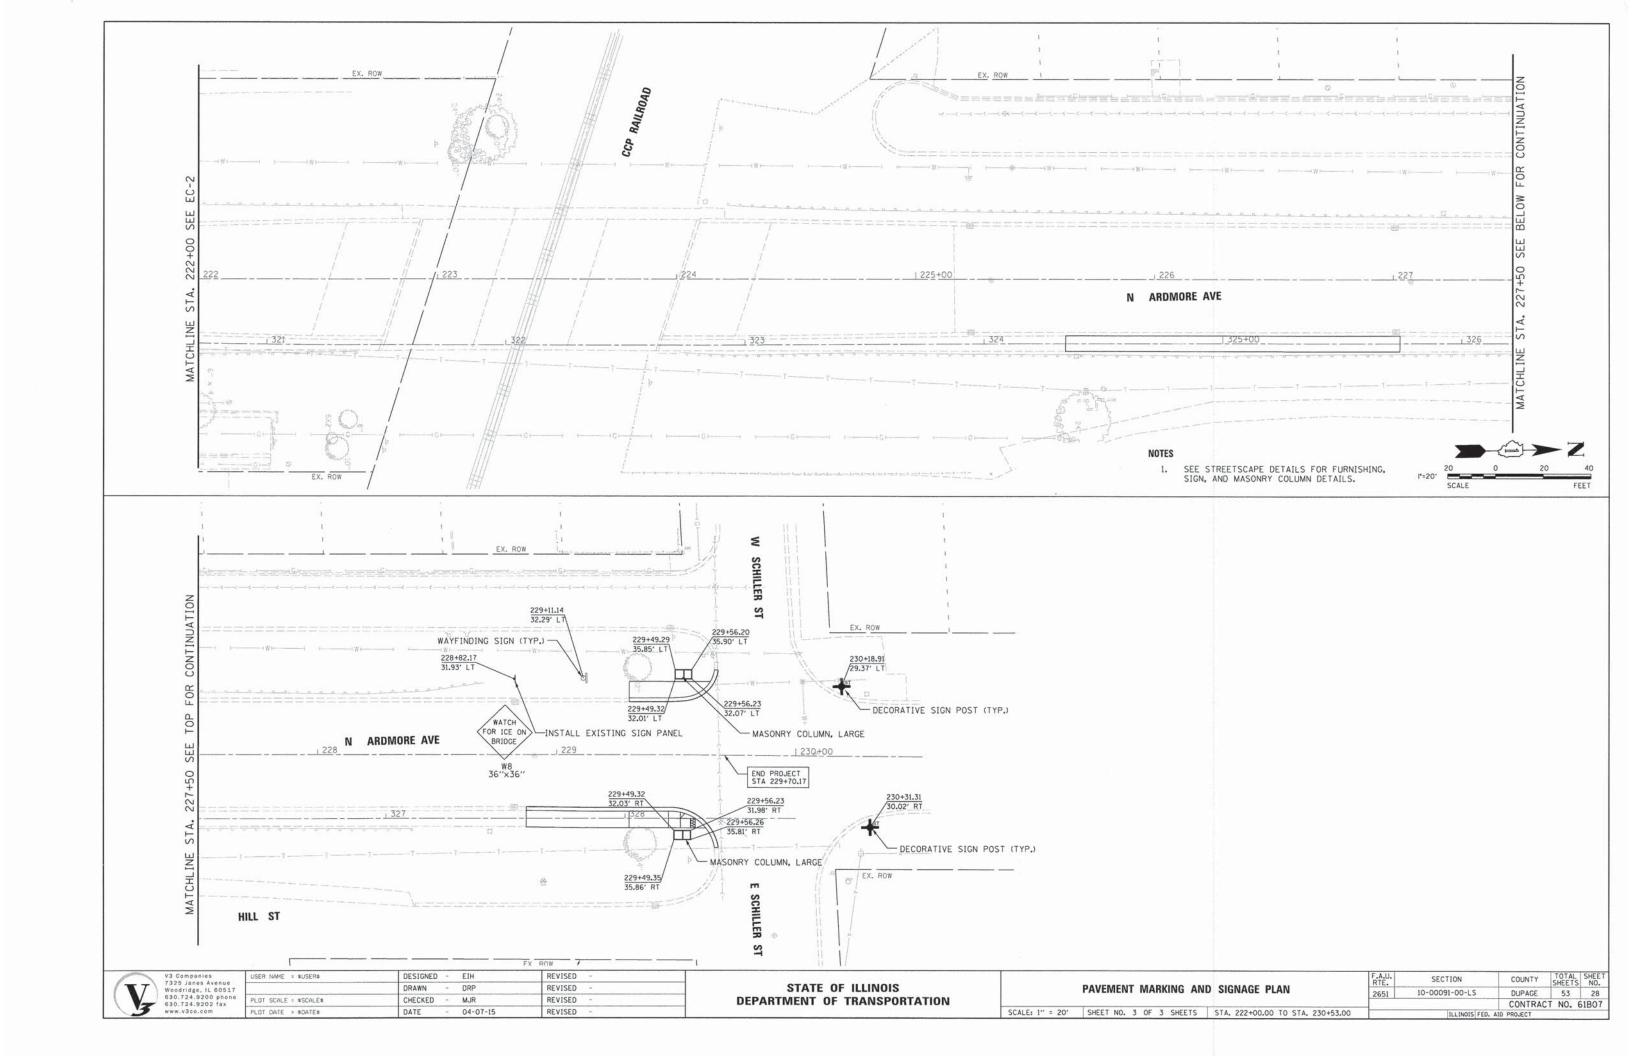


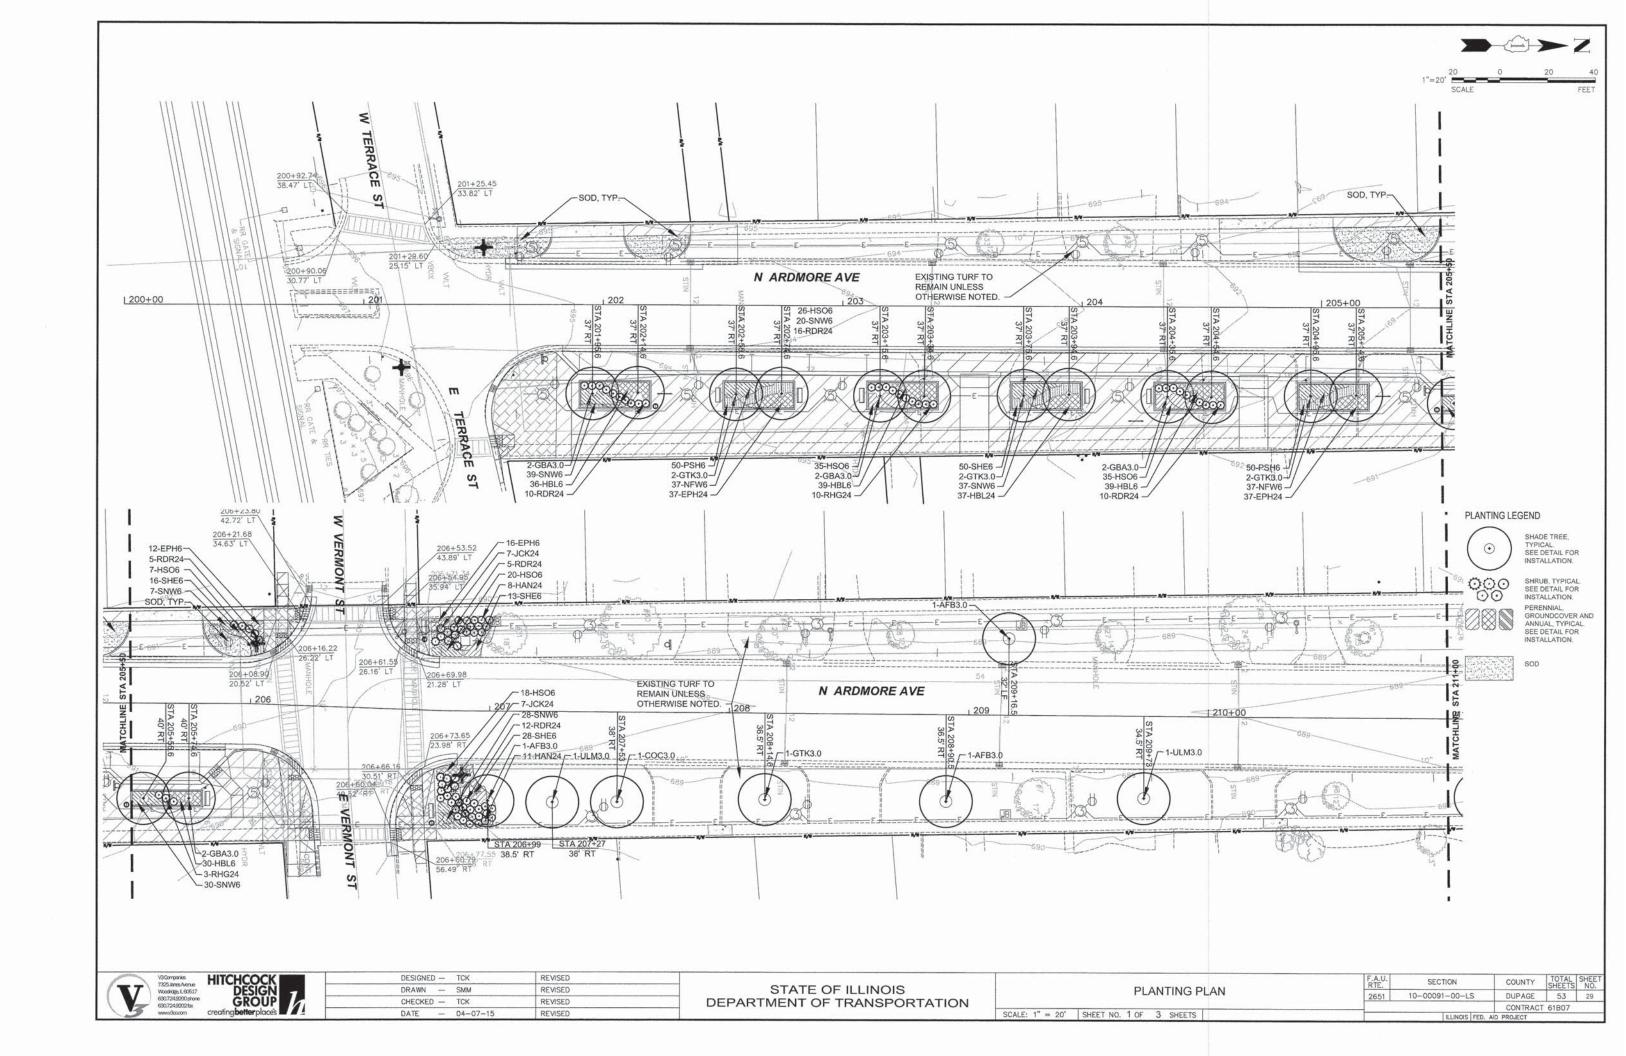

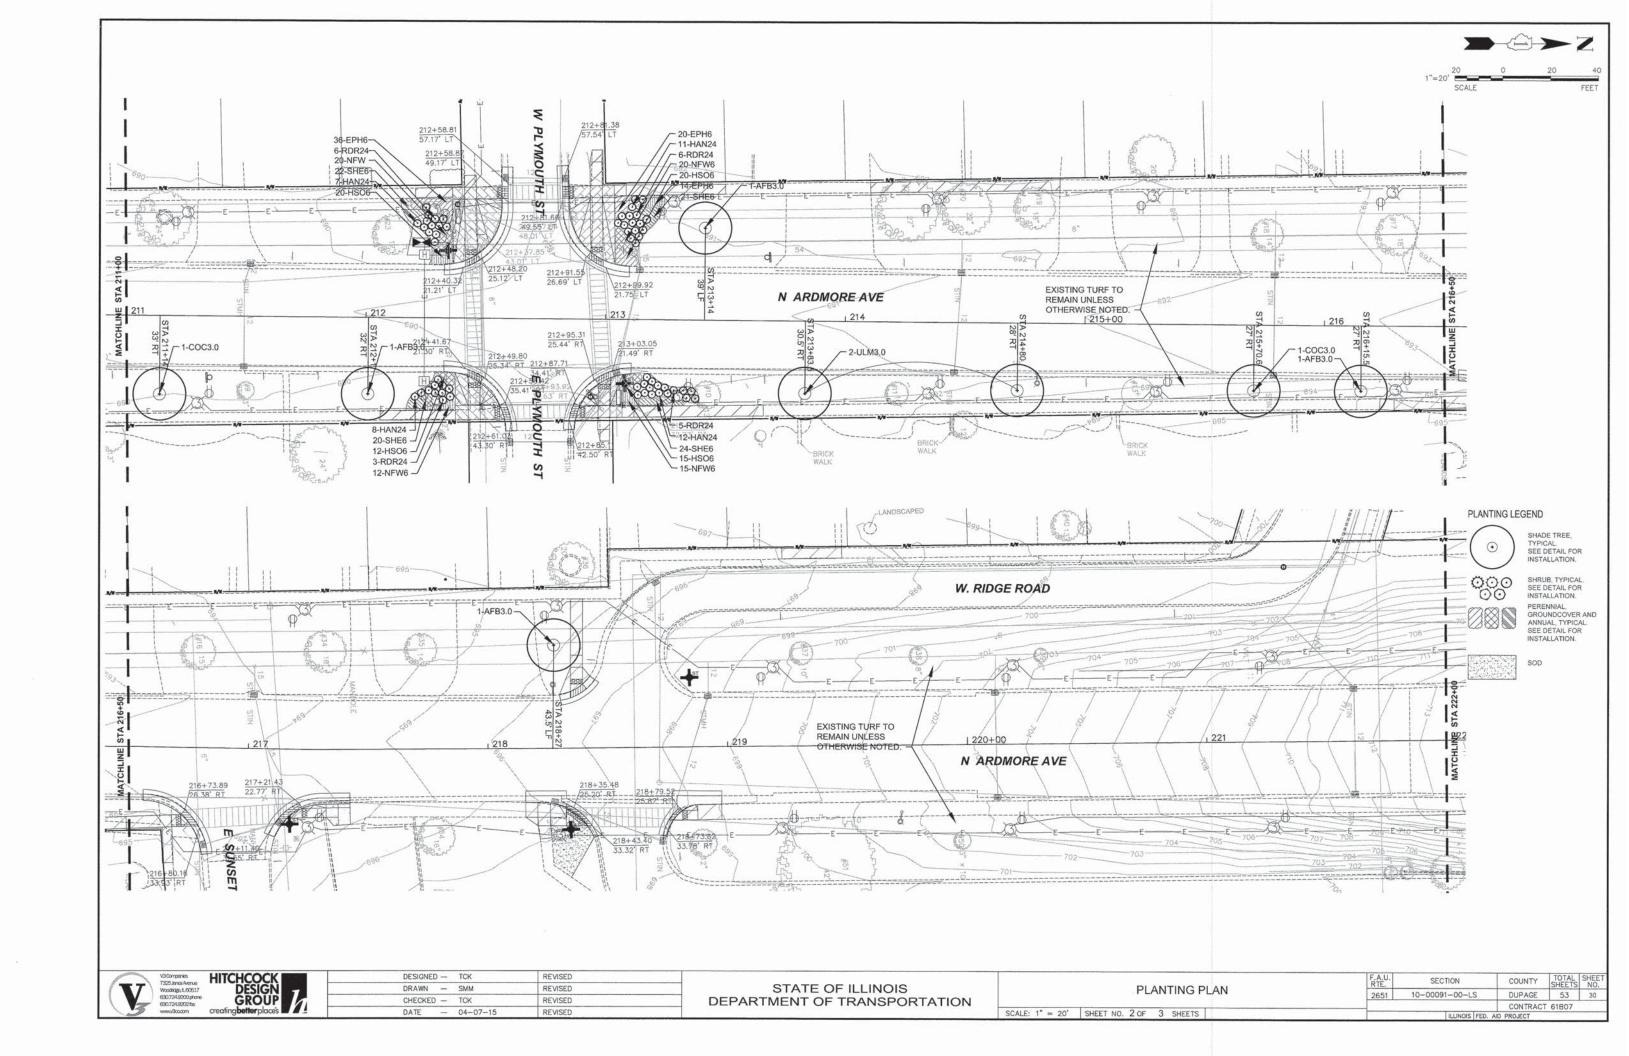


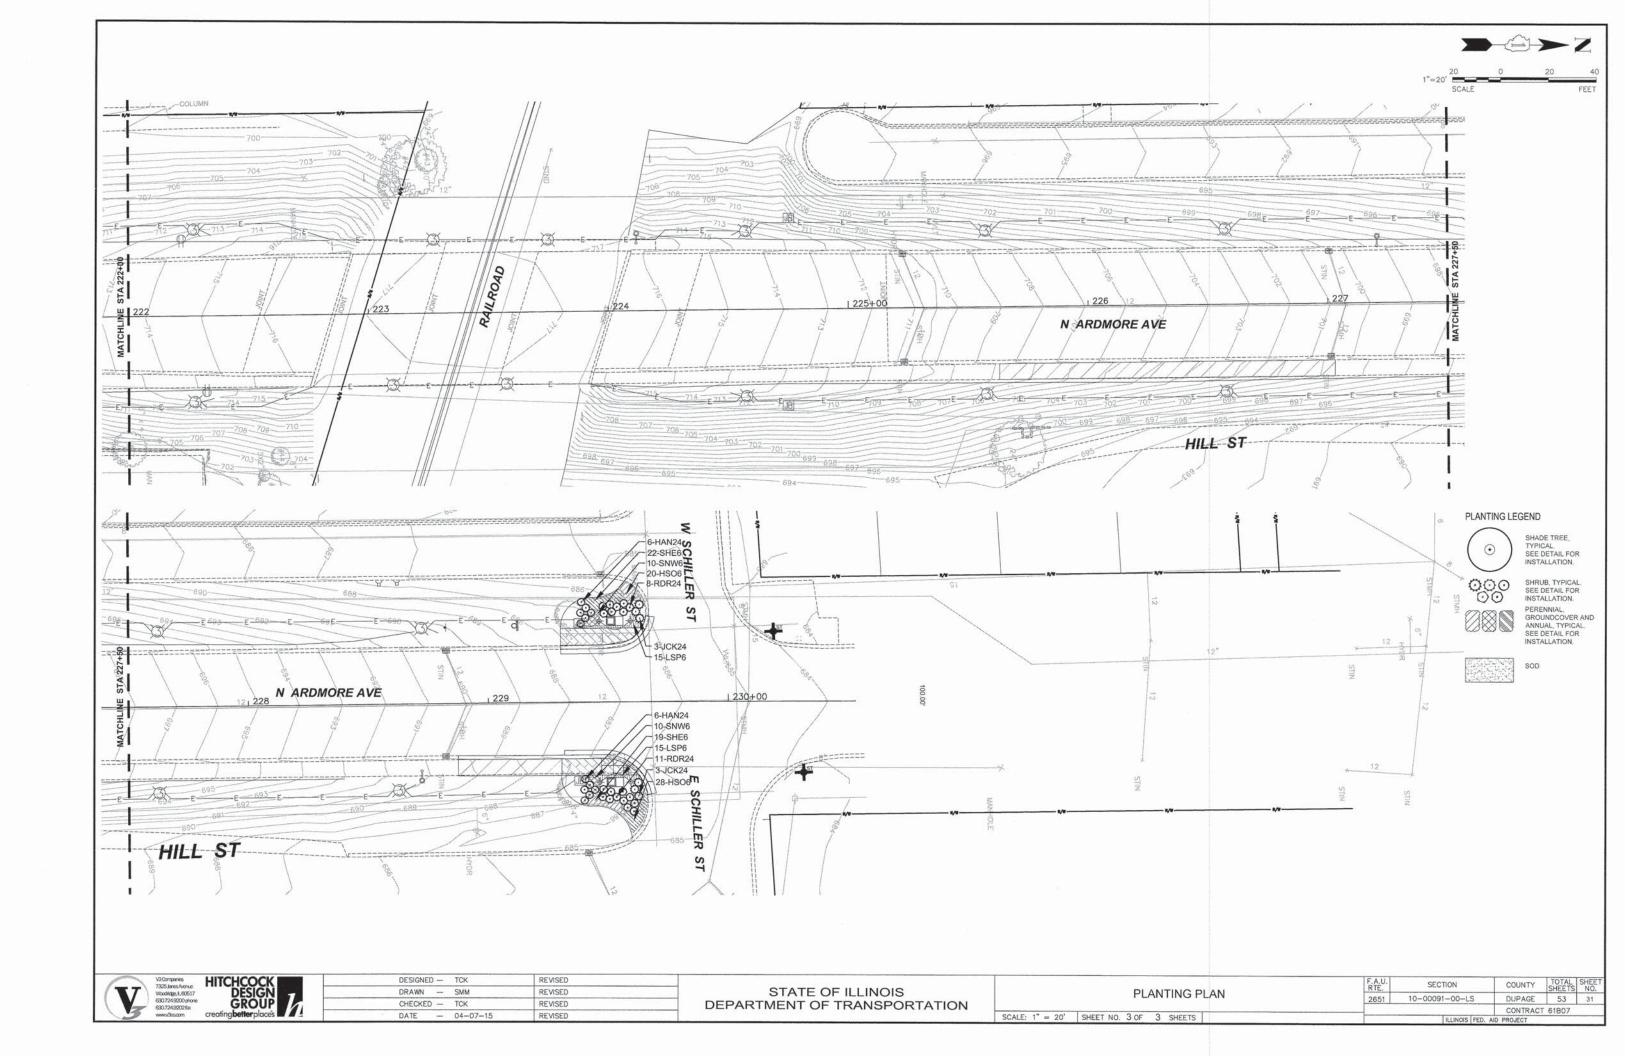

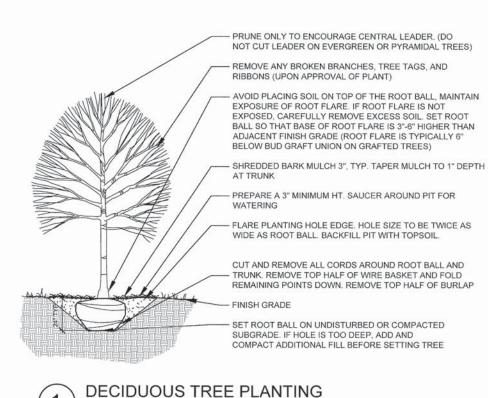

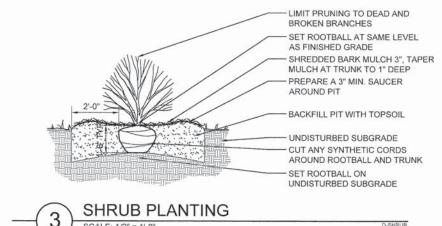

SET ROOTBALL A MINIMUM OF 6" HIGHER THAN FINISH GRADE SHREDDED BARK MULCH 3", TAPER TO 1" AT TRUNK PREPARE A 3" MINIMUM SAUCER AROUND PIT, DISCARD EXCESS EXCAVATED MATERIAL - BACKFILL PIT WITH TOPSOIL FINISH GRADE CUT AND REMOVE ANY SYNTHETIC OR NATURAL CORDS AROUND ROOTBALL AND TRUNK WITHOUT CAUSING DAMAGE TO ROOTBALL OR TRUNK SET ROOTBALL ON ORNAMENTAL TREE PLANTING

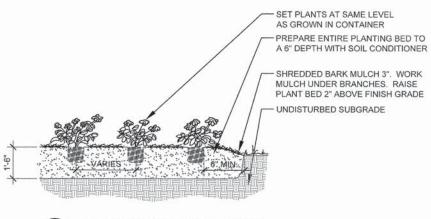

# PERENNIAL PLANTING

#### PLANTING MATERIAL LIST

Code	Botanical Name	Common Name	Size	Qty
Shad	e Trees			
AFB3.0	Acer x freemanii 'Autumn Blaze'	Autumn Blaze Freeman Maple	3" C	7
COC3.0	Celtis occidentalis "	Common Hackberry	3" C	3
GBA3.0	Ginkgo biloba 'Autumn Gold'	Autumn Gold Ginkgo	3"C	8
GTK3.0	Gleditsia triacanthos var. inermis 'Skyline'	Skyline Thornless Honeylocust	3" C	7
ULM3.0 Ulmus japonica x wilsoniana 'Morton'		Accolade™ Elm	3" C	4
Decid	duous Shrubs			
HAN24	Hydrangea arbor. 'Annabelle'	Annabelle Smooth Hydrangea	24" HT	69
RHG24 Rhus aromatica 'Gro-Low'		Gro-Low Fragrant Sumac	24" HT	13
RDR24	Rosa 'Radtko'	Double Red Knockout Rose	24" HT	81
Everg	reen Shrubs			
JCK24	Juniperus chinensis 'Kallay Compact'	Kallay Compact Chinese Juniper	24" HT	20
Groui	ndcovers			
LSP6	Liriope spicata "	Creeping Lilyturf	1 GAL	30
Perer	nnials			
EPH6	Echinacea purpurea 'Kim's Knee High'	Kim's Knee High Purple Coneflower	1 GAL	172
HSO6	Hemerocallis 'Stella de Oro'	Stella de Oro Dwarf Daylily	1 GAL	230
HBL6	Heuchera 'Blackout'	Blackout Coral Bells	1 GAL	181
NFW6	Nepeta x faassenii Walker's Low'	Walker's Low Catmint	1 GAL	141
PSH6	Panicum virgatum 'Shenandoah'	Shenandoah Switch Grass	1 GAL	100
SNW6	Salvia nemorosa 'Wesuwe'	Wesuwe Salvia	1 GAL	161
SHE6	Sporobolus heterolepis "	Prairie Dropseed	1 GAL	235

ALL PERENNIALS TO BE PAID FOR AS PERENNIAL PLANTS, ORNAMENTAL TYPE, GALLON POT (1 UNIT = 100 PLANTS)

TOTAL PERENNIALS: 1220 TOTAL UNITS: 12.20

## PLANTING NOTES

- 1. SOD TO LIMITS OF DISTURBANCE FOR RESTORATION ONLY. CONTRACTOR IS RESPONSIBLE FOR RESTORATION OF ANY UNAUTHORIZED DISRUPTION OUTSIDE OF DESIGNATED CONSTRUCTION AREA.
- 2. CONTRACTOR IS RESPONSIBLE FOR EROSION CONTROL IN ALL DISTURBED AREAS. ALL DISTURBED AREAS ARE TO BE PROTECTED WITHIN 24 HOURS. DO NOT DISTURB MORE AREA THAN CAN BE COMPLETED AND PROTECTED WITHIN 24 HOURS.
- 3. PLANTS AND OTHER MATERIALS ARE QUANTIFIED AND SUMMARIZED FOR THE CONVENIENCE OF THE DEPARTMENT AND LOCAL AGENCY. CONFIRM AND INSTALL SUFFICIENT QUANTITIES TO COMPLETE THE WORK AS DRAWN AND SPECIFIED.
- 4. REFER TO THE SPECIAL PROVISIONS FOR ADDITIONAL CONDITIONS, STANDARDS AND NOTES.
- 5. PLACE 6" OF TOPSOIL FOR ALL SOD AREAS, TO BE PAID FOR AS TOPSOIL FURNISH AND PLACE, 6".
- 6. PROVIDE 18" OF TOPSOIL FOR ALL PLANTING AREAS WITHOUT ANY TREE PLANTINGS, TO BE PAID FOR AS TOPSOIL FURNISH AND PLACE, 18".
- 7. PROVIDE 24" OF TOPSOIL FOR ALL RAISED PLANTING BEDS WITHIN PLANTER CURB AREAS, TO BE PAID FOR AS TOPSOIL FURNISH AND PLACE, 24".






HCOCK THE	DESIGNED - TCK	REVISED	
HCOCK DESIGN GROUP Betterplaces	DRAWN - SMM	REVISED	
GROUP	CHECKED - TCK	REVISED	
gbetterplace's # # 4	DATE - 04-07-15	REVISED	

STATE OF ILLINOIS **DEPARTMENT OF TRANSPORTATION** 

PLANTING MATERIALS, NOTES AND DETAILS

SCALE: 1" = 20' SHEET NO. 1 OF 1 SHEETS


	F.A.U. RTE.	SEC	TION			COUNTY	TOTAL	SHEE NO.
	2651 10-00091-00-LS					DUPAGE	53	32
2	1000					CONTRACT	61B07	
			ILLINOIS	FED.	AID	PROJECT		

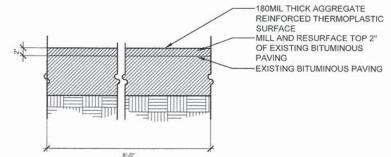

STAMPED ASPHALT CROSSWALK


Scale: 1" = 1'-0"

d-stamped assphalt crosswalk

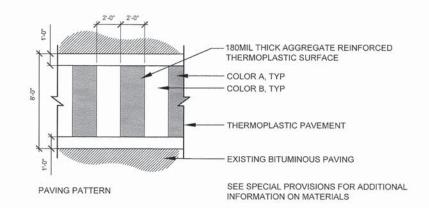

2 STAMPED ASPHALT CROSSWALK PATTERN
SCALE: 1/4" = 1'-0"

Getamped auchiel crosswalk

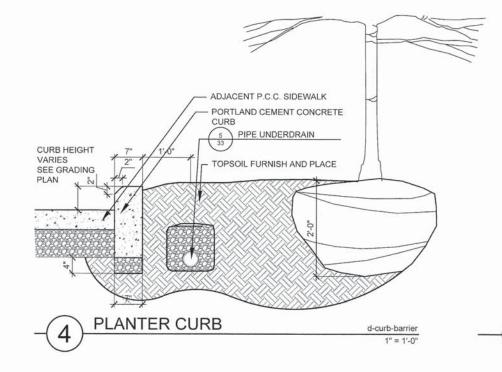

TOPSOIL MIX


AGGREGATE BACKFILL SHALL BE CA-16. OVERLAP FABRIC 6" MIN. ALL SEAMS

4"DIA. CORRUGATED, PERFORATED, POLYETHYLENE PIPE, FABRIC 6"MIN. AT JOINTS AND ENDS.

UNDISTURBED SUBGRADE

ALL MATERIAL NECESSARY TO INSTALL UNDERDRAIN SHALL BE PAID FOR AS PIPE UNDERDRAING.

SEE DRAINAGE AND UTILITY PLANS FOR PIPE SLOPE AND INVERT ELEVATION. d-underdrain

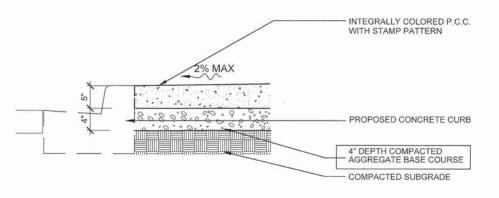

COLOR A, TYP

COLOR B, TYP

INTEGRALLY COLORED P.C.C.
WITH RUNNING BOND NATURAL
SLATE STAMP PATTERN


STAMPED COLORED P.C.C. SIDEWALK, 5 INCH

SCALE: 1/4" = 1'-0"

V	V3 Companies 7325 Janes Avenue Woodridge, IL 60517 630,724,9200 phor
13	630,724,9202 tax www.3co.com

STATE OF ILLINOIS DEPARTMENT OF TRANSPORTATION

STREETSCARE DETAILS		SECTION	COUNTY	TOTAL	SHEET NO.
STREETSCAPE DETAILS	2651	10-00091-00-LS	DUPAGE	53	33
			CONTRACT	61807	
ALE: 1" = 20' SHEET NO. 1 OF 5 SHEETS     ILLINOIS FED. AID PROJECT					

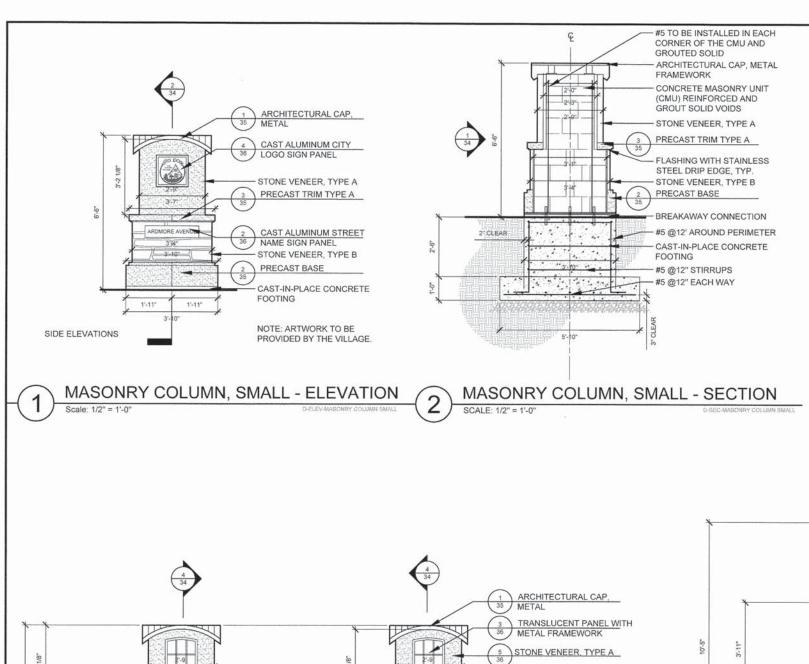


#### COLUMN STRUCTURAL NOTES

- 1. MINIMUM CONCRETE STRENGTH TO BE IDOT CLASS SI, FC=3500 PSI WITH 5% TO 8% AIR ENTRAINMENT.
  2. ALL REINFORCED STEEL TO BE ASTM A706, GR-60 ÉPOXY COATED. MINIMUM BAR LAPS: #5 (3'-3"), #6 (3'-10"), #7 (5'-2")
  3. ALL CONSTRUCTION TO CONFORM TO LOCAL CODES AND ADOPTED ORDINANCES, AND IDOT STANDARDS SPECIFICATIONS FOR ROAD AND BRIDGE CONSTRUCTION.
- 4. EXCAVATION CONTRACTOR TO NOTIFY "JULIE" (1-800-892-0124) 48 HRS. PRIOR TO EXCAVATION WORK.
- 5. IT SHALL BE THE CONTRACTOR'S RESPONSIBILITY TO VERIFY DIMENSIONS, ELEVATIONS AND DETAILS IN THE FIELD AND MAKE NECESSARY APPROVED ADJUSTMENT PRIOR TO BIDDING, ORDERING OF MATERIALS AND/OR STARTING CONSTRUCTION. SUCH VARIATION WILL NOT BE CAUSE FOR ADDITIONAL COMPENSATION OR A CHANGE IN THE SCOPE OF MACRIC
- 6. ALL UTILITY LOCATIONS SHALL BE VERIFIED BY THE TRADE DOING THE WORK AND ANY DISCREPANCIES OF LOCATIONS BE REPORTED TO THE ENGINEER BEFORE CONSTRUCTION BEGINS.
- 7. ANY DISCREPANCIES, CONFLICTS, OR AMBIGUITIES ON THE DRAWINGS SHALL BE BROUGHT TO THE ATTENTION OF THE ENGINEER. FAILURE TO DO SO WILL NOT RELIEVE CONTRACTOR OF ADDITIONAL COSTS REGARDING THE ABOVE ITEMS.
  8. ALL EXPOSED CONCRETE EDGES SHALL HAVE A 1" CHAMFER, EXCEPT WHERE SHOWN OTHERWISE. CHAMFER VERTICAL EDGES SHALL BE CONTINUED. A MINIMUM OF ONE FOOT BELOW FINISHED GROUND LEVEL.
- 9. ALL FOOTING MUST BE POURED ON UNDISTURBED SOIL WITH A MINIMUM SAFE BEARING CAPACITY OF 2000 PSF. CONTRACTOR TO HAVE THE SOIL BEARING CAPACITY FIELD VERIFIED BY A SOILS TECHNICIAN UNDER THE DIRECTION OF A GEOTECHNICAL ENGINEER LICENSED AS PROFESSIONAL ENGINEER BY THE STATE OF ILLINOIS. IF THE GEOTECHNICAL ENGINEER FINDS THE SOIL TO BE UNSUITABLE THE CONTRACTOR SHALL FOLLOW THE GEOTECHNICAL ENGINEER'S RECOMMENDATIONS TO ACHIEVE THE BEARING CAPACITY. IF THE BEARING CAPACITY CAN NOT BE ACHIEVED. THEN THE ENGINEER SHOULD BE NOTIFIED FOR REDESIGN OF FOOTING AS DIRECTED BY THE GEOTECHNICAL ENGINEER.

  10. ALL ORGANIC AND/OR OTHER UNSUITABLE MATERIALS SHALL BE REMOVED FROM FOOTING AND BACKFILL AREAS, AND THEN BACKFILLED WITH ACCEPTABLE STRUCTURAL FILL, COMPACTED TO 95 PERCENT OF MAXIMUM DENSITY PER ASTM
- 11. ANY AREAS OUTSIDE OF THE PROPOSED CONSTRUCTION, DISTURBED BY THE CONTRACTOR'S ACTIONS SHALL BE RESTORED BY THE CONTRACTOR AT THE CONTRACTOR'S EXPENSE, AT NO ADDITIONAL COST TO THE OWNER.

  12. THE FOUNDATION CONTRACTOR IS RESPONSIBLE FOR PROVIDING ANY TEMPORARY SHORING AND/OR EARTH RETENTION SYSTEMS THAT MAY BE REQUIRED. TEMPORARY SHORING AND EARTH RETENTION SYSTEMS SHALL BE DESIGNED AND DETAILED BY AN ILLINOIS LICENSED STRUCTURAL ENGINEER.

  13. THE CONTRACTOR IS RESPONSIBLE FOR THE MEANS AND METHOS OF CONSTRUCTION. SHORING, EARTH RETENTION.
- AND COFFERDAMS AS REQUIRED FOR STABILITY OF EXISTING AND PROPOSED CONSTRUCTION IS THE CONTRACTORS RESPONSIBILITY.
- 14. THE CONTRACTOR SHALL BE RESPONSIBLE FOR OBTAINING ALL NECESSARY PERMITS.
- 15. FOOTINGS SHALL NOT BE PLACE ON FROZEN GROUND.

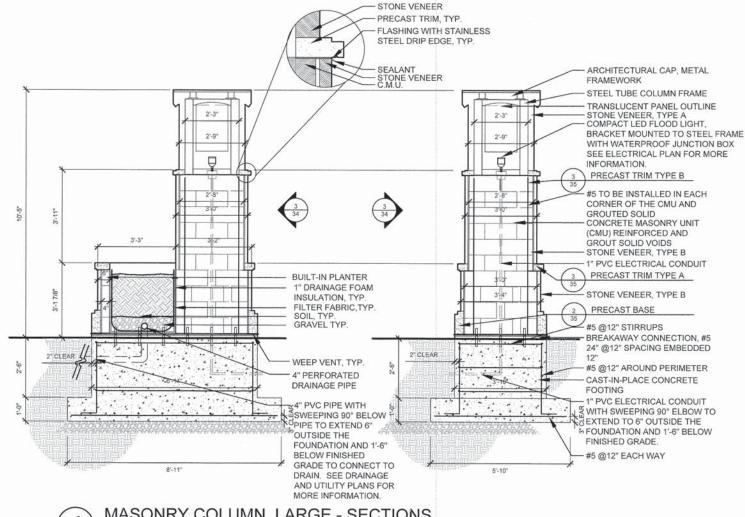



BUILT IN PLANTER

D-ELEV-MASONRY COLUMN LARGE

ALUMINUM STREET NAME

PRECAST TRIM TYPE B

ALUMINUM CITY LOGO

STONE VENEER, TYPE B

PRECAST TRIM TYPE A

- STONE VENEER, TYPE B

CAST-IN-PLACE CONCRETE

NOTE: ARTWORK TO BE

PROVIDED BY VILLAGE

PRECAST BASE

**FOOTING** 

SIGN PANEL

MASONRY COLUMN, LARGE - SECTIONS
Scale: 1/2" = 1'-0"

SCALE: 1" = 20' SHEET NO

STATE OF ILLINOIS	
DEPARTMENT OF TRANSPORTATION	1

STREETSCAPE DETAILS	F.A.U. RTE.	SECTION	COUNTY	TOTAL	SHEET NO.
	2651	10-00091-00-LS	DUPAGE	53	34
			CONTRAC	T 61B07	
T NO. 2 OF 5 SHEETS		ILLINOIS FED. AID PROJECT			

#### V3 Companies 7325 Janes Avenue Woodridge IL 60517 630,724,9200 pho 630,724,9200 pho

SIDE ELEVATIONS

HITCHCOCK
DESIGN
GROUP
creatingbetterplaces

B-5"

RDMORE AVENUE

 DESIGNED —
 TCK
 REVISED

 DRAWN —
 SMM
 REVISED


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 DATE —
 04-07-15
 REVISED

FRONT/BACK ELEVATIONS


SCHILLER STREET


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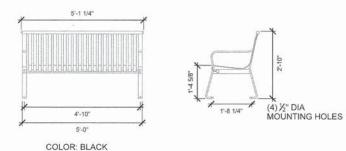
V3 Companies T355 Arrich Arcue Vocariège L 60617 6307349000 prore 6307349000 prore 6307349000 prore GROUP 7	DESIGNED — TCK	REVISED			F.A.U.	SECTION	COUNTY	TOTAL	SHEET
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630.724.92026x www.32xxxxxx creating <b>better</b> place's	DATE - 04-07		DEFARTMENT OF TRANSPORTATION	SCALE: 1" = 20' SHEET NO. 3 OF 5 SHEETS		ILLINOIS FED.	CONTRACT AID PROJECT	T 61B07	

5. ALL PERFORATED METAL PANELS ALLOW FOR AIR MOVEMENT

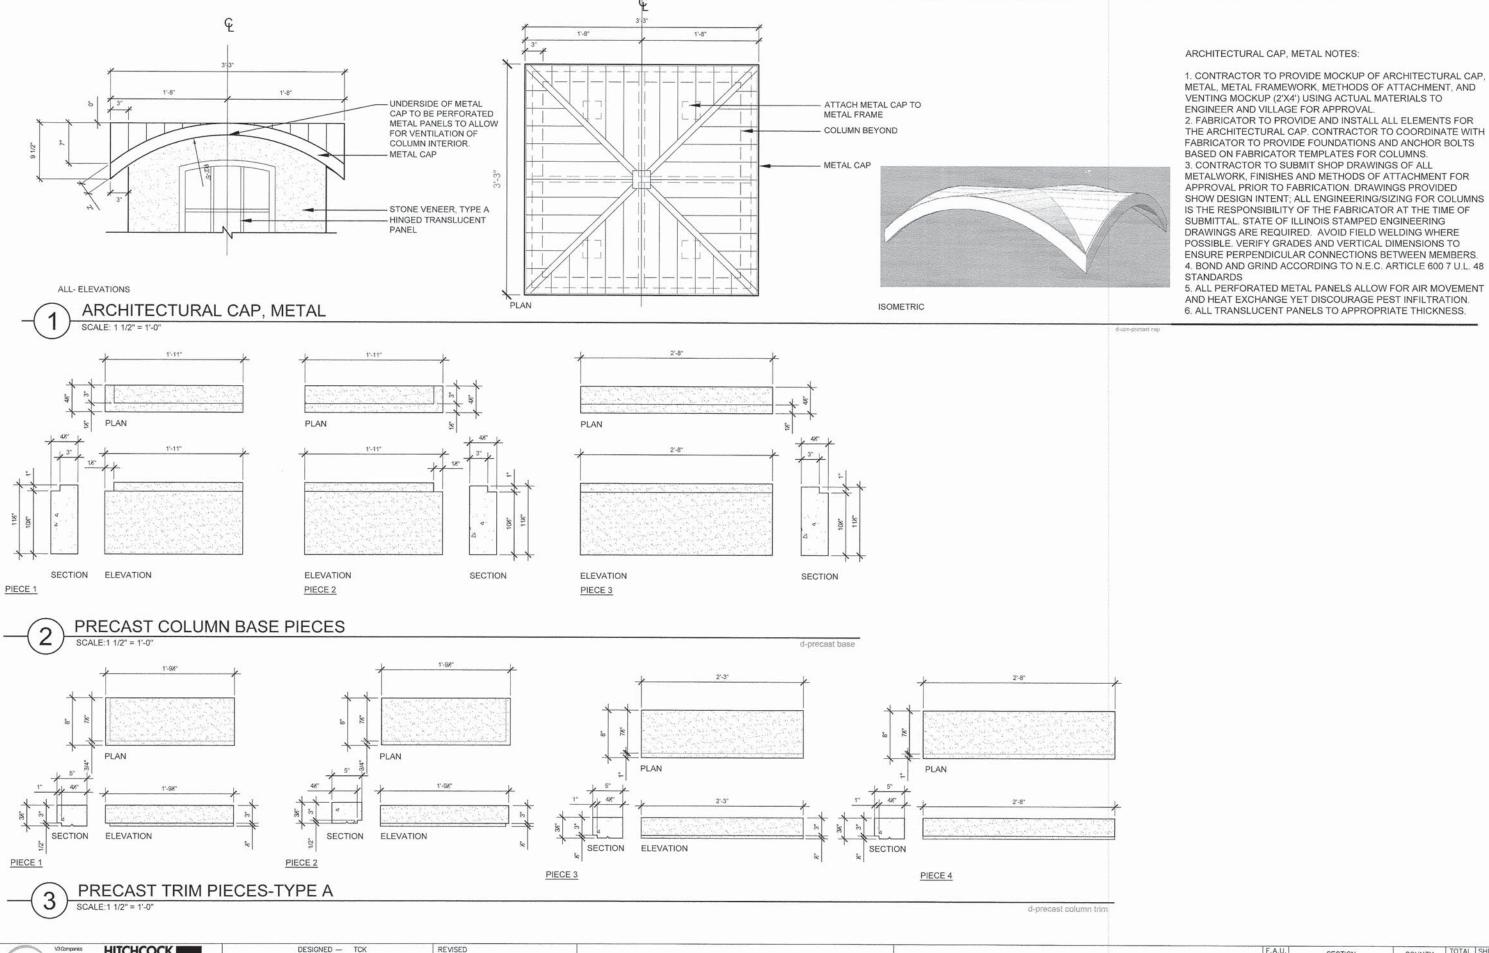


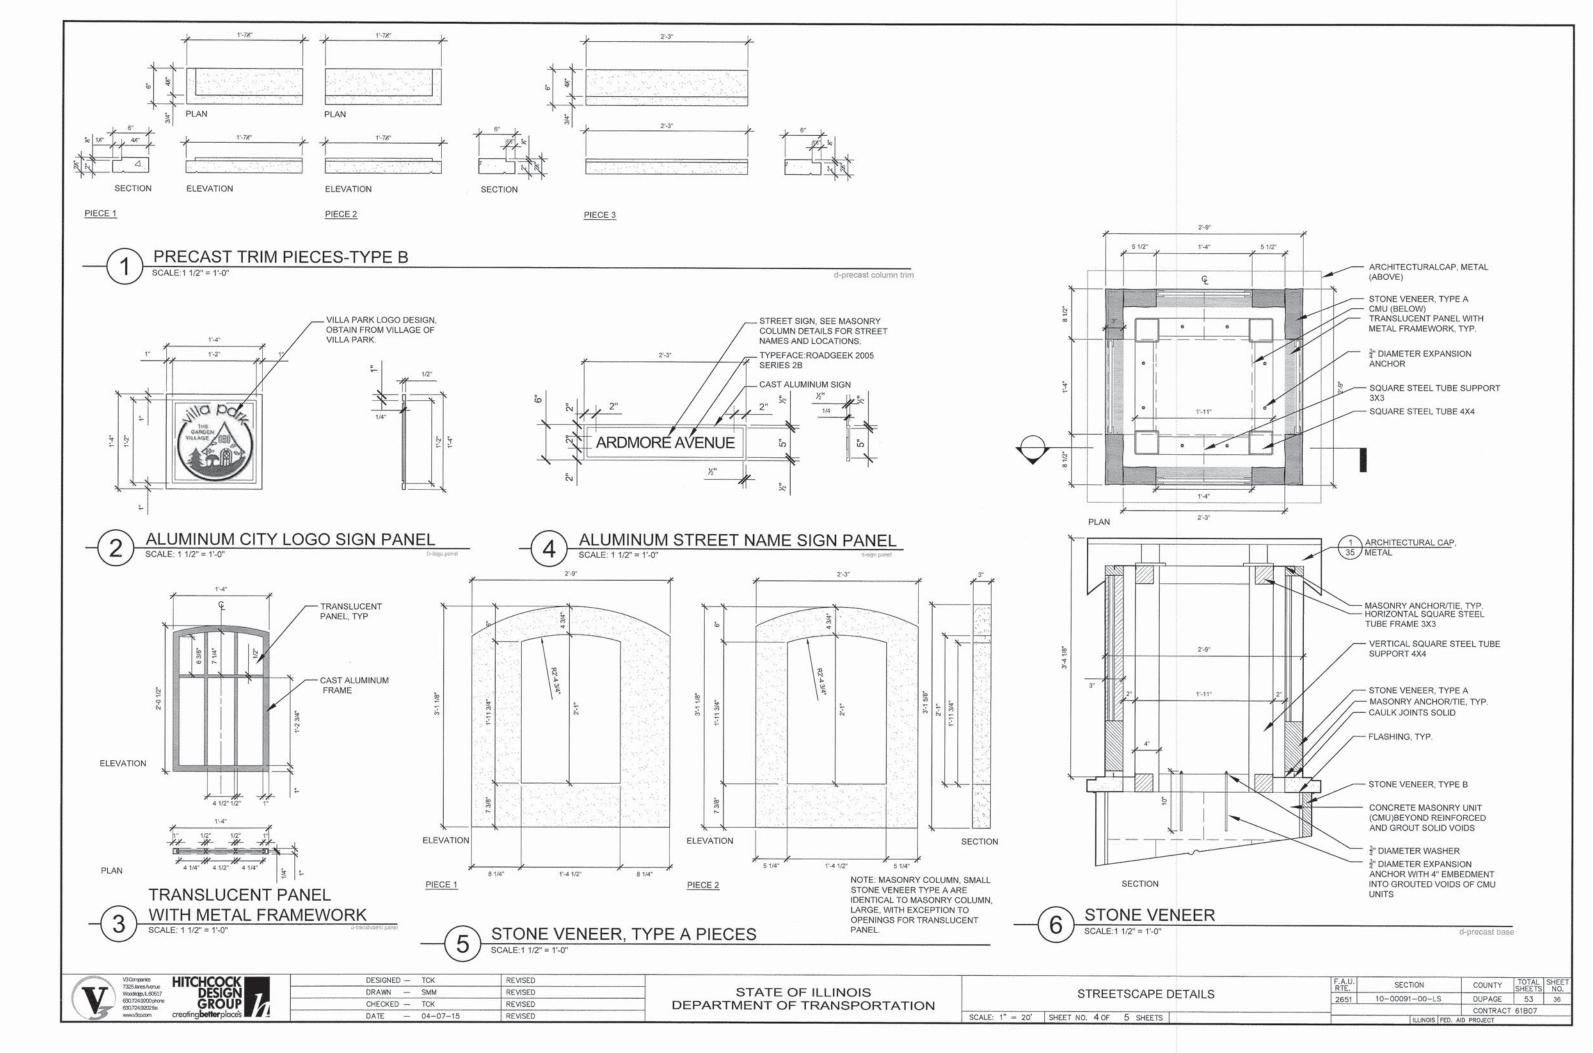


DECORATIVE SIGN POST
SCALE: NTS -d-decorative sign

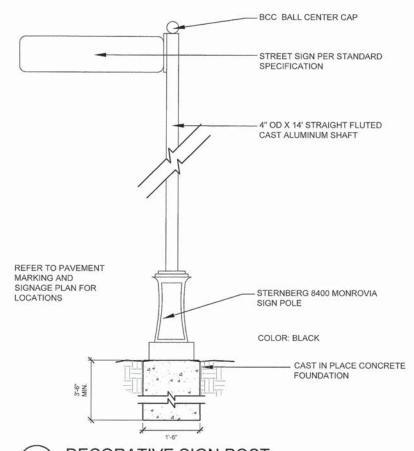


BENCHES
NTS delum-bonch

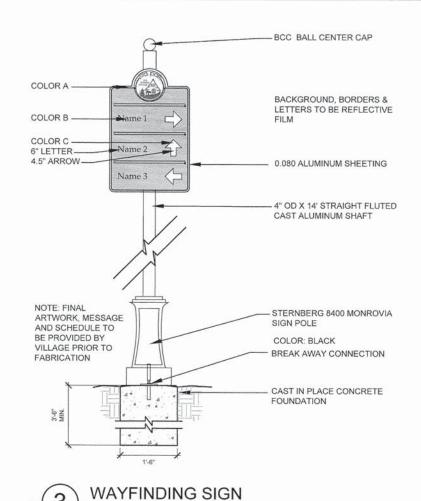

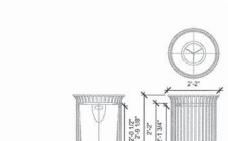


COLOR: BLACK

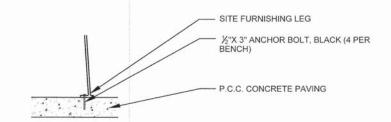

BENCH / TRASH/ BICYCLE RACK
INSTALLATION
Scale: 1" = 1'-0"

d- site-furnishang-attacts

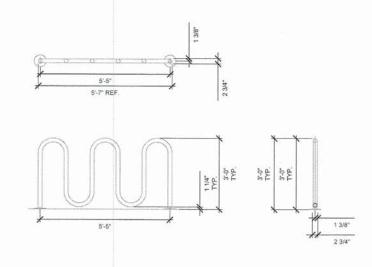

COLOR: BLACK

6 BICYCLE RACKS
NTS d-fuir-biddrack

(==	V3 Companies 7325 Janes Avenue
	Woodridge, IL-6051
W	630.724.9200 pho
	630.724.9202tpx
	www.vGco.com



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STATE OF ILLINOIS DEPARTMENT OF TRANSPORTATION

	STREETSCAPE DETAILS
SCALE: 1" = 20'	SHEET NO. 5 OF 5 SHEETS

A.U.	SECTION		COUNTY	SHEETS	SHEET NO.
2651	10-00091-00-L	S	DUPAGE	53	37
			CONTRACT	F 61807	
	ILLINOIS	FED. All	D PROJECT		

CONDUIT AND	) WIRE TABLE
A	UNIT DUCT, 3-1/C =4 & 1/C =4 GND WIRE, 600 VOLT (XLP-TYPE USE), 1 1/4" DIA POLYETHYLENE
(B)	UNIT DUCT, 3-1/C #6 & 1/C #6 GND WIRE, 600 VOLT (XLP-TYPE USE), 1 1/4" DIA POLYETHYLENE
©	UNIT DUCT, 2-1/C =2 & 1/C =4 GND WIRE, 600 VOLT (XLP-TYPE USE), 1 1/4" DIA UNDERGROUND COILABLE NONMETALLIC CONDUIT
0	UNIT DUCT, 3-1/C =2 & 1/C =4 GND WIRE, 600 VOLT (XLP-TYPE USE), 1 1/2" DIA UNDERGROUND COILABLE NONMETALLIC CONDUIT
(E)	UNIT DUCT, 5-1/C "2 & 1/C "4 GND WIRE, 600 VOLT (XLP-TYPE USE), 2" DIA UNDERGROUND COILABLE NONMETALLIC CONDUIT
<b>(F)</b>	UNIT DUCT, 6-1/C "2 & 1/C "4 GND WIRE, 600 VOLT (XLP-TYPE USE), 2" DIA UNDERGROUND COILABLE NONMETALLIC CONDUIT
©	UNIT DUCT, 8-1/C =2 & 1/C =4 GND WIRE, 600 VOLT (XLP-TYPE USE), 2 1/2" DIA UNDERGROUND COILABLE NONMETALLIC CONDUIT
$\oplus$	UNIT DUCT, 2-1/C #10 & 1/C #10 GND WIRE, 600 VOLT (XLP-TYPE USE), 3/4" DIA UNDERGROUND COILABLE NONMETALLIC CONDUIT
1	3-1/C *4 & 1/C *4 GND WIRE, 600 VOLT (XLP-TYPE USE), IN EXISTING CONDUIT
<b>①</b>	EMPTY CONDUIT WITH PULL STRING (FOR FUTURE WORK), 1 1/2" DIA UNDERGROUND COILABLE NONMETALLIC CONDUIT

(A)(A)(A)

#### 3 66 WATT LED LUMINAIRE, TYPE III, 120V, WITH DUPLEX RECEPTACLE (SEE SHEET 43 FOR LIGHT POLE DETAILS) PROPOSED LIGHTING UNIT, 14'-9" HEIGHT (12'-0" MOUNTING HEIGHT) 66 WATT LED LUMINAIRE, TYPE V 120V, WITH DUPLEX RECEPTACLE (SEE SHEET 43 FOR LIGHT POLE DETAILS) PROPOSED DUPLEX RECEPTACLE MOUNTED ON LIGHT POLE, 120V Ф (SEE SHEET 43 FOR LIGHT POLE DETAILS) -LANDSCAPING UPLIGHT (SEE PLANTING PLAN SHEETS FOR DETAILS) COLUMN INTERNAL LIGHTING UNIT (SEE PLANTING PLAN SHEETS FOR DETAILS) PROPOSED CONDUIT AND WIRE (SEE TABLE FOR DETAILS) ------PROPOSED CONDUIT AND WIRE IN EXISTING CONDUIT EMBEDDED IN STRUCTURE PROPOSED RIGID GALVANIZED STEEL CONDUIT SLEEVE (SIZE NOTED IN PLAN) PROPOSED STREET LIGHT CONTROLLER AND CABINET WITH FOUNDATION H PROPOSED ELECTRICAL HANDHOLE JB PROPOSED ELECTRICAL JUNCTION BOX D EXISTING LIGHTING UNIT

PROPOSED LIGHTING UNIT, 14'-9" HEIGHT (12'-0" MOUNTING HEIGHT)

#### CIRCUIT DESIGNATION IDENTIFICATION

ELECTRICAL SYMBOLS LEGEND

STA XXX+XX; O/S -RECEPTACLE NO. ON GIVEN CIRCUIT RECEPTACLE CIRCUIT DESIGNATION -LIGHTING CONTROLLER DESIGNATION -POLE NO. ON GIVEN CIRCUIT -LIGHTING CIRCUIT DESIGNATION -LIGHTING CONTROLLER DESIGNATION

#### LIGHTING SCHEDULE OF QUANTITIES

CONDUIT AND WIRE IDENTIFICATION

(A)(A)

-1 RUN OF CONDUIT/WIRE

-2 RUNS OF CONDUIT/WIRE

PAY ITEM	DESCRIPTION	UNIT	TOTAL
80400100	ELECTRIC SERVICE INSTALLATION	EACH	1
80400200	ELECTRIC UTILITY SERVICE CONNECTION	LSUM	1
81028220	UNDERGROUND CONDUIT, GALVANIZED STEEL, 3" DIA.	FOOT	995
81028240	UNDERGROUND CONDUIT, GALVANIZED STEEL, 4" DIA.	FOOT	47
81028260	UNDERGROUND CONDUIT, GALVANIZED STEEL, 6" DIA.	FOOT	47
81028740	UNDERGROUND CONDUIT, COILABLE NONMETALLIC CONDUIT, 1 1/2" DIA.	FOOT	989
81400100	HANDHOLE	EACH	2
81500120	GULFBOX JUNCTION, COMPOSITE CONCRETE	EACH	8
81603010	UNIT DUCT, 600V, 2-1C NO.10, 1/C NO.10 GROUND, (XLP-TYPE USE), 3/4" DIA. POLYETHYLENE	FOOT	336
81603047	UNIT DUCT, 600V, 3-1C NO.6, 1/C NO.6 GROUND, (XLP-TYPE USE), 1 1/4" DIA. POLYETHYLENE	FOOT	2539
81603070	UNIT DUCT, 600V, 2-1C NO.2, 1/C NO.4 GROUND, (XLP-TYPE USE), 1 1/4" DIA. POLYETHYLENE	FOOT	4556
81603081	UNIT DUCT, 600V, 3-1C NO.2, 1/C NO.4 GROUND, (XLP-TYPE USE), 1 1/2" DIA. POLYETHYLENE	FOOT	3019
81603085	UNIT DUCT, 600V, 3-1C NO.4, 1/C NO.4 GROUND, (XLP-TYPE USE), 1 1/4" DIA. POLYETHYLENE	FOOT	3585
81603156	UNIT DUCT, 600V, 5-1C NO.2, 1/C NO.4 GROUND, (XLP-TYPE USE), 2" DIA. POLYETHYLENE	FOOT	61
81702140	ELECTRIC CABLE IN CONDUIT, 600V (XLP-TYPE USE) 1/C NO. 4	FOOT	1188
81702220	ELECTRIC CABLE IN CONDUIT, 600V (XLP-TYPE USE) 1/C 350MCM	FOOT	597
X8250500	LIGHTING UNIT COMPLETE, SPECIAL	EACH	61
X8250505	LIGHTING CONTROLLER, SPECIAL	EACH	1
X8360210	LIGHT POLE FOUNDATION, 24" DIAMETER, SPECIAL	FOOT	382
	UNIT DUCT, 600V, 6-1C NO.2, 1/C NO.4 GROUND, (XLP-TYPE USE), 2" DIA. POLYETHYLENE	FOOT	746
	UNIT DUCT, 600V, 8-1C NO.2, 1/C NO.4 GROUND, (XLP-TYPE USE), 2 1/2" DIA. POLYETHYLENE	FOOT	61

-3 RUNS OF CONDUIT/WIRE

-4 RUNS OF CONDUIT/WIRE

#### LIGHTING AND ELECTRICAL GENERAL NOTES

- LOCATION OF LIGHTING CONDUIT, DUCT HANDHOLES AND APPURTENANCES ARE SHOWN DIAGRAMMATICALLY. THR ACTUAL LOCATION IN THE FIELD MUST MEET THE APPROVAL
- 2. IT SHALL BE THE CONTRACTOR'S RESPONSIBILITY TO MARK THE PROPOSED LOCATIONS OF ALL LIGHT POLES FOR EXAMINATION AND CONFIRMATION WITH THE ENGINEER. THE CONTRACTOR SHALL VERIFY ALL UTILITY LOCATIONS PRIOR TO AUGURING FOR LIGHT POLE FOUNDATIONS. THE EXACT LOCATIONS OF ALL ITEMS SHALL BE CONFIRMED WITH THE ENGINEER PRIOR TO STARTING WORK.
- PRIOR TO INSTALLATION OF THE NEW UNIT DUCT, CONDUITS, JUNCTION BOXES, LIGHT STANDARD FOUNDATIONS AND APPURTENANCES, THE CONTRACTOR MUST DETERMINE THE EXACT LOCATION OF EXISTING CONDUITS, CABLE AND UNDERGROUND UTILITIES. THE CONTRACTOR SHALL CALL J.U.L.I.E. (1-800-892-0123 OR 811) TO AID IN THIS TASK.
- NO MATERIAL OR EQUIPMENT SHALL BE DELIVERED TO THE JOB SITE WITHOUT PRIOR INSPECTION AND APPROVAL BY THE ENGINEER, ANY MATERIAL AND EQUIPMENT NOT APPROVED BY THE ENGINEER MUST BE REMOVED FROM THE JOB SITE AT THE CONTRACTOR'S EXPENSE.
- 5. ALL ELECTRICAL SYSTEMS, EQUIPMENT AND APPURTENANCES SHALL BE PROPERLY GROUNDED IN STRICT CONFORMANCE WITH THE NATIONAL ELECTRICAL CODE.
- 6. GROUNDING OF POLE AND CONTROLLER INCLUDING GROUND ROD, CONDUCTOR AND LUGS INCLUDING EXOTHERMIC WELD TO GROUND ROD SHALL BE INCLUDED IN THE COST OF THE PAY ITEM FOR WHICH IT IS INSTALLED.
- 7. THE NEW ELECTRICAL INSTALLATION AND MATERIALS MUST MEET REQUIREMENTS OF STANDARDS BY THE FOLLOWING ORGANIZATIONS:

  - ILLINOIS DEPARTMENT OF TRANSPORTATION (IDOT)
     NATIONAL ELECTRICAL AND ELECTRONICS ENGINEERS (IEEE)
     ILLUMINATING ENGINEERING SOCIETY OF NORTH AMERICA (IES)
  - AMERICAN ASSOCIATION OF TRANSPORTATION OFFICIALS (AATO)
  - U.S. DEPARTMENT OF TRANSPORTATION (USDOT)
  - UNDERWRITERS LABORATORIES (UL)
  - AMERICAN STANDARD INSTITUTE (ASI)
  - INSULATED POWER AND CABLE ENGINEERS ASSOCIATION (IPCEA)
  - NATIONAL ELECTRICAL SAFETY CODE (NESC)
     NATIONAL ELECTRICAL CODE 2011

  - AMERICAN ASSOCIATION OF STATE HIGHWAY AND TRANSPORTATION OFFICIALS (AASHTO)
  - AMERICAN NATIONAL STANDARD PRACTICE FOR ROADWAY LIGHTING (ANSI/IESNA RP-8)
- 8. ALL LIGHT POLES SHALL BE FURNISHED WITH THE DUPLEX RECEPTACLE INSTALLED BY THE MANUFACTURER. ONLY DUPLEX RECEPTACLES ON THE LIGHT POLES SHOWN IN THE PLAN SHALL BE CONNECTED TO THE ELECTRICAL SYSTEM.
- 9. ALL SPLICING MUST BE IN POLE BASES OR JUNCTION BOXES ABOVE GRADE WITH WATERPROOF SEALANT AND HEAT SHRINKABLE PLASTIC CAPS.
- 10. PARALLEL ELECTRICAL CONDUIT RUNS SHALL BE PLACED IN A COMMON TRENCH IF
- 11. EQUIPMENT GROUND CONDUCTORS SHALL BE SPLICED AND BONDED TO EACH ELECTRICAL HANDHOLE THEY PASS THROUGH AS WELL AS EACH LIGHT POLE OR OTHER PIECE OF EQUIPMENT, BOXES SHALL BE EQUIPPED FOR THE GROUNDING WIRE TERMINATIONS WITHOUT DEGRADATION OF BOX RATING.
- 12. ELECTRICAL SERVICE SHALL BE 120/240V, SINGLE-PHASE, UNLESS OTHERWISE NOTED.
- 13. INSTALL CABLE IN CONTINUOUS UNCUT LENGTHS BETWEEN HANDHOLES AND LIGHT
- 14. ALL EMPTY UNIT DUCT RUNS SHALL INCLUDE A TRACER WIRE FOR LOCATING.
- 15. HANDHOLE COVER ON LIGHT POLES SHALL HAVE STEEL/STAINLESS SCREWS. NO NYLON
- 16. UNLESS OTHERWISE NOTED, ALL LIGHT POLES LOCATED ON THE SAME BLOCK SHALL HAVE A CONSTANT OFFSET FROM THE EDGE OF SIDEWALK.
- 17. ONLY EMPTY CONDUITS (FOR FUTURE WORK) AND CONDUITS WITH CONDUCTORS REQUIRED AT THE LIGHT POLE SHALL BE ROUTED INTO THE LIGHT POLE BASE.
- 18. CONDUITS TERMINATING FOR STUB OUTS AT THE LIGHT POLE BASE SHALL BE INSTALLED TO 36" BELOW GRADE AND CAPPED.


And the same of	V3 Companies
/	. 7325 Janes Avenue
/	Woodridge, IL 8051
<b>1</b>	630.724.9200 phon
\ \	630.724.9202 fax
	www.v3co.com


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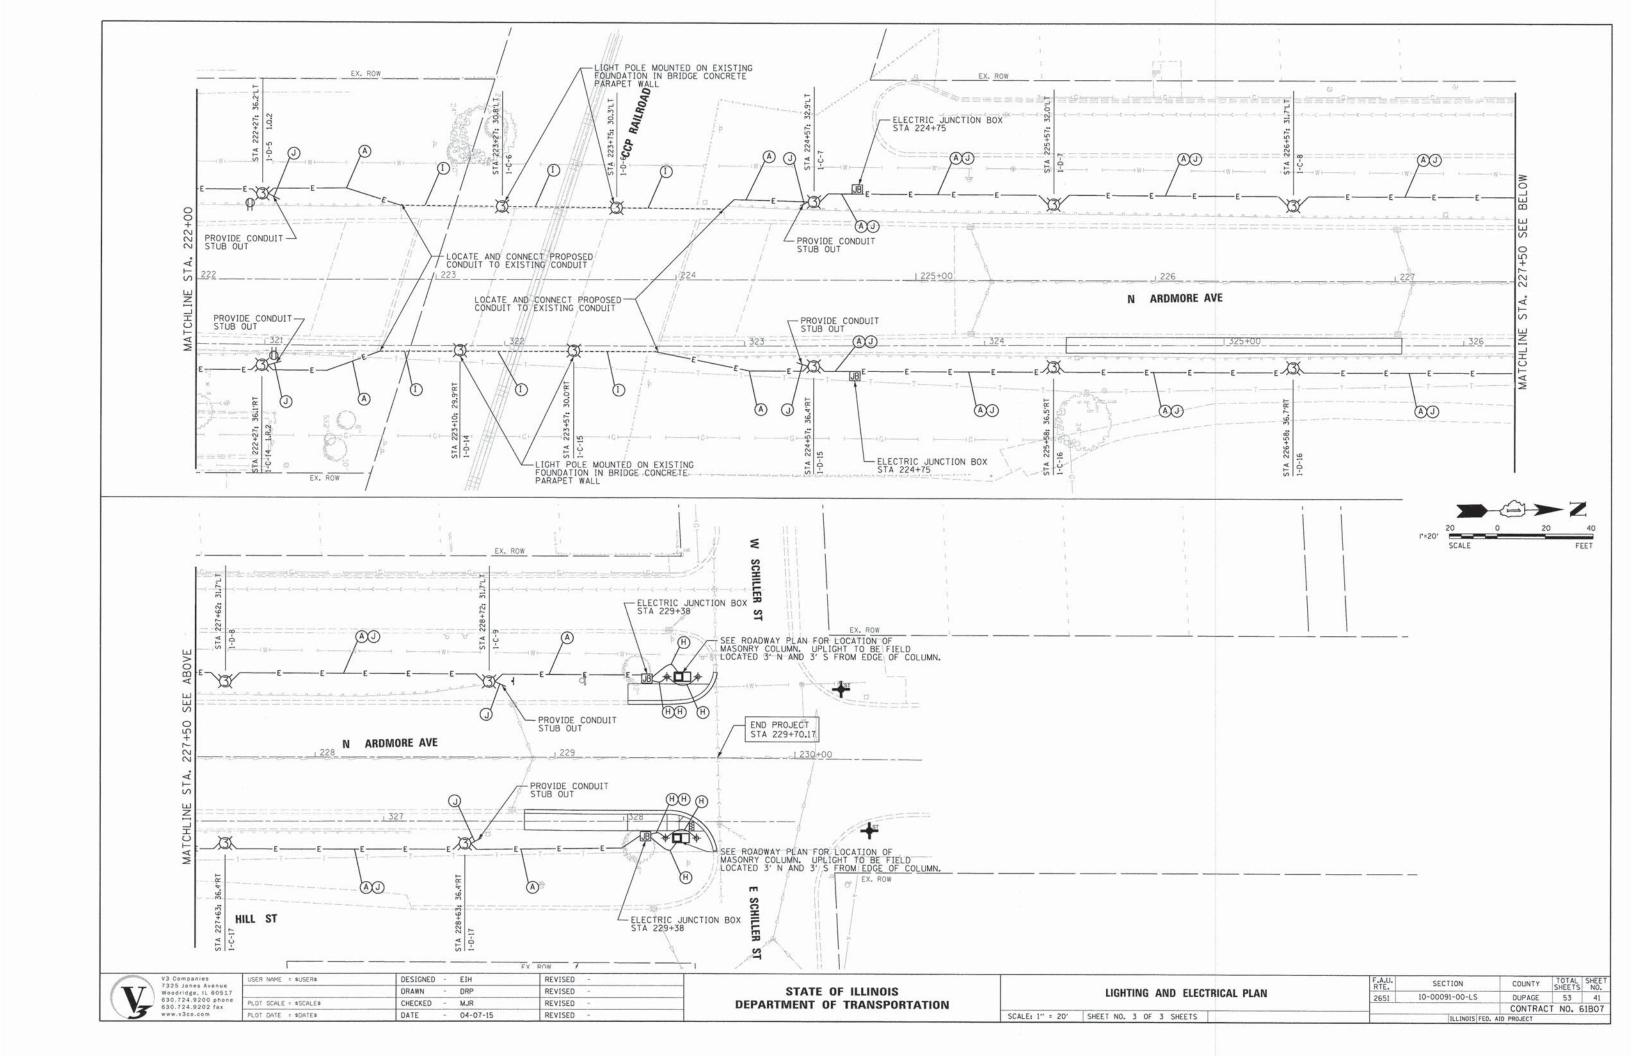
STATE OF ILLINOIS DEPARTMENT OF TRANSPORTATION


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SCALE: 1" = 80"	SHEET	NO.	1	OF	1	SHEETS	5


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	ILLINOIS FED. A	ID PROJECT		



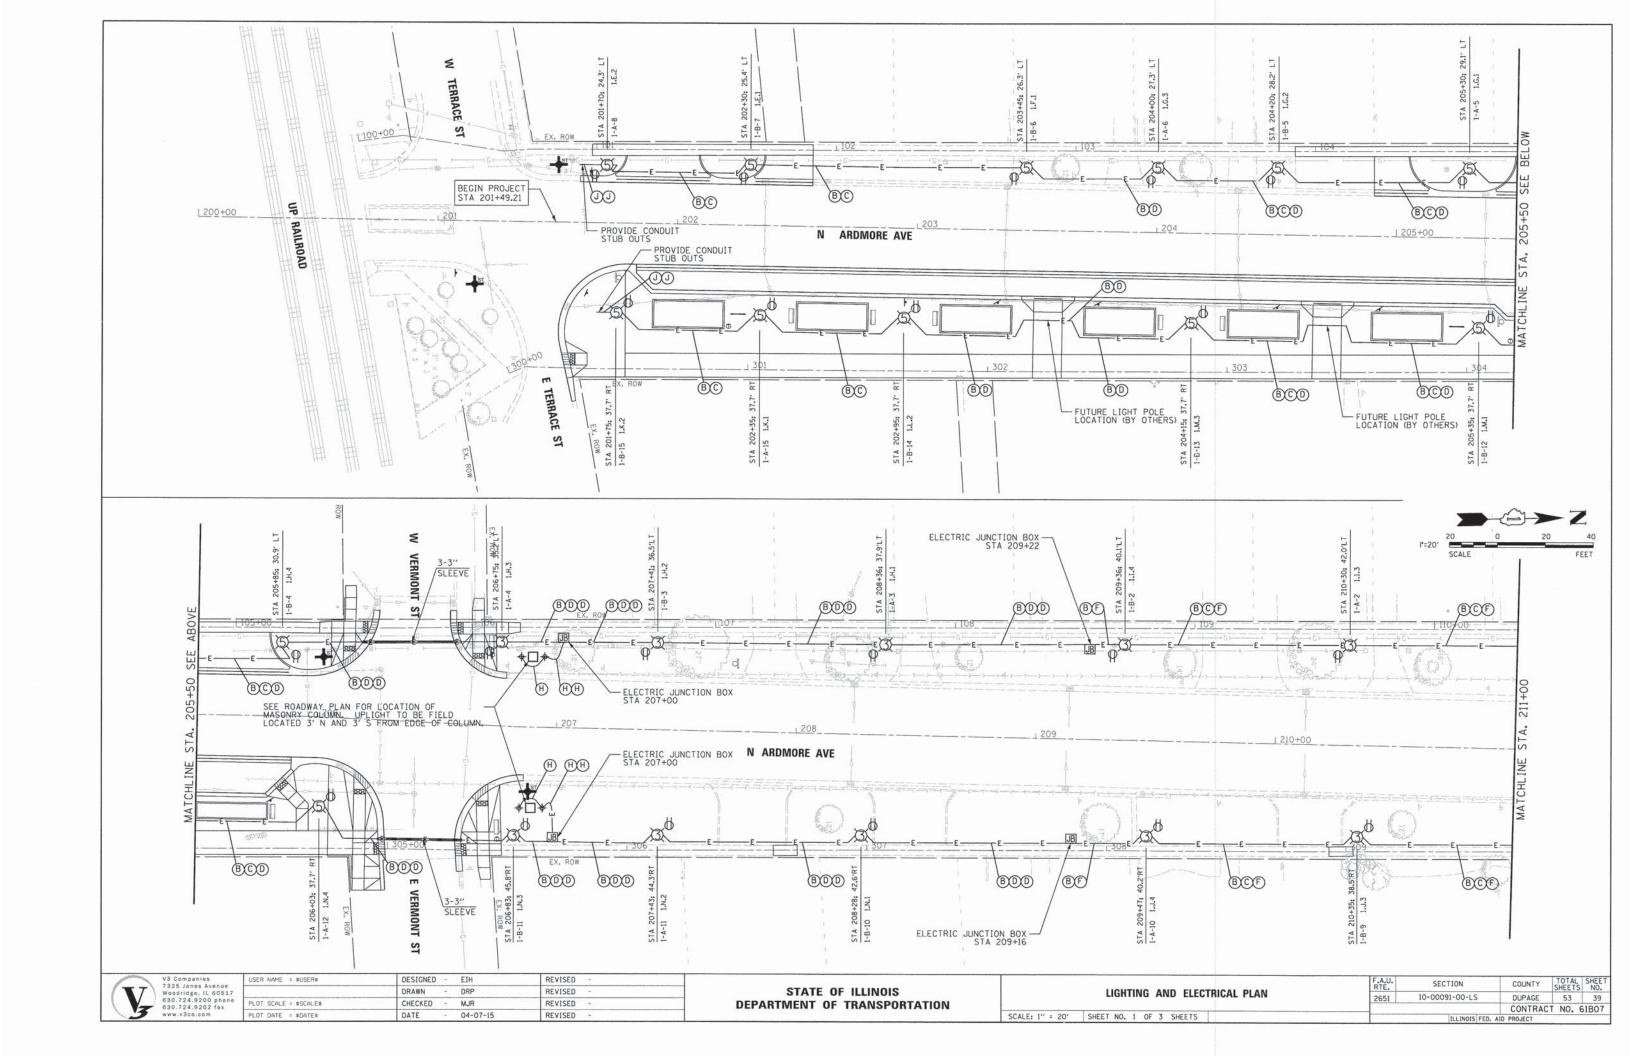


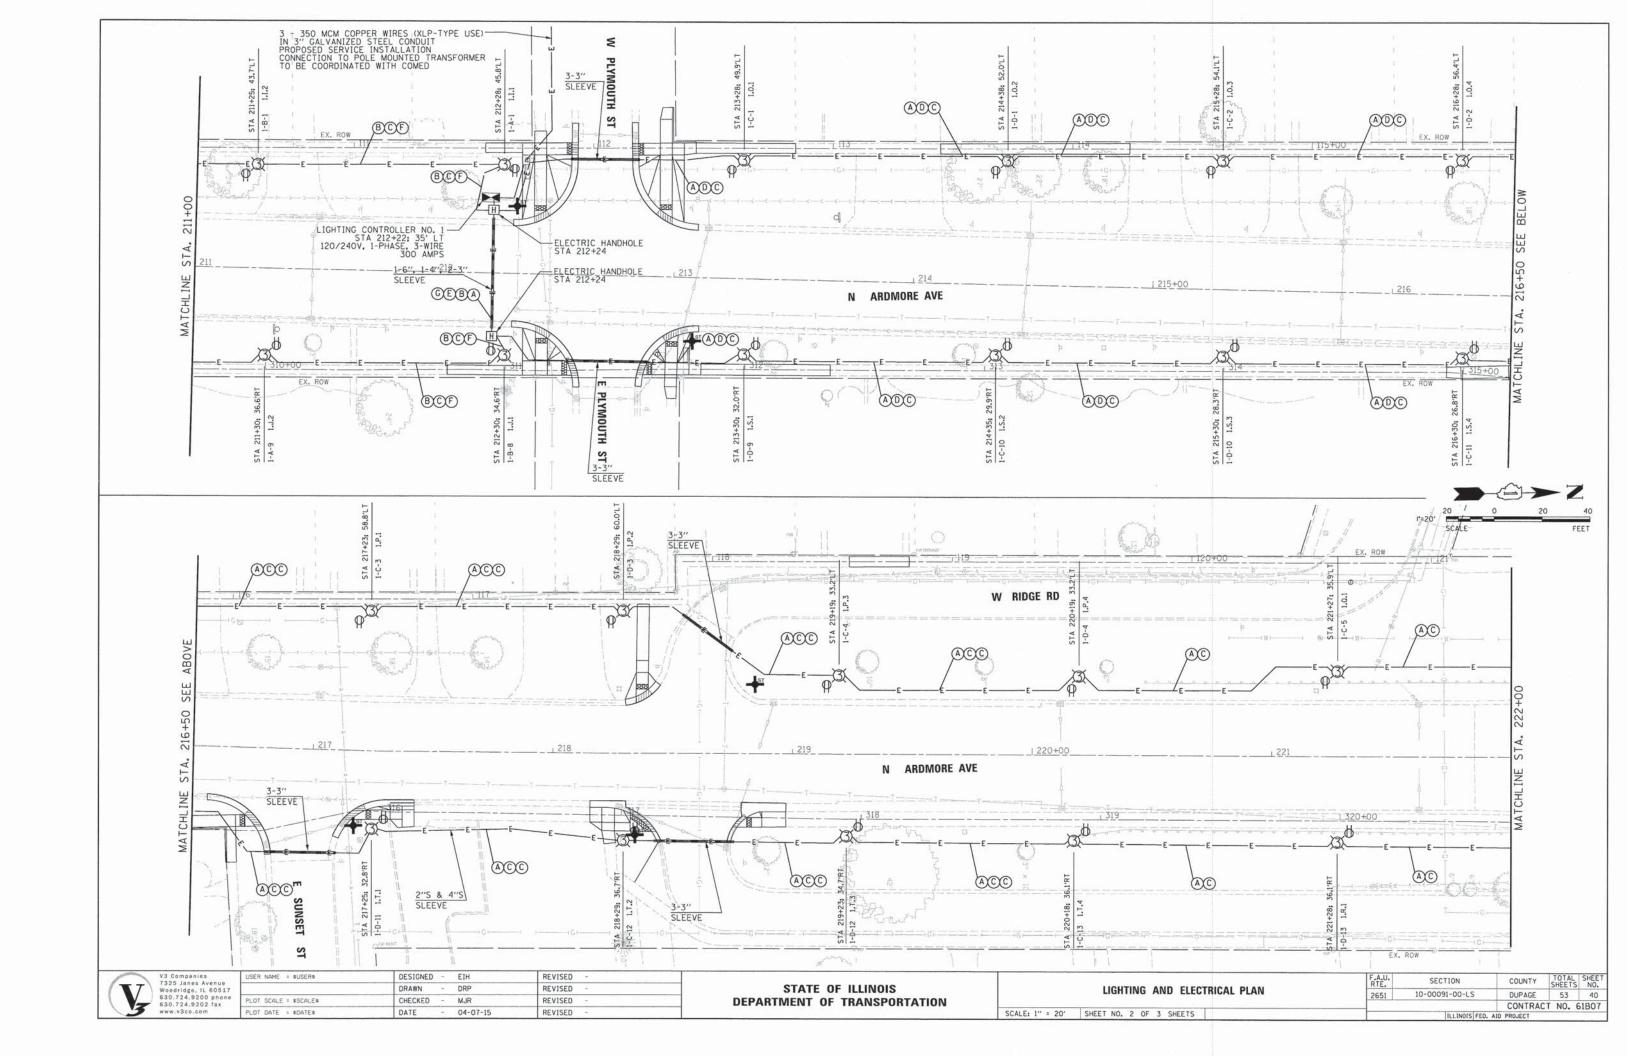

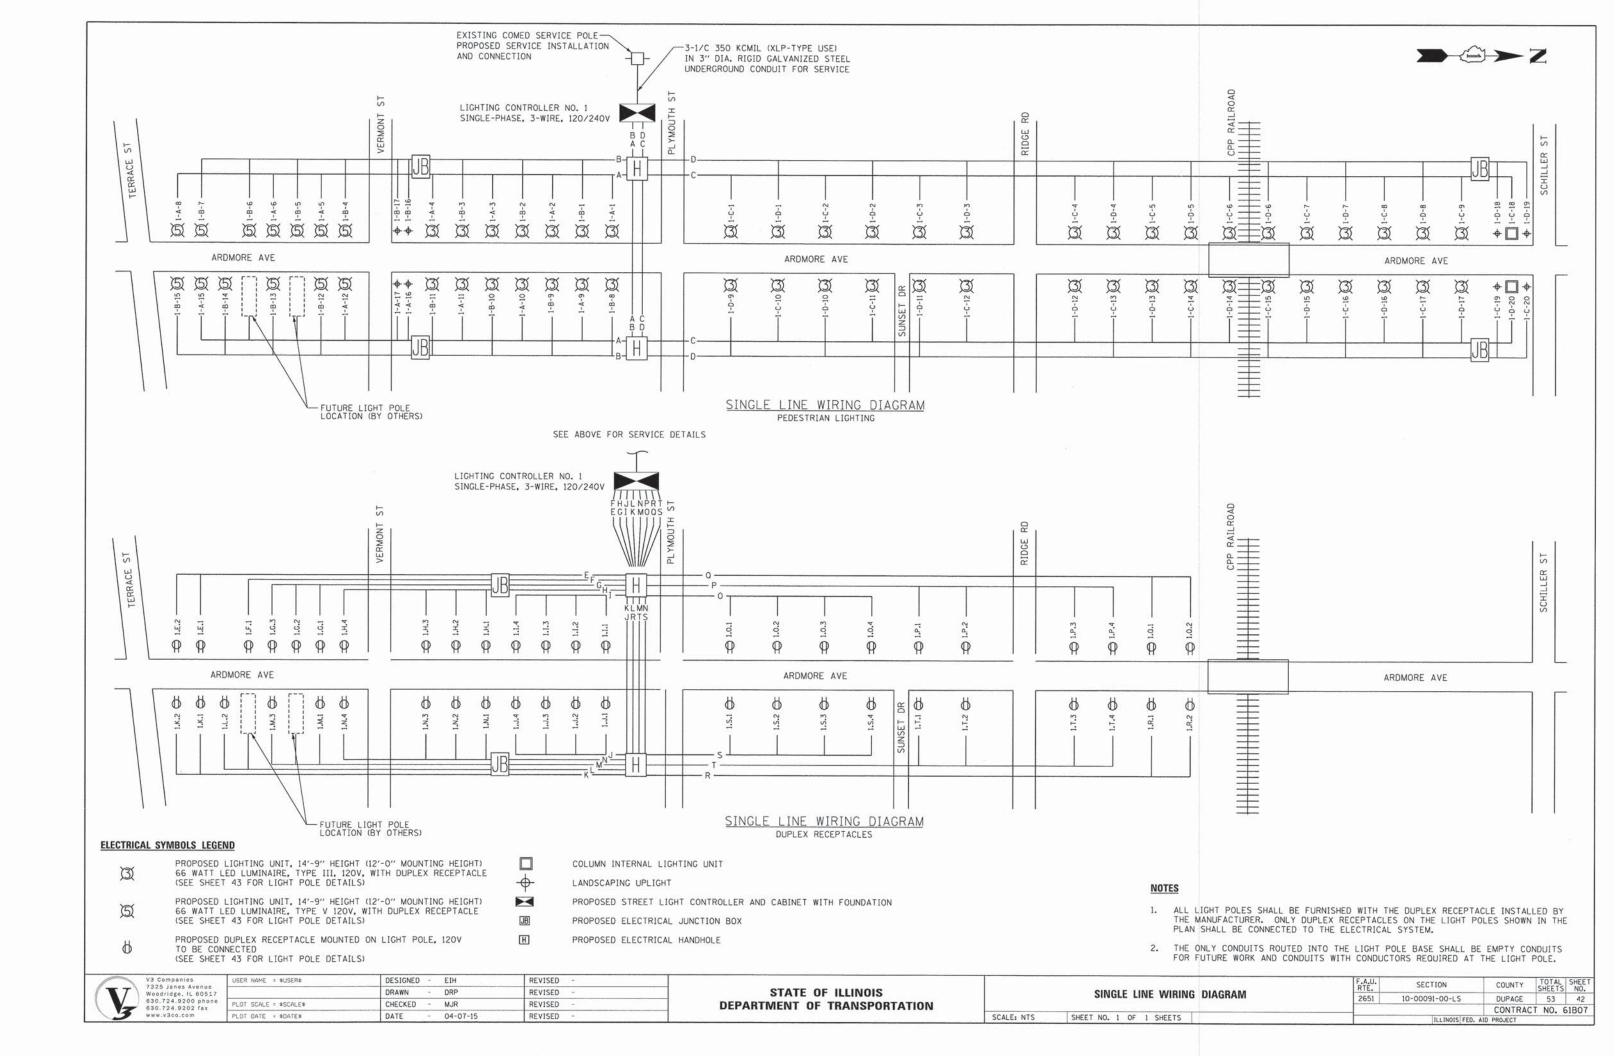

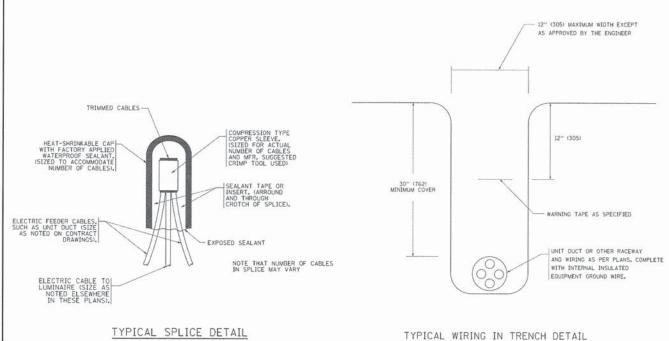


N.T.S.

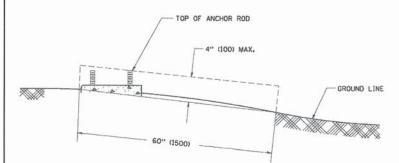

ANCHOR BOLTS AND BOLT CIRCLE PER MANUFACTURER'S REQUIREMENTS

### FOUNDATION EXTENSION DETAIL

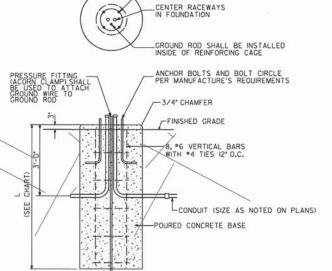

5/8" X IO' COPPER GROUND ROD

- 1. ALL DIMENSIONS ARE IN INCHES (MILLIMETERS) UNLESS OTHERWISE SHOWN.
- THE ANCHOR RODS AND RACEWAYS SHALL BE PROPERLY SECURED IN PLACE BEFORE THE CONCRETE IN PLACED.
- THE FOUNDATION SHALL NOT PROTRUDE MORE THAN 4 IN. (100 mm) ABOVE THE FINISHED GRADE WITHIN A 60 IN. (1,5 m) CHORD ACROSS THE FOUNDATION, WITH ANCHOR RODS INCLUIDED, IN ACCORDANCE WITH AASTHO GUIDELINES, IF THE FOUNDATION HEIGHT, INCLUING ANCHOR RODS, EXTENDS BEYOND THESE SPECIFIED LIMITS, THE FOUNDATION SHALL BE REPLACED AT THE CONTRACTOR'S EXPENSE. SEE FOUNDATION EXTENSION DETAIL.
- THE HOLE FOR THE FOUNDATION SHALL BE MADE BY DRILLING WITH AN AUGER, OF THE SAME DIAMETER AS THE FOUNDATION. IF SOIL CONDITIONS REQUIRE THE USE OF A LINER TO FORM THE HOLE, THE LINER SHALL BE WITHDRAWN AS THE CONCRETE IS DEPOSITED.
- THE TOP OF THE FOUNDATION SHALL BE CONSTRUCTED LEVEL. A LINER OR FORM SHALL BE USED TO PRODUCE A UNIFORM SMOOTH SIDE TO THE TOP OF THE FOUNDATION, FOUNDATION TOP SHALL BE CHAMFERED  $\frac{1}{2}$ -IN. (20 mm).
- THE CONCRETE SHALL BE CLASS SI. CONCRETE SHALL CURE ACCORDING TO ARTICLE 1020.13 BEFORE LIGHT POLES ARE INSTALLED.
- THE ANCHOR ROD SHALL BE A HOOK ROD TYPE, COLD BENDING OF THE ANCHOR ROD WILL NOT BE ALLOWED. THE RADIUS OF THE HOOK BEND SHALL NOT BE LESS THAN 4 TIMES THE NOMINAL DIAMETER OF THE ANCHOR ROD, A TACK WELDED ANCHOR ROD MAY BE SUBSTITUTED WITH THE APPROVAL OF THE ENGINEER.
- THE ANCHOR RODS SHALL BE ACCORDING TO ASTM F1554 GRADE 125 (GRADE 105), NUTS SHALL BE HEXAGON NUTS ACCORDING TO ASTM A 194 2H OR ASTM A 563 DH, AND WASHERS SHALL BE ACCORDING TO ASTM F 436.
- 9. ANCHOR RODS, NUTS AND WASHERS SHALL BE COMPLETELY GALVANIZED BY EITHER THE HOT-DIPPED PROCESS CONFORMING WITH AASHTO M 232, THE MECHANICAL PLATING METHOD CONFORMING TO AASHTO M 298, CLASS 50 WITH A MAXIMUM COATING THICKNESS OF 150 LIMIG MILS) OR THE ELECTROLYTIC PROCESS ACCORDING TO ASTM F 1136.
- THE ANCHOR RODS SHALL BE THREADED A MINIMUM OF 6 INCHES (150 mm) WITH A MINIMUM OF 3 INCHES (75 mm) OF THREADED ANCHOR ROD EMBEDDED IN THE FOUNDATION.
- 11. ANCHOR RODS SHALL PROJECT 23/" (69.9 mm) ABOVE THE TOP OF THE FOUNDATION, IF RREAKAWAY COUPLINGS ARE SPECIFIED. THE CONTRACTOR SHALL CAREFULLY COORDINATE THE ANCHOR ROD PROJECTION WITH THE INSTALLATION REQUIREMENTS OF THE BREAKAWAY COUPLINGS.
- THE CONTRACTOR SHALL USE A \*3 SPIRAL AT 6" (152.4 mm) PITCH OR MAY SUBSTITUTE \*3 TIES AT 12" (304.8 mm) O.C. WITH THE APPROVAL OF THE ENGINEER.
- 13. THE CABLE TRENCHES AND FOUNDATION SHALL BE BACK FILLED AND COMPACTED AS SPECIFIED BEFORE THE LIGHT POLE IS ERECTED.
- 14. THE RACEWAYS SHALL PROJECT 1" (25.4 mm) ABOVE THE TOP OF THE FOUNDATION.

FINISHED GRADE SLOPE	FOUNDATION LENGTH,
FLATTER THAN 2.5V : 1H	6'-0"
2.5V : 1H AND STEEPER	8'-0"

N.T.S.

## LIGHTING UNIT COMPLETE, SPECIAL


SEE PLANS FOR DISTRIBUTION TYPE: TYPE 3

CLEAR ACRYLIC LENS


-120V PHOTOCELL WITH KTK-R-5 DOUBLE FUSE AND HEB-AA HOLDERS

ACCESS DOOR SECURED WITH STAINLESS STEEL ALLEN HEAD SCREWS

BANNER ARM BRACKETS (FUTURE INSTALLATION OF BANNER ARMS BY OTHERS)

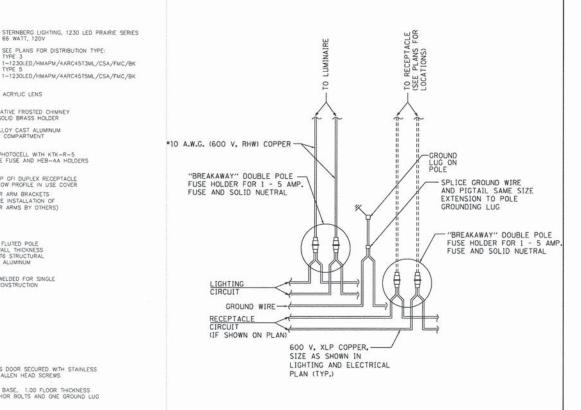

LIGHT POLE WIRING DETAIL

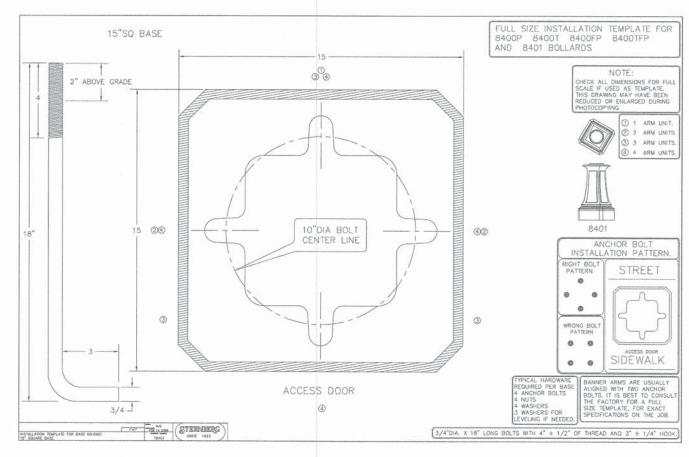

#### LIGHT POLE FOUNDATION, 24" DIAMTER, SPECIAL

V3 Companies 7325 Janes Avenue Woodridge, IL 60517 630,724,9200 phone 630.724.9202 fax

USER NAME = SUSERS	DESIGNED - EIH	REVISED -	
	DRAWN - DRP	REVISED -	2.112
PLOT SCALE = #SCALE#	CHECKED - MJR	REVISED -	
PLOT DATE = SDATES	DATE - 04-07-15	REVISED -	

STATE OF ILLINOIS **DEPARTMENT OF TRANSPORTATION** 

	LIGHTING AND ELECTRICAL DETAILS	F.A.U. RTÉ.	SECTION	COUNTY	TOTAL	SHEET NO.
LIGHTING AND ELECTRICAL DETAILS	2651	10-00091-00-LS	DUPAGE	53	43	
				CONTRAC	T NO. 6	51B07
SCALE: NTS	SHEET NO. 1 OF 2 SHEETS		ILLINOIS FED.	AID PROJECT		

#### PANEL EQUIPMENT

- (A) MAIN CIRCUIT BREAKER, 2 POLE, 600 VOLT, 300 AMP FRAME, 300 AMP, NON-INTERCHANGABLE TRIP INTERRUPTING RATING NEMA 22,000 AMP AT 240 VOLTS.
- B LIGHTING CONTACTOR, ELECTRICALLY OPERATED, MECHANICALLY HELD, 2 POLE, SINGLE THROW, 100 AMP., 600 VOLTS CONTROL CIRCUIT 120 VOLT.
- C CONTROL CIRCUIT BREAKERS, 1 POLE, 120 VOLT, 100 AMP. FRAME, NON-INTERCHANGEABLE TRIP INTERRUPTING RATING NEMA 10,000 AMP. AT 120/240V, SIZE AS SHOWN.
- D PHOTOCELL WITH INTEGRAL SURGE ARRESTER
- E SPST 20A SWITCH ON DOOR, TO TURN LIGHT ON WHEN DOOR IS OPEN
- INCANDESCENT LIGHTING FIXTURE ENCLOSED AND GASKETED WITH 60 WATT. 120 V. LAMP.

- G 20 A., 120 V., DUPLEX RECEPTACLE, GFCI.
- HAND-OFF-AUTO TOGGLE SWITCHES MOUNTED IN 4" (101.6) X 4" (101.6 mm) BOX.
- (I) PHOTO ELECTRIC CELL TERMINAL BLOCK
- J COPPER GROUND BUS (NEUTRAL) 1/4" X 1" X 12" LONG MOUNTED ON PANEL WITH LUGS AND 4 SPARE LUGS
- (K) COPPER GROUND BUS 1/4" X 1" X 12" LONG MOUNTED ON PANEL WITH LUGS AND 4 SPARE LUGS
- (L) SURGE ARRESTER
- M CABINET HEATER WITH THERMOSTAT, 100W


- ALL DIMENSIONS ARE IN INCHES (MILLIMETERS) UNLESS OTHERWISE SHOWN.
- FOUNDATION SIZE SHALL BE COORDINATED WITH CABINET SIZE AND MFR.
- IN FRONT OF CONTROL CABINET DOOR, REMOVE BAR CONNECTORS.

  VEGETATION AND 2" (50.8 mm) TOP SOIL, LEVEL THE 12.

  ALL WIRING WITHIN THE CABINET SHALL BE TO CONTROL CABINET, A CONCRETE PAD 36" (914.4 mm) x 60" (18.288 m) x 4" (101 mm) MIN. SIZE. THE COST OF LABOR AND MATERIALS ARE INCLUDED IN THE COST OF THE CONTROLLER.
- DOOR SHALL BE CONSTRUCTED FROM SAME TYPE OF MATERIAL AND THICKNESS AS CABINET.
- DOOR SHALL BE EQUIPPED WITH THREE POINT LATCHING MECHANISM WITH NYLON ROLLERS AT TOP THE BOTTOM.
- DOOR HINGE SHALL BE A HEAVY GAUGE CONTINUOUS HINGE WITH A 1/4" (6.35 mm) DIA. STAINLESS STEEL HINGE PIN.
- ALL EXTERNAL HARDWARE SHALL BE STAINLESS STEEL.
- CONTROL WIRING TO BE #12 AWG, 600V, TYPE "SIS" GRAY SWITCH BOARD WIRE, STRANDED
- METER BOX SHALL BE MOUNTED ON THE SIDE OF CONTROL CABINET. NEAR TO THE SERVICE POLE.


- 10. CABINETS SHALL BE PRIMED AND PAINTED AS SPECIFIED.
- 11. THE HEADS OF CONNECTORS SCREWS SHALL BE PAINTED WHITE FOR NEUTRAL BAR CONNECTION AND GREEN FOR GROUND
- COLOR CODED AS INDICATED.


  R = RED BL = BLUE B = BLACK Y = YELLOW
- 13. PROVIDE SEALING GROMMETS FOR ALL OPEN WIRING EXTENDED FROM DEVICES IN BOXES OR CABINETS WITHIN THE CONTROL CABINET.
- 14. ALL WIRING SHALL BE NEATLY DRESSED AND SUPPORTED.
- 15. THE CONTROLLER SHALL BE CONSTRUCTED TO U.L. STD. 508 AND BEAR THE U.L. LABEL "ENCLOSED INDUSTRIAL CONTROL PANEL".
- 16. 12" (304.8) X 16" (406.4 mm) STAINLESS STEEL EXTERIOR NAMEPLATE SHALL BE ENGRAVED TO "VILLAGE OF VILLA PARK LIGHTING CONTROLS" UNLESS OTHERWISE SPECIFIED.

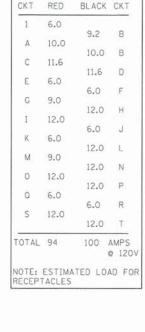

LOAD TABLE



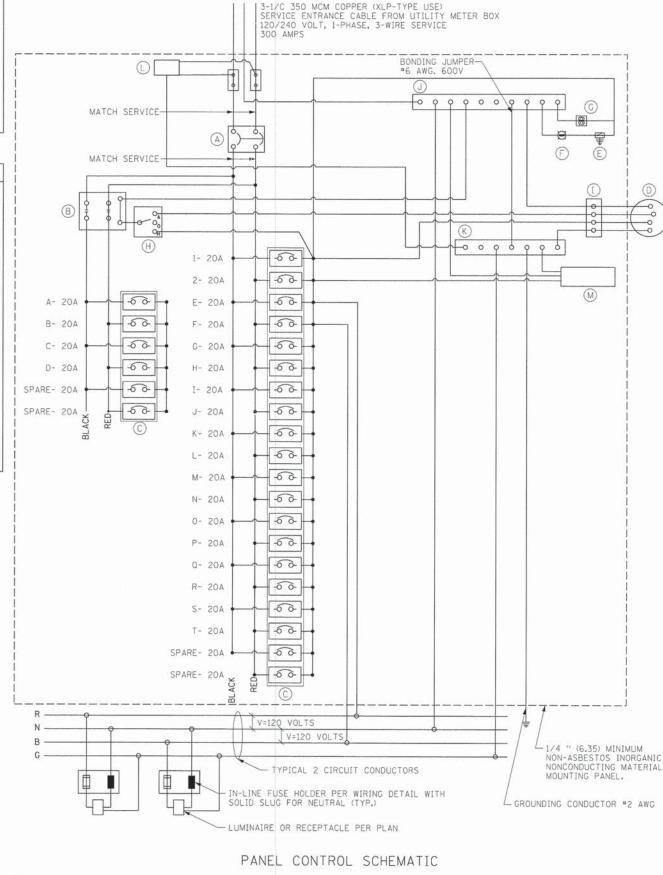

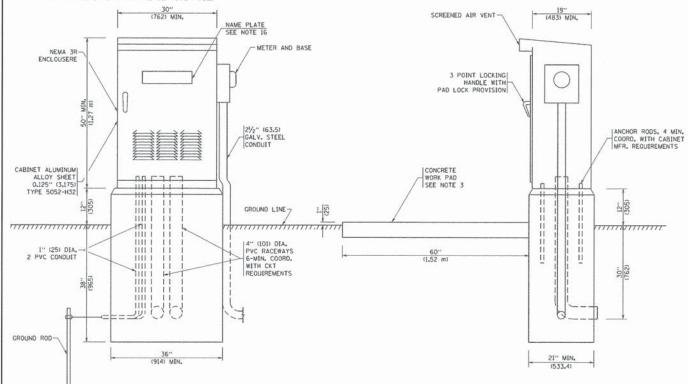

CABINET AND FOUNDATION DETAILS


#### LIGHTING CONTROLLER NO. 1

USER NAME = SUSERS	DESIGNED - EIH	REVISED -	
	DRAWN - DRP	REVISED -	
PLOT SCALE = #SCALE#	CHECKED - MJR	REVISED -	
PLOT DATE = SDATES	DATE - 04-07-15	REVISED -	

STATE OF ILLINOIS **DEPARTMENT OF TRANSPORTATION** 

SCALE:


		F.A.U. RTE.	SECTION	COUNTY	TOTAL	SHEET NO.
	LIGHTING AND ELECTRICAL DETAILS	2651	10-00091-00-LS	DUPAGE	53	44
				CONTRAC	T NO. 6	51B07
: NTS	SHEET NO. 2 OF 2 SHEETS		ILLINOIS FED.	AID PROJECT		

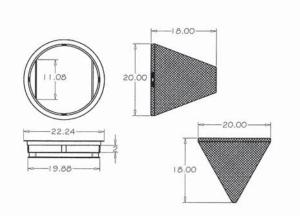

#### GENERAL NOTES:

- FRAME: TOP FLANGE FABRICATED FROM 1.25 X 1.25 X 0.125 ANGLE, BASE RIM FABRICATED FROM 1.5 X 0.5 X 0.125 CHAINEL HANDLES AND SUSPENSION BRACKETS FABRICATED FROM 1.25 X 0.25 FLAT STOCK, ALL DOMESTIC STELL CONTROMING TO A STATE.

  ACRONORMING TO A STATE A STATE

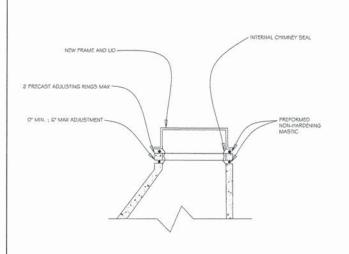

#### GENERAL NOTES:

- MEW FRAME AND UD (SANITARY):
   NEENAM R-1015-2000 FRAME
   NEENAM R-1015-2001 SELF SEALING UD

TYPICAL ADJUSTMENT

# GENERAL NOTES:

V: RMS DATE: JUL 2004 GAWN BY: VV DATE: JAN 2003

NOT TO SCALE


VILLAGE OF VILLA PARK

SANITARY - 06

- PROVIDE PRECAST REINFORCED CONCRETE BARREL AND RISER SECTION. CONCRETE BLOCK CONSTRUCTION IS NOT PERMITED.
- PROVIDE GRANUAR BACHTUR AROUND INTET TO SUBGRADE ELEVATION IN PAVED AREAS, MATERIAL SHALL MEET THE REQUIREMENTS OF IDOT STANDARD SPECIFICATIONS FOR ROAD AND BRIDGE CONSTRUCTION FOR COARSE AGREGATE (CAE GRANDITION)
- WHEN THE FRAME DOES NO MEET PROPOSED ELEVATION, A MAXIMUM OF TWO PRECAST CONCRETE RINGS MAY BE LUSED TO A MAXIMUM HIGHT OF 12 INCHES. THE RINGIS) AND FRAME SHALL BE SET IN A BED OF PREFORMED NON-HARDENINS MASTIG (RUBE-ARICK, EZ SHOCK) OR APPROVED EQUAL).
- PRECAST ADJUSTING RINGS SHALL BE REINFORCED WITH NO. 3 GAUGE WIRE OR EQUIVALENT AND SHALL HAVE A MINIMUM THICKNESS OF TWO INCHES.

INLET TYPE "A"

- MORTAR SHALL NOT BE USED TO DRESS UP ADJUSTING RINGS AND/OR FRAME.
   IN PAYED AREAS, DRAIN HOLESWEEP HOLES SHALL BE COVERED WITH FILTER FABRIC, FILTER FABRIC SHALL BE SECURED TO THE OUTSIDE OF STRUCTURE PRIOR TO BACKFILL.
   IN GRASSED AREAS, DRAIN HOLESWEEP HOLES SHALL BE PLUGGED WITH HYDRAULIC CEMENT.

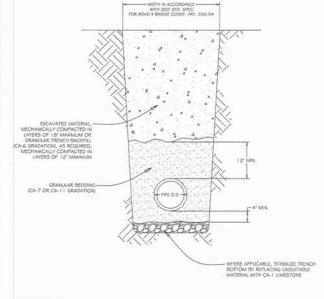

PIPE INSTALLATION


#### GENERAL NOTES:

VILLAGE OF VILLA PARK

VILLAGE OF VILLA PARK

EV: DATE: JUL 2004

PRAWN BY: VV DATE: JAN 2003 INLET FILTER

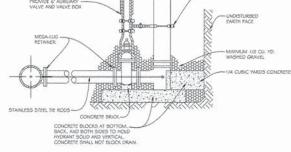

#### GENERAL NOTES:

- 1. MAXIMUM BARREL EXTENSIONS ARE 18 INCHES AND SHALL BE WATEROUS EXTENSION FOR WATEROUS HYDRANTS.

VILLAGE OF VILLA PARK

NOT TO SCALE

VILLAGE OF VILLA PARK

DRIP LINE -TREE PROTECTION FENCE, SEE NOTE BELOW DIRECT BURIED POST -EXISTING GRADE 6'-0" MIN. FROM TRUNK DRIPLINE VARIES

FENCE SHALL BE SIMILAR TO A 48" HIGH PLASTIC POLY-TYPE OR ANY OTHER TYPE OF HIGHLY VISIBLE BARRIER. FENCE SHALL BE PROPERLY MAINTAINED AND SHALL REMAIN ERECT UNTIL COMPLETION OF THE CONSTRUCTION

PROJECT.

**TEMPORARY FENCE DETAIL** 


USER NAME = \$USER\$ DESIGNED - EIH REVISED DRAWN REVISED PLOT SCALE = #SCALE# CHECKED - MJR REVISED DATE 04-07-15 REVISED

STATE OF ILLINOIS **DEPARTMENT OF TRANSPORTATION** 


	CONSTRUCTION DETAILS	F.A.U. RTE.	SECTION	COUNTY	TOTAL	SHEET NO.
	CONSTRUCTION DETAILS		10-00091-00-LS	DUPAGE	53	45
				CONTRAC	T NO. 6	1B07
SCALE: N/A	SHEET NO. 1 OF 1 SHEETS		ILLINOIS FED.	AID PROJECT		

ALL HYDRANTS ARE TO BE SUPPLIED WITH A C' FLANGED AND MECHANICAL JOINT ALXILIARY VALVE THAT CONFORMS TO AWWA 500-80. ALL TRIM BOLTS ARE TO BE STAINLESS STEEL.


RMS DATE JUL 2004
FIRE HYDRANT SETTING V3 Companies 7325 Janes Avenue Woodridge, IL 60517 630.724.9200 phone 630.724.9202 fax www.v3co.com

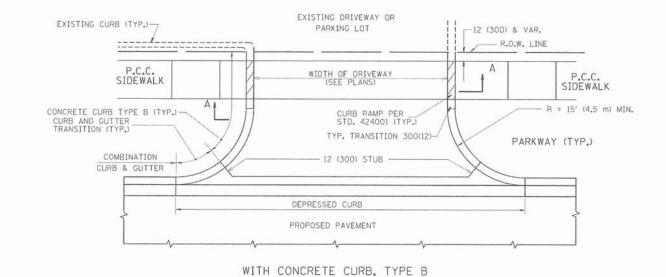


#### -SEE NOTE 3 EXISTING DRIVEWAY OR PARKING LOT EXISTING CURB (TYP.)--12 (300) & VAR. - R.O.W. LINE P.C.C. SIDEWALK SIDEWALK - CONCRETE CURB TYPE B (TYP.) PARKWAY (TYP.) -R=15' (4.5 m) (TYP.) MIN. -CURB & GUTTER TRANSITION (TYP.) R=10' (3.0 m) TYP. MIN. 12 (300) STUB COMBINATION CURB & GUTTER FLOW LINE OF GUTTER -DEPRESSED CURB PAVEMENT

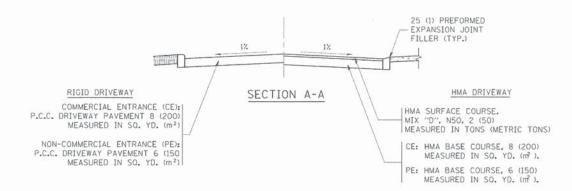

WITH CONCRETE CURB, TYPE B

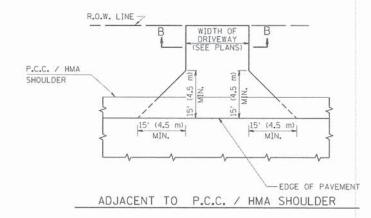

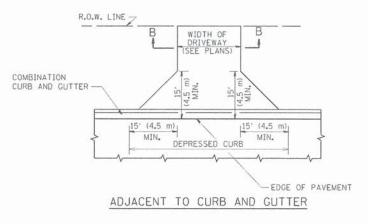

RURAL FIELD ENTRANCE (FE)


MEASURED IN TONS (METRIC TONS)

AGGREGATE BASE CSE., TYPE B, 8 (200)

HMA SURFACE COURSE.

MEASURED IN SQ. YD. (m2).

MIX "D", N50, 2 (50)

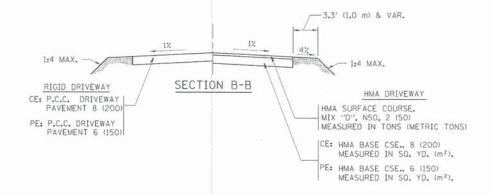

## GENERAL NOTES:

DRIVEWAY SLOPES, LOCATIONS, & GEOMETRIC LAYOUT SHALL BE IN ACCORDANCE WITH THE LATEST EDITION OF THE "HANDBOOK FOR POLICY ON PERMITS FOR ACCESS DRIVEWAYS TO STATE HIGHWAYS". FOR FURTHER LAYOUT REQUIREMENTS, REFER TO ILLUSTRATIONS IN THE PERMIT HANDBOOK. DRIVEWAYS SHALL BE REPLACED IN KIND, UNLESS OTHERWISE NOTED ON THE PLANS.

COMMERCIAL DRIVEWAYS SHALL BE CONSTRUCTED WITH CONCRETE CURB, TYPE B RETURNS EXCEPT WHEN THE SIDEWALK EDGE IS 4 FEET (1.2 METERS) OR LESS FROM THE BACK OF CURB, CONSTRUCT A FLARE DRIVEWAY WITHOUT CURE

AT 847/ 705-4131 FOR ANY QUESTIONS ON DRIVEWAYS SHOWN IN THE PLANS; SPECIFICALLY IN REFERENCE TO ADDITIONAL AND/OR RELOCATION/REMOVAL OF A DRIVEWAY.

BE ALLOWED FOR THE CURB & GUTTER TRANSITION.

(25) PREFORMED EXPANSION JOINT FILLER WILL NOT BE PAID SEPARATELY, BUT SHALL BE CONSIDERED INCLUDED IN THE COST OF THE P.C.C. DRIVEWAY PAVEMENT OR P.C.C. SIDEWALK.

THRU DRIVEWAY AREA TO BE A MAXIMUM OF 1:50.

SCALE: NONE

B							
?	SHALL	CONTACT	THE	TRAFFIC	PERMIT	OFFICE	


COMBINATION CONCRETE CURB & GUTTER SHALL BE MEASURED STRAIGHT ACROSS THE DRIVEWAY. NO ADDITIONAL COMPENSATION WILL

WHEN THE P.C.C. SIDEWALK EXTENDS THROUGH THE DRIVEWAY, THE THICKNESS OF THE SIDEWALK IN THE DRIVEWAY AREA SHALL BE THE SAME AS THE DRIVEWAY THICKNESS. SIDEWALK WILL BE PAID FOR AS P.C.C. SIDEWALK OF THE THICKNESS SPECIFIED. SIDEWALK CROSS SLOPE

FILE NAME =	USER NAME = legae	DESIGNED - R. SHAH	REVISED - P. LaFLUER 04-15-03
us\pw_work\pwtdot\leysa\d8188315\bd81.dgr		DRAWN -	REVISED - R. BORO 01-01-07
	PLCT SCALE = 50.0000 1/ in.	CHECKED -	REVISED - R. BORO 06-11-08
	PLDT DATE = 9/6/2011	DATE - 11-04-95	REVISED - R. BORO 09-06-11

STATE	OF	ILLINOIS
DEPARTMENT	OF '	TRANSPORTATION


DRIVEWAY DETAILS - DISTANCE BETWEEN R.O.W.	F.A.U. RTE.	SECTION	COUNTY	TOTAL	SHEET NO.
AND FACE OF CURB & EDGE OF SHOULDER > = 15' (4.5 m)	2651	10-00091-00-LS	DUPAGE	53	46
AND TACE OF COMB & EDGE OF SHOOLDER >= 13 (4.3 III)	BE	00156-07 (BD-01)	CONTRACT	NO.	51B07
SHEET NO. 1 OF 1 SHEETS STA. TO STA.	FED. ROAD	DIST. NO. 1 ILLINOIS FED.	AID PROJECT		

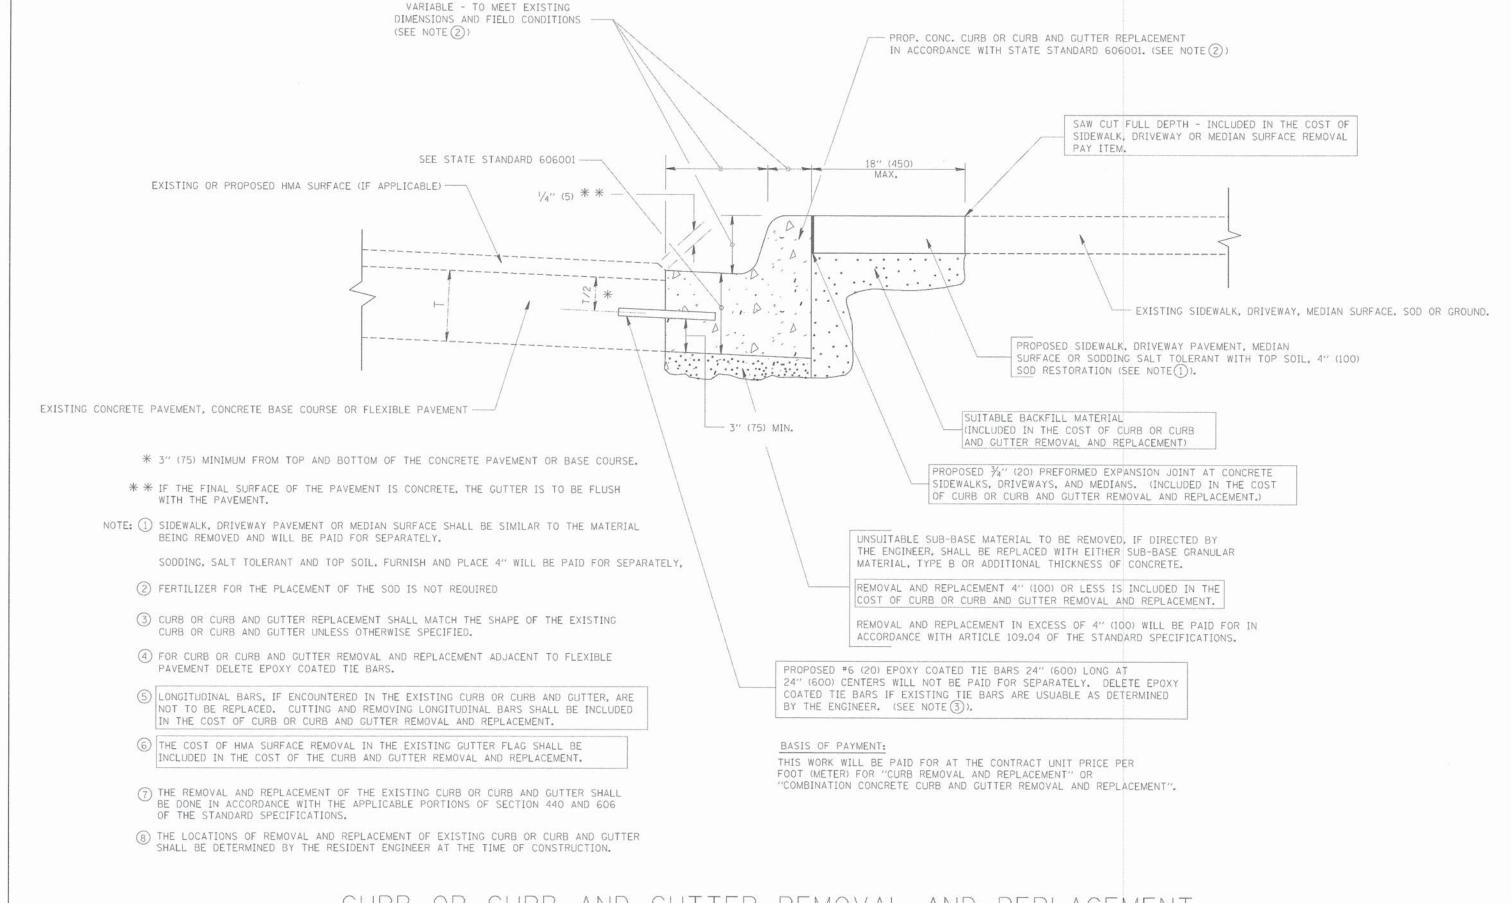

## CURB OR CURB AND GUTTER REMOVAL AND REPLACEMENT

ALL DIMENSIONS ARE IN INCHES (MILLIMETERS) UNLESS OTHERWISE SHOWN.

ILE NAME =	USER NAME = drivakasgn	DESIGNED - A. HOUSEH	REVISED -	R. SHAH 10-03-96				F.A.U.	SECTION	COUNTY	TOTAL SHE
ci\pw.work\pwidot\drivakcagn\d81883;5\bd	24,dgn	DRAWN -	REVISED -	A. ABBAS 03-21-97	STATE OF ILLINOIS		CURB OR CURB AND GUTTER	RTE.	10 00001 00 10	COUNTY	SHEETS NO
	PLOT SCALE = 50,000 1/ IN.	CHECKED -	REVISED -	M. GOMEZ 01-22-01	DEPARTMENT OF TRANSPORTATION		REMOVAL AND REPLACEMENT	2651	10-00091-00-LS	DUPAGE	to the same of
	PLOT DATE = 12/15/2009	DATE - 03-11-94	REVISED -	R. BORO 12-15-09		SCALE: NONE	SHEET NO. 1 OF 1 SHEETS STA. TO STA.	FED B	BD600-06 (BD-24)	AID PROJECT	CT NO. 61BO

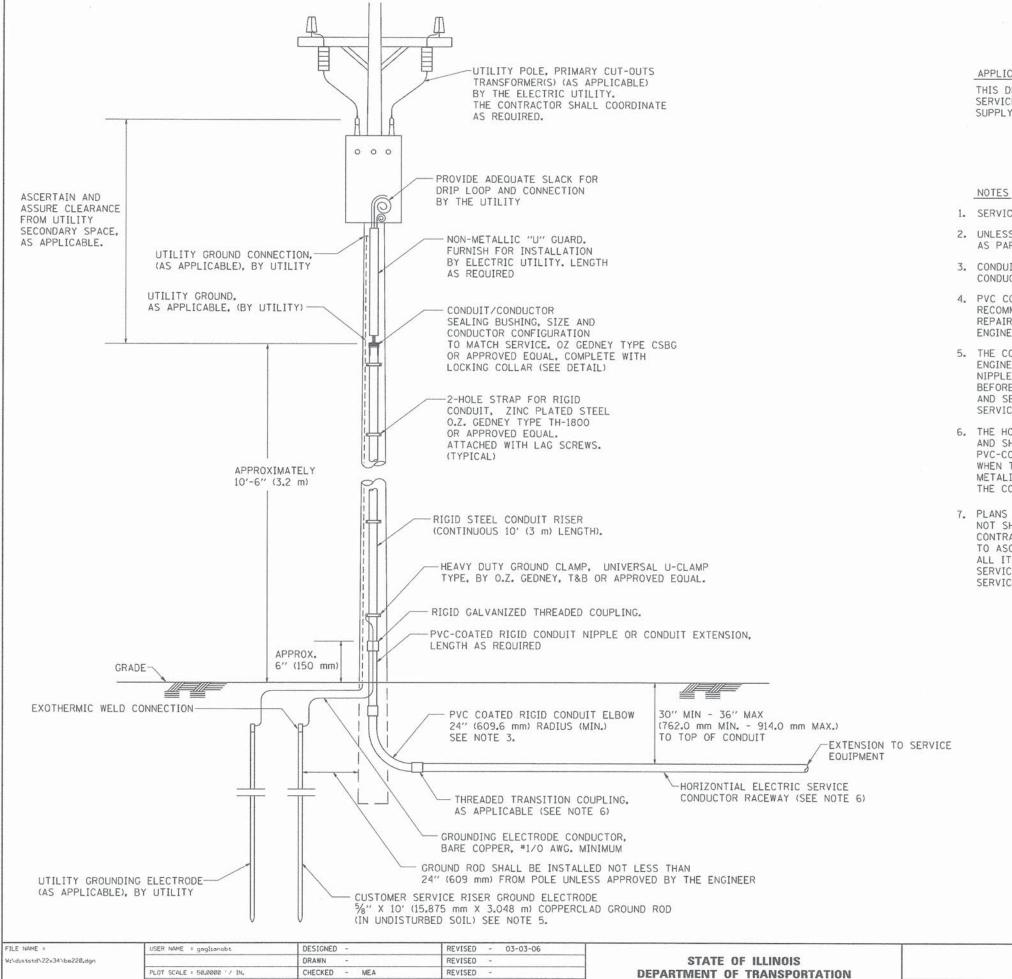

REVISED

PLOT DATE = 1/4/2008


DATE

#### APPLICATION


THIS DETAIL APPLIES FOR LOW VOLTAGE ELECTRIC SERVICE (660 V OR LESS) FROM AN OVERHEAD UTILITY SUPPLY TO SEPERATLY-MOUNTED SERVICE EQUIPMENT.

SCALE: NONE

- 1. SERVICE VOLTAGE SHALL BE AS INDICATED ELSEWHERE IN THE DRAWINGS.
- 2. UNLESS OTHERWISE INDICATED, ITEMS AND WORK SHALL BE INCLUDED AND PAID AS PART OF THE ELECTRIC UTILITY SERVICE INSTALLATION PAY ITEM.
- 3. CONDUIT AND CONNECTOR DIAMETER SHALL MATCH THE DIAMETER OF THE SERVICE CONDUCTOR RACEWAY AS INDICATED ON THE PLANS.
- 4. PVC COATED RACEWAYS AND ACCESSORIES SHALL BE CAREFULLY INSTALLED WITH MFR RECOMMENDED TOOLS AND PROCEDURES TO AVOID DAMAGE. ANY DAMAGE SHALL BE REPAIRED WITH COMPATIBLE PVC TOUCH-UP MATERIAL TO THE SATISFACTION OF THE ENGINEER OR THE DAMAGED MATERIAL SHALL BE REPLACED AT NO ADDITIONAL COST.
- 5. THE CONTRACTOR SHALL OBTAIN INSPECTION AND APPROVAL BY THE ENGINEER OF SERVICE RISER GROUND ELECTRODE, RISER ELBOW, NIPPLE AND CONNECTION TO SERVICE CONDUCTOR RACEWAY EXTENSION BEFORE BACKFILL AND SHALL ALSO OBTAIN INSPECTION OF SERVICE RISER AND SEALING BUSHING BEFORE UTILITY "U" GUARD INSTALLATION AND SERVICE CONNECTION.
- 6. THE HORIZONTAL ELECTRIC SERVICE CONDUCTOR RACEWAY SHALL BE AS INDICATED AND SHALL BE MEASURED SEPARATELY FOR PAYMENT. WHEN THE RACEWAY IS PVC-COATED RIGID GALVANIZED STEEL, THE COUPLING SHALL BE THE SAME. WHEN THE RACEWAY IS PVC CONDUIT (IN CONCRETE), THE COUPLING SHALL BE A METALIC TO NON METALIC ADAPTER. WHEN THE RACEWAY IS ENCASED IN CONCRETE. THE CONCRETE SHALL EXTEND TO COVER THE COUPLING.
- 7. PLANS AND DETAILS INDICATE THE GENERAL NATURE AND REQUIREMENTS. THEY DO NOT SHOW EVERY ACCESSORY AND ATTACHMENT, AND THEY DO NOT RELIEVE THE CONTRACTOR OF THE REQUIREMENTS OF THE SPECIFICATIONS AND SPECIAL PROVISIONS TO ASCERTAIN UTILITY REQUIREMENTS AND TO COORDINATE ACCORDINGLY, FURNISHING ALL ITEMS AND WORK NOT PROVIDED BY THE UTILITY, BUT NECESSARY FOR A COMPLETE SERVICE INSTALLATION IS REQUIRED AND SHALL BE INCLUDED IN THE ELECTRIC UTILITY SERVICE INSTALLATION PAY ITEM.

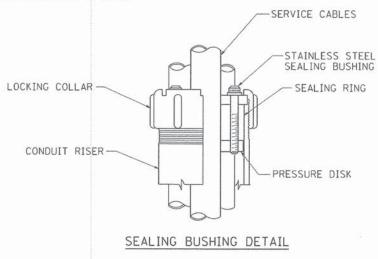

ELECTRIC S	ERVICE IN	STALLATION		F.A.U. RTE.	SECTION	COUNTY	TOTAL	SHEET NO.
AERIAL, RI	EMOTE DIS	COMMECT		2651	10-00091-00-LS	DUPAGE	53	48
ALIIAL, III	LIVIOIL DI	3GOTHINE GT			BE-220	CONTRACT	NO.	61B07
SHEET NO. 1 OF 1	SHEETS	STA.	TO STA.	FED. ROAD	DIST. NO. 1   ILLINOIS FED.	AID PROJECT		

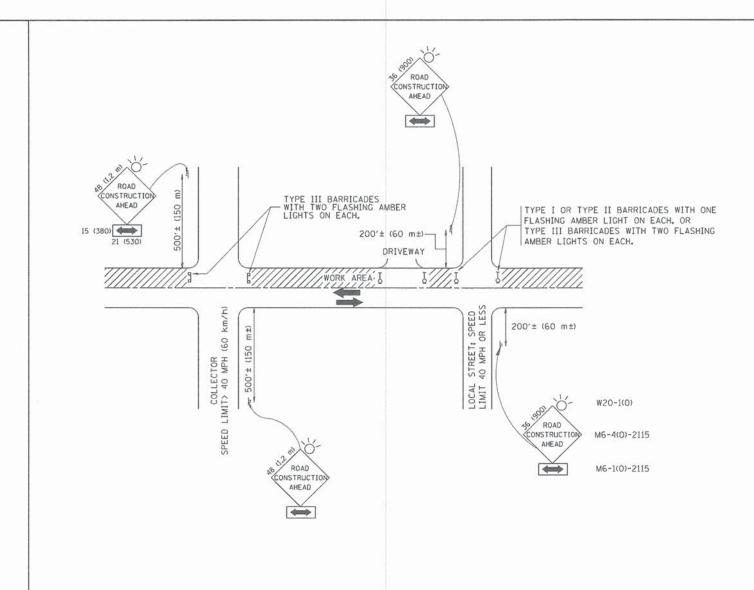

#### TRAFFIC CONTROL AND PROTECTION FOR SIDE ROADS, INTERSECTIONS, AND DRIVEWAYS

#### NOTES:

- A. FOR NO LANE RESTRICTION ON THE SIDE ROAD OR DRIVEWAYS
- SIDE ROAD WITH A SPEED LIMIT OF 40 MPH (60 km/h) OR LESS AS SHOWN ON THE DRAWING AND AS DIRECTED BY THE ENGINEER:
- O) ONE ROAD CONSTRUCTION AHEAD SIGN 36 x 36 (900x900) WITH A FLASHER AND FLAG MOUNTED ON IT APPROXIMATELY 200' (60 m) IN ADVANCE OF THE MAIN ROUTE.
- b) THE CLOSED PORTION OF THE MAIN ROUTE SHALL BE PROTECTED BY BLOCKING WITH TYPE I, TYPE II OR TYPE III BARRICADES, 1/3 OF THE CROSS SECTION OF THE CLOSED PORTION,
- 2. SIDE ROAD WITH A SPEED LIMIT GREATER THAN 40 MPH (60 km/h)
  AS SHOWN ON THE DRAWING AND AS DIRECTED BY THE ENGINEER₂
- O) ONE ROAD CONSTRUCTION AHEAD SIGN 48 x 48 (1.2 m x 1.2 m) WITH A FLASHER MOUNTED ON IT APPROXIMATELY 500' (150 m) IN ADVANCE OF THE MAIN ROUTE.
- b) THE CLOSED PORTION OF THE MAIN ROUTE SHALL BE PROTECTED BY BLOCKING WITH TYPE III BARRICADES, 1/2 OF THE CROSS SECTION OF THE CLOSED PORTION.
- 3. WHEN THE SIDE ROAD LIES BETWEEN THE BEGINNING OF THE MAINLINE SIGNING AND THE WORK ZONE, A SINGLE HEADED ARROW (MG-1) SHALL BE USED IN LIEU OF THE DOUBLE HEADED ARROW (MG-4).

SCALE: NONE

#### B. FOR A LANE CLOSURE ON A SIDE ROAD OR DRIVEWAY:


- USE APPLICABLE PORTIONS OF THE TYPICAL APPLICATION OF TRAFFIC CONTROL DEVICES (STD. 701501, STD. 701606 OR THE APPROPRIATE STANDARD). THE SPACING OF SIGNS AND BARRICADES SHALL BE ADJUSTED FOR FIELD CONDITIONS AS DIRECTED BY THE ENGINEER. THE DIRECTIONAL ARROW SHALL BE COVERED OR REMOVED WHEN NO LONGER CONSISTENT WITH THE SIDE ROAD LANE CLOSURE.
- C. ADVANCE WARNING SIGNS ARE TO BE OMITTED ON DRIVEWAY UNLESS OTHERWISE NOTED.
- D. THE TRAFFIC CONTROL AND PROTECTION FOR SIDE ROADS, INTERSECTIONS, AND DRIVEWAYS SHALL BE INCIDENTAL TO THE COST OF SPECIFIED TRAFFIC CONTROL STANDARDS OR ITEMS.

All dimensions are in millimeters (inches) unless otherwise shown.

FILE NAME =	USER NAME = gaglianobt	DESIGNED - LHA	REVISED - J. OBERLE 10-18-95
W:\diststd\22x34\tc10.dgn		DRAWN -	REVISED - A. HOUSEH 03-06-96
	PLOT SCALE = 50.000 ' / IN.	CHECKED -	REVISED - A. HOUSEH 10-15-96
	PLOT DATE = 1/4/2008	DATE - 06-89	REVISED -T. RAMMACHER 01-06-00

STATE	E OF	ILLINOIS
DEPARTMENT	OF	TRANSPORTATION

	TRAFFIC CONTR	ROTECTION	F.A.U. RTE.	SECTION	COUNTY	TOTAL	SHEET NO.		
SIDE ROADS, INTERSECTIONS, AND DRIVEWAYS					2651	10-00091-00-LS	DUPAGE	53	49
						TC-10	CONTRACT	NO.	61B07
	SHEET NO. 1 OF 1	SHEETS	STA.	TO STA.	FED. ROAD	DIST, NO. 1 ILLINOIS FED.	AID PROJECT		

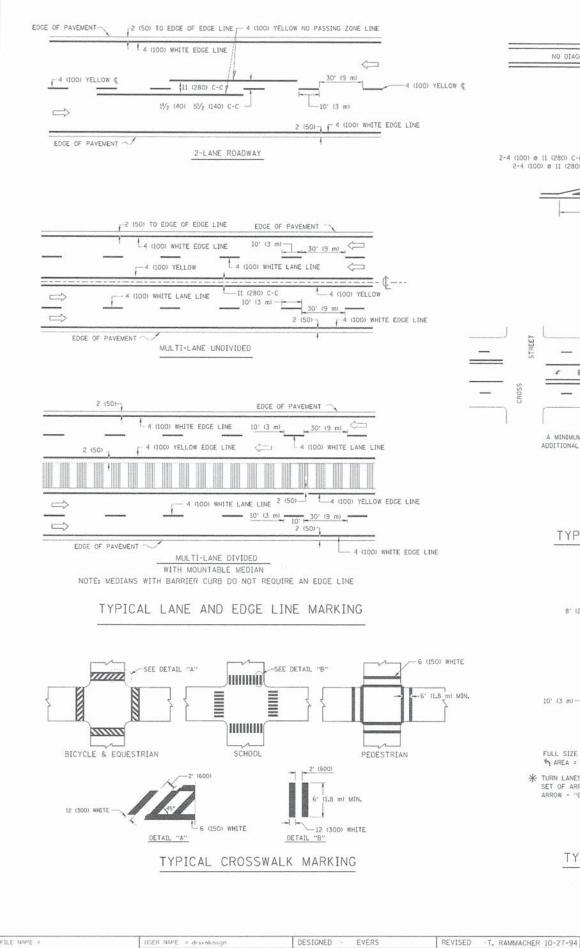



DRAWN

DATE

PLOT SCALE = 50,000 1/ IN.


CHECKED

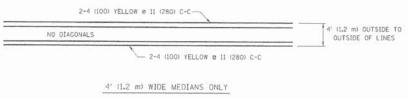

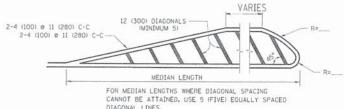

DIAGONAL LINE SPACING: 50' (15 m) C-C (LESS THAN 30MPH (50 km/h)) 75' (25 m) C-C 30MPH (50 km/h) TO 45MPH (70 km/h)) 150' (45 m) C-C (MORE THAN 45MPH (70 km/h))

#### MEDIANS OVER 4' (1.2 m) WIDE

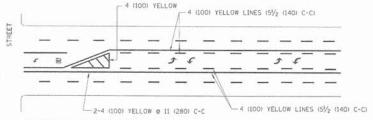


A MINIMUM OF TWO PAIRS OF TURN ARROWS SHALL BE USED, WHITE IN COLOR, ADDITIONAL PAIRS SHALL BE PLACED AT 200' (60 m) TO 300' (90 m) INTERVALS.



MEDIAN WITH TWO-WAY LEFT TURN LANE

#### TYPICAL PAINTED MEDIAN MARKING

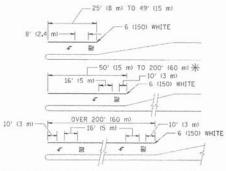


FULL SIZE LETTERS 8 (2.4 m) AND ARROWS SHALL BE USED.  $\P$  AREA = 15.6 SO. FT. (1.5 m² )  $\Pi$  AREA = 20.8 SO. FT. (1.9 m²)

\* TURN LAMES IN EXCESS OF 400' (120 m) IN LENGTH MAY HAVE AN ADDITIONAL SET OF ARROW - "ONLY" INSTALLED MIDWAY BETWEEN THE OTHER TWO SETS OF ARROW - "ONLY".

TYPICAL LEFT (OR RIGHT) TURN LANE

#### TYPICAL TURN LANE MARKING

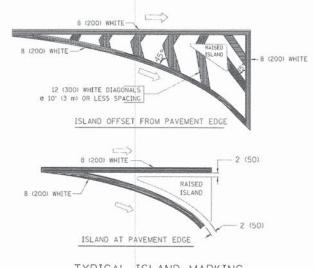

#### TYPICAL ISLAND MARKING

TYPE OF MARKING	WIDTH OF LINE	PATTERN	COLOR	SPACING / REMARKS
CENTERLINE ON 2 LANE PAVEMENT	4 (100)	SKIP-DASH	YELLOW	10' (3 m) LINE WITH 30' (9 m) SPACE
CENTERLINE ON MULTI-LANE UNDIVIDED PAVEMENT	2 @ 4 (100)	SOLID	YELLOW	11 (280) C-C
NO PASSING ZONE LINES: FOR ONE DIRECTION FOR BOTH DIRECTIONS	4 (100) 2 @ 4 (100)	SOLID SOLID	YELLOW	5/2 (140) C-C FROM SKIP-DASH CENTERLINE 11 (280) C-C OMIT SKIP-DASH CENTERLINE BETWEEN
LANE LINES	4 (100) 5 (125) ON FREEWAYS	SKIP-DASH SKIP-DASH	WHITE WHITE	10' (3 m) LINE WITH 30' (9 m) SPACE
DOTTED LINES (EXTENSIONS OF CENTER, LANE OR TURN LANE MARKINGS)	SAME AS LINE BEING EXTENDED	SKIP-DASH	SAME AS LINE BEING EXTENDED	2' (600) LINE WITH 6' (1.8 m) SPACE
EDGE LINES	4 (100)	SOLID	YELLOW-LEFT WHITE-RIGHT	OUTLINE MOUNTABLE MEDIANS IN YELLOW: EDGE LINES ARE NOT USED NEXT TO BARRIER CURB
TURN LANE MARKINGS	6 (150) LINE: FULL SIZE LETTERS & SYMBOLS (8' (2.4m))	SOLID	WHITE	SEE TYPICAL TURN LANE MARKING DETAIL
TWO WAY LEFT TURN MARKING	2 @ 4 (100) EACH DIRECTION	SKIP-DASH AND SOLID	YELLOW	10' (3 m) LINE WITH 30' (9 m) SPACE FOR SKIP-DASH: 5½ (140) C-C BETWEEN SOLID LINE AND SKIP-DASH LINE
	8' (2.4m) LEFT ARROW	IN PAIRS	WHITE	SEE TYPICAL TWO-WAY LEFT TURN MARKING DETAIL
CROSSWALK LINES (PEDESTRIAN) A. DÍAGONALS (BIKE & EQUESTRIAN) B. LONGITUDINAL BARS (SCHOOL)	2 @ 6 (150) 12 (300) @ 45° 12 (300) @ 90°	SOLID SOLID	WHITE WHITE WHITE	NOT LESS THAN 6' (L8 m) APART 2' (600) APART 2' (600) APART SEE TYPICAL CROSSWALK MARKING DETAILS.
STOP LINES	24 (600)	SOLID	WHITE	PLACE 4' (1.2 m) IN ADVANCE OF AND PARALLEL TO CROSSMALM, IF PRESENT. OTHERWISE, PLACE AT DESIRED STOPPING POINT, PARALLEL TO CROSSROAD CENTERLINE, WHERE POSSIBLE
PAINTED MEDIANS	2 @ 4 (100) WITH 12 (300) DIAGONALS @ 45° NO DIAGONALS USED FOR 4' (1.2 m) WIPE MEDIANS	SOLTO	YELLOW: TWO WAY TRAFFIC WHITE: ONE WAY TRAFFIC	11 (280) C-C FOR THE DOUBLE LINE SEE TYPICAL PAINTED MEDIAN MARKING.
GORE MARKING AND CHANNELIZING LINES	8 (200) WITH 12 (300) DIAGONALS @ 45°	SOLID	WHITE	DIAGONALS: 15' (4,5 m) C-C (LESS THAN 30MPH (50 km/h)) 20' (6 m) C-C 30MPH (50 km/h) TO 45MPH (70 km/h)) 30' (9 m) C-C (0VER 45MPH (70 km/h))
RAILROAD CROSSING	24 (600) TRANSVERSE LINES; "RR" IS 6' (1.8 m) LETTERS; 16 (400) LINE FOR "X"	SOLID	WHITE	SEE STATE STANDARD 780001 AREA OF: "R"=3.6 SO. FT. (0.33 m <sup>2</sup> ) EACH "X"=54.0 SO. FT. (5.0 m <sup>2</sup> )
SHOULDER DIAGONALS	12 (300) a 45°	SOLIO	WHITE - RIGHT YELLOW - LEFT	50' (15 m) C-C (LESS THAN 30MPH (50 km/h)) 75' (25 m) C-C (30 MPH (50 km/h) TO 45MPH (70 km/l) 150' (45 m) C-C (0VER 45MPH (70 km/h))

FOR FURTHER DETAILS ON PAVEMENT MARKING REFER TO STANDARD SPECIFICATIONS FOR ROAD AND BRIDGE CONSTRUCTION AND STATE STANDARD 780001.

All dimensions are in inches (millimeters) unless otherwise shown.

DUPAGE 53


CONTRACT NO. 61B07


REVISED -C. JUCIUS 09-09-09

REVISED

REVISED

STATE OF ILLINOIS		DISTRICT ONE TYPICAL PAVEMENT MARKINGS			F.A.U. SECTION		COUNTY
					2651	10-00091-00-LS	DUPAGE
DEPARTMENT OF TRANSPORTATION					TC-13		CONTRAC
	SCALE: NONE	SHEET NO. 1 OF 1 SHEETS	STA.	TO STA.	FED. ROAD DIST. NO. 1 ILLINO		AID PROJECT

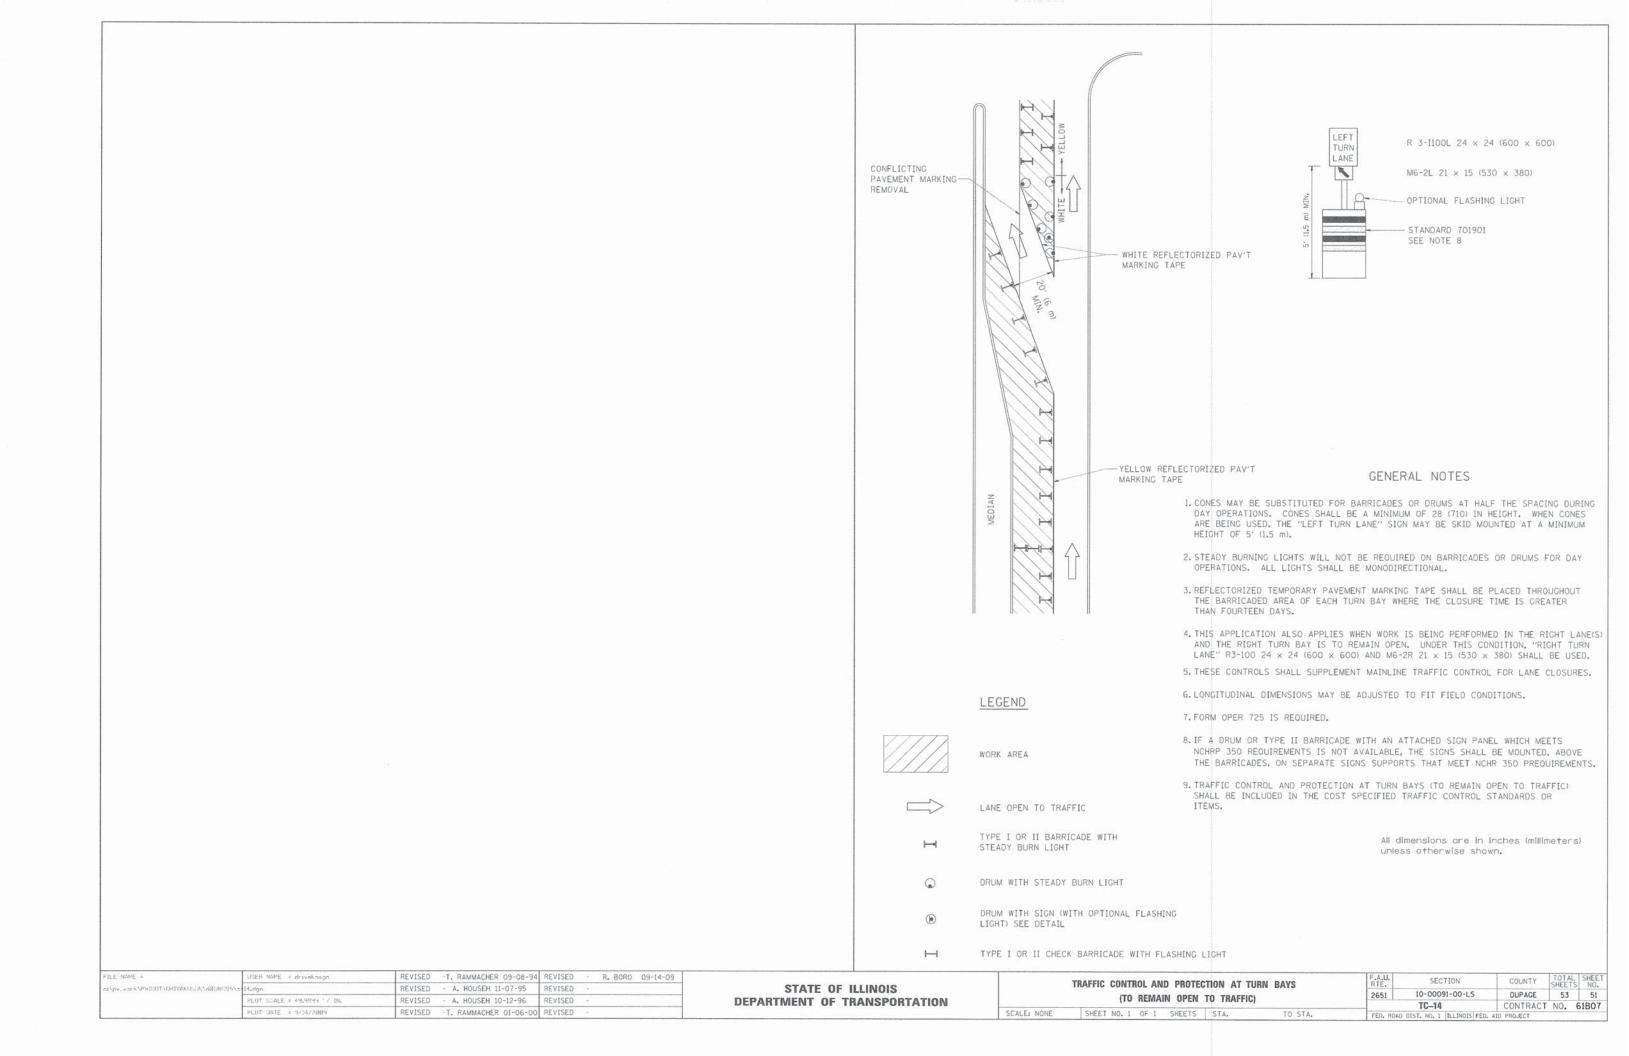

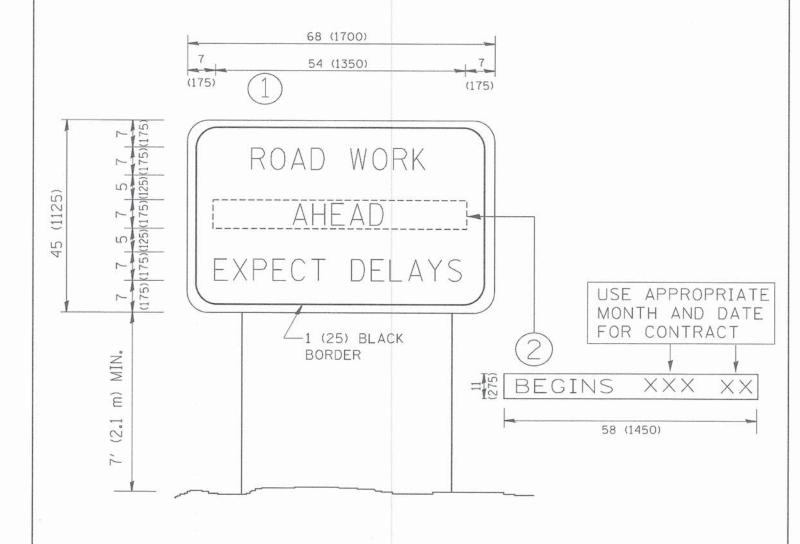

## NOTES:

- 1. USE BLACK LETTERING ON ORANGE BACKGROUND.
- 2. ERECT SIGNS IN ADVANCE OF THE LOCATION FOR THE "ROAD CONSTRUCTION AHEAD" SIGN AT LOCATIONS AS DIRECTED BY THE ENGINEER.
- 3. ERECT SIGN (1) WITH INSTALLED PANEL (2) ONE WEEK PRIOR TO THE START OF CONSTRUCTION.
- 4. REMOVE PANEL 2 SOON AFTER THE START OF CONSTRUCTION.
- 5. SEE SPECIAL PROVISION FOR "TEMPORARY INFORMATION SIGNING" FOR ADDITIONAL INFORMATION.
- 6. ONE SIGN ASSEMBLY EQUALS 25.70 SQ. FT. (2.3 SQ. M.)
- 7. SHALL BE PAID FOR AS TEMPORARY INFORMATION SIGNING.

ALL DIMENSIONS ARE IN INCHES (MILLIMETERS)
UNLESS OTHERWISE SHOWN.

Marie Committee of the							
FILE NAME =	USER NAME = gaglianobt	DESIGNED -	REVISED - R. MIRS 09-15-97	Name and the second		F.A.U. SECTION	COUNTY TOTAL SHEET
W:\diststd\22x34\tc22.dgn		DRAWN -	REVISED - R. MIRS 12-11-97	STATE OF ILLINOIS	ARTERIAL ROAD	RTE. SECTION	SHEETS NO.
	PLOT SCALE = 50.000 ° / IN.	CHECKED -	REVISED -T. RAMMACHER 02-02-99	DEPARTMENT OF TRANSPORTATION	INFORMATION SIGN	2651 10-00091-00-LS	DUPAGE 53 52
	PLOT DATE = 1/4/2008	DATE -	REVISED - C. JUCIUS 01-31-07	DEFAITMENT OF THANGS OFFATION	SCALE, NOVE SUFFER NO. 1 OF 1 SUFFER ST.	TC-22	CONTRACT NO. 61B07
	TEOT DATE - DITTEGED	DAIL	THE FISCH C. OSCIOS OF STOT		SCALE: NONE   SHEET NO. 1 OF 1 SHEETS   STA. TO STA.	FED. ROAD DIST, NO. 1 ILLINOIS FED.	AID PROJECT



3.0" RADIUS, 0.5" BORDER, WHITE ON GREEN; REFLECTORIZED "DRIVEWAY" D; "ENTRANCE" D; STANDARD ARROW CUSTOM 12.0" x 5.0"

### NOTES:

- 1. HALF OF THE SIGNS WILL REQUIRE A LEFT HAND FACING ARROW.
- 2. TWO SIGNS SHALL BE USED AT EACH COMMERCIAL ENTRANCE PLACED BACK-TO-BACK: ONE WITH A RIGHT HAND ARROW (SHOWN) SHALL BE PLACED ON THE NEAR RIGHT SIDE THE DRIVEWAY AND ONE WITH A LEFT HAND ARROW SHALL BE PLACED ON THE FAR LEFT SIDE OF THE DRIVEWAY.
- 3. SIGNS TO BE PAID FOR AS ITEM "TEMPORARY INFORMATION SIGNING".

FILE NAME :	USER NAME = gaglionobil	DESIGNED -	REVISED - C. JUCIUS 02-15-07
ci\pw_work\pwidet\gaglianobt\d0108315\tc	26.dgn	DRAWN -	REVISED -
	PLOT SCALE = 50.000 1/ 10.	CHECKED -	REVISED -
	PLOT DATE = 12/13/2012	DATE -	REVISEO -

STATE	OF	ILLINOIS
DEPARTMENT	OF	TRANSPORTATION

	DRIVEWAY	DRIVEWAY ENTRANCE		SIGNING		SECTION	COUNTY	TOTAL	SHEET NO.
					2651	10-00091-00-LS	DUPAGE	53	53
					TC-26		CONTRACT NO. 61B		51B07
LE: NONE	SHEET NO. 1 OF 1	SHEETS	STA.	TO STA.	FED. ROAD	FED. ROAD DIST. NO. 1 ILLINOIS FED. AID PROJECT			