STATE OF ILLINOIS

DEPARTMENT OF TRANSPORTATION

DIVISION OF HIGHWAYS

FOR INDEX OF SHEETS, SEE SHEET NO. 2

PROPOSED HIGHWAY PLANS

F.A.P. ROUTE 347 /ILL 38 (ROOSEVELT ROAD)

AT GARY'S MILL ROAD

SECTION: 2 Y-N


CHANNELIZATION

PROJECT: H5IP-0347 (022)

DUPAGE COUNTY

C-91-499-08

PROJECT IS LOCATED IN UNINCORPORATED DUPAGE COUNTY

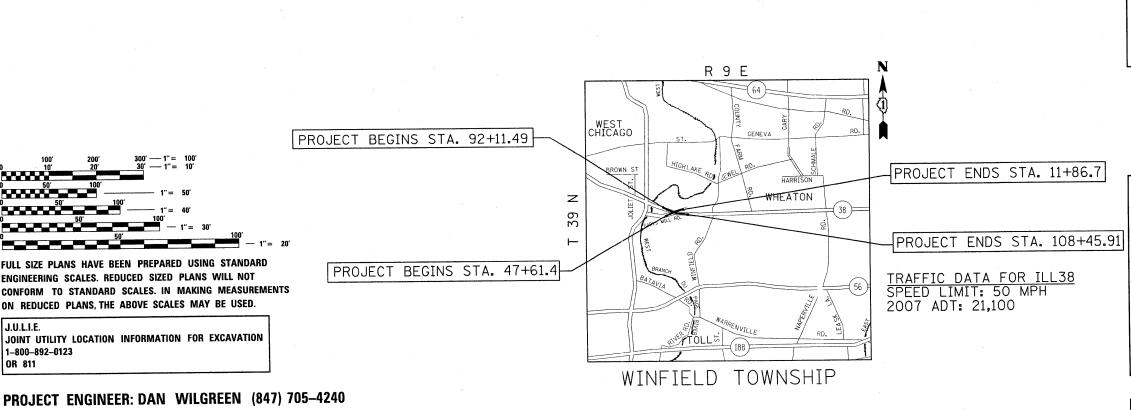

GROSS LENGTH OF PROJECT = NET LENGTH OF PROJECT = 1634.4 FEET (0.31 MILES)

DUPAGE 40 1

D-91-499-08



STATE OF ILLINOIS DEPARTMENT OF TRANSPORTATION

DEPUTY DIRECTOR OF HIGHWAYS, REGION ENGINEER May 8,20 09

PRINTED BY THE AUTHORITY OF THE STATE OF ILLINOIS

CONTRACT NO. 60E65

PROJECT MANAGER: KEN ENG

1-800-892-0123

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ENGINEERING SCALES. REDUCED SIZED PLANS WILL NOT

ON REDUCED PLANS, THE ABOVE SCALES MAY BE USED.

JOINT UTILITY LOCATION INFORMATION FOR EXCAVATION

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	6	SCHEDULE OF QUANTITIES (EARTHWORK)	
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LIST OF STANDARDS

000001-05 STANDARD SYMBOLS, ABBREVIATIONS AND PATTERNS

	280001 <i>-04</i>	TEMPORARY EROSION CONTROL SYSTEMS	
	442201 -03	CLASS C & D PATCHES	
	482001 <i>-02</i>	BITUMINOUS SHOULDER ADJACENT TO FLEXIBLE PAVEMENT	
	542301- <i>02</i>	PRECAST REINFORCED CONCRETE FLARED END SECTIONS	
	601001-03	SUB-SURFACE DRAINS	
	601101-01	CONCRETE HEADWALL FOR PIPE DRAIN	
	602001 <i>-01</i>	CATCH BASIN, TYPE A	
	604036- <i>0</i> 2	GRATE, TYPE 8	
	606001- <i>04</i>	CONCRETE CURB TYPE B AND COMBINATION CONCRETE CURB AND GUTTER	*.
	630001- <i>08</i>	STEEL PLATE BEAM GUARDRAIL	
	630201- <i>06</i>	PCC/HMA STABILIZATION AT STEEL PLATE BEAM GUARDRAIL	1
	701421 - 0 Z	LANE CLOSURES, MULTILANE, DAY OPERATIONS ONLY, FOR SPEEDS \geq 45 MPH	TO 55 MPH
	701422- <i>02</i>	LANE CLOSURES, MULTILANE, FOR SPEEDS 245 MPH TO 55 MPH	
	701901-01	TRAFFIC CONTROL DEVICES	
		and the second of the second o	4 - 4 - 40 - 40 - 40 - 40 - 40 - 40 - 4
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GENERAL NOTES

BEFORE STARTING ANY EXCAVATION, THE CONTRACTOR SHALL CALL "JULIE" AT 800-892-0123 FOR FIELD LOCATIONS OF BURIED ELECTRIC, TELEPHONE AND GAS FACILITIES. (48 HOUR NOTIFICATION IS REQUIRED)

THE CONTRACTOR SHALL COORDINATE CONSTRUCTION ACTIVITIES WITH UTILITY COMPANIES AND THE COUNTY OF DUPAGE. THE CONTRACTOR WILL NOT BE ALLOWED TO SET UP A YARD OR FIELD OFFICE ON STATE PROPERTY WITHOUT WRITTEN PERMISSION FROM THE DEPARTMENT.

BUTT JOINTS WILL BE INSTALLED AT THE ENDS OF ALL RESURFACING (WHERE RESURFACING MEETS EXISTING PAVEMENT), IN ACCORDANCE WITH THE "BUTT JOINT AND HMA TAPER DETAILS" SHEET INCLUDED IN THE PLANS, UNLESS OTHERWISE SPECIFIED.

WHEN MILLED PAVEMENT IS OPEN TO TRAFFIC THE MAXIMUM GRADE DIFFERENTIAL BETWEEN PASSES OF THE MILLING MACHINE SHALL NOT EXCEED 1/2INCHES (40MM) WHERE THE SPEED LIMIT IS 45 MPH (80KM/H) OR LESS AND 1 INCH (25 MM) WHERE THE SPEED LIMIT IS GREATER THAN 45 MPH (80 KM/H), WITH WRITTEN APPROVAL FROM THE ENGINEER, A MAXIMUM GRADE DIFFERENTIAL OF 3 INCHES (75 MM) MAY BE ALLOWED IF THE EDGE OF THE MILLING IS SLOPED A MINIMUM 1:3 (V:H).

THE RESIDENT ENGINEER SHALL VERIFY THE LOCATIONS OF ALL EXISTING PAVEMENT MARKINGS PRIOR TO MILLING OR RESURFACING.

ALL PAVEMENT MARKINGS SHALL BE PLACED THROUGHOUT THE IMPROVEMENT ACCORDING TO DISTRICT 1 TYPICAL PAVEMENT MARKING.

THE RESIDENT ENGINEER SHALL CONTACT MR. DON CHIARUGI, AREA TRAFFIC FIELD ENGINEER AT (847) 741-5302 (OFFICE) A MINIMUM OF 2 WEEKS PRIOR TO PLACEMENT OF PERMANENT PAVEMENT MARKINGS.

RAISED REFLECTIVE PAVEMENT MARKERS SHALL BE PLACED THROUGHOUT THE IMPROVEMENT ACCORDING TO THE DISTRICT STANDARDS AS NOTED IN THE DETAIL.

PRIOR TO EMBANKMENT PLACEMENT, ALL VEGETATION, LOOSE MATERIAL, AND UNSTABLE MATERIAL SHOULD BE REMOVED TO DEPTH ENCOUNTERED AND REPLACED WITH SUITABLE EMBANKMENT MATERIAL. ANY EMBANKMENT WIDENING ON EXISTING SLOPES SHOULD BE BENCHED IN ACCORDANCE WITH ARTICLE 205.04 OF THE STANDARD SPECIFICATIONS FOR ROAD AND BRIDGE CONSTRUCTION.

THE UNIT WEIGHT (CONVERSION FACTOR) QUOTED IS FOR THE ESTIMATING PLAN QUANTITIES ONLY. ACTUAL QUANTITIES TO FULFILL CONTRACT REQUIREMENTS WILL BE DETERMINED BASED ON UNIT WEIGHT OF APPROVED MIX DESIGN, PLAN DIMENSIONS, AND DENSITY LIMITATIONS. MAXIMUM PAYMENT WILL BE COMPUTED BASED ON WEIGHT AVERAGE DENSITIES OF THE IN-PLACE MIXTURE.

THE CONTRACTOR SHALL CONTACT THE DISTRICT ONE ARTERIAL TRAFFIC CONTROL SUPERVISOR A MINIMUM OF 72 HOURS PRIOR TO BEGINNING WORK AT (847) 705-4470.

THE RESIDENT ENGINEER SHALL CONTACT THE TRAFFIC CONTROL SUPERVISOR AT (847) 705-4470 A MINIMUM OF 72 HOURS PRIOR TO THE PLACEMENT OF ANY TEMPORARY TRAFFIC CONTROL DEVICES.

COMED WIRES ARE NOT INSULATED AND EXTRA CAUTION AND VIGILANCE MUST BE ADHERED TO WHEN WORKING AROUND THEM. CONTRACTORS SHOULD ALWAYS USE CAUTION IN OPERATING CRANES AND OR OTHER EQUIPMENT NEAR OVERHEAD ELECTRICAL FACILITIES. THE OCCUPATIONAL HEALTH AND SAFETY ORGANIZATION (OSHA) RULES REQUIRE THAT WORKERS AND EQUIPMENT SHALL NOT APPROACH WITHIN TEN (10) FEET AWAY OF OVERHEAD ELECTRICAL EQUIPMENT WITHOUT APPROPRIATE SUPPLEMENTAL PROTECTION. PLEASE BE CERTAIN THAT ALL WORKERS ON THIS PROJECT HAVE BEEN FULLY TRAINED AND CONFORM TO OSHA RULES AND OTHER APPLICABLE GUIDELINES REGARDING WORKING SAFELY AROUND ELECTRICAL POWER INFS.

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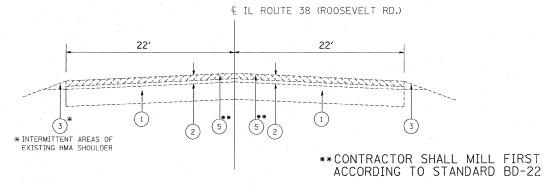
ILL	38	(ROOSEVELT	ROAD)	АТ	GARY'S	MILL	ROAD	RTE. 347	
		SHEET NO. OF	SHEET	S ST	Δ.	TO STA		CED D	OAD DI

F.A.P. RTE.		SECT	TION		COUNTY	TOTAL	SHEET NO.
347		2Y	-N		DUPAGE	40	2
					CONTRACT	NO. E	50E65
FED, RO	DAD DIST. M	NO. 1	ILLINOIS	FED. AIL	D PROJECT		


	SUMMARY OF QUANTITIES		110001	· · · · · · · · · · · · · · · · · · ·	CONS	STRUCTION	TYPE CO	DE			SUMMAF	RY OF QUANTITIES				C	ONSTRUCT	ION TYPE	CODE	
			TOTAL	1000										TOTAL	1000			-		
CODE NO	ITEM	UNIT	QUANTITIES	FED. 90% STATE 10%						CODE NO		ITEM	UNIT	OUANTITIES	FED. 90% STATE 10%				^	
20200100	EARTH EXCAVATION	CU YD	1235	1235						550A0040	STORM SEWERS	CLASS A. TYPE 1 10"	FOOT	25	25					
20201006	GRADING AND SHAPING SHOULDERS	UNIT	2	2						60107600	PIPE UNDERDR	AINS 4"	FOOT	400	400					
20201200	REMOVAL AND DISPOSAL OF UNSUITABLE MATERIAL	CU YD	1039	1039						60200805	CATCH BASINS	TYPE A, 4'-DIAMETER,	EACH	1	1					
20800150	TRENCH BACKFILL	CU YD	29	29						60600605	CONCRETE CUR	3, TYPE B	FOOT	294	294					
21101615	TOPSOIL FURNISH AND PLACE, 4"	SQ YD	3631	3631						60602800	CONCRETE GUT	TER, TYPE B	FOOT	664	664					
25000210	SEEDING. CLASS 2A	ACRE	0.8	0.8				-		60603300	GUTTER OUTLE	T	EACH	4	. 4					
25000400	NITROGEN FERTILIZER NUTRIENT	POUND	71	71						¥ 6300000€	STEEL PLATE	BEAM GUARD RAIL, TYPE A,	FOOT	12.5	12.5					
25000500	PHOSPHORUS FERTILIZER NUTRIENT	POUND	71	71						67000400	6 FOOT POSTS ENGINEER'S F	IELD OFFICE, TYPE A	CAL MO	6	. 6					
25000600	POTASSIUM FERTILIZER NUTRIENT	POUND	71	71						67100100	MOBILIZATION		L SUM	1	1					4
25100630	EROSION CONTROL BLANKET	SO YD	3800	3800						70101800	TRAFFIC CONT	ROL AND PROTECTION.	L SUM	1	1					
25200200	SUPPLEMENTAL WATERING	UNIT	38	38		-					(SPECIAL)									
28000250	TEMPORARY EROSION CONTROL SEEDING	POUND	79	79						70300100	SHORT-TERM P	AVEMENT MARKING	FOOT	1060	1060					
28000300	TEMPORARY DITCH CHECKS	EACH	16	16	5					70300220	TEMPORARY PA	VEMENT MARKING	FOOT	9496	9496					
28000400	PERIMETER EROSION BARRIER	FOOT	3265	3265						70300240		VEMENT MARKING	FOOT	430	430		-			
35501308	HOT-MIX ASPHALT BASE COURSE, 6"	SO YD	130	130							- LINE 6"	·	5007							
35501316	HOT-MIX ASPHALT BASE COURSE, 8"	SO YD	939	939						70300260	- LINE 12"	VEMENT MARKING	FOOT	60	60					
40600200	BITUMINOUS MATERIALS (PRIME COAT)	TON	4.3	4.3						70300280		VEMENT MARKING	FOOT	87	87					
40600300	AGGREGATE (PRIME COAT)	TON	21.7	21.7							- LINE 24"									
40600400	MIXTURE FOR CRACKS, JOINTS,	TON	2. 7	2.7						70301000		VEMENT MARKING REMOVAL	SO FT	177	177					
	AND FLANGEWAYS							4	. *	X 78000100	- LETTERS AN	C PAVEMENT MARKING D SYMBOLS	SO FT	154.8	154.8					
40600895	CONSTRUCTING TEST STRIP	EACH	1	1						× 78000200		C PAVEMENT MARKING	FOOT	9496	9496					
40600982	HOT-MIX ASPHALT SURFACE REMOVAL - BUTT	SO YD	66	66							- LINE 4"			470	470					
40603310	HOT-MIX ASPHALT SURFACE COURSE, MIX "C", N50	TON	120	120						X 78000400	- LINE 6"	C PAVEMENT MARKING	FOOT	430	430					
40603595	POLYMERIZED HOT-MIX ASPHALT SURFACE COURSE, MIX "F", N90	TON	1250	1250						X 78000600	THERMOPLASTI	C PAVEMENT MARKING	FOOT	60	60					-
42001300	PROTECTIVE COAT	SQ YD	163	163						78000650	THERMOPLASTI	C PAVEMENT MARKING	FOOT	87	87	7				
44000157	HOT-MIX ASPHALT SURFACE REMOVAL, 2"	SO YD	9069	9069			1.4		,	× 78100100		CTIVE PAVEMENT MARKER	EACH	186	186					
44000200	DRIVEWAY PAVEMENT REMOVAL	SO YD	2567	2567						78300100	PAVEMENT MAR		SQ FT	625	625					
44000300		FOOT	511	511	*				1	78300200		CTIVE PAVEMENT MARKER	EACH	140	140					
44201815	CLASS D PATCHES. TYPE II. 14 INCH	SO YD	74	74							REMOVAL									
48102100	AGGREGATE WEDGE SHOULDER, TYPE B	TON	8	8						¥ 81018900	CONDUIT PUSH	ED, 4" DIA., GALVANIZED	FOOT	60	60					
48203021	HOT-MIX ASPHALT SHOULDERS, 6"	SO YD	1816	1816						× 81900200		ACKFILL FOR ELECTRICAL WORK	FOOT	30	30					
50104400	CONCRETE HEADWALL REMOVAL	EACH	1	1						× 84400105		STING LIGHTING UNIT	EACH	1	1					
54010202	PRECAST CONCRETE BOX CULVERT 2' X 2'	FOOT	12	12						× 89501510		STING FLASHING BEACON	EACH	2	2	4 N				
54200430		FOOT	501	501						× 89502300		RIC CABLE FROM CONDUIT	FOOT	150	150					
54213660	PRECAST REINFORCED CONCRETE FLARED END SECTIONS 15"	EACH	14	14						× 89502375		ING TRAFFIC SIGNAL	EACH	2	2			* Specia	14 Hems	
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Ī	CODE NO	ITEM	UNIT	TOTAL	I000 FED. 90%			·	٠		CODE NO		ITEM		UNIT	TOTAL	1000 FED. 90%					
	CODE NO	IIEW	ONT	OUANTITIES	STATE 10%						CODE NO		11EM		UNIT	OUANTITIES	STATE 10%					
*	x0301503	RELOCATE EXISTING METAL POLE FOUNDATION	EACH	1	1									1.9				,,,,,,,,,,,,,,,,,,,,,,,,,,,,,,,,,,,,,,,				
	X0322256	TEMPORARY INFORMATION SIGNING	SQ FT	51.4	51.4																	
	X0322654	GRADE AND SHAPE MEDIAN DITCH CHECKS	EACH	1	1													-				
¥	X0322730	TELEVISION INSPECTION OF BOX CULVERT	L SUM	1	. 1																	
¥	X0323574	MAINTENANCE OF LIGHTING SYSTEM	CAL MO	6	6																	
ı "l	X0324387	LUMINAIRE SAFETY CABLE ASSEMBLY	EACH	1	1																	
	X0325775	WET REFLECTIVE TEMPORARY TAPE,	FOOT	22058	22058																	
		TYPE III, 4 INCH			1																	
	X0325837	WET REFLECTIVE TEMPORARY TAPE TYPE III, 6 INCH	FOOT	1078	1078					-									1	'	-	
	X0325842	WET REFLECTIVE TEMPORARY TAPE, TYPE III, LETTERS AND SYMBOLS	SQ FT	77.2	77.2																	
	X0545000	BOX CULVERT REMOVAL	FOOT	5	5		·		,										-	,	·	
-	X0914000	PRECAST CONCRETE BOX CULVERT END SECTIONS 2' X 2'	EACH	1	1,	4				:									·			
	X4021000	TEMPORARY ACCESS (PRIVATE ENTRANCE)	EACH	2	2																	
	X4022000	TEMPORARY ACCESS (COMMERCIAL ENTRANCE)	EACH	10	10										1					And the second s		
	XX000856	MAILBOX REMOVAL AND RELOCATION	EACH	5	5										5							
	Z0001050	AGGREGATE SUBGRADE 12"	SO YD	1765	1765	8																
NP	Z0005305	BOX CULVERTS TO BE CLEANED	FOOT	75	75						-	. :										
	Z0013798	CONSTRUCTION LAYOUT	L SUM	1	1	-		-													-	
	X8160310	UNIT DUCT, 600V, 2-1C NO. 10, 1/C NO. 10	FOOT	~ 100	100		-	***	÷ .											* .		
		GROUND, (EPR-TYPE RHW), 1", POLYETHYLENE DIA.											* .									
	35600718	HOT-MIX ASPHALT BASE COURSE 10 1/2" WIDENING,	SO YD	1765	1765										,							
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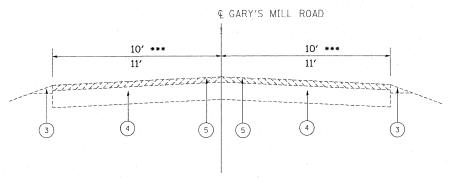
EXISTING TYPICAL SECTION
IL 38
STA. 92+11.5 TO STA 108+45.9




PROPOSED TYPICAL SECTION
IL 38
STA. 92+11.5 TO STA 108+45.9

LEGEND

- 1) EXISTING PCC BASE COURSE 8"
- 2 EXISTING HMA OVERLAY ± 8"
- (3) EXISTING AGGREGATE SHOULDER
- 4 EXISTING HMA PAVEMENT ±6.5"
- 5 PROSPOSED HOT-MIX ASPHALT SURFACE REMOVAL, 2"
- PROPOSED POLYMERIZED HOT-MIX ASPHALT SURFACE COURSE, MIX "F", N90, IL 9.5 (2")
- 7) PROPOSED HOT-MIX ASPHALT SHOULDER, 6"
- 8) PROPOSED POLYMERIZED HOT-MIX ASPHALT BINDER IL 19, N90, 101/2"
- 9 PROPOSED AGGREGATE SUBGRADE 12"
- (10) PROPOSED AGGREGATE SHOULDER

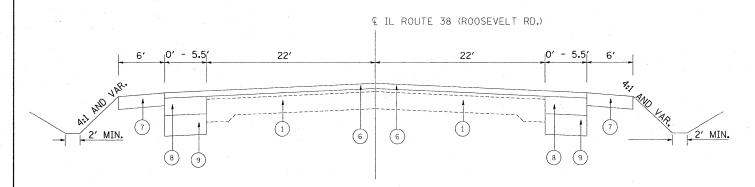

EXISTING TYPICAL SECTION
GARY'S MILL ROAD
STA. 10+00 TO STA 11+86.7
STA. 47+61.4 TO STA. 50+00 ***

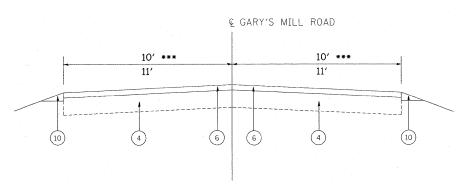

PROPOSED TYPICAL SECTION
GARY'S MILL ROAD
STA. 10+00 TO STA 11+86.7
STA. 47+61.4 TO STA. 50+00 ***

HOT-MIX ASPHALT MIXTURE REQUIREMENTS		
MIXTURE TYPE	AC TYPE	AIR VOIDS
SHOULDERS		
HOT-MIX ASPHALT SHOULDERS, 6"	PG:64-22**	2% @ 30 GYF
RESURFACING		-
POLYMERIZED HOT-MIX ASPHALT SURFACE COURSE, MIX "F", N90 (IL 9.5 mm)	SBS/SBR PG 70-22	4% @ 90 GYF
PAVEMENT WIDENING		, w.
POLYMERIZED HOT-MIX ASPHALT SURFACE COURSE, MIX "F", N90 (IL 9.5 mm)	SBS/SBR PG 70-22	4% @ 90 GYF
POLYMERIZED HOT-MIX ASPHALT BINDER IL19, N90	SBS/SBR PG 70-22	4% @ 90 GYF
DRIVEWAYS		
HMA SURFACE COURSE, MIX C, N50 (IL 9.5 mm); 2"	PG 64-22	4% @ 50 GYI
HMA BASE COURSE (HMA BINDER IL-19mm); PE - 6", CE - 8"	PG 64-22**	4% © 50 GYI
PATCHING		
CLASS D PATCHES (HMA BINDER IL-19 mm).	PG 64-22**	4% @ 70 GY

"THE UNIT WEIGHT USED TO CALCULATE ALL HMA SURFACE MIXTURE QUANTITIES IS 112 LB/ SQ YD/IN"

**WHEN RAP EXCEEDS 20%, THE NEW ASPHALT BINDER IN THE MIX SHALL BE PG 58 -22.

FILE NAME =	USER NAME = banksl	DESIGNED -	REVISED -		ILL 38 (F	ROOSEVEL	_T RO	AD) AT	T GARY'	S MILL ROAD	F.A.P.	SECTION	COUNTY	TOTAL SHEETS	SHEET NO.
c:\pw_work\PWIDOT\BANKSL\dms93602\P1326	77-design.dgn	DRAWN -	REVISED -	STATE OF ILLINOIS							347	2 Y-N	DUPAGE	40	5
	PLOT SCALE = 50.000 '/ IN.	CHECKED -	REVISED -	DEPARTMENT OF TRANSPORTATION			TYPICA	AL SEC	TIONS		_	'	CONTRA	CT NO. 6	0E65
	PLOT DATE = 3/19/2009	DATE -	REVISED -		SCALE: NTS	SHEET NO.	0F	SHEETS	STA. X	TO STA. X	FED. ROAD	DIST. NO. 1 ILLINOIS	ED. AID PROJECT		

		EARTH	WORK				* .					
1	2	2		3 .		4		5		6		7
IL. ROUTE 38 AT GARY'S MILL ROAD	EXCAV	RTH /ATION YD)	MAT	ITABLE ERIAL YD)		NKMENT I YD)	ADJUS F(SHRIN (CU	OR IKAGE	BAL WASTE SHORT	HWORK ANCE (+) OR AGE (-) YD)	FURNI PL	SOIL SH AND ACE YD)
	STAGE I	STAGE II	STAGE I	STAGE II	STAGE I	STAGE II	STAGE I	STAGE II	STAGE I	STAGE II	STAGE I	STAGE II
IL ROUTE 38 (STA. 92+33.28 TO STA. 93+00)	14	31	12	32	1	9	11.9	26.4	10.9	17.4		
IL ROUTE 38 (STA. 93+00 TO STA. 94+00)	47	77	42	54	4	21	40	65.5	36	44.5		-
IL ROUTE 38 (STA. 94+00 TO STA. 95+00)	79	64	49	56	2	14	67.2	54.4	65.2	40.4		
IL ROUTE 38 (STA. 95+00 TO STA. 95+30.82)	18	33	8	17	0	1	15.3	28.1	15.3	27.1		·
IL ROUTE 38 (STA. 95+30.82 TO STA. 95+56.63)	7	29	3	7	0	0	6.0	24.7	6.0	24.7		·
IL ROUTE 38 (STA. 95+56.63 TO STA. 96+00)	14	22	8	13	1	6	11.9	18.7	10.9	12.7		
IL ROUTE 38 (STA. 96+00 TO STA. 96+22.69)	7.	11	10	12	1	4	6.0	9.4	5.0	5.4		
IL ROUTE 38 (STA. 96+22.69 TO STA. 97+00)	56	32	48	38	0	6	47.6	27.2	47.6	21.2		
IL ROUTE 38 (STA. 97+00 TO STA. 98+00)	73	36	45	49	. 4	42	62.1	30.6	58.1	-11.4		
IL ROUTE 38 (STA. 98+00 TO STA. 99+00)	. 17	24	18	45	4	46	14.5	20.4	10.5	-25.6		
IL ROUTE 38 (STA. 99+00 TO STA. 99+53)	0	12	0	11	0	7	0	10.2	0	3.2		
IL ROUTE 38 (STA. 99+53 TO STA. 100+00)	11	22	7	12	0	4	9.4	18.7	9.4	14.7		
IL ROUTE 38 (STA. 100+00 TO STA. 101+00)	31	36	14	26	4	6	26.4	30.6	22.4	24.6		
IL ROUTE 38 (STA. 101+00 TO STA. 101+25.04)	4	0	0	0	2	0	3.4	0	1.4	0		
IL ROUTE 38 (STA. 101+25.04 TO STA. 102+00)	22	11	14	11	4	. 0	18.7	9.4	14.7	9.4		-
IL ROUTE 38 (STA. 102+00 TO STA. 103+00)	42	28	38	- 35	5	2	35.7	23.8	30.7	21.8		
IL ROUTE 38 (STA. 103+00 TO STA. 104+00)	43	28	39	36	6	3	36.6	23.8	30.6	20.8		
IL ROUTE 38 (STA. 104+00 TO STA. 105+00)	33	51	20	41	6	5	28.1	43.4	22.1	38.4		
IL ROUTE 38 (STA. 105+00 TO STA. 105+04.71)	1	3	0	2	0	0	0.9	2.6	0.9	2.6		
IL ROUTE 38 (STA. 105+04.71 TO STA. 105+85.25)	24	32	12	21	6	12	20.4	27.2	14.4	15.2		
IL ROUTE 38 (STA. 105+85.25 TO STA. 106+00)	5	1	6	0	4	3	4.3	0.9	0.3	-2.1		
IL ROUTE 38 (STA. 106+00 TO STA. 106+25)	10	9	11.	6	12	3	8.5	7.7.	-3.5	4.7		
IL ROUTE 38 (STA. 106+25 TO STA. 106+85	23	31	32	28	63	3	19.6	26.4	-43.4	23.4		
IL ROUTE 38 (STA. 106+85 TO STA. 107+00)	4	5	9	6	- 28	2	3.4	4.3	-24.6	2.3		
IL ROUTE 38 (STA. 107+00 TO STA. 107+56.38)	7	8	34	12	107	13	6.0	6.8	-101.0	-6.2		
IL ROUTE 38 (STA. 107+56.38 TO STA. 108+00)	3	2	21	6	45	9	2.6	1.7	-42.4	-7.3		
IL ROUTE 38 (STA. 108+00 TO STA. 108+26.61)	0	2	5	7	9	2	0	1.7	-9.0	-0.3		
TOTAL	595	640	456	583	318	223	506.5	520.8	188.5	321.6	1548	2083

COLUMN 1: LOCATION FROM PLANS
COLUMN 2: CUT QUANTITIES FROM CROSS SECTIONS, WHICH
DOES NOT INCLUDE UNSUITABLE MATERIAL

COLUMN 3: CUT MATERIAL THAT IS DETERMINED TO BE EITHER UNSTABLE OR UNSUITABLE FOR USE IN EMBANKMENT, ASSUME 6" OF UNSUITABLE MATERIAL

COLUMN 4: QUANTITIES FROM CROSS SECTIONS (FILL)

COLUMN 5: EARTH EXCAVATION THAT IS TO BE USED AS FILL
MATERIAL IN THE EMBANKMENT, SHRINKAGE FACTOR

WAS DETERMINED TO BE 15%

COLUMN 6: COLUMN 5 - COLUMN 4, POSITIVE QUANTITY=


EXTRA EXCAVATION, NEGETIVE QUANTITY= FURNISHED


EXCAVATION NEEDED


COLUMN 7: TOPSOIL FURNISH AND PLACE AREA OF SEEDING AND


		CONTRACT	NO. 60	FPD
F.A.P. RTE.	SECTION	COUNTY	TOTAL	SHEET NO.
347	2 Y-N	DUPAGE	40	6
STA.		TO STA.	•	
FED. RC	AD DIST. NO. 1	LLINOIS FED. AID	PROJECT	

REVISIONS NAME	DATE	ILLINOIS DEPAR	TMENT OF TRANSPORTATION
		IL ROUTE 38	AT GARY'S MILL ROAD
-		SCHEDU	JLE OF QUANTITIES
		SCALE: VERT. HORIZ. DATE	DRAWN BY CHECKED BY

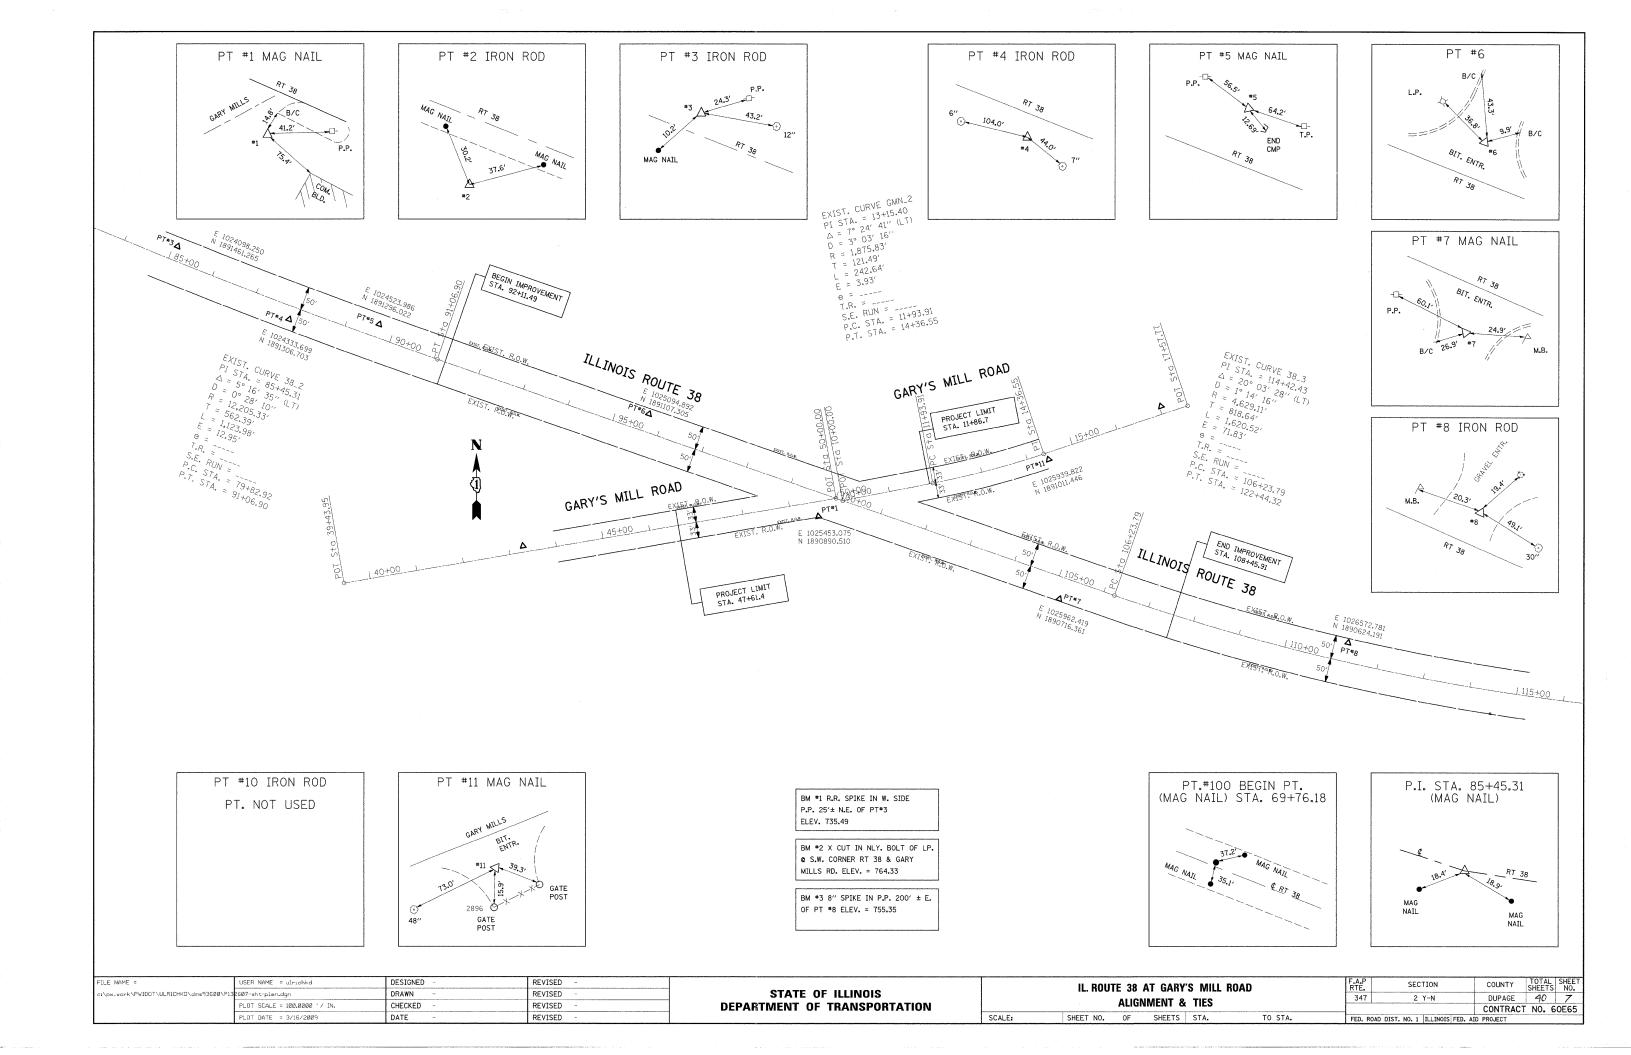


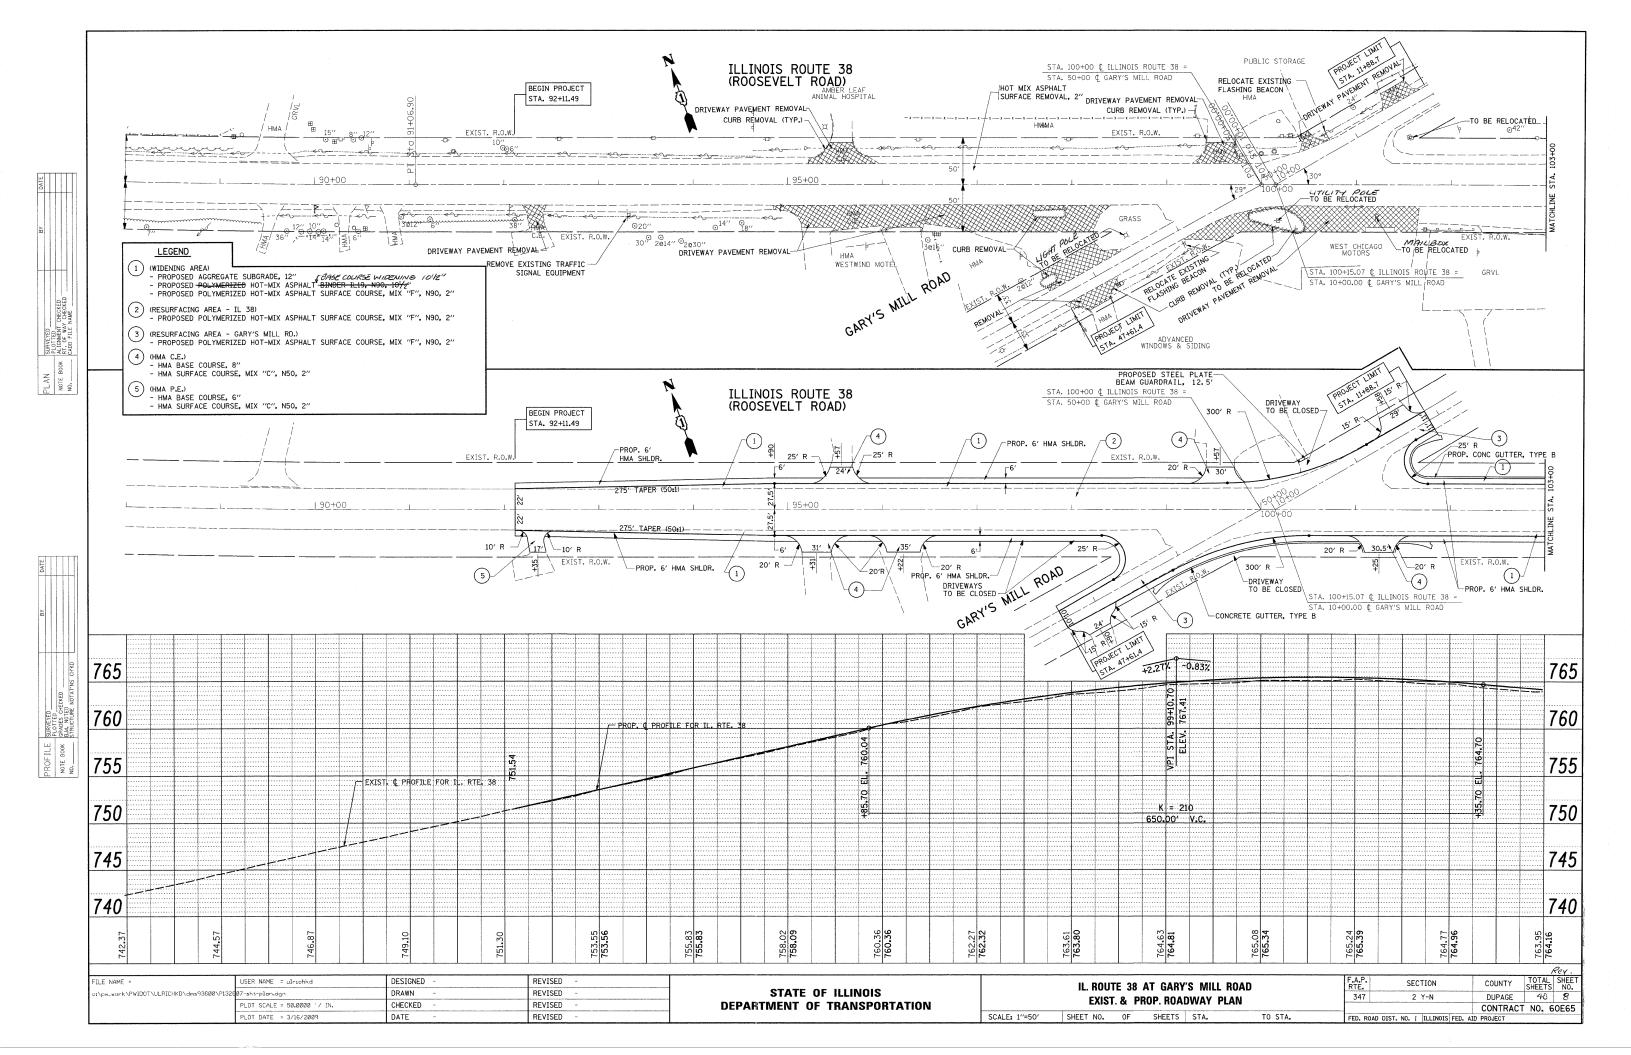

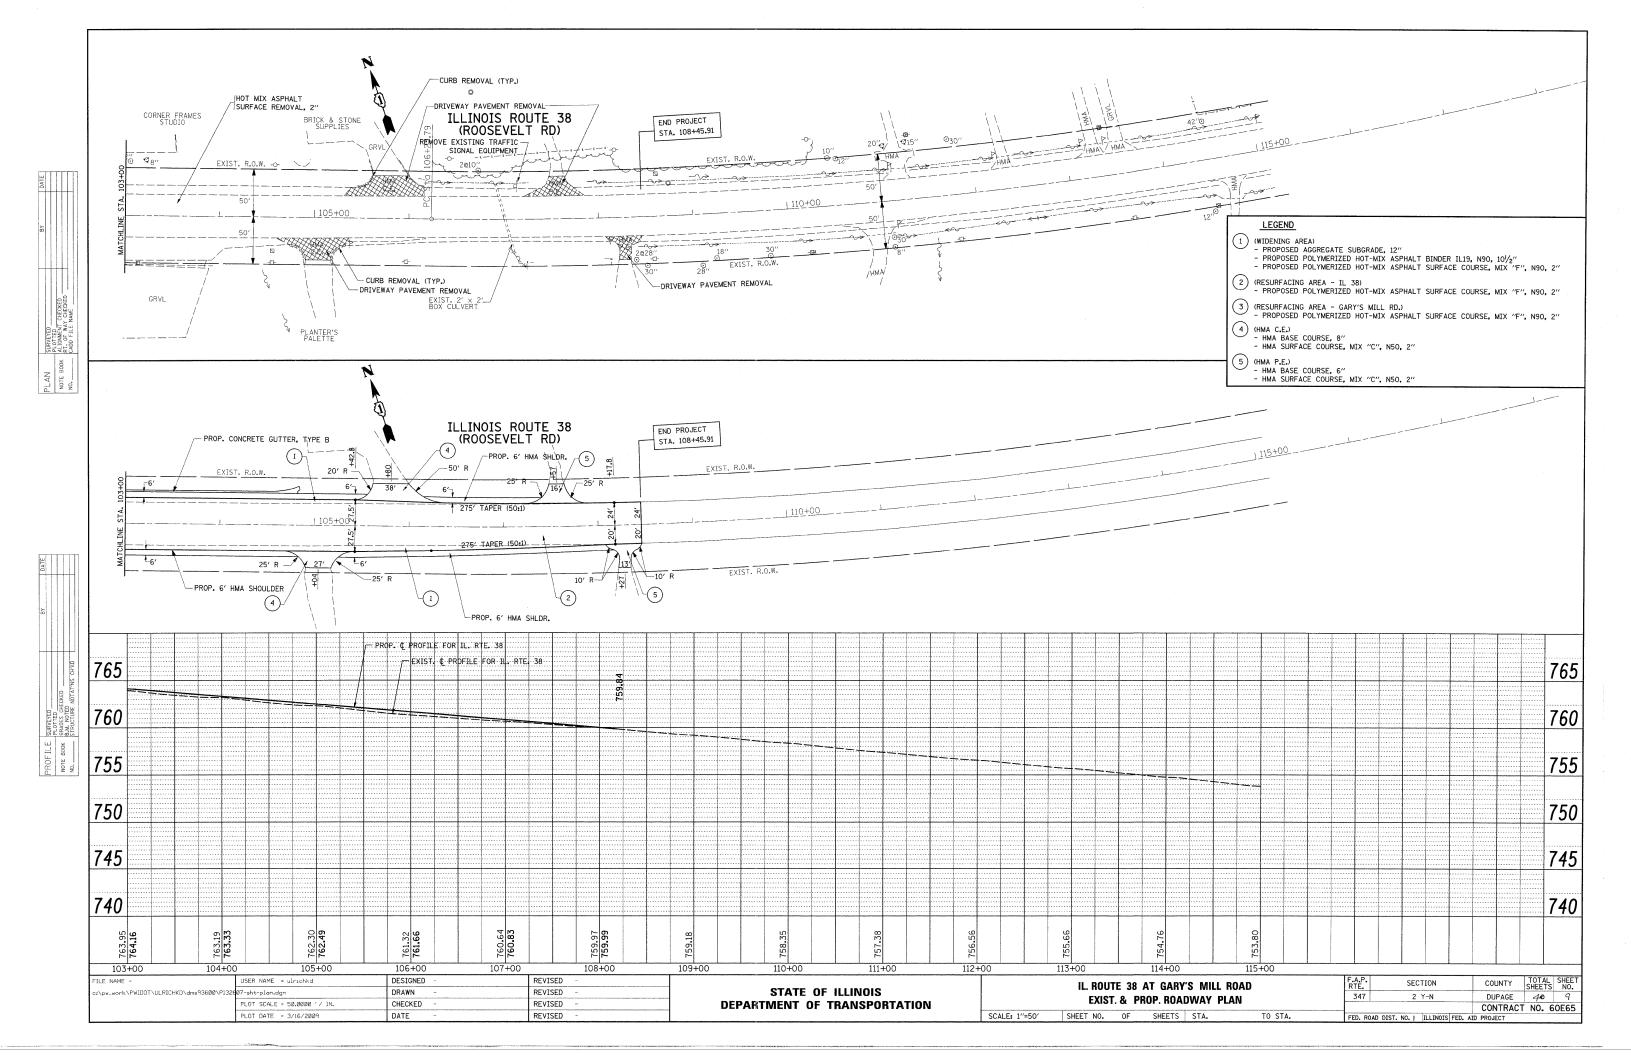

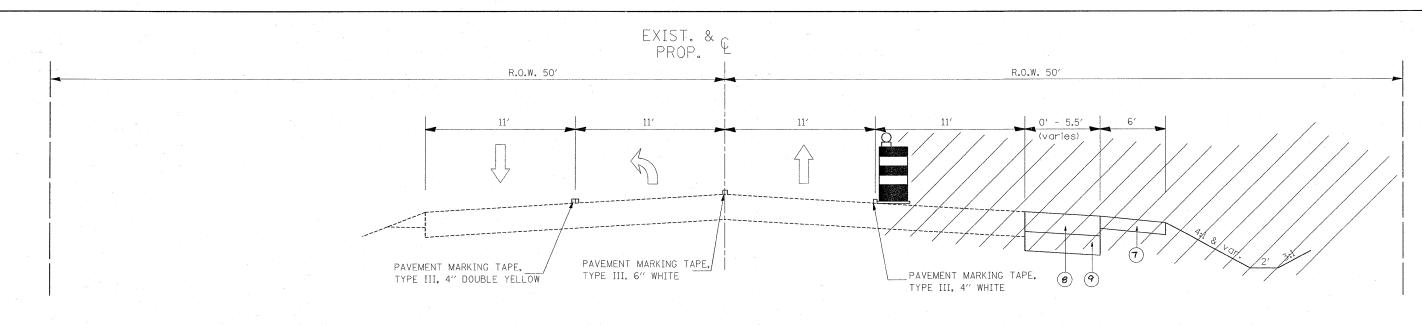

STAGE I TYPICAL SECTION IL 38

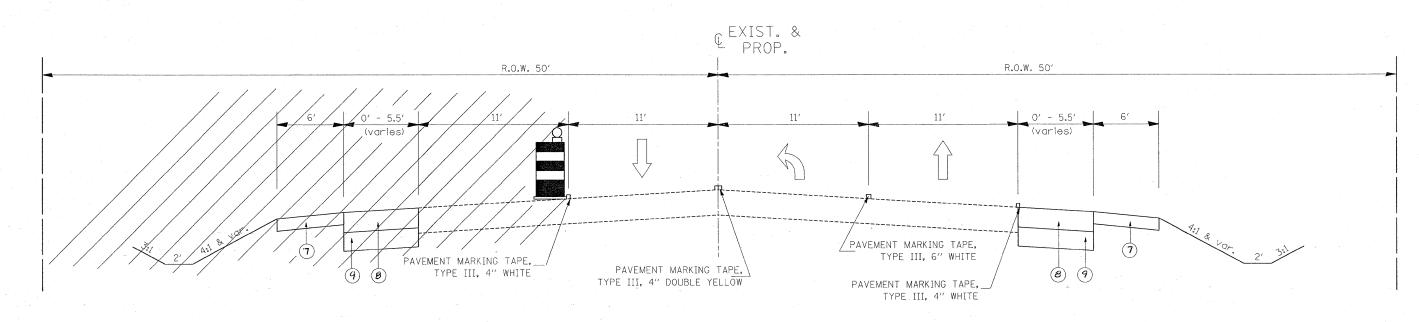



STAGE II TYPICAL SECTION IL 38


LEGEND

- 1) EXISTING PCC BASE COURSE 8"
- 2 EXISTING HMA OVERLAY ± 8"
- (3) EXISTING AGGREGATE SHOULDER
- 4 EXISTING HMA PAVEMENT ±6.5"
- 5 PROSPOSED HOT-MIX ASPHALT SURFACE REMOVAL, 2"
- PROPOSED POLYMERIZED HOT-MIX ASPHALT SURFACE COURSE, MIX "F", N90, IL 9.5 (2")
- 7) PROPOSED HOT-MIX ASPHALT SHOULDER, 6"
- 8) PROPOSED POLYMERIZED HOT-MIX ASPHALT BINDER IL 19, N90, 101/2"
- 9 PROPOSED AGGREGATE SUBGRADE 12"
- 10) PROPOSED AGGREGATE SHOULDER

								Rev.
FILE NAME =	USER NAME = banksl	DESIGNED -	REVISED -		ILL 38 (ROOSEVELT ROAD) AT GARY'S MILL ROAD	F.A.P. RTE.	SECTION	COUNTY TOTAL SHEET NO.
c:\pw_work\PWIBOT\BANKSE\dms93602\P1326	07-design.dgn	DRAWN -	REVISED -	STATE OF ILLINOIS		347	2 Y-N	DUPAGE 40 10
	PLOT SCALE = 50.000 '/ IN.	CHECKED -	REVISED -	DEPARTMENT OF TRANSPORTATION	STAGING TYPICAL SECTIONS			CONTRACT NO. 60E65
	PLOT DATE = 3/19/2009	DATE -	REVISED -		SCALE: NTS SHEET NO. OF SHEETS STA. X TO STA. X	FED. ROAD DIS	T. NO. 1 ILLINOIS FEE	D. AID PROJECT

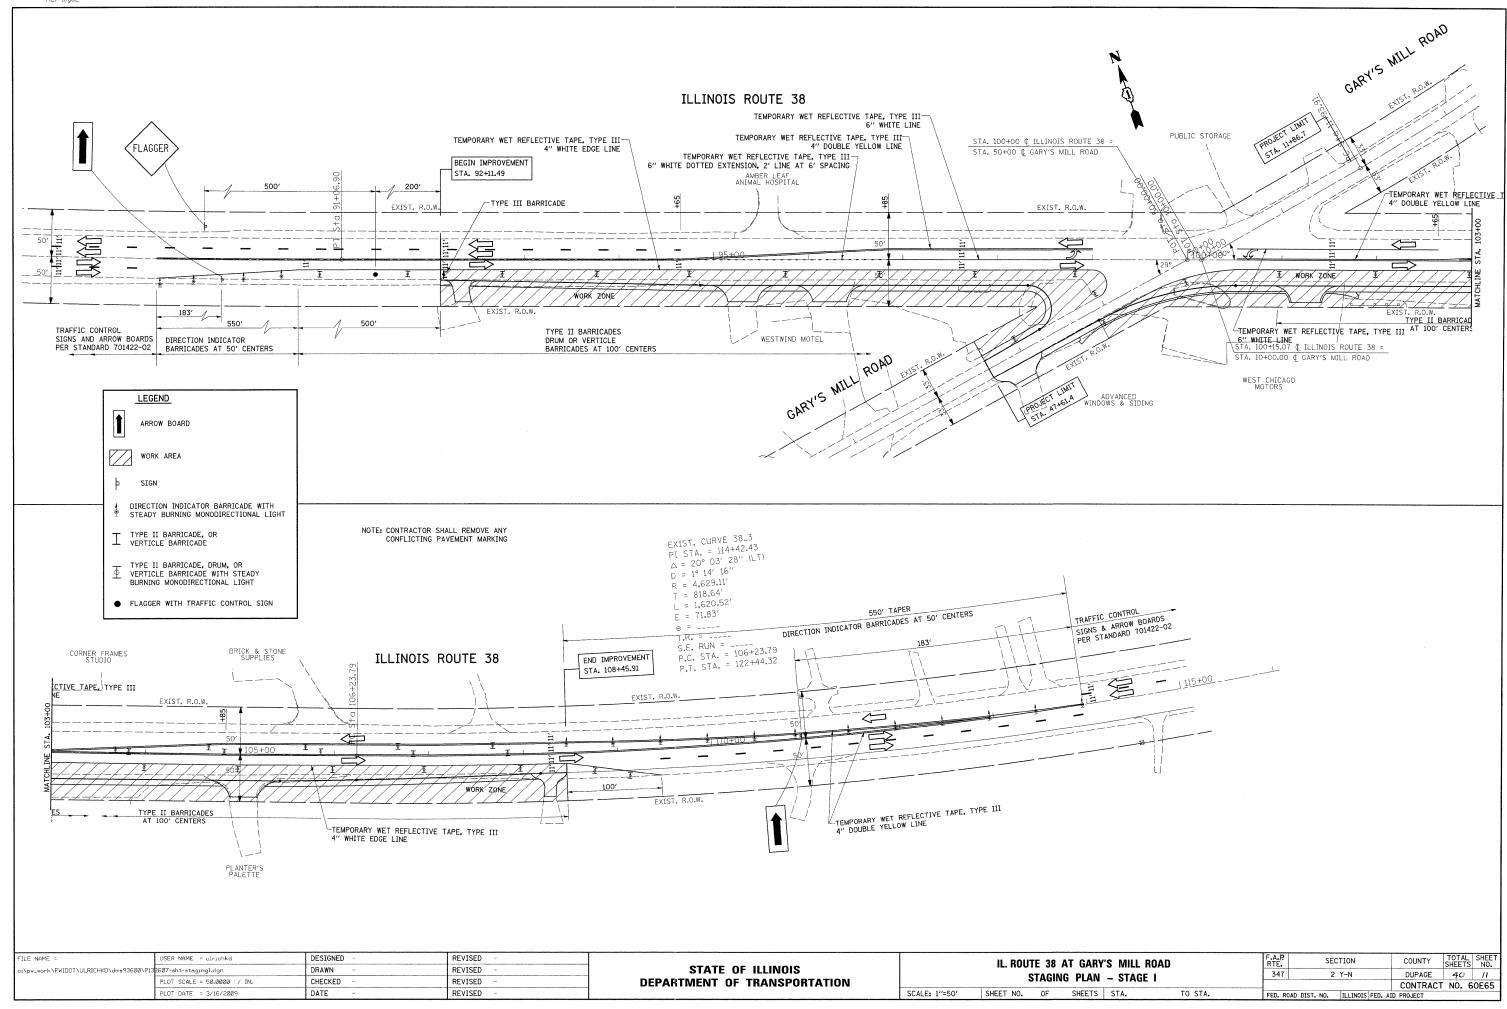

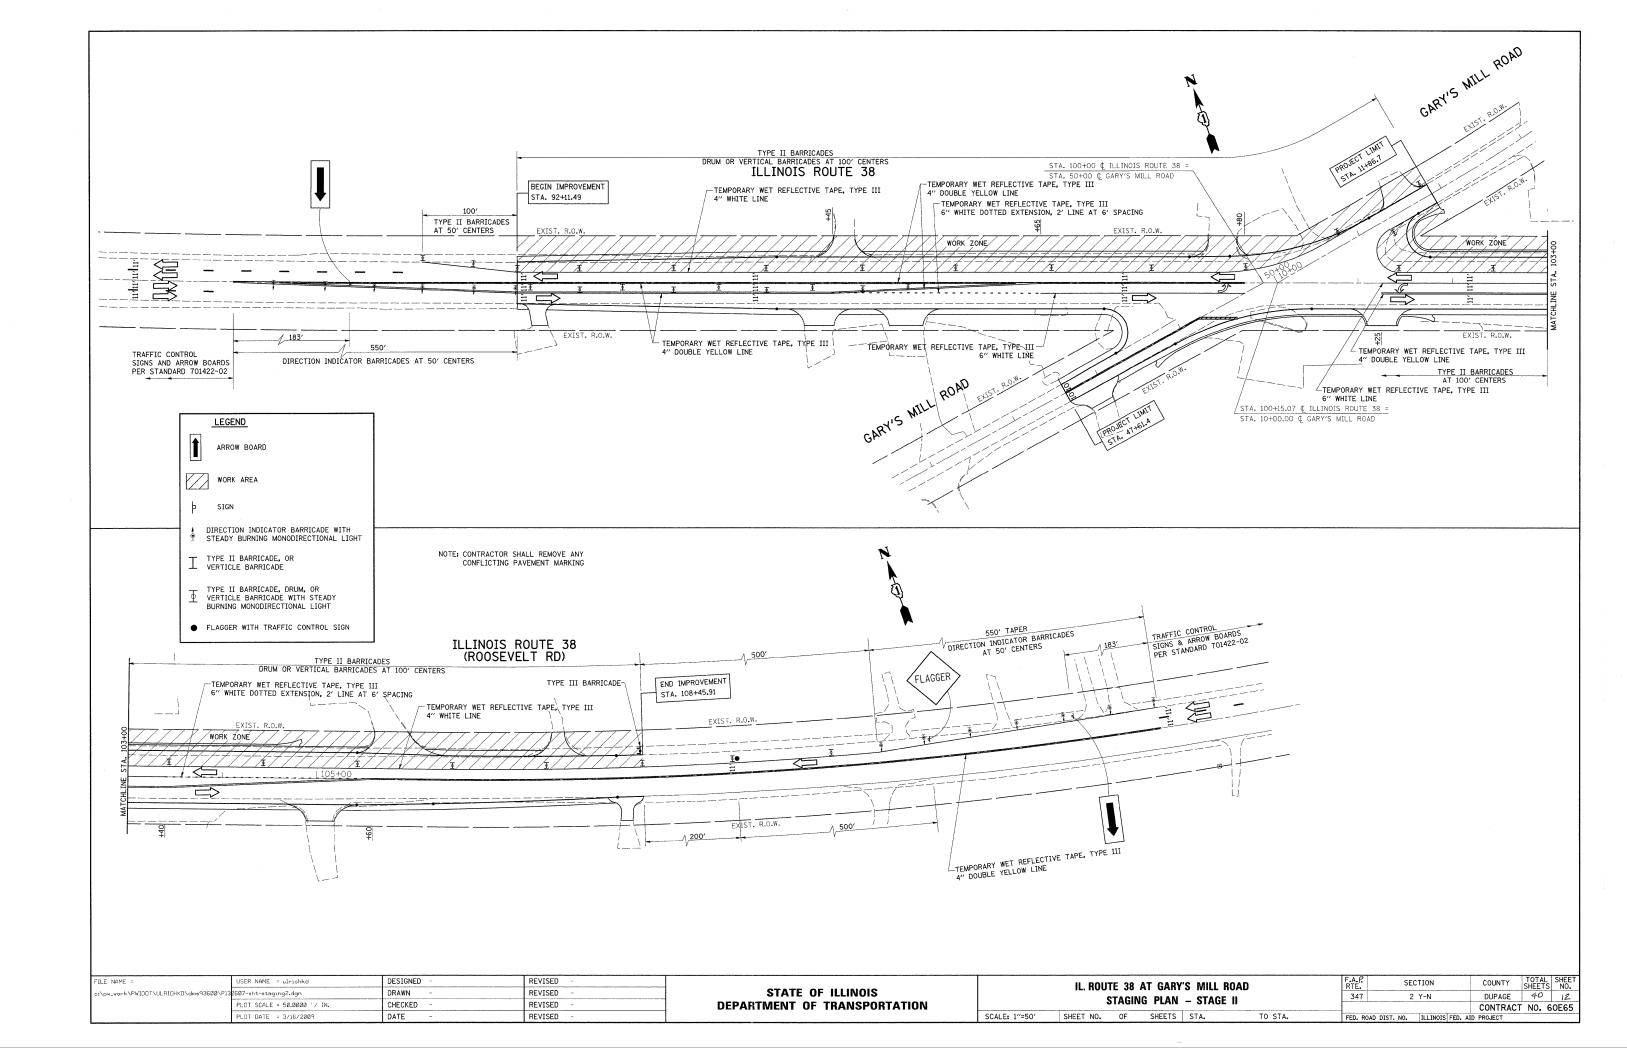

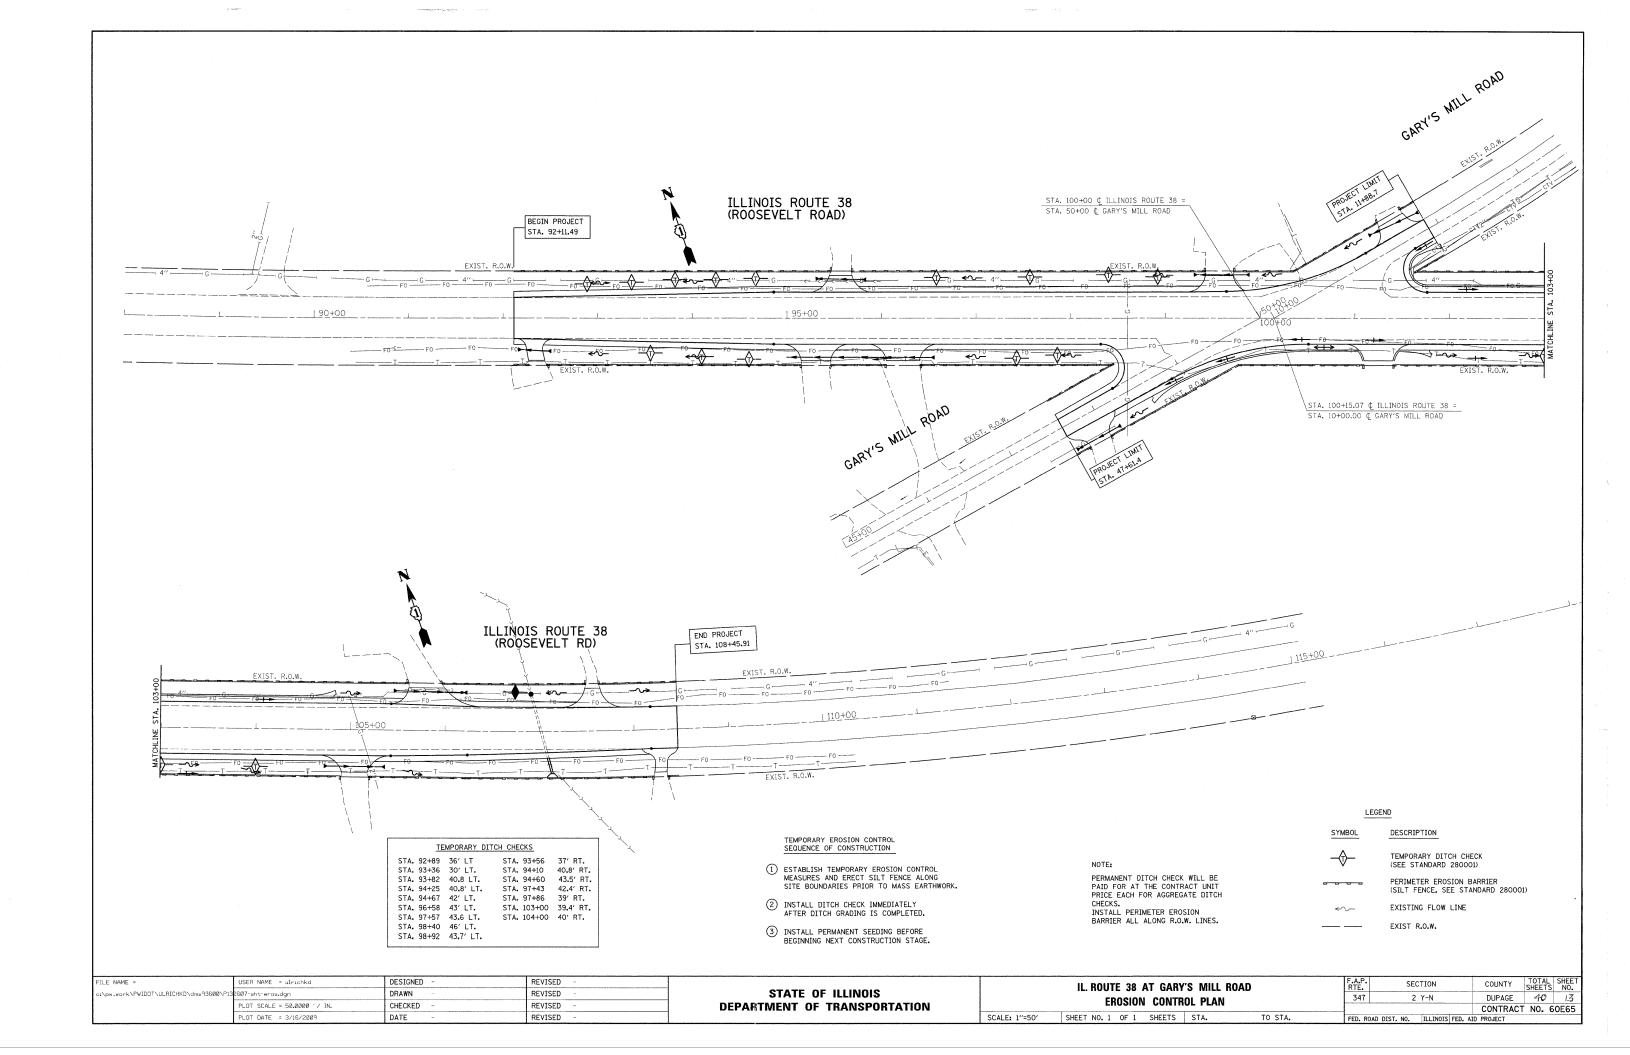

THE CONTRACTOR WILL BE REQUIRED TO IMPLEMENT AND MAINTAIN EROSION CONTROL MEASURES IMMEDIATELY AFTER STRIPPING OF EXISTING VEGETATION.

NO RUNOFF FROM STRIPPED AREAS WILL LEAVE THE SITE OTHER THAN THROUGH SEDIMENTATION/STILLING BASINS. THE CONTRACTOR WILL ADJUST HIS OPERATIONS AND IMPLEMENT EROSION CONTROL MEASURES ACCORDINGLY.

THE QUANTITIES SHOWN SURROUND FOR TEMPORARY DITCH CHECKS AND INLET AND PIPE PROTECTION ARE MEASURED AS EACH, REGARDLESS OF TYPE OR CONFIGURATION

THE CONTRACTOR SHALL SURROUND ALL EARTH STOCKPILES WITH SILT FENCE AND SHALL BE PAID FOR AS PERIMETER EROSION BARRIER, EROSION CONTROL MEASURES SHALL BE INSPECTED BY THE CONTRACTOR AND ENGINEER WITHIN 24 HOURS OR ANY STORM EXCEEDING 0.5 INCH OF PRECIPITATION.

STOCKPILES OF SOIL AND OTHER BUILDING MATERIALS TO REMAIN IN PLACE MORE THAN THREE (3) DAYS SHALL BE FURNISHED WITH EROSION AND SEDIMENT CONTROL MEASURES (I.E. PERIMETER SILT FENCE). STOCKPILES TO REMAIN IN PLACE FOR 21 DAYS OR MORE SHALL RECEIVE TEMPORARY SEEDING.

ALL CONSTRUCTION ACTIVITIES SHALL BE IN ACCORDANCE WITH THE NATIONAL POLLUTANT DISCHARGE ELIMINATION SYSTEM STORM WATER PERMIT.

THE CONTRACTOR SHALL TAKE ALL PRECAUTIONS TO PREVENT POLLUTION OF STORM WATER AND SHALL FOLLOW IEPA & IDOT CONSTRUCTION MEMORANDUM NO. 95-60.

EROSION CONTROL SHALL BE PROVIDED IN ACCORDANCE WITH SEQUENCE OF STAGE CONSTRUCTION.

STABILIZATION MEASURES SHALL BE INTIATED AS SOON AS PRACTICAL, BUT IN NO CASE EXCEED 14 DAYS AFTER CONSTRUCTION ACTIVITY IN THAT PORTION OF THE SITE HAS TEMPORARILY OR PERMANENTLY CEASED ON ALL DISTURBED PORTIONS OF THE SITE WHERE CONSTRUCTION ACTIVITY WILL NOT OCCUR FOR A PERIOD OF 21 OR MORE CALENDER DAYS.

THE CONTRACTOR SHALL APPLY TEMPORARY EROSION CONTROL SEEDING TO ALL ERODIBLE BARE EARTH AREAS WITHIN THE CONTRACT LIMITS EACH WEEK, REGARDLESS OF WEATHER CONDITIONS OR PROGRESS OF THE WORK. UNLESS OTHERWISE DIRECTED BY THE ENGINEER. ERODIBLE EMBANKMEN+AND EXCAVATION AREAS WHERE WORK IS IN PROGRESS SHALL BE INCLUDED ON THE AREAS TO BE SEEDED. SEE SPECIAL PROVISION FOR TEMPORARY EROSION CONTROL SEEDING.

ALL PERIMETER EROSION BARRIER SHALL BE PLACED IN STAGE I, IF REQUIRED IN STAGE II IT SHALL BE LEFT IN PLACE. IT SHALL ONLY BR REPLACED IF DAMAGED, AT THE DIRECTION OF THE ENGINEER.

REFER TO LANDSCAPING PLAN FOR AREA TO BE SEEDED.

UNLESS OTHERWISE INDICATED, ALL VEGETATIVE AND STRUCTURAL EROSION AND SEDIMENT CONTROL PRACTICES WILL BE CONSTRUCTED ACCORDING TO MINIMUM STANDARDS AND SPECIFICATIONS IN THE ILLINOIS URBAN MANUAL REVISED FEBRUARY

A COPY OF THE APPROVED EROSION AND SEDIMENT CONTROL PLAN SHALL BE MAINTAINED ON THE SITE AT ALL TIMES.

DURING DEWATERING OPERATIONS, WATER WILL BE PUMPED INTO SEDIMENT BASINS OR SILT TRAPS. DEWATERING INTO DRAIN TILES IS STRICTLY PROHIBITED. COMPROMISED DRAIN TILES SHOULD BE IMMEDIATELY REPAIRED OR INCORPORATED INTO STORM WATER FACILITIES.

ALL DROP INLETS ON AND ADJACENT TO THE SITE MUST HAVE A SEDIMENT TRAPPING OR CONTAINMENT DEVICE INSTALLED DURING CONSTRUCTION ACTIVITIES.

ALL ADJACENT STREETS MUST BE KEPT CLEAR OF DEBRIS, INSPECTED DAILY AND CLEANED WHEN NECESSARY.

ALL EROSION CONTROL MEASURES MUST BE INSPECTED WEEKLY AND AFTER EACH 1/2" RAIN EVENT.

EROSION CONTROL BLANKET AND/OR STRAW MULCH WITH NETTING (DEPENDING ON SLOPE, SLOPE LENGTH, AND FLOW RATES) SHALL BE INSTALLED ON ALL SLOPES AND IN CRITICAL AREAS (I.E. DETENTION BASIN PERIMETERS, BERMS ETC.) IMMEDIATELY UPON FINAL GRADING.

PRIORITY SHALL BE GIVEN TO THE COMPLETION AND STABILIZATION OF THE DETENTION AREAS. WORK IN THESE AREAS SHALL NOT BE PROLONGED IN ATTEMPT THAT ALL FINAL GRADING AND STABILIZATION CAN TAKE PLACE AT ONE TIME.

THE CONDITION OF THE CONSTRUCTION SITE FOR WINTER SHUTDOWN SHALL BE ADDRESSED EARLY IN THE FALL GROWING SEASON SO THAT SLOPES AND OTHER BARE EARTH AREAS MAY BE STABILIZED WITH TEMPORARY AND/OR PERMANENT VEGETATIVE COVER FOR PROPER EROSION AND SEDIMENT CONTROL. ALL OPEN AREAS THAT ARE TO REMAIN IDLE THROUGHOUT THE WINTER SHALL RECEIVE TEMPORARY EROSION CONTROL MEASURES INCLUDING TEMPORARY SEEDING, MULCHING AND/OR EROSION CONTROL BLANKET PRIOR TO THE END OF THE FALL GROWING SEASON. THE AREAS TO BE WORKED BEYOND THE END OF THE GROWING SEASON MUST INCORPORATE SOIL STABILIZATION MEASURES THAT DO NOT RELY ON VEGETATIVE COVER SUCH AS EROSION CONTROL BLANKET AND HEAVY MULCHING.

SILT FENCE IS TO BE INSTALLED FOLLOWING THE COMPLETION AND STABILIZATION OF THE STORM WATER FACILITIES AND IS TO REMAIN IN PLACE UNTIL THE CONTRIBUTING AREA IS STABILIZED.


BERMS MUST BE STABILIZED IMMEDIATELY UPON RECEIVING FINAL GRADING. STRAW MULCH WITH NETTING OR EROSION CONTROL BLANKET SHALL BE USED ON SIDE SLOPES AND SUMMIT.


IN AREAS WHERE WORK IS COMPLETE, PERMANENT STABILIZATION SHALL OCCUR WITHIN 7 DAYS OF COMPLETION, AND IN AREAS WHERE WORK HAS TEMPORARILY CEASED FOR 21 DAYS OR MORE, TEMPORARY STABILIZATION SHALL OCCUR BY THE 14TH DAY AFTER WORK HAS CEASED.


COMPLETED SLOPES SHALL BE SEEDED AND MULCHED (OR BLANKETED, IF APPLICABLE) AS THE EXCAVATION PROCEEDS TO THE EXTENT CONSIDERED DESIRABLE AND PRACTICAL. PERMANENT SEEDING SHALL BE USED WHENEVER POSSIBLE. UNDER NO CIRCUMSTANCES SHALL THE CONTRACTOR PROLONG FINAL GRADING AND SHAPING SO THAT THE ENTIRE PROJECT CAN BE PERMANENTLY SEEDED AT ONE TIME. NO WORK SHALL BE PERFORMED IN FLOWING WATER. WATER IN AND NEAR THE CRITICAL AREAS SHOULD BE ISOLATED FROM CONCENTRATED FLOWS OR STREAM FLOW. THE STREAM BANKS SHOULD BE STABILIZED AT THE END OF EACH DAY. ONCE WORK IN THIS AREA BEGINS, PRIORITY SHALL BE GIVEN TO THE COMPLETION OF THE WORK AND FINAL STABILIZATION OF ALL DISTURBED AREAS.

FILE NAME =	USER NAME = benksl	DESIGNED -	REVISED ~
-c:\pw_work\pwidot\banksl\dms936Ø2\P13260	7-design.dgn	DRAWN -	REVISED -
	PLOT SCALE = 50.000 '/ IN.	CHECKED -	REVISED -
·	PLOT DATE = 3/19/2009	DATE -	REVISED -

71.1	70	/DAACEVEL 3	- D	ADI	A T	CADVIC	A A T L L	DOAD	-
ILL	აგ	(ROOSEVEL)	RC	JADI	ΑΙ	GART S	WILL	RUAD	
		EROSIC	N C	ONTI	ROL	NOTES			
SCALE:		SHEET NO.	0F	SHEE	TS	STA.	TO S	TA.	-

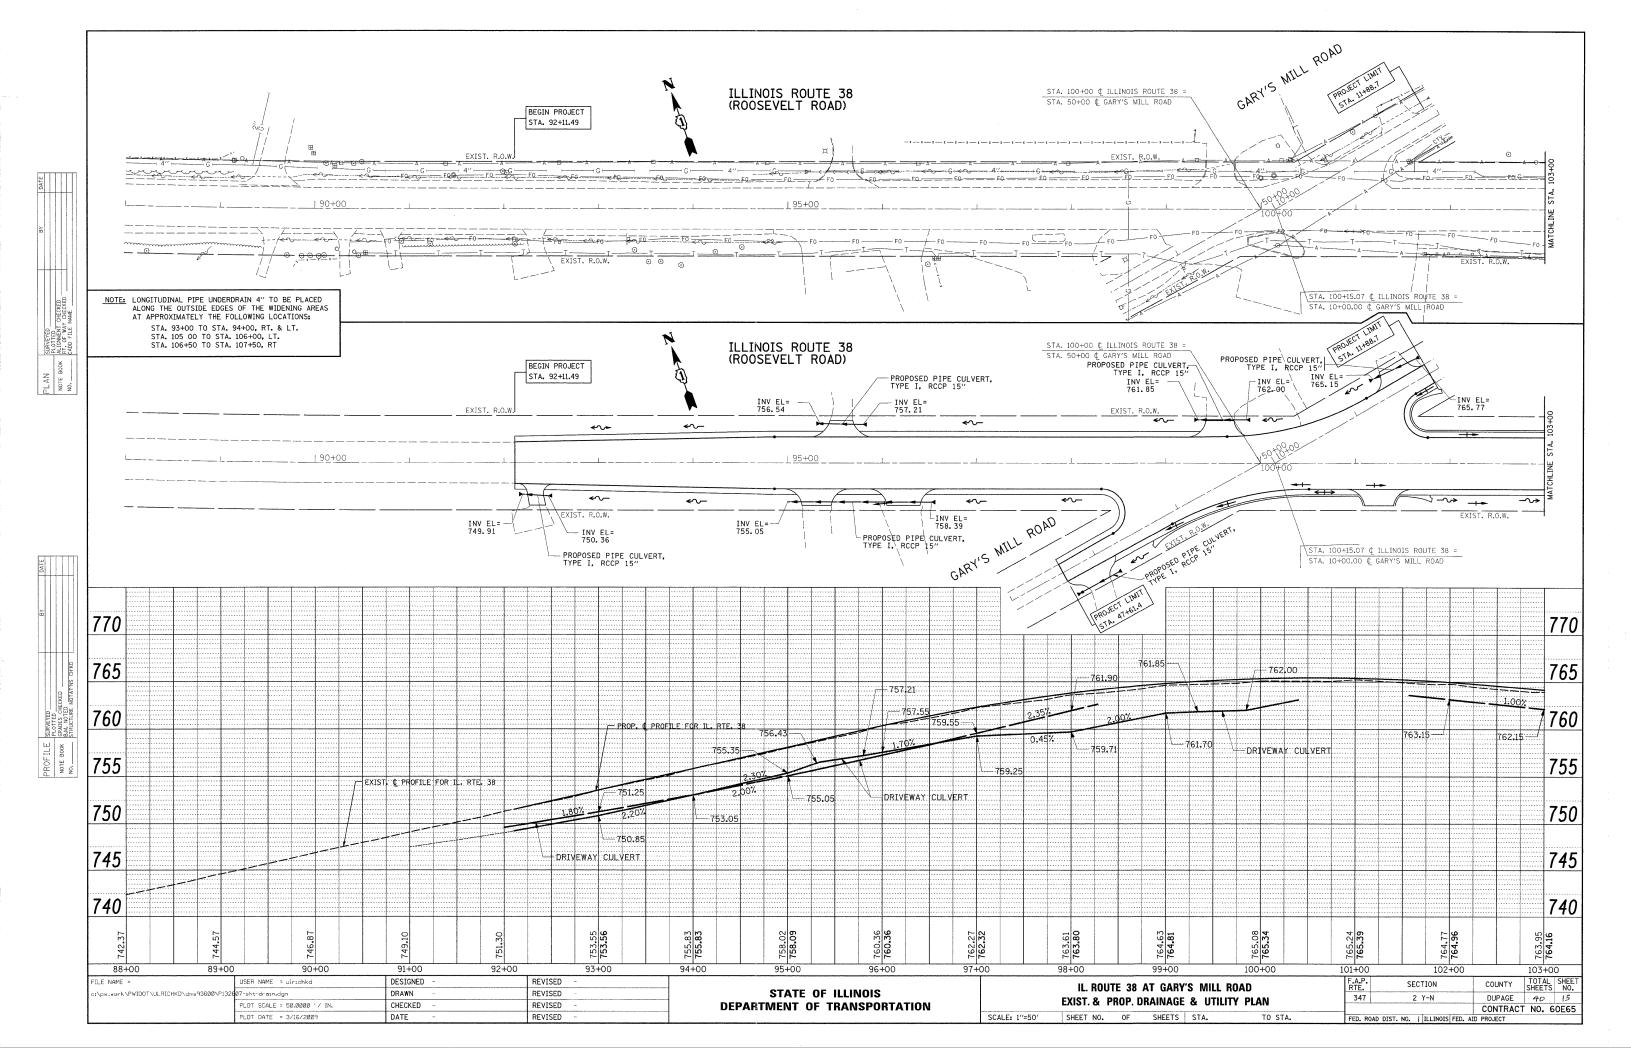

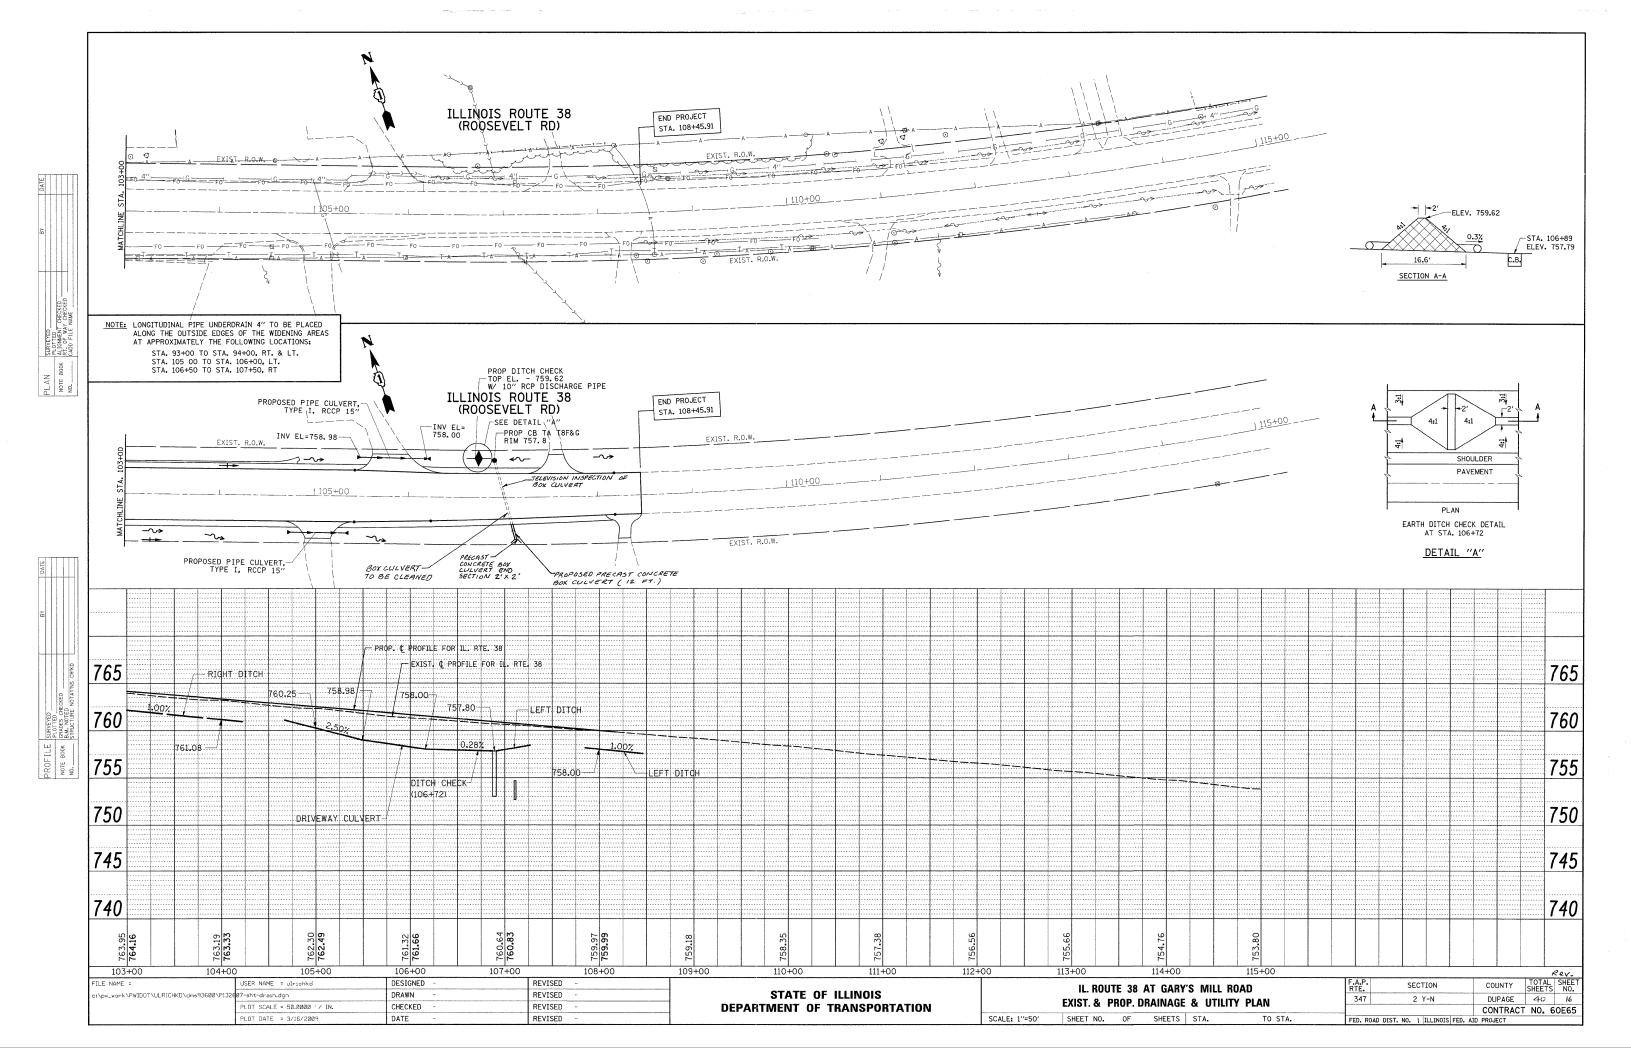

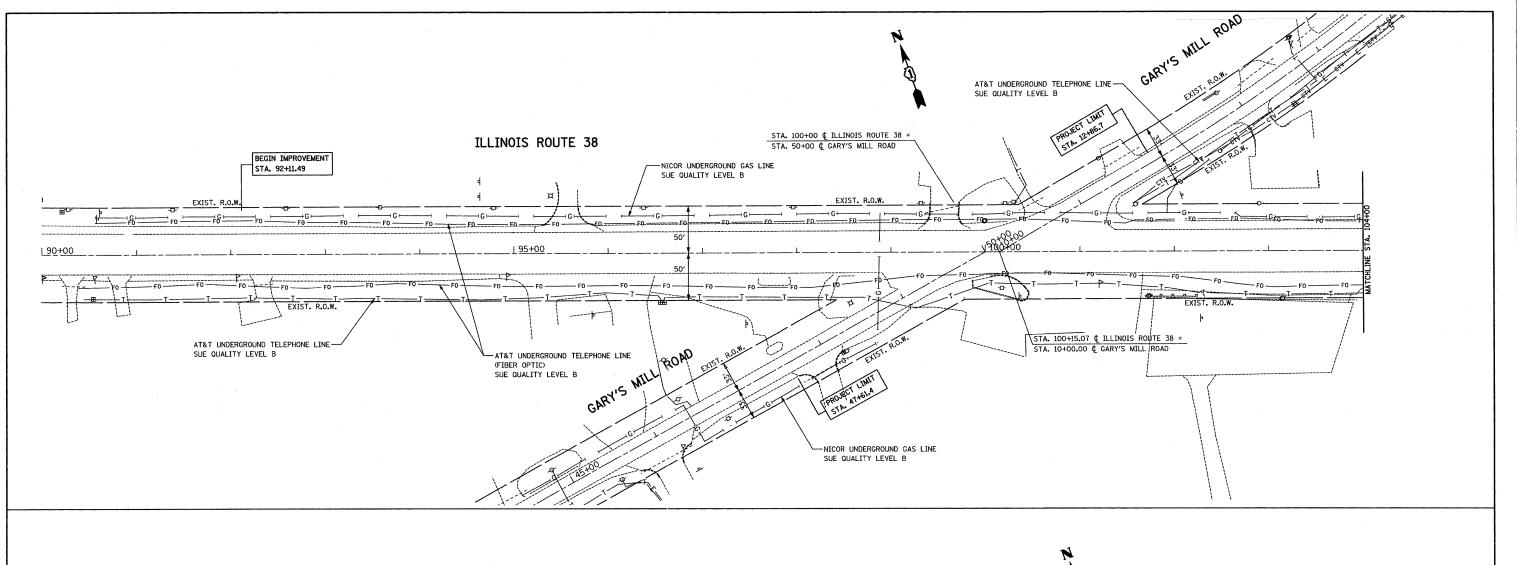

FOR INFORMATION CHLY

STATE OF ILLINOIS)
COUNTY OF COOK)

UTILITY(IES) SHOWN HEREON HAVE BEEN INVESTIGATED BY ASE IN ACCORDANCE WITH SUE INDUSTRY STANDARDS QUALITY LEVEL B (QLB). ALL OTHER INFORMATION SHOWN HAS BEEN PROVIDED BY OTHERS.

FIELD WORK WAS PERFORMED BETWEEN THE 13TH AND 15TH DAY OF OCTOBER, A.D., 2008.

IN WITNESS WHEREOF, I HAVE HEREUNTO SET MY HAND AND SEAL THIS 21ST DAY OF OCTOBER A.D., 2008. CHICAGO, IL.



PLOT DATE = 10/21/2008



STEVEN M. RIENKS - ILLINOIS PROFESSIONAL ENGINEER NUMBER 62-044619 MY LICENSE EXPIRES 11/30/2009

REVISED

-NICOR UNDERGROUND GAS LINE SUE QUALITY LEVEL B END IMPROVEMENT **ILLINOIS ROUTE 38** STA. 108+45.91 EXIST. R.O.W. --- F0 --AT&T UNDERGROUND TELEPHONE LINE-SUE QUALITY LEVEL B LEGEND AT&T UNDERGROUND TELEPHONE LINE (FIBER OPTIC) SUE QUALITY LEVEL B NOTES:

HORIZONTAL CONTROL, VERTICAL CONTROL, CENTERLINE ALIGNMENT, AND TOPOGRAPHIC FEATURES WERE SUPPLIED BY ILLINOIS DEPARTMENT OF TRANSPORTATION, CONTRACT NUMBER 60E65, DATED SEPTEMBER 22, 2008.

DESIGNED -REVISED -USER NAME = DRAWN REVISED PLOT SCALE = 1"=50" CHECKED -REVISED -


DATE


STATE OF ILLINOIS **DEPARTMENT OF TRANSPORTATION**


IL. ROUTE 38 AT GARY'S MILL ROAD SUE INVESTIGATION OF UNDERGROUND UTILITIES SHEET NO. OF SHEETS STA.


COUNTY TOTAL SHEETS NO.


DUPAGE 40 17 SECTION CONTRACT NO. 60E65

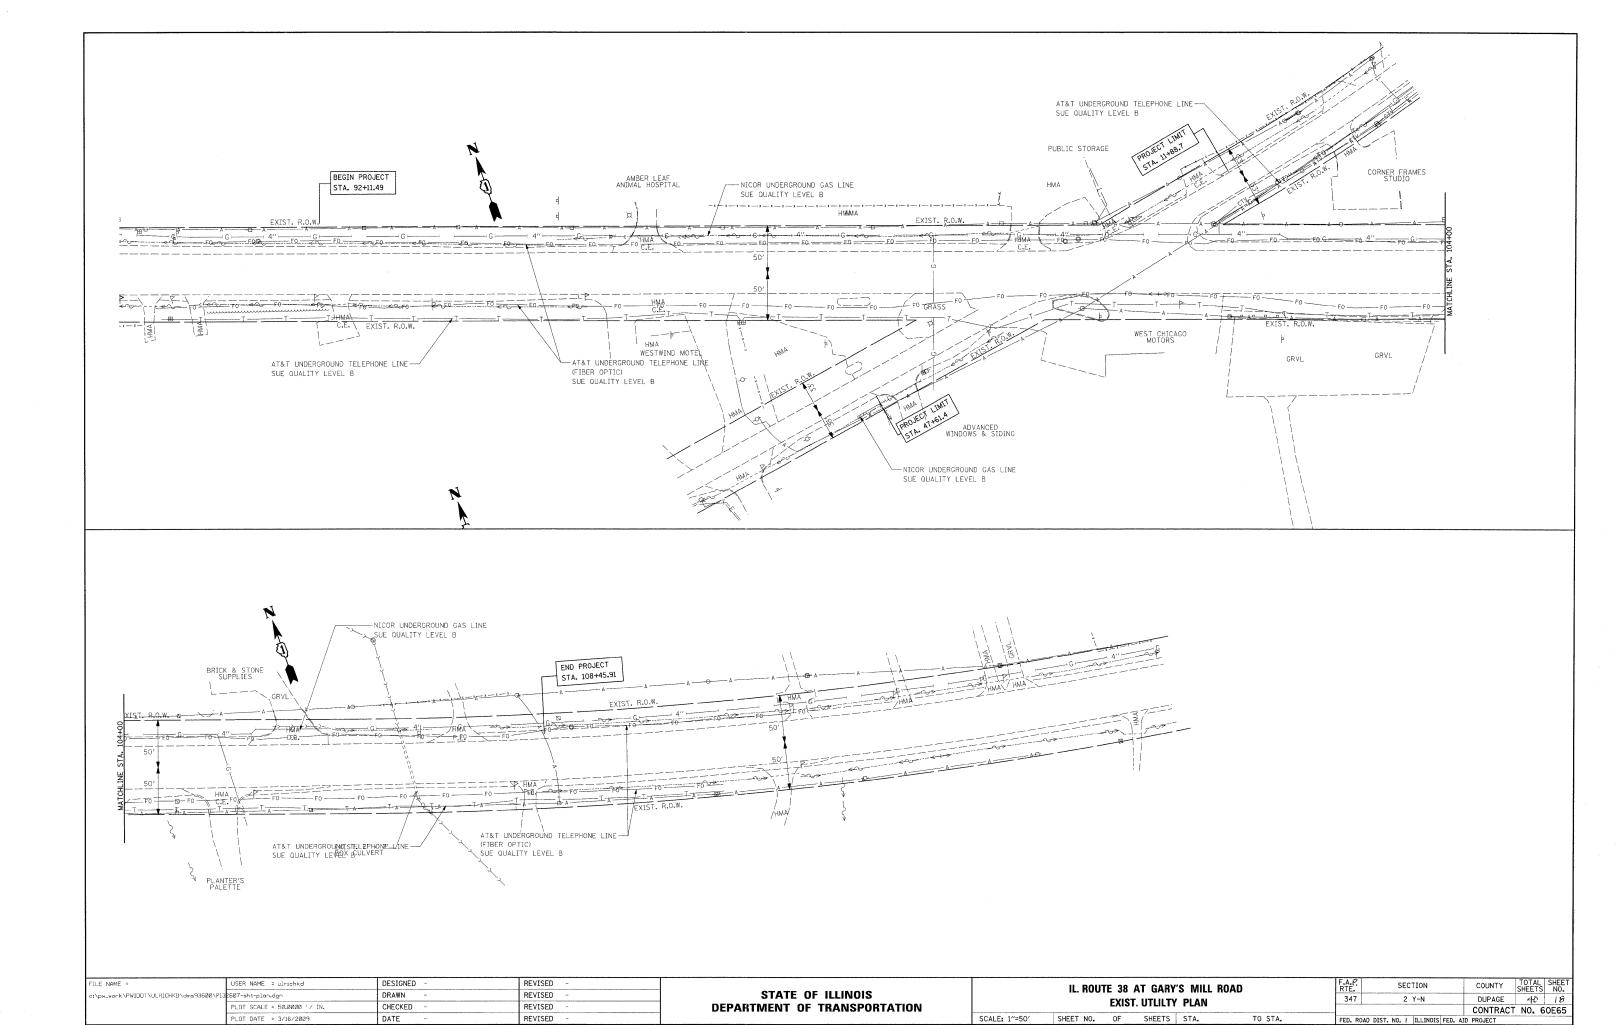


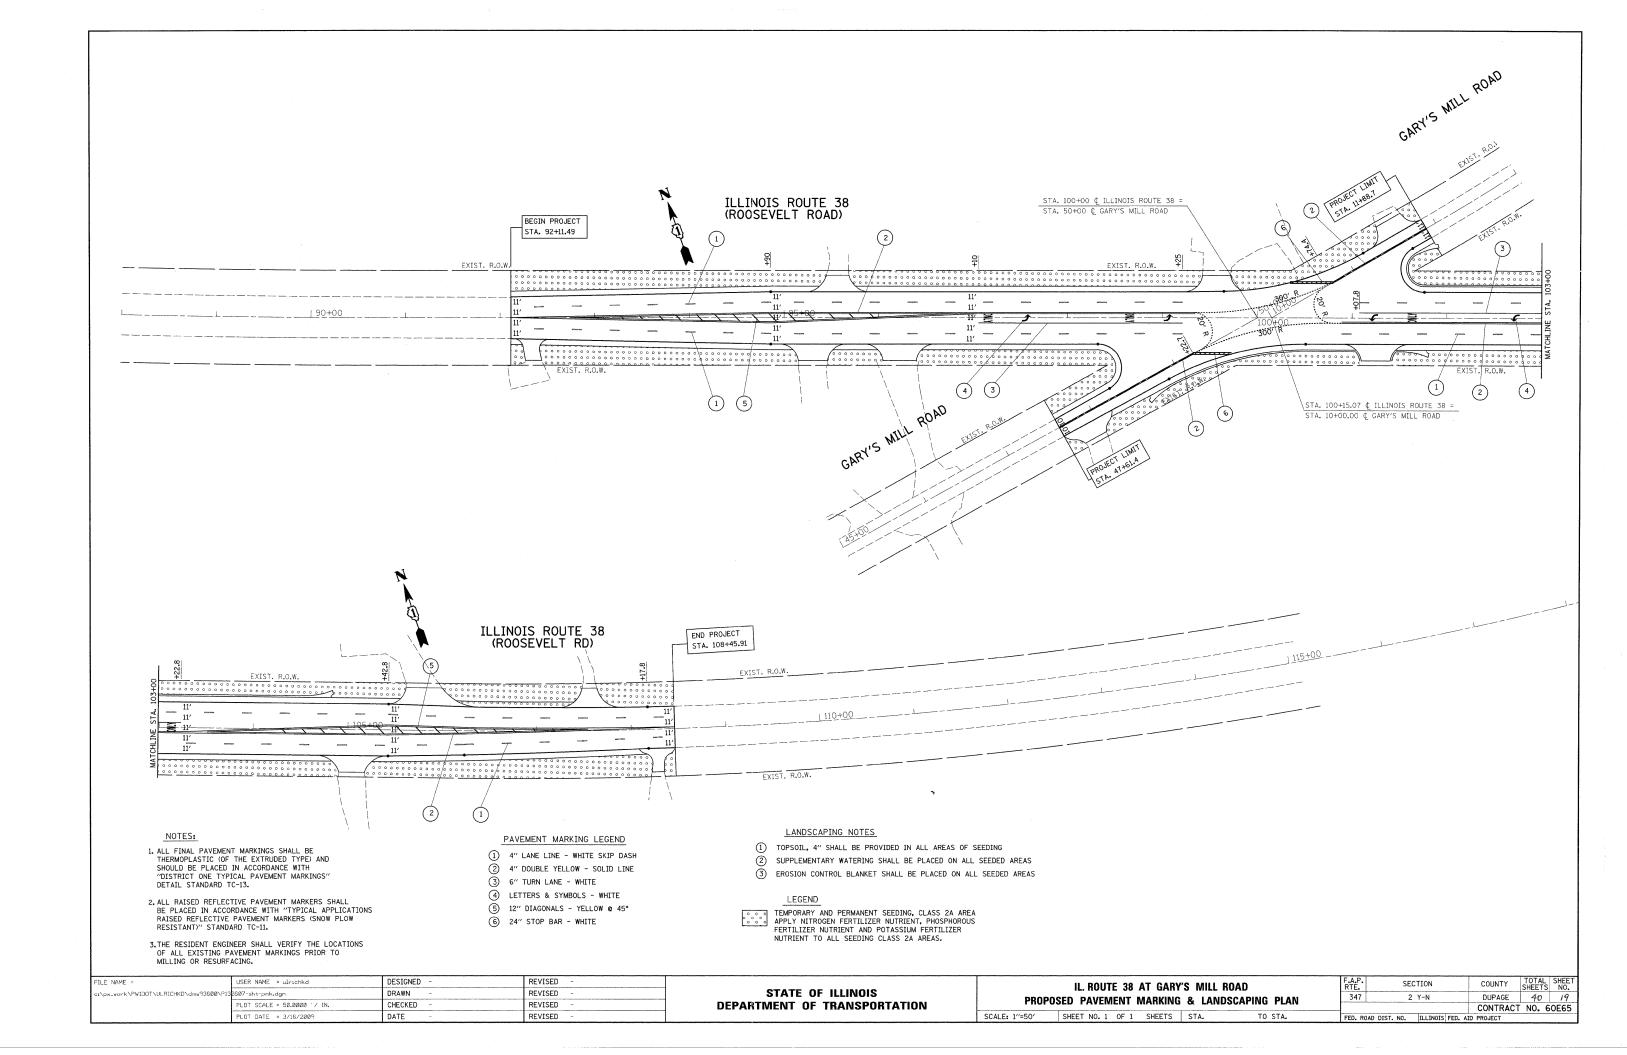


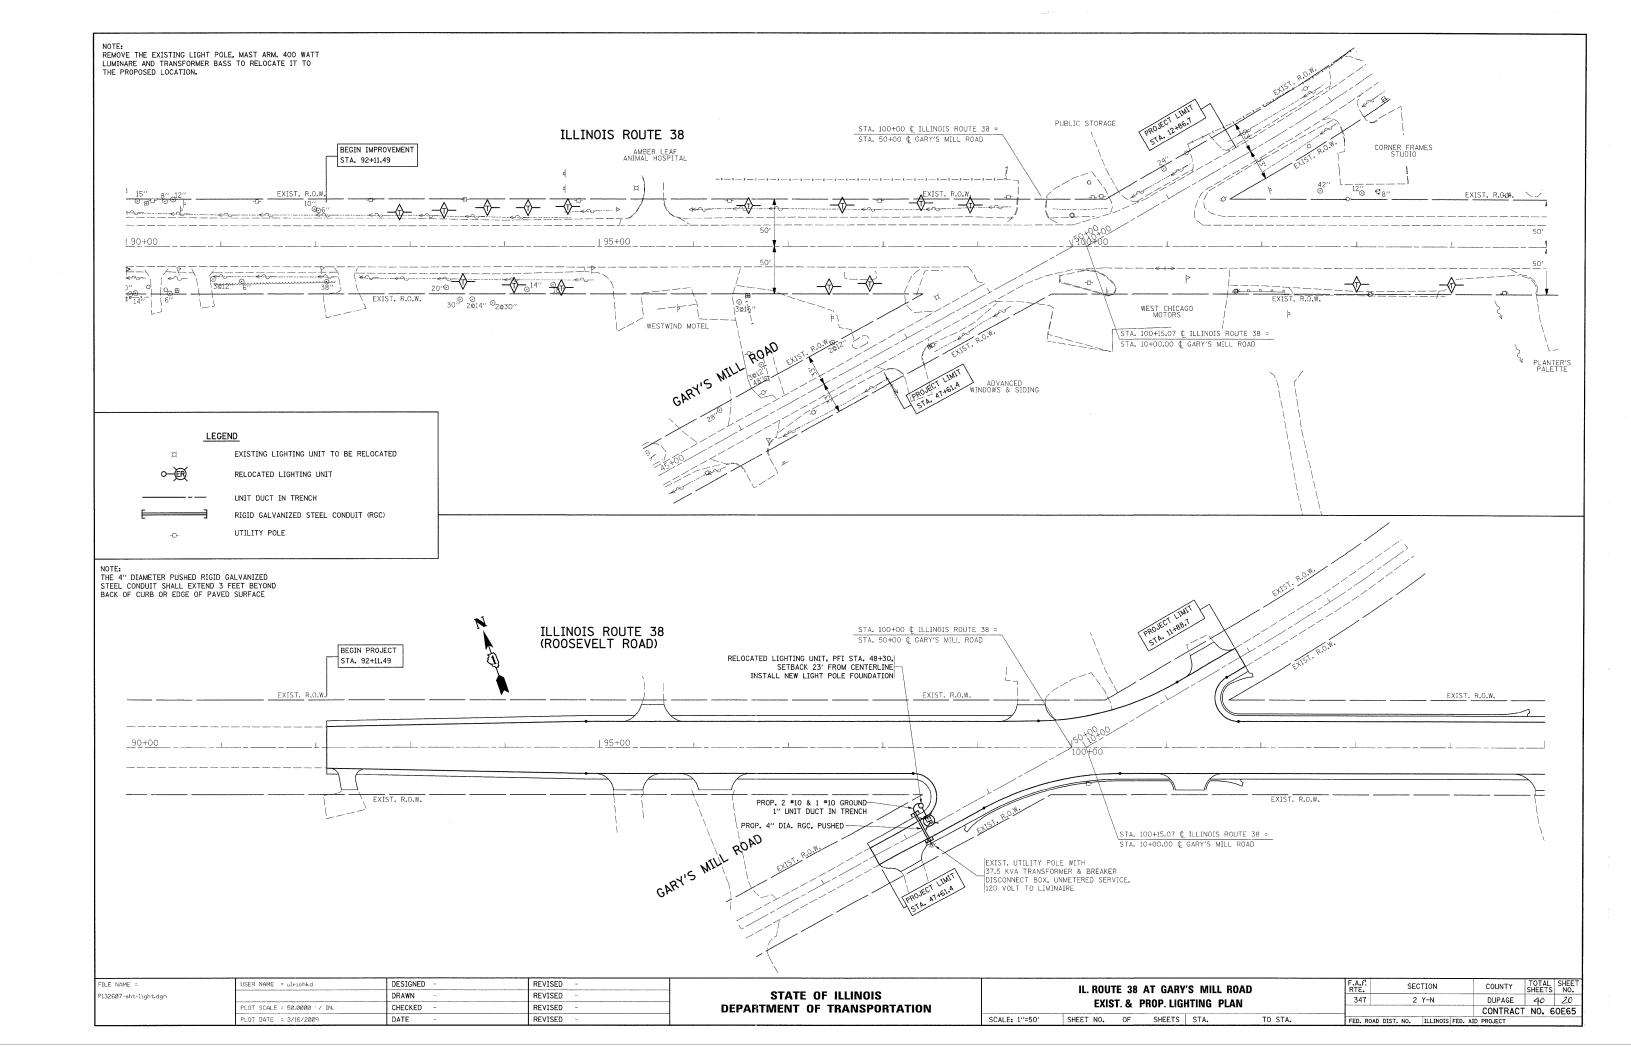


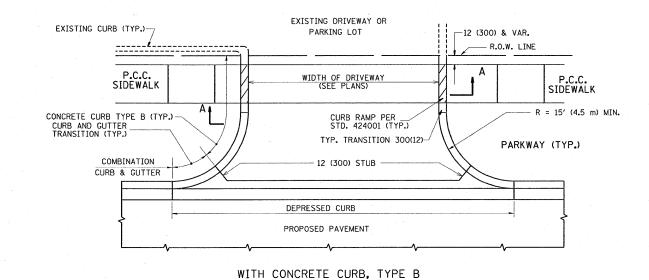


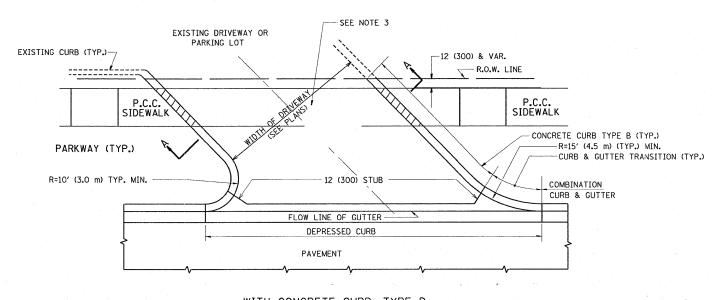


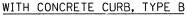

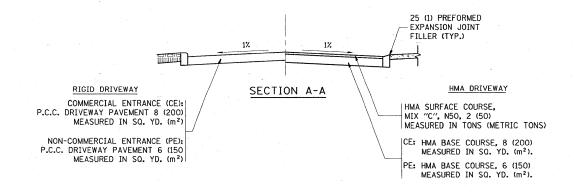

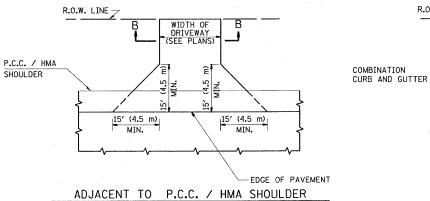

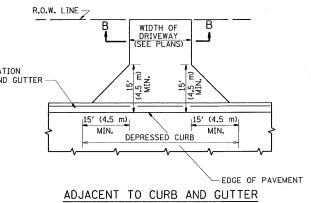

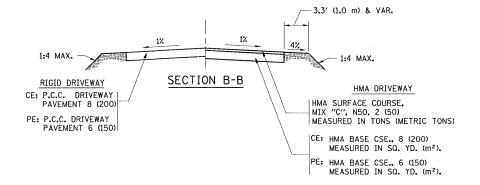

RURAL FIELD ENTRANCE (FE)

HMA SURFACE COURSE, MIX "C", N5O, 2 (50) MEASURED IN TONS (METRIC TONS)

AGGREGATE BASE CSE., TYPE B, 8 (200) MEASURED IN SQ. YD. (m²).

GENERAL NOTES:

DRIVEWAY SLOPES, LOCATIONS, & GEOMETRIC LAYOUT SHALL BE IN ACCORDANCE WITH THE LATEST EDITION OF THE "HANDBOOK FOR POLICY ON PERMITS FOR ACCESS DRIVEWAYS TO STATE HIGHWAYS". FOR FURTHER LAYOUT REQUIREMENTS, REFER TO ILLUSTRATIONS IN THE PERMIT HANDBOOK. DRIVEWAYS SHALL BE REPLACED IN KIND, UNLESS OTHERWISE NOTED ON THE PLANS.

COMMERCIAL DRIVEWAYS SHALL BE CONSTRUCTED WITH CONCRETE CURB, TYPE B RETURNS EXCEPT WHEN THE SIDEWALK EDGE IS 4 FEET (1.2 METERS) OR LESS FROM THE BACK OF CURB, CONSTRUCT A FLARE DRIVEWAY WITHOUT CURB.

THE RESIDENT ENGINEER SHALL CONTACT THE TRAFFIC PERMIT OFFICE AT 847/ 705-4131 FOR ANY QUESTIONS ON DRIVEWAYS SHOWN IN THE PLANS; SPECIFICALLY IN REFERENCE TO ADDITIONAL AND/OR RELOCATION/REMOVAL OF A DRIVEWAY.

COMBINATION CONCRETE CURB & GUTTER SHALL BE MEASURED STRAIGHT ACROSS THE DRIVEWAY. NO ADDITIONAL COMPENSATION WILL BE ALLOWED FOR THE CURB & GUTTER TRANSITION.


1 (25) PREFORMED EXPANSION JOINT FILLER WILL NOT BE PAID SEPARATELY, BUT SHALL BE CONSIDERED INCLUDED IN THE COST OF THE P.C.C. DRIVEWAY PAVEMENT OR P.C.C. SIDEWALK.

WHEN THE P.C.C. SIDEWALK EXTENDS THROUGH THE DRIVEWAY, THE THICKNESS OF THE SIDEWALK IN THE DRIVEWAY AREA SHALL BE THE SAME AS THE DRIVEWAY THICKNESS. SIDEWALK WILL BE PAID FOR AS P.C.C. SIDEWALK OF THE THICKNESS SPECIFIED. SIDEWALK CROSS SLOPE THRU DRIVEWAY AREA TO BE A MAXIMUM OF 1:50.

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FILE NAME =	USER NAME = banksl	DESIGNED -	R. SHAH	REVISED	- M. GOMEZ 04-06-01
c:\pw_work\PWIDOT\BANKSL\dms93602\DistS	td.dgn	DRAWN -		REVISED	- P. LaFLUER 04-15-03
	PLOT SCALE = 50.0000 '/ IN.	CHECKED ~		REVISED	- R. BORO 01-01-07
	PLOT DATE = 3/19/2009	DATE -	11-04-95	REVISED	- R. BORO 06-11-08
<u> </u>					

STATE OF ILLINOIS DEPARTMENT OF TRANSPORTATION

T	DR	VEWAY DETAILS D	ISTANCE	BETWEEN	N R.O.W.	F.A.P. RTE.	SECTION	COUNTY	TOTAL	SHEET NO.
١		AND FACE OF CURB & EDGE OF SHOULDER > = 15' (4.5 m)					2 Y-N	DUPAGE	40	21
l	ANU	ALE UT LUND & ED	GE OF SE	IUULDEN	> = 15 (4.5 M)		BD0156-07 (BD-01)	CONTRACT	NO.	60E65
İ	SCALE: NONE	SHEET NO. 1 OF 1	SHEETS	STA.	TO STA.	FED. RO	DAD DIST. NO. 1 ILLINOIS FED. A	ID PROJECT		

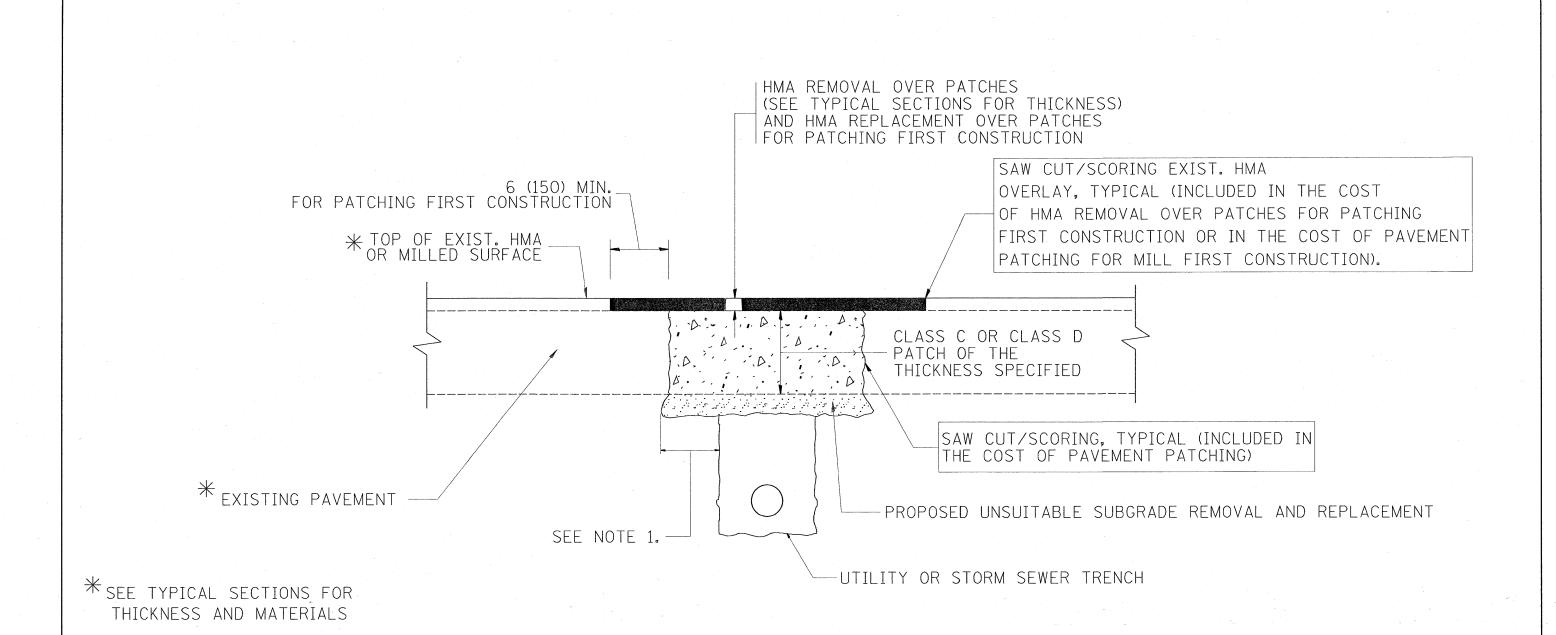

NOTES:

- 1. THE WIDTH OF THE FULL DEPTH PATCH OVER A TRENCH SHALL BE 12 (300) WIDER ON EACH SIDE OF THE TRENCH.
- 2. FOR METHOD OF MEASUREMENT AND BASIS OF PAYMENT, SEE RECURRING SPECIAL PROVISION "PATCHING WITH HOT-MIX ASPHALT OVERLAY REMOVAL".

SEQUENCE OF CONSTRUCTION (PATCHING FIRST)


- 1. REMOVE THE EXISTING HMA MATERIAL OVER THE AREA TO BE PATCHED.
- 2. REMOVE AND REPLACE WITH CLASS C OR D PATCH.
- 3. REPLACE HMA MATERIAL OVER THE AREA TO BE PATCHED.

SEQUENCE OF CONSTRUCTION (MILLING FIRST)

- 1. MILL HMA FIRST IF THERE IS AT LEAST 41/2 INCHES OR MORE OF HMA MATERIAL ON TOP OF THE EXISTING PAVEMENT OR IF THE PAVEMENT IS FULL DEPTH HMA. A MINIMUM OF 2 INCHES OF HMA MATERIAL SHALL BE IN PLACE AFTER MILLING.
- 2. REMOVE AND REPLACE WITH FULL DEPTH CLASS D PATCHES TO TOP OF MILLED SURFACE.

ALL DIMENSIONS ARE IN INCHES (MILLIMETERS) UNLESS OTHERWISE SHOWN.


FILE NAME =	USER NAME = benksl	DESIGNED - R. SHAH	REVISED - A. ABBAS 04-27-98		PAVEMENT PATCHING FOR	F.A.P. SECTION	COUNTY TOTAL SHEET NO.
ci\pw_work\PWIDOT\BANKSL\dms93602\DistS	d-dgn	DRAWN -	REVISED - R. BORO 01-01-07	STATE OF ILLINOIS	HMA SURFACED PAVEMENT	347 2 Y-N	DUPAGE 40 22
	PLOT SCALE = 50.0000 '/ IN.	CHECKED -	REVISED - R. BORO 09-04-07	DEPARTMENT OF TRANSPORTATION		BD400-04 (BD-22)	CONTRACT NO. 60E65
	PLOT DATE = 3/19/2009	DATE - 10-25-94	REVISED - K. ENG 10-27-08		SCALE: NONE SHEET NO. 1 OF 1 SHEETS STA. TO STA.	FED. ROAD DIST. NO. 1 ILLINOIS FED.	AID PROJECT

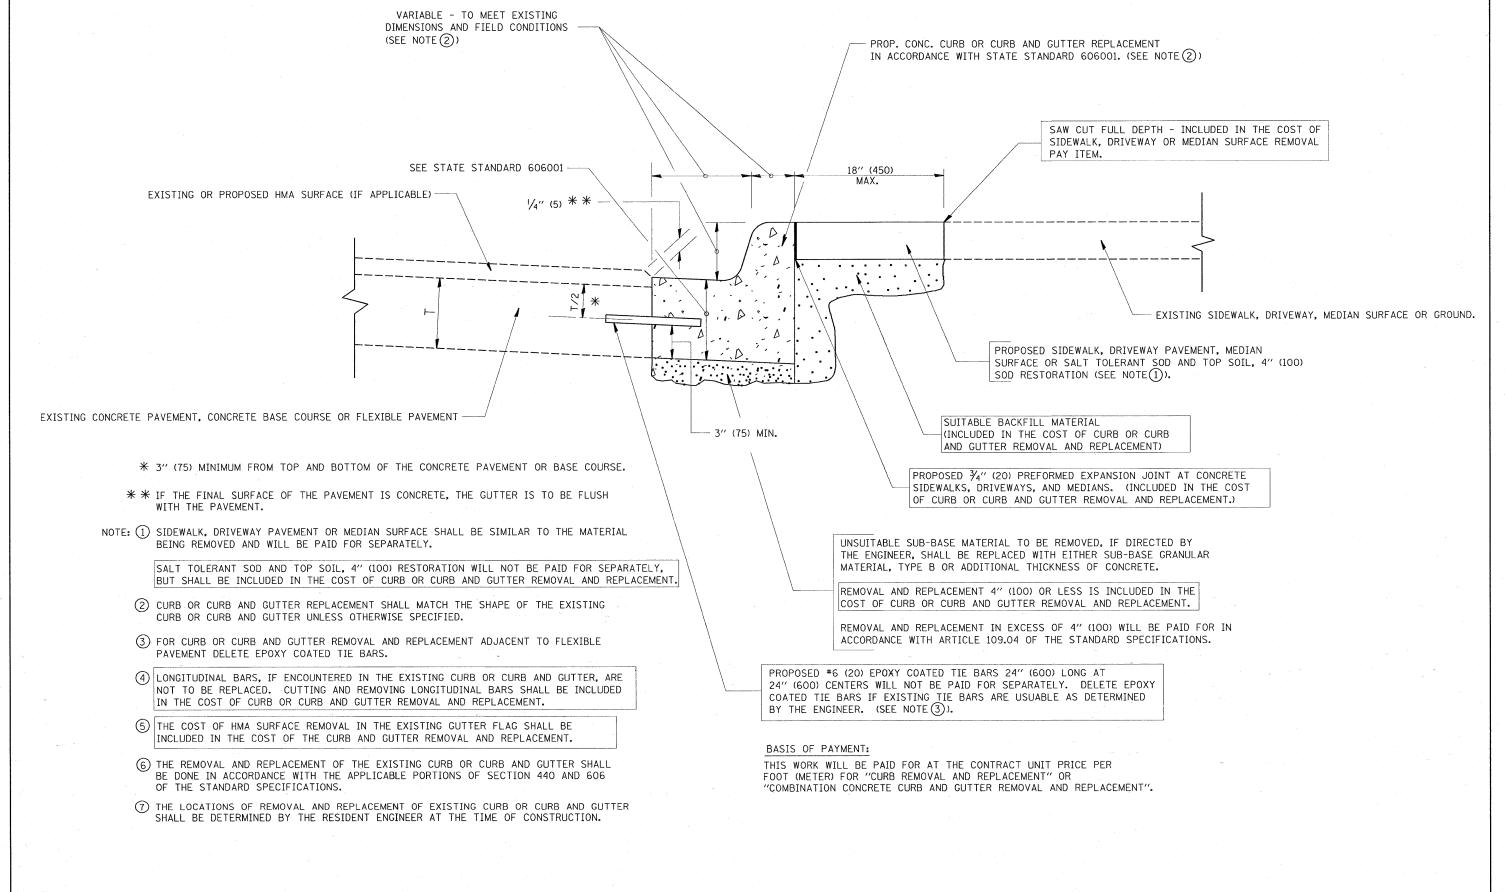

CURB OR CURB AND GUTTER REMOVAL AND REPLACEMENT

ALL DIMENSIONS ARE IN INCHES (MILLIMETERS)
UNLESS OTHERWISE SHOWN.


FILE NAME =	USER NAME = banksl	DESIGNED - A. HOUSEH	REVISED - R. SHAH 10-03-96			CURB OR CURB AND	CULTER	F.A.P.	SECTION	COUNTY TOTAL SHEET
c:\pw_work\PWIDOT\BANKSL\dms93602\DistS	didgn	DRAWN -	REVISED - A. ABBAS 03-21-97	STATE OF ILLINOIS	REMOVAL AND REPLACEMENT		347		2 Y-N	DUPAGE 40 23
	PLOT SCALE = 50.0000 '/ IN.	CHECKED -	REVISED - M. GOMEZ 01-22-01	DEPARTMENT OF TRANSPORTATION			ICEIVIEN I	BDe	600-06 (BD-24)	CONTRACT NO. 60E65
	PLOT DATE = 3/19/2009	DATE - 03-11-94	REVISED ~ R. BORO 01-01-07		SCALE: NONE	SHEET NO. 1 OF 1 SHEETS	STA. TO STA.	FED. ROAD D	IST. NO. 1 ILLINOIS FED. A	ID PROJECT

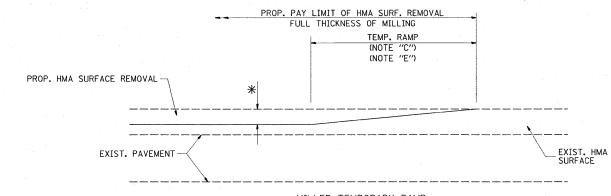

MILLED TEMPORARY RAMP

(FOR BUTT JOINT AND HMA TAPER SEE DETAIL BELOW)

OPTION 1

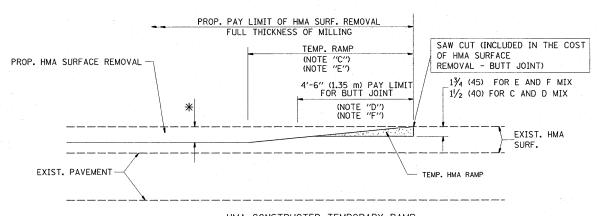


HMA CONSTRUCTED TEMPORARY RAMP


(FOR BUTT JOINT AND HMA TAPER SEE DETAIL BELOW)


OPTION 2

TYPICAL TEMPORARY RAMP

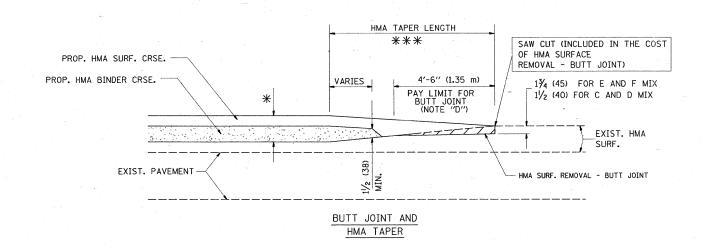

TYPICAL BUTT JOINT AND HMA TAPER FOR MILLING AND RESURFACING

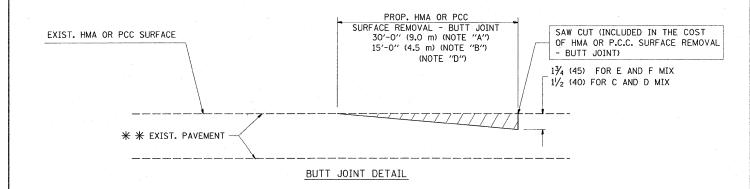

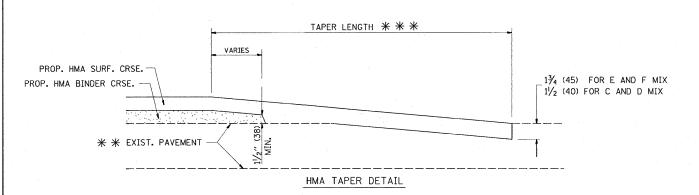

TYPICAL BUTT JOINT AND HMA TAPER FOR RESURFACING ONLY

* * PC CONCRETE, HMA OR HMA RESURFACED PAVEMENT.

NOTES

- A: MAINLINE ROADWAYS AND MAJOR SIDE ROADS.
- B: MINOR SIDE ROADS.
- C: THE TEMP. RAMP SHALL BE CONSTRUCTED IMMEDIATELY UPON REMOVAL OF THE EXISTING HMA SURFACE.
- D: THE BUTT JOINT SHALL BE CONSTRUCTED IMMEDIATELY PRIOR TO PLACING THE PROPOSED HMA COURSES.
- E: TAPER THE TEMP. RAMP AT A RATE OF 3'-O" (900 mm) PER 1 INCH (25 mm) OF MILLING THICKNESS.
- F: INSTALLATION AND REMOVAL OF THE 4'-6" (1.35 m) TEMP. RAMP IS INCLUDED IN COST OF HMA SURFACE REMOVAL BUTT JOINT
- G: SEE ARTICLE 406.08 AND 406.14 OF THE STANDARD SPECIFICATIONS FOR "HMA AND/OR PCC SURFACE REMOVAL, BUTT JOINT".
- * SEE TYPICAL SECTIONS FOR MILLING THICKNESS.
- ** * 20'-0" (6.1 m) PER 1 (25) RESURFACING (NOTE "A") 10'-0" (3.0 m) PER 1 (25) RESURFACING (NOTE "B")

BASIS OF PAYMENT:


THE BUTT JOINT WILL BE PAID FOR AT THE CONTRACT UNIT PRICE PER SQUARE YARD (SQUARE METER) FOR "HOT-MIX ASPHALT SURFACE REMOVAL - BUTT JOINT" OR FOR "PORTLAND CEMENT CONCRETE SURFACE REMOVAL- BUTT JOINT".

ALL DIMENSIONS ARE IN INCHES (MILLIMETERS) UNLESS OTHERWISE SHOWN.

FILE NAME =	USER NAME = banksl	DESIGNED	-	M. DE YONG	REVISED	-	R. SHAH 10-25-94
c:\pw_work\PWIDOT\BANKSL\dms93602\DistS	td.dgn	DRAWN	-		REVISED	-	A. ABBAS 03-21-97
	PLOT SCALE = 50.0000 '/ IN.	CHECKED			REVISED	_	M. GOMEZ 04-06-01
	PLOT DATE = 3/19/2009	DATE	~	06-13-90	REVISED	~	R. BORO 01-01-07

STATE OF ILLINOIS DEPARTMENT OF TRANSPORTATION

 BUTT JOINT AND		F.A.P. RTE.	SECTION	COUNTY	TOTAL SHEETS	SHEE NO.
HMA TAPER DETAILS	347	2 Y-N	DUPAGE	40	24	
MINIA TAPER DETAILS			BD400-05 BD32	CONTRACT	NO.	60E6
SCALE: NONE SHEET NO. 1 OF 1 SHEETS STA	TO STA.	FED. R	OAD DIST. NO. 1 ILLINOIS FED. A	ID PROJECT		

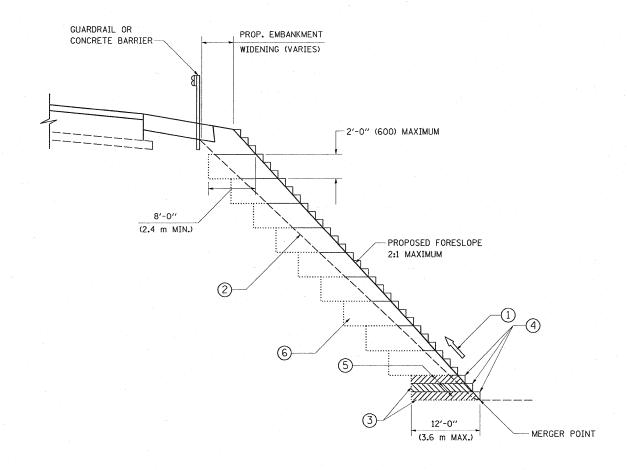


TYPICAL BENCHING DETAIL FOR EMBANKMENT

NOTES:

- ② EXISTING FORESLOPE PREPARED IN ACCORDANCE WITH ARTICLE 205.03 OF THE STANDARD SPECIFICATIONS.
- 3 BENCH CUT EXISTING SLOPE TYPICAL FOR EACH STEP.
- 4 TRIM TO FINAL SLOPE.
- EQUAL 8-INCH (200) LIFTS OF EMBANKMENT COMPACTED IN ACCORDANCE WITH ARTICLE 205.05 OF THE CTANDESS OF THE STANDARD OF THE STAN WITH ARTICLE 205.05 OF THE STANDARD SPECIFICATIONS.
- 6 EXCAVATION OF BENCH CUTS WITHIN EXISTING EMBANKMENT WILL BE PAID FOR AT THE CONTRACT UNIT PRICE PER CUBIC METER OR CUBIC YARD FOR "EARTH EXCAVATION". THIS PRICE WILL INCLUDE ALL LABOR AND MATERIAL, NO ADDITIONAL COMPENSATION WILL BE ALLOWED.
- 7 SLOPES SHALL BE BENCHED ACCORDING TO THIS DETAIL WHEN THE SLOPE IS STEEPER THAN 4:1 AND THE HEIGHT IS GREATER THAN 5' (1.5 m).

ALL DIMENSIONS ARE IN INCHES (MILLIMETERS) UNLESS OTHERWISE SHOWN.

-	FILE NAME = .	USER NAME = banksl	DESIGNED -	REVISED -			BENCHING DETAIL	F.A.P.	SECTION	COUNTY	TOTAL SHEET SHEETS NO.
	c:\pw_work\PWIDOT\BANKSL\dms93602\DistS	td.dgn	DRAWN - CADD	REVISED -	STATE OF ILLINOIS	FOR EMBANKMENT WIDENING		347	2 Y-N	DUPAGE	40 25
		PLOT SCALE = 50.0000 '/ IN.	CHECKED - S.E.B.	REVISED -	DEPARTMENT OF TRANSPORTATION				BD-51	CONTRACT	NO. 60E65
. L		PLOT DATE = 3/19/2009	DATE - 06-16-04	REVISED		SCALE: NONE	SHEET NO. 1 OF 1 SHEETS STA. TO STA.	FED. ROAD DIS	T. NO. 1 ILLINOIS FED. AI	ID PROJECT	

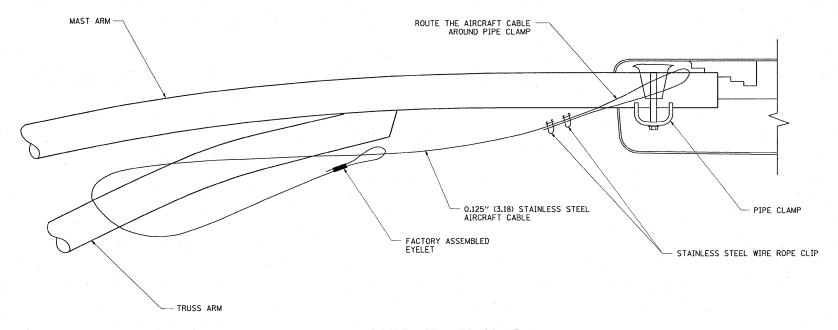

SIDE VIEW (TRUSS ARM) N.T.S.

MAST ARM

FACTORY ASSEMBLED
EYELET

STAINLESS STEEL

U-BOLT HAYARD


ROUTE THE CABLE
AROUND PIPE CLAMP

O.125" (3.18) STAINLESS
STEEL AIRCRAFT CABLE
WIRE ROPE CLIP

STAINLESS STEEL
WIRE ROPE CLIP


SIDE VIEW (SINGLE MEMBER OR DAVIT ARM)

N.T.S.

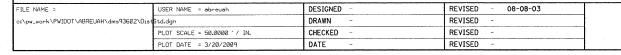

STAINLESS STEEL U-BOLT HAYARD

STATE OF ILLINOIS
DEPARTMENT OF TRANSPORTATION

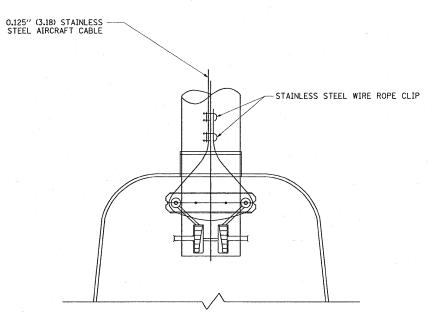


BOTTOM VIEW

N.T.S.


NOTES:


- 1. ALL DIMENSIONS ARE IN MILLIMETERS (INCHES) UNLESS OTHERWISE SHOWN.
- 2. CONTRACTOR SHALL ADJUST THE WIRE CLIP TO ELIMINATE ANY SLACK FROM THE WIRE ROPE.
- 3. THE 0.125" (3.18) STAINLESS STEEL AIRCRAFT CABLE SHALL REMAIN VISIBLE FROM THE GROUND LEVEL.
- 4. THE BREAKING STRENGTH OF THE CABLE SHALL BE 1700 LBS. MIN.

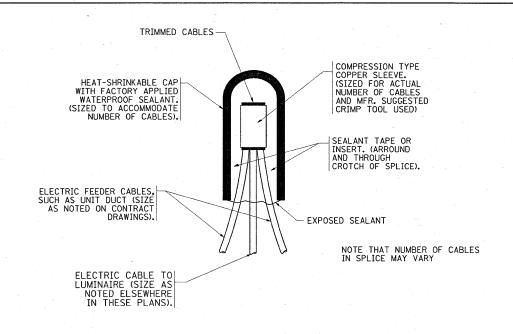

TYPICAL SPLICE DETAIL

N.T.S.

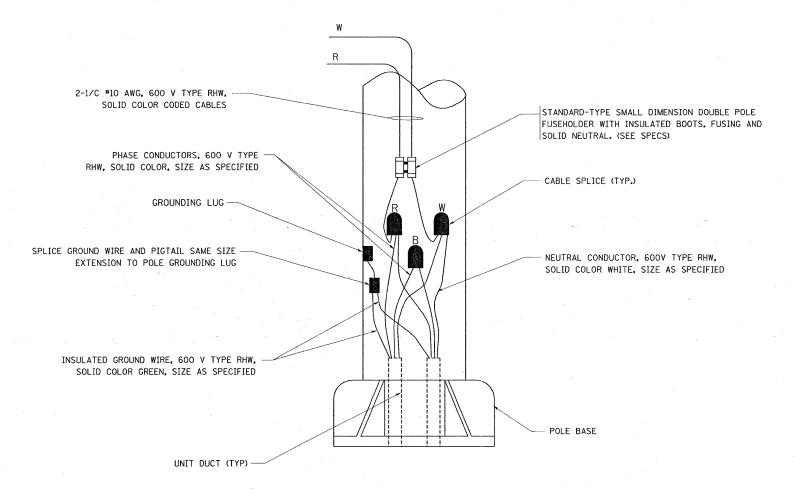

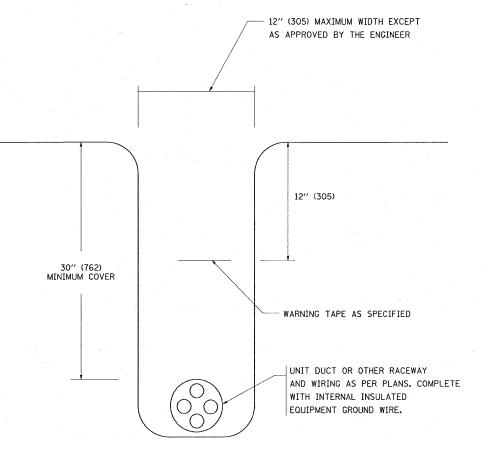

TYPICAL WIRING IN TRENCH DETAIL

N.T.S.


POLE WIRING DETAIL


N.T.S.

FILE NAME = .	USER NAME = abrevah	DESIGNED -	REVISED - 08-08-03			MISC. ELECTRICAL DETAILS		F.A.P.	SECTION	COUNTY	TOTAL SHEET
c:\pw_work\PWIDOT\ABREUAH\dms93602\Dist	Std.dgn	DRAWN -	REVISED -	STATE OF ILLINOIS				347	2Y-N	DUPAGE	40 27
	PLOT SCALE = 50.0000 '/ IN.	CHECKED -	REVISED -	DEPARTMENT OF TRANSPORTATION		SHEET A			BE-702	CONTRACT	NO. 60E65
· ·	PLOT DATE = 3/20/2009	DATE -	REVISED -		SCALE: NONE	SHEET NO. 1 OF 1 SHEETS STA.	TO STA.	FED. ROAD DIS	T. NO. 1 ILLINOIS FED. A	ID PROJECT	

SIGNING FOR FLAGGING OPERATIONS AT WORK ZONE OPENINGS

WORK ZONE EXIT OPENING

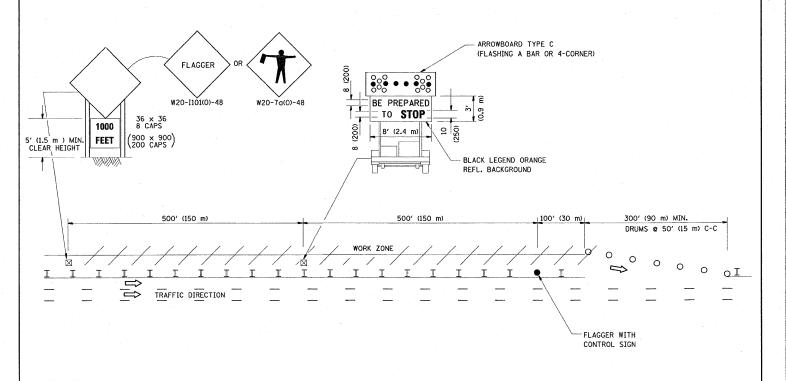

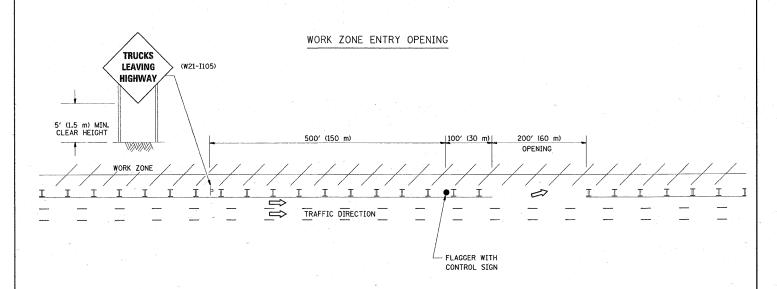


NOTES:

- The Arrowboard, the Flagger Ahead trailer mounted sign, and the Trucks Leaving Highway sign shall be removed or turned away from traffic and the exit and entry openings shall be closed when the flagging operation ceases.
- 2. Work Zone Exit Openings should be a minimum of one half mile apart.
- 3. Exiting the work zone at any place other than at a Work Zone Exit Opening will be prohibited.
- 4. All vehicles shall enter the work zone at entry openings, using their turn signals to warn motorists

ALL DIMENSIONS ARE IN INCHES (MILLIMETERS)
UNLESS OTHERWISE SHOWN

. [FILE NAME =	USER NAME = benksl	DESIGNED -	REVISED -	D.W.S. 08-98			SIGNING FOR FLAGGING OPERATIONS		F.A.P.	SECTION	COUNTY	TOTAL S	HEET NO.
- 1	c:\pw_work\PWIDOT\BANKSL\dms93602\DistSt	d.dgn	DRAWN -	REVISED -	J.A.F. 04-03	STATE OF ILLINOIS				347	2 Y-N	DUPAGE	40	28
- 1		PLOT SCALE = 50.0000 '/ IN.	CHECKED -	REVISED -	J.A.F. 02-06	DEPARTMENT OF TRANSPORTATION		AT WORK ZONE OPENINGS			TC-18	CONTRACT	NO. 6	DE65
L		PLOT DATE = 3/19/2009	DATE -	REVISED -	S.P.B. 01-07		SCALE: NONE	SHEET NO. 1 OF 1 SHEETS STA.	TO STA.	FED. ROAD	DIST. NO. 1 ILLINOIS FED.	AID PROJECT		

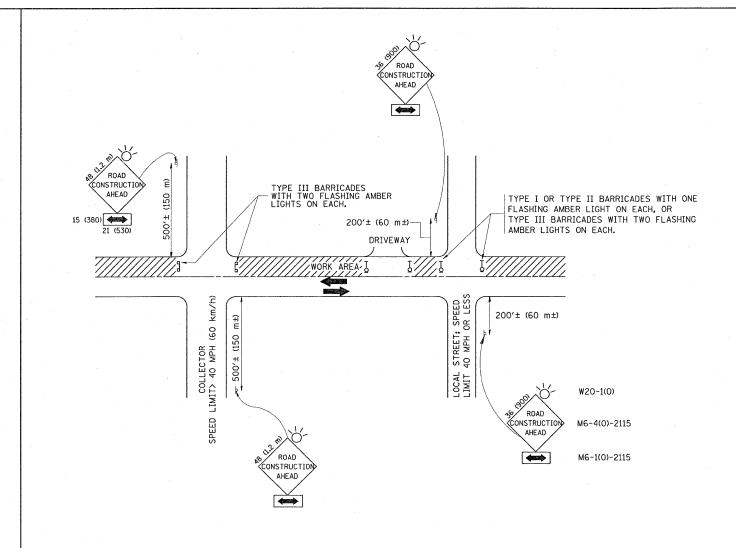

TRAFFIC CONTROL AND PROTECTION FOR SIDE ROADS, INTERSECTIONS, AND DRIVEWAYS

NOTES:

- A. FOR NO LANE RESTRICTION ON THE SIDE ROAD OR DRIVEWAYS
- 1. SIDE ROAD WITH A SPEED LIMIT OF 40 MPH (60 km/h) OR LESS AS SHOWN ON THE DRAWING AND AS DIRECTED BY THE ENGINEER:
- Q) ONE ROAD CONSTRUCTION AHEAD SIGN 36 x 36 (900x900) WITH A FLASHER AND FLAG MOUNTED ON IT APPROXIMATELY 200' (60 m) IN ADVANCE OF THE MAIN ROUTE.
- b) THE CLOSED PORTION OF THE MAIN ROUTE SHALL BE PROTECTED BY BLOCKING WITH TYPE I, TYPE II OR TYPE III BARRICADES, 1/3 OF THE CROSS SECTION OF THE CLOSED PORTION.
- 2. SIDE ROAD WITH A SPEED LIMIT GREATER THAN 40 MPH (60 km/h) AS SHOWN ON THE DRAWING AND AS DIRECTED BY THE ENGINEER:
- g) ONE ROAD CONSTRUCTION AHEAD SIGN 48 \times 48 (1.2 m \times 1.2 m) WITH A FLASHER MOUNTED ON IT APPROXIMATELY 500' (150 m) IN ADVANCE OF THE MAIN ROLLIF.
- b) THE CLOSED PORTION OF THE MAIN ROUTE SHALL BE PROTECTED BY BLOCKING WITH TYPE III BARRICADES, 1/2 OF THE CROSS SECTION OF THE CLOSED PORTION.
- 3. WHEN THE SIDE ROAD LIES BETWEEN THE BEGINNING OF THE MAINLINE SIGNING AND THE WORK ZONE, A SINGLE HEADED ARROW (MG-1) SHALL BE USED IN LIEU OF THE DOUBLE HEADED ARROW (MG-4).

B. FOR A LANE CLOSURE ON A SIDE ROAD OR DRIVEWAY:

USE APPLICABLE PORTIONS OF THE TYPICAL APPLICATION OF TRAFFIC CONTROL DEVICES (STD. 701501, STD. 701606 OR THE APPROPRIATE STANDARD). THE SPACING OF SIGNS AND BARRICADES SHALL BE ADJUSTED FOR FIELD CONDITIONS AS DIRECTED BY THE ENGINEER. THE DIRECTIONAL ARROW SHALL BE COVERED OR REMOVED WHEN NO LONGER CONSISTENT WITH THE SIDE ROAD LANE CLOSURE.

- C. ADVANCE WARNING SIGNS ARE TO BE OMITTED ON DRIVEWAY UNLESS OTHERWISE NOTED.
- D. THE TRAFFIC CONTROL AND PROTECTION FOR SIDE ROADS, INTERSECTIONS, AND DRIVEWAYS SHALL BE INCIDENTAL TO THE COST OF SPECIFIED TRAFFIC CONTROL STANDARDS OR ITEMS.


All dimensions are in millimeters (inches) unless otherwise shown.

FILE NAME =	USER NAME = banksl	DESIGNED - LHA	REVISED - J. OBERLE 10-18-95
c:\pw_work\PWIDOT\BANKSL\dms93602\DistS	td.dgn	DRAWN -	REVISED - A. HOUSEH 03-06-96
	PLOT SCALE = 50.0000 '/ IN.	CHECKED -	REVISED - A. HOUSEH 10-15-96
ļ	PLOT DATE = 3/19/2009	DATE - 06-89	REVISED -T. RAMMACHER 01-06-00

STATE	OF	ILLINOIS	
DEPARTMENT	OF	TRANSPOR	TATION

	TRA	AFFI	C	CON	TF	OL AND P	ROTEC	TION FOR
	SIDE	ROA	DS	, IN	TE	RSECTIONS	, AND	DRIVEWAYS
SCALE: NONE	SHEET	NO.	1	OF	1	SHEETS	STA.	TO STA.

	F.A.P. RTE.	SECTION	COUNTY	TOTAL SHEETS	SHEET NO.	
-	347	2 Y-N	DUPAGE	40	29	
-		TC-10	CONTRACT	NO. 6	0E65	
	FED. R	OAD DIST. NO. 1 ILLINOIS FED. A	ID PROJECT			

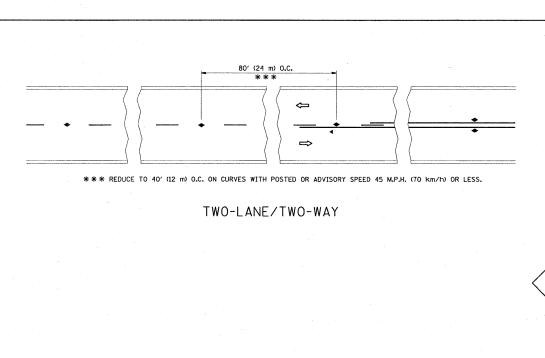

80' (24 m) O.C.

SEE NOTE B

MULTI-LANE/UNDIVIDED


3 @ 40' (12 m)

SEE NOTE A


 \Rightarrow

3 @ 80' (24 m) O.C. -


 \Rightarrow

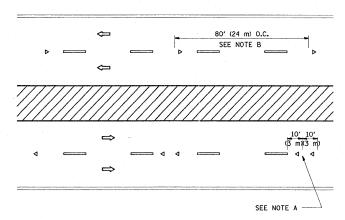

MULTI-LANE/DIVIDED

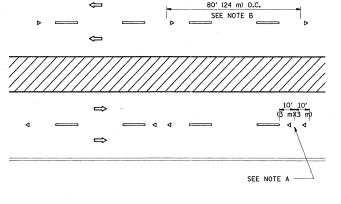

 \Leftrightarrow

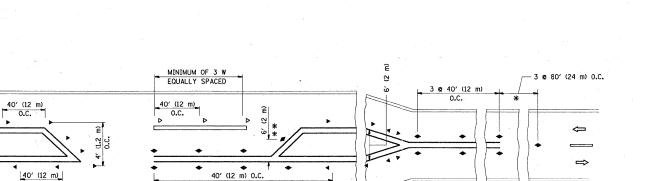

* SEE TWO-LANE/TWO-WAY WHERE MARKERS CONTINUE ** WHERE THE MEDIAN WIDTH IS 6' (2 m) OR LESS USE TWO-WAY MARKERS.

LEFT TURN

GENERAL NOTES

LANE REDUCTION TRANSITION

- 1. MARKERS USED WITH DASHED LINES SHALL BE CENTERED IN THE GAP BETWEEN SEGMENTS.
- 2. MARKERS USED ADJACENT TO SOLID LINES SHALL BE OFFSET 2 TO 3 (50 TO 75) TOWARD TRAFFIC AS SHOWN.
- 3. MARKERS THROUGH TANGENTS LESS THAN 500' (150 m) IN LENGTH BETWEEN CURVES SHALL BE INSTALLED AT THE LESSER OF THE TWO CURVE SPACINGS.

LANE MARKER NOTES

- B. REDUCE TO 40' (12 m) O.C. ON CURVES WHERE ADVISORY SPEEDS ARE 10 M.P.H (20 km/h) LOWER THAN POSTED SPEEDS.
- A. USE DOUBLE LANE LINE MARKERS SPACED AS SHOWN.

SYMBOLS

---- YELLOW STRIPE

80' (24 m) 0.C. SEE NOTE B

40' (12 m) O.C.

1

SEE NOTE A

TWO-WAY LEFT TURN


- WHITE STRIPE
- ONE-WAY CRYSTAL MARKER (W/O)
- ◆ TWO-WAY AMBER MARKER

DESIGN NOTES

- 1. DOUBLE LANE LINE MARKERS SHALL BE USED UNLESS SPECIFIED OTHERWISE.
- 2. EXCEPT AS SHOWN ON THE LANE REDUCTION TRANSITION AND FREEWAY EXIT RAMP DETAIL, MARKERS ARE NOT TO BE SPECIFIED ON RIGHT EDGE
- 3. THE EXACT MARKER LIMITS, SPACING, AND COLOR SHOULD BE INCLUDED IN THE PLANS.
- 4. MARKERS SHOULD NOT BE USED ALONGSIDE CURBS EXCEPT FOR EXTREMELY SHORT SECTIONS OF CURBS WHERE NOT MORE THAN TWO MARKERS WOULD BE INVOLVED.

All dimensions are in inches (millimeters) unless otherwise shown.

FILE NAME =	USER NAME = banksI	DESIGNED -	REVISED - T. RAMMACHER 09-19-94		TYPICAL APPLICATIONS	F.A.P. SECTION	COUNTY TOTAL SHEET
o:\pw_work\PWIDOT\BANKSL\dms93602\DistS	td.dgn	DRAWN -	REVISED - T. RAMMACHER 03-12-99	0.7.1.2 0. 1.2		347 2 Y-N	DUPAGE 40 30
j .	PLOT SCALE = 50.0000 '/ IN.	CHECKED -	REVISED -T. RAMMACHER 01-06-00	DEPARTMENT OF TRANSPORTATION	RAISED REFLECTIVE PAVEMENT MARKERS (SNOW-PLOW RESISTANT)	TC-11	CONTRACT NO. 60E65
	PLOT DATE = 3/19/2009	DATE -	REVISED -		SCALE: NONE SHEET NO. 1 OF 1 SHEETS STA. TO STA.	FED. ROAD DIST. NO. 1 ILLINOIS FED. A	AID PROJECT

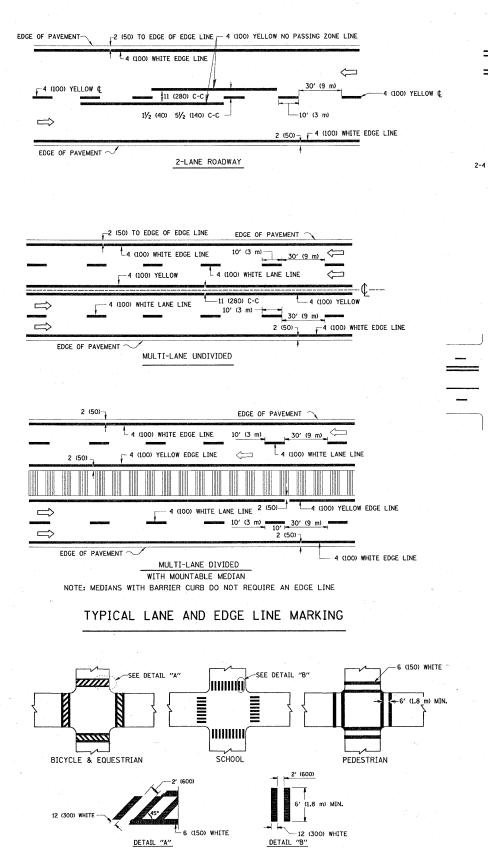


2-4 (100) YELLOW @ 11 (280) C-C

NO DIAGONALS

4' (1.2 m) OUTSIDE TO OUTSIDE OF LINES

2-4 (100) YELLOW @ 11 (280) C-C

4' (1.2 m) WIDE MEDIANS ONLY

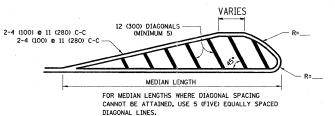


DIAGONAL LINE SPACING: 50' (15 m) C-C (LESS THAN 30MPH (50 km/h))


75' (25 m) C-C 30MPH (50 km/h) TO 45MPH (70 km/h))

150' (45 m) C-C (MORE THAN 45MPH (70 km/h))

MEDIANS OVER 4' (1.2 m) WIDE

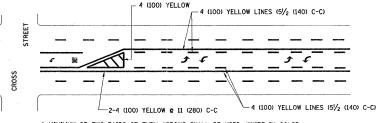


A MINIMUM OF TWO PAIRS OF TURN ARROWS SHALL BE USED, WHITE IN COLOR. ADDITIONAL PAIRS SHALL BE PLACED AT 200' (60 m) TO 300' (90 m) INTERVALS.

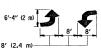

MEDIAN WITH TWO-WAY LEFT TURN LANE

TYPICAL PAINTED MEDIAN MARKING

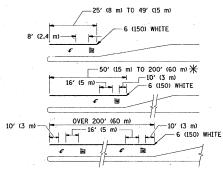



FULL SIZE LETTERS 8' (2.4 m) AND ARROWS SHALL BE USED. \footnotemark AREA = 15.6 SQ. FT. (1.5 m²) \footnotemark AREA = 20.8 SQ. FT. (1.9 m²)

** TURN LANES IN EXCESS OF 400' (120 m) IN LENGTH MAY HAVE AN ADDITIONAL SET OF ARROW - "ONLY" INSTALLED MIDWAY BETWEEN THE OTHER TWO SETS OF ARROW - "ONLY".

TYPICAL LEFT (OR RIGHT) TURN LANE

TYPICAL TURN LANE MARKING

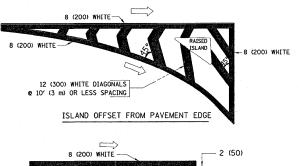

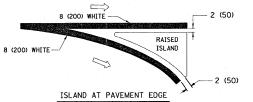

TYPICAL ISLAND MARKING

			·	
TYPE OF MARKING	WIDTH OF LINE	PATTERN	COLOR	SPACING / REMARKS
CENTERLINE ON 2 LANE PAVEMENT	4 (100)	SKIP-DASH	YELLOW	10' (3 m) LINE WITH 30' (9 m) SPACE
CENTERLINE ON MULTI-LANE UNDIVEDED PAVEMENT	2 & 4 (100)	SOLID	YELLOW	11 (280) C-C
NO PASSING ZONE LINES: FOR ONE DIRECTION FOR BOTH DIRECTIONS	4 (100) 2 @ 4 (100)	SOLID SOLID	YELLOW YELLOW	5½ (140) C-C FROM SKIP-DASH CENTERLINE 11 (280) C-C OMIT SKIP-DASH CENTERLINE BETWEEN
LANE LINES	4 (100) 5 (125) ON FREEWAYS	SKIP-DASH SKIP-DASH	WHITE WHITE	10' (3 m) LINE WITH 30' (9 m) SPACE
DOTTED LINES (EXTENSIONS OF CENTER, LANE OR TURN LANE MARKINGS)	SAME AS LINE BEING EXTENDED	SKIP-DASH	SAME AS LINE BEING EXTENDED	2' (600) LINE WITH 6' (1.8 m) SPACE
EDGE LINES	4 (100)	SOLID	YELLOW-LEFT WHITE-RIGHT	OUTLINE MOUNTABLE MEDIANS IN YELLOW; EDGE LINES ARE NOT USED NEXT TO BARRIER CURB
TURN LANE MARKINGS	6 (150) LINE; FULL SIZE LETTERS & SYMBOLS (8' (2.4m))	SOLID	WHITE	SEE TYPICAL TURN LANE MARKING DETAIL
TWO WAY LEFT TURN MARKING	2 @ 4 (100) EACH DIRECTION	SKIP-DASH AND SOLID	YELLOW	10' (3 m) LINE WITH 30' (9 m) SPACE FOR SKIP-DASH; 5½ (140) C-C BETWEEN SOLID LINE AND SKIP-DASH LINE
	8' (2.4m) LEFT ARROW	IN PAIRS	WHITE	SEE TYPICAL TWO-WAY LEFT TURN MARKING DETAIL
CROSSWALK LINES (PEDESTRIAN) A. DIAGONALS (BIKE & EQUESTRIAN) B. LONGITUDINAL BARS (SCHOOL)	2 @ 6 (150) 12 (300) @ 45° 12 (300) @ 90°	SOLID SOLID SOLID	WHITE WHITE WHITE	NOT LESS THAN 6' (1.8 m) APART 2' (600) APART 2' (600) APART 5EE TYPICAL CROSSWALK MARKING DETAILS.
STOP LINES	24 (600)	SOLID	WHITE	PLACE 4' (1.2 m) IN ADVANCE OF AND PARALLEL TO CROSSWALK, IF PRESENT. OTHERWISE, PLACE AT DESIRED STOPPING POINT. PARALLEL TO CROSSROAD CENTERLINE, WHERE POSSIBLE
PAINTED MEDIANS	2 @ 4 (100) WITH 12 (300) DIAGONALS @ 45° NO DIAGONALS USED FOR 4' (1.2 m) WIDE MEDIANS	SOLID	YELLOW: TWO WAY TRAFFIC WHITE: ONE WAY TRAFFIC	11 (280) C-C FOR THE DOUBLE LINE SEE TYPICAL PAINTED MEDIAN MARKING.
GORE MARKING AND CHANNELIZING LINES	8 (200) WITH 12 (300) DIAGONALS & 45°	SOLID	WHITE	DIACONALS: 15' (4.5 m) C-C (LESS THAN 30MPH (50 km/h)) 20' (6 m) C-C 30MPH (50 km/h) TO 45MPH (70 km/h)) 30' (9 m) C-C (OVER 45MPH (70 km/h))
RAILROAD CROSSING	24 (600) TRANSVERSE LINES; "RR" IS 6' (1.8 m) LETTERS; 16 (400) LINE FOR "X"	SOLID	WHITE	SEE STATE STANDARD 780001 AREA OF: "R"-3.6 S0. FT. (0.33 m ²) EACH "X"-54.0 S0. FT. (5.0 m ²)
SHOULDER DIAGONALS	12 (300) & 45°	SOLID	WHITE - RIGHT YELLOW - LEFT	50' (15 m) C-C (LESS THAN 30MPH (50 km/h)) 75' (25 m) C-C (30 MPH (50 km/h) TO 45MPH (70 km/h)) 150' (45 m) C-C (0VER 45MPH (70 km/h))

FOR FURTHER DETAILS ON PAVEMENT MARKING REFER TO STANDARD SPECIFICATIONS FOR ROAD AND BRIDGE CONSTRUCTION AND STATE STANDARD 780001.


All dimensions are in inches (millimeters) unless otherwise shown.


		· ·	·
ILE NAME =	USER NAME = banks1	DESIGNED - EVERS	REVISED ~T. RAMMACHER 10-27-94
:\pw_work\PWIBOT\BANKSL\dms93602\DistS	td.dgn	DRAWN -	REVISED -A. HOUSEH 10-09-96
•	PLOT SCALE = 50.0000 '/ IN.	CHECKED -	REVISED -A. HOUSEH 10-17-96
	PLOT DATE = 3/19/2009	DATE - 03-19-90	REVISED -T. RAMMACHER 01-06-00

TYPICAL CROSSWALK MARKING


STATE	OF	ILLINOIS	
PEPARTMENT	OF	TRANSPORTATION	

	DISTRICT ON	F.A.P. RTE.	SECTION	COUNTY	TOTAL	SHEET NO.			
	TYPICAL PAVEMENT	347	2 Y-N TC-13	DUPAGE CONTRACT	40 NO.	60E65			
SCALE: NONE SHEET NO. 1 OF 1 SHEETS STA. TO STA. FED. ROAD DIST. NO. 1 ILLINOIS FED. AID PROJECT									

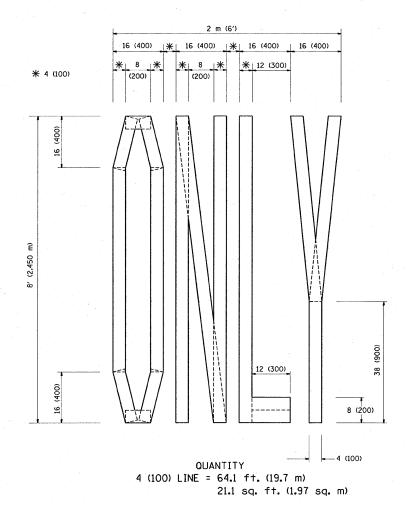

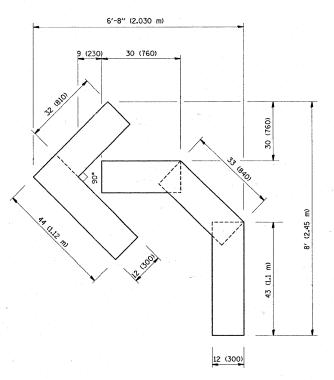


QUANTITY 4 (100) LINE = 45.5 ft. (13.9 m) 15.2 sq. ft. (1.39 sq. m)

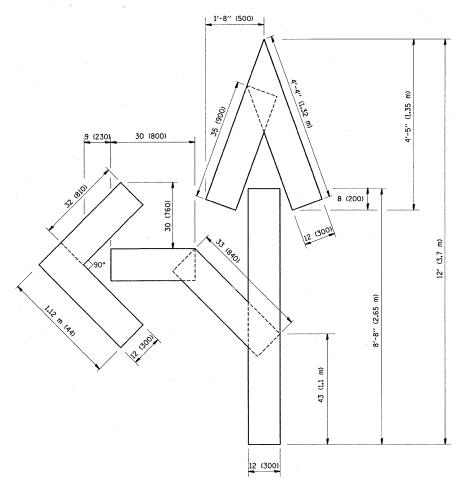

QUANTITY 4 (100) LINE = 82.5 ft. (25.3 m) 27.5 sq. ft. (2.53 sq. m)

All dimensions are in inches (millimeters) unless otherwise shown.

FILE NAME =	USER NAME = banksl	DESIGNED -	REVISED -T. RAMMACHER 06-05-96			PAVEMENT MARKING LETTERS AND SYMB	ni s	F.A.P.	SECTION	COUNTY	TOTAL SHEET
c:\pw_work\PWIDOT\BANKSL\dms93602\DistS	td.dgn	DRAWN -	REVISED -T. RAMMACHER 11-04-97	STATE OF ILLINOIS				347	2 Y-N	DUPAGE	40 32
	PLOT SCALE = 50.0000 '/ IN.	CHECKED -	REVISED -T. RAMMACHER 03-02-98	DEPARTMENT OF TRANSPORTATION		FOR TRAFFIC STAGING			TC-16	CONTRACT	NO. 60E65
·	PLOT DATE = 3/19/2009	DATE - 09-18-94	REVISED - E. GOMEZ 08-28-00		SCALE: NONE	SHEET NO. 1 OF 1 SHEETS STA.	TO STA.	FED. ROAD E	IST. NO. 1 ILLINOIS FED.	AID PROJECT	

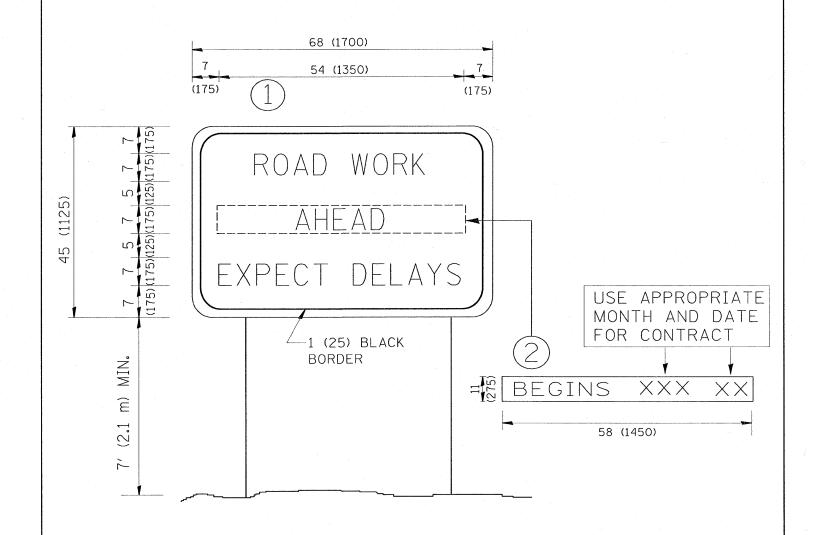

NOTES:

- 1. USE BLACK LETTERING ON ORANGE BACKGROUND.
- 2. ERECT SIGNS IN ADVANCE OF THE LOCATION FOR THE "ROAD CONSTRUCTION AHEAD" SIGN AT LOCATIONS AS DIRECTED BY THE ENGINEER.
- 3. ERECT SIGN (1) WITH INSTALLED PANEL (2) ONE WEEK PRIOR TO THE START OF CONSTRUCTION.
- 4. REMOVE PANEL (2) SOON AFTER THE START OF CONSTRUCTION.
- 5. SEE SPECIAL PROVISION FOR "TEMPORARY INFORMATION SIGNING" FOR ADDITIONAL INFORMATION.
- 6. ONE SIGN ASSEMBLY EQUALS 25.70 SQ. FT. (2.3 SQ. M.)
- 7. SHALL BE PAID FOR AS TEMPORARY INFORMATION SIGNING.

ALL DIMENSIONS ARE IN INCHES (MILLIMETERS) UNLESS OTHERWISE SHOWN.

FILE NAME :	± .	USER NAME = banksl	DESIGNED -	REVISED - R. MIRS 09-15-97			ARTERIAL RO	An	F.A.P. SECT	ION COUNTY	Y TOTAL SHEET
c:\pw_work\l	\PWIDOT\BANKSL\dms9360 2\D istS	td.dgn	DRAWN -	REVISED - R. MIRS 12-11-97	STATE OF ILLINOIS		INFORMATION		347 2 Y-	N DUPAG	GE 40 33
		PLOT SCALE = 50.0000 '/ IN.	CHECKED ~	REVISED -T. RAMMACHER 02-02-99	DEPARTMENT OF TRANSPORTATION				TC-22	CONTRA	ACT NO. 60E65
		PLOT DATE = 3/19/2009	DATE -	REVISED - C. JUCIUS 01-31-07		SCALE: NONE	SHEET NO. 1 OF 1 SHEETS	STA. TO STA.	FED. ROAD DIST. NO. 1	LLINOIS FED. AID PROJECT	

