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3 SUMMARY OF QUANTITIES

12 27"X36" PPC DECK BEAM 13 27"X36" PPC DECK BEAM DETAILS 14 SOUTH ABUTMENT DETAILS 15 NORTH ABUTMENT DETAILS 16 STEEL RAILING, TYPE S-1 DETAILS

17 HP PILE DETAILS 18-21 BORING LOGS 22-28 CROSS SECTIONS

4 TYPICAL SECTIONS 5 SCHEDULE OF QUANTITIES 6-7 PLAN AND PROFILE 8-9 EROSION CONTROL PLAN 10 GENERAL PLAN AND ELEVATION 11 RIPRAP AND PILE LAYOUT

1 COVER SHEET 06-11-2021 LETTING ITEM 194 2 GENERAL NOTES AND PROJECT CONTROL

STATE OF ILLINOIS


DEPARTMENT OF TRANSPORTATION

SECTION 17-14123-00-BR BUREAU 29 WHA* 1340D20 Contract No. 87762


PLANS FOR PROPOSED FEDERAL AID PROJECT SURFACE TRANSPORTATION PROGRAM - BRIDGE (FY-21)

T.R. 130 (1100 E. ST.) SECTION 17-14123-00-BR PROJECT 92AN(359) STRUCTURE REPLACEMENT **BUREAU COUNTY**

C-93-049-21

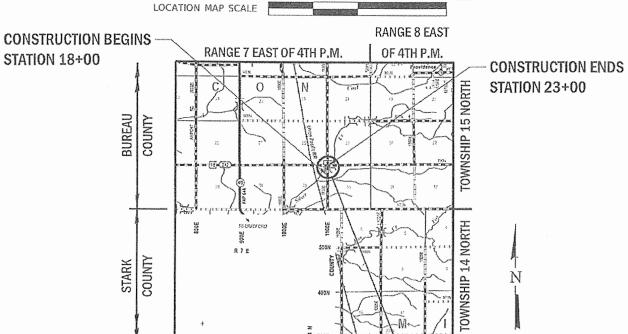

LOCATION OF SECTION INDICATED THUS: - -

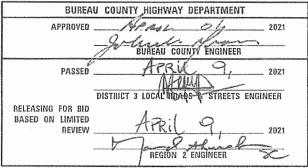




809 EAST 2ND STREET, DIXON, IL 61021-0367 T: 815-284-3381 DESIGN FIRM: #184-000918

	<u>STANDARDS</u>				
000001-08	STANDARD SYMBOLS, ABBREVIATIONS, AND PATTERNS				
001001-02	AREAS OF REINFORCEMENT BARS				
280001-07	TEMPORARY EROSION CONTROL SYSTEMS				
515001-04	NAME PLATE FOR BRIDGES				
606001-07	CONCRETE CURB TYPE B AND COMBINATION CONCRETE CURB AND GUTTER				
701301-04	LANE CLOSURE, 2L, 2W, SHORT TIME OPERATIONS				
701801-06	SIDEWALK CLOSURE OR CROSSWALK CLOSURE				
701901-08	TRAFFIC CONTROL DEVICES				
720001-01	SIGN PANEL MOUNTING DETAILS				
720011-01	METAL POSTS FOR SIGNS, MARKERS & DELINEATORS				
728001-01	TELESCOPING STEEL SIGN SUPPORT				
729001-01	APPLICATIONS OF TYPE A & B METAL POSTS (FOR SIGNS & MARKERS)				
725001-01	OBJECT AND TERMINAL MARKERS				

29 REGION 2 STANDARD (TRAFFIC CONTROL FOR ROAD CLOSURE)

FOR LIST OF UTILITIES SEE SHEET NO. 2

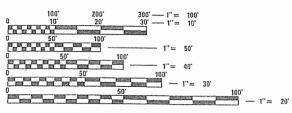

FULL SIZE PLANS HAVE BEEN PREPARED USING STANDARD ENGINEERING SCALES, REDUCED SIZED PLANS WILL NOT CONFORM TO STANDARD SCALES, IN MAKING MEASUREMENTS ON REDUCED PLANS, THE ABOVE SCALES MAY BE USED.

JOINT UTILITY LOCATION INFORMATION FOR EXCAVATION 1-800-892-0123 OR 811

PROJECT ENGINEER - JKP PROJECT MANAGER - DCB

CONTRACT NO. 87762

FUNCTIONAL CLASSIFICATION LOCAL ROAD (NON-URBAN) **DESIGN SPEED 30 NIPH** 2021 ADT = 90

STATION 18+00

PROPOSED STRUCTURE: S.N. 006-4191 A SINGLE SPAN (1@60'-0") PRECAST PRESTRESSED CONCRETE

DECK BEAM BRIDGE ON SPILL-THRU ABUTMENTS, SKEWED 10°

NET LENGTH = 500 FT. = 0.095 MILE

GROSS LENGTH = 500 FT. = 0.095 MILE

Know what's below. Call before you dig.

3R GUIDELINES

GENERAL NOTES

EXISTING STRUCTURES (INCLUDING FOUNDATIONS, WALLS, CISTERNS, WELLS, OR OTHER UNDERGROUND STRUCTURES) WITHIN THE RIGHT OF WAY SHALL BE REMOVED IN ACCORDANCE WITH ARTICLE 501.04 AND 501.05 OF THE STANDARD SPECIFICATIONS, WITHOUT ADDITIONAL COMPENSATION, UNLESS OTHERWISE NOTED IN THE PLANS OR

WHERE THE PROPOSED CONSTRUCTION MEETS AN EXISTING BITUMINOUS OR CONCRETE SURFACE, OR WHERE SAWING IS STATED ON THE PLANS, THE EXISTING SURFACE SHALL BE SAWED TO A SUFFICIENT DEPTH AND IN A NEAT, STRAIGHT LINE WITH NO DAMAGE TO THE EXISTING PAVEMENT TO REMAIN. COST OF SAWING SHALL BE INCIDENTAL TO THE CONTRACT.

THE FINAL TOP FOUR INCHES OF SOIL IN ANY RIGHT-OF-WAY AREA DISTURBED BY THE CONTRACTOR MUST BE A COHESIVE SOIL CAPABLE OF SUPPORTING VEGETATION.

THE CONTRACTOR SHALL SEED ALL DISTURBED AREAS WITHIN THE PROJECT LIMITS.

THE LOCATION AND ELEVATION OF UNDERGROUND UTILITIES AS SHOWN ON THE PLANS ARE NOT TO BE TAKEN AS EXACT. THE CONTRACTOR SHALL VERIFY AND LOCATE ALL EXISTING UTILITIES ON OR ADJACENT TO THE SITE. PRIOR TO BEGINNING CONSTRUCTION ACTIVITIES, CONTACT J.U.L.I.E. AT 1-800-892-0123 FOR EXACT FIELD LOCATION OF UTILITIES. CONTRACTOR SHALL USE SPECIAL CARE WHEN CONDUCTING CONSTRUCTION OPERATIONS NEAR THEM TO PREVENT DAMAGE. DAMAGE, AND THE COST TO REPAIR SAID DAMAGE, SHALL BE THE SOLE RESPONSIBILITY OF THE CONTRACTOR.

A MINIMUM OF 48 HOURS ADVANCED NOTICE IS REQUIRED FOR NON-EMERGENCY WORK. THE JULIE NUMBER IS 800-892-0123. THE FOLLOWING UTILITIES ARE LOCATED WITHIN THE PROJECT LIMITS OR IMMEADIATELY ADJACENT TO THE PROJECT CONSTRUCTION LIMITS:

CORN BELT ENERGY CORPORATION ATTN: JAY IVERS 1 ENERGY WAY BLOOMINGTON, IL 61028 309-662-5330

ATTN: TERRY SPURGEON 112 ELM STREET SYCAMORE IL 61078 PHONE: (815) 895--1515

FRONTIER COMMUNICATION ATTN: WILLIAM CONOVER 8515 N INDUSTRIAL RD. PEORIA, IL 61615 PHONE: (309) 686-3317

IDOT IS NOT A MEMBER OF JULIE. IF YOU ARE NEAR ANY OVERHEAD LIGHTING, INTERSECTION LIGHTING, OR TRAFFIC SIGNALS, PLESE CONTACT IDOT DISTRICT 3OFFICE AT 815 - 434 - 6131

SEE CROSS SECTIONS FOR SPECIAL DITCHES AND BACK SLOPES.

WHENEVER, DURING CONSTRUCTION OPERATIONS, ANY DEBRIS IS DEPOSITED IN THE FLOW LINE OF DRAINAGE STRUCTURES, DITCHES, ETC. SUCH THAT THE NATURAL FLOW LINE OF WATER IS OBSTRUCTED, THIS DEBRIS SHALL BE REMOVED AT THE CLOSE OF EACH WORKING DAY. AT THE CONCLUSION OF CONSTRUCTION OPERATIONS, ALL DRAINAGE STRUCTURES AND FLOW LINES SHALL BE FREE FROM DIRT AND DEBRIS.

DURING CONSTRUCTION OPERATIONS, THE CONTRACTOR SHALL INSURE POSITIVE SITE DRAINAGE AT THE CONCLUSION OF EACH DAY. SITE DRAINAGE MAY BE ACHIEVED BY DITCHING, PUMPING, OR ANY OTHER METHOD ACCEPTABLE TO THE ENGINEER. THE CONTRACTORS FAILURE TO PROVIDE THE ABOVE WILL PRECLUDE AND POSSIBLE ADDED COMPENSATION REQUIRED DUE TO DELAYS OR UNSUITABLE MATERIALS CREATED AS A RESULT THEREOF.

THE CONTRACTOR SHALL BE RESPONSIBLE FOR ADJUSTING THE EROSION CONTROL MEASURES DURING THE COURSE OF THE PROJECT.

AT THE END OF EACH WORK DAY, THE CONTRACTOR SHALL SWEEP OR CLEAN (NOT FLUSH) ANY CONSTRUCTION SOIL MATERIAL FROM THE STREET TO PREVENT TRACKING

THE ENGINEER SHALL HAVE AUTHORIZATION TO DETERMINE THE ADEQUACY OF THE CONTRACTOR'S EROSION CONTROL EFFORTS. THE OWNER SHALL HAVE AUTHORITY TO SUSPEND OR LIMIT THE CONTRACTOR'S OPERATIONS PENDING ADEQUATE PERFORMANCE.

VIIA	WILLETT HOFMANN & A S S O C I A T E S I N C
	ENGINEERING ARCHITECTURE LAND SURVEYING
	809 EAST 2ND STREET, DIXON, IL 61021-0367 T: 815-284-3381 DESIGN FIRM: #184-000918

DESIGNED	-	JKP	REVISED -	
CHECKED	-	DCB	REVISED -	
DRAWN	-	RDA	REVISED -	
CHECKED	-	BKC	REVISED -	

T.R. 130

HORIZONTAL CONTROL

	BUREAU COUNTY BRIDGE REPLACEMENT T.R. 130 OVER SILVER CREEK							
PT # LOCATION NORTHING EASTING DESCRIPTION								
MN 1	22.15' LT. STA. 16+69.21	1,668,398.773	2,440,073.069	%" IPS				
MN 2	10.60' LT. STA. 19+45.02	1,668,674.859	2,440,082.789	%" IPS				
MN 3	13.48 RT. STA. 20+45.81	1,668,775.707	2,440,106.629	%" IPS				
MN 4	18.48' LT. STA. 23+11.45	1,669,041.321	2,440,074.754	%" IPS				

BENCHMARKS

BUREAU COUNTY BRIDGE REPLACEMENT T.R. 130 OVER SILVER CREEK					
B.M. LOCATION DESCRIPTION ELEV.					
MN 400	2ND POLE S. OF STRUCTURE	RR SPIKE IN UTILITY POLE	763.21		
MN 401	30' RT. STA. 17+79	RR SPIKE IN UTILITY POLE	761.67		
MN 402	10' LT. STA. 20+23	CHIS "□" ON NW COR. OF STRUCTURE	762.25		
MN 403	34' RT. STA. 23+03	RR SPIKE IN UTILITY POLE	765.12		

							Ę
BUREAU COUNTY	OFNERAL MOTES & RRO JEST CONTROL	T.R.	SECTION	COUNTY	TOTAL SHEETS	SHEET NO.	ent
0 (1100 E. STREET) OVER SILVER CREEK	GENERAL NOTES & PROJECT CONTROL	130	17-14123-00-BR	BUREAU	29	2	E n o
STATION 20 + 00			Contract No. 87762	WHA#	1340D20		° G
STATION ZUTOU	SHEET NO. 1 OF 1 SHEET		ILLINOIS	PN# S	2AN(359)		Ē

SUMMARY OF QUANTITIES CONSTRUCTION TYPE CODE: 0010

		CONSTRUCTION TYPE CODE: 0010		
	CODE NO.	ITEM	UNIT	QUANTITY
	20300100	CHANNEL EXCAVATION	CU YD	71
	20400800	FURNISHED EXCAVATION	CU YD	116
	25100630	EROSION CONTROL BLANKET	SQ YD	1,700
	28000250	TEMPORARY EROSION CONTROL SEEDING	POUND	37
	28000305	TEMPORARY DITCH CHECKS	FOOT	64
	28000400	PERIMETER EROSION BARRIER	FOOT	538
		· · · · · · · · · · · · · · · · · · ·	1001	330
*	28100209	STONE RIPRAP, CLASS A5	TON	475
	20100203	STORE RITINAL, CEASS AS	TON	4/3
	40200100	AGGREGATE SURFACE COURSE, TYPE A	TON	665
	40200100	AGGREGATE SURFACE COURSE, TIPE A	TON	665
	50100100	DEMONIT OF THE THE STREET		
	50100100	REMOVAL OF EXISTING STRUCTURES	EACH	1

*	50300225	CONCRETE STRUCTURES	CU YD	29.4
	50300280	CONCRETE ENCASEMENT	CU YD	3.6
	50400505	PRECAST PRESTRESSED CONCRETE DECK BEAMS (27" DEPTH)	SQ FT	1,440
	50800205	REINFORCEMENT BARS, EPOXY COATED	POUND	3,560
*	50900205	STEEL RAILING, TYPE S1	FOOT	123
	51201610	FURNISHING STEEL PILES HP12X63	FOOT	316
		1 of a filter of a part of the		
	51202305	DRIVING PILES	FOOT	316
	51203610	TEST PILE STEEL HP12X63	EACH	2
				The state of the s
	51204650	PILE SHOES	EACH	10
	51500100	NAME PLATES	EACH	1
			1,7011	-
	67100100	MOBILIZATION	L SUM	1
	0,100100	PROTETZATION	L SUM	1
	72500200	ODUSCE MADINED TYPE 2		
4	72500300	OBJECT MARKER - TYPE 3	EACH	4
Δ	72900100	METAL POST - TYPE A	FOOT	44

SUMMARY OF QUANTITIES
CONSTRUCTION TYPE CODE: 0010

ſ	CODE NO.	<u>I TEM</u>	UNIT	QUANTITY
*	Z0013798	CONSTRUCTION LAYOUT	L SUM	1
*	X2020410	EARTH EXCAVATION (SPECIAL)	CU YD	244
*	X2070302	POROUS GRANULAR EMBANKMENT, SPECIAL	TON	138
*	X2501100	SEEDING, CLASS 3 (SPECIAL)	ACRE	0.37
*	X7010216	TRAFFIC CONTROL AND PROTECTION, (SPECIAL)	L SUM	1

*SEE SPECIAL PROVISIONS

*SEE SPECIAL PROVISIONS A SPECTALTY ITEMS




DESIGNED	-	JKP	REVISED -	Ī
CHECKED	-	DCB	REVISED -	
DRAWN	-	RDA	REVISED -	
CHECKED	-	BKC	REVISED -	

BUREAU COUNTY
T.R. 130 (1100 E. STREET) OVER SILVER CREEK
STATION 20+00

SUMMARY OF QUANTITIES	T.R.	SECT
SUMMARY OF QUANTITIES	130	17-14123
	Co	ntract No. 8
SHEET NO 1 OF 1 SHEET		

T.R.	SECTION	COUNTY	TOTAL	SHEE NO.
130	17-14123-00-BR	BUREAU	29	3
Coi	ntract No. 87762	WHA#	1340D20	
	ILLINOIS	PN= 9	2AN(359)	

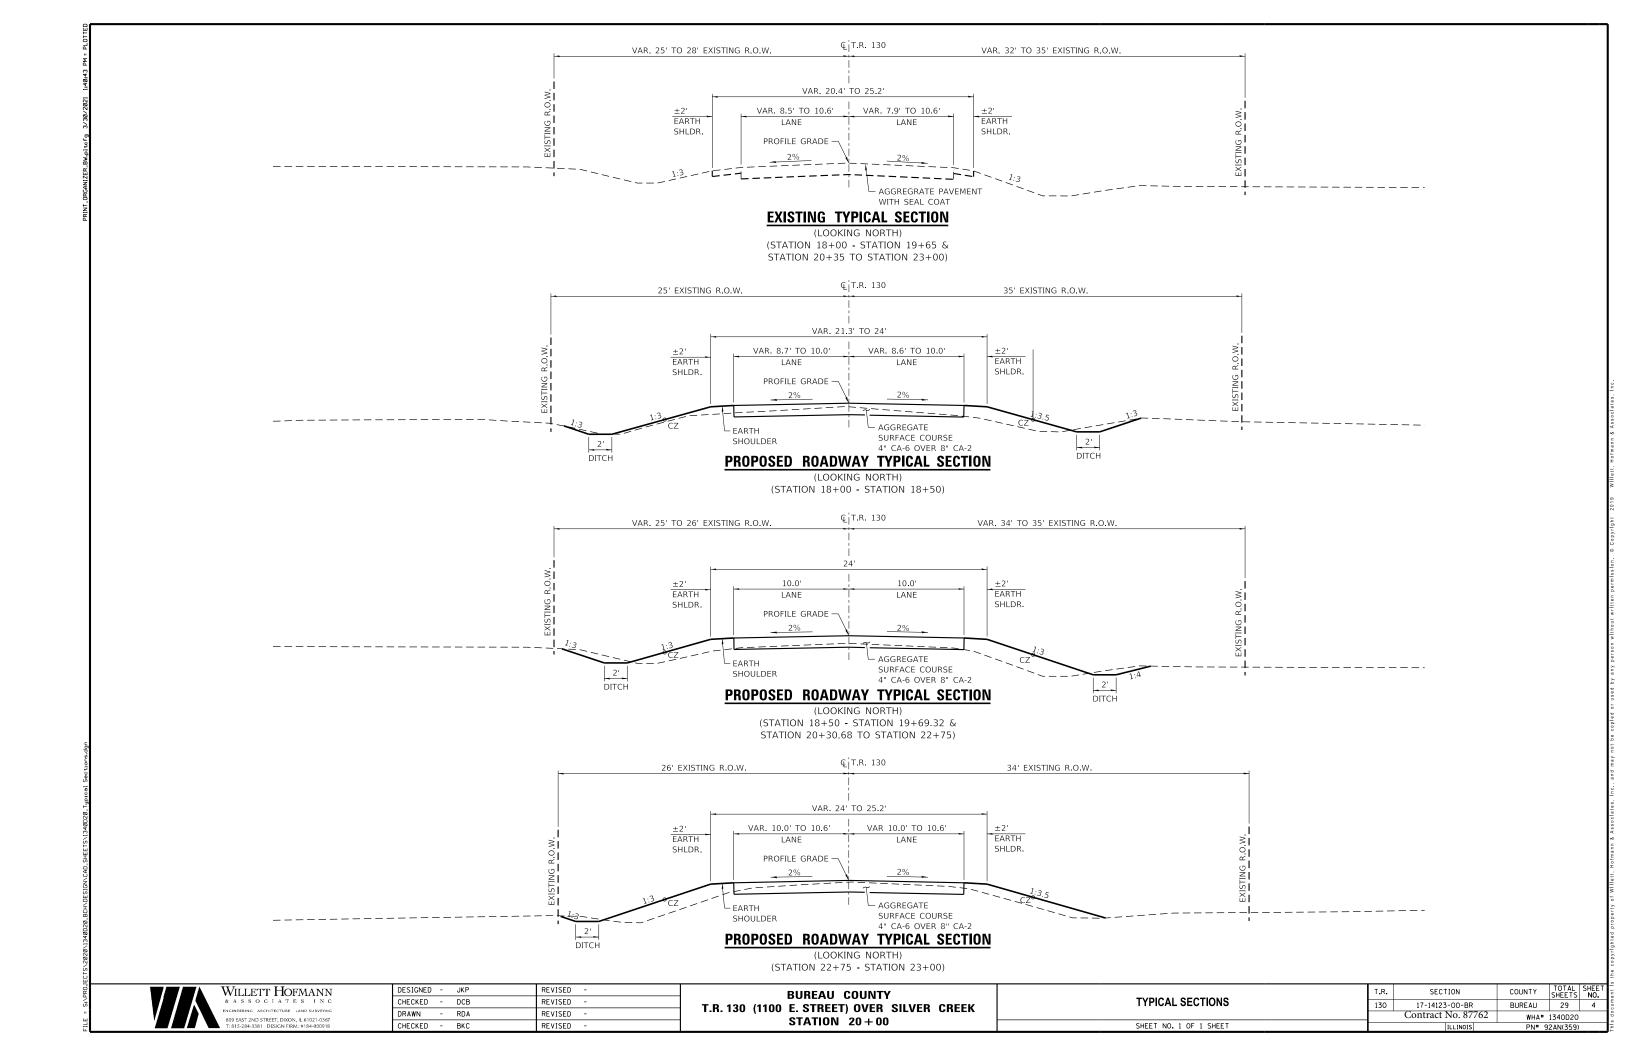

SCHEDULE OF QUANTITIES

	TR 130 EAR	THWORK TOTALS		
LOCATION	EARTH EXCAVATION (SPECIAL) *X2020410	EARTH EXCAVATION ADJUSTED FOR SHRINKAGE 25%	*EMBANKMENT	EARTHWORK BALLANCE (+) WASTE OR (-) FURNISHED EXCAVATION 20400800
	CU YD	CU YD	CU YD	CU YD
STA 18+00 - 23+00	244	183	299	-116
PROJECT TOTAL	244	183	299	-116
FOR INFORMATION ONLY, SEE SPE	CIAL PROVISIONS	FOR EARTH EXCA	VATION (SPECIAL	_)

EROSION CONTROL BLANKET				
STATION	SQ. YD.	REMARKS		
LT STA 18+00 - 19+68	239			
RT STA 18+00 - 19+72	419			
LT STA 20+28 - 23+00	400			
RT STA 20+33 - 23+00	642			
PROJECT TOTAL	1700			
25100630				

TEMPORARY	ERC	SION	CONTROL	SEEDING
STATION		POUND		REMARKS
			100 lb. /	ACRE
LT STA 18+00 - 19+68		5		
RT STA 18+00 - 19+72		9		
LT STA 20+28 - 23+00		9		
RT STA 20+33 - 23+00		14		
PROJECT TOTAL		37		
28000250				

TEMPORARY DITCH CHECKS				
FOOT	REMARKS			
8				
8				
8				
8				
8				
8				
8				
8				
64				
	8 8 8 8 8 8 8 8 8 8 8 8			

SCHEDULE OF QUANTITIES - CONT.

PERIMETER	EROSIC	NC	BARRIER
STATION	FOOT		REMARKS
LT STA 18+00 - 19+57	157		
RT STA 18+00 - 19+63	163		
LT STA 20+38 - 21+00	62		
RT STA 20+44 - 22+00	156		
PROJECT TOTAL	538		
28000400			

AGGREGATE SU	IRFACE	COURSE, TYPE A
STATION	TON	REMARKS
		4" CA-6 OVER 8" CA-2
STA 18+00 - 19+71	254	ROADWAY BASE - 12"
STA 20+29 - 23+00	411	ROADWAY BASE - 12"
		2.05 TON / CU YD
PROJECT TOTAL	665	
200100		


OBJECT MARKER – TYPE 3				
STATION	EACH	REMARKS		
13.8' LT STA 19+65.87	1			
14.2' RT STA 19+70.80	1			
14.2' LT STA 20+29.20	1			
13.8' RT STA 20+34.13	1			
PROJECT TOTAL	4			
72500300				


METAL POST — TYPE A				
STATION	FOOT	REMARKS		
13.8' LT STA 19+65.87	11	OBJECT MARKER - TYPE 3		
14.2' RT STA 19+70.80	11	OBJECT MARKER - TYPE 3		
14.2' LT STA 20+29.20	11	OBJECT MARKER - TYPE 3		
13.8' RT STA 20+34.13	11	OBJECT MARKER - TYPE 3		
PROJECT TOTAL	44			
72500300				


SCHEDULE OF QUANTITIES - CONT.

SEEDING, (CLASS 3	B (SPECIAL)
STATION	ACRE	REMARKS
LT STA 18+00 - 19+68	0.05	
RT STA 18+00 - 19+72	0.09	
LT STA 20+28 - 23+00	0.09	
RT STA 20+33 - 23+00	0.14	
PROJECT TOTAL	0.37	
*X2501100		

DESIGNED	-	JKP	KENIZED -
CHECKED	-	DCB	REVISED -
DRAWN	-	RDA	REVISED -
CHECKED	-	BKC	REVISED -

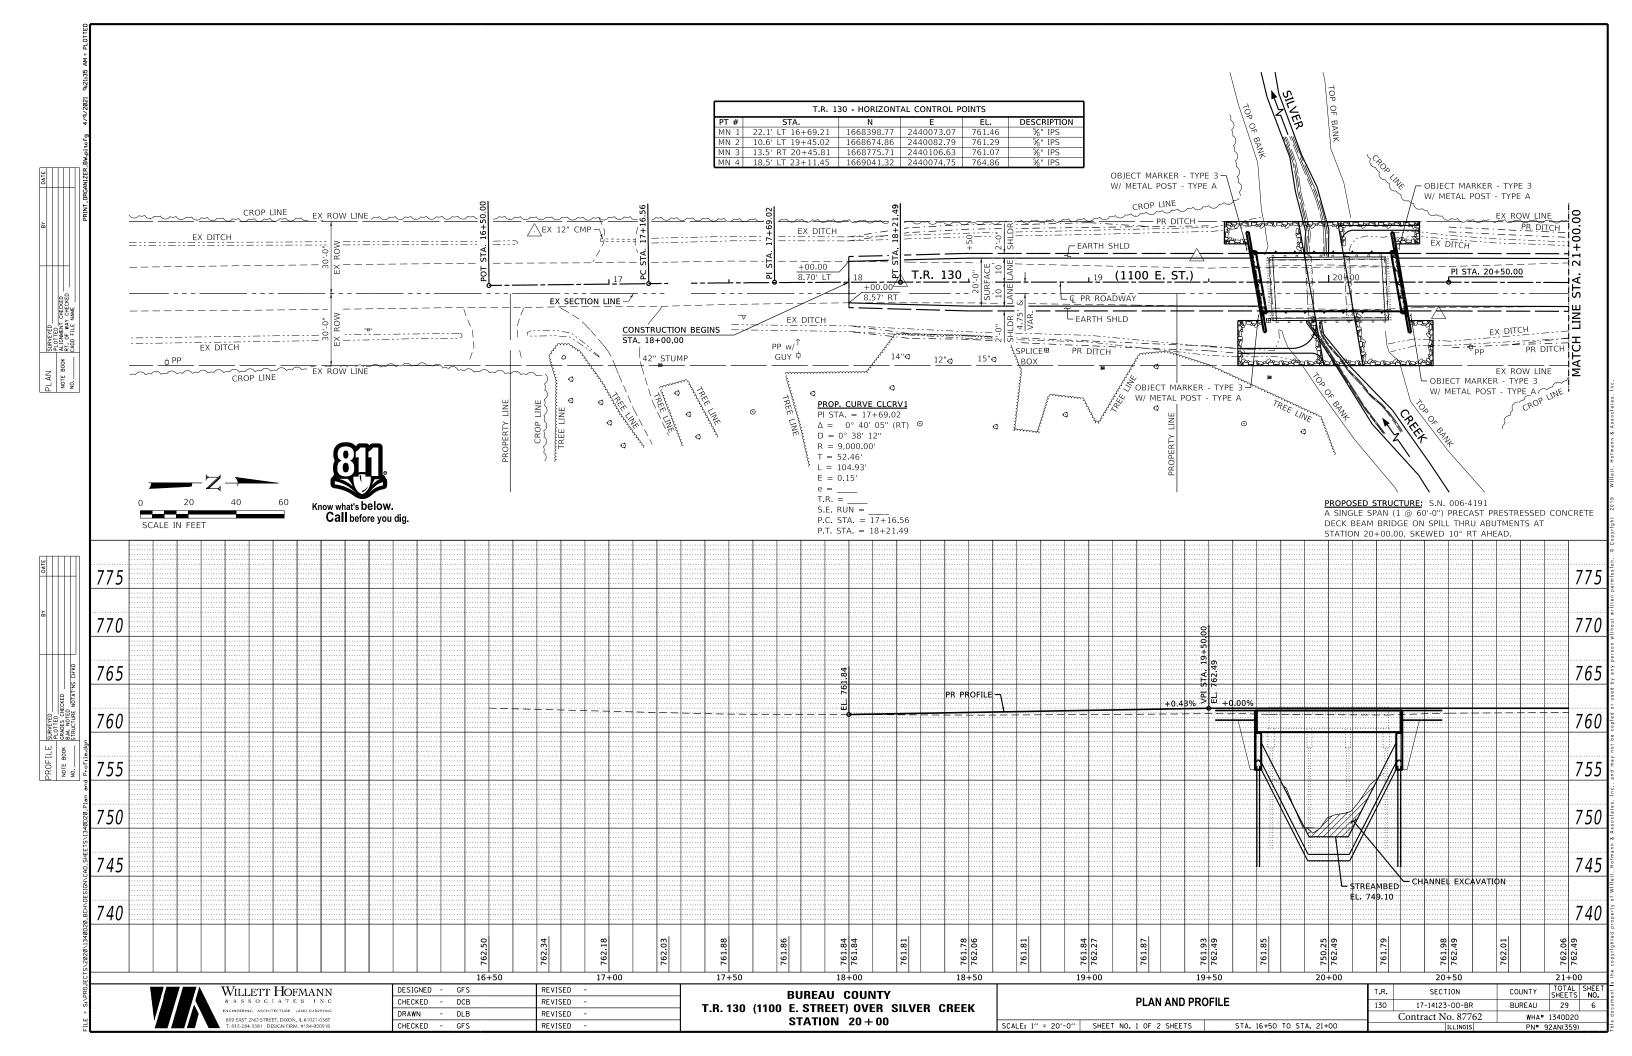

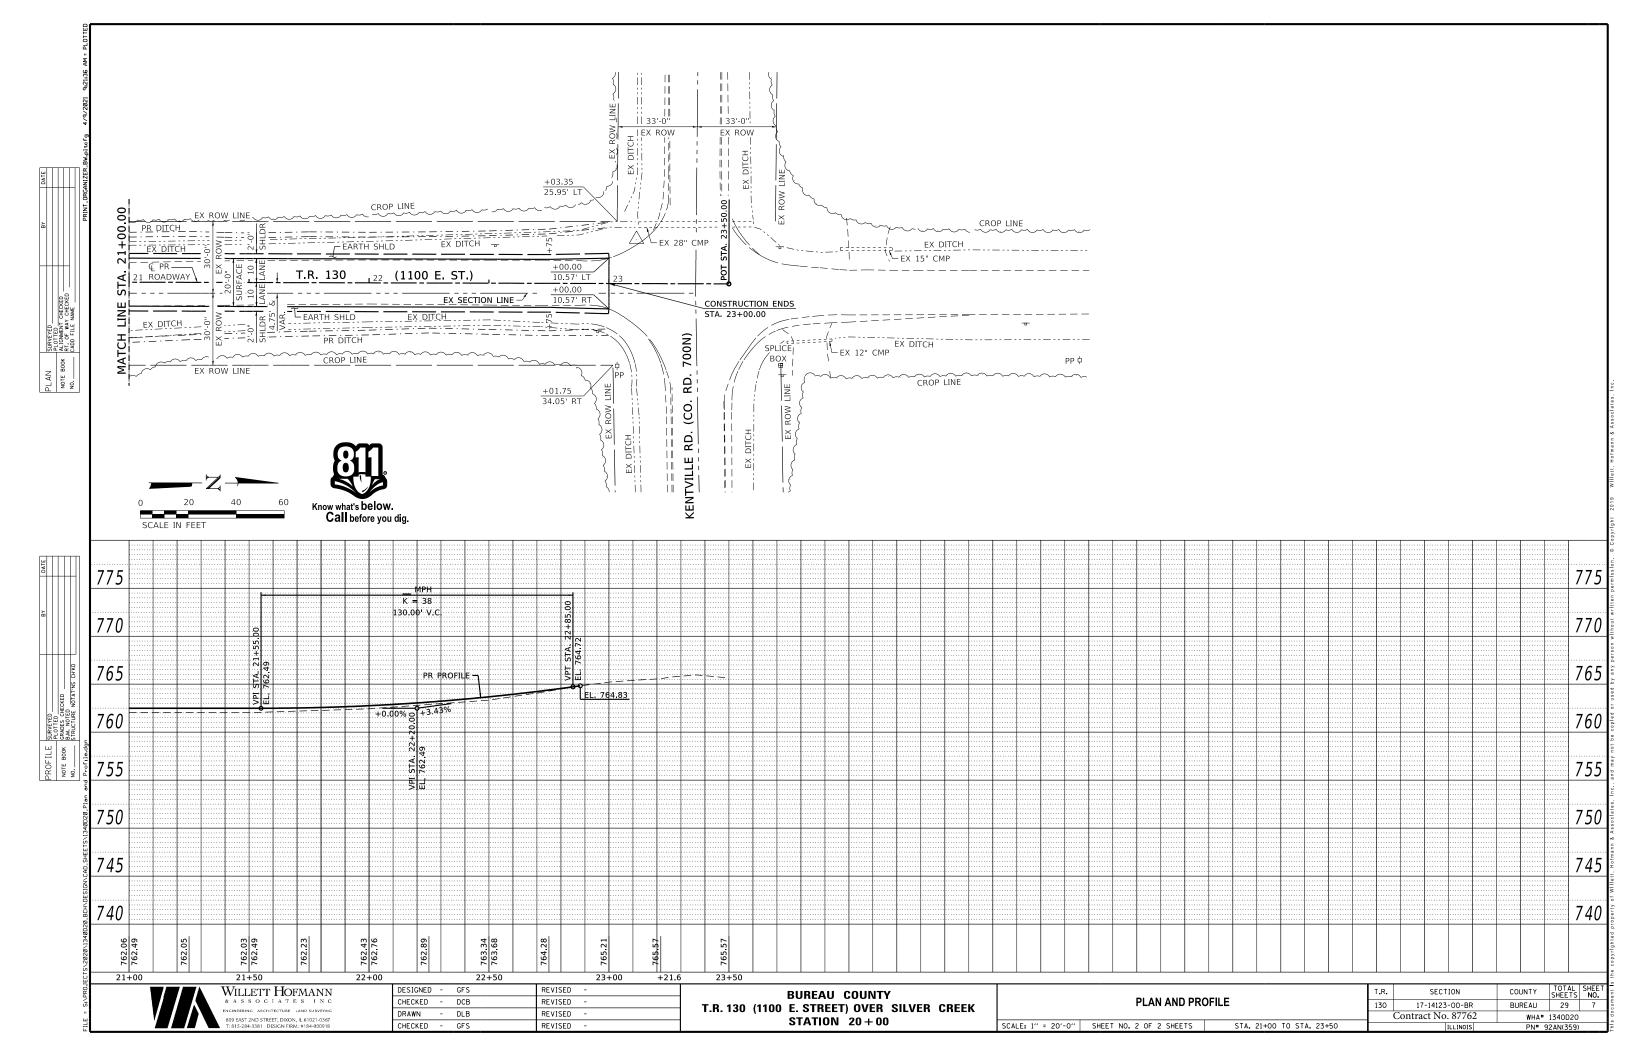

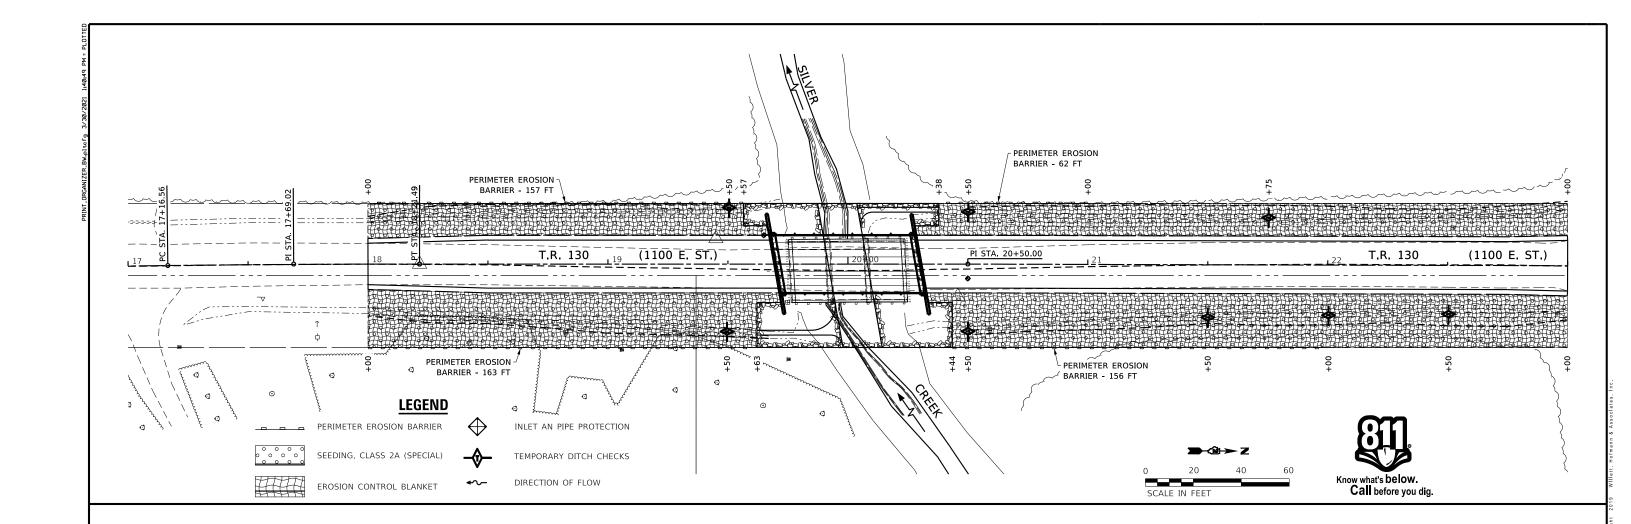

EROSION CONTROL NOTES

THE SOIL EROSION AND SEDIMENT CONTROL PRACTICES WILL BE INSPECTED WEEKLY AND AFTER ½" OF RAIN OR MORE BY THE INDIVIDUAL ON SITE IN CHARGE OF SOIL EROSION AND SEDIMENT CONTROL DURING THE CONSTRUCTION OF THE PROJECT.

PERIMETER EROSION BARRIER SHALL COMPLY WITH SECTION 280 OF THE STANDARD SPECIFICATIONS AND SHALL BE PLACED AS SHOWN ON THE EROSION CONTROL PLAN AND IN ACCORDANCE WITH STATIONS SHOWN ON THE SCHEDULE OF QUANTITIES SHEET OR AS DIRECTED BY THE ENGINEER.

SILT FENCE SHALL BE INSTALLED FOLLOWING THE COMPLETION AND STABILIZATION OF ALL AREAS ADJACENT TO THE ON-SITE DRAINAGES. THE SILT FENCE WILL REMAIN IN PLACE UNTIL THE CONTRIBUTING AREA IS STABILIZED.

FOR SEEDING, CLASS 3 (SPECIAL) SEE SPECIAL PROVISIONS.

EROSION CONTROL BLANKET SHALL BE PLACED IN DITCHES AND TO ALL DISTURBED AREAS AS SHOWN ON THIS EROSION CONTROL PLAN SHEET AND IN ACCORDANCE WITH SECTION 251 OF THE STANDARD SPECIFICATIONS FOR ROAD AND BRIDGE CONSTRUCTION.

THE USE OF GREEN DYE IN THE EROSION CONTROL BLANKET IS NOT ACCEPTABLE.

TEMPORARY DITCH CHECKS SHALL COMPLY WITH SECTION 280 OF THE STANDARD SPECIFICATIONS FOR ROAD AND BRIDGE CONSTRUCTION AND STANDARD 280001-07.

TEMPORARY DITCH CHECKS SHALL BE PLACED AT STATIONS CALLED OUT IN THE SCHEDULE OF QUANTITIES OR AS DIRECTED BY THE ENGINEER.

STOCKPILES OF SOIL AND OTHER BUILDING MATERIALS TO REMAIN IN PLACE MORE THAN THREE (3) DAYS SHALL BE FURNISHED WITH EROSION AND SEDIMENT CONTROL MEASURES (I.E. PERIMETER SILT FENCE). STOCKPILES TO REMAIN IN PLACE FOR 14 DAYS OR MORE SHALL RECEIVE TEMPORARY SEEDING.

ALL ADJACENT ENTRANCES MUST BE KEPT CLEAR OF DEBRIS. INSPECTED DAILY AND CLEANED WHEN NECESSARY.

BILL OF MATERIAL

ITEM	UNIT	QUANTITY
EROSION CONTROL BLANKET	SQ YD	1700
TEMPORARY EROSION CONTROL SEEDING	POUND	37
TEMPORARY DITCH CHECKS	FOOT	64
PERIMETER EROSION BARRIER	FOOT	538
SEEDING, CLASS 3 (SPECIAL)	ACRE	0.37

VIIA	WILLETT HOFMANN
	ENGINEERING ARCHITECTURE LAND SURVEYING
	809 EAST 2ND STREET, DIXON, IL 61021-0367 T: 815-284-3381 DESIGN FIRM: #184-000918

CHECKED	-	BKC	REVISED -
DRAWN	-	RDA	REVISED -
CHECKED	-	DCB	REVISED -
DESIGNED	-	JKP	REVISED -

BUREAU COUNTY
T.R. 130 (1100 E. STREET) OVER SILVER CREEK
STATION 20+00

		T.R.	SECTION	COUNTY	TOTAL SHEETS	SHEET NO.
EROSION CONTR	OL PLAN	130	17-14123-00-BR	BUREAU	29	8
	Contract No. 87762		WHA#	1340D20		
SCALE: 1" = 20'-0" SHEET NO. 1 OF 2 SHEETS	STA. 17+00 TO STA. 23+00		ILLINOIS	PN# S	(2AN(359)	

THE FOLLOWING PLAN IS ESTABLISHED AND INCORPORATED IN THE PROJECT TO DIRECT THE CONTRACTOR IN THE PLACEMENT OF TEMPORARY EROSION CONTROL SYSTEMS AND TO PROVIDE A STORM SEWER WATER POLLUTION PREVENTION PLAN FOR COMPLIANCE UNDER NPDES.

THE PURPOSE OF THIS PLAN IS TO MINIMIZE EROSION WITHIN THE CONSTRUCTION SITE AND TO LIMIT SEDIMENTS FROM LEAVING THE CONSTRUCTION SITE BY UTILIZING PROPER TEMPORARY EROSION CONTROL SYSTEMS AND PROVIDING GROUND COVER WITHIN A REASONABLE AMOUNT OF TIME.

CERTAIN EROSION CONTROL FACILITIES SHALL BE INSTALLED BY THE CONTRACTOR AT THE BEGINNING OF CONSTRUCTION. OTHER ITEMS SHALL BE INSTALLED BY THE CONTRACTOR AS DIRECTED BY THE ENGINEER ON A CASE BY CASE SITUATION DEPENDING ON THE CONTRACTOR'S SEQUENCE OF ACTIVITIES, TIME OF YEAR, AND EXPECTED WEATHER CONDITIONS.

THE CONTRACTOR SHALL INSTALL PERMANENT EROSION CONTROL SYSTEMS AND SEEDING WITHIN A TIME FRAME SPECIFIED HEREIN AND AS DIRECTED BY THE ENGINEER, THEREFORE MINIMIZING THE AMOUNT OF AREA SUSCEPTIBLE TO EROSION AND REDUCING THE AMOUNT OF TEMPORARY SEEDING. THE ENGINEER WILL DETERMINE IF ANY TEMPORARY EROSION CONTROL SYSTEMS SHOWN IN THE PLAN CAN BE DELETED AND IF ANY ADDITIONAL TEMPORARY EROSION CONTROL SYSTEMS, WHICH ARE NOT INCLUDED IN THIS PLAN, SHALL BE ADDED. THE CONTRACTOR SHALL PERFORM ALL WORK AS DIRECTED BY THE ENGINEER AND AS SHOWN IN STANDARD 280001 OF THE PLANS.

SECTION 280, TEMPORARY EROSION CONTROL, OF THE STANDARD SPECIFICATIONS ADDITIONALLY SUPPLEMENTS, THIS PLAN

SITE DESCRIPTION

DESCRIPTION OF CONSTRUCTION ACTIVITY:

- THE PROJECT CONSISTS OF A BRIDGE REPLACEMENT ON T.R. 130 OVER SILVER CREEK & APPROACH ROADWAY WORK THERETO.
- 2. CONSTRUCTION INCLUDES EARTH EXCAVATION, CHANNEL EXCAVATION, VARIOUS PAVEMENT ITEMS, AND OTHER MISCELLANEOUS ITEMS OF CONSTRUCTION.

DESCRIPTION OF INTENDED SEQUENCE FOR MAJOR CONSTRUCTION ACTIVITIES WHICH WILL DISTURB SOILS FOR MAJOR PORTIONS OF THE CONSTRUCTION SITE:

- 1. EARTH EXCAVATION.
- 2. CHANNEL EXCAVATION
- 3. FURNISHED EXCAVATION.
- 4. ROADWAY AGGREGATE BASE AND SHOULDERS
- 5. PLACEMENT OF PERMANENT EROSION CONTROL INCLUDING SEEDING AND RIPRAP.

AREA OF CONSTRUCTION SITE:

THE TOTAL AREA OF THE CONSTRUCTION SITE IS ESTIMATED TO BE 0.69 ACRES OF WHICH 0.69 ACRES WILL BE DISTURBED BY EXCAVATION, GRADING, AND OTHER ACTIVITIES.

OTHER REPORTS, STUDIES AND PLANS WHICH AID IN THE DEVELOPMENT OF THE STORM WATER POLLUTION PREVENTION PLAN AS REFERENCED DOCUMENTS:

- INFORMATION OF THE SOILS AND TERRAIN WITHIN THE SITE WAS OBTAINED FROM SOIL BORINGS THAT WERE UTILIZED FOR THE DEVELOPMENT OF THE PROPOSED TEMPORARY EROSION CONTROL SYSTEMS.
- 2. PROJECT PLAN DOCUMENTS, SPECIFICATIONS AND SPECIAL PROVISIONS, AND PLAN DRAWINGS INDICATING DRAINAGE PATTERNS AND APPROXIMATE SLOPES ANTICIPATED AFTER GRADING ACTIVITIES WERE UTILIZED FOR THE PROPOSED PLACEMENT OF THE TEMPORARY EROSION CONTROL SYSTEMS.

DRAINAGE TRIBUTARIES AND SENSITIVE AREAS RECEIVING RUNOFF FROM THIS CONSTRUCTION SITE:

SILIVER CREEK AND FOX CREEK

CONTROLS — EROSION CONTROLS AND SEDIMENT CONTROL DESCRIPTION OF STABILIZATION PRACTICES AT THE BEGINNING OF CONSTRUCTION.

- 1. THE DRAWINGS, SPECIFICATIONS AND SPECIAL PROVISIONS WILL ENSURE THAT EXISTING VEGETATION IS PRESERVED WHERE ATTAINABLE AND DISTURBED PORTIONS OF THE SITE WILL BE STABILIZED. STABILIZATION PRACTICES INCLUDE: TEMPORARY SEEDING, PERMANENT SEEDING, PERIMETER EROSION BARRIER, AND OTHER APPROPRIATE MEASURES AS DIRECTED BY THE ENGINEER. STABILIZATION MEASURES SHALL BE INITIATED AS SOON AS PRACTICABLE IN PORTIONS OF THE SITE WHERE CONSTRUCTION ACTIVITIES HAVE TEMPORARILY OR PERMANENTLY CEASED, BUT IN NO CASE MORE THAN 7 DAYS AFTER THE CONSTRUCTION ACTIVITY IN THAT PORTION OF THE SITE HAS TEMPORARILY OR PERMANENTLY CEASED.
- (A) AREAS OF EXISTING VEGETATION (WOOD AND GRASSLANDS) OUTSIDE THE PROPOSED CONSTRUCTION LIMITS SHALL BE IDENTIFIED BY THE ENGINEER FOR PRESERVING AND SHALL BE PROTECTED FROM CONSTRUCTION ACTIVITIES.
- (B) DEAD, DISEASED, OR UNSUITABLE VEGETATION WITHIN THE SITE SHALL BE REMOVED AS DIRECTED BY THE ENGINEER, ALONG WITH REQUIRED TREE REMOVAL.

- (C) AS SOON AS REASONABLE ACCESS IS AVAILABLE TO ALL LOCATIONS WHERE WATER DRAINS AWAY FROM THE PROJECT, TEMPORARY DITCH CHECKS AND PERIMETER EROSION BARRIER SHALL BE INSTALLED AS CALLED OUT IN THIS PLAN AND DIRECTED BY THE ENGINEER.
- (D) BARE AND SPARSELY VEGETATED GROUND IN HIGHLY ERODIBLE AREAS AS DETERMINED BY THE ENGINEER SHALL BE TEMPORARILY SEEDED AT THE BEGINNING OF CONSTRUCTION WHERE NO CONSTRUCTION ACTIVITIES ARE EXPECTED WITHIN 7 DAYS.
- (E) AT LOCATIONS WHERE A SIGNIFICANT AMOUNT OF WATER DRAINS INTO THE CONSTRUCTION ZONE FROM OUTSIDE AREAS (ADJACENT LANDOWNERS), TEMPORARY DITCH CHECKS WILL BE UTILIZED TO LOCALLY DIVERT WATER, REDUCE FLOW RATES, AND COLLECT OUTSIDE SILTATION INSIDE THE RIGHT-OF-WAY LINE
- ESTABLISHMENT OF THESE TEMPORARY EROSION CONTROL MEASURES WILL HAVE ADDITIONAL BENEFITS TO THE PROJECT. DESIRABLE GRASS SEED WILL BECOME ESTABLISHED IN THESE AREAS AND WILL SPREAD SEEDS ONTO THE CONSTRUCTION SITE UNTIL PERMANENT SEEDING/MOWING AND OVER SEEDING CAN BE COMPLETED.

DESCRIPTION OF STABILIZATION PRACTICES DURING CONSTRUCTION:

- 1. DURING CONSTRUCTION, AREAS OUTSIDE THE CONSTRUCTION LIMITS AS OUTLINED PREVIOUSLY HEREIN SHALL BE PROTECTED. THE CONTRACTOR SHALL NOT USE THIS AREA FOR STAGING (EXCEPT AS DESCRIBED ON THE PLANS AND DIRECTED BY THE ENGINEER), PARKING OF VEHICLES OR CONSTRUCTION EQUIPMENT, STORAGE OF MATERIALS, OR OTHER CONSTRUCTION RELATED ACTIVITIES.
- (A) WITHIN THE CONSTRUCTION LIMITS, AREAS WHICH MAY BE SUSCEPTIBLE TO EROSION AS DETERMINED BY THE ENGINEER SHALL REMAIN UNDISTURBED UNTIL FULL SCALE CONSTRUCTION IS UNDERWAY TO PREVENT UNNECESSARY SOIL EROSION.
- (B) EARTH STOCKPILES SHALL BE TEMPORARILY SEEDED IF THEY ARE TO REMAIN UNUSED FOR MORE THAN 14 DAYS.
- (C) AS CONSTRUCTION PROCEEDS, THE CONTRACTOR SHALL INSTITUTE THE FOLLOWING AS DIRECTED BY THE ENGINEER:
 - PLACE TEMPORARY EROSION CONTROL FACILITIES AT LOCATIONS SHOWN ON THE PLANS.
 - . TEMPORARILY SEED ERODIBLE BARE EARTH ON A WEEKLY BASIS TO MINIMIZE THE AMOUNT OF ERODIBLE SURFACE AREA WITHIN THE CONTRACT LIMITS.
- (D) EXCAVATED AREAS AND EMBANKMENT SHALL BE PERMANENTLY SEEDED IMMEDIATELY AFTER FINAL GRADING. IF NOT, THEY SHALL BE TEMPORARILY SEEDED IF NO CONSTRUCTION ACTIVITY IN THE AREA IS PLANNED FOR 7 DAYS.
- (E) CONSTRUCTION EQUIPMENT SHALL BE STORED AND FUELED ONLY AT DESIGNATED LOCATIONS. ALL NECESSARY MEASURES SHALL BE TAKEN TO CONTAIN ANY FUEL OR OTHER POLLUTANT IN ACCORDANCE WITH EPA WATER QUALITY REGULATIONS. LEAKING EQUIPMENT OR SUPPLIES SHALL BE IMMEDIATELY REPAIRED OR REMOVED FROM THE SITE.
- (F) THE RESIDENT ENGINEER SHALL INSPECT THE PROJECT DAILY DURING CONSTRUCTION ACTIVITIES. INSPECTION SHALL ALSO BE DONE WEEKLY AND AFTER RAINS OF 1/2 INCH OR GREATER OR EQUIVALENT SNOWFALL DURING THE WINTER SHUTDOWN PERIOD. THE PROJECT SHALL ADDITIONALLY BE INSPECTED BY THE CONSTRUCTION FIELD ENGINEER ON A BI-WEEKLY BASIS TO DETERMINE THAT EROSION CONTROL EFFORTS ARE IN PLACE AND EFFECTIVE AND IF OTHER EROSION CONTROL WORK IS NECESSARY.
- (G) SEDIMENT COLLECTED DURING CONSTRUCTION OF THE VARIOUS TEMPORARY EROSION CONTROL SYSTEMS SHALL BE DISPOSED OF ON THE SITE ON A REGULAR BASIS AS DIRECTED BY THE ENGINEER. THE COST OF THIS MAINTENANCE SHALL BE INCLUDED IN THE UNIT BID PRICE FOR VARIOUS TEMPORARY EROSION CONTROL PAY ITEMS.
- (H) THE TEMPORARY EROSION CONTROL SYSTEMS SHALL BE REMOVED AS DIRECTED BY THE ENGINEER AFTER USE IS NO LONGER NEEDED OR NO LONGER FUNCTIONING. THE COST OF THIS REMOVAL SHALL BE INCLUDED IN THE UNIT BID PRICE FOR VARIOUS TEMPORARY EROSION CONTROL PAY ITEMS.

DESCRIPTION OF STRUCTURAL PRACTICES AFTER FINAL GRADING

- 1. TEMPORARY EROSION CONTROL SYSTEMS SHALL BE LEFT IN PLACE WITH PROPER MAINTENANCE UNTIL PERMANENT EROSION CONTROL IS IN PLACE AND WORKING PROPERLY AND ALL PROPOSED TURF AREAS SEEDED AND ESTABLISHED.
- ONCE PERMANENT EROSION CONTROL SYSTEMS AS PROPOSED IN THE PLANS ARE FUNCTIONAL AND ESTABLISHED, TEMPORARY ITEMS SHALL BE REMOVED, CLEANED UP, AND DISTURBED TURF RESEEDED.

MAINTENANCE AFTER CONSTRUCTION


1. CONSTRUCTION IS COMPLETE AFTER ESTABLISHED GROWTH & DIRECTED TO REMOVE EROSION CONTROL


MISCELLANEOUS


ALL EROSION CONTROL PRODUCTS FURNISHED SHALL BE SPECIFICALLY RECOMMENDED BY THE MANUFACTURER FOR THE USE SPECIFIED IN THE EROSION CONTROL PLAN. PRIOR TO THE APPROVAL AND USE OF THE PRODUCT, THE CONTRACTOR SHALL SUBMIT TO THE ENGINEER A NOTARIZED CERTIFICATION BY THE PRODUCER STATING THE INTENDED USE OF THE PRODUCT AND THAT THE PHYSICAL PROPERTIES REQUIRED FOR THIS APPLICATION ARE MET OR EXCEEDED. THE CONTRACTOR SHALL PROVIDE MANUFACTURER INSTALLATION PROCEDURES TO FACILITATE THE ENGINEER IN CONSTRUCTION INSPECTION.





DESIGNED	-	JKP	REVISED	-
CHECKED	-	DCB	REVISED	-
DRAWN	-	RDA	REVISED	-
CHECKED	-	BKC	REVISED	-

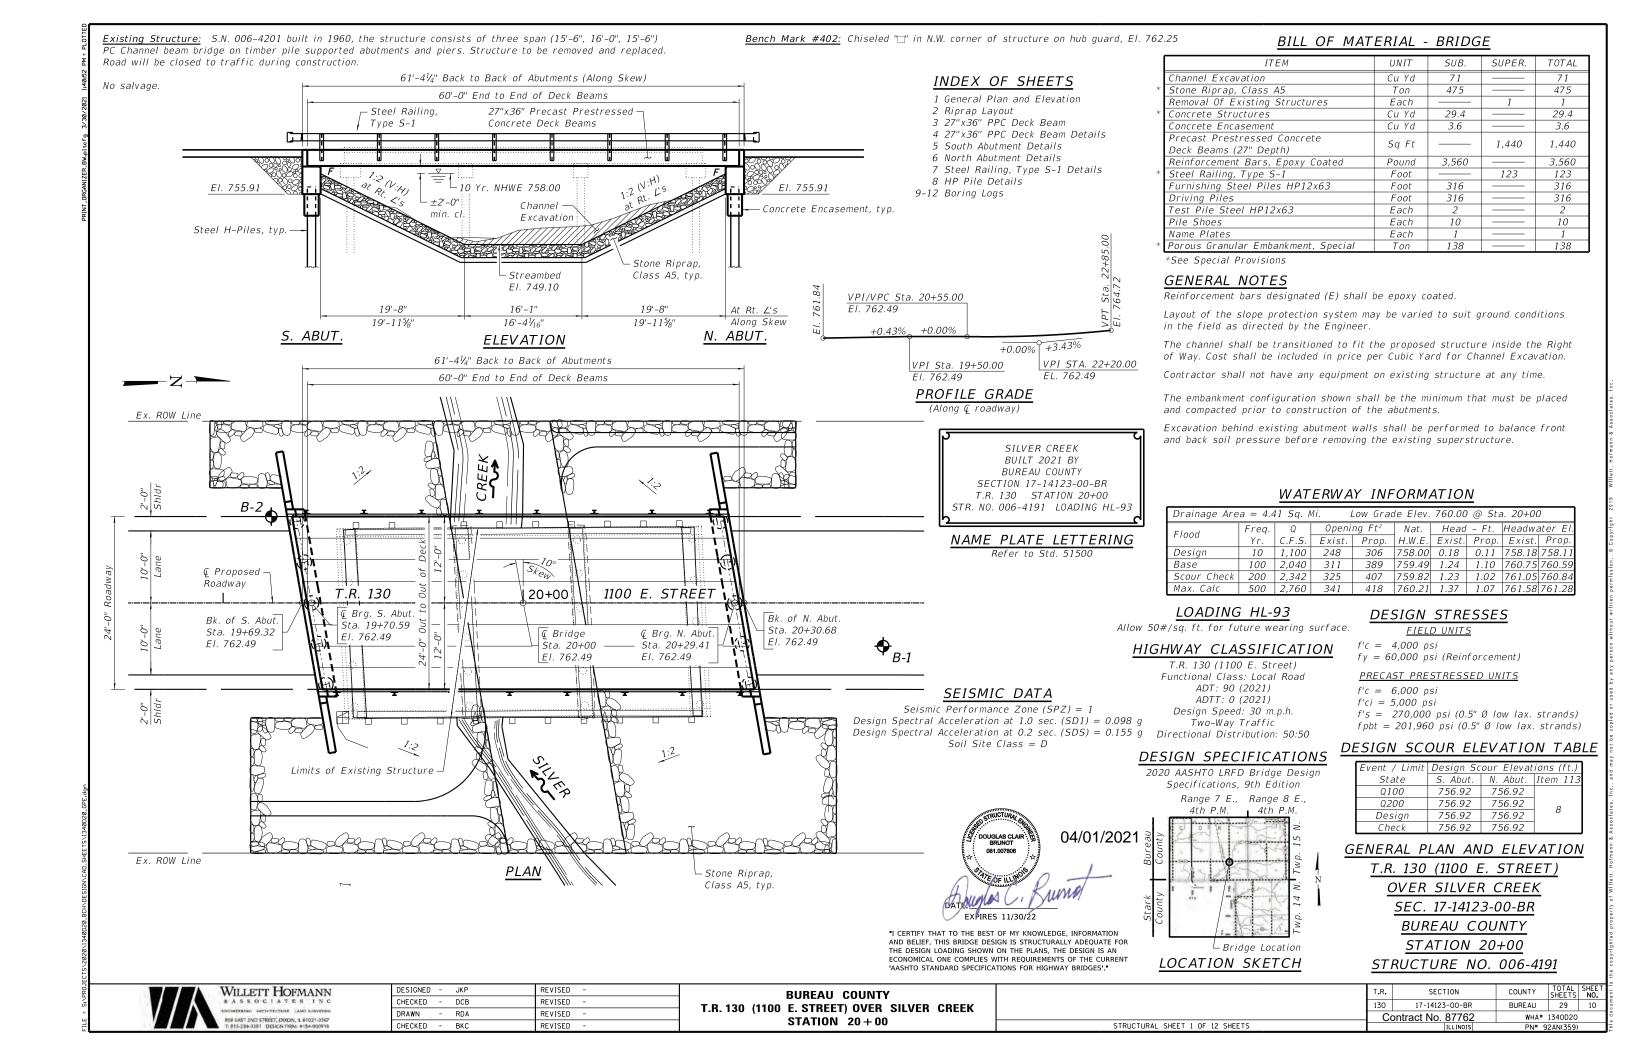


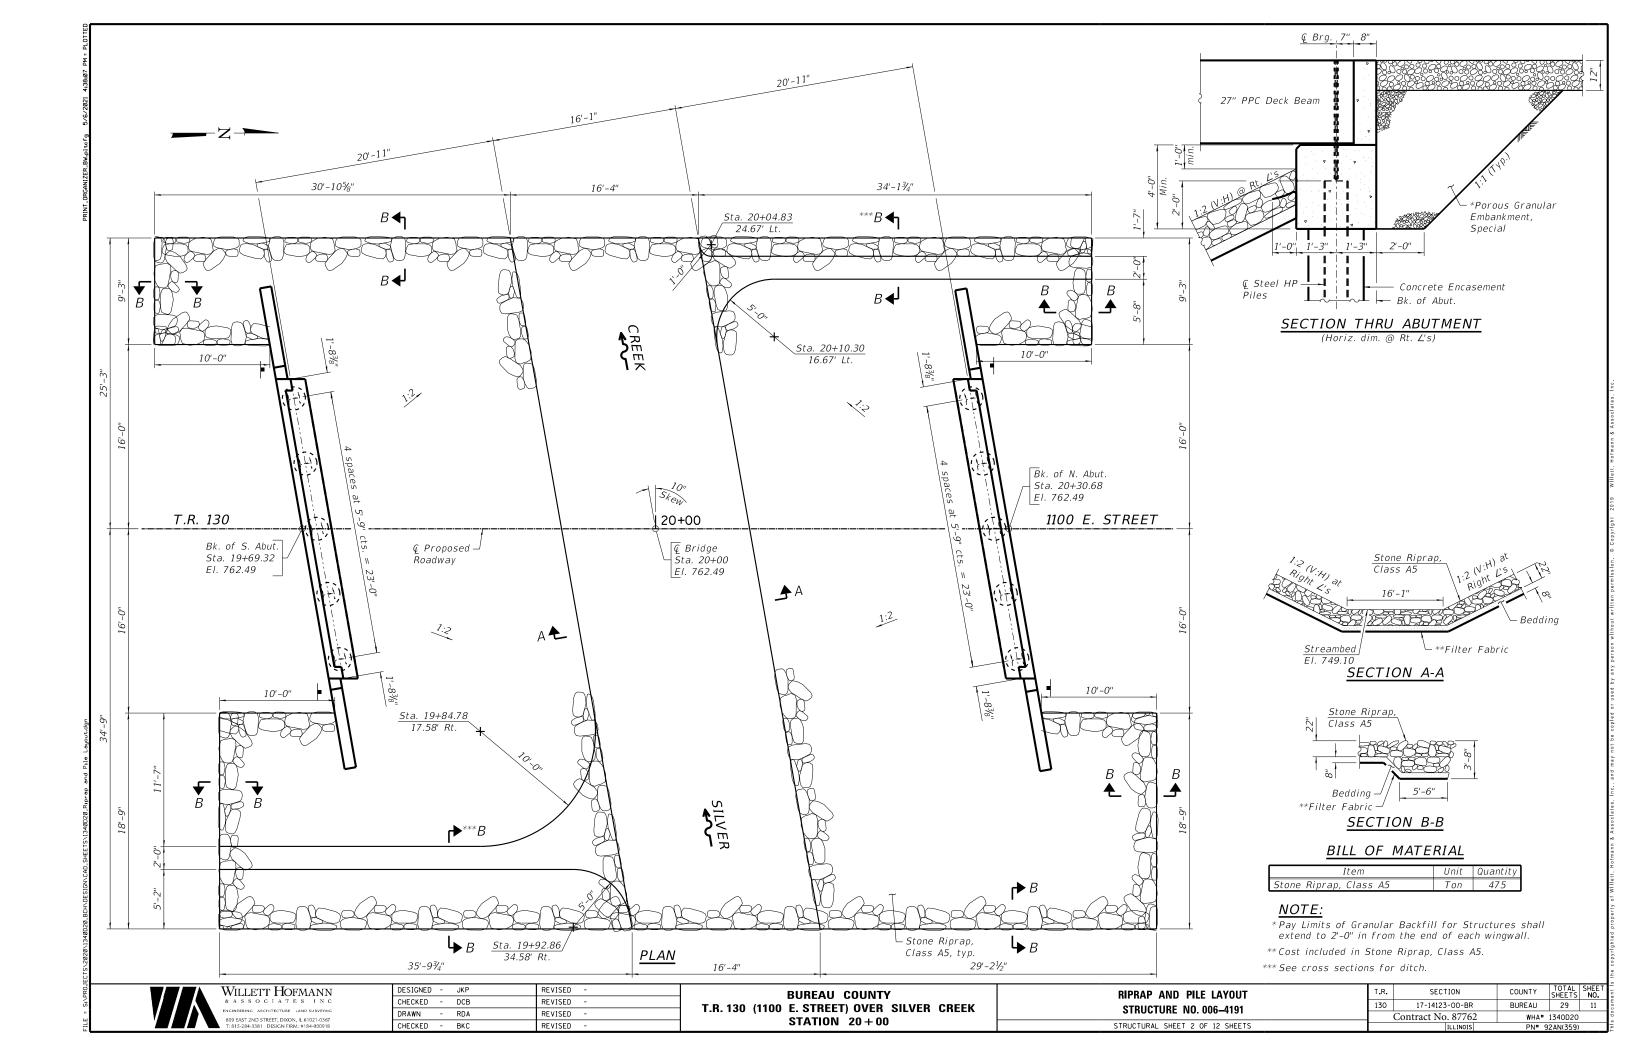


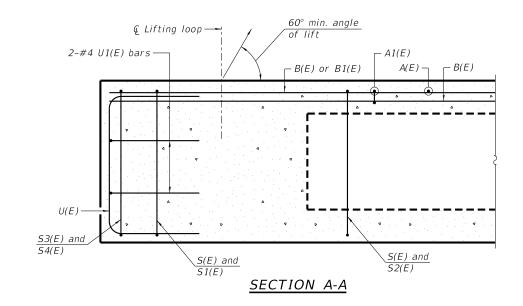

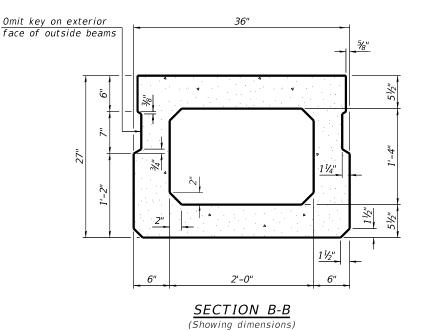

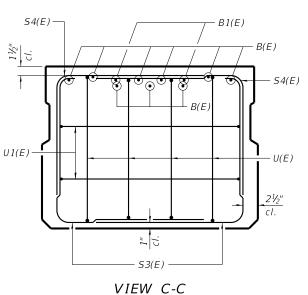

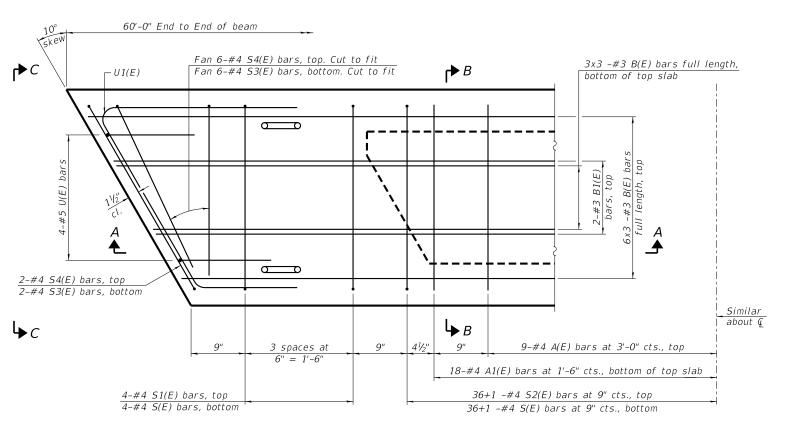

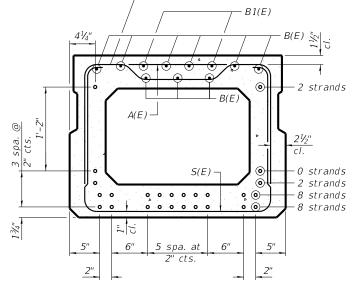

- A1(E) or S2(E)

SECTION B-B

(Showing reinforcement and permissible strand locations)

NOTE

Place the number of strands specified in each row symmetrically about the centerline of beam in the permissible strand locations shown.

$\frac{MINIMUM BAR LAP}{#3 bar = 1'-6''}$

BAR LIST ONE BEAM ONLY (For information only)

Bar No. Size Length Shape 18 #4 2'-7" A1(E) 36 #4 2'-10" ---#3 21'-0" 4 #3 10'-0" B1(E) 81 #4 7'-5" #4 5'-11" 73 #4 6'-2" #4 5'-2" S3(E) | 16 | #4 U(E) 8 #5 4'-6"

NOTE:

See structural sheet 4 of 12 for additional details and Bill of Material.

#4 5'-11"

PLAN VIEW

<u>VOTES:</u>

Spacing of S(E) and S2(E) bars may be adjusted up to 4" in the immediate area of the transverse tie diaphragms to miss the block outs for the transverse ties.

Bars indicated thus 6x3 -#3 etc., indicates 6 lines of bars with 3 lengths per line.

Bars indicated thus 36+1 -#4 etc., indicates 36 bars each side of $\not\in$ plus 1 additional bar at $\not\in$.

VIII	WILLETT HOFMANN
	ENGINEERING ARCHITECTURE LAND SURVEYING
	809 EAST 2ND STREET, DIXON, IL 61021-0367 T: 815-284-3381 DESIGN FIRM: #184-000918

DESIGNED	-	JKP	REVISED -
CHECKED	-	DCB	REVISED -
DRAWN	-	RDA	REVISED -
CHECKED	-	BKC	REVISED -

BUREAU COUNTY
T.R. 130 (1100 E. STREET) OVER SILVER CREEK
STATION 20+00


27" x 36" PPC DECK BEAM	T.R.	SECTIO
STRUCTURE NO. 006-4191		17-14123-0
3111001011L NO. 000-4131		Contract N
STRUCTURAL SHEET 3 OF 12		TI.


 R.
 SECTION
 COUNTY
 TOTAL SHEETS NO.


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 17-14123-00-BR
 BUREAU
 29
 12


 Contract No. 87762
 WHA# 1340020


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 PN# 92AN(35.9)

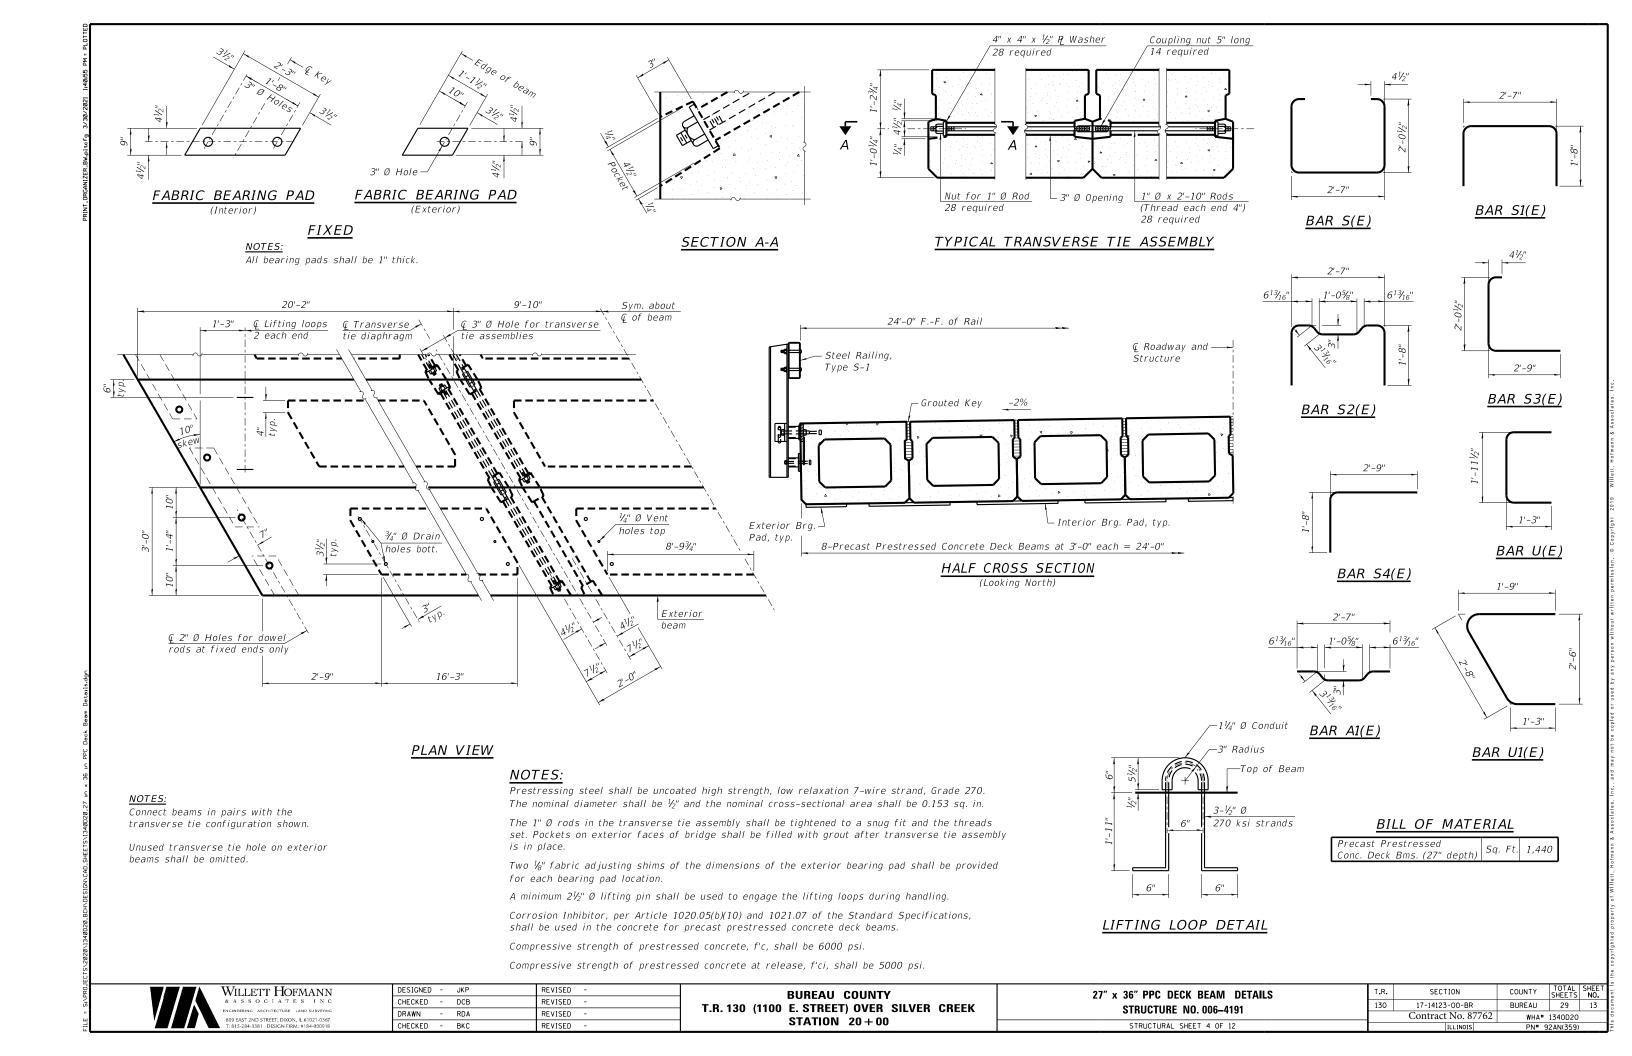

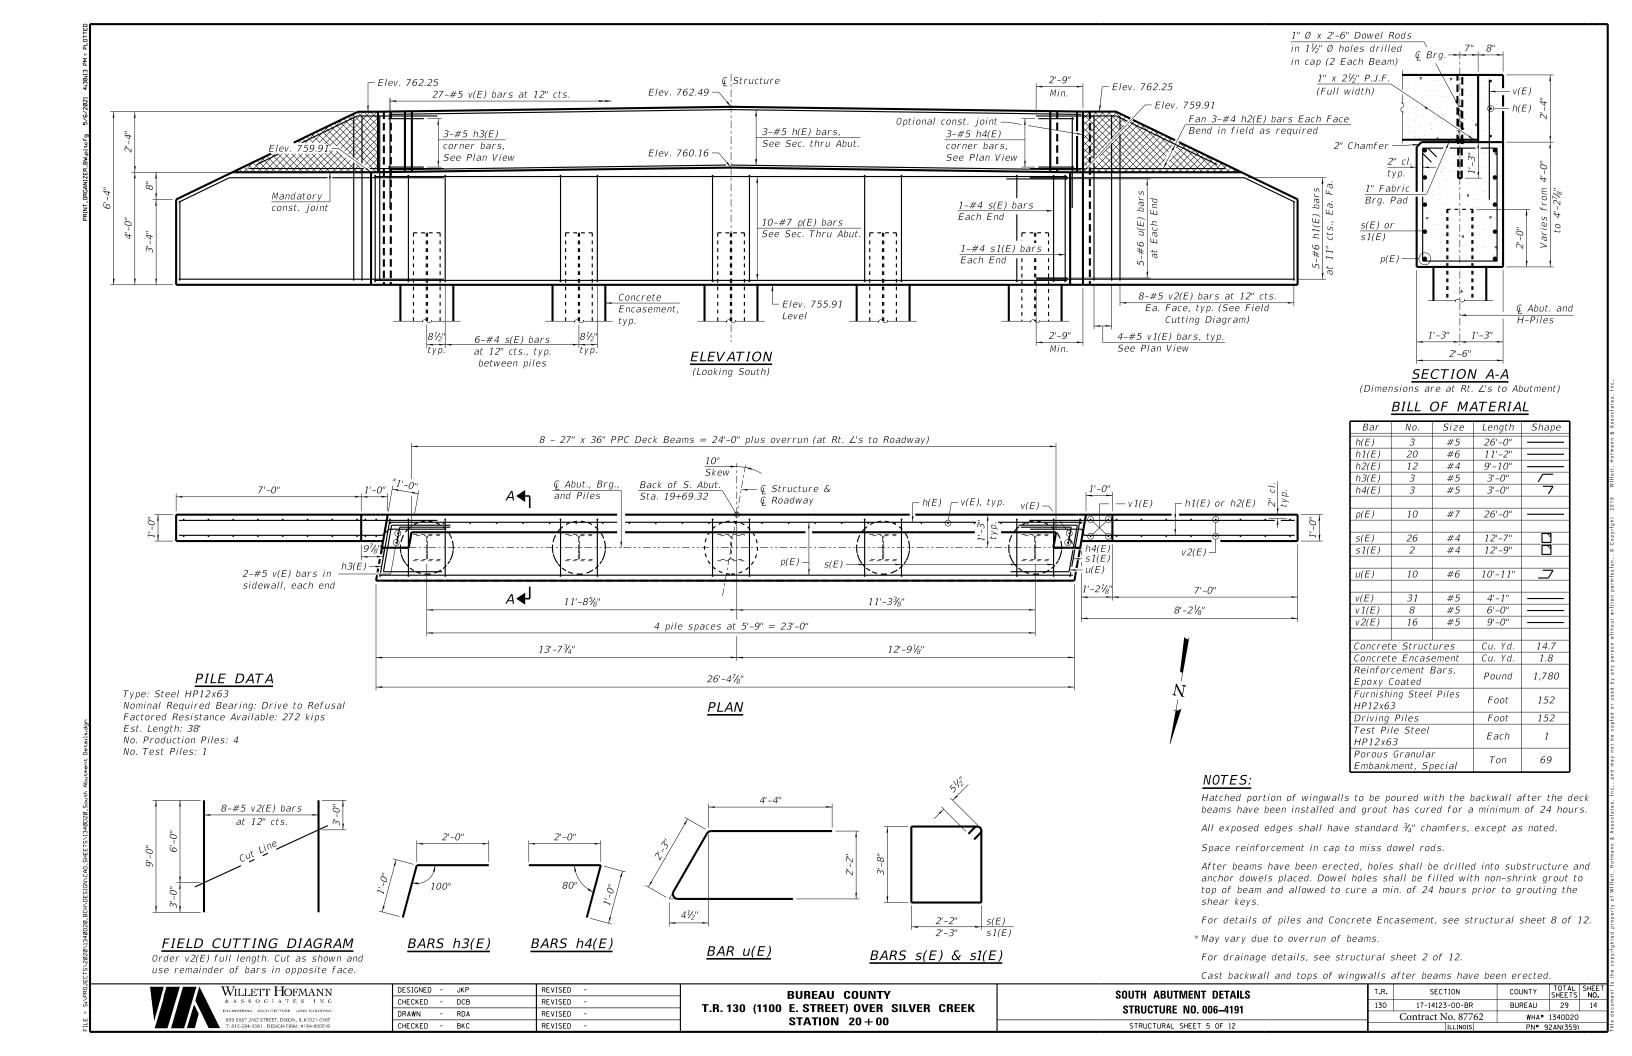

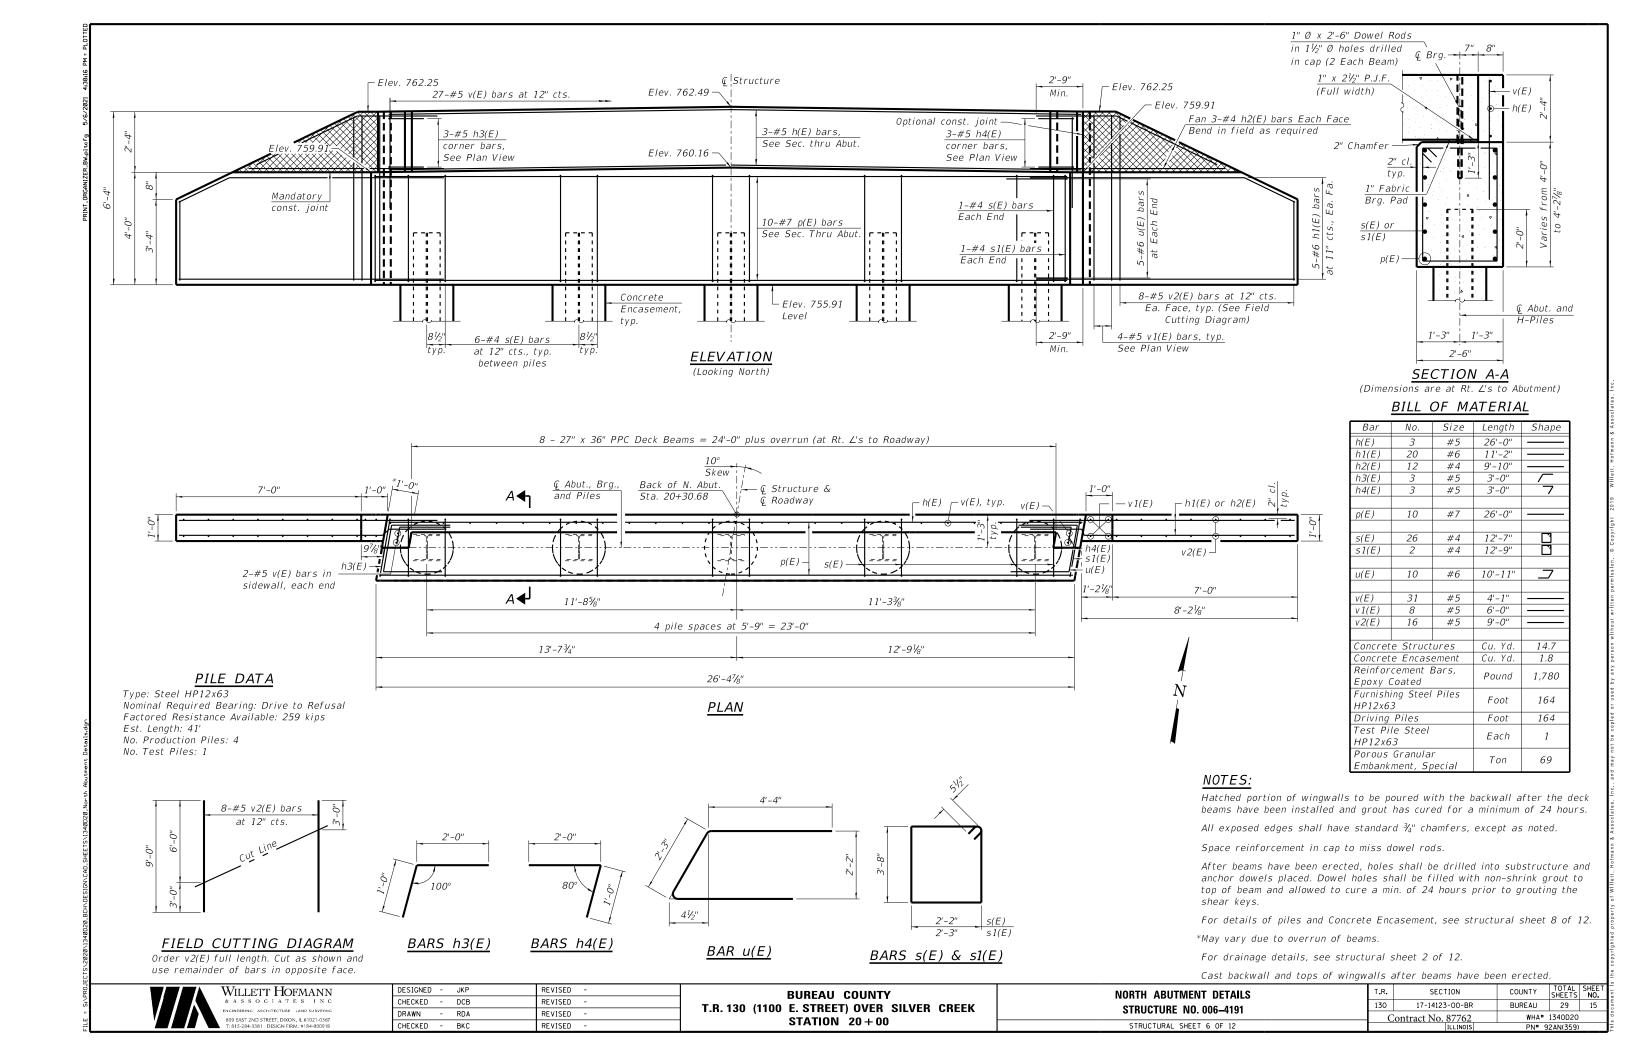


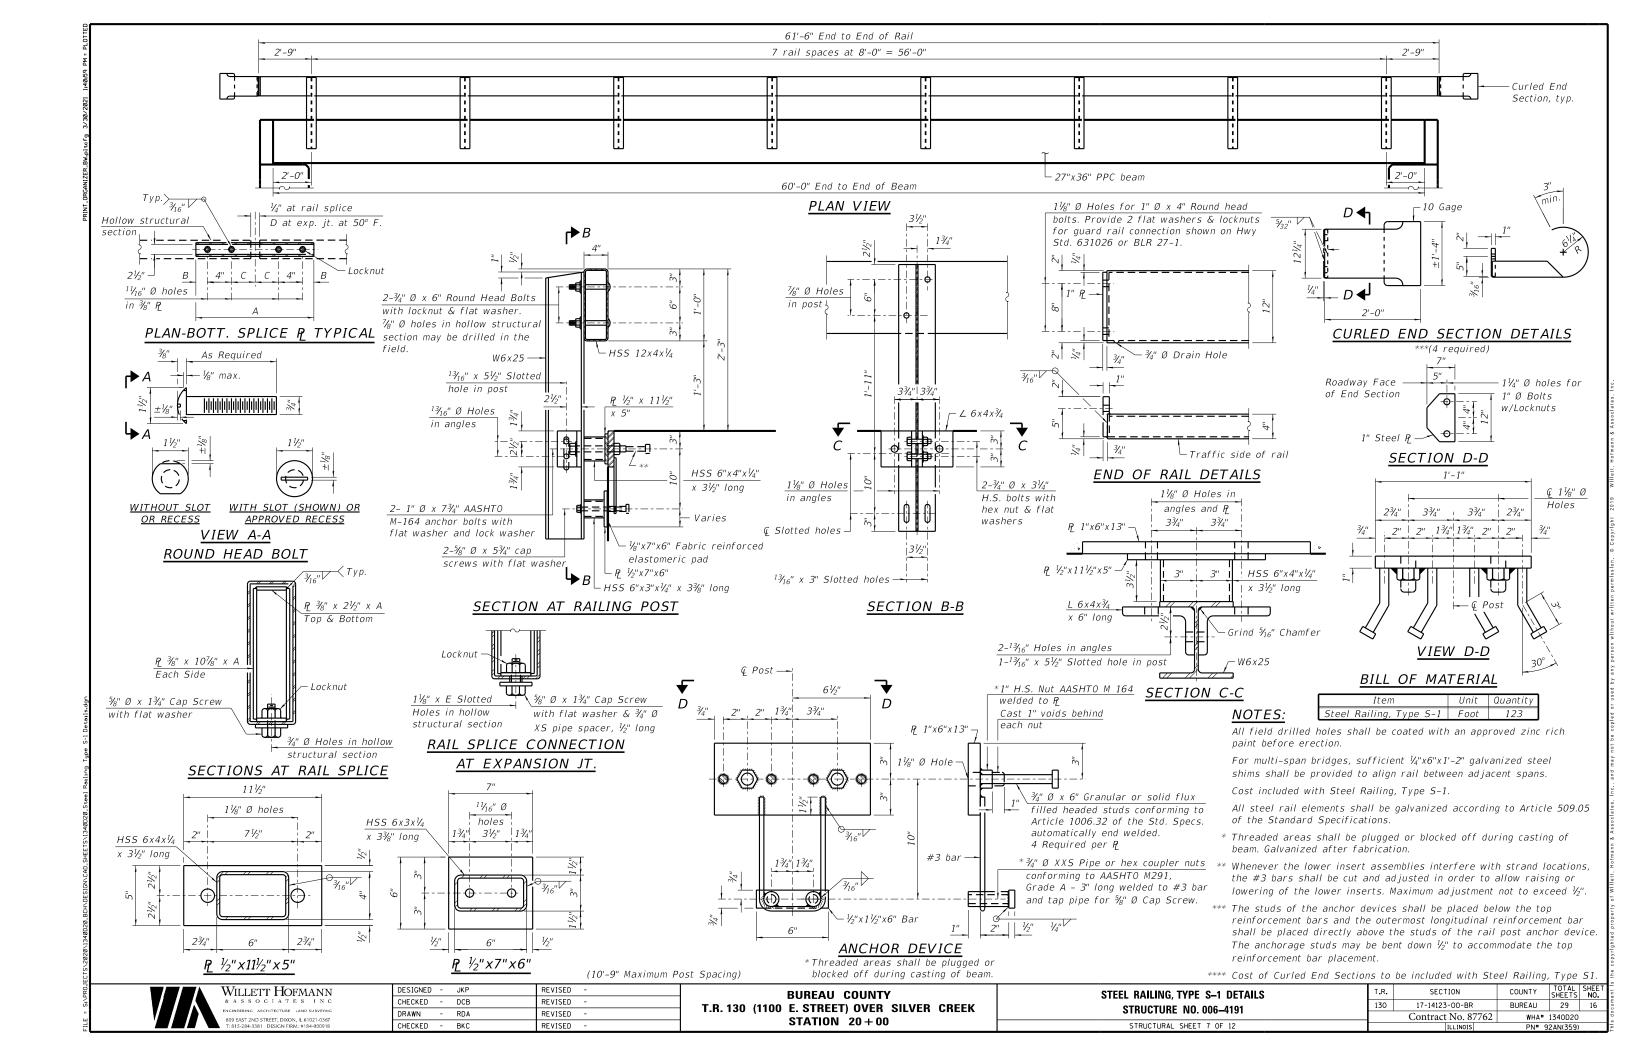

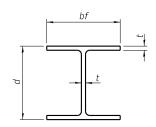


STEEL PILE TABLE

Designation	Depth d	Flange width bf	Web and Flange thickness t	Encasement diameter A
HP 14x117	14½"	14 ⁷ / ₈ "	13/ ₁₆ "	30"
x102	14"	14¾"	11/ ₁₆ "	30"
x89	131/8"	1 43/4"	5/8"	30"
x73	13%"	145%"	1/2"	30"
HP 12x84	121/4"	12½"	11/ ₁₆ "	24"
x74	121/8"	121/4"	5/8"	24"
x63	12"	12½"	1/2"	24"
x53	1 1 3/4"	12"	7/ ₁₆ "	24"
HP 10x57	10"	101/4"	%16"	24"
x42	9¾"	101/8"	7/16"	24"
HP 8x36	8"	8½"	⁷ / ₁₆ "	18"

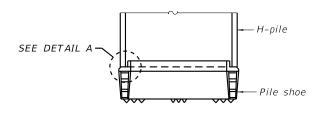


ELEVATION

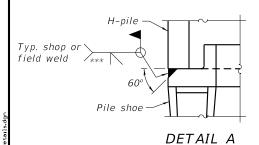

SHOE ATTACHMENT


NOTE:

The steel H-piles shall be according to AASHTO M270 Grade 50.

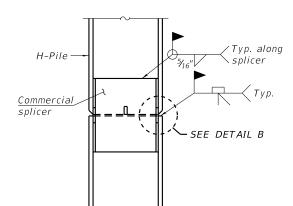


ELEVATION

DETAIL "B"

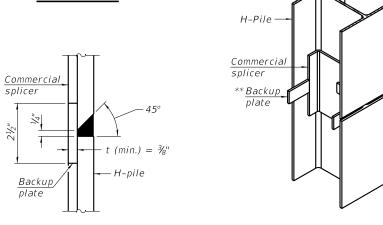


WELDED COMMERCIAL SPLICE

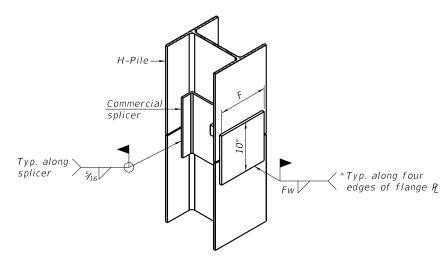


ISOMETRIC VIEW

WELDED COMMERCIAL SPLICE ALTERNATE

- * Interrupt welds \mathcal{V}_4 " from end of web and/or each flange.
- ** Remove portions of backup plates that extend outside the flanges.

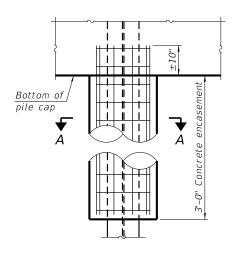

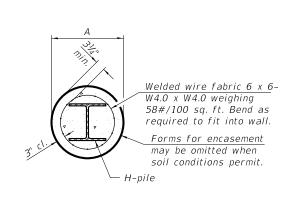



ELEVATION

SECTION A-A

<u>INDIVIDUAL PILE</u> <u>CONCRETE ENCASEMENT</u>


(when specified)

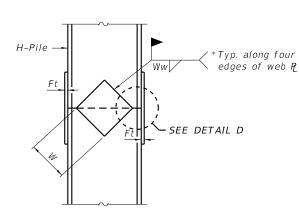

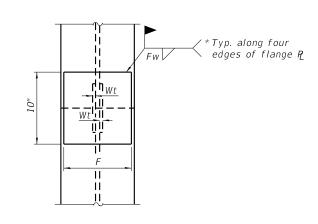

ELEVATION

END VIEW

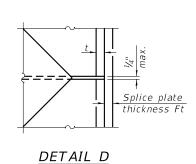

Designation	F	Ft	Fw	W	Wt	Ww
HP 14x117	12½"	1"	7/8"	73/4"	5/8"	1/2"
x102	12½"	7/8"	3/4"	73/4"	5/8"	1/2"
x89	121/2"	3/4"	11/ ₁₆ "	73/4"	5/8"	1/2"
x73	121/2"	5%"	%16"	73/4"	5/8"	1/2"
HP 12x84	10"	7/8"	11/ ₁₆ "	6½"	5/8"	1/2"
x74	10"	⁷ /8"	11/ ₁₆ "	6½"	5/8"	1/2"
x63	10"	5%"	1/2"	6½"	1/2"	3/8″
x53	10"	5/8"	1/2"	6½"	1/2"	3/8″
HP 10x57	8"	3/4"	%16"	5½"	1/2"	3/8″
x42	8"	5/8"	%16"	51/4"	1/2"	3/8″
HP 8x36	7"	5/8"	7/ ₁₆ "	41/4"	1/2"	3/8″

WELDED PLATE FIELD SPLICE



DESIGNED	-	JKP	REVISED	-
CHECKED	-	DCB	REVISED	-
DRAWN	-	RDA	REVISED	-
CHECKED	-	BKC	REVISED	-

BUREAU COUNTY T.R. 130 (1100 E. STREET) OVER SILVER CREEK STATION 20 + 00

ISOMETRIC VIEW

HP PILE DETAILS	T.R.	SECTION	COUNTY	TOTAL SHEETS	SHEET NO.
STRUCTURE NO. 006-4191	130	17-14123-00-BR	BUREAU	29	17
3111001011E 110.000-4131		Contract No. 87762	WHA#	1340D20	
STRUCTURAL SHEET 8 OF 12		TI LINOIC	DM# C	24417770	

^{***} Weld size per pile shoe manufacturer (\S_{16} " min.).

Midwest Testing Services, Inc.

Willet Hofmann & Associates

Section No. 17-14123-00-BR

Project Name: TR-130 Over Silver Creek

Project Site: Macon Township, Bureau County

3705 Progress Blvd. Peru, IL 61354

BORING LOG

Phone: 815-223-6696 Fax: 815-223-6659

e-mail: mts37@comcast.net

Sheet 1 of 3 Boring No.

Surface Elev.

Auger Depth

Start Date

B-1 762.10


51' Rotary Depth 11/28/20 Finish Date

NA 11/28/20

					SAMPLES			SAMPLES			DRILLED BY
Location:	6' Rt.of Station 20+50			0.	ype		N Value (Blows)		(%)	Dry Density (PCF)	Randy Safranski Diedrich D-120
(DEPTH)		Graphic Log	Depth in feet	Sample No.	Sample No. Sample Type	Qu (TSF)	lue (Bulge / Shear	Moisture (%)	Dens	
*ELEV. 762.10	DESCRIPTION OF MATERIALS	Graj	De _l in f	Sam	Samp	ηÒ	N V	Bulg	Mois	Dry]	REMARKS
	Stiff Black Brown Clay (Fill)		1 1 2								
759.10	Ciay (Fili)		3	1	SS	1.1	6	В	19		
—758.10 —	Stiff Black Clay		4 								
-757.10 - -756.10	Still Black Clay		5 6	2	SS	1.4	8	В	17		
755.10											
754.10			_8	3	SS	1.2	6	В	18		
753.10	Stiff Brown Silty Clay		9 9								
-752.10			—10 —	4	SS	1.2	7	В	19		
-751.10 - -750.10			—11 —								
- -749.10	Very Stiff Brownish Gray Silty		- 13	5	SS	2.2	13	S	19		
748.10	Clay Loam Till		14								
-747.10 -			—15 —	6	SS	2.5	16	S	18		
-746.10 - -745.10			—16 — —17								
744.10	Very Stiff Gray		-	7	SS	3.4	18	S	15		
743.10	Silty Clay Loam Till		- -19								
742.10			20	0	ee.	2.7	10	6	15		

Groundwater Data: Static water level after auger removal -Elevation. 742.0.

Comments:

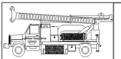

Midwest Testing Services, Inc.

3705 Progress Blvd. Peru, IL 61354

Sheet 2 of 3

BORING LOG

Phone: 815-223-6696 Fax: 815-223-6659

e-mail: mts37@comcast.net

NA

Willet Hofmann & Associates B-1 Boring No. Project Name: TR-130 Over Silver Creek 762.10 Surface Elev. Project Site: Macon Township, Bureau County Auger Depth 51' Rotary Depth

Section No. 17-14123-00-BR 11/28/20 Finish Date 11/28/20 Start Date SAMPLES DRILLED BY

Location:	6' Rt.of Station 20+50						oe e		lows)	ar	%)	y (PCF)	Randy Safranski Diedrich D-120
(DEPTH)		ii .	e p	le No.	le Tyj	rsf)	ne (B	/ She	ure (ensit			
ELEV. 741.10	DESCRIPTION OF MATERIALS	Graphic Log Depth in feet	Samp	Sample Type	Qu (TSF)	N Value (Blows)	Bulge / Shear	Moisture (%)	Dry Density	REMARKS			
-			L										
740.10			22										
739.10	Very Stiff Gray Silty		23	9	SS	3.0	18	S	16				
738.10	Clay Loam Till		24										
737.10			_25	10	G C	2.2	10		1.5				
736.10				10	22	3.2	18	S	15				
735.10			27										
734.10			L ₂₈	11	SS	4.1	21	s	14				
733.10													
- I	Hard Gray Clayey Sandy Clay		F										
732.10			30	12	SS	4.5	24	S	13				
731.10			-31		Г								
730.10			32										
729.10			33										
728.10			_34										
727.10			35										
726.10	Very Dense Gray			13	SS	5.4	52	S	12				
725.10	Weathered Sandy Shale		37										
⊢ I			┝										
-724.10 -			38										
723.10			39										
722.10			H40	14	SS		86		10				
721.10			L-41										
			\Box										

Groundwater Data: Static water level after auger removal -Elevation. 742.0.

Comments:



DESIGNED	-	JKP	REVISED -
CHECKED	-	DCB	REVISED -
DRAWN	-	RDA	REVISED -
CHECKED	-	BKC	REVISED -

BUREAU COUNTY T.R. 130 (1100 E. STREET) OVER SILVER CREEK STATION 20+00

BORING LOGS	T.R.	SECTION	COUNTY	TOTAL SHEETS	SHEET NO.
STRUCTURE NO. 006-4191	130	17-14123-00-BR	BUREAU	29	18
3111001011E 140. 000-4131	_	Contract No. 87762	WHA# 1340D20		
STRUCTURAL SHEET 9 OF 12		TI L INDIS	PN# 9	2AN(359)	

) managaman (

Midwest Testing Services, Inc.

3705 Progress Blvd. Peru, IL 61354 **BORING LOG**

Sheet <u>3</u> of <u>3</u>

Phone: 815-223-6696 Fax: 815-223-6659

e-mail: mts37@comcast.net

Client: Willet Hofmann & Associates
Project Name: TR-130 Over Silver Creek
Project Site: Macon Township, Bureau County

Section No. 17-14123-00-BR

Boring No. B-1 Surface Elev. 762.10

Auger Depth Start Date 51' Rotary Depth 11/28/20 Finish Date NA 11/28/20

SAMPLES DRILLED BY 6' Rt.of Station 20+50 Location: Randy Safranski Diedrich D-120 Qu (TSF) (DEPTH ELEV. **DESCRIPTION OF MATERIALS** REMARKS 720.10 ---719.10 **—**718.10 ---717.10 --- 93 ---10 15 SS Very Dense Gray ---716.10 Sandy Shale ---715.10 **-**47 ---714.10 ---713.10 **-**49 ---712.10 100 8" 16 SS 10 ---711.10 Bottom Of Boring ---710.10 **—**52 ---709.10 **—**53 ---708.10 **-**54 **—**55 **-**706.10 **-**56 **-**705.10 **—**57 --704.10 **-**703.10 **-**702.10 **-**701.10 --700.10

Groundwater Data: Static water level after auger removal -Elevation. 742.0. Comments:

WILLETT HOFMANN
& ASSOCIATES INC
ENGINEERING ARCHITECTURE LAND SURVEYING
809 EAST 2ND STREET, DIXON, IL 61021-0367

DESIGNED	-	JKP	REVISED -
CHECKED	-	DCB	REVISED -
DRAWN	-	RDA	REVISED -
CHECKED	-	BKC	REVISED -

BORING LOGS STRUCTURE NO. 006-4191 STRUCTURAL SHEET 10 OF 12		SECTION	COUNTY	TOTAL SHEETS	SHE!
		17-14123-00-BR	BUREAU	29	19
		Contract No. 87762	WHA# 1340D20		
		ILLINOIS	PN# 9	2AN(359)	

January and American American

Client:

Midwest Testing Services, Inc.

Willet Hofmann & Associates

Section No. 17-14123-00-BR

Project Name: TR-130 Over Silver Creek

Project Site: Macon Township, Bureau County

3705 Progress Blvd. Peru, IL 61354

BORING LOG

15

12

SS 3.9 17 B

SS 3.5 19 S

Sheet	1	of	3	

Phone: 815-223-6696 Fax: 815-223-6659 e-mail: mts37@comcast.net

B-2 Boring No. Surface Elev. Auger Depth Start Date

762.30 51' Rotary Depth NA 11/28/20 Finish Date 11/28/20

DRILLED BY Location: 12' Left of Station 19+65 Randy Safranski Dry Density (PCF) Diedrich D-120 *ELEV. DESCRIPTION OF MATERIALS REMARKS **-**761.30 Stiff Black And Brown **-**760.30

Clay (Fill) 1 SS 1.0 6 B 18 **-**759.30 **-**758.30 **-**757.30 2 SS 1.5 7 B 19 **-**756.30 Stiff Brown -755.30Silty Clay 3 SS 1.2 7 B 20 **-**754.30

-753.30 Loose Brown -752.30 Gravely Loam SS --- 5 **-**751.30 -750.30Medium Brown ---749.30 5 SS --- | 14 | ---

-747.30 **-**746.30 Vert Stiff Gray Silty -745.30Clay Loam Till

-742.30 Groundwater Data: Static water level after auger removal -Elevation. 732.0. Comments:

Gravely Loam

Client:

Midwest Testing Services, Inc.

3705 Progress Blvd. Peru, IL 61354

Sheet 2 of 3

BORING LOG

Phone: 815-223-6696 Fax: 815-223-6659 e-mail: mts37@comcast.net

Willet Hofmann & Associates B-2 Boring No. Project Name: TR-130 Over Silver Creek 762.30 Surface Elev.

Project Site: Macon Township, Bureau County Auger Depth 51' Rotary Depth NA Section No. 17-14123-00-BR 11/28/20 Finish Date 11/28/20 Start Date

Location:	12' Left of Station 19+65				pe		N Value (Blows)	ear	(%)	Dry Density (PCF)	Randy Safranski Diedrich D-120			
(DEPTH)		ji ,	e p	le No	le Ty	TSF)	ne (B	/ She	nre (ensit				
ELEV. 741.30	DESCRIPTION OF MATERIALS	Graphic Log	Depth in feet	Sample No.	Sample Type	Qu (TSF)	N Val	Bulge / Shear	Moisture (%)	Dry D	REMARKS			
-			_											
740.30	Very Stiff Gray Silty Clay Loam Till		—22 —		Ш									
739.30	Clay Loani Tili		23	9	SS	3.6	21	S	15					
			— 24											
737.30			25											
- -736.30	W.F. T.D. G		_ 26	10	SS		33		14					
735.30	Medium To Dense Gray Stratified Sandy Clay		27											
- I			-											
734.30			—28 —	11	SS		28		14					
733.30			29											
732.30			30	12	SS		75		1.1					
731.30			31	12	22		/3		11					
730.30			32											
729.30			_ 33											
⊢ I			-											
728.30	Very Dense Gray Weathered Sandy Shale				34	34								
727.30	Weathered Sandy Share		—35 —	13	SS		67		12					
726.30			36											
725.30			37											
724.30														
723.30														
722.30			40											
⊢ I			-	14	SS		78		11					
721.30			—41 —		Н									
	Pote: Static water level ofter auger removal. Flore	tion 73	12.0		Ш									

Groundwater Data: Static water level after auger removal -Elevation. 732.0.

WILLETT HOFMANN

-744.30

-743.30

DESIGNED	-	JKP	REVISED	-
CHECKED	-	DCB	REVISED	-
DRAWN	-	RDA	REVISED	-
CHECKED	-	BKC	REVISED	-

BUREAU COUNTY T.R. 130 (1100 E. STREET) OVER SILVER CREEK STATION 20+00

Comments:

BORING LOGS	T.R.	SECTION	COUNTY	TOTAL SHEETS	SHEE NO.
STRUCTURE NO. 006-4191	130	17-14123-00-BR	BUREAU	29	20
3111001011E 140. 000-4131		Contract No. 87762	WHA# 1340D20		
STRUCTURAL SHEET 11 OF 12		ILLINOIS	PN# 92AN(359)		

) managaman (

Midwest Testing Services, Inc.

3705 Progress Blvd. Peru, IL 61354 Sheet 3 of 3

BORING LOG

Phone: 815-223-6696 Fax: 815-223-6659

e-mail: mts37@comcast.net

NA

11/28/20

Client: Willet Hofmann & Associates
Project Name: TR-130 Over Silver Creek
Project Site: Macon Township, Bureau County

Section No. 17-14123-00-BR

Boring No. B-2 Surface Elev. 762.30

Auger Depth 51' Rotary Depth Start Date 11/28/20 Finish Date

SAMPLES DRILLED BY Location: 12' Left of Station 19+65 Randy Safranski Diedrich D-120 N Value (Blows) Moisture (%) Qu (TSF) (DEPTH ELEV. **DESCRIPTION OF MATERIALS** REMARKS 720.30 ---719.30 **—**718.30 ---717.30 100 10" 10 15 SS Very Dense Gray ---716.30 Sandy Shale ---715.30 **-**47 ---714.30 ---713.30 **-**49 ---712.30 100 6" 16 SS Bottom Of Boring ---710.30 **—**52 **-**709.30 **—**53 **-**708.30 **-**54 **-**707.30 **—**55 **-**706.30 **-**56 **-**705.30 **—**57 **-**704.30 **-**703.30 **-**702.30 **-**701.30 --700.30

Groundwater Data: Static water level after auger removal -Elevation. 732.0. Comments:

WILLETT HOFMANN			
& ASSOCIATES INC			
ENGINEERING ARCHITECTURE LAND SURVEYING			
809 EAST 2ND STREET, DIXON, IL 61021-0367			

DESIGNED	-	JKP	REVISED -
CHECKED	-	DCB	REVISED -
DRAWN	-	RDA	REVISED -
CHECKED	-	BKC	REVISED -

BORING LOGS Structure No. 006–4191		SECTION	COUNTY	TOTAL SHEETS	SHEET NO.
		17-14123-00-BR	BUREAU	29	21
		Contract No. 87762	WHA# 1340D20		
STRUCTURAL SHEET 12 OF 12	ILLINOIS PN# 92AN(359)				

