06-11-2021 LETTING ITEM 171

FOR INDEX OF SHEETS, SEE SHEET NO. 2

STATE OF ILLINOIS DEPARTMENT OF TRANSPORTATION


* 9 + 1 = 10 TOTAL SHEETS

D-96-041-21

PROPOSED CONTRACT MAINTENANCE

FAI ROUTE 55 (I-55)
SECTION (84-4-3)BRR-1 (84-4-1)BRR
PROJECT (STATE)
BRIDGE SUPERSTRUCTURE REPAIRS
SANGAMON COUNTY

C-96-112-21

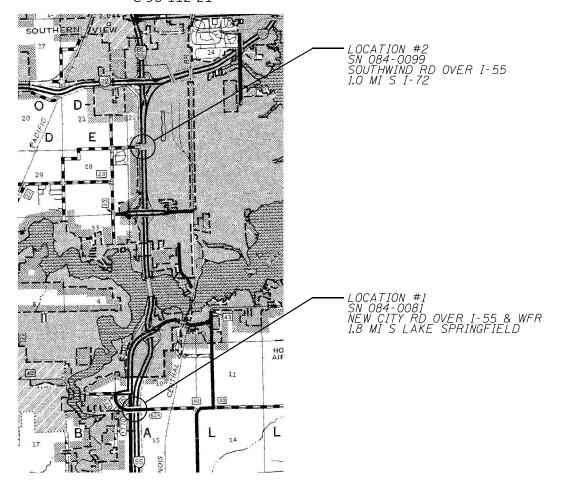

GROSS LENGTH = x.xx FT. = x.xxx MILE

NET LENGTH = x.xx FT. = x.xxx MILE

100' 200' 300' — 1" = 100'
10' 20' 30' — 1" = 10'
50' 100' — 1" = 50'
50' 100' — 1" = 40'

FULL SIZE PLANS HAVE BEEN PREPARED USING STANDARD ENGINEERING SCALES. REDUCED SIZED PLANS WILL NOT CONFORM TO STANDARD SCALES. IN MAKING MEASUREMENTS ON REDUCED PLANS, THE ABOVE SCALES MAY BE USED.

J.U.L.I.E.
JOINT UTILITY LOCATION INFORMATION FOR EXCAVATORS
1–800–892–0123
OR 811

BRIDGE MAINTENANCE ENGINEER: BRANDON DUDLEY - (217) 785-9290

CONTRACT NO. 72M90

 \circ

TO DAVIESS STEPHENSON WINNEEDED DOORE ME HERRY LAKE

CARROLL

WHETESDE

LEE

DE KALE

ROCK INLAND

HERRY

WARREN

TORD

STATE OF ILLINOIS
DEPARTMENT OF TRANSPORTATION

SUBMITTED March 24 20 21

REGIONAL ENGINEER

May 7, 2021

ENGINEER OF DESIGN AND ENVIRONMENT

May 7, 2021

DIRECTOR OF HIGHWAYS PROJECT IMPLEMENTATION 13

PRINTED BY THE AUTHORITY OF THE STATE OF ILLINOIS

REV. - MS

 INDEX OF SHEETS
 STANDARDS

 1 COVER SHEET
 000001-08

 2 INDEX, STANDARDS, SIGNATURES, & GENERAL NOTES
 001001-02

 3 SUMMARY OF QUANTITIES
 001006


 4-6A SN 084-0081 BRIDGE PLANS
 701001-02

 7-9 SN 084-0099 BRIDGE PLANS
 701006-05

 701101-05
 701106-02

 701201-05
 701201-05

GENERAL NOTES:

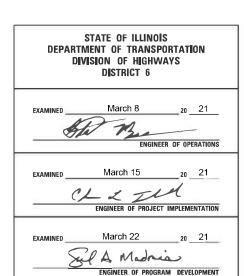

REV. - MS

USER NAME == dudleybm	DESIGNED =	REVISED =			INDEX	OF SHE	FTS GFN	IERAL NOTES.		F.A.I.	SECTION	COUNTY	TOTAL	SHEET
	DRAWN	REVISED =	STATE OF ILLINOIS					NATURES		55	(84-4-3)BRR-1 (84-4-1)BRR	SANGAMON	1 9	2
PLOT SCALE = 100.0000 / in.	CHECKED	REVISED -	DEPARTMENT OF TRANSPORTATION		31	ANDARD	JS, & SIC	INA I UNES				CONTRAC	T NO. 7	72M90
PLOT DATE = 3/23/2021	DATE	REVISED +		SCALE:	SHEET	OF	SHEETS	STA.	TO STA.	ij.	ILLINOIS FED.	AID PROJECT		

701301**-**04 701901-08


0-02176-6004 0-02176-6005 SN 084-0081 SN 084-0099 100% STATE 100% STATE

				100% 31///12	100% 317/12
					BRIDGE/URBAN
CODE			TOTAL	0047	0047
NO.	ITEM	UNIT	QUANTITY	SANGAMON	SANGAMON
50500405	FURNISHING AND ERECTING STRUCTURAL STEEL	POUND	2950	1800	1150
52100010	ELASTOMERIC BEARING ASSEMBLY, TYPE I	EACH	20	10	10
52100520	ANCHOR BOLTS, 1"	EACH	40	20	20
67100100	MOBILIZATION	L SUM	1	0.5	0.5
70100450	TRAFFIC CONTROL AND PROTECTION, STANDARD 701201	L SUM	1	0.5	0.5
Z0001899	JACK AND REMOVE EXISTING BEARINGS	EACH	20	10	10
Z0001905	STRUCTURAL STEEL REPAIR	POUND	460	460	0
Z0021914	SILICONE JOINT SEALER, 2.75"	FOOT	64	0	64

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USER NAME = dudleybm	DESIGNED -	REVISED -
	DRAWN -	REVISED -
PLOT SCALE = 100.0000 ' / in.	CHECKED -	REVISED -
PLOT DATE = 3/23/2021	DATE -	REVISED -

						F.A.I. RTE.	SEC	TION		COUNTY	TOTAL SHEETS	SHEET NO.
SUMMARY OF QUANTITIES				55	(84-4-3)BRR-1	l (84-4-1	l)BRR	SANGAMON	9	3		
						_[CONTRACT	NO. 72	2M90
SCALE:	SHEET	OF	SHEETS	STA.	TO STA.			ILLINOIS	FED. AI	D PROJECT		

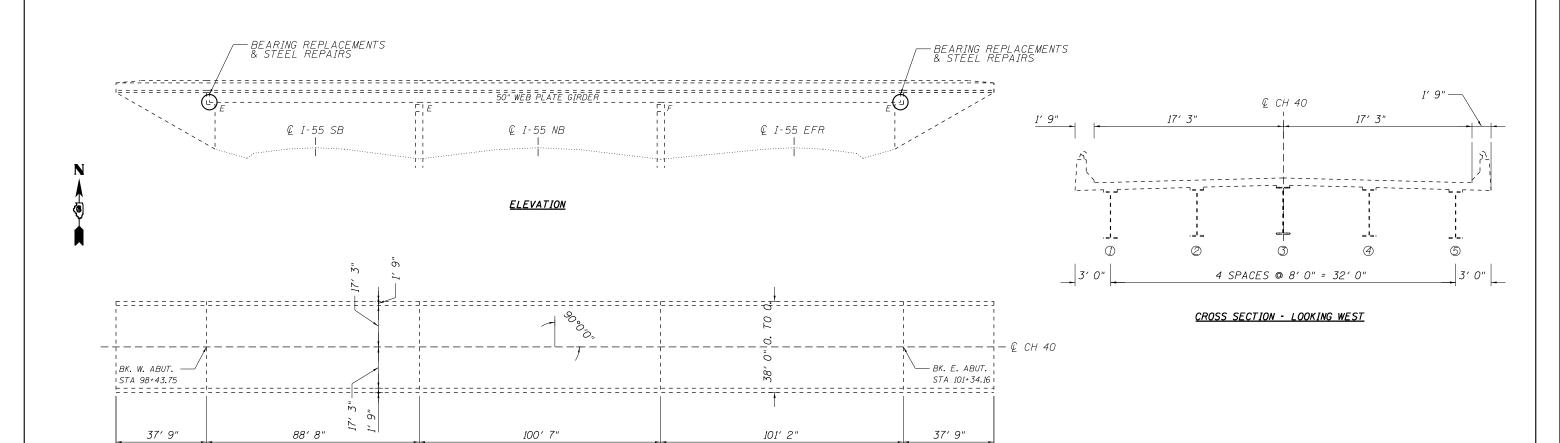

<u>PL AN</u>

365' 11" BK. TO BK. APPR. BENTS



Expires 11-30-2022

05/05/202

STRUCTURE GENERAL NOTES:

PLAN DIMENSIONS AND DETAILS RELATIVE TO EXISTING PLANS ARE SUBJECT TO NOMINAL CONSTRUCTION VARIATIONS. THE CONTRACTOR SHALL FIELD VERIFY EXISTING DIMENSIONS AND DETAILS AFFECTING NEW CONSTRUCTION AND MAKE NECESSARY APPROVED ADJUSTMENTS PRIOR TO CONSTRUCTION OR ORDERING OF MATERIALS. SUCH VARIATIONS SHALL NOT BE CAUSE FOR ADDITIONAL COMPENSATION FOR A CHANGE IN THE SCOPE OF WORK, HOWEVER, THE CONTRACTOR WILL BE PAID FOR THE QUANTITY ACTUALLY FURNISHED AT THE UNIT PRICE BID FOR THE WORK.

ALL STRUCTURAL STEEL SHALL BE AASHTO M270 GRADE 36 UNLESS OTHERWISE NOTED.

EXISTING STRUCTURAL STEEL THAT WILL BE IN CONTACT WITH NEW STRUCTURAL STEEL SHALL BE CLEANED AND PAINTED PRIOR TO ERECTION AS REQUIRED BY THE SPECIAL PROVISION "CLEANING AND PAINTING CONTACT SURFACE AREAS OF EXISTING STEEL STRUCTURES".

ALL NEW STRUCTURAL STEEL AND BEARING ASSEMBLIES SHALL BE HOT-DIP GALVANIZED. SEE SPECIAL PROVISIONS FOR "HOT DIP GALVANIZING FOR STRUCTURAL STEEL".

TOTAL BILL OF MATERIAL (084-0081)

ITEM	UNIT	QUANTITY
Structural Steel Repair	Pound	460
Elastomeric Bearing Assembly, Type I	Each	10
Jack and Remove Existing Bearings	Each	10
Furnishing and Erecting Structural Steel	Pound	1800
Anchor Bolts, 1" Ø	Each	20

 USER NAME
 = dudleybm
 DESIGNED
 REVISED

 DRAWN
 REVISED

 PLOT SCALE
 = 100,0000 ' / in.
 CHECKED
 REVISED

 PLOT DATE
 = 3/23/2021
 DATE
 REVISED

STATE OF ILLINOIS
DEPARTMENT OF TRANSPORTATION

| SHEET 1 OF 3 SHEET | STA. | TO STA. | SHEET 1 OF 3 SHEET | STA. | TO STA. | SHEET 1 OF 3 SHEET | STA. | TO STA. | SHEET 1 OF 3 SHEET | STA. | TO STA. | SHEET 1 OF 3 SHEET | STA. | TO STA. | SHEET 1 OF 3 SHEET 1 OF 3 SHEET | STA. | TO STA. | SHEET 1 OF 3 SHEET 1 O

$\langle D \rangle$ $\langle D \rangle$ *(4)*- $\langle D \rangle$ $\langle B \rangle$ N $\langle D \rangle$ $\langle D \rangle$ 51/2" ₡ Brg. ∉ Brg. E. Abut W. Abut. 287'-2" End to End of Girder PARTIAL FRAMING PLAN ⟨A⟩ - Girder Repair Detail "A" $\langle B \rangle$ – Girder Repair Detail "B" $\langle C \rangle$ - Remove & Replace Bearing (See sheet 2 of 3) $\langle \overline{D} \rangle$ - Remove & Replace Bearing (See sheet 3 of 3) Brg. Stiffener P_ 3/4" x 7" 1/2" Brg. Stiffener No exterior Cross <u>Exist</u>. Cross Frame. PL 3/4" x 7" Web Frame at Beam 5 /(Typ. except as noted) Exist. Cross 3½" 2" Web 3" 6-Alt. Spa. at_ Frame (Typ.) $2\frac{1}{4}$ " = $1'-1\frac{1}{2}$ " $\rightarrow B$ ¹/₂" x 12" x 1'-5¹/₂" 01 10 Bent P (Typ. ea. side) ½" x 45%" x 12" IP 1/2" x 5" x 7"

Typ. ea. side

GIRDER REPAIR DETAIL "A"

(Beam 2 shown, Beam 5 similar except as noted.)

31/8" | 31/8" | 43/8" | 41/2" | 41/2" |

TYPICAL REPAIR PLAN

Cross Frame Connection P's not shown for clarity.

(Typ. ea. side)

Brg. Ext.

2 of 3)

(See sheet


 \blacktriangleright_B

P2 1/2" x 5" x 7"

Typ. ea. side

½" x 45%" x 12"

(Typ. ea. side)

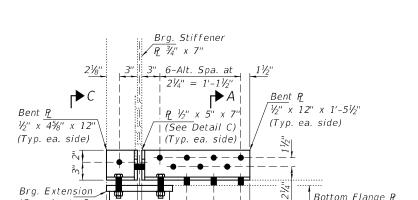

GENERAL NOTES All structural steel shall conform to AASHTO Classification M-270 Gr. 36,

Plan dimensions and details relative to existing plans are subject to nominal construction variations. The Contractor shall field verify existing dimensions and details affecting new construction and make necessary approved adjustments prior

to construction or ordering of materials. Such variations shall not be cause for

Cost of removal and re-installation of all members necessary to complete the work as detailed on the plans and as specified in the Special Provisions shall

Cleaning & painting of all connections on this sheet shall meet the requirements for Primary Connections as specified in the special provision for "Cleaning and


additional compensation for a change in scope of the work, however, the Contractor will be paid for the quantity actually furnished at the unit price bid for the work. Fasteners shall be high strength bolts. Bolts $\frac{3}{4}$ "Ø, open holes $\frac{13}{16}$ "Ø, unless

unless otherwise noted.


otherwise noted.

be included with Structural Steel Repair.

Painting Contact Surface Areas of Existing Steel Structures".

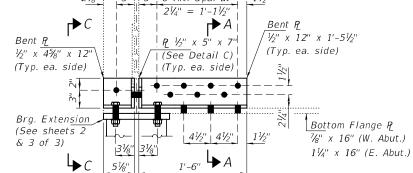

GIRDER REPAIR DETAIL "B"

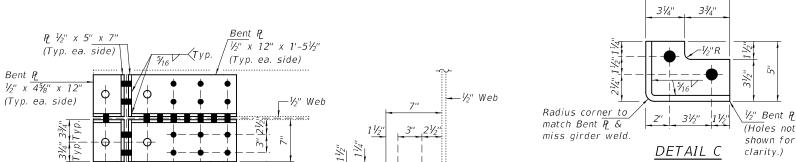

Brg. Extension

q 7/8"Ø 133/4"

Holes Typ

VIEW C-C

Bottom Flange R

7/8" x 16" (W. Abut.)

1½" x 16" (E. Abut.)

(See sheets 2

& 3 of 3)

Bottom Flange

P₂ 7/8" × 16"

BEAM 3 END PLATES

7"

Brg. Stiffener

P₂ ½" x 5" x 7"

(See Detail A) (Typ. ea. side)

 $\frac{1}{1/2}$ " x $4\frac{5}{8}$ " x 12"

(Typ. ea. side)

Bent P

P_ ¾" x 7"

 $R^{1/2}$ " x 5" x 7" (8-Required; 4-as shown, 4-opposite)

ITEM UNIT QUANTITY Structural Steel Repair Pound 460 10 Jack and Remove Existing Bearings Each Elastomeric Bearing Assembly, Type I Each 10 Furnishing and Erecting Structural Steel Pound 1800 Anchor Bolts, 1"Ø Each 20

TOTAL BILL OF MATERIAL

Expires: November 30, 2022

Bearing Extension

(See sheet 2 of 3)

Q 1/8"0 33/4"

VIEW B-B


Holes

DESIGNED -	STEPHEN M. RYAN	EXAMINED		DATE -	MAY 5, 2021
CHECKED -	CHI-CHEUNG CHAU		ENGINEER OF STRUCTURAL SERVICES		
DRAWN -	STEFFEN	PASSED		REVISED	-
CHECKED -	SMR CCC]	ENGINEER OF BRIDGES AND STRUCTURES	REVISED	-


STATE OF ILLINOIS **DEPARTMENT OF TRANSPORTATION**

SECTION A-A

F.A.I. RTE	SECTION		COUNTY	TOTAL SHEETS	SHEET NO.
55	(84-4-3)BRR-1 (84-4-1)	BRR	SANGAMON	9	5
			CONTRACT	NO. 72	M90
	LLINOIS	EED A	D DDO JECT		

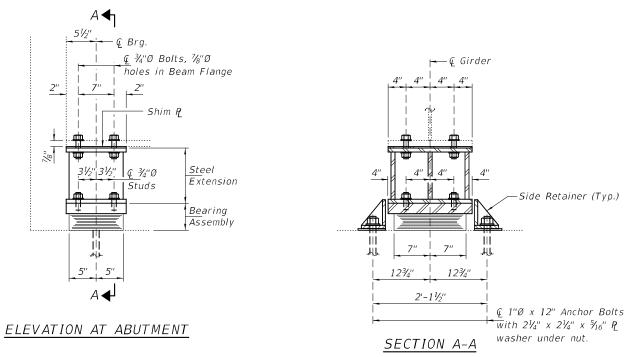


TYPE I ELASTOMERIC EXP. BRG.

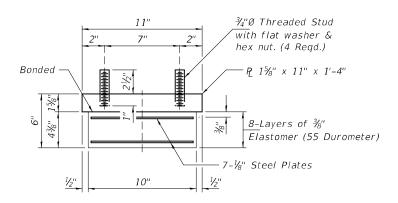

BEARING ASSEMBLY

Shim plates shall not be placed under Bearing Assembly.

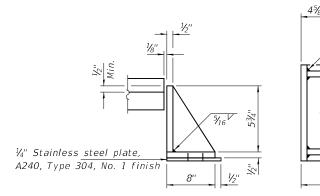

SIDE RETAINER

Equivalent rolled angle with stiffeners will be allowed in lieu of welded plates.

BEAM REACTIONS

R₽	(K)	47.3
R Ł	(K)	45.5
Imp.	(K)	13.5
R (Total)	(K)	106.3

Notes:

Diaphragm removal and reinstallation may be required to facilitate drilling holes. Cost included with Furnishing and Erecting Structural Steel.


New steel extensions, shim plates and connection bolts are included with Furnishing and Erecting Structural Steel.

Prior to ordering any material, the Contractor shall verify in the field all bearing height and shim thickness dimensions. Adjustment must account for deck heave due to pack rust (if present).


Min. jack capacity = 58 Tons. Anchor bolts shall be ASTM F1554 all-thread (or an Engineer-approved alternate material) of the grade(s) and diameter(s) specified. ASTM A307 Grade C anchor bolts may be used in lieu of ASTM F1554 Grade 36 (Fy=36ksi). The corresponding specified grade of AASHTO M314 anchor bolts may be used in lieu of ASTM F1554.


Drilled and set anchor bolts shall be installed according to Article 521.06 of the Standard Specifications.

Cost of Side retainers and Stainless Steel plates shall be included in the cost of Elastomeric Bearing Assembly, Type I.

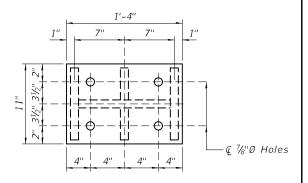


PLAN TOP AND BOTTOM PLATE

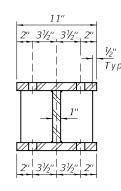

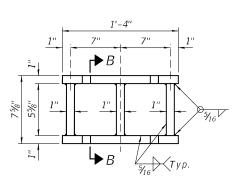

SECETION B-B

STEEL EXTENSION DETAIL

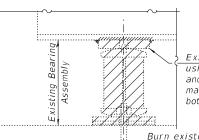

Existing R to be removed using the air-arc method and grind smooth all weld material remaining on the bottom flange.

Burn existing anchor bolts flush with existing concrete surface. Grind existing anchor bolt smooth and seal with epoxy.

EXISTING BEARING REMOVAL DETAIL

Cost included with Jack and Remove Existing Bearings.

BILL OF MATERIAL

Item	Unit	Total
Elastomeric Bearing Assembly, Type I	Each	5
Jack and Remove Existing Bearings	Each	5
Furnishing and Erecting Structural Steel	Pound	850
Anchor Bolts, 1"Ø	Each	10

TYI/REPS 5-17-2018


DESIGNED -	SMR	EXAMINED	Inot A. All 4	DATE -	MAY 5, 2021
CHECKED -	CCC		ENGINEER OF STRUCTURAL SERVICES		
DRAWN -	STEFFEN	PASSED	d. Carl Prayer	REVISED	-
CHECKED -	SMR CCC		ENGINEER OF RRIDGES AND STRUCTURES	REVISED	_

STATE OF ILLINOIS **DEPARTMENT OF TRANSPORTATION**


Q 11/4"Ø Hole

WEST ABUTMENT BEARING REPLACEMENT DETAILS SN 084-0081 SHEET NO. 2 OF 3 SHEETS

COUNTY TOTAL SHEET NO.
SANGAMON 9 6 (84-4-3)BRR-1 (84-4-1)BRR 55 CONTRACT NO. 72M90

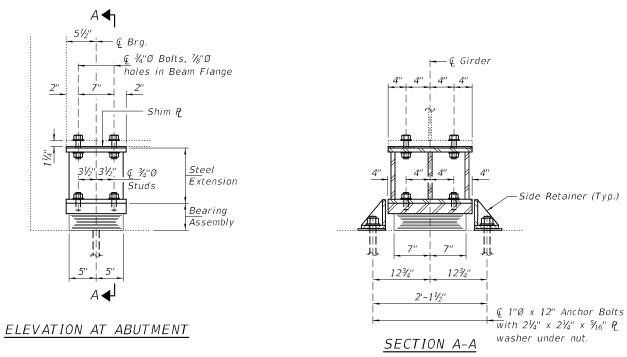


TYPE I ELASTOMERIC EXP. BRG.

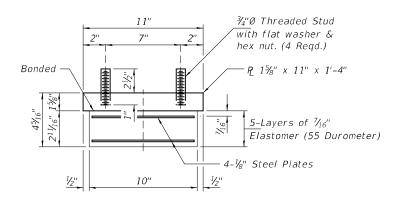

BEARING ASSEMBLY

Shim plates shall not be placed under Bearing Assembly.

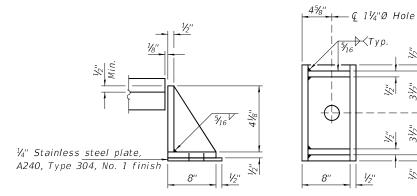

SIDE RETAINER

Equivalent rolled angle with stiffeners will be allowed in lieu of welded plates.

BEAM REACTIONS

R₽	(K)	56.2
R Ł	(K)	46.4
Imp.	(K)	10.3
R (Total)	(K)	1129

Notes:

Diaphragm removal and reinstallation may be required to facilitate drilling holes. Cost included with Furnishing and Erecting Structural Steel.


New steel extensions, shim plates and connection bolts are included with Furnishing and Erecting Structural Steel.

Prior to ordering any material, the Contractor shall verify in the field all bearing height and shim thickness dimensions. Adjustment must account for deck heave due to pack rust (if present).


Min. jack capacity = 63 Tons. Anchor bolts shall be ASTM F1554 all-thread (or an Engineer-approved alternate material) of the grade(s) and diameter(s) specified. ASTM A307 Grade C anchor bolts may be used in lieu of ASTM F1554 Grade 36 (Fy=36ksi). The corresponding specified grade of AASHTO M314 anchor bolts may be used in lieu of ASTM F1554.


Drilled and set anchor bolts shall be installed according to Article 521.06 of the Standard Specifications.

Cost of Side retainers and Stainless Steel plates shall be included in the cost of Elastomeric Bearing Assembly, Type I.

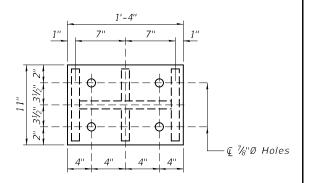


PLAN TOP AND BOTTOM PLATE

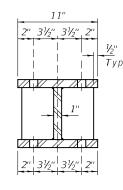

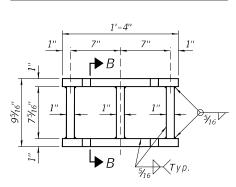

SECETION B-B

STEEL EXTENSION DETAIL

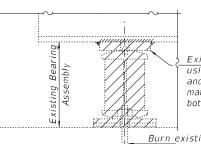

Existing R to be removed using the air-arc method and grind smooth all weld material remaining on the bottom flange.

Burn existing anchor bolts flush with existing concrete surface. Grind existing anchor bolt smooth and seal with epoxy.

EXISTING BEARING REMOVAL DETAIL

Cost included with Jack and Remove Existing Bearings.

BILL OF MATERIAL


Item	Unit	Total
Elastomeric Bearing Assembly, Type I	Each	5
Jack and Remove Existing Bearings	Each	5
Furnishing and Erecting Structural Steel	Pound	950
Anchor Bolts, 1"Ø	Each	10

TYI/REPS 5-17-2018

DESIGNED -	SMR	EXAMINED	I mot A M. 1 Co	DATE -	MAY 5, 2021
CHECKED -	CCC		ENGINEER OF STRUCTURAL SERVICES		
DRAWN -	STEFFEN	PASSED	d. Carl Prayer	REVISED	-
CHECKED -	SMR CCC		ENGINEER OF RRIDGES AND STRUCTURES	REVISED	_

STATE OF ILLINOIS **DEPARTMENT OF TRANSPORTATION** EAST ABUTMENT BEARING REPLACEMENT DETAILS SN 084-0081 SHEET NO. 3 OF 3 SHEETS

COUNTY TOTAL SHEET NO.
SANGAMON 9 6A SECTION (84-4-3)BRR-1 (84-4-1)BRR 55 CONTRACT NO. 72M90

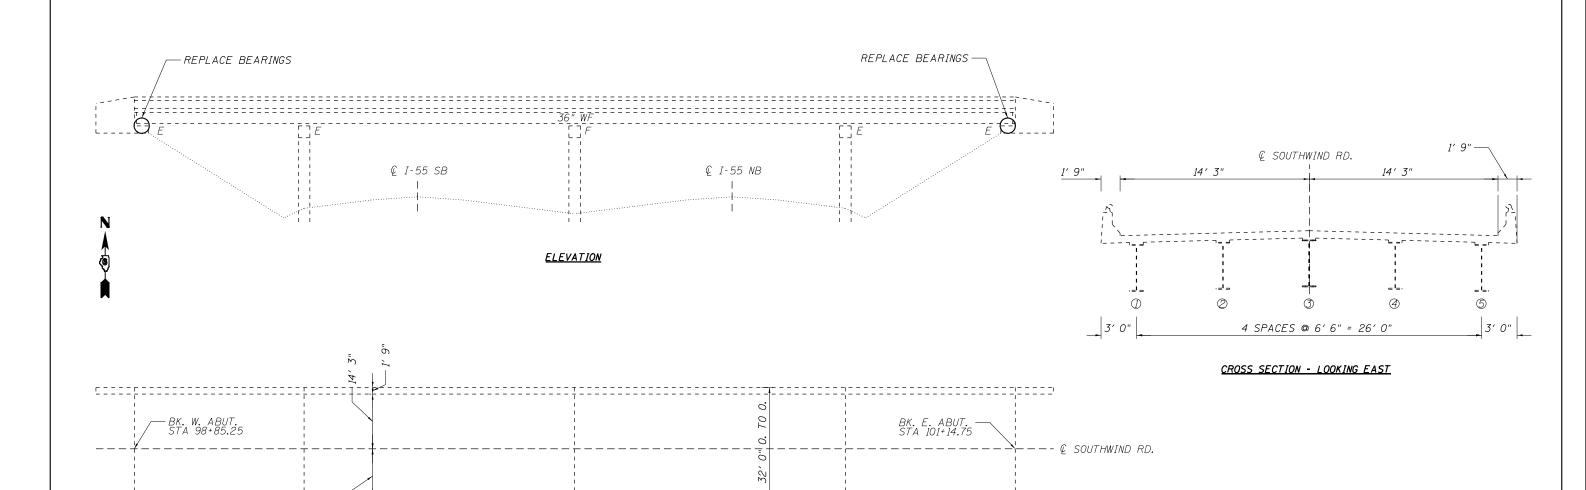

2' 3-1/2" (@ BRG)

DAVID CARL PUZEY

081-005470

* SPRINGIS

* OF ILL

Expires 11-30-2022

05/05/2021

<u>PLAN</u>

229' 6" BK. TO BK. ABUTS.

70′ 5"

STRUCTURE GENERAL NOTES:

PLAN DIMENSIONS AND DETAILS RELATIVE TO EXISTING PLANS ARE SUBJECT TO NOMINAL CONSTRUCTION VARIATIONS. THE CONTRACTOR SHALL FIELD VERIFY EXISTING DIMENSIONS AND DETAILS AFFECTING NEW CONSTRUCTION AND MAKE NECESSARY APPROVED ADJUSTMENTS PRIOR TO CONSTRUCTION OR ORDERING OF MATERIALS. SUCH VARIATIONS SHALL NOT BE CAUSE FOR ADDITIONAL COMPENSATION FOR A CHANGE IN THE SCOPE OF WORK, HOWEVER, THE CONTRACTOR WILL BE PAID FOR THE QUANTITY ACTUALLY FURNISHED AT THE UNIT PRICE BID FOR THE WORK.

ALL STRUCTURAL STEEL SHALL BE AASHTO M270 GRADE 36 UNLESS OTHERWISE NOTED.

42' 0-1/2"

-2′3-1/2" (€ BRG)

EXISTING STRUCTURAL STEEL THAT WILL BE IN CONTACT WITH NEW STRUCTURAL STEEL SHALL BE CLEANED AND PAINTED PRIOR TO ERECTION AS REQUIRED BY THE SPECIAL PROVISION "CLEANING AND PAINTING CONTACT SURFACE AREAS OF EXISTING STEEL STRUCTURES".

ALL NEW STRUCTURAL STEEL AND BEARING ASSEMBLIES SHALL BE HOT-DIP GALVANIZED. SEE SPECIAL PROVISIONS FOR "HOT DIP GALVANIZING FOR STRUCTURAL STEEL".

70′ 5"


TOTAL BILL OF MATERIAL (084-0099)

ITEM	UNIT	QUANTITY
Elastomeric Bearing Assembly, Type I	Each	10
Jack and Remove Existing Bearings	Each	10
Furnishing and Erecting Structural Steel	Pound	1150
Anchor Bolts, 1" Ø	Each	20
Silicone Joint Sealer, 2-3/4"	Foot	64

USER NAME = dudleybm	DESIGNED -	REVISED -
	DRAWN -	REVISED -
PLOT SCALE = 100.0000 / in.	CHECKED -	REVISED -
PLOT DATE = 3/23/2021	DATE -	REVISED -

STATE OF ILLINOIS DEPARTMENT OF TRANSPORTATION | SHEET 1 OF 3 SHEET | STA. TO STA. | SECTION | SHEET STA. TO STA. | SHEET SHEET STA. TO STA. | SECTION | SCOUNTY | SHEET SHEET STA. TO STA. | SECTION | SECTION | SECTION | SECTION | SHEET SHEET SHEET SHEET SHEET SHEET STA. TO STA. | SECTION | SECTION | SHEET SHEE

ABUTMENTJOINT CROSS SECTION: SILICONE JOINT SEALER, 2-3/4"

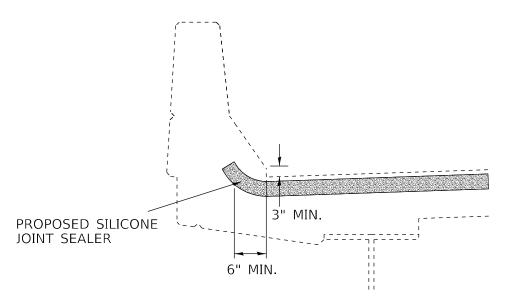

TYPICAL PARAPET CROSS SECTION: SILICONE JOINT SEALER END TREATMENT


NOTES:

- JOINT WIDTHS SPECIFIED IN PLANS ARE AT 50° F. THE CONTRACTOR SHALL INSTALL BACKER ROD HAVING A DIAMETER 25% GREATER THAN THE JOINT OPENING AT THE TIME OF INSTALLATION.
- THE COST OF REMOVING AND DISPOSING OF EXISTING JOINT SEAL MATERIAL SHALL BE INCLUDED IN THE BID PRICE FOR SILICONE JOINT SEALER.

JOINT REPAIR (084-0099)

ITEM	UNIT	QUANTITY
Silicone Joint Sealer 2-3/4"	Foot	64

USER NAME = dudleybm	DESIGNED -	REVISED -				JOINT R	FPAIR I	DETAILS		F.A.I.	SECTION	COUNTY	TOTAL	SHEET
	DRAWN -	REVISED -	STATE OF ILLINOIS							55	(84-4-3)BRR-1 (84-4-1)BRR	SANGAMON	9	8
PLOT SCALE = 100.0000 / in.	CHECKED -	REVISED -	DEPARTMENT OF TRANSPORTATION				084-00				(00)= (0=/=	CONTRACT	NO. 72	M90
PLOT DATE = 3/23/2021	DATE -	REVISED -		SCALE:	SHEET 2	OF 3	SHEETS	STA.	TO STA.		ILLINOIS FED. A	ID PROJECT		

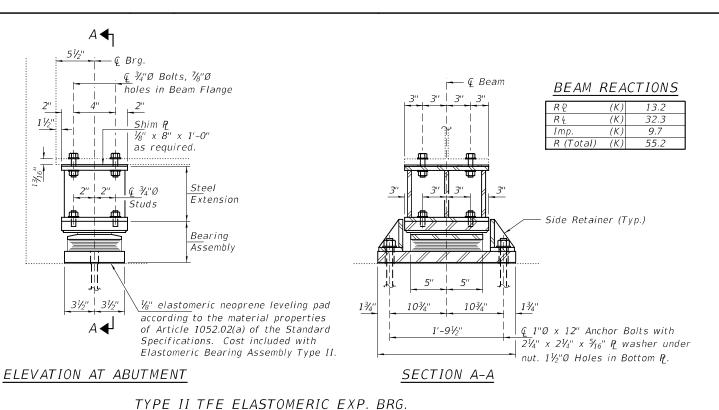

1/8" PTFE with dimpled,

— ¾" ₽_

SECTION THRU PTFE

1/4"Ø Dimples on 1/2" centers

 $\setminus \frac{1}{16}$ " deep, or equivalent.

unlubricated surface

¾"Ø Threaded Stud with flat washer & hex nut. (4 Regd.)

* 1/8" PTFE dimpled,

Elastomer (55 Durometer)

unlubricated

5-Layers of ⅓₁₆"

-4-14 ga. Steel Plates

R 13/8" x 7" x 2'-1"

P2 11/2" x 8" x 1'-0"

Max.

TOP BEARING ASSEMBLY

31/2"

BOTTOM BEARING ASSEMBLY

← Ç 1½"Ø Holes

Bonded-

1/16" Stainless Steel

Diaphragm removal and reinstallation may be required to facilitate drilling holes. Cost included with Furnishing and Frecting Structural Steel.

New steel extensions, shim plates and connection bolts are included with Furnishing and Erecting Structural Steel Prior to ordering any material, the Contractor shall verify in the field all bearing height and shim thickness dimensions.

Adjustment must account for deck heave due to pack rust (if present).

224'-11" @ Brg. to @ Brg

PARTIAL FRAMING PLAN

Remove & Replace Bearing Assemblies

at West & East Abutments.

(10-Locations)

Min. jack capacity = 26 Tons. Anchor bolts shall be ASTM F1554 all-thread (or an Engineer-approved alternate material) of the grade(s) and diameter(s) specified. ASTM A307 Grade anchor bolts may be used in lieu of ASTM F1554 Grade 36 (Fy=36ksi). The corresponding specified grade of AASHTO M314 anchor bolts may be used in lieu of ASTM F1554.

Anchor bolts at fixed bearings may be either cast in place or installed in holes drilled after the supported member is in place.

Anchor bolts for Type II bearings shall be placed in holes drilled through the bottom bearing plate after members are in place. Side retainers shall be placed

after bolts are installed.


Drilled and set anchor bolts shall be installed according to Article 521.06 of the Standard Specifications.

Side retainers shall be included in the cost of Elastomeric Bearing Assembly, Type II.


The 1/8" PTFE sheet shall be bonded directly to the top steel plate with a two-component, medium viscosity epoxy resin, conforming to the requirements of the Federal Specification MMM-A-134, Type I. The bond agent shall be applied on the full area of the contact


Bonding of 1/8" PTFE sheet during vulcanizing process will be permitted provided the process and method of adjusting assembly height is approved by the Engineer.

€ Brg.

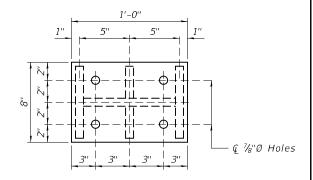

PLAN TOP AND BOTTOM PLATE

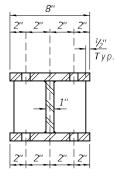

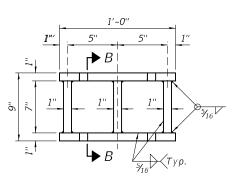


SECTION B-B

STEEL EXTENSION DETAIL

Note:

Height of the steel extensions shown is required in order to raise the end of the deck to match the Approach elevation. See Special Provision for Jack and Remove Existing Bearing.

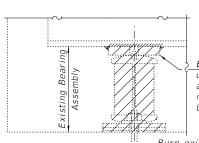


Existing P to be removed using the air-arc method and grind smooth all weld material remaining on the bottom flange.

Burn existing anchor bolts flush with existing concrete surface. Grind existing anchor bolt smooth and seal with epoxy.

EXISTING BEARING REMOVAL DETAIL

Cost included with Jack and Remove Existing Bearings.

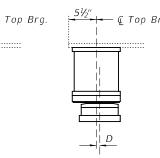

€ Bott. Brg. € Bott. Brg. →

BELOW 50° F. ABOVE 50° F. (Move bott. brg. away from fixed brg.) (Move bott. brg. toward fixed brg.)

SETTING ANCHOR BOLTS AT EXP. BRG.

 $D = \frac{1}{8}$ " per each 100' of expansion for every 15° temp. change from the normal temp. of 50°F.

BILL OF MATERIAL

Item	Unit	Total
Elastomeric Bearing Assembly, Type II	Each	10
Jack and Remove Existing Bearings	Each	10
Furnishing and Erecting Structural Steel	Pound	1150
Anchor Bolts 1"Ø	Each	20

Expires: November 30, 2022


DESIGNED - STEPHEN M. RYAN EXAMINED MAY 3, 2021 CHECKED - ADRIAN T. HALLOWAY ENGINEER OF STRUCTURAL SERVICES DRAWN - STEFFEN REVISED -PASSED CHECKED - SMR ATH REVISED

STATE OF ILLINOIS **DEPARTMENT OF TRANSPORTATION**

ABUTMENT BEARING REPLACEMENT DETAILS SOUTHWIND ROAD OVER F.A.I. 55 SN 084-0099 SHEET NO. 1 OF 1 SHEETS

A.I. RTE	SECTION	COUNTY	TOTAL SHEETS	SHEET NO.				
55	(84-4-3)BRR-1 (84-4-1)BRR	SANGAMON	9	9				
CONTRACT NO. 72M90								

\circ \circ TFE Surface PLAN-PTFE SURFACE

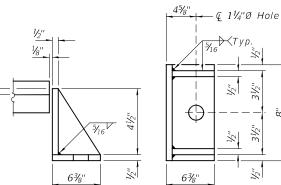

(4)-

N

SIDE RETAINER

Equivalent rolled angle with stiffeners will be allowed in lieu of welded plates.