


NOTE:  
 1. IF TEMPORARY EXCAVATED MATERIAL STOCKPILE IS REQUIRED EITHER STOCKPILE ON PAVEMENT IN WORK ZONE OR IN INFIELDS OF INTERCHANGE WITH PEB IF INFIELD STOCKPILE IS IN PLACE MORE THAN SEVEN (7) DAYS THAN ADD TECS & B  
 2. TEMPORARY DITCH CHECK SHALL BE PLACED 100' C-C

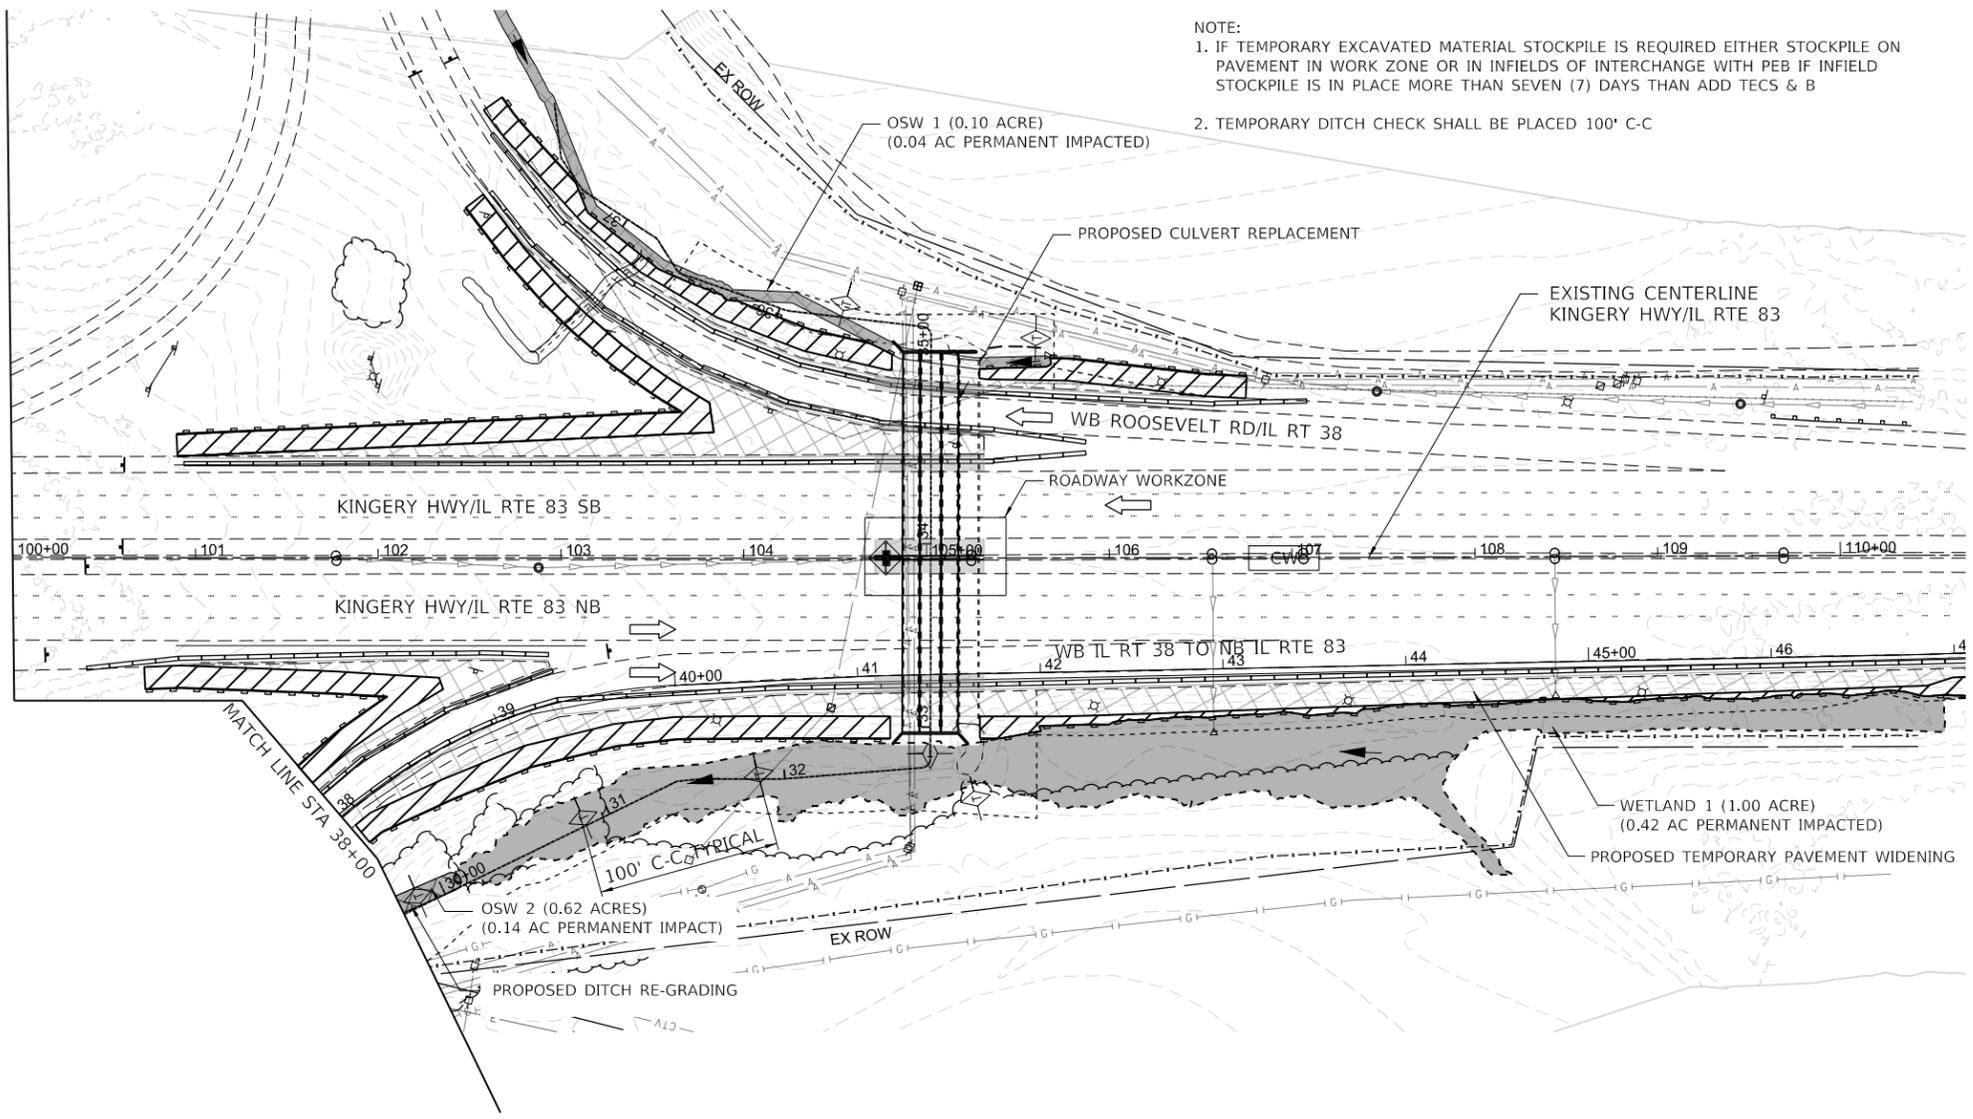

**LEGEND**

- RIPRAP
- WETLANDS
- OTHER SURFACE WATERS (OSW)
- WETLAND OR OSW PERMANENT IMPACT
- TEMPORARY DITCH CHECKS (28000305)
- TEMPORARY EROSION CONTROL SEEDING AND BLANKET (28000250, 28001100)
- DOUBLE PERIMETER EROSION BARRIER (28000305)
- TOPSOIL 4" (21101615) SEEDING, CLASS 4B (25000314) WITH EROSION CONTROL BLANKET (25100630)
- CW CONCRETE WASHOUT (X0326806)
- INLET FILTER (28000510)
- DIRECTION OF FLOW
- EXISTING/PROPOSED CONTOUR LINE
- DIRECTION OF TRAFFIC
- TOPSOIL FURNISH & PLACE, 4" SEEDING, CLASS 2A EROSION CONTROL BLANKET POTASSIUM & NITROGEN FERTILIZERS
- TOPSOIL FURNISH & PLACE, 8" SEEDING, CLASS 4 (MODIFIED) SEEDING, CLASS 5A (MODIFIED) HEAVY DUTY EROSION CONTROL BLANKET, SPECIAL
- TOPSOIL FURNISH & PLACE, 8" SEEDING, CLASS 4B (MODIFIED) SEEDING, CLASS 5B (MODIFIED) HEAVY DUTY EROSION CONTROL BLANKET, SPECIAL

MODEL: 1400BELMAME  
 FILE: 1400BELMAME.DWG  
 DATE: 2/26/2021 10:02:40

**AMES Engineering, Inc.**  
 CONSULTING ENGINEERS  
 6330 Belmont Road, Suite 4B  
 Downers Grove, IL 60515

USER NAME = mdeitche	DESIGNED - JAR	REVISED -
	DRAWN - MD	REVISED -
PLOT SCALE = \$SCALE\$	CHECKED - AS	REVISED -
PLOT DATE = 2/26/2021	DATE - 2/26/2021	REVISED -

**STATE OF ILLINOIS  
 DEPARTMENT OF TRANSPORTATION**

**IL ROUTE 83 OVER DITCH AT IL 38 (WB) RAMP  
 STAGE 1 LANDSCAPING AND EROSION CONTROL PLAN**

SCALE: 1"=50' SHEET 2 OF 2 SHEETS STA. TO STA.

F.A.P. RTE.	SECTION	COUNTY	TOTAL SHEETS	SHEET NO.
344	2020-196-T	DUPAGE	122	40
CONTRACT NO. 62M69			ILLINOIS FED. AID PROJECT	