06-11-2021 LETTING ITEM 100

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SUBSURFACE UTILITY ENGINEERING (S.U.E) UTILIZED ON THIS PROJECT

FOR INDEX OF SHEETS, SEE SHEET NO. 2

FOR LIST OF HIGHWAY STANDARDS, SEE SHEET NO. 2

**FUNCTIONAL CLASSIFICATION:** 

OTHER PRINCIPAL ARTERIAL 130TH ST 2019 ADT = 18,200130TH ST POSTED SPEED LIMIT: 35 MPH

 $1-94\ 2019\ ADT = 148.900$ 

# STATE OF ILLINOIS **DEPARTMENT OF TRANSPORTATION**

EQOK 85 1

\* 85 + 2 = 87 TOTAL SHEETS

D-91-562-20

FAP ROUTE 0344 (130TH ST)
AT I-94 (BISHOP FORD EXPRESSWAY) & CSSS & IHB RR
SECTION 2020-153-BR

PROJECT NHPP-KJ9T(288) **BRIDGE DECK OVERLAY AND JOINT REPAIRS** 

**COOK COUNTY** 

C-91-361-20

**BRIDGE REPAIRS** SN 016-2600 STA 38 + 91.98

LOCATION OF SECTION INDICATED THUS:-

**PROPOSED HIGHWAY PLANS** 


I-94 POSTED SPEED LIMIT: 55 MPH APPLIES TO SHEETS 1-29, 31-34 APPLIES TO SHEET 30 LICENSED CIVIL ENGINEER, STATE OF ILLINOI EXPIRES: 11/30/2021 APPLIES TO SHEETS 66-70 LICENSED CIVIL ENGINEER, STATE OF ILLINOIS LICENSED CIVIL ENGINEER, STATE OF ILLINOIS EXPIRES: 11/30/2021

LICENSED STRUCTURAL ENGINEER, STATE OF ILLINOIS

**MUNICIPALITIES:** CITY OF CHICAGO

APPLIES TO SHEETS 35-65

EXPIRES: 11/30/2022

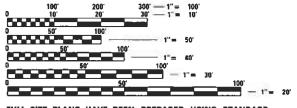

ENGINEERING SCALES, REDUCED SIZED PLANS WILL NOT ON REDUCED PLANS, THE ABOVE SCALES MAY BE USED.

JOINT UTILITY LOCATION INFORMATION FOR EXCAVATION 1-800-892-0123 OR 811

PROJECT ENGINEER: PRAVEEN KAINI, PE (847)-705-4237 PROJECT MANAGER: J. ALAIN MIDY, PE (847)-221-3056

SN 016-2600 GROSS LENGTH = 409.54 FT. = 0.078 MILE GROSS LENGTH = 375.28 FT. = 0.071 MILE NET LENGTH = 375.28 FT. = 0.071 MILE

**LOCATION MAP** 


NOT TO SCALE

SUBMITTED MACLY 11 20 21

STATE OF ILLINOIS

**REV-SEP** 

PRINTED BY THE AUTHORITY OF THE STATE OF ILLINOIS

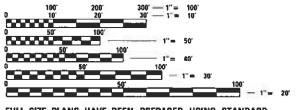

CONFORM TO STANDARD SCALES. IN MAKING MEASUREMENTS

SN 016-2434

**BRIDGE REPAIRS** SN 016-2434 STA 24+37.61

NET LENGTH = 409.54 FT. = 0.078 MILE

CONTRACT NO. 62M41

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1	COVER SHEET
	INDEX OF SHEETS AND HIGHWAY STANDARDS
	GENERAL NOTES AND COMMITMENTS
	SUMMARY OF QUANTITIES
	SCHEDULE OF QUANTITIES
	MAINTENANCE OF TRAFFIC NOTES
	MAINTENANCE OF TRAFFIC TYPICAL SECTIONS
	DETOUR PLAN
	MAINTENANCE OF TRAFFIC SIGNS
	MAINTENANCE OF TRAFFIC STAGE 1 - 130TH STREET
	MAINTENANCE OF TRAFFIC STAGE 2 - 130TH STREET
	MAINTENANCE OF TRAFFIC STAGE 3 - 130TH STREET
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	PROPOSED MEDIAN PLAN - I-94
	REMOVAL PLAN - 130TH STREET
	PROPOSED MEDIAN AND PAVEMENT MARKING PLAN - 130TH STREET
	PROPOSED GUARDRAIL PLAN - I-94
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35	GENERAL PLAN AND ELEVATION - SN 016-2434
36	GENERAL NOTES AND BILL OF MATERIALS - SN 016-2434
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38	DECK & APPROACH SLABS REPAIRS AND OVERLAY PLANS - SN 016-2434
39	ADJUSTING DRAINAGE SCUPPER DETAILS - SN 016-2434
40	JOINT REPAIR LIMITS - SN 016-2434
41	EXPANSION JOINT DETAILS - SN 016-2434
42	PREFORMED JOINT STRIP SEAL - SN 016-2434
43	JOINTS AND BRIDGE DRAINAGE AS-BUILT PLANS - SN 016-2434
44	PIER 1 REPAIRS - SN 016-2434
45	PIER 2 REPAIRS - SN 016-2434
46	PIER 3 REPAIRS - SN 016-2434
	EAST AND WEST ABUTMENT REPAIRS - SN 016-2434
	BAR SPLICER ASSEMBLY - SN 016-2434
	GENERAL PLAN AND ELEVATION - SN 016-2600
	GENERAL NOTES AND BILL OF MATERIALS - SN 016-2600
	MAINTENANCE OF TRAFFIC DETAILS - SN 016-2600
	DECK & APPROACH SLABS REPAIRS AND OVERLAY PLANS - SN 016-2600
	JOINT REPAIR LIMITS - SN 0.16-2600
	EXPANSION JOINT DETAILS - SN 016-2600
	PREFORMED JOINT STRIP SEAL - SN 016-2600
	JOINTS AND BRIDGE DRAINAGE AS-BUILT PLANS - SN 016-2600
	BEARING REPLACEMENT LOCATIONS - SN 016-2600
	NEW BEARING DETAILS - SN 016-2600
	BEARING DETAILS - AS-BUILT PLANS - SN 016-2600
	PARAPET AND HANDRAIL REPAIR - SN 016-2600
	FENCE RAIL REPAIR - AS-BUILT PLANS - SN 016-2600
	EAST ABUTMENT REPAIR - SN 016-2600
	WEST ABUTMENT REPAIR - SN 016-2600
	VAULTED ABUTMENT DOOR DETAIL
	PIER REPAIR - SN 016-2600
	BAR SPLICER ASSEMBLY - SN 016-2600
	GENERAL NOTES, BILL OF MATERIALS AND LEGEND - 130TH ST. OVER I-94
	UNDERPASS LIGHTING REMOVAL PLAN - 130TH ST. OVER I-94
	UNDERPASS LIGHTING PROPOSED PLAN - 130TH ST. OVER I-94
	SINGLE LINE WIRING DIAGRAM - 130TH ST, OVER I-94
	MISC. ELETRICAL DETAILS SHEET A - 130TH ST. OVER I-94
	SUSPENDED MOUNT LED UNDERPASS LUMINAIRE INSTALLATION DETAILS - 130TH ST. OVER 1-94
	BD-49 DETAIL FOR CENTERLINE SAW CUT 16' AND VARIABLE JOINTED PCC PAVEMENT FOR RAMPS
	BM-21 REMOVE AND REERECT STEEL PLATE BEAM GUARDRAIL
	TC-08 ENTRANCE AND EXIT RAMP CLOSURE DETAILS
	TC-10 TRAFFIC CONTROL AND PROTECTION FOR SIDE ROADS, INTERSECTIONS, AND DRIVEWAYS
	TC-13 DISTRICT ONE TYPICAL PAVEMENT MARKINGS
	TC-14 TRAFFIC CONTROL AND PROTECTION AT TURN BAYS (TO REMAIN OPEN TO TRAFFIC)
	TC-16 SHORT TERM PAVEMENT MARKING LETTERS AND SYMBOLS
	TC-17 TRAFFIC CONTROL DETAILS FOR FREEWAY SHOULDER CLOSURES AND PARTIAL RAMP CLOSURES
	TC-18 FREEWAY/EXPRESSWAY SIGNING FOR FLAGGING OPERATIONS AT WORK ZONE OPENINGS ON FREEWAYS/EXPRESSWAYS
	TC-21 DETOUR SIGNING FOR CLOSING STATE HIGHWAYS
85	TC-22 ARTERIAL ROAD INFORMATION SIGN

### **IDOT HIGHWAY STANDARDS**

000001-08	STANDARD SYMBOLS, ABBREVIATIONS, AND PATTERNS
001006	DECIMAL OF AN INCH AND OF A FOOT
420001-09	PAVEMENT JOINTS
606001-07	CONCRETE CURB TYPE B AND COMBINATION CONCRETE CURB AND GUTTER
606301-04	PC CONCRETE ISLANDS AND MEDIANS
630001-12	STEEL PLATE BEAM GUARDRAIL
630301-09	SHOULDER WIDENING FOR TYPE I (SPECIAL) GUARDRAIL TERMINALS
631011-10	TRAFFIC BARRIER TERMINAL, TYPE 2
643001-02	SAND MODULE IMPACT ATTENUATORS
701106-02	OFF-ROAD OPERATIONS, MULTILANE, MORE THAN 15 (4.5 M) AWAY
701400-10	APPROACH TO LANE CLOSURE, FREEWAY/EXPRESSWAY
701401-12	LANE CLOSURE, FREEWAY/EXPRESSWAY
701411-09	LANE CLOSURE, MULTILANE, AT ENTRANCE OR EXIT RAMP, FOR SPEEDS ? 45 MPH
701427-05	LANE CLOSURE, MULTILANE, INTERMITTENT OR MOVING OPERATIONS, FOR SPEEDS ? 40 MPH
701428-01	TRAFFIC CONTROL SETUP AND REMOVAL FREEWAY/EXPRESSWAY
701446-11	TWO LANE CLOSURE, FREEWAY/EXPRESSWAY
701601-09	URBAN LANE CLOSURE, MULTILANE, 1W OR 2W, WITH NONTRAVERSABLE MEDIAN
701606-10	URBAN SINGLE LANE CLOSURE, MULTILANE, 2W WITH MOUNTABLE MEDIAN
701611-01	URBAN HALF ROAD CLOSURE, MULTILANE, 2W WITH MOUNTABLE MEDIAN
701701-10	URBAN LANE CLOSURE, MULTILANE, INTERSECTION
701901-08	TRAFFIC CONTROL DEVICES
704001-08	TEMPORARY CONCRETE BARRIER
725001-01	OBJECT AND TERMINAL MARKERS
780001-05	TYPICAL PAVEMENT MARKINGS
782006-01	GUARDRAIL AND BARRIER WALL REFLECTOR MOUNTING DETAILS
880001-01	SPAN WIRE MOUNTED SIGNALS AND FLASHING BEACON INSTALLATION

Bowman 311 S. Waster Drive, Suite 1950 Construction of State 1950 www.bowmanconstiting.com

	USER NAME = apatel	DESIGNED	-	KH	REVISED -
1950		DRAWN	-	KM	REVISED -
om	PLOT SCALE = 2.0000 / in	CHECKED	-	AP	REVISED -
	PLOT DATE = 3/17/2021	DATE	-	3/17/2021	REVISED -

STATE OF ILLINOIS
DEPARTMENT OF TRANSPORTATION

SCALE: NONE

	F.A.P. RTE	SECTION	COUNTY	TOTAL SHEETS	SHEET NO.
INDEX OF SHEETS AND HIGHWAY STANDARDS	0344	2020-261-BR	COOK	85	2
			CONTRACT	NO.	62M41
SHEET 1 OF 1 SHEETS STA. TO STA.		ILLINOIS FED. AL	D PROJECT		-

#### **GENERAL NOTES**

- THE CONTRACTOR SHALL COORDINATE CONSTRUCTION ACTIVITIES WITH UTILITY COMPANIES AND THE CITY OF CHICAGO.
- THE CONTRACTOR WILL NOT BE ALLOWED TO SET UP A YARD OR FIELD OFFICE ON STATE PROPERTY WITHOUT WRITTEN PERMISSION FROM THE DEPARTMENT.
- 3. ALL DAMAGE TO EXISTING PAVEMENT MARKINGS OR RAISED REFLECTIVE PAVEMENT MARKERS
  OUTSIDE THE REMOVAL LINE SHOWN ON THE PLANS SHALL BE REPLACED AT NO ADDITIONAL COST
  TO THE DEPARTMENT
- 4. IT SHALL BE THE CONTRACTORS RESPONSIBILITY TO VERIFY ALL DIMENSIONS AND CONDITIONS EXISTING IN THE FIELD PRIOR TO CONSTRUCTION AND ORDERING OF MATERIALS.
- FRAMES AND GRATES ADJUSTMENT OF PRIVATE UTILITIES WITHIN THE LIMITS OF THE IMPROVEMENTS
  SHALL BE DONE BY THEIR RESPECTIVE OWNERS AND ARE NOT PART OF THIS CONTRACT.
- 6. THE CONTRACTOR SHALL CONTACT THE EXPRESSWAY TRAFFIC CONTROL SUPERVISOR AT (847) 705-4155 AND THE DISTRICT ONE TRAFFIC CONTROL SUPERVISOR AT KALPANA.KANNAN-HOSADURGA@ILLINOIS.GOV A MINIMUM OF 72 HOURS IN ADVANCE OF BEGINNING WORK.
- 7. THE RESIDENT ENGINEER SHALL CONTACT THE EXPRESSWAY TRAFFIC FIELD ENGINEER REGINA COOPER AT (847) 705-4153, AND ARTERIAL FIELD ENGINEER AND AREA TRAFFIC FIELD TECHNICIAN PATRICE HARRIS AT (847) 705-4413 AND PATRICE.HARRIS@ILLINOIS.GOV A MINIMUM OF TWO (2) WEEKS PRIOR TO THE PLACEMENT OF PERMANENT PAVEMENT MARKINGS
- 8. WHERE SECTION OR SUB-SECTION MONUMENTS ARE ENCOUNTERED, THE ENGINEER SHALL BE NOTIFIED BEFORE SUCH MONUMENTS ARE REMOVED. THE CONTRACTOR SHALL PROTECT AND CAREFULLY PRESERVE ALL PROPERTY MARKERS AND MONUMENTS UNTIL THE OWNER, AN AUTHORIZED SURVEYOR OR AGENT HAS WITNESSED THEIR LOCATION.
- THE CONTRACTOR SHALL BE REQUIRED TO PROVIDE ACCESS TO ABUTTING PROPERTY AT ALL TIMES DURING THE CONSTRUCTION OF THIS PROJECT.
- 10. THE CONTRACTOR WILL BE REQUIRED TO KEEP A RECORD OF THE LOCATIONS OF THE BURIED STRUCTURES ACCORDING TO THE STATION AND DISTANCE LEFT OR RIGHT OF THE CENTERLINE OF PAVEMENT. UPON COMPLETION OF THE WORK, THE CONTRACTOR WILL DELIVER THE RECORD TO THE ENGINEER.
- 11. EXISTING BROKEN FRAMES AND LIDS SHALL BE REMOVED AND DISPOSED OF BY THE CONTRACTOR AND SHALL BE REPLACED AS DIRECTED BY THE ENGINEER. REPLACEMENT FRAMES AND LIDS WILL BE PAID FOR IN ACCORDANCE WITH ARTICLE 109.04 OF THE STANDARD SPECIFICATIONS UNLESS A A SEPARATE PAY ITEM HAS BEEN PROVIDED.
- 12. FOR FRAMES AND LIDS ADJUSTMENT WITHOUT MILLING, REUSE EXISTING FRAME AND LID UNLESS OTHERWISE SPECIFIED IN THE PLANS.
- 13. THE CONTRACTOR SHALL BE RESPONSIBLE FOR THE NOTIFICATION OF ALL EMERGENCY SERVICES, SCHOOL DISTRICTS, I.D.O.T.'S COMMUNICATIONS CENTER, SPRINGFIELD TRUCK PERMIT SECTION AND OTHER AGENCIES AFFECTED BY THE CLOSURE. THE CONTRACTOR SHALL ALSO BE RESPONSIBLE FOR POSTING SIGNS THAT WILL INDICATE THE DATES THE CLOSURE WILL BE IN PLACE.
- 14. DO NOT SCALE PLANS FOR CONSTRUCTION DIMENSIONS.
- 15. ANY REFERENCE TO A STANDARD IN THESE PLANS SHALL BE INTERPRETED TO MEAN THE EDITION AS INDICATED BY THE SUBNUMBER SHOWN IN THE LIST OF STANDARDS OR THE COPY INCLUDED IN THESE PLANS.
- 16. SAWING OF REMOVAL ITEMS AS NOTED ON THE PLANS, SPECIFIED IN THE STANDARD SPECIFICATIONS, OR AS REQUIRED BY THE ENGINEER SHALL BE INCLUDED IN THE COST OF THE ITEM BEING REMOVED.
- 17. ABANDONED UNDERGROUND UTILITIES THAT CONFLICT WITH CONSTRUCTION SHALL BE DISPOSED OF OUTSIDE THE LIMITS OF THE RIGHT OF WAY ACCORDING TO ARTICLE 202.03 OF THE STANDARD SPECIFICATIONS AND AS DIRECTED BY THE ENGINEER. THIS WORK WILL NOT BE PAID FOR SEPARATELY, BUT SHALL BE INCLUDED IN THE COST OF EARTH EXCAVATION.
- 18. IT IS THE CONTRACTOR'S RESPONSIBILITY TO ASCERTAIN EXISTING FIELD CONDITIONS BEFORE BIDDING ON THIS CONTRACT.

- 19. THE LOCATIONS OF EXISTING DRAINAGE STRUCTURES, STORM SEWER, WATER MAIN, SANITARY SEWER, AND OTHER PUBLIC OR PRIVATE UTILITIES AS SHOWN ON THE PLANS IS APPROXIMATE, AND THEIR EXACT LOCATION IS TO BE DETERMINED IN THE FIELD BY THE CONTRACTOR. THIS WORK SHALL BE PER ARTICLES 105.07 AND 107.31 OF THE STANDARD SPECIFICATIONS. WHEN REQUIRED, LOCATING UTILITIES SHALL BE PAID FOR AT THE CONTRACT UNIT PRICE PER FOOT FOR EXPLORATION TRENCH, SPECIAL.
- 20. MEMBERS OF JULIE KNOWN TO BE WITHIN THE LIMITS OF THE IMPROVEMENT ARE: COMMONWEALTH EDISON CO. AND AT&T
- 21. THE CONTRACTORS SHALL CONTACT JULIE AT LEAST 48 HOURS PRIOR TO EXCAVATION TO DETERMINE WHICH UTILITIES ARE IN THE AREA
- 22. THE REMOVAL OF GUARDRAIL TERMINAL SECTIONS SHALL BE INCLUDED IN THE UNIT PRICE PER FOOT FOR GUARDRAIL REMOVAL.
- 23. BEFORE BEGINNING ANY WORK, THE CONTRACTOR SHALL RETAIN AND RECORD FOR FUTURE REFERENCE, ALL EXISTING PAVEMENT MARKING LINES AND RAISED REFLECTIVE PAVEMENT MARKERS, IN ORDER THAT THESE LOCATIONS CAN BE RE-STABLISHED FOR STRIPING. EXACT LOCATIONS OF ALL PAVEMENT MARKINGS SHALL BE AS DIRECTED BY THE ENGINEER.
- 24. THE SUBGRADE STABILITY SHALL BE VERIFIED BY PROOF ROLLING WITH A FULLY LOADED TANDEM-AXI F TRUCK.
- 25. THE CONTRACTOR SHALL CONTACT THE IDOT ROADSIDE DEVELOPMENT UNIT AT (847) 705-4171 AT LEAST TWO WEEKS PRIOR TO BEGINNING LANSCAPE AND FORESTRY WORK.
- 26. ALL TEMPORARY EROSION CONTROL MEASURES SHALL BE PROVIDED TO PROTECT ROADWAY, ADJACENT PROPERTIES, AND WATER COURSES AS PER SECTION 280 OF THE STANDARD SPECIFICATIONS FOR ROAD AND BRIDGE CONSTRUCTION, LATEST EDITION.
- 27. THE CONTRACTOR SHALL REQUEST AND GAIN APPROVAL FROM THE ILLINOIS DEPARTMENT OF TRANSPORTATION'S EXPRESSWAY TRAFFIC OPERATIONS ENGINEER AT WWW.IDOTLCS.COM TWENTY-FOUR (24) HOURS IN ADVANCE OF ALL DAILY LANE, RAMP AND SHOULDER CLOSURES AND 7 DAYS IN ADVANCE OF ALL PERMANENT AND WEEKEND CLOSURES ON ALL FREEWAYS AND/OR EXPRESSWAYS IN DISTRICT ONE. THE ADVANCE NOTIFICATION IS CALCULATED BASED ON MONDAY THROUGH FRIDAY AND SHALL NOT INCLUDE WEEKENDS OR HOLIDAYS.
- 28. ALL STAGE CHANGES REQUIRING THE STOPPING AND/OR THE PACING OF TRAFFIC SHALL
  TAKE PLACE DURING THE ALLOWABLE HOURS FOR FULL EXPRESSWAY CLOSURES AND SHALL
  BE APPROVED BY THE DEPARTMENT. THE CONTRACTOR SHALL NOTIFY THE DISTRICT ONE
  EXPRESSWAY TRAFFIC CONTROL SUPERVISOR AT LEAST 3 WORKING DAYS (WEEKENDS
  AND HOLIDAYS DO NOT COUNT INTO THIS 72 HOURS NOTIFICATION) IN ADVANCE OF
  ANY PROPOSED STAGE CHANGE.
- 29. USE EXTREME CAUTION NEAR GAS FACILITIES DURING CONSTRUCTION AND RELATED EXCAVATION ACTIVITIES. HAND DIG OR NON-INVASIVE EXCAVATION IS REQUIRED TO FIELD VERIFY THE HORIZONTAL AND VERTICAL LOCATION OF GAS FACILITIES PRIOR TO CROSSING AND WORKING WITHIN 3 FEET OF ALL GAS FACILITIES. A MINIMUM OF 3' HORIZONTAL EDGE TO EDGE CLEARANCE IS REQUIRED FOR GAS FACILITIES WITH DIAMETERS OF 16" OR SMALLER, AND 5FT EDGE TO EDGE CLEARANCE FOR GAS FACILITIES WITH DIAMETERS 18" AND LARGER. MAINTAIN A MINIMUM OF 18"EDGE TO EDGE VERTICAL CLEARANCE WHEN CROSSING GAS FACILITIES 16" OR LESS IN DIAMETER, AND 24" EDGE TO EDGE VERTICAL CLEARANCE WHEN CROSSING 18" AND LARGER DIAMETER GAS FACILITIES. CONTACT 811 CHICAGO/DIGGER 312-744-7000 FOR LOCATES 48 HOURS PRIOR TO START OF CONSTRUCTION.
- 30. THE USE OF CONCRETE, FLOW FILL, OR THE LIKE IS PROHIBITED WITHIN 24 INCHES OF ALL GAS FACILITIES, NOR SHALL IT ENCASE ANY GAS FACILITY. A BUFFER OF 24" SAND IS TO BE USED BETWEEN FLOW FILL AND ALL GAS FACILITIES. A MINIMUM OF 6" FA-02 OR FM-02 SAND SHALL BE USED WHEN BACKFILLING OTHER MATERIALS AROUND ANY EXPOSED GAS FACILITY. CONTRACTOR EXPOSING GAS FACILITY IS RESPONSIBLE FOR PROVIDING THE SAND. ANY DAMAGES TO PEOPLES GAS FACILITIES SHALL BE THE RESPONSIBILITY OF THE INSTALLING UTILITY AND THEIR CONTRACTOR(S). CALL 866-556-6002 IMMEDIATELY FOR ANY DAMAGES TO THE GAS FACILITIES. VERTICAL ADJUSTMENTS REQUIRED FOR VALVE BASIN FRAMES, COVERS, GAS SHUT-OFF VALVES, ROADWAY BOXES SHALL BE COMMUNICATED TO JACIE SPUDIC, PLANNING-PERMIT GROUP, JACIE.SPUDIC@PEOPLESGASDELIVERY.COM, 4 WEEKS PRIOR TO THE START OF RESTORATION FOR PLANNING & SCHEDULING. ALL GAS FACILITIES ARE TO BE MAINTAINED.

31. PLEASE CONTACT QUENTIN SHIPLEY-MELLON AT MINIMUM TWO (2) WEEKS BEFORE CONSTRUCTION TO COORDINATE IMPACTS TO BUS SERVICE.

OSHIPLEY-MELLON@TRANSITCHICAGO.COM OR (312) 681-4119

#### COMMITMENTS

NONE

	USER NAME = kmaus	DESIGNED - KH	REVISED -				F.A.P. RTE	SECTION	COUNTY TO	TAL SHEET NO.
Wman 311 S. Wacker Drive, Suite 1950 Chicago, Illinois 60606		DRAWN - KM	REVISED -	STATE OF ILLINOIS		GENERAL NOTES AND COMMITMENTS	0344	2020-261-BR	соок 8	85 3
S U L T I N G www.bowmanconsulting.com	PLOT SCALE = 2 0000 / in	CHECKED - AP	REVISED -	DEPARTMENT OF TRANSPORTATION					CONTRACT NO	O 62M41
	PLOT DATE = 3/17/2021	DATE - 3/17/2021	REVISED -		SCALE: NONE	SHEET 1 OF 1 SHEETS STA TO STA.		TILLINOIS FED	AID PROJECT	

				CONSTRUCTIO	N CODE	
				80% FED 209	% STATE	
CODE			TOTAL		BRIDGE REHAB	
NO.	ITEM	UNIT	QUANTITY URBAN	0059	0059	
_			`URBAN	SN 016-2434	SN 016-2600	
20200100	EARTH EXCAVATION	CU YD	224		224	
31101200	SUBBASE GRANULAR MATERIAL, TYPE B 4"	SQ YD	576		576	
44000100	PAVEMENT REMOVAL	SQ YD	576		576	
44000500	COMBINATION CURB AND GUTTER REMOVAL	FOOT	668		668	
44003103	MED LAN DEMOVAL	60.57	6 522		6 522	
	MEDIAN REMOVAL	SQ FT	6,532		6,532	-
	CLASS A PATCHES , TYPE I , 12 INCH	SQ YD	20	10.1	20	
	CONCRETE REMOVAL	CU YD	48.3	19.1	29.2	
	CLASS A PATCHES, TYPE II, 12 INCH	SQ YD	20		20	
	PROTECTIVE SHIELD	SQ YD	2,728	650	2,078	
	CLASS A PATCHES, TYPE III, 12 INCH	SQ YD	40		40	
	CONCRETE STRUCTURES	CU YD	19.1		19.1	
	CLASS A PATCHES, TYPE IV, 12 INCH	SQ YD	720		720	
50300255	CONCRETE SUPERSTRUCTURE	CU YD	48.3	19.1	29.2	
				0.754	2 020	
50300260	BRIDGE DECK GROOVING	SQ YD	6,693	2,761	3,932	_
50300200	PROTECTIVE COAT	SQ YD	7,053	2,959	4,094	-
30300300	THOTEGIVE COM	130 10	,,055	2,333	7,034	
50800205	REINFORCEMENT BARS, EPOXY COATED	POUND	7,950	2,560	5,390	
		1			•	
50800515	BAR SPLICERS	EACH	44	22	22	
						-
52000110	PREFORMED JOINT STRIP SEAL	FOOT	378.0	152.0	226.0	-
52100010	ELASTOMERIC BEARING ASSEMBLY, TYPE I	EACH	4		4	_
				1		

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	PLOT DATE = 3/17/2021	DATE	-	3/17/2021	REVISED	-

STATE OF ILLINOIS
DEPARTMENT OF TRANSPORTATION

	S	UMMARY	OF QUA	NTITIES	
SCALE: NONE	SHEET 1	OF 6	SHEETS	STA.	TO STA.

				CONSTRUCTIO	N CODE	
				80% FED 20	% STATE	
CODE	I.T.C.M.		TOTAL		BRIDGE REHAB	
NO.	ITEM	UNIT	QUANTITY URBAN	0059 SN 016-2434	0059 SN 016-2600	
58700300	CONCRETE SEALER	SQ FT	26,606	16,278	10,328	
59000200	EPOXY CRACK INJECTION	FOOT	60.0	20.0	40.0	
59200101	BRIDGE WASHING NO. 1	EACH	1	1		
59200102	BRIDGE WASHING NO. 2	EACH	1		1	
60609200	COMBINATION CONCRETE CURB AND GUTTER, TYPE M-6.12	FOOT	668		668	
60618320	CONCRETE MEDIAN SURFACE, 6 INCH	SQ FT	2,001		2,001	
60619200	CONCRETE MEDIAN, TYPE SB-6.06	SQ FT	6,335		6,335	
			.,,,,,,		, 	
<b>*</b> 63000001	STEEL PLATE BEAM GUARDRAIL, TYPE A, 6 FOOT POSTS	FOOT	450		450	
<b>*</b> 63100045	TRAFFIC BARRIER TERMINAL, TYPE 2	EACH	2		2	
<b>4</b> 63100169	TRAFFIC BARRIER TERMINAL, TYPE 1 (SPECIAL) FLARED	EACH	2		2	
<b>*</b> 03100103			_		-	
63302700	REMOVE AND REERECT TRAFFIC BARRIER TERMINALS, TYPE 6	EACH	4		4	
* 66900200	NON-SPECIAL WASTE DISPOSAL	CU YD	192		192	
<b>*</b> 66900530	SOIL DISPOSAL ANALYSIS	EACH	2		2	
			_			
<b>*</b> 66901001	REGULATED SUBSTANCES PRE-CONSTRUCTION PLAN	LSUM	1		1	
<b>*</b> 66901003	REGULATED SUBSTANCES FINAL CONSTRUCTION REPORT	LSUM	1		1	
<b>*</b> 66001006	REGULATED SUBSTANCES MONITORING	CAL DA	1		1	
00301000	THEOREM SOUSTANCES MONTTONTING	CAL DA				

Bowman 211 S. Wicker Drive, Suits 107 Chizago, Illinois 10000 314-014-0200 www.bowmanconsulting.com

STATE OF ILLINOIS DEPARTMENT OF TRANSPORTATION

	su	JMMARY	OF QU	ANTITIES	
SCALE: NONE	SHEET 2	OF 6	SHEETS	STA.	TO STA.

\* SPECIALTY ITEM

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Page					80% FED 20°		
MOST							
Marie   Mari		ITEM	LINIT	TOTAL			
10.000   1	NO.	1 I □V!	ONII	QUANTITY			
MATHIC CONTROLS APPELLANCE				URBAN	3N 010-2434	3N 010-2000	
	67100100	MOBILIZATION	L SUM	1		1	
PRINCIPAL   PRIN	70103815	TRAFFIC CONTROL SURVEILLANCE	CAL DA	133		133	
100   100	70107005	PAVEMENT MARKING BLACKOUT TAPE , 5"	FOOT	1088		1088	
	70107025	CHANGEABLE MESSAGE SIGN	CAL DA	133		133	
TOTAL   TOTA	70107009	PAVEMENT MARKING BLACKOUT TAPE, 9"	FOOT	93		1088	
PARTICIPATION   PARTICIPATIO	70200100	NIGHTTIME WORK ZONE LIGHTING	L SUM	1		1	
10	70300280	TEMPORARY PAVEMENT MARKING - LINE 24"	FOOT	50		50	
1.00   1.00	70300900	PAVEMENT MARKING TAPE, TYPE IV - LETTERS AND SYMBOLS	SQ FT	73		73	
1.00   1.00							
TRANSPORT MARKING TAPE, TYPE IV 8"   FOOT   1,143	70300904	PAVEMENT MARKING TAPE, TYPE IV 4"	FOOT	41,108		41,108	
TRANSPORT MARKING TAPE, TYPE IV 8"   FOOT   1,143							
TAMPORARY CONCRETE BARRIER	70300906	PAVEMENT MARKING TAPE, TYPE IV 6"	FOOT	350		350	
TAMPORARY CONCRETE BARRIER							
TO   TO   TEMPORARY CONCRETE BARRIER	70300908	PAVEMENT MARKING TAPE, TYPE IV 8"	FOOT	1,143		1,143	
TO   TO   TEMPORARY CONCRETE BARRIER							
70600255 IMPACT ATTENUATORS, TEMPORARY (FULLY REDIRECTIVE, NARROW), TEST LEVEL 2  FACH  10600260 IMPACT ATTENUATORS, TEMPORARY (FULLY REDIRECTIVE, NARROW), TEST LEVEL 3  FACH  10600322 IMPACT ATTENUATORS, RELOCATE (FULLY REDIRECTIVE, NARROW), TEST LEVEL 2  FACH  10600322 IMPACT ATTENUATORS, RELOCATE (FULLY REDIRECTIVE, NARROW), TEST LEVEL 2  FACH  10600322 IMPACT ATTENUATORS, RELOCATE (FULLY REDIRECTIVE, NARROW), TEST LEVEL 2  FACH  10600322 IMPACT ATTENUATORS, RELOCATE (FULLY REDIRECTIVE, NARROW), TEST LEVEL 2  FACH  10600322 IMPACT ATTENUATORS, RELOCATE (FULLY REDIRECTIVE, NARROW), TEST LEVEL 2  FACH  10600322 IMPACT ATTENUATORS, RELOCATE (FULLY REDIRECTIVE, NARROW), TEST LEVEL 2  FACH  10600322 IMPACT ATTENUATORS, RELOCATE (FULLY REDIRECTIVE, NARROW), TEST LEVEL 2  FACH  10600322 IMPACT ATTENUATORS, RELOCATE (FULLY REDIRECTIVE, NARROW), TEST LEVEL 2  FACH  10600322 IMPACT ATTENUATORS, RELOCATE (FULLY REDIRECTIVE, NARROW), TEST LEVEL 2  FACH  10600322 IMPACT ATTENUATORS, RELOCATE (FULLY REDIRECTIVE, NARROW), TEST LEVEL 2  FACH  10600322 IMPACT ATTENUATORS, RELOCATE (FULLY REDIRECTIVE, NARROW), TEST LEVEL 3  FACH  10600322 IMPACT ATTENUATORS, RELOCATE (FULLY REDIRECTIVE, NARROW), TEST LEVEL 3  FACH  10600322 IMPACT ATTENUATORS, RELOCATE (FULLY REDIRECTIVE, NARROW), TEST LEVEL 3  FACH  10600322 IMPACT ATTENUATORS, RELOCATE (FULLY REDIRECTIVE, NARROW), TEST LEVEL 3  FACH  10600322 IMPACT ATTENUATORS, RELOCATE (FULLY REDIRECTIVE, NARROW), TEST LEVEL 3  FACH  10600322 IMPACT ATTENUATORS, RELOCATE (FULLY REDIRECTIVE, NARROW), TEST LEVEL 3  FACH  10600322 IMPACT ATTENUATORS, RELOCATE (FULLY REDIRECTIVE, NARROW), TEST LEVEL 3  FACH  10600322 IMPACT ATTENUATORS, RELOCATE (FULLY REDIRECTIVE, NARROW), TEST LEVEL 3  FACH  10600322 IMPACT ATTENUATORS, TEMPORARY (FULLY REDIRECTIVE, NARROW), TEST LEVEL 3  FACH  10600322 IMPACT ATTENUATORS, TEMPORARY (FULLY REDIRECTIVE, NARROW), TEST LEVEL 3  FACH  10600322 IMPACT ATTENUATORS, TEMPORARY (FULLY REDIRECTIVE, NARROW), TEST LEVEL 3  FACH  10600322 IMPACT ATTENUATORS, TEMPORARY (	70400100	TEMPORARY CONCRETE BARRIER	FOOT	6,250		6,250	
70600255 IMPACT ATTENUATORS, TEMPORARY (FULLY REDIRECTIVE, NARROW), TEST LEVEL 2 EACH 4 4 4 7 7 7 7 7 7 7 7 7 7 7 7 7 7 7 7							
70600260 IMPACT ATTENUATORS, TEMPORARY (FULLY REDIRECTIVE, NARROW), TEST LEVEL 3  EACH 2 2  70600322 IMPACT ATTENUATORS, RELOCATE (FULLY REDIRECTIVE, NARROW), TEST LEVEL 2  EACH 6 6  72501000 TERMINAL MARKER - DIRECT APPLIED  EACH 2 2  78008200 POLYUREA PAVEMENT MARKING TYPE 1 - LETTERS AND SYMBOLS  SQ FT 73 73	70400200	RELOCATE TEMPORARY CONCRETE BARRIER	FOOT	1,613		1,613	
70600260 IMPACT ATTENUATORS, TEMPORARY (FULLY REDIRECTIVE, NARROW), TEST LEVEL 3  EACH 2  2  70600322 IMPACT ATTENUATORS, RELOCATE (FULLY REDIRECTIVE, NARROW), TEST LEVEL 2  EACH 6  72501000 TERMINAL MARKER - DIRECT APPLIED  EACH 2  2  78008200 POLYUREA PAVEMENT MARKING TYPE 1 - LETTERS AND SYMBOLS  SQ FT 73  73							
TOGO0322   IMPACT ATTENUATORS, RELOCATE (FULLY REDIRECTIVE, NARROW), TEST LEVEL 2   EACH   6   6   6	70600255	IMPACT ATTENUATORS, TEMPORARY (FULLY REDIRECTIVE, NARROW), TEST LEVEL 2	EACH	4		4	
70600322 IMPACT ATTENUATORS, RELOCATE (FULLY REDIRECTIVE, NARROW), TEST LEVEL 2  FACH 6 6 6  72501000 TERMINAL MARKER - DIRECT APPLIED  FACH 2 2  78008200 POLYUREA PAVEMENT MARKING TYPE I - LETTERS AND SYMBOLS  SQ FT 73 73							
T2501000   TERMINAL MARKER - DIRECT APPLIED	70600260	IMPACT ATTENUATORS, TEMPORARY (FULLY REDIRECTIVE, NARROW), TEST LEVEL 3	EACH	2		2	
T2501000   TERMINAL MARKER - DIRECT APPLIED							
78008200 POLYUREA PAVEMENT MARKING TYPE I - LETTERS AND SYMBOLS  78 T 73 73 73 73 73 73 73 73 73 73 73 73 73	70600322	IMPACT ATTENUATORS, RELOCATE (FULLY REDIRECTIVE, NARROW), TEST LEVEL 2	EACH	6		6	
78008200 POLYUREA PAVEMENT MARKING TYPE I - LETTERS AND SYMBOLS  78 T 73 73 73 73 73 73 73 73 73 73 73 73 73							
	72501000	TERMINAL MARKER - DIRECT APPLIED	EACH	2		2	
	78008200	POLYUREA PAVEMENT MARKING TYPE I - LETTERS AND SYMBOLS	SQ FT	73			

\* SPECIALTY ITEM

TO STA.

CONSTRUCTION CODE

REV-SEP

Bowman 311 S. Wacker Drive, Sults 19 Chisago, Blancis 60808 512-614-0380 www.bowmacconsulting.com

	USER NAME = kmaus	DESIGNED	-	KH	REVISED -
1950		DRAWN	-	KM	REVISED -
com	PLOT SCALE = 2.0000 ' / in.	CHECKED	-	AP	REVISED -
	PLOT DATE = 3/17/2021	DATE	-	3/17/2021	REVISED -

STATE OF ILLINOIS
DEPARTMENT OF TRANSPORTATION

			SUMMAR	Y OF	Qυ	ANTITIES
SCALE: NONE	SHEET	3	OF 6	SHE	ETS	STA.

F.A.P. RTE. 2020-261-BR

					CONSTRUCTION CODE
					80% FED 20% STATE
	CODE	1.TEM		TOTAL	BRIDGE REHAB BRIDGE REHAB
	NO.	ITEM	UNIT	QUANTITY URBAN	0059 0059 SN 016-2434 SN 016-2600
* 78	8008210	POLYUREA PAVEMENT MARKING TYPE I - LINE 4"	FOOT	10,219	10,219
* 78	8008240	POLYUREA PAVEMENT MARKING TYPE I - LINE 8"	FOOT	5 , 997	5 , 997
* 78	8008250	POLYUREA PAVEMENT MARKING TYPE I - LINE 12"	FOOT	1,242	1,242
* 78	8200006	GUARDRAIL REFLECTORS, TYPE B	EACH	10	10
* 78	8200011	BARRIER WALL REFLECTORS, TYPE C	EACH	333	333
<b>14</b>					
*   8:	1100320	CONDUIT ATTACHED TO STRUCTURE, 1" DIA., PVC COATED GALVANIZED STEEL	FOOT	642	642
* 8	1100805	CONDUIT ATTACHED TO STRUCTURE, 3" DIA., PVC COATED GALVANIZED STEEL	FOOT	15	15
* 0.	1200220	JUNCTION BOX, STAINLESS STEEL, ATTACHED TO STRUCTURE, 6"X6"X4"	EACH	12	12
	1300220	JONETION BOX, STATNEESS STEEL, ATTACHED TO STRUCTURE, 0 X0 X4	LACIT		
* 8:	1300530	JUNCTION BOX, STAINLESS STEEL, ATTACHED TO STRUCTURE, 12"X10"X6"	EACH	6	6
* 8	1300830	JUNCTION BOX, STAINLESS STEEL, ATTACHED TO STRUCTURE, 18"X18"X8"	EACH	2	2
	1300030	Total Joseph Strategy All Montes for Strategy 18 Alle Ac	L/terr		-
* 8	1603081	UNIT DUCT, 600V, 3-1C NO. 2, 1/C NO.4 GROUND, (XLP-TYPE USE), 1 1/2" DIA. POLYETHYLENE	FOOT	200	200
* 8:	1702110	ELECTRIC CABLE IN CONDUIT, 600V (XLP-TYPE USE) 1/C NO. 10	FOOT	2,136	2,136
		LUMINAIRE, LED, UNDERPASS, WALL MOUNTED, OUTPUT DESIGNATION D	EACH	6	6
* 82	2110026	LUMINAIRE, LED, UNDERPASS, SUSPENDED, OUTPUT DESIGNATION D	EACH	6	6
		TEMPORARY TRAFFIC SIGNAL INSTALLATION	EACH	2	2
		CLEANING BRIDGE SCUPPERS AND DOWNSPOUTS	EACH	10	10
		CLEANING AND PAINTING EXPOSED REBAR  ACCESS DOOR	SQ FT EACH	24	24
			LACII		· CDECIALTY ITEM

Bowman 311 S. Wecker Drive, Suite 11 Chicago, Illinois 60606 ST4-014-0300 www.hoommacorsutting.com

	USER NAME = kmaus	DESIGNED	-	KH	REVISED	-
e 1950		DRAWN	-	KM	REVISED	-
.com	PLOT SCALE = 2.0000 ' / in.	CHECKED	-	AP	REVISED	-
	PLOT DATE = 3/17/2021	DATE	-	3/17/2021	REVISED	-

STATE OF ILLINOIS
DEPARTMENT OF TRANSPORTATION

				-110	/ 1 1 / 1111	100/0	5171
		SUMMA	ARY OF	QUANT	ITIES		
SCALE: NONE	SHEET 4	OF	6 SH	EETS STA	١.	TO 9	TΑ.

\* SPECIALTY ITEM SECTION 2020-261-BR

		80% FED 20% STATE					
CODE			TOTAL		BRIDGE REHAB		
NO.	ITEM	UNIT	OUANTITY	0059	0059		
			QUANTITY URBAN	SN 016-2434	SN 016-2600		
78300202	PAVEMENT MARKING REMOVAL - WATER BLASTING	SQ FT	8,356		8,356		
X4402020	CONCRETE MEDIAN SURFACE REMOVAL	SQ FT	2,001		2,001		
X6700410	ENGINEER'S FIELD OFFICE, TYPE A (SPECIAL)	CAL MO	12		12		
X7010216	TRAFFIC CONTROL AND PROTECTION, (SPECIAL)	L SUM	1		1		
X7010210	THE CONTINUE THE PROPERTY.	2 3014	<u> </u>		-		
X7011015	TRAFFIC CONTROL AND PROTECTION (EXPRESSWAYS)	L SUM	1		1		
X7013820	TRAFFIC CONTROL SURVEILLANCE, EXPRESSWAYS	CAL DA	180		180		
X7030005	TEMPORARY PAVEMENT MARKING REMOVAL	SQ FT	44,512		44,512		
X8430100	REMOVE EXISTING CONDUIT ATTACHED TO STRUCTURE	FOOT	612.5		612.5		
X0430100	TEMOVE EXISTING CONDUIT ATTACHED TO STROCTORE	1 001	012.3		31213		
Z0001700	APPROACH SLAB REPAIR (FULL DEPTH)	SQ YD	58.9	38.7	20.2		
Z0001800	APPROACH SLAB REPAIR (PARTIAL DEPTH)	SQ YD	6.4	5.0	1.4		
Z0005874	BONDED PREFORMED JOINT SEALER, 3 INCH	FOOT	323.4	133.0	190.4		
Z0006012	BRIDGE DECK LATEX CONCRETE OVERLAY, 2 1/4 INCHES	SQ YD	6,875	2,863	4,012		
Z0012130	BRIDGE DECK SCARIFICATION 3/4"	SQ YD	5,497	2,257	3,240		
			,				
Z0012142	BRIDGE DECK SCARIFICATION 2 1/4"	SQ YD	1,378	606	772		

\* SPECIALTY ITEM

TO STA.

CONSTRUCTION CODE

REV-SEP

Bowman 311 S. Warder Drive, Sults Chicago, Illinois 60606 ST2-64-0300 C O N S U L T I N C CON Down Downseconsulting or

	USER NAME = kmaus	DESIGNED	-	KH	REVISED -
te 1950		DRAWN	-	KM	REVISED -
g.com	PLOT SCALE = 2.0000 ' / in.	CHECKED	-	AP	REVISED -
	PLOT DATE = 3/17/2021	DATE	-	3/17/2021	REVISED -

STATE OF ILLINOIS
DEPARTMENT OF TRANSPORTATION

			SUMMAR	Y OF	QU	ANTITIES
SCALE: NONE	SHEET	5	OF 6	SHE	ETS	STA.

				CONSTRUCTIO	N CODE		
				80% FED 20			
CODE			TOTAL	BRIDGE REHAB	BRIDGE REHAB		
NO.	ITEM	UNIT	OHARTITY	0059	0059		
110.			QUANTITY URBAN	SN 016-2434	SN 016-2600		
Z0012754	STRUCTURAL REPAIR OF CONCRETE (DEPTH EQUAL TO OR LESS THAN 5 INCHES)	SQ FT	868.3	139	729.3		
					120.5		
Z0012755	STRUCTURAL REPAIR OF CONCRETE (DEPTH GREATER THAN 5 INCHES)	SQ FT	171.5	41	130.5		
Z0016001	DECK SLAB REPAIR (FULL DEPTH, TYPE I)	SQ YD	0.9	0.4	0.5		
Z0016002	DECK SLAB REPAIR (FULL DEPTH, TYPE II)	SQ YD	11.6	0.7	10.9		
Z0018051	DRAINAGE SCUPPERS TO BE ADJUSTED	EACH	10	10			
Z0018500	DRAINAGE STRUCTURES TO BE CLEANED	EACH	4		4		
70001000			226.0		226.0		
20021902	SILICONE JOINT SEALER, 1/2"	FOOT	226.0		226.0		
Z0029603	HANDRAIL REPAIRS	L SUM	1		1		
Z0030850	TEMPORARY INFORMATION SIGNING	SQ FT	43		43		
<b>Z</b> 0033028	MAINTENANCE OF LIGHTING SYSTEM	CAL MO	12		12		
Z0048665	RAILROAD PROTECTIVE LIABILITY INSURANCE	L SUM	1	1			
Z0062456	TEMPORARY PAVEMENT	SQ YD	576		576		
25052430		24 15	-, -				
Z0073200	TEMPORARY SHORING AND CRIBBING	EACH	8	4	4		
	TEMPORARY TRAFFIC SIGNAL TIMING	EACH	2		2		
Ø 20076600	TRAINEES	HOURS	500	500			
Ø 20076604	TRAINEES - TRAINING PROGRAM GRADUATE	HOURS	500	500			
		<b>d</b> 0		IONI DADT 1000/ C		CIALTVITEN	

Bowman 311 S. Wacker Drive, Suits Chiago, Illinois 806068 CO. N. S. U. L. T. I. N. G. Waw.bowmencossutting.

USER NAME = kmaus DESIGNED - KH REVISED DRAWN - KM REVISED PLOT SCALE = 2.0000 ' / in. CHECKED - AP REVISED -PLOT DATE = 3/17/2021 DATE - 3/17/2021 REVISED -

STATE OF ILLINOIS **DEPARTMENT OF TRANSPORTATION** 

		<b>ø</b> 0	042	_	NON-PA	ART 100% STATE
		SU	JMMARY	OF QU	ANTITIES	
Ì	SCALE: NONE	SHEET 6	OF 6	SHEETS	STA.	TO STA.

\* SPECIALTY ITEM REV-SEP SECTION 0344 2020-261-BR

COUNTY TOTAL SHEET NO.

COOK 85 9 CONTRACT NO. 62M41

PAVEMENT	REMOV	AL (COD	Εſ	NUMBER	44000100)
DRAWING #	BEGIN STA	END STA	L/R	AREA (SF)	AREA (SY)
Sheet 26	20+27.90	21+69.40	CL	1164.49	129.3877778
Bottom View	27+49.29	29+69.85	CL	1047.96	116.44
Sheet 27	35+37.47	36+09.54	CL	347.12	38.56888889
Top View	41+69.28	45+00.00	CL	1585.31	176.1455556
Sheet 27, Bot.	45+00.00	47+16.51	CL	1036.4	115.1555556

LI	POLYUREA PAVEMI ETTERS AND SYMBOL				
DRAWING #	DESCRIPTION	STA	OFFSET	L/R	AREA (SQ FT)
Sheet 28	Right Only Turn Symbol	13+09.98	30.77	R	36.4
Top View	Left Only Turn Symbol	13+14 47	4 91		36 4

	POLYUREA PAVEM	ENT MAR	KING TY	PE I – LINE	4" (COD	F IV	IUMBER 78	8008210)	
DRAWING #	DESCRIPTION	BEGIN STA	END STA	BEGIN OFFSET	END OFFSET	L/R	TOTAL LENGTH	MULTIPLIER*	MARKING LENGTH(FT
	4" Solid White	17+88.85	27+52.26	31.19	38.70	R	1152.67	1.00	1152.67
	4" Skip Dash White (10' Dash 30' Skip)	17+88.88	30+00.00	18.86	14.70	R	1422.06	0.25	355.52
heet 28	4" Solid Yellow	17+89.23	30+00.00	6.52	2.70	R	1422.14	1.00	1422.14
ottom View	4" Solid White	19+00.03	2668.11	34.87	45.07	L	774.61	1.00	774.61
	4" Skip Dash White(10' Dash 30' Skip)	18+59.50	30+00.00	21.19	15.63	L	1140.5	0.25	285.13
	4" Solid Yellow	18+73.31	30+00.00	8.81	3.63	L	1126.68	1.00	1126.68
	4" Skip Dash White (10' Dash 30' Skip)	30+00.00	45+00.00	15.63	15.51	L	1500.00	0.25	375.00
	4" Solid Yellow	30+00.00	45+00.00	3.63	3.58	L	1500.00	1.00	1500.00
	4" Solid Yellow	30+00.00	45+00.00	2.70	2.79	R	1500.00	1.00	1500.00
heet29	4" Skip Dash White (10' Dash 30' Skip)	30+00.00	45+00.00	14.70	14.79	R	1500.00	0.25	375.00
op View	4" Solid White	30+69.73	31+00.15	59.32	74.17	L	34.29	1.00	34.29
	4" Solid Yellow	30+75.71	31+08.72	44.51	60.71	L	37.16	1.00	37.16
	4" Solid White	33+73.80	33+97.02	105.97	88.79	L	29.33	1.00	29.33
	4" Solid Yellow	41+86.89	42+09.71	42.02	54.64	L	26.10	1.00	26.10
	4" Solid White	43+89.35	44+34.82	55.40	80.94	R	50.98	1.00	50.98
	4" Solid White	45+00.00	46+42.52	27.44	27.18	L	142.5	1.00	142.50
heet29	4" Skip Dash White (10' Dash 30' Skip)	45+00.00	49+69.38	15.51	14.11	L	469.38	0.25	117.35
ottom View	4" Solid Yellow	45+00.00	49+85.91	3.58	2.61	L	485.91	1.00	485.91
	4" Solid Yellow	45+00.00	48+44.22	2.79	2.18	R	344.22	1.00	344.22
	4" Skip Dash White (10' Dash 30' Skip)	45+00.00	48+37.05	14.79	13.52	R	337.05	0.25	84.26

<sup>\*</sup>MULTIPLIER USED TO CONVERT FROM LINEAR FEET MEASURED TO LINEAR FEET OF MARKING

POLYUREA PAVEMENT MARKING TYPE I – LINE 8" (CODE NUMBER 78008240)									
	POLYUREA PAVEM	ENT MAR	KING TYF	PE I — LINE	8" (COD	E N	UMBER 7	8008240)	
DRAWING #	DESCRIPTION	BEGIN STA	END STA	BEGIN OFFSET	TEND OFFSET	L/R	TOTAL LENGTH	H MULTIPLIER:	*MARKING LENGTH(F
	8" Skip Dash White (3' Dash 9' Skip)	23+43.78	28+78.20	27.22	26.70	R	534.42	0.25	133.61
	8" Solid White	27+17.49	30+00.00	63.52	40.77	L	294.94	1.00	294.94
Sheet 28	8" Skip Dash White (3' Dash 9' Skip)	27+51.22	30+00.00	27.63	27.63	L	248.78	0.25	62.20
ottom View	8" Solid White	27+52.26	30+00.00	38.70	82.04	R	253.14	1.00	253.14
	8" Solid White	28+78.20	30+00.00	26.70	26.70	R	121.04	1.00	121.04
	8" Solid White	28+78.20	30+00.00	26.70	64.48	R	127.49	1.00	127.49
	8" Solid White	30+00.00	30+69.73	40.77	59.32	L	73.12	1.00	73.12
	8" Skip Dash White (3' Dash 9' Skip)	30+00.00	30+17.39	27.63	27.63	L	17.50	0.25	4.38
	8" Solid White	30+00.00	34+83.17	26.70	26.69	R	483.17	1.00	483.17
heet 29	8" Solid White	30+00.00	30+37.15	64.48	89.60	R	34.29	1.00	34.29
op View	8" Solid White	30+00.00	30+33.46	82.04	106.07	R	40.64	1.00	40.64
	8" Solid White	30+17.39	30+75.71	27.63	44.51	L	61.29	1.00	61.29
	8" Solid White	30+17.39	35+49.13	27.63	27.61	L	531.74	1.00	531.74
	8" Solid White	33+97.02	41+60.75	88.79	47.63	L	747.83	1.00	747.83
	8" Solid White	33+61.76	34+54.54	70.67	26.71	R	102.85	1.00	102.85
	8" Solid White	34+15.22	35+16.34	60.78	27.61	L	107.83	1.00	107.83
	8" Solid White	33+75.63	43+56.47	78.93	59.87	R	902.68	1.00	902.68
	8" Skip Dash White (3' Dash 9' Skip)	34+83.17	42+35.20	26.69	26.59	R	837.27	0.25	209.32
	8" Skip Dash White (3' Dash 9' Skip)	35+49.13	41+19.16	27.61	27.61	L	570.03	0.25	142.51
	8" Solid White	41+19.16	45+00.00	27.61	27.44	L	380.84	1.00	380.84
	8" Solid White	41+46.70	41+86.89	27.72	42.02	L	44.69	1.00	44.69
	8" Solid White	42+93.43	43+89.35	26.71	55.40	R	98.58	1.00	98.58
	8" Solid White	43+35.20	45+00.00	26.59	26.79	R	164.80	1.00	164.80
neet 29	8" Solid White	45+00.00	48+27.18	26.79	25.02	R	327.18	1.00	327.18
ottom View	8" Solid White	46+42.52	48+67.81	27.18	26.30	L	225.29	1.00	225.29
heet 24	8" Solid White	189+69.99	191+30.54	54.58	55.81	R	160.55	1.00	160.55
op View	8" Solid White	190+44.84	192+05.26	56.86	56.58	L	160.42	1.00	160.42

<sup>\*</sup>MULTIPLIER USED TO CONVERT FROM LINEAR FEET MEASURED TO LINEAR FEET OF MARKING

POLYUREA PAVEMENT MARKING TYPE I – LINE 12" (CODE NUMBER 78008250)									
DRAWING #	DESCRIPTION	BEGIN STA	END STA	BEGIN OFFSET	END OFFSET	L/R	TOTAL LENGTH	MULT I PL I ER*	MARKING LENGTH(FT)
Sheet 28, Bot	12" Diagonal White	29+23.06	30+00.00	Var.	Var.	R	89.21	1.00	89.21
	12" Diagonal White	30+07.00	34+43.45	Var.	Var.	R	287.88	1.00	287.88
Sheet29	12" Diagonal White	30+31.94	34+93.49	Var.	Var.	L	353.43	1.00	353.43
Top View	12" Diagonal White	41+57.46	41+75.95	Var.	Var.	L	15.84	1.00	15.84
· ·	12" Diagonal White	43+09.64	45+00.00	Var.	Var.	R	182.71	1.00	182.71
Sheet29	12" Diagonal White	45+00.00	47+46.50	Var.	Var.	R	128.01	1.00	128.01
Bottom View	12" Diagonal White	46+47.74	48+20.38	Var.	Var.	L	184.47	1.00	184.47

<sup>\*</sup>MULTIPLIER USED TO CONVERT FROM LINEAR FEET MEASURED TO LINEAR FEET OF MARKING

SCALE: NONE

	USER NAME = apatel	DESIGNED	-	KH	REVISED -
۰		DRAWN	-	KM	REVISED -
	PLOT SCALE = 2.0000 / in	CHECKED	-	AP	REVISED -
	PLOT DATE = 3/17/2021	DATE	-	3/17/2021	REVISED -

	F.A.P. RTE	SECTION	COUNTY	TOTAL SHEETS	SHEET NO.
SCHEDULE OF QUANTITIES	0344	2020-261-BR	соок	85	10
			CONTRACT	NO.	62M41
SHEET 1 OF 1 SHEETS STA. TO STA.		ILLINOIS FED. A	AID PROJECT		

### MAINTENANCE OF TRAFFIC NOTES

130TH STREET TRAFFIC CONTROL PLAN & DETOUR

PRE-STAGE: CURB & GUTTER/MEDIAN REMOVAL AND PLACEMENT OF TEMPORARY HMA PAVEMENT

STAGE 1: WESTBOUND VEHICLES WILL OCCUPY THE INSIDE EASTBOUND LANE, AND THE EASTBOUND VEHICLES WILL OCCUPY THE OUTSIDE EASTBOUND LANE. THE I-94 WB TO 130TH STREET WB LOOP RAMP WILL BE CLOSED AND VEHICLES WILL DETOUR AT 115TH STREET.

SEE DISTRICT TRAFFIC CONTROL STANDARD TC-08 FOR RAMP CLOSURE SIGNAGE REQUIREMENTS.

ADDITIONALLY, PLEASE NOTIFY THE EXPRESSWAY TRAFFIC CONTROL SUPERVISOR 21 DAYS IN ADVANCE OF RAMP CLOSURES 1-847-705-4155.

STAGE 2: THE EASTBOUND VEHICLES WILL OCCUPY THE INSIDE WESTBOUND LANE, AND THE WESTBOUND VEHICLES WILL OCCUPY THE OUTSIDE WESTBOUND LANE. THE I-94 EB TO 130TH STREET EB LOOP RAMP WILL BE CLOSED AND VEHICLES WILL DETOUR AT 137TH STREET. 137TH STREET RAMPS SHALL BE REPAIRED WITH CONCRETE PATCHING. DUE TO ADDED TRAFFIC VOLUMES AND EXISTING CONDITION OF THE CONCRETE PAVEMENT.

STAGE 3: TWO LANES IN THE EASTBOUND AND WESTBOUND DIRECTIONS WILL BE MAINTIANED WITH REDUCED WIDTHS. THE TEMPORARY PAVEMENT WILL BE REMOVED AND THE MEDIAN WILL BE REPLACED.

ADVANCED WARNING SIGNS AND TEMPORARY BARRELS WILL BE SET UP PRIOR TO THE START
OF THE PROJECT. TEMPORARY CONCRETE BARRIERS WILL BE UTILIZED TO CREATE A SAFER WORK ENVIRONMENT
DURING CONSTRUCTION. SIGNS, BARRICADES, AND TEMPORARY STRIPING TO CONFORM TO "MANUAL ON UNIFORM
TRAFFIC CONTROL DEVICES", LATEST VERSION.

#### I-94 TRAFFIC CONTROL PLAN

THE PROPOSED TRAFFIC CONTROL PLAN (TCP) CONSISTS OF TWO (2) STAGES OF CONSTRUCTION.

STAGE 1: THE EXISTING OUTSIDE SHOULDERS WILL BE CLOSED TO ALLOW WORK TO BE PERFORMED ABOVE.

NO LANE CLOSURES OR MODIFICATION OF EXISTING TRAFFIC IS PROPOSED. SIGNAGE TO CONFORM TO DETAIL TC-17.

STAGE 2: THE WORK WILL BE PERFORMED IN THE MEDIAN BETWEEN THE DIRECTIONS OF TRAFFIC. THE INSIDE LANE
OF EACH DIRECTION WILL BE CLOSED, REDUCING THE THROUGH LANES IN EACH DIRECTION FROM 3
TO 2. NO ADDITIONAL TRAFFIC MODIFICATION IS PROPOSED. ALL WORK DURING THIS STAGE WILL BE PERFORMED
OVERNIGHT PER THE SPECIFICATIONS AS OUTLINED BELOW. PER THE BDE MANUAL, TRAFFIC CONTROL STANDARDS
701400 & 701401 SHOULD BE UTILIZED FOR OVERNIGHT LANE CLOSURES, WHICH INCLUDES GUIDANCE ON ALL TRAFFIC
CONTROL DEVICES, SIGNAGE, TAPERS, AND TEMPORARY PAVEMENT MARKINGS. STANDARDS 701400 & 701401 WILL BE
UTILIZED WITH A 45 MPH WORK ZONE SPEED LIMIT. PER CHAPTER 13-3.04 OF THE WORK ZONE TMP, NIGHT WORK SHOULD
ALSO MEET ALL LIGHTING SPECIFICATIONS OUTLINED IN SECTION 702 OF THE ILLINOIS HIGHWAY STANDARDS FOR TRAFFIC
CONTROL AND DISTRICT ONE SPECIAL PROVISION FOR NIGHTTIME WORK LIGHTING. ALL OVERNIGHT WORK INCLUDING
ALLOWABLE LANE CLOSURE HOURS TO CONFORM TO THE STANDARDS AS OUTLINED IN THE MEMORANDUM "KEEPING THE
EXPRESSWAY OPEN TO TRAFFIC." NIGHTTIME FLAGGING AND SPOTTING SHALL BE PROVIDED PER "TRAFFIC SPOTTERS" SPECIAL
PROVISION 80410.

STAGE 2 I-94 MOT PLANS NOT INCLUDED. FOLLOW THE DISTRICT ONE AND BDE STANDARDS IDENTIFIED ABOVE FOR TEMPORARY TRAFFIC CONTROL STAGING.

ALL ON AND OFF RAMPS AND AUXILIARY LANES WILL BE OPEN AND MAINTAINED AS EXISTING IN BOTH STAGES.

ADVANCED WARNING SIGNS WILL BE SET UP PRIOR TO THE START OF THE PROJECT. TEMPORARY CONCRETE BARRIERS WITH IMPACT ATTENUATORS WILL BE UTILIZED DURING STAGE 1 TO CREATE A SAFER WORK ENVIRONMENT DURING CONSTRUCTION. SIGNS, BARRICADES, AND TEMPORARY STRIPING TO CONFORM TO "MANUAL ON UNIFORM TRAFFIC CONTROL DEVICES", LATEST VERSION.

#### NOTE ON WORK ORDER PRECEDENCE

130TH STREET AND I-94 MOT STAGING SHALL NOT BE ACTIVE SIMULATANEOUSLY. DUE TO THE NORTHEAST AND SOUTWEST LOOP RAMP CLOSURE REQUIRED AS PART OF 130TH MOT, I-94 MOT STAGING SHALL NOT BE IMPLEMENTED AT THE SAME TIME. ALL RAMPS AT 130TH STREET AND I-94 WILL BE OPEN WHILE I-94 SUBSTRUCTURE REPAIR WORK IS BEING CONDUCTED AND STAGING IS IN PLACE. RAMP CLOSURES ARE SHOWN IN THE MOT PLANS FOR 130TH STREET AND RAILROAD SUPERSTRUCTURE WORK ONLY.

#### MOT SHEETS LABELING NOTATION

LETTERS WILL BE USED DESIGNATE TEMPORARY PAVEMENT MARKINGS ON MOT LAYOUT (SEE MOT LEGEND AND SYMBOLS).


NUMBERS WILL BE USED TO DESIGNATE TEMPORARY SIGNAGE USED IN MOT LAYOUT (SEE SHEET 17).

#### 130TH STREET WIDTH RESTRICTION ADVANCED SIGNAGE


MOT STAGES 1 AND 2 WILL CREATE A WIDTH RESTRICTION ON 130TH STREET. TRAFFIC APPROACHING 130TH STREET FROM THE EAST AND WEST MUST BE INFORMED OF THESE WIDTH RESTRICTIONS WITH ADVANCE SIGNING DESCRIBED BELOW. IN ADDITION, TRAFFIC ENTERING 130TH STREET FROM 1-94 MUST BE ADVISED OF THIS WIDTH RESTRICTION FOR RAMPS NOT CLOSED DUE TO MAINTENANCE OF TRAFFIC SCHEME.

IN STAGE 1, EB TRAFFIC SHALL BE SHOWN A POSTED 10'-11" WIDTH RESCTRICTION, AND WB TRAFFIC SHALL BE SHOWN A POSTED 10'-6" WIDTH RESTRICTION.


IN STAGE 2, EB TRAFFIC SHALL BE SHOWN A POSTED 10'-6" WIDTH RESCTRICTION, AND WB TRAFFIC SHALL BE SHOWN A POSTED 11'-5' WIDTH RESTRICTION

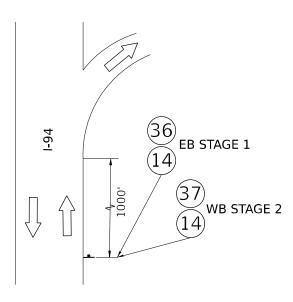

WIDTH RESTRICTION ADVANCE SIGNAGE I-94 TO 130TH STREET RAMPS (TYPICAL)

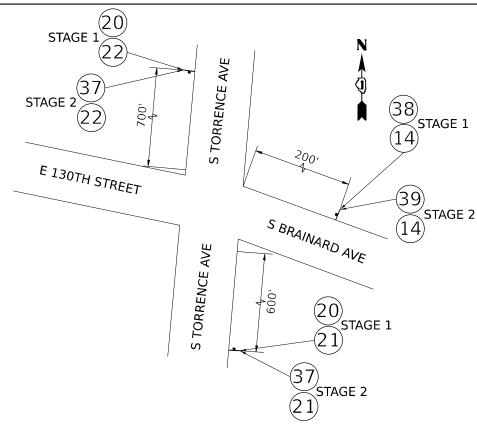

WIDTH RESTRICTION ADVANCE SIGNAGE E 130TH ST/S BRAINARD AVE/S TORRENCE AVE

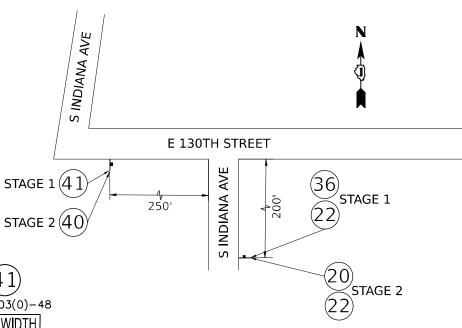

	20			36	37)
(14)	W12-I102-48	(21)	(22)	W12-I102-48	W12-I102-48
130TH ST.	4401011	M6-1(L)	M6-1(R)		
6" (8" on I-94) BLACK LETTERS ON	<b>4</b> 10'-6"			10'-11"	11'-5"
orange reflective background 36"X10"		21"x15"	21"x15		

W20-I103(0)-48

MAX WIDTH

10'-6"

AHEAD ON

W20-I103(0)-48 W.

11-5"

AHEAD ON

W20-I103(0)-48

MAX WIDTH

10'-6"

1 MILE

AHEAD

SCALE:

W20-I103(0)-48

MAX WIDTH

10'-11"

1 MILE

AHEAD

WIDTH RESTRICTION ADVANCE SIGNAGE E 130TH ST/S INDIANA AVE

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Bowman 311 S. Wacker Drive, Suite 1950 Chicago, Illinois 60606							
CONSULTING	312-614-0360 www.bowmanconsulting.com						
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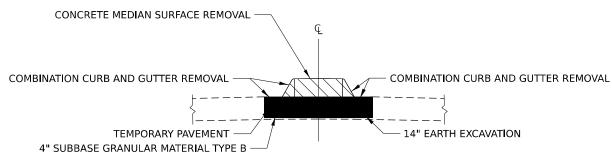
STATE OF ILLINOIS
DEPARTMENT OF TRANSPORTATION

MAINTENANCE OF TRAFFIC NOTES							
MAINTENANCE OF TRAFFIC NOTES						034	
						┰	
SHEET 1	OF	1	SHEETS	STA.	TO STA.	Г	

	F.A.P. RTE	SECTION	COUNTY TOTAL SHEET NO.
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4			CONTRACT NO. 62M41
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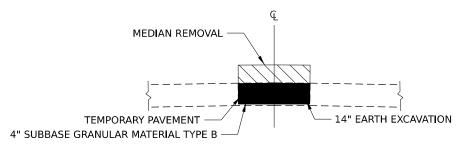
### SN 016-2434 EXISTING TYPICAL SECTION - 130TH STREET

BRIDGE OVER CSSS AND IHB RR STA 22+33.22 TO 26+42.76



### **MOT PRESTAGE - 130TH STREET**

STA 20+27.90 TO 21+69.40




### **MOT PRESTAGE - 130TH STREET**

STA 27+49.29 TO 29+69.85 STA 35+37.47 TO 36+09.54 STA 41+69.28 TO 47+16.51


HMA MIX REQUIREMENTS TABLE		
MIXTURE TYPE	AIR VOIDS @ NDES	QMP
OPTION 1 - FULL DEPTH TEMPORARY HMA PAVEMENT		
10" HOT-MIX ASPHALT BINDER COURSE, IL-19.0, N70	4% @ 70 GYR.	QC/QA
QMP DESIGNATIONS: QUALITY CONTROL/QUALITY ASSURANCE (QC/C	(A)	

- 1. THE "AC TYPE" FOR POLYMERIZED HMA MIXES SHALL BE "SBS/SBR PG-76-22" AND FOR NON-POLYMERIZED HMA THE "AC TYPE" SHALL BE "PG 64-22" UNLESS MODIFIED BY SPECIAL PROVISIONS.
- 2. FOR USE OF RECYLCED MATERIALS SEE SPECIAL PROVISIONS.
- 3. QUALITY MANAGEMENT PROGRAM (QMP) IDENTIFIES THE PARTICULAR QUALITY CONTROL SPECIFICATION THAT APPLIES TO THE HMA MIXTURE.
- 4. TEMPORARY PAVEMENT OPTION 2 IS 8" TEMPORARY PCC. THIS SHALL CONSIST OF CLASS PV CONCRETE MEETING
  THE REQUIREMENTS OF ART 1020 OF THE STANDARD SPECIFICATIONS. TEMPORARY PCC PAVEMENT DOES NOT REQUIRE
  DOWNEL PAGE
- 5. BOTH TEMPORARY PAVEMENT OPTIONS WILL INCLUDE 4" SUBBASE GRANULAR MATERIAL TYPE B (CA-6). THIS ITEM WILL BE PAID PER SQUARE YARD (PAY ITEM NUMBER 31101200).

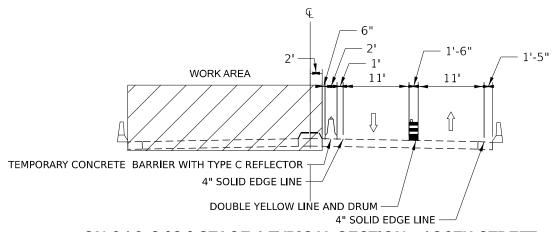


### SN 016-2434 STAGE 1 TYPICAL SECTION - 130TH STREET

BRIDGE OVER CSSS AND IHB RR STA 22+33.22 TO 26+42.76

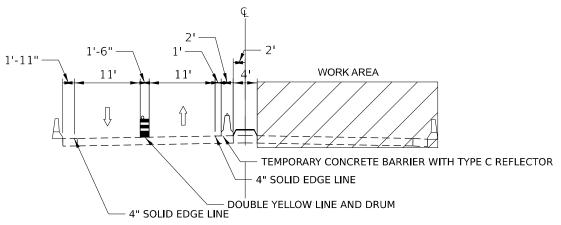

### SN 016-2434 STAGE 2 TYPICAL SECTION - 130TH STREET

BRIDGE OVER CSSS AND IHB RR STA 22+33.22 TO 26+42.76

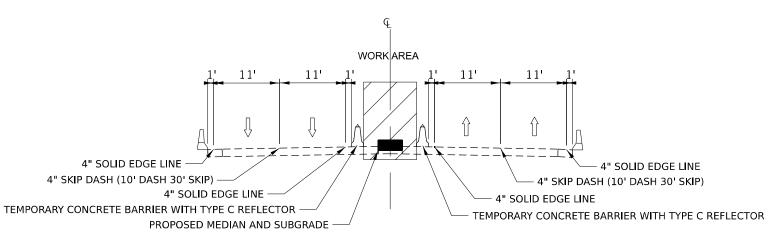


### SN 016-2434 STAGE 3 TYPICAL SECTION - 130TH STREET

BRIDGE OVER CSSS AND IHB RR STA 22+33.22 TO 26+42.76

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	CONSULTING WWw.bowmanconsulting.com	

USER NAME = khejtmanek	DESIGNED - KH	REVISED -
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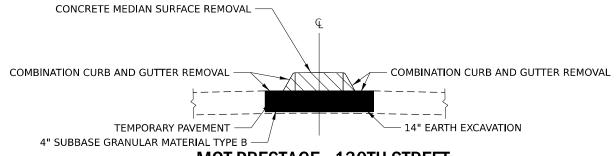
MAINTENANCE OF TRAFFIC – TYPICAL SECTIONS SN 016–2434		SECTION	COUNTY	TOTAL SHEETS	SHEET NO.
		2020-261-BR	соок	85	12
ON 010-2404			CONTRACT	NO.	62M41
SHEET 1 OF 3 SHEETS STA TO STA.		TILLINOIS FED AL	D DROIECT		-

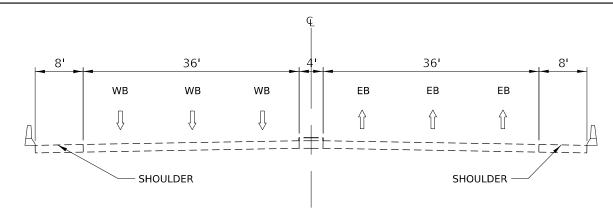

### SN 016-2600 EXISTING TYPICAL SECTION - 130TH STREET


BRIDGE OVER I-94

STA 37+04.44 TO 40+79.72




### **MOT PRESTAGE - 130TH STREET**

STA 20+27.90 TO 21+69.40

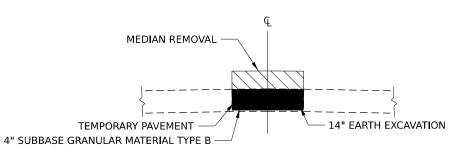


### **MOT PRESTAGE - 130TH STREET**

STA 27+49.29 TO 29+69.85 STA 35+37.47 TO 36+09.54 STA 41+69.28 TO 47+16.51

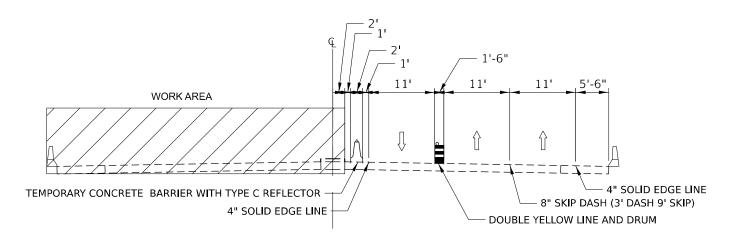


### SN 016-2600 STAGE 1 TYPICAL SECTION - 130TH STREET

BRIDGE OVER I-94 STA 37+04.44 TO 40+79.72

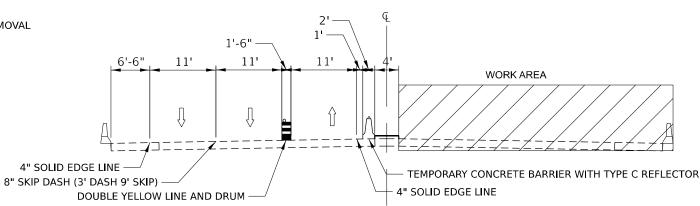

## SN 016-2600 STAGE 2 TYPICAL SECTION - 130TH STREET

BRIDGE OVER I-94 STA 37+04.44 TO 40+79.72

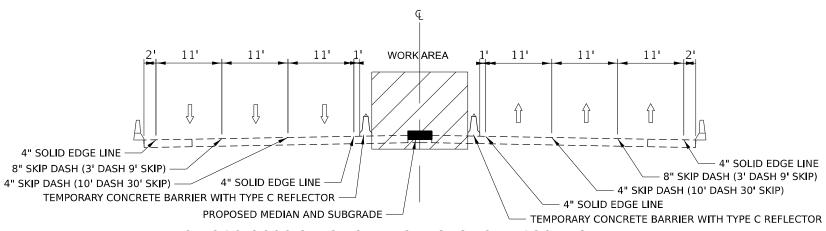


### SN 016-2600 STAGE 3 TYPICAL SECTION - 130TH STREET

BRIDGE OVER I-94 STA 37+04,44 TO 40+79,72

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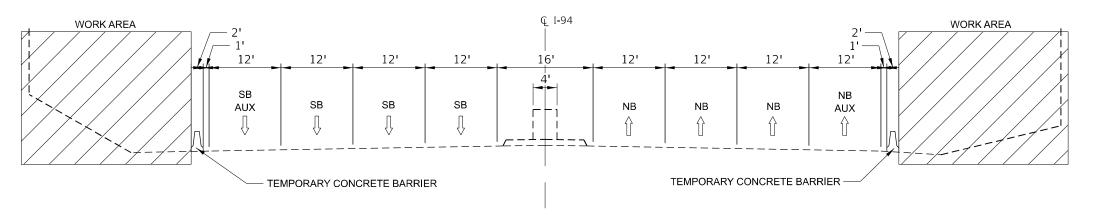
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MAINTENANCE OF TRAFFIC - TYPICAL SECTIONS	F.A.P. RTE	SECTION	COUNTY	TOTAL SHEETS	
SN 016-2600		2020-261-BR	соок	85	13
			CONTRAC	ΓNO.	62M41
SHEET 2 OF 3 SHEETS STA TO STA.		TILLINOIS FED	ID DDOJECT		




### **EXISTING TYPICAL SECTION - INTERSTATE 94**

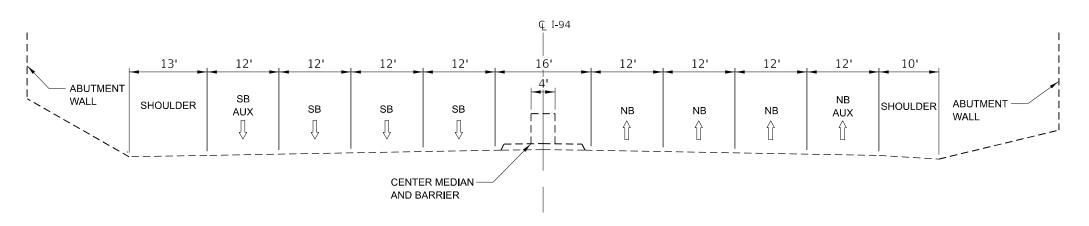UNDER 130TH STREET BRIDGE STA 189+75 TO 192+00



## STAGE 1 TYPICAL SECTION - INTERSTATE 94

UNDER 130TH STREET BRIDGE STA 189+75 TO 192+00

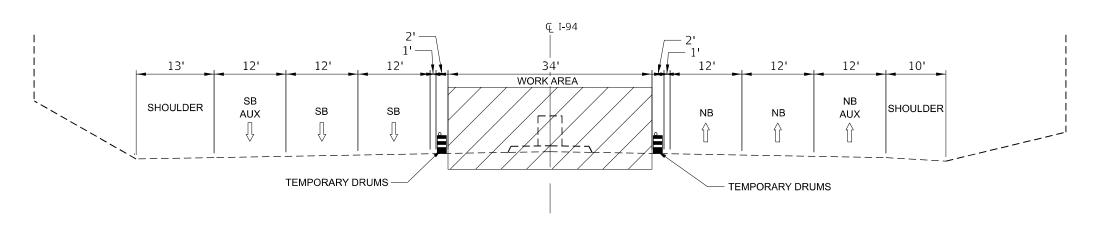

## NOTE:

SEE KEEPING THE EXPRESSWAY OPEN TO TRAFFIC CONTRACT SPECIAL PROVISION FOR ALLOWABLE NIGHT TIME LANE CLOSURES HOURS ON I-94.

### STAGE 2 TYPICAL SECTION - INTERSTATE 94

UNDER 130TH STREET BRIDGE STA 189+75 TO 192+00

REFERNECE STANDARDS 701400 AND 701401 FOR ALL STAGE 2 LAYOUTS


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Bowman	311 S. Wacker Drive, Suite 1959 Chicago, Illinois 60606		
CONSULTING	312-614-0360 www.bowmanconsulting.com	PLOT SCALE	= 40.0000 / in.
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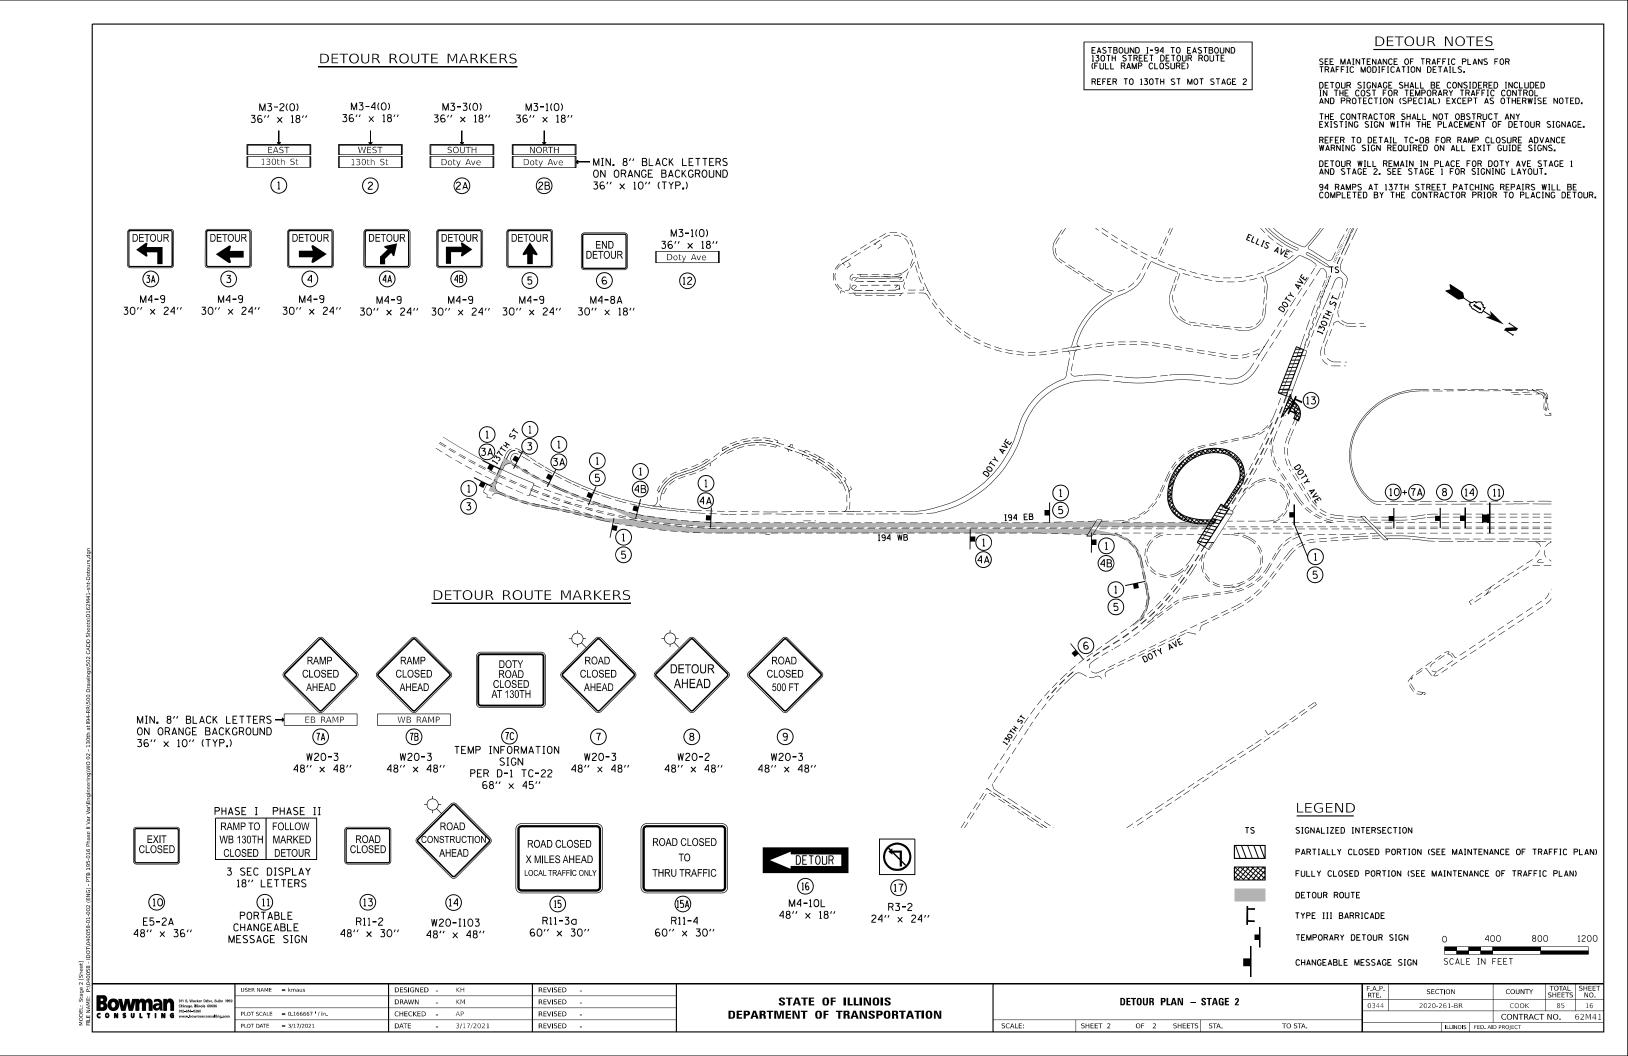
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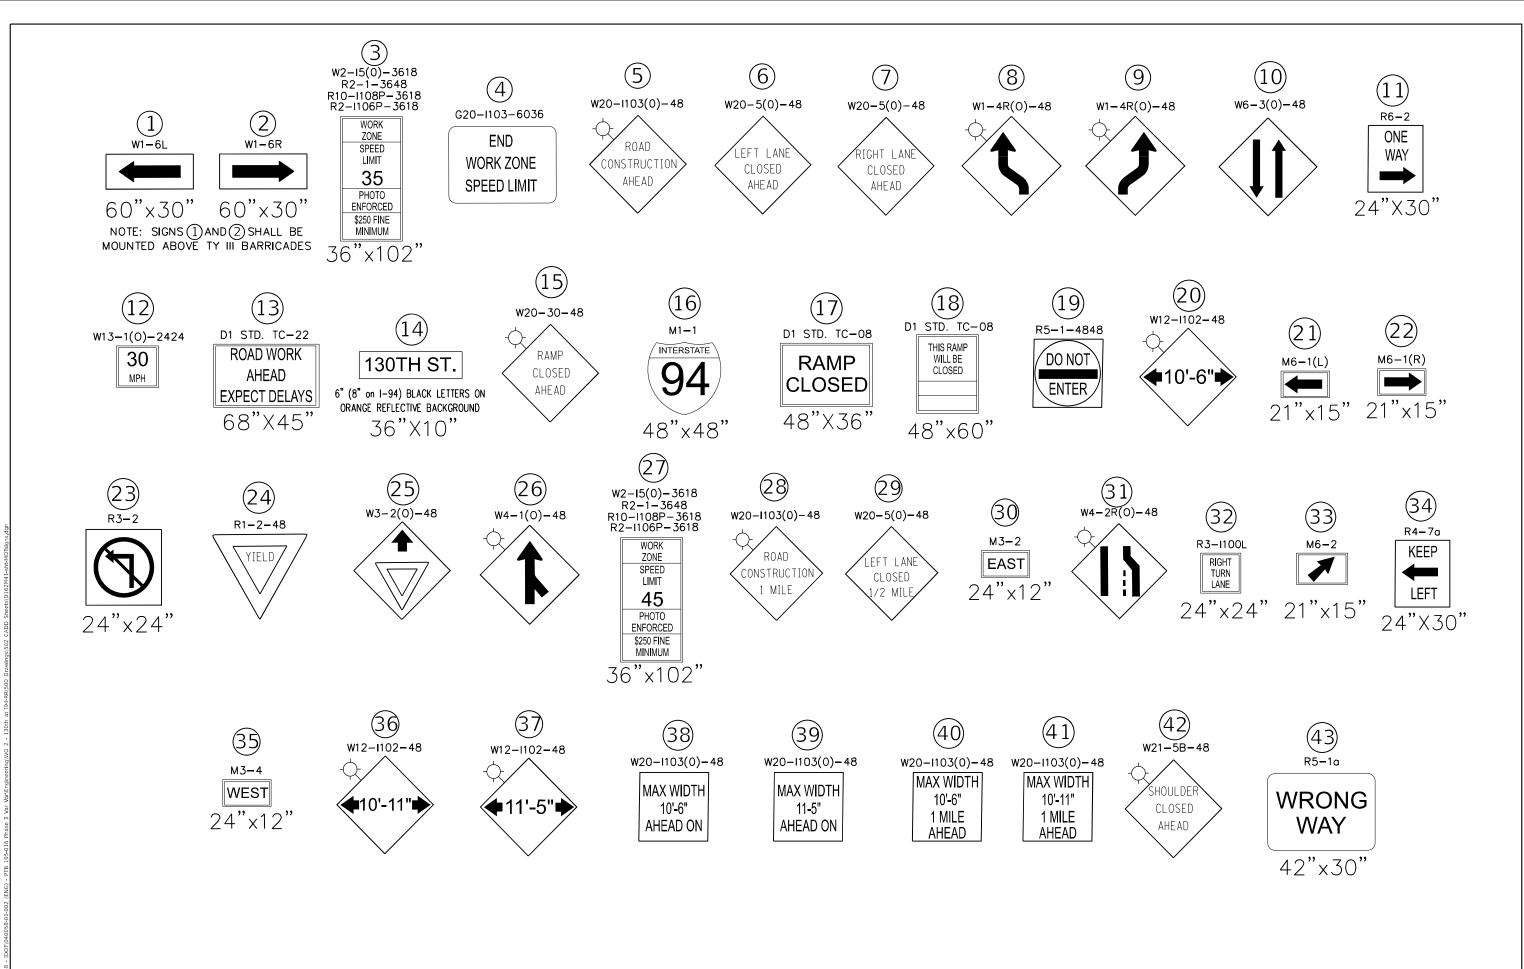
STATE OF ILLINOIS
DEPARTMENT OF TRANSPORTATION

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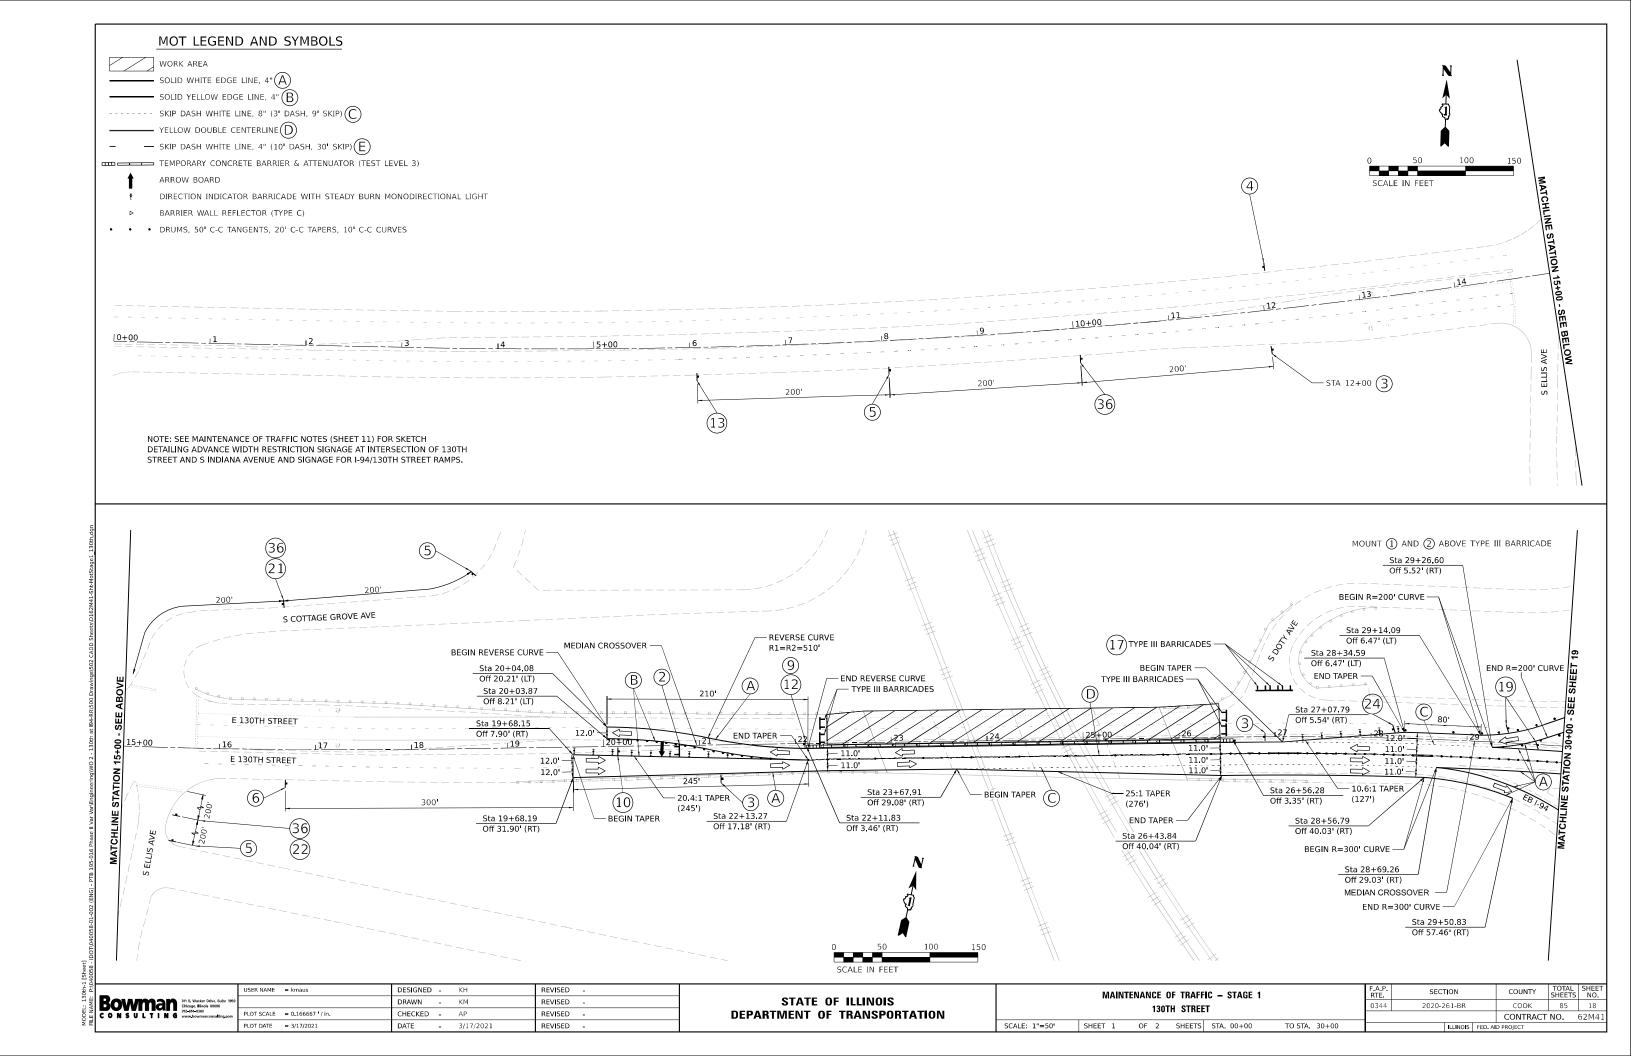
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		2020-261-BR	соок	85	14
			CONTRACT	NO.	62M41
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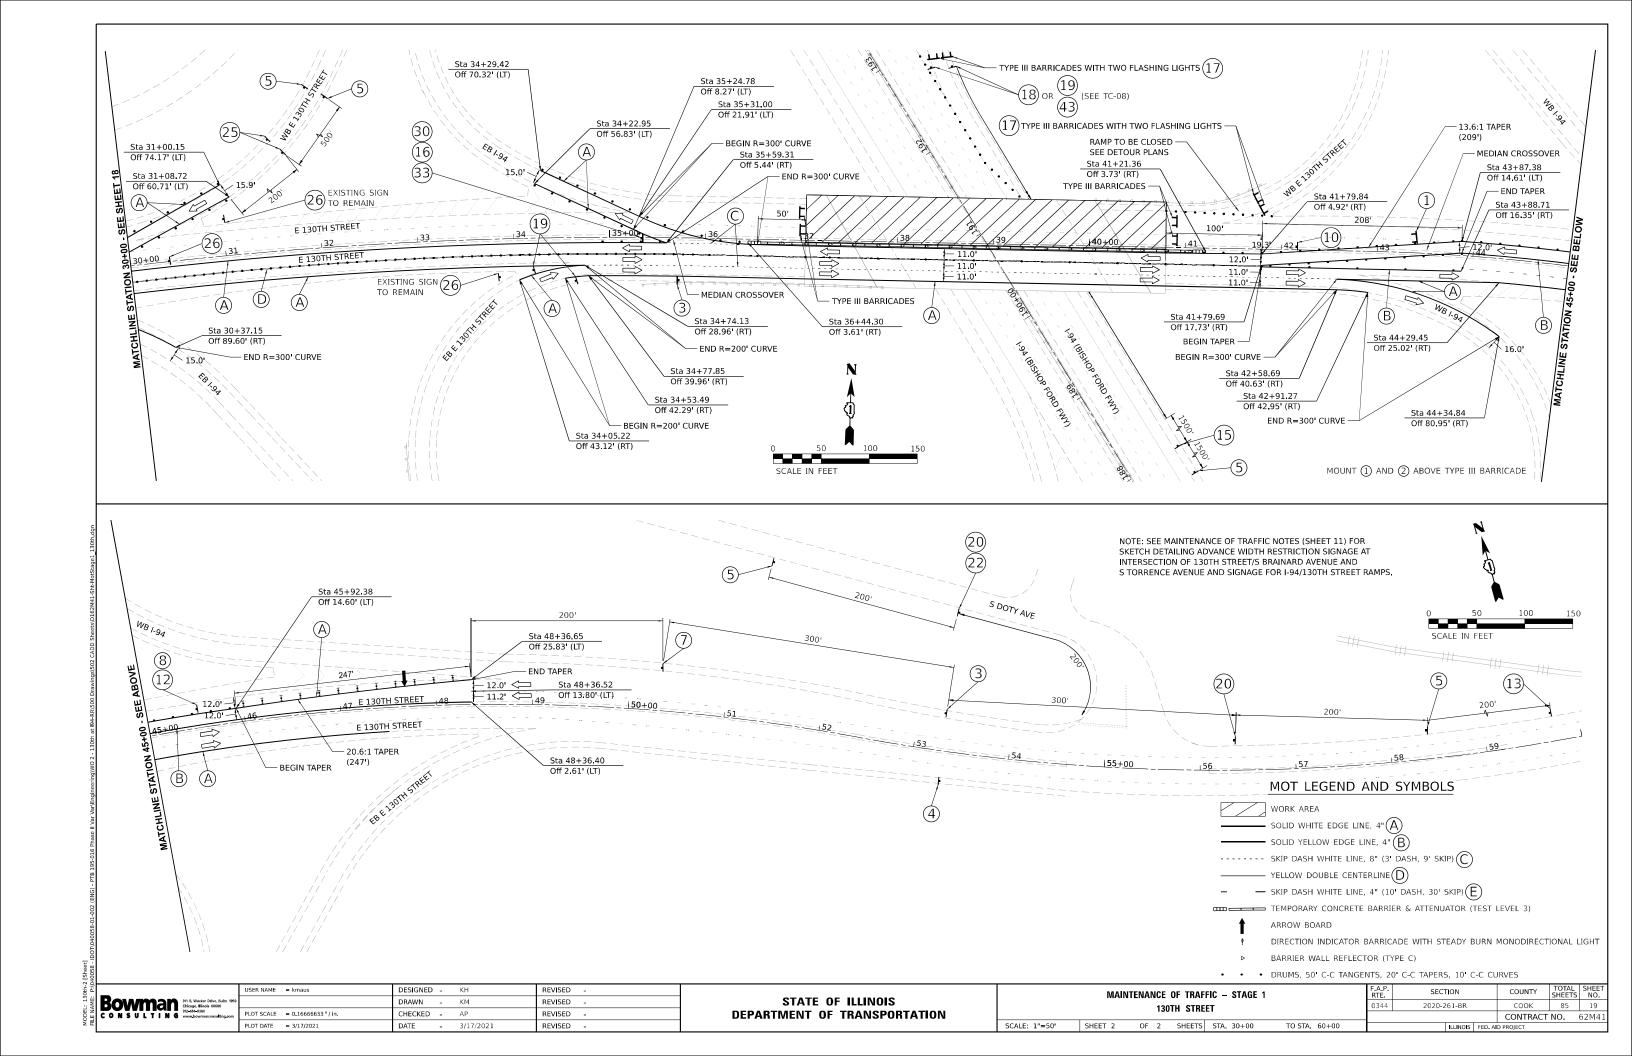









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	ONSULTING www.bowmenconsulting.com	PLOT SCALE = 2.0000 / in	CHECKED - AP	REVISED -	DEPARTMENT OF TRANSPORTATION						CONTRACT NO. 62M41
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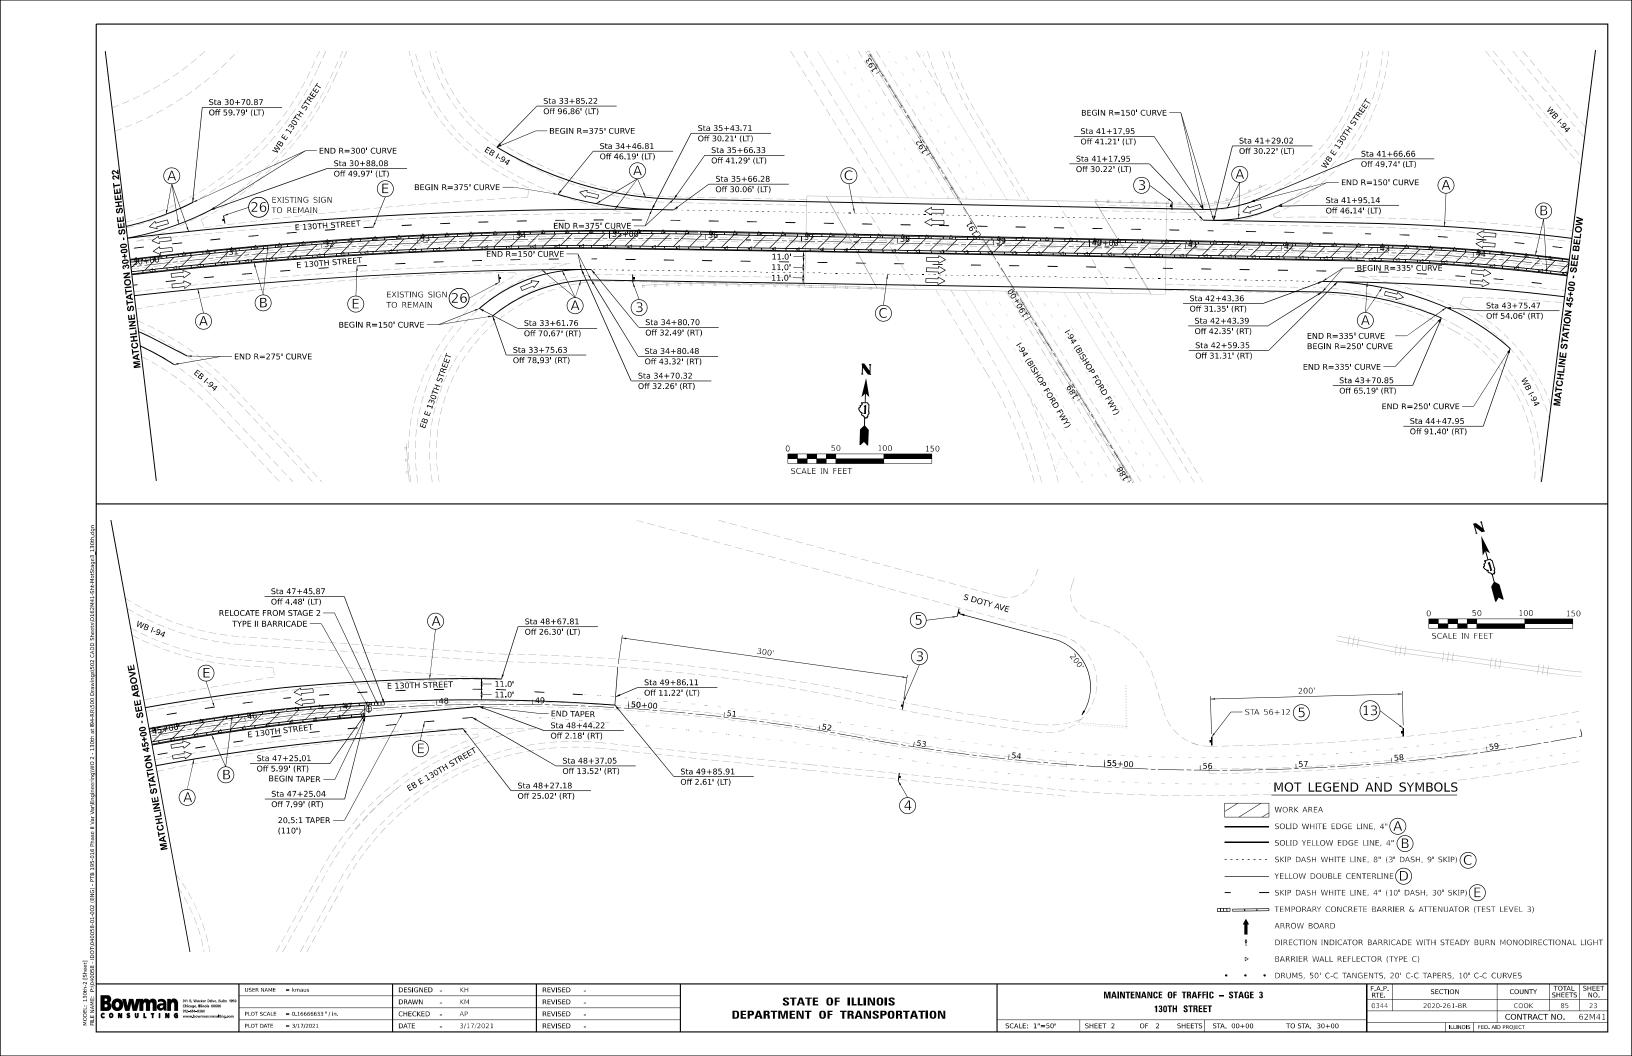


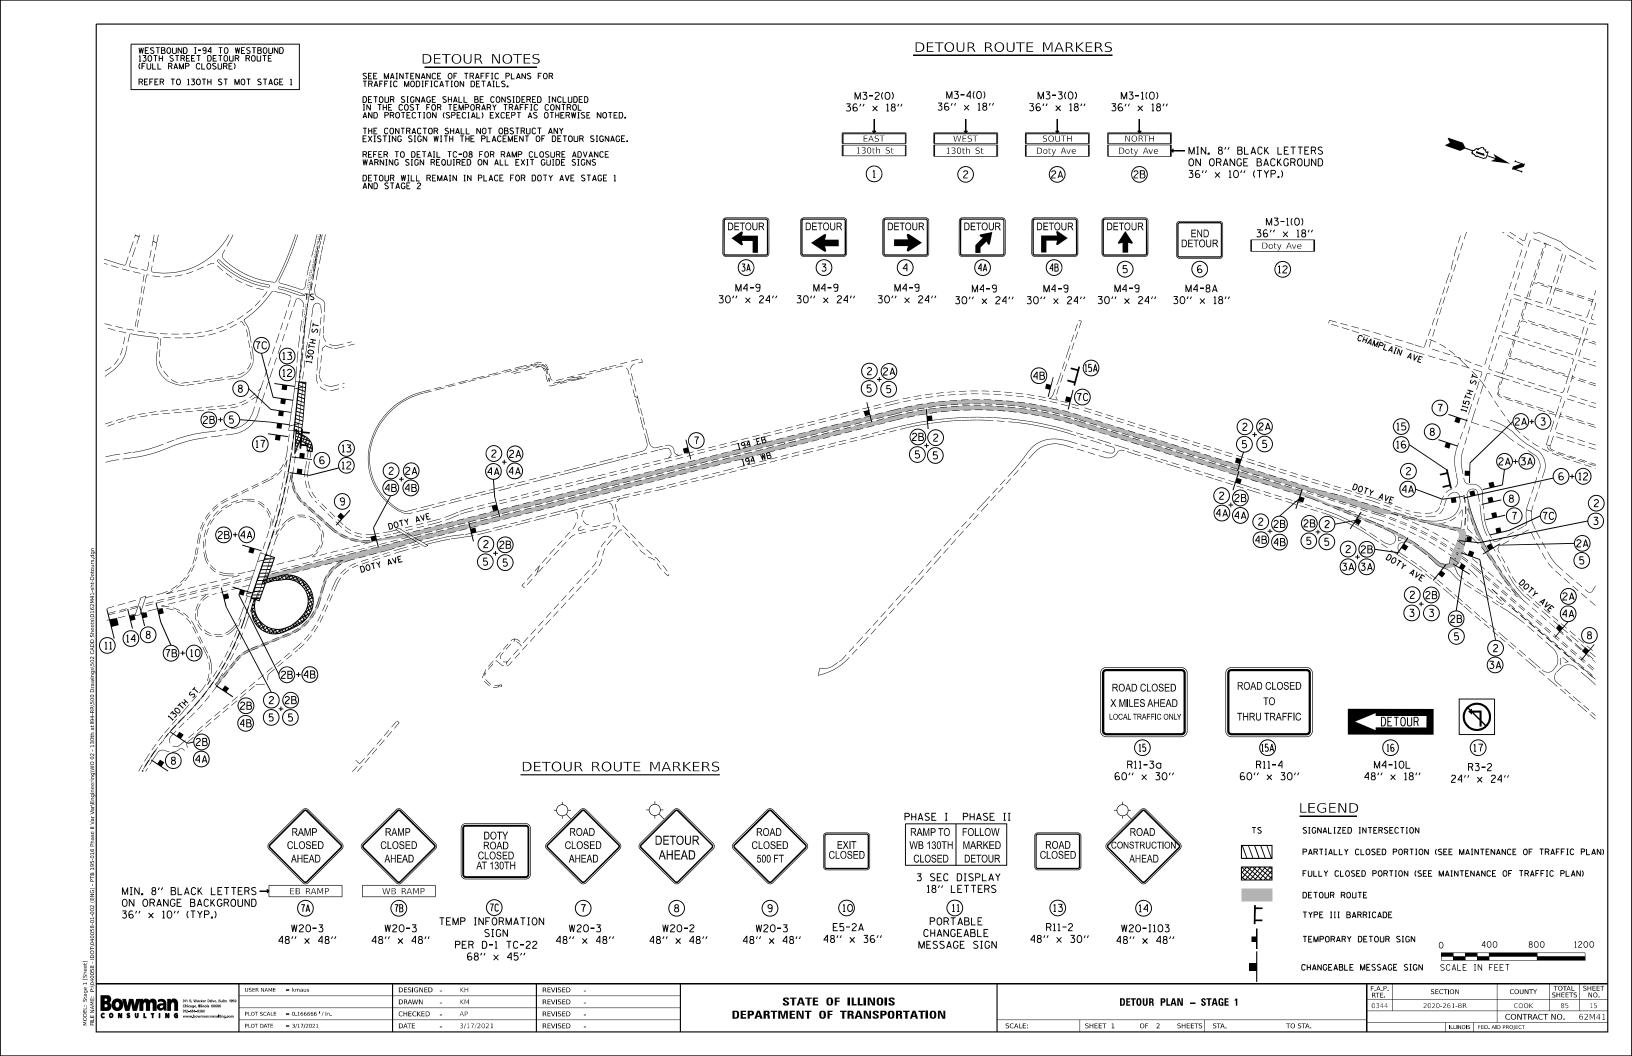




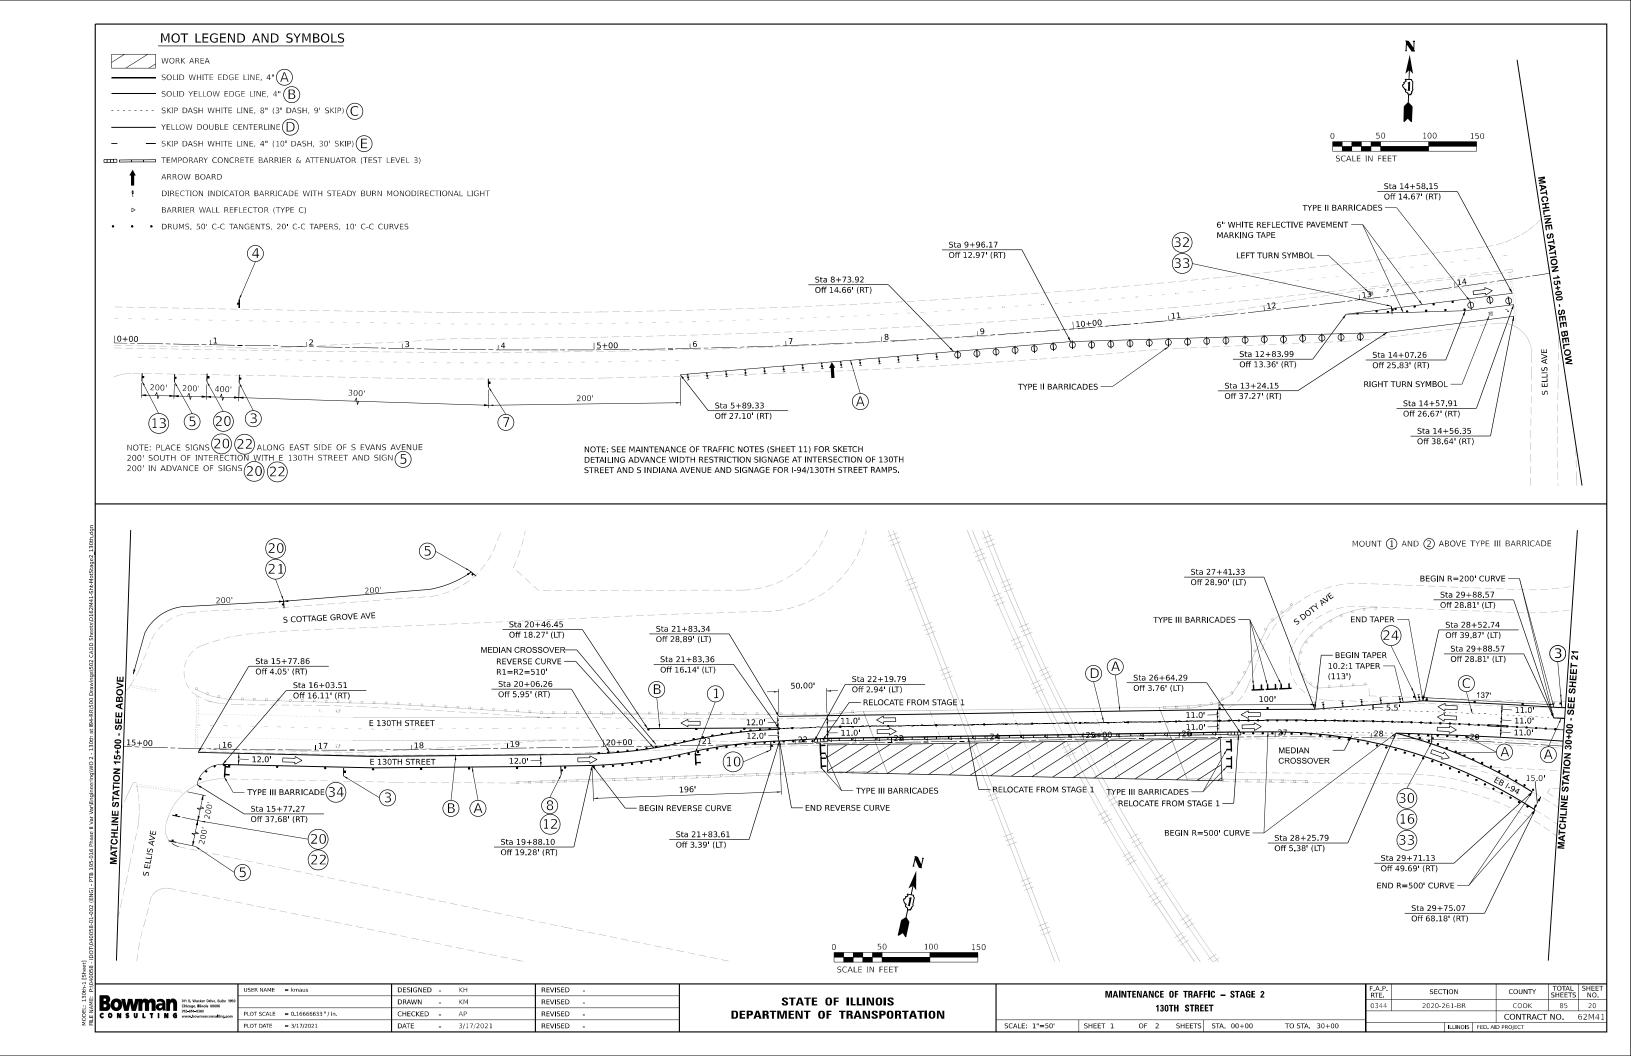

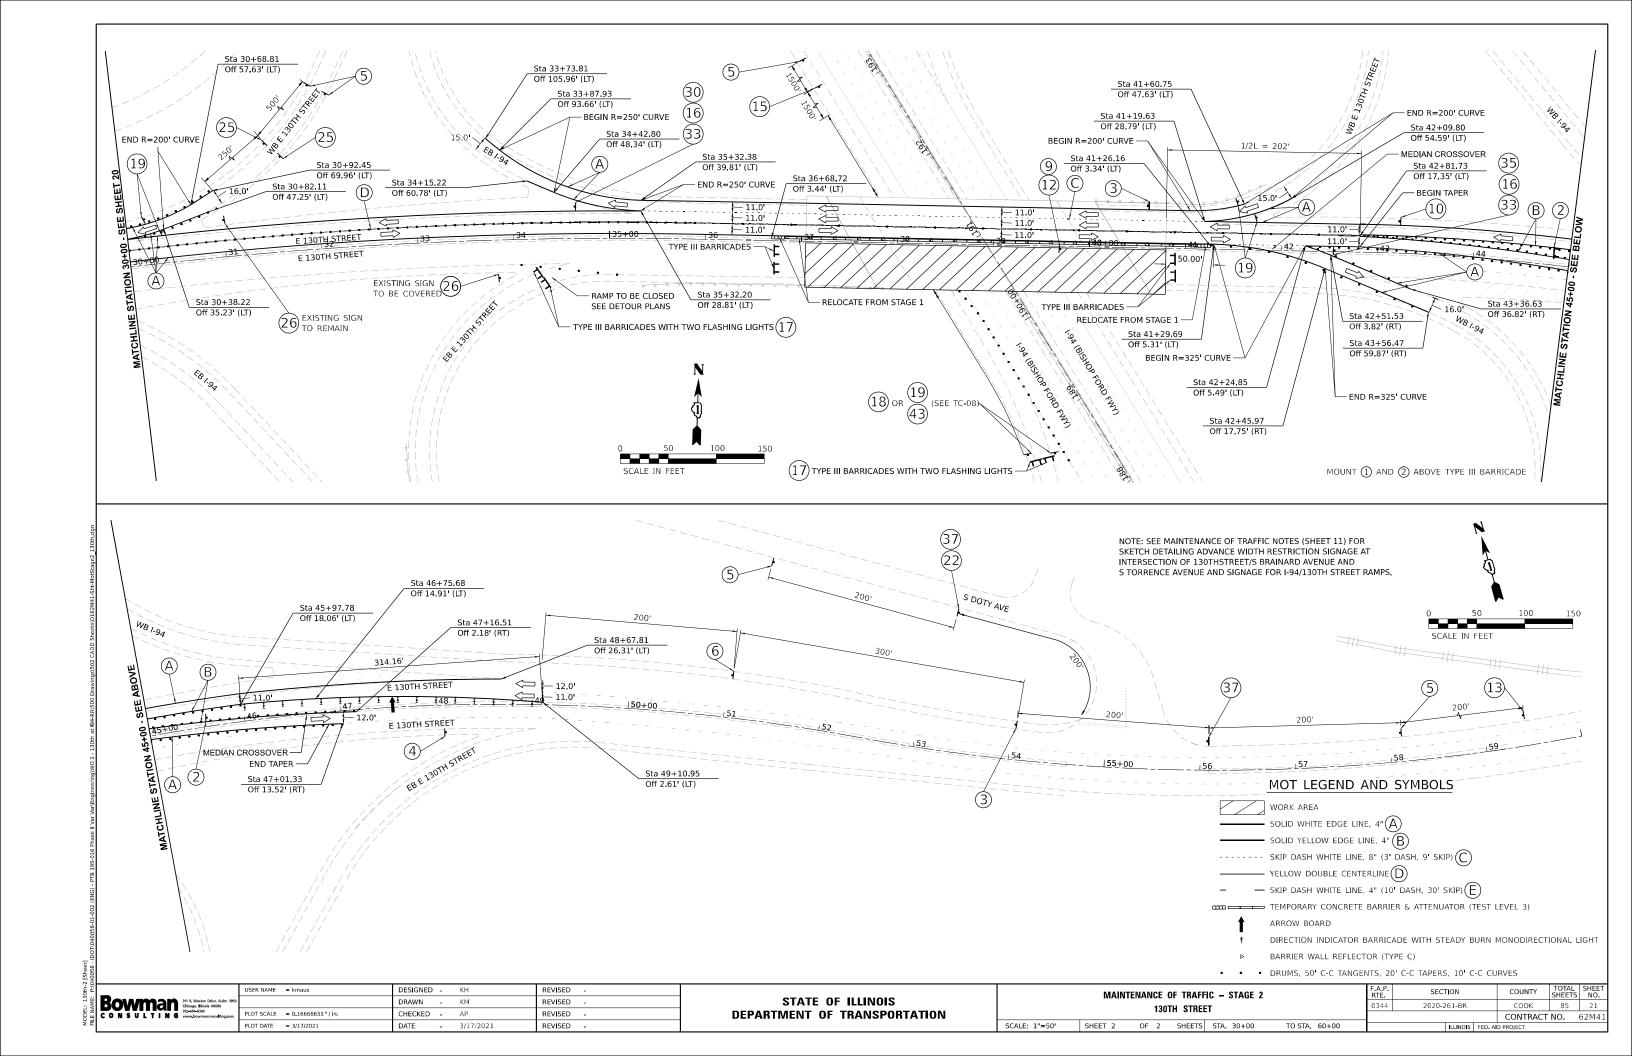

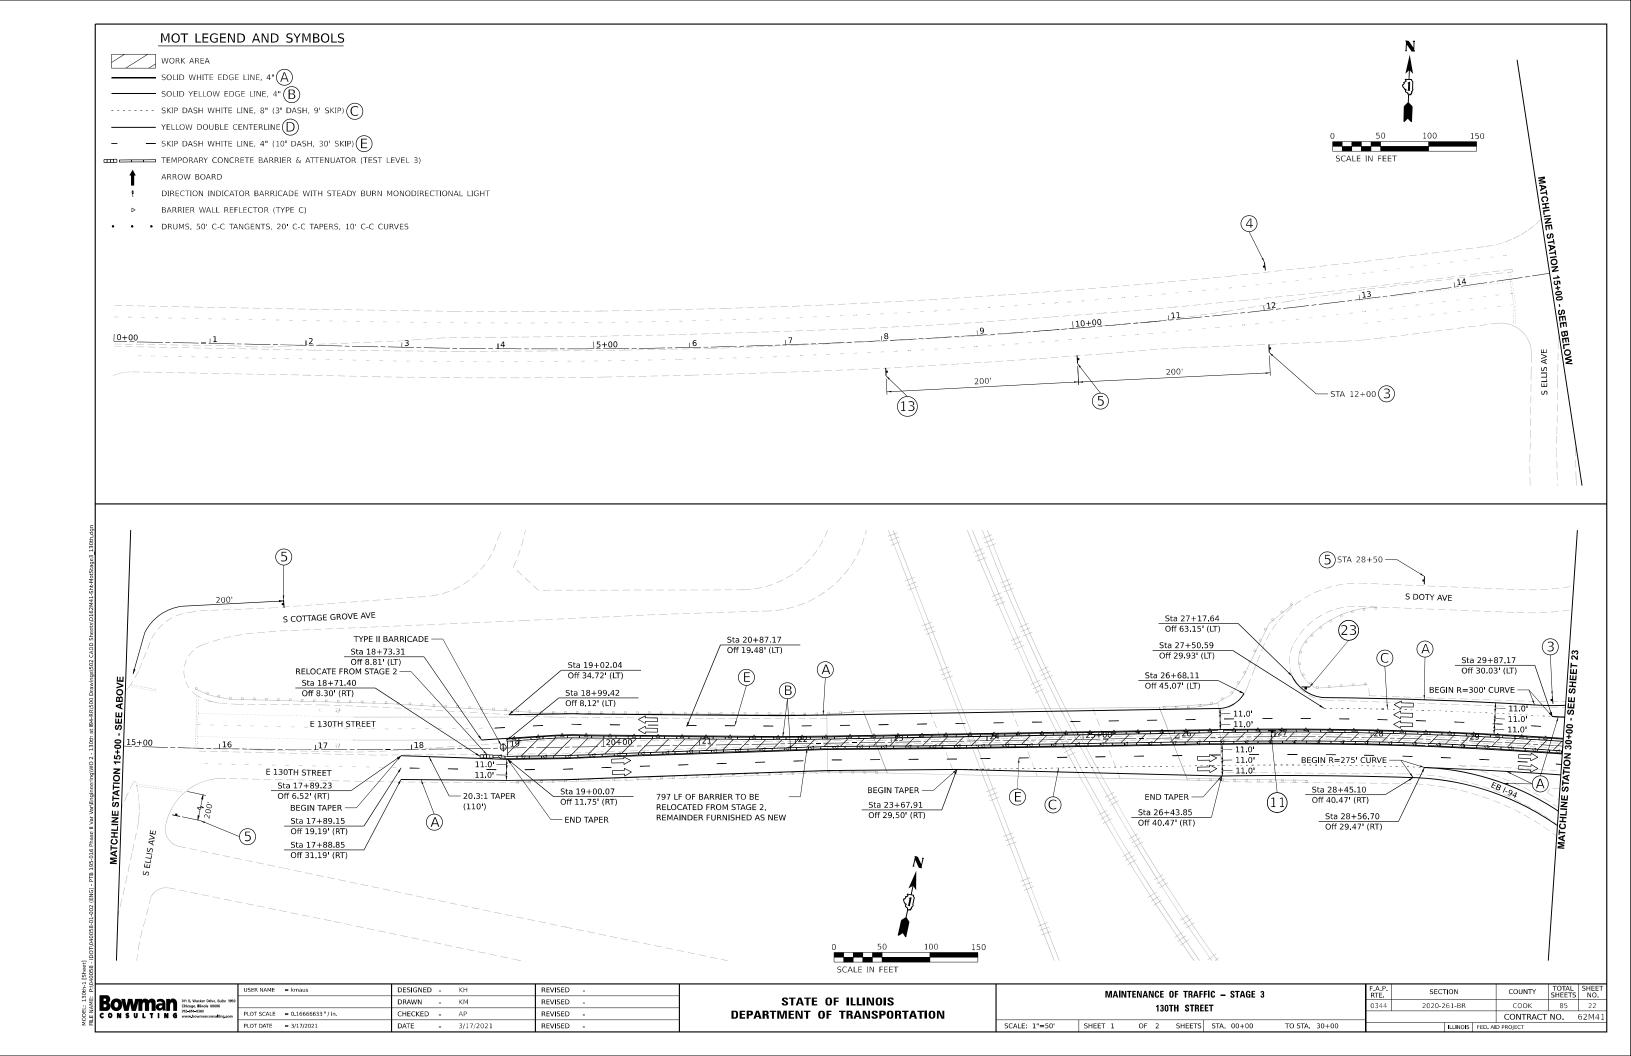

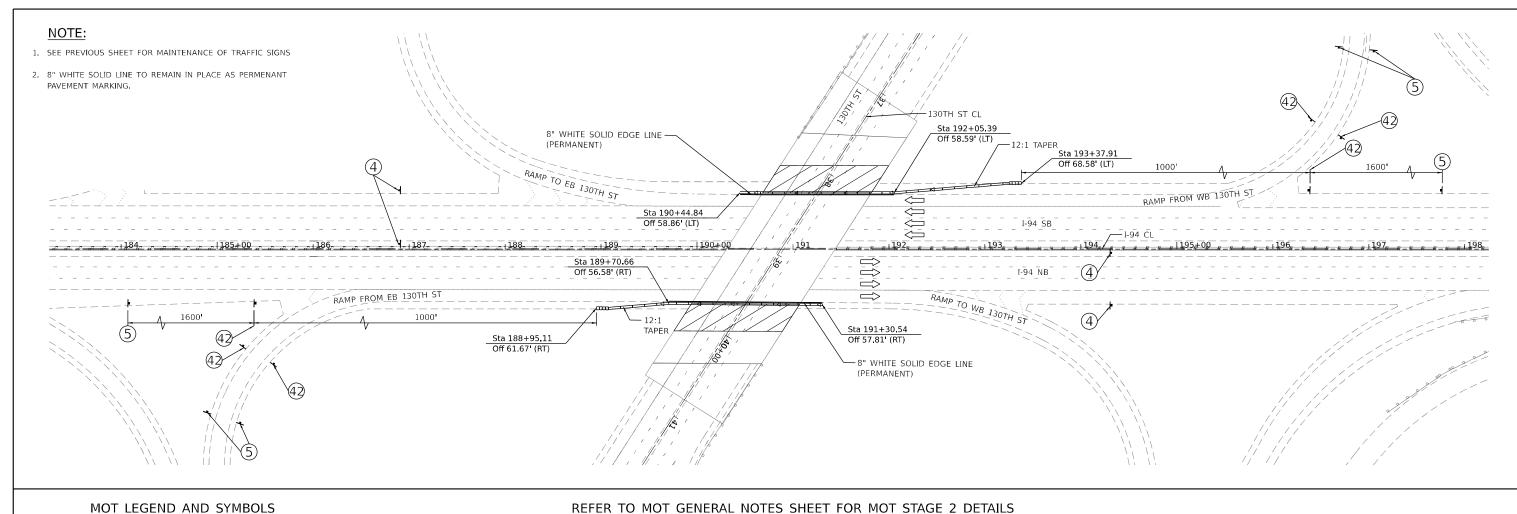

SOLID WHITE EDGE LINE, 4"(A)

RECTIONAL LIGHT

SOLID YELLOW EDGE LINE, 4"(B)

YELLOW DOUBLE CENTERLINE (D)


- SKIP DASH WHITE LINE, 4" (10' DASH, 30' SKIP) TEMPORARY CONCRETE BARRIER & ATTENUATOR (TEST LEVEL 3)

DIRECTION INDICATOR BARRICADE WITH STEADY BURN MONODIRECTIONAL LIGHT

BARRIER WALL REFLECTOR (TYPE C)

DRUMS, 50' C-C TANGENTS, 20' C-C TAPERS, 10' C-C CURVES

ALL RAMPS TO REMAIN OPEN DURING I-94 SUBSTRUCTURE WORK. REFER TO MOT GENERAL NOTES AND DETAILS.

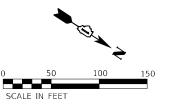



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	311 S. Wacker Drive, Suite 1959 Chicago, Illinois 60606	
CONSULTING	312-614-0360 www.bowmanconsulting.com	PLOT
		PLOT


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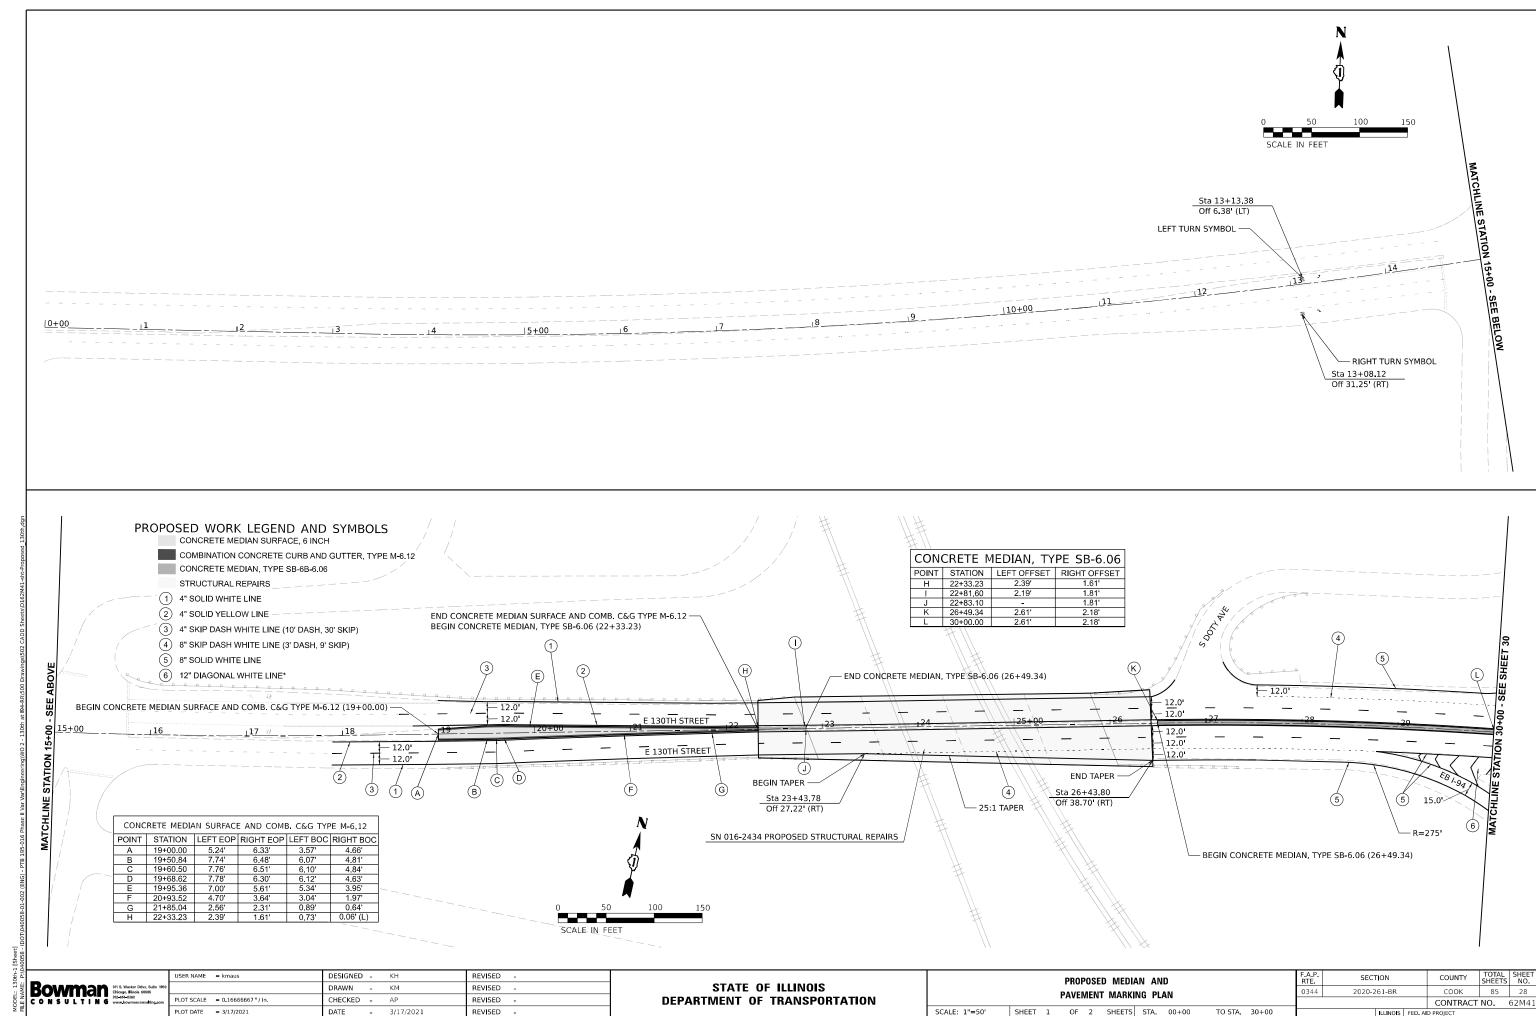
STATE OF ILLINOIS **DEPARTMENT OF TRANSPORTATION** 


MAINTENANCE OF TRAFFIC – STAGE 1		MAINTENANCE OF TRAFFIC - STAGE 1		SECTION	COUNTY	TOTAL SHEETS	SHEET NO.
I-94 (BISHOP FORD FREEWAY)	0344	2020-261-BR	соок	85	24		
1 of (Bioliot Tollo Tillettivit)			CONTRACT	NO.	62M41		
SCALE: 1"=50' SHEET 1 OF 2 SHEETS STA. 183+00 TO STA. 198+00		ILLINOIS FED. AI	D PROIECT				




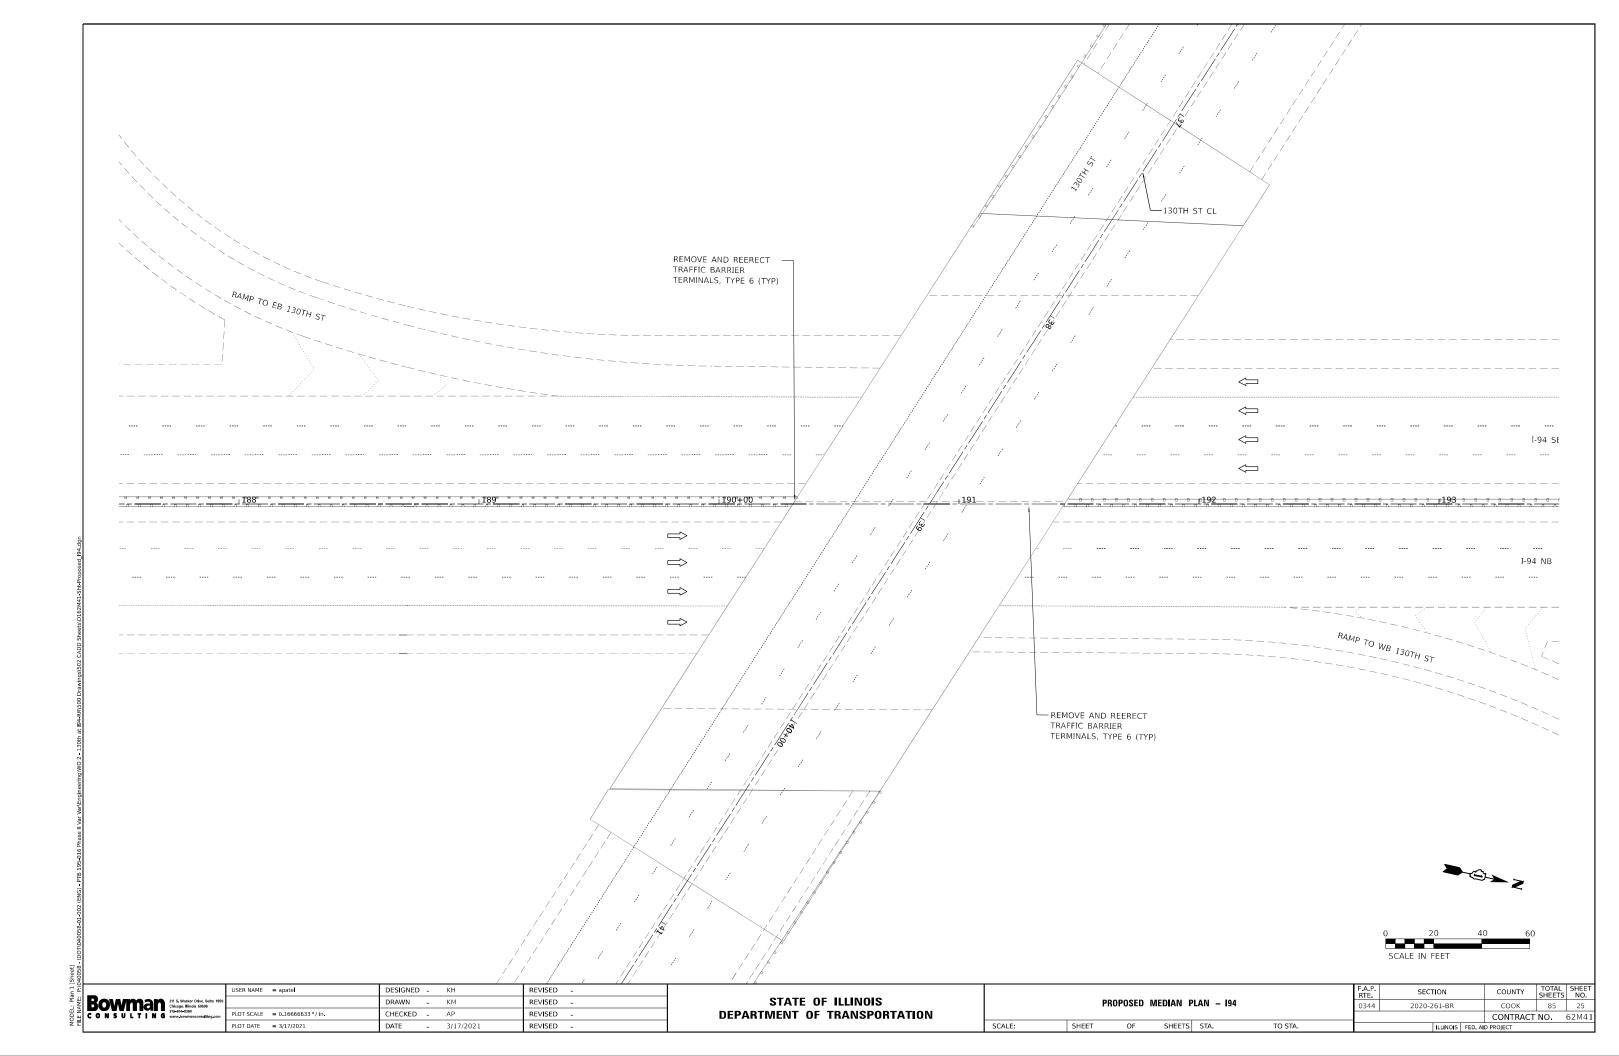


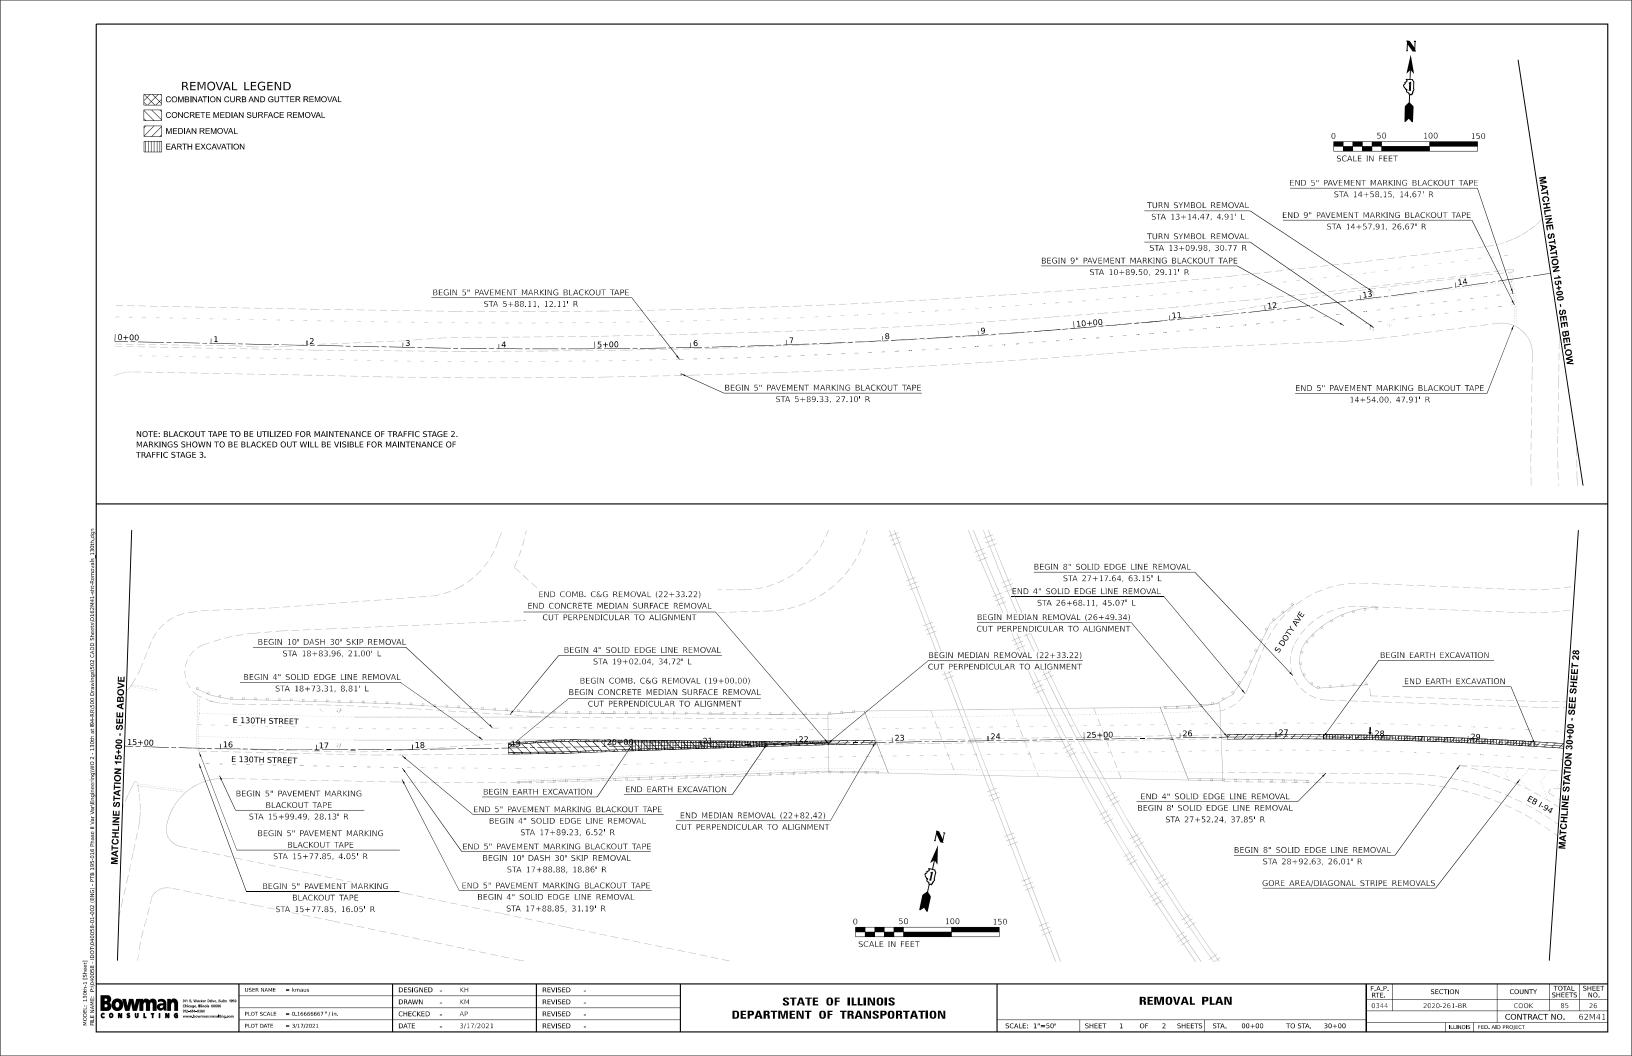


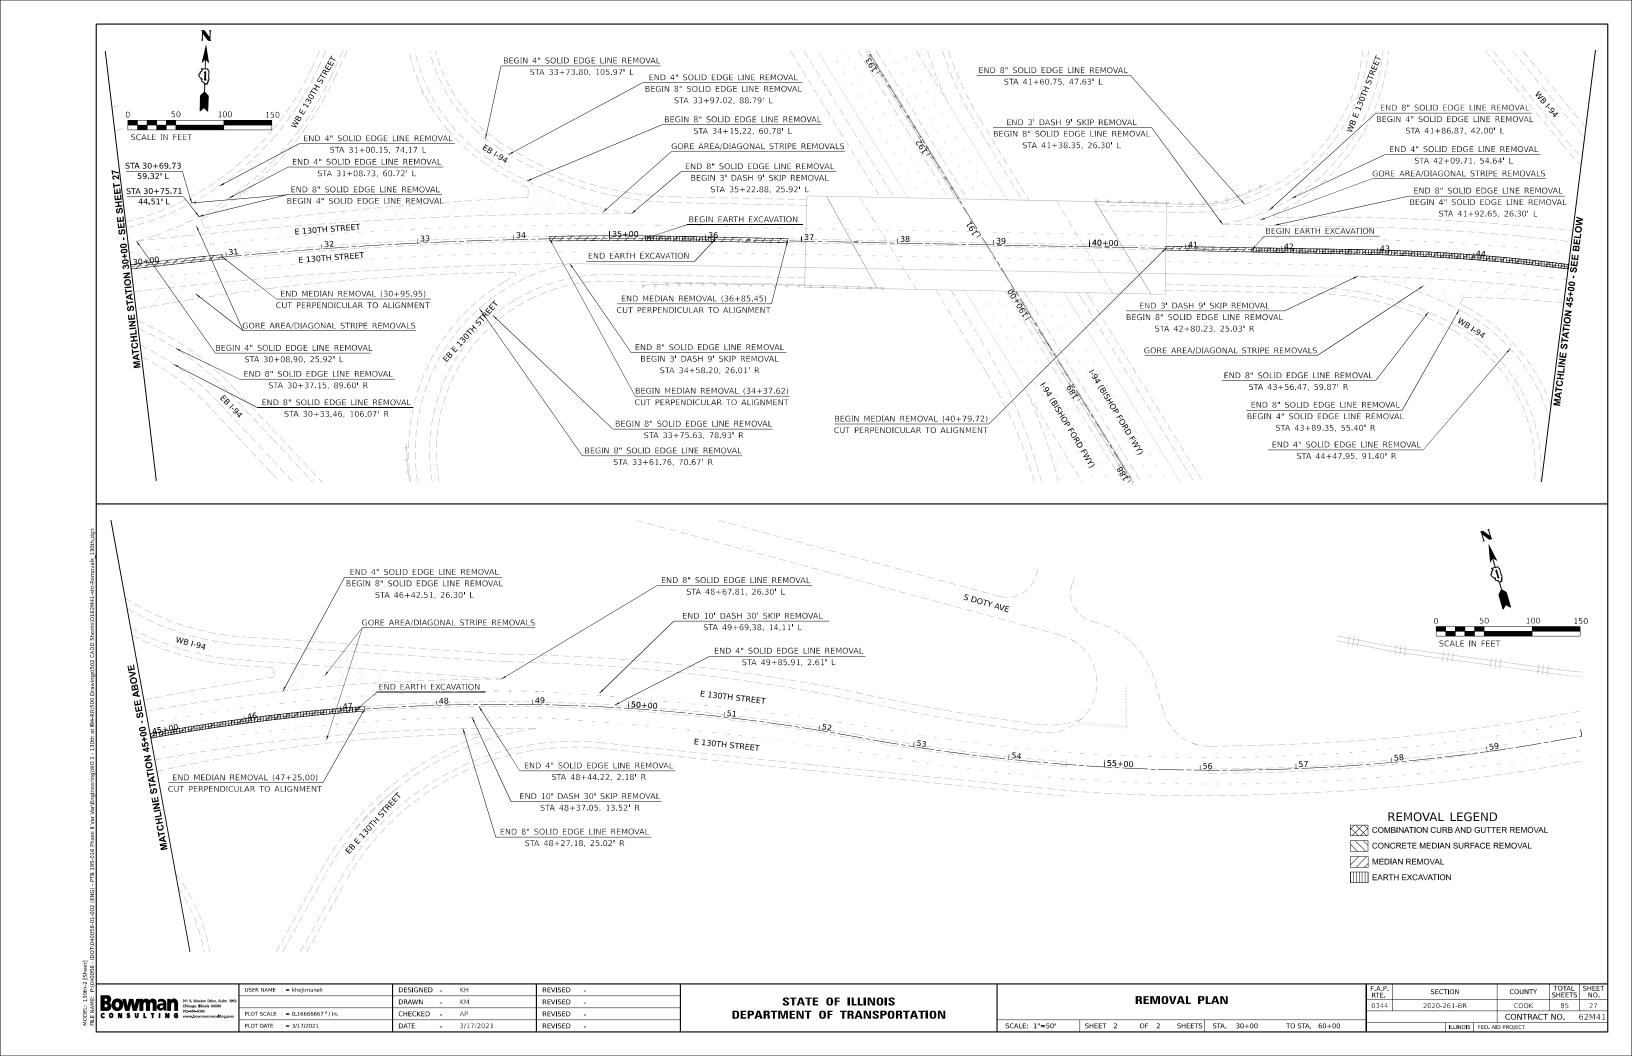


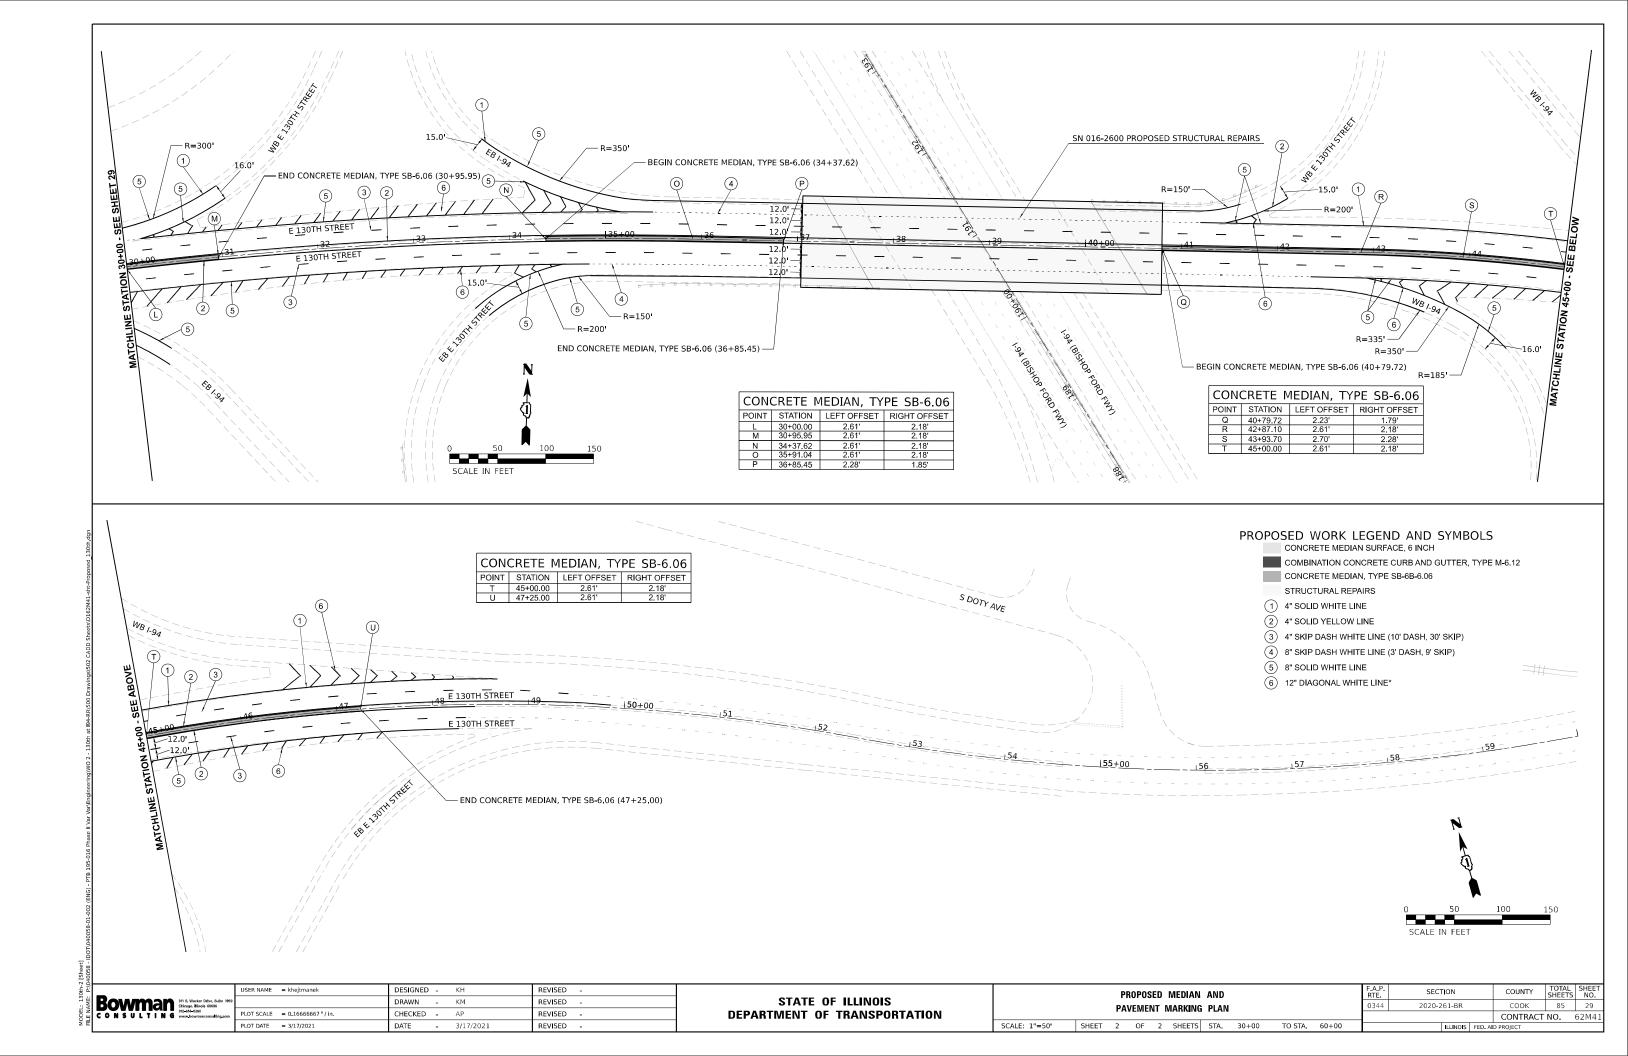

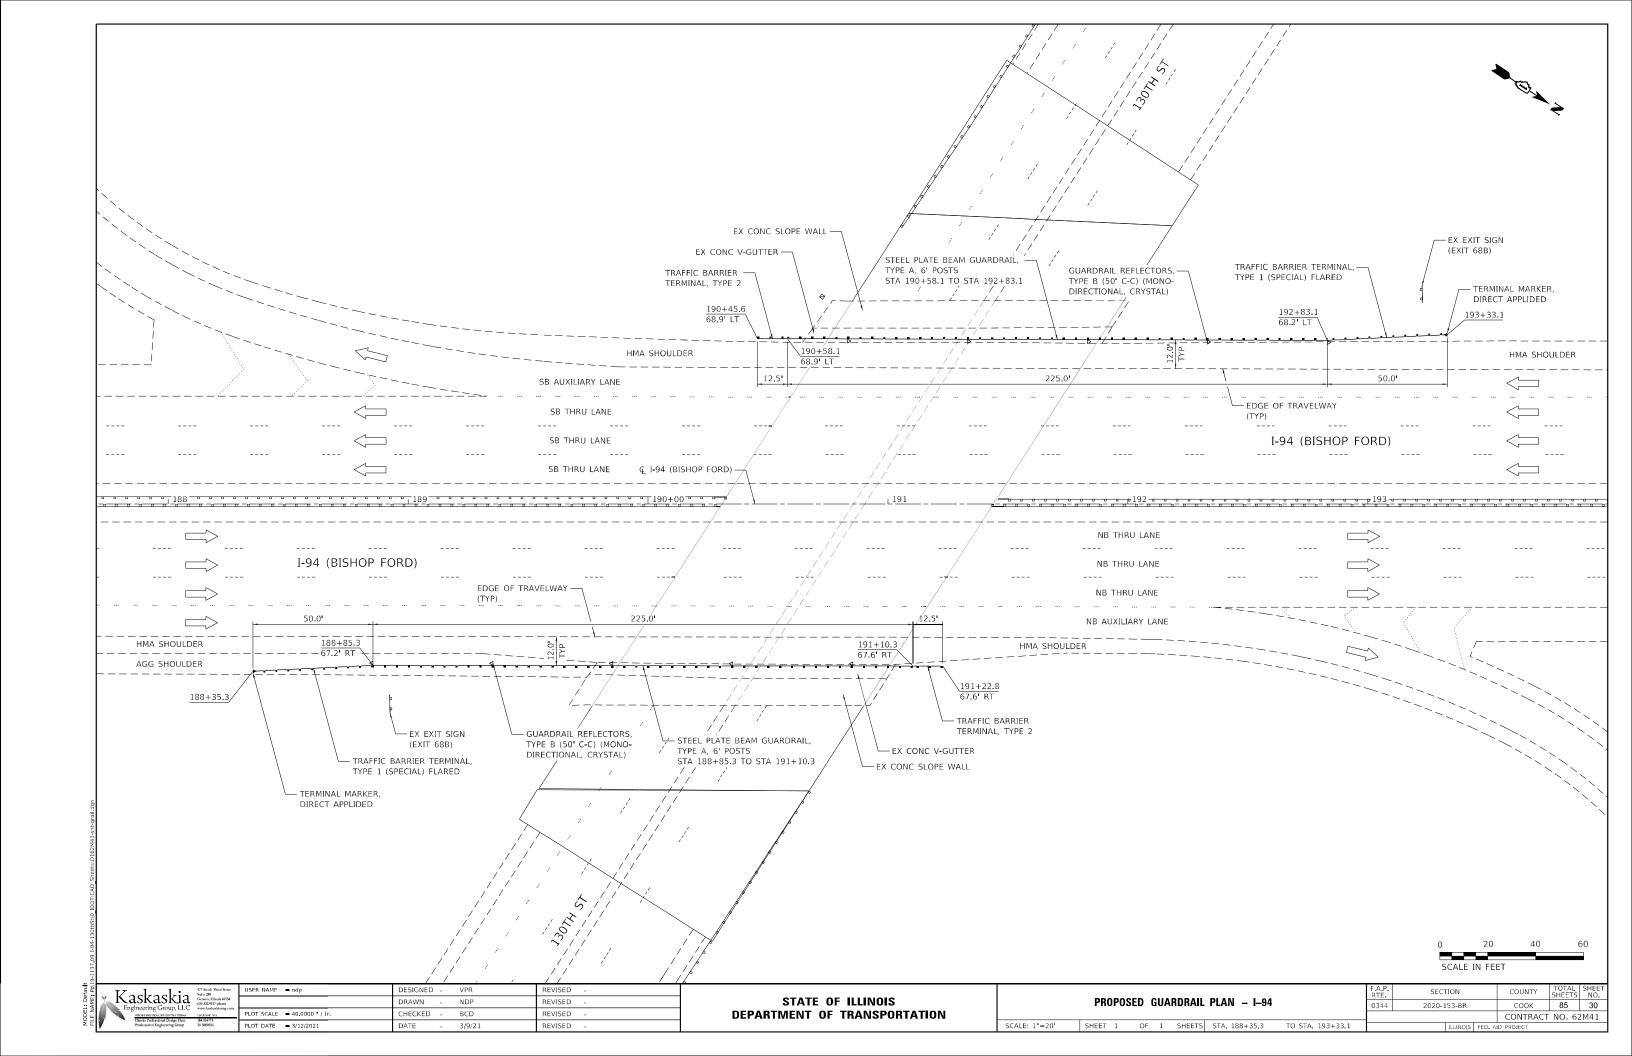


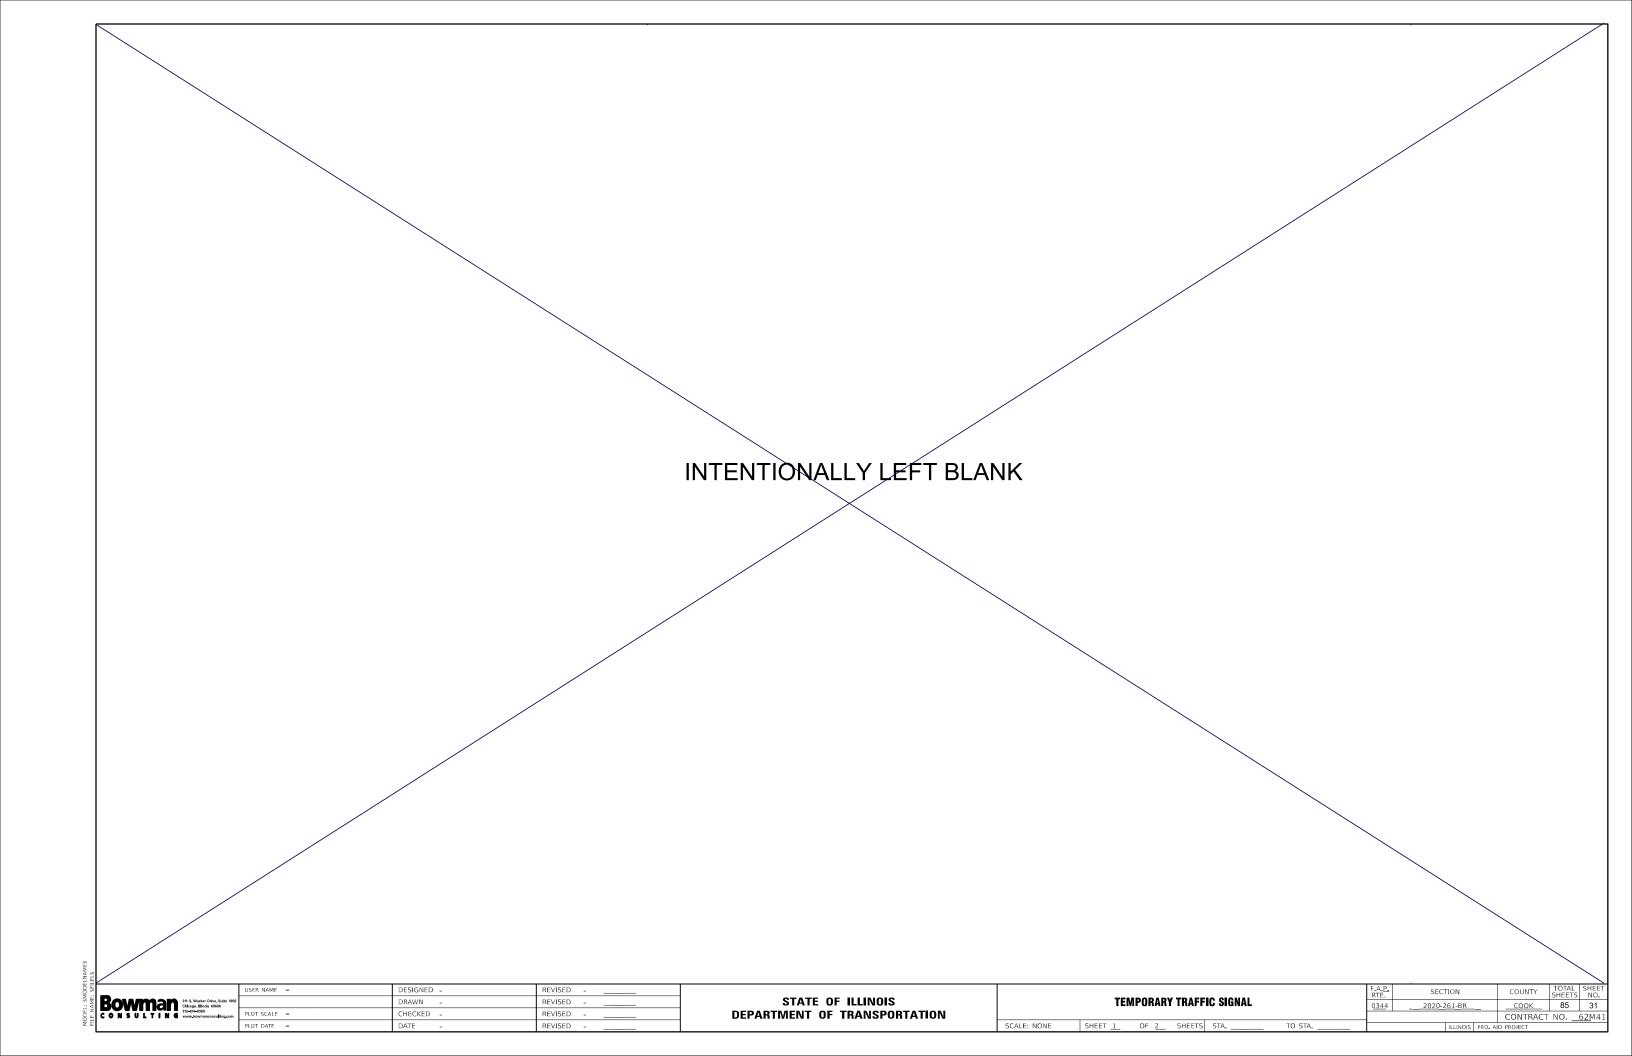

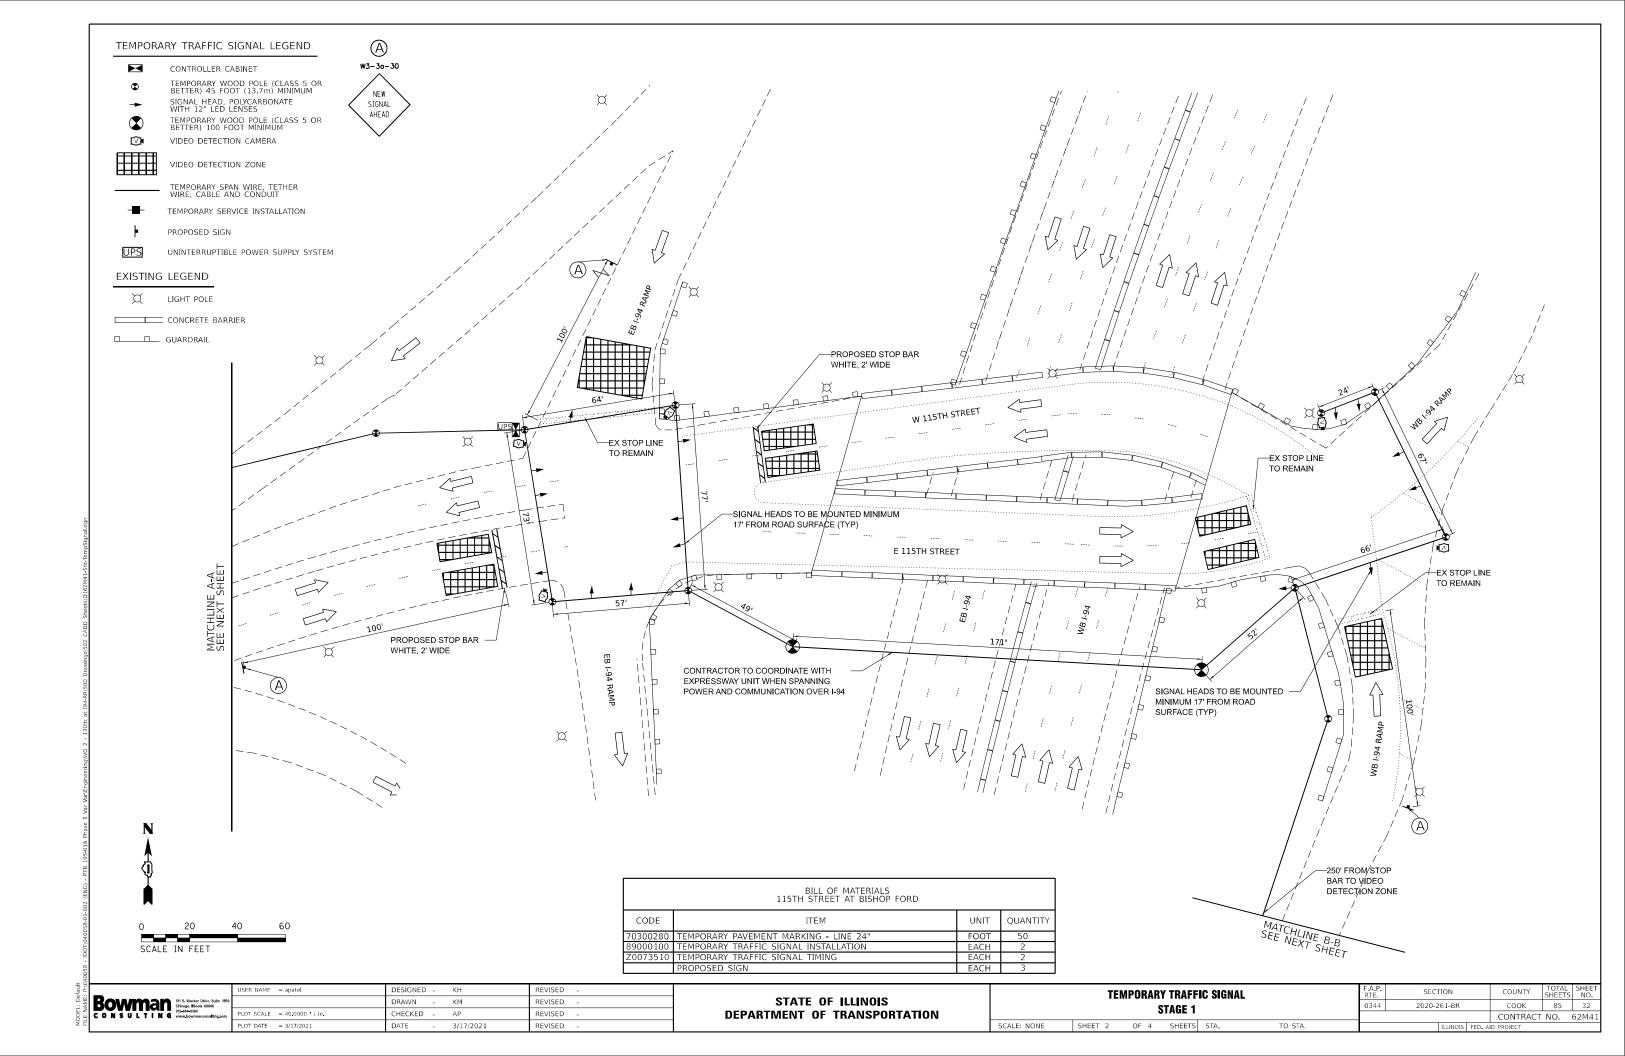

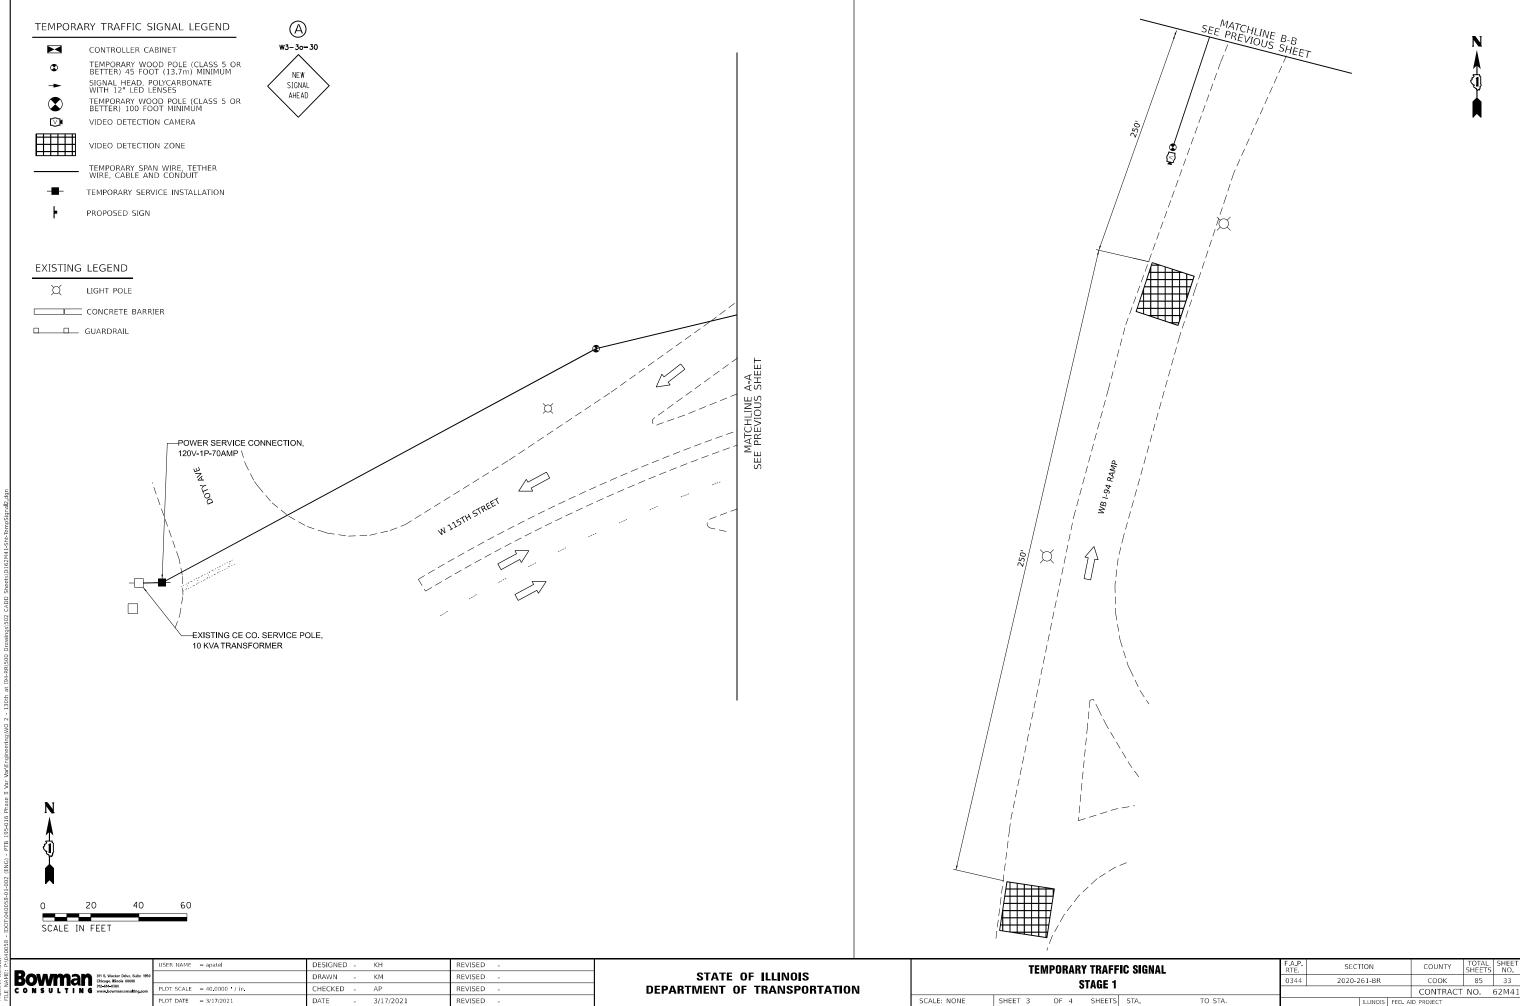

3/17/2021

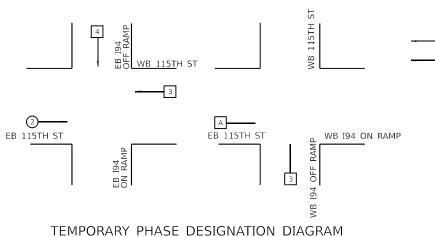

OVERLAP PHASE DESIGNATION:


**PHASES** 2 + 4

N.T.S.

TEMPORARY ELECTRIC 11	TOTAL					
TYPE	NO. LAMPS	WAT INCAND	TAGE DLED.	% OPERATION	WATTAGE	
SIGNAL (RED)	15		17	0.50	127.50	
SIGNAL (YELLOW)	15		25	0.25	93.75	
SIGNAL (GREEN)	15		15	0.25	56.25	
ARROW	2		12	0.10	2.40	
PED. SIGNAL				1.00		
CONTROLLER	1	100		1.00	100.00	
FLASHER						
				TOTAL -	270.00	

#### RESTORATION OF WORK AREA:

RESTORATION OF THE TRAFFIC SIGNAL WORK AREA SHALL BE INCIDENTAL TO THE RELATED PAY ITEM SUCH AS FOUNDATION, CONDUIT, HANDHOLE, TRENCH AND BACKFILL, ETC. AND NO EXTRA COMPENSATION SHALL BE ALLOWED. ALL ROADWAY SURFACES SUCH AS SHOULDERS, MEDIAN, SIDEWALKS, PAVEMENT, ETC. SHALL BE REPLACED IN KIND, ALL DAMAGE TO MOWED LAWNS SHALL BE REPLACED WITH AN APPROVED SOD, AND ALL DAMAGE TO UNMOWED FIELDS SHALL BE SEEDED IN ACCORDANCE WITH STANDARD SPECIFICATIONS 252 AND 250 RESPECTIVELY.

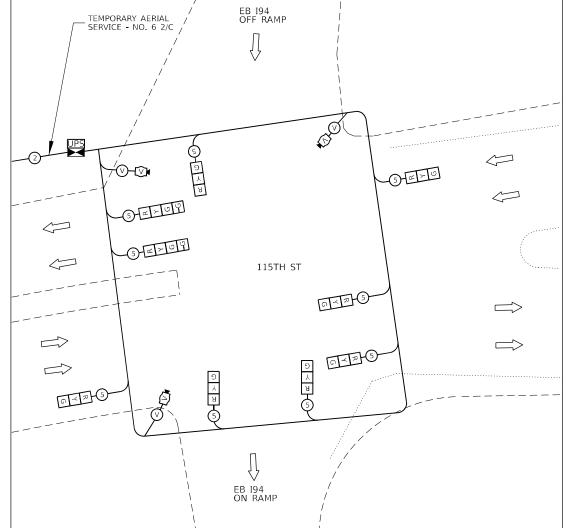

TEMPORARY CABLE PLAN - EASTBOUND 94 AT 115TH STREET

#### TEMPORARY CABLE DIAGRAM LEGEND lacksquareCONTROLLER CABINET

G TEMPORARY TRAFFIC SIGNAL SECTION


INDICATES NUMBER OF CONDUCTORS IN CABLE. ALL CONDUCTORS TO BE NUMBER 14 AWG WIRE UNLESS OTHERWISE NOTED (5)

 $\bigcirc$ VIDEO DETECTION CAMERA

VIDEO DETECTOR CABLE AS RECOMMENDED BY VIDEO CAMERA MANUFACTURER  $\bigcirc$ 

FIBER OPTIC CABLE - NO. 62.5/125, MM12F 12

UPS UNINTERRUPTIBLE POWER SUPPLY SYSTEM

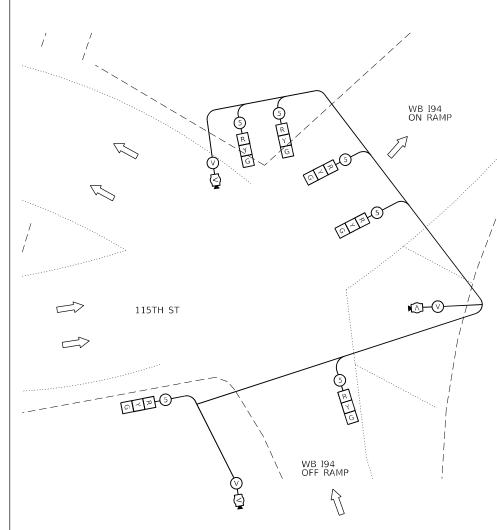

TEMPORARY CABLE PLAN - WESTBOUND 94 AT 115TH STREET

SCALE: NONE

- 1. CONTRACTOR SHALL RESTORE INTERSECTION TO PRE-CONSTRUCTION CONDITIONS AFTER COMPLETION OF DETOUR STAGE
- 2. PROPOSED SERVICE TO THE TEMPORARY TRAFFIC SIGNAL CONTROLLER SHALL BE FROM TEMPORARY SERVICE 120V-1P-70 AMPS

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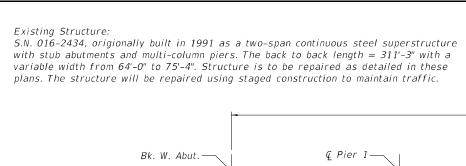
LEGEND


SINGLE ENTRY PHASE


DUAL ENTRY PHASE

NUMBER REFERS TO ASSOCIATED PHASE

TEMPORARY CABLE PLAN, PHASE DESIGNATION DIAGRAM			SECTION	COUNTY	TOTAL SHEETS	SHEET NO.
	AND OVERLAP PHASE DESIGNATION - STAGE 1	0344	2020-261-BR	COOK	85	34
	MID OVEREAL THASE DESIGNATION - STAGE I			CONTRACT	NO.	62M41
ONE	CHEET 4 OF 4 CHEETC CTA TO CTA			 		



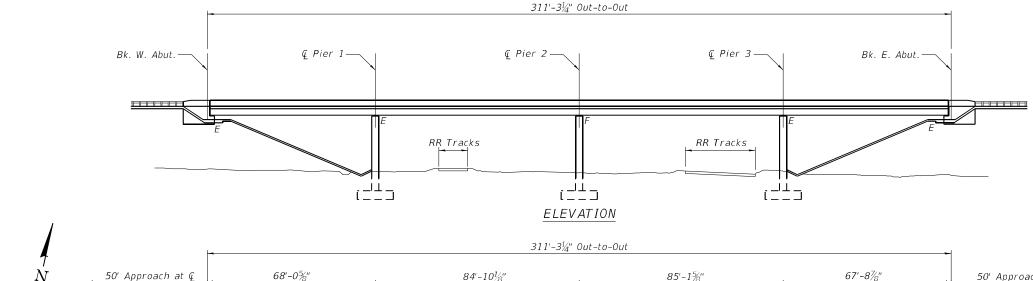

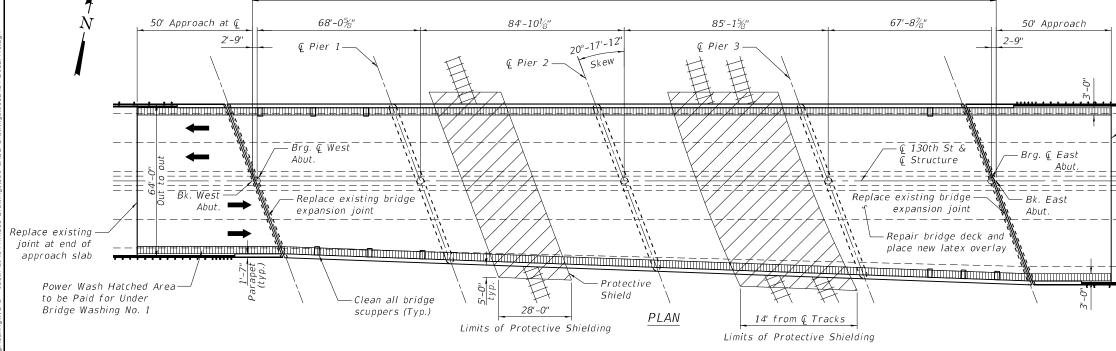

#### DESIGN STRESSES

#### FIELD UNITS (EXIST. CONST.)

f'c = 3,500 psi

fy = 60,000 psi

fy = 50,000 psi M223 Gr.50 & M222

fy = 36,000 psi M183

### FIELD UNITS (NEW CONST.)

f'c = 4,000 psi (Superstructure)f'c = 3,500 psi (Substructure)fy = 60,000 psi (Reinforcement)

#### DESIGN SPECIFICATIONS

2002 AASHTO Standard Specifications for Highway Bridges

### LOADING HS20-44

Existing and Proposed

#### LEGEND

Protective Shield

| | | Area to be Power Washed

SIGNED: 03/18/2021 EXPIRES: 11/30/2022

#### INDEX OF SHEETS

SA-1 General Plan and Elevation

SA-2 General Notes & Bill of Materials

SA-3 Maintenance of Traffic Details

SA-4 Deck & Approach Slabs Repairs and Overlay Plans

SA-5 Adjusting Drainage Scupper Details

SA-6 Joint Repair Limits

SA-7 Expansion Joint Details

SA-8 Preformed Joint Strip Seal

SA-9 Joints and Scuppers As-Built Plans

SA-10 Pier 1 Repairs

SA-11 Pier 2 Repairs

SA-12 Pier 3 Repairs

SA-13 East and West Abutments Repairs


SA-14 Bar Splicer Assembly Details

#### SCOPE OF WORK

- 1. Deck Scarification and Latex Concrete Overlay
- 2. Deck & approach slab partial and full depth repair
- 3. Substructure repair
- 4. Replace existing expansion joints with strip seal joints
- 5. Replace relief joints
- 6. Clean bridge and adjust scuppers
- 7. Apply Concrete Sealer for bridge substructure, parapets

Replace existing bridge expansion joint



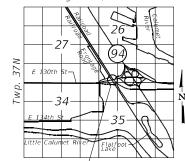

Project Location →

LOCATION SKETCH

GENERAL PLAN AND ELEVATION

130TH ST. OVER CSS RR & IHB RR SECTION 2020-153-BR

COOK COUNTY STRUCTURE NO. 016-2434

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STATE OF ILLINOIS **DEPARTMENT OF TRANSPORTATION** 

**GENERAL PLAN AND ELEVATION** 130TH ST. BRIDGE OVER RAILROADS - SN 016-2434 SHEET SA-01 OF SA-14 SHEETS

					SA-1
F.A.P. RTE	SECTION		COUNTY	TOTAL SHEETS	SHEE NO.
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			CONTRACT	NO. 6	52M41
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Reinforcement bars designated (E) shall be epoxy coated.

Concrete Sealer shall be applied to all faces of the pier, front face of both abutments, below the bearing seats and above the ground line. Concrete Sealer shall also be applied to front and top face of bridge parapets and entire surface of the median between the ends of the bridge approach slabs.

Protective Coat shall be applied to the top and front face of the new parapet and concretre deck, including new concrete overlay.


Joint openings shall be adjusted according to Article 520.04 of the Standard Specifications when the deck is poured at an ambient temperature other than 50° F.

#### **CONSTRUCTION**

- 1. The contractor shall not scale dimensions from the contract plans for construction purposes. Scales shown are for information only.
- Plan dimensions and details relative to the existing structure have been taken from existing plans and are subject to nominal construction variations. It shall be the Contractor's responsibility to verify such dimensions and details in the field and make necessary approved adjustment prior to construction of or ordering of materials. Such variations shall not be cause for additional compensation for a change in scope of the work. However, the Contractor will be paid for the quantity actually furnished at the unit price for the work.
- 3. No concrete cutting shall be permitted until the cutting limits have been outlined by the contractor and approved by the engineer.
- The location and extent of repair items are based on visual observation made during field investigations, and are not guaranteed to be accurate or all inclusive. The location, extent of repair, and quantity or repair shall be field verified by the field engineer.
- 5. Whenever any material is deposited into a drainage system or drainage structures, the deposited material shall be removed at the close of each working day. At the conclusion of construction operations, all drainage systems and structures shall be free from dirt and debris deposited during the various construction operations. The work specified above will not be paid for separately, but shall be considered included in the cost of "Cleaning Bridge Scuppers and Downspouts".
- 6. It shall be the contractor's responsibility to verify the location of all utilities prior to starting construction. Contact J.U.L.I.E., 800-892-0123.
- The Contractor shall not store any construction equipment nor stock pile any material within the railroad clearance diagram.
- 8. The end diaphragms shall not be used for jacking purposes during temporary cribbing and shoring operations unless checked and verified by an Illinois Licensed Structural Engineer.

### TOTAL BILL OF MATERIAL

ITEM NO.	DESCRIPTION	Unit	Super	Sub	Total
50102400	Concrete Removal	Cu. Yd.	19.1	-	19.1
50157300	Protective Shield	Sq. Yd.	650	-	650
50300255	Concrete Superstructure	Cu. Yd.	19.1	-	19.1
50300260	Bridge Deck Grooving	Sq. Yd.	2,761	-	2,761
50300300	Protective Coat	Sq. Yd.	2,959	-	2,959
50800205	Reinforcement Bars, Epoxy Coated	Pound	2,560	-	2,560
50800515	Bar Splicers	Each	22	-	22
52000110	Preformed Joint Strip Seal	Foot	152.0	-	152.0
58700300	Concrete Sealer	Sq. Ft.	3,775	12,503	16,278
59000200	Epoxy Crack Injection	Foot	10.0	10.0	20.0
59200101	Bridge Washing No. 1	Each	1	-	1
X0322215	Cleaning Bridge Scuppers and Downspouts	Each	10	-	10
Z0001700	Approach Slab Repair (Full Depth)	Sq. Yd.	38.7	-	38.7
Z0005874	Bonded Preformed Joint Sealer, 3 Inch	Foot	133.0	-	133.0
Z0006012	Bridge Deck Latex Concrete Overlay, 21/4"	Sq. Yd.	2,863	-	2,863
Z0012130	Bridge Deck Scarification ¾"	Sq. Yd.	2,257	-	2,257
Z0012142	Bridge Deck Scarification 2¼"	Sq. Yd.	606	-	606
Z0012754	Structural Repair of Concrete (Depth Equal to or Less Than 5")	Sq. Ft.	-	139	139
Z0012755	Structural Repair of Concrete (Depth Greater Than 5")	Sq. Ft.	-	41	41
Z0016001	Deck Slab Repair (Full Depth, Type I)	Sq. Yd.	0.4	=	0.4
Z0016002	Deck Slab Repair (Full Depth, Type II)	Sq. Yd.	0.7	-	0.7
Z0018051	Drainage Scuppers to be Adjusted	Each	10	-	10
Z0048665	Railroad Protective Liability Insurance	L Sum		1	1
Z0073200	Temporary Shoring and Cribbing	Each	-	4	4

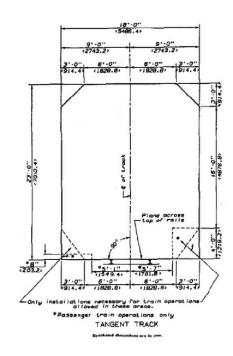


RAILROAD CLEARANCE DIAGRAM

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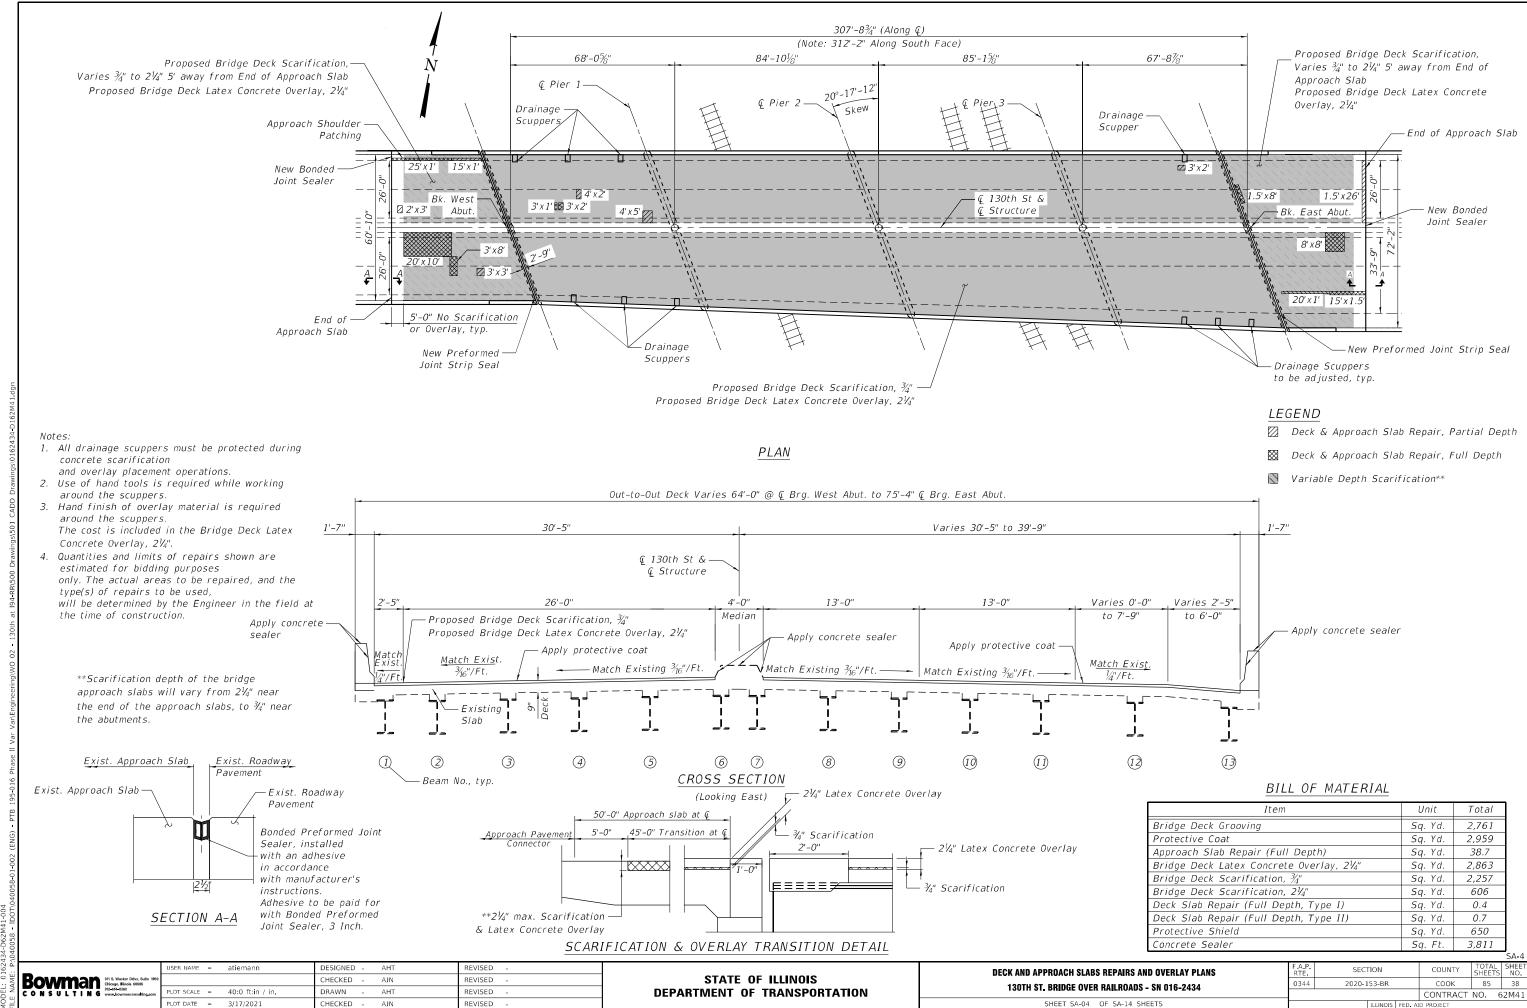
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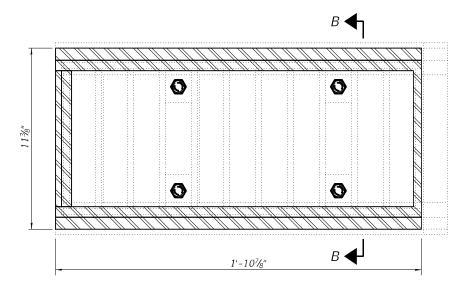
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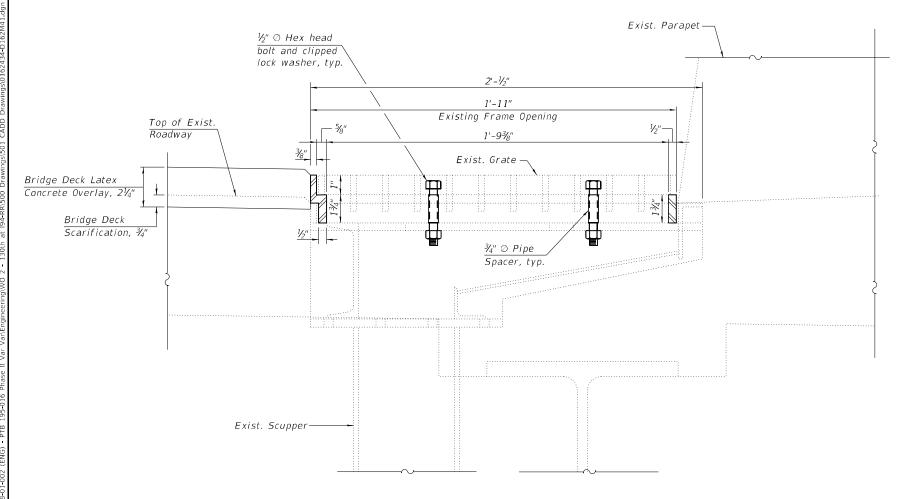
STATE OF ILLINOIS **DEPARTMENT OF TRANSPORTATION**  130TH ST. BRIDGE OVER RAILROAD - SN 016-2434 SHEET SA-03 OF SA-14 SHEETS

0344 2020-153-BR COOK 85 37 CONTRACT NO. 62M41



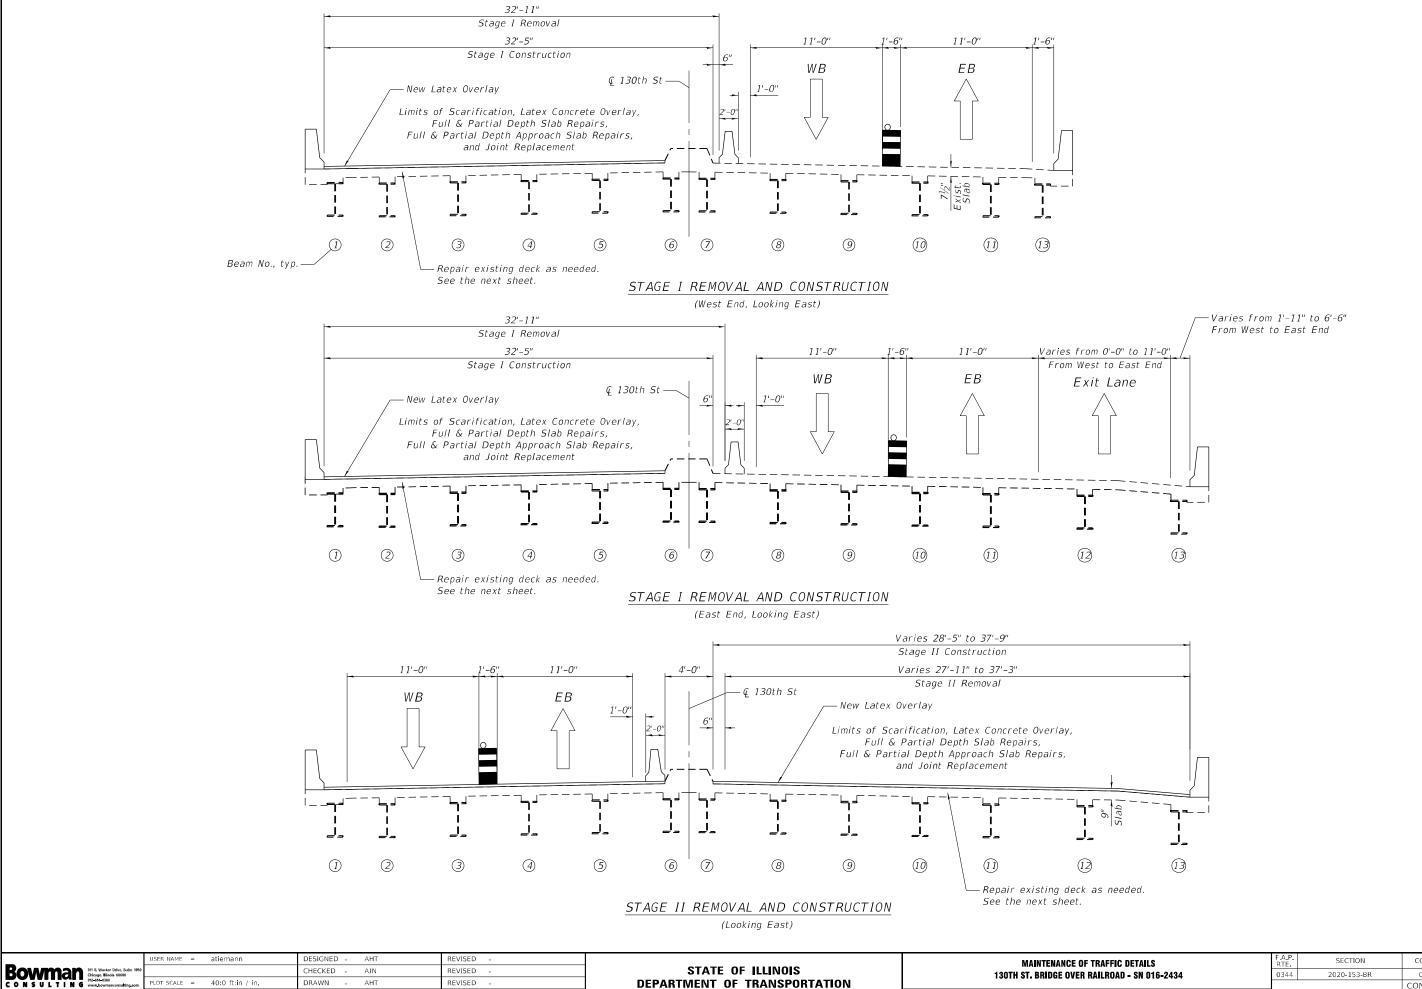


TYPICAL PLAN



TYPICAL SCUPPER DETAIL

#### NOTES

- 1. The Contractor shall field verify Existing Dimensions and Details of the Existing Scuppers and make necessary adjustments prior to construction of New Adjusting Ring or ordering of material for Adjusting Drainage Scuppers.
- 2. All Cast Iron Parts shall be Grey Iron conforming to the requirements of AASHTO M 105. Class 35B.
- 3. Bolts, Anchor Studs, Washers, and Nuts shall conform to the requirements of AASHTO M 232.
- 4. Cast Iron Parts shall be unfinished.
- 5. Adjusting Ring shall be from Neenah and approved equal. Structural Steel weldments or equal sections and of the same configuration may be submitted for Cast Iron. Fillet or full Penetration Welds may be used for weldments. Details shall be submitted to the Engineer for approval.
- 6. Provide a ½" Fillet Weld around perimeter of new Adjusting Ring to secure to existing Scupper. Electrode shall be compatible with Cast Iron.
- 7. Cost of all labor and materials necessary to clean all existing floor drains and scuppers, install adjusting scupper rings, remove and re-install grates is included in the cost for Drainage Scupper to be Adjusted.

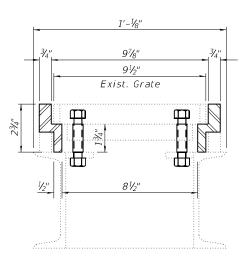

SECTION B-B

#### BILL OF MATERIAL


ITEM	UNIT	QUANTITY
Drainage Scupper to be Adjusted	Each	10

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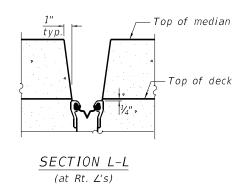
STATE OF ILLINOIS
DEPARTMENT OF TRANSPORTATION

ADJUSTING DRAINAGE SCUPPER DETAILS
130TH ST. BRIDGE OVER RAILROADS - SN 016-2434

SHEET SA-05 OF SA-14 SHEETS

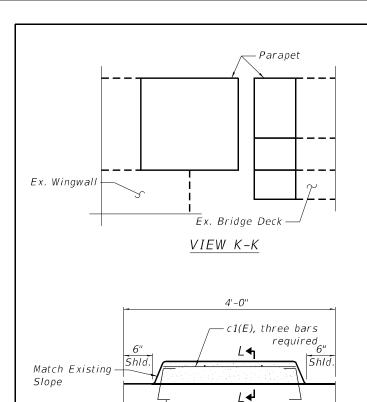

#### MEDIAN REINFORCEMENT DETAIL



#### Notes:

c(E), three pairs required

Any reinforcement bars that are damaged during concrete removal operation shall be repaired or replaced using an approved bar splicer or anchorage system. Cost included with Concrete Removal.

Existing transverse, longitudinal, and vertical reinforcements remaining and extending into the removal area shall be cleaned, straightened and incorporated into the new construction. Cost included with Concrete Removal.

See Sheet SA-7 of 14 for Bill of Material, bar details and sections.

For Overlay details see cross section on sheet SA-4 of 14.

See Sheet SA-8 of 14 for joint seal details.

See Sheet SA-14 of 14 for Bar Splicer details.

LEGEND Concrete Removal -⊊ Beam 1 4-#4 d( $\dot{E}$ ) and #5 d1(E) bars Flair to Fit F.F. of Parapet -F.F. of Parapet 2-#6 a3(E) bars lapped with a1(E) bars, Top. 32-#5 x(E) bars at 12" cts. between 20° 17' 12 D ¢ 130th St & 7-Bar`splicers (E) \_for #5 bars ← Structure 4-Bar splicers\ Median 37' (E) for #6 bars 27'-11" to Back of Abut. Back of Abut. 29-#5 x(E) bars at 12" cts End of Deck between beams, West Abut. 39-#5 x(E) bars at 12" cts. between beams, East Abut. G **1** 2½" 1 3-#4 d(E) and #5 d1(E) bars Equally Spaced F.F. of Parapet F.F. of Parapet 2-#6 a3(E) bars lapped with a(E) or a2(E) bars, <sub>1'-7%"</sub>H◀G◀<sub>1'-6½"</sub> Тор. **\_★**K

#### CONCRETE REMOVAL PLAN

(West Abutment Shown, East Abutment Similar)

#### CONCRETE REPLACEMENT PLAN

(West Abutment Shown, East Abutment Similar)

\* a(E) and h(E) bars at West Abut. \* a2(E) and h2(E) bars at East Abut.

Bars indicated thus 3x2-#5 h1(E) bars indicates 3 lines of bars with 2 lengths per line

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Splice Length #5 bar - 3'-6"

Splice Length #6 bar - 4'-0"

STATE OF ILLINOIS
DEPARTMENT OF TRANSPORTATION


JOINT REPAIR LIMITS

130TH ST. BRIDGE OVER RAILROADS - SN 016-2434


SHEET SA-06 OF SA-14 SHEETS

CONTRACT NO. 62M41

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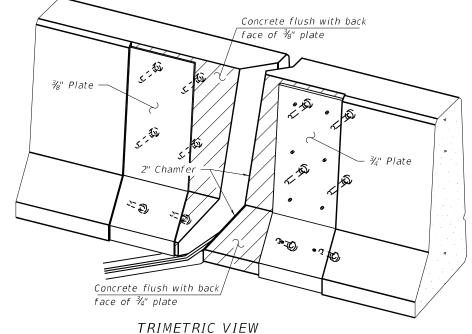
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DETAIL A

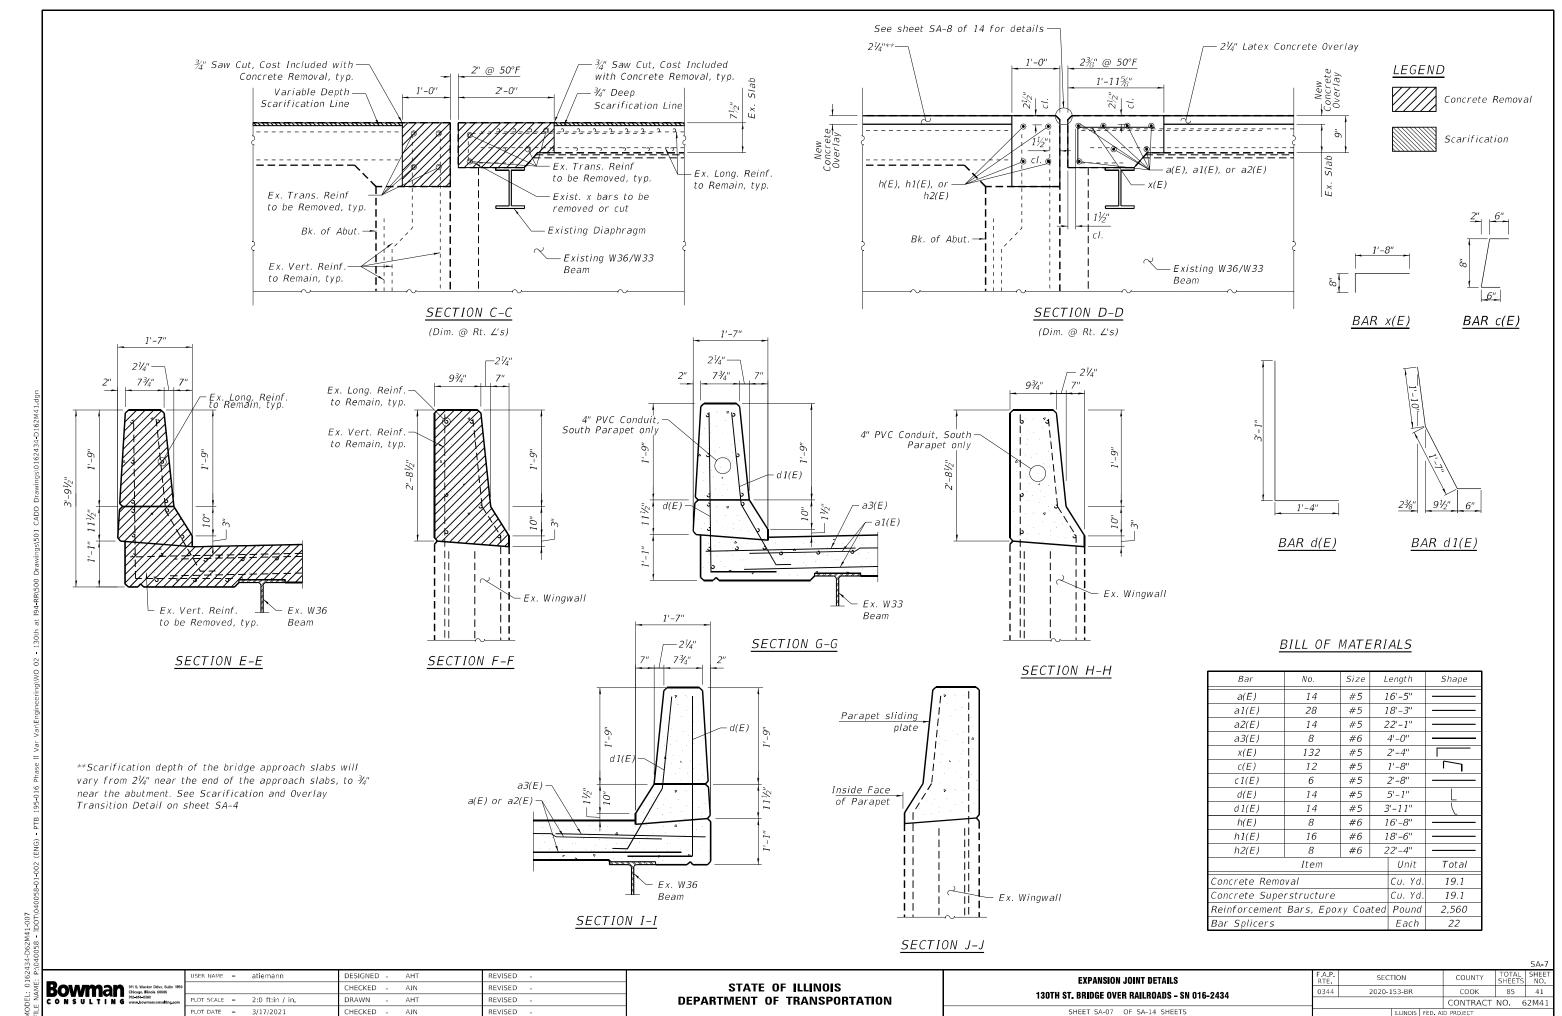off flush with the plates after concrete is set.

SECTION A-A \* Granular or solid flux filled headed studs conforming to Article 1006.32 of the Std. Specs., automatically end welded.

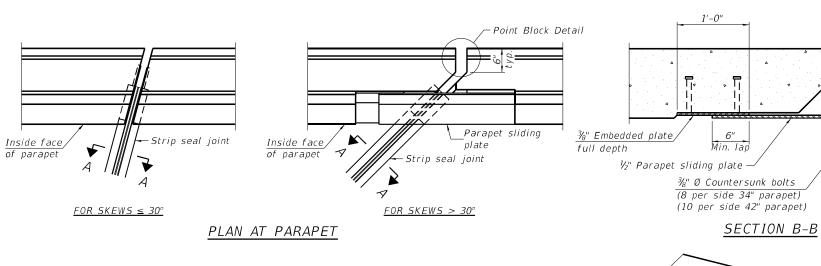

(Showing embedded plates only)

1'-0"

<u>Direction</u> of traffic

Notes:

The strip seal shall be made continuous and shall have a minimum thickness of  $\frac{1}{4}$ ". The configuration of the strip seal shall match the configuration of the locking edge rails. Open or "webbed" strip seal gland configurations are not permitted. The gland shall be sized for a maximum rated movement of 4 inches.

The locking edge rails depicted are configured for typical applications and are conceptual only. The actual configuration of the locking edge rails and matching strip seal may vary from manufacturer to manufacturer provided they fit the application and meet the minimum anchorage shown. Flanged edge rails, however, will not be allowed. Locking edge rails may exceed the 4½" maximum depth provided the anchorage system is revised according to the manufacturer's recommendation.

The manufacturer's recommended installation methods shall be followed.

All steel components shall be galvanized after fabrication according to Article 520.03 of the Standard Specifications.

The Maximum space between locking edge rail segments shall be  $\frac{3}{16}$ " and sealed with a suitable sealant; however, any rail joint within 10' measured perpendicular to the face of the curb or parapet shall be welded as shown in the locking edge rail splice detail.

Cost of parapet sliding plates, embedded plates, and anchorage studs included with Preformed Joint Strip Seal.

34" F-shape barrier shown, 42" F-shape similar as noted. The concrete opening below the strip seal will vary based on the locking edge rail chosen by the Contractor. Deck and parapet lengths shown elsewhere in the plans are dimensioned to the concrete opening, not the joint opening, and are based on the rolled locking edge rail. If the Contractor elects to use a different locking edge rail, dimensional adjustments may be required. One exception to this would be the strip seal joint at the end of the precast bridge approach slab. For these cases the pavement connector length shall be adjusted, not the length of the bridge approach slab.

#### ELEVATION AT PARAPET

<u>6" cts.,</u> typ.

Locking edge rail-

Top of concrete

Parapet sliding

Inside Face

of Parapet

Top of locking

Top of deck


edge rail

at 50° F


Strip seal

2" Max.

(Skews > 30° shown. Skews ≤ 30° similar except as shown in plan view.)

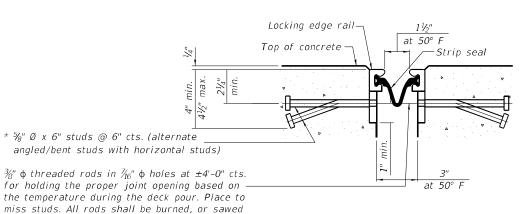

SHOWING WELDED RAIL JOINT

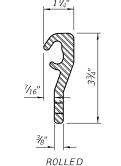

\* ¾" Ø x 6" Studs

ီ 🎵 ¾" Embedded plate

. | full depth

(6 per side 34" parapet)


(8 per side 42" parapet)



# WELDED RAIL

#### LOCKING EDGE RAILS

\*\* Back gouge not required if complete joint penetration is verified by mock-up.

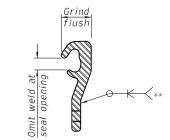

#### LOCKING EDGE RAIL SPLICE

The inside of the locking edge rail groove shall be free of weld residue. Rolled rail shown, welded rail similar.

#### BILL OF MATERIAL

Item	Unit	Total
Preformed Joint Strip Seal	Foot	152

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at 50° i

SHOWING ROLLED RAIL JOINT

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STATE OF ILLINOIS **DEPARTMENT OF TRANSPORTATION** 

PREFORMED JOINT STRIP SEAL 130TH ST. BRIDGE OVER RAILROADS - SN 016-2434 SHEET SA-08 OF SA-14 SHEETS


SECTION 0344 2020-153-BR COOK 85 42 CONTRACT NO. 62M41

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Detail A

%" Ø x 6" Studs

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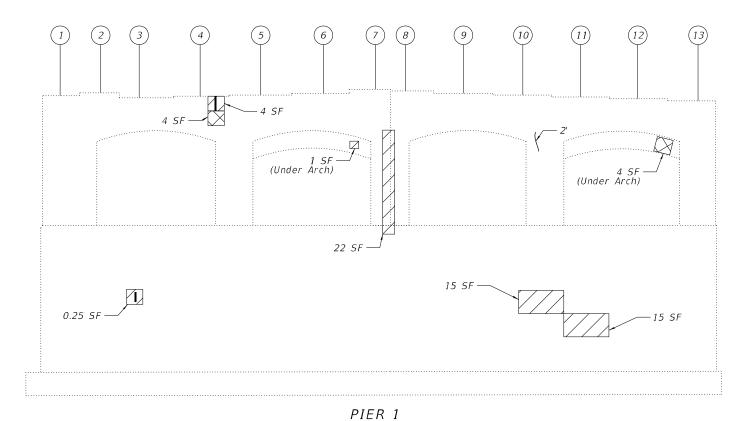
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**DEPARTMENT OF TRANSPORTATION** 

130TH ST, BRIDGE OVER RAILROAD - SN 016-2434

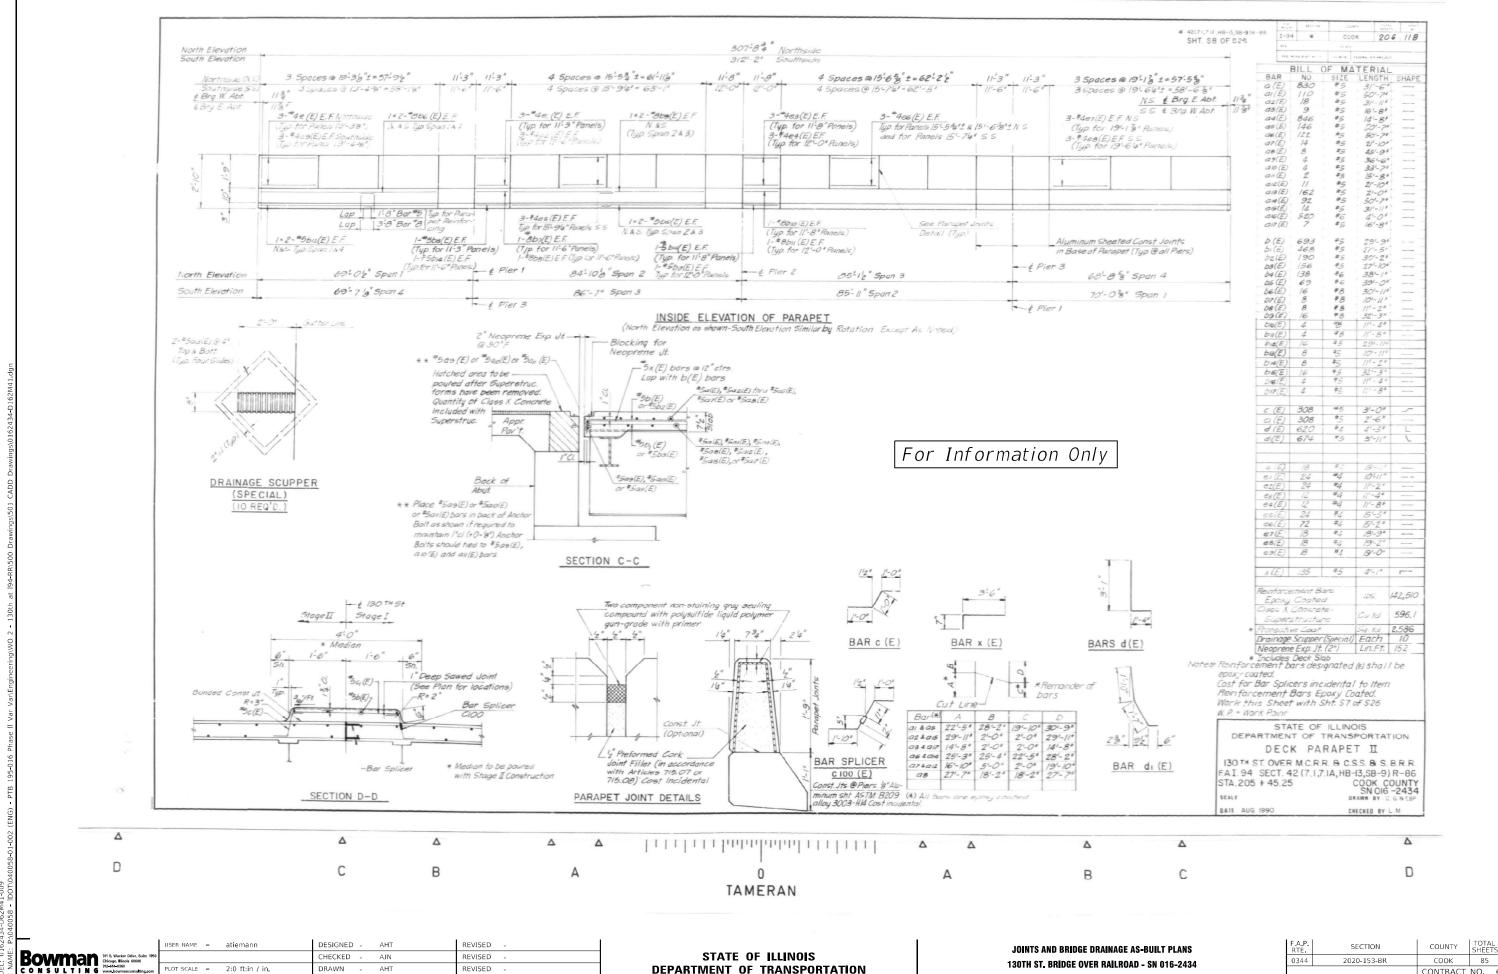2020-153-BR COOK 85 43 CONTRACT NO. 62M41

<u>PIER 1</u> (Looking East)



(Looking West)

#### NOTES:

- 1. Quantities and limits shown are estimated for bidding purposes only. The actual areas to be repaired, and the type(s) of repairs to be used, will be determined by the Engineer in the field at the time of construction.
- Prior to removal of concrete, the existing beams over the repair area shall be temporarily supported (See Beam Reaction Table on this sheet and Special Provision for Temporary Shoring and Cribbing).


#### BEAM REACTION TABLE

Pier 1	Load (kips)
DL	70.2
LL	49.3
IM	8.9
Total	128.4

Reactions shown in table are per girder and are Service Loads.

\* Temporary Shoring and Cribbing shall be performed at this bearing location

#### LEGEND:

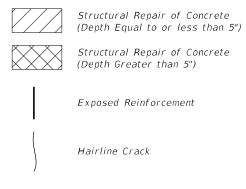

# BILL OF MATERIAL

Square Foot

<u> </u>	117 12	
ITEM	UNIT	QUANTITY
Structural Repair of Concrete (Depth Equal to or Less Than 5")	Sq Ft	97.25
Structural Repair of Concrete (Depth Greater Than 5")	Sq Ft	4
Epoxy Crack Injection	Foot	10
Temporary Shoring and Cribbing	Each	1

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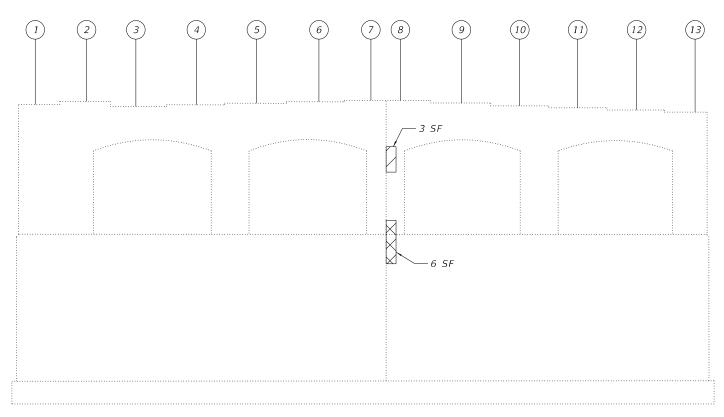
STATE OF ILLINOIS **DEPARTMENT OF TRANSPORTATION**  PIER 1 REPAIRS STRUCTURE NO. 016-2434 SHEET SA-10 OF SA-14 SHEETS

COUNTY TOTAL SHEET NO.

COOK 83 39 SECTION COUNTY 2020-135-BR CONTRACT NO. 62M41

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PIER 2
(Looking East)



<u>PIER 2</u> (Looking West)

#### <u>NOTES:</u>

 Quantities and limits shown are estimated for bidding purposes only. The actual areas to be repaired, and the type(s) of repairs to be used, will be determined by the Engineer in the field at the time of construction.

#### <u>LEGEND:</u>

Structural Repair of Concrete (Depth Equal to or less than 5")

Structural Repair of Concrete (Depth Greater than 5")

Exposed Reinforcement

Hairline Crack

SF Square Foot

#### BILL OF MATERIAL

ITEM	UNIT	QUANTITY
Structural Repair of Concrete (Depth Equal to or Less Than 5")	Sq Ft	11
Structural Repair of Concrete (Depth Greater Than 5")	Sq Ft	6

SA-1

A c c u r a t e

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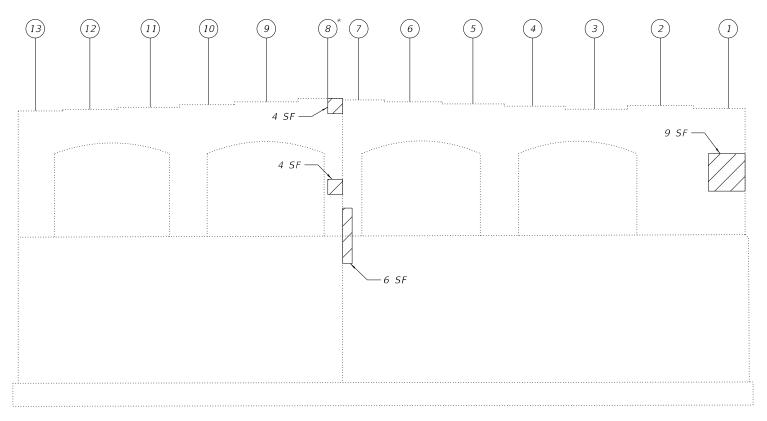
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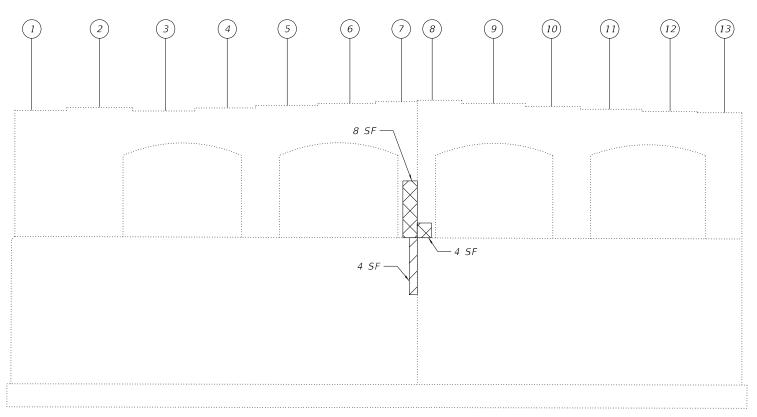
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STATE OF ILLINOIS
DEPARTMENT OF TRANSPORTATION

PIER 2 REPAIRS STRUCTURE NO. 016-2434 SHEET SA-11 OF SA-14 SHEETS



<u>PIER 3</u> (Looking East)



PIER 3 (Looking West)

#### <u>NOTES:</u>

- Quantities and limits shown are estimated for bidding purposes only. The actual areas to be repaired, and the type(s) of repairs to be used, will be determined by the Engineer in the field at the time of construction.
- Prior to removal of concrete, the existing beams over the repair area shall be temporarily supported (See Beam Reaction Table on this sheet and Special Provision for Temporary Shoring and Cribbing).

#### BEAM REACTION TABLE

Pier 3	Load (kips)
DL	83.3
LL	51.4
IM	9.2
Total	143.9

Reactions shown in table are per girder and are Service Loads.

\* Temporary Shoring and Cribbing shall be performed at this bearing location

#### LEGEND:

Structural Repair of Concrete (Depth Equal to or less than 5")
Structural Repair of Concrete (Depth Greater than 5")
Exposed Reinforcement
Hairline Crack

SF Square Foot

#### BILL OF MATERIAL

IT CM	
ITEM UNIT	QUANTITY
Structural Repair of Concrete (Depth Equal to or Less Than 5") Sq F	t 27
Structural Repair of Concrete (Depth Greater Than 5")	t 12
Temporary Shoring and Cribbing   Each	1

SA-12

Accurate GROUP, INC.

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 =
 Imraeh
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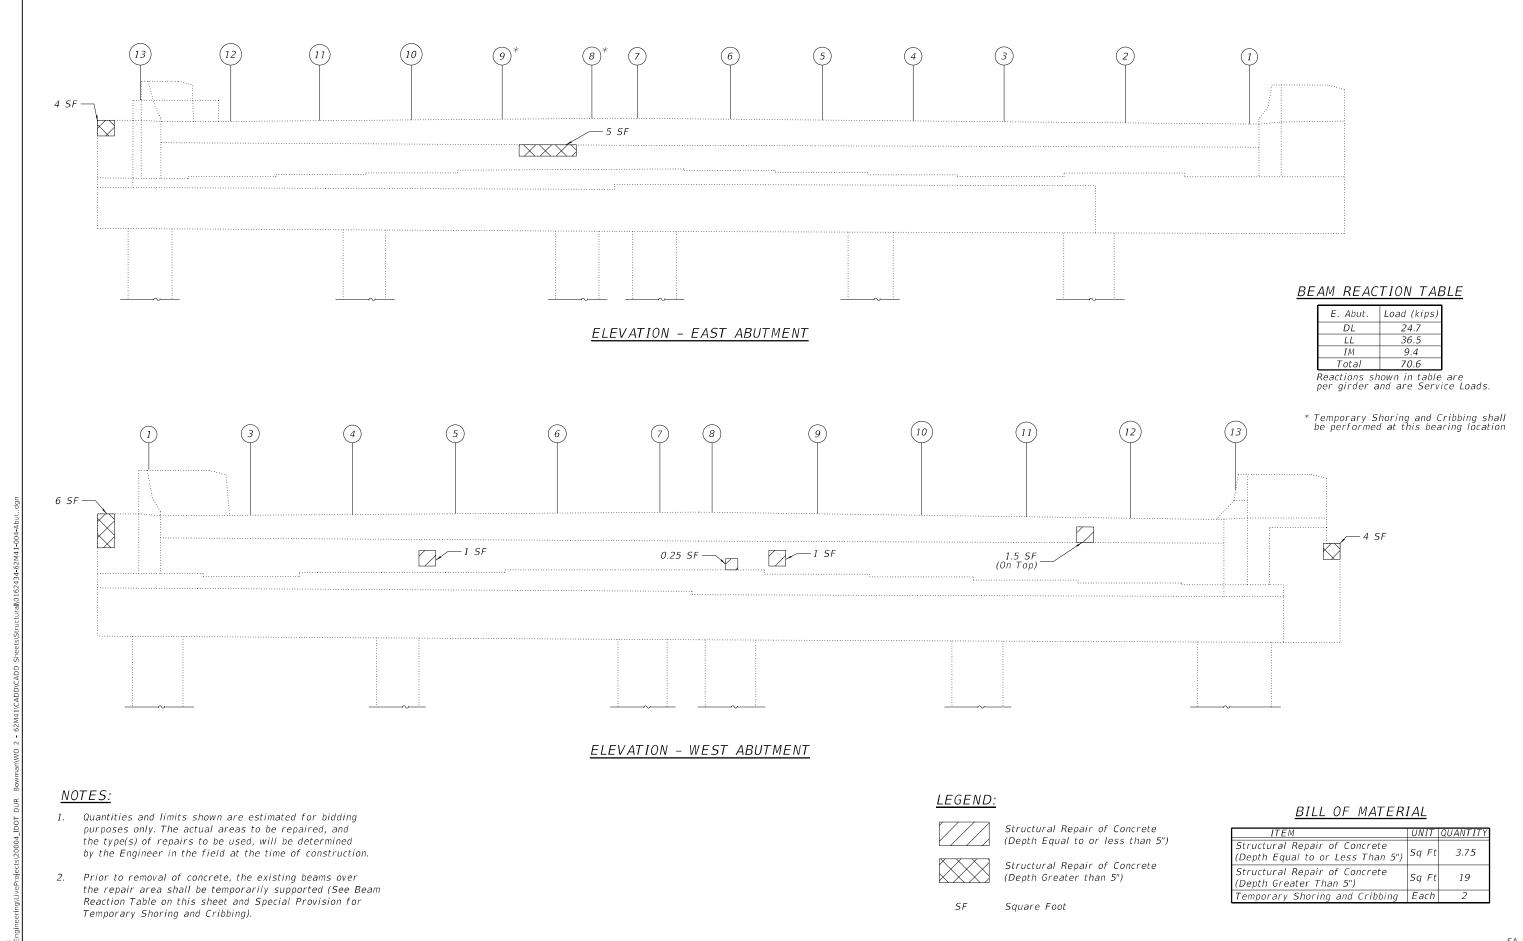
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 PLOT SCALE
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 DM
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 PLOT DATE
 =
 10/28/2020
 CHECKED
 JMT
 REVISED

STATE OF ILLINOIS
DEPARTMENT OF TRANSPORTATION

PIER 3 REPAIRS STRUCTURE NO. 016-2434 SHEET SA-12 OF SA-14 SHEETS



CHECKED - SPS REVISED -DRAWN - DM REVISED PLOT DATE = 10/28/2020 CHECKED - JMT REVISED -

DESIGNED - IH

REVISED -

JSER NAME = Imranh

STATE OF ILLINOIS **DEPARTMENT OF TRANSPORTATION**  EAST AND WEST ABUTMENT REPAIRS STRUCTURE NO. 016-2434 SHEET SA-13 OF SA-14 SHEETS


SECTION COUNTY COOK 83 42 2020-135-BR CONTRACT NO. 62M41

#### STANDARD BAR SPLICER ASSEMBLY

Threaded splicer bar length = min. lap length +  $1\frac{1}{2}$ " + thread length


\* Epoxy not required on Bar Splicer Assembly components used in conjunction with black bars.

	Bar	No. assemblies	Minimum
Location	size	required	lap length
W. End of Deck	#5	7	3'-6"
W. Abut. Hatched Block	#6	4	4'-0"
E. End of Deck	#5	7	3'-6"
E. Abut. Hatched Block	#6	4	4'-0"

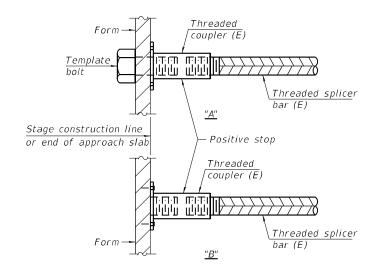


#### INSTALLATION AND SETTING METHODS

"A" : Set bar splicer assembly by means of a template bolt. "B" : Set bar splicer assembly by nailing to wood forms or cementing to steel forms. (E): Indicates epoxy coating.

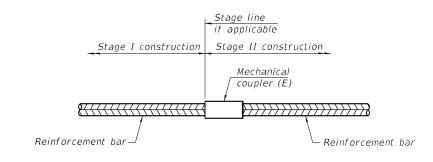

#### STANDARD MECHANICAL SPLICER

Location	Bar size	No. assemblies required

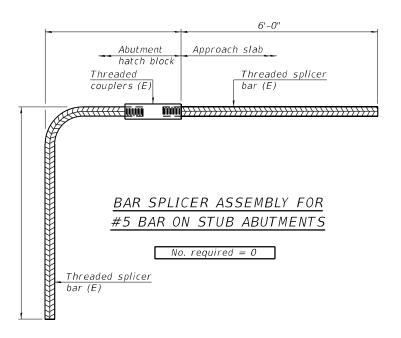

#### NOTES

Splicer bars shall be deformed with threaded ends and have a minimum 60 ksi yield strength.

All reinforcement shall be lapped and tied to the splicer bars.

Bar splicer assemblies shall be epoxy coated according to the requirements for reinforcement bars. See Section 508 of the Standard Specifications.

See approved list of bar splicer assemblies and mechanical splicers for alternatives.

BSD-1

2-17-2017

 			USER NAME	=	atieman
AME	<b>Bowman</b>	311 S. Wacker Drive, Suite 1959 Chicago, Illinois 60606			
E NA	CONSULTING	312-614-0360 www.bowmanconsulting.com	PLOT SCALE	=	2:0 ft:in
ij			PLOT DATE	=	3/17/202

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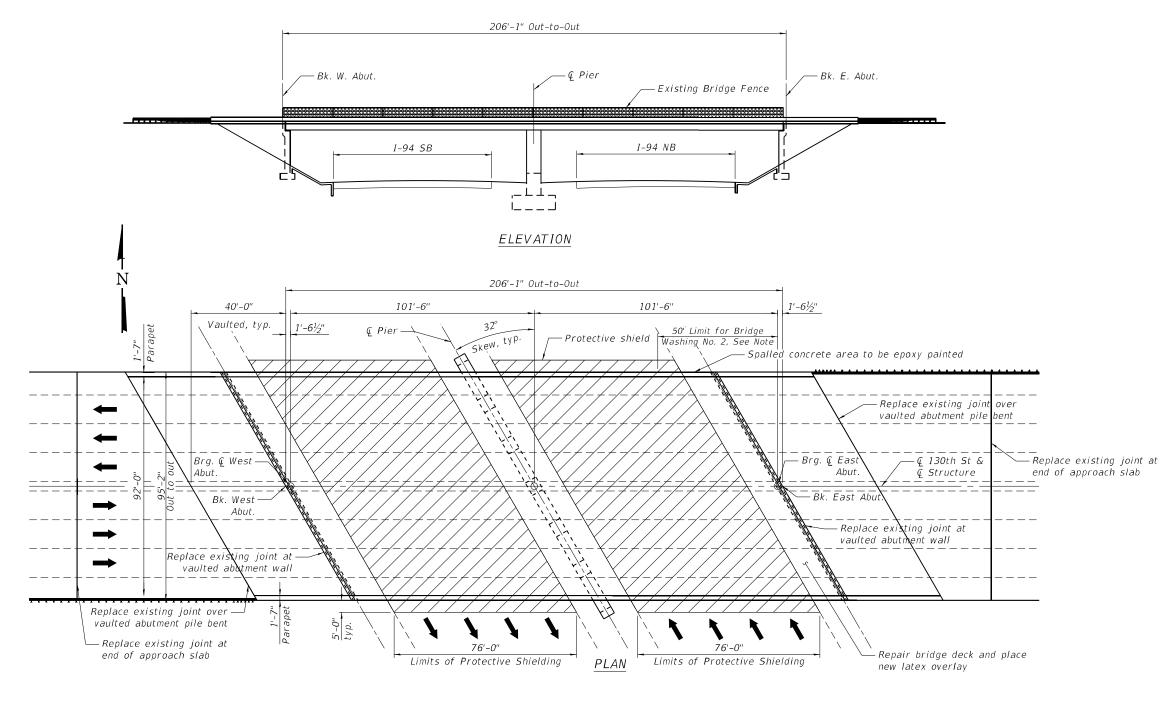
STATE OF ILLINOIS **DEPARTMENT OF TRANSPORTATION** 

**BAR SPLICER ASSEMBLY** 130TH ST. BRIDGE OVER RAILROAD - SN 016-2434 SHEET SA-14 OF SA-14 SHEETS

SECTION 0344 2020-153-BR COOK 85 48 CONTRACT NO. 62M41

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Existing Structure: S.N. 016-2600, originally built in 1991 as a two-span continuous steel superstructure with vaulted abutments and a multi-column trapezoidal pier. The back to back length = 206'-01" and the out to out width = 95'-2". Structure is to be repaired as detailed in these plans. The structure will be repaired using staged construction to maintain traffic.




#### INDEX OF SHEETS

- SB-1 General Plan and Elevation
- SB-2 General Notes & Bill of Material
- SB-3 Maintenance of Traffic Details
- SB-4 Deck & Approach Slabs Repairs and Overlay Plans
- SB-5 Joint Repair Limits
- SB-6 Expansion Joint Details
- SB-7 Preformed Joint Strip Seal
- SB-8 Joints and Bridge Drainage As-Built Plans
- SB-9 Bearing Replacement Locations
- SB-10 New Bearing Details
- SB-11 Bearing Details As-Built Plans
- SB-12 Parapet Repair
- SB-13 Fence Rail Repair As-Built Plans
- SB-14 East Abutment Repair
- SB-15 West Abutment Repair
- SB-15A Vaulted Abutment Door Detail
- SB-16 Pier Repair and New Crash Wall
- SB-17 Bar Splicer Assembly Details

#### SCOPE OF WORK

- 1. Replace expansion joints at locations shown on plans
- 2. Deck Scarification and Latex Concrete Overlay
- 3. Deck slab full and partial depth repair
- 4. Approach slabs full and partial depth repair
- 5. Pedestrian handrail repair
- 6. Remove and replace bearings at abutments at locations shown on plans
- 7. Remove and replace Access Doors at both abutments.
- 8. Concrete repair of pfer and abutments
- 9. Pier crash wall modi ications
- 10. Replace relief joints
- 11. Clean bridge scuppers
- 12. Concrete sealer for bridge substructure, parapets and median
- 13. Clean fire damaged area
- 14. Apply Epoxy Paint to fire damaged concrete

Range 14E, 3rd P.M.

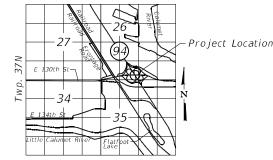

LOCATION SKETCH

#### DESIGN STRESSES

#### FIELD UNITS (EXIST. CONST.)

 $f'c = 3,500 \ psi$ 

fy = 60,000 psi

fy = 50,000 psi M223 Gr.50 & M222

fy = 36,000 psi M183

#### FIELD UNITS (NEW CONST.)

f'c = 4,000 psi (Superstructure)

f'c = 3,500 psi (Substructure)fy = 60,000 psi (Reinforcement)

#### DESIGN SPECIFICATIONS

2002 AASHTO Standard Specifications for Highway Bridges

> LOADING HS20-44 Existing and Proposed

Area to be washed under Bridge Washing No. 2 will include beams 1 & 2 and the deck soffit area in bay 1 as well as the outside face of the parapet. This area extends to a point about 50LF West of the East Abutment in span 2 over the NB lanes.

GENERAL PLAN AND ELEVATION 130TH ST. OVER I-94 BISHOP FORD SECTION 2020-153-BR COOK COUNTY STRUCTURE NO. 016-2600

SIGNED: 03/18/2021 EXPIRES: 11/30/2022

atiemann DESIGNED -REVISED SECTION GENERAL PLAN AND ELEVATION STATE OF ILLINOIS Bowman 311 S. Wacker II Chicago, Illinois 312-614-0360 HECKED -AJN REVISED 0344 2020-153-BR соок 85 49 130TH ST. BRIDGE OVER I-94 - SN 016-2600 40:0 ft:in / in. DRAWN REVISED **DEPARTMENT OF TRANSPORTATION** CONTRACT NO. 62M41 SHEET SB-01 OF SB-17 SHEETS LOT DATE = 3/17/2021 REVISED CHECKED -

Concrete Sealer shall be applied to all faces of the pier, front face of both abutments, slopewalls, bearing seats, backwalls and above the ground line. Concrete Sealer shall also be applied to front and top face of bridge parapets and entire surface of the median between the ends of the bridge approach slabs.

Protective Coat shall be applied to the new concrete joint headings, including new

Joint openings shall be adjusted according to Article 520.04 of the Standard Specifications when the deck is poured at an ambient temperature other than 50° F.

#### CONSTRUCTION

- 1. The contractor shall not scale dimensions from the contract plans for construction purposes. Scales shown are for information only.
- Plan dimensions and details relative to the existing structure have been taken from existing plans and are subject to nominal construction variations. It shall be the Contractor's responsibility to verify such dimensions and details in the field and make necessary approved adjustment prior to construction of or ordering of materials. Such variations shall not be cause for additional compensation for a change in scope of the work. However, the Contractor will be paid for the quantity actually furnished at the unit price for the work.
- No concrete cutting shall be permitted until the cutting limits have been outlined by the contractor and approved by the engineer.
- The location and extent of repair items are based on visual observation made during field investigations, and are not guaranteed to be accurate or all inclusive. The location, extent of repair, and quantity or repair shall be field verified by the field engineer.
- Whenever any material is deposited into a drainage system or drainage structures, the deposited material shall be removed at the close of each working day. At the conclusion of construction operations, all drainage systems and structures shall be free from dirt and debris deposited during the various construction operations. The work specified above will not be paid for separately, but shall be considered included in the cost of "Drainage Structures to be Cleaned".
- It shall be the contractor's responsibility to verify the location of all utilities prior to starting construction. Contact J.U.L.I.E., 800-892-0123.
- The end diaphragms shall not be used for jacking purposes during temporary cribbing and shoring operations unless checked and verified by an Illinois Licensed Structural Enaineer

#### TOTAL BILL OF MATERIAL

Item No.	Description	Unit	Super	Sub	Total
50102400	Concrete Removal	Cu. Yd.	29.2	-	29.2
50157300	Protective Shield	Sq. Yd.	2,078	-	2,078
50300225	Concrete Structures	Cu. Yd.	-	19.1	19.1
50300255	Concrete Superstructure	Cu. Yd.	29.2	-	29.2
50300260	Bridge Deck Grooving	Sq. Yd.	3,932	-	3,932
50300300	Protective Coat	Sq. Yd.	4,094	-	4,094
50800205	Reinforcement Bars, Epoxy Coated	Pound	3,480	1,910	5,390
50800515	Bar Splicers	Each	22	-	22
52000110	Preformed Joint Strip Seal	Foot	226.0	-	226.0
52100010	Elastomeric Bearing Assembly, Type 1	Each	4	-	4
58700300	Concrete Sealer	Sq. Ft.	3,403	6,925	10,328
59000200	Epoxy Crack Injection	Foot	40.0	-	40.0
59200102	Bridge Washing No. 2	Each	1	-	1
X0323818	Cleaning and Painting Exposed Rebar	Sq. Ft.	24	-	24
X0327773	Access Door	Each	1	2	2
X8430100	Remove Existing Conduit Attached To Structure	Foot	-	612.5	612.5
Z0001700	Approach Slab Repair (Full Depth)	Sq. Yd.	20.2	-	20.2
Z0001899	Jack and Remove Existing Bearings	Each	4	-	4
Z0005874	Bonded Preformed Joint Sealer, 3 Inch	Foot	190.4	-	190.4
Z0006012	Bridge Deck Latex Concrete Overlay, 21/4"	Sq. Yd.	4,012	-	4,012
Z0012130	Bridge Deck Scarification ¾"	Sq. Yd.	3,240	-	3,240
Z0012142	Bridge Deck ScariFication 21⁄4"	Sq. Yd.	77 <i>2</i>	-	772
Z0012754	Structural Repair of Concrete (Depth Equal to or Less Than 5")	Sq. Ft.	17.5	711.8	729.3
Z0012755	Structural Repair of Concrete (Depth Greater Than 5")	Sq. Ft.	33.5	97	130.5
Z0016001	Deck Slab Repair (Full Depth, Type I)	Sq. Yd.	0.5	-	0.5
Z0016002	Deck Slab Repair (Full Depth, Type II)	Sq. Yd.	10.9	-	10.9
Z0018500	Drainage Structures to be Cleaned	Each	4	-	4
Z0021902	Silicone Joint Sealer, ½"	Foot	226.0	-	226.0
Z0029603	Handrail Repairs	L SUM	1	-	1
Z0073200	Temporary Shoring and Cribbing	Each	4	-	4


Bowman 311 S. Wacker Driv Chicago, Illinois 60 312-414-0380

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STATE OF ILLINOIS **DEPARTMENT OF TRANSPORTATION** 

GENERAL NOTES AND BILL OF MATERIAL 130TH ST. BRIDGE OVER I-94 - SN 016-2600 SHEET SB-02 OF SB-17 SHEETS

SECTION 0344 2020-153-BR COOK 85 50 CONTRACT NO. 62M41

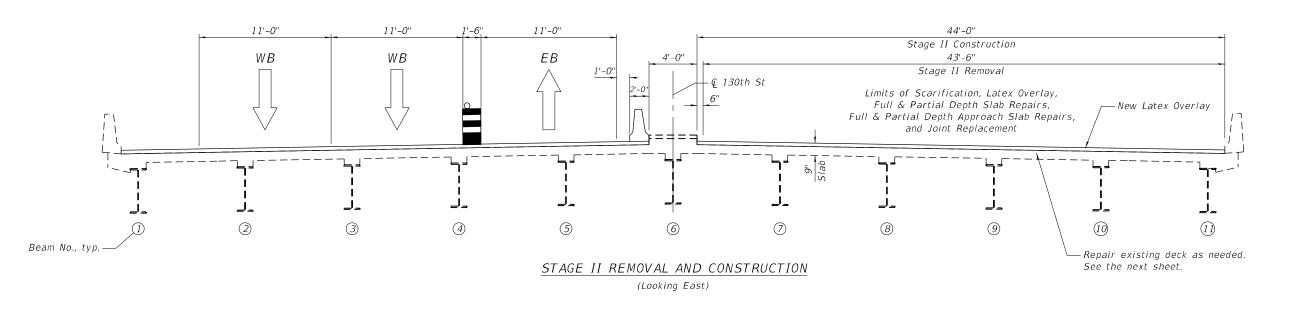


STATE OF ILLINOIS
DEPARTMENT OF TRANSPORTATION

MAINTENANCE OF TRAFFIC DETAILS
130TH ST. BRIDGE OVER I-94 - SN 016-2600


SHEET SB-03 OF SB-17 SHEETS

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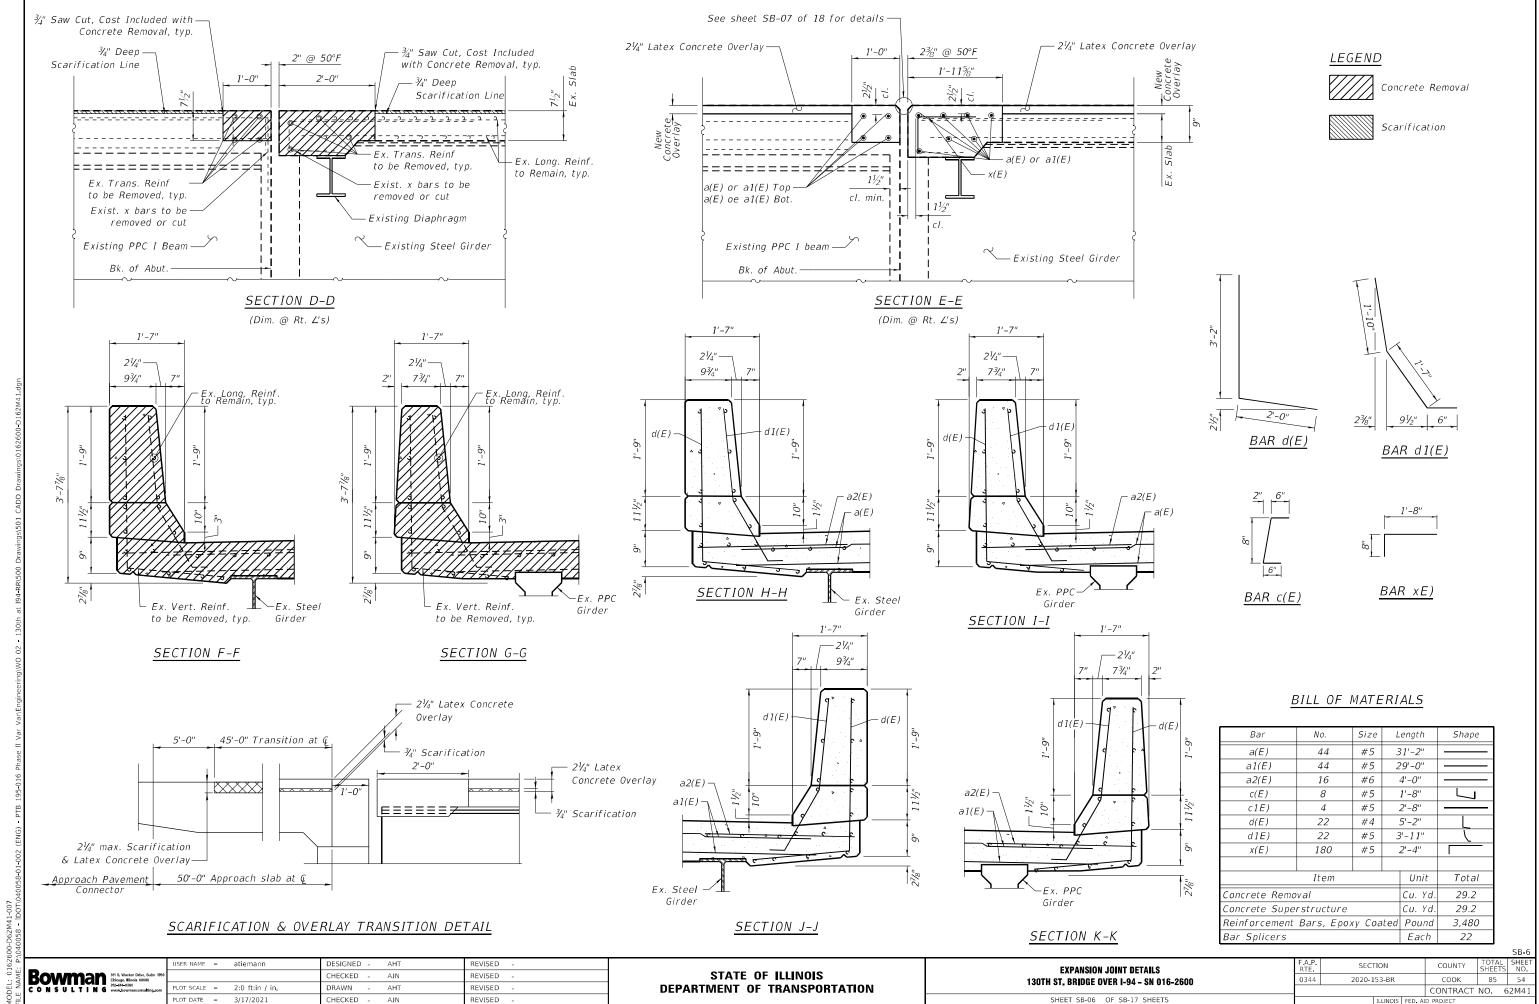
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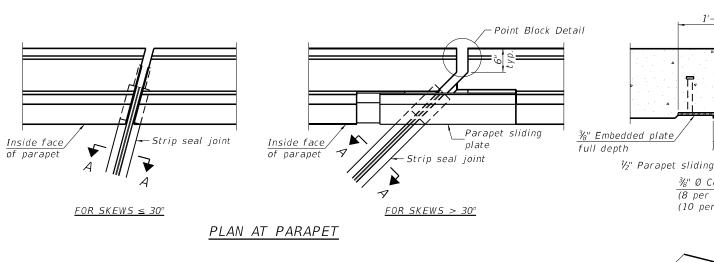
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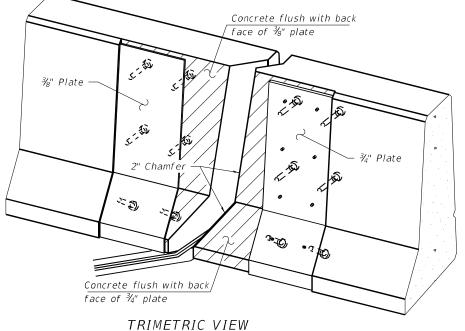
DETAIL A

off flush with the plates after concrete is set.

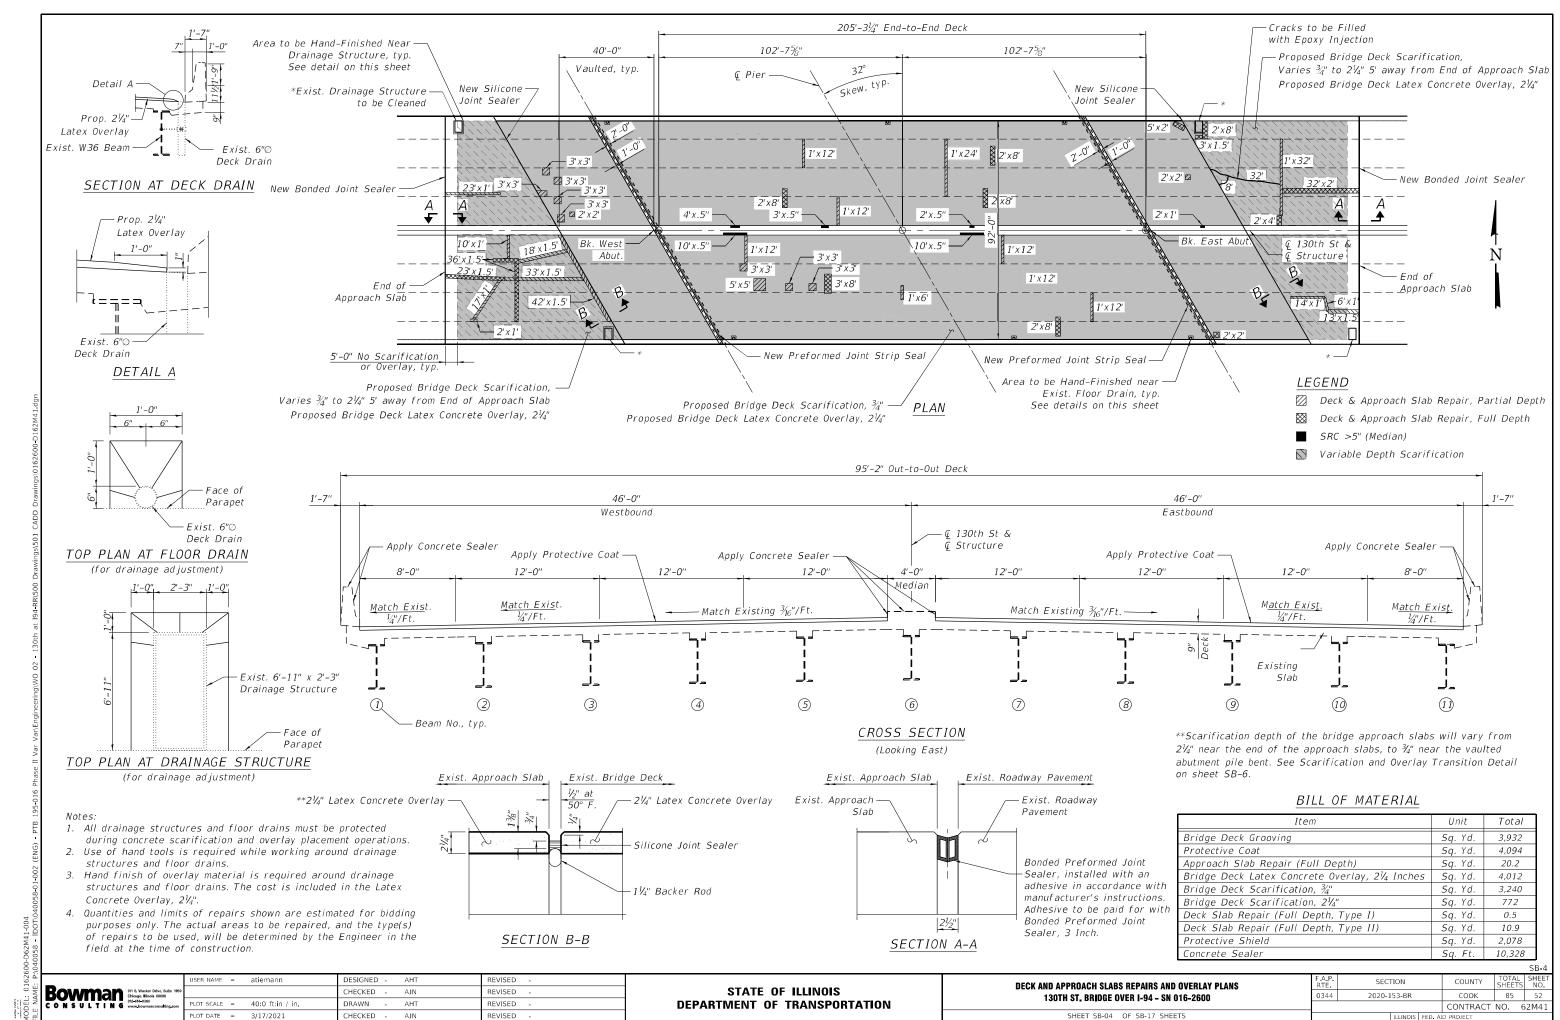SECTION A-A \* Granular or solid flux filled headed studs conforming to Article 1006.32 of the Std. Specs., automatically end welded.

#### \* ¾" Ø x 6" Studs (6 per side 34" parapet) (8 per side 42" parapet) ኘ 📅 ¾" Embedded plate . | full depth 6" 1/2" Parapet sliding plate ¾" Ø Countersunk bolts 1'-0" (8 per side 34" parapet) (10 per side 42" parapet) <u>Direction</u> of traffic
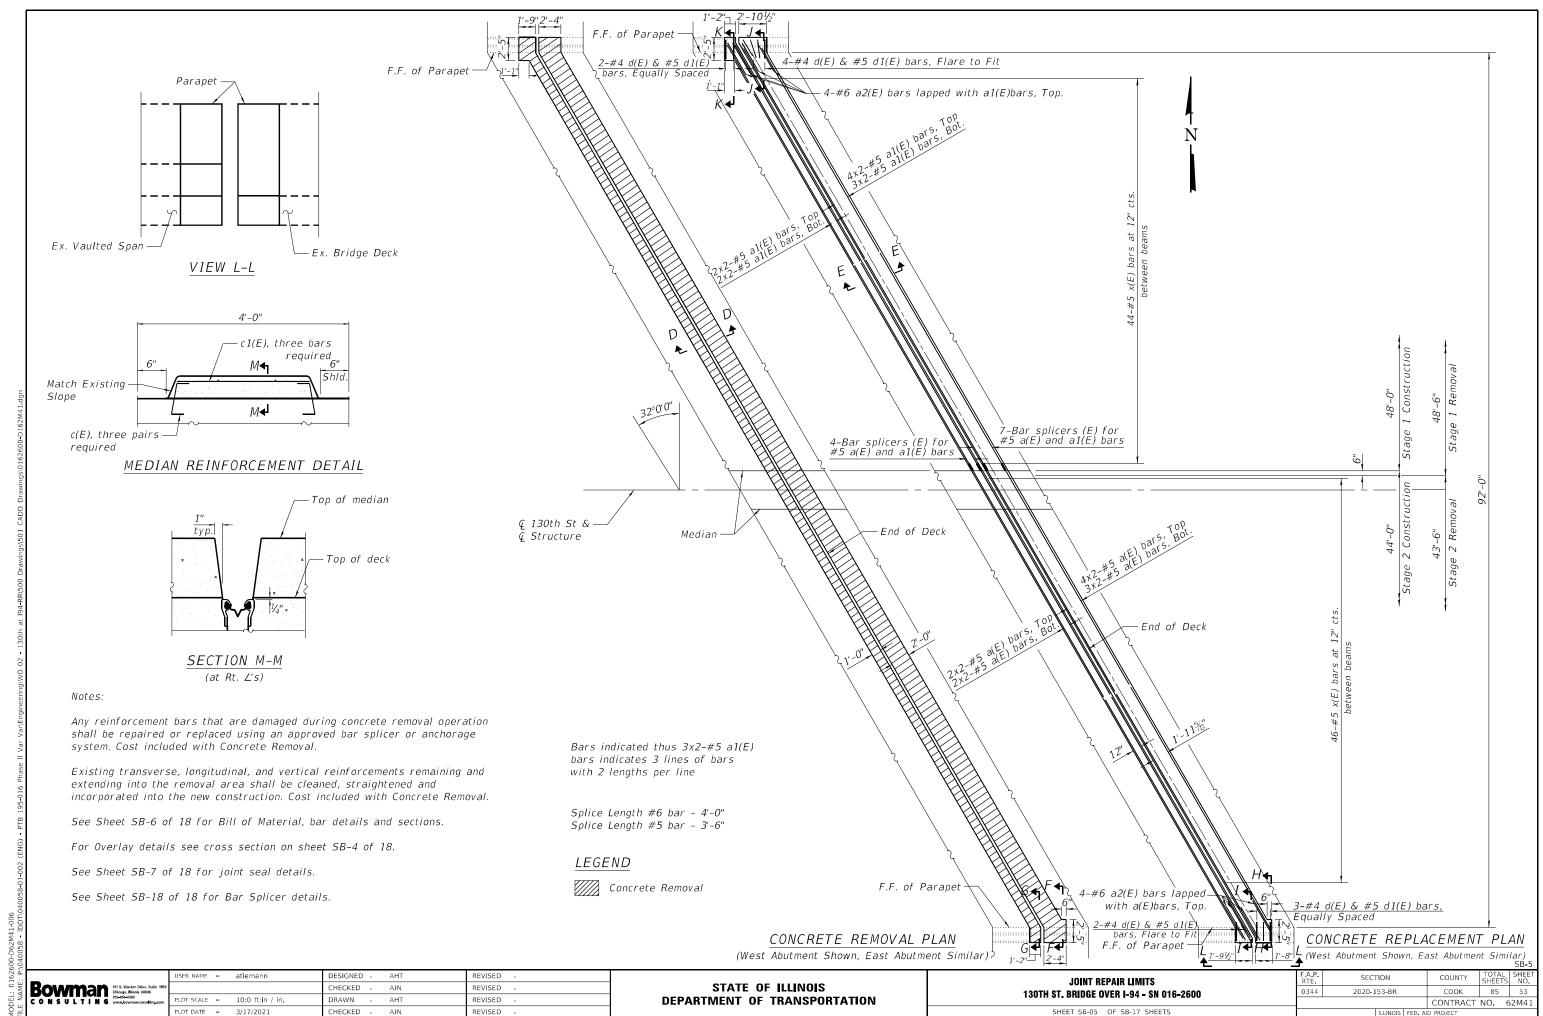
#### SECTION\_B-B



(Showing embedded plates only)

#### Notes:

The strip seal shall be made continuous and shall have a minimum thickness of  $\frac{1}{4}$ ". The configuration of the strip seal shall match the configuration of the locking edge rails. Open or "webbed" strip seal gland configurations are not permitted. The gland shall be sized for a maximum rated movement of 4 inches.

The locking edge rails depicted are configured for typical applications and are conceptual only. The actual configuration of the locking edge rails and matching strip seal may vary from manufacturer to manufacturer provided they fit the application and meet the minimum anchorage shown. Flanged edge rails, however, will not be allowed. Locking edge rails may exceed the 4½" maximum depth provided the anchorage system is revised according to the manufacturer's recommendation.

The manufacturer's recommended installation methods shall be followed.

All steel components shall be galvanized after fabrication according to Article 520.03 of the Standard Specifications.

The Maximum space between locking edge rail segments shall be  $\frac{3}{16}$ " and sealed with a suitable sealant; however, any rail joint within 10' measured perpendicular to the face of the curb or parapet shall be welded as shown in the locking edge rail splice detail.

Cost of parapet sliding plates, embedded plates, and anchorage studs included with Preformed Joint Strip Seal.

34" F-shape barrier shown, 42" F-shape similar as noted. The concrete opening below the strip seal will vary based on the locking edge rail chosen by the Contractor. Deck and parapet lengths shown elsewhere in the plans are dimensioned to the concrete opening, not the joint opening, and are based on the rolled locking edge rail. If the Contractor elects to use a different locking edge rail, dimensional adjustments may be required. One exception to this would be the strip seal joint at the end of the precast bridge approach slab. For these cases the pavement connector length shall be adjusted, not the length of the bridge approach slab.

#### ELEVATION AT PARAPET

<u>6" cts.,</u> typ.

Locking edge rail-

Top of concrete

Parapet sliding

Inside Face

of Parapet

Top of locking

Top of deck

edge rail

at 50° F


Strip seal

2" Max.


(Skews > 30° shown. Skews ≤ 30° similar except as shown in plan view.)

at 50° F

SHOWING ROLLED RAIL JOINT

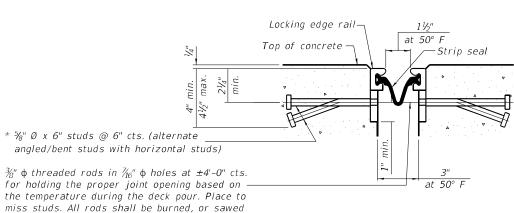


# SHOWING WELDED RAIL JOINT

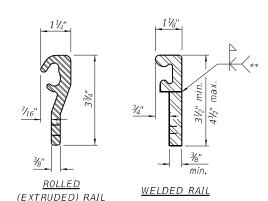

#### LOCKING EDGE RAILS

\*\* Back gouge not required if complete joint penetration is verified by mock-up.

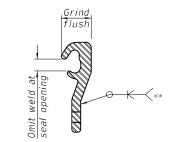

#### LOCKING EDGE RAIL SPLICE

The inside of the locking edge rail groove shall be free of weld residue. Rolled rail shown, welded rail similar.

#### BILL OF MATERIAL

Item	Unit	Total
Preformed Joint Strip Seal	Foot	226.0

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STATE OF ILLINOIS **DEPARTMENT OF TRANSPORTATION** 


PREFORMED JOINT STRIP SEAL 130TH ST. BRIDGE OVER I-94 - SN 016-2600 SHEET SB-07 OF SB-17 SHEETS

SECTION 0344 2020-153-BR COOK 85 55 CONTRACT NO. 62M41


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Detail A

%" Ø x 6" Studs

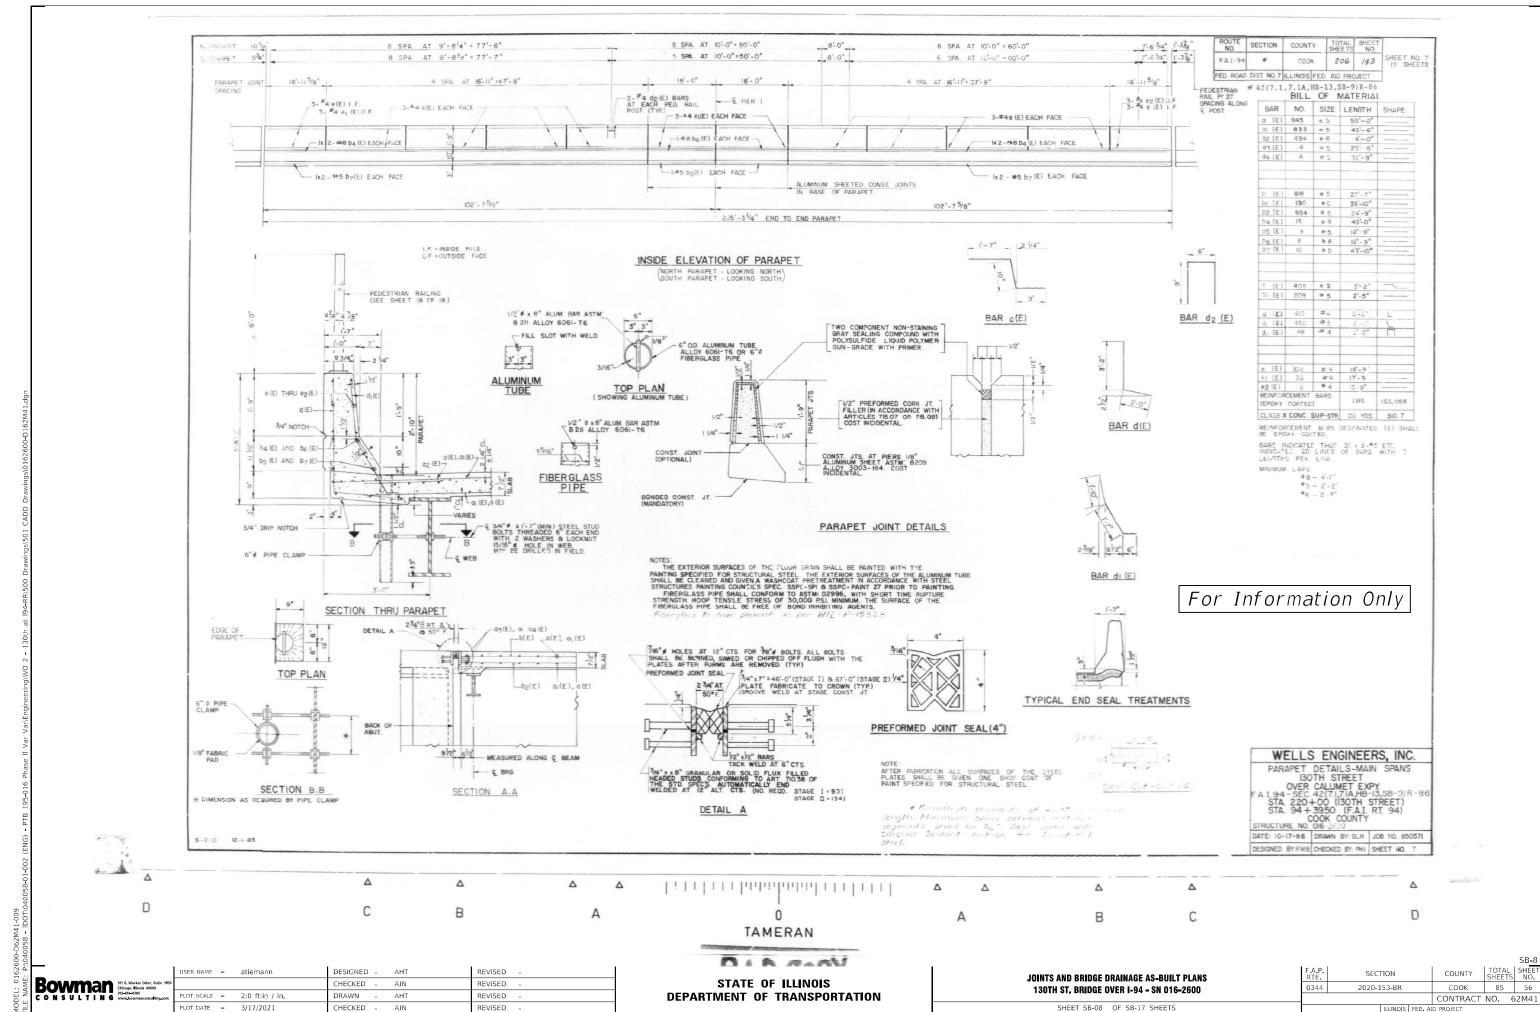

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STATE OF ILLINOIS
DEPARTMENT OF TRANSPORTATION


BEARING REPLACEMENT LOCATIONS
130TH ST. BRIDGE OVER I-94 - SN 016-2600

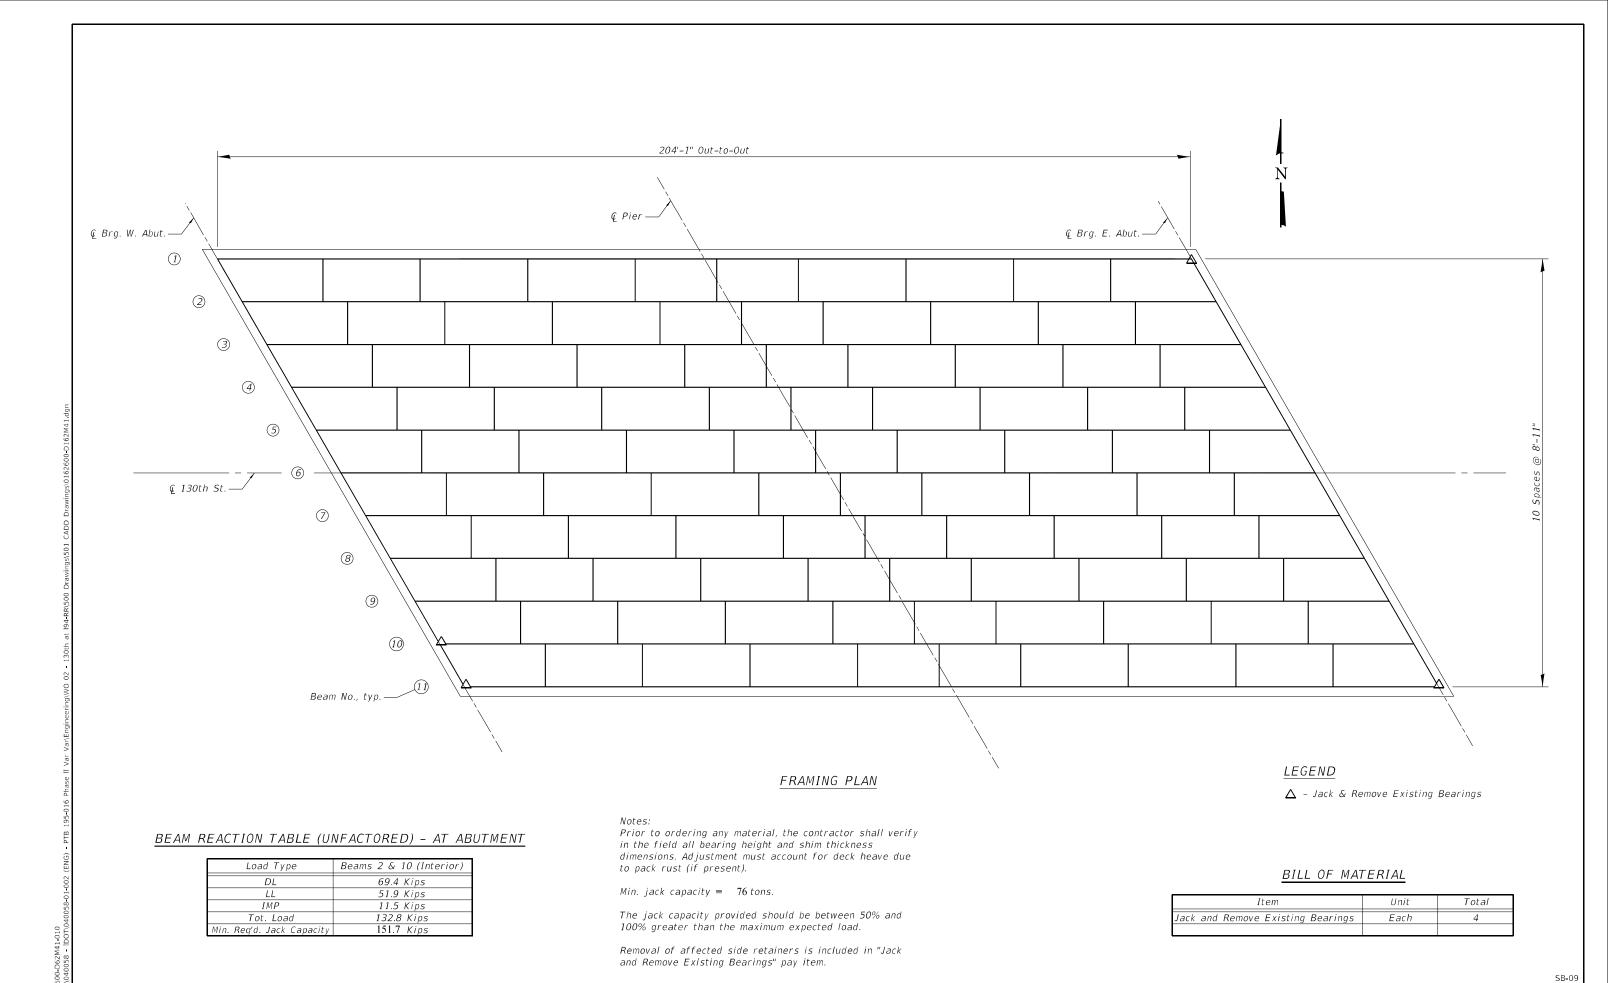
SHEET SB-09 OF SB-17 SHEETS

 
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 COUNTY
 TOTAL SHEETS
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 CONTRACT NO. 62M41




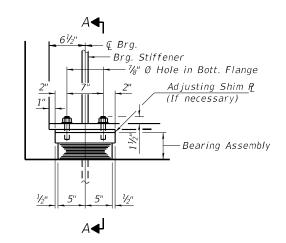

ELEVATION AT ABUT.

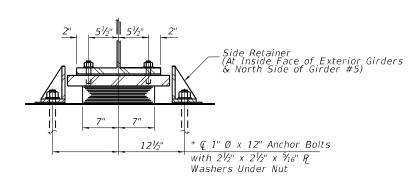
SECTION A-A

#### TYPE I ELASTOMERIC EXP. BRG.

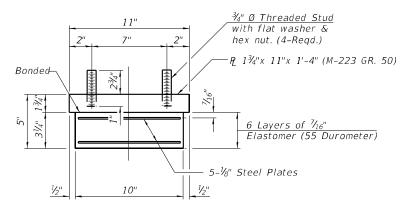

#### BEARING ASSEMBLY

Note: Shim Plates Shall Not Be Placed Under Bearing Assembly.

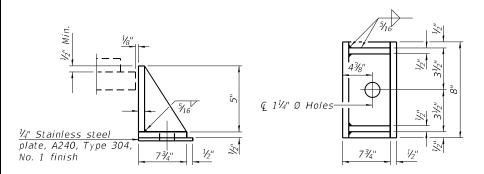

#### SIDE RETAINER

Equivalent Rolled Angle With Stiffeners Will Be Allowed in Lieu of Welded Plates. (Side Retainers Shall Be M-183)

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consulting.com	PLOT SCALE	-	40:0 ft:in / in.	DRAWN	-	AHT	REVISED	-
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STATE OF ILLINOIS **DEPARTMENT OF TRANSPORTATION** 

**NEW BEARING DETAILS** 130TH ST. BRIDGE OVER I-94 - SN 016-2600 SHEET SB-10 OF SB-17 SHEETS


SECTION 0344 2020-153-BR COOK 85 58 CONTRACT NO. 62M41

BILL OF MATERIAL


Item	Unit	Total
Elastomeric Bearing Assembly Type I	Each	4
Anchor Bolts	Each	8

Anchor Bolts for the new side retainers are included in the pay item "Elastomeric Bearing Assembly Type 1".


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(North Wall, South Face)

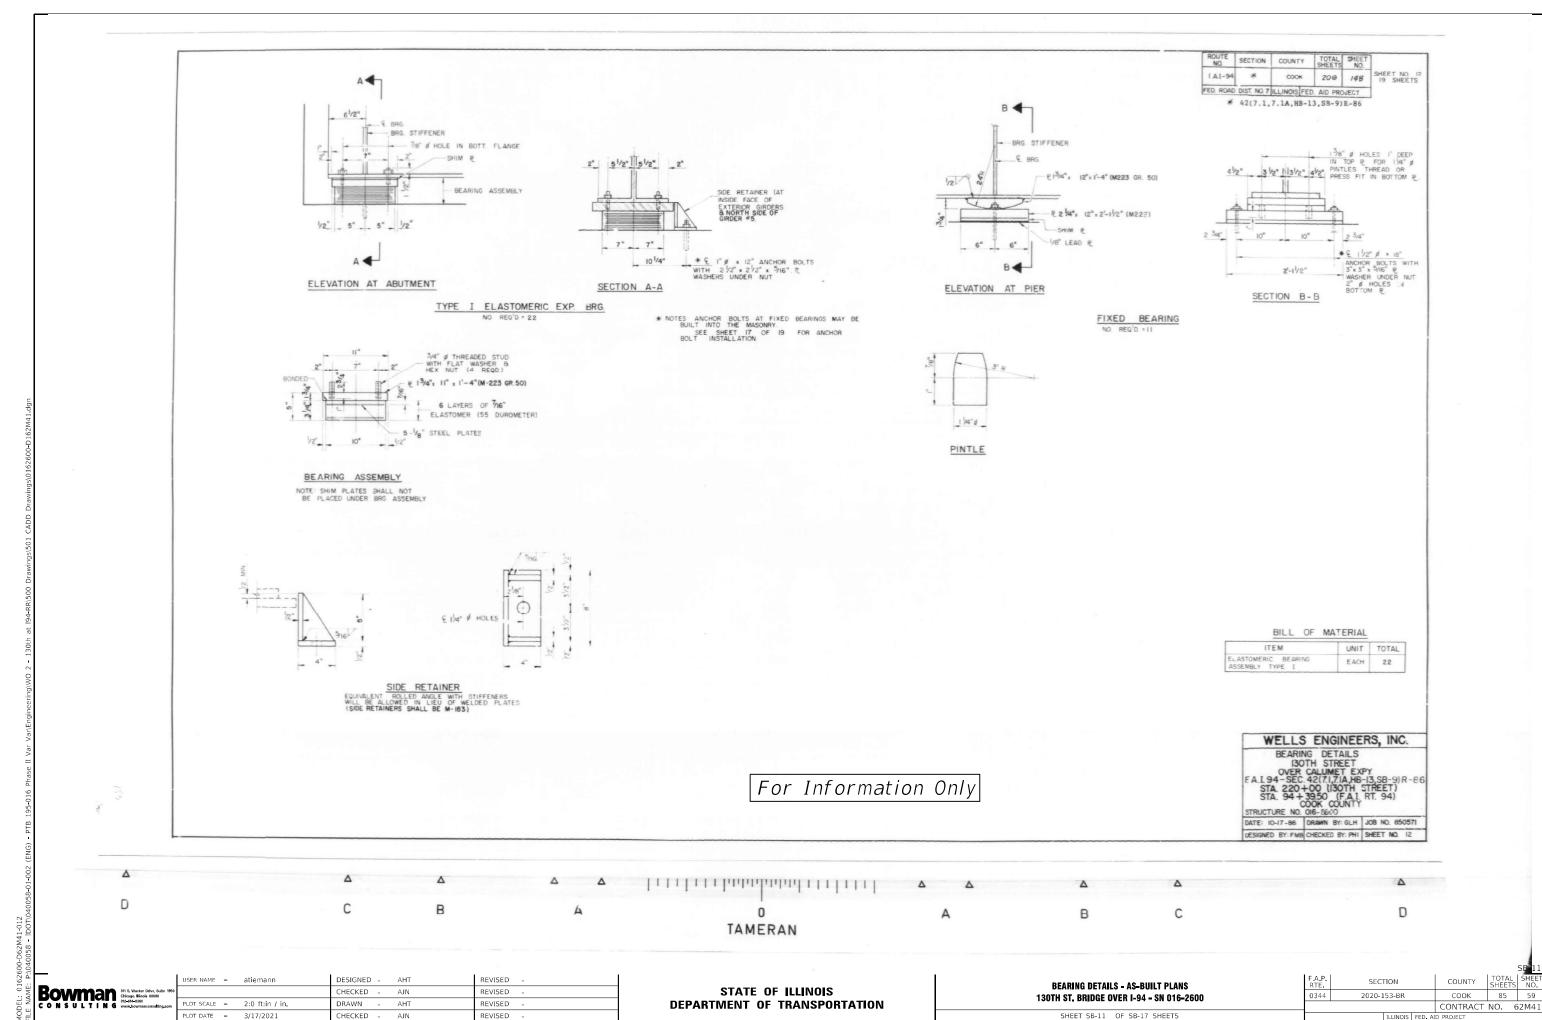

#### PARAPET AND HANDRIAL

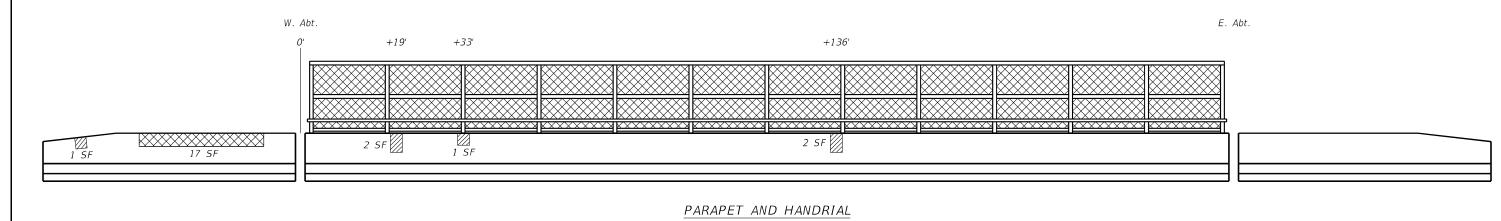(South Wall, North Face)

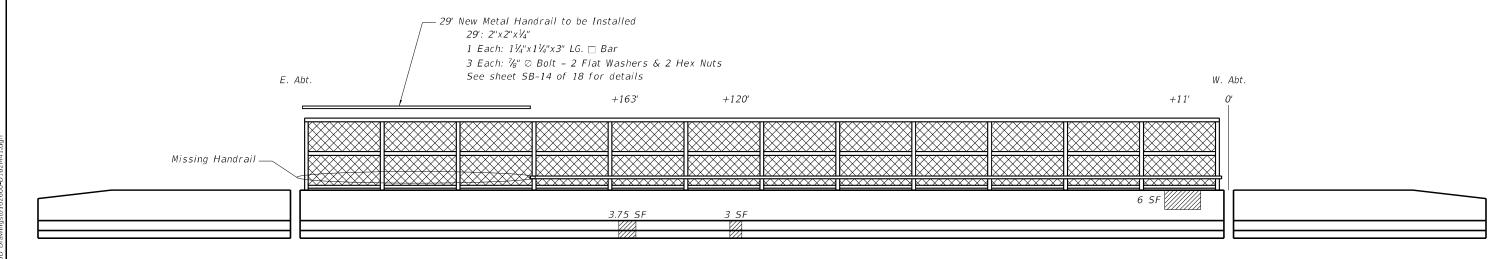

MISSING HANDRAIL




HANDRAIL ATTACHMENT DETAIL


Note:
The work associated with the missing metal
handrail reinstallation will be paid for as
lump sum under "Handrail Repairs" pay item.
See sheet SB-13 of this set for details and
material specifications.

#### LEGEND

Structural Repair of Concrete > 5"


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102 :- P:	_	USER NAME =	atiemann	DESIGNED - AHT	-	REVISED -		PARAPET REPAIR	F.A.P.	SECTION	COUNTY	TOTAL SHEF	ET
AME	Bowman 311 S, Wacker Drive, Suite 1950 Chicago, Illinois 60606			CHECKED - AJN		REVISED -	STATE OF ILLINOIS	130TH ST. BRIDGE OVER I-94 - SN 016-2600	0344	2020-153-BR	соок	85 60	<u>.</u>
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₽⊒		PLOT DATE =	3/17/2021	CHECKED - AJN		REVISED -		SHEET SB-12 OF SB-17 SHEETS		ILLINOIS FED.	AID PROJECT		

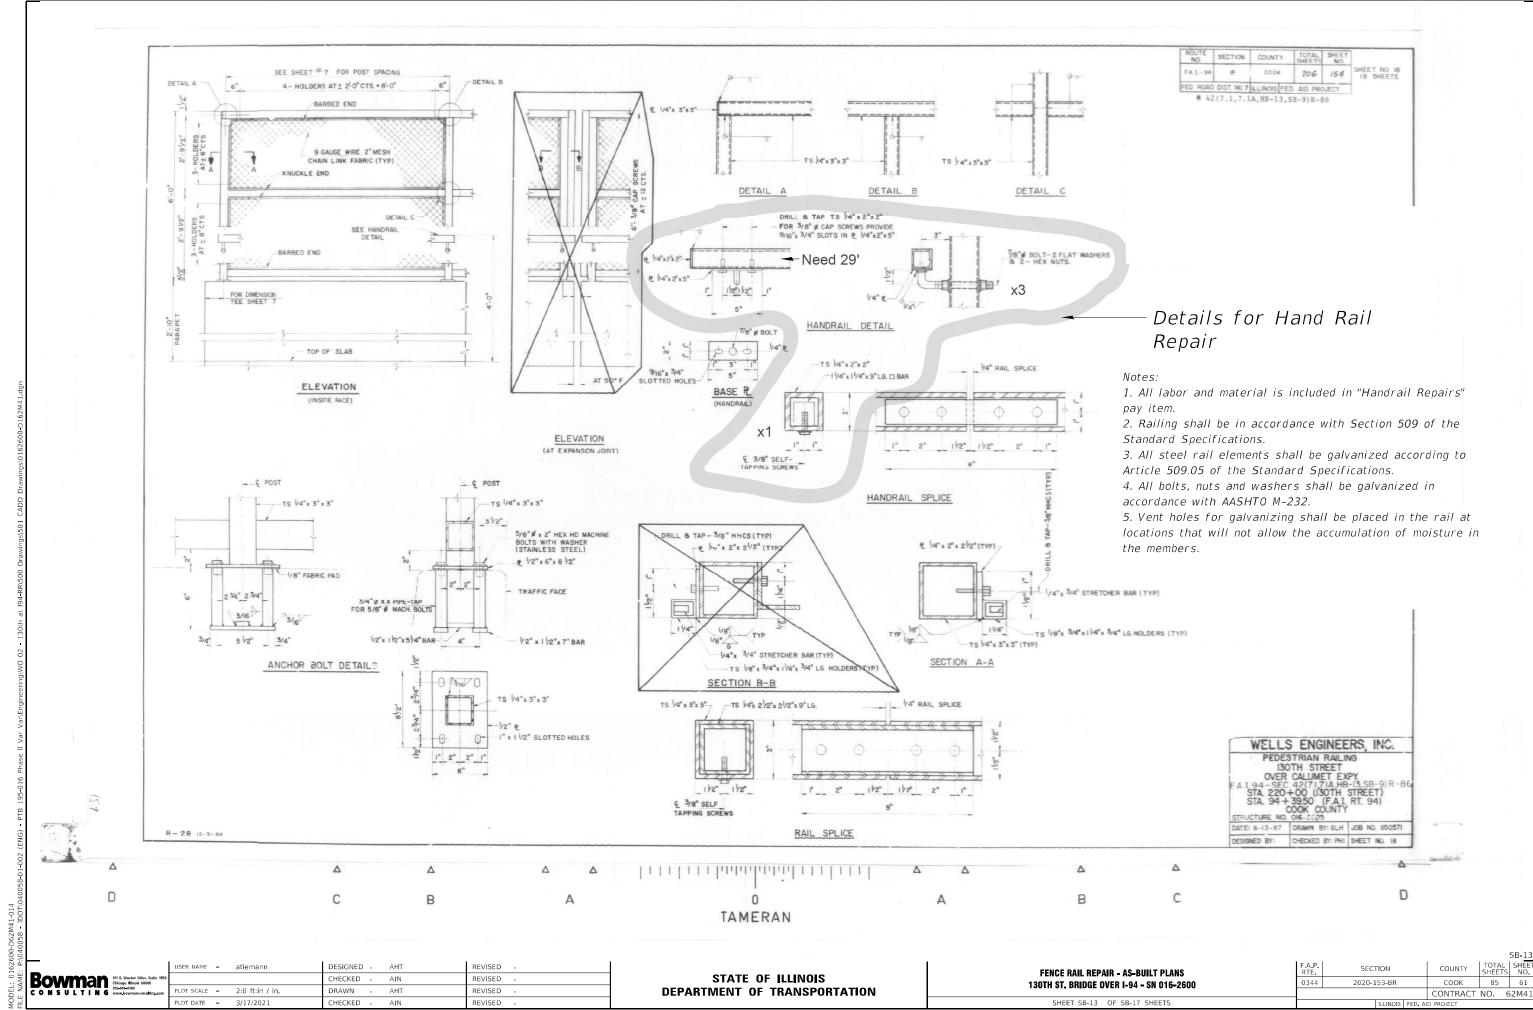

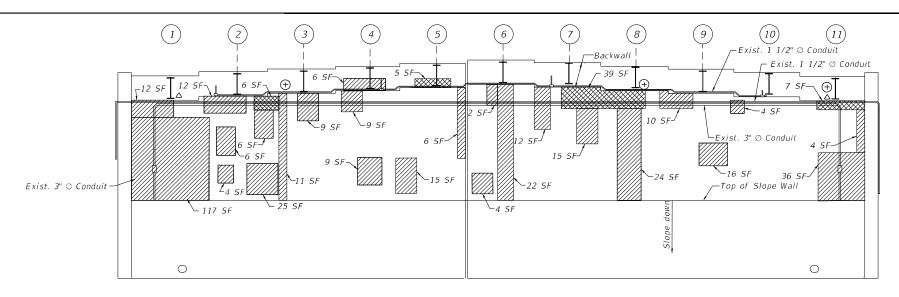


#### EAST ABUTMENT ELEVATION

West Face, Looking East

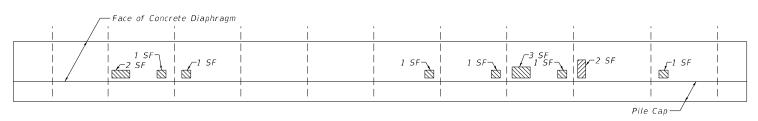

#### EAST PILE BENT ELEVATION

Looking East

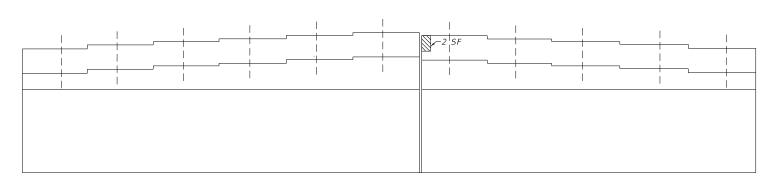


#### EAST ABUTMENT ELEVATION


East Face, Looking West

#### Notes

- 1. Existing Electrical conduits attached to abutment, will need to be removed before commencement of Structural Repair of Concrete at the abutments
- 2. Apply concrete sealer to all exterior faces of the vaulted abutment walls, beam seats, backwalls and slopewall.
- 3. Quantities and limits of repairs shown are estimated for bidding purposes only. The actual areas to be repaired, and the type(s) of repairs to be used, will be determined by the Engineer in the field at the time of construction.
- Prior to removal of concrete, the existing beams over the repair area shall be temporarily supported (See Beam Reaction Table on sheet SB-9 and Special Provision for Temporary Shoring and Cribbing.)

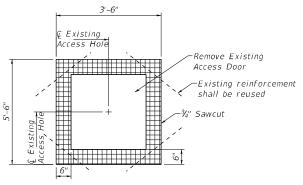

<u>CONCRETE REMOVAL AT</u> EXISTING ACCESS DOOR

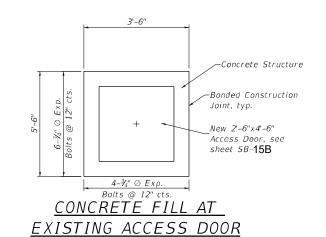

#### BILL OF MATERIAL Description Quantity Remove Existing Conduit attached to Structure 368 Concrete Sealer Sq. Ft. 3,284 Structural Repair of Sq. Ft. 438 Concrete, Denth Equal to or Less than 5 In. Structural Repair of 57 Sq. Ft. Concrete, Depth Equal to or Gréater than 5 In Temporary Shoring and Each Cribbing

#### Legend


△ Jack and remove existing bearings

Temporary Shoring and Cribbing

Structural Repair of Concrete
Depth less than or equal to 5 In.


Structural Repair of Concrete
Depth Greater Than 5 In.

Concrete Removal for Access Door

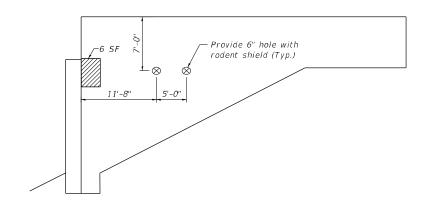

## EAST ABUTMENT - SOUTH WALL ELEVATION

Looking North

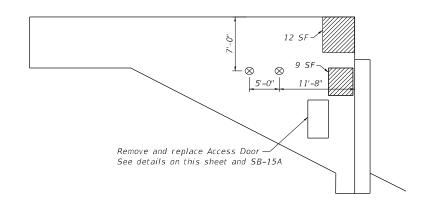

## <u>EAST ABUTMENT - NORTH WALL ELEVATION</u>

Looking

Notes

- -Remove and Replace Concrete cost included in cost of "Access Door".
- -Expansion bolts shall be ¾" diameter hooked bolts & shall extend 9" min.
- into concrete. Cost included in cost of "Access Door".
  -Installation of two 6" dia. vent holes with rodent screens
- at each vaulted abutment is included with the "Access Door" pay item.


SB-14

<u>6</u>	_	USER NAME = atiemann	DESIGNED - AHT	REVISED -		EAST ABUTMENT REPAIR	F.A.P.	SECTION	COUNTY	TOTAL	SHEET
AME	Sowman 311 S, Wacker Drive, Suite 1950 Chicago, Illinois 60608 312-414-47380		CHECKED - AJN	REVISED -	STATE OF ILLINOIS		0344	2020-153-BR	соок	85	62
ႍ   Ⴀ	ONSULTING 312-614-9380 www.bowmanconsulting.com	PLOT SCALE = 16:0.0000 ':" / in.	DRAWN - JDK	REVISED -	DEPARTMENT OF TRANSPORTATION	130TH ST. BRIDGE OVER I-94 - SN 016-2600			CONTRACT	NO. (	2M41
		PLOT DATE = 3/17/2021	CHECKED - AJN	REVISED -		SHEET SB-14 OF SB-17 SHEETS		ILLINOIS FED. AI	D PROJECT		

BILL OI	BILL OF MATERIAL							
Description	Unit	Quantity						
Remove Existing Conduit attached to Structure	Feet	244.5						
Concrete Sealer	Sq. Ft.	3,284						
Structural Repair of Concrete, Depth Equal to or Less than 5 In.	Sq. Ft.	268						
Structural Repair of Concrete, Depth Greater than 5 In.	Sq. Ft.	40						
Temporary Shoring and Cribbing	Each	1						


#### WEST ABUTMENT ELEVATION

East Face, Looking West

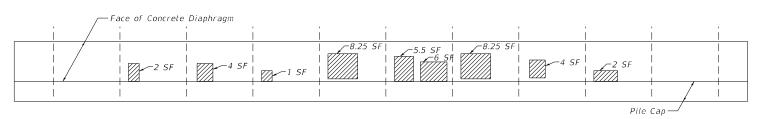

#### WEST PILE BENT ELEVATION

Looking West

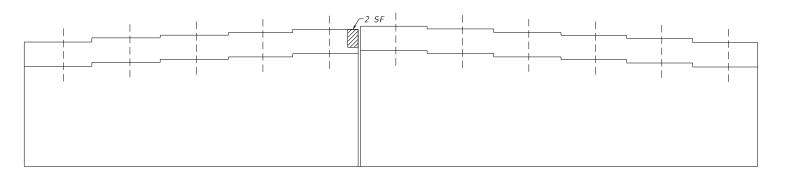

#### WEST ABUTMENT ELEVATION

West Face, Looking East

#### Legend

- ∆ Jack and remove existing bearings
- ① Temporary Shoring and Cribbing
- Structural Repair of Concrete

  Depth less than or equal to 5 In.
- Structural Repair of Concrete
  Depth Greater Than 5 In.


#### Notes:

- 1. Existing Electrical conduits attached to abutment, will need to be removed before commencement of Structural Repair of Concrete at the abutments
- Apply concrete sealer to all exterior faces of the vaulted abutment walls, beam seats, backwalls and slopewall.
- 3. Quantities and limits of repairs shown are estimated for bidding purposes only. The actual areas to be repaired, and the type(s) of repairs to be used, will be determined by the Engineer in the field at the time of construction.
- 4. Prior to removal of concrete, the existing beams over the repair area shall be temporarily supported (See Beam Reaction Table on sheet SB-09 and Special Provision for Temporary Shoring and Cribbing.)

# Provide 6" hole with rodent shield (Typ.)

#### WEST ABUTMENT - NORTH WALL ELEVATION

Looking South

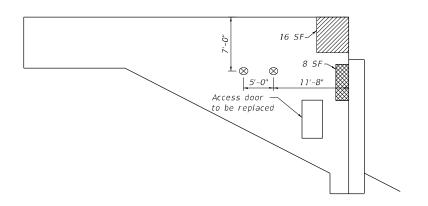

#### WEST ABUTMENT - SOUTH WALL ELEVATION


Looking North

Note:

Installation of two 6" dia. vent holes with rodent screens at each vaulted abutment is included with the "Access Door" pay item.

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:: P.		USER NAME =	atiemann	DESIGNED - AHT	REVISED -		WEST ABUTMENT REPAIR	F.A.P. RTE	SECTION	COUNTY	TOTAL SHEET SHEETS NO.
AME	Bowman 311 S. Wecker Drive, Sulte 1950 Chicago, Blinois 60606 312-416-40380 vww.bowmasconsulting.com			CHECKED - AJN	REVISED -	STATE OF ILLINOIS	130TH ST. BRIDGE OVER I-94 - SN 016-2600	0344	2020-153-BR	соок	85 63
E N	CONSULTING www.bowmanconsulting.com	PLOT SCALE =	16:0.0000 ':" / in.	DRAWN - JDK	REVISED -	DEPARTMENT OF TRANSPORTATION	1301H 31. DRIDGE UVER 1-34 - 3N 010-2000	_		CONTRACT	NO. 62M41
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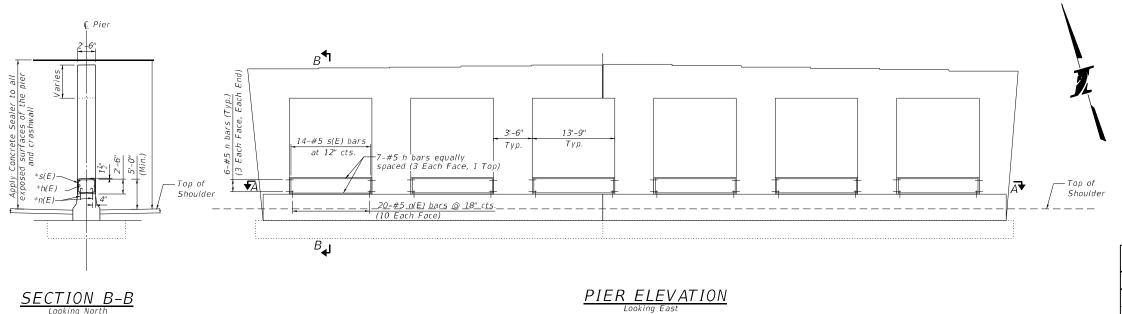
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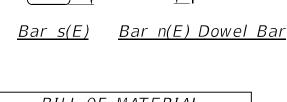


Bowman 311 8. Weeker Dr. 1911 8. Weeker Dr. 1912 8.

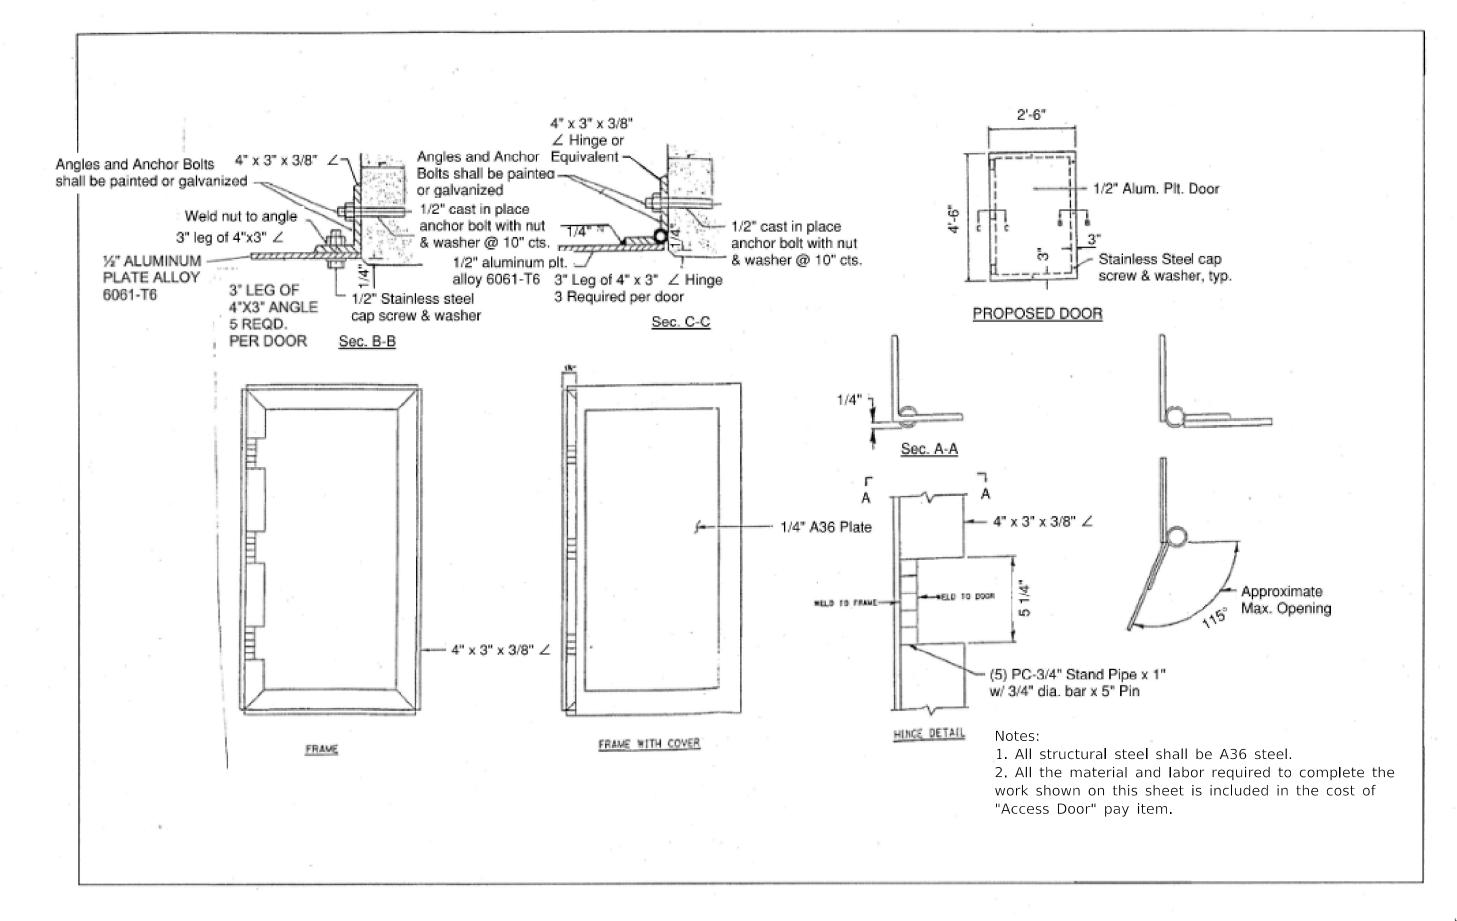STATE OF ILLINOIS
DEPARTMENT OF TRANSPORTATION

VAULTED ABUTMENT DOOR DETAIL 130TH ST. BRIDGE OVER I-94 - SN 016-2600






	В	ILL C	F MATE	RIAL
Bar	No.	Size	Length	Shape
h(E)	42	#5	13'-6"	
n(E)	192	#5	2'-5"	
s(E)	84	#5	9'-7"	
D	escriptio	วก	Unit	Quantity
Concre	te Struc	tures	Cu. Yd.	19.10
	rcement Coated	Bars,	Pound	1,910
Concrete Sealer			Sq. Ft.	412.5
Concre	ural Rep ete, Dept Less tha	h Equal	Sq. Ft.	6

# 13'-9"

# SECTION A-A

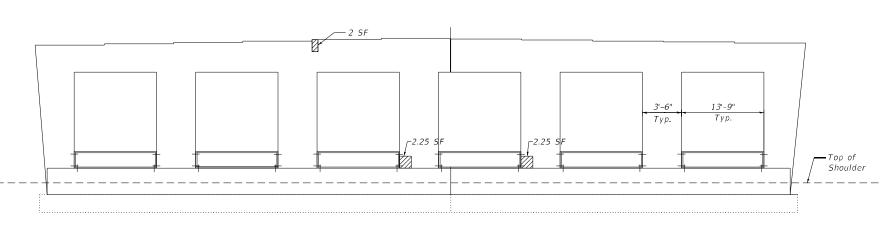

- Notes:
  1. Quantities and limits of repairs shown are estimated for bidding purposes only. The actual areas to be repaired, and the type(s) of repairs to be used, will be determined by the Engineer in the field at the time of construction.
- Prior to removal of concrete, the existing beams over the repair area shall be temporarily supported (See Beam Reaction Table on sheet SB-09 and Special Provision for Temporary Shoring and Cribbing.)

Structural Repair of Concrete
Depth less than or equal to 5 In.

Legend

0344

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STATE OF ILLINOIS **DEPARTMENT OF TRANSPORTATION** 

PIER ELEVATION

PIER REPAIR AND NEW CRASH WALL 130TH ST. BRIDGE OVER I-94 - SN 016-2600 SHEET SB-16 OF SB-17 SHEETS

SECTION 2020-153-BR COOK 85 64 CONTRACT NO. 62M41


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#### STANDARD BAR SPLICER ASSEMBLY

Threaded splicer bar length = min. lap length +  $1\frac{1}{2}$ " + thread length


\* Epoxy not required on Bar Splicer Assembly components used in conjunction with black bars.

Location	Bar size	No. assemblies required	Minimum lap length
W. End of Deck	#5	7	3'-6"
W. Abut. Hatched Block	#5	4	3'-6"
E. End of Deck	#5	7	3'-6"
E. Abut. Hatched Block	#5	4	3'-6"

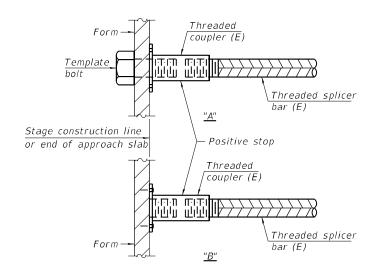


#### INSTALLATION AND SETTING METHODS

"A": Set bar splicer assembly by means of a template bolt.
"B": Set bar splicer assembly by nailing to wood forms or cementing to steel forms.
(E): Indicates epoxy coating.

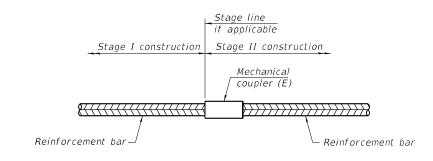

#### STANDARD MECHANICAL SPLICER

Location	Bar size	No. assemblies required

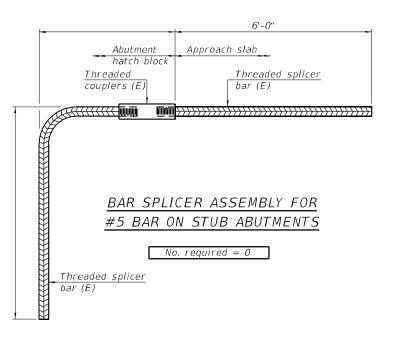

#### NOTES

Splicer bars shall be deformed with threaded ends and have a minimum 60 ksi yield strength.

All reinforcement shall be lapped and tied to the splicer bars.

Bar splicer assemblies shall be epoxy coated according to the requirements for reinforcement bars. See Section 508 of the Standard Specifications.

See approved list of bar splicer assemblies and mechanical splicers for alternatives.

BSD-1

2-17-2017

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ME	Bowman ST S. Wacker Drive, Suite 1950 Chicago, Illinois 60608 312-814-6380 312-8140		CHECKED - AJN	REVISED -
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STATE OF ILLINOIS
DEPARTMENT OF TRANSPORTATION

BAR SPLICER ASSEMBLY
130TH ST. BRIDGE OVER I-94 - SN 016-2600
SHEET SB-17 OF SB-17 SHEETS

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#### **GENERAL NOTES:**

- 1. THIS PROJECT INCLUDES THE INSTALLATION OF A NEW UNDERPASS LIGHTING SYSTEM IN CONJUNCTION WITH BRIDGE RECONSTRUCTION AT 130TH ST. OVER I-94. THE EXISTING UNDERPASS LIGHTING IS OWNED BY THE STATE OF ILLINOIS.
- 2. THE EXISTING UNDERPASS LIGHTING IS CONNECTED TO EXISTING LIGHTING CONTROLLERS "V" AND "W".
- 3. THE EXISTING UNDERPASS LIGHTING SHALL BE MAINTAINED DURING CONSTRUCTION AS TEMPORARY LIGHTING CONSIDERING VARIOUS PHASES OF CONSTRUCTION, UNTIL THE PROPOSED LIGHTING IS INSTALLED AND OPERATIONAL.
- 4. THE CONTRACTOR SHALL NOTIFY J.U.L.I.E. TO LOCATE AND MARK/STAKE ALL UNDERGROUND UTILITIES.
- 5. THE PROPOSED UNDERPASS LUMINAIRES SHALL BE RECONNECTED TO CIRCUITS "CD" ON BOTH THE "V" CONTROLLER AND THE "W" CONTROLLER.
- 6. TRENCHES FOR LIGHTING RACEWAYS SHALL HAVE A MINIMUM DEPTH OF 30".
- LIGHTING SYSTEM INSTALLATION SHALL CONFORM TO THE LATEST NEC IDOT STANDARDS, AND LOCAL CODES.
- 8. ALL ELECTRICAL EQUIPMENT AND PRODUCTS SHALL BE UL LISTED AND LABELED.
- 9. THE CONTRACTOR SHALL TAKE CARE WHEN INSTALLING UNIT DUCT TO AVOID CONFLICTS WITH EXISTING UNDERGROUND UTILITIES AND TREE ROOTS. THE CONTRACTOR SHALL BE RESPONSIBLE FOR ANY DAMAGE AS DETERMINED BY THE ENGINEER.

#### **BILL OF MATERIALS**

PAY ITEM	DESCRIPTION	UNIT	QUANTITY
81100320	CONDUIT ATTACHED TO STRUCTURE, 1" DIA., PVC COATED GALVANIZED STEEL	FOOT	642
81100805	CONDUIT ATTACHED TO STRUCTURE, 3" DIA., PVC COATED GALVANIZED STEEL	FOOT	15
81300220	JUNCTION BOX, STAINLESS STEEL, ATTACHED TO STRUCTURE, 6"X6"X4"	EACH	12
81300530	JUNCTION BOX, STAINLESS STEEL, ATTACHED TO STRUCTURE, 12"X10"X6"	EACH	6
81300830	JUNCTION BOX, STAINLESS STEEL, ATTACHED TO STRUCTURE, 18"X18"X8"	EACH	2
81603081	UNIT DUCT, 600V, 3-1C NO. 2, 1/C NO.4 GROUND, (XLP-TYPE USE), 1 1/2" DIA. POLYETHYLENE	FOOT	200
81702110	ELECTRIC CABLE IN CONDUIT, 600V (XLP-TYPE USE) 1/C NO. 10	FOOT	2136
82110021	LUMINAIRE, LED, UNDERPASS, WALLMOUNTED, OUTPUT DESIGNATION D	EACH	6
82110026	LUMINAIRE, LED, UNDERPASS, SUSPENDED, OUTPUT DESIGNATION D	EACH	6
Z0033024	MAINTENANCE OF LIGHTING SYSTEM	CAL MO	12

#### **LEGEND**

	1111
1	$\langle \dot{E} \rangle$
_	

EXISTING HIGH MAST LIGHT TOWER TO REMAIN

ELECTRIC CABLE IN CONDUIT 1" DIA.

UNIT DUCT, 600V, 3-1/C NO. 2, 1/C NO. 4 GROUND (XLP-TYPE USE)
1 1/4" DIA. POLYETHYLENE

■ R EXISTING UNDERPASS LUMINAIRE TO BE REMOVED


■ PROPOSED UNDERPASS LUMINAIRE LED

JUNCTION BOX, STAINLESS STEEL, ATTACHED TO STRUCTURE 18"x18"x8"

DB JUNCTION BOX, STAINLESS STEEL, ATTACHED TO STRUCTURE 12"x10"x6"

 ${\tt mc}$  Junction box, stainless steel, attached to structure  ${\tt 6"x6"x4"}$ 

erault : F:\Projects\1060-var var -Bowman\WO3\Design\Sht\D162M41-

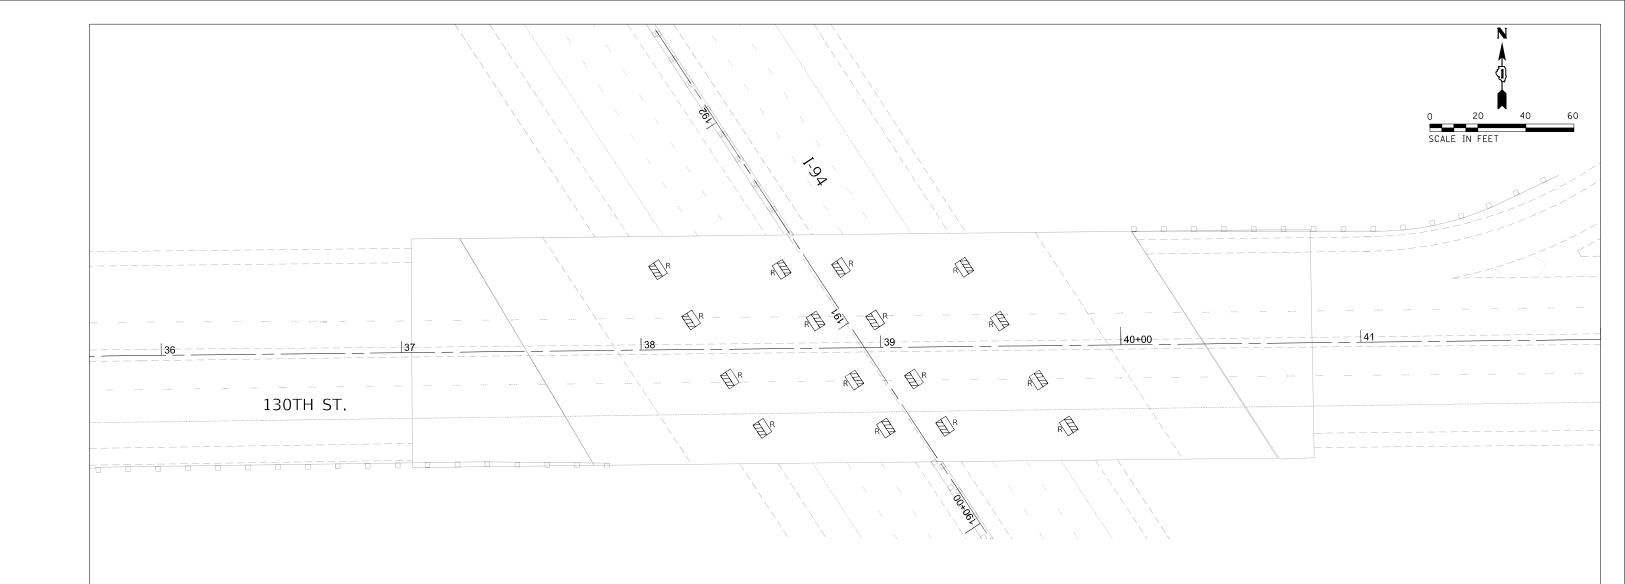

#### NOTES:

- 1. FOR GENERAL NOTES AND LEGEND SEE SHEET LT-01.
- 2. MAINTENANCE OF THE EXISTING UNDERPASS LIGHTING SYSTEM SHALL BE TRANSFERRED FROM IDOT TO THE CONTRACTOR PRIOR TO THE BEGINNING OF ANY WORK. IT SHALL BE USED AS TEMPORARY LIGHTING DURING CONSTRUCTION PER MOT.
- 3. EXISTING JUNCTION BOXES, CONDUIT AND ELECTRICAL CABLES SHALL BE REMOVED ALONG WITH THE UNDERPASS LIGHTING UNITS AND DISPOSE OF FROM SITE PER INSTRUCTIONS FROM THE FIELD ENGINEER/IDOT.
- 4. THE EXISTING UNDERPASS LUMINAIRES SHALL BE MAINTAINED AND REMOVED AS REQUIRED WITH BRIDGE REMOVAL AND COORDINATED WITH THE INSTALLATION OF THE PROPOSED UNDERPASS LUMINAIRES TO PROVIDE UNDERPASS LIGHTING THROUGHOUT CONSTRUCTION WORK AS NEEDED. THIS WORK SHALL BE INCLUDED IN COST OF MAINTENANCE OF LIGHTING SYSTEM.

LT-02

AMES Engineering, Inc.
CONSULTING ENGINEERS
6330 Belmont Road, Suite 4B
Downers Grove, IL 60515

 USER NAME
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 BL
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 PLOT SCALE
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 PLOT DATE
 =
 DATE
 04-14-2021
 REVISED

STATE OF ILLINOIS
DEPARTMENT OF TRANSPORTATION

UNDERPASS LIGHTING REMOVAL PLAN

130TH ST. OVER I-94


SHEET OF SHEETS

FA.P. RTE.
TBD 2020-15

P. SECTION COUNTY TOTAL SHEETS NO.

D 2020-153-BR COOK 85 67

CONTRACT NO. 62M41

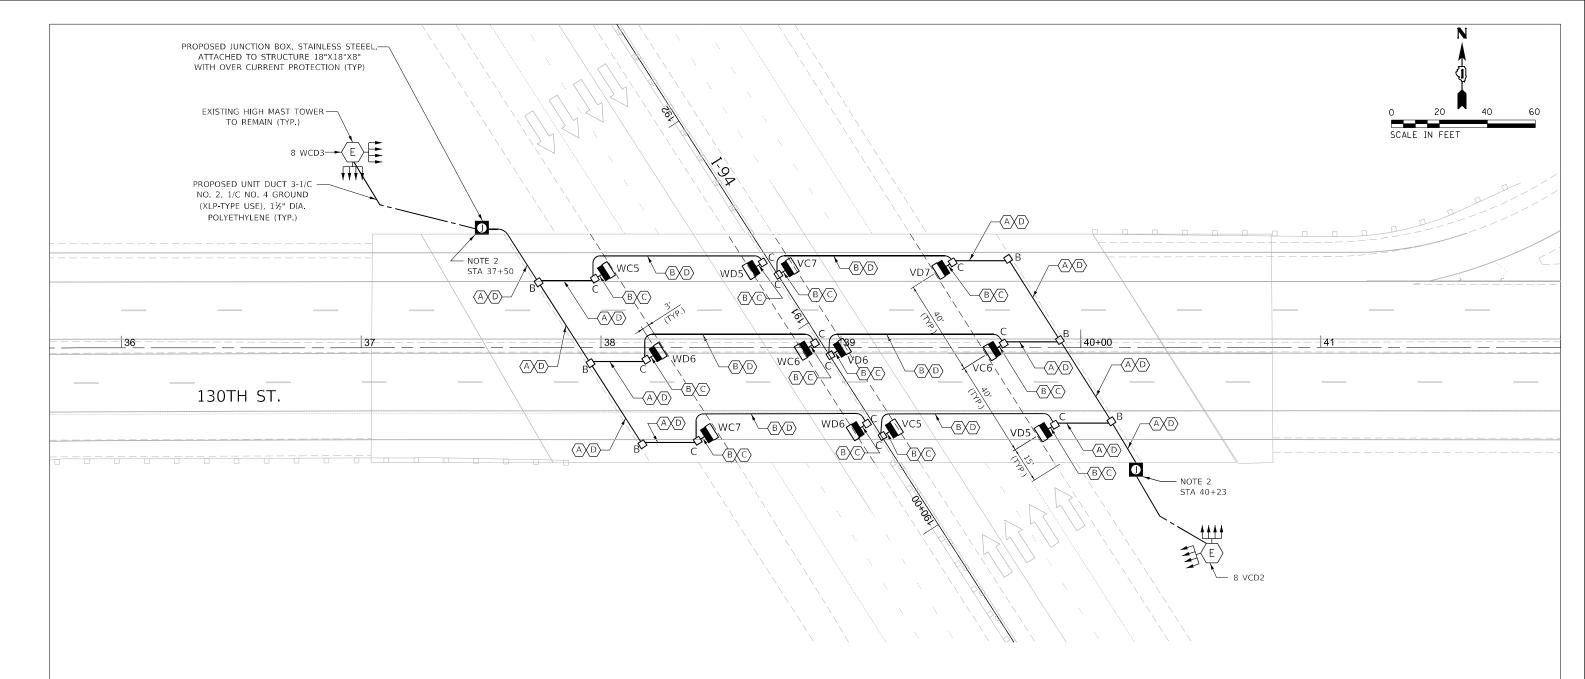

#### NOTES:

- 1. FOR GENERAL NOTES AND LEGEND SEE SHEET LT-01.
- 2. INSTALL TWO 30 AMP PROTECTIVE FUSES WITH FUSE HOLDER AND SOLID NEUTRAL SLUG AS OVER CURRENT PROTECTION FOR UNDERPASS LIGHTING.
- 3. THE PROPOSED UNDERPASS LIGHTING OVER SB I-94 WILL CONTINUE TO BE FED FROM THE HIGH MAST TOWER WCD3. THE EXISTING "W" LIGHTING CONTROLLER IS LOCATED IN THE SW QUADRANT OF THE I-94/130TH ST. INTERCHANGE.
- 4. THE PROPOSED UNDERPASS LIGHTING NB I-94 WILL CONTINUE TO BE FED FROM THE HIGH MAST TOWER VCD2. THE EXISTING "V" LIGHTING CONTROLLER IS LOCATED IN THE NE QUADRANT OF THE I-94/130TH ST. INTERCHANGE.
- 5. THE EXISTING FEEDS TO THE UNDERPASS LIGHTING UNITS SHALL BE DISCONNECTED WHEN THE EXISTING UNDERPASS LIGHTING IS REMOVED AS PER PHASES OF CONSTRUCTION.
- FOR SUSPENDED MOUNT LED UNDERPASS LUMINAIRE INSTALLATION DETAILS, SEE SHEET LT-06.
  THESE LUMINAIRES ARE SET BACK 3 FT. FROM THE EDGE OF PAVEMENT.
- FOR THE SIX CENTER PIER MOUNTED LED UNDERPASS LUMINAIRE INSTALLATION DETAILS, SEE SHEET LT-07.
  THESE LUMINAIRES ARE SET BACK 6 FT. FROM THE EDGE OF PAVEMENT.

#### CABLE AND CONDUIT DESCRIPTION

- $\begin{tabular}{lll} \hline \end{tabular} A) & ELECTRIC CABLE IN CONDUIT, 3-1/C NO. 10 AND 1/C NO. 10 GROUND, 600V (XLP-TYPE USE) \end{tabular}$
- $\begin{tabular}{lll} \hline $B$ & ELECTRIC CABLE IN CONDUIT, 2-1/C NO. 10 AND 1/C NO. 10 GROUND, 600V (XLP-TYPE USE) \\ \hline \end{tabular}$
- C LIQUID-TIGHT FLEXIBLE CONDUIT, 3/4" DIA.
- $\left\langle \overline{D}\right\rangle$  conduit attached to structure, PVC coated galvanized steel, 1" dia.

LT-03

AMES Engineering, Inc.
CONSULTING ENGINEERS
6330 Belmont Road, Suite 4B

 USER NAME =
 DESIGNED - BL REVISED 

 CHECKED - MB REVISED 

 PLOT SCALE =
 DRAWN - SR REVISED 

 PLOT DATE =
 DATE - 04-14-2021 REVISED


STATE OF ILLINOIS
DEPARTMENT OF TRANSPORTATION

UNDERPASS LIGHTING PROPOSED PLAN
130TH ST. OVER I-94
SHEET OF SHEETS


 
 F.A.P. RTE.
 SECTION
 COUNTY
 TOTAL SHEETS
 SHEET NO.

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 COOK
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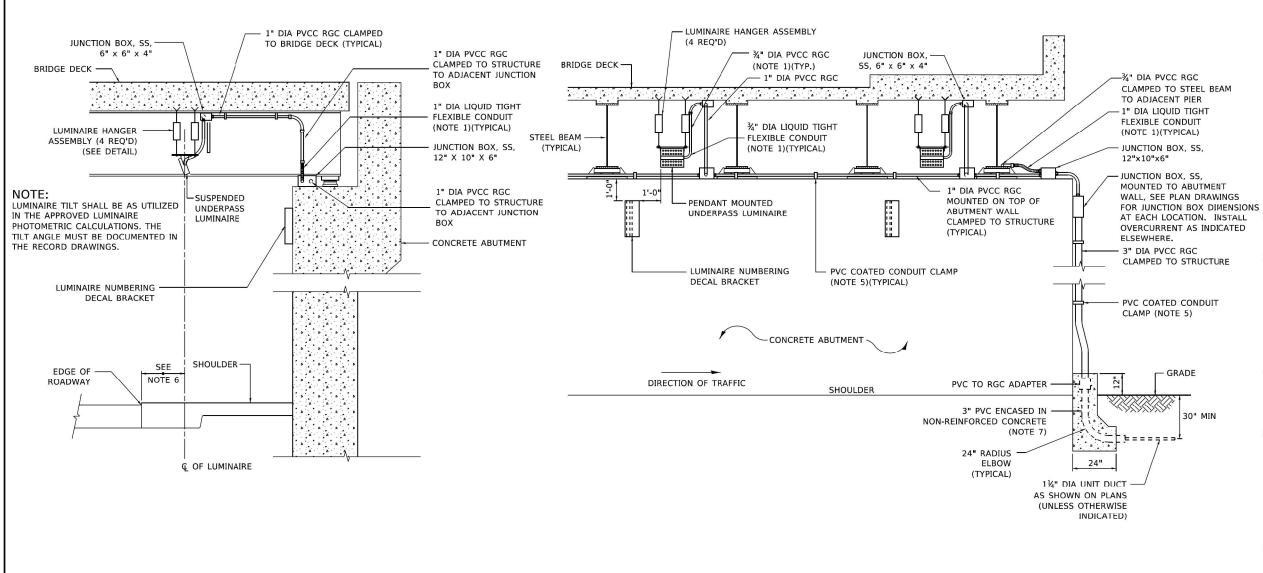
 CONTRACT NO.62M41

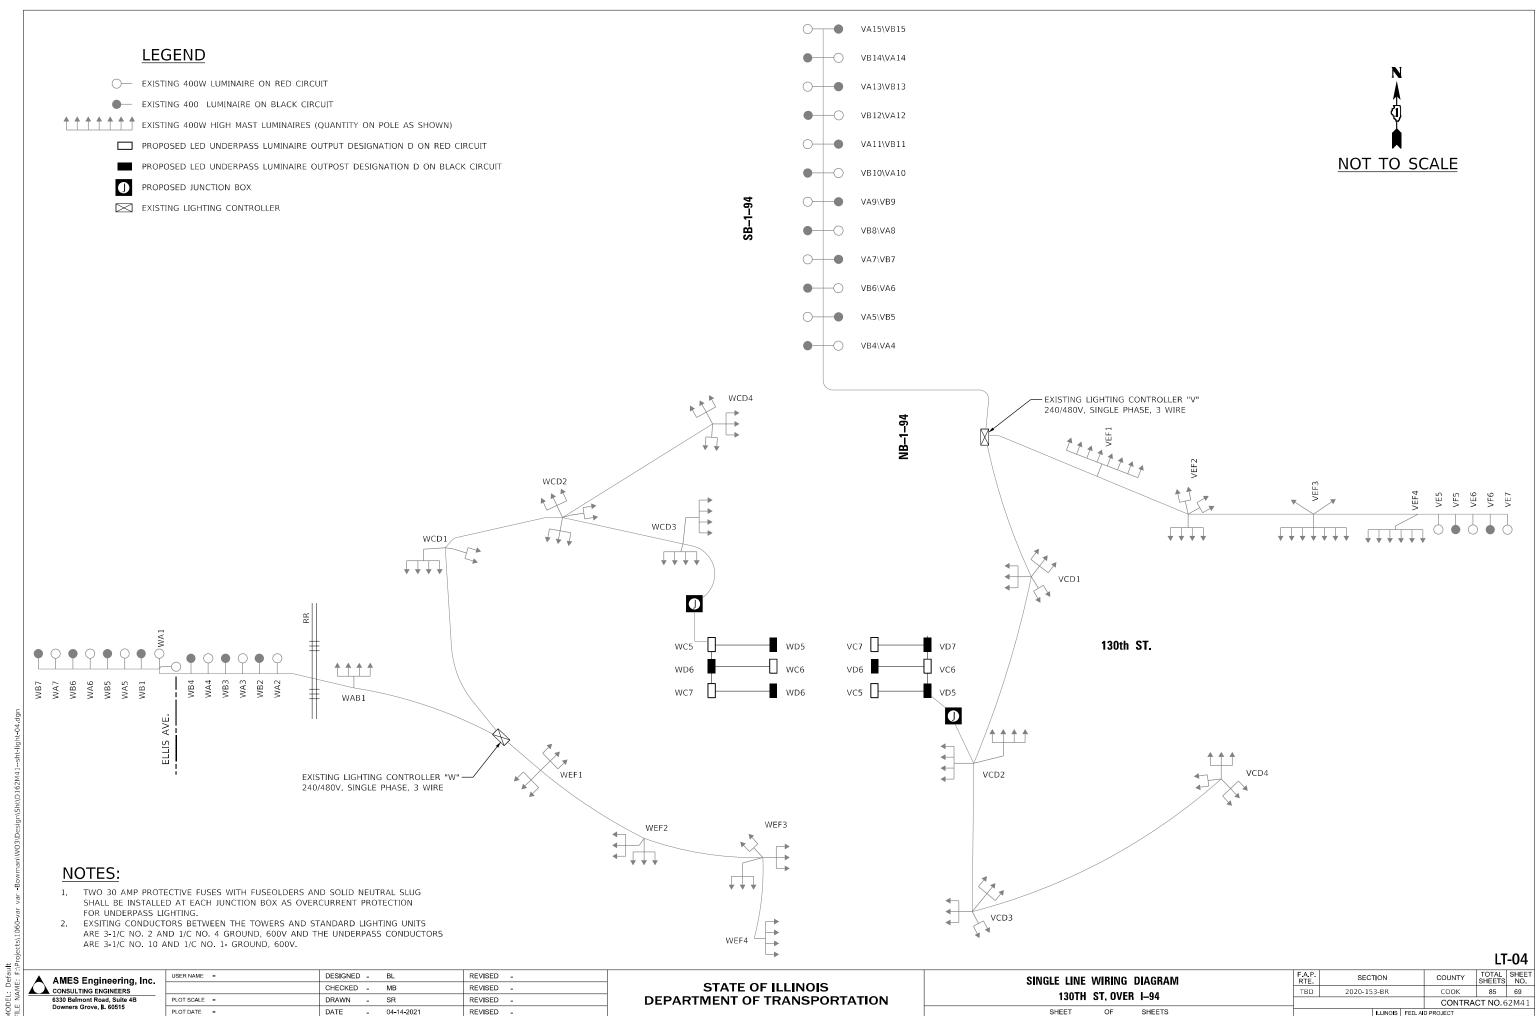

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NEW BRIDGE DECK

**NEW BRIDGE DECK INSTALLATION** 

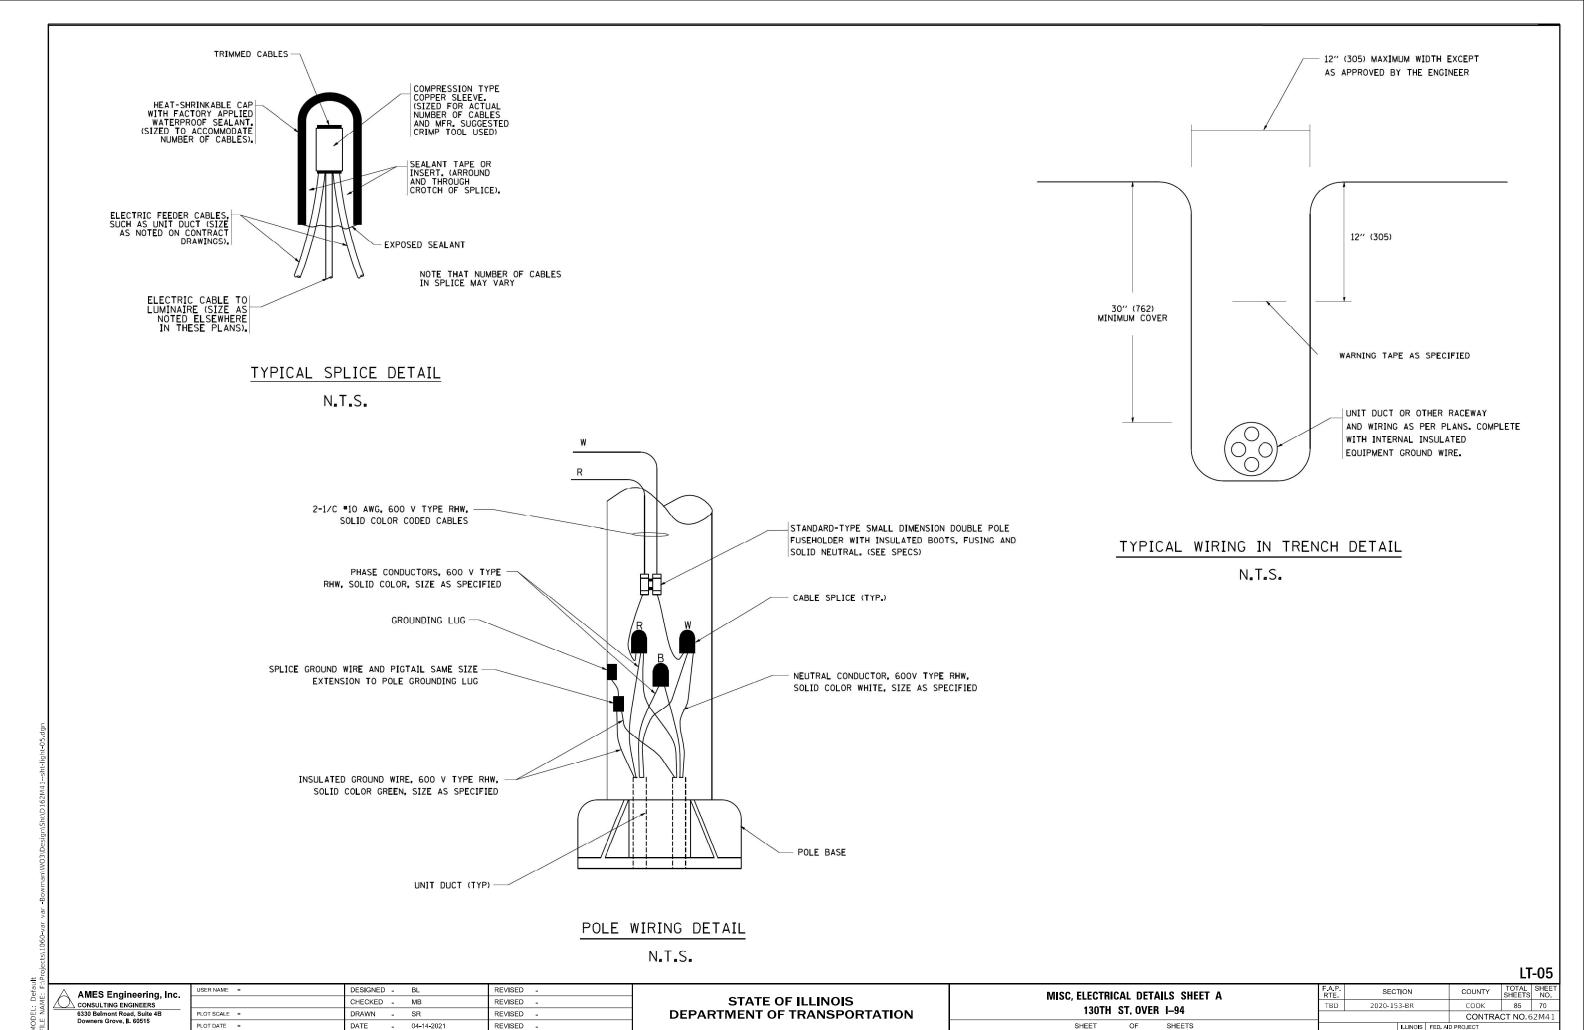STAINLESS STEEL STUD BOLT

½" DIA THREADED BOTH ENDS

FLAT WASHER (SS)

- LUMINAIRE MOUNTING PLATE

-STEEL SPRING

LENGTH AS REQUIRED (TYPICAL)

NUT. LOCK WASHER &

FLAT WASHER & LOCKNUT (SS)

VIBRATION DAMPER ASSEMBLY

SINGLE COIL, FLARED

LOOP INSERTS CAST

STUD BOLTS (NOTE 4)

NEOPRENE CUSHION-

NUT. LOCK WASHER

& FLAT WASHER (SS)

LOCKNUT, FLAT WASHER.

NEOPRENE WASHER &

CUPPED WASHER (SS)

IN DECK FOR ½"

#### NOTES:

- 1. LIQUID TIGHT FLEXIBLE METAL CONDUIT. MAXIMUM LENGTH 6'-0". TYPICAL FOR EACH INSTANCE AS SHOWN, PROVIDE PVC COATED RIGID GALVANIZED STEEL CONDUIT AS REQUIRED NOT TO EXCEED 6'-0" OF FLEXIBLE LIQUID TIGHT METAL CONDUIT. LIQUID TIGHT FLEXIBLE METAL CONDUIT WILL BE INCLUDED IN THE COST OF THE CONDUIT ATTACHED TO STRUCTURE, OF THE CORRESPONDING DIA., GALVANIZED STEEL, PVC COATED PAY ITEM EXCEPT THAT " DIA. CONDUIT AND " DIA. FLEXIBLE CONDUIT SHALL BE INCLUDED IN THE COST OF UNDERPASS LUMINAIRE INSTALLATION.
- 2. SEE UNDERPASS LIGHTING PLANS FOR INSTALLATION LOCATION OF UNDERPASS LIGHTING LUMINAIRES.
- 3. THE CONTRACTOR SHALL USE APPROVED SINGLE COIL FLARED LOOP INSERTS WHEN SUSPENDED MOUNTING AN UNDERPASS LUMINAIRE TO A NEW BRIDGE DECK. THE FLARED LOOP INSERTS MUST BE CAST INTO THE CONCRETE DECK. THE CONTRACTOR IS RESPONSIBLE FOR LOCATING AND COORDINATING THE INSERT LOCATIONS FOR MOUNTING THE UNDERPASS LIGHTING SYSTEM AS SHOWN ON THE PLANS WITH THE BRIDGE DECK CONTRACTOR, SEE DETAIL.
- 4. THE UNDERPASS LUMINAIRE HANGER ASSEMBLY COMPLETE WITH HEAVY DUTY ANCHORS/INSERTS AND ALL APPLICABLE HARDWARE SHALL BE INCLUDED IN THE COST OF THE UNDERPASS LUMINAIRE PAY ITEM.
- 5. SECURE THE CONDUIT WITH PVC COATED CONDUIT CLAMPS OR CONDUIT BEAM CLAMPS AS SHOWN AT 5'-0" INTERVALS FOR LATERALS AND WITHIN 2'-0" MAXIMUM FROM ANY JUNCTION BOX, FLEXIBLE CONDUIT, OR CHANGE IN DIRECTION. ALL PVC COATED CONDUIT CLAMPS OR BEAM CLAMPS SHALL BE INCLUDED WITH THE COST OF THE "CONDUIT ATTACHED TO STRUCTURE, OF THE CORRESPONDING DIA., GALVANIZED STEEL, PVC COATED" PAY ITEM.
- 6. ALL UNDERPASS LUMINAIRES MUST BE CENTERED IN THE BEAM SPACE AS INDICATED ON THE PLANS UNLESS OTHERWISE DIRECTED BY THE ENGR. LUMINAIRE SETBACK SHALL BE AS INDICATED IN PLANS FOR EACH SPECIFIC UNDERPASS
- 7. THE CONCRETE ENCASED CONDUIT TRANSITION SHALL BE INCLUDED IN THE COST OF THE GALVANIZED RIGID STEEL CONDUIT PAY ITEMS.
- 8. ALL CONDUIT ATTACHED TO STRUCTURE SHALL BE PVC COATED RIGID STEEL CONDUIT (PVCC RGC)
- 9. IN NO INSTANCE SHALL ANY UNDERPASS LUMINAIRE OR ANY OTHER ELECTRICAL EQUIPMENT BE INSTALLED BELOW THE ELEVATION OF THE BOTTOM OF THE BRIDGE BEAM WHEN OVER ANY PAVEMENT (ROADWAY OR SHOULDER).

## LUMINAIRE NUMBERING DECAL BRACKET

HEXAGON HEAD

ANCHOR AS APPROVED

ALUMINUM BUSHING

ALUMINUM BRACKET

BOLT 1/4" DIA

(3-REQUIRED)

BY ENGINEER

½" LONG

**TOP VIEW** 

NOT TO SCALE



**PVC COATED CONDUIT BEAM CLAMP** NOT TO SCALE

**PVC COATED CONDUIT CLAMP** NOT TO SCALE

LT-06

AMES Engineering, Inc. CONSULTING ENGINEERS

EXPANSION ANCHOR, -HEAVY DUTY AS APPROVED BY THE ENGINEER

NEOPRENE CUSHION

NUT, LOCK WASHER — & FLAT WASHER (SS)

LOCKNUT, FLAT WASHER, NEOPRENE WASHER & CUPPED WASHER (SS)

-EXISTING BRIDGE DECK

**EXISTING BRIDGE DECK INSTALLATION** 

-NUT, LOCK WASHER & FLAT WASHER (SS)

- LUMINAIRE MOUNTING PLATE

-STEEL SPRING

FLAT WASHER & LOCKNUT (SS)

VIBRATION DAMPER ASSEMBLY

DESIGNED -REVISED CHECKED - MB REVISED . REVISED PLOT DATE = 04-14-2021 REVISED .

TYPICAL LUMINAIRE HANGER ASSEMBLY DETAILS


**STATE OF ILLINOIS DEPARTMENT OF TRANSPORTATION**  SUSPENDED MOUNT LED UNDERPASS LUMINAIRE INSTALLATION DETAILS RIE. 2020-153-BR 130TH ST. OVER I-94 SHEET


2" L<sub>1"</sub> (TYPICAL)

**ELEVATION** 

COUNTY COOK 85 71 CONTRACT NO.62M41

4/14/2021 11:43:21 AM

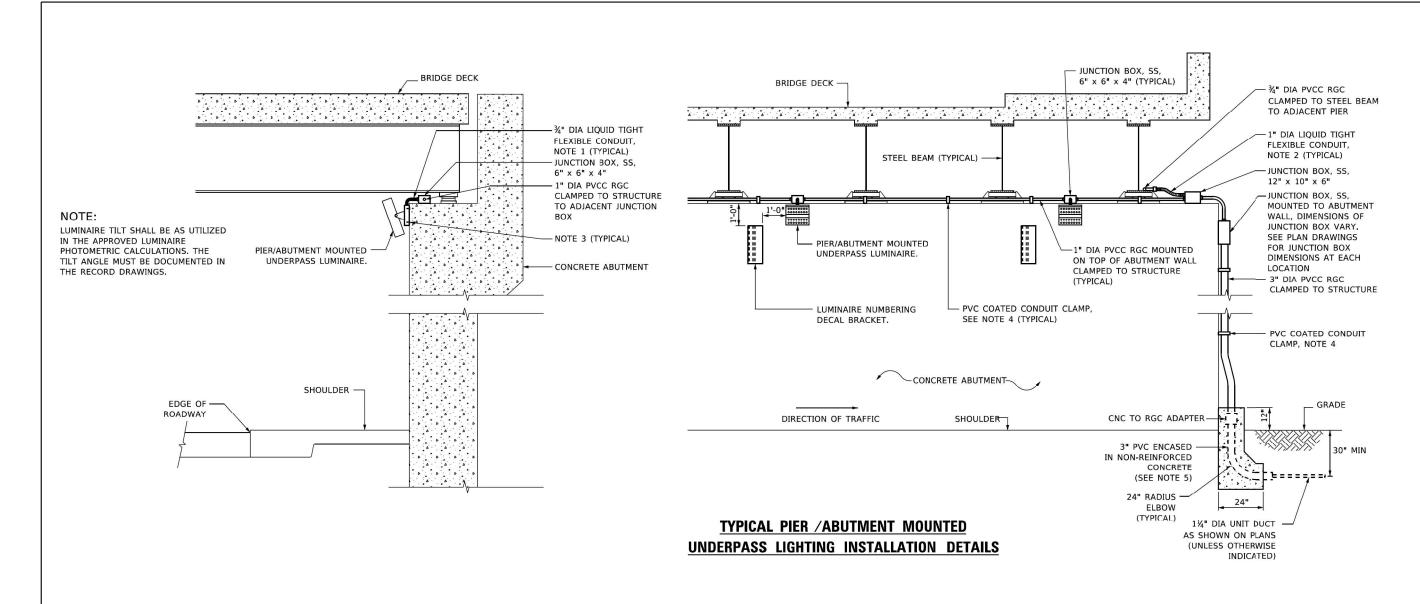

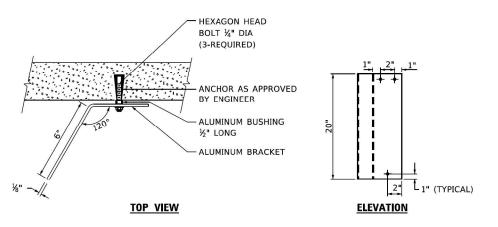

# PVC COATED CONDUIT BEAM CLAMP

NOT TO SCALE



<u>PVC COATED</u> CONDUIT CLAMP

NOT TO SCALE

**LUMINAIRE NUMBERING DECAL BRACKET** 

NOT TO SCALE

# NOTES:

- 1. LIQUID TIGHT FLEXIBLE METAL
  CONDUIT, MAXIMUM LENGTH 6'-0", TYPICAL
  FOR EACH INSTANCE AS SHOWN. PROVIDE PVC
  COATED RIGID GALVANIZED STEEL CONDUIT AS
  REQUIRED NOT TO EXCEED 6'-0" OF FLEXIBLE
  LIQUID TIGHT METAL CONDUIT. LIQUID TIGHT
  FLEXIBLE METAL CONDUIT WILL BE INCLUDED
  IN THE COST OF THE CONDUIT ATTACHED TO
  STRUCTURE, OF THE CORRESPONDING DIA.,
  GALVANIZED STEEL, PVC COATED PAY ITEM
  EXCEPT THAT THE COST OF THE " DIA.
  RIGID STEEL CONDUIT AND " DIA. FLEXIBLE
  CONDUIT SHALL BE INCLUDED IN THE LUMINAIRE
  INSTALLATION.
- 2. SEE UNDERPASS LIGHTING PLANS FOR INSTALLATION LOCATION OF UNDERPASS LIGHTING LUMINAIRES.
- 3. UNDERPASS LUMINAIRE MOUNTED TO FACE OF PIER OR ABUTMENT WALL WITH ½" ALUMINUM SPACERS, MOUNTING HEIGHT OF 1" BELOW THE TOP OF PIER OR ABUTMENT WALL TYPICAL FOR ALL PIER/ABUTMENT MOUNTED UNDERPASS LUMINAIRES UNLESS OTHERWISE NOTED.

- EXPANSION ANCHOR, POWDER ACTUATED FASTENERS WILL NOT BE ALLOWED. EXPANSION ANCHOR MUST BE SIZED IN ACCORDANCE WITH MANUFACTURERS REQUIREMENTS.
- 5. SECURE THE CONDUIT WITH PVC COATED CONDUIT CLAMPS OR CONDUIT BEAM CLAMPS AS SHOWN AT 5'-0" INTERVALS FOR LATERALS AND WITHIN 2'-0" MAXIMUM FROM ANY JUNCTION BOX, FLEXIBLE CONDUIT, OR CHANGE IN DIRECTION. ALL PVC COATED CONDUIT CLAMPS OR BEAM CLAMPS SHALL BE INCLUDED WITH THE COST OF THE "CONDUIT ATTACHED TO STRUCTURE, OF THE CORRESPONDING DIA., GALVANIZED STEEL, PVC COATED" PAY ITEM.
- 6. THE CONCRETE ENCASED CONDUIT TRANSITION SHALL BE INCLUDED IN THE COST OF THE GALVANIZED RIGID STEEL CONDUIT PAY ITEMS.
- ALL CONDUIT ATTACHED TO STRUCTURE SHALL BE PVC COATED RIGID STEEL CONDUIT (PVCC RGC) TYPICAL.

LT-07

AMES Engineering, Inc.
CONSULTING ENGINEERS
6330 Belmont Road, Suite 4B
Downers Grove, IL 60515

 USER NAME
 =
 DESIGNED
 BL
 REVISED

 CHECKED
 MB
 REVISED

 PLOT SCALE
 =
 DRAWN
 SR
 REVISED

 PLOT DATE
 =
 DATE
 04-14-2021
 REVISED

STATE OF ILLINOIS
DEPARTMENT OF TRANSPORTATION

PIER MOUNTED LED UNDERPASS LUMINAIRE INSTALLATION DETAILS

130TH ST. OVER I-94

SHEET OF SHEETS


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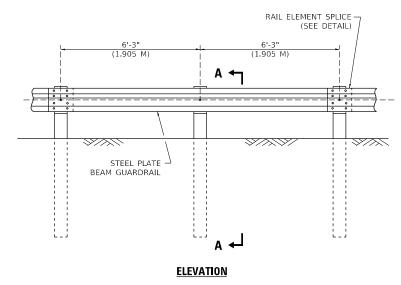
TOTAL SHEETS NO. 85 71A

CONTRACT NO.62M41


COOK




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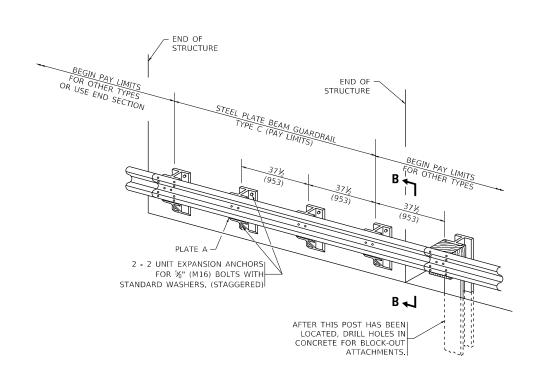
TYPE A
6'-3" (1.905 M) TYPICAL POST SPACING

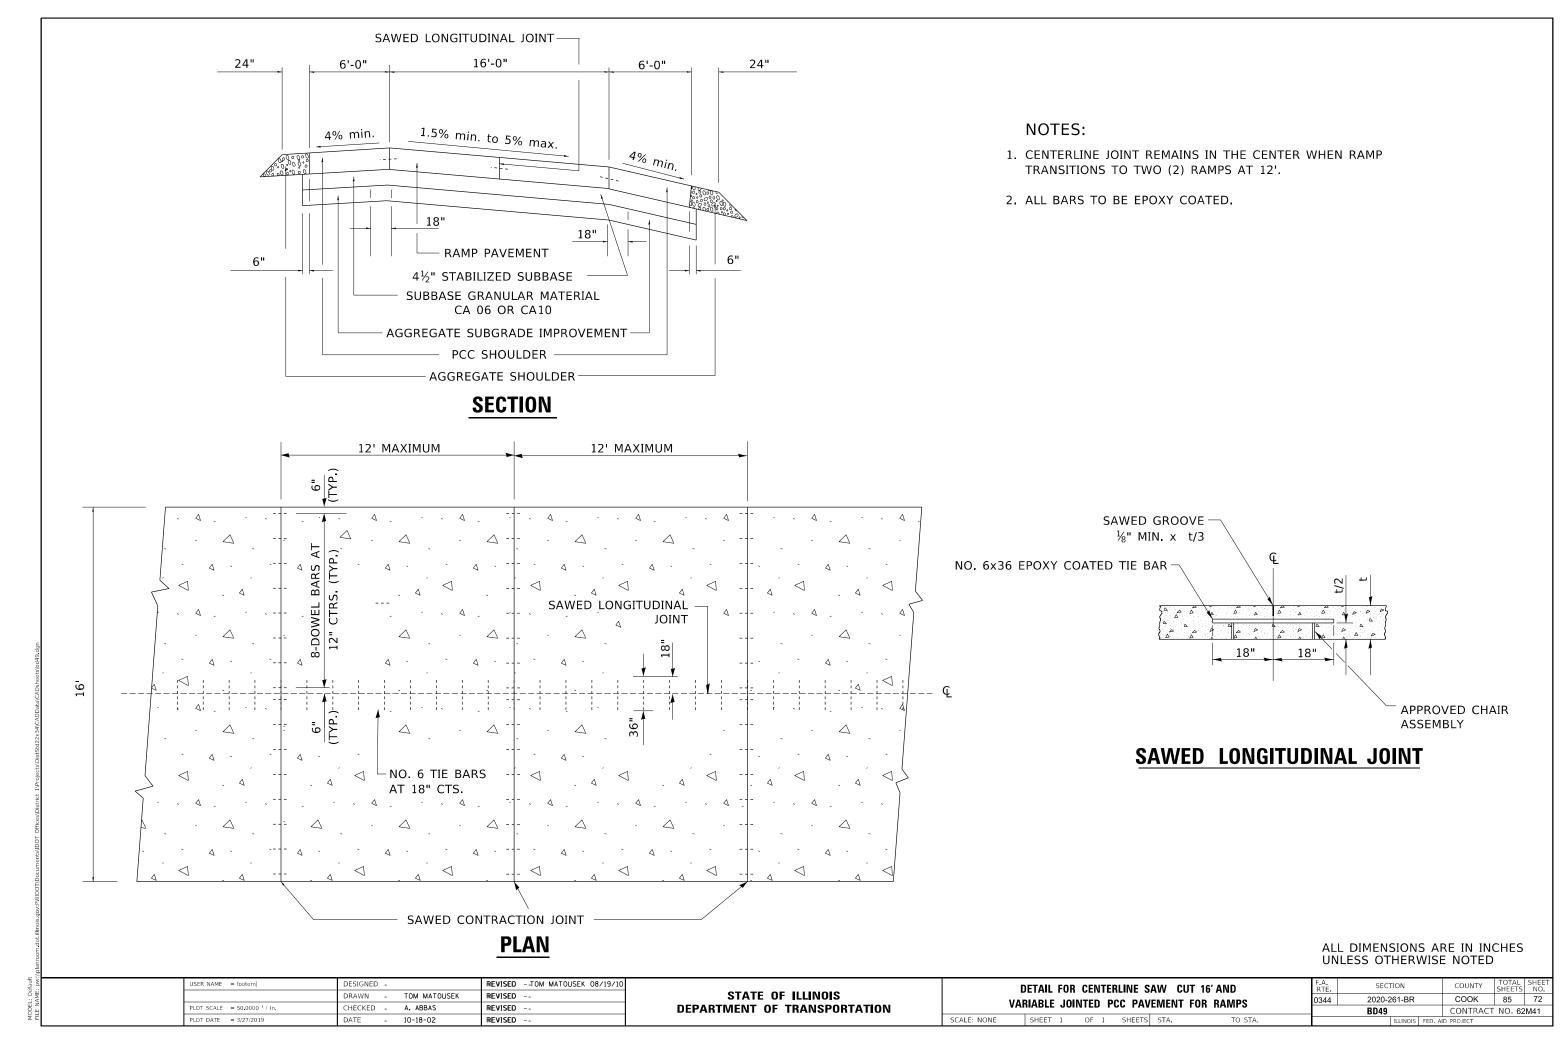

SECTION A-A

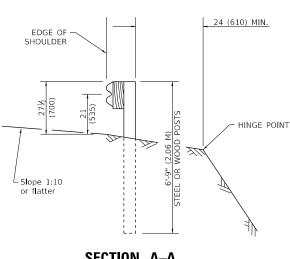

TYPE A
37½ (953) CLOSED POST SPACING

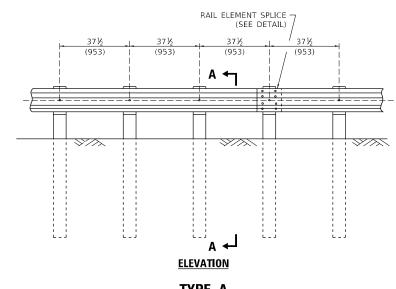


<u>TYPE C</u> 37½ (953) BLOCK-OUT SPACING


REVISED

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REVISED

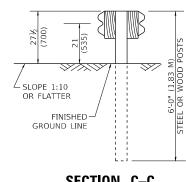


SECTION C-C

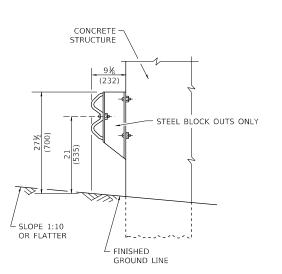

SECTION B-B

SCALE: NONE

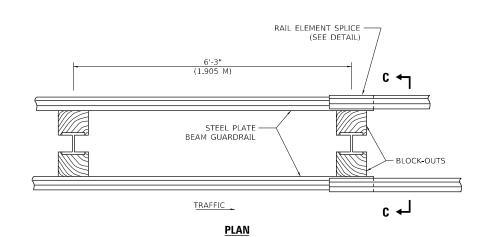

### TYPE D

DOUBLE STEEL PLATE BEAM GUARDRAIL 6'-3" (1.905 M) TYPICAL POST SPACING

#### **GENERAL NOTES**

ALL SLOPE RATIOS ARE EXPRESSED AS UNITS OF VERTICAL DISPLACEMENT TO UNITS OF HORIZONTAL DISPLACEMENT (V:H).

ALL DIMENSIONS ARE IN INCHES (MILLIMETERS) UNLESS OTHERWISE SHOWN.

THE EXISTING STEEL POSTS MAY BE DRILLED TO MATCH THE BOLT PATTERN SHOWN HEREIN FOR THE WOOD BLOCK-OUT, OR A NEW STEEL POST SHALL BE PROVIDED.

THIS DETAIL IS APPLICABLE TO THE GUARDRAIL SYSTEM USED PRIOR TO JANUARY 1, 2007, FOR DETAILS ON THE MIDWEST GUARDRAIL SYSTEM, SEE STANDARD 630001.

JSER NAME = footemj	DESIGNED -	REVISED -	

DRAWN

DATE


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CHECKED


STATE OF ILLINOIS
DEPARTMENT OF TRANSPORTATION

					F.A. RTE	SECTION		COUNTY	TOTAL SHEETS	SHEET NO.	
						0344	2020-261-BR		COOK	85	73
SIEEL PLAIE BEAWI GUARDRAIL					BM-21		CONTRACT	NO. 62	2M41		
SHEET 1	OF 4	SHEETS	STA.	TO STA.			ILLINOIS	FED. A	D PROJECT		

MODEL: Default

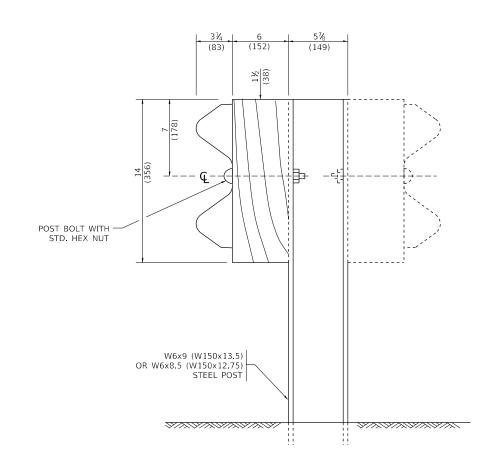


# STEEL POST CONSTRUCTION

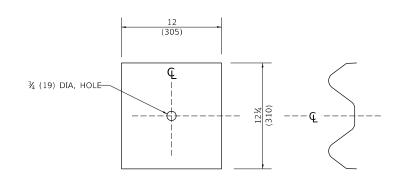


#### NOTE:

PLATE A SHALL BE PLACED BETWEEN RAIL ELEMENT AND BLOCK-OUT AT NON-SPLICE MOUNTING POINTS ONLY WHEN STEEL BLOCK-OUTS ARE USED.


# PLATE A

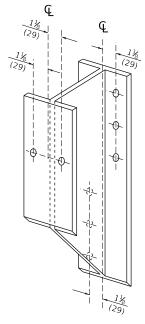

# STEEL BLOCK-OUT DETAIL

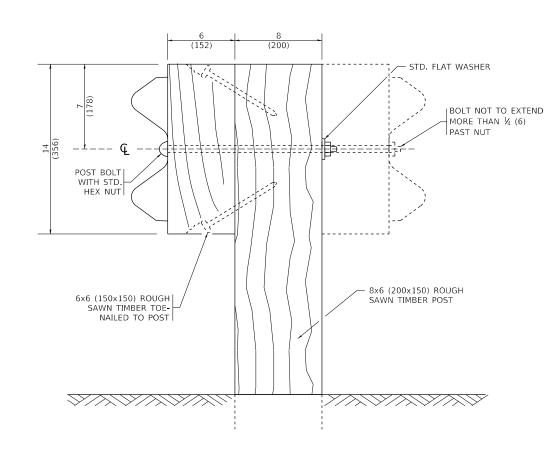


# **WOOD POST CONSTRUCTION**

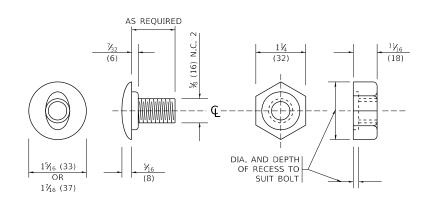


POST OR SPLICE BOLT & NUT


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	DRAWN -	REVISED -
PLOT SCALE = 50.0000 / in.	CHECKED -	REVISED -
PLOT DATE = 3/11/2019	DATE -	REVISED -

	REMOVE AND REERECT							COUNTY TOTAL SHEET NO.		
	STEEL PLATE BEAM GUARDRAIL						0344 2020-261-BR			74
	SILLE ILAIL DEAW	UUAIIDIIAIL			BM-21			CONTRACT	NO. 6	2M41
SCALE: NONE	SHEET 2 OF 4 SHEETS	STA.	TO STA.			ILLINOIS	FED. AI	D PROJECT		

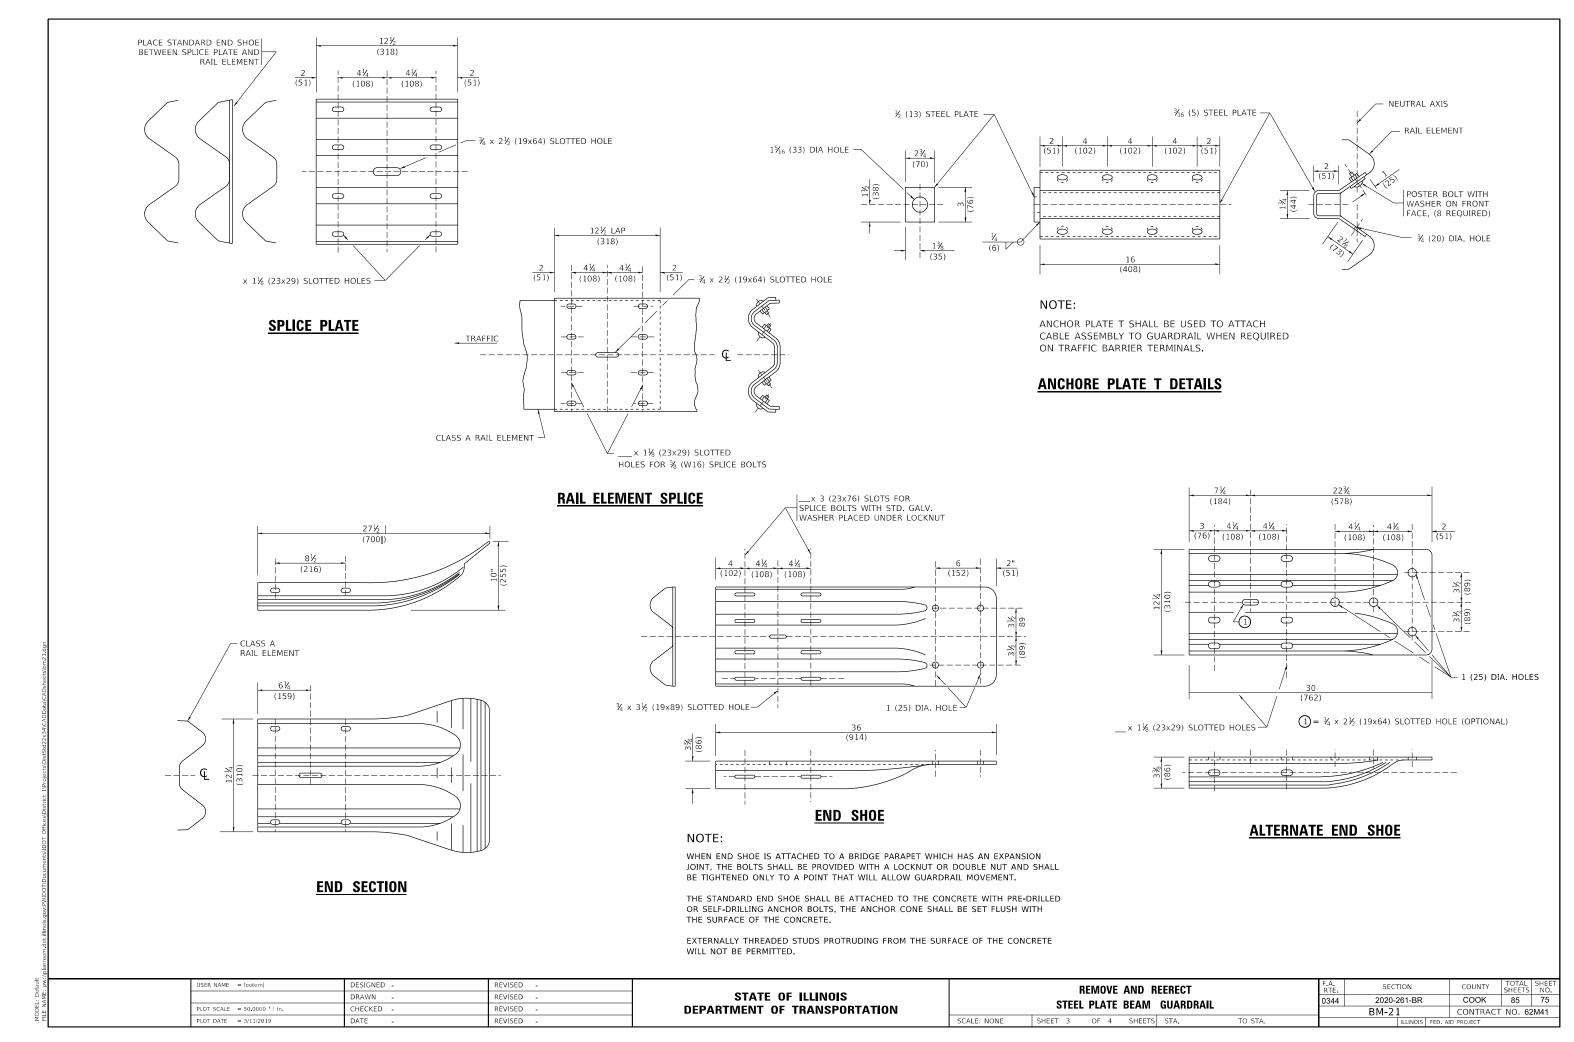

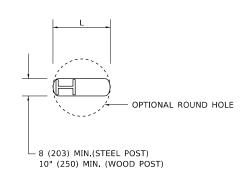

#### <u>PLAN</u>

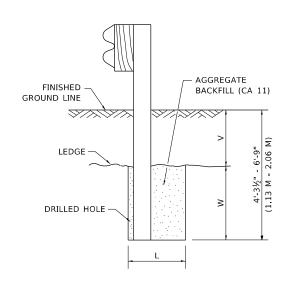


## NOTE:

LEDGE LINE IS TOP OF ROCK LEDGE OR HARD SLAG FILL.

#### **ELEVATION**

# FOOTING FOR POST WHEN IMPERVIOUS MATERIAL IS ENCOUNTERED

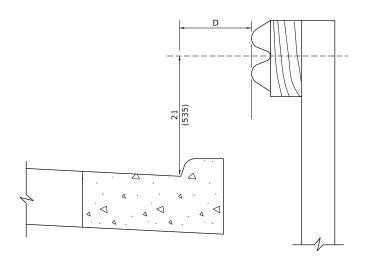


#### NOTE:

IF IT IS NECESSARY FOR D TO BE MORE THAN 12 (300) AND LESS THAN 10'-0" (3.0 M) TYPE M-2 (M-5) CURB AND GUTTER (STD. 606001) SHALL BE USED IN FRONT OF AND IN ADVANCE OF THE GUARDRAIL.


#### **GUARDRAIL PLACED BEHIND CURB**

(D = O DESIRABLE TO 12 (300) MAXIMUM)

V	w	ı	L	
V	VV	STEEL POST	WOOD POST	
0 - 18	24	21	23	
(0 - 460)	(610)	(530)	(580)	
>18 - 41.5	12	8	10	
(> 460 - 825)	(305)	(203)	(250)	
>41.5 - 53.5	12 - 0	8	10	
(> 825 - 1.13 M)	(350 - 0)	(203)	(250)	

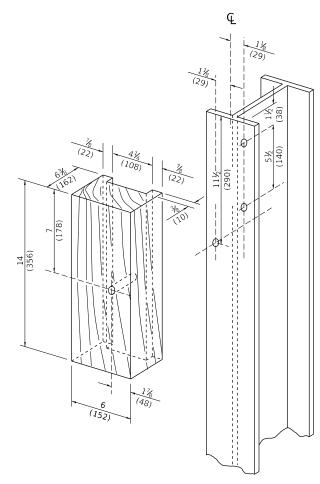

# WOOD BLOCK - OUT AND STEEL POST DETAILS

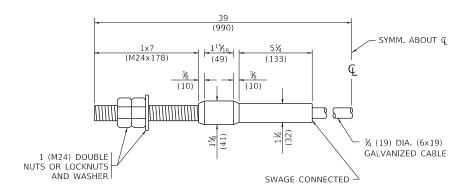

# **CABLE ASSEMBLY**


(40,000 LBS (18,100 KG) MIN. BREAKING STRENGTH)
TIGHTEN TO TAUT TENSION


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	DRAWN -	REVISED -
PLOT SCALE = 50.0000 ' / in.	CHECKED -	REVISED -
PLOT DATE = 3/11/2019	DATE -	REVISED -

STATE OF ILLINOIS	
DEPARTMENT OF TRANSPORTATION	N

SCALE: NONE

REMOVE AND REERECT							F.A. RTE	SECTION	COUNTY	UNTY TOTAL SHEET NO.	
STEEL PLATE BEAM GUARDRAIL					GUARDRAIL	0344	2020-261-BR	COOK	85	76	
J 1	ILLL	1 6		DLAW	GUAIIDIIAIL			BM-21	CONTRACT	NO. 6	2M41
SHEET	4	OF	4	SHEETS	STA.	TO STA.		ILLINOIS FED. A	ID PROJECT		

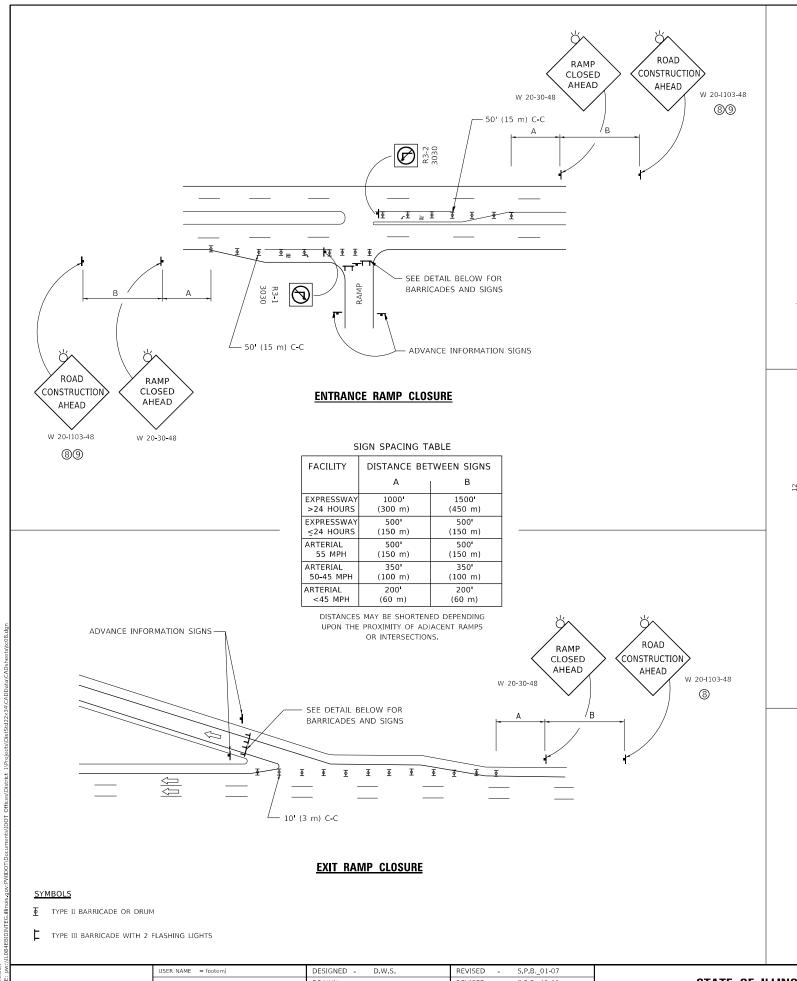

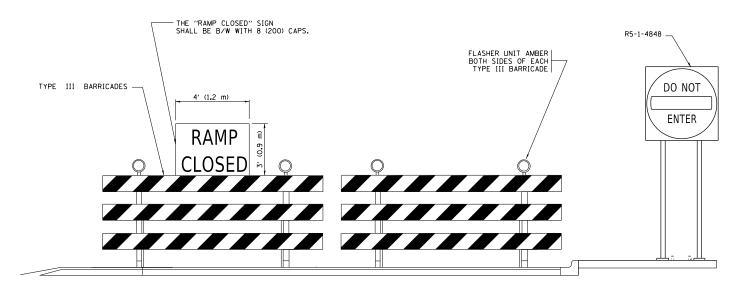


**DETAIL FOR REQUIRED BARRICADES & SIGNS** 

#### RAMP CLOSURE ADVANCE WARNING SIGN



BLACK LEGEND ON ORANGE BACKGROUND MOUNTED DIAGONALLY E MOD FONT

1 (25) BORDER
THESE SIGNS ARE REQUIRED ON ALL THE EXIT
GUIDE SIGNS FOR EXIT RAMPS THAT WILL BE
CLOSED FOR MORE THAN FOUR (4) CONSECUTIVE DAYS.

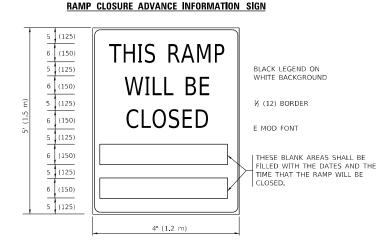

THESE SIGNS ARE REQUIRED ON BOTH SIDES OF THE RAMP, MINIMUM OF 1 WEEK IN ADVANCE OF THE CLOSURE.

THESE SIGNS SHALL BE FABRICATED AND PAID FOR ACCORDING TO THE TEMPORARY INFORMATION SIGNING SPECIAL PROVISION

#### GENERAL NOTES:

- ONES MAY BE SUBSTITUTED FOR DRUMS OR TYPE II
  BARRICADES DURING DAY OPERATIONS. CONES SHALL BE
  A MINIMUM OF 28 (700) HIGH.
- (2) VERTICAL BARRICADES SHALL NOT BE USED FOR RAMP CLOSURES.
- 3 A FLAGGER SHALL BE POSITIONED AT EACH CLOSED RAMP THAT IS OPEN TO CONSTRUCTION VEHICLES, PRECEEDED BY A W20-7 FLAGGER WARNING SIGN.
- ALL ROUTE MARKERS AND TRAILBLAZER ASSEMBLIES WHICH
  DIRECT MOTORISTS TO A CLOSED ENTRANCE RAMP SHALL BE
  COVERED WHEN THE RAMP IS CLOSED FOR MORE THAN FOUR (4) DAYS.
- (3) THE SIGNING AND BARRICADING WHICH IS REQUIRED BY THIS DETAIL SHALL BE INCLUDED IN THE COST OF TRAFFIC CONTROL AND PROTECTION (EXPRESSWAYS).

- 6 AUTHORIZATION FROM THE DISTRICT'S BUREAU OF TRAFFIC IS REQUIRED FOR ALL RAMP CLOSURES.
- THE RAMP CLOSURE ADVANCE INFORMATION SIGNS SHALL BE ERECTED
  IF THE CLOSURE TIME EXCEEDS TWENTY-FOUR (24) HOURS. ADDITIONAL
  ADVANCE WARNING SIGNS ON EXIT GUIDE SIGNING WILL BE
  REQUIRED FOR EXIT RAMP CLOSURES THAT EXCEED FOUR (4) DAYS IN LENGTH
- (8) ROAD CONSTRUCTION AHEAD SIGNS MAY BE OMITTED WHEN THIS DETAIL IS USED IN CONJUNCTION WITH OTHER TRAFFIC CONTROL THAT ALREADY INCLUDES A ROAD CONSTRUCTION AHEAD SIGN.
- ARTERIAL ROAD CONSTRUCTION AHEAD SIGNS SHALL BE INSTALLED
   ON THE LEFT SIDE OF TRAFFIC IF THE MEDIAN IS MORE THAN 10 FT WIDE.


ALL DIMENSIONS ARE IN INCHES (MILLIMETERS)
UNLESS OTHERWISE SHOWN.

COUNTY

COOK 85 77 CONTRACT NO. 62M41

USER NAME = footemj	DESIGNED - D.W.S. REVISED - S.P.B01-07			ENTRANCE AND EXIT RAMP					SECTION
	DRAWN -	REVISED - S.P.B12-09	STATE OF ILLINOIS		_	E DETAILS		0344	2020-261-BR
PLOT SCALE = 50.0000 / in.	CHECKED -	REVISED - M.D06-13	DEPARTMENT OF TRANSPORTATION		CLUSUK	E_DETAILS			TC-08
PLOT DATE = 3/4/2019	DATE - 02-83	REVISED - M.D. 01-18		SCALE: NONE	SHEET 1 OF 1	SHEETS STA.	TO STA.		ILLINOIS FED.

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#### NOTES:

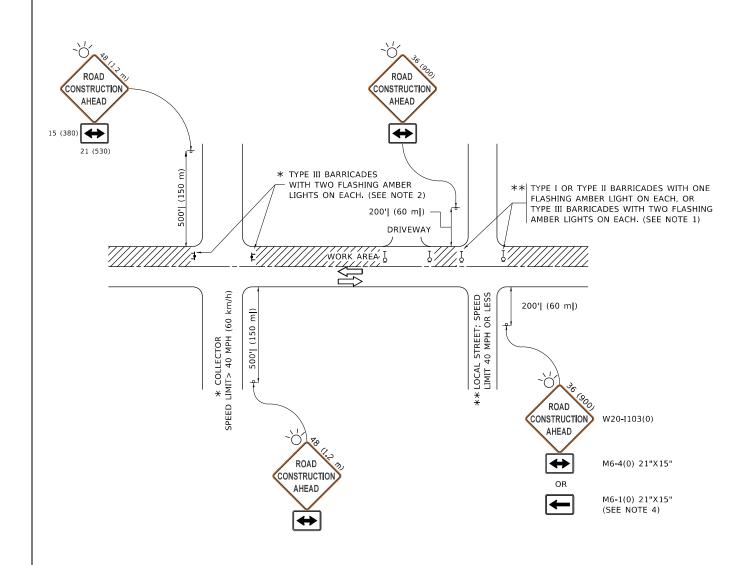- 1. SIDE ROAD WITH A SPEED LIMIT OF 40 MPH (60 km/h) OR LESS AS SHOWN ON THE DRAWING AND AS DIRECTED BY THE ENGINEER:
- a) ONE "ROAD CONSTRUCTION AHEAD" SIGN 36 x 36 (900x900) WITH A FLASHER MOUNTED ON IT APPROXIMATELY 200' (60 m) IN ADVANCE OF THE MAIN ROUTE.
- b) THE CLOSED PORTION OF THE MAIN ROUTE SHALL BE PROTECTED BY BLOCKING WITH TYPE I, TYPE II OR TYPE III BARRICADES, 1/3 OF THE CROSS SECTION OF THE CLOSED PORTION.
- SIDE ROAD WITH A SPEED LIMIT GREATER THAN 40 MPH (60 km/h) AS SHOWN ON THE DRAWING AND AS DIRECTED BY THE ENGINEER:
- a) ONE "ROAD CONSTRUCTION AHEAD" SIGN 48 x 48 (1.2 m x 1.2 m) WITH A FLASHER MOUNTED ON IT APPROXIMATELY 500' (150 m) IN ADVANCE OF THE MAIN ROUTE.
- THE CLOSED PORTION OF THE MAIN ROUTE SHALL BE PROTECTED BY
  b) BLOCKING WITH TYPE III BARRICADES, 1/2 OF THE CROSS SECTION
  OF THE CLOSED PORTION.
- 3. CONES MAY BE SUBSTITUTED FOR BARRICADES OR DRUMS AT HALF THE SPACING DURING DAY OPERATIONS. CONES SHALL BE A MINIMUM OF 28 (710)
- WHEN THE SIDE ROAD LIES BETWEEN THE BEGINNING OF THE MAINLINE
  4. SIGNING AND THE WORK ZONE, A SINGLE HEADED ARROW (M6-1) SHALL
  BE USED IN LIEU OF THE DOUBLE HEADED ARROW (M6-4).

- 5. WHEN WORK IS BEING PERFORMED ON A SIDE ROAD OR DRIVEWAY, FOLLOW THE APPLICABLE STANDARD(S). THE DIRECTIONAL ARROW (M6-1 OR M6-4) SHALL BE COVERED OR REMOVED WHEN NO LONGER CONSISTENT WITH THE TRAFFIC CONTROL SET-UP.
- 6. ADVANCE WARNING SIGNS ARE TO BE OMITTED ON DRIVEWAYS UNLESS OTHERWISE SPECIFIED IN THE PLANS OR BY THE ENGINEER
- 7. THE TRAFFIC CONTROL AND PROTECTION FOR SIDE ROADS, INTERSECTIONS, AND DRIVEWAYS SHALL BE INCLUDED IN THE COST OF SPECIFIED TRAFFIC CONTROL STANDARDS OR ITEMS.

All dimensions are in inches (millimeters) unless otherwise shown.


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	DRAWN -	REVISED - T. RAMMACHER 01-06-00
PLOT SCALE = 50.0000 / in.	CHECKED -	REVISED - A. SCHUETZE 07-01-13
PLOT DATE = 3/4/2019	DATE - 06-89	REVISED _ A. SCHUETZE 09-15-16


STATE OF ILLINOIS
DEPARTMENT OF TRANSPORTATION

s					TION FOR DRIVEWAYS
SCALE: NONE	SHEET 1	OF 1	SHEETS	STA.	TO STA.

F.A. RTE	SEC		COUNTY	TOTAL SHEETS	SHE				
0344	2020-2	T	COOK	85	78				
TC-10					CONTRACT NO. 62M41				
TILINOIS SED A					DROJECT				

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TYPE OF MARKING	WIDTH OF LINE	PATTERN	COLOR	SPACING / REMARKS
CENTERLINE ON 2 LANE PAVEMENT	4 (100)	SKIP-DASH	YELLOW	10' (3 m) LINE WITH 30' (9 m) SPACE
CENTERLINE ON MULTI-LANE UNDIVIDED PAVEMENT	2 @ 4 (100)	SOLID	YELLOW	11 (280) C-C
NO PASSING ZONE LINES: FOR ONE DIRECTION FOR BOTH DIRECTIONS	4 (100) 2 @ 4 (100)	SOLID SOLID	YELLOW YELLOW	5½ (140) C-C FROM SKIP-DASH CENTERLINE 11 (280) C-C OMIT SKIP-DASH CENTERLINE BETWEEN
LANE LINES	4 (100) 5 (125) ON FREEWAYS	SKIP-DASH SKIP-DASH	WHITE WHITE	10' (3 m) LINE WITH 30' (9 m) SPACE
DOTTED LINES (EXTENSIONS OF CENTER, LANE OR TURN LANE MARKINGS)	SAME AS LINE BEING EXTENDED	SKIP-DASH	SAME AS LINE BEING EXTENDED	2' (600) LINE WITH 6' (1.8 m) SPACE
EDGE LINES	4 (100)	SOLID	YELLOW-LEFT WHITE-RIGHT	OUTLINE MEDIANS IN YELLOW
TURN LANE MARKINGS	6 (150) LINE; FULL SIZE LETTERS & SYMBOLS (8' (2.4m))	SOLID	WHITE	SEE TYPICAL TURN LANE MARKING DETAIL
TWO WAY LEFT TURN MARKING	2 @ 4 (100) EACH DIRECTION 8' (2.4m) LEFT ARROW	SKIP-DASH AND SOLID IN PAIRS	YELLOW	10' (3 m) LINE WITH 30' (9 m) SPACE FOR SKIP-DASH; 5½ (140) C-C BETWEEN SOLID LINE AND SKIP-DASH LINE SEE TYPICAL TWO-WAY LEFT TURN MARKING DETAIL
CROSSWALK LINES (PEDESTRIAN) A. DIAGONALS (BIKE & EQUESTRIAN) B. LONGITUDINAL BARS (SCHOOL)	2 @ 6 (150) 12 (300) @ 45° 12 (300) @ 90°	SOLID SOLID SOLID	WHITE WHITE WHITE	NOT LESS THAN 6' (1.8 m) APART 2' (600) APART 2' (600) APART 5'ET TYPICAL CROSSWALK MARKING DETAILS.
STOP LINES	24 (600)	SOLID	WHITE	PLACE 4' (1.2 m) IN ADVANCE OF AND PARALLEL TO CROSSWALK, IF PRESENT. OTHERWISE, PLACE AT DESIRED STOPPING POINT. PARALLEL TO CROSSROAD CENTERLINE, WHERE POSSIBLE
PAINTED MEDIANS	2 @ 4 (100) WITH 12 (300) DIAGONALS @ 45° NO DIAGONALS USED FOR 4' (1.2 m) WIDE MEDIANS	SOLID	YELLOW: TWO WAY TRAFFIC WHITE: ONE WAY TRAFFIC	11 (280) C-C FOR THE DOUBLE LINE SEE TYPICAL PAINTED MEDIAN MARKING.
GORE MARKING AND CHANNELIZING LINES	8 (200) WITH 12 (300) DIAGONALS @ 45°	SOLID	WHITE	DIAGONALS: 15' (4.5 m) C-C (LESS THAN 30MPH (50 km/h)) 20' (6 m) C-C 30MPH (50 km/h) TO 45MPH (70 km/h)) 30' (9 m) C-C (OVER 45MPH (70 km/h))
RAILROAD CROSSING	24 (600) TRANSVERSE LINES; "RR" IS 6' (1.8 m) LETTERS; 16 (400) LINE FOR "X"	SOLID	WHITE	SEE STATE STANDARD 780001 AREA OF: "R"=3.6 SQ. FT. (0.33 m PEACH "X"=54.0 SQ. FT. (5.0 m )2
SHOULDER DIAGONALS (REQUIRED FOR SHOULDERS > 8')	12 (300) @ 45°	SOLID	WHITE - RIGHT YELLOW - LEFT	50' (15 m) C-C (LESS THAN 30MPH (50 km/h)) 75' (25 m) C-C (30 MPH (50 km/h) TO 45MPH (70 km/h)) 150' (45 m) C-C (OVER 45MPH (70 km/h))
U TURN ARROW	SEE DETAIL	SOLID	WHITE	16.3 SF
2 ARROW COMBINATION LEFT AND U TURN	SEE DETAIL	SOLID	WHITE	30.4 SF

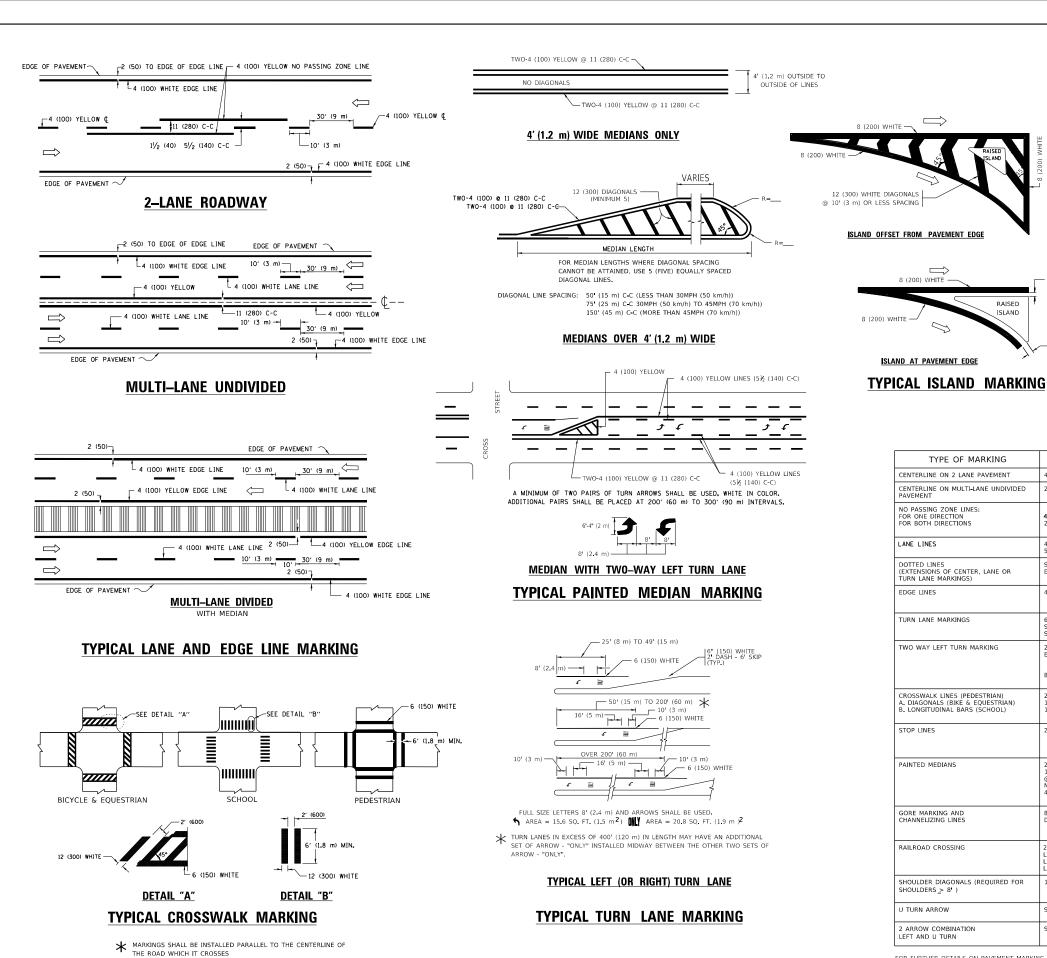FOR FURTHER DETAILS ON PAVEMENT MARKING REFER TO STANDARD SPECIFICATIONS FOR ROAD AND BRIDGE CONSTRUCTION AND STATE STANDARD 780001.

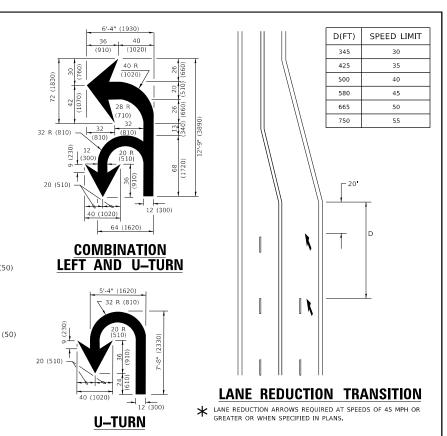SCALE: NONE

RAISED


All dimensions are in inches (millimeters) unless otherwise shown.

USER NAME = footemj	DESIGNED	-	EVERS	REVISED	-	C. JUCIUS 09-09-09
	DRAWN	-		REVISED	-	C. JUCIUS 07-01-13
PLOT SCALE = 50.0000 / in.	CHECKED	-		REVISED	-	C. JUCIUS 12-21-15
PLOT DATE = 3/4/2019	DATE	-	03-19-90	REVISED	-	C. JUCIUS 04-12-16

STATE OF ILLINOIS **DEPARTMENT OF TRANSPORTATION** 

	DISTRICT ONE				F.A. RTE	SECTION	COUNTY	TOTAL SHEETS	SHEET NO.		
TYPICAL PAVEMENT MARKINGS			0344	2020-261-BR	COOK	85	79				
			TC-13 CONTRACT NO. 6								
EΤ	1	OF	2	SHEETS	STA.	TO STA.		ILLINOIS FED. A	ID PROJECT		

# TURN BAY ENTRANCE AT START OF LANE CLOSURE TAPER

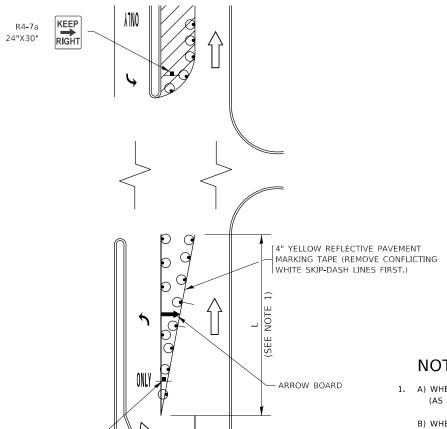

# FIGURE 1

SEE DETAIL "A"


# **LEGEND** WORK AREA LANE OPEN TO TRAFFIC ARROW BOARD TYPE I OR II BARRICADE OR DRUM WITH STEADY BURN LIGHT DRUM WITH STEADY BURN LIGHT SIGN ASSEMBLY

TYPE I OR II CHECK BARRICADE WITH FLASHING LIGHT

#### NOTES:

- 1. A) WHEN "L" IS ≤ THE STORAGE LENGTH OF THE TURN LANE (AS SHOWN IN FIG. 1), USE FIGURE 1.
  - B) WHEN "L" IS > THE STORAGE LENGTH OF THE TURN LANE OR THE TURN LANE IS WITHIN THE LANE CLOSURE, USE FIGURE 2.
- 2. CONES MAY BE SUBSTITUTED FOR BARRICADES OR DRUMS AT HALF THE SPACING DURING DAY OPERATIONS, CONES SHALL BE A MINIMUM OF 28 (710) IN HEIGHT.
- 3. LIGHTS WILL NOT BE REQUIRED ON BARRICADES OR DRUMS FOR DAY OPERATIONS. ALL LIGHTS SHALL BE MONODIRECTIONAL.
- 4. REFLECTIVE TEMPORARY PAVEMENT MARKINGS SHALL BE PLACED THROUGHOUT THE BARRICADED AREAS OF EACH TURN BAY AS SHOWN WHERE THE CLOSURE TIME IS GREATER THAN FOURTEEN (14) DAYS.
- 5. THIS APPLICATION ALSO APPLIES WHEN WORK IS BEING PERFORMED IN THE RIGHT LANE(S) AND THE RIGHT TURN BAY IS TO REMAIN OPEN. UNDER THIS CONDITION, "RIGHT TURN LANE" R3-I100R 24 x 24 (600 x 600) AND M6-2R 21 x 15 (530 x 380) SHALL BE USED.
- 6. THESE CONTROLS SHALL SUPPLEMENT MAINLINE TRAFFIC CONTROL FOR LANE CLOSURES.
- 7. THE SIGNS SHALL BE MOUNTED ABOVE THE BARRICADES/DRUMS ON SEPARATE SIGN SUPPORTS THAT MEET NCHRP 350 OR MASH PREOUIREMENTS.
- 8. TRAFFIC CONTROL AND PROTECTION AT TURN BAYS (TO REMAIN OPEN TO TRAFFIC) SHALL BE INCLUDED IN THE COST OF SPECIFIED TRAFFIC CONTROL STANDARDS OR ITEMS.

# **TURN BAY ENTRANCE** WITHIN A LANE CLOSURE

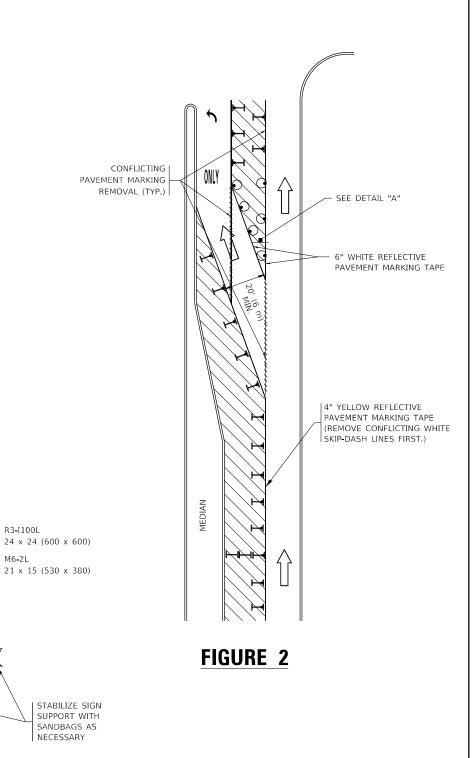

# **DETAIL A**

TURN

LANE


All dimensions are in inches (millimeters) unless otherwise shown.

USER NAME = rootemj	DESIGNED	- 1.	RAMMACHER	09-08-94	KEVISED	-	R. BORO 09-14-09
	DRAWN	-	A. HOUSEH	11-07-95	REVISED	- A.	SCHUETZE 07-01-13
PLOT SCALE = 50.0000 / in.	CHECKED	-	A. HOUSEH	10-12-96	REVISED	- A.	SCHUETZE 09-15-16
PLOT DATE = 3/4/2019	DATE	- T.	RAMMACHER	01-06-00	REVISED	-	

STATE OF ILLINOIS **DEPARTMENT OF TRANSPORTATION** 


TRAFFIC CONTROL AND PROTECTION AT TURN BAYS									
	(TO REMAIN OPEN TO TRAFFIC)								
(TO REIVIAIN OFEN TO TRAITIO)									Т
SCALE: NONE	SHEET	1	OF	1	SHEETS	STA.	TO STA.		

SECTION COOK 85 80 2020-261-BR TC-14 CONTRACT NO. 62M41

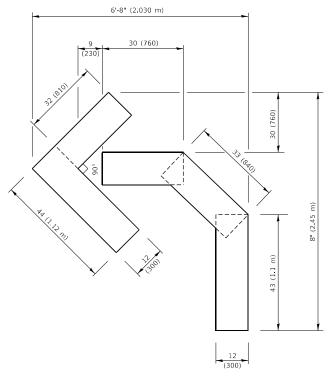


#### QUANTITY

4 (100) LINE = 45.5 ft. (13.9 m) 15.2 sq. ft. (1.41 sq. m)

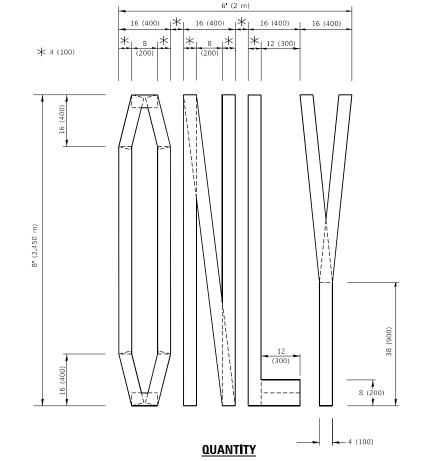

4 (100) LINE = 64.1 ft. (19.5 m) 21.4 sq. ft. (1.99 sq. m)

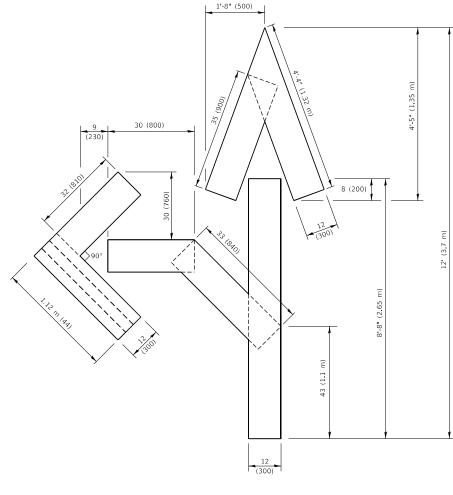


#### **QUANTITY**

4 (100) LINE = 82.5 ft. (25.1 m) 27.5 sq. ft. (2.53 sq. m)

## NOTE:

ALL QUANTITIES OF PLACEMENT ARE REPRESENTED IN LINEAR FEET OF 4" LINES TO MATCH THE 4" TEMPORARY TAPE PAY ITEM AND REPRESENTS THE TOTAL QUANTITY OF 4" TAPE REQUIRED.

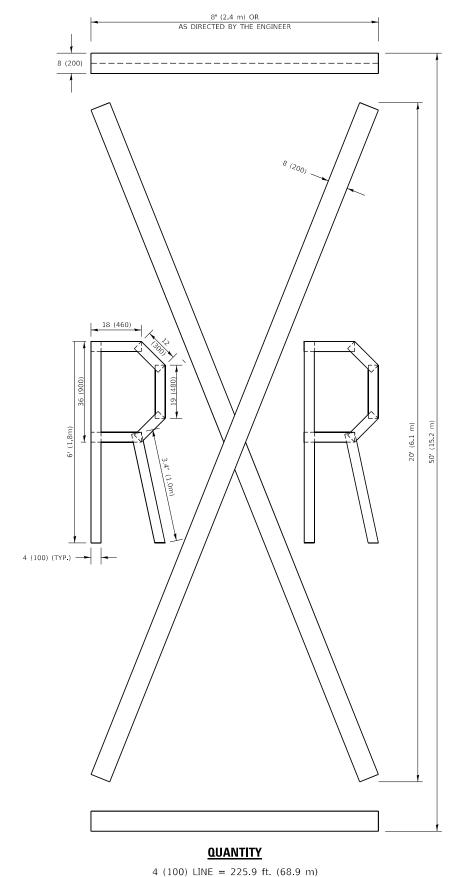

75.3 sq. ft. (68.9 m)

All dimensions are in inches (millimeters) unless otherwise shown.


USER NAME = footemj	DESIGNED	-		REVISED	- T. RAMMACHER 03-02-98
	DRAWN	-		REVISED	- E. GOMEZ 08-28-00
PLOT SCALE = 50.0068 / in.	CHECKED	-		REVISED	- E. GOMEZ 08-28-00
PLOT DATE = 3/4/2019	DATE	-	09-18-94	REVISED	- A. SCHUETZE 09-15-16

STATE OF ILLINOIS
DEPARTMENT OF TRANSPORTATION

SCALE: NONE SHEET 1 OF 1 SHEETS STA. TO STA.

F.A. RTE	SECT	ΠΟN		COUNTY	COUNTY TOTAL SHEETS		
0344	2020-2	261-BR		COOK	85	81	
	TC-16		CONTRACT NO. 62M41				
		ILLINOIS	ID PROJECT				


MODEL: Default

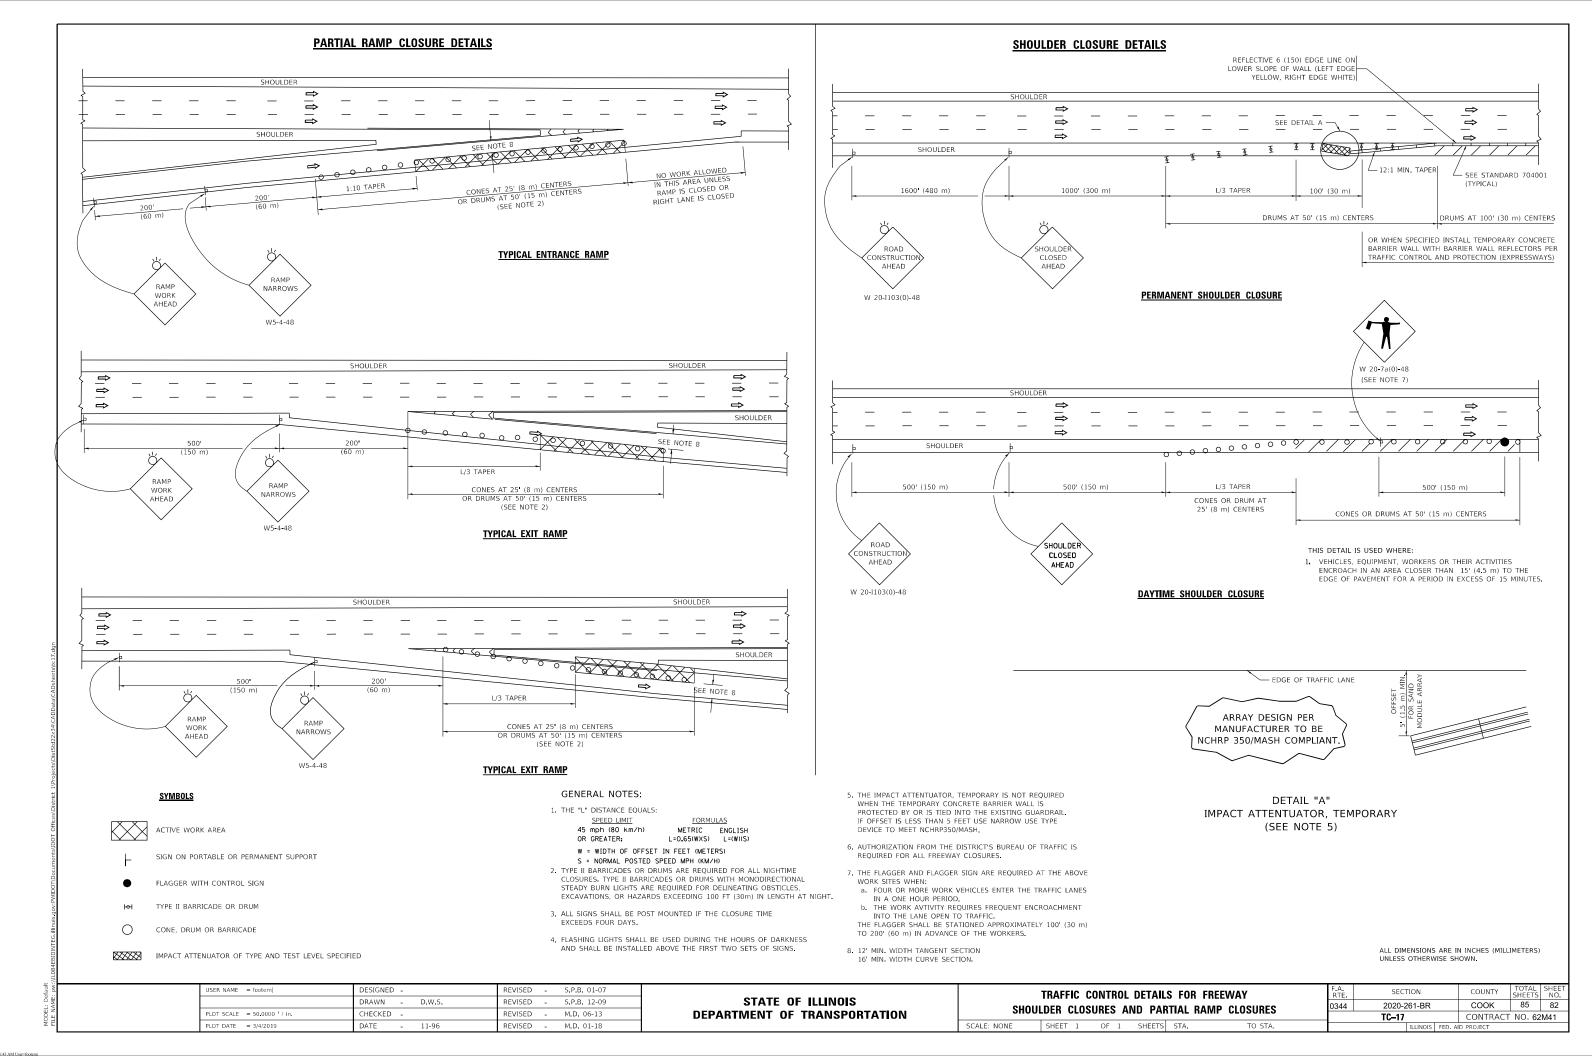


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#### SIGNING FOR FLAGGING OPERATIONS AT WORK ZONE OPENINGS

#### WORK ZONE EXIT OPENING

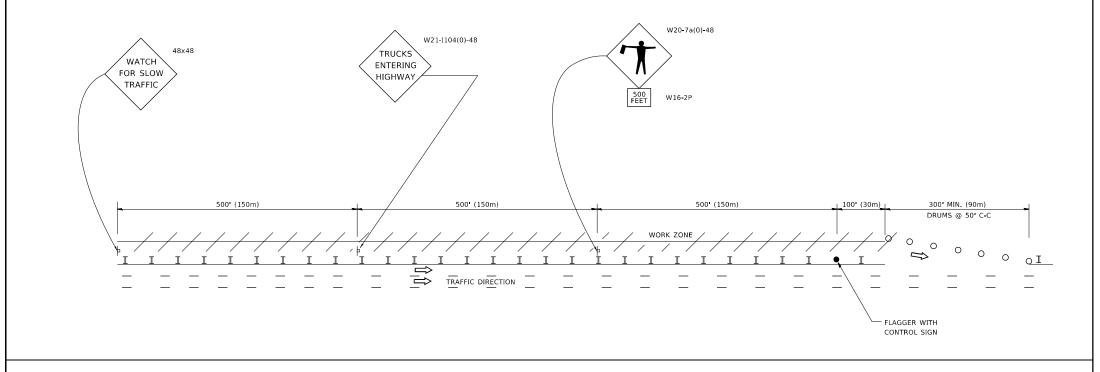

#### WORK ZONE ENTRY OPENING

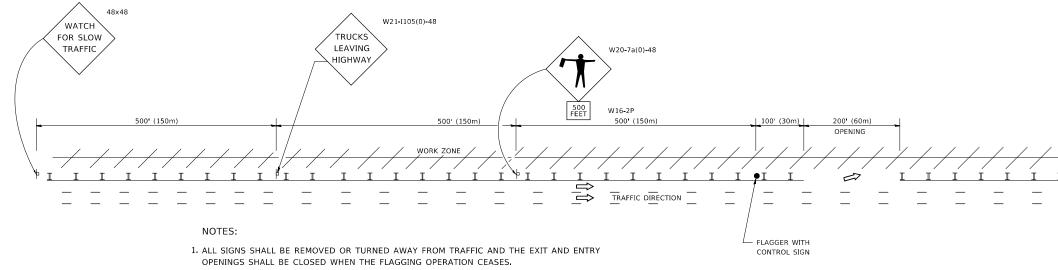

- NON OPERATING EQUIPMENT SHALL COMPLY WITH ARTICLE 701.11
- 2. WORK ZONE OPENINGS SHALL BE A MINIMUM OF ONE HALF MILE APART AND A MINIMUM OF ONE QUARTER MILE FROM ALL ENTRANCE AND EXIT RAMPS.
- 3. EXITING THE WORK ZONE AT ANY PLACE OTHER THAN AT A WORK ZONE EXIT OPENING WILL BE PROHIBITED.
- 4. ALL VEHICLES SHALL ENTER THE WORK ZONE AT ENTRY OPENINGS, USING THEIR TURN SIGNALS TO WARN MOTORISTS
- 5. FLAGGERS SHALL NOT STOP TRAFFIC OR DIRECT TRAFFIC INTO AN ADJACENT LANE.


ALL DIMENSIONS ARE IN INCHES (MILLIMETERS) UNLESS OTHERWISE SHOWN

USER NAME = footemj	DESIGNED -	REVISED	-	J.A.F. 02-06
	DRAWN -	REVISED	-	S.P.B. 01-07
PLOT SCALE = 50.0000 ' / in.	CHECKED -	REVISED	-	S.P.B. 12-09
PLOT DATE = 3/4/2019	DATE -	REVISED	-	M.D.06-13


STATE OF ILLINOIS **DEPARTMENT OF TRANSPORTATION** 

FREEWAY	/EXPRESS	SWAY SIGN	IING FOR FLA	GGING OPERATIONS
AT WOR	K ZONE	OPENINGS	ON FREEWAY	'S /EXPRESSWAYS
SCALE: NONE	SHEET 1	OF 1	SHEETS STA.	TO STA.

F.A. RTE.	SECTION	COUNTY	TOTAL SHEETS	SHEE NO.	
0344	2020-261-BR	COOK	85	83	
	TC-18	CONTRACT NO. 62M41			
	ILLINOIS	FED. A	ID PROJECT		

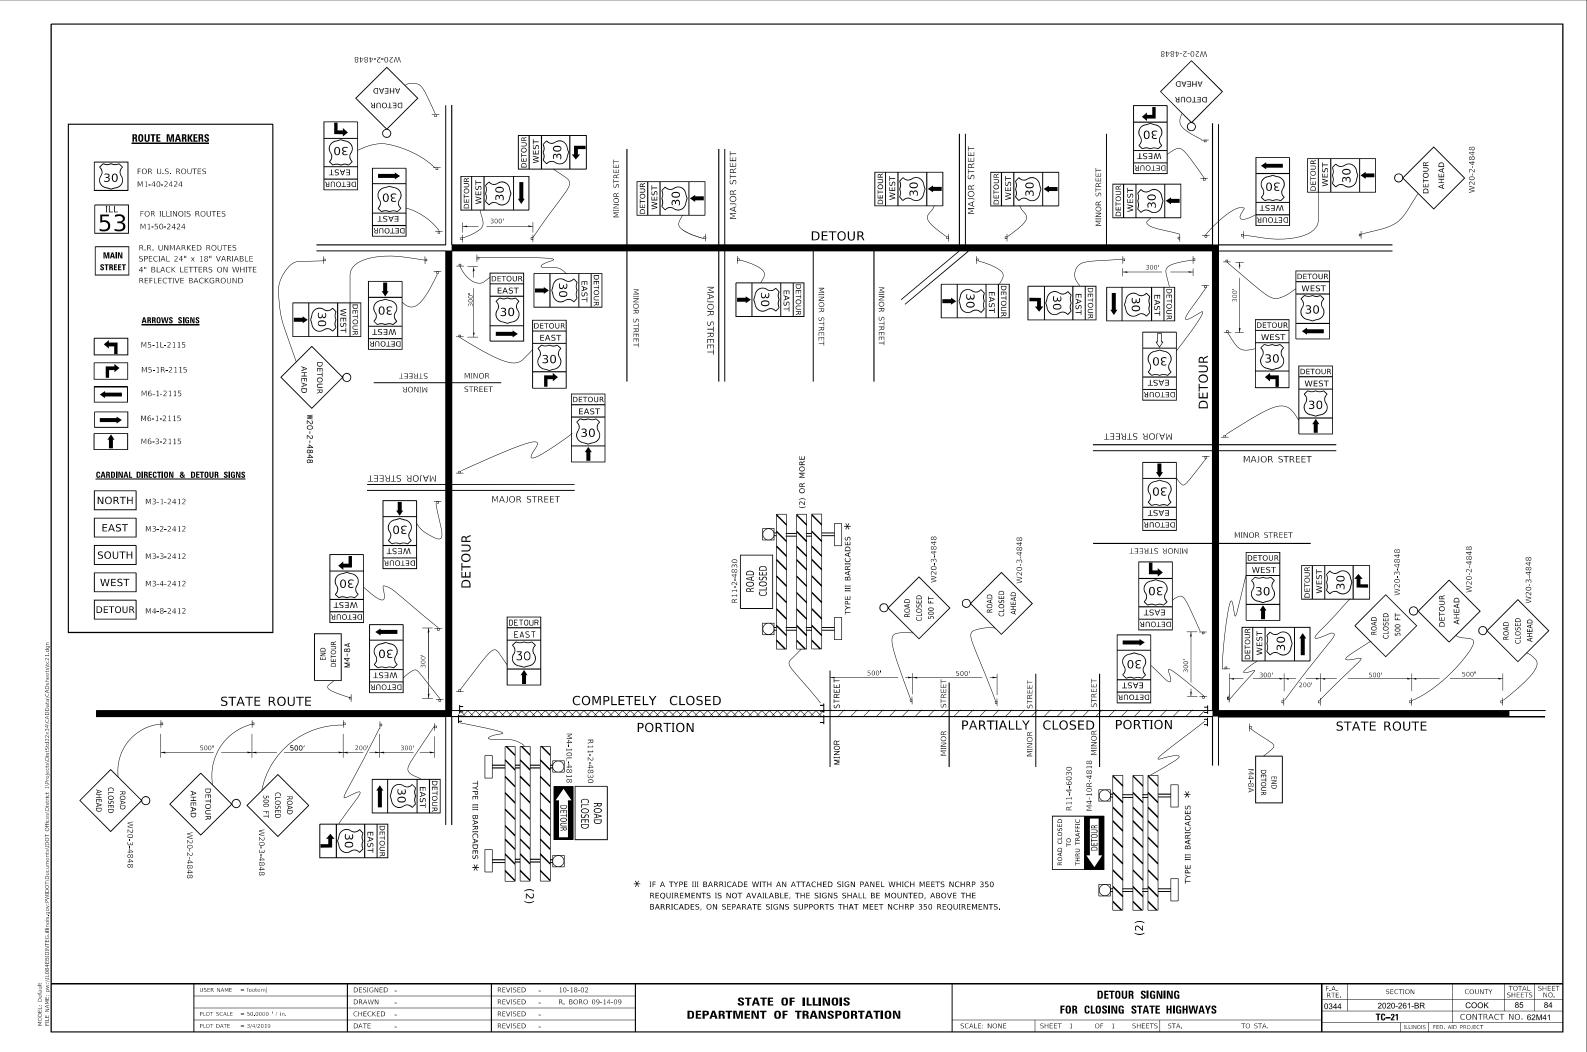

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# NOTES:

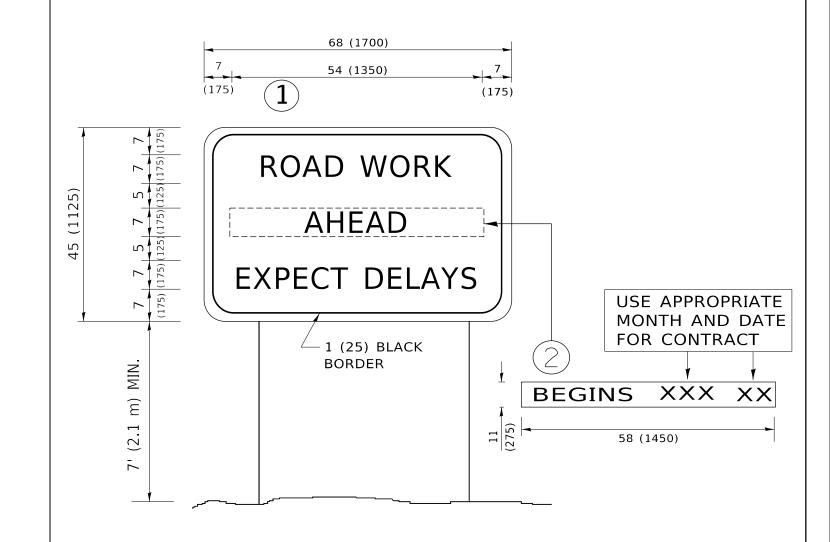- 1. USE BLACK LETTERING ON ORANGE BACKGROUND.
- 2. ERECT SIGNS IN ADVANCE OF THE LOCATION FOR THE "ROAD CONSTRUCTION AHEAD" SIGN AT LOCATIONS AS DIRECTED BY THE ENGINEER.
- 3. ERECT SIGN 1 WITH INSTALLED PANEL 2 ONE WEEK PRIOR TO THE START OF CONSTRUCTION.
- 4. REMOVE PANEL(2)SOON AFTER THE START OF CONSTRUCTION.
- 5. SEE SPECIAL PROVISION FOR "TEMPORARY INFORMATION SIGNING" FOR ADDITIONAL INFORMATION.
- 6. ONE SIGN ASSEMBLY EQUALS 25.70 SQ. FT. (2.3 SQ. M.)

SCALE: NONE

7. SHALL BE PAID FOR AS TEMPORARY INFORMATION SIGNING.

ALL DIMENSIONS ARE IN INCHES (MILLIMETERS) UNLESS OTHERWISE SHOWN.

USER NAME = footemj	DESIGNED -	REVISED	-	R. MIRS 09-15-97
	DRAWN -	REVISED	-	R. MIRS 12-11-97
PLOT SCALE = 50.0000 ' / in.	CHECKED -	REVISED	- T.	RAMMACHER 02-02-9
PLOT DATE = 3/4/2019	DATE -	REVISED		C JUCIUS 01-31-07

STATE OF ILLINOIS					
DEPARTMENT	OF	TRANSPORTATION			

	ARTE	RIAL RO	AD		F.A. RTE	SECTION
	INFORM	NOITAN	CICN		0344	2020-261-BR
	IIII OIII	IAIIUN	JIGIN			TC-22
1	OF 1	SHEETS	STA.	TO STA.		ILLINOIS I