FOR INDEX OF SHEETS, SEE SHEET NO. 2 06-11-2021 LETTING ITEM 093

STATE OF ILLINOIS

DEPARTMENT OF TRANSPORTATION

PLANS FOR PROPOSED FEDERAL AID HIGHWAY

FOR LIST OF HIGHWAY STANDARDS, SEE SHEET NO. 2


WOLF ROAD (F.A.U. 2689) SHARED-USE PATH
U.S. 34 (OGDEN AVENUE) TO S/O BEMIS WOODS TRAIL
SECTION NO. 16-00095-00-BT
PROJECT NO. 0QDI(381)
VILLAGE OF WESTERN SPRINGS, COOK COUNTY
JOB NO. C-91-123-17

TRAFFIC DATA:

DESIGN DESIGNATION: WOLF ROAD = MINOR ARTERIAL

ADT: WOLF ROAD = 19,000 (2018)

POSTED SPEED: WOLF ROAD - 40 MPH

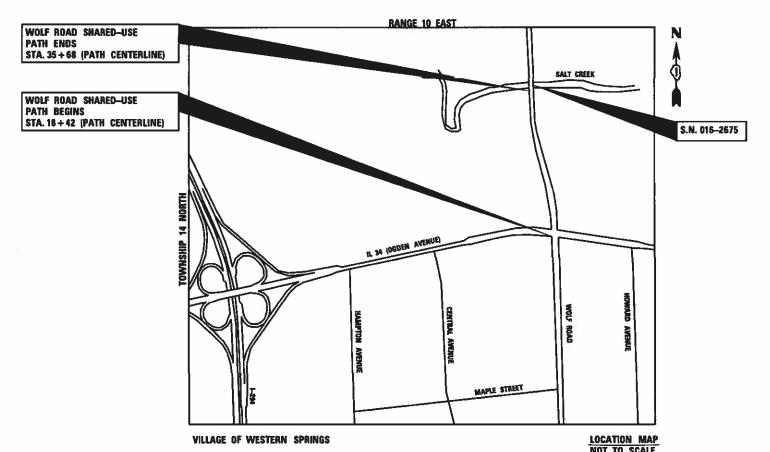

100' 200' 300'— 1''=100' 10' 20' 30'— 1''=10' 50' 100' 1''=50' 50' 100' - 1''=40' 100' - 1''=30' - 1''=20'

FULL SIZE PLANS HAVE BEEN PREPARED USING STANDARD ENGINEERING SCALES. REDUCED SIZED PLANS WILL NOT CONFORM TO STANDARD SCALES. IN MAKING MEASUREMENTS ON REDUCED PLANS, THE ABOVE SCALES MAY BE USED.

J.U.L.I.E.

JOINT UTILITY LOCATION INFORMATION FOR EXCAVATION 1-800-892-0123 OR 811

GROSS AND NET LENGTH = 1,726 FT. = 0.327 MILE

V3
MICHAEL J. RECHTORIK, P.E. # 062-058827

062-058827

03-31-2021

EXPIRATION DATE: 11-30-2021



TATE OF ILL	INOIS DEPARTMENT OF TRANSPORTATION
Approved	Monterellyn
	ew Supert Director of Municipal Services VILLAGE OF WESTERN SPRINGS
Approved .	Eric L. Otto
	Eric L. Otto, Civil Eng.
	FOREST PRESERVES OF CODK COUNTY
Passed	April 2, 2021
	College
	District 1 Engineer of Local Roads & Streets
eleasing for Bid sed on Limited Review	Area 2,2021
	Regional Engineer

PRINTED BY THE AUTHORITY OF THE STATE OF ILLINOIS

CONTRACT NO. 61H13

PROGRAM ENGINEER: CARMEN E. RAMO

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GENERAL NOTES

- ALL EXISTING TOPOGRAPHY, UNDERGROUND UTILITIES, STRUCTURES AND ASSOCIATED FACILITIES SHOWN ON THESE DRAWINGS HAVE BEEN PLOTTED FROM AVAILABLE SURVEYS AND RECORDS. THEREFORE, THEIR LOCATIONS AND ELEVATIONS MUST BE CONSIDERED APPROXIMATE ONLY. THERE MAY BE OTHER FACILITIES. THE EXISTENCE OF WHICH ARE NOT PRESENTLY KNOWN. THE EXACT LOCATIONS AND ELEVATIONS ARE TO BE VERIFIED
- ALL REFERENCES TO "ENGINEER" SHALL BE INTERPRETED AS THE RESIDENT ENGINEER. AND ALL REFERENCES TO "VILLAGE" AND TO "OWNER" SHALL BE INTERPRETED AS THE VILLAGE OF WESTERN SPRINGS.
- BEFORE STARTING ANY EXCAVATION, THE CONTRACTOR SHALL CALL "JULIE" AND THE VILLAGE OF WESTERN SPRINGS FOR FIELD LOCATIONS OF BURIED UTILITIES AT LEAST 48 HOURS IN ADVANCE OF WORK.
- 4. ALL UTILITY COMPANIES, SCHOOL DISTRICTS, AND LOCAL POLICE AND FIRE DEPARTMENT SHALL BE NOTIFIED BY THE CONTRACTOR AT LEAST 72 HOURS PRIOR TO THE START OF CONSTRUCTION. UTILITY INFORMATION CAN BE FOUND IN THE "STATUS OF UTILITIES (D-1)"

DEPARTMENT OF FIRE AND EMS: 708-246-1800 EXT. 171 DEPARTMENT OF LAW ENFORCEMENT SERVICES: 708-246-8540 SCHOOL DISTRICT 101: 708-246-3700

- 5. IT SHALL BE THE CONTRACTOR'S RESPONSIBILITY TO FIELD CHECK ALL DIMENSIONS AND ELEVATIONS OF EXISTING UTILITY LINES AND STRUCTURES THAT MAY BE IMPACTED BY THE PROPOSED WORK PRIOR TO ORDERING MATERIAL OR BEGINNING CONSTRUCTION. ANY DISCREPANCIES FROM THE PLANS SHALL BE REPORTED TO THE ENGINEER IMMEDIATELY
- 6. ANY DAMAGE TO EXISTING UTILITIES SHALL BE REPAIRED BY THE UTILITY COMPANY.
- THE CONTRACTOR SHALL USE ALL NECESSARY PRECAUTIONARY AND PROTECTIVE MEASURES REQUIRED TO MAINTAIN AND PROTECT EXISTING UTILITIES, SEWERS, MAINS AND APPURTENANCES THAT MUST BE KEPT IN OPERATION. IN PARTICULAR, THE CONTRACTOR SHALL TAKE ADEQUATE MEASURES TO PREVENT THE UNDERMINING OF UTILITIES, SEWERS AND MAINS WHICH WILL REMAIN IN SERVICE. THE CONTRACTOR SHALL COORDINATE WITH THE ENGINEER AND UTILITY COMPANY TO DETERMINE IF TEMPORARY BRACING OR SUPPORT OF THE UTILITIES IS REQUIRED.
- THE CONTRACTOR WILL NOT BE PERMITTED TO SET UP A YARD OR FIELD OFFICE ON STATE OR VILLAGE PROPERTY WITHOUT PRIOR WRITTEN PERMISSION OF THE DEPARTMENT
- WHERE SECTION OR SUBSECTION MONUMENTS ARE ENCOUNTERED, THE ENGINEER SHALL BE NOTIFIED BEFORE SUCH MONUMENTS ARE DISTURBED. THE CONTRACTOR SHALL CAREFULLY PRESERVE ALL PROPERTY MARKERS AND MONUMENTS UNTIL THE OWNER, AN AUTHORIZED SURVEYOR OR AGENT HAS WITNESSED OR OTHERWISE REFERENCED EACH LOCATION.
- 10. ALL APPLICABLE PROVISIONS OF THE CURRENT OCCUPATIONAL SAFETY AND HEALTH ACT ARE HEREIN INCORPORATED BY REFERENCE.
- 11. NO WORK SHALL COMMENCE UNTIL TRAFFIC CONTROL REQUIREMENTS ARE MET
- EXCEPT WHERE MODIFIED BY THE CONTRACT DOCUMENTS, ALL CONSTRUCTION SHALL BE IN ACCORDANCE WITH THE FOLLOWING SPECIFICATIONS:
 - "STANDARD SPECIFICATIONS FOR ROAD AND BRIDGE CONSTRUCTION" BRIDGE CONSTRUCTION", ADOPTED BY THE ILLINOIS DEPARTMENT OF TRANSPORTATION, APRIL 1, 2016.
 - "SUPPLEMENTAL SPECIFICATIONS AND RECURRING SPECIAL PROVISIONS" ADOPTED BY THE ILLINOIS DEPARTMENT OF TRANSPORTATION, JANUARY 1, 2021.
 - THE LATEST EDITIONS OF THE MUNICIPAL CODE AND STANDARDS OF THE VILLAGE OF WESTERN SPRINGS.
 - THE ILLINOIS ACCESSIBILITY CODE.
 - THE LATEST EDITIONS OF THE "MANUAL ON UNIFORM TRAFFIC CONTROL DEVICES FOR STREETS AND HIGHWAYS", AND THE "ILLINOIS SUPPLEMENT TO THE NATIONAL MANUAL ON UNIFORM TRAFFIC CONTROL DEVICES"
 - "STANDARD SPECIFICATIONS FOR WATER AND SEWER MAIN CONSTRUCTION IN ILLINOIS", LATEST EDITION
 - "ILLINOIS RECOMMENDED STANDARDS FOR SEWAGE WORKS," AS PUBLISHED BY THE IEPA, LATEST EDITION
 - "MANUAL OF TEST PROCEDURES FOR MATERIALS", LATEST EDITION
 - "ILLINOIS URBAN MANUAL", LATEST EDITION
 - THE NATIONAL ELECTRIC CODE, LATEST EDITION.
- 13. THE CONTRACTOR IS SOLELY RESPONSIBLE FOR THE CONSTRUCTION MEANS, METHODS, TECHNIQUES, SEQUENCES OR PROCEDURES, TIME OF PERFORMANCE, PROGRAMS OR ANY SAFETY PRECAUTIONS USED BY THE CONTRACTOR. THE CONTRACTOR IS SOLELY RESPONSIBLE FOR EXECUTION OF HIS/HER WORK IN ACCORDANCE WITH THE CONTRACT DOCUMENTS AND SPECIFICATIONS.

- 14. THE CONTRACTOR IS RESPONSIBLE FOR HAVING A SET OF "APPROVED" ENGINEERING PLANS WITH THE LATEST REVISION DATE ON THE JOB SITE PRIOR TO THE START OF CONSTRUCTION AND AT ALL TIMES DURING CONSTRUCTION.
- 15. THE CONTRACTOR SHALL NOTIFY THE ENGINEER, RESIDENTS, BUSINESSES, AND THE VILLAGE WHEN ACCESS TO DRIVEWAYS WILL BE TEMPORARILY CLOSED OR IMPACTED DUE TO CURB AND GUTTER AND/OR DRIVEWAY REPLACEMENT. THE CONTRACTOR SHALL DISTRIBUTE NOTICES PROVIDED BY THE VILLAGE TO RESIDENTS AND BUSINESSES AT LEAST 24 HOURS PRIOR TO PLANNED CLOSURE. EVERY EFFORT SHALL BE MADE TO ACCOMMODATE ACCESS TO THESE PROPERTIES INCLUDING KNOCKING ON DOORS WHEN DRIVEWAYS ARE ABOUT TO BE CLOSED.
- 16. PORTABLE/CHANGEABLE ELECTRONIC MESSAGE BOARDS SHALL BE USED IN ADVANCE OF THE PROJECT ACCORDING TO IDOT STANDARDS AND SHALL BE IN PLACE A MINIMUM OF 72 HOURS PRIOR TO COMMENCING THE WORK AND REMAIN THROUGHOUT THE ROADWAY CONSTRUCTION
- 17. AREAS TO BE RESTORED OUTSIDE THE FURNISHED TOPSOIL PLACEMENT SHALL BE PREPARED ACCORDING TO SECTION 252 OF THE STANDARD SPECIFICATIONS.
- 18. THE CONTRACTOR SHALL CONTACT THE DISTRICT ONE TRAFFIC CONTROL SUPERVISOR FOR ARTERIALS AT KALPANA.KANNAN-HOSADURGA@ILLINOIS.GOV AT LEAST 72 HOURS BEFORE BEGINNING WORK.
- 19. ALL STATION AND OFFSETS SHOWN IN THE PLANS ARE FROM SHARED-USE PATH CL ALIGNMENT UNLESS
- DURING CONSTRUCTION OF PROPOSED IMPROVEMENTS ALONG COOK COUNTY HIGHWAYS, TWO-WAY TRAFFIC SHALL REMAIN OPEN FOR ALL TRAFFIC AT ALL TIMES. IF ANY ACTIVITY REQUIRES ENCROACHMENT INTO A LANE, THAT ACTIVITY SHALL BE RESTRICTED TO WITHIN THE HOURS OF 9:00 A.M. TO 3:00 P.M., FOLLOWING THE APPLICABLE IDOT AND IDOT DISTRICT 1 TRAFFIC CONTROL STANDARDS INCLUDED IN THE PLANS FOR OFF-ROAD AND ON-ROAD APPLICATIONS.
- 21. IF ANY EXISTING PAVEMENT MARKING AND/OR SIGNING ALONG COOK COUNTY ROADWAYS IS DAMAGED DUE TO CONSTRUCTION OF PROPOSED IMPROVEMENTS. THE CONTRACTOR SHALL REPLACE THE DAMAGED TRAFFIC CONTROL DEVICES TO THE SATISFACTION OF COOK COUNTY PER IDOT AND IDOT DISTRICT 1. STANDARDS FOR TRAFFIC CONTROL DEVICES, PAVEMENT MARKING, AND SIGNAGE INCLUDED IN THE PLANS.
- 22. AGGREGATE SUBGRADE IMPROVEMENT (CU.YD.) HAS BEEN PROVIDED FOR USE AT THE LOCATION INDICATED FOR SOILS THAT TEND TO BE UNSTABLE AND/ OR UNSUITABLE. THE ACTUAL NEED FOR REMOVAL AND REPLACEMENT WITH AGGREAGTE SUBGRADE IMPROVEMENT (CU.YD.) WILL BE DETERMINED IN THE FIELD AT THE TIME OF CONSTRUCTION BY THE GEOTECHNICAL ENGINEER. ALL POTENTIALLY UNSTABLE SOIL SHOULD WITH A STATIC AND/OR DYNAMIC CONE PENETROMETER AND TREATED IN ACCORDANCE WITH ARTICLE 301.04 OF THE SSRBC STANDARD AND CURRENT IDOT SUBGRADE STABILITY MANUAL. IF UNSTABLE AND/OR UNSUITABLE SOIL ARE NOT ENCOUNTER, THEN THE QUANTITY SHALL BE DEDUCTED AND NO ADDITIONAL COMPENSATION WILL BE DUE TO THE CONTRACTOR.

REMOVALS, SIDEWALK, CURB AND GUTTER, AND PAVING NOTES

- ALL EXISTING PAVEMENT OR CONCRETE CURB AND GUTTER TO BE REMOVED SHALL BE SAWCUT ALONG LIMITS OF PROPOSED REMOVAL BEFORE COMMENCEMENT OF PAVEMENT
- THE CONTRACTOR IS RESPONSIBLE FOR THE PROPER AND LAWFUL REMOVAL AND DISPOSAL OF EXCAVATED MATERIALS FROM THE JOBSITE.
- NO HOLES ARE TO BE LEFT OPEN IN THE PAVEMENT OR PARKWAY OVER A HOLIDAY WEEKEND OR AFTER 3:00 P.M. ON THE DAY PRECEDING A HOLIDAY OR A WEEKEND.
- PAVEMENT AND CURBS TO REMAIN SHALL BE PROTECTED FROM DAMAGE. IF DAMAGED, IT SHALL BE REPLACED PROMPTLY IN CONFORMANCE WITH THE MUNICIPALITY OR IDOT STANDARD SPECIFICATIONS IN MATERIALS AND WORKMANSHIP AND BY CONTRACTOR.
- ALL CURB RADII REFER TO EDGE OF PAVMENT UNLESS OTHERWISE NOTED.
- PROPOSED ELEVATIONS INDICATE FINISHED CONDITIONS. FOR ROUGH GRADING ELEVATIONS ALLOW FOR THICKNESS OF PROPOSED PAVING (ROADS, WALKS, DRIVES, ETC.) OR TOPSOIL AS INDICATED ON DRAWINGS

DRAINAGE NOTES

- STRUCTURE OFFSET LOCATIONS ARE TO THE EDGE OF PAVEMENT IF THE STRUCTURE IS IN THE CURB LINE OR TO THE CENTER OF THE STRUCTURE IF THE STRUCTURE IS NOT IN THE
- 2. WHENEVER, DURING CONSTRUCTION OPERATIONS, LOOSE MATERIAL IS DEPOSITED IN THE FLOW LINE OF GUTTERS. DRAINAGE STRUCTURES. DITCHES ETC., SUCH THAT THE NATURAL FLOW LINE OF WATER IS OBSTRUCTED. THE LOOSE MATERIAL SHALL BE REMOVED AT THE CLOSE OF EACH WORKING DAY. PRIOR TO ACCEPTANCE OF THE IMPROVEMENT, ALL DRAINAGE STRUCTURES AND FLOW LINES SHALL BE FREE FROM DIRT AND DEBRIS
- THE CONTRACTOR IS RESPONSIBLE FOR VERIFYING ALL EXISTING PIPE SIZES, INVERTS FLOW DIRECTION, AND CONNECTIONS PRIOR TO ORDERING ANY MATERIALS TO CONFIRM THAT THE PROPOSED PIPES AND STRUCTURES ARE ADEQUATE AND RESULT IN POSITIVE

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- SHARED USE PATH PLAN AND PROFILE ADA DETAILS
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001001-02	AREAS OF REINFORCEMENT BARS
001006	DECIMAL OF AN INCH AND OF A FOOT
280001-07	TEMPORARY EROSION CONTROL SYSTEMS
424001-11	PERPENDICULAR CURB RAMPS FOR SIDEWALKS
E 42 40 1 0 4	METAL FLADED FND SECTION FOR DIDE CHILLEDTS

- METAL FLARED END SECTION FOR PIPE CULVERTS 542401-04 602011-02 CATCH BASIN, TYPE C
- PRECAST MANHOLE, TYPE A, 5"(1.52 M) DIAMETER 602402-03
- 602601-06 PRECAST REINFORCED CONCRETE FLAT SLAB TOP
- 602701-02 MANHOLE STEPS 604001-05 FRAME AND LIDS, TYPE 1
- 604036-03 GRATE, TYPE 8
- CONCRETE CURB TYPE B AND COMBINATION CONCRETE CURB AND GUTTER OFF-ROAD OPERATIONS, 2L, 2W, MORE THAN $15^{\circ}(4.5\ \text{M})$ AWAY 606001-07 701001-02
- OFF-ROAD OPERATIONS, 2L, 2W, 15'(4.5 M) TO 24"(600 MM) FROM PAVEMENT EDGE 701006-05
- OFF-ROAD MOVING OPERATIONS, 2L, 2W, DAY ONLY 701011-04
- 701101-05 OFF-ROAD OPERATIONS, MULTILANE, 15'(4.5 M) TO 24"(600 MM) FROM PAVEMENT EDGE 701106-02 OFF-ROAD OPERATIONS, MULTILANE, MORE THAN 15'(4.5 M) AWAY
- LANE CLOSURE, MULTILANE, INTERMITTENT OR MOVING OPERATION, FOR SPEEDS <=40 MPH 701427-05
- 701606-10 URBAN SINGLE LANE CLOSURE, MULTILANE, 2W WITH MOUNTABLE MEDIAN
- 701701-10 URBAN LANE CLOSURE, MULTILANE INTERSECTION
- 701801-06 SIDEWALK, CORNER OR CROSSWALK CLOSURE
- 701901-08 TRAFFIC CONTROL DEVICES
- 720001-01 SIGN PANEL MOUNTING DETAILS
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- 878001-11 CONCRETE FOUNDATION DETAILS
- TRAFFIC SIGNAL MOUNTING DETAILS 880006-01
- 886001-01 DETECTOR LOOP INSTALLATIONS
- 886006-01 TYPICAL LAYOUT FOR DETECTION LOOPS


IDOT DISTRICT ONE STANDARDS

- PAVEMENT PATCHING FOR HMA SURFACED PAVEMENT
- CURB OR CURB AND GUTTER REMOVAL AND REPLACEMENT RD-24
- TRAFFIC CONTROL AND PROTECTION FOR SIDE ROADS, INTERSECTIONS AND DRIVEWAYS
- DISTRICT ONE TYPICAL PAVEMENT MARKINGS
- TRAFFIC CONTROL AND PROTECTION AT TURN BAYS (TO REMAIN OPEN TO TRAFFIC)
- ATERIAL ROAD INFORMATION SIGN
- STANDARD TRAFFIC SIGNAL DESIGN DETAILS

COMMITMENTS

SHEET 1 OF 2 SHEETS STA.

SCALE: NONE

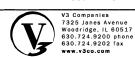

USER NAME = cschwarzer	DESIGNED -	CAS	REVISED -
	DRAWN -	DRP	REVISED -
PLOT SCALE = 2'	CHECKED -	MJR	REVISED -
PLOT DATE = 4/14/2021	DATE -	3/31/2021	REVISED -

STATE OF ILLINOIS **DEPARTMENT OF TRANSPORTATION** INDEX OF SHEETS, HIGHWAY STANDARDS, AND GENERAL NOTES

COUNTY SECTION 2689 16-00095-00-BT COOK 54 CONTRACT NO. 61H13 ILLINOIS FED AID PROJECT TENDI (0.66)

SIGNING AND PAVEMENT MARKING NOTES

- 1. TWO WEEKS PRIOR TO PLACEMENT OF PERMANENT PAVEMENT MARKINGS, THE ENGINEER SHALL CONTACT EMAD ALHUSSEINI, AREA TRAFFIC FIELD ENGINEER AT EMAD.ALHUSSEINI@ILLINOIS.GOV.
- BEFORE BEGINNING ANY WORK, THE CONTRACTOR SHALL RETAIN AND RECORD FOR FUTURE REFERENCE, ALL EXISTING PAVEMENT MARKING LINES (AND RAISED REFLECTIVE PAVEMENT MARKERS IN ORDER THAT THESE LOCATIONS CAN BE REESTABLISHED FOR STRIPING. EXACT LOCATIONS OF ALL PAVEMENT MARKINGS SHALL BE DIRECTED BY THE ENGINEER.
- 3. PAVEMENT MARKING ON US 34 (OGDEN AVENUE) SHALL BE COORDINATED WITH IDOT CONTRACTOR (IDOT CONTRACT 62J73).

GENERAL SOIL AND EROSION CONTROL NOTES

- SOIL DISTURBANCE SHALL BE CONDUCTED IN SUCH A MANNER AS TO MINIMIZE EROSION. SOIL STABILIZATION MEASURES SHALL CONSIDER THE TIME OF YEAR, SITE CONDITIONS, AND THE USE OF TEMPORARY OR PERMANENT MEASURES.
- 2. SOIL EROSION AND SEDIMENT CONTROL FEATURES SHALL BE CONSTRUCTED PRIOR TO THE COMMENCEMENT OF UPLAND DISTURBANCE.
- 3. DISTURBED AREAS SHALL BE STABILIZED WITH TEMPORARY OR PERMANENT MEASURES WITHIN 14 CALENDAR DAYS OF THE END OF ACTIVE HYDROLOGIC DISTURBANCE.
- 4. ALL STORM SEWER FACILITIES THAT ARE OR WILL BE FUNCTIONING DURING CONSTRUCTION SHALL BE PROTECTED BY AN APPROPRIATE EROSION CONTROL MEASURE.
- 5. ALL TEMPORARY EROSION AND SEDIMENT CONTROL MEASURES SHALL BE REMOVED WITHIN 30 CALENDAR DAYS AFTER FINAL SITE STABILIZATION IS ACHIEVED OR AFTER THE TEMPORARY MEASURES ARE NO LONGER NEEDED. TRAPPED SEDIMENT AND OTHER DISTURBED SOIL AREAS SHALL BE PERMANENTLY STABILIZED.
- 6. ALL TEMPORARY AND PERMANENT EROSION CONTROL MEASURES SHALL BE MAINTAINED AND REPAIRED AS NEEDED. THE CONTRACTOR SHALL BE ULTIMATELY RESPONSIBLE FOR INSPECTION, MAINTENANCE AND REPAIR OF EROSION CONTROL MEASURES DURING CONSTRUCTION.
- 7. THE EROSION AND SEDIMENT CONTROL MEASURES INDICATED ON THE PLANS ARE THE MINIMUM REQUIREMENTS. ADDITIONAL MEASURES MAY BE REQUIRED AS COORDINATED WITH THE VILLAGE OR DIRECTED BY THE ENGINEER.
- 8. THE CONTRACTOR SHALL PROVIDE EROSION CONTROL MEASURES FOR STOCKPILES TO REMAIN FOR MORE THAN 3 DAYS.
- 9. ALL PROVIDED MEASURES, INSPECTIONS, MAINTENANCE, AND REPAIRS SHALL BE IN ACCORDANCE WITH THE STORM WATER POLLUTION PREVENTION PLAN AND ILLINOIS URBAN MANUAL.

	V3 Companies
/\	7325 Janes Avenue
	Woodridge, IL 60517
	630.724.9200 phone
\ V	630.724.9202 fax
\ . '	www.v3co.com

USER NAME = cfigus	DESIGNED -	CAS	REVISED -
	DRAWN -	DRP	REVISED -
PLOT SCALE = 2'	CHECKED -	MJR	REVISED -
PLOT DATE = 3/31/2021	DATE -	3/31/2021	REVISED -

STATE OF ILLINOIS
DEPARTMENT OF TRANSPORTATION

	OFNEDAL MOTEO	F.A.U. RTE	SECTION	COUNTY	TOTAL SHEETS	SHEET NO.
	GENERAL NOTES	2689	16-00095-00-BT	соок	54	3
				CONTRAC	T NO. 61	H13
SCALE: NONE	SHEET 2 OF 2 SHEETS STA. TO STA.		ILLINOIS FED. A	ID PROJECT TE-01	D1(066)	

SPECIALTY ITEM	SPECIAL PROVISION	CODE NO.	ITEM	UNIT	TOTAL QUANTITY	ROADWAY 80% FEDERAL 20% LOCAL 0028
- Hara		20100110	TREE REMOVAL (6 TO 15 UNITS DIAMETER)	UNIT	1,534	1,534
#		20100210	TREE REMOVAL (OVER 15 UNITS DIAMETER)	LINIT	C 40	649
		20100210	TREE REMOVAL (OVER 13 UNITS DIAMETER)	UNIT	649	049
		20101100	TREE TRUNK PROTECTION	EACH	29	29
*		20101200	TREE ROOT PRUNING	EACH	29	29
		20200100	EARTH EXCAVATION	CU YD	335	335
,	·				•	
		20201200	REMOVAL AND DISPOSAL OF UNSUITABLE MATERIAL	CU YD	805	805
	*	20400800	FURNISHED EXCAVATION	CU YD	520	520
		20800150	TRENCH BACKFILL	CU YD	14	14
		21101615	TOPSOIL FURNISH AND PLACE, 4"	SQ YD	4,911	4,911
#		25000210	SEEDING, CLASS 2A	ACRE	0.75	0.75
		28000250	TEMPORARY EROSION CONTROL SEEDING	POUND	101	101
		28000400	PERIMETER EROSION BARRIER	FOOT	1,761	1,761
		28000510	INLET FILTERS	EACH	4	4
		28001100	TEMPORARY EROSION CONTROL BLANKET	SQ YD	4,911	4,911
	*	30300001	AGGREGATE SUBGRADE IMPROVEMENT	CU YD	25	25
		35101800	AGGREGATE BASE COURSE, TYPE B 6"	SQ YD	2,096	2,096
		40600275	BITUMINOUS MATERIALS (PRIME COAT)	POUND	4,706	4,706
		40604060	HOT-MIX ASPHALT SURFACE COURSE, IL-9.5, MIX "D", N50	TON	319	319
		40604062	HOT-MIX ASPHALT SURFACE COURSE, IL-9.5, MIX "D", N70	TON	1	1

$\overline{\mathbf{V}}$	V3 Companies 7325 Janes Avenue Woodridge, IL 60517 630.724.9200 phone 630.724.9202 fax
\	www.v3co.com

USER NAME = cfigus	DESIGNED -	 CAS	REVISED	-
	DRAWN -	DRP	REVISED	-
PLOT SCALE = 2'	CHECKED -	MJR	REVISED	-
PLOT DATE = 3/31/2021	DATE -	 3/31/2021	REVISED	-

STATE OF ILLINOIS
DEPARTMENT OF TRANSPORTATION

SUMMARY OF QUANTITIES										SECT	TION		COUNTY	SHEETS	SHE
			S	UMM	IAR	OF QUA	ANIIIIES	i	2689	16-0009	5-00-BT		соок	54	4
													CONTRACT	NO. 6	1H13
	SCALE: NONE	SHEET	1	OF	4	SHEETS	STA.	TO STA.			ILLINOIS	FED. A	ID PROJECT TE-010	1(066)	

SPECIALTY ITEM	SPECIAL PROVISION	CODE NO.	ITEM	UNIT	TOTAL QUANTITY	ROADWAY 80% FEDERAL 20% LOCAL 0028
IICM	PROVISION	CODE NO.	TIEM TIEM		QOANTITY	0028
		42400200	PORTLAND CEMENT CONCRETE SIDEWALK 5 INCH	SQ FT	260	260
		42400800	DETECTABLE WARNINGS	SQ FT	43	43
-						
	*	44000600	SIDEWALK REMOVAL	SQ FT	287	287
		50104400	CONCRETE HEADWALL REMOVAL	EACH	1	1
		54213657	PRECAST REINFORCED CONCRETE FLARED END SECTIONS 12"	EACH	1	1
		,		,		
		54213669	PRECAST REINFORCED CONCRETE FLARED END SECTIONS 24"	EACH	1	1
		54262712	METAL FLARED END SECTIONS 12"	EACH	1	1
		542C0217	PIPE CULVERTS, CLASS C, TYPE 1 12"	FOOT	18	18
		34200217	THE COLVENTS, CENSS C, THE T12		10	
		550A0050	STORM SEWERS, CLASS A, TYPE 1 12"	FOOT	78	78
		330A0030	STORM SEWERS, CLASS A, TIPE 1 12	7001	76	76
		55040430	CTODM CEWEDS CLASS A TYPE 1 24	FOOT	10	10
		550A0120	STORM SEWERS, CLASS A, TYPE 1 24"	FOOT	19	19
		55100500	STORM SEWER REMOVAL 12"	FOOT	10	10
		60207605	CATCH BASINS, TYPE C, TYPE 8 GRATE	EACH	3	3
		60218400	MANHOLES, TYPE A, 4'-DIAMETER, TYPE 1 FRAME, CLOSED LID	EACH	1	1
		60236200	INLETS, TYPE A, TYPE 8 GRATE	EACH	1	1
#	*	66900200	NON-SPECIAL WASTE DISPOSAL	CU YD	6	6
#	*	66900530	SOIL DISPOSAL ANALYSIS	EACH	1	1
#	*	66901001	REGULATED SUBSTANCES PRE-CONSTRUCTION PLAN	L SUM	1	1
#	*	66901003	REGULATED SUBSTANCES FINAL CONSTRUCTION REPORT	L SUM	1	1
,.						
#	*	66901006	REGULATED SUBSTANCES MONITORING	CAL DA	10	10
17		00501000	NEGOTITE SUBSTRICES PIONITORING	CAL DA	10	10

Q	V3 Companies 7325 Janes Avenue Woodridge, IL 60517 630.724.9200 phone 630.724.9202 fax www.v3co.com

USER NAME = cfigus	DESIGNED	-	CA5	REVISED	-
	DRAWN	-	DRP	REVISED	-
PLOT SCALE = 2'	CHECKED	-	MJR	REVISED	-
PLOT DATE = 3/31/2021	DATE	-	3/31/2021	REVISED	-

STATE OF ILLINOIS	
DEPARTMENT OF TRANSPORT	TATION

CLIMANA DV OF QUANTITIES									RTE.	SECTION	COUNTY	SHEETS	NO.
SUMMARY OF QUANTITIES							2689	16-00095-00-BT	COOK	54	5		
	·										CONTRAC	T NO. 6	1H13
SCALE: NONE SHEET 2 OF 4 SHEETS STA. TO STA.									ILLINOIS FED. A	AID PROJECT TE-0	1D1(066)		

DEE: Default NAME: N120201203411DrawingsMethC

SPECIALTY ITEM	SPECIAL PROVISION	CODE NO.	ITEM	UNIT	TOTAL QUANTITY	ROADWAY 80% FEDERAL 20% LOCAL 0028
	*	67000400	ENGINEER'S FIELD OFFICE, TYPE A	CAL MO	3	3

		67100100	MOBILIZATION	L SUM	1	1
		70102625	TRAFFIC CONTROL AND PROTECTION, STANDARD 701606	L SUM	1	1

		70102635	TRAFFIC CONTROL AND PROTECTION, STANDARD 701701	L SUM	1	1
		70102640	TRAFFIC CONTROL AND PROTECTION, STANDARD 701801	L SUM	1	1
#		72000100	SIGN PANEL - TYPE 1	SQ FT	6	6
#		72400100	REMOVE SIGN PANEL ASSEMBLY - TYPE A	EACH	4	4
#		72400310	REMOVE SIGN PANEL - TYPE 1	SQ FT	40	40
77		72400310	NEMOVE SIGN TANGE THE I	3011	70	40
#		72800100	TELESCOPING STEEL SIGN SUPPORT	FOOT	15	15
#		78000400	THERMOPLASTIC PAVEMENT MARKING - LINE 6"	FOOT	179	179
#		78000600	THERMOPLASTIC PAVEMENT MARKING - LINE 12"	FOOT	446	446
#		78300202	PAVEMENT MARKING REMOVAL - WATER BLASTING	SQ FT	159	159
#	*	81028200	UNDERGROUND CONDUIT, GALVANIZED STEEL, 2" DIA.	FOOT	61	61
.,		01020200	The control of the co	, 501	01	
#	*	81028240	UNDERGROUND CONDUIT, GALVANIZED STEEL, 4" DIA.	FOOT	110	110
#	*	85000200	MAINTENANCE OF EXISTING TRAFFIC SIGNAL INSTALLATION	EACH	1	1
#	*	87301215	ELECTRIC CABLE IN CONDUIT, SIGNAL NO. 14 2C	FOOT	217	217
#	*	87301225	ELECTRIC CABLE IN CONDUIT, SIGNAL NO. 14 3C	FOOT	235	235
#	*	87301900	ELECTRIC CABLE IN CONDUIT, EQUIPMENT GROUNDING CONDUCTOR, NO. 6 1C	FOOT	87	87
#	•	0.201200	ELECTRIC CADLE IN CONDUIT, EQUIPMENT GROUNDING CONDUCTOR, NO. 6 10	FUUT	0/	0/

	V3 Companies
/\	7325 Janes Avenue
	Woodridge, IL 60517
(TA /)	630.724.9200 phone
\ V	630.724.9202 fax
\ <u>'</u>	www.v3co.com

USER NAME = cfigus	DESIGNED	-	CAS	REVISED	-
	DRAWN	-	DRP	REVISED	-
PLOT SCALE == 2'	CHECKED	-	MJR	REVISED	•
PLOT DATE = 3/31/2021	DATE	-	3/31/2021	REVISED	-

STATE OF ILLINOIS
DEPARTMENT OF TRANSPORTATION

CHAMADY OF CHANTITIES									SECTION	COUNTY	TOTAL SHEETS	SHEET NO.
SUMMARY OF QUANTITIES							2689	16-00095-00-BT	соок	54	6	
										CONTRACT	NO. 6	1H13
SCALE: NONE	SHEET	3	OF	4	SHEETS	STA.	TO STA.		ILLINOIS FED. A	D PROJECT TE-010	1(066)	

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SPECIALTY ITEM	SPECIAL PROVISION	CODE NO.	ITEM	UNIT	TOTAL QUANTITY	ROADWAY 80% FEDERAL 20% LOCAL 0028
#		87900200	DRILL EXISTING HANDHOLE	EACH	6	6
#	*	88102717	PEDESTRIAN SIGNAL HEAD, LED, 1-FACE, BRACKET MOUNTED WITH COUNTDOWN TIMER	EACH	4	4
#	*	88800100	PEDESTRIAN PUSH-BUTTON	EACH	2	2
#	*	89500400	RELOCATE EXISTING PEDESTRIAN PUSH-BUTTON	EACH	2	2
W						
#		89502200	MODIFY EXISTING CONTROLLER	EACH	1	1
#	*	89502210	MODIFY EXISTING CONTROLLER CABINET	EACH	1	1
		00502250	DEMOVE AND DEDICTALL FLECTING CARLE FROM CONDUCT			127
#		89502350	REMOVE AND REINSTALL ELECTRIC CABLE FROM CONDUIT	FOOT	137	137
#	*	89502375	REMOVE EXISTING TRAFFIC SIGNAL EQUIPMENT	EACH	2	2
#	*	89502376	REBUILD EXISTING HANDHOLE	EACH	1	1
#	*	89502400	REMOVE EXISTING FLASHING BEACON INSTALLATION COMPLETE	EACH	2	2
						_
#	*	X1400367	PEDESTRIAN SIGNAL POST, 10 FT.	EACH	2	2
#	*	X1400378	PEDESTRIAN SIGNAL POST, 5 FT.	EACH	2	2
#	*	X2502014	SEEDING, CLASS 4A (MODIFIED)	ACRE	0.50	0.50
#	*	X2511630	EROSION CONTROL BLANKET (SPECIAL)	SQ YD	4,911	4,911
	*	V4400501				
	*	X4400501	COMBINATION CURB AND GUTTER REMOVAL AND REPLACEMENT LESS THAN OR EQUAL TO 10 FEET	FOOT	42	42
#	*	X5090810	PEDESTRIAN RAIL (SPECIAL)	FOOT	76	76
					-	
#	*	X8780012	CONCRETE FOUNDATION, TYPE A 12-INCH DIAMETER	FOOT	16	16
	*	Z0013798	CONSTRUCTION LAYOUT	L SUM	1	1
	*	70020050	TEMPORARY INFORMATION CICAUNG		103	103
	*	Z0030850	TEMPORARY INFORMATION SIGNING	SQ FT	103	103
#	*	Z0033044	RE-OPTIMIZE TRAFFIC SIGNAL SYSTEM LEVEL 1	EACH	1	1
					_	

$\overline{\mathbf{V}}$	V3 Con 7325 J Woodri 630.72 630.72 www.v3

 USER NAME
 = cfigus
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 DRP
 REVISED

 PLOT SCALE
 = 2'
 CHECKED
 MJR
 REVISED

 PLOT DATE
 = 3/31/2021
 DATE
 3/31/2021
 REVISED

STATE OF ILLINOIS DEPARTMENT OF TRANSPORTATION

SCALE: NONE SHEET

_	CURANACTV OF CUANTITIES						SECTION	COUNTY	TOTAL SHEETS	SHEET NO.
SUMMARY OF QUANTITIES					2689	16-00095-00-BT	соок	54	7	
								CONTRACT	NO. 6	1H13
4	OF	4	SHEETS	STA.	TO STA.		ILLINOIS FED. A	D PROJECT TE-010	1(066)	

STATION	EARTH EXCAVATION 20200100	EARTH EXCAVATION ADJUSTED FOR SWELL (15%)	FURNISHED EXCAVATION	REMOVAL AND DISPOSAL OF UNSUITABLE MATERIAL
	CU YD	CU YD	CU YD	CU YD
17+34.34	0.00	0.00	0.00	0.00
17+50.00	0.00	0.00	0.00	0.00
18+00.00	0.00	0.00	0.00	0.00
18+50.00	0.39	0.45	3.30	7.85
19+00.00	0.39	0.45	21.03	22.57
19+50.00	0.00	0.00	37.98	29.50
20+00.00	0.00	0.00	27.49	25.55
20+50.00	0.00	0.00	13.05	22.65
21+00.00	0.07	0.08	13.26	23.47
21+50.00	0.75	0.86	9.36	19.56
22+00.00	2.94	3.38	2.60	14.56
22+50.00	15.37	17.68	4.04	20.42
23+00.00	25.63	29.47	7.03	27.42
23+50.00	27.95	32.14	6.54	27.03
24+00.00	29.30	33.70	5.32	25.71
24+50.00	24.00	27.60	4.64	23.69
25+00.00	10.13	11.65	30.17	25.82
25+23.24	3.72	4.28	20.44	16.28
25+50.00	4.30	4.95	24.03	17.88
26+00.00	0.77	0.89	31.49	22.09
26+50.00	9.98	11.48	5.40	22.74
27+00.00	14.38	16.54	5.35	25.00
27+50.00	16.21	18.64	5.15	24.47
28+00.00	23.00	26.45	5.59	26.54
28+50.00	19.26	22.15	5.16	24.62
29+00.00	15.16	17.43	5.19	25.25
29+50.00	11.81	13.58	6.55	28.57
30+00.00	6.04	6.95	15.16	29.43
30+50.00	2.19	2.52	29.78	30.24
31+00.00	0.14	0.16	26.99	27.02
31+50.00	6.15	7.07	9.71	19.21
32+00.00	11.30	13.00	1.91	15.27
32+50.00	6.59	7.58	6.59	15.87
33+00.00	1.43	1.64	19.41	19.25
33+50.00	0.00	0.00	24.06	22.13
34+00.00	0.00	0.00	15.31	20.67
34+50.00	0.00	0.00	18.10	19.67
35+00.00	0.58	0.67	19.77	17.82
35+50.00	0.58	0.67	23.03	16.46
35+83.05	0.00	0.00	11.63	5.57
TOTALS	290.51	334.09	521.61	802.28


	V3 Companies
/ — -\	7325 Janes Avenue
	Woodridge, IL 60517
	630.724.9200 phone
\ V	630.724.9202 fax
	www.v3co.com

USER NAME = cfigus	DESIGNED -	CAS	REVISED -
	DRAWN -	DRP	REVISED -
PLOT SCALE = 20'	CHECKED -	MJR	REVISED -
PLOT DATE = 3/31/2021	DATE -	3/31/2021	REVISED -

STATE OF ILLINOIS DEPARTMENT OF TRANSPORTATION

	COLLEGE OF CHANTITIES	F.A.U. RTE	SECTION	COUNTY	TOTAL SHEETS	SHEET NO.
	SCHEDULE OF QUANTITIES	2689	16-00095-00-BT	соок	54	8
				CONTRAC	T NO. 6	1H13
SCALE: NONE	SHEET 1 OF 1 SHEETS STA. TO STA.		ILLINOIS FED. A	ID PROJECT TE-01	D1(066)	

Y	V3 Companies 7325 Janes Avenu Woodridge, IL 605 630.724.9200 pho 630.724.9202 fax www.v3co.com

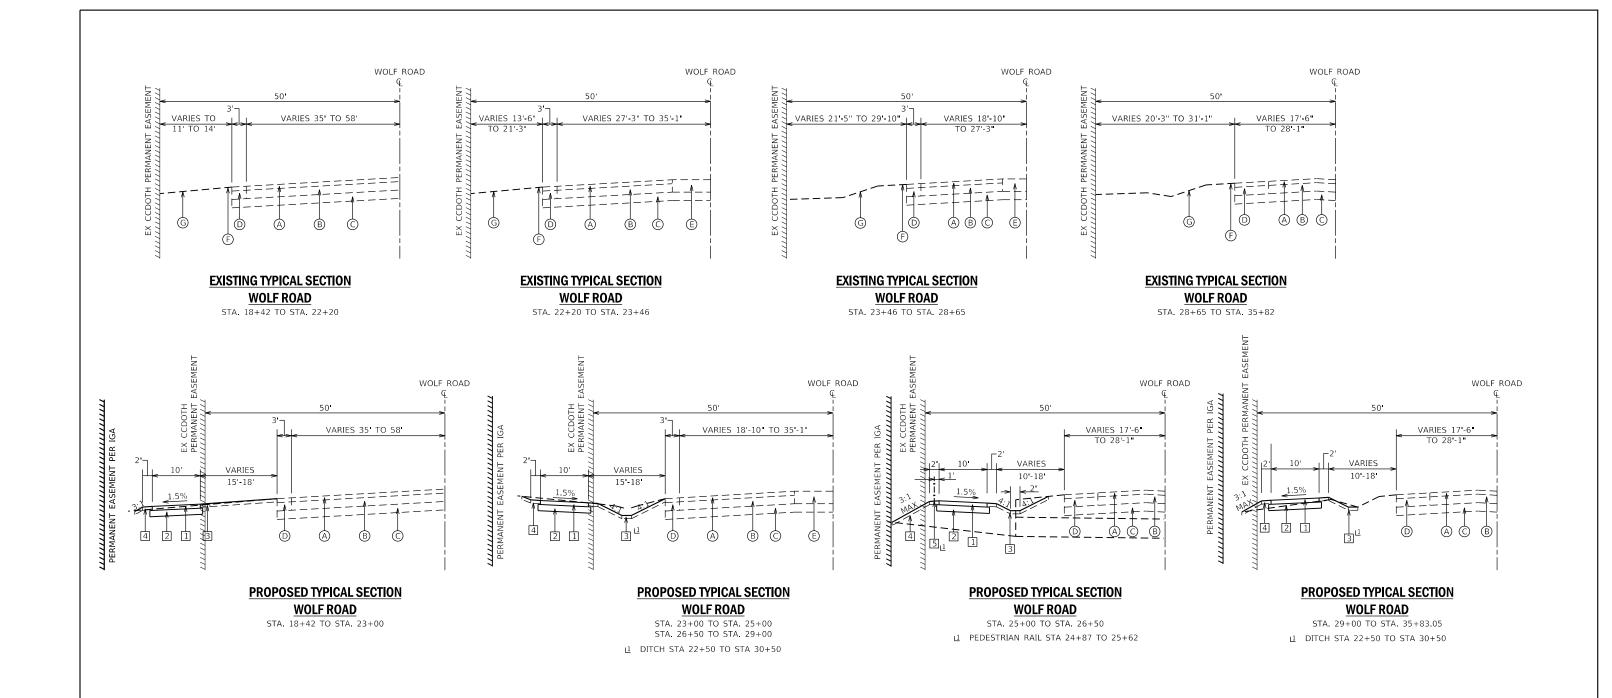

EXISTING LEGEND

- (A) EXISTING HOT-MIX ASPHALT SURFACE COURSE, 2" & VARIES
- B EXISTING HOT-MIX ASPHALT PAVEMENT, 6" & VARIES
- © EXISTING AGGREGATE BASE, THICKNESS VARIES
- D EXISTING HOT-MIX ASPHALT SHOULDER
- E EXISTING CONCRETE MEDIAN
- F EXISTING AGGREGATE SHOULDER
- © EXISTING GROUND

PROPOSED LEGEND

- 1 HOT-MIX ASPHALT SURFACE COURSE IL-9.5, MIX "D", N50 3"
- 2 AGGREGATE BASE COURSE, TYPE B 6"
- 3 SEEDING, CLASS 2A TOPSOIL FURNISH AND PLACE, 4"
- 4 SEEDING, CLASS 4A (MODIFIED) TOPSOIL FURNISH AND PLACE, 4"
- 5 PEDESTRIAN RAIL (SPECIAL)

NOTES

- REFERENCE CROSS SECTIONS FOR SHARED-USE PATH CROSS SLOPES, VARYING PARKWAY SLOPES, AND DITCHES.
- 2. STATIONING SHOWN IS CENTERLINE OF PATH.

HOT-MIX ASPHALT REQUIREMENTS


MIXTURE TYPE	VOIDS
SHARED-USE PATH	
HOT-MIX ASPHALT SURFACE COURSE, IL-9.5, MIX "D", N50 - 3"	4% @ 50 GYR
HMA RESURFACING (2' WIDE)	
HOT-MIX ASPHALT SURFACE COURSE, IL-9.5, MIX "D", N70 - 2 $\frac{1}{2}$ "	4% @ 70 GYR
NOTES:	
THE UNIT WEIGHT USED TO CALCULATE ALL HMA SURFACE MIXTURE QUANTITIES IN 112 LBS/SQ. YD.	/IN.
 THE "AC TYPE" FOR POLYMERIZED HMA MIXES SHALL BE "PG 76-22" AND FOR NON -POLYMERIZED HI	ЛΑ
THE "AC-TYPE" SHALL BE "PG 64-22" UNLESS MODIFIED BY SPECIAL PROVISIONS.	
FOR USE WITH RECYCLED MATERIAL, SEE SPECIAL PROVISIONS.	



USER NAME = cfigus	DESIGNED -	CAS	REVISED -
	DRAWN -	DRP	REVISED -
PLOT SCALE = 20'	CHECKED -	MJR	REVISED -
PLOT DATE = 3/31/2021	DATE -	3/31/2021	REVISED -

STATE OF ILLINOIS
DEPARTMENT OF TRANSPORTATION

	T/DIO AL OFOTIONO	F.A.U. RTE	SECTION	COUNTY		HEET NO.
	TYPICAL SECTIONS	2689	16-00095-00-BT	СООК	54	9
				CONTRAC	T NO. 61H	.13
SCALE: NONE	SHEET 1 OF 1 SHEETS STA. TO STA.		ILLINOIS FED. A	ID PROJECT TE-01	D1(066)	

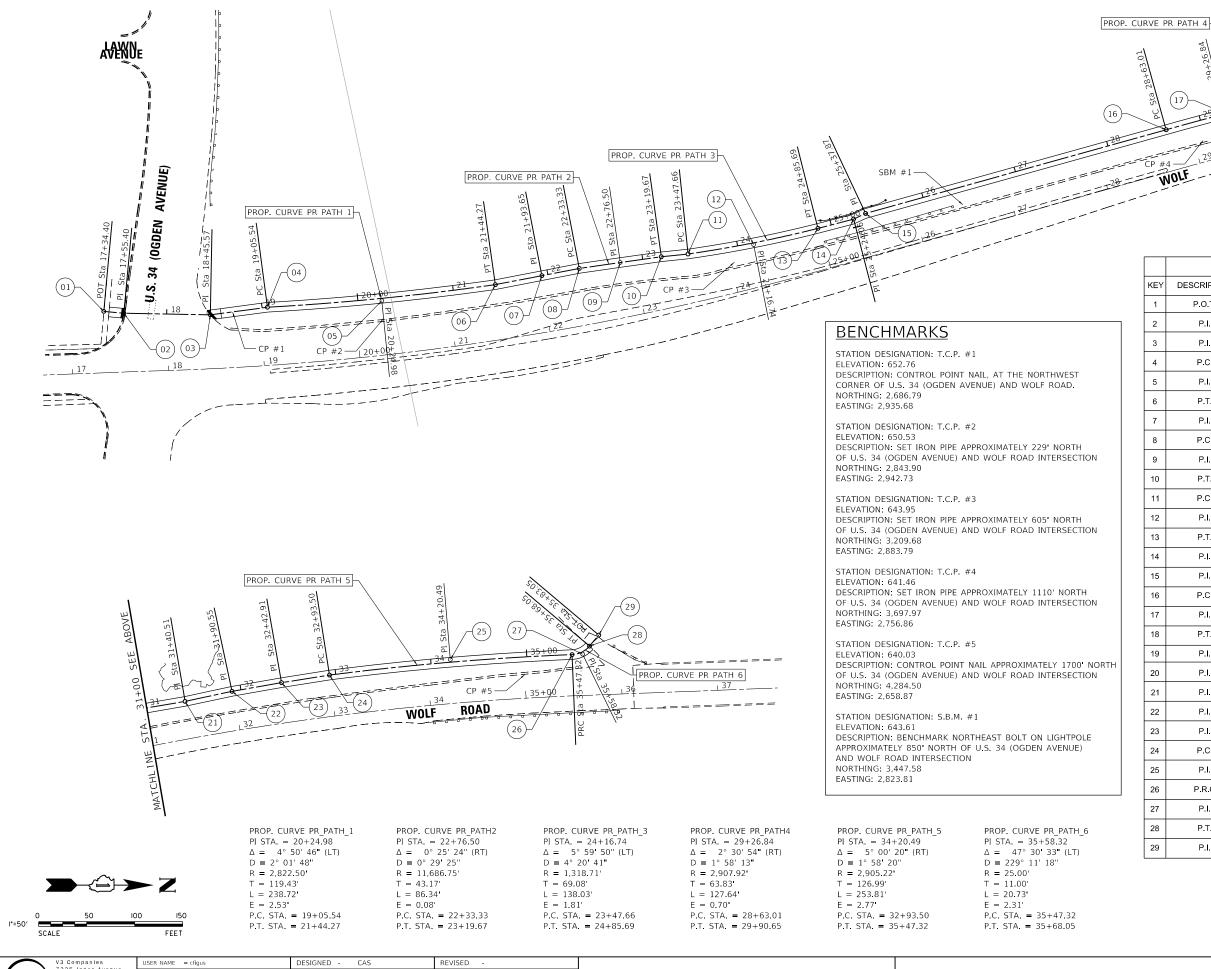


			COORE	DINATES
KEY	DESCRIPTION	STATION	NORTHING	EASTING
1	P.O.T.	17+34.34	2,552.57	2,935.00
2	P.I.	17+55.34	2,573.48	2,936.93
3	P.I.	18+45.51	2,663.63	2,938.63
4	P.C.	19+05.54	2,723.08	2,930.70
5	P.I.	20+24.98	2,842.32	2,923.94
6	P.T.	21+44.27	2,960.57	2,907.13
7	P.I.	21+93.65	3,009.05	2,897.77
8	P.C.	22+33.33	3,048.02	2,890.27
9	P.I.	22+76.50	3,090.73	2,884.02
10	P.T.	23+19.67	3,133.49	2,878.09
11	P.C.	23+47.66	3,161.34	2,875.23
12	P.I.	24+16.74	3,229.72	2,865.41
13	P.T.	24+85.69	3,296.70	2,848.51
14	P.I.	25+24.06	3,333.83	2,838.85
15	P.I.	25+37.87	3,346.33	2,832.98
16	P.C.	28+63.01	3,659.55	2,745.75
17	P.I.	29+26.84	3,720.97	2,728.35
18	P.T.	29+90.65	3,783.09	2,713.67
19	P.I.	30+39.97	3,831.46	2,704.08
20	P.I.	30+90.42	3,881.14	2,695.32
21	P.I.	31+40.51	3,930.52	2,686.84
22	P.I.	31+90.55	3,979.44	2,676.36
23	P.I.	32+42.91	4,031.02	2,667.32
24	P.C.	32+93.50	4,080.99	2,659.45
25	P.I.	34+20.49	4,206.94	2,643.23
26	P.R.C	35+47.32	4,333.82	2,638.07
27	P.I.	35+58.32	4,344.82	2,637.62
28	P.T.	35+68.05	4,351.91	2,629.22
29	P.I.	35+83.05	4,361.59	2,617.75




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		DRAWN	-	DRP	REVISED -
١	PLOT SCALE = 100'	CHECKED	-	MJR	REVISED -
	PLOT DATE = 3/31/2021	DATE	-	3/31/2021	REVISED -


SCALE: 1"=50'


	LICHMENT TIES AND DENOUMADES					F.A.U. RTE				COUNTY	TOTAL SHEETS	SHEET NO.		
\LI(LIGNMENT, TIES AND BENCHMARKS				2689	9 16-00095-00-BT			COOK	54	10			
								CONTRACT	NO. 63	lH13				
ΞT	1	OF	1	SHEETS	STA.	Т	TO STA.	TILINOIS FED AID PROJECT TE-01D1(066)						

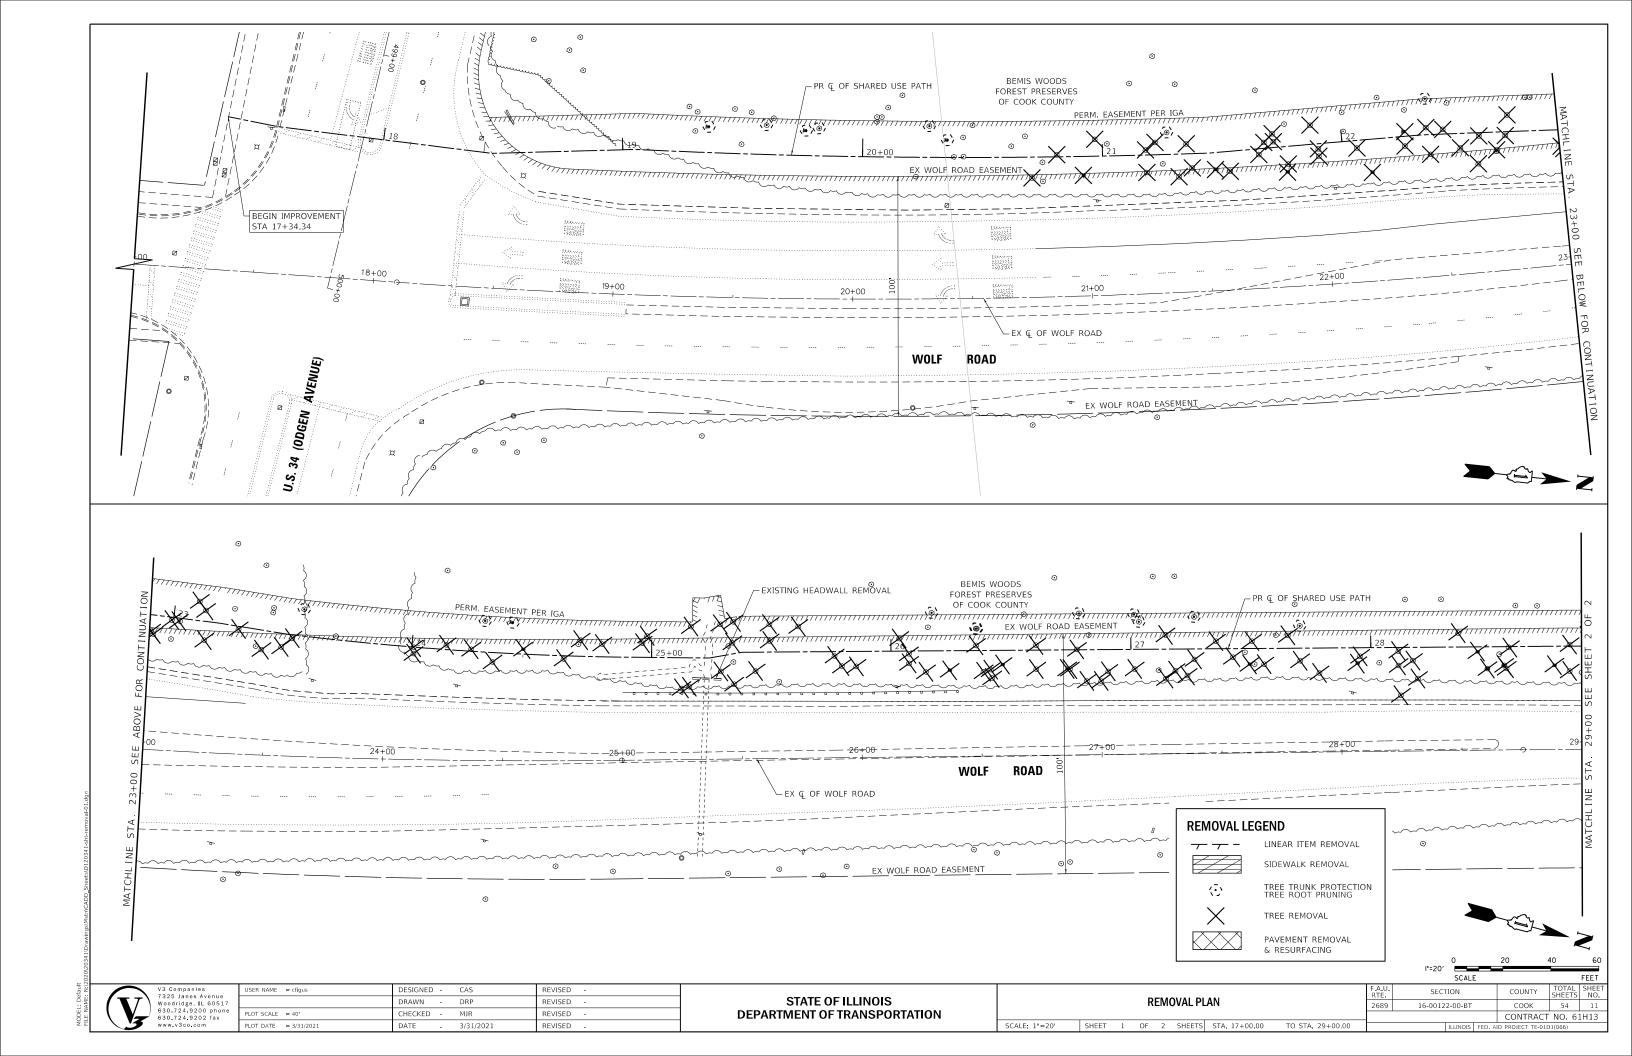


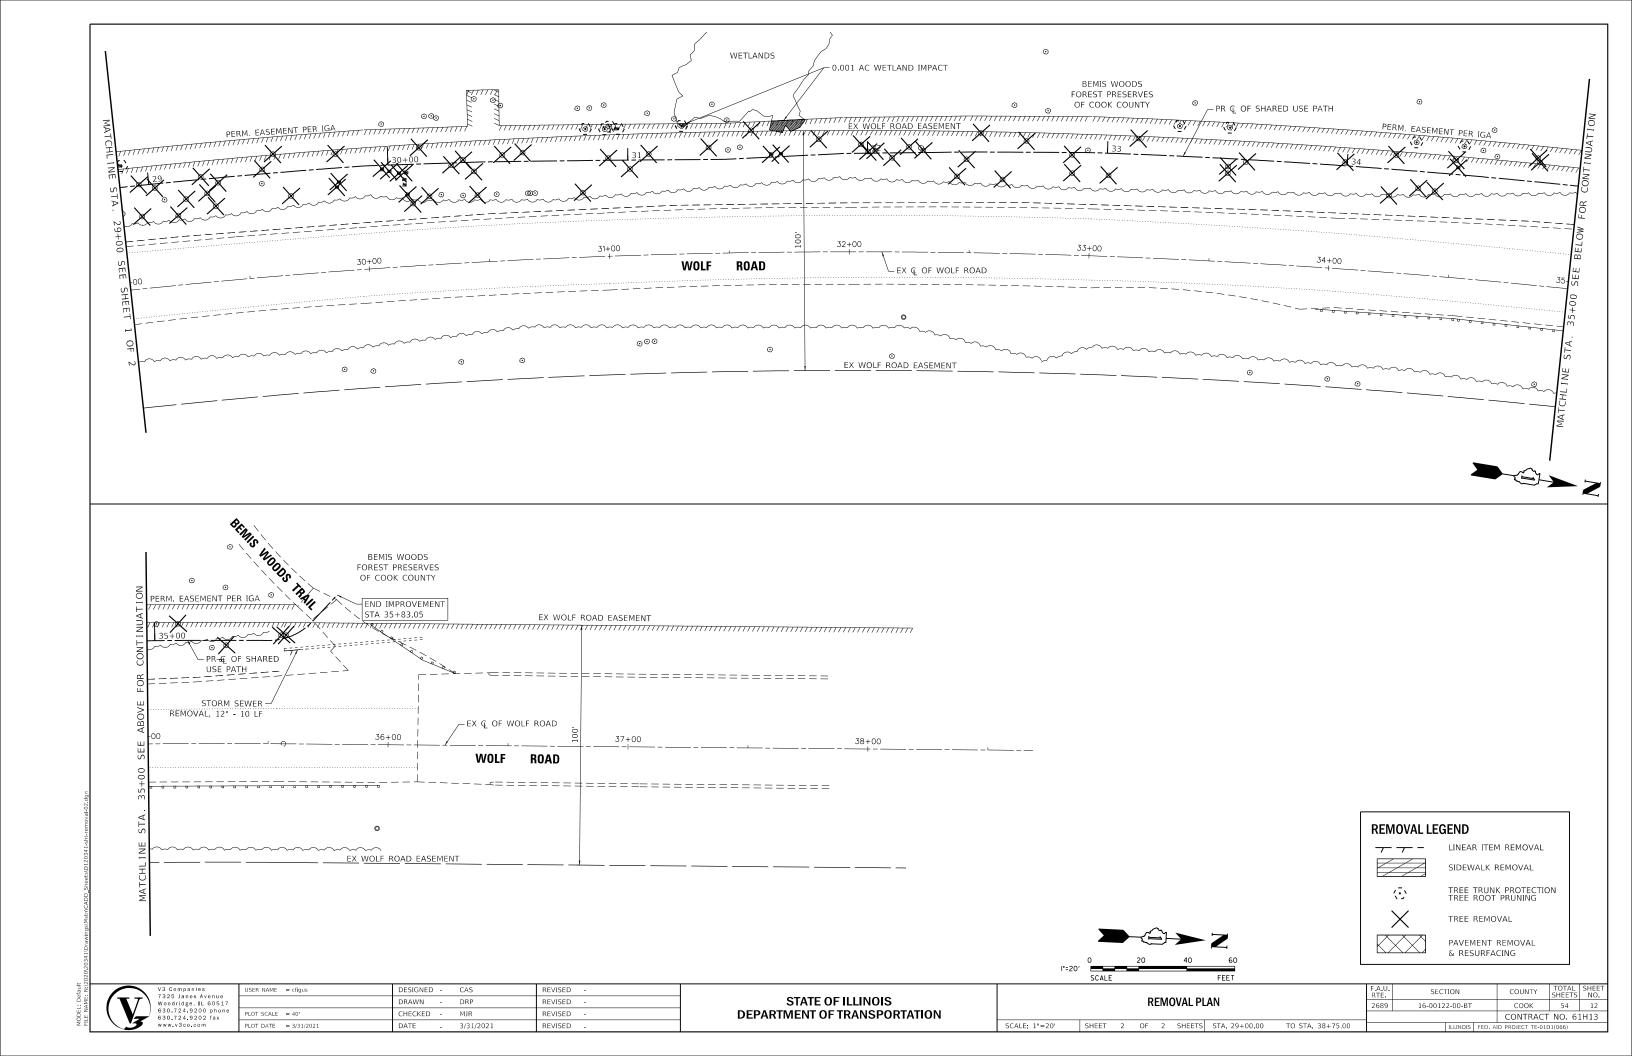

NOTES:

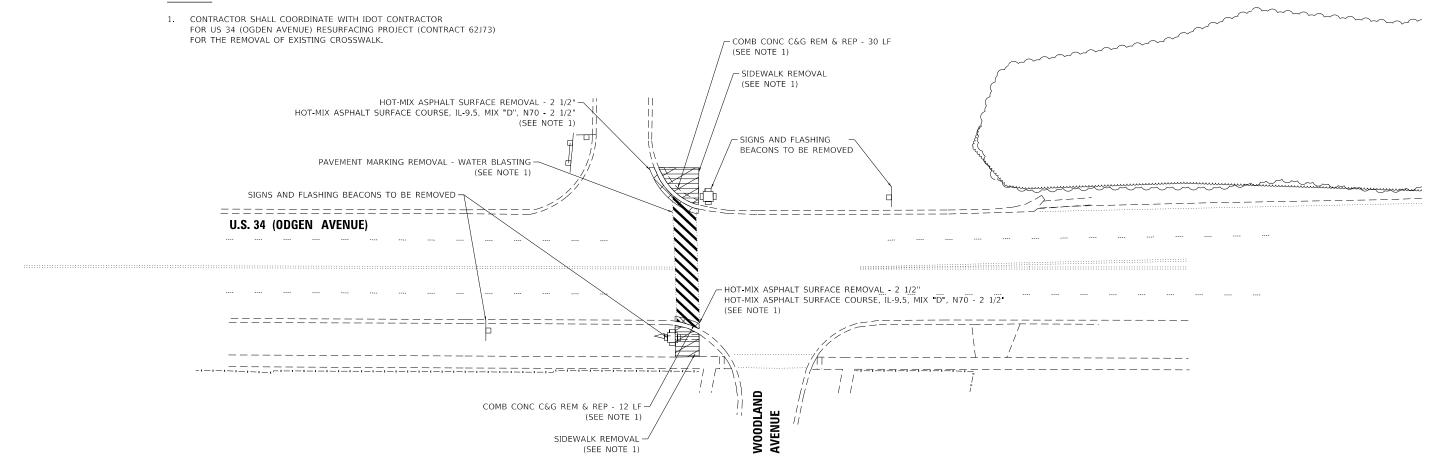

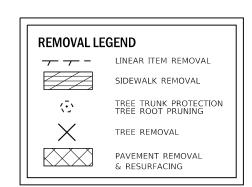

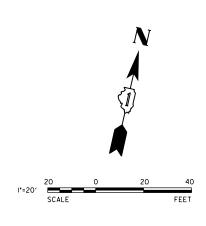


Y	V3 Companies 7325 Janes Avenue Woodridge, IL 6051 630.724.9200 phon 630.724.9202 fax www.v3co.com


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	DRAWN -	DRP	REVISED -	
PLOT SCALE = 40'	CHECKED -	MJR	REVISED -	
PLOT DATE = 3/31/2021	DATE -	3/31/2021	REVISED -	


STATE OF ILLINOIS
DEPARTMENT OF TRANSPORTATION


	W00	DLA	ND A	VE (CROSSV	VALK REMOVAL		T
	1	WOL	F RO	AD :	SHARED	USE PATH		F
SCALE: 1"=20'	SHEET	3	OF	3	SHEETS	STA. 100+00.00	TO STA. 100+00.00	┲


- A.U. RTE	SECT	ΠΟN		COUNTY	TOTAL SHEETS	SHEET NO.
2689	16-0009	5-00-BT		СООК	54	13
			CONTRACT	NO. 6	1H13	
		ILLINOIS	D PROJECT TE-010	1(066)		

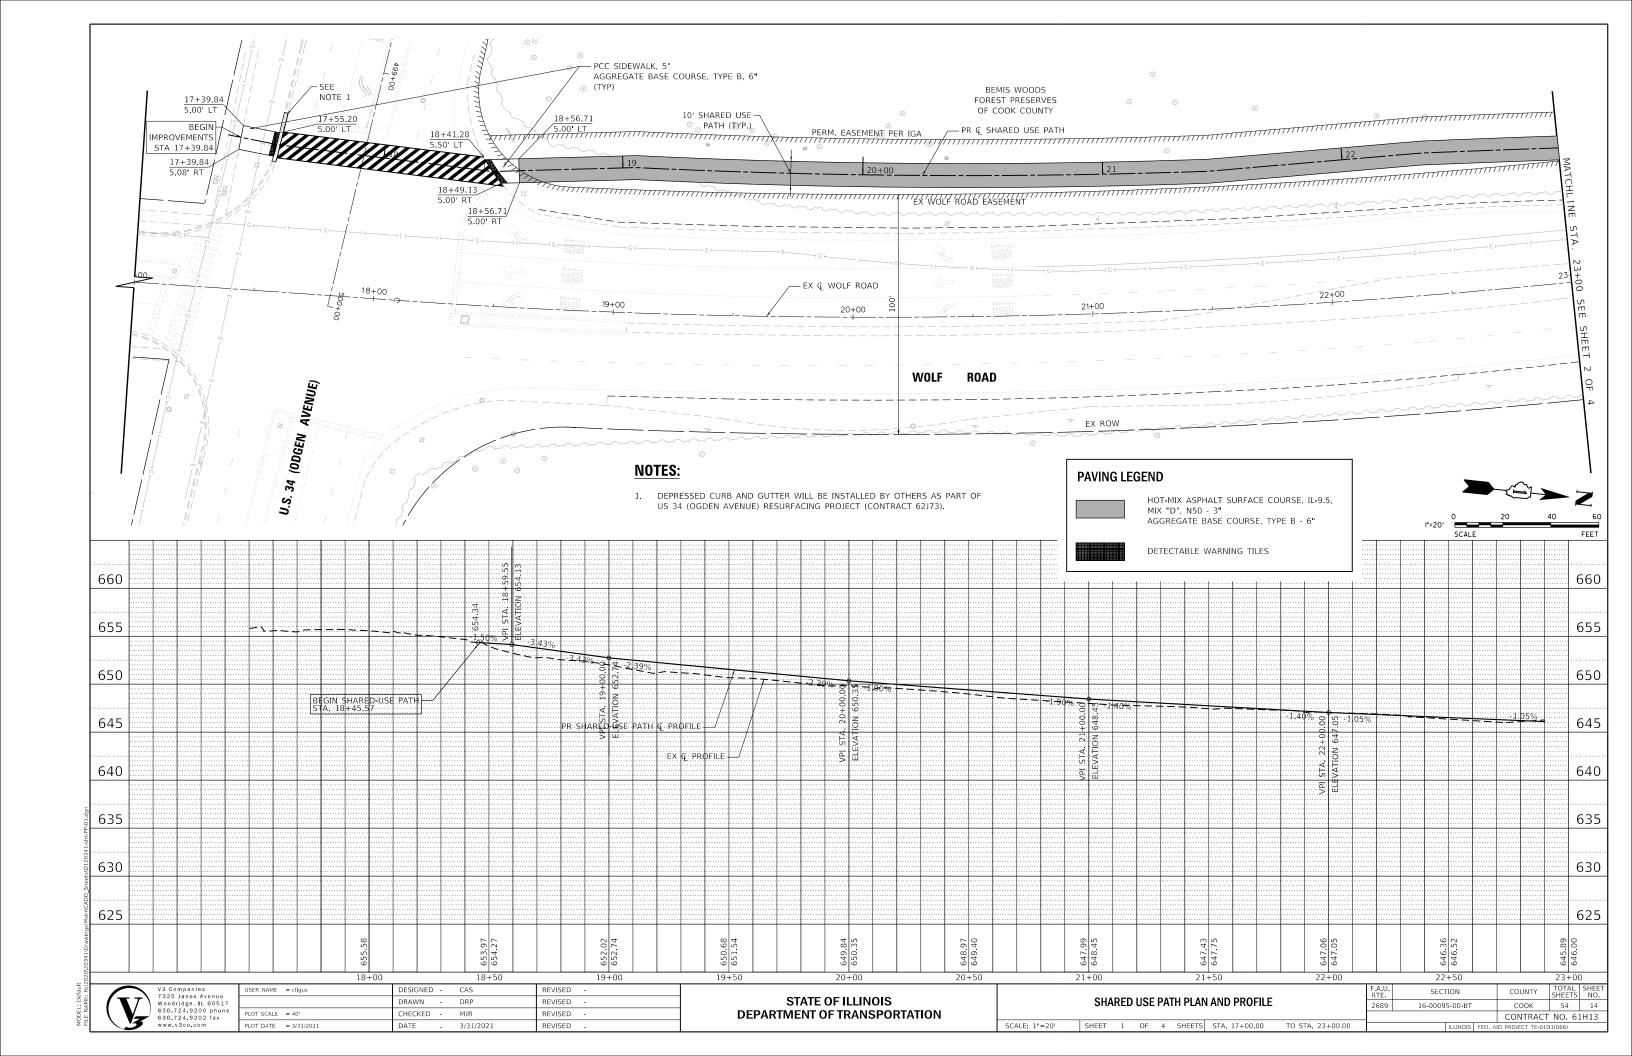


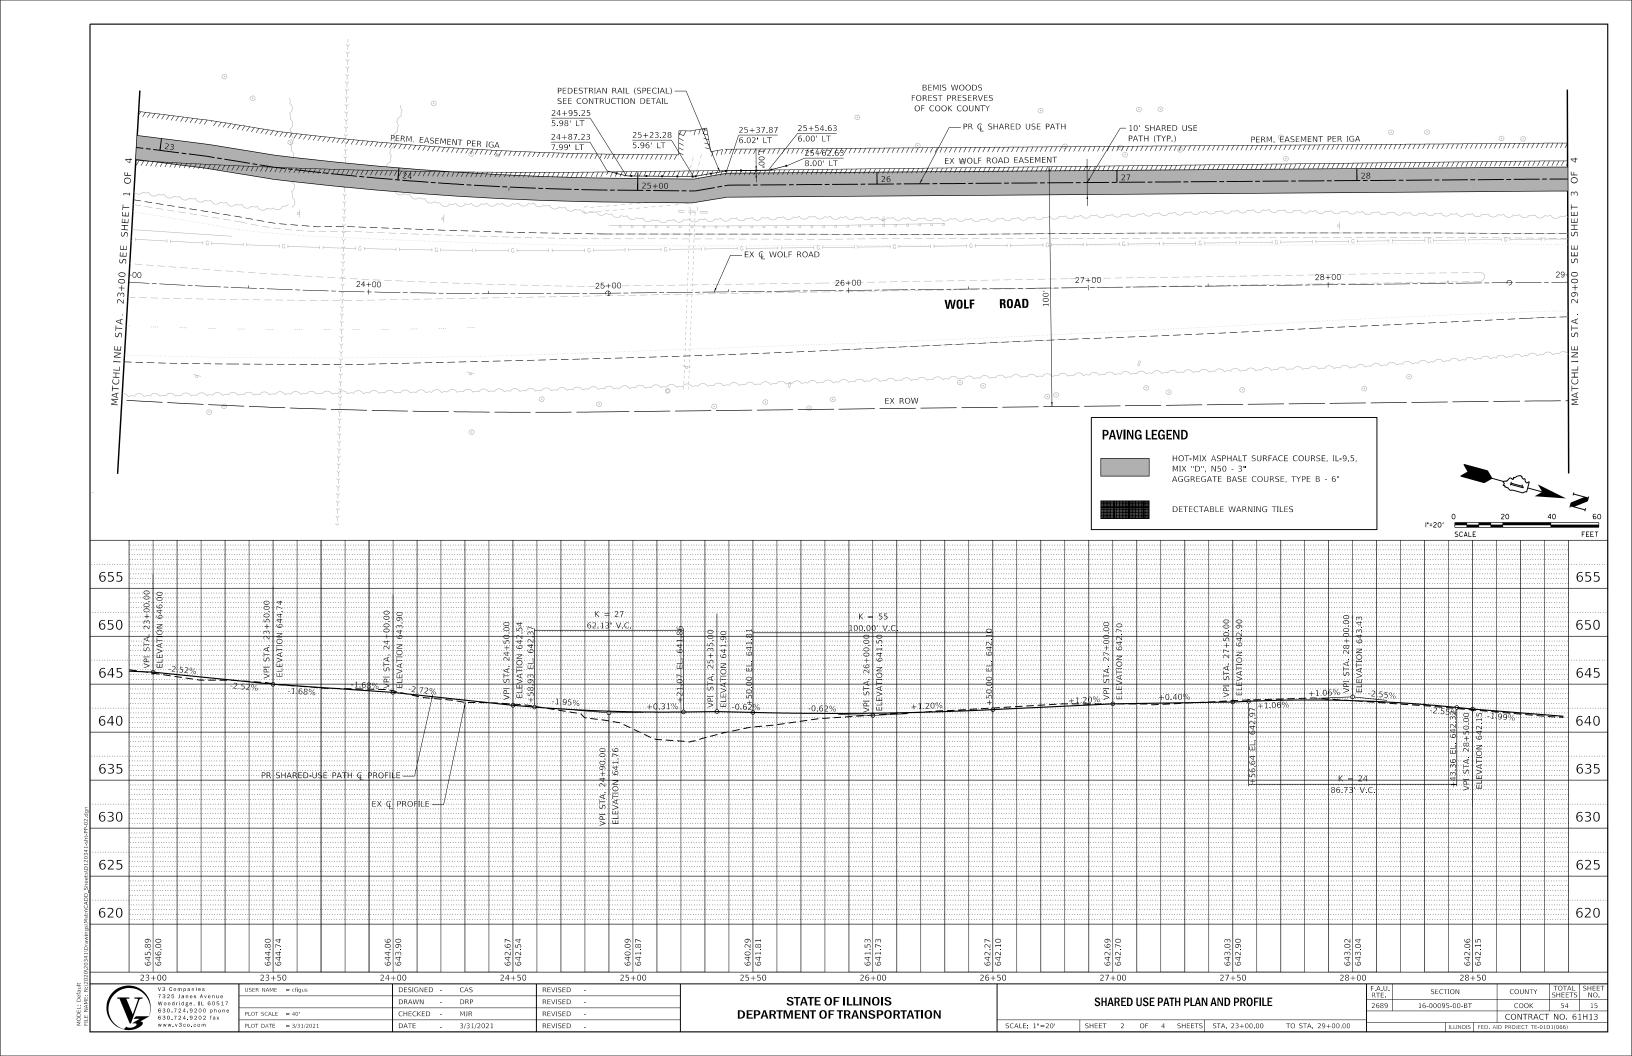


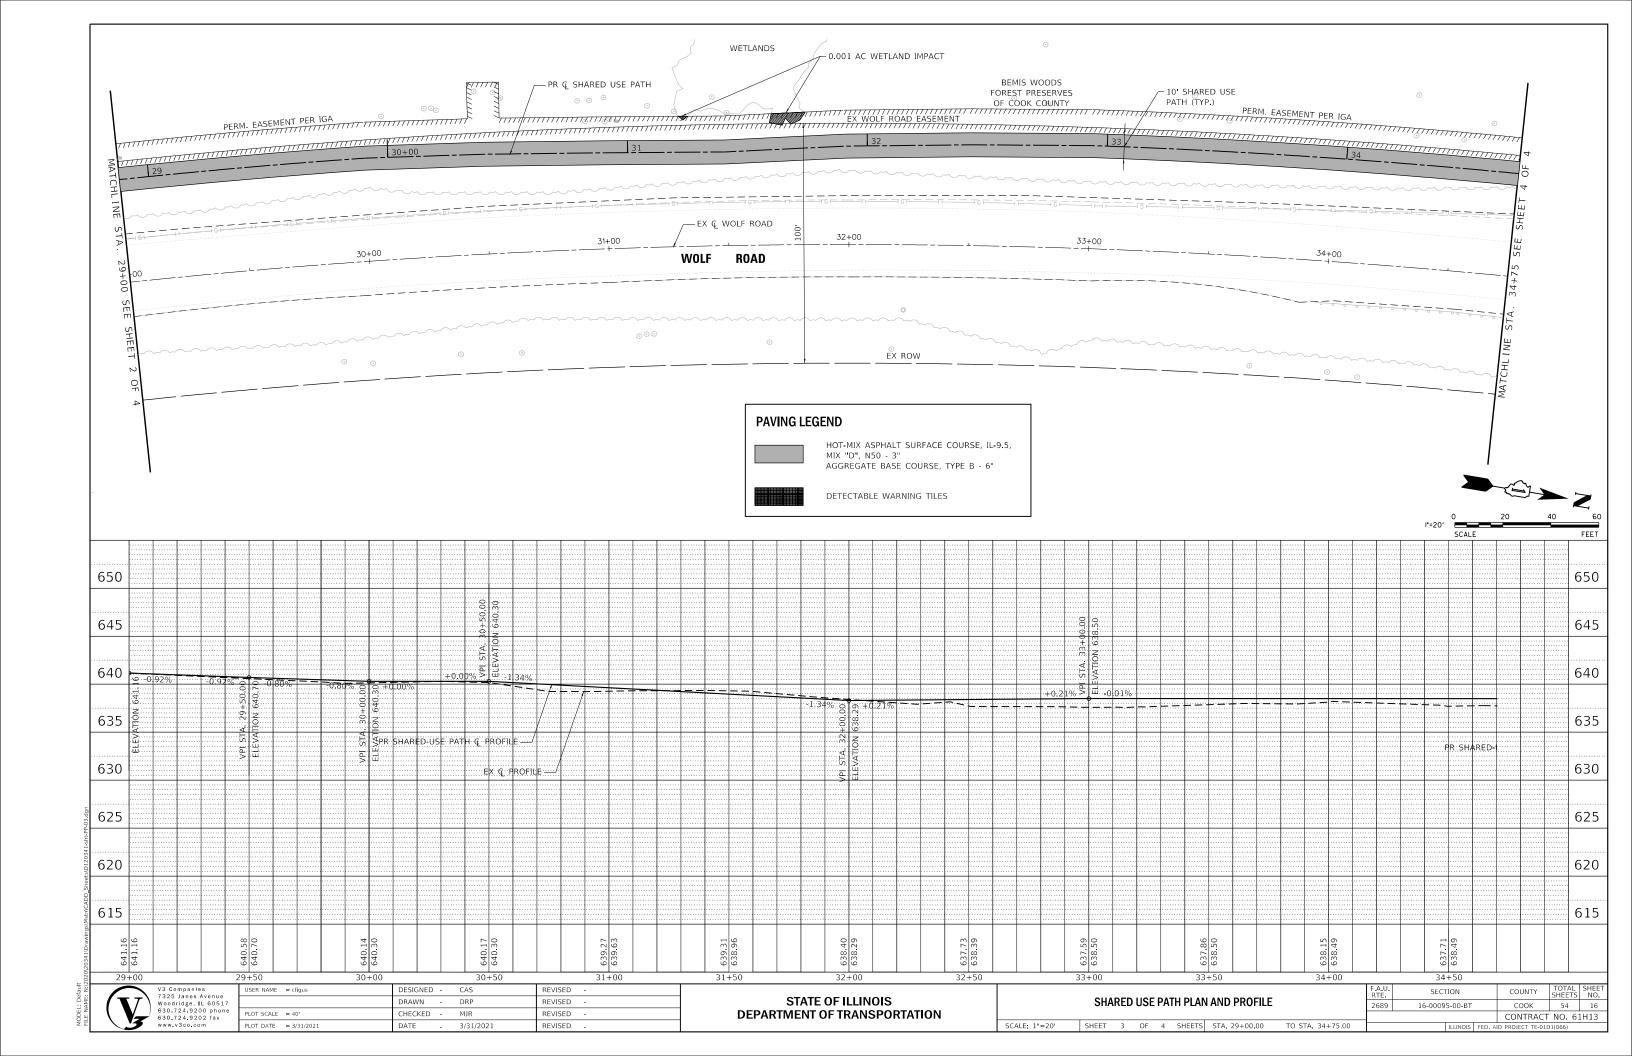

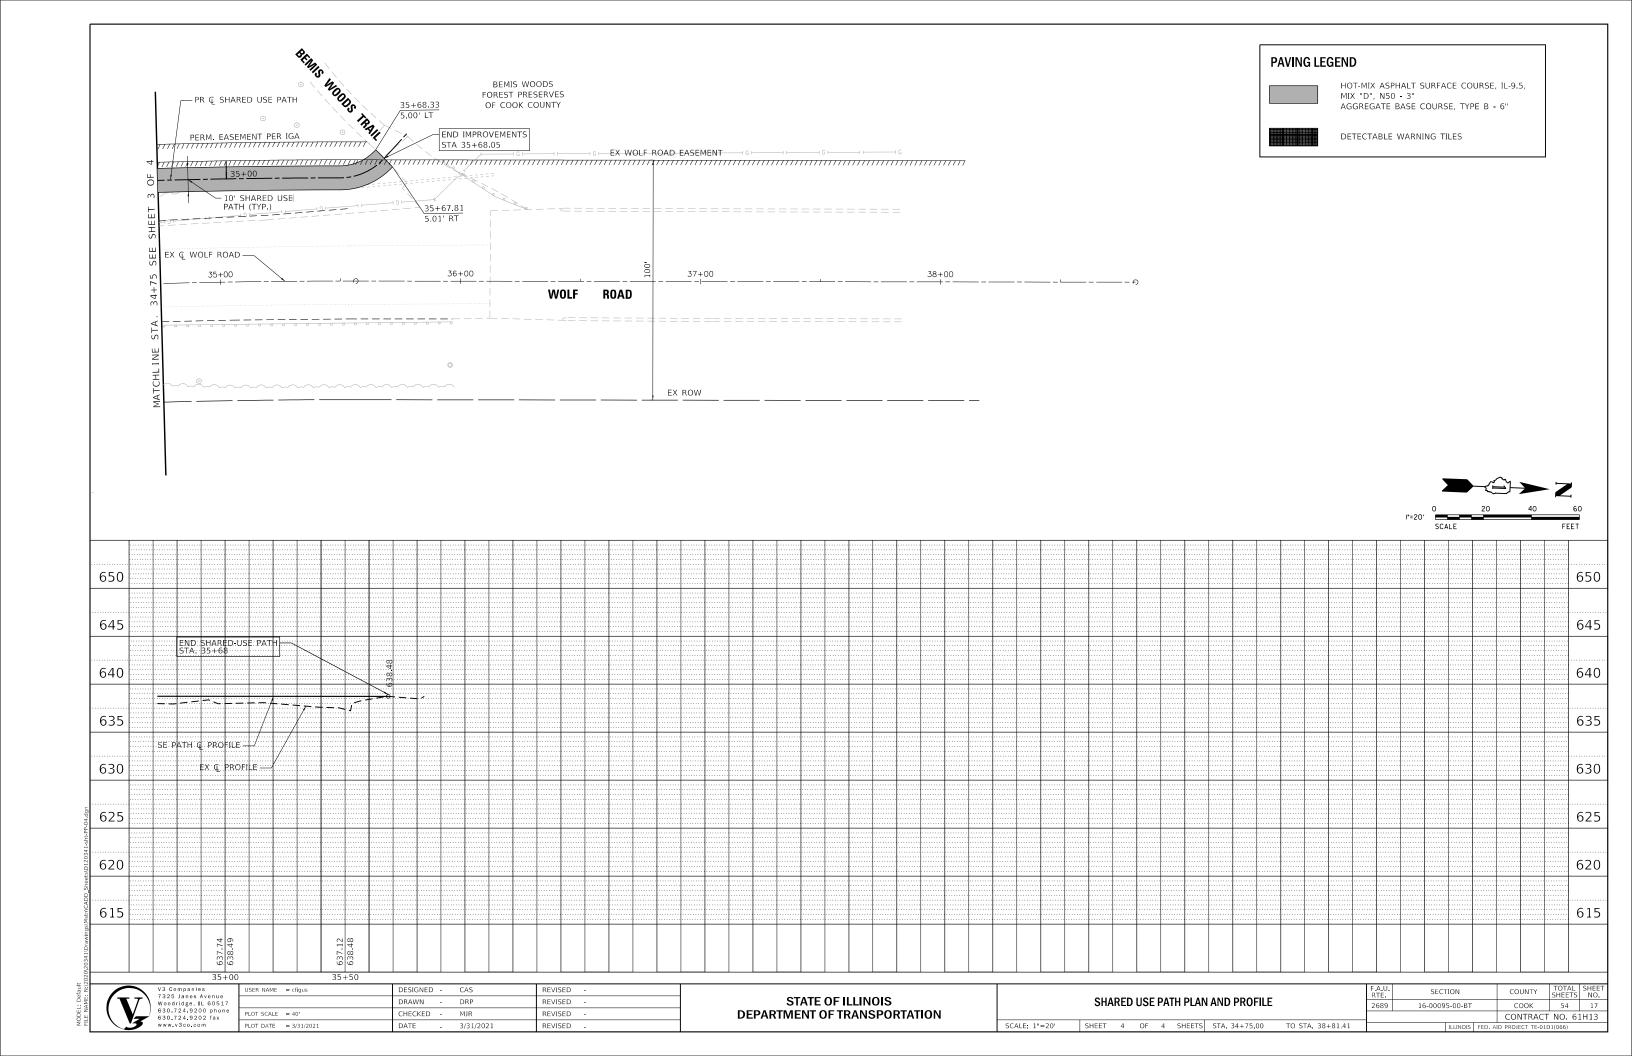

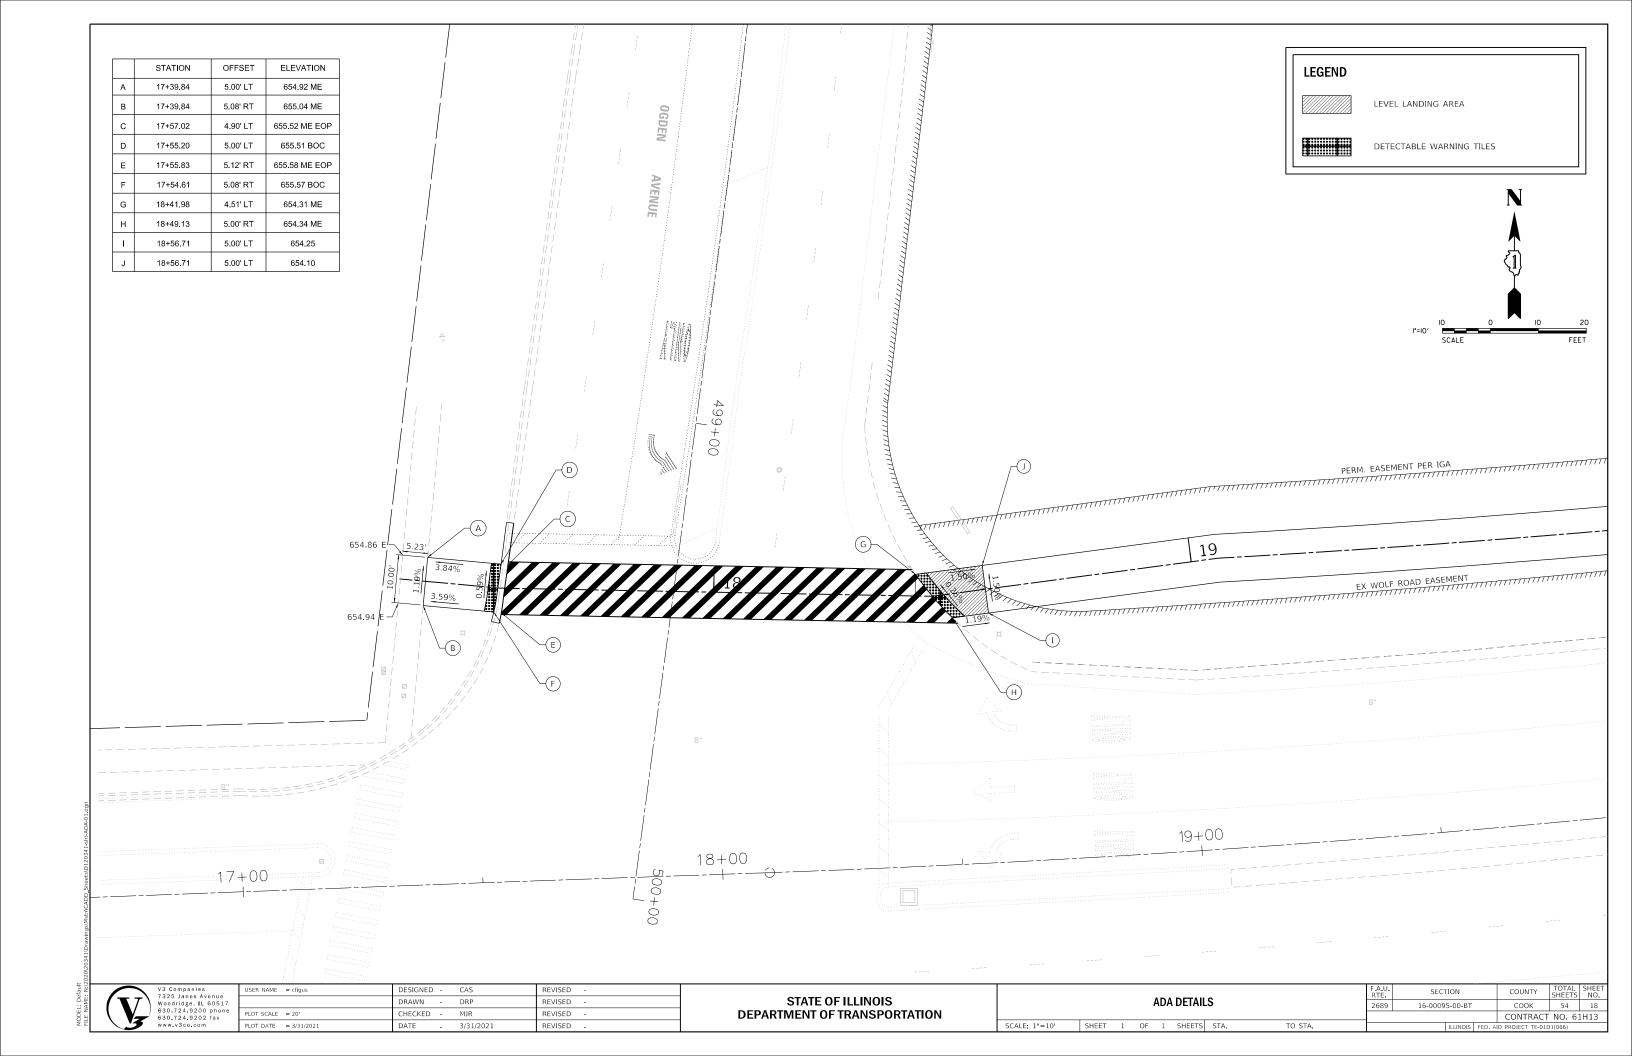

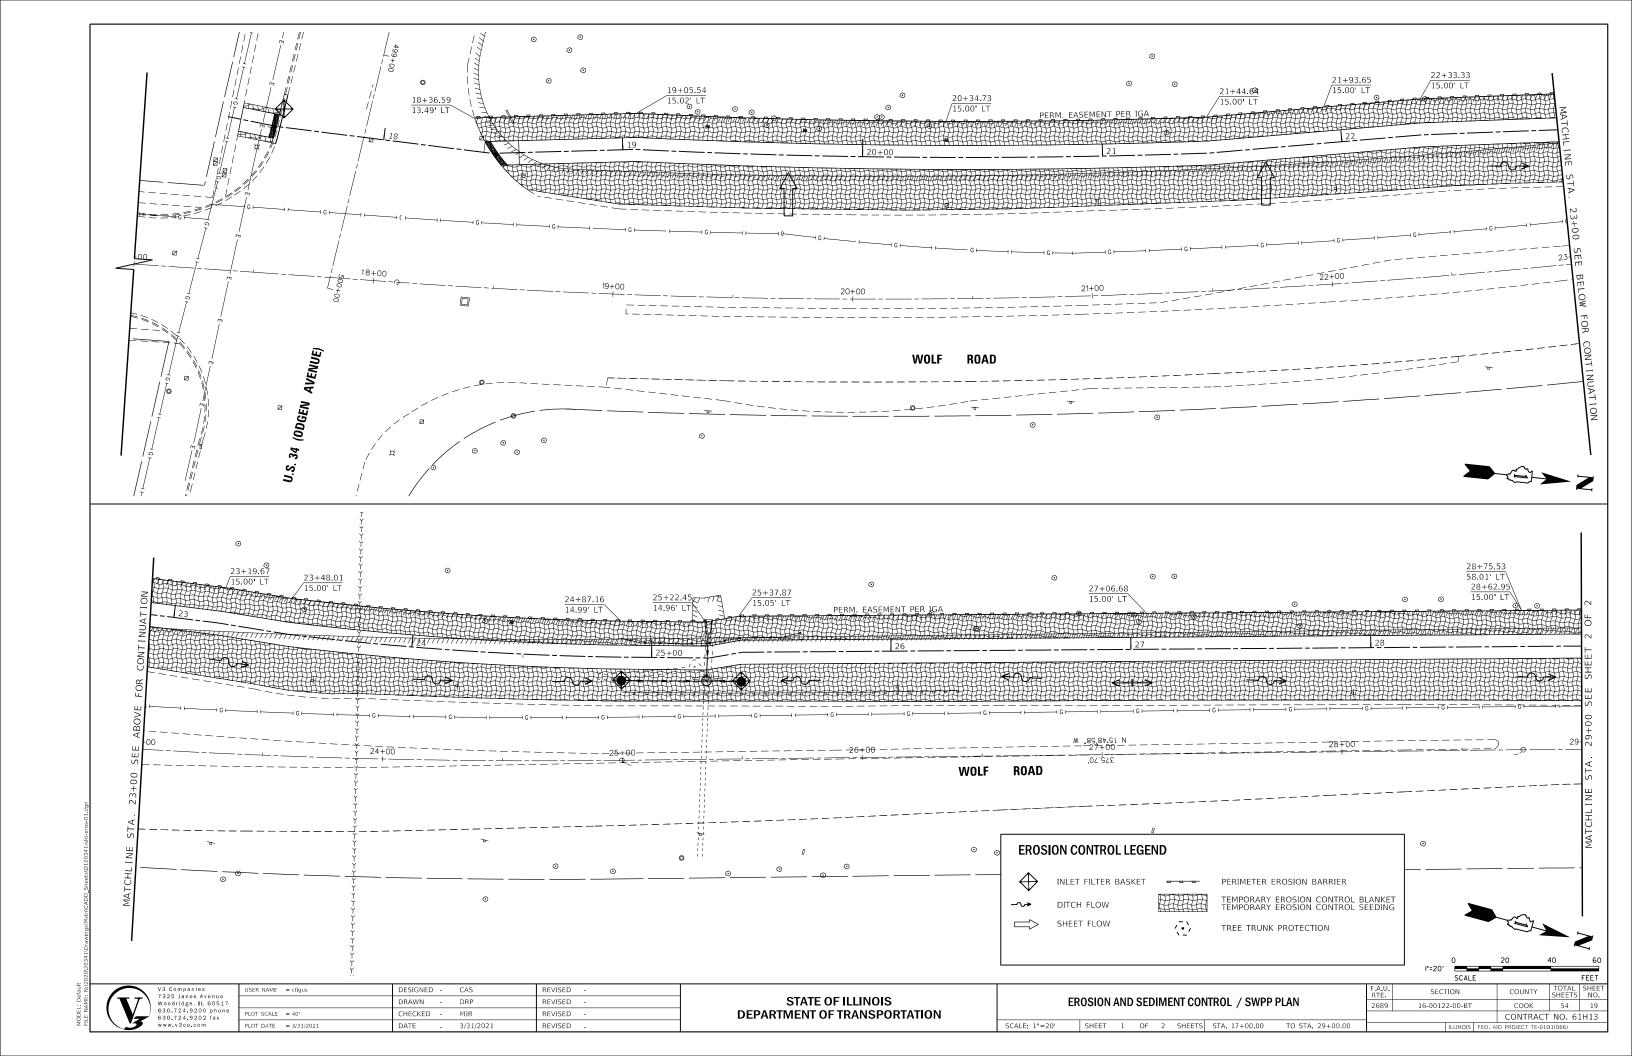

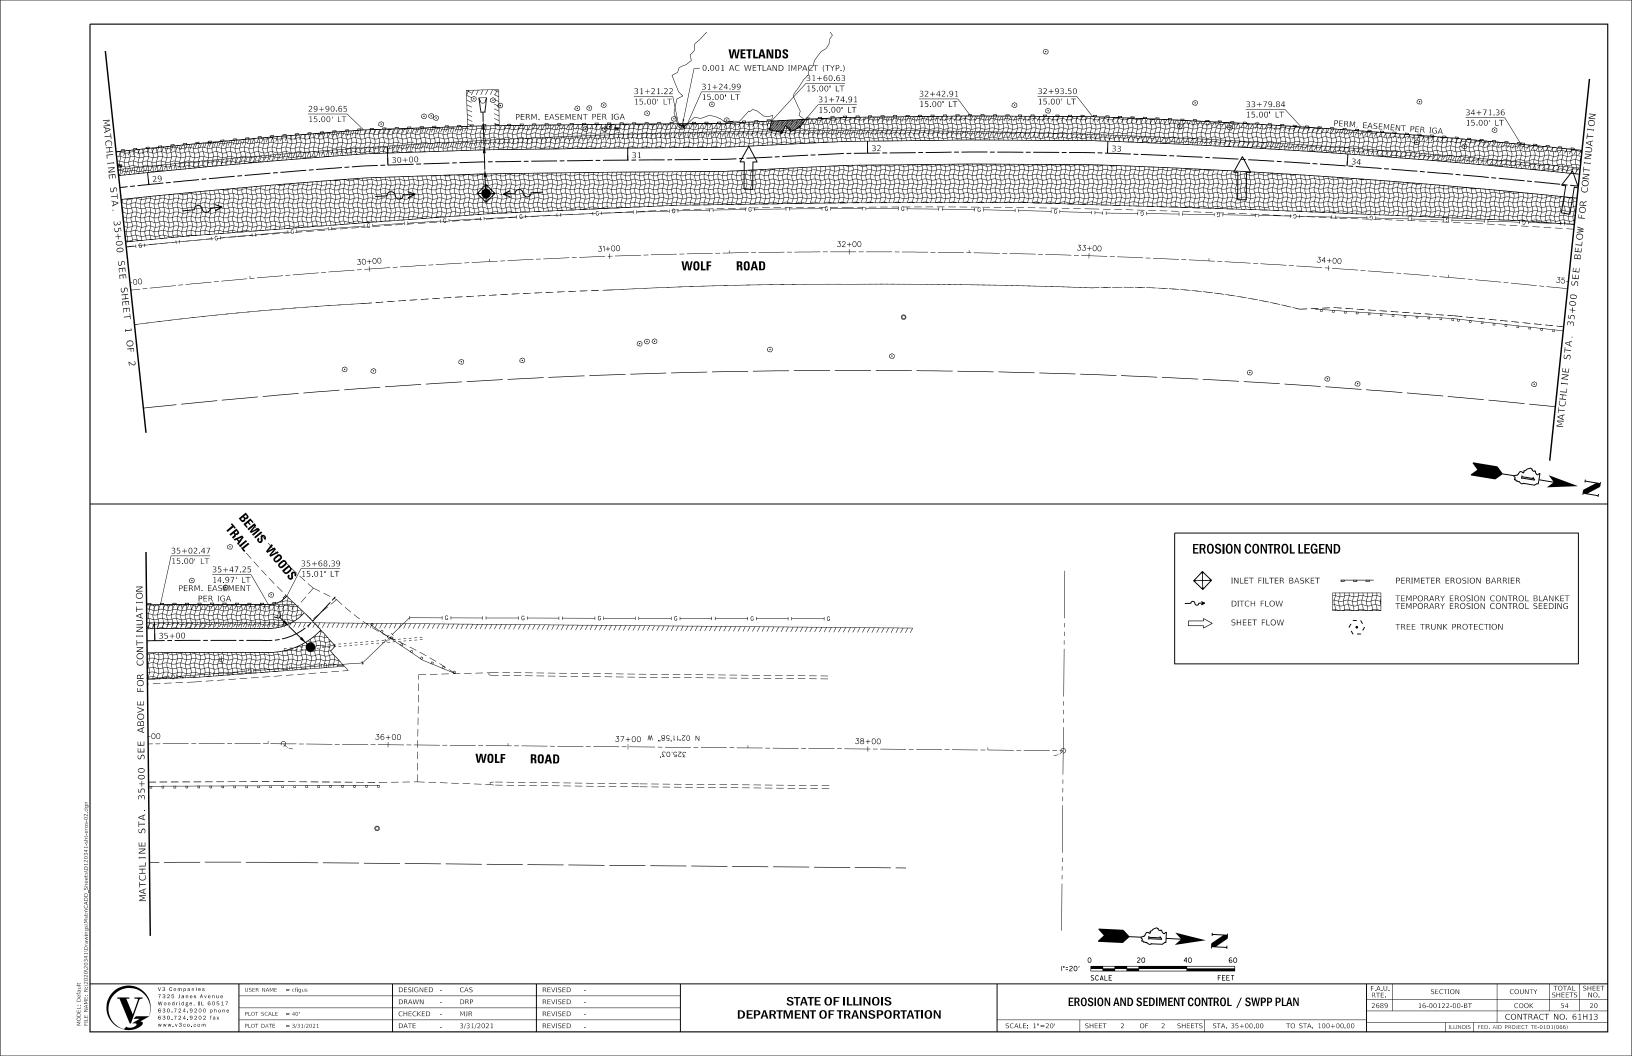

STORM WATER POLLUTION PREVENTION NOTES

1. SITE DESCRIPTION:

- A. THE CONSTRUCTION ACTIVITY WILL INCLUDE THE CONSTRUCTION OF A SHARED USE PATH ALONG THE WEST SIDE OF WOLF ROAD.
- B. THE INTENDED SEQUENCE OF CONSTRUCTION ACTIVITIES IS AS FOLLOWS: 1) INSTALL SILT FENCE, 2) CLEARING AND GRUBBING, 3) STRIPPING OF TOPSOIL, 4) MASS GRADING AND SOIL AMENDMENT, 5) PATH AND DRAINAGE CONSTRUCTION, 6) FINE GRADING AND TOPSOIL PLACEMENT, 7) SEEDING AND EROSION CONTROL BLANKET, AND 8) SILT FENCE REMOVAL WHEN TURF IS ESTABLISHED.
- C. THE PROJECT AREA THAT IS EXPECTED TO BE DISTURBED BY GRADING, OR OTHER ACTIVITIES IS APPROXIMATELY 1.5 ACRES.
- D. THE RUNOFF COEFFICIENT OF THE SITE AFTER CONSTRUCTION ACTIVITIES ARE COMPLETED IS ESTIMATED TO BE 0.51. THE SOIL TYPES THAT ARE PREVALENT ON THE SITE ARE ALFIC ADARENTS, BLOUNT SILT LOAM, AND OZAUKEE SILT LOAM. THE PROJECT CONSISTS OF PREDOMINANTLY HYDROLOGIC GROUP C SOILS ACCORDING TO THE SOIL SURVEY OF COOK COUNTY.
- E. THIS PLAN INDICATES DRAINAGE PATTERNS AND APPROXIMATE SLOPES ANTICIPATED BEFORE AND AFTER MAJOR GRADING ACTIVITIES, LOCATIONS WHERE VEHICLES ENTER AND EXIT THE SITE AND CONTROLS TO PREVENT OFFSITE SEDIMENT TRACKING, AREAS OF SOIL DISTURBANCE, THE LOCATION OF MAJOR STRUCTURAL AND NONSTRUCTURAL CONTROLS IDENTIFIED IN HE PLAN, THE LOCATION OF AREAS WHERE STABILIZATION PRACTICES ARE EXPECTED TO OCCUR, AND LOCATIONS WHERE STORM WATER IS DISCHARGED.
- F. THE RECEIVING WATER IS SALT CREEK.

2. CONTROLS:

A. EROSION AND SEDIMENT CONTROLS.

(I) STABILIZATION PRACTICES

- THE SILT FENCE WILL BE INSTALLED BEFORE GRADING ACTIVITIES BEGIN.
- INLET FILTERS WILL BE INSTALLED FOR ALL OPEN LID STORM SEWER STRUCTURES AS SHOWN ON THE EROSION CONTROL / SWPPP PLAN OR AS NEEDED AS CONSTRUCTION PROGRESSES.
- ALL DISTURBED AREAS OF THE SITE SHALL BE BROUGHT TO FINAL GRADE, RESPREAD WITH TOPSOIL AND ESTABLISHED WITH PERMANENT VEGETATION AS SOON AS PRACTICABLE
- THESE CONTROLS SHALL BE ACTIVELY MAINTAINED UNTIL FINAL STABILIZATION OF THOSE PORTIONS OF THE SITE UPWARD OF THE PERIMETER CONTROL EXCEPT AS PROVIDED IN PARAGRAPHS (A) AND (B) BELOW, STABILIZATION MEASURES SHALL BE INITIATED AS SOON AS PRACTICABLE IN PORTIONS OF THE SITE WHERE CONSTRUCTION ACTIVITIES HAVE TEMPORARILY OR PERMANENTLY CEASED, BUT IN NO CASE MORE THAN 14 DAYS AFTER THE CONSTRUCTION ACTIVITY IN THAT PORTION OF THE SITE HAS TEMPORARILY OR PERMANENTLY CEASED.
- (A) WHERE THE INITIATION OF STABILIZATION MEASURES BY THE 14TH DAY AFTER CONSTRUCTION ACTIVITY TEMPORARY OR PERMANENTLY CEASE IS PRECLUDED BY SNOW COVER, STABILIZATION MEASURES SHALL BE INITIATED AS SOON AS PRACTICABLE
- (B) WHERE CONSTRUCTION ACTIVITY WILL RESUME ON A PORTION OF THE SITE WITHIN 7 DAYS FROM WHEN ACTIVITIES CEASED, (E.G. THE TOTAL TIME PERIOD THAT CONSTRUCTION ACTIVITY IS TEMPORARILY CEASED IS LESS THAN 7 DAYS) THEN STABILIZATION MEASURES DO NOT HAVE TO BE INITIATED ON THAT PORTION OF THE SITE BY THE 7TH DAY AFTER CONSTRUCTION ACTIVITY TEMPORARILY CEASED.

THE CONTRACTOR SHALL PROVIDE TEMPORARY STABILIZATION ON STOCKPILES WHERE CONSTRUCTION ACTIVITY WILL NOT RESUME FOR 3 DAYS.

(II) STRUCTURAL PRACTICES

- DISTURBED AREAS OF THE SITE SHALL BE GRADED TO DRAIN TO THE PROPOSED DRAINAGE STRUCTURES.
- SILT FENCE SHALL BE INSTALLED DOWNSTREAM OF ANY AREAS THAT DO NOT DRAIN
 THROUGH THE STORM WATER FACILITIES. SILT FENCE SHALL BE ACTIVELY MAINTAINED
 UNTIL FINAL STABILIZATION OF THOSE PORTIONS OF THE SITE UPWARD OF THE PERIMETER
 CONTROL.
- B. STORM WATER MANAGEMENT
- (I) THE SITE CURRENTLY DRAINS VIA OVERLAND FLOW TO THE WEST. DUE TO THE FACT THAT ONLY A VERY SMALL AMOUNT OF IMPERVIOUS AREA IS BEING ADDED, NO STORMWATER DETENTION IS PROPOSED.
- (II) EXISTING DRAINAGE PATTERNS SHOULD BE MAINTAINED.

C. OTHER CONTROLS.

- (I) WASTE DISPOSAL. NO SOLID MATERIALS, INCLUDING BUILDING MATERIALS, SHALL BE DISCHARGED TO WATERS OF THE STATE, EXCEPT AS AUTHORIZED BY A SECTION 404 PERMIT.
- (II) THE CONTRACTOR IS RESPONSIBLE FOR COMPLIANCE WITH APPLICABLE STATE AND/OR LOCAL WASTE DISPOSAL AND SANITARY SEWER OR SEPTIC SYSTEM REGULATIONS.
- D. ENVIRONMENTAL PROTECTION AGENCY'S ILLINOIS URBAN MANUAL, LATEST EDITION IN THE EVENT OF CONFLICTING SPECIFICATIONS WITH REGARD TO SITEWORK ISSUES DESIGNED BY THE ENGINEER, THE MORE STRINGENT REQUIREMENT SHALL GOVERN.

3. MAINTENANCE:

THE CONTRACTOR SHALL MAINTAIN THE SEDIMENT AND EROSION CONTROL MEASURES IDENTIFIED ON THIS PLAN UNTIL THE SITE IS STABILIZED. ITEMS IN NEED OF REPAIR SHALL BE ADDRESSED AS SOON AS PRACTICABLE. MAINTENANCE ITEMS INCLUDE STRAW BALES, INLET FILTERS, SILT FENCE, CONSTRUCTION ENTRANCES, AND VEGETATION THROUGHOUT THE SITE. FURTHERMORE, ANY SOIL THAT IS TRANSPORTED OFFSITE SHALL BE CLEANED DAILY, OR AS REQUESTED BY THE LOCAL AGENCY.

4. INSPECTIONS:

- A. QUALIFIED PERSONNEL (PROVIDED BY THE PERMITTEE) SHALL INSPECT DISTURBED AREAS OF THE CONSTRUCTION SITE THAT HAVE NOT BEEN FINALLY STABILIZED, STRUCTURAL CONTROL MEASURES, AND LOCATIONS WHERE VEHICLES ENTER OR EXIT THE SITE AT LEAST ONCE EVERY SEVEN CALENDAR DAYS AND WITHIN 24 HOURS OF THE END OF A STORM THAT IS 0.5 INCHES OR GREATER OR EQUIVALENT SNOWFALL. QUALIFIED PERSONNEL MEANS A PERSON KNOWLEDGEABLE IN THE PRINCIPLES AND PRACTICE OF EROSION AND SEDIMENT CONTROLS, SUCH AS A LICENSED PROFESSIONAL ENGINEER OR OTHER KNOWLEDGEABLE PERSON WHO POSSESSES THE SKILLS TO ASSESS CONDITIONS AT THE CONSTRUCTION SITE THAT COULD IMPACT STORM WATER QUALITY AND TO ASSESS THE EFFECTIVENESS OF ANY SEDIMENT AND EROSION CONTROL MEASURES SELECTED TO CONTROL THE QUALITY OF STORM WATER DISCHARGES FROM THE CONSTRUCTION ACTIVITIES.
- B. DIS1URBED AREAS AND AREAS USED FOR STORAGE OF MATERIALS THAT ARE EXPOSED TO PRECIPITATION SHALL BE INSPECTED FOR EVIDENCE OF OR THE POTENTIAL FOR, POLLUTANTS ENTERING THE DRAINAGE SYSTEM. EROSION AND SEDIMENT CONTROL MEASURES IDENTIFIED IN THE PLAN SHALL BE OBSERVED TO ENSURE THAT THEY ARE OPERATING CORRECTLY WHERE DISCHARGE LOCATIONS OR POINTS ARE ACCESSIBLE, THEY SHALL BE INSPECTED TO ASCERTAIN WHETHER EROSION CONTROL MEASURES ARE EFFECTIVE IN PREVENTING SIGNIFICANT IMPACTS TO RECEIVING WATERS. LOCATIONS WHERE VEHICLES ENTER OR EXIT THE SITE SHALL BE INSPECTED FOR EVIDENCE OF OFFSITE SEDIMENT TRACKING. WOLF ROAD SHOULD BE KEPT CLEAN AND FREE OF DEBRIS AT ALL TIMES.
- C. BASED ON THE RESULTS OF THE INSPECTION, THE DESCRIPTION OF POTEROADNTIAL POLLUTANT SOURCES IDENTIFIED IN THE PLAN IN ACCORDANCE WITH PARAGRAPH 1 (SITE DESCRIPTION) OF THESE NOTES AND POLLUTION PREVENTION MEASURES IDENTIFIED IN THE PLAN IN ACCORDANCE WITH PARAGRAPH 2 (CONTROLS) OF THESE NOTES SHALL BE REVISED AS APPROPRIATE AS SOON AS PRACTICABLE AFTER SUCH INSPECTION. SUCH MODIFICATIONS SHALL PROVIDE FOR TIMELY IMPLEMENTATION OF ANY CHANGES TO THE PLAN WITHIN 7 CALENDAR DAYS FOLLOWING THE INSPECTION
- D. A REPORT SUMMARIZING THE SCOPE OF THE INSPECTION, NAME(S) AND QUALIFICATIONS OF PERSONNEL MAKING THE INSPECTION, THE DATE(S) OF THE INSPECTION, MAJOR OBSERVATIONS RELATING TO THE IMPLEMENTATION OF THE STORM WATER POLLUTION PREVENTION PLAN, AND ACTIONS TAKEN IN ACCORDANCE WITH PARAGRAPH C ABOVE SHALL BE MADE AND RETAINED AS PART OF THE STORM WATER POLLUTION PREVENTION PLAN FOR AT LEAST THREE YEARS FROM THE DATE THAT THE PERMIT COVERAGE EXPIRES OR IS TERMINATED THE REPORT SHALL BE SIGNED BY THE PERMITEE.
- E. THE PERMITTEE SHALL COMPLETE AND SUBMIT WITHIN 5 DAYS AN "INCIDENCE OF NONCOMPLIANCE" (ION) REPORT FOR ANY VIOLATION OF THE STORM WATER POLLUTION PREVENTION PLAN OBSERVED DURING AN INSPECTION CONDUCTED, INCLUDING THOSE NOT REQUIRED BY THE PLAN SUBMISSION. REPORTS SHALL BE ON FORMS PROVIDED BY THE AGENCY AND INCLUDE SPECIFIC INFORMATION ON THE CAUSE OF NONCOMPLIANCE, ACTIONS WHICH WERE TAKEN TO PREVENT ANY FURTHER CAUSES OF NONCOMPLIANCE, AND A STATEMENT DETAILING ANY ENVIRONMENTAL IMPACT THAT MAY HAVE RESULTED FROM THE NONCOMPLIANCE.
- F. ALL REPORTS OF NONCOMPLIANCE SHALL BE SIGNED BY THE PERMITTEE.
- G. ALL REPORTS OF NONCOMPLIANCE SHALL BE MAILED TO THE AGENCY AT THE FOLLOWING ADDRESS:

ILLINOIS ENVIRONMENTAL PROTECTION AGENCY DIVISION OF WATER POLLUTION CONTROL COMPLIANCE ASSURANCE SECTION 1021 NORTH GRAND AVENUE EAST POST OFFICE BOX 19276 SPRINGFIELD, ILLINOIS 62794-9276

5. NON-STORM WATER DISCHARGES:

THE FOLLOWING SOURCES OF NON-STORMWATER MAY BE COMBINED WITH STORMWATER DISCHARGES ASSOCIATED WITH THE INDUSTRIAL ACTIVITY ADDRESSED IN THIS PLAN.

- FIRE FIGHTING ACTIVITIES
- WATER MAIN HYDRANT FLUSHING
- WATERING FOR DUST CONTROL
- IRRIGATION DRAINAGE FOR VEGETATIVE GROWTH
- WASH WATER WHERE DETERGENTS ARE NOT USED
- UNCONTAMINATED GROUND WATER

NON-FIRE FIGHTING DISCHARGES FROM WATER MAINS AND PUMPS SHALL NOT BE PERMITTED TO FLOW DIRECTLY ONTO THE SOIL WITHOUT ENERGY DISSIPATERS SUFFICIENT TO REDUCE VELOCITIES TO A NON-EROSIVE RATE. ALL WATER PUMPED OF WHICH IS OTHERWISE DISCHARGED FROM THE SITE DURING CONSTRUCTION DEWATERING SHALL BE FILTERED AND A MEANS PROVIDED TO REDUCE FROSION

6. RETENTION OF RECORDS:

- A. THE PERMITTEE SHALL RETAIN COPIES OF STORM WATER POLLUTION PREVENTION PLANS AND ALL REPORTS AND NOTICES REQUIRED BY THIS PERMIT, AND RECORDS OF ALL DATA USED TO COMPLETE THE NOTICE OF INTENT TO BE COVERED BY THIS PERMIT, FOR A PERIODS OF AT LEAST THREE YEARS FROM THE DATE THAT THE PERMIT COVERAGE EXPIRES OR IS TERMINATED. THIS PERIOD MAY BE EXTENDED BY REQUEST OF THE AGENCY AT ANY TIME.
- B. THE PERMITTEE SHALL RETAIN A COPY OF THE STORM WATER POLLUTION PREVENTION PLAN.

7. NOTICE OF TERMINATION

UPON FINAL STABILIZATION OF THE SITE THE PERMITTEE SHALL SUBMIT A COMPLETED NOTICE OF TERMINATION IN ACCORDANCE WITH NPDES PERMIT NO. ILR10.

8. CERTIFICATION STATEMENT

DATED THIS

THE FOLLOWING STATEMENT SHALL BE SIGNED PRIOR TO ANY WORK AUTHORIZED BY THE NPDES PERMIT NO. ILR10 IS PERFORMED AT THE SITE. THE UNDERSIGNED IS RESPONSIBLE FOR IMPLEMENTATION OF ALL MEASURES IDENTIFIED ON THIS PLAN.

CONTRACTOR CERTIFICATION STATEMENT

DAY OF


I CERTIFY UNDER PENALTY OF LAW THAT I UNDERSTAND THE TERMS AND CONDITIONS OF THE GENERAL NATIONAL POLLUTANT DISCHARGE ELIMINATION SYSTEM PERMIT (ILR10) THAT AUTHORIZES THE STORMWATER DISCHARGES ASSOCIATED WITH THE INDUSTRIAL ACTIVITY FROM THE CONSTRUCTION SITE IDENTIFIED AS PART OF THIS CERTIFICATION.


20


BY:	TITLE:	
COMPANY:		
ADDRESS:		
TELEPHONE:		
ADDITIONAL REQUIRED SIGNATURES:		
OWNER		DATE
SUBCONTRACTOR		DATE


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	DRAWN -	DRP	REVISED -
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PLOT DATE = 3/31/2021	DATE -	3/31/2021	REVISED -


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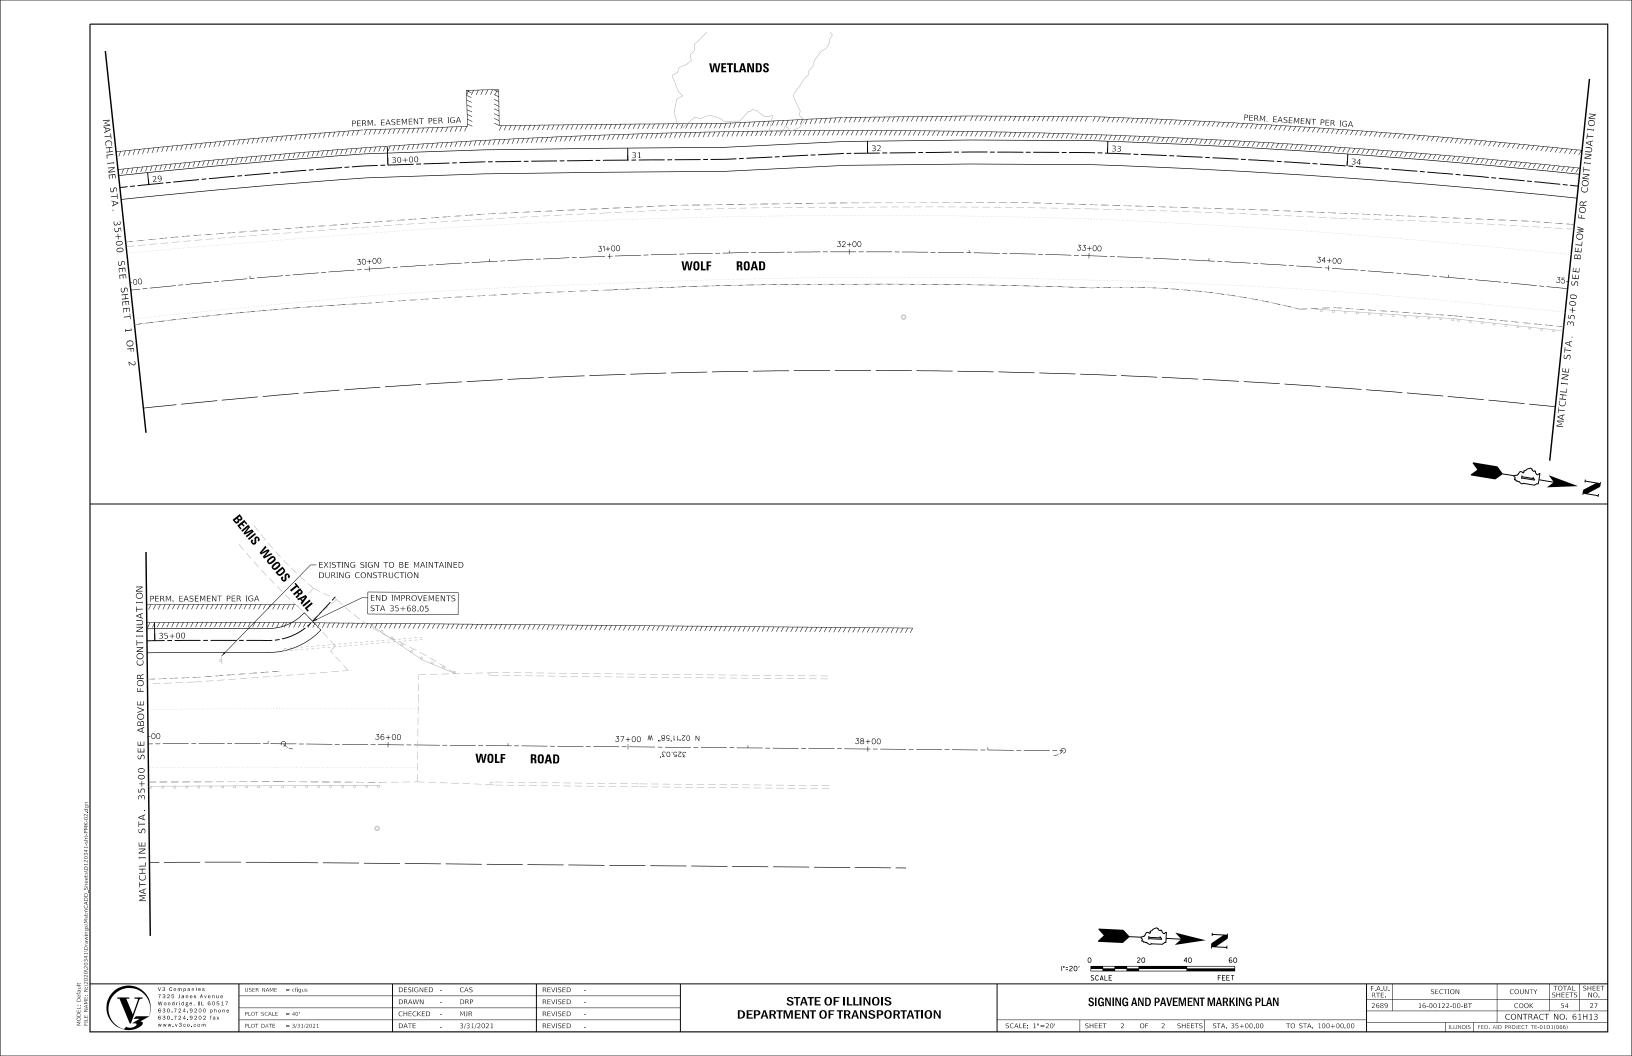


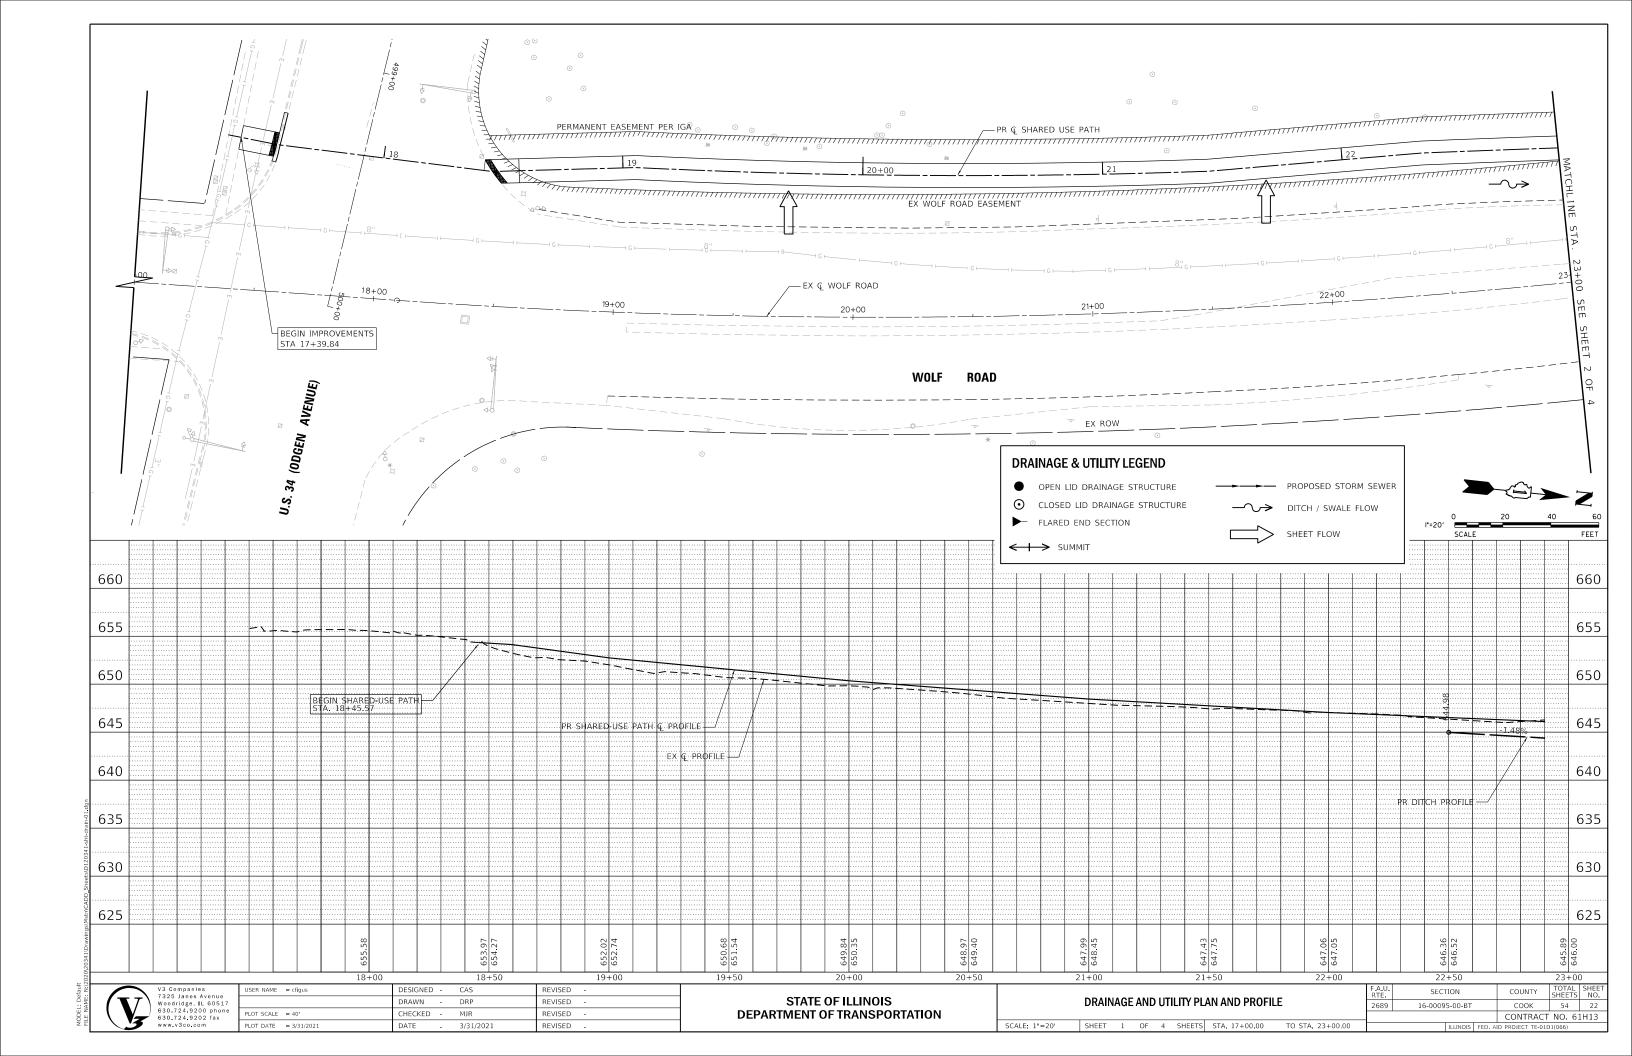


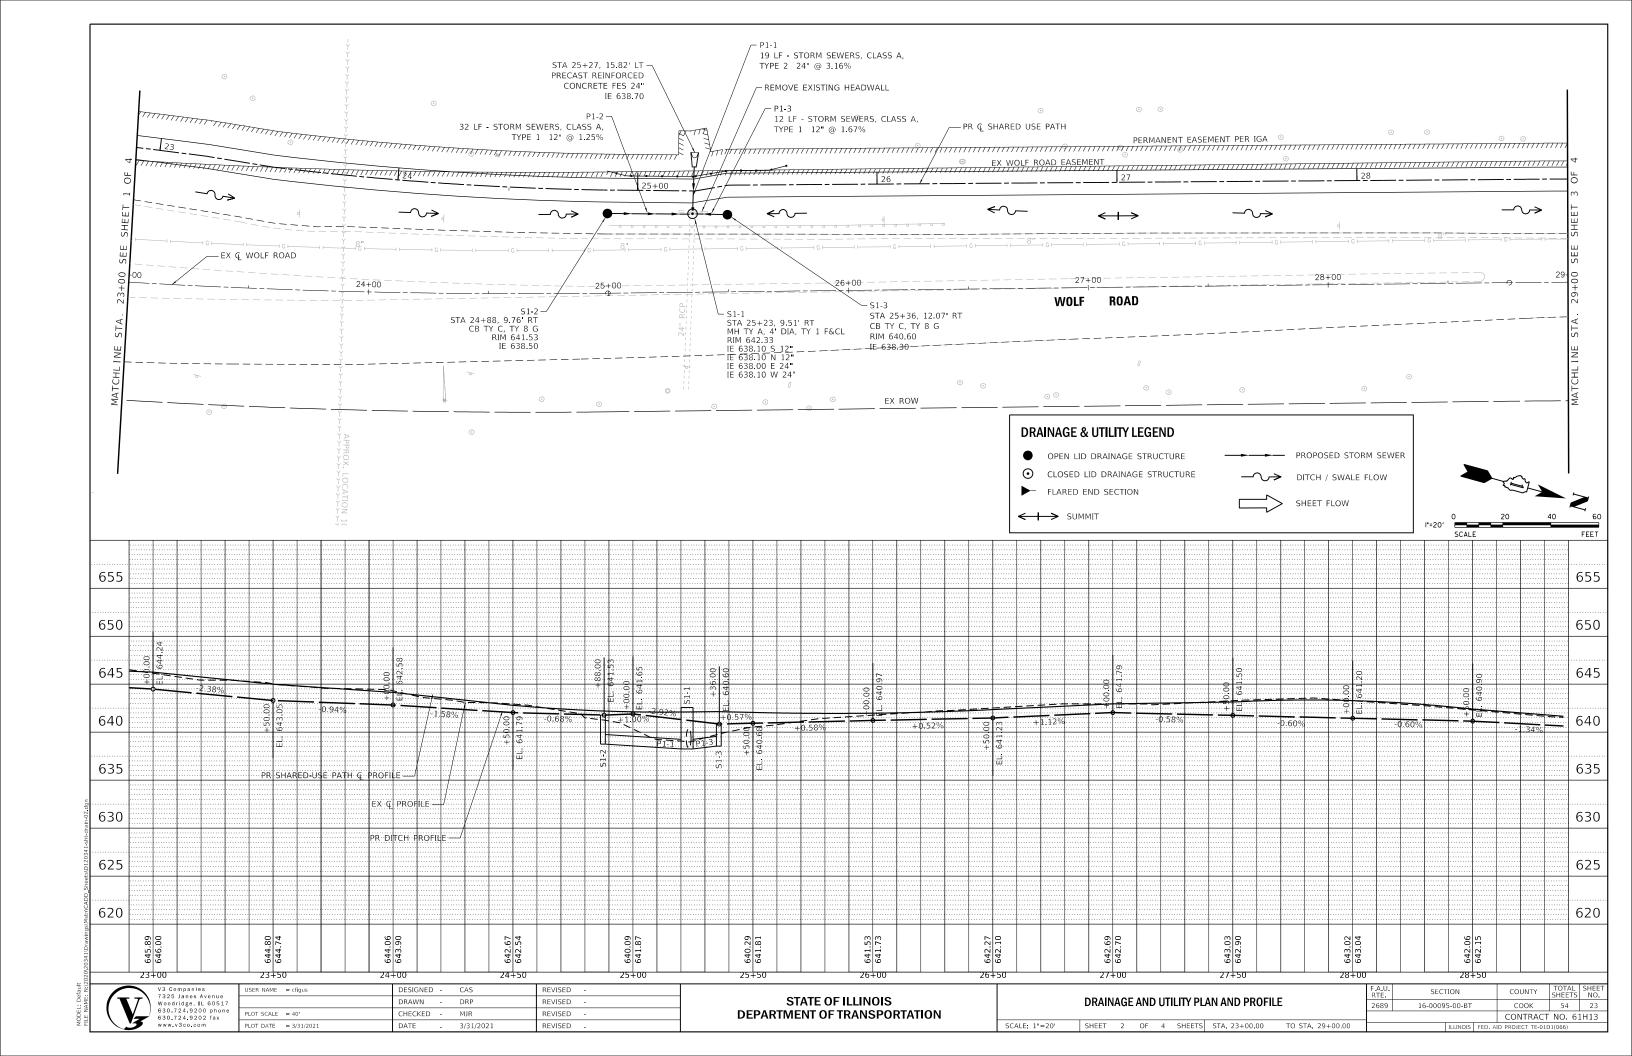

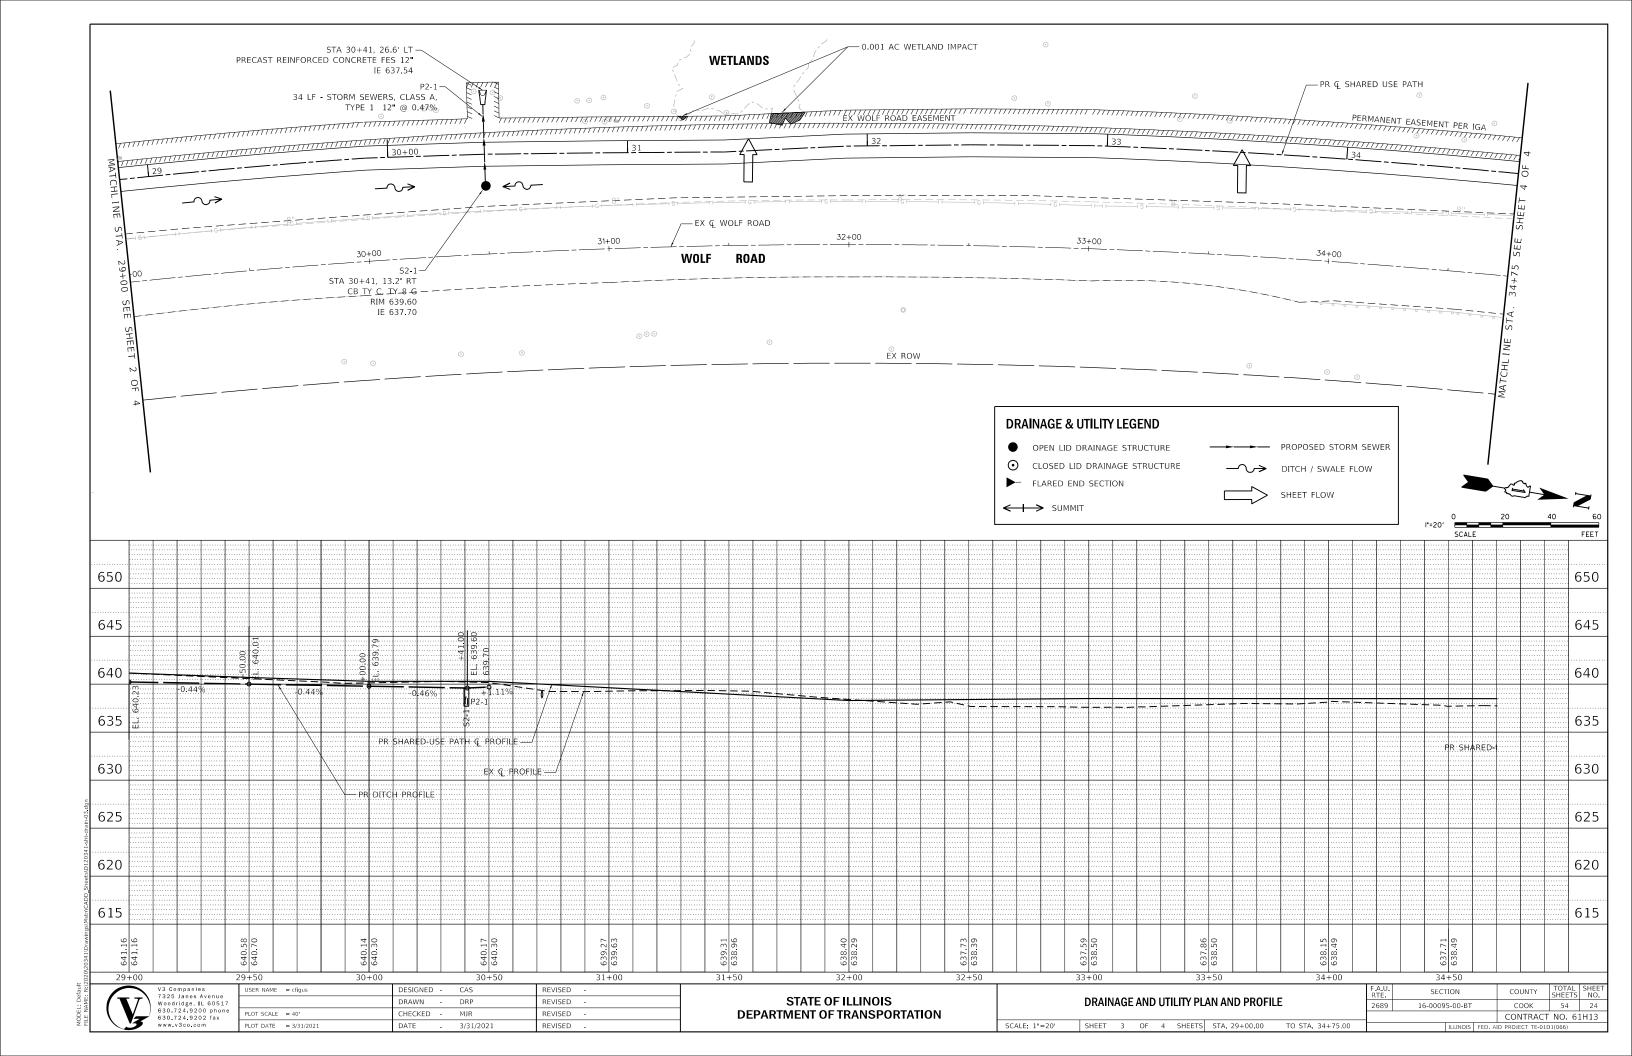

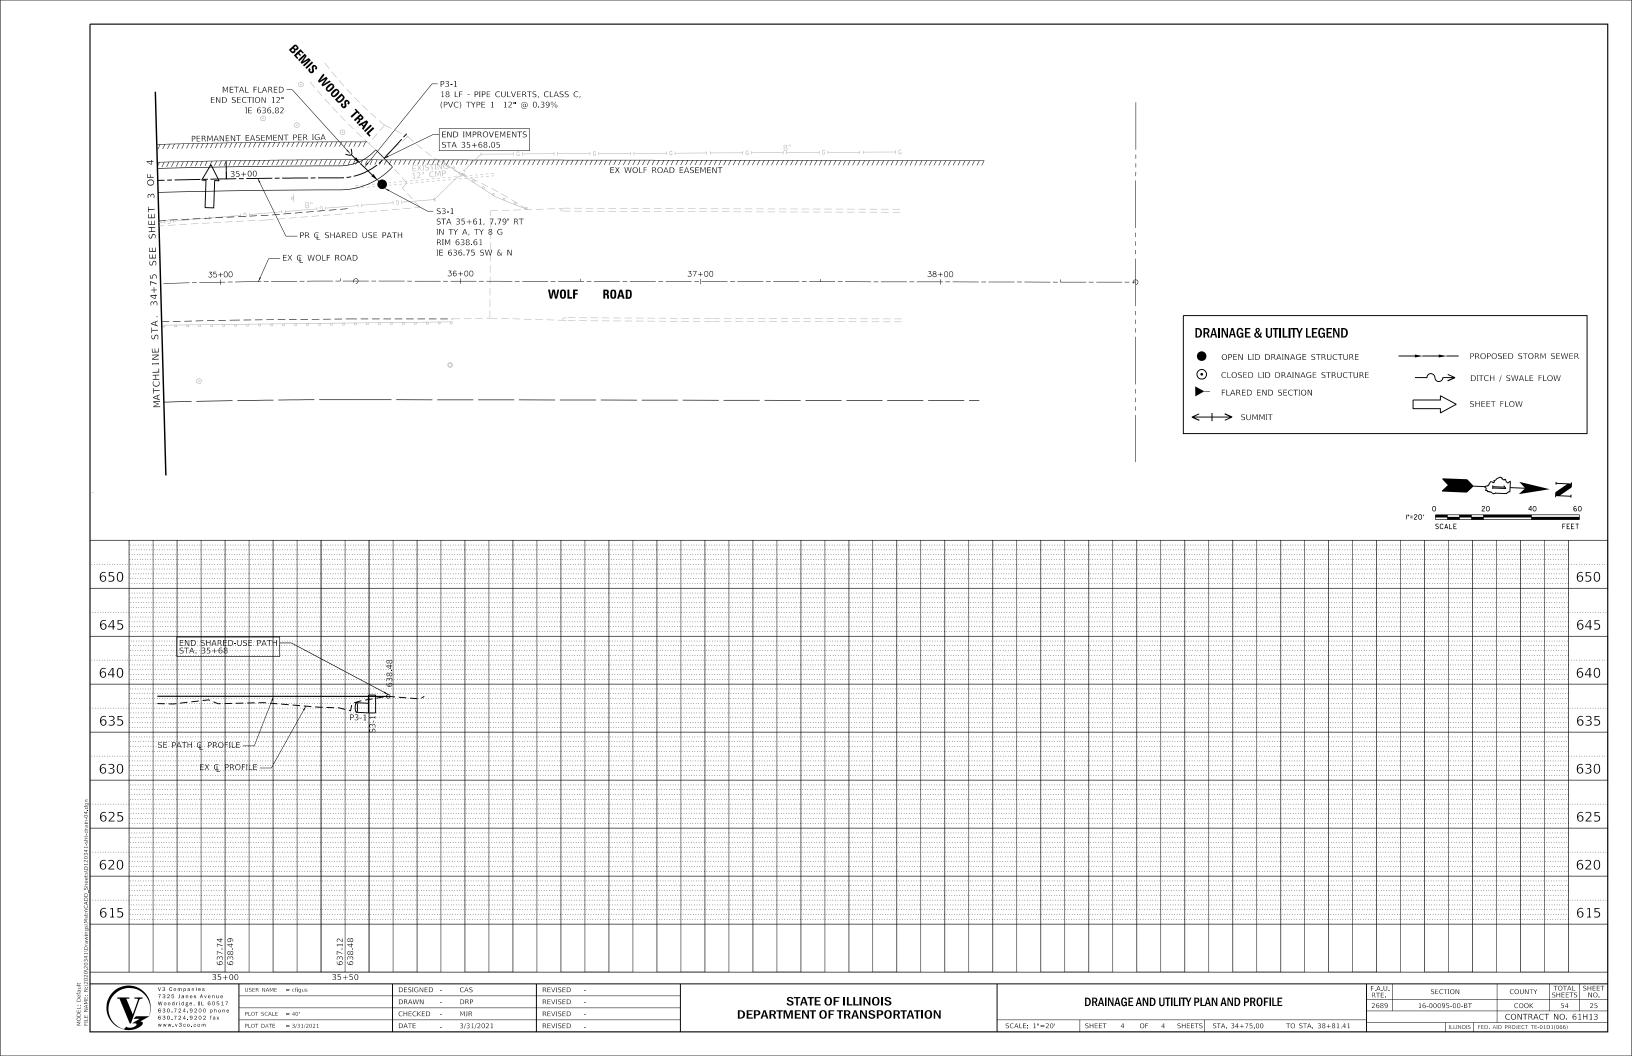

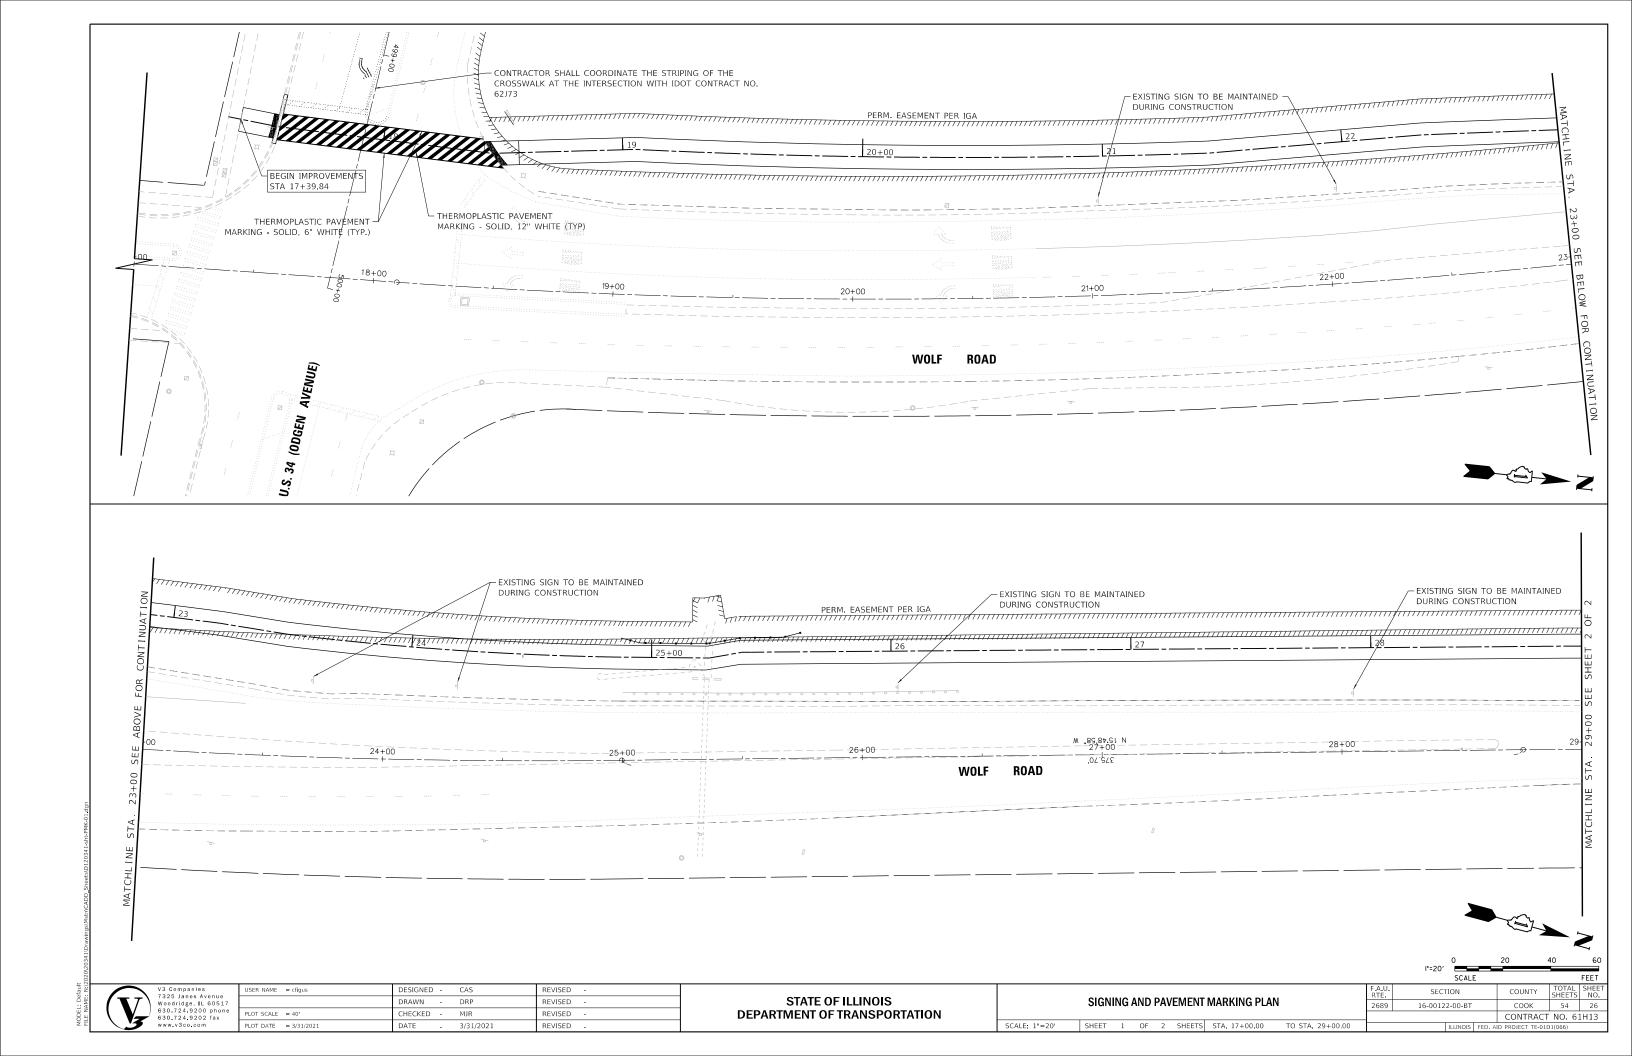

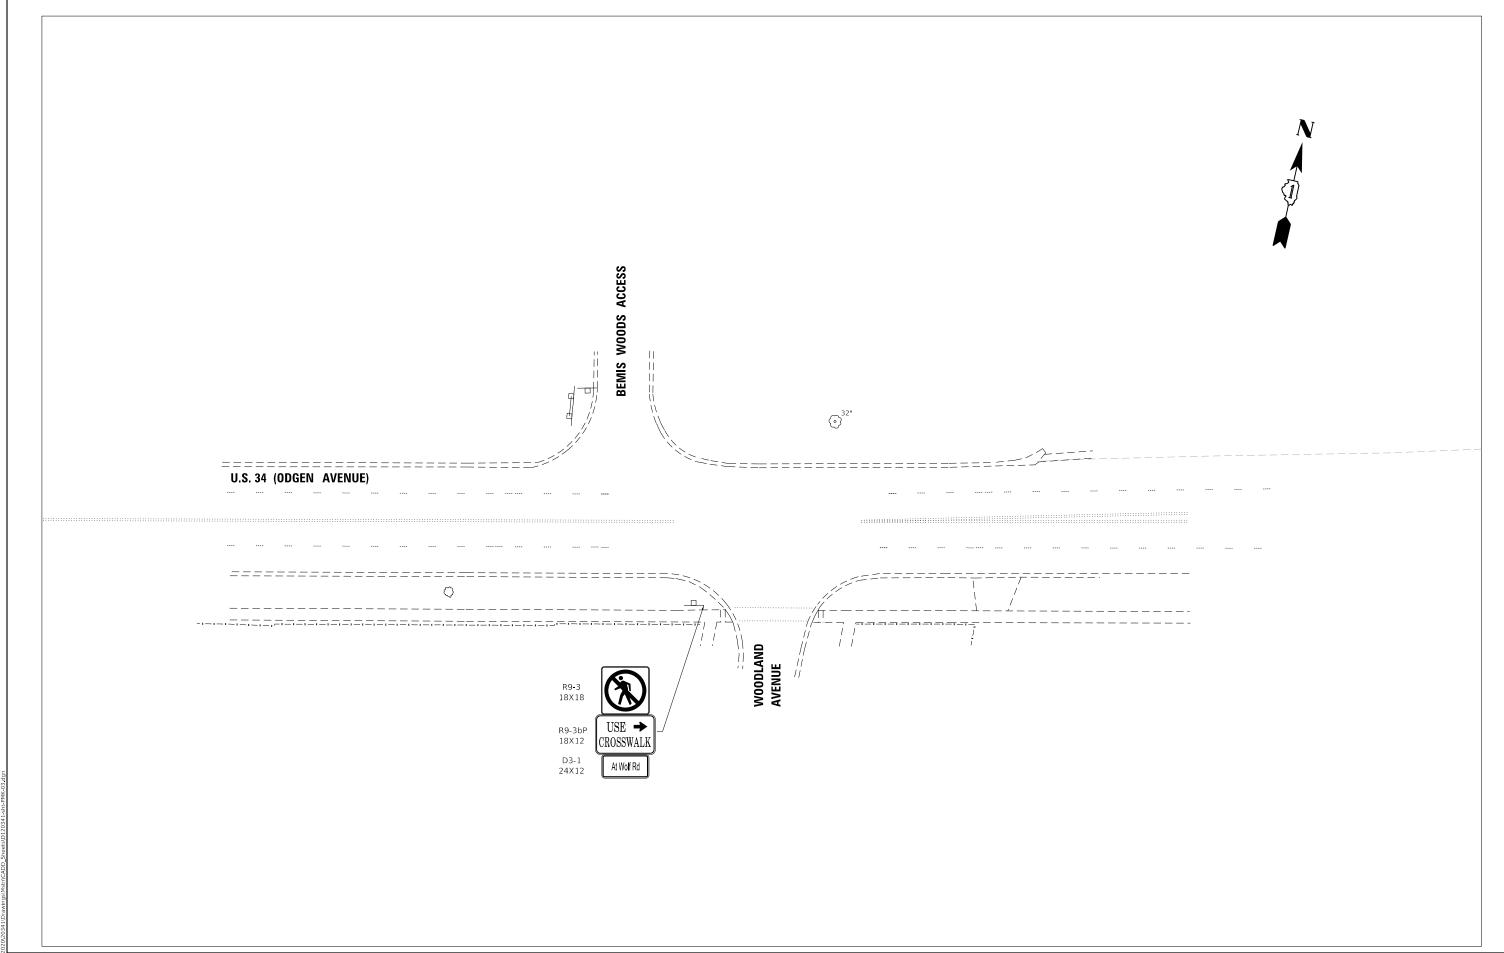


V3 Companies
7325 Janes Avenue
Woodridge, IL 60517
630.724.9200 phone
630.724.9202 fax
www.v3co.com


STATE OF ILLINOIS DEPARTMENT OF TRANSPORTATION


 SIGNING AND PAVEMENT MARKING PLAN


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 SHEET 3 OF 3 SHEETS STA. 100+00.00 TO STA. 100+00.00


MODEL: Default

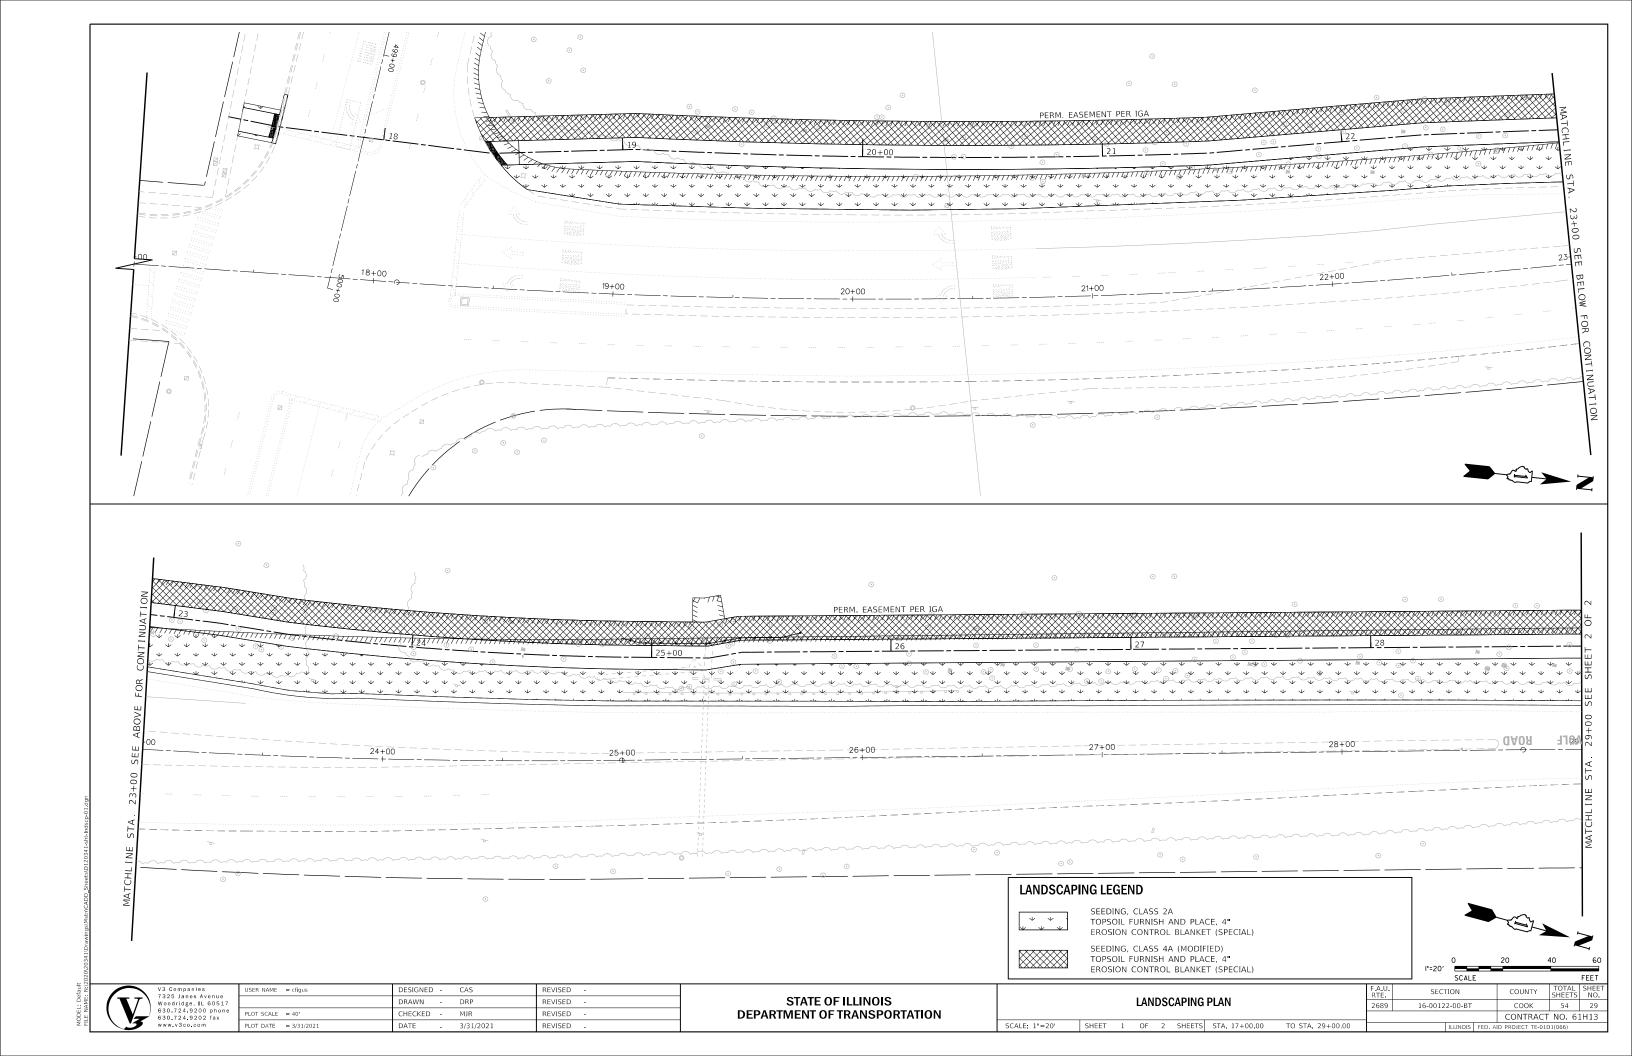

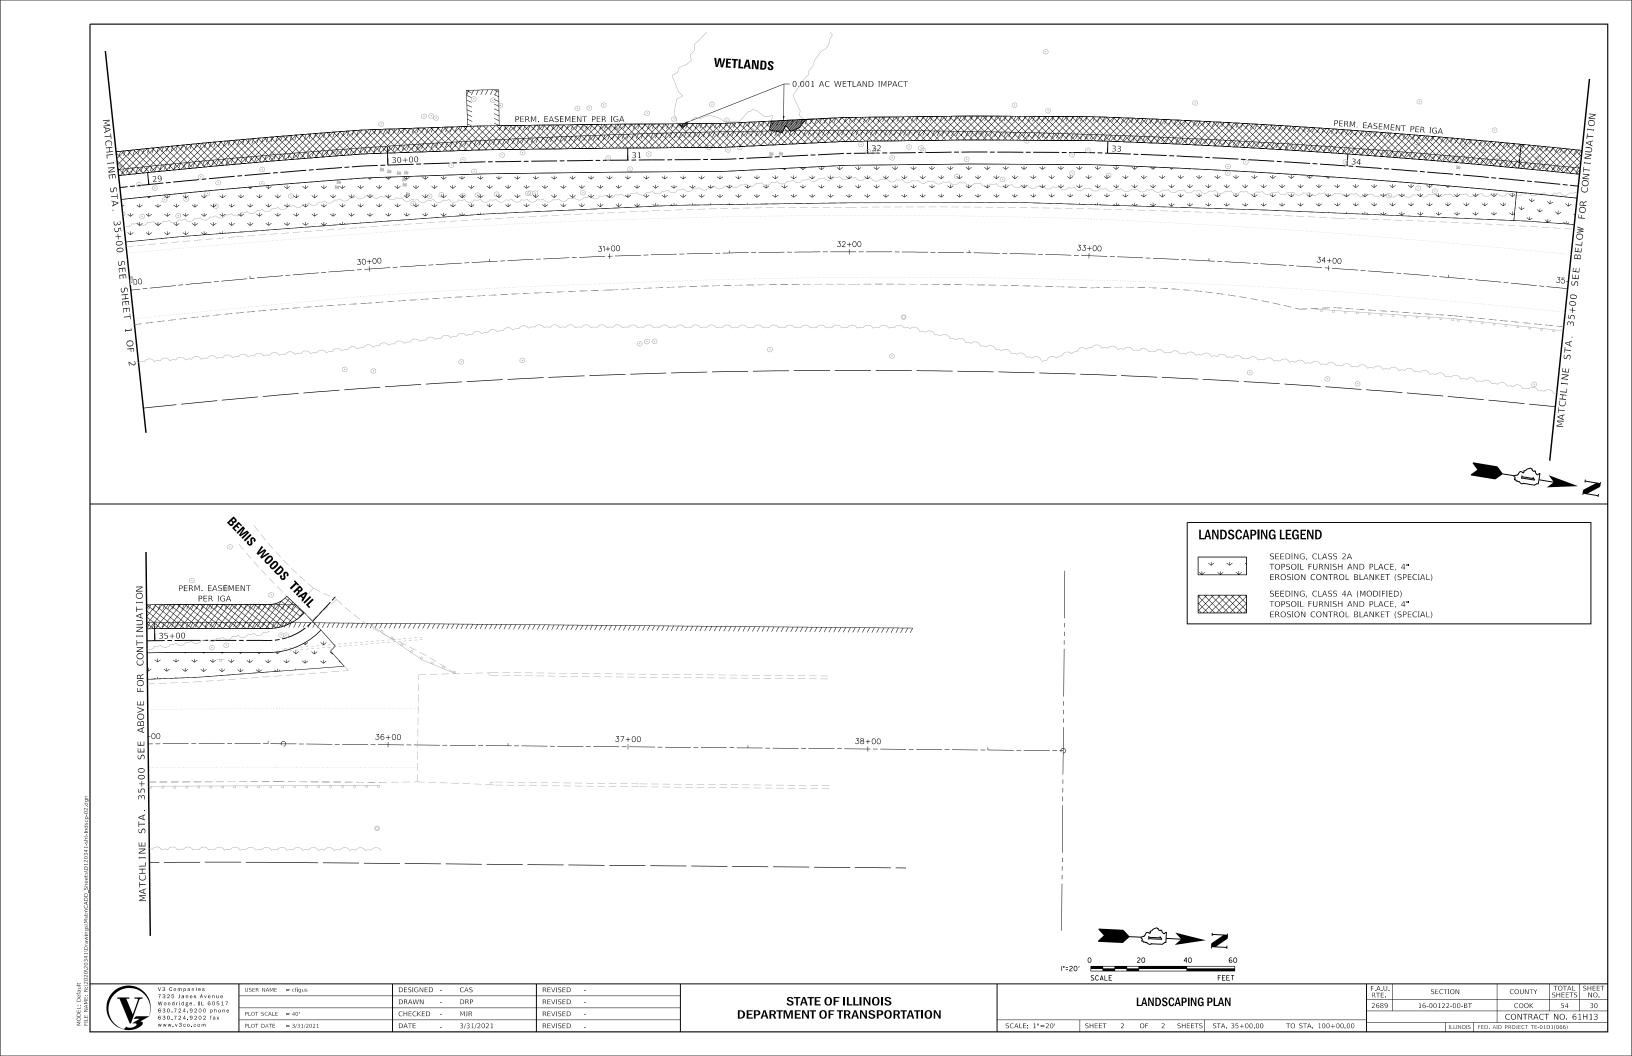

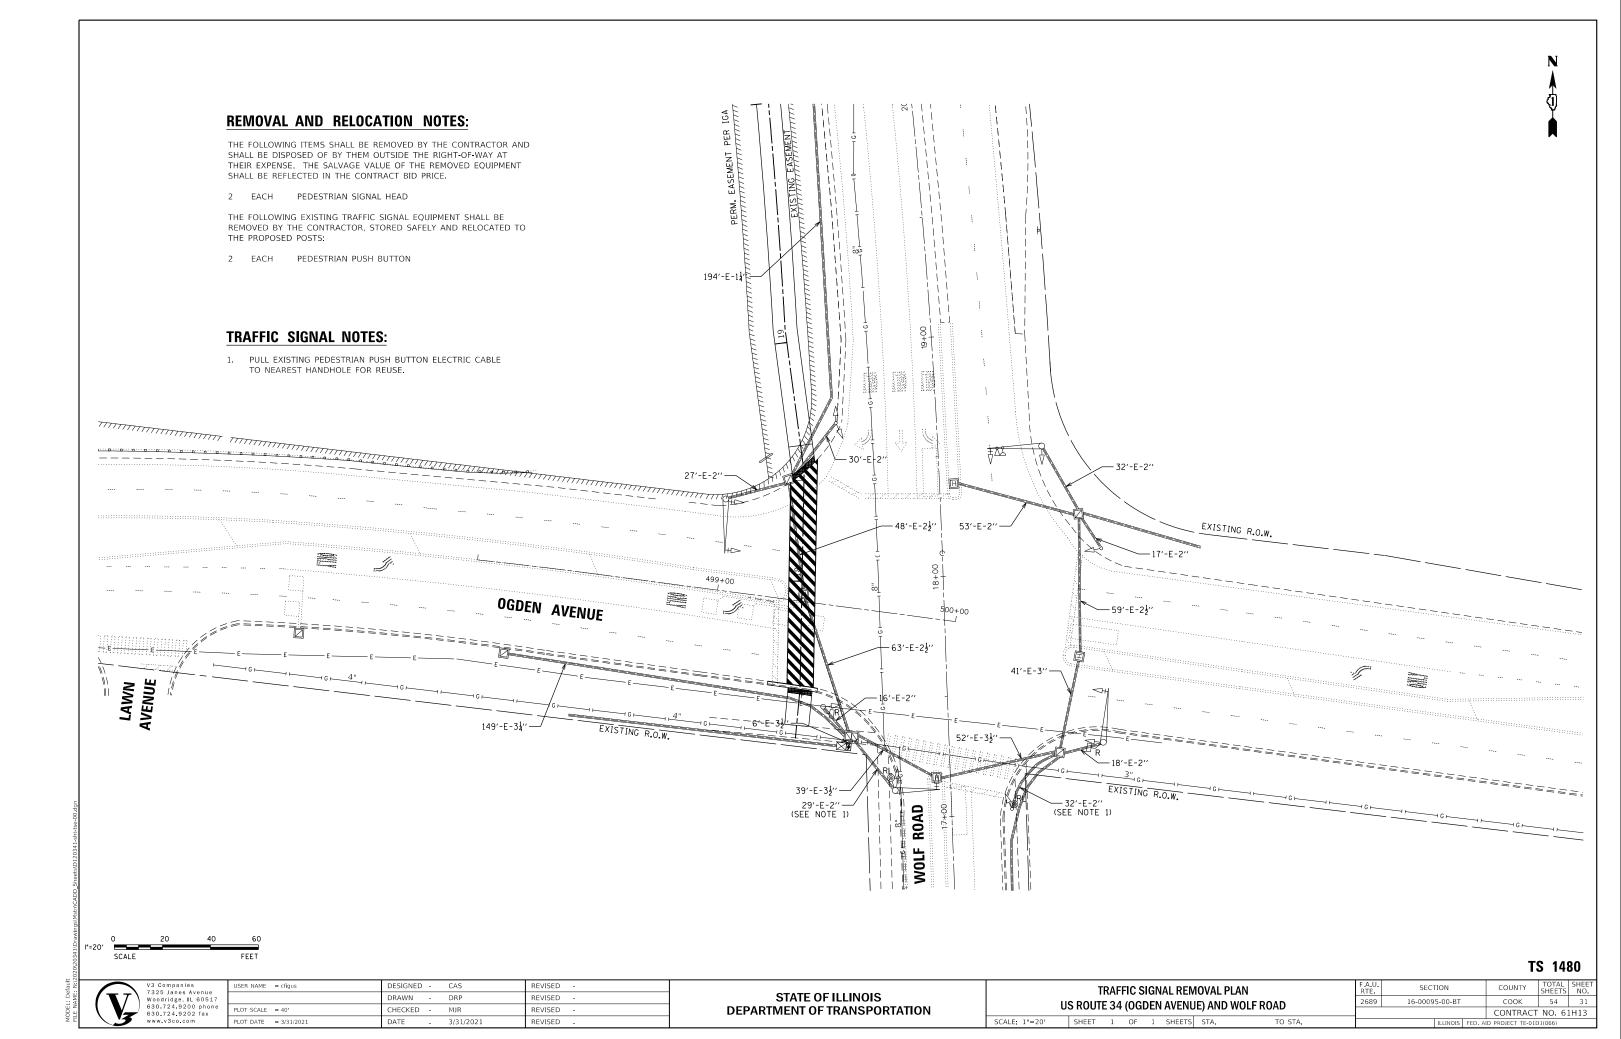

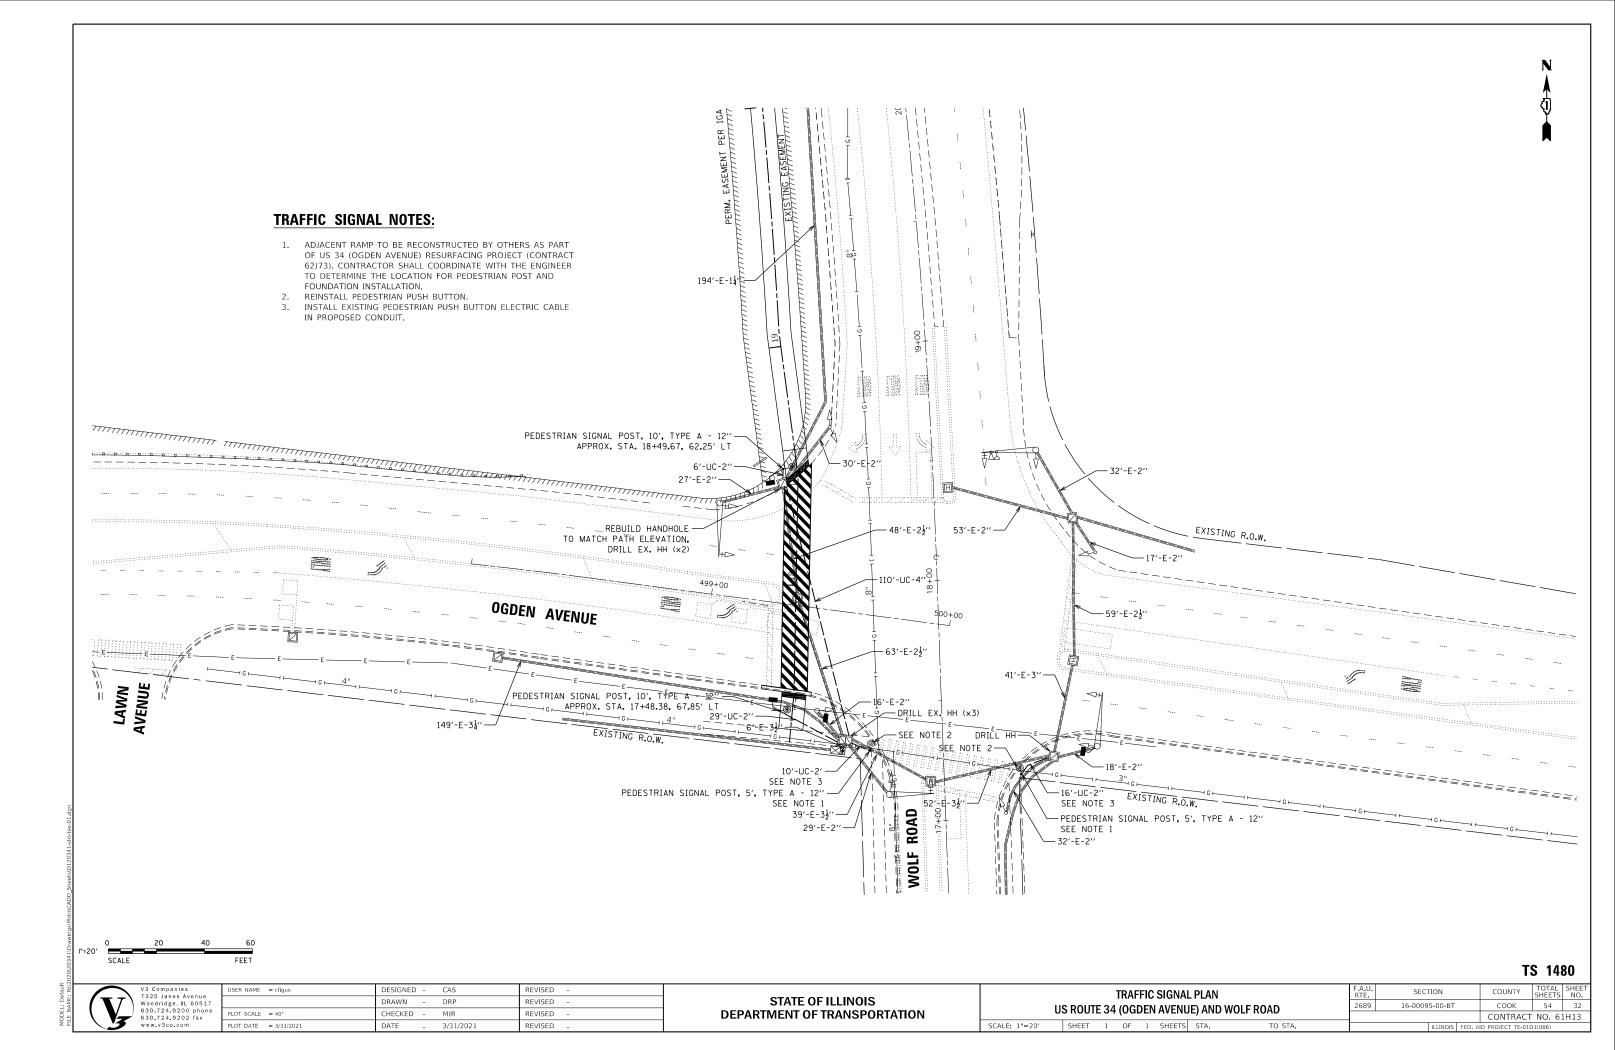

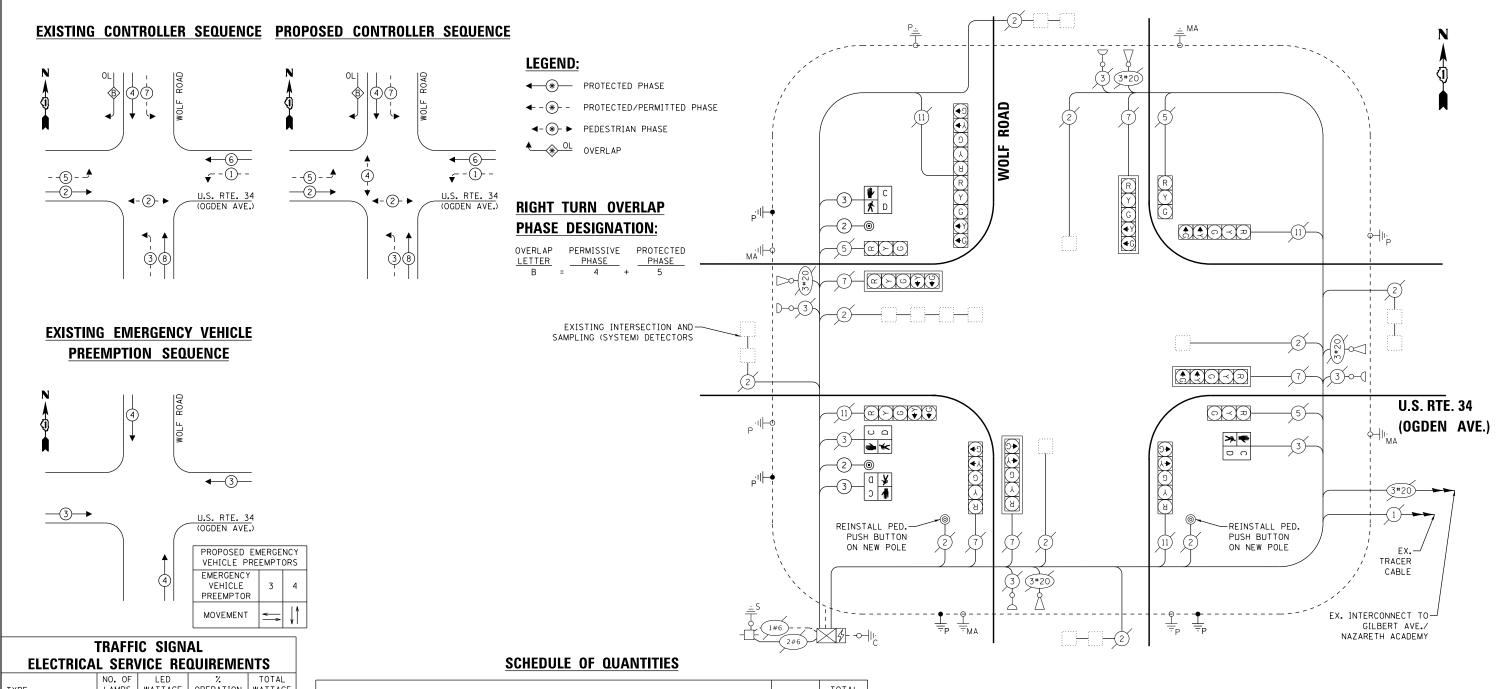

	I NO. OF	l LED	/•	I TOTAL
TYPE	LAMPS	WATTAGE	OPERATION	WATTAGE
SIGNAL (RED)) 12	1 1	50	66.0
(YELLOW	1) 12	20	5	12.0
(GREEN	1) 12	12	45	64.8
PERMISSIVE ARRO	W 20	10	10	20.0
PED. SIGNAL	4	20	100	80.0
CONTROLLER	1	100	100	100.0
UPS	1	25	100	25.0
	•			367.8
ENERCY COSTS TO	١-			

ENERGY COSTS TO:

ILLINOIS DEPARTMENT OF TRANSPORTATION

ENERGY SUPPLY: CONTACT:_ PHONE:_ COMPANY:

ITEM DESCRIPTION	UNITS	TOTAL QTY.
UNDERGROUND CONDUIT, GALVANIZED STEEL, 2" DIA.	FOOT	61
UNDERGROUND CONDUIT, GALVANIZED STEEL, 4" DIA.	FOOT	110
MAINTENANCE OF EXISTING TRAFFIC SIGNAL INSTALLATION	EACH	1
ELECTRIC CABLE IN CONDUIT, SIGNAL NO. 14 2C	FOOT	217
ELECTRIC CABLE IN CONDUIT, SIGNAL NO. 14 3C	FOOT	235
ELECTRIC CABLE IN CONDUIT, EQUIPMENT GROUNDING CONDUCTOR, NO. 6 1C	FOOT	87
DRILL EXISTING HANDHOLE	EACH	6
PEDESTRIAN SIGNAL HEAD, LED, 1-FACE, BRACKET MOUNTED WITH COUNTDOWN TIMER	EACH	4
PEDESTRIAN PUSH-BUTTON	EACH	2
RELOCATE EXISTING PEDESTRIAN PUSH-BUTTON	EACH	2
MODIFY EXISTING CONTROLLER	EACH	1
MODIFY EXISTING CONTROLLER CABINET	EACH	1
REMOVE AND REINSTALL ELECTRIC CABLE FROM CONDUIT	FOOT	137
REMOVE EXISTING TRAFFIC SIGNAL EQUIPMENT	EACH	2
REBUILD EXISTING HANDHOLE	EACH	1
PEDESTRIAN SIGNAL POST, 10 FT.	EACH	2
PEDESTRIAN SIGNAL POST, 5 FT.	EACH	2
CONCRETE FOUNDATION, TYPE A 12-INCH DIAMETER	FOOT	16
RE-OPTIMIZE TRAFFIC SIGNAL SYSTEM LEVEL 1	EACH	1

CABLE PLAN (NOT TO SCALE)

TS 1480



USER NAME = cfigus	DESIGNED -	CAS	REVISED -
	DRAWN -	DRP	REVISED -
PLOT SCALE = 40'	CHECKED -	MJR	REVISED -
PLOT DATE = 3/31/2021	DATE -	3/31/2021	REVISED -

STATE OF ILLINOIS **DEPARTMENT OF TRANSPORTATION**

							I DIAGRAM,	F.A.U. RTE	SECTION
							ION SEQUENCE D WOLF ROAD	2689	16-00095-00-
SCALE: NONE	SHEET	1	OF	1	SHEETS	STA.	TO STA.		ILLING

COUNTY COOK 54 33 CONTRACT NO. 61H13

TRAFFIC SIGNAL LEGEND


(NOT TO SCALE)

				(NUT TO SCALE)				
ITEM	EXISTING	PROPOSED	<u>ITEM</u>	<u>existing</u>	PROPOSED	ITEM	<u>EXISTING</u>	PROPOSED
CONTROLLER CABINET		\blacksquare	HANDHOLE -SQUARE			SIGNAL HEAD -(P) PROGRAMMABLE SIGNAL HEAD	R	RR
COMMUNICATION CABINET	ECC	СС	-ROUND			(17 Nosiviin) Bee sisting in the		Y G G G 4Y 4Y 4G
MASTER CONTROLLER	EMC	MC	HEAVY DUTY HANDHOLE -SQUARE -ROUND	H (H)	H (1)			4 G 4 G
MASTER MASTER CONTROLLER	EMMC	ммд	DOUBLE HANDHOLE			CICNAL LIFAS WITH DIGITAL TE		
UNINTERRUPTABLE POWER SUPPLY	4	•	JUNCTION BOX		•	SIGNAL HEAD WITH BACKPLATE -(P) PROGRAMMABLE SIGNAL HEAD -(RB) RETROREFLECTIVE BACKPLATE		R R R Y
SERVICE INSTALLATION	-□- ^P	- ■ -P	RAILROAD CANTILEVER MA	AST ARM	X OX X	(,		G
-(P) POLE MOUNTED SERVICE INSTALLATION			RAILROAD FLASHING SIGN	JAL ∑⊖ ∑	X•X		P RB	P RB
-(G) GROUND MOUNTED -(GM) GROUND MOUNTED METERED	$\boxtimes^{G}\boxtimes^{GM}$	⊠ G ⊠ GM	RAILROAD CROSSING GATI	E ₹0 ₹	X•X-	PEDESTRIAN SIGNAL HEAD		
TELEPHONE CONNECTION	ET	Т	RAILROAD CROSSBUCK	₹	*	AT RAILROAD INTERSECTIONS	K	Ŕ
STEEL MAST ARM ASSEMBLY AND POLE	O	•——	RAILROAD CONTROLLER C.	CABINET	▶ ∢	PEDESTRIAN SIGNAL HEAD WITH COUNTDOWN TIMER	(F) C	₩ C ★ D
ALUMINUM MAST ARM ASSEMBLY AND POLE			UNDERGROUND CONDUIT GALVANIZED STEEL	(UC),				
STEEL COMBINATION MAST ARM ASSEMBLY AND POLE WITH LUMINAIRE	o - ¤—	•**	TEMPORARY SPAN WIRE, TETHER WIRE, AND CABLE			ILLUMINATED SIGN "NO LEFT TURN"/"NO RIGHT TURN"		
SIGNAL POST -(BM) BARREL MOUNTED - TEMPORARY	0	● • BM	SYSTEM ITEM INTERSECTION ITEM	S	SP	NUMBER OF CONDUCTORS, ELECTRIC CABLE NO. 14, UNLESS NOTED OTHERWISE. ALL DETECTOR LOOP CABLE TO BE SHIELDED		
WOOD POLE	\otimes	•	REMOVE ITEM	·	r R	GROUND CABLE IN CONDUIT,	1#6	
GUY WIRE	>-	>-	RELOCATE ITEM		RL	NO. 6 SOLID COPPER (GREEN)	-	
SIGNAL HEAD		-	ABANDON ITEM		А	ELECTRIC CABLE IN CONDUIT, TRACER NO. 14 1/C		
SIGNAL HEAD WITH BACKPLATE	+->	+	CONTROLLER CABINET AND		RCF	COAXIAL CABLE	— <u>c</u> —	<u> </u>
SIGNAL HEAD OPTICALLY PROGRAMMED	-⊳ ^P +⊳ ^P	→ P + → P	FOUNDATION TO BE REMC	JVED		VENDOR CABLE		(v)
FLASHER INSTALLATION -(FS) SOLAR POWERED	od⊳ F od⊳ FS	•► FS	FOUNDATION TO BE REMO	OVED	RMF	COPPER INTERCONNECT CABLE,		_
	□+⇒ ^F □+⇒ ^{FS}	■→ ^F ■→ ^{FS}	SIGNAL POST AND FOUNDATION TO BE REMO	OVED	RPF	NO. 18, 3 PAIR TWISTED, SHIELDED	(6#18)	<u>—</u>
PEDESTRIAN SIGNAL HEAD	-[]	-1	DETECTOR LOOP, TYPE I			FIBER OPTIC CABLE -NO. 62.5/125, MM12F	——————————————————————————————————————	——————————————————————————————————————
PEDESTRIAN PUSH BUTTON -(APS) ACCESSIBLE PEDESTRIAN PUSH BUTTON	⊚	⊚ APS	PREFORMED DETECTOR LC	OOP P P	PP	-NO. 62.5/125, MM12F SM12F -NO. 62.5/125, MM12F SM24F		— (24F)—
RADAR DETECTION SENSOR	R	R	SAMPLING (SYSTEM) DETE	ector S S	5 5			—(36F)—
VIDEO DETECTION CAMERA	[V]	V ■	INTERSECTION AND SAMPL (SYSTEM) DETECTOR	LING IS (IS)	IS (IS)			
RADAR/VIDEO DETECTION ZONE			QUEUE AND SAMPLING	QS QS	QS QS	GROUND ROD -(C) CONTROLLER -(M) MAST ARM	$\stackrel{\stackrel{\perp}{=}C}{\stackrel{\uparrow}{=}}\stackrel{\stackrel{M}}{\stackrel{\downarrow}{=}}\stackrel{P}{\stackrel{\stackrel{\perp}{=}S}{\stackrel{\downarrow}{=}}}$	$\stackrel{\stackrel{\cdot}{=}^{C}}{\stackrel{\cdot}{=}}^{C} \stackrel{\stackrel{\cdot}{=}^{M}}{\stackrel{\bullet}{=}}^{M} \stackrel{\stackrel{\cdot}{=}^{C}}{\stackrel{\bullet}{=}}^{S}$
PAN, TILT, ZOOM (PTZ) CAMERA	PTZ	PTZ	(SYSTEM) DETECTOR WIRELESS DETECTOR SEN:		®	-(N) POST -(S) SERVICE		
EMERGENCY VEHICLE LIGHT DETECTOR	\bowtie	~	WIRELESS ACCESS POINT		—			
CONFIMATION BEACON	○ —(]	•-•	- Indiana in the second of the		_			
WIRELESS INTERCONNECT	o ∙1 	•-+ -						
WIRELESS INTERCONNECT RADIO REPEATER	ERR	RR						
USER NAME = footemj PLOT SCALE = 50.0000 '	DESIGNED - DRAWN -	IP REVISED	-	STATE OF ILLINOIS DEPARTMENT OF TRANSPORTATION	s	DISTRICT ONE STANDARD TRAFFIC SIGNAL DESIGN DETAILS	F.A. SECTIC RTE. 2689 16-00095-0	O-BT COOK 54
PLOT DATE = 3/4/2019		9/29/2016 REVISED	-	DEFARITULINE OF TRANSPORTATION	SCALE: NONE	SHEET 1 OF 7 SHEETS STA. TO STA.	TS-05	CONTRACT NO. 61H LINOIS FED. AID PROJECT TE-01D1(066)


LOOP DETECTOR NOTES

- 1. EACH PAIR OF LOOP WIRES SHALL BE PLACED IN A SEPARATE EMPTY COILABLE NONMETALLIC CONDUIT FROM THE EDGE OF PAVEMENT TO THE HANDHOLE. SPACING BETWEEN THE HOLES DRILLED IN THE PAVEMENT SHALL NOT BE LESS THAN 6" (150 mm). EMPTY COILABLE NONMETALLIC CONDUIT SHALL BE INCLUDED IN THE COST OF THE LOOP WIRE.
- THE NUMBER OF LOOP TURNS SHALL BE AS RECOMMENDED BY THE AMPLIFIER MANUFACTURER. ALL ADJACENT SIDES OF THE LOOPS SHALL BE INSTALLED IN SUCH A WAY THAT THE CURRENT FLOW IS IN THE SAME DIRECTION TO REINFORCE ITS MAGNETIC FIELDS FOR SMALL VEHICLE DETECTION.
- 3. EACH LOOP LEAD-IN SHALL BE IDENTIFIED AND PERMANENTLY TAGGED IN THE HANDHOLE. EACH LEAD-IN CABLE TAG SHALL INDICATE THE LOCATION OF THE LOOP, LOOP ROTATION (CLOCKWISE/COUNTERCLOCKWISE), LOOP LEAD-IN DIRECTION (IN OR OUT), LOOP CABLE NUMBER AND LOCATION IN CABINET, AND NUMBER OF TURNS IN THE DETECTOR LOOPS IN WATER PROOF INK AS INDICATED ON THE DISTRICT 1 STANDARD TRAFFIC SIGNAL DESIGN DETAIL. THE CONTRACTOR SHALL MARK LOOP LOCATIONS ON RECORD DRAWINGS AND PRESENT TO THE ENGINEER AFTER FINAL INSPECTION. LOOPS SHALL BE MARKED BY LANE AND LOOP NUMBER. SEE DETAIL BELOW.
- 4. ALL LOOP CABLE SHALL BE FASTENED WITH PLASTIC TIE WRAP TO THE HANDHOLE HOOKS.
- 5. IN ASPHALT PAVEMENT, LOOPS SHOULD BE PLACED IN THE BINDER AND DIVEHOLES MARKED AT THE CURB WITH A SAW-CUT. THE SAW-CUT SHALL BE CUT IN ACCORDANCE WITH LOCAL AND E.P.A. DUST CONTROL REQUIREMENTS. DETECTOR LOOP(S) SHALL NOT BE INSTALLED IN WET CONDITIONS AND THE SAW-CUTS MUST BE FREE OF DEBRIS AND RESIDUE SUCH AS DUST AND WATER WHICH IS TO BE ACHIEVED BY THE USE OF COMPRESSED AIR, WIRE BRUSHING AND HEAT DRYING ACCORDING TO SEALANT MANUFACTURER REQUIREMENTS. THE DETECTOR WIRE SHALL BE HELD IN PLACE BY THE USE OF FORM WEDGES. WEDGES SHALL BE SPACED NO MORE THAN 18" (450 mm) APART.
- LOOP SPLICES SHALL BE SOLDERED USING A SOLDERING IRON. BLOW TORCHES OR OTHER DEVICES WHICH OXIDIZE COPPER CABLE SHALL NOT BE ALLOWED FOR SOLDERING OPERATIONS. SEE DETAIL BELOW RIGHT.
- 7. PREFORMED DETECTOR LOOPS SHALL BE USED, AS SHOWN ON THE PLANS, WHERE NEW CONCRETE PAVEMENT IS PROPOSED. THE INSTALLATION OF PREFORMED LOOPS SHALL BE IN ACCORDANCE WITH THE DISTRICT 1 SPECIFICATIONS OR AS DIRECTED BY THE ENGINEER.

LOOP LEAD-IN CABLE TAG

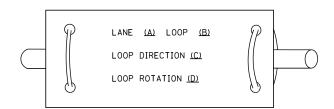



- A. LANE 1 IS THE LANE CLOSEST TO THE CENTERLINE OF THE ROADWAY
- B. LOOP #1 IS THE LOOP IN THE LANE CLOSEST TO THE INTERSECTION.
- C. LABEL LOOP CABLE "IN" OR LOOP CABLE "OUT".
- D. LABEL LOOP CABLE CLOCKWISE OR LOOP CABLE COUNTERCLOCKWISE.

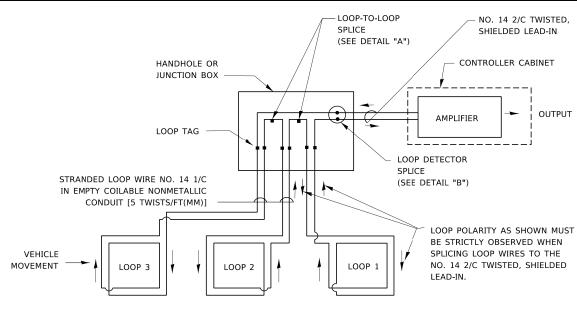

DETECTOR LOOP WIRING SCHEMATIC

- LOOPS SHALL BE SPLICED IN SERIES.
 SAW-CUTS SHALL BE A MINIMUM WIDTH OF 5/16" (8 mm).
- SAW-CUT DEPTHS SHALL BE 3" (75 mm). IF IN CONCRETE,
- THE SAW-CUT DEPTH SHALL BE TO THE TOP OF THE REINFORCEMENT.
- LOOP CORNERS SHALL BE DRILLED WITH A 2" (50 mm) DIAMETER CORE.

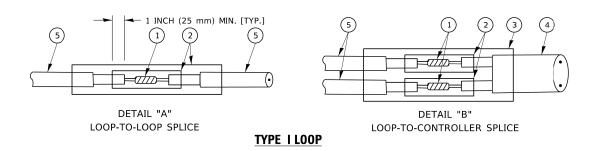

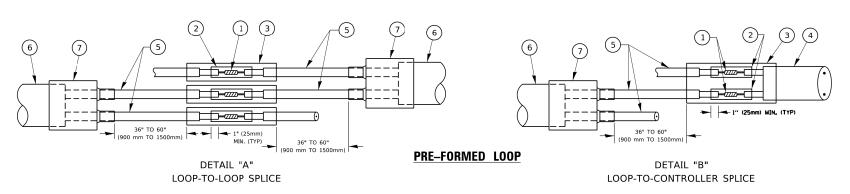

LOOP DETECTOR SPLICE

- 1) WESTERN UNION SPLICE SOLDERED WITH ROSIN CORE FLUX. ALL EXPOSED SURFACES OF THE SOLDER SHALL BE SMOOTH. THE WESTERN UNION SPLICES SHALL BE STAGGERED.
- (2) WCSMW 30/100 HEAT SHRINK TUBE, MINIMUM LENGTH 3" (75 mm), UNDERWATER GRADE.
- (3) WCS 200/750 HEAT SHRINK TUBE, MINIMUM LENGHT 6" (150 mm), UNDERWATER GRADE.
- (4) NO. 14 2/C TWISTED, SHIELDED CABLE.

- 5 LOOP CONDUCTOR WITH FLEXIBLE PLASTIC TUBE. PRE-FORMED LOOP
- (6) XL POLYOLEFIN 2 CONDUCTOR
- (7) BREAKOUT SEALS. TYCO CBR-2 OR APPROVED EQUAL


USER NAME = footemj	DESIGNED -	REVISED -
	DRAWN -	REVISED -
PLOT SCALE = 50.0000 ' / in.	CHECKED -	REVISED -
PLOT DATE = 3/4/2019	DATE -	REVISED -

STATE OF ILLINOIS
DEPARTMENT OF TRANSPORTATION

TRAFFIC SIGNAL MAST ARM AND SIGNAL POST


MAST ARM MOUNTED SIGNALS IN EXISTING, PROPOSED OR FUTURE SIDEWALK/BICYCLE PATH AREA. INTERSECTION SHOWN WITH PEDESTRIAN SIGNALS AND

PEDESTRIAN PUSHBUTTON DETECTORS

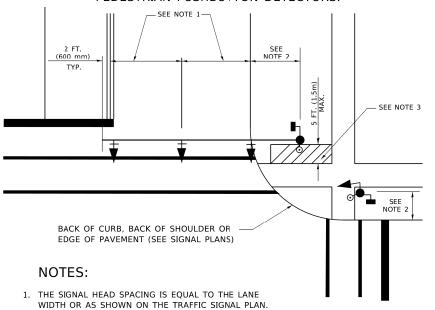


- 2. REFER TO THE TRAFFIC SIGNAL EQUIPMENT OFFSET TABLE.
- 3. PROVIDE A LEVEL ALL-WEATHER SURFACE (CONCRETE SIDEWALK, ASPHALT BICYCLE PATH SURFACE OR MATCHING MATERIAL TO THE ADJACENT SURFACE) UP TO THE MAST ARM SHAFT OR
- 4. THE FACE OF THE PEDESTRIAN PUSHBUTTON SHALL BE PARALLEL TO THE CROSSWALK TO BE USED.
- 5. THE LOCATIONS AND INSTALLATION OF PEDESTRIAN SIGNAL HEADS AND PEDESTRIAN PUSHBUTTONS SHALL MEET THE REQUIREMENTS OF THE MUTCD AND INFORMATION FOUND IN THE "AMERICANS WITH DISABILITIES ACT ACCESSIBILITY GUIDELINES FOR BUILDINGS AND FACILITIES.'

PEDESTRIAN SIGNAL POST AND PEDESTRIAN PUSH BUTTON POST

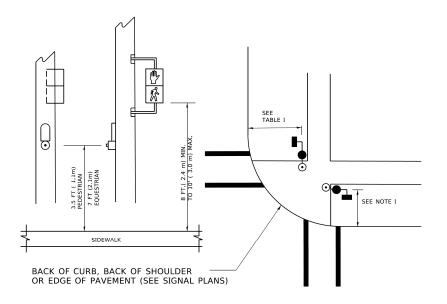

NOTES:

- 1. REFER TO THE TRAFFIC SIGNAL EQUIPMENT OFFSET TABLE.
- 2. PROVIDE A LEVEL ALL-WEATHER SURFACE (CONCRETE SIDEWALK, ASPHALT BICYCLE PATH SURFACE OR MATCHING MATERIAL TO THE ADJACENT SURFACE) UP TO THE PEDESTRIAN SIGNAL POST OR THE PEDESTRIAN PUSH BUTTON POST
- 3. THE FACE OF THE PEDESTRIAN PUSHBUTTON SHALL BE PARALLEL TO THE CROSSWALK TO BE USED.
- 4. THE LOCATIONS AND INSTALLATION OF PEDESTRIAN SIGNAL HEADS AND PEDESTRIAN PUSHBUTTONS SHALL MEET THE REQUIREMENTS OF THE MUTCD AND INFORMATION FOUND IN THE "AMERICANS WITH DISABILITIES ACT ACCESSIBILITY GUIDELINES FOR

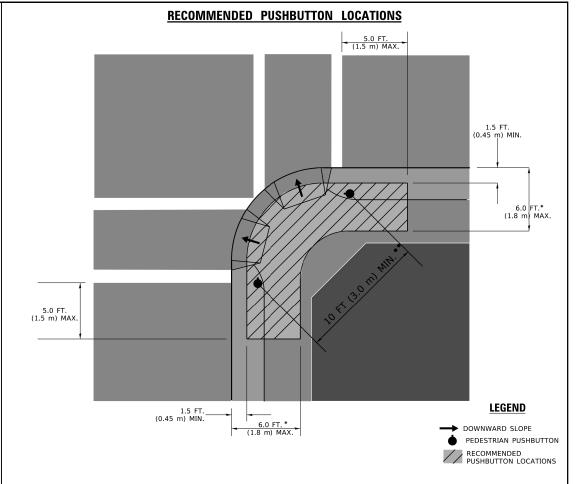

- * WHERE THERE ARE CONSTRAINTS THAT MAKE IT IMPRACTICAL TO PLACE THE PEDESTRIAN PUSHBUTTON BETWEEN 1.5 FT (0.45 m) AND 6 FT (1.8 m) FROM THE EDGE OF THE CURB, SHOULDER, OR PAVEMENT, IT SHOULD NOT BE FURTHER THAN 10 FT (3 m) FROM THE EDGE OF CURB, SHOULDER, OR PAVEMENT.
- ** WHERE THERE ARE CONSTRAINTS ON A PARTICULAR CORNER THAT MAKE IT IMPRACTICAL TO PROVIDE THE 10 FT (3 m) SEPERATION BETWEEN THE TWO PEDESTRIAN PUSHBUTTONS, THE PUSHBUTTONS MAY BE PLACED CLOSER TOGETHER OR ON THE SAME POLE.

NOTES:

- 1. PEDESTRIAN SIGNAL HEADS SHALL BE MOUNTED WITH THE BOTTOM OF THE SIGNAL HOUSING INCLUDING BRACKETS NOT LESS THAN 8 FT (2.4 m) OR MORE THAN 10 FT (3 m) ABOVE SIDEWALK LEVEL, AND SHALL BE POSITIONED AND ADJUSTED TO PROVIDE MAXIMUM VISIBILITY AT THE BEGINNING OF THE CONTROLLED CROSSWALK.
- 2. THE BOTTOM OF THE SIGNAL HOUSING (INCLUDING BRACKETS) OF A VEHICULAR SIGNAL FACE THAT IS NOT LOCATED OVER A HIGHWAY SHALL BE AT LEAST 8 FT (2.4 m) BUT NOT MORE THAN 19 FT (5.8 m) ABOVE THE SIDEWALK OR, IF THERE IS NO SIDEWALK, ABOVE THE PAVEMENT GRADE AT THE CENTER OF THE ROADWAY
- 3. THE BOTTOM OF THE SIGNAL HOUSING AND ANY RELATED ATTACHMENTS TO A SIGNAL FACE LOCATED OVER ANY PORTION OF A HIGHWAY SHALL BE ACCORDING TO CURRENT STATE STANDARDS 877001, 877002, 877006, 877011 AND 877012 WITH A MINIMUM OF 16 FT (5.0 m) AND A MAXIMUM OF 18 FT. (5.5 m) FROM THE HIGHEST POINT OF PAVEMENT
- 4. THE BOTTOM OF THE TEMPORARY SPAN WIRE MOUNTED SIGNAL HOUSING AND ANY RELATED ATTACHMENTS TO A SIGNAL FACE LOCATED OVER ANY PORTION OF A HIGHWAY SHALL BE ACCORDING TO CURRENT STATE STANDARD 880001 WITH A MINIMUM OF 17 FT (5.18 m) FROM THE HIGHEST POINT OF PAVEMENT.
- 5. THE TOP OF THE SIGNAL HOUSING OF A SIGNAL FACE LOCATED OVER ANY PORTION OF A HIGHWAY SHALL NOT BE MORE THAN 25.6 FT (7.8 m) ABOVE THE PAVEMENT.

TRAFFIC SIGNAL EQUIPMENT OFFSET

TRAFFIC SIGNAL EQUIPMENT	COMBINATION CONCRETE CURB AND GUTTER (MINIMUM DISTANCE FROM BACK OF CURB TO CENTERLINE OF FOUNDATION)	SHOULDER/NON-CURBED AREA (MINIMUM DISTANCE FROM EDGE OF PAVEMENT TO CENTERLINE OF FOUNDATION)			
TRAFFIC SIGNAL MAST ARM POLE	6 FT (1.8m)	SHOULDER WIDTH + 2 FT (0.6m), MINIMUM 10 FT (3.0m)			
TRAFFIC SIGNAL POST	4 FT (1.2m)	SHOULDER WIDTH + 2 FT (0.6m), MINIMUM 10 FT (3.0m)			
PEDESTRIAN SIGNAL POST	4 FT (1.2m)	SHOULDER WIDTH + 2 FT (0.6m), MINIMUM 10 FT (3.0m)			
PEDESTRIAN PUSHBUTTON POST	4 FT (1.2m)	SHOULDER WIDTH + 2 FT (0.6m), MINIMUM 10 FT (3.0m)			
TEMPORARY WOOD POLE	6 FT (1.8m)	SHOULDER WIDTH + 2 FT (0.6m), MINIMUM 10 FT (3.0m)			
CONTROLLER CABINET	6 FT (1.8m) MINIMUM DISTANCE SEE NOTE 2	SHOULDER WIDTH + 6 FT (1.8m), MINIMUM 16 FT (4.9m) SEE NOTE 3.			
SERVICE INSTALLATION, GROUND MOUNT	6 FT (1.8m) MINIMUM DISTANCE SEE NOTE 2	SHOULDER WIDTH + 6 FT (1.8m), MINIMUM 16 FT (4.9m) SEE NOTE 3.			


NOTES:


- 1. CONTACT THE "AREA TRAFFIC SIGNAL MAINTENANCE AND OPERATIONS ENGINEER" FOR ASSISTANCE IN LOCATING THE TRAFFIC SIGNAL EQUIPMENT WHEN THERE ARE CONFLICTS WITH DITCHES OR THE MINIMUM OFFSET DISTANCES CANNOT BE MET.
- 2. MINIMUM DISTANCE FROM THE BACK OF CURB TO THE ROADWAY SIDE OF THE FOUNDATION.
- 3. MINIMUM DISTANCE FROM THE EDGE OF PAVEMENT TOTHE ROADWAY SIDE OF THE FOUNDATION.
- 4. ANY CHANGES TO THE OFFSETS OF THE FOUNDATIONS, FROM THE MINIMUM DISTANCES LISTED IN THE "TRAFFIC SIGNAL EQUIPMENT OFFSET" CHART AND THE TRAFFIC SIGNAL INSTALLATION PLAN, COULD EFFECT THE PLACEMENT OF THE SIGNAL HEADS, PEDESTRIAN SIGNAL HEADS AND THE PEDESTRIAN PUSHBUTTONS. THE SIGNAL HEAD PLACEMENT ON THE MAST ARMS SHALL REMAIN AS PER THE TRAFFIC SIGNAL INSTALLATION PLAN AND THE "TRAFFIC SIGNAL MAST ARM AND SIGNAL POST" DETAIL ABOVE. THE PROPOSED MAST ARM LENGTHS MAY NEED TO BE REVISED TO MEET THE ABOVE REQUIREMENTS. THE PEDESTRIAN SIGNAL HEADS AND PEDESTRIAN PUSHBUTTONS MUST MEET THE REQUIREMENTS UNDER THE DETAILS ON THIS SHEET.


USER NAME = footemj	DESIGNED -	REVISED -
	DRAWN -	REVISED -
PLOT SCALE = 50.0000 ' / in.	CHECKED -	REVISED -
PLOT DATE = 3/4/2019	DATE -	REVISED -

STATE OF ILLINOIS **DEPARTMENT OF TRANSPORTATION**


SECTION COUNTY DISTRICT ONE 54 16-00095-00-BT COOK STANDARD TRAFFIC SIGNAL DESIGN DETAILS CONTRACT NO. 61H13 TS-05 SHEET 3 OF 7 SHEETS STA.

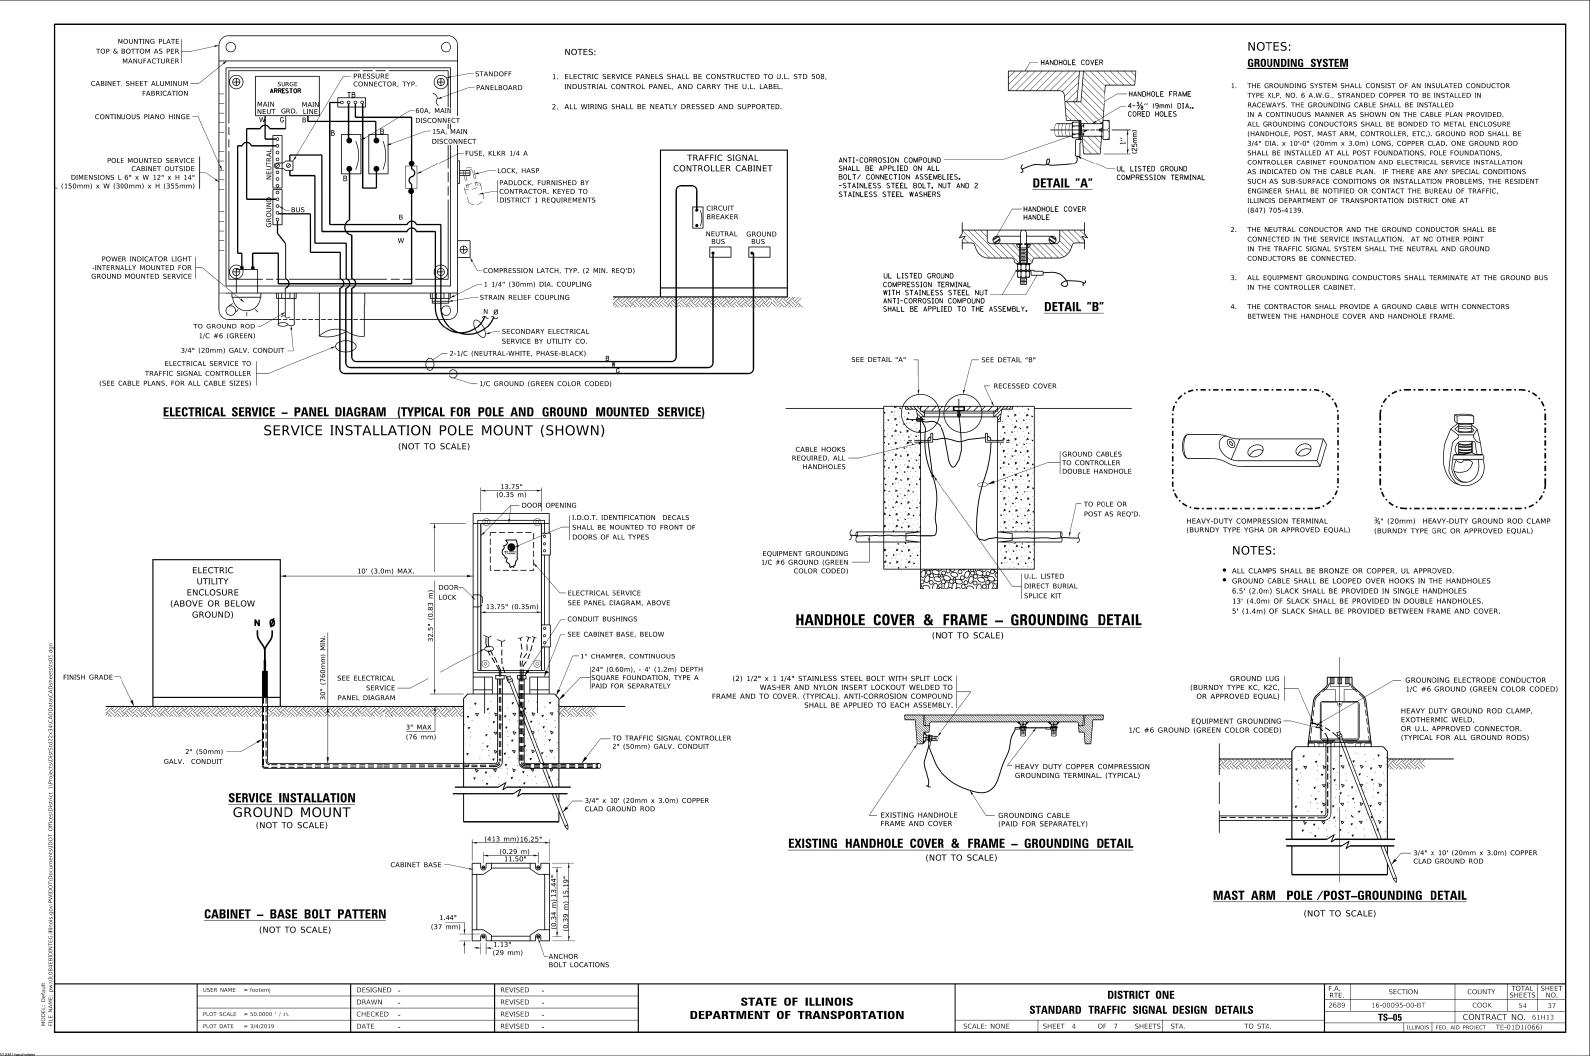

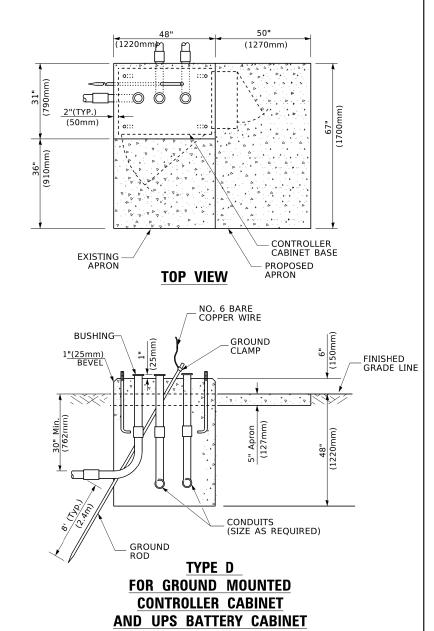

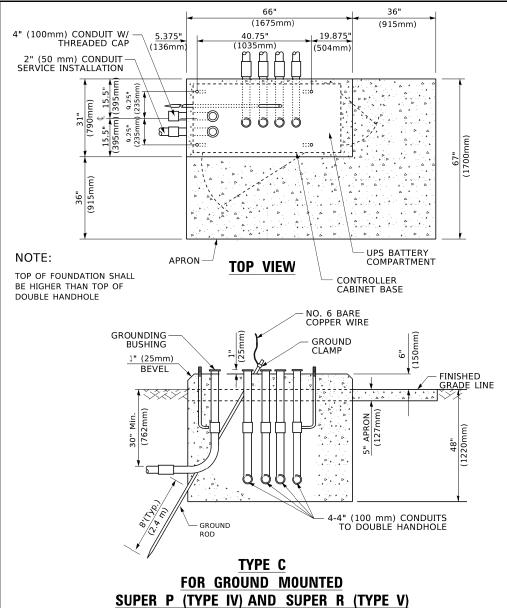

CONTROLLER CABINETS

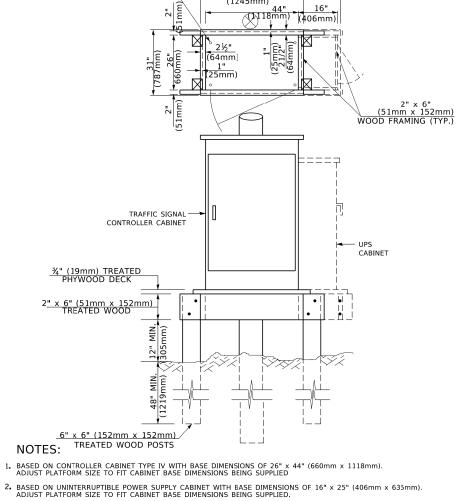

65" (SEE NOTE 4) (1651mm)

49" (SEE NOTE 3) (1245mm)

SEE NOTE 5-

- 3. PLATFORM SIZE FOR CONTROLLER CABINET TYPE IV.
- 4. PLATFORM SIZE FOR CONTROLLER CABINET TYPE IV AND UNINTERRUPTIBLE POWER SUPPLY CABINET.
- 5. DRILLED HOLES THROUGH THE PLATFORM BASE TO MATCH THE CONTROLLER CABINET BOLT TEMPLATE. FASTEN THE CONTROLLER CABINET TO THE PLATFORM WITH CARRIAGE BOLTS, WASHERS AND NUTS.
- 6. FASTEN ALL SUPPORT WOOD FRAMING TO THE WOOD POSTS WITH 2 LAG SCREWS FOR EACH CONNECTION.

TEMPORARY SIGNAL CONTROLLER WOOD SUPPORT PLATFORM

CABLE SLACK LENGTH	FEET	METER
HANDHOLE	6.5	2.0
DOUBLE HANDHOLE	13.0	4.0
SIGNAL POST	2.0	0.6
MAST ARM	2.0	0.6
CONTROLLER CABINET	1.5	0.5
FIBER OPTIC AT CABINET	13.0	4.0
ELECTRIC SERVICE AT (CABINET OR SERVICE LOCATION)	1.5	0.5
GROUND CABLE (SIGNAL POST, MAST ARM, CABINET)	1.5	0.5
GROUND CABLE (BETWEEN FRAME AND COVER)	5.0	1.6

VERTICAL CABLE LENGTH	FEET	METER
MAST ARM POLE (MAST ARM MOUNTED SIGNAL HEAD)		
(L = MAST ARM LENGTH - DISTANCE TO SIGNAL HEAD FROM END OF ARM)	20.0+L	6.0+L
BRACKET MOUNTED (MAST ARM POLE OR SIGNAL POLE)	13.0	4.0
PEDESTRIAN PUSH BUTTON	6.0	2.0
SERVICE INSTALLATION POLE MOUNT TO SERVICE DROP	13.5	4.1
SERVICE INSTALLATION POLE MOUNT TO GROUND	13.5	4.1
SERVICE INSTALLATION GROUND MOUNT	6.0	2.0
FOUNDATION (SIGNAL POST, MAST ARM POLE, CONTROLLER CABINET, SERVICE-GROUND MOUNT)	3.0	1.0

VERTICAL CABLE LENGTH

CABLE SLACK

FOUNDATION	DEPTH
TYPE A - Signal Post	4'-0" (1.2m)
TYPE C - CONTROLLER W/ UPS	4'-0" (1.2m)
TYPE D - CONTROLLER	4'-0" (1.2m)
SERVICE INSTALLATION, GROUND MOUNT, TYPE A - SQUARE	4'-0" (1.2m)

DEPTH OF FOUNDATION


Mast Arm Length	① Foundation Depth	Foundation Diameter	Spiral Diameter	Quantity of Rebars	Size of Rebars
Less than 30′ (9.1 m)	10'-0" (3.0 m)	30" (750mm)	24" (600mm)	8	6(19)
Greater than or equal to	13'-6" (4.1 m)	30" (750mm)	24" (600mm)	8	6(19)
30' (9.1 m) and less than 40' (12.2 m)	11'-0'' (3.4 m)	36" (900mm)	30" (750mm)	12	7(22)
Greater than or equal to 40' (12.2 m) and less than 50' (15.2 m)	13'-0'' (4.0 m)	36" (900mm)	30" (750mm)	12	7(22)
Greater than or equal to 50' (15.2 m) and up to 55' (16.8 m)	15'-0'' (4.6 m)	36'' (900mm)	30'' (750mm)	12	7(22)
Greater than or equal to 56' (16.8 m) and less than 65' (19.8 m)	21'-0'' (6.4 m)	42'' (1060mm)	36" (900mm)	16	8(25)
Greater than or equal to 65' (19.8 m) and up to 75' (22.9 m)	25'-0'' (7.6 m)	42'' (1060mm)	36" (900mm)	16	8(25)

NOTES:

- 1. These foundation depths are for sites which have cohesive soils (clayey silt, sandy clay, etc.) along the length of the shaft, with an average Unconfined Compressive Strength (Ou) > 1.0 tsf (100 kpa). This strength shall be verified by boring data prior to construction or with testing by the Engineer during foundation drilling. The Bureau of Bridges & structures should be contacted for a revised design if other conditions are encountered.
- 2. Combination mast arm assemblies under 55 feet (16.8 m) shall use 36" (900 mm) diameter foundations.
- 3. Combination mast arm assemblies under 56 feet (16.8 m) through 75 feet (22.9 m) shall use 42" (1060 mm) diameter foundations
- 4. For most arm assemblies with dual arms refer to state standard 878001...


DEPTH OF MAST ARM FOUNDATIONS, TYPE E


USER NAME = footemj	DESIGNED -	REVISED -		DISTRICT ONE	F.A.	SECTION	COUNTY	TOTAL	SHEET
	DRAWN -	REVISED -	STATE OF ILLINOIS		2689	16-00095-00-BT	соок	54	38
PLOT SCALE = 50.0000 ' / in.	CHECKED -	REVISED -	DEPARTMENT OF TRANSPORTATION	STANDARD TRAFFIC SIGNAL DESIGN DETAILS		TS-05	CONTRACT	NO. 61	H13
PLOT DATE = 3/4/2019	DATE -	REVISED -		SCALE: NONE SHEET 5 OF 7 SHEETS STA. TO STA.		ILLINOIS FED. A	ID PROJECT TE-	01D1(066)

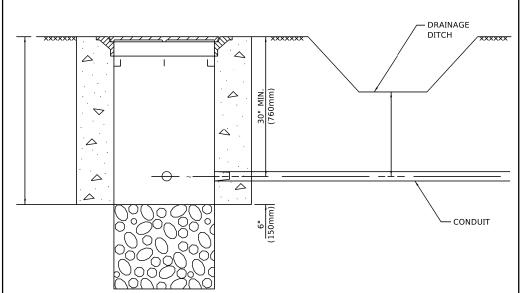

- CONDUIT DEPTH SHALL BE A MINIMUM OF 30" (760mm) BELOW THE BOTTOM OF THE DRAINAGE DITCH OR ANY SLOPING GROUND
- THE MINIMUM CONDUIT DEPTH APPLIES TO ALL CONDUIT PLACED UNDER ROADWAY PAVEMENT, MULTI-USE PATHS, SIDEWALKS AND SOIL SURFACES.
- THE MINIMUM CONDUIT DEPTH APPLIES TO ALL HANDHOLES, HEAVY DUTY HANDHOLES AND DOUBLE HANDHOLES.

HANDHOLE WITH MINIMUM CONDUIT DEPTH

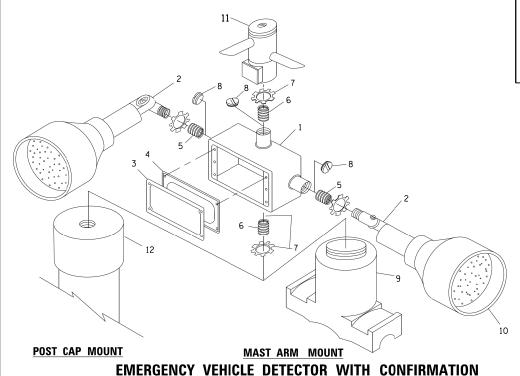


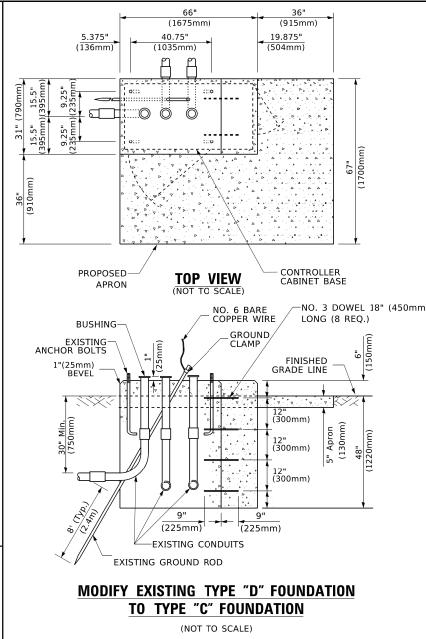

ITEM NO. IDENTIFICATION 1 OUTLET BOX- GALV. 21 CU.IN. (0.000344 CU-M) 2 LAMP HOLDER AND COVER 3 OUTLET BOX COVER 4 RUBBER COVER GASKET 5 REDUCING BUSHING 6 ¾"(19 mm) CLOSE NIPPLE 7 ¾"(19 mm) LOCKNUT 8 ¾"(19 mm) HOLE PLUG 9 SADDLE BRACKET - GALV. 10 6 WATT PAR 38 LED FLOOD LAMP 11 DETECTOR UNIT 12 POST CAP [18 FT. (5.4 m) POST MIN.]

NOTES:

- ALL ELECTRICAL ITEMS, EXCEPT ITEMS #2 AND #11 SHALL BE ALUMINUM OR GALVANIZED
- 2. ITEM #1- OZ/GEDNEY FSX-1-50 OR EQUIVALENT ITEM #2- MULBERRY CON-O-SHADE LAMP SHIELD OR EQUIVALENT ITEM #9- "BAND-IT" SADDLE BRACKET OR EQUIVALENT
- 3. WHEN POST MOUNTING IS SPECIFIED, ITEM #9 SHALL NOT BE REQUIRED. THE DETECTION UNIT SHALL BE MOUNTED DIRECTLY ON TOP OF THE CAP BY DRILLING AND TAPPING A 3/4 "(19 mm) HOLE WITH PIPE THREADS. THE POST CAP SHALL EITHER BE SCREWED TO THE TOP OF THE POST OR A MINIMUM OF 3 TIGHTENING SCREWS SHALL BE REQUIRED ON EACH CAP.

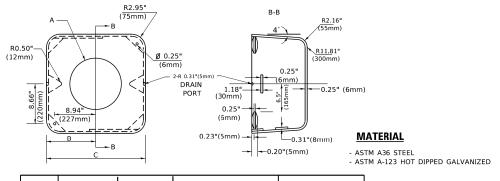



Α	В	С	HEIGHT	WEIGHT
VARIES	9.5"(241mm)	19"(483mm)	7" (178mm) - 12" (300mm)	53 lbs (24kg)
VARIES	10.75"(273mm)	21.5"(546mm)	7" (178mm) - 12" (300mm)	68 lbs (31 kg)
VARIES	13.0"(330mm)	26"(660mm)	7" (178mm) - 12" (300mm)	81 lbs (37 kg)
VARIES	18.5"(470mm)	37"(940mm)	7" (178mm) - 12" (300mm)	126 lbs (57 kg)

SHROUD

NOTES:

- DIMENSION "A" IS EQUAL TO THE DIAMETER OF THE MAST ARM POLE AT THE TOP OF THE SHROUD.
 THE SHROUD SHALL BE TIGHT TO THE MAST ARM POLE.
- 2. THE SUPPLIER SHALL VERIFIED THE ABOVE DIMENSIONS BASED ON MAST ARM REQUIREMENTS.
- 3. THE HEIGHT OF THE SHROUD SHALL COVER THE ANCHOR BOLTS, NUTS AND MAST ARM POLE BASE.

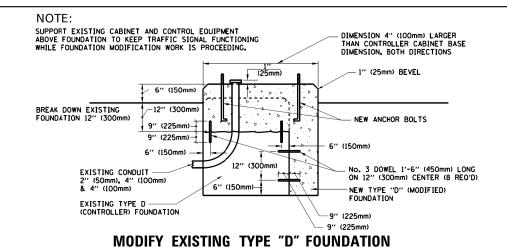

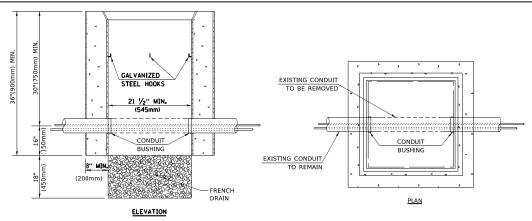

NOTES:


- 1. HANDHOLE CONSTRUCTED PER STATE STANDARD 814001.
- 2. REMOVAL OF THE EXISTING CONDUIT FROM THE HANDHOLE AND THE INSTALLATION OF THE CONDUIT BUSHINGS SHALL BE INCLUDED WITH THE COST OF THE HANDHOLE.

HANDHOLE TO INTERCEPT EXISTING CONDUIT

STATE OF ILLINOIS
DEPARTMENT OF TRANSPORTATION

MODEL: Default

BEACON MOUNTING DETAIL

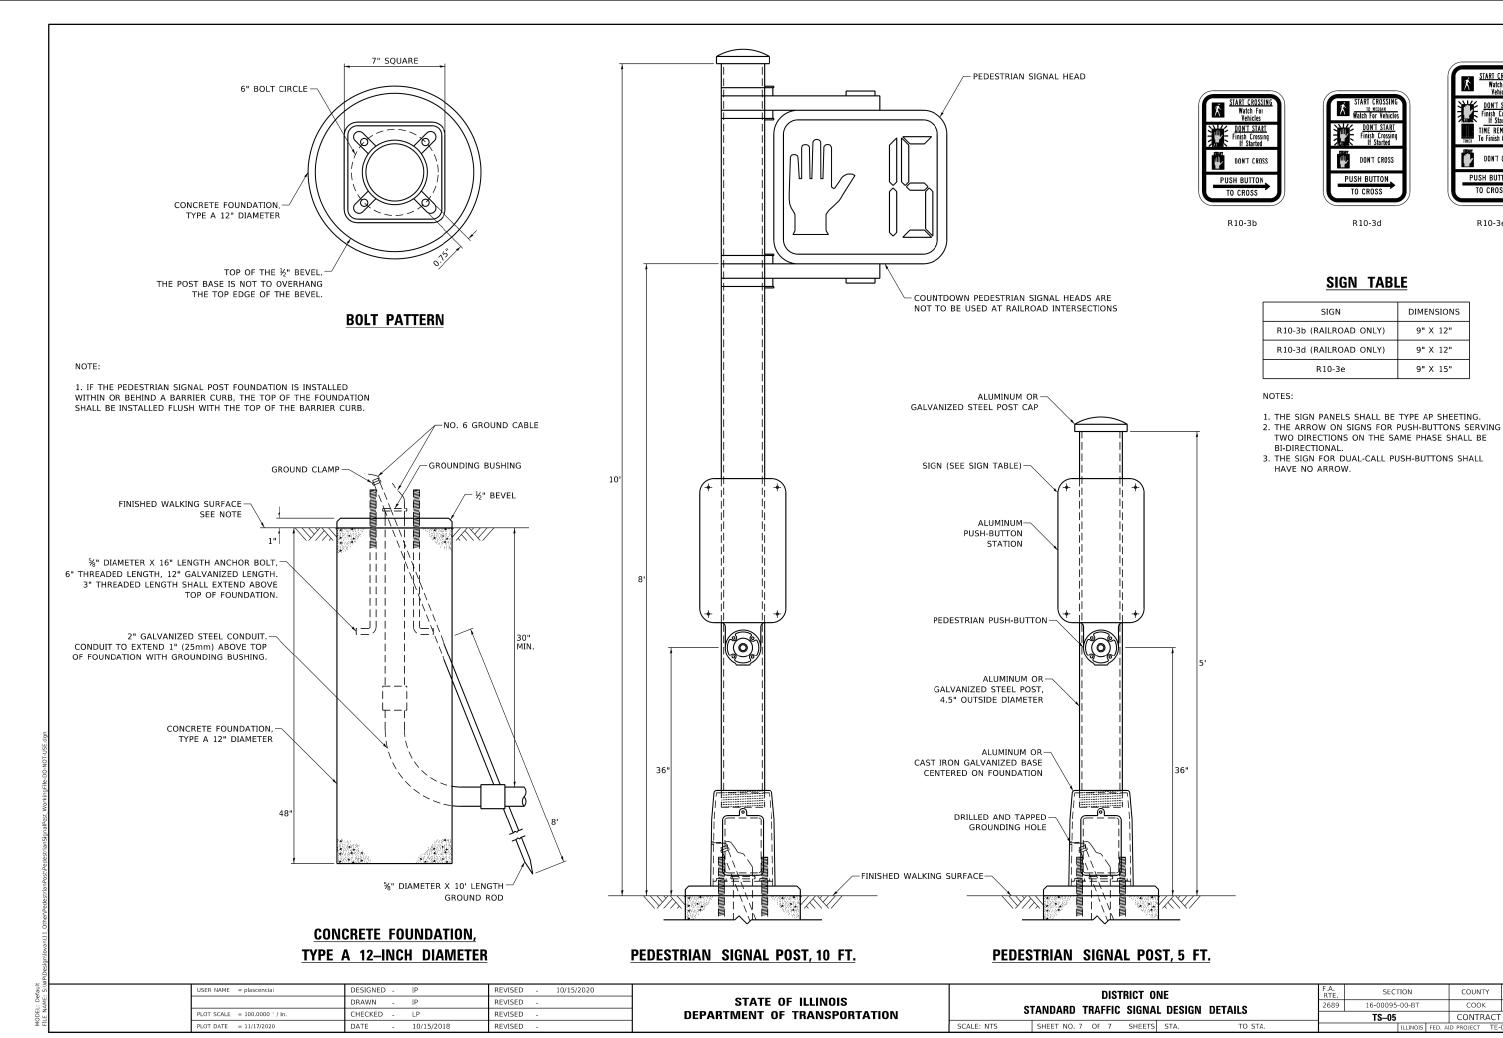

DON'T START Finish Crossing If Started TIME REMAINING To Finish Crossing

DON'T CROSS

PUSH BUTTON

R10-3e

DIMENSIONS

9" X 12"

9" X 12"

9" X 15"

16-00095-00-BT

COOK

54


CONTRACT NO. 61H13

DON'T CROSS

PUSH BUTTON

TO CROSS

R10-3d

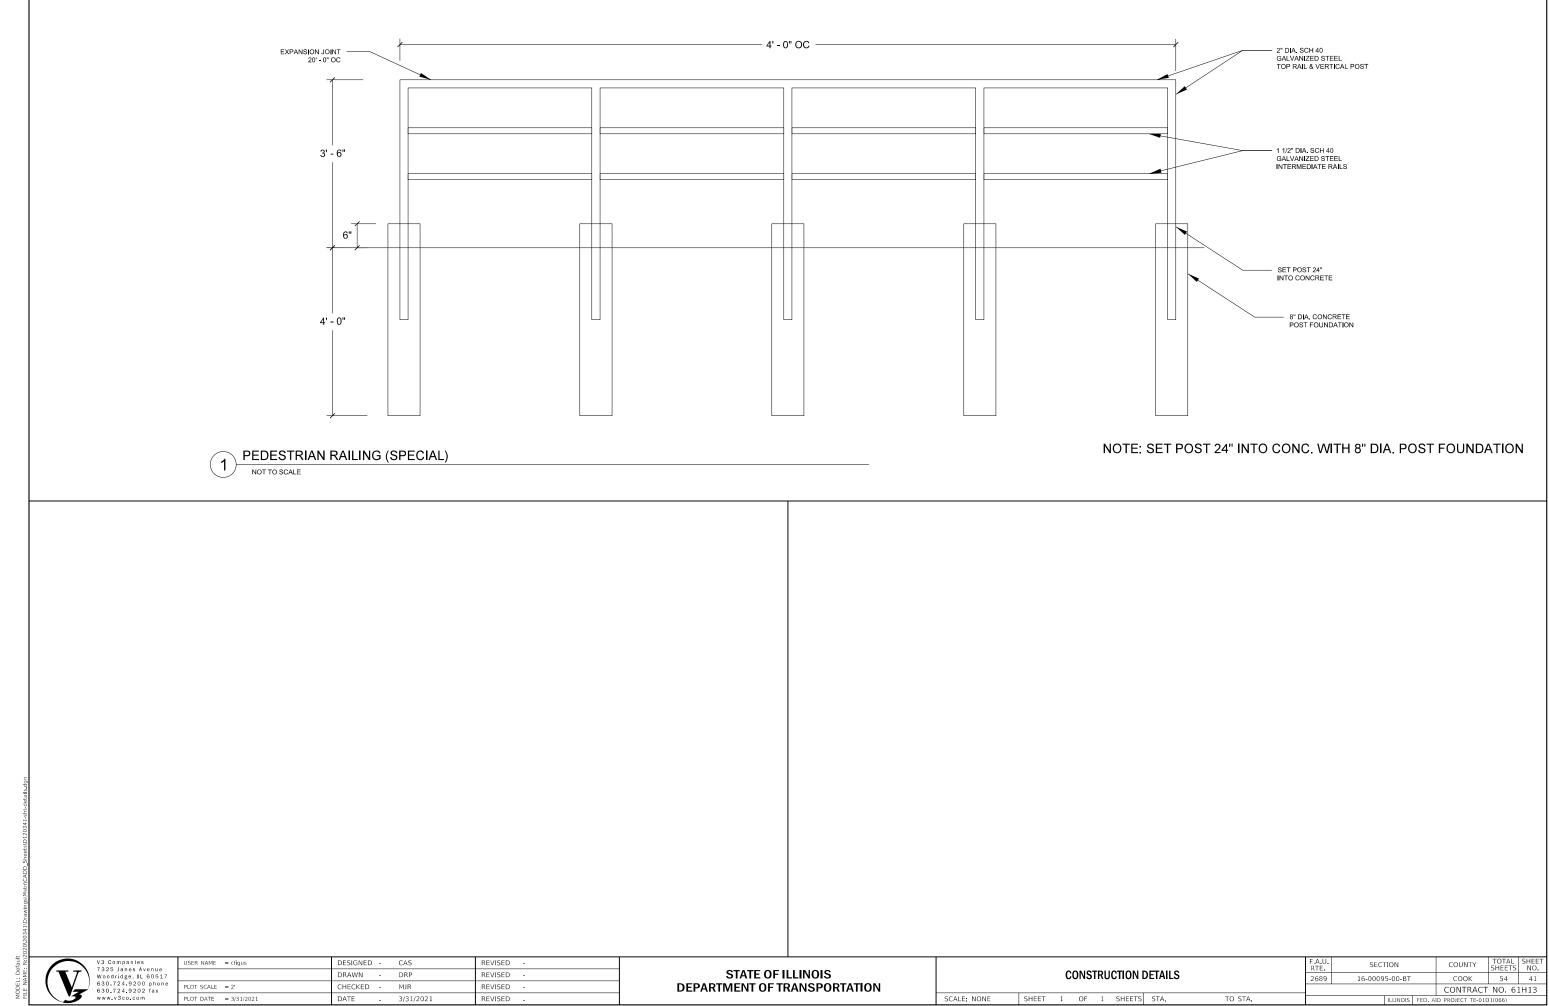


DRAWN - DRP REVISED -PLOT SCALE = 2' CHECKED -MJR REVISED PLOT DATE = 3/31/2021 DATE 3/31/2021 REVISED

STATE OF ILLINOIS DEPARTMENT OF TRANSPORTATION

SCALE: NONE

COUNTY TOTAL SHEET NO.

COOK 54 41 SECTION **CONSTRUCTION DETAILS** 2689 16-00095-00-BT CONTRACT NO. 61H13 SHEET 1 OF 1 SHEETS STA. TO STA.

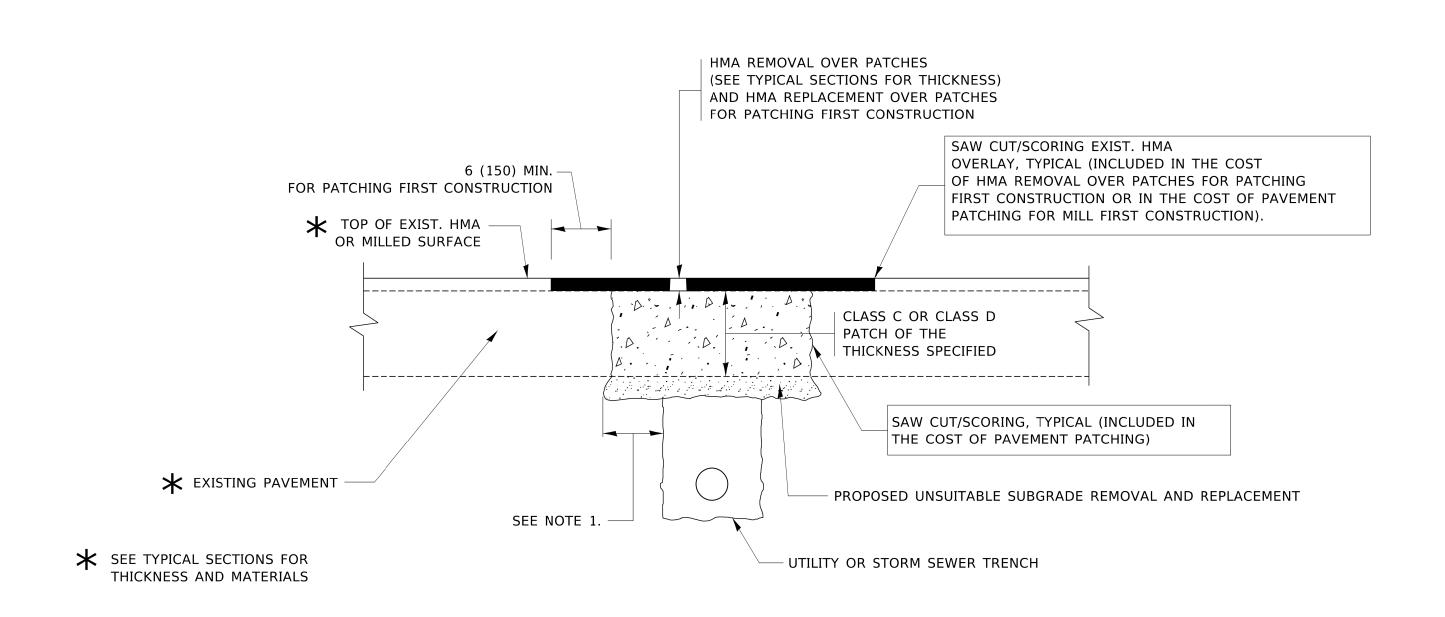

- 1. THE WIDTH OF THE FULL DEPTH PATCH OVER A TRENCH SHALL BE 12 (300) WIDER ON EACH SIDE OF THE TRENCH.
- 2. FOR METHOD OF MEASUREMENT AND BASIS OF PAYMENT, SEE RECURRING SPECIAL PROVISION "PATCHING WITH HOT-MIX ASPHALT OVERLAY REMOVAL".

SEQUENCE OF CONSTRUCTION (PATCHING FIRST)


- 1. REMOVE THE EXISTING HMA MATERIAL OVER THE AREA TO BE PATCHED.
- 2. REMOVE AND REPLACE WITH CLASS C OR D PATCH.
- 3. REPLACE HMA MATERIAL OVER THE AREA TO BE PATCHED.

SEQUENCE OF CONSTRUCTION (MILLING FIRST)

- 1. MILL HMA FIRST IF THERE IS AT LEAST $4\frac{1}{2}$ INCHES OR MORE OF HMA MATERIAL ON TOP OF THE EXISTING PAVEMENT OR IF THE PAVEMENT IS FULL DEPTH HMA. A MINIMUM OF 2 INCHES OF HMA MATERIAL SHALL BE IN PLACE AFTER MILLING.
- 2. REMOVE AND REPLACE WITH FULL DEPTH CLASS D PATCHES TO TOP OF MILLED SURFACE.

ALL DIMENSIONS ARE IN INCHES (MILLIMETERS) UNLESS OTHERWISE SHOWN.

USER NAME = TOOTEM)	DESIGNED - R. SHAH	REVISED - A. ABBAS 04-27-98			PAVEMENT PATCHING FOR	RTF.	SECTION	COUNTY SHEET	TS NO.
	DRAWN -	REVISED - R. BORO 01-01-07	STATE OF ILLINOIS			2689	16-00095-00-BT	COOK 54	42
PLOT SCALE = 50.0000 ' / in.	CHECKED -	REVISED - R. BORO 09-04-07	DEPARTMENT OF TRANSPORTATION		HMA SURFACED PAVEMENT		3D400-04 (BD-22)	CONTRACT NO.	61H13
PLOT DATE = 3/27/2019	DATE - 10-25-94	REVISED - K. ENG 10-27-08		SCALE: NONE	SHEET 1 OF 5 SHEETS STA. TO STA.		ILLINOIS FED. A	ID PROJECT TE-01D1(066)	

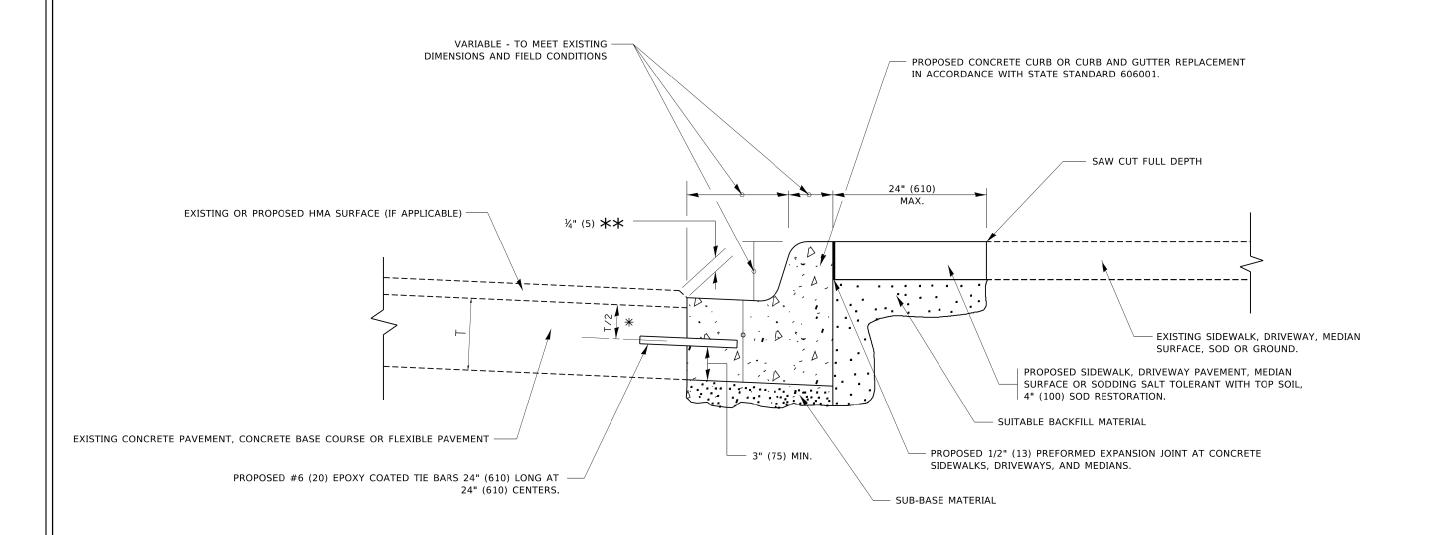


- 💥 3" (75) MINIMUM FROM TOP AND BOTTOM OF THE CONCRETE PAVEMENT OR BASE COURSE.
- $\star\star$ IF THE FINAL SURFACE OF THE PAVEMENT IS CONCRETE, THE GUTTER IS TO BE FLUSH WITH THE PAVEMENT.

CURB OR CURB AND GUTTER REMOVAL AND REPLACEMENT

ALL DIMENSIONS ARE IN INCHES (MILLIMETERS) UNLESS OTHERWISE SHOWN.

USER NAME = footemj	DESIGNED - A. HOUSEH	REVISED - A. ABBAS 03-21-97		CURB OR CURB AND GUTTER	RTF.	SECTION	COUNTY	SHEETS	SHEET I
	DRAWN -	REVISED - M. GOMEZ 01-22-01	STATE OF ILLINOIS		2689	16-00095-00-BT	соок	54	43
PLOT SCALE = 50.0000 ' / in.	CHECKED -	REVISED - R. BORO 12-15-09	DEPARTMENT OF TRANSPORTATION	REMOVAL AND REPLACEMENT		BD600-06 (BD-24)	CONTRAC	T NO. 6	51H13
PLOT DATE = 7/11/2019	DATE - 03-11-94	REVISED - K. SMITH 07-11-19		SCALE: NONE SHEET 2 OF 5 SHEETS STA. TO STA.		ILLINOIS FED.	AID PROJECT TE-0	1D1(066)	

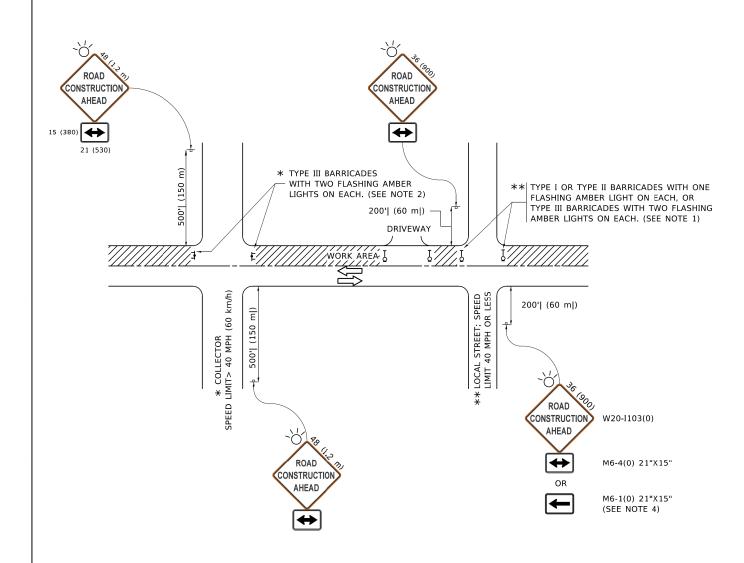

- 1. SIDE ROAD WITH A SPEED LIMIT OF 40 MPH (60 km/h) OR LESS AS SHOWN ON THE DRAWING AND AS DIRECTED BY THE ENGINEER:
- a) ONE "ROAD CONSTRUCTION AHEAD" SIGN 36 x 36 (900x900) WITH A FLASHER MOUNTED ON IT APPROXIMATELY 200' (60 m) IN ADVANCE OF THE MAIN ROUTE.
- b) THE CLOSED PORTION OF THE MAIN ROUTE SHALL BE PROTECTED BY BLOCKING WITH TYPE I, TYPE II OR TYPE III BARRICADES, 1/3 OF THE CROSS SECTION OF THE CLOSED PORTION.
- 2. SIDE ROAD WITH A SPEED LIMIT GREATER THAN 40 MPH (60 km/h) AS SHOWN ON THE DRAWING AND AS DIRECTED BY THE ENGINEER:
- a) ONE "ROAD CONSTRUCTION AHEAD" SIGN 48 x 48 (1.2 m x 1.2 m) WITH A FLASHER MOUNTED ON IT APPROXIMATELY 500' (150 m) IN ADVANCE OF THE MAIN ROUTE.
- THE CLOSED PORTION OF THE MAIN ROUTE SHALL BE PROTECTED BY
 b) BLOCKING WITH TYPE III BARRICADES, 1/2 OF THE CROSS SECTION
 OF THE CLOSED PORTION.
- 3. CONES MAY BE SUBSTITUTED FOR BARRICADES OR DRUMS AT HALF THE SPACING DURING DAY OPERATIONS. CONES SHALL BE A MINIMUM OF 28 (710) IN HEIGHT
- WHEN THE SIDE ROAD LIES BETWEEN THE BEGINNING OF THE MAINLINE
 4. SIGNING AND THE WORK ZONE, A SINGLE HEADED ARROW (M6-1) SHALL
 BE USED IN LIEU OF THE DOUBLE HEADED ARROW (M6-4).

- 5. WHEN WORK IS BEING PERFORMED ON A SIDE ROAD OR DRIVEWAY, FOLLOW THE APPLICABLE STANDARD(S). THE DIRECTIONAL ARROW (M6-1 OR M6-4) SHALL BE COVERED OR REMOVED WHEN NO LONGER CONSISTENT WITH THE TRAFFIC CONTROL SET-UP.
- 6. ADVANCE WARNING SIGNS ARE TO BE OMITTED ON DRIVEWAYS UNLESS OTHERWISE SPECIFIED IN THE PLANS OR BY THE ENGINEER
- 7. THE TRAFFIC CONTROL AND PROTECTION FOR SIDE ROADS, INTERSECTIONS, AND DRIVEWAYS SHALL BE INCLUDED IN THE COST OF SPECIFIED TRAFFIC CONTROL STANDARDS OR ITEMS.


All dimensions are in inches (millimeters) unless otherwise shown.


USER NAME = footemj	DESIGNED - L.H.A.	REVISED - A. HOUSEH 10-15-96
	DRAWN -	REVISED - T. RAMMACHER 01-06-00
PLOT SCALE = 50.0000 ' / in.	CHECKED -	REVISED - A. SCHUETZE 07-01-13
PLOT DATE = 3/4/2019	DATE - 06-89	REVISED _ A. SCHUETZE 09-15-16

STATE O	F ILLINOIS
DEPARTMENT OF	TRANSPORTATION

SI							TION FOR DRIVEWAYS
	SHEET	3	OF	5	SHEETS	STA.	TO STA.

F.A. RTE.	SEC.	COUNTY	TOTAL SHEETS	SHE	
2689	16-0009	5-00-BT	COOK	54	44
	TC-10	CONTRACT	NO. 6	1H13	
		ID PROJECT TE-010	01(066)		

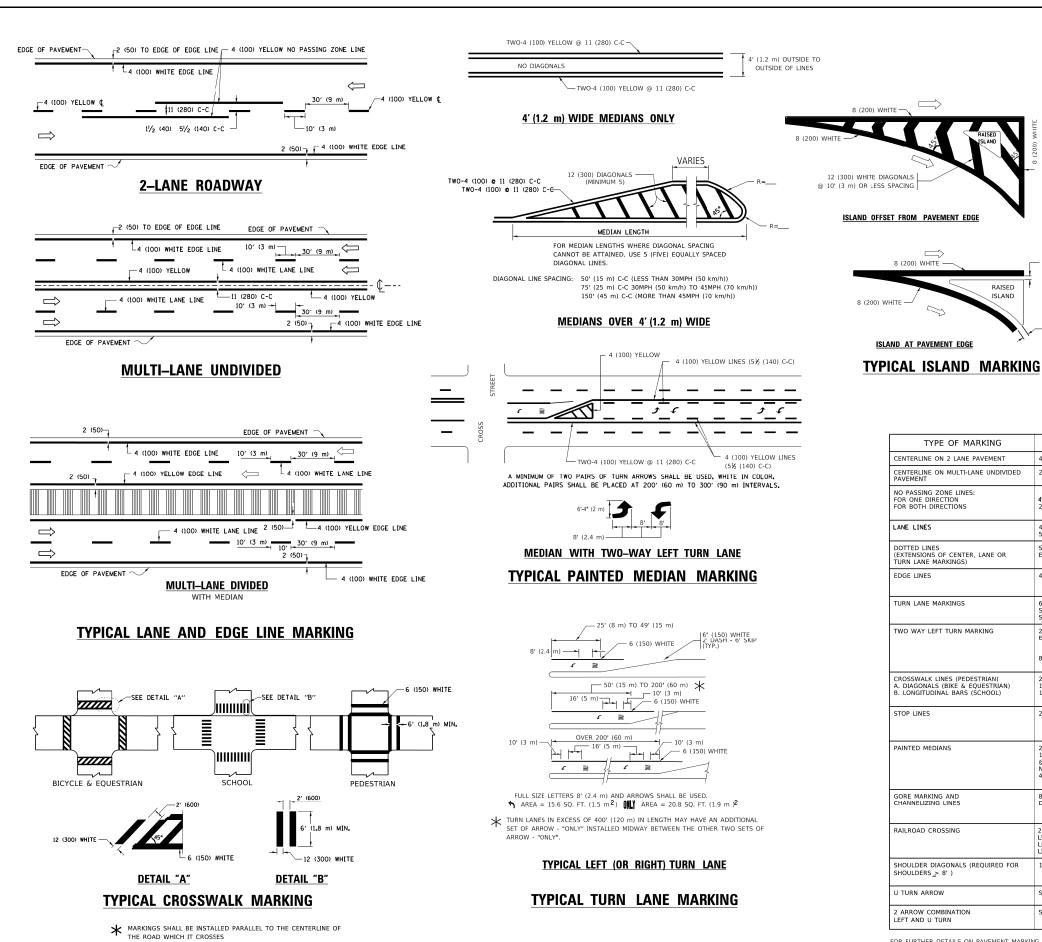

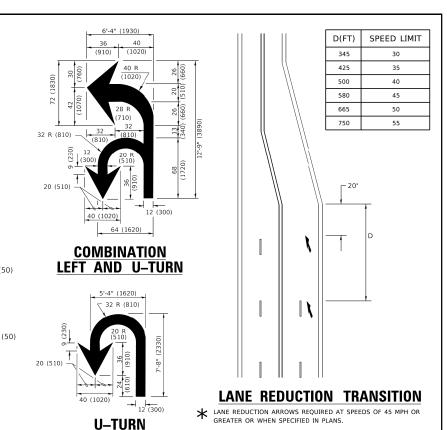

TYPE OF MARKING	WIDTH OF LINE	PATTERN	COLOR	SPACING / REMARKS
CENTERLINE ON 2 LANE PAVEMENT	4 (100)	SKIP-DASH	YELLOW	10' (3 m) LINE WITH 30' (9 m) SPACE
CENTERLINE ON MULTI-LANE UNDIVIDED PAVEMENT	2 @ 4 (100)	SOLID	YELLOW	11 (280) C-C
NO PASSING ZONE LINES: FOR ONE DIRECTION FOR BOTH DIRECTIONS	4 (100) 2 @ 4 (100)	SOLID SOLID	YELLOW YELLOW	5½ (140) C-C FROM SKIP-DASH CENTERLINE 11 (280) C-C OMIT SKIP-DASH CENTERLINE BETWEEN
LANE LINES	4 (100) 5 (125) ON FREEWAYS	SKIP-DASH SKIP-DASH	WHITE WHITE	10' (3 m) LINE WITH 30' (9 m) SPACE
DOTTED LINES (EXTENSIONS OF CENTER, LANE OR TURN LANE MARKINGS)	SAME AS LINE BEING EXTENDED	SKIP-DASH	SAME AS LINE BEING EXTENDED	2' (600) LINE WITH 6' (1.8 m) SPACE
EDGE LINES	4 (100)	SOLID	YELLOW-LEFT WHITE-RIGHT	OUTLINE MEDIANS IN YELLOW
TURN LANE MARKINGS	6 (150) LINE; FULL SIZE LETTERS & SYMBOLS (8' (2.4m))	SOLID	WHITE	SEE TYPICAL TURN LANE MARKING DETAIL
TWO WAY LEFT TURN MARKING	2 @ 4 (100) EACH DIRECTION 8' (2.4m) LEFT ARROW	SKIP-DASH AND SOLID IN PAIRS	YELLOW	10' (3 m) LINE WITH 30' (9 m) SPACE FOR SKIP-DASH; 5½ (140) C-C DETWEEN SOLID LINE AND SKIP-DASH LINE SEE TYPICAL TWO-WAY LEFT TURN MARKING DETAIL
CROSSWALK LINES (PEDESTRIAN) A. DIAGONALS (BIKE & EQUESTRIAN) B. LONGITUDINAL BARS (SCHOOL)	2 @ 6 (150) 12 (300) @ 45° 12 (300) @ 90°	SOLID SOLID SOLID	WHITE WHITE WHITE	NOT LESS THAN 6' (1.8 m) APART 2' (600) APART 2' (600) APART 5EE TYPICAL CROSSWALK MARKING DETAILS.
STOP LINES	24 (600)	SOLID	WHITE	PLACE 4' (1.2 m) IN ADVANCE OF AND PARALLEL TO CROSSWALK, IF PRESENT. OTHERWISE, PLACE AT DESIRED STOPPING POINT: PARALLEL TO CROSSROAD CENTERLINE, WHERE POSSIBLE
PAINTED MEDIANS	2 @ 4 (100) WITH 12 (300) DIAGONALS @ 45° NO DIAGONALS USED FOR 4' (1.2 m) WIDE MEDIANS	SOLID	YELLOW: TWO WAY TRAFFIC WHITE: ONE WAY TRAFFIC	11 (280) C-C FOR THE DOUBLE LINE SEE TYPICAL PAINTED MEDIAN MARKING.
GORE MARKING AND CHANNELIZING LINES	8 (200) WITH 12 (300) DIAGONALS @ 45°	SOLID	WHITE	DIAGONALS: 15' (4.5 m) C-C (LESS THAN 30MPH (50 km/h)) 20' (6 m) C-C 30MPH (50 km/h) TO 45MPH (70 km/h)) 30' (9 m) C-C (OVER 45MPH (70 km/h))
RAILROAD CROSSING	24 (600) TRANSVERSE LINES; "RR" IS 6' (1.8 m) LETTERS; 16 (400) LINE FOR "X"	SOLID	WHITE	SEE STATE STANDARD 780001 AREA OF: "R"=3.6 SQ. FT. (0.33 m PEACH "X"=54.0 SQ. FT. (5.0 m PEACH
SHOULDER DIAGONALS (REQUIRED FOR SHOULDERS > 8')	12 (300) @ 45°	SOLID	WHITE - RIGHT YELLOW - LEFT	50' (15 m) C-C (LESS THAN 30MPH (50 km/h)) 75' (25 m) C-C (30 MPH (50 km/h) TO 45MPH (70 km/h)) 150' (45 m) C-C (OVER 45MPH (70 km/h))
U TURN ARROW	SEE DETAIL	SOLID	WHITE	16.3 SF
2 ARROW COMBINATION LEFT AND U TURN	SEE DETAIL	SOLID	WHITE	30.4 SF

FOR FURTHER DETAILS ON PAVEMENT MARKING REFER TO STANDARD SPECIFICATIONS FOR ROAD AND BRIDGE CONSTRUCTION AND STATE STANDARD 780001.

8 (200) WHITE -

RAISED

All dimensions are in inches (millimeters) unless otherwise shown.

USER NAME = footemj	DESIGNED - EVERS	REVISED - C. JUCIUS 09-09-09
	DRAWN -	REVISED - C. JUCIUS 07-01-13
PLOT SCALE = 50.0000 ' / in.	CHECKED -	REVISED - C. JUCIUS 12-21-15
PLOT DATE = 3/4/2019	DATE - 03-19-90	REVISED - C. JUCIUS 04-12-16

STATE OF ILLINOIS DEPARTMENT OF TRANSPORTATION

DISTRICT ONE			F.A. RTE.	SECTION	COUNTY	TOTAL SHEETS	SHEET NO.				
TYPICAL PAVEMENT MARKINGS					MARKINGS		2689	16-00095-00-BT	соок	54	45
							TC-13	CONTRACT NO. 61H			
CHEET	- 1	OF	5	CHEETC	CTA	TO CTA				2440000	

TURN BAY ENTRANCE AT START OF LANE CLOSURE TAPER

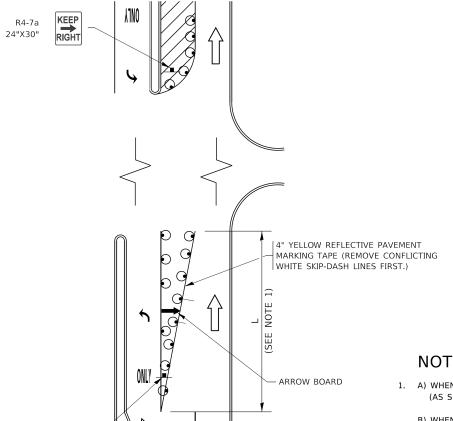


FIGURE 1

SEE DETAIL "A"


LEGEND WORK AREA LANE OPEN TO TRAFFIC ARROW BOARD TYPE I OR II BARRICADE OR DRUM WITH STEADY BURN LIGHT DRUM WITH STEADY BURN LIGHT SIGN ASSEMBLY

TYPE I OR II CHECK BARRICADE WITH FLASHING LIGHT

NOTES:

- 1. A) WHEN "L" IS ≤ THE STORAGE LENGTH OF THE TURN LANE (AS SHOWN IN FIG. 1), USE FIGURE 1.
 - B) WHEN "L" IS > THE STORAGE LENGTH OF THE TURN LANE OR THE TURN LANE IS WITHIN THE LANE CLOSURE, USE FIGURE 2.
- 2. CONES MAY BE SUBSTITUTED FOR BARRICADES OR DRUMS AT HALF THE SPACING DURING DAY OPERATIONS. CONES SHALL BE A MINIMUM OF 28 (710) IN HEIGHT.
- 3. LIGHTS WILL NOT BE REQUIRED ON BARRICADES OR DRUMS FOR DAY OPERATIONS. ALL LIGHTS SHALL BE MONODIRECTIONAL.
- 4. REFLECTIVE TEMPORARY PAVEMENT MARKINGS SHALL BE PLACED THROUGHOUT THE BARRICADED AREAS OF EACH TURN BAY AS SHOWN WHERE THE CLOSURE TIME IS GREATER THAN FOURTEEN (14) DAYS.
- 5. THIS APPLICATION ALSO APPLIES WHEN WORK IS BEING PERFORMED IN THE RIGHT LANE(S) AND THE RIGHT TURN BAY IS TO REMAIN OPEN. UNDER THIS CONDITION, "RIGHT TURN LANE" R3-I100R 24 x 24 (600 x 600) AND M6-2R 21 x 15 (530 x 380) SHALL BE USED.
- THESE CONTROLS SHALL SUPPLEMENT MAINLINE TRAFFIC CONTROL FOR LANE CLOSURES.
- 7. THE SIGNS SHALL BE MOUNTED ABOVE THE BARRICADES/DRUMS ON SEPARATE SIGN SUPPORTS THAT MEET NCHRP 350 OR MASH PREOUIREMENTS.
- 8. TRAFFIC CONTROL AND PROTECTION AT TURN BAYS (TO REMAIN OPEN TO TRAFFIC) SHALL BE INCLUDED IN THE COST OF SPECIFIED TRAFFIC CONTROL STANDARDS OR ITEMS.

TURN BAY ENTRANCE WITHIN A LANE CLOSURE

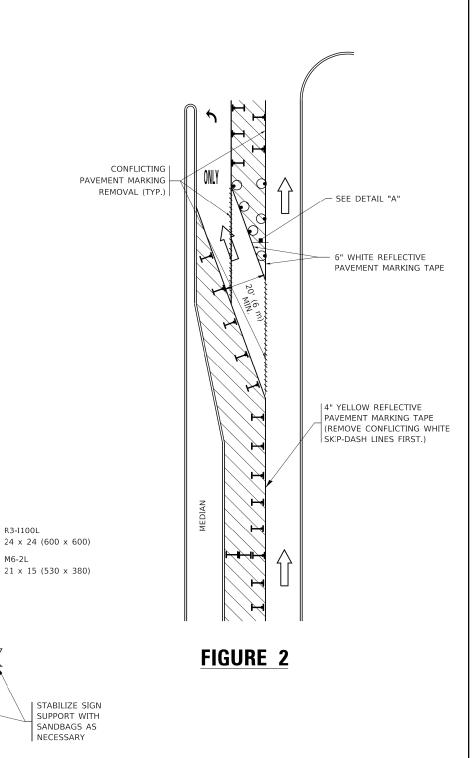

DETAIL A

TURN

LANE


All dimensions are in inches (millimeters) unless otherwise shown

USER NAME = rootemj	DESIGNED	- 1.	RAMMACHER	09-08-94	KEVISED	-	R. BORO 09-14-09
	DRAWN	-	A. HOUSEH	11-07-95	REVISED	- A.	SCHUETZE 07-01-13
PLOT SCALE = 50.0000 ' / in.	CHECKED	-	A. HOUSEH	10-12-96	REVISED	- A.	SCHUETZE 09-15-16
PLOT DATE = 3/4/2019	DATE	- T.	RAMMACHER	01-06-00	REVISED	-	

STATE OF ILLINOIS DEPARTMENT OF TRANSPORTATION

TRA	AFFIC CONT	ROL ANI	D PROTEC	CTION AT	TURN BAYS	F.A. RTE.	SECTION
	/TO	DEMAIN	I ODENI :	TO TRAFF	IC/	2689	16-00095-00-BT
	-	TC-14					
SCALE: NONE	SHEET	OF	SHEETS	STA.	TO STA.		ILLINOIS

COOK 54 45A CONTRACT NO. 61H13

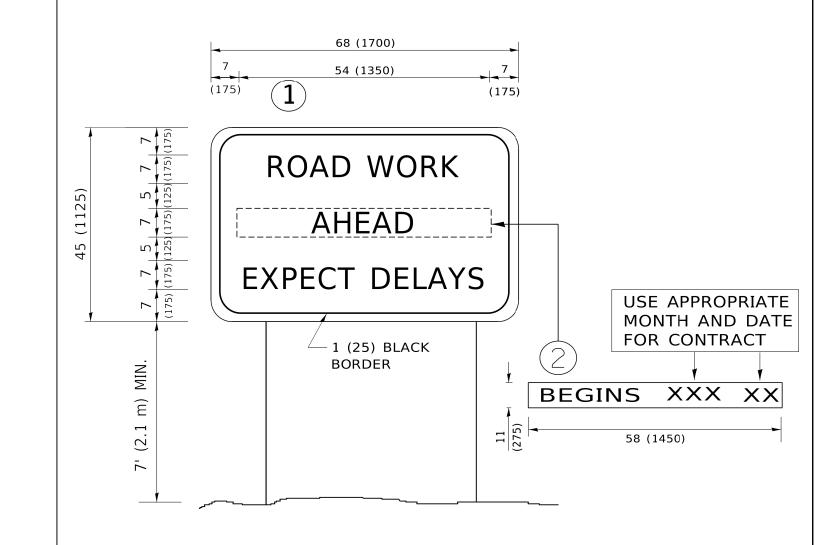

- 1. USE BLACK LETTERING ON ORANGE BACKGROUND.
- 2. ERECT SIGNS IN ADVANCE OF THE LOCATION FOR THE "ROAD CONSTRUCTION AHEAD" SIGN AT LOCATIONS AS DIRECTED BY THE ENGINEER.
- 3. ERECT SIGN(1)WITH INSTALLED PANEL(2)ONE WEEK PRIOR TO THE START OF CONSTRUCTION.
- 4. REMOVE PANEL(2)SOON AFTER THE START OF CONSTRUCTION.
- 5. SEE SPECIAL PROVISION FOR "TEMPORARY INFORMATION SIGNING" FOR ADDITIONAL INFORMATION.
- 6. ONE SIGN ASSEMBLY EQUALS 25.70 SQ. FT. (2.3 SQ. M.)
- 7. SHALL BE PAID FOR AS TEMPORARY INFORMATION SIGNING.

ALL DIMENSIONS ARE IN INCHES (MILLIMETERS) UNLESS OTHERWISE SHOWN.

USER NAME = footemj	DESIGNED -	REVISED - R. MIRS 09-15-97		ARTERIAL ROAD		F.A. RTE.	SECTION	COUNTY	TOTAL SHEET SHEETS NO.
	DRAWN -	REVISED - R. MIRS 12-11-97	STATE OF ILLINOIS	INFORMATION SIGN			16-00095-00-BT	соок	54 46
PLOT SCALE = 50.0000 ' / in.	CHECKED -	REVISED -T. RAMMACHER 02-02-99	DEPARTMENT OF TRANSPORTATION	INFUNIWATION SIGN		TC-22		CONTRACT NO. 61H13	
PLOT DATE = 3/4/2019	DATE -	REVISED - C. JUCIUS 01-31-07		SCALE: NONE SHEET 5 OF 5 SHEETS STA.	TO STA.		ILLINOIS FED.	AID PROJECT TE-0:	ID1(066)

