

STATE OF ILLINOIS
DEPARTMENT OF TRANSPORTATION

F.A.P. RTE.	SECTION	COUNTY	TOTAL SHEETS	SHEET NO.
301	(1-1,1,2)RS-2	WINNEBAGO	158*	1
		ILLINOIS	CONTRACT NO. 64M18	

* 158 + 2 = 160 TOTAL SHEETS

D-92-026-17



FOR INDEX OF SHEETS, SEE SHEET NO. 2

PROPOSED HIGHWAY PLANS

FUNCTIONAL CLASSIFICATION
FREEWAY / EXPRESSWAY
2021 ADT = 22,100
PV = 87.7% SU = 3.4% MU = 8.9%

FAP ROUTE 301 (US 20)
SECTION (1-1,1,2)RS-2
PROJECT NHPP-VL8B(244)
MILLING AND HMA RESURFACING
WINNEBAGO COUNTY

C-92-020-20

STATION EQUATION (WB ONLY)
565 + 00 BK = 563 + 40 AH

WINNEBAGO TOWNSHIP T 26 N SECTIONS (2,3,11,12)
ROCKFORD TOWNSHIP T 43 N SECTIONS (4,5)
ROCKFORD TOWNSHIP T 44 N SECTIONS (19,29,30,32)


PROJECT BEGINS
STA. 493 + 00

PAVING GAP
STA. 546 + 42 TO 549 + 67

PAVING GAP
STA. 692 + 28 TO 695 + 34
STA. 705 + 81 TO 707 + 25

PAVING GAP
STA. 840 + 28 TO 842 + 42


PROJECT ENDS
STA. 847 + 49

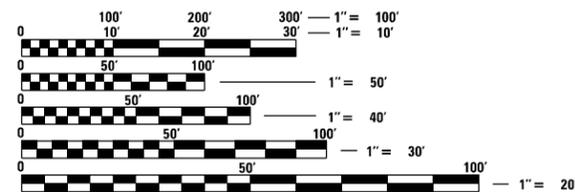

FULL SIZE PLANS HAVE BEEN PREPARED USING STANDARD ENGINEERING SCALES. REDUCED SIZED PLANS WILL NOT CONFORM TO STANDARD SCALES. IN MAKING MEASUREMENTS ON REDUCED PLANS, THE ABOVE SCALES MAY BE USED.

J.U.L.I.E.
JOINT UTILITY LOCATION INFORMATION FOR EXCAVATORS
1-800-892-0123
OR 811

PROJECT ENGINEER: STEVE ROBERY
TEAM LEADER: COREY CONDERMAN (815) 284-5936
PROJECT MANAGER: GUELORD MPAGAZIHE (815) 284-5375
EMAIL: Guelord.Mpagazihe@Illinois.gov
CONTRACT NO. 64M18

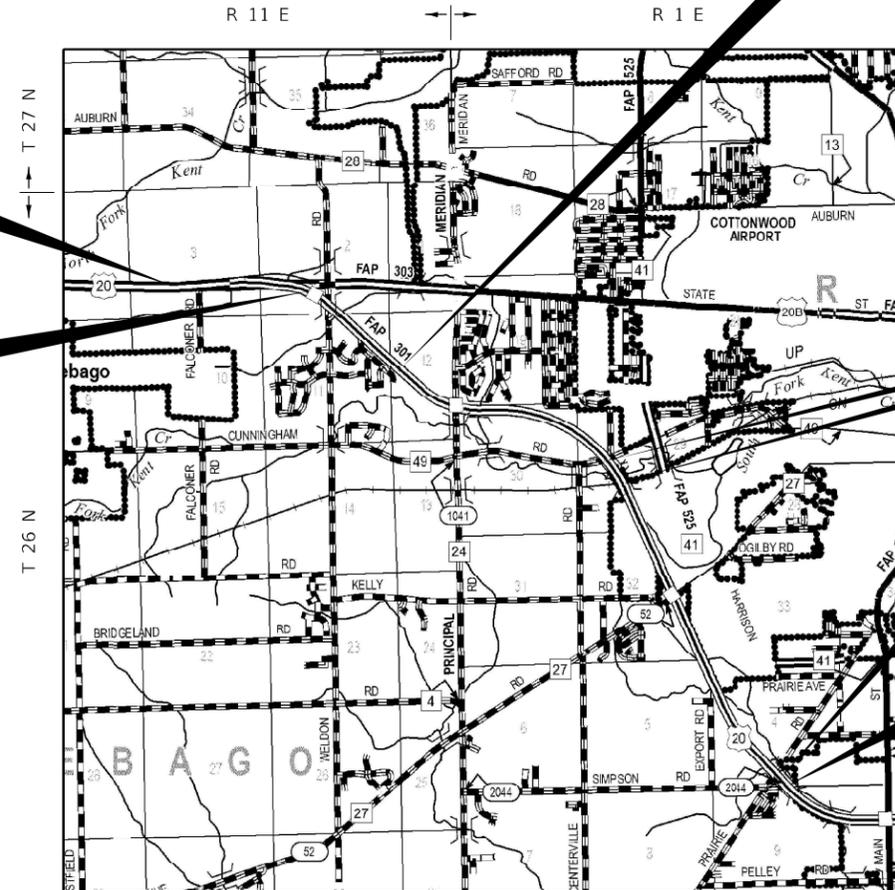

GROSS LENGTH = 35,449 FT. = 6.71 MILE
NET LENGTH = 34,460 FT. = 6.53 MILE

STATE OF ILLINOIS
DEPARTMENT OF TRANSPORTATION

SUBMITTED 03/19 2021

David Alford
REGIONAL ENGINEER

May 7, 2021
Joe A. Elk
ENGINEER OF DESIGN AND ENVIRONMENT

May 7, 2021
James J. ...
DIRECTOR OF HIGHWAYS PROJECT IMPLEMENTATION

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OF THE STATE OF ILLINOIS

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HIGHWAY STANDARDS

000001 - 08	STANDARD SYMBOLS ABBREVIATIONS & PATTERNS
001006	DECIMAL OF INCH & FOOT
420001 - 09	PAVEMENT JOINTS
420701 - 03	PAVEMENT WELDED WIRE REINFORCEMENT
442101 - 09	CLASS B PATCHES
630001 - 12	STEEL PLATE BEAM GUARDRAIL
630101 - 10	STRONG POST GUARDRAIL ATTACHED TO CULVERT
630201 - 07	PCC/HMA STABILIZATION AT STEEL PLATE BEAM GUARDRAIL
630301 - 09	SHOULDER WIDENING FOR TYPE 1 (SPECIAL) GUARDRAIL TERMINALS
631011 - 10	TRAFFIC BARRIER TERMINAL, TYPE 2
631033 - 08	TRAFFIC BARRIER TERMINAL, TYPE 6B
635001 - 02	DELINEATORS
642001 - 02	SHOULDER RUMBLE STRIPS, 16 IN.
701101 - 05	OFF-RD OPERATIONS, MULTILANE, 15' TO 24" FROM PAVEMENT EDGE
701106 - 02	OFF-RD OPERATIONS, MULTILANE, MORE THAN 15' AWAY
701400 - 10	APPROACH TO LANE CLOSURE, FREEWAY / EXPRESSWAY
701401 - 12	LANE CLOSURE, FREEWAY / EXPRESSWAY
701406 - 12	LANE CLOSURE, FREEWAY/EXPRESSWAY, DAY OPERATIONS ONLY
701411 - 09	LANE CLOSURE, MULTILANE, AT ENTRANCE OR EXIT RAMP, FOR SPEEDS \geq 45 MPH
701421 - 08	LANE CLOSURE, MULTILANE, DAY OPERATIONS ONLY, FOR SPEEDS \geq 45 MPH TO 55 MPH
701422 - 10	LANE CLOSURE, MULTILANE, FOR SPEEDS \geq 45 MPH TO 55 MPH
701426 - 09	LANE CLOSURE, MULTILANE, INTERMITTENT OR MOVING OPER., FOR SPEEDS \geq 45 MPH
701428 - 01	TRAFFIC CONTROL SETUP AND REMOVAL FREEWAY / EXPRESSWAY
701456 - 05	PARTIAL EXIT RAMP CLOSURE FREEWAY / EXPRESSWAY
701901 - 08	TRAFFIC CONTROL DEVICES
720011 - 01	METAL POSTS FOR SIGNS, MARKERS, AND DELINEATORS
725001 - 01	OBJECT AND TERMINAL MARKERS
728001 - 01	TELESCOPING STEEL SIGN SUPPORT
729001 - 01	APPLICATIONS OF TYPES A & B POSTS (FOR SIGNS AND MARKERS)
780001 - 05	TYPICAL PAVEMENT MARKINGS
781001 - 04	TYPICAL APPLICATIONS RAISED REFLECTIVE PAVEMENT MARKERS
782006 - 01	GUARDRAIL AND BARRIER WALL REFLECTOR MOUNTING DETAILS

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**STATE OF ILLINOIS
DEPARTMENT OF TRANSPORTATION**

INDEX OF SHEETS & HIGHWAY STANDARDS				
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F.A.P. RTE.	SECTION	COUNTY	TOTAL SHEETS	SHEET NO.
301	(1-1,1,2)RS-2	WINNEBAGO	158	2
CONTRACT NO. 64M18				
ILLINOIS FED. AID PROJECT				

SUMMARY OF QUANTITIES

CODE NUMBER	ITEM	UNIT	URBAN	ROADWAY
			TOTAL QUANTITY	80% FED 20% STATE 0005
44200970	CLASS B PATCHES, TYPE II, 10 INCH	SQ YD	673	673
44200974	CLASS B PATCHES, TYPE III, 10 INCH	SQ YD	56	56
44200976	CLASS B PATCHES, TYPE IV, 10 INCH	SQ YD	825	825
44201039	CLASS B PATCHES, TYPE I, 16 INCH	SQ YD	28	28
44201043	CLASS B PATCHES, TYPE II, 16 INCH	SQ YD	5,935	5,935
44201047	CLASS B PATCHES, TYPE III, 16 INCH	SQ YD	498	498
44201048	CLASS B PATCHES, TYPE IV, 16 INCH	SQ YD	3,367	3,367
44201299	DOWEL BARS 1 1/2"	EACH	18,292	18,292
44213200	SAW CUTS	FOOT	62,136	62,136
44213204	TIE BARS 3/4"	EACH	1,739	1,739
48101200	AGGREGATE SHOULDERS, TYPE B	TON	207	207
48102100	AGGREGATE WEDGE SHOULDER, TYPE B	TON	383	383
48203014	HOT-MIX ASPHALT SHOULDERS, 4 1/4"	SQ YD	1,210	1,210
48203021	HOT-MIX ASPHALT SHOULDERS, 6"	SQ YD	1,602	1,602

* SPECIALTY ITEM

△ 100% STATE

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						ILLINOIS		FED. AID PROJECT	

CONTRACT NO. 64M18

SUMMARY OF QUANTITIES

CODE NUMBER	ITEM	UNIT	URBAN	ROADWAY
			TOTAL QUANTITY	80% FED 20% STATE 0005
78300200	RAISED REFLECTIVE PAVEMENT MARKER REMOVAL	EACH	1,521	1,521
78300201	PAVEMENT MARKING REMOVAL - GRINDING	SQ FT	1,000	1,000
* X2700006	PREFORMED PLASTIC PAVEMENT MARKING, TYPE D - LINE 4"	FOOT	162,288	162,288
* X2700008	PREFORMED PLASTIC PAVEMENT MARKING, TYPE D - LETTERS AND SYMBOLS	SQ FT	109	109
* X2700010	PREFORMED PLASTIC PAVEMENT MARKING, TYPE D - LINE 6"	FOOT	17,590	17,590
* X2700012	PREFORMED PLASTIC PAVEMENT MARKING, TYPE D - LINE 8"	FOOT	8,627	8,627
* X2700025	PREFORMED PLASTIC PAVEMENT MARKING, TYPE D - LINE 9"	FOOT	310	310
* X2700026	PREFORMED PLASTIC PAVEMENT MARKING, TYPE D - LINE 12"	FOOT	1,804	1,804
* X0320100	GROOVING FOR RECESSED PAVEMENT MARKING 10"	FOOT	310	310
X0325201	SHOULDER RUMBLE STRIP REMOVAL	SQ YD	24,880	24,880
X3550015	HOT-MIX ASPHALT BASE COURSE, (VARIABLE DEPTH)	TON	5,356	5,356
X4420682	CLASS B PATCHES, TYPE II, 10 INCH (SPECIAL)	SQ YD	1,187	1,187
X4420683	CLASS B PATCHES, TYPE III, 10 INCH (SPECIAL)	SQ YD	150	150
X4420684	CLASS B PATCHES, TYPE IV, 10 INCH (SPECIAL)	SQ YD	673	673

* SPECIALTY ITEM

△ 100% STATE

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ILLINOIS FED. AID PROJECT												

SUMMARY OF QUANTITIES

CODE NUMBER	ITEM	UNIT	URBAN	ROADWAY
			TOTAL QUANTITY	80% FED 20% STATE 0005
X4400196	HOT-MIX ASPHALT SURFACE REMOVAL, SPECIAL	SQ YD	8,904	8,904
X4401198	HOT-MIX ASPHALT SURFACE REMOVAL, VARIABLE DEPTH	SQ YD	9,637	9,637
* X7820007	GUARDRAIL RELECTORS, TYPE C (SPECIAL)	EACH	76	76
* X7830060	GROOVING FOR RECESSED PAVEMENT MARKING, LETTERS AND SYMBOLS	SQ FT	137	137
* X7830070	GROOVING FOR RECESSED PAVEMENT MARKING 5"	FOOT	162,288	162,288
* X7830074	GROOVING FOR RECESSED PAVEMENT MARKING 7"	FOOT	17,590	17,590
* X7830076	GROOVING FOR RECESSED PAVEMENT MARKING 9"	FOOT	8,627	8,627
* X7830078	GROOVING FOR RECESSED PAVEMENT MARKING 13"	FOOT	1,804	1,804
* X7830084	GROOVING FOR RECESSED PAVEMENT MARKING 19"	FOOT	72	72
Z0008758	AERIAL SPEED CHECK MARKING	FOOT	72	72
Z0013798	CONSTRUCTION LAYOUT	L SUM	1	1
Z0033700	LONGITUDINAL JOINT SEALANT	FOOT	88,235	88,235
Z0034105	MATERIAL TRANSFER DEVICE	TON	51,776	51,776
∅ Z0076600	TRAINEES	HOUR	2,000	2,000
Z0058670	GRADING AND SHAPING FORESLOPES	UNIT	1,127	1,127
∅ Z0076604	TRAINEES - TRAINING PROGRAM GRADUATE	HOUR	2,000	2,000

* SPECIALTY ITEM
 Δ 100% STATE
 ∅ 0042

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ILLINOIS FED. AID PROJECT							

GENERAL NOTES

The Contractor shall seed all disturbed areas within the project limits. Seeding Class 4 or 2A shall be used, except in front of properties where the grass will be mowed, then use Seeding, Class 1A. Class 2A shall be used on front slopes and ditch bottoms. Class 4 shall be used behind Type A gutter, on all backslopes and areas behind the backslope, and beyond the toe of front slope on fill sections without ditches.

Fertilizer Nutrients shall be applied at the rate specified in Sections 250 and 252 of the Standard Specifications. This shall be included in the cost of the SEEDING or SODDING.

Closed expansion joints on jointed pavements shall be re-established during the patching operations. Class B Patches - when the pavement requires patching at the location of the expansion joint, a new joint should be established using a dowelled expansion patch as shown on Highway Standard 442101. When the joint is closed, but does not require patching, an expansion joint may be formed by sawing the pavement and filling the saw cut with a preformed expansion joint filler meeting the requirements of Section 1051 of the Standard Specifications as shown on Standard 420001.

When laying out for patching, the minimum distance between new patches (saw cut to saw cut) shall be 15 feet. When patch spacing is less than 15 feet, the pavement between patches shall also be removed and replaced.

The following Mixture Requirements are applicable for this project:

Location and Mixture Uses(s):	Mainline Resurfacing			Variable Depth	Shoulders	
	Surface	Surface	Binder	Binder 1.25" min - 2.5" max	Top Lift - Surface	Top Lift - Binder
PG:	SBS PG 70-28	SBS PG 70-28	SBS PG 70-28	PG 58-28	PG 58-28	PG 58-28
Design Air Voids	4.0 @ N70	4.0 @ N70	4.0 @ N70	4.0 @ N50	4.0 @ N50	4.0 @ N50
Mixture Composition (Gradation Mixture)	IL 9.5	IL 9.5	IL 9.5FG	IL 9.5FG	IL 9.5, or 9.5FG	IL 9.5FG
Friction Aggregate	D	E	N/A	N/A	C	N/A
20 Year ESAL	10.7	10.7	10.7	10.7	10.7	10.7
Mix Unit Weight	112 lbs/sy/in	119 lbs/sy/in	N/A	N/A	112 lbs/sy/in	N/A
Quality Management Program to be Used	PFP	QCQA	PFP	QCP for mix, QC/QA for density	QCP	QCP
Sublot Tonnage	1000	N/A	1000	1000	1000	1000

- 1) When a number of roller passes is specified, the Contractor may opt to use intelligent compaction in lieu of density testing under the Quality Control for Performance (QCP) program.

The Contractor will be required to furnish 5 1/2" high brass stencils as approved by the Engineer and install stationing at 250' intervals. Stationing shall be placed on both lanes of 2-lane highways and on the outside lanes in both directions on 4-lane highways. The stations shall be placed 6" inside the pavement marking edge so they can be read from the shoulder. This work will be included in the cost of the final pavement surface.

The area to be tacked or primed shall be limited to that which can be covered with HMA on the next day's production, but no more than five days in advance of the placement of the HMA, unless approved by the Engineer.

The Contractor shall supply the Resident Engineer with the manufacturer's installation requirements for the type of Steel Plate Beam Guardrail Terminal Type 1 Special (Tangent) or Steel Plate Beam Guardrail Terminal Type I Special (Flared).

Delineators shall be installed as shown in Standard 635001, except that the post shall be rotated 180° and only metal-backed delineators shall be permitted. Delineators shall be placed at the ends of approach guardrail terminal sections, and at each headwall or end section of AR Culverts. This work will be paid for at the contract unit price each for DELINEATORS.

The Contractor shall be responsible for collecting and maintaining an electronic log of all stakeout survey that is performed on the job, either by him/her or any sub-contractor performing the stakeout. Upon request, all logs shall be submitted to the Department. No additional compensation will be allowed for this work, but shall be considered included in the cost for CONSTRUCTION LAYOUT.

Pavement Marking shall be done according to Standard 780001, except as follows:

1. All words, such as ONLY, shall be 8 feet high.
2. All non-freeway arrows shall be the large size.
3. The distance between yellow no-passing lines shall be 8 inches, not 7 inches, as shown in the detail of Typical Lane and Edge Lines.
4. Centerline Skip Dash Pavement Marking on multi-lane divided, multi-lane undivided, and one-way roadway shall be according to District Standard 41.1.

Permanent Survey Markers, Type II shall be cast-in-place as shown on District Standard 66.2, or another option would be to install a vaulted style, monumented as described by NGS as a 3D monument (Top Security Sleeve Rod Monument), with installation instructions provided by the District Chief of Surveys. If poured in place, the bottom of the marker shall be 5'-0" below the ground surface.

The Permanent Survey Markers, if possible, shall be installed at the beginning of the job and protected throughout.

The Contractor shall submit to the Engineer a description of location, elevation, and coordinates for each permanent survey marker. The horizontal coordinates must be derived by GPS and the elevation derived using an electronic level. The meta data, such as the Geoid used, (NGS adjustment ie: 97 HARN, 03, 07), and the base point(s) name or number shall be submitted along with a complete collection log. If collected using RTK method, it will require either 3 collections (averaged) from 2 different bases, or a minimum of 3 collections (averaged), at least 2 hours apart, from the same base. If using a CORS type network, the collection procedure shall include localizing with check shots on at least 2 different HARN monuments both before and after collection. The level circuit shall be run from furnished mark to furnished mark and then adjusted. The error of closure shall be submitted with the electronic level notes in a recognized format approved by the Engineer and/or the Chief of Surveys. The Engineer shall submit this information to the District Chief of Surveys.

The Contractor shall be responsible for locating and protecting utility property during construction operations as outlined in Article 107.39 of the Standard Specifications. A minimum of 48 hours advance notice is required for non-emergency work. The JULIE number is 800-892-0123.

IDOT is not a member of JULIE. If you are near any overhead lighting, intersection lighting or traffic signals, contact the IDOT Traffic Office at 815/284-5469 at least 48 hours prior to work.

Based on our structural analysis, the following structures can be crossed with an empty MTD with the following maximum gross weight restrictions: 101-0046 (40 tons), 101-0047 (40 tons), 101-0048 (40 tons), 101-0049 (40 tons), 101-0050 (40 tons), 101-0051 (40 tons), 101-0052 (40 tons), 101-0053 (40 tons), 101-0054 (40 tons), 101-1012 (40 tons), 101-1013 (40 tons), 101-1014 (40 tons), 101-2006 (40 tons), 101-2007 (40 tons), and 101-2008 (40 tons).

The Class B Patches, 10 inch (Special) will be laid out after the Hot-Mix Asphalt Surface Removal and the additional Mobilization will be included in the cost of the Class B Patches, 10 inch (Special).

The Hot-Mix Asphalt Binder Course (Hand Method) will be used for potholing during the winter of 2020/2021.

The removal of the Slotted Drains, Pipe Culverts, and End Treatments at the crossover areas will not be paid separately but shall be included in the cost of the PAVEMENT REMOVAL.

All of the excavated material needed for the guardrail work shall be used adjacent to the proposed Hot-Mix Asphalt Shoulders, 6". This earthwork shall be seeded, fertilized, and mulched. This work shall not be paid for separately but shall be included in the cost of HOT-MIX ASPHALT SHOULDERS, 6".

Some existing HMA shoulders for bituminous stabilization shall remain as called out on Guardrail Schedule. The Contractor shall fill the holes after the existing guardrail is removed with CA 6 and capped off with 3" of hot-mix asphalt. This work shall not be paid for separately but shall be included in the cost of GUARDRAIL REMOVAL.


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		DATE - 3/22/2021 8:02 AM	REVISED -											

TYPICAL SECTIONS

WESTBOUND
 STA. 563+40 - STA. 690+64
 STA. 722+50 - STA. 804+92
 STA. 826+51 - STA. 831+01

EASTBOUND
 STA. 568+04 - STA. 688+89
 STA. 722+50 - STA. 804+97
 STA. 826+51 - STA. 831+73

US 20
 ☉

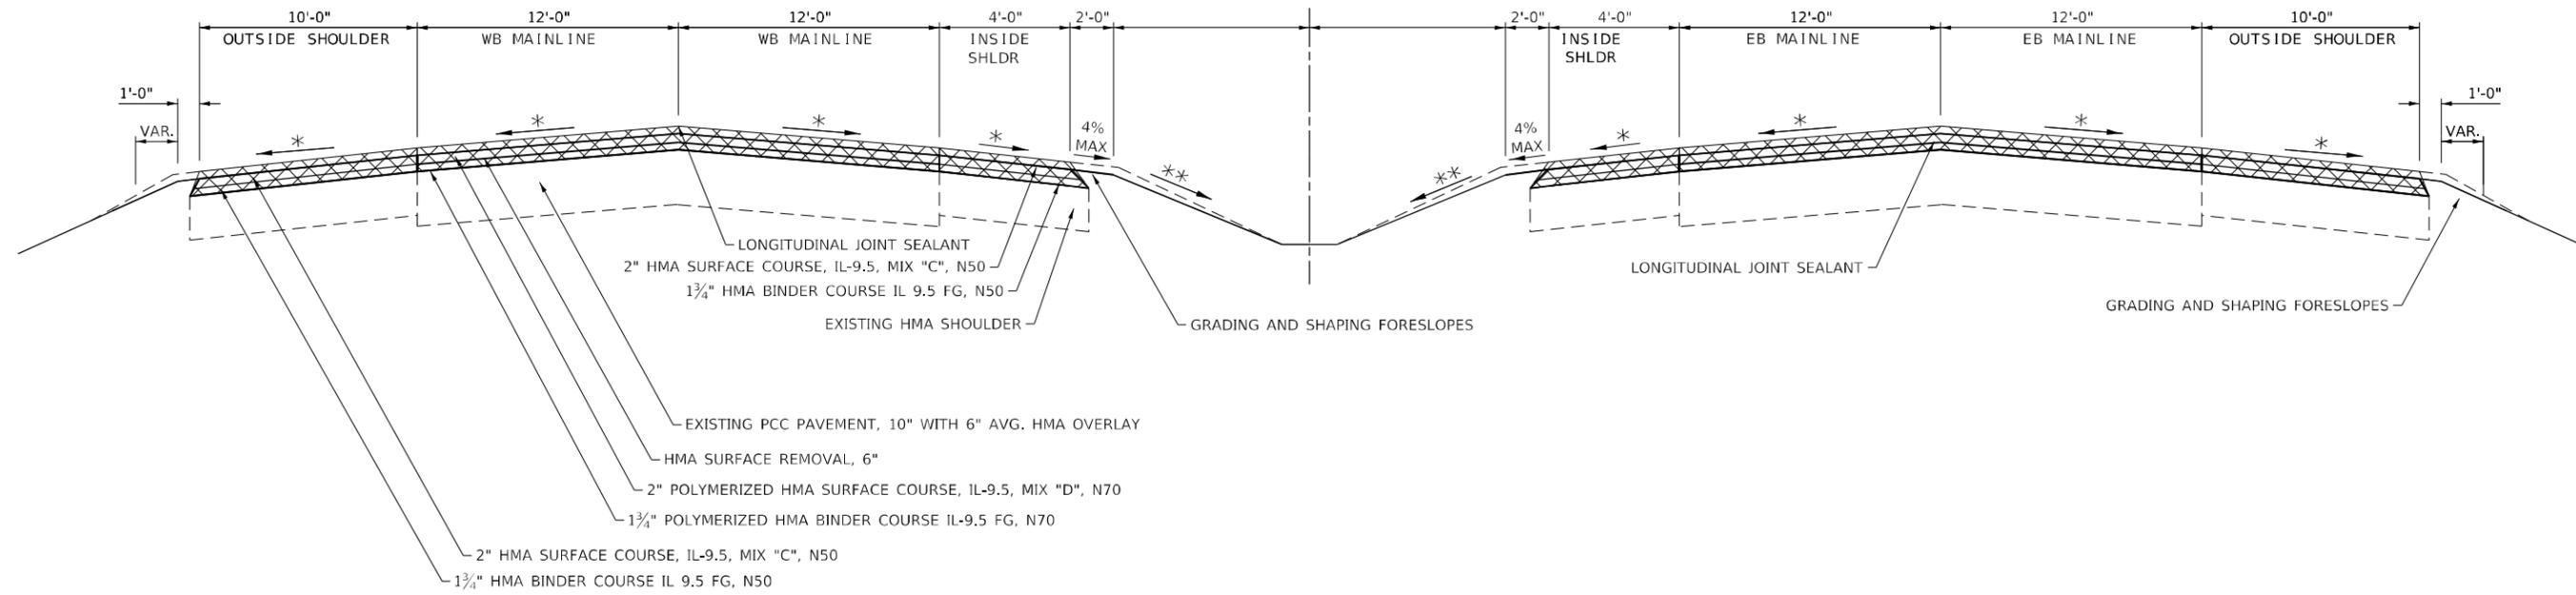

- ☒ REMOVAL
- 112# / IN / SQ YD
- * MATCH EXISTING CROSS SLOPE (MINIMUM 1/8"/FT.)
- ** MAINTAIN EXISTING FORESLOPE

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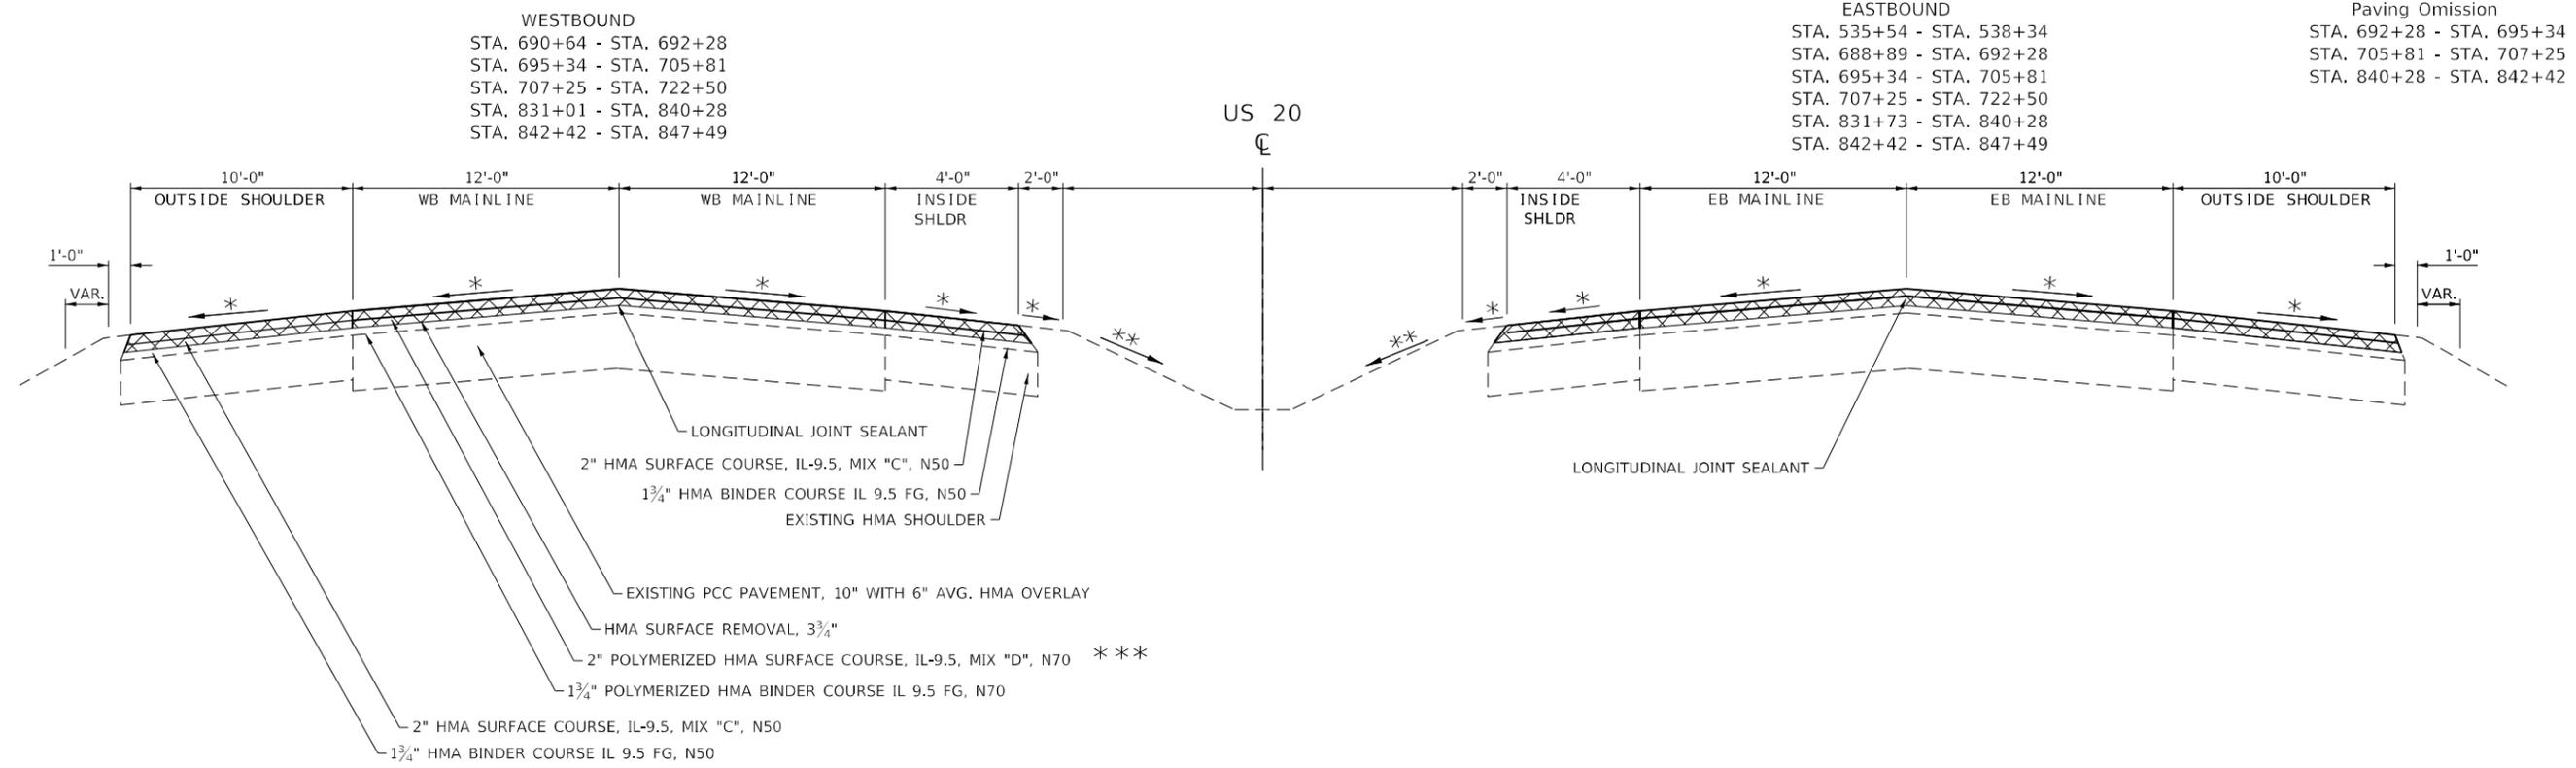
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**STATE OF ILLINOIS
 DEPARTMENT OF TRANSPORTATION**


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F.A.P. RTE.	SECTION	COUNTY	TOTAL SHEETS	SHEET NO.
301	(1-1,1,2)RS-2	WINNEBAGO	158	12
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ILLINOIS FED. AID PROJECT				

TYPICAL SECTIONS



WESTBOUND
 STA. 549+67 - STA. 553+35

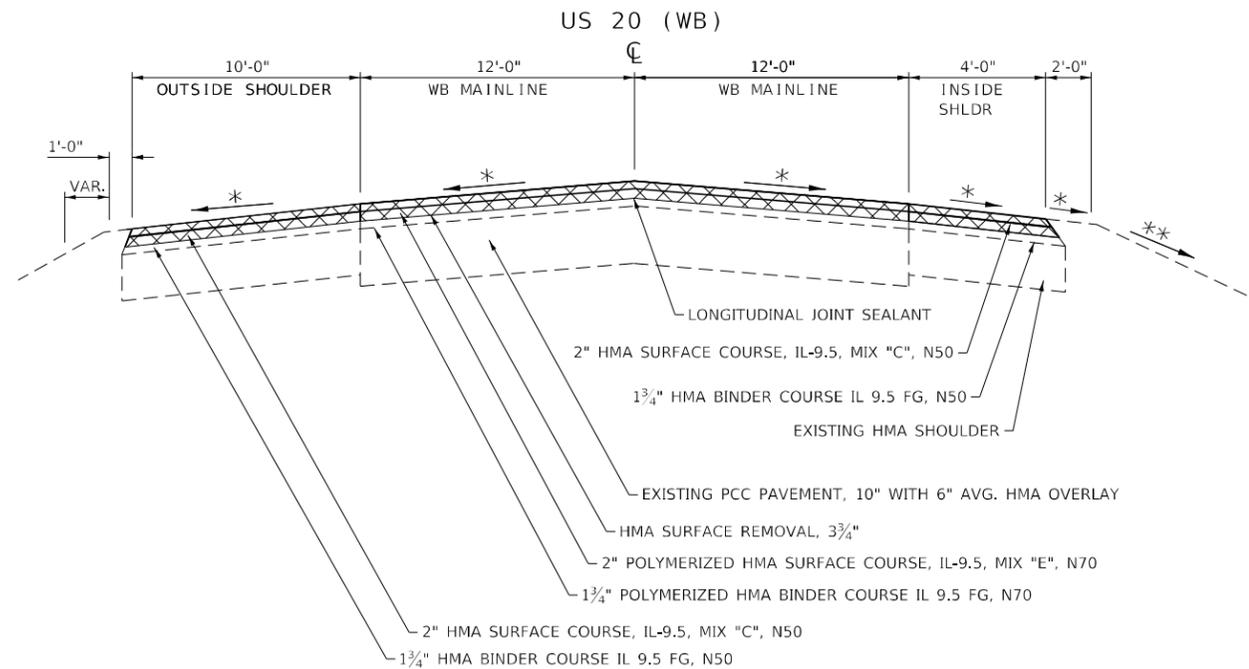

☒ REMOVAL

112# / IN / SQ YD

* MATCH EXISTING CROSS SLOPE (MINIMUM 1/8"/FT.)

** MAINTAIN EXISTING FORESLOPE

*** WESTBOUND, STA. 528+64 - 555+03 - 2" POLYMERIZED HMA SURFACE COURSE, IL-9.5, MIX "E", N70 (119# / IN / SQ YD)

STATE OF ILLINOIS
 DEPARTMENT OF TRANSPORTATION

TYPICAL SECTIONS

USER NAME = anikneyde	DESIGNED - TJ	REVISED -
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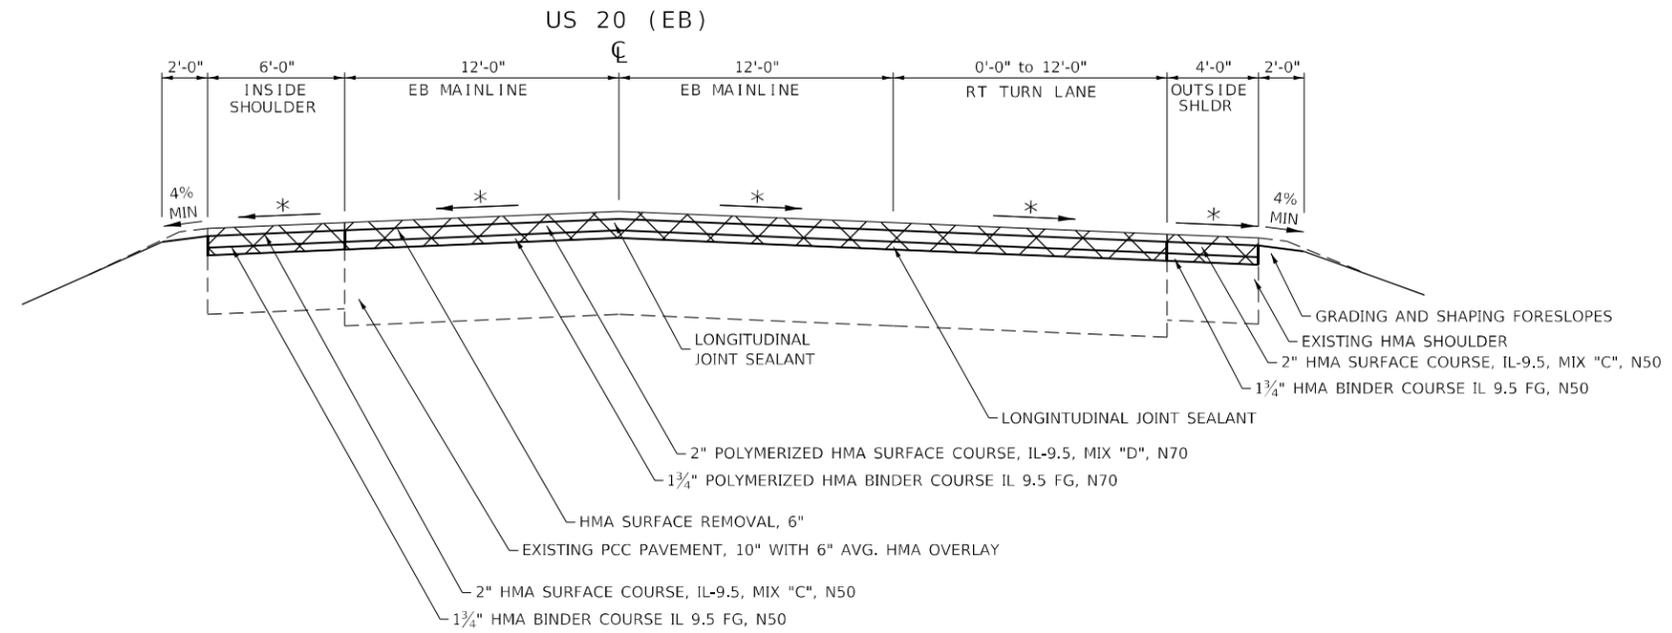
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F.A.P. RTE.	SECTION	COUNTY	TOTAL SHEETS	SHEET NO.
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ILLINOIS FED. AID PROJECT			CONTRACT NO. 64M18	


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TYPICAL SECTIONS

STA. 500+87 - STA. 502+59



STA. 503+85 - STA. 506+55

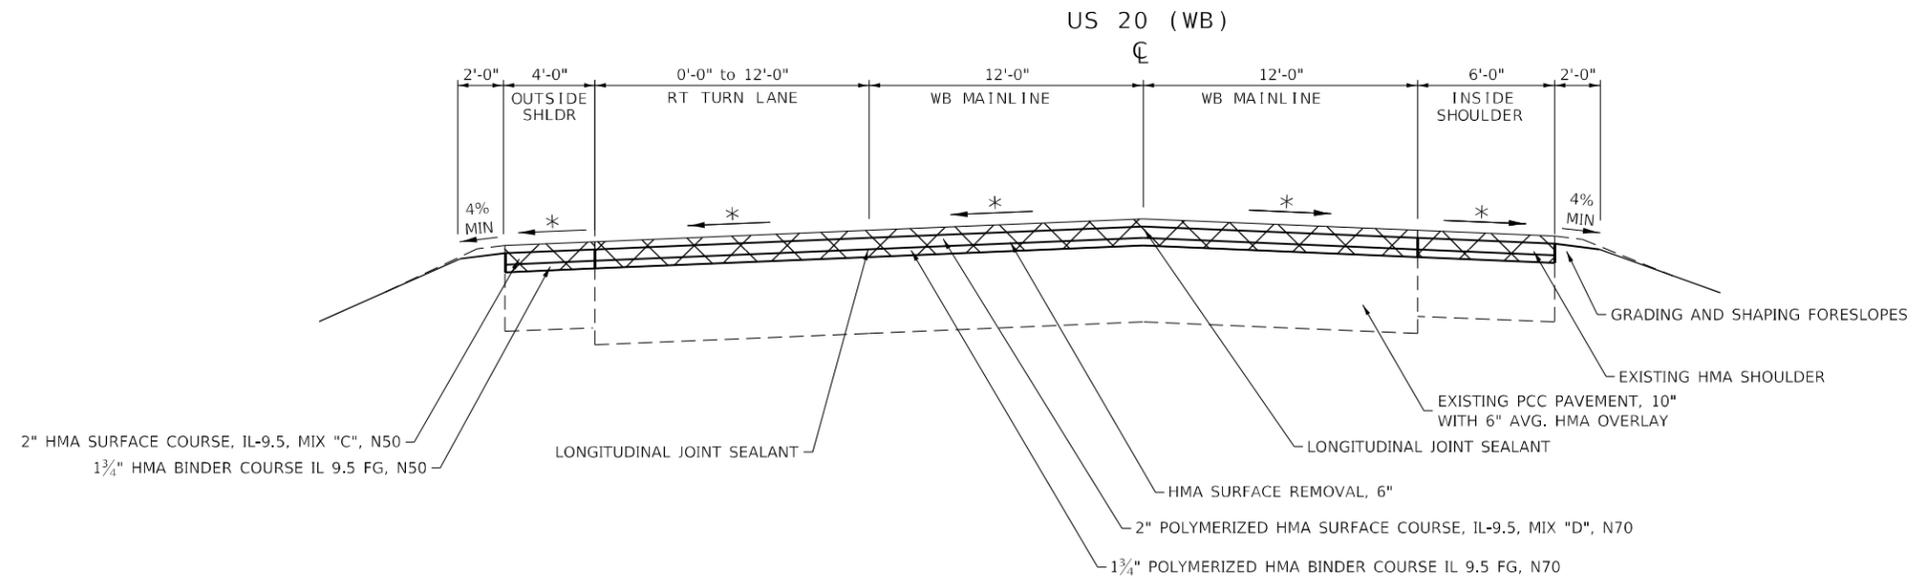

☒ REMOVAL

112# / IN / SQ YD

* MATCH EXISTING CROSS SLOPE (MINIMUM 1/8"/FT.)

** MAINTAIN EXISTING FORESLOPE

STATE OF ILLINOIS
DEPARTMENT OF TRANSPORTATION

TYPICAL SECTIONS

USER NAME = anikneyde	DESIGNED - TJ	REVISED -
DRAWN - SV	REVISOR -	REVISOR -
PLOT SCALE = 8,000' / in.	CHECKED - RWB	REVISOR -
PLOT DATE = Mar-19-2021 12:41:10 PM	DATE - 6/6/2019	REVISOR -

SCALE:	SHEET 1	OF 1	SHEETS	STA.	TO STA.
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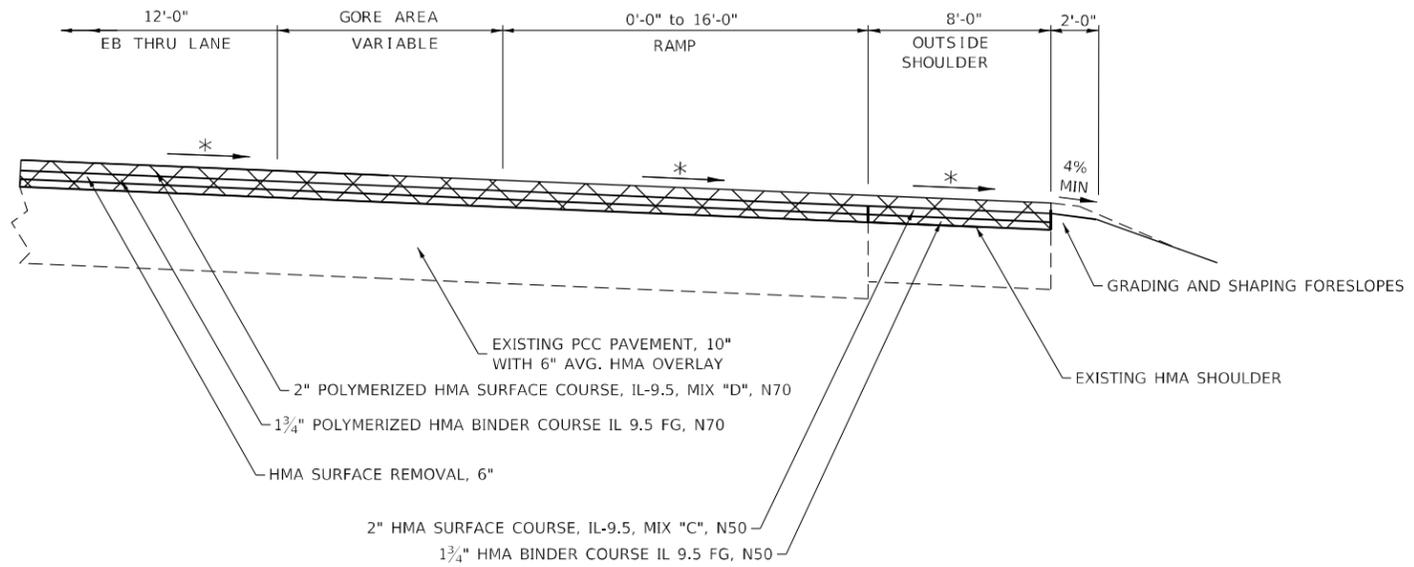
F.A.P. RTE.	SECTION	COUNTY	TOTAL SHEETS	SHEET NO.
301	(1-1,1,2)RS-2	WINNEBAGO	158	14
CONTRACT NO. 64M18			ILLINOIS FED. AID PROJECT	

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TYPICAL SECTIONS


MERIDIAN ROAD (EB RAMP)
 STA. 00+00 - STA. 7+16 OFF RAMP
 STA. 7+94 - STA. 19+24 ON RAMP

MONTAGUE ROAD (EB RAMP)
 STA. 00+00 - STA. 7+10 OFF RAMP
 STA. 9+93 - STA. 21+80 ON RAMP



MERIDIAN RD RAMP (WB RAMP)
 STA. 00+00 - STA. 12+61 ON RAMP
 STA. 10+98 - STA. 19+24 OFF RAMP

MONTAGUE RD (WB RAMP)
 STA. 00+00 - STA. 12+00 ON RAMP
 STA. 10+58 - STA. 17+83 OFF RAMP

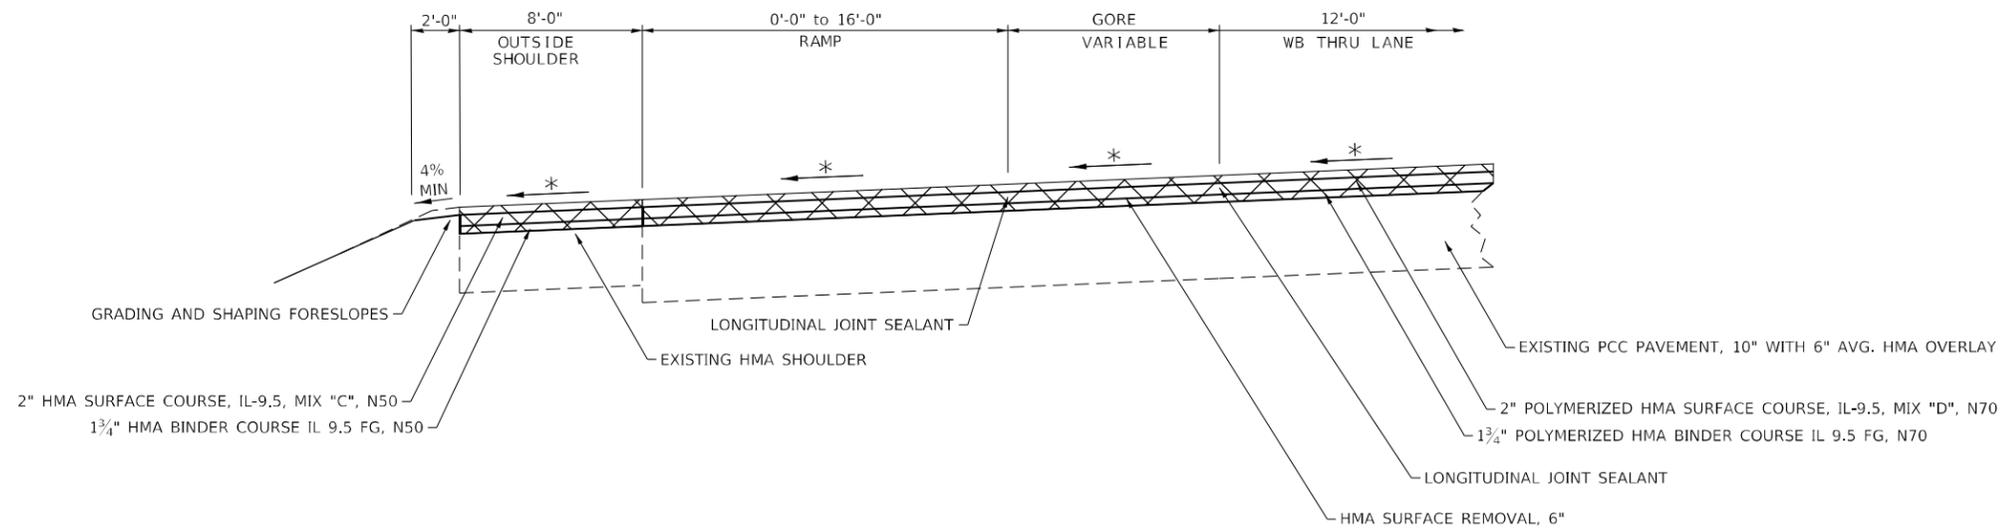

REMOVAL

112# / IN / SQ YD

* MATCH EXISTING CROSS SLOPE (MINIMUM 1/8"/FT.)

** MAINTAIN EXISTING FORESLOPE

STATE OF ILLINOIS
DEPARTMENT OF TRANSPORTATION


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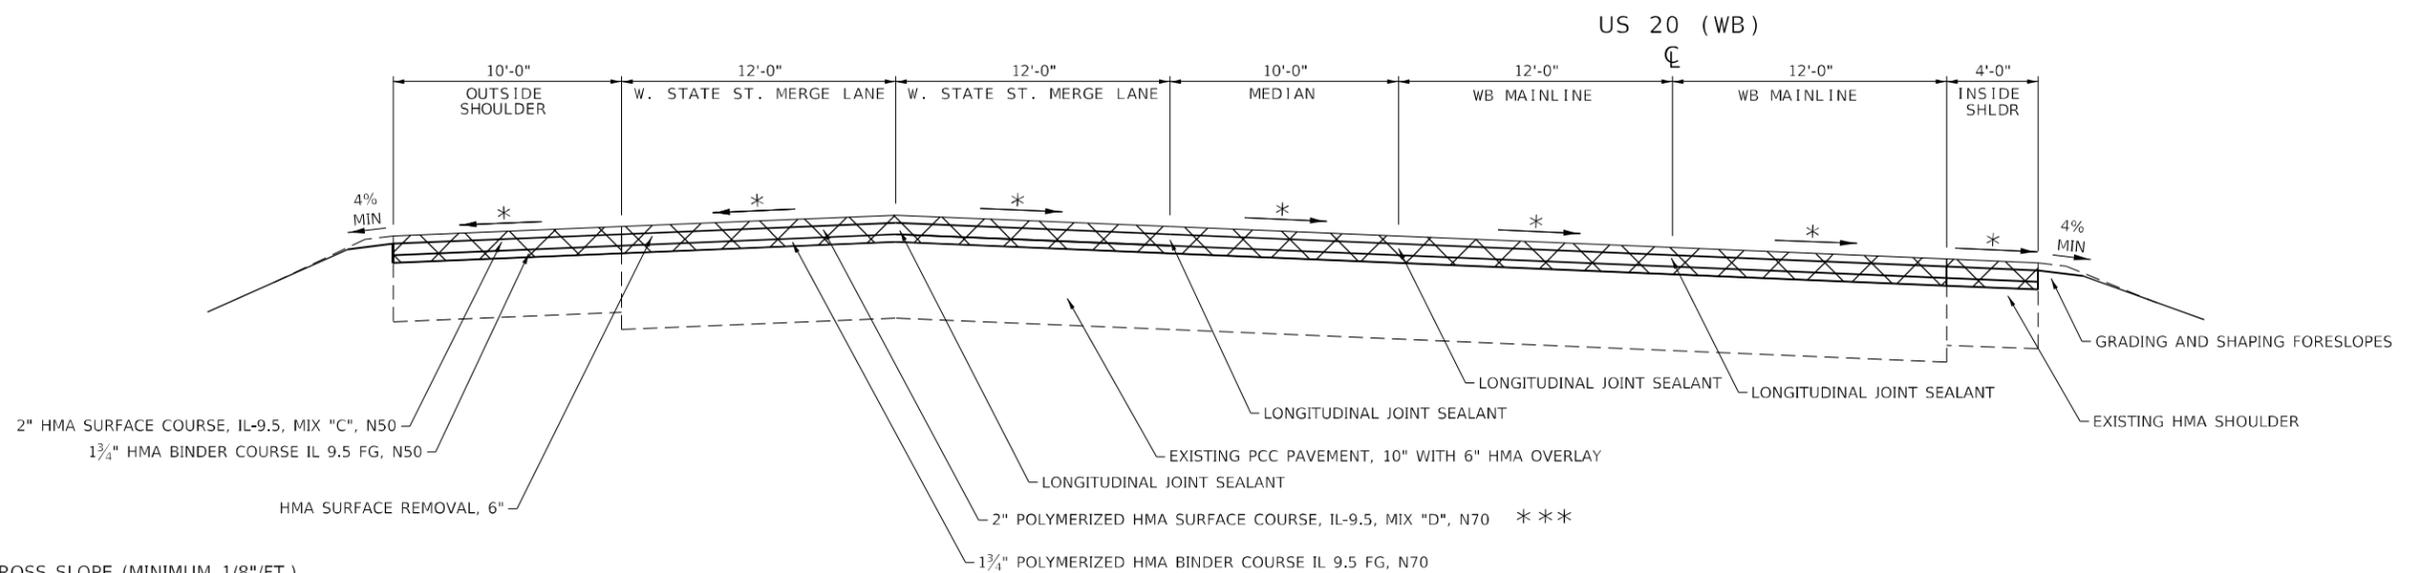
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 PROJECT: 64M18
 OFFICE: District 2
 DATE: 6/6/2019
 DRAWN: SV
 CHECKED: RWB
 PLOT DATE: Mar-19-2021 12:41:10 PM

TYPICAL SECTIONS

STA. 526+72 - STA. 537+70



STA. 537+70 - STA. 544+64

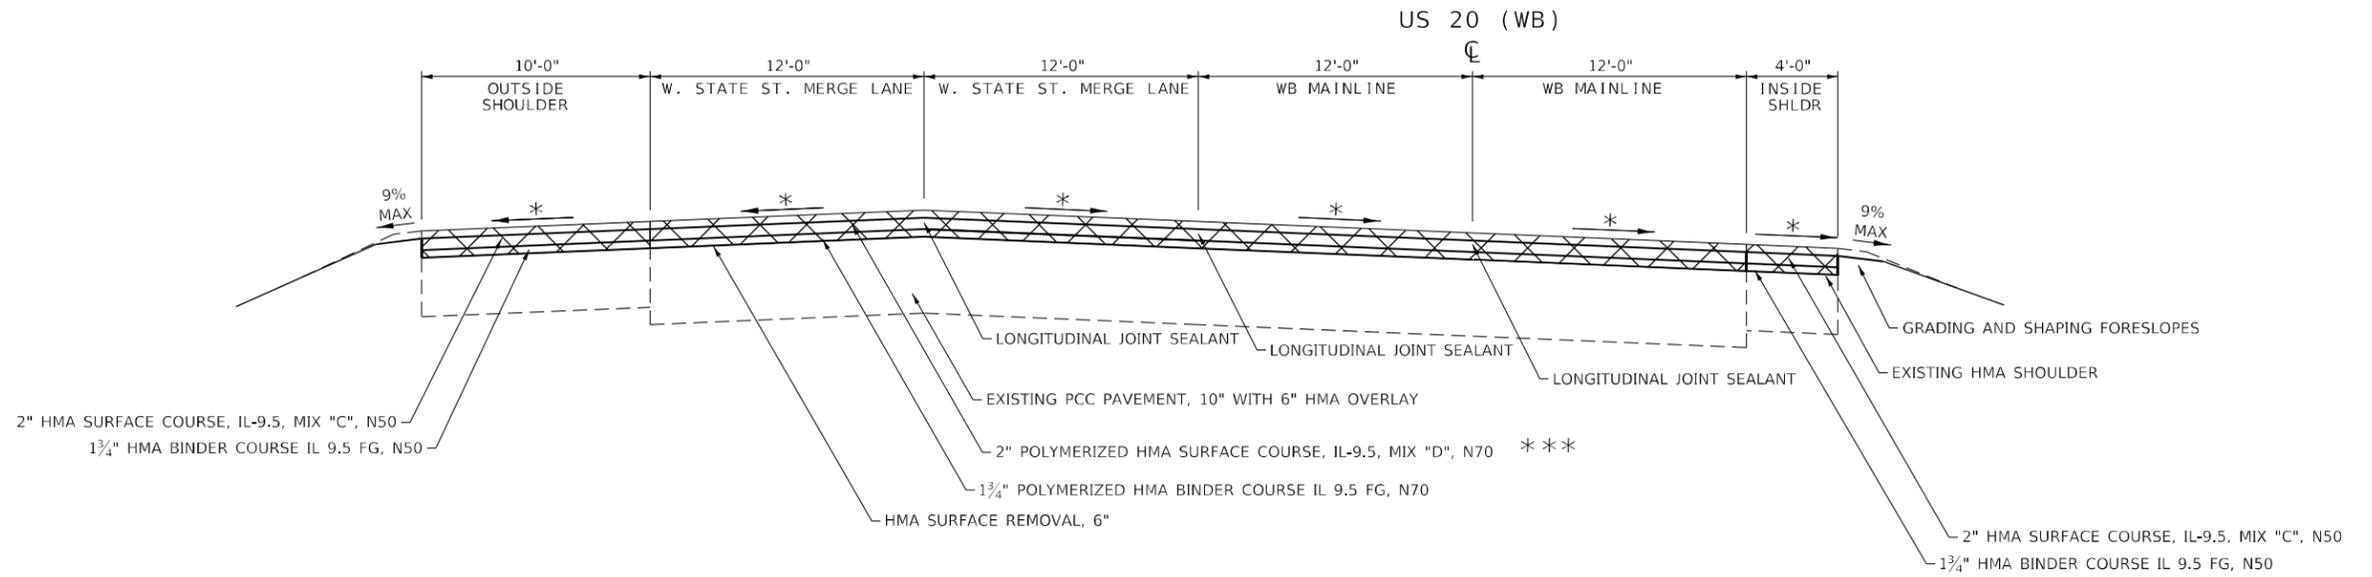

☒ REMOVAL

112# / IN / SQ YD

* MATCH EXISTING CROSS SLOPE (MINIMUM 1/8"/FT.)

** MAINTAIN EXISTING FORESLOPE

*** WESTBOUND, STA. 528+64 - 555+03 - 2" POLYMERIZED HMA SURFACE COURSE, IL-9.5, MIX "E", N70 (119# / IN / SQ YD)

STATE OF ILLINOIS
DEPARTMENT OF TRANSPORTATION

TYPICAL SECTIONS

SCALE: SHEET 1 OF 1 SHEETS STA. TO STA.

F.A.P. RTE.	SECTION	COUNTY	TOTAL SHEETS	SHEET NO.
301	(1-1,1,2)RS-2	WINNEBAGO	158	16
CONTRACT NO. 64M18				
ILLINOIS FED. AID PROJECT				

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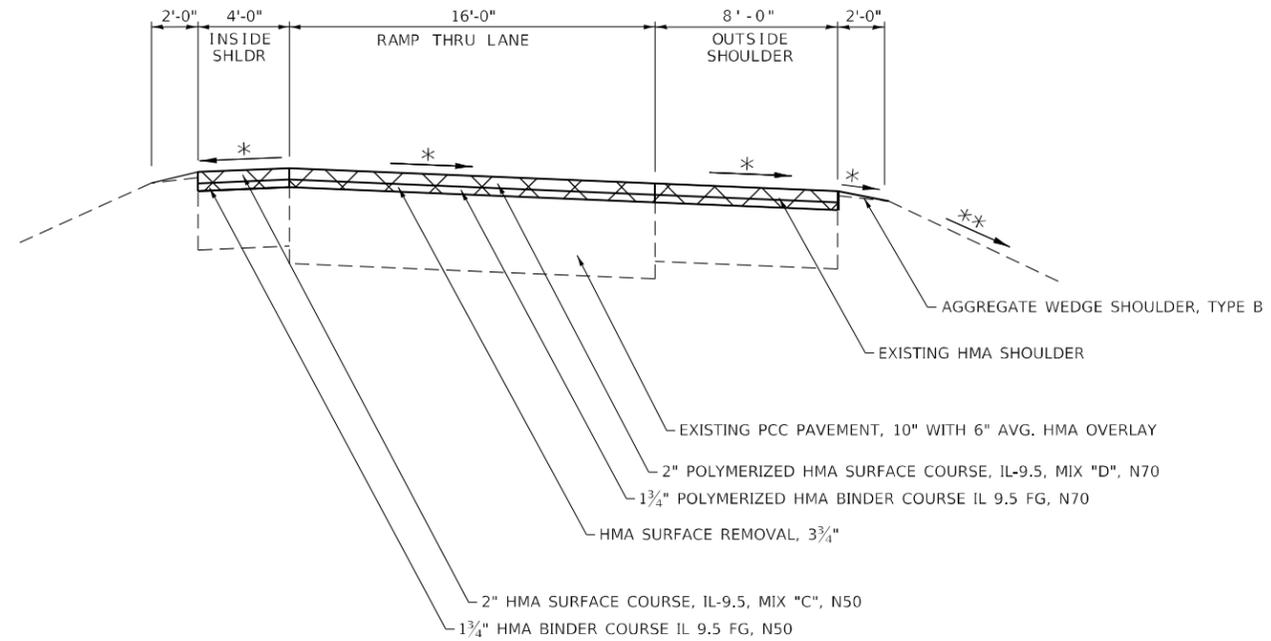
TYPICAL SECTIONS

MEDIRIAN RD EB ON RAMP
STA. 00+96 - STA. 7+94

MEDIRIAN RD WB ON RAMP
STA. 12+61 - STA. 19+61

MEDIRIAN RD EB OFF RAMP
STA. 7+16 - STA. 17+58

MEDIRIAN RD WB OFF RAMP
STA. 00+94 - STA. 10+98





MONTAGUE RD EB ON RAMP
STA. 00+69 - STA. 09+93

MONTAGUE RD EB OFF RAMP
STA. 07+50 - STA. 17+13

MONTAGUE RD WB ON RAMP
STA. 12+00 - STA. 21+22

MONTAGUE RD WB OFF RAMP
STA. 0+87 - STA. 10+58

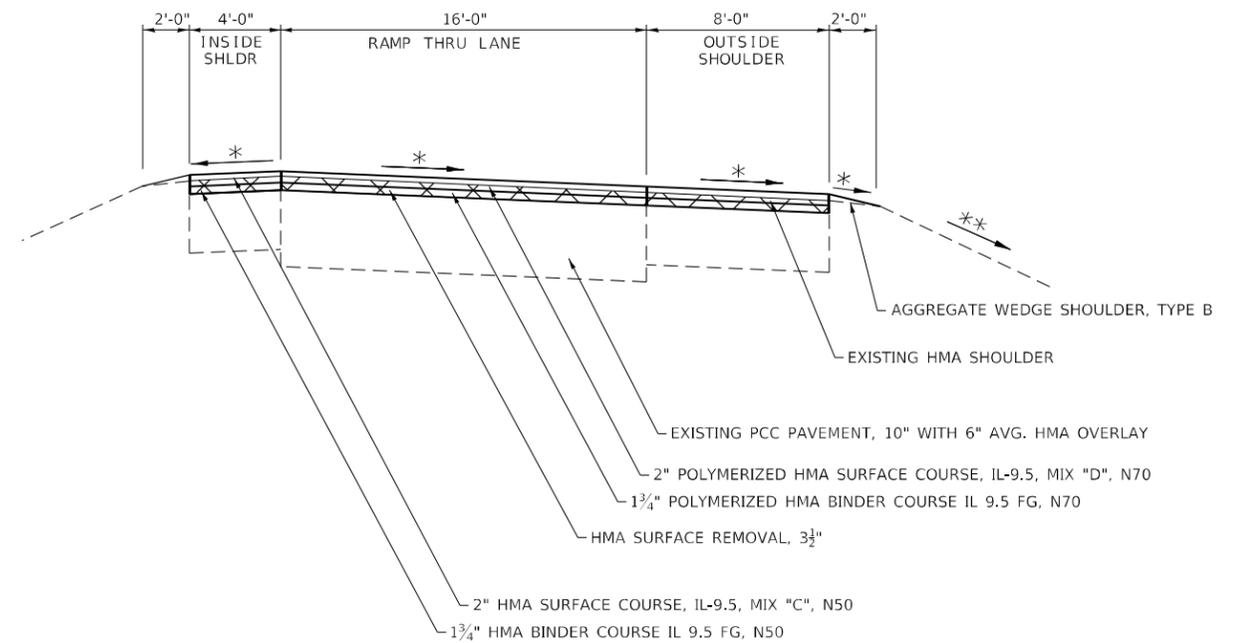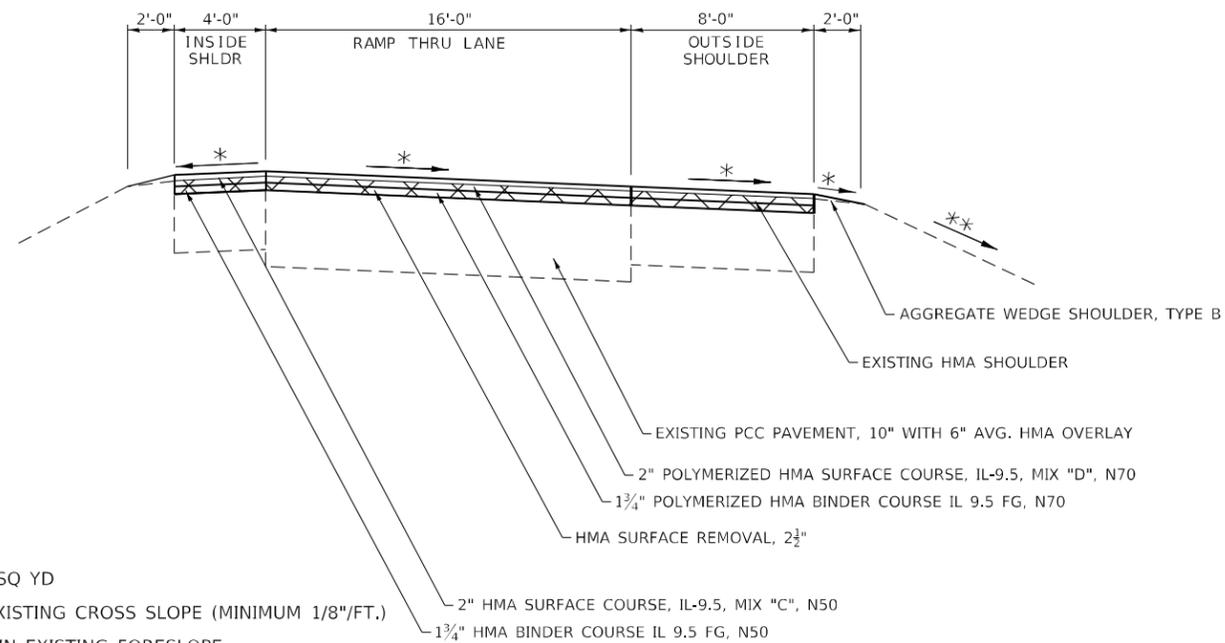

☒ REMOVAL

112# / IN / SQ YD

* MATCH EXISTING CROSS SLOPE (MINIMUM 1/8"/FT.)

** MAINTAIN EXISTING FORESLOPE

STATE OF ILLINOIS
DEPARTMENT OF TRANSPORTATION

TYPICAL SECTIONS

USER NAME = anikneyde	DESIGNED - TJ	REVISED -
DRAWN - SV	REVISIONS -	
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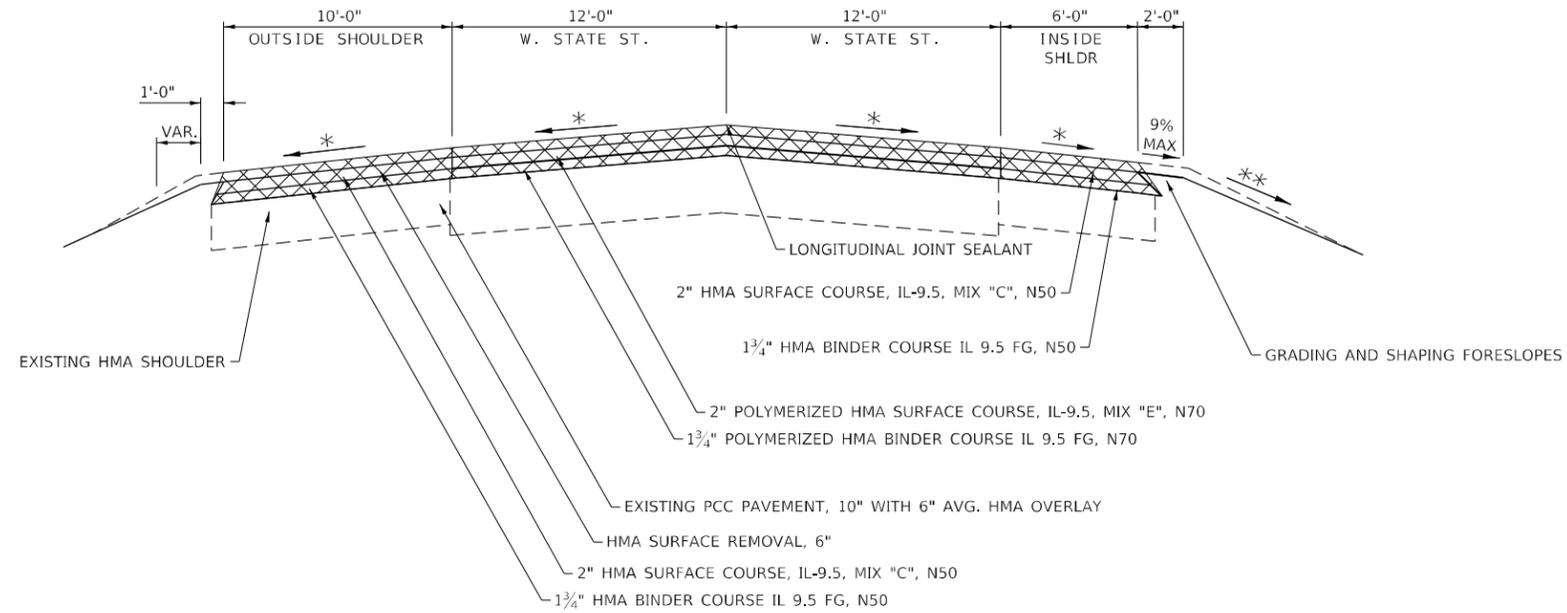
SCALE:	SHEET 1	OF 1	SHEETS	STA.	TO STA.
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F.A.P. RTE.	SECTION	COUNTY	TOTAL SHEETS	SHEET NO.
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CONTRACT NO. 64M18				
ILLINOIS FED. AID PROJECT				


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TYPICAL SECTIONS

STA. 26+05 - STA. 34+40
US 20 (W. STATE ST.)



STA. 34+40 - STA. 36+12
US 20 (W. STATE ST.)

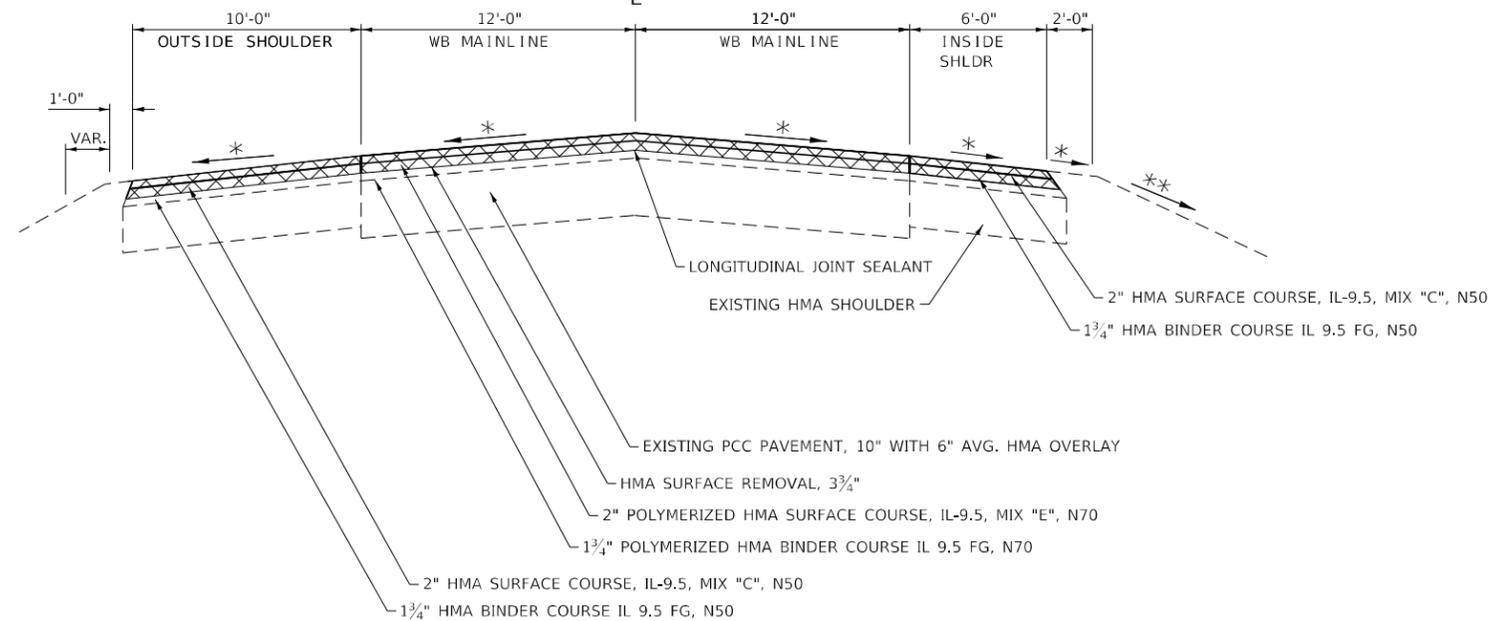

☒ REMOVAL

112# / IN / SQ YD

* MATCH EXISTING CROSS SLOPE (MINIMUM 1/8"/FT.)

** MAINTAIN EXISTING FORESLOPE

STATE OF ILLINOIS
DEPARTMENT OF TRANSPORTATION

TYPICAL SECTIONS



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DRAWN - SV	REVISIONS -	
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PLOT DATE = Mar-19-2021 12:41:12 PM	DATE - 6/6/2019	REVISED -

SCALE: SHEET 1 OF 1 SHEETS STA. TO STA.

F.A.P. RTE.	SECTION	COUNTY	TOTAL SHEETS	SHEET NO.
301	(1-1,1,2)RS-2	WINNEBAGO	158	19
CONTRACT NO. 64M18				
ILLINOIS FED. AID PROJECT				

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TYPICAL SECTIONS

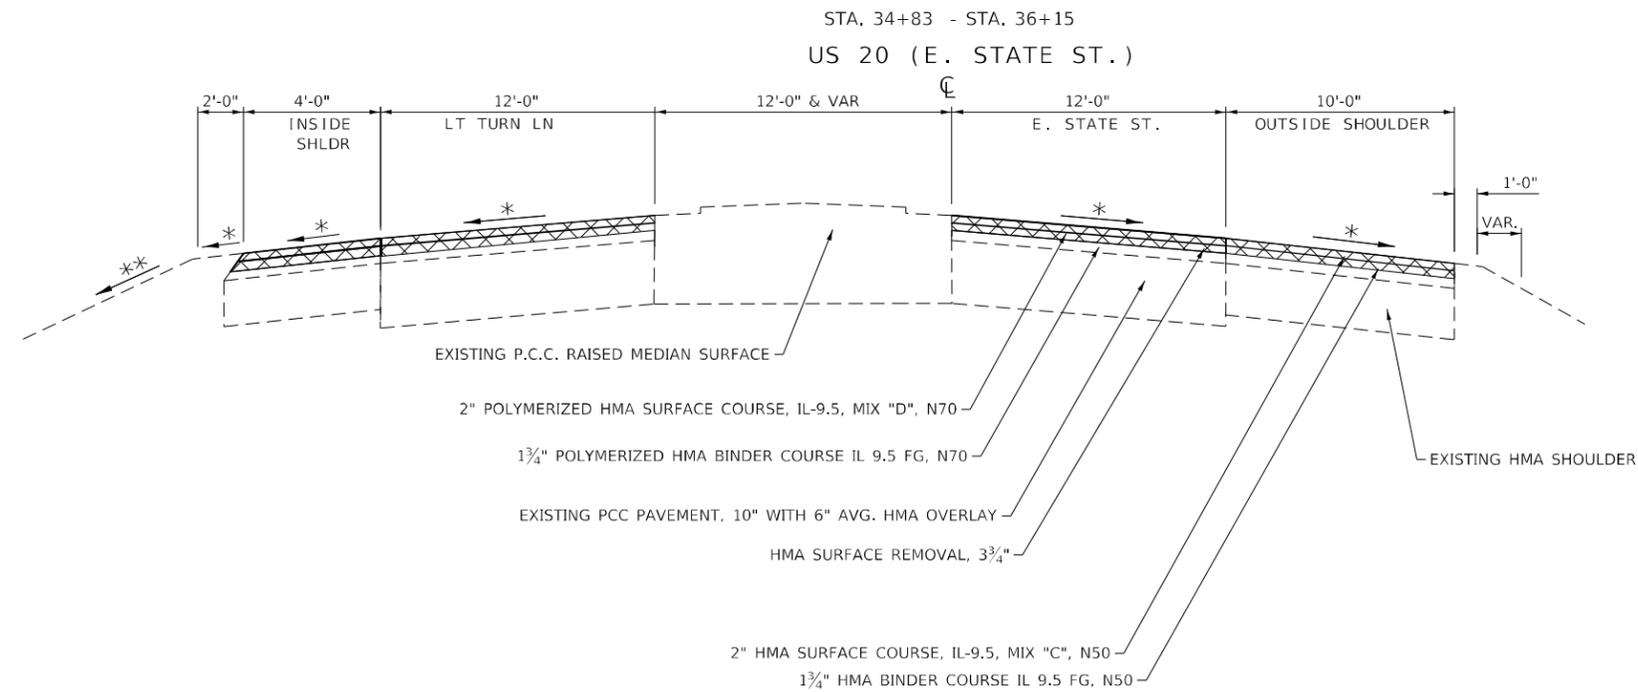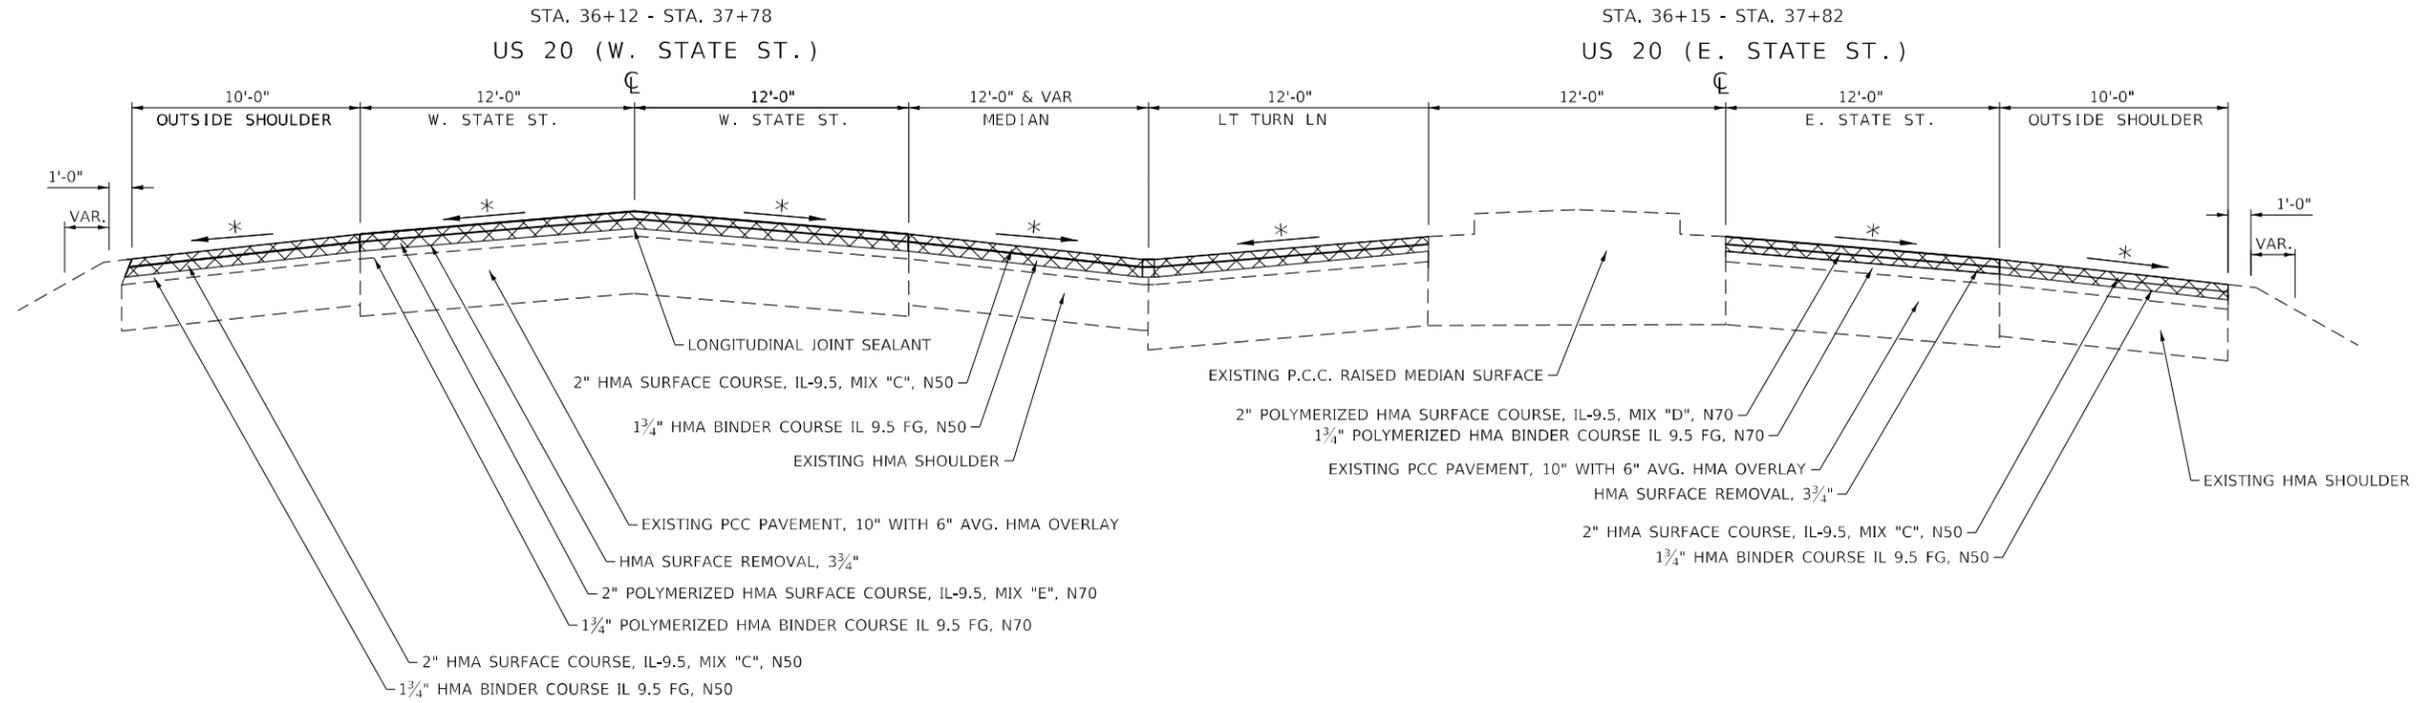

- ☒ REMOVAL
112# / IN / SQ YD
- * MATCH EXISTING CROSS SLOPE (MINIMUM 1/8"/FT.)
- ** MAINTAIN EXISTING FORESLOPE

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USER NAME = ankneyde	DESIGNED - TJ	REVISED -
DRAWN - SV	REVISIONS -	
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PLOT DATE = Mar-19-2021 12:41:12 PM	DATE - 6/6/2019	REVISED -

**STATE OF ILLINOIS
DEPARTMENT OF TRANSPORTATION**

TYPICAL SECTIONS			
SCALE:	SHEET 1	OF 1 SHEETS	STA. TO STA.

F.A.P. RTE.	SECTION	COUNTY	TOTAL SHEETS	SHEET NO.
301	(1-1,1,2)RS-2	WINNEBAGO	158	20
CONTRACT NO. 64M18				
ILLINOIS FED. AID PROJECT				

TYPICAL SECTIONS

HOT-MIX ASPHALT REMOVAL, VARIABLE DEPTH

A = 6", B = 3 3/4", C = 115'

US 20 WESTBOUND

STA. 493+00 - 494+15
 STA. 545+27 - 546+42
 STA. 553+35 - 554+50
 STA. 689+49 - 690+64
 STA. 722+50 - 723+65
 STA. 829+86 - 831+01

US 20 EASTBOUND

STA. 493+00 - 494+15
 STA. 687+74 - 688+89
 STA. 722+50 - 723+65
 STA. 830+58 - 831+73

MERIDIAN RD WB RAMP

STA. 9+83 - 10+98 OFF RAMP
 STA. 12+61 - 13+76 ON RAMP

MERIDIAN RD EB RAMP

STA. 6+79 - 7+94 ON RAMP
 STA. 7+16 - 8+31 OFF RAMP

WEST STATE ST (WB)

STA. 33+25 - 34+40

EAST STATE ST (EB)

STA. 33+25 - 34+40

A = 6", B = 3 1/2", C = 125'


MONTAGUE RD WB RAMP

STA. 9+33 - 10+58 OFF RAMP
 STA. 12+00 - 13+25 ON RAMP


A = 6", B = 2 1/2", C = 175'

MONTAGUE RD EB RAMP

STA. 7+10 - 8+85 OFF RAMP
 STA. 8+18 - 9+93 ON RAMP

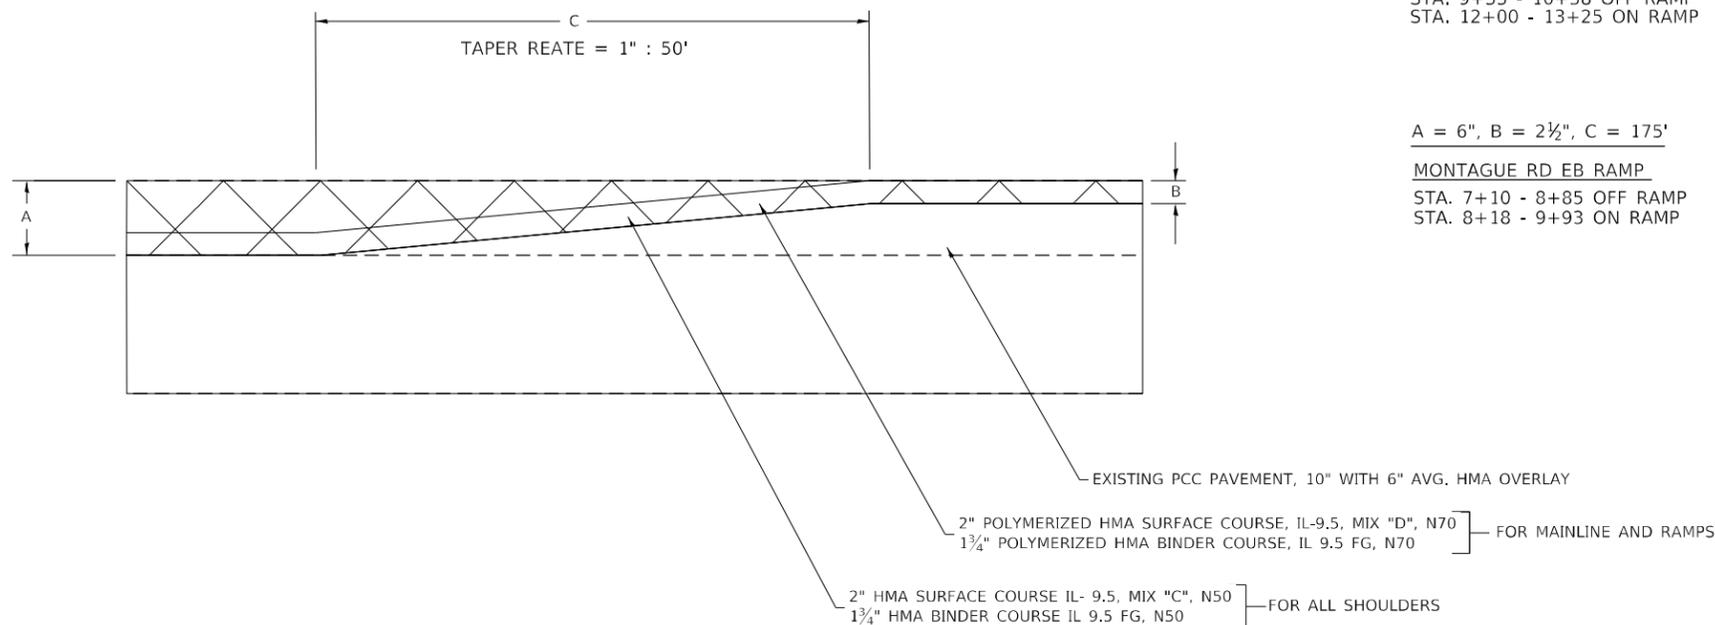

HOT-MIX ASPHALT SURFACE REMOVAL - BUTT JOINT

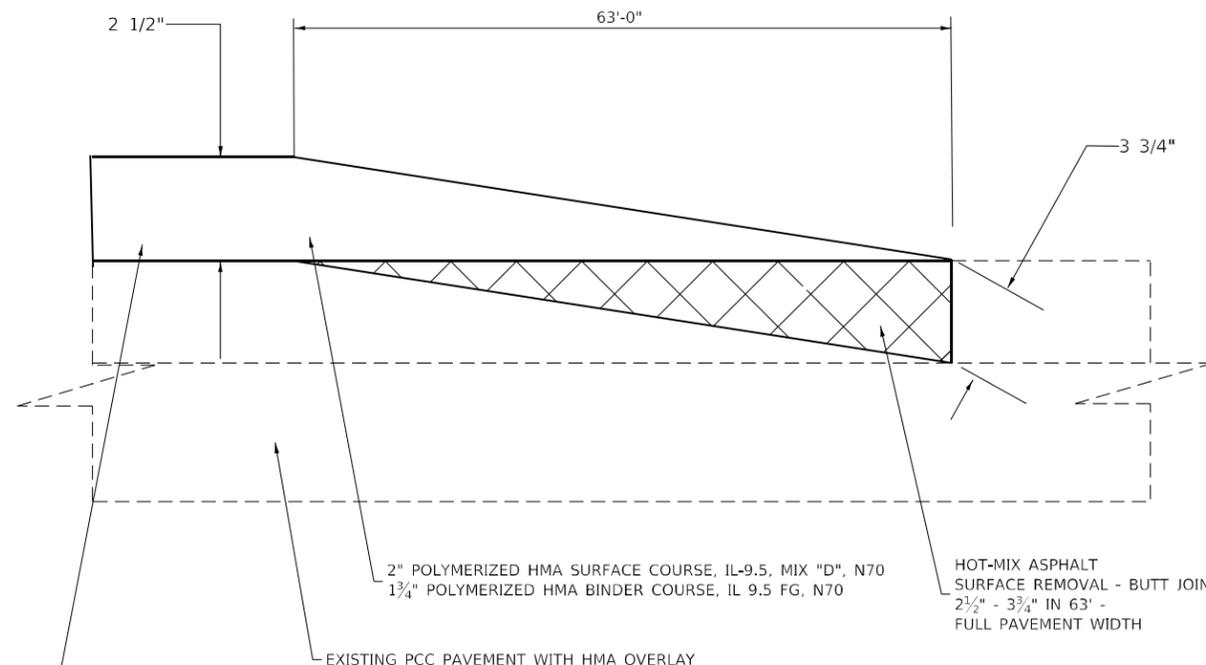

MONTAGUE RD EB RAMP

STA. 0+69 - 1+32 ON RAMP
 STA. 16+51 - 17+13 OFF RAMP

☒ REMOVAL
 112# / IN / SQ YD

2" HMA SURFACE COURSE IL- 9.5, MIX "C", N50
 1 3/4" HMA BINDER COURSE IL 9.5 FG, N50

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DRAWN - SV	REVISOR -	
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**STATE OF ILLINOIS
 DEPARTMENT OF TRANSPORTATION**


TYPICAL SECTIONS

SCALE: SHEET 1 OF 1 SHEETS STA. TO STA.

F.A.P. RTE.	SECTION	COUNTY	TOTAL SHEETS	SHEET NO.
301	(1-1,1,2)RS-2	WINNEBAGO	158	21
ILLINOIS FED. AID PROJECT			CONTRACT NO. 64M18	

TYPICAL SECTIONS

CROSSOVER REMOVAL
 STA. 636+00 - STA. 640+50
 STA. 817+58 - STA. 824+75

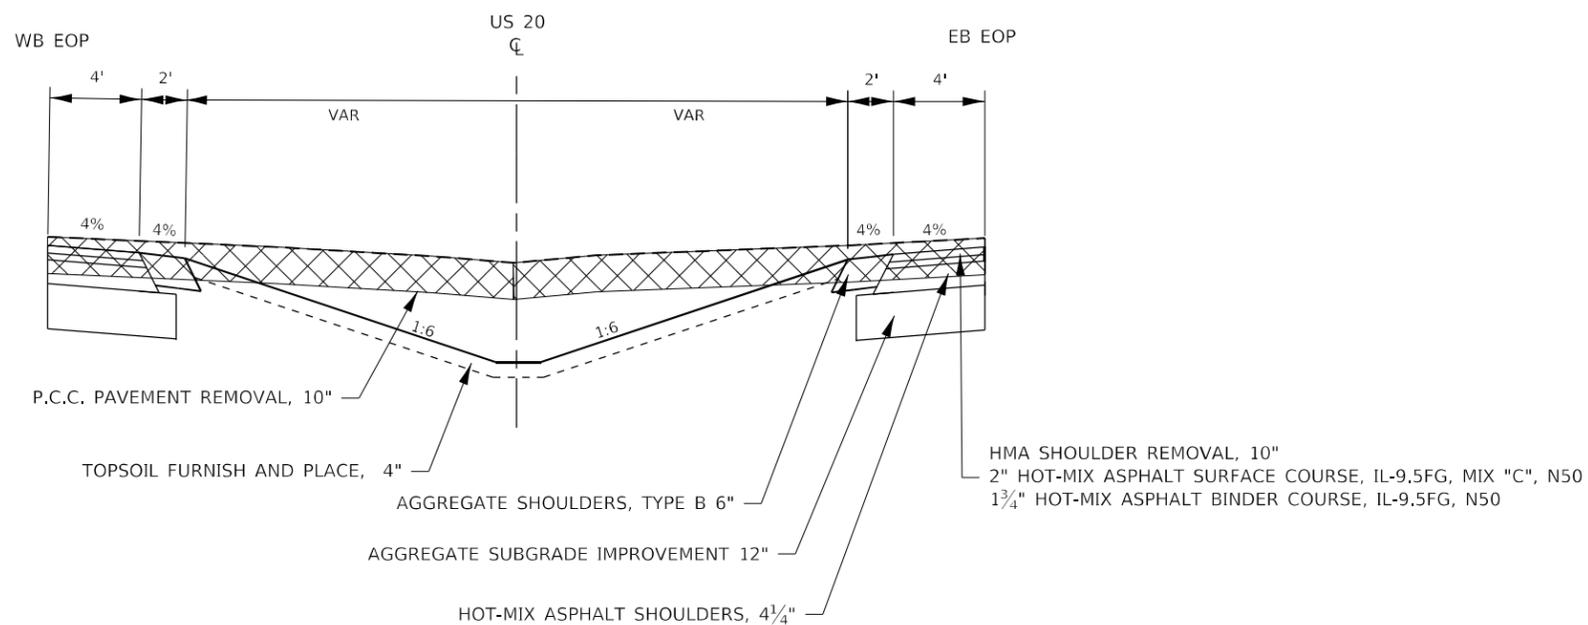

☒ REMOVAL
 112# / IN / SQ YD

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**STATE OF ILLINOIS
 DEPARTMENT OF TRANSPORTATION**



TYPICAL SECTIONS

SCALE: SHEET 1 OF 1 SHEETS STA. TO STA.

F.A.P. RTE.	SECTION	COUNTY	TOTAL SHEETS	SHEET NO.
301	(1-1,1,2)RS-2	WINNEBAGO	158	22
CONTRACT NO. 64M18				
ILLINOIS FED. AID PROJECT				

SUPERELEVATION DETAILS

STA. 515+21 TO STA. 516+00

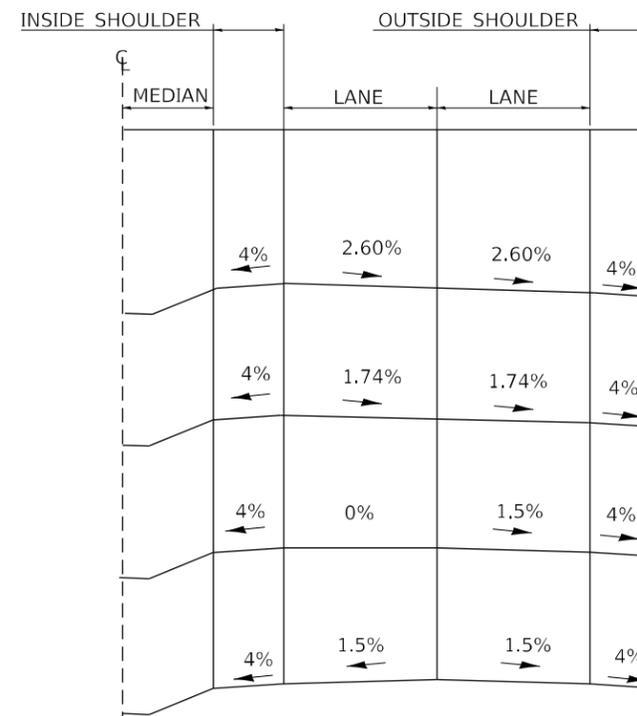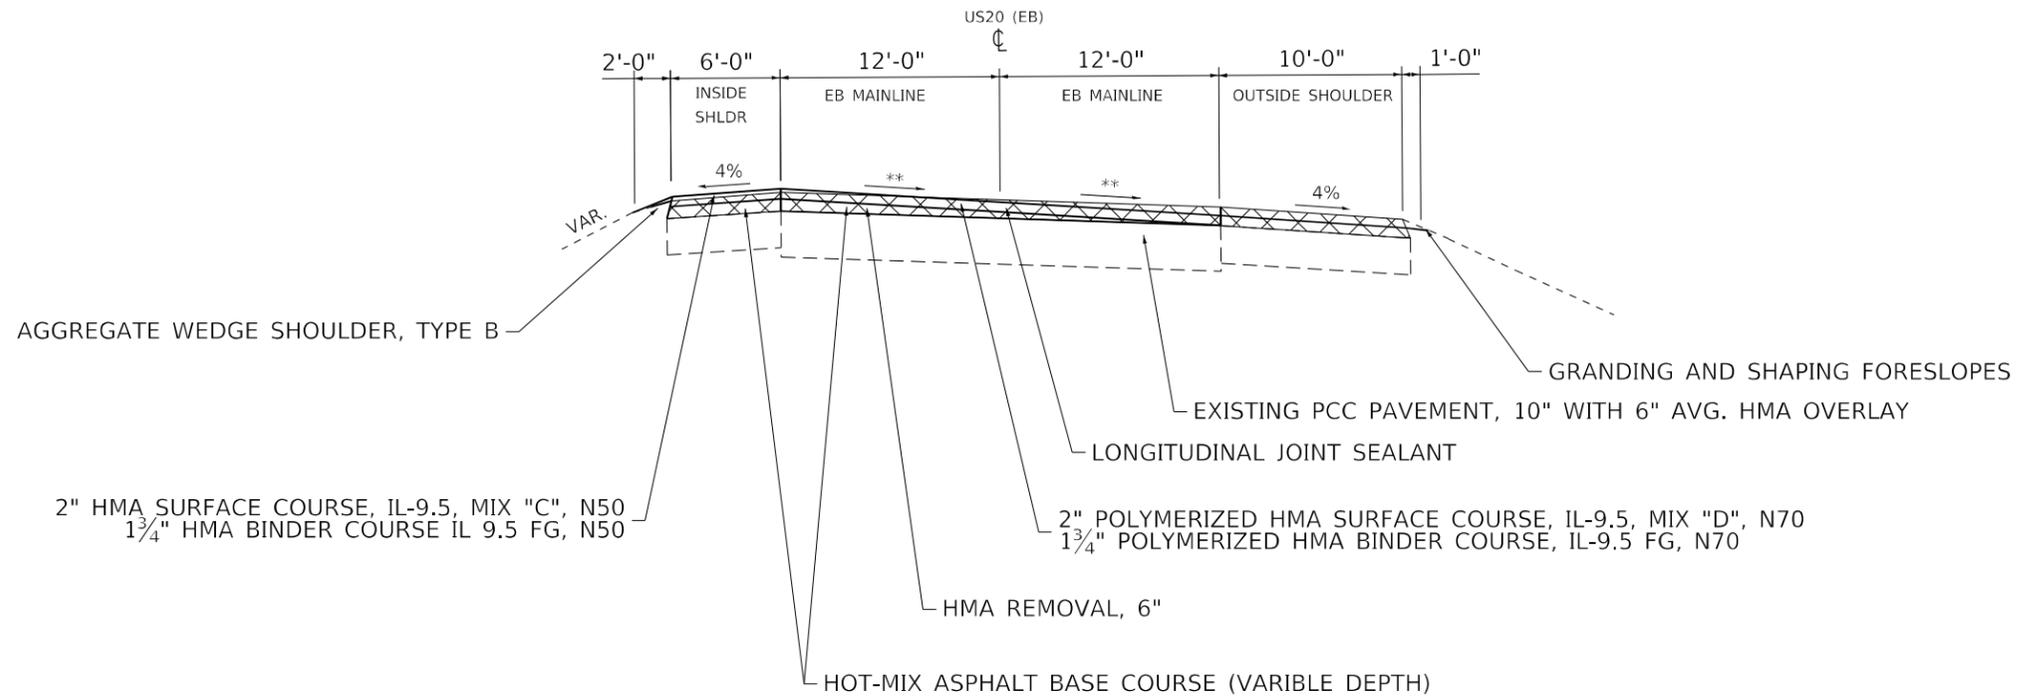

FULL SUPERELEVATION
516+85 TO 533+68

67% SUPERELEVATION (PC / PT) = 1.74%
516+46 / 534+07

RIGHT LANE ROTATES UNTIL IT REACHES 0%
515+68 / 534+85

CROWN
515+21 / 535+33

**
TRANSITION STATIONING
515+21 TO 516+85
533+68 TO 535+33
FULL SUPERELEVATION = 2.60%
516+85 TO 533+68

☒ REMOVAL
112# / IN / SQ YD

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**STATE OF ILLINOIS
DEPARTMENT OF TRANSPORTATION**


**TYPICAL SECTIONS
SUPERELEVATIONS**

SCALE: SHEET OF SHEETS STA. TO STA.

F.A.P. RTE.	SECTION	COUNTY	TOTAL SHEETS	SHEET NO.
301	(1-1,1,2)RS-2	WINNEBAGO	158	23
CONTRACT NO. 64M18				
ILLINOIS FED. AID PROJECT				


SUPERELEVATION DETAILS

STA. 520+56 TO 524+50

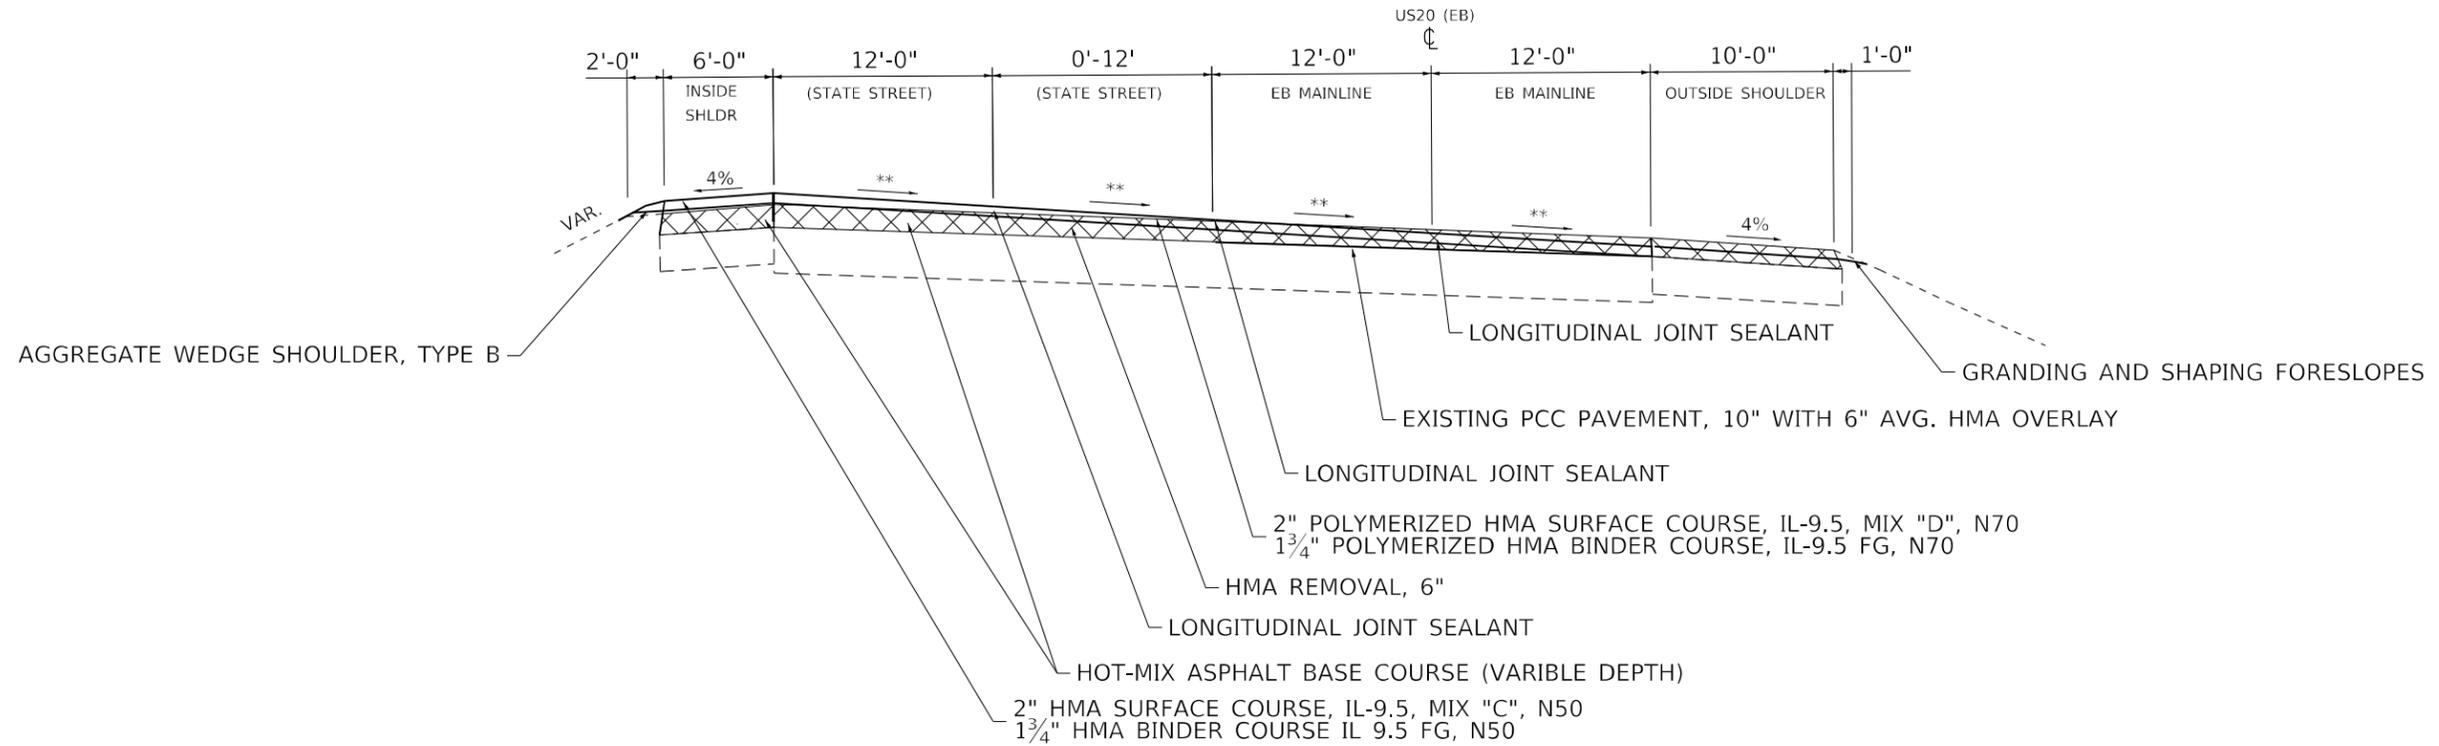

**
TRANSITION STATIONING
515+21 TO 516+85
533+68 TO 535+33
FULL SUPERELEVATION = 2.60%
516+85 TO 533+68

⊗ REMOVAL
112# / IN / SQ YD

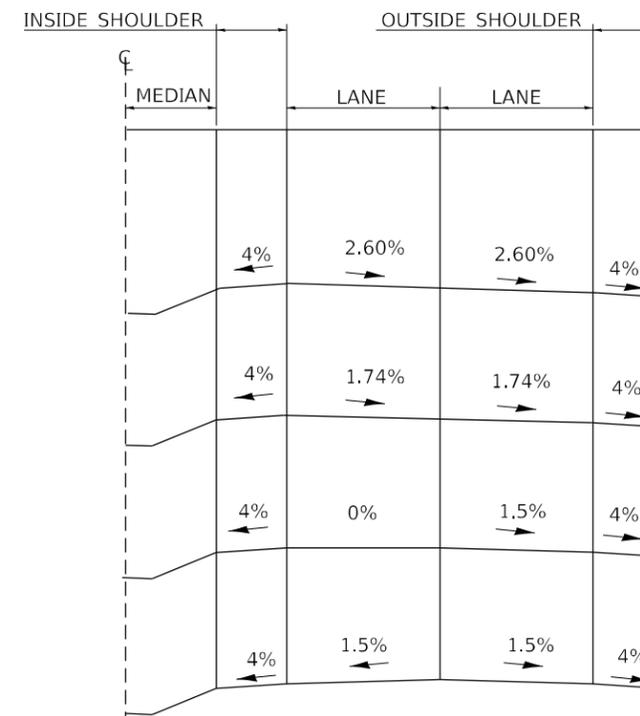

FULL SUPERELEVATION
516+85 TO 533+68

67% SUPERELEVATION (PC / PT) = 1.74%
516+46 / 534+07

RIGHT LANE ROTATES UNTIL IT REACHES 0%
515+68 / 534+85

CROWN
515+21 / 535+33

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**STATE OF ILLINOIS
DEPARTMENT OF TRANSPORTATION**



**TYPICAL SECTIONS
SUPERELEVATIONS**

SCALE: SHEET OF SHEETS STA. TO STA.

F.A.P. RTE.	SECTION	COUNTY	TOTAL SHEETS	SHEET NO.
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			CONTRACT NO. 64M18	
ILLINOIS FED. AID PROJECT				

SUPERELEVATION DETAILS

STA. 533+31 TO STA. 535+33

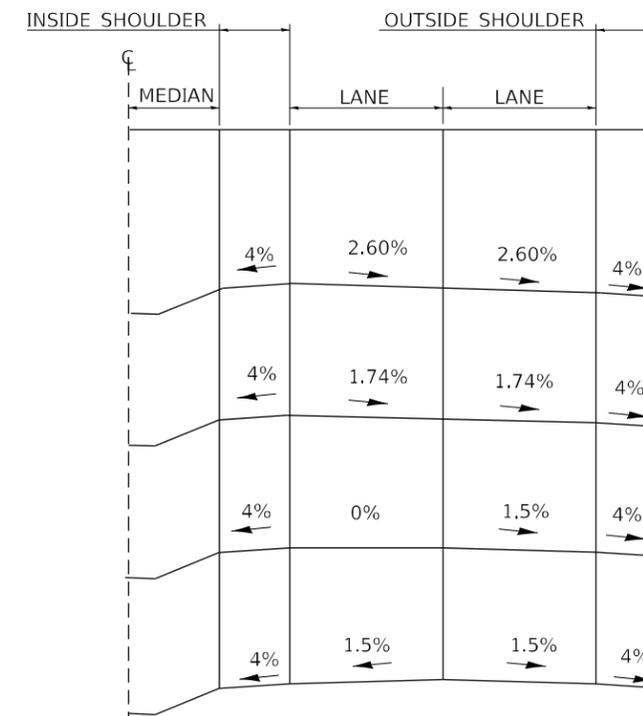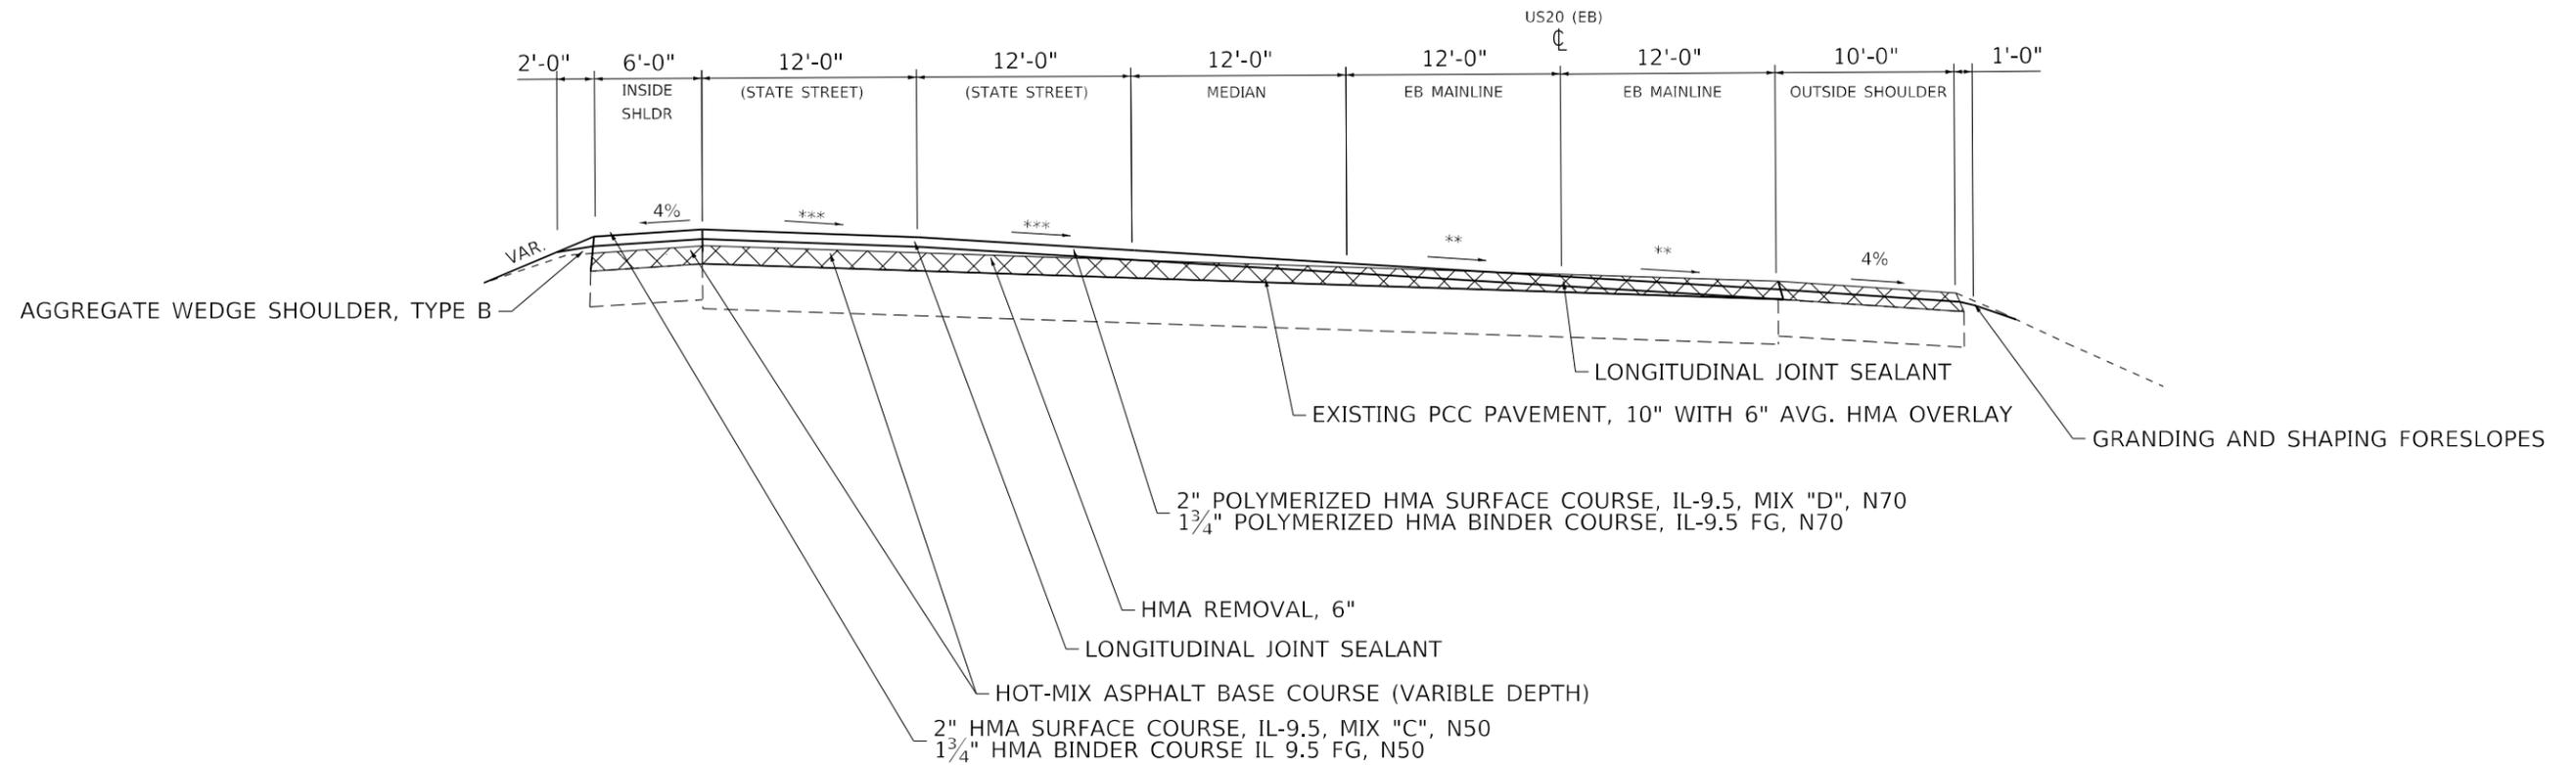

FULL SUPERELEVATION
516+85 TO 533+68

67% SUPERELEVATION (PC / PT) = 1.74%
516+46 / 534+07

RIGHT LANE ROTATES UNTIL IT REACHES 0%
515+68 / 534+85

CROWN
515+21 / 535+33

** TRANSITION STATIONING
515+21 TO 516+85
533+68 TO 535+33
FULL SUPERELEVATION = 2.60%
516+85 TO 533+68

*** SEE SHEET # for EB US20 (STATE ST) SUPER CORRECTION

REMOVAL
112# / IN / SQ YD

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**STATE OF ILLINOIS
DEPARTMENT OF TRANSPORTATION**


**TYPICAL SECTIONS
SUPERELEVATIONS**

SCALE: SHEET OF SHEETS STA. TO STA.

F.A.P. RTE.	SECTION	COUNTY	TOTAL SHEETS	SHEET NO.
301	(1-1,1,2)RS-2	WINNEBAGO	158	27
CONTRACT NO. 64M18				
ILLINOIS FED. AID PROJECT				

SUPERELEVATION DETAILS

STA. 538+35 TO STA. 559+76

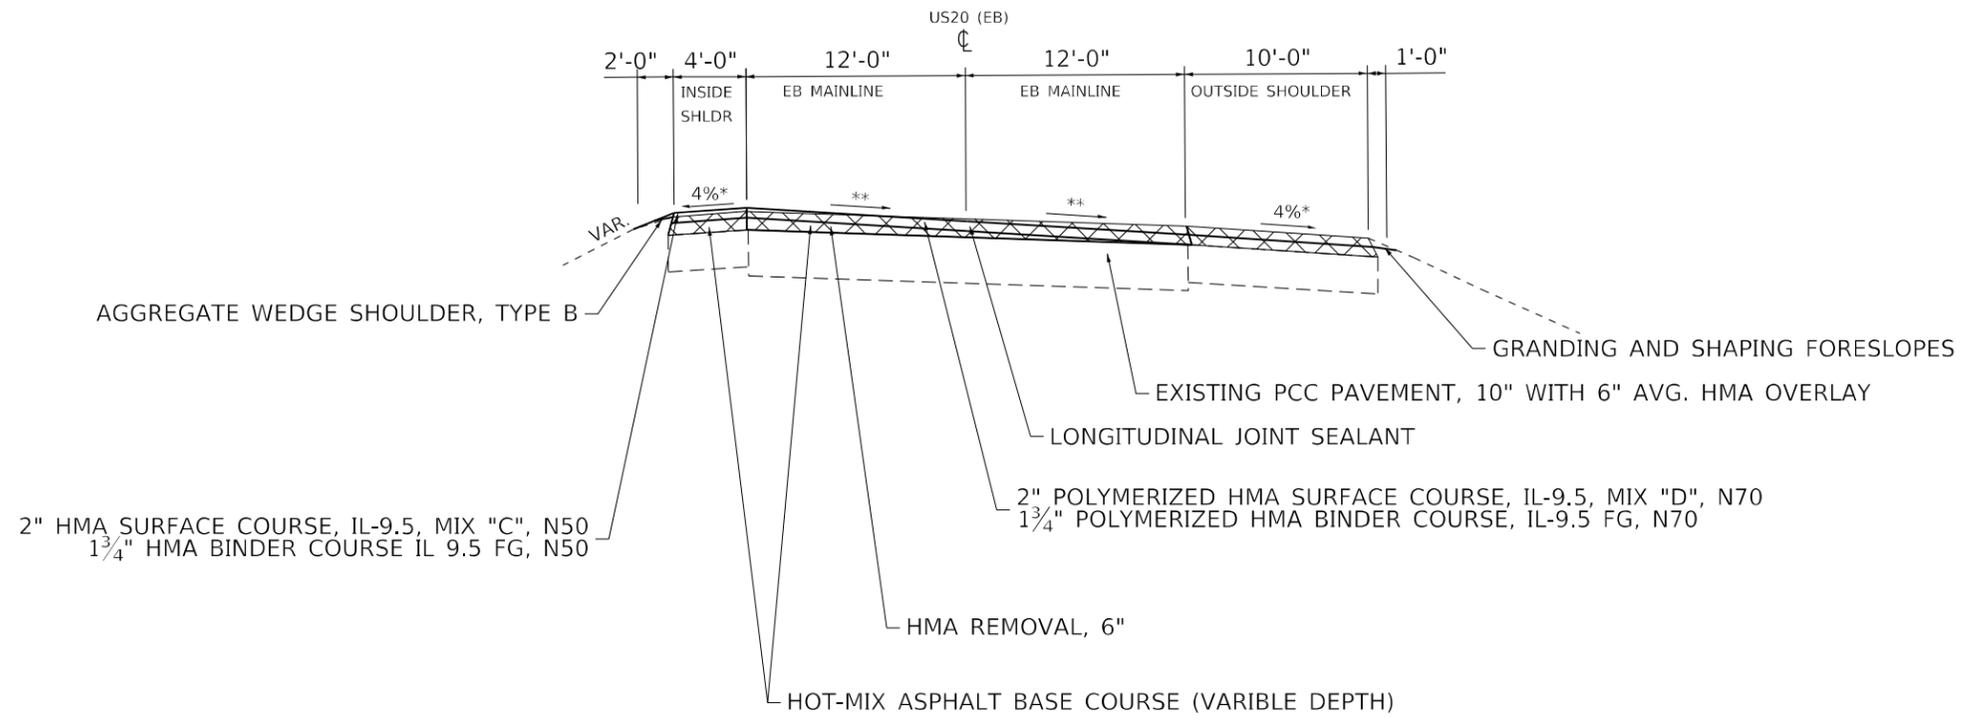


* OUTSIDE EDGE SHALL MAINTAIN A MAX OF 8% OF SUPERELEVATION WITH RESPECT TO THE PAVEMENT.

INSIDE EDGE SHALL MATCH SUPERELEVATION AFTER 4%.

** TRANSITION STATIONING
538+34 TO 541+17
556+94 TO 559+76

FULL SUPERELEVATION = 5.40%
541+17 TO 556+94

REMOVAL
112# / IN / SQ YD

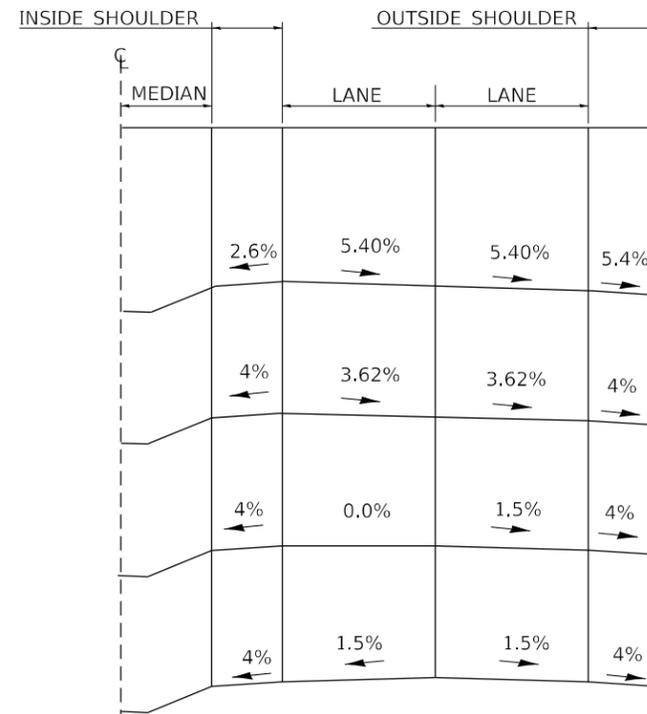

FULL SUPERELEVATION
541+17 TO 556+94

67% SUPERELEVATION (PC / PT) = 3.62%
540+36 / 557+75

RIGHT LANE ROTATES UNTIL IT REACHES 0%
538+74 / 559+37

CROWN
538+34 / 559+76

**STATE OF ILLINOIS
DEPARTMENT OF TRANSPORTATION**

**TYPICAL SECTIONS
SUPERELEVATIONS**

USER NAME = anikneyde	DESIGNED -	REVISED -
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SCALE: SHEET OF SHEETS STA. TO STA.




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			CONTRACT NO. 64M18	
ILLINOIS FED. AID PROJECT				

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SUPERELEVATION DETAILS

EB US20 (STATE ST)

STA. 533+44 TO STA. 35+44
(STA 535+54 BK = 17+24 AH)

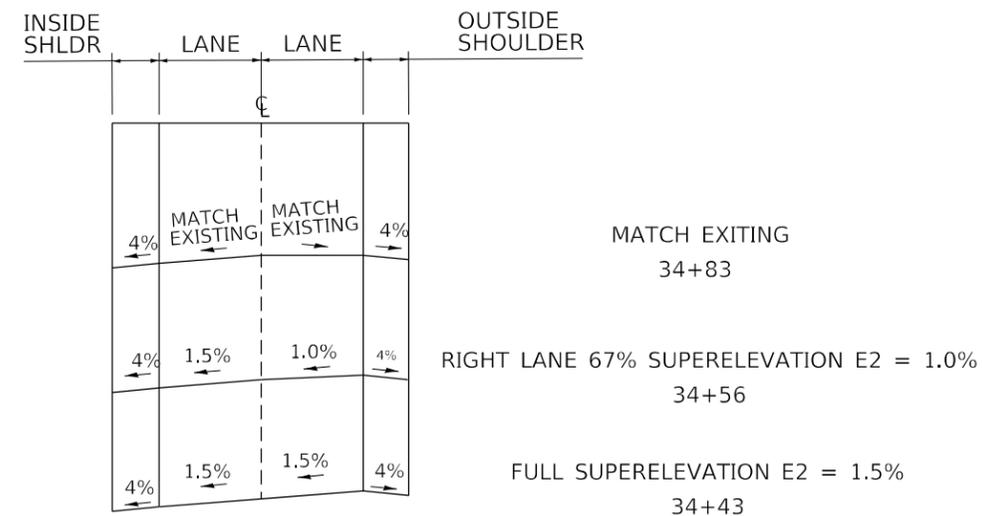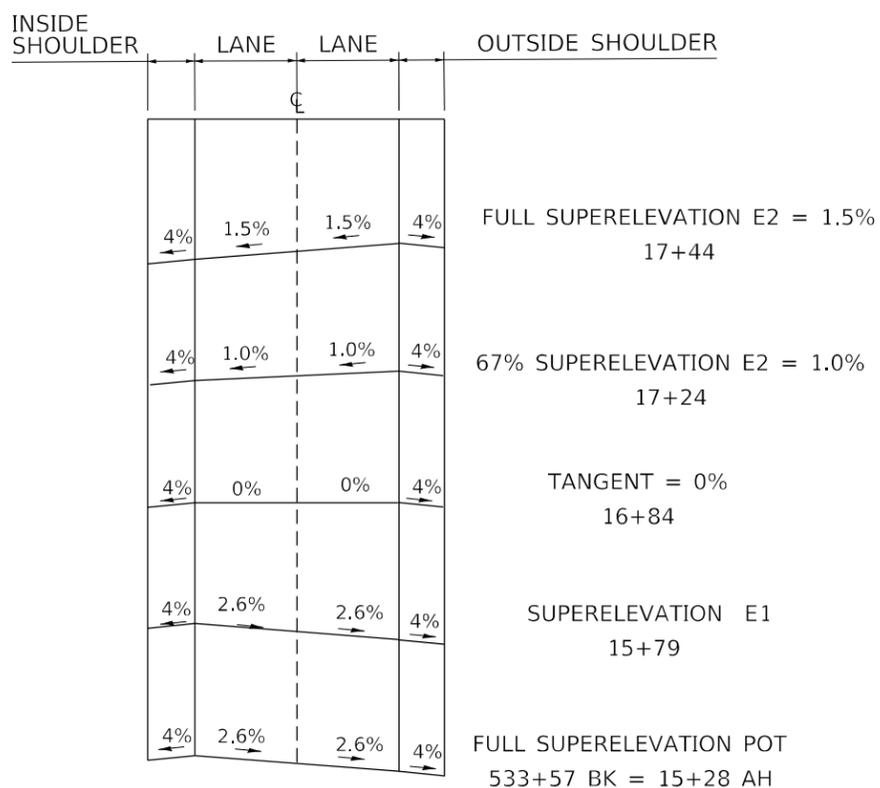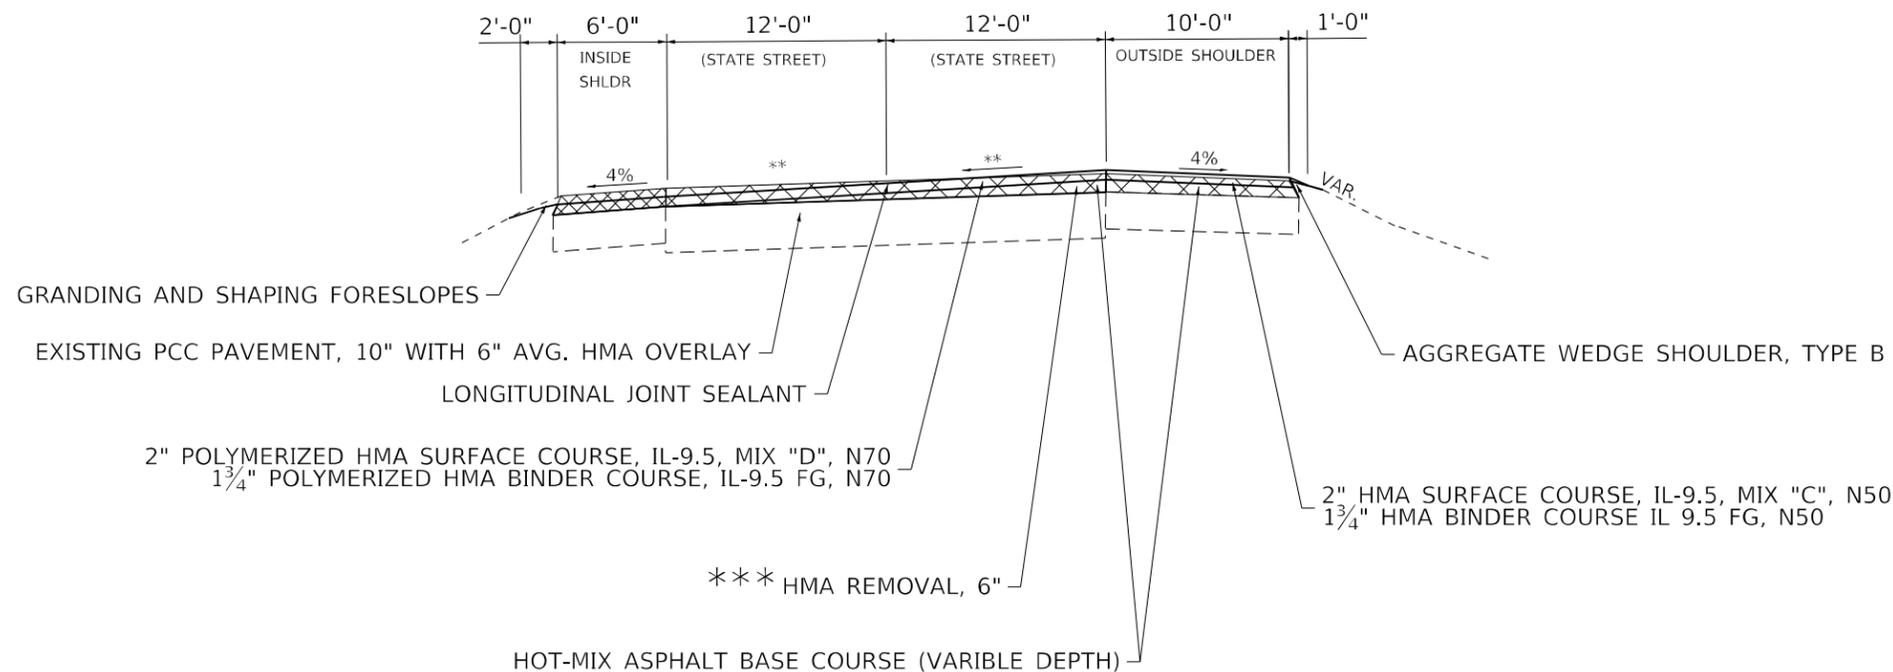

** FULL SUPERELEVATION E1 = 2.6%
533+17 TO 534+07

FULL SUPERELEVATION E2 = 1.5%
17+44 TO 34+43

REMOVAL

112# / IN / SQ YD

*** HMA REMOVAL 3 3/4" STA. 34+40 - 34+83

STATE OF ILLINOIS
DEPARTMENT OF TRANSPORTATION

TYPICAL SECTIONS
SUPERELEVATIONS

USER NAME = anikneyde	DESIGNED -	REVISED -
PLOT SCALE = 10,0000 * / in.	DRAWN -	REVISIED -
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	DATE -	REVISIED -


SCALE:	SHEET	OF	SHEETS	STA.	TO	STA.
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F.A.P. RTE.	SECTION	COUNTY	TOTAL SHEETS	SHEET NO.
301	(1-1,1,2)RS-2	WINNEBAGO	158	29
			CONTRACT NO. 64M18	
ILLINOIS FED. AID PROJECT				

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SUPERELEVATION DETAILS

STA. 804+97 TO 826+51



FULL SUPERELEVATION = 3.40%
806+74 TO 824+55

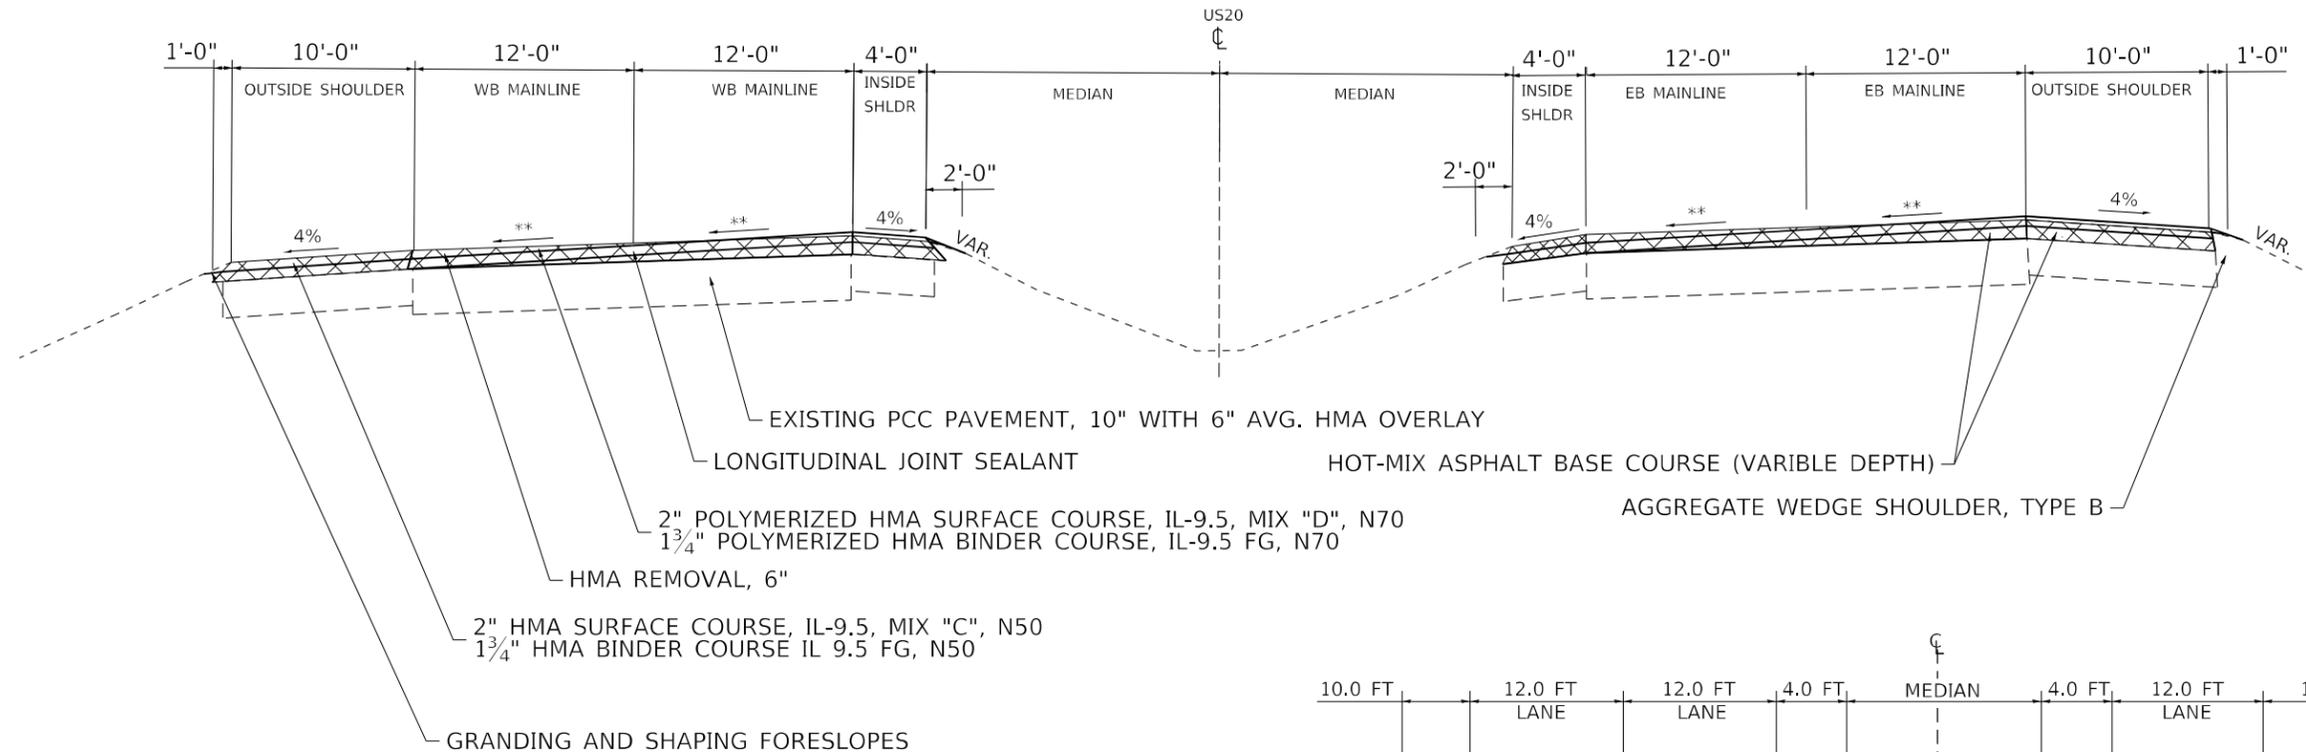67% SUPERELEVATION (PC / PT) = 2.28%
806+23 / 825+06

RIGHT LANE ROTATES UNTIL IT REACHES 1.5%
805+96 / 825+40

RIGHT LANE ROTATES UNTIL IT REACHES 0%
805+88 / 825+40

CROWN
804+77 / 826+51

10.0 FT	12.0 FT LANE	12.0 FT LANE	4.0 FT	MEDIAN	4.0 FT	12.0 FT LANE	12.0 FT LANE	10.0 FT
4%	3.40%	3.40%	4%		4%	3.40%	3.40%	4%
4%	2.28%	2.28%	4%		4%	2.28%	2.28%	4%
4%	1.5%	1.5%	4%		4%	1.5%	1.5%	4%
4%	1.5%	0%	4%		4%	1.5%	0%	4%
4%	1.5%	1.5%	4%		4%	1.5%	1.5%	4%

** TRANSITION STATIONING
804+77 TO 806+74
824+55 TO 826+51

FULL SUPERELEVATION = 3.40%
806+72 TO 824+55

REMOVAL
112# / IN / SQ YD

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**STATE OF ILLINOIS
DEPARTMENT OF TRANSPORTATION**


**TYPICAL SECTIONS
SUPERELEVATIONS**

SCALE: SHEET OF SHEETS STA. TO STA.


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301	(1-1,2)RS-2	WINNEBAGO	158	30
CONTRACT NO. 64M18				
ILLINOIS FED. AID PROJECT				

MOT TYPICAL SECTIONS


US 20 WB
BRIDGE LOCATIONS
W STATE ST. AND US 20

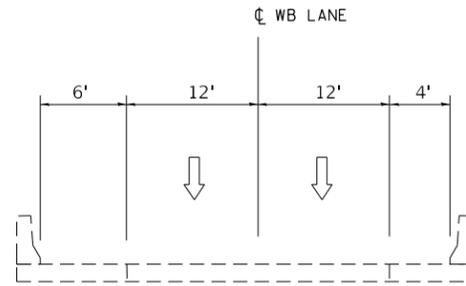


US20

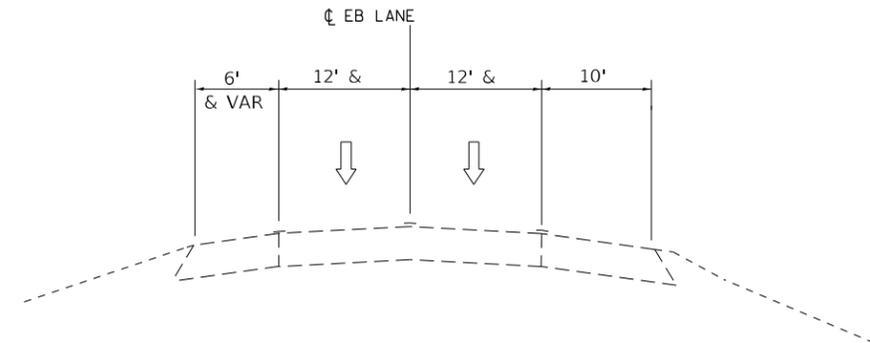

STAGING TYPICAL 3
US 20
STA 546+42 TO STA 549+67

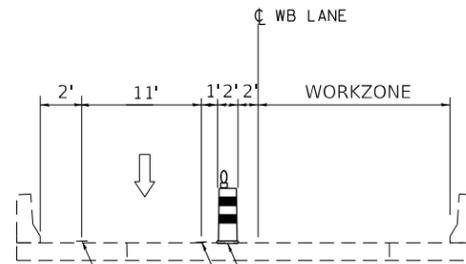

US20

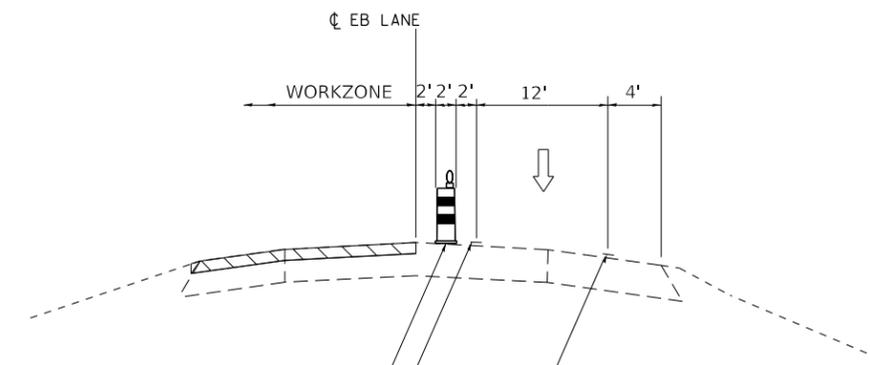

TYPE II BARRICADE OR DRUM
SPACED AT 80' C-C TYP.

TEMPORARY PAVEMENT MARKING 4" (YELLOW)

TEMPORARY PAVEMENT MARKING 4" (WHITE)

MODEL: Default
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	DRAWN -	REVISED -
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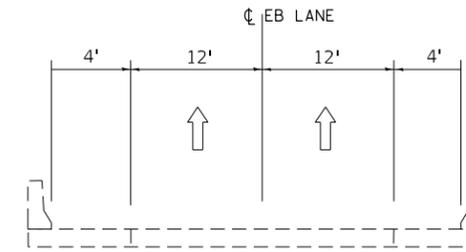
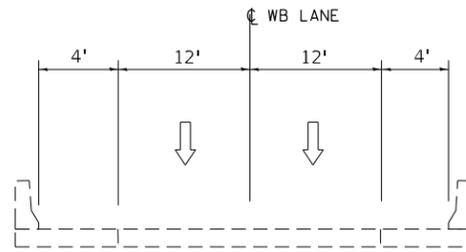
**STATE OF ILLINOIS
DEPARTMENT OF TRANSPORTATION**

US ROUTE 20 TYPICAL SECTIONS MOT				
SCALE:	SHEET	OF	SHEETS	STA. TO STA.



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			CONTRACT NO. 64M18	
ILLINOIS FED. AID PROJECT				

MOT TYPICAL SECTIONS

US 20 EB/WB
BRIDGE LOCATIONS
CUNNINGHAM RD AND US 20



STAGING TYPICAL 5
US 20
STA 692+28 TO STA 695+34

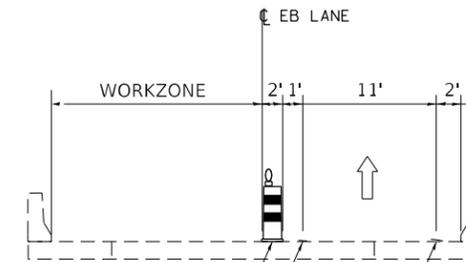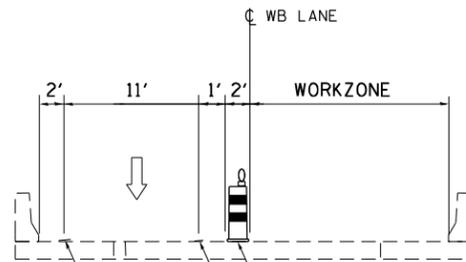

TYPE II BARRICADE OR DRUM
SPACED AT 80' C-C TYP.
TEMPORARY PAVEMENT MARKING 4" (YELLOW)
TEMPORARY PAVEMENT MARKING 4" (WHITE)

MODEL: Default
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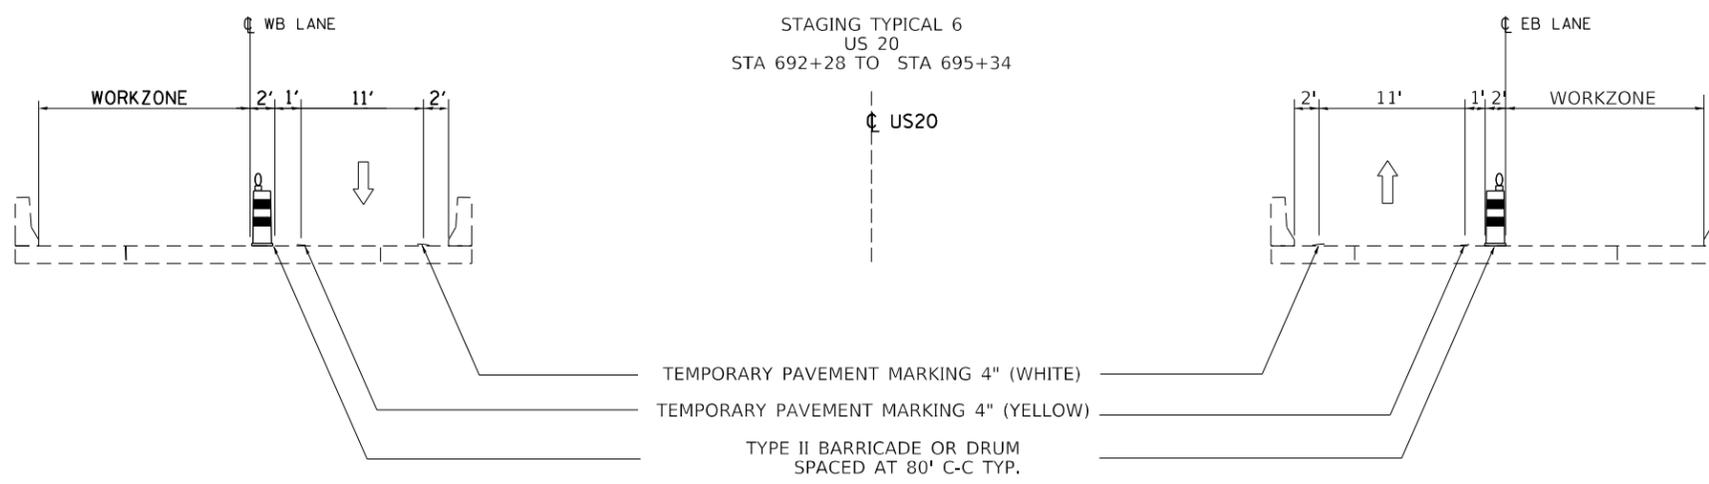
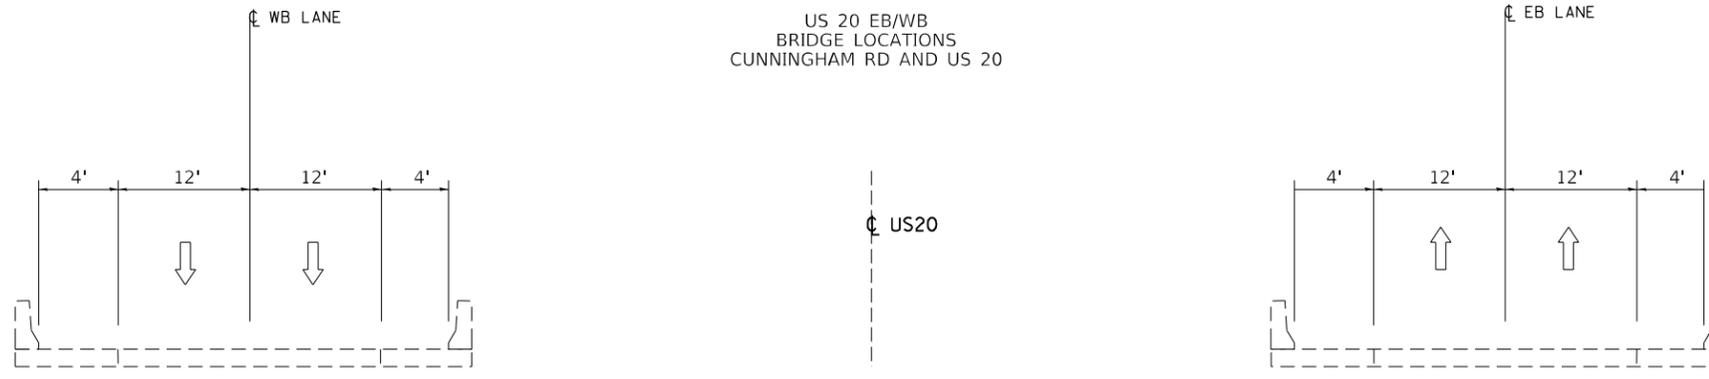
**STATE OF ILLINOIS
DEPARTMENT OF TRANSPORTATION**

**US ROUTE 20
TYPICAL SECTIONS MOT**

SCALE: SHEET OF SHEETS STA. TO STA.

F.A.P. RTE.	SECTION	COUNTY	TOTAL SHEETS	SHEET NO.
301	(1-1,1,2)RS-2	WINNEBAGO	158	35
CONTRACT NO. 64M18			ILLINOIS FED. AID PROJECT	

MOT TYPICAL SECTIONS



TEMPORARY PAVEMENT MARKING 4" (WHITE)
 TEMPORARY PAVEMENT MARKING 4" (YELLOW)
 TYPE II BARRICADE OR DRUM
 SPACED AT 80' C-C TYP.

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	DRAWN -	REVISED -
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PLOT DATE = Mar-19-2021 01:24:30 PM	DATE -	REVISED -

**STATE OF ILLINOIS
DEPARTMENT OF TRANSPORTATION**

US ROUTE 20 TYPICAL SECTIONS MOT				
SCALE:	SHEET	OF	SHEETS	STA. TO STA.

F.A.P. RTE.	SECTION	COUNTY	TOTAL SHEETS	SHEET NO.
301	(1-1,1,2)RS-2	WINNEBAGO	158	36
CONTRACT NO. 64M18			ILLINOIS FED. AID PROJECT	

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HORIZONTAL CONTROL POINTS							
POINT	NORTH	EAST	ELEVATION	CHAIN	STATION	OFFSET	DESCRIPTION
WIN2	2027961.9914	2576859.4300	774.3530	WINN_US20A	816+58.0573	3.6535' RT	PERM. SURVEY MARKER, TOPO SURVEY POINT
WIN9	2040896.3544	2568280.4113	818.6570	WINN_US20A	655+47.7943	6.4423' RT	PERM. SURVEY MARKER, TOPO SURVEY POINT
WIN10	2040443.8278	2569840.0301	827.7860	WINN_US20A	671+63.5836	84.6759' LT	PERM. SURVEY MARKER, TOPO SURVEY POINT
WIN11	2039103.0204	2571440.8599	799.6640	WINN_US20A	692+45.0705	8.0599' LT	PERM. SURVEY MARKER, TOPO SURVEY POINT
WIN12	2037987.0953	2572217.1763	803.2610	WINN_US20A	706+05.9154	6.7442' LT	PERM. SURVEY MARKER, TOPO SURVEY POINT
WIN36	2044816.7764	2560082.7897	820.3720	WINN_US20A	561+69.5749	394.957' RT	PERM. SURVEY MARKER, TOPO SURVEY POINT
WIN38	2046016.6217	2559111.8457	811.3570	WINN_US20WB	547+76.2957	97.3651' RT	PERM. SURVEY MARKER, TOPO SURVEY POINT
WIN39	2043626.8440	2562018.2658	821.9500	WINN_US20A	584+06.4324	3.132' LT	PERM. SURVEY MARKER, TOPO SURVEY POINT
WIN40	2041454.2121	2565513.7839	775.1600	WINN_US20A	626+74.9800	332.9283' LT	PERM. SURVEY MARKER, TOPO SURVEY POINT
WIN41	2041624.6017	2564723.8110	779.6630	WINN_US20A	618+15.6252	201.9447' LT	PERM. SURVEY MARKER, TOPO SURVEY POINT
AH3043	2032951.3137	2574598.3324	791.7009	WINN_US20A	764+75.3371	87.2769' LT	PERM. SURVEY MARKER, TOPO SURVEY POINT
AH3044	2037014.3726	2572667.0350	805.8395	WINN_US20A	716+77.4125	3.4235' LT	PERM. SURVEY MARKER, TOPO SURVEY POINT
DE7362	2024378.8966	2582292.5626	742.9534	WINN_US20A	885+49.6402	138.7346' LT	PERM. SURVEY MARKER, TOPO SURVEY POINT

CURVE POINT NUMBERS					
CHAIN	CURVE	PI	CC	PC	PT
WINN_US20A	A007200	007200	7201	7202	7203
WINN_US20A	A007210	007210	7211	7212	7213
WINN_US20A	A007220	007220	7221	7222	7223
WINN_US20A	A007230	007230	7231	7232	7233
WINN_US20A	05907200	5907200	5907201	5907202	5907203
WINN_US20A	12500240	12500240	12500241	12500242	12500243
WINN_US20A	A12500220	12500220	12500221	12500222	12500223
WINN_US20A	12500280	12500280	12500281	12500282	12500283
WINN_US20A	12500270	12500270	12500271	12500272	12500273
WINN_US20A	A125370	125370	125371	125372	125373
WINN_US20A	A125380	125380	125381	125382	125383

BENCH MARKS							
POINT	NORTH	EAST	ELEVATION	CHAIN	STATION	OFFSET	DESCRIPTION
ASE400	2025516.5390	2579091.2070	759.5590	WINN_US20A	849+71.0464	14.0029' LT	VERTICAL CONTROL STATION, CHISELED "X"
ASE401	2026107.8280	2578593.1130	766.6360	WINN_US20A	841+99.0186	55.1534' LT	VERTICAL CONTROL STATION, CHISELED "X"
ASE402	2032185.4930	2574938.8730	785.5630	WINN_US20A	770+13.4410	81.6937' LT	VERTICAL CONTROL STATION, CHISELED "X"
ASE403	2034255.3070	2573784.5140	779.7000	WINN_US20A	746+51.7787	116.3612' RT	VERTICAL CONTROL STATION, CHISELED "X"
ASE406	2044772.5929	2560600.5894	810.6520	WINN_US20A	565+85.7152	83.6759' RT	VERTICAL CONTROL STATION, CHISELED "X"
ASE407	2026820.4220	2577850.8830	769.8030	WINN_US20A	831+71.5046	1.2035' LT	VERTICAL CONTROL STATION, CHISELED SQUARE
ASE409	2033453.4200	2574348.9380	788.0270	WINN_US20A	756+15.0668	67.1414' LT	VERTICAL CONTROL STATION, CHISELED SQUARE
ASE411	2046022.7132	2559333.5921	830.0140	WINN_US20WB	549+67.9942	18.7871' LT	VERTICAL CONTROL STATION, DISK

CURVE POINT NUMBERS					
CHAIN	CURVE	PI	CC	PC	PT
EBBUS20	1220	1220	1221	1222	1223
EBBUS20	1270	1270	1271	1272	1273
EBBUS20	1290	1290	1291	1292	1293

CURVE POINT NUMBERS					
CHAIN	CURVE	PI	CC	PC	PT
WBBUS20	1230	1230	1231	1232	1233
WBBUS20	1260	1260	1261	1262	1263
WBBUS20	1280	1280	1281	1282	1283

USER NAME = anikneyde	DESIGNED -	REVISED -
	DRAWN -	REVISED -
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STATE OF ILLINOIS
DEPARTMENT OF TRANSPORTATION

US ROUTE 20
HORIZONTAL & VERTICAL CONTROL

SCALE: SHEET OF SHEETS STA. TO STA.

F.A.P. RTE.	SECTION	COUNTY	TOTAL SHEETS	SHEET NO.
301	(1-1,1,2)RS-2	WINNEBAGO	158	41
CONTRACT NO. 64M18			ILLINOIS FED. AID PROJECT	

Chain WINN_US20EB contains:
 PPP1018 CUR L260 CUR A200 CUR A079210 CUR A079220 CUR PPP1210
 CUR PPP1220 UR PPP1230 CUR PPP1240 CUR PPP1250 CUR PPP1260
 CUR PPP1270 CUR A081200 CUR A081210 CUR PPP1280 CUR PPP1290
 CUR A060330 A0601034

Beginning chain WINN_US20EB description
 =====

Point PPP1018 N 2,047,053.6120 E 2,504,753.6902 Sta 0+00.0000

Course from PPP1018 to PC L260 55° 38' 22.0071" Dist 388.1271'

Curve Data

Curve L260
 P.I. Station 15+49.3945 N 2,047,928.0884 E 2,506,032.7189
 Delta = 33° 29' 06.6393" (RT)
 Degree = 1° 29' 03.2625"
 Tangent = 1,161.2674'
 Length = 2,256.0494'
 Radius = 3,860.2784'
 External = 170.8866'
 Long Chord = 2,224.0793'
 Mid. Ord. = 163.6425'
 P.C. Station 3+88.1271 N 2,047,272.6704 E 2,505,074.0900
 P.T. Station 26+44.1764 N 2,047,945.8297 E 2,507,193.8507
 C.C. N 2,044,086.0019 E 2,507,252.8265

Course from PT L260 to PC A200 89° 07' 28.6465" Dist 5,458,7228'

Curve Data

Curve A200
 P.I. Station 85+87.3588 N 2,048,036.6273 E 2,513,136.3395
 Delta = 4° 08' 33.9919" (LT)
 Degree = 0° 25' 39.9111"
 Tangent = 484.4596'
 Length = 968.4969'
 Radius = 13,394.5919'
 External = 8,7582'
 Long Chord = 968.2860'
 Mid. Ord. = 8,7525'
 P.C. Station 81+02.8992 N 2,048,029.2259 E 2,512,651.9364
 P.T. Station 90+71.3962 N 2,048,079.0036 E 2,513,618.9421
 C.C. N 2,061,422.2546 E 2,512,447.2992

Course from PT A200 to PC A079210 84° 58' 54.6545" Dist 848.5741'

Curve Data

Curve A079210
 P.I. Station 103+86.8834 N 2,048,194.0710 E 2,514,929.3871
 Delta = 1° 54' 18.7940" (RT)
 Degree = 0° 12' 14.5506"
 Tangent = 466.9131'
 Length = 933.7402'
 Radius = 28,080.4079'
 External = 3,8816'
 Long Chord = 933.6971'
 Mid. Ord. = 3,8810'
 P.C. Station 99+19.9703 N 2,048,153.2295 E 2,514,464.2636
 P.T. Station 108+53.7105 N 2,048,219.4264 E 2,515,395.6112
 C.C. N 2,020,180.4528 E 2,516,920.4944

Course from PT A079210 to PC A079220 86° 53' 13.4485" Dist 1,914.0532'

Curve Data

Curve A079220
 P.I. Station 132+86.3381 N 2,048,351.5282 E 2,517,824.6493
 Delta = 6° 15' 23.6637" (RT)
 Degree = 0° 36' 13.8513"
 Tangent = 518.5744'
 Length = 1,036.1180'
 Radius = 9,488.4506'
 External = 14,1603'
 Long Chord = 1,035.6033'
 Mid. Ord. = 14.1392'
 P.C. Station 127+67.7637 N 2,048,323.3674 E 2,517,306.8402
 P.T. Station 138+03.8816 N 2,048,323.0899 E 2,518,342.4434
 C.C. N 2,038,848.9176 E 2,517,822.1026

Course from PT A079220 to PC PPP1210 93° 08' 37.1123" Dist 1,478.6266'

Curve Data

Curve PPP1210
 P.I. Station 158+16.6606 N 2,048,212.7103 E 2,520,352.1934
 Delta = 1° 40' 37.6370" (LT)
 Degree = 0° 09' 25.2010"
 Tangent = 534.1523'
 Length = 1,068.2283'
 Radius = 36,494.0639'
 External = 3,9089'
 Long Chord = 1,068.1902'
 Mid. Ord. = 3.9085'
 P.C. Station 152+82.5083 N 2,048,242.0029 E 2,519,818.8449
 P.T. Station 163+50.7366 N 2,048,199.0399 E 2,520,886.1708
 C.C. N 2,084,681.1502 E 2,521,820.1569

Course from PT PPP1210 to PC PPP1220 91° 27' 59.4753" Dist 2,422.8563'

Curve Data

Curve PPP1220
 P.I. Station 192+87.8104 N 2,048,123.8719 E 2,523,822.2826
 Delta = 2° 58' 24.7032" (RT)
 Degree = 0° 17' 21.1066"
 Tangent = 514.2176'
 Length = 1,028.2043'
 Radius = 19,812.0727'
 External = 6,6721'
 Long Chord = 1,028.0889'
 Mid. Ord. = 6,6698'
 P.C. Station 187+73.5929 N 2,048,137.0321 E 2,523,308.2335
 P.T. Station 198+01.7972 N 2,048,084.0632 E 2,524,334.9569
 C.C. N 2,028,331.4489 E 2,522,801.1866

Course from PT PPP1220 to PC PPP1230 94° 26' 24.1785" Dist 2,749.3476'

Curve Data

Curve PPP1230
 P.I. Station 232+45.4076 N 2,047,817.4729 E 2,527,768.2327
 Delta = 0° 34' 48.8455" (LT)
 Degree = 0° 02' 30.4375"
 Tangent = 694.2629'
 Length = 1,388.5138'
 Radius = 137,109.9636'
 External = 1,7577'
 Long Chord = 1,388.5079'
 Mid. Ord. = 1,7577'
 P.C. Station 225+51.1447 N 2,047,871.2199 E 2,527,076.0534
 P.T. Station 239+39.6586 N 2,047,770.7382 E 2,528,460.9208
 C.C. N 2,184,569.7004 E 2,537,690.5510

Course from PT PPP1230 to PC PPP1240 93° 51' 35.3329" Dist 1,219.0679'

Curve Data

Curve PPP1240
 P.I. Station 256+74.1604 N 2,047,653.9793 E 2,530,191.4883
 Delta = 0° 53' 09.1174" (RT)
 Degree = 0° 05' 09.3686"
 Tangent = 515.4339'
 Length = 1,030.8473'
 Radius = 66,672.8423'
 External = 1,9923'
 Long Chord = 1,030.8371'
 Mid. Ord. = 1.9923'
 P.C. Station 251+58.7265 N 2,047,688.6760 E 2,529,677.2235
 P.T. Station 261+89.5738 N 2,047,611.3358 E 2,530,705.1552
 C.C. N 1,981,167.0652 E 2,525,189.1056

Course from PT PPP1240 to PC PPP1250 94° 44' 44.4504" Dist 2,700.2497'

Curve Data

Curve PPP1250
 P.I. Station 296+45.7254 N 2,047,325.3978 E 2,534,149.4582
 Delta = 0° 22' 47.6517" (LT)
 Degree = 0° 01' 30.4652"
 Tangent = 755.9019'
 Length = 1,511.7982'
 Radius = 228,004.5117'
 External = 1,2530'
 Long Chord = 1,511.7954'
 Mid. Ord. = 1,2530'
 P.C. Station 288+89.8235 N 2,047,387.9359 E 2,533,396.1478
 P.T. Station 304+01.6217 N 2,047,267.8559 E 2,534,903.1667
 C.C. N 2,274,610.7893 E 2,552,259.6631

Course from PT PPP1250 to PC PPP1260 94° 21' 56.7987" Dist 3,559.8398'

Curve Data

Curve PPP1260
 P.I. Station 343+50.8084 N 2,046,967.2301 E 2,538,840.8944
 Delta = 2° 05' 32.2935" (RT)
 Degree = 0° 16' 07.4061"
 Tangent = 389.3469'
 Length = 778.6072'
 Radius = 21,321.4286'
 External = 3,5546'
 Long Chord = 778.5639'
 Mid. Ord. = 3,5540'
 P.C. Station 339+61.4615 N 2,046,996.8685 E 2,538,452.6773
 P.T. Station 347+40.0687 N 2,046,923.4378 E 2,539,227.7707
 C.C. N 2,025,737.3061 E 2,536,829.6160

Course from PT PPP1260 to PC PPP1270 96° 27' 29.0921" Dist 2,102.3271'

Curve Data

Curve PPP1270
 P.I. Station 372+10.2869 N 2,046,645.5969 E 2,541,682.3139
 Delta = 2° 24' 48.5688" (LT)
 Degree = 0° 19' 41.0361"
 Tangent = 367.8911'
 Length = 735.6734'
 Radius = 17,464.7337'
 External = 3,8743'
 Long Chord = 735.6191'
 Mid. Ord. = 3,8735'
 P.C. Station 368+42.3958 N 2,046,686.9759 E 2,541,316.7573
 P.T. Station 375+78.0693 N 2,046,619.6485 E 2,542,049.2888
 C.C. N 2,064,040.8856 E 2,543,281.1253

Course from PT PPP1270 to PC A081200 94° 02' 40.5234" Dist 4,164.4292'

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**STATE OF ILLINOIS
 DEPARTMENT OF TRANSPORTATION**

**US ROUTE 20
 HORIZONTAL & VERTICAL CONTROL**

SCALE: SHEET OF SHEETS STA. TO STA.

F.A.P. RTE.	SECTION	COUNTY	TOTAL SHEETS	SHEET NO.
301	(1-1,2)RS-2	WINNEBAGO	158	44
ILLINOIS FED. AID PROJECT			CONTRACT NO. 64M18	

Chain WINN_US20WB continued:

Curve Data

Curve A081220
P.I. Station 421+51.1134 N 2,046,370.9958 E 2,546,614.8054
Delta = 0° 08' 41.2812" (RT)
Degree = 0° 02' 02.5353"
Tangent = 212.7066'
Length = 425.4130'
Radius = 168,330.9132'
External = 0.1344'
Long Chord = 425.4129'
Mid. Ord. = 0.1344'
P.C. Station 419+38.4068 N 2,046,385.9967 E 2,546,402.6284
P.T. Station 423+63.8198 N 2,046,355.4587 E 2,546,826.9439
C.C. N 1,878,474.2111 E 2,534,531.2926

Course from PT A081220 to PC A081230 94° 11' 19.9446" Dist 2,405.8292'

Curve Data

Curve A081230
P.I. Station 452+41.9947 N 2,046,145.2238 E 2,549,697.4303
Delta = 3° 22' 12.8254" (LT)
Degree = 0° 21' 24.6865"
Tangent = 472.3458'
Length = 944.4192'
Radius = 16,055.6535'
External = 6.9465'
Long Chord = 944.2830'
Mid. Ord. = 6.9435'
P.C. Station 447+69.6489 N 2,046,179.7261 E 2,549,226.3463
P.T. Station 457+14.0681 N 2,046,138.4751 E 2,550,169.7279
C.C. N 2,062,192.4898 E 2,550,399.1238

Course from PT A081230 to PC PPP280 90° 49' 07.1192" Dist 3,382.6328'

Curve Data

Curve PPP280
P.I. Station 497+73.4133 N 2,046,080.4770 E 2,554,228.6587
Delta = 6° 59' 55.5495" (LT)
Degree = 0° 31' 03.9325"
Tangent = 676.7124'
Length = 1,351.7415'
Radius = 11,066.1091'
External = 20.6718'
Long Chord = 1,350.9013'
Mid. Ord. = 20.6332'
P.C. Station 490+96.7009 N 2,046,090.1456 E 2,553,552.0154
P.T. Station 504+48.4424 N 2,046,153.3281 E 2,554,901.4383
C.C. N 2,057,155.1252 E 2,553,710.1230

Course from PT PPP280 to PC A0601200 83° 49' 11.5696" Dist 2,558.4463'

Curve Data

Curve A0601200
P.I. Station 536+43.2109 N 2,046,497.2590 E 2,558,077.6400
Delta = 23° 58' 21.8417" (RT)
Degree = 1° 54' 41.9923"
Tangent = 636.3222'
Length = 1,254.0241'
Radius = 2,997.1670'
External = 66.8036'
Long Chord = 1,244.8970'
Mid. Ord. = 65.3471'
P.C. Station 530+06.8887 N 2,046,428.7561 E 2,557,445.0159
P.T. Station 542+60.9128 N 2,046,302.8164 E 2,558,683.5261
C.C. N 2,043,449.0075 E 2,557,767.6741

Course from PT A0601200 to PC A0601210 107° 47' 33.4112" Dist 2.7273'

Curve Data

Curve A0601210
P.I. Station 548+68.3607 N 2,046,117.1970 E 2,559,261.9190
Delta = 23° 52' 27.5508" (RT)
Degree = 2° 00' 11.0250"
Tangent = 604.7205'
Length = 1,191.8909'
Radius = 2,860.4090'
External = 63.2234'
Long Chord = 1,183.2869'
Mid. Ord. = 61.8562'
P.C. Station 542+63.6401 N 2,046,301.9830 E 2,558,686.1230
P.T. Station 554+55.5310 N 2,045,715.1792 E 2,559,713.6585
C.C. N 2,043,578.3909 E 2,557,812.0605

Course from PT A0601210 to A0601024 131° 40' 00.9621" Dist 2,222.5671'

Point A0601024 N 2,044,237.6180 E 2,561,373.9650 Sta 576+78.0982

=====
Ending chain WINN_US20WB description

Chain WBBUS20 contains:
1027 CUR 1230 CUR 1260 CUR 1280 1028

Beginning chain WBBUS20 description
=====

Point 1027 N 2,046,344.0470 E 2,558,644.0000 Sta 23+50.1758

Course from 1027 to PC 1230 107° 02' 21.4021" Dist 103.1882'

Curve Data

Curve 1230
P.I. Station 30+84.8448 N 2,046,128.7690 E 2,559,346.4200
Delta = 18° 44' 38.2361" (LT)
Degree = 1° 29' 51.0237"
Tangent = 631.4808'
Length = 1,251.6776'
Radius = 3,826.0786'
External = 51.7617'
Long Chord = 1,246.1035'
Mid. Ord. = 51.0708'
P.C. Station 24+53.3640 N 2,046,313.8101 E 2,558,742.6586
P.T. Station 37+05.0416 N 2,046,147.5542 E 2,559,977.6213
C.C. N 2,049,971.9395 E 2,559,863.8038

Course from PT 1230 to PC 1260 88° 17' 43.1659" Dist 865.6901'

Curve Data

Curve 1260
P.I. Station 51+82.9819 N 2,046,191.5197 E 2,561,454.9076
Delta = 5° 35' 25.5855" (RT)
Degree = 0° 27' 24.8802"
Tangent = 612.2503'
Length = 1,223.5290'
Radius = 12,539.8074'
External = 14.9375'
Long Chord = 1,223.0437'
Mid. Ord. = 14.9197'
P.C. Station 45+70.7316 N 2,046,173.3066 E 2,560,842.9283
P.T. Station 57+94.2606 N 2,046,150.0291 E 2,562,065.7504
C.C. N 2,033,639.0489 E 2,561,215.9602

Course from PT 1260 to PC 1280 93° 53' 08.7514" Dist 2,811.5680'

Curve Data

Curve 1280
P.I. Station 91+05.8287 N 2,045,925.6127 E 2,565,369.7057
Delta = 0° 03' 09.9410" (LT)
Degree = 0° 00' 18.9941"
Tangent = 500.0000'
Length = 1,000.0000'
Radius = 1,085,941.3104'
External = 0.1151'
Long Chord = 1,000.0000'
Mid. Ord. = 0.1151'
P.C. Station 86+05.8286 N 2,045,959.4964 E 2,564,870.8551
P.T. Station 96+05.8286 N 2,045,892.1884 E 2,565,868.5873
C.C. N 3,129,404.3875 E 2,638,462.2784

Course from PT 1280 to 1028 93° 49' 58.8104" Dist 5,984.8584'

Point 1028 N 2,045,492.1088 E 2,571,840.0583 Sta 155+90.6870

=====
Ending chain WBBUS20 description

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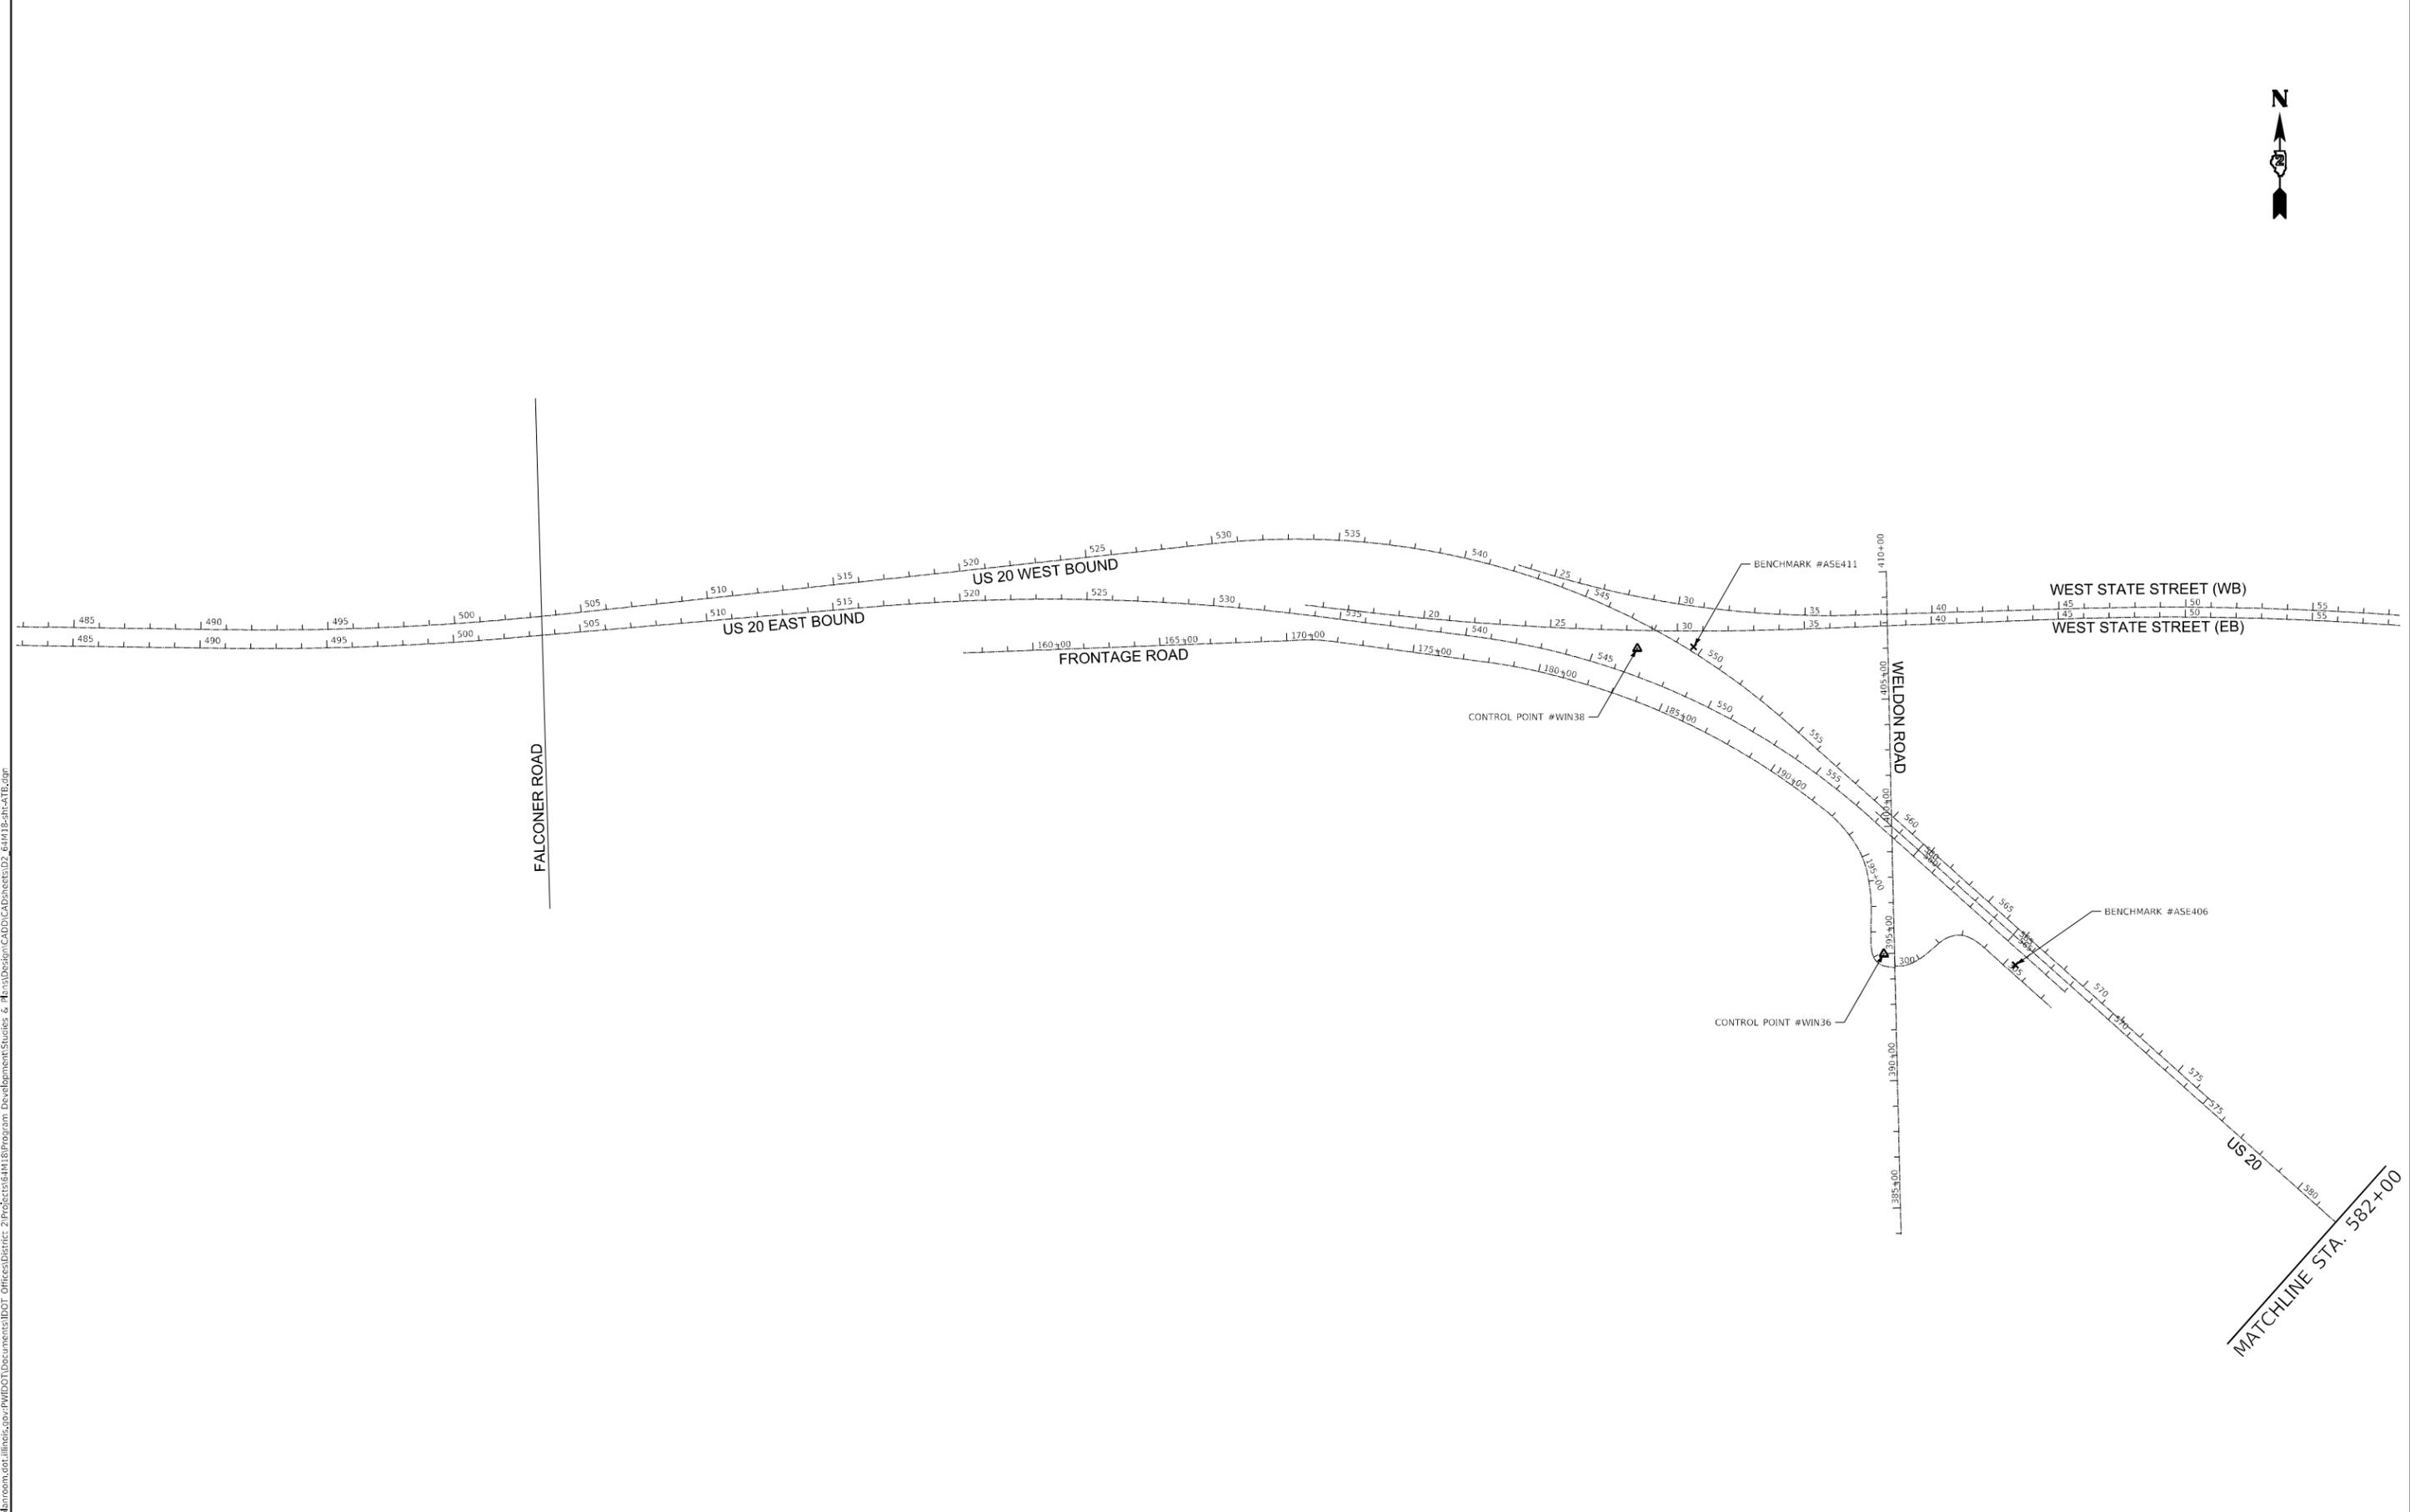
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**STATE OF ILLINOIS
DEPARTMENT OF TRANSPORTATION**

**US ROUTE 20
HORIZONTAL & VERTICAL CONTROL**

SCALE: SHEET OF SHEETS STA. TO STA.

F.A.P. RTE.	SECTION	COUNTY	TOTAL SHEETS	SHEET NO.
301	(1-1,1,2)RS-2	WINNEBAGO	158	47
			CONTRACT NO. 64M18	
		ILLINOIS	FED. AID PROJECT	



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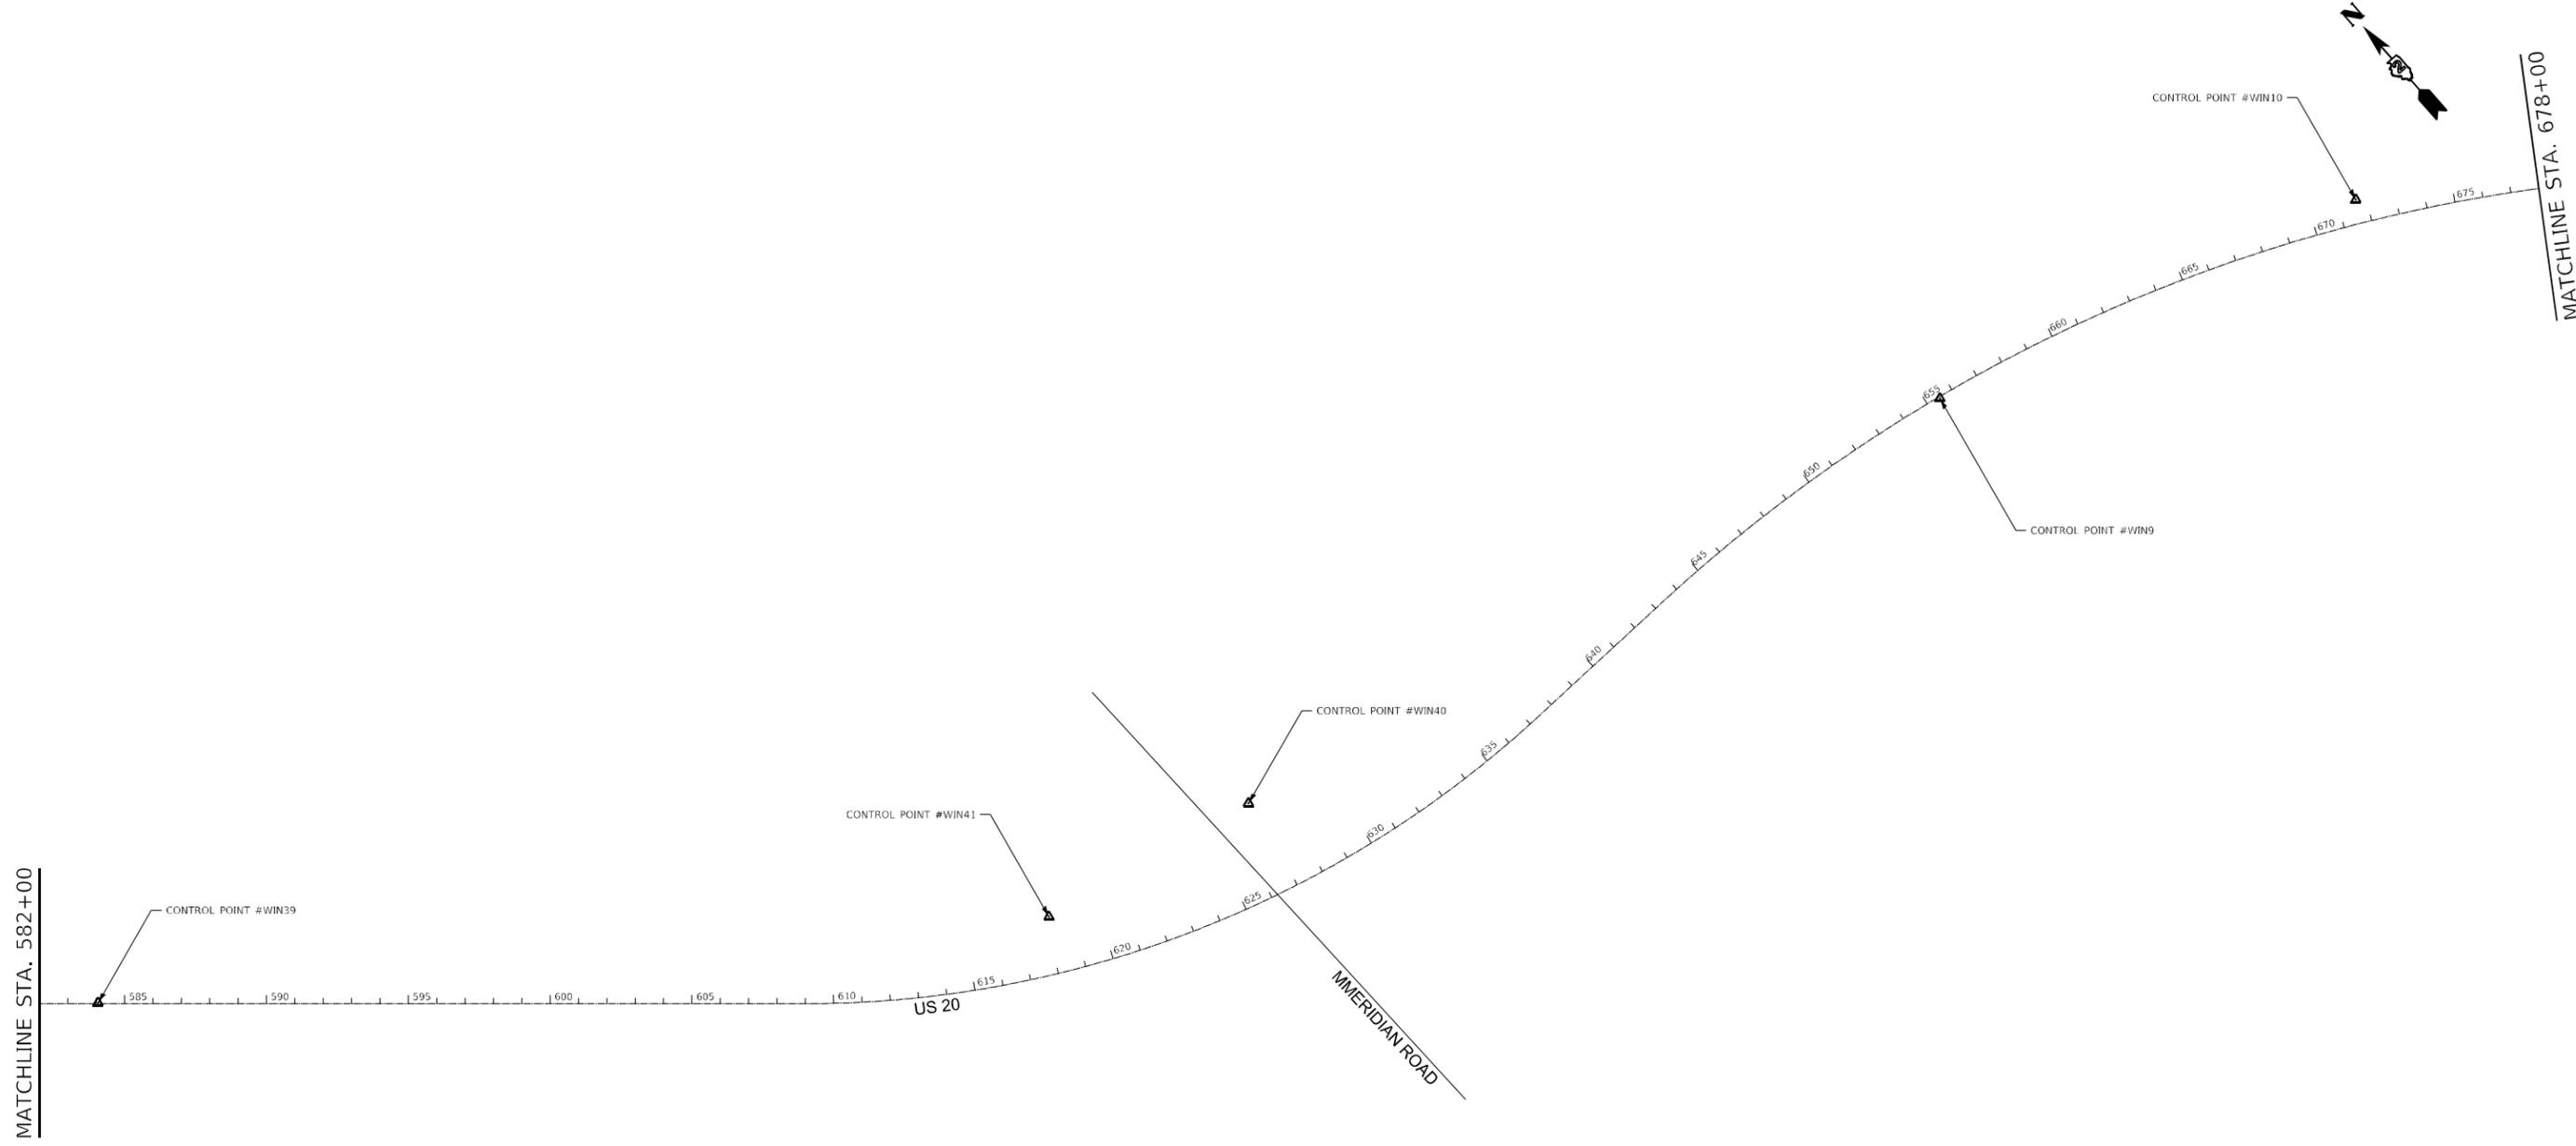
STATE OF ILLINOIS
DEPARTMENT OF TRANSPORTATION

US ROUTE 20
HORIZONTAL & VERTICAL CONTROL

F.A.P. RTE.	SECTION	COUNTY	TOTAL SHEETS	SHEET NO.
301	(1-1,1,2)RS-2	WINNEBAGO	158	48
CONTRACT NO. 64M18				
ILLINOIS FED. AID PROJECT				

SCALE: SHEET OF SHEETS STA. TO STA.

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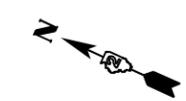
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**STATE OF ILLINOIS
 DEPARTMENT OF TRANSPORTATION**


**US ROUTE 20
 HORIZONTAL & VERTICAL CONTROL**

SCALE:	SHEET	OF	SHEETS	STA.	TO STA.
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F.A.P. RTE.	SECTION	COUNTY	TOTAL SHEETS	SHEET NO.
301	(1-1,1,2)RS-2	WINNEBAGO	158	49
CONTRACT NO. 64M18				
ILLINOIS FED. AID PROJECT				



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STATE OF ILLINOIS
DEPARTMENT OF TRANSPORTATION


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HORIZONTAL & VERTICAL CONTROL			
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	STA.	TO	STA.

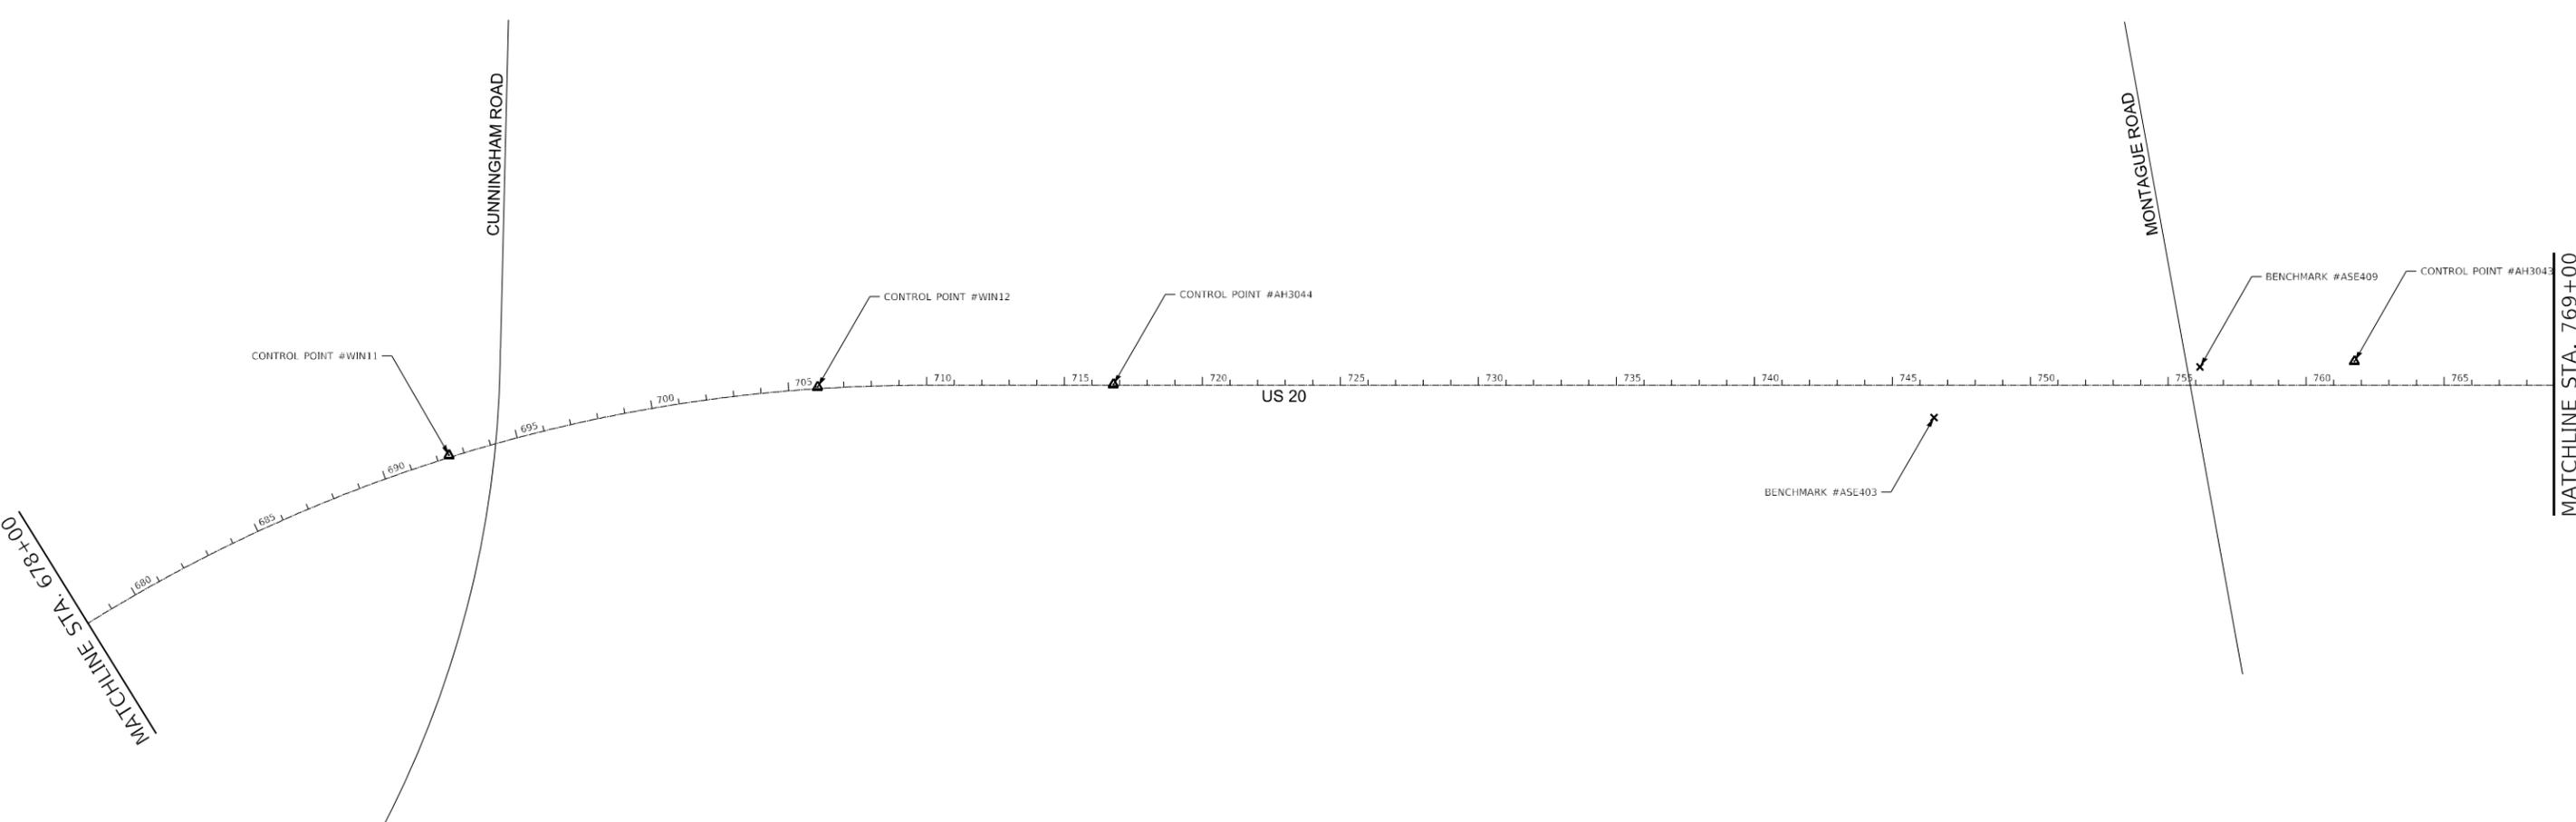F.A.P. RTE.	SECTION	COUNTY	TOTAL SHEETS	SHEET NO.
301	(1-1,1,2)RS-2	WINNEBAGO	158	50
CONTRACT NO. 64M18				
ILLINOIS FED. AID PROJECT				



MATCHLINE STA. 769+00

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**STATE OF ILLINOIS
DEPARTMENT OF TRANSPORTATION**

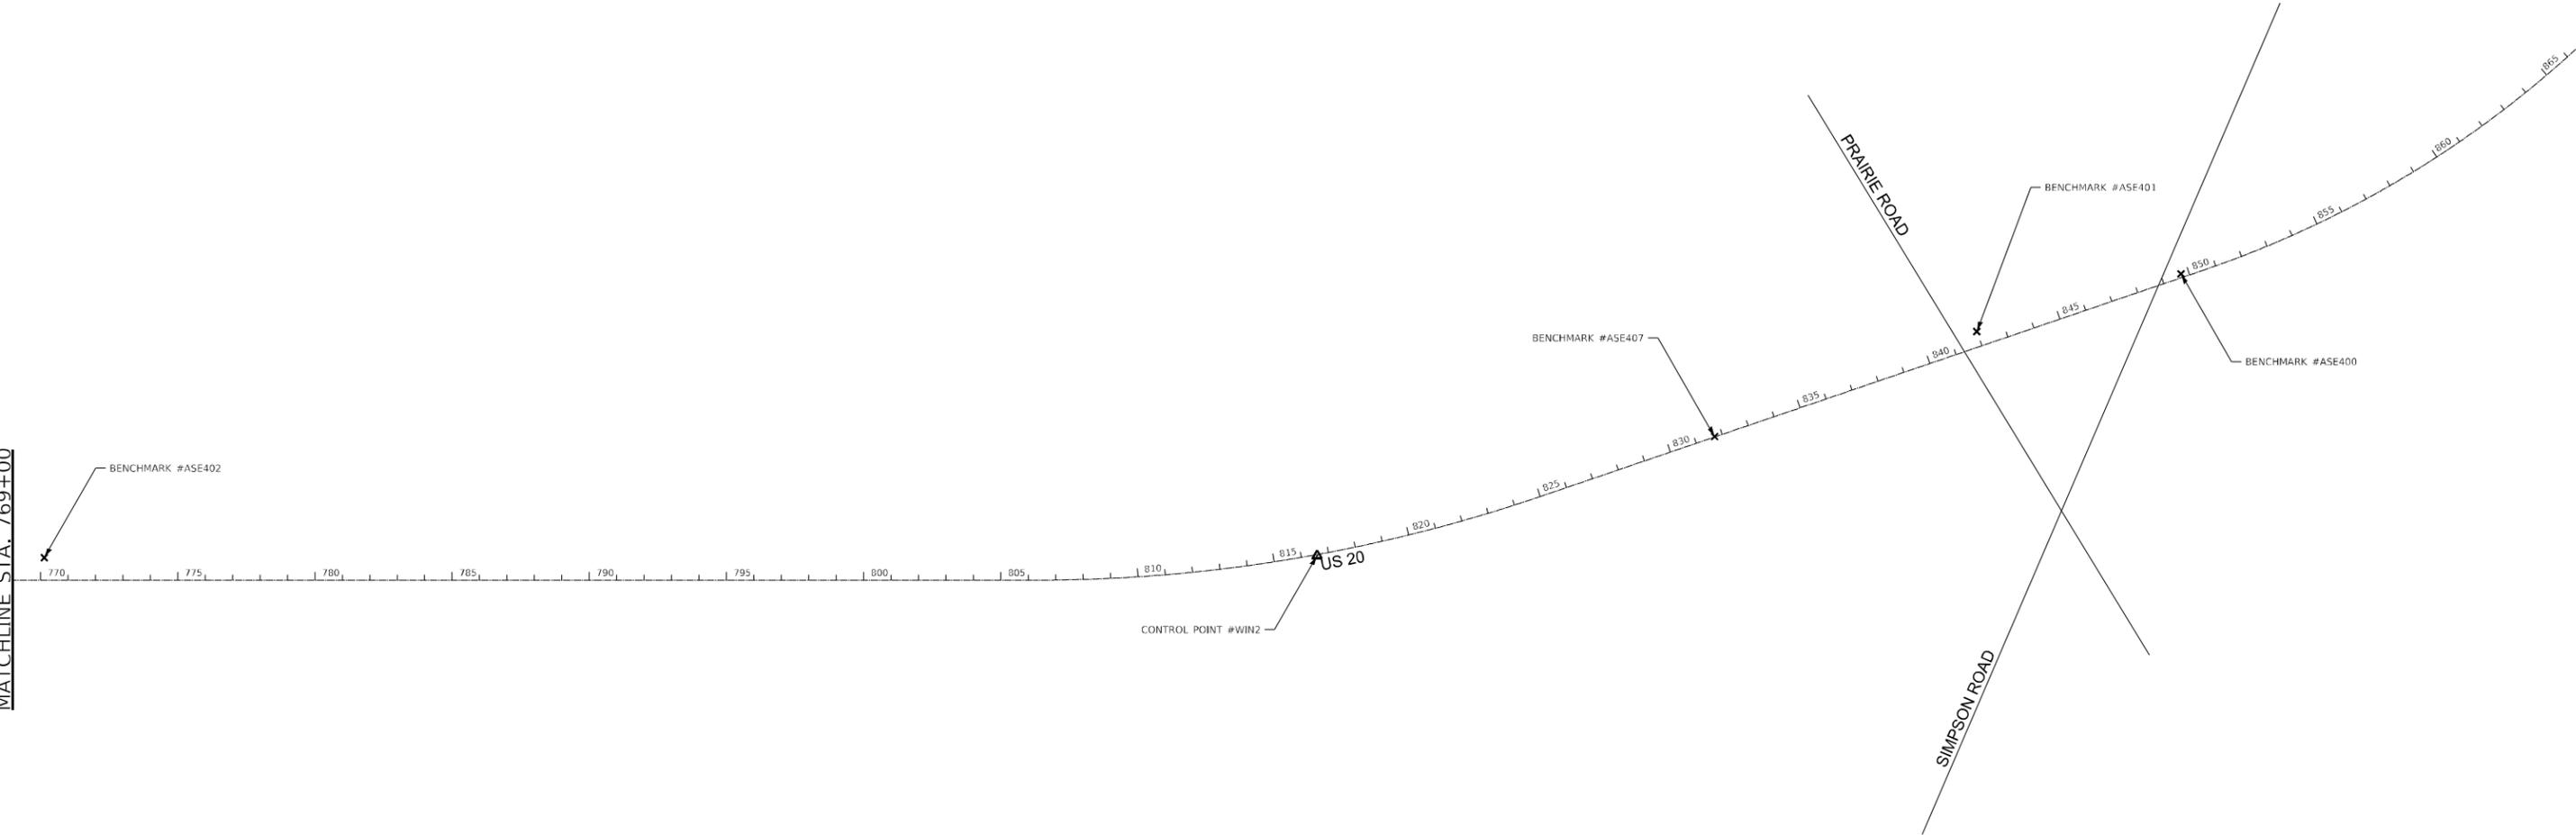**US ROUTE 20
HORIZONTAL & VERTICAL CONTROL**

F.A.P. RTE.	SECTION	COUNTY	TOTAL SHEETS	SHEET NO.
301	(1-1,1,2)RS-2	WINNEBAGO	158	51
CONTRACT NO. 64M18				
ILLINOIS FED. AID PROJECT				

SCALE:	SHEET	OF	SHEETS	STA.	TO	STA.
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EARTH WORK SCHEDULE

LOCATION	20200100			
	EARTH EXC (CUT)	EARTH EXC ADJ SHRINK 25%	EMBANK (FILL)	EARTH WORK BALANCE WASTE (+) SHORTAGE (-)
	CU YD	CU YD	CU YD	CU YD
EB SE CORRECTION 2.6%				
515 + 38 - 527 + 95	53	39	68	-29
527 + 95 - 535 + 72	26	20	244	-224
SUB TOTAL	79	59	312	-253
E. STATE ST. SE CORRECTION 1.5%				
17 + 43 - 25 + 00	31	23	3	20
25 + 00 - 33 + 80	67	50	6	44
SUB TOTAL	97	73	9	64
EB SE CORRECTION 5.4%				
538 + 74 - 548 + 65	44	33	148	-115
548 + 65 - 559 + 37	79	60	126	-67
SUB TOTAL	123	92	274	-182
CROSSOVER 1				
635 + 50 - 642 + 00	1039	779	62	718
SUB TOTAL	1039	779	62	718
CROSSOVER 2 AND SE CORRECTION 3.4%				
805 + 00 - 817 + 00	190	143	39	104
817 + 00 - 827 + 00	897	672	111	562
SUB TOTAL	1087	815	149	666
TOTAL	2425	1819	807	1012

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**STATE OF ILLINOIS
DEPARTMENT OF TRANSPORTATION**

EARTH WORK SCHEDULE

SCALE: SHEET OF SHEETS STA. TO STA.

F.A.P. RTE.	SECTION	COUNTY	TOTAL SHEETS	SHEET NO.
301	(1-1,1,2)RS-2	WINNEBAGO	158	52
CONTRACT NO. 64M18				
ILLINOIS FED. AID PROJECT				

Schedule of Quantities

21101615 TOPSOIL FURNISH AND PLACE, 4"

SQ YD	LOCATION	REMARK
2147	Sta 635 + 56 - 642 + 00	Crossover
1167	Sta 819 + 00 - 822 + 50	Crossover

3,313 TOTAL

25000210 SEEDING, CLASS 2A

ACRE	LOCATION	REMARK
0.50	Sta 635 + 56 - 642 + 00	Crossover
0.25	Sta 817 + 58 - 824 + 75	Crossover

0.75 TOTAL

25000750 MOWING

ACRE	LOCATION	REMARK
0.50	Sta 635 + 56 - 642 + 00	Crossover
0.25	Sta 817 + 58 - 824 + 75	Crossover

0.75 TOTAL

25100125 MULCH, METHOD 3

ACRE	LOCATION	REMARK
0.25	Sta 635 + 56 - 642 + 00	Crossover
0.25	Sta 817 + 58 - 824 + 75	Crossover

0.50 TOTAL

25100630 EROSION CONTROL BLANKET

SQ YD	LOCATION	REMARK
1002	Sta 635 + 56 - 642 + 00	Crossover
544	Sta 819 + 00 - 822 + 50	Crossover

1,546 TOTAL

280002500 TEMPORARY EROSION CONTROL SEEDING

POUND	LOCATION	REMARK
100	Sta 635 + 56 - 642 + 00	Crossover
50	Sta 817 + 58 - 824 + 75	Crossover

150 TOTAL

28000305 TEMPORARY DITCH CHECKS

FOOT	LOCATION	REMARK
120	Sta 635 + 56 - 642 + 00	10' ditch check every 50'
120	Sta 819 + 00 - 824 + 75	10' ditch check every 50'

240 TOTAL

30300112 AGGREGATE SUBGRADE IMPROVEMENT 12"

SQ YD	LOCATION	REMARK
572	Sta 635 + 56 - 642 + 00	Crossover (Under HMA Shoulders)
637	Sta 817 + 58 - 824 + 75	Crossover (Under HMA Shoulders)

1,210 TOTAL

40600985 PORTLAND CEMENT CONCRETE SURFACE REMOVAL - BUTT JOINT

SQ YD	LOCATION	REMARK
196	Sta 0 + 69 - 1 + 32	Montague Road EB ON Ramp
193	Sta 16 + 51 - 17 + 13	Montague Road EB OFF Ramp

389 TOTAL

40600990 TEMPORARY RAMP

SQ YD	LOCATION	REMARK
5,000	As Needed & Directed by the Resident (at mainline stops, sideroads, & entrances)	

5,000 TOTAL

40604000 HOT-MIX ASPHALT SURFACE COURSE, IL 9.5FG, MIX "C" N50

TON	LOCATION	(0.5" FILL FOR RUMBLE STRIP REMOVAL)	REMARK
21	Sta 15 + 29 - 37 + 82		EB STATE ST-RT
13	Sta 23 + 50 - 37 + 78		WB STATE ST - RT
186	Sta 493 + 00 - 692 + 28		EB - RT
50	Sta 493 + 00 - 546 + 42		WB - RT
15	Sta 526 + 27 - 542 + 11		WB STATE ST - RT
133	Sta 549 + 67 - 692 + 44		WB - RT
10	Sta 695 + 35 - 706 + 05		EB - RT
10	Sta 695 + 35 - 706 + 05		WB - RT
124	Sta 707 + 00 - 840 + 36		EB - RT
124	Sta 707 + 00 - 840 + 21		WB - RT
5	Sta 842 + 42 - 847 + 58		EB - RT
5	Sta 842 + 42 - 847 + 58		WB - RT

697 TOTAL

64200116 SHOULDER RUMBLE STRIPS, 16 INCH

FT	LOCATION	REMARK
EB STATE ST		
2055	Sta 17 + 27 - 37 + 82	EB STATE ST-RT
1885	Sta 17 + 27 - 36 + 12	EB STATE ST - LT
WB STATE ST		
1173	Sta 26 + 05 - 37 + 78	WB STATE ST - RT
1007	Sta 26 + 05 - 36 + 12	WB STATE ST - LT
US 20 - EB		
21305	Sta 493 + 00 - 706 + 05	EB - LT
21305	Sta 493 + 00 - 706 + 05	EB - RT
13336	Sta 707 + 00 - 840 + 36	EB - LT
13336	Sta 707 + 00 - 840 + 36	EB - RT
516	Sta 842 + 42 - 847 + 58	EB - LT
516	Sta 842 + 42 - 847 + 58	EB - RT
US 20 - WB		
5342	Sta 493 + 00 - 546 + 42	WB - LT
5342	Sta 493 + 00 - 546 + 42	WB - RT
15638	Sta 549 + 67 - 706 + 05	WB - LT
15638	Sta 549 + 67 - 706 + 05	WB - RT
13321	Sta 707 + 00 - 840 + 21	WB - LT
13321	Sta 707 + 00 - 840 + 21	WB - RT
516	Sta 842 + 42 - 847 + 58	WB - LT
516	Sta 842 + 42 - 847 + 58	WB - RT

146,068 TOTAL

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**STATE OF ILLINOIS
DEPARTMENT OF TRANSPORTATION**

SCHEDULE OF QUANTITIES

SCALE: SHEET OF SHEETS STA. TO STA.

F.A.P. RTE.	SECTION	COUNTY	TOTAL SHEETS	SHEET NO.
301	(1-1,1,2)RS-2	WINNEBAGO	158	52A
				CONTRACT NO. 64M18
		ILLINOIS	FED. AID PROJECT	

66700305 PERMANENT SURVEY MARKERS, TYPE II

EACH	LOCATION	REMARK
1	Directed by the Chief of Survey	Around Montague Road Intersection
1	TOTAL	

70300100 SHORT TERM PAVEMENT MARKING

FOOT	LOCATION	(1 Applications - Surface)	REMARK
WB STATE ST			
70	Sta 30 + 55	- 37 + 55	WHITE (30 - GAP - 10' DASH) WB STATE ST
US 20			
3545	Sta 493 + 00	- 847 + 49	EB
3545	Sta 493 + 00	- 847 + 49	WB
MERIDIAN RD RAMP			
32	Sta 0 + 96	- 9 + 04	WHITE - diagonal (100' - GAP - 4' DIAGONAL) MERIDIAN EB ON RAMP
52	Sta 0 + 94	- 14 + 00	MERIDIAN WB OFF RAMP
53	Sta 4 + 41	- 17 + 58	MERIDIAN EB OFF RAMP
40	Sta 9 + 65	- 19 + 61	MERIDIAN WB ON RAMP
MONTAGUE RD RAMP			
41	Sta 0 + 69	- 10 + 89	MONTAGUE EB ON RAMP
49	Sta 0 + 86	- 13 + 00	MONTAGUE WB OFF RAMP
49	Sta 5 + 00	- 17 + 14	MONTAGUE EB OFF RAMP
40	Sta 10 + 10	- 20 + 21	MONTAGUE WB ON RAMP
EB STATE ST			
90	Sta 15 + 29	- 37 + 82	
53	Sta 520 + 44	- 533 + 57	
WB STATE ST			
57	Sta 23 + 50	- 37 + 78	
36	Sta 533 + 03	- 542 + 11	
US 20			
1418	Sta 493 + 00	- 847 + 49	EB
1418	Sta 493 + 00	- 847 + 49	WB
MERIDIAN RD RAMP			
32	Sta 0 + 96	- 9 + 04	YELLOW - diagonal (100' - GAP - 4' DIAGONAL) MERIDIAN EB ON RAMP
52	Sta 0 + 94	- 14 + 00	MERIDIAN WB OFF RAMP
53	Sta 4 + 41	- 17 + 58	MERIDIAN EB OFF RAMP
40	Sta 9 + 65	- 19 + 61	MERIDIAN WB ON RAMP
MONTAGUE RD RAMP			
41	Sta 0 + 69	- 10 + 89	MONTAGUE EB ON RAMP
49	Sta 0 + 86	- 13 + 00	MONTAGUE WB OFF RAMP
49	Sta 5 + 00	- 17 + 14	MONTAGUE EB OFF RAMP
40	Sta 10 + 10	- 20 + 21	MONTAGUE WB ON RAMP
EB STATE ST			
90	Sta 15 + 29	- 37 + 82	
53	Sta 520 + 44	- 533 + 57	
WB STATE ST			
57	Sta 23 + 50	- 37 + 78	
36	Sta 533 + 03	- 542 + 11	
US 20			
1418	Sta 493 + 00	- 847 + 49	EB
1418	Sta 493 + 00	- 847 + 49	WB
EB STATE ST			
8	Sta 35 + 04		WHITE (LETTER & SYMBOLS) LT Turn Lane - 1 Stripe
8	Sta 36 + 06		LT Turn Lane - 1 Stripe
8	Sta 37 + 09		LT Turn Lane - 1 Stripe
US 20			
8	Sta 501 + 65		EB RT Turn Lane - 1 Stripe
8	Sta 502 + 70		EB RT Turn Lane - 1 Stripe
8	Sta 507 + 02		WB RT Turn Lane - 1 Stripe
8	Sta 507 + 03		WB RT Turn Lane - 1 Stripe
14,071	TOTAL		

70300150 SHORT TERM PAVEMENT MARKING REMOVAL

SQ FT	LOCATION	(Removal of Surface Only)
WB STATE ST		
23	Sta 30 + 55	- 37 + 55 WHITE (30 - GAP - 10' DASH) WB STATE ST
US 20		
1182	Sta 493 + 00	- 847 + 49 EB
1182	Sta 493 + 01	- 847 + 49 WB
MERIDIAN RD RAMP		
11	Sta 0 + 96	- 9 + 04 WHITE - diagonal (100' - GAP - 4' DIAGONAL) MERIDIAN EB ON RAMP
17	Sta 0 + 94	- 14 + 00 MERIDIAN WB OFF RAMP
18	Sta 4 + 41	- 17 + 58 MERIDIAN EB OFF RAMP
13	Sta 9 + 65	- 19 + 61 MERIDIAN WB ON RAMP
MONTAGUE RD RAMP		
14	Sta 0 + 69	- 10 + 89 MONTAGUE EB ON RAMP
16	Sta 0 + 86	- 13 + 00 MONTAGUE WB OFF RAMP
16	Sta 5 + 00	- 17 + 14 MONTAGUE EB OFF RAMP
13	Sta 10 + 10	- 20 + 21 MONTAGUE WB ON RAMP
EB STATE ST		
30	Sta 15 + 29	- 37 + 82 EB STATE ST
18	Sta 520 + 44	- 533 + 57 EB STATE ST - US20
WB STATE ST		
19	Sta 23 + 50	- 37 + 78 WB STATE ST
12	Sta 533 + 03	- 542 + 11 WB STATE ST - US20
US 20		
473	Sta 493 + 00	- 847 + 49 EB
473	Sta 493 + 00	- 847 + 49 WB
MERIDIAN RD RAMP		
18	Sta 4 + 41	- 17 + 58 YELLOW - diagonal (100' - GAP - 4' DIAGONAL) MERIDIAN EB OFF RAMP
11	Sta 0 + 96	- 9 + 04 MERIDIAN EB ON RAMP
17	Sta 0 + 94	- 14 + 00 MERIDIAN WB OFF RAMP
13	Sta 9 + 65	- 19 + 61 MERIDIAN WB ON RAMP
MONTAGUE RD RAMP		
16	Sta 5 + 00	- 17 + 14 MONTAGUE EB OFF RAMP
14	Sta 0 + 69	- 10 + 89 MONTAGUE EB ON RAMP
16	Sta 0 + 86	- 13 + 00 MONTAGUE WB OFF RAMP
13	Sta 10 + 10	- 20 + 21 MONTAGUE WB ON RAMP
EB STATE ST		
30	Sta 15 + 29	- 37 + 82 EB STATE ST
18	Sta 520 + 44	- 533 + 57 EB STATE ST
WB STATE ST		
19	Sta 23 + 50	- 37 + 78 WB STATE ST
12	Sta 533 + 03	- 542 + 11 WB STATE ST
US 20		
473	Sta 493 + 00	- 847 + 49 EB
473	Sta 493 + 00	- 847 + 49 WB
EB STATE ST		
15.6	Sta 35 + 04	WHITE (LETTER & SYMBOLS) LT Turn Lane - 1 Stripe
15.6	Sta 36 + 06	LT Turn Lane - 1 Stripe
15.6	Sta 37 + 09	LT Turn Lane - 1 Stripe
US 20		
15.6	Sta 501 + 65	EB RT Turn Lane - 1 Stripe
15.6	Sta 502 + 70	EB RT Turn Lane - 1 Stripe
15.6	Sta 507 + 02	WB RT Turn Lane - 1 Stripe
15.6	Sta 507 + 03	WB RT Turn Lane - 1 Stripe
4,781	TOTAL	

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DRAWN -	REVISED -	
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STATE OF ILLINOIS
DEPARTMENT OF TRANSPORTATION

SCHEDULE OF QUANTITIES

SCALE:	SHEET	OF	SHEETS	STA.	TO STA.
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F.A.P. RTE.	SECTION	COUNTY	TOTAL SHEETS	SHEET NO.
301	(1-1,1,2)RS-2	WINNEBAGO	158	53
CONTRACT NO. 64M18				
ILLINOIS FED. AID PROJECT				

78300200 RAISED REFLECTIVE PAVEMENT MARKER REMOVAL

EACH	LOCATION		
<u>US 20 - EB</u>			
32	Sta 17 + 26	-	34 + 83
8	Sta 361 + 12	-	371 + 17
622	Sta 493 + 00	-	847 + 49
6	Sta 501 + 45	-	502 + 90
54	Sta 520 + 56	-	535 + 56
26	Sta 610 + 68	-	617 + 77
12	Sta 615 + 04	-	617 + 78
26	Sta 739 + 90	-	746 + 99
8	Sta 744 + 99	-	747 + 00
<u>US 20 - WB</u>			
14	Sta 30 + 55	-	37 + 55
622	Sta 493 + 01	-	847 + 49
4	Sta 503 + 83	-	504 + 83
26	Sta 635 + 84	-	643 + 20
15	Sta 635 + 84	-	639 + 27
37	Sta 764 + 49	-	774 + 75
9	Sta 764 + 49	-	766 + 99
1,521	TOTAL		

78300201 PAVEMENT MARKING REMOVAL - GRINDING

SQ FT	LOCATION		
(4" WIDE REMOVAL FOR STAGING PURPOSES AS NEEDED)			
1000	Sta 493 + 00	-	847 + 49 EB - WB
1,000	TOTAL		

X2700006 PREFORMED PLASTIC PAVEMENT MARKING, TYPE D - LINE 4"

FOOT	LOCATION			REMARK
(See Pavement Marking Sheets)				
<u>MERIDIAN RD RAMP</u>				
808	Sta 0 + 96	-	9 + 04	MERIDIAN EB ON RAMP
1006	Sta 0 + 94	-	11 + 00	MERIDIAN WB OFF RAMP
1042	Sta 7 + 16	-	17 + 58	MERIDIAN EB OFF RAMP
996	Sta 9 + 65	-	19 + 61	MERIDIAN WB ON RAMP
<u>MONTAGUE RD RAMP</u>				
1020	Sta 0 + 69	-	10 + 89	MONTAGUE EB ON RAMP
973	Sta 0 + 86	-	10 + 59	MONTAGUE WB OFF RAMP
1014	Sta 7 + 00	-	17 + 14	MONTAGUE EB OFF RAMP
1011	Sta 10 + 10	-	20 + 21	MONTAGUE WB ON RAMP
<u>EB STATE ST</u>				
2055	Sta 17 + 27	-	37 + 82	EB STATE ST
502	Sta 348 + 83	-	373 + 34	EB STATE ST
<u>WB STATE ST</u>				
1428	Sta 235 + 50	-	377 + 78	WB STATE ST
<u>US 20</u>				
35449	Sta 493 + 00	-	847 + 49	EB
4911	Sta 493 + 00	-	542 + 11	WB
30284	Sta 544 + 65	-	847 + 49	WB
<u>MERIDIAN RD RAMP</u>				
1042	Sta 7 + 16	-	17 + 58	MERIDIAN EB OFF RAMP
700	Sta 0 + 96	-	7 + 96	MERIDIAN EB ON RAMP
1006	Sta 0 + 94	-	11 + 00	MERIDIAN WB OFF RAMP
701	Sta 12 + 60	-	19 + 61	MERIDIAN WB ON RAMP
<u>MONTAGUE RD RAMP</u>				
1004	Sta 7 + 10	-	17 + 14	MONTAGUE EB OFF RAMP
931	Sta 0 + 69	-	10 + 00	MONTAGUE EB ON RAMP
973	Sta 0 + 86	-	10 + 59	MONTAGUE WB OFF RAMP
916	Sta 11 + 05	-	20 + 21	MONTAGUE WB ON RAMP
<u>EB STATE ST</u>				
1998	Sta 17 + 27	-	37 + 25	EB STATE ST
<u>WB STATE ST</u>				
1119	Sta 26 + 06	-	37 + 25	WB STATE ST
<u>US 20</u>				
2756	Sta 493 + 00	-	520 + 56	EB
35449	Sta 493 + 00	-	847 + 49	WB
31194	Sta 535 + 55	-	847 + 49	EB
162,288	TOTAL			

X2700008 PERFORMED THERMOPLASTIC PAVEMENT MARKING - LETTERS AND SYMBOLS

SQ FT	LOCATION		
(See Pavement Marking Sheets)			
15.6	Sta 35 + 04	-	12.92 LT
15.6	Sta 36 + 06	-	20.45 LT
15.6	Sta 37 + 09	-	21.58 LT
15.6	Sta 501 + 65	-	21.63 RT
15.6	Sta 502 + 70	-	21.51 RT
15.6	Sta 504 + 03	-	22.05 LT
15.6	Sta 504 + 63	-	21.49 RT
109.2	TOTAL		

X2700010 PREFORMED PLASTIC PAVEMENT MARKING, TYPE D - LINE 6"

FOOT	LOCATION			REMARK
(See Pavement Marking Sheets)				
<u>WB STATE ST</u>				
175	Sta 30 + 55	-	37 + 55	STATE ST (30 - GAP - 10' DASH)
<u>US 20</u>				
8732	Sta 493 + 00	-	847 + 49	EB CENTERLINE @ 30 - GAP - 10' DASH
8682	Sta 493 + 00	-	847 + 49	WB CENTERLINE @ 30 - GAP - 10' DASH
17,590	TOTAL			

X2700012 PREFORMED PLASTIC PAVEMENT MARKING, TYPE D - LINE 8"

FOOT	LOCATION			REMARK
(See Pavement Marking Sheets)				
<u>FALCONER RD</u>				
145	Sta 501 + 45	-	502 + 90	EB RT (FALCONER RD)
80	Sta 504 + 03	-	504 + 83	WB RT (FALCONER RD)
<u>MERIDIAN RD RAMP</u>				
38	Sta 613 + 28	-	614 + 80	MERIDIAN WB ON RAMP (30 - GAP - 10' DASH)
219	Sta 614 + 80	-	616 + 99	MERIDIAN WB ON RAMP
548	Sta 615 + 04	-	617 + 78	MERIDIAN EB OFF RAMP - LT - RT
108	Sta 634 + 29	-	635 + 37	MERIDIAN EB ON RAMP
67	Sta 635 + 37	-	638 + 04	MERIDIAN EB ON RAMP (30 - GAP - 10' DASH)
686	Sta 635 + 84	-	639 + 27	MERIDIAN WB OFF RAMP - LT - RT
<u>MONTAGUE RD RAMP</u>				
48	Sta 742 + 21	-	744 + 11	MONTAGUE WB ON RAMP (30 - GAP - 10' DASH)
402	Sta 744 + 99	-	747 + 00	MONTAGUE EB OFF RAMP - LT - RT
192	Sta 744 + 11	-	746 + 03	MONTAGUE WB ON RAMP
498	Sta 764 + 50	-	766 + 99	MONTAGUE WB OFF RAMP - LT - RT
97	Sta 765 + 80	-	766 + 77	MONTAGUE EB ON RAMP
98	Sta 766 + 77	-	770 + 67	MONTAGUE EB ON RAMP (30 - GAP - 10' DASH)
<u>EB STATE ST</u>				
82	Sta 32 + 37	-	34 + 83	EB STATE ST
<u>US 20</u>				
2998	Sta 520 + 56	-	535 + 55	EB MEDIAN - LT RT
2322	Sta 533 + 03	-	544 + 64	WB MEDIAN - LT RT
8,627	TOTAL			

X2700025 PREFORMED PLASTIC PAVEMENT MARKING, TYPE D - LINE 9"

FOOT	LOCATION			REMARK
(See Pavement Marking Sheets)				
<u>US 20</u>				
70	Sta 692 + 61	-	695 + 01	EB CENTERLINE (30 - GAP - 10' DASH)
20	Sta 706 + 11	-	706 + 95	EB CENTERLINE (30 - GAP - 10' DASH)
40	Sta 840 + 59	-	842 + 11	EB CENTERLINE (30 - GAP - 10' DASH)
60	Sta 546 + 74	-	549 + 35	WB CENTERLINE (30 - GAP - 10' DASH)
60	Sta 692 + 61	-	695 + 01	WB CENTERLINE (30 - GAP - 10' DASH)
20	Sta 706 + 11	-	706 + 95	WB CENTERLINE (30 - GAP - 10' DASH)
40	Sta 840 + 59	-	842 + 11	WB CENTERLINE (30 - GAP - 10' DASH)
310	TOTAL			

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**STATE OF ILLINOIS
DEPARTMENT OF TRANSPORTATION**

SCHEDULE OF QUANTITIES

SCALE:	SHEET	OF	SHEETS	STA.	TO STA.
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F.A.P. RTE.	SECTION	COUNTY	TOTAL SHEETS	SHEET NO.
301	(1-1,1,2)RS-2	WINNEBAGO	158	55
			CONTRACT NO. 64M18	
		ILLINOIS	FED. AID PROJECT	

X2700026 PREFORMED PLASTIC PAVEMENT MARKING, TYPE D - LINE 12"

FOOT	LOCATION	(See Pavement Marking Sheets)		REMARK
	<u>MERIDIAN RD RAMP</u>			White
108	Sta 615 + 03	-	617 + 77	MERIDIAN EB OFF RAMP
129	Sta 635 + 84	-	639 + 53	MERIDIAN WB OFF RAMP
	<u>MONTAGUE RD RAMP</u>			
56	Sta 744 + 99	-	747 + 00	MONTAGUE EB OFF RAMP
80	Sta 764 + 49	-	766 + 99	MONTAGUE WB OFF RAMP
	<u>US 20</u>			
468	Sta 520 + 55	-	535 + 55	EB
232	Sta 533 + 03	-	544 + 65	WB
	<u>EB STATE ST</u>			Yellow
389	Sta 12 + 83	-	32 + 37	EB STATE ST
93	Sta 32 + 37	-	35 + 03	EB STATE ST
89	Sta 36 + 12	-	37 + 25	EB + WB STATE ST
	<u>WB STATE ST</u>			
160	Sta 26 + 05	-	30 + 26	WB STATE ST
1,804	TOTAL			

X0320100 GROOVING FOR RECESSED PAVEMENT MARKING - 10"

FOOT	LOCATION	(See Pavement Marking Sheets)		REMARK
	<u>US 20</u>			White
70	Sta 692 + 61	-	695 + 01	EB CENTERLINE (30 - GAP - 10' DASH)
20	Sta 706 + 11	-	706 + 95	EB CENTERLINE (30 - GAP - 10' DASH)
40	Sta 840 + 59	-	842 + 11	EB CENTERLINE (30 - GAP - 10' DASH)
60	Sta 546 + 74	-	549 + 35	WB CENTERLINE (30 - GAP - 10' DASH)
60	Sta 692 + 61	-	695 + 01	WB CENTERLINE (30 - GAP - 10' DASH)
20	Sta 706 + 11	-	706 + 95	WB CENTERLINE (30 - GAP - 10' DASH)
40	Sta 840 + 59	-	842 + 11	WB CENTERLINE (30 - GAP - 10' DASH)
310	TOTAL			

X0325201 SHOULDER RUMBLE STRIP REMOVAL

SQ YD	LOCATION	(3 FT WIDE REMOVAL INCLUDING EXISTING PAVEMENT MARKING)		REMARK
	<u>EB STATE ST</u>			
751	Sta 15 + 29	-	37 + 82	EB STATE ST- RT
	<u>WB STATE ST</u>			
476	Sta 23 + 50	-	37 + 78	WB STATE ST - RT
528	Sta 526 + 27	-	542 + 11	WB STATE ST - RT
	<u>US 20</u>			
6643	Sta 493 + 00	-	692 + 28	EB - RT
357	Sta 695 + 35	-	706 + 05	EB - RT
4445	Sta 707 + 00	-	840 + 36	EB - RT
172	Sta 842 + 42	-	847 + 58	EB - RT
1781	Sta 493 + 00	-	546 + 42	WB - RT
4759	Sta 549 + 67	-	692 + 44	WB - RT
357	Sta 695 + 35	-	706 + 05	WB - RT
4440	Sta 707 + 00	-	840 + 21	WB - RT
172	Sta 842 + 42	-	847 + 58	WB - RT
24,880	TOTAL			

X7830060 GROOVING FOR RECESSED PAVEMENT MARKING - LETTER AND SYMBOLS

SQ FT	LOCATION	(See Pavement Marking Sheets)		REMARK
				White
19.5	Sta 35 + 04	-		12.92 LT
19.5	Sta 36 + 06	-		20.45 LT
19.5	Sta 37 + 09	-		21.58 LT
19.5	Sta 501 + 65	-		21.63 RT
19.5	Sta 502 + 70	-		21.51 RT
19.5	Sta 504 + 03	-		22.05 LT
19.5	Sta 504 + 63	-		21.49 RT
136.5	TOTAL			

X7830070 GROOVING FOR RECESSED PAVEMENT MARKING - 5"

FOOT	LOCATION	(See Pavement Marking Sheets)		REMARK
	<u>MERIDIAN RD RAMP</u>			White
808	Sta 0 + 96	-	9 + 04	MERIDIAN EB ON RAMP
1006	Sta 0 + 94	-	11 + 00	MERIDIAN WB OFF RAMP
1042	Sta 7 + 16	-	17 + 58	MERIDIAN EB OFF RAMP
996	Sta 9 + 65	-	19 + 61	MERIDIAN WB ON RAMP
	<u>MONTAGUE RD RAMP</u>			
1020	Sta 0 + 69	-	10 + 89	MONTAGUE EB ON RAMP
973	Sta 0 + 86	-	10 + 59	MONTAGUE WB OFF RAMP
1014	Sta 7 + 00	-	17 + 14	MONTAGUE EB OFF RAMP
1011	Sta 10 + 10	-	20 + 21	MONTAGUE WB ON RAMP
	<u>EB STATE ST</u>			
2055	Sta 17 + 27	-	37 + 82	EB STATE ST
502	Sta 348 + 83	-	373 + 34	EB STATE ST
	<u>WB STATE ST</u>			
1428	Sta 235 + 50	-	377 + 78	WB STATE ST
	<u>US 20</u>			
35449	Sta 493 + 00	-	847 + 49	EB
4911	Sta 493 + 00	-	542 + 11	WB
30284	Sta 544 + 65	-	847 + 49	WB
	<u>MERIDIAN RD RAMP</u>			Yellow
1042	Sta 7 + 16	-	17 + 58	MERIDIAN EB OFF RAMP
700	Sta 0 + 96	-	7 + 96	MERIDIAN EB ON RAMP
1006	Sta 0 + 94	-	11 + 00	MERIDIAN WB OFF RAMP
701	Sta 12 + 60	-	19 + 61	MERIDIAN WB ON RAMP
	<u>MONTAGUE RD RAMP</u>			
1004	Sta 7 + 10	-	17 + 14	MONTAGUE EB OFF RAMP
931	Sta 0 + 69	-	10 + 00	MONTAGUE EB ON RAMP
973	Sta 0 + 86	-	10 + 59	MONTAGUE WB OFF RAMP
916	Sta 11 + 05	-	20 + 21	MONTAGUE WB ON RAMP
	<u>EB STATE ST</u>			
1998	Sta 17 + 27	-	37 + 25	EB STATE ST
	<u>WB STATE ST</u>			
1119	Sta 26 + 06	-	37 + 25	WB STATE ST
	<u>US 20</u>			
2756	Sta 493 + 00	-	520 + 56	EB
35449	Sta 493 + 00	-	847 + 49	WB
31194	Sta 535 + 55	-	847 + 49	EB
162,288	TOTAL			

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**STATE OF ILLINOIS
DEPARTMENT OF TRANSPORTATION**

SCHEDULE OF QUANTITIES

SCALE:	SHEET	OF	SHEETS	STA.	TO	STA.
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F.A.P. RTE.	SECTION	COUNTY	TOTAL SHEETS	SHEET NO.
301	(1-1,1,2)RS-2	WINNEBAGO	158	56
			CONTRACT NO. 64M18	
		ILLINOIS	FED. AID PROJECT	

X7830074 GROOVING FOR RECESSED PAVEMENT MARKING - 7"

FOOT	LOCATION	(See Pavement Marking Sheets)	REMARK
	<u>WB STATE ST</u>		White
175	Sta 30 + 55 - 37 + 55		STATE ST (30 - GAP - 10' DASH)
	<u>US 20</u>		
8732	Sta 493 + 00 - 847 + 49		EB CENTERLINE @ 30 - GAP - 10' DASH
8682	Sta 493 + 00 - 847 + 49		WB CENTERLINE @ 30 - GAP - 10' DASH
17,590	TOTAL		

X7830076 GROOVING FOR RECESSED PAVEMENT MARKING - 9"

FOOT	LOCATION	(See Pavement Marking Sheets)	REMARK
	<u>FALCONER RD</u>		White
145	Sta 501 + 45 - 502 + 90		EB RT (FALCONER RD)
80	Sta 504 + 03 - 504 + 83		WB RT (FALCONER RD)
	<u>MERIDIAN RD RAMP</u>		
38	Sta 613 + 28 - 614 + 80		MERIDIAN WB ON RAMP (30 - GAP - 10' DASH)
219	Sta 614 + 80 - 616 + 99		MERIDIAN WB ON RAMP
548	Sta 615 + 04 - 617 + 78		MERIDIAN EB OFF RAMP - LT RT
108	Sta 634 + 29 - 635 + 37		MERIDIAN EB ON RAMP
67	Sta 635 + 37 - 638 + 04		MERIDIAN EB ON RAMP (30 - GAP - 10' DASH)
686	Sta 635 + 84 - 639 + 27		MERIDIAN WB OFF RAMP - LT RT
	<u>MONTAGUE RD RAMP</u>		
48	Sta 742 + 21 - 744 + 11		MONTAGUE WB ON RAMP (30 - GAP - 10' DASH)
402	Sta 744 + 99 - 747 + 00		MONTAGUE EB OFF RAMP - LT RT
192	Sta 744 + 11 - 746 + 03		MONTAGUE WB ON RAMP
498	Sta 764 + 50 - 766 + 99		MONTAGUE WB OFF RAMP - LT RT
97	Sta 765 + 80 - 766 + 77		MONTAGUE EB ON RAMP
98	Sta 766 + 77 - 770 + 67		MONTAGUE EB ON RAMP (30 - GAP - 10' DASH)
	<u>EB STATE ST</u>		
82	Sta 32 + 37 - 34 + 83		EB STATE ST
	<u>US 20</u>		
2998	Sta 520 + 56 - 535 + 55		EB MEDIAN - LT RT
2322	Sta 533 + 03 - 544 + 64		WB MEDIAN - LT RT
8,627	TOTAL		

X7830078 GROOVING FOR RECESSED PAVEMENT MARKING - 13"

FOOT	LOCATION	(See Pavement Marking Sheets)	REMARK
	<u>MERIDIAN RD RAMP</u>		White
108	Sta 615 + 03 - 617 + 77		MERIDIAN EB OFF RAMP
129	Sta 635 + 84 - 639 + 53		MERIDIAN WB OFF RAMP
	<u>MONTAGUE RD RAMP</u>		
56	Sta 744 + 99 - 747 + 00		MONTAGUE EB OFF RAMP
80	Sta 764 + 49 - 766 + 99		MONTAGUE WB OFF RAMP
	<u>US 20</u>		
468	Sta 520 + 55 - 535 + 55		EB
232	Sta 533 + 03 - 544 + 65		WB
			Yellow
	<u>EB STATE ST</u>		
389	Sta 17 + 26 - 32 + 37		EB STATE ST
93	Sta 32 + 37 - 35 + 03		EB STATE ST
89	Sta 36 + 12 - 37 + 25		EB + WB STATE ST
	<u>WB STATE ST</u>		
160	Sta 26 + 05 - 30 + 26		WB STATE ST
1,804	TOTAL		

X7830084 GROOVING FOR RECESSED PAVEMENT MARKING - 19"

FOOT	LOCATION	(See Pavement Marking Sheets)	REMARK
	<u>US 20</u>		White
12	Sta 568 + 20		Aerial Speed Check Zone Stripes (WB)
12	Sta 574 + 80		Aerial Speed Check Zone Stripes (WB)
12	Sta 581 + 40		Aerial Speed Check Zone Stripes (WB)
12	Sta 586 + 50		Aerial Speed Check Zone Stripes (EB)
12	Sta 595 + 10		Aerial Speed Check Zone Stripes (EB)
12	Sta 601 + 70		Aerial Speed Check Zone Stripes (EB)
72	TOTAL		

Z0008758 AERIAL SPEED CHECK MARKING

FOOT	LOCATION	REMARK
	<u>US 20</u>	
12	Sta 568 + 20	Aerial Speed Check Zone Stripes (WB)
12	Sta 574 + 80	Aerial Speed Check Zone Stripes (WB)
12	Sta 581 + 40	Aerial Speed Check Zone Stripes (WB)
12	Sta 588 + 50	Aerial Speed Check Zone Stripes (EB)
12	Sta 595 + 10	Aerial Speed Check Zone Stripes (EB)
12	Sta 601 + 70	Aerial Speed Check Zone Stripes (EB)
72	TOTAL	

Z0058670 GRADING AND SHAPING FORESLOPES

UNIT	LOCATION	REMARK
	<u>EB STATE ST</u>	
34	Sta 17 + 24 - 34 + 40	LT - RT
	<u>WB STATE ST</u>	
17	Sta 26 + 05 - 34 + 40	LT - RT
	<u>US 20 EB</u>	
44	Sta 493 + 00 - 515 + 21	LT - RT
20	Sta 515 + 21 - 535 + 33	RT
6	Sta 535 + 33 - 538 + 34	LT - RT
21	Sta 538 + 34 - 559 + 76	RT
258	Sta 559 + 76 - 688 + 89	LT - RT
165	Sta 722 + 50 - 804 + 97	LT - RT
22	Sta 804 + 97 - 826 + 51	RT
10	Sta 826 + 51 - 831 + 73	LT - RT
	<u>US 20 WB</u>	
107	Sta 493 + 00 - 546 + 42	LT - RT
23	Sta 553 + 35 - 565 + 00	LT - RT
254	Sta 563 + 40 - 690 + 64	LT - RT
165	Sta 722 + 50 - 804 + 97	LT - RT
22	Sta 804 + 97 - 826 + 51	RT
9	Sta 826 + 51 - 831 + 01	LT - RT
1,127	TOTAL	

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**STATE OF ILLINOIS
DEPARTMENT OF TRANSPORTATION**

SCHEDULE OF QUANTITIES				
SCALE:	SHEET	OF	SHEETS	STA. TO STA.

F.A.P. RTE.	SECTION	COUNTY	TOTAL SHEETS	SHEET NO.
301	(1-1,1,2)RS-2	WINNEBAGO	158	57
			CONTRACT NO. 64M18	
		ILLINOIS	FED. AID PROJECT	

MODEL: Default
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Location	Remarks	Length	MainLine Surface		Shoulder		40600290*	40600295*	40602965**	40603218**	40604000**	40604162**	40604122***	40800050**	44000100
			Width (Ft)	Sq Yd	Width (Ft)	Sq Yd	Bituminous Materials (Tack Coat)	Polymer Bituminous Materials (Tack Coat)	HMA Binder Course IL-9.5FG N50	Polymerized HMA Binder Course IL-9.5FG N70	Hot-Mix Asphalt Surface Course, IL-9.5FG, MIX "C" N50	Polymerized HMA Surface Course, IL-9.5, MIX "D" N70	Polymerized HMA Surface Course, IL-9.5, MIX "E", N70	Incidental Hot-Mix Asphalt Surfacing	Pavement Removal
		Feet	Width (Ft)	Sq Yd	Width (Ft)	Sq Yd	Pound	Pound	Ton	Ton	Ton	Ton	Ton	Ton	Sq Yd
WESTBOUND															
Sta 493 + 00 - 494 + 15	Taper 3 3/4" - 6"	115	24	306.7	16	204.4	138.0	207.0	22.9	34.3	25.8	35.9			
Sta 494 + 15 - 503 + 85		970	24	2,586.7	16	1,724.4	1,164.0	1746.0	193.1	289.7	217.3	302.5			
Sta 503 + 85 - 506 + 55	Right Turn to W State Rd	270	var	1,217.2	var	370.7	250.2	821.6	41.5	136.3	46.7	139.9			
Sta 506 + 55 - 524 + 56		1,801	24	4,802.7	16	3,201.8	2,161.2	3241.8	353.6	537.9	403.4	561.7			
Sta 524 + 56 - 526 + 72		216	24	576.0	14	336.0	226.8	388.8	37.6	64.5	42.3	67.4			
Sta 526 + 72 - 528 + 64	(STATE ST) merge lane	192	var	910.7	14	298.7	201.6	614.7	33.5	102.0	37.6	104.5			
Sta 528 + 64 - 537 + 70	(STATE ST) merge lane + Mix E: Start	906	var	3,386.6	14	1,409.3	951.3	2286.0	157.8	379.3	177.6	391.3			
Sta 537 + 70 - 544 + 64	(STATE ST) merge lane + gore	694	48	3,701.3	14	1,438.6	971.0	2498.4	161.1	414.5	181.3	449.6			
Sta 544 + 64 - 545 + 27		63	24	168.0	14	98.0	66.2	113.4	11.0	18.8	12.3	20.8			
Sta 545 + 27 - 546 + 42	Taper 6" - 3 3/4"	115	24	306.7	14	178.9	120.8	207.0	20.0	34.3	22.5	38.0			
Sta 546 + 42 - 549 + 67	Paving Omissions	325							-	-	-				
Sta 549 + 67 - 553 + 35	3 3/4" mill & fill	368	24	981.3	14	572.4	386.4	662.4	64.1	109.9	72.1	121.6			
Sta 553 + 35 - 554 + 50	Taper 3 3/4" - 6"	115	24	306.7	14	178.9	120.8	207.0	20.0	34.3	22.5	38.0			
Sta 554 + 50 - 555 + 03	Mix E - End	53	24	141.3	14	82.4	55.7	95.4	9.2	15.8	10.4	17.5			
Sta 555 + 03 - 565 + 00		997	24	2,658.7	14	1,550.9	1,046.9	1794.6	173.7	297.8	195.4	311.0			
565+00 BK = 563+40 AH															
Sta 563 + 40 - 604 + 25		4,085	24	10,893.3	14	6,354.4	4,289.3	7353.0	711.7	1,220.1	800.7	1,274.1			
Sta 604 + 25 - 616 + 95	Meridian RD on ramp	1,270	var	4,864.1	12	1,926.6	1,300.4	3283.3	215.8	544.8	242.7	561.6			
Sta 616 + 95 - 635 + 82		1,887	24	5,032.0	14	2,935.3	1,981.4	3396.6	328.8	563.6	369.9	588.5			
Sta 635 + 82 - 643 + 20	Meridian RD off ramp	738	var	2,940.0	12	1,293.9	873.4	1984.5	144.9	329.3	163.0	339.0			
Sta 643 + 20 - 689 + 49		4,629	24	12,344.0	14	7,200.7	4,860.5	8332.2	806.5	1,382.5	907.3	1,443.7			
Sta 689 + 49 - 690 + 64	Taper 6" - 3 3/4"	115	24	306.7	14	178.9	120.8	207.0	20.0	34.3	22.5	35.9			
Sta 690 + 64 - 692 + 28	3 3/4" mill & fill	164	24	437.3	14	255.1	172.2	295.2	28.6	49.0	32.1	51.1			
Sta 692 + 28 - 695 + 34	Paving Omissions	306							-	-					
Sta 695 + 34 - 705 + 81	3 3/4" mill & fill	1,047	24	2,792.0	14	1,628.7	1,099.4	1884.6	182.4	312.7	205.2	326.5			
Sta 705 + 81 - 707 + 25	Paving Omissions	144													
Sta 707 + 25 - 722 + 50	3 3/4" mill & fill	1,525	24	4,066.7	14	2,372.2	1,601.3	2745.0	265.7	455.5	298.9	475.6			
Sta 722 + 50 - 723 + 65	Taper 3 3/4" - 6"	115	24	306.7	14	178.9	120.8	207.0	20.0	34.3	22.5	35.9			
Sta 723 + 65 - 734 + 00		1,035	24	2,760.0	14	1,610.0	1,086.8	1863.0	180.3	309.1	202.9	322.8			
Sta 734 + 00 - 746 + 04	Montague RD on ramp	1,204	var	4,625.4	12	1,751.7	1,182.4	3122.2	196.2	518.0	220.7	534.0			
Sta 746 + 04 - 764 + 48		1,844	24	4,917.3	14	2,868.4	1,936.2	3319.2	321.3	550.7	361.4	575.1			
Sta 764 + 48 - 771 + 74	Montague RD off ramp	726	var	1,936.0	12	1,149.3	775.8	1306.8	128.7	216.8	144.8	226.4			
Sta 771 + 74 - 804 + 97		3,323	24	9,836.7	14	5,169.1	3,489.2	6639.8	578.9	1,101.7	651.3	1,145.6			
Sta 804 + 97 - 826 + 51	Super Correction	2,154	24	5,744.0	14	3,350.7	9,750.2	2584.8	375.3	643.3	422.2	671.8			
Sta 826 + 51 - 829 + 86		335	24	893.3	14	521.1	351.8	603.0	58.4	100.1	65.7	104.5			
Sta 829 + 86 - 831 + 01	Taper 6" - 3 3/4"	115	24	306.7	14	178.9	120.8	207.0	20.0	34.3	22.5	35.9			
Sta 831 + 01 - 840 + 28	3 3/4" mill & fill	927	24	2,472.0	14	1,442.0	973.4	1668.6	161.5	276.9	181.7	289.1			
Sta 840 + 28 - 842 + 42	Paving Omissions	214													
Sta 842 + 42 - 847 + 49	3 3/4" mill & fill	507	24	1,352.0	14	788.7	532.4	912.6	88.3	151.4	99.4	158.1			
SUB TOTAL							44,479	66,799	6,138	11,298	6,905	11,110	686		

* Bituminous Materials (Tack Coat) Rate of Application = 0.05 Lb / Sq Ft on Existing HMA, 0.025 Lb / Sq Ft Between Lifts
 ** Hot-Mix Asphalt Rate of Application = 112 Lbs / Sq Yd / in
 *** Hot-Mix Asphalt Rate of Application = 119 Lbs / Sq Yd / in

USER NAME = anikneyde	DESIGNED -	REVISED -
DRAWN -	REVISED -	
PLOT SCALE = 100,0000' / in.	CHECKED -	REVISED -
PLOT DATE = Mar-19-2021 04:42:10 PM	DATE -	REVISED -

STATE OF ILLINOIS
DEPARTMENT OF TRANSPORTATION

HOT-MIX ASPHALT SCHEDULE

SCALE: SHEET OF SHEETS STA. TO STA.

F.A.P. RTE.	SECTION	COUNTY	TOTAL SHEETS	SHEET NO.
301	(1-1,1,2)RS-2	WINNEBAGO	158	58
CONTRACT NO. 64M18				
ILLINOIS FED. AID PROJECT				

Location	Remarks	Length	MainLine Surface		Shoulder		40600290*	40600295*	40602965**	40603218**	40604000**	40604162**	40604122***	40800050**	44000100
			Feet	Width (Ft)	Sq Yd	Width (Ft)	Sq Yd	Bituminous Materials (Tack Coat)	Polymer Bituminous Materials (Tack Coat)	HMA Binder Course IL-9.5FG N50	Polymerized HMA Binder Course IL-9.5FG N70	Hot-Mix Asphalt Surface Course, IL-9.5FG, MIX "C" N50	Polymerized HMA Surface Course, IL-9.5, MIX "D" N70	Polymerized HMA Surface Course, IL-9.5, MIX "E", N70	Incidental Hot-Mix Asphalt Surfacing
							Pound	Pound	Ton	Ton	Ton	Ton	Ton	Ton	Sq Yd
EASTBOUND															
Sta 493 + 00 - 494 + 15	Taper 3 3/4" - 6"	115	24	306.7	16	204.4	138.0	207.0	22.9	34.3	25.8	35.9			
Sta 494 + 15 - 500 + 87		672	24	1,792.0	16	1,194.7	806.4	1209.6	133.8	200.7	150.5	209.6			
Sta 500 + 87 - 502 + 59	Right Turn Lane to Falconer Rd	172	var	1,112.2	var	374.1	252.5	750.8	41.9	124.6	47.1	126.8			
Sta 502 + 59 - 515 + 21		1,262	24	3,365.3	16	2,243.6	1,514.4	2271.6	251.3	376.9	282.7	393.6			
Sta 515 + 21 - 516 + 00	BEGIN: Super Correction	79	24	210.7	16	140.4	303.6	94.8	15.7	23.6	17.7	24.6			
Sta 516 + 00 - 520 + 56	Aux lane transition (3 lanes)	456	var	1,455.7	16	810.7	1,959.7	655.1	90.8	163.0	102.1	169.1			
Sta 520 + 56 - 524 + 50	Aux lane transition (4 lanes)	394	var	1,832.4	16	700.4	2,190.2	824.6	78.4	205.2	88.3	210.4			
Sta 524 + 50 - 533 + 31	4 lanes + gore area	881	48	4,698.7	16	2,757.7	6,447.7	2114.4	308.9	526.3	347.5	537.9			
Sta 533 + 31 - 535 + 33	END: Super Correction	202	48	1,077.3	16	359.1	1,242.1	484.8	40.2	120.7	45.2	123.3			
Sta 535 + 33 - 535 + 54		21	48	112.0	16	37.3	25.2	75.6	4.2	12.5	4.7	12.8			
Sta 535 + 54 - 538 + 34		280	24	746.7	14	435.6	294.0	504.0	48.8	83.6	51.9	87.3			
Sta 538 + 34 - 559 + 76	Super Correction	2,142	24	5,712.0	14	3,332.0	9,461.5	2570.4	373.2	639.7	419.8	668.1			
Sta 559 + 76 - 610 + 68		5,092	24	13,578.7	14	7,920.9	5,346.6	6110.4	887.1	1,520.8	998.0	1,588.1			
Sta 610 + 68 - 617 + 77	Meridian RD off ramp	709	var	2,924.3	12	1,221.5	824.5	1973.9	136.8	327.5	153.9	336.9			
Sta 617 + 77 - 634 + 28		1,651	24	4,402.7	14	2,568	1,733.6	2971.8	287.6	493.1	323.6	514.9			
Sta 634 + 28 - 645 + 58	Meridian RD on ramp	1,130	var	4,450.0	12	1,611.9	1,088.0	3003.8	180.5	498.4	203.1	513.3			
Sta 645 + 58 - 687 + 74		4,216	24	11,242.7	14	6,558.2	4,426.8	7588.8	734.5	1,259.2	826.3	1,314.9			
Sta 687 + 74 - 688 + 89	Taper 6" - 3 3/4"	115	24	306.7	14	178.9	120.8	207.0	20.0	34.3	22.5	35.9			
Sta 688 + 89 - 692 + 28	3 3/4" mill & fill	339	24	904.0	14	527.3	356.0	610.2	59.1	101.2	66.4	105.7			
Sta 692 + 28 - 695 + 34	Paving Omissions	306													
Sta 695 + 34 - 705 + 81	3 3/4" mill & fill	1,047	24	2,792.0	14	1,628.7	1,099.4	1884.6	182.4	312.7	205.2	326.5			
Sta 705 + 81 - 707 + 25	STA	144													
Sta 707 + 25 - 722 + 50	3 3/4" mill & fill	1,525	24	4,066.7	14	2,372.2	1,601.3	2745.0	265.7	455.5	298.9	475.6			
Sta 722 + 50 - 723 + 65	Taper 3 3/4" - 6"	115	24	306.7	14	178.9	120.8	207.0	20.0	34.3	22.5	35.9			
Sta 723 + 65 - 739 + 90		1,625	24	4,333.3	14	2,527.8	1,706.3	2925.0	283.1	485.3	318.5	506.8			
Sta 739 + 90 - 747 + 00	Montague RD off ramp	710	var	2,870.7	12	1,090.3	736.0	1937.7	122.1	321.5	137.4	330.9			
Sta 747 + 00 - 765 + 80		1,880	24	5,013.3	14	2,924.4	1,974.0	3384.0	327.5	561.5	368.5	586.4			
Sta 765 + 80 - 777 + 68	Montague RD on ramp	1,188	var	4,591.3	12	1,677.7	1,132.4	3099.2	187.9	514.2	211.4	529.9			
Sta 777 + 68 - 804 + 97		2,729	24	7,277.3	14	4,245.1	2,865.5	4912.2	475.5	815.1	534.9	851.1			
Sta 804 + 97 - 826 + 51	Super Correction	2,154	24	5,744.0	14	3,350.7	9,750.2	2584.8	375.3	643.3	422.2	671.8			
Sta 826 + 51 - 830 + 58		407	24	1,085.3	14	633.1	427.4	732.6	70.9	121.6	79.8	126.9			
Sta 830 + 58 - 831 + 73	Taper 6" - 3 3/4"	115	24	306.7	14	178.9	120.8	207.0	20.0	34.3	22.5	35.9			
Sta 831 + 73 - 840 + 28	3 3/4" mill & fill	855	24	2,280.0	14	1,330.0	897.8	1539.0	149.0	255.4	167.6	266.7			
Sta 840 + 28 - 842 + 42	Paving Omissions	214													
Sta 842 + 42 - 847 + 49	3 3/4" mill & fill	507	24	1,352.0	14	788.7	532.4	912.6	88.3	151.4	99.4	158.1			
WEST STATE ST (WB)															
Sta 26 + 05 - 33 + 25	Mix E entire ramp	720	24	1,920.0	16	1,280.0	864.0	1296.0	143.4	215.0	161.3	228.5			
Sta 33 + 25 - 34 + 40	Taper 6" - 3 3/4"	115	24	306.7	16	204.4	138.0	207.0	22.9	34.3	25.8	36.5			
Sta 34 + 40 - 37 + 78	Mix E entire ramp	338	24	901.3	16	600.9	405.6	608.4	67.3	100.9	75.7	107.3			
EAST STATE ST (EB)															
Sta 17 + 05 - 17 + 24	Super Correction Transition	19	24	50.7	16	33.8	59.9	22.8	3.8	5.7	4.3	5.9			
Sta 17 + 24 - 32 + 00	Super Correction	1,476	24	3,936.0	16	2,624.0	4,652.4	1771.2	293.9	440.8	330.6	460.3			
Sta 32 + 00 - 35 + 44	Super Correction	344	24	917.3	16	611.6	1,084.3	412.8	68.5	102.7	77.1	107.3			
Sta 33 + 25 - 34 + 40	SE Corr/Taper 6" - 3 3/4"	115	var	328.2	16	204.4	377.8	147.7	22.9	36.8	25.8	38.3			
Sta 34 + 40 - 34 + 83	Super Correction	43	var	127.8	16	76.4	144.8	57.5	8.6	14.3	9.6	14.9			
Sta 34 + 83 - 37 + 34	raised median	251	24	669.3	16	446.2	301.2	451.8	50.0	75.0	56.2	78.3			
Sta 37 + 34 - 37 + 82		48	36	192.0	20	106.7	72.0	129.6	11.9	21.5	13.4	22.1			
SUB TOTAL							69,595	66,404	6,977	12,499	7,849	12,639	372		

* Bituminous Materials (Tack Coat) Rate of Application = 0.05 Lb / Sq Ft on Existing HMA, 0.025 Lb / Sq Ft Between Lifts

** Hot-Mix Asphalt Rate of Application = 112 Lbs / Sq Yd / in

*** Hot-Mix Asphalt Rate of Application = 119 Lbs / Sq Yd / in

MODEL: Default
 FILE NAME: p:\pub\baronon.dwg
 PROJECT: 64118 Program Development Studies & Plan Design
 CADD: CADDirect02_64118-Plan-HMA-schedule.dwg

USER NAME = anikneyde	DESIGNED -	REVISED -
	DRAWN -	REVISED -
PLOT SCALE = 100,0000' / in.	CHECKED -	REVISED -
PLOT DATE = Mar-19-2021 04:42:32 PM	DATE -	REVISED -

**STATE OF ILLINOIS
DEPARTMENT OF TRANSPORTATION**

HOT-MIX ASPHALT SCHEDULE

SCALE: SHEET OF SHEETS STA. TO STA.

F.A.P. RTE.	SECTION	COUNTY	TOTAL SHEETS	SHEET NO.
301	(1-1,1,2)RS-2	WINNEBAGO	158	59
CONTRACT NO. 64M18				
ILLINOIS		FED. AID PROJECT		

Location	Remarks	Length	MainLine Surface		Shoulder		44000159	44000163	44000164	44000173	44004250	48101200	48102100	48203014	X3550015**	X4400196	X4401198	Z0033700
			Hot-Mix Asphalt Surface Removal, 2 1/2"	Hot-Mix Asphalt Surface Removal, 3 1/2"	Hot-Mix Asphalt Surface Removal, 3 3/4"	Hot-Mix Asphalt Surface Removal, 6"	Paved Shoulder Removal	Aggregate shoulder, Type B	Aggregate Wedge shoulder, Type B	Hot-Mix Asphalt Shoulders 4 1/4"	Hot-Mix Asphalt Base Course (Variable Depth)	HMA Surface Removal, Special	Hot-Mix Asphalt Surface Removal, Variable Depth	Longitudinal Joint Sealing				
		Feet	Width (Ft)	Sq Yd	Width (Ft)	Sq Yd	Sq Yd	Sq Yd	Sq Yd	Sq Yd	Sq Yd	Ton	Ton	Sq Yd	Ton	Sq Yd	Sq Yd	Foot
WESTBOUND																		
Sta 493 + 00 - 494 + 15	Taper 3 3/4" - 6"	115	24	306.7	16	204.4										12.8	511.1	115
Sta 494 + 15 - 503 + 85		970	24	2,586.7	16	1,724.4				4,311.1						107.8		970
Sta 503 + 85 - 506 + 55	Right Turn to W State Rd	270	var	1,217.2	var	370.7				1,588.0						30.0		540
Sta 506 + 55 - 524 + 56		1,801	24	4,802.7	16	3,201.8				8,004.4						200.1		1,801
Sta 524 + 56 - 526 + 72		216	24	576.0	14	336.0				912.0						24.0		216
Sta 526 + 72 - 528 + 64	(STATE ST) merge lane	192	var	910.7	14	298.7				1,209.4						21.3		576
Sta 528 + 64 - 537 + 70	(STATE ST) merge lane + Mix E: Start	906	var	3,386.6	14	1,409.3				4,796.0						100.7		2,718
Sta 537 + 70 - 544 + 64	(STATE ST) merge lane + gore	694	48	3,701.3	14	1,438.6				5,139.9						77.1		2,776
Sta 544 + 64 - 545 + 27		63	24	168.0	14	98.0				266.0						7.0		63
Sta 545 + 27 - 546 + 42	Taper 6" - 3 3/4"	115	24	306.7	14	178.9										12.8	485.6	115
Sta 546 + 42 - 549 + 67	Paving Omissions	325																325
Sta 549 + 67 - 553 + 35	3 3/4" mill & fill	368	24	981.3	14	572.4			1,553.8							40.9		368
Sta 553 + 35 - 554 + 50	Taper 3 3/4" - 6"	115	24	306.7	14	178.9										12.8	485.6	115
Sta 554 + 50 - 555 + 03	Mix E - End	53	24	141.3	14	82.4				223.8						5.9		53
Sta 555 + 03 - 565 + 00		997	24	2,658.7	14	1,550.9				4,209.6						110.8		997
565+00 BK = 563+40 AH																		
Sta 563 + 40 - 604 + 25		4,085	24	10,893.3	14	6,354.4				17,247.8						453.9		4,085
Sta 604 + 25 - 616 + 95	Meridian RD on ramp	1,270	var	4,864.1	12	1,926.6				6,790.7						141.1		1,905
Sta 616 + 95 - 635 + 82		1,887	24	5,032.0	14	2,935.3				7,967.3						209.7		1,887
Sta 635 + 82 - 643 + 20	Meridian RD off ramp	738	var	2,940.0	12	1,293.9				4,233.9						82.0		1,107
Sta 643 + 20 - 689 + 49		4,629	24	12,344.0	14	7,200.7				19,544.7						514.3		4,629
Sta 689 + 49 - 690 + 64	Taper 6" - 3 3/4"	115	24	306.7	14	178.9										12.8	485.6	115
Sta 690 + 64 - 692 + 28	3 3/4" mill & fill	164	24	437.3	14	255.1			692.4							18.2		164
Sta 692 + 28 - 695 + 34	Paving Omissions	306																306
Sta 695 + 34 - 705 + 81	3 3/4" mill & fill	1,047	24	2,792.0	14	1,628.7			4,420.7							116.3		1,047
Sta 705 + 81 - 707 + 25	Paving Omissions	144																144
Sta 707 + 25 - 722 + 50	3 3/4" mill & fill	1,525	24	4,066.7	14	2,372.2			6,438.9							169.4		1,525
Sta 722 + 50 - 723 + 65	Taper 3 3/4" - 6"	115	24	306.7	14	178.9										12.8	485.6	115
Sta 723 + 65 - 734 + 00		1,035	24	2,760.0	14	1,610.0				4,370.0						115.0		1,035
Sta 734 + 00 - 746 + 04	Montague RD on ramp	1,204	var	4,625.4	12	1,751.7				6,377.1						133.8		1,806
Sta 746 + 04 - 764 + 48		1,844	24	4,917.3	14	2,868.4				7,507.8						204.9		1,844
Sta 764 + 48 - 771 + 74	Montague RD off ramp	726	var	1,936.0	12	1,149.3				3,085.3						80.7		1,089
Sta 771 + 74 - 804 + 97		3,323	24	9,836.7	14	5,169.1				15,005.8						369.2		3,323
Sta 804 + 97 - 826 + 51	Super Correction	2,154	24	5,744.0	14	3,350.7				9,094.7		61.3		1250.6		239.3		2,154
Sta 826 + 51 - 829 + 86		335	24	893.3	14	521.1				1,414.4						37.2		335
Sta 829 + 86 - 831 + 01	Taper 6" - 3 3/4"	115	24	306.7	14	178.9										12.8	485.6	115
Sta 831 + 01 - 840 + 28	3 3/4" mill & fill	927	24	2,472.0	14	1,442.0			3,914.0							103.0		927
Sta 840 + 28 - 842 + 42	Paving Omissions	214																214
Sta 842 + 42 - 847 + 49	3 3/4" mill & fill	507	24	1,352.0	14	788.7			2,140.7							56.3		507
SUB TOTAL									19,160	133,300			61		1,251	3,847	2,939	41,768

* Bituminous Materials (Tack Coat) Rate of Application = 0.05 Lb / Sq Ft on Existing HMA, 0.025 Lb / Sq Ft Between Lifts

** Hot-Mix Asphalt Rate of Application = 112 Lbs / Sq Yd / in

*** Hot-Mix Asphalt Rate of Application = 119 Lbs / Sq Yd / in

MODEL: Default
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USER NAME = anikneyde	DESIGNED -	REVISED -
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PLOT DATE = Mar-19-2021 04:43:13 PM	CHECKED -	REVISED -
	DATE -	REVISED -

**STATE OF ILLINOIS
DEPARTMENT OF TRANSPORTATION**

HOT-MIX ASPHALT SCHEDULE

SCALE: SHEET OF SHEETS STA. TO STA.

F.A.P. RTE.	SECTION	COUNTY	TOTAL SHEETS	SHEET NO.
301	(1-1,1,2)RS-2	WINNEBAGO	158	61
CONTRACT NO. 64M18				
ILLINOIS FED. AID PROJECT				

MODEL: Default
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Location	Remarks	Length	MainLine Surface		Shoulder		44000159	44000163	44000164	44000173	44004250	4E101200	48102100	48203014	X3550015**	X4400196	X4401198	Z0033700
			Feet	Width (Ft)	Sq Yd	Width (Ft)	Sq Yd	Hot-Mix Asphalt Surface Removal, 2 1/2"	Hot-Mix Asphalt Surface Removal, 3 1/2"	Hot-Mix Asphalt Surface Removal, 3 3/4"	Hot-Mix Asphalt Surface Removal, 6"	Paved Shoulder Removal	Aggregate shoulder, Type B	Aggregate Wedge shoulder, Type B	Hot-Mix Asphalt Shoulders 4 1/4"	Hot-Mix Asphalt Base Course (Variable Depth)	HMA Surface Removal, Special	Hot-Mix Asphalt Surface Removal, Variable Depth
EASTBOUND																		
Sta 493 + 00 - 494 + 15	Taper 3 3/4" - 6"	115	24	306.7	16	204.4										12.8	511.1	115
Sta 494 + 15 - 500 + 87		672	24	1,792.0	16	1,194.7			2,986.7							74.7		672
Sta 500 + 87 - 502 + 59	Right Turn Lane to Falconer Rd	172	var	1,112.2	var	374.1			1,486.4							19.1		172
Sta 502 + 59 - 515 + 21		1,262	24	3,365.3	16	2,243.6			5,608.9							140.2		1,262
Sta 515 + 21 - 516 + 00	BEGIN: Super Correction	79	24	210.7	16	140.4			351.1			2.2		30.6	8.8			79
Sta 516 + 00 - 520 + 56	Aux lane transition (3 lanes)	455	var	1,455.7	16	810.7			2,266.3			13.0		235.3	50.7			456
Sta 520 + 56 - 524 + 50	Aux lane transition (4 lanes)	394	var	1,832.4	16	700.4			2,532.9			11.2		271.1	43.8			394
Sta 524 + 50 - 533 + 31	4 lanes + gore area	881	48	4,698.7	16	2,757.7			7,456.4			25.1		606.2	97.9			881
Sta 533 + 31 - 535 + 33	END: Super Correction	202	18	1,077.3	16	359.1			1,136.1			5.8		139.0	22.4			202
Sta 535 + 33 - 535 + 54		21	48	112.0	16	37.3			149.3						2.3			21
Sta 535 + 54 - 538 + 34		280	24	746.7	14	435.6			1,182.2						31.1			280
Sta 538 + 34 - 559 + 76	Super Correction	2,142	24	5,712.0	14	3,332.0			9,044.0			61.0		1191.8	238.0			2,142
Sta 559 + 76 - 610 + 68		5,092	24	13,578.7	14	7,920.9			21,499.6						565.8			5,092
Sta 610 + 68 - 617 + 77	Meridian RD off ramp	709	var	2,924.3	12	1,221.5			4,145.8						78.8			709
Sta 617 + 77 - 634 + 28		1,651	24	4,402.7	14	2,568			6,970.9						183.4			1,651
Sta 634 + 28 - 645 + 58	Meridian RD on ramp	1,130	var	4,450.0	12	1,611.9			6,061.9						125.6			1,130
Sta 645 + 58 - 687 + 74		4,216	24	11,242.7	14	6,558.2			17,800.9						468.4			4,216
Sta 687 + 74 - 688 + 89	Taper 6" - 3 3/4"	115	24	306.7	14	178.9									12.8	485.6		115
Sta 688 + 89 - 692 + 28	3 3/4" mill & fill	339	24	904.0	14	527.3		1,431.3							37.7			339
Sta 692 + 28 - 695 + 34	Paving Omissions	306																
Sta 695 + 34 - 705 + 81	3 3/4" mill & fill	1,047	24	2,792.0	14	1,628.7		4,420.7							116.3			1,047
Sta 705 + 81 - 707 + 25	STA	144																
Sta 707 + 25 - 722 + 50	3 3/4" mill & fill	1,525	24	4,066.7	14	2,372.2		6,438.9							169.4			1,525
Sta 722 + 50 - 723 + 65	Taper 3 3/4" - 6"	115	24	306.7	14	178.9									12.8	485.6		115
Sta 723 + 65 - 739 + 90		1,625	24	4,333.3	14	2,527.8			6,861.1						180.6			1,625
Sta 739 + 90 - 747 + 00	Montague RD off ramp	710	var	2,870.7	12	1,090.3			3,961.0						78.9			1,065
Sta 747 + 00 - 765 + 80		1,880	24	5,013.3	14	2,924.4			7,937.8						208.9			1,880
Sta 765 + 80 - 777 + 68	Montague RD on ramp	1,188	var	4,591.3	12	1,677.7			6,269.0						132.0			1,782
Sta 777 + 68 - 804 + 97		2,729	24	7,277.3	14	4,245.1			11,522.4						303.2			2,729
Sta 804 + 97 - 826 + 51	Super Correction	2,154	24	5,744.0	14	3,350.7			9,094.7			61.3		1389.6	239.3			2,154
Sta 826 + 51 - 830 + 58		407	24	1,085.3	14	633.1			1,718.4						45.2			407
Sta 830 + 58 - 831 + 73	Taper 6" - 3 3/4"	115	24	306.7	14	178.9									12.8	485.6		115
Sta 831 + 73 - 840 + 28	3 3/4" mill & fill	855	24	2,280.0	14	1,330.0		3,610.0							95.0			855
Sta 840 + 28 - 842 + 42	Paving Omissions	214																
Sta 842 + 42 - 847 + 49	3 3/4" mill & fill	507	24	1,352.0	14	788.7		2,140.7							56.3			507
WEST STATE ST (WB)																		
Sta 26 + 05 - 33 + 25	Mix E entire ramp	720	24	1,920.0	16	1,280.0			3,200.0						80.0			720
Sta 33 + 25 - 34 + 40	Taper 6" - 3 3/4"	115	24	306.7	16	204.4									12.8	511.1		115
Sta 34 + 40 - 37 + 78	Mix E entire ramp	338	24	901.3	16	600.9			1,502.2						37.6			338
EAST STATE ST (EB)																		
Sta 17 + 05 - 17 + 24	Super Correction Transition	19	24	50.7	16	33.8			84.4			0.5		2.3	2.1			19
Sta 17 + 24 - 32 + 00	Super Correction	1,476	24	3,936.0	16	2,624.0			6,560.0			42.0		178.5	164.0			1,476
Sta 32 + 00 - 35 + 44	Super Correction	344	24	917.3	16	611.6			1,528.9			9.8		41.6	38.2			344
Sta 33 + 25 - 34 + 40	SE Corr/Taper 6" - 3 3/4"	115	var	328.2	16	204.4								13.9	12.8	532.7		115
Sta 34 + 40 - 34 + 83	Super Correction	43	var	127.8	16	76.4			204.2			1.2		5.2	4.8			43
Sta 34 + 83 - 37 + 34	raised median	251	24	669.3	16	446.2			1,115.6						27.9			251
Sta 37 + 34 - 37 + 82		48	36	192.0	20	106.7			298.7						5.3			48
SUB TOTAL							-	-	18,042	152,838	-	-	233	-	4,105	4,250	3,012	39,203

* Bituminous Materials (Tack Coat) Rate of Application = 0.05 Lb / Sq Ft on Existing HMA, 0.025 Lb / Sq Ft Between Lifts

** Hot-Mix Asphalt Rate of Application = 112 Lbs / Sq Yd / in

*** Hot-Mix Asphalt Rate of Application = 119 Lbs / Sq Yd / in

USER NAME = anikneyde	DESIGNED -	REVISED -
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	DATE -	REVISED -

**STATE OF ILLINOIS
DEPARTMENT OF TRANSPORTATION**

HOT-MIX ASPHALT SCHEDULE

SCALE: SHEET OF SHEETS STA. TO STA.

F.A.P. RTE.	SECTION	COUNTY	TOTAL SHEETS	SHEET NO.
301	(1-1,1,2)RS-2	WINNEBAGO	158	62
ILLINOIS FED. AID PROJECT			CONTRACT NO. 64M18	

GUARDRAIL SCHEDULE															
LOCATION	STATION OF HAZARD*	HAZARD DESCRIPTION*	72501000	63100167	63100169	63100089	63000001	63000030	63100045	78200005	63200310	20200100	48203021	63500105	
			TERM	TBT	TBT	TBT	SPBGR TY A	STRONG POST GR,	TBT	GR	GR	EARTH	HMA SHLD,	DELINEATORS	
			MARKER, DA	TY1 SP (TANG)	TY1 SP (FLARED)	TY6B	6' POSTS	ATTACHED TO STRUCTURES	TY2	REFLECTORS, TYPE A	REM	EXCAVATION	6"	EACH	
STATION TO STATION	SIDE		EA	EA	EA	EA	FT	FOOT	EA	EA	FOOT	CU YD	SQ YD	EACH	
EB LANE															
495+81 TO 498+19.5	RT	497+82	OVERHEAD TRUSS	1	1			160		1	2	128	14	83	1
496+19 TO 498+27.5	LT	497+82	OVERHEAD TRUSS	1		1		130		1	2	163	12	73	1
506+28 TO 509+16.5***	RT	509+16	OVERHEAD TRUSS	1	1			210		1	3	250	4	22	1
506+33 TO 509+36.5***	LT	509+16	OVERHEAD TRUSS	1	1			225		1	3	205	13	78	1
520+77 TO 523+65.5***	RT	523+68	OVERHEAD TRUSS	1	1			210		1	3	251	5	30	1
520+29 TO 523+42.5***	LT	523+68	OVERHEAD TRUSS	1	1			235		1	3	287	4	22	1
537+31 TO 540+01.5	RT	539+64	CULVERT	1	1			180	12	1	2	214	15	90	2
555+98 TO 558+50.5	LT	558+44	PIER	1	1			174		1	2	253	15	88	1
561+27 TO 564+23.5***	RT	564+00	CULVERT	1	1			218		1	3	215	5	28	2
523+00 TO 626+42.5	LT	626+20	PIER	1	1			264		1	3	253	7	43	1
752+15 TO 755+79	RT	755+79	PIER	1	1		1	260.5			3	261	19	117	1
752+52 TO 755+94.5	LT	755+72	PIER	1	1			264		1	3	266	20	118	1
797+63 TO 797+64.5	RT	797+60	CULVERT	1	1			223		1	3	281	17	104	2
WB LANE															
797+85.5 TO 800+87	RT	797+90	CULVERT	1	1			223		1	3	289	17	104	2
626+27 TO 629+71	RT	626+75	PIER	1	1		1	266.5			3	254	20	119	1
626+07.5 TO 629+50	LT	626+75	PIER	1	1			264		1	3	252	20	118	1
558+41.5 TO 561+87	LT	558+65	PIER	1	1			266		1	3	254	20	119	1
509+55.5 TO 512+97.5	LT	509+16	OVERHEAD TRUSS	1	1			233		1	3	285	18	108	1
498+12.5 TO 500+23	LT	497+82	OVERHEAD TRUSS	1	1			232		1	3	285	18	107	1
GRAND TOTAL				19	18	1	2	4238	12	17	53	4646	261	1569	23

*GUARDRAIL LAYOUT SHOULD USE STATION OF HAZARD AS REFERENCE POINT. FOR THE EB LANES, THE HAZARD REFERENCE POINT IS THE EASTMOST POINT OF THE HAZARD, AND FOR THE WB LANES, THE HAZARD REFERENCE POINT IS THE WESTMOST POINT OF THE HAZARD

**NO EXCAVATED MATERIAL SHALL BE REMOVED FROM THE JOBSITE. ALL MATERIAL SHALL BE USED ADJACENT TO THE PROPOSED HMA SHOULDER, 6" THIS EARTHWORK SHALL BE SEEDED, FERTILIZED, AND MULCHED. THIS WORK SHALL NOT BE PAID FOR SEPARATELY BUT SHALL BE INCLUDED IN THE COST OF EARTH EXCAVATION

***THESE LOCATIONS HAVE SOME EXISTING HMA SHOULDERS FOR BITUMINOUS STABILIZATION AND THESE SHALL REMAIN. THE CONTRACTOR SHALL FILL THE HOLES AFTER THE EXISTING GUARDRAIL IS REMOVED WITH CA 6 AND CAPPED OFF WITH 3" OF HOT-MIX ASPHALT. THIS WORK SHALL NOT BE PAID FOR SEPARATELY BUT SHALL BE INCLUDED IN THE COST OF GUARDRAIL REMOVAL.

TRAFFIC BARRIER TERMINAL, TYPE 1 (SPECIAL) TANGENT						
LOCATION	STATION	SIDE	72501000	63100167	63200310	63500105
			TERM	TBT	GR	DELINEATORS
			MARKER, DA	TY1 SP (TANG)	REM	
			EA	EA	FOOT	EACH
EB LANE						
		(RT/LT)				
537+78		LT	1	1	50	1
557+00		RT	1	1	50	1
623+80		RT	1	1	50	1
689+18		RT	1	1	50	1
689+67		LT	1	1	50	1
704+91		LT	1	1	50	1
831+98		RT	1	1	50	1
837+97		LT	1	1	50	1
WB LANE						
552+91		LT	1	1	50	1
553+08		LT	1	1	50	1
561+78		LT	1	1	50	1
567+78		LT	1	1	50	1
698+43		RT	1	1	50	1
709+92		RT	1	1	50	1
710+26		LT	1	1	50	1
758+40		LT	1	1	50	1
758+75		RT	1	1	50	1
GRAND TOTAL			17	17	850	17

SEE GUARDRAIL SCHEDULE FOR OTHER LOCATIONS OF TBT, TYP 1 (SPECIAL) TANGENT

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USER NAME = Marc.A.Personette
DESIGNED - PCB
DRAWN - MAP
PLOT SCALE = 20.0000' / in.
PLOT DATE = 3/2/2021

REVISOR -
REVISION -
CHECKED - JWD
DATE -

REVISOR -
REVISION -
CHECKED - JWD
DATE -

STATE OF ILLINOIS
DEPARTMENT OF TRANSPORTATION

GUARDRAIL SCHEDULES

SCALE: 1" = 20' SHEET OF SHEETS STA. TO STA.

F.A.P. RTE.	SECTION	COUNTY	TOTAL SHEETS	SHEET NO.
301	(1-1,1,2)RS-2	WINNEBAGO	158	64
			CONTRACT NO. 64M18	
ILLINOIS FED. AID PROJECT				



STA. 493+00 - 494+15
HMA SURFACE REMOVAL
VARIABLE DEPTH 3³/₄" - 6"


HMA SURFACE REMOVAL, 6"
2" POLYMERIZED HMA SURFACE COURSE, IL-9.5, MIX "D", N70
1³/₄" POLYMERIZED HMA BINDER COURSE, IL-9.5FG, N70

HMA SURFACE REMOVAL, 6"
3³/₄" INCIDENTAL HMA SURFACING

HMA SURFACE REMOVAL, 6"
3³/₄" INCIDENTAL HMA SURFACING

SEE GUARDRAIL DETAIL FOR
GUARDRAIL IMPROVEMENT LOCATIONS

SECTION / PROJECT BEGINS
STA. 493+00

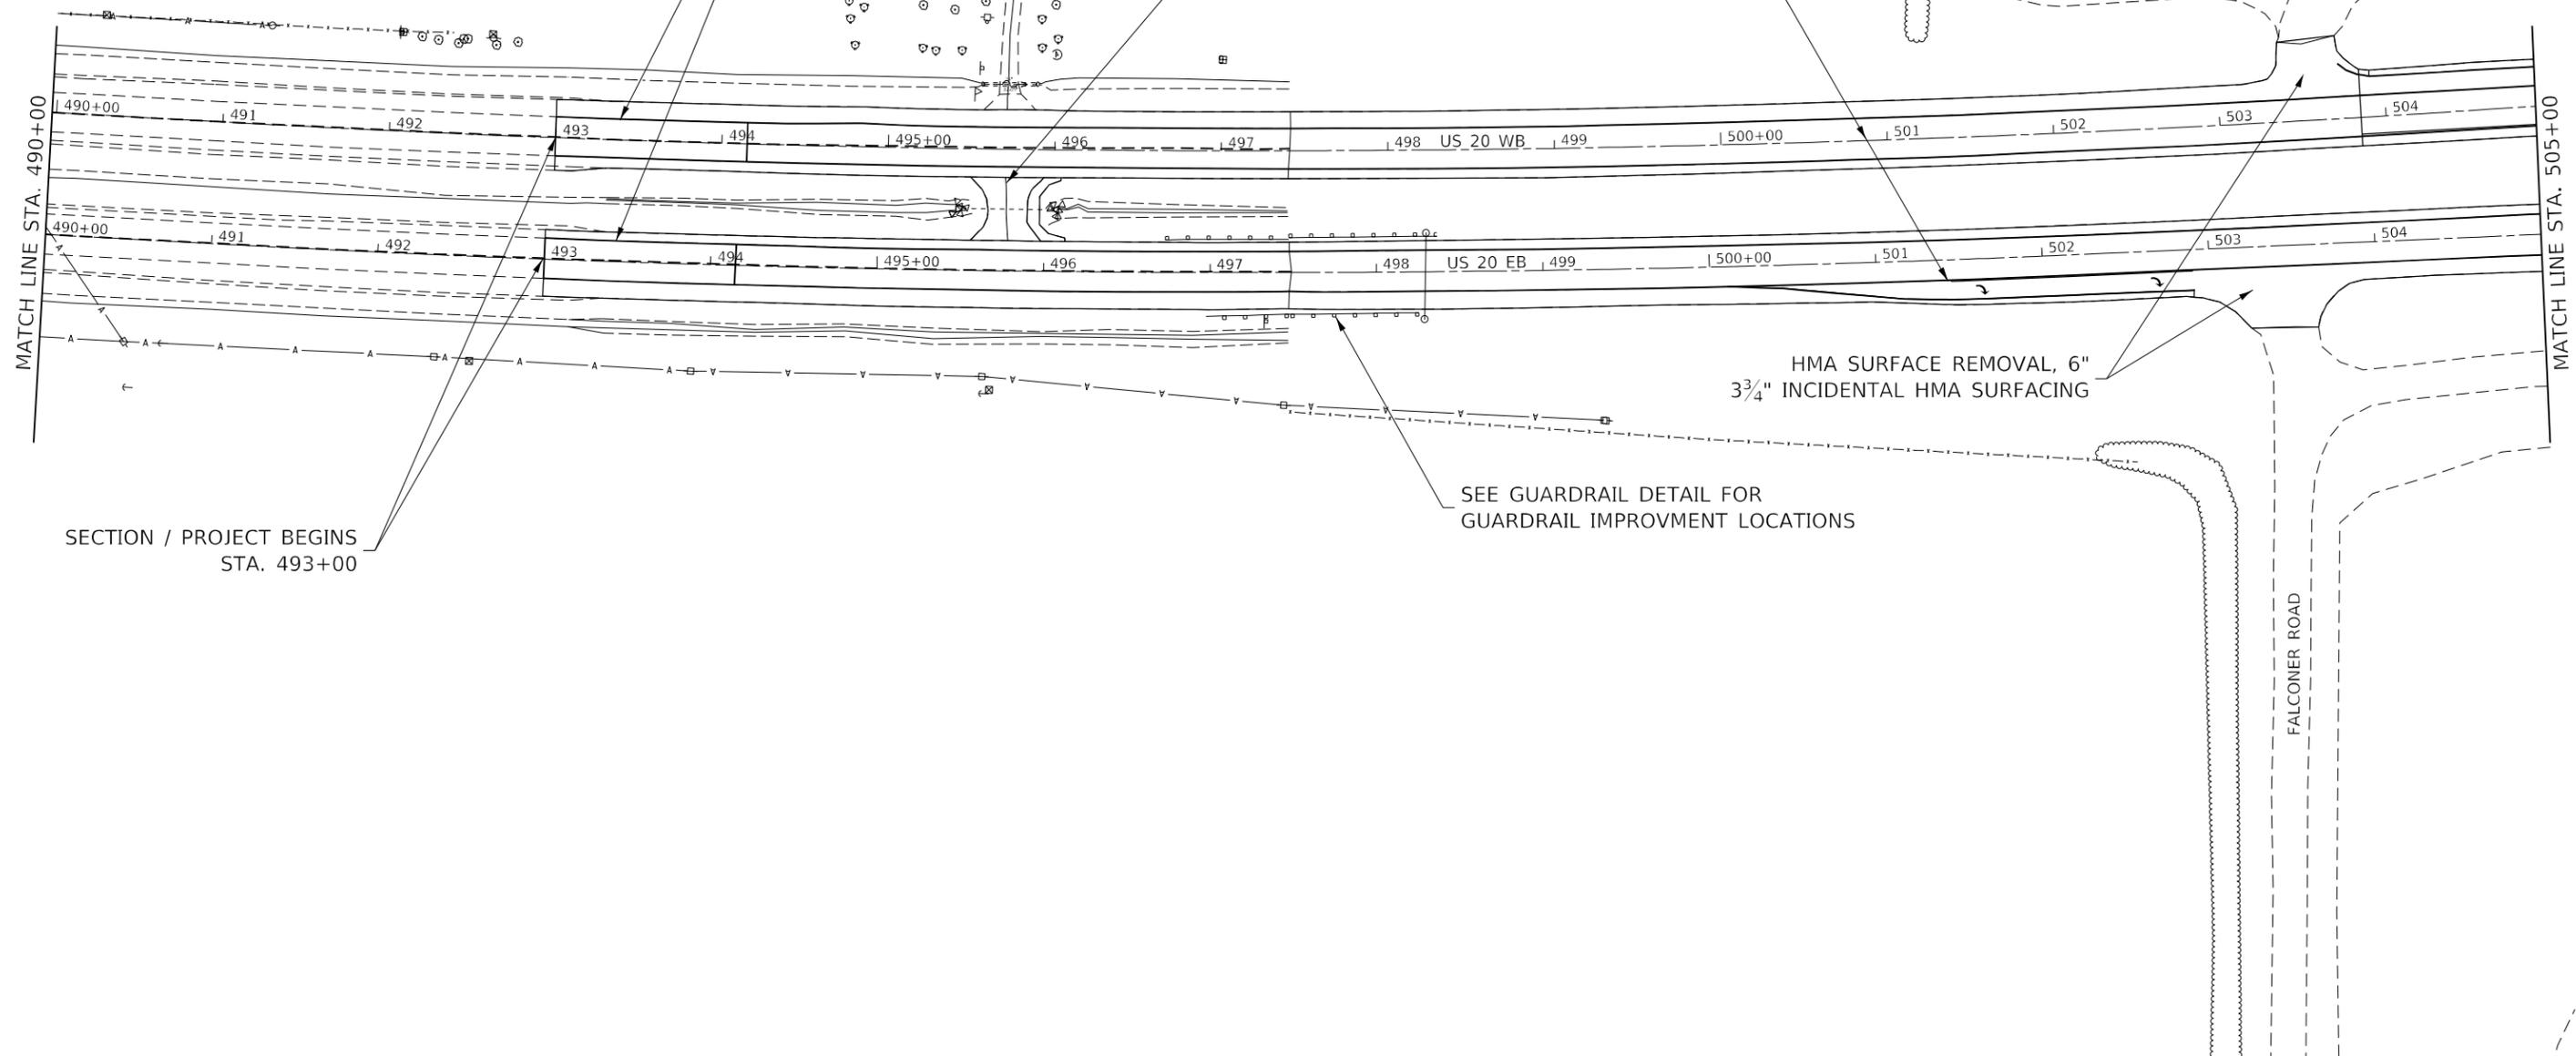

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DRAWN -	REVISED -	
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**STATE OF ILLINOIS
DEPARTMENT OF TRANSPORTATION**

US 20 PLAN SHEET				
SCALE:	SHEET	OF	SHEETS	STA. TO STA.

F.A.P. RTE.	SECTION	COUNTY	TOTAL SHEETS	SHEET NO.
301	(1-1,1,2)RS-2	WINNEBAGO	158	65
			CONTRACT NO. 64M18	
ILLINOIS FED. AID PROJECT				



HMA SURFACE REMOVAL, 6"
 2" POLYMERIZED HMA SURFACE COURSE, IL-9.5, MIX "D", N70
 1 3/4" POLYMERIZED HMA BINDER COURSE, IL-9.5FG, N70

HMA SURFACE REMOVAL, 6"


STA. 528+64 - 555+03
 2" POLYMERIZED HOT-MIX ASPHALT SURFACE COURSE, IL-9.5, MIX "E", N70
 1 3/4" POLYMERIZED HOT-MIX ASPHALT BINDER COURSE, IL-9.5FG, N70

STA. 15+79 - 16+84
 SUPER ELEVATION TRANSITION 2.6%-0%

MATCH LINE STA. 520+00

MATCH LINE STA. 535+00

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**STATE OF ILLINOIS
 DEPARTMENT OF TRANSPORTATION**

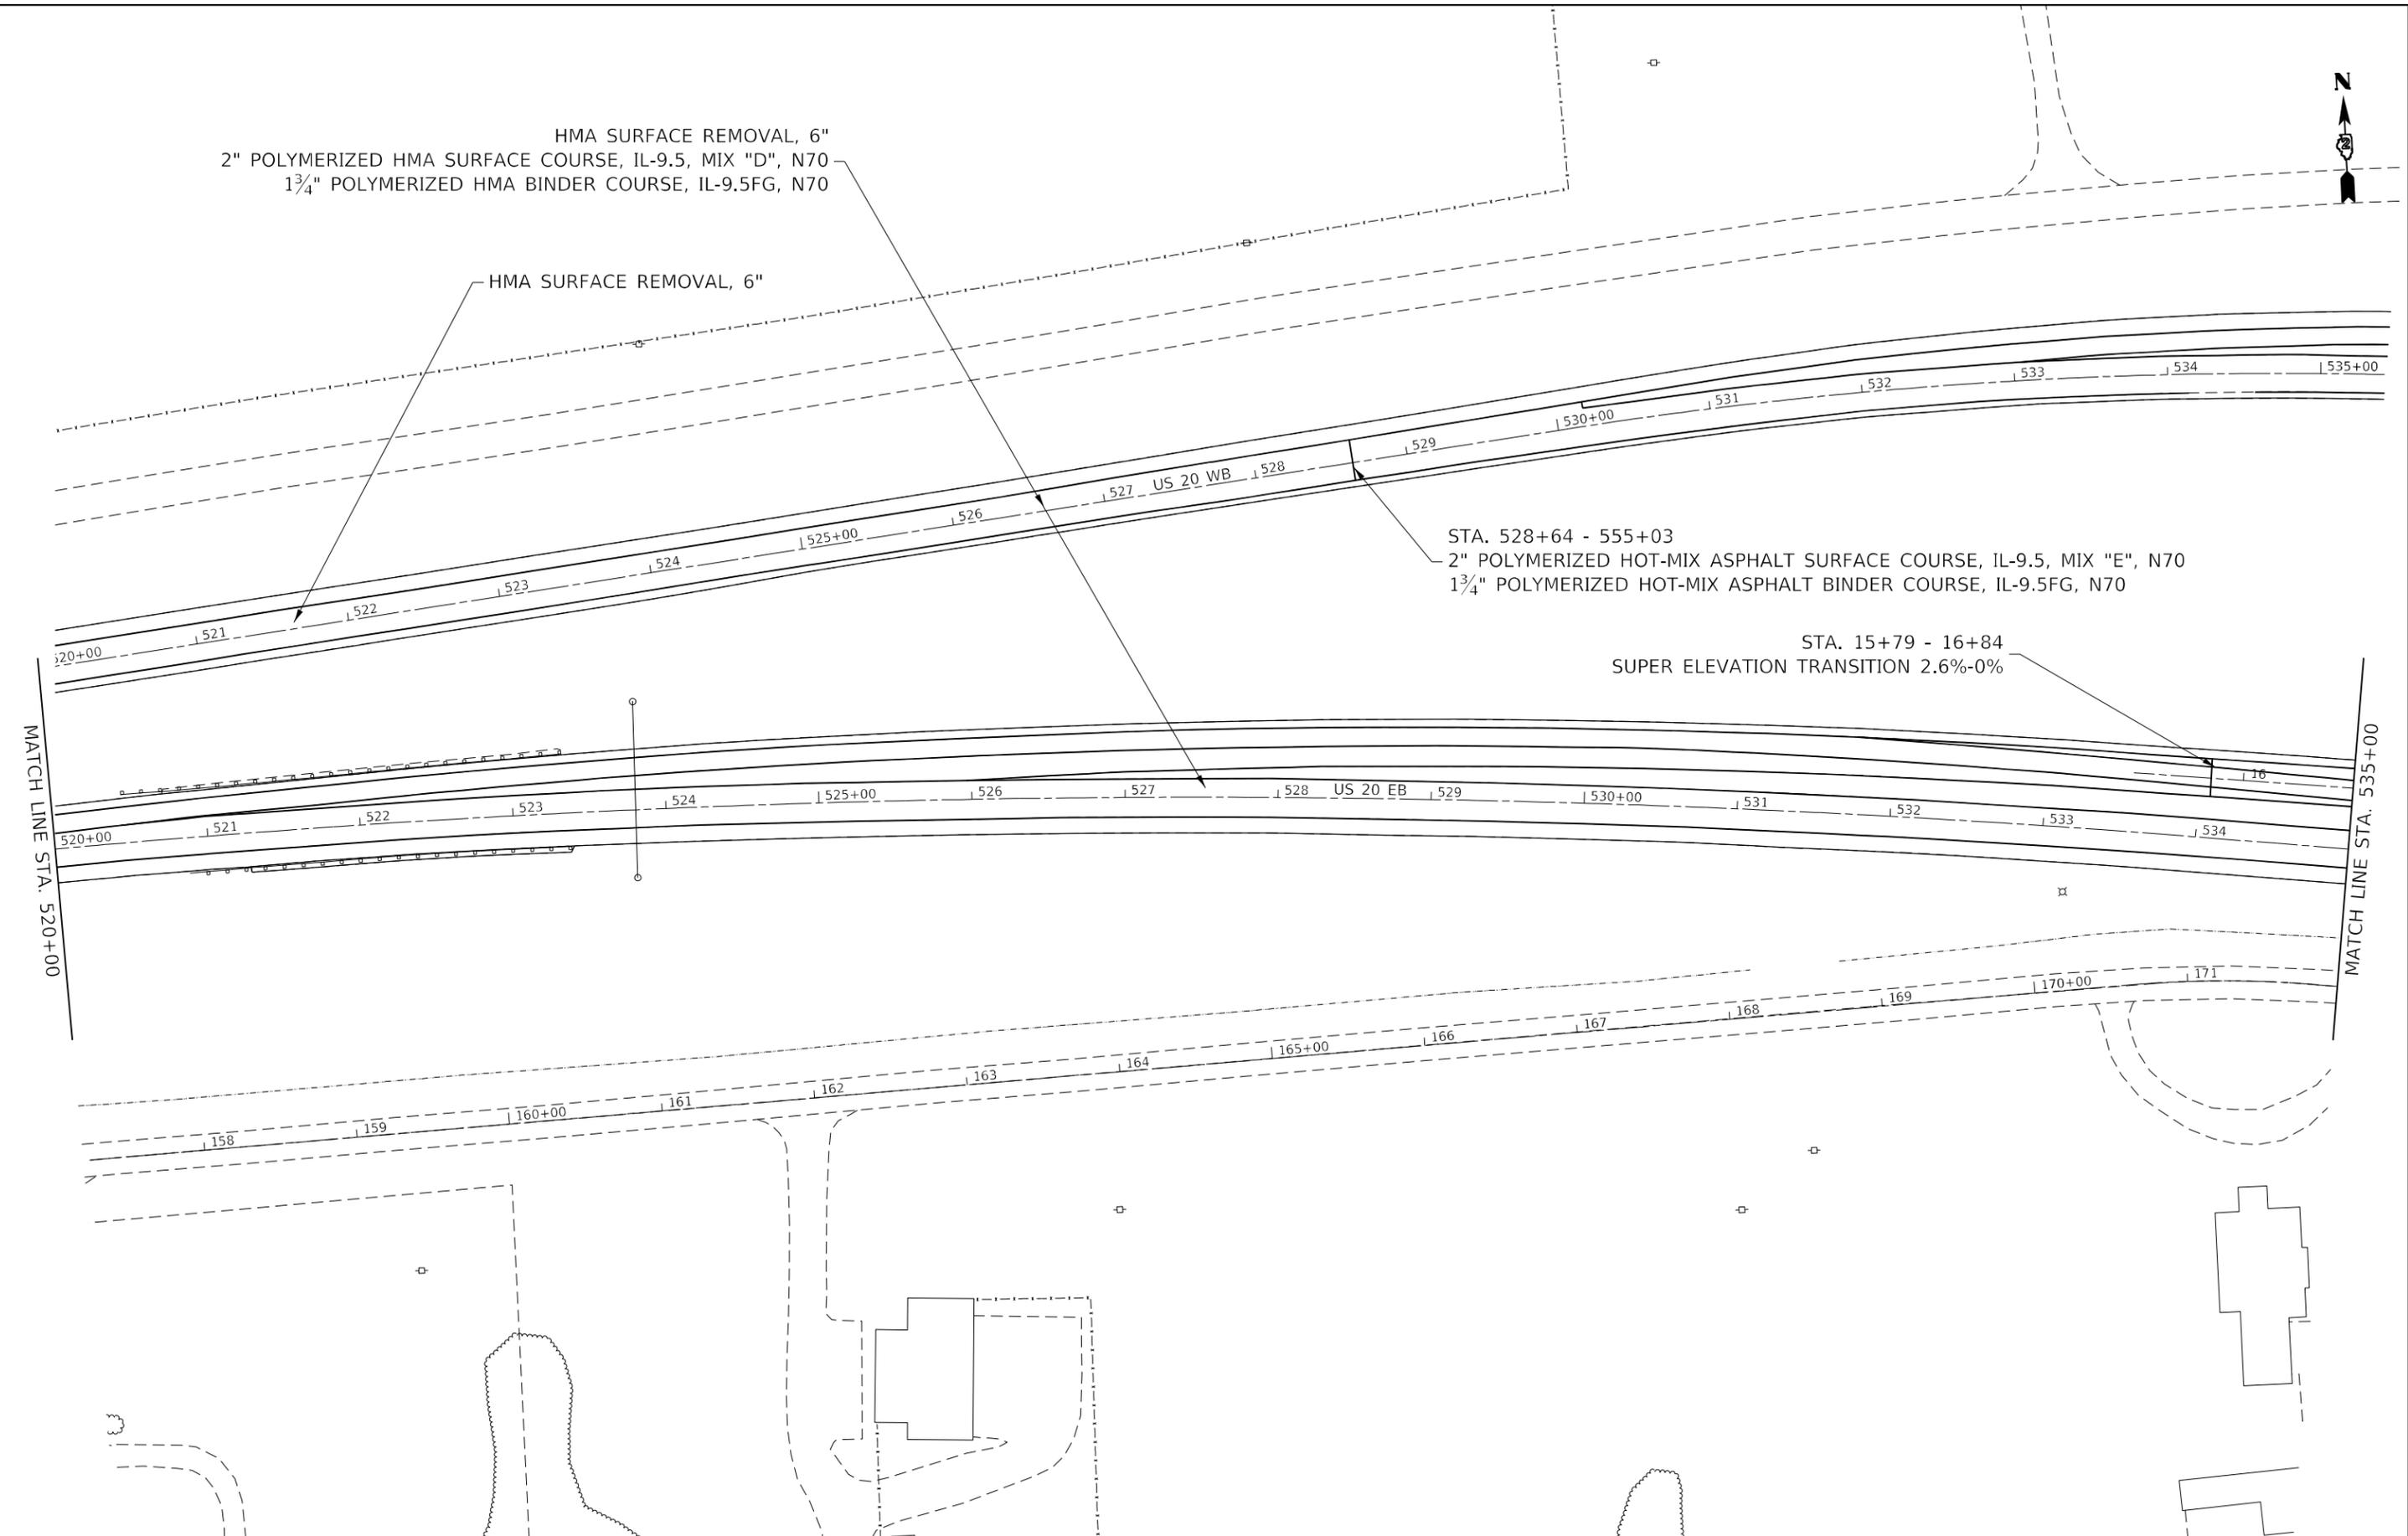US 20 PLAN SHEET	
SCALE:	SHEET OF SHEETS STA. TO STA.

F.A.P. RTE.	SECTION	COUNTY	TOTAL SHEETS	SHEET NO.
301	(1-1,1,2)RS-2	WINNEBAGO	158	67
			CONTRACT NO. 64M18	
		ILLINOIS	FED. AID PROJECT	



STA 26+05 - STA 37+78
 2" POLYMERIZED HMA SURFACE COURSE, IL-9.5, MIX "E", N70
 1 3/4" POLYMERIZED HMA BINDER COURSE, IL-9.5FG, N70

HMA SURFACE REMOVAL, 6"

STA. 545+27 - 546+42
 HMA SURFACE REMOVAL
 VARIABLE DEPTH 6" - 3 3/4"

STA 528+64 - STA 555+03
 2" POLYMERIZED HMA SURFACE COURSE, IL-9.5 MIX "E", N70
 1 3/4" POLYMERIZED HMA BINDER COURSE, IL-9.5FG, N70
 HMA SURFACE REMOVAL, 6"

STA. 16+84 - 17+44
 SUPER ELEVATION TRANSITION 0%-1.5%

PAVING GAP
 STA 546+42 - 549+67


SEE GUARDRAIL DETAIL FOR
 GUARDRAIL IMPROVEMENT LOCATIONS

BEGIN STA 538+34
 5.4% SUPERELEVATION CORRECTION

END STA 535+33
 2.6% SUPERELEVATION CORRECTION

HMA SURFACE REMOVAL, 6"
 2" POLYMERIZED HMA SURFACE COURSE, IL-9.5, MIX "D", N70
 1 3/4" POLYMERIZED HMA BINDER COURSE, IL-9.5FG, N70

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 PROJECT TITLE: US 20 WB EB
 PROJECT DESCRIPTION: US 20 WB EB
 PROJECT LOCATION: US 20 WB EB
 PROJECT STATUS: In Progress
 PROJECT OWNER: State of Illinois
 PROJECT CONTRACT: 64M18
 PROJECT SHEET: 158 of 158
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 PROJECT TITLE: US 20 WB EB
 PROJECT DESCRIPTION: US 20 WB EB
 PROJECT LOCATION: US 20 WB EB
 PROJECT STATUS: In Progress
 PROJECT OWNER: State of Illinois
 PROJECT CONTRACT: 64M18
 PROJECT SHEET: 158 of 158
 PROJECT DATE: 3/19/2021 8:43:51 AM
 PROJECT USER: anikneyde

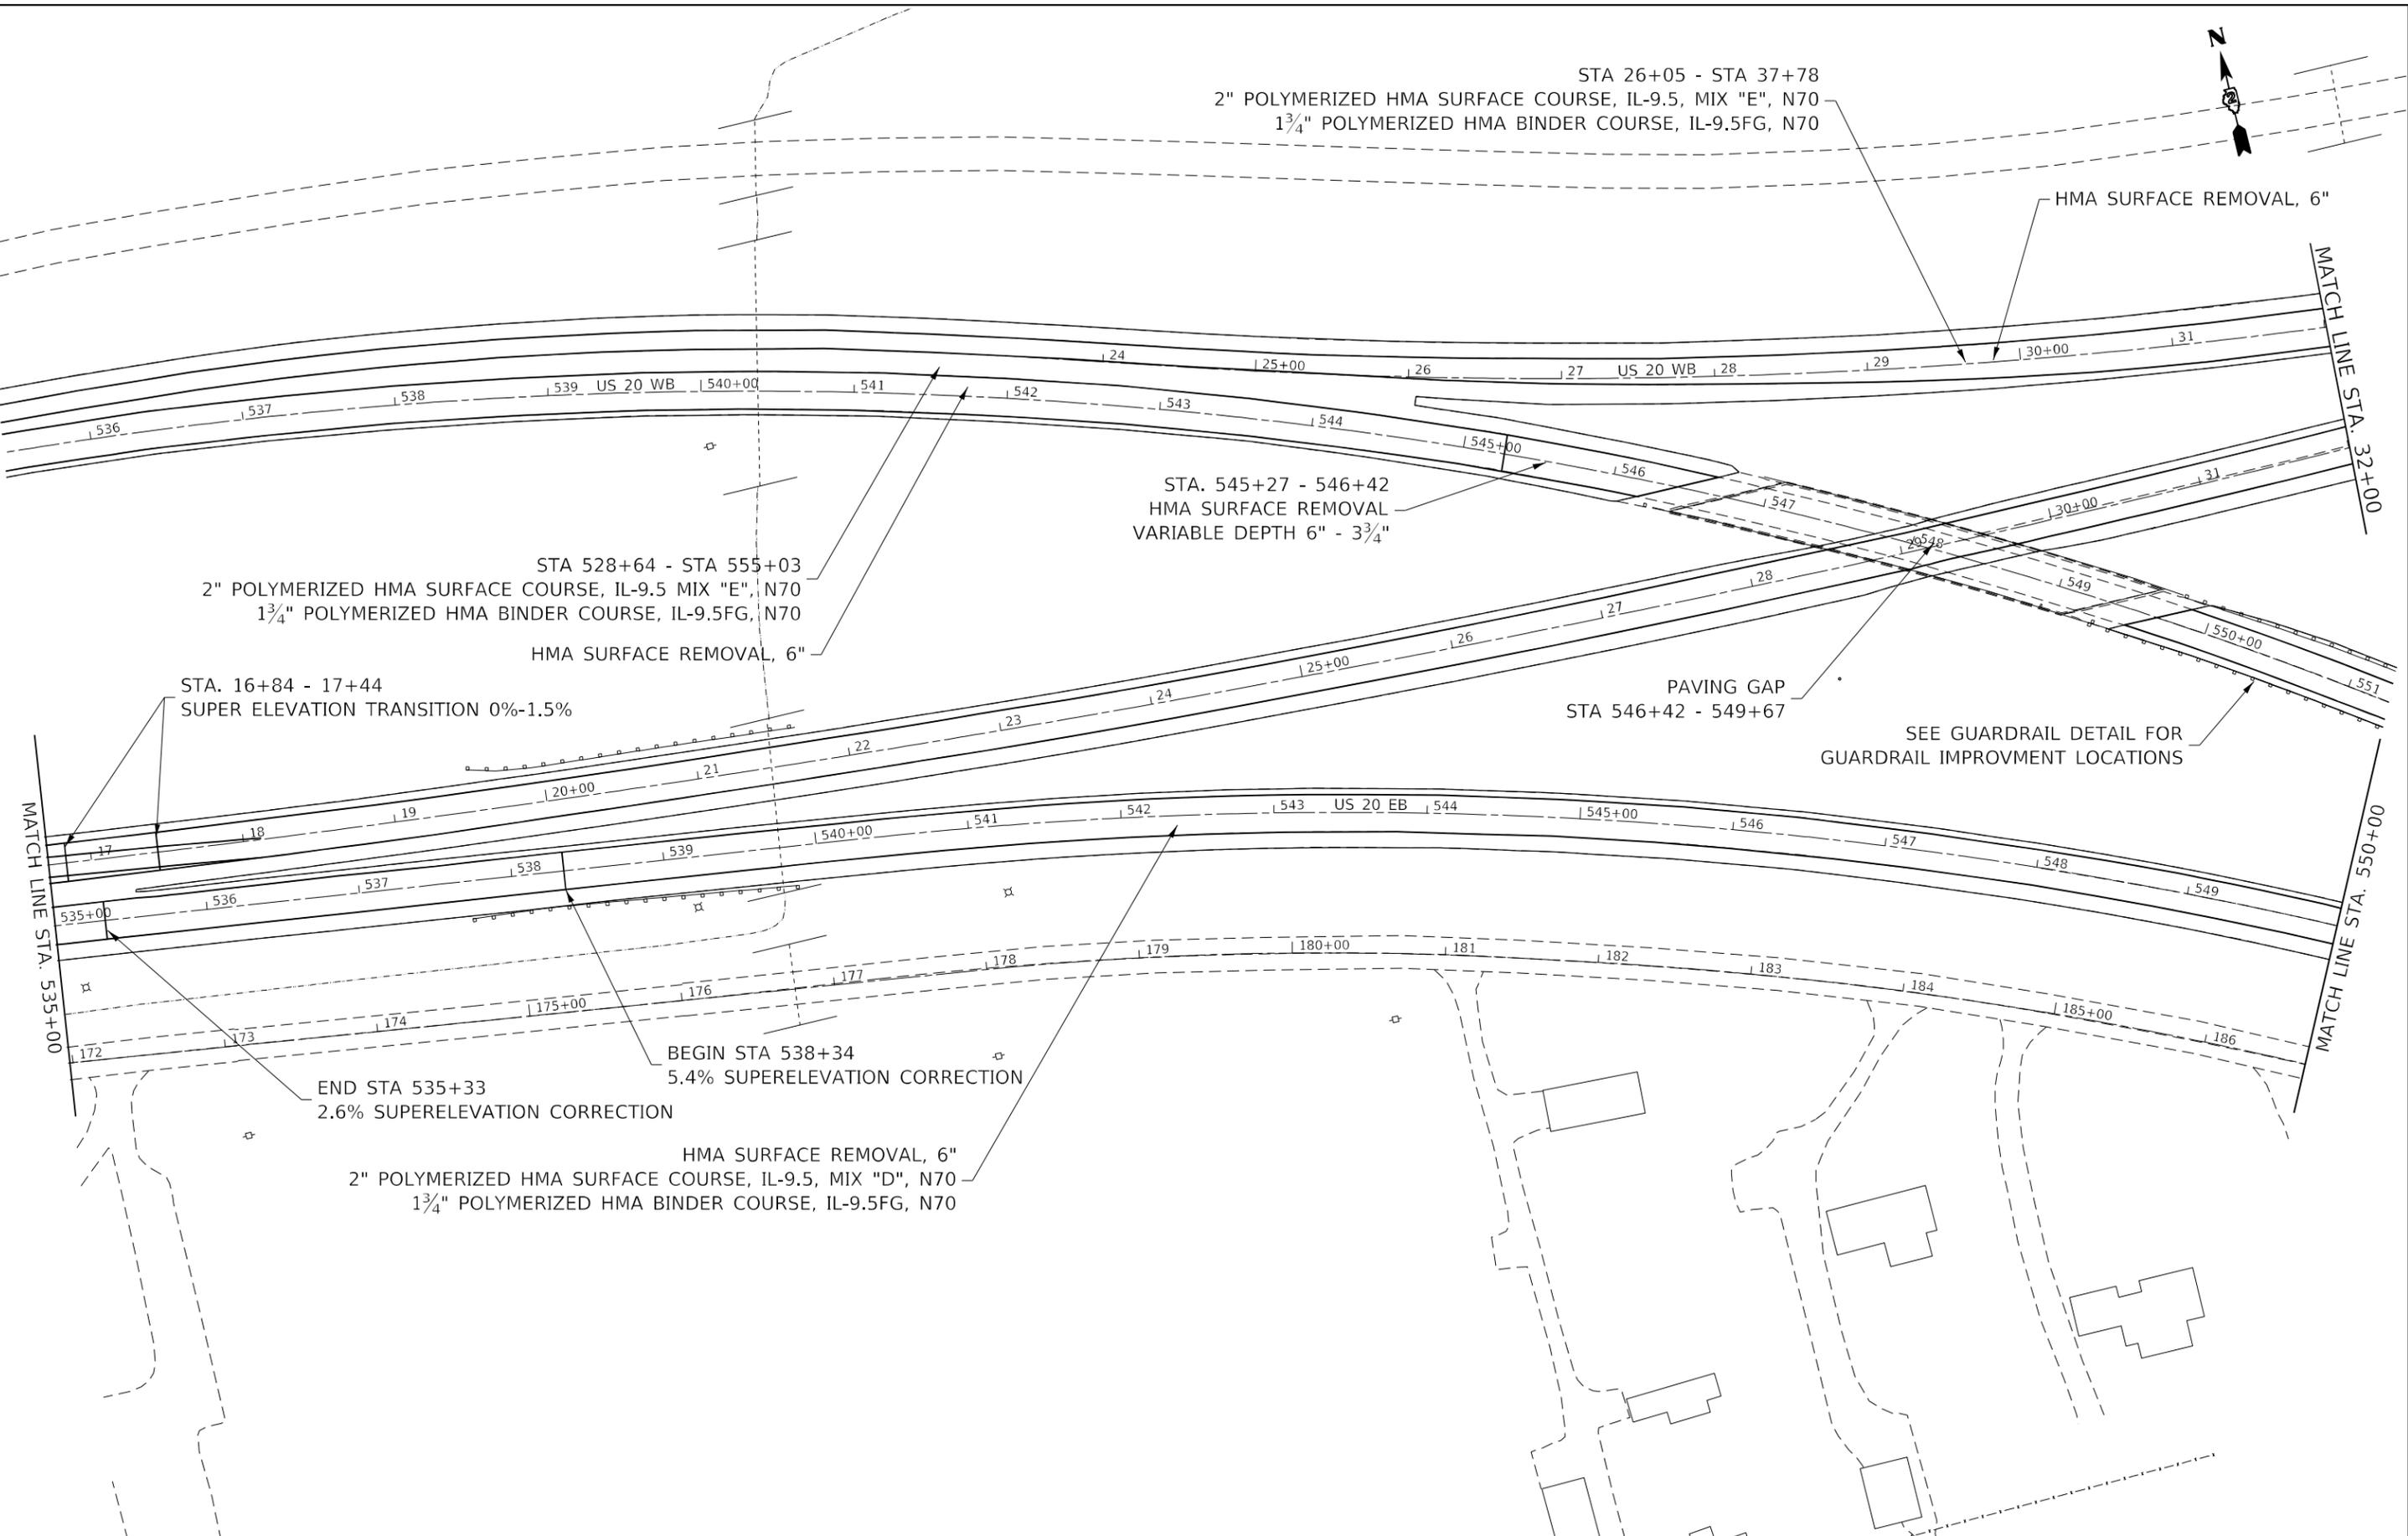


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DRAWN -	REVISED -	REVISED -
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**STATE OF ILLINOIS
 DEPARTMENT OF TRANSPORTATION**

US 20 PLAN SHEET	
SCALE:	SHEET OF SHEETS STA. TO STA.

F.A.P. RTE.	SECTION	COUNTY	TOTAL SHEETS	SHEET NO.
301	(1-1,1,2)RS-2	WINNEBAGO	158	68
			CONTRACT NO. 64M18	
ILLINOIS FED. AID PROJECT				

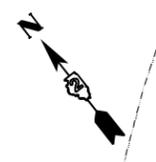

STA. 528+64 - STA 555+03
 2" POLYMERIZED HMA SURFACE COURSE, IL-9.5, MIX "E", N70
 1 3/4" POLYMERIZED HMA BINDER COURSE, IL-9.5FG, N70


HMA SURFACE REMOVAL 6"
 2" POLYMERIZED HMA SURFACE COURSE, IL-9.5, MIX "D", N70
 1 3/4" POLYMERIZED HMA BINDER COURSE, IL-9.5FG, N70

HMA SURFACE REMOVAL 3 3/4"

STA 553+35 - STA 554+50
 HMA SURFACE REMOVAL VARIABLE
 DEPTH 3 3/4" - 6"

SEE GUARDRAIL DETAIL FOR
 GUARDRAIL IMPROVMENT LOCATIONS

END STA. 559+76
 5.4% SUPER ELEVATION CORRECTION

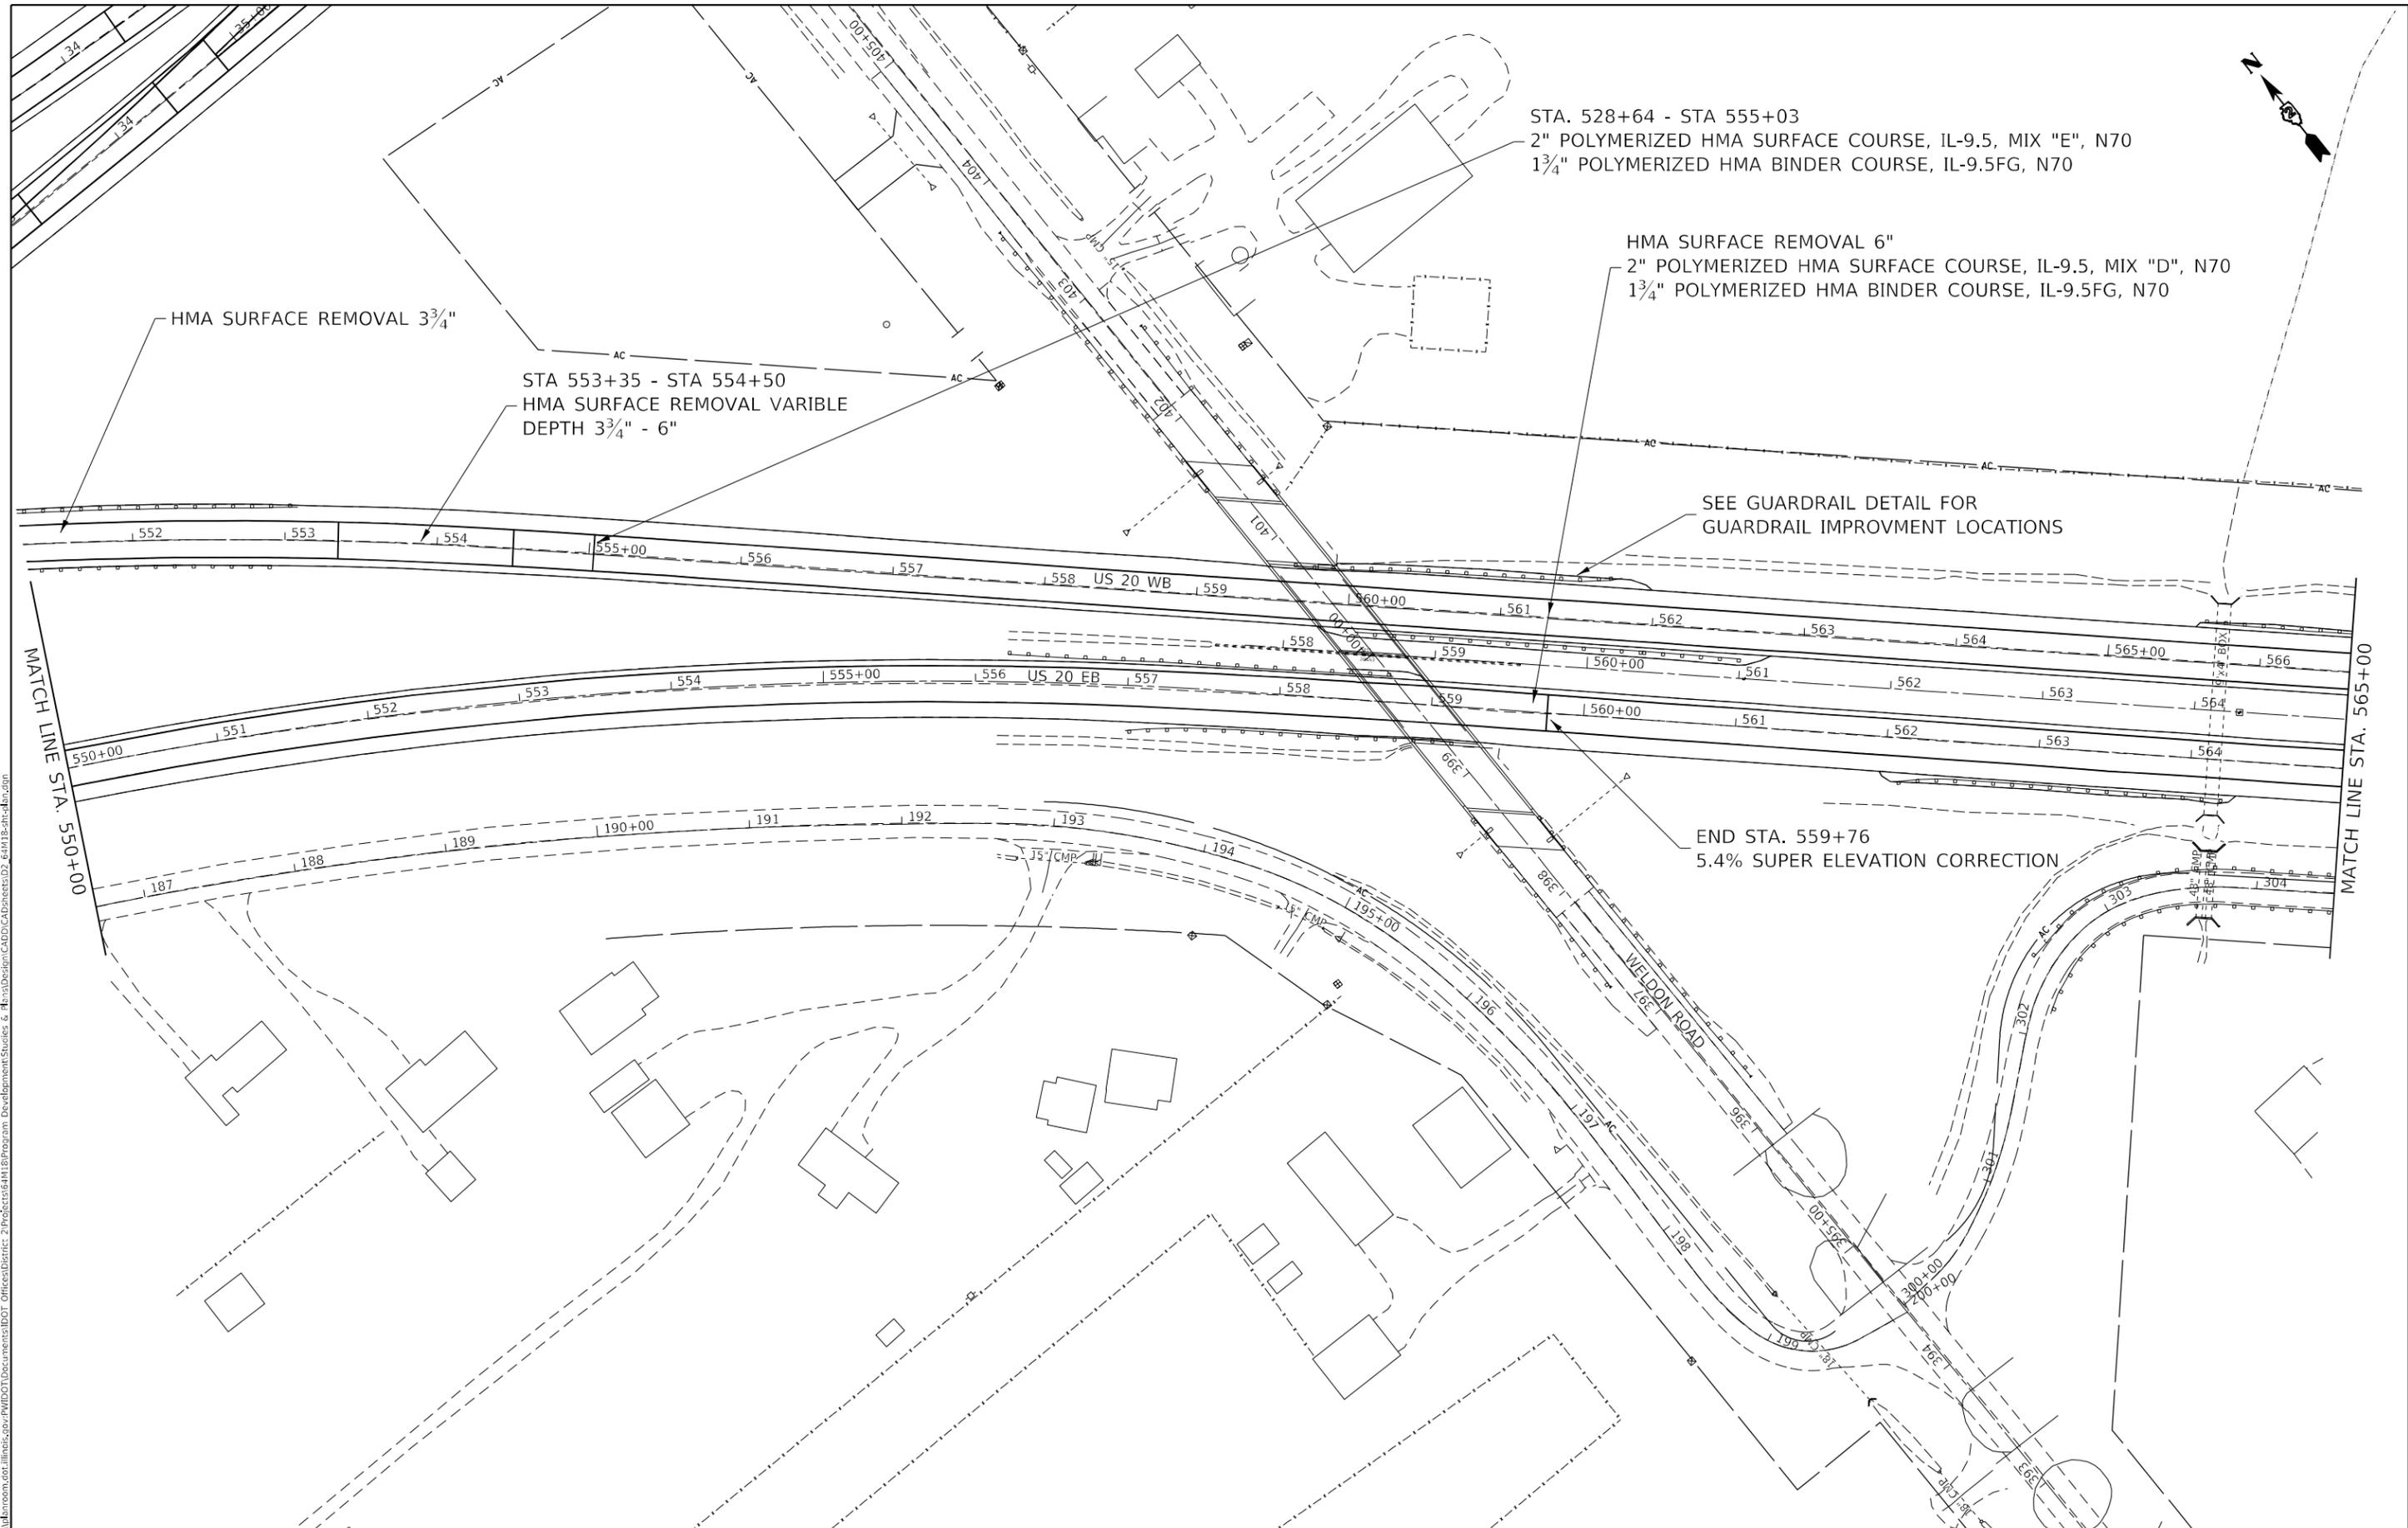

MODEL: Default
 FILE NAME: p:\pub\barroom.dwg
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USER NAME = ankneyde	DESIGNED -	REVISED -
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**STATE OF ILLINOIS
 DEPARTMENT OF TRANSPORTATION**


US 20 PLAN SHEET				
SCALE:	SHEET	OF	SHEETS	STA. TO STA.

F.A.P. RTE.	SECTION	COUNTY	TOTAL SHEETS	SHEET NO.
301	(1-1,1,2)RS-2	WINNEBAGO	158	69
			CONTRACT NO. 64M18	
ILLINOIS FED. AID PROJECT				



HMA SURFACE REMOVAL, 6"
 2" POLYMERIZED HMA SURFACE COURSE, IL-9.5, MIX "D", N70
 1 3/4" POLYMERIZED HMA BINDER COURSE, IL-9.5FG, N70

SEE GUARDRAIL DETAIL FOR
 GUARDRAIL IMPROVEMENT
 LOCATIONS

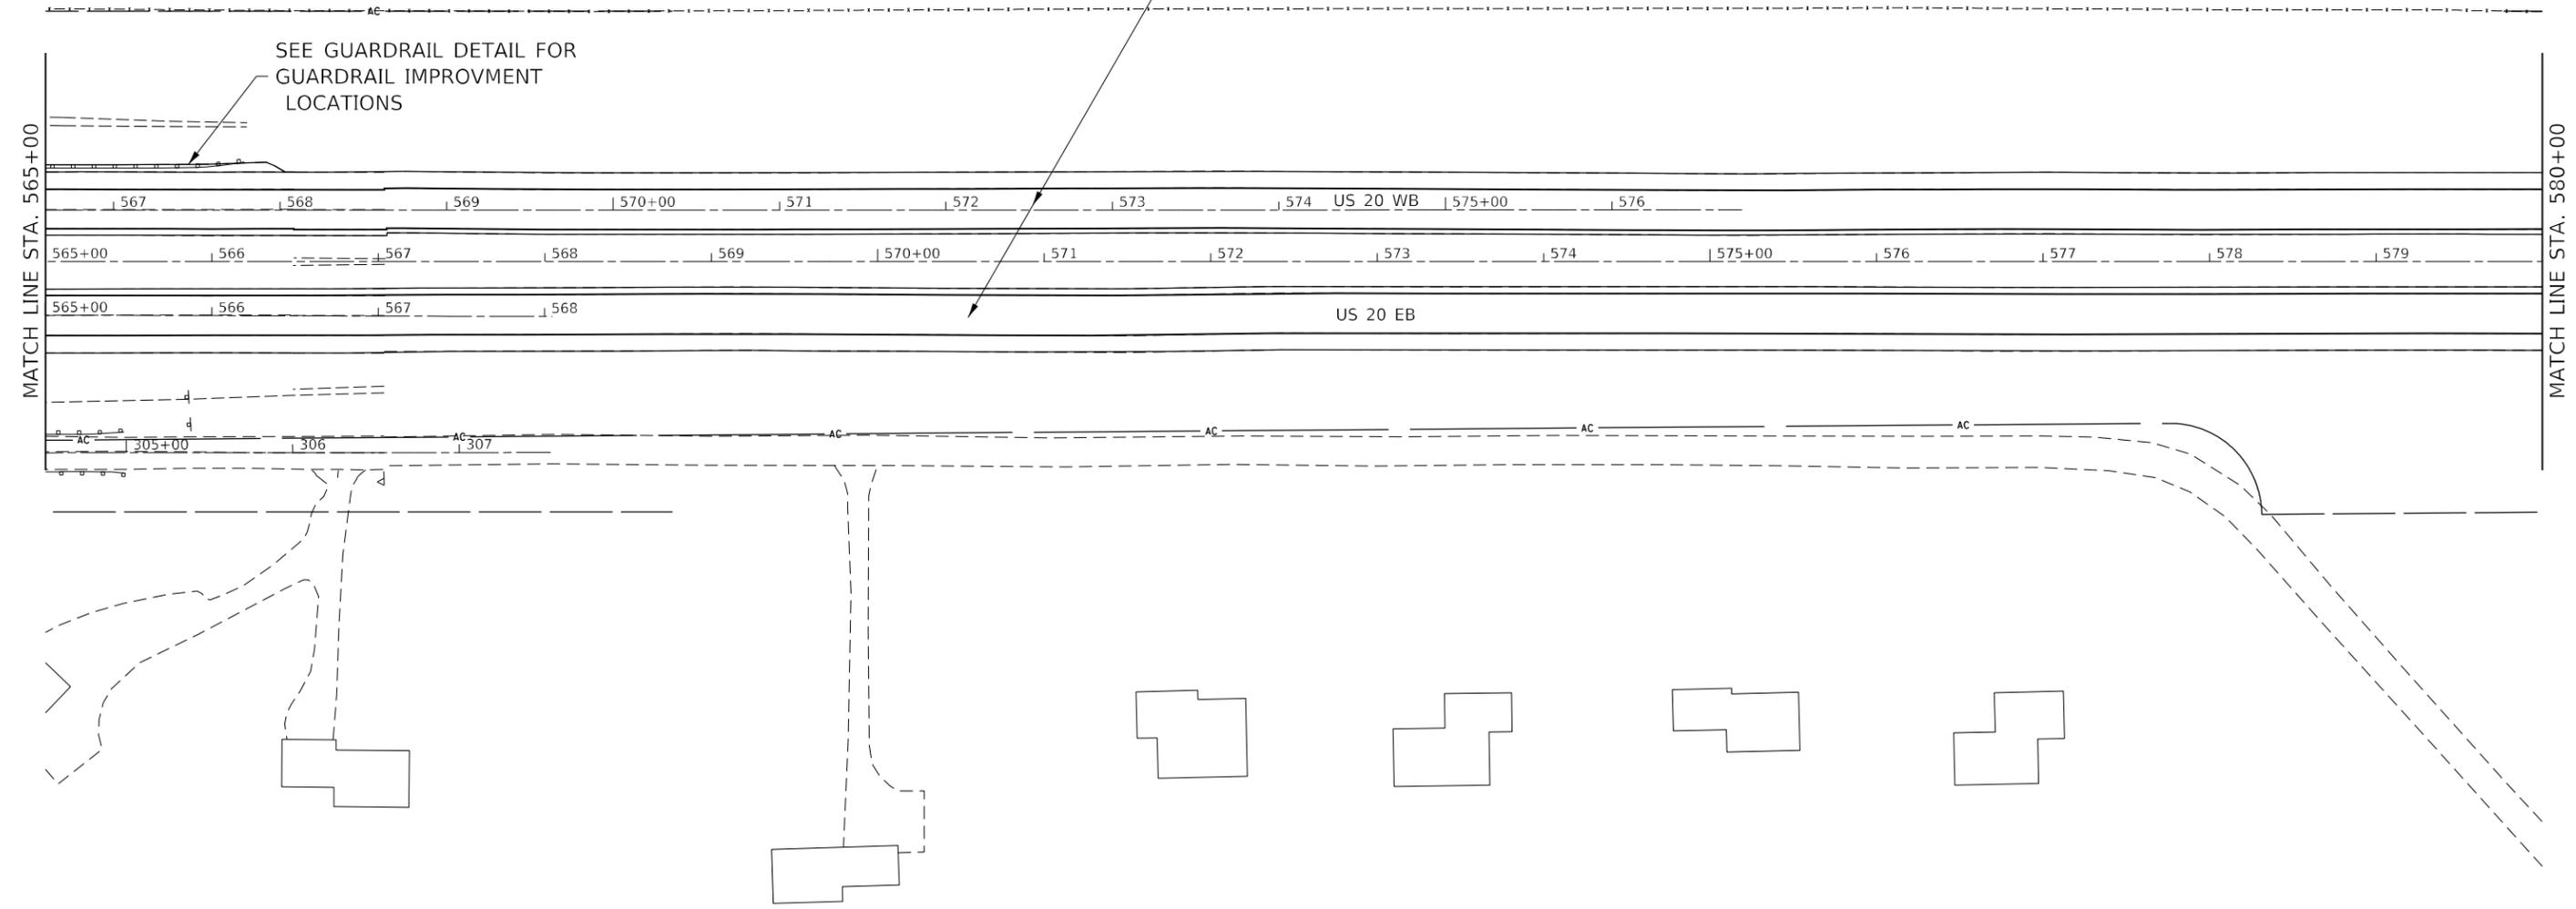

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DRAWN -	REVISED -	
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PLOT DATE = Mar-19-2021 08:43:52 AM	DATE -	REVISED -

STATE OF ILLINOIS
DEPARTMENT OF TRANSPORTATION

US 20
PLAN SHEET

F.A.P. RTE.	SECTION	COUNTY	TOTAL SHEETS	SHEET NO.
301	(1-1,1,2)RS-2	WINNEBAGO	158	70
CONTRACT NO. 64M18				
ILLINOIS FED. AID PROJECT				

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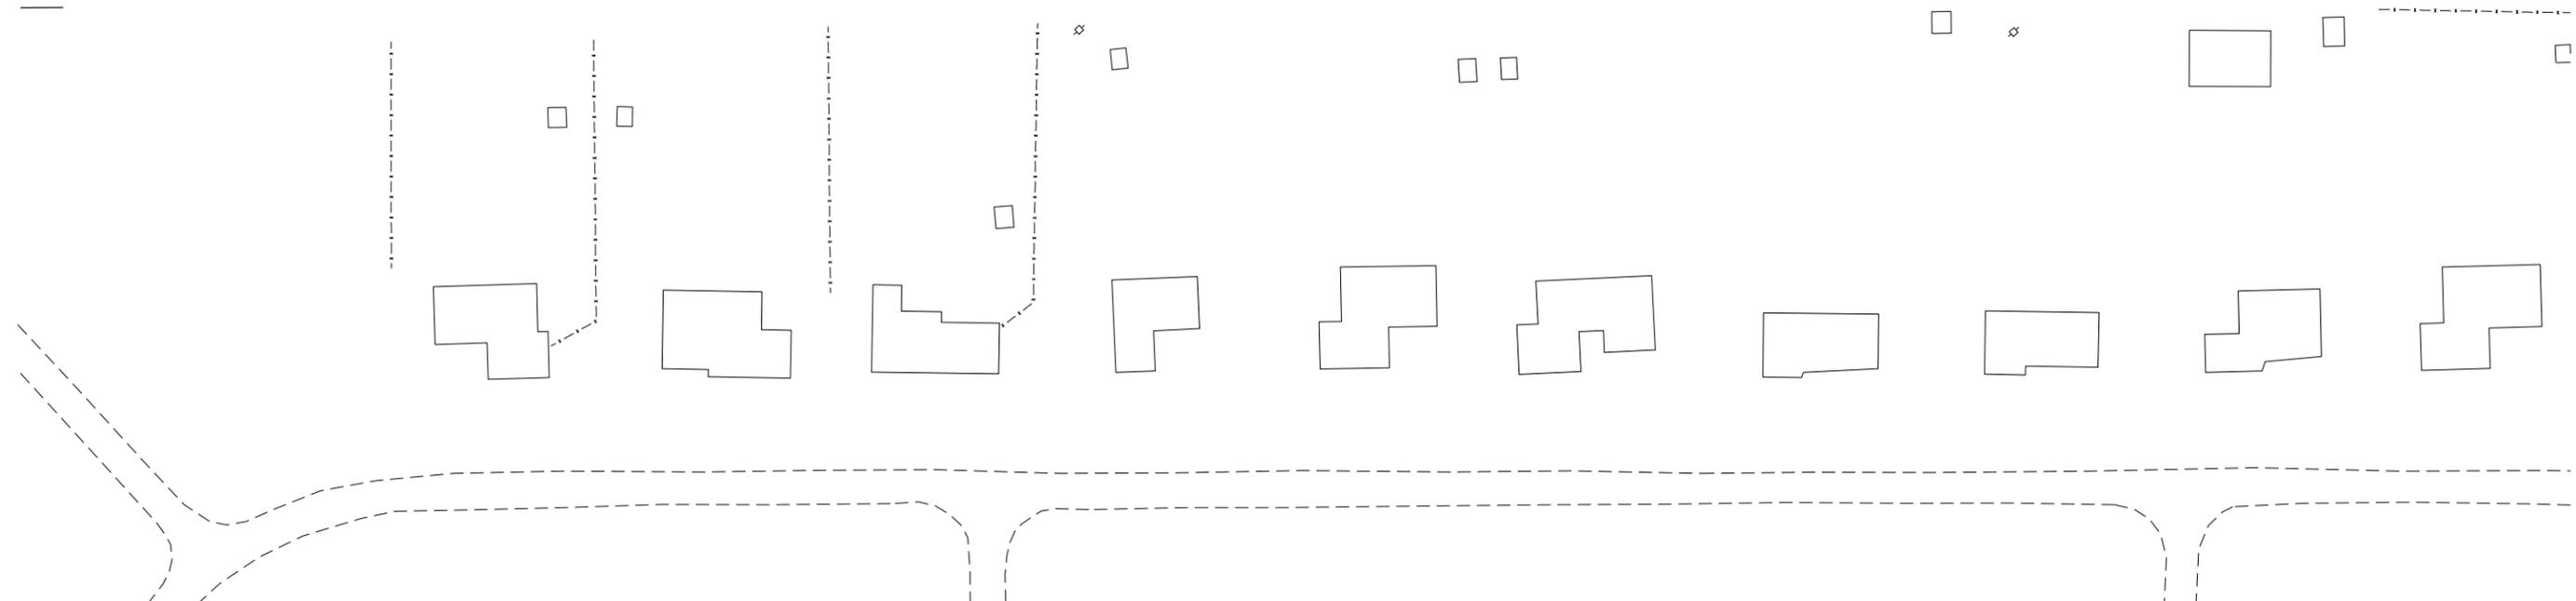
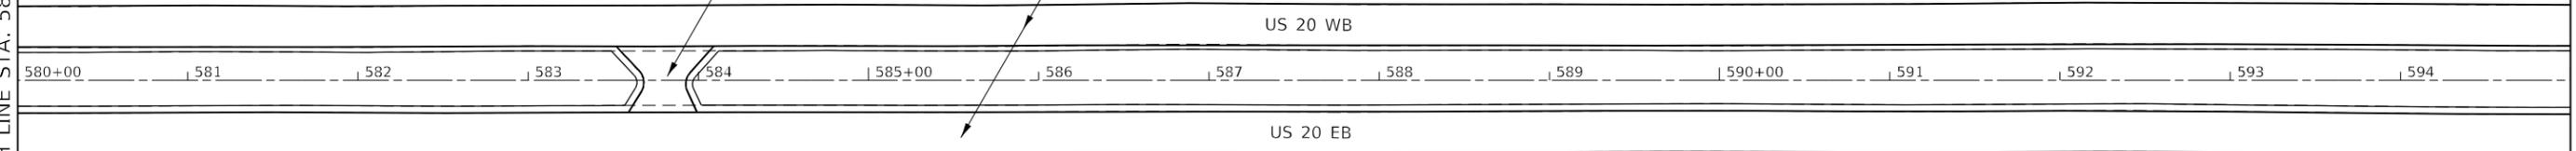


HMA SURFACE REMOVAL, 6"
3 3/4" INCIDENTAL HMA SURFACING

HMA SURFACE REMOVAL, 6"
2" POLYMERIZED HMA SURFACE COURSE, IL-9.5, MIX "D", N70
1 3/4" POLYMERIZED HMA BINDER COURSE, IL-9.5FG, N70

MATCH LINE STA. 580+00

MATCH LINE STA. 595+00



MODEL: Default
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	DATE -	REVISED -

STATE OF ILLINOIS
DEPARTMENT OF TRANSPORTATION


US 20
PLAN SHEET

SCALE: SHEET OF SHEETS STA. TO STA.

F.A.P. RTE.	SECTION	COUNTY	TOTAL SHEETS	SHEET NO.
301	(1-1,1,2)RS-2	WINNEBAGO	158	71
CONTRACT NO. 64M18				
ILLINOIS FED. AID PROJECT				



HMA SURFACE REMOVAL, 6"
 2" POLYMERIZED HMA SURFACE COURSE, IL-9.5, MIX "D", N70
 1 3/4" POLYMERIZED HMA BINDER COURSE, IL-9.5FG, N70

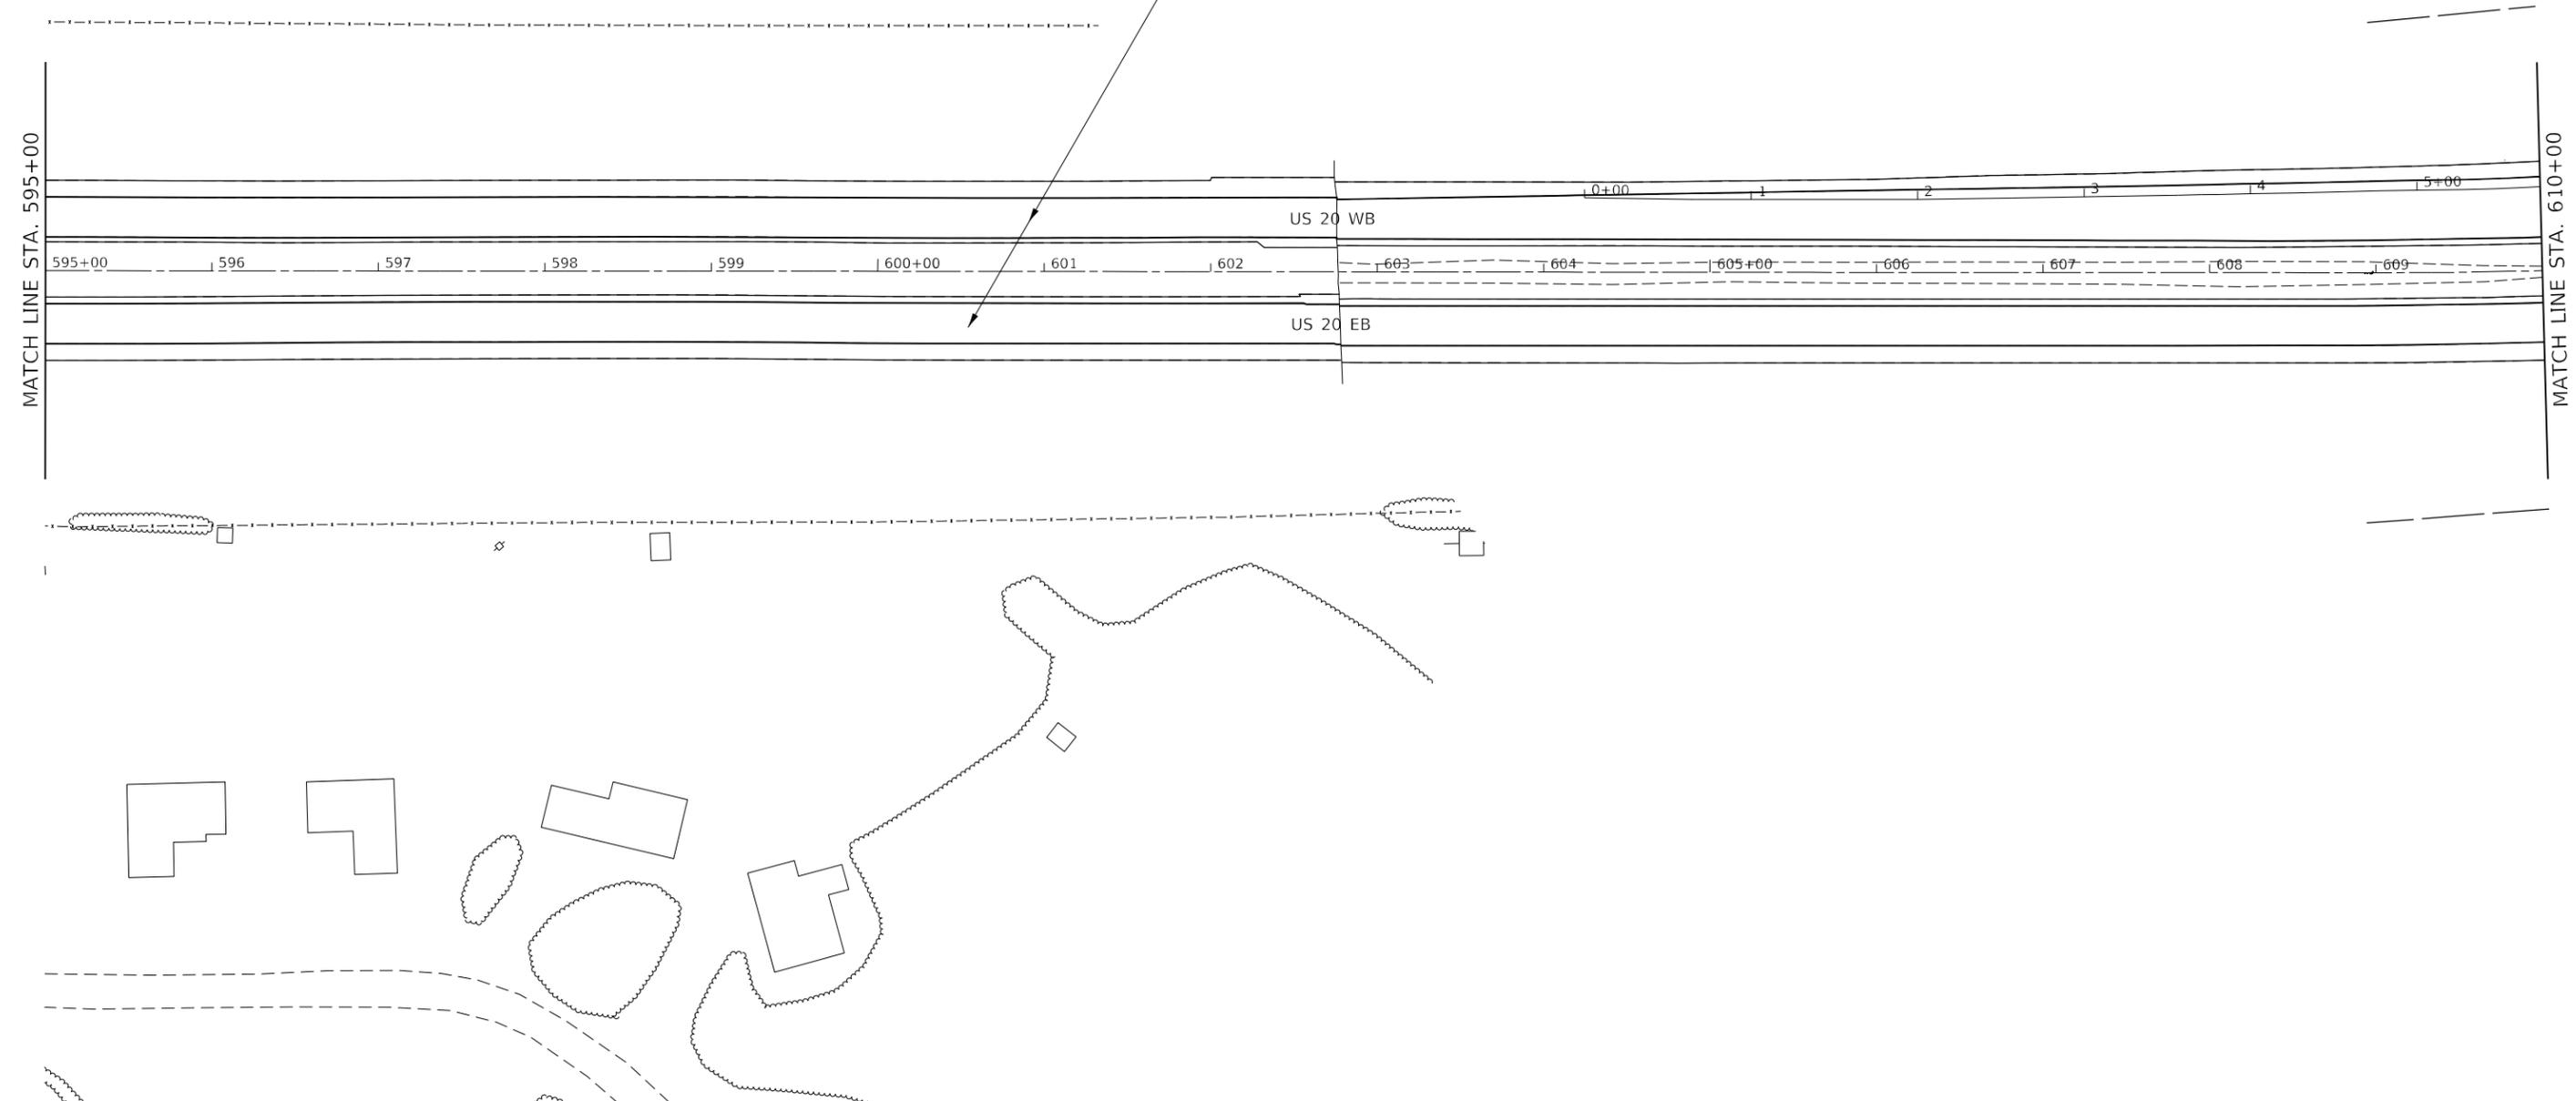

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MATCH LINE STA. 595+00

MATCH LINE STA. 610+00

USER NAME = ankneyde	DESIGNED -	REVISED -
DRAWN -	REVISED -	
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**STATE OF ILLINOIS
 DEPARTMENT OF TRANSPORTATION**

US 20 PLAN SHEET				
SCALE:	SHEET	OF	SHEETS	STA. TO STA.

F.A.P. RTE.	SECTION	COUNTY	TOTAL SHEETS	SHEET NO.
301	(1-1,1,2)RS-2	WINNEBAGO	158	72
CONTRACT NO. 64M18				
ILLINOIS FED. AID PROJECT				



END STATION
19+61


HMA SURFACE REMOVAL, 6"
2" POLYMERIZED HMA SURFACE COURSE, IL-9.5, MIX "D", N70
1 3/4" POLYMERIZED HMA BINDER COURSE, IL-9.5FG, N70

STA 12+61 - STA 13+76
HMA SURFACE REMOVAL
VARIABLE DEPTH 6" - 3 3/4"

HMA SURFACE REMOVAL, 3 3/4"
2" POLYMERIZED HMA SURFACE COURSE, IL-9.5, MIX "D", N70
1 3/4" POLYMERIZED HMA BINDER COURSE, IL-9.5FG, N70

STA 7+16 - STA 8+31
HMA SURFACE REMOVAL
VARIABLE DEPTH 6" - 3 3/4"

SEE GUARDRAIL DETAIL FOR
GUARDRAIL IMPROVMENT LOCATIONS

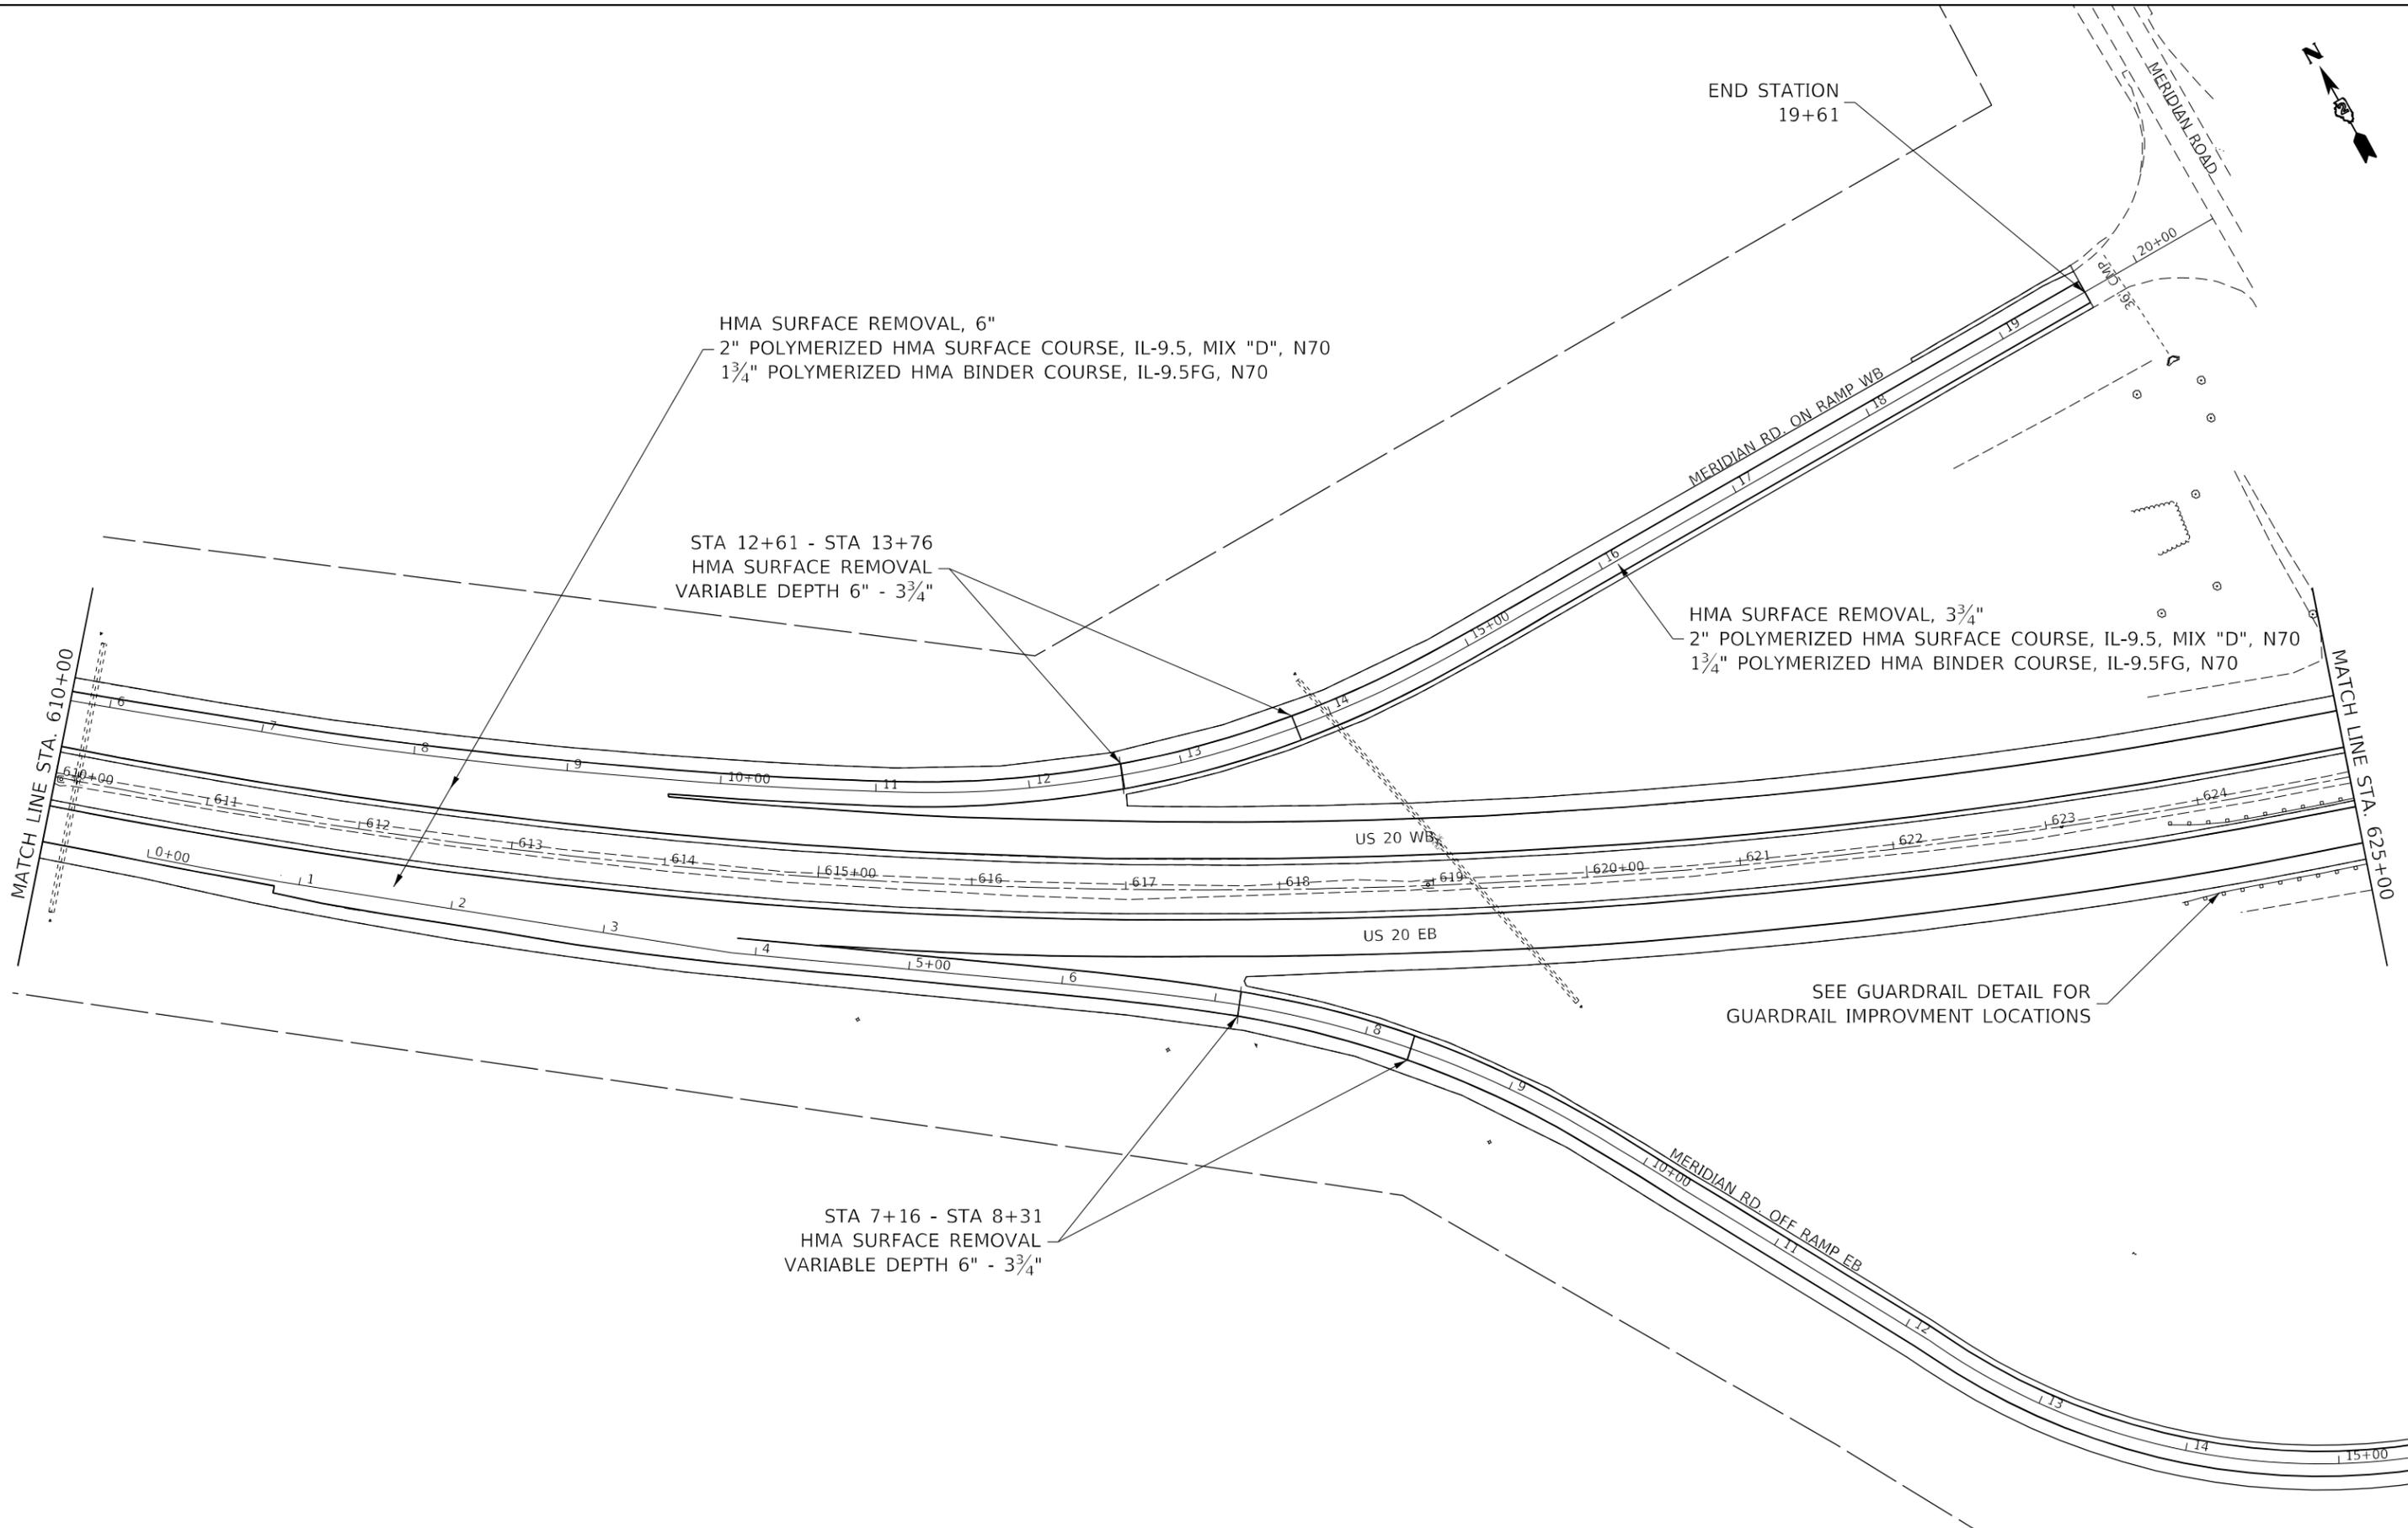

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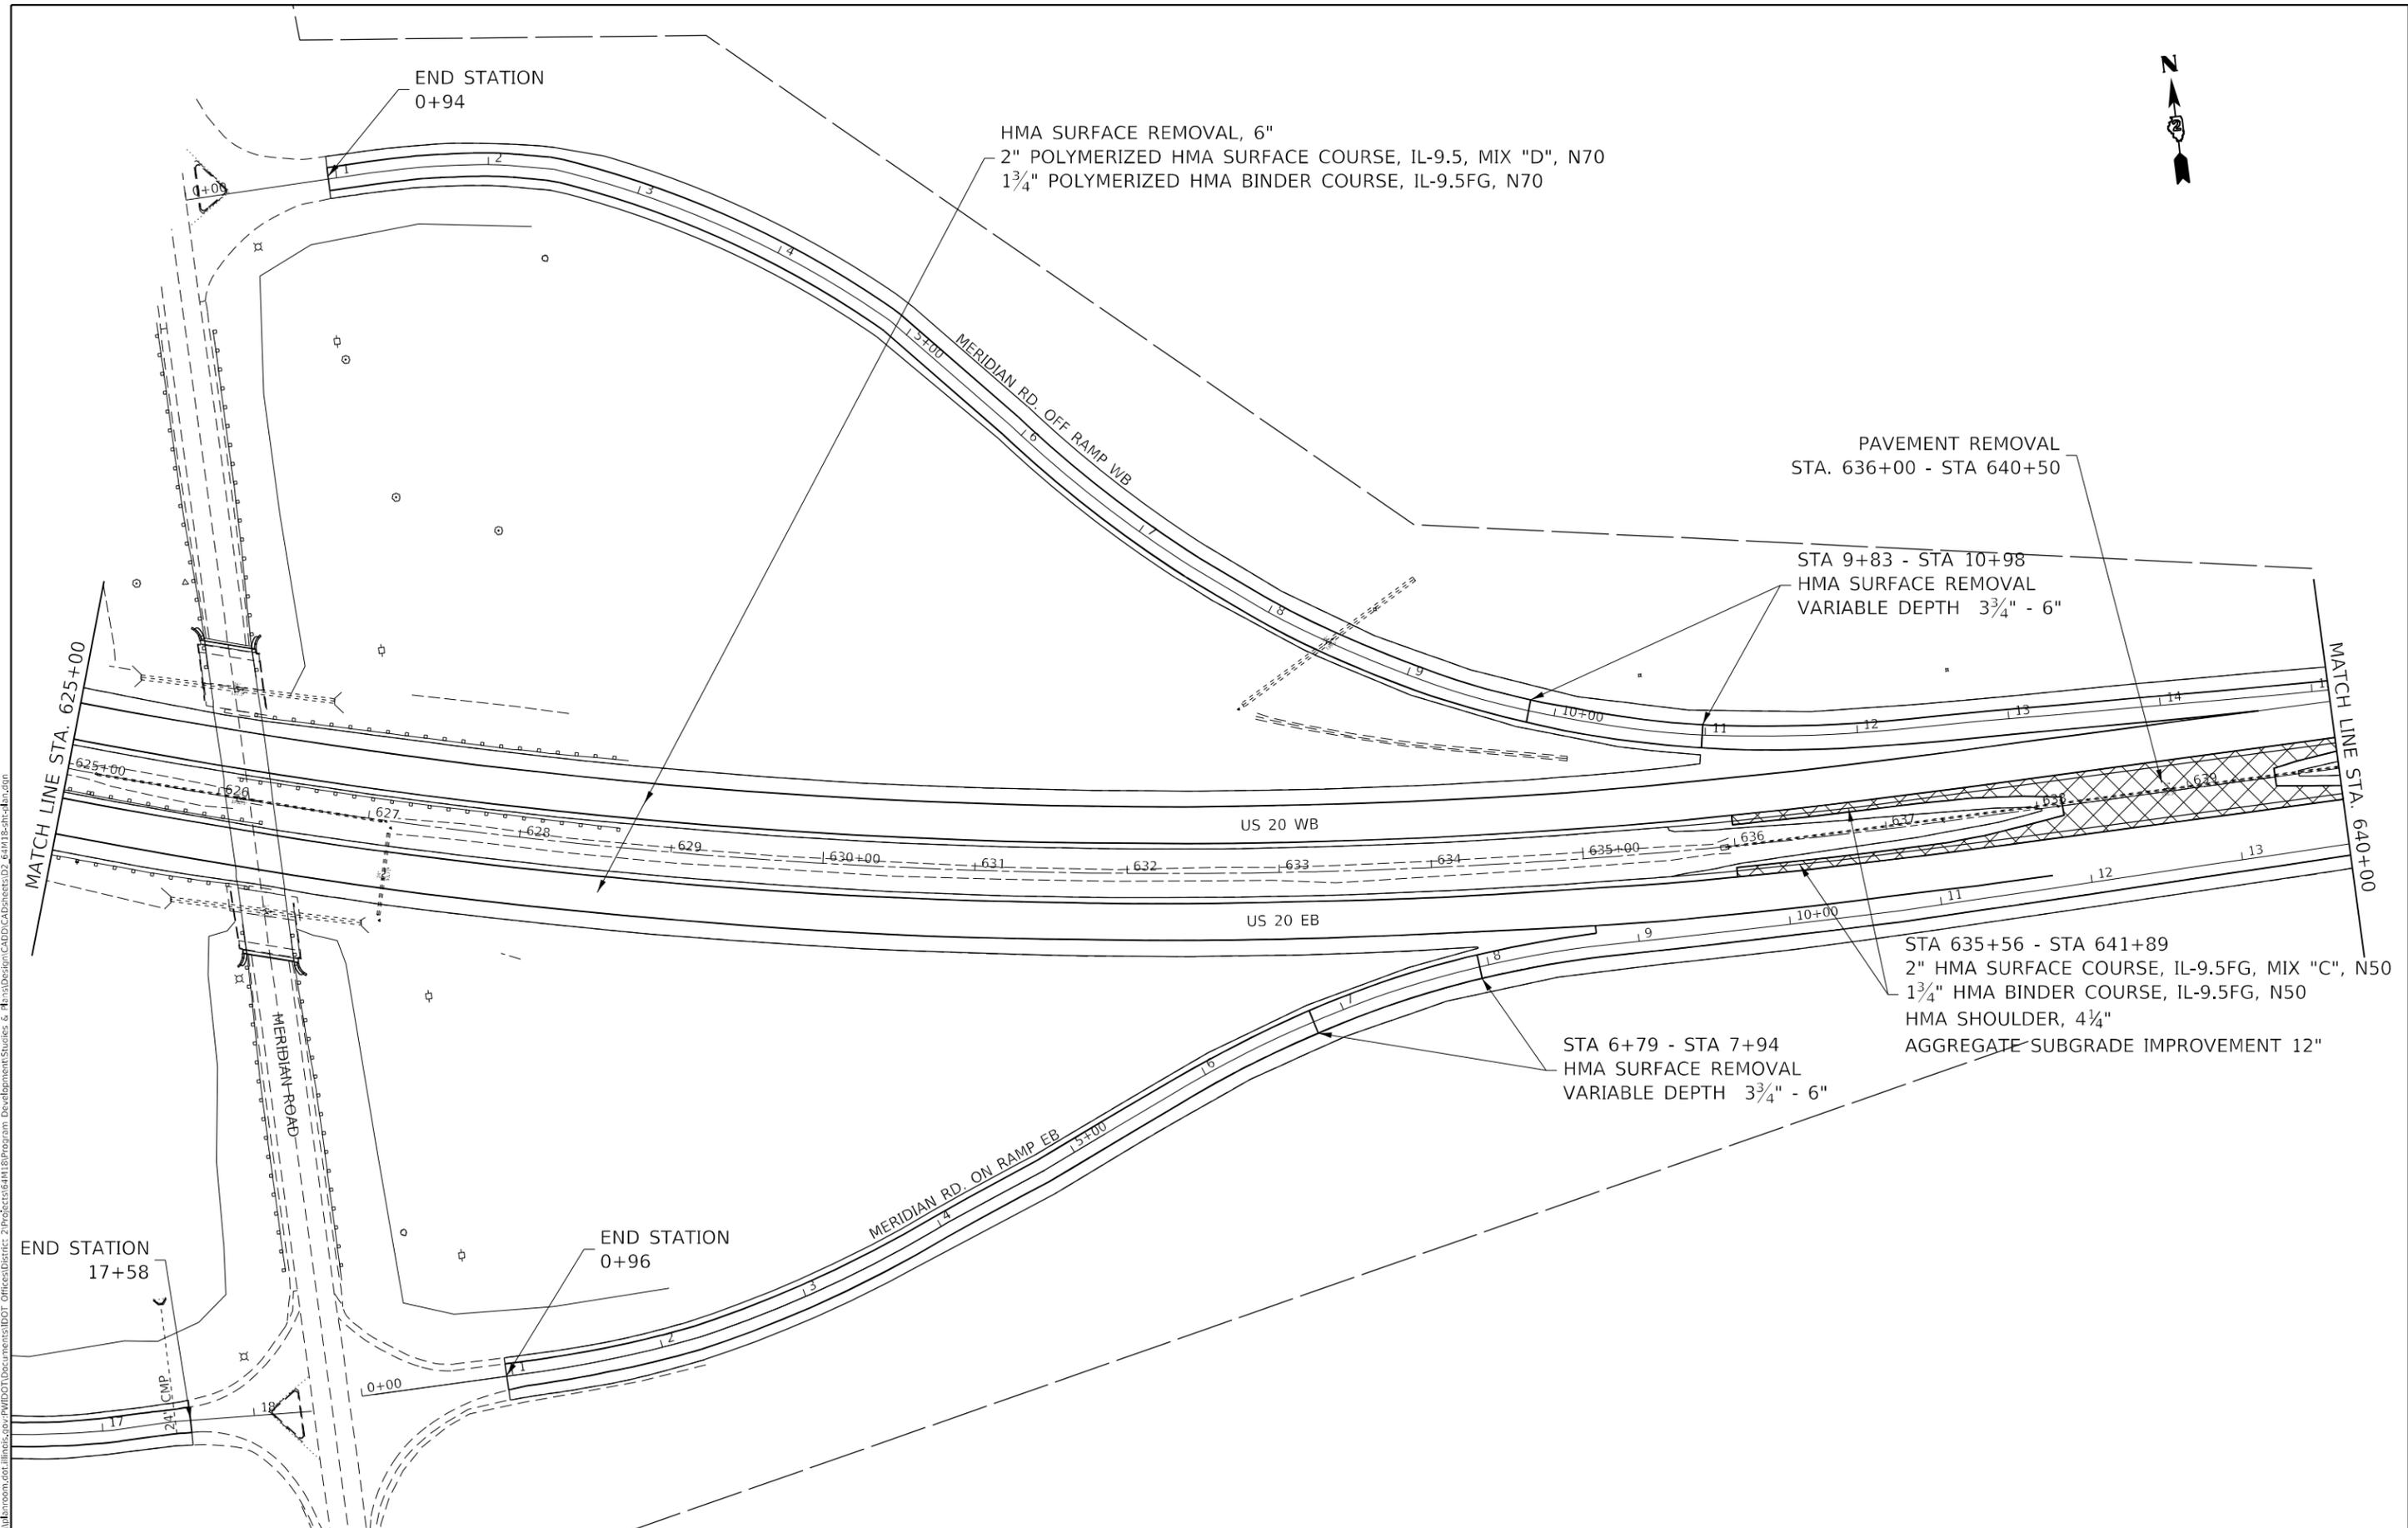
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**STATE OF ILLINOIS
DEPARTMENT OF TRANSPORTATION**

**US 20
PLAN SHEET**

SCALE: SHEET OF SHEETS STA. TO STA.

F.A.P. RTE.	SECTION	COUNTY	TOTAL SHEETS	SHEET NO.
301	(1-1,1,2)RS-2	WINNEBAGO	158	73
			CONTRACT NO. 64M18	
ILLINOIS FED. AID PROJECT				




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STATE OF ILLINOIS
DEPARTMENT OF TRANSPORTATION

US 20				
PLAN SHEET				
SCALE:	SHEET	OF	SHEETS	STA. TO STA.

F.A.P. RTE.	SECTION	COUNTY	TOTAL SHEETS	SHEET NO.
301	(1-1,1,2)RS-2	WINNEBAGO	158	74
ILLINOIS FED. AID PROJECT			CONTRACT NO. 64M18	



STA 635+56 - STA 641+89
 2" HMA SURFACE COURSE, IL-9.5FG, MIX "C", N50
 1 3/4" HMA BINDER COURSE, IL-9.5FG, N50
 HMA SHOULDER, 4 1/4"
 AGGREGATE SUBGRADE IMPROVEMENT 12"

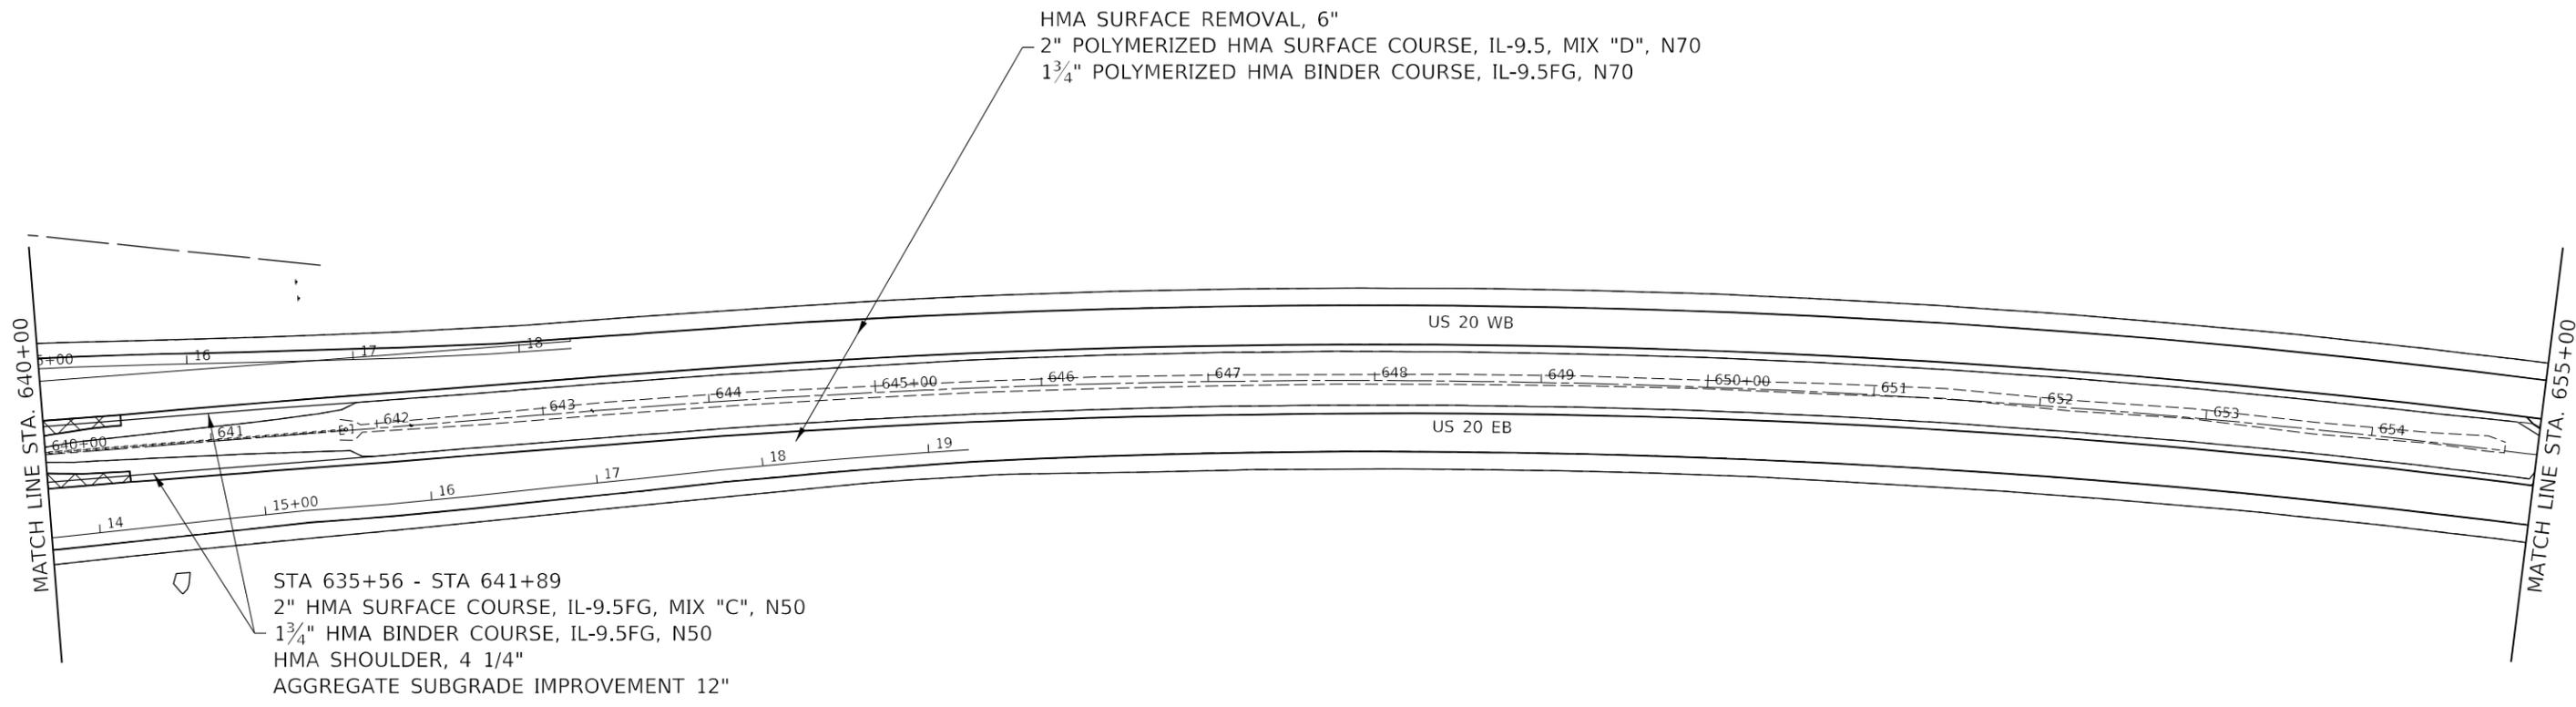
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	DATE -	REVISED -

STATE OF ILLINOIS
DEPARTMENT OF TRANSPORTATION

US 20			
PLAN SHEET			
SCALE:	SHEET	OF	SHEETS
	STA.	TO	STA.

F.A.P. RTE.	SECTION	COUNTY	TOTAL SHEETS	SHEET NO.
301	(1-1,1,2)RS-2	WINNEBAGO	158	75
CONTRACT NO. 64M18				
ILLINOIS FED. AID PROJECT				

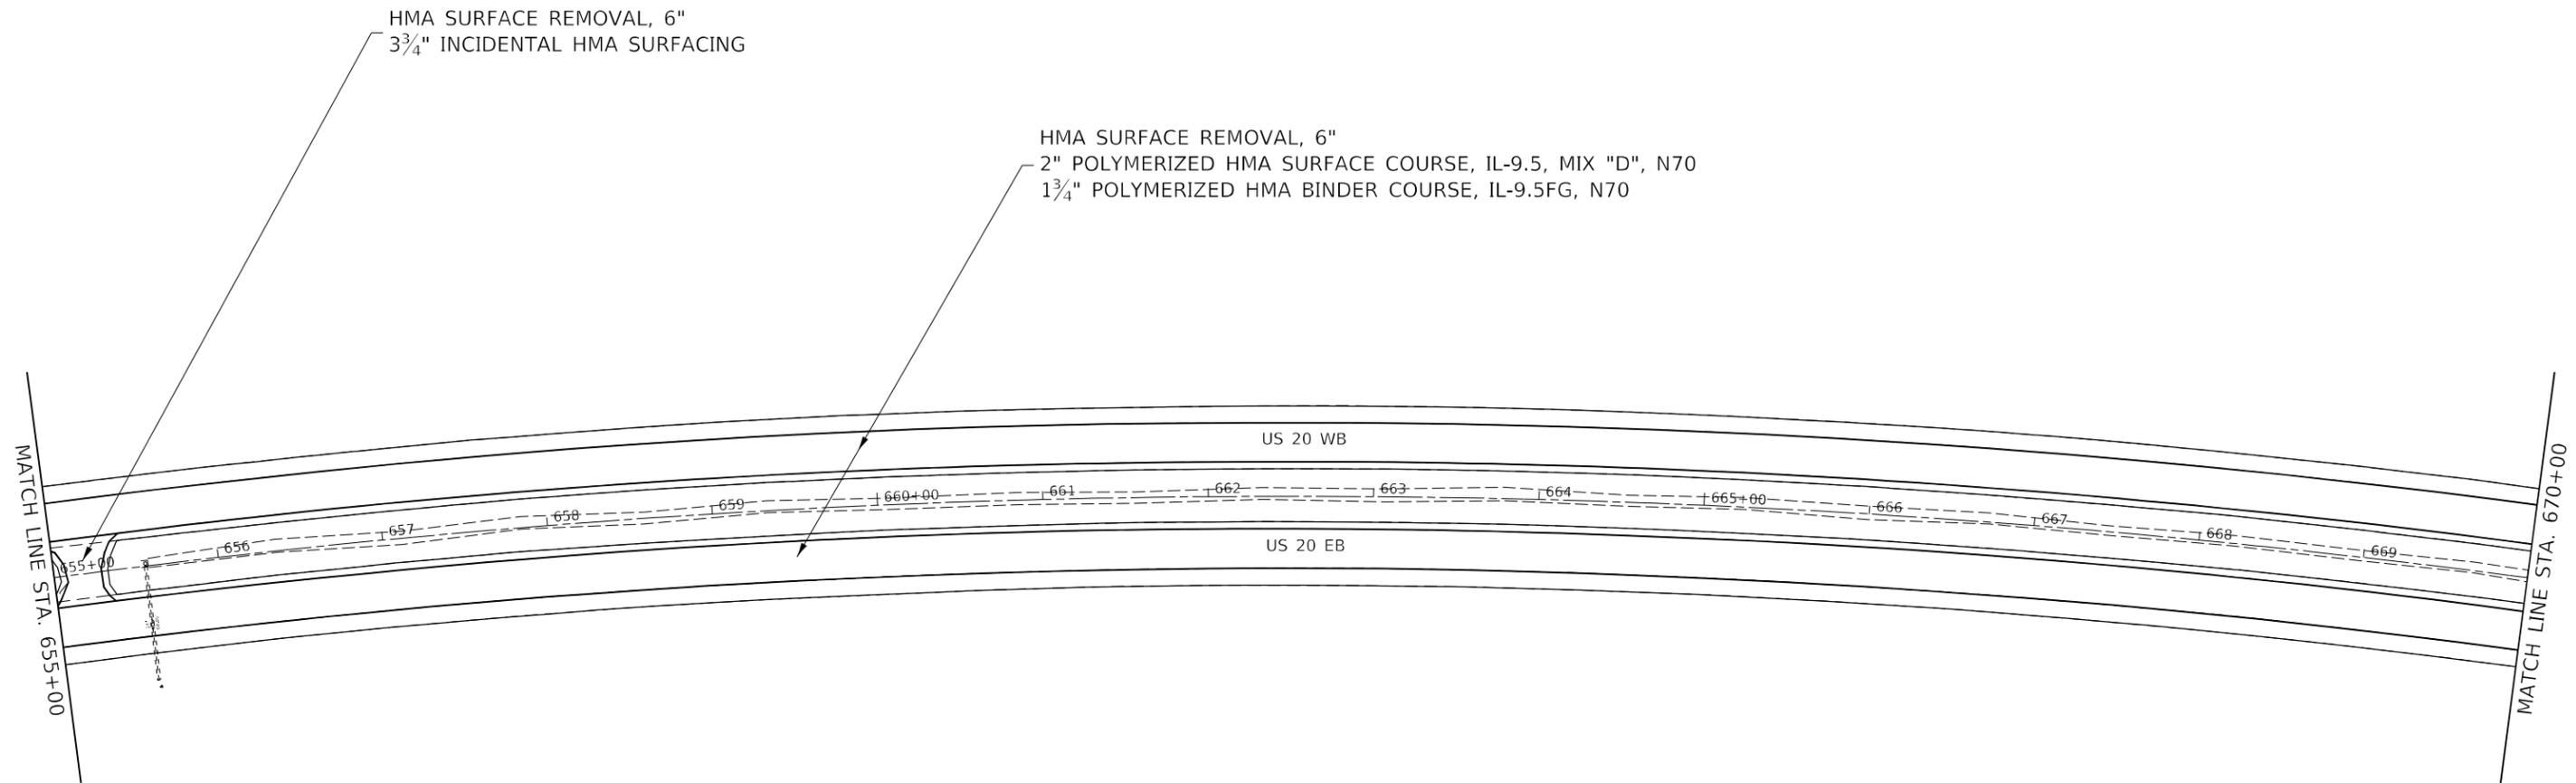

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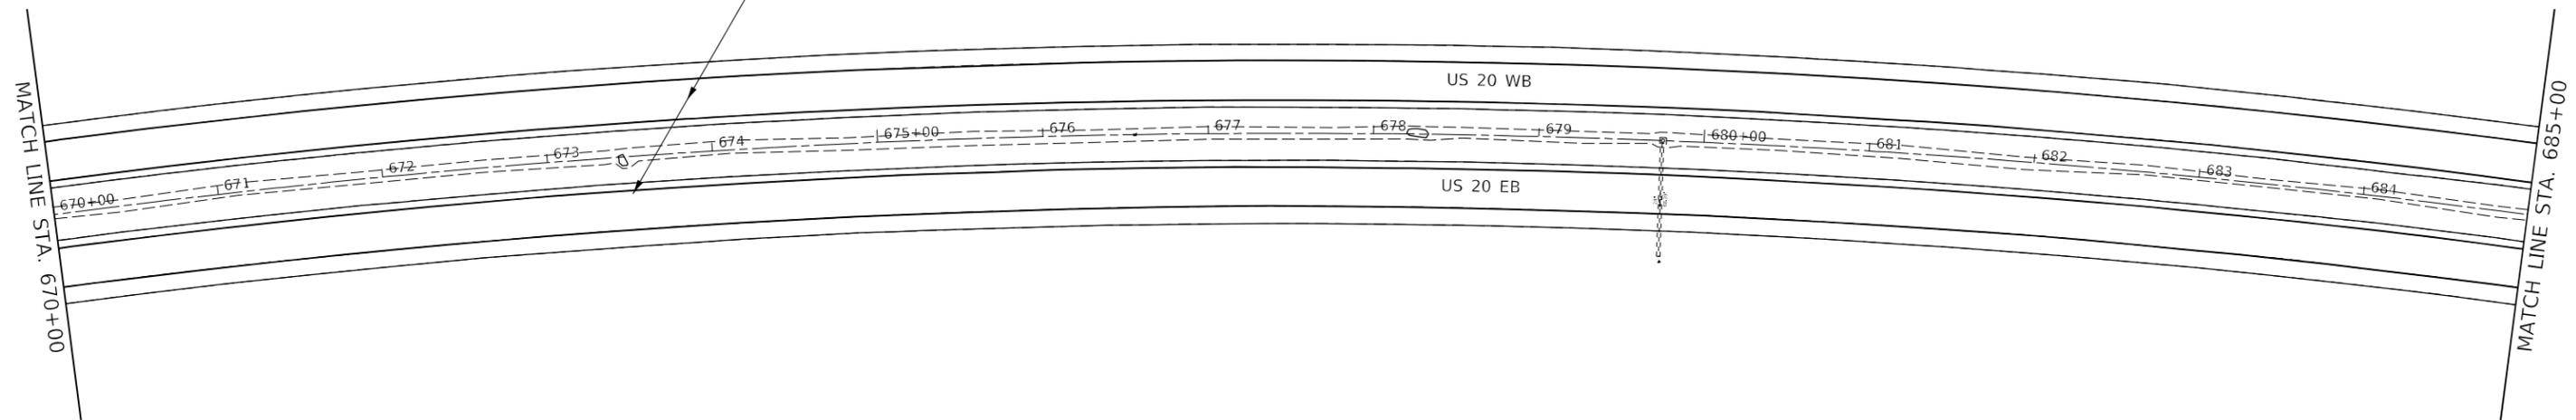
STATE OF ILLINOIS
DEPARTMENT OF TRANSPORTATION

US 20			
PLAN SHEET			
SCALE:	SHEET	OF	SHEETS
	STA.	TO	STA.

F.A.P. RTE.	SECTION	COUNTY	TOTAL SHEETS	SHEET NO.
301	(1-1,1,2)RS-2	WINNEBAGO	158	76
CONTRACT NO. 64M18				
ILLINOIS FED. AID PROJECT				



HMA SURFACE REMOVAL, 6"
 2" POLYMERIZED HMA SURFACE COURSE, IL-9.5, MIX "D", N70
 1 3/4" POLYMERIZED HMA BINDER COURSE, IL-9.5FG, N70




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USER NAME = anikneyde	DESIGNED -	REVISED -
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**STATE OF ILLINOIS
 DEPARTMENT OF TRANSPORTATION**

US 20 PLAN SHEET			
SCALE:	SHEET	OF	SHEETS
	STA.	TO	STA.

F.A.P. RTE.	SECTION	COUNTY	TOTAL SHEETS	SHEET NO.
301	(1-1,1,2)RS-2	WINNEBAGO	158	77
CONTRACT NO. 64M18				
ILLINOIS FED. AID PROJECT				



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 DESIGN: CAD
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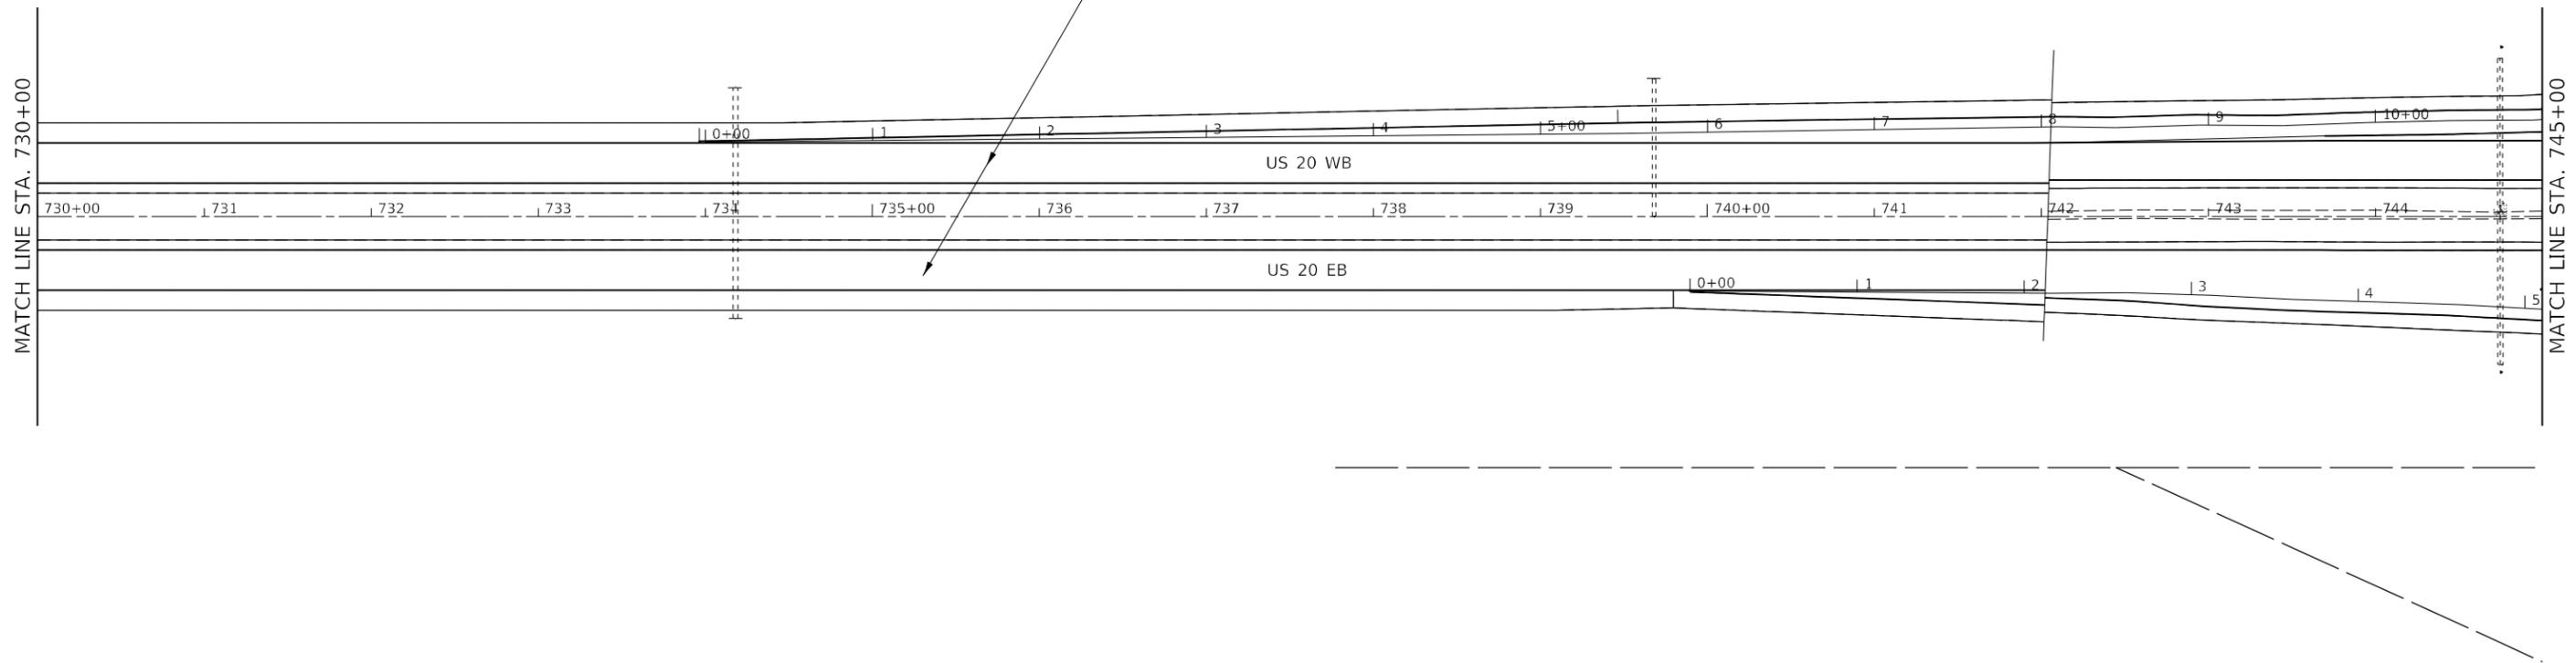
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	DATE -	REVISED -

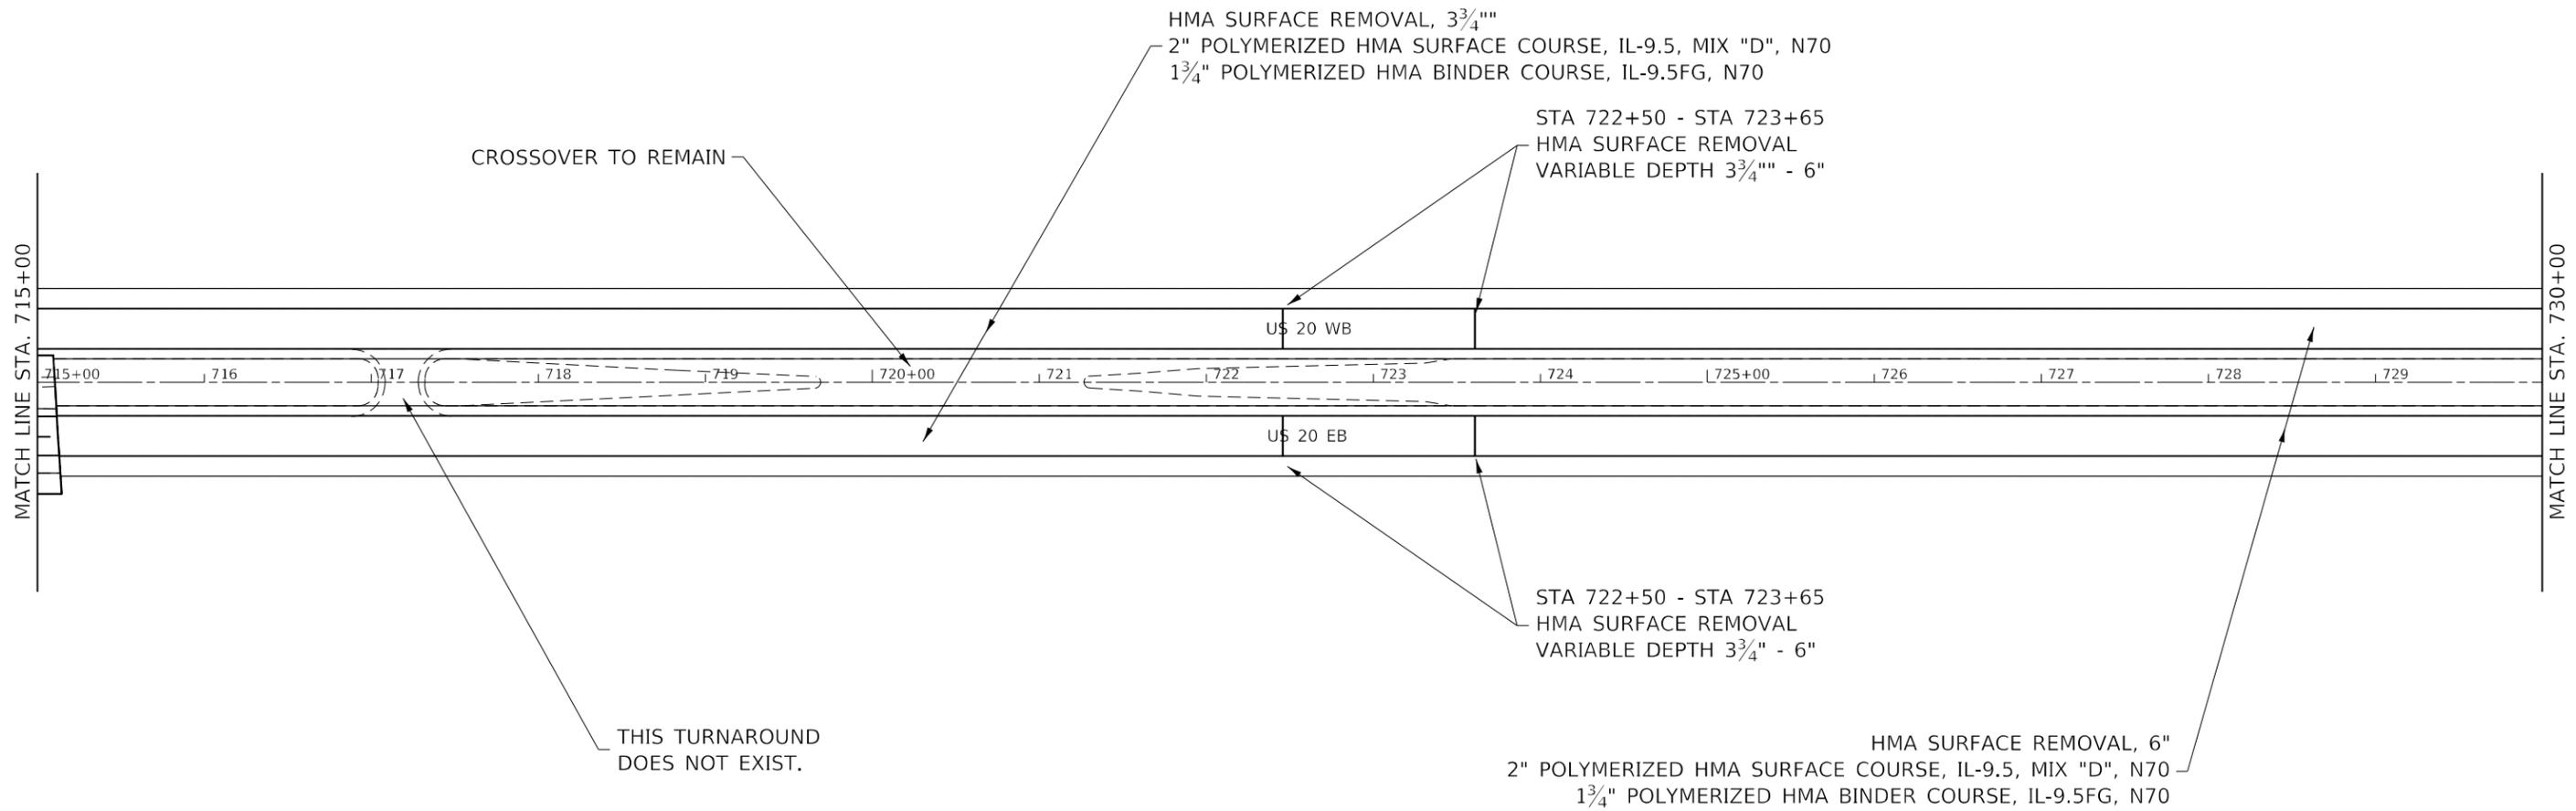STATE OF ILLINOIS
DEPARTMENT OF TRANSPORTATION

US 20 PLAN SHEET			
SCALE:	SHEET	OF	SHEETS
	STA.	TO	STA.

F.A.P. RTE.	SECTION	COUNTY	TOTAL SHEETS	SHEET NO.
301	(1-1,1,2)RS-2	WINNEBAGO	158	80
CONTRACT NO. 64M18				
ILLINOIS FED. AID PROJECT				

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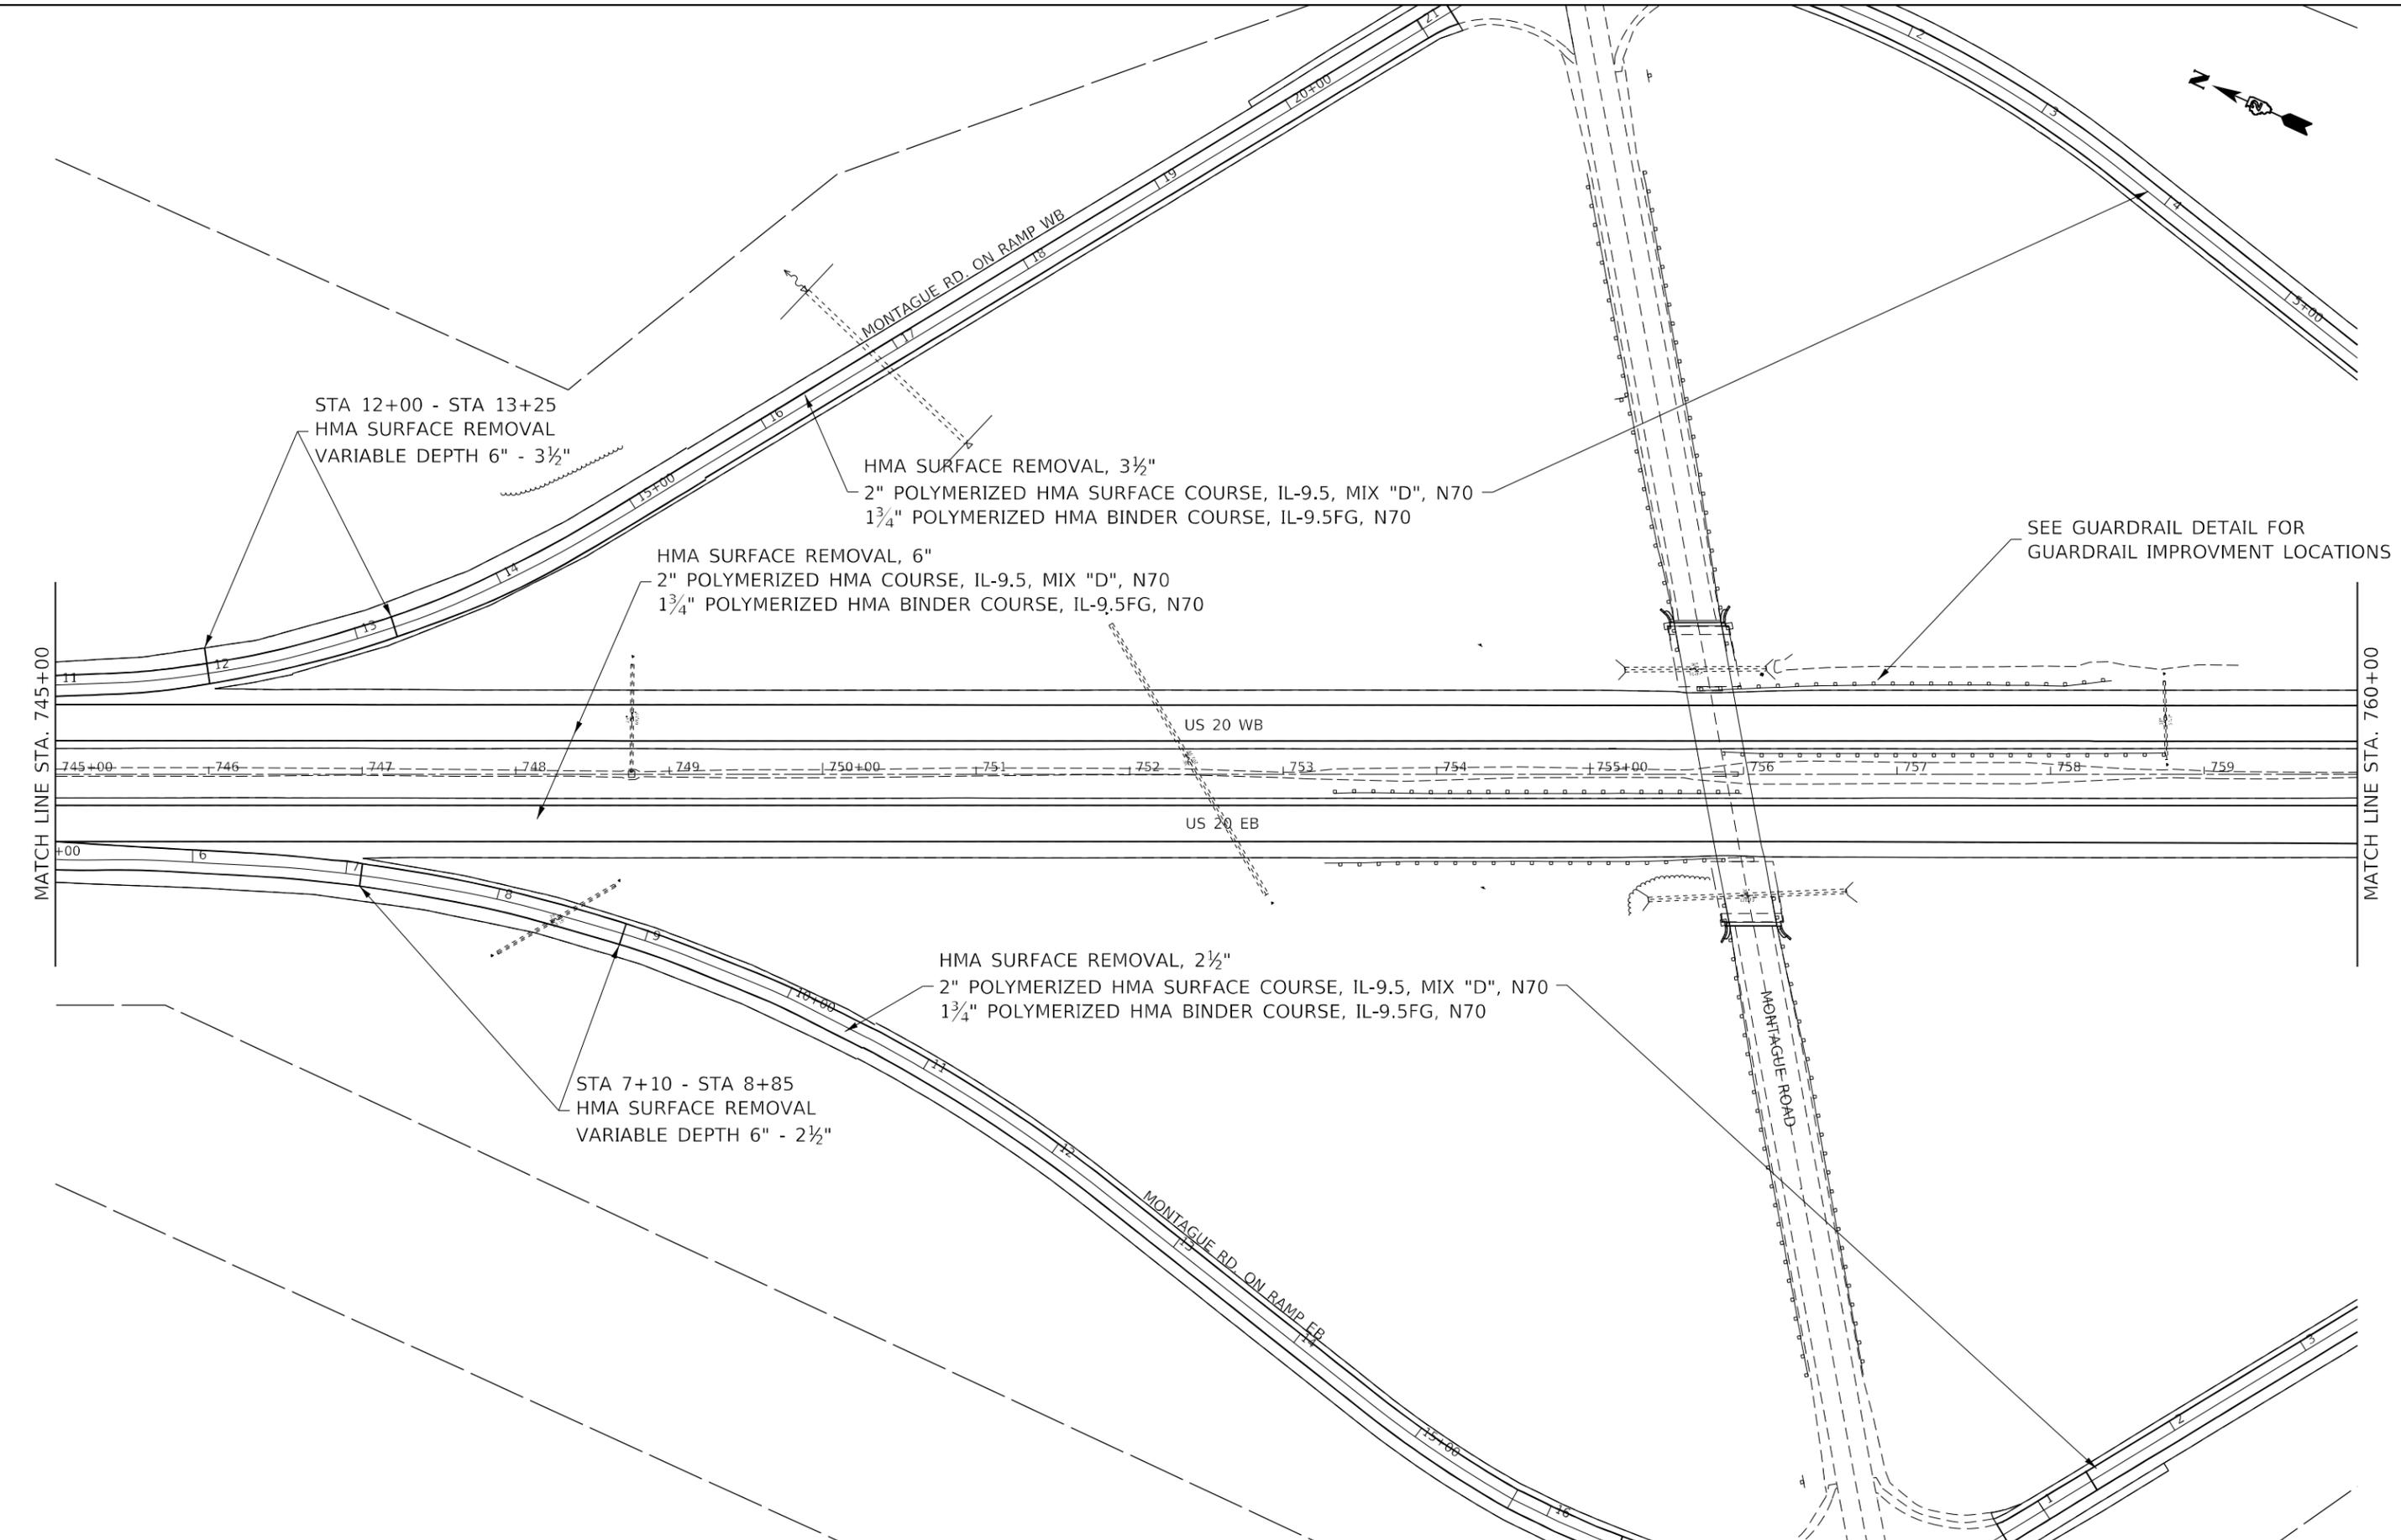
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**STATE OF ILLINOIS
 DEPARTMENT OF TRANSPORTATION**

US 20 PLAN SHEET			
SCALE:	SHEET	OF	SHEETS
	STA.	TO	STA.

F.A.P. RTE.	SECTION	COUNTY	TOTAL SHEETS	SHEET NO.
301	(1-1,1,2)RS-2	WINNEBAGO	158	81
CONTRACT NO. 64M18				
ILLINOIS FED. AID PROJECT				

MODEL: Default
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 PROGRAM: DevelopmentStudies & PlanDesign
 OFFICE: District 2
 DISTRICT: 2
 SHEET: 158



STA 12+00 - STA 13+25
HMA SURFACE REMOVAL
VARIABLE DEPTH 6" - 3 1/2"

HMA SURFACE REMOVAL, 3 1/2"
2" POLYMERIZED HMA SURFACE COURSE, IL-9.5, MIX "D", N70
1 3/4" POLYMERIZED HMA BINDER COURSE, IL-9.5FG, N70

HMA SURFACE REMOVAL, 6"
2" POLYMERIZED HMA COURSE, IL-9.5, MIX "D", N70
1 3/4" POLYMERIZED HMA BINDER COURSE, IL-9.5FG, N70

SEE GUARDRAIL DETAIL FOR
GUARDRAIL IMPROVEMENT LOCATIONS

HMA SURFACE REMOVAL, 2 1/2"
2" POLYMERIZED HMA SURFACE COURSE, IL-9.5, MIX "D", N70
1 3/4" POLYMERIZED HMA BINDER COURSE, IL-9.5FG, N70

STA 7+10 - STA 8+85
HMA SURFACE REMOVAL
VARIABLE DEPTH 6" - 2 1/2"


**STATE OF ILLINOIS
DEPARTMENT OF TRANSPORTATION**

**US 20
PLAN SHEET**

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	DATE -	REVISED -

SCALE:	SHEET	OF	SHEETS	STA.	TO	STA.
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F.A.P. RTE.	SECTION	COUNTY	TOTAL SHEETS	SHEET NO.
301	(1-1,1,2)RS-2	WINNEBAGO	158	82
CONTRACT NO. 64M18				
ILLINOIS FED. AID PROJECT				

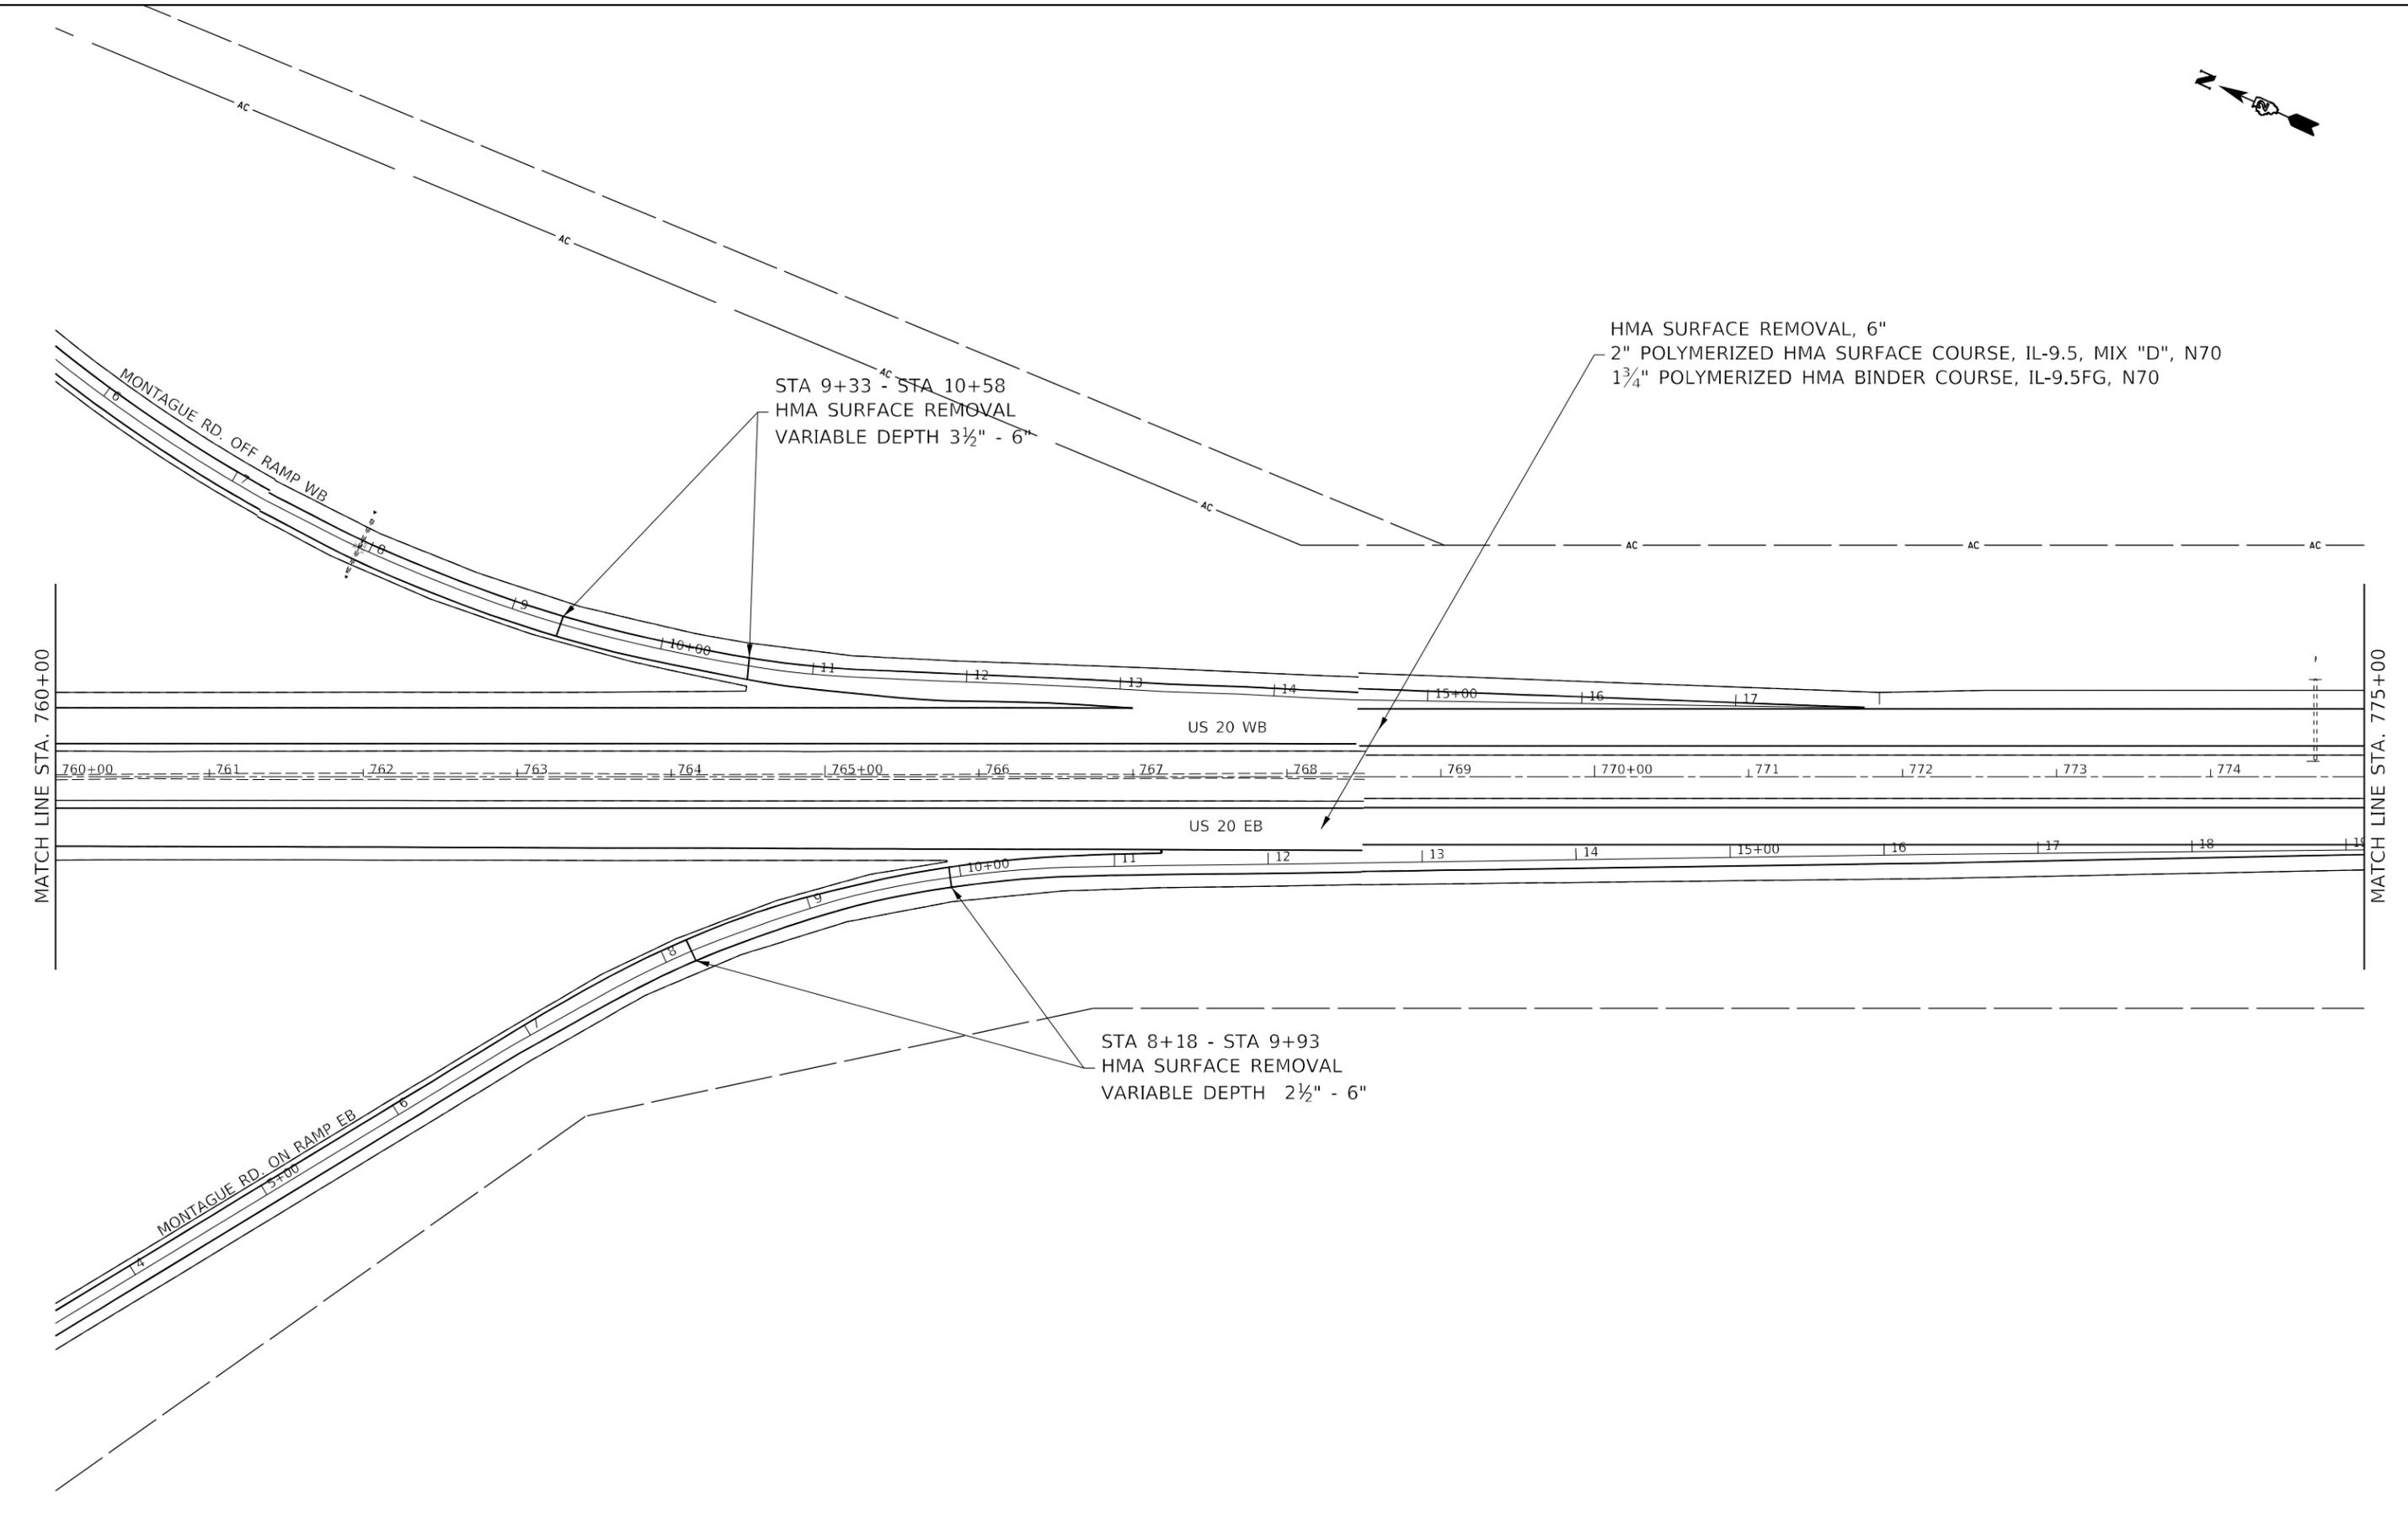

MODEL: Default
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STATE OF ILLINOIS
DEPARTMENT OF TRANSPORTATION


US 20			
PLAN SHEET			
SCALE:	SHEET	OF	SHEETS
	STA.	TO	STA.

F.A.P. RTE.	SECTION	COUNTY	TOTAL SHEETS	SHEET NO.
301	(1-1,1,2)RS-2	WINNEBAGO	158	83
			CONTRACT NO. 64M18	
ILLINOIS FED. AID PROJECT				



HMA SURFACE REMOVAL, 6"
 3 3/4" INCIDENTAL HMA SURFACING

HMA SURFACE REMOVAL, 6"
 2" POLYMERIZED HMA SURFACE COURSE, IL-9.5, MIX "D", N70
 1 3/4" POLYMERIZED HMA BINDER COURSE, IL-9.5FG, N70

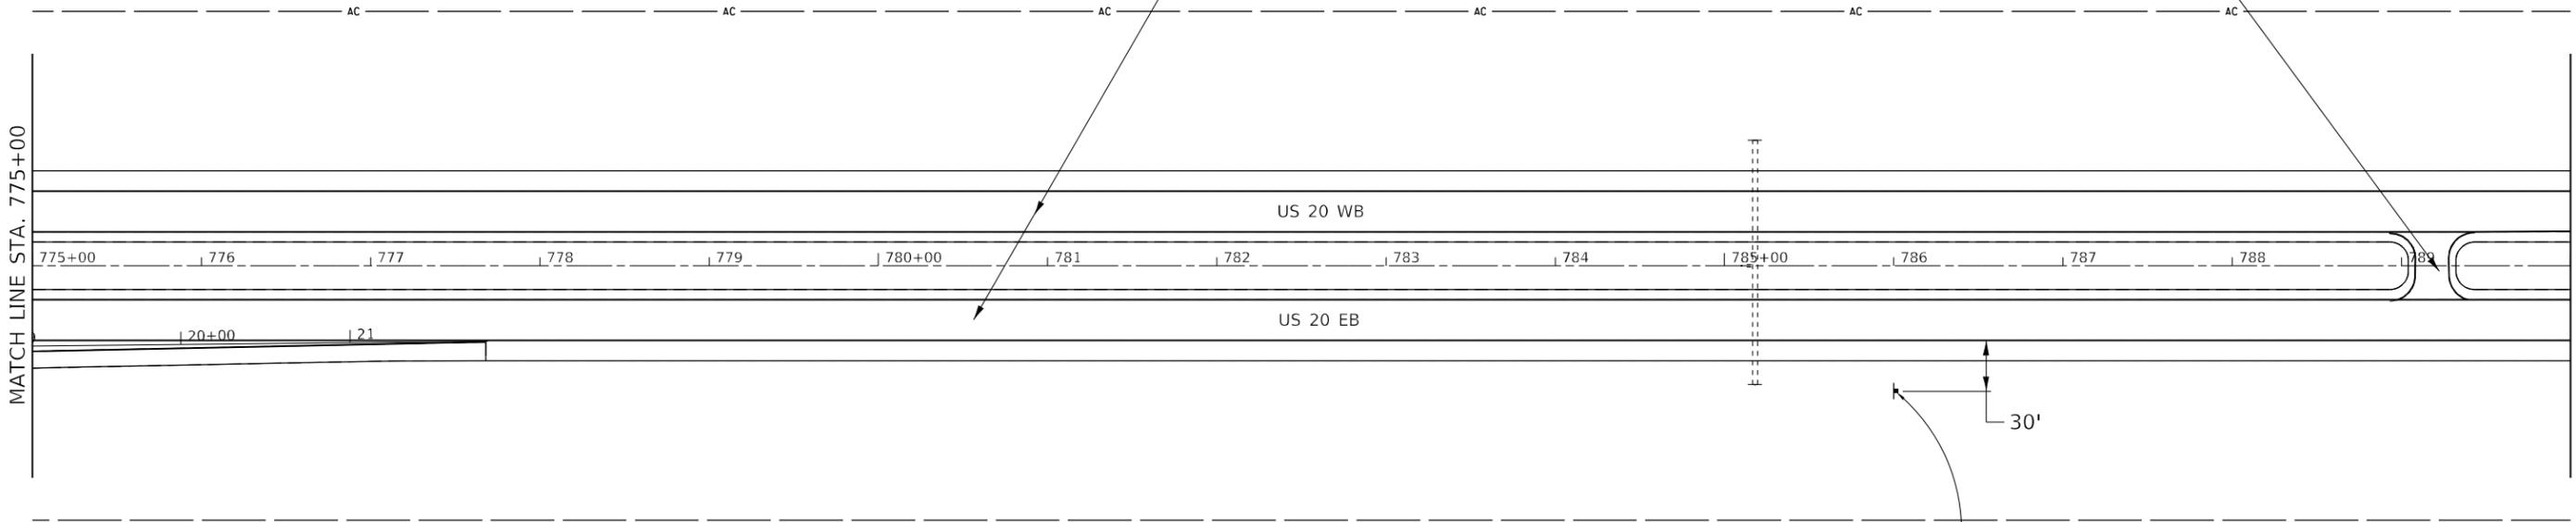

LOCATE AT STA. 786+00

Illinois 2 - Main St	1 1/2
Illinois 251- 11th St	3 1/2
Alpine Rd	5 1/2

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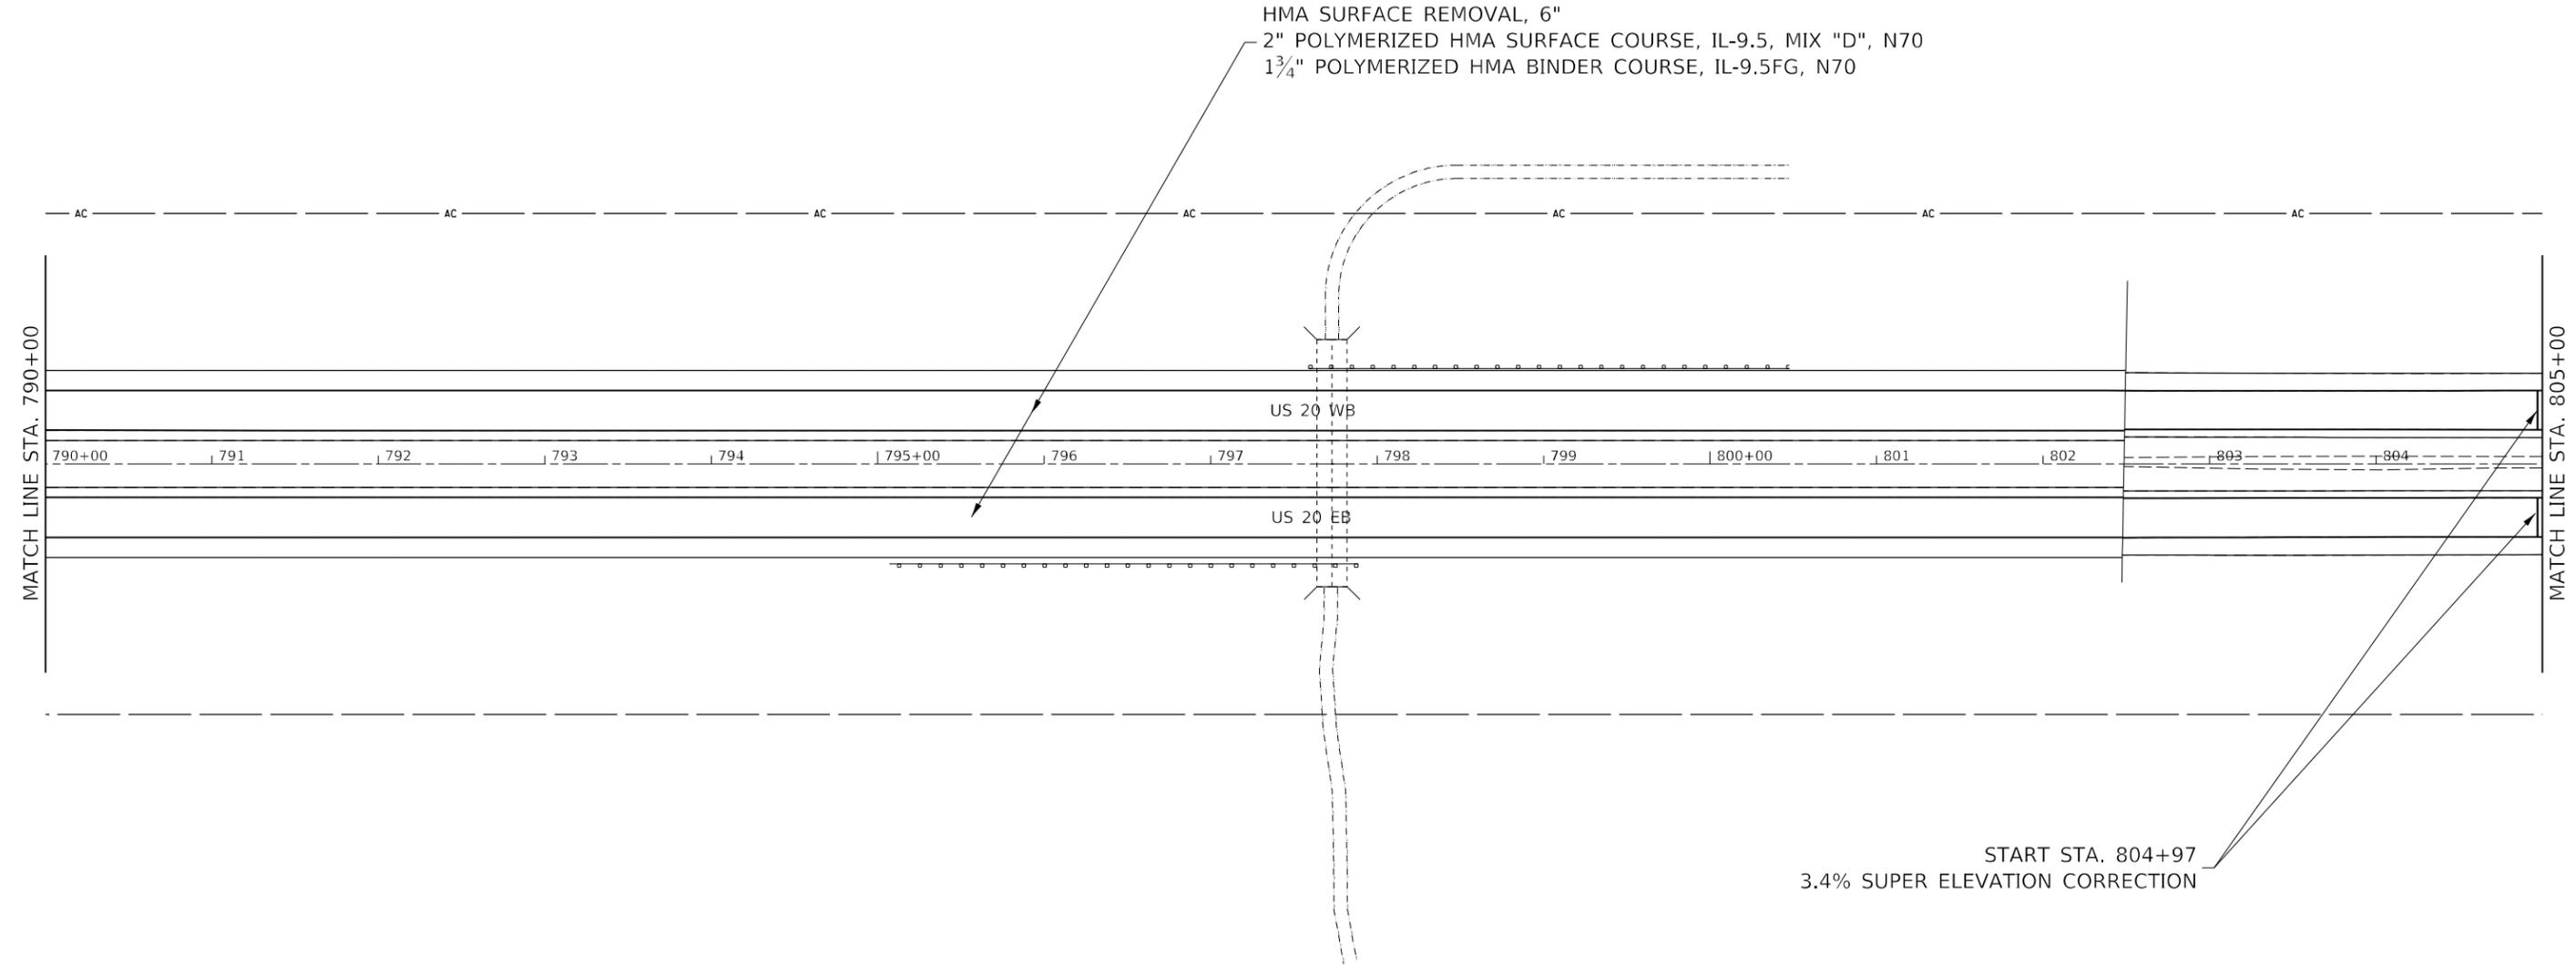
**STATE OF ILLINOIS
 DEPARTMENT OF TRANSPORTATION**

US 20 PLAN SHEET				
SCALE:	SHEET	OF	SHEETS	STA. TO STA.

F.A.P. RTE.	SECTION	COUNTY	TOTAL SHEETS	SHEET NO.
301	(1-1,1,2)RS-2	WINNEBAGO	158	84
CONTRACT NO. 64M18				
ILLINOIS FED. AID PROJECT				



HMA SURFACE REMOVAL, 6"
 2" POLYMERIZED HMA SURFACE COURSE, IL-9.5, MIX "D", N70
 1 3/4" POLYMERIZED HMA BINDER COURSE, IL-9.5FG, N70



START STA. 804+97
 3.4% SUPER ELEVATION CORRECTION



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	DATE -	REVISED -

**STATE OF ILLINOIS
 DEPARTMENT OF TRANSPORTATION**

US 20 PLAN SHEET			
SCALE:	SHEET	OF	SHEETS
	STA.	TO	STA.

F.A.P. RTE.	SECTION	COUNTY	TOTAL SHEETS	SHEET NO.
301	(1-1,1,2)RS-2	WINNEBAGO	158	85
CONTRACT NO. 64M18				
ILLINOIS FED. AID PROJECT				

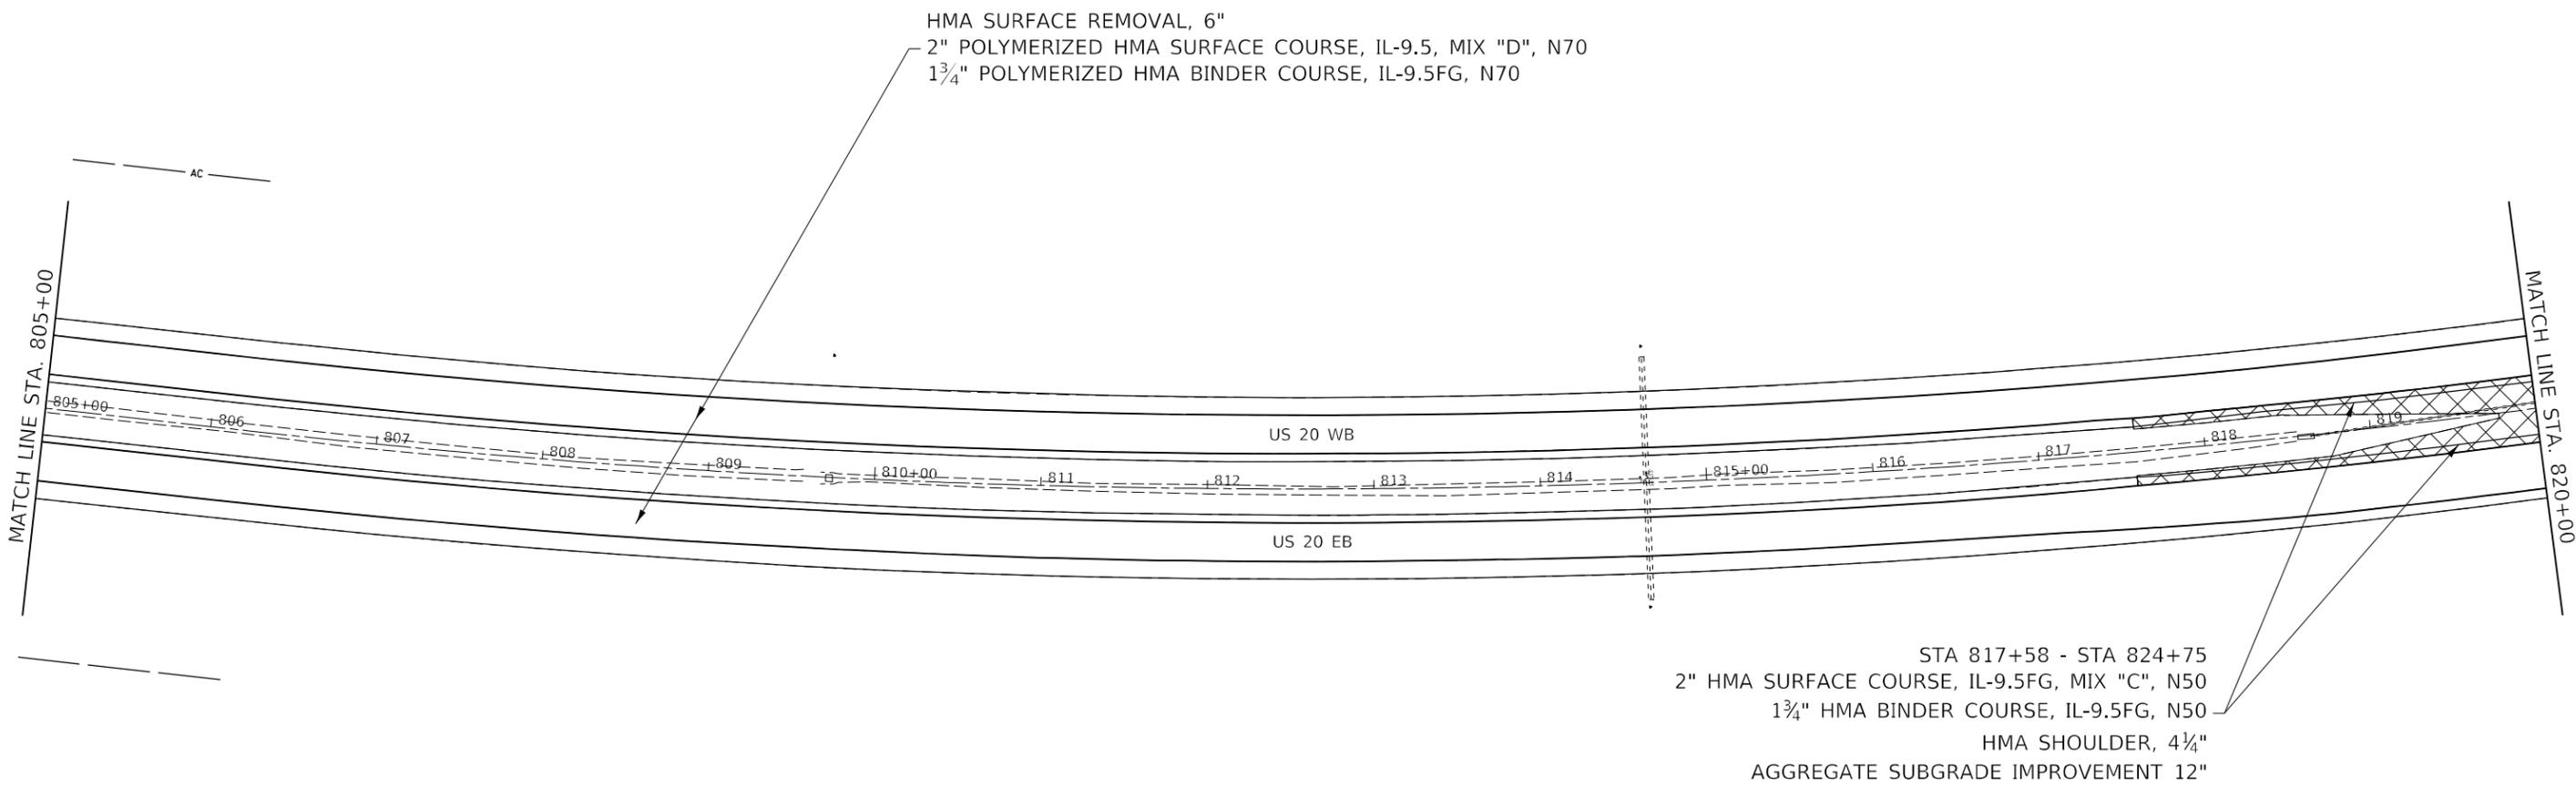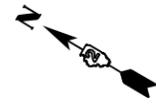

STA 817+58 - STA 824+75
 2" HMA SURFACE COURSE, IL-9.5FG, MIX "C", N50
 1 3/4" HMA BINDER COURSE, IL-9.5FG, N50
 HMA SHOULDER, 4 1/4"
 AGGREGATE SUBGRADE IMPROVEMENT 12"

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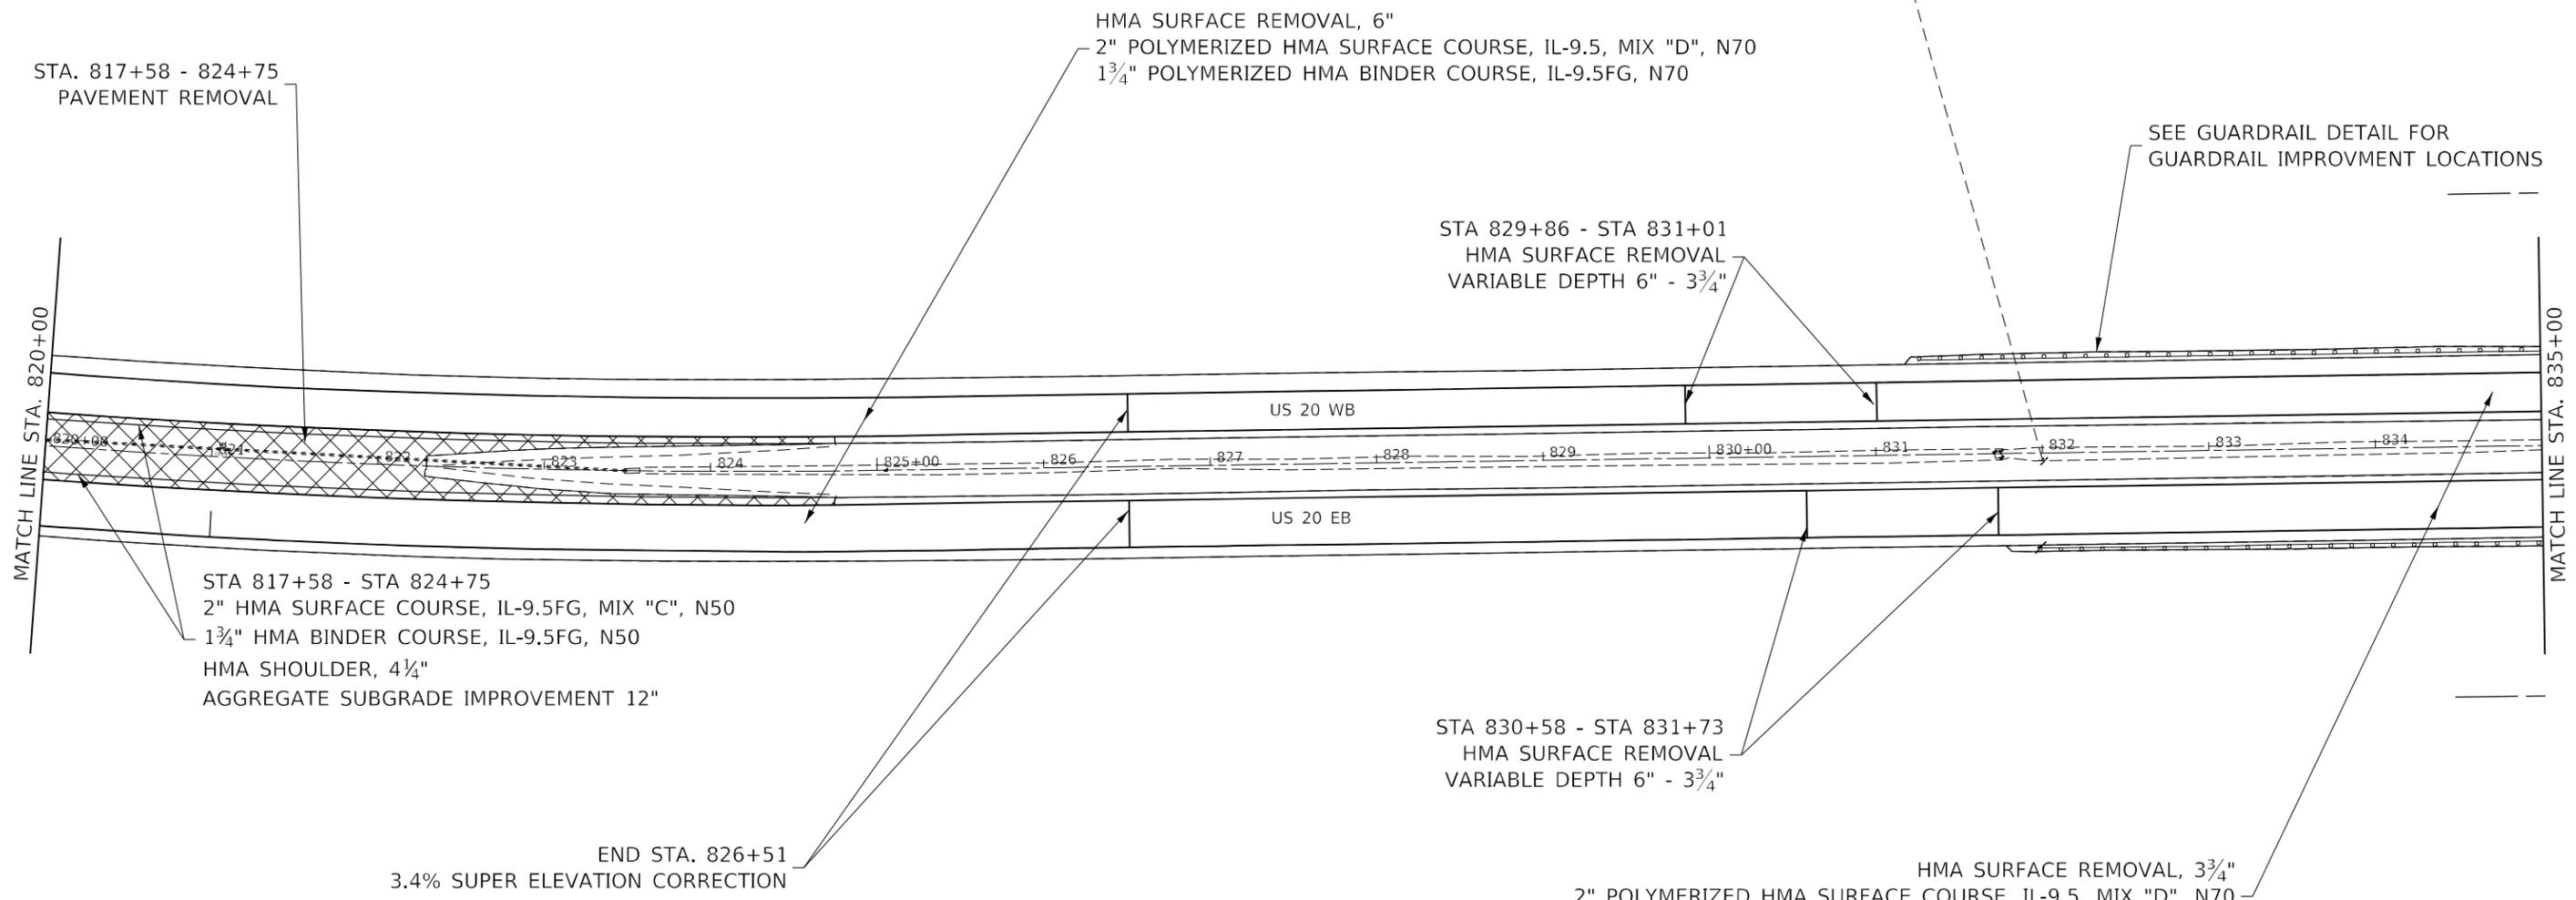
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STATE OF ILLINOIS
DEPARTMENT OF TRANSPORTATION

US 20
PLAN SHEET

F.A.P. RTE.	SECTION	COUNTY	TOTAL SHEETS	SHEET NO.
301	(1-1,1,2)RS-2	WINNEBAGO	158	86
CONTRACT NO. 64M18				
ILLINOIS FED. AID PROJECT				

SCALE: SHEET OF SHEETS STA. TO STA.



MODEL: Default
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	DATE -	REVISED -

STATE OF ILLINOIS
DEPARTMENT OF TRANSPORTATION

US 20	
PLAN SHEET	
SCALE:	SHEET OF SHEETS STA. TO STA.

F.A.P. RTE.	SECTION	COUNTY	TOTAL SHEETS	SHEET NO.
301	(1-1,1,2)RS-2	WINNEBAGO	158	87
CONTRACT NO. 64M18				
ILLINOIS FED. AID PROJECT				



PAVING GAP
STA 840+28 - 842+42

SECTION / PROJECT ENDS
STA. 847+49


SEE GUARDRAIL DETAIL FOR
GUARDRAIL IMPROVMENT LOCATIONS

SEE GUARDRAIL DETAIL FOR
GUARDRAIL IMPROVMENT LOCATIONS

HMA SURFACE REMOVAL, 3 3/4"
2" POLYMERIZED HMA SURFACE COURSE, IL-9.5, MIX "D", N70
1 3/4" POLYMERIZED HMA BINDER COURSE, IL-9.5FG, N70

MATCH LINE STA. 835+00

MATCH LINE STA. 850+00

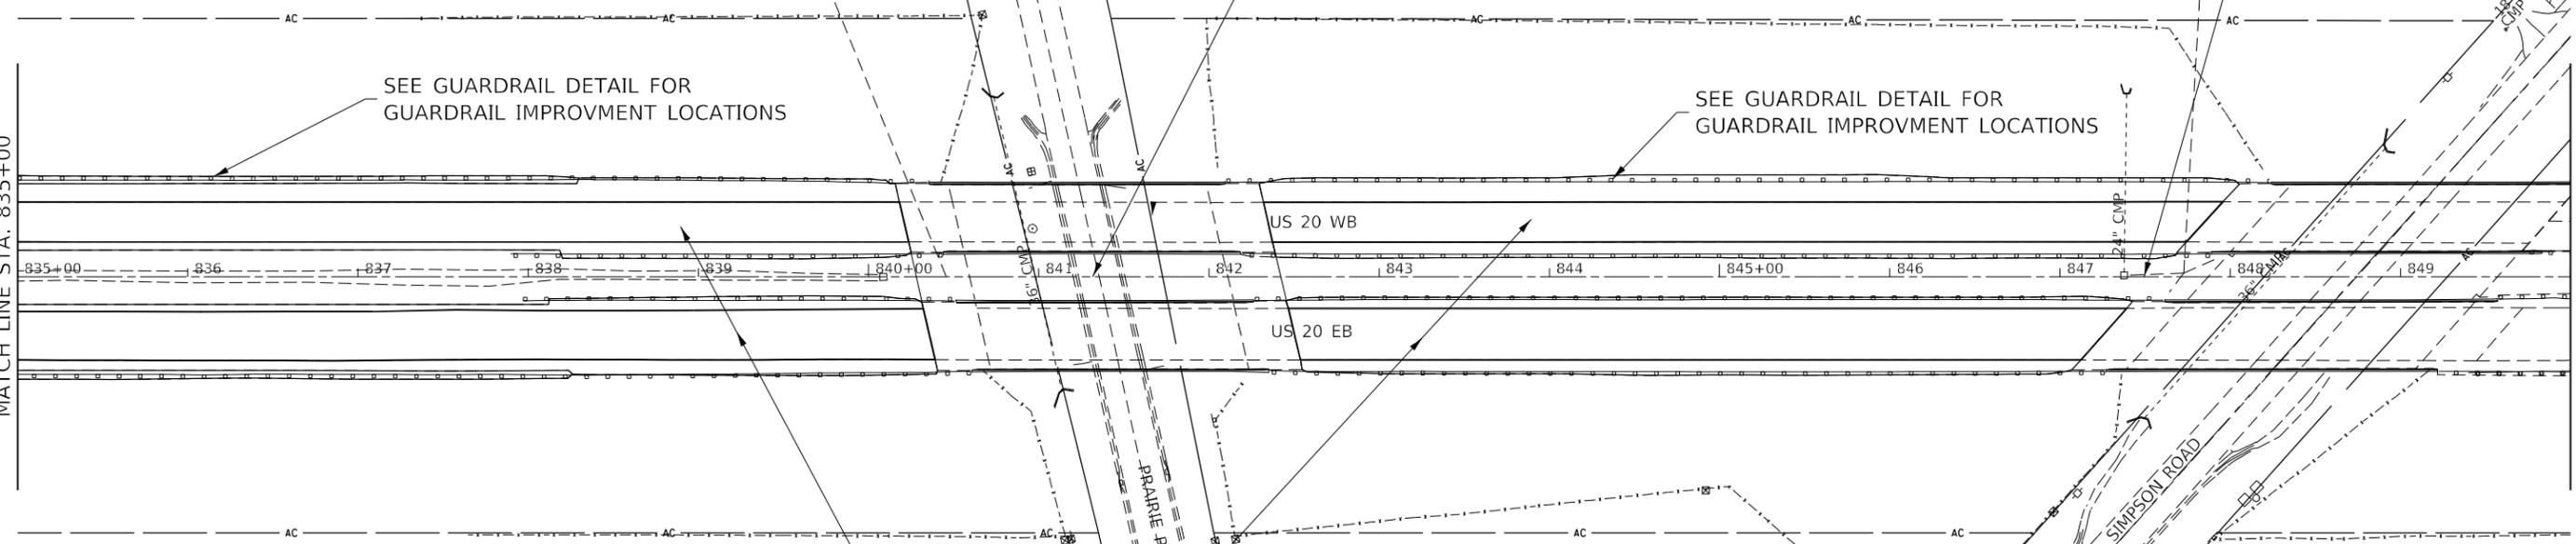




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PLOT DATE = Mar-19-2021 08:44:06 AM	DATE -	REVISED -

**STATE OF ILLINOIS
DEPARTMENT OF TRANSPORTATION**

US 20 PLAN SHEET				
SCALE:	SHEET	OF	SHEETS	STA. TO STA.

F.A.P. RTE.	SECTION	COUNTY	TOTAL SHEETS	SHEET NO.
301	(1-1,1,2)RS-2	WINNEBAGO	158	88
ILLINOIS FED. AID PROJECT			CONTRACT NO. 64M18	

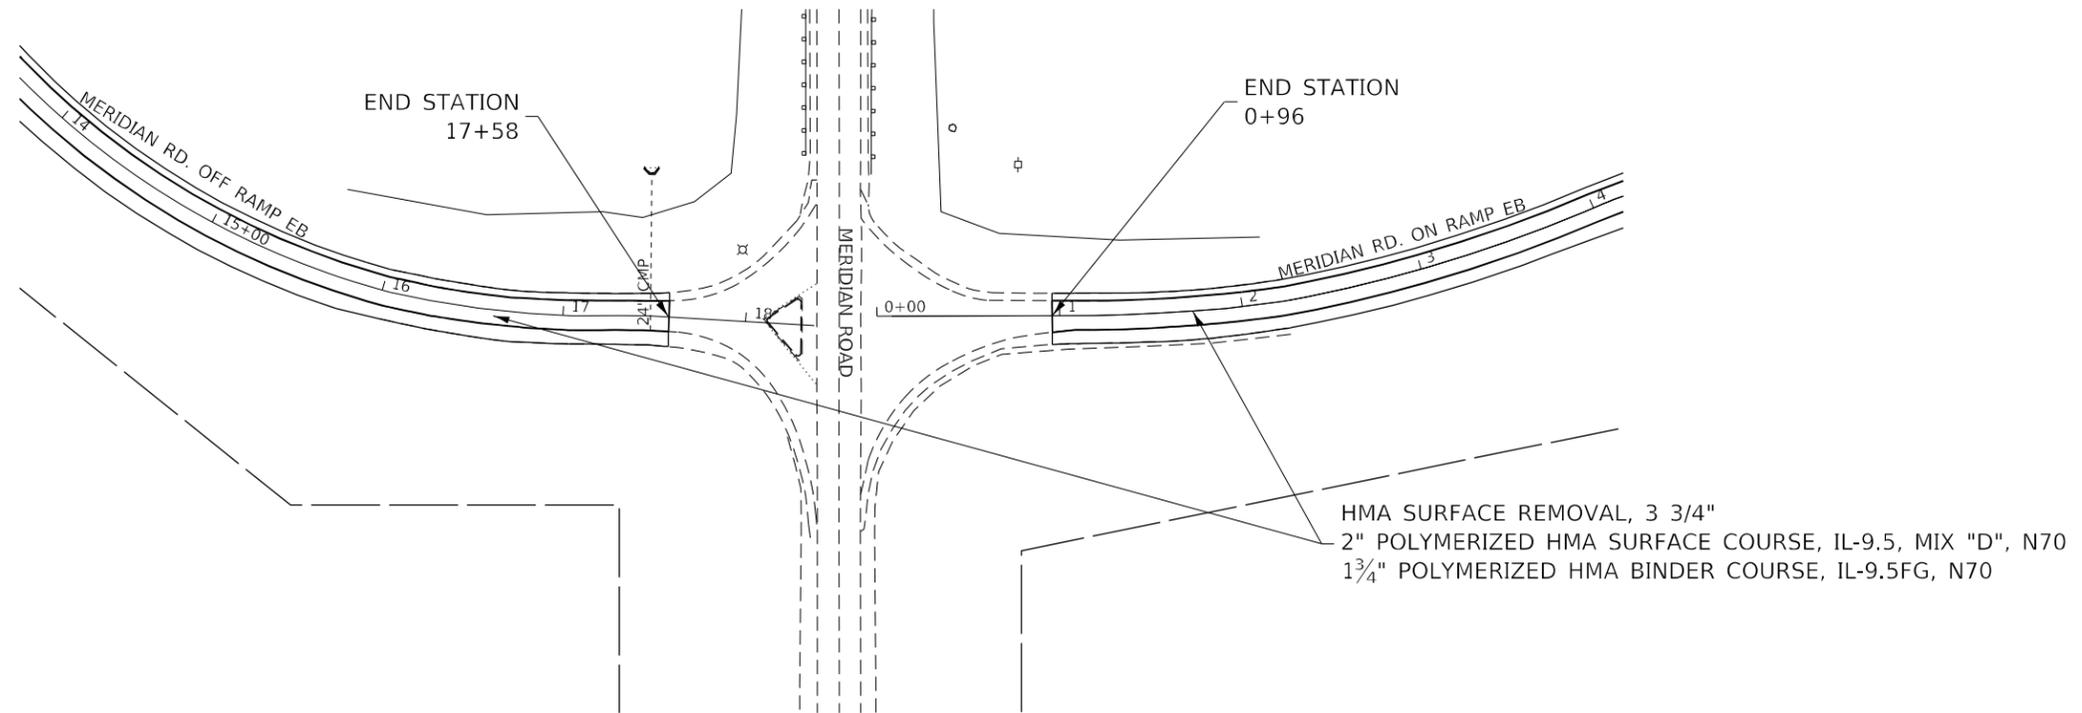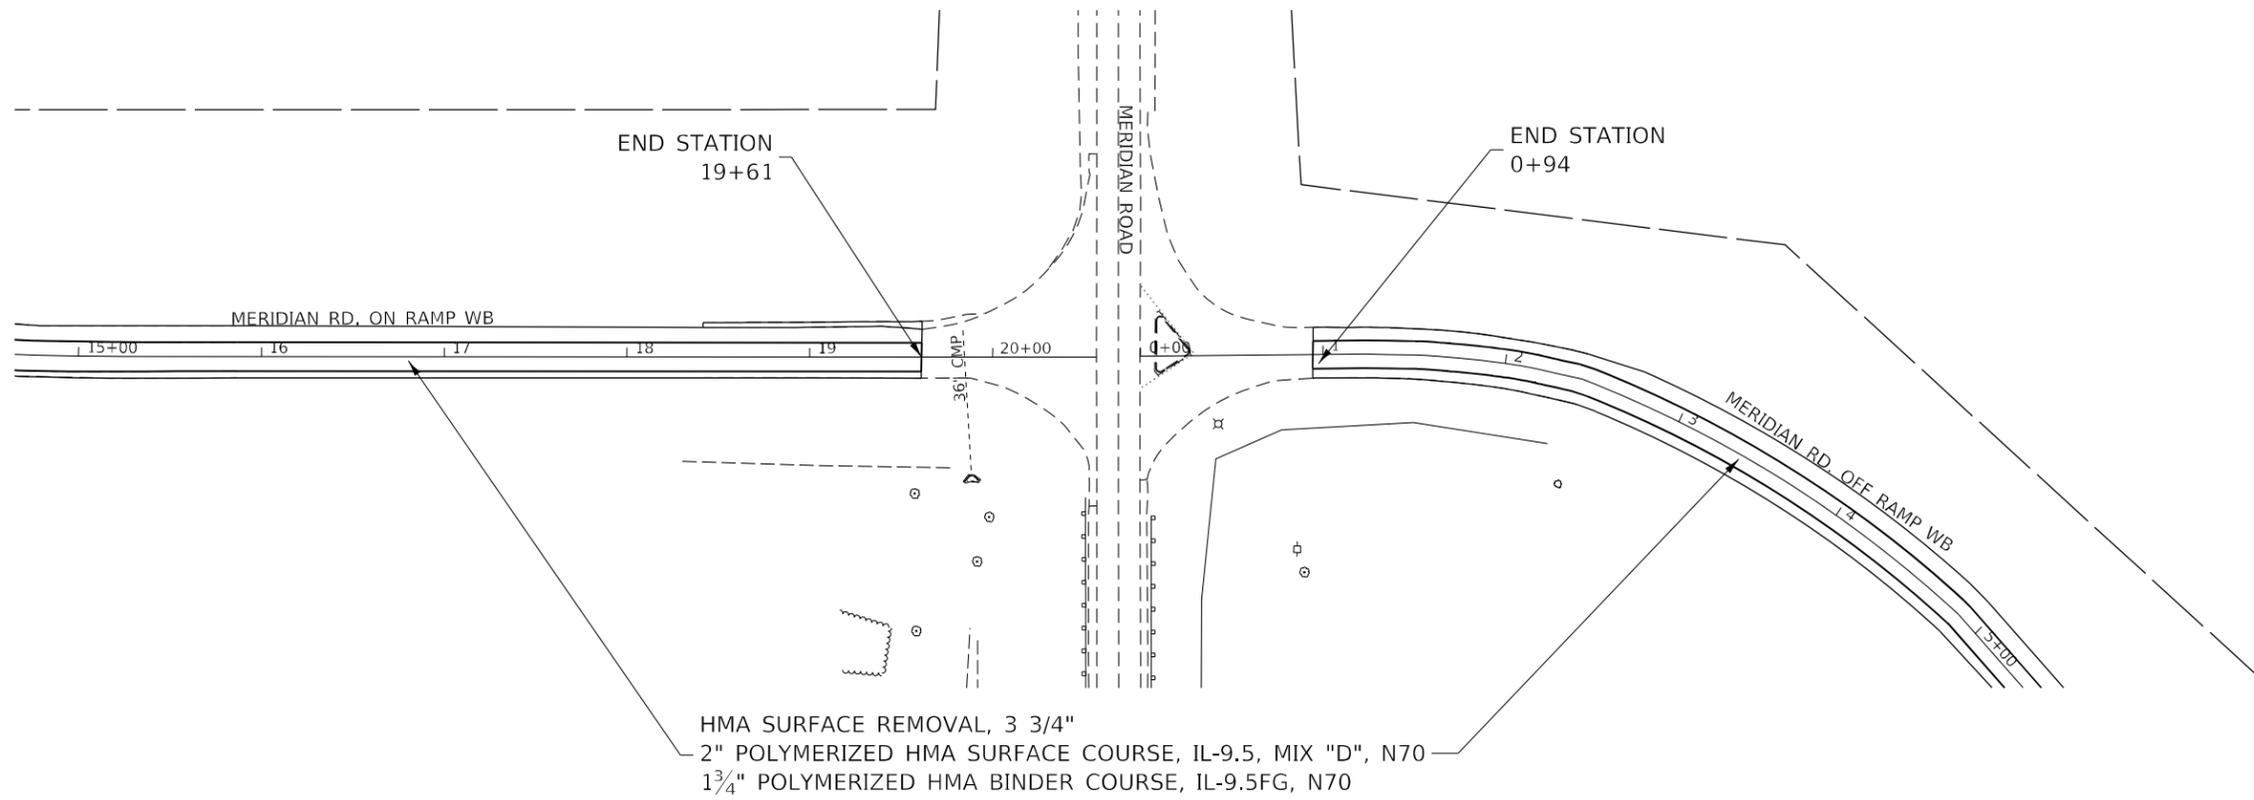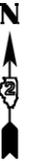





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PLOT DATE = Mar-19-2021 08:44:06 AM	DATE -	REVISED -

STATE OF ILLINOIS
DEPARTMENT OF TRANSPORTATION

US 20				
PLAN SHEET				
SCALE:	SHEET	OF	SHEETS	STA. TO STA.

F.A.P. RTE.	SECTION	COUNTY	TOTAL SHEETS	SHEET NO.
301	(1-1,1,2)RS-2	WINNEBAGO	158	89
			CONTRACT NO. 64M18	
ILLINOIS FED. AID PROJECT				

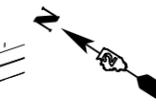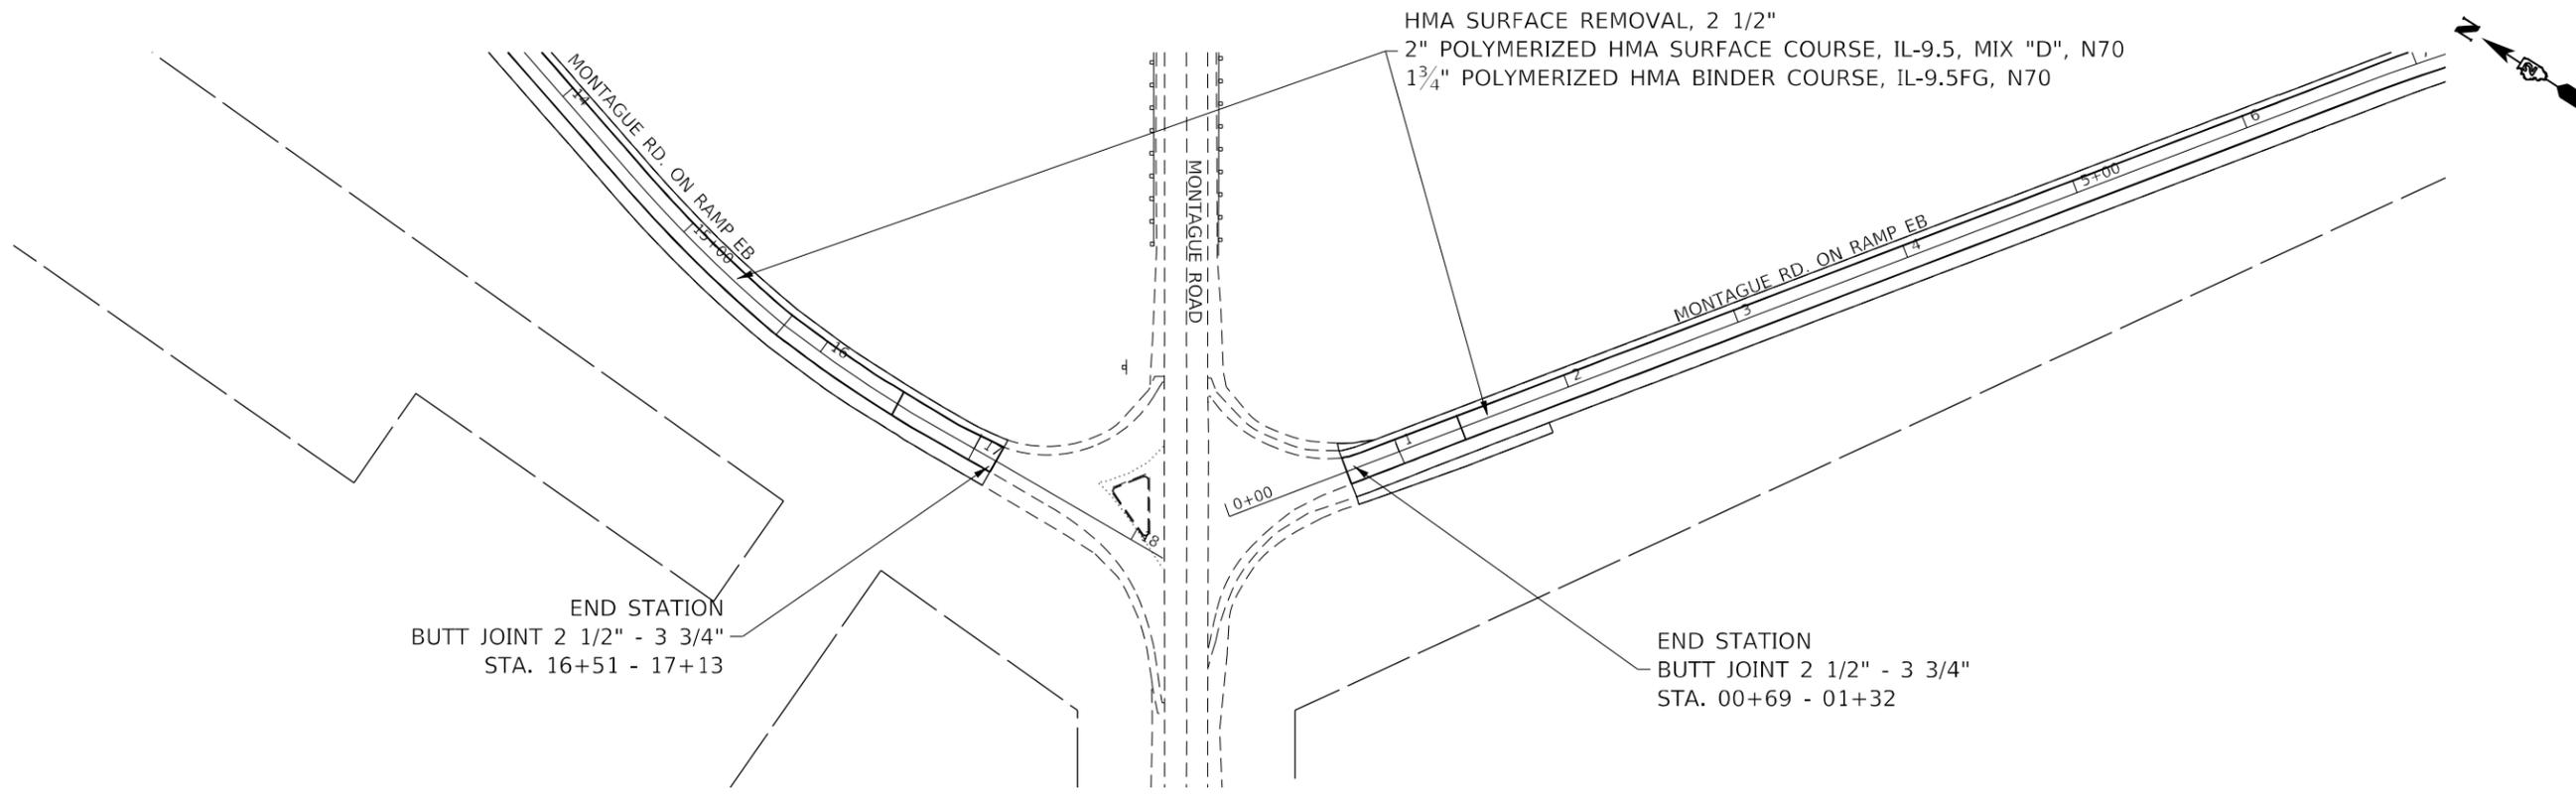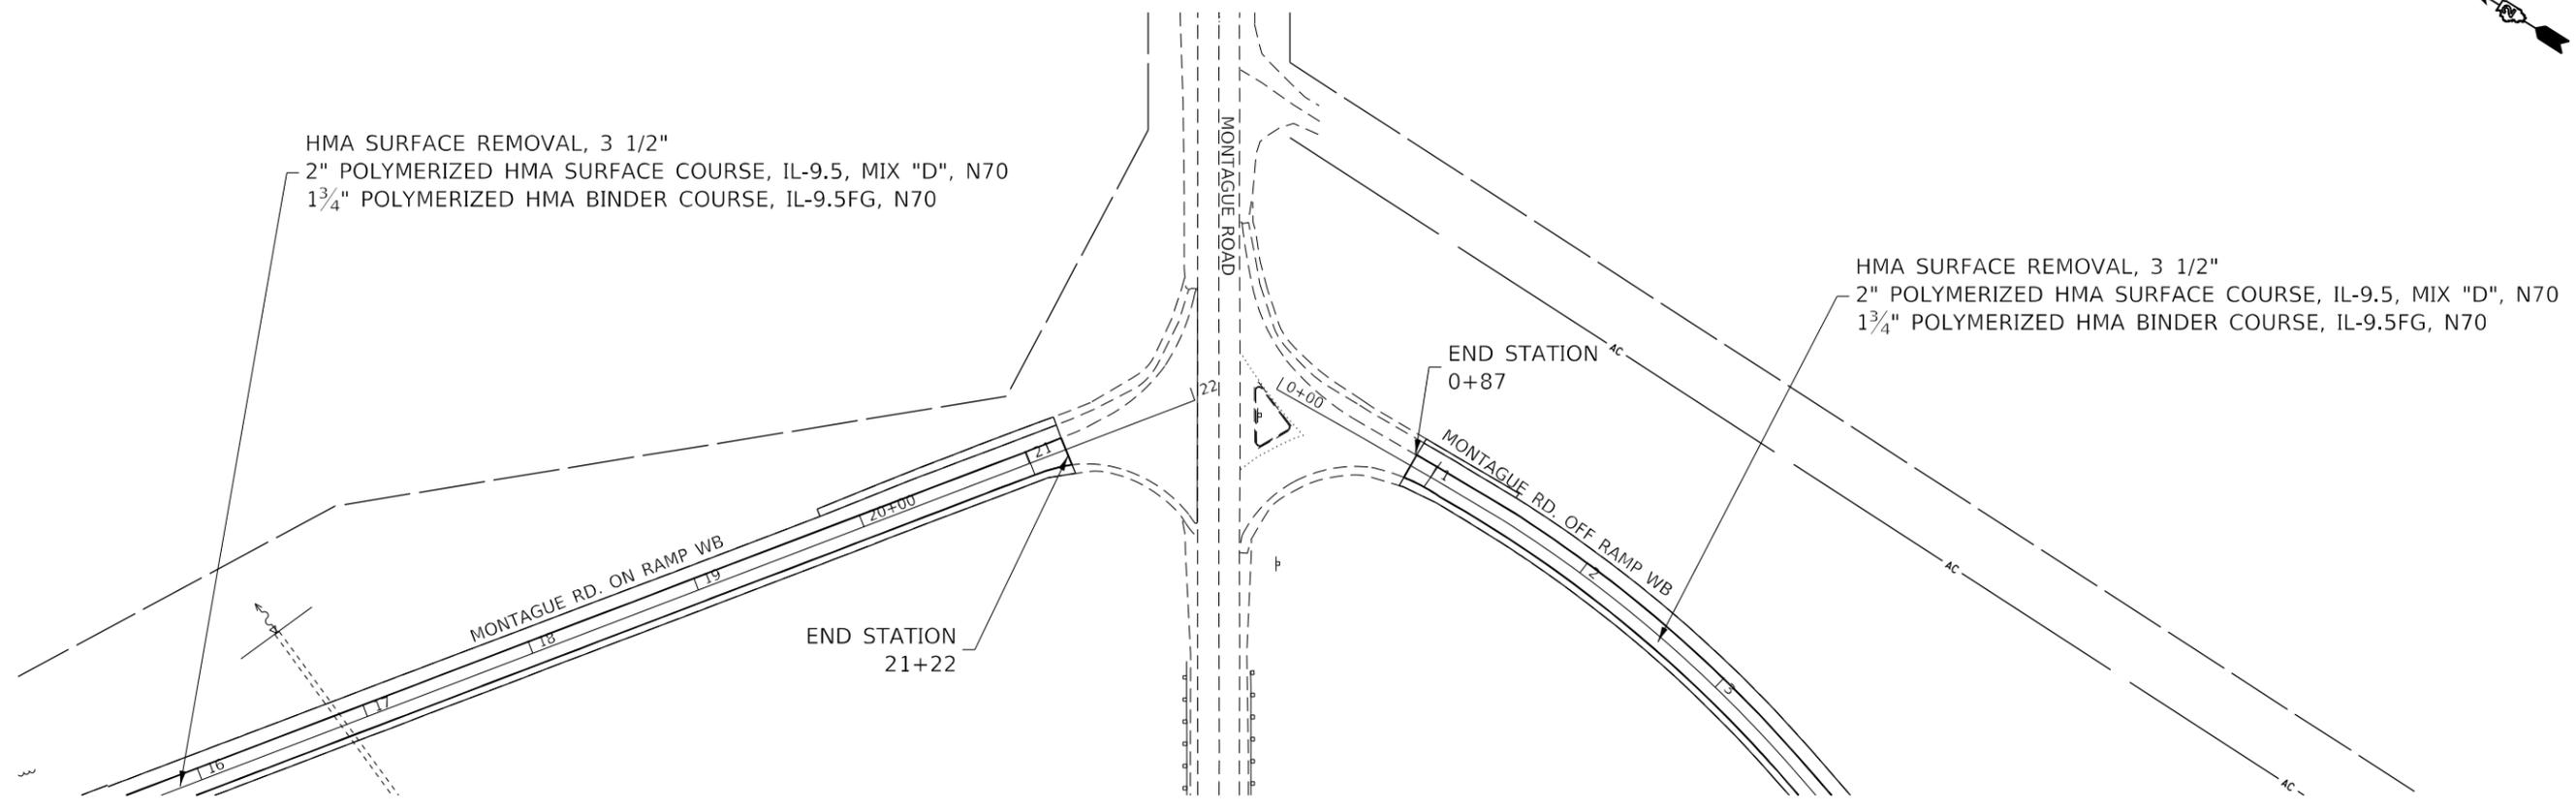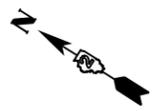

MODEL: Default
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USER NAME = ankneyde	DESIGNED -	REVISED -
	DRAWN -	REVISED -
PLOT SCALE = 100,0000' / in.	CHECKED -	REVISED -
PLOT DATE = Mar-19-2021 08:44:07 AM	DATE -	REVISED -

**STATE OF ILLINOIS
DEPARTMENT OF TRANSPORTATION**

US 20 PLAN SHEET				
SCALE:	SHEET	OF	SHEETS	STA. TO STA.

F.A.P. RTE.	SECTION	COUNTY	TOTAL SHEETS	SHEET NO.
301	(1-1,1,2)RS-2	WINNEBAGO	158	90
CONTRACT NO. 64M18				
ILLINOIS FED. AID PROJECT				



MODEL: Default
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HMA SURFACE REMOVAL, 3³/₄"
 2" POLYMERIZED HMA SURFACE COURSE, IL-9.5, MIX "E", N70
 1³/₄" POLYMERIZED HMA BINDER COURSE, IL-9.5FG, N70

STA 33+25 - 34+40
 HMA SURFACE REMOVAL
 VARIABLE DEPTH 6" - 3³/₄"

HMA SURFACE REMOVAL, 6"
 2" POLYMERIZED HMA SURFACE COURSE, IL-9.5, MIX "E", N70
 1³/₄" POLYMERIZED HMA BINDER COURSE, IL-9.5FG, N70

MATCH LINE STA. 32+00
 SEE SHEET #

END STATION
 37+82

END STA. 34+83
 1.5% SUPER ELEVATION CORRECTION

HMA SURFACE REMOVAL, 3³/₄"
 2" POLYMERIZED HMA SURFACE COURSE, IL-9.5, MIX "D", N70
 1³/₄" POLYMERIZED HMA BINDER COURSE, IL-9.5FG, N70

HMA SURFACE REMOVAL, 6"
 2" POLYMERIZED HMA SURFACE COURSE, IL-9.5, MIX "D", N70
 1³/₄" POLYMERIZED HMA BINDER COURSE, IL-9.5FG, N70




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	DRAWN -	REVISED -
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PLOT DATE = Mar-19-2021 08:44:08 AM	DATE -	REVISED -

**STATE OF ILLINOIS
 DEPARTMENT OF TRANSPORTATION**

US 20 PLAN SHEET			
SCALE:	SHEET	OF	SHEETS
	STA.	TO	STA.

F.A.P. RTE.	SECTION	COUNTY	TOTAL SHEETS	SHEET NO.
301	(1-1,1,2)RS-2	WINNEBAGO	158	91
CONTRACT NO. 64M18				
ILLINOIS FED. AID PROJECT				

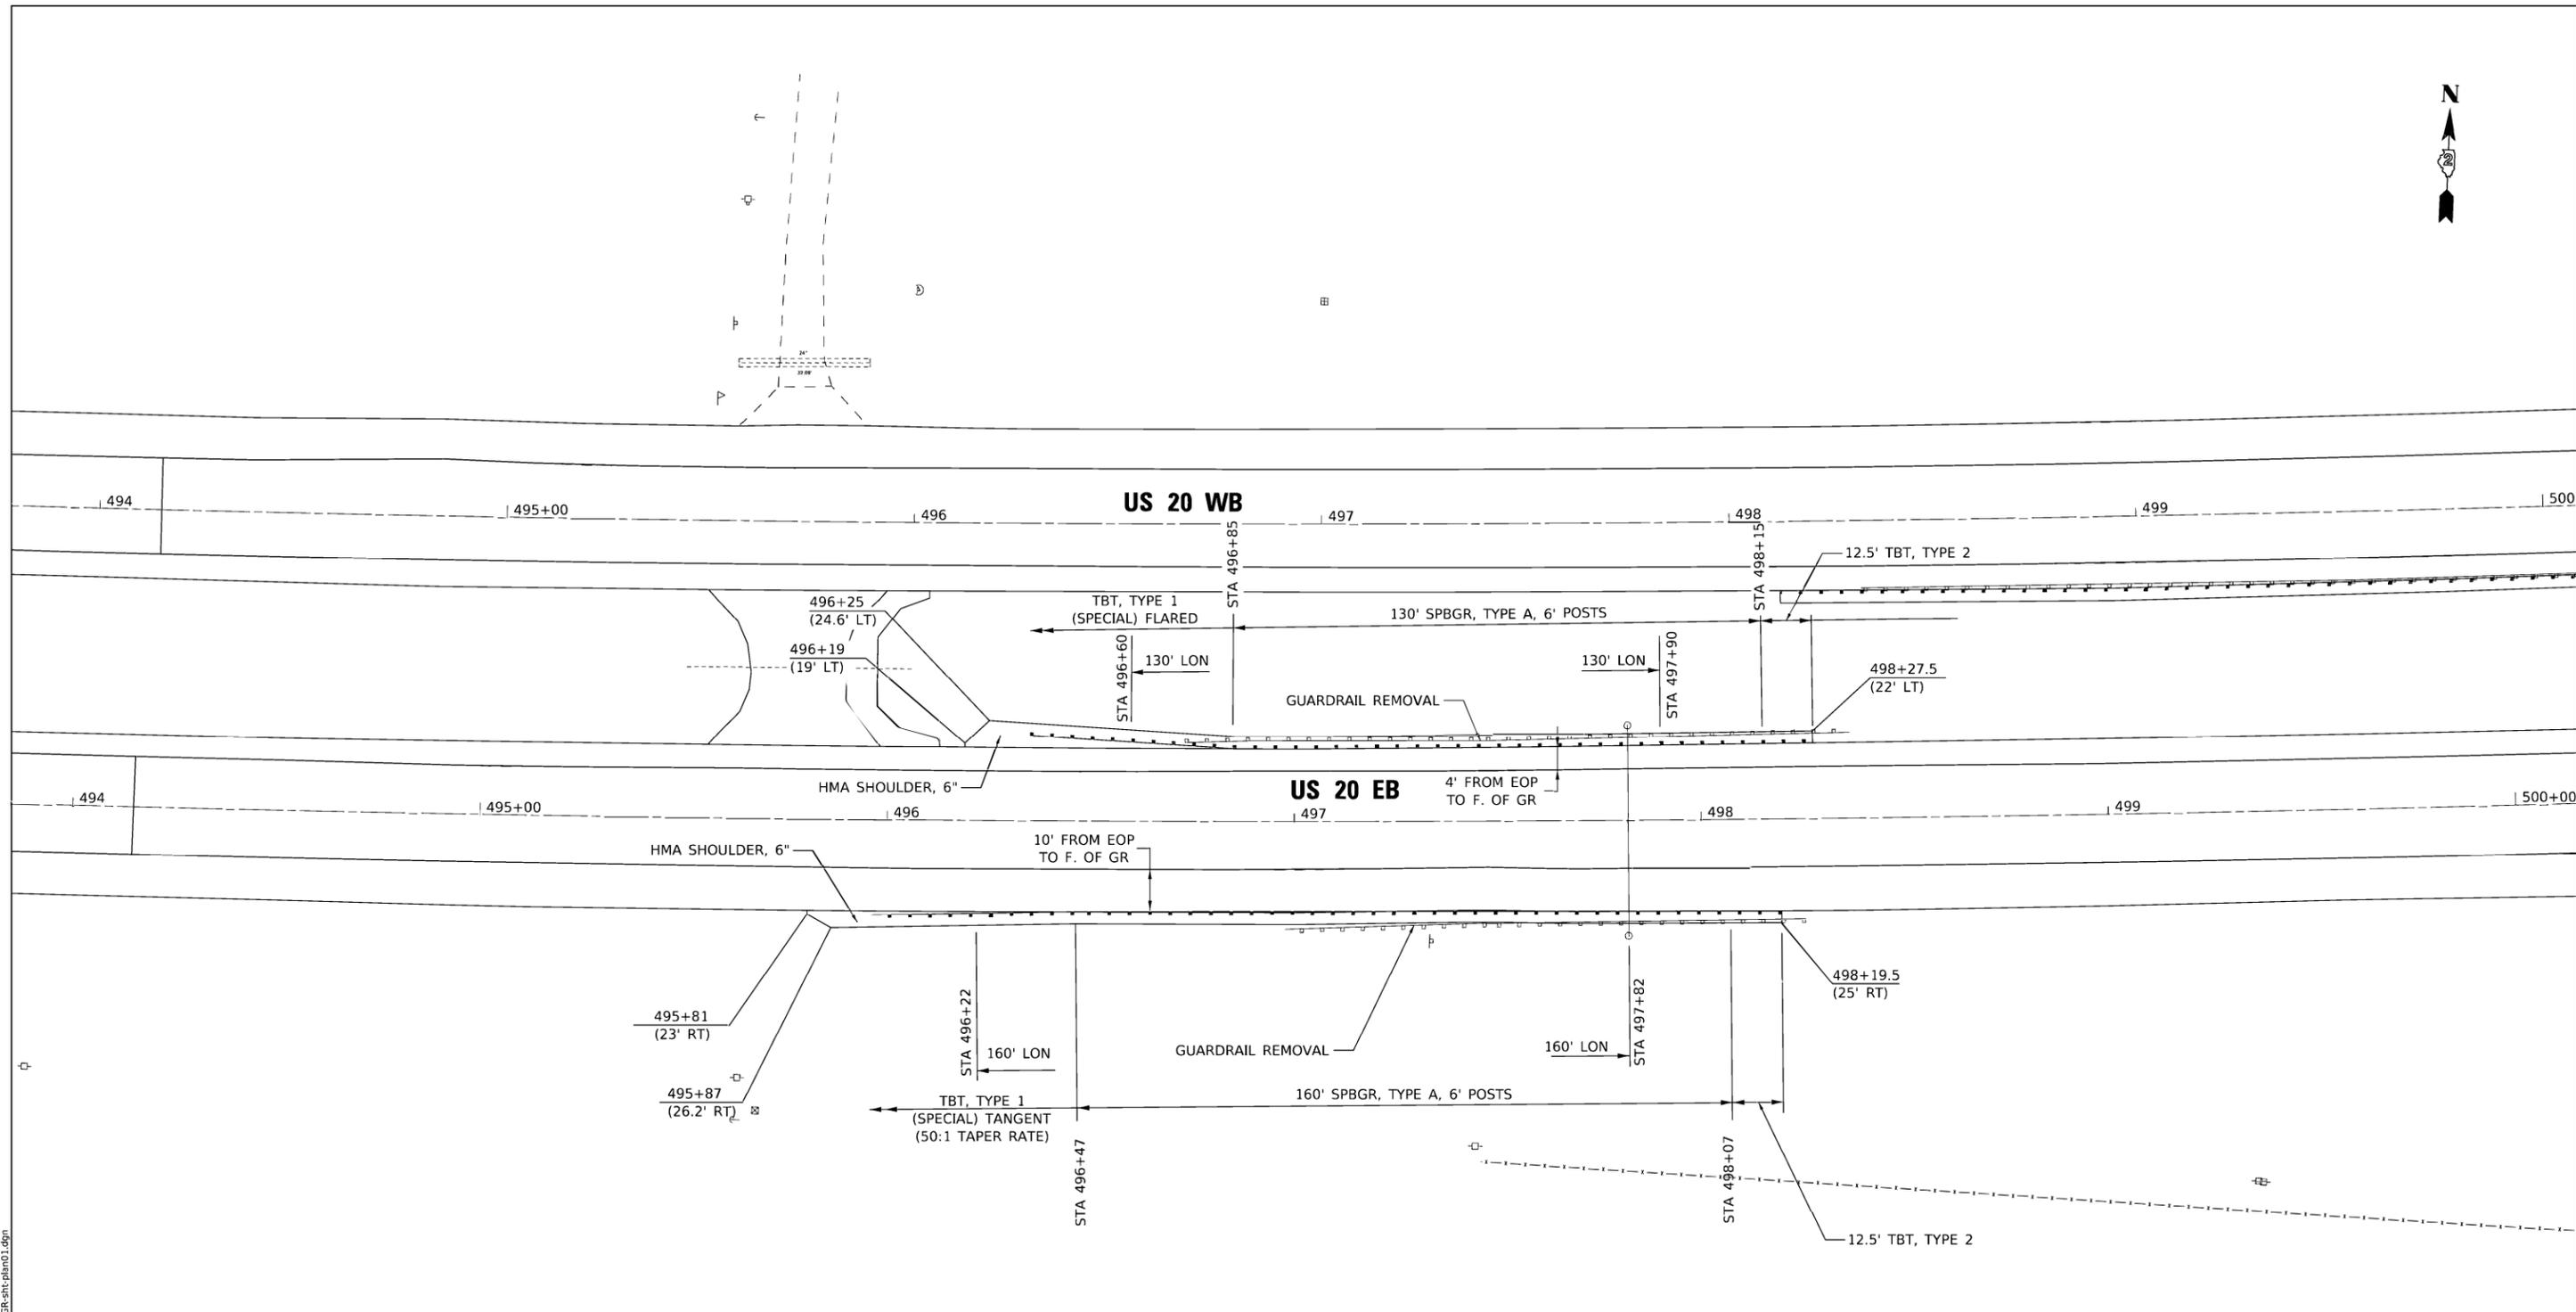

NOTE:

OFFSETS LISTED ARE FROM CENTERLINE OF EASTBOUND LANES

LEGEND:

SPBGR = STEEL PLATE BEAM GUARDRAIL
 LON = LENGTH OF NEED
 TBT = TRAFFIC BARRIER TERMINAL

MODEL: Default
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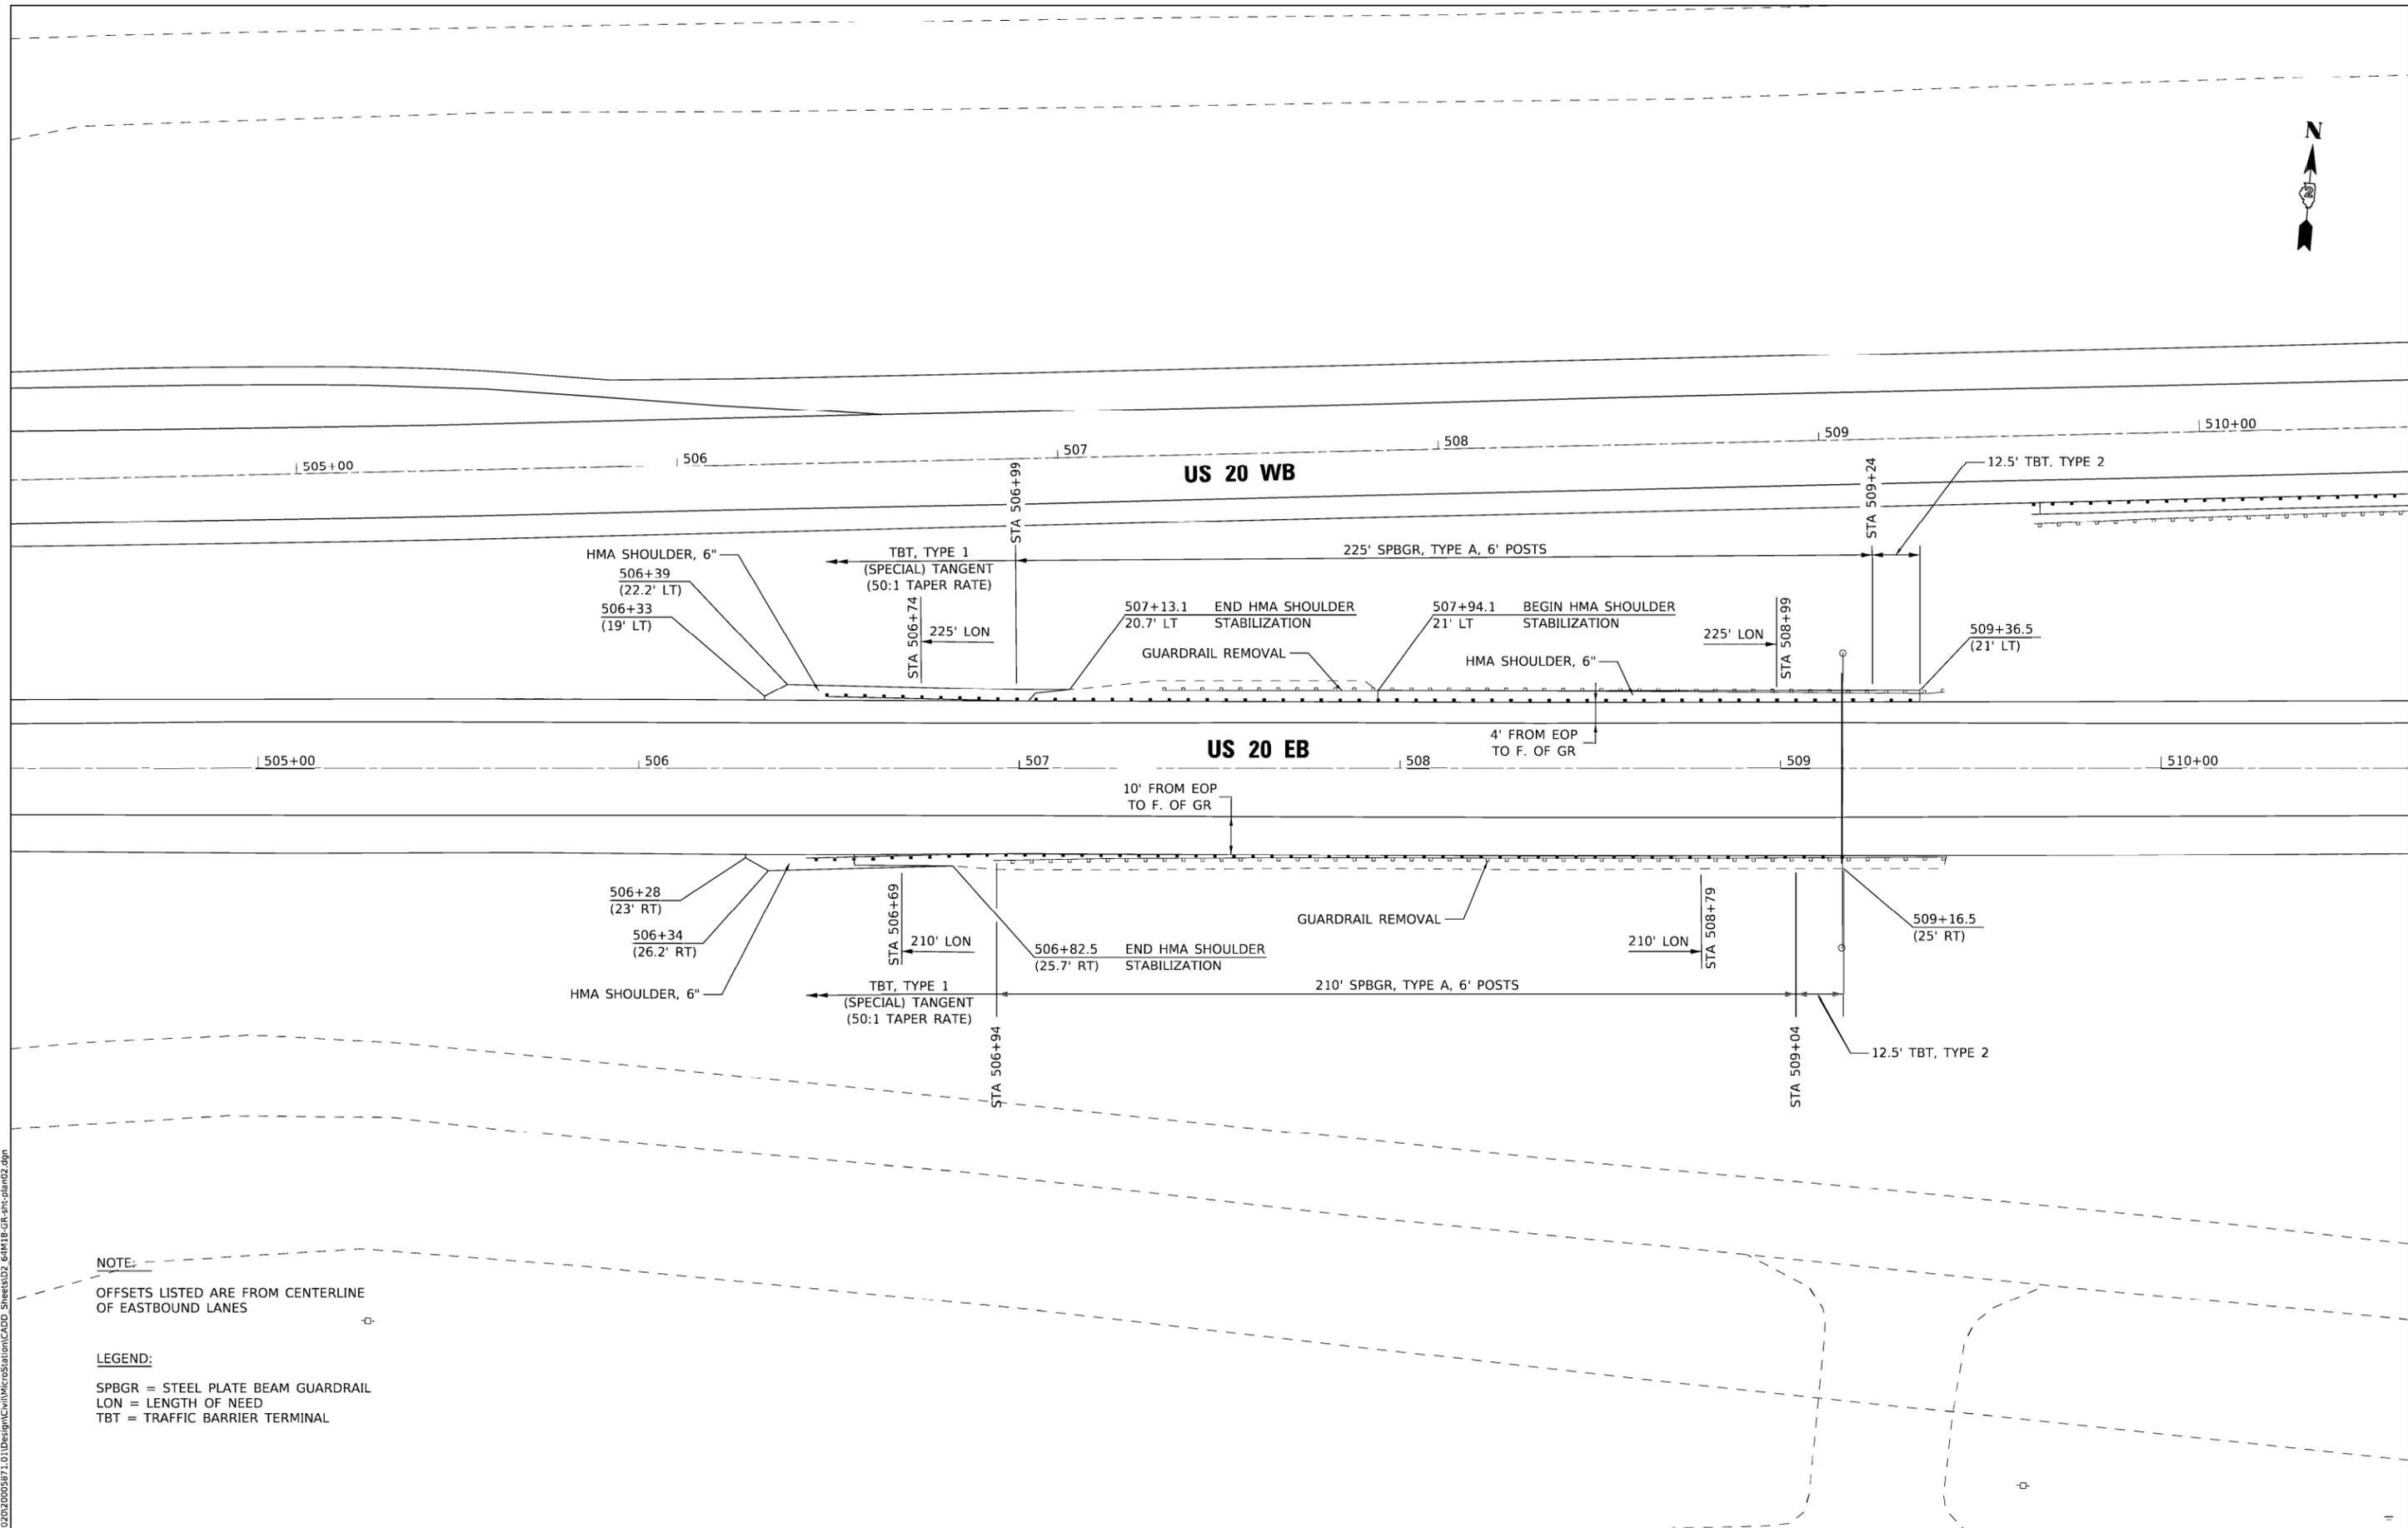
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	DRAWN - MAP	REVISED -
PLOT SCALE = 20.0000' / in.	CHECKED - JWD	REVISED -
PLOT DATE = 3/2/2021	DATE -	REVISED -

**STATE OF ILLINOIS
 DEPARTMENT OF TRANSPORTATION**

**GUARDRAIL AT STATION 497+50 EB
 DETAIL SHEET**

SCALE: 1" = 20' SHEET OF SHEETS STA. TO STA.

F.A.P. RTE.	SECTION	COUNTY	TOTAL SHEETS	SHEET NO.
301	(1-1,1,2)RS-2	WINNEBAGO	158	92
			CONTRACT NO. 64M18	
ILLINOIS FED. AID PROJECT				



NOTE:

OFFSETS LISTED ARE FROM CENTERLINE OF EASTBOUND LANES

LEGEND:

SPBGR = STEEL PLATE BEAM GUARDRAIL
 LON = LENGTH OF NEED
 TBT = TRAFFIC BARRIER TERMINAL

MODEL: Default
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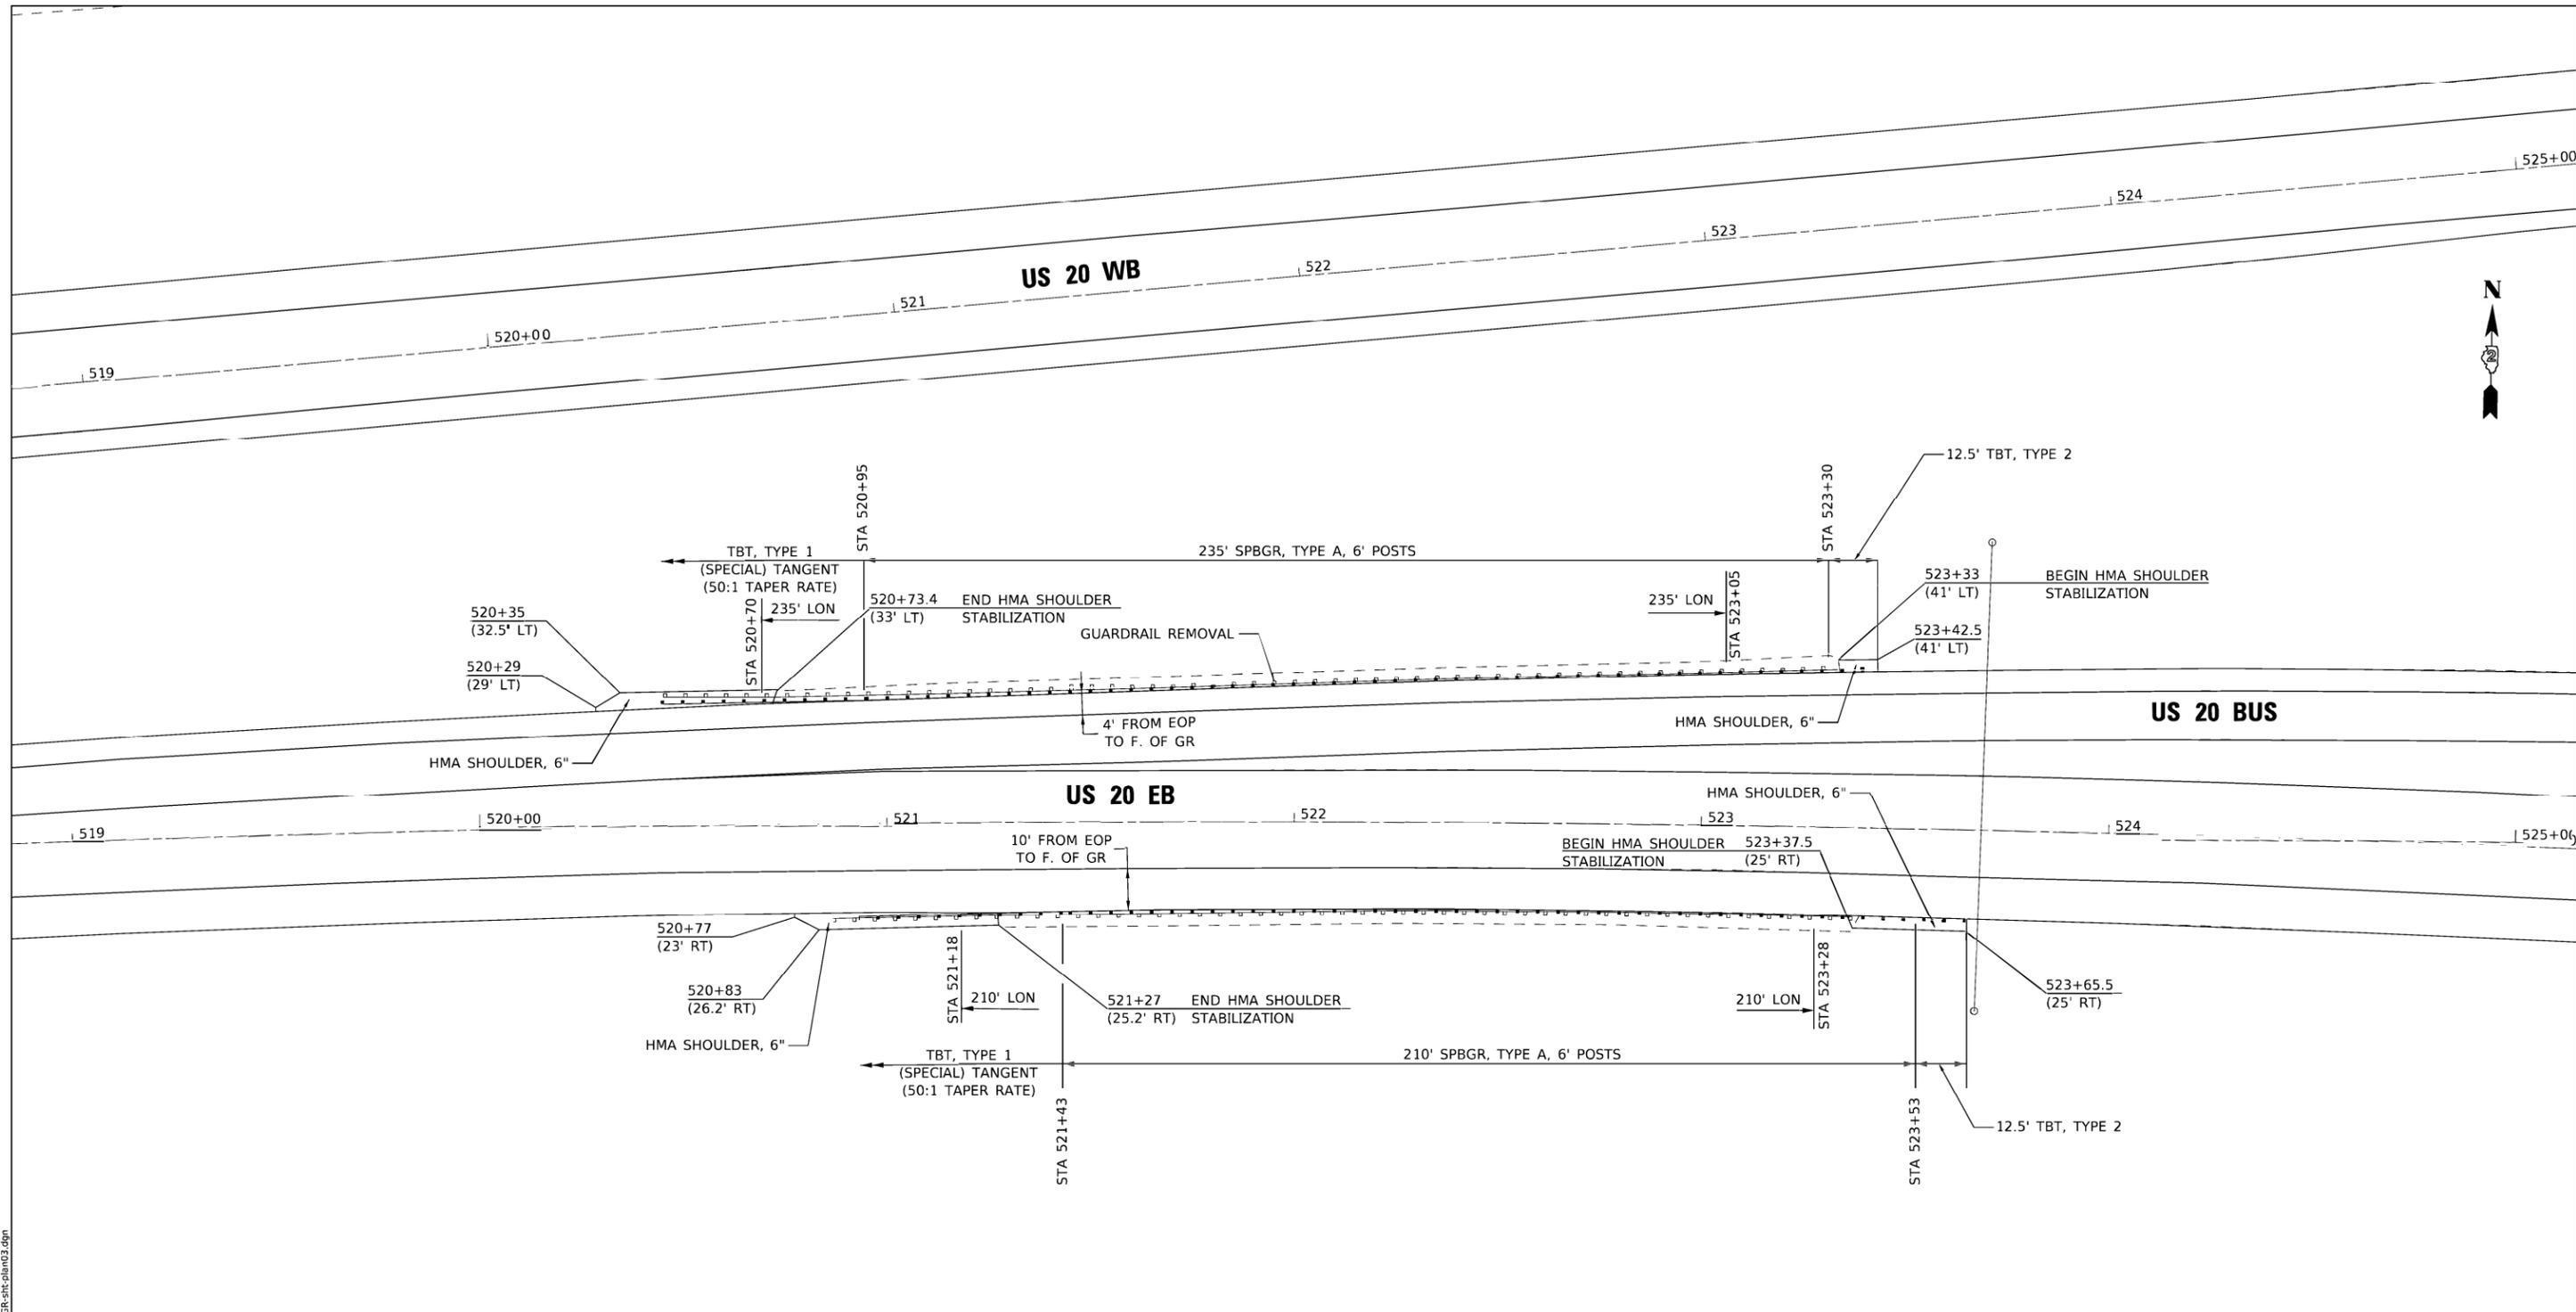
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PLOT SCALE = 20.0000' / in.	CHECKED - JWD	REVISED -
PLOT DATE = 3/2/2021	DATE -	REVISED -

**STATE OF ILLINOIS
 DEPARTMENT OF TRANSPORTATION**

**GUARDRAIL AT STATION 507+50
 DETAIL SHEET**

SCALE: 1" = 20' SHEET OF SHEETS STA. TO STA.

F.A.P. R.T.E.	SECTION	COUNTY	TOTAL SHEETS	SHEET NO.
301	(1-1,1,2)RS-2	WINNEBAGO	158	93
CONTRACT NO. 64M18			ILLINOIS FED. AID PROJECT	



NOTE:

OFFSETS LISTED ARE FROM CENTERLINE OF EASTBOUND LANES

LEGEND:

SPBGR = STEEL PLATE BEAM GUARDRAIL
 LON = LENGTH OF NEED
 TBT = TRAFFIC BARRIER TERMINAL

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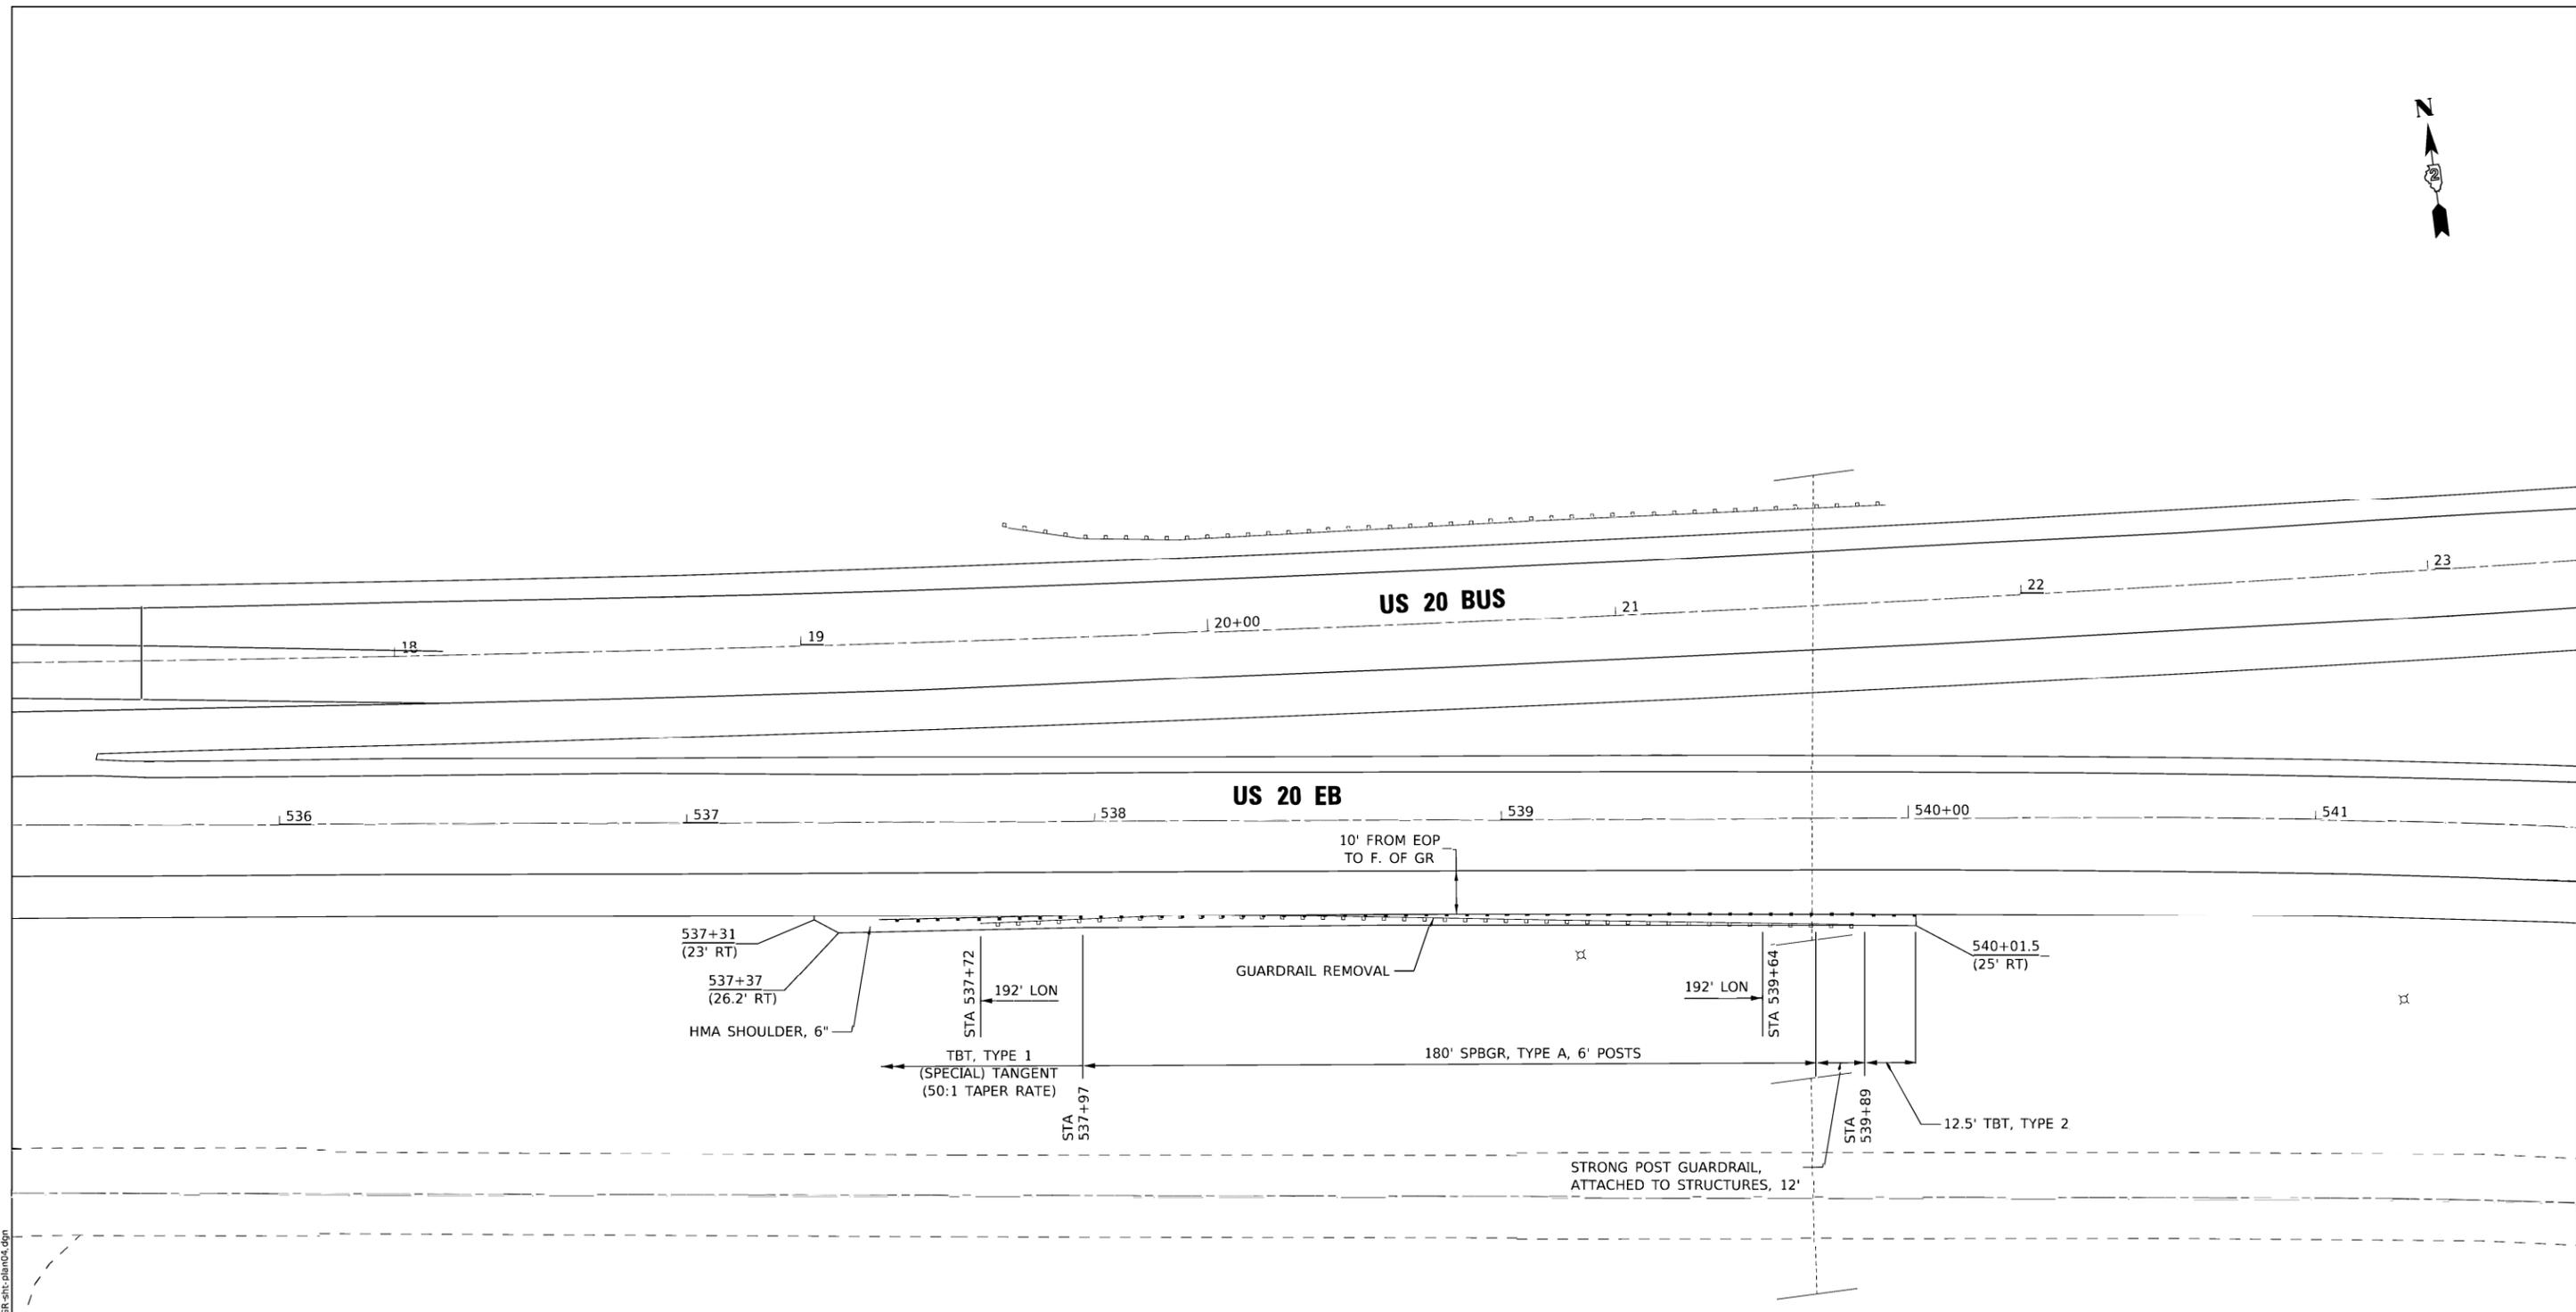


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PLOT SCALE = 20.0000' / in.	CHECKED - JWD	REVISED -
PLOT DATE = 3/2/2021	DATE -	REVISED -

**STATE OF ILLINOIS
 DEPARTMENT OF TRANSPORTATION**

GUARDRAIL AT STATION 521 + 50 DETAIL SHEET			
SCALE: 1" = 20'	SHEET	OF	SHEETS
STA.	TO	STA.	TO

F.A.P. RTE.	SECTION	COUNTY	TOTAL SHEETS	SHEET NO.
301	(1-1,1,2)RS-2	WINNEBAGO	158	94
CONTRACT NO. 64M18				
ILLINOIS FED. AID PROJECT				



NOTE:

OFFSETS LISTED ARE FROM CENTERLINE OF EASTBOUND LANES

LEGEND:

SPBGR = STEEL PLATE BEAM GUARDRAIL
 LON = LENGTH OF NEED
 TBT = TRAFFIC BARRIER TERMINAL

MODEL: Default
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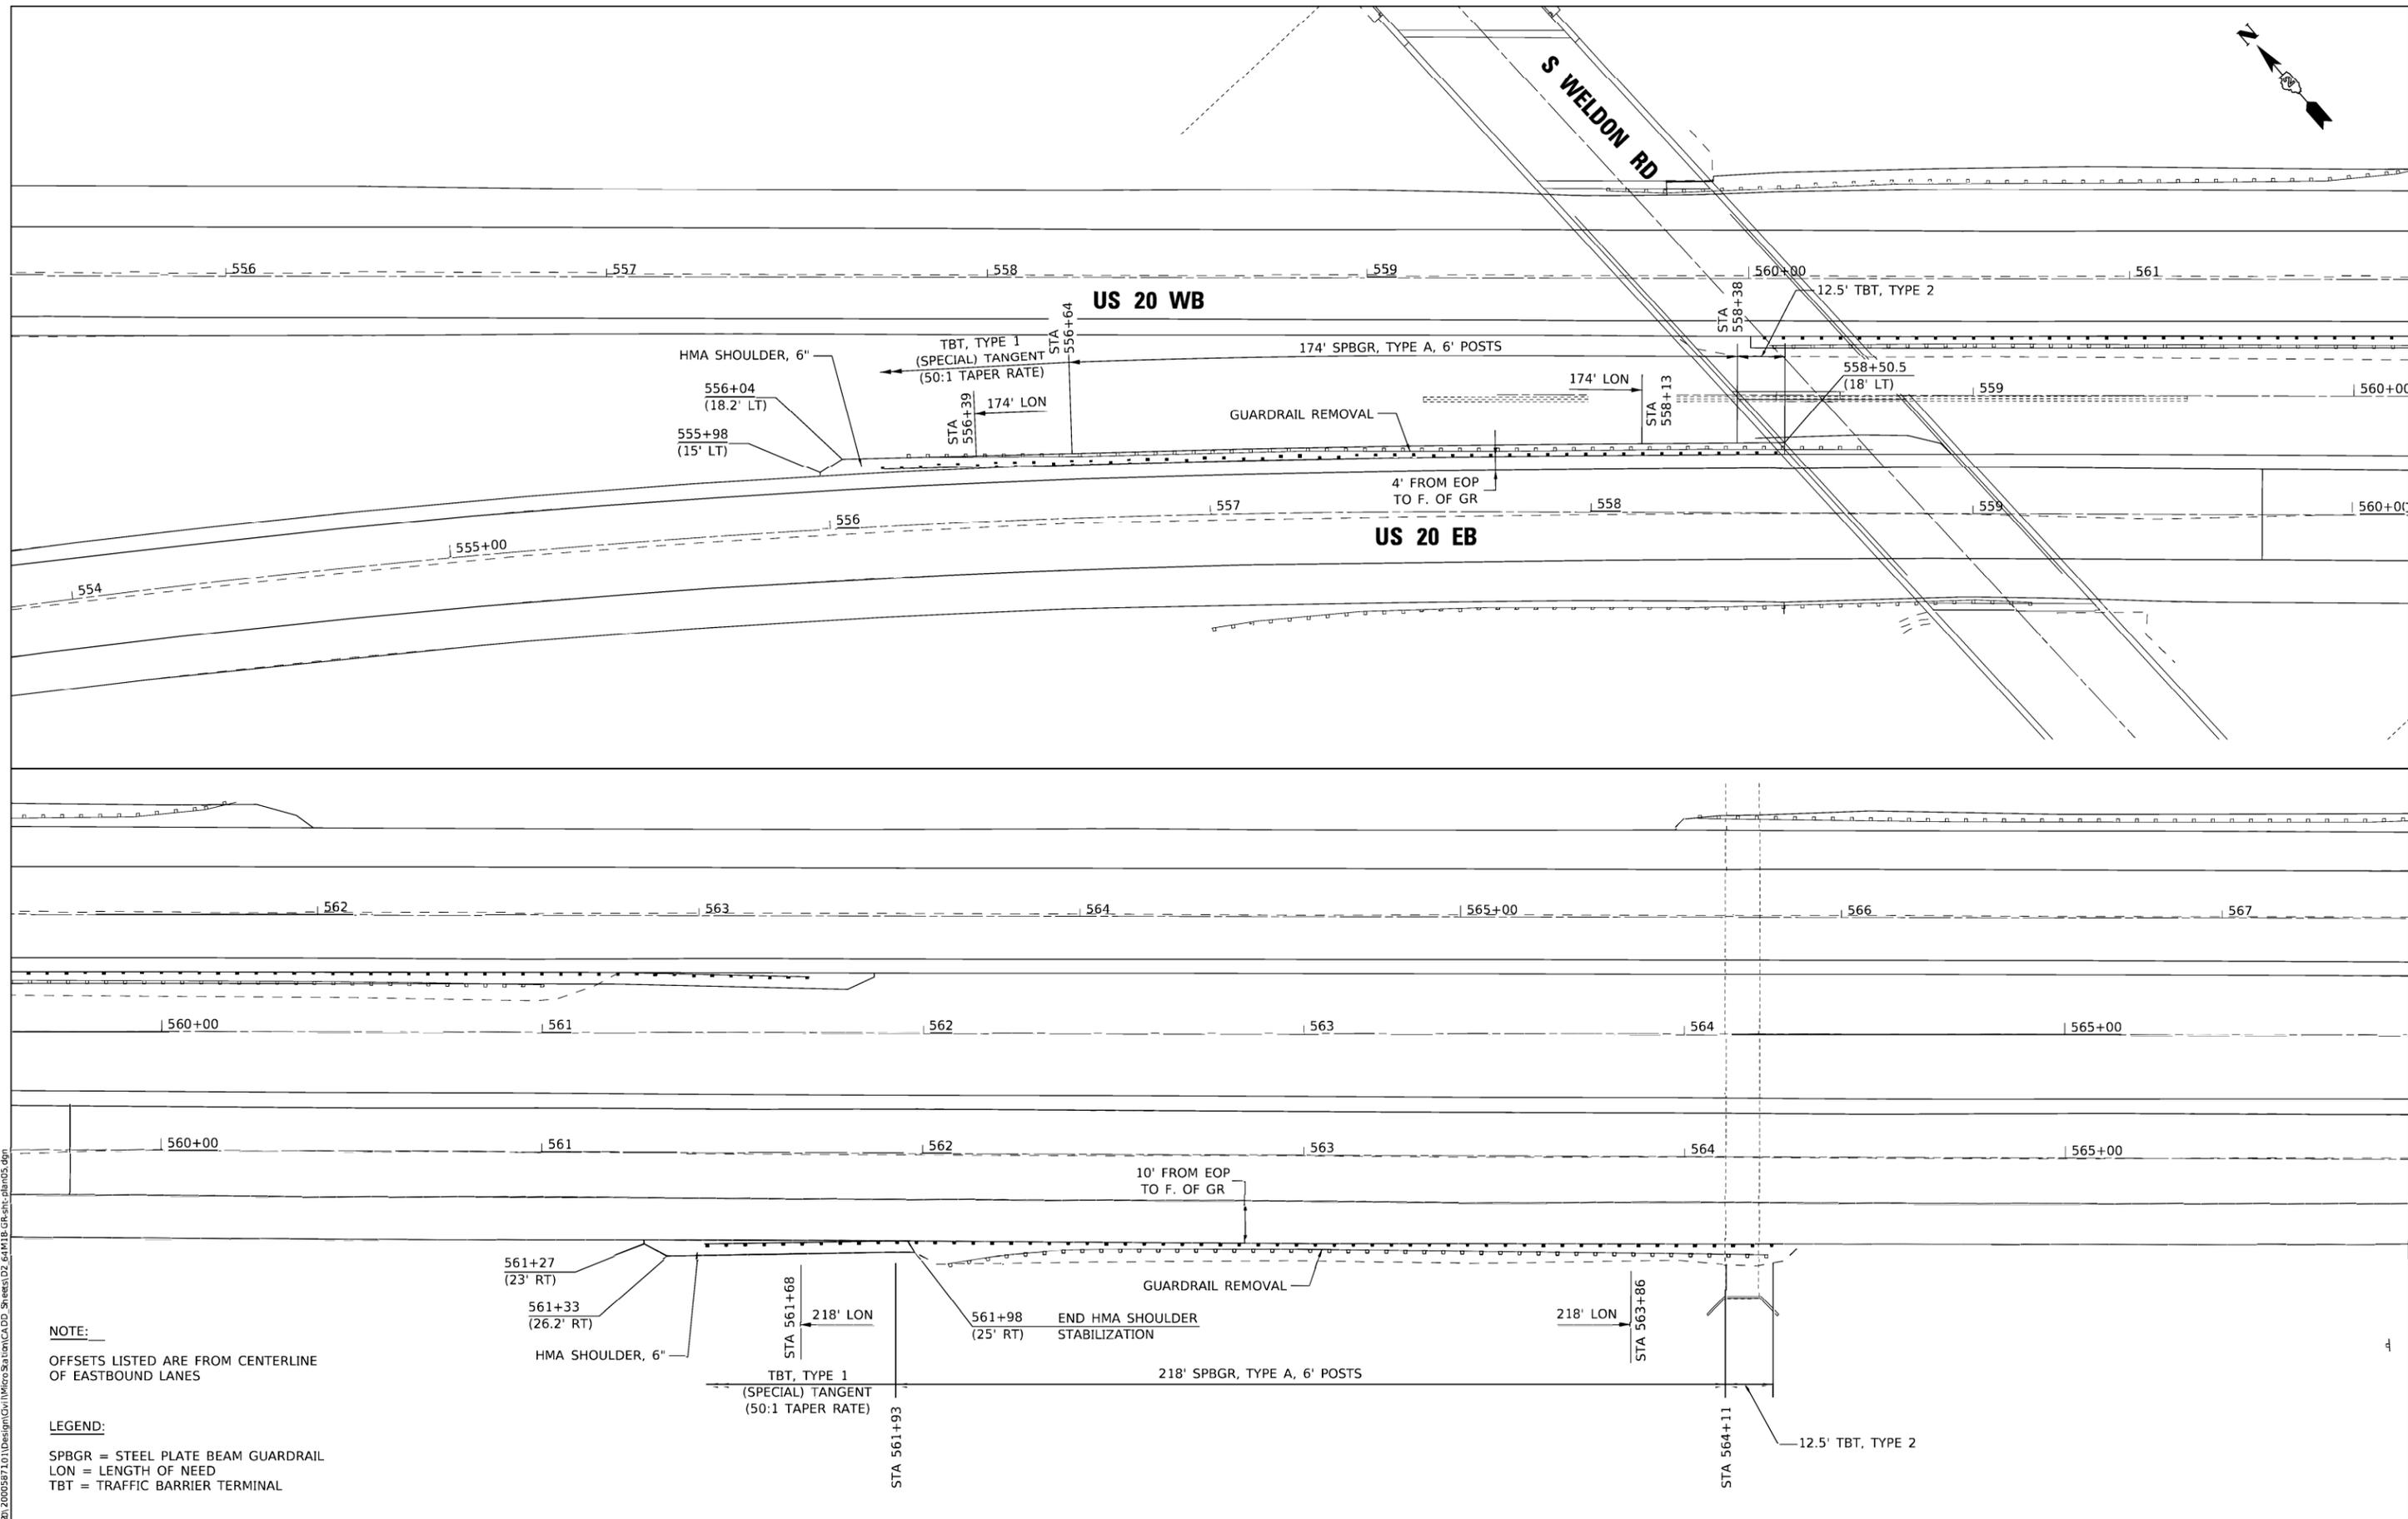
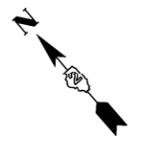
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PLOT SCALE = 20.0000' / in.	CHECKED - JWD	REVISED -
PLOT DATE = 3/2/2021	DATE -	REVISED -

**STATE OF ILLINOIS
 DEPARTMENT OF TRANSPORTATION**

**GUARDRAIL AT STATION 538+50 EB
 DETAIL SHEET**

SCALE: 1" = 20' SHEET OF SHEETS STA. TO STA.

F.A.P. RTE.	SECTION	COUNTY	TOTAL SHEETS	SHEET NO.
301	(1-1,1,2)RS-2	WINNEBAGO	158	95
			CONTRACT NO. 64M18	
ILLINOIS FED. AID PROJECT				



NOTE:
 OFFSETS LISTED ARE FROM CENTERLINE OF EASTBOUND LANES

LEGEND:
 SPBGR = STEEL PLATE BEAM GUARDRAIL
 LON = LENGTH OF NEED
 TBT = TRAFFIC BARRIER TERMINAL

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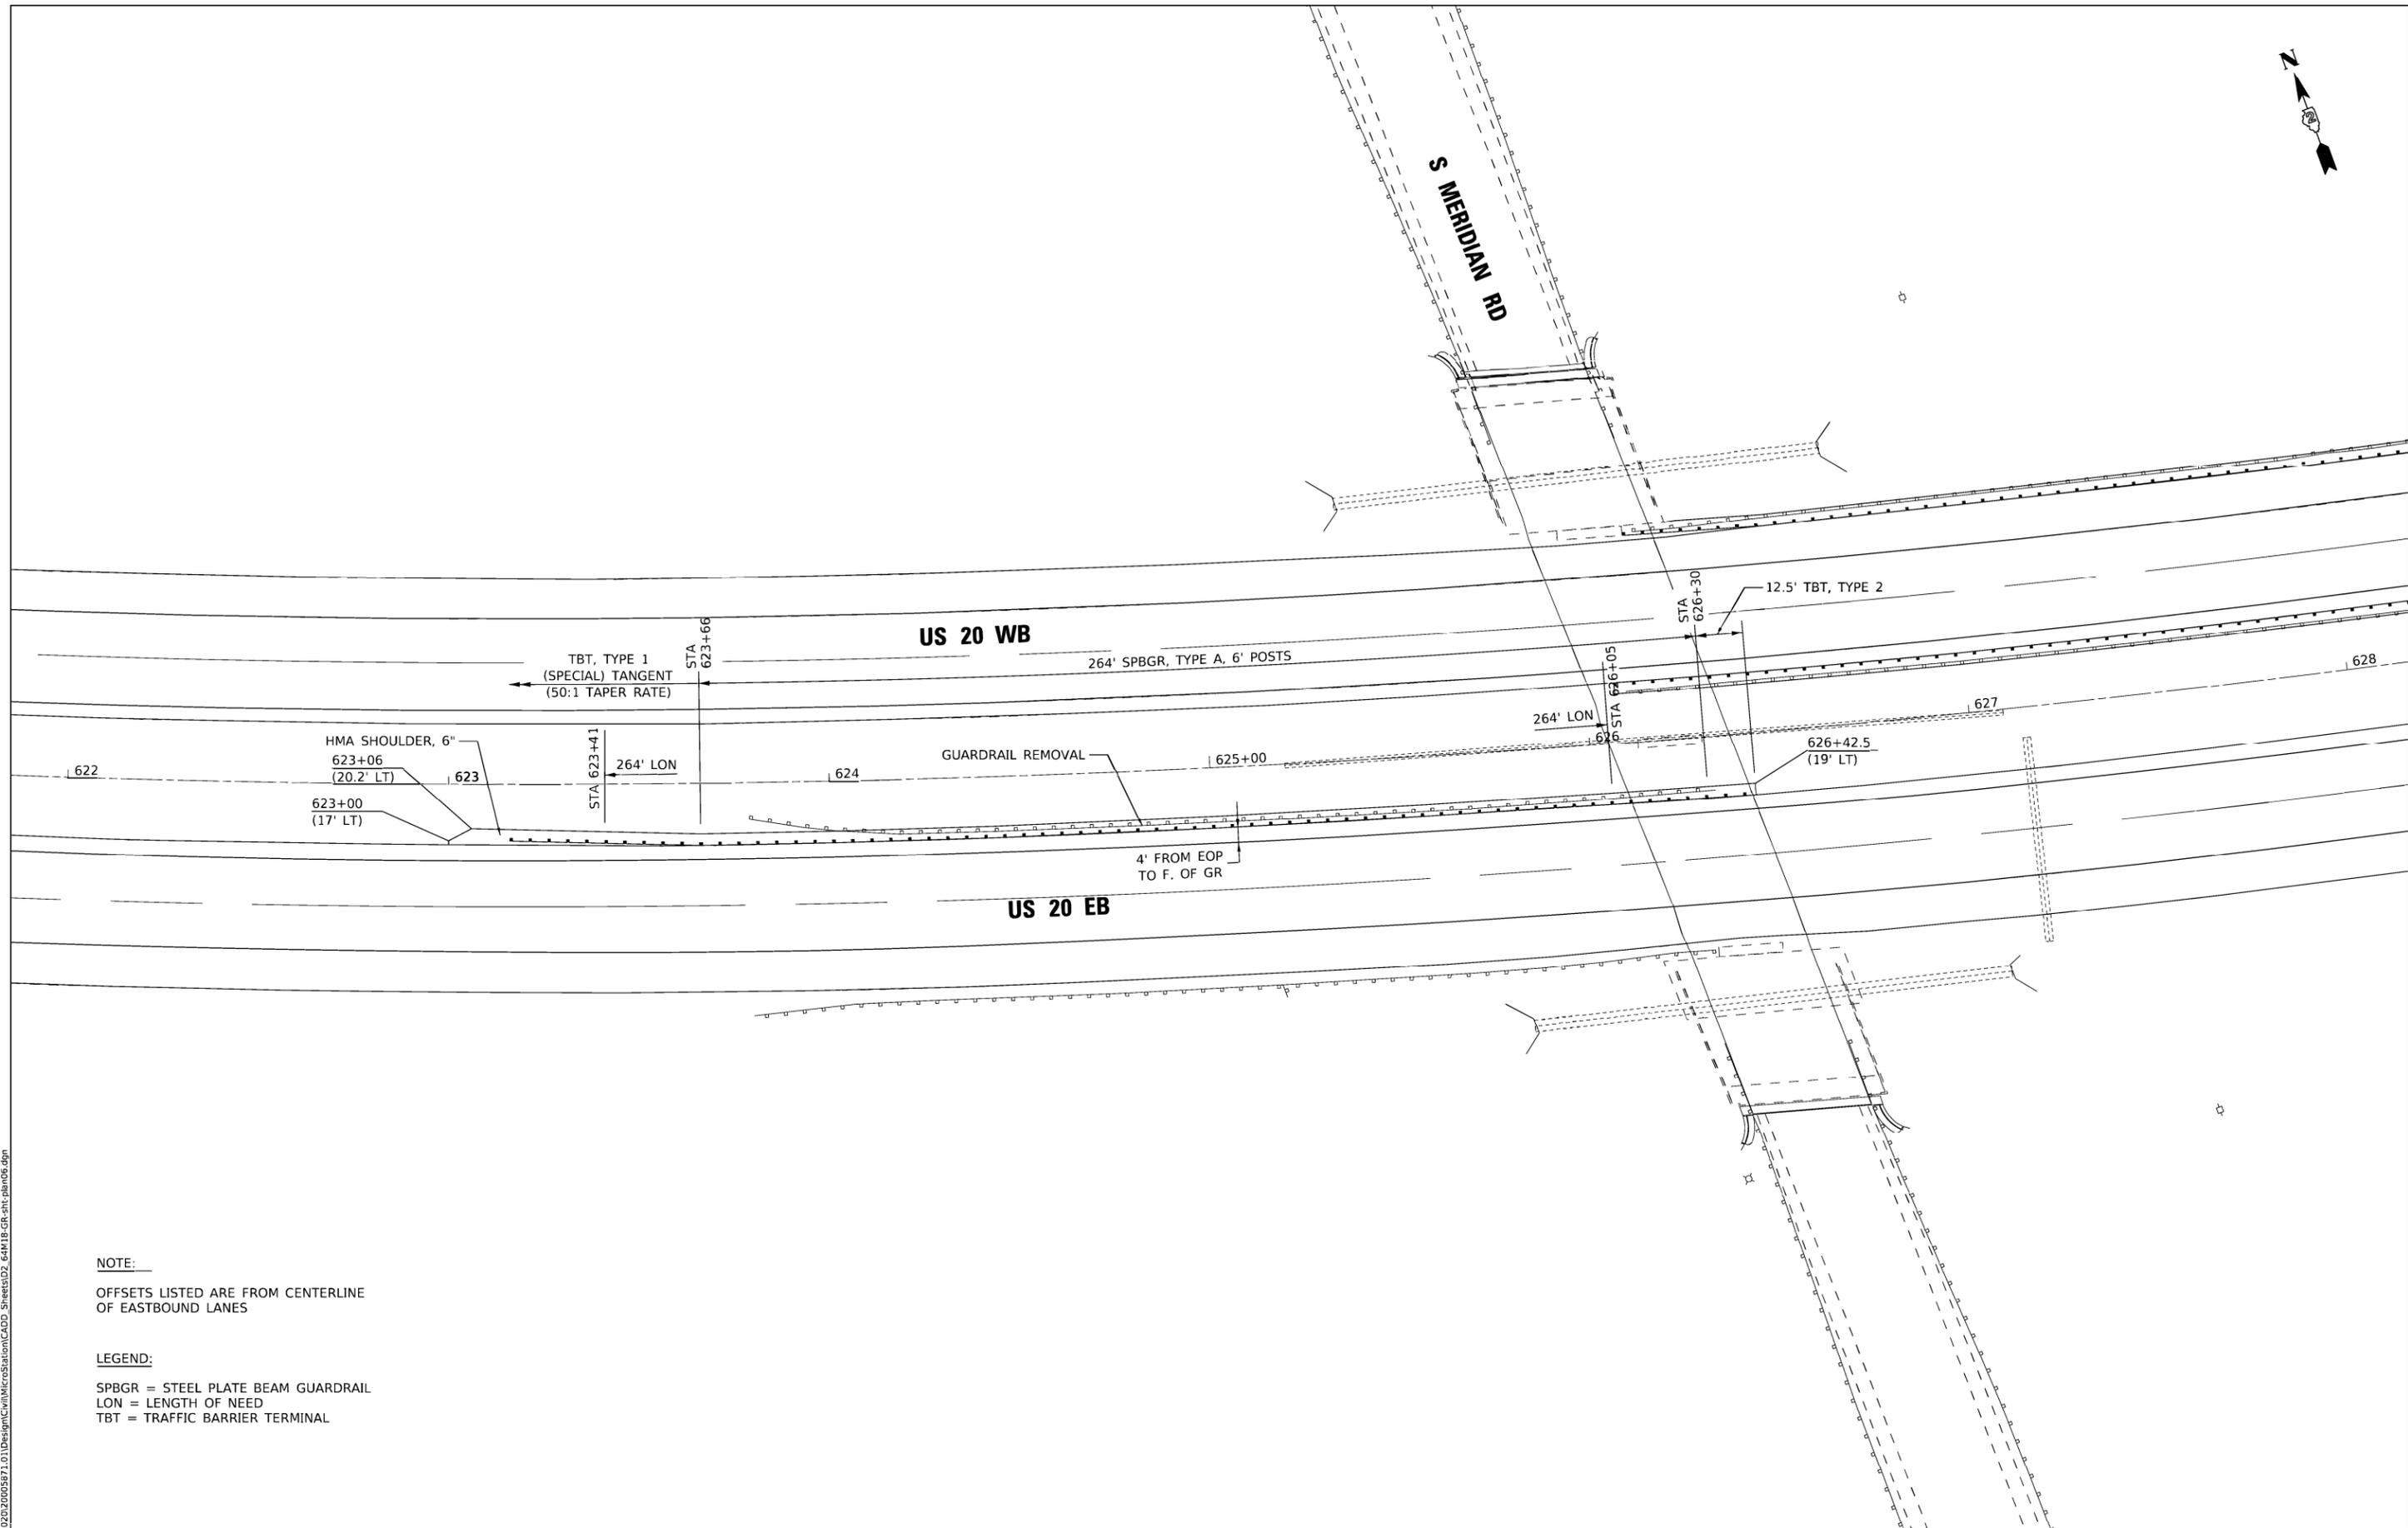


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PLOT DATE = 3/2/2021	CHECKED - JWD	REVISED -
	DATE -	REVISED -

**STATE OF ILLINOIS
 DEPARTMENT OF TRANSPORTATION**

GUARDRAIL AT STATION 557+50 & 562+75 EB DETAIL SHEET			
SCALE: 1" = 20'	SHEET	OF SHEETS	STA. TO STA.

F.A.P. RTE.	SECTION	COUNTY	TOTAL SHEETS	SHEET NO.
301	(1-1,1,2)RS-2	WINNEBAGO	158	96
			CONTRACT NO. 64M18	
ILLINOIS FED. AID PROJECT				



NOTE:

OFFSETS LISTED ARE FROM CENTERLINE OF EASTBOUND LANES

LEGEND:

SPBGR = STEEL PLATE BEAM GUARDRAIL
 LON = LENGTH OF NEED
 TBT = TRAFFIC BARRIER TERMINAL

MODEL: Default
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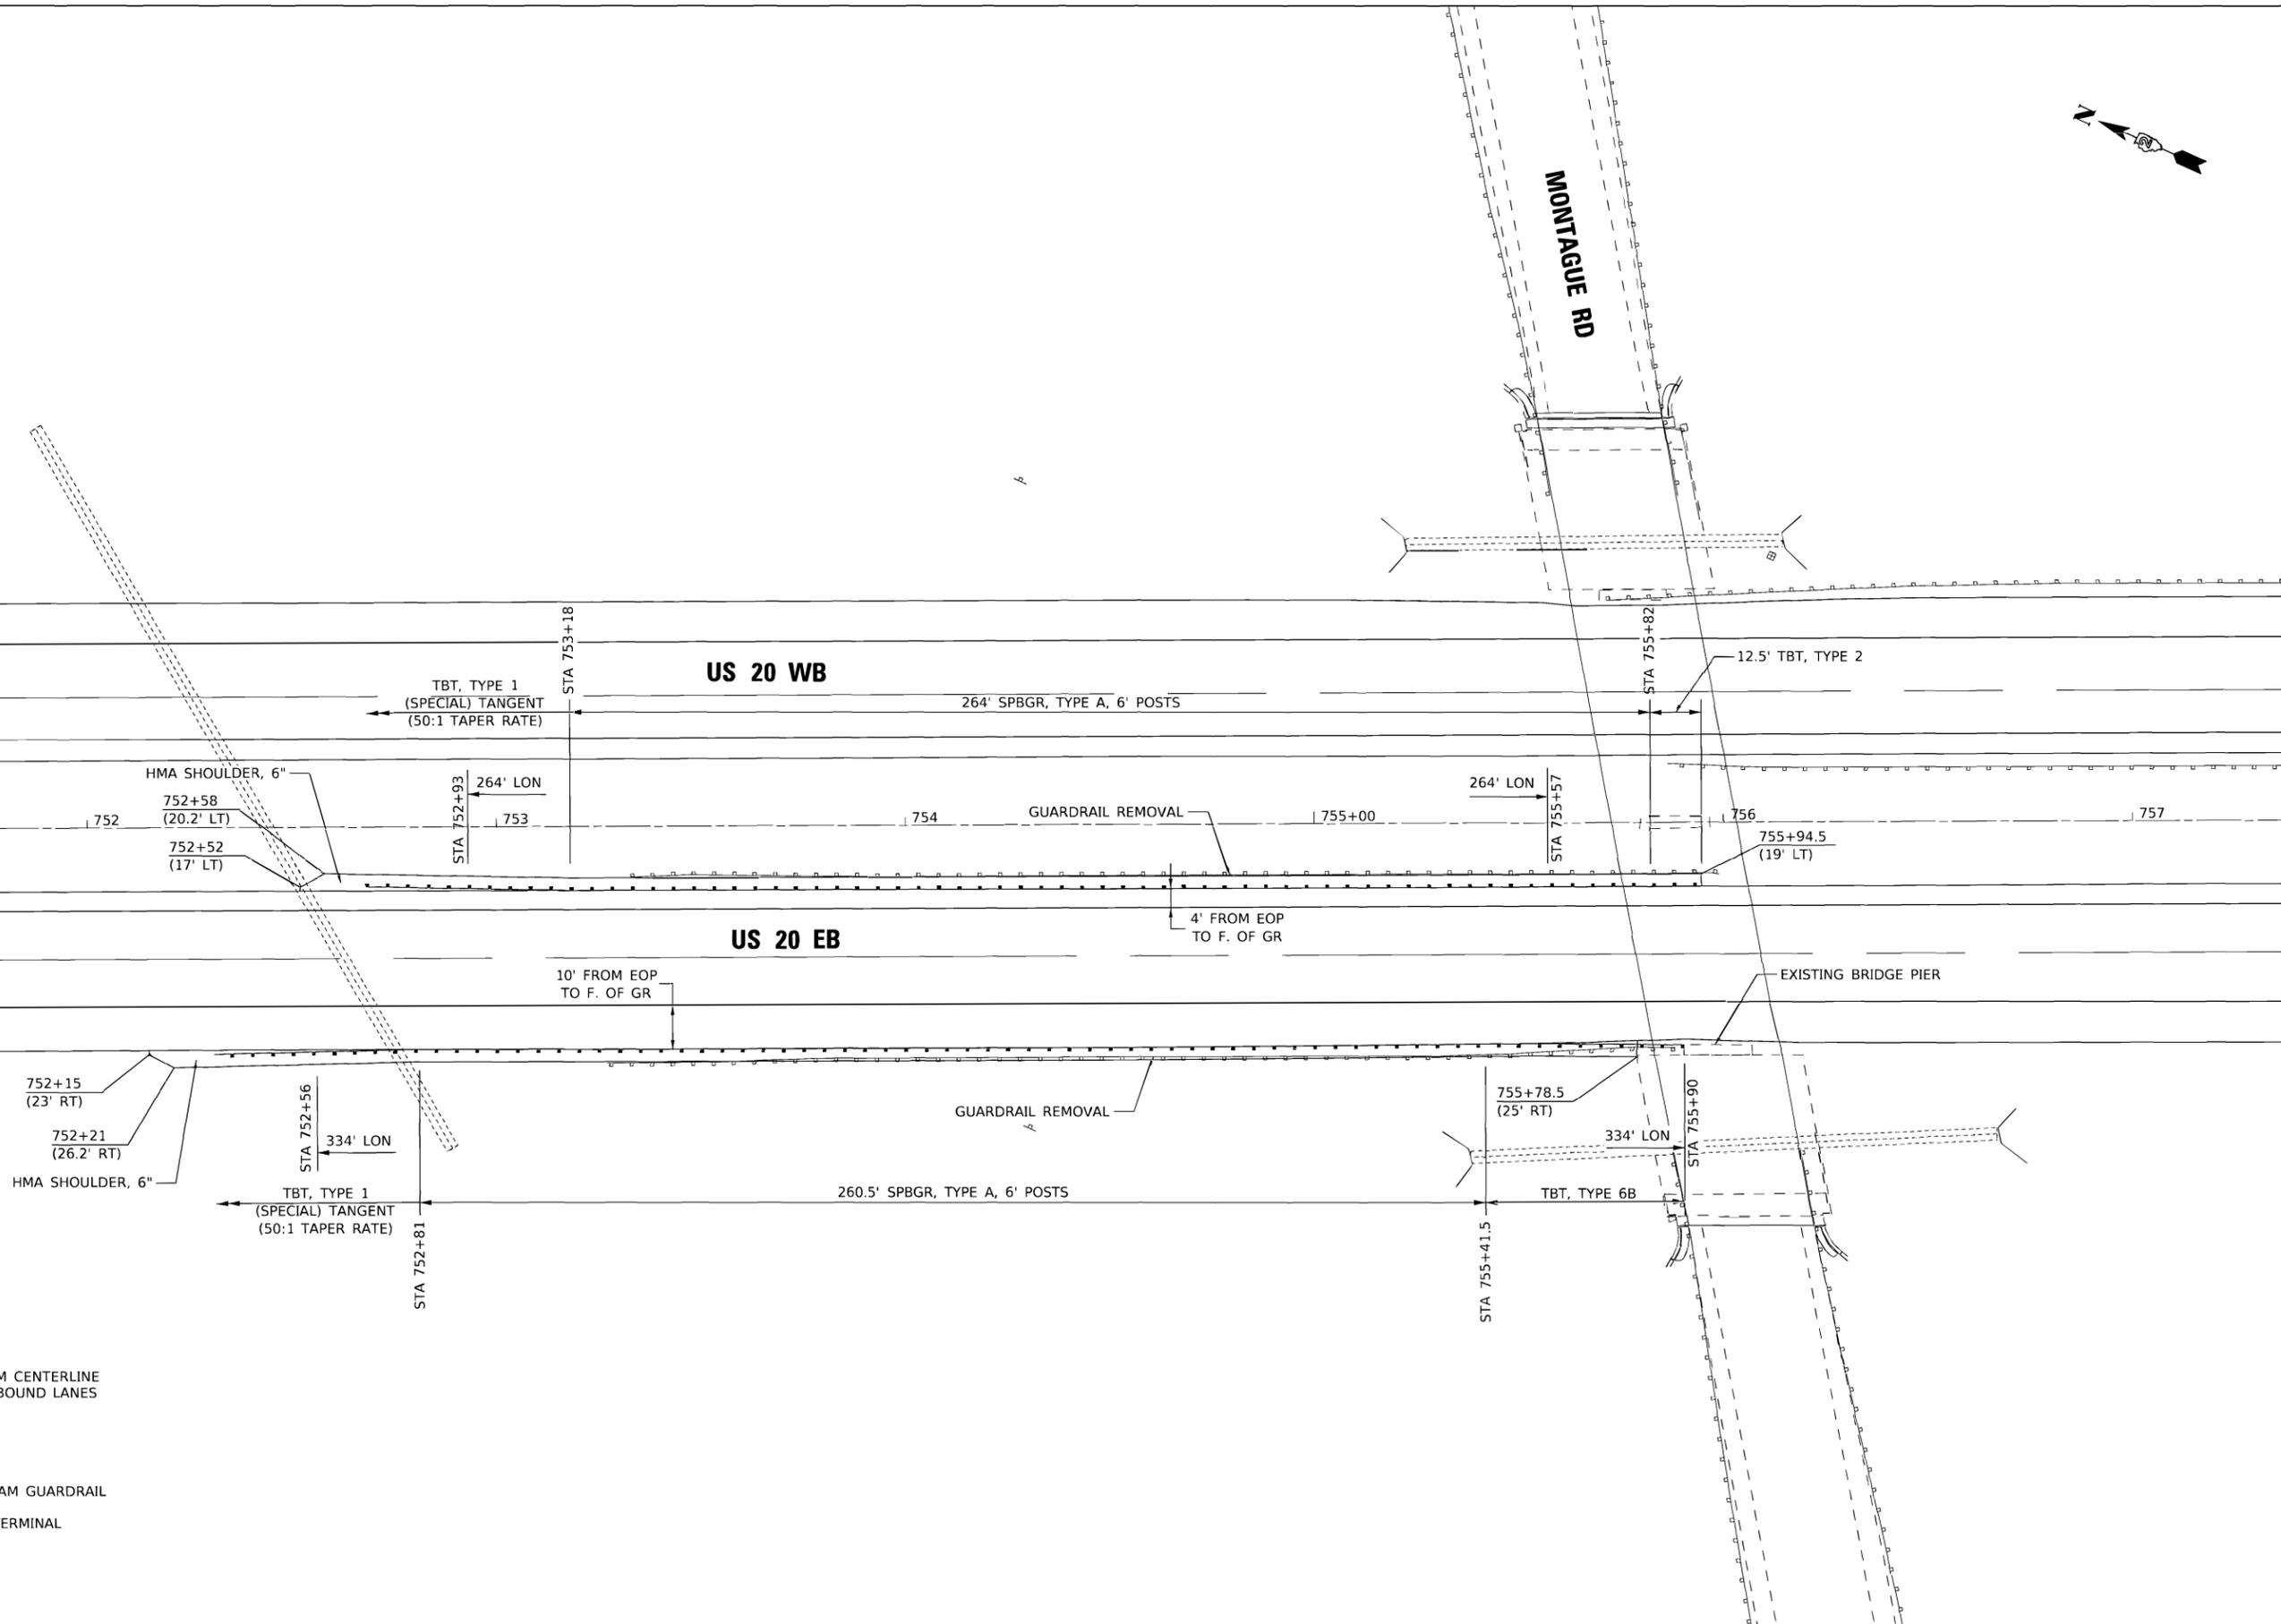


USER NAME = Marc.A.Personette	DESIGNED - PCB	REVISED -
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PLOT DATE = 3/2/2021	CHECKED - JWD	REVISED -
	DATE -	REVISED -

**STATE OF ILLINOIS
 DEPARTMENT OF TRANSPORTATION**

GUARDRAIL AT STATION 625+00 EB DETAIL SHEET			
SCALE: 1" = 20'	SHEET	OF	SHEETS
	STA.	TO	STA.

F.A.P. RTE.	SECTION	COUNTY	TOTAL SHEETS	SHEET NO.
301	(1-1,1,2)RS-2	WINNEBAGO	158	97
			CONTRACT NO. 64M18	
ILLINOIS FED. AID PROJECT				



NOTE:

OFFSETS LISTED ARE FROM CENTERLINE OF EASTBOUND OR WESTBOUND LANES

LEGEND:

SPBGR = STEEL PLATE BEAM GUARDRAIL
 LON = LENGTH OF NEED
 TBT = TRAFFIC BARRIER TERMINAL

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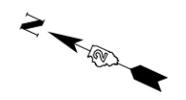
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PLOT DATE = 3/2/2021	DATE -	REVISED -

**STATE OF ILLINOIS
 DEPARTMENT OF TRANSPORTATION**

**GUARDRAIL AT STATION 754+00 EB
 DETAIL SHEET**

SCALE: 1" = 20' SHEET OF SHEETS STA. TO STA.

F.A.P. RTE. 301	SECTION (1-1,1,2)RS-2	COUNTY WINNEBAGO	TOTAL SHEETS 158	SHEET NO. 98
			CONTRACT NO. 64M18	
ILLINOIS FED. AID PROJECT				




AC AC

US 20 WB

US 20 EB

793 794 795+00 796 797 798 799

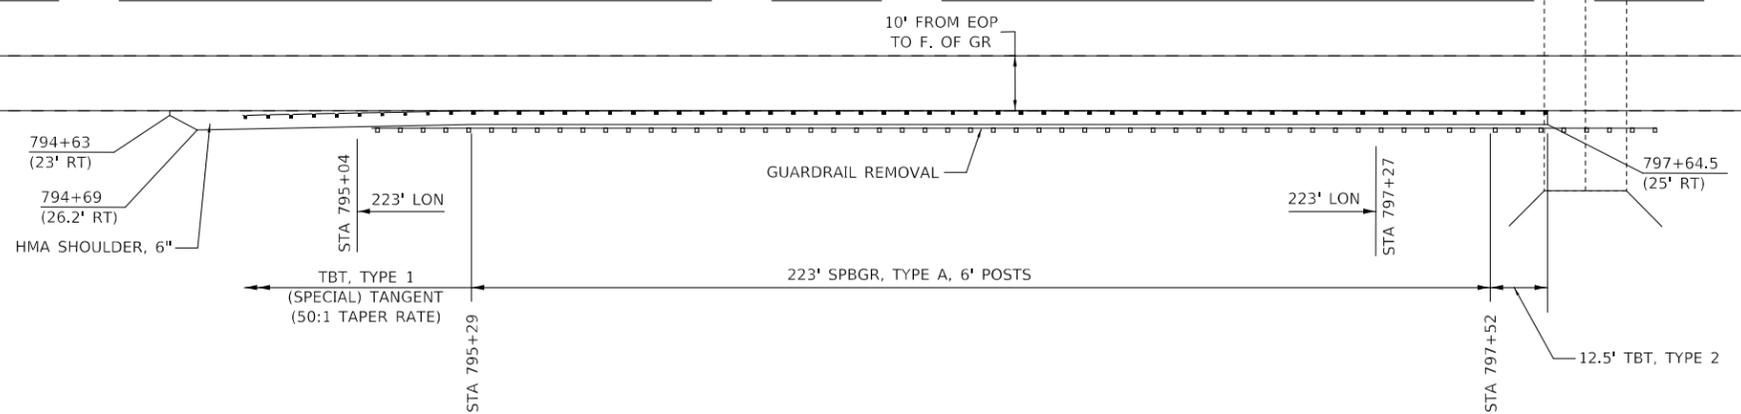

LEGEND:
 SPBGR = STEEL PLATE BEAM GUARDRAIL
 LON = LENGTH OF NEED
 TBT = TRAFFIC BARRIER TERMINAL

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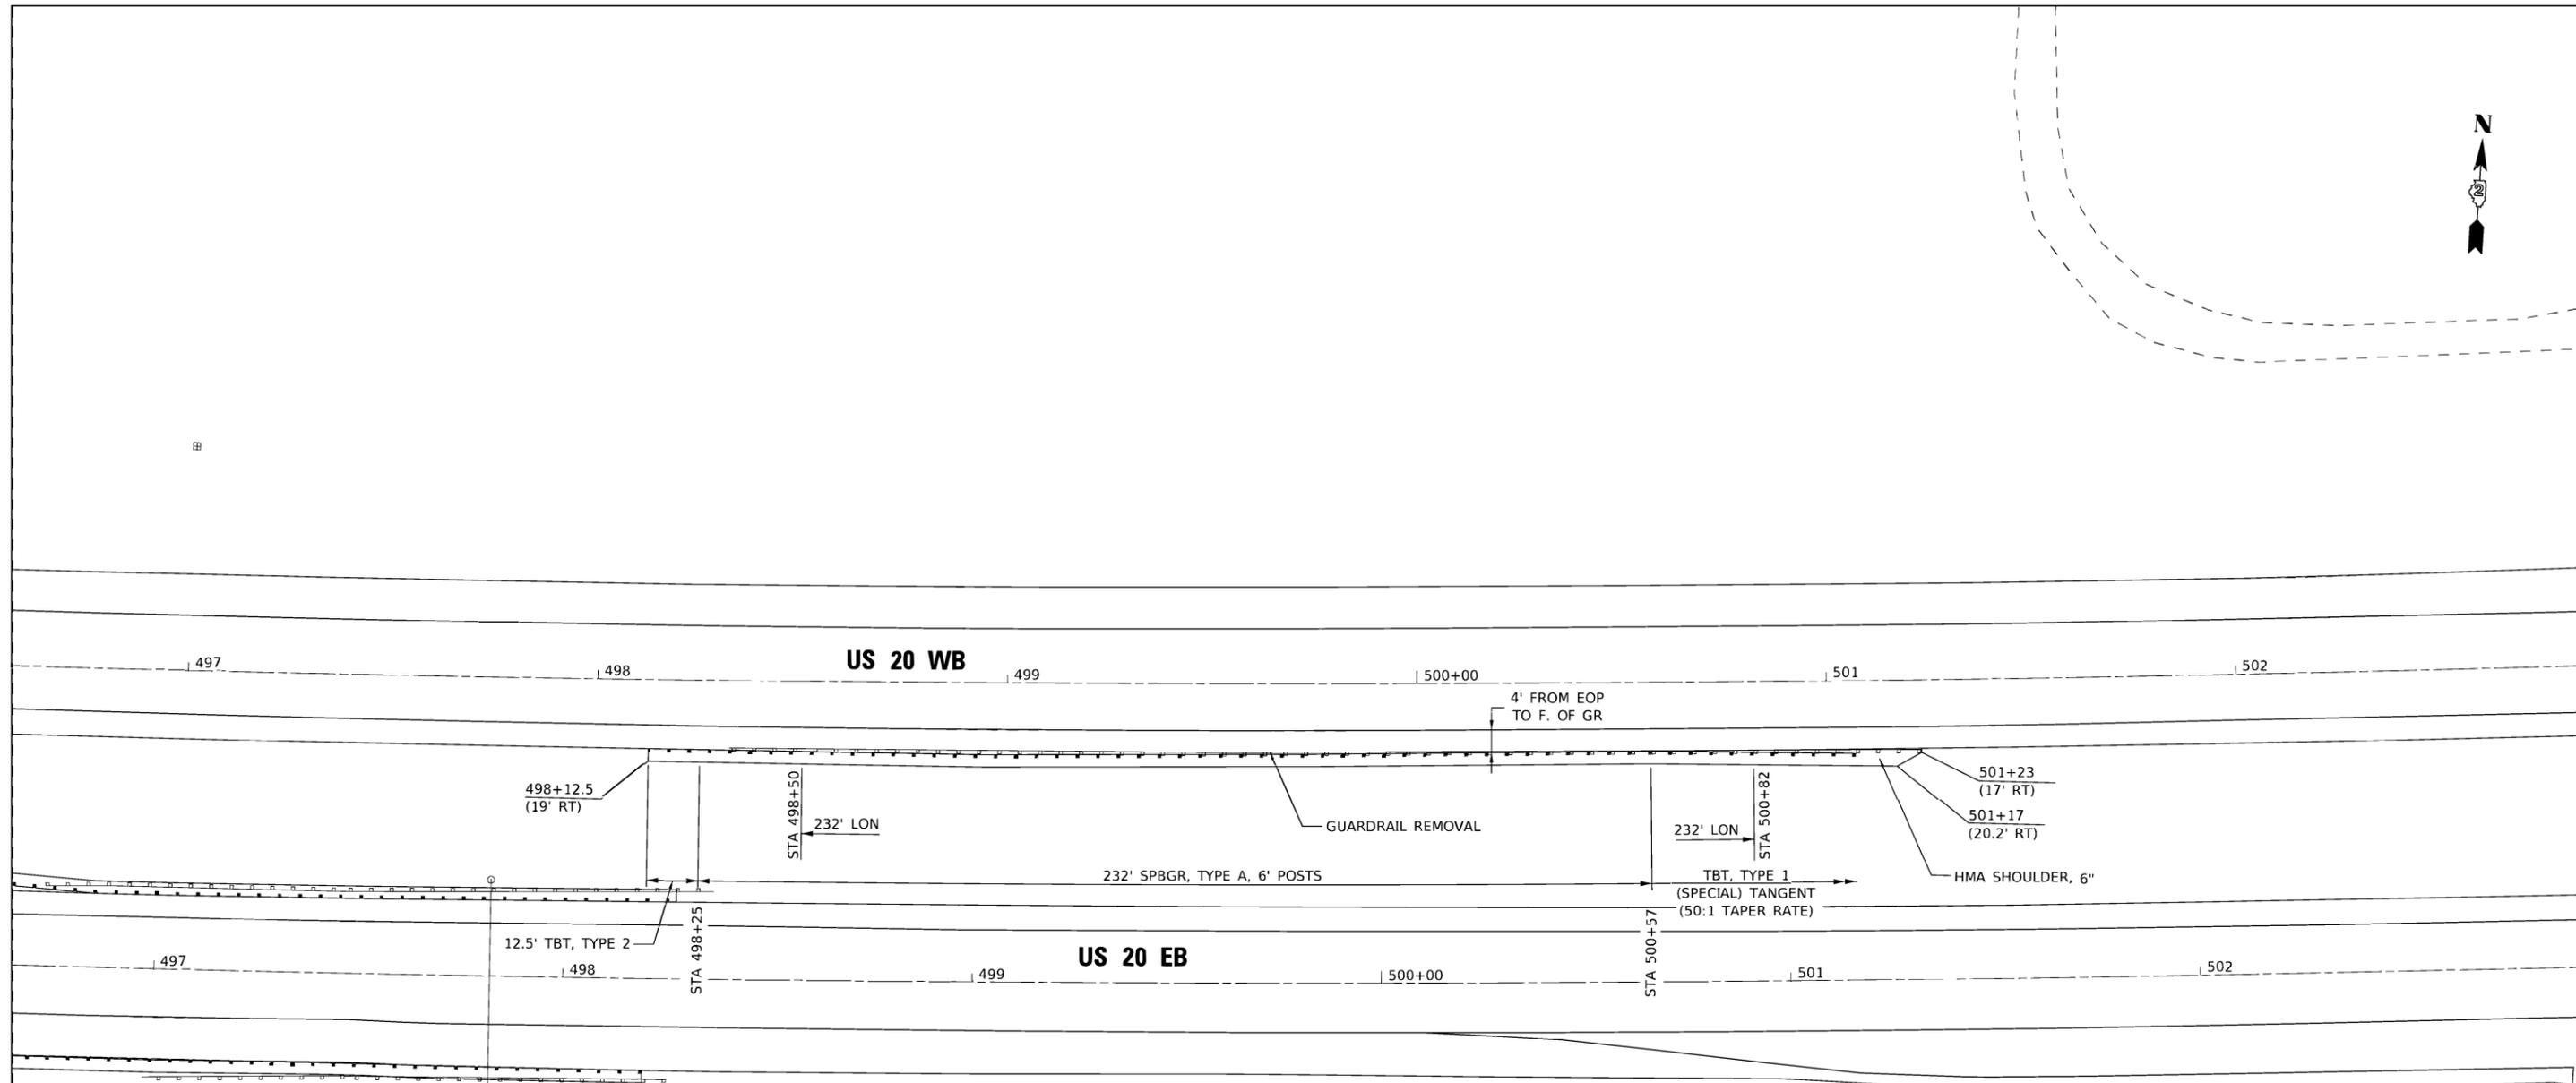
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PLOT DATE = 3/2/2021	DATE -	REVISED -

**STATE OF ILLINOIS
 DEPARTMENT OF TRANSPORTATION**

**GUARDRAIL AT STATION 796 + 25 EB
 DETAIL SHEET**

SCALE: 1" = 20' SHEET OF SHEETS STA. TO STA.

F.A.P. RTE.	SECTION	COUNTY	TOTAL SHEETS	SHEET NO.
301	(1-1,1,2)RS-2	WINNEBAGO	158	99
CONTRACT NO. 64M18				
		ILLINOIS	FED. AID PROJECT	



NOTE:

OFFSETS LISTED ARE FROM CENTERLINE OF WESTBOUND LANES

LEGEND:

SPBGR = STEEL PLATE BEAM GUARDRAIL
 LON = LENGTH OF NEED
 TBT = TRAFFIC BARRIER TERMINAL

MODEL: Default
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USER NAME = Marc.A.Personette	DESIGNED - PCB	REVISED -
	DRAWN - MAP	REVISED -
PLOT SCALE = 20.0000' / in.	CHECKED - JWD	REVISED -
PLOT DATE = 3/2/2021	DATE -	REVISED -

**STATE OF ILLINOIS
 DEPARTMENT OF TRANSPORTATION**

**GUARDRAIL AT STATION 499+50 WB
 DETAIL SHEET**

SCALE: 1" = 20' SHEET OF SHEETS STA. TO STA.

F.A.P. RTE.	SECTION	COUNTY	TOTAL SHEETS	SHEET NO.
301	(1-1,1,2)RS-2	WINNEBAGO	158	100
CONTRACT NO. 64M18			ILLINOIS FED. AID PROJECT	