# FOR INDEX OF SHEETS SEE SHEET NO. 2

# TRAFFIC DATA

2030 ADT = 8.000POSTED SPEED LIMIT: 20 MPH DESIGN SPEED LIMIT: 30 MPH **URBAN COLLECTOR STREET** 

PROJECT LOCATED IN THE VILLAGE OF MELROSE PARK

STATE OF ILLINOIS **DEPARTMENT OF TRANSPORTATION DIVISION OF HIGHWAYS** PLANS FOR PROPOSED **FEDERAL AID HIGHWAY FAU ROUTE 2406 (BROADWAY AVENUE) LAKE STREET TO DIVISION STREET RECONSTRUCTION SECTION NO. 09-00114-00-FP PROJECT ARA-M-9003(516) VILLAGE OF MELROSE PARK COOK COUNTY JOB NO. C-91-144-10** 

PROJECT ENDS **STATION 26+29 BROADWAY AVENUE** (19th AVENUE)

SCALE: 1" = 10' SCALE: 1" = 20' SCALE: 1" = 30' SCALE: 1" = 40' SCALE: 1" = 50'

FULL SIZE PLANS HAVE BEEN PREPARED USING STANDARD ENGINEERING SCALES. REDUCED SIZED PLANS WILL NOT CONFORM TO STANDARD SCALES. IN MAKING MEASUREMENTS ON REDUCED PLANS, THE ABOVE SCALES MAY BE USED.



# Know what's **below**. Call before you dig.

JOINT UTILITY LOCATION INFORMATION FOR EXCAVATION (J.U.L.I.E.) CALL TOLL FREE 1-800-892-0123 OR 811.

CONTRACT NO. 63455

LOCATION MAP

R12E OF 3rd PRINCIPAL MERIDIAN DRWOOD STREET NORWOOD STREET DRIVE DIVISION STREET (NOT TO SCALE) CORTEZ VILLAGE HALL

PROVISO TOWNSHIP

GROSS AND NET LENGTH OF PROJECT = 2,527 FT = 0.479 MI

- AREA OF IMPROVEMENT

FAU 2406 09-00114-00-FP COOK ILLINOIS PROJECT ARA-M-9003(516) CONTRACT NO. 63455



STATE OF ILLANOIS DEPARTMENT/OF TRANSPORTATION DIVISION OF HIGHWAYS (PRINTED BY AUTHORITY OF THE STATE OF ILLINOIS)



PROJECT BEGINS STATION 1+02

**BROADWAY AVENUE** (19th AVENUE)

E.H.E. NO. 600-09-00101

11	<b>d</b>	FX	ΛE	CL	CCT	-e
	-			31		-

HEET NO.	DESCRIPTION
1	TITLE SHEET, LOCATION MAP
2	INDEX OF SHEETS, LEGEND OF SYMBOLS, BENCHMARKS, AND I.D.O.T. STANDARD DRAWINGS
3	GENERAL NOTES
4-5	SUMMARY OF QUANTITIES
6	TYPICAL CROSS SECTIONS
7 - 8	MAINTENANCE OF TRAFFIC PLAN, DETOUR FOR THROUGH TRAFFIC SIGNING PLAN
9 - 10	LOCAL ACCESS SIGNING PLAN
11 - 14	BROADWAY AVENUE (19th AVENUE) PAVING PLAN AND PROFILE
15	ROADWAY DETAILS
16 - 19	BROADWAY AVENUE (19th AVENUE) DRAINAGE AND UTILITIES PLAN AND PROFILE
20 - 21	DRAINAGE AND UTILITIES DETAILS
22 - 23	PAVEMENT MARKING AND SIGNING PLAN
24 - 25	EROSION CONTROL AND ASPHALT PLAN
26	TRAFFIC CONTROL AND PROTECTION FOR SIDE ROADS, INTERSECTIONS, AND DRIVEWAYS (TC-10)
27	DISTRICT ONE TYPICAL PAVEMENT MARKINGS (TC-13)
28	TRAFFIC CONTROL AND PROTECTION AT TURN BAYS (TO REMAIN OPEN TO TRAFFIC) (TC-14)
29	BUTT JOINTS AND BITUMINOUS TAPER DETAILS (BD-32)
30 - 33	STATION CROSS SECTIONS

# I D O T STANDARD DRAWINGS

1.0.0.1.	HANDAND DRAWINGS					
STANDARD NO.	TITLE OR DESCRIPTION					
000001-05	STANDARD SYMBOLS, ABBREVIATIONS AND PATTERNS					
280001-05	TEMPORARY EROSION CONTROL SYSTEMS					
424001-05	CURB RAMPS FOR SIDEWALKS					
602601-02	PRECAST REINFORCED CONCRETE FLAT SLAB TOP					
701501-05	URBAN LANE CLOSURE, 2 L, 2 W, UNDIVIDED					
701701-06	URBAN LANE CLOSURE, MULTILANE INTERSECTION					
701801-04	LANE CLOSURE, MULTILANE, 1 W OR 2 W CROSSWALK OR SIDEWALK CLOSURE					
701901-01	TRAFFIC CONTROL DEVICES					

# **BENCHMARKS**

(NAVD 1988)

NORTHWEST BONNET BOLT OF	N FIRE HYDRANT AT IOWA ST. AND
BROADWAY AVE.	

636.67

#### NORTH-NORTHWEST BONNET BOLT ON FIRE HYDRANT AT BM-279 NORTHWEST CORNER OF IOWA ST. AND 18TH AVENUE.

635.62

636.24

635.29

635.86

633.40

636.40

#### TBM-1 NORTH-NORTHWEST BONNET BOLT ON FIRE HYDRANT AT NORTHWEST CORNER OF WALTON AVE. AND BROADWAY AVENUE.

639.29

#### NORTH-NORTHWEST BONNET BOLT ON FIRE HYDRANT AT TBM-2 NORTHWEST CORNER OF AUGUSTA AVE. AND BROADWAY

638.48 AVENUE.

#### BM-265 NORTHWEST FLANGE BOLT ON FIRE HYDRANT AT NORTHWEST **CORNER OF CORTEZ AVENUE AND BROADWAY AVENUE**

CORNER OF THOMAS AVENUE AND BROADWAY AVENUE

NORTHWEST FLANGE BOLT ON FIRE HYDRANT AT NORTHWEST

# TBM-4

TBM-3

BM-280

NORTH-NORTHWEST BONNET BOLT ON FIRE HYDRANT AT NORTHWEST CORNER OF HADDON AVENUE AND BROADWAY **AVENUE** 

# BM-96

NORTHWEST FLANGE BOLT ON FIRE HYDRANT AT SOUTHWEST CORNER OF DIVISION AVENUE AND BROADWAY AVENUE

# TBM-5

NORTH-NORTHWEST BONNET BOLT ON FIRE HYDRANT AT NORTHWEST CORNER OF RICE AVENUE AND BROADWAY AVENUE

# **STATE OF ILLINOIS DEPARTMENT OF TRANSPORTATION**

## INDEX OF SHEETS, LEGEND OF SYMBOLS, SCALE: NONE SHEET NO. 1 OF 1 SHEETS STA.

ROUTE SECTION			С	OUNTY	SHEETS	SH				
2406	3	(	9-00	114	1-00-FP			соок	33	T
 FIELD	B00	K NO.	1588	/A	ERIALS/LI	-	CC	NTRACT	NO. 63	455
FED.	ROAD	DIST.	NO.	1	ILLINOIS	FED.	AID	PROJECT	ARA-M-90	03 (
							E.H.E	PROJECT	NO 600-	09-00

**LEGEND OF SYMBOLS** (TO BE USED IN CONJUNCTION WITH I.D.O.T. STANDARD 000001-05)

EXISTING POWER POLE  EXISTING GAS VALVE  EXISTING STREET LIGHT  EXISTING WATER MAIN BUFFALO BOX  EXISTING FIRE HYDRANT  EXISTING WATER MAIN VALVE VAULT  EXISTING MANHOLE  EXISTING INLET  EXISTING CATCH BASIN  EXISTING TREE	
EXISTING STREET LIGHT  EXISTING WATER MAIN BUFFALO BOX  EXISTING FIRE HYDRANT  EXISTING WATER MAIN VALVE VAULT  EXISTING MANHOLE  EXISTING INLET  EXISTING CATCH BASIN	
EXISTING WATER MAIN BUFFALO BOX EXISTING FIRE HYDRANT EXISTING WATER MAIN VALVE VAULT EXISTING MANHOLE EXISTING INLET EXISTING CATCH BASIN	
EXISTING FIRE HYDRANT  EXISTING WATER MAIN VALVE VAULT  EXISTING MANHOLE  EXISTING INLET  EXISTING CATCH BASIN	
EXISTING WATER MAIN VALVE VAULT  EXISTING MANHOLE  EXISTING INLET  EXISTING CATCH BASIN	
<ul> <li>EXISTING MANHOLE</li> <li>EXISTING INLET</li> <li>EXISTING CATCH BASIN</li> </ul>	
EXISTING INLET  EXISTING CATCH BASIN	
EXISTING CATCH BASIN	
EXISTING TREE	
EXISTING HOT-MIX ASPHALT AREA	
c EXISTING CONCRETE AREA	
G EXISTING GRASS AREA	
s EXISTING STONE OR GRAVEL AREA	
EXISTING STORM SEWER	
EXISTING COMBINATION SEWER	
EXISTING SANITARY SEWER	
EXISTING ELECTRIC LINE	
G	
EXISTING TELEPHONE LINE	
EXISTING WATER MAIN	
EXISTING CURB AND GUTTER	
EXISTING RIGHT OF WAY	
X RM EXISTING STRUCTURE TO BE REMOVED	
EXISTING CURB AND GUTTER TO BE REMOVED EXISTING HOT-MIX ASPHALT SURFACE TO BE REMOVED EXISTING HOT-MIX ASPHALT AREA TO BE REMOVED	
EXISTING CONCRETE AREA TO BE REMOVED	
PROPOSED STORM SEWER	
PROPOSED MANHOLE	
■ PROPOSED INLET	
PROPOSED CATCH BASIN	
A* FRAMES AND LIDS TO ADJUSTED (SPECIAL)	
1C TYPE 1 FRAME & CLOSED LID	
1P TYPE 1 FRAME & OPEN LID	
PROPOSED DIRECTION OF FLOW	
→\$-> PROPOSED SUMMIT	
PROPOSED HOT-MIX ASPHALT AREA	
C PROPOSED CONCRETE AREA	
G PROPOSED GRASS AREA	
PROPOSED COMBINATION CONCRETE CURB & GUTTER, TYPE B-6.12	
EXISTING WATERMAIN RIM ELEVATION EXISTING WATERMAIN TOP OF PIPE ELEVATION	
EXISTING SANITARY RIM ELEVATION EXISTING SANITARY INVERT ELEVATION	
EXISTING STORM RIM ELEVATION EXISTING STORM INVERT ELEVATION	
PROPOSED STORM RIM ELEVATION PROPOSED STORM INVERT ELEVATION	

REVISED -MK/LEV/DMM DRAWN -REVISED 9933 Roservit Road

nter, Hitser's 60154-2780

Phone: 708/065-2212

PLOT DATE -CHECKED -REVISED DATE -REVISED -3-29-10

BENCHMARKS, AND I.D.O.T. STANDARD DRAWINGS

#### **ACCESS**

THE CONTRACTOR WILL BE REQUIRED TO MAINTAIN INGRESS AND EGRESS FOR EMERGENCY VEHICLES INGRESS AND EGRESS ONTO PRIVATE & COMMERCIAL PROPERTY DURING THE CONSTRUCTION PERIOD. DURING CONSTRUCTION, GARBAGE TRUCKS MUST BE PERMITTED ACCESS TO THE WORK ZONE IN ORDER TO PICK UP RESIDENTIAL AND COMMERCIAL GARBAGE FOR THOSE PROPERTIES FRONTING THE WORK ZONE. IF GARBAGE TRUCK ACCESS IS NOT PROVIDED, THE CONTRACTOR WILL BE REQUIRED TO MOVE TRASH CONTAINERS TO AN ACCESSIBLE LOCATION.

#### **STANDARDS**

ANY REFERENCE TO STANDARDS THROUGHOUT THE PLANS OR SPECIAL PROVISIONS SHALL BE INTERPRETED TO BE THE LATEST STANDARD OF THE DEPARTMENT AS SHOWN ON THE INDEX OF SHEETS IN THE PLANS.

#### **UNDERGROUND UTILITIES**

THE LOCATIONS OF THE UNDERGROUND UTILITIES AS SHOWN ON THE PLANS HAVE BEEN OBTAINED BY FIELD SURVEYS AND SEARCHES OF AVAILABLE RECORDS. IT IS BELIEVED THAT THE DATA IS ESSENTIALLY CORRECT, BUT THE VILLAGE OF MELROSE PARK, THE ILLINOIS DEPARTMENT OF TRANSPORTATION AND/OR OTHER OFFICES AND AGENCIES ASSOCIATED WITH THE DEVELOPMENT OF THESE PLANS DO NOT GUARANTEE THEIR ACCURACY OR COMPLETENESS. THE CONTRACTOR WILL BE REQUIRED TO VERIFY THE EXACT LOCATION OF EACH FACILITY WITH THE UTILITY COMPANY, AND SHALL TAKE DUE CARE IN ALL PHASES OF THE CONSTRUCTION TO PROTECT ANY SUCH FACILITIES WHICH MAY BE AFFECTED BY THE WORK. ANY DAMAGE TO EXISTING UTILITIES SHALL BE REPAIRED AT THE CONTRACTOR'S EXPENSE.

ADJUSTMENTS REQUIRED BY UTILITY COMPANIES WILL BE PERFORMED BY THE COMPANY INVOLVED OR ITS CONTRACTOR.

COORDINATION OF ALL UTILITY WORK INVOLVED IN THE CONSTRUCTION AREA WILL BE DISCUSSED AT A PRE-CONSTRUCTION CONFERENCE.

THE CONTRACTOR SHALL USE EXTREME CAUTION IN THE REMOVAL OF ABANDONED EXISTING GAS LINES SINCE RESIDUAL MATERIALS CONTAINED THEREIN ARE HIGHLY EXPLOSIVE, FLAMMABLE, AND TOXIC. ONCE THE MAINS ARE ABANDONED BY THE OWNER, THE CONTRACTOR SHALL ASSUME ALL RESPONSIBILITY FOR ANY DAMAGE AND/OR INJURY OCCURRING ON THE PROJECT DUE TO HIS OPERATIONS NEXT TO THE MAINS AND/OR THE METHOD OF REMOVAL OF THE ABANDONED MAINS. UNDER NO CIRCUMSTANCE SHALL THE UTILITY COMPANIES BE HELD LIABLE FOR ANY DAMAGE AND/OR INJURY ONCE THEIR MAINS HAVE BEEN RELOCATED AND THE EXISTING ABANDONED.

#### **STORM SEWER**

THE VERTICAL AND HORIZONTAL CLEARANCES BETWEEN WATER MAINS AND PROPOSED OR EXISTING STORM SEWERS SHALL CONFORM TO THE REQUIREMENTS OF SECTIONS 41-1.02A THROUGH 41-1.02D OF THE "STANDARD SPECIFICATIONS FOR WATER & SEWER MAIN CONSTRUCTION IN ILLINOIS".

#### **FRAMES AND GRATES**

THE TYPE OF FRAMES AND GRATES REQUIRED FOR ALL CATCH BASINS AND MANHOLES LISTED IN THE SUMMARY OF QUANTITIES MAY BE FOUND ON THE PLANS AT THEIR RESPECTIVE LOCATIONS. WHERE LIDS ARE CALLED FOR ON THE PLANS, THEY SHALL BE IN ACCORDANCE WITH ARTICLE 604.01 OF THE STANDARD SPECIFICATIONS AND THE TERM LID IS USED IN LIEU OF GRATE.

ON ALL IMPROVEMENTS, THE FRAMES AND LIDS OF EXISTING CATCH BASINS, INLETS, MANHOLES, AND VALVE VAULTS WHICH ARE TO BE ABANDONED DUE TO CONSTRUCTION OF THIS IMPROVEMENT ARE TO REMAIN THE PROPERTY OF THE VILLAGE OF MELROSE PARK AND BE SALVAGED. THE CONTRACTOR IS TO DELIVER FRAMES AND LIDS TO THE VILLAGE OF MELROSE PARK PUBLIC WORKS YARD LOCATED AT 1002 N. 27th AVENUE.

# **HOT-MIX ASPHALT PAVING OPERATIONS**

RESURFACING AREA: THE HOT-MIX ASPHALT BINDER COURSE SHALL BE PLACED IN FOUR (4) PASSES WITH A COLD JOINT LOCATED A MINIMUM OF SIX INCHES (6") FROM THE CENTERLINE OF THE PAVEMENT. THE HOT-MIX ASPHALT SURFACE COURSE WILL BE PLACED IN FOUR (4) PASSES WITH A COLD JOINT LOCATED AT THE CENTERLINE OF THE PAVEMENT. THE WIDTH OF THE HOT-MIX ASPHALT SURFACE PASSES ALONG THE CENTERLINE SHALL BE NINETEEN AND ONE-HALF FEET (19.5"), LEAVING A THIRTEEN FOOT (13") WIDE PASS ALONG EACH EDGE OF PAVEMENT. THE CONTRACTOR WILL BE REQUIRED TO SCHEDULE HIS OPERATIONS SO THAT NO SECTIONS OF PAVEMENT WILL HAVE A COLD JOINT OVERNIGHT.

RECONSTRUCTION AREA: THE HOT-MIX BINDER COURSE WILL BE PLACED IN TWO (2) PASSES WITH A COLD JOINT LOCATED A MINIMUM OF SIX INCHES (6") FROM THE CROWN LINE OF THE PAVEMENT. THE HOT-MIX ASPHALT SURFACE COURSE WILL BE PLACED IN TWO (2) PASSES WITH A COLD JOINT LOCATED AT THE CROWN LINE OF THE PAVEMENT. THE CONTRACTOR WILL BE REQUIRED TO SCHEDULE HIS OPERATIONS SO THAT NO SECTIONS OF PAVEMENT ALONG THE CROWN LINE WILL HAVE A COLD JOINT OVERNIGHT.

#### **MAINTENANCE OF SEWER FLOWS**

THE CONTRACTOR SHALL CONDUCT HIS OPERATIONS SO AS TO MAINTAIN AT ALL TIMES FLOWS THROUGH EXISTING STORM AND SANITARY SEWER SYSTEMS. HE SHALL ALSO PROVIDE AND MAINTAIN AN EFFICIENT PUMPING PLANT IF NECESSARY AND A TEMPORARY OUTLET AND BE PREPARED AT ALL TIMES TO DISPOSE OF THE WATER COLLECTED IN A SAFE MANNER WITHOUT DAMAGE OF ANY KIND TO ADJACENT PROPERTIES. THE ENDS OF EXISTING DRAINAGE LINES WHICH ARE NOT TO BE INCORPORATED INTO THE PROJECT ARE TO BE SEALED AS SPECIFIED IN THE SPECIAL PROVISIONS. THE COST OF ALL THE PREVIOUSLY MENTIONED WORK SHALL BE INCLUDED IN THE RESPECTIVE SEWER PAY ITEMS. ALL ACCUMULATION OF MATERIAL IN THE STRUCTURE DUE TO CONSTRUCTION OPERATIONS AS WELL AS MATERIAL EXISTING BEFORE CONSTRUCTION, SHALL BE REMOVED BY THE CONTRACTOR AT HIS EXPENSE.

#### **EXISTING STRUCTURE MODIFICATIONS**

ALL KNOWN EXISTING STRUCTURES IN THE PAVEMENT OR ADJACENT AREAS WHICH ARE INVOLVED IN THE CONSTRUCTION HAVE BEEN SHOWN ON THE PLANS AND NOTED AS TO BE REMOVED, FILLED, RECONSTRUCTED, OR ADJUSTED BY THE CONTRACTOR EXCEPT THOSE OF AMERITECH, COMED, AND THE NICOR GAS COMPANY, WHICH ARE TO BE ADJUSTED BY THE APPROPRIATE UTILITY FORCE. WHERE EXISTING STRUCTURES ARE TO BE REMOVED OR FILLED, OR THE EXISTING CASTING REPLACED, THE CASTINGS REMOVED FROM THE STRUCTURE ARE TO REMAIN THE PROPERTY OF THE VILLAGE OF MELROSE PARK AND BE SALVAGED. THE CONTRACTOR IS TO DELIVER FRAMES AND LIDS TO THE VILLAGE OF MELROSE PARK PUBLIC WORKS YARD LOCATED AT 1002 N. 27th AVENUE.

#### **SHEETING OR SHORING**

IT SHOULD BE NOTED THAT ANY SHEETING OR SHORING REQUIRED FOR THE STORM SEWER INSTALLATION OR OTHER CONSTRUCTION ELEMENTS REQUIRING RELATIVELY DEEP EXCAVATIONS, SHALL BE INCLUDED IN THE PARTICULAR PAYMENT ITEM AND NO ADDITIONAL COMPENSATION WILL BE ALLOWED FOR ANY SUPPLEMENTAL WORK ASSOCIATED WITH THE MAINTENANCE OF TRENCH SIDES OR OTHER EXCAVATED AREAS.

## MAINTENANCE OF EXISTING DRAINAGE STRUCTURES

WHEN DURING THE CONSTRUCTION OPERATIONS, ANY LOOSE MATERIAL IS DEPOSITED IN THE FLOW LINE OF ANY GUTTERS OR DRAINAGE STRUCTURE SO THAT THE NATURAL FLOW OF WATER IS OBSTRUCTED, IT SHALL BE REMOVED AT THE CLOSE OF EACH WORKING DAY. AT THE CONCLUSION OF THE CONSTRUCTION OPERATIONS, ALL DRAINAGE FACILITIES SHALL BE CLEAN AND FREE OF ALL OBSTRUCTIONS. THE COST OF THIS WORK SHALL BE INCLUDED IN THE RESPECTIVE SEWER PAY ITEMS.

#### SAW CUTTING

THE CONTRACTOR SHALL SAW CUT ASPHALT PAVEMENT AND CONCRETE PAVEMENT AS INDICATED ON THE PLANS OR AS DIRECTED BY THE ENGINEER, TO SEPARATE THE EXISTING PAVEMENT TO BE REMOVED BY MEANS OF AN APPROVED CONCRETE SAW TO A DEPTH AS DIRECTED BY THE ENGINEER. SUITABLE GUIDELINES OR DEVICES SHALL BE USED TO ASSURE CUTTING A NEAT, STRAIGHT LINE AS SHOWN ON THE PLANS. CARE SHALL BE TAKEN BY THE CONTRACTOR SO AS NOT TO DAMAGE THE REMAINING PAVEMENT DIRECTLY ADJACENT TO THE PAVEMENT TO BE REMOVED. ANY DAMAGE TO THE EXISTING PAVEMENT RESULTING FROM PAVEMENT REMOVAL OPERATIONS SHALL BE REPAIRED AT THE CONTRACTOR'S EXPENSE. THE PRICE OF SAW CUTTING, AS NOTED ABOVE, SHALL BE INCLUDED IN THE PARTICULAR PAY ITEMS.

## **PROPOSED STRUCTURES**

THE CONTRACTOR SHALL NOT ORDER PROPOSED STRUCTURES UNTIL A JULIE REQUEST HAS BEEN EXECUTED AND THE ENGINEER HAS BEEN NOTIFIED BY THE CONTRACTOR OF ANY CONFLICTS.

#### **ITEMS TO BE SALVAGED**

WHERE SPECIFIED ON THE PLANS OR AS DIRECTED BY THE ENGINEER, EXISTING FRAMES, VALVE BOXES, FIRE HYDRANTS, AND OTHER CASTINGS ARE TO BE REMOVED BY THE CONTRACTOR TO COMPLETE THE WORK. THESE ITEMS ARE TO BE COLLECTED AND DELIVERED BY THE CONTRACTOR TO THE OWNER AT ITS PUBLIC WORKS FACILITY LOCATED AT 1002 N. 27TH AVENUE, FOR THEIR USE OR DISPOSAL. THIS ITEM WILL NOT BE PAID FOR SEPARATELY BUT WILL BE INCLUDED IN THE UNIT PRICE FOR THE VARIOUS STORM SEWER STRICTURES IN THE CONTRACT

#### **NOTIFICATION OF RESIDENTS**

THE CONTRACTOR WILL BE RESPONSIBLE FOR PROVIDING WRITTEN NOTICE TO ALL RESIDENCES AND/OR PLACES OF BUSINESS AT LEAST ONE (1) WORKING DAY PRIOR TO PERFORMING ANY CONSTRUCTION ACTIVITY THAT WILL ELIMINATE ACCESS TO THEIR PROPERTY. THE WRITTEN NOTICE SHALL BE APPROVED BY THE ENGINEER AND THE VILLAGE PRIOR TO THE BEGINNING OF CONSTRUCTION.

## TRAFFIC PROTECTION

CONTRACTOR'S ATTENTION IS DIRECTED TO THE FACT THAT WHEN WORK COMMENCES, THE CONTRACTOR SHALL ASSUME THE MAINTENANCE OF ANY PAVEMENT, SHOULDERS, DRAINAGE FACILITIES, TRAFFIC CONTROL SIGNS, PAVEMENT MARKINGS, AND OTHER APPURTENANCES ON ROADWAYS WITHIN THE LIMITS OF THE CONTRACT WHICH ARE TO BE USED BY THE PUBLIC DURING CONSTRUCTION AND TO RETAIN THIS MAINTENANCE RESPONSIBILITY UNTIL THE VILLAGE ASSUMES THE MAINTENANCE. NEED FOR SNOW AND ICE CONTROL DURING THE CONSTRUCTION PERIOD SHALL, BE ACCOMMODATED FOR BY OTHERS. ALL UNBALLASTED TYPE I & TYPE II BARRICADES SHALL HAVE TWO SANDBAGS ONE ACROSS EACH BOTTOM RAIL.

#### **EXISTING ROADWAY SIGNS**

ALL EXISTING ROADWAY SIGNS, MARKERS, ETC., LOCATED WITHIN THE ROADWAY RIGHT-OF-WAY WHICH ARE INVOLVED IN THIS CONSTRUCTION SHALL BE REMOVED AND DELIVERED TO THE VILLAGE PUBLIC WORKS YARD LOCATED AT 1002 N. 27th AVENUE. ALL WORK ASSOCIATED WITH THIS ITEM SHALL BE CONSIDERED INCLUDED IN THIS RESPECTIVE TRAFFIC CONTROL PAY ITEMS AND NO EXTRA COMPENSATION WILL BE ALLOWED.

#### **SOILS REPORT**

A SOILS REPORT HAS BEEN PREPARED CONTAINING CERTAIN INFORMATION RELATING TO GENERAL SOIL CONDITIONS TO BE ENCOUNTERED ALONG THE ROUTE OF THE WORK. THE CONTRACTOR WILL BE PERMITTED TO EXAMINE THIS INFORMATION AND DETERMINE ITS VALUE. ANY ADDITIONAL BORINGS DEEMED NECESSARY BY THE CONTRACTOR SHALL BE MADE AT HIS OWN EXPENSE.

## PLUGGING EXISTING SEWERS AND DRAINS

UNLESS OTHERWISE SPECIFIED, ABANDONED SEWERS AND DRAINS, AS DESIGNATED BY THE ENGINEER, SHALL BE PLUGGED AT BOTH ENDS WITH A MINIMUM OF TWO (2) FOOT LONG NON-SHRINK/MORTAR PLUG. THIS WORK SHALL NOT BE PAID FOR SEPARATELY, BUT SHALL BE INCLUDED IN THE PAY ITEMS FOR REMOVING AND/OR FILLING THE VARIOUS TYPES OF STRUCTURES.

## **SCHEDULE OF WORK OPERATIONS**

EXCAVATION: NO MORE THAN 100' OF EXCAVATION SHALL BE LEFT OPEN WITHOUT INSTALLATION OF GEOFABRIC AND AT LEAST NINE-INCHES (9") OF AGGREGATE BASE COURSE.

PAVING: THE 1" HOT-MIX ASPHALT LEVELING BINDER COURSE SHALL BE INSTALLED WITHIN FIVE (5) CALENDAR DAYS OF HOT-MIX ASPHALT SURFACE REMOVAL. THE 7" HOT-MIX ASPHALT BINDER COURSE SHALL BE INSTALLED WITHIN THIRTY (30) CALENDAR DAYS OF COMMENCEMENT OF PAVEMENT REMOVAL.

# UNDERCUT AND POROUS GRANULAR EMBANKMENT (PGE)

A QUANTITY OF POROUS GRANULAR EMBANKMENT, SUBGRADE (PGES), HAS BEEN PROVIDED FOR USE IF THE EXISTING SOILS ARE UNSUITABLE OR UNSTABLE. THE ACTUAL NEED FOR REMOVAL AND REPLACEMENT WITH PGES WILL BE DETERMINED IN THE FIELD AT THE TIME OF CONSTRUCTION BY THE ENGINEER. ALL POTENTIALLY UNSTABLE SOILS SHALL BE TESTED WITH A STATIC CONE PENETROMETER AND TREATED IN ACCORDANCE WITH ARTICLE 301 03 AND THE UNDERCUT GUIDELINES IN THE IDOT SUBGRADE STABILITY MANUAL. IF UNSUITABLE MATERIAL IS ENCOUNTERED, THE SOIL SHALL BE REMOVED AND REPLACED WITH PGES AS DETERMINED BY THE ENGINEER. IF UNSUITABLE MATERIAL IS NOT ENCOUNTERED, THEN THE QUANTITY OF PGES WILL REMAIN UNUSED AND NO ADDITIONAL COMPENSATION WILL BE DUE TO THE CONTRACTOR. THE 3-INCH CAPPING AGGREGATE (CA-6 GRADATION) WILL NOT BE REQUIRED SINCE GRANULAR SUBBASE WILL BE PLACED ON TOP OF THE PGE.

#### **STORM SEWER STRUCTURES**

SCALE: NONE

PRE-CAST REINFORCED CONCRETE SECTIONS FABRICATED IN ACCORDANCE WITH ASTM C-478 WILL BE USED ON ALL STRUCTURES AND RECONSTRUCTED STRUCTURES. FINAL ADJUSTMENT SHALL BE MADE USING PRE-CAST ADJUSTING RINGS. A MAXIMUM C F 6" OF ADJUSTING RINGS WILL BE PERMITTED. THE WORK DESCRIBED WITHIN THE SPECIAL PROVISION FOR FRAMES AND LIDS TO BE ADJUSTED (SPECIAL) SHALL BE PERFORMED WHEN INSTALLING A NEW STORM SEWER STRUCTURE. THIS ITEM WILL NOT BE PAID FOR SEPARATELY BUT WILL BE INCLUDED IN THE UNIT PRICE FOR THE VARIOUS PROPCISED STORM SEWER STRUCTURES IN THE CONTRACT

HANCOC	K NG
♦ Civil Engineers	9813 Weskbester, III
<ul> <li>Municipal Consultants</li> </ul>	Phoe
Established 1911	F

1000

1000

CODE	PAYITEM DESCRIPTION	UNIT	TOTAL QUANTITY	80% FEDERAL 20% LOCAL
20200100	EARTH EXCAVATION	CU YD	3,600	3,60
20700420	POROUS GRANULAR EMBANKMENT, SUBGRADE	CU YD	650	65
20800150	TRENCH BACKFILL	CU YD	75	7
21101615	TOPSOIL FURNISH AND PLACE, 4"	SQ YD	300	30
25200100	SODDING	SQ YD	300	30
25200200	SUPPLEMENTAL WATERING	UNIT	50	5
28000510	INLET FILTERS	EACH	20	2
40201000	AGGREGATE FOR TEMPORARY ACCESS	TON	200	20
40600100	BITUMINOUS MATERIALS (PRIME COAT)	GALLON	1,850	1,85
40600300	AGGREGATE (PRIME COAT)	TON	40	4
40600400	MIXTURE FOR CRACKS, JOINTS, AND FLANGEWAYS	TON	5	
40600625	LEVELING BINDER (MACHINE METHOD), N50	TON	250	25
40603335	HOT-MIX ASPHALT SURFACE COURSE, MIX "D", N50	TON	525	52
40701861	HOT-MIX ASPHALT PAVEMENT (FULL-DEPTH), 9"	SQ YD	8,000	8,00
42101300	PROTECTIVE COAT	SQ YD	250	25
42300720	PORTLAND CEMENT CONCRETE DRIVEWAY PAVEMENT, 7 INCH, SPECIAL	SQ YD	50	
42400430	PORTLAND CEMENT CONCRETE SIDEWALK 5 INCH, SPECIAL	SQ FT	1,000	1,00
42400800	DETECTABLE WARNINGS	SQ FT	64	6
44000198	HOT-MIX ASPHALT SURFACE REMOVAL, VARIABLE DEPTH	SQ YD	4,700	4,70
44000200	DRIVEWAY PAVEMENT REMOVAL	SQ YD	50	;
44000500	COMBINATION CURB AND GUTTER REMOVAL	FOOT	500	50
44004400	PAVEMENT REMOVAL (SPECIAL)	SQ YD	8,000	8,00
44004700	SIDEWALK REMOVAL (SPECIAL)	SQ FT	1,000	1,00
550A0330	STORM SEWERS, CLASS A, TYPE 2 10"	FOOT	183	18
60213300	CATCH BASINS, SPECIAL	EACH	11	,
60224600	RESTRICTED DEPTH MANHOLES, 4'-DIAMETER, TYPE 1 FRAME, CLOSED LID	EACH	2	
60238900	INLETS, TYPE A, SPECIAL, TYPE 1 FRAME, OPEN LID	EACH	2	
60300310	FRAMES AND LIDS TO BE ADJUSTED (SPECIAL)	EACH	10	•
60406100	FRAMES AND LIDS, TYPE 1, CLOSED LID	EACH	10	
60604200	COMBINATION CONCRETE CURB AND GUTTER, TYPE B-6.12 (SPECIAL)	FOOT	500	50
67100100	MOBILIZATION	L SUM	1	

9933 thestor, III Phon Fo

	USER NAME -	DESIGNED -	WOP	REVISED -
		DRAWN -	MK/LEV/DMM	REVISED -
ad RO	PLOT SCALE -	CHECKED -	WOP '	REVISED -
12	PLOT DATE -	DATE -	3-29-10	REVISED -

STATE OF ILLINOIS **DEPARTMENT OF TRANSPORTATION** 

SUMMARY OF QUANTITIES									
 SCALE:	NOT TO SCALE	SHEET NO.	1.	OF	2	SHEETS	STA.		

TO STA.

<sup>→</sup> DENOTES SPECIAL PROVISION HAS BEEN PROVIDED

Apr 19, 2010 - 11:15am	
Reconstruction\DETAILS.dwg Apr 19	

[				1000	1000
				TOTAL	80% FEDERAL
ļ	CODE	PAY ITEM DESCRIPTION	UNIT	QUANTITY	20% LOCAL
~	70102550	TRAFFIC CONTROL AND PROTECTION FOR TEMPORARY DETOUR	EACH	1	1,
	70102620	TRAFFIC CONTROL AND PROTECTION, STANDARD 701501	LSUM	1	1
	70102635	TRAFFIC CONTROL AND PROTECTION, STANDARD 701701	LSUM	1	1
	70102640	TRAFFIC CONTROL AND PROTECTION, STANDARD 701801	LSUM	1	1
	70106800	CHANGEABLE MESSAGE SIGN	CAL MO	0.5	0.5
*	78000100	THERMOPLASTIC PAVEMENT MARKING - LETTERS AND SYMBOLS	SQ FT	60	60
*	78000200	THERMOPLASTIC PAVEMENT MARKING - LINE 4"	FOOT	4,500	4,500
*	78000400	THERMOPLASTIC PAVEMENT MARKING - LINE 6"	FOOT	1,000	1,000
*	78000650	THERMOPLASTIC PAVEMENT MARKING - LINE 24"	FOOT	200	200
~	X0325526	TEMPORARY PAVEMENT (VARIABLE DEPTH)	TON	10	10
~	X0326210	GEOTECHNICAL FABRIC, SPECIAL	SQ YD	8,000	8,000
~	X0326408	REMOVAL AND DISPOSAL OF UNSUITABLE MATERIAL, SPECIAL	CU YD	650	650
~	XX000541	EXPLORATORY EXCAVATION	CU YD	20	20
~	XX002260	STRUCTURES TO BE REMOVED	EACH	16	16
~	XX005636	PIPE UNDERDRAINS, PERFORATED POLYVINYL CHLORIDE PIPE, 6"	FOOT	80	80
~	XX007228	STORM SEWERS, TYPE 2, WATERMAIN QUALITY PIPE, 10"	FOOT	152	152
~	Z0001050	AGGREGATE SUBGRADE 12"	SQ YD	8,000	8,000
~	Z0019600	DUST CONTROL WATERING	UNIT	100	100
Δ~	Z0076600	TRAINEES	HOUR	500	500

- \* DENOTES SPECIALTY ITEM
- ∼ DENOTES SPECIAL PROVISION HAS BEEN PROVIDED

EARTHWORK TABLE								
LOCATION	REMOVAL & DISPOSAL MATERIAL (PGES) (CU YD)	EARTH EXCAVATION (CU YD)	TOTAL SUITABLE EXCAVATION (CU YD)	EXCAVATION TO BE USED IN EMBANKMENT (ADJ. FOR 15% SHRINKAGE) (CU YD)	EMBANKMENT (CU YD)	EARTHWORK BALANCE WASTE (+) OR SHORTAGE (-) (CU YD)		
BROADWAY AVENUE STA. 6+80 TO STA. 26+29	650	3,600	3,600	3,600	0	+3,060		

# **POROUS GRANULAR EMBANKMENT** SUBGRADE LOCATIONS PER SOIL REPORT

LOCATION	EAST	SIDE	WEST SIDE		
LOCATION	WIDTH	DEPTH	WIDTH	DEPTH	
BROADWAY AVENUE					
STA. 9+50 TO STA. 13+00 STA. 16+00 TO STA. 19+50	12.0'	0.75'	19.5'	0.75'	

# NOTE:

\*\*POROUS GRANULAR EMBANKMENT, SUBGRADE (PGES) HAS BEEN PROVIDED FOR USE AT THE LOCATIONS INDICATED FOR SOILS THAT TEND TO BE UNSUITABLE OR UNSTABLE. THE ACTUAL NEED FOR REMOVAL AND REPLACEMENT WITH PGES WILL BE DETERMINED IN THE FIELD AT THE TIME OF CONSTRUCTION BY THE GEOTECHNICAL ENGINEER. ALL POTENTIALLY UNSTABLE SOILS SHOULD BE TESTED WITH A STATIC CONE PENETROMETER AND TREATED IN ACCORDANCE WITH ARTICLE 301.03 AND THE UNDERCUT GUIDELINES IN THE IDOT SUBGRADE STABILITY MANUAL. IF UNSTABLE AND/OR UNSUITABLE MATERIAL IS ENCOUNTERED, THE SOIL SHALL BE REMOVED AND REPLACED WITH PGES OR EMBANKMENT AS DETERMINED BY THE GEOTECHNICAL ENGINEER. IF UNSTABLE AND/OR UNSUITABLE MATERIAL IS NOT ENCOUNTERED, THEN THE QUANTITY SHALL BE DEDUCTED AND NO ADDITIONAL COMPENSATION WILL BE DUE TO THE CONTRACTOR.

**ACTUAL LOCATIONS, WIDTHS,** AND DEPTHS TO BE DETERMINED


ENGINEER  Civil Engineers  Municipal Consultants Established 1911	K ING Westeh

	USER NAME -	DESIGNED -	WOP	REVISED -	_
		DRAWN -	MK/LEV/DMM	REVISED -	
	PLOT SCALE -	CHECKED -	WOP	REVISED -	
_	PLOT DATE -	DATE -	3-29-10	REVISED -	_
_			· ·		

STAT	E OF	ILLINO	S
DEPARTMENT	OF 1	TRANSPO	PRTATION

	ROUTE NO.	SECTION	COUNTY	TOTAL	SHEE NO.
SUMMARY OF QUANTITIES		09-00114-00-FP	соок	33	5
	FIELD BO	OK NO. 1588/AERIALS/LL	CONTRACT	NO. <b>63</b> 4	155
SCALE: NOT TO SCALE SHEET NO. 1 OF 2 SHEETS STA. TO STA.	FED. ROA	D DIST. NO. 1 ILLUNOIS FED	. AID PROJECT A	ARA-M-900	3 (516

# EXISTING TYPICAL CROSS SECTION BROADWAY AVENUE STATION 1+02 TO STATION 6+80

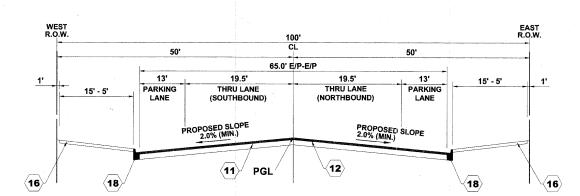


# PROPOSED TYPICAL CROSS SECTION BROADWAY AVENUE

STATION 1+02 TO STATION 6+80

# WEST R.O.W. 100' R.O.W. 50' 50' 1' 5' 1' 31.5' E/P-E/P 5' 1' 1' 1' 2 9 7 PGL 3 4 2 5 1

# EXISTING TYPICAL CROSS SECTION BROADWAY AVENUE

**STATION 6+80 TO STATION 26+29** 

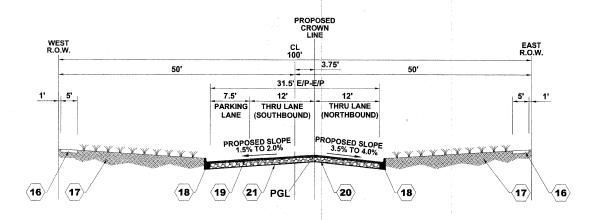

# PROPOSED TYPICAL CROSS SECTION BROADWAY AVENUE

STATION 6+80 TO STATION 26+29

# **TYPICAL CROSS SECTION LEGEND**

#### **EXISTING CONDITIONS**

- 1 PORTLAND CEMENT CONCRETE SIDEWALK, 5"
- 2 COMBINATION CONCRETE CURB AND GUTTER, TYPE B-6.12
- 3 PORTLAND CEMENT CONCRETE BASE COURSE, 9.0"±
- 4 HOT MIX ASPHALT BINDER AND SURFACE COURSE, 4"±
- 5 GRASS PARKWAY
- 7 PAVEMENT REMOVAL (SPECIAL)
- 8 HOT MIX ASPHALT SURFACE REMOVAL, VARIABLE DEPTH
- 9 GRANULAR SUBBASE, 2"±

#### PROPOSED CONDITIONS

- 11 HOT-MIX ASPHALT SURFACE COURSE, MIX D, N50, (IL 9.5mm), 2"
- (12) LEVELING BINDER (MACHINE METHOD), N50, (IL 9.5mm), 1"
- PORTLAND CEMENT CONCRETE SIDEWALK, 5"
- PORTLAND CEMENT CONCRETE SIDEWALK, 5" (INTERMITTENT REPLACEMENT)
- TOPSOIL FURNISH AND PLACE, 4" SODDING, (INTERMITTENT REPLACEMENT)
- COMBINATION CONCRETE CURB AND GUTTER, TYPE B-6.12 (SPECIAL) (INTERMITTENT REPLACEMENT)
- HOT-MIX ASPHALT PAVEMENT (FULL DEPTH), 9"
   HOT-MIX ASPHALT SURFACE COURSE, MIX D, N50, 2"
   HOT-MIX ASPHALT BINDER COURSE, IL-19.0, N50, 7"
  (INSTALLED IN 2 LIFTS)
- 20 AGGREGATE SUBGRADE, 12"
- 21 GEOTECHNICAL FABRIC

# PAVEMENT CORE SUMMARY FRACTURED

		,		CONCRETE BASE & CRUSHED
CORE	STATION	0/\$	ASPHALT	STONE
SB-1	8+00	13'L	6.0"	11.0"
PC-1	8+00	13'R	5.5"	8.5"
SB-2	10+65	13'L	8.5"	10.5"
PC-2	10+67	13'R	5.5"	18"
PC-2A	10+65	10'R	5.25"	6.0"
PC-2B	10+65	10'L	8.25"	6.0"
SB-3	13+97	11'L	2.75"	13.5"
PC-3	14+00	13'R	4.0"	15.5"
PC-3A	14+00	6'R	4.25"	6.0"
SB-4	18+03	8'R	3.0"	8.0"
PC-4	18+00	13'L	4.75"	13.5"
SB-5	21+00	12'R	4.0**	11.5"
PC-5	21+00	11'L	4.25"	11.75"
PC-5A	21+00	4'L	2.75"	6.0"
PC-5B	21+00	4'R	2.75"	7.0"
SB-6	24+97	10'R	4.0"	9.0"
PC-6	25+00	10'L	4.25"	8.0"

SCALE: NONE

## HOT-MIX ASPHALT (HMA) MIXTURE REQUIREMENTS

MIXTURE TYPE	AIR VOIDS @ Ndes
FULL DEPTH PAVEMENT (STA. 6+80 TO STA. 26+29)	
HOT-MIX ASPHALT SURFACE COURSE, MIX D, N50, (IL 9.5mm), 2"	4% @ 50 GYR.
HOT-MIX ASPHALT BINDER COURSE, IL-19.0, N50, 7"	4% @ 50 GYR.
RESURFACING (STA. 1+02 TO STA. 6+80)	
HOT-MIX ASPHALT SURFACE COURSE, MIX D, N50, (IL 9.5mm), 2"	4% @ 50 GYR.
LEVELING BINDER (MACHINE METHOD), N50 (IL 9.5 mm), 1"	4% @ 50 GYR.
TEMPORARY PAVEMENT	
HOT-MIX ASPHALT SURFACE COURSE, MIX D, N50 (IL 9.5mm), 1.5"	4% @ 50 GYR.

THE UNIT WEIGHT USED TO CALCULATE ALL HMA SURFACE MIXTURE QUANTITIES IS 112 LBS/SQ YD/IN.

THE "AC TYPE" FOR POLYMERIZED HMA MIXES SHALL BE "SBS/SBR PG 70 -22" AND FOR NON-POLYMERIZED HMA THE "AC TYPE" SHALL BE "PG 64 -22" UNLESS MODIFIED BY DISTRICT ONE SPECIAL PROVISIONS. FOR "PERCENT OF RAP" SEE DISTRICT ONE SPECIAL PROVISIONS.

TO STA.

HANCOCK	<u>C</u>
♦ Civil Engineers	Wester
<ul> <li>Municipal Consultants</li> </ul>	
♦ Established 1911	


CK	-	USER NAME -	DESIGNED -	WOP	REVISED -
ERIN	·		DRAWN -	MK/LEV/DMM	REVISED -
ts	9933 Romewelt Road Westchester, Illinois 60154-2780 Phone: 708/905-0300	PLOT SCALE -	CHECKED -	WOP	REVISED -
	Fax: 708/865-1212	PLOT DATE -	DATE -	3-29-10	REVISED -

STATE OF ILLINOIS
DEPARTMENT OF TRANSPORTATION

EXISTIN	G AND	PROPO	SED
TYPICAL	CROS	S SECT	IONS

SHEET NO. 1 OF 1 SHEETS STA.

ROUTE NO.		SE	С	OUNTY	TOTAL	SHE			
2406		09-00	114		соок	33	6		
FIELD BO	OK NO.	158	8/AE	CC	NTRACT	NO. <b>63</b>	455		
FED ROA	n nist	NIO	1	PLUMOIS	CED	AID	DROJECT	ADA M DO	02 /54

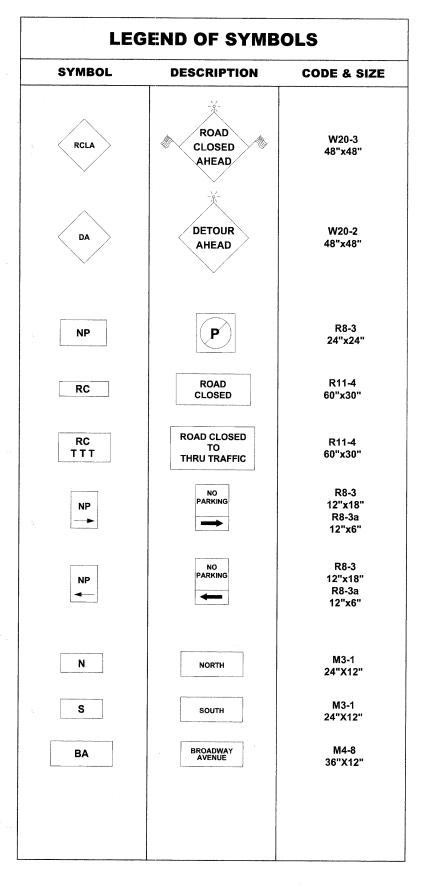

SYMBOL	DESCRIPTION	CODE & SIZE
ED	END DETOUR	M4-8 24"x18"
LBO	LOCAL BUSINESSES OPEN	M4-8 36"x24"
D	DETOUR	M4-9 30"x24"
D	DETOUR	M4-9 30"x24"
D	DETOUR	M4-9 30"x24"
D	PETOUR	M4-9R 24"x30"
D	DETOUR	M4-9L 24"x30"
D -	DETOUR	M4-10 48"X18"
<b>■</b> D —	DETOUR	M4-10 48"X18"

# NOTE:

SCALE: NONE

CONTRACTOR TO NOTIFY IDOT HEAD OF TRAFFIC MAINTENANCE (842)705-4470, SEVENTY-TWO HOURS IN ADVANCE OF SETTING UP DETOUR ROUTE.

HANCOCI	K VG
◆ Civil Engineers	Westbest
◆ Municipal Consultants	W CHE MEST
◆ Established 1911	


	USER NAME -	DESIGNED -	WOP	REVISED -
Rossevelt Road acts 69354-2789 ac 708/305-0380		DRAWN -	MK/LEV/DMM	REVISED -
	PLOT SCALE -	CHECKED -	WOP	REVISED -
e: 708/965-0390 x: 708/965-1212	PLOT DATE -	DATE -	3-29-10	REVISED -


STATE OF ILLINOIS
DEPARTMENT OF TRANSPORTATION

MAINTENANCE OF TRAFFIC PLAN STAGE I													
	SHEET NO.	1	OF	1	SHEETS	STA.							

TO STA.

ROU NO	TE		SE	СТ	ION		С	OUNTY	TOTAL	SHEET NO.
240	6	(	9-00	114	-00-FP			соок	33	7
FIELD	B00	K NO.	1588	88/AERIALS/LL				NTRACT	NO. 63	3455
FED.	ROAD	DIST.	NO.	1	ILLINOIS	FED	. AID	PROJECT	ARA-M-90	003 (516)

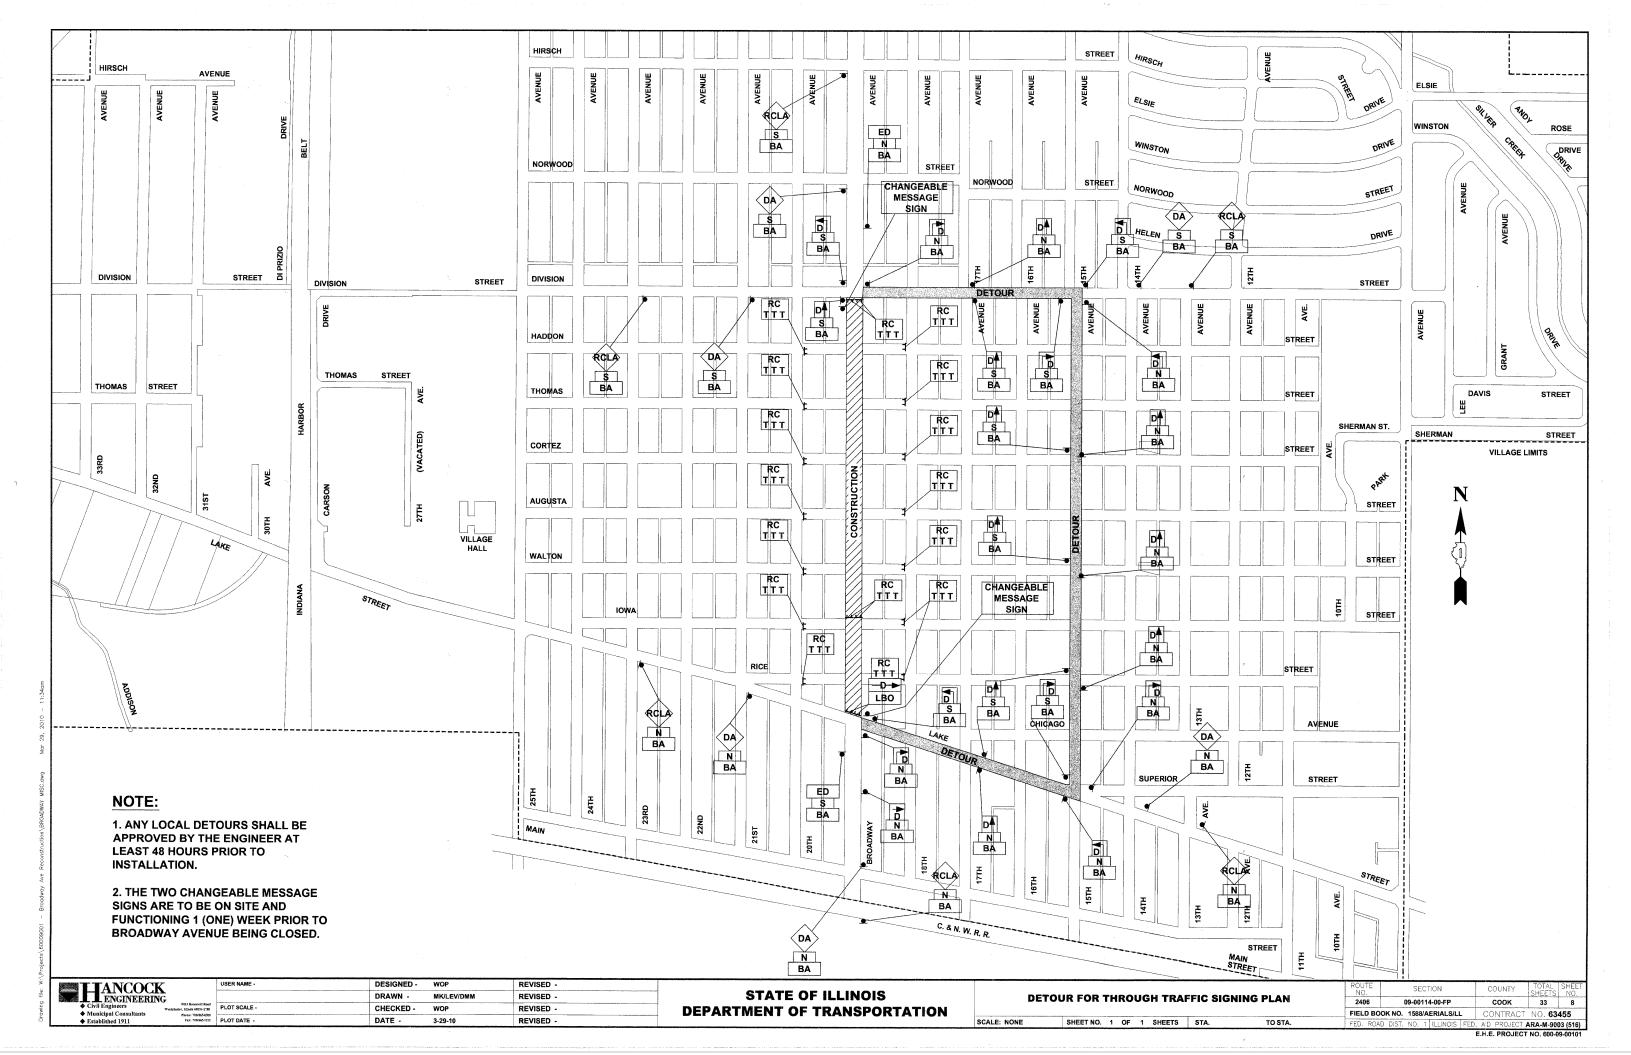

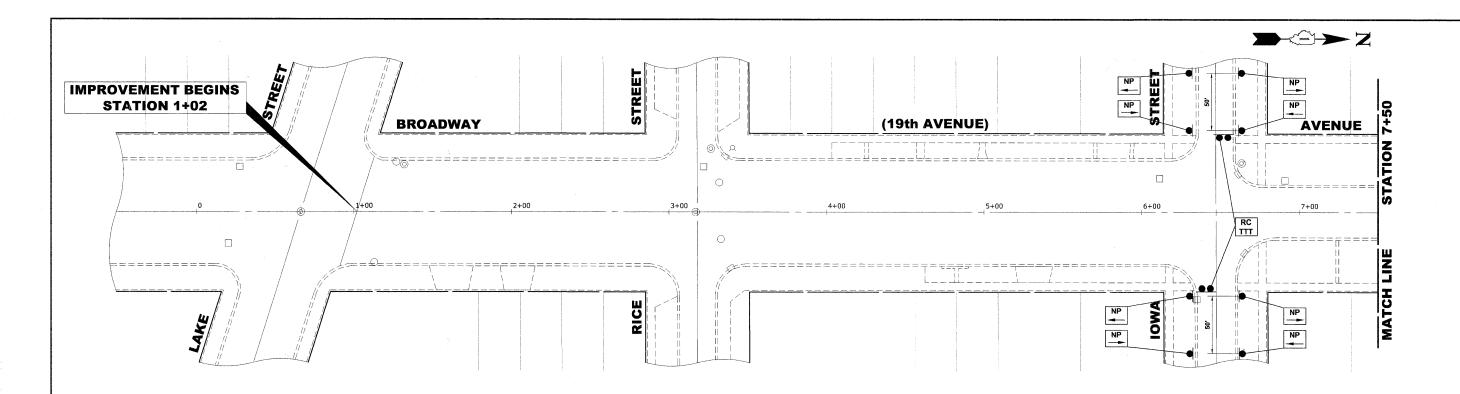


## PROJECT STAGING & LOCAL ACCESS

- 1. ACCESS MUST ME MAINTAINED AT ALL TIMES TO AT LEAST ONE OF THE FOLLOWING PARKING LOCATIONS FOR THE PUBLIC LIBRARY:

  A. ON STREET PARKING ON BROADWAY


  B. PARKING LOT FACILITIES
- 2. THE TRENCHES FOR STORM SEWER LATERALS SHALL BE BACKFILLED TO THE TOP OF THE EXISTING PAVEMENT TO PROVIDE LOCAL ACCESS.
- 3. THE CONTRACTOR SHALL BE RESPONSIBLE FOR BAGGING ALL REGULATORY SIGNS THAT ARE NOT APPLICABLE DURING CONSTRUCTION.
- 4. TEMPORARY STONE RAMPS SHALL BE PROVIDED TO ALL DRIVEWAYS WITHIN THE LIMITS OF THE RECONSTRUCTION (TO BE PAID FOR UNDER THE ITEM: AGGREGATE SURFACE COURSE, TYPE B).

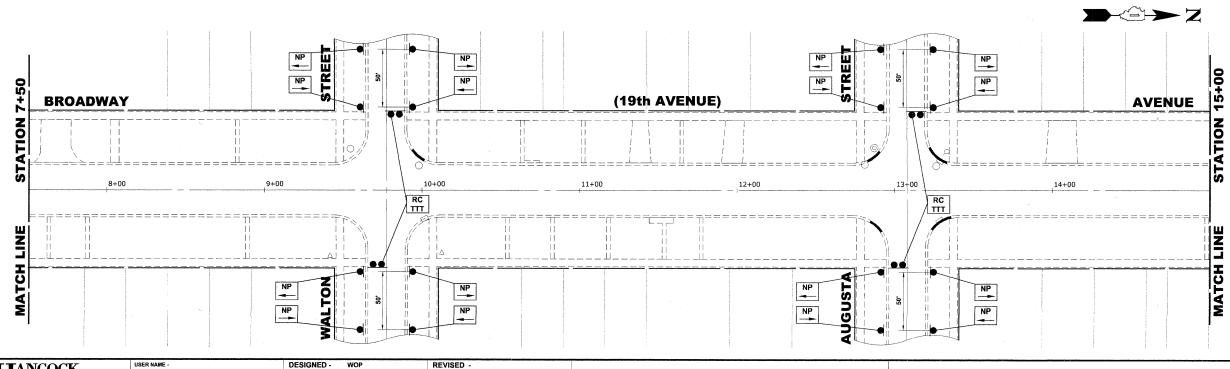

DESIGNED -REVISED HANCOCK SECTION **STATE OF ILLINOIS** MK/LEV/DMM REVISED DRAWN -**LOCAL ACCESS SIGNING PLAN** 2406 09-00114-00-FP соок PLOT SCALE CHECKED -WOP REVISED **DEPARTMENT OF TRANSPORTATION** FIELD BOOK NO. 1588/AERIALS/LL CONTRACT NO. 63455 Phone: 708/965-0369 Fax: 708/965-1212 PLOT DATE -DATE -REVISED 3-29-10 SCALE: 1" = 30' SHEET NO. 1 OF 2 SHEETS STA. 1+02 TO STA. 15+00 ECT ARA-M-9003 (516)

# **PROJECT STAGING & LOCAL ACCESS**

- 1. ACCESS MUST ME MAINTAINED AT ALL TIMES TO AT LEAST ONE OF THE FOLLOWINGS PARKING LOCATIONS FOR THE PUBLIC LIBRARY:
  - A. ON STREET PARKING ON BROADWAY
    B. PARKING LOT FACILITIES
- 2. THE TRENCHES FOR STORM SEWER LATERALS SHALL BE BACKFILLED TO THE TOP OF THE EXISTING PAVEMENT TO PROVIDE LOCAL ACCESS.
- 3. THE CONTRACTOR SHALL BE RESPONSIBLE FOR BAGGING ALL REGULATORY SIGNS THAT ARE NOT APPLICABLE DURING CONSTRUCTION.
- 4. TEMPORARY STONE RAMPS SHALL BE PROVIDED TO ALL DRIVEWAYS WITHIN THE LIMITS OF THE RECONSTRUCTION (TO BE PAID FOR UNDER THE ITEM: AGGREGATE SURFACE COURSE, TYPE B).

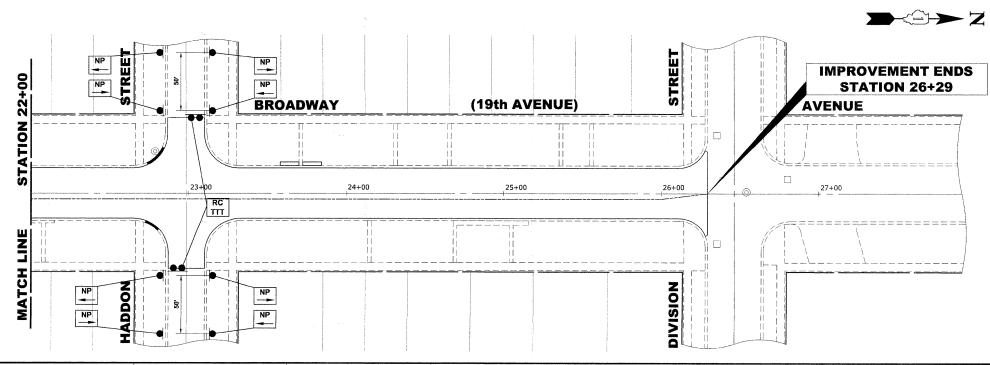

	HANCOCK	G.
ı	◆ Civil Engineers	9933 R Westehester, III no
ı	♦ Municipal Consultants	Phone:
ı	♦ Established 1911	Fax:


	USER NAME -	DESIGNED -	WOP	REVISED -
		DRAWN -	MK/LEV/DMM	REVISED -
933 Roservelt Road Ethnole 60154-2780 Phone: 768/865-6380 Fax: 768/865-1212	PLOT SCALE -	CHECKED -	WOP	REVISED -
	PLOT DATE -	DATE -	3-29-10	REVISED -


STAT	E OF	FILLINOIS	
DEPARTMENT	OF	TRANSPORTATION	


LOCAL ACCESS SIGNING PLAN													
	SHEET NO.	2	OF	2	SHEETS	STA.	15+00	3	TO STA.	26+29			


SCALE: 1" = 30'


NC			SE	CT	ION		С	OUNTY	SHEETS	NO.
240		9-00	114	1-00-FP			соок	33	10	
 FIEL	D B00	K NO.	1588	8/A	ERIALS/LI	- 1	CC	NTRACT	NO. 63	455
 FED.	ROAD	DIST.	NO.	1	ILLINOIS	FED.	A:D	PROJECT	ARA-M-90	03 (516)
				_		_		DEO IEO	E NIO COO	0040

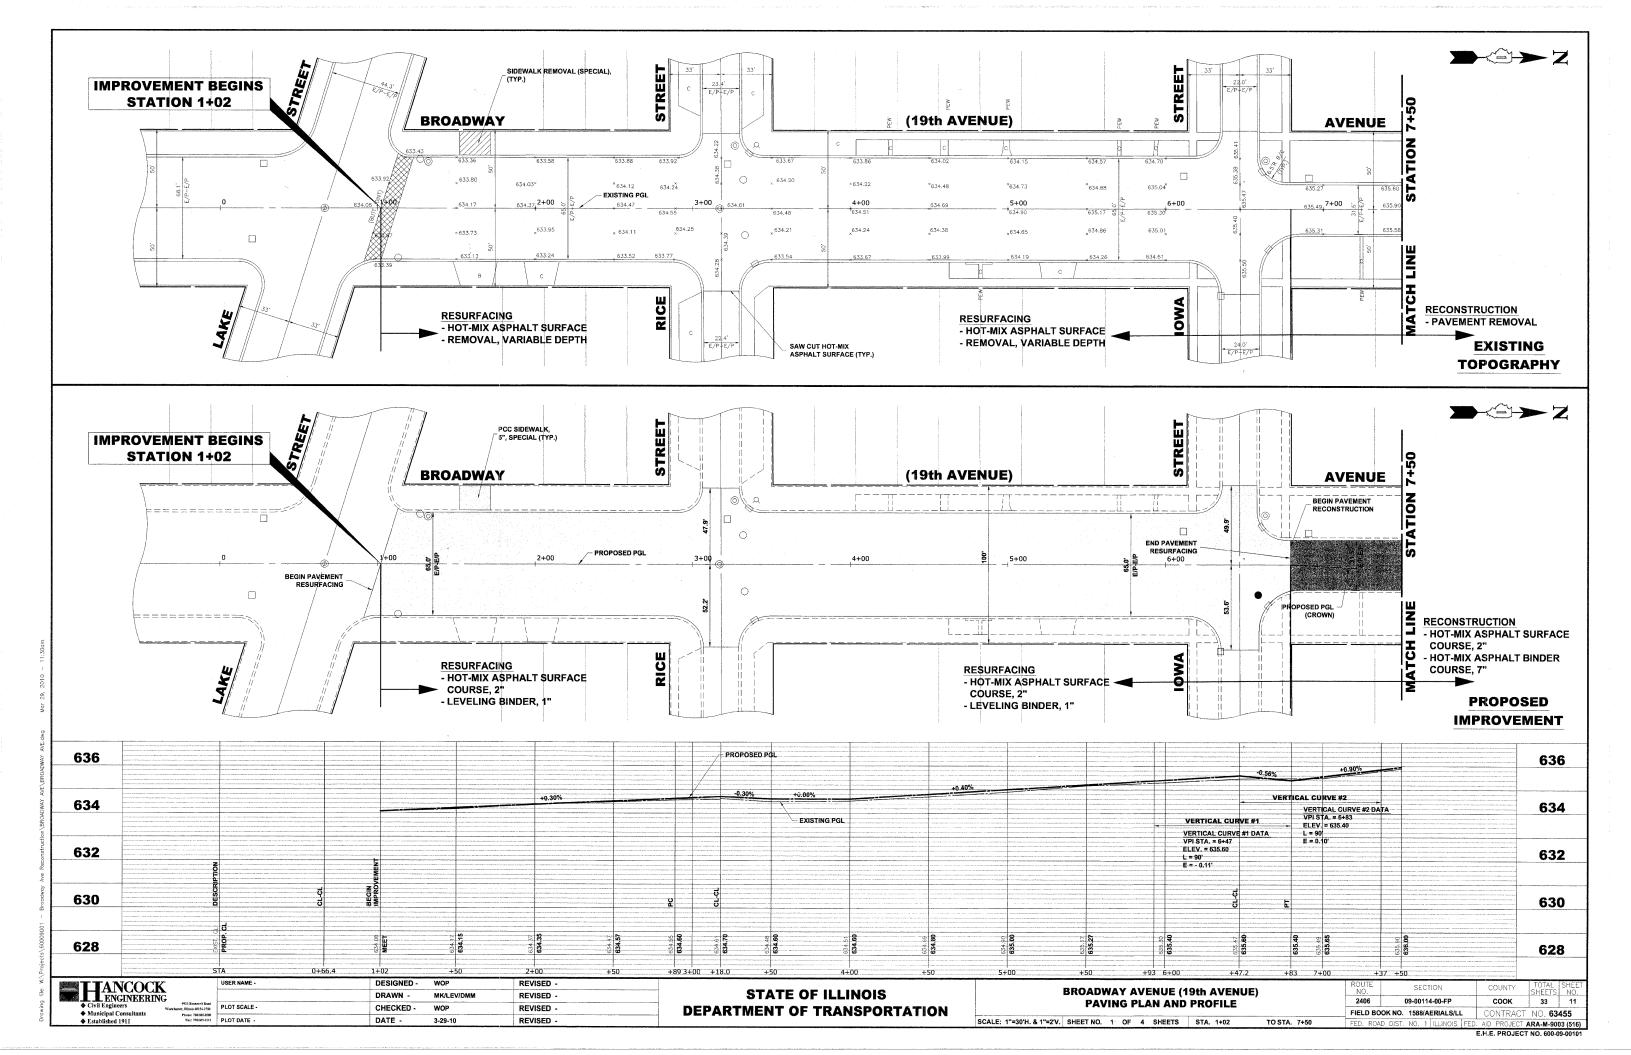


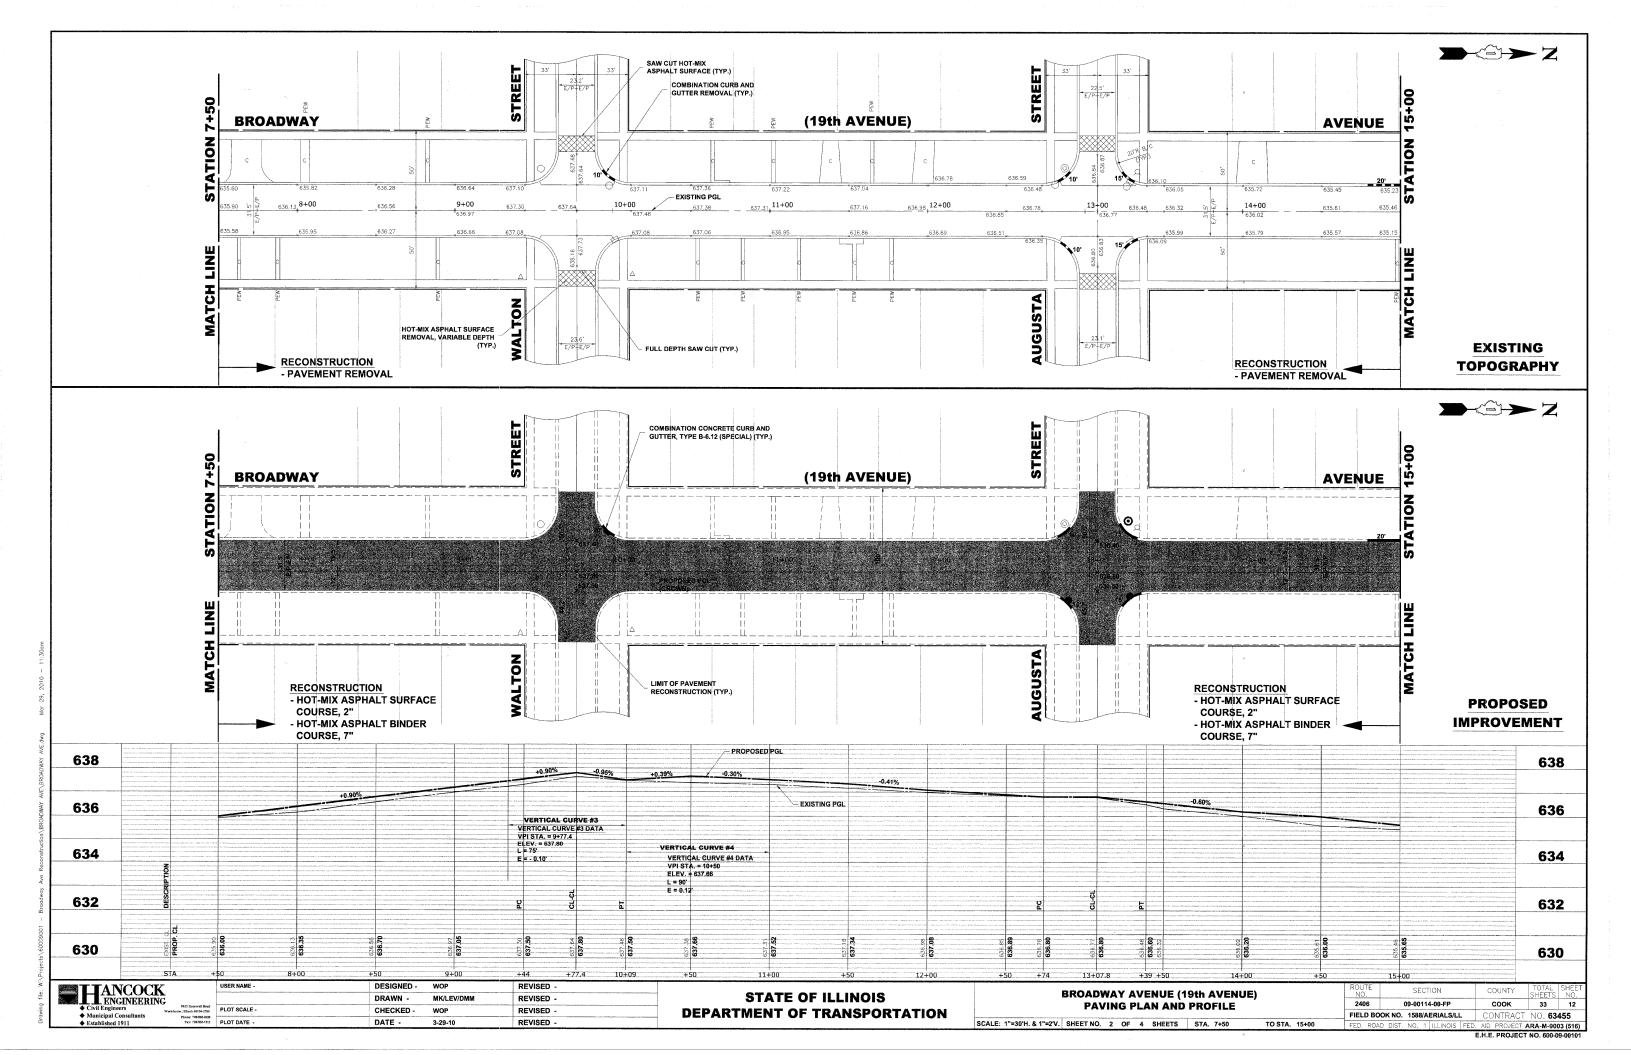

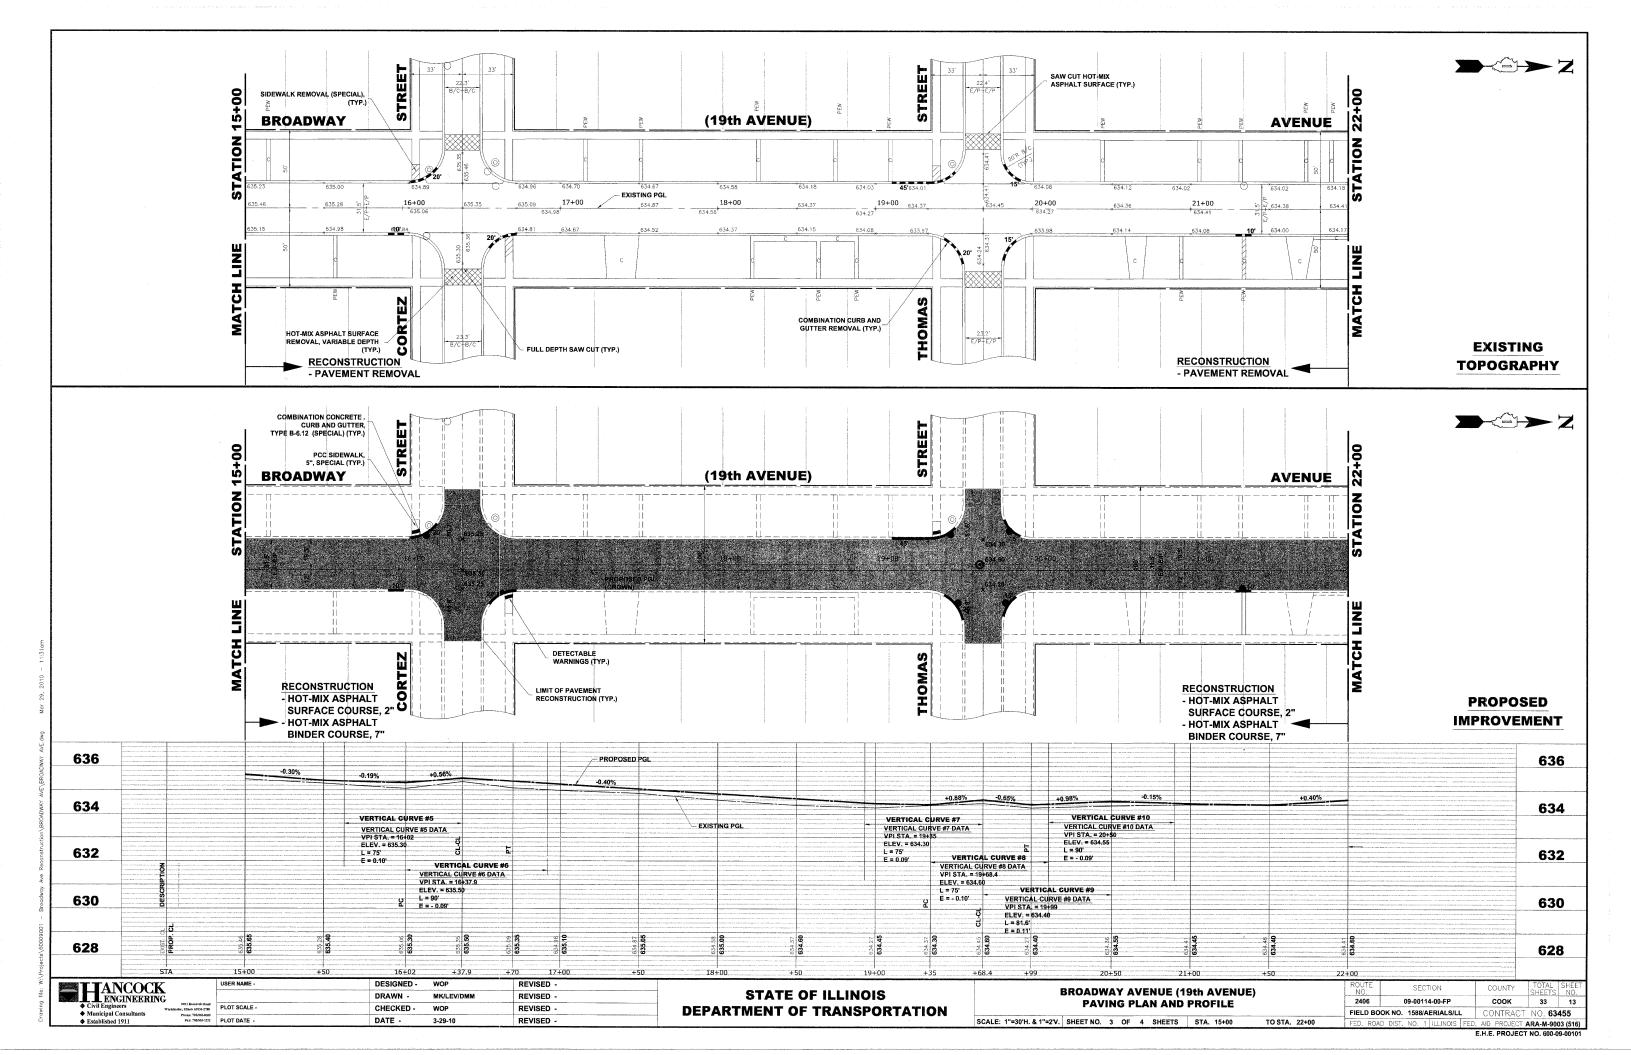

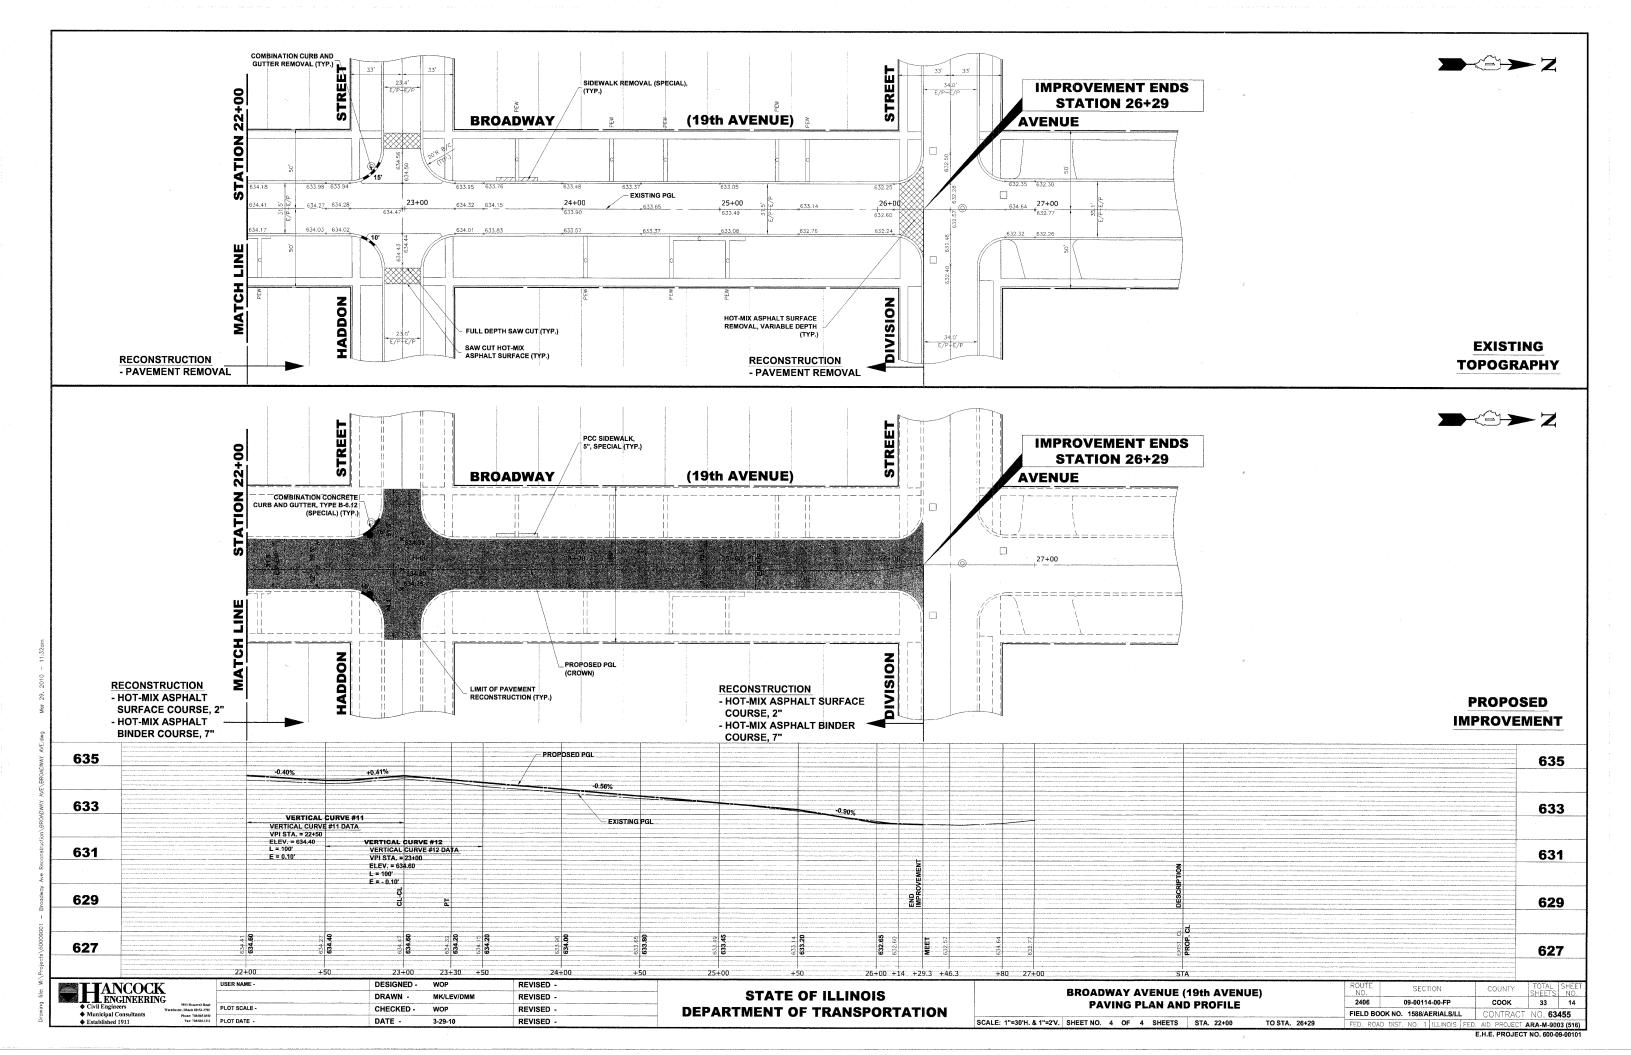

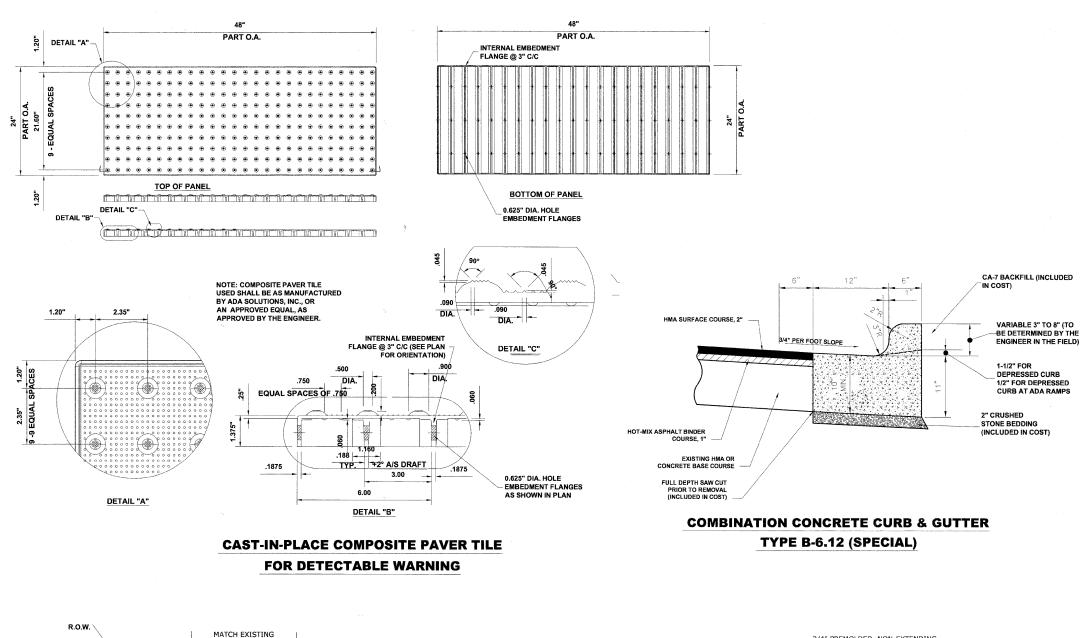

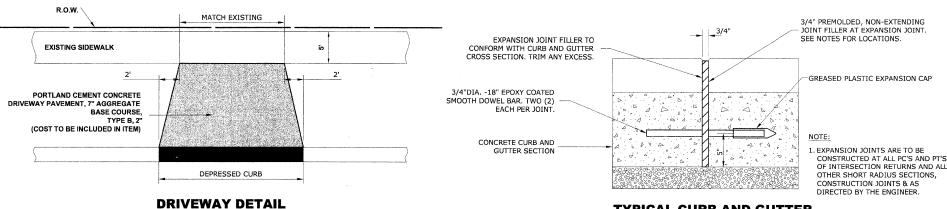

# **GENERAL NOTES**

DEPRESSED CURBS - THE TOP OF CURBS SHALL BE DEPRESSED WHERE THE CURB AND GUTTER IS CONSTRUCTED AT HANDICAP ACCESSIBLE SIDEWALK RAMPS AT ALLEY RETURNS AND STREET INTERSECTIONS, AND FOR PRIVATE DRIVES AND AS DIRECTED BY THE ENGINEE

DRAINAGE OPENINGS - AT ALL LOCATIONS WHERE CASTINGS ARE TO BE INCORPORATED IN THE CURB AND GUTTER, A 3/4" EXPANSION JOINT SHALL BE INSTALLED IN THE CURB AND GUTTER A DISTANCE OF 5 FT. FROM EACH SIDE OF THE CASTING. 2-NO. 4 RE-BARS, 9' IN LENGTH, SHALL BE INCORPORATED IN THE CONTINUOUS PORTION OF CONCRETE CURB BEHIND THE CASTING

<u>SLIPFORM CONSTRUCTION</u> - VERTICAL FACES MAY BE BATTERED AT THE RATE OF 3/4" PER FOOT OF HEIGHT TO AID IN SLIPFORM OPERATIONS.

DEPRESSED CURB HEIGHT - THE HEIGHT OF THE DEPRESSED CURB SHALL BE 1-1/2" AT DRIVEWAYS. SEE IDOT STANDARD 424001-05 FOR HEIGHT AT SIDEWALK RAMP.

BITUMINOUS EXPANSION JOINTS - THREE QUARTER INCH (3/4") BITUMINOUS PREMOLDED INORGANIC FIBER EXPANSION JOINTS SHALL BE INSTALLED WHERE NEW SIDEWALK OR CURB AND GUTTER OR DRIVEWAY PAVEMENT ABUTS AN EXISTING CONCRETE WALK, DRIVE, OR CURB WHICH IS TO REMAIN IN PLACE, AND AT NOT LESS THAN NINETY FOOT (90°) INTERVALS AT LOCATIONS WHERE CURB REPLACEMENT IS IN EXCESS OF NINETY FEET (90°); AT RADIUS POINTS, AT BOTH SIDES OF FRAMES AND GRATES WHICH FALL IN THE CURB; AND AS DIRECTED BY THE ENGINEER.

ALL EXPANSION JOINTS LOCATED IN THE CURB AND GUTTER SHALL HAVE TWO (2) THREE QUARTER INCH (3/4") DIAMETER, SMOOTH, ROUND, EPOXY COATED DOWEL BARS, EIGHTEEN INCHES (18") INCH (3/4") DIAME 1ER, SMOOTH, ROUND, EPOXY COATED DOWEL BARS, EIGHTEEN INCHES (18")
IN LENGTH, WITH GREASED PLASTIC END CAPS INSERTED TO ALLOW THE CURB AND GUTTER TO
EXPAND AND CONTRACT LATERALLY. CONTRACTION JOINTS SHALL BE TOOLED INTO THE CURB AND
GUTTER AT INTERVALS NOT TO EXCEED FIFTEEN FEET (15"). THESE CONTRACTION JOINTS SHALL
BE SAW CUT TO A DEPTH OF TWO INCHES (2") WITHIN TWENTY-FOUR (24) HOURS OF CONCRETE
PLACEMENT. THE COST OF THE ABOVE WORK SHALL BE INCLUDED INT THE RESPECTIVE ITEMS FOR CONCRETE INSTALLATION

#### **CURB AND GUTTER REMOVAL**

THE COSTS FOR REMOVAL OF ANY ASPHALT OVERLAY THAT EXTENDS INTO THE GUTTER PORTION OF THE CURB AND GUTTER WILL BE INCLUDED IN THE PRICE FOR COMBINATION CURB AND GUTTER REMOVAL.

#### FORMS FOR CONCRETE SIDEWALKS, DRIVEWAYS, AND GUTTER FLAGS

A 2" X 6" BOARD WILL BE USED AS A FORM FOR ALL SIEDWALKS TO BE INSTALLED FIVE INCHES (5") IN THICKNESS, A 2" X 8" BOARD WILL BE USED AS A FORM FOR ALL SIDEWALKS AND DRIVEWAYS
TO BE INSTALLED SEVEN INCHES (7") IN THICKNESS, ALL FORMS MUST BE OF A MINIMUM HEIGHT
OF THE PROPOSED THICKNESS OF THE RESPECTIVE CONCRETE ITEMS TO BE INSTALLED.

#### AGGREGATE BEDDING FOR CONCRETE WORK

NEW SIDEWALK AND DRIVEWAY PAVEMENT SHALL BE REPLACED ON A MINIMUM OF TWO INCHES (2") OF COMPACTED CA-6 STONE BEDDING. ADDITIONAL AGGREGATE REQUIRED TO ADJUST THE EXISTING ELEVATION OF THE SUBGRADE TO THE PROPOSED ELEVATIONWILL BE INCLUDED AS

BASIS OF PAYMENT: THIS ITEM WILL NO BE PAID FOR SEPARATELY BUT WILL BE INCLUDED IN THE UNIT PRICE FOR THE RESPECTIVE CONCRETE ITEMS IN THE CONTRACT

#### **CURING AND PROTECTION**

AFTER THE CONCRETE HAS BEEN FINISHED AND THE WATER SHEEN HAS DISAPPEARED FROM THE SURFACE OF THE CONCRETE, THESURFACE SHALL BE SEALED WITH A MEMBRANE CURING COMPOUND OF A TYPE APPROVED BY THE ENGINEER. THE SEAL SHALL BE MAINTAINED FOR THE SPECIFIED CURING PERIOD. THE EDGES OF THE CONCRETE SHALL ALSO BE SEALED IMMEDIATELY AFTER THE FORMS ARE REMOVED. IN ADDITION, ALL CONCRETE PLACED DURING PERIODS OF COLD WEATHER SHALL BE PROTECTED IN ACCORDANCE WITH ARTICLE 720.13 OF THE STANDARD SPECIFICATIONS. THIS WORK SHALL BE CONSIDERED INCLUDED IN THE RESPETIVE CONCRETE PAY

THE WORK SHALL BE UNDER THE CHARGE AND CARE OF THE CONTRACTOR UNTIL FINAL ACCEPTANCE BY THE VILLAGE. THE CONTRACTOR SHALL ASSUME ALL RESPONSIBILITY FOR ANY INJURY OR DAMAGE TO THE WORK FROM ANY CAUSE WHATSOEVER AND HE SHALL REBUILD, REPAIR OR RESTORE THE DAMAGED WORK AT HIS OWN EXPENSE

BASIS OF PAYMENT: THIS ITEM WILL NOT BE PAID FOR SEPARATELY BUT WILL BE INCLUDED IN THE UNIT PRICE FOR THE VARIOUS CONCRETE ITEMS IN THE CONTRACT.

#### PROTECTION OF NEWLY POURED CONCRETE

THE CONTRACTOR SHALL HAVE WATCHMEN AT THE JOB SITE AFTER CONCRETE HAS BEEN POURED UNTIL THE CONCRETE HAS CURED SUFFICIENTLY SO THAT NO GRAFFITI CAN BE INSCRIBED IN THE NEWLY POURED CONCRETE SURFACES. THE EXPOSED FACES OF CONCRETE OF ANY ITEMS THAT ARE DEFACED SHALL BE REPLACED BY THE CONTRACTOR AT HIS OWN EXPENSE.

#### **BITUMINOUS EXPANSION JOINTS**

THREE-QUARTER INCH (3/4") BITUMINOUS PREMOLDED INORGANIC FIBER EXPANSION JOINTS SHALL BE INSTALLED WHERE NEW SIDEWALK OR CURB AND GUTTER OR DRIVEWAY PAVEMENT ABUTS AN EXISTING CONCRETE WALK, DRIVE, OR CURB WHICH IS TO REMAIN IN PLACE, AND AT NOT LESS THAN FIFTY FOOT (50'), INTERVALS AT LOCATIONS WHERE SIDEWALK REPLACEMENT IS IN EXCESS OF FIFTY FOOT (50'), AND AT LOCATIONS AS DIRECTED BY THE ENGINEER.

EXPANSION JOINTS WILL BE PLACED IN CURB AND GUTTER AT ALL RADIUS POINTS, ALL BEND POINTS. ON BOTH SIDES FO FRAMES AND GRATES THAT ARE IN THE CURB AND GUTTER. AND AT NOT LESS THAN NINETY FOOT (90") INTERVALS AT LOCATIONS WHERE CURB REPLACEMENT IS IN EXCESS OF NINETY FEET (90"), AND AT LOCATIONS AS DIRECTED BY THE ENGINEER.


ALL EXPANSION JOINTS LOCATED IN THE CURB AND GUTTER SHALL HAVE TWO (2) THREE QUARTER INCH (3/4") DIAMETER, SMOOTH, ROUND, EPOXY COATED DOWEL BARS, EIGHTEEN INCHES (18") IN LENGTH, WITH PLASTIC END CAPS INSERTED TO ALLOW THE CURB AND GUTTER TO


THIS WORK WILL NOT BE PAID FOR SEPARATELY BUT WILL BE INCLUDED IN THE COST OF THE


<b>TIANCOCK</b>		USER NAME -		WOP	REVISED -					ROUTE	SECTION	COUNTY	TOTAL SHEET	1
L ENGINEERING	3 Received Read		DRAWN -	MK/LEV/DMM	REVISED -	STATE OF ILLINOIS DEPARTMENT OF TRANSPORTATION SO		ROADWAY DETAILS		2406	09-00114-00-FP	COOK	33 15	1
Westchester, E	3 Reasevelt Read taols 69154-2786 as: 788/865-6380	PLOT SCALE -	CHECKED -	WOP	REVISED -						K NO. 1588/AERIALS/LL	CONTRACT	NO. <b>63455</b>	1
♦ Established 1911		PLOT DATE -	DATE -	3-29-10	REVISED -		SCALE: NONE	SHEET NO. 1 OF 1 SHEETS STA.	TO STA.	FED. ROAD DIST. NO. 1 ILLINOIS FF		AID PROJECT	ARA-M-9003 (516)	1
									· · · · · · · · · · · · · · · · · · ·			E.H.E. PROJECT	T NO. 600-09-00101	~


**TYPICAL CURB AND GUTTER** 


**EXPANSION JOINT** 

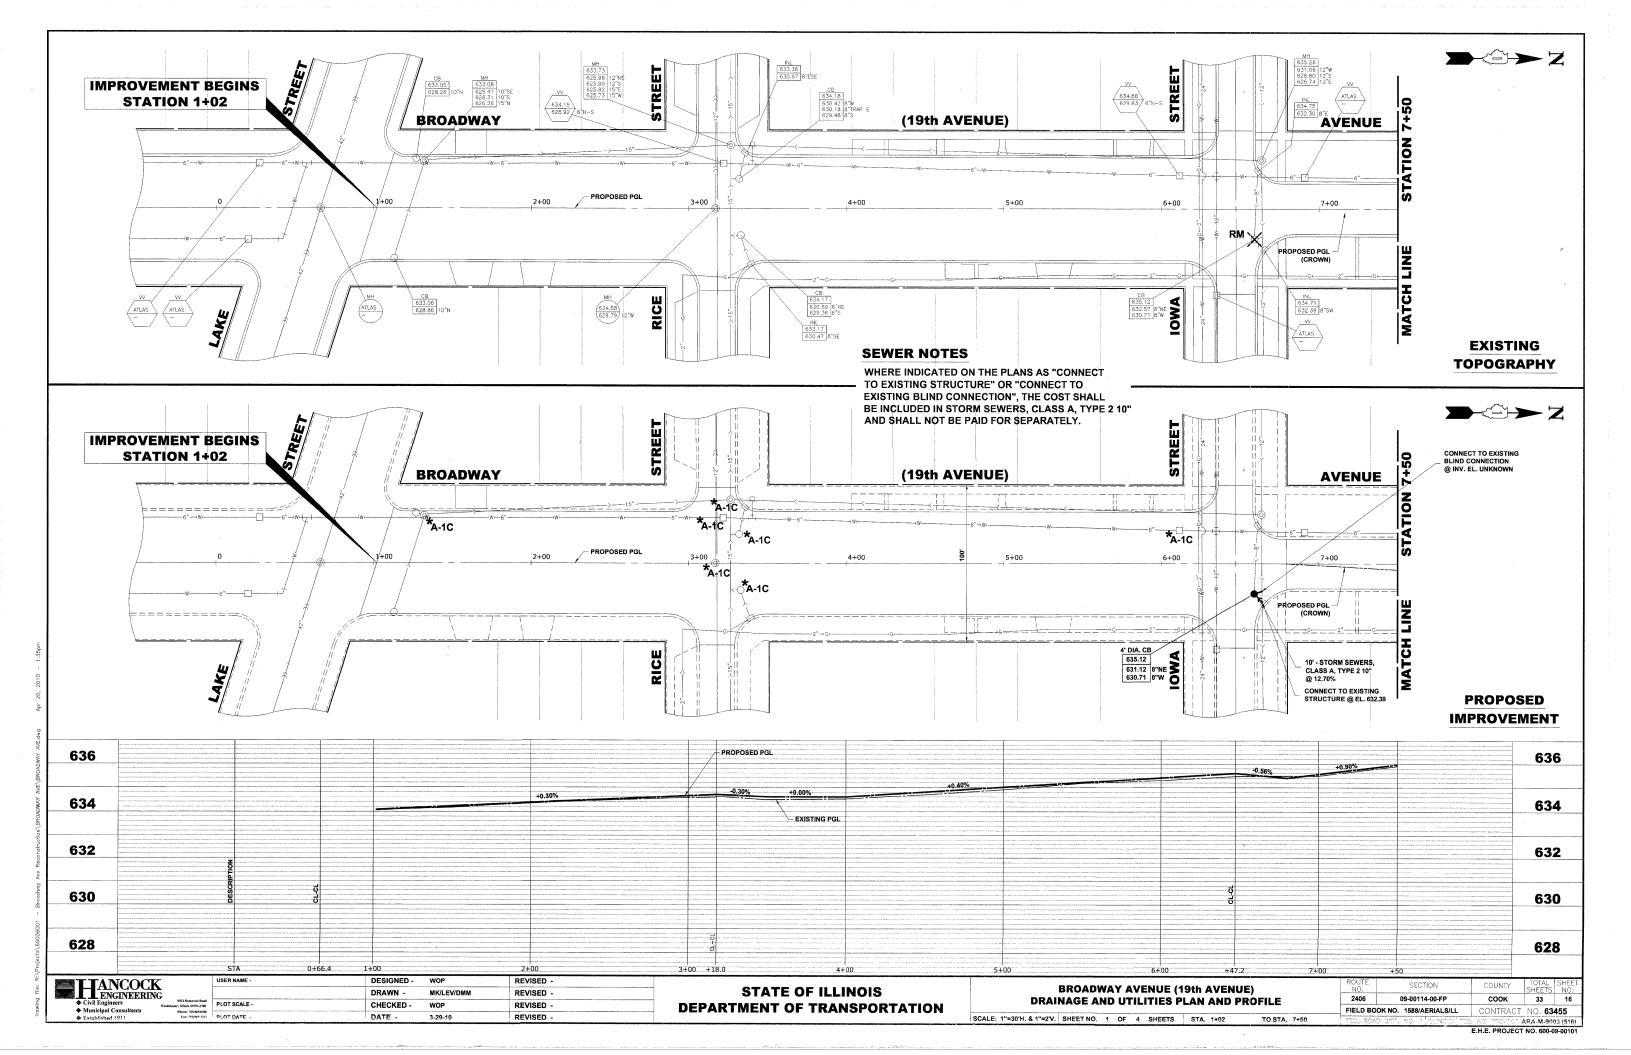


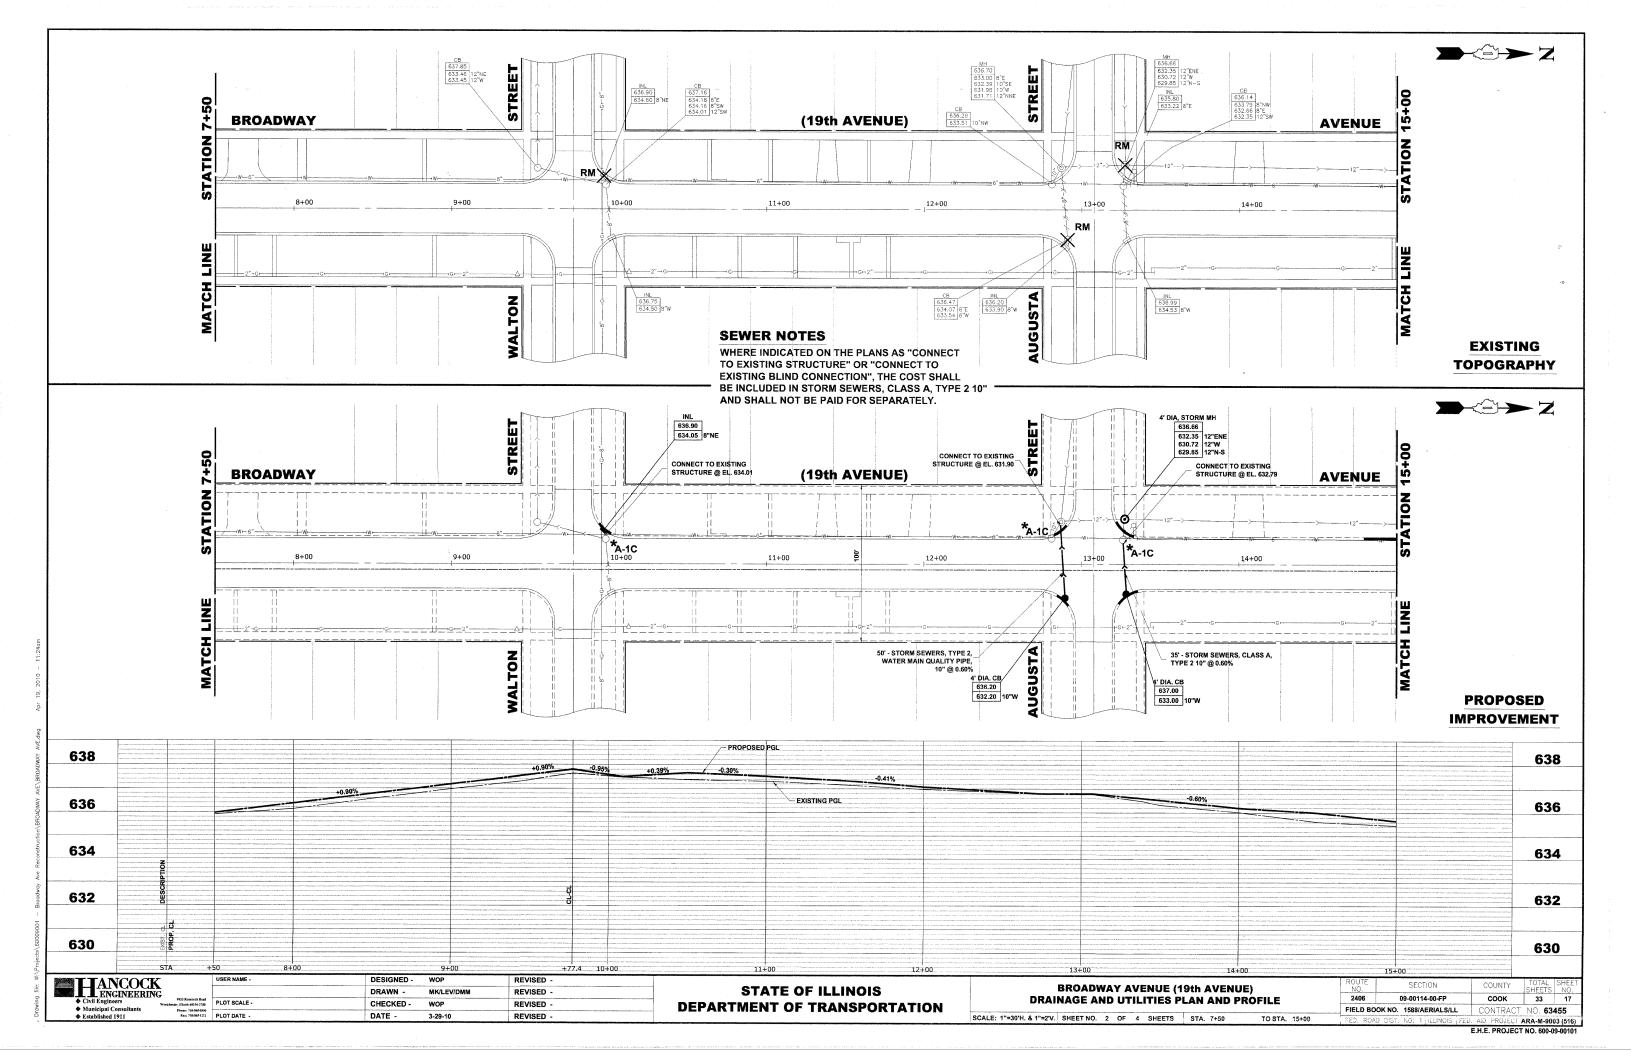

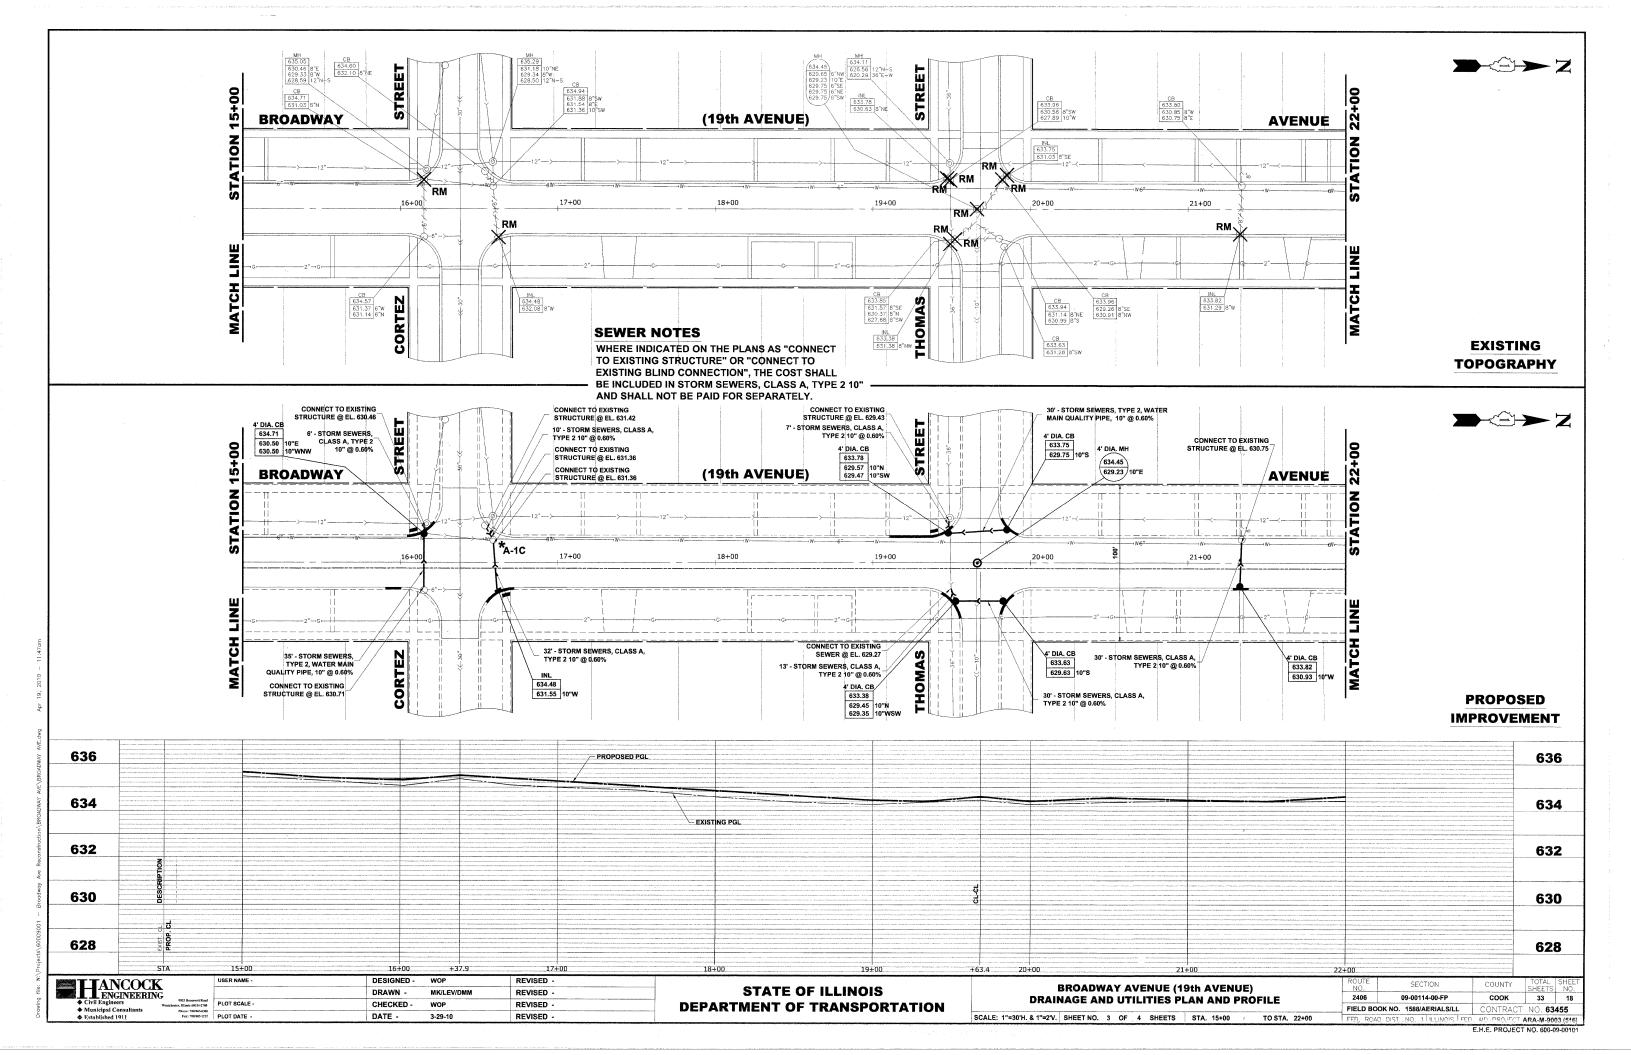

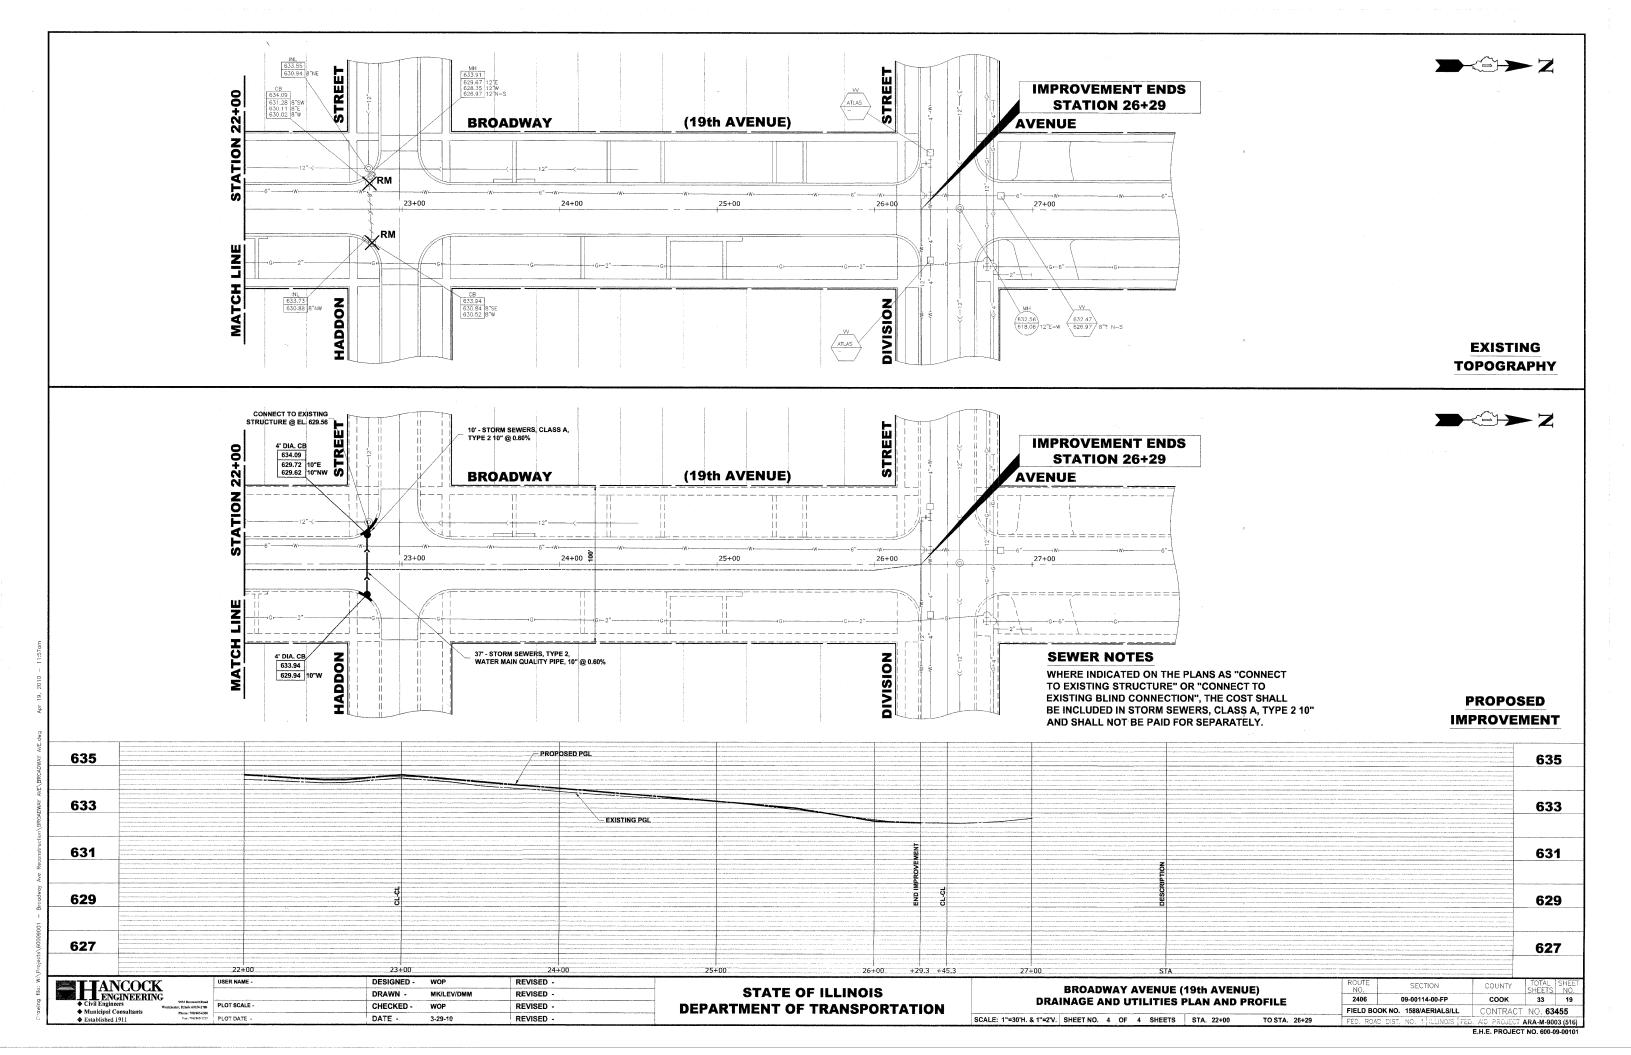


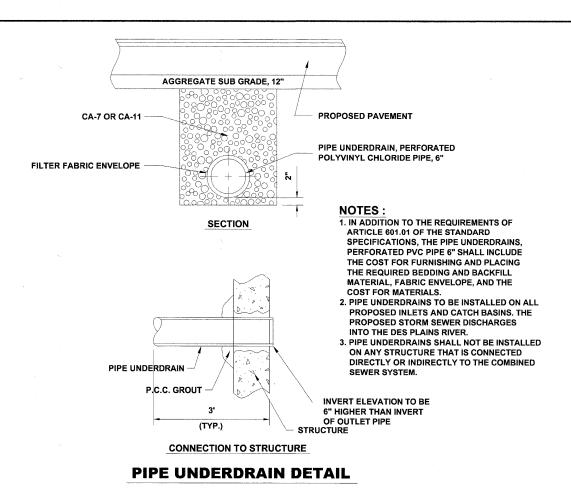


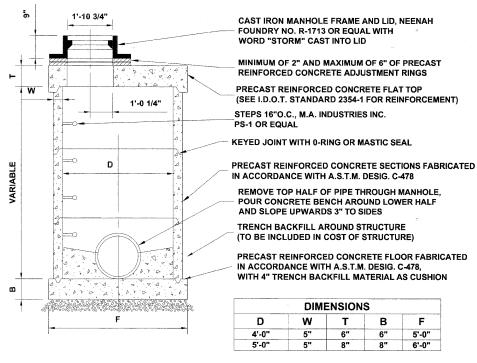

# RESTRICTED DEPTH MANHOLE

SCALE: NONE

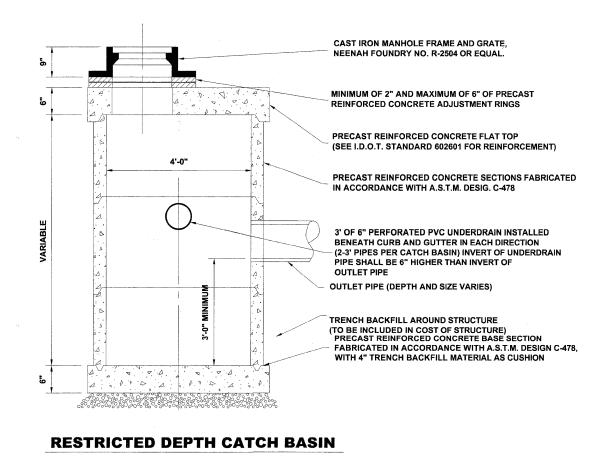

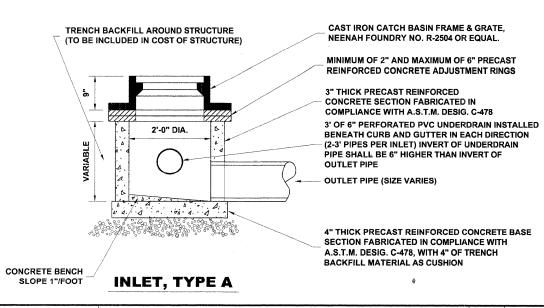

ANCOCK

ENCINEERING

Civil Engineers

Municipal Consultants

Established 1911

STATE OF ILLINOIS
DEPARTMENT OF TRANSPORTATION

DRAINAGE AND UTILITIES DETAILS

SHEET NO. 1 OF 2 SHEETS STA. TO STA.

## M.W.R.D.G.C. GENERAL NOTES

- THE MWRDGC LOCAL SEWER SYSTEMS SECTION FIELD OFFICE MUST BE NOTIFIED AT LEAST TWO (2) WORKING DAYS PRIOR TO THE COMMENCEMENT OF WORK AT (708) 588-4055.
- 2. ELEVATION DATUM IS U.S.G.S.
- 3. ALL FLOOR DRAINS SHALL DISCHARGE TO THE SANITARY SEWER SYSTEM.
- 4. ALL DOWNSPOUTS AND FOOTING DRAINS SHALL DISCHARGE INTO THE STORM SEWER SYSTEM.
- 5. ALL PVC STORM, COMBINED, AND SANITARY SEWER PIPE JOINTS SHALL.
  CONFORM TO ASTM D-3139, AND THE PIPE SHALL CONFORM TO ASTM D-2241. ALL
  PVC SEWER PIPE SHALL BE SDR 26. ALL RCCP SEWER TO MEET ASTM C-76 AND
  JOINTS SHALL CONFORM TO ASTM C-443.
- 6. ALL SANITARY SEWER CONSTRUCTION, AND ALSO STORM SEWER CONSTRUCTION IN COMBINED SEWER AREAS, REQUIRES STONE BEDDING 1/2" TO 1" IN SIZE, WITH A MINIMUM THICKNESS EQUAL TO 1/4 THE OUTSIDE DIAMETER OF THE SEWER PIPE, BUT NOT LESS THAN FOUR INCHES (4") NOR MORE THAN EIGHT INCHES (8"). MATERIAL SHALL BE CA-11 OR CA-13 AND SHALL BE EXTENDED AT LEAST 12" ABOVE THE TOP OF THE PIPE WHEN USING PVC PIPE.
- "BAND SEAL" OR SIMILAR FLEXIBLE-TYPE COUPLINGS SHALL BE USED IN THE CONNECTION OF SEWER PIPE OF DISSIMILAR MATERIALS.
- 8. WHEN CONNECTING TO AN EXISTING SEWER MAIN BY MEANS OTHER THAN AN EXISTING WYE, TEE, OR AN EXISTING MANHOLE, ONE OF THE FOLLOWING METHODS SHALL BE USED:
  - 1) CIRCULAR SAW-CUT OF SEWER MAIN BY MECHANICAL CORING MACHINE, AND PROPER INSTALLATION OF HUB-WYE SADDLE OR HUB-TEE SADDLE, IN ACCORDANCE WITH THE MANUFACTURER'S RECOMMENDATIONS.
  - 2) REMOVE AN ENTIRE SECTION OF PIPE (BREAKING ONLY THE TOP OF ONE BELL)
    AND REPLACE WITH A WYE OR TEE BRANCH SECTION. AFTER THE WYE OR TEE
    BRANCH IS INSERTED, CONCRETE SHALL BE PLACED OVER THE BROKEN AREA TO
    A MINIMUM THICKNESS OF 4" AND TO A DIMENSION OF 8" IN ALL DIRECTIONS.
  - 3) USING PIPE CUTTER, NEATLY AND ACCURATELY CUT OUT DESIRED LENGTH OF PIPE FOR INSERTION OF PROPER FITTING. USE "BAND SEAL" OR SIMILAR COUPLINGS TO HOLD IT FIRMLY IN PLACE. FOLLOW MANUFACTURER'S RECOMMENDATIONS FOR THE INSTALLATION.
- 9. WHEREVER A SANITARY/COMBINED SEWER CROSSES UNDER A WATER MAIN, THE MINIMUM VERTICAL DISTANCE FROM THE TOP OF THE SEWER TO THE BOTTOM OF THE WATER MAIN SHALL BE 18 INCHES. FURTHERMORE, A MINIMUM HORIZONTAL DISTANCE OF 10 FEET BETWEEN SANITARY/ COMBINED SEWERS AND WATER MAINS SHALL BE MAINTAINED UNLESS: THE SEWER IS LAID IN A SEPARATE TRENCH, KEEPING A MINIMUM 18" VERTICAL SEPARATION; OR THE SEWER IS LAID IN THE SAME TRENCH WITH THE WATER MAIN LOCATED AT THE OPPOSITE SIDE ON BENCH OF UNDISTURBED EARTH, KEEPING A MINIMUM 18" VERTICAL SEPARATION. IF EITHER THE VERTICAL OR HORIZONTAL DISTANCES DESCRIBED ABOVE CANNOT BE MAINTAINED, OR THE SEWER CROSSES ABOVE THE WATER MAIN, THE SEWER SHALL BE CONSTRUCTED TO WATER MAIN STANDARDS.
- 10. ALL EXISTING SEPTIC SYSTEMS SHALL BE ABANDONED. ABANDONED TANKS SHALL BE FILLED WITH GRANULAR MATERIAL OR REMOVED.
- 11. ALL SANITARY MANHOLES, (AND STORM MANHOLES IN COMBINED SEWER AREAS), SHALL HAVE A MINIMUM INSIDE DIAMETER OF 48 INCHES, AND SHALL BE CAST IN PLACE OR PRE-CAST REINFORCED CONCRETE.
- 12. ALL ABANDONED SANITARY SEWERS SHALL BE PLUGGED AT BOTH ENDS WITH A MINIMUM OF TWO (2) FOOT LONG, NON-SHRINK CONCRETE/MORTAR PLUG.
- 13. ALL INLET AND OUTLET PIPES OF SANITARY SEWER MANHOLES AND OTHER UNDERGROUND STRUCTURES (IN COMBINED SEWER AREAS, ALSO INCLUDED ARE ALL COMBINED/STORM SEWER MANHOLES, CATCH BASINS, INLETS, AND UNDERGROUND DETENTION STORAGE STRUCTURES) SHALL BE JOINED WITH WATERTIGHT FLEXIBLE RUBBER CONNECTORS CONFORMING TO ASTM C-443 AND C-923 WITH STAINLESS STEEL-BAND.

SCALE: NONE

# DRAINAGE AND UTILITIES NOTES

THE LOCATIONS OF EXISTING DRAINAGE STRUCTURES, STORM SEWERS, COMBINED SEWERS, TELEPHONE LINES, COMMUNICATION LINES, ELECTRIC LINES, GAS MAINS, AND WATER SERVICES ARE APPROXIMATE AND THEIR SPECIFIC LOCATIONS ARE TO BE DETERMINED IN THE FIELD AT NO COMPENSATION TO THE CONTRACTOR

COORDINATION OF ALL UTILITY WORK INVOLVED WITHIN THE CONSTRUCTION AREAS SHALL BE SUBJECT TO DISCUSSION AND CLARIFICATION AT A PRECONSTRUCTION MEETING.

WHEN EXISTING DRAINAGE FACILITIES ARE DISTURBED, THE CONTRACTOR SHALL PROVIDE AND MAINTAIN TEMPORARY OUTLETS AND CONNECTIONS FOR ALL PRIVATE OR PUBLIC DRAINAGE STRUCTURES OR SEWERS UNTIL PERMANENT CONNECTIONS TO SEWERS ARE BUILT AND IN SERVICE. THIS WORK SHALL NOT BE PAID FOR DIRECTLY, BUT SHALL BE CONSIDERED INCLUDED IN THE RESPECTIVE SEWER PAY ITEMS.

WHEN, DURING CONSTRUCTION OPERATIONS, ANY LOOSE MATERIALS ARE DEPOSITED IN THE FLOW LINES OF GUTTERS OR DRAINAGE STRUCTURES SO THAT THE NATURAL FLOW OF WATER IS OBSTRUCTED, THE OBSTRUCTING MATERIALS SHALL BE REMOVED AT THE CLOSE OF EACH WORK DAY. AT THE CONCLUSION OF THE CONSTRUCTION OPERATIONS, ALL DRAINAGE STRUCTURES ARE TO BE FREE OF ALL DIRT, DEBRIS, AND OBSTRUCTING MATERIALS. THE WORK SPECIFIED ABOVE WILL NOT BE PAID FOR SEPARATELY, BUT SHALL BE CONSIDERED AS INCLUDED IN THE RESPECTIVE SEWER PAY ITEMS.

ALL COSTS INVOLVED IN CONNECTING OF PROPOSED STORM SEWERS OR STORM STRUCTURES TO EXISTING STORM SEWERS OR STORM STRUCTURES SHALL BE CONSIDERED INCLUDED IN THE PROPOSED SEWER ITEMS BEING CONSTRUCTED.

THE TYPE OF FRAMES AND GRATES REQUIRED FOR ALL CATCH BASINS AND MANHOLES LISTED IN THE SUMMARY OF QUANTITIES MAY BE FOUND ON THE PLANS AT THEIR RESPECTIVE LOCATIONS. WHERE LIDS ARE CALLED FOR ON THE PLANS, THEY SHALL BE IN ACCORDANCE WITH ARTICLE 604.01 OF THE STANDARD SPECIFICATIONS AND THE TERM LID IS USED IN LIEU OF GRATE.

ON ALL IMPROVEMENTS, THE FRAMES AND LIDS OF EXISTING CATCH BASINS, INLETS, MANHOLES, AND VALVE VAULTS WHICH ARE TO BE ABANDONED DUE TO CONSTRUCTION OF THIS IMPROVEMENT ARE TO REMAIN THE PROPERTY OF THE VILLAGE OF MELROSE PARK AND BE SALVAGED. THE CONTRACTOR IS TO DELIVER FRAMES AND LIDS TO THE VILLAGE OF MELROSE PARK PUBLIC WORKS YARD LOCATED AT 1002 N. 27th AVENUE.

ANY COSTS FOR SHEETING OR SHORING REQUIRED FOR THE STORM SEWER INSTALLATION OR OTHER CONSTRUCTION ELEMENTS REQUIRING RELATIVELY DEEP EXCAVATIONS SHALL BE INCLUDED IN THE PARTICULAR PAYMENT ITEM AND NO ADDITIONAL COMPENSATION WILL BE ALLOWED FOR ANY SUPPLEMENTAL WORK ASSOCIATED WITH THE MAINTENANCE OF TRENCH SIDES OR OTHER EXCAVATED AREAS.

UNLESS OTHERWISE SPECIFIED, ABANDONED SEWERS AND DRAINS, AS DESIGNATED BY THE ENGINEER, SHALL BE PLUGGED AT BOTH ENDS WITH A MINIMUM OF TWO (2) FOOT LONG, NON-SHRINK CONCRETE/MORTAR PLUG. THIS WORK SHALL NOT BE PAID FOR SEPARATELY, BUT SHALL BE INCLUDED IN THE PAY ITEMS FOR REMOVING AND/OR FILLING THE VARIOUS TYPES OF STRUCTURES.

SEWER PIPE INSTALLED ON THIS PROJECT SHALL CONFORM TO MWRD STANDARDS.

FINAL ADJUSTMENT OF ALL STRUCTURES IN THE PAVEMENT, INCLUDING THOSE IN THE PROPOSED BASE COURSE, SHALL NOT BE COMPLETED UNTIL AFTER THE PLACEMENT OF THE HOT-MIX ASPHALT BINDER COURSE.

A 3 FOOT PIECE OF PIPE UNDERDRAIN SHALL BE INSTALLED IN EACH DIRECTION PARALLEL TO THE CURB AND GUTTER AT EACH DRAINAGE STRUCTURE.

FLEXIBLE CONNECTORS SHALL BE USED WHEE NEW SEWER PIPES ARE TO BE CONNECTED TO EXISTING SEWER PIPES. THE FLEXIBLE CONNECTORS SHALL CONSIST OF A SYNTHETIC RUBBER SLEEVE, WHICH WILL RESIST DETERIORATION CAUSED BY WASTES FOUND IN SEWERS AND TWO STAINLESS STEEL STRAPS. THE CONNECTORS SHALL BE "MISSION" COUPLINGS, "FERNCO" COUPLINGS, OR EQUAL. ALL LABOR AND MATERIAL REQUIRED TO CONNECT NEW SEWER PIPE TO EXISTING SEWER PIPE SHALL BE CONSIDERED INCLUDED IN THE RESPECTIVE SEWER PAY ITEMS.

THE PAY ITEM STRUCTURES TO BE REMOVED SHALL INCLUDE THE REMOVAL OF EXISTING STRUCTURES AS INDICATED ON THE PLAN OR AS DIRECTED BY THE ENGINEER. INCLUDED IN THIS ITEM IS THE REMOVAL OF EXISTING INLETS, CATCH BASINS, OR MANHOLES. THE WORK SHALL BE PERFORMED IN ACCORDANCE WITH ARTICLE 605 EXCEPT THAT THE BACKFILL USED SHALL BE CRUSHED STONE, GRADATION CA-6. MAXIMUM COMPACTION MUST BE OBTAINED BY METHOD 1 (MECHANICAL COMPACTION) AS DESCRIBED IN ARTICLE 550.07 OFTHE "STANDARD SPECIFICATIONS FOR ROAD AND BRIDGE CONSTRUCTION".

THE USE OF CRUSHED CONCRETE WILL NOT BE PERMITTED. THE TRENCH BACKFILL MUST BE APPROVED BY THE ENGINEER.

ANCOCK
ENGINEERING

O Civil Engineers

Municipal Consultants

Established 1911


Page


Factor


STATE OF ILLINOIS
DEPARTMENT OF TRANSPORTATION

DRAINAGE AND UTILITIES DETAILS

SHEET NO. 2 OF 2 SHEETS STA. TO STA.

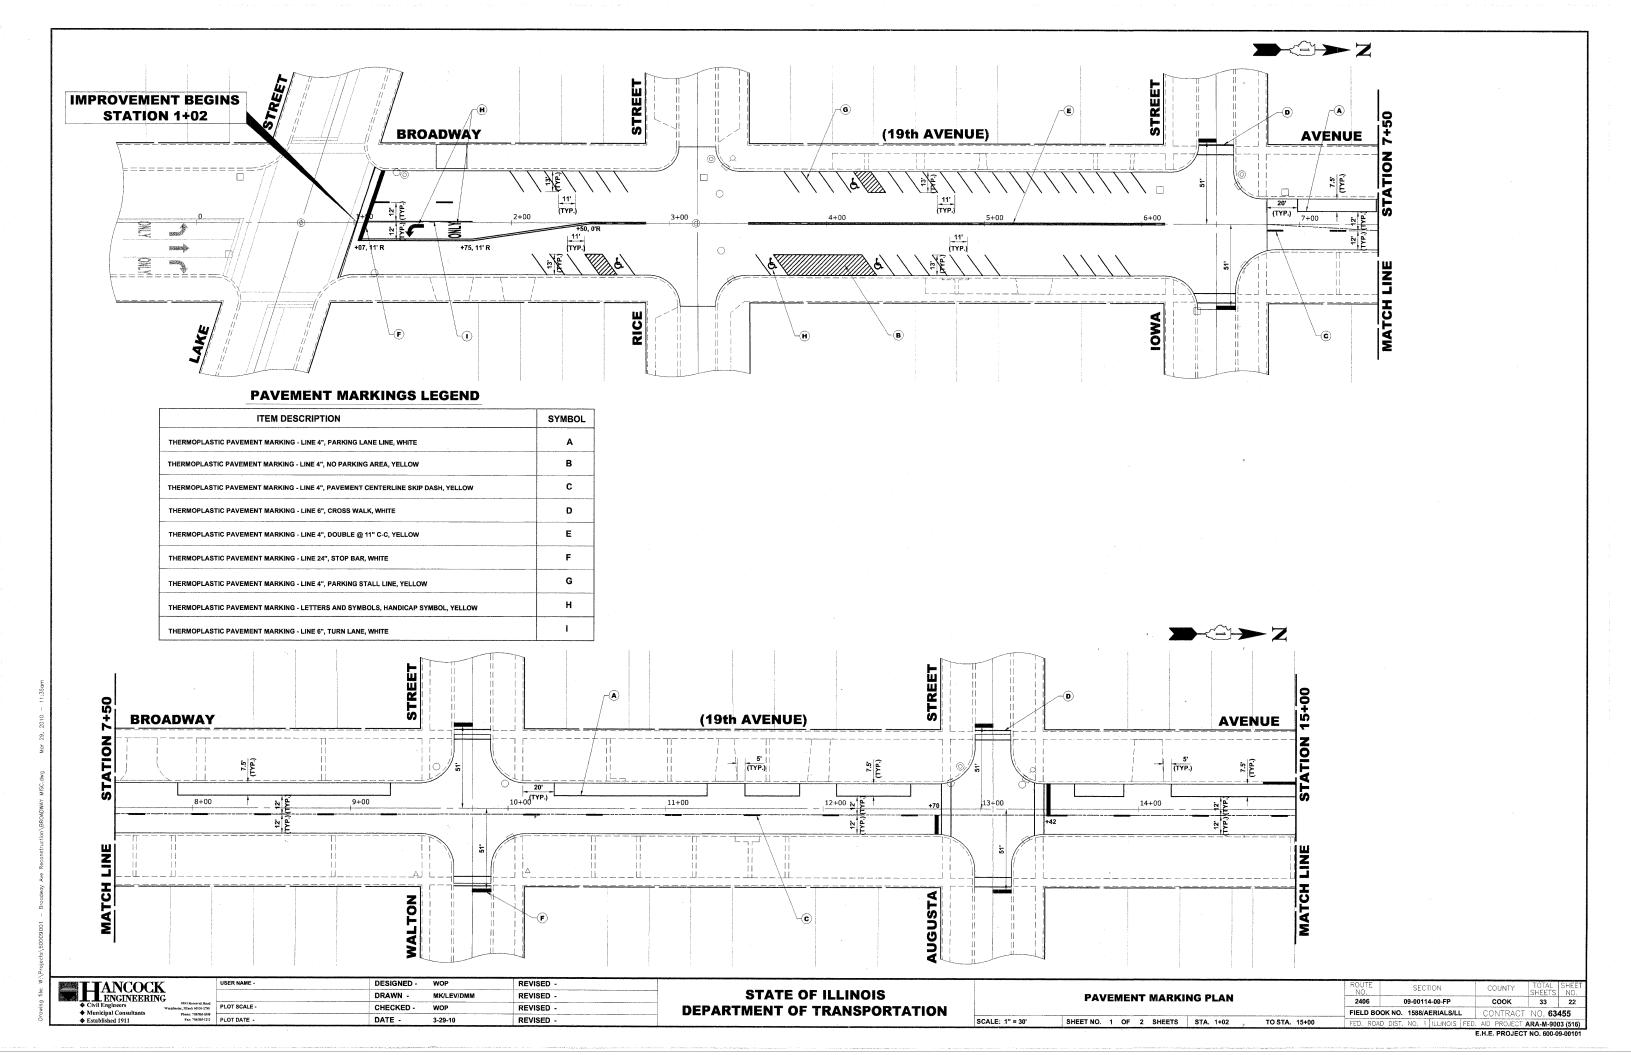

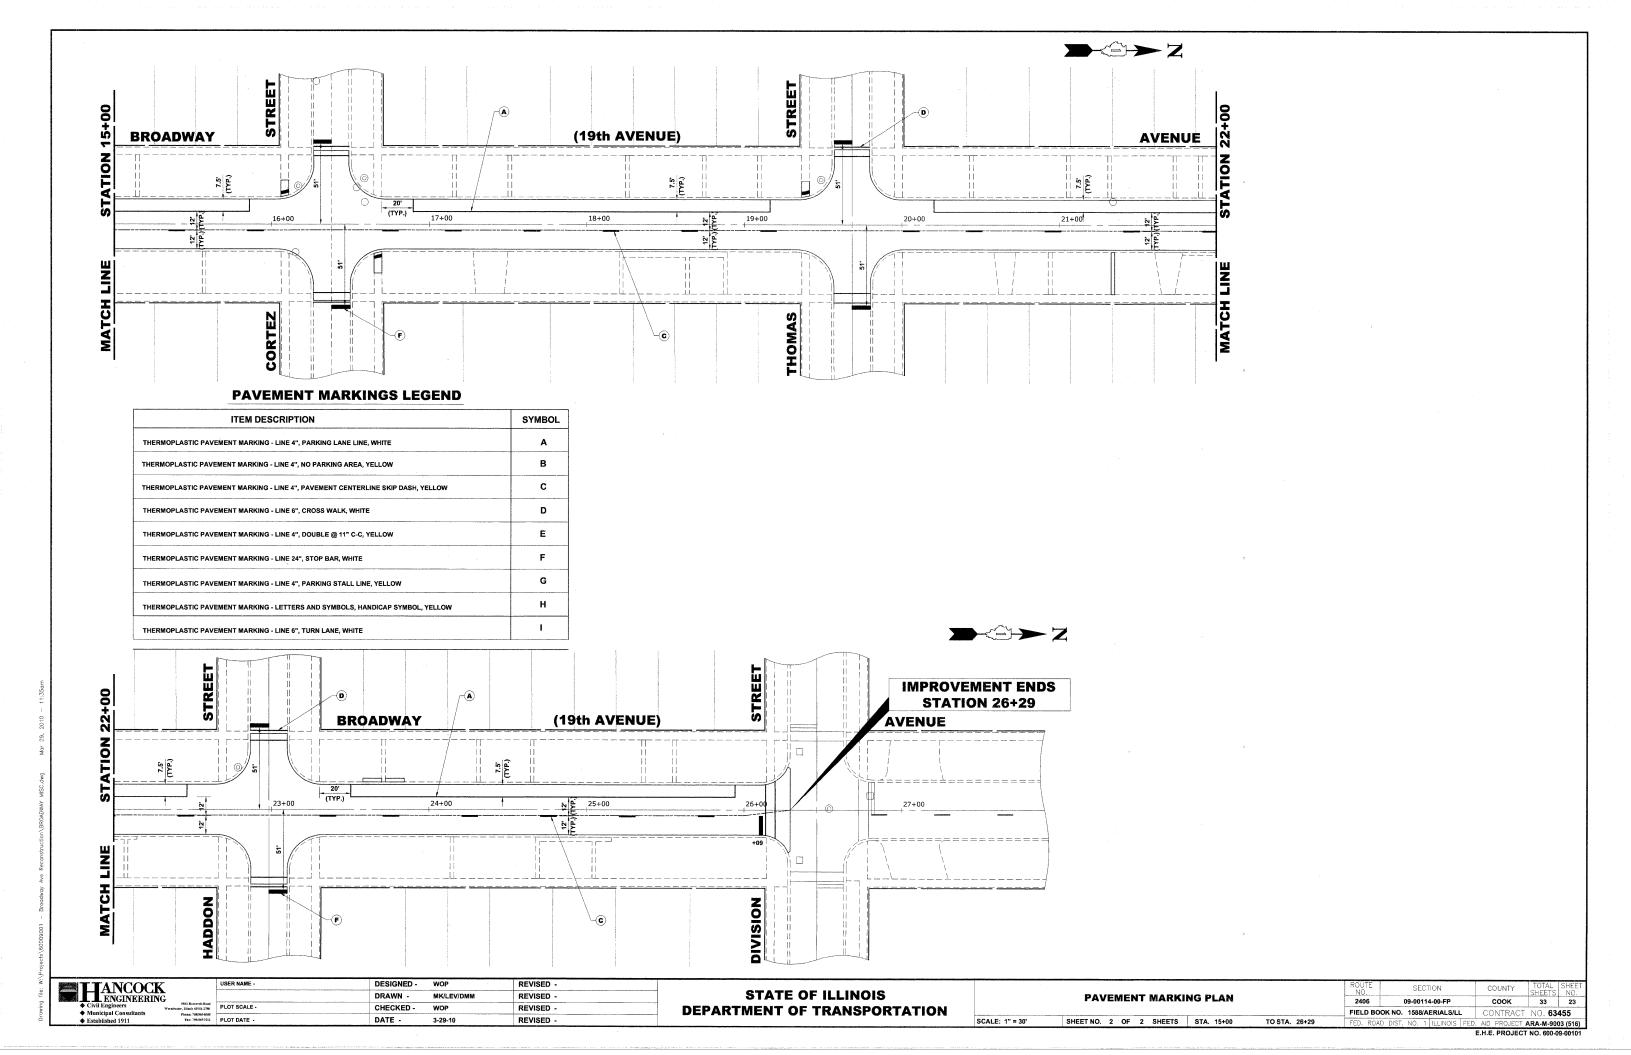

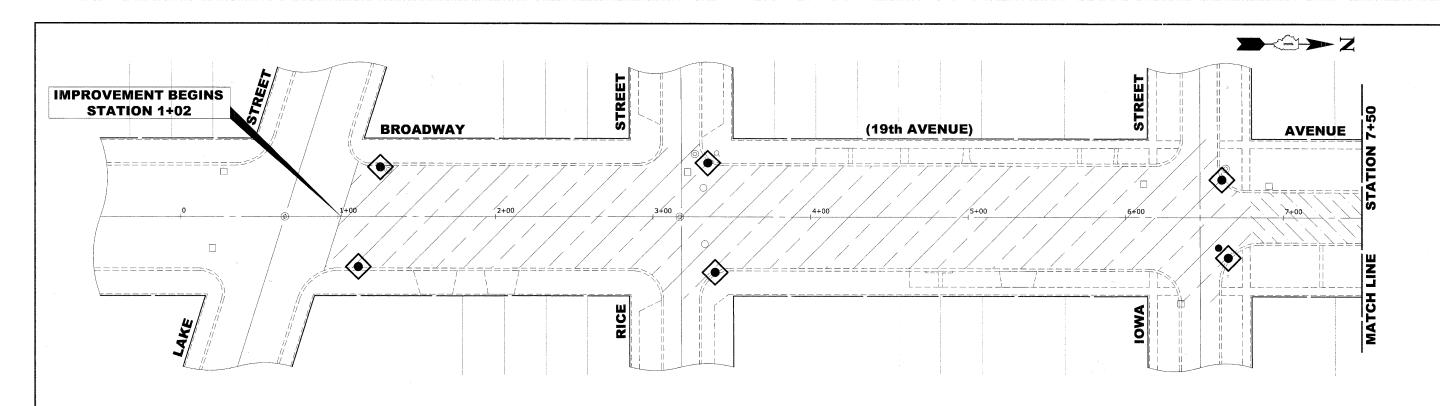

#### **EROSION CONTROL NOTES**

- 1. SEE IDOT STANDARD 280001-05 FOR TEMPORARY EROSION CONTROL SYSTEMS.
- 2. THE CONTRACTOR SHALL ENSURE THAT ADJACENT PROPERTIES REMAIN PROTECTED FROM SEDIMENT DEPOSITION.
- 3. SOIL STOCKPILES SHALL BE PROTECTED WITH PERIMETER EROSION BARRIER OR OTHER EROSION PROTECTION SPECIFIED BY THE RESIDENT ENGINEER. THE COST SHALL BE INCLUDED IN THE UNIT PRICE FOR THE INDIVIDUAL SOIL MATERIALS.
- 4. WHEREVER CONSTRUCTION VEHICLE ACCESS ROUTES INTERSECT PAVED PUBLIC ROADS. PROVISIONS SHALL BE MADE TO MINIMIZE THE TRANSPORT OF SEDIMENT BY RUNOFF OR VEHICLE TRACKING ONTO THE PAVED SURFACE. THE PROVISIONS MAY INCLUDE SPRAYING VEHICLE WHEELS TO CLEAR SEDIMENT BEFORE EXITING THE CONSTRUCTION SITE OR OTHER MEASURES APPROVED BY THE ENGINEER.

# **LEGEND OF SYMBOLS**

SYMBOL

DESCRIPTION


PROPOSED HOT-MIX ASPHALT AREA, PAVEMENT RECONSTRUCTION

77

PROPOSED HOT-MIX ASPHALT AREA, PAVEMENT RESURFACING

**③** 

INLET FILTER

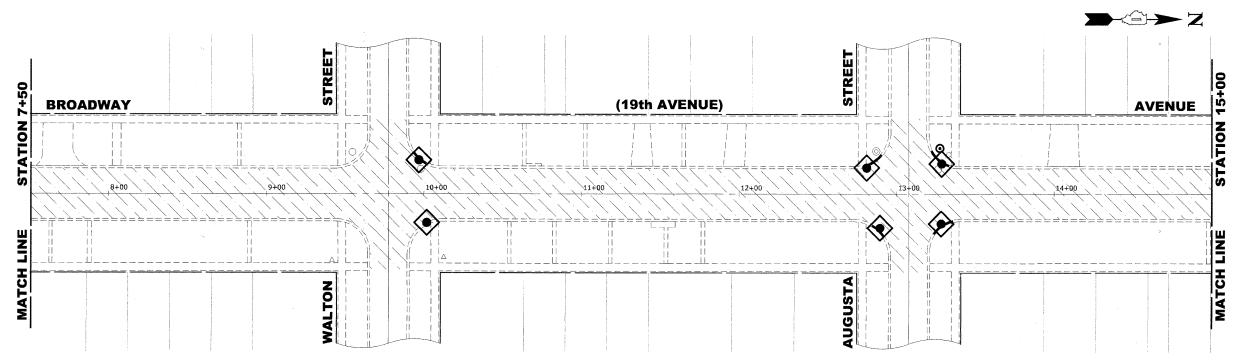


HANCOCK ENGINEERIN	G 9933 Rosservit Road
◆ Municipal Consultants ◆ Established 1911	Westchester, Illinois 60134-2788 Phone: 708/865-0300 Fax: 708/865-1212

	USER NAME -	DESIGNED -	WOP	REVISED -
		DRAWN -	MK/LEV/DMM	REVISED -
798	PLOT SCALE -	CHECKED -	WOP	REVISED -
1360 F212	PLOT DATE -	DATE -	3-29-10	REVISED -

STATE OF ILLINOIS
DEPARTMENT OF TRANSPORTATION

 EROSION CONTROL AND ASPHALT PLAN

 SCALE: 1" = 30'
 SHEET NO. 1 OF 2 SHEETS
 STA. 1402
 TO STA. 15400

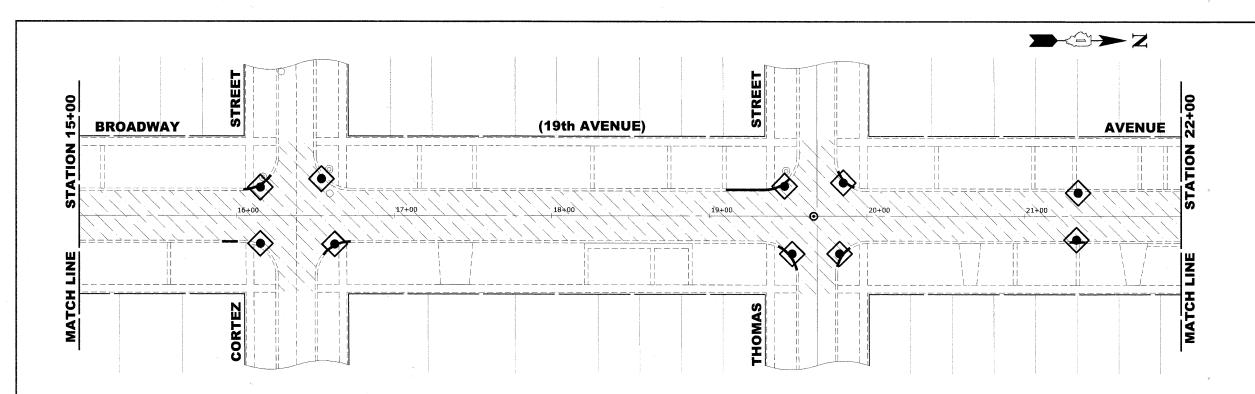

#### **EROSION CONTROL NOTES**

- 1. SEE IDOT STANDARD 280001-05 FOR TEMPORARY EROSION CONTROL SYSTEMS.
- 2. THE CONTRACTOR SHALL ENSURE THAT ADJACENT PROPERTIES REMAIN PROTECTED FROM SEDIMENT DEPOSITION.
- SOIL STOCKPILES SHALL BE PROTECTED WITH PERIMETER EROSION BARRIER OR OTHER EROSION PROTECTION SPECIFIED BY THE RESIDENT ENGINEER. THE COST SHALL BE INCLUDED IN THE UNIT PRICE FOR THE INDIVIDUAL SOIL MATERIALS.
- 4. WHEREVER CONSTRUCTION VEHICLE ACCESS ROUTES INTERSECT PAVED PUBLIC ROADS. PROVISIONS SHALL BE MADE TO MINIMIZE THE TRANSPORT OF SEDIMENT BY RUNOFF OR VEHICLE TRACKING ONTO THE PAVED SURFACE. THE PROVISIONS MAY INCLUDE SPRAYING VEHICLE WHEELS TO CLEAR SEDIMENT BEFORE EXITING THE CONSTRUCTION SITE OR OTHER MEASURES APPROVED BY THE ENGINEER.

## **LEGEND OF SYMBOLS**

SYMBOL


DESCRIPTION

**(** 

PROPOSED HOT-MIX ASPHALT AREA, PAVEMENT RECONSTRUCTION

PROPOSED HOT-MIX ASPHALT AREA, PAVEMENT RESURFACING

INLET FILTER

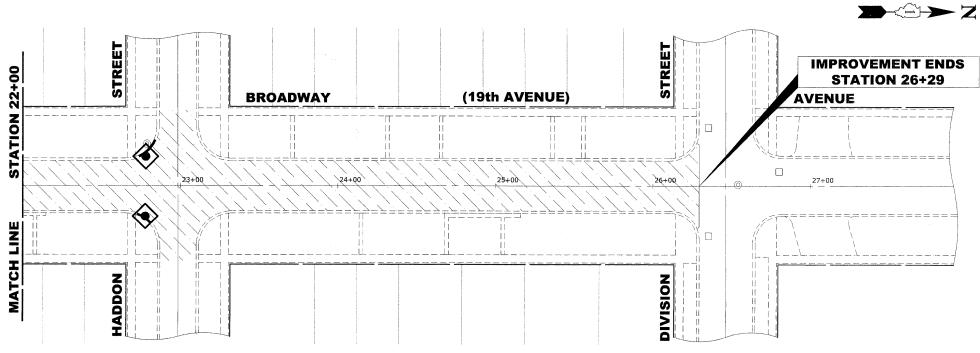

HANCOCK 9933 Rossevell Raad eller, Illianda 60154-2768 PLOT SCALE -Phone: 708/895-0390 Fax: 708/895-2212 PLOT DATE -

REVISED -DRAWN -MK/LEV/DMM REVISED CHECKED -WOP REVISED -DATE -3-29-10 REVISED

**STATE OF ILLINOIS DEPARTMENT OF TRANSPORTATION** 

**EROSION CONTROL AND ASPHALT PLAN** SCALE: 1" = 30" SHEET NO. 2 OF 2 SHEETS STA. 15+00 TO STA. 26+29

COUNTY 09-00114-00-FP CONTRACT NO. 63455 FIELD BOOK NO. 1588/AERIALS/LL ARA-M-9003 (516)

TRAFFIC CONTROL AND PROTECTION FOR SIDE ROADS, INTERSECTIONS, AND DRIVEWAYS

# NOTES:

- A. FOR NO LANE RESTRICTION ON THE SIDE ROAD OR DRIVEWAYS
- SIDE ROAD WITH A SPEED LIMIT OF 40 MPH (60 km/h) OR LESS AS SHOWN ON THE DRAWING AND AS DIRECTED BY THE ENGINEER:
- d) ONE ROAD CONSTRUCTION AREAD SIGN 36 x 36 (900x900) WITH A FLASHER AND FLAG MOUNTED ON IT APPROXIMATELY 200' (60 m) IN ADVANCE OF THE MAIN ROUTE.
- b) THE CLOSED PORTION OF THE MAIN ROUTE SHALL BE PROTECTED BY BLOCKING WITH TYPE I, TYPE II OR TYPE III BARRICADES, 1/3 OF THE CROSS SECTION OF THE CLOSED PORTION.
- SIDE ROAD WITH A SPEED LIMIT GREATER THAN 40 MPH (60 km/h) AS SHOWN ON THE DRAWING AND AS DIRECTED BY THE ENGINEER:
- d) ONE moad construction whead Sign 48  $\times$  48 (1.2 m  $\times$  1.2 m) With A Flasher mounted on it approximately 500' (150 m) in advance of the main route.
- b) THE CLOSED PORTION OF THE MAIN ROUTE SHALL BE PROTECTED BY BLOCKING WITH TYPE III BARRICADES, 1/2 OF THE CROSS SECTION OF THE CLOSED PORTION.

SCALE: NONE

3. WHEN THE SIDE ROAD LIES BETWEEN THE BEGINNING OF THE MAINLINE SIGNING AND THE WORK ZONE, A SINGLE HEADED ARROW (MG-1) SHALL BE USED IN LIEU OF THE DOUBLE HEADED ARROW (MG-4).

#### B. FOR A LANE CLOSURE ON A SIDE ROAD OR DRIVEWAY:

USE APPLICABLE PORTIONS OF THE TYPICAL APPLICATION OF TRAFFIC CONTROL DEVICES (STD. 701501, STD. 701606 OR THE APPROPRIATE STANDARD). THE SPACING OF SIGNS AND BARRICADES SHALL BE ADJUSTED FOR FIELD CONDITIONS AS DIRECTED BY THE ENGINEER. THE DIRECTIONAL ARROW SHALL BE COVERED OR REMOVED WHEN NO LONGER CONSISTENT WITH THE SIDE ROAD LANE CLOSURE.

- C. ADVANCE WARNING SIGNS ARE TO BE OMITTED ON DRIVEWAY UNLESS OTHERWISE NOTED.
- D. THE TRAFFIC CONTROL AND PROTECTION FOR SIDE ROADS, INTERSECTIONS, AND DRIVEWAYS SHALL BE INCIDENTAL TO THE COST OF SPECIFIED TRAFFIC CONTROL STANDARDS OR ITEMS.

All dimensions are in millimaters (inches) unless otherwise shown.

FILE NAME = USER NAME = gaglianobit DESIGNED - LHA REVISED - J. 08ERLE 10-18-95
Whichstarted N22x341 to 18.dgn

DRAWN - REVISED - A. HOUSEH 03-06-96
PLOT SCALE = 68.686 '/ IN. CHECKED - REVISED - A. HOUSEH 10-15-96
PLOT GATE = 1/4/2886 DATE - 06-89 REVISED -T. RAMMACHER 01-06-00

STATE OF ILLINOIS
DEPARTMENT OF TRANSPORTATION

TRAFFIC CONTROL AND PROTECTION FOR
SIDE ROADS, INTERSECTIONS, AND DRIVEWAYS


SHEET NO. 1 OF 1 SHEETS STA. TO STA.


F.A. SECTION COUNTY TOTAL SHEET NO.


2406 09-00114-00-FP COOK 33 26

TC-10 CONTRACT NO. 63455

FED. RDAD DIST. NO. 1 | ILLINOIS| FED. AID PROJECT M-9003 (516)

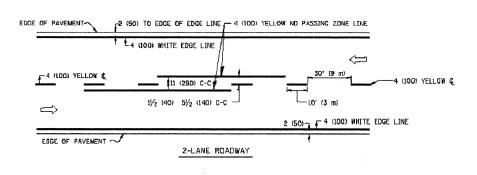


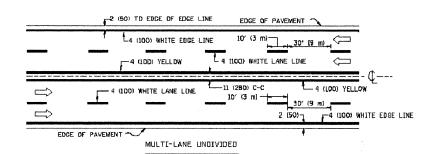

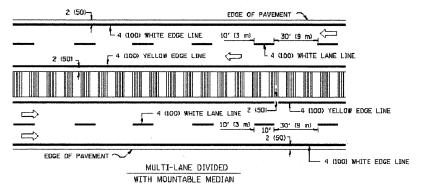


NOTE: MEDIANS WITH BARRIER CURB DO NOT REQUIRE AN EDGE LINE


TYPICAL LANE AND EDGE LINE MARKING

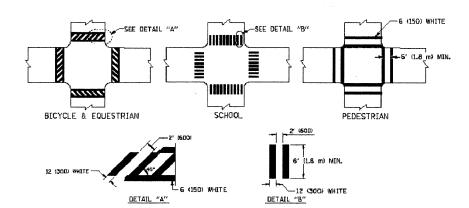

TYPICAL CROSSWALK MARKING

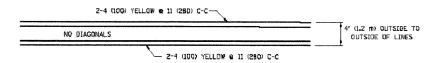

#### 4' (1.2 m) WIDE MEDIANS ONLY

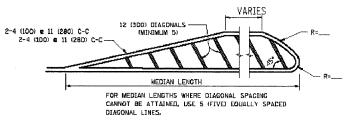


DIAGONAL LINE SPACING: 50' (15 m) C-C (LESS THAM 30MPH (50 km/h))


75' (25 m) C-C 30MPH (50 km/h) TO 45MPH (70 km/h))

150' (45 m) C-C (MORE THAN 45MPH (10 km/h))

#### MEDIANS OVER 4' (1.2 m) WIDE

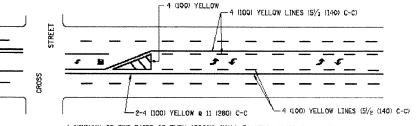


A MINIMUM OF TWO PAIRS OF TURN ARROWS SHALL BE USED, WHITE IN COLOR. ADDITIONAL PAIRS SHALL BE PLACED AT 200' (60 m) TO 300' (90 m) INTERVALS.

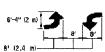

MEDIAN WITH TWO-WAY LEFT TURN LANE


# TYPICAL PAINTED MEDIAN MARKING

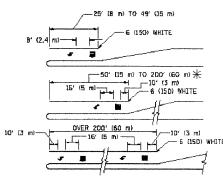

\* TURN LANES IN EXCESS OF 400' (120 m) IN LENGTH MAY HAVE AN ADDITIONAL SET OF ARROW - "ONLY" INSTALLED MIDWAY BETWEEN THE OTHER TWD SETS OF ARROW - "ONLY" INSTALLED MIDWAY BETWEEN THE OTHER TWD SETS OF

TYPICAL LEFT (OR RIGHT) TURN LANE

# TYPICAL TURN LANE MARKING

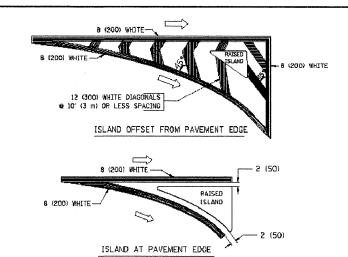

# TYPICAL ISLAND MARKING

	T	· · · · · · · · · · · · · · · · · · ·	[	
TYPE OF MARKING	WIDTH OF LINE	PATTERN	COLOR	SPACING / REMARKS
CENTERLINE ON 2 LANE PAVEMENT	4 (100)	SKIP-DASH	YELLOW	3D' (3 m) LINE WITH 3O' (9 m) SPACE
CENTERLINE ON MULTI-LANE UNDIVIDED PAVEMENT	2 @ 4 (100)	SOLID	YELLOW	11 (28¢) C-C
NO PASSING ZONE LINES: FOR ONE DIRECTION FOR BOTH DIRECTIONS	4 (100) 2 @ 4 (100)	SOLID SOLID	YELLOW YELLOW	5/ <sub>2</sub> (14D) C-C FROM SKIP-DASH CENTERLINE 11 (28D) C-C OMIT SKIP-DASH CENTERLINE BETWEEN
LANE LINES	4 (100) 5 (125) ON FREEWAYS	SKIP-DASH SKIP-DASH	WHITE WHITE	10' (3 m) LINE WITH 30' (9 m) SPACE
DOTTED LINES LEXTENSIONS OF CENTER, LANE OR TURN LANE MARKINGS)	SAME AS LINE BEING EXTENDED	SKIP-DASH	SAME AS LINE BEING EXTENDED	2" (600) LINE WITH 6" (1.8 m) SPACE
EDBE LINES	4 (100)	SOLID	YELLOW-LEFT WHITE-RIGHT	OUTLINE MOUNTABLE MEDIANS IN YELLOW, EDGE LINES ARE MDT USED NEXT TO BARRIER CURB
TURN LANE MARKINGS	6 (150) LINE, FULL SIZE LETTERS & SYMBOLS (8' (2.4m))	SOLIO	WHITE	SEE TYPICAL TURN LANE MARKING DETAIL
TWO WAY LEFT TURN MARKING	2 m 4 (100) EACH DIRECTION	SKIP-DASH AND SOLID	YELLOW	10' (3 m) LINE WITH 30' (8 m) SPACE FOR SKIP-DASH; 5½ (140) C-C BETWEEN SOLID LINE AND SKIP-DASH LINE
	8' (2.4m) LEFT ARROW	IN PAIRS	WHITE	SEE TYPICAL TWO-WAY LEFT TURN MARKING DETAIL
CROSSWALK LINES (PEDESTRIAN) A. DIAGONALS (BIKE & EQUESTRIAN) B. LONGITUDINAL BARS (SCHOOL)	2 @ 5 (150) 12 (300) @ 45° 12 (300) @ 90°	SOLID SOLID SOLID	WHITE WHITE WHITE	NDT LESS THAN 6' d.8 m) APART 2' (600) APART 2' (500) APART SEE TYPICAL CROSSWALK MARKING DETAILS.
STOP LINES	24 (600)	SOLIO	WHITE	PLACE 4' 11.2 ml IN AUVANCE OF AND PARALLEL TO CROSSMALK, IF PRESENT. OTHERWISE, PLACE AT DESIRED STREPTIME POINT. PARALLEL TO CROSSROAD CENTERLINE, WHERE POSSIBLE
PAINTED MEDIANS	2 @ 4 (100) WITH 12 (300) DIAGONALS	SOLID	YELLOW: TWO WAY TRAFFIC	11 (280) C-C FOR THE DOUBLE LINE
	ND DIAGONALS USED FOR 4' (1.2 m) WIDE MEDIANS		WHITE: DNE WAY TRAFFIC	SEE TYPICAL PAINTED MEDIAN MARKING.
DORE MARKING AND CHANNELIZING LINES	8 (ZOD) WITH 1Z (300) DIAGONALS & 45°	SOLIO	WHITE	DIACDNALS: 15' (4.5 m) C-C (LESS THAN 30MPH (50 km/h)) 20' (6 m) C-C 30MPH (50 km/h) TO 45MPH (70 km/h)) 30' (9 m) C-C (DVER 45MPH (70 km/h))
RAILROAD CROSSING	24 (600) TRANSVERSE LINES, "RR" IS 5' (1.8 ml LETTERS; 16 (400) LINE FOR "X"	SOLIO	WHITE	SEE STATE STANDARD 78000L AREA OF: "R"=3.6 SQ. FT. (0.33 m²) EACH "X"=54.0 SQ. FT. (5.0 m²)
SHOULDER DIAGONALS	12. (300) @ 45°	\$OLID *	WHITE - RIGHT YELLOW - LEFT	50' (15 m) C-C (LESS THAN 30MPH [50 km/h)) 75' (25 m) C-C (30 MPH (50 km/h) TO 45MPH 170 km/h)] 150' (45 m) C-C (0VER 45MPH (70 km/h))


FOR FURTHER DETAILS ON PAVEMENT MARKING REFER TO STANDARD SPECIFICATIONS FOR ROAD AND BRIDGE CONSTRUCTION AND STATE STANDARD 780001.

All dimensions one in inches imilimeters) unless otherwise shown.

FILE NAME =	USER NAME = drivakoagn	DESIGNED	-	EVERS	REVISED	-T.	RAMMACHER	10-27-94
ar/pe_eark/pezdat/drzvakaagn/d0108315/ta	DRAWN	-		REVISED	-C.	JUCIUS	09-09-09	
	PLOT SCALE = 50.000 '/ IN.	CHECKED	-		REVISED	-		
	PLOT DATE = 9/9/2009	DATE	-	03-19-90	REVISED	-		

STATE OF ILLINOIS
DEPARTMENT OF TRANSPORTATION

							F.A RTE.	SEC	TION	COUNTY TOTAL SHEETS				
1							2406	09-0011	4-00-FP	соок	33	27		
1	HITIMIL INDUMENT MARRIOD								TC-13	CONTRACT NO. 63455				
	SCALE: NONE	SHEET N	0. 1	OF	1	SHEETS	STA.	TO STA.	FEO. RI	FEG. ROAD DIST. NO. 1 ILLINOIS FED. AID PROJECT M-6003 (5116)				
	E.H.E. PROJECT NO. 600-09-00101													

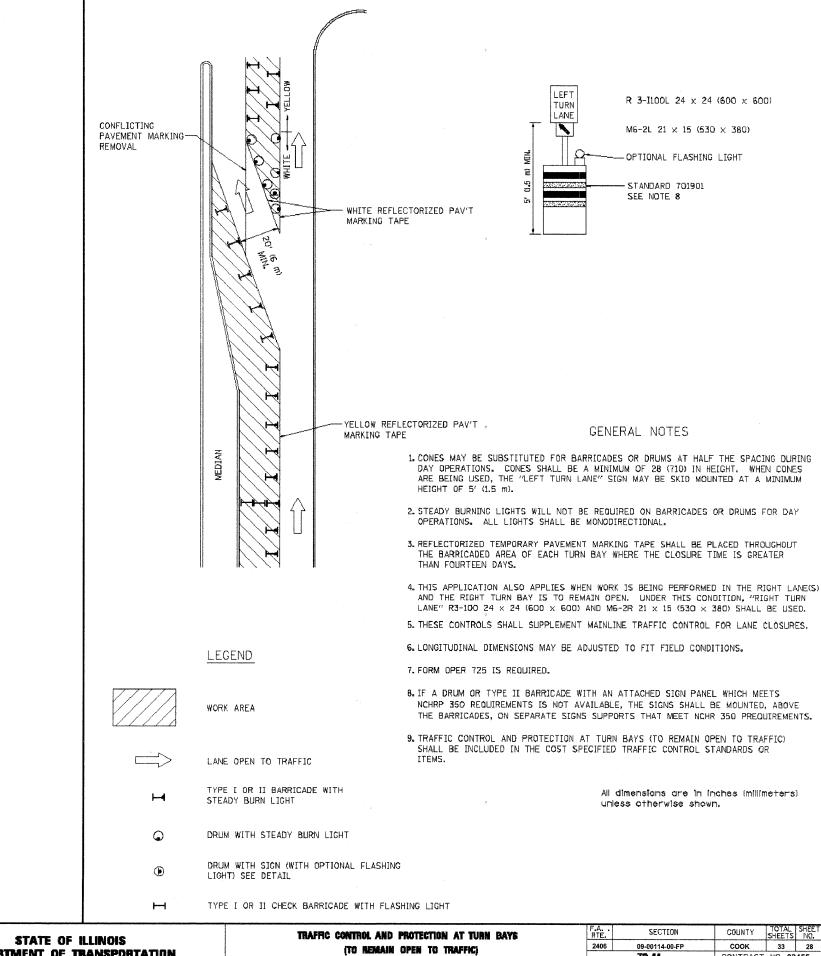


REVISED -T. RAMMACHER 09-08-94 REVISED - R. BORO 09-14-09 USER NAME = dravekoagn ar\aw\_work\PWIOOT\ORIVAKOSGN\dØ1983I5\ta14.don REVISED - A. HOUSEH 11-07-95 REVISED -PLOT SCALE = 49.9999 '/ INL REVISED - A. HOUSEH 10-12-96 REVISED -PLOT DATE = 9/14/2009 REVISED -T, RAMMACHER 01-06-00 REVISED -

**DEPARTMENT OF TRANSPORTATION** 

(TO REMAIN OPEN TO TRAFFIC) SCALE: NONE SHEET NO. 1 OF 1 SHEETS STA.

SHEETS NO. 33 28 CONTRACT NO. 63455 TC-14 FED. ROAD DIST. NO. 1 | ILLINOIS FED. AID PROJECT M-9003 (516)


# OPTION 1

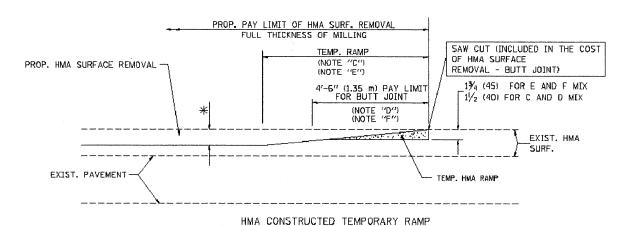


(FOR BUTT JOINT AND HMA TAPER SEE DETAIL BELOW)


# OPTION 2

#### TYPICAL TEMPORARY RAMP

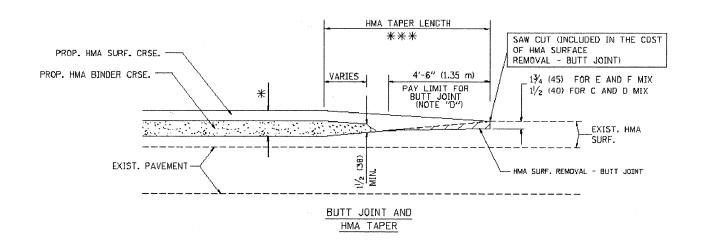

# TYPICAL BUTT JOINT AND HMA TAPER FOR MILLING AND RESURFACING

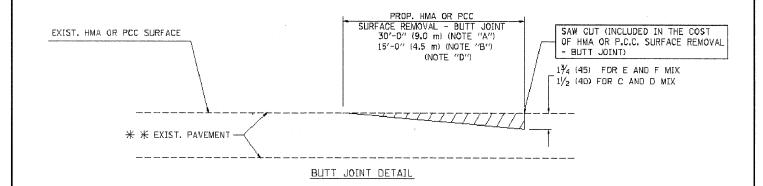

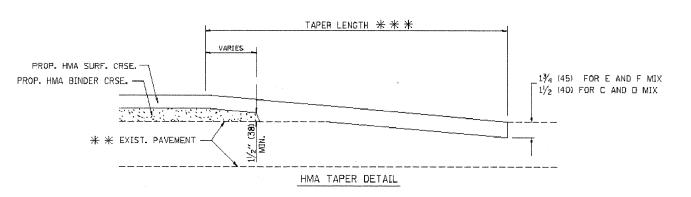

# TYPICAL BUTT JOINT AND HMA TAPER FOR RESURFACING ONLY

\* \* PC CONCRETE, HMA OR HMA RESURFACED PAVEMENT.

#### NOTES

- A: MAINLINE ROADWAYS AND MAJOR SIDE ROADS.
- B: MINOR SIDE ROADS.
- C: THE TEMP. RAMP SHALL BE CONSTRUCTED IMMEDIATELY UPON REMOVAL OF THE EXISTING HMA SURFACE.
- D: THE BUTT JOINT SHALL BE CONSTRUCTED IMMEDIATELY PRIOR TO PLACING THE PROPOSED HMA COURSES.
- E: TAPER THE TEMP. RAMP AT A RATE OF 3'-0" (900 mm) PER 1 INCH (25 mm) OF MILLING THICKNESS.
- F: INSTALLATION AND REMOVAL OF THE 4'-6" (1.35 m) TEMP. RAMP IS INCLUDED IN COST OF HMA SURFACE REMOVAL BUTT JOINT
- G: SEE ARTICLE 406.08 AND 406.14 OF THE STANDARD SPECIFICATIONS FOR "HMA AND/OR PCC SURFACE REMOVAL, BUTT JOINT".
- \* SEE TYPICAL SECTIONS FOR MILLING THICKNESS.

# BASIS OF PAYMENT:

THE BUTT JOINT WILL BE PAID FOR AT THE CONTRACT UNIT PRICE PER SQUARE YARD (SQUARE METER) FOR "HOT-MIX ASPHALT SURFACE REMOVAL - BUTT JOINT" OR FOR "PORTLAND CEMENT CONCRETE SURFACE REMOVAL - BUTT JOINT".

SCALE: NONE

ALL DIMENSIONS ARE IN INCHES (MILLIMETERS) UNLESS OTHERWISE SHOWN.

STATE OF ILLINOIS
DEPARTMENT OF TRANSPORTATION

