STATE OF ILLINOIS **DEPARTMENT OF TRANSPORTATION**

PROPOSED HIGHWAY PLANS

FAP 342 (IL ROUTE 53) SECTION 531-1-T NORTHBOUND RAMP TO IL-62 (ALGONQUIN ROAD) DRAINAGE IMPROVEMENT **COOK COUNTY** C-91-114-15

FOR INDEX OF SHEETS, SEE SHEET NO. 2

IMPROVEMENT LOCATED IN THE VILLAGE OF ROLLING MEADOWS AND VILLAGE OF SCHAUMBURG

DESIGN DESIGNATION:

SPEED LIMIT: 35 - 40 M.P.H. 2013 ADT = 38.000

FULL SIZE PLANS HAVE BEEN PREPARED USING STANDARD ENGINEERING SCALES. REDUCED SIZED PLANS WILL NOT CONFORM TO STANDARD SCALES. IN MAKING MEASUREMENTS ON REDUCED PLANS, THE ABOVE SCALES MAY BE USED.

(IDOT) PROJECT MANAGER: KARI SMITH (847) 705-4437

J.U.L.I.E. JOINT UTILITY LOCATION INFORMATION FOR EXCAVATION 1-800-892-0123 OR 811

LOCATION MAP N.T.S. IMPROVEMENT BEGINS STA. 112 + 50 R 10 E R 11 E ongiree Di

> IMPROVEMENT ENDS STA. 151 + 25

ELK GROVE TOWNSHIP

(HRGREEN) PROJECT ENGINEER: BENJAMIN HARTMAN (815) 385-1778


PALATINE TOWNSHIP

GROSS LENGTH OF IMPROVEMENT = 3,875 FEET = 0.734 MILE NET LENGTH OF IMPROVEMENT = 3,875 FEET = 0.734 MILE

D-91-114-15

531-1-T



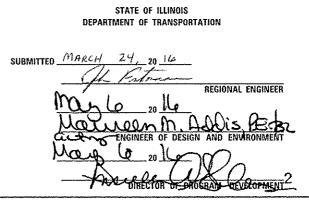

PROFESSIONAL ENGINEER'S SIGN & SEAL EXPIRES: 11-30-17

PRINTED BY THE AUTHORITY OF THE STATE OF ILLINOIS

CONTRACT NO. 62A27

0

0

0

INDEX OF SHEETS

24 ARTERIAL ROAD INFORMATION SIGN (TC-22)

1	COVER SHEET
2	INDEX OF SHEETS, LIST OF STATE STANDARDS, AND DISTRICT ONE DETAILS
3	GENERAL NOTES
4-5	SUMMARY OF QUANTITIES
6-7	SUGGESTED MAINTENANCE OF TRAFFIC PLANS
8-9	REMOVAL PLANS
10-11	DRAINAGE PLANS
12	IL ROUTE 53 RAMP GRADING IMPROVEMENT PLAN
13	IL ROUTE 53 RAMP EROSION CONTROL PLAN
14	IL ROUTE 53 RAMP LANDSCAPING PLAN
15	CONSTRUCTION DETAIL RESTRICTOR STRUCTURE
16	DETAIL OF STORM SEWER CONNECTION TO EXISTING SEWER (80-07)
17	CURB OR CURB AND GUTTER REMOVAL AND REPLACEMENT (80-24)
18	PCC PAVEMENT ROUNDOUTS AT CURB AND GUTTER (80-48)
19	TRAFFIC CONTROL AND PROTECTION FOR SIDE ROADS, INTERSECTIONS, AND DRIVEWAYS (TC-10)
20	TRAFFIC CONTROL AND PROTECTION AT TURN BAYS (TC- 14)
21	PAVEMENT MARKING LETTERS AND SYMBOLS FOR TRAFFIC STAGING (TC-16)
22	TRAFFIC CONTROL DETAILS FOR FREEWAY SHOULDER CLOSURES AND PARTIAL RAMP CLOSURES (TC-17)
23	SIGNING FOR FLAGGING OPERATIONS AT WORK ZONE OPENINGS (TC-18)

LIST OF STATE STANDARDS

-		
	STANDARD NO.	OESCRIPTION
	000001 - 06	STANDARD SYMBOLS, ABBREVIATIONS AND PATTERNS
	280001 - 07	TEMPORARY EROSION CONTROL SYSTEMS
	442101 - 07	CLASS B PATCHES
	542301 - <i>03</i>	PRECAST REINFORCED CONCRETE FLARED END SECTION
	602006 -04	CATCH BASINS TYPE B
	602011 - 02	CATCH BASINS TYPE C
	602301 - 04	INLETS TYPE A
	602401 - 03	MANHOLE TYPE A
	602601 - 04	PRECAST REINFORCED CONCRETE FLAT SLAB TOP
	604001 - 04	FRAME AND LIDS TYPE 1
	604031 - <i>03</i>	GRATE TYPE 7
	604051 - 04	FRAME AND GRATE TYPE II
	604091 - 03	FRAME AND GRATE TYPE 24
	606001 - <i>06</i>	CONCRETE CURB TYPE B AND COMBINATION CONCRETE CURB AND GUTTER
	664001 - 02	CHAIN LINK FENCE
	701101 - 05	OFF-RD OPERATIONS, MULTILANE, 15' TO 24" FROM PAVEMENT EDGE
	701427 - 04	LANE CLOSURE, MULTILANE, INTERMITTENT OR MOVING OPER., FOR SPEEDS < 40 MPH
	701601 - 09	URBAN LANE CLOSURE, MULTILANE, IW OR 2W WITH NONTRAVERSABLE MEDIAN
	701701 - 10	URBAN LANE CLOSURE, MULTILANE INTERSECTION
	701801 - <i>06</i>	SIDEWALK, CORNER OR CROSSWALK CLOSURE
	701901 - <i>05</i>	TRAFFIC CONTROL DEVICES

1)1 aPROCELLOWINGTS
10/15/2015 122534 PM
10/15/2015 122534 PM
16/10/16/2015 12

TABLES P.O.



USER NAME : bhorton	DESIGNED	^	8H	REVISED -
FILE NAME : 85188196-52-sht-gen-01.dgn	DRAWN	^	DS	REVISED -
PLOT SCALE : H.T.S.	CHECKED	-	TH	REVISEO -
PLOT DATE + 10/15/2015	DATE	-	10/15/15	REVISEO -

STATE	: 01	ILLINOIS
DEPARTMENT	OF	TRANSPORTATION

-	INDEX	OF	SHEETS.	STAT	F S	TAN	DARDS	AND	DISTRICT	ON	E DETAILS	F.A.U RTE.	sec	TION	COUNTY	TOTAL SHEETS	SH
	1,702,1	**	J				-,					342	531	-1-T	COOK	24	
															CONTRACT	NO.	62
	SCALE: N.T.	s.	SHEET	NO. 1	OF	1	SHEETS	STA.		TO S	TA.	FEO.	ROAD DIST. NO.	ILLIMOIS FED. AL	D PROJECT		

GENERAL NOTES

- BEFORE STARTING ANY EXCAVATION, THE CONTRACTOR SHALL CALL "JULIE" (JOINT UTILITY LOCATION INFORMATION FOR EXCAVATION) AT 8-1-1 OR (800) 892-0123 FOR FIELD LOCATIONS OF BURIED ELECTRIC, TELEPHONE, AND GAS FACILITIES (48 HOUR NOTIFICATION IS REQUIRED).
- THE CONTRACTOR WILL NOT BE ALLOWED TO SET UP A YARD OR FIELD OFFICE ON STATE PROPERTY WITHOUT WRITTEN PERMISSION FROM THE DEPARTMENT.
- SAW CUTTING OF PAVEMENTS, SIDEWALK, CURB & GUTTER, ETC. SHALL BE TO FULL DEPTH AND SHALL RESULT IN A CLEAN STRAIGHT EDGE ON THE PORTION REMAINING, ALL SAW CUTTING SHALL BE CONSIDERED INCLUDED IN THE COST OF THE ITEM REMOVED.
- SAW CUTTING OF EXISTING STORM SEWER TO BE REMOVED SHALL BE INCLUDED IN THE COST OF THE ITEM
- DO NOT SCALE PLANS FOR CONSTRUCTION DIMENSIONS. 5.
- THE CONTRACTOR SHALL USE CARE IN REMOVING OR EXCAVATING NEAR ALL EXISTING ITEMS WHICH WILL REMAIN. ANY DAMAGE DONE TO EXISTING ITEMS BY THE CONTRACTOR SHALL BE REPAIRED AT THE
- THE CONTRACTOR SHALL CONTACT THE TRAFFIC CONTROL SUPERVISOR AT (84T) 705-4470 A MINIMUM OF 72 HOURS PRIOR TO THE PLACEMENT OF ANY TEMPORARY TRAFFIC CONTROL DEVICES.
- THE CONTRACTOR SHALL CONTACT MS. DEBBIE HANLON THE AREA TRAFFIC FIELD ENGINEER, AT (847) 438-2300 AT LEAST TWO (2) WEEKS PRIOR TO THE PLACEMENT OF PERMANENT PAVEMENT MARKINGS.
- THE CONTRACTOR SHALL BE RESPONSIBLE FOR CONTACTING OWNERS OF ALL UTILITIES PRIOR TO CONSTRUCTION TO DETERMINE THE LOCATION OF ALL UTILITY EQUIPMENT, THE CONTRACTOR SHALL COOPERATE WITH ALL UTILITY OWNERS IN ACCORDANCE WITH THE STANDARD SPECIFICATIONS IF UTILITY RELOCATION, ADJUSTMENT, OR PROTECTION IS NECESSARY.
- THE LOCATION OF EXISTING DRAINAGE STRUCTURES, STORM SEWERS, WATER MAINS, SANITARY SEWERS, AND ANY OTHER PUBLIC OR PRIVATE UTILITIES AS SHOWN ON THE PLANS IS APPROXIMATE AND THEIR EXACT LOCATION IS TO BE DETERMINED IN THE FIELD BY THE CONTRACTOR
- THE CONTRACTOR SHALL BE RESPONSIBLE FOR THE PROTECTION OF ALL UNDERGROUND AND SURFACE UTILITIES EVEN THOUGH THEY MIGHT NOT BE SHOWN ON THE PLANS ANY UTILITY PROPERTY DAMAGED DURING CONSTRUCTION SHALL BE REPAIRED OR REPLACED TO THE SATISFACTION OF THE ENGINEER.
- THE WORK ASSOCIATED WITH THE CONNECTION OF EXISTING STORM SEWER SYSTEMS TO PROPOSED STORM SEWER STRUCTURES WILL NOT BE PAID FOR SEPARATELY BUT SHALL BE INCLUDED IN THE COST OF THE
- THE CONTRACTOR SHALL ONLY BE ALLOWED TO PLACE TRENCH BACKILL FOR STORM SEWER BY EITHER METHOD 1 OR METHOD 2 ACCORDING TO ARTICLE 550.07 OF THE STANDARD SPECIFICATIONS.
- ANY LOOSE MATERIAL DEPOSITED IN THE FLOW LINE OF DRAINAGE STRUCTURES, WHICH OBSTRUCTS THE NATURAL FLOW OF WATER SHALL BE REMOVED AT THE CLOSE OF EACH WORKING DAY. PRIOR TO ACCEPTANCE OF THE IMPROVEMENT, ALL DRAINAGE STRUCTURES SHALL BE FREE OF DIRT AND DEBRIS. THIS WORK WILL NOT BE PAID FOR SEPARATELY, BUT SHALL BE CONSIDERED AS INCLUDED IN THE UNIT
- FOR WORK OUTSIDE THE LIMITS OF BRIDGE APPROACH PAVEMENT, ALL REFERENCES IN THE HIGHWAY STANDARDS AND STANDARD SPECIFICATIONS FOR REINFORCEMENT, DOWEL BARS AND TIE BARS IN PAVEMENT, CURB, GUTTER, COMBINATION CURB AND GUTTER AND MEDIAN, AND CHAIR SUPPORTS FOR CRC PAVEMENT, SHALL BE EPOXY COATED, UNLESS NOTED ON THE PLAN.
- EXISTING BROKEN FRAMES AND LIDS SHALL BE REMOVED AND DISPOSED OF BY THE CONTRACTOR AND SHALL BE REPLACED AS DIRECTED BY THE ENGINEER REPLACEMENT FRAMES AND LIDS WILL BE PAID FOR ACCORDING TO ARTICLE 109.04 OF THE STANDARD SPECIFICATIONS UNLESS A SEPARATE PAY ITEM HAS
- ALL EXCAVATED SOIL SHALL BE PLACED WITHIN THE IDOT RIGHT-OF-WAY, WITHIN THE PROJECT LIMITS
- CONTRACTOR CONSTRUCTION ACCESS TO IL-53 RAMP BASIN AREA SHALL ONLY BE FROM IL-62. THE CONTRACTOR WILL NOT BE ALLOWED TO ACCESS THE SITE FROM IL-63 EXIT RAMP.

SIGNING AND STRIPING

- SEE IDOT STANDARD DETAIL 780001, DISTRICT ONE DETAIL AND PLAN SHEETS FOR PAVEMENT MARKING
- SIGNS SHALL NOT BE MOVED OR COVERED UNTIL PROGRESS OF WORK NECESSITATES IT.
- THE CONTRACTOR WILL BE REQUIRED TO TEMPORARILY RESET ALL SUCH SIGNS THAT INTERFERE WITH HIS CONSTRUCTION OPERATIONS. ALL SUCH SIGNS MUST BE MAINTAINED STRAIGHT AND CLEAN FOR THE DURATION OF THE TEMPORARY SETTING AND MUST BE RE-ERECTED AT A TEMPORARY LOCATION IN A WORKMANLIKE MANNER AND BE VISIBLE TO THE TRAFFIC FOR WHICH ITS INTENDED. THIS WORK WILL NOT BE PAID FOR SEPARATELY, BUT SHALL BE INCLUDED IN THE UNIT BID PRICES OF THE CONTRACT.

PROJECT CONTROL

- SET IRON BAR AT THE NORTHWEST CORNER OF IL-62 AND ENTRANCE/EXIT RAMP FOR IL-53. (STA. 135+99.62, 137.4' LT) COORDINATES: 1067742.9500, 1965530.4740 ELEV: 711.916
- SET IRON BAR, APPROXIMATELY 700' NORTH OF IL-62 AND ENTRANCE/EXIT RAMP FOR IL-53. ISTA. 135+41.51. 697.78' LT) CORROINATES: 1067834.7030, 1966086.2900

1433 HRGreei



USER NOME + bhartma	DESIGNED - BH	REVISED -
FILE NAME + 85100196-52-sht-gen-01.dgn	DRAWN - DS	REVISED -
PLOT SCALE = N.T.S.	CHECKED - TH	REVISED -
 PLOT DATE + 10/15/2015	DATE - 10/15/15	REVISED -

STATE OF ILLINOIS DEPARTMENT OF TRANSPORTATION

GENERAL NOTES CDOK 342 531-1-T 24 3 CONTRACT NO. 62A27 SCALE: N.T.S. SHEET NO. 1 OF 1 SHEETS | STA. TO STA. FEB. ROAD DIST. NO. ILLINOIS FED. AID PROJECT

GENERAL NOTES

EROSION CONTROL

- SOIL DISTURBANCE SHALL BE CONDUCTED IN SUCH A MANNER AS TO MINIMIZE EROSION. AREAS OF THE SITE THAT ARE NOT TO BE GRADED SHALL BE PROTECTED FROM CONSTRUCTION TRAFFIC OR OTHER DISTURBANCE UNTIL FINAL SEEDING IS PERFORMED.
- PROPERTIES AND CHANNELS ADJOINING THE SITE SHALL BE PROTECTED FROM EROSION AND
- SOIL EROSION AND SEDIMENT CONTROL FEATURES SHALL BE CONSTRUCTED PRIOR TO THE COMMENCEMENT OF HYDROLOGIC DISTURBANCE OF UPLAND AREAS.
- DISTURBED AREAS SHALL BE STABILIZED WITH TEMPORARY OR PERMANENT MEASURES WITHIN ONE () CALENDAR DAY FOLLOWING THE END OF ACTIVE HYDROLOGIC DISTURBANCE,
- ALL STORM SEWERS THAT ARE OR WILL BE FUNCTIONING DURING CONSTRUCTION SHALL BE PROTECTED BY AN APPROPRIATE SEDIMENT CONTROL MEASURE.
- IF DEWATERING SERVICES ARE USED, ADJOINING PROPERTIES AND DISCHARGE LOCATIONS SHALL BE PROTECTED FROM EROSION, DISCHARGES SHALL BE ROUTED THROUGH AN EFFECTIVE SEDIMENT CONTROL MEASURE (E.G. SEDIMENT TRAP, SEDIMENT BASIN, OR OTHER APPROPRIATE MEASURE).
- ALL TEMPORARY SOIL EROSION AND SEDIMENT CONTROL MEASURES SHALL BE REMOVED WITHIN THIRTY (30) DAYS AFTER FINAL SITE STABILIZATION IS ACHIEVED OR AFTER THE TEMPORARY MEASURES ARE NO LONGER NEEDED. TRAPPED SEDIMENT AND OTHER DISTURBED SOIL AREAS SHALL BE PERMANENTLY
- THE CONTRACTOR SHALL PROVIDE ADEQUATE RECEPTACLES FOR THE DEPOSITION OF ALL CONSTRUCTION MATERIAL DEBRIS GENERATED DURING THE DEVELOPMENT PROCESS THE CONTRACTOR SHALL NOT CAUSE OR PERMIT DUMPING, DEPOSITING, DROPPING, THROWING, DISCARDING OR LEAVING OF CONSTRUCTION MATERIAL DEBRIS UPON OR INTO THE CONSTRUCTION SITE, CHANNEL, WATERS OF THE UNITED STATES THE CONTRACTOR SHALL MAINTAIN THE CONSTRUCTION SITE FREE OF CONSTRUCTION MATERIAL DEBRIS.
- ALL TEMPORARY AND PERMANENT EROSION AND SEDIMENT CONTROL MEASURES SHALL BE MAINTAINED IN AN EFFECTIVE WORKING CONDITION. 9.
- PERMANENT EROSION CONTROL SHALL INCLUDE TOPSOIL EXCAVATION AND PLACEMENT, TOPSOIL FURNISH AND PLACE, 4", SEEDING, CLASS 2A SEEDING, CLASS 4 IMODIFIED), AND SEEDING, CLASS 4B (MODIFIED) TO BE PROVIDED IN ACCORDANCE WITH ARTICLE 250 OF THE STANDARD SPECIFICATIONS.
- ALL ESC MEASURES WILL BE MAINTAINED IN ACCORDANCE WITH THE 100T EROSION AND SEDIMENT CONTROL FIELD GUIDE FOR CONSTRUCTION INSPECTION AND 100TS BEST MANAGEMENT PRACTICES MAINTENANCE GUIDE; (HTTP://www.idot.illindis.gov/transportation-system/environment/erosion-and-sediment-co
- THE CONTRACTOR WILL ASSUME RESPONSIBILITY FOR MAINTENANCE OF ALL SOIL EROSION CONTROL DURING CONSTRUCTION.
- THE CONTRACTOR SHALL CHECK ALL ESC MEASURES WEEKLY AND AFTER EACH RAINFALL, O.5 INCHES OR CREATER IN A 24-HOUR PERIOD, OR EQUIVALENT SNOWFALL, ADDITIONALLY DURING WINTER MONTHS, ALL MEASURES SHOULD BE CHECKED BY THE CONTRACTOR AFTER EACH SIGNIFICANT SNOWMELT. 13.
- THE CONTRACTOR SHOULD PROVIDE TO THE RESIDENT ENGINEER A PLAN TO ENSURE THAT A STABILIZED FLOW LINE WILL BE PROVIDED DURING STORM SEWER CONSTRUCTION. THE USE OF A STABILIZED FLOW LINE BETWEEN INSTALLED STORM SEWER AND OPEN DISTURBANCE WILL REDUCE THE POTENTIAL FOR THE OFFSITE DISCHARGE OF SEDIMENT-BEARING WATERS, ESPECIALLY WHEN RAIN IS FORECASTED, SO THAT FLOW WILL NOT EROOE, LACK OF APPROVED PLAN OR FAILURE TO COMPLY WILL RESULT IN AN ESC
- ANY LOOSE MATERIAL DEPOSITED IN THE FLOW LINE OF DRAINAGE STRUCTURES, WHICH OBSTRUCTS THE NATURAL FLOW OF WATER, SHALL BE REMOVED AT THE CLOSE OF EACH WORKING DAY, PRIOR TO ACCEPTANCE OF THE IMPROVEMENT, ALL ORAINAGE STRUCTURES SHALL BE FREE OF DIRT AND DEBRIS, THIS WOK WILL NOT BE PAID FOR SEPARATELY BUT SHALL BE CONSIDERED AS INCIDENTAL.
- TEMPORARY OR PERMANENT STABILIZATION SHALL BE INITIATED IMMEDIATELY UPON COMPLETION OF DISTURBANCE OR IF THE WORK AREA IS TO BE LEFT UNDISTURBED FOR 14 DAYS OR MORE.
- LINDER NO CIRCUMSTANCE SHALL THE CONTRACTOR PROLONG FINAL GRADING AND SHAPING SO THAT THE ENTIRE PROJECT CAN BE PERMANENTLY SEEDED AT ONE TIME.
- EROSION CONTROL ITEMS ARE CONSIDERED TO BE A HIGH PRIORITY ON THIS CONTRACT. THE CONTRACTOR IS RESPONSIBLE FOR INSTALLATION OF ANY ADDITIONAL EROSION CONTROL MEASURES NECESSARY TO PREVENT EROSION AND SEDIMENTATION AS DETERMINED BY THE RESIDENT ENGINEER.
- THE DEPARTMENT HAS NOT OBTAINED ANY PERMITS FOR OFFSITE BORROW, WASTE, USE (BWU) AREAS. PRIOR TO WORKING IN BWU AREAS, IF THE CONTRACTOR CHOOSES TO USE ACTIVITIES REQUIRING PERMITS IT IS THE CONTRACTORS RESPONSIBILITY TO SECURE THE PROPER PERMITS. IN ADDITION TO THE BORROW REVIEW (BDE 2289) AND USE/WASTE REVIEW (BDE 2290) SUBMITTALS, THE CONTRACTOR SHALL SUBMIT AND EROSION AND SEDIMENT CONTROL (ESC) PLAN FOR EVERY BWU SITE TO THE DEPARTMENT FOR ACCEPTANCE, QUIDELINES FOR ACCEPTABLE BWU PRACTICES CAN BE FOUND IN SECTION IL.G.I AND 2 OF THE SWPPP. THE COST OF ALL MATERIALS AND LABOR DECESSARY TO COMPLY WITH THE ABOVE PROVISIONS TO PREPARE AND IMPLEMENT ESC PLANS WILL NOT BE PAID FOR SEPARATELY, BUT SHALL BE CONSIDERED AS INCLUDED IN THE UNIT BID PRICES OF THE CONTRACT AND NO ADDITIONAL COMPENSATION WILL BE ALLOWED. COMPENSATION WILL BE ALLOWED.

POLICE CONTACT: 4590-ECT.CO CAUNT.

DATE PLOTEG. 1907-2018 SA FLE MANS: 66100156-52-1 RLI ORNES. 11_00F.be-201 FN 1AB.E. portobella

HRGreen.com

Study Professional Declary New

194401322

 USER NAME * bhartea
 DESIGNED 8H
 REVISED

 FILE NAME * 88100196-52-aht-sum.dgn
 ORAWN DS
 REVISED

 PLOT SCALE * N.T.S.
 CHECKED TH
 REVISED

 PLOT ONTE * 37/8/2016
 DATE 03/08/16
 REVISED

STATE OF ILLINOIS DEPARTMENT OF TRANSPORTATION

SCALE: N.T.S. SHEET NO. 1 OF 2 SHEETS STA.

JMMARY OF QUANTITIES

1 OF 2 SHEETS STA. TO STA. F

*	SPECIALTY	ITEMS	

	SUMMARY OF QUANTITIES		UNOAN	CONSTRUCTION T
CODE NO.	ITEM DESCRIPTION	UNIT	TOTAL OUANTITIES	DRAINAGE 100%, STATE
CODE NO.	I CON DESCRIPTION	0,41	OUANTI SICO	1007, 31412
20100110	TREE REMOVAL (6 TO 15 UNITS DIAMETER)	UNIT	117	117
20200100	EARTH EXCAVATION	CU YD	15,545	15,545
20800150	TRENCH BACKFILL	CU YO	86	86
21101505	TOPSOIL EXCAVATION AND PLACEMENT	CU YD	1.090	1,090
21101615	TOPSOIL FURNISH AND PLACE, 4"	\$0 YO	21,495	21,495
25000210	SEEDING, CLASS ZA	ACRE	1.00	1.00
25000400	NITROCEN FERTILIZER NUTRIENT	POUND	675	675
25000500	PHOSPHORUS FERTILIZER NUTRIENT	POUND	675	675
25000600	POTASSIUM FERTILIZER NUTRIENT	POUNO	675	675
25100115	MULCH, METHOD 2	ACRE	7.50	7,50
28000250	TEMPORARY EROSION CONTROL SEEDING	POUND	750	750
28000305	TEMPORARY DITCH CHECKS	F001	30	30
28000400	PERIMETER EROSION BARRIER	F001	425	425
28000510	INLET FILTERS	EACH	6	6
28100107	STONE RIPRAP, CLASS A4	50 YD	59.	59
28200200	FILTER FABRIC	50 YD	70	70
44200050	WELDED WIRE REINFORCEMENT	SO YD	107	107
44200974	CLASS 8 PATCHES, TYPE III, 10 INCH	50 YD	107	107
44201299	DOWEL BARS 1 1/2"	EACH	50	50
44213200	SAW CUTS	FOOT	412	412
44213208	TIE BARS 11/4"	EACH	50	50
54213669	PRECAST REINFORCED CONCRETE FLARED END SECTIONS 24"	EACH	2	ż
55040050	STORM SEWERS, CLASS A, TYPE 1 12"	FOOT	20	20
550A0340	STORM SEWERS, CLASS A, TYPE 2 12"	F00T	10	10
550A0360	STORM SEWERS, CLASS A, TYPE 2 15"	FOOT	52	\$2

	SUMMARY OF QUANTITIES		URBAN	CONSTRUCTION TYPE
CODE NO.	ITEM DESCRIPTION	UNIT	TOTAL QUANTITIES	DRAINAGE 100% STATE
S50A0380	STORM SEWERS, CLASS A, TYPE 2 18"	F001	35	35
550A0410	STORM SEWERS, CLASS A, TYPE 2 24"	FOOT	60	60
550A0710	STORM SEWERS, CLASS A, TYPE 3 24"	FOOT	318	318
55100700	STORM SEWER REMOVAL 15"	FOOT	52	52
55100900	STORM SEWER REMOVAL 18"	FOOT	155	155
60201340	CATCH BASINS, TYPE 4. 4'-DIAMETER, TYPE 24 FRAME AND GRATE	EACH	1	
60506600	CATCH BASINS, TYPE B, TYPE 7 CRATE	EACH	1	1
60208240	CATCH BASINS, TYPE C. TYPE 24 FRAME AND GRATE	EACH	1	
60221100	MANHOLES, TYPE A, 5'-DIAMETER, TYPE 1 FRAME, CLOSED LID	EACH	1	
60237470	INLETS, TYPE A, TYPE 24 FRAME AND GRATE	EACH	2	2
60500040	REMOVING MANHOLES	EACH	1	1 I
60500050	REMOVING CATCH BASINS	EACH	1	1
60500060	REMOVING INLETS	EACH	. 1	1
66400105	CHAIN LINK FENCE. 4'	F001	50	50
-				
61000400	ENGINEER'S FIELD OFFICE, TYPE A	CAL MO	6	6
67100100	MOBIL:ZATION	LSUM	I	1
		~		· · · · · · · · · · · · · · · · · · ·
70107004	PAVEMENT MARKING BLACKOUT TAPE, 4"	FOOT	80	80
70300150	SHORT TERM PAVEMENT MARKING REMOVAL	SO FT	1.524	1.524
10300510	PAVEMENT MARKING TAPE, TYPE III - LETTERS AND SYMBOLS	50 FT	72.6	72.6
70300520	PAVEMENT MARKING TAPE, TYPE III 4"	COOT	210 5	7 210
.0200320	7	FODT	3,919	3,919
70300540	PAVEMENT MARKING TAPE, TYPE III 6"	FOOT	289	289
7000000				
/8008210	POLYUREA PAVEMENT MARKING TYPE I - LINE 4"	FOOT	50	50
78008230	FOLYUREA PAVEMENT MARKING TYPE 1 - LINE 6"	F001	10	10
				-
85000200	MAINTENANCE OF EXISTING TRAFFIC SIGNAL INSTALLATION	EACH	4	4
				reference

USER NAME : bhortmo	DESIGNED	-	BH	REVISED	•
FILE NAME + 86100196-52-sht-sum,dgn	DRAWN	-	os	REVISED	•
PLOT SCALE : N.T.S.	CHECKED	-	TH	REVISED	•
 PLOT DATE = 3/8/2016	DATE	-	03/08/16	REVISED	*

STATE OF ILLINOIS DEPARTMENT OF TRANSPORTATION

IL ROUTE 53	F.A.	A.U. SECT	TION		TOTAL SHEETS	SHEET NO.
SUMMARY OF QUANTITIES	34	42 531-	1-T	COOK	24	5
CONTINUES OF ECKIETIES					NO.	62A27
SCALE: N.T.S. SHEET NO. 2 OF 2 SHEETS STA, TO ST	A. FED.		ILLINOIS FED. AID	PROJECT		

٠.	VUE HOL	I TON OCCUPANT FOR	J.,.,	00111171100	10000000000
A	2002916	TREE, CELTIS OCCIDENTALIS (COMMON HACKBERRY), 2" CALIPER, BALLED AND BURLAPPED	EACH	5	5
A	2016818	TREE, OUERCUS SCHUETTI (SWAMP BUR OAK), 1-3/4" CALIPER, BALLED AND BURLAPPED	EACH	4	4
X	0322916	PROPOSED STORM SEWER CONNECTION TO EXISTING STORM SEWER	EACH	17	17
Xŧ	0322917	PROPOSED STORM SEWER CONNECTION TO EXISTING MANHOLE	EACH	1	1
	 				
X	2501800	SEEDING, CLASS 4 (MODIFIED)	ACRE	5,50	5.50
	·		ļ		
X2	2502024	SEEDING, CLASS 46 (MODIFIED)	ACRE	1.00	1.00
X	2511630	EROSION CONTROL BLANKET (SPECIAL)	SO YD	36,300	36,300
٧,	C37000	STADU SEWEDS TO BE SUFAMED 15"	COOT	600	500
A2		STORM SEWERS TO BE CLEANED 15"	FODT	508	508
y 6	DOORER	STORM SEWERS TO BE CLEANED 18"	FOOT	658	658
^-	1320000	THE SEACH OF COMICS IS	1	030	020
x:	538200	STORM SEWERS TO BE CLEANED 24"	FOOT	1,697	1,697
_					
Χŧ	020094	MANHOLES, TYPE A, 6'-DIAMETER. TYPE I FRAME, CLOSED LID. RESTRICTOR PLATE	EACH	1	1
-					
X.	7010216	TRAFFIC CONTROL AND PROTECTION, (SPECIAL)	LSUM	1	1
					_
X	7011015	TRAFFIC CONTROL AND PROTECTION (EXPRESSWAYS)	LSUM	,1	1
ZC	0004562	COMBINATION CONCRETE CURB AND GUTTER REMOVAL AND REPLACEMENT	FOOT	170	170
Z	0013797	STABILIZED CONSTRUCTION ENTRANCE	50 YD	160	160
_			<u> </u>		
20	2013798	CONSTRUCTION LAYOUT	LSUM	1	1
			ļ		
Ζ(0018500	DRAINAGE STRUCTURES TO BE CLEANED	EACH	10	10
ZC	0022800	FENCE REMOVAL	FOOT	50	50
		TOURGARY INCOMESTAL FIGURE	50.57	70	70
۷.	030850	TEMPORARY INFORMATION SIGNING	SO FT	-18	78
		TEMPORARY TRAFFIC SIGNAL TIMING	EACH	4	4
71	1073610				


SUMMARY OF QUANTITIES


CODE NO. ITEM DESCRIPTION

URBAH CONSTRUCTION TYPE

TOTAL UNIT QUANTITIES DRAINAGE 100% STATE

	EMELITATION	CHCCOCHIJON	
LOCATION	TOTAL CUT	TOPSOIL EXE	EARTH EXC (CU YO)
IL-53 INFIELD	16,635	1,090	15,545

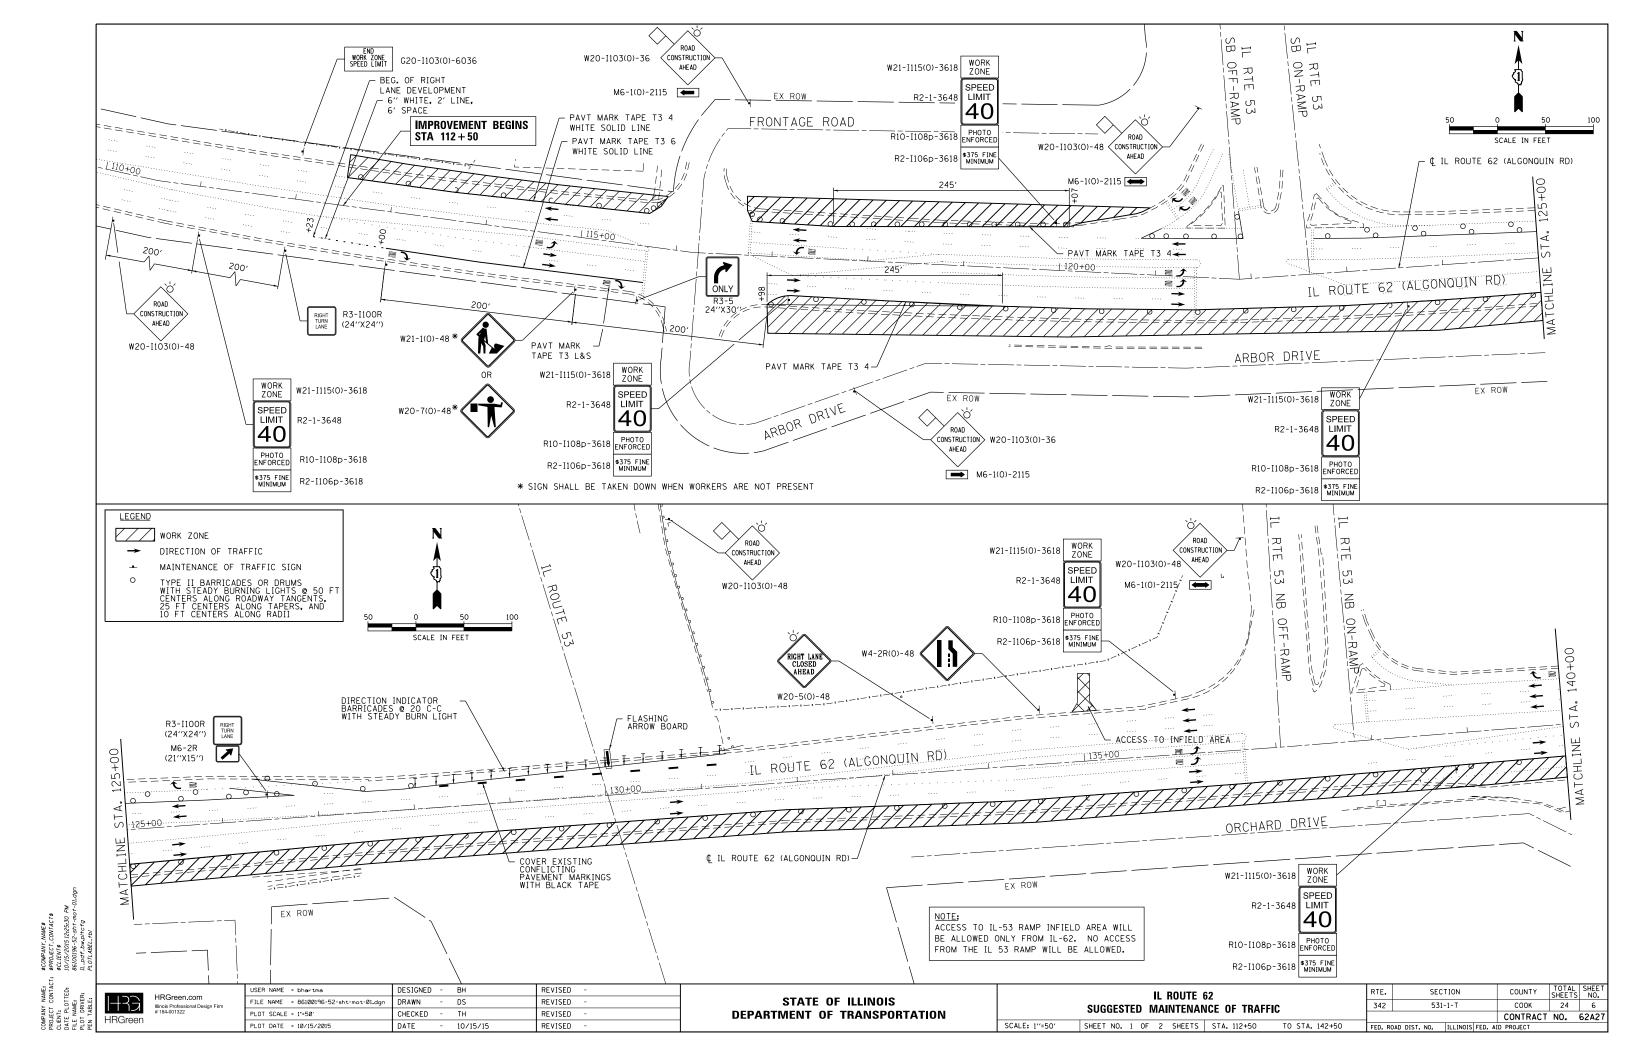

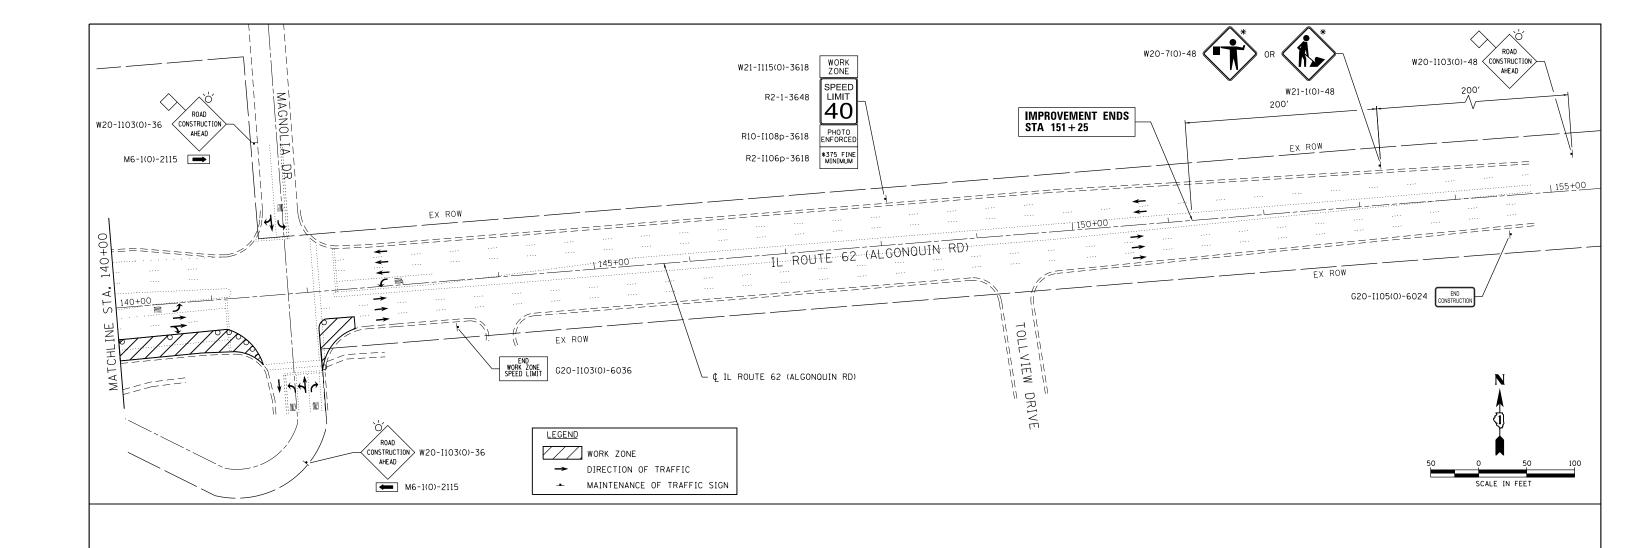

11. \$PROJECT.CONTACTS
\$CLIENT
10/15/2015 12/25:33 PM
86100195-25-517-mot-02.dgn
1L.pdf. 2bw.plt.fg
P.OTLABEL.YD


HRGreen.com
Illinois Professional Design Firm
#184-001322


USER NAME = bhartma	DESIGNED	-	Вн	REVISED -	
FILE NAME = 86100196-52-sht-mot-02.dgn	DRAWN	-	DS	REVISED -	
PLOT SCALE = I*=50'	CHECKED	-	TH	REVISED -	
PLOT DATE = 10/15/2015	DATE	-	10/15/15	REVISED -	

STATE OF ILLINOIS							
DEPARTMENT	OF TRANSPORTA	LION					

SCALE: 1"=50"

IL ROUTE 62	RTE. SECTION		COUNTY	TOTAL SHEETS	SHEET NO.
SUGGESTED MAINTENANCE OF TRAFFIC	342	531-1-T	COOK	24	7
OUGEDIED MAINTENANCE OF THAT TO			CONTRACT	NO.	62A27
SHEET NO. 2 OF 2 SHEETS STA. 142+50 TO STA. 151+25	FED. RO	DAD DIST. NO. ILLINOIS FED. AI	D PROJECT		

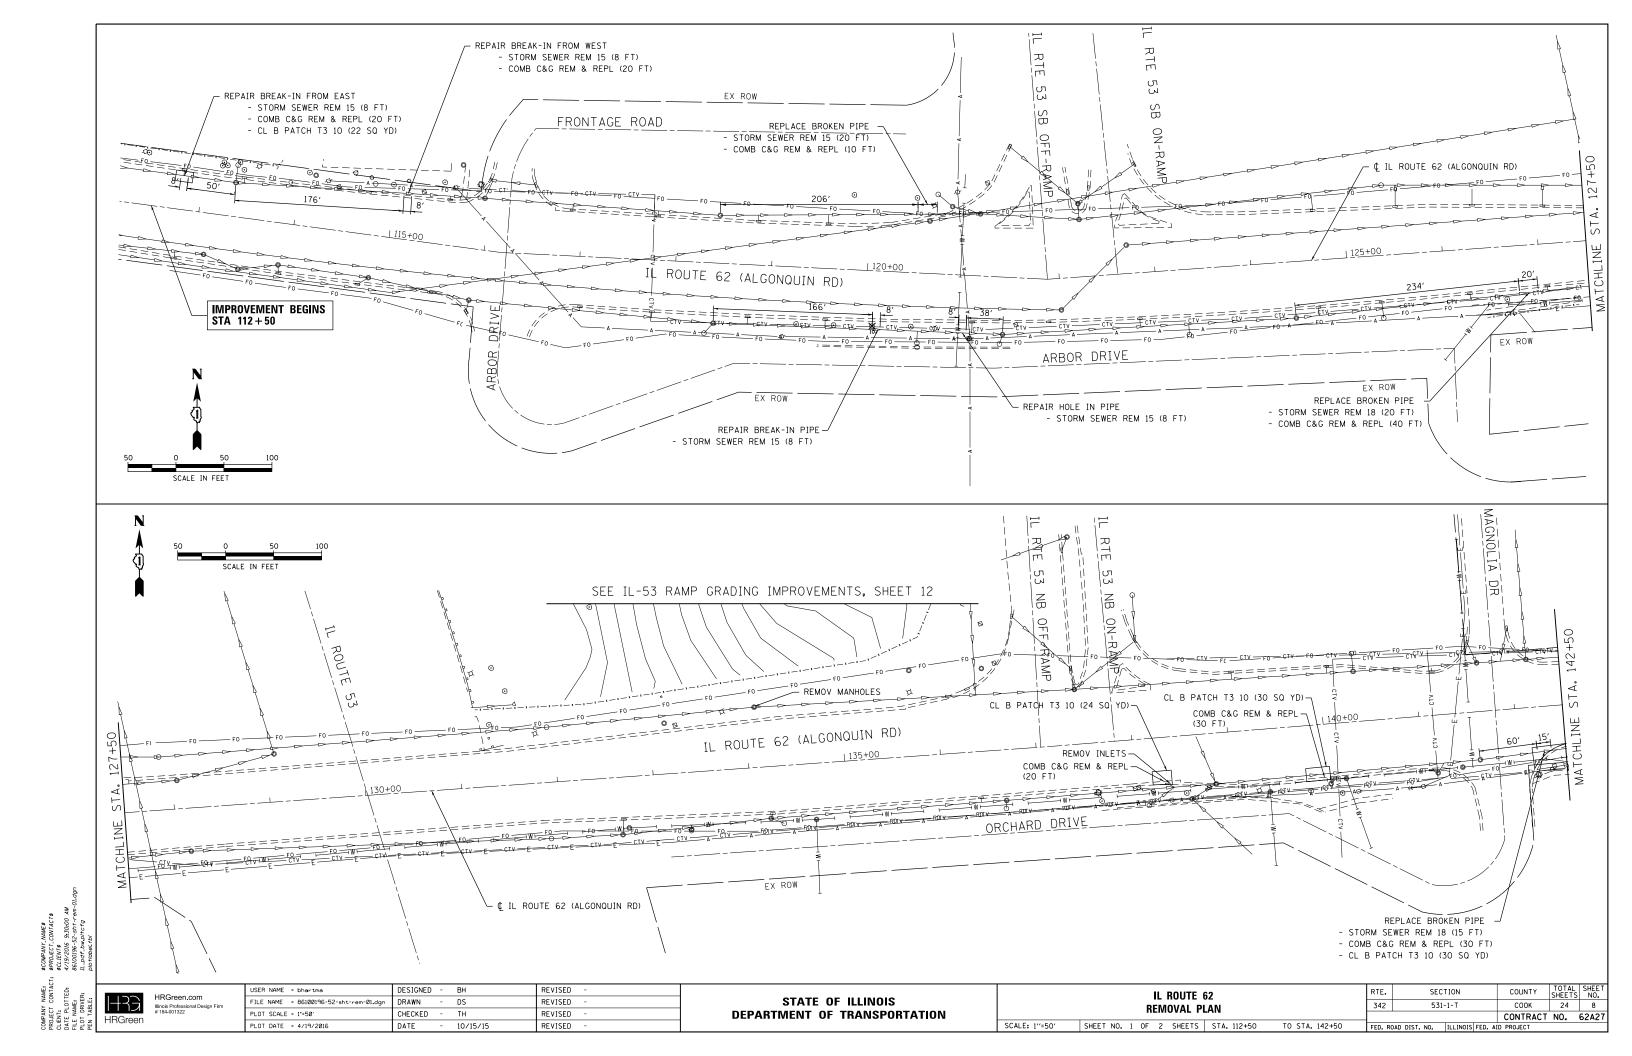

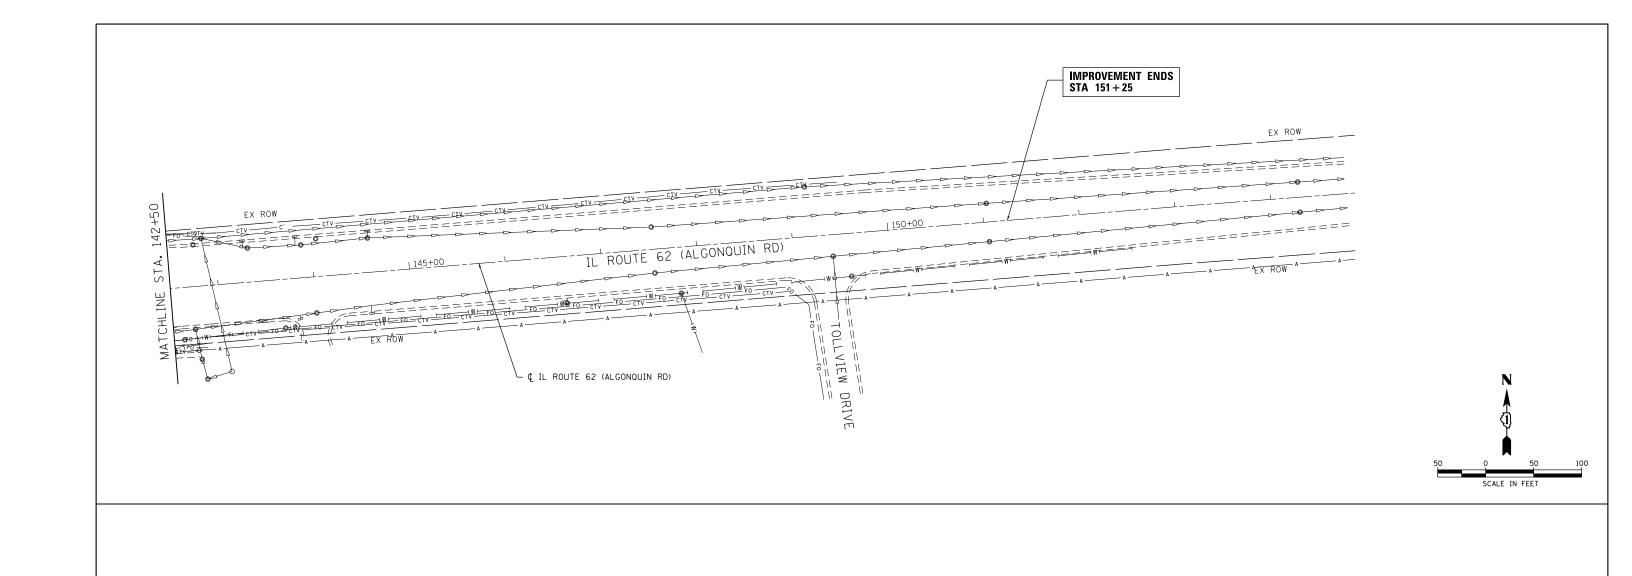

NVTACT: #PROJECT_CONTACT\$


\$CLIENT\$


*CLIENT\$

HRGreen.com
Illinois Professional Design Firm
184-001322

STATE OF ILLINOIS
DEPARTMENT OF TRANSPORTATION

| RTE. | SECTION | COUNTY | SHEET NO. | 2 | OF 2 | SHEET NO. | 2 | OF 2 | SHEET NO. | 2 | OF 2 | SHEET NO. | OF 2 | OF 2 | SHEET NO. | OF 2 |

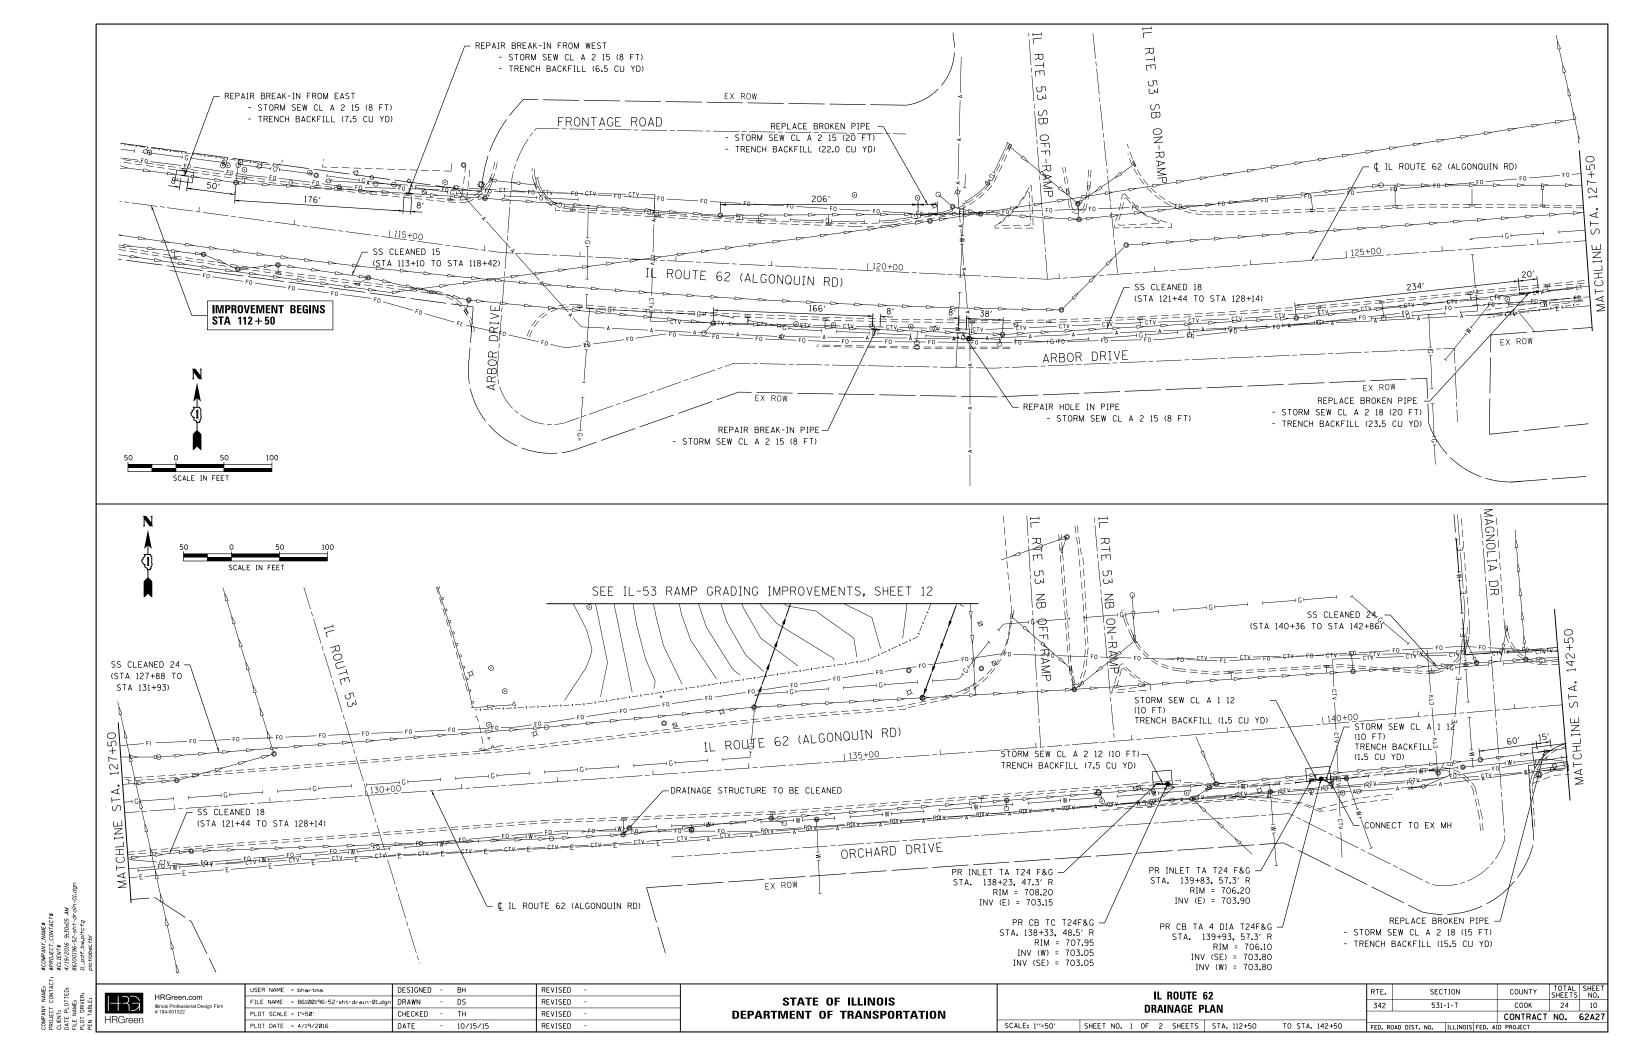


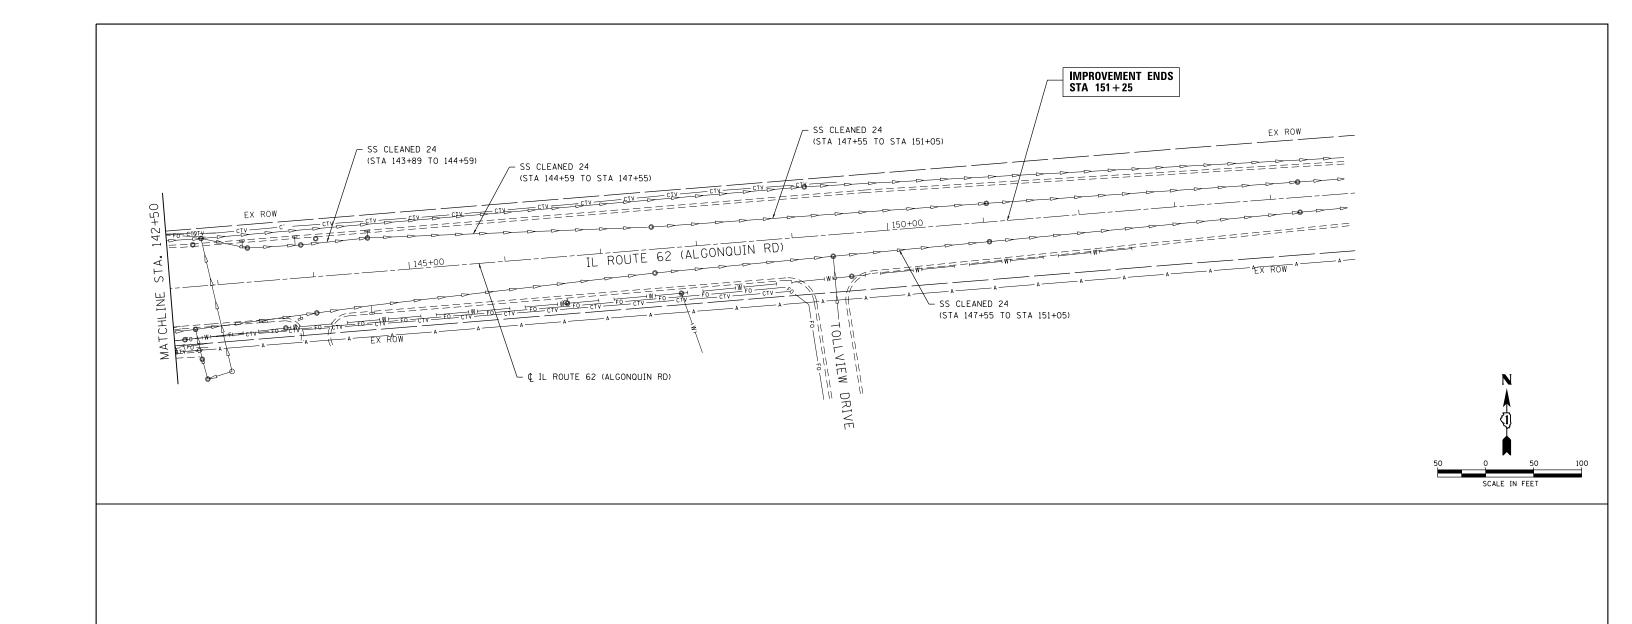



HRGreen.com
Illinois Professional Design Firm
184-001322


STATE OF ILLINOIS
DEPARTMENT OF TRANSPORTATION

| RTE. | SECTION | COUNTY | SHEET | SOUTE 62 | SECTION | COUNTY | SHEET | STEET | STEE

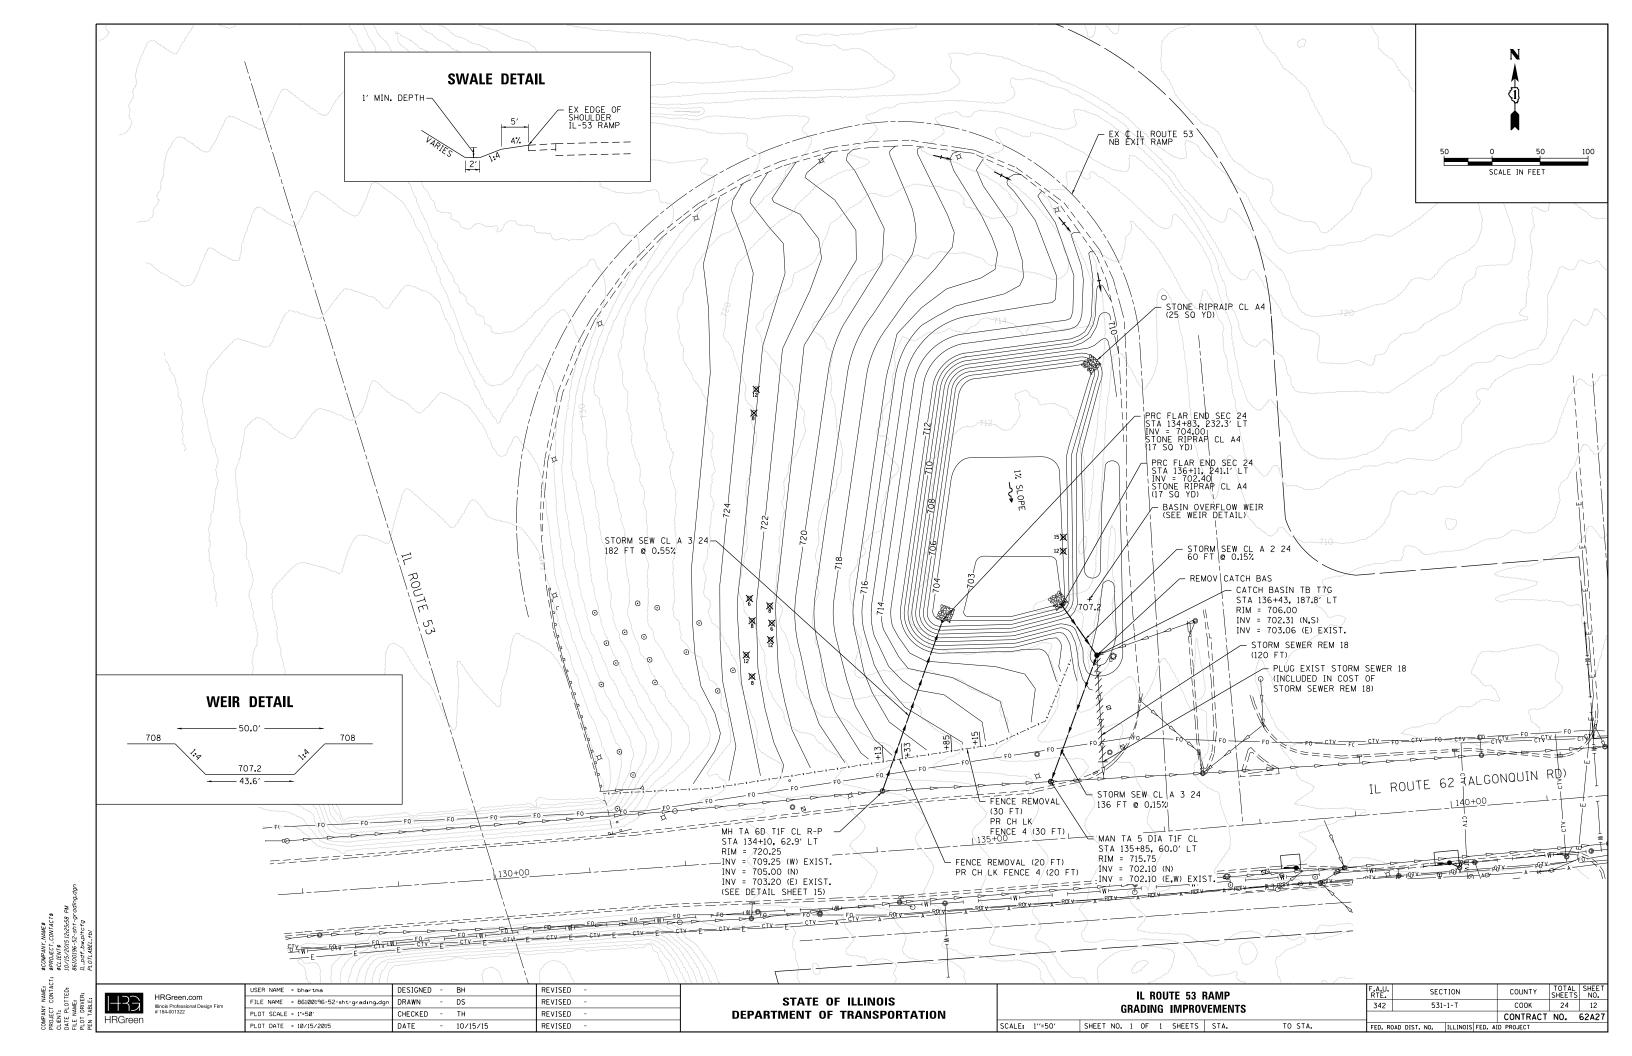

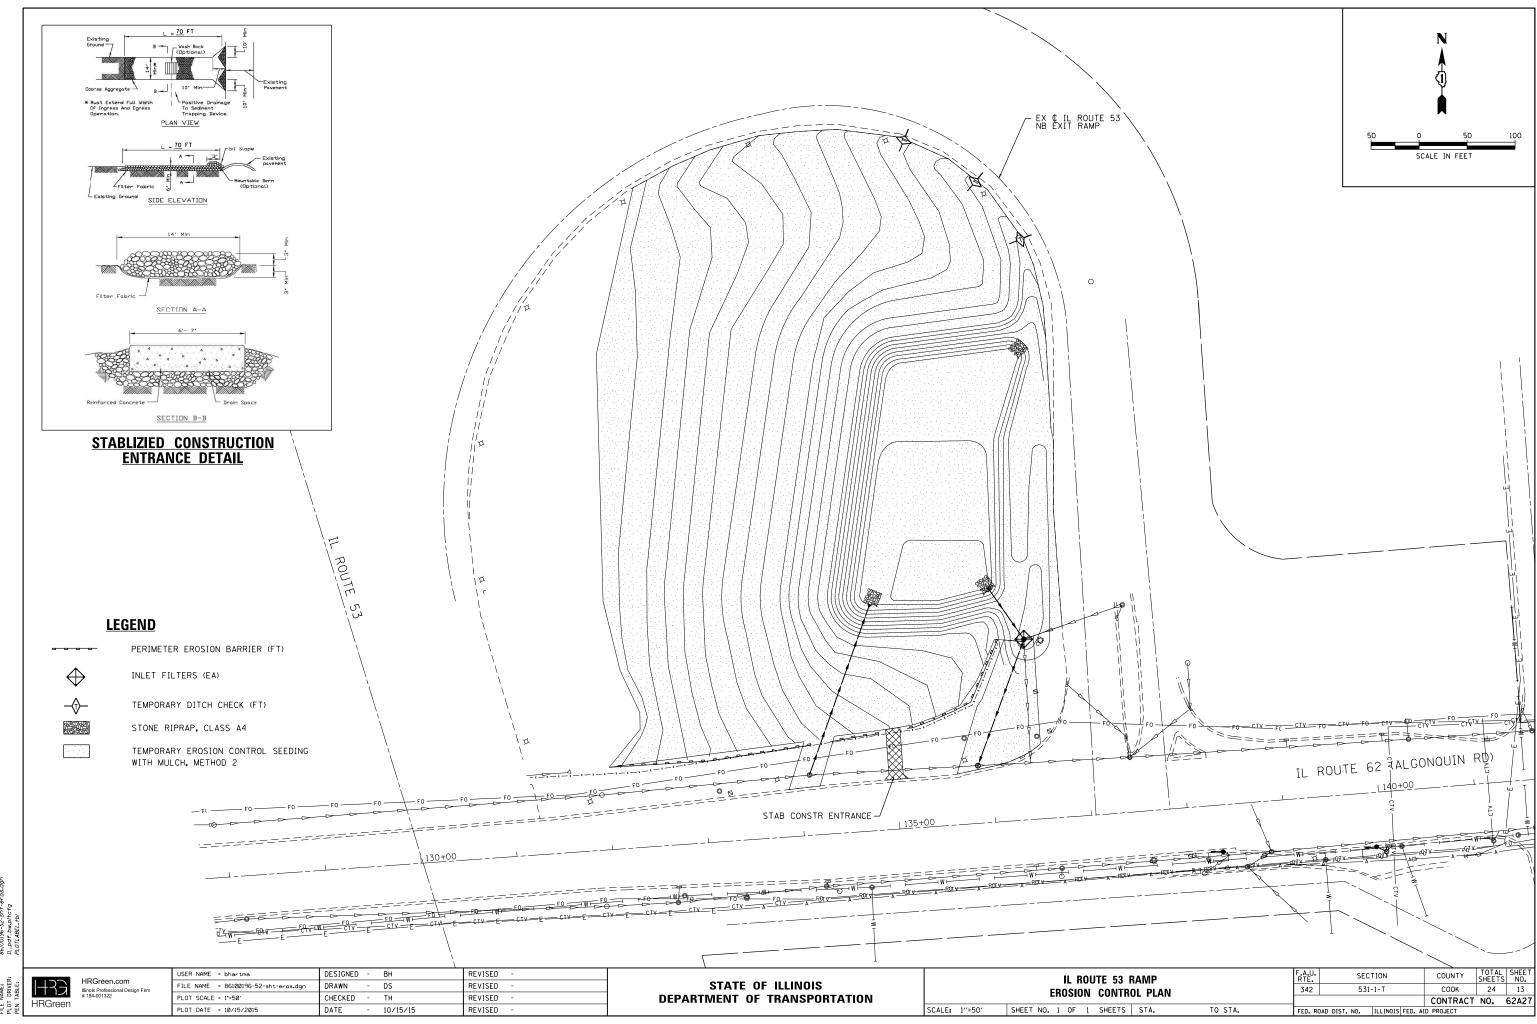

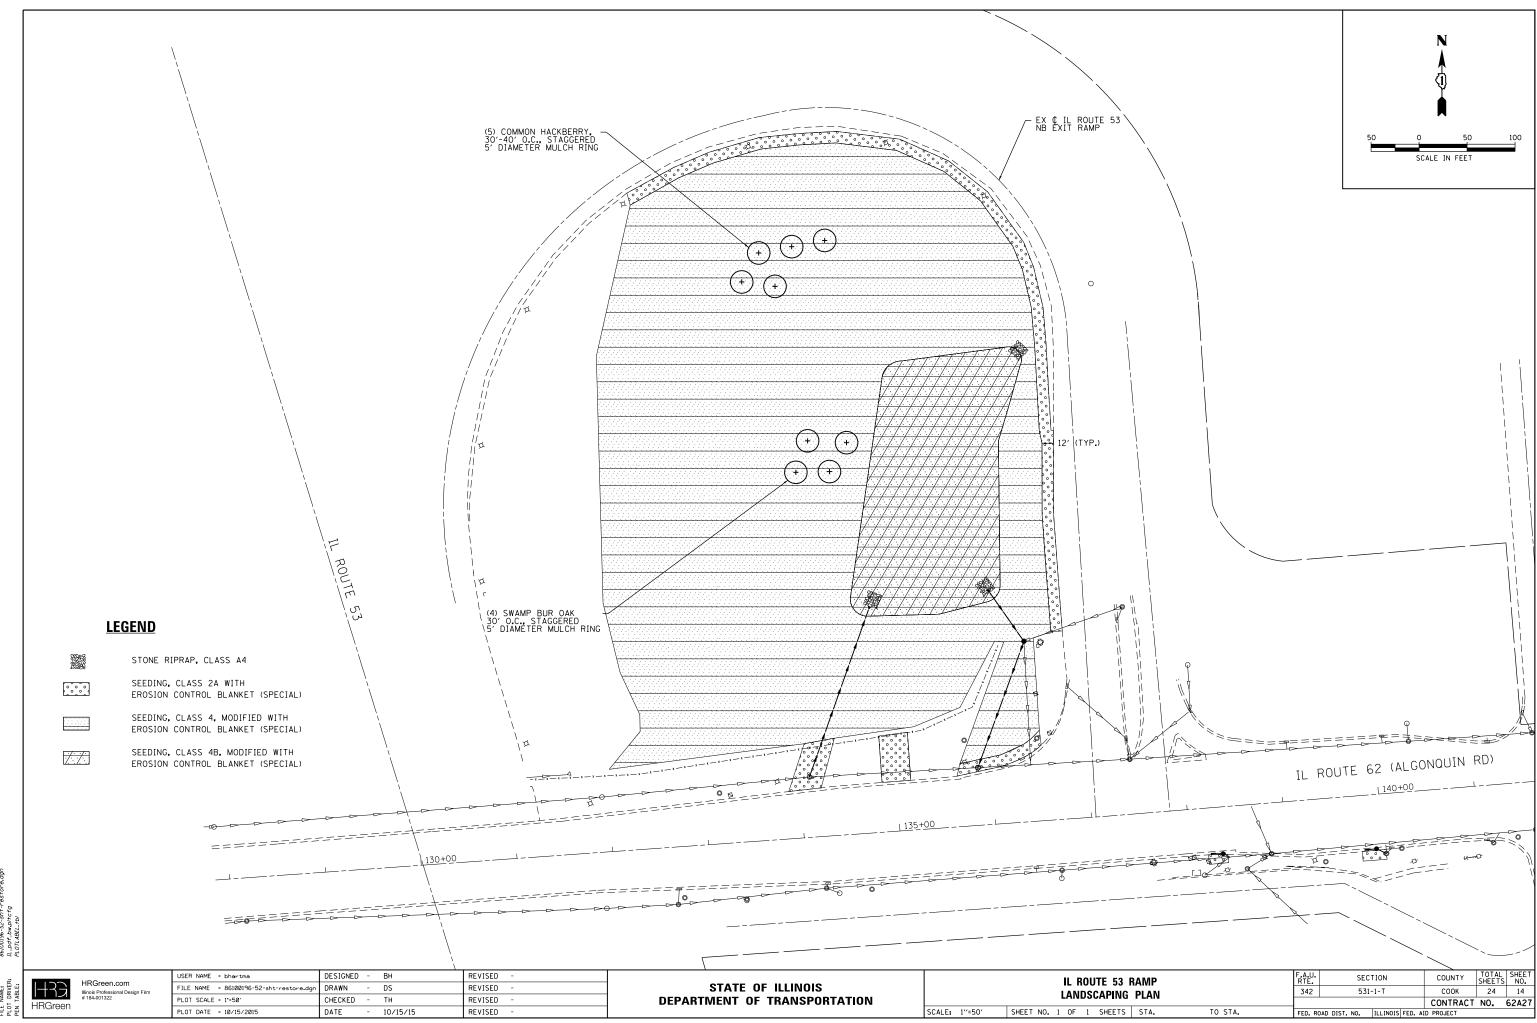


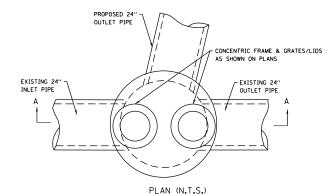


2-24" (600) DIA. OPENINGS IN FLAT SLAB TOP WITH 2 FRAMES AND GRATES/LIDS 5/8" (16) STEEL RESTRICTOR PLATE TOP OF GRATE LID ELEVATION - 3'x3' (75x75) STEEL ANGLES RESTRICTOR TYPE AS NOTED -IN RESTRICTOR TABLE - MANHOLE, TYPE A 2 SETS OF STEPS (STD. 602406) INLET PIPE ¬ OUTLET PIPE

SECTION A-A (N.T.S.)


STATION	MANHOLE DIAMETER	FRAME AND GRATE	RESTRICTOR TYPE	INSIDE RESTRICTOR TYPE DIAMETER	INVERT OF RESTRICTOR TYPE	ELEVATION OF TOP OF PLATE OVERFLOW
134+10	6	T1 F&G CL	3	12''	703.20	707.2

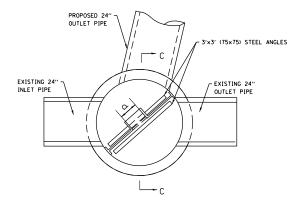


SECTION B-B (N.T.S.)

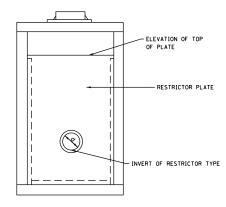

SECTION C-C (N.T.S.)

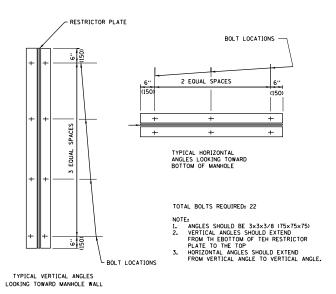


STEEL ANGLE BOLTING DETAILS

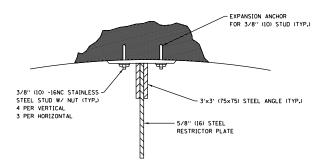

ANGLE FASTENER DETAIL

SCALE: N.T.S.

- 1. ALL STEEL ANGLES AND PLATES TO BE GALVANIZED AFTER FABRICATION 2. ALL RESTRICTOR PLATES, ANGLES AND HARDWARE TO BE INCLUDED IN THE COST OF THE MANHOLE 3. BASIS OF PAYMENT: "MANHOLES, TYPE A, CLOSED LID, RESTRICTOR PLATE", EACH

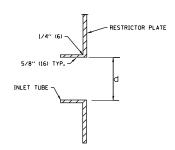

INLET TUBE DETAIL

RESTRICTOR TYPE										
1	2	3	5	6						
RE-ENTRANT TUBE	SHARP EDGED	SQUARE EDGED	RE-ENTRANT TUBE	SQUARE EDGED	ROUNDED					
LENGTH 0.5 TO 1 DIA		STREAM CLEARS SIDE		LENGTH: 2.5 DIA.						
C=.52	C=.61	C=.61	C=.73	C=.82	C=.98					

VALUES OF "C" FOR CIRCULAR AND SQUARE ORIFICES

ALL DIMENSIONS ARE IN INCHES (MILLIMETERS) UNLESS OTHERWISE SHOWN.

HRGreen.com HRGreen


	USER NAME = bhartma	DESIGNED	-	ВН	REVISED -
Г	FILE NAME = 86100196-52-sht-detail-restr	cBaR-AdMgN	-	DS	REVISED -
Г	PLOT SCALE = N.T.S.	CHECKED	-	TH	REVISED -
Г	PLOT DATE = 10/15/2015	DATE	-	10/15/15	REVISED -


STATE OF ILLINOIS **DEPARTMENT OF TRANSPORTATION**


CONSTRUCTION DETAILS		F.A.U. RTE.	SEC	TION	COUNTY	TOTAL SHEETS	SHEET NO.		
RESTRICTOR STRUCTURE				342	531	-1-T	COOK	24	15
	neormoron on	OUTOIL		_			CONTRACT	NO.	62A27
	SHEET NO. 1 OF 10 SHEETS	STA.	TO STA.	FED. RO	DAD DIST, NO.	ILLINOIS FED. AI	D PROJECT		

DETAIL "A"

LATERAL CONNECTION TO EXISTING SEWER OF 27" (675) OR SMALLER

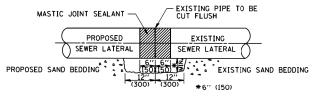

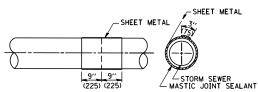


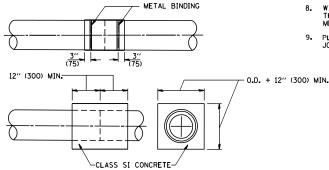

DETAIL "B" CLASS SI CONCRETE COLLAR

CONSTRUCTION SEQUENCE

- 1. CUT THE EXISTING END OF THE PIPE SO AS TO PRESENT A FLUSH BUTT JOINT. BRUSH AND CLEAN ALL PIPES.
- 2. APPLY THE MASTIC JOINT SEALANT TO THE FIRST 6" (150) OF EACH PIPE.
- 3. Butt the PiPEs together leaving a minimum of 12' \times 6' (300 \times 150) DEEP EXCAVATION UNDER AND AROUND EACH PIPE END.
- 4. CUT A PIECE OF SHEET METAL GAGE NO. 19 1.1 (0.0418) 18" (450) WIDE BY THE OUTSIDE CIRCUMFERANCE OF THE PIPE PLUS 3" (75) LONG.
- WRAP THE SHEET METAL AROUND THE PIPES, 9" (225) ON EACH SIDE OF THE JOINT, STARTING AT THE TOP OF THE PIPE.
- LAP THE SHEET METAL AT LEAST 3" (75) AT THE TOP OF THE PIPE AND PLACE THE MASTIC JOINT SEALANT BETWEEN THE LAP.
- PLACE TWO METAL BANDS AROUND THE SHEET METAL AND TIGHTEN.
- 8. WIPE OFF ANY EXCESS MASTIC JOINT SEALANT THAT OOZES OUT FROM BETWEEN THE SHEET METAL AND THE PIPES.
- 9. PLACE CLASS SI CONCRETE AROUND THE JOINT.

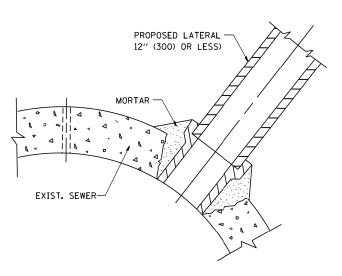

DETAIL "C"

PROPOSED LATERAL CONNECTION TO EXISTING SEWER OF 30" (750) OR LARGER

NOTES

MATERIAL

MATERIAL USED FOR THE TEE OR WYE SECTION SHALL BE COMPATIBLE WITH THE EXISTING STORM SEWER OR THE PROPOSED STORM SEWER.

- I. THIS WORK SHALL BE CONSTRUCTED IN CONFORMANCE WITH THE APPLICABLE PORTIONS OF SECTION 550 OF THE STANDARD SPECIFICATIONS.
- II. CONNECTION TO AN EXISTING STORM SEWER SHALL BE BY EITHER OF THE FOLLOWING METHODS: A) PROPOSED STORM SEWER CONNECTION TO EXISTING SEWER OF 27" (675) OR SMALLER SEE
 - B) PROPOSED STORM SEWER CONNECTION TO EXISTING SEWER OF 30" (750) OR LARGER SEE

IF THE EXISTING SEWER PIPE IS CRACKED, BROKEN OR OTHERWISE DAMAGED BY THE CONTRACTOR IN MAKING THE CIRCULAR OPENING, THE CONTRACTOR SHALL REPLACE THAT SECTION OF PIPE WITH PIPE EQUAL AND SIMILAR IN ALL RESPECTS TO THE PIPE IN THE EXISTING SEWER, IN A CAREFUL WORKMANLIKE MANNER, WITHOUT EXTRA COMPENSATION

GENERAL

CARE MUST BE TAKEN TO PREVENT DEBRIS FROM ENTERING THE SEWER. DEBRIS WHICH ENTERS THE SEWER MUST BE REMOVED. THE SEWER MUST BE LEFT CLEAN AND UNOBSTRUCTED UPON COMPLETION OF THE CONTRACT.

CARE MUST BE TAKEN TO PREVENT ANY PART OF THE NEW PIPE CONNECTION FROM PROJECTING INTO THE EXISTING SEWER.

BASIS OF PAYMENT

TEE OR WYE CONNECTIONS SHALL BE PAID FOR AT THE CONTRACT UNIT PRICE EACH FOR STORM SEWER TEE OR WYE OF THE TYPE AND SIZE SPECIFIED IN THE PLANS, THIS PRICE SHALL INCLUDE ALL EXCAVATION OF THE TRENCH, REMOVAL OF THE EXISTING STORM SEWER, FURNISHING AND INSTALLING THE SPECIFIED TEE OR WYE SECTION, FURNISHING AND INSTALLING THE REQUIRED CONCRETE COLLAR, AND ALL OTHER MATERIAL NECESSARY TO COMPLETE THIS WORK AS SHOWN AND SPECIFIED.


REMOVAL AND REINSTALLATION OF EXISTING STORM SEWER ADJACENT TO THE PROPOSED TEE OR WYE SECTION, FOR THE PURPOSE OF FACILITATING THE INSTALLATION OF THE TEE OR WYE SECTION, WILL NOT BE PAID FOR SEPARATELY BUT SHALL BE INCLUDED IN THE UNIT PRICE BID FOR THE WORK.

TRENCH BACKFILL, EXCAVATION IN ROCK AND REMOVAL AND REPLACEMENT OF UNSUITABLE MATERIAL BELOW PLAN BEDDING GRADE WILL BE PAID FOR SEPARATELY.

CONCRETE COLLAR FOR CONNECTING A PROPOSED STORM SEWER TO AN EXISTING STORM SEWER WILL NOT BE PAID PAID FOR SEPARATELY BUT SHALL BE INCLUDED IN THE COST OF THE PROPOSED STORM SEWER.

ALL DIMENSIONS ARE IN INCHES (MILLIMETERS) UNLESS OTHERWISE SHOWN.

DESIGNED - M. DE YONG FILE NAME = REVISED - M. DE YONG 05-08-92 USER NAME = gaglianobt SECTION COUNTY **DETAIL OF STORM SEWER** /:\diststd\22×34\bd07.dqr DRAWN REVISED - R. SHAH 09-09-94 STATE OF ILLINOIS 531-1-T COOK 24 16 CONNECTION TO EXISTING SEWER PLOT SCALE = 50.000 '/ [N. CHECKED REVISED - R. SHAH 10-25-94 **DEPARTMENT OF TRANSPORTATION** BD500-01 (BD-7) CONTRACT NO. 62A2 SCALE: NONE SHEET NO. 1 OF 1 SHEETS STA. TO STA. PLOT DATE = 1/4/2008 DATE 07-25-90 REVISED - R. SHAH 06-12-96 FED. ROAD DIST. NO. 1 | ILLINOIS | FED. AID PROJECT

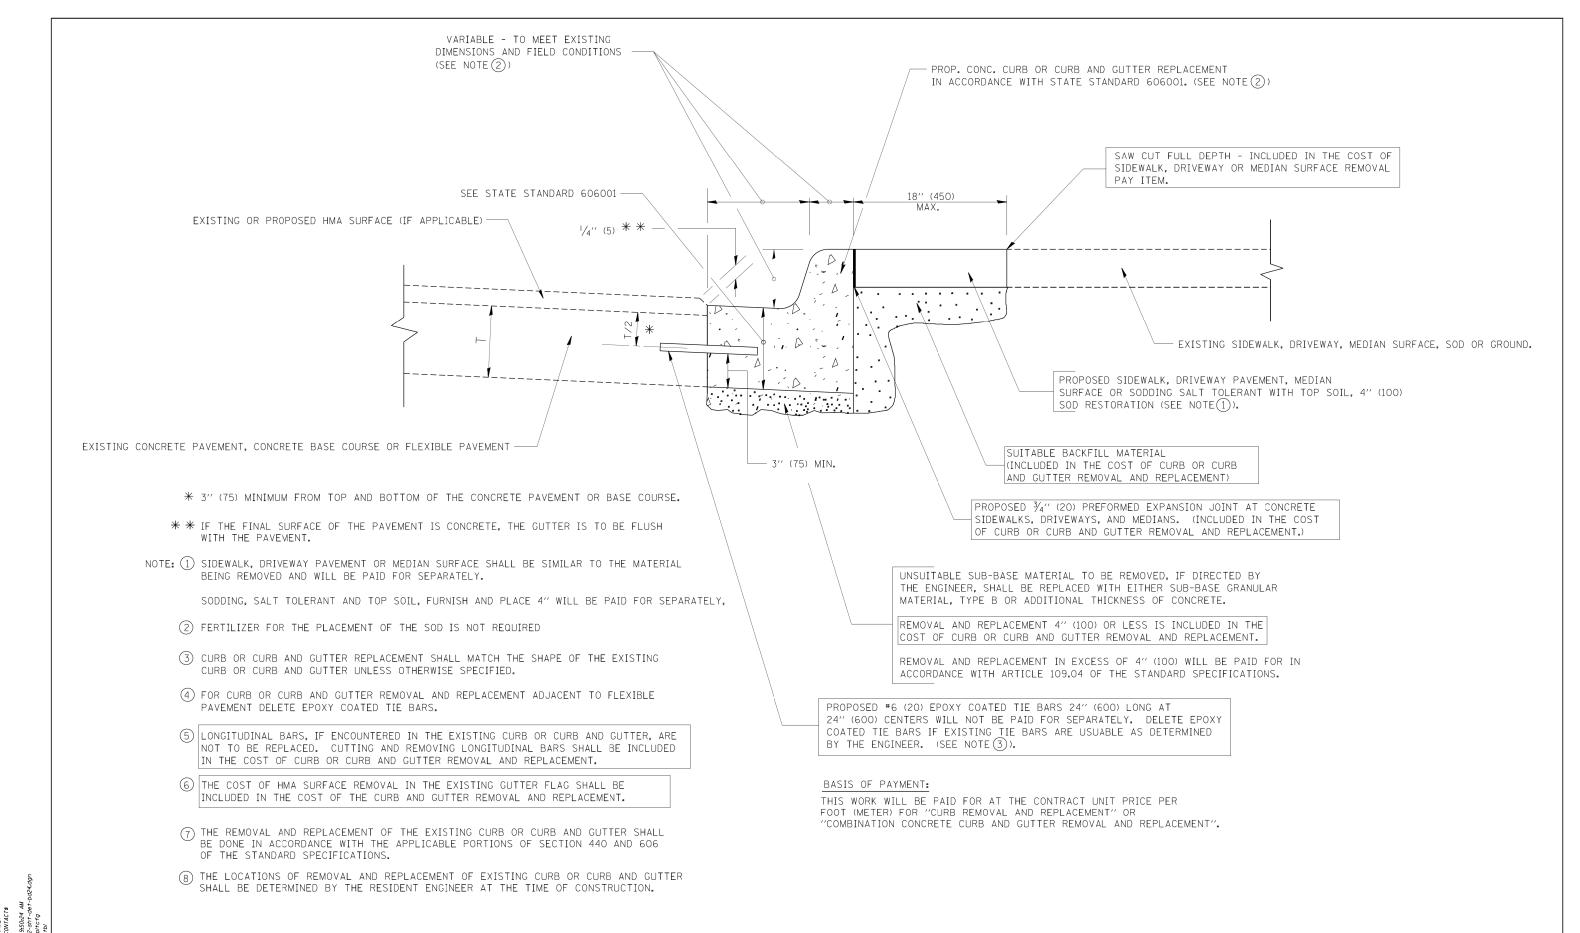

CURB OR CURB AND GUTTER REMOVAL AND REPLACEMENT

SCALE: NONE

ALL DIMENSIONS ARE IN INCHES (MILLIMETERS) UNLESS OTHERWISE SHOWN.

STATE OF ILLINOIS
DEPARTMENT OF TRANSPORTATION

 CURB OR CURB AND GUTTER
 F.A. SECTION
 COUNTY SHEETS NO.

 REMOVAL AND REPLACEMENT
 BD600-06 (BD-24)
 CONTRACT NO. 62A27

 SHEET NO. 1 OF 1 SHEETS
 STA.
 TO STA.
 FED. ROAD DIST, NO. 1 | |LLINDIS |FED. AID PROJECT

C00K 531-1-T 86100196-52-sht-det-bd24.dgn INTO PAVEMENT DIAMETER DIAMETER UP TO 8" (200) 3'-6" (1.1 m) 4'-0" (1.2 m) > 8" (200) 4'-0" (1.2 m) 4'-6" (1.4 m) 14" (360)

INNER HOOP

REINFORCEMENT

DESIGNED - A. ABBAS

CHECKED - A. ABBAS

- TOM MATOUSEK

- 01-04-99

DRAWN

DATE

REVISED - T. MATOUSEK 08-28-00

REVISED - T. MATOUSEK 10-02-00

REVISED - P. LAFLEUR 08-27-02

- T. MATOUSEK 04-25-02

REVISED

FRAME EXTENSION

THIS DETAIL IS TO BE USED WHEN THE GUTTER FLAG IS

DESIGNER NOTE:

LESS THAN 24"

LEGEND:

USER NAME = gaglianobt

PLOT DATE = 1/4/2008

PLOT SCALE = 50.0000 '/ IN.

FILE NAME =

W:\diststd\22x34\bd48.dar

NOTES :

- 1. THE ROUNDOUT AND ADDED REINFORCEMENT WILL NOT BE PAID SEPARATELY. BUT SHALL BE INCLUDED IN THE CONTRACT UNIT PRICE FOR THE PAVEMENT.
- 2. TRANSVERSE JOINTS MAY BE MOVED TO ACCOMMODATE ROUNDOUT, EDGE OF CIRCULAR JOINT SHALL BE MINIMUM 12" (300) FROM TRANSVERSE JOINT. RELOCATED TRANSVERSE JOINT SHALL BE CONTINUOUS FROM EDGE OF PAVEMENT TO EDGE OF PAVEMENT.
- 3. SEMI-CIRCULAR FORM SHALL BE REMOVED PRIOR TO DRILL AND GROUT OF TIE BARS.
- 4. ALL REINFORCED BARS SHALL BE EPOXY COATED.
- 5. DRILL AND GROUT IS PREFERRED, HOWEVER TIE BARS CAN BE POURED IN PLACE IF CLEARANCE IS PROVIDED TO OUTER EDGE OF FRAME. MINIMUM 2" (50) CLEARANCE.

SECTION

531-1-T

FED. ROAD DIST. NO. 1 ILLINOIS FED. AID PROJECT

BD-48

342

TO STA.

COUNTY

COOK

CONTRACT NO. 62A27

24 18


- 6. WOOD SHIMS SHALL BE USED TO ADJUST ALL FRAMES. AFTER ADJUSTING MORTAR HAS CURED, THE WOOD SHIMS SHALL BE REMOVED AND THE VOIDS UNDER THE FRAMES FILLED WITH NON SHRINK GROUT.
- 7. HOOP REINFORCEMENT SHALL BE ONE PIECE CONSTRUCTION.
- 8. CIRCULAR FRAMES AND GRATES MAY BE SUBSTITUTED.
- 9. CURB DOWELS MUST BE PLACED LEVEL & TRUE TO ALLOW CONTRACTION MOVEMENT.

PCC PAVEMENT ROUNDOUTS AT

CURB AND GUTTER

SHEET NO. 1 OF 1 SHEETS STA.

SCALE: NONE

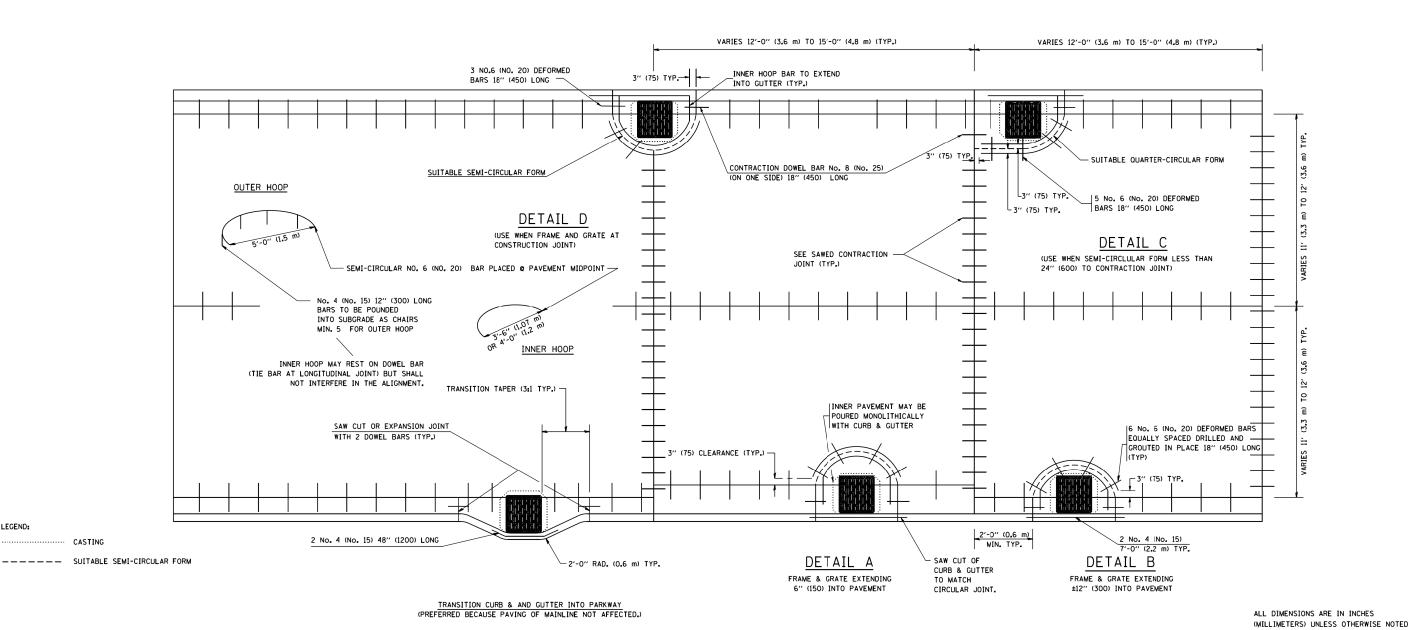

STATE OF ILLINOIS

DEPARTMENT OF TRANSPORTATION

OUTER HOOP

REINFORCEMENT

DIAMETER

5'-0" (1.5 m)

5'-0" (1.5 m)

SEMI CIRCULAR FORM

ROAD CONSTRUCTION AHEAD ROAD TYPE III BARRICADES WITH TWO FLASHING AMBER LIGHTS ON EACH. AHEAD TYPE I OR TYPE II BARRICADES WITH ONE FLASHING AMBER LIGHT ON EACH, OR TYPE III BARRICADES WITH TWO FLASHING 15 (380) 200'± (60 m±)-AMBER LIGHTS ON EACH. DRIVEWAY WORK AREA J 200'± (60 m±) 09) COLLECTOR LIMIT> 40 MPH ST 40 OCAL W20-1(0) SPEED CONSTRUCTION M6-4(0)-2115 ROAD M6-1(0)-2115 CONSTRUCTION AHEAD

TRAFFIC CONTROL AND PROTECTION FOR SIDE ROADS, INTERSECTIONS, AND DRIVEWAYS

NOTES:

- A. FOR NO LANE RESTRICTION ON THE SIDE ROAD OR DRIVEWAYS
- 1. SIDE ROAD WITH A SPEED LIMIT OF 40 MPH (60 km/h) OR LESS AS SHOWN ON THE DRAWING AND AS DIRECTED BY THE ENGINEER:
- 0) ONE ROAD CONSTRUCTION AHEAD SIGN 36 \times 36 (900 \times 900) WITH A FLASHER AND FLAG MOUNTED ON IT APPROXIMATELY 200' (60 m) IN ADVANCE OF THE MAIN ROUTE.
- b) THE CLOSED PORTION OF THE MAIN ROUTE SHALL BE PROTECTED BY BLOCKING WITH TYPE I, TYPE II OR TYPE III BARRICADES, 1/3 OF THE CROSS SECTION OF THE CLOSED PORTION.
- 2. SIDE ROAD WITH A SPEED LIMIT GREATER THAN 40 MPH (60 km/h) AS SHOWN ON THE DRAWING AND AS DIRECTED BY THE ENGINEER:
- g) ONE ROAD CONSTRUCTION AHEAD SIGN 48 \times 48 (1.2 m \times 1.2 m) WITH A FLASHER MOUNTED ON IT APPROXIMATELY 500' (150 m) IN ADVANCE OF THE MAIN ROUTE.
- b) THE CLOSED PORTION OF THE MAIN ROUTE SHALL BE PROTECTED BY BLOCKING WITH TYPE III BARRICADES, 1/2 OF THE CROSS SECTION OF THE CLOSED PORTION.
- 3. WHEN THE SIDE ROAD LIES BETWEEN THE BEGINNING OF THE MAINLINE SIGNING AND THE WORK ZONE, A SINGLE HEADED ARROW (MG-1) SHALL BE USED IN LIEU OF THE DOUBLE HEADED ARROW (MG-4).

SCALE: NONE

B. FOR A LANE CLOSURE ON A SIDE ROAD OR DRIVEWAY:

USE APPLICABLE PORTIONS OF THE TYPICAL APPLICATION OF TRAFFIC CONTROL DEVICES (STD. 701501, STD. 701606 OR THE APPROPRIATE STANDARD). THE SPACING OF SIGNS AND BARRICADES SHALL BE ADJUSTED FOR FIELD CONDITIONS AS DIRECTED BY THE ENGINEER. THE DIRECTIONAL ARROW SHALL BE COVERED OR REMOVED WHEN NO LONGER CONSISTENT WITH THE SIDE ROAD LANE CLOSURE.

- C. ADVANCE WARNING SIGNS ARE TO BE OMITTED ON DRIVEWAY UNLESS OTHERWISE NOTED.
- D. THE TRAFFIC CONTROL AND PROTECTION FOR SIDE ROADS, INTERSECTIONS, AND DRIVEWAYS SHALL BE INCIDENTAL TO THE COST OF SPECIFIED TRAFFIC CONTROL STANDARDS OR ITEMS.

All dimensions are in millimeters (inches) unless otherwise shown.

REVISED - J. OBERLE 10-18-95

REVISED - A. HOUSEH 03-06-96

REVISED - A. HOUSEH 10-15-96

REVISED - T. RAMMACHER 01-06-00

DESIGNED - LHA

06-89

DRAWN

DATE

CHECKED

USER NAME = gaglianobt

PLOT DATE = 1/4/2008

PLOT SCALE = 50.000 '/ [N.

STATE OF ILLINOIS
DEPARTMENT OF TRANSPORTATION

TRAFFIC CONTROL AND PROTECTION FOR
SIDE ROADS, INTERSECTIONS, AND DRIVEWAYS

SHEET NO. 1 OF 1 SHEETS STA. TO STA

00X 31-1-1 5100196-52-sht-det-tc10.dgn FILE NAME =

W:\diststd\22x34\tc10.dqn

R 3-I100L 24 x 24 (600 x 600) TURN LANE CONFLICTING M6-2L 21 × 15 (530 × 380) PAVEMENT MARKING REMOVAL OPTIONAL FLASHING LIGHT STANDARD 701901 SEE NOTE 8 WHITE REFLECTORIZED PAV'T MARKING TAPE YELLOW REFLECTORIZED PAV'T GENERAL NOTES MARKING TAPE 1. CONES MAY BE SUBSTITUTED FOR BARRICADES OR DRUMS AT HALF THE SPACING DURING DAY OPERATIONS. CONES SHALL BE A MINIMUM OF 28 (710) IN HEIGHT. WHEN CONES ARE BEING USED, THE "LEFT TURN LANE" SIGN MAY BE SKID MOUNTED AT A MINIMUM HEIGHT OF 5' (1.5 m). 2. STEADY BURNING LIGHTS WILL NOT BE REQUIRED ON BARRICADES OR DRUMS FOR DAY OPERATIONS. ALL LIGHTS SHALL BE MONODIRECTIONAL. 3. REFLECTORIZED TEMPORARY PAVEMENT MARKING TAPE SHALL BE PLACED THROUGHOUT THE BARRICADED AREA OF EACH TURN BAY WHERE THE CLOSURE TIME IS GREATER THAN FOURTEEN DAYS. 4. THIS APPLICATION ALSO APPLIES WHEN WORK IS BEING PERFORMED IN THE RIGHT LANE(S) AND THE RIGHT TURN BAY IS TO REMAIN OPEN. UNDER THIS CONDITION, "RIGHT TURN LANE" R3-100 24 \times 24 (600 \times 600) AND M6-2R 21 \times 15 (530 \times 380) SHALL BE USED. 5. THESE CONTROLS SHALL SUPPLEMENT MAINLINE TRAFFIC CONTROL FOR LANE CLOSURES. 6. LONGITUDINAL DIMENSIONS MAY BE ADJUSTED TO FIT FIELD CONDITIONS. LEGEND 7. FORM OPER 725 IS REQUIRED. 8. IF A DRUM OR TYPE II BARRICADE WITH AN ATTACHED SIGN PANEL WHICH MEETS NCHRP 350 REQUIREMENTS IS NOT AVAILABLE, THE SIGNS SHALL BE MOUNTED, ABOVE THE BARRICADES, ON SEPARATE SIGNS SUPPORTS THAT MEET NCHR 350 PREQUIREMENTS. 9. TRAFFIC CONTROL AND PROTECTION AT TURN BAYS (TO REMAIN OPEN TO TRAFFIC) SHALL BE INCLUDED IN THE COST SPECIFIED TRAFFIC CONTROL STANDARDS OR ITEMS. LANE OPEN TO TRAFFIC TYPE I OR II BARRICADE WITH All dimensions are in inches (millimeters) STEADY BURN LIGHT unless otherwise shown. DRUM WITH STEADY BURN LIGHT DRUM WITH SIGN (WITH OPTIONAL FLASHING LIGHT) SEE DETAIL TYPE I OR II CHECK BARRICADE WITH FLASHING LIGHT TOTAL SHEET NO. 24 20 REVISED -T. RAMMACHER 09-08-94 REVISED R. BORO 09-14-09 COUNTY TRAFFIC CONTROL AND PROTECTION AT TURN BAYS **STATE OF ILLINOIS** REVISED - A. HOUSEH 11-07-95 REVISED 342 531-1-T COOK (TO REMAIN OPEN TO TRAFFIC) REVISED - A. HOUSEH 10-12-96 REVISED **DEPARTMENT OF TRANSPORTATION** CONTRACT NO. 62A27 SCALE: NONE SHEET NO. 1 OF 1 SHEETS STA.

FED. ROAD DIST. NO. 1 | ILLINOIS FED. AID PROJECT

REVISED -T. RAMMACHER 01-06-00 REVISED

1-1 COMPANY COMPANY COMPANY CLIENT: CLIENT: DATE PLOT DEPLOT PROFESSION OF TABLE PLOT

16 (400) | | 16 (400) | | 16 (400) | 16 (400)

***** 4 (100)

* 12 (300)

12 (300)

21.1 sq. ft. (1.97 sq. m)

OUANTITY 4 (100) LINE = 64.1 ft. (19.7 m) 4 (100)

STATE OF ILLINOIS DEPARTMENT OF TRANSPORTATION PAVEMENT MARKING LETTERS AND SYMBOLS
FOR TRAFFIC STAGING

SCALE: NONE SHEET NO. 1 OF 1 SHEETS STA. TO S

IND SYMBOLS

IG

A. TO STA.

F.A. RTE.


342

TO
FED. ROAD DIST. N


unless otherwise shown.


All dimensions are in inches (millimeters)

OUANTITY 4 (100) LINE = 45.5 ft. (13.9 m) 15.2 sq. ft. (1.39 sq. m)

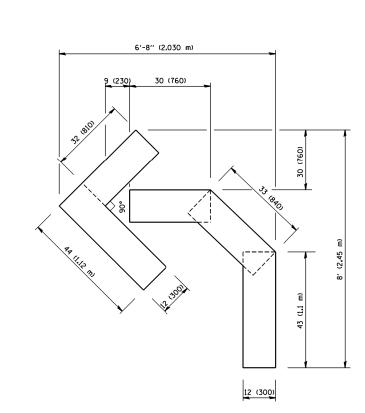

OUANTITY 4 (100) LINE = 82.5 ft. (25.3 m) 27.5 sq. ft. (2.53 sq. m)

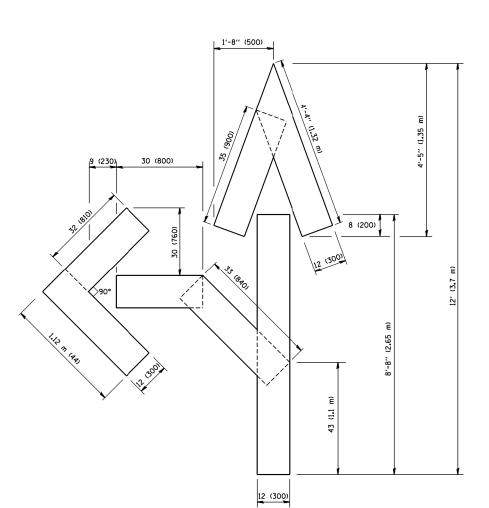


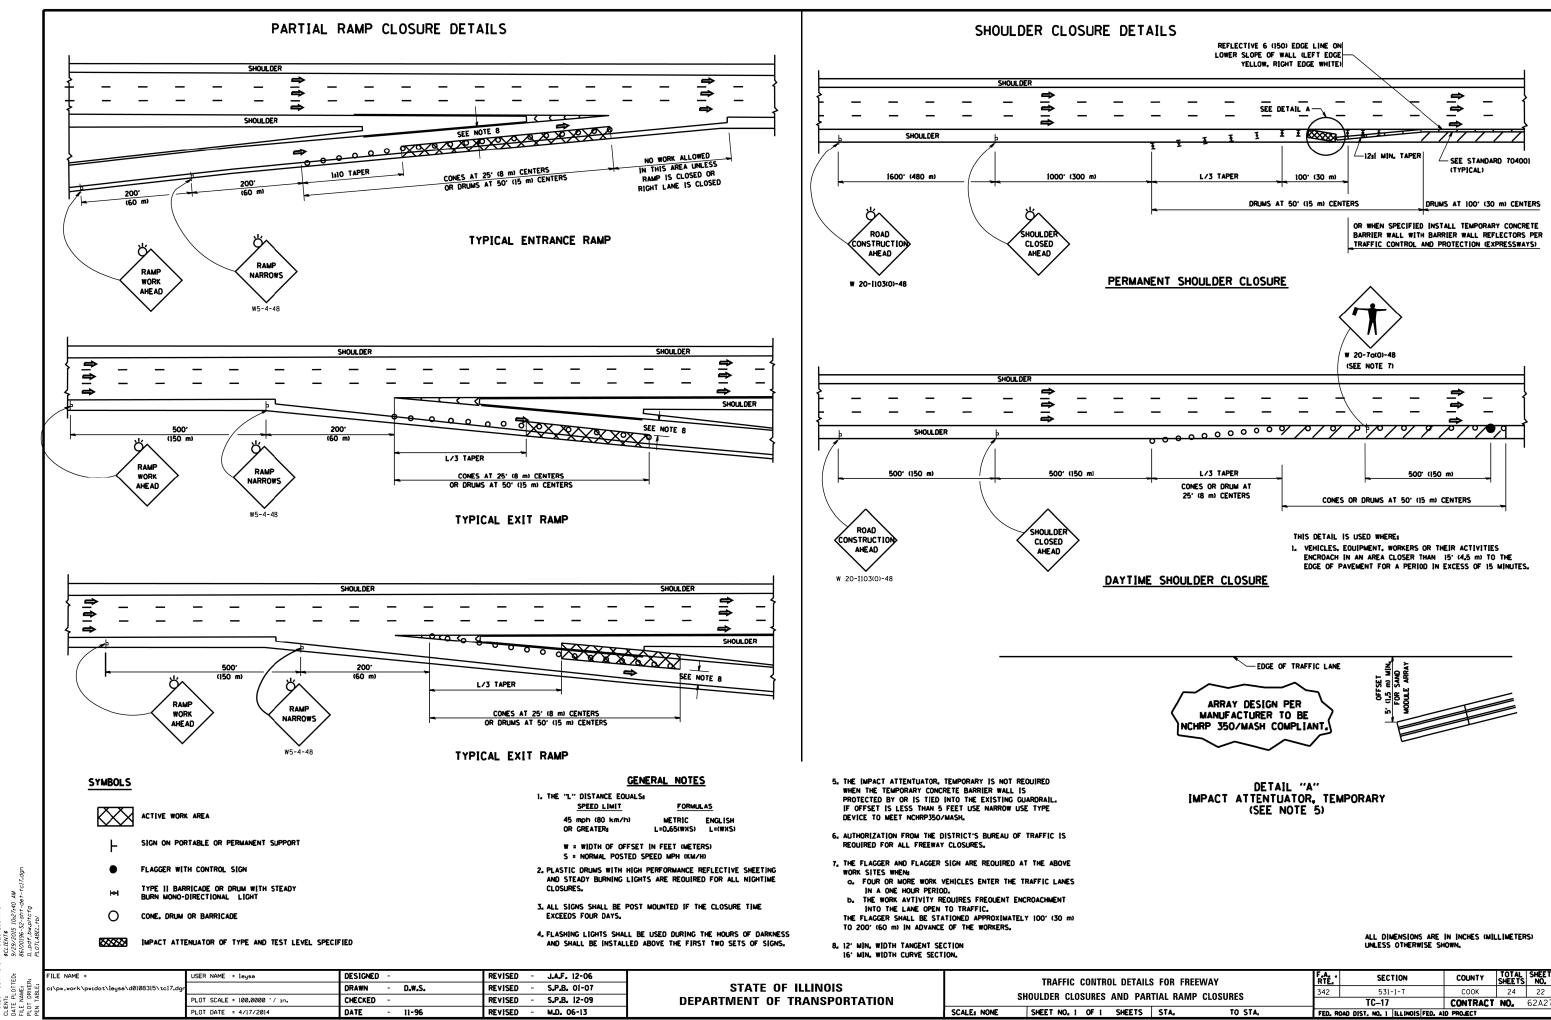


c17 don 4/17/2014 8:48:55 AM User=levsa

SIGNING FOR FLAGGING OPERATIONS AT WORK ZONE OPENINGS

WORK ZONE EXIT OPENING

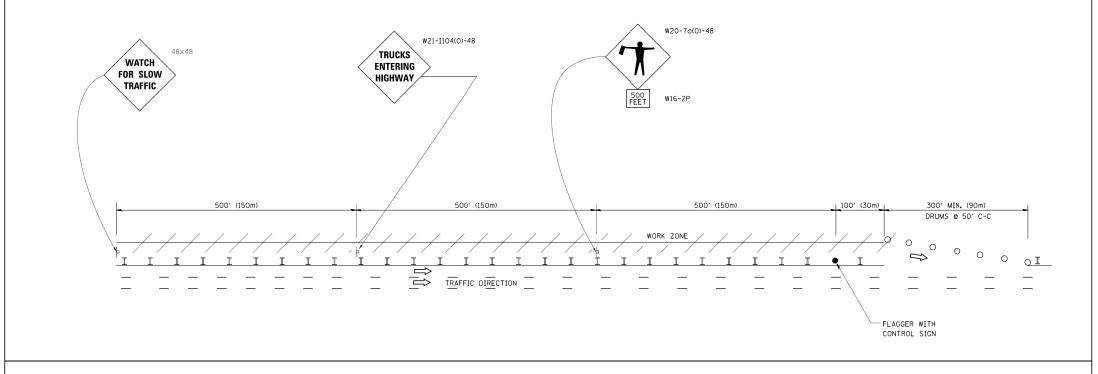

WORK ZONE ENTRY OPENING

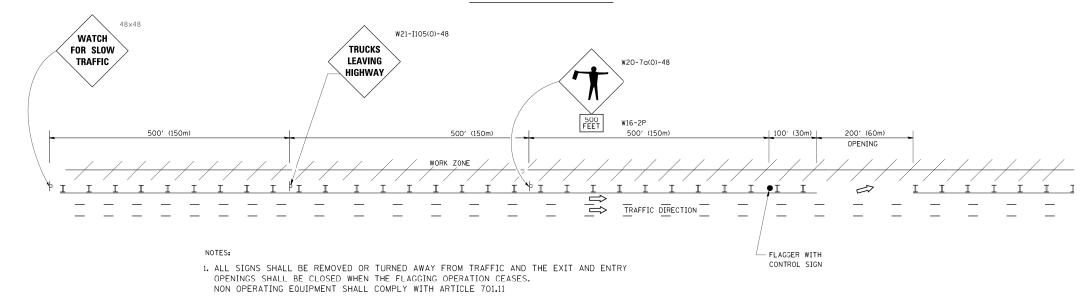

- 2. WORK ZONE OPENINGS SHALL BE A MINIMUM OF ONE HALF MILE APART AND A MINIMUM OF ONE QUARTER MILE FROM ALL ENTRANCE AND EXIT RAMPS.
- 3. EXITING THE WORK ZONE AT ANY PLACE OTHER THAN AT A WORK ZONE EXIT OPENING WILL BE PROHIBITED.
- 4. ALL VEHICLES SHALL ENTER THE WORK ZONE AT ENTRY OPENINGS, USING THEIR TURN SIGNALS TO WARN MOTORISTS
- 5. FLAGGERS SHALL NOT STOP TRAFFIC OR DIRECT TRAFFIC INTO AN ADJACENT LANE.

ALL DIMENSIONS ARE IN INCHES (MILLIMETERS)
UNLESS OTHERWISE SHOWN

STATE OF ILLINOIS
DEPARTMENT OF TRANSPORTATION

FREEWAY/EXPRESSWAY SIGNING FOR FLAGGING OPERATIONS
AT WORK ZONE OPENINGS ON FREEWAYS/EXPRESSWAYS

SCALE: NONE SHEET NO. 1 OF 1 SHEETS STA. TO STA.

USER NAME = gaglianobt DESIGNED -REVISED - R. MIRS 09-15-97 W:\diststd\22x34\tc22.dar DRAWN REVISED - R. MIRS 12-11-97 PLOT SCALE = 50.000 '/ [N. CHECKED REVISED - T. RAMMACHER 02-02-99 PLOT DATE = 1/4/2008 REVISED - C. JUCIUS 01-31-07 DATE

STATE OF ILLINOIS DEPARTMENT OF TRANSPORTATION


ARTERIAL ROAD INFORMATION SIGN SCALE: NONE SHEET NO. 1 OF 1 SHEETS STA. TC-22

TO STA.

COUNTY TOTAL SHEET NO.

COOK 24 24

CONTRACT 531-1-T CONTRACT NO. 62A2

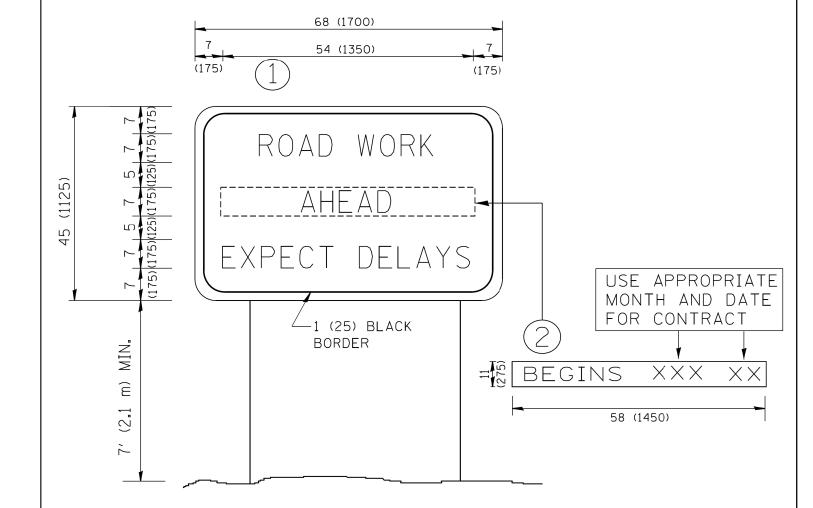

NOTES:

- 1. USE BLACK LETTERING ON ORANGE BACKGROUND.
- 2. ERECT SIGNS IN ADVANCE OF THE LOCATION FOR THE "ROAD CONSTRUCTION AHEAD" SIGN AT LOCATIONS AS DIRECTED BY THE ENGINEER.
- 3. ERECT SIGN (1) WITH INSTALLED PANEL (2) ONE WEEK PRIOR TO THE START OF CONSTRUCTION.
- 4. REMOVE PANEL 2) SOON AFTER THE START OF CONSTRUCTION.
- 5. SEE SPECIAL PROVISION FOR "TEMPORARY INFORMATION SIGNING" FOR ADDITIONAL INFORMATION.
- 6. ONE SIGN ASSEMBLY EQUALS 25.70 SQ. FT. (2.3 SQ. M.)
- 7. SHALL BE PAID FOR AS TEMPORARY INFORMATION SIGNING.

ALL DIMENSIONS ARE IN INCHES (MILLIMETERS) UNLESS OTHERWISE SHOWN.