06-10-2016 LETTING ITEM 021

FOR INDEX OF SHEETS, SEE SHEET NO. 2

PROJECT LOCATED IN THE VILLAGE OF CHANNAHON

ADT (2040) DESIGN SPEED POSTED SPEED TRAFFIC DATA: FAI 55 I-55 71.000 70 MPH 65 MPH 40 MPH 25,600 45 MPH U.S. 6

PROJECT DESCRIPTION

THE PROJECT CONSISTS OF THE RECONSTRUCTION AND WIDENING OF U.S. ROUTE 6, RELOCATION AND RECONSTRUCTION OF RAMP 'C', RESURFACING NORTHWEST FRONTAGE ROAD, LIGHTING, TRAFFIC SIGNAL, DRAINAGE AND ALL INCIDENTAL WORK NECESSARY TO COMPLETE THE IMPROVEMENT.

DEPARTMENT OF TRANSPORTATION

STATE OF ILLINOIS

DIVISION OF HIGHWAYS

PROPOSED HIGHWAY PLANS

F.A.I. RTE. 55 AT U.S. 6 (EAMES ST.)

SECTION: 2014-065-R

PROJECT: ACNHPP - 0055 (450)

ROADWAY AND FRONTAGE ROAD RECONSTRUCTION

WILL COUNTY C-91-047-15

DESIGN DESIGNATION:

U.S. 6

0

0

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2,769(40) MINOR ARTERIAL (URBAN) (P.C.C.-30)

1.146(40) INTERSTATE - CLASS | TRUCK ROUTE (P.C.C.-30) RAMP 'C' (NORTHWEST)

> U.S. 6 PROJECT LIMIT STA. 192 + 02.75

ENGINEERING SCALES, REDUCED SIZED PLANS WILL NOT CONFORM TO STANDARD SCALES. IN MAKING MEASUREMENTS ON REDUCED PLANS, THE ABOVE SCALES MAY BE USED.

J.U.L.I.E. JOINT UTILITY LOCATING INFORMATION FOR EXCAVATORS 1-800-892-0123

PROJECT MANAGER: HELEN PAZON (847) 705-4523


CONTRACT NO. 62A00

CHANNAHON TOWNSHIP R. 9 E. CITY OF JOLIET **VILLAGE OF CHANNAHON**

U.S. 6 - GROSS LENGTH OF PROJECT = 1.517.25 FEET = 0.287 MILES

LOCATION MAP

U.S. 6 - NET LENGTH OF PROJECT = 1.517.25 FEET = 0.287 MILES

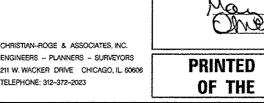

D-91-013-10




EXPIRES: 11-30-2015

8-10-15

EXPIRES: 11-30-2015 APPLIES TO SHEETS: 81-99 TRAFFIC SIGNALS 100-115 ITS 116-123 ROADWAY LIGHTING

U.S. 6 PROJECT LIMIT STA. 207 + 20

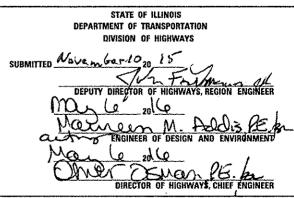

PRINTED BY THE AUTHORITY OF THE STATE OF ILLINOIS

SHEET NO.	INDEX OF SHEETS
1	COVER SHEET
2	INDEX OF SHEETS
3	LIST OF STATE STANDARDS
4 - 4A	GENERAL NOTES AND COMMITMENTS
5 - 20A	SUMMARY OF QUANTITIES
21	EXISTING TYPICAL SECTIONS - U.S. 6
22	PROPOSED TYPICAL SECTIONS - U.S. 6
23	EXISTING AND PROPOSED TYPICAL SECTIONS - NW FRONTAGE ROAD
24	EXISTING AND PROPOSED TYPICAL SECTIONS - RAMP C
25 - 26	SCHEDULE OF QUANTITIES
27	ALIGNMENT PLAN AND TIES - U.S. 6
28	ALIGNMENT PLAN - SW / NW FRONTAGE ROAD AND RAMP C
29 - 30	EXISTING CONDITIONS & REMOVAL PLAN - U.S. 6
31	EXISTING CONDITIONS & REMOVAL PLAN - RAMP C
32 - 33	PROPOSED PLAN AND PROFILE - U.S. 6
34	PROPOSED PLAN AND PROFILE - RAMP C
35	PROPOSED PLAN AND PROFILE - NORTHWEST FRONTAGE ROAD
36 - 37	PROPOSED PLAN - NW FRONTAGE ROAD RESURFACING
38	MAINTENANCE OF TRAFFIC GENERAL NOTES
39	MAINTENANCE OF TRAFFIC SUGGESTED STAGES OF CONSTRUCTION AND STAGING NOTES
40 - 42	SUGGESTED TRAFFIC CONTROL AND PROTECTION - STAGE I - U.S. 6
43 - 45A	SUGGESTED TRAFFIC CONTROL AND PROTECTION - PRE-STAGE, STAGE IA, IB AND IC - RAMP C
46	SUGGESTED TRAFFIC CONTROL AND PROTECTION - STAGE I - SOUTHWEST FRONTAGE ROAD
47 - 48	EROSION AND SEDIMENT CONTROL GENERAL NOTES
49 - 50	EROSION AND SEDIMENT CONTROL PLANS - U.S. 6
51	EROSION AND SEDIMENT CONTROL PLANS - RAMP C
52 - 54	SUE DRAWINGS
55 - 56	EXISTING DRAINAGE AND UTILITIES - U.S. 6
57	EXISTING DRAINAGE AND UTILITIES - RAMP C
58 - 59	PROPOSED DRAINAGE AND UTILITIES - U.S. 6
60	PROPOSED DRAINAGE AND UTILITIES - RAMP C
61 - 71	PLAT OF HIGHWAYS
72	DETAILS AND ELEVATIONS U.S. 6 AT RAMPS 'C' AND 'D'
73	RAISED MEDIAN DETAILS - U.S. 6
74 - 75	PAVEMENT MARKING AND SIGNING PLAN - U.S. 6
76	PAVEMENT MARKING AND SIGNING PLAN - RAMP C
77 - 79	SIGNING DETAILS
80 - 81	LANDSCAPING PLAN - U.S. 6
82	LANDSCAPING PLAN - RAMP C
83 - 89	DISTRICT 1 STANDARD TRAFFIC SIGNAL DESIGN DETAILS
90 - 97	TRAFFIC SIGNAL PLANS - U.S. 6 AND RAMPS C / D
98 - 101	INTERCONNECT PLANS
102 - 114	FIBER OPTIC CABLE REPLACEMENT PLANS
115 - 118	DISTRICT 1 TRAFFIC SYSTEMS CENTER DESIGN DETAILS
119 - 125	ROADWAY LIGHTING PLANS
126 - 135	LIGHTING DETAILS
136	LIGHTING PAD DETAILS
137	NOT USED
138 - 149	NORTHWEST FRONTAGE ROAD RETAINING WALL PLANS - S.N. 099-0606
150 - 151	RAISED BRIDGE MEDIAN PLANS - STRUCTURE NO. 099-0277

SHEET NO.	INDEX OF SHEETS
152	DRIVEWAY DETAILS - DISTANCE BETWEEN ROW AND CURB OR EDGE GREATER THAN OR EQUAL TO 15 (BD-01)
153	DRIVEWAY DETAILS - DISTANCE BETWEEN ROW AND FACE OF CURB < 15' (BD-02)
154	STORM SEWER CONNECTION TO EXISTING SEWER (BD-07)
155	BUTT JOINT AND HMA TAPER DETAILS (BD-32)
156	DETAILS FOR DEPRESSED CURB & GUTTER AND SHOULDER TREATMENT AT 18Y TY 1 SPL. (BD-34)
157	BENCHING CONSTRUCTION DETAIL (BD-51)
158	DETAIL OF PAVEMENT SEPARATION JOINT FOR JOINTED PCC PAVEMENTS AT INTERSECTIONS (BD-52)
159	ENTRANCE AND EXIT RAMP CLOSURE DETAILS (TC-08)
160	TRAFFIC CONTROL DETAILS FOR FREEWAY SINGLE & MULTI-LANE WEAVE (TC-09)
161	TRAFFIC CONTROL AND PROTECTION FOR SIDE ROADS, INTERSECTIONS AND DRIVEWAYS (TC-10)
162	TYPICAL APPLICATIONS RAISED REFLECTIVE PAVEMENT MARKERS (SNOW-PLOW RESISTANT) (TC-11)
163 - 164	MULTI-LANE FREEWAY PAVEMENT MARKING DETAILS (TC-12)
165	DISTRICT 1 TYPICAL PAVEMENT MARKINGS (TC-13)
166	TRAFFIC CONTROL AND PROTECTION AT TURN BAYS (TO REMAIN OPEN TO TRAFFIC) (TC-14)
167	PAVEMENT MARKING LETTERS AND SYMBOLS FOR TRAFFIC STAGING (TC-16)
168	TRAFFIC CONTROL DETAILS FOR FREEWAY SHOULDER CLOSURES AND PARTIAL RAMP CLOSURES (TC-17)
169	ARTERIAL ROAD INFORMATION SIGN (TC-22)
170	DRIVEWAY ENTRANCE SIGNING (TC-26)
171	MILE POST MARKERS - GORE SIGNS - MAJOR GUIDE SIGN LAYOUT - ARROWS (TC-27)
172 - 177	CROSS SECTIONS - U.S. 6
178 - 184	CROSS SECTIONS - RAMP C

File NAME =0162AZZ-eht-Index.dgn PLOT DATE +1/19/2018 PLOT SCALE: 120.2282 1/ 34.

CHRISTIAN-ROGE & ASSOCIATES, INC.

ENGINEERS-PLANNERS-SURVEYORS
221 NORTH LASALLE STREET, SURF 300
CHICAGO, ILLINOIS 66001
PHONE: [312] 577-3300

DATE - JANUARY 18, 2016

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STATE OF ILLINOIS DEPARTMENT OF TRANSPORTATION

SCALE: NONE

INDEX OF SHEETS TO STA. SHEET NO. 1 OF 1 SHEETS STA.

LIST OF ILLINOIS DOT HIGHWAY STANDARDS

LIST OF ILLINOIS DOT HIGHWAY STANDARDS (CONTINUED)

STANDARD NO.	DESCRIPTION	STANDARD NO.	DESCRIPTION
000001-06	STANDARD SYMBOLS, ABBREVIATIONS, AND PATTERNS	701101-05	OFF-RD OPERATIONS, MULTILANE. 15' (4.5 M) TO 24" (600 MM) FROM PAVEMENT EDGE
001001-02	AREAS OF REINFORCEMENT BARS	701201-04	LANE CLOSURE, 2L, 2W, DAY ONLY, FOR SPEEDS > 45 MPH
001006	DECIMAL OF AN INCH AND OF A FOOT	701301-04	LANE CLOSURE, 2L, 2W, SHORT TIME OPERATIONS
280001-07	TEMPORARY EROSION CONTROL SYSTEMS	701311-03	LANE CLOSURE, 2L, 2W, MOVING OPERATIONS - DAY ONLY
420001-08	PAVEMENT JOINTS	701326-04	LANE CLOSURE, 2L, 2W, PAVEMENT WIDENING, FOR SPEEDS > 45 MPH
420101-05	24" (7.2M) JOINTED P.C.C. PAVEMENT	701400-08	APPROACH TO LANE CLOSURE, FREEWAY/EXPRESSWAY
420111-03	P.C.C. PAVEMENT ROUNDOUTS	701401-09	LANE CLOSURE, FREEWAY/EXPRESSWAY
424001-08	PERPENDICULAR CURB RAMPS FOR SIDEWALKS	701411-09	LANE CLOSURE, MULTILANE, AT ENTRANCE OR EXIT RAMP, FOR SPEEDS > 45 MPH
424011-02	CORNER PARALLEL CURB RAMPS FOR SIDEWALKS	701428-01	TRAFFIC CONTROL, SETUP AND REMOVAL, FREEWAY/EXPRESSWAY
424031-01	MEDIAN PEDESTRIAN CROSSINGS	701501-06	URBAN LANE CLOSURE, 2L, 2W, UNDIVIDED
442101-07	CLASS B PATCHES	701601-09	URBAN LANE CLOSURE, MULTILANE, 1W OR 2W WITH NONTRAVERSABLE MEDIAN
442201-03	CLASS C AND D PATCHES	701606-10	URBAN LANE CLOSURE, MULTILANE, 2W WITH MOUNTABLE MEDIAN
482011-03	HMA SHOULDER STRIPS/SHOULDERS WITH RESURFACING OR WIDENING AND RESURFACING PROJECTS	701701-10	URBAN LANE CLOSURE, MULTILANE INTERSECTION
483001-04	PCC SHOULDER	701801-06	SIDEWALK, CORNER OR CROSSWALK CLOSURE
515001-03	NAME PLATE FOR BRIDGES	701901-05	TRAFFIC CONTROL DEVICES
542001-05	CONCRETE END SECTIONS FOR PIPE CULVERTS 15" (375mm) THRU 84" (2100mm) DIA	704001-08	TEMPORARY CONCRETE BARRIER
601001-05	SUB-SURFACE DRAINS	720001-01	SIGN PANEL MOUNTING DETAILS
601101-02	CONCRETE HEADWALL FOR PIPE DRAIN	720006-04	SIGN PANEL ERECTION DETAILS
602001-02	CATCH BASIN, TYPE A	720011-01	METAL POSTS FOR SIGNS, MARKERS & DELINEATORS
602401-03	MANHOLE, TYPE A	720016-03	MAST ARM MOUNTED STREET NAME SIGNS
602406-07	MANHOLE, TYPE A, 6' (1.8 M) DIAMETER	720021-02	SIGN PANELS, EXTRUDED ALUMINUM TYPE
602601-04	PRECAST REINFORCED CONCRETE FLAT SLAB TOP	728001-01	TELESCOPING STEEL SIGN SUPPORT
602701-02	MANHOLE STEPS	729001-01	APPLICATIONS OF TYPES A AND B METAL POSTS (FOR SIGNS & MARKERS)
604001-04	FRAME AND LIDS, TYPE 1	780001-05	TYPICAL PAVEMENT MARKINGS
604091-03	FRAME AND GRATE, TYPE 24	781001-04	TYPICAL APPLICATIONS RAISED REFLECTIVE PAVEMENT MARKERS
606001-06	CONCRETE CURB TYPE B AND COMBINATION CONCRETE CURB AND GUTTER	782006	GUARDRAIL AND BARRIER WALL REFLECTOR MOUNTING DETAILS
606006-03	OUTLETS FOR CONCRETE CURB AND GUTTER TYPE B-6.24 (B-15.60)	805001-01	ELECTRICAL SERVICE INSTALLATION DETAILS
606301-04	P.C. CONCRETE ISLANDS AND MEDIANS	814001-03	HANDHOLES
606306-04	CORRUGATED P.C. CONCRETE MEDIANS	814006-02	DOUBLE HANDHOLES
635001-02	DELINEATORS	857001-01	STANDARD PHASE DESIGNATION DIAGRAMS AND PHASE SEQUENCES
664001-02	CHAIN LINK FENCE	862001-01	UNITERRUPTABLE POWER SUPPLY (UPS)
		873001-02	TRAFFIC SIGNAL GROUNDING AND BONDING
		878001-10	CONCRETE FOUNDATION DETAILS
		886001-01	DETECTOR LOOP INSTALLATIONS

	F.A.I.	SECTION	COUNTY	TOTAL SHEETS	SHEET NO.
LIST OF ILLINOIS DOT HIGHWAY STANDARDS	55	2014-065-R	WILL	184	3
			CONTRACT	NO. 6	2A00
SCALE: NONE SHEET NO. 1 OF 1 SHEETS STA. TO STA.	FED. 8	DAD DIST. NO. 1 ILLENOIS FED. AT	D PROJECT		

GENERAL NOTES

- THE CONTRACTOR WILL NOT BE ALLOWED TO SET UP A YARD OR FIELD OFFICE ON STATE PROPERTY WITHOUT WRITTEN PERMISSION
 FROM THE DEPARTMENT.
- 2. FORTY-EIGHT HOURS BEFORE STARTING EXCAVATION, THE CONTRACTOR SHALL CALL J.U.L.I.E. AT 1-800-892-0123 OR 811 TO HAVE THE LOCATION OF EXISTING UTILITIES MARKED.
- 3. THE CONTRACTOR SHALL OBTAIN ALL NECESSARY PERMITS, AS REQUIRED, PRIOR TO COMMENCING WITH CONSTRUCTION, NPDES STORMWATER PERMIT IS REQUIRED FOR THIS PROJECT.
- DO NOT SCALE PLANS FOR CONSTRUCTION DIMENSIONS.
- 5. POLLUTION CONTROL: THE CONTRACTOR SHALL BE REQUIRED TO COMPLY WITH STATE REGULATIONS REGARDING AIR, WATER AND NOISE POLLUTION.
- 6. WHERE ARTIFICIAL LIGHTING IS UTILIZED IN NIGHT OPERATIONS, THE CONTRACTOR SHALL EXERCISE THE UTMOST PRECAUTIONS IN PREVENTING ADVERSE VISIBILITY TO THE MOTORING PUBLIC AND ADJOINING RESIDENTIAL AREAS.
- 7. ACCESS MUST BE MAINTAINED TO ALL EXISTING PROPERTIES DURING CONSTRUCTION PER ARTICLE 107.09.
- 3. 10 FT. (3 M) TRANSITIONS SHALL BE USED TO MATCH PROPOSED ITEMS OF WORK TO EXISTING ITEMS IN THE FIELD, UNLESS OTHERWISE SHOWN. THE TRANSITIONS SHALL BE PAID FOR AT THE CONTRACT UNIT PRICE FOR THE PROPOSED ITEM OF WORK SPECIFIED.
- 9. SAW CUTTING PRIOR TO THE REMOVAL OF ANY ITEMS NOTED ON THE PLANS OR AS DIRECTED BY THE ENGINEER SHALL BE INCLUDED IN THE COST OF THE ITEMS BEING REMOVED.
- 10. THE CONTRACTOR SHALL USE CARE IN REMOVING OR EXCAVATING NEAR ALL EXISTING ITEMS WHICH WILL REMAIN. ANY DAMAGE DONE
 TO EXISTING ITEMS BY THE CONTRACTOR SHALL BE REPAIRED AT THE CONTRACTOR'S EXPENSE.
- 11. THE CONTRACTOR WILL BE REQUIRED TO MAINTAIN THE EXISTING PAVEMENT AS DIRECTED BY THE ENGINEER. THIS WORK SHALL BE PAID FOR ACCORDING TO ARTICLE 109,04 OF THE STANDARD SPECIFICATIONS.
- 12. BUTT JOINTS WILL BE INSTALLED AT THE ENDS OF ALL RESURFACING (WHERE RESURFACING MEETS EXISTING PAVEMENT), IN ACCORDANCE WITH THE "BUTT JOINT AND HMA TAPER DETAILS" INCLUDED IN THE PLANS, UNLESS OTHERWISE SPECIFIED.
- 13. THE CONTRACTOR IS RESPONSIBLE FOR MAINTAINING DRAINAGE THROUGHOUT THE CONSTRUCTION OF THIS PROJECT.
- 14. IN ACCORDANCE WITH SECTION 550 OF THE STANDARD SPECIFICATIONS, THE CONNECTING OF EXISTING DRAIN TILES, PIPE CULVERTS, OR STORM SEWERS TO THE PROPOSED DRAINAGE SYSTEM STRUCTURES WILL NOT BE PAID FOR SEPARATELY BUT SHALL BE CONSIDERED AS INCLUDED IN THE PAY ITEMS INVOLVED.
- 15. NOT USED.
- 16. STORM SEWER (WATER MAIN REQUIREMENTS) IS TO BE USED AT LOCATIONS WHERE LATERAL SEPARATION BETWEEN THE SEWER AND WATER MAIN IS LESS THAN 10 FT. AND THE WATER MAIN INVERT IS LESS THAN 1.5 FT. ABOVE THE STORM SEWER CROWN.
- 17. LOCATIONS OF EXISTING UTILITIES SHOWN ON THE PLANS ARE FROM BEST AVAILABLE RECORD INFORMATION AND MUST BE FIELD VERIFIED BY THE CONTRACTOR. PLAN DIMENSIONS AND DETAILS RELATIVE TO EXISTING PLANS ARE SUBJECT TO ROUTINE VARIATIONS. THE CONTRACTOR SHALL FIELD VERIFY EXISTING DIMENSIONS AND DETAILS AFFECTING NEW CONSTRUCTION AND MAKE NECESSARY APPROVED ADJUSTMENTS PRIOR TO CONSTRUCTION OR ORDERING MATERIALS. SUCH VARIATIONS SHALL NOT BE CAUSE FOR ADDITIONAL COMPENSATION FOR A CHANGE IN THE SCOPE OF THE WORK, HOWEVER, THE CONTRACTOR WILL BE PAID FOR THE QUANTITY ACTUALLY FURNISHED BASED UPON THE UNIT PRICE.

GENERAL NOTES (CONTINUED)

- 18. THE CONTRACTOR SHALL PROTECT EXISTING AND NEW UTILITIES AND SHALL BRACE AND SUPPORT THE UTILITIES PROPERLY IN ORDER TO PREVENT SETTLEMENT, DISPLACEMENT, OR DAMAGE TO THE UTILITIES. THE PROTECTION OF THE UTILITIES AS SPECIFIED HEREIN WILL NOT BE PAID FOR SEPARATELY, BUT SHALL BE CONSIDERED AS INCLUDED IN THE CONTRACT.
- 19. THE CONTRACTOR WILL BE REQUIRED TO TEMPORARY RELOCATE ALL ROAD SIGNS WHICH INTERFERE WITH CONSTRUCTION OPERATIONS
 AND TO TEMPORARILY RESET ALL SUCH SIGNS DURING ALL STAGES OF CONSTRUCTION. THIS WORK SHALL BE INCLUDED IN THE COST
 OF THE TRAFFIC CONTROL AND PROTECTION (SPECIAL).

ALL WORK INVOLVING ROAD SIGNS SHALL BE GOVERNED BY THE FOLLOWING REQUIREMENTS:

- A. SIGNS SHALL NOT BE MOVED UNTIL NECESSITATED BY THE PROGRESS OF WORK.
- B. EVERY SIGN REMOVED MUST BE RE-ERECTED AT A TEMPORARY LOCATION IN A WORKMANLIKE MANNER AND VISIBLE TO TRAFFIC FOR WHICH IT IS INTENDED. ALL SUCH SIGNS MUST BE MAINTAINED STRAIGHT AND CLEAN FOR THE DURATION OF THE TEMPORARY SETTING.
- C. ALL UNUSED SIGNS SHALL BE RETURNED TO THE APPROPRIATE GOVERNING BODY AS DIRECTED BY THE ENGINEER.
- 20. BARRICADES: TYPE I, TYPE II AND TYPE III BARRICADES SHALL BE WEIGHTED IN A MANNER APPROVED BY THE MANUFACTURER SO THAT THEY ARE NOT MOVED BY TRAFFIC.
- 21. THE CONTRACTOR SHALL CONTACT THE TRAFFIC CONTROL SUPERVISOR AT (847) 705-4470 AND EXPRESSWAY TRAFFIC CONTROL SUPERVISOR AT (847) 705-4155 A MINIMUM OF 72 HOURS PRIOR TO THE PLACEMENT OF ANY TEMPORARY TRAFFIC CONTROL DEVICES.
- 22. THE ENGINEER SHALL CONTACT ERIC CAMPOS, IDOT'S AREA TRAFFIC FIELD ENGINEER FOR WILL COUNTY, VIA E-MAIL AT ERIC.CAMPOS@ILLINOIS.GOV AND, OR AT (815)485-6475, A MINIMUM OF TWO (2) WEEKS PRIOR TO THE PLACEMENT OF PERMANENT PAVEMENT MARKINGS.
- 23. FOR WORK OUTSIDE THE LIMITS OF BRIDGE APPROACH PAVEMENT, ALL REFERENCES IN THE HIGHWAY STANDARDS AND SPECIFICATIONS
 FOR REINFORCEMENT, DOWEL BARS AND TIE BARS IN PAVEMENT, SHOULDERS, CURB, GUTTER, COMBINATION CURB AND GUTTER, MEDIAN
 AND CHAIR SUPPORTS FOR CRC PAVEMENT, SHALL BE EPOXY COATED, UNLESS NOTED ON THE PLAN.
- 24. THE DEPARTMENT HAS NOT OBTAINED ANY PERMITS FOR OFFSITE BORROW OR WASTE/USE (BWU) AREAS. PRIOR TO WORKING IN BWU AREAS, IF THE CONTRACTOR CHOOSES TO USE ACTIVITIES REQUIRING PERMITS IT IS THE CONTRACTOR'S RESPONSIBILITY TO SECURE THE PROPER PERMITS. IN ADDITION TO THE BORROW REVIEW (BDE 2289) AND USE/WASTE REVIEW (BDE 2290) SUBMITTALS, THE CONTRACTOR WILL NEED TO SUBMIT AN EROSION AND SEDIMENT CONTROL (ESC) PLAN FOR EVERY BWU SITE TO THE DEPARTMENT FOR ACCEPTANCE. GUIDELINES FOR ACCEPTABLE BWU PRACTICES CAN BE FOUND IN SECTION II.G.1 AND 2 OF THE SWPPP, THE COST OF ALL MATERIALS AND LABOR NECESSARY TO COMPLY WITH THE ABOVE PROVISIONS TO PREPARE AND IMPLEMENT ESC PLANS WILL NOT BE PAID FOR SEPARATELY, BUT SHALL BE CONSIDERED AS INCLUDED IN THE UNIT BID PRICES OF THE CONTRACT AND NO ADDITIONAL COMPENSATION WILL BE ALLOWED.
- 25. ALL PIPE UNDERDRAINS SHALL BE PLACED AT A DEPTH OF 30" BELOW THE TOP OF PROPOSED PAVEMENT OR AS DEEP AS POSSIBLE AND
 IN ACCORDANCE WITH CHECK SHEET *19 OF THE SUPPLEMENTAL SPECIFICATIONS AND RECURRING SPECIAL PROVISIONS. THE COST OF
 MAKING PIPE UNDERDRAIN CONNECTIONS TO DRAINAGE STRUCTURES SHALL BE INCLUDED IN THE COST OF PIPE UNDERDRAINS ITEM,
- 26. METHOD 3 IN ARTICLE 550.07(a) OF THE STANDARD SPECIFICATIONS, USING WATER TO COMPACT TRENCH BACKFILL MATERIAL, WILL NOT BE ALLOWED.

COMMITMENTS

 THERE IS A COMMITMENT TO THE VILLAGE OF CHANNAHON THAT THE NORTHWEST FRONTAGE ROAD WILL BE PATCHED USING A LIMIT OF 10% OF THE TOTAL AREA OR 1,300 SQ YD.

GENERAL NOTES (CONTINUED)

TRAFFIC SIGNAL GENERAL NOTES

- 27. CONTAMINATED SOILS ARE LOCATED WITHIN THE PROJECT LIMIT. PRIOR TO CONSTRUCTION WITHIN THE CONTAMINATED AREAS, THE CONTRACTOR SHALL BE RESPONSIBLE FOR HIRING AN ENVIRONMENTAL FIRM THAT IS PREQUALIFIED IN HAZARDOUS WASTES BY THE DEPARTMENT TO REMEDIATE THE SOIL CONTAMINATION AND MONITOR FOR WORKER PROTECTION. ALL UTILITY COMPANIES RELOCATING WITHIN THE FOLLOWING AREAS SHOULD BE NOTIFIED OF THE POTENTIAL SOIL CONTAMINATION. ANY WASTE GENERATED AS A SPECIAL WASTE OR WASTE NOT CERTIFIED AS A NON SPECIAL WASTE FROM THIS PROJECT SHOULD BE MANIFESTED OFF-SITE USING THE GENERATOR NUMBER ASSOCIATED WITH THE COUNTY. ALL REMEDIAL WORK SHALL BE DOCUMENTED FOR POTENTIAL ILLEGAL TRESPASS ACTION. PRIOR TO ANY REMEDIAL WORK, CONTACT CRAIG MCCAMMACK (847-705-4588).
- 28. BEFORE STARTING ANY EXCAVATION, THE CONTRACTOR SHALL CALL "J.U.L.I.E." AT (800) 892-0123 OR 811 FOR FIELD LOCATIONS OF BURIED ELECTRIC, TELEPHONE AND GAS UTILITIES. 48 HOUR NOTIFICATION IS REQUIRED.
- 29. THE CONTRACTOR SHALL CONTACT THE TRAFFIC CONTROL SUPERVISOR AT (847) 705-4470 72 HOURS IN ADVANCE OF BEGINNING WORK.
- 30. IT SHALL BE THE CONTRACTOR'S RESPONSIBILITY TO VERIFY ALL DIMENSIONS AND CONDITIONS EXISTING IN THE FIELD PRIOR TO ORDERING MATERIALS AND BEGINNING CONSTRUCTION, THIS SHALL INCLUDE LOCATING THE MAST ARM FOUNDATIONS AND VERIFYING THE MAST ARMS LENGTHS.
- 31. THE EXACT LOCATION OF ALL UTILITIES SHALL BE FIELD VERIFIED BY THE CONTRACTOR BEFORE ORDERING ANY MATERIALS AND STARTING ANY WORK. FOR LOCATIONS OF UTILITIES, LOCALLY OWNED EQUIPMENT, LEASED ENFORCEMENT CAMERA SYSTEM FACILITIES AND IDOT UNDERGROUND FACILITIES, CONTACT THE LOCAL COUNTIES, MUNICIPALITIES AND IDOT FOR LOCATES. THE CONTRACTOR SHALL CALL "JULIE" AT (800) 892-0123 OR 811, IN THE CITY OF CHICAGO CONTACT DIGGER AT (312) 744-7000 FOR FIELD LOCATIONS OF BURIED UTILITIES (48 HOURS NOTIFICATION REQUIRED).
- 32. IF THIS CONTRACT REQUIRES THE SERVICES OF AN ELECTRICAL CONTRACTOR, THE CONTRACTOR SHALL BE RESPONSIBLE AT HIS/HER OWN EXPENSE FOR LOCATING EXISTING IDOT ELECTRICAL FACILITIES PRIOR TO PERFORMING ANY WORK. IF THIS CONTRACT DOES NOT REQUIRE THE SERVICES OF AN ELECTRICAL CONTRACTOR, THE CONTRACTOR MAY REQUEST ONE FREE LOCATE FOR EXISTING IDOT ELECTRICAL FACILITIES FROM THE DISTRICT ONE ELECTRICAL MAINTENANCE CONTRACTOR PRIOR TO THE START OF ANY WORK. ADDITIONAL REQUESTS MAY BE AT THE EXPENSE OF THE CONTRACTOR. THE LOCATION OF UNDERGROUND TRAFFIC FACILITIES DOES NOT RELIEVE THE CONTRACTOR OF THEIR RESPONSIBILITY TO REPAIR ANY FACILITIES DAMAGED DURING CONSTRUCTION AT THEIR EXPENSE.
- 33. THE CONTRACTOR SHALL CHECK THE PROPOSED TRAFFIC SIGNAL EQUIPMENT LOCATIONS FOR OVERHEAD UTILITY CONFLICTS. THE CONTRACTOR SHALL COORDINATE ANY CONFLICTS WITH THE UTILITY COMPANIES AND THE RESIDENT ENGINEER BEFORE ORDERING MATERIALS.
- 34. THE CONTRACTOR SHALL COORDINATE CONSTRUCTION ACTIVITIES WITH UTILITY COMPANIES, LOCAL GOVERNMENT AGENCIES AND IDOT.
- 35. RESTORATION OF THE TRAFFIC SIGNAL WORK AREA SHALL BE INCLUDED IN THE RELATED PAY ITEM SUCH AS FOUNDATION, CONDUIT, HANDHOLE, ETC., AND NO EXTRA COMPENSATION SHALL BE ALLOWED. ALL ROADWAY SURFACES SUCH AS SHOULDERS, MEDIAN, SIDEWALKS, PAYEMENT ETC. SHALL BE REPLACED IN KIND. ALL DAMAGE TO MOWED LAWNS SHALL BE REPLACED WITH AN APPROVED SOD, AND ALL DAMAGE TO UNMOWED FIELDS SHALL BE SEEDED IN ACCORDANCE WITH STANDARD SPECIFICATIONS 252 AND 250 RESPECTIVELY.

SCALE

OFFICE AND CONSESSES	F.A.I RTE.	SECTION	COUNTY	SHEETS	SHEET NO.
GENERAL NOTES AND COMMITMENTS		2014-065-R	WILL	184	4A
			CONTRACT	NO. 5	COAS
NONE SHEET NO. 2 OF 2 SHEETS STA.	TO STA. FED.	ROAD DIST. NO. 1 ILLINOIS FED. A	ID PROJECT		

						~	COI	STRUCTION CO	DDE	0	7 <i>90</i>
		SUMMARY OF QUANTITIES		(ne A.)	0003 ROADWAY	001 0021 TRAFFIC SIGNALS RAMP C	0021 INTER CONNECT	65 0021 ITS	091 0021 IDOT LIGHTING	0021 VILLAGE LIGHTING	0021 EMERGENCY VEHICLE PREEMPTION
L	CODE NO	ITEM	UNIT	TOTAL QUANTITY	90% FED. 10% STATE	90% FED. 10% STATE	90% FED 10% STATE	90% FED 10% STATE	90% FED 10% STATE	100% VILLAGE	100% VILLAGE
										······································	
	20200100	EARTH EXCAVATION	CU YD	9, 343	9, 343						
	20201200	REMOVAL AND DISPOSAL OF UNSUITABLE MATERIAL	CU YD	3,577	3, 577				:	<u> </u>	
-	20800150	TRENCH BACKFILL	CU YD	144	144					**************************************	
r					<u> </u>						
l	21001000	GEOTECHNICAL FABRIC FOR GROUND STABILIZATION	SQ YD.	7, 647	7,647						
l											
ŀ	21101615	TOPSOIL FURNISH AND PLACE, 4"	SQ YD	11,133	11, 133					•••••	
	25000210	SEEDING, CLASS 2A	ACRE	2.5	2.5						
l	25000400	NITROGEN FERTILIZER NUTRIENT	POUND	207	207						
1	23000400	NITROGEN FERTILIZER NOTRIENT	70000	201	201						
.	25000600	POTASSIUM FERTILIZER NUTRIENT	POUND	207	207				,		
:	25100115	MULCH, METHOD 2	ACRE	4.75	4.75		THE STATE OF THE S				
	25100135	MULCH, METHOD 4	ACRE	0.25	0.25		AA-0-0-0-0-0-0-0-0-0-0-0-0-0-0-0-0-0-0-				<u> </u>
-	, , , , , , , , , , , , , , , , , , , 										
	25100630	EROSION CONTROL BLANKET	SQ YD	11,591	11,591						
					<u> </u>		The state of the s		-		
*	25100900	TURF REINFORCEMENT MAT	SQ YD	10	10						
,	25200110	SODDING, SALT TOLERANT	SQ YD	132	132						
ŀ					<u> </u>						
	28000200	EARTH EXCAVATION FOR EROSION CONTROL	CU YD	100	100						
1						-					

FILE NAME = 0152482-sht-500.dgn PLOT DATE = 1/22/3816 PLOT SCALE=188.8888 1/ in, CHRISTIAN-ROGE & ASSOCIATES, INC.
ENGINEERS-PLANNERS-SURVEYORS
221 NORTH LASALLE STREET, SUITE 300
CHICAGO, BLIMOIS 60601
PHONE: (312) 577-3300

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ING.	DESIGNED	-	5,J,P,	REVISED	-	Ī
RS	DRAWN	-	8,K.	REVISED	-	
300	CHECKED	-	M.P.	REVISED	-	l
	DATE	-	JANUARY 22, 2016	REVISED	^	

STATE OF ILLINOIS
DEPARTMENT OF TRANSPORTATION

· · · · · · · · · · · · · · · · · · ·				CONSTRUCTION CODE						
	SUMMARY OF QUANTITIES			0003 ROADWAY	0021 TRAFFIC SIGNALS RAMP C	0021 INTER CONNECT	0021 ITS	0021 IDOT LIGHTING	0021 VILLAGE LIGHTING	0021 EMERGENCY VEHICLE PREEMPTION
			URBAN					90% FED		
CODE NO	ITEM	UNIT	TOTAL QUANTITY	90% FED. 10% STATE	90% FED. 10% STATE	90% FED 10% STATE	90% FED 10% STATE	10% STATE	100% VILLAGE	100% VILLAGE
28000250	TEMPORARY EROSION CONTROL SEEDING	POUND	511	511						
	,			-						
28000305	TEMPORARY DITCH CHECKS	FOOT	348	348						
28000400	PERIMETER EROSION BARRIER	FOOT	2, 259	2, 259		WA AND AND AND AND AND AND AND AND AND AN				
000000	TWEET CALLEDO	FAOIL		4.5			-			
28000510	INLET FILTERS	EACH	15	15						
30300001	AGGREGATE SUBGRADE IMPROVEMENT	CU YD	256	256						
30300112	AGGREGATE SUBGRADE IMPROVEMENT, 12"	SQ YD	7, 647	7, 647						
31200500	STABILIZED SUBBASE - HOT-MIX ASPHALT, 4"	SQ YD	5,609	5,609						
35102000	AGGREGATE BASE COURSE, TYPE B, 8"	SQ YD	314	314						
40600290	BITUMINOUS MATERIALS (TACK COAT)	POUND	8, 228	8, 228						
40600982	HOT-MIX ASPHALT SURFACE REMOVAL - BUTT JOINT	SQ YD	190	190						
40603085	HOT-MIX ASPHALT BINDER COURSE, IL-19.0, N70	TON	1,505	1,505						
4			7.0				Account to the second	·		
40603335	HOT-MIX ASPHALT SURFACE COURSE, MIX "D", N50	TON	35	35						
40603340	HOT-MIX ASPHALT SURFACE COURSE, MIX "D", N70	TON	1,567	1,567						
42000506	PORTLAND CEMENT CONCRETE PAVEMENT 10 1/4" (JOINTED)	SQ YD	5, 153	5, 153						Variation and the second secon
		_								-

File NAME = 0162822-kht-500.dgn PLOT DATE =1/22/2216 PLOT SCALE=182.8288 // in. CHRISTIAN-ROGE & ASSOCIATES INC.

ENGINEERS-PLANNERS-SURVEYORS
221 NORTH LASALLE STREET, SUITE 300
CHICKGO, ILLINOIS 66601
PHONE: (312) 577-3300
DATE - JANUARY 22, 2016
REVISED -

	F.A.I. RTE.	SECTION	COUNTY	TOTAL	SHEET NO.
SUMMARY OF QUANTITIES	55	2014-065-R	WILL	184	6
			CONTRACT	NO. 6	COAS
SCALE: NONE SHEET NO. 2 OF 17 SHEETS STA. TO STA.	FED. R	OAD DIST. NO. 1 ILLINOIS FED. A	ID PROJECT		

			***************************************		T	CO	NSTRUCTION C	ODE		1	
	SUMMARY OF QUANTITIES			0003 ROADWAY	0021 TRAFFIC SIGNALS RAMP C	0021 INTER CONNECT	0021 ITS	0021 IDOT LIGHTING	0021 VILLAGE LIGHTING	0021 EMERGENCY VEHICLE PREEMPTION	0021 SIDEWALK
CODE NO	ITEM	UNIT	URBAN TOTAL QUANTITY	90% FED. 10% STATE	90% FED. 10% STATE	90% FED 10% STATE	90% FED 10% STATE	90% FED 10% STATE	100% VILLAGE	100% VILLAGE	80% FED 20% STATE
42001300	PROTECTIVE COAT	SQ YD	7,692	7,692	_						
42300400	PORTLAND CEMENT CONCRETE DRIVEWAY PAVEMENT, 8 INCH	SQ YD	51	51							
42400200	PORTLAND CEMENT CONCRETE SIDEWALK, 5 INCH	SQ FT	5, 200								5, 200
42400410	PORTLAND CEMENT CONCRETE SIDEWALK, 8 INCH	SQ FT	515	515			<u> </u>				
										-	
42400800	DETECTABLE WARNINGS	SQ FT	190	190							
44000100	PAVEMENT REMOVAL	SQ YD	3, 782	3, 782							
44000155	HOT-MIX ASPHALT SURFACE REMOVAL, 1 1/2"	SQ YD	12, 910	12, 910							
44000200	DRIVEWAY PAVEMENT REMOVAL	SQ YD	437	437							
44000500	COMBINATION CURB AND GUTTER REMOVAL	FOOT	982	982				W			
					·						
44000600	SIDEWALK REMOVAL	SQ FT	3, 234	3, 234							
44004250	PAVED SHOULDER REMOVAL	SQ YD	950	950					**************************************		
44200970	CLASS B PATCHES, TYPE II, 10 INCH	SQ YD	24	24			<u> </u>				
44201299	DOWEL BARS, 1 1/2"	EACH	36	36							
44201761	CLASS D PATCHES, TYPE I, 10 INCH	SQ YD	32	32							

FILE NAME = DIGZACE-aht-SCO.dgn PLOT DATE =1/22/2016 PLOT SCALE = 188,8888 17 14.

Z 85 6 V	Other actions of the proportion of the contract of the contrac	DESIGNED	-	S.J.P.	REVISED	-
177	ENGINEERS-PLANNERS-SURVEYORS 221 NORTH LASALLE STREET, SUITE 300	DRAWN		8.K.	REVISED	-
H) AV	CHICAGO, ILLINOIS 50501	CHECKED	-	M.P.	REVISED	-
	PHONE: (312) 577-3300	DATE	-	JANUARY 22, 2016	REVISED	_

REVISED -

	STATE	0F	ILLINOIS	;
DEPARTI	VIENT	OF .	TRANSPO	RTATION

٦	CHANNY OF OUNITATION	F.A.I. RTE.	SECTION	COUNTY	TOTAL	SHEET NO.
1	SUMMARY OF QUANTITIES	55	2014-065-R	WILL	184	7
1				CONTRACT	NO. 5	COAS
╛	SCALE; NONE SHEET NO. 3 OF 17 SHEETS STA. TO STA.	FED. R	OAD DIST, NO. 1 ILLINOIS FED. A	O PROJECT		

				CONSTRUCTION CODE							
	SUMMARY OF QUANTITIES			0003 ROADWAY	0021 TRAFFIC SIGNALS RAMP C	0021 INTER CONNECT	0021 ITS	0021 IDOT LIGHTING	0021 VILLAGE LIGHTING	0021 EMERGENCY VEHICLE PREEMPTION	
CODE NO	ITEM	UNIT	TOTAL QUANTITY	90% FED. 10% STATE	90% FED. 10% STATE	90% FED 10% STATE	90% FED 10% STATE	90% FED 10% STATE	100% VILLAGE	100% VILLAGE	
		A CONTRACTOR OF THE CONTRACTOR									
44201765	CLASS D PATCHES, TYPE II, 10 INCH	SQ YD	182	182							
44201769	CLASS D PATCHES, TYPE III, 10 INCH	SQ YD	564	564							
44201771	CLASS D PATCHES, TYPE IV, 10 INCH	SQ YD	496	496							
44213200	SAW CUTS	FOOT	102	102							
44213208	TIE BARS, 1 1/4"	EACH	36	36			**************************************				
48101620	AGGREGATE SHOULDERS, TYPE B, 10"	SQ YD	556	556							
48102100	AGGREGATE WEDGE SHOULDER, TYPE B	TON	293	293							
48203021	HOT-MIX ASPHALT SHOULDERS, 6"	SQ YD	543	543							
						name in the second seco					
48203037	HOT-MIX ASPHALT SHOULDERS, 10"	SQ YD	263	263							
48300505	PORTLAND CEMENT CONCRETE SHOULDERS, 10 1/4"	SQ YD	1,149	1, 149							
									A13	ļ	
50105220	PIPE CULVERT REMOVAL	FOOT	57	57	**************************************						
50200100	STRUCTURE EXCAVATION	CU YD	324	324							
50300225	CONCRETE STRUCTURES	CU YD	164.0	164, 0							
	·		104.0	103,0							
50300255	CONCRETE SUPERSTRUCTURE	CU YD	27.5	27.5							
						-		`		<u> </u>	

File NAME <0162422-wht-500.dgn PLOT DATE *1/22/2816 PLOT SCALE=182.6862 */ in-

PARTES!	CHEST STATE COLD OF MASSOCIATES, SILO,	DESIGNED	-	S.J.P.
	ENGINEERS-PLANNERS-SURVEYORS 221 NORTH LASALLE STREET, SUITE 300	DRAWN	-	B.K.
TIN AV	CHICAGO, ILLINOIS 60601	CHECKED	-	W.P.
	PHONE: (312) 577-3300	DATE	-	JANUARY 22, 2016

1/41943		-
REVISED		STATE OF ILLINOIS
REVISED	-	DEPARTMENT OF TRANSPORTATION
REVISED	-	

IN			
	SCALE	MONE	-

	SU	M	AF	₹Y	OF O	UANTITIE:	5
SHEET	NO.	4	٥F	17	SHEETS	STA.	TO STA

-	RTE.	SECTION	COUNTY	SHEETS	NO.
	55	2014-065-R	WILL	184	₿
			CONTRACT	NO. 6	2A00
	FEO. RO	AD DIST. NO. 1 ILLENOIS FED. AT	D PROJECT		

				CONSTRUCTION CODE							
	SUMMARY OF QUANTITIES			0003 ROADWAY	0021 TRAFFIC SIGNALS RAMP C	0021 INTER CONNECT	0021 ITS	0021 IDOT LIGHTING	0021 VILLAGE LIGHTING	0021 EMERGENCY VEHICLE PREEMPTION	
CODE NO	ITEM	UNIT	TOTAL QUANTITY	90% FED. 10% STATE	90% FED. 10% STATE	90% FED 10% STATE	90% FED 10% STATE	90% FED 10% STATE	100% VILLAGE	100% VILLAGE	
50300300	PROTECTIVE COAT	SQ YD	604	604							
50500505	STUD SHEAR CONNECTORS	EACH	704	704							
30300303	SIOU SHEAR CONNECTORS	EACO	104	, , ,	Annual and Constitution of the Constitution of						
50800205	REINFORCEMENT BARS, EPOXY COATED	POUND	19,710	19,720							
51204650	PILE SHOES	EACH	60	60					***************************************		
51500100	NAME PLATES	EACH	1	1							
52200100	FURNISHING SOLDIER PILES (HP SECTION)	FOOT	1,324	1,324							
52200150	DRIVING SOLDIER PILES	FOOT	1,251	1,251							
52200200	DRILLING AND SETTING SOLDIER PILES (IN SOIL)	CU-FT-	397	397							
52200205	DRILLING AND SETTING SOLDIER-PILES (IN-ROCK)	- CU-FT-	3, 148	3, 148							
52200250	UNTREATED TIMBER LAGGING	SQ FT	3, 266	3, 266							
54213657	PRECAST REINFORCED CONCRETE FLARED END SECTIONS 12"	EACH	1	1							
54261424	CONCRETE END SECTION, STANDARD 542001, 24", 1: 4	EACH	1	1							
550A0050	STORM SEWERS, CLASS A, TYPE 1, 12"	FOOT	324	324							
550A0090	STORM SEWERS, CLASS A, TYPE 1, 18"	FOOT	114	114							
550A0120	STORM SEWERS, CLASS A, TYPE 1, 24"	F00T	485	485							
55100500	STORM SEWER REMOVAL, 12"	FOOT	290	290							
		· · · · · · · · · · · · · · · · · · ·						<u> </u>			

FILE NAME = 0362428-int-SOO.dgn PLOT DATE *1/22/2816 PLOT SCALE = 128.8888 // in.

2800	CHRISTIAN-ROGE & ASSOCIATES, INC.	DESIGNED	- 5.4.	2.		REVISED	-	
VIII.	ENGINEERS-PLANNERS-SURVEYORS 21 NORTH LASALLE STREET, SUITE 300	DRAWN	- B.K.			REVISED	-	
The state of the s	CHICAGO, ILLINOIS 60601	CHECKED	- M.P.			REVISED	-	
	PHONE: (312) 577-3300	DATE	~ JANL	JARY 22, 201	6	REVISED	~	

CHARLES OF AUNITITIES	F.A.I. RTE.	SECTION	COUNTY	TOTAL SHEET:	SHEE
SUMMARY OF QUANTITIES	55	2014-065-R	WILL	184	9
	1		CONTRACT	NO.	5ZADO
CALE: NONE SHEET NO. 5 OF 17 SHEETS STA. TO STA.	FED. R	OAD DIST. NO. 1 ILLENOIS FED. A	D PROJECT		

				CONSTRUCTION CODE							
	SUMMARY OF QUANTITIES			0003 ROADWAY	0021 TRAFFIC SIGNALS RAMP C	0021 INTER CONNECT	0021 ITS	0021 IDOT LIGHTING	0021 VILLAGE LIGHTING	0021 EMERGENCY VEHICLE PREEMPTION	
			URBAN	August 1	***************************************	000/ 550					
CODE NO	ITEM	UNIT	TOTAL QUANTITY	90% FED. 10% STATE	90% FED. 10% STATE	90% FED 10% STATE	90% FED 10% STATE	90% FED 10% STATE	100% VILLAGE	100% VILLAGE	
55100700	STORM SEWER REMOVAL, 15"	FOOT	60	60							
				Vando de la companya del companya de la companya de la companya del companya de la companya del companya de la companya de la companya de la companya del companya de la companya dela companya de la companya del companya de la companya de la companya del companya de la companya del companya del companya de							
59100100	GEOCOMPOSITE WALL DRAIN	SQ YD	243	243							
60100060	CONCRETE HEADWALLS FOR PIPE DRAINS	EACH	. 2	2							
60100905	PIPE DRAINS, 4"	FOOT	40	40							
			to a contract of the contract								
60108104	PIPE UNDERDRAINS, TYPE 1, 4"	FOOT	1,050	1,050							
60200105	CATCH BASINS, TYPE A, 4'-DIAMETER, TYPE 1 FRAME, OPEN LID	EACH	4	1		On the state of th					
60200805	CATCH BASINS, TYPE A, 4'-DIAMETER, TYPE 8 GRATE	EACH	4	4						-	
60201340	CATCH BASINS, TYPE A, 4' -DIAMETER, TYPE 24 FRAME AND GRATE	EACH	5	5							
60204505	CATCH BASINS, TYPE A, 5'-DIAMETER, TYPE 8 GRATE	EACH	1	1							
60218400	MANHOLES, TYPE A, 4'-DIAMETER, TYPE 1 FRAME, CLOSED LID	EACH	3	3							
60250200	CATCH BASINS TO BE ADJUSTED	EACH	4	4							
				TOTAL CONTRACTOR OF THE CONTRA		STATE AND A STATE					
60255500	MANHOLES TO BE ADJUSTED	EACH	4	4							
60259340	MANHOLES TO BE RECONSTRUCTED WITH NEW TYPE 24 FRAME AND GRATE	EACH	\$	1							
60500050	PENDVING CATCH RASINS	EACH	1	1		TATALON TO THE TATALO					
60300030	REMOVING CATCH BASINS	EACH	1	1							

FILE NAME = 0162400 tht 500.dgn PLOT DATE = 1/22/2016 PLOT SCOLE = 108.0000 1/ in CHRISTIAN-ROGE & ASSOCIATES, INC.
ENGINEERS-PLANNERS-SURVEYORS
221 NORTH LASALLE STREET, SUITE 300
CHICAGO, ILLINOIS 68661
PHONE: (312) 577-3300

DATE

DATE

DATE

DESIGNED - S.J.P.
REVISED REVISED CHECKED - M.P.
REVISED DATE

DATE

JANUARY 22, 2016

REVISED -

		F.A.I. RTE.	SECTION	COUNTY	SHEETS	SHEET NO.
1	SUMMARY OF QUANTITIES	55	2014-065-R	WILL	184	10
1				CONTRACT	NO.	52ADD
1	SCALE: NONE SHEET NO. 6 OF 17 SHEETS STA. TO STA.	FED. R	OAD DIST. NO. 1 ILLENOIS FED. A	D PROJECT		

			:			CO	NSTRUCTION C	ODE		T
	SUMMARY OF QUANTITIES			0003 ROADWAY	0021 TRAFFIC SIGNALS RAMP C	0021 INTER CONNECT	0021 ITS	0021 IDOT LIGHTING	0021 VILLAGE LIGHTING	0021 EMERGENCY VEHICLE PREEMPTIO
CODE	ITEM	UNIT	TOTAL QUANTITY	90% FED. 10% STATE	90% FED. 10% STATE	90% FED 10% STATE	90% FED	90% FED	100%	100%
			QUANTITY	10% STATE	10% STATE	10% STATE	10% STATE	10% STATE	VILLAGE	VILLAGE
605002	5 FILLING CATCH BASINS	EACH	9	9						
606038	COMBINATION CONCRETE CURB AND GUTTER, TYPE B-6.12	FOOT	110	110						
										
606050	O COMBINATION CONCRETE CURB AND GUTTER, TYPE 8-6.24	FOOT	1,089	1,089						
606104	O COMBINATION CONCRETE CURB AND GUTTER, TYPE M-6.24	FOOT	221	221					·	
		<u> </u>								
606183	O CONCRETE MEDIAN SURFACE, 4 INCH	SQ FT	1,438	1,438						·
606243	O CONCRETE BARRIER MEDIAN, 4 FT. (DOWELLED)	SQ FT	745	745						
202040	4300 CONCRETE BARRIER MEDIAN, 4 FT. (DOWELLED) 4600 CORRUGATED MEDIAN									
600246	J CORNOGATED MEDIAN	SQ FT	69	69			<u> </u>		·	<u> </u>
630000	1 STEEL PLATE BEAM GUARDRAIL, TYPE A, 6 FOOT POSTS	FOOT	1, 125	1, 125						
67000	7. CTEEL DUATE DEAL OUIDDRAY, TYPE A O FOOT DOCTO	5007	020	250				ì	·	
630000	3 STEEL PLATE BEAM GUARDRAIL, TYPE A, 9 FOOT POSTS	FOOT	250	250	ì			70 mm		
631000	5 TRAFFIC BARRIER TERMINAL, TYPE 2	EACH	1	1						
				· · · · · · · · · · · · · · ·					*	
631001	7 TRAFFIC BARRIER TERMINAL, TYPE 1 (SPECIAL) TANGENT	EACH	3	3						
635001	5 DELINEATORS	EACH	37	37						
664001	5 CHAIN LINK FENCE, 4'	FOOT	541	541					······································	
										
6690020	O NON-SPECIAL WASTE DISPOSAL	CU YD	-3, 900	3, 900						

FRE NAME *0162022-he-500.dgn PLOT DATE *1/22/2816 PLOT SCALE:188.8228 */ 1n. CHRISTIAN-ROGE & ASSOCIATES, INC.
ENGINEERS-PLANNERS-SURVEYORS
221 NORTH LASALLE STREET, SURITE 300
CHICAGO, ELITIOIS 60601
PHONE: (312) 577-3300

	DESIGNED	~	S.J.P.	REVISED	~
RS 300	DRAWN	~	8.K.	REVISED	^
. 400	CHECKED	-	y.P.	REVISED	~
	DATE	-	JANUARY 22, 2016	REVISED	-

STATE OF ILLINOIS
DEPARTMENT OF TRANSPORTATION

SUMMARY OF QUANTITIES

SCALE: NONE | SHEET NO. 7 OF 17 SHEETS | STA. TO STA.

						COI	NSTRUCTION C	ODE		
	SUMMARY OF QUANTITIES		den.	COO3 ROADWAY	0021 TRAFFIC SIGNALS RAMP C	0021 INTER CONNECT	0021 ITS	0021 IDOT LIGHTING	0021 VILLAGE LIGHTING	0021 EMERGEN VEHICL PREEMPT
CODE NO	ITEM	UNIT	URBAN TOTAL QUANTITY	90% FED. 10% STATE	90% FED. 10% STATE	90% FED 10% STATE	90% FED 10% STATE	90% FED 10% STATE	100% VILLAGE	1000 VILLA
				The state of the s		THE STATE OF THE S				
66900450	SPECIAL WASTE PLANS AND REPORTS	L SUM	1							
										<u> </u>
66900530	SOIL DISPOSAL ANALYSIS	EACH	2	2						
67100100	MOBILIZATION	L SUM	1	1		14 14 14 14 14 14 14 14 14 14 14 14 14 1				
				ALAN PROPERTY AND		CARACTER TRANSPORT				
70103815	TRAFFIC CONTROL SURVEILLANCE	CAL DA	80	80		outer and a second a second and				
				**************************************			Andrews			ļ
70106800	CHANGEABLE MESSAGE SIGN	CAL MO	24	24			A ANGELON AND ANGE			
70300100	SHORT TERM PAVEMENT MARKING	FOOT	2, 496	2, 496			Veranda in the second s			-
70300150	SHORT TERM PAVEMENT MARKING REMOVAL	SQ FT	832	832		ANALYSIS				
70300220	TEMPORARY PAVEMENT MARKING - LINE 4"	FOOT	16, 124	16, 124		THE CASE OF THE CA		****		
		 								
70400100	TEMPORARY CONCRETE BARRIER	FOOT	1, 461	1,461						
70400200	RELOCATE TEMPORARY CONCRETE BARRIER	FOOT	585	585						
70600240	IMPACT ATTENUATORS, TEMPORARY (NON-REDIRECTIVE), TEST LEVEL 2	EACH	*	1	s	***************************************		The state of the s		-
			1							
70600251	IMPACT ATTENUATORS, TEMPORARY (NON-REDIRECTIVE, NARROW), TEST LEVEL 3	VEMENT MARKING REMOVAL SO FT 832 832 EMENT MARKING - LINE 4" FOOT 16,124 16,124 CRETE BARRIER FOOT 1,461 1,461 ORARY CONCRETE BARRIER FOOT 585 585 ATORS, TEMPORARY (NON-REDIRECTIVE), TEST LEVEL 2 EACH 1 1 ATORS, TEMPORARY (NON-REDIRECTIVE, NARROW), TEST LEVEL 3 EACH 1 1 ATORS, TEMPORARY (FULLY REDIRECTIVE, NARROW), TEST LEVEL 3 EACH 1 1 ATORS, TEMPORARY (FULLY REDIRECTIVE, NARROW), TEST LEVEL 3 EACH 1 1								
70600260	IMPACT ATTENUATORS, TEMPORARY (FULLY REDIRECTIVE, NARROW), TEST LEVEL 3	EACH	1	1						
70600332	IMPACT ATTENUATORS, RELOCATE (FULLY REDIRECTIVE, NARROW), TEST LEVEL 3	EACH	1	1						
					÷					

STATE OF ILLINOIS

SPECIALTY ITEM *

FILE NAME + DI62A88-sht-508.dgn PLOT DATE =1/22/22/6 PLOT SCALE = 122,2223 1/ ja.

CHRISTIAN-ROGE & ASSOCIATES, INC.

ENGINEERS-PLANNERS-SURVEYORS
221 NORTH LASALLE STREET, SUITE 300
CHECAGO, LLIANOIS 66601
PHONE: (312) 577-3300

DATE - JANUAR DATE - JANUARY 22, 2016 REVISED -

DEPARTMENT OF TRANSPORTATION

REVISED -

REVISED -

SUMMARY OF QUANTITIES SCALE: NONE SHEET NO. 8 OF 17 SHEETS STA.

TO STA.

Γ			***************************************				CO	NSTRUCTION C	ODE		
		SUMMARY OF QUANTITIES			OOO3 ROADWAY	0021 TRAFFIC SIGNALS RAMP C	0021 INTER CONNECT	0021 ITS	0021 IDOT LIGHTING	0021 VILLAGE LIGHTING	0021 EMERGENCY VEHICLE PREEMPTION
	CODE NO	ITEM	UNIT	TOTAL QUANTITY	90% FED. 10% STATE	90% FED. 10% STATE	90% FED 10% STATE	90% FED 10% STATE	90% FED 10% STATE	100% VILLAGE	100% VILLAGE
										i	
*	72000100	SIGN PANEL - TYPE 1	SQ FT	102	66	36					
*	72000200	SIGN PANEL - TYPE 2	SQ FT	12	12						
*	72400310	REMOVE SIGN PANEL - TYPE 1	SQ FT	4	4						
*	72400320	REMOVE SIGN PANEL - TYPE 2	SQ FT	12	12						
*	72400710	RELOCATE SIGN PANEL - TYPE 1	SQ FT	146	146						
*	72400730	RELOCATE SIGN PANEL - TYPE 3	SQ FT	275	275						
Ī											
*	72700100	STRUCTURAL STEEL SIGN SUPPORT - BREAKAWAY	POUND	2, 444	2, 444						
*	72800100	TELESCOPING STEEL SIGN SUPPORT	FOOT	60	60						
l	,,,,,,,,,,,,,,,,,,,,,,,,,,,,,,,,,,,,,										
*	72900100	METAL POST - TYPE A	F00T	51	51						
*	72900200	METAL POST - TYPE B	FOOT	85	85						
"											
*	73000100	WOOD SIGN SUPPORT	FOOT	117	117						
*	73400100	CONCRETE FOUNDATIONS	CU YD	6	6						
*	73700100	REMOVE GROUND MOUNTED SIGN SUPPORT	EACH	8	8						
f											
*	73700200	REMOVE CONCRETE FOUNDATION - GROUND MOUNT	EACH	8	8						
۸ [
*											

FILE NAME = DI62A82-whe-500.dgm PLOT DATE + 1/22/2016 PLOT SCALE < 102.0202 1/ 1n, CHRISTIAN-ROGE & ASSOCIATES, INC.
ENGINEERS-PLANNERS-SURVEYORS
221 NORTH LASALLE STREET, SUITE 300
CHICKGO, BLINOIS 56691
PHONE: [312] 577-3300

DATE.

, INC.	DESIGNED	- \$.J.P.	REVISED -
ORS.	DRAWN	- 8.K.	REVISED -
1E 300	CHECKED	- м.Р.	REVISED -
	DATE	- JANUARY 22, 2016	REVISED -

	F.A.I. RTE.	SECTION .	COUNTY	SHEET	SHEET NO.
SUMMARY OF QUANTITIES	55	2014-065-R	WILL	184	13
	_		CONTRACT	ND.	52A00
SCALE NONE SHEET NO. 9 OF 17 SHEETS STA. TO STA.	FED. R	OAD DIST, NO. 1 ILLINOIS FED. A	D PROJECT		

Γ						·	COI	NSTRUCTION C	ODE		
		SUMMARY OF QUANTITIES			COO3 ROADWAY	0021 TRAFFIC SIGNALS RAMP C	0021 INTER CONNECT	0021 ITS	0021 IDOT LIGHTING	0021 VILLAGE LIGHTING	0021 EMERGENCY VEHICLE PREEMPTION
	CODE NO	ITEM	UNIT	URBAN TOTAL QUANTITY	90% FED. 10% STATE	90% FED. 10% STATE	90% FED 10% STATE	90% FED 10% STATE	90% FED 10% STATE	100% VILLAGE	100% VILLAGE
r											
	78000200	THERMOPLASTIC PAVEMENT MARKING - LINE 4"	FOOT	11,640	11,640						
	78000500	THERMOPLASTIC PAVEMENT MARKING - LINE 8"	FOOT	193	193						
_	78000600	THERMOPLASTIC PAVEMENT MARKING - LINE 12"	FOOT	106	106						
	78000650	THERMOPLASTIC PAVEMENT MARKING - LINE 24"	FOOT	54	54				-		
-	78008200	POLYUREA PAVEMENT MARKING TYPE I - LETTERS AND SYMBOLS	SQ FT	770	770						
l											
	78008210	POLYUREA PAVEMENT MARKING TYPE I - LINE 4"	FOOT	3, 487	3, 487						
-	78008230	POLYUREA PAVEMENT MARKING TYPE I - LINE 6"	FOOT	2, 482	2,482			·			
-	78008240	POLYUREA PAVEMENT MARKING TYPE I ~ LINE 8"	FOOT	419	419						
_	78008250	POLYUREA PAVEMENT MARKING TYPE I - LINE 12"	FOOT	832	832						
	78008270	POLYUREA PAVEMENT MARKING TYPE I - LINE 24"	FOOT	172	172						
											-
	78100100	RAISED REFLECTIVE PAVEMENT MARKER	EACH	175	175						
ŀ	78100200	TEMPORARY RAISED REFLECTIVE PAVEMENT MARKER	EACH	72	72						
	78200530	BARRIER WALL MARKERS, TYPE C	EACH	116	116						
-	78300100	PAVEMENT MARKING REMOVAL	SQ FT	11, 100	11,100						
L				<u> </u>	<u> </u>	<u> </u>	l	<u> </u>	<u> </u>	<u> </u>	

FILE NAME = 0162428-wht-500.dgn PLOT DATE #1/22/2016 PLOT SCALE=188.8228 17 in.

CHRISTIAN-ROGE & ASSOCIATES, INC.
ENGINEERS-PLANNERS-SURVEYORS
221 NORTH LASALLE STREET, SUITE 300
CHICAGO, LILINOIS 6001
PHONE: (312) 577-3300

DATE

DATE

JANUARY 22, 2016

REVISED

DATE
JANUARY 22, 2016

REVISED
-

 DEPART

REVISED -

		F.A.I. RTE.	SECTION	COUNTY	TOTAL	
1	SUMMARY OF QUANTITIES	55	2014-065-R	WILL	184	14
1				CONTRACT	NO. E	SZADD
-	SCALE: NONE SHEET NO. 10 OF 17 SHEETS STA. TO STA.	FED. R	OAD DIST. NO. 1 ILLINOIS FED. AT	D PROJECT		

Γ						······································	со	NSTRUCTION C	ODE		
***************************************		SUMMARY OF QUANTITIES		Urban	0003 ROADWAY	0021 TRAFFIC SIGNALS RAMP C	0021 INTER CONNECT	0021 ITS	0021 IDOT LIGHTING	0021 VILLAGE LIGHTING	0021 EMERGENCY VEHICLE PREEMPTION
	CODE NO	ITEM	UNIT	TOTAL	90% FED. 10% STATE	90% FED. 10% STATE	90% FED 10% STATE	90% FED 10% STATE	90% FED 10% STATE	100% VILLAGE	100% VILLAGE
ļ							age as a second and a second an			·····	
-	78300200	RAISED REFLECTIVE PAVEMENT MARKER REMOVAL	EACH	118	118						
*	80500020	SERVICE INSTALLATION - POLE MOUNTED	EACH			1					
							Average de la constant de la constan				
*	81028200	UNDERGROUND CONDUIT, GALVANIZED STEEL, 2" DIA.	FOOT	1,417		693	594	130			
*	81028210	UNDERGROUND CONDUIT, GALVANIZED STEEL, 2 1/2" DIA.	FOOT	201		201					
I											
*	81028220	UNDERGROUND CONDUIT, GALVANIZED STEEL, 3" DIA.	FOOT	318		318					
*	81028240	UNDERGROUND CONDUIT, GALVANIZED STEEL. 4" DIA.	FOOT	906		486		300	120		
*	81400100	HANDHOLE	EACH	3		3					
*	81400200	HEAVY-DUTY HANDHOLE	EACH	2		2					
*	81400300	DOUBLE HANDHOLE	EACH	3		3					
*	81603081	UNIT DUCT, 600V, 3-1C NO. 2, 1/C NO. 4 GROUND, (XLP-TYPE USE), 1 1/2" DIA. POLYETHYLENE	FOOT	1,400					200	1,200	
ľ		·									
*	81702130	ELECTRIC CABLE IN CONDUIT, 600V (XLP-TYPE USE) 1/C NO. 6	FOOT	260	The state of the s			260			
*	81800230	AERIAL CABLE, 2-1/C NO. 6 WITH MESSENGER WIRE	FOOT	120	S and the second			120			
	· · · · · · · · · · · · · · · · · · ·										
*	82102400	LUMINAIRE, SODIUM VAPOR, HORIZONTAL MOUNT, 400 WATT	EACH	2					2		
*	83007200	LIGHT POLE, ALUMINUM, 35 FT. M. H., 6 FT. MAST ARM	EACH	5	1000 1000 1000 1000 1000 1000 1000 100					5	
(-			

FILE NAME = DISZARR-whe-500.dgn PLOT DATE = 1/22/2816 PLOT SCALE=188.8228 1/ yn. CHRISTIAN-ROGE & ASSOCIATES, INC.
ENGINEERS-PLANNERS-SURVEYORS
221 NORTH LASALLE STREET, SUITE 300
CHICAGO, ILLINOIS 60601
PHONE: [312] 577-3300

DATE
JANUARY 22, 2016

REVISED
-

STATE OF ILLINOIS
DEPARTMENT OF TRANSPORTATION

CODE NO ITEM		· · · · · · · · · · · · · · · · · · ·			-			COI	STRUCTION C	ODE		
COOR NO			SUMMARY OF QUANTITIES		W052-1	0003 ROADWAY	TRAFFIC SIGNALS	INTER	0021 ITS	IDOT	VILLAGE	0021 EMERGENCY VEHICLE PREEMPTION
# 33600200 LICHT POLE FOLNDATION, 24" DIAMSTER FOOT 10 20 50 50 # 33600200 SPEAKAMAY DEVICE, TRANSFORMER 9452, 11.5 INCH 90LT CIRCLE EACH 5 5 5 5 5 5 5 5 5 5 5 5 5 5 5 5 5 5 5		CODE NO	ITEM	UNIT		90% FED. 10% STATE	90% FED. 10% STATE	90% FED 10% STATE	90% FED 10% STATE	90% FED 10% STATE	100% VILLAGE	100% VILLAGE
# 33600200 LICHT POLE FOLNDATION, 24" DIAMSTER FOOT 10 20 50 50 # 33600200 SPEAKAMAY DEVICE, TRANSFORMER 9452, 11.5 INCH 90LT CIRCLE EACH 5 5 5 5 5 5 5 5 5 5 5 5 5 5 5 5 5 5 5								THE PROPERTY OF THE PROPERTY O				
# 93800105 BREAKMAY DEVICE, TRANSFORMER BASE, 11. S INCH BOLT CIRCLE	*	83050810	LIGHT POLE, ALUMINUM, 47.5 FT. M. H., 15 FT. MAST ARM	EACH	2					2		
# 63800205 DREAAWAY DEVICE, TRANSFORMER BASE, 15 INCH BOLT CIRCLE EACH 2 2 2 2 2 2 2 2 2 2 2 2 2 2 2 2 2 2 2	*	83600200	LIGHT POLE FOUNDATION, 24" DIAMETER	FOOT	70					20	50	
# 84200500 REMOVAL OF LIGHTING UNIT, SALVAGE # 84200500 REMOVAL OF POLE FOUNDATION # 84200500 REMOVAL OF POLE FOUNDATION # 84400405 RELOCATE EXISTING WOOD POLES # 88000200 MAINTERNANCE OF EXISTING TRAFFIC SIGNAL INSTALLATION # 88000200 MAINTERNANCE OF EXISTING TRAFFIC SIGNAL INSTALLATION # 87200400 SFAN WIRE # 87200500 TEPHER WIRE # 87300925 ELECTRIC CABLE IN CONDUIT, TRACER, NO. 14 1C # 87300925 ELECTRIC CABLE IN CONDUIT, SIGNAL NO. 14 2C # 87301225 ELECTRIC CABLE IN CONDUIT, SIGNAL NO. 14 2C # 87301225 ELECTRIC CABLE IN CONDUIT, SIGNAL NO. 14 30 # 87301225 ELECTRIC CABL	*	83800105	BREAKAWAY DEVICE, TRANSFORMER BASE, 11.5 INCH BOLT CIRCLE	EACH	5						5	
# 84200500 REMOVAL OF LIGHTING UNIT, SALVAGE # 84200500 REMOVAL OF POLE FOUNDATION # 84200500 REMOVAL OF POLE FOUNDATION # 84400405 RELOCATE EXISTING WOOD POLES # 88000200 MAINTERNANCE OF EXISTING TRAFFIC SIGNAL INSTALLATION # 88000200 MAINTERNANCE OF EXISTING TRAFFIC SIGNAL INSTALLATION # 87200400 SFAN WIRE # 87200500 TEPHER WIRE # 87300925 ELECTRIC CABLE IN CONDUIT, TRACER, NO. 14 1C # 87300925 ELECTRIC CABLE IN CONDUIT, SIGNAL NO. 14 2C # 87301225 ELECTRIC CABLE IN CONDUIT, SIGNAL NO. 14 2C # 87301225 ELECTRIC CABLE IN CONDUIT, SIGNAL NO. 14 30 # 87301225 ELECTRIC CABL	3 4 2	93900205	BDEAVAWAY DEVICE TRANSCORMED BASE 15 INCH BOLT CIDOLE	EVCH	2					2		
# 88200804 REMOVAL OF POLE FOUNDATION EACH 5	75	83800203	BREANAHAT DEVICE, TRANSFORMER BASE, 15 INCH BOLT CIRCLE	EAGR	-					-		
# 84400405 RELOCATE EXISTING WOOD POLES EACH 1 1 1 1	*	84200500	REMOVAL OF LIGHTING UNIT, SALVAGE	EACH	5						5	
# 85000200 MAINTENANCE OF EXISTING TRAFFIC SIGNAL INSTALLATION EACH 3 1 2	*	84200804	REMOVAL OF POLE FOUNDATION	EACH	5						5	
# 87200400 SPAN WIRE FOOT 1, 280 280 1,000 # 87200500 TETHER WIRE FOOT 280 280 1,000 # 87300925 ELECTRIC CABLE IN CONDUIT, TRACER, NO. 14 1C FOOT 1, 681 1, 681 # 87301215 ELECTRIC CABLE IN CONDUIT, SIGNAL NO. 14 2C FOOT 2, 515 2, 515 # 87301225 ELECTRIC CABLE IN CONDUIT, SIGNAL NO. 14 3C FOOT 2, 515 2, 515 # 87301225 ELECTRIC CABLE IN CONDUIT, SIGNAL NO. 14 3C FOOT 2, 515 2, 515 # 87301225 ELECTRIC CABLE IN CONDUIT, SIGNAL NO. 14 3C FOOT 2, 515 2, 515 # 87301225 ELECTRIC CABLE IN CONDUIT, SIGNAL NO. 14 3C FOOT 2, 515 2, 515 # 87301225 ELECTRIC CABLE IN CONDUIT, SIGNAL NO. 14 3C FOOT 2, 515 2, 515 # 87301225 ELECTRIC CABLE IN CONDUIT, SIGNAL NO. 14 3C FOOT 2, 515 2, 515 # 87301225 ELECTRIC CABLE IN CONDUIT, SIGNAL NO. 14 3C FOOT 2, 515 2, 515 # 87301225 ELECTRIC CABLE IN CONDUIT, SIGNAL NO. 14 3C FOOT 2, 515 2, 515 # 87301225 ELECTRIC CABLE IN CONDUIT, SIGNAL NO. 14 3C FOOT 2, 515 2, 515 # 87301225 ELECTRIC CABLE IN CONDUIT, SIGNAL NO. 14 3C FOOT 2, 515 2, 515 # 87301225 ELECTRIC CABLE IN CONDUIT, SIGNAL NO. 14 3C FOOT 2, 515 2, 515 # 87301225 ELECTRIC CABLE IN CONDUIT, SIGNAL NO. 14 3C FOOT 2, 515 2, 515 # 87301225 ELECTRIC CABLE IN CONDUIT, SIGNAL NO. 14 3C FOOT 2, 515 2, 515 # 87301225 ELECTRIC CABLE IN CONDUIT, SIGNAL NO. 14 3C FOOT 2, 515 2, 515 # 87301225 ELECTRIC CABLE IN CONDUIT, SIGNAL NO. 14 3C FOOT 2, 515 2, 515 # 87301225 ELECTRIC CABLE IN CONDUIT, SIGNAL NO. 14 3C FOOT 2, 515 2, 515 # 87301225 ELECTRIC CABLE IN CONDUIT, SIGNAL NO. 14 3C FOOT 2, 515 2, 515 # 87301225 ELECTRIC CABLE IN CONDUIT, SIGNAL NO. 14 3C FOOT 2, 515 2, 515 # 87301225 ELECTRIC CABLE IN CONDUIT, SIGNAL NO. 14 3C FOOT 2, 515 2, 515 # 87301225 ELECTRIC CABLE IN CONDUIT, SIGNAL NO. 14 3C FOOT 2, 515 2, 515 # 87301225 ELECTRIC CABLE IN CONDUIT, SIGNAL NO. 14 3C FOOT 2, 515 2, 515 # 87301225 ELECTRIC CABLE IN CONDUIT, SIGNAL NO. 14 3C FOOT 2, 515 2, 515 # 87301225 ELECTRIC CABLE IN CONDUIT, SIGNAL NO. 14 3C FOOT 2, 515 2, 515 # 87301225 ELECTRIC CABLE IN CONDUIT, SIGNAL NO. 14 3C FOOT 2, 515 2, 515 ELECTRIC CABLE IN CONDUIT, SIGNAL NO	*	84400405	RELOCATE EXISTING WOOD POLES	EACH	1		1				- 1	
# 87200400 SPAN WIRE FOOT 1, 280 280 1,000 # 87200500 TETHER WIRE FOOT 280 280 1,000 # 87300925 ELECTRIC CABLE IN CONDUIT, TRACER, NO. 14 1C FOOT 1, 681 1, 681 # 87301215 ELECTRIC CABLE IN CONDUIT, SIGNAL NO. 14 2C FOOT 2, 515 2, 515 # 87301225 ELECTRIC CABLE IN CONDUIT, SIGNAL NO. 14 3C FOOT 2, 515 2, 515 # 87301225 ELECTRIC CABLE IN CONDUIT, SIGNAL NO. 14 3C FOOT 2, 515 2, 515 # 87301225 ELECTRIC CABLE IN CONDUIT, SIGNAL NO. 14 3C FOOT 2, 515 2, 515 # 87301225 ELECTRIC CABLE IN CONDUIT, SIGNAL NO. 14 3C FOOT 2, 515 2, 515 # 87301225 ELECTRIC CABLE IN CONDUIT, SIGNAL NO. 14 3C FOOT 2, 515 2, 515 # 87301225 ELECTRIC CABLE IN CONDUIT, SIGNAL NO. 14 3C FOOT 2, 515 2, 515 # 87301225 ELECTRIC CABLE IN CONDUIT, SIGNAL NO. 14 3C FOOT 2, 515 2, 515 # 87301225 ELECTRIC CABLE IN CONDUIT, SIGNAL NO. 14 3C FOOT 2, 515 2, 515 # 87301225 ELECTRIC CABLE IN CONDUIT, SIGNAL NO. 14 3C FOOT 2, 515 2, 515 # 87301225 ELECTRIC CABLE IN CONDUIT, SIGNAL NO. 14 3C FOOT 2, 515 2, 515 # 87301225 ELECTRIC CABLE IN CONDUIT, SIGNAL NO. 14 3C FOOT 2, 515 2, 515 # 87301225 ELECTRIC CABLE IN CONDUIT, SIGNAL NO. 14 3C FOOT 2, 515 2, 515 # 87301225 ELECTRIC CABLE IN CONDUIT, SIGNAL NO. 14 3C FOOT 2, 515 2, 515 # 87301225 ELECTRIC CABLE IN CONDUIT, SIGNAL NO. 14 3C FOOT 2, 515 2, 515 # 87301225 ELECTRIC CABLE IN CONDUIT, SIGNAL NO. 14 3C FOOT 2, 515 2, 515 # 87301225 ELECTRIC CABLE IN CONDUIT, SIGNAL NO. 14 3C FOOT 2, 515 2, 515 # 87301225 ELECTRIC CABLE IN CONDUIT, SIGNAL NO. 14 3C FOOT 2, 515 2, 515 # 87301225 ELECTRIC CABLE IN CONDUIT, SIGNAL NO. 14 3C FOOT 2, 515 2, 515 # 87301225 ELECTRIC CABLE IN CONDUIT, SIGNAL NO. 14 3C FOOT 2, 515 2, 515 # 87301225 ELECTRIC CABLE IN CONDUIT, SIGNAL NO. 14 3C FOOT 2, 515 2, 515 # 87301225 ELECTRIC CABLE IN CONDUIT, SIGNAL NO. 14 3C FOOT 2, 515 2, 515 # 87301225 ELECTRIC CABLE IN CONDUIT, SIGNAL NO. 14 3C FOOT 2, 515 2, 515 # 87301225 ELECTRIC CABLE IN CONDUIT, SIGNAL NO. 14 3C FOOT 2, 515 2, 515 # 87301225 ELECTRIC CABLE IN CONDUIT, SIGNAL NO. 14 3C FOOT 2, 515 2, 515 ELECTRIC CABLE IN CONDUIT, SIGNAL NO								THE PROPERTY OF THE PROPERTY O				
* 87200400 SPAN WIRE FOOT 1, 280 280 1,000 * 87200500 TETHER WIRE FOOT 280 280 * 87300925 ELECTRIC CABLE IN CONDUIT, TRACER, NO. 14 1C FOOT 1, 681 1, 681 * 87301215 ELECTRIC CABLE IN CONDUIT, SIGNAL NO. 14 2C FOOT 1, 625 1, 625 * 87301225 ELECTRIC CABLE IN CONDUIT, SIGNAL NO. 14 3C FOOT 2, 515 2, 515	*	85000200	MAINTENANCE OF EXISTING TRAFFIC SIGNAL INSTALLATION	EACH	3		1	2				
* 87200500 TETHER WIRE FOOT 280 280	*	86400100	TRANSCEIVER - FIBER OPTIC	EACH	1			1				
# 87300925 ELECTRIC CABLE IN CONDUIT, TRACER, NO. 14 1C FOOT 1, 681 1, 681	*	87200400	SPAN WIRE	FOOT	1,280		280		1,000			
# 87300925 ELECTRIC CABLE IN CONDUIT, TRACER, NO. 14 1C FOOT 1, 681 1, 681	·			- 	<u> </u>							
# 87301215 ELECTRIC CABLE IN CONDUIT, SIGNAL NO. 14 2C FOOT 1, 625 1, 625	*	87200500	TETHER WIRE	FOOT	280		280					
* 87301225 ELECTRIC CABLE IN CONDUIT, SIGNAL NO. 14 3C FOOT 2, 515 2, 515	*	87300925	ELECTRIC CABLE IN CONDUIT, TRACER, NO. 14 10	FOOT	1,681			1,681				
* 87301225 ELECTRIC CABLE IN CONDUIT, SIGNAL NO. 14 3C FOOT 2, 515 2, 515	*	87301215	ELECTRIC CABLE IN CONDUIT, SIGNAL NO. 14 2C	FOOT	1,625		1, 625					
	- 1	87301225	ELECTRIC CABLE IN CONDUIT, SIGNAL NO. 14 3C	FOOT	2, 515		2,515					
	ηω\ * N	· · · · · · · · · · · · · · · · · · ·										

FILE NAME = 0182428-sht-500.agn PLOT DATE >1/22/2818 PLOT SCALE=182.8282 1/10. CHRISTIAN-ROCE & ASSOCIATES, INC.
ENGINEERS-PLANNERS-SURVEYORS
221 NORTH LASALLE STREET, SUITE 300
CHICAGO, FLINOIS 66601
PHONE: (312) 577-3300

INC.	DESIGNED	-	S.J.P.	REVISED -	-
RS	ORAWN	,,,,,,,,,,,,,,,,,,,,,,,,,,,,,,,,,,,,,,,	B.K.	REVISED -	
E 300	CHECKED	-	H.P.	REVISED -	
	DATE	-	JANUARY 22, 2016	REVISED -	

	CHARLEY OF CHARLESTEE	F.A.I. RTE.	SECTION	COUNTY	SHEETS	SHEET NO.
1	SUMMARY OF QUANTITIES	55	2014-065-R	WILL	184	16
1				CONTRACT	NO. 6	2A00
1	SCALE: NONE SHEET NO. 12 OF 17 SHEETS STA. TO STA.	FED. R	DAD DIST, NO. 1 BULDHOIS FED. AT	d project		

					CONSTRUCTION CODE							
		SUMMARY OF QUANTITIES			0003 0021 0021 0021 TRAFFIC SIGNALS CONNECT L					0021 VILLAGE LIGHTING	0021 EMERGENCY VEHICLE PREEMPTIO	
_	CODE NO	ITEM	UNIT	URBAN TOTAL QUANTITY	90% FED. 10% STATE	90% FED. 10% STATE	90% FED 10% STATE	90% FED 10% STATE	90% FED 10% STATE	100% VILLAGE	100% VILLAGE	
8	7301245	ELECTRIC CABLE IN CONDUIT, SIGNAL NO. 14 50	FOOT	2, 025		2, 025						
8	37301255	ELECTRIC CABLE IN CONDUIT, SIGNAL NO. 14 7C	FOOT	2,050		2,050						
8	37301305	ELECTRIC CABLE IN CONDUIT, LEAD-IN, NO. 14 1 PAIR	FOOT	4,776		4,776						
8	37301805	ELECTRIC CABLE IN CONDUIT, SERVICE, NO. 6 2C	FOOT	70		70						
-	87301900	ELECTRIC CABLE IN CONDUIT, EQUIPMENT GROUNDING CONDUCTOR, NO. 6 1C	FOOT	1,190		1,190						
	3,501300											
-	87502440	TRAFFIC SIGNAL POST, GALVANIZED STEEL, 10 FT.	EACH	1		1						
8	87502480	TRAFFIC SIGNAL POST, GALVANIZED STEEL, 14 FT.	EACH	1		1						
	87502500	TRAFFIC SIGNAL POST, GALVANIZED STEEL, 16 FT.	EACH	5		5						
	87700140	STEEL MAST ARM ASSEMBLY AND POLE, 20 FT.	EACH	1		1						
	87700170	STEEL MAST ARM ASSEMBLY AND POLE, 26 FT.	EACH	1		1						
	87700220	STEEL MAST ARM ASSEMBLY AND POLE, 36 FT.	EACH	1		1						
	87702240	STEEL MAST ARM ASSEMBLY AND POLE WITH DUAL MAST ARMS, 20 FT. AND 46 FT.	EACH	1		1						
	87800100	CONCRETE FOUNDATION, TYPE A	FOOT	28		28						
	87800150	CONCRETE FOUNDATION, TYPE C	FOOT	4		4						
					<u></u>	1				F.A.I. SE		

FILE NAME * DI62A80**aht*\$00.dgn

PLOT DATE *1/22/2016

PLOT SCRLE*180.0000 '/ in.

CHRISTIAN-ROGE & ASSOCIATES, INC.
ENGINEERS-PLANNERS-SURVEYORS
221 NORTH LASALLE STREET, SUITE 300
CHICAGO, ILLINOIS 60601
PHONE: (312) 577-3300
DATE JANUARY 22, 2016
REVISED -

STATE OF ILLINOIS
DEPARTMENT OF TRANSPORTATION

		RTE.	SECTIO
	SUMMARY OF QUANTITIES	55	2014-065
Ì	SCALE: NONE SHEET NO. 13 OF 17 SHEETS STA. TO STA.	FED. R	AD DIST, NO. 1 JLL

Γ					CONSTRUCTION CODE						
		SUMMARY OF QUANTITIES			0003 ROADWAY	0021 TRAFFIC SIGNALS RAMP C	0021 IDOT LIGHTING	0021 VILLAGE LIGHTING	0021 EMERGENCY VEHICLE PREEMPTION		
				URBAN	90% FED.	90% FED.	90% FED	90% FED	90% FED	100%	100%
-	CODE NO	ITEM	UNIT	QUANTITY	10% STATE	10% STATE	10% STATE		10% STATE	VILLAGE	VILLAGE
*	87800400	CONCRETE FOUNDATION, TYPE E, 30-INCH DIAMETER	FOOT	20		20					
*	87800415	CONCRETE FOUNDATION, TYPE E, 36-INCH DIAMETER	FOOT	25		25					
-						i					***************************************
*	87900200	DRILL EXISTING HANDHOLE	EACH	4	-	2	2				
*	88030020	SIGNAL HEAD, LED, 1-FACE, 3-SECTION, MAST-ARM MOUNTED	EACH	6		6					
*	88030050	SIGNAL HEAD, LED, 1-FACE, 3-SECTION, BRACKET MOUNTED	EACH	2		2					
*	88030100	SIGNAL HEAD, LED, 1-FACE, 5-SECTION, BRACKET MOUNTED	EACH	- 6		6					
*	88030110	SIGNAL HEAD, LED, 1-FACE, 5-SECTION, MAST-ARM MOUNTED	EACH	5.		5					
*	88102717	PEDESTRIAN SIGNAL HEAD, LED, 1-FACE, BRACKET MOUNTED WITH COUNTDOWN TIMER	EACH	10		10					
*	88200410	TRAFFIC SIGNAL BACKPLATE, LOUVERED, FORMED PLASTIC	EACH	11		11					
*	88500100	INDUCTIVE LOOP DETECTOR	EACH	13		13					
	00500100	DETECTOR LOOP, TYPE I	FOOT	90		90					
*	88600100	DETECTOR ECOP, TIPE I									
*	88600700	PREFORMED DETECTOR LOOP	FOOT	800		800					
*	88700200	LIGHT DETECTOR	EACH	3							3
*	88700300	LIGHT DETECTOR AMPLIFIER	EACH	1							1
ا ^{با} ر								***************************************		F,A.I. SE	CCTION CO

SPECIALTY ITEM * FILE NAME + 0162482-441-500.dgn PLOT DATE +1/22/2816

PLOT SCALE-182.8288 1/ in.

CHRISTIAN-ROGE & ASSOCIATES, INC.

ENGINEERS-PLANNERS-SURVEYORS
221 NORTH LASALLE STREET, SUITE 300
CHICAGO, LLINOIS 66601
PHONE: (312) 577-3300

DATE JANUARY 22, 2016

REVISED
CHECKED
DATE JANUARY 22, 2016

REVISED -REVISED -

· · · · · · · · · · · · · · · · · · ·	F.A.I. SECTION	COUNTY	SHEETS	NO.
SUMMARY OF QUANTITIES	55 2014-065-R	WILL	184	18
		CONTRACT	NO. 6	2A00
SCALE: NONE SHEET NO. 14 OF 17 SHEETS STA. TO STA.	FED. ROAD DIST, NO. 1 ILLENDIS FED. AL	PROJECT		

Γ			····		CONSTRUCTION CODE								
		SUMMARY OF QUANTITIES			0003 ROADWAY	0021 TRAFFIC SIGNALS RAMP C	0021 INTER CONNECT	0021 ITS	0021 IDOT LIGHTING	0021 VILLAGE LIGHTING	0021 EMERGENCY VEHICLE PREEMPTION		
L	CODE NO	ITEM	UNIT	URBAN TOTAL QUANTITY	90% FED. 10% STATE	90% FED. 10% STATE	90% FED 10% STATE	90% FED 10% STATE	90% FED 10% STATE	100% VILLAGE	100% VILLAGE		
Г													
_	88800100	PEDESTRIAN PUSH-BUTTON	EACH	10		10							
_	89502375	REMOVE EXISTING TRAFFIC SIGNAL EQUIPMENT	EACH	1		1							
_	A2004820	TREE, GLEDITSIA TRIACANTHOS INERMIS SKYLINE (SKYLINE THORNLESS COMMON HONEYLOCUST), 2-1/2" CALIPER, BALLED AND BURLAPPED	EACH	7	7								
	B2001620	TREE, CRATAEGUS CRUSGALLI INERMIS (THORN LESS COCKSPUR HAWTHORN), 2-1/2" CALIPER TREE FORM, BALLED AND BURLAPPED	EACH	8	8								
		THE POST WINDOWOLL (VALORYOUT POST) DAW HETCHT CONTAINED	EACH	200	200								
H	C2007224	SHRUB, ROSA KNOCKOUT (KNOCKOUT ROSE), 24" HEIGHT, CONTAINER PERENNIAL PLANT CARE	5Q YD	370	370								
H	K0026850 X0322247	MAINTENANCE OF EXISTING TRAFFIC SURVEILLANCE	L SUM	1				1					
H	K0029624	WEED CONTROL, PRE-EMERGENT GRANULAR HERBICIDE	GALLON	14	14		· ·						
\vdash	X0322433	LIGHT TOWER, SERVICE PAD	EACH	1	1								
ľ											ļ		
	X0322765	RELOCATE VIDEO VEHICLE DETECTION SYSTEM	EACH	1		1							
_	X0323914	FIBER OPTIC CABLE SPLICE - LATERAL	EACH	14				14					
-	X0323957	FIBER OPTIC CABLE SPLICE - MAINLINE	EACH	8				8					
			FOOT	785							785		
-	X0324085	EMERGENCY VEHICLE PRIORITY SYSTEM LINE SENSOR CABLE, NO. 20 3/C	1001										
	X0325040	FIBER OPTIC INNERDUCT, 1 1/4" DIA.	FOOT	1,500				1,500					
	X0327392	WOOD POLE, 60 FT, CLASS 4	EACH	2		2							
	X1400081	FULL-ACTUATED CONTROLLER AND TYPE SUPER P CABINET (SPECIAL)	EACH	4		1							
H									1	1			

File NAME #0162A88-shv-920.dgn PLOT DATE =1/22/2016 PLOT SCALE#180.8282 // in. CHRISTIAN-ROGE & ASSOCIATES, INC.
ENDINERS—PLANNERS—SURVEYORS
21 NORTH LASALLE STREET, SUITE 380
CHICAGO, ILLINOIS 66601
PHONE: (312) 577–3300
DATE - JANUARY 22, 2016
REVISED
CHICAGO
DATE - JANUARY 22, 2016
REVISED -

1	F.A.I. RTE.	SECTION	COUNTY	SHEETS	NO.
SUMMARY OF QUANTITIES	55	2014-065-R	WILL	184	19
			CONTRACT	NO. 6	COAS
SCALE NONE SHEET NO. 15 OF 17 SHEETS STA. TO STA.	FED. R	DAD DEST. NO. 1 ILLUNOIS FED. AT	D PROJECT		

i					CONSTRUCTION CODE						
		SUMMARY OF QUANTITIES			0003 ROADWAY	0021 TRAFFIC SIGNALS RAMP C	0021 INTER CONNECT	0021 ITS	0021 IDOT LIGHTING	0021 VILLAGE LIGHTING	0021 EMERGENCY VEHICLE PREEMPTION
CODE	E NO	ITEM	UNIT	URBAN TOTAL QUANTITY	90% FED. 10% STATE	90% FED. 10% STATE	90% FED 10% STATE	90% FED 10% STATE	90% FED 10% STATE	100% VILLAGE	100% VILLAGE
									-		
X4022	2000	TEMPORARY ACCESS (COMMERCIAL ENTRANCE)	EACH	11.	1						
						<u> </u>					-
X6640	0525	CHAIN LINK FENCE, 4' ATTACHED TO STRUCTURE	FOOT	450	450		un transporter				
X6700	0410	ENGINEER'S FIELD OFFICE, TYPE A (SPECIAL)	CAL MO	12	12						
X7010	0216	TRAFFIC CONTROL AND PROTECTION, (SPECIAL)	L SUM	4-4	1						
X7011	1015	TRAFFIC CONTROL AND PROTECTION (EXPRESSWAYS)	L SUM	1	1						
X7030	0025	WET REFLECTIVE TEMPORARY TAPE, TYPE III - LETTERS AND SYMBOLS	SQ FT	255	255						
	 								-		
X7030	0030	WET REFLECTIVE TEMPORARY TAPE TYPE III, 4 INCH	FOOT	21, 438	21, 438						
X7030	0050	WET REFLECTIVE TEMPORARY TAPE TYPE III, 12 INCH	FOOT	220	220						
X7030	0055	WET REFLECTIVE TEMPORARY TAPE TYPE III, 24 INCH	FOOT	106	106						
X8102	2035	REMOVAL OF UNDERGROUND CABLE	FOOT	3,000						3,000	
70102	2033	NEMOVAL OF ONDERGROUND CADLE	1001	3,000							
X8620	0200	UNINTERRUPTABLE POWER SUPPLY, SPECIAL	EACH	1		1					

X8710	0024	FIBER OPTIC CABLE IN CONDUIT, NO. 62. 5/125, MM12F SM24F	FOOT	1,681			1,681				
X8710	0035	FIBER OPTIC CABLE 96 FIBERS, SINGLE MODE	FOOT	30,000				30,000			
X8850	0102	INDUCTION LOOP	FOOT	108				108			
70036	V1V6	INDUITAGE COS									

FILE NAME = 0182028-sht-390.dgn PLOT DATE = 1/22/2216 PLOT SCALE=182.2822 // :n. CHRISTIAN-BOGE & ASSOCIATES, INC.
ENGINEERS-PLANNERS-SURVEYORS
221 NORTH LASALLE STREET, SUITE 300
CHICAGO, ILLINOIS 60601
PHONE: (312) 577-3300

DATE - JANUARY

NE, DESIGNED - S.J.P. REVISED
DRAWN - B.K. REVISED
CHECKED - M.P. REVISED
DATE - JANUARY 22, 2016 REVISED -

STATE OF ILLINOIS
DEPARTMENT OF TRANSPORTATION

SUMMARY OF QUANTITIES


SCALE: NONE | SHEET NO. 16 OF 17 SHEETS | STA. TO STA.

ſ					CONSTRUCTION CODE				T		
		SUMMARY OF QUANTITIES			0003 ROADWAY	0021 TRAFFIC SIGNALS RAMP C	0021 INTER CONNECT	0021 1TS	0021 IDOT LIGHTING	0021 VILLAGE LIGHTING	EMEI VEI PREE
	CODE NO	ITEM	UNIT	URBAN TOTAL QUANTITY	90% FED. 10% STATE	90% FED. 10% STATE	90% FED 10% STATE	90% FED 10% STATE	90% FED 10% STATE	100% VILLAGE	VI
	7052 110			WOMEN	10.017.12		1070 017112				
	Z0013797	STABILIZED CONSTRUCTION ENTRANCE	SQ YD	200	200				-		
	Z0013798	CONSTRUCTION LAYOUT	L SUM	\$ prod	1						
	Z0030850	TEMPORARY INFORMATION SIGNING	SQ FT	49	49				•		
*	Z0033028	MAINTENANCE OF LIGHTING SYSTEM	CAL MO	11					2	9	
*	Z0033056	OPTIMIZE TRAFFIC SIGNAL SYSTEM	EACH	1			Pro-A				
	Z0046304	PIPE UNDERDRAINS FOR STRUCTURES, 4"	FOOT	490	490						
	20056608	STORM SEWER (WATER MAIN REQUIREMENTS), 12 INCH	FOOT	20	20						
	Z0062456	TEMPORARY PAVEMENT	SQ YD	504	504						
	Z0064800	SELECTIVE CLEARING	UNIT	43	43						
*	Z0073510	TEMPORARY TRAFFIC SIGNAL TIMING	EACH	1		1					
*	X1400153	TEMPORARY WOOD POLE, 50 FOOT, CLASS 3	EACH	5				5			
*	X1400154	TEMPORARY AERIAL FIBER OPTIC CABLE, 96 FIBERS, SINGLE MODE	FOOT	1,000				1,000			
*	X1400155	REMOVAL OF FIBER OPTIC CABLE	FOOT	30,000				30,000			
	Z0076600	TRAINEES	Hour	500	5∞						
*	X1400156	RADAR VEHICLE DETECTION SYSTEM, SINGLE APPROACH, FAR BACK	EACH	1		1		<u> </u>			
φ	20076604	TRAINEES TRAINING PROGRAM GRADUATE	HOUR	500	500					<u></u>	

PILE NAME %DI82488-444-500.dgn PLOT DAYE %1/82/2816 PLOT SCALE%188/8888 */ inCHRISTIAN-ROGE & ASSOCIATES, INC. DESIGNED - S.J.P. REVISED - ENGINEERS-PLANNERS-SURVEYORS DRAWN - B.K. REVISED - CHICAGO, ILLINOIS 50501 CHICAGO, ILLINOIS 50501 PHONE (312) 577-2300 DATE - JANUARY 22, 2016 REVISED -

STATE OF ILLINOIS
DEPARTMENT OF TRANSPORTATION



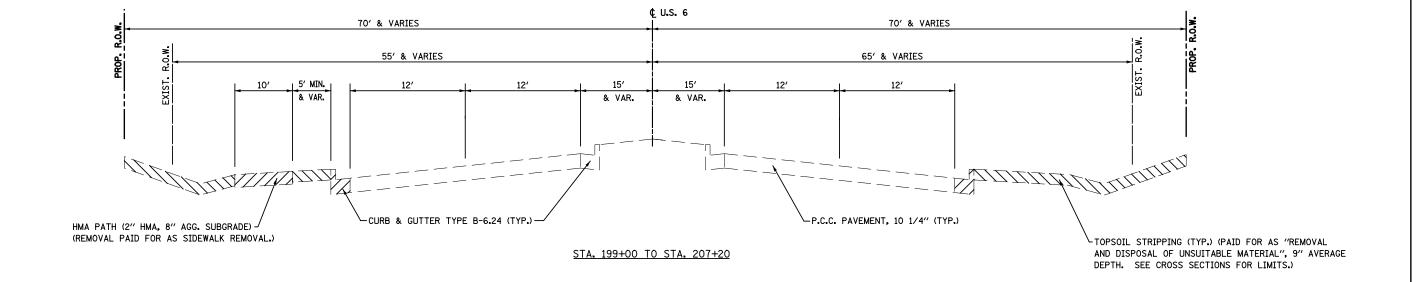


TYP-1

FILE NAME =D162A00-sht-typicall.dgn PLOT DATE =1/19/2016 PLOT SCALE=100.000 '/ in.



;.	DESIGNED	-	S.J.P.	REVISED	-
00	DRAWN	-	A.C.S.	REVISED	-
UU	CHECKED	-	M.P.	REVISED	-
	DATE	-	JANUARY 18, 2016	REVISED	-

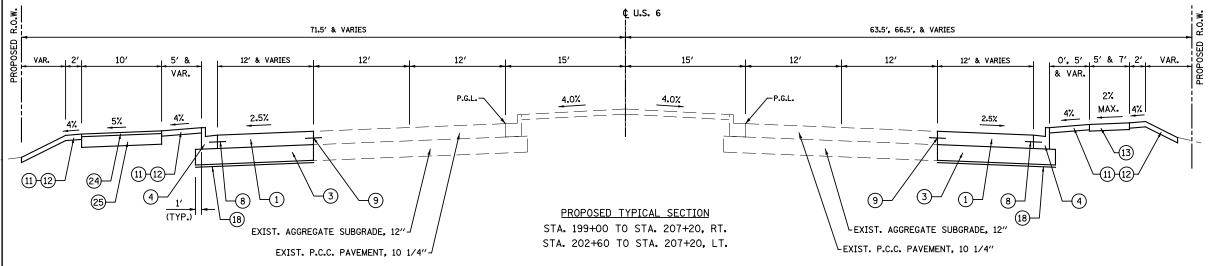

NOTE:

ALL PIPE UNDERDRAINS SHALL BE PLACED AT A DEPTH OF 30" BELOW THE TOP OF PROPOSED PAVEMENT OR AS DEEP AS POSSIBLE AND IN ACCORDANCE WITH CHECK SHEET *19 OF THE SUPPLEMENTAL SPECIFICATIONS AND RECURRING SPECIAL PROVISIONS. THE COST OF MAKING PIPE UNDERDRAIN CONNECTIONS TO DRAINAGE STRUCTURES SHALL BE INCLUDED IN THE COST OF PIPE UNDERDRAINS ITEM.

NOTES:

- THE UNIT WEIGHT USED TO CALCULATE ALL HMA SURFACE MIXTURE QUANTITIES IS 112 LBS/SQ YD/IN.
- 2. THE "AC TYPE" FOR POLYMERIZED HMA MIXES SHALL BE
 "SBS/SBR PG 76-22" AND FOR NON-POLYMERIZED HMA THE
 "AC TYPE" SHALL BE "PG 64-22" UNLESS MODIFIED BY
 DISTRICT ONE SPECIAL PROVISIONS.
 FOR "USE OF RECYCLED MATERIALS" SEE SPECIAL PROVISIONS.
 QUALITY MANAGEMENT PROGRAM (QMP) IDENTIFIES THE PARTICULAR
 QUALITY CONTROL SPECIFICATION THAT APPLIES TO THE MIXTURE.
- 3. TEMPORARY PAVEMENT: THE CONTRACTOR HAS THE OPTION OF HOT MIX ASPHALT OR CONCRETE. IF THE CONTRACTOR CHOOSES CONCRETE, THE THICKNESS SHALL BE 8" P.C. CONCRETE WITH 4" SUBBASE GRANULAR MATERIAL. P.C. CONCRETE TEMPORARY PAVEMENT SHALL CONSIST OF CLASS PV CONCRETE MEETING THE REQUIREMENTS OF ARTICLE 1020 OF THE STANDARD SPECIFICATIONS.
- 4. THE CONTRACTOR SHALL PATCH BEFORE MILLING.

HOT-MIX ASPHALT MIXTURE REQUIREMENTS	QUALITY MANAGEMENT	
MIXTURE TYPE	AIR VOIDS • Ndes	PROGRAM (QMP)
NORTHWEST FRONTAGE ROAD - PAVEMENT RESURFACING		
HMA SURFACE COURSE, MIX "D", N70 (IL 9.5 mm) - 2"	4% @ 70 GYR.	QCP
HMA BINDER COURSE, IL-19.0, N70, 21/2"	4% @ 70 GYR.	QCP
STABILIZIED SUBBASE - HOT MIX ASPHALT, 4"		
HMA BINDER IL-19.0 mm, - 4"	3% © 50 GYR.	QCP
TEMPORARY PAVEMENT FOR TRAFFIC STAGING - RAMP 'C'	•	
HMA SURFACE COURSE, MIX "D", N50 (IL 9.5 mm) - 2"	4% @ 50 GYR.	QC / QA
HMA BINDER IL-19 mm, N50 - 10" (3 LIFTS)	4% @ 50 GYR.	QC / QA
HMA RAMP FOR TRAFFIC STAGING		
HMA SURFACE COURSE, MIX "D", N50 (IL 9.5 mm) - 2" & VARIES	4% @ 50 GYR.	QC / QA
NORTHWEST FRONTAGE ROAD - HMA SHOULDERS, 6"		
HMA SURFACE COURSE, MIX "D", N50 (IL 9.5 mm) - 2"	4% @ 50 GYR.	QC / QA
HMA BINDER IL-19 mm, N50 - 4"	4% @ 50 GYR.	QC / QA
RAMP 'C' - HMA SHOULDERS, 10"		
HMA SURFACE COURSE, MIX "D", N70 (IL 9.5 mm) - 2"	4% @ 70 GYR.	QC / QA
HMA BASE COURSE (HMA BINDER IL-19 mm) - 8" (3 LIFTS)	4% @ 70 GYR.	QC / QA
MULTI - USE PATH		
HMA SURFACE COURSE, MIX "D", N50 (IL 9.5 mm) - 2"	4% @ 50 GYR.	QC / QA
CLASS D PATCHES		
CLASS D PATCHES (HMA BINDER IL-19mm) - 10"	4% @ 70 GYR.	QC / QA
QMP Designation: Quality Control/Quality Assurance (QC/QA); Qualit Pay for Performance (PFP) $$	y Control for F	Performance (QCP);

PROPOSED LEGEND

- 1 P.C.C. PAVEMENT, 101/4" (JOINTED)
- 2) STABILIZED SUBBASE HOT MIX ASPHALT, 4"
- (3) AGGREGATE SUBGRADE IMPROVEMENT, 12"
- (4) COMBINATION CONCRETE CURB & GUTTER, TYPE B-6.24
- (5) NOT USED
- 6 P.C.C. SHOULDERS, 101/4"
- 7 NOT USED
- (8) NO. 6 24" LONG, EPOXY-COATED TIE-BARS
 24" c-c. DRILLED AND GROUTED
 (COST WILL BE INCLUDED IN P.C.C. PAVEMENT)
- (9) LONGITUDINAL CONSTRUCTION JOINT WITH NO. 6
 24" LONG EPOXY-COATED TIE-BARS @ 24" c-c.
 (COST WILL BE INCLUDED IN P.C.C. PAVEMENT)
- (10) SAWED LONGITUDINAL JOINT WITH NO. 6
 30" LONG EPOXY-COATED TIE-BARS © 24" c-c.
 (COST WILL BE INCLUDED IN P.C.C. PAVEMENT)
- (11) TOPSOIL, FURNISH & PLACE, 4"
- (12) SEEDING, CLASS 2A
- (13) PORTLAND CEMENT CONCRETE SIDEWALK, 5"
- (14) AGGREGATE SHOULDER, TYPE B, 10"
- (15) HOT-MIX ASPHALT SURFACE COURSE, MIX 'D', N70, 2"
- (16) HOT-MIX ASPHALT BINDER COURSE, IL-19.0, N70, 21/2"
- .,,,
- 17 NOT USED
- (18) GEOTECHNICAL FABRIC FOR GROUND STABILIZATION
- (19) HOT-MIX ASPHALT SHOULDERS, 6"
- (20) HOT-MIX ASPHALT SHOULDERS, 10"
- (21) NOT USED
- 22) STEEL PLATE BEAM GUARDRAIL
- 23 NOT USED
- (24) HOT-MIX ASPHALT SURFACE COURSE, MIX 'D', N50, 2"
- (25) AGGREGATE BASE COURSE, TYPE B, 8"

TYP-2

FILE NAME =D162A00-sht-typical2.dgn PLOT DATE =2/1/2016 PLOT SCALE=120.000 '/ in. CHRISTIAN-ROGE & ASSOCIATES, INC.
ENGINEERS-PLANNERS-SURVEYORS
21 NORTH LASALLE STREET, SUITE 300
CHICAGO, ILLINOIS 60601
PHONE: (312) 577–3300

DATE


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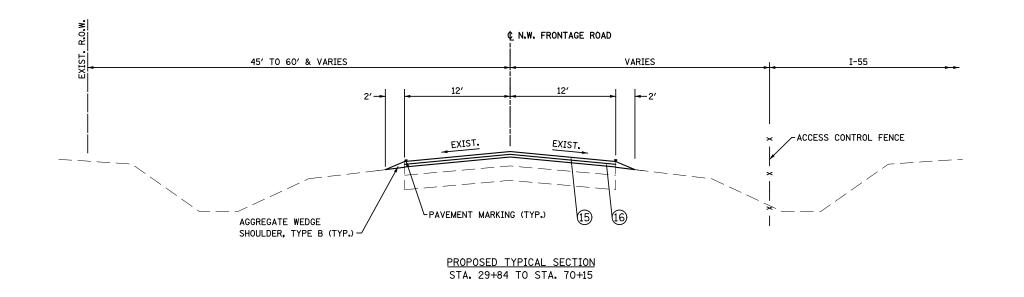
DATE

- S.J.P.
DRAWN
- A.C.S.
CHECKED
- M.P.
DATE
- FEBRUA

	PROPOSED	TYPICAL SECTION U.S. 6	
SCALE: NONE	SHEET NO. 2 OF 4	SHEETS STA.	TO STA.

F.A.I. RTE.			S	EC.	TIC		COUNTY	TOTAL SHEET		SHEE NO.			
55 2014-065-R									WILL	184		22	
									CONTRACT	NO.	6	2A00	
CED B	OAD DI	тст	NO	•	TI I	TNATE	FED	ATE	PROJECT				



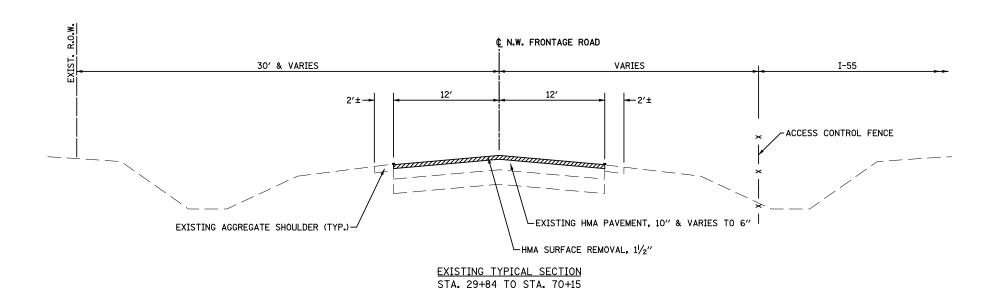

TYP-

FILE NAME = 0162A00-sht-typical5.dgn PLOT DATE = 1/19/2016 PLOT SCALE=100.000 ' / in. CHRISTIAN-ROGE & ASSOCIATES, INC. ENGINEERS-PLANNERS-SURVEYORS 221 NORTH LASALLE STREET, SUITE 300 CHICAGO, ILLINOIS 6001 PHONE: (312) 577-3300 DATE JANUAF

STATE OF ILLINOIS
DEPARTMENT OF TRANSPORTATION

EXISTING AND PROPOSED TYPICAL SECTIONS NORTHWEST FRONTAGE ROAD

SHEET NO. 3 OF 4 SHEETS STA. TO STA.

EXISTING LEGEND

PROPOSED LEGEND

1 P.C.C. PAVEMENT, 101/4" (JOINTED)

6 P.C.C. SHOULDERS, 101/4"

11) TOPSOIL, FURNISH & PLACE, 4"

(14) AGGREGATE SHOULDER, TYPE B, 10"

(19) HOT-MIX ASPHALT SHOULDERS, 6"

(20) HOT-MIX ASPHALT SHOULDERS, 10"

22) STEEL PLATE BEAM GUARDRAIL

(25) AGGREGATE BASE COURSE, TYPE B, 8"

13 PORTLAND CEMENT CONCRETE SIDEWALK, 5"

12) SEEDING, CLASS 2A

(17) NOT USED

21) NOT USED

23 NOT USED

STABILIZED SUBBASE - HOT MIX ASPHALT, 4"
 AGGREGATE SUBGRADE IMPROVEMENT, 12"

(8) NO. 6 - 24" LONG, EPOXY-COATED TIE-BARS © 24" c-c. DRILLED AND GROUTED

(9) LONGITUDINAL CONSTRUCTION JOINT WITH NO. 6

(10) SAWED LONGITUDINAL JOINT WITH NO. 6
- 30" LONG EPOXY-COATED TIE-BARS @ 24" c-c.

(15) HOT-MIX ASPHALT SURFACE COURSE, MIX 'D', N70, 2"

(16) HOT-MIX ASPHALT BINDER COURSE, IL-19.0, N70, 21/2"

(18) GEOTECHNICAL FABRIC FOR GROUND STABILIZATION

(24) HOT-MIX ASPHALT SURFACE COURSE, MIX 'D', N50, 2"

(4) COMBINATION CONCRETE CURB & GUTTER, TYPE B-6.24

(COST WILL BE INCLUDED IN P.C.C. PAVEMENT)


- 24" LONG EPOXY-COATED TIE-BARS @ 24" c-c. (COST WILL BE INCLUDED IN P.C.C. PAVEMENT)

(COST WILL BE INCLUDED IN P.C.C. PAVEMENT)

REMOVAL ITEMS

5 NOT USED

7 NOT USED

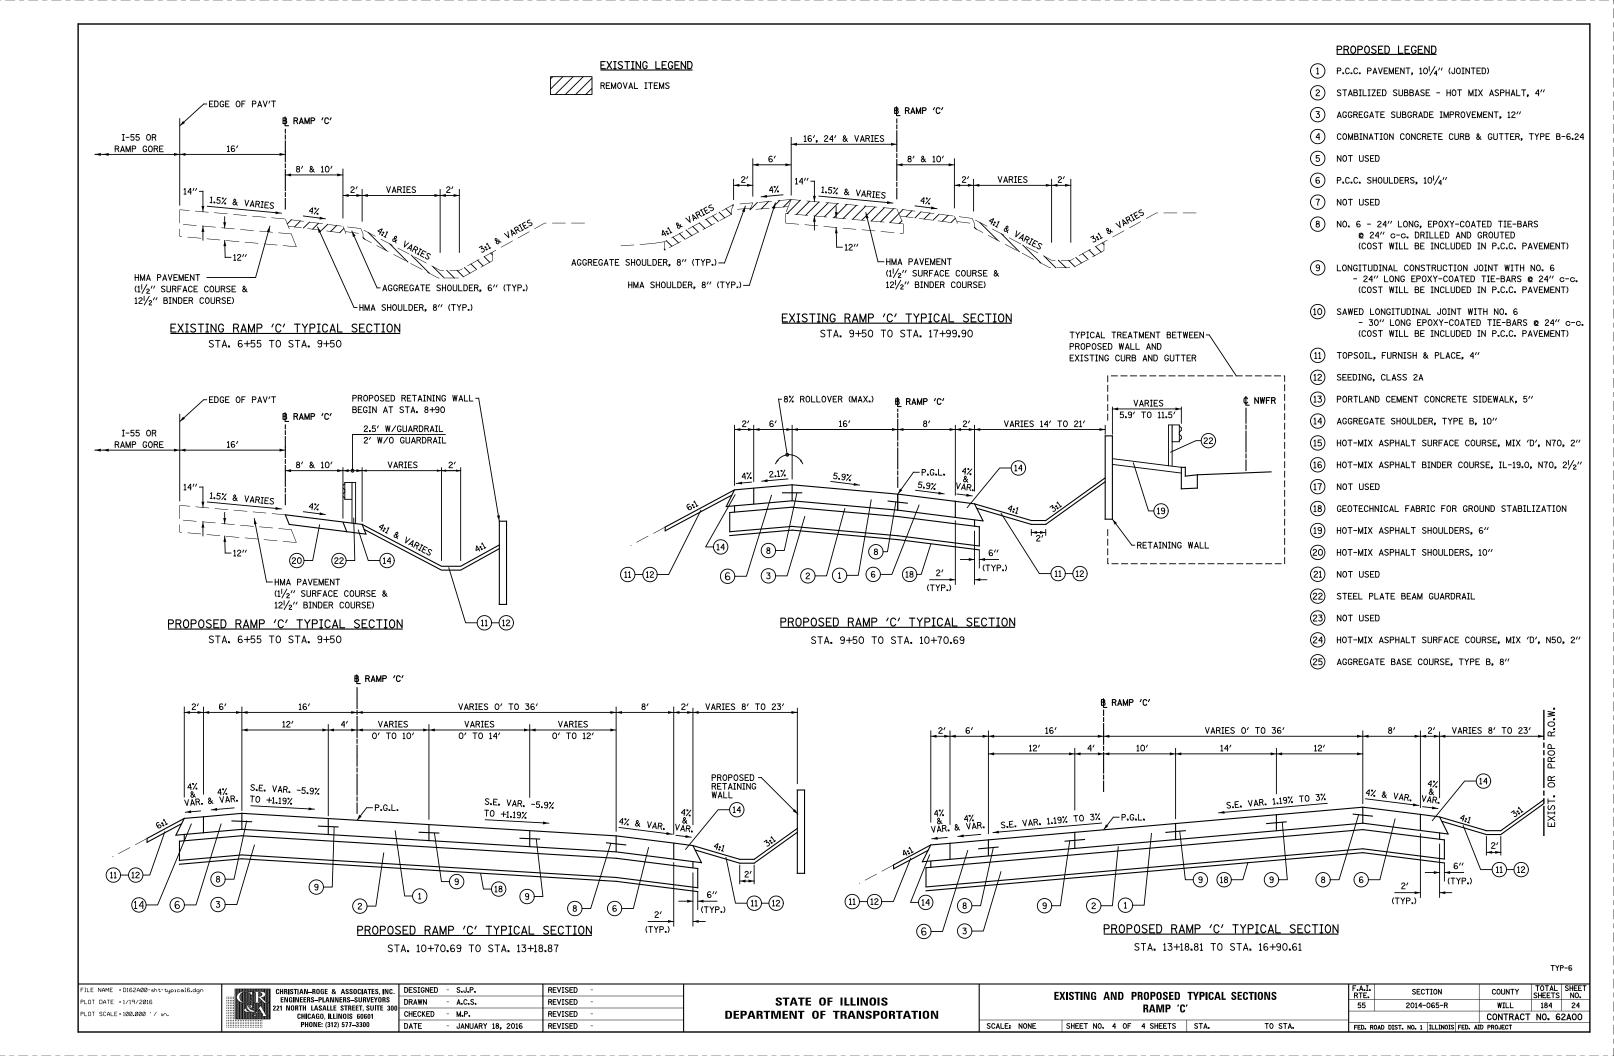

					DRAINAG	E STRUCTURE	SCHEDULE					
		PAY ITEN	1 NUME	BER	60200105	60200805	60201340	60204505	60259340	54213657	54261424	60218400
DESC.	STATION	OFFSET		STRUCTURE	CB TA 4 DIA	CB TA 4 DIA	CB TA 4 DIA	CB TA 5 DIA	MH RECON	PRC FLAR	CES,	MH TA 4 DIA
					T1F OL	T8G	T24F&G	T8G	W/ T24F&G	END SEC 12	24" 1:4	T1F CL
1	200+40	51.0	RT	CB TA 4'DIA. T24F&G			1					
3	201+60	5.0	RT	CB TA 4'DIA. T1F OL	1							
4	201+60	47.0	RT	MH TA 4'DIA. T1F CL								1
5	202+75	51.0	LT	CB TA 4'DIA. T24F&G			1					
6	202+90	51.0	LT	MH RECON W/ T24F&G					1			
7	202+75	51.0	RT	CB TA 4'DIA. T24F&G			1					
8	202+90	51.0	RT	CB TA 4'DIA. T24F&G			1					
9	202+94	45.0	RT	MH TA 4'DIA. T1F CL								1
9A	204+10	45.0	RT	MH TA 4'DIA. T1F CL								1
10	10+25	14.0	RT	CB TA 5'DIA. T8G				1				
11	10+25	47.0	LT	CES, 24" 1:4							1	
12	11+50	34.0	RT	CB TA 4'DIA. T8G		1						
13	13+75	59.0	RT	CB TA 4'DIA. T8G		1						
14	13+50	28.0	LT	CB TA 4'DIA. T8G		1						
15	13+50	57.0	RT	CB TA 4'DIA. T8G		1						
16	17+10	10.0	RT	CB TA 4'DIA. T24F&G			1					
17	17+10	40.0	LT	PRCFES, 12"						1		
		то	TAL	·	1	4	5	1	1	1	1	3

			DRAIN	AGE PIPE SCI	HEDULE						
PAY ITEM	NUMBER	20800150	550A0050	550A0090	550A0120	Z0056608					
			12"	18"	24"	12"	1				
STRUCTURE		TRENCH BACKFILL	CLASS A	CLASS A	CLASS A	SS	SIKUC	STRUCTURE			
		DACKFILL	TYPE 1	TYPE 1	TYPE 1 TYPE 1 WMR						
FROM	то	CU YD	FEET	FEET	FEET	FEET	FROM	то			
1	4	26.4	114				1	4			
3	4	8.4	36				3	4			
4	9	24.0	110			20	4	9			
7	8	2.7	10				7	8			
8	9	1.1	4				8	9			
9	9A	45.8		114			9	9A			
10	11	5.6			53		10	11			
12	10	0.0			122		12	10			
15	12	0.0			198		15	12			
14	15	25.7			75		14	15			
13	15	0.0			37		13	15			
16	17	4.1	50				16	17			
TOTAL		144	324	114	485	20	TO	ΓAL			

						20201200			
PAY ITEM LOCATION		20200100					L AND DISPOSAL OF		
		EARTH EXCAVATION (CUT)	EARTH EX ADJ SHRINK 15% EARTH	EMBANKMENT (FILL)	EARTHWORK BALANCE WASTE (+) SHORTHAGE (-)	WORK BALANCE UNSUITABLE WASTE (+) EXCAVATION			
STATION T	O STATION	CU YD	CU YD	CU YD	CU YD	CU YD	CU YD		
U.S. ROUTE 6	STAGE 1								
199+00	205+00	869	739	290	449	256	350		
RAMP 'C' STA	AGE 1A								
9+50	17+50	3,713	3,156	1,917	1,239	0	1,947		
RAMP 'C' STA	AGE 1B								
9+50	17+50	4,724	4,015	351	3,664	0	1,024		
Remove exis	ting aggregat	te shoulder alon	g RAMP 'C'						
1+56	8+80	37							
		•							
SUB-1	TOTAL					256	3,321		
TOTAL		9,343	7,910	2,558	5,352	3,5	577		

		PIPE UNI	DERDRAIN SCHEDULE							
	PAY ITEM		60100060	60100905	60107600					
STATION	TO STATION	OFFSET	CONCRETE HEADWALLS FOR PIPE DRAINS	PIPE DRAINS	PIPE UNDERDRAINS 4"					
			(EACH)	(FOOT)	(FOOT)					
U.S. 6										
201+25	202+75	RT			150					
202+90	204+40	RT			150					
RAMP 'C'										
9+50	10+25	RT			75					
10+25	11+50	RT			125					
11+50	14+00	LT			250					
14+00	17+00	LT			300					
11+61		LT	1	20						
14+00		LT	1	20						
	TOTAL		2	40	1,050					

C.	DESIGNED	-	S.J.P.	REVISED -	1
300	DRAWN	-	B.K.	REVISED -	
300	CHECKED	-	M.P.	REVISED -	
	DATE	-	JANUARY 18, 2016	REVISED -	

						SI	GNING S	CHEDULE									
			PAY ITEM					72000100	72000200	72400310	72400320	72400710	72400730	73000100	72900100	72900200	7280010
SIGN NAME	LOCATION		SIGN DESCRIPTION	1	č	IGN SI	3E	SIGN PANEL TYPE 1	SIGN PANEL TYPE 2	REMOVE SIGN PANEL TYPE 1	REMOVE SIGN PANEL TYPE 2	RELOCATE SIGN PANEL TYPE 1	RELOCATE SIGN PANEL TYPE 3	WOOD SIGN SUPPORT	METAL POST - TYPE A	METAL POST - TYPE B	TELESCO ING STEEL SIGN SUPPOR
	STATION	OFFSET			W (IN)	D (IN)	(SQ FT)	(SQ FT)	(SQ FT)	(SQ FT)	(SQ FT)	(SQ FT)	(SQ FT)	(FOOT)	(FOOT)	(FOOT)	(FOOT)
U.S. 6 @		011021			, ,==-,	- (,	1-2/	\-~/	V- 2,7	1-2/	1-2/	V-27	1 1 2 7	(/	(,	(====/	
EB-MP-1	195+25	RT	SHARE THE DRIVE		36	36	9.0					9.0		I	27.0		Т
EB-PM-2A	201+03	RT	JCT	M2-1	30	21	4.4					4.4					+
EB-PM-2B	201+03	RT	INTERSTATE 55	M1-1	24	24	4.0					4.0					+
EB-PM-2C	201+03	RT	RIGHT LANE MUST TURN RIGHT	R3-7R	36	36	9.0					9.0					
EB-PM-3	204+10	RT	RIGHT ONLY	R3-5R	24	30	5.0					5.0					
WB-PM-4	204+10	LT	RIGHT LANE MUST TURN RIGHT	R3-7R	36	36	9.0	9.0									+
RC-WP-5	7+00	RT	RAMP 30 MPH	W13-3	36	48	12.0		12.0					15.0			1
RC-WP-6	8+70	LT	EXIT 248	E5-1a	96	60	40.0						40.0	34.0			1
RC-WP-7A	10+00	LT	DOUBLE LEFT TURN ONLY	R3-30ab	36	30	7.5	7.5						34.0			+
RC-WP-7B	10+00	LT	WRONG WAY	R5-1a	36	24	6.0					6.0					
RC-WP-8A	10+00	RT	DOUBLE RIGHT TURN ONLY	R3-30ab	36	30	7.5	7.5						34.0			1
RC-WP-8B	10+00	RT	WRONG WAY	R5-1a	36	24	6.0					6.0					+
RC-GM-9	13+35	RT	LODGING INFORMATION		114	96	76.0						76.0				+
RC-GM-10	14+25	RT	JOLIET / MORRIS		78	48	26.0						26.0				
RC-MP-11	15+00	LT	WRONG WAY	R5-1a	36	24	6.0					6.0				13.0	1
RC-GM-12A	15+00	RT	FOOD INFORMATION		114	96	76.0						76.0				+
RC-GM-12B	15+00	RT	WRONG WAY	R5=1a	36	24	6.0					6.0					1
RC-MP-13	16+00	LT	PARK AND RIDE	D4-2	30	36	7.5					7.5			24.0		+
RC-GM-14A	16+00	RT	GAS INFORMATION		114	72	57.0						57.0				1
RC-GM-14B	16+00	RT	BIODIESEL		24	24	4.0					4.0					1
RC-GM-14C	16+00	RT	DIR ARROW	M6-1	21.6	15.6	2.3					2.3					1
RC-MP-15A	16+60	LT	RIVERBOAT CASINO		24	24	4.0					4.0				36.0	
RC-MP-15B	16+60	LT	DIR ARROW	M6-1	21.6	15.6	2.3					2.3					1
RC-MP-15C	16+60	LT	PEDESTRIAN	W11-2	36	36	9.0	9.0									
RC-MP-16A	16+80	RT	PARK AND RIDE	D4-2	30	36	7.5					7.5				36.0	1
RC-MP-16B	16+80	RT	STATE PARK		36	36	9.0					9.0					
RC-MP-16C	16+80	RT	PEDESTRIAN	W11-2	36	36	9.0	9.0									
RC-TS-17A	17+15	LT	DOUBLE LEFT TURN ONLY	R3-30ab	36	30	7.5	7.5									30.0
RC-TS-17B	17+15	LT	DO NOT ENTER	R5-1	36	36	9.0					9.0					
RC-TS-17C	17+15	LT	ONE WAY RIGHT	R6-1R	54	18	6.8					6.8					
RC-TS-17D	17+15	LT	ONE WAY LEFT	R6-1L	54	18	6.8					6.8					
RC-TS-18A	17+30	RT	DO NOT ENTER	R5-1	36	36	9.0					9.0					30.0
RC-TS-18B	17+30	RT	DOUBLE RIGHT TURN ONLY	R3=30ab	36	30	7.5	7.5									
RC-TS-18C	17+30	RT	ONE WAY RIGHT	R6-1R	54	18	6.8					6.8					
RC-TS-18D	17+30	RT	ONE WAY LEFT	R6-1L	54	18	6.8					6.8					
RC-MP-19	17+35	RT	NO TURN ON RED	R10-11b	36	36	9.0					9.0					
RC-MP-20	17+35	RT	NO TURN ON RED	R10-11b	36	36	9.0	9.0									
	17+40	LT	MON-FRI (WITH TIMES)	R10-20aP	24	24	4.0			4.0							
	7+23	RT	RAMP 35 MPH	W13-3	36	48	12.0				12.0						
			TOTAL					66.0	12.0	4.0	12.0	146.1	275.0	117.0	51.0	85.0	60.0


NOTE: THE STATIONING IS PROVIDED FOR REFERENCE PURPOSES ONLY. THE CONTRACTOR SHALL FIELD VERIFY ALL SIGN MESSAGES AND CONFIGURATIONS IN THE FIELD PRIOR TO ORDERING SIGNS AND THEIR SUPPORTS.


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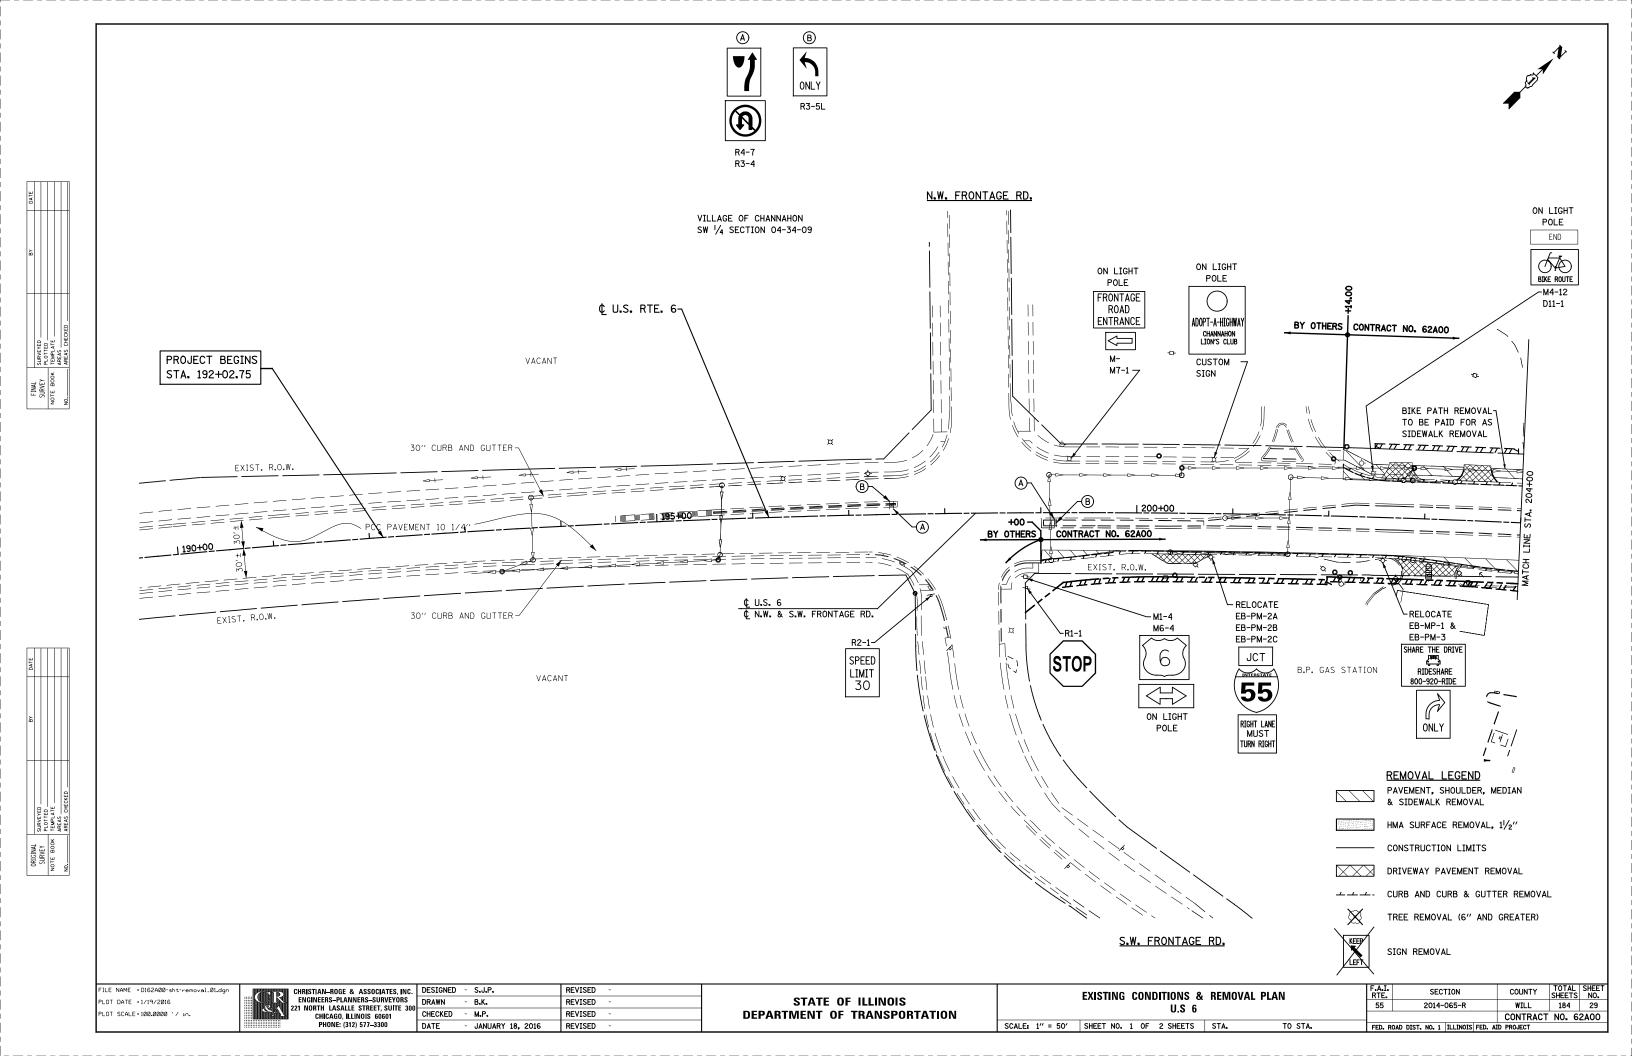



C.	DESIGNED	-	S.J.P.	REVISED -	
300	DRAWN	-	B.K.	REVISED -	
טטנ	CHECKED	-	M.P.	REVISED -	
	DATE	-	JANUARY 18, 2016	REVISED -	


	F.A.I. RTE.	SECTION	COUNTY	TOTAL SHEETS		
SCHEDULE OF QUANTITIES	S .	55	2014-065-R	WILL	184	26
			CONTRACT	NO. 6	2A00	
SCALE: NONE SHEET NO. 2 OF 2 SHEETS STA.	FED. R	OAD DIST, NO. 1 ILLINOIS FED. A	ID PROJECT			




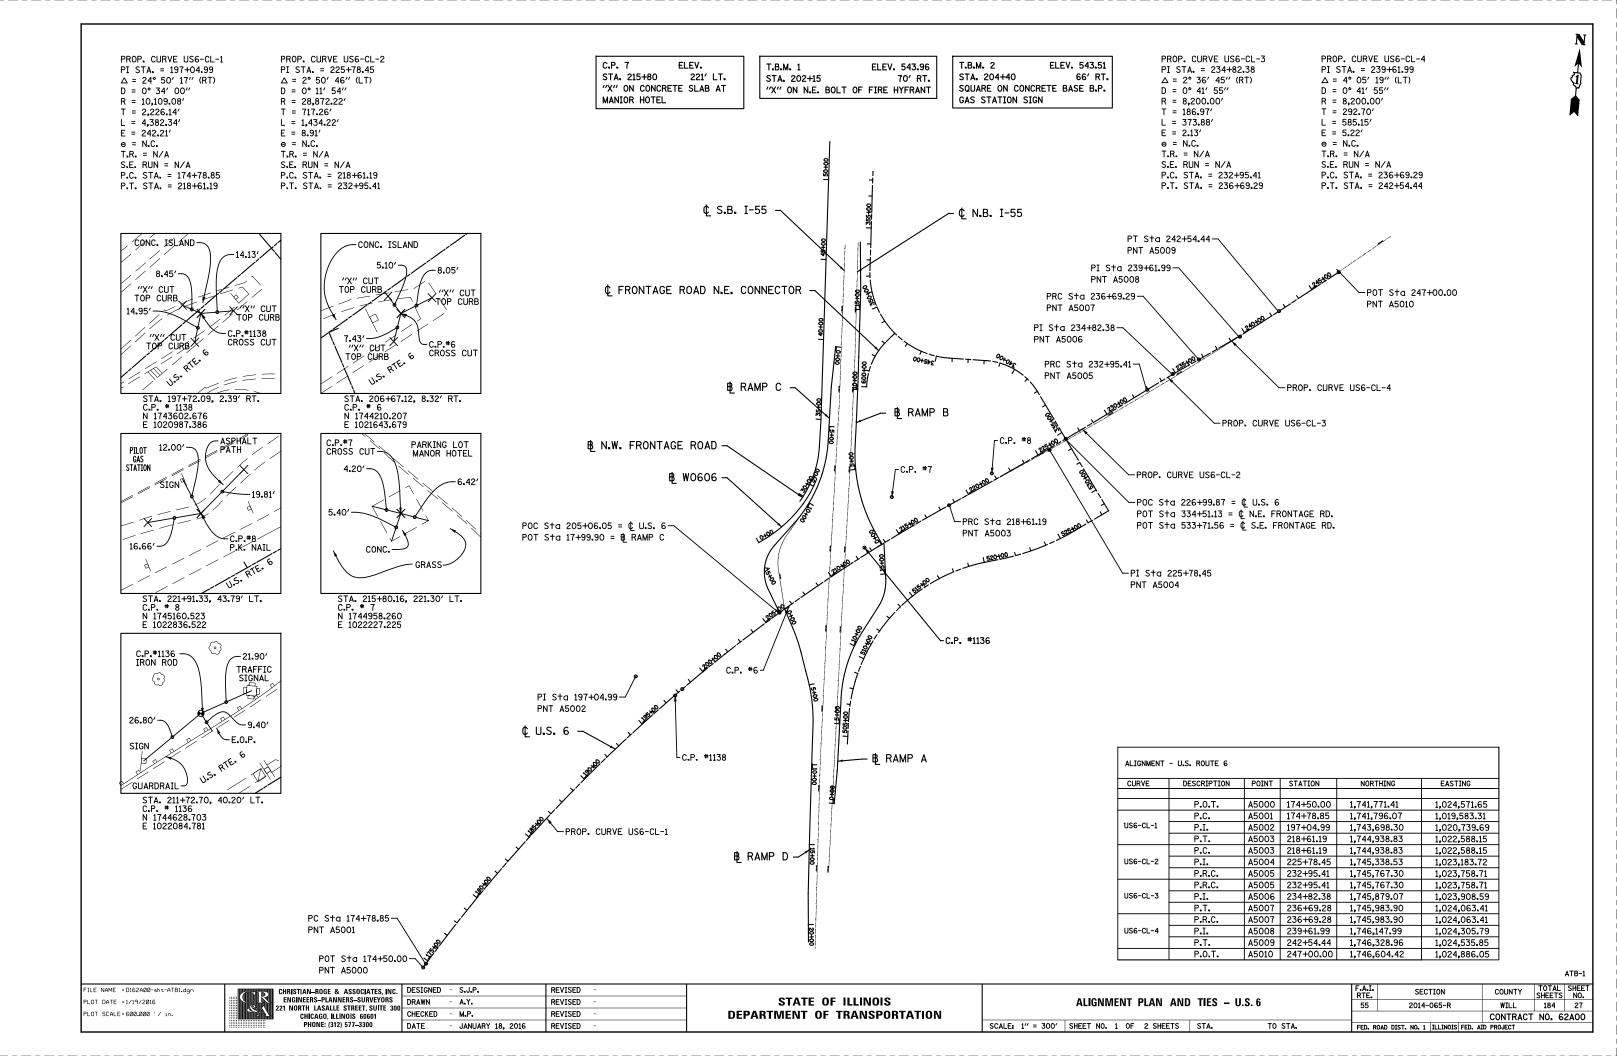


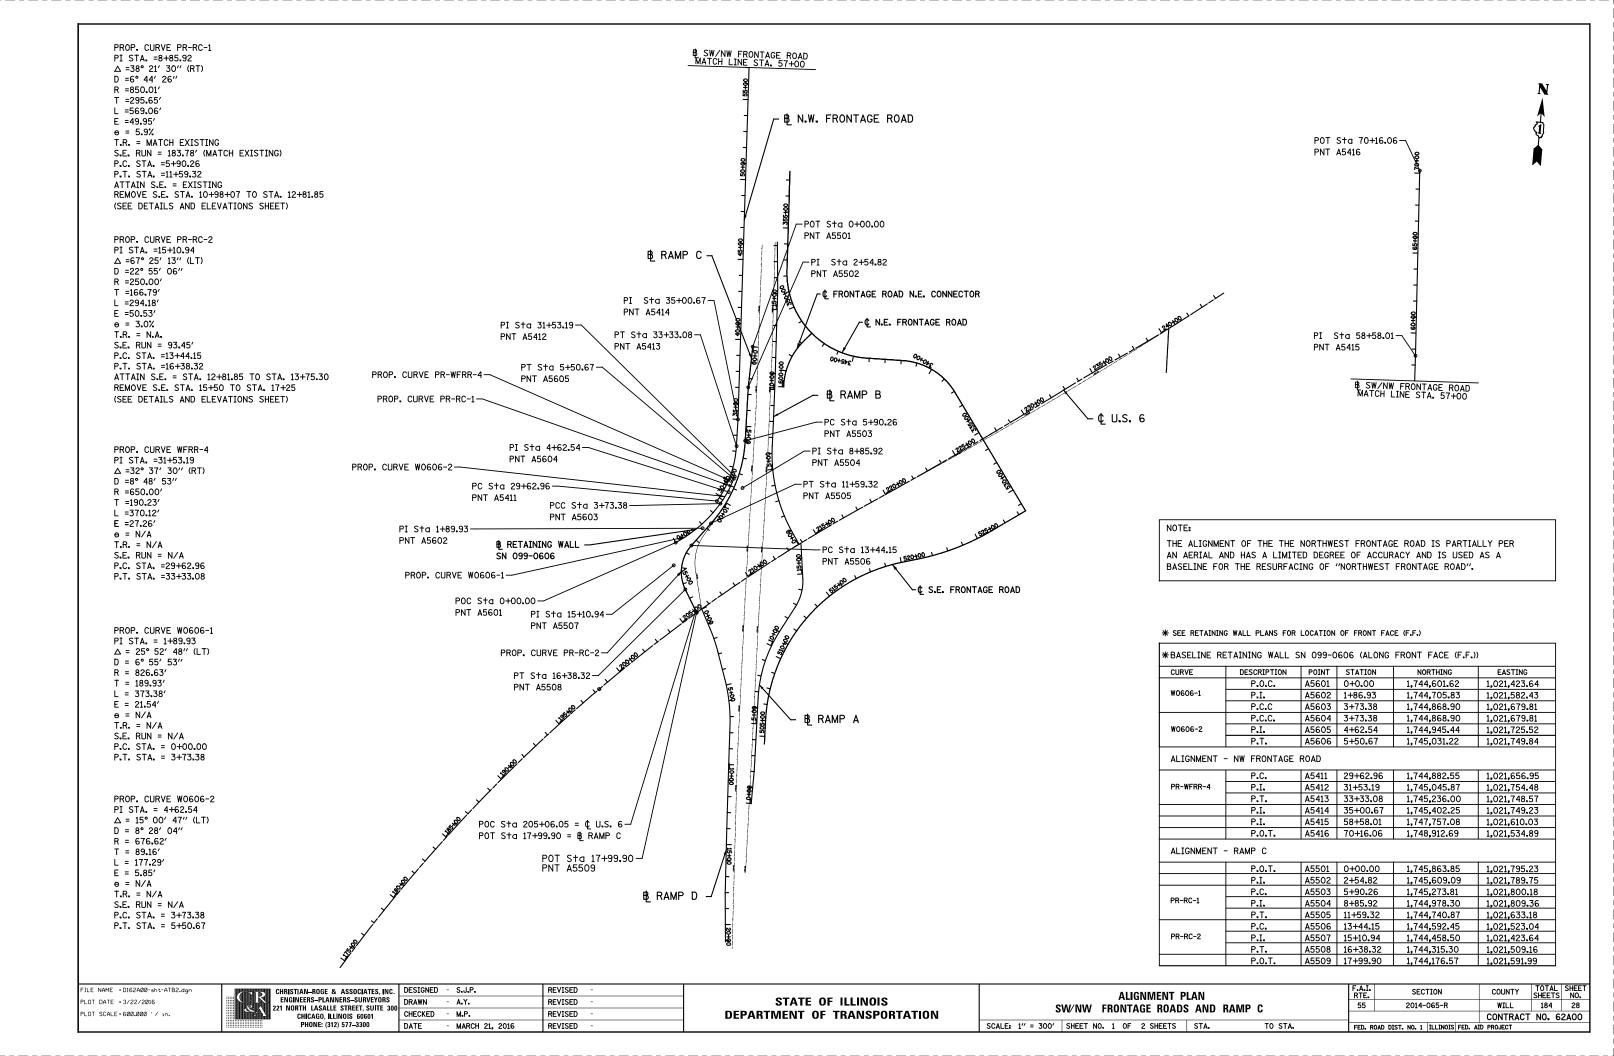


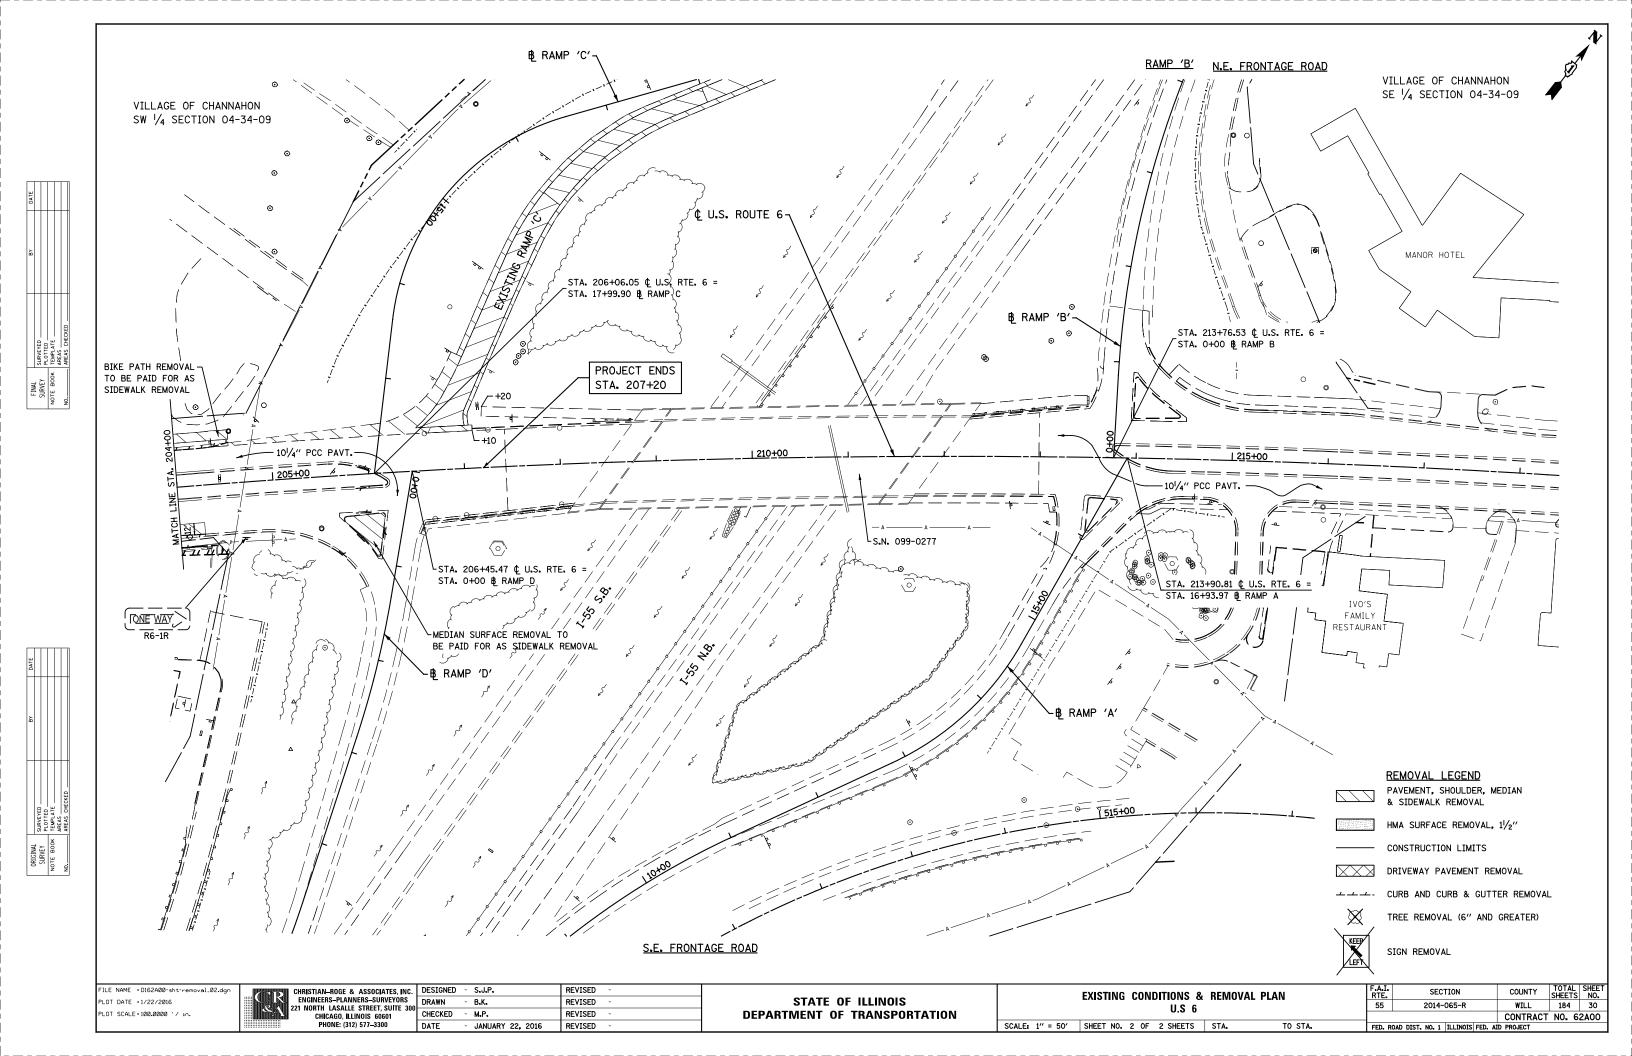


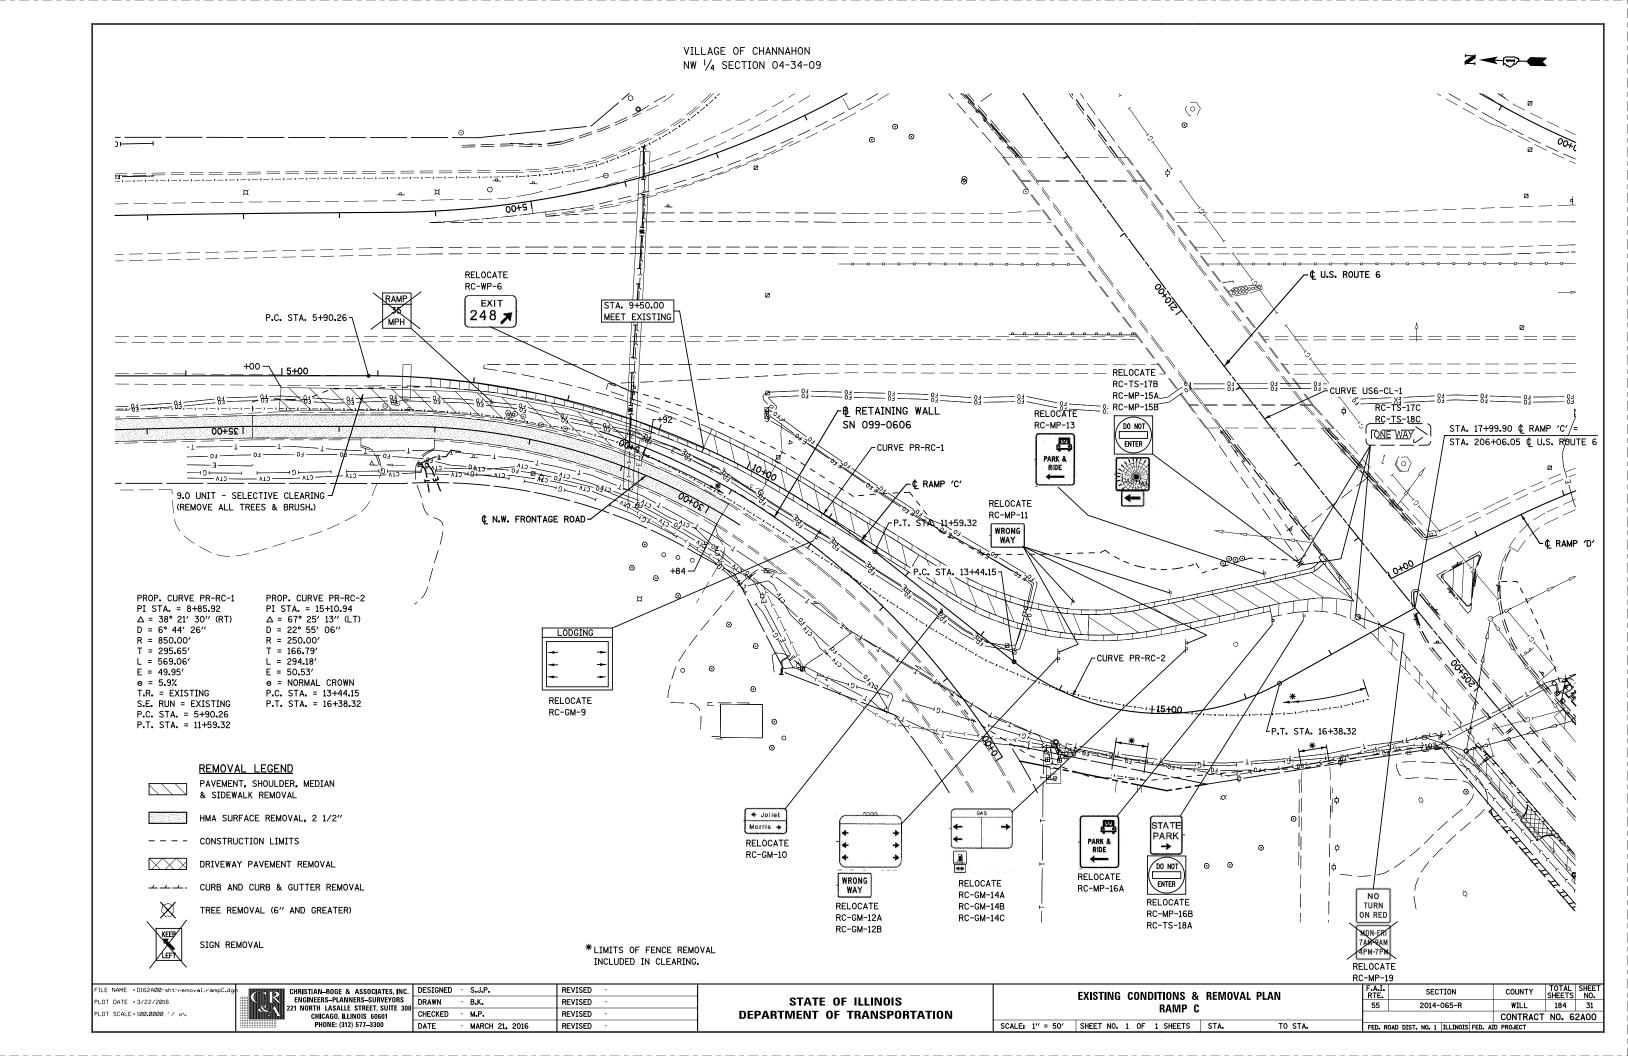


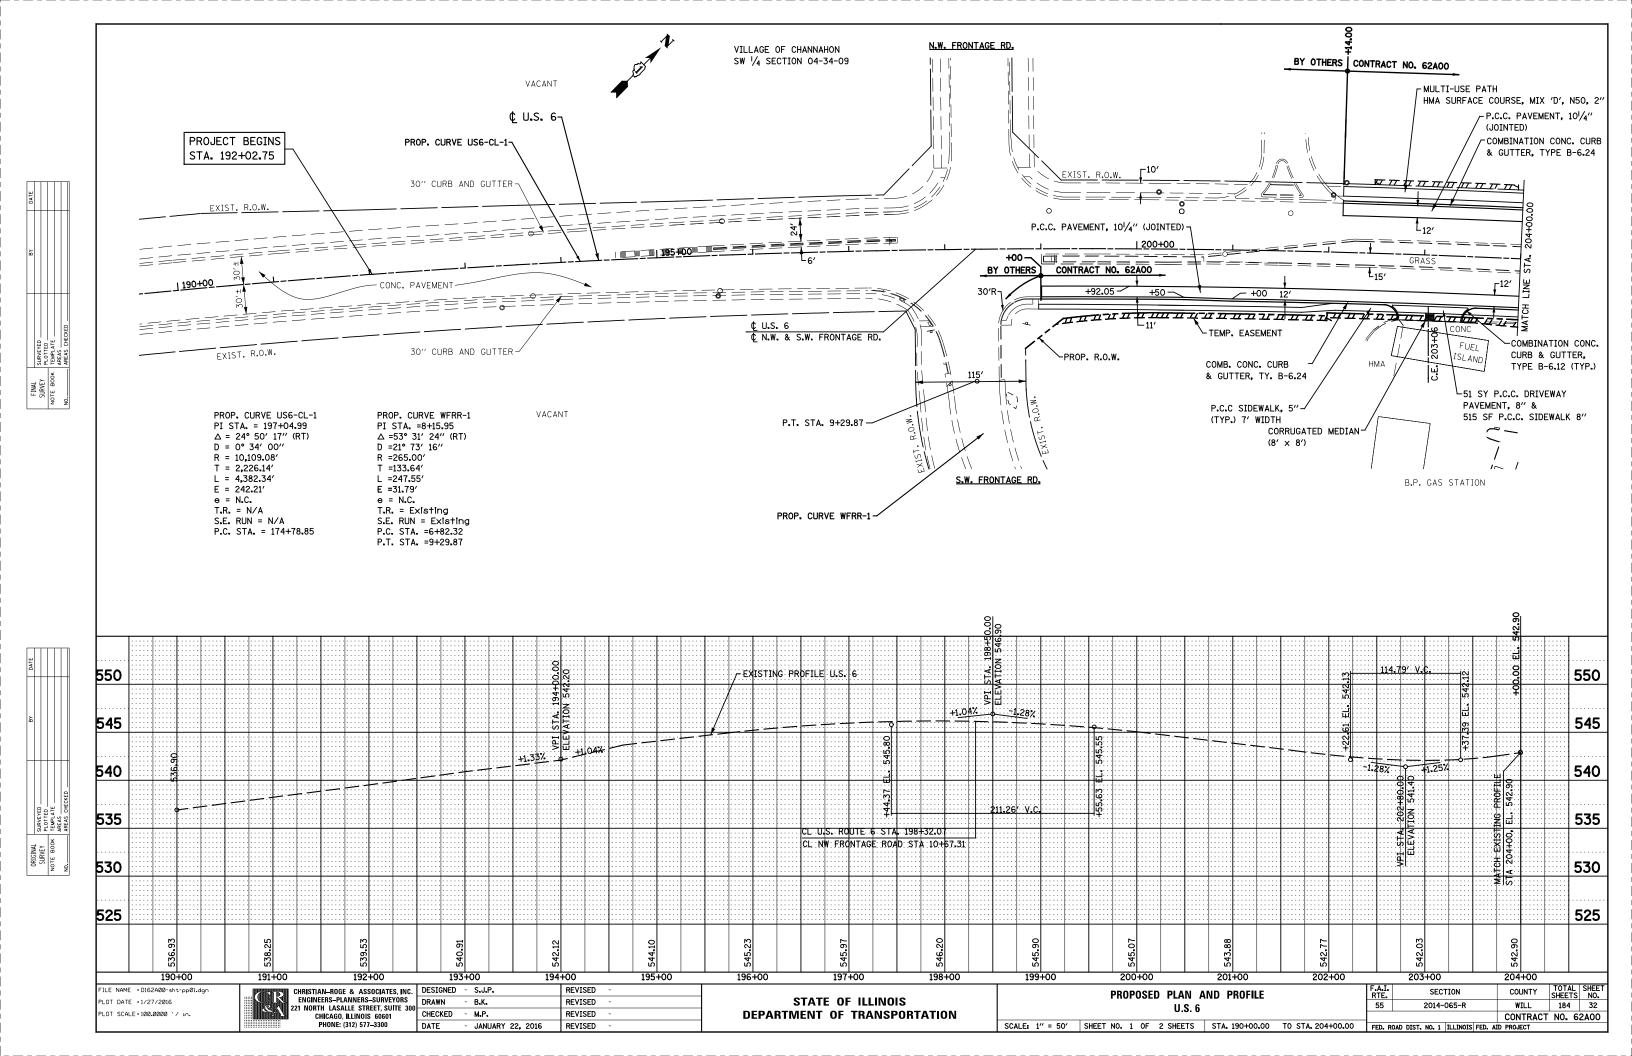


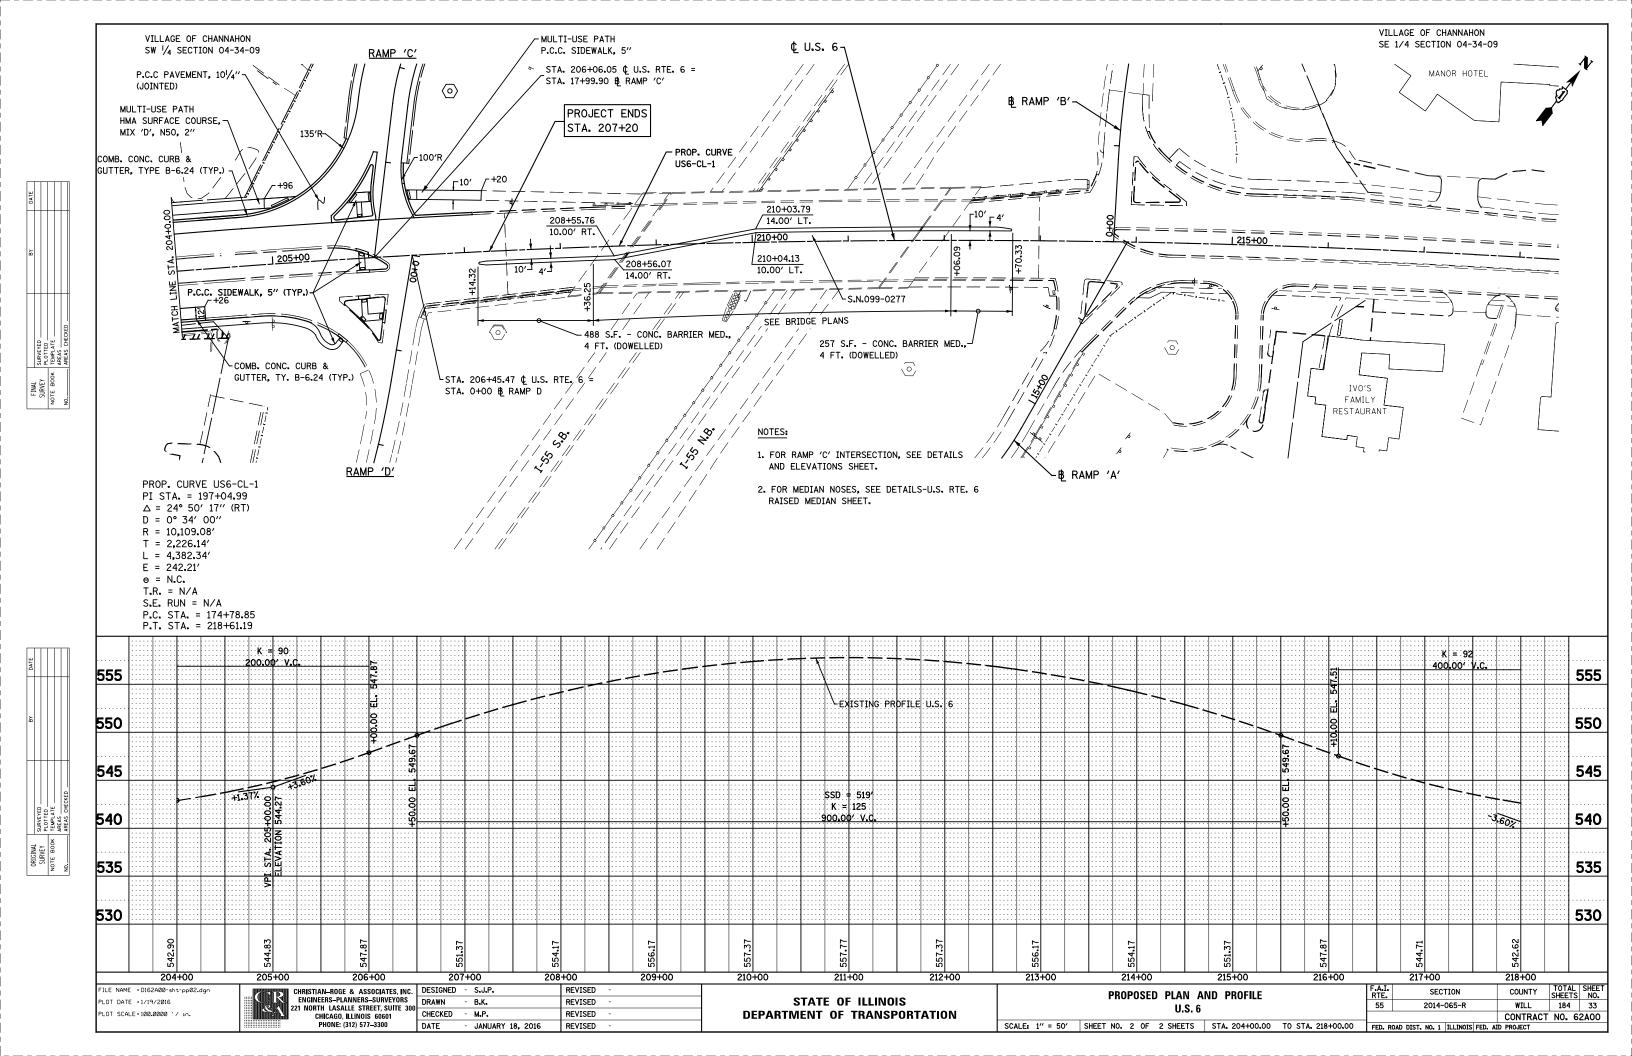

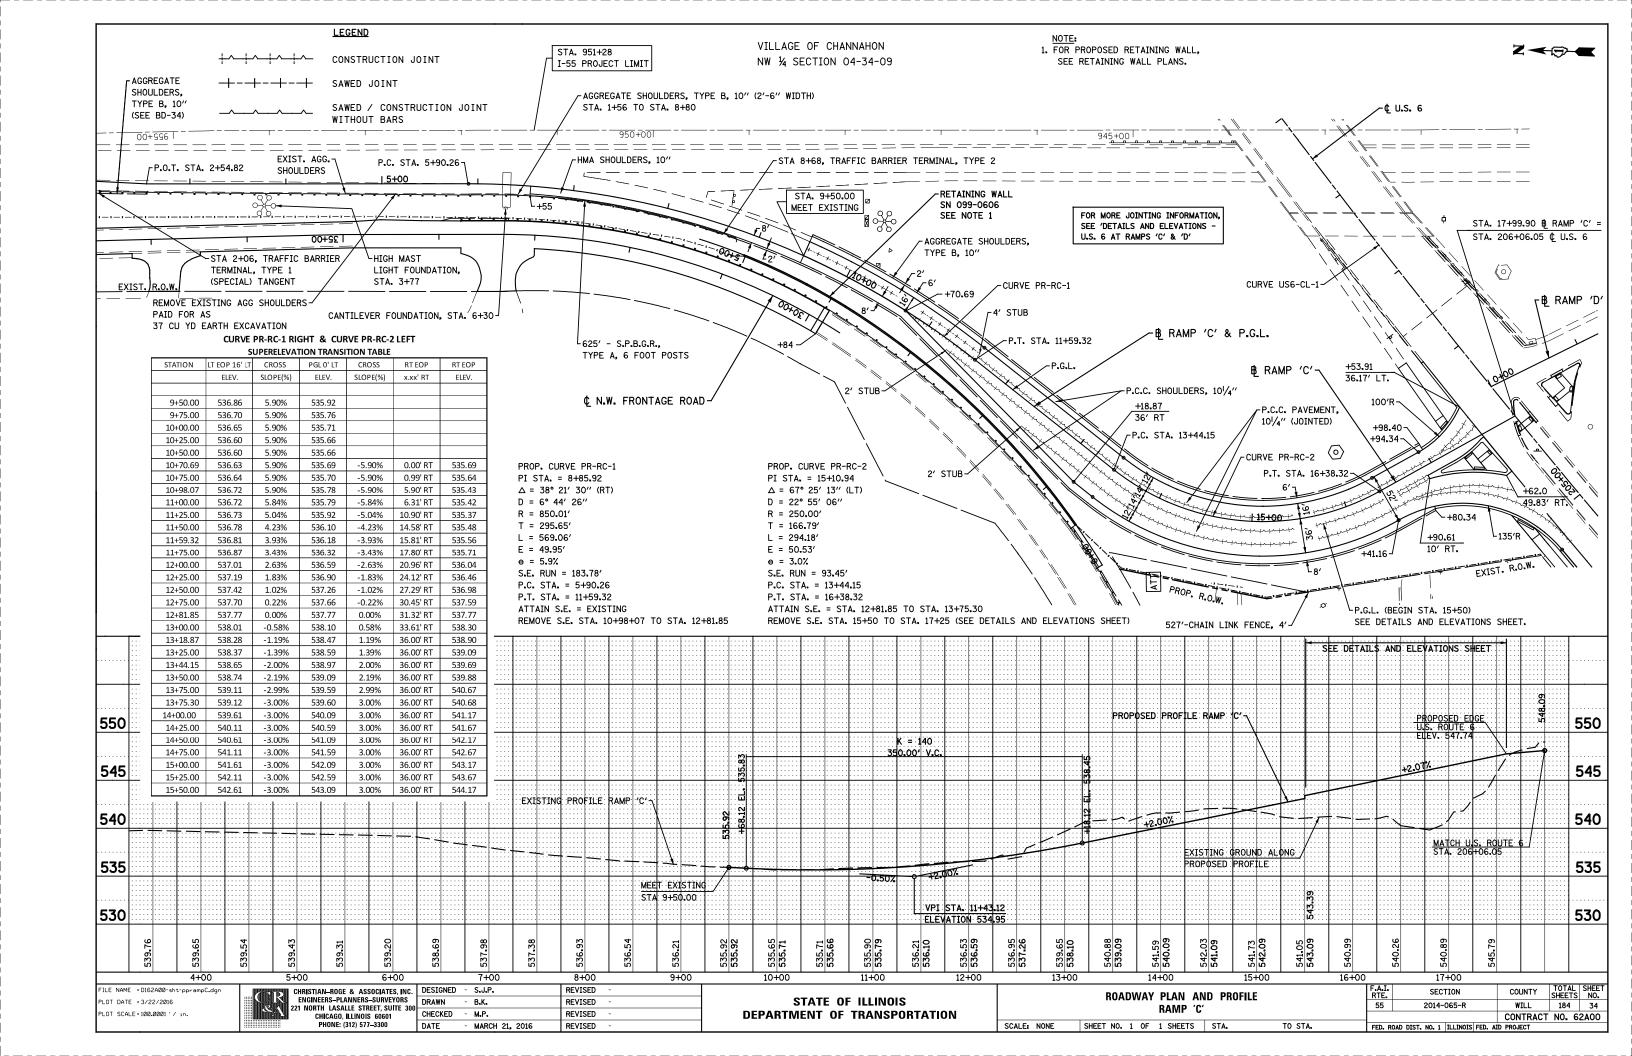

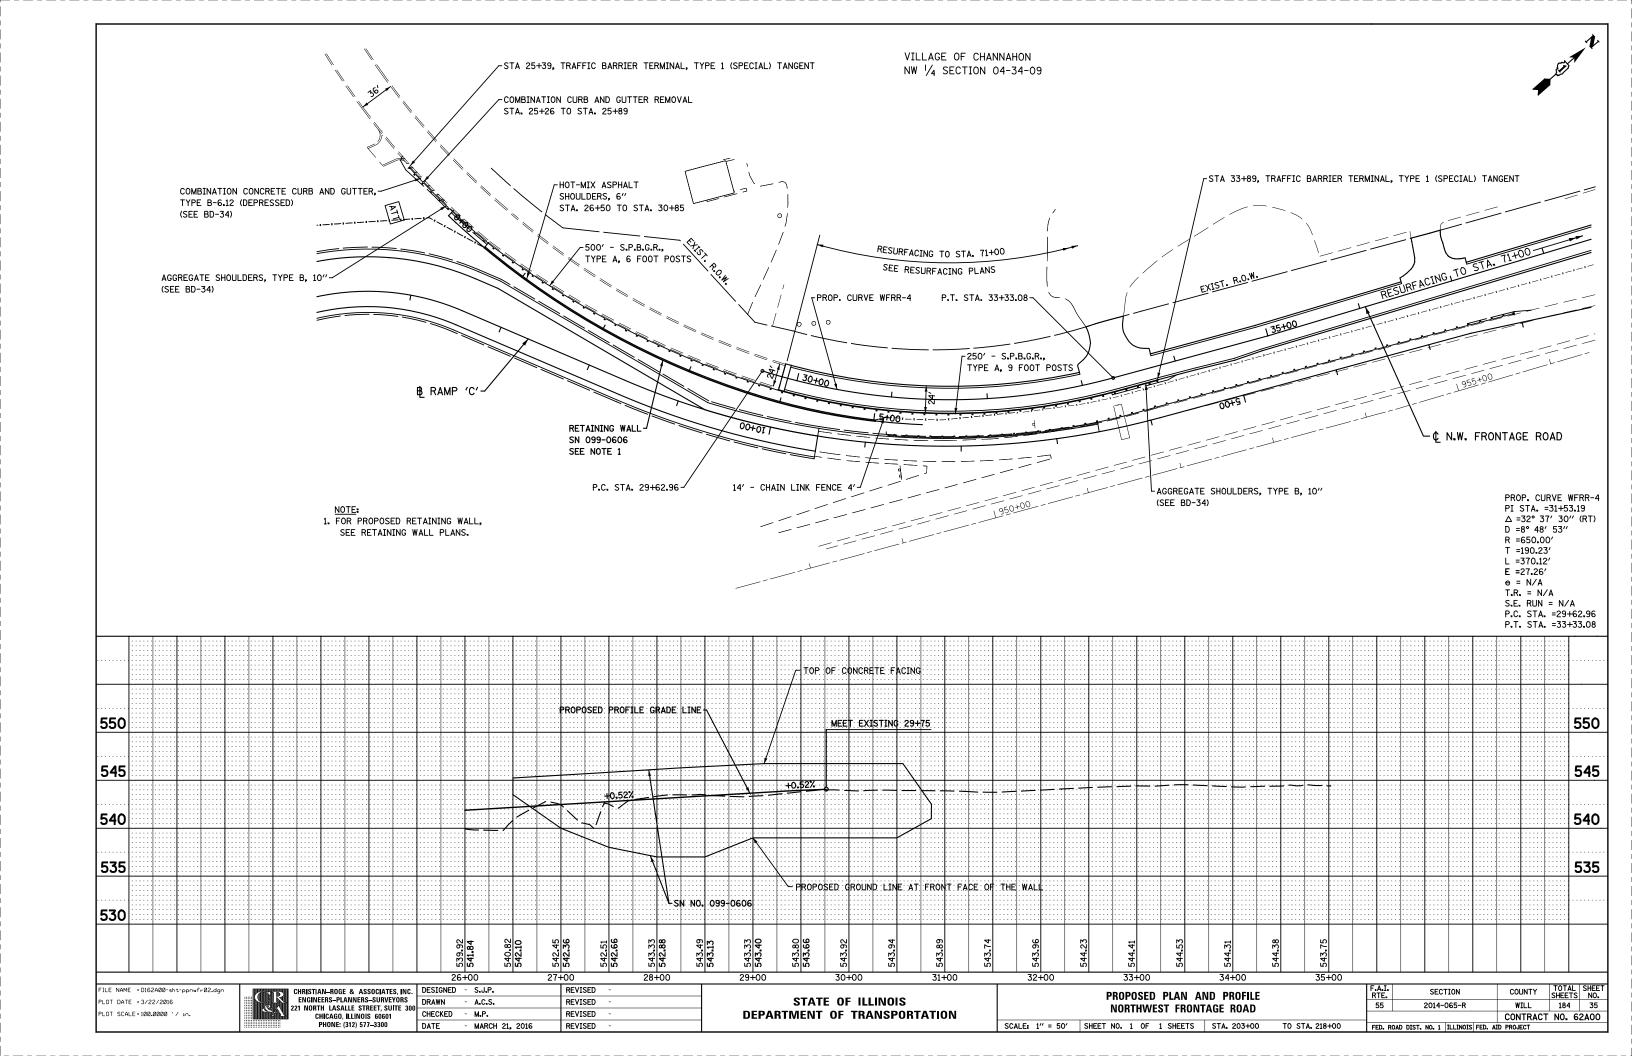

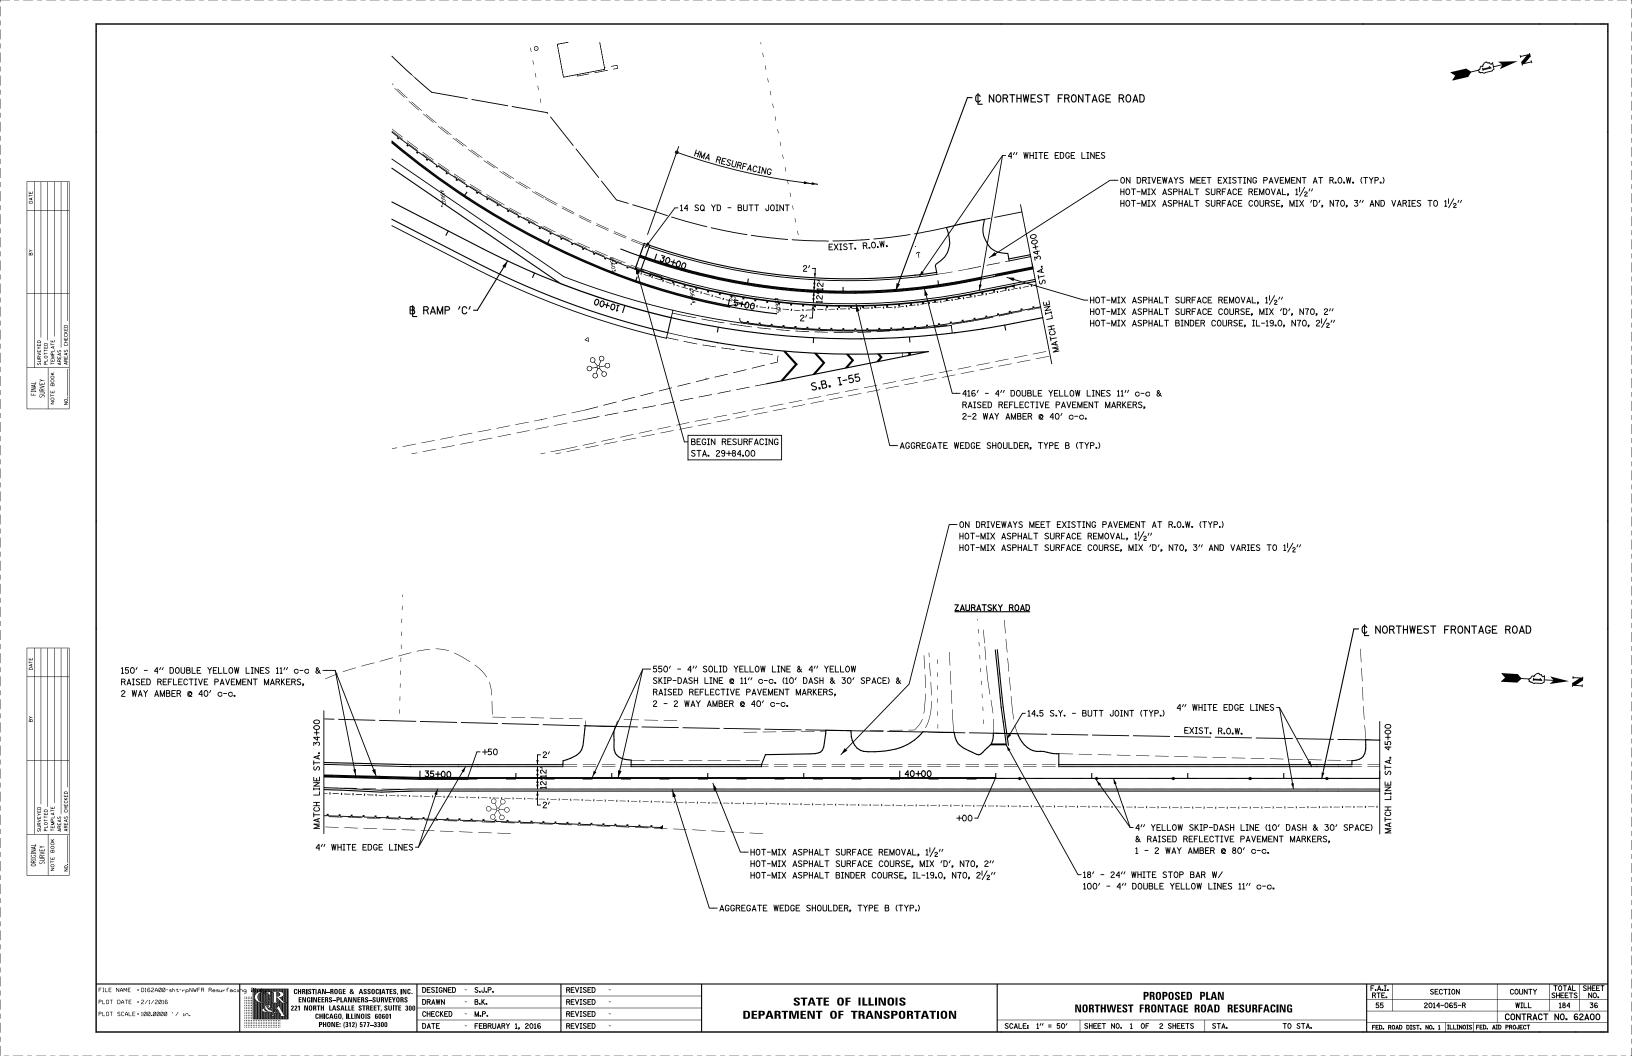

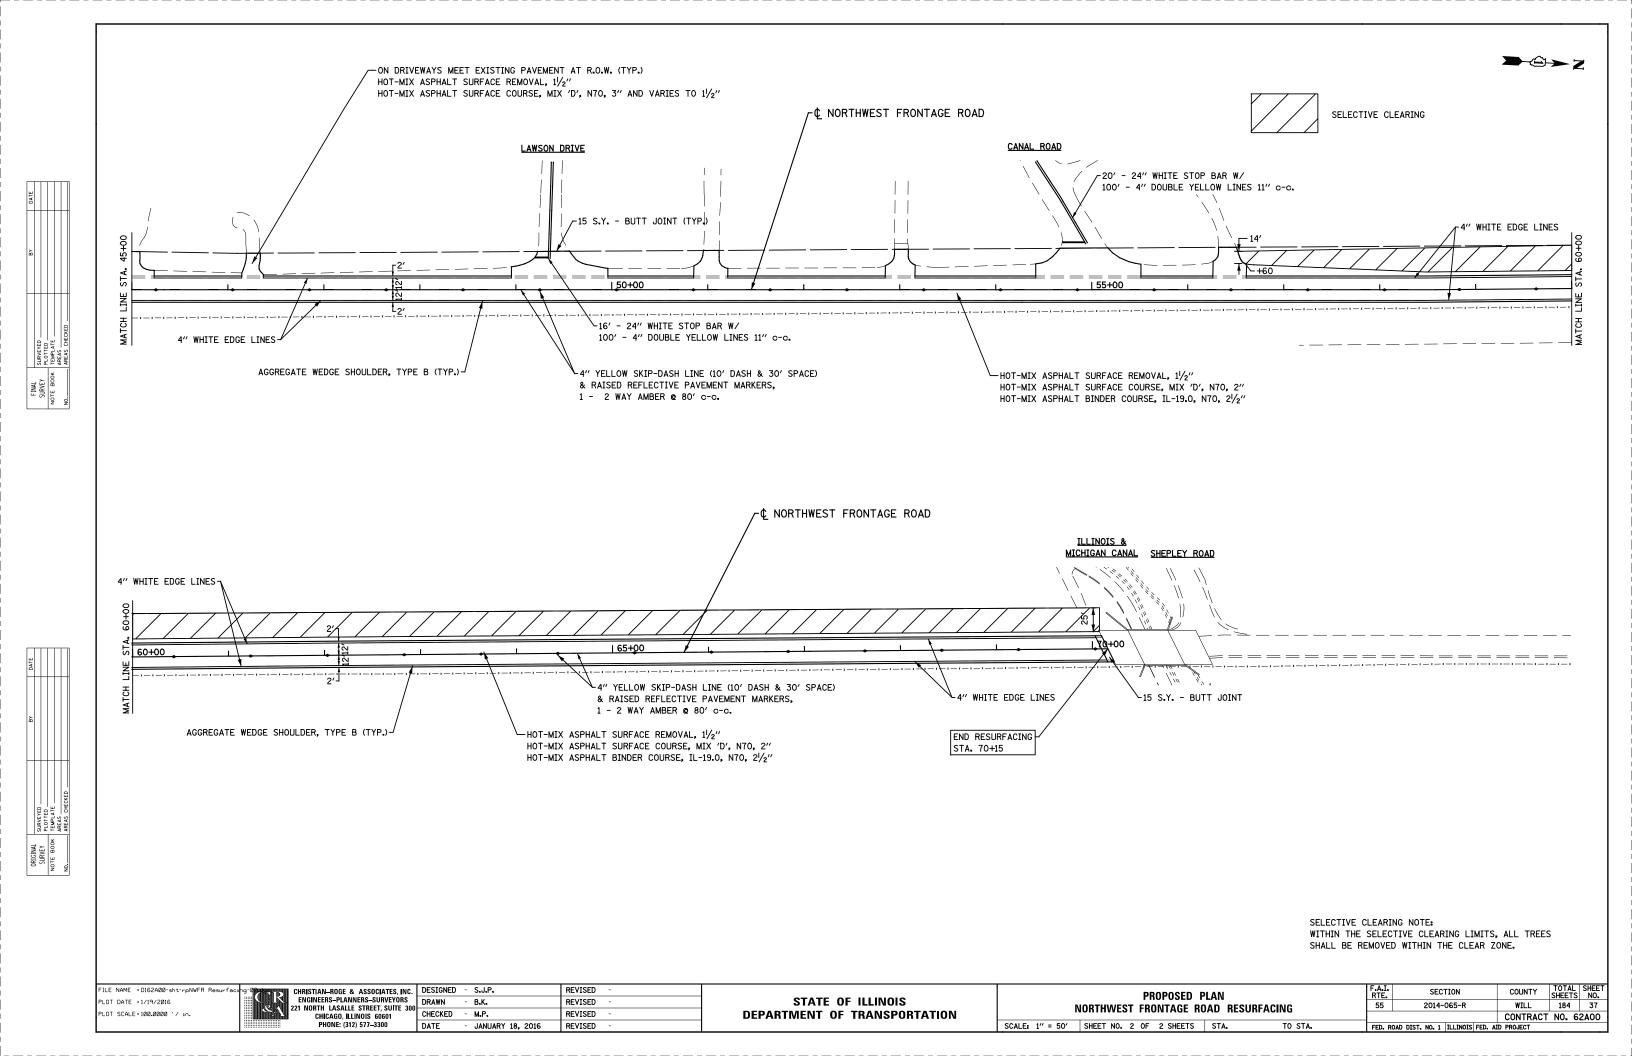

MAINTENANCE OF TRAFFIC GENERAL NOTES

- 1. THE TRAFFIC CONTROL PLANS SHALL SERVE AS A GUIDE FOR SAFE DIVERSION OF TRAFFIC DURING EXECUTION OF THIS CONTRACT. HOWEVER, THE CONTRACTOR MAY MODIFY THE TRAFFIC CONTROL PLANS TO MEET CONSTRUCTION NEEDS, BUT NOT AT THE EXPENSE OF PUBLIC SAFETY OR CONVENIENCE. ANY CHANGES TO THE TRAFFIC CONTROL PLAN SHALL BE SUBMITTED TO THE ENGINEER FOR APPROVAL. THE ENGINEER SHALL BE INFORMED IN WRITING A MINIMUM OF TWO (2) WEEKS IN ADVANCE OF ANY CHANGE TO THE TRAFFIC CONTROL PLANS. NO ADDITIONAL COMPENSATION SHALL BE DUE TO THE CONTRACTOR IF A MODIFIED PLAN IS PROPOSED.
- 2. THE CONTRACTOR SHALL PROVIDE, INSTALL, MAINTAIN, AND REMOVE ALL SIGNS AND SIGN SUPPORTS REQUIRED FOR TRAFFIC CONTROL AND PROTECTION. THIS WORK SHALL NOT BE PAID FOR SEPARATELY BUT SHALL BE INCLUDED IN THE CONTRACT UNIT PRICE PER LUMP SUM FOR "TRAFFIC CONTROL AND PROTECTION, (SPECIAL) (X7010216)" AS NOTED IN THE TRAFFIC CONTROL AND PROTECTION (ARTERIALS) SPECIAL PROVISION AND "TRAFFIC CONTROL AND PROTECTION (EXPRESSWAYS)".
- 3. ALL HIGHWAY TRAFFIC CONTROL STANDARDS WILL NOT BE PAID FOR SEPARATELY, BUT WILL BE INCLUDED IN THE LUMP SUM PRICE FOR "TRAFFIC CONTROL AND PROTECTION, (SPECIAL) (X7010216)" AS NOTED IN THE TRAFFIC CONTROL AND PROTECTION (ARTERIALS) SPECIAL PROVISION AND "TRAFFIC CONTROL AND PROTECTION (FXPRESSWAYS)".
- 4. A CHANGEABLE MESSAGE SIGN SHALL BE PLACED ON U.S. 6 AT EACH END OF THE PROJECT TO INFORM MOTORISTS OF UPCOMING CONSTRUCTION ACTIVITIES AND STAGE CHANGES. THE CMS SHALL BE IN PLACE A MINIMUM OF 72 HOURS PRIOR TO COMMENCING THE WORK. THIS WORK IS TO BE PAID FOR AT THE CONTRACT UNIT PRICE PER CALENDAR MONTH FOR "CHANGEABLE MESSAGE SIGN (70106800)."
- 5. TRAFFIC CONDITIONS, ACCIDENTS, AND OTHER UNFORESEEN EMERGENCY CONDITIONS MAY REQUIRE THE ENGINEER TO RESTRICT, MODIFY, OR REMOVE LANE CLOSURES OR CHANNELIZATION SHOWN IN THE PLANS. THE CONTRACTOR SHALL MAKE THE NECESSARY ADJUSTMENTS AS DIRECTED BY THE ENGINEER WITHOUT DELAY. THE CONTRACTOR SHALL RESPOND, WITHIN THIRTY (30) MINUTES FROM THE TIME OF NOTIFICATION, TO ANY REQUEST MADE BY THE ENGINEER FOR CORRECTION, IMPROVEMENT, OR MODIFICATION OF THE MAINTENANCE OF TRAFFIC CONTROL DEVICES. FAILURE TO RESPOND WITHIN THE ABOVE TIME LIMIT WILL RESULT IN A PENALTY ACCORDING TO ARTICLE 105.03 (b) OF THE IDOT STANDARD SPECIFICATIONS WHENEVER THE ENGINEER DETERMINES THAT THE CONTRACTOR OR HIS SUBCONTRACTOR HAS NOT COMPLIED.
- 6. THE CONTRACTOR SHALL BE RESPONSIBLE FOR ENSURING THAT ALL BARRICADES, SIGNS, LIGHTS, AND OTHER DEVICES INSTALLED ARE IN PLACE AND OPERATING TWENTY-FOUR (24) HOURS EACH DAY INCLUDING SUNDAYS AND HOLIDAYS DURING THE TIME CONSTRUCTION IS IN EFFECT.
- 7. THE CONTRACTOR SHALL CONTACT THE DISTRICT ONE TRAFFIC CONTROL SUPERVISOR AT (847) 705-4470 AND EXPRESSWAY TRAFFIC CONTROL SUPERVISOR AT (847) 705-4155 A MINIMUM OF 72 HOURS IN ADVANCE OF BEGINNING WORK.

- 8. THE CONTRACTOR SHALL REMOVE ALL EXISTING OR TEMPORARY PAVEMENT MARKINGS THAT ARE IN CONFLICT WITH THE MAINTENANCE OF TRAFFIC PLAN.
 REMOVAL OF EXISTING PAVEMENT MARKINGS SHALL BE PAID FOR AS "PAVEMENT MARKING REMOVAL (78300100)." REMOVAL OF TEMPORARY TAPE PAVEMENT MARKINGS SHALL BE PAID FOR AS "WORK ZONE PAVEMENT MARKING REMOVAL (70301000)."
- 9. EXISTING TRAFFIC CONTROL SIGN AND MESSAGES THAT ARE IN CONFLICT WITH THE PROPOSED MAINTENANCE OF TRAFFIC SHALL BE TEMPORARILY COVERED, RELOCATED, OR MODIFIED WITH TEMPORARY OVERLAY AS SHOWN ON THE PLANS AND AS DIRECTED BY THE ENGINEER.
- 10. THE ENGINEER SHALL BE INFORMED 2 WEEKS IN ADVANCE OF ANY CHANGE IN CONSTRUCTION STAGING.
- 11. THE RESIDENT ENGINEER SHALL FILE A FORM OPER 2410 WITH IDOT ROAD INFO
 21 DAYS PRIOR TO PLACING A MAXIMUM WIDTH RESTRICTION ON RAMP C.

TRAFFIC CONTROL AND STAGING NOTES

- 1. THE CONTRACTOR SHALL MAINTAIN DRIVEWAY AND SIDE ROAD ACCESS AT ALL TIMES DURING CONSTRUCTION, THIS WORK SHALL BE PAID FOR AT THE CONTRACT UNIT PRICE PER EACH FOR TEMPORARY ACCESS (PRIVATE ENTRANCE), TEMPORARY ACCESS (COMMERCIAL ENTRANCE) AND TEMPORARY ACCESS (ROAD). EACH DRIVEWAY AND SIDE ROAD SHALL ONLY BE MEASURED FOR PAYMENT ONCE.
- 2. TEMPORARY DRIVEWAY ENTRANCE SIGNS WILL BE REQUIRED DURING ALL STAGES OF CONSTRUCTION AT LOCATIONS DESIGNATED BY THE ENGINEER. FOR SIGN DETAILS SEE TC-26.
- 3. THE CONTRACTOR SHALL USE WET REFLECTIVE TEMPORARY TAPE, TYPE III FOR ALL TEMPORARY LANE MARKINGS ON ALL PERMANENT PAVEMENT. TEMPORARY PAVEMENT MARKINGS SHALL BE USED ON SURFACES TO BE REMOVED OR OVERLAID.
- 4. ALL TRAFFIC CONTROL DEVICES SHALL BE IN ACCORDANCE WITH STD. 701901.
- 5. THE CONTRACTOR IS ADVISED THAT IN THE EVENT OF SNOW, HE WILL BE RESPONSIBLE FOR THE IMMEDIATE REMOVAL OF ANY MAINTENANCE OF TRAFFIC PROTECTIVE DEVICES REQUIRED FOR HIS OPERATIONS THAT WOULD INTERFERE WITH SNOW REMOVAL OPERATIONS PERFORMED BY IDOT OR OTHER AGENCIES.
- 6. TYPE III BARRICADES SHALL BE PLACED AT BOTH ENDS OF THE CLOSED PORTION OF ROADS UNDER CONSTRUCTION. THE CONTRACTOR SHALL PROVIDE ENOUGH TYPE III BARRICADES TO CROSS THE ENTIRE ROADWAY AS DEPICTED ON THE PLANS.
- 7. INCIDENTAL HOT-MIX ASPHALT SURFACING SHALL BE USED FOR RAMPS AND TRANSITIONS FROM PROPOSED PAVEMENT TO EXISTING PAVEMENT. AN ESTIMATED 60 TONS HAS BEEN PROVIDED FOR THIS WORK.
- 8. THE CONTRACTOR SHALL COORDINATE THE STAGING AND USE OF TRAFFIC CONTROL DEVICES WITH CONTRACT 60X84 AS DIRECTED BY THE ENGINEER. THE COST OF THIS WORK SHALL BE INCLUDED IN THE BID PRICE FOR TRAFFIC CONTROL AND PROTECTION (SPECIAL).

MOT-1

CONSTRUCTION STAGING NOTES:

CONSTRUCTION - PRESTAGE

- 1. US 6 REMOVAL OF EXISTING PAVEMENT MARKINGS.
- 2.I-55 AND RAMP C PLACE TEMPORARY PAVEMENT NEEDED FOR TRAFFIC IN STAGE I. INSTALL TEMPORARY FIBER OPTIC CABLES.

CONSTRUCTION - STAGE I

- 1. US 6 CONSTRUCT EB AND WB RIGHT TURN LANES, STORM SEWER, INSTALL ROADWAY LIGHTING, SIDEWALK AND MULTI-USE PATH.
- 2. RAMP C STAGE IA CONSTRUCT THE RETAINING WALL, EMBANKMENT AND PAVEMENT AREAS AS SHOWN ON THE STAGING PLANS
- 3. RAMP C STAGE IB CONSTRUCT THE REMAINDER OF THE RAMP C PAVEMENT AND REMOVE OLD RAMP C PAVEMENT AND REGRADE INFIELD.
- 4. RAMP C STAGE IC BEGIN STAGE IC AFTER ALL RAMP C CONSTRUCTION ALONG US 6 IS COMPLETE. CONSTRUCT THE US 6 RAISED MEDIAN AND COMPLETE RAMP C.
- 5. AS SOON AS PRACTICAL, BEGIN THE INSTALLATION OF THE CONDUIT, INNERDUCT AND REPLACEMENT OF THE FIBER OPTIC CABLES.

CONSTRUCTION - STAGE II

- 1. US 6 COMPLETE THE TRAFFIC SIGNALS AT THE US 6 AT RAMP C/D INTERSECTION.
- 2. INSTALL THE PERMANENT FIBER OPTIC CABLES.
- 3. NORTHWEST FRONTAGE ROAD RESURFACE FROM STA. 29+84 TO STA. 70+15.

CONSTRUCTION MOT NOTES:

TRAFFIC CONTROL - PRESTAGE

- 1. US 6 CLOSE THE OUTSIDE LANES ALONG US 6 LANE. UTILIZE STD 701326, 701501, 701606, 701701, 701801, 701901 AND DISTRICT DETAILS TC-10, 14, 16, 22 & 26 TO INSTALL THE PERMANENT LANES CLOSURES FOR STAGE I.
- 2.I-55 AND RAMP C USE STD 701400, 701401 & 704001 AND DISTRICT STANDARD TC-17, PARTIAL RAMP CLOSURE TO REMOVE THE RIGHT SHOULDER AND CONSTRUCT THE TEMPORARY PAVEMENT AND TO INSTALL THE TEMPORARY FIBER OPTIC CABLE LINE. SEE TRAFFIC CONTROL PLANS.

TRAFFIC CONTROL - STAGE I


- 1. US 6 MAINTAIN ONE LANE OF TRAFFIC IN EACH DIRECTION AND LEFT TURN LANES AT THE WEST FRONTAGE ROADS AND I-55 ON-RAMPS. SEE TRAFFIC CONTROL PLANS FOR THIS STAGE.
- 2. STAGE IA RAMP C AND RETAINING WALL SHIFT TRAFFIC ONTO TEMPORARY PAVEMENT & PLACE TEMPORARY CONCRETE BARRIER, MAINTAIN TWO LANES OF TRAFFIC AT THE US 6 INTERSECTION, SEE TRAFFIC CONTROL PLANS.
- 3. STAGE IB RAMP C SHIFT TRAFFIC ONTO NEW RAMP PAVEMENT. MAINTAIN TWO LANES OF TRAFFIC AT THE US 6 INTERSECTION. SEE TRAFFIC CONTROL PLANS.
- 4. STAGE IC RAMP C AND US 6 RAISED MEDIAN MAINTAIN RAMP C TRAFFIC AND EB US 6 LANE CLOSURE AS SHOWN IN STAGE IB.
 - OPEN WB US 6 TO 2 LANES OF TRAFFIC ACROSS BRIDGE.
 - BETWEEN THE HOURS OF 9:00 AM TO 3:30 PM, CLOSE LEFT TURN LANES AND INSIDE LANES OF US 6 AS SHOWN ON STAGE IC STAGING PLAN.
 - WEST OF BRIDGE CLOSE US 6 INSIDE LANE USING STANDARD 701606.
 - AT THE END OF THIS STAGE REMOVE WB LANE CLOSURE EAST OF BRIDGE.


TRAFFIC CONTROL - STAGE II

- 1. US 6 MAINTAIN ONE LANE OF TRAFFIC USING DAILY LANE CLOSURES IN EACH DIRECTION AND MAINTAIN LEFT TURN LANE AT THE I-55 SOUTHBOUND RAMP. UTILIZE STD 701701 AND TC-14 FOR THE TRAFFIC SIGNAL INSTALLATION.
- 2. SOUTHBOUND I-55 AND RAMP C CLOSE SHOULDERS USING STD 701400, 701401 & 704001 AND DISTRICT STANDARD TC-17, USING TC-17 TO INSTALL FIBER OPTIC CABLES.
- 3. NORTHWEST FRONTAGE ROAD DAILY LANE CLOSURES USING STD, 701201, 701301, 701306 AND 701311

NOTE: DAYTIME LANE CLOSURES ON I-55 WILL NOT BE PERMITTED ON THIS CONTRACT.


MOT-2

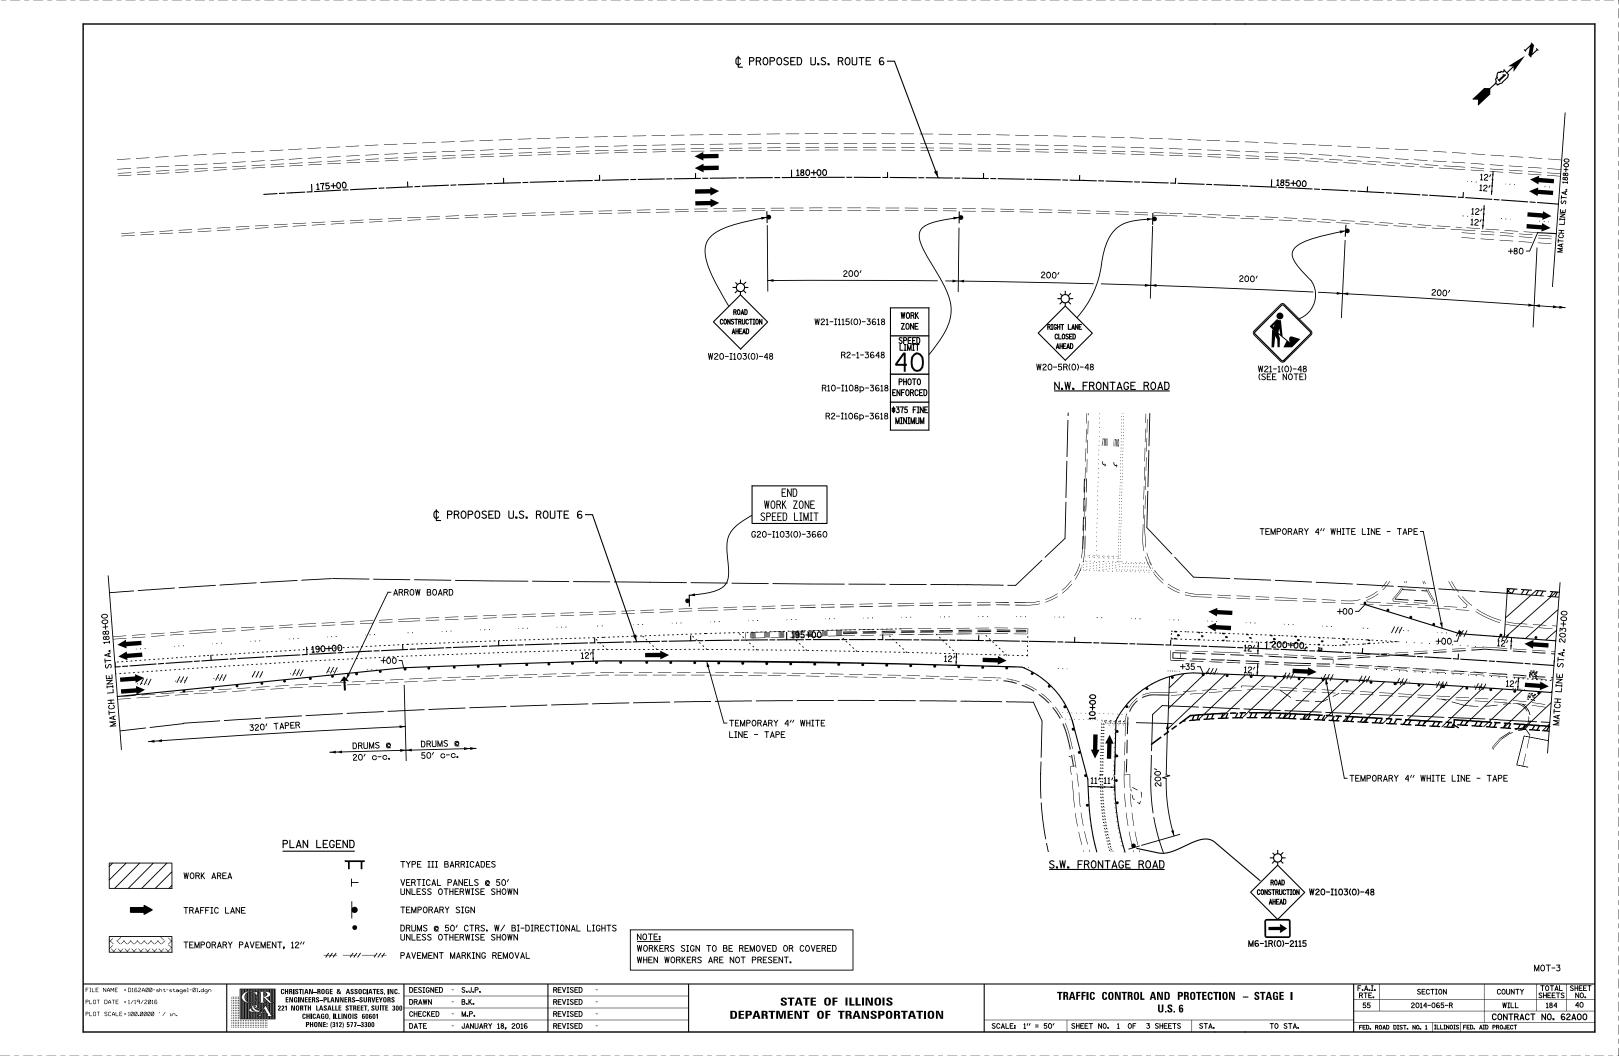


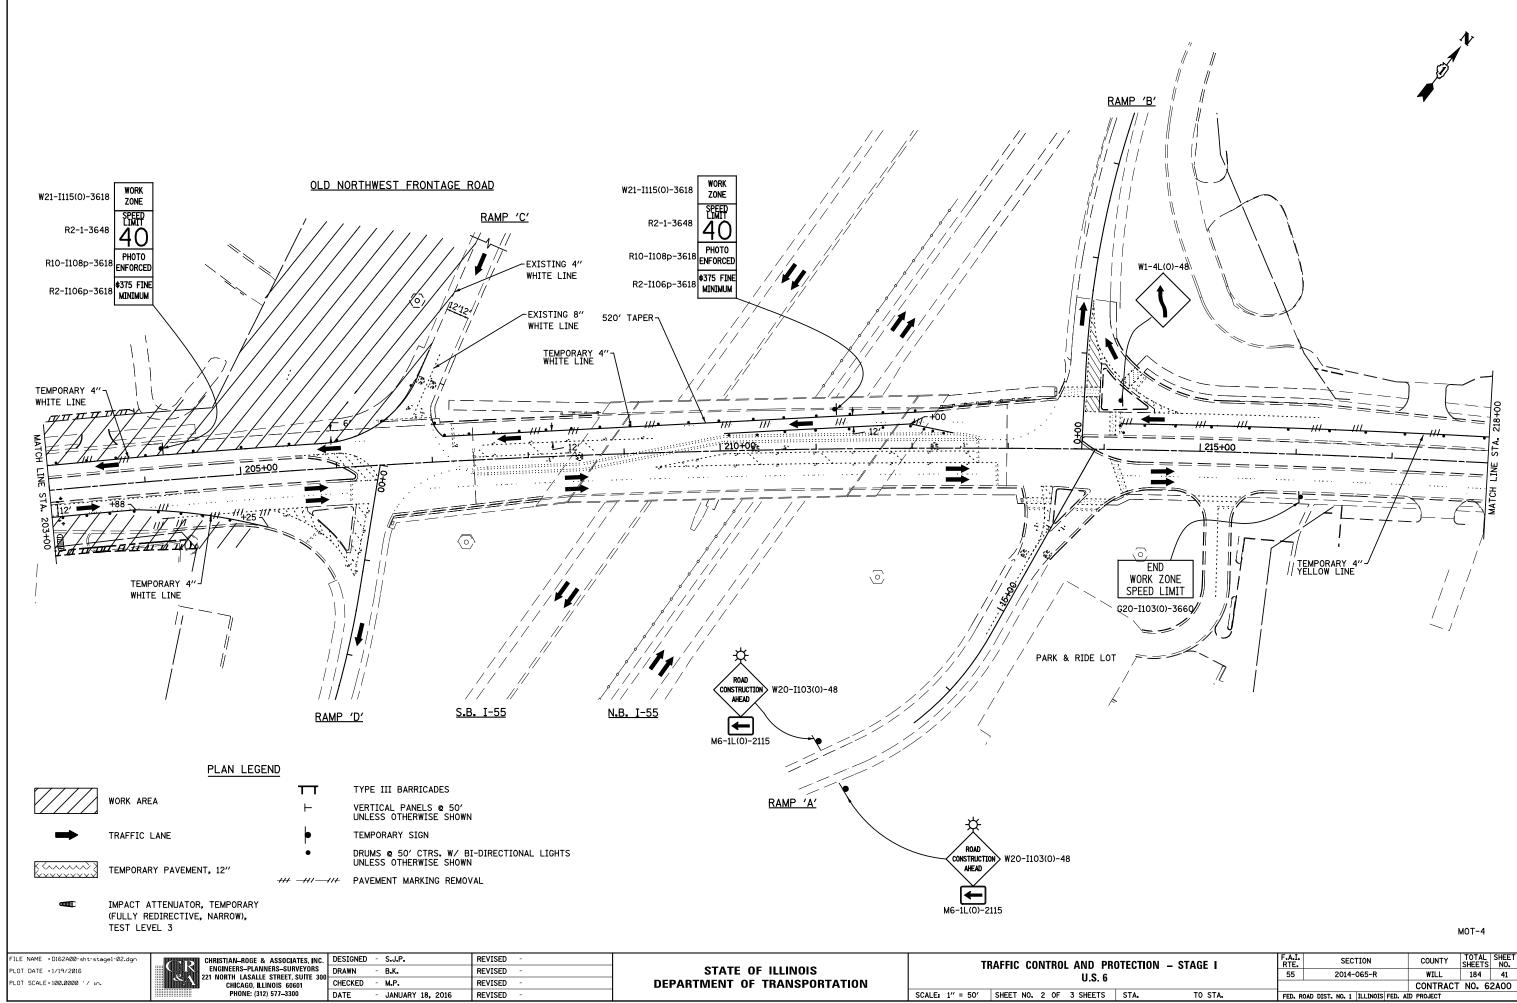



- JANUARY 18, 2016 REVISED


SCALE: 1" = 50' SHEET NO. 2 OF 3 SHEETS STA.

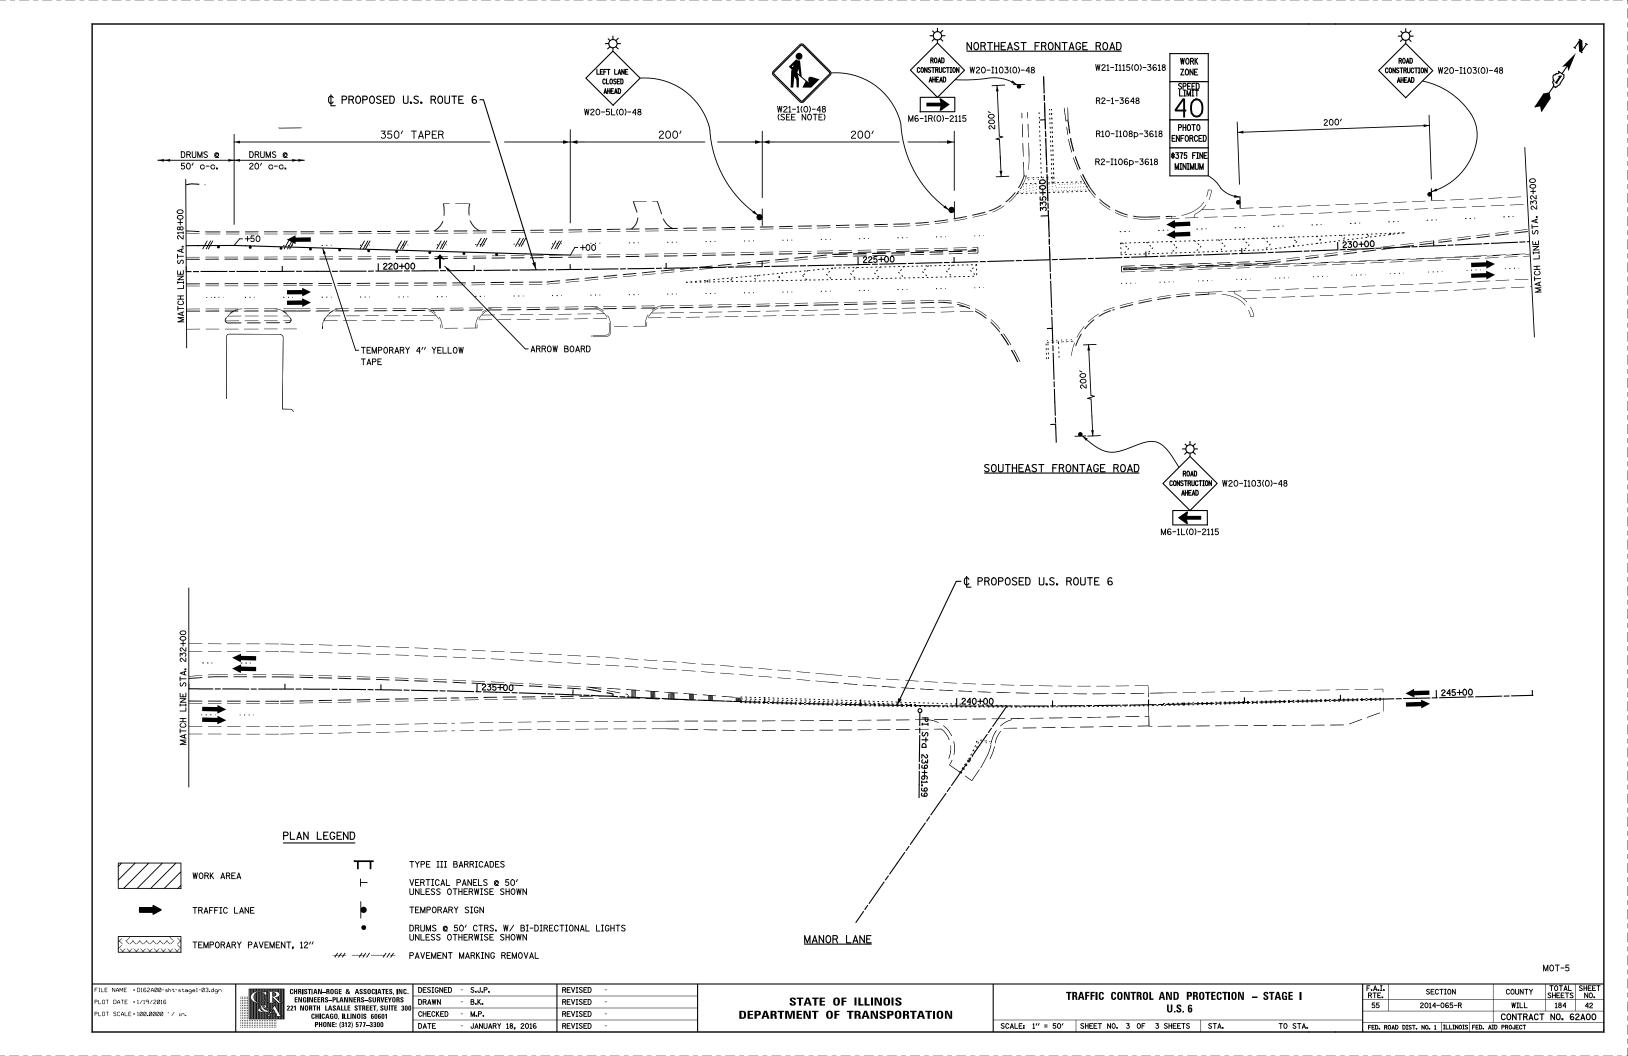

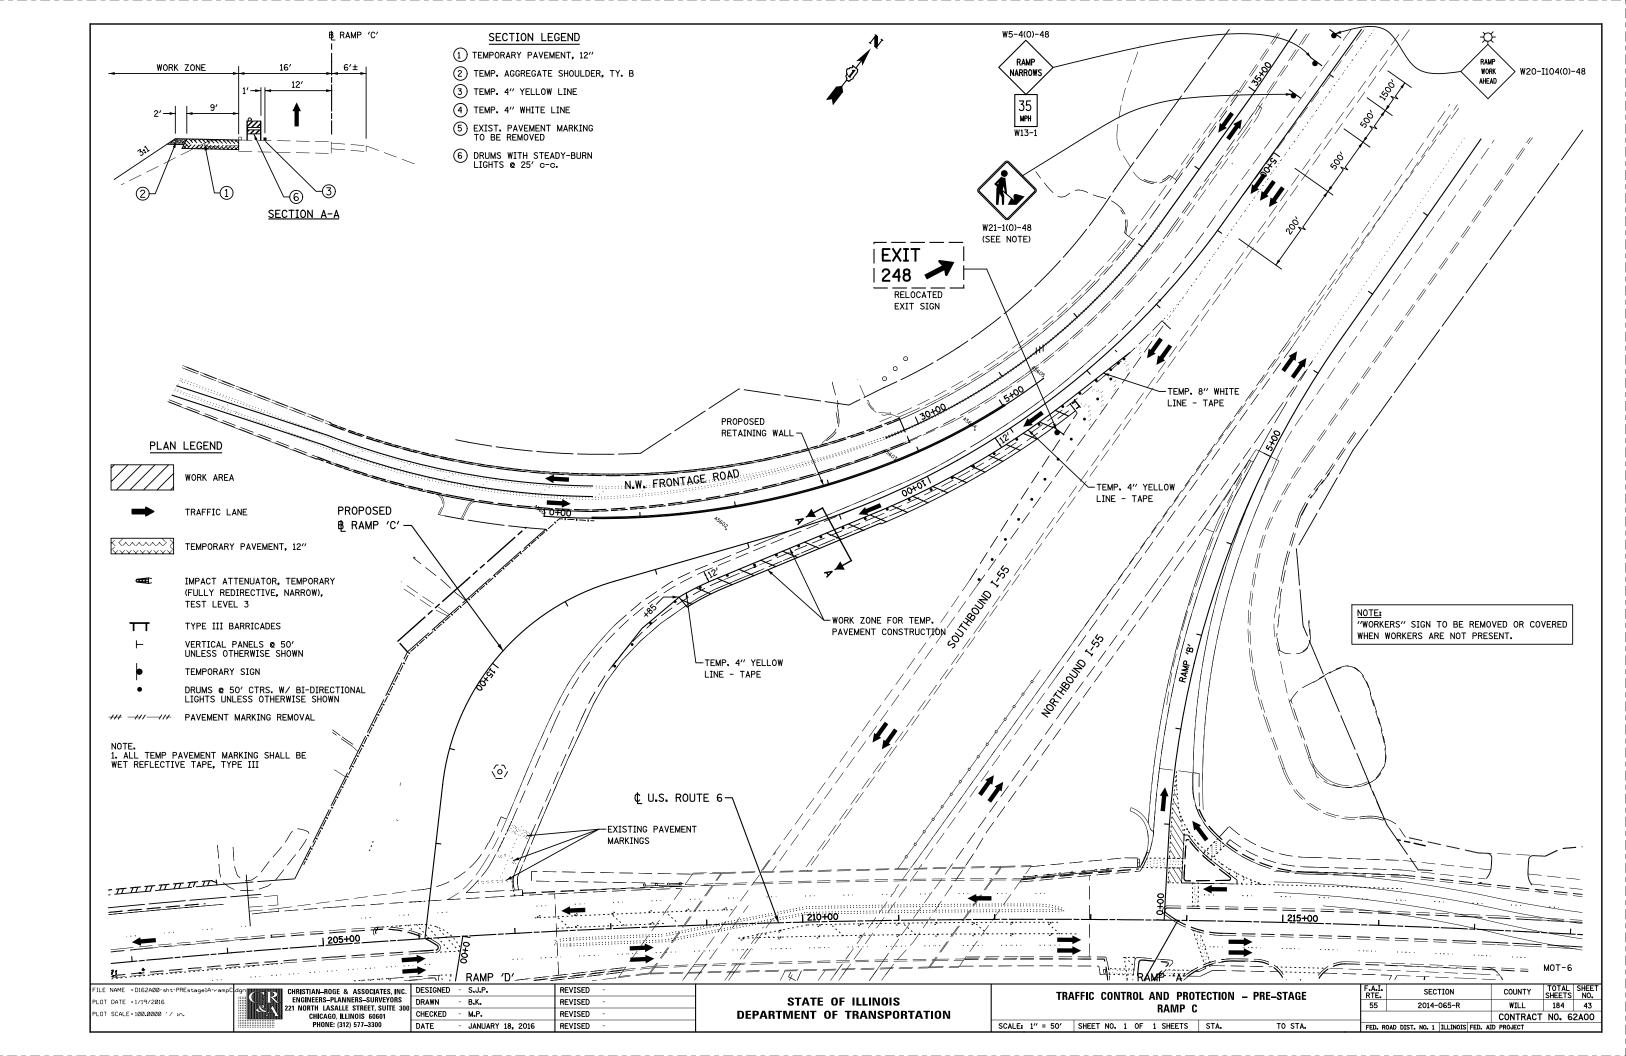

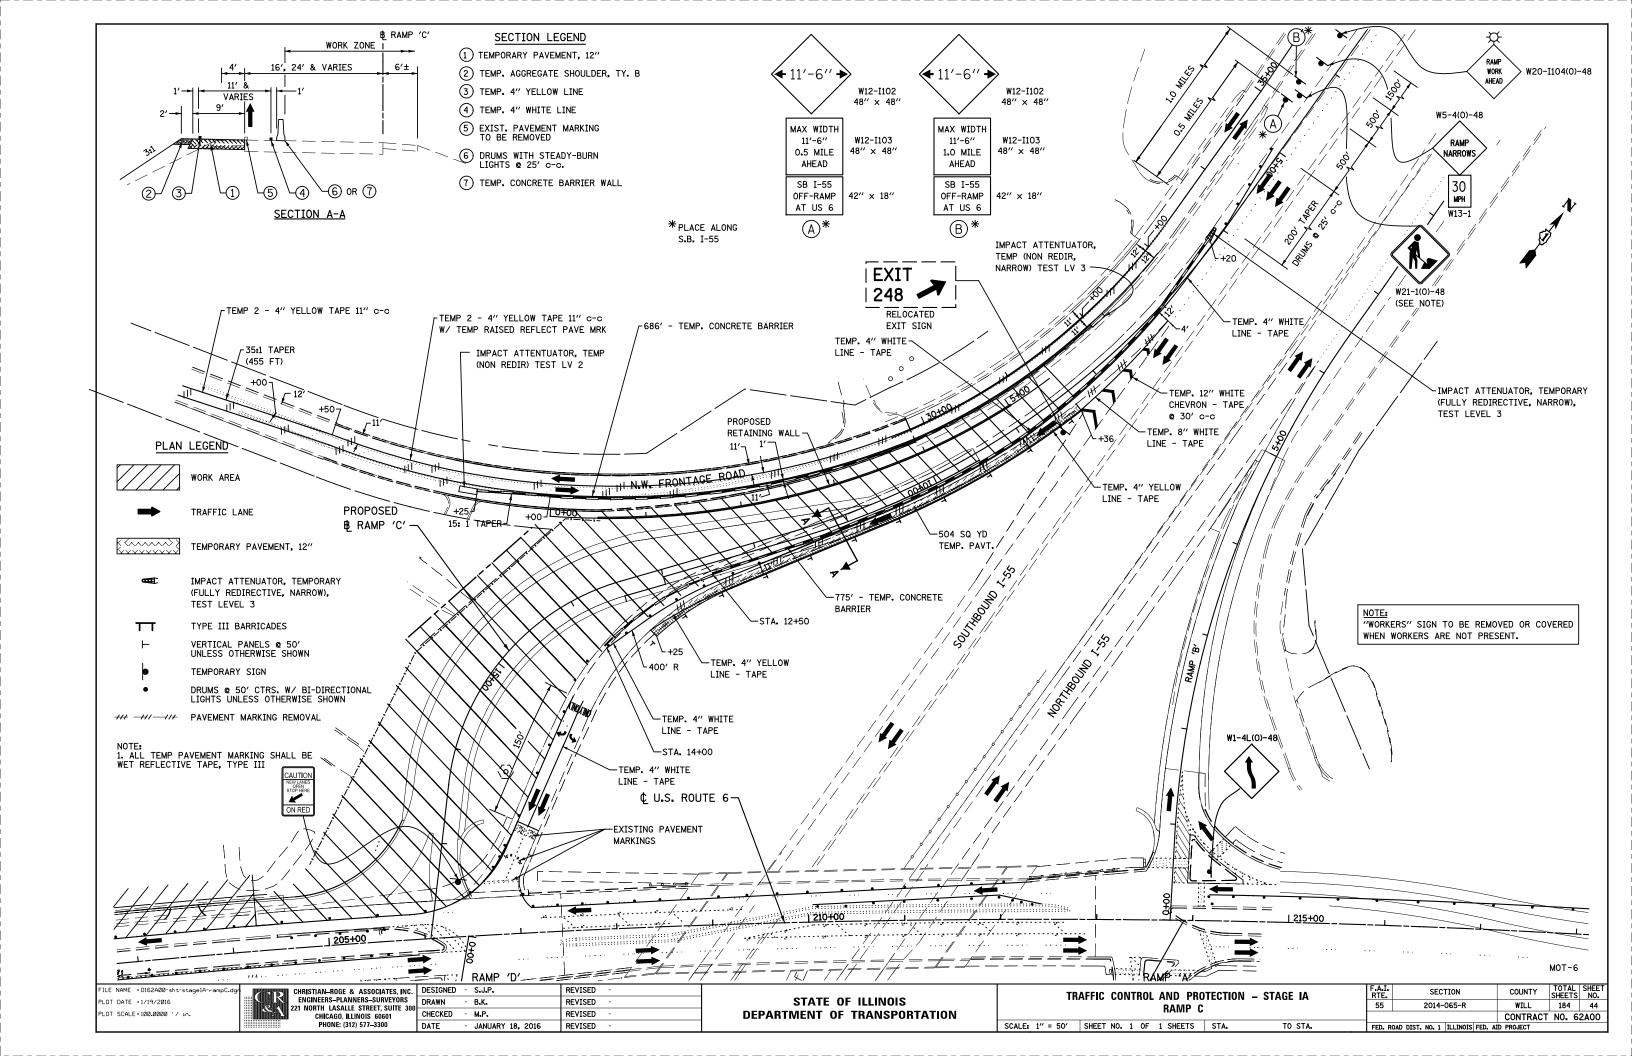

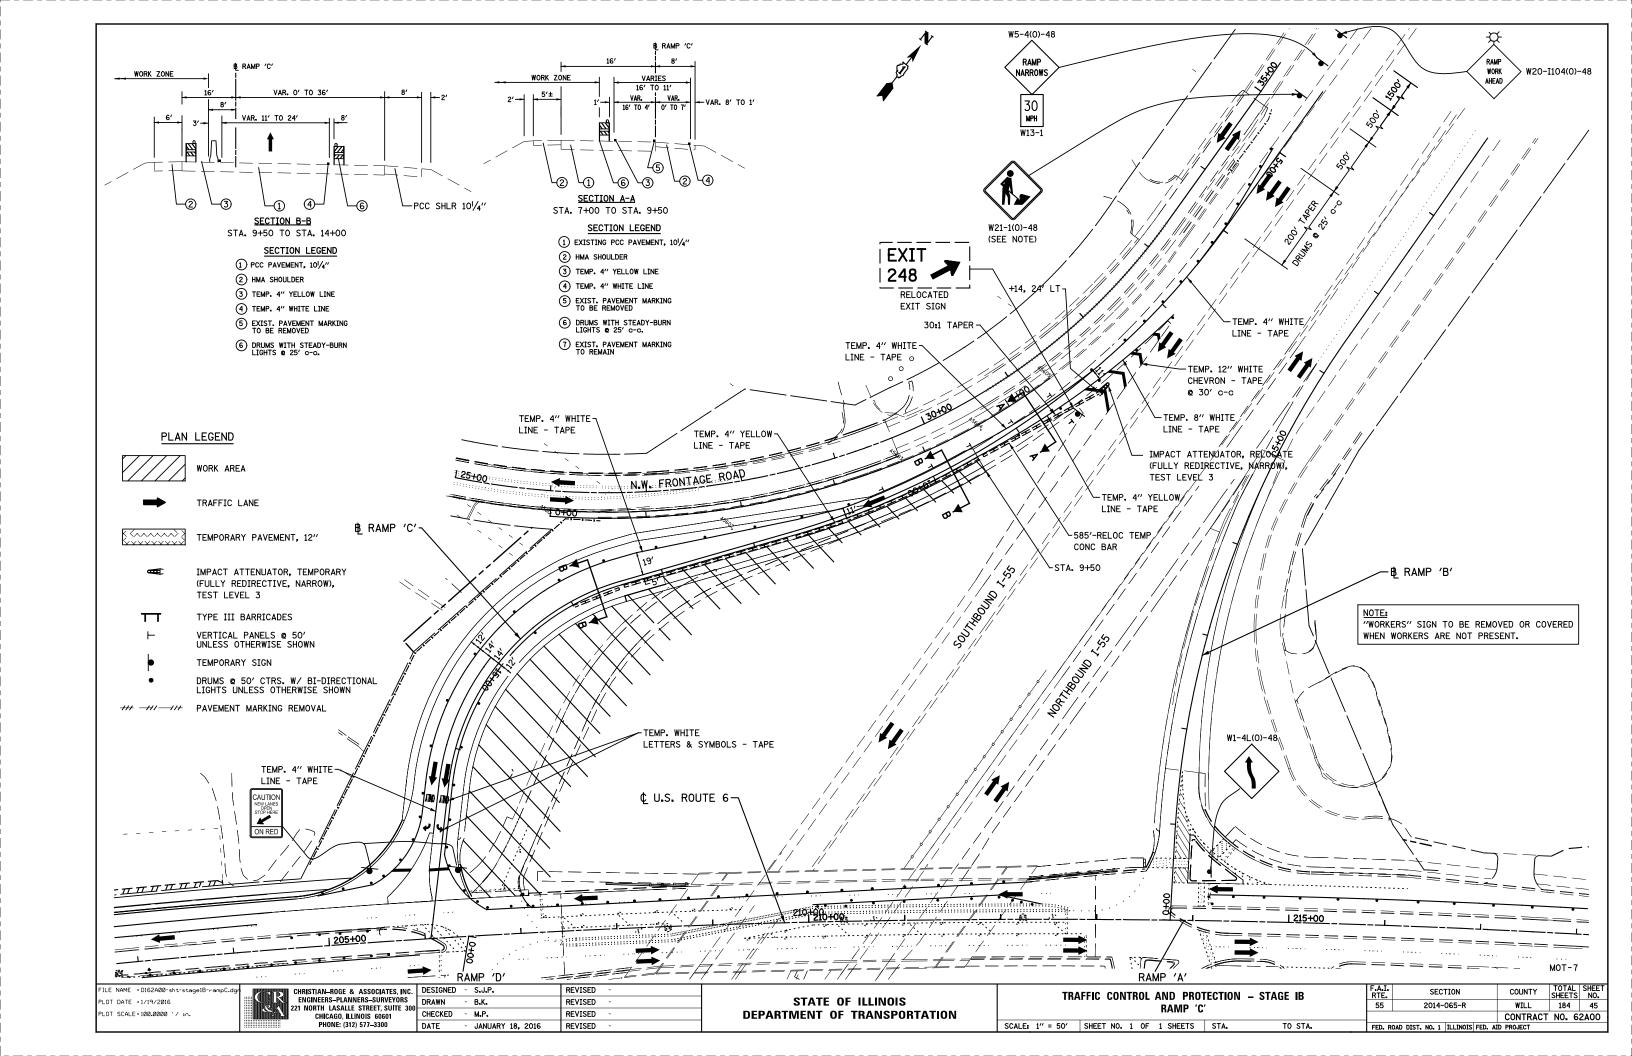

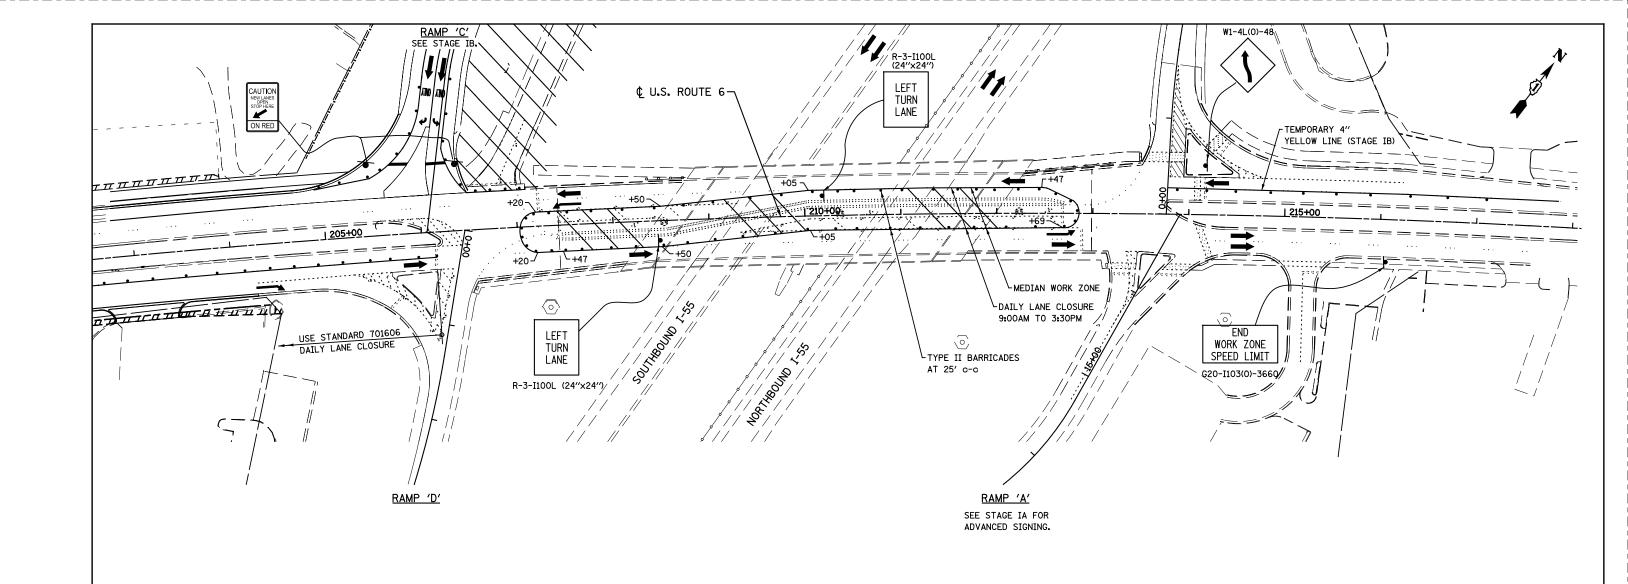

PLAN LEGEND

WORK AREA

TRAFFIC LANE

{ TEMPORARY PAVEMENT, 12"

IMPACT ATTENUATOR, TEMPORARY (FULLY REDIRECTIVE, NARROW), TEST LEVEL 3

TYPE III BARRICADES \Box

VERTICAL PANELS **©** 50' UNLESS OTHERWISE SHOWN

TEMPORARY SIGN

DRUMS © 50' CTRS. W/ BI-DIRECTIONAL LIGHTS UNLESS OTHERWISE SHOWN

##/—## PAVEMENT MARKING REMOVAL

FILE NAME = D162A00-sht-stage1C-rampC&US PLOT DATE =1/19/2016 PLOT SCALE = 100.0000 '/ in.

CHRISTIAN-ROGE & ASSOCIATES, INC. ENGINEERS-PLANNERS-SURVEYORS 221 NORTH LASALLE STREET, SUITE 30 CHICAGO, ILLINOIS 60601 PHONE: (312) 577–3300


VC. S 300	DESIGNED	-	S.J.P.	REVISED	-
	DRAWN	-	B.K.	REVISED	-
	CHECKED	-	M.P.	REVISED	-
	DATE	-	JANUARY 18, 2016	REVISED	-
			•		·

STATE OF ILLINOIS
DEPARTMENT OF TRANSPORTATION

SCALE: 1" = 50'

TRAF	FIC CONTROL AND PROTI	F.A.I. RTE. 55	SECTION 2014-065-R	COUNTY	TOTAL SHEETS 184	SHEET NO. 45A		
	NAIVIF C & U.S. N	CONTRACT NO. 62AO			2A00			
= 50'	SHEET NO. 1 OF 1 SHEETS	STA.	TO STA.	FED. R	OAD DIST. NO. 1 ILLINOIS FED. A	D PROJECT		

MOT-7

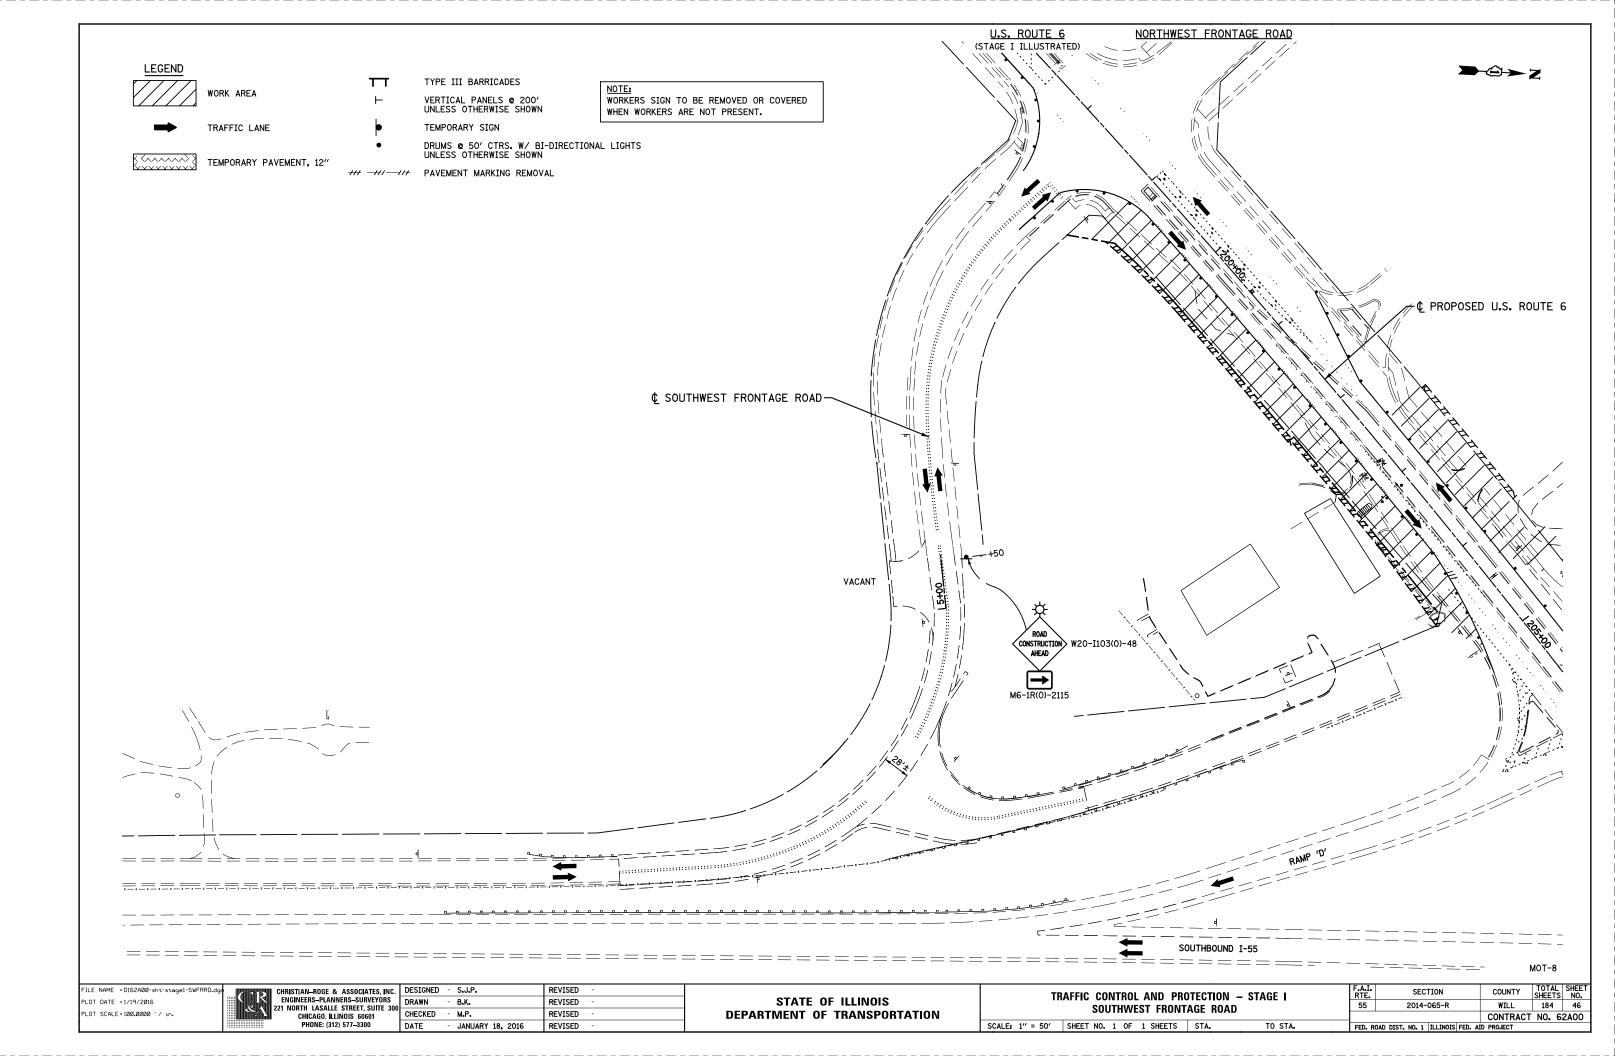

EROSION AND SEDIMENT CONTROL GENERAL NOTES

- 1. THE WORK DESCRIBED ON THESE DRAWINGS IS AN INTEGRAL PART OF THE STORM WATER POLLUTION PREVENTION PLAN USED TO OBTAIN A NPDES PERMIT FROM IEPA FOR THE CONSTRUCTION OF THIS PROJECT. FULL COMPLIANCE WITH ALL TERMS OF THE NPDES PERMIT MUST BE STRICTLY ADHERED TO.
- 2. THE PURPOSE OF THE EROSION AND SEDIMENT CONTROL MEASURES INCLUDED FOR THIS PROJECT IS TO LIMIT THE SEDIMENT POLLUTION IMPACT OF ANY STORM WATER DISCHARGES THAT ORIGINATE ON THIS SITE OR FROM OFF-SITE AND FLOW OVER THE DISTURBED AREAS.
- 3. IT IS THE RESPONSIBILITY OF THE CONTRACTOR TO ENSURE THAT SEDIMENT TRANSPORT OF THE SITE IS REDUCED BY A COMBINATION OF MINIMIZING EROSION AT THE SOURCE AND INSTALLING OF SPECIFIC MEASURES TO CONTROL OR REDUCE THE TRANSPORT OF SEDIMENT. A COPY OF THE EROSION AND SEDIMENT CONTROL SCHEDULE BEING IMPLEMENTED BY THE CONTRACTOR SHOULD BE ON THE CONSTRUCTION SITE AT ALL TIMES.
- 4. TO THE MAXIMUM EXTENT POSSIBLE, ALL FLOWS ORIGINATING OFF THE CONSTRUCTION SITE SHALL BE DIVERTED AROUND DISTURBED AREAS OR SHALL NOT BE CONVEYED THROUGH THE SITE IN A MANNER THAT UNTREATED ON-SITE RUNOFF DOES NOT MIX WITH THE OFF-SITE RUNOFF.
- 5. ALL RUNOFF ORIGINATING ON DISTURBED AREAS ASSOCIATED WITH THIS PROJECT SHALL PASS THROUGH ONE OR MORE MEASURES THAT SHALL REDUCE OVERLAND FLOW RATES AS WELL AS CURTAIL ON AND OFF-SITE SEDIMENT IMPACTS OF THE CONSTRUCTION ACTIVITY.
- 6. ALL PERMANENT SEDIMENT BASINS, PERMANENT STORM WATER CONTROL MEASURES, AND RUNOFF CONTROL MEASURES REQUIRED TO KEEP OFF-SITE RUNOFF FROM FLOWING OVER THE CONSTRUCTION AREA SHALL BE INSTALLED BEFORE CLEARING AND STRIPPING OF THE SITE PROCEEDS. PRIOR TO PROCEEDING WITH GENERAL EARTHWORK ON A PROJECT THE CONTRACTOR SHALL OBTAIN APPROVAL OF HIS PROPOSED EARTHWORK AND STABILIZATION SCHEDULE.
- 7. A MAXIMUM OF 10 ACRES MAY BE IN SOME STAGE OF GRADING AT A SINGLE TIME. ADDITIONAL AREAS (UP TO 10 ACRES) MAY BE CLEARED BUT SHALL NOT BE STRIPPED FROM VEGETATION UNTIL THE GRADED AREAS HAVE BEEN PROTECTED FROM EROSION THROUGH INSTALLATION OF EITHER TEMPORARY OR PERMANENT MEASURES. WHENEVER POSSIBLE, THE GRADING SHALL BE COMPLETED TO THE DESIGN GRADE AND THE PERMANENT VEGETATION PLAN IMPLEMENTED PRIOR TO STARTING GRADING ACTIVITIES ON THE NEXT SITE.
 - (A) WHEN BALANCING EARTHWORK (BORROW FROM A CUT USED AS FILL AT A LOCATION DISTANT FROM THE CUT) THE ENGINEER SHALL CONSIDER ALLOWING MORE THAN 10 ACRES OF GRADING AT A TIME. THE 10 ACRE LIMITATION DOES NOT INCLUDE HAUL ROADS, BRIDGE CONSTRUCTION WORK AREAS OR STORAGE AREAS.
 - (B) VARIATIONS TO THE ABOVE MAY BE CONSIDERED BY THE ENGINEER UNDER ALL THE FOLLOWING CONDITIONS:
 - -IF THE CONTRACTOR FALLS BEHIND SCHEDULE THROUGH NO FAULT OF HIS OWN.
 - -THE CONTRACTOR MUST PRESENT A SCHEDULE DEMONSTRATING THE NEED FOR SUCH VARIATION IN ORDER TO COMPLETE WORK ON TIME
- 8. DISTURBED AREAS ARE TO BE PROTECTED FROM EROSION IN A TIMELY MANNER, UPON COMPLETION OF GRADING OR CONSTRUCTION, THE AREA SHALL BE STABILIZED (USING PERMANENT MEASURES WHEN POSSIBLE) WITHIN 1 CALENDAR DAYS, TEMPORARY STABILIZATION THROUGH USE OF TEMPORARY EROSION CONTROL SEEDING WITH MULCH METHOD 2, SHALL BE INITIATED WITHIN SEVEN DAYS AFTER GRADING OR OTHER EARTH DISTURBING ACTIVITIES HAS CEASED. TEMPORARY STABILIZATION SHALL BE INSTALLED WITHIN 1 DAY WHENEVER GRADING OR OTHER EARTH DISTURBING ACTIVITIES CEASE TO BE CONTINUOUS FOR A PERIOD EXCEEDING 14 CALENDAR DAYS, THE 1/14 DAY REQUIREMENT IS TAKEN TO MEAN THAT THE STABILIZATION OPERATION IS COMPLETE OR NEARING COMPLETION IN THE DEFINED TIME.
- 9. STABILIZATION OF CUT OR FILL SLOPES WITH PERMANENT EROSION CONTROL MEASURES IS REQUIRED WHENEVER THE CUT OR FILL ACTIVITY REACHES 10 FEET VERTICALLY OR THE FINISHED SLOPE HEIGHT EQUALS 30 FEET, WHICHEVER IS MORE RESTRICTIVE. ONCE THE STABILIZATION MEASURES ARE INSTALLED, THE PLACEMENT OF FILL OR EXCAVATION ACTIVITIES IS ALLOWED TO PROCEED. TEMPORARY STABILIZATION OF THE CUT OR FILL SLOPES SHALL BE INSTALLED WITHIN 1 DAYS WHEN ACTIVITY ON THE CUT OR FILL SLOPE CEASE TO BE CONTINUOUS FOR A PERIOD EXCEEDING 14 CALENDAR DAYS.

- 10. THE CONTRACTOR SHALL DESIGNATE ONE OF HIS EMPLOYEES TO BE RESPONSIBLE FOR IMPLEMENTATION OF THE EROSION AND SEDIMENT CONTROL PLAN ON ALL DISTURBED AREAS. THIS PERSON MUST POSSESS KNOWLEDGE ABOUT INSTALLATION AND MAINTENANCE OF THE REQUIRED MEASURES. THIS EMPLOYEE IS TO HAVE THE AUTHORITY TO CARRY OUT THE IMPLEMENTATION OF ANY INSTRUCTIONS CONCERNING THE EROSION AND SEDIMENT CONTROL PLAN GIVEN BY THE ENGINEER ON A REGULAR BASIS (AT LEAST ONCE EVERY 7 DAYS) AND AFTER RAINFALL EVENTS GREATER THAN 0.5 IN. OR EQUIVALENT SNOWFALL. DURING THE WINTER MONTHS, EROSION CONTROL MEASURES SHALL ALSO BE INSPECTED AFTER SIGNIFICANT SNOW MELT EVENTS.
- 11. SEDIMENT TRAPS, SEDIMENT BASINS, DITCHES, SEDIMENT CONTROL, SILT FENCE, STONE OUTLET STRUCTURES, EARTH BERMS, ETC. SHALL BE INSPECTED REGULARLY AND MAINTAINED DURING THE CONSTRUCTION SEASON AS WELL AS THE WINTER MONTHS AND OTHER TIMES WHEN THE PROJECT IS CLOSED DOWN. SEDIMENT SHALL BE REMOVED AND THE TRAP RESTORED TO ITS ORIGINAL DIMENSIONS WHEN SEDIMENT HAS ACCUMULATED TO ONE-HALF THE DESIGN DEPTH OF THE TRAP. ALL SEDIMENTS SHALL BE REMOVED TO AN APPROVED SITE. STONE OUTLET STRUCTURES SHALL HAVE SEDIMENT REMOVED WHEN THE SEDIMENT LEVEL/HEIGHT REACHED 50% OF THE HEIGHT OF THE CONTROL DEVICE. THE DEBRIS SHALL BE REMOVED TO AN APPROVED SITE.
- 12. SALVAGED TOPSOIL SHALL BE PLACED ON WELL DRAINED LAND AWAY FROM INTERMITTENT AND LIVE STREAMS OR WETLANDS WITH APPROPRIATE RUNOFF CONTROL AND SEDIMENT CONTROL MEASURES INSTALLED AROUND THE STORAGE SITE IT SHOULD ALSO BE STABILIZED IMMEDIATELY AFTER FINAL SHAPING OF THE PILE WITH APPROVED STABILIZATION MEASURES. THE CONTRACTOR SHALL PROVIDE AN ADEQUATE QUANTITY OF SILT FENCE TO CONTROL THE PERIMETER OF THE STOCKPILE.
- MATERIAL EXCAVATED FOR THE CONSTRUCTION OR CLEANOUT OF SEDIMENT TRAPS OR SEDIMENT BASINS SHALL NOT BE STOCKPILED IN (THE VICINITY OF) THE TRAP OR BASIN. IT SHALL EITHER BE PLACED IN AN EMBANKMENT OR WASTED AS DIRECTED BY THE ENGINEER.
- 14. EXCAVATION TO BE USED FOR EMBANKMENTS SHALL NOT BE STOCKPILED UNLESS PERIMETER CONTROLS ARE UTILIZED. WHEN THIS MATERIAL IS STOCKPILED FOR THE CONVENIENCE OF THE CONTRACTOR, THE COST OF THE CONTROLS TO BE BORNE BY THE CONTRACTOR. IF THE MATERIAL IS STOCKPILED AT THE DIRECTION OF THE ENGINEER, THE DEPARTMENT SHALL ASSUME THE COST OF THE CONTROLS.
- 5. SEDIMENT LADEN DEWATERING DISCHARGE MUST BE DIRECTED TO AN APPROVED SEDIMENT TRAPPING MEASURE PRIOR TO RELEASE FROM THE SITE.
- 16. WHEN THE CONTRACTOR REQUESTS A CHANGE TO POSTPONE COMPLETION OF THE EXCAVATION OF A SPECIFIC AREA AS A CONTINUOUS OPERATION AND PLACING THE TOPSOIL AS DEFINED IN THE STANDARD SPECIFICATION, THE ENGINEER MAY ALLOW THE CONTRACTOR TO STABILIZE THE AREA USING TEMPORARY STABILIZATION WITH MULCH METHOD 2 PROVIDING THAT THE FOLLOWING CONDITIONS ARE MET:
 - (A) ALL AREAS BEING STABLIZED ARE 3:1 SLOPES OR FLATTER.
 - (B) THE CONTRACTOR BEARS THE COST OF PREPARING THE SEED BED AND STABILIZING THE AREA WITH TEMPORARY MULCH METHOD 2
 - C) ALL REQUIRED SEDIMENT CONTROL MEASURES FOR THE SECTION OF ROAD IN QUESTION HAVE BEEN INSTALLED AND ARE BEING MAINTAINED.

17. SEEDING USAGE:

CLASS 2A SALT TOLERANT ROADSIDE MIX TO BE USED FOR NEW CONSTRUCTION OF LIMITED ACCESS ROUTES, INTENDED TO BE MOWED BY IDOT.

SODDING SALT TOLERANT TO BE USED IN AREAS ADJACENT TO OTHER AREAS REQUIRING A HIGH ORDER OR APPEARANCE INTENDED TO BE MOWED BY SOMEONE OTHER THAN IDOT.

TEMPORARY EROSION CONTROL SEEDING TO BE USED FOR SHORT TERM. PLACE MULCH METHOD 2 WITHIN 24 HOURS OF SEED PLACEMENT.
TEMPORARY SEEDING MUST BE INITIATED NO MORE THAN SEVEN DAYS AFTER CONSTRUCTION ACTIVITY HAS CEASED AND IS APPLIED TO ALL DISTURBED AREAS.

18. TOP SOIL PLACEMENT:

TOPSOIL SHALL NOT BE PLACED AT AREAS COMPLETED WHERE FURTHER CONSTRUCTION SHALL BE DONE AS PART OF THIS CONTRACT.

EROSION AND SEDIMENT CONTROL GENERAL NOTES (CONTINUED)


- 19. SEDIMENT CONTROL DRAINAGE STRUCTURE INLET FILTER SHALL BE INSTALLED AND MAINTAINED AT EACH EXISTING AND PROPOSED INLET WITHIN THE PROJECT LIMITS.
- 20. INLET AND PIPE PROTECTION: INSPECT REGULARLY AND AFTER EVERY STORM. MAKE REPAIRS AS NECESSARY TO ENSURE THAT THE MEASURE IS IN GOOD WORKING ORDER. CLEAN OR REMOVE AND REPLACE THE FILTER FABRIC IF IT BECOMES CLOGGED. WORK IS INCLUDED IN COST OF INLET AND PIPE PROTECTION. INLET AND PIPE PROTECTION SHALL BE COMPRISED OF DITCH CHECKS, TEMPORARY EROSION CONTROL SEEDING AND EROSION CONTROL BLANKET. STRAW BALES AND SILT FENCE SHALL NOT BE USED AS INLET AND PIPE PROTECTION.
- 21. SILT FENCE IS NOT REQUIRED WHERE THE PERIMETER IS HIGHER THAN THE WORK ZONE, AND SILT FENCE SHALL NOT BE INSTALLED ACROSS CONCENTRATED FLOW, OR ACROSS CONTOURS WITHOUT J-HOOKS (HIGHWAY STANDARD SHEET 280001). IN AREAS OF CONCENTRATED FLOW, TEMPORARY DITCH CHECKS ARE A SUITABLE ALTERNATIVE IN PLACE OF SILT FENCE.
- 22. PORTABLE TOILETS SHALL BE PLACED AWAY FROM INLETS AND WATER COURSES.
- 23. TEMPORARY FENCING, PERIMETER EROSION BARRIER AND "WETLAND NO INTRUSION" SIGNAGE SHOULD BE PROVIDED AT THE BOUNDARY


 OF ALL UN-IMPACTED WETLANDS AND/OR WATERS OF THE US WITHIN THE ROW. SIGNS SHALL BE ATTACHED TO THE POST OF THE


 PERIMETER EROSION BARRIER ITEM. THE SIGNS AND MOUNTING OF THE SIGNS SHALL BE CONSIDERED INCLUDED IN THE UNIT COST OF


 THE PERIMETER EROSION BARRIER, THREE SIGNS MINIMUM SHALL BE POSTED AT EACH WETLAND LOCATION EQUALLY SPACED.
- 24. ALL ESC MEASURES WILL BE MAINTAINED IN ACCORDANCE WITH THE IDOT EROSION AND SEDIMENT CONTROL FIELD GUIDE FOR CONSTRUCTION INSPECTION AND IDOT'S BEST MANAGEMENT PRACTICES MAINTENANCE GUIDE:
 - HTTP://WWW.IDOT.ILLINOIS.GOV/TRANSPORTATION-SYSTEM/ENVIRONMENT/EROSION-AND-SEDIMENT-CONTROL.
- 25. THE CONTRACTOR WILL ASSUME RESPONSIBILITY FOR MAINTENANCE OF ALL SOIL EROSION CONTROL DURING CONSTRUCTION.
- 26. THE CONTRACTOR SHOULD PROVIDE TO THE RE A PLAN TO ENSURE THAT A STABILIZED FLOW LINE WILL BE PROVIDED DURING STORM SEWER CONSTRUCTION. THE USE OF A STABILIZED FLOW LINE BETWEEN INSTALLED STORM SEWER AND OPEN DISTURBANCE WILL REDUCE THE POTENTIAL FOR THE OFFSITE DISCHARGE OF SEDIMENT BEARING WATERS, ESPECIALLY WHEN RAIN IS FORECASTED, SO THAT FLOW WILL NOT ERODE. LACK OF APPROVED PLAN OR FAILURE TO COMPLY WILL RESULT IN AN ESC DEFICIENCY DEDUCTION.
- 27. ANY LOOSE MATERIAL DEPOSITED IN THE FLOW LINE OF DRAINAGE STRUCTURES, WHICH OBSTRUCTS THE NATURAL FLOW OF WATER, SHALL BE REMOVED AT THE CLOSE OF EACH WORKING DAY, PRIOR TO ACCEPTANCE OF THE IMPROVEMENT, ALL DRAINAGE STRUCTURES SHALL BE FREE OF DIRT AND DEBRIS. THIS WORK WILL NOT BE PAID FOR SEPARATELY BUT SHALL BE CONSIDERED AS INCIDENTAL.
- 28. TEMPORARY OR PERMANENT STABILIZATION SHALL BE INITIATED IMMEDIATELY UPON COMPLETION OF DISTURBANCE OF WORK AREA OR INITIATED NO MORE THAN SEVEN DAYS AFTER CONSTRUCTION ACTIVITY HAS CEASED WITHIN THE WORK AREA USING TEMPORARY EROSION CONTROL SEEDING IN ACCORDANCE TO IDOT STANDARD SPECIFICATIONS FOR ROAD AND BRIDGE CONSTRUCTION AND IDOT EROSION AND SEDIMENT CONTROL FIELD GUIDE FOR CONSTRUCTION INSPECTION AND IDOT'S BEST MANAGEMENT PRACTICES MAINTENANCE GUIDE.
- 29. UNDER NO CIRCUMSTANCES SHALL THE CONTRACTOR PROLONG FINAL GRADING AND SHAPING SO THAT THE ENTIRE PROJECT CAN BE PERMANENTLY SEEDED AT ONE TIME.
- 30. TEMPORARY EROSION CONTROL DEVICES SHALL BE CONSTRUCTED AS SHOWN ON THE PLANS OR AS DIRECTED BY THE ENGINEER, THE EROSION CONTROL PLANS SHALL BE COORDINATED WITH THE SUGGESTED STAGES OF TRAFFIC CONTROL AND PROTECTION PLANS, THE SEQUENCE OF CONSTRUCTION SHALL BE CONSULTED BEFORE APPLYING EROSION AND SEDIMENT CONTROL MEASURES.

IC. 3 300	DESIGNED	-	S.J.P.	REVISED -	
	DRAWN	-	B.K.	REVISED -	
	CHECKED	-	M.P.	REVISED -	
	DATE	-	JANUARY 18, 2016	REVISED -	

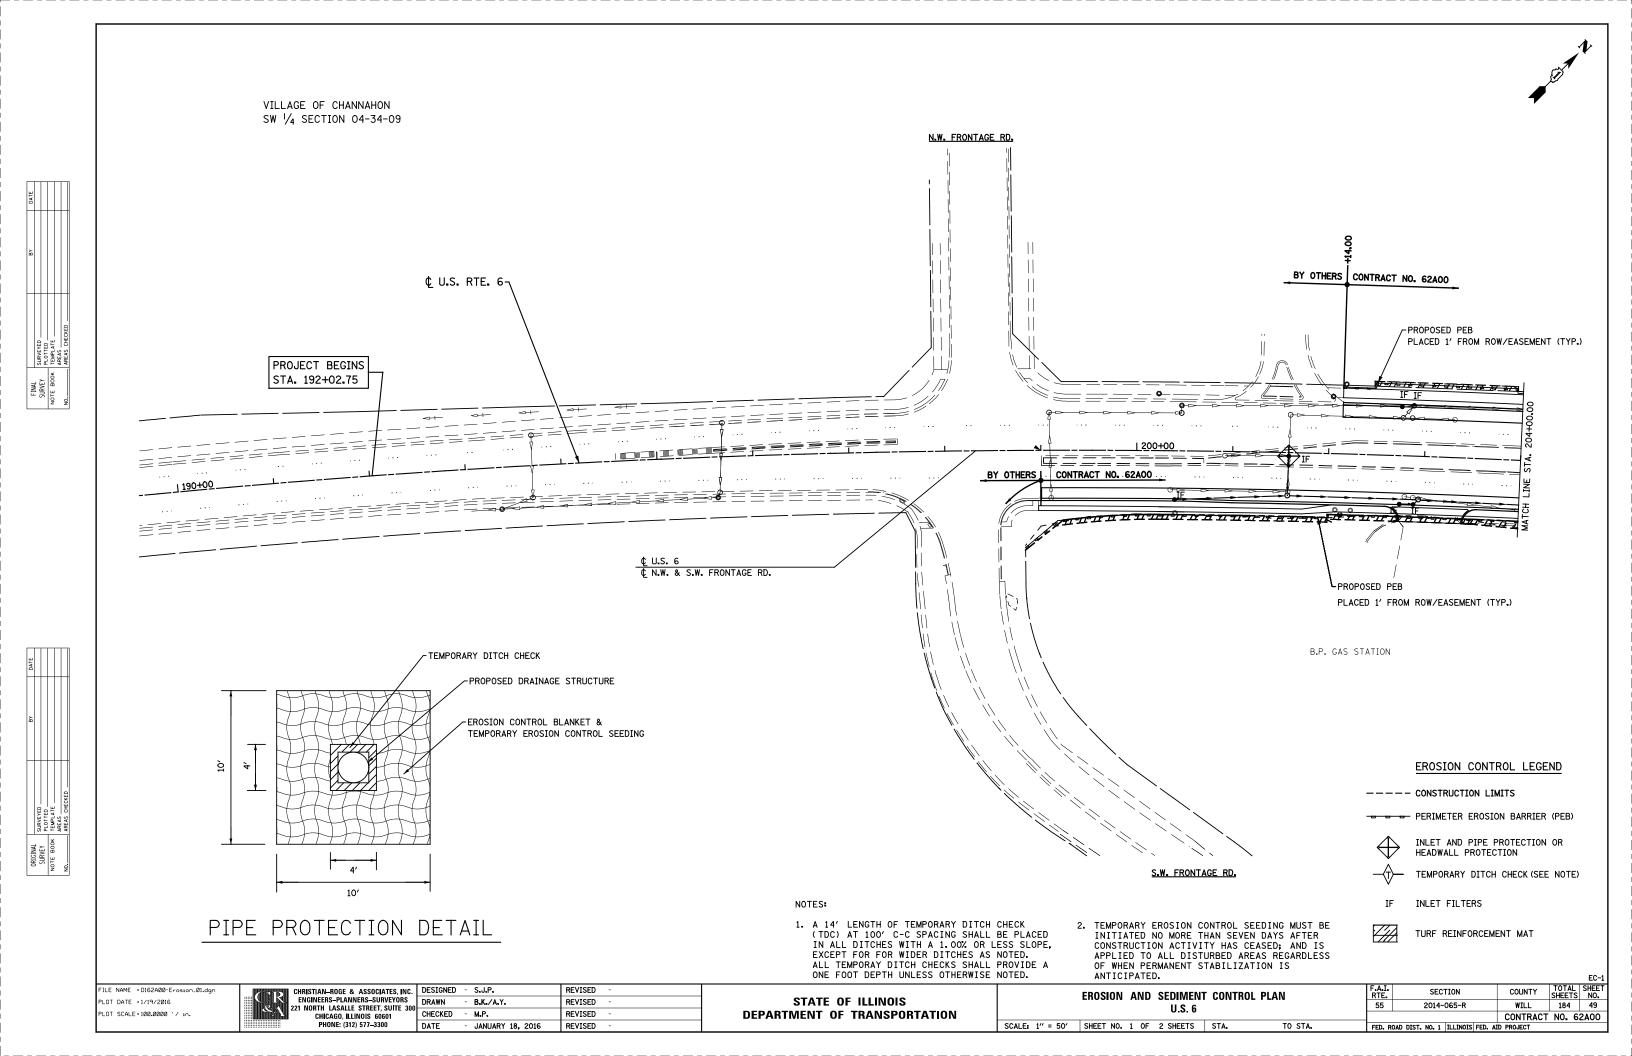

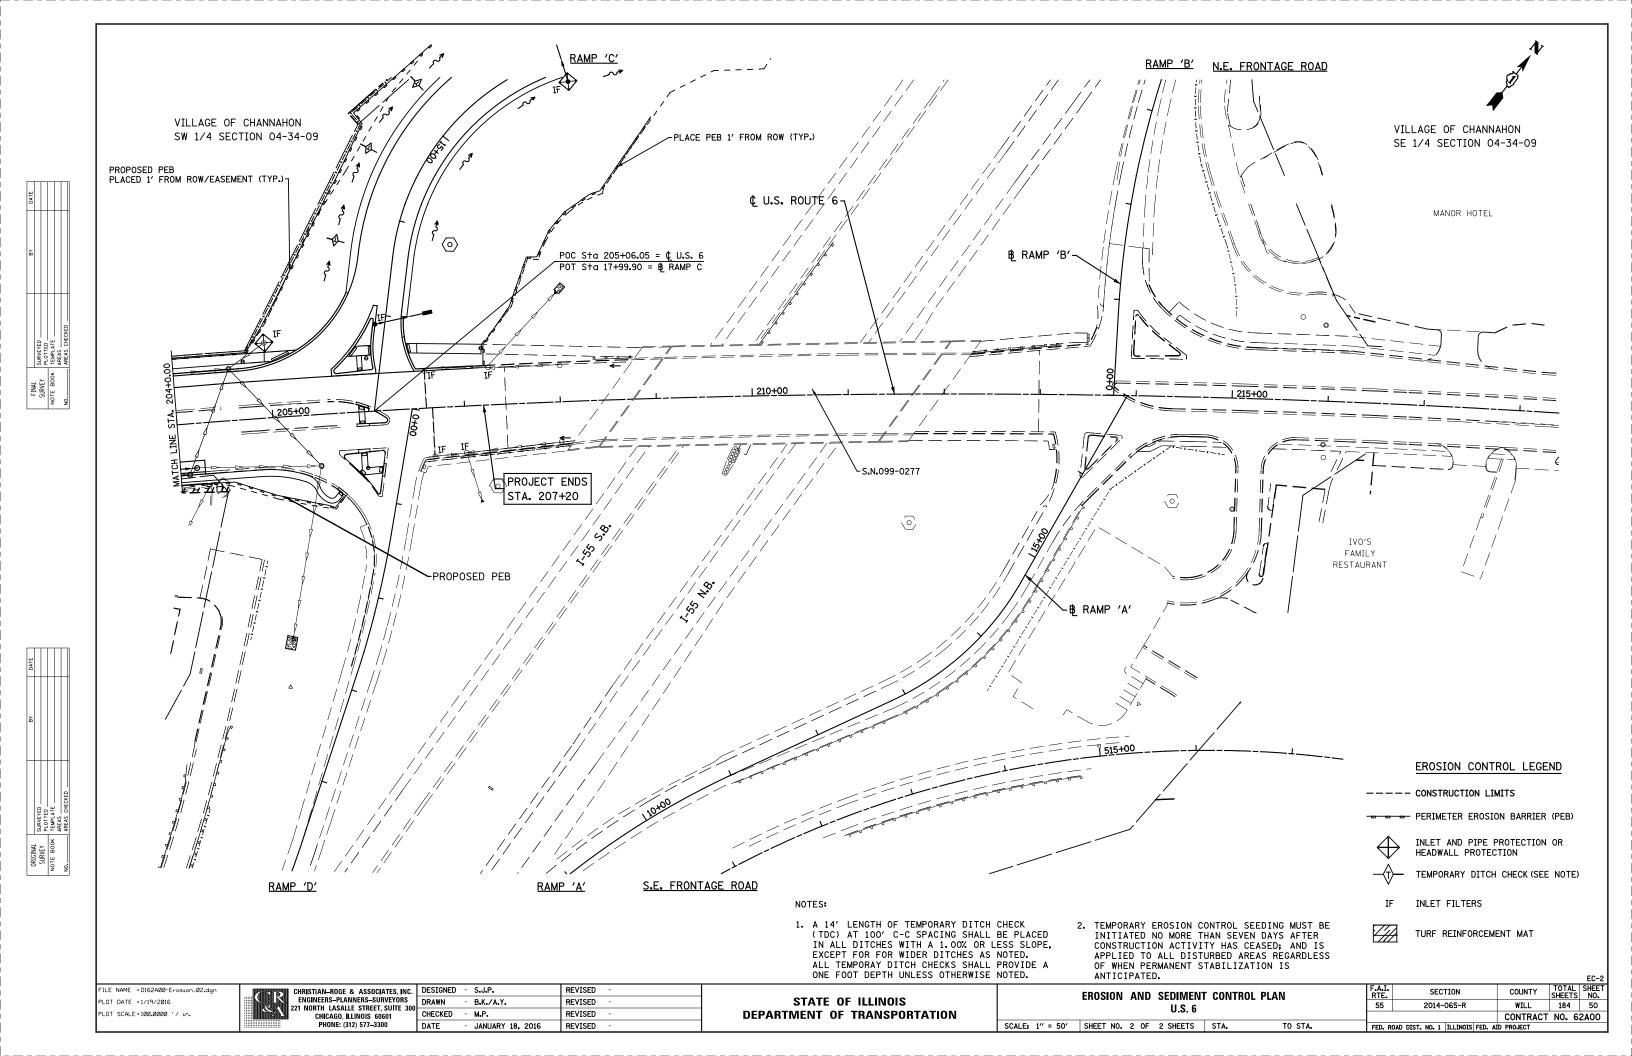

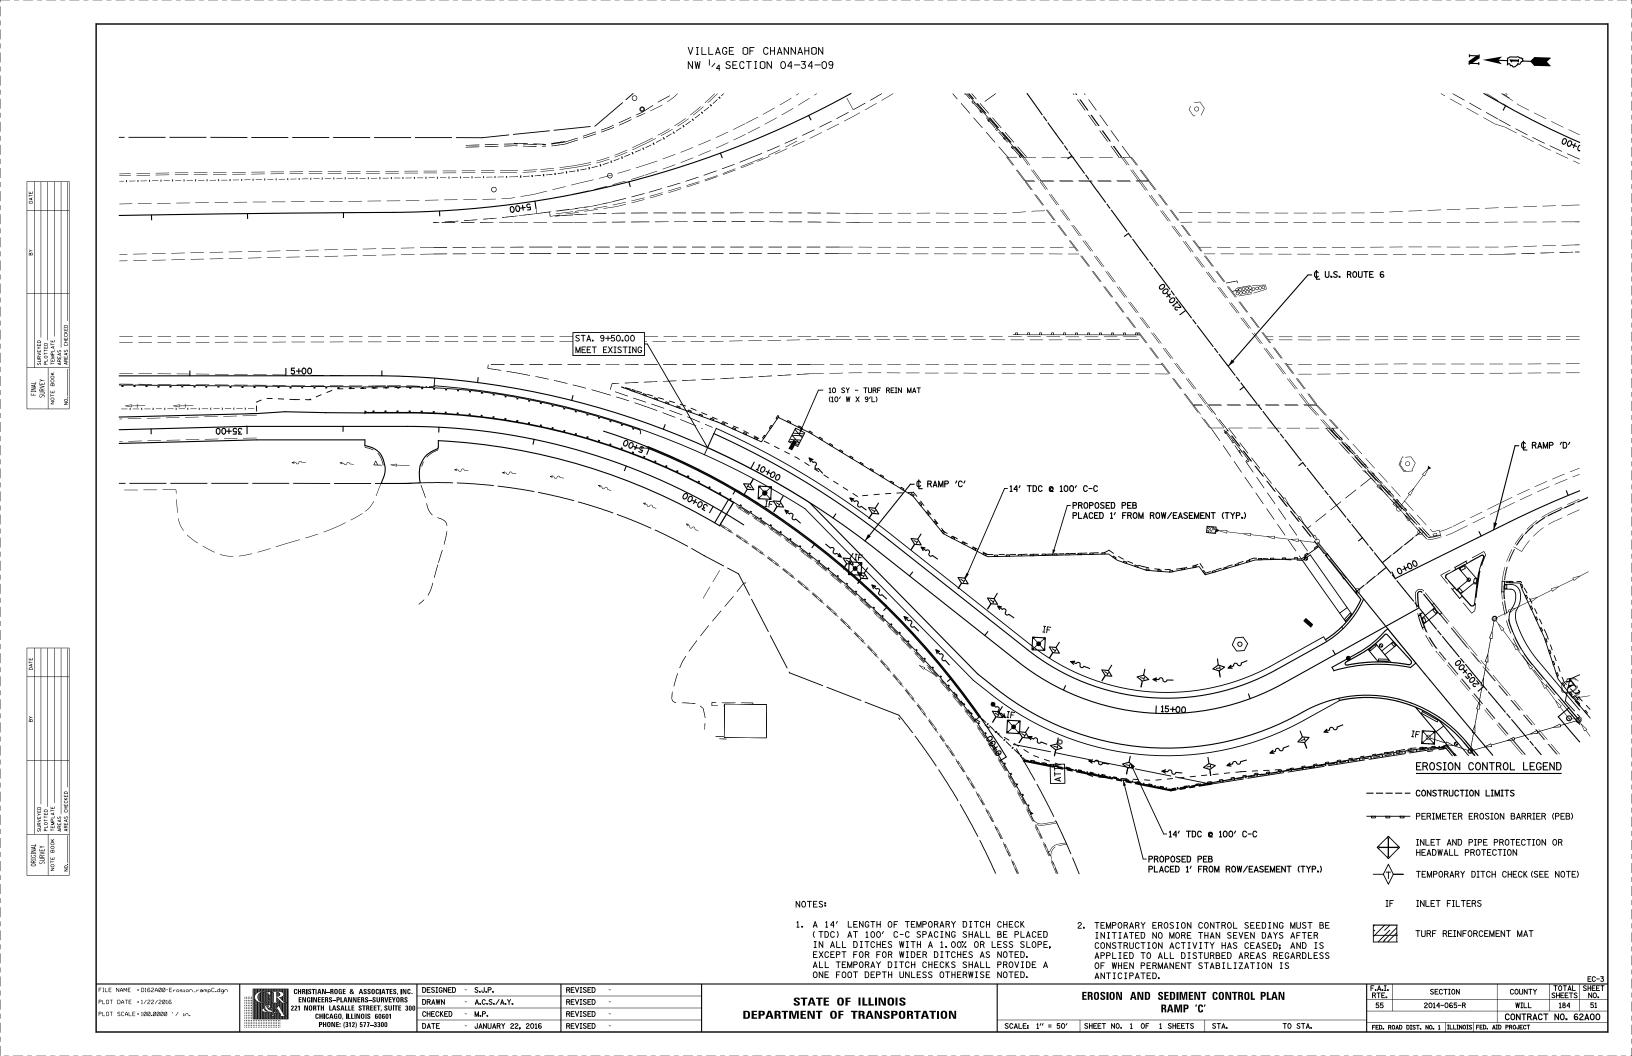

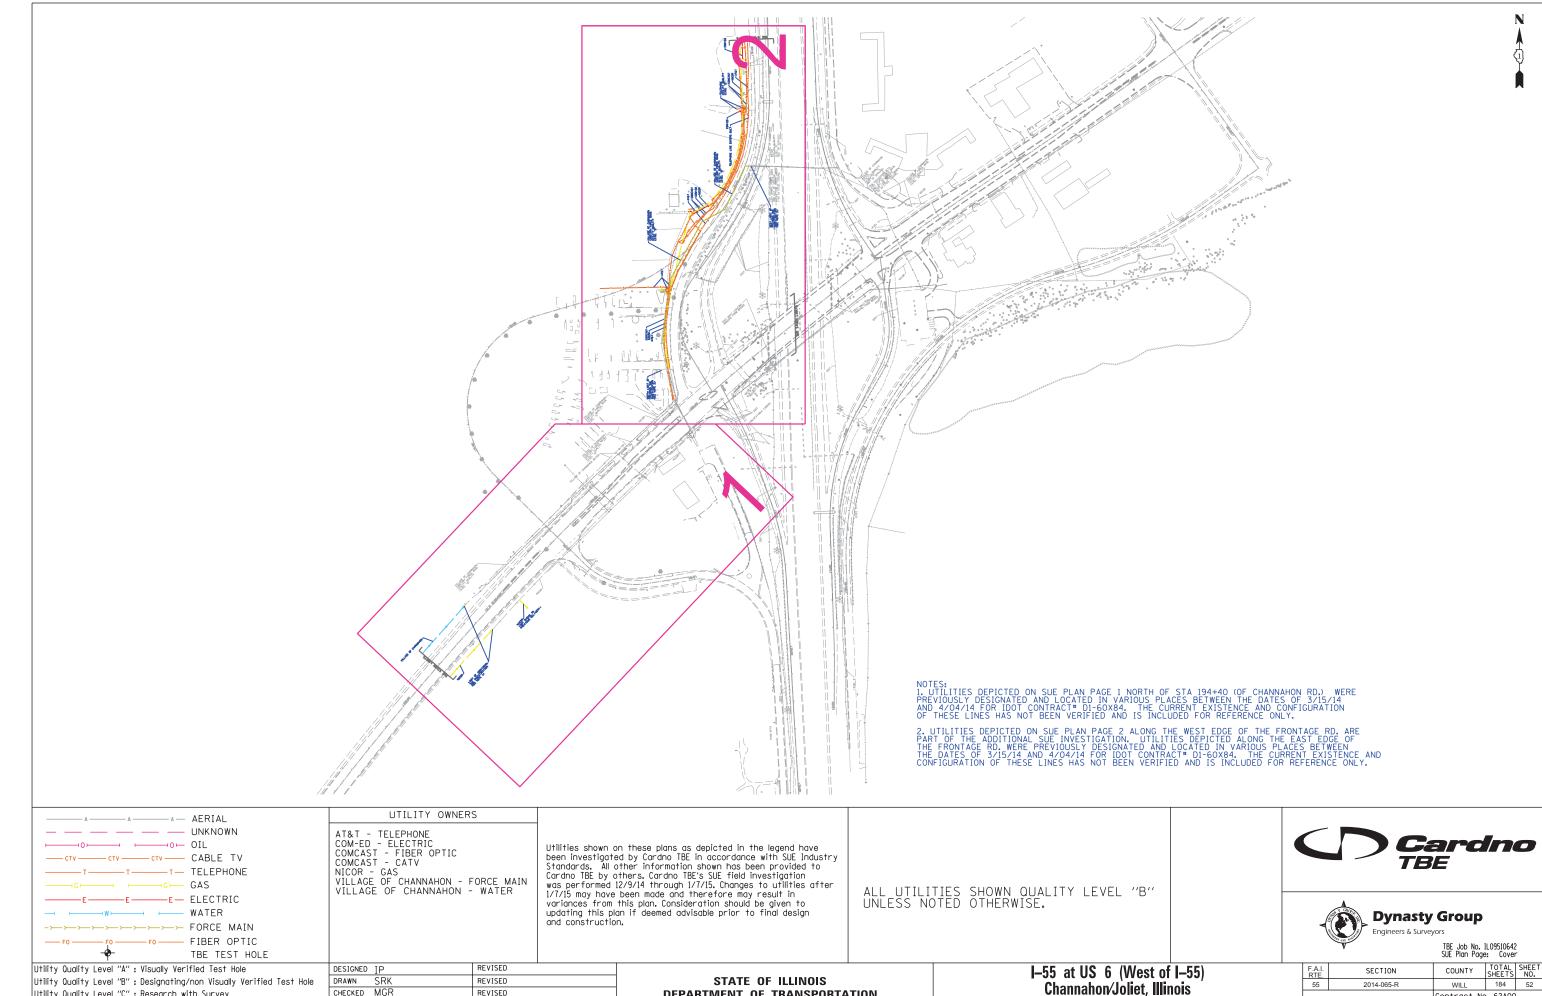

DEPARTMENT OF TRANSPORTATION

Utility Quality Level "C": Research with Survey Utility Quality Level "D": Records Research


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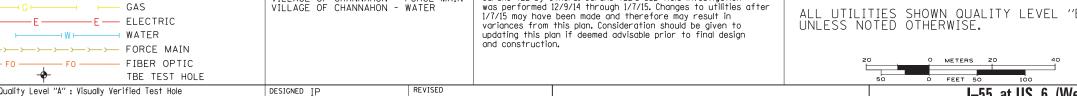
DATE 1/17/14

REVISED

REVISED

55 2014-065-R WILL 184 52 Contract No. 62A00



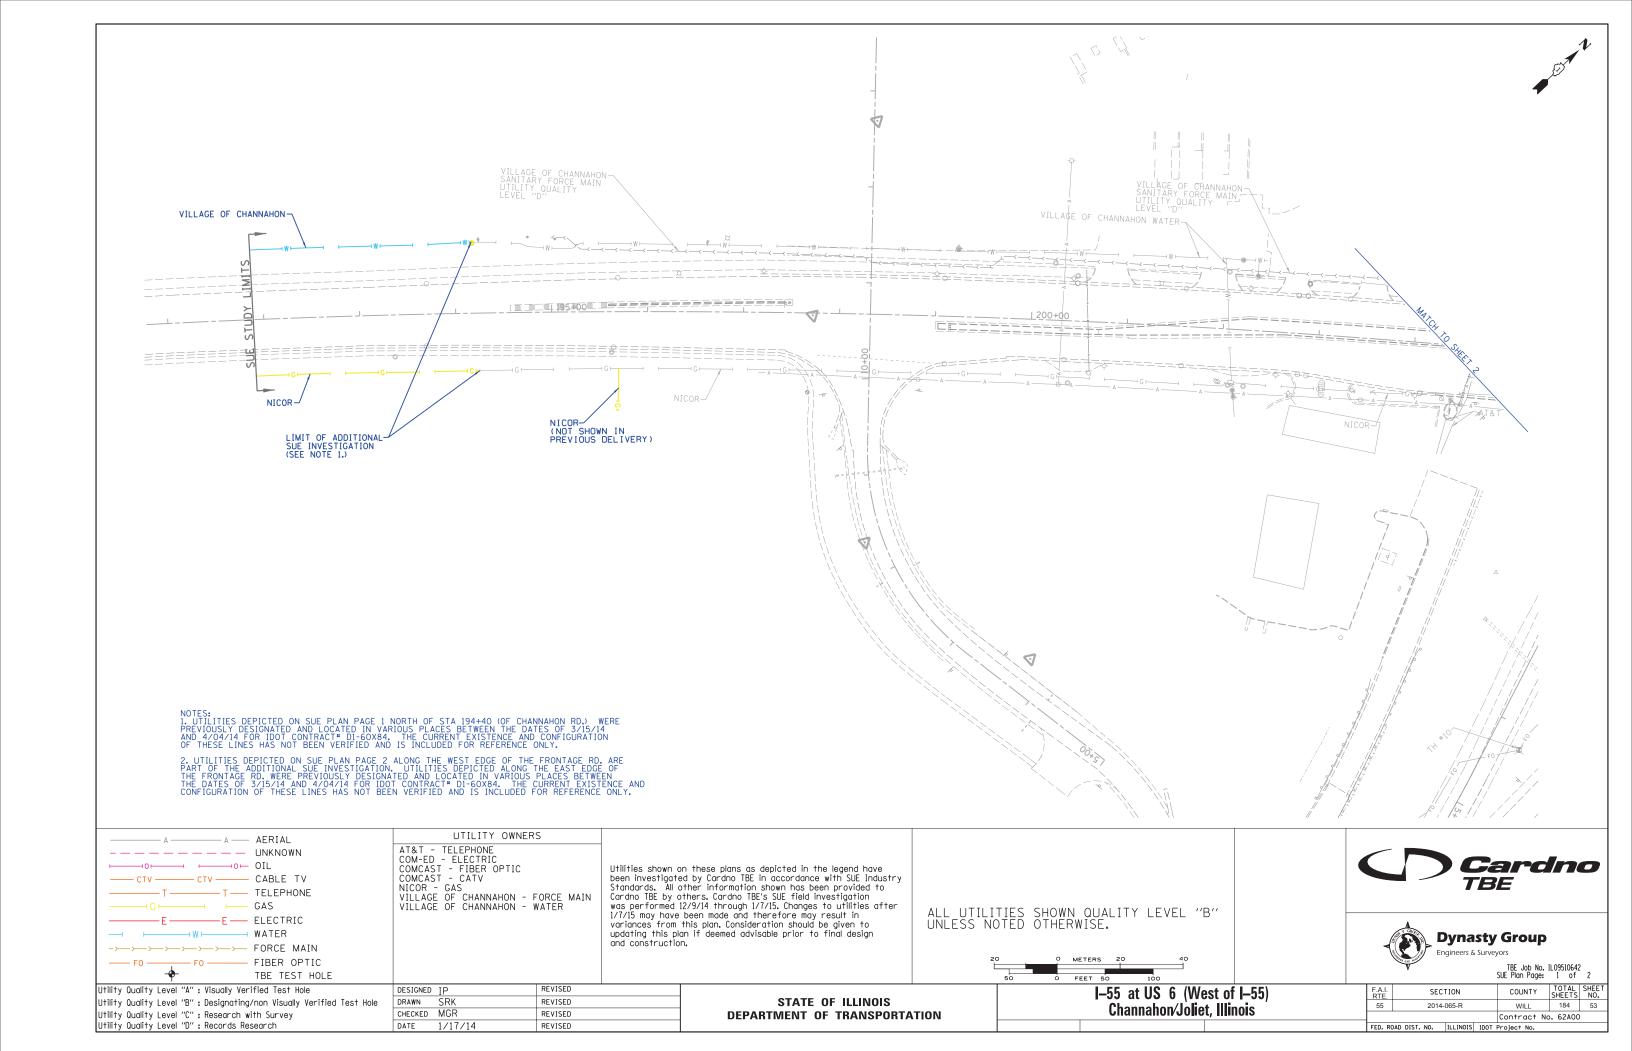





Utility Quality Level "A" : Visually Verified Test Hole Utility Quality Level "B": Designating/non Visually Verified Test Hole Utility Quality Level "C": Research with Survey Utility Quality Level "D": Records Research


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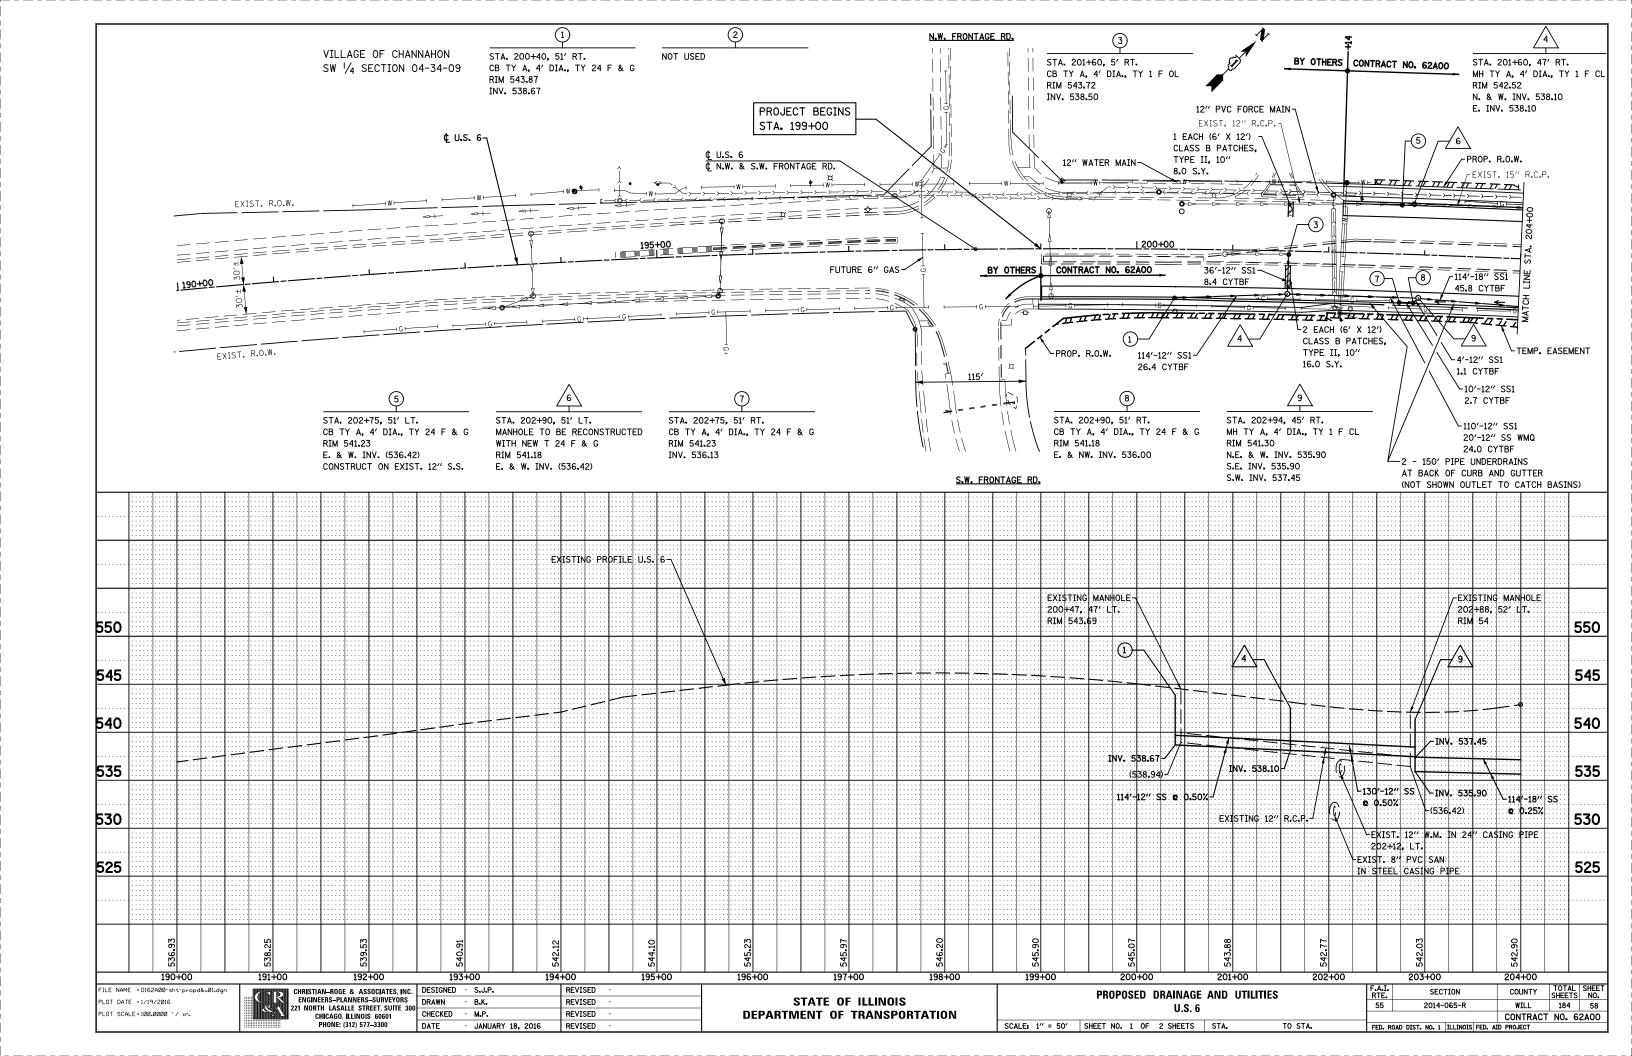
STATE OF ILLINOIS **DEPARTMENT OF TRANSPORTATION** I-55 at US 6 (West of I-55) Channahon/Joliet, Illinois


A.I. TE.	SECTION	COUNTY	TOTAL SHEETS	SHEET NO.				
55	2014-065-R	WILL	184	54				
Contract No. 62A00								




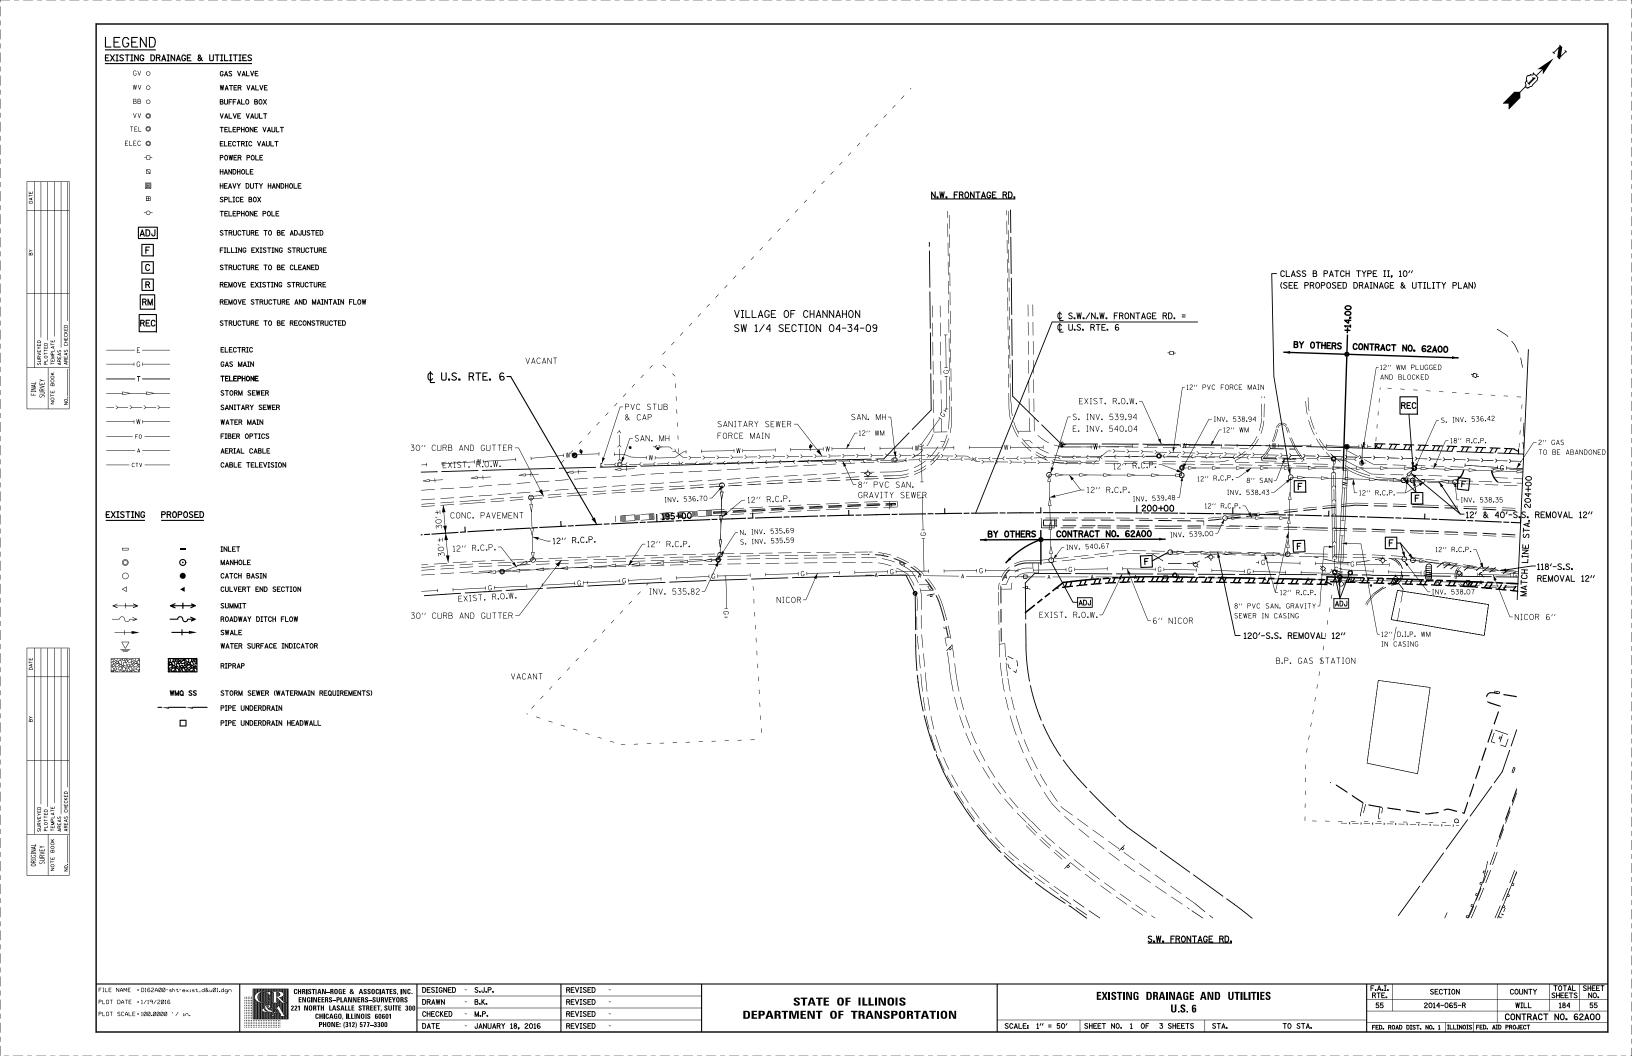

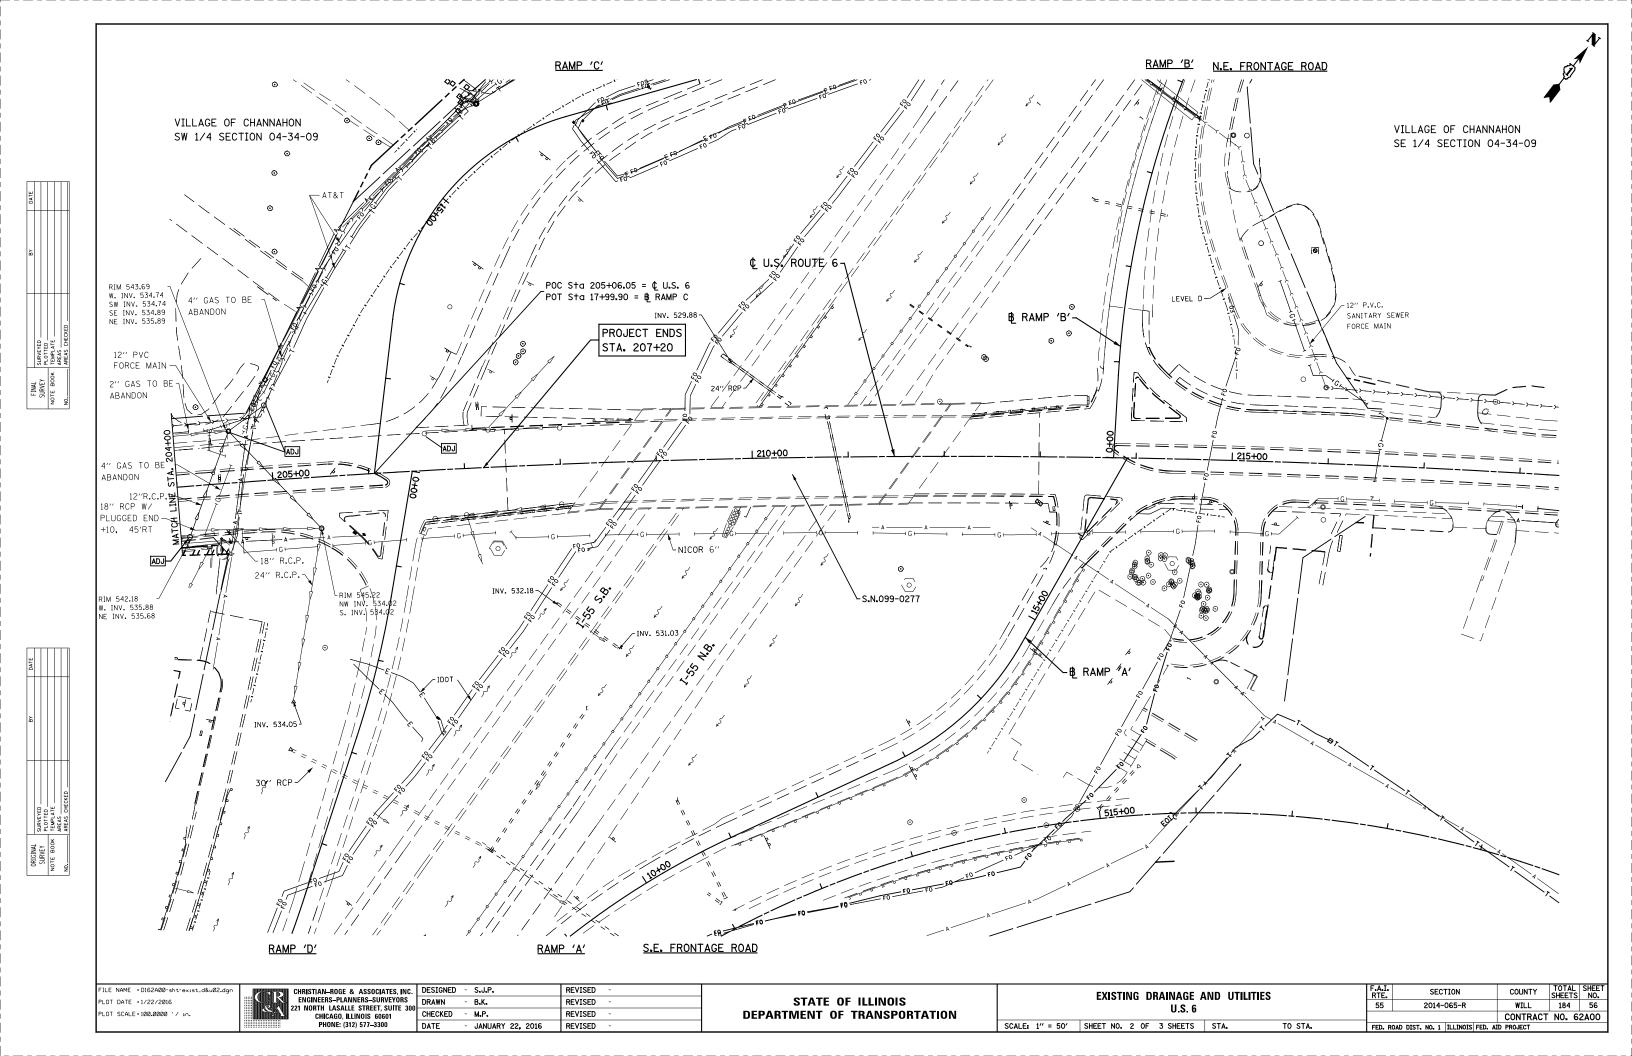

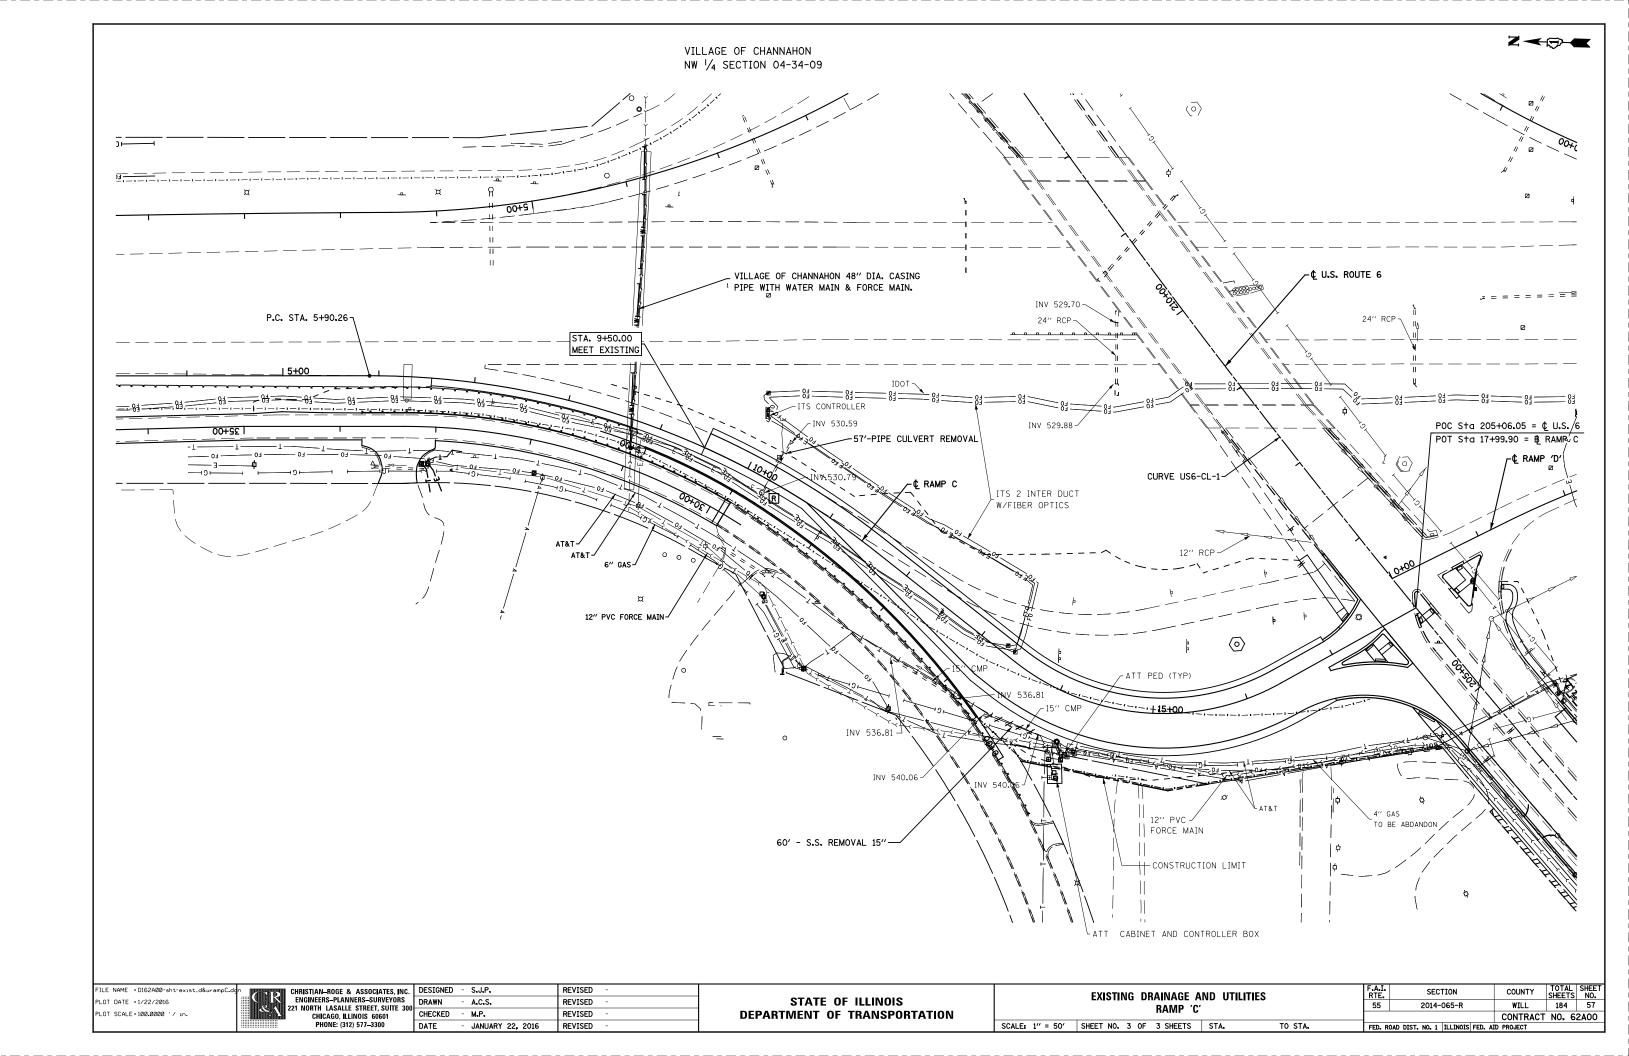

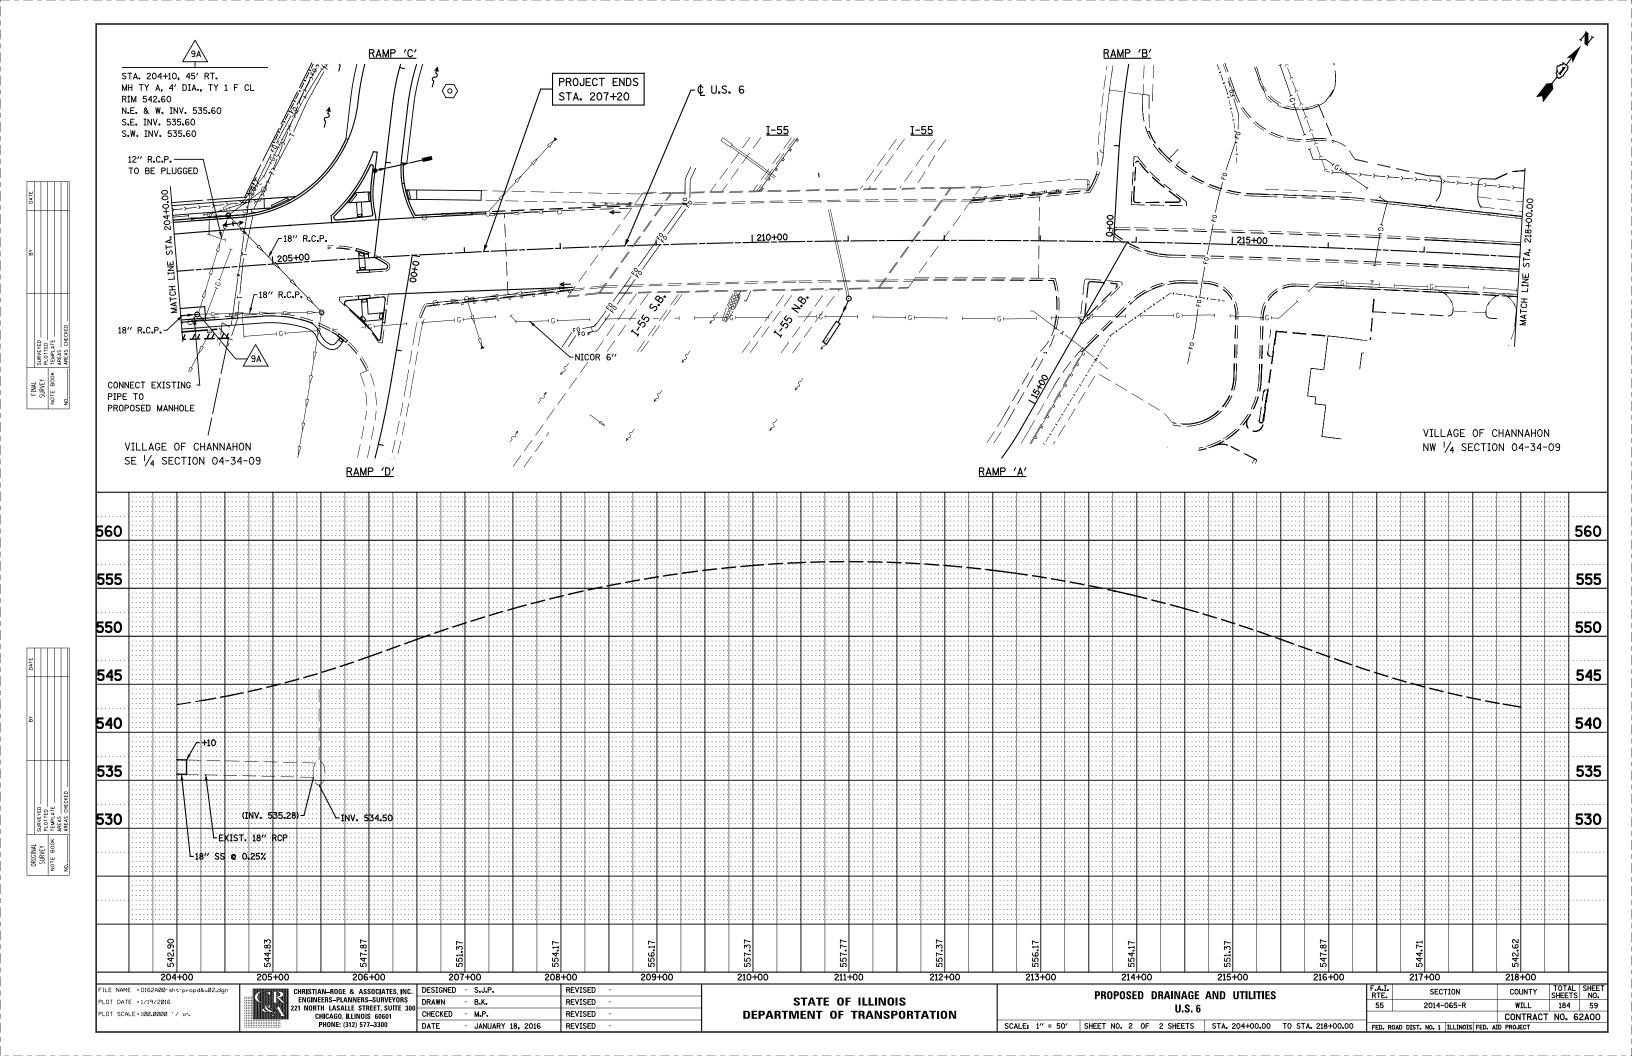

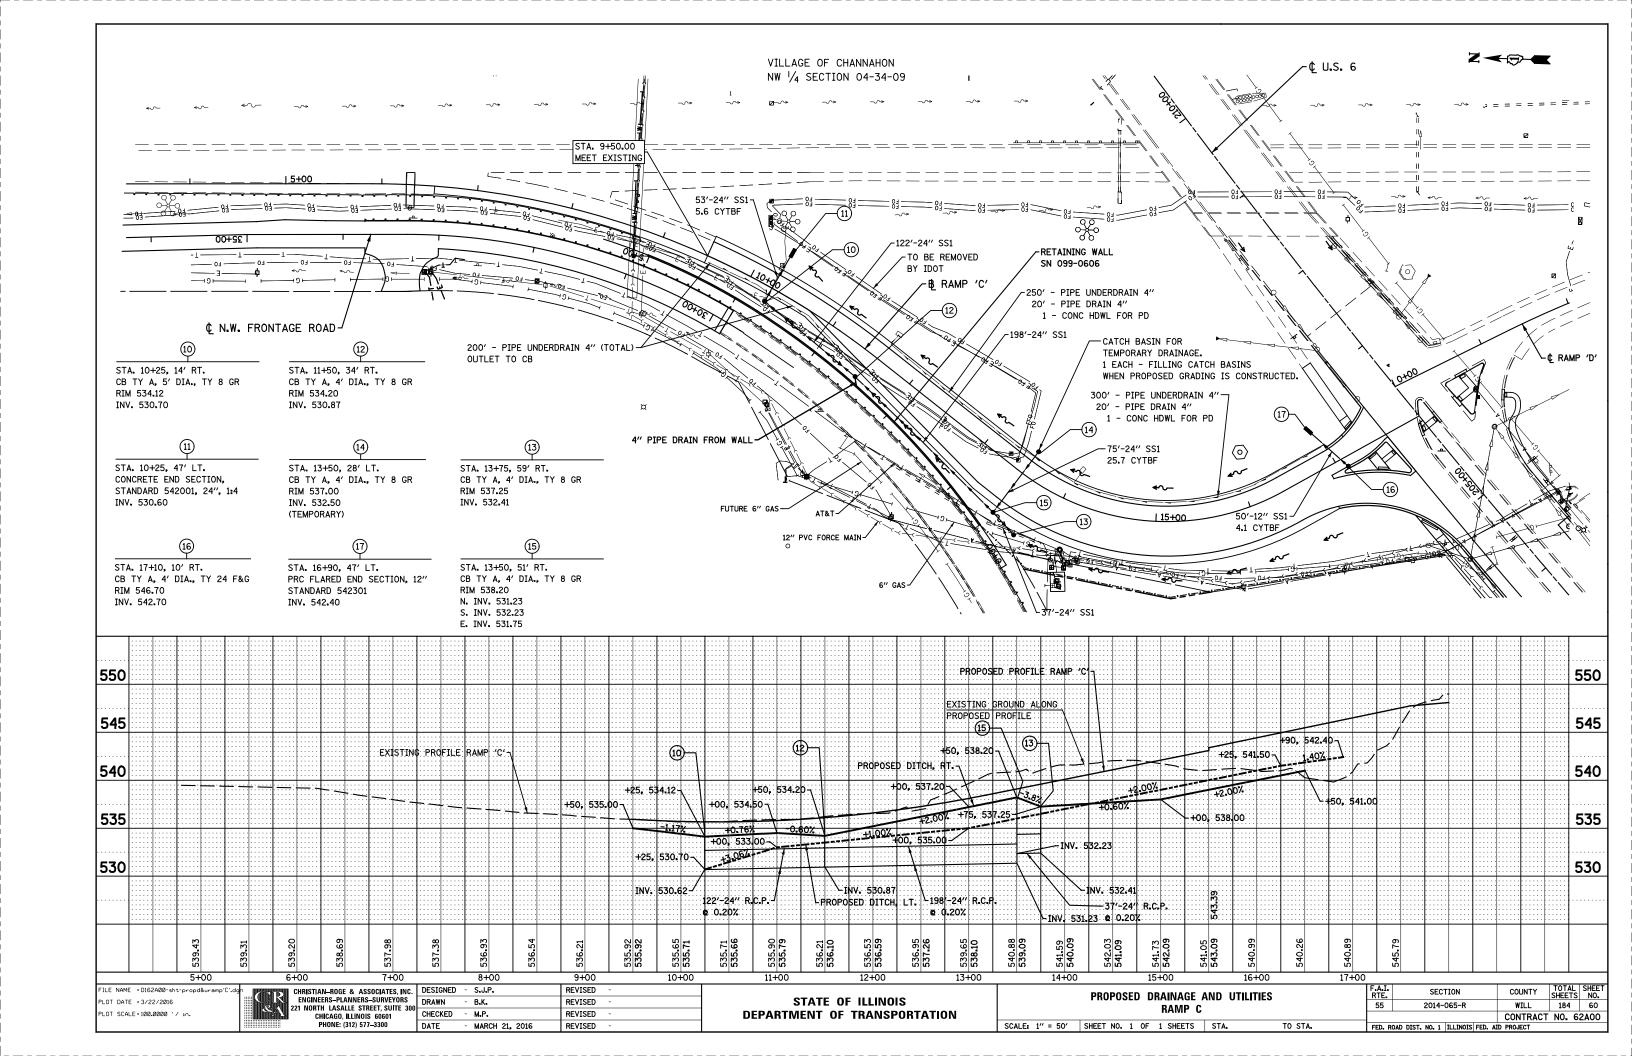

STATE OF ILLINOIS **DEPARTMENT OF TRANSPORTATION DIVISION OF HIGHWAYS**

PLAT OF HIGHWAYS


ROUTE: U.S. ROUTE 6


SECTION: AT INTERSTATE 55

COUNTY: WILL

LIMITS:

JOB NO.: R-91-033-01

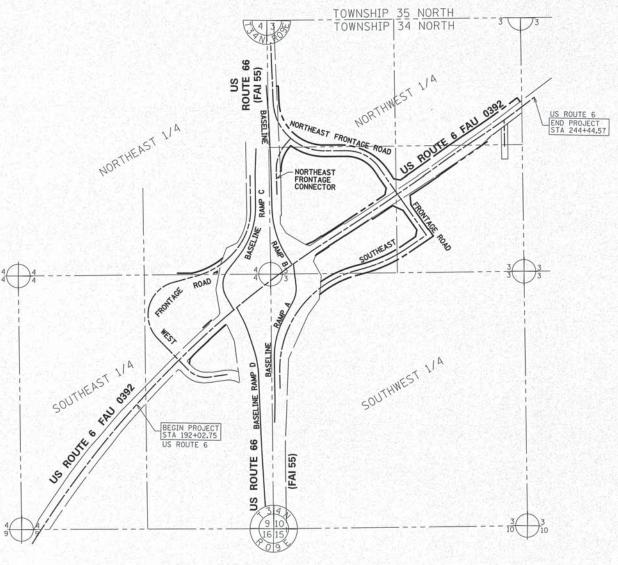

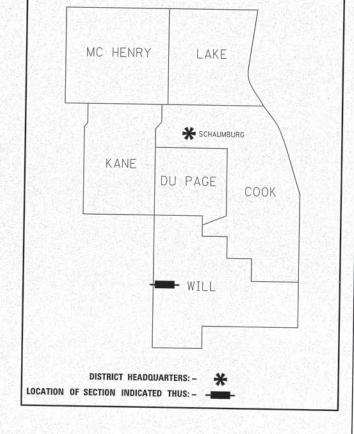

PRINTED BY THE AUTHORITY OF THE STATE OF ILLINOIS

LOCATION MAP

LENGTH = 5241.82 FT. = 0.993 MILE

IDOT USE ONLY RECEIVED JAN 3 0 2015 PLATS & LEUTLS

SHEET NO. 61 OF 184

PARCEL

1KN0006TE

1KN0013B 1KN0013TE

1KN0016 1KN0016TE

1KN0017TE

1KN0018

1KN0019TE

OWNER

FIRST MIDWEST BANK, AS TRUSTEE UNDER THE PROVISIONS OF A TRUST AGREEMENT DATED JANUARY 30, 1951, AND KNOWN AS TRUST NUMBER 77: BETH W. HIXON: DIAN K. DELEHANTY AND W. JEFFREY WINDERLICH AS CO-TRUSTEES OF THE WILLIAM C. WINDERLICH FAMILY TRUST DATED FEBRUARY 1, 2014, AS THEIR INTERESTS MAY APPEAR

NORTH STAR TRUST COMPANY, AS TRUSTEE UNDER THE PROVISIONS OF A TRUST AGREEMENT DATED JANUARY 22, 2008, AND KNOWN AS TRUST NUMBER 08-11156

NORTH STAR TRUST COMPANY, AS TRUSTEE UNDER THE PROVISIONS OF A TRUST AGREEMENT DATED JANUARY 22, 2008, AND KNOWN AS TRUST NUMBER 08-11145

CHICAGO TITLE LAND TRUST COMPANY AS SUCCESSOR TO NORTH STAR TRUST COMPANY AS TRUSTEE UNDER THE PROVISIONS OF A TRUST AGREEMENT DATED JANUARY 22, 2008 AS TRUSTEE UNDER TRUST NUMBER 08-11156

LGP REALTY HOLDINGS LP, A DELAWARE LIMITED PARTNERSHIP

FIRST MIDWEST BANK, AS TRUSTEE UNDER THE PROVISIONS OF A TRUST AGREEMENT DATED SEPTEMBER 21, 2012, AND KNOWN AS TRUST NUMBER 8715

THE PRIVATE BANK AND TRUST COMPANY, SUCCESSOR TO FOUNDERS BANK, AS TRUSTEE UNDER THE PROVISIONS OF A TRUST AGREEMENT DATED OCTOBER 21, 2004, AND KNOWN AS TRUST NUMBER 6570

THE PRIVATEBANK AND TRUST COMPANY, AN ILLINOIS BANKING ASSOCIATION

REVOCABLE LIVING TRUST OF KATHARINE ANDERSON RUSHING, TRUST AGREEMENT DATED JANUARY 6, 2012 PILOT TRAVEL CENTERS LLC, A DELAWARE LIMITED LIABILITY COMPANY

FIRST MIDWEST BANK, AS TRUSTEE UNDER THE PROVISIONS OF A TRUST AGREEMENT DATED SEPTEMBER 21, 2012, AND KNOWN AS TRUST NUMBER 8715

MARINE PROPERTIES, LLC, A NEVADA LIMITED LIABILITY COMPANY AS TO AN UNDIVIDED 1/2 INTEREST: MARY P. LEWIS AS SUCCESSOR CO-TRUSTEE AND MIDLAND STATES BANK AS SUCCESSOR CORPORATE CO-TRUSTEE OF THE HARVEY J. LEWIS TRUST DATED JANUARY 31, 1983 AS TO AN UNDIVIDED 1/4 INTEREST: AND MARY P. LEWIS TRUST DATED JANUARY 31, 1983 AS TO AN UNDIVIDED 1/4 INTEREST

NORTH STAR TRUST COMPANY, AS TRUSTEE UNDER THE PROVISIONS OF A TRUST AGREEMENT DATED JANUARY 22, 2008, AND KNOWN AS TRUST NUMBER 08-11145

FIRST MIDWEST BANK, AS TRUSTEE UNDER THE PROVISIONS OF A TRUST AGREEMENT DATED SEPTEMBER 21, 2012, AND KNOWN AS TRUST NUMBER 8715

LINDA B. POLLOCK

CHANNAHON PETROLEUM, INC.

SENECA PETROLEUM COMPANY, INC.

PROPERTY ACQUIRED BY

6, 7


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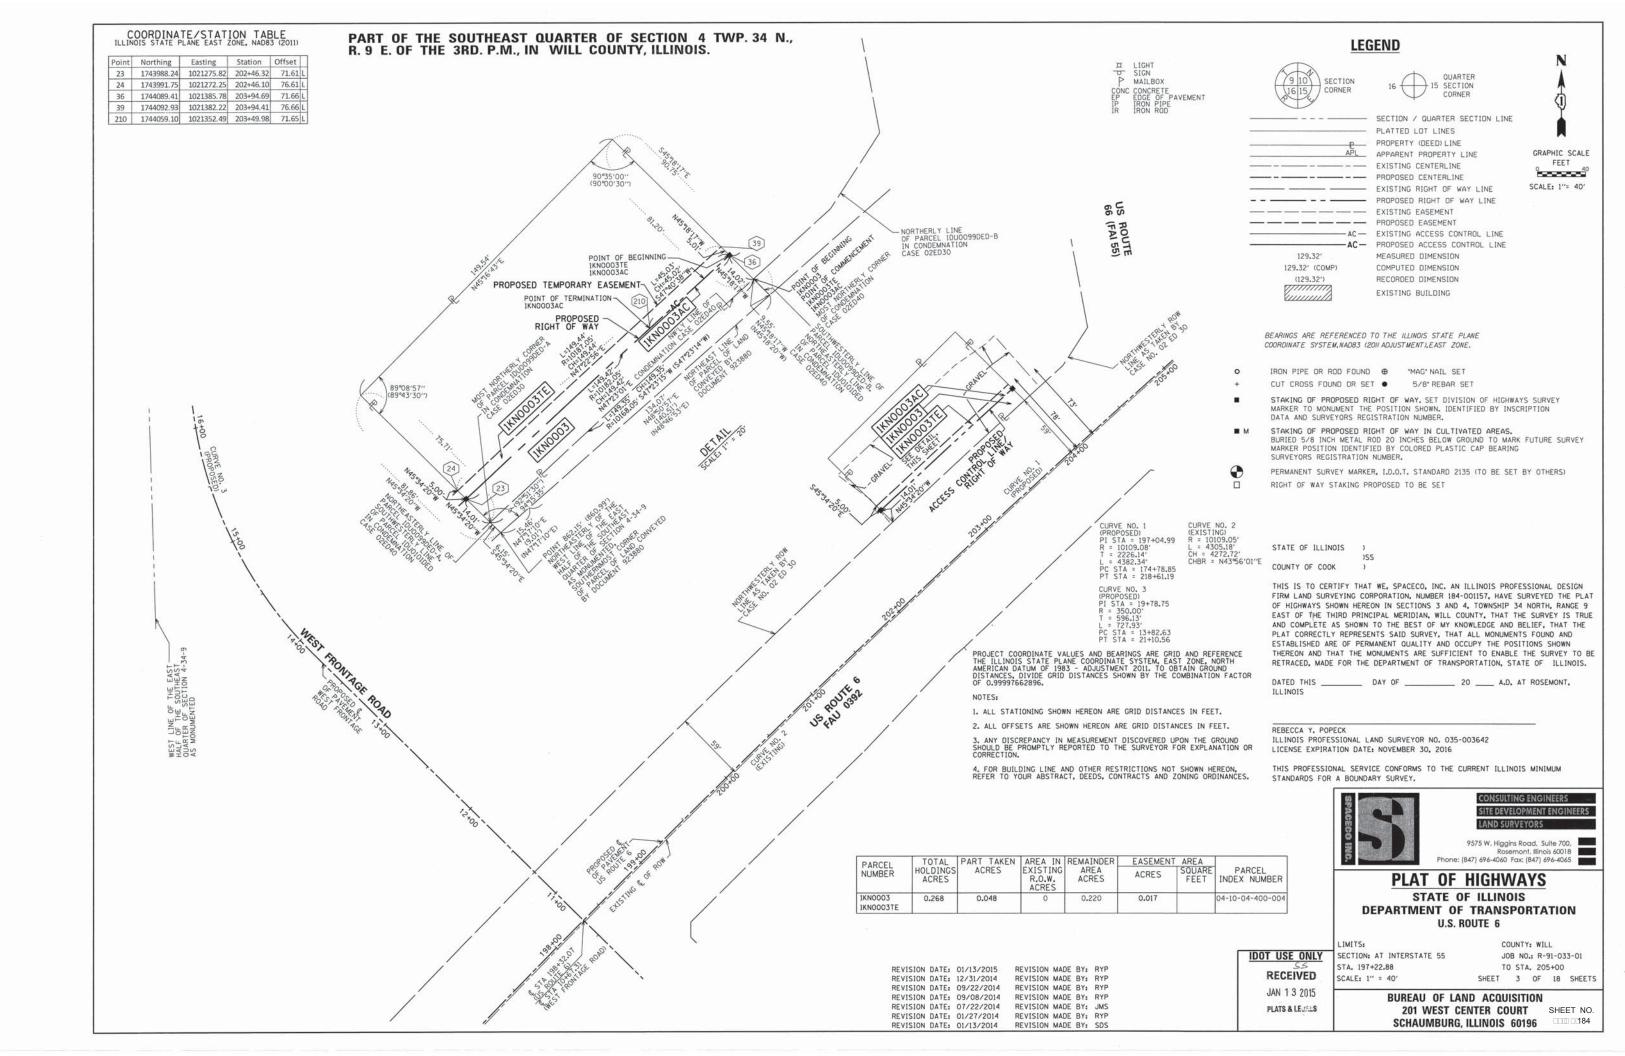
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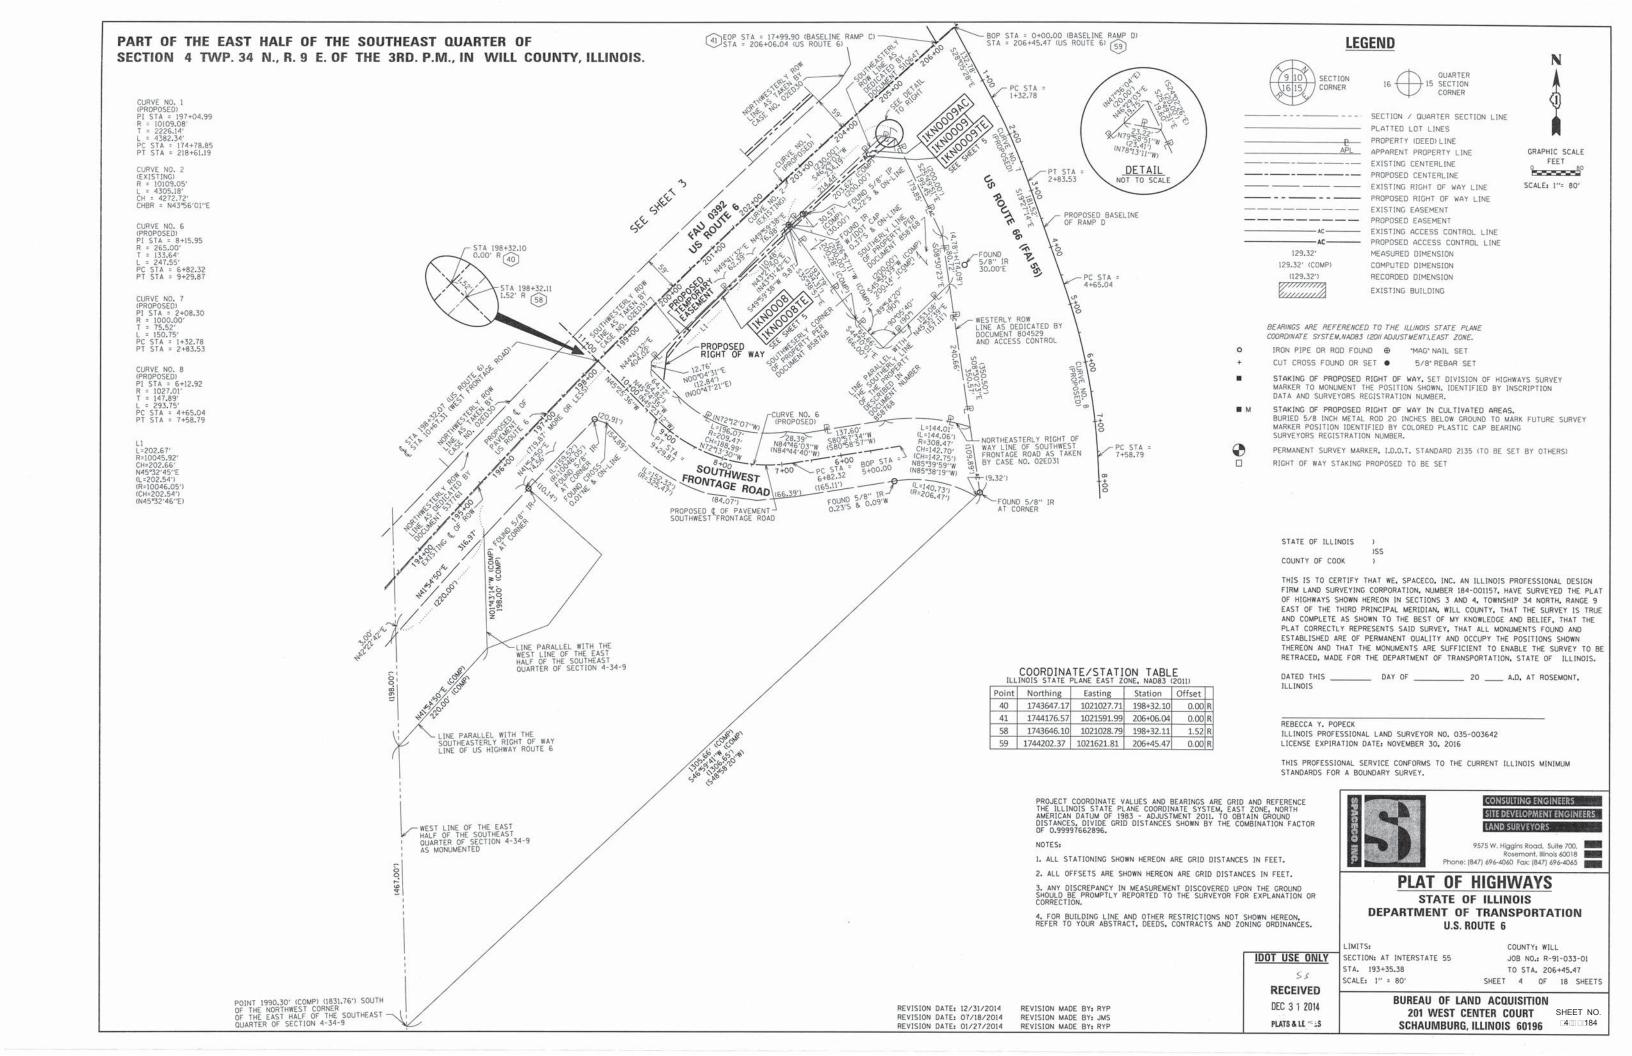
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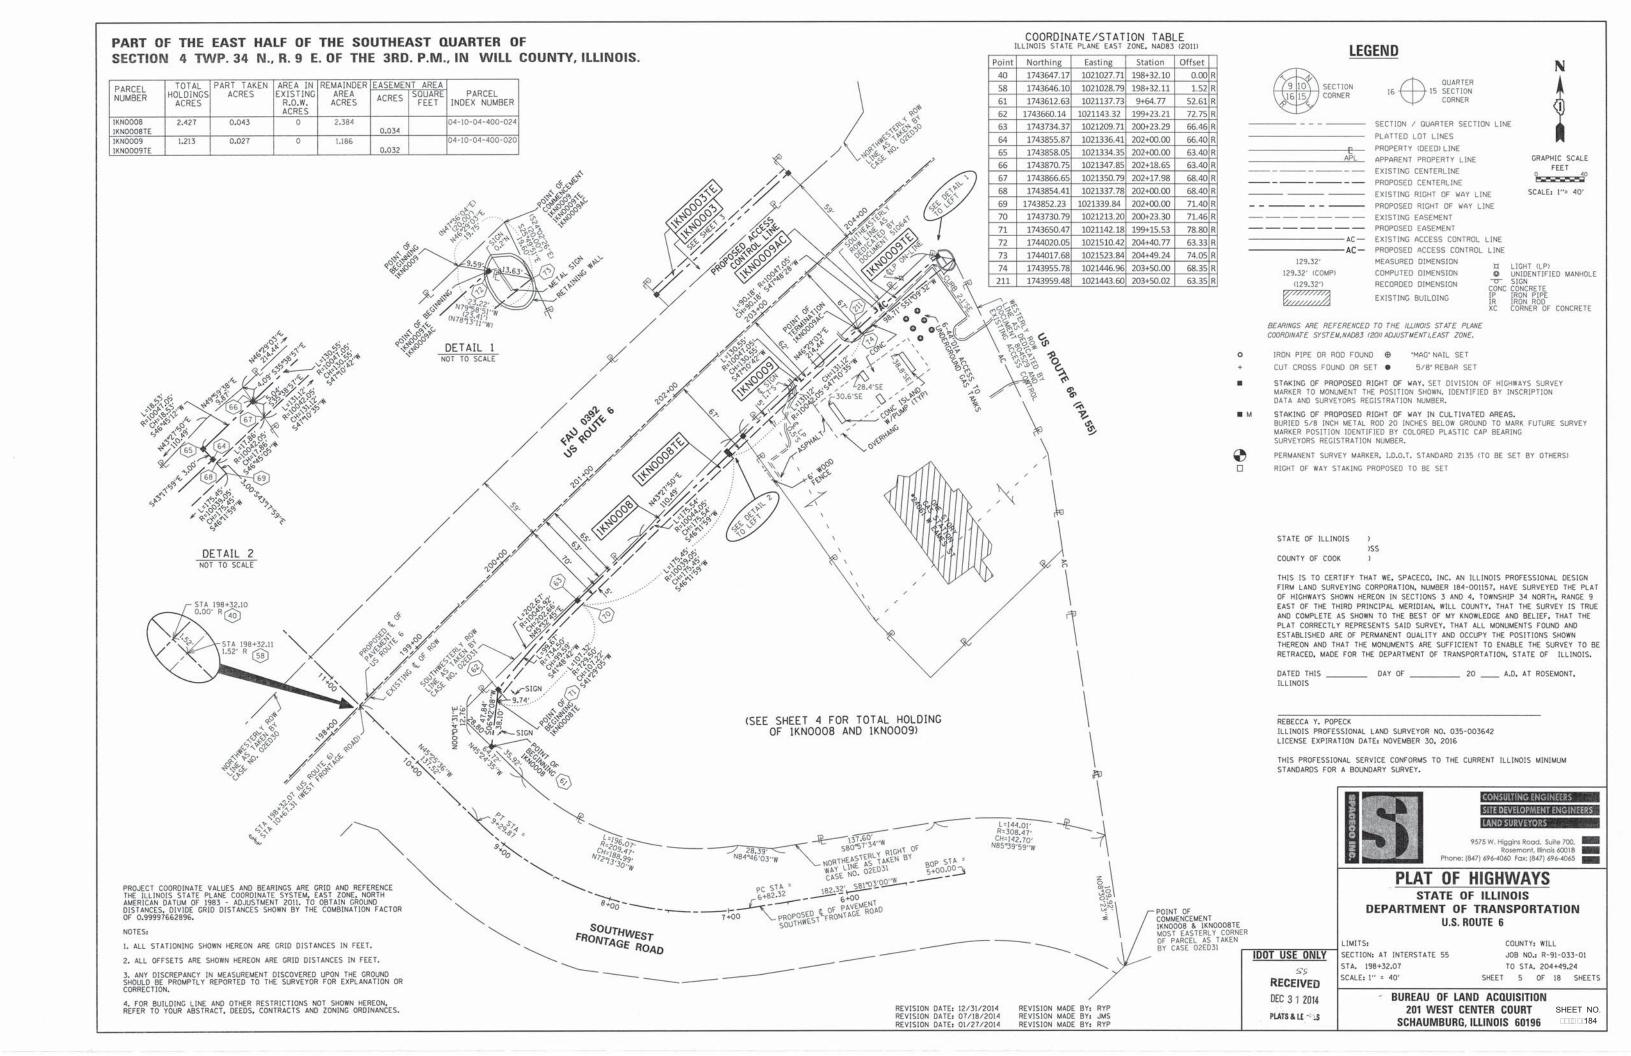
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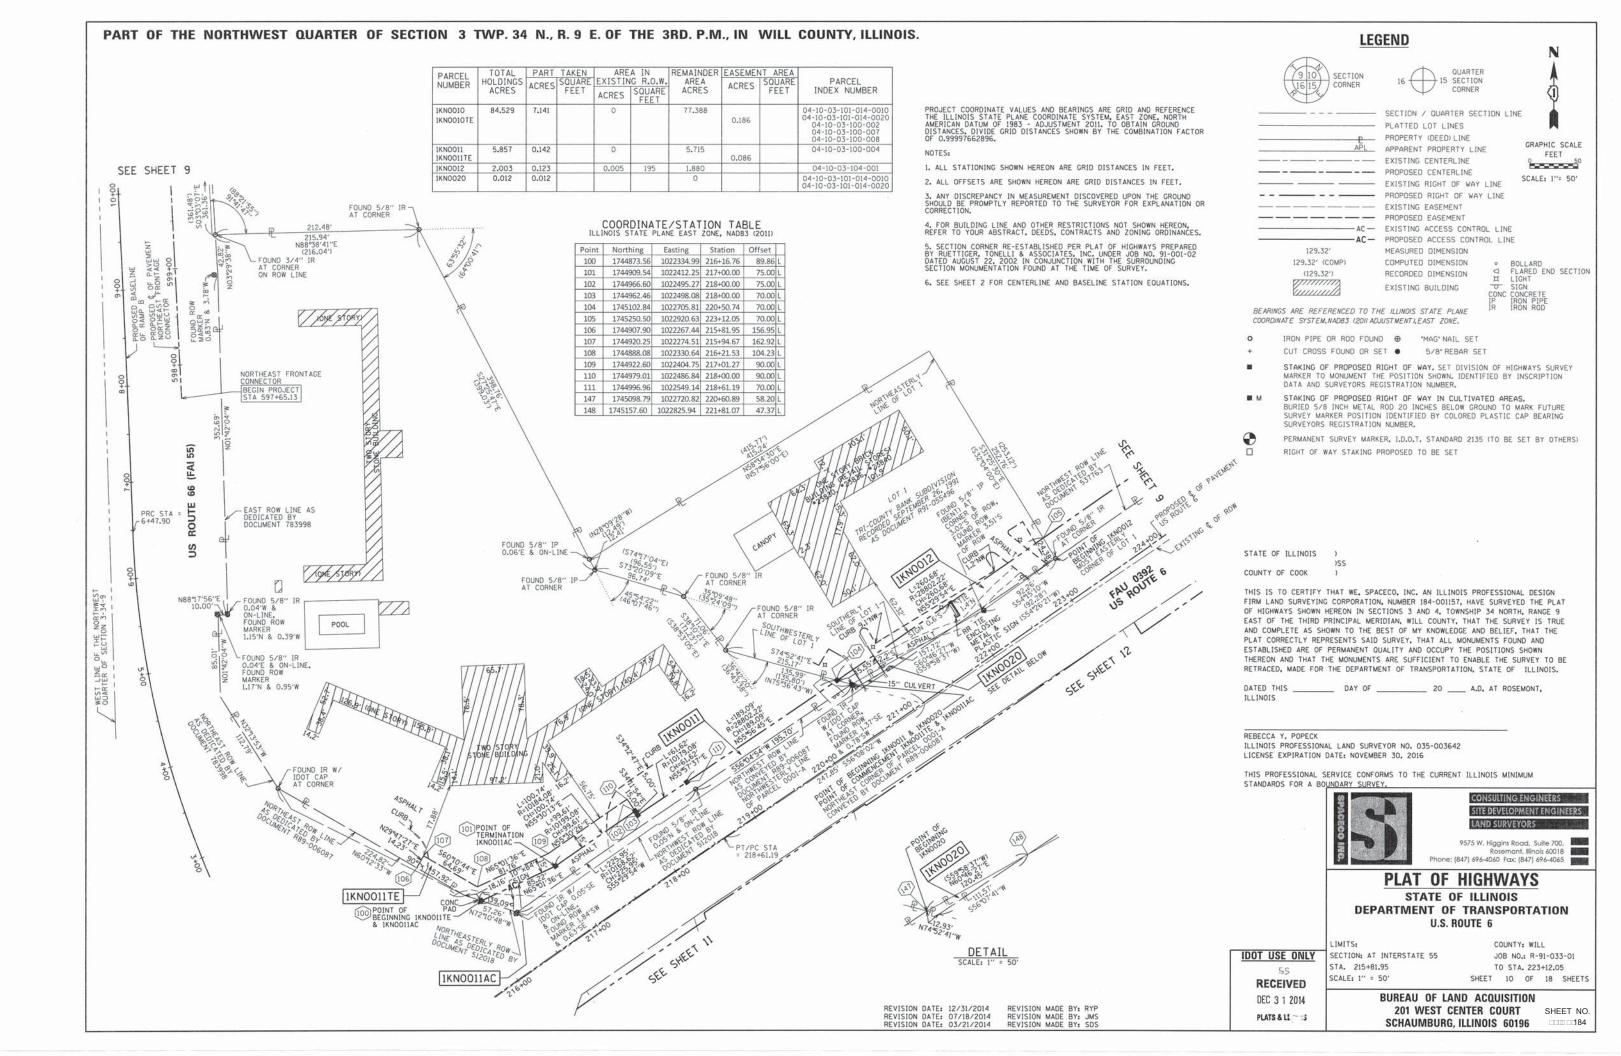
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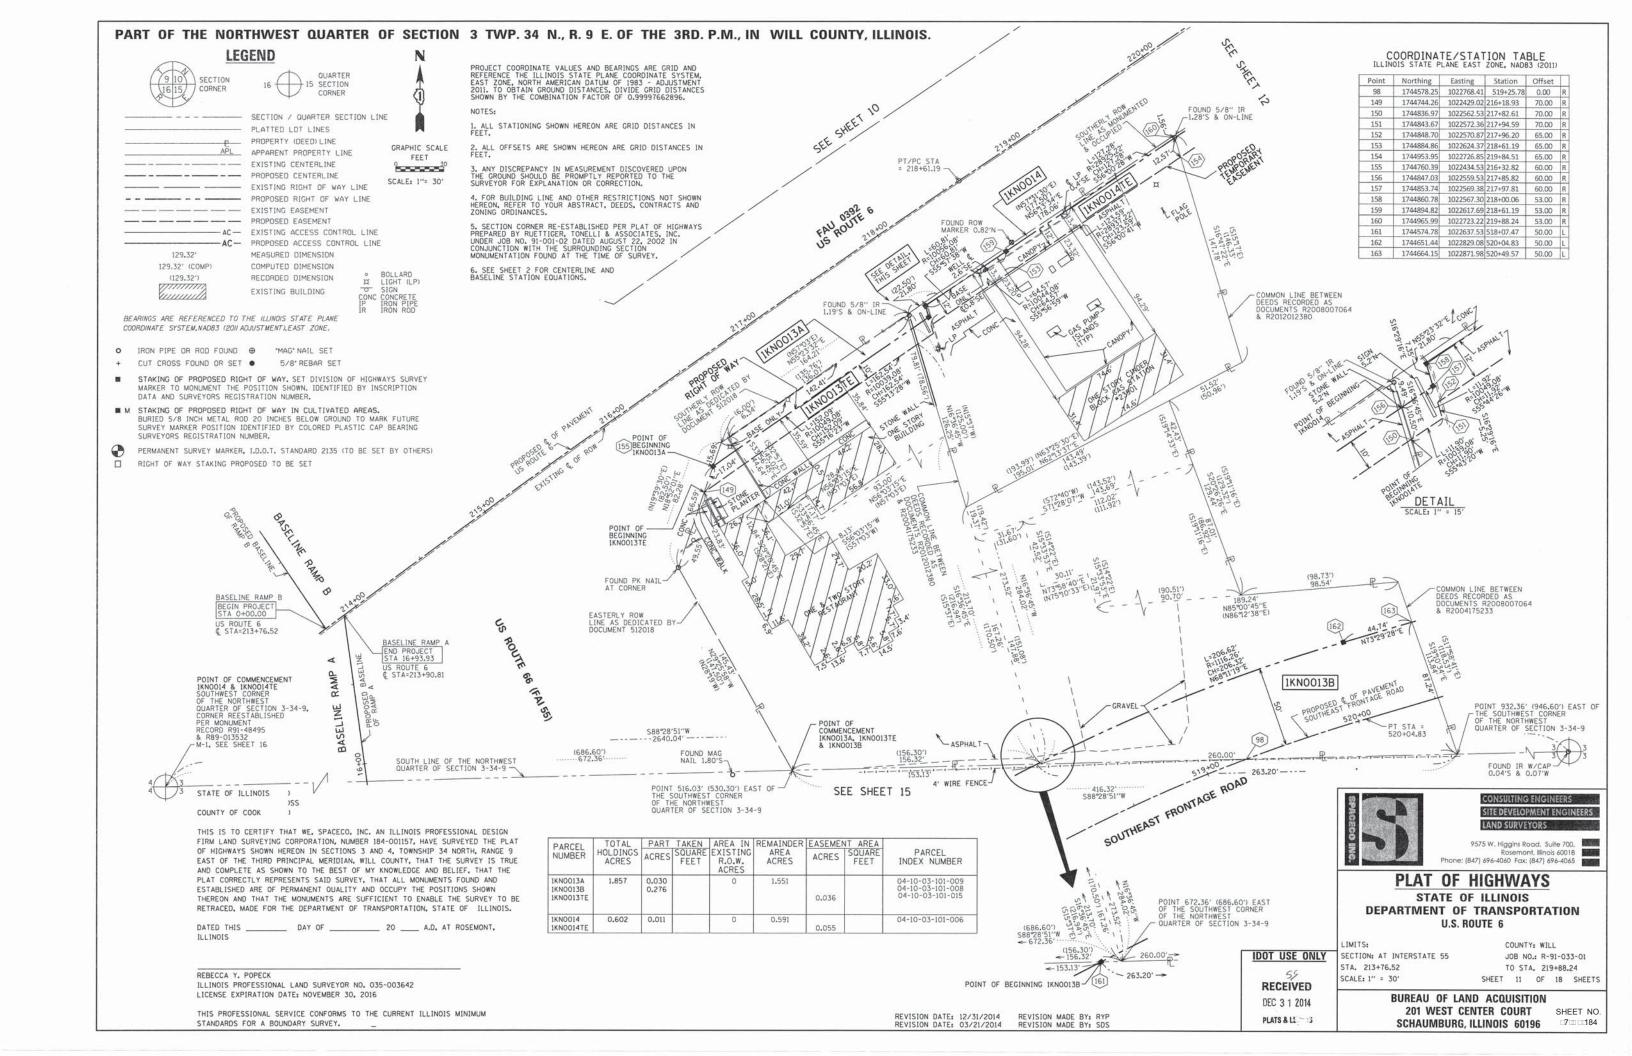












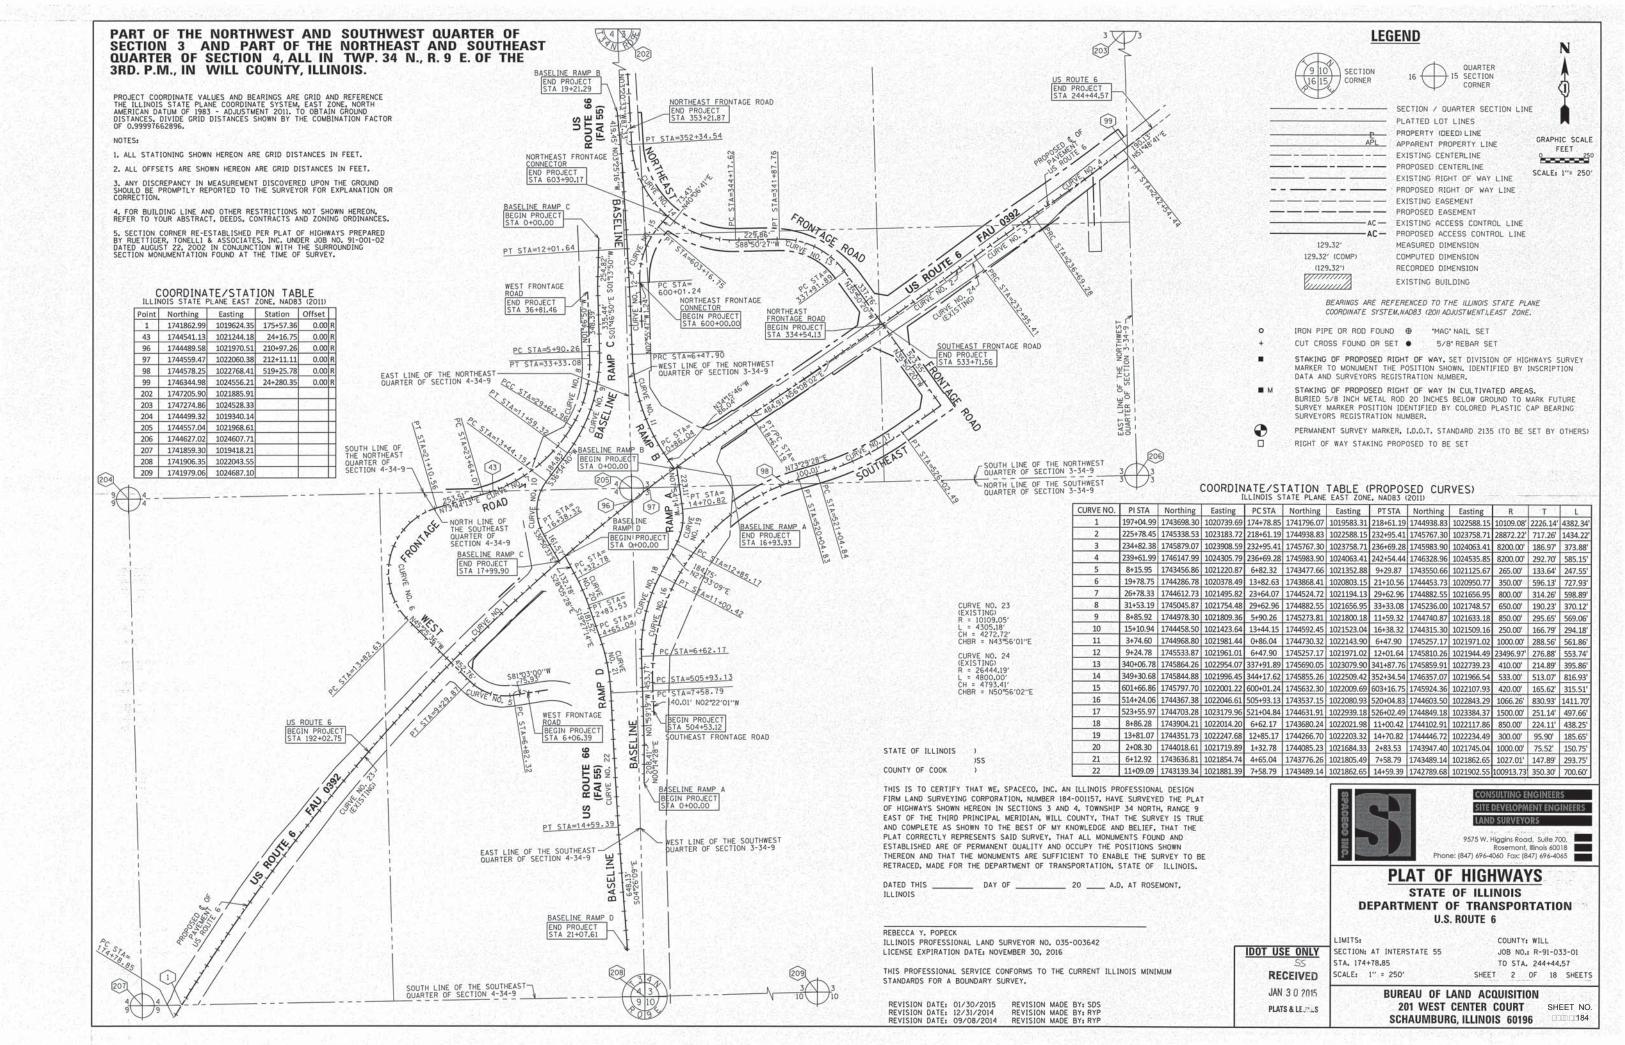

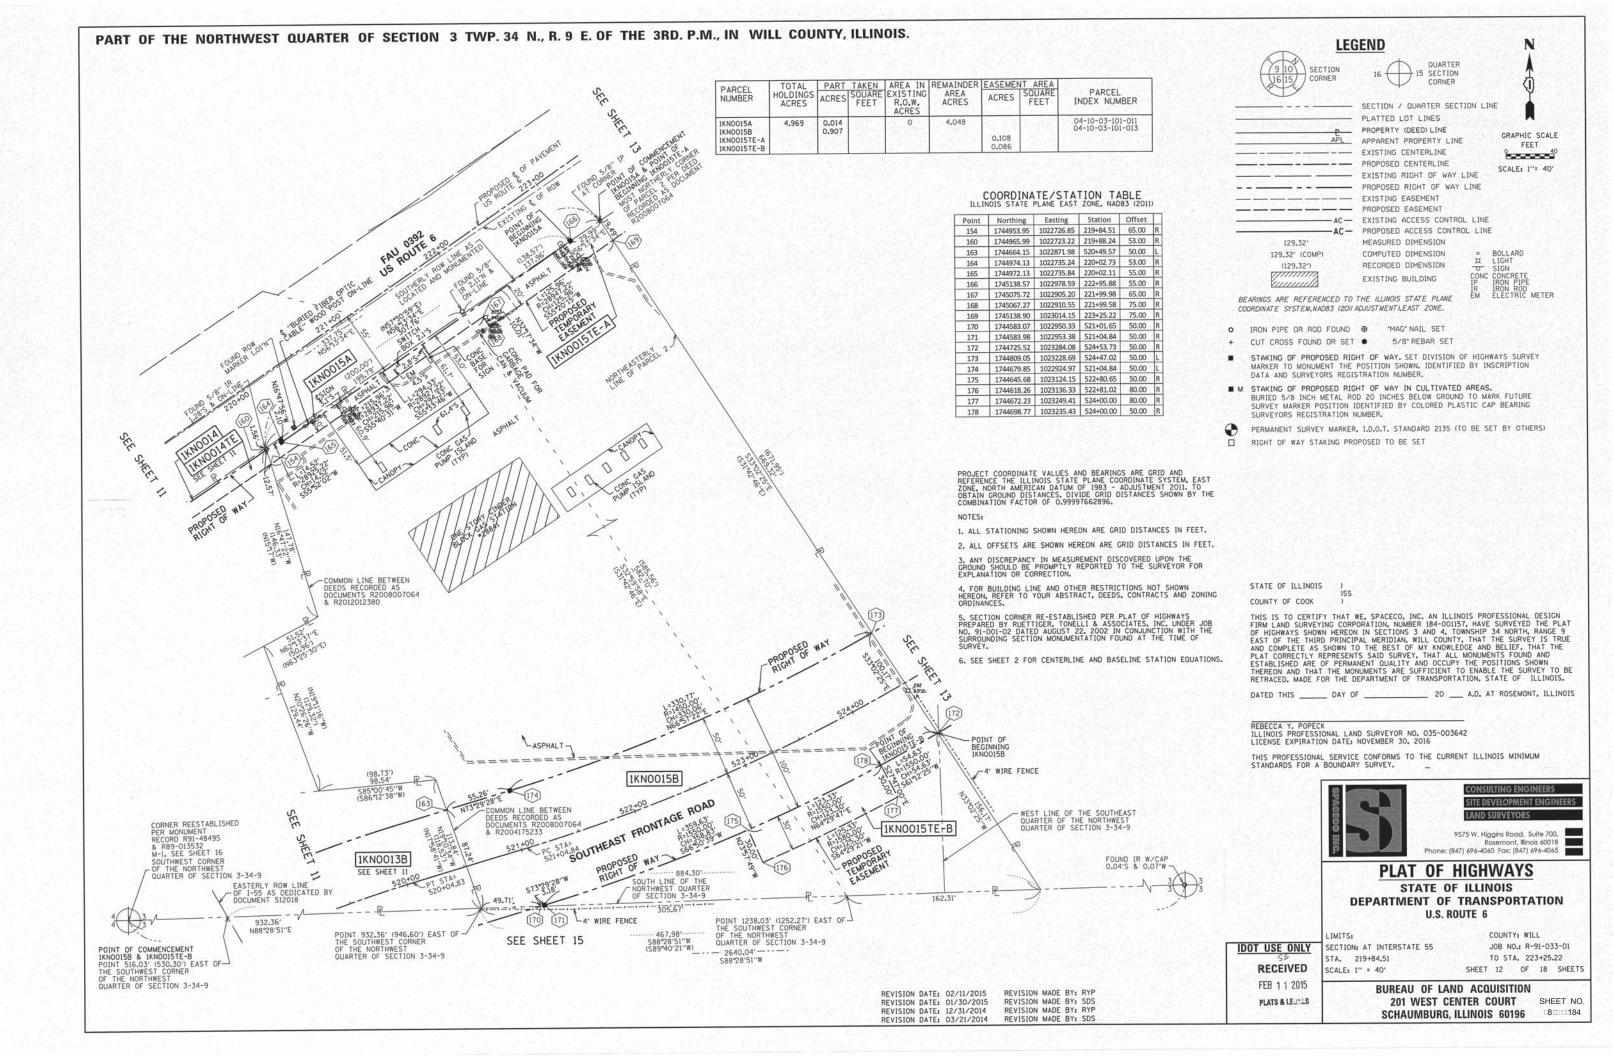

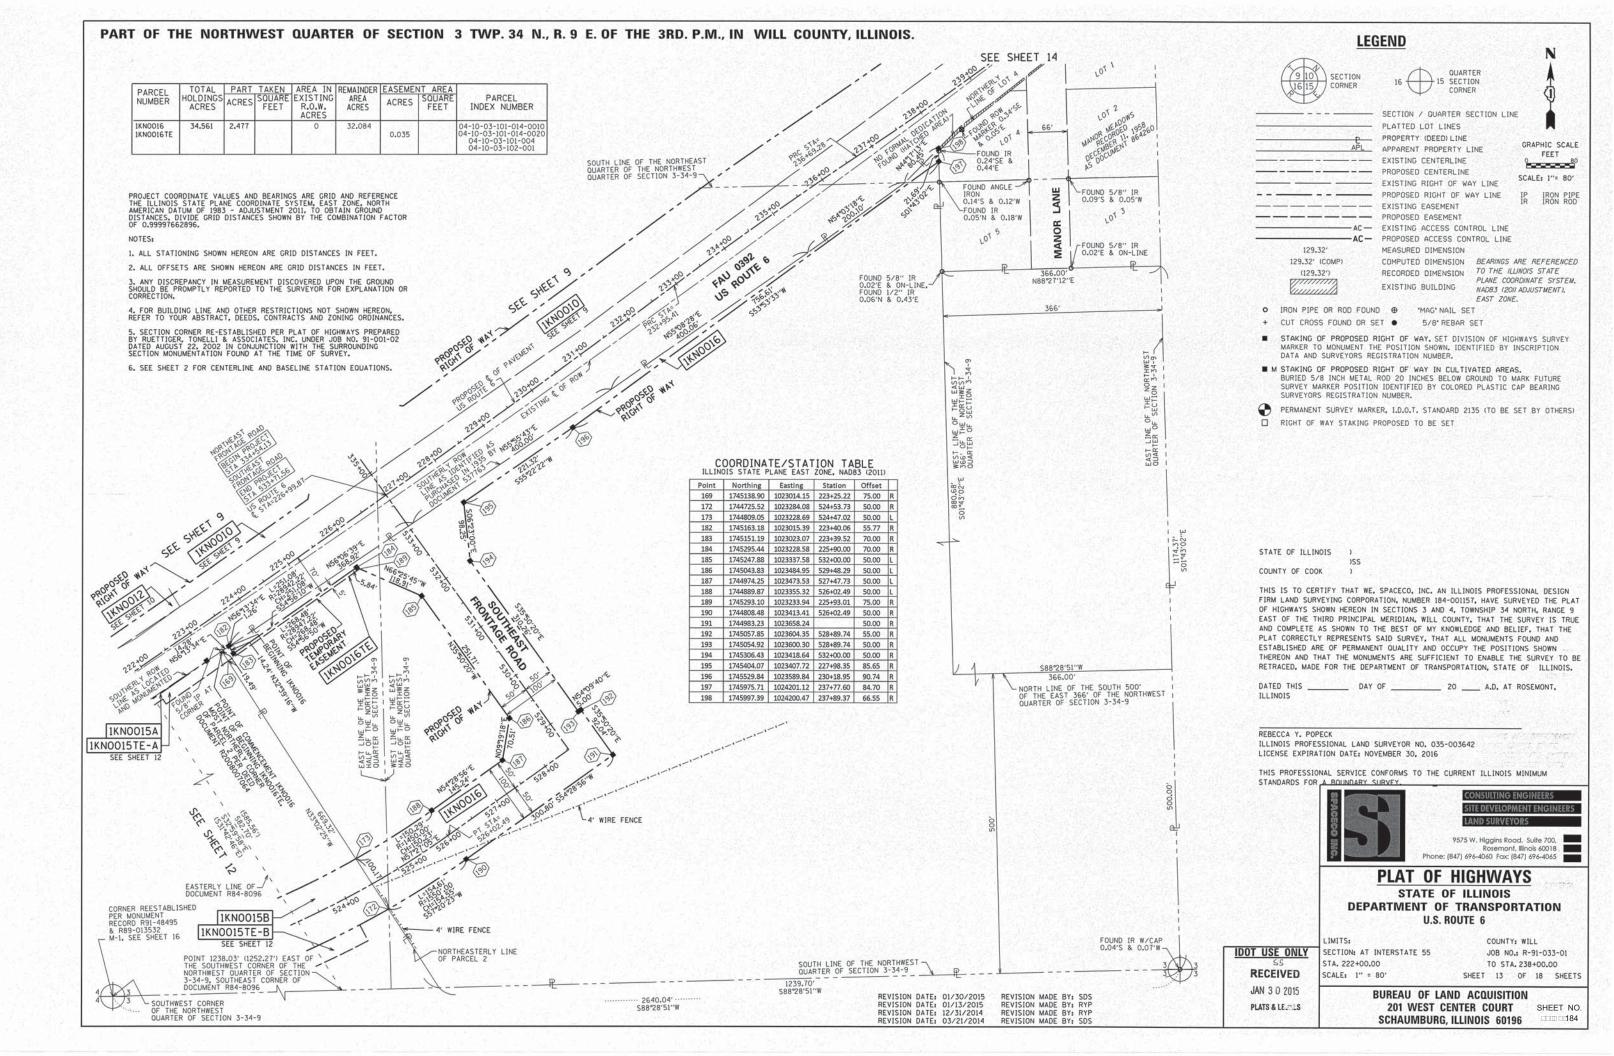

PROJECT COORDINATE VALUES AND BEARINGS ARE GRID AND REFERENCE THE ILLINOIS STATE PLANE COORDINATE SYSTEM, EAST ZONE, NORTH AMERICAN DATUM OF 1983 - ADJUSTMENT ZOIL TO OBTAIN GROUND DISTANCES, DIVIDE GRID DISTANCES SHOWN BY THE COMBINATION FACTOR OF 0.99997662896.

NOTES:

- 1. ALL STATIONING SHOWN HEREON ARE GRID DISTANCES IN FEET.
- 2. ALL OFFSETS ARE SHOWN HEREON ARE GRID DISTANCES IN FEET.
- 3. ANY DISCREPANCY IN MEASUREMENT DISCOVERED UPON THE GROUND SHOULD BE PROMPTLY REPORTED TO THE SURVEYOR FOR EXPLANATION OR CORRECTION.
- 4. FOR BUILDING LINE AND OTHER RESTRICTIONS NOT SHOWN HEREON, REFER TO YOUR ABSTRACT, DEEDS, CONTRACTS AND ZONING ORDINANCES.
- 5. SECTION CORNER RE-ESTABLISHED PER PLAT OF HIGHWAYS PREPARED BY RUETTIGER, TONELLI & ASSOCIATES, INC. UNDER JOB NO. 91-001-02 DATED AUGUST 22, 2002 IN CONJUNCTION WITH THE SURROUNDING SECTION MONUMENTATION FOUND AT THE TIME OF SURVEY.
- 6. SEE SHEET 2 FOR CENTERLINE AND BASELINE STATION EQUATIONS.

COORDINATE/STATION TABLE ILLINOIS STATE PLANE EAST ZONE, NADB3 (2011)		21/200	POINT OF BEGINNING IKNOOITTE, NORTHEAST CORNER OF LOT 1
Point Northing Easting Station Offset 99 1746344.98 1024556.21 24+280.35 0.00 R 179 1746163.43 1024411.48 240+55.68 55.64 R 180 1746279.61 1024558.17 242+41.56 52.60 R		Reft Int of	2.16' 1943.02''E
	241,400 Indian		180
	ISH ROUTE 6	18 P.	CHAIN LINK
240,100	MORTHWEST DOCUMENTS	CONT. A STATE OF THE STATE OF T	
	NS 345.67	EAST LINE OF LOT 1	
Or Switchen, 533400	ASPHALT WEST LINE OF LOT 1	LOT I MANOR MEADOWS RECORDED DECEMBER 11, 1958 AS DOCUMENT 864260	į.
PROPROSE LE CON ROW	LANE	150.11' \$8827'12''W (150.00')	
NORTHERLY LINE OF LOT 4	MANOR L'NE MAST ROW L'INE DOCUMENT 864260 MANOR L'A MANOR L'A SA DEDICATED BY DOCUMENT 864260	LOT 2	
NO CONTROL OF THE PORT OF THE	969. ANSO ANSO ANSO ANSO ANSO ANSO ANSO ANSO	FAST LINE OF THE NORTHWEST	
12 12 12 12 12 12 12 12 12 12 12 12 12 1		QUARTER OF SECTION 3-34-9	

TOTAL PART TAKEN AREA IN REMAINDER EASEMENT AREA
HOLDINGS ACRES SOUARE EXISTING AREA
ACRES ACRES SOUARE PARCEL PARCEL NUMBER ACRES ACRES FEET ACRES INDEX NUMBER ACRES 1KNO017TE 0.434 0.434 0.011 04-10-03-103-001

REVISION DATE: 12/31/2014 REVISION MADE BY: RYP
REVISION DATE: 02/07/2014 REVISION MADE BY: SDS

-STA 242+79.43 1.25' R

LEGEND







FEET

SECTION / QUARTER SECTION LINE - PLATTED LOT LINES P PROPERTY (DEED) LINE GRAPHIC SCALE

APL APPARENT PROPERTY LINE --- EXISTING CENTERLINE SCALE: 1"= 30" - EXISTING RIGHT OF WAY LINE - PROPOSED RIGHT OF WAY LINE

----- EXISTING EASEMENT -AC- EXISTING ACCESS CONTROL LINE -AC- PROPOSED ACCESS CONTROL LINE

129.32' (COMP) COMPUTED DIMENSION (129.32") RECORDED DIMENSION 7/11/11/11 EXISTING BUILDING

MEASURED DIMENSION BOLLARD
 BIGHT
 SIGN
 SONG CONCRETE

BEARINGS ARE REFERENCED TO THE ILLINOIS STATE PLANE COORDINATE SYSTEM, NAD83 (2011 ADJUSTMENT), EAST ZONE.

- O IRON PIPE OR ROD FOUND ⊕ "MAG" NAIL SET
- CUT CROSS FOUND OR SET 5/8" REBAR SET
- STAKING OF PROPOSED RIGHT OF WAY, SET DIVISION OF HIGHWAYS SURVEY MARKER TO MONUMENT THE POSITION SHOWN. IDENTIFIED BY INSCRIPTION DATA AND SURVEYORS REGISTRATION NUMBER.
- M STAKING OF PROPOSED RIGHT OF WAY IN CULTIVATED AREAS. BURIED 5/8 INCH METAL ROD 20 INCHES BELOW GROUND TO MARK FUTURE SURVEY MARKER POSITION IDENTIFIED BY COLORED PLASTIC CAP BEARING SURVEYORS REGISTRATION NUMBER.
- PERMANENT SURVEY MARKER, I.D.O.T. STANDARD 2135 (TO BE SET BY OTHERS) RIGHT OF WAY STAKING PROPOSED TO BE SET

STATE OF ILLINOIS

COUNTY OF COOK

THIS IS TO CERTIFY THAT WE, SPACECO, INC. AN ILLINOIS PROFESSIONAL DESIGN FIRM LAND SURVEYING CORPORATION, NUMBER 184-001157, HAVE SURVEYED THE PLAT OF HIGHWAYS SHOWN HEREON IN SECTIONS 3 AND 4, TOWNSHIP 34 NORTH, RANGE 9 EAST OF THE THIRD PRINCIPAL MERIDIAN, WILL COUNTY, THAT THE SURVEY IS TRUE AND COMPLETE AS SHOWN TO THE BEST OF MY KNOWLEDGE AND BELIEF. THAT THE PLAT CORRECTLY REPRESENTS SAID SURVEY, THAT ALL MONUMENTS FOUND AND ESTABLISHED ARE OF PERMANENT QUALITY AND OCCUPY THE POSITIONS SHOWN THEREON AND THAT THE MONUMENTS ARE SUFFICIENT TO ENABLE THE SURVEY TO BE RETRACED, MADE FOR THE DEPARTMENT OF TRANSPORTATION, STATE OF ILLINOIS.

DATED THIS _____ ___ DAY OF ______ 20 ____ A.D. AT ROSEMONT.

REBECCA Y. POPECK ILLINOIS PROFESSIONAL LAND SURVEYOR NO. 035-003642 LICENSE EXPIRATION DATE: NOVEMBER 30, 2016

THIS PROFESSIONAL SERVICE CONFORMS TO THE CURRENT ILLINOIS MINIMUM STANDARDS FOR A BOUNDARY SURVEY.



SCALE: 1" = 30"



9575 W. Higgins Road, Suite 700, 95/5 W. Higgins Road, Suite 700, Rosemont, Illinois 60018 Phone: (847) 696-4060 Fax: (847) 696-4065

PLAT OF HIGHWAYS STATE OF ILLINOIS **DEPARTMENT OF TRANSPORTATION** U.S. ROUTE 6

IMITS: IDOT USE ONLY STA. 238+00.00 4


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PLATS & LEGS

COUNTY: WILL SECTION: AT INTERSTATE 55 JOB NO.: R-91-033-01 TO STA. 242+79.43 SHEET 14 OF 18 SHEETS

> BUREAU OF LAND ACQUISITION 201 WEST CENTER COURT SHEET NO. SCHAUMBURG, ILLINOIS 60196 7 184



LEGEND

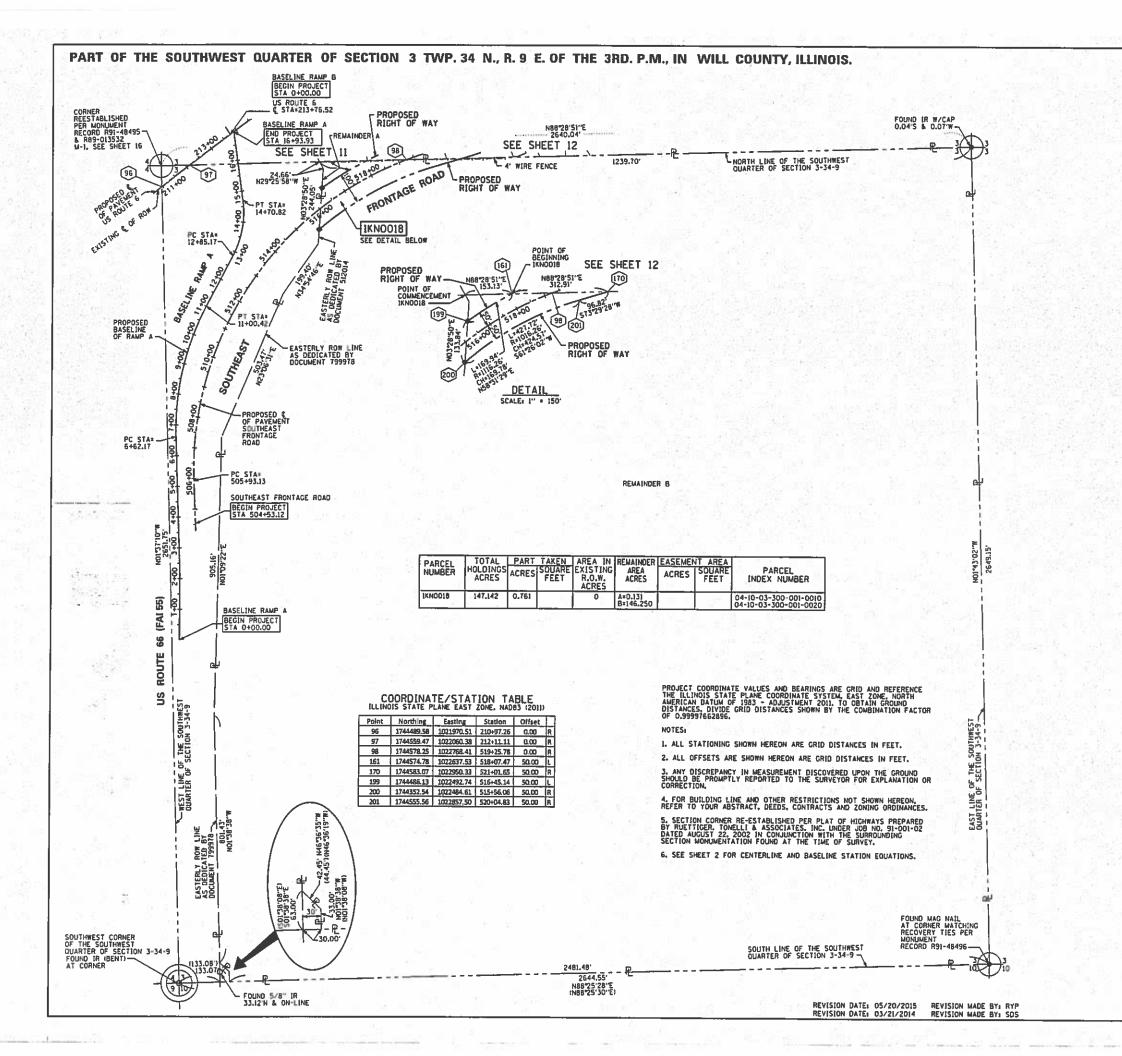15 SECTION SECTION / QUARTER SECTION LINE PLATTED LOT LINES PROPERTY (DEED) LINE APPARENT PROPERTY LINE --- EXISTING CENTERLINE

> SCALE: 1"4 150" - EXISTING RIGHT OF WAY LINE PROPOSED RIGHT OF WAY LINE - EXISTING EASEMENT PROPOSED EASEMENT AC - EXISTING ACCESS CONTROL LINE

--- PROPOSED CENTERLINE

AC- PROPOSED ACCESS CONTROL LINE MEASURED DIMENSION

COMPUTED DIMENSION BEARINGS ARE REFERENCED TO THE ILLINOIS STATE RECORDED DIMENSION PLANE COORDINATE SYSTEM. EXISTING BUILDING NAD83 12011 ADJUSTNENTI. EAST ZONE.

GRAPHIC SCALE

0 150

IRON PIPE

FEET

O IRON PIPE OR ROD FOUND @ "MAG" NAIL SET CUT CROSS FOUND OR SET . 5/8' REBAR SET

129.32"

129.32' (COMP)

(129.321)

- STAKING OF PROPOSED RIGHT OF WAY, SET DIVISION OF HIGHWAYS SURVEY MARKER TO MONUMENT THE POSITION SHOWN. IDENTIFIED BY INSCRIPTION DATA AND SURVEYORS REGISTRATION NUMBER.
- M STAKING OF PROPOSED RIGHT OF WAY IN CULTIVATED AREAS.
 BURIED 5/8 INCH METAL ROD 20 INCHES BELOW GROUND TO MARK FUTURE
 SURVEY MARKER POSITION IDENTIFIED BY COLORED PLASTIC CAP BEARING
- PERMANENT SURVEY MARKER, LO.O.T. STANDARD 2135 (TO BE SET BY OTHERS) RIGHT OF WAY STAKING PROPOSED TO BE SET

STATE OF ILLINOIS COUNTY OF COOK


THIS IS TO CERTIFY THAT WE, SPACECO, INC. AN ILLINOIS PROFESSIONAL DESIGN FIRM LAND SURVEYING CORPORATION, NUMBER 184-001157, HAVE SURVEYED THE PLAT OF HIGHWAYS SHOWN HEREON IN SECTIONS 3 AND 4, TOWNSHIP 34 NORTH, RANGE 9 EAST OF THE THIRD PRINCIPAL MERIDIAN, WILL COUNTY, THAT THE SURVEY IS TRUE AND COMPLETE AS SHOWN TO THE BEST OF MY KNOWLEDGE AND BELIEF, THAT THE PLAT CORRECTLY REPRESENTS SAID SURVEY, THAT ALL MONUMENTS FOUND AND ESTABLISHED ARE OF PERMANENT QUALITY AND OCCUPY THE POSITIONS SHOWN THEREON AND THAT THE MONUMENTS ARE SUFFICIENT TO ENABLE THE SURVEY TO BE RETRACED, MADE FOR THE DEPARTMENT OF TRANSPORTATION. STATE OF ILLINOIS.

___ A.D. AT ROSEMONT. ILL INOIS

REBECCA Y. POPECK ILLINOIS PROFESSIONAL LAND SURVEYOR NO. 035-003642 LICENSE EXPIRATION DATE: NOVEMBER 30, 2016

THIS PROFESSIONAL SERVICE CONFORMS TO THE CURRENT ILLINOIS MINIMUM STANDARDS FOR A BOUNDARY SURVEY.



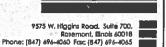

PLAT OF HIGHWAYS

STATE OF ILLINOIS **DEPARTMENT OF TRANSPORTATION** U.S. ROUTE 6


IDOT USE ONLY RECEIVED APR 2 0 2015


PLATS & LEATERS

LIMITS SECTION: AT INTERSTATE 55 STA. 504+53.12 SCALE: 1" = 150"

COUNTY: WILL JOB NO. R-91-033-01 TO STA, 519+25.78 SHEET 15 OF 18 SHEETS


BUREAU OF LAND ACQUISITION 201 WEST CENTER COURT 71 184 SCHAUMBURG, ILLINOIS 60196

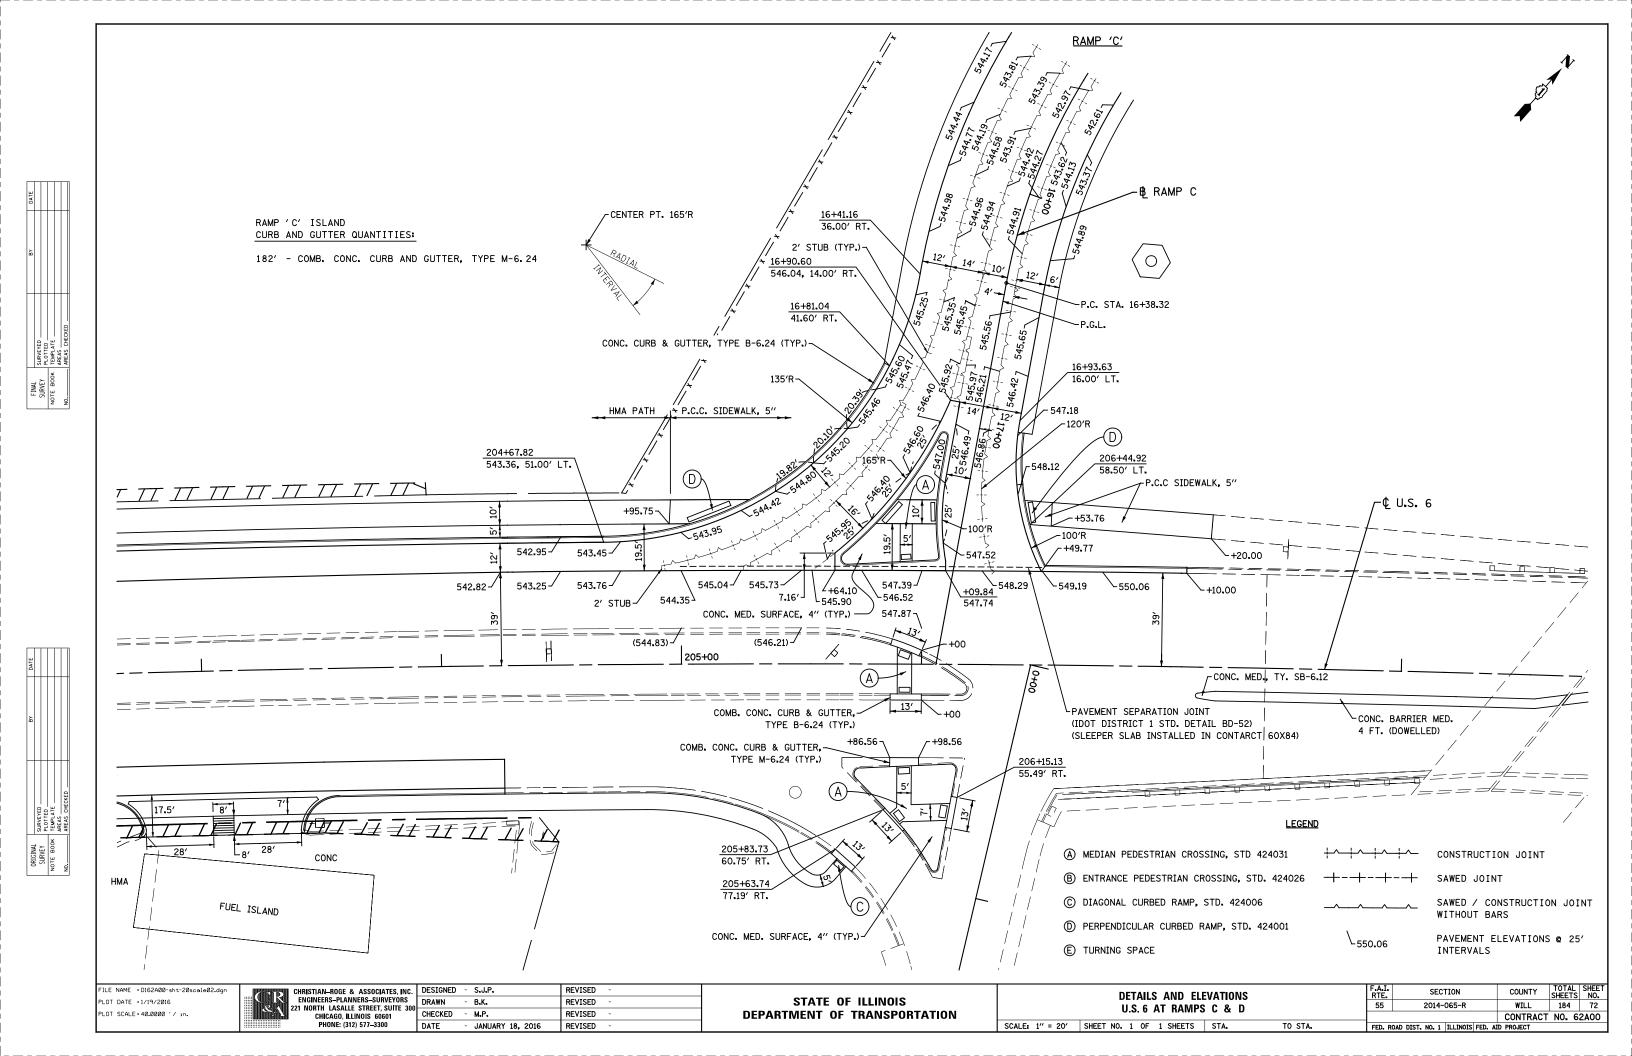

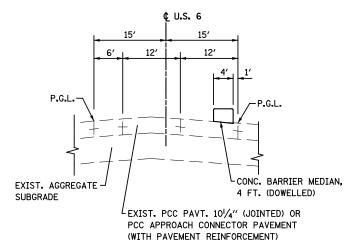


PROPOSED MEDIAN TYPICAL SECTION

STA. 207+14.32 TO STA. 208+36.25

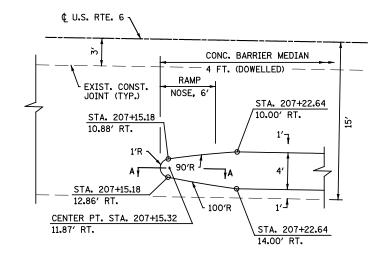

MEDIAN NOSE DETAIL (N.T.S.) STA. 207+14.32 TO STA. 208+36.25

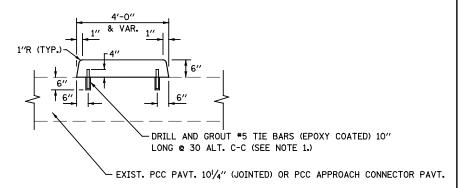


MEDIAN DETAIL - CONCRETE BARRIER MEDIAN, 4 FT, (DOWELLED)


NOTES


SCALE: NONE SHEET NO.

- 1. TIE BARS WILL BE INCLUDED IN THE COST OF "CONCRETE BARRIER MEDIAN, 4 FT. (DOWELLED)"
- 2. SEE PLAN AND PROFILE DRAWING FOR LOCATION.

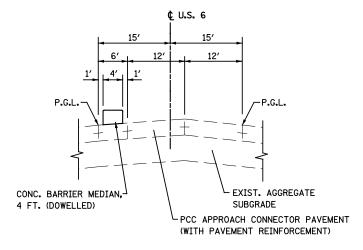

PROPOSED MEDIAN TYPICAL SECTION STA. 212+06.90 TO STA. 212+70.33

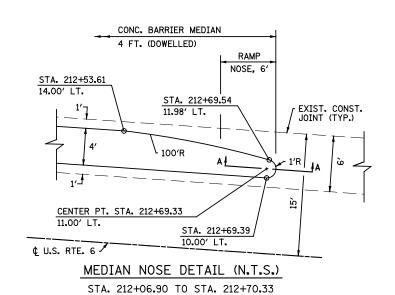

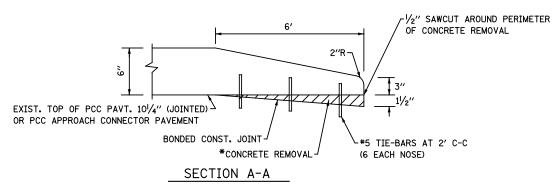


*REMOVE PORTIONS OF EXISTING CONCRETE IN ORDER TO MAINTAIN MINIMUM 4/2" THICKNESS OF MEDIAN CONCRETE. CONCRETE REMOVAL AND SAWCUT IS INCLUDED IN THE COST OF "CONCRETE BARRIER MEDIAN, 4 FT. (DOWELLED)"


TYP-7


FILE NAME =D162A00-sht-typical7.dgn PLOT DATE =1/19/2016 PLOT SCALE=100.000 '/ in. CHRISTIAN-ROGE & ASSOCIATES, INC. ENGINEERS-PLANNERS-SURVEYORS 221 NORTH LASALLE STREET, SUITE 300 CHICAGO, LILINOIS 60601 PHONE: (312) 577-3300 PATE JANUAR

STATE OF ILLINOIS
DEPARTMENT OF TRANSPORTATION

RAI	SED	MEDIAN	DETAILS			RTE.	SECTION	COUNTY	TOTAL SHEETS	SHEET NO.
		U.S. 6				55	2014-065-R	WILL	184	73
		0.0.0						CONTRACT	NO. 6	2A00
1	0F	1 SHEETS	STA.	TO STA.	F	FED. RO	AD DIST, NO. 1 ILLINOIS FED. AI	D PROJECT		

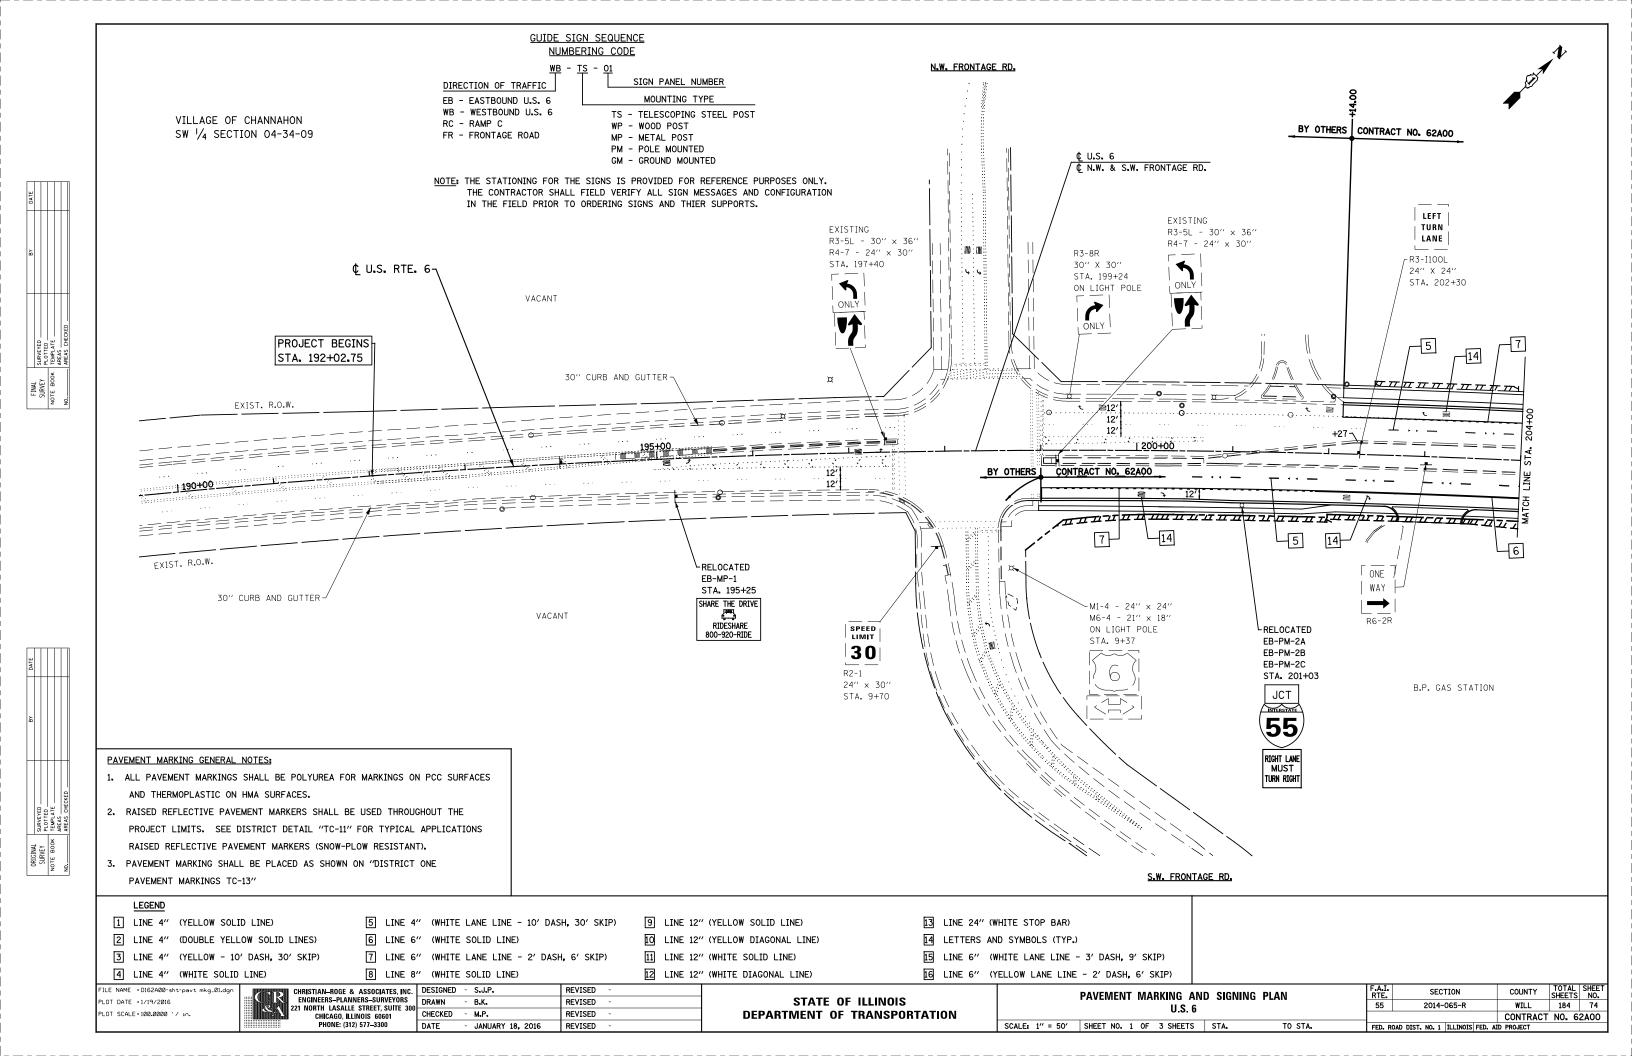

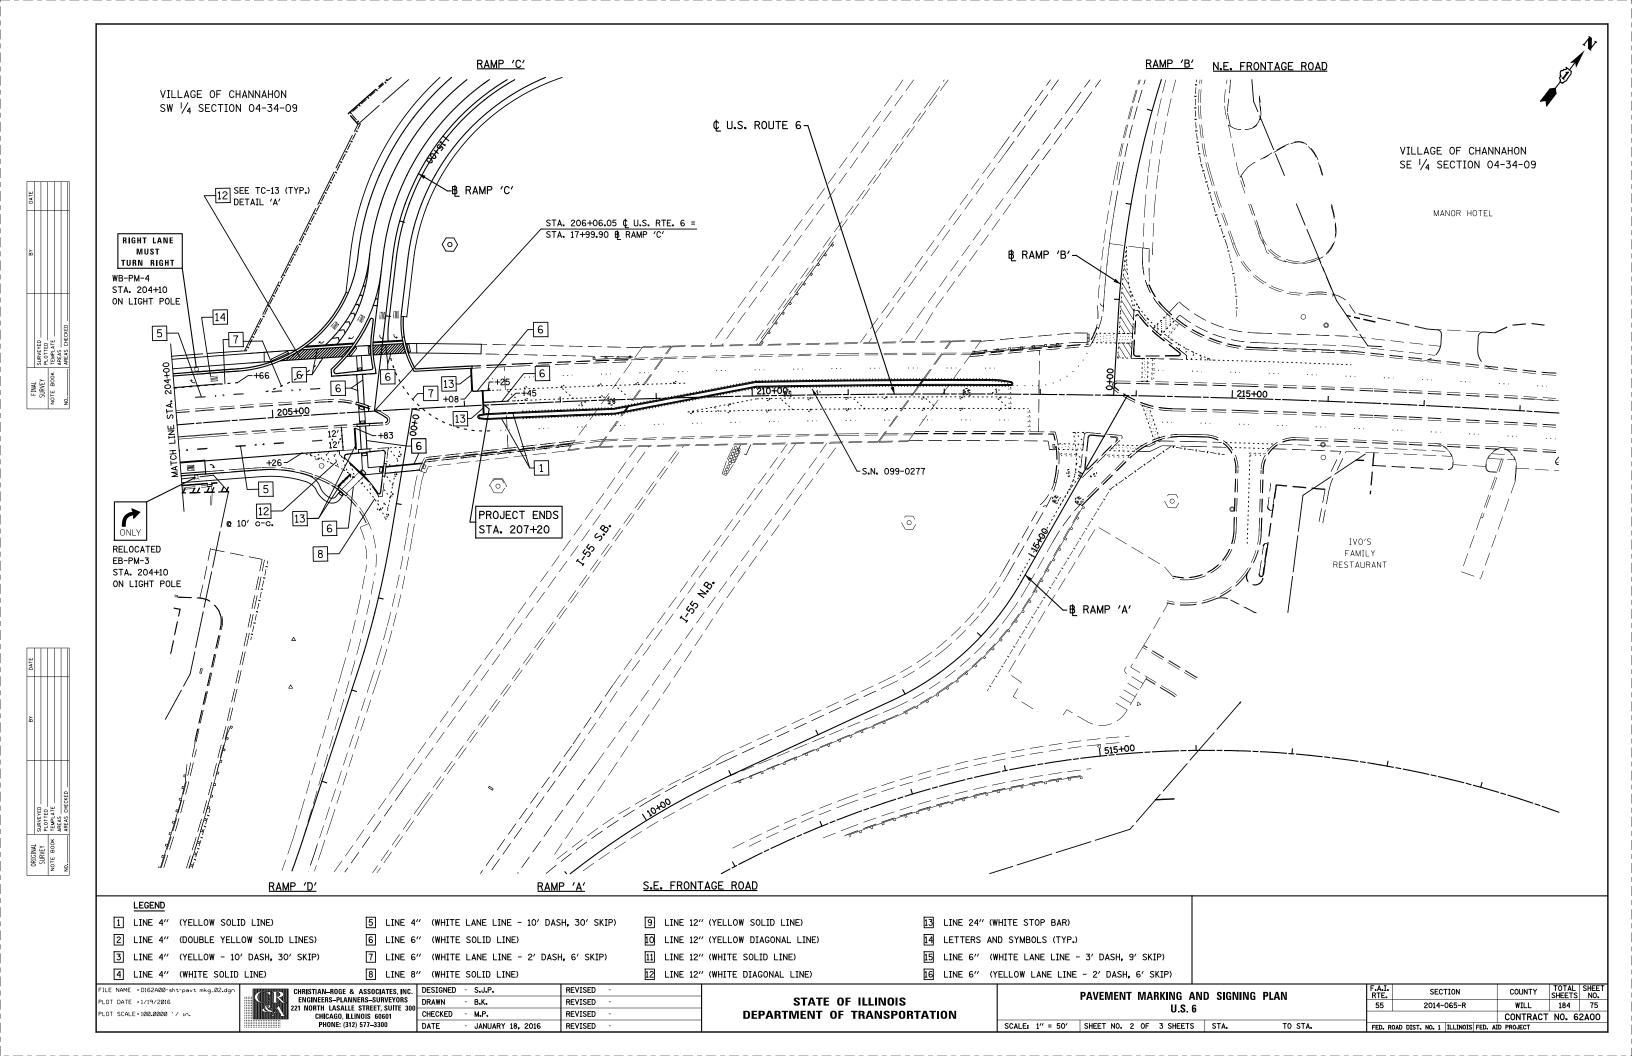

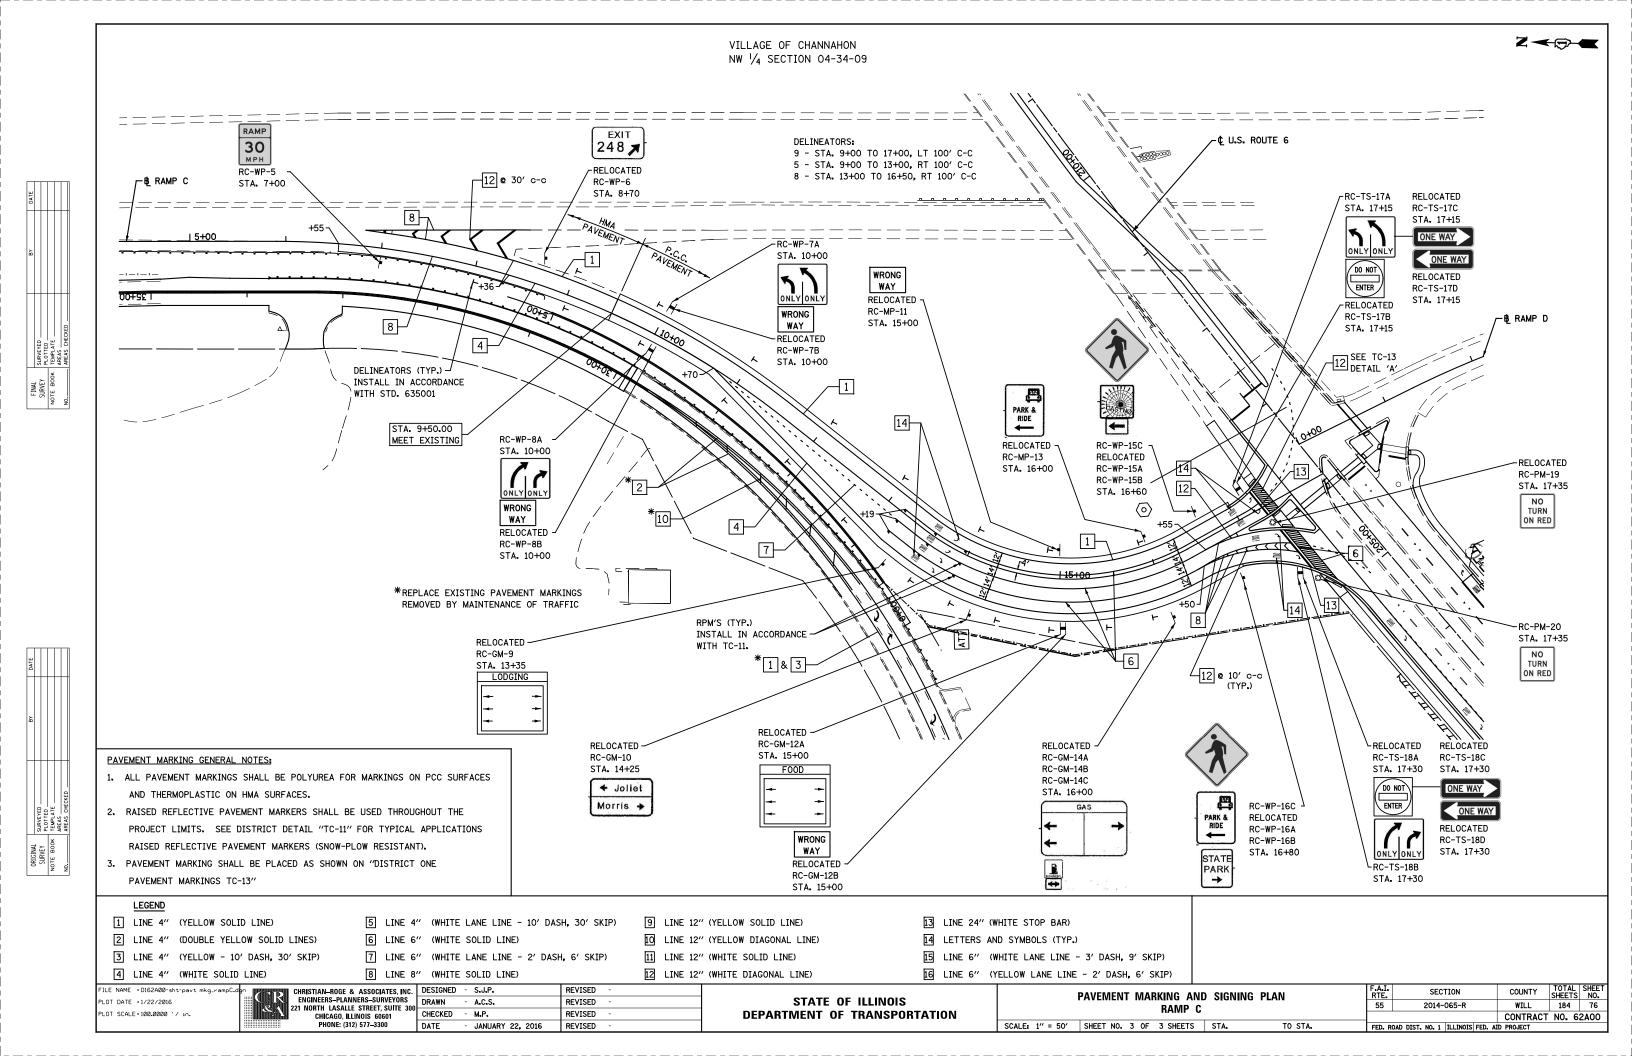

			PAY ITEM														72700100	73400100	73700100	73700200
SIGN NAME	LOCAT	ION	SIGN DESCRIPTION			SIGN SIZ	E	X 1	X2	хз	Y1	Y2	У 3	NUMBER OF POSTS	POST TYPE	TOTAL LENGTH (Y2+Y3)	STRUCTURAL STEEL SIGN SUPPORT - BREAKAWAY	CONCRETE	REMOVE GROUND MOUNTED SIGN SUPPORT	REMOVE CONCRETE FOUNDATION- GROUND MOUNT
	STATION	OFFSET			W (FT)	D (FT)	(SQ FT)									(FOOT)	(POUNDS)	(CU YD)	(EACH)	(EACH)
RAMP C						•												•		
RC-GM-9	13+35	RT	LODGING INFORMATION		9.5	8.0	76.0	14.0	15.9	21.6	7.0	18.0	20.0	2	W8 X 18	38.0	684.0	1.4	2	2
RC-GM-10	14+25	RT	JOLIET / MORRIS		6.5	4.0	26.0	14.0	15.3	19.2	7.0	13.5	15.0	2	W6 X 15	28.5	427.5	1.4	2	2
RC-GM-12A	15+00	RT	FOOD INFORMATION		9.5	8.0	76.0	14.0	15.9	21.6	7.0	18.0	20.0	2	W8 X 18	38.0	684.0	1.4	2	2
RC-GM-12B			WRONG WAY	R5-1a	3.0	2.0	6.0													
RC-GM-14A	16+00	RT	GAS INFORMATION		9.5	6.0	57.0	14.0	15.9	21.6	7.0	16.5	19.5	2	W8 X 18	36.0	648.0	1.4	2	2
RC-GM-14B			BIODIESEL		2.0	2.0	4.0													
RC-GM-14C			DIR ARROW	M6-1	1.8	1.3	2.2													
					•	•			•				•							
			TOTAL														2,444	5.6	8	8

NOTE: THE CONTRACTOR SHALL FIELD VERIFY ALL SIGN MESSAGES AND CONFIGURATIONS IN THE FIELD PRIOR TO ORDERING SIGNS AND STEEL POSTS.


CLEAR HEIGHT FOR LONGEST POST = Y3 - SIGN DEPTH D(FT)

NOTE : FOR ADDITIONAL DETAILS, SEE STANDARDS BAW-A-1 AND STANDARD BAW-A-2

IC.	DESIGNED	-	S.J.P.	REVISED -	I
S 300	DRAWN	-	A.C.S.	REVISED -	ı
300	CHECKED	-	M.P.	REVISED -	ı
	DATE	-	JANUARY 18, 2016	REVISED -	ı

	GROUND MOUNTED SIG	N STRI	UCTURES	F.A.I. RTE.	SECTIO
	PANEL DETAILS	- U.S. (6	55	2014-06
SCALE: NONE	SHEET NO. 1 OF 1 SHEETS	STA.	TO STA.	FED. RO	DAD DIST. NO. 1 ILL

COUNTY TOTAL SHEET NO.
WILL 184 77
CONTRACT NO. 62A00

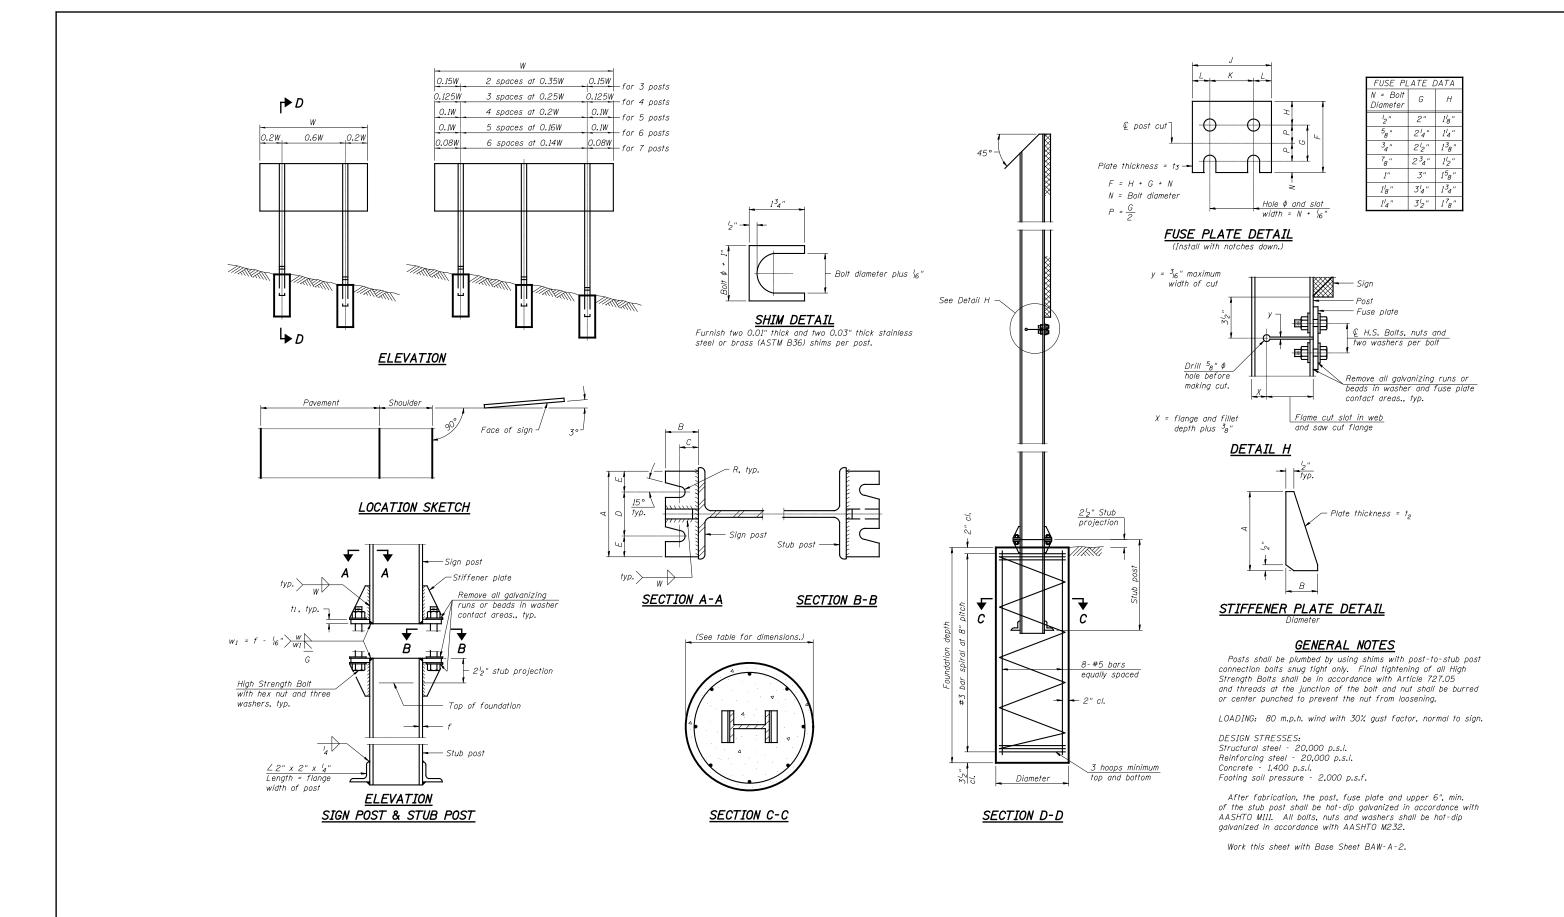

BAW-A-1 FILE NAME = D162A00-sht-sign_stl_post-l.dg

PLOT DATE =1/19/2016 PLOT SCALE = 40.0001 '/ in. 6-1-12

ENGINEERS-PLANNERS-SURVEYORS	DR
221 NORTH LASALLE STREET, SUITE 300 - CHICAGO, ILLINOIS 60601	CHI
PHONE: (312) 577–3300	DA

S, INC.	DESIGNED	-	S.J.P.	REVISED -
YORS ITE 300	DRAWN	-	B.K.	REVISED -
11E 300	CHECKED	-	M.P.	REVISED -
	DATE	-	JANUARY 18, 2016	REVISED -

STATI	E OI	FILLINOIS
DEPARTMENT	0F	TRANSPORTATION

SCALE: NONE


SHEET NO.

(Sheet I of 2)							
BREAK-AWAY WIDE	FLANGE		F.A.I. RTE.	SEC ⁻	ΓΙΟΝ	COUNTY	TOTAL SHEETS	SHEET NO.
STEEL SIGN POST	DETAILS		55	2014-	065-R	WILL	184	78
0.222 0.00. 100.						CONTRACT	NO. 6	2A00
1 OF 2 SHEETS	STA.	TO STA.	FED. RO	DAD DIST. NO. 1	ILLINOIS FED. A	ID PROJECT		

			CONCF	RETE FOUNDAT	ION TABL	.E				P0:	ST TO	STUB	POST (CONNEC	TION L	DATA			FUSE PLATE DATA				
POST		Foundation		Re	einforceme	nt		Stub Post															
7 037	Diameter	* Minimum Depth	Concrete (1) cu. yds.)	Vertical Bars Length	Bar S Diameter	Spirals Length	lbs. 2	Length	Bolt Size	Α	В	С	D	Ε	†1	†2	R	W	J	K	L	†3	
W6x9	2'-0"	6′-0"	0.70	5′-9"	1'-812"	79′-0"	78	2'-3"	⁵ 8" x 3 ¹ 4"	6"	24"	14"	312"	14"	34"	2"	"32 "	14"	4"	24"	78"	4"	
W6x15	2'-0"	6′-0"	0.70	5′-9"	1'-8'2"	79′-0"	78	2'-6"	5 _{8"} x 31 ₄ "	6"	24"	14"	31/2"	14"	34"	2"	"32 "	4"	6"	3½"	14"	38"	
W8x18	2'-0"	6′-0"	0.70	5′-9"	1'-8'2"	79′-0"	78	2'-6"	3 ₄ " x 3 ³ 4"	6"	212"	138"	34"	138"	1"	2"	1332 "	⁵ 16 "	54"	234"	14"	38"	
W10x22	2'-6"	6′-6"	1.18	6′-3"	2'-2'2"	105′-0"	92	3'-0"	3 ₄ " x 3 ³ 4"	6"	21/2"	138"	34"	138"	1"	2"	1332 "	⁵ /6 "	53 ₄ "	234"	1/2"	2"	
W10x26	2'-6"	7′-0"	1.27	6′-9"	2'-212"	112'-0"	98	3'-0"	⁷ 8" x 4"	7"	234"	1/2"	4"	1/2"	1"	34"	1532 "	38"	53 ₄ "	234"	1/2"	58"	
W12x26	2'-6"	7′-9"	1.41	7′-6"	2'-212"	119′-0"	107	3'-0"	⁷ 8" x 4"	7"	234"	1/2"	4"	1/2"	1"	34"	1532 "	3 ₈ "	61/2"	31/2"	1/2"	58"	
W14x30	3′-0"	7′-3"	1.90	7′-0"	2'-812"	145′-0"	113	3′-0"	⁷ 8" x 4"	7"	234"	12"	4"	12"	1"	34"	1532 "	³ 8"	63 ₄ "	312"	1 ⁵ 8"	2"	
W14x38	3′-0"	8'-0"	2.09	7′-9"	2'-812"	153′-0"	122	3′-6"	1" x 4 ¹ ₂ "	7 ¹ 2"	3"	134"	4"	134"	14"	34"	17,32 "	3 ₈ "	63 ₄ "	312"	1 ⁵ 8"	2"	
W16x45	3'-0"	8′-6"	2.23	8'-3"	2'-812"	162'-0"	130	3′-6"	1" x 41/2"	712"	3"	134"	4"	134"	14"	34"	1732 "	38"	7"	312"	134"	12"	

^{*}Dimensional changes required for varying site conditions shall be approved by the Engineer.

										FUS		BOLT SIZ	Ł								
POST											Sign i	Height									
7 037	4'-0"	5′-0"	6′-0"	7′-0"	8′-0"	9′-0"	10'-0"	11'-0"	12′-0"	13′-0"	14′-0"	<i>15′-0</i> "	16′-0"	17'-0''	18'-0''	19'-0''	20′-0′′	21'-0''	22'-0''	23'-0''	24'-0''
W6x9	'2" x 1'2"	½" x 1½"	'2" x 1'2"	'2" x 1'2"																	
W6x15	12" x 134"	$^{1}\!\!_{2}$ " \times $1^{3}\!\!_{4}$ "	$^{1}\!_{2}$ " \times $1^{3}\!_{4}$ "	⁵ 8" x 2"	⁵ 8" x 2"	3 ₄ " x 2"	3 ₄ " x 2"	3 ₄ " x 2"	3 ₄ " x 2"												
W8x18	12" x 134"	$^{1}\!\!_{2}$ " \times $1^{3}\!\!_{4}$ "	$^{1}\!\!_{2}$ " \times $1^{3}\!\!_{4}$ "	1 ₂ " x 1 ³ 4"	⁵ 8" x 2"	⁵ 8" x 2"	3 ₄ " x 2"	³ 4" x 2"	3 ₄ " x 2"	3 ₄ " x 2"											
W10x22	¹ 2" x 2"	½" x 2"	¹ 2" x 2"	½" x 2"	½" x 2"	⁵ 8" x 2"	⁵ 8" x 2"	3 _{4"} x 21 _{4"}	34" x 214"	3 ₄ " x 2 ¹ 4"	3 _{4"} x 21 _{4"}	3 _{4"} x 21 _{4"}	3 _{4"} x 21 _{4"}								
W10x26	¹ 2" x 2"	½" x 2"	¹ 2" x 2"										3 ₄ " x 2 ¹ 2"								
W12x26	¹ 2" x 2"	½" x 2"	¹ 2" x 2"	½" x 2"	½" x 2"	⁵ 8" x 2 ¹ 4"	⁵ 8" x 2 ¹ 4"	3 _{4"} x 2 ¹ 2"	3 ₄ " x 2 ¹ 2"	3 ₄ " x 2 ¹ 2"	3 ₄ " x 21 ₂ "	3 _{4"} x 21 _{2"}	3 ₄ " x 2 ¹ 2"	3 ₄ " x 2 ¹ 2"	3 ₄ " x 2 ¹ 2"						
W14x30	¹ 2" x 2"	½" x 2"	¹ 2" x 2"	½" x 2"	¹ 2" x 2"	⁵ 8" x 2"	⁵ 8" x 2"	3 _{4"} x 21 _{4"}	3 ₄ " x 2 ¹ 4"	3 ₄ " x 2 ¹ 4"	3 _{4"} x 21 _{4"}	3 ₄ " x 2 ¹ 4"	3 _{4"} x 21 _{4"}	3 ₄ " x 2 ¹ 4"							
W14 x 38	½" x 2"	½" x 2"	¹ 2" x 2"	½" x 2"	½" x 2"	⁵ 8" x 2 ¹ 4"	⁵ 8" x 2 ¹ 4"	3 ₄ " x 2 ¹ ₂ "	3 ₄ " x 2 ¹ 2"	3 ₄ " x 2 ¹ 2"	3 ₄ " x 21 ₂ "	⁷ 8" x 2 ¹ 2"	⁷ 8" x 2½"	1" x 2 ³ 4"	1" x 2 ³ 4"	1" x 2 ³ 4"	1" x 2 ³ 4"	1" x 2 ³ 4"	1" x 23 ₄ "	1" x 23 ₄ "	1" x 23 ₄ "
W16x45		½" x 2"	¹ 2" x 2"	½" x 2"	¹ 2" x 2"	¹ 2" x 2"	½" x 2"	58" x 214"	58" x 214"	58" x 214"	3 ₄ " x 21 ₂ "	3 ₄ " x 21 ₂ "	⁷ 8" x 2½"	⁷ 8" x 2 ¹ 2"	⁷ 8" x 2 ¹ 2"	1" x 2 ³ 4"	1" x 2 ³ 4"	1" x 2 ³ 4"	1" x 2 ³ 4"	1" x 2 ³ 4"	1" x 2 ³ 4"

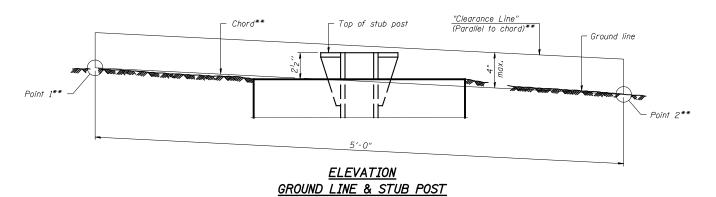

- ① Quantity includes all concrete necessary for one foundation.
- ② Includes reinforcement bars and spiral hooping for one foundation.

** For all "Point 1" and "Point 2" locations, "Clearance Line" must be at or above top of stub post.

BAW-A-2 6 - 1 - 12

FILE NAME =D162A00-sht-sign_stl_post-II.dg PLOT DATE =1/19/2016 PLOT SCALE = 40.0001 ' / in.


CHRISTIAN-ROGE & ASSOCIATES, IN ENGINEERS-PLANNERS-SURVEYORS 221 NORTH LASALLE STRET, SUITE 3 CHICAGO, ILLINOIS 60601 PHONE: (312) 577-3300


INC.	DESIGNED	-	S.J.P.	REVISED -
RS 300	DRAWN	-	B.K.	REVISED -
300	CHECKED	-	M.P.	REVISED -
	DATE	-	JANUARY 18, 2016	REVISED -


STATE OF ILLINOIS **DEPARTMENT OF TRANSPORTATION**

BREAK-AWAY	<u> </u>	VID.	
	_		

COUNTY TOTAL SHEET NO.
WILL 184 79
CONTRACT NO. 62A00 F.A.I. RTE. 55 SECTION DE FLANGE 2014-065-R STEEL SIGN POST TABLES SCALE: NONE SHEET NO. 2 OF 2 SHEETS STA. TO STA. FED. ROAD DIST. NO. 1 ILLINOIS FED. AID PROJECT

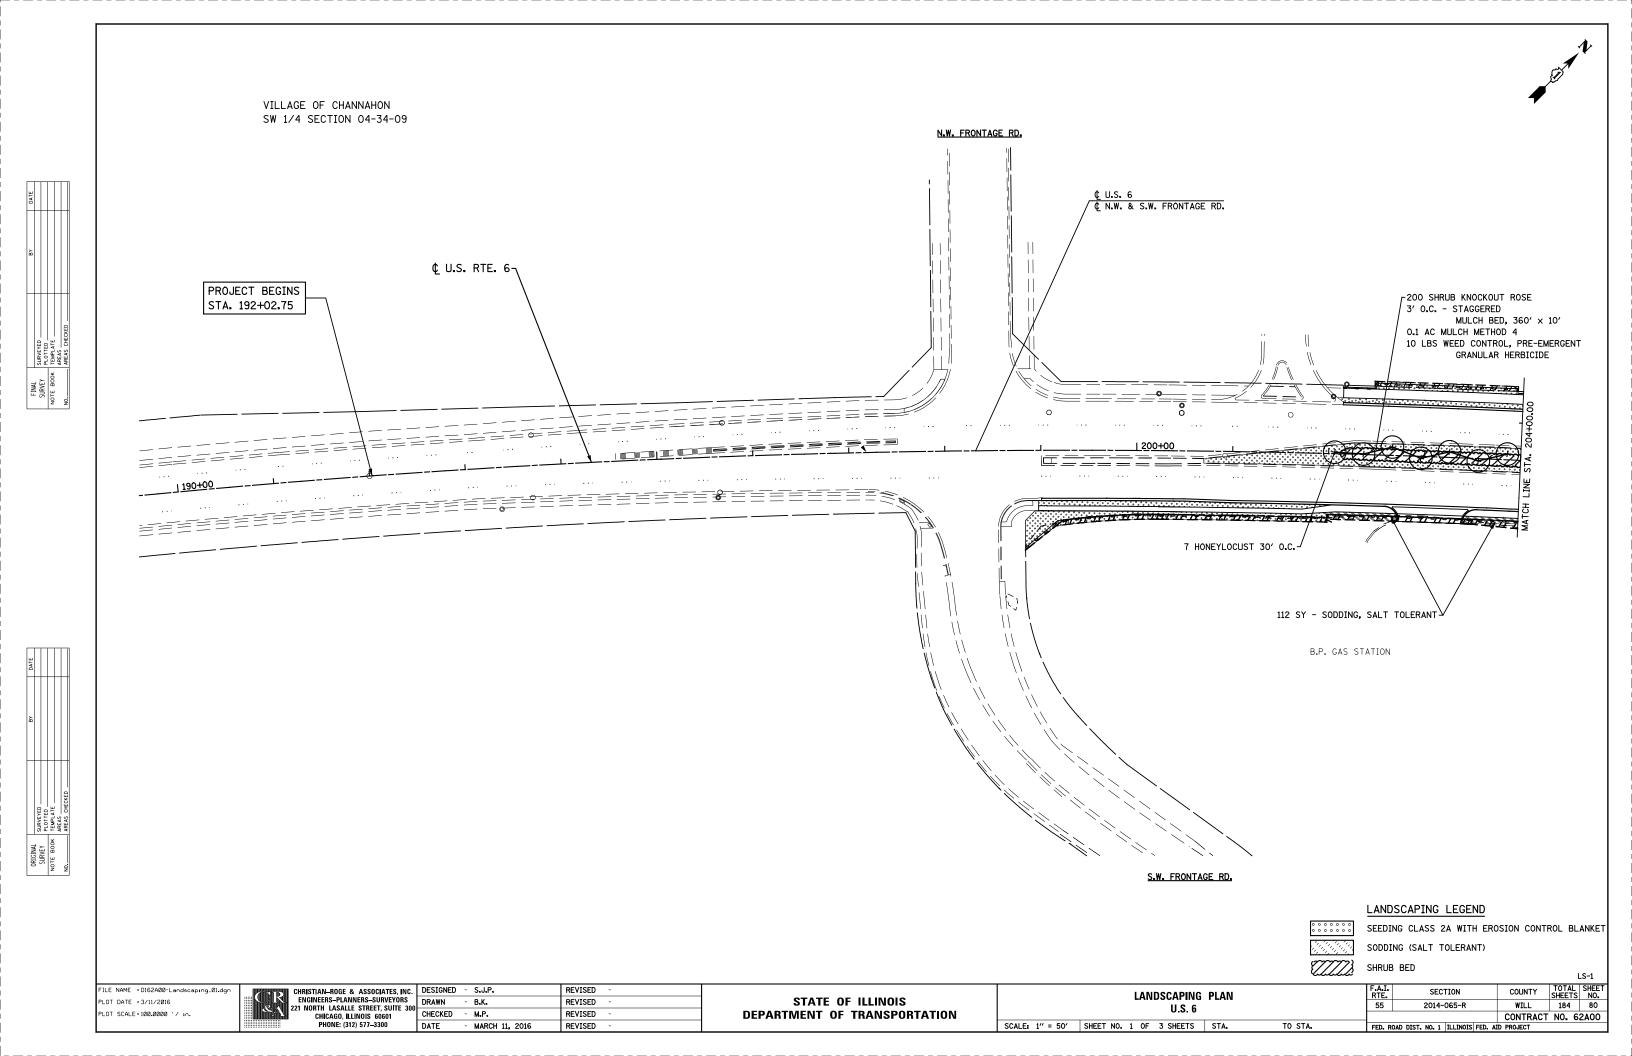

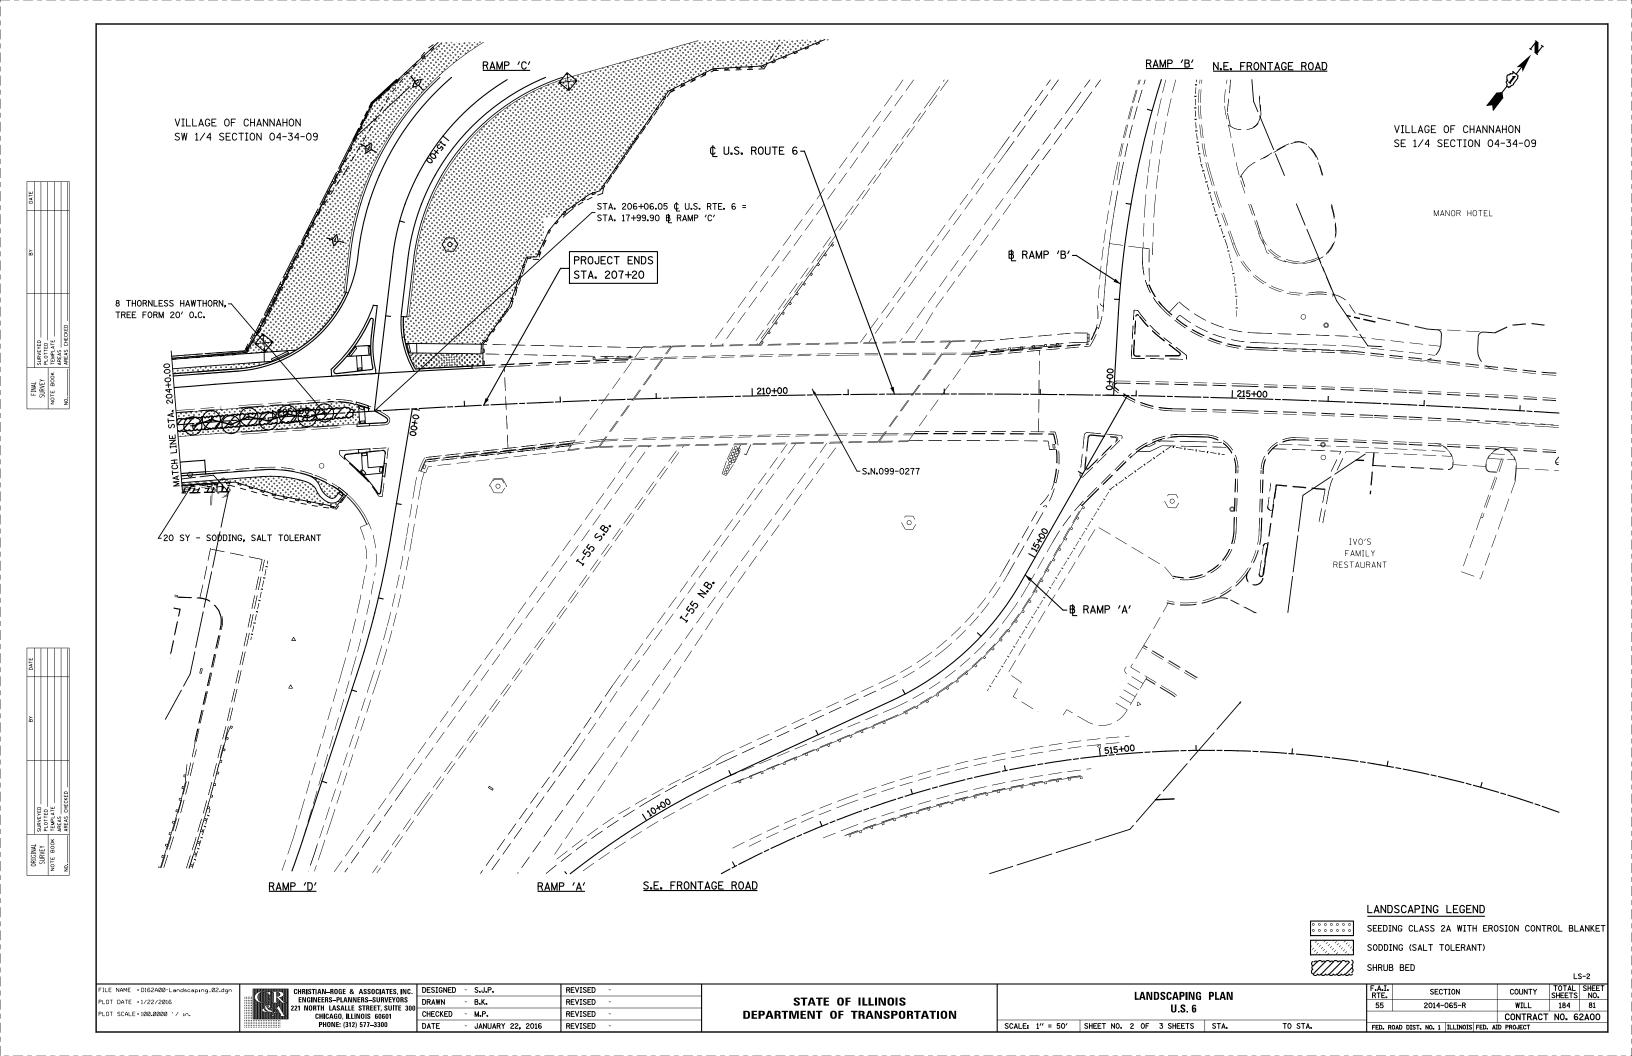

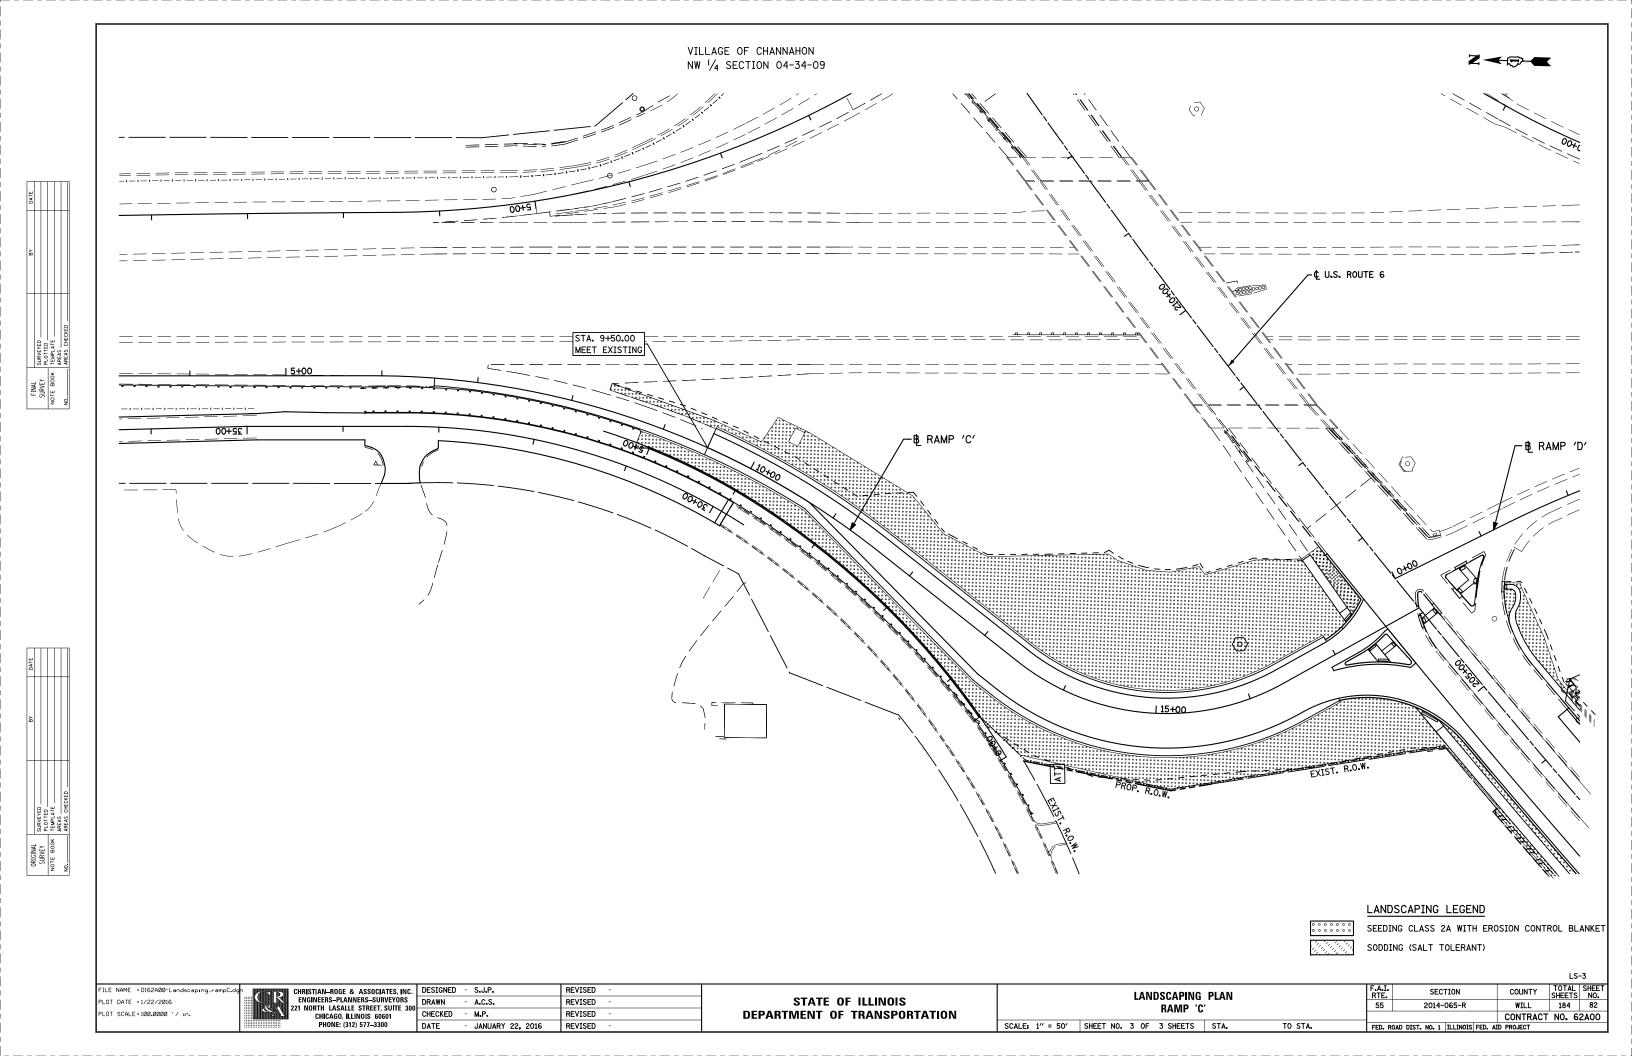


TRAFFIC SIGNAL LEGEND

ITEM	REMOVAL	EXISTING	PROPOSED	ITEM	REMOVAL	EXISTING	PROPOSED	ITEM	REMOVAL	EXISTING	PROPOSED
CONTROLLER CABINET	R			EMERGENCY VEHICLE LIGHT DETECTOR	R≪	\ll	~	ELECTRIC CABLE IN CONDUIT, TRACER, NO. 14 1/C, UNLESS NOTED OTHERWISE			
AILROAD CONTROL CABINET				CONFIRMATION BEACON	R_{O-O}	○ —(]	•			\prec	
MMUNICATIONS CABINET	C C	E C C	CC	HANDHOLE	R □			COAXIAL CABLE		<u></u>	<u> </u>
STER CONTROLLER		EMC	MC		R		_	VENDOR CABLE FOR CAMERA			
STER MASTER CONTROLLER	R	EMMC	MMC	HEAVY DUTY HANDHOLE		Н	H	COPPER INTERCONNECT CABLE,		<i>,</i> ,	
NINTERRUPTABLE POWER SUPPLY	UPS	EUPS	UPS	DOUBLE HANDHOLE	R O		0	NO. 18 3 PAIR TWISTED, SHIELDED		<u> </u>	_6_
RVICE INSTALLATION, POLE OR (G) GROUND MOUNT	-□- ^R	-□ ^P	- <u>P</u>	JUNCTION BOX UNDERGROUND CONDUIT.	\big 		v	FIBER OPTIC CABLE		—(12F)—	
LEPHONE CONNECTION POLE OR (G) GROUND MOUNT	R	Р	P	GALVANIZED STEEL (UC) TEMPORARY SPAN WIRE, TETHER WIRE,	R			NO. 62.5/125, MM12F FIBER OPTIC CABLE NO. 62.5/125, MM12F SM12F		— <u>(24</u> F)—	<u> </u>
EEL MAST ARM ASSEMBLY AND POLE	R	0	•	AND CABLE				NO. 02.37123, WWIZI SWIZI		,	
UMINUM MAST ARM ASSEMBLY AND POLE	R	0		COMMON TRENCH			СТ	FIBER OPTIC CABLE NO. 62.5/125, MM12F SM24F		—36F—	—(36F)—
EEL COMBINATION MAST ARM SEMBLY AND POLE WITH LUMINAIRE	^R O¤	O-¤	• × ·	COILABLE NONMETALLIC CONDUIT (EMPTY)			CNC	GROUND ROD AT (C) CONTROLLER.			
EEL COMBINATION MAST ARM SEMBLY AND POLE WITH PTZ CAMERA	R [PTZ]	Q	PTZ	SYSTEM ITEM INTERSECTION ITEM		S	S IP	(H) HANDHOLE, (P) POST, (M) MAST ARM, OR (S) SERVICE		C	^C ıl —•
SNAL POST	_	0	•	REMOVE ITEM	R			CONTROLLER CABINET AND	RCF		
MPORARY WOOD POLE (CLASS 5 OR	R ○ R⊗	⊗	⊗	RELOCATE ITEM	RL			FOUNDATION TO BE REMOVED			
TTER) 45 FOOT (13.7m) MINIMUM				ABANDON ITEM	А			STEEL MAST ARM POLE AND FOUNDATION TO BE REMOVED	ORMF		
Y WIRE	>R	>	>	12" (300mm) TRAFFIC SIGNAL SECTION		R	R	ALUMINUM MAST ARM POLE AND	RMF		
SNAL HEAD	R →	\rightarrow	-	12" (300mm) RED WITH 8" (200mm)		R		FOUNDATION TO BE REMOVED	0		
NAL HEAD CONSTRUCTION STAGES MBERS INDICATE THE CONSTRUCTION STAGE)			→ ²	YELLOW AND GREEN TRAFFIC SIGNAL FACE			R	STEEL COMBINATION MAST ARM ASSEMBLY AND POLE WITH LUMINAIRE AND FOUNDATION TO BE REMOVED	RMF ○-¤——		
NAL HEAD WITH BACKPLATE	+\(\sigma\)	+->	+-			\bigcirc	Y				
NAL HEAD OPTICALLY PROGRAMMED	R →⊃′′P′′	— ▽ ′′p′′	-► "P"	SIGNAL FACE		<u>G</u>	G ◆ Y	SIGNAL POST AND FOUNDATION TO BE REMOVED	RPF O		
ASHER INSTALLATION DENOTES SOLAR POWER)	R ○>''F''	O-⊳" ^F "	●→ "F"			C C	◆ G	INTERSECTION & SAMPLING (SYSTEM) DETECTOR		[IS]	IS
DESTRIAN SIGNAL HEAD	R -∐	-0	-1			R	R	SAMPLING (SYSTEM) DETECTOR		[s]	S
DESTRIAN PUSHBUTTON DETECTOR	R	©	©	SIGNAL FACE WITH BACKPLATE. "P" INDICATES PROGRAMMED HEAD			Y G	QUEUE DETECTOR		<u>[a]</u>	Q
CESSIBLE PEDESTRIAN PUSHBUTTON DETECTOR	R APS		APS	"RB" INDICATES REFLECTIVE BACKPLATE		(+ y) (+ G)	← Y				
UMINATED SIGN	R					"P"	"P"	PREFORMED QUEUE DETECTOR		ÎPQÎ	PO
) LEFT TURN"		•	\odot	12" (300mm) PEDESTRIAN SIGNAL HEAD		OW) W		PREFORMED INTERSECTION AND SAMPLING		PIS	PIS
LUMINATED SIGN O RIGHT TURN''	R			WALK/DON'T WALK SYMBOL 12" (300mm) PEDESTRIAN SIGNAL HEAD				(SYSTEM) DETECTOR			
TECTOR LOOP, TYPE I		 		INTERNATIONAL SYMBOL, OUTLINED				PREFORMED SAMPLING (SYSTEM) DETECTOR		ÎPSÎ	PS
FORMED DETECTOR LOOP		1 b ; 33 ,1	P	12" (300mm) PEDESTRIAN SIGNAL HEAD INTERNATIONAL SYMBOL, SOLID		(*	RAILROA	D SYMBO	DLS	
CROWAVE VEHICLE SENSOR	R M	(W)⊅	→	PEDESTRIAN SIGNAL HEAD, INTERNATIONAL SYMBOL, WITH COUNTDOWN TIMER		© C	₽ C			EXISTING	PROPOSED
DEO DETECTION CAMERA	R [V]j	[Vþ	V ■	STANSOE, ATTACOUNT OF THE INC.				DAY DOAD CONTDO: CASTAST			
	ΓΛħ			RADIO INTERCONNECT	## * O	###0	 •	RAILROAD CONTROL CABINET			
EO DETECTION ZONE				RADIO REPEATER	RERR	ERR	RR	RAILROAD CANTILEVER MAST ARM	Σ	X OX X X	XXX
, TILT, ZOOM CAMERA	r Pīzļi	PTZ[1	<u>PTZ</u> ¶	DENOTES NUMBER OF CONDUCTORS, ELECTRIC		-/		FLASHING SIGNAL		$\times \ominus \times$	XOX
RELESS DETECTOR SENSOR	R(W)	(W)	(W)	CABLE NO. 14, UNLESS NOTED OTHERWISE, ALL DETECTOR LOOP CABLE TO BE SHIELDED				CROSSING GATE		\\\\\\\\\\\\\\\\\\\\\\\\\\\\\\\\\\\\\	***
RELESS ACCESS POINT	R D		w)	GROUND CABLE IN CONDUIT NO. 6 SOLID COPPER (GREEN)		1	1	CROSSBUCK		≥	*
NAME = USER NAME = footemj	DE	ESIGNED - DAG/BCK		- DAG 1-1-14		· 		DISTRICT ONE	F.A.I. RTE.	SECTION	COUNTY TOTAL
.work\pwidot\footemj\d0108315\ts05.dgn PLOT SCALE = 50.0000 '		RAWN - BCK HECKED - DAD	REVISED REVISED		OF ILLINOI	S		STANDARD TRAFFIC SIGNAL DESIGN DETAILS	55	2014-065-R	WILL 184


LOOP DETECTOR NOTES

- 1. EACH PAIR OF LOOP WIRES SHALL BE PLACED IN A SEPARATE EMPTY COILABLE NONMETALLIC CONDUIT FROM THE EDGE OF PAVEMENT TO THE HANDHOLE. SPACING BETWEEN THE HOLES DRILLED IN THE PAVEMENT SHALL NOT BE LESS THAN 6" (150 mm). EMPTY COILABLE NONMETALLIC CONDUIT SHALL BE INCLUDED IN THE COST OF THE LOOP WIRE.
- 2. THE NUMBER OF LOOP TURNS SHALL BE AS RECOMMENDED BY THE AMPLIFIER MANUFACTURER. ALL ADJACENT SIDES OF THE LOOPS SHALL BE INSTALLED IN SUCH A WAY THAT THE CURRENT FLOW IS IN THE SAME DIRECTION TO REINFORCE ITS MAGNETIC FIELDS FOR SMALL VEHICLE DETECTION.
- 3. EACH LOOP LEAD-IN SHALL BE IDENTIFIED AND PERMANENTLY TAGGED IN THE HANDHOLE. EACH LEAD-IN CABLE TAG SHALL INDICATE THE LOCATION OF THE LOOP, LOOP ROTATION (CLOCKWISE/COUNTERCLOCKWISE), LOOP LEAD-IN DIRECTION (IN OR OUT), LOOP CABLE NUMBER AND LOCATION IN CABINET, AND NUMBER OF TURNS IN THE DETECTOR LOOPS IN WATER PROOF INK AS INDICATED ON THE DISTRICT 1 STANDARD TRAFFIC SIGNAL DESIGN DETAIL. THE CONTRACTOR SHALL MARK LOOP LOCATIONS ON RECORD DRAWINGS AND PRESENT TO THE ENGINEER AFTER FINAL INSPECTION. LOOPS SHALL BE MARKED BY LANE AND LOOP NUMBER. SEE DETAIL BELOW.
- 4. ALL LOOP CABLE SHALL BE FASTENED WITH PLASTIC TIE WRAP TO THE HANDHOLE HOOKS.
- 5. IN ASPHALT PAVEMENT, LOOPS SHOULD BE PLACED IN THE BINDER AND DIVEHOLES MARKED AT THE CURB WITH A SAW-CUT. THE SAW-CUT SHALL BE CUT IN ACCORDANCE WITH LOCAL AND E.P.A. DUST CONTROL REQUIREMENTS. DETECTOR LOOP(S) SHALL NOT BE INSTALLED IN WET CONDITIONS AND THE SAW-CUTS MUST BE FREE OF DEBRIS AND RESIDUE SUCH AS DUST AND WATER WHICH IS TO BE ACHIEVED BY THE USE OF COMPRESSED AIR, WIRE BRUSHING AND HEAT DRYING ACCORDING TO SEALANT MANUFACTURER REQUIREMENTS. THE DETECTOR WIRE SHALL BE HELD IN PLACE BY THE USE OF FORM WEDGES. WEDGES SHALL BE SPACED NO MORE THAN 18" (450 mm) APART.
- 6. LOOP SPLICES SHALL BE SOLDERED USING A SOLDERING IRON. BLOW TORCHES OR OTHER DEVICES WHICH OXIDIZE COPPER CABLE SHALL NOT BE ALLOWED FOR SOLDERING OPERATIONS. SEE DETAIL BELOW RIGHT.
- 7. PREFORMED DETECTOR LOOPS SHALL BE USED, AS SHOWN ON THE PLANS, WHERE NEW CONCRETE PAVEMENT IS PROPOSED. THE INSTALLATION OF PREFORMED LOOPS SHALL BE IN ACCORDANCE WITH THE DISTRICT 1 SPECIFICATIONS OR AS DIRECTED BY THE ENGINEER.

LOOP LEAD-IN CABLE TAG

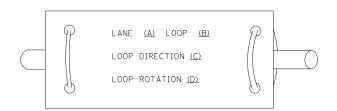



- A. LANE 1 IS THE LANE CLOSEST TO THE CENTERLINE OF THE ROADWAY
- B. LOOP #1 IS THE LOOP IN THE LANE CLOSEST TO THE INTERSECTION.
- C. LABEL LOOP CABLE "IN" OR LOOP CABLE "OUT".
- D. LABEL LOOP CABLE CLOCKWISE OR LOOP CABLE COUNTERCLOCKWISE.

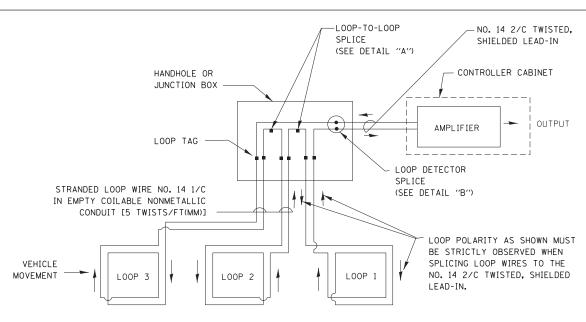

DETECTOR LOOP WIRING SCHEMATIC

- LOOPS SHALL BE SPLICED IN SERIES.
- SAW-CUTS SHALL BE A MINIMUM WIDTH OF 5/16" (8 mm).
- SAW-CUT DEPTHS SHALL BE 3" (75 mm), IE IN CONCRETE. THE SAW-CUT DEPTH SHALL BE TO THE TOP OF THE REINFORCEMENT.
- LOOP CORNERS SHALL BE DRILLED WITH A 2" (50 mm) DIAMETER CORE.

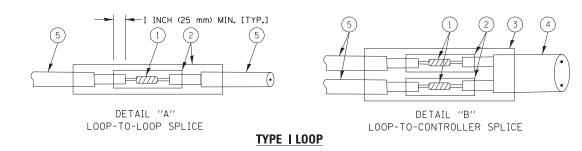

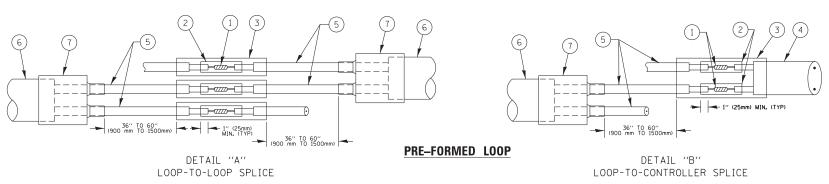

LOOP DETECTOR SPLICE

- (1) WESTERN UNION SPLICE SOLDERED WITH ROSIN CORE FLUX. ALL EXPOSED SURFACES OF THE SOLDER SHALL BE SMOOTH. THE WESTERN UNION SPLICES SHALL BE STAGGERED.
- (2) WCSMW 30/100 HEAT SHRINK TUBE, MINIMUM LENGTH 3" (75 mm), UNDERWATER GRADE.
- (3) WCS 200/750 HEAT SHRINK TUBE, MINIMUM LENGHT 6" (150 mm), UNDERWATER GRADE.

SCALE: NONE

(4) NO. 14 2/C TWISTED, SHIELDED CABLE.


- 5 LOOP CONDUCTOR WITH FLEXIBLE PLASTIC TUBE.
- 6 PRE-FORMED LOOP
- XL POLYOLEFIN 2 CONDUCTOR BREAKOUT SEALS. TYCO CBR-2 OR APPROVED EQUAL

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	PLOT DATE = 1/13/2014	DATE	-	10-28-09	REVISED	-

STATE OF ILLINOIS **DEPARTMENT OF TRANSPORTATION**

	DI	STRICT OF	NE.		F.A.I. RTE.	SECTION	COUNTY	TOTAL SHEETS	SHEET NO.
				DETAILS	55	2014-065-R	WILL	184	84
STANDARD TRAFFIC SIGNAL DESIGN DETAILS						TS-05	CONTRACT	NO. 62	A00
	SHEET NO 2 OF 7	CHEETS	STA	TO STA	EED D	OAD DICT NO 1 THE INDIC EED A	ID DDO IECT		

TRAFFIC SIGNAL MAST ARM AND SIGNAL POST MAST ARM MOUNTED SIGNALS IN EXISTING, PROPOSED OR FUTURE SIDEWALK BICYCLE PATH AREA. INTERSECTION SHOWN WITH PEDESTRIAN SIGNALS AND PEDESTRIAN PUSHBUTTON DETECTORS.

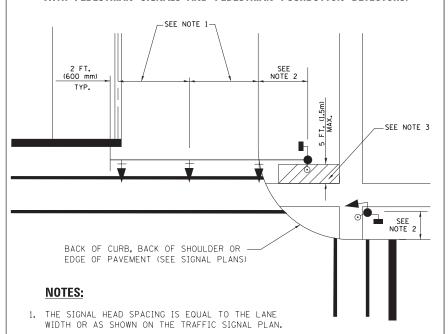


- 2. REFER TO THE TRAFFIC SIGNAL EQUIPMENT OFFSET TABLE.
- PROVIDE A LEVEL ALL-WEATHER SURFACE (CONCRETE SIDEWALK, ASPHALT BICYCLE PATH SURFACE OR MATCHING MATERIAL TO THE ADJACENT SURFACE) UP TO THE MAST ARM SHAFT OR THE SIGNAL POST.
- 4. THE FACE OF THE PEDESTRIAN PUSHBUTTON SHALL BE PARALLEL TO THE CROSSWALK TO BE USED.
- 5. THE LOCATIONS AND INSTALLATION OF PEDESTRIAN SIGNAL HEADS AND PEDESTRIAN PUSHBUTTONS SHALL MEET THE REQUIREMENTS OF THE MUTCD AND INFORMATION FOUND IN THE "AMERICANS WITH DISABILITIES ACT ACCESSIBILITY GUIDELINES FOR BUILDINGS AND FACILITIES."

NOTES:


- PEDESTRIAN SIGNAL HEADS SHALL BE MOUNTED WITH THE BOTTOM OF THE SIGNAL HOUSING INCLUDING BRACKETS NOT LESS THAN 8 FT (2.4 m) OR MORE THAN 10 FT (3 m) ABOVE SIDEWALK LEVEL, AND SHALL BE POSITIONED AND ADJUSTED TO PROVIDE MAXIMUM VISIBILITY AT THE BEGINNING OF THE CONTROLLED CROSSWALK.
- 2. THE BOTTOM OF THE SIGNAL HOUSING (INCLUDING BRACKETS) OF A VEHICULAR SIGNAL FACE THAT IS NOT LOCATED OVER A HIGHWAY SHALL BE AT LEAST 8 FT (2.4 m) BUT NOT MORE THAN 19 FT (5.8 m) ABOVE THE SIDEWALK OR, IF THERE IS NO SIDEWALK, ABOVE THE PAVEMENT GRADE AT THE CENTER OF THE ROADWAY.
- 3. THE BOTTOM OF THE SIGNAL HOUSING AND ANY RELATED ATTACHMENTS TO A SIGNAL FACE LOCATED OVER ANY PORTION OF A HIGHWAY SHALL BE ACCORDING TO CURRENT STATE STANDARDS 877001, 877002, 877006, 877011 AND 877012 WITH A MINIMUM OF 16 FT (5.0 m) AND A MAXIMUM OF 18 FT. (5.5 m) FROM THE HIGHEST POINT OF PAVEMENT.
- 4. THE BOTTOM OF THE TEMPORARY SPAN WIRE MOUNTED SIGNAL HOUSING AND ANY RELATED ATTACHMENTS TO A SIGNAL FACE LOCATED OVER ANY PORTION OF A HIGHWAY SHALL BE ACCORDING TO CURRENT STATE STANDARD 880001 WITH A MINIMUM OF 17 FT (5.18 m) FROM THE HIGHEST POINT OF PAVEMENT.
- THE TOP OF THE SIGNAL HOUSING OF A SIGNAL FACE LOCATED OVER ANY PORTION OF A HIGHWAY SHALL NOT BE MORE THAN 25.6 FT (7.8 m) ABOVE THE PAYEMENT.

PEDESTRIAN SIGNAL POST AND PEDESTRIAN PUSH BUTTON POST

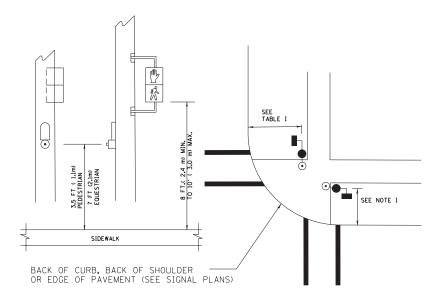

NOTES:

- 1. REFER TO THE TRAFFIC SIGNAL EQUIPMENT OFFSET TABLE.
- 2. PROVIDE A LEVEL ALL-WEATHER SURFACE (CONCRETE SIDEWALK, ASPHALT BICYCLE PATH SURFACE OR MATCHING MATERIAL TO THE ADJACENT SURFACE) UP TO THE PEDESTRIAN SIGNAL POST OR THE PEDESTRIAN PUSH BUTTON POST.
- 3. THE FACE OF THE PEDESTRIAN PUSHBUTTON SHALL BE PARALLEL TO THE CROSSWALK TO BE USED.
- 4. THE LOCATIONS AND INSTALLATION OF PEDESTRIAN SIGNAL HEADS AND PEDESTRIAN PUSHBUTTONS SHALL MEET THE REQUIREMENTS OF THE MUTCD AND INFORMATION FOUND IN THE "AMERICANS WITH DISABILITIES ACT ACCESSIBILITY GUIDELINES FOR

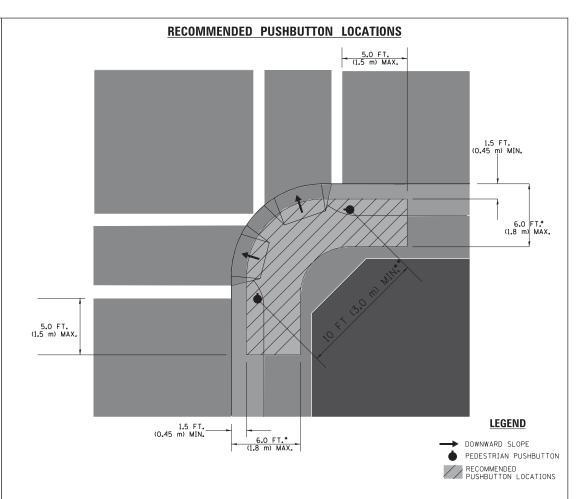

- WHERE THERE ARE CONSTRAINTS THAT MAKE IT IMPRACTICAL TO PLACE THE PEDESTRIAN PUSHBUTTON BETWEEN 1.5 FT (0.45 m) AND 6 FT (1.8 m) FROM THE EDGE OF THE CURB, SHOULDER, OR PAVEMENT, IT SHOULD NOT BE FURTHER THAN 10 FT (3 m) FROM THE EDGE OF CURB, SHOULDER, OR PAVEMENT.
- •• WHERE THERE ARE CONSTRAINTS ON A PARTICULAR CORNER THAT MAKE IT IMPRACTICAL TO PROVIDE THE 10 FT (3 m) SEPERATION BETWEEN THE TWO PEDESTRIAN PUSHBUTTONS, THE PUSHBUTTONS MAY BE PLACED CLOSER TOGETHER OR ON THE SAME POLE.

COUNTY

WILL

184 85

CONTRACT NO. 62A00

TRAFFIC SIGNAL EQUIPMENT OFFSET


TRAFFIC SIGNAL EQUIPMENT	COMBINATION CONCRETE CURB AND GUTTER (MINIMUM DISTANCE FROM BACK OF CURB TO CENTERLINE OF FOUNDATION)	SHOULDER/NON-CURBED AREA (MINIMUM DISTANCE FROM EDGE OF PAVEMENT TO CENTERLINE OF FOUNDATION)
	CENTEREINE OF FOUNDATION	TO CENTENEINE OF TOUNDATION
TRAFFIC SIGNAL MAST ARM POLE	6 FT (1.8m)	SHOULDER WIDTH + 2 FT (0.6m), MINIMUM 10 FT (3.0m)
TRAFFIC SIGNAL POST	4 FT (1.2m)	SHOULDER WIDTH + 2 FT (0.6m), MINIMUM 10 FT (3.0m)
PEDESTRIAN SIGNAL POST	4 FT (1.2m)	SHOULDER WIDTH + 2 FT (0.6m), MINIMUM 10 FT (3.0m)
PEDESTRIAN PUSHBUTTON POST	4 FT (1.2m)	SHOULDER WIDTH + 2 FT (0.6m), MINIMUM 10 FT (3.0m)
TEMPORARY WOOD POLE	6 FT (1.8m)	SHOULDER WIDTH + 2 FT (0.6m), MINIMUM 10 FT (3.0m)
CONTROLLER CABINET	6 FT (1.8m) MINIMUM DISTANCE SEE NOTE 2	SHOULDER WIDTH + 6 FT (1.8m), MINIMUM 16 FT (4.9m) SEE NOTE 3.
SERVICE INSTALLATION, GROUND MOUNT	6 FT (1.8m) MINIMUM DISTANCE SEE NOTE 2	SHOULDER WIDTH + 6 FT (1.8m), MINIMUM 16 FT (4.9m) SEE NOTE 3.


NOTES:


- 1. CONTACT THE "AREA TRAFFIC SIGNAL MAINTENANCE AND OPERATIONS ENGINEER" FOR ASSISTANCE IN LOCATING THE TRAFFIC SIGNAL EQUIPMENT WHEN THERE ARE CONFLICTS WITH DITCHES OR THE MINIMUM OFFSET DISTANCES CANNOT BE MET.
- 2. MINIMUM DISTANCE FROM THE BACK OF CURB TO THE ROADWAY SIDE OF THE FOUNDATION.
- 3. MINIMUM DISTANCE FROM THE EDGE OF PAVEMENT TOTHE ROADWAY SIDE OF THE FOUNDATION.
- 4. ANY CHANGES TO THE OFFSETS OF THE FOUNDATIONS, FROM THE MINIMUM DISTANCES LISTED IN THE "TRAFFIC SIGNAL EQUIPMENT OFFSET" CHART AND THE TRAFFIC SIGNAL INSTALLATION PLAN, COULD EFFECT THE PLACEMENT OF THE SIGNAL HEADS, PEDESTRIAN SIGNAL HEADS AND THE PEDESTRIAN PUSHBUTTONS. THE SIGNAL HEAD PLACEMENT ON THE MAST ARMS SHALL REMAIN AS PER THE TRAFFIC SIGNAL INSTALLATION PLAN AND THE "TRAFFIC SIGNAL MAST ARM AND SIGNAL POST" DETAIL ABOVE. THE PROPOSED MAST ARM LENGTHS MAY NEED TO BE REVISED TO MEET THE ABOVE REQUIREMENTS. THE PEDESTRIAN SIGNAL HEADS AND PEDESTRIAN PUSHBUTTONS MUST MEET THE REQUIREMENTS UNDER THE DETAILS ON THIS SHEET.

DAG 1-1-14 FILE NAME : DESIGNED -DAD REVISED USER NAME = footemj SECTION DISTRICT ONE c:\pw_work\pwidot\footem.j\d0108315\ts05 STATE OF ILLINOIS DRAWN BCK REVISED 55 2014-065-R STANDARD TRAFFIC SIGNAL DESIGN DETAILS LOT SCALE = 50.0000 '/ in. HECKED DAD REVISED **DEPARTMENT OF TRANSPORTATION** TS-05 SCALE: NONE SHEET NO. 3 OF 7 SHEETS STA. PLOT DATE = 1/13/2014 DATE 10-28-09 REVISED FED. ROAD DIST. NO. 1 IL

or 1 1/12/2014 1 1/2 20 PM 4/1

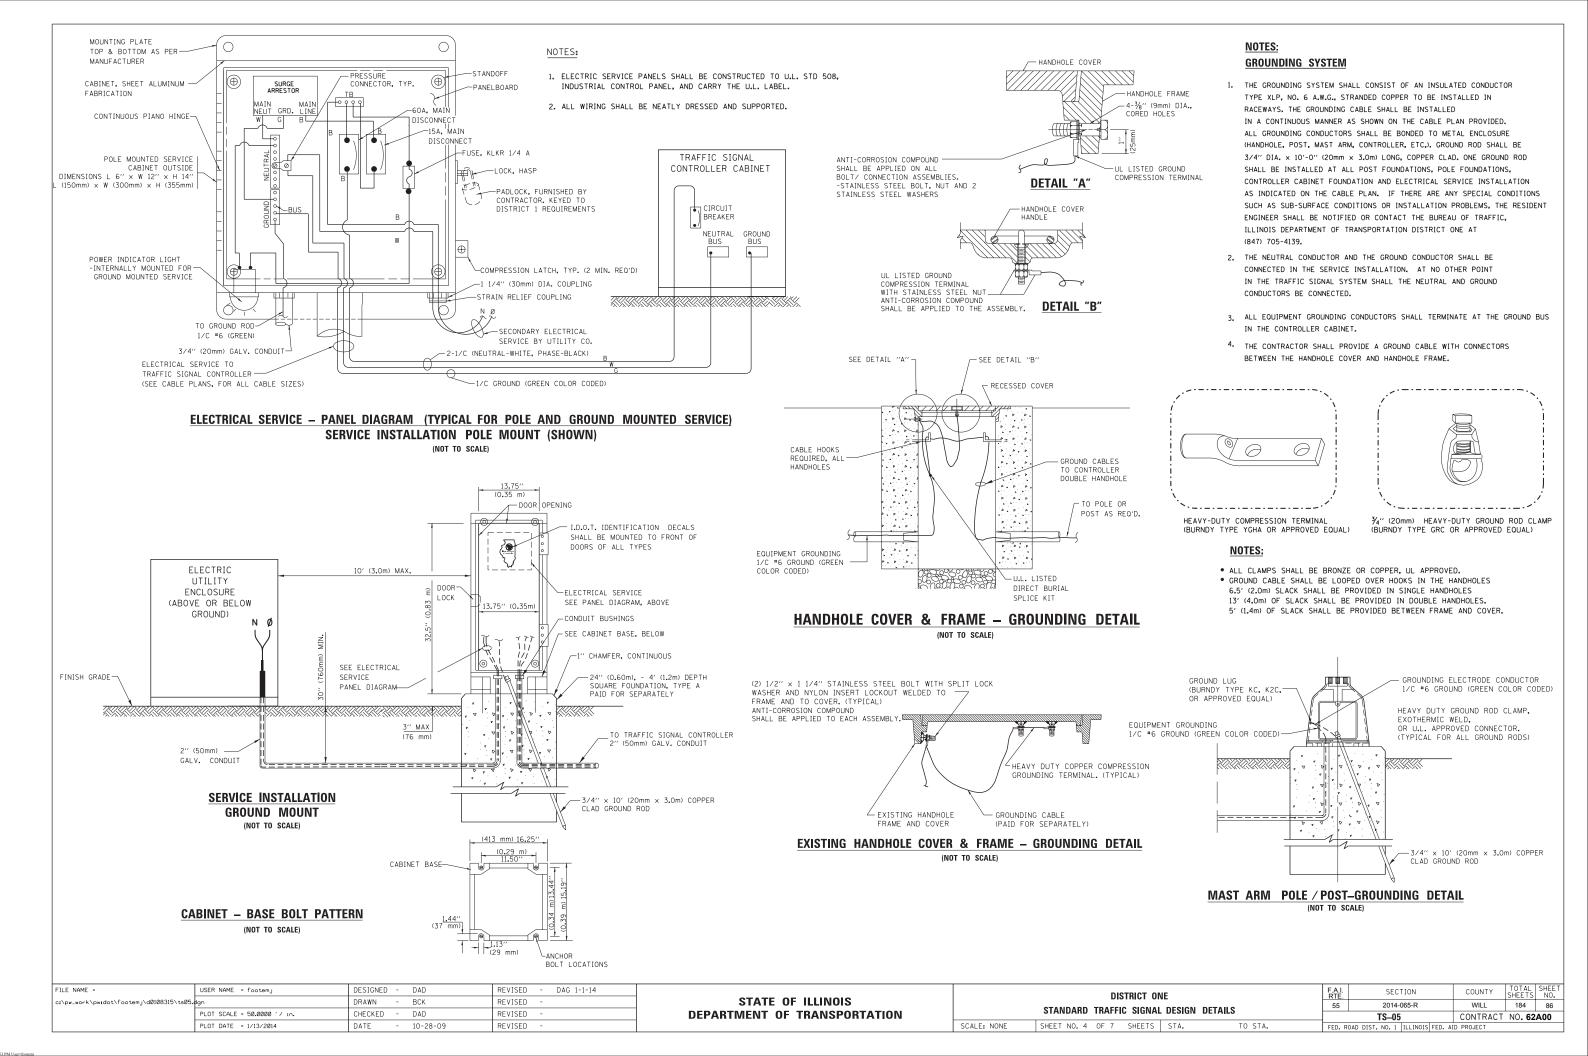

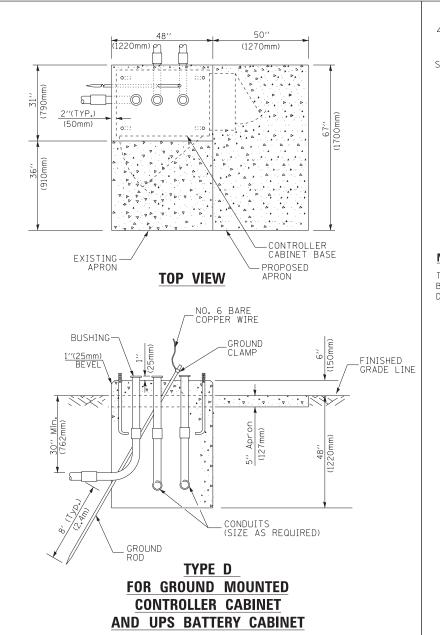

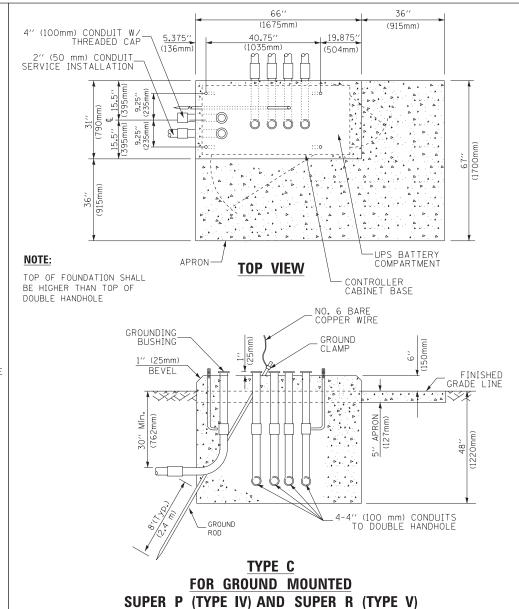

CONTROLLER CABINETS

-	65'' (SEE_NOTE_4) (1651mm)
	49" (SEE NOTE 3) (1245mm) 44" 16"
2,′, (51mm)	44'' 16'' (406mm)
1	21/2"
775 375	(64mm) TEXTE II
8 199	(25mm)
* 	2" × 6"
2″. (51mm)	(51mm x 152mm) WOOD FRAMING (TYP.)
T	
	===7
TRAFFIC SIGNAL CONTROLLER CABINET	
¾′′ (19mm) TREATED	CADINET
PHYWOOD DECK	
2" × 6" (51mm × 152mm) TREATED WOOD	• •
- 1 + + +	
2" MIN. 305mm)	
48" MIN ((1219mm)	· <u>-</u>
(121)	- - - - - - - - - -
6" × 6" (152mm × 152mm)	
NOTES: TREATED WOOD POSTS	L_J
. BASED ON CONTROLLER CABINET TYPE IV WITH BASE	SE DIMENSIONS OF 26" x 44" (660mm x 1118mm).

- BASED ON CONTROLLER CABINET TYPE IV WITH BASE DIMENSIONS OF 26" x 44" ADJUST PLATFORM SIZE TO FIT CABINET BASE DIMENSIONS BEING SUPPLIED
- 2. BASED ON UNINTERRUPTIBLE POWER SUPPLY CABINET WITH BASE DIMENSIONS OF 16" x 25" (406mm x 635mm). ADJUST PLATFORM SIZE TO FIT CABINET BASE DIMENSIONS BEING SUPPLIED.
- 3. PLATFORM SIZE FOR CONTROLLER CABINET TYPE IV.
- 4. PLATFORM SIZE FOR CONTROLLER CABINET TYPE IV AND UNINTERRUPTIBLE POWER SUPPLY CABINET.
- 5. DRILLED HOLES THROUGH THE PLATFORM BASE TO MATCH THE CONTROLLER CABINET BOLT TEMPLATE. FASTEN THE CONTROLLER CABINET TO THE PLATFORM WITH CARRIAGE BOLTS, WASHERS AND NUTS.
- 6. FASTEN ALL SUPPORT WOOD FRAMING TO THE WOOD POSTS WITH 2 LAG SCREWS FOR EACH CONNECTION.

TEMPORARY SIGNAL CONTROLLER **WOOD SUPPORT PLATFORM**

CABLE SLACK LENGTH	FEET	METER
HANDHOLE	6.5	2.0
DOUBLE HANDHOLE	13.0	4.0
SIGNAL POST	2.0	0.6
MAST ARM	2.0	0.6
CONTROLLER CABINET	1.5	0.5
FIBER OPTIC AT CABINET	13.0	4.0
ELECTRIC SERVICE AT (CABINET OR SERVICE LOCATION)	1.5	0.5
GROUND CABLE (SIGNAL POST, MAST ARM, CABINET)	1.5	0.5
GROUND CABLE (BETWEEN FRAME AND COVER)	5.0	1.6

VERTICAL CABLE LENGTH	FEET	METER
MAST ARM POLE (MAST ARM MOUNTED SIGNAL HEAD)		
(L = MAST ARM LENGTH - DISTANCE TO SIGNAL HEAD FROM END OF ARM)	20.0+L	6.0+L
BRACKET MOUNTED (MAST ARM POLE OR SIGNAL POLE)	13.0	4.0
PEDESTRIAN PUSH BUTTON	6.0	2.0
SERVICE INSTALLATION POLE MOUNT TO SERVICE DROP	13.5	4.1
SERVICE INSTALLATION POLE MOUNT TO GROUND	13.5	4.1
SERVICE INSTALLATION GROUND MOUNT	6.0	2.0
FOUNDATION (SIGNAL POST, MAST ARM POLE, CONTROLLER CABINET, SERVICE-GROUND MOUNT)	3.0	1.0

VERTICAL CABLE LENGTH

CABLE SLACK

	FEET	METER	
ROM END OF ARM)	20.0+L	6.0+L	
	13.0	4.0	
	6.0	2.0	
	13.5	4.1	
<u> </u>	13.5	4.1	
	6.0	2.0	
ER CABINET, SERVICE-GROUND MOUNT)	3.0	1.0	

DEPTH OF FOUNDATION

FOUNDATION TYPE A - Signal Post TYPE C - CONTROLLER W/ UPS TYPE D - CONTROLLER SERVICE INSTALLATION, GROUND MOUNT, TYPE A - SQUARE

Mast Arm Length	① Foundation Depth	Foundation Diameter	Spiral Diameter	Quantity of Rebars	Size of Rebars
Less than 30′ (9.1 m)	10'-0'' (3.0 m)	30" (750mm)	24" (600mm)	8	6(19)
Greater than or equal to	13'-6" (4.1 m)	30'' (750mm)	24" (600mm)	8	6(19)
30' (9.1 m) and less than 40' (12.2 m)	11'-0'' (3.4 m)	36'' (900mm)	30" (750mm)	12	7(22)
Greater than or equal to 40' (12.2 m) and less than 50' (15.2 m)	13'-0'' (4.0 m)	36'' (900mm)	30'' (750mm)	12	7(22)
Greater than or equal to 50' (15.2 m) and up to 55' (16.8 m)	15'-0'' (4.6 m)	36'' (900mm)	30'' (750mm)	12	7(22)
Greater than or equal to 56' (16.8 m) and less than 65' (19.8 m)	21'-0" (6.4 m)	42'' (1060mm)	36" (900mm)	16	8(25)
Greater than or equal to 65' (19.8 m) and up to 75' (22.9 m)	25'-0'' (7.6 m)	42'' (1060mm)	36'' (900mm)	16	8(25)


NOTES:

4'-0'' (1.2m)

- 1. These foundation depths are for sites which have cohesive soils (clayey silt, sandy clay, etc.) along the length of the shaft, with an average Unconfined Compressive Strength (Ou) > 1.0 tsf (100 kpa). This strength shall be verified by boring data prior to construction or with testing by the Engineer during foundation drilling. The Bureau of Bridges & structures should be contacted for a revised design if other conditions are encountered.
- 2. Combination mast arm assemblies under 55 feet (16.8 m) shall use 36" (900 mm) diameter foundations.
- 3. Combination mast arm assemblies under 56 feet (16.8 m) through 75 feet (22.9 m) shall use 42" (1060 mm) diameter foundations
- 4. For mast arm assemblies with dual arms refer to state standard 878001...

DEPTH OF MAST ARM FOUNDATIONS, TYPE E


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	PLOT SCALE = 50.0000 ' / in.	CHECKED - DAD	REVISED -	DEPARTMENT OF TRANSPORTATION		STANDARD TRAFFIC SIGNAL DESIGN DETAILS		TS-05	CONTRACT	T NO. 62	2A00
	PLOT DATE = 1/13/2014	DATE - 10-28-09	REVISED -		SCALE: NONE	SHEET NO. 5 OF 7 SHEETS STA. TO STA.	FED. R	DAD DIST. NO. 1 ILLINOIS FED. A	ID PROJECT		

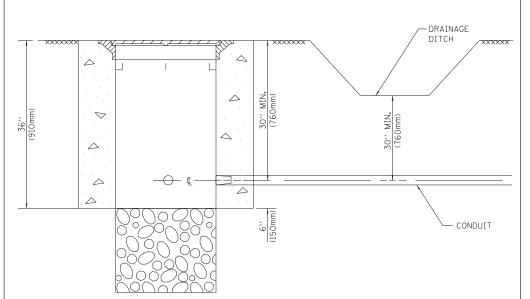

NOTES:

- 1. CONDUIT DEPTH SHALL BE A MINIMUM OF 30" (760mm) BELOW THE BOTTOM OF THE DRAINAGE DITCH OR ANY SLOPING GROUND
- 2. THE MINIMUM CONDUIT DEPTH APPLIES TO ALL CONDUIT PLACED UNDER ROADWAY PAVEMENT, MULTI-USE PATHS, SIDEWALKS AND SOIL SURFACES.
- 3. THE MINIMUM CONDUIT DEPTH APPLIES TO ALL HANDHOLES, HEAVY DUTY HANDHOLES AND DOUBLE HANDHOLES.

HANDHOLE WITH MINIMUM CONDUIT DEPTH (NOT TO SCALE)

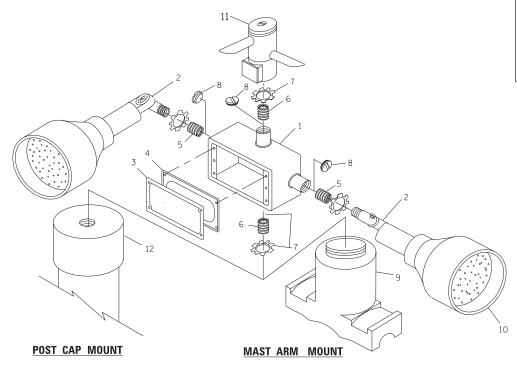

5.375" 40.75" (136mm) (1035mm) (504mm) PROPOSED -APRON -CONTROLLER CABINET BASE **TOP VIEW** NO. 3 DOWEL 18" (450mm) LONG (8 REQ.) BUSHING -GROUND ANCHOR BOLTS FINISHED GRADE LINE 1''(25mm) BEVEL (300mm) -EXISTING CONDUITS EXISTING GROUND ROD

(1675mm)

(915mm) 19**.**875''

MODIFY EXISTING TYPE "D" FOUNDATION TO TYPE "C" FOUNDATION

(NOT TO SCALE

ITEM	NO. IDENTIFICATION
1	OUTLET BOX- GALV. 21 CU.IN. (0.000344 CU-M)
2	LAMP HOLDER AND COVER
3	OUTLET BOX COVER
4	RUBBER COVER GASKET
5	REDUCING BUSHING
6	¾′′(19 mm) CLOSE NIPPLE
7	¾4′′(19 mm) LOCKNUT
8	¾4′′(19 mm) HOLE PLUG
9	SADDLE BRACKET - GALV.
10	6 WATT PAR 38 LED FLOOD LAMP
11	DETECTOR UNIT
12	POST CAP [18 FT. (5.4 m) POST MIN.]

NOTES:

- 1. ALL ELECTRICAL ITEMS, EXCEPT ITEMS #2 AND #11 SHALL BE ALUMINUM OR GALVANIZED
- 2. ITEM #1- OZ/GEDNEY FSX-1-50 OR EQUIVALENT ITEM #2- MULBERRY CON-O-SHADE LAMP SHIELD OR EQUIVALENT ITEM #9- "BAND-IT" SADDLE BRACKET OR EQUIVALENT
- POST CAP MOUNT


 MAST ARM MOUNT

 MOUNT

 MAST ARM MOUNT

 MOUNTING DETAIL

 3. WHEN POST MOUNTING IS SPECIFIED, ITEM *9 SHALL NOT BE REQUIRED. THE DETECTION UNIT SHALL BE MOUNTED DIRECTLY ON TOP OF THE CAP BY DRILLING AND TAPPING A 3/4 "(19 mm) HOLE WITH PIPE THREADS. THE POST CAP SHALL EITHER BE SCREWED TO THE TOP OF THE POST OR A MINIMUM OF 3 TIGHTENING SCREWS SHALL BE REQUIRED ON EACH CAP.

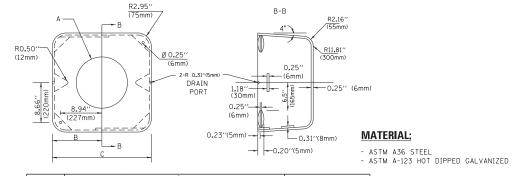



A	В	С	HEIGHT	WEIGHT
VARIES	9.5′′(241mm)	19''(483mm)	7'' (178mm) - 12'' (300mm)	53 lbs (24kg)
VARIES	10.75"(273mm)	21.5"(546mm)	7'' (178mm) - 12'' (300mm)	68 lbs (31 kg)
VARIES	13.0''(330mm)	26''(660mm)	7" (178mm) - 12" (300mm)	81 lbs (37 kg)
VARIES	18.5''(470mm)	37''(940mm)	7" (178mm) - 12" (300mm)	126 lbs (57 kg)

SHROUD

VOTES:

- DIMENSION "A" IS EQUAL TO THE DIAMETER OF THE MAST ARM POLE AT THE TOP OF THE SHROUD.
 THE SHROUD SHALL BE TIGHT TO THE MAST ARM POLE.
- 2. THE SUPPLIER SHALL VERIFIED THE ABOVE DIMENSIONS BASED ON MAST ARM REQUIREMENTS.
- 3. THE HEIGHT OF THE SHROUD SHALL COVER THE ANCHOR BOLTS, NUTS AND MAST ARM POLE BASE.

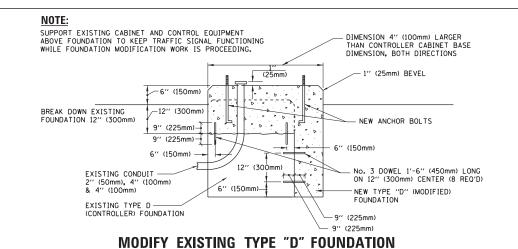

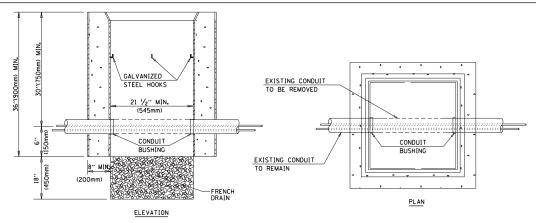

NOTES:

SCALE: NONE


- 1. HANDHOLE CONSTRUCTED PER STATE STANDARD 814001.
- 2. REMOVAL OF THE EXISTING CONDUIT FROM THE HANDHOLE AND THE INSTALLATION OF THE CONDUIT BUSHINGS SHALL BE INCLUDED WITH THE COST OF THE HANDHOLE.


HANDHOLE TO INTERCEPT EXISTING CONDUIT

STATE OF ILLINOIS DEPARTMENT OF TRANSPORTATION

DISTRICT ONE STANDARD TRAFFIC SIGNAL DESIGN DETAILS			F.A.I. RTE.	SECTION	COUNTY	TOTAL SHEETS	SHEET NO.			
			55	2014-065-R	WILL	184	88			
			TS-05 CONTRACT NO. 62A00				A00			
	SHEET NO. 6	OF 7	SHEETS	STA.	TO STA.	FED. R	DAD DIST. NO. 1 ILLINOIS FED. A	ID PROJECT		

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CHRISTIAN-ROGE & ASSOCIATES, INC.
ENGINEERS-PLANNERS-SURVEYORS
211 WEST WACKER DRIVE
CHICAGO, ILLINOIS 60606
PHONE: (312/372-2023 FAX: (312/372-5274
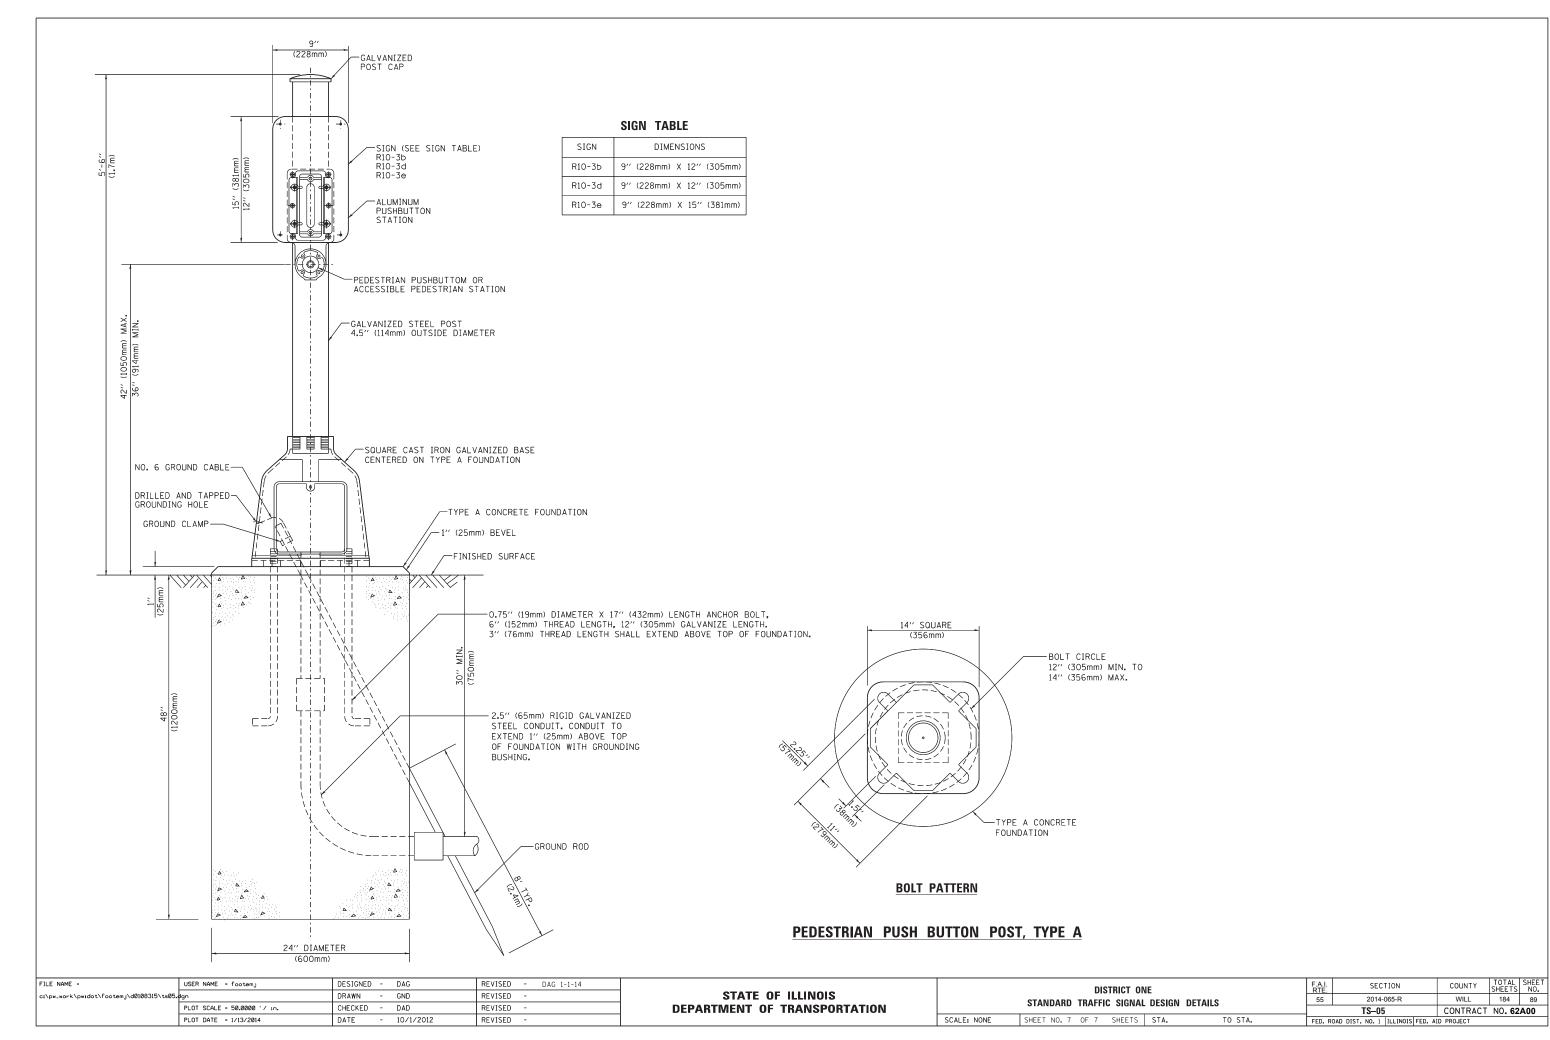
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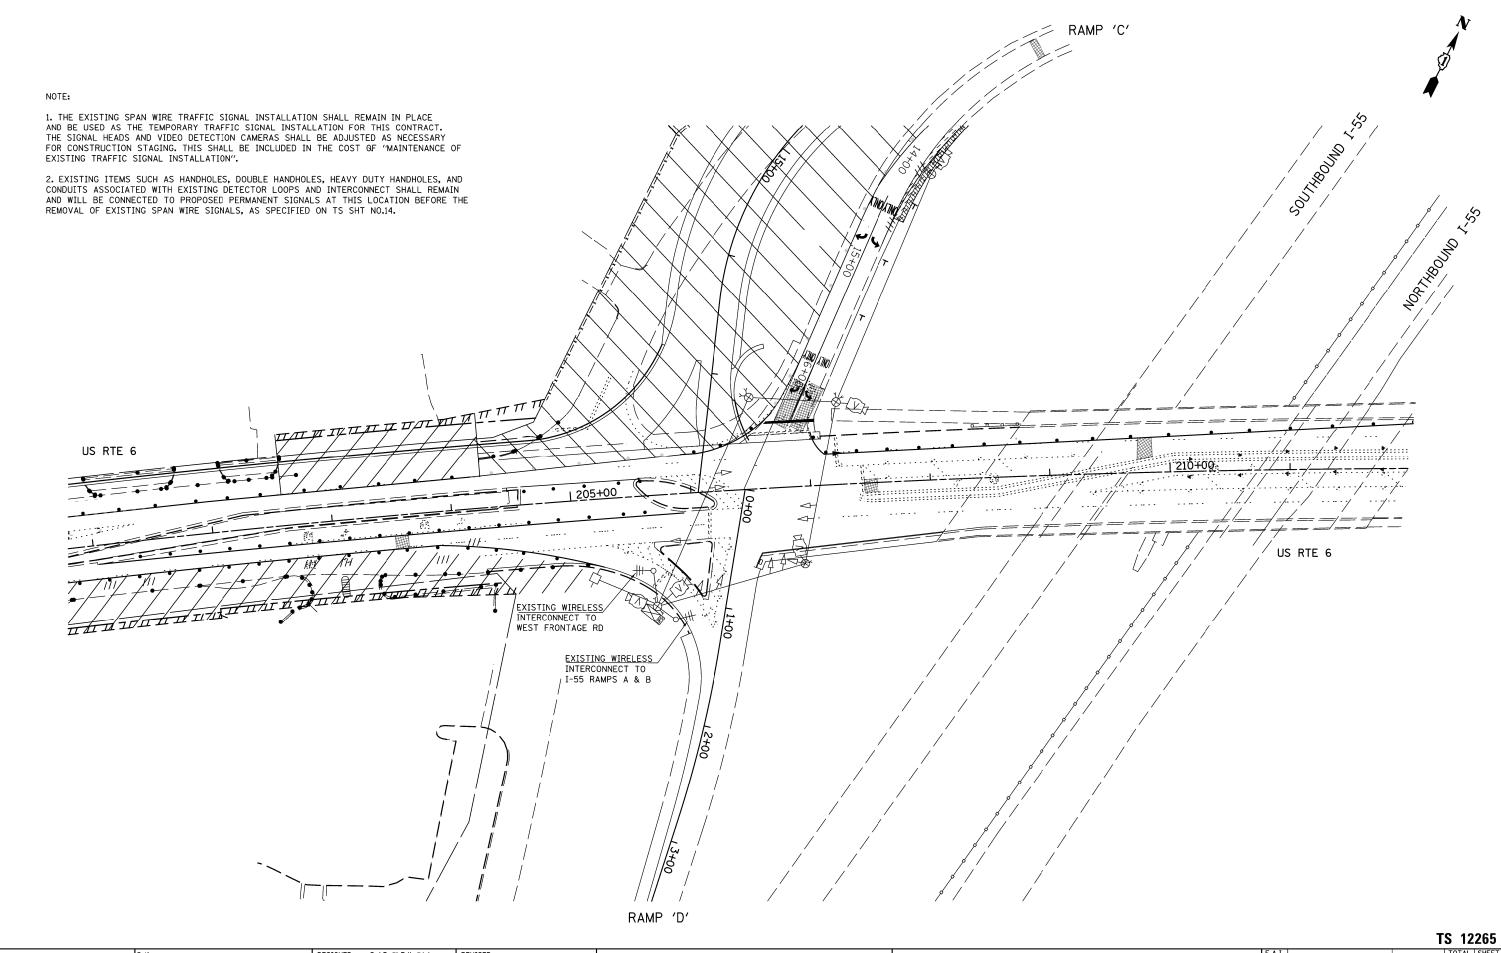
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SPAAN Tech, Inc.

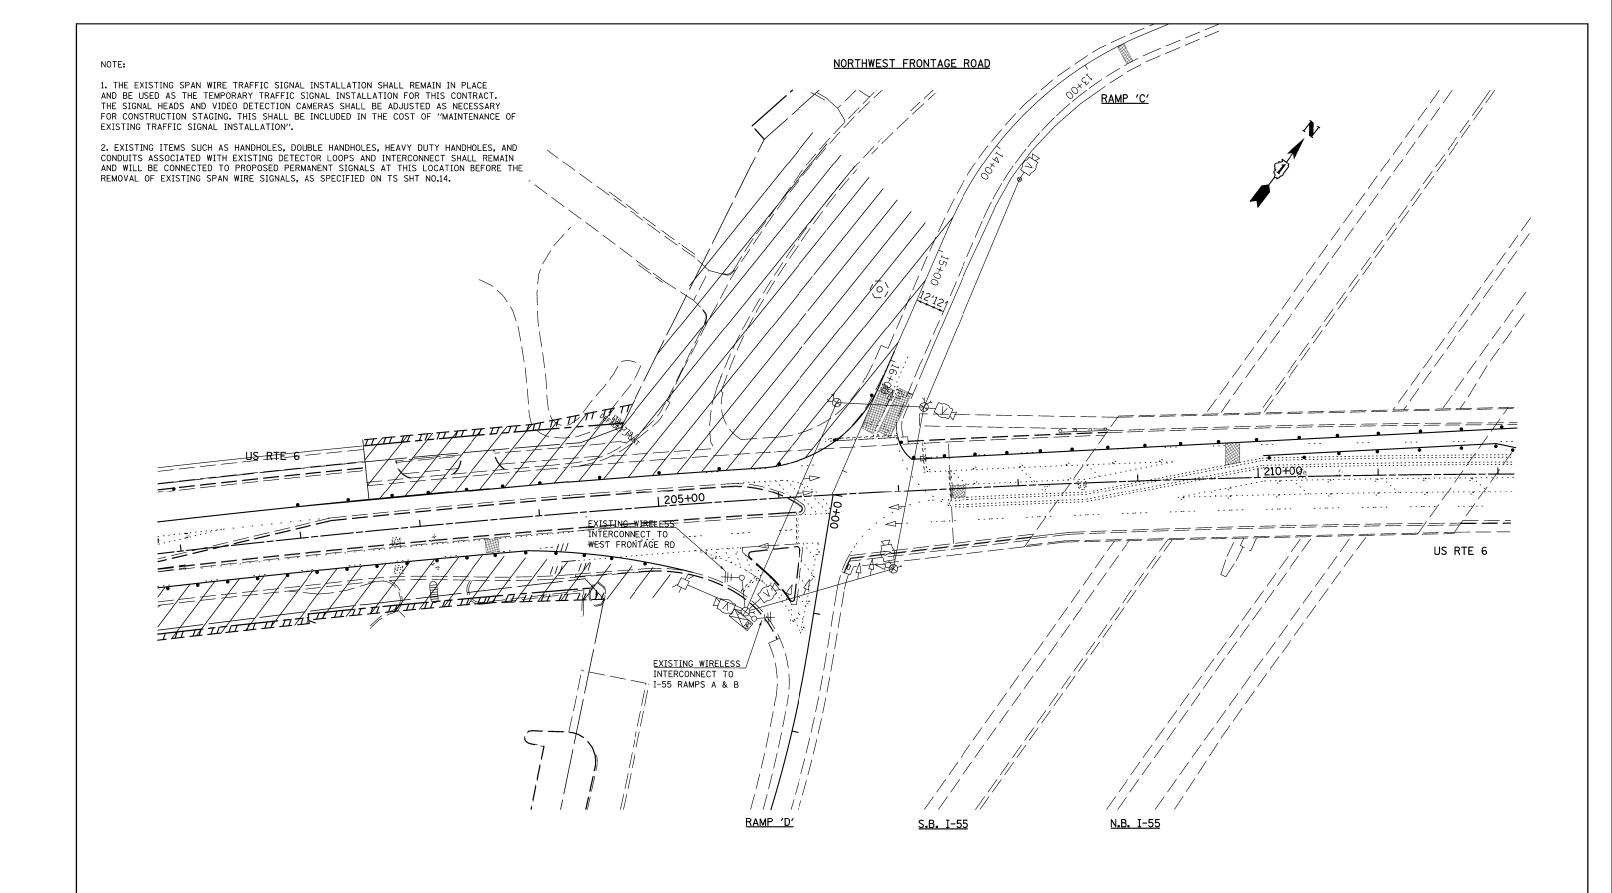DESIGNED - S.J.P./K.R.K./M.A REVISED DRAWN - B.K. REVISED CHECKED - M.P. REVISED - DECEMBER, 2015 DATE REVISED

STATE OF ILLINOIS **DEPARTMENT OF TRANSPORTATION**

COUNTY TOTAL SHEET NO. WILL 184 90 SECTION **EXISTING TEMPORARY TRAFFIC SIGNAL** 55 2014-065-R US RTE 6 AT I-55 RAMPS C & D - STAGE I CONTRACT NO. 62A00 SCALE: 1" = 40' SHEET NO. OF SHEETS STA.



. 1

SHT

CHRISTIAN-HUGE & ASSOCIATES, INC. ENGINEERS-PLANNERS-SURVEYORS 211 WEST WACKER DRIVE CHICAGO, ILLINOIS 60606 HONE: (312)372-2023 FAX: (312)372-527

SPAAN Tech, Inc.

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STATE OF ILLINOIS **DEPARTMENT OF TRANSPORTATION**

EXISTING TEMPORARY TRAFFIC SIGNAL US RTE 6 AT I-55 RAMPS C & D - STAGE IA SHEET NO. OF SHEETS STA. TO STA.

COUNTY TOTAL SHEET NO.
WILL 184 91 SECTION 55 2014-4-065-R CONTRACT NO. 62A00

CHRISTIAN-ROGE & ASSOCIATES, INC.
ENGINEERS-PLANNERS-SURVEYORS
211 WEST WACKER DRIVE
CHICAGO, ILLINOIS 66066

PHONE: (312)372-2023 FAX: (312)372-5274


SPAAN Tech, Inc.

phone: 312,277.880 fax: 312,277.880 web: www.SpaanTech.cor

DESIGNED - S.J.F./K.R.K./M.A REVISED DRAWN - B.K. REVISED
CHECKED - M.P./M.A REVISED
CHECKED - M.P./M.A REVISED
DATE - DECEMBER, 2015 REVISED -

STATE OF ILLINOIS DEPARTMENT OF TRANSPORTATION EXISTING TEMPORARY TRAFFIC SIGNAL AND PROPOSED EXTENSION
US 6 AT RAMP C - STAGE IB

SCALE: 1" = 40' SHEET NO. OF SHEETS STA. TO STA.

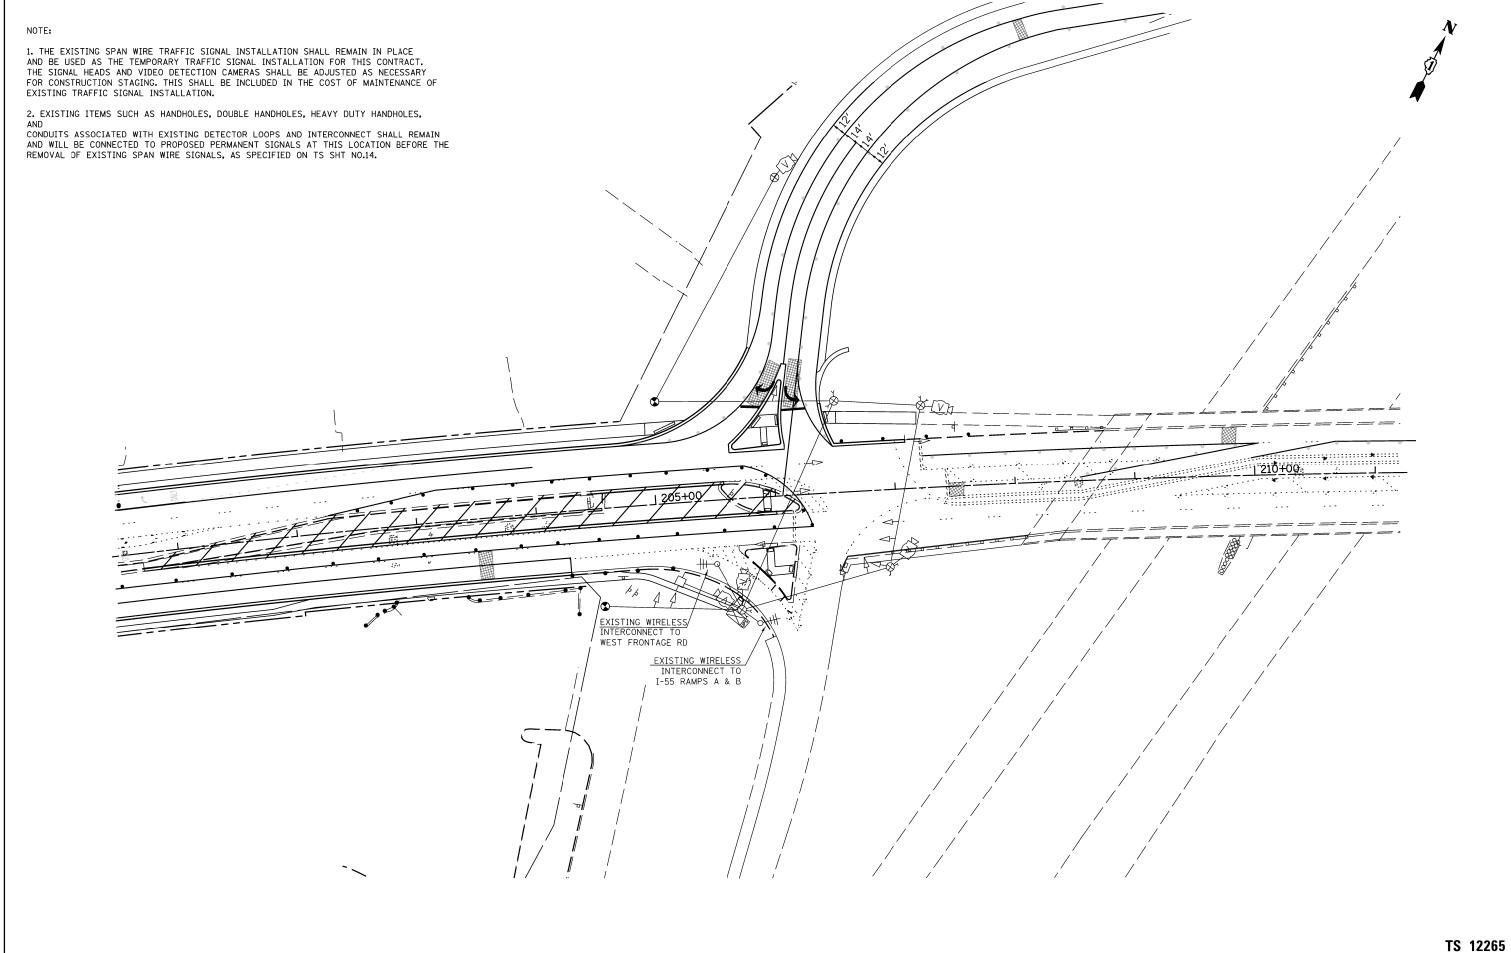

CHRISTIAN-ROGE & ASSOCIATES, INC.
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211 WEST WACKER DRIVE
CHICAGO, LILHOIS 50606
PHONE: (312)372-2023 FAX: (312)372-5274


SPAAN Tech, Inc.

DESIGNED - S.J.P./K.R.K./M.A REVISED DRAWN - B.K. REVISED CHECKED - M.P./M.A REVISED - DECEMBER, 2015 DATE REVISED

STATE OF ILLINOIS **DEPARTMENT OF TRANSPORTATION**

EXISTING TEMPORARY TRAFFIC SIGNAL AND PROPOSED EXTENSION US 6 AT I-55 RAMP C & D - STAGE II SCALE: 1" = 40' SHEET NO. OF SHEETS STA.

COUNTY TOTAL SHEET NO. WILL 184 93 SECTION 55 2014-065-R CONTRACT NO. 62A00

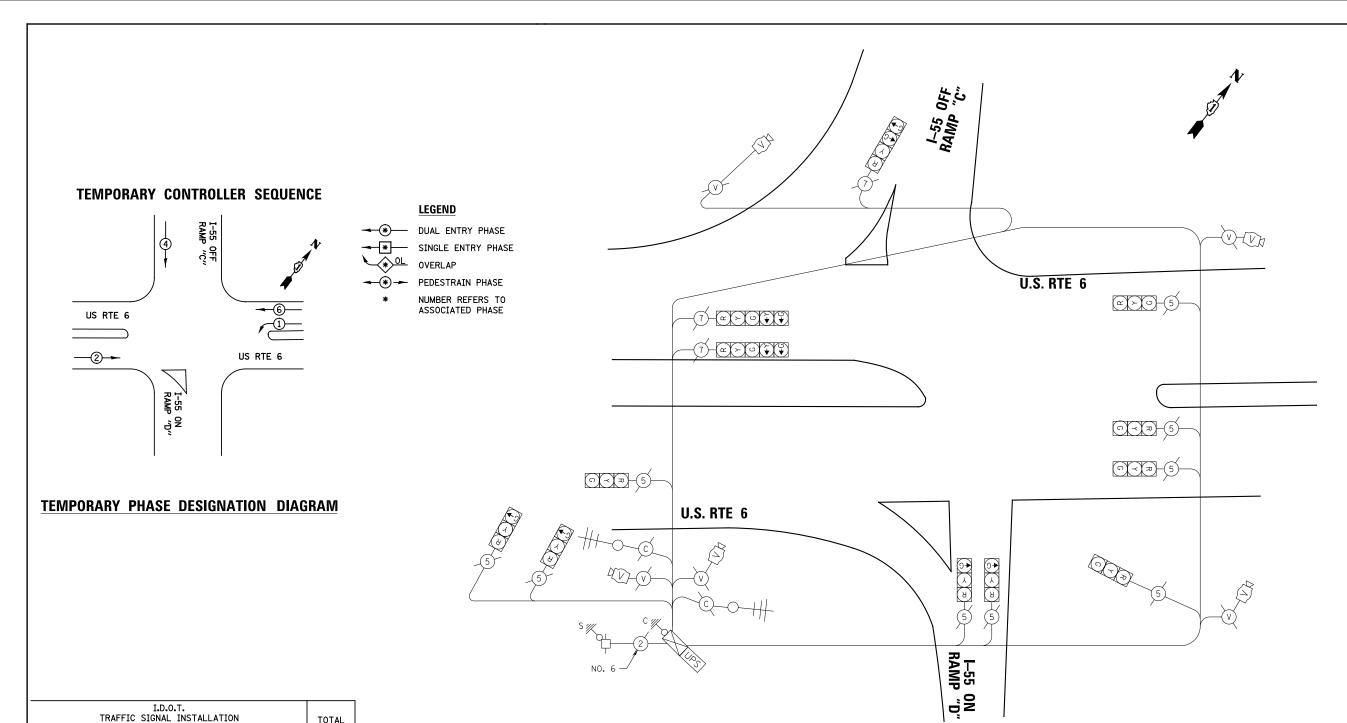

I.D.O.T. TRAFFIC SIGNAL INSTALLATION ELECTRICAL SERVICE REQUIREMENTS						
TYPE	NO. OF LAMPS		TAGE LED :	X % OPERATION	WATTAGE	
SIGNAL (RED)	12		17	0.50	102	
(YELLOW)	12		25	0.25	75	
(GREEN)	13		15	0.25	48.75	
ARROW	4		12	0.10	4.8	
PED, SIGNAL	-		25	1.00	-	
CONTROLLER	1		100	1.00	100.00	
ILLUM. SIGN	-		25	0.05	-	
VIDEO SYSTEM	1		150	1.00	150.00	
UPS	1		25	1.00	25.0	
FLASHER				0.50		
ENERGY COSTS TO: TOTAL =						

VILLAGE OF CHANNAHON

24555 S. NAVAJO DRIVE CHANNAHON, ILLINOIS 60410

CABLE PLAN

SCHEDULE OF QUANTITIES

DESCRIPTION	UNIT	QUANTITY
RELOCATE EXISTING WOOD POLES	EACH	1
WOOD POLE, 60 FT, CLASS 4	EACH	2
SPAN WIRE	FOOT	280
TETHER WIRE	FOOT	280
RELOCATE VIDEO VEHICLE DETECTION SYSTEM	EACH	1

ENERGY SUPPLY: CONTACT: MARK ANDERSON PHONE: 815-724-5988 COMPANY: COMED

		٦
	CHRISTIAN-ROGE & ASSOCIATES, INC.	ı
K	ENGINEERS-PLANNERS-SURVEYORS	ı
C.A	211 WEST WACKER DRIVE	ı
	CHICAGO, ILLINOIS 60606	
	PHONE: (312)372-2023 FAX: (312)372-5274	

C T		υ
SPAAN Tech, Inc.	ī	D
phone: 312.277 South Wacker Drive, Suite 2400 fax: 312.277		
South Wacker Drive, Suite 2400 fax: 312.277 cago, IL 60606 web: www.SpaanTecl	h.com	D


	DESIGNED	MA	REVISED
	DRAWN	CADD	REVISED
	CHECKED	MA	REVISED
2.277.8808 nTech.com	DATE	DECEMBER, 2015	REVISED

NOTE: THE TRAFFIC SIGNAL CONTROLLER EQUIPMENT FOR THIS PROJECT SHALL BE ECONOLITE TO MATCH THE EXISTING ADJACENT SYSTEM

STATE OF ILLINOIS	
DEPARTMENT OF TRANSPORTATION	

				TS 12	2265
EXISTING TEMPORARY TRAFFIC SIGNAL AND EXTENSION CABLE PLAN,	F.A.I. RTE.	SECTION	COUNTY	TOTAL SHEETS	SHEET NO.
AND TEMPORARY PHASE DESIGNATION DIAGRAM	55	2014-065-R	WILL	184	94
U.S. RTE 6 AND I-55 RAMPS "C" & "D"			CONTRAC	T NO.62	A00
SCALE: N.T.S. SHEET NO. OF SHEETS STA TO STA	FED. RO	AD DIST, NO. 1 ILLINOIS FED. AT	D PROJECT		

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CHRISTIAN-ROGE & ASSOCIATES
ENGINEERS-PLANNERS-SURVEY
211 WEST WACKER DRIVE
CHICAGO, ILLINOIS 60606
PHONE: (312)372-2023 FAX: (312)37
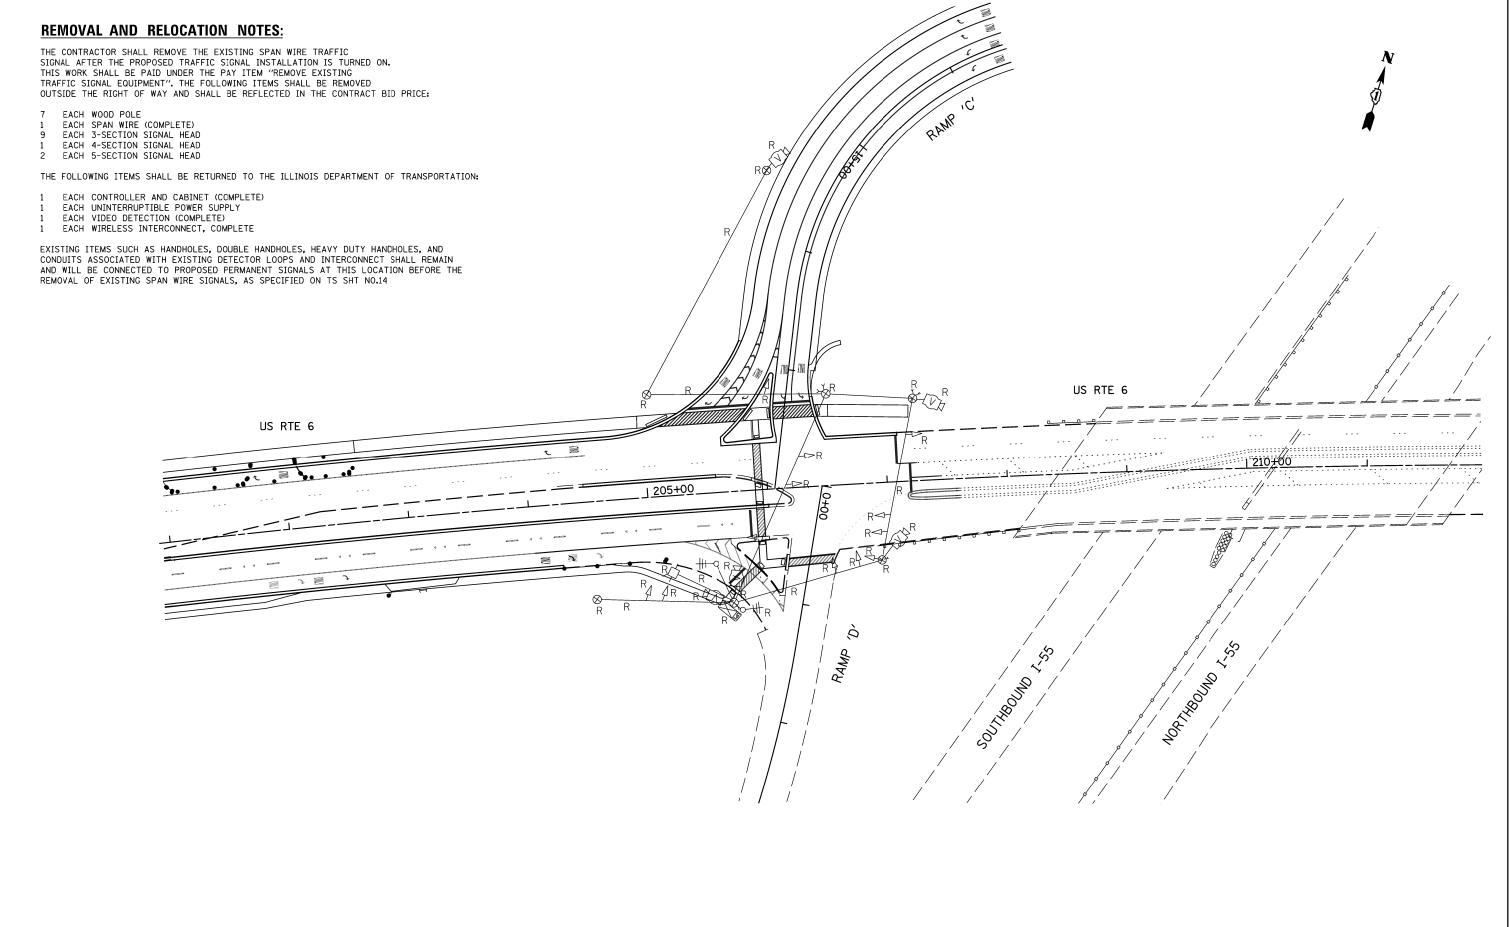
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SPAAN Tech, Inc.

DRAWN DATE


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STATE OF ILLINOIS **DEPARTMENT OF TRANSPORTATION**

EXISTING SPAN WIRE TRAFFIC SIGNAL REMOVAL PLAN US RTE 6 AT I-55 RAMPS C & D SCALE: 1"=40' SHEET NO. OF SHEETS STA. TO STA.

COUNTY TOTAL SHEET NO. WILL 184 95 SECTION 2014-065-R 55 CONTRACT NO. 62A00

TS 12265

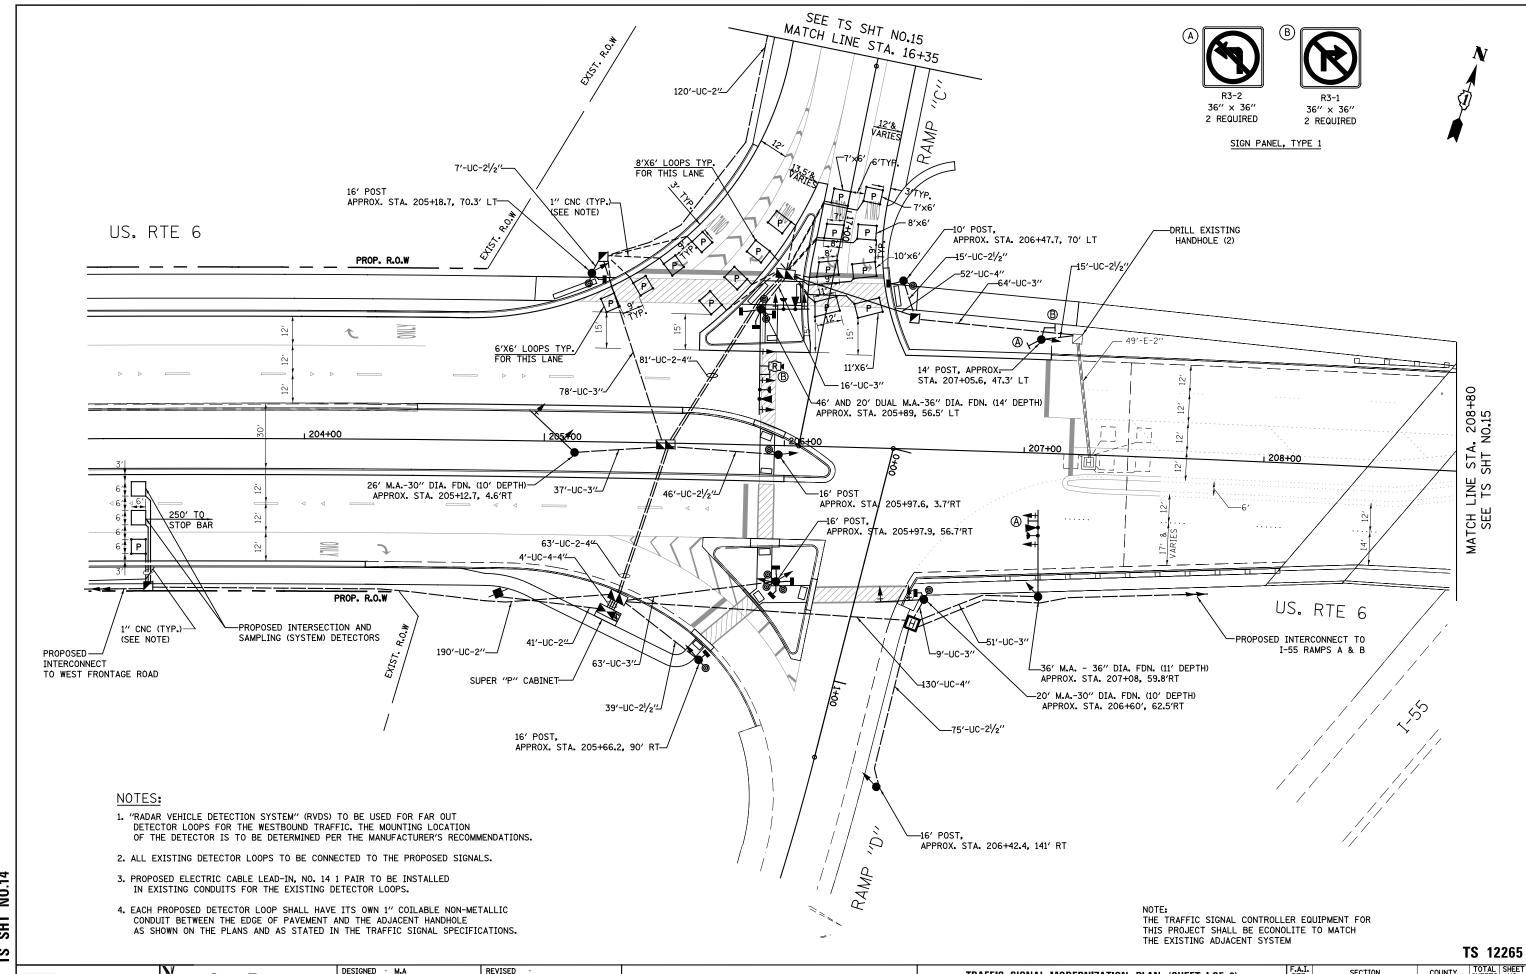

NO.14 SHT

> HRISTIAN-ROGE & ASSOCIATES, INC ENGINEERS-PLANNERS-SURVEYORS 211 WEST WACKER DRIVE
> CHICAGO, ILLINOIS 60606
> PHONE: (312)372–2023 FAX: (312)372–3

SPAAN Tech, Inc. 311 South Wacker Drive, Suite 2400 Chlcago, IL 60606


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STATE OF ILLINOIS **DEPARTMENT OF TRANSPORTATION**

TRAFFIC SIGNAL MODERNIZATION PLAN (SHEET I OF 2) U.S. RTE 6 AND I-55 AT RAMPS 'C' & 'D' SCALE: 1"=20' SHEET NO. OF SHEETS STA.

SECTION COUNTY 2014-065-R WILL 55 CONTRACTNO. 62A00

TOTAL SHEET SHEETS NO. 184 96

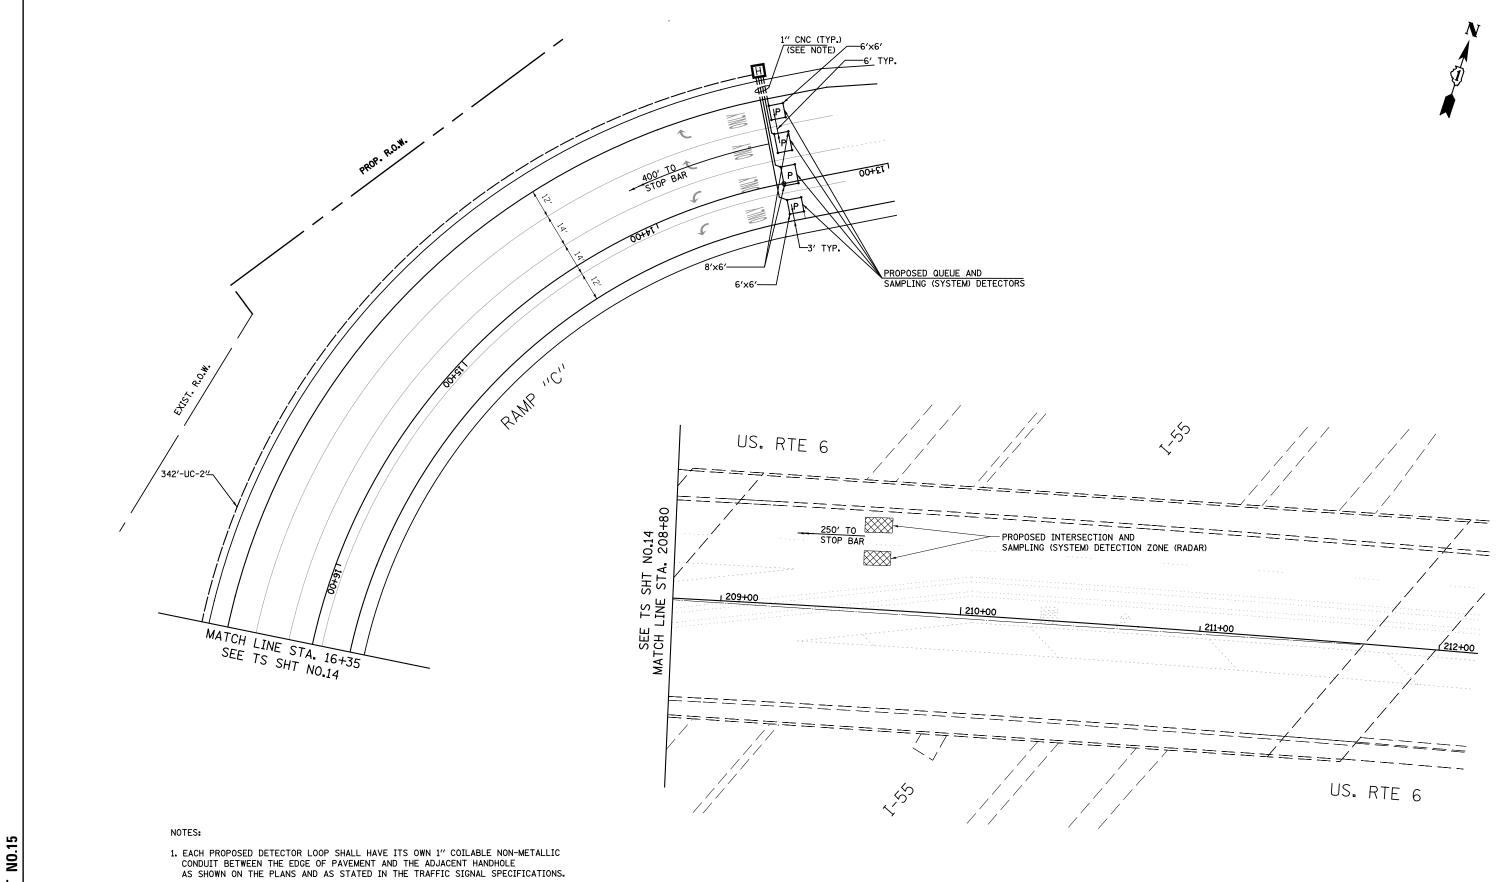

STATE OF ILLINOIS

DEPARTMENT OF TRANSPORTATION

TS 12265

COUNTY | TOTAL | SHEET | NO. |
WILL | 184 | 97

CONTRACTNO. 62A00

F.A.I. RTE. 55

TRAFFIC SIGNAL MODERNIZATION PLAN (SHEET 2 OF 2)

U.S. RTE 6 AND I-55 AT RAMPS 'C' & 'D'

SCALE: 1"=20' SHEET NO. OF SHEETS STA.

SECTION

2014-065-R

TS SHT NO.

CHRISTIAN-ROGE & ASSOCIATES, INC.
ENGINEERS-PLANNERS-SURVEYORS
211 WEST WACKER DRIVE
CHICAGO, ILLINOIS 66066
PHONE: (312)372-2023 FAX: (312)372-527

2. THE TRAFFIC SIGNAL CONTROLLER EQUIPMENT FOR THIS PROJECT SHALL BE ECONOLITE TO MATCH THE EXISTING ADJACENT SYSTEM.

SPAAN Tech, Inc.

311 South Wacker Drive, Suite 2400 Chicago, IL 60606 DESIGNED - M.A

- CADD

- DECEMBER, 2015

DRAWN

DATE


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SPAAN Tech, Inc. 311 South Wacker Drive, Suite 2400 Chicago, IL 60606

	DESIGNED	-	M.A	REVISED	-
	DRAWN	-	CADD	REVISED	-
800 808	CHECKED	-	M.A	REVISED	-
com	DATE	-	DECEMBER, 2015	REVISED	-

STATE OF ILLINOIS **DEPARTMENT OF TRANSPORTATION**

TEMPORARY INTERCONNECT SCHEMATIC PLAN US RTE 6 - WEST FRONTAGE RD TO I-55 RAMPS "A, B, C, & D SHEET NO. OF SHEETS STA.

COUNTY TOTAL SHEET NO.
WILL 184 99
CONTRACTNO. 62A00 F.A.I. RTE. 55 SECTION 2014-065-R

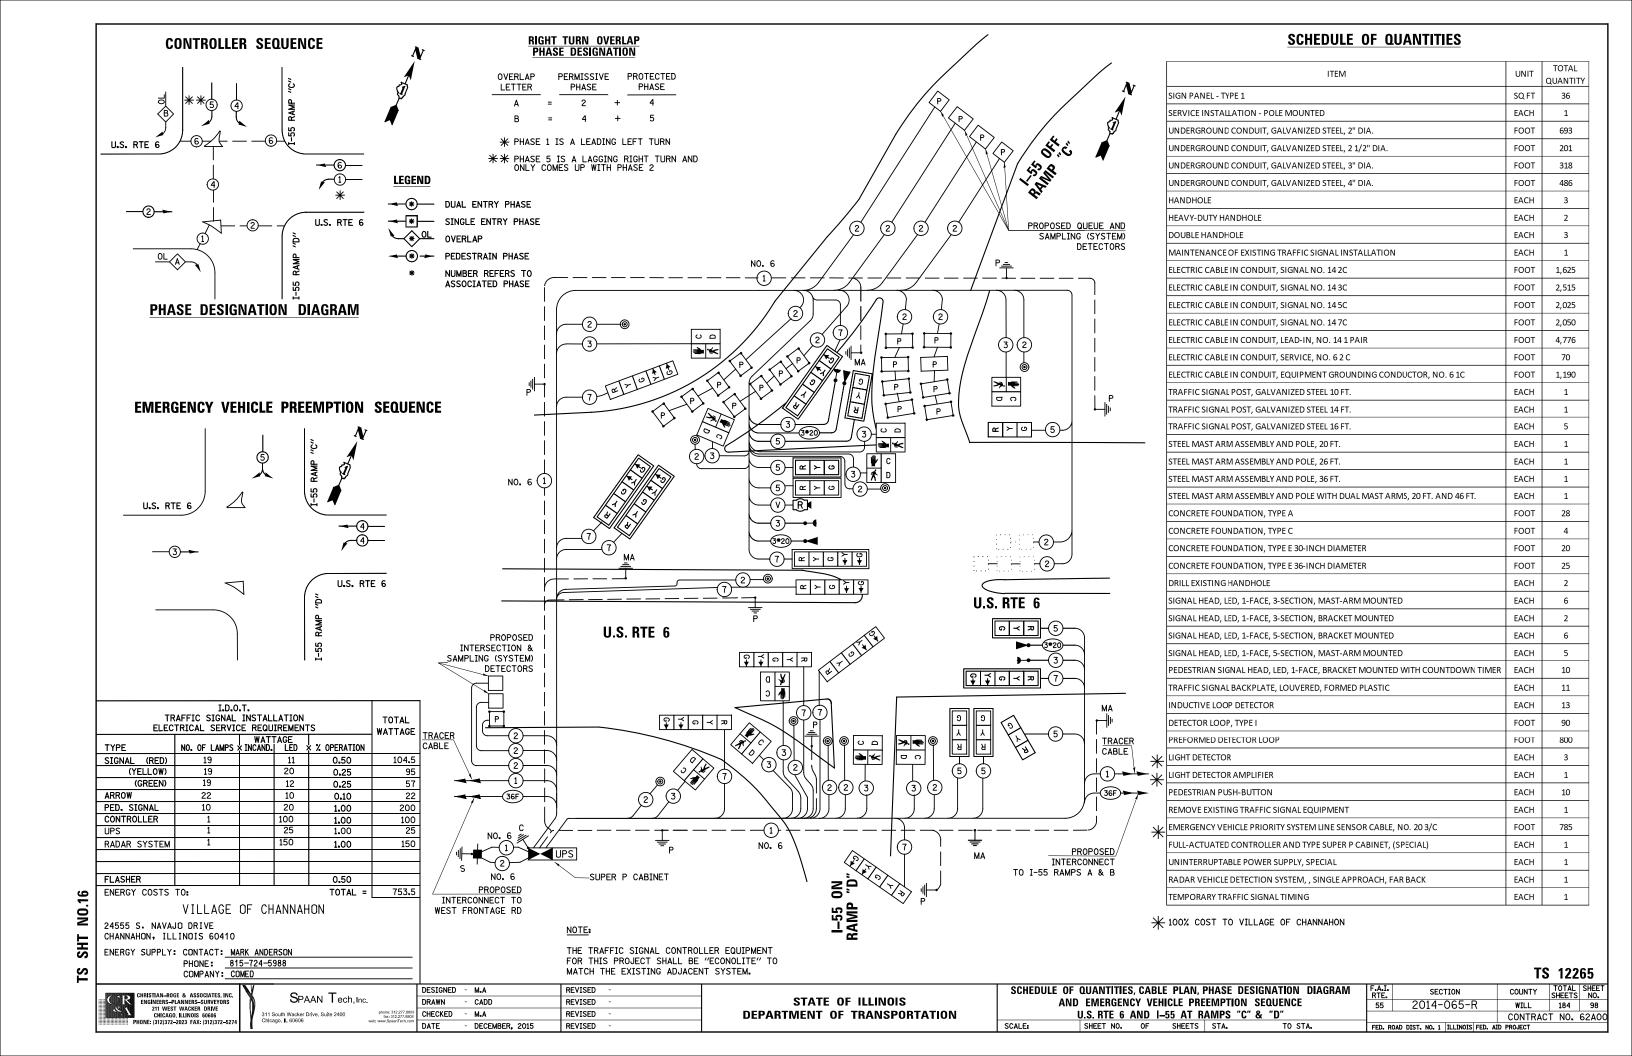CHRISTIAN-ROGE & ASSOCIATES, INC. ENGINEERS-PLANNERS-SURVEYORS 211 WEST WACKER DRIVE CHICAGO, ILLINOIS 60606 PHONE: (312)372-2023 FAX: (312)372-527

311 South Wacker Drive, Suite 2400 Chlcago, IL 60606

CHECKED REVISED DATE - DECEMBER, 2015 REVISED

DEPARTMENT OF TRANSPORTATION

SCALE: 1" = 50' SHEET NO. OF SHEETS STA.