






						,			-			γ.		·		·								————			.,	,												, , ,				·				EAT	·				TOTAL	CUEET
																																																F.A.I RTE.		• CTION	CC	оок	TOTAL SHEETS 916	112
	20																																															FED.	ROAD DIST.	NO. ILLI	INOIS FE	STA. 2316 ED. AID F	PROJECT	•
	15																UNIC	ON P	ACIF	IC R	R																											,	(1516.1,	1717, 8	(1818)	R-4	6	2304 15
·	15																																																					13
	10	Ž																	ш U						6	ex = 0.02	-0,45																								228+50			10
DATE	10 5		37.50			0.19		, 10 (1											CLEARA							K = 138 0.00′ V.C	, iii							41474																	228			
	5 5	<u>a</u>	.		150.0	‡ 147 00′ V.	.c	Š											NIN.						22.0		+05.00					B NB	OSED F 1-57	PROFIL	E \	\													- 9					5
<u> </u>	7.	l	02:00					55.00											15,91′						- 220		221														===		7						5.58		S 7 S			
	0 =	ا ا	214					55																	S _T		STA.																/						EECV.		1-57		u	0
9	<u></u>		S _T					₹ S																	+0.50%	220-80.00 ELEV0.66	+0.867													XISTI AT PRO	POSED	8							02:00		2	OPOS:	ਸ਼ੂ ਤੋਂ	г
CHECKED IV CHECKE NAME	-5 5	5		(0.52%	3.56	0,50%																			250 EK																							8		EINE EINE	AT P	¥	-5
SURVEYED PLOTHENT CHECKE RT. OF WAY CHECK CADD FILE NAME	-10 \$	- ₹ Σ				214H ELEV.																				¥ 15																							15		MATCHLI	SROUND AT PROPOSED	물	-10
X001	10					**************************************																				\$																									3			10
PLAN NOTE B	-15					\$																																														EXISTING	- -	-15
		Φ ∾	o ru≀r	⊗ 1≻	ο 4 . 2	E 15- 15-	© 0	= m =	1 5 6	. p. 10. u	ত ৰ ব	.52.1	5 0 0	o ∞ 4	£ 5 +	, 6.	9.5	4 O **	~ თ.	4 W ~	4 00	# W	5 G Y	6 C 4		7. 1. 0	5 65 4 5 65 4	80 4 7	? ::	K K 4		O M .	4				O	0	W 44 W	10 m	. 01 66		44 VI W	M (A)	0.41.10	w ee e	0.00.00	**		m m				
-	-20	2. E.	214±0		ki ki k	215		ri ri r	i m	아 하 아 216+00	4 4 4	6 .0	217+	00 2 2 2	7 7 7	218	ος γ. γ	7 7 7	1 T	9+00	7.7	7 7	ਜੋ ਂ 220+€		9 9	0 0 0	ं ं 1 + 00	000	0.0	22+00	0.5	S 5 5	223+00	0 11 8 25	1.66	224	ර ම ද ර : ද	4 19 5	221	+00 6 %	W W W	2 6 2 6	1 80 0 m m m 26+00	4 H	4 4 4	27+00	4 4 4	2. 4.	228+0	10 10 1	ń		-	20
			21410			213			-	.10.00			211			210				1							.,		<u></u>	LE			ZEJ					·				-	20,00		-	21,100						-		
_																	- [<u> </u>							NB	I-57																										
· -						: ::::::::																																																
DATE	25								ç	0.0		WENT	TWOF	RTH /	ιVΕ.															77 13																				+ 125				25
									5	, ,									:::К	≃ 2.67 ≃ 174 O′ V.	c.									à													 							243+2				
20	20	Ę								00																				6.00																				STA.				20
										230+3					NC NC NC NC NC NC NC NC NC NC NC NC NC N															237+6						11.61														I-57 S				
	15 5	4			0					S A					CLEAR															¥ 15		_				ELEV. 15																9	ž	15
CHECKED NAME	10				33 229										Z Z	PI 18	ROPOSE NB I-	D PRO 57	FILE —	\																90 E														<u>8</u>		PROPO:	3 3	10
PLAN SURVEYD NOT BOOK RT. OF WAY CHECKED NO. —— CADD FILE NAME	10 =				V. 6.83	0.50%									17.66										===	+=										38+85														MATCHLINE		CROUND AT PROPOSED	4 5	IU
N E BOOK	5 ½									•											-	-														STA. 2														ATC		SROUN	HO-	5
PL,	Ē									-+									0.50%	385	₹.00%		_ ₁	EXISTI	NG PR	OFILE D.B																								2		EXISTING	E S	
	0	Z								, ,										ELEV.				ALTER	OPOSE	D. 18																										EXIS	2	0
				K.	= -0.4 = 212 00' V	1				95.00 ELEV. 6.10										Ą.																					, 7	3.80	8 4. 5	24.88	2 7 E	4.60	4 00 m 0 4 5 0 10 1∞	5.35	7.5.7 2.5.4 2.5.4	5.73				
	-5			250,0	, v	.,,														2 																							41+00	0	2	42+00 50	100		243+0	0		5	10	<u>-5</u>
	-10 🕏	. 26 . 92 . 46	59	65 83	33.71	3.75		T.	į	STA.																								AID T		то .	'												VEDTT	241 66	AL E- 11	- F1		
_	IO my	ຳນ. ໝ. ກນຸ	229+0	. w. w.	NU 1.00.1 H	230	100																											CONN	-57 VECT(OR R	AMP							NTAL S VISIONS E		E	ILL:	INOIS I	EPARTI	WENT O	F TRA	1" = 5'- ANSPORT	TATION	
							5.36	0 10 0 4 0 0	6.19	5.68 7.07	ა ი ა	5.31	5.12	0 0 5 0 0 5 0 0 5	5.29 2.01 2.01	6.12 5.30	5.27	6.52	5.94 6.94	7.23	7.56	7.93	7.99	9.62	9.75 8.75	10.30	10.88	11.49 12.09	12.83	13.45 13.56	14.31	15,06	16.53 16.56	-6.49 17.31	-7.20 1 8.06 -6.89	18.81 6.50	7.93	20.22 20.23 20.23 20.23	21.61	22.23	22.82 22.35		- AF HA									XPRES		Y)
=							+00			231+00			232+	00		233	+00			4+00			235+0				6+00		2	37+00			238+00	0		2394	ю0		240	00+		E							N	B I-5	7	PROF1		
						1	ı		- 1	- 1	11 1	1		1	- 1	1.				ı	1	- 1		1		- 1		ı	- 1	1		1	1	Ī	1	i		1 .	1	1 1	1	L				- 1						- · · · ·	^^	
	TYL	.ININ	TERN	IATI(IANC	-					-																	I-57													·							STA. 2 1"=50" 1"=5" VE) . 00 T		13+25.0 DRAWN BY		

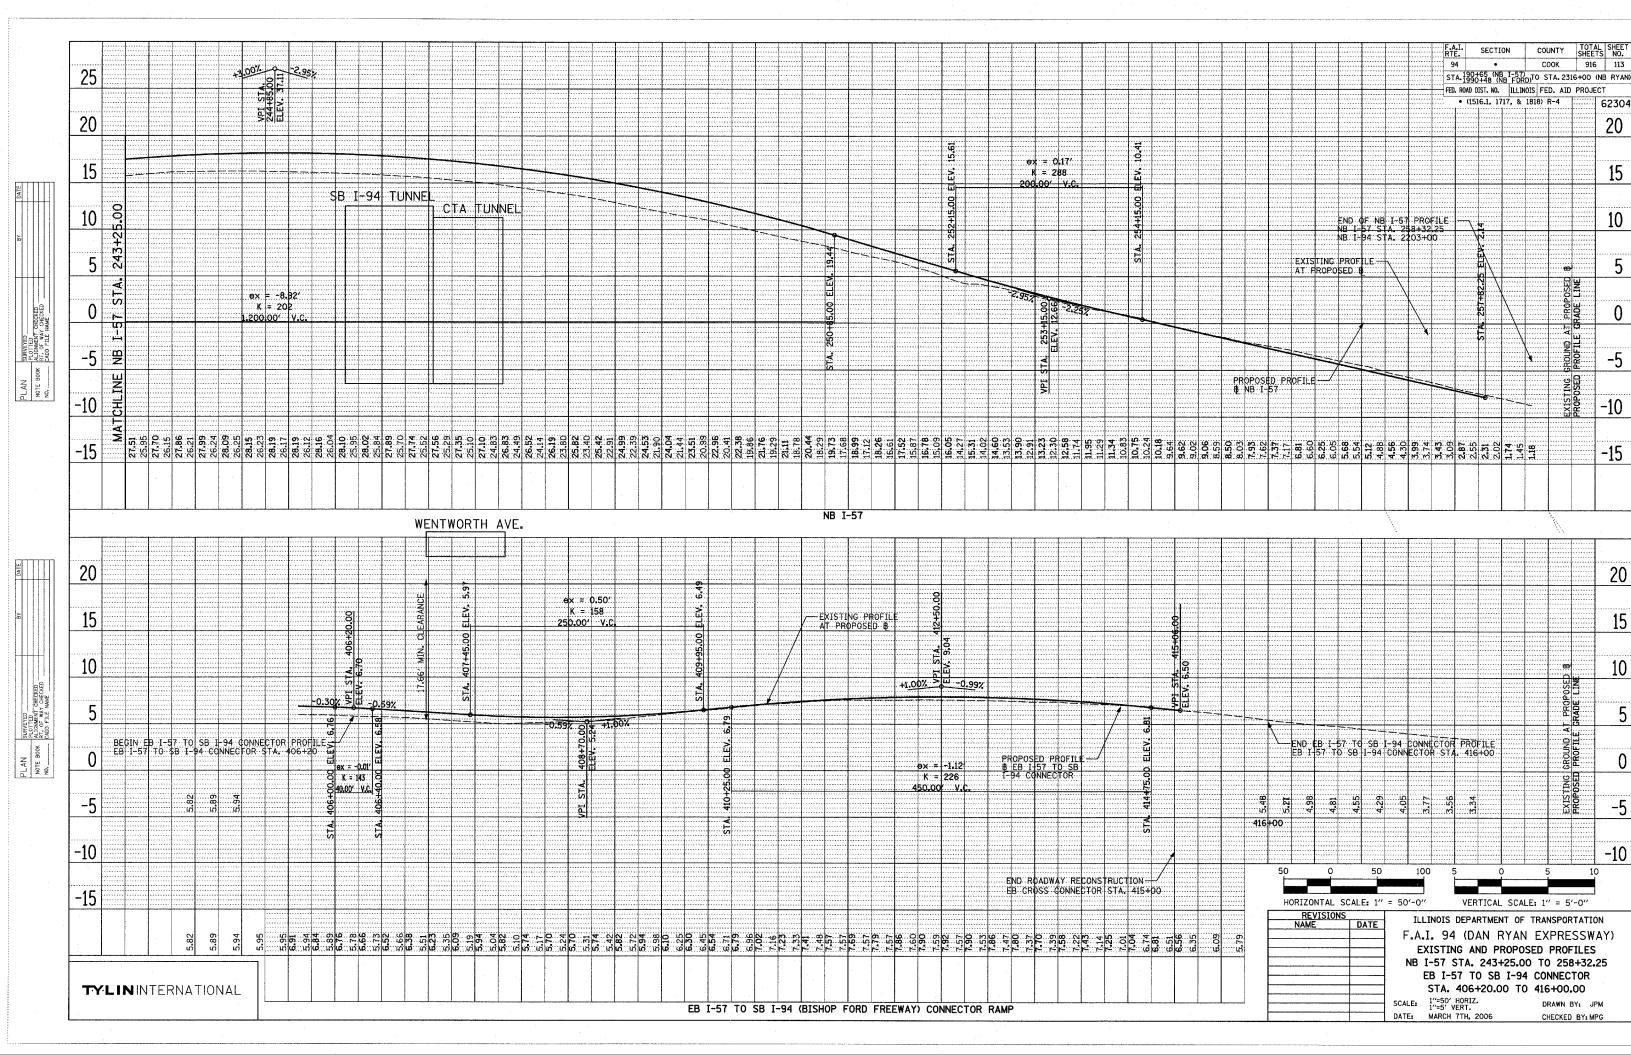


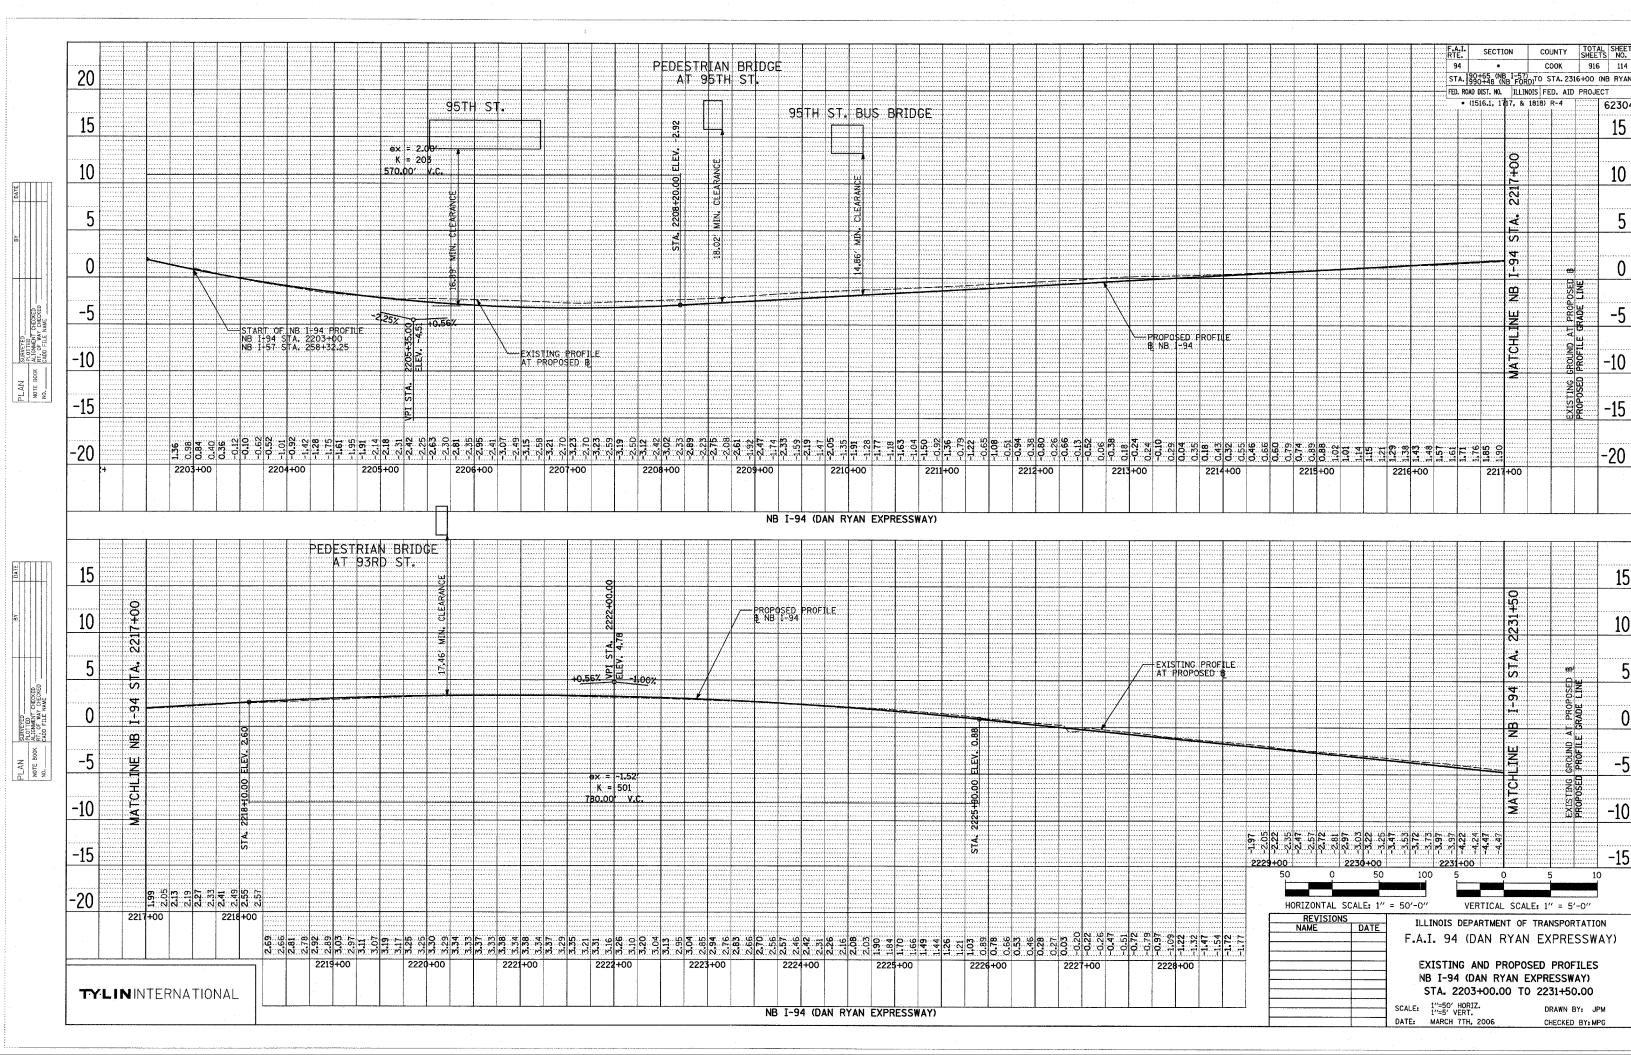


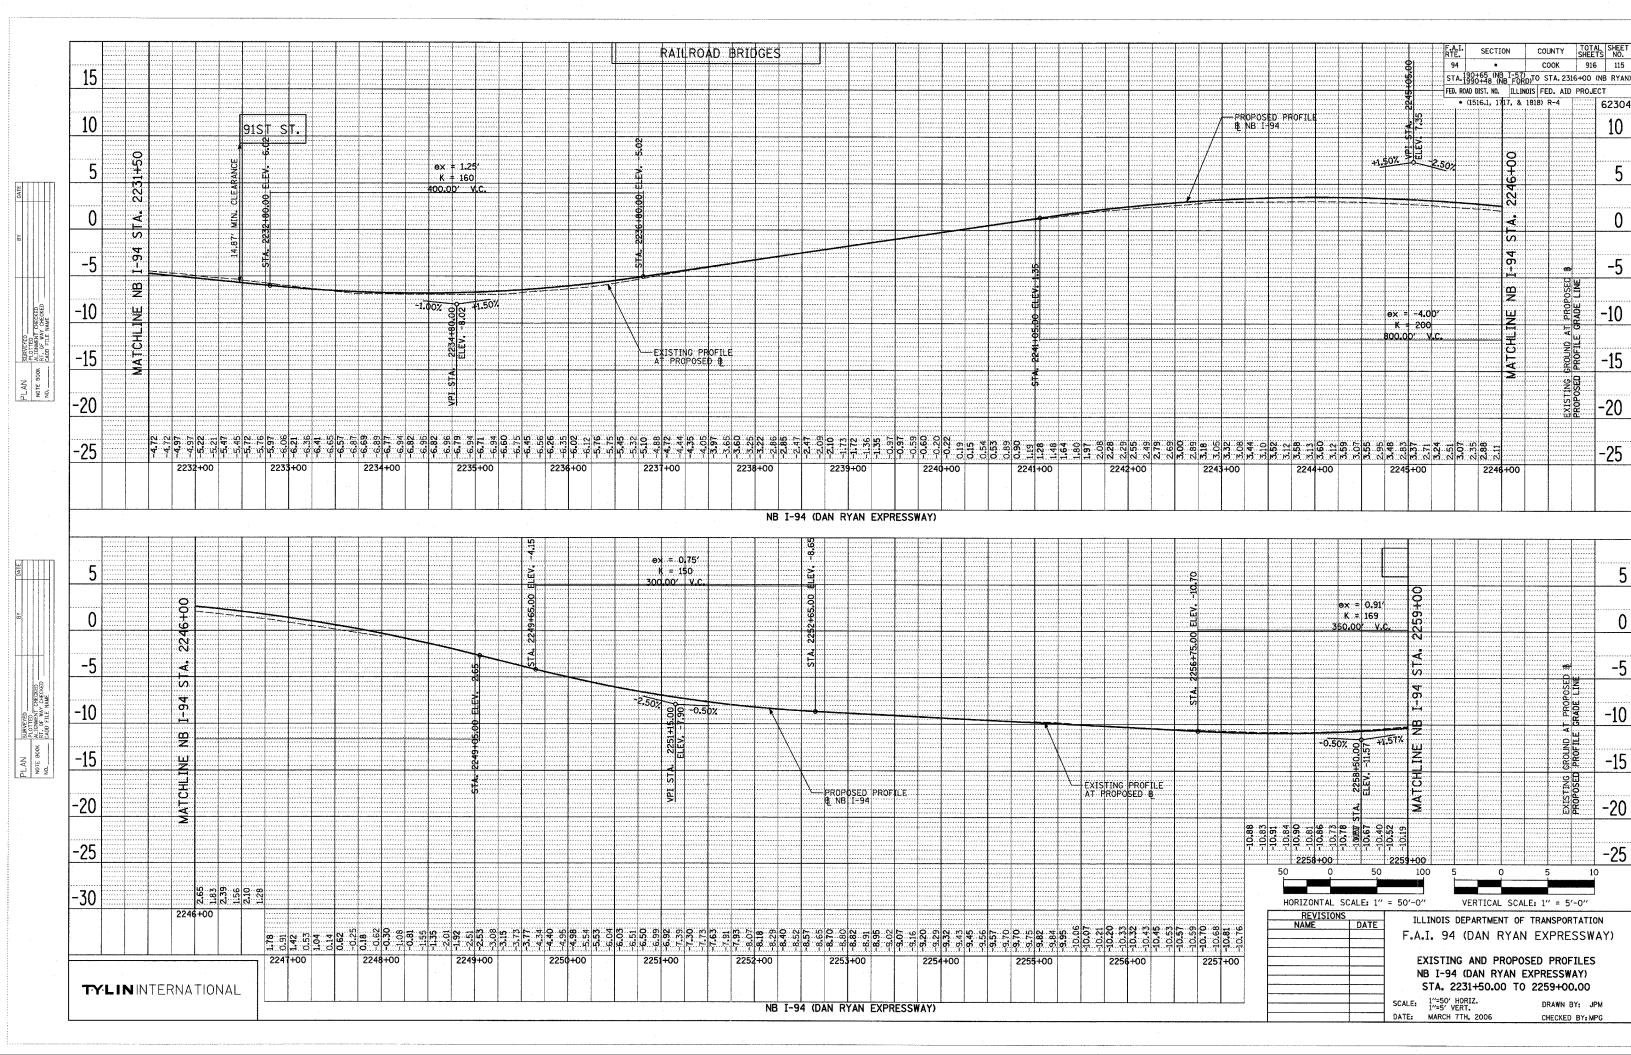


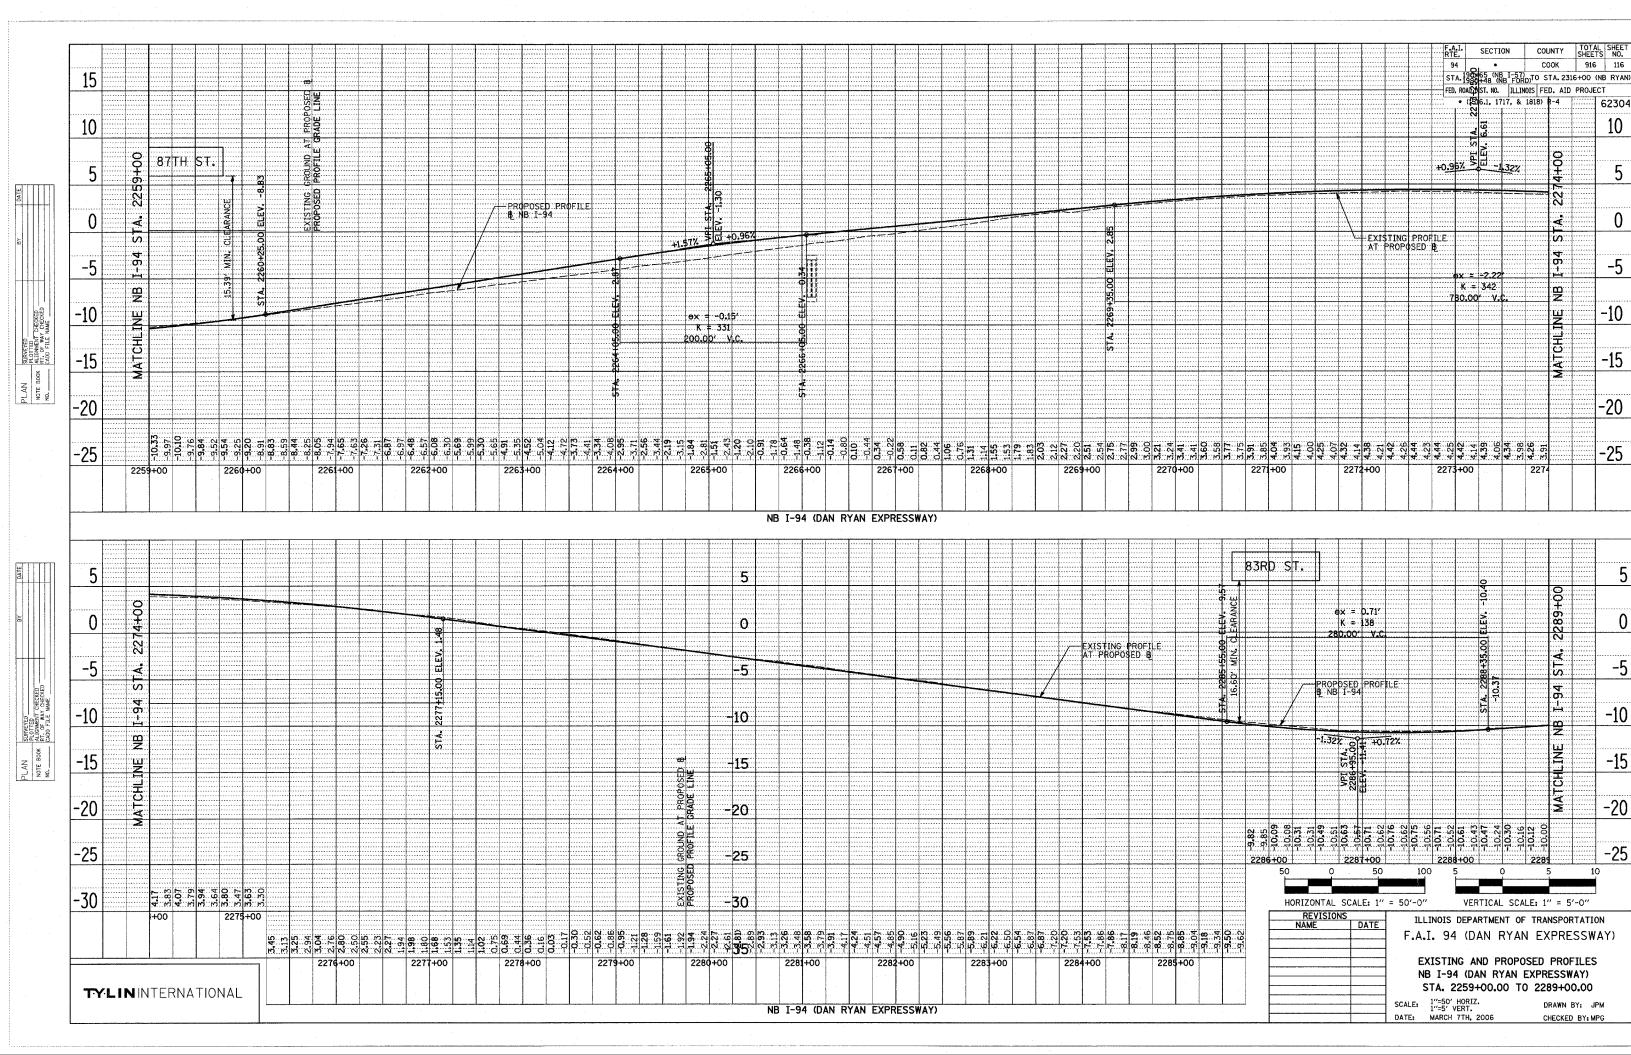


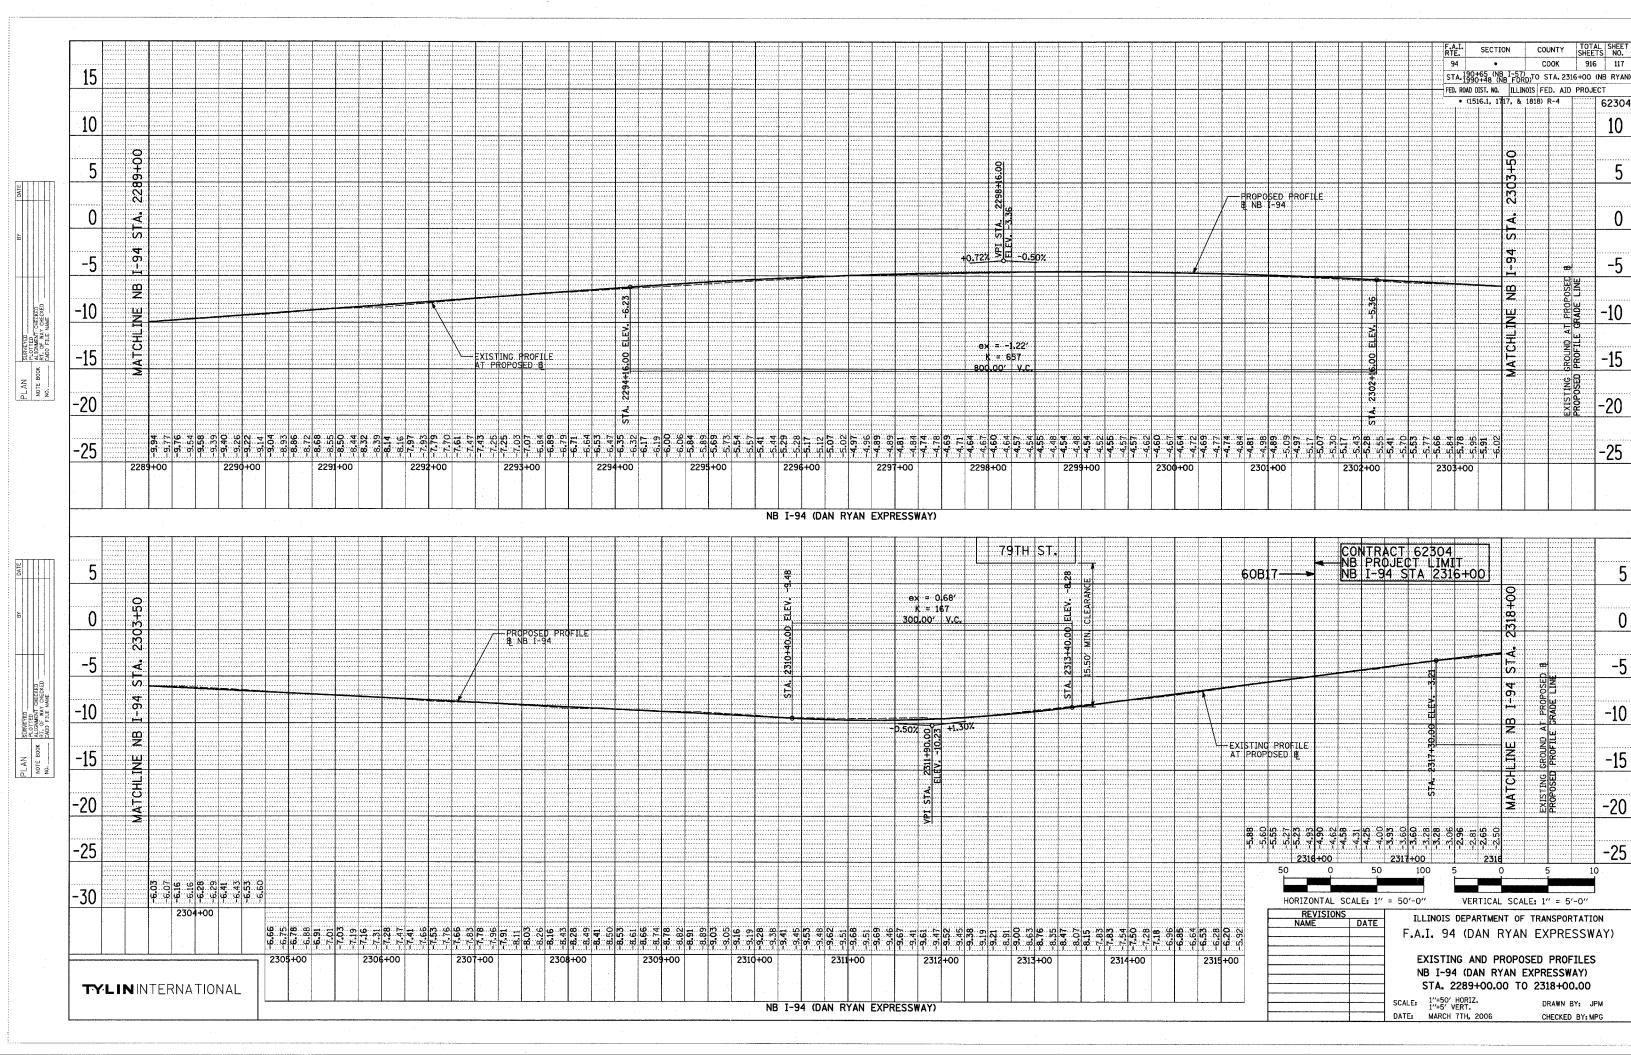


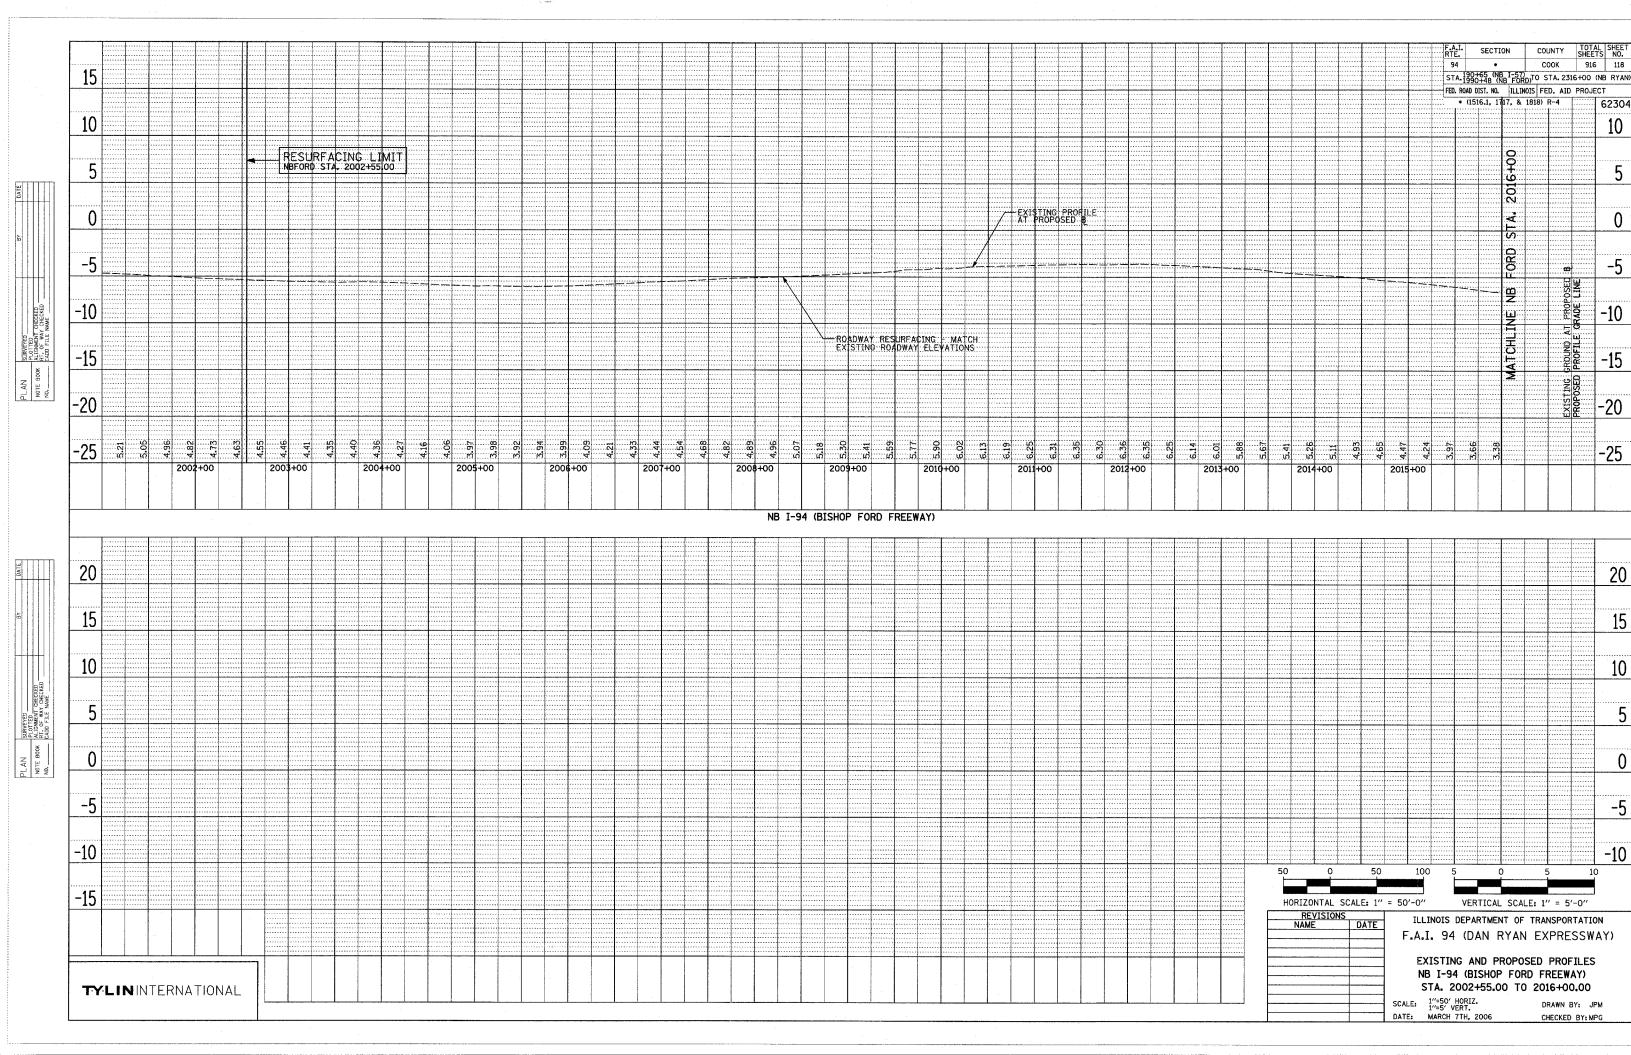

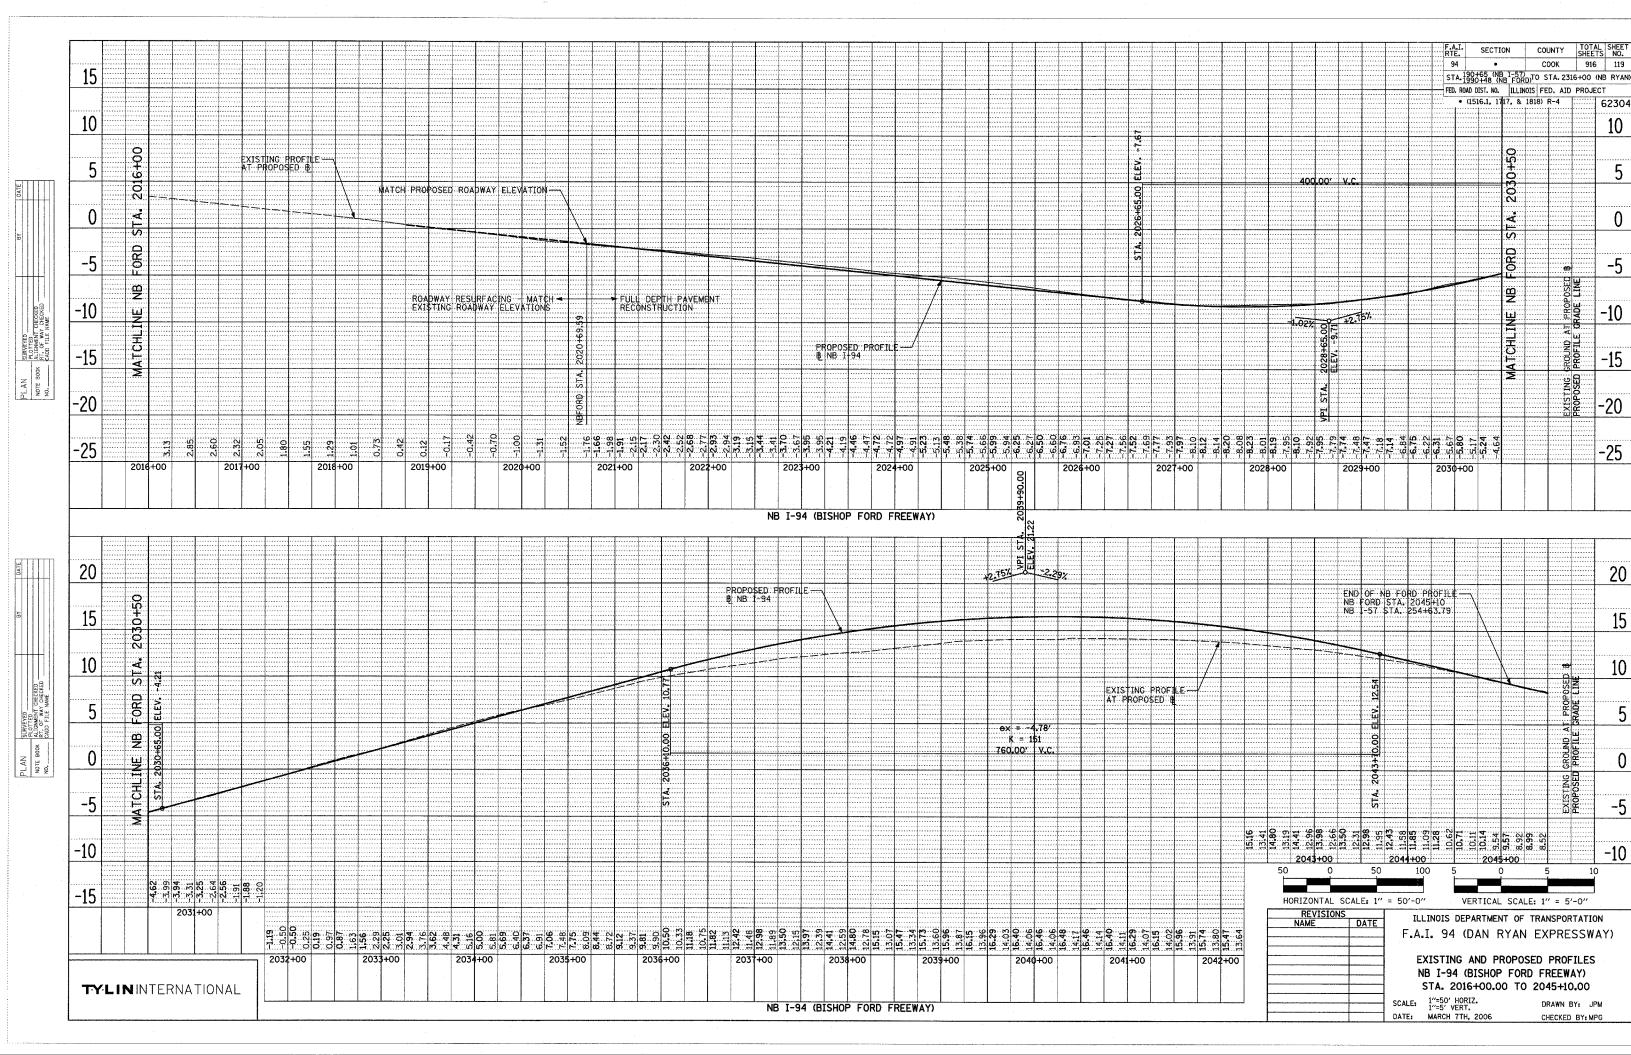

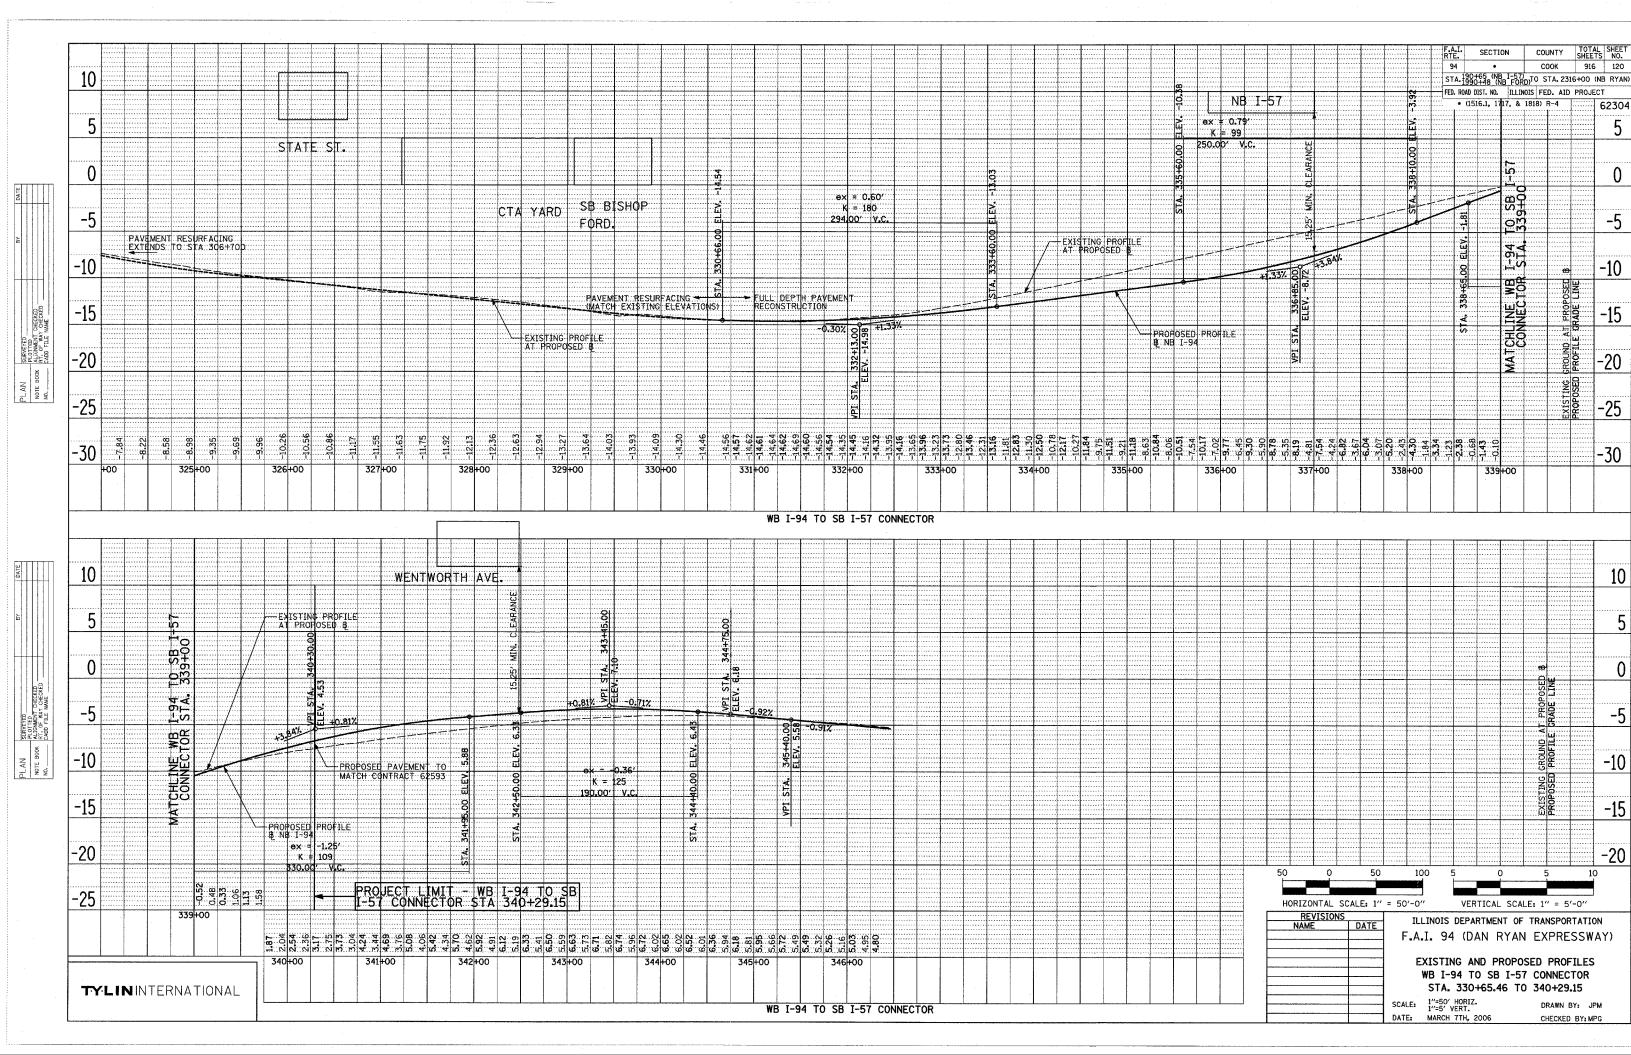

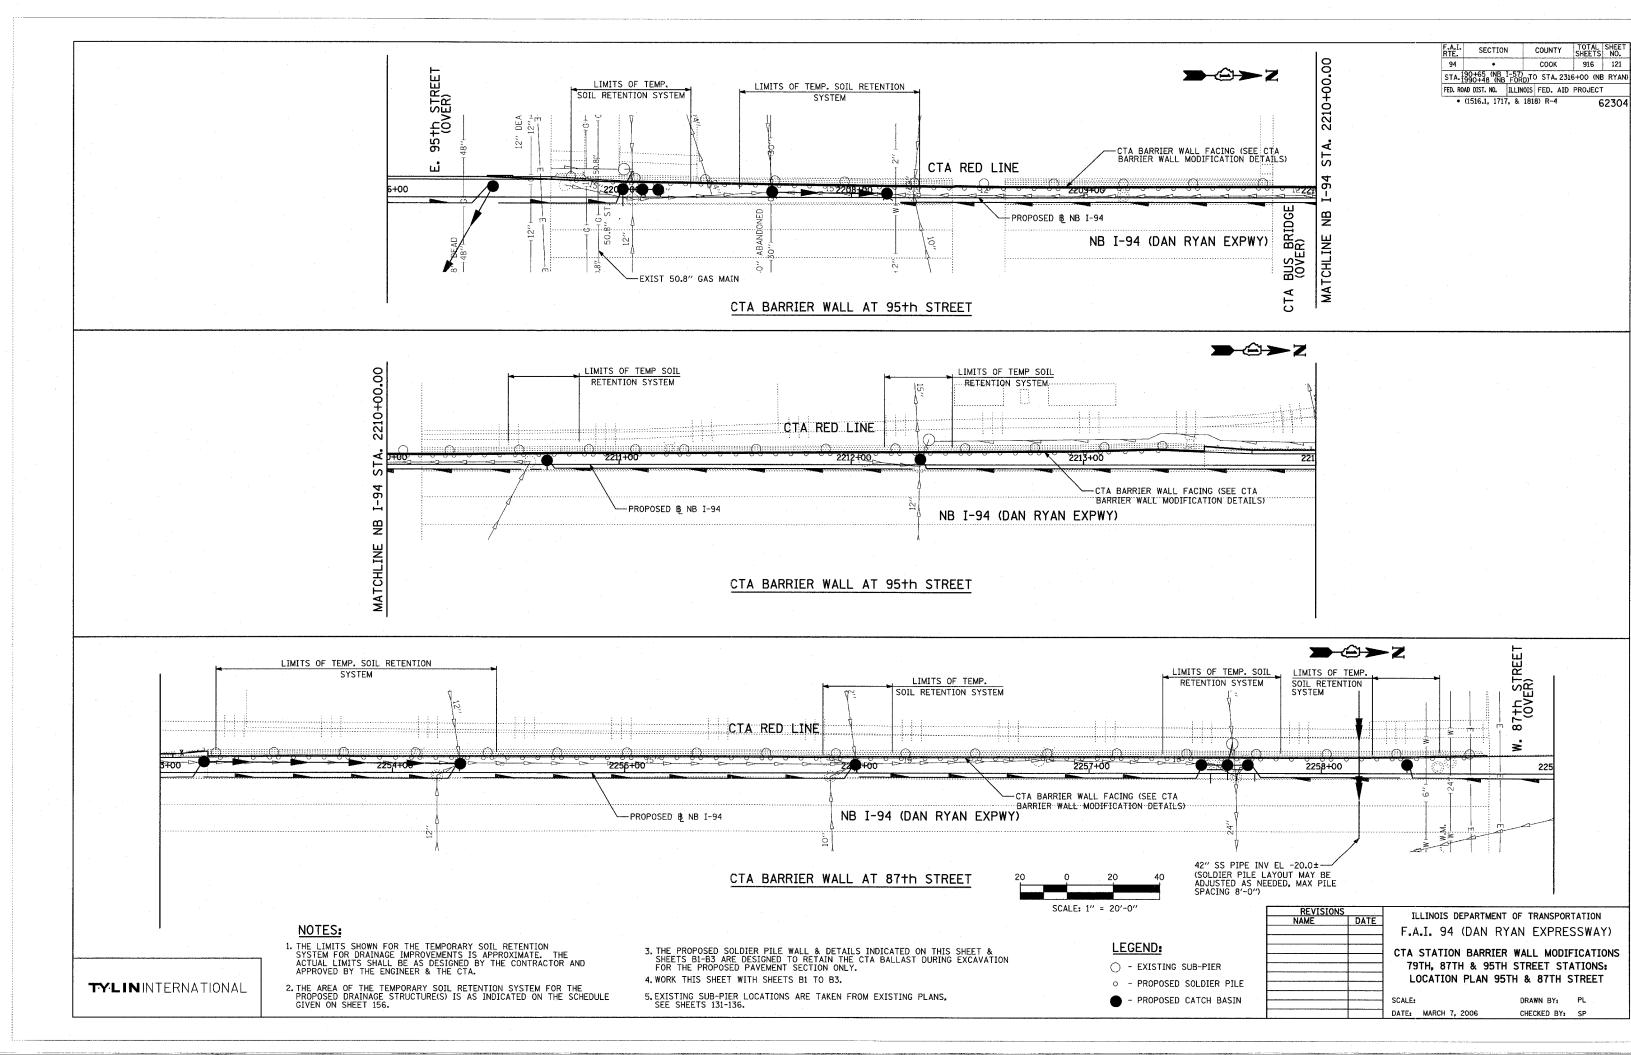


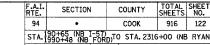

FED. ROAD DIST. NO. | ILLINOIS | FED. AID PROJECT 62304

* (1516.1, 1717, & 1818) R-4

>≥ Z STREET SOIL RETENTION SYSTEM LIMITS OF TEMP. SOIL RETENTION SYSTEM W, 79+h (ÖVER) CTA RED LINE 2311+00 2308+0 230,9+00 2310+00 2312+00 NB I-94 (DAN RYAN EXPWY) -PROPOSED & NB I-94 -CTA BARRIER WALL FACING (SEE CTA BARRIER WALL MODIFICATION DETAILS)

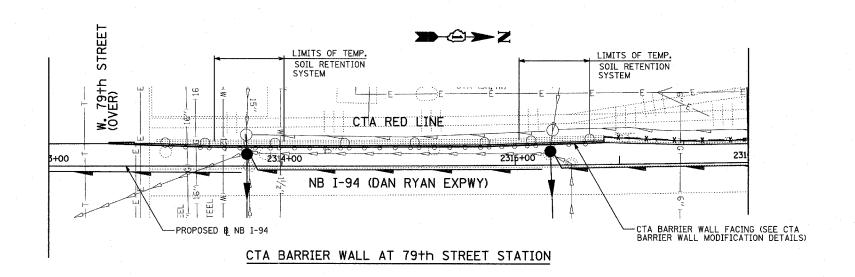

CTA BARRIER WALL AT 79th STREET STATION

SCALE: 1" = 20'-0"

NOTES:

- 1. THE LIMITS SHOWN FOR THE TEMPORARY SOIL RETENTION SYSTEM FOR DRAINAGE IMPROVEMENTS IS APPROXIMATE. THE ACTUAL LIMITS SHALL BE AS DESIGNED BY THE CONTRACTOR AND APPROVED BY THE ENGINEER & THE CTA.
- 2. THE AREA OF THE TEMPORARY SOIL RETENTION SYSTEM FOR THE PROPOSED DRAINAGE STRUCTURE(S) IS AS INDICATED ON THE SCHEDULE GIVEN ON SHEET 156.
- 3. THE PROPOSED SOLDIER PILE WALL & DETAILS INDICATED ON THIS SHEET & SHEETS B1-B3 ARE DESIGNED TO RETAIN THE CTA BALLAST DURING EXCAVATION FOR THE PROPOSED PAVEMENT SECTION ONLY.
- 4. WORK THIS SHEET WITH SHEETS B1 TO B3.

LEGEND:

- - EXISTING SUB-PIER
- - PROPOSED SOLDIER PILE
- PROPOSED CATCH BASIN

-42" SS PIPE INV EL. -22.5± (SOLDIER PILE LAYOUT MAY BE ADJUSTED AS NEEDED, MAX PILE SPACING 8'-0")

INT ATOTOM	•	J THI THINTS DED						
NAME	DATE	ILLINOIS DEP						
		F.A.I. 94 (D						
		CTA STATION B						
		79TH. 87TH 8						
		LOCATIO						
		SCALE:						
		JUALES						

PARTMENT OF TRANSPORTATION DAN RYAN EXPRESSWAY) BARRIER WALL MODIFICATIONS & 95TH STREET STATIONS: ON PLAN 79TH STREET

DATE: MARCH 7, 2006

DRAWN BY: PL CHECKED BY: SP

TYLININTERNATIONAL

230,7+00


5. EXISTING SUB-PIER LOCATIONS ARE TAKEN FROM EXISTING PLANS, SEE SHEETS 131-136.

CTA BARRIER WALL LOCATION AND MODIFICATION TABLE

STATION	LOCATION	l
STATION	STATIONS	MODIFICATION
95th ST.	STA, 2205+51 TO 2213+32	REFACING
87th ST.	STA. 2253+21 TO 2258+72	REFACING
79th ST.	STA. 2307+02 TO 2312+85	REFACING
79th ST.	STA. 2313+44 TO 2315+38	REFACING

DESIGN STRESSES:


FIELD UNITS f'c = 3,500 PSI fy = 60,000 PSI (REINF.)

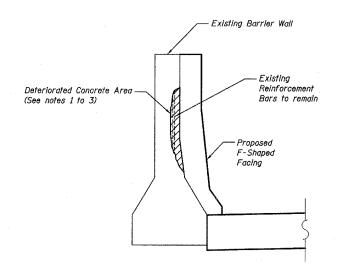


CONCRETE REPAIR DETAIL

NOTES ON CONCRETE REPAIR DETAIL

- REMOVE DETERIORATED CONCRETE TO SOUND CONCRETE IN ACCORDANCE WITH SECTION 501.03 OF THE STANDARD SPECIFICATIONS. UNDERCUT EXPOSED REINFORCEMENT BARS BY 3/" TO PROVIDE CLEARANCE BETWEEN EXISTING REINFORCEMENT BARS AND THE REMAINING CONCRETE.
- 2. EXPOSED EXISTING REINFORCEMENT BARS SHALL REMAIN IN PLACE AND BE BLAST CLEANED TO GRAY METAL. REINFORCEMENT BARS THAT HAVE BEEN CUT OR HAVE LOST 25% OR MORE OF THEIR ORIGINAL CROSS SECTIONAL AREA SHALL BE SUPPLEMENTED BY NEW EPOXY COATED REINFORCEMENT BARS.
- 3. THE COST OF REMOVING DETERIORATED CONCRETE AND SUPPLEMENTING AND CLEANING EXISTING REINFORCEMENT BARS SHALL BE INCLUDED IN THE COST PER CUBIC YARD OF "CONCRETE STRUCTURES".

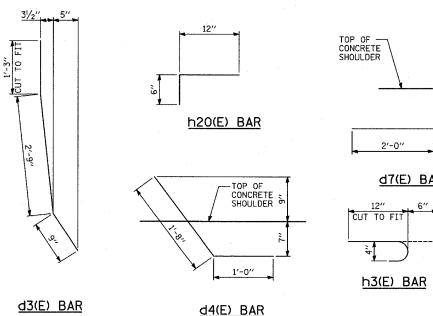

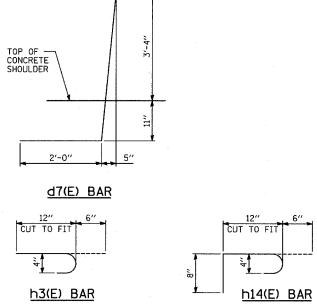


62304

* (1516.1, 1717, & 1818) R-4

GENERAL NOTES:

- IN LOCATIONS WHERE THE MAIN SEWERS, DRAINAGE STRUCTURES, PUBLIC AND PRIVATE DRAIN CONNECTIONS ARE DISTURBED OR DAMAGED DURING CONSTRUCTION BY THE CONTRACTOR, IT WILL BE THE CONTRACTOR'S RESPONSIBILITY TO RESTORE AND REPLACE THE DAMAGED FACILITIES AT HIS/HER OWN EXPENSE TO THE SATISFACTION OF THE DEPARTMENT OF WATER MANAGEMENT. THE SEWER FLOWS MUST BE MAINTAINED AT ALL TIMES.
- 2. IN LOCATIONS WHERE PILINGS/DRILLED SHAFTS ARE BEING PROPOSED IN THE VICINITY OF THE EXISTING SEWER FACILITIES, THE CONTRACTOR MUST PROVIDE A PLAN OF CONSTRUCTION METHODS WITH CALCULATIONS SEALED BY A STRUCTURAL ENGINEER LICENSED BY THE STATE OF ILLINOIS PROVING NO DAMAGE OR HARM TO THE STRUCTURAL INTEGRITY OF THE CITY'S SEWER SYSTEM. THE PLAN MUST BE APPROVED BY THE RESIDENT ENGINEER AND THE CHICAGO DEPARTMENT OF WATER MANAGEMENT PRIOR TO CONSTRUCTION.
- 3. IT SHALL BE THE CONTRACTOR'S RESPONSIBILITY TO ENSURE THAT NO GAP REMAINS BETWEEN PROPOSED CTA FENCING OR WHERE PROPOSED CTA FENCING TERMINATES AND EXISTING CTA FENCE REMAINS IN PLACE.
- PLAN DIMENSIONS AND DETAILS RELATING TO EXISTING STRUCTURES HAVE BEEN TAKEN FROM EXISTING PLANS AND ARE SUBJECT TO NOMINAL CONSTRUCTION VARIATIONS. IT SHALL BE THE CONTRACTOR'S RESPONSIBILITY TO VERIFY SUCH DIMENSIONS AND DETAILS IN THE FIELD AND MAKE NECESSARY APPROVED ADJUSTMENTS PRIOR TO CONSTRUCTION OR ORDERING MATERIALS. SUCH VARIATIONS SHALL NOT BE CAUSE FOR ADDITIONAL COMPENSATION OR A CHANGE IN THE SCOPE OF WORK. THE CONTRACTOR WILL BE PAID FOR THE QUANTITY ACTUALLY FURNISHED AT THE UNIT PRICE FOR THE WORK.
- 5. ALL CONSTRUCTION JOINTS SHALL BE BONDED.
- ALL EXPOSED CONCRETE EDGES SHALL HAVE A 3/4" BY 45° CHAMFER EXCEPT WHERE SHOWN OTHERWISE, CHAMFER ON VERTICAL EDGES SHALL BE CONTINUED A MINIMUM OF 1 FOOT BELOW THE FINISHED GROUND LINE.
- 7. A PROTECTIVE COAT SHALL BE APPLIED WITHIN THE LIMITS SHOWN ON THE PLANS ACCORDING TO SECTION 503.19 OF THE STANDARD SPECIFICATIONS.
- REINFORCEMENT BARS SHALL CONFORM TO THE REQUIREMENTS OF AASHTO M31 OR M322 GRADE 60.
- 9. REINFORCEMENT BARS DESIGNATED "(E)" SHALL BE EPOXY COATED.
- THE CONTRACTOR IS RESPONSIBLE FOR THE DESIGN AND PERFORMANCE OF THE LAGGING USING NO LESS THAN 3" NOMINAL ROUGH-SAWN THICKNESS AND THE MINIMUM TABULATED UNIT STRESS IN BENDING (fb), USED IN THE DESIGN OF THE TIMBER LAGGING SHALL BE 1000 psi.
- 11. HAMMER DRIVING OF PILES WILL NOT BE ALLOWED.

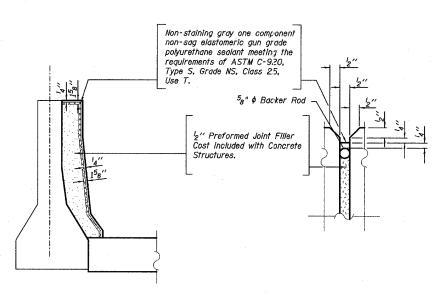

BARRIER JOINT DETAILS


(AT EXISTING BARRIER JOINT LOCATIONS)

SHEET B1 OF 8

CHECKED BY: SP, PF


REVISIONS		T1 1	ILLINOIS DEFARTMENT OF TRANSPORTATION								
NAME	DATE	166	.INOIS D	CI MILLIM	ENT OF	INAMOR	ONTAILO	14			
		F.A.	I. 94	(DAN	RYAN	EXPF	RESSWA	٩Y)			
		CTA S	TATION	BARR:	IER WA	LL MOI	DIFICAT	IONS			
		L0	CATION	I AND	MODIFI	CATION	TABLE				
		G	ENERAL	NOTE	S AND	BAR D	ETAILS				
·											
		SCALE: I	NONE		DF	RAWN BY:	MPG,	SP			

DATE: MARCH 7, 2006

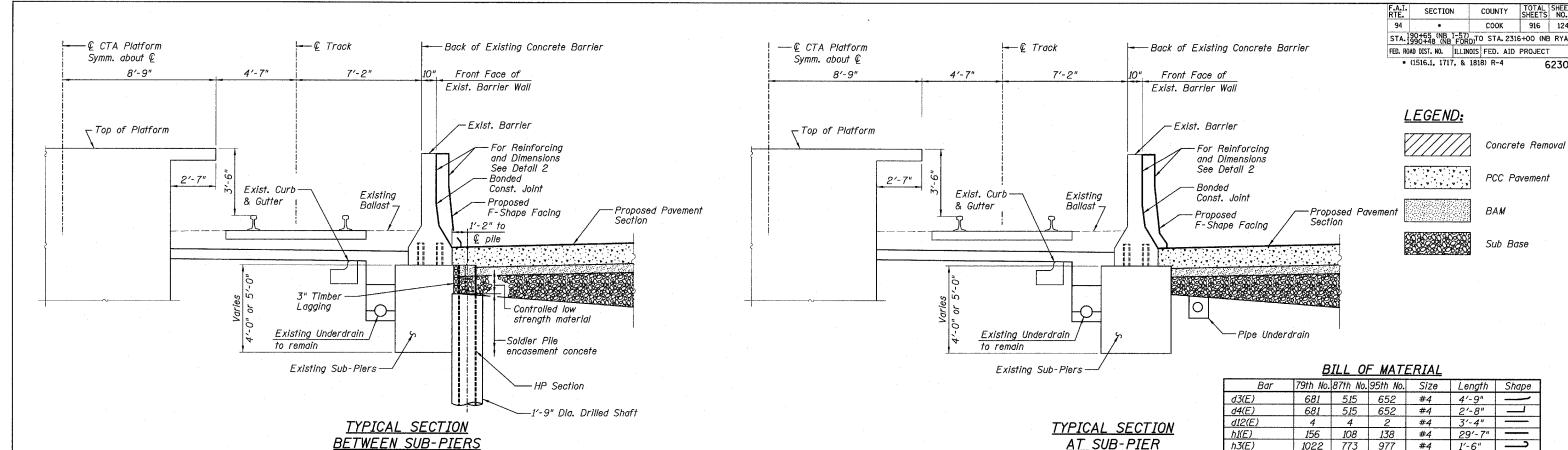

Contractor to cut and dispose of soldier pile tops as required for paving and as directed by the Engineer. Cost to be included in "Furnishing Soldier Piles (HP Section)".

(Pipe Underdrain not shown)

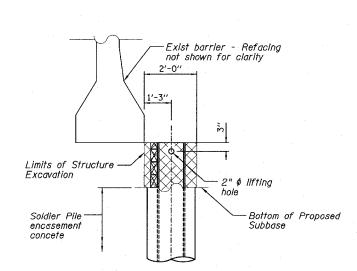

MISCELLANEOUS DETAILS

10" 33₈" Drill and Epoxy Grout h3(E) Bars © 2'-0" Horiz. cts. (5" Min. Embedment) #5 Ø 12 - Bonded Const. Joint (Typ.) #4 d3(E) Bar @ 12" cts. #6 @ 12 -#4 d4(E) Bars 🛭 12" cts. 1'-2" 1'-4" -Shoulder Pay Limit (Typ.) DETAIL 2

	₽	<u>ILL UI</u>	- MAI	ERIAL		
Bar	79th No.	87th No.	95th No.	Size	Length	Shape
d3(E)	681	<i>51</i> 5	652	#4	4'-9"	
d4(E)	681	<i>51</i> 5	652	#4	2'-8"	
d12(E)	4	4	2	#4	3'-4"	
h1(E)	156	108	138	#4	29'-7"	
h3(E)	1022	773	977	#4	1'-6"	
h12(E)	6	6	3	#4	1'-4"	
h14(E)	8	8	4	#4	2'-2"	
It e	m		Unit	79th Qty	87th Qty	95th Qty
Furnishing Soldi	er Piles		Foot	1428	1068	1320
(HP Section)						
Drilling and Sett	ting		Cu. Ft.	3731	2803	3703
Soldier Piles (in	Soil)					
Untreated Timbe	r Laggin	7	Sq. Ft.	1138	860	981
Reinforcement E	Bars,					
Epoxy Coated			Pound	7520	5490	6950
Concrete Struct	ures		Cu. Yd.	83	63	80
Protective Coat			Sq. Yd.	483	366	463
Structure Excav	ration		Cu. Yd.	141	108	147


* Coarse Aggregate shall meet the requirements of Article 1004.01-1004.02 of the Standard Specifications except the gradation will be limited to CA-11 or CA-14.


NOTES:

- 1. Drilling and grouting of #4 h3(E) bars shall be in accordance with Section 584 of the Standard Specifications.
- 2. #4 d4(E) bars shall be seated in their final position prior to the placement of the concrete shoulder. Bars shall not be mucked into place.
- The cost of drilling holes, furnishing and placing Epoxy Grout and setting #4 h3(E) bars shall be included in the cost for Concrete Structures.
- 4. Provide joints in facing to match those in the existing barrier, see Sht B1 for details.
- 5. h1(E) bars shall be cut as needed for fit.
- 6. See Sht. B1 for bar detailing.

SHEET B2 OF 8

VE A 1210L		ILLINOIS DEPARTMENT OF TRANSPORTATION								
NAME	DATE	ILLI	NOIS DEFANIA	MENT OF TRANSFO	KINITON					
		F.A.I	. 94 (DAN	RYAN EXPR	ESSWAY)					
		CTA ST	TATION BARF	RIER WALL MOD	IFICATIONS					
		79TH.	. 87TH AND	95TH STREET S	STATIONS					
				CTIONS & DETA						
		SCALE: N	ONE	DRAWN BY:	MPG, SP					
		DATE: M	ARCH 7, 2006	CHECKED BY	SP. PDF					

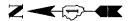

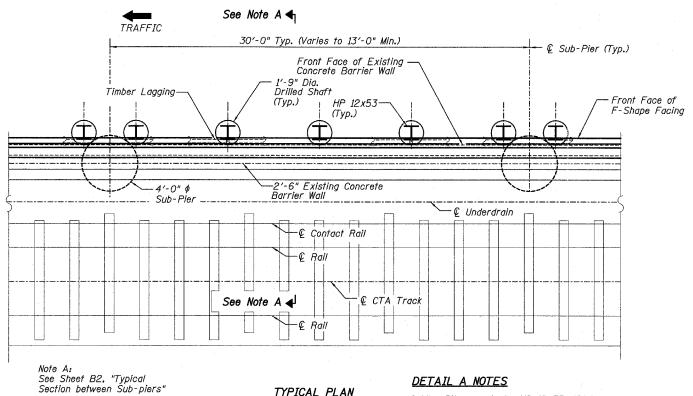

TYPICAL PLAN


DETAIL A NOTES

Soldier Piles are to be HP 12x53, 12' Long (288 required.) Fy min = 36,000 psi (M270 Grade 36)


Pile locations can be adjusted to miss proposed drainage structures. Maximum pile spacing 8'-0".

COUNTY TOTAL SHEET NO. SECTION COOK 916 125 STA. 190+65 (NB 1-57) STA. 1990+48 (NB FORD)TO STA. 2316+00 (NB RYAN FED. ROAD DIST. NO. ILLINOIS FED. AID PROJECT

• (1516.1, 1717, & 1818) R-4 62304 Plug Existing Conduit ---

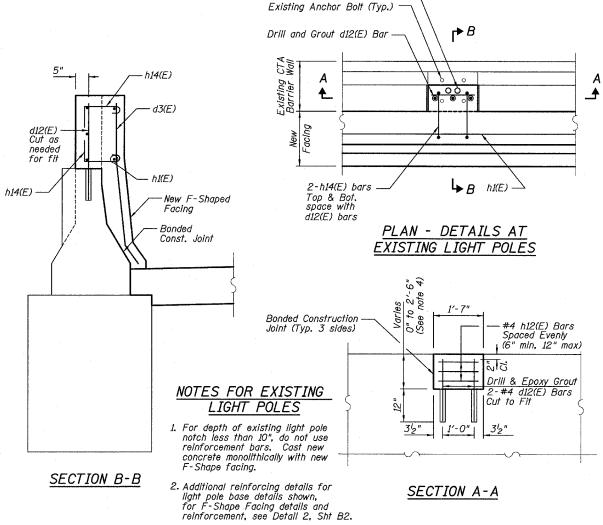

		SHEET B3 OF 8
REVISIONS	TILINOIS DEPARTMENT	OF TRANSPORTATION
NAME DATE		
	│ F.A.I. 94 (DAN R`	YAN EXPRESSWAY)
	CTA STATION BARRIER	R WALL MODIFICATIONS
	79TH, 87TH AND 951	TH STREET STATIONS
	TYPICAL PLA	AN/SECTIONS
	1	
	SCALE: NONE	DRAWN BY: SP
	DATE: MARCH 7, 2006	CHECKED BY: PDF

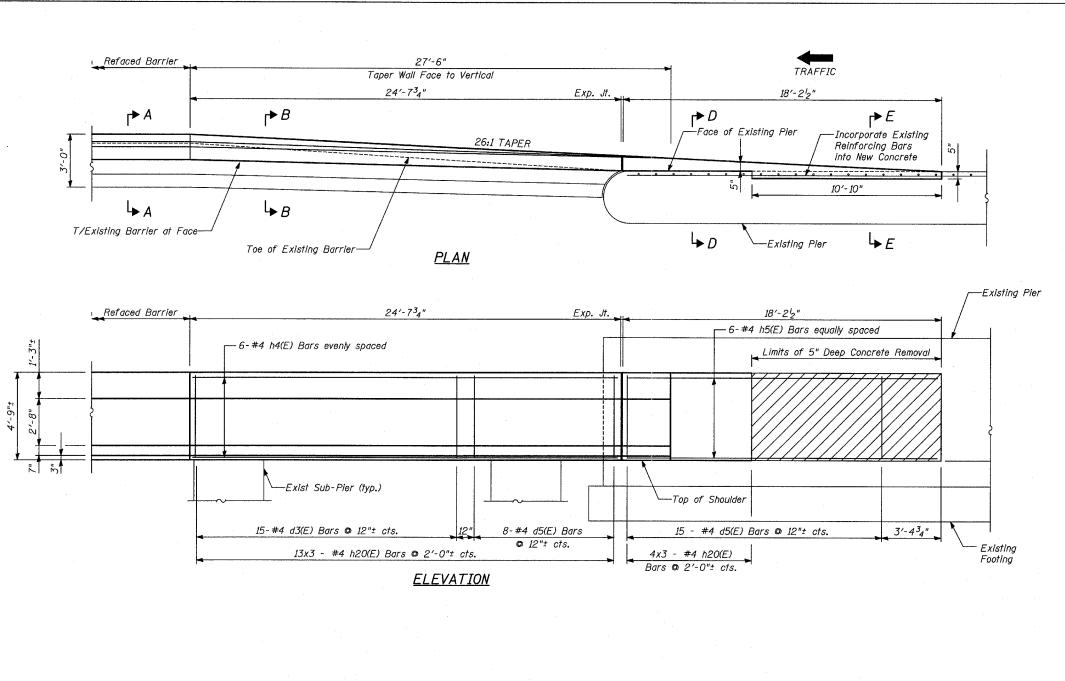

LEGEND:



Concrete Removal

NOTES:

- 1. Drilling and grouting of #4 h20(E) bars shall be in accordance with Section 584 of the Standard Specifications.
- 2. The cost of drilling holes, furnishing and placing Epoxy Grout and setting #4 h2O(E) bars shall be included in the cost for Concrete Structures.
- Provide joints in facing to match those in the existing barrier. See Sht B1 for joint details.
- 4. For Refaced Barrier details, see Sheet B2.
- 5. For Sections A-A thru H-H see Sheet B6.
- 6. For locations of Transition, see Roadway Plans.

DILL OF WATERIAL

<u>BILL OF MATERIAL</u>										
Bar	No.	Size	Length	Shape						
d3(E)	<i>1</i> 5	#4	4'-9"							
d5(E)	23	#4	4'-4"							
h4(E)	24'-4"									
h5(E)	6	#4	18'-0"							
h20(E)	51	#4	1'-6"							
Item			Unit	Quantity						
Reinforcement Ba	rs,									
Epoxy Coated			Pound	340						
Concrete Structur		Cu. Yd.	5							
Protective Coat	Sq. Yd.	28								
Concrete Removal		Cu. Yd.	1							

SHEET B4 OF 8

CHECKED BY: SP

COUNTY TOTAL SHEETS NO.

COOK 916 126

62304


SECTION

* (1516.1, 1717, & 1818) R-4

STA. 190+65 (NB T-577)TO STA. 2316+00 (NB RYAN FED. ROAD DIST. NO. | ILLINOIS | FED. AID | PROJECT

		SHEET D4 OF 6
REVISIONS	THE THOTE DEPART	TMENT OF TRANSPORTATION
NAME DATE	E ILLINOIS DEFARI	IMENI OF IRANSPORTATION
		N RYAN EXPRESSWAY)
	 CTA STATION BAR	RRIER WALL MODIFICATIONS
	79TH S	STREET STATION
	REFACED BARRI	IER TO PIER TRANSITION
		PLAN AND ELEVATION
	SCALE: NONE	DRAWN BY: MPG

DATE: MARCH 7, 2006

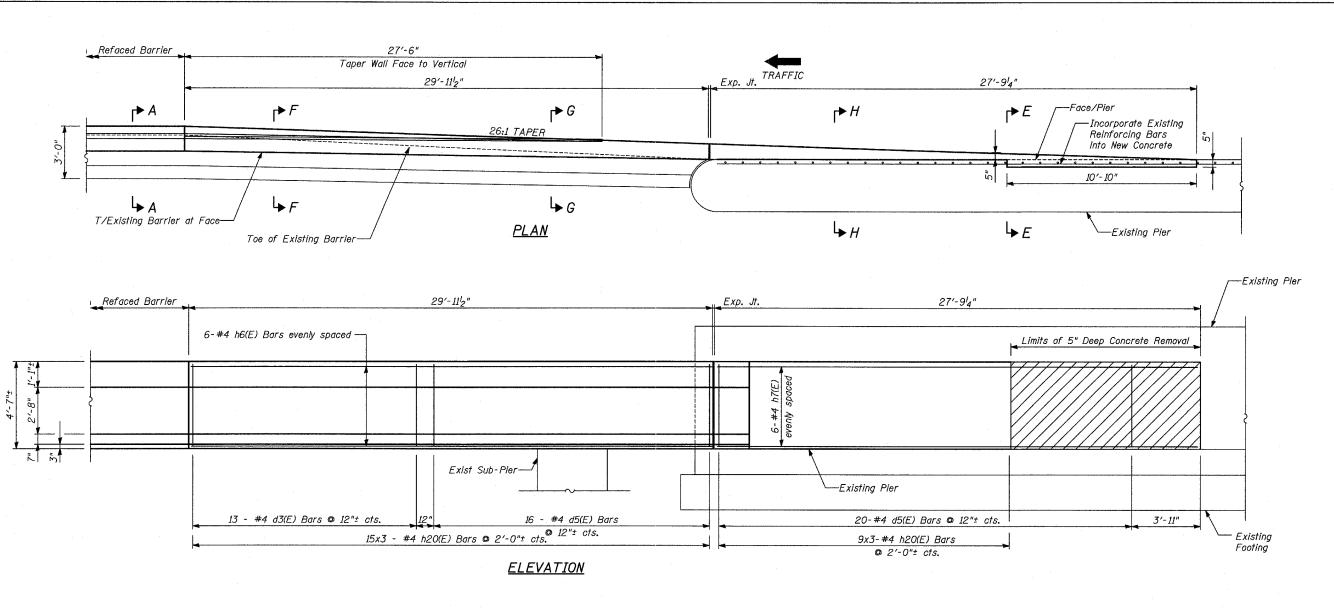

LEGEND: Concrete Removal

NOTES:

- Drilling and grouting of #4 h2O(E) bars shall be in accordance with Section 584 of the Standard Specifications.
- 2. The cost of drilling holes, furnishing and placing Epoxy Grout and setting #4 h20(E) bars shall be included in the cost for Concrete Structures.
- 3. Provide joints in facing to match those in the existing barrier. See Sht B1 for
- 4. For Refaced Barrier details, see Sheet B2.
- 5. For Sections A-A thru H-H see Sheet B6.
- 6. For locations of Transition, see Roadway Plans.

BILL OF MATERIAL

DILL OF MITTELLIAL										
Bar	No.	Size	Length	Shape						
d3(E)	13	#4	4'-9"							
d5(E)	25	#4	4'-4"							
h6(E)	6	#4	29'-9"							
h7(E)	6	#4	27'-6"							
h20(E)	72	#4	1'-6"							
Item			Unit	Quantity						
Reinforcement Ba	rs,									
Epoxy Coated			Pound	420						
Concrete Structur	es		Cu. Yd.	7						
Protective Coat			Sq. Yd.	37						
Concrete Removal	Concrete Removal Cu. Yd. 1									

SHEET B5 OF 8

COUNTY TOTAL SHEET NO.

916 127

62304


COOK

STA. 190+65 (NB 1-57) TO STA. 2316+00 (NB RYAN FED. ROAD DIST. NO. ILLINOIS FED. AID PROJECT

SECTION

* (1516.1, 1717, & 1818) R-4

REVISIONS NAME DATE	ILLINOIS DEPARTMEN	T OF TRANSPORT	TATION							
	F.A.I. 94 (DAN R									
	CTA STATION BARRIE	R WALL MODIF	ICATIONS							
	95TH STRE	ET STATION								
	SOM SINEE! STATION									
	REFACED BARRIER	TO PIER TRAN	SITION							
	DETAILS: PLAN	AND ELEVATI	ON							
	SCALE: NONE	DRAWN BY:	MPG							
	DATE: MARCH 7, 2006	CHECKED BY:	SP							

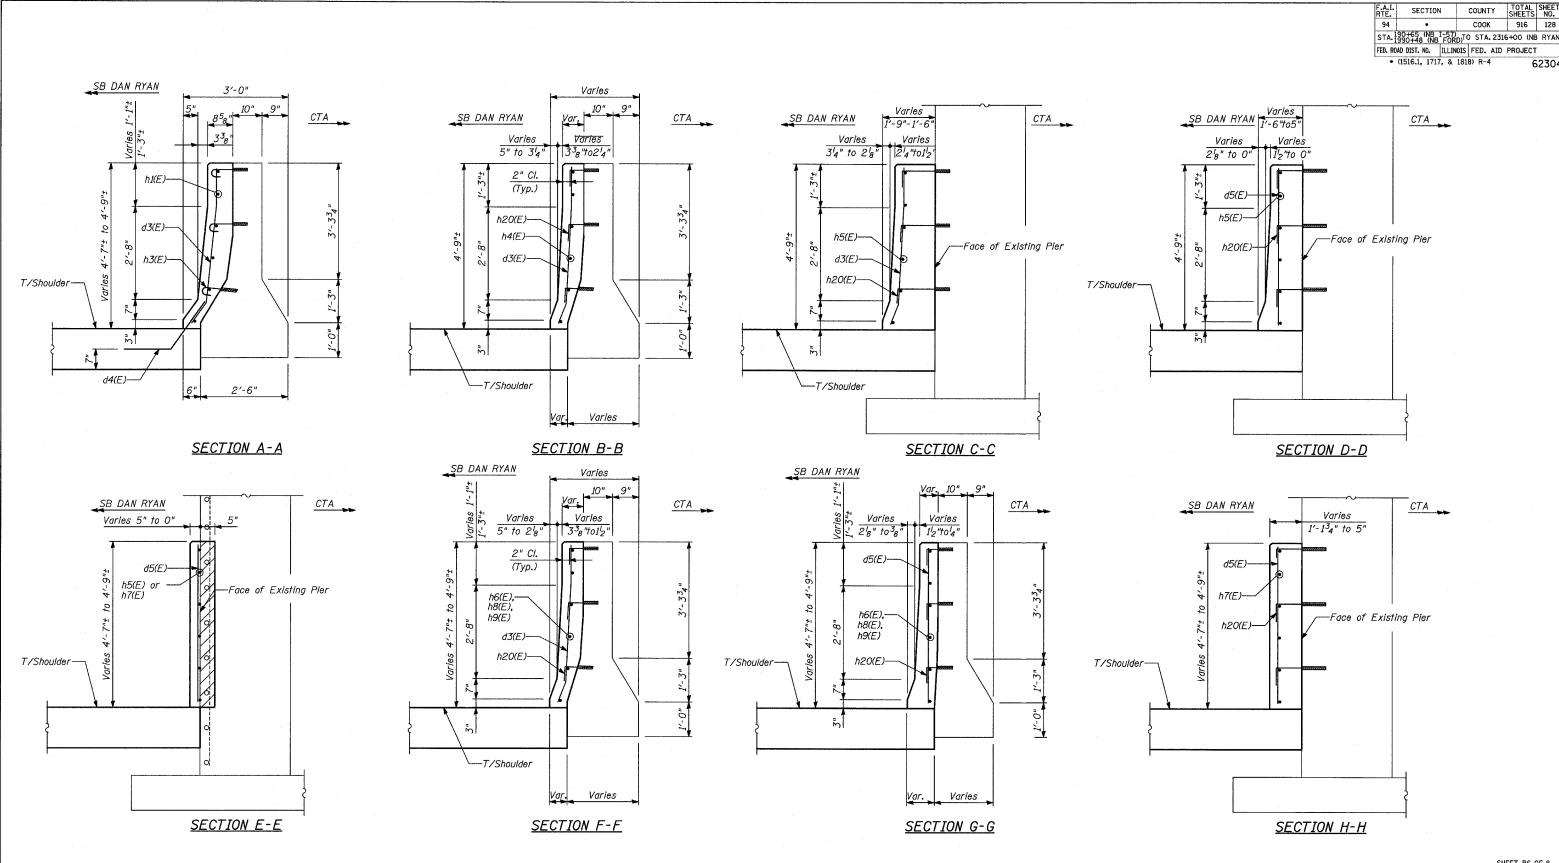


<u>NOTE</u>


Drill and Epoxy Grout h3(E) and h2O(E) Bars (5" Min. Embedment)

TYLININTERNATIONAL

			SHEET BO UP 8
REVISIONS		ILLINOIS DEPARTMENT OF TRA	NCDODTATION
NAME	DATE	ILLINOIS DEFARIMENT OF TRA	INSPURIATION
		F.A.I. 94 (DAN RYAN E)	(PRESSWAY)
		CTA STATION BARRIER WALL	MODIFICATIONS
		79TH, 87TH AND 95TH STRE	ET STATIONS
		REFACED BARRIER TO PIER	TRANSITION
		DETAILS: TYPICAL SE	CTIONS
		DETAILS: THICAL SE	CITONS
		SCALE: NONE DRAWN	BY: MPG
		DATE: MARCH 7, 2006 CHECK	ED BY: SP

62304

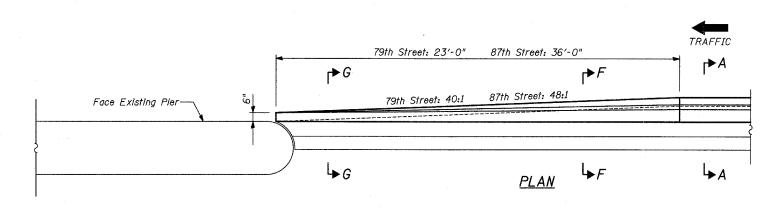

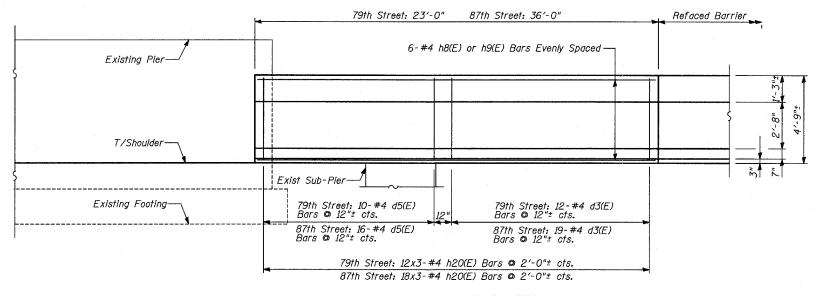

ELEVATION

NOTES:

- Drilling and grouting of #4 h20(E) bars shall be in accordance with Section 584 of the Standard Specifications.
- 2. The cost of drilling holes, furnishing and placing Epoxy Grout and setting #4 h20(E) bars shall be included in the cost for Concrete Structures.
- 3. Provide joints in facing to match those in the existing barrier. See Sht B1 for joint details.
- 4. For Refaced Barrier details, see Sheet B2.
- 5. For Sections A-A thru H-H see Sheet B6.
- 6. For locations of Transition, see Roadway Plans.

BILL OF MATERIAL

MA MA W 17 17 17 1 1 1 1 1 1 1 1 1 1 1 1 1 1						
Bar	79th No.	87th No.	Size	Length	Shape	
h8(E)	6		#4	22'-9"		
h9(E)		6	#4	35′-9"		
h20(E)	36	54	#4	1'-6"		
d3(E)	12	19	#4	4'-9"		
d5(E)	10	16	#4	4'-4"		
Ite	m		Unit	79th Qty	87th Qty	
Reinforcement	Bars,					
Epoxy Coated			POUND	200	310	
Concrete Struc	tures		CU YD	2	4	
Protective Coat			SQ YD	<i>1</i> 5	25	

SECTION

* (1516.1, 1717, & 1818) R-4


COUNTY


STA. 1990-65 (NB T-57) TO STA. 2316-00 (NB RYAM FED. ROAD DIST. NO. | ILLINOIS | FED. AID | PROJECT

COOK 916 129

SHEET B7 OF 8

REVISIONS		T,	LINOTE	DEPARTM	CNT O	TDAK	COADT	ATTON	
IAME	DATE	1 1	LINUI2	DEPARIM	ENI U	IKAN	ISPUR I	AIION	
		F.A	.I. 94	(DAN	RYA	N EX	PRES	SWAY)
				N BARR					
			79TH	& 87TI	STR	EET S	TATI	NC	
		REI	FACED	BARRIEI	R TO	PIER	TRANS	NOITIE	
		DETAIL:	S: PLAN	N, ELEV	ATION	I & T	YPICA	L SECT	TOI
		SCALE:	NONE			DRAWN	BY:	MPG	
		DATE:	MARCH 7	2006		CHECKE	BY:	SP	

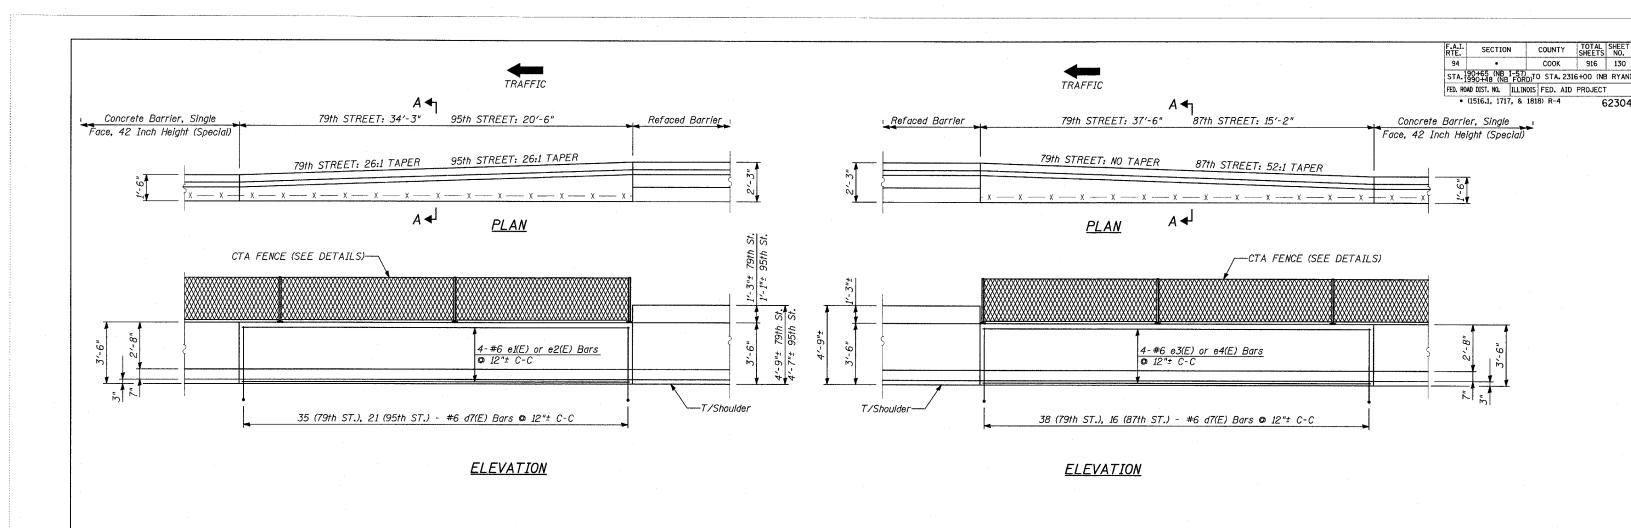

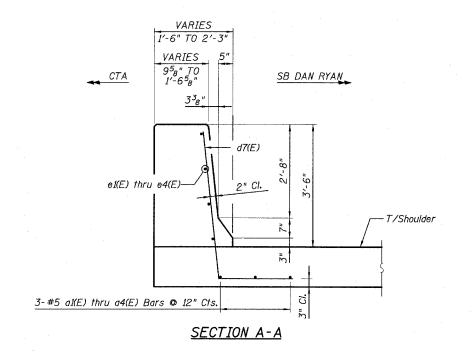

TYLININTERNATIONAL

NOTES:


- Provide joints in facing to match those in the Existing Barrier. See Sht B1 for ioint details.
- 2. For Refaced Barrier details, see Sheet B2.
- 3. For Concrete Barrier, Single Face, 42" (Special), see Typical Section details.
- 5. For locations of Transition, see Roadway Plans.

BILL OF MATERIAL

79th N.	79th S.	87th	95th	Size	Length	Shape
3	-	-	-	#5	34'-0"	
-	1	-	3	#5	20'-2"	
-	3	-	-	#5	37'-3"	
-	•	3	-	#5	14'-10"	
34	38	<i>1</i> 6	21	#6	6'-3"	
4	-	-	-	#6	34'-0"	
-		-	4	#6	20'-2"	
-	4	-	-	#6	37′-3"	
-	-	4	-	#6	14'-10"	
Item			79th N.	79th S.	87th	95†h
cement E	Bars.					
Epoxy Coated		Pound	630	700	290	390
Concrete Structures			7	7	3	4
Protective Coat			19	21	9	12
	3 34 4 Ite cement E coated e Structe	3 3 34 38 4 4 Item coment Bars, Coated by Structures	3	3 3 - 3 - 3 - 3 - 3 - 3 3 - 3 3 - 4 4 - 4 4 - 4 4 - 1tem Unit 79th N. coment Bars, coated Pound 630 e Structures Cu. Yd. 7	3 #5 3 #5 - 3 #5 - 3 #5 - 3 #5 34 38 16 21 #6 4 #6 4 #6 - 4 #6 - 4 #6 - 1tem Unit 79th N. 79th S. coment Bars, coated Pound 630 700 e Structures Cu. Yd. 7	3 #5 34'-0" 3 #5 20'-2" - 3 #5 37'-3" 3 - #5 14'-10" 34 38 16 21 #6 6'-3" 4 #6 34'-0" 4 #6 20'-2" - 4 - #6 37'-3" 4 - #6 37'-3" Item Unit 79th N. 79th S. 87th cement Bars, coated Pound 630 700 290 e Structures Cu. Yd. 7 7 3

SHEET B8 OF 8

							01112	_,,	•
REVISIONS		TI	I THOTS I	TEDART	MENT O	F TRANSI	DART	ATTON	
NAME	DATE	1	LINUIS I	JEPARI	MEN I	r iransi	PORT	AIIUN	
		F.A	.I. 94	(DAN	I RYA	N EXP	RES	SWAY)	
						ALL MO			
		797	H, 87TH	- AND	95TH	STREET	ST	ATIONS	
		REFA	CED BAR	RRIER	TO NE	W 42 II	NCH	BARRIE	R
						N & TYF			
		OC I ALL	0. 1 Ent	,	17110	ν ω	IOA	J. J.C.	
		SCALE:	NONE			DRAWN BY	:	MPG	
		DATE:	MARCH 7,	2006		CHECKED I	BY:	SP	

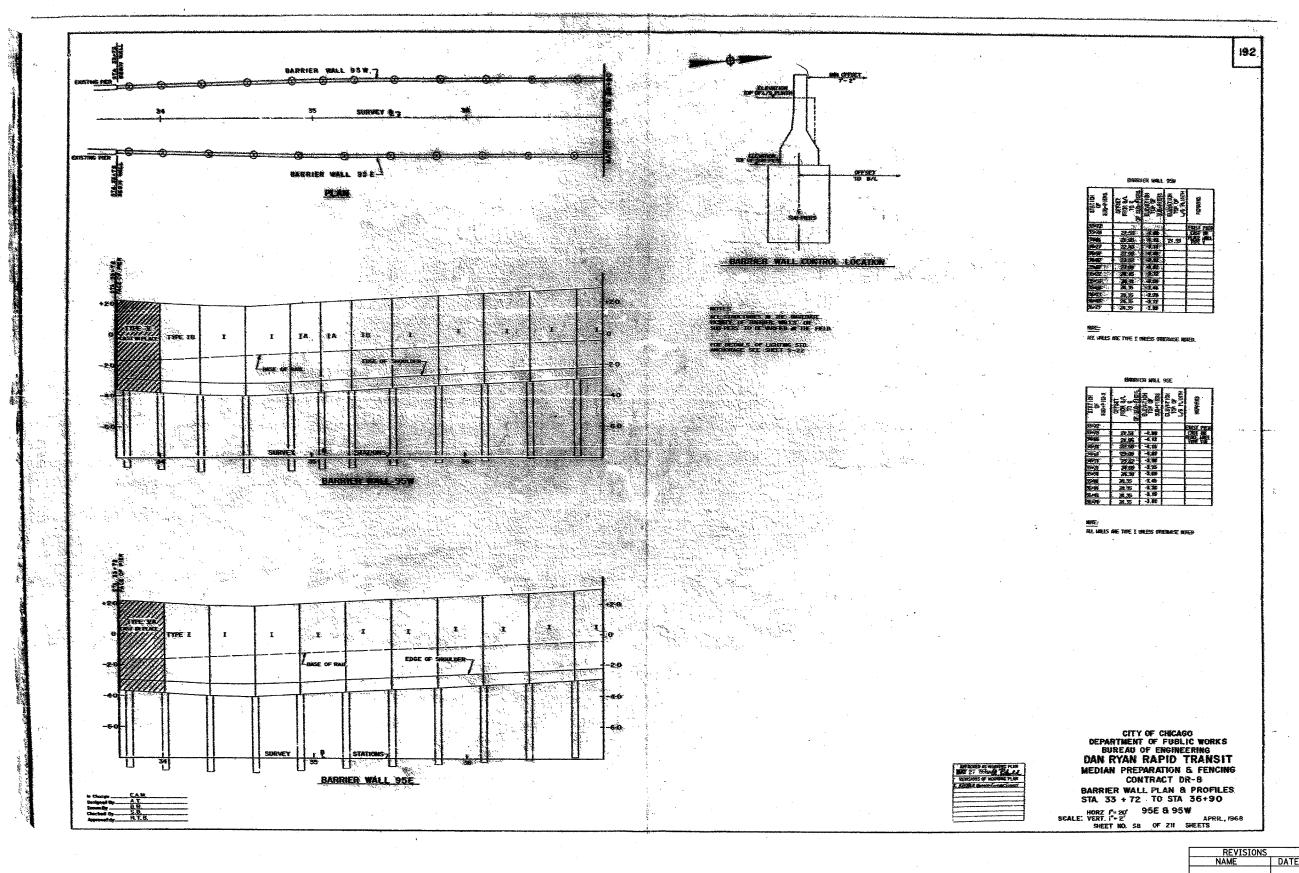

COUNTY TOTAL SHEET NO.

COOK 916 131 STA. 190465 (NB 1-577) TO STA. 2316+00 (NB RYAN
FED. ROAD DIST. NO. | ILLINOIS | FED. AID PROJECT


• (1516.1, 1717, & 1818) R-4 62304

FOR INFORMATION ONLY

REVISIO		ILLINOIS DEPARTMENT OF TRANSPORTATION
AME	DATE	TEETHOIS DEFAITMENT OF THANSFORTATION
		F.A.I. 94 (DAN RYAN EXPRESSWAY)
		EVICTING CONCERT DARRED AT
		EXISTING CONCRETE BARRIER AT
		CTA STATIONS:

95TH STREET (1 OF 2) SCALE: NONE

DRAWN BY: JJS CHECKED BY: TGB

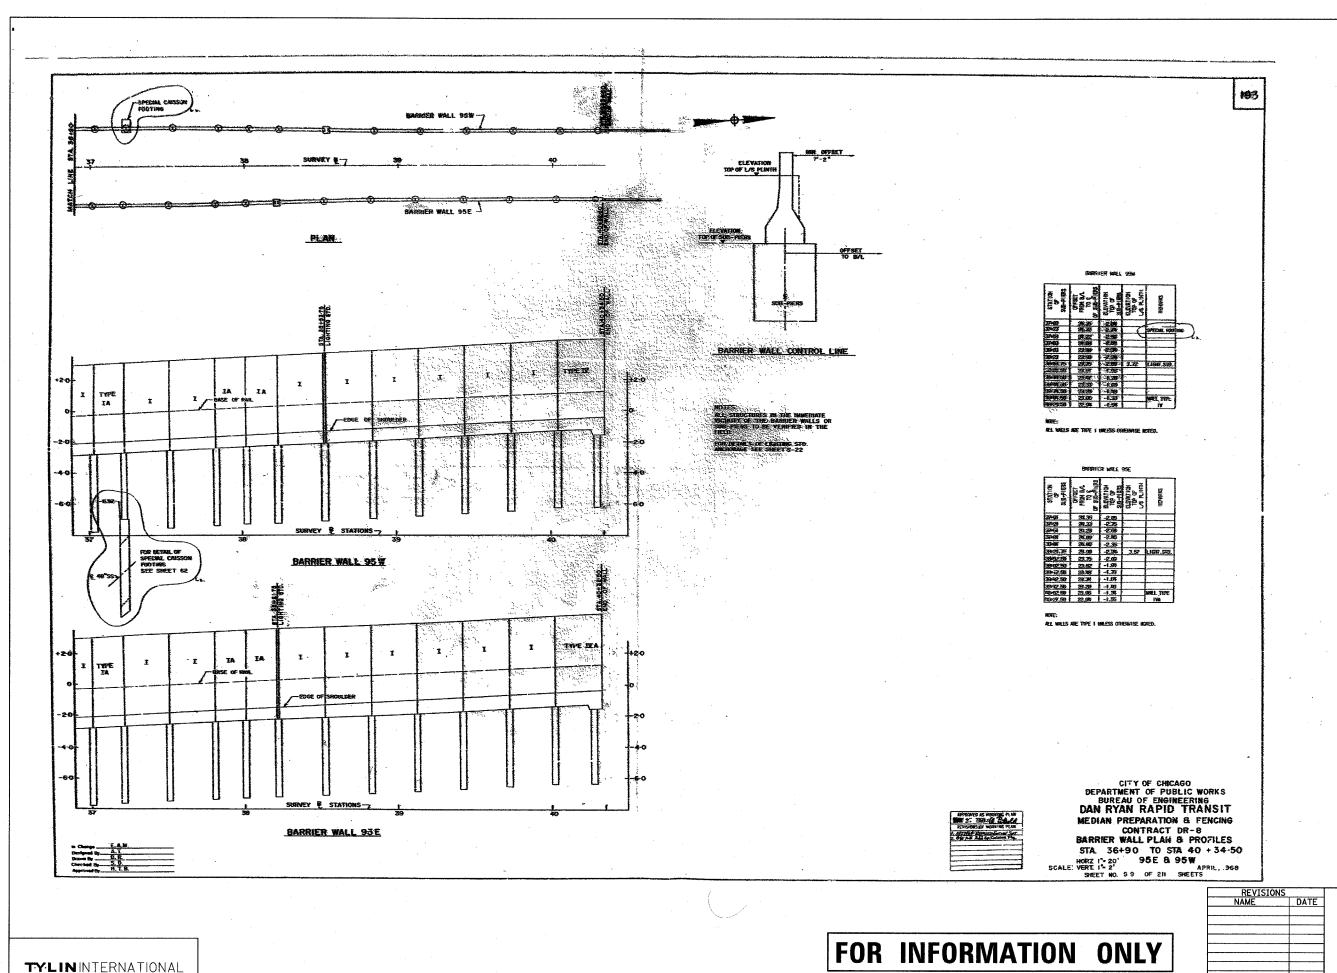

COUNTY TOTAL SHEE NO. COOK 916 132 STA. 190+65 (NB 1-57) TO STA. 2316+00 (NB RYAN FED. ROAD DIST. NO. ILLINOIS FED. AID PROJECT

* (1516.1, 1717, & 1818) R-4


ILLINOIS DEPARTMENT OF TRANSPORTATION F.A.I. 94 (DAN RYAN EXPRESSWAY)

EXISTING CONCRETE BARRIER AT CTA STATIONS: 95TH STREET (2 OF 2)

SCALE: NONE

DRAWN BY: JJS CHECKED BY: TGB

DATE: MARCH 7, 2006

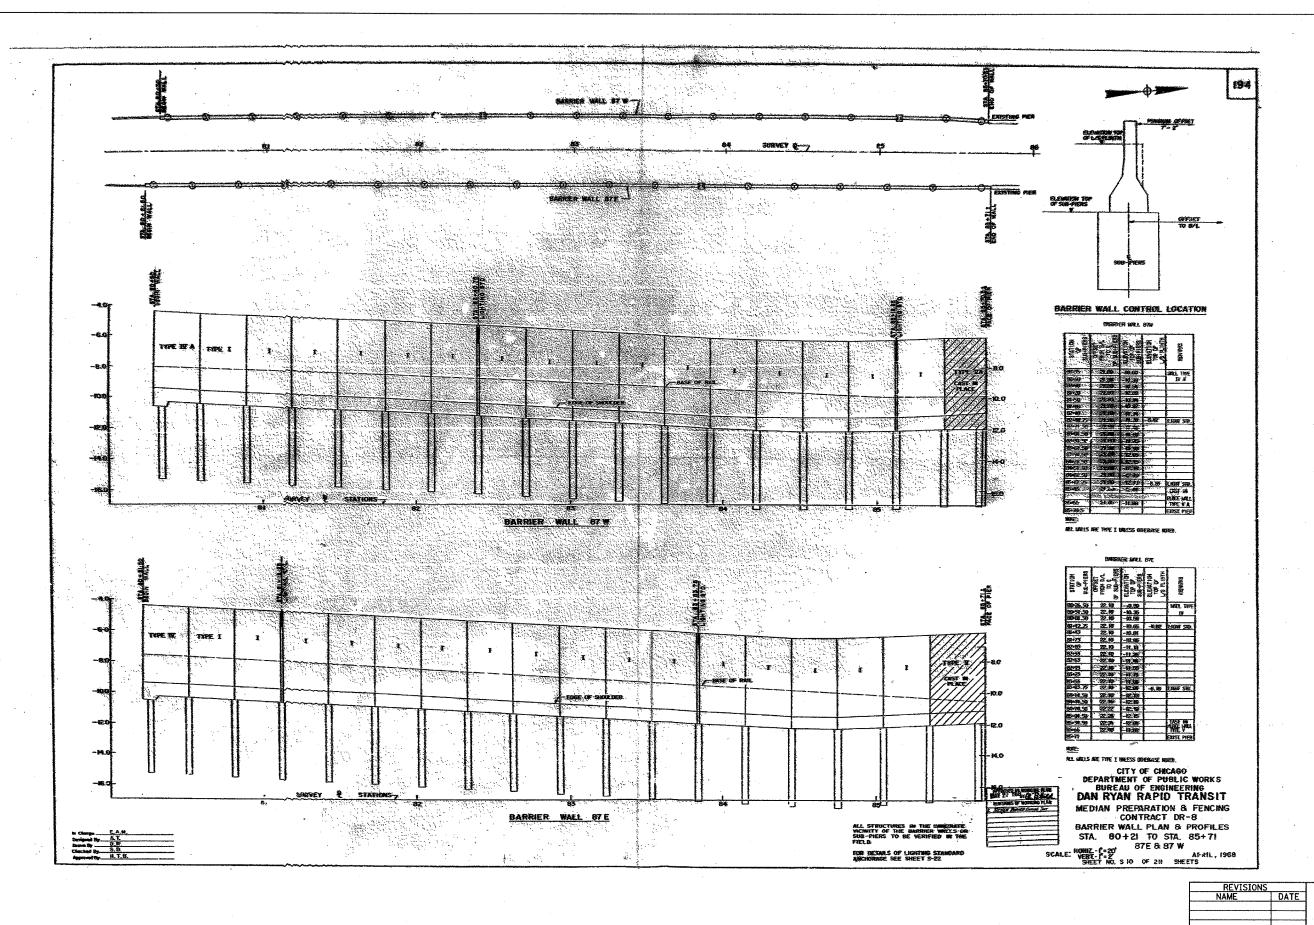

SECTION COUNTY TOTAL SHEET NO. COOK 916 133 STA. 190+65 (NB I-57) STA. 1990+48 (NB FORD)TO STA. 2316+00 (NB RYAN FED. ROAD DIST. NO. ILLINOIS FED. AID PROJECT

• (1516.1, 1717, & 1818) R-4

ILLINOIS DEPARTMENT OF TRANSPORTATION F.A.I. 94 (DAN RYAN EXPRESSWAY)


> EXISTING CONCRETE BARRIER AT CTA STATIONS: 87TH STREET (1 OF 1)

SCALE: NONE DATE: MARCH 7, 2006

DRAWN BY: JJS CHECKED BY: TGB

TYLININTERNATIONAL

FOR INFORMATION ONLY

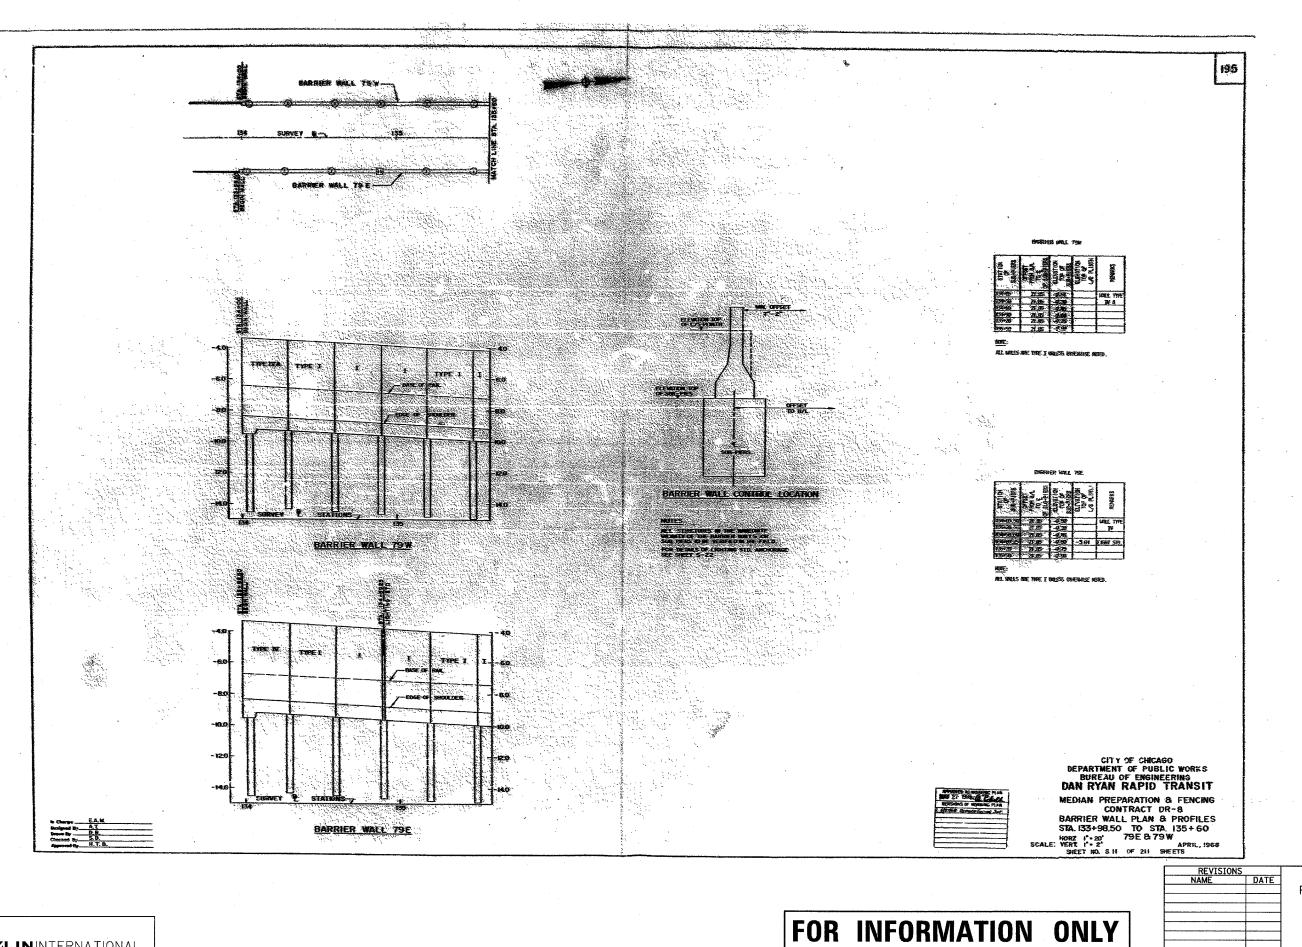


TYLININTERNATIONAL

COOK 916 134 STA. 190+65 (NB I-57) TO STA. 2316+00 (NB RYAN) FED. ROAD DIST. NO. | ILLINOIS | FED. AID | PROJECT |
• (1516.1, 1717, & 1818) R-4 | 62

ILLINOIS DEPARTMENT OF TRANSPORTATION F.A.I. 94 (DAN RYAN EXPRESSWAY)

EXISTING CONCRETE BARRIER AT CTA STATIONS: 79TH STREET (1 OF 2)

CHECKED BY: TGB

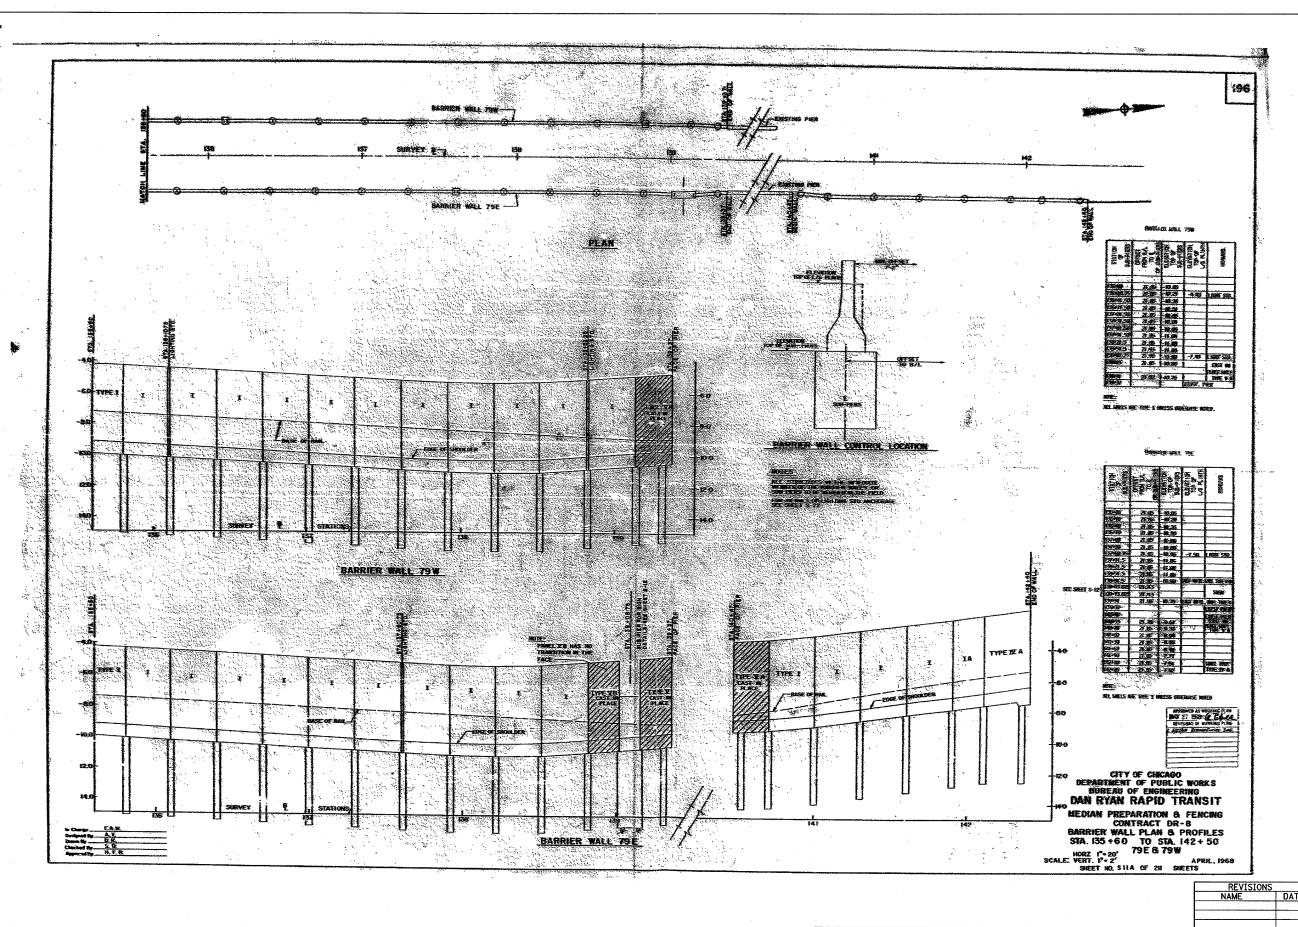

TYLININTERNATIONAL

FED. ROAD DIST. NO. | ILLINOIS | FED. AID PROJECT • (1516.1, 1717, & 1818) R-4 62


F.A.I. 94 (DAN RYAN EXPRESSWAY)

EXISTING CONCRETE BARRIER AT CTA STATIONS: 79TH STREET (2 OF 2)

CALE: NONE

DRAWN BY: JJS
CHECKED BY: TGB

FOR INFORMATION ONLY

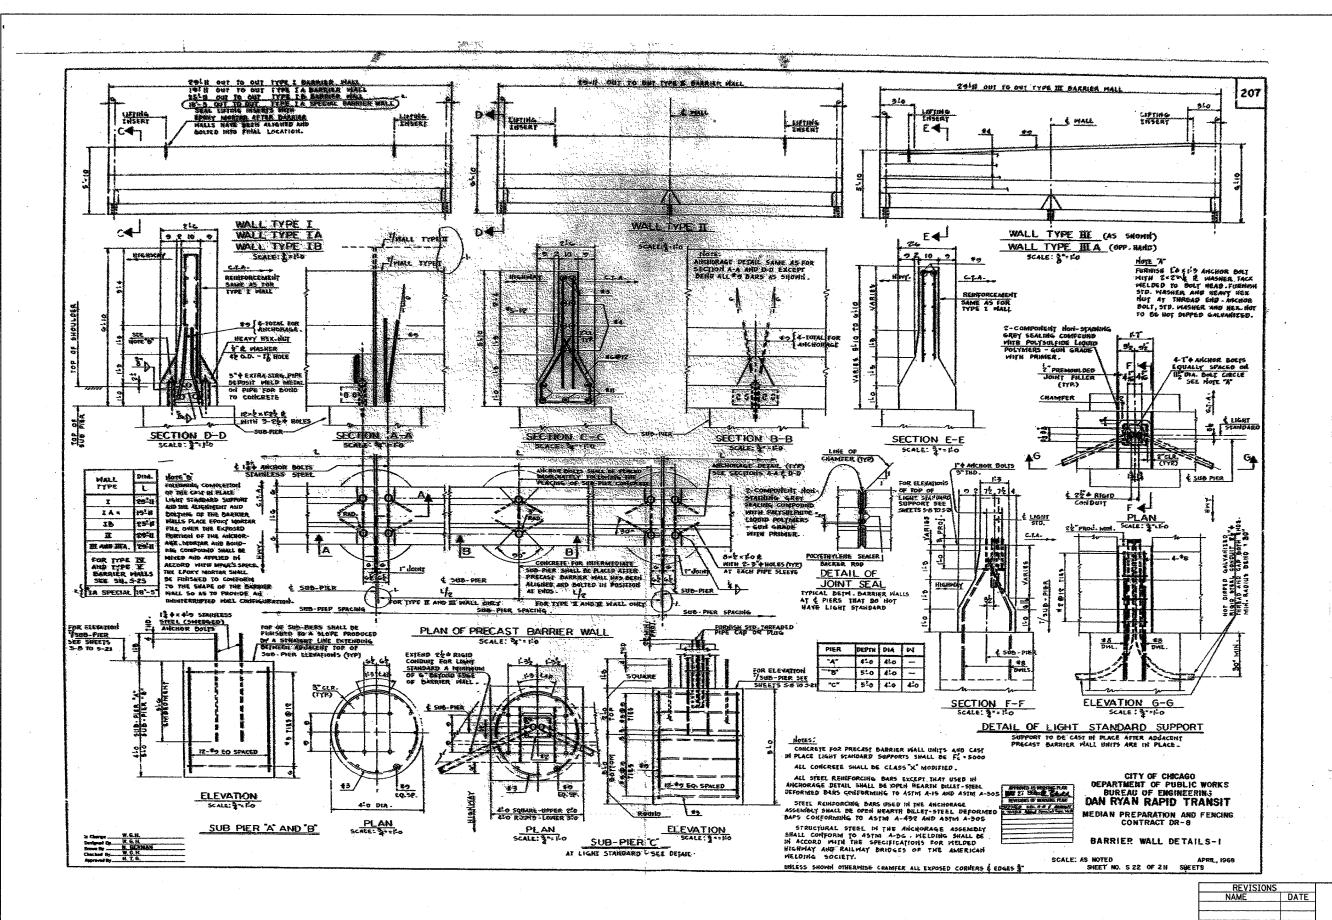

• (1516.1, 1717, & 1818) R-4


ILLINOIS DEPARTMENT OF TRANSPORTATION
F.A.I. 94 (DAN RYAN EXPRESSWAY)

EXISTING CONCRETE BARRIER AT CTA STATIONS:
BARRIER DETAILS

SCALE: NONE
DATE: MARCH 7, 2006

DRAWN BY: JJS
CHECKED BY: TGB

FOR INFORMATION ONLY

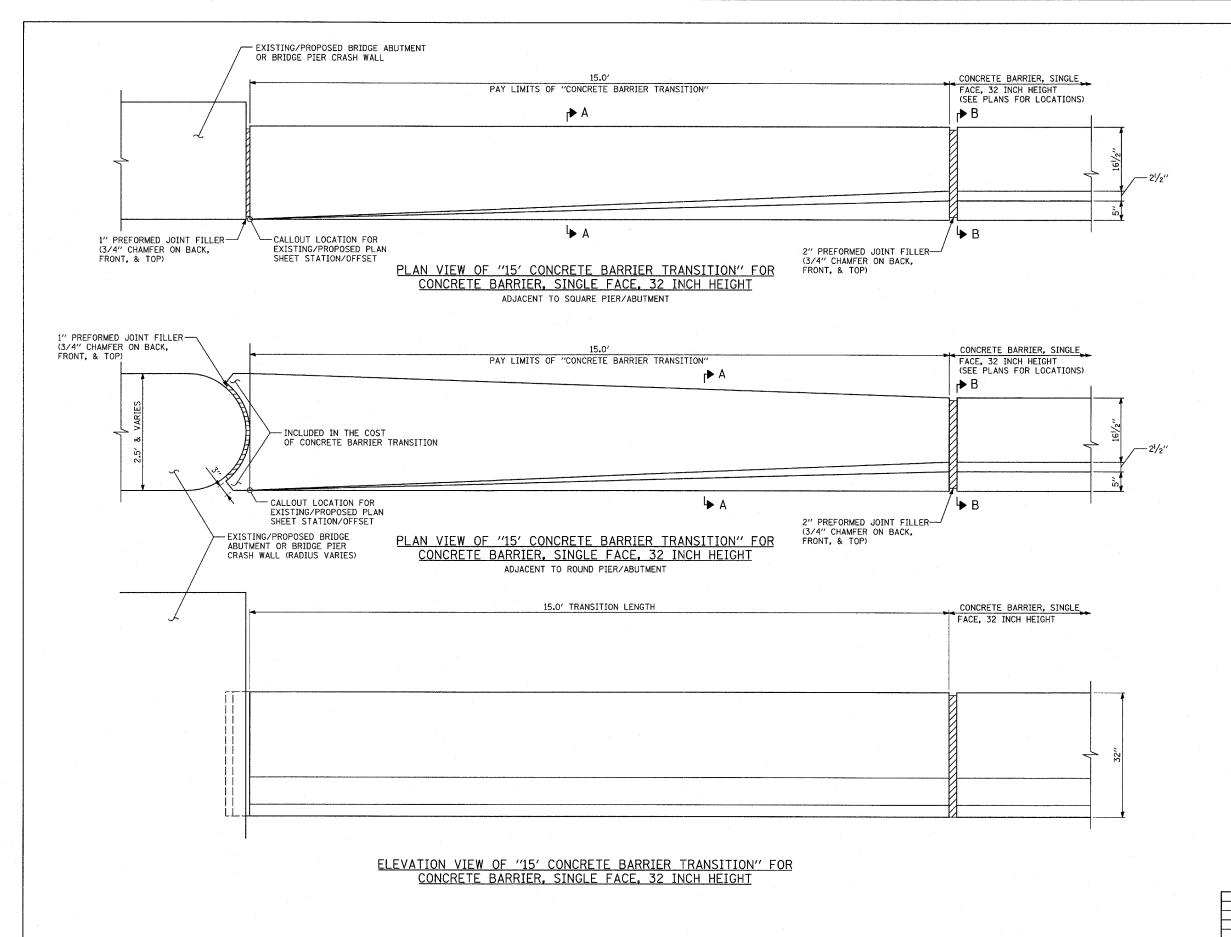

COUNTY TOTAL SHEET NO. SECTION COOK 916 137 STA. 190+65 (NB I-57) TO STA. 2316+00 (NB RYAN FED. ROAD DIST. NO. | ILLINOIS | FED. AID PROJECT

62304


• (1516.1, 1717, & 1818) R-4

NOTE: ALL PREFORMED JOINT FILLER INCLUDED IN THE COST OF "CONCRETE BARRIER TRANSITION"

CHECKED BY: TGB

REVISIONS NAME D	DATE	ILLINOIS DEPARTMENT OF TRANSPORTATION							
		F.A.	.I. 94	(DA	N F	RYAN	EX	PRES	SWAY)
						EOUS (-
		FOR	CONC	RETE	BAR	RRIER RIER.	TRA 32	NSITI INCH	ON HEIGHT
		SCALE:	NONE			DR	AWN	BY:	MPG

DATE: MARCH 7, 2006

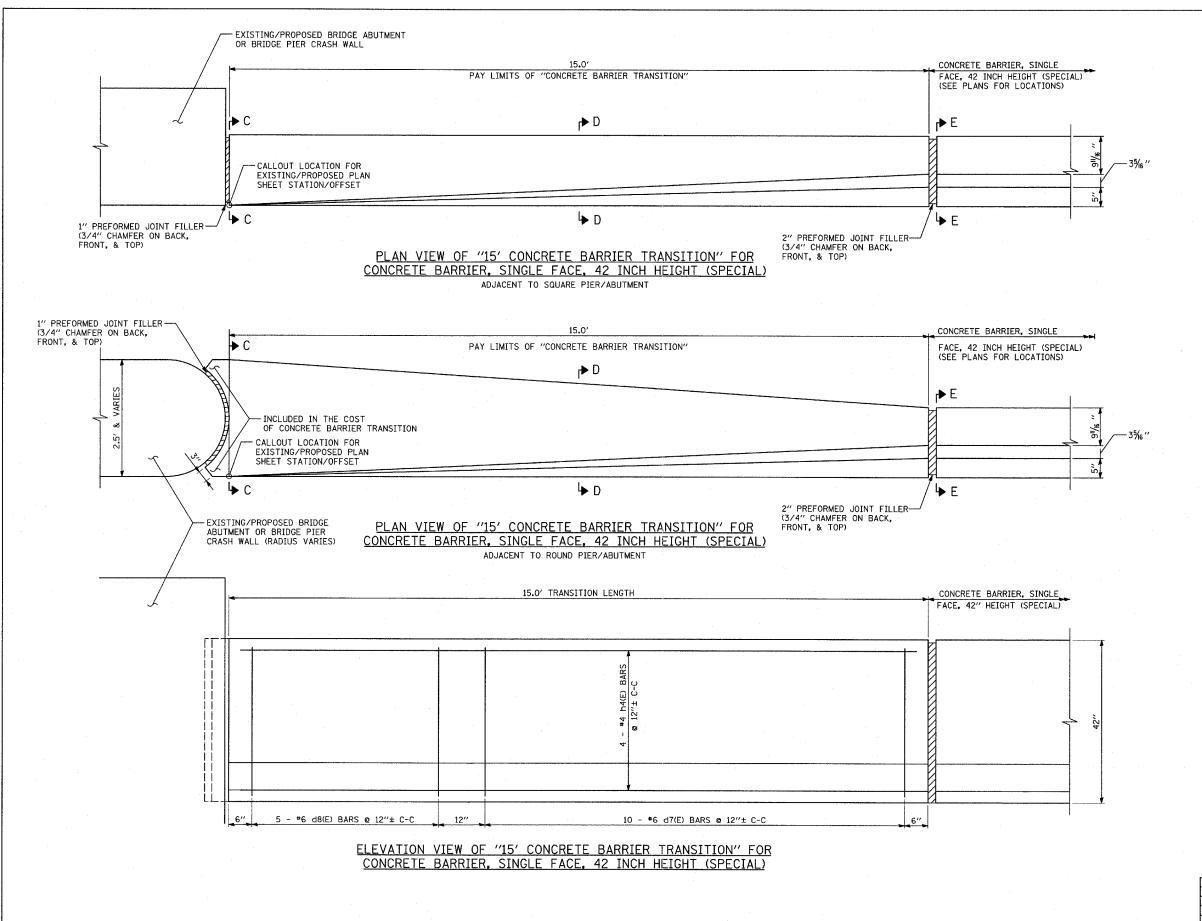


TY:LININTERNATIONAL


COUNTY TOTAL SHEET NO. SECTION COOK 916 138 STA. 190+65 (NB T-57) TO STA. 2316+00 (NB RYAN FED. ROAD DIST. NO. ILLINOIS FED. AID PROJECT 62304

* (1516.1, 1717, & 1818) R-4

ALL PREFORMED JOINT FILLER INCLUDED IN THE COST OF "CONCRETE BARRIER TRANSITION"

REVISIONS NAME DATE			MENT OF TRANSPORT RYAN EXPRES	
	CONCRE	MISCELLA ONCRETE BARI ETE BARRIER,	NEOUS DETAILS: RIER TRANSITION 42 INCH HEIGHT	FOR (SPECIAL
	SCALE:	NONE MARCH 7, 2006	DRAWN BY: CHECKED BY:	MPG TGB

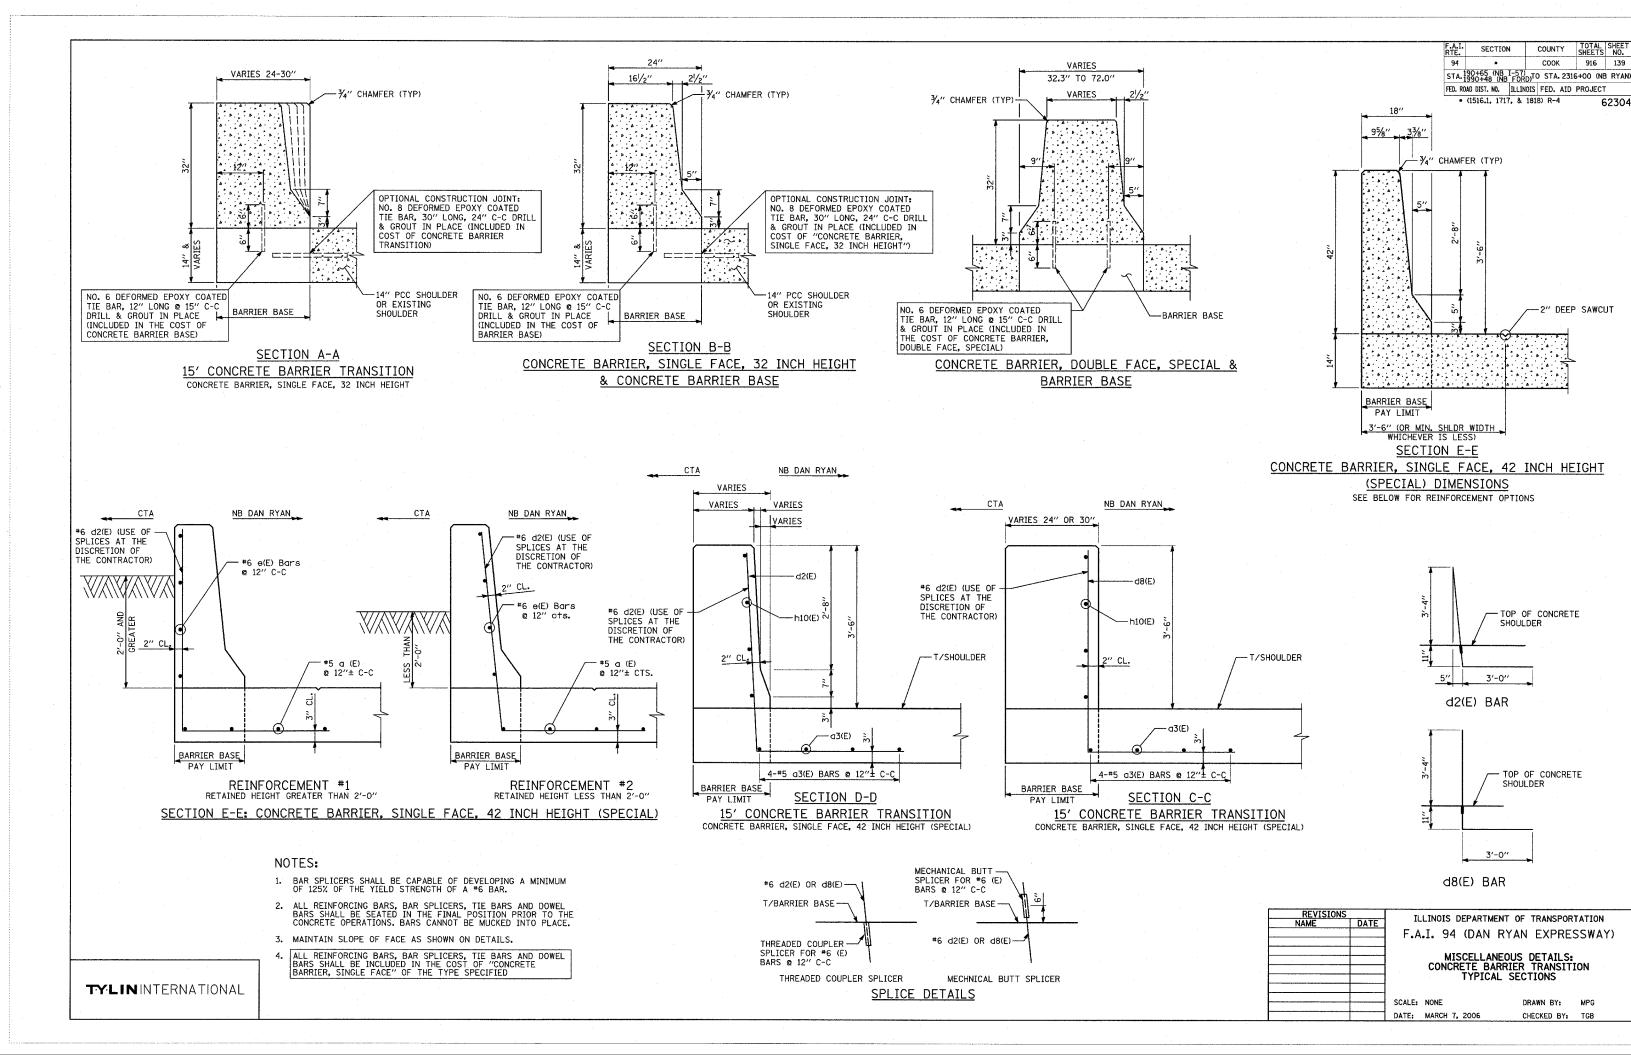

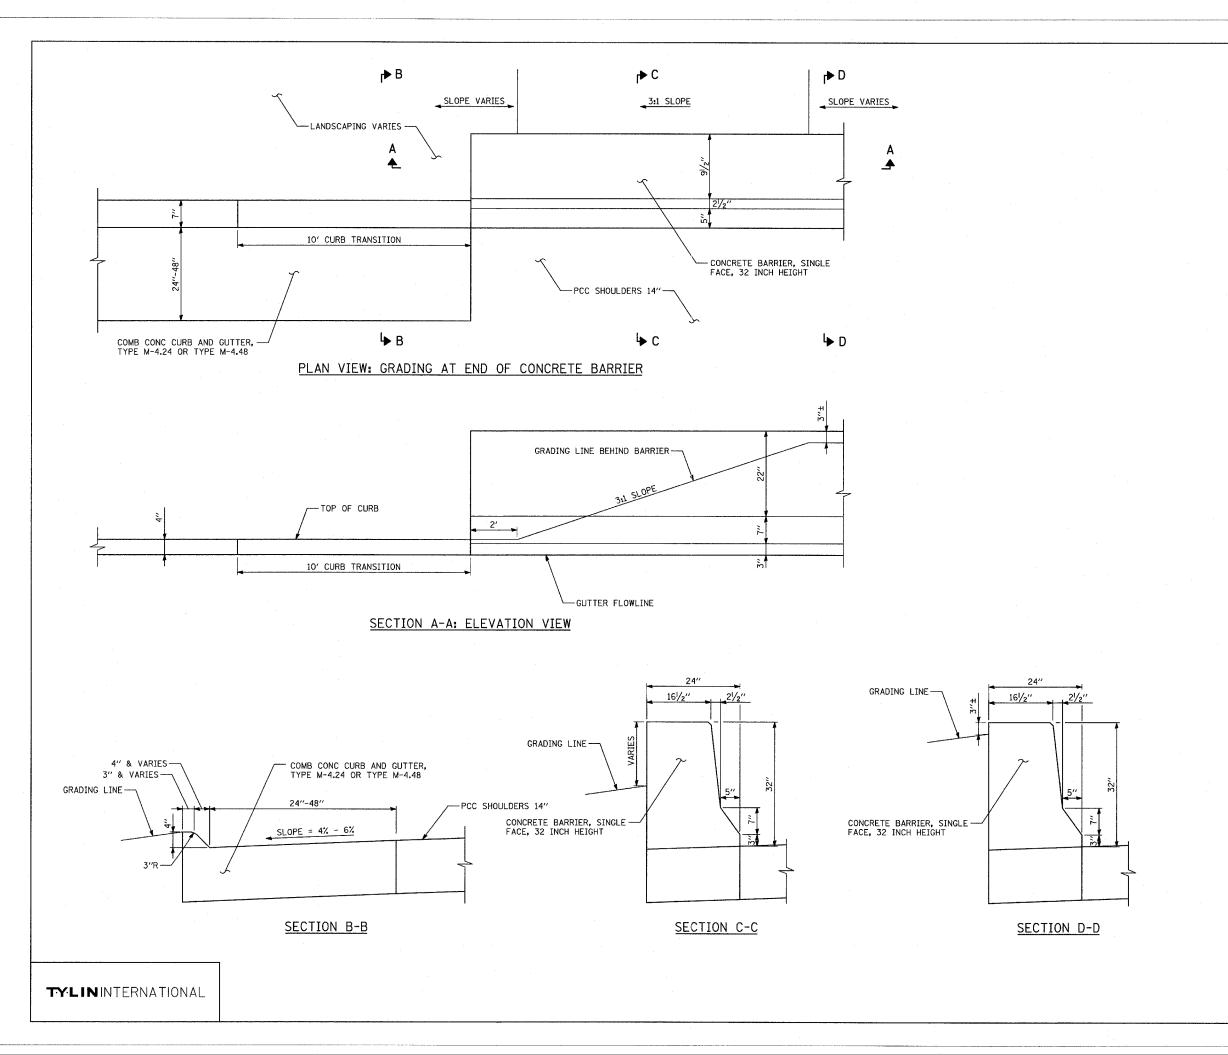


COUNTY TOTAL SHEETS NO.


COOK 916 140 SECTION STA. 190+65 (NB I-57) TO STA. 2316+00 (NB RYAN FED. ROAD DIST. NO. | ILLINOIS | FED. AID PROJECT * (1516.1, 1717, & 1818) R-4 62 62304

NOTES:


1. SEE DRAINAGE AND UTILITY PLANS, CROSS-SECTIONS, AND LANDSCAPING PLANS FOR GRADING LIMITS AND DETAILS.


REVISIONS		ILLINOIS DEPARTMENT OF TRANSPORTATION						
NAME	DATE	TELINOIS DEPARTMENT OF INANSFORTATION						
		F.A	.I. 94 (DAN	RYA	V FXPRES	SSWAY)		
		MISCELLANEOUS DETAILS:						
					L AT END			
			GUADING	DEIVI	BARRIER			
			UF CUN	CKEIE	DAKKIEK			
		SCALE:	NONE		DRAWN BY:	MPG		
		DATE:	MARCH 7, 2006		CHECKED BY:	TGB		
.l		DATE:	MARCH 1, 2000		CILCRED DIS	100		

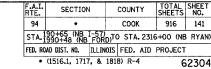

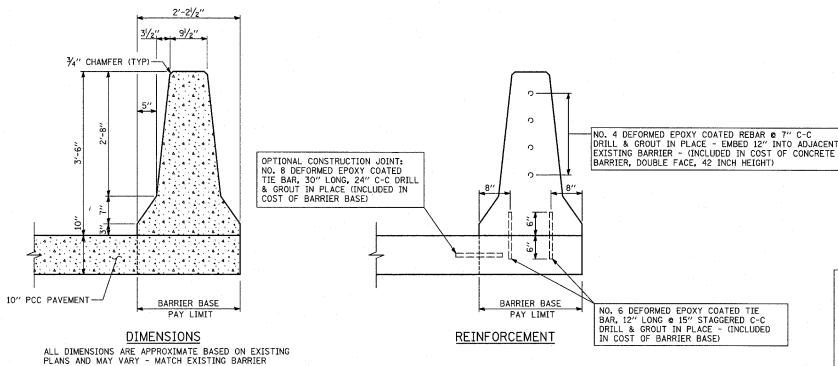

CONCRETE BARRIER, DOUBLE FACE, 42 INCH HEIGHT ALONG NB I-57

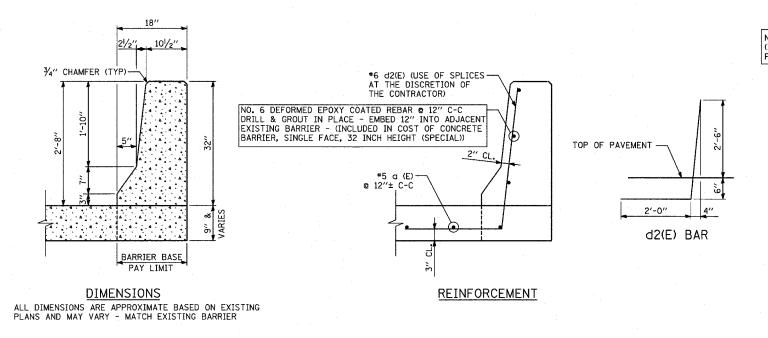

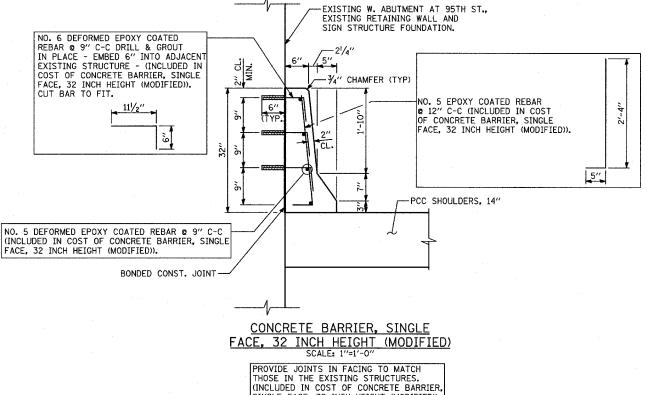

SINGLE FACE, 32 INCH HEIGHT (MODIFIED)).

CONCRETE BARRIER, SINGLE FACE, 32 INCH HEIGHT (SPECIAL)


ALONG NB I-94 (BISHOP FORD FREEWAY) & WB I-94 TO I-57 CONNECTOR


REVISIONS
NAME
DATE

F.A.I. 94 (DAN RYAN EXPRESSWAY)


MISCELLANEOUS DETAILS:
PLAN AND TYPICAL SECTION DETAILS
SHEET 1 OF 2

SCALE: AS SHOWN
DATE: MARCH 7, 2006 CHECKED BY: TGB

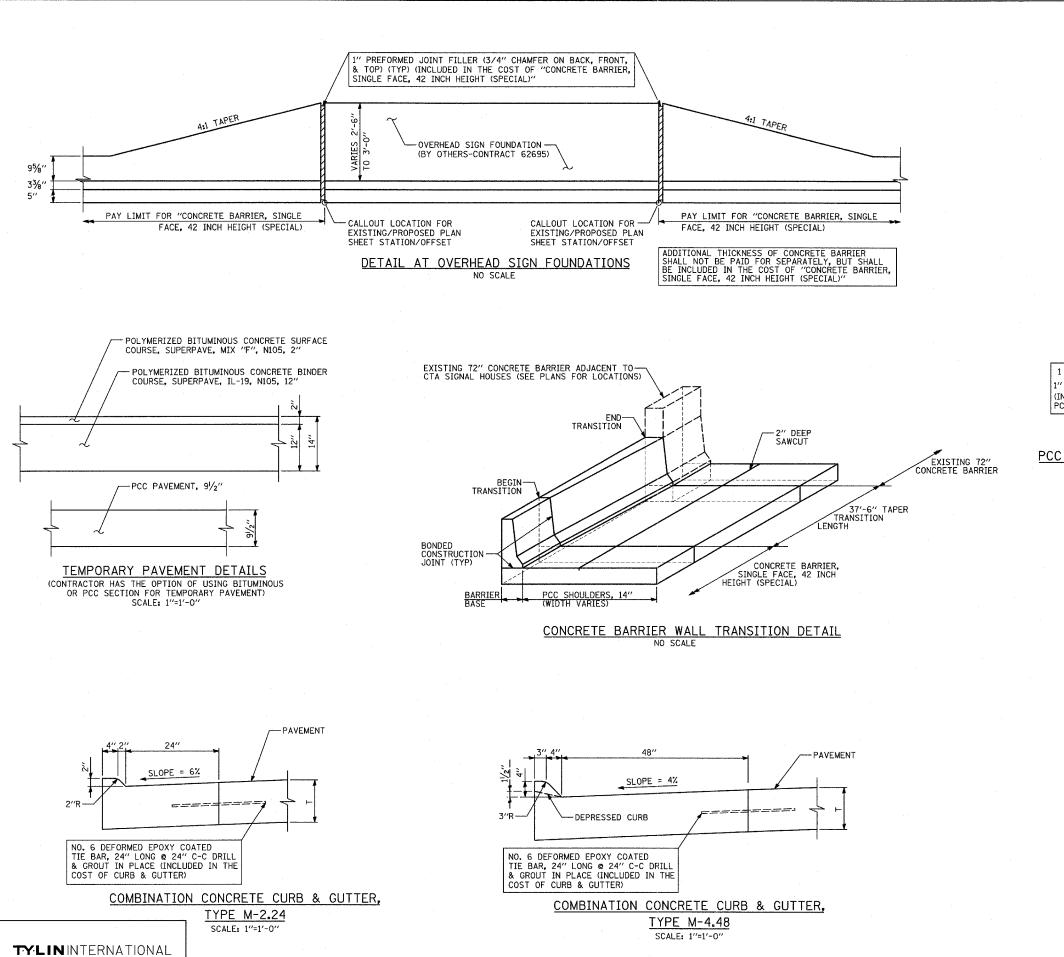

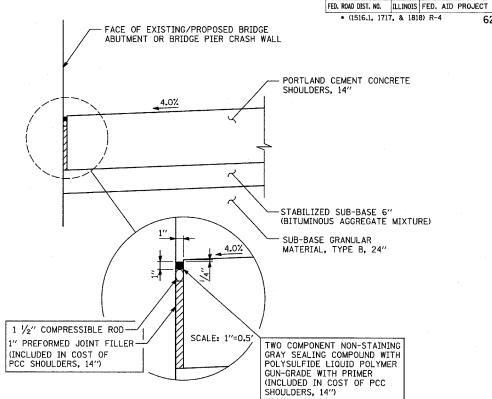

PCC SHOULDERS ADJACENT TO BRIDGE ABUTMENT/CRASH WALL SCALE: 1"=1'-0"

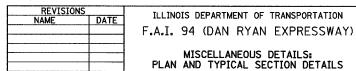

SCALE: AS SHOWN
DATE: MARCH 7. 2006

DRAWN BY: MPG CHECKED BY: TGB

SHEET 2 OF 2

TOTAL SHEETS NO.

916 142


62304


COUNTY


COOK


STA. 190+65 (NB I-57) TO STA. 2316+00 (NB RYAN


SECTION

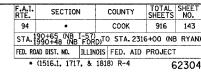

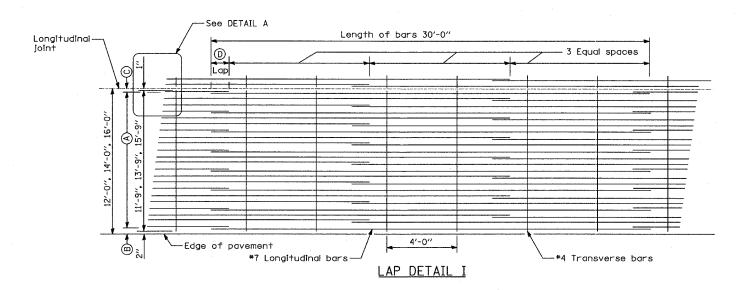

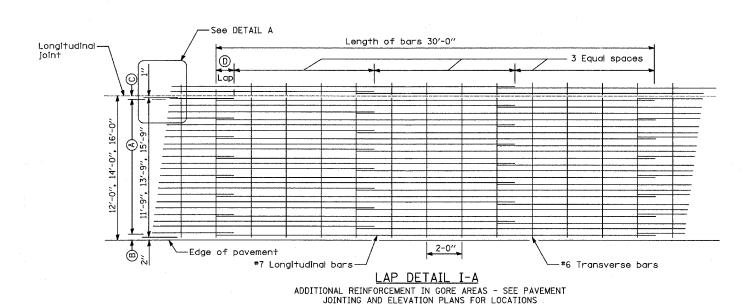


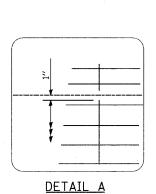

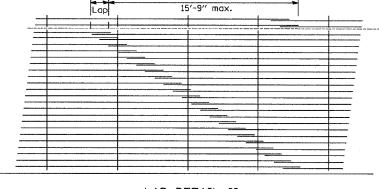

10'-6" min.

LAP DETAIL II

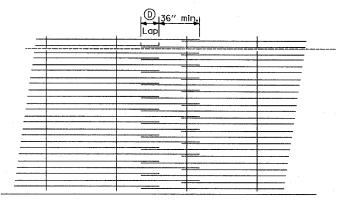

LAP DETAIL III

GENERAL NOTES

- 1. THE PAVEMENT REINFORCEMENT SHALL BE 4.5" FROM THE TOP OF PAVEMENT.
- EXCEPT AS NOTED OR SHOWN, THE DIMENSIONS AND NOTES SPECIFIED FOR LAP DETAIL I ARE TYPICAL FOR LAP DETAIL II AND III.
- 3. THE ® DIMENSION AND THE DISTANCE FROM THE END OF THE TRANSVERSE BAR TO THE EDGE OF PAVEMENT MAY BE INCREASED BY 1" FOR SI IP FORM PAVING.


Pavement Width	Bar Size	Pavement Thickness	(A) (Approx. Spacing)	®	0	0
12 feet	#7	14"	23 spaces (24 bars) @ 6"	31/2"	3′′	26"
14 feet	#7	14"	27 spaces (28 bars) @ 6"	31/2"	3"	26"
16 feet	#7	14"	31 spaces (32 bars) @ 6"	31/2"	3"	26"

REVISIONS		ILLINOIS DEPARTMENT OF TRANSPORTATION						
NAME	DATE	166	111013	JEI ANTIN	ICINI OF	INANSI	ONTAIL	/IX
		F.Δ.1	94	$(D\Delta N)$	RYAN	FXP	RESSW.	AY)
		1 1/312		(DAI)	1717014	L/\	120011	~ ' '
					NEOUS			
		EX.	Tende	D LANE	REINF	ORCEM	ENT FO	R
		CONTI	NUOUS	LY RE	INFORCE	D PCC	PAVEN	JENT
		SCALE:	NONE		DI	RAWN BY	CTE,	MPG

CHECKED BY:

DATE: MARCH 7, 2006

* (1516.1, 1717, & 1818) R-4

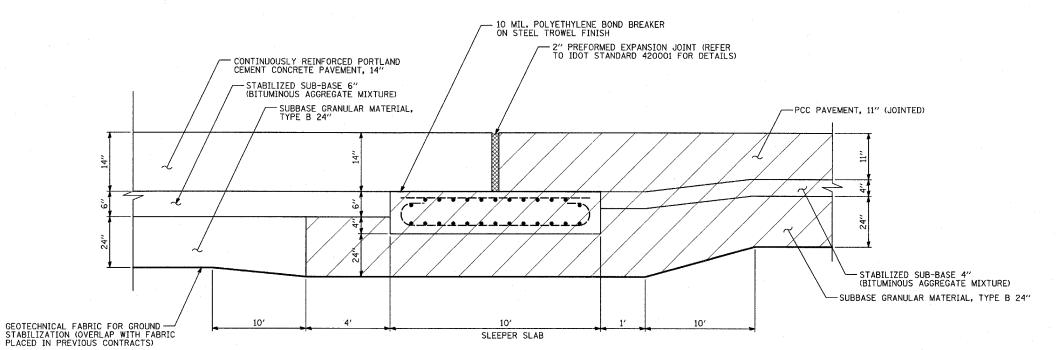

RAMP TERMINAL DETAILS AT EXISTING SLEEPER SLAB


NOTES:


1. THE THICKENED EDGE OF THE SUB-BASE SHALL BE INCLUDED IN THE COST OF "SUB-BASE GRANULAR MATERIAL, TYPE B 24""

EXISTING PAVEMENT ITEMS CONSTRUCTED IN PREVIOUS CONTRACTS.

REVISIONS
NAME
DATE
F.A.I. 94 (DAN RYAN EXPRESSWAY)
MISCELLANEOUS DETAILS:
MISCELLANEOUS PAVEMENT ELEVATION
AND JOINTING DETAILS
SHEET 1 OF 2

SCALE: NONE DRAWN BY: MPG
DATE: MARCH 7, 2006 CHECKED BY: TGB

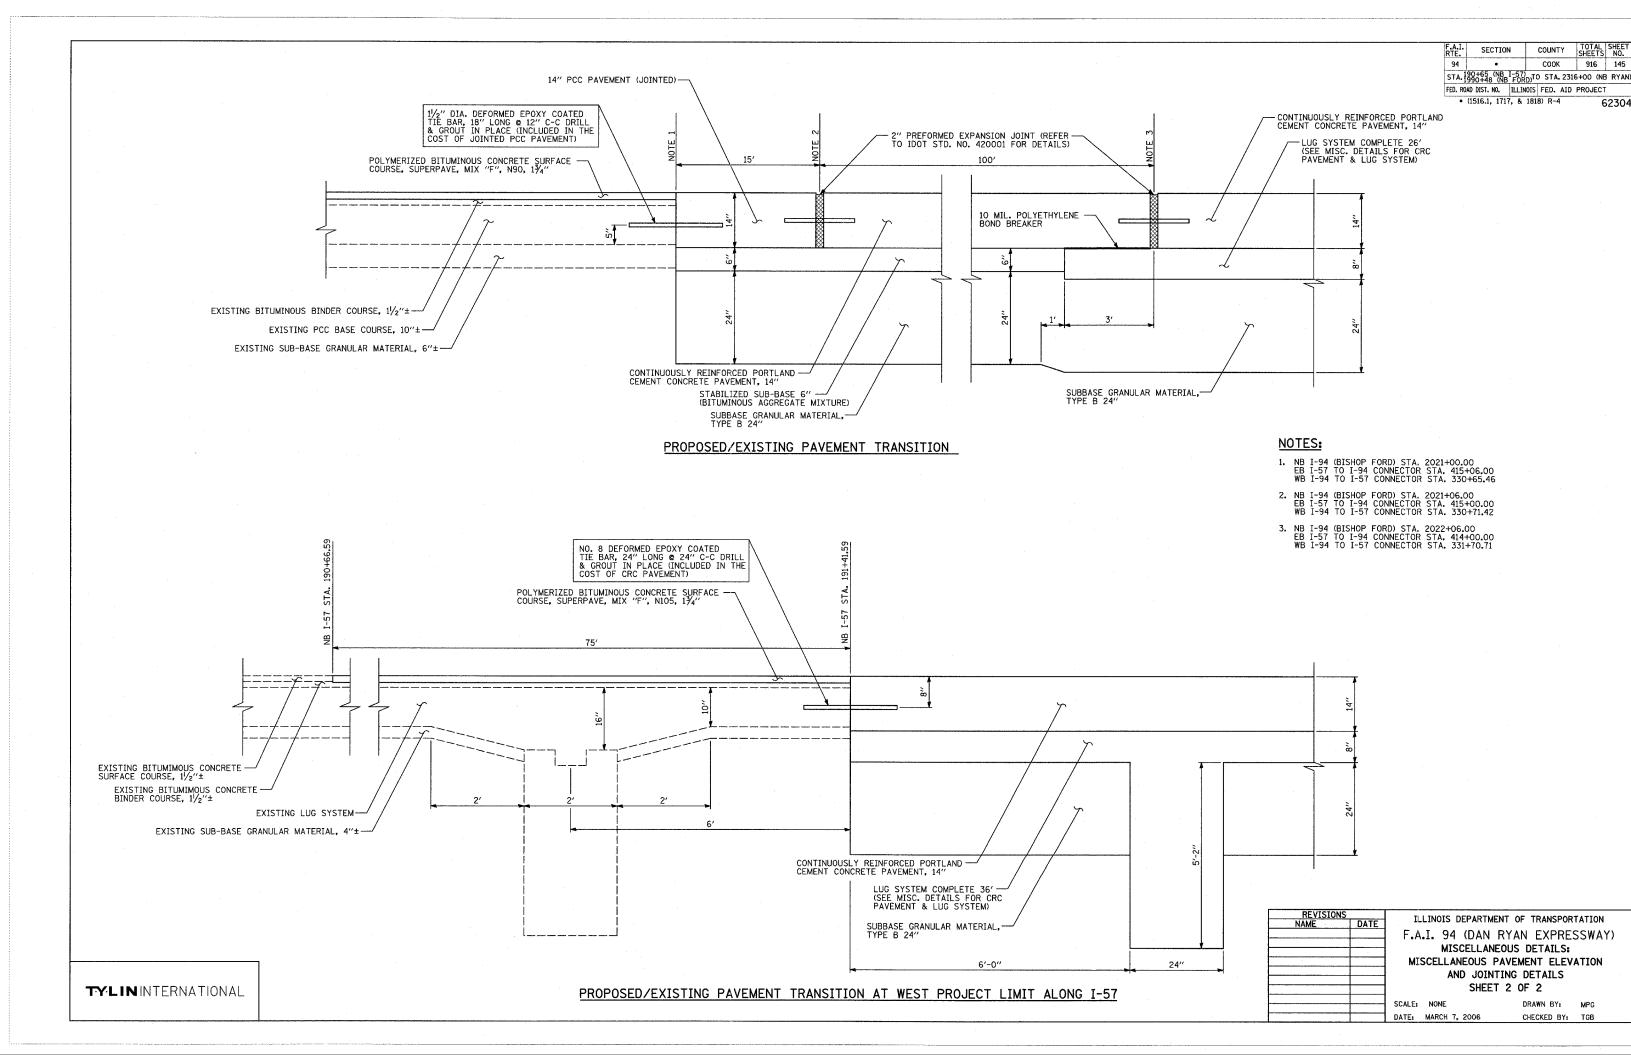

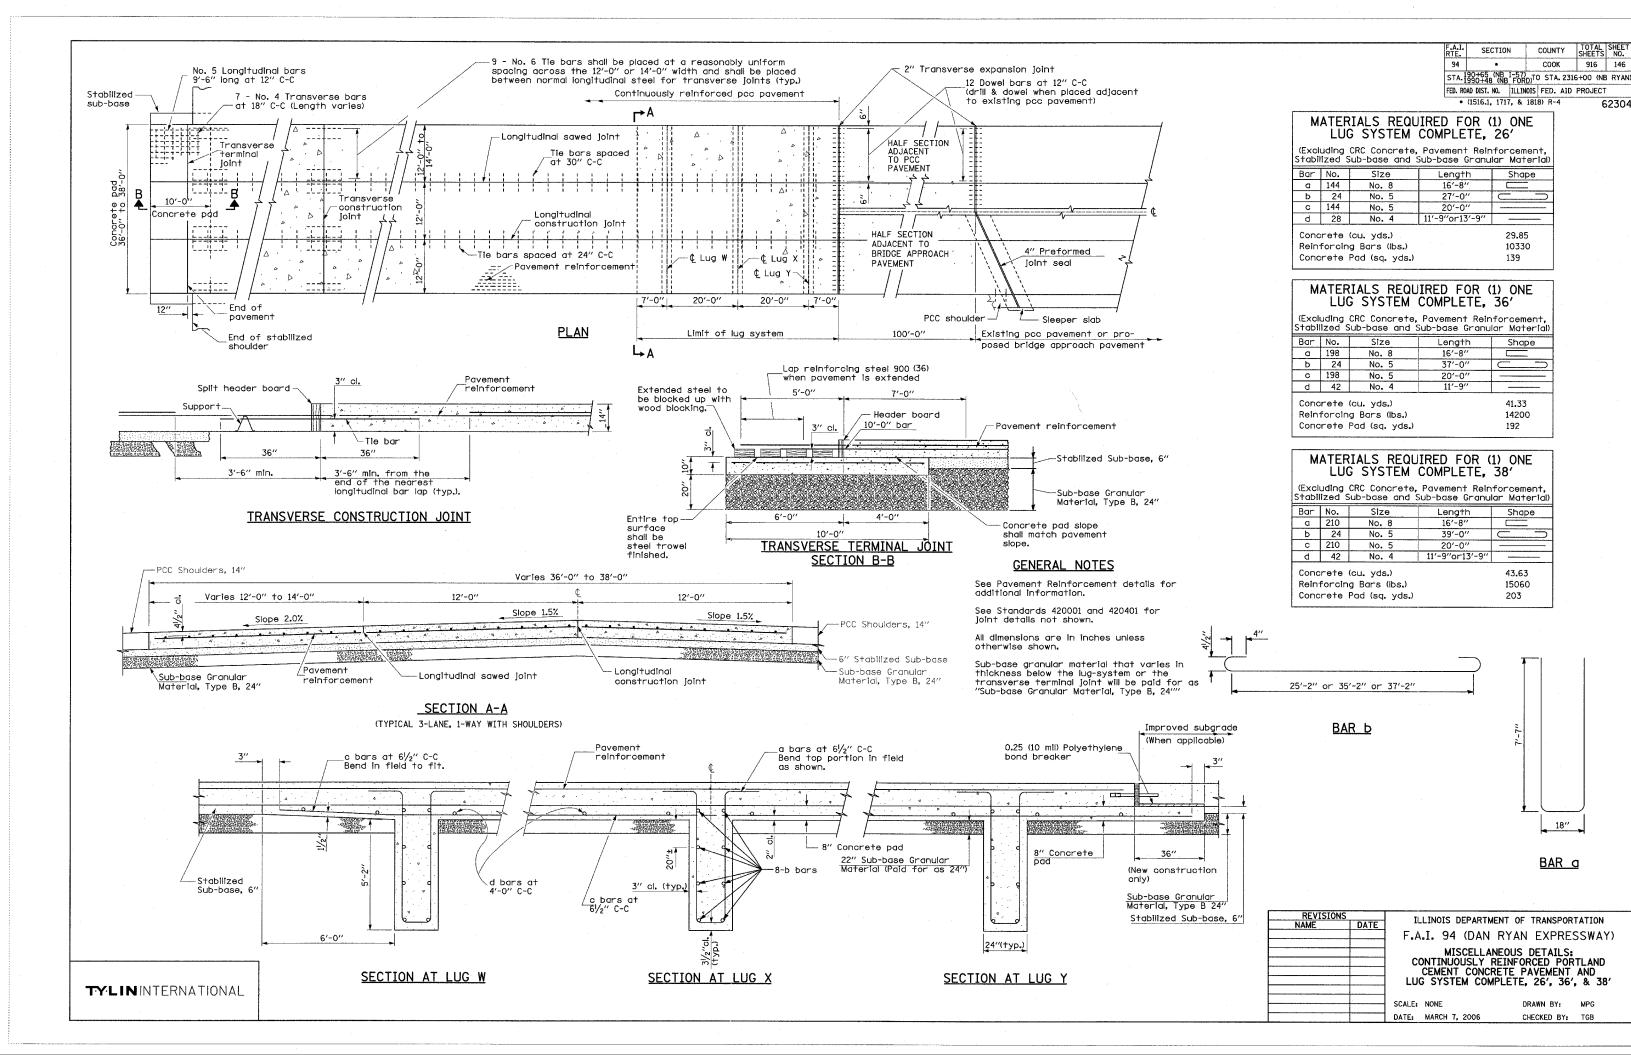

• (1516.1, 1717, & 1818) R-4 62304


-CCC&G, TYPE 4-4.24 OR M-4.48 (DEPRESS ADJACENT TO TBT, TYPE 1 (SPECIAL) PER IDOT DIST.1 STD. BD--34 CONCRETE MEDIAN SURFACE, 6" (SPECIAL)
(DO NOT STAMP WITH BRICK PATTERN) -TOOLED JOINT (TYP) ½" P.J.F.— TRAFFIC BARRIER TERMINAL, TYPE 1 (SPECIAL) TRAFFIC BARRIER TERMINAL, TYPE 6 2'-9" (TYP) 8 8 8 8 8 8 6:1 TAPER 75:1 TAPER 4 SPACES - 5'-0"± PER SPACE 4'-6"± 12 SPACES - 6'-3"± PER SPACE 5'-8"± JOINTING DETAIL FOR CONCRETE MEDIAN SURFACE, 6" (SPECIAL) AT TRAFFIC BARRIER TERMINAL, TYPE 1 (SPECIAL) AND TYPE 6 CONCRETE BARRIER-

REVISIONS
NAME DATE


F.A.I. 94 (DAN RYAN EXPRESSWAY)

MISCELLANEOUS DETAILS:
PAVEMENT JOINTING DETAILS
FOR CONCRETE MEDIAN SURFACE, 6" (SPECIAL)
AT TRAFFIC BARRIER TERMINALS


SCALE: NONE DRAWN BY: MPG
DATE: MARCH 7, 2006 CHECKED BY: TGB

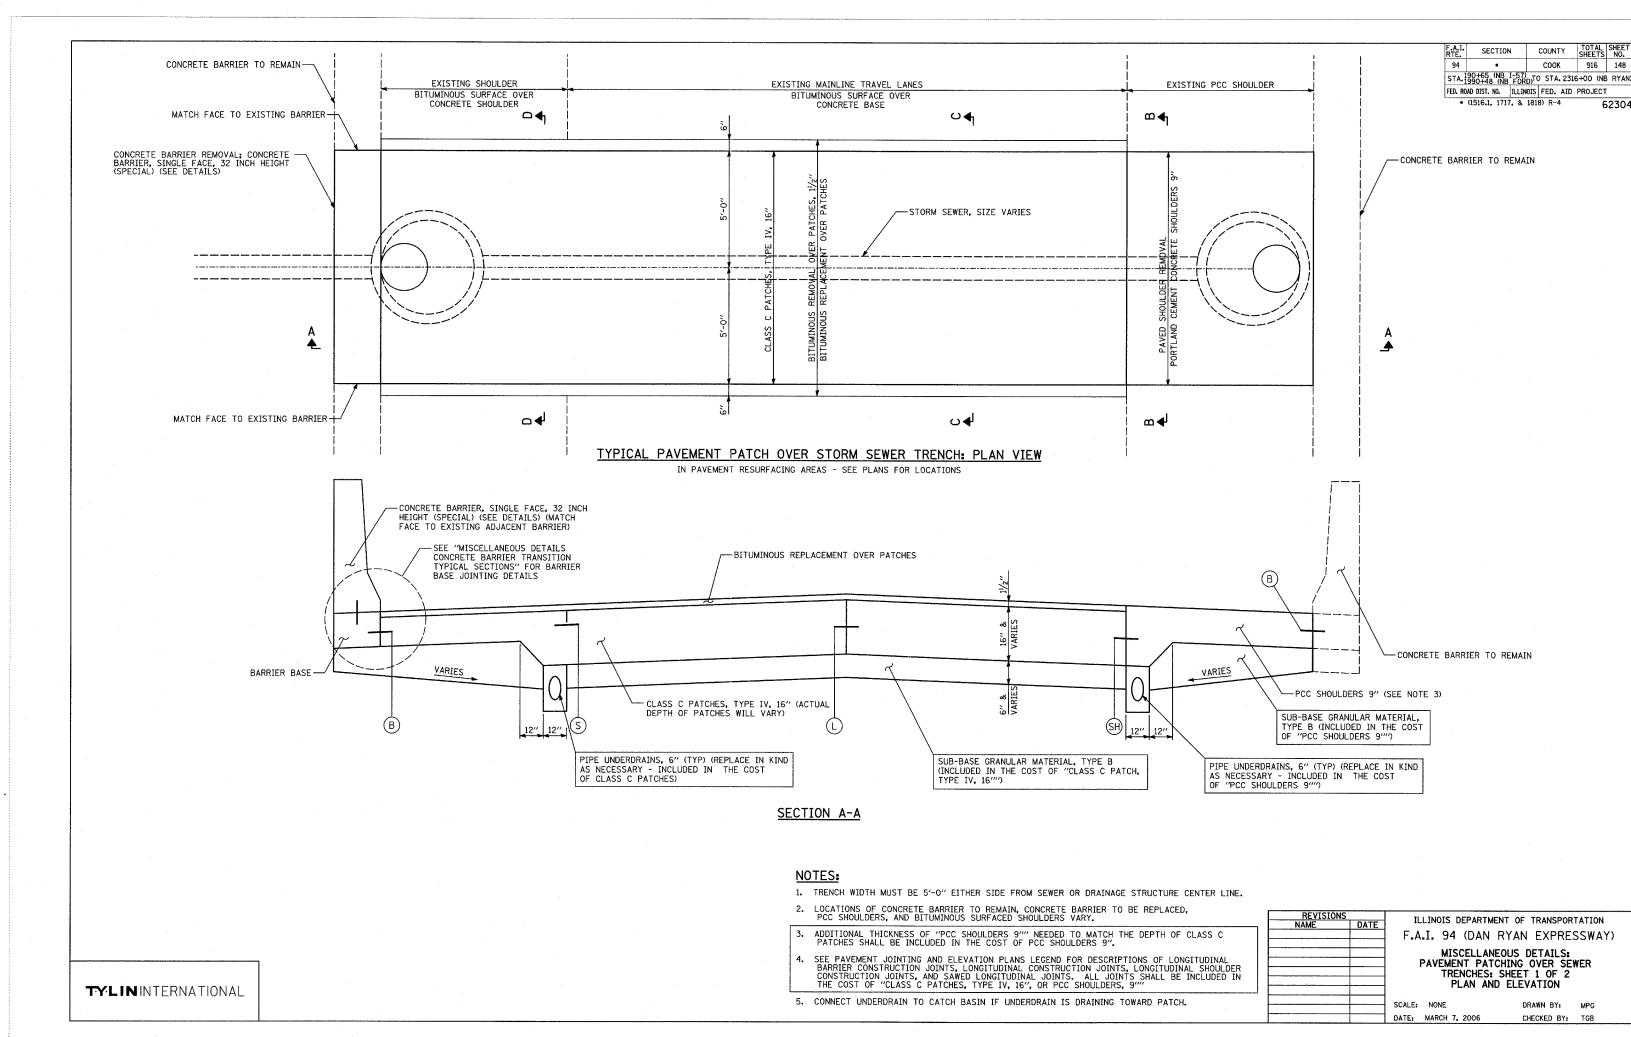


COUNTY TOTAL SHEET NO. SECTION COOK 916 149 STA. 190+65 (NB 1-57) TO STA. 2316+00 (NB RYAN FED. ROAD DIST. NO. ILLINOIS FED. AID PROJECT * (1516.1, 1717, & 1818) R-4 62304

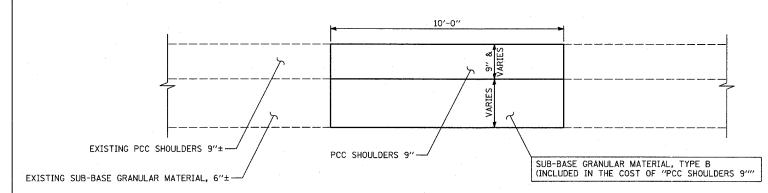

SECTION B-B PCC SHOULDER WITH NO OVERLAY

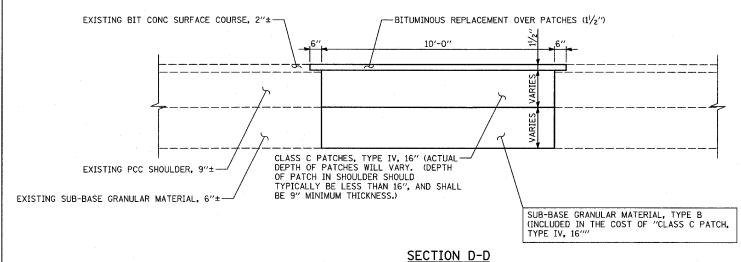

BITUMINOUS SURFACE OVER CONCRETE SHOULDER

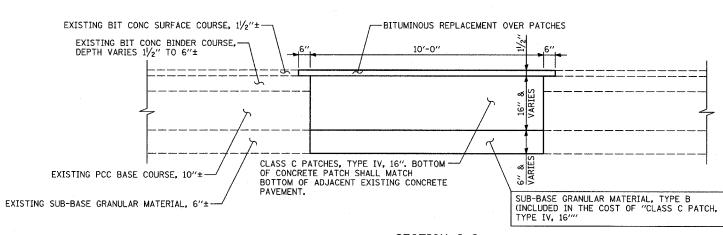

SECTION C-C BITUMINOUS SURFACE OVER CONCRETE BASE


NOTES:

- 1. TRENCH WIDTH MUST BE 5'-0" EITHER SIDE FROM SEWER OR DRAINAGE STRUCTURE CENTER LINE.
- 2. LOCATIONS OF CONCRETE BARRIER TO REMAIN, CONCRETE BARRIER TO BE REPLACED, PCC SHOULDERS, AND BITUMINOUS SURFACED SHOULDERS VARY.
- ADDITIONAL THICKNESS OF "PCC SHOULDERS 9"" NEEDED TO MATCH THE DEPTH OF CLASS C PATCHES SHALL BE INCLUDED IN THE COST OF PCC SHOULDERS 9".

ILLINOIS DEPARTMENT OF TRANSPORTATION F.A.I. 94 (DAN RYAN EXPRESSWAY) MISCELLANEOUS DETAILS:


PAVEMENT PATCHING OVER SEWER TRENCHES: SHEET 2 OF 2 TYPICAL SECTIONS


SCALE: NONE DATE: MARCH 7, 2006 DRAWN BY: MPG CHECKED BY: TGB

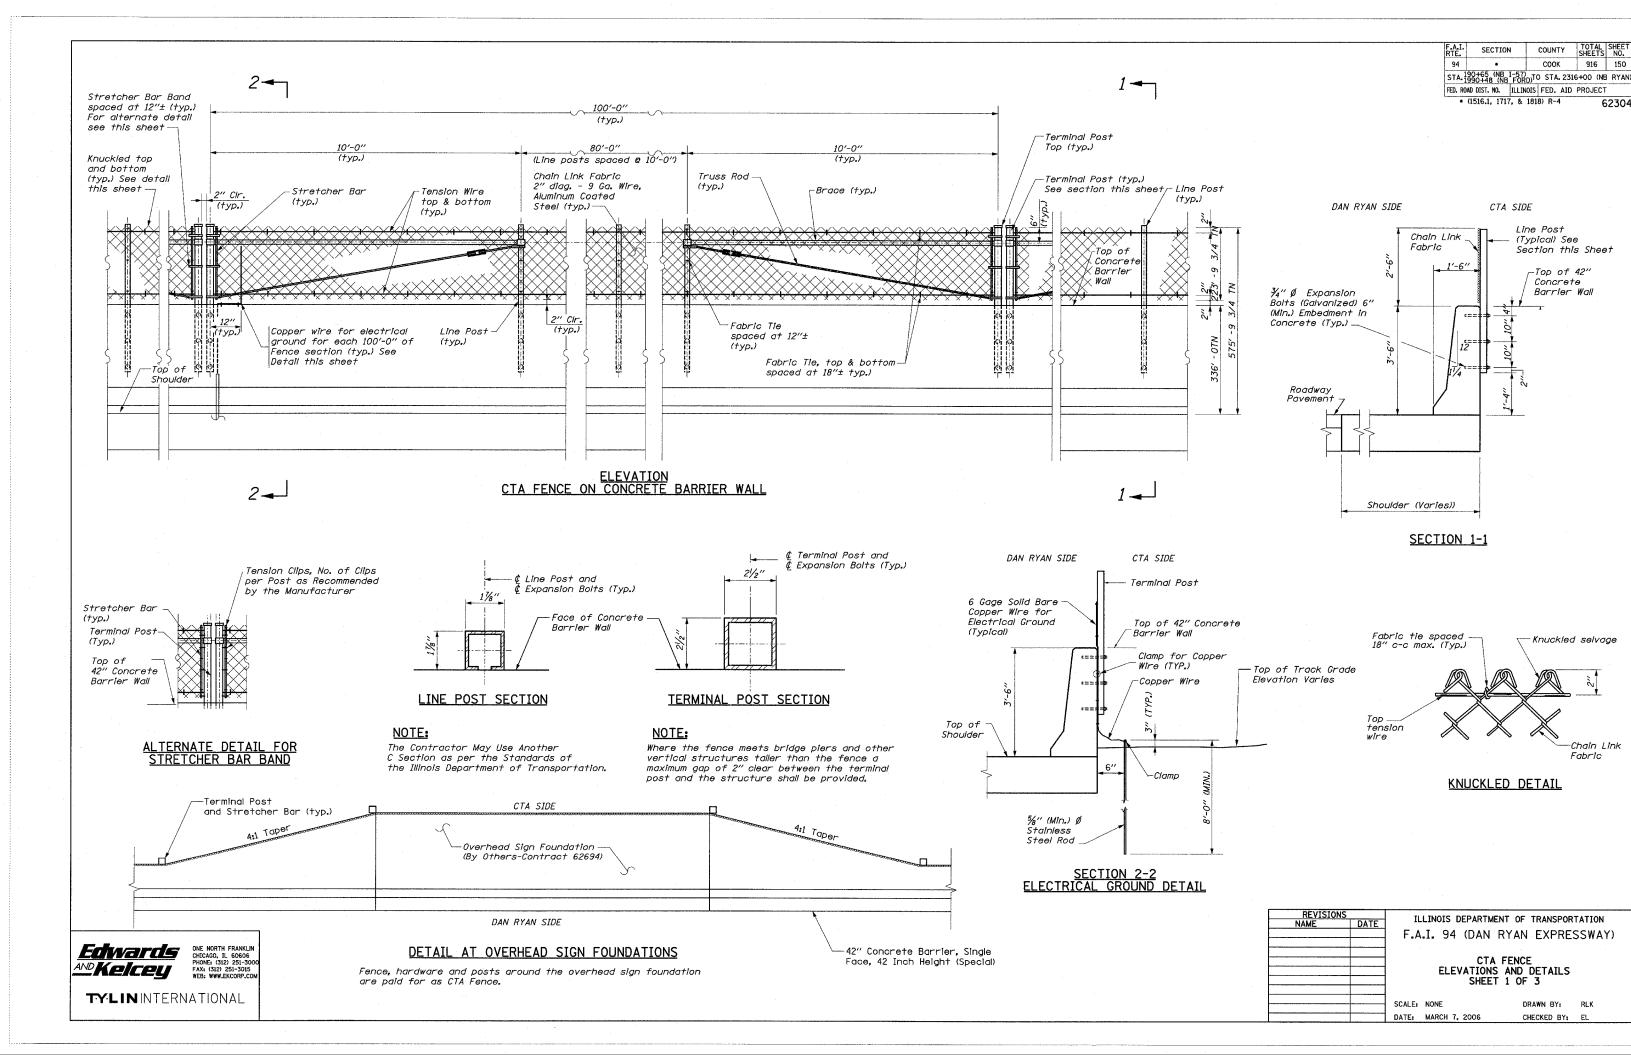







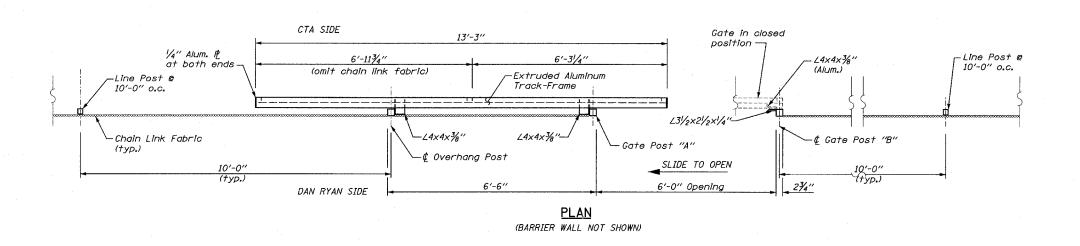

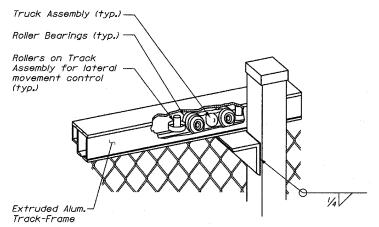

ROLLER BEARING TRUCK ASSEMBLY DETAIL

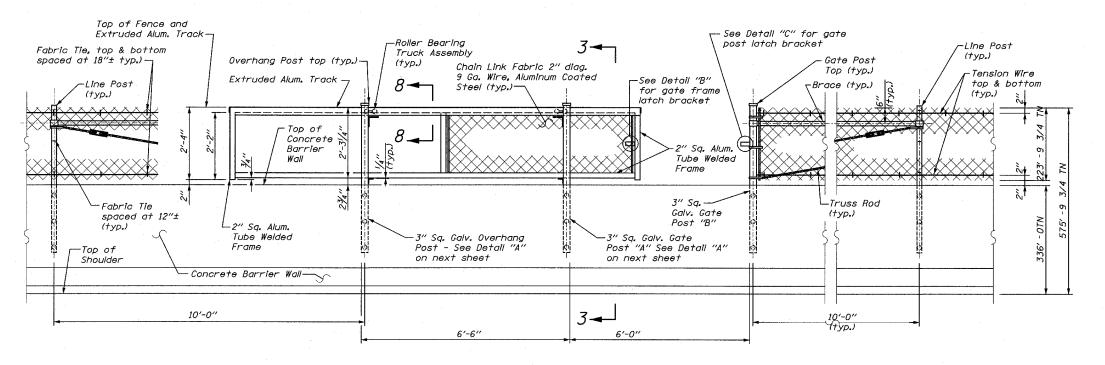

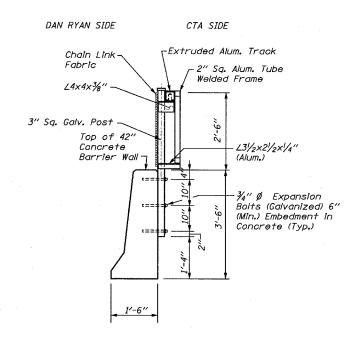


<u>ELEVATION</u> CTA FENCE & CTA GATE

(FOOTING NOT SHOWN)

SECTION 3-3

E	REVISIONS NAME	ILLINOIS DEPARTMENT OF TRANSPORTATION F.A.I. 94 (DAN RYAN EXPRESSWAY)							
				ELE\	/ATION	A FENO S AND T 2 0	DETAIL	.s	
			SCALE: DATE:	NONE MARCH 7,	2006		DRAWN BY: CHECKED B		RLK EL

Edwards ONE NORTH FRANKLIN CHICAGO, TL 60606 PHONEL (3):22 251-3005 WEB: WWW.EKCORP.COM

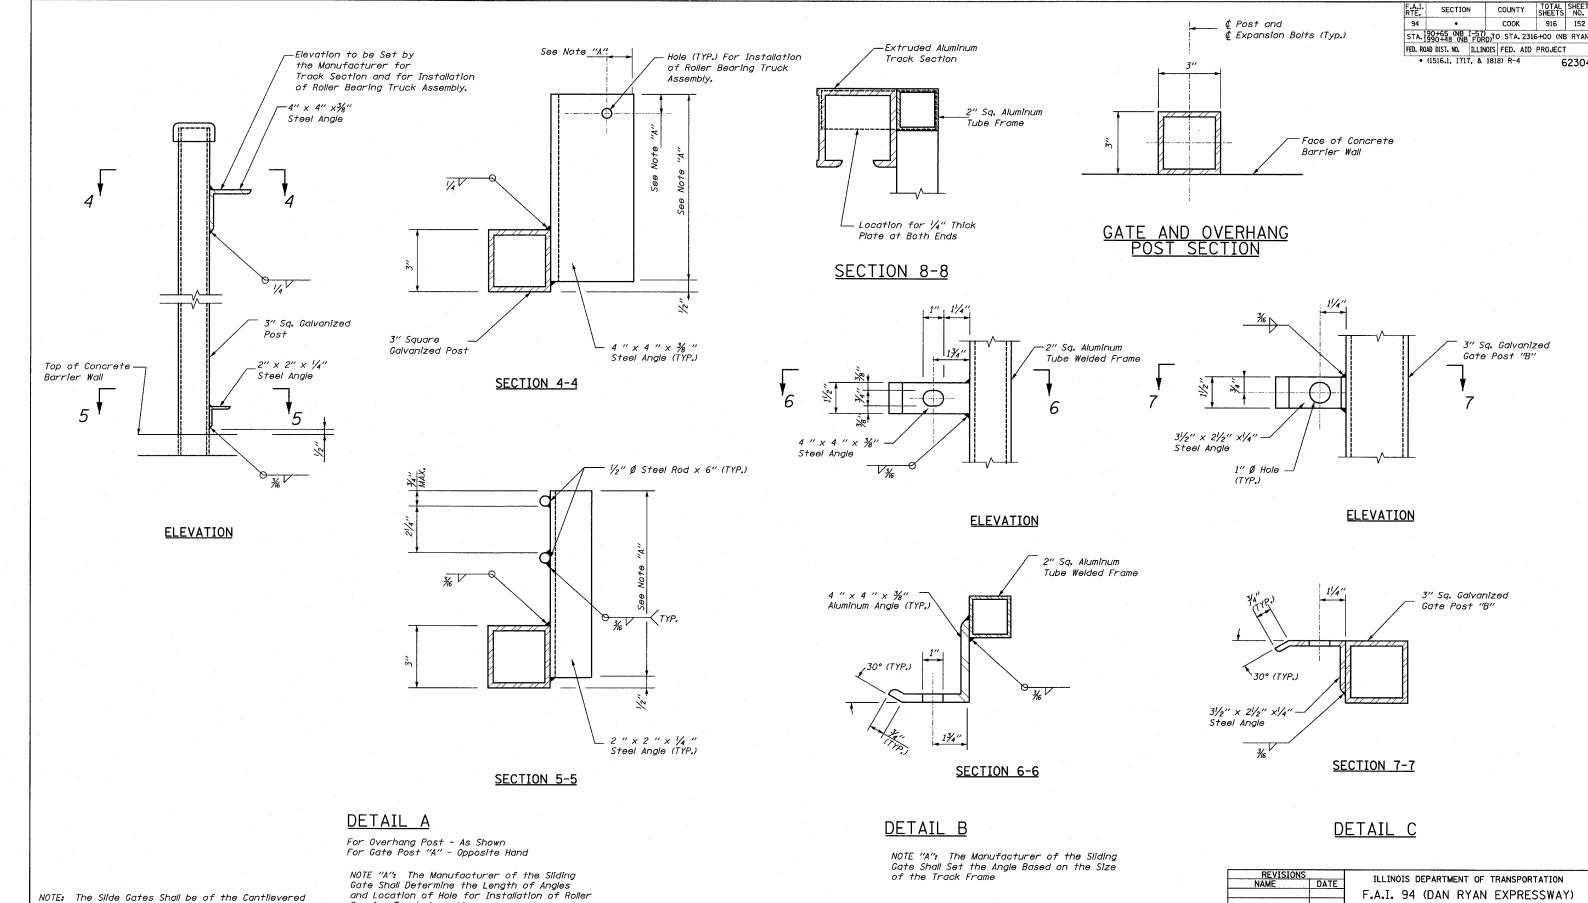

Bearing Truck Assembly.

Type with no Track or Support Across the Opening.

AND KEICEU

ONE NORTH FRANKLIN CHICAGO, IL 60606

AND KEICEU

FAX: G312: 251-305

FEB: WWW.EXCORP.COM

AND Kelcey

F.A.I. 94 (DAN RYAN EXPRESSWAY) CTA FENCE ELEVATIONS AND DETAILS SHEET 3 OF 3 SCALE: NONE DRAWN BY: RLK DATE: MARCH 7, 2006 CHECKED BY: EL

62304


* (1516.1, 1717, & 1818) R-4


STAGE 1 PAVEMENT REMOVAL LIMIT EXISTING LANES TEMPORARY PROPOSED PAVEMENT PAVEMENT -ELEVATION "A" (SLOPE TO MATCH EXISTING) 12.0'± -- CRC PAVEMENT, 14" BITUMINOUS SURFACE REMOVAL 1"
(ACTUAL DEPTH VARIES FROM 0-2") --- STABILIZED SUB-BASE, 6" SUB-BASE GRANULAR MATERIAL, TYPE B, 24" -ELEVATION "B -BIT. CONC. SURFACE COURSE, 11/2"± BREAKER -BIT. CONC. BINDER COURSE, 43/4"± -PCC BASE COURSE, 10"± SUB-BASE GRANULAR MATERIAL, 6"± TEMPORARY PAVEMENT (SEE NOTE BELOW) -

DETAIL OF MAINLINE TEMPORARY PAVEMENT FOR POST-STAGE 1 WINTER LANE CONFIGURATION

USE WHERE ELEVATION "A" IS MORE THAN 2" BELOW ELEVATION "B"

SEE MAINTENANCE OF TRAFFIC PLANS FOR LOCATIONS

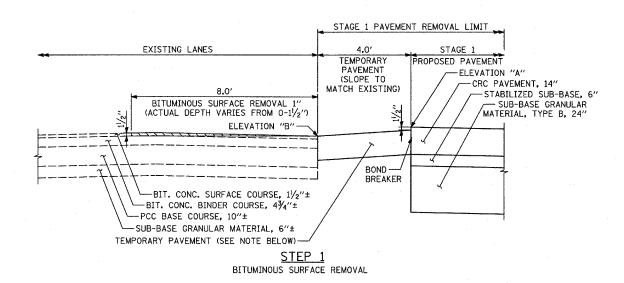


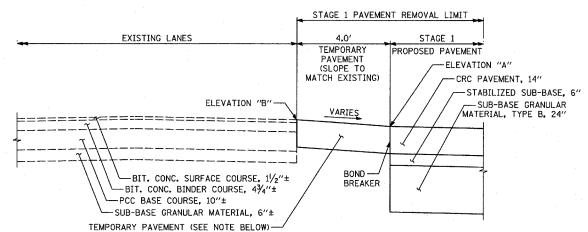

DETAIL OF MAINLINE TEMPORARY PAVEMENT FOR POST-STAGE 1 WINTER LANE CONFIGURATION

USE WHERE ELEVATION "A" IS 0-2" BELOW ELEVATION "B"

SEE MAINTENANCE OF TRAFFIC PLANS FOR LOCATIONS

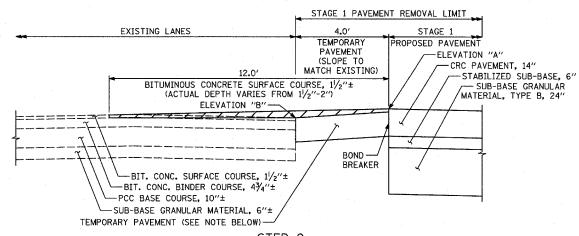

STEP 2
PLACEMENT OF BITUMINOUS SURFACE COURSE

NOTE:

CONTRACTOR MUST USE A 14" THICK CONCRETE TEMPORARY PAVEMENT OPTION. ADDITIONAL THICKNESS OF CONCRETE TEMPORARY PAVEMENT WILL NOT BE PAID FOR SEPARATELY BUT BE INCLUDED IN THE COST OF THE TEMPORARY PAVEMENT.

REVISIONS
NAME DATE


F.A.I. 94 (DAN RYAN EXPRESSWAY)


MISCELLANEOUS DETAILS:
TEMPORARY PAVEMENT & MILLING OPERATIONS


SCALE: AS SHOWN DRAWN BY: MPG


CHECKED BY: TGB


DATE: MARCH 7, 2006

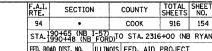

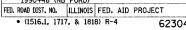

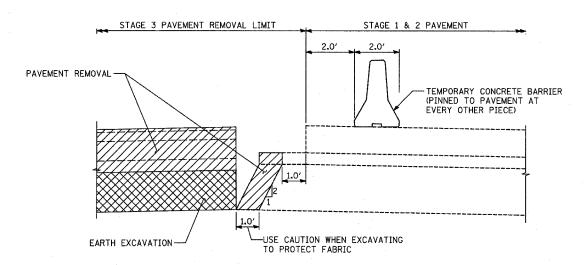

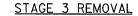


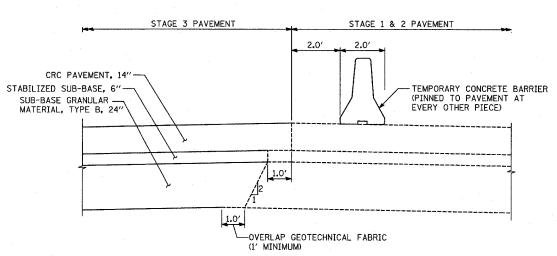


STAGE 3 PAVEMENT


NOTE:

THESE SECTIONS DEPICT MAINLINE DAN RYAN. SIMILAR SITUATIONS OCCUR ALONG I-57 WITH A LESSER NUMBER OF LANES, BUT SAME CONSTRUCTION REQUIREMENTS.

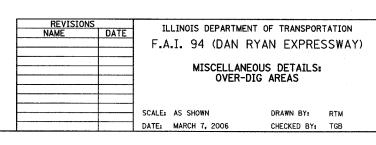


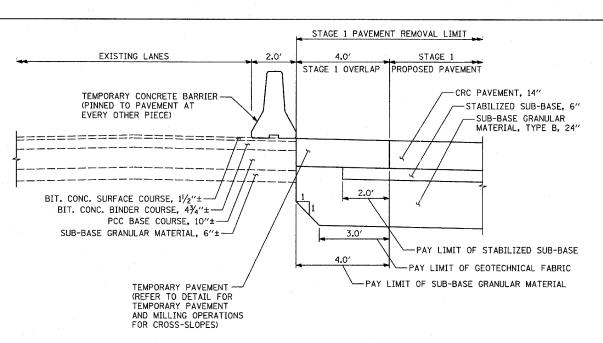

STAGE 1 PAVEMENT

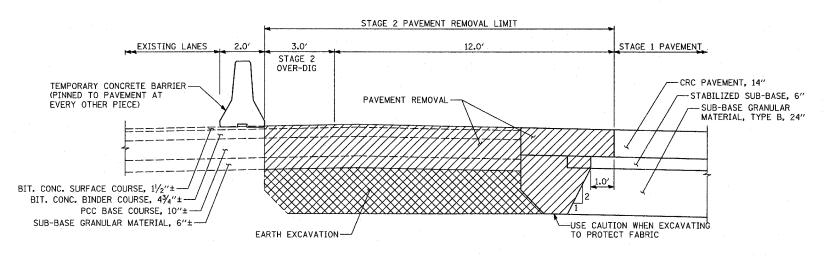

STAGE 2 REMOVAL & OVER-DIG

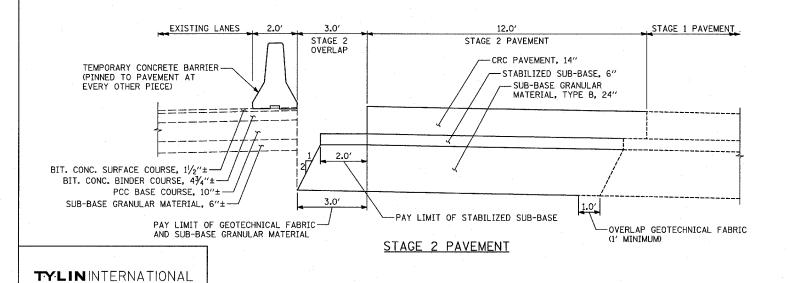


COUNTY TOTAL SHEETS NO.

COOK 916 155 SECTION STA. 190+65 (NB 1-57) STA. 1990+48 (NB FORD)TO STA. 2316+00 (NB RYAN FED. ROAD DIST. NO. ILLINOIS FED. AID PROJECT

62304

* (1516.1, 1717, & 1818) R-4

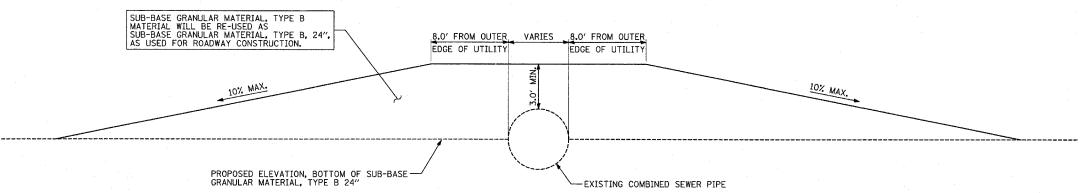

COMBINED SEWER CONSTRUCTION PROTECTION

(SEE COMBINED SEWER CROSSING STATIONS)

COMBINED SEWER CROSSING STATIONS:

- 1. NB I-57 STA. 192+25.30 (60")
- 2. NB I-57 STA 231+94.12/ EB I-57 TO I-94 CONN. STA. 407+29.83 (5'-8" x 3'-7" BOX)
- 3. NB I-94 (BISHOP FORD) STA. 2038+68.07 (7'-6" x 6'-0" DOUBLE BOX)
- 4. NB I-94 STA. 2245+78.13 (48")
- 5. NB I-94 STA. 2266+11.42 (DOUBLE 48")
- 6. NB I-94 STA. 2279+47.75 (TRIPLE 48")

NOTES:

- CONTRACTOR WILL PROVIDE A MINIMUM COVER, AS SHOWN ABOVE AT ALL TIMES DURING CONSTRUCTION AND PRIOR TO THE INSTALLATION OF THE PERMANENT PROTECTION SLAB AND/OR ROADWAY. CONSTRUCTION TRAFFIC SHALL NOT CROSS THE SEWER PIPE WITHOUT PROTECTION IN PLACE.
- CONTRACTOR IS RESPONSIBLE FOR THE INTEGRITY OF SEWER PIPE THROUGH THE DURATION OF THE PROJECT, AND WILL NOT BE PAID FOR ANY REPAIRS REQUIRED, AS DETERMINED BY THE ENGINEER, TO THE PIPE, DUE TO CONSTRUCTION ACTIVITIES.

REVISIONS DATE	⊣	.I. 94 (DAN MISCELLAN	ENT OF TRANSPOR RYAN EXPRES NEOUS DETAILS: TILITY PROTECT	SSWAY)
	SCALE:	NONE	DRAWN BY:	RTM
	DATE:	MARCH 7, 2006	CHECKED BY:	TGB

F.A.I.	SECTION	COUNTY	SHEETS	NO.
94	•	соок	916	156
STA.	90+65 (NB I-57) 990+48 (NB FOR	D)TO STA. 2316	5+00 (NE	RYAN)
FFD. RC	AD DIST. NO. TILIN	IOIS FED. AID	PROJECT	

62304

* (1516.1, 1717, & 1818) R-4

- TEMPORARY PROPOSED 8 SB I-94 PROPOSED B SB I-94 -- TEMPORARY FENCE FENCE - MINIMUM DISTANCE TO CTA TRACK CENTERLINE - MINIMUM DISTANCE TO CTA TRACK CENTERLINE - 1:1 SLOPE FOR EXCAVATION ALONG CTA TRACK PROPOSED PAVEMENT SECTION PROPOSED PAVEMENT SECTION 1:1 SLOPE FOR EXCAVATION ALONG CTA TRACK HEIGHT OF SOIL RETENTION REQUIRED AT BACK OF HEIGHT OF SOIL RETENTION, 0.5' RT. FROM BACK OF BARRIER BASE/SUBBASE (0.77' + 6")

SOIL RETENTION SCHEDULE

SOIL NETENTION SCHEDULE							
NBDR STATION	HEIGHT OF RETENTION FT (SET 6" BEHIND BARRIER BASE)	SOIL RETENTION AREA SF					
2216+00	0.00	0.0					
2216+50	0.83	41.5					
2217+00	0.75	37.5					
2217+50	0.60	30.0					
2218+00	0.64	32.0					
2218+50	0.85	42.5					
2219+00	0.89	44.5					
2219+50	0.55	27.5					
2220+00	0.81	40.5					
2220+50	0.67	33.5					
2221+00	0.00	0.0					
2259+50	0.00	0.0					
2260+00	0.00	0.0					
2260+50	0.90	45.0					
2261+00	0.00	0.0					
NUMBER OF							
DRAINAGE STRUCTURES	89	7120.0					
2207+50 - 2208+29		369.0					
2253+24 - 2254+45		729.0					
WB CONNECTOR		3463.0					
	TOTAL	12055.5					

SOIL RETENTION SYSTEM


TEMP SOIL SUPPORT REQUIRED


TEMP SOIL SUPPORT NOT REQUIRED

CALCULATION OF HEIGHT OF TEMP SOIL SUPPORT


- * 80 SF OF SOIL RETENTION IS REQUIRED FOR EACH DRAINAGE STRUCTURE. SEE DRAINAGE SCHEDULES FOR DRAINAGE STRUCTURES REQUIRING RETENTION
- ** AREA REFLECTS SOIL RETENTION SYSTEM REQUIRED IN ADDITION TO THAT REQUIRED FOR THE PROPOSED DRAINAGE STRUCTURES, SEE SHEET 121.
- *** AREA REFLECTS SOIL RETENTION SYSTEM REQUIRED FOR TEMPORARY SOIL RETENTION ALONG THE WB CONNECTOR, SEE FOLLOWING SHEET FOR SECTIONS AND SCHEDULE (SHEET 157).

REVISIONS NAME	DATE	F.A	.I. 94 MIS	(DAN SCELLA Y SOIL	RYAN NEOUS RETE	TRANSPO N EXPRE DETAILS INTION SI ALONG CT	ESSWAY)
		SCALE:	NONE			DRAWN BY:	JJS
		DATE:	MARCH 7,	2006		CHECKED BY:	JPM

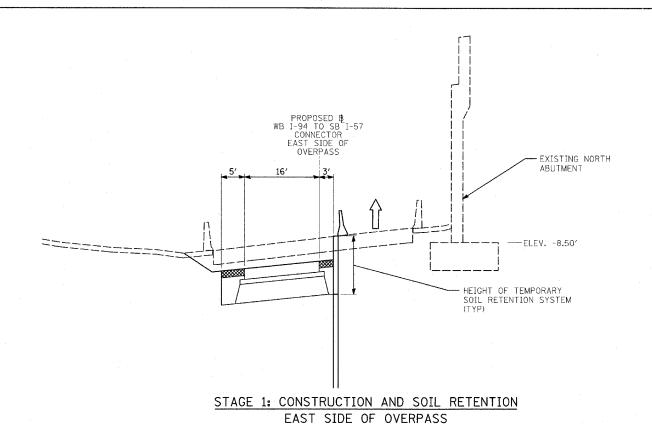

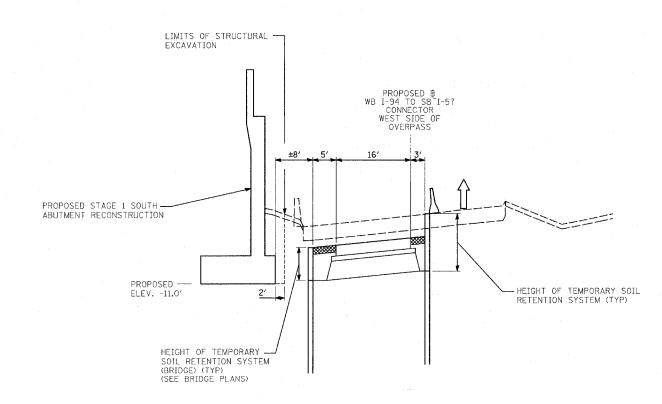

STAGE 1: CONSTRUCTION AND SOIL RETENTION WEST SIDE OF OVERPASS

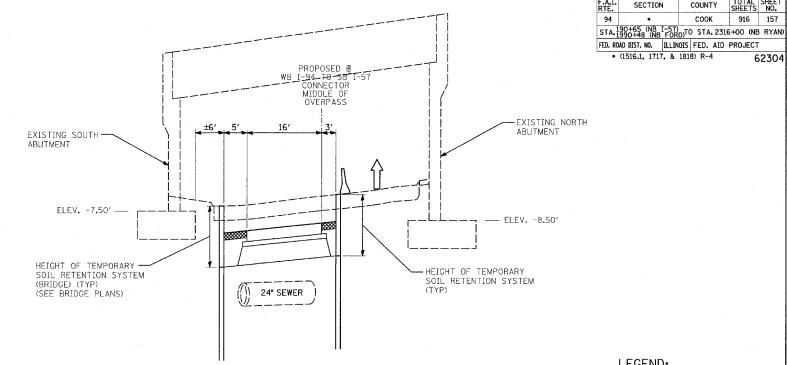

STAGE 1: CONSTRUCTION AND SOIL RETENTION MIDDLE OF OVERPASS

TEMPORARY SOIL RETENTION SCHEDULE ALONG NORTH SIDE OF WB CONNECTOR

	WBX STATION	EXISTING PAV'T ELEV. (FT)	PROPOSED PAV'T ELEV. (FT)	HEIGHT OF RETENTION (ELEV. DIFF. PLUS 3.67' FOR EXCAV.) (FT)	SOIL RETENTION AREA (SF)
	333+00	-13.23	-13.73	4.17	0.00
	333+25	-12.80	-13.46	4.33	106.25
	333+50	-12.31	-13.16	4.52	110.63
	333+75	-11.81	-12.83	4.69	115.13
	334+00	-11.30	-12.50	4.87	119.50
	334+25	-10.78	-12.17	5.06	124,13
	334+50	-10.27	-11.84	5.24	128.75
	334+75	-9.75	-11.51	5.43	133.38
	335+00	-9.21	-11.18	5.64	138.38
	335+25	-8.63	-10.84	5.88	144.00
	335+37	-8,35	-10.68	6.00	71.28
	335+50	-8.06	-10.51	6.12	78.78
	335+75	-7.54	-10.17	6.30	155.25
	336+00	-7.02	-9.77	6.42	159.00
	336+25	-6.45	-9.30	6.52	161.75
	336+50	-5.90	-8.78	6.55	163.38
	336+75	-5.35	-8.19	6.51	163.25
	337+00	-4.81	-7.54	6.40	161.38
	337+25	-4.24	-6.82	6.25	158.13
an man	337+50	-3.67	-6.04	6.04	153.63
	337+61	-3.43	-5.68	5.92	65.78
	337+75	-3.07	-5.20	5.80	82.04
	338+00	-2.43	-4.30	5.54	141.75
	338+25	-1.84	-3.34	5.17	133.88
	338+50	-1.23	-2.38	4.82	124.88
	338+75	-0.68	-1.43	4.42	115.50
	339+00	-0.10	-0.52	4.09	106.38
	339+25	0.48	0.33	3.82	98.88
	339+50	N/A	N/A	0.00	47.75

* DENOTES AREAS WHERE THE FULL DEPTH OF THE PROPOSED PAVEMENT IS REQUIRED TO BE RETAINED. THE ADDITIONAL DEPTH OF 3.67 FT IS INCLUDED IN THE HEIGHT OF RETENTION

LEGEND:

TEMPORARY CONCRETE BARRIER

TEMPORARY PAVEMENT

COUNTY TOTAL SHEET NO.

916 157

62304

COOK

SECTION

TRAVEL LANE

ILLINOIS DEPARTMENT OF TRANSPORTATION F.A.I. 94 (DAN RYAN EXPRESSWAY)


MISCELLANEOUS DETAILS TEMPORARY SOIL RETENTION ALONG THE WB CONNECTOR SECTIONS AND SCHEDULE

SCALE: NONE DATE: MARCH 7, 2006 DRAWN BY: JDF CHECKED BY: TGB

 F.A.I. RTE.	SECTION	COUNTY	TOTAL SHEETS	SHEET NO.
94		соок	916	157A
STA.	90+65 (NB I-57 990+48 (NB FOR	D)TO STA. 2316	5+00 (NE	RYAN)
FED. RO	AD DIST. NO. ILLIN	OIS FED. AID	PROJECT	

• (1516.1, 1717, & 1818) R-4

62304

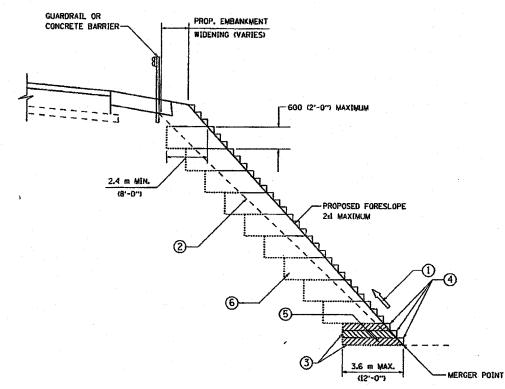

TYPICAL BENCHING DETAIL FOR EMBANKMENT

NOTES:

- O CONSTRUCT SUCCEEDING BENCH CUTS AND EMBANKMENT PLACEMENT AND COMPACTION FROM BOTTOM TO TOP IN STAIRSTEP FASHION.
- ② EXISTING FORESLOPE PREPARED IN ACCORDANCE WITH ARTICLE 205.03 OF THE STANDARD SPECIFICATIONS.
- 3 BENCH CUT EXISTING SLOPE TYPICAL FOR EACH STEP.
- 4 TRIM TO FINAL SLOPE.
- 5 EQUAL 200 (8-INCH) LIFTS OF EMBANKMENT COMPACTED IN ACCORDANCE WITH ARTICLE 205.05 OF THE STANDARD SPECIFICATIONS.
- EXCAVATION OF BENCH CUTS WITHIN EXISTING EMBANKMENT WILL BE PAID FOR AT THE CONTRACT UNIT PRICE PER CUBIC METER OR CUBIC YARD FOR *.

 THIS PRICE WILL INCLUDE ALL LABOR AND MATERIAL, NO ADDITIONAL COMPENSATION WILL BE ALLOWED.
- SLOPES SHALL BE BENCHED ACCORDING TO THIS DETAIL WHEN THE SLOPE IS STEEPER THAN 4:1 AND THE HEIGHT IS GREATER THAN 5: (1.5)

ALL DIMENSIONS ARE IN MILLIMETERS (INCHES) UNLESS OTHERWISE SHOWN.

REVISIONS		
NAME DATE]	
		NG DETAIL BANKMENT
	1	ENING
	SCALE: VERT.	DRAWN B
	DATE 3/16/2005	CHECKED

* - EARTH EXCAVATION (SPECIAL)

15 1000E

EARTH EXCAVATION (SPECIAL) SCHEDULE

STATION

FROM

236+50

240+00

247+00

TO

236+50

244+00

251+00

TOTAL

ALIGNMENT

NB I-57

NB I-57

NB I-57

EARTH EXCAVATION (SPECIAL) (CU YD)

46

385


294


725


CHECKED BY: S.E.B.
REVISION DATE: 6-16-2004


DRAWN BY: CADD

972000

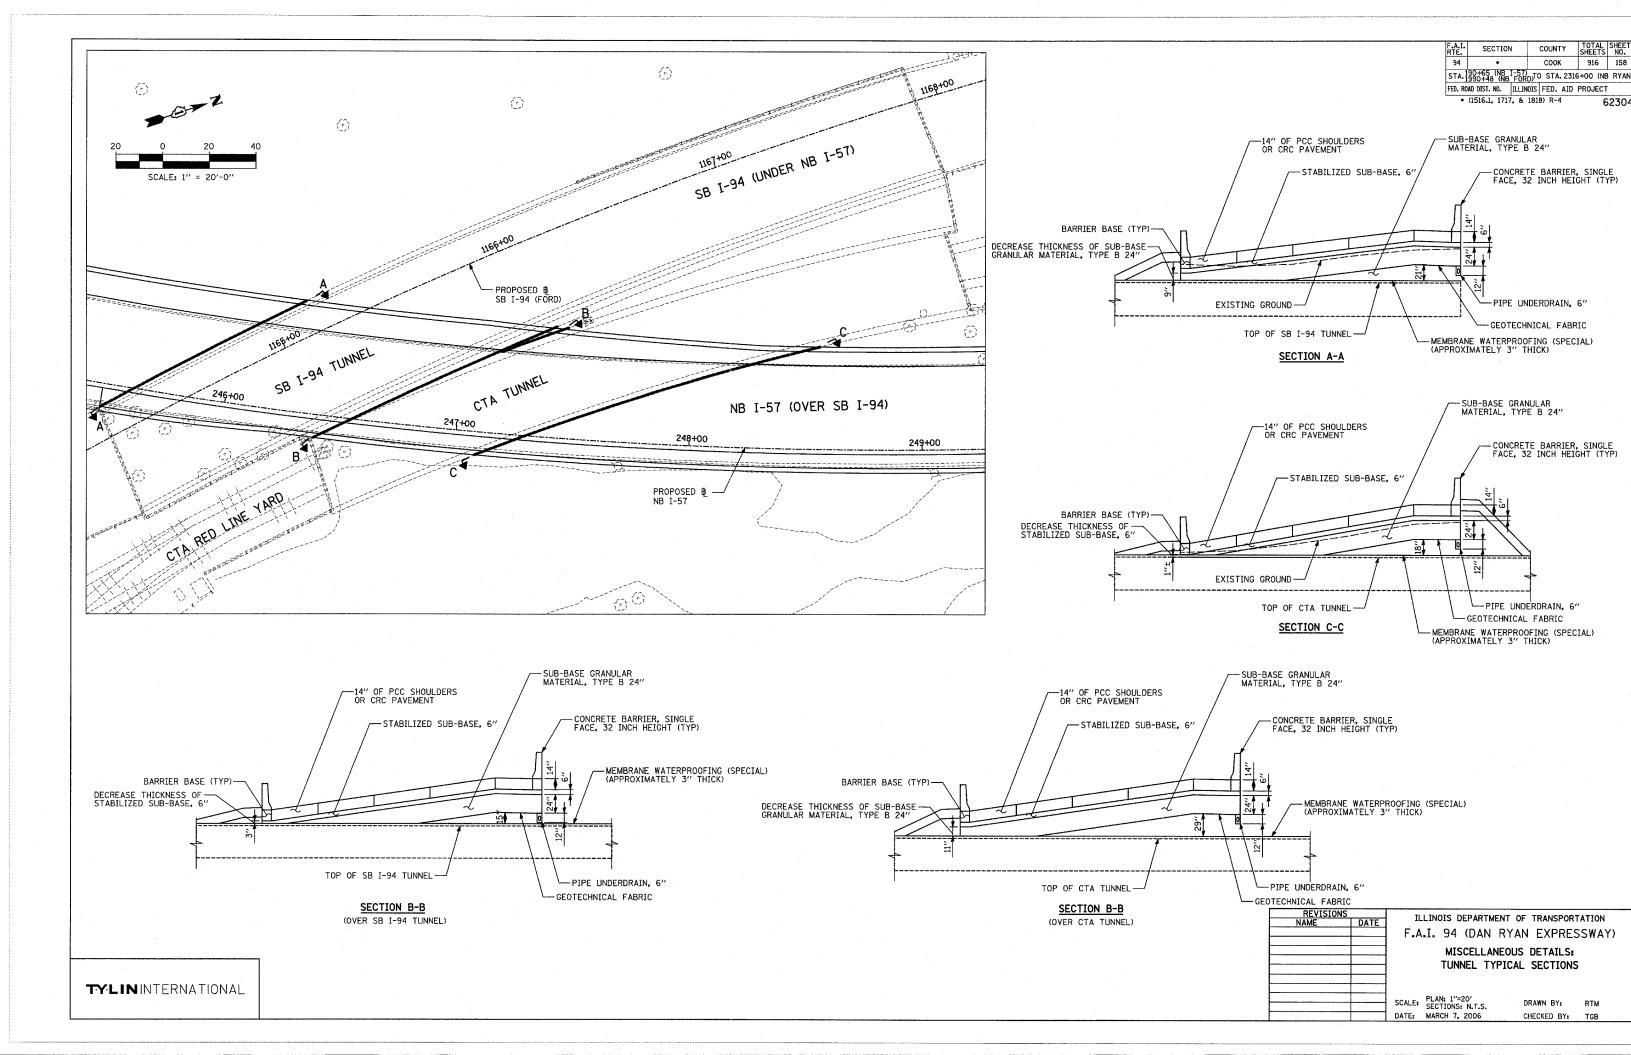

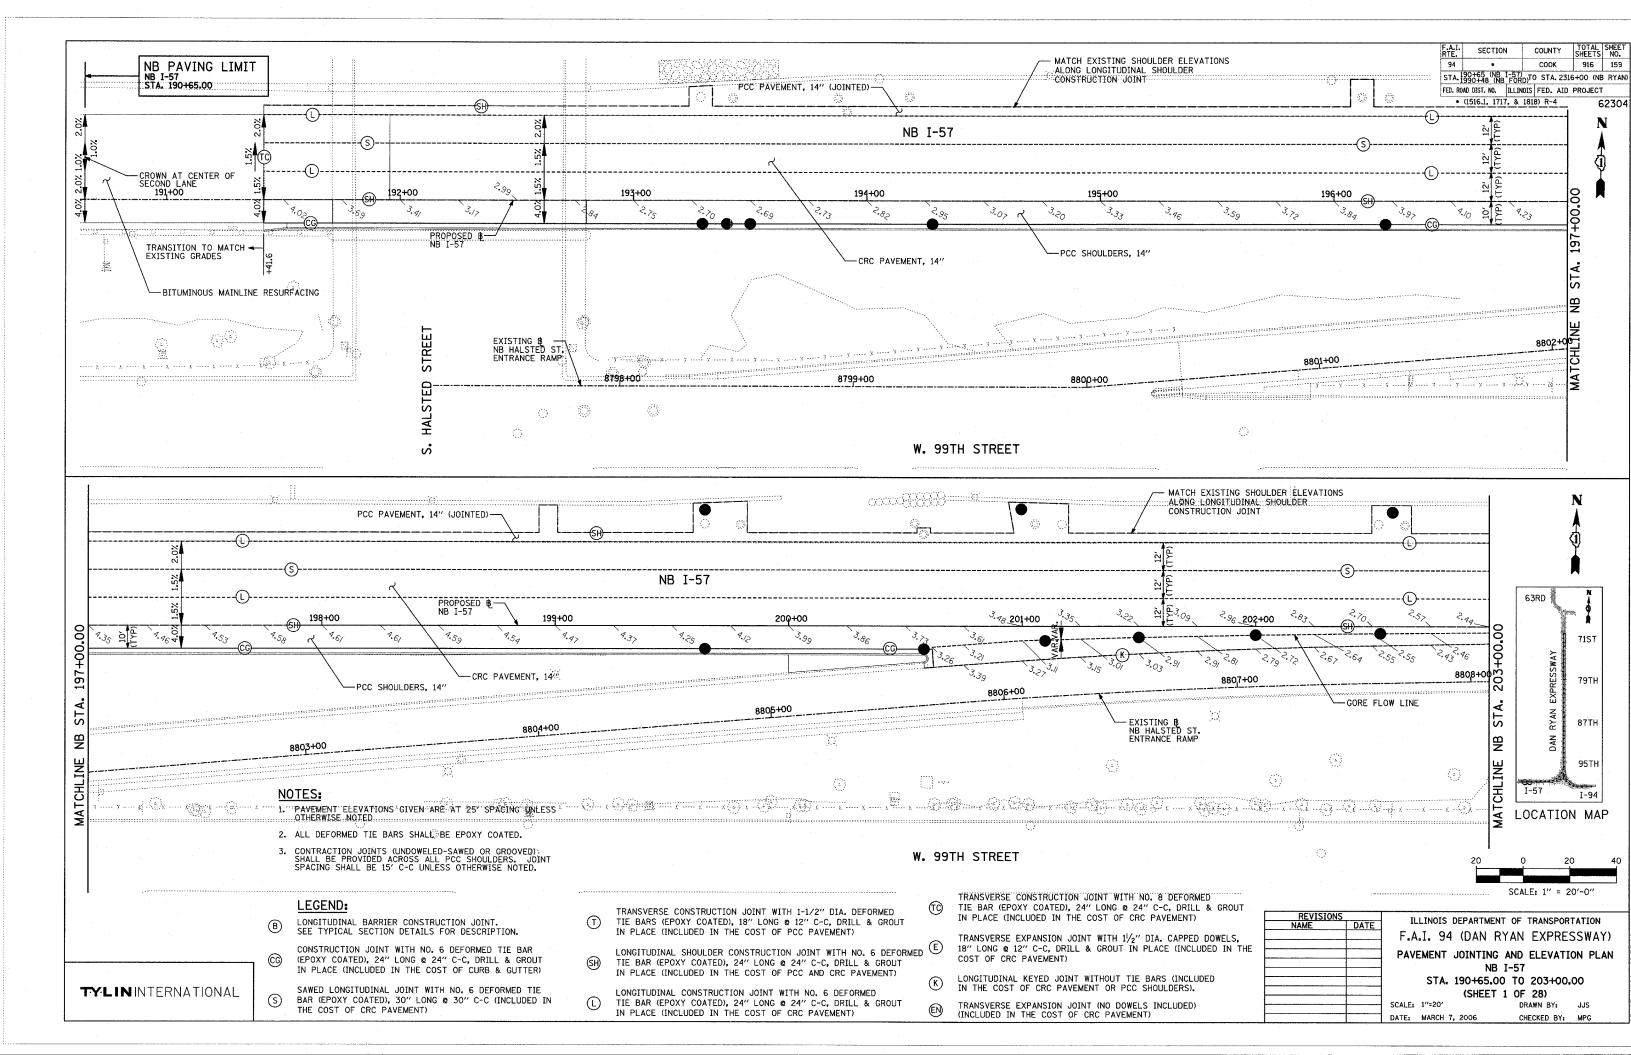


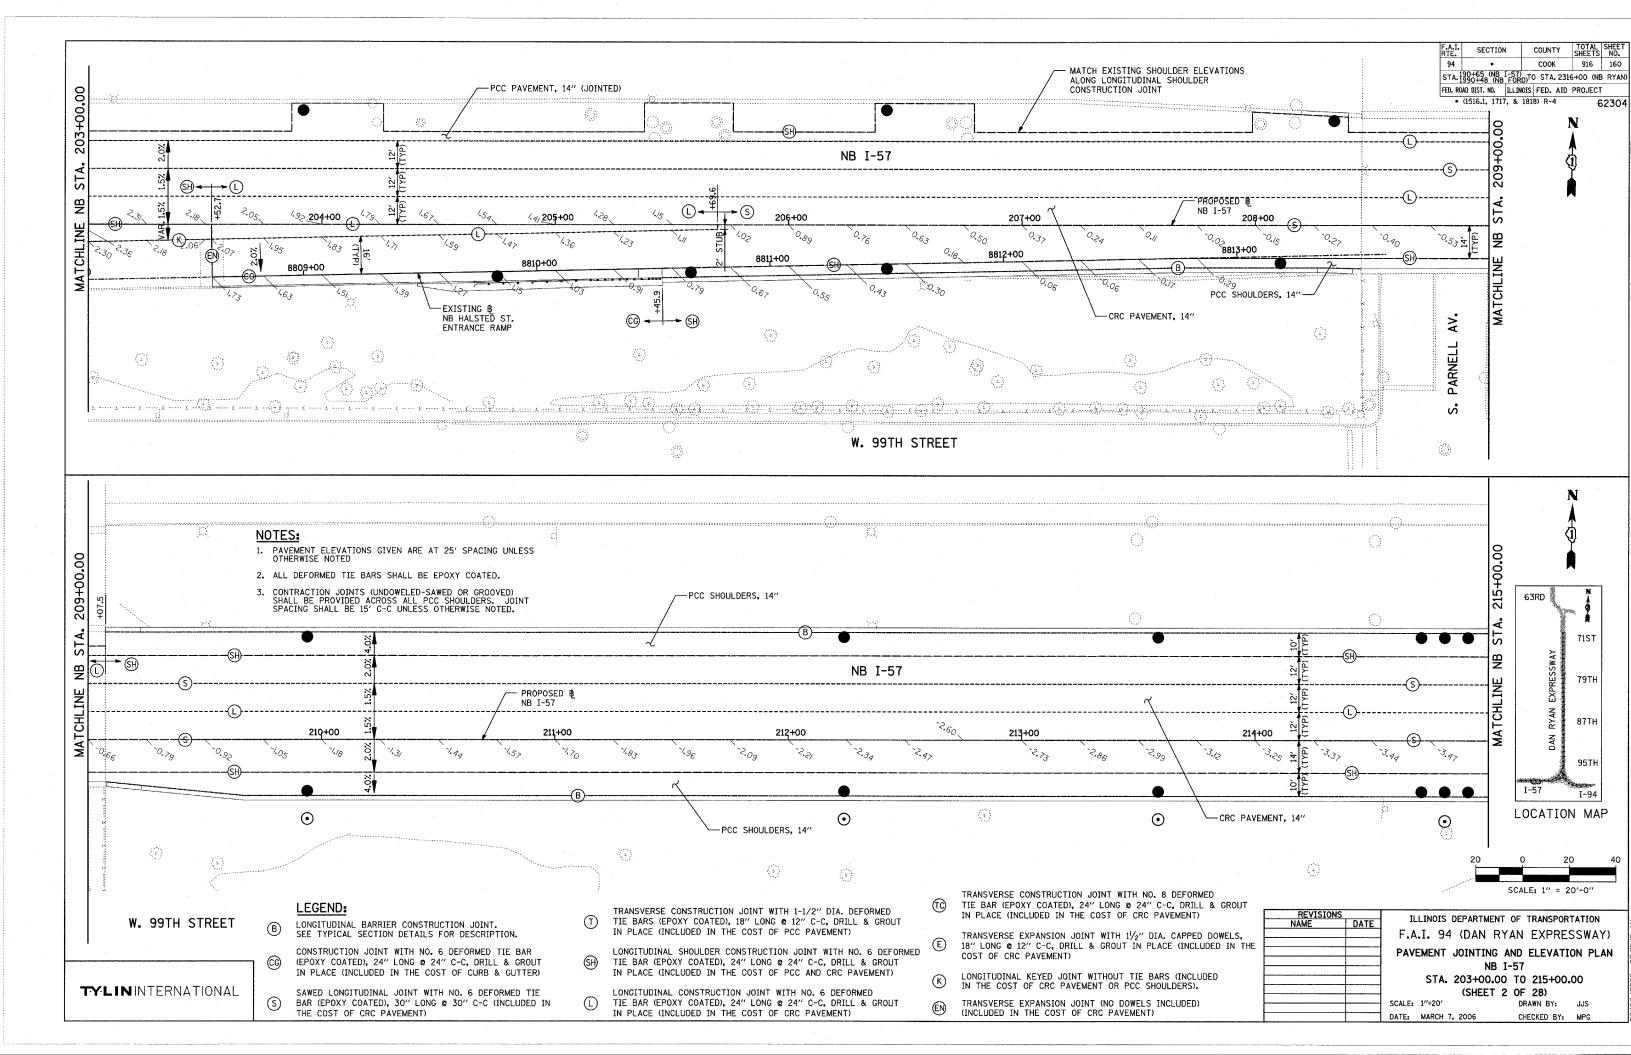

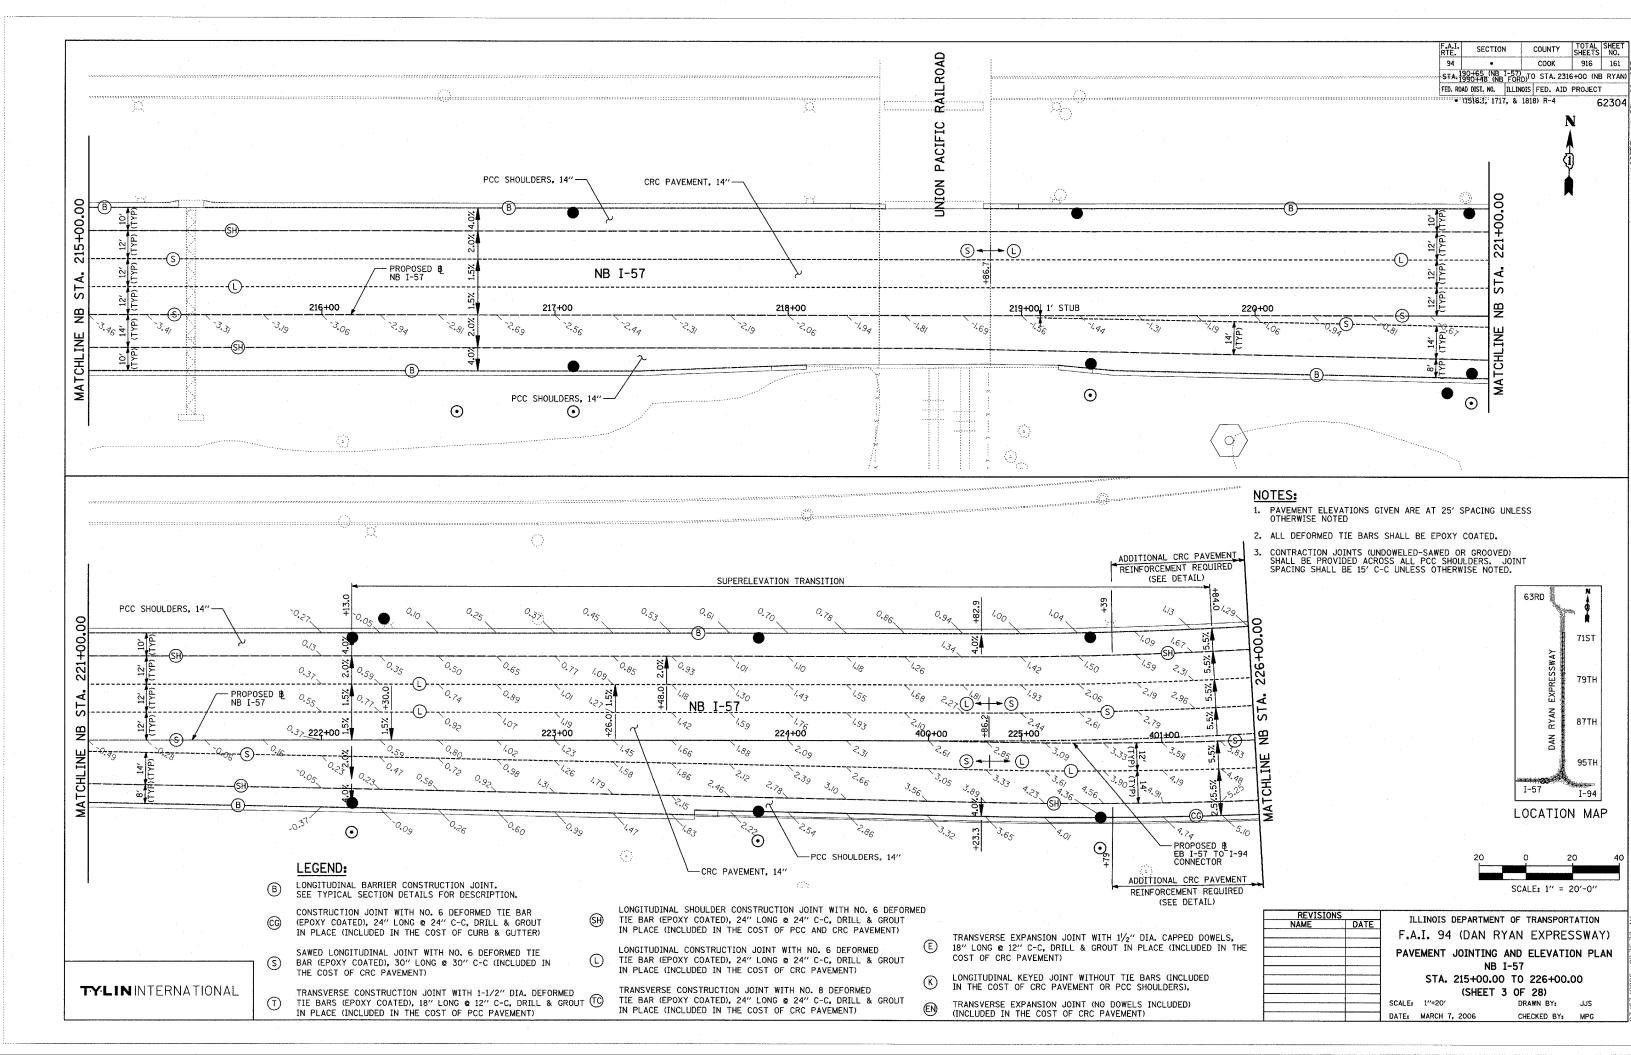

COUNTY TOTAL SHEET NO. SECTION COOK 916 162 STA. 190+65 (NB I-57) 1990+48 (NB FORD)TO STA. 2316+00 (NB RYAN) FED. ROAD DIST. NO. ILLINOIS FED. AID PROJECT • (1516.1, 1717, & 1818) R-4 62304

SB I-57

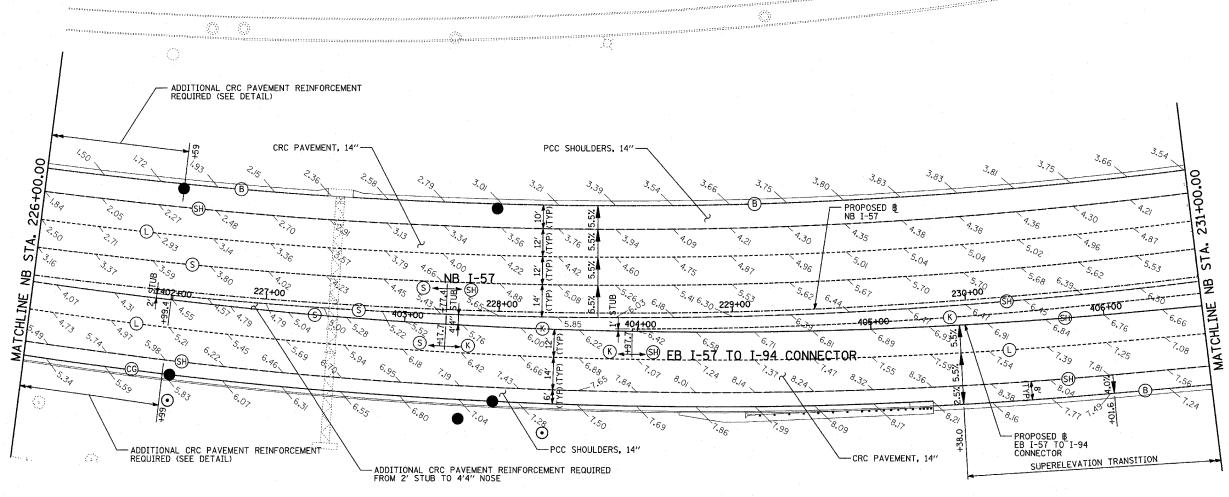

LOCATION MAP


71ST

LEGEND:


- LONGITUDINAL BARRIER CONSTRUCTION JOINT. SEE TYPICAL SECTION DETAILS FOR DESCRIPTION.
- CONSTRUCTION JOINT WITH NO. 6 DEFORMED TIE BAR (EPOXY COATED), 24" LONG @ 24" C-C, DRILL & GROUT IN PLACE (INCLUDED IN THE COST OF CURB & GUTTER)
- SAWED LONGITUDINAL JOINT WITH NO. 6 DEFORMED TIE BAR (EPOXY COATED), 30" LONG @ 30" C-C (INCLUDED IN THE COST OF CRC PAVEMENT)
- TRANSVERSE CONSTRUCTION JOINT WITH 1-1/2" DIA, DEFORMED TIE BARS (EPOXY COATED), 18" LONG @ 12" C-C, DRILL & GROUT IN PLACE (INCLUDED IN THE COST OF PCC PAVEMENT)
- LONGITUDINAL SHOULDER CONSTRUCTION JOINT WITH NO. 6 DEFORMED TIE BAR (EPOXY COATED), 24" LONG @ 24" C-C, DRILL & GROUT IN PLACE (INCLUDED IN THE COST OF PCC AND CRC PAVEMENT)

- LONGITUDINAL CONSTRUCTION JOINT WITH NO. 6 DEFORMED TIE BAR (EPOXY COATED), 24" LONG @ 24" C-C, DRILL & GROUT IN PLACE (INCLUDED IN THE COST OF CRC PAVEMENT)
- TRANSVERSE CONSTRUCTION JOINT WITH NO. 8 DEFORMED TIE BAR (EPOXY COATED), 24" LONG @ 24" C-C, DRILL & GROUT IN PLACE (INCLUDED IN THE COST OF CRC PAVEMENT)
- TRANSVERSE EXPANSION JOINT WITH $1/_2{''}$ DIA. CAPPED DOWELS, 18" LONG @ 12" C-C, DRILL & GROUT IN PLACE (INCLUDED IN THE
- LONGITUDINAL KEYED JOINT WITHOUT TIE BARS (INCLUDED IN THE COST OF CRC PAVEMENT OR PCC SHOULDERS).
- TRANSVERSE EXPANSION JOINT (NO DOWELS INCLUDED) (INCLUDED IN THE COST OF CRC PAVEMENT)

- 1. PAVEMENT ELEVATIONS GIVEN ARE AT 25' SPACING UNLESS OTHERWISE NOTED
- 2. ALL DEFORMED TIE BARS SHALL BE EPOXY COATED.
- 3. CONTRACTION JOINTS (UNDOWELED-SAWED OR GROOVED)
 SHALL BE PROVIDED ACROSS ALL PCC SHOULDERS. JOINT
 SPACING SHALL BE 15' C-C UNLESS OTHERWISE NOTED.

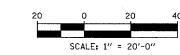

REVISION	S	ILLINOIS DEPARTMENT OF TRANSPORTATION
NAME	DATE	ILLINOIS DEPARTMENT OF TRANSPORTATION
		F.A.I. 94 (DAN RYAN EXPRESSWAY)
		PAVEMENT JOINTING AND ELEVATION PLAN
		NB I~57
		CTA 000 100 00 TO 074 100 00
		STA. 226+00.00 TO 231+00.00
		(SHEET 4 OF 28)
		SCALE: 1"=20" DRAWN BY: JJS
		30ACC 1 -20 BIANN BI. 303
		DATE: MARCH 7, 2006 CHECKED BY: MPG

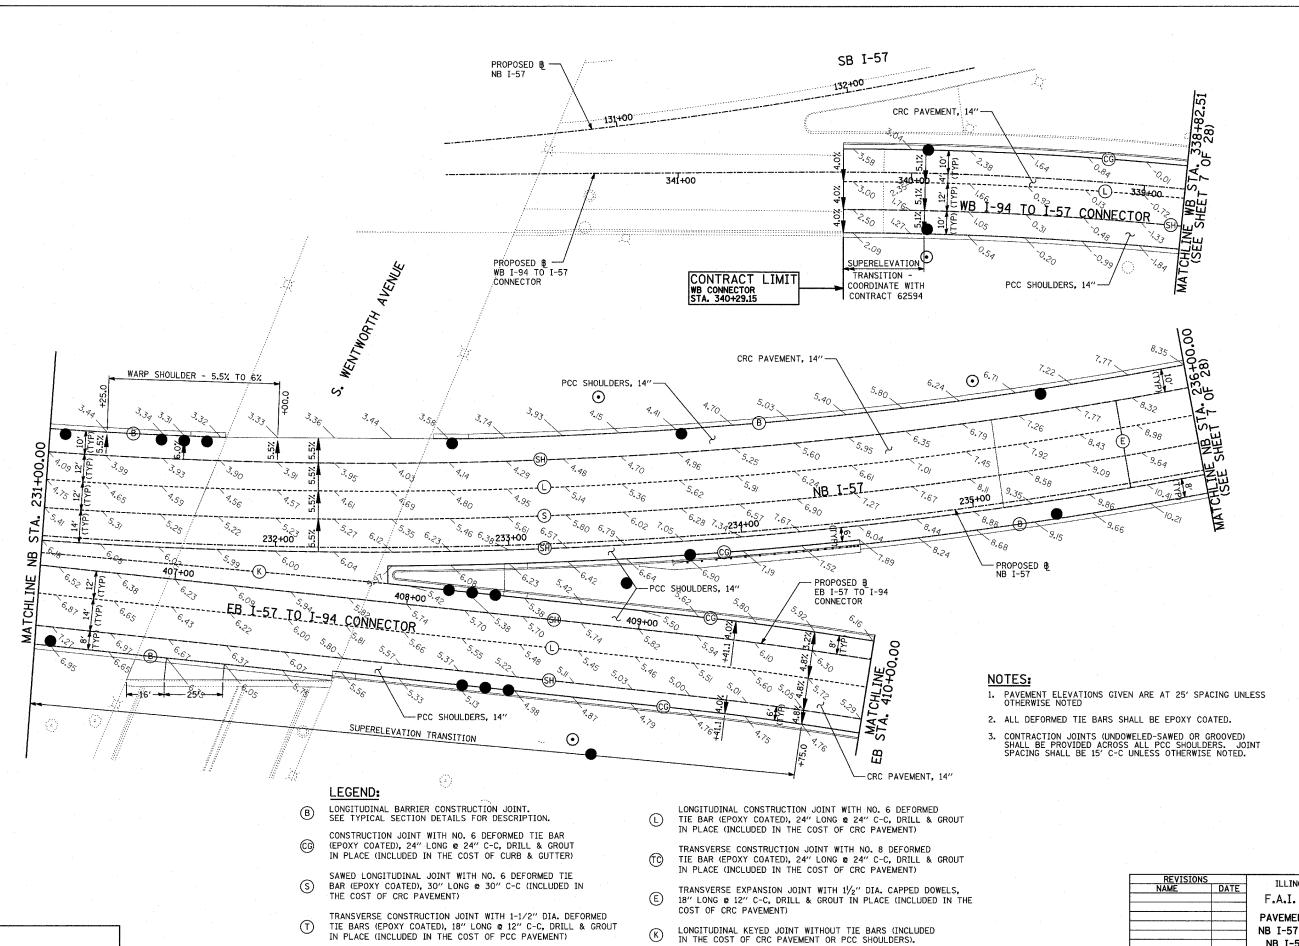

(EN)

LONGITUDINAL SHOULDER CONSTRUCTION JOINT WITH NO. 6 DEFORMED

TIE BAR (EPOXY COATED), 24" LONG & 24" C-C, DRILL & GROUT IN PLACE (INCLUDED IN THE COST OF PCC AND CRC PAVEMENT)

TRANSVERSE EXPANSION JOINT (NO DOWELS INCLUDED) (INCLUDED IN THE COST OF CRC PAVEMENT)


TY:LIN INTERNATIONAL


F.A.I. SECTION COUNTY TOTAL SHEET NO.

94 • COOK 916 163


STA.1990+65 (NB 1-57) TO STA. 2316+00 (NB RYAN)


FED. ROAD DIST. NO. | ILLINOIS | FED. AID | PROJECT • (1516.1, 1717, & 1818) R-4 62304

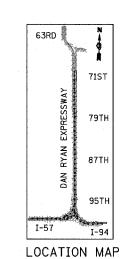

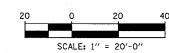


REVISIONS	
NAME DAT	ILLINOIS DEPARTMENT OF TRANSPORTATION
	F.A.I. 94 (DAN RYAN EXPRESSWAY)
	PAVEMENT JOINTING AND ELEVATION PLAN
·····	→ NB I-57 AND EB I-57 TO I-94 CONNECTOR.
	NB I-57 STA. 231+00.00 TO 236+00.00
	(SHEET 5 OF 28)
	SCALE: 1"=20' DRAWN BY: JJS
	DATE: MARCH 7, 2006 CHECKED BY: MPG

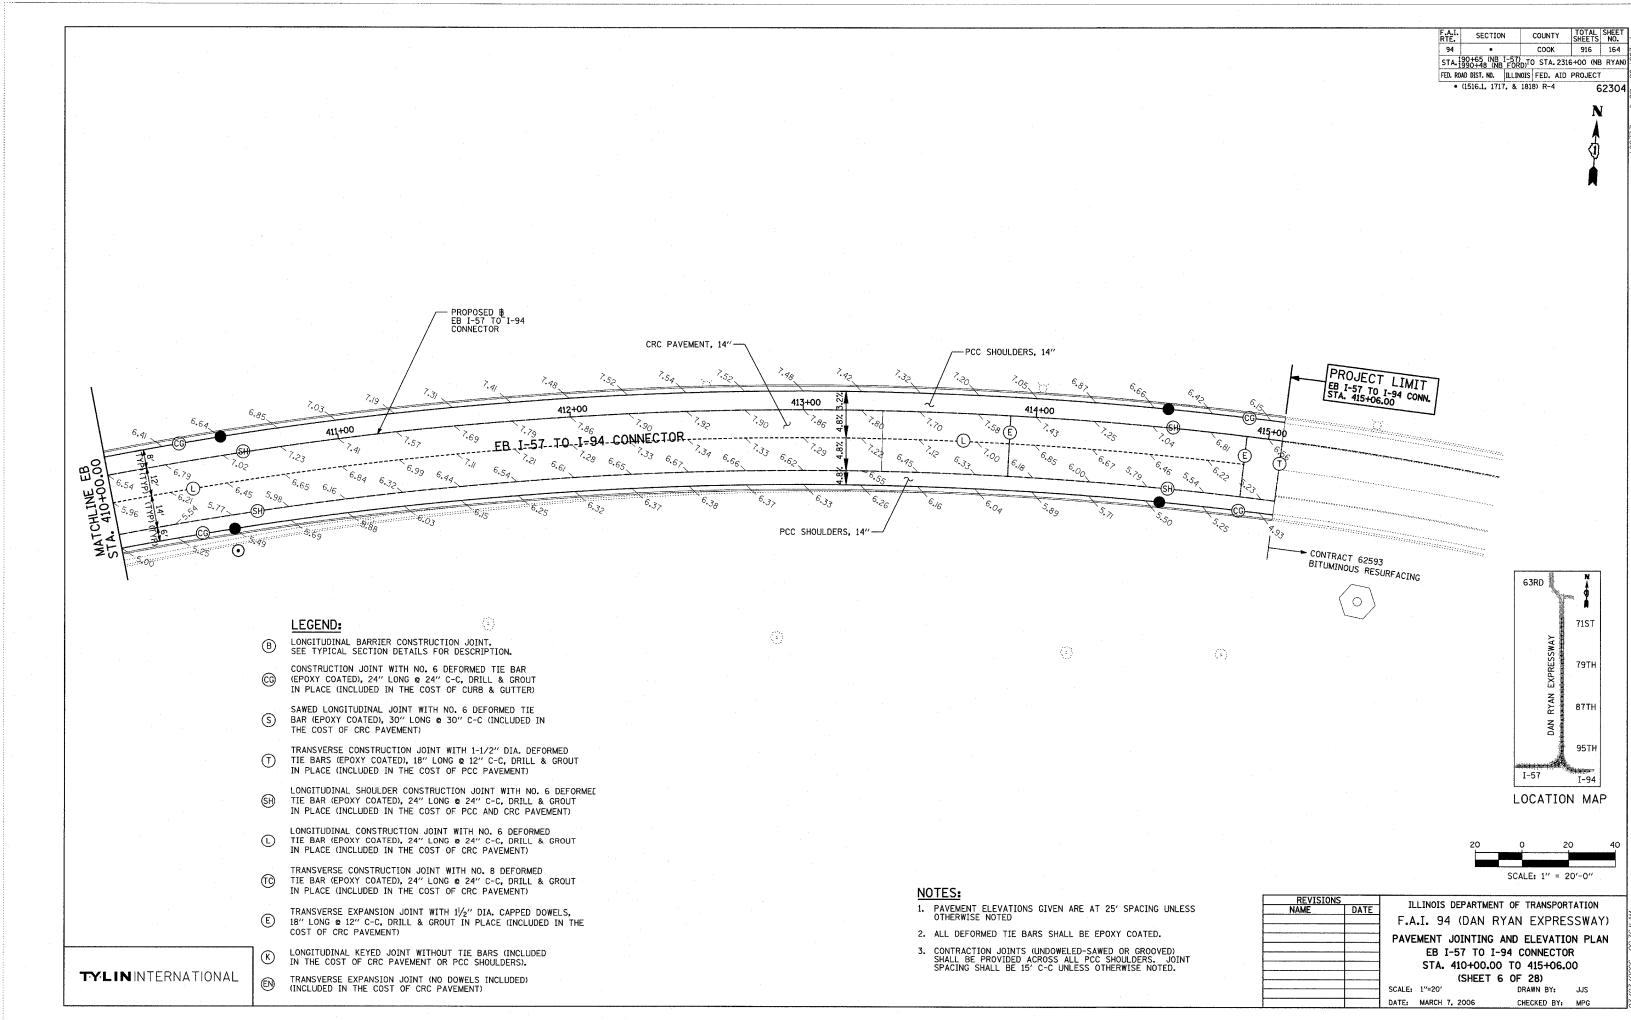

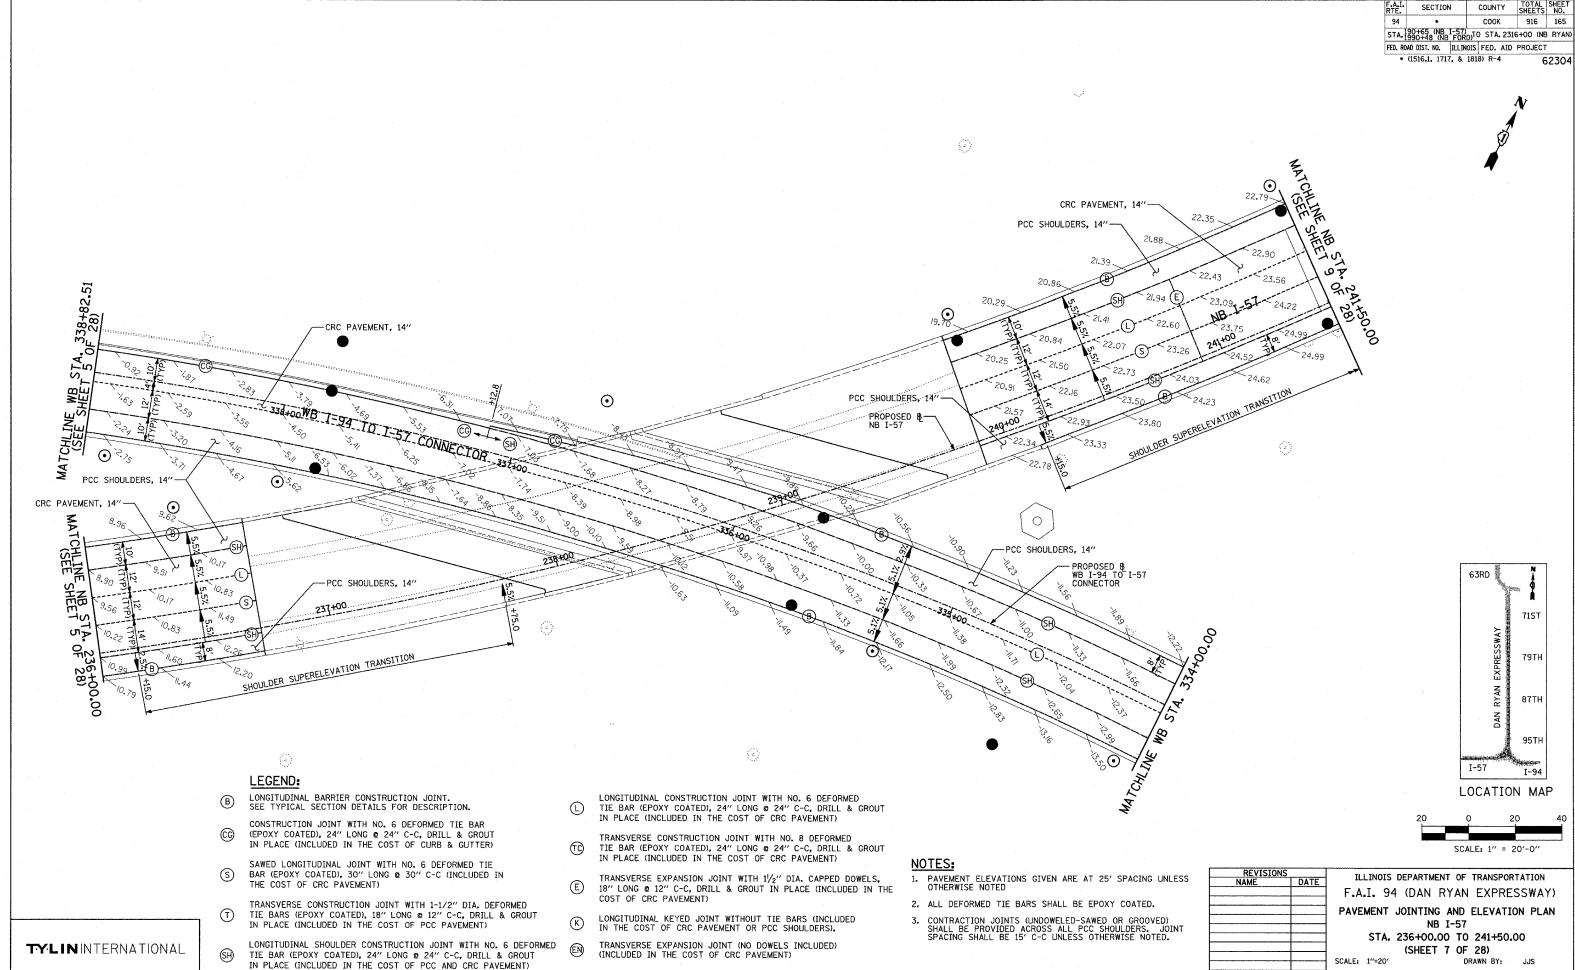

CHECKED BY: MPG

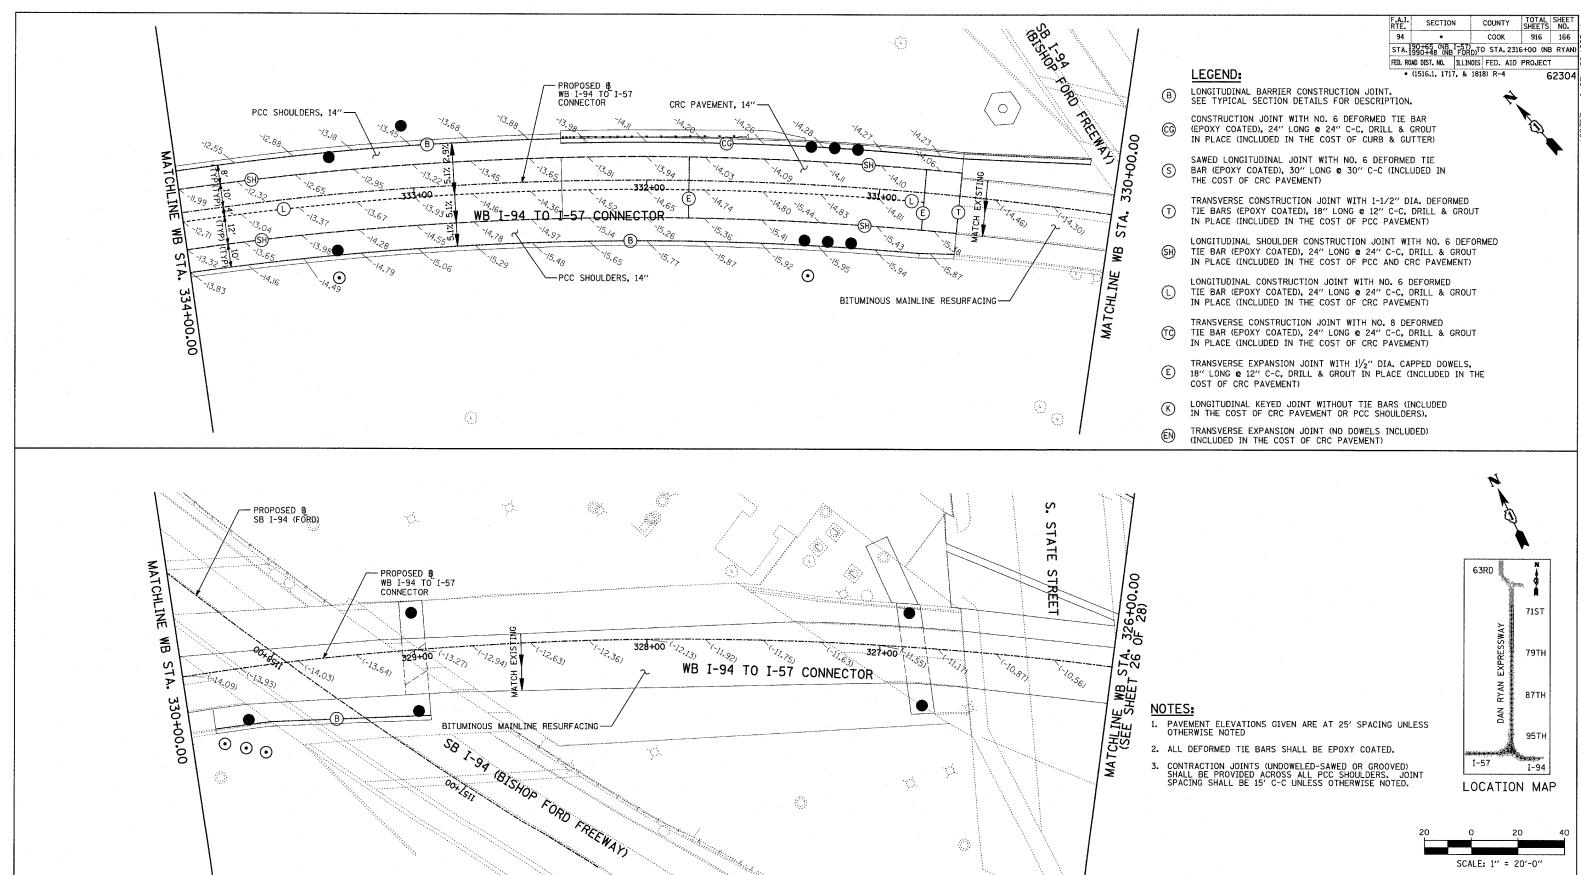

 $\langle \langle \rangle \rangle$

TYLININTERNATIONAL

(3)


LOCATION MAP


SCALE: 1" = 20'-0"

ILLINOIS DEPARTMENT OF TRANSPORTATION F.A.I. 94 (DAN RYAN EXPRESSWAY) PAVEMENT JOINTING AND ELEVATION PLAN WB I-94 TO I-57 CONNECTOR STA. 326+00.00 TO 334+00.00 (SHEET 8 OF 28) SCALE: 1"=20" DRAWN BY:

DATE: MARCH 7, 2006

CHECKED BY:

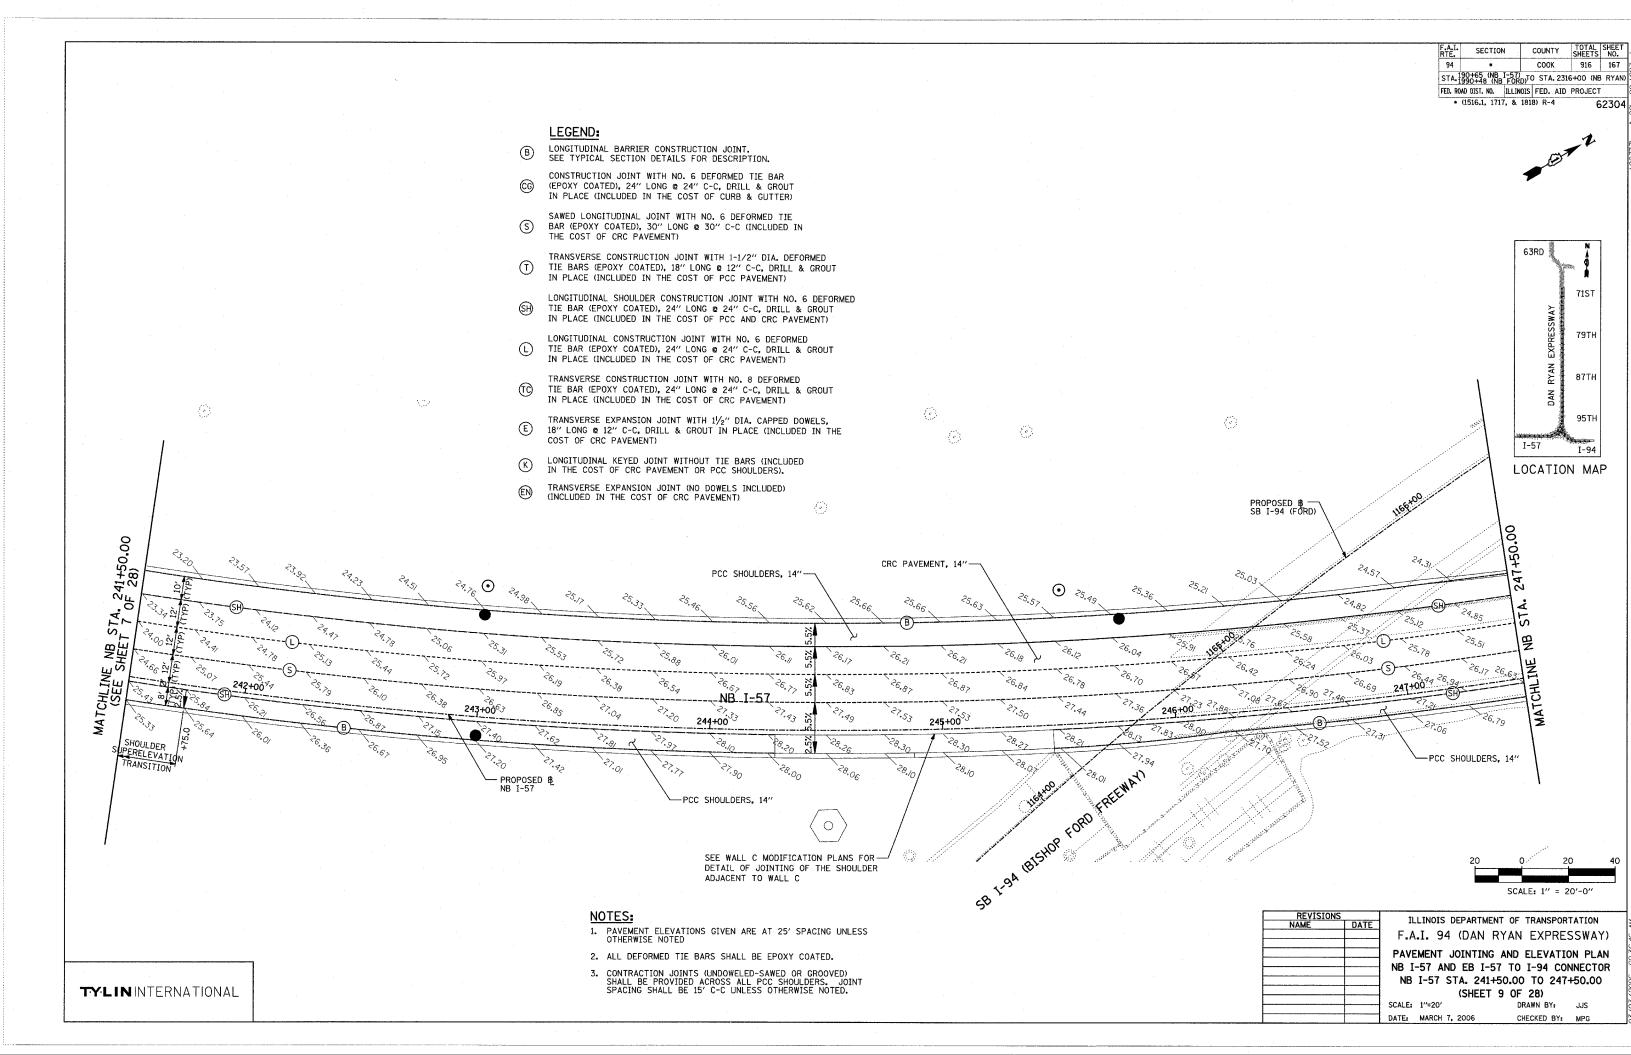

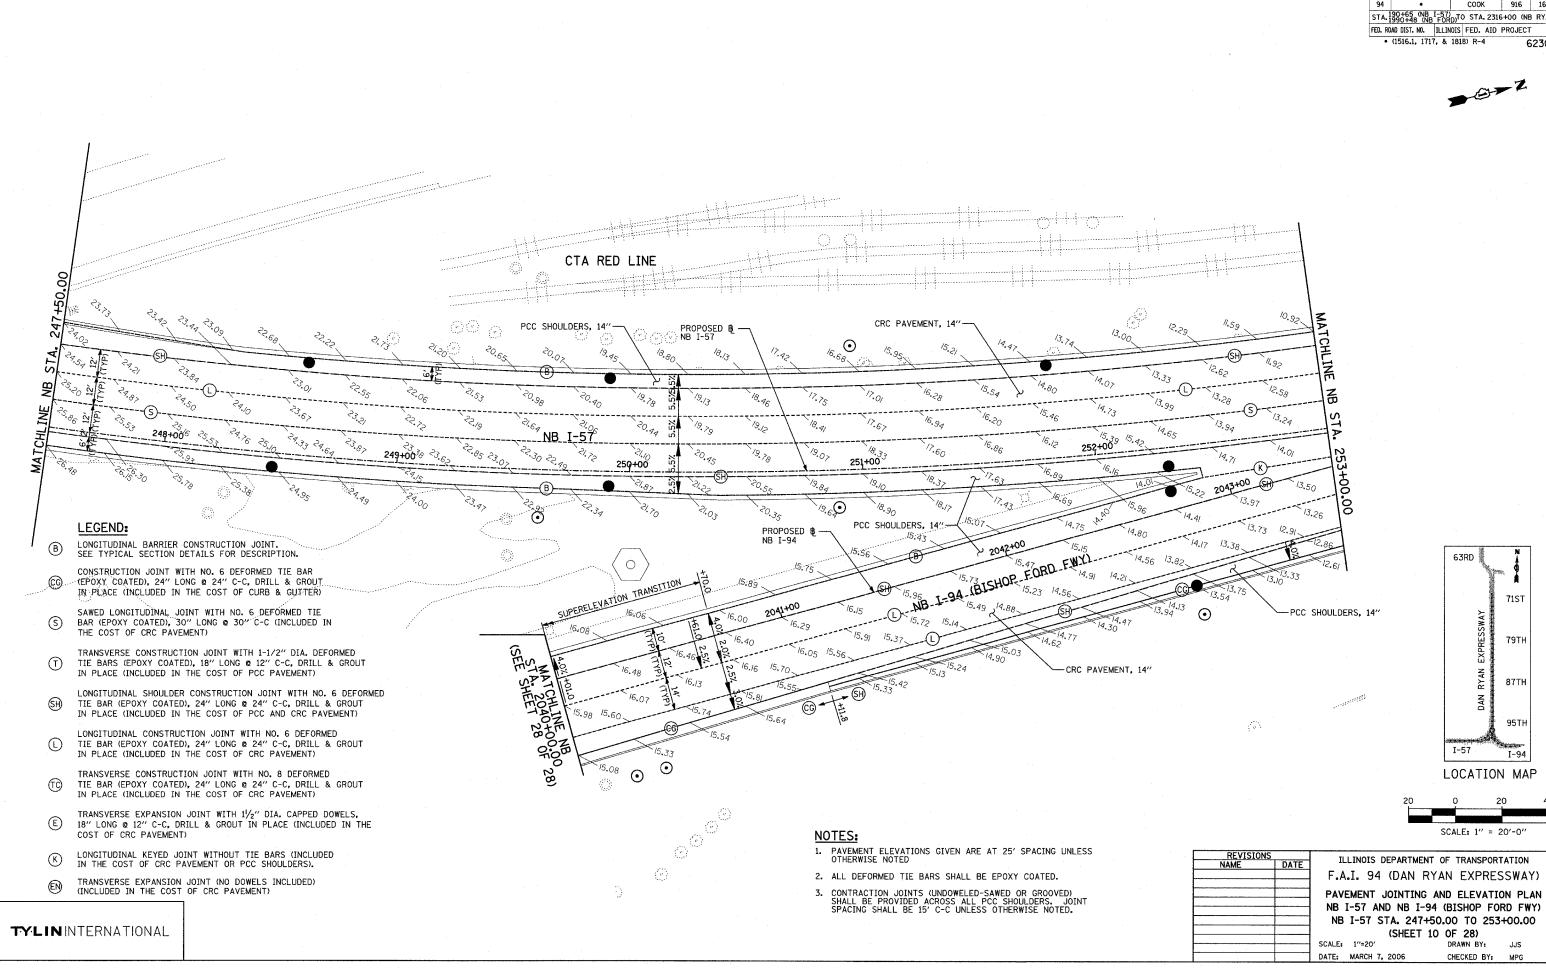


COUNTY TOTAL SHEET NO. SECTION COOK 916 168 STA. 190+65 (NB I-57) TO STA. 2316+00 (NB RYAN)

62304

71ST


LOCATION MAP

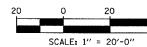



ILLINOIS DEPARTMENT OF TRANSPORTATION F.A.I. 94 (DAN RYAN EXPRESSWAY)


> NB I-57 AND NB I-94 (BISHOP FORD FWY) NB I-57 STA. 247+50.00 TO 253+00.00


> > CHECKED BY: MPG

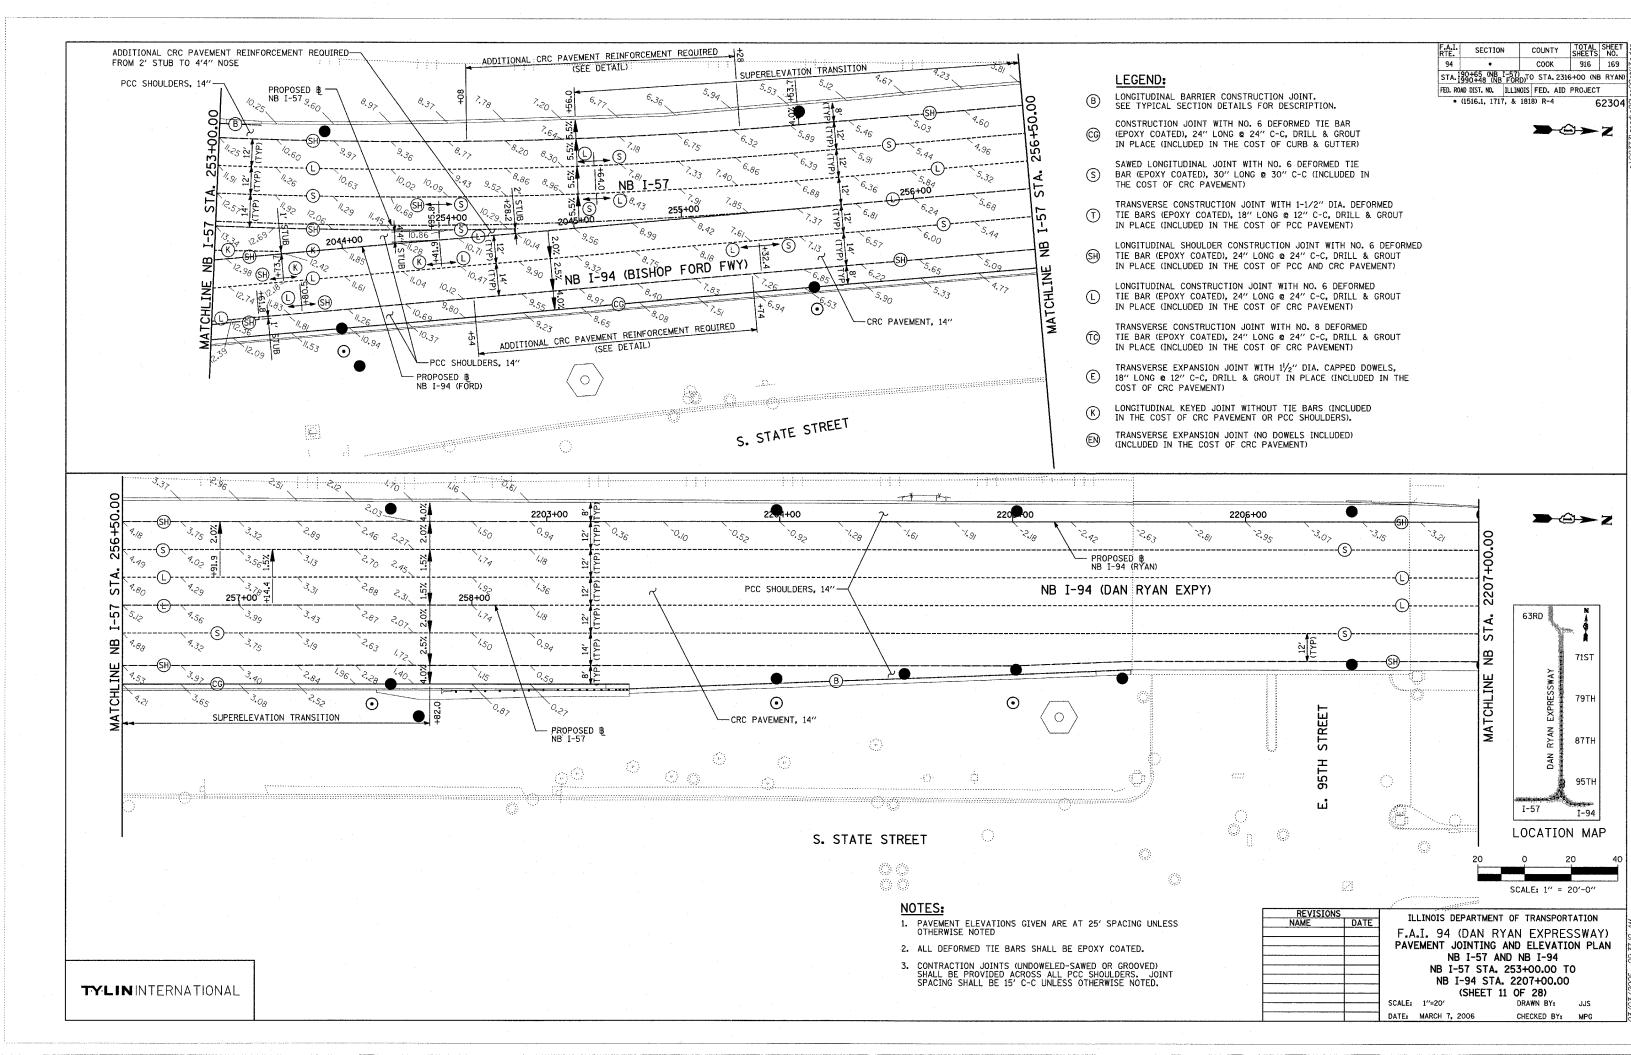


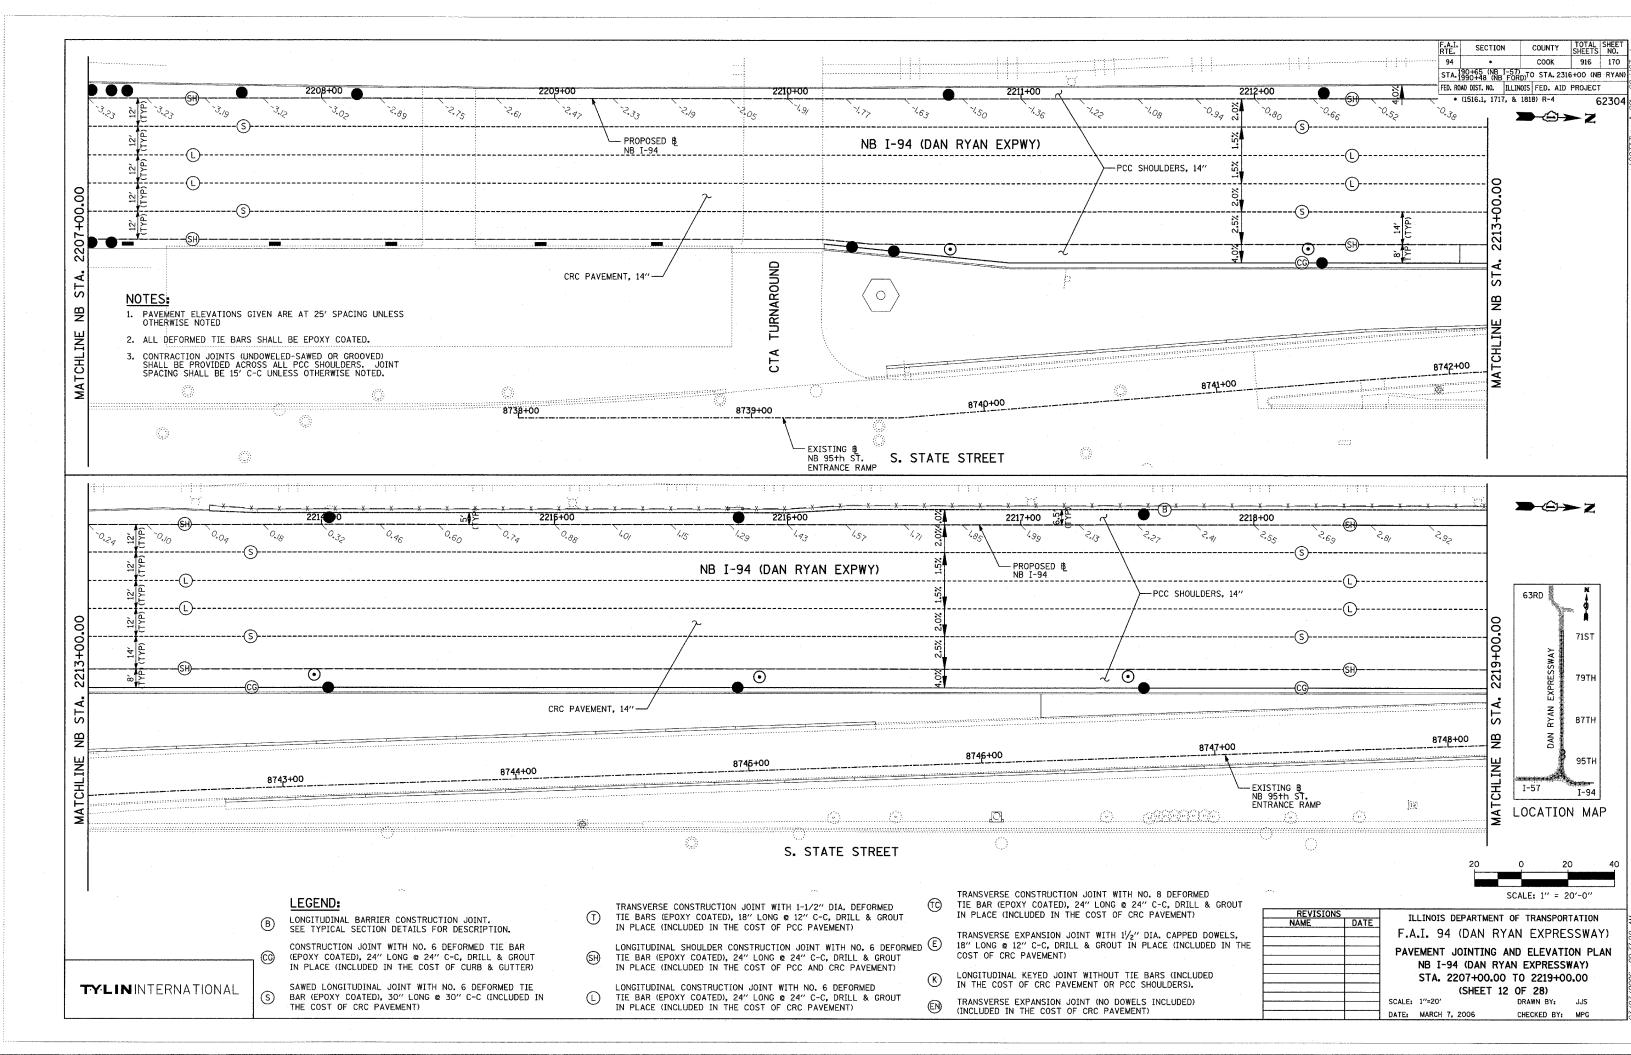


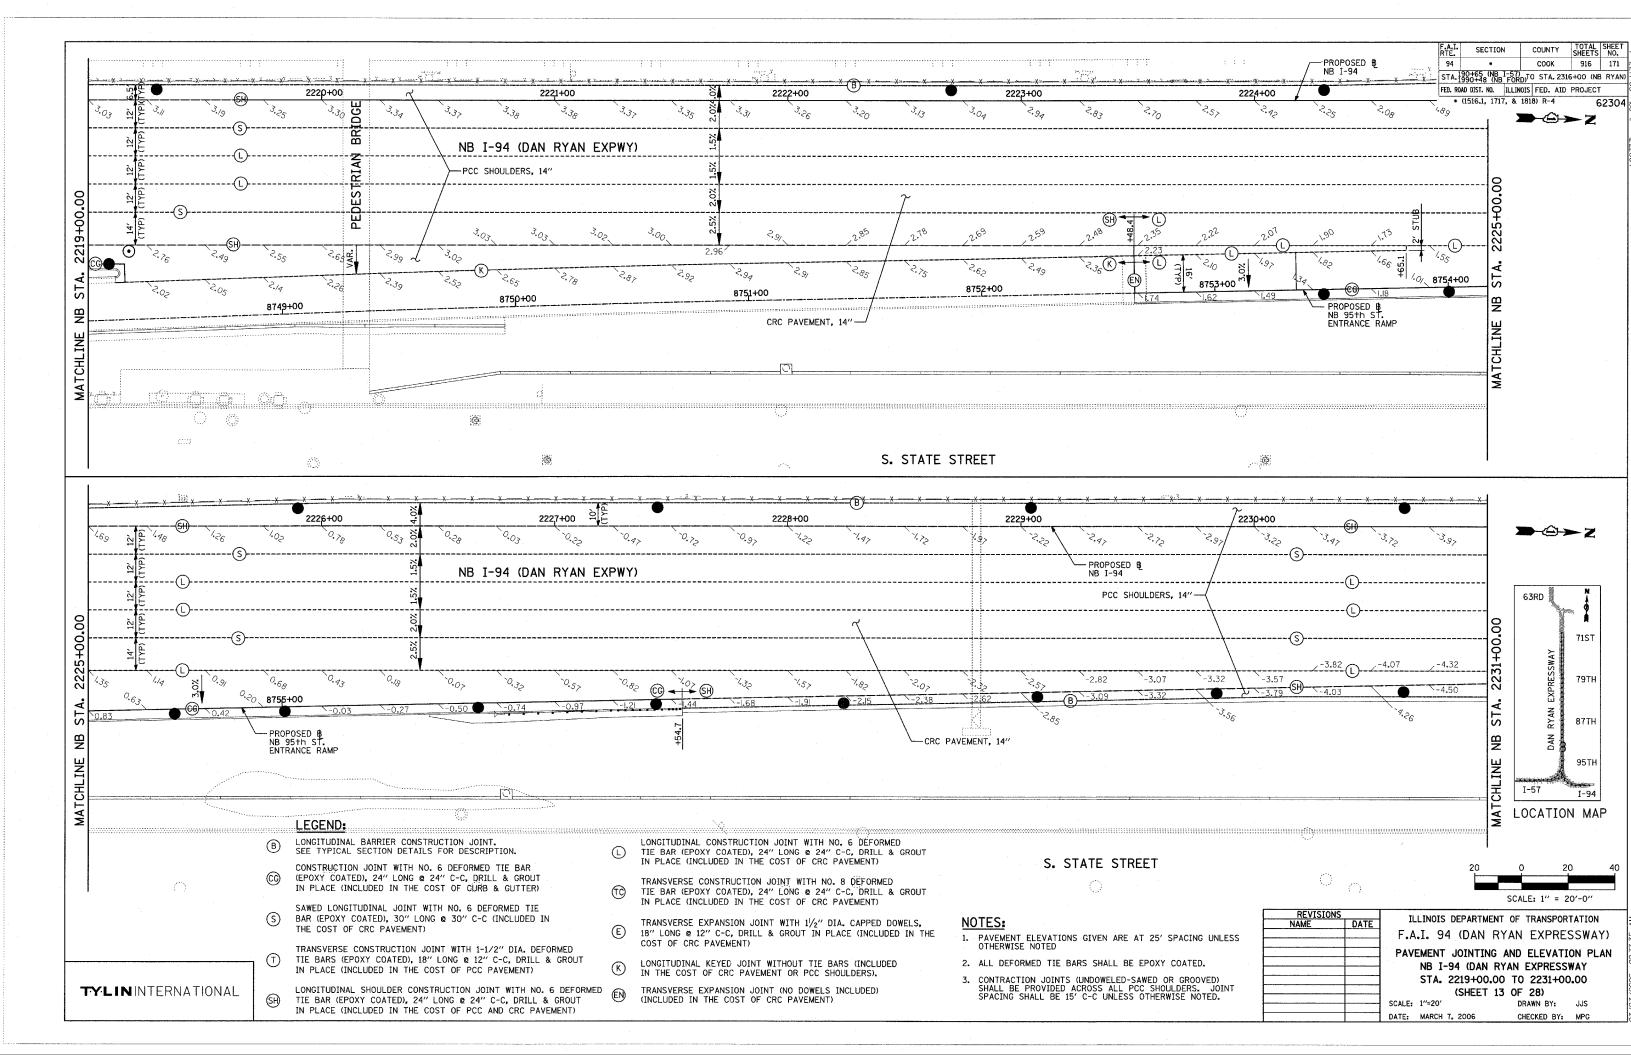


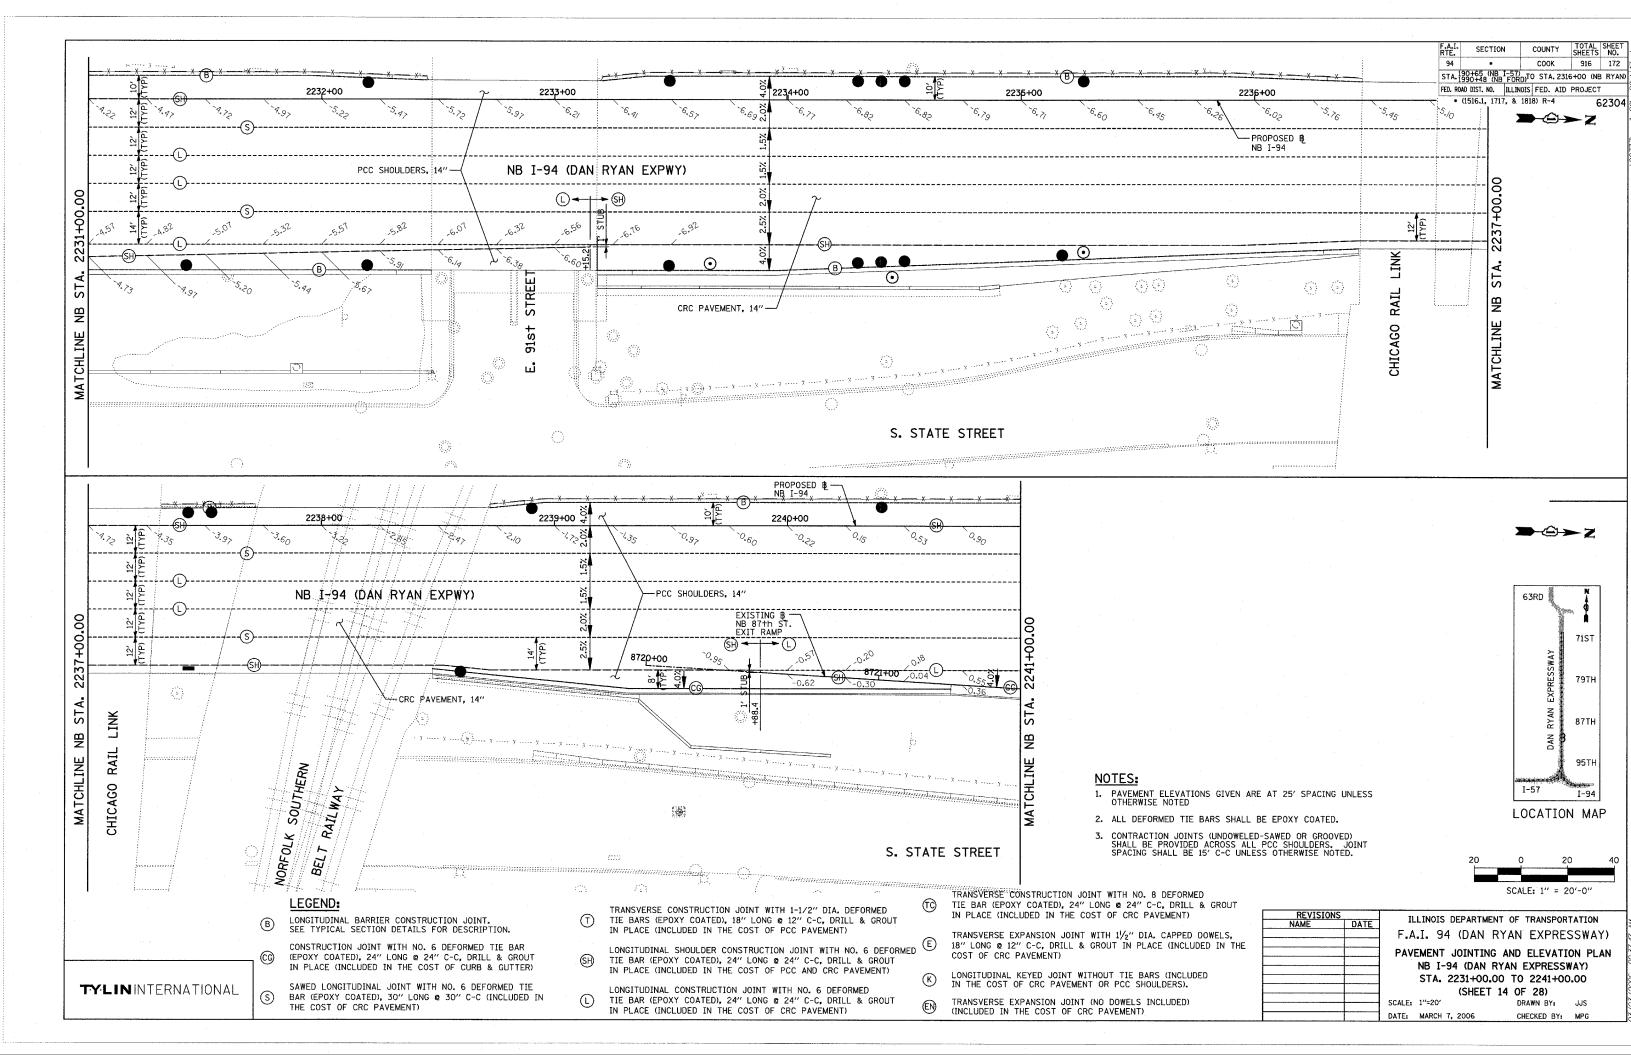


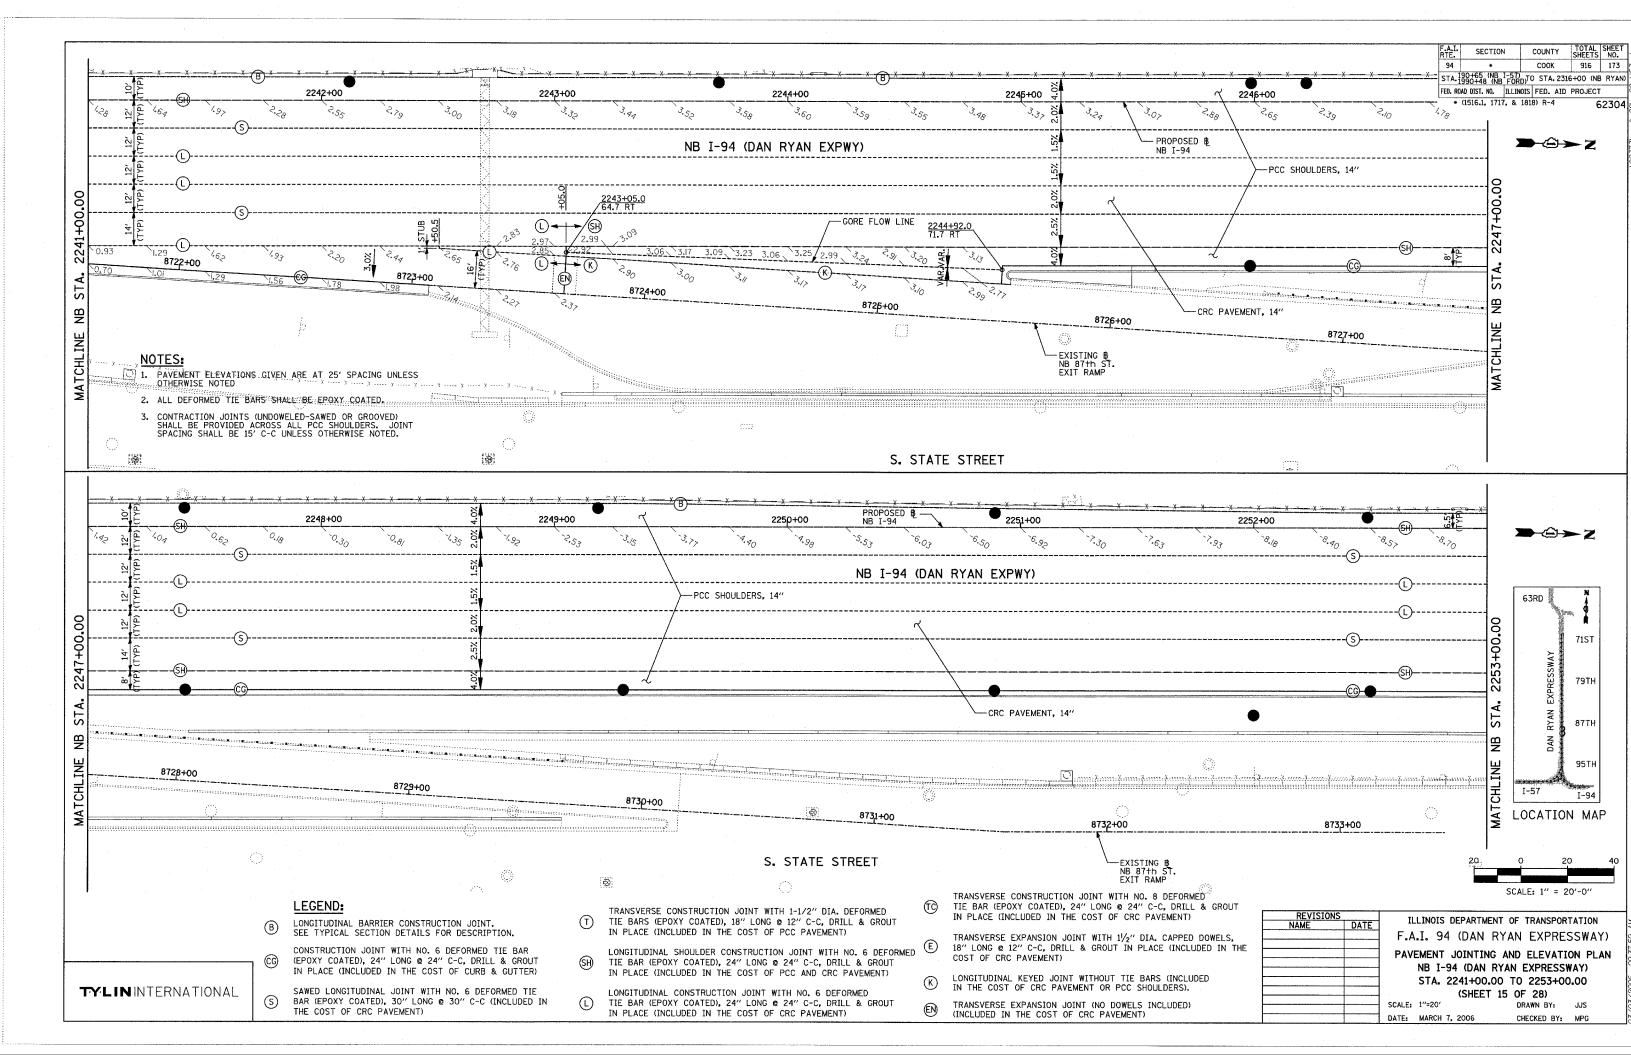


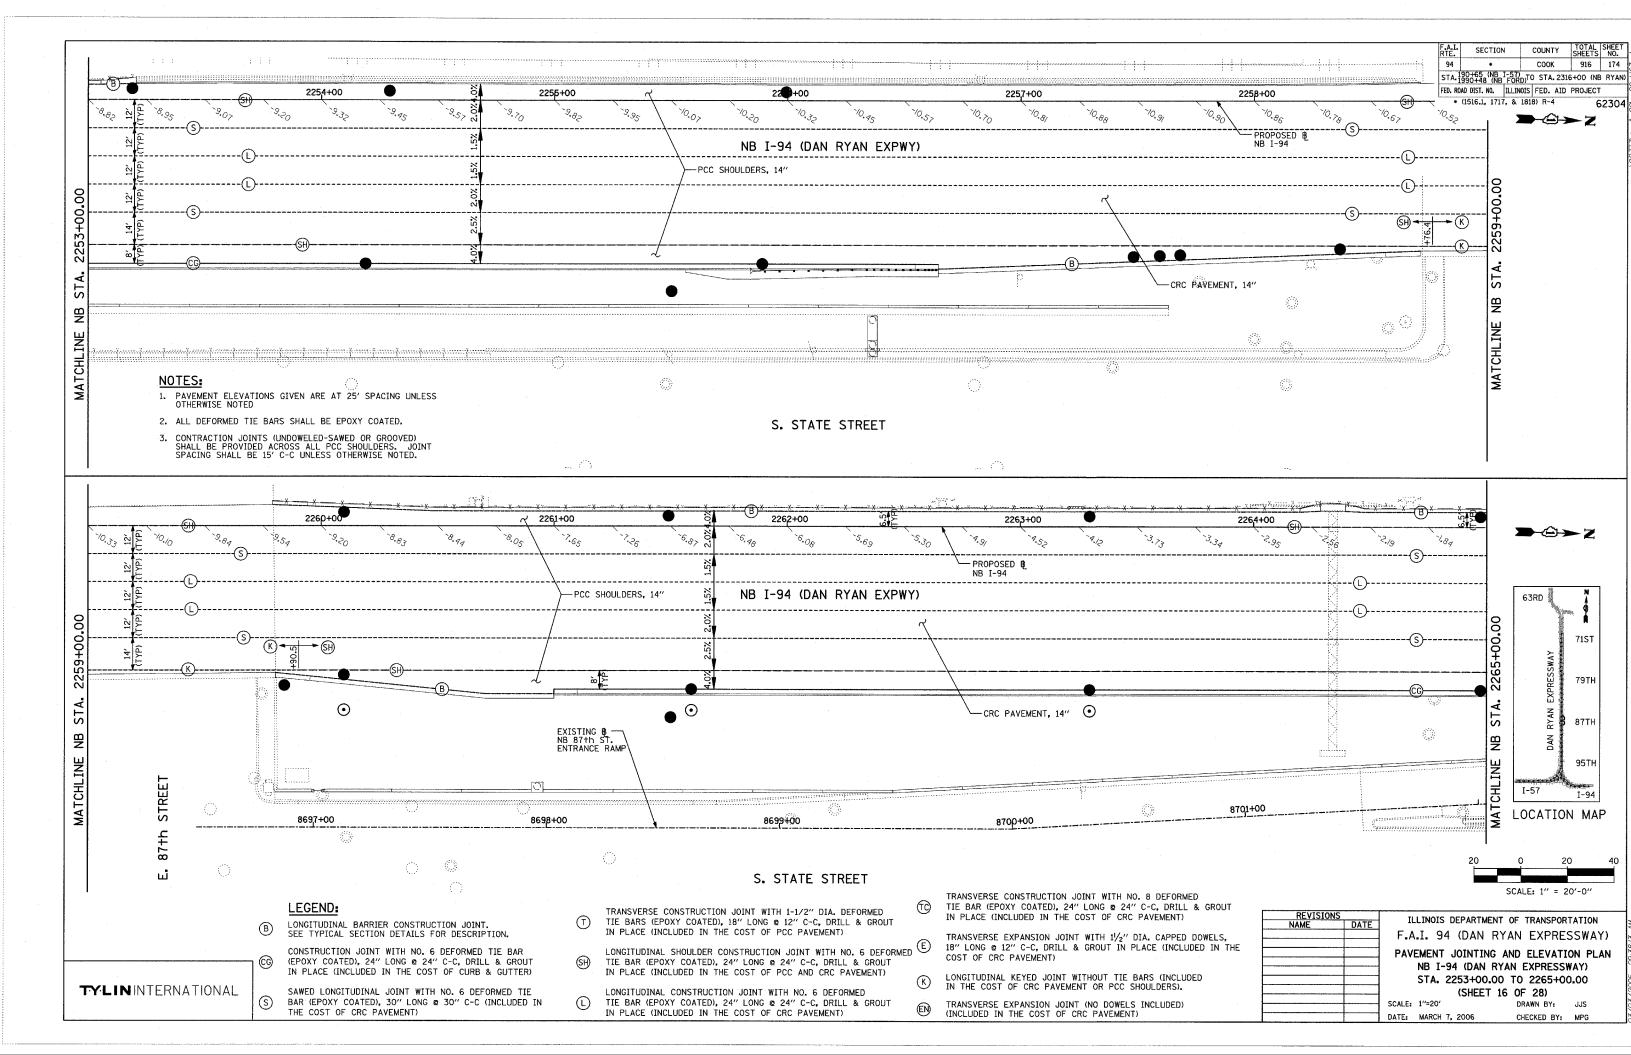


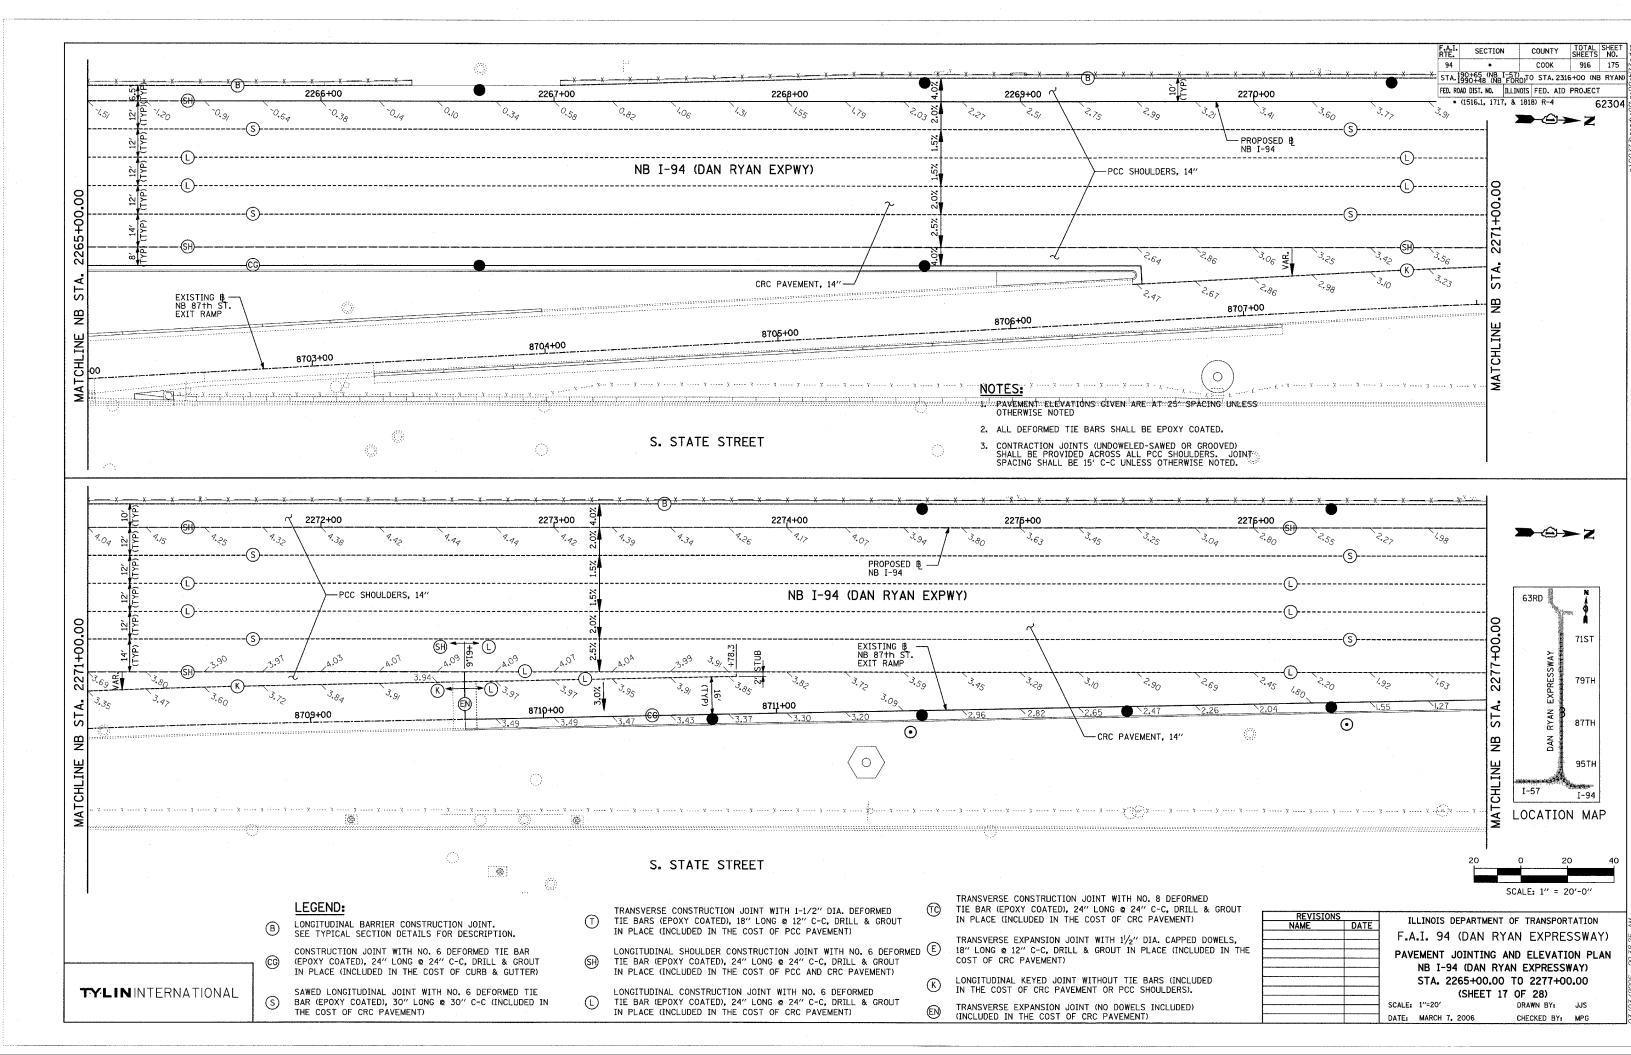

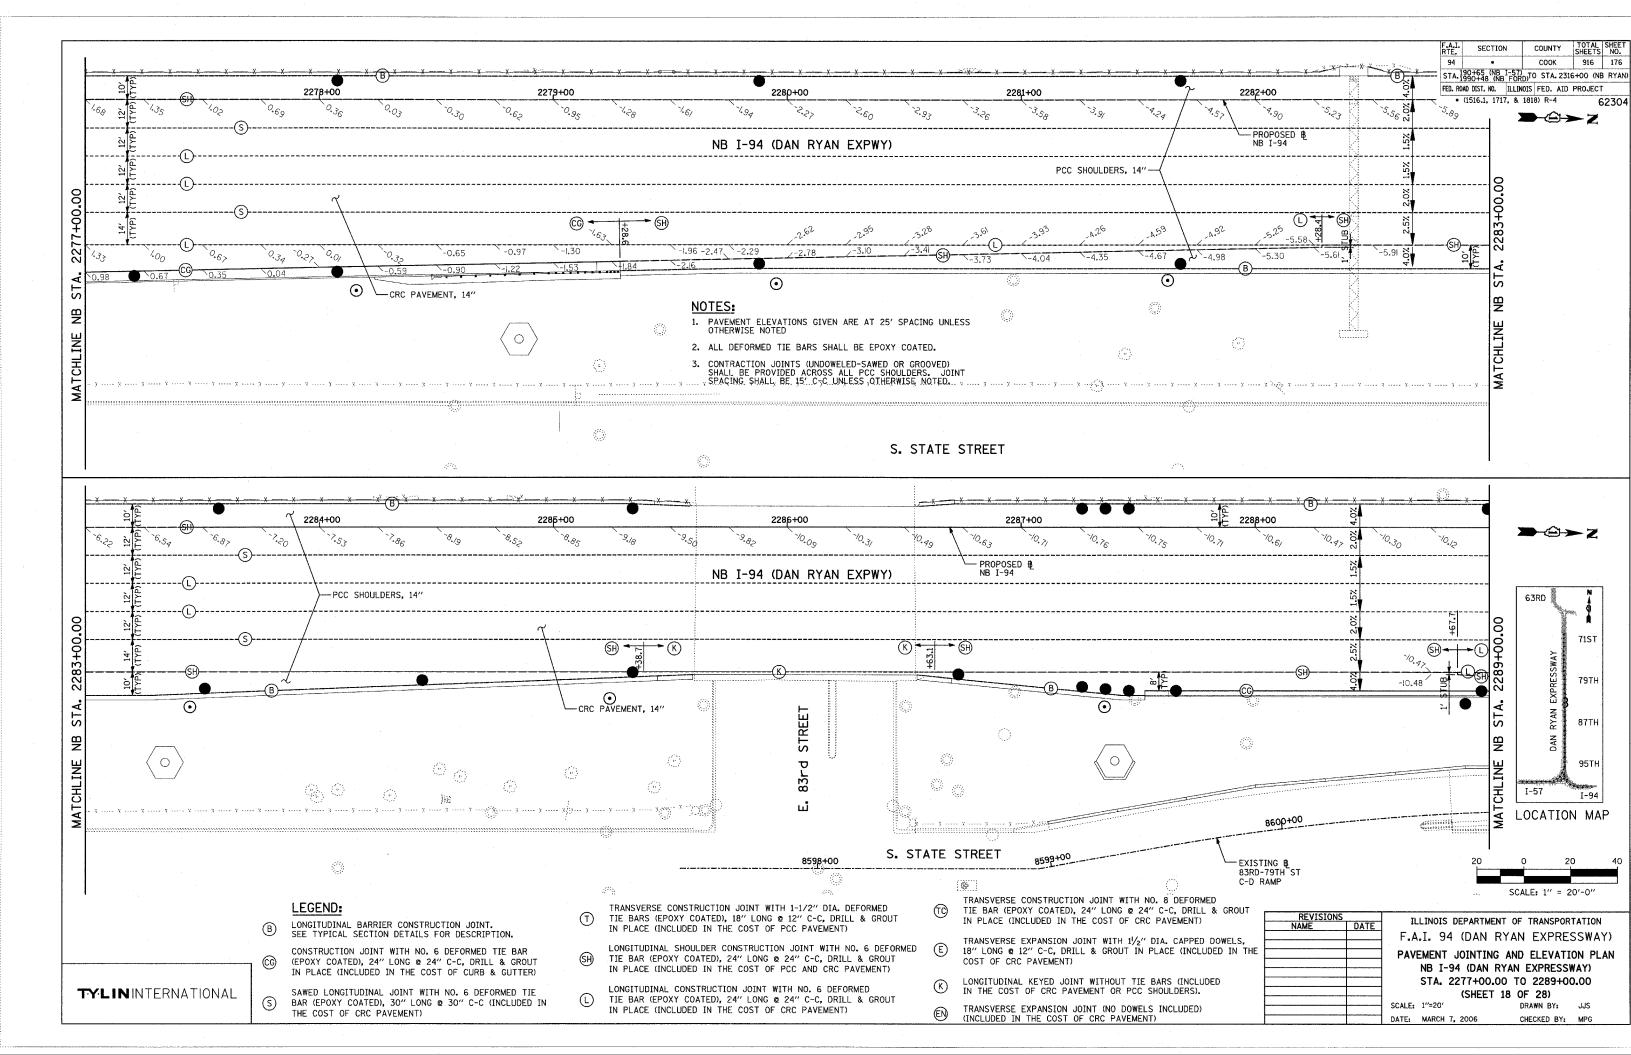


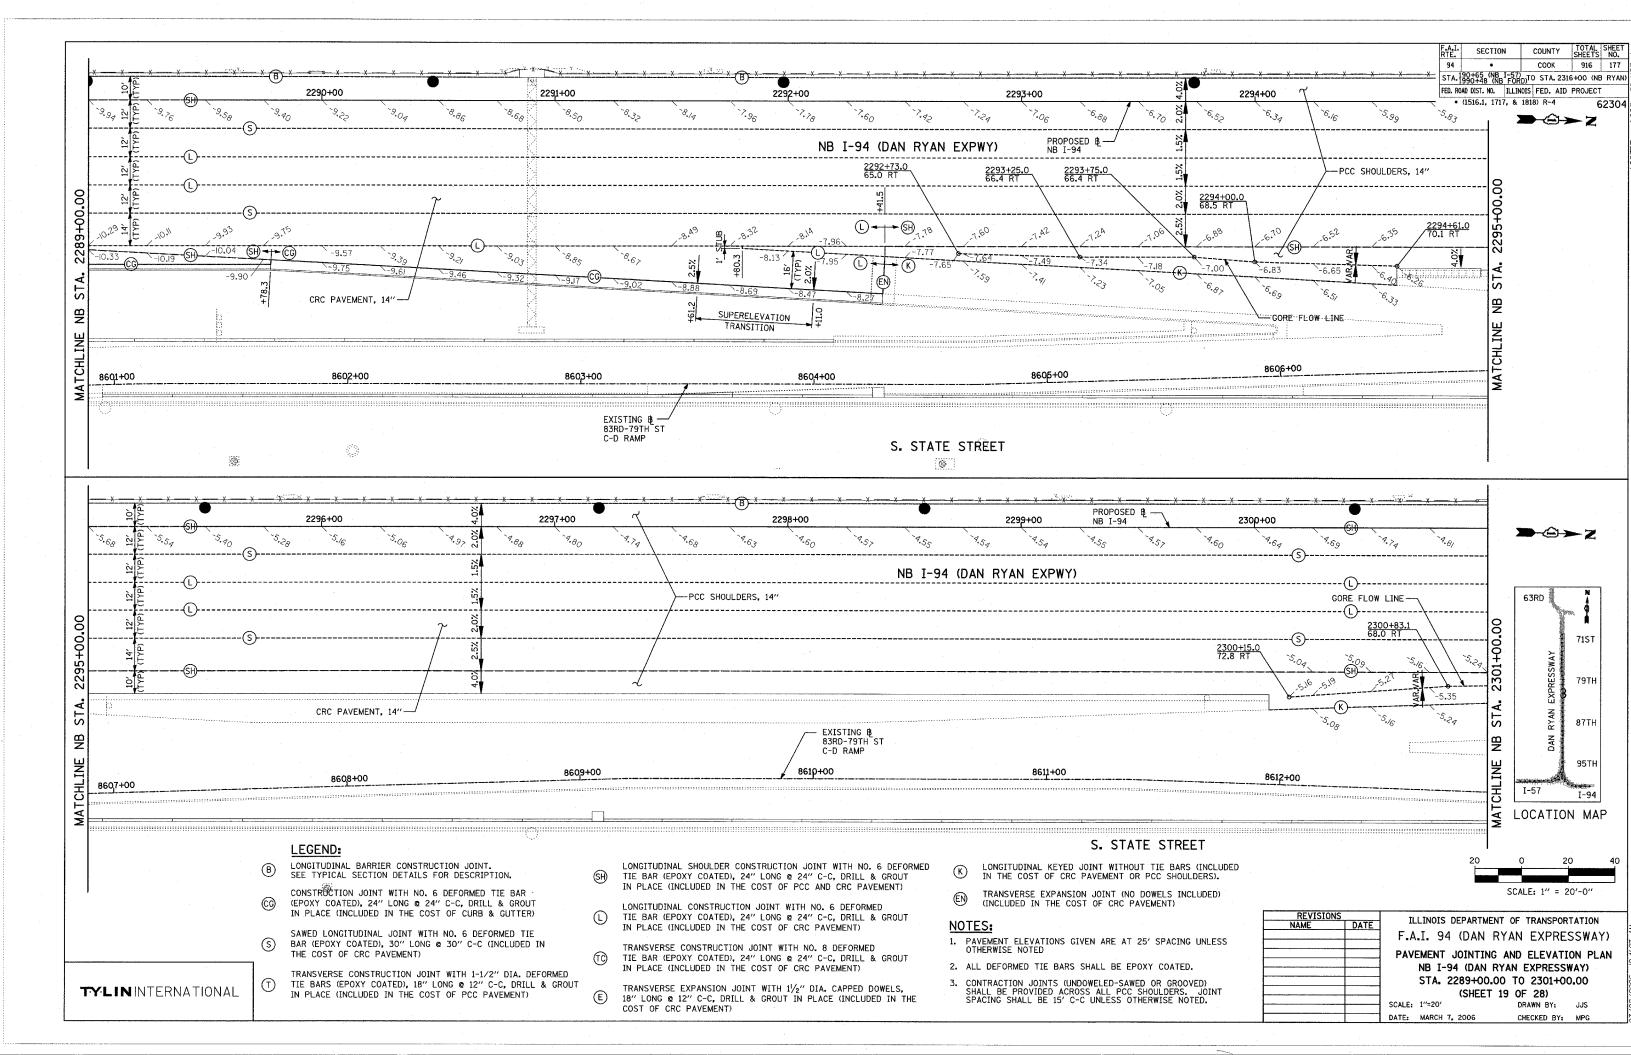

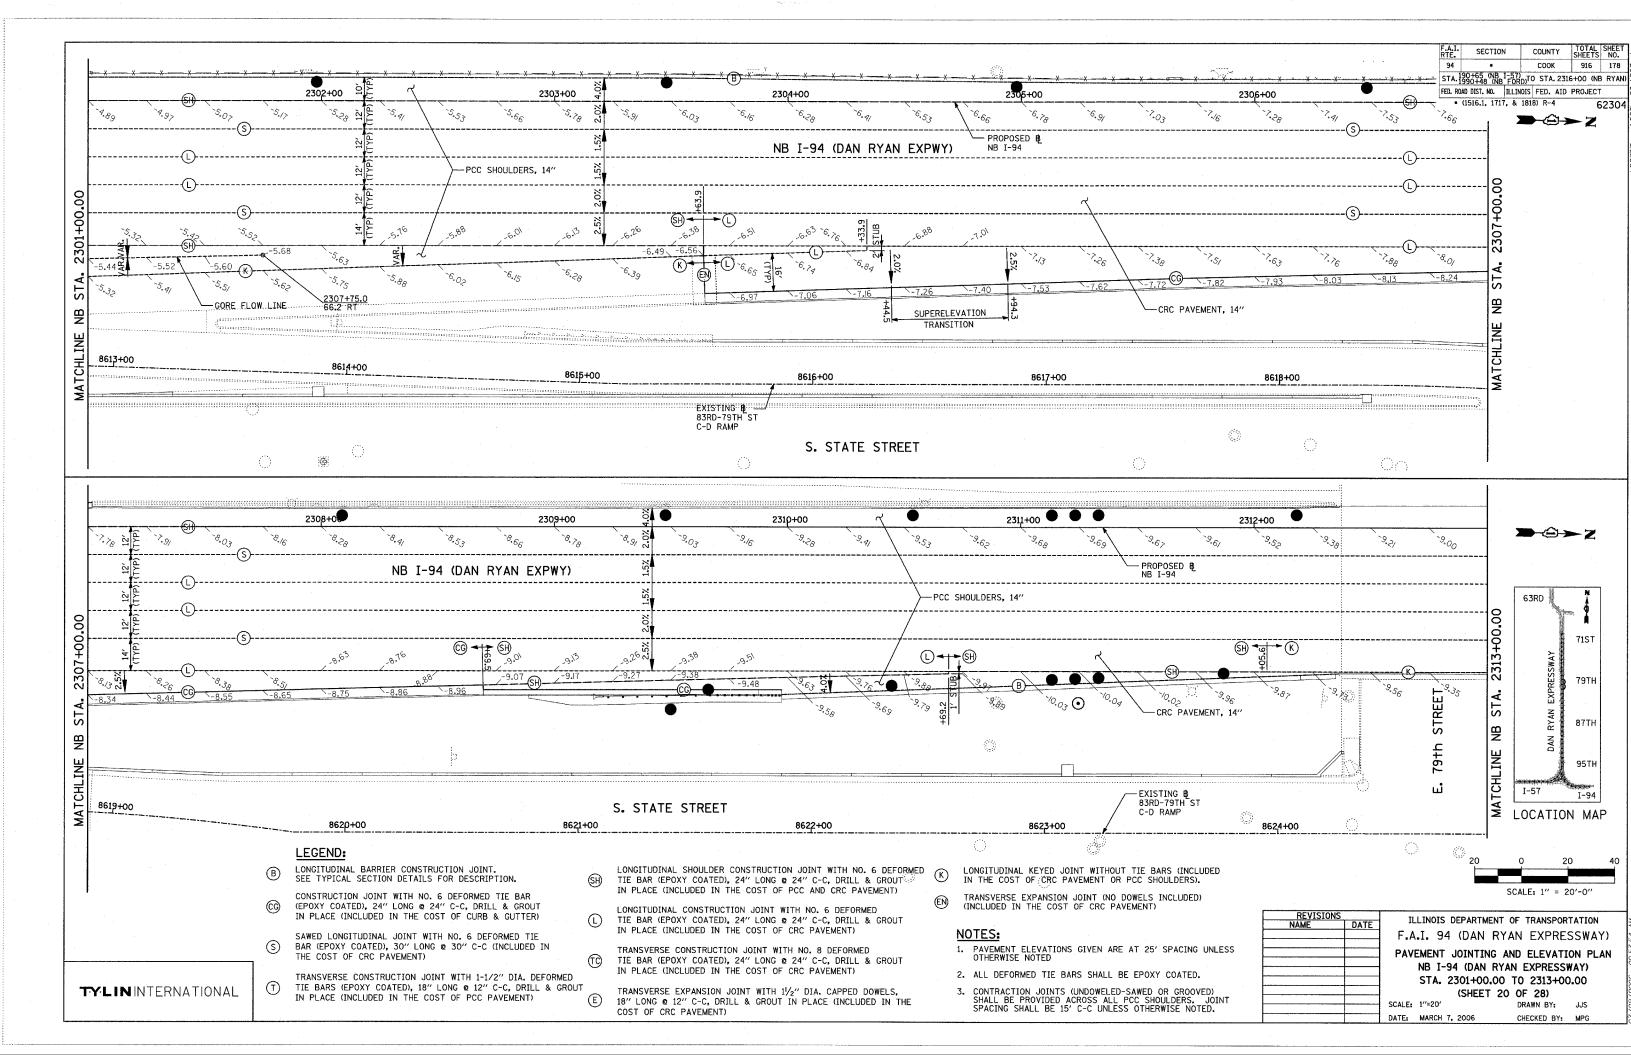

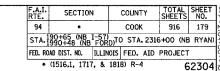


→©→ Z

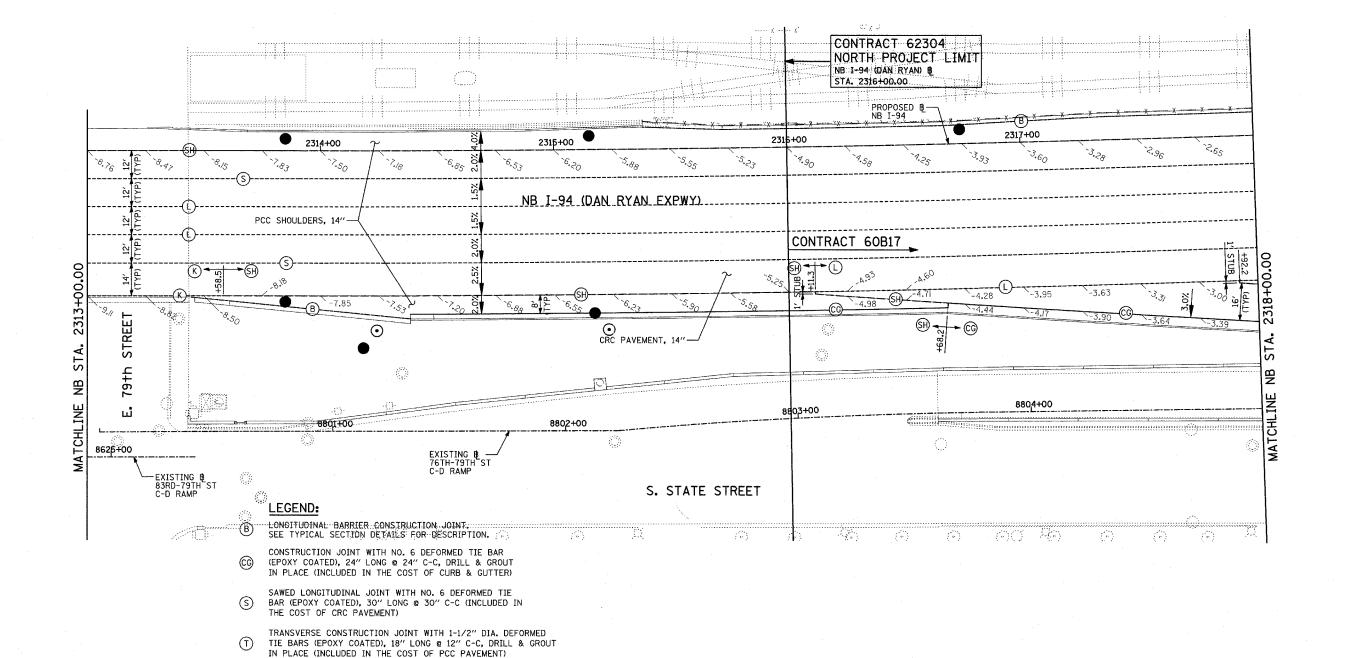

63RD 7157 79TH 95TH

LOCATION MAP

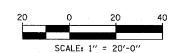

- 1. PAVEMENT ELEVATIONS GIVEN ARE AT 25^{\prime} SPACING UNLESS OTHERWISE NOTED
- 2. ALL DEFORMED TIE BARS SHALL BE EPOXY COATED.
- CONTRACTION JOINTS (UNDOWELED-SAWED OR GROOVED) SHALL BE PROVIDED ACROSS ALL PCC SHOULDERS. JOINT SPACING SHALL BE 15' C-C UNLESS OTHERWISE NOTED.

NAME	DATE

ILLINOIS DEPARTMENT OF TRANSPORTATION F.A.I. 94 (DAN RYAN EXPRESSWAY)

PAVEMENT JOINTING AND ELEVATION PLAN NB I-94 (DAN RYAN EXPRESSWAY) STA. 2313+00.00 TO 2318+00.00

SCALE: 1"=20'

(SHEET 21 OF 28) DRAWN BY: JJS CHECKED BY: MPG

TY:LININTERNATIONAL

TRANSVERSE EXPANSION JOINT (NO DOWELS INCLUDED) (INCLUDED IN THE COST OF CRC PAVEMENT)

LONGITUDINAL KEYED JOINT WITHOUT TIE BARS (INCLUDED IN THE COST OF CRC PAVEMENT OR PCC SHOULDERS).


COST OF CRC PAVEMENT)


LONGITUDINAL SHOULDER CONSTRUCTION JOINT WITH NO. 6 DEFORMED TIE BAR (EPOXY COATED), 24" LONG & 24" C-C, DRILL & GROUT IN PLACE (INCLUDED IN THE COST OF PCC AND CRC PAVEMENT)


LONGITUDINAL CONSTRUCTION JOINT WITH NO. 6 DEFORMED TIE BAR (EPOXY COATED), 24" LONG @ 24" C-C, DRILL & GROUT IN PLACE (INCLUDED IN THE COST OF CRC PAVEMENT)

TRANSVERSE CONSTRUCTION JOINT WITH NO. 8 DEFORMED TIE BAR (EPOXY COATED), 24" LONG @ 24" C-C, DRILL & GROUT IN PLACE (INCLUDED IN THE COST OF CRC PAVEMENT)

TRANSVERSE EXPANSION JOINT WITH $1^1\!\!/_2{}^{\prime\prime}$ DIA. CAPPED DOWELS, 18" LONG @ 12" C-C, DRILL & GROUT IN PLACE (INCLUDED IN THE

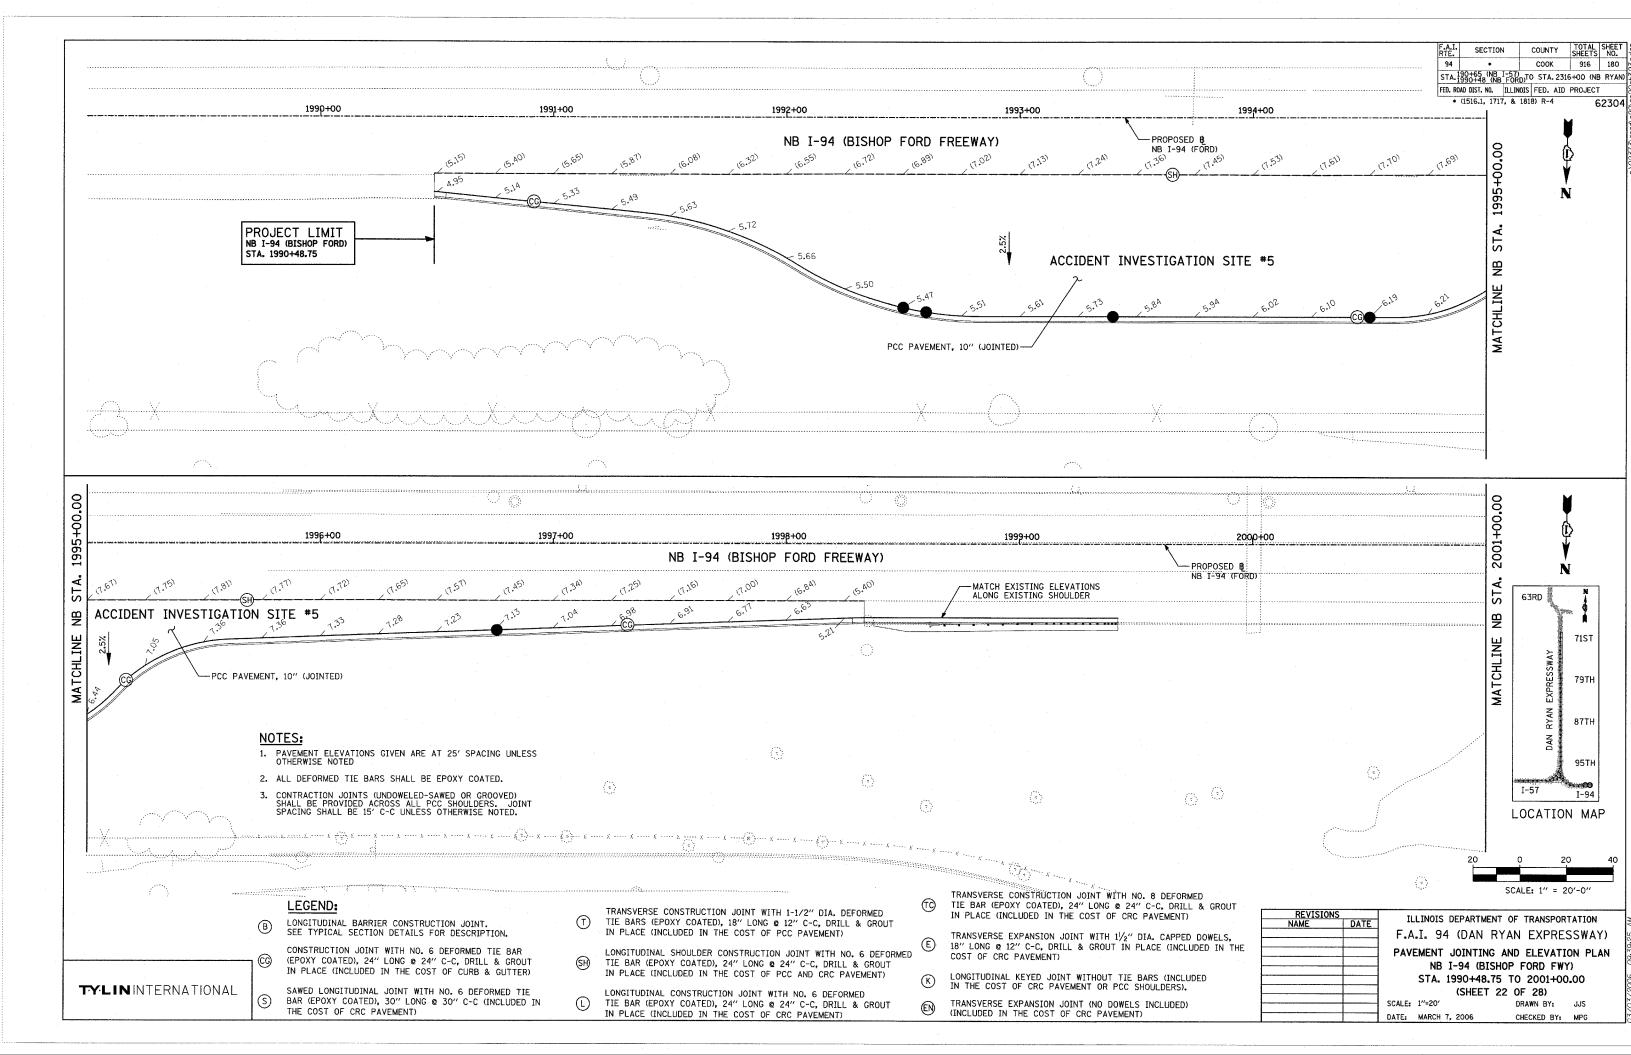


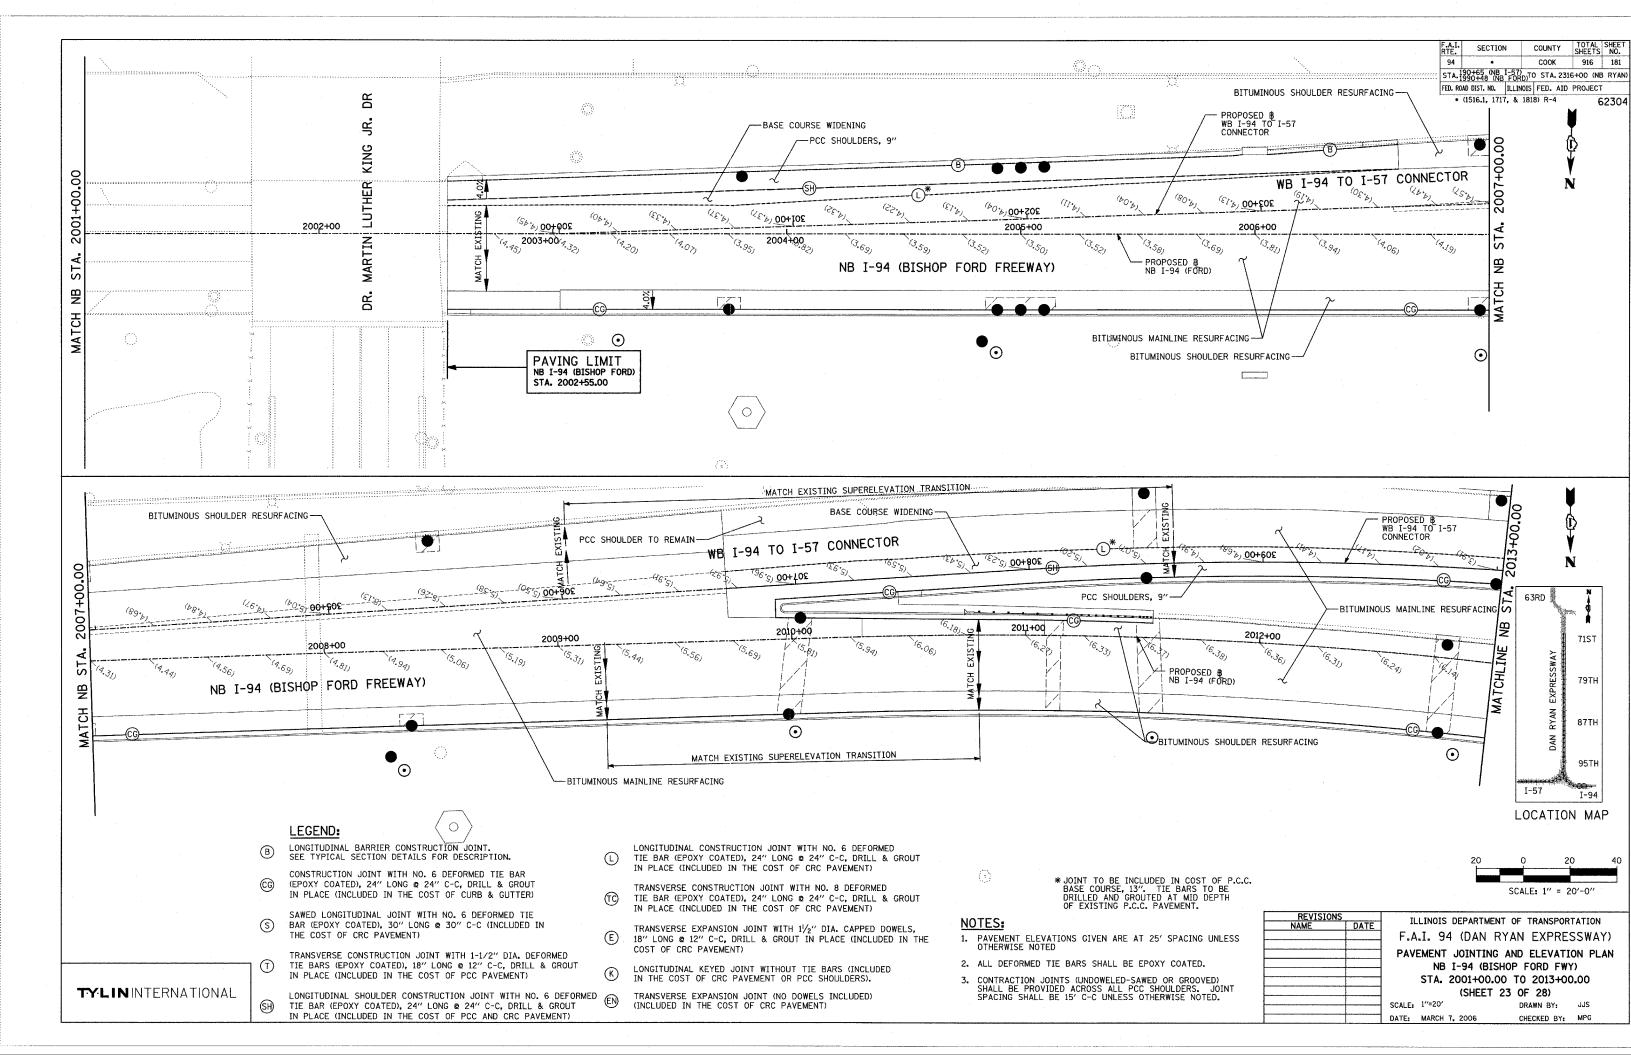


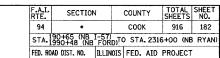


* (1516.1, 1717, & 1818) R-4



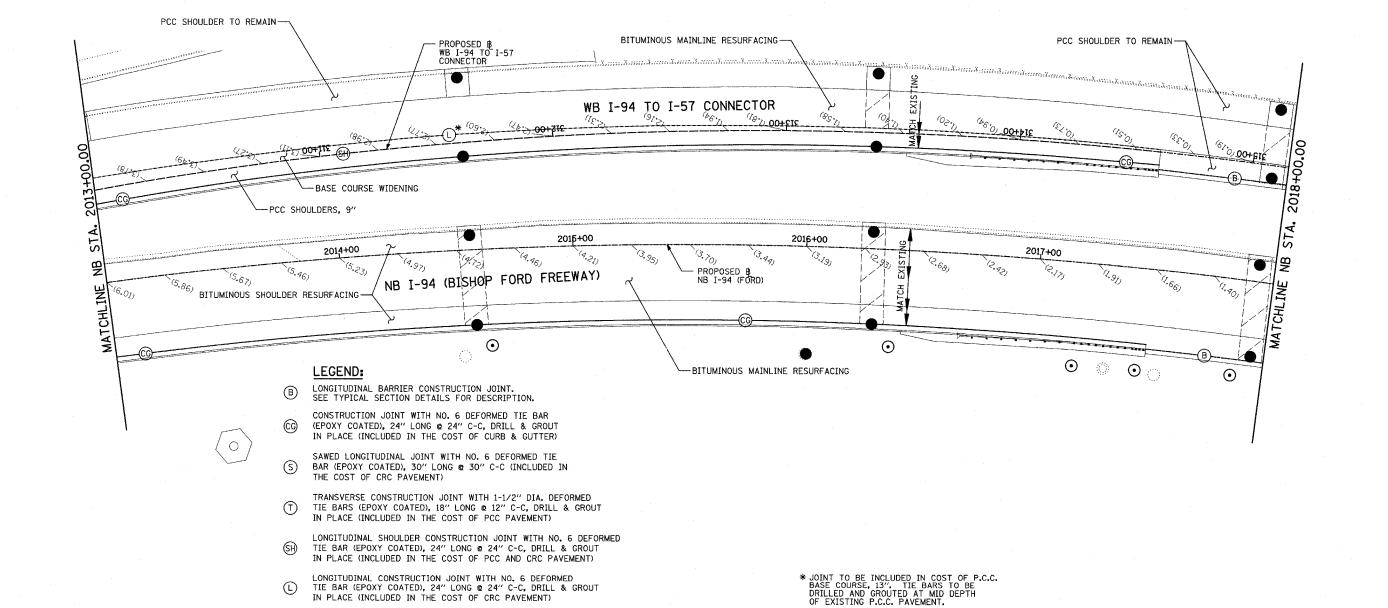

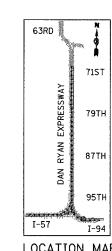

LOCATION MAP

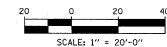

- 1. PAVEMENT ELEVATIONS GIVEN ARE AT 25' SPACING UNLESS OTHERWISE NOTED
- 2. ALL DEFORMED TIE BARS SHALL BE EPOXY COATED.
- CONTRACTION JOINTS (UNDOWELED-SAWED OR GROOVED) SHALL BE PROVIDED ACROSS ALL PCC SHOULDERS. JOINT SPACING SHALL BE 15' C-C UNLESS OTHERWISE NOTED.

REVISIONS		ILLINOIS DEPARTMENT OF TRANSPORTATION
NAME	DATE	ILLINOIS DEPARTMENT OF TRANSPORTATION
		F.A.I. 94 (DAN RYAN EXPRESSWAY)
~		PAVEMENT JOINTING AND ELEVATION PLAN
		NB I-94 (BISHOP FORD FWY)
		STA. 2013+00.00 TO 2018+00.00
		(SHEET 24 OF 28)
-	-	SCALE: 1"=20" DRAWN BY: JJS

DATE: MARCH 7, 2006

CHECKED BY: MPG

TYLININTERNATIONAL

TRANSVERSE EXPANSION JOINT (NO DOWELS INCLUDED) (INCLUDED IN THE COST OF CRC PAVEMENT)


IN PLACE (INCLUDED IN THE COST OF CRC PAVEMENT)


IN PLACE (INCLUDED IN THE COST OF CRC PAVEMENT)

LONGITUDINAL KEYED JOINT WITHOUT TIE BARS (INCLUDED IN THE COST OF CRC PAVEMENT OR PCC SHOULDERS).

TRANSVERSE CONSTRUCTION JOINT WITH NO. 8 DEFORMED TIE BAR (EPOXY COATED), 24" LONG @ 24" C-C, DRILL & GROUT

TRANSVERSE EXPANSION JOINT WITH $1/\!\!/_2$ " DIA. CAPPED DOWELS, 18" LONG @ 12" C-C, DRILL & GROUT IN PLACE (INCLUDED IN THE COST OF CRC PAVEMENT)

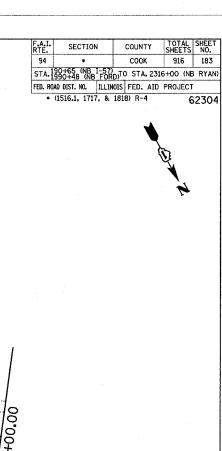


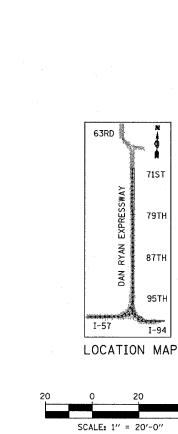

71ST

95TH

I-94

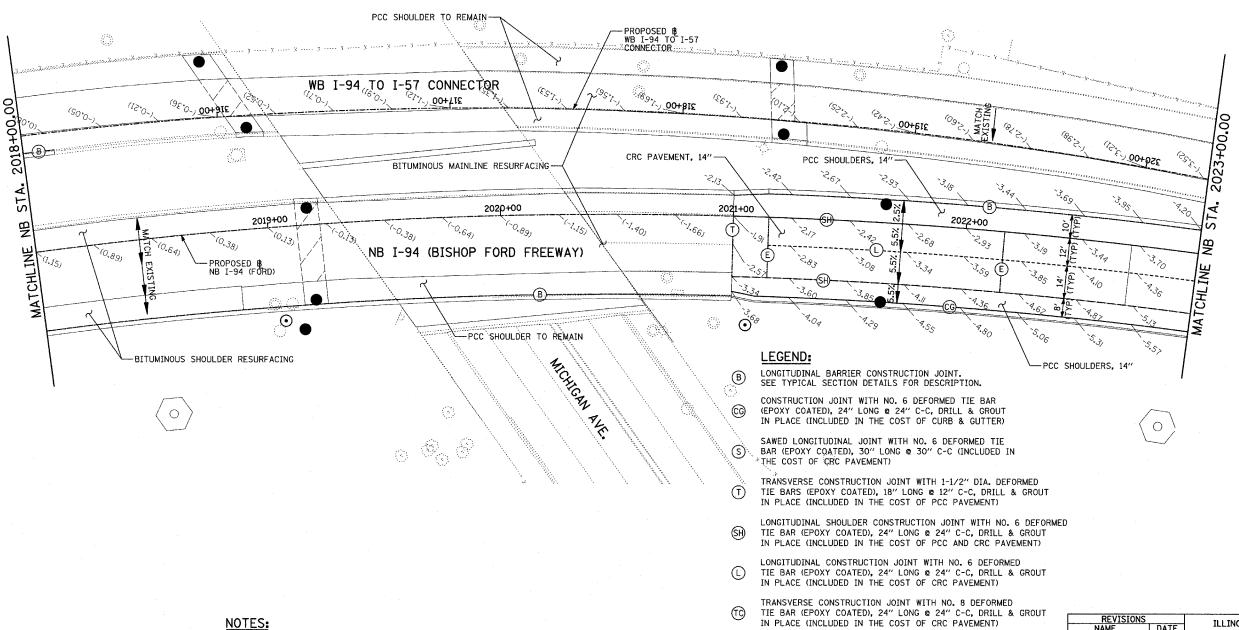

- PAVEMENT ELEVATIONS GIVEN ARE AT 25' SPACING UNLESS OTHERWISE NOTED
- 2. ALL DEFORMED TIE BARS SHALL BE EPOXY COATED.
- 3. CONTRACTION JOINTS (UNDOWELED-SAWED OR GROOVED) SHALL BE PROVIDED ACROSS ALL PCC SHOULDERS. JOIN SPACING SHALL BE 15' C-C UNLESS OTHERWISE NOTED.

TRANSVERSE EXPANSION JOINT WITH 11/2" DIA. CAPPED DOWELS, 18" LONG @ 12" C-C, DRILL & GROUT IN PLACE (INCLUDED IN THE COST OF CRC PAVEMENT)

LONGITUDINAL KEYED JOINT WITHOUT TIE BARS (INCLUDED IN THE COST OF CRC PAVEMENT OR PCC SHOULDERS).


TRANSVERSE EXPANSION JOINT (NO DOWELS INCLUDED) (INCLUDED IN THE COST OF CRC PAVEMENT)


		REVISIONS
	DATE	NAME
F		
•		
PA		


ILLINOIS DEPARTMENT OF TRANSPORTATION .A.I. 94 (DAN RYAN EXPRESSWAY) AVEMENT JOINTING AND ELEVATION PLAN

NB I-94 (BISHOP FORD FREEWAY) STA. 2018+00.00 TO 2023+00.00 (SHEET 25 OF 28)

DRAWN BY: JJS CHECKED BY: MPG

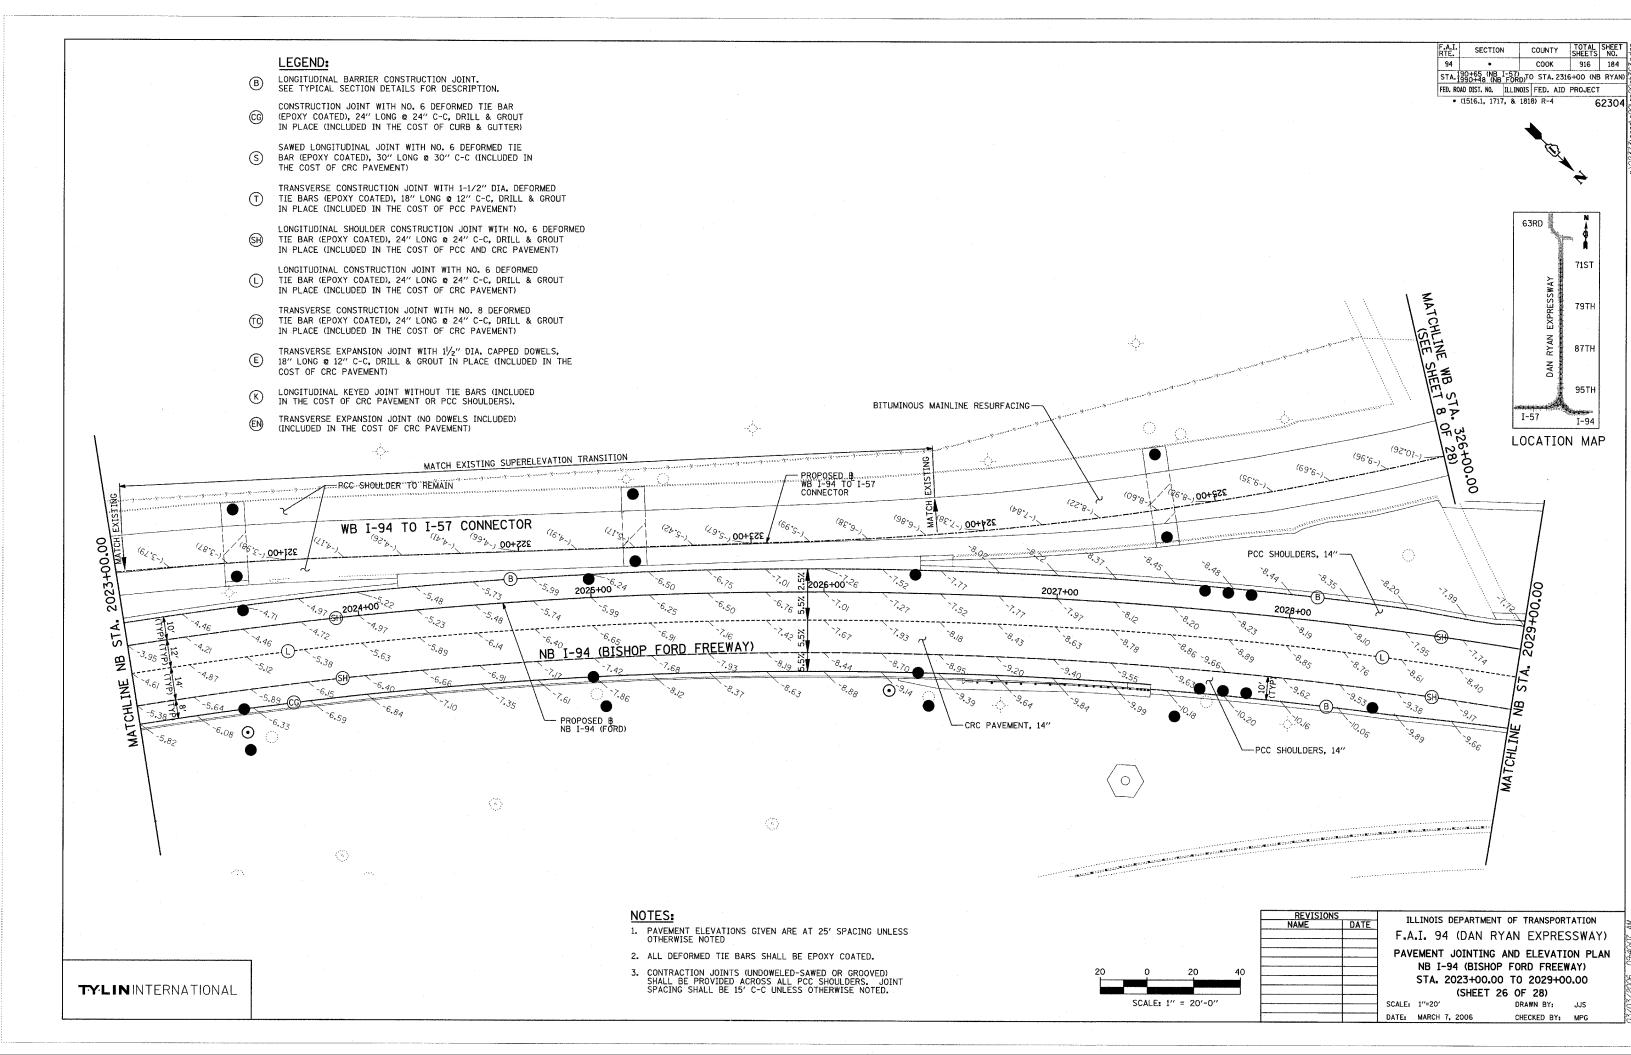

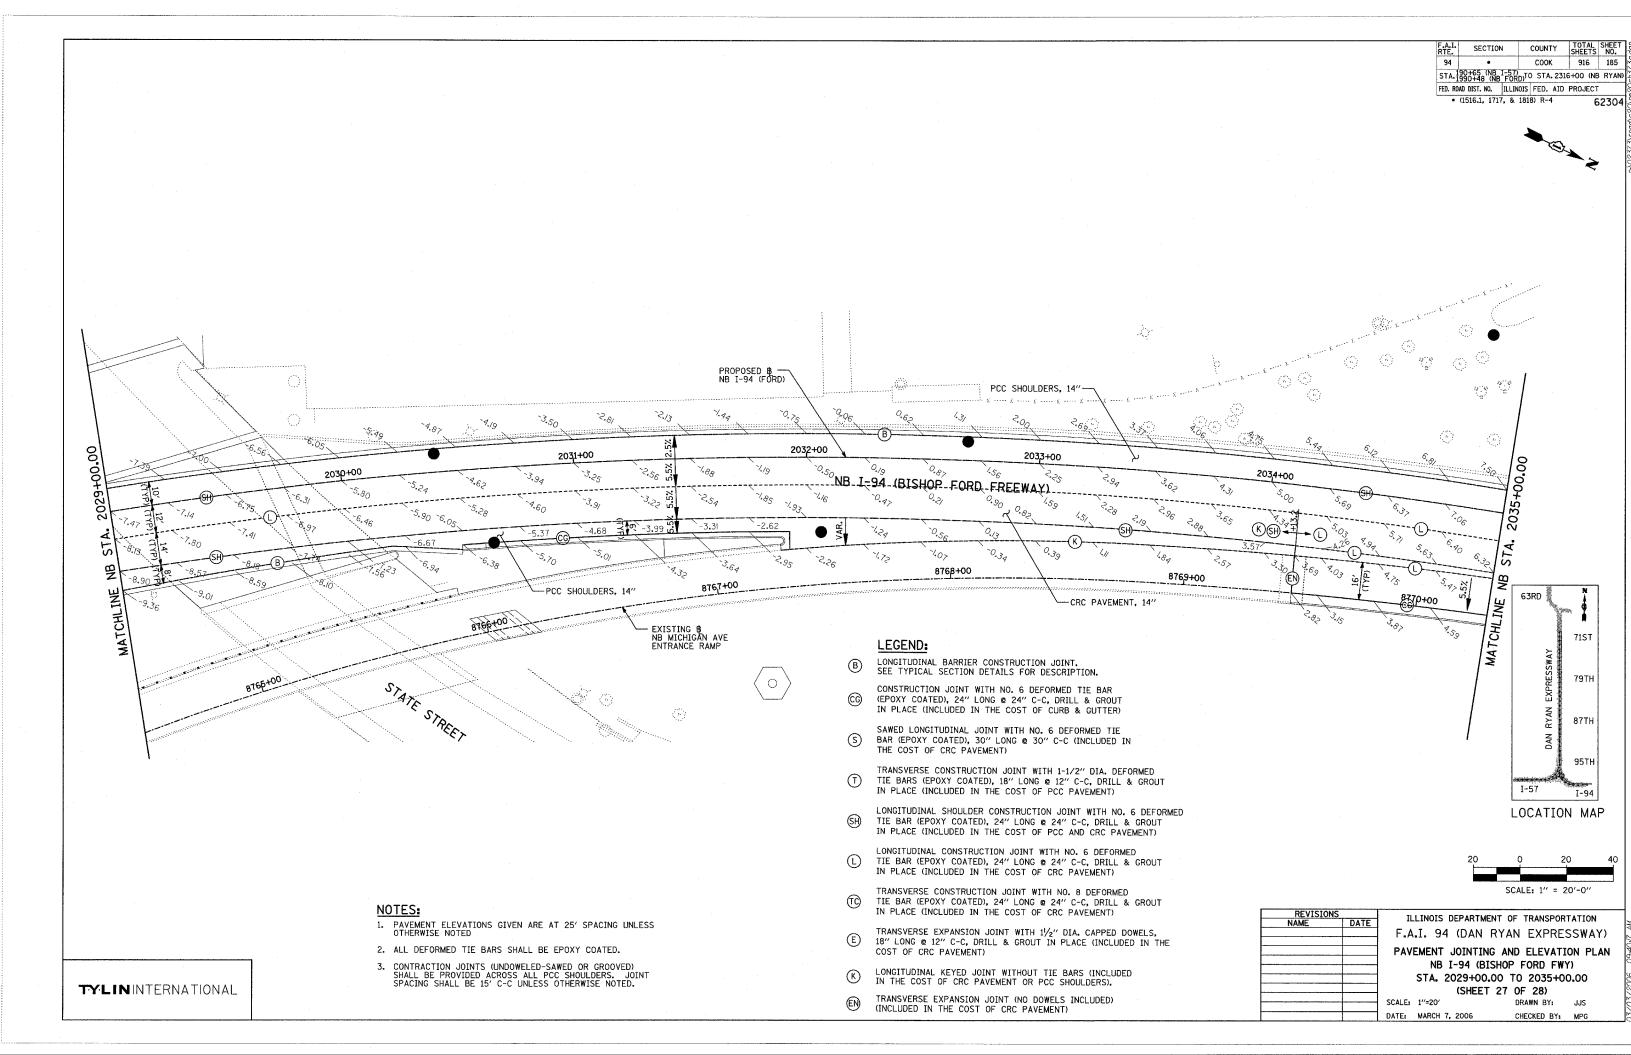

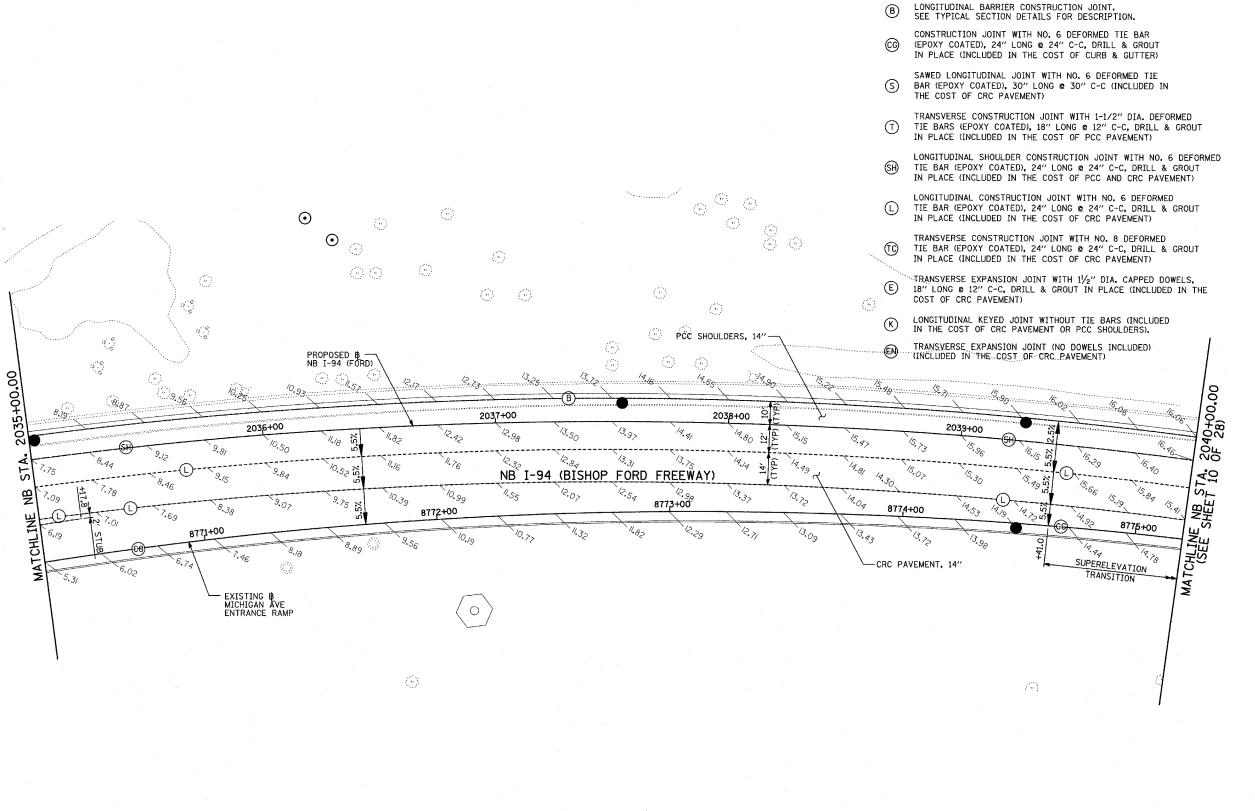

F.A.I. SECTION COUNTY TOTAL SHEET NO.

94 • COOK 916 186

STA. 190-65 (NB 1-57) TO STA. 2316+00 (NB RYAN)

FED. ROAD DIST. NO. | ILLINOIS | FED. AID PROJECT | (1516.1, 1717, & 1818) R-4

→©→Z

62304

<u>NOTES</u>

- 1. PAVEMENT ELEVATIONS GIVEN ARE AT 25' SPACING UNLESS OTHERWISE NOTED
- 2. ALL DEFORMED TIE BARS SHALL BE EPOXY COATED.
- 3. CONTRACTION JOINTS (UNDOWELED-SAWED OR GROOVED) SHALL BE PROVIDED ACROSS ALL PCC SHOULDERS. JOINT SPACING SHALL BE 15' C-C UNLESS OTHERWISE NOTED.

REVISIONS
NAME DATE
F.

ILLINOIS DEPARTMENT OF TRANSPORTATION
F.A.I. 94 (DAN RYAN EXPRESSWAY)

63RD

71ST

87TH

95TH

I-94

LOCATION MAP

SCALE: 1" = 20'-0"

PAVEMENT JOINTING AND ELEVATION PLAN NB I-94 (BISHOP FORD FREEWAY) STA. 2035+00.00 TO 2040+00.00

(SHEET 28 OF 28)
E: 1"=20' DRAWN BY: JJS

DATE: MARCH 7, 2006

CHECKED BY: MPG

GENERAL NOTES:

SEE SPECIAL PROVISION TITLED TRAFFIC CONTROL AND PROTECTION (EXPRESSWAYS)

A WORK ZONE SPEED LIMIT OF 45 M.P.H. MUST BE MAINTAINED AT ALL TIMES.

QUANTITY FOR TEMPORARY PAVEMENT MARKING - LINE 6" WAS ASSUMED EQUAL TO THE LENGTH OF TEMPORARY CONCRETE BARRIER. UTILIZED WHEN THE BARRIER IS LOCATED ONE FOOT OR LESS FROM THE EDGE OF TRAVELED WAY.

ALL TEMPORARY PAVEMENT MARKINGS PLACED DURING THE WINTER SHUTDOWN STAGE OR ON EXISTING PAVEMENT SHALL BE PAID FOR AS EPOXY PAVEMENT MARKING OF THE LINE TYPE AND WIDTH SPECIFIED.

ALL TEMPORARY PAVEMENT MARKINGS PLACED ON NEW PAVEMENT SHALL BE PAID FOR AS PAVEMENT MARKING TAPE, TYPE III OF THE LINE TYPE AND WIDTH SPECIFIED EXCEPT WHEN DIRECTED OTHERWISE.

A TOTAL OF 10 CHANGEABLE MESSAGE SIGNS SHALL BE LOCATED ALONG THE MAINLINE AND NEAR RAMP CLOSURES FOR THE DURATION OF THIS CONTRACT. EXACT PLACEMENT OF THE SIGNS SHALL BE DETERMINED BY THE RESIDENT ENGINEER.

ANY RAISED REFLECTIVE PAVEMENT MARKERS THAT CONFLICT WITH THE TEMPORARY TRAFFIC LANES MUST HAVE THE REFLECTIVE LENSES REMOVED AS DIRECTED BY THE RESIDENT ENGINEER, MEASURE OF PAYMENT FOR REMOVAL OF REFLECTORS IS INCLUDED IN THE CONTRACT UNIT PRICE FOR TRAFFIC CONTROL AND PROTECTION (FXPRESSWAYS).

FOR ACCESS CONTROL, THE CONTRACTOR IS REQUIRED TO PLACE CHAIN LINK FENCE 6' (SPECIAL), 7'-2" CLEAR FROM THE CENTERLINE OF CTA TRACK, PRIOR TO REMOVING EXISTING CTA CHAIN LINK FENCE AND BARRIER WALL. THE CONTRACTOR MUST ALSO PLACE CHAIN LINK GATES, 6' X 6' SINGLE AT ALL LOCATIONS WHERE THERE ARE EXISTING CTA FENCE GATES. THE CHAIN LINK FENCE 6' (SPECIAL) MUST REMAIN IN PLACE UNTIL THE NEW PERMANENT CTA FENCE IS COMPLETED.

REFER TO MISCELLANEOUS DETAIL SHEETS FOR TEMPORARY PAVEMENT AND MILLING OPERATIONS AND FOR OVERDIG AREAS DETAILS.

THE RESIDENT ENGINEER SHALL ASSESS THE EXISTING CONDITION OF THE PAVEMENT LOCATED ALONG THE INSIDE SHOULDER. DAMAGED AREAS WILL REQUIRE SHOULDER REHABILITATION INCLUDING MILLING AND RESURFACING. ADDITIONAL QUANTITIES OF 147 SO VD FOR BITUMINOUS SURFACE REMOVAL, 1/2" AND 13 TONS FOR BITUMINOUS CONCRETE SURFACE COURSE, SUPERPAVE, MIX "D", N7O HAVE BEEN INCLUDED 18 THE PLANS.

CONSTRUCTION STAGING NOTES

PRE STAGE 1, 1A, 1B, & 1C - NIGHT TIME OPERATIONS

INSTALL RAMP CLOSURE ADVANCE INFORMATION SIGNS ON STAGE 1 RAMP CLOSURES A MINIMUM OF 2 WEEKS IN ADVANCE OF THE CLOSURE. SEE STAGE 1 RAMP CLOSURE GUIDELINES IN THE SPECIAL PROVISIONS.

INSTALL RAMP CLOSURE ADVANCE INFORMATION SIGNS ON THE MICHIGAN AVE. ENTRANCE RAMP A MINIMUM OF 2 WEEKS IN ADVANCE OF THE START OF STAGE 1. CLOSE RAMP FOR THE DURATION OF STAGE 1 AND 1A OR AT ANY TIME NB I-94 (BISHOP FORD) IS IN A 1 LANE CONFIGURATION.

UTILIZE STATE STANDARDS 701400 - APPROACH TO LANE CLOSURE, 701401 - LANE CLOSURE AND DISTRICT 1 DETAIL TC-09 - MULTI-LANE WEAVE AT NB I-57 STA. 188+28 AND NB I-94 (BISHOP FORD) STA. 1990+00.

COORDINATE THREE LANES OF TRAFFIC AT NB I-94 (DAN RYAN) STA. 2316+00 WITH CONTRACT *60B17 IN ORDER TO MAINTAIN TRAFFIC FLOW.

COORDINATE SINGLE LANE OF TRAFFIC AT WB I-94 TO I-57 CONNECTOR STA. 340+29 WITH CONTRACT *62593 IN ORDER TO MAINTAIN TRAFFIC FLOW.

UTILIZE DISTRICT 1 DETAIL TC-17 TRAFFIC CONTROL DETAILS FOR FREEWAY SHOULDER CLOSURES TO INSTALL TEMPORARY PAVEMENT WIDENING FROM WB I-94 TO SB I-94 CONNECTOR STA. 330+34 TO STA. 333+92 AND FROM STA. 338+98 TO STA. 339+79 PRIOR TO STAGE 1.

UTILIZE DISTRICT 1 DETAIL TC-17 TRAFFIC CONTROL DETAILS FOR FREEWAY SHOULDER CLOSURES TO INSTALL TEMPORARY PAVEMENT WIDENING AND AGGREGATE SHOULDER FROM NB I-57 STA. 219+16 TO EB I-57 TO I-94 CONNECTOR STA. 406+88 PRIOR TO STAGE 1A.

PERFORM THE FOLLOWING MEDIAN REMOVAL PARTIAL DEPTH OPERATION PRIOR TO THE START OF STAGE 1: ON NB I-57 FROM STA. 228+74 TO STA. 232+63 AT THE NB I-57/EB I-57 DIVERGING GORE.

PERFORM THE FOLLOWING TEMPORARY PAVEMENT AND COLD MILLING OPERATIONS PRIOR TO STAGE 1A: ON NB I-57 FROM STA. 190-65 TO STA. 207+92 AND FROM STA. 218+87 TO STA. 218+91; ON WB I-94 TO SB I-57 FROM STA. 330+66 TO STA. 340+29; ON MAINLINE NB I-94 (DAN RYAN) FROM STA. 2252+02 TO STA. 2257+02.

PERFORM THE FOLLOWING TEMPORARY PAVEMENT AND COLD MILLING OPERATIONS PRIOR TO STAGE 1B: ON NB I-94 (BISHOP FORD) FROM STA, 2042+78 TO STA, 2045+79; ON NB I-57 FROM STA, 255+32 TO STA, 258+32; ON MAINLINE NB I-94 (DAN RYAN) FROM STA, 2203+00 TO STA, 2252+02 AND FROM STA, 2252+02 TO 2252+06.

COMPLETE SHOULDER REHABILITATION FOR AREAS OF DAMAGED PAVEMENT PRIOR TO SHIFTING TRAFFIC.

IMPLEMENT HALSTED ENTRANCE RAMP TEMPORARY DETOUR FOR TRAFFIC REQUIRING ACCESS TO 87TH STREET.

REMOVE EXISTING PAVEMENT MARKINGS AND REPLACE WITH EPOXY PAVEMENT MARKINGS.

REMOVE LENSES FROM RAISED REFLECTIVE PAVEMENT MARKERS.

INSTALL AND RELOCATE TEMPORARY CONCRETE BARRIER WALL AND REMAINING TEMPORARY TRAFFIC CONTROL DEVICES FOR STAGE 1, 1A, 1B, & 1C CONSTRUCTION.

COVER PERMANENT AND TEMPORARY SIGNS AS NEEDED.

STAGE 1, 1A, 1B, & 1C CONSTRUCTION (AUGUST 1ST, 2006 - NOVEMBER 30, 2006)

STAGE 1 CONSTRUCTS THE FOLLOWING: LANE 3 & THE OUTSIDE SHOULDER ALONG NB I-57 FROM STA. 190+71 TO STA. 205+70: LANES 3, 4 & THE OUTSIDE SHOULDER ALONG NB I-57 FROM STA. 205+70 TO STA. 218+87; LANE 1 & THE INSIDE SHOULDER ALONG I-57 FROM STA. 232+56 TO STA. 248+30 INCLUDING THE INSIDE SECTION OF THE NB I-57 BRIDGE EXCLUDING THE BRIDGE APPROACH PAVEMENT; ACCIDENT INVESTIGATION SITE #5 ALONG NB I-94 (BISHOP FORD) FROM STA. 1990+49 TO STA. 1999+42; OUTSIDE SHOULDER CURB & GUTTER AND STORM SEWER INSTALLATION ALONG I-94 (BISHOP FORD) FROM STA. 2002+99; LANE 2 AND THE OUTSIDE SHOULDER ALONG I-94 (BISHOP FORD) FROM STA. 2002-99 TO STA. 2020+99; INSIDE LANE ALONG THE WB I-94 TO SB I-57 CONNECTOR FROM STA. 330+65 TO STA. 340+29; LANES 4, 5, & THE OUTSIDE SHOULDER ALONG THE MAINLINE I-94 (DAN RYAN) FROM STA. 2203+00 TO STA. 2316+00. THE AREAS MENTIONED ABOVE INCLUDE ALL ADDITIONAL WORK WITHIN THEIR PROPOSED LIMITS.

NB I-57 TRAFFIC WILL BE SHIFTED LEFT TO THE INSIDE SHOULDER IN 2-11' LANES UP TO THE SPLIT WITH THE EB I-57 TO I-94 CONNECTOR. TRAFFIC APPROACHING THE NB BRIDGE WILL BE SHIFTED RIGHT TO THE OUTSIDE SHOULDER IN 2-11' LANES AND MERGE WITH NB I-94 (BISHOP FORD). NB I-94 (BISHOP FORD) TRAFFIC WILL BE SHIFTED LEFT TO THE INSIDE SHOULDER IN 2-11' LANES UP TO THE WB I-94 TO I-57 SPLIT THE INSIDE LANE OF NB I-94 (BISHOP FORD) WILL EXIT TO THE WB I-94 TO I-57 CONNECTOR. THE OUTSIDE LANE OF NB I-94 (BISHOP FORD) WILL REMAIN SHIFTED TO THE LEFT UNTIL MERGING WITH NB I-57. WB I-94 TO I-57 CONNECTOR TRAFFIC WILL BE SHIFTED RIGHT TO THE OUTSIDE SHOULDER IN 1-11' LANE UP TO THE MERGE WITH SB I-57 AND CONTRACT #62593, MAINLINE NB I-94 (DAN RYAN) TRAFFIC WILL BE SHIFTED LEFT TO THE INSIDE SHOULDER IN 3-11' LANES UP TO STA. 2316+00 AND CONTRACT #60BIT.

THE CONTRACTOR MUST COORDINATE WITH CONTRACT *62593 CONCERNING THE SB I-94 (BISHOP FORD) AND CTA TUNNEL REPAIR WORK, WORK ON TOP OF EITHER TUNNEL ROOF WILL NOT BE ALLOWED UNTIL THE REPAIR WORK IN CONTRACT *62593 IS COMPLETED.

THE CONTRACTOR MUST COORDINATE WITH CONTRACT #62593 CONCERNING STORM SEWER JACKING OPERATIONS WHICH SPANS ACROSS CONTRACT #62304'S CONSTRUCTION ZONE.

THE CONTRACTOR MUST COMPLETE ALL WORK IN THE FOLLOWING AREAS BEFORE IMPLEMENTING STAGE 1A: NB I-57 STA. 190+71 TO STA. 218+87; NB I-94 (BISHOP FORD) STA. 1990+49 TO 2045+77; WB I-94 TO SB I-57 STA 330+65 TO STA. 340+29; MAINLINE NB I-94 STA. 2203+00 TO 2257+02.

STAGE 1A CONSTRUCTS THE FOLLOWING: LANES 1, 2, & INSIDE SHOULDER ALONG NB I-57 FROM STA. 190+71 TO STA. 218+87; LANE 1, THE INSIDE SHOULDER, TEMPORARY CONCRETE PAVEMENT IN PLACE OF THE PERMANENT BRIDGE APPROACH PAVEMENT ALONG NB I-57 FROM STA. 218+87 TO STA. 248+30 INCLUDING THE NB I-57 BRIDGE; WB I-94/NB I-94 (BISHOP FORD) GORE AND STORM SEWER INSTALLATION ALONG NB I-94 (BISHOP FORD) FROM STA. 2009+72 TO STA. 2020+99; LANE 1 AND INSIDE SHOULDER ALONG I-94 (BISHOP FORD) FROM STA. 2020+99 TO STA. 2045+79; LANE 3 ALONG THE MAINLINE NB I-94 (DAN RYAN) FROM STA. 2203+00 TO STA. 2252+02. THIS WILL COINCIDE WITH THE WORK REMAINING FROM STAGE 1.

NB I-57 TRAFFIC WILL BE SHIFTED TO THE RIGHT ALONG THE OUTSIDE SHOULDER IN 2-11' LANES. NB I-94 (BISHOP FORD) TRAFFIC WILL BE SHIFTED RIGHT TO THE OUTSIDE SHOULDER IN 2-11' UP TO THE WB I-94 TO I-57 SPLIT. THE INSIDE LANE OF NB I-94 (BISHOP FORD) WILL EXIT TO THE WB I-94 TO I-57 CONNECTOR, THE OUTSIDE LANE OF NB I-94 (BISHOP FORD) WILL REMAIN SHIFTED TO THE RIGHT UNTIL MERGING WITH NB I-57. WB I-94 TO SB I-57 TRAFFIC WILL BE SHIFTED TO THE INSIDE SHOULDER IN I-11' LANE UP TO STA. 326+00. TRAFFIC TRAVELING BELOW THE NB I-57 BRIDGE WILL BE SHIFTED TO THE NEWLY CONSTRUCTED LANE THROUGH THE MERGE WITH SB I-57 AND CONTRACT *62593. MAINLINE NB I-94 (DAN RYAN) TRAFFIC WILL BE SPLIT WITH 2-11' LANES ON THE INSIDE SHOULDER AND 1-11' LANE ON THE OUTSIDE SHOULDER UNTIL MERGING INTO 3-11' LANES AT STA. 2257+02.

DURING STAGE 1 AND 1A CONSTRUCTION ALONG NB I-94 (DAN RYAN), ALL CONSTRUCTION VEHICLES MUST STAY WITHIN THE HAUL ROAD. CROSSING EXIT RAMP TRAFFIC IS PROHIBITED. ADDITIONALLY, THE CONTRACTOR SHALL BE RESPONSIBLE TO DIFFERENTIATE BETWEEN THE RAMP EXIT AND HAUL ROAD ENTRANCE. THE CONTRACTOR SHALL UTILIZE EITHER THE A.I.S. OR C-D ROADWAY TO MERGE HAUL ROAD AND RAMP TRAFFIC. A STOP SIGN SHALL BE PLACED AT THE UPSTREAM END OF THE C-D ROADWAY TO STOP TRAFFIC ON THE RAMP FROM THE FRONTAGE ROAD. ALL SIGNING REQUIRED BY TC-18 SHALL BE APPLIED TO ANY WORK ZONE ACCESS OPTION EMPLOYED BY THE CONTRACTOR.

THE CONTRACTOR MUST COMPLETE ALL CONSTRUCTION ON NB I-57 FROM STA. 190+71 TO STA. 207+70 EXCEPT WORK WHICH IS CONSTRAINED BY THE LIMITED WORKING SPACE BEFORE IMPLEMENTING STAGE 1B.

THE CONTRACTOR MUST ALSO COMPLETE ALL WORK ON THE NB I-94 (BISHOP FORD) BEFORE IMPLEMENTING STAGE 18.

STAGE 1B IS REQUIRED TO GIVE THE CONTRACTOR ADEQUATE WORKING SPACE TO POUR LANES 1 AND 2 ON NB I-57 FROM STA. 190+71 TO 207+70. TRAFFIC WILL BE SHIFTED AND CLOSED TO 1-11' LANE. NB I-94 (BISHOP FORD) TRAFFIC WILL BE SHIFTED LEFT IN 2-11' LANES UP TO THE MERGE WITH NB I-57. MAINLINE NB I-94 (DAN RYAN) TRAFFIC WILL BE IN 4-11' LANES UP TO THE 87TH STREET EXIT WHEN ONE LANE OF TRAFFIC WILL BE DROPPED AND WHERE THE STAGE 1 LANE CONFIGURATION WILL BE MAINTAINED. DUE TO THE SEVERE TRAFFIC CONSTRAINTS THIS STAGE WILL BE LIMITED TO A 14 DAY DURATION AND WILL COINCIDE WITH THE WORK REMAINING FROM STAGES 1 AND 1A.

STAGE 1C IS REQUIRED TO RETURN NB I-57 TO A 2-11' LANE CONFIGURATION ALONG THE OUTSIDE SHOULDER FROM STA. 190+71 TO 207+70. THIS CONFIGURATION WILL REMAIN UNTIL NOVEMBER 30, 2006 AND COINCIDE WITH WORK REMAINING IN STAGES 1 AND 1A.

RTE.	SECTION	1	COUN	TY	SHEET	Š	NO.
94	•		COOL	K	916		187
STA. 15	0+65 (NB 190+48 (NB	I-57) FORD) ^{TO}	ATS C	. 231	6+00 (NB	RYAN)
FED. ROA	D DIST. NO.	ILLINOIS	FED.	AID	PROJEC	CT	
* (1516.1, 1717	. & 181	8) R-	4		6	2304

TOTAL CUEET

PRE WINTER LANE CONFIGURATION - NIGHT TIME OPERATIONS

PERFORM THE FOLLOWING TEMPORARY PAVEMENT AND COLD MILLING OPERATIONS: ALONG NB I-57 BETWEEN NEWLY CONSTRUCTED LANE 1 AND EXISTING LANE 2 FROM STA. 218+87 TO STA. 232+57; ALONG MAINLINE NB I-94 (DAN RYAN) BETWEEN EXISTING LANE 3 AND NEWLY CONSTRUCTED LANE 4 FROM STA. 2257+02 TO STA. 2316+00.

COORDINATE FOUR LANES OF TRAFFIC AT NB I-94 (DAN RYAN) STA. 2316+00 TO WITH CONTRACT *60B17 IN ORDER TO MAINTAIN TRAFFIC FLOW.

COORDINATE SINGLE LANE OF TRAFFIC AT WB I-94 TO I-57 CONNECTOR MERGE WITH CONTRACT \pm 62593 AT STA. 340+29 IN ORDER TO MAINTAIN TRAFFIC FLOW.

REMOVE CONFLICTING TEMPORARY PAVEMENT MARKINGS FROM STAGES 1, 1A, & 1C AND REPLACE WITH EPOXY PAVEMENT MARKINGS.

RELOCATE TEMPORARY CONCRETE BARRIER WALL TO CREATE ADEQUATE SHOULDERS FOR SNOW STORAGE AND RELOCATE REMAINING TEMPORARY TRAFFIC CONTROL DEVICES FOR THE WINTER LANE CONFIGURATION.

COVER & UNCOVER PERMANENT AND TEMPORARY SIGNS AS NEEDED.

WINTER LANE CONFIGURATION (DECEMBER 1, 2006 - APRIL 1, 2007)

NB I-57 TRAFFIC WILL BE SHIFTED LEFT TO THE INSIDE SHOULDER IN 3-11' LANES FROM STA. 190+71 TO STA. 224+86. TRAFFIC APPROACHING THE NB I-57 BRIDGE WILL BE SHIFTED TO THE OUTSIDE SHOULDER IN 2-11' LANES AND MERGE WITH NB I-94 (BISHOP FORD). THE OUTSIDE LANE OF NB I-57 WILL EXIT TO THE EB I-57 TO I-94 CONNECTOR. NB I-94 (BISHOP FORD) TRAFFIC WILL BE SHIFTED LEFT TO THE INSIDE SHOULDER IN 3-11' LANES FROM STA. 1995+79 TO STA. 2004+12. THE INSIDE LANE OF NB I-94 (BISHOP FORD) WILL EXIT TO THE WB I-94 TO I-57 CONNECTOR. THE OUTSIDE 2 LANES WILL MERGE WITH NB I-57. WB I-94 TO I-57 CONNECTOR TRAFFIC WILL BE SHIFTED TO THE OUTSIDE SHOULDER FROM STA. 307+43 TO STA. 328+00. TRAFFIC WILL THEN BE SHIFTED TOWARD THE CENTER OF THE NEWLY CONSTRUCTED PAVEMENT AND CONTRACT® 2593, MAINLINE NB I-94 (DAN RYAN) TRAFFIC WILL BE SHIFTED LEFT TO THE LEFT SHOULDER FROM STA. 2203+00 TO STA. 2316+00.

PRE STAGE 2 - NIGHT TIME OPERATIONS

COORDINATE THREE LANES OF SPLIT TRAFFIC AT NB I-94 (DAN RYAN) STA. 2316+00 WITH CONTRACT #60B17 IN ORDER TO MAINTAIN TRAFFIC FLOW.

COORDINATE SINGLE LANE OF TRAFFIC AT WB I-94 TO I-57 CONNECTOR STA. 340+29 WITH CONTRACT #62593 IN ORDER TO MAINTAIN TRAFFIC FLOW.

COORDINATE SINGLE LANE OF TRAFFIC AT EB I-57 TO I-94 CONNECTOR STA. 415+06 WITH CONTRACT #62593 IN ORDER TO MAINTAIN TRAFFIC FLOW.

UTILIZE DISTRICT 1 DETAIL TC-17 TRAFFIC CONTROL DETAILS FOR FREEWAY SHOULDER CLOSURES TO INSTALL TEMPORARY PAVEMENT WIDENING FROM NB 1-57 STA. 248+30 TO STA. 253+23.

REMOVE CONFLICTING TEMPORARY PAVEMENT MARKINGS FROM THE WINTER LANE CONFIGURATION STAGE AND REPLACE WITH EPOXY OR PAVEMENT MARKING TAPE.

RELOCATE TEMPORARY CONCRETE BARRIER WALL AND REMAINING TEMPORARY TRAFFIC CONTROL DEVICES FOR STAGE 2.

COVER & UNCOVER PERMANENT AND TEMPORARY SIGNS AS NEEDED.

STAGE 2 CONSTRUCTION (APRIL 2, 2007 - MAY 31, 2007)

STAGE 2 CONSTRUCTS THE FOLLOWING: LANE 2 AND EB I-57 / NB I-57 DIVERGING GORE ALONG NB I-57 FROM STA. 218+87 TO STA. 232+98; LANES 2, 3, THE OUTSIDE SHOULDER, INCLUDING THE NB I-57 BRIDGE ALONG NB I-57 FROM STA. 232+98 TO STA. 255+32; LANE 1, AND INSIDE SHOULDER ALONG THE EB I-57 TO I-94 CONNECTOR FROM STA. 408+41 TO STA. 415+06; INSIDE SHOULDER, CURB AND GUTTER, & STORM SEWER INSTALLATION ALONG WB I-94 TO I-57 CONNECTOR FROM STA. 299+53 TO STA. 329+05; LANE 3 ALONG MAINLINE NB I-94 (DAN RYAN) FROM STA. 2252+02 TO STA. 2316+00

REVISIONS
NAME
DATE
F.A.I. 94 (DAN RYAN EXPRESSWAY)
GENERAL NOTES
CONSTRUCTION STAGING NOTES
MAINTENANCE OF TRAFFIC DETAILS
SHEET 1 OF 13

SCALE: NO SCALE

DRAWN BY: RTM

DATE: MARCH 7, 2006

CHECKED BY:

TGB

STAGE 2 CONSTRUCTION (APRIL 2, 2007 - MAY 31, 2007) - CONTINUE

NB I-57 TRAFFIC WILL BE SHIFTED RIGHT TO THE OUTSIDE SHOULDER UNTIL SPLITTING AT STA. 212+39. THE INSIDE LANE APPROACHING THE NB I-57 BRIDGE WILL BE SHIFTED LEFT TO THE INSIDE SHOULDER UNTIL MERGING WITH NB I-94 (BISHOP FORD). THE OUTSIDE LANE WILL EXIT TO THE BI -57 TO I-94 CONNECTOR AND WILL BE SHIFTED RIGHT ALONG THE OUTSIDE SHOULDER IN 1-11' LANE UP TO STA. 415+06 AND CONTRACT #62593. NB I-94 (BISHOP FORD) TRAFFIC WILL REMAIN IN THE SAME CONFIGURATION AS IT WAS DURING THE WINTER LANE CONFIGURATION. WB I-94 TO SB I-57 CONNECTOR TRAFFIC WILL REMAIN IN THE SAME CONFIGURATION AS IT WAS DURING THE WINTER LANE CONFIGURATION AND MATCH CONTRACT #62593 AT STA. 340+29. MAINLINE NB I-94 (DAN RYAN) TRAFFIC WILL BE SHIFTED AND LEFT TO THE INSIDE SHOULDER IN 3-11' LANES FROM STA. 2203+00 TO 2231+32. FROM MAINLINE NB I-94 (DAN RYAN) STA. 2231+32 TO STA. 2239+95, TRAFFIC WILL ADD 1-11' EXIT ONLY / MERGE LANE. FROM NB I-94 (DAN RYAN) STA. 2231+32 TO STA. 2239+95 TO STA. 2244+03, TRAFFIC WILL RETURN TO 3-11' LANES ALONG THE INSIDE SHOULDER. RROM NB I-94 (DAN RYAN) STA. 2244+03 TO STA. 2316+00, TRAFFIC WILL BE SPLIT INTO 2-11' LANES ALONG THE INSIDE SHOULDER.

THE CONTRACTOR MUST COMPLETE LANE 3 FROM MAINLINE NB I-94 (DAN RYAN) STA. 2252+02 TO STA. 2316+00 DURING THE TIME PROVIDED IN STAGE 2.

PRE STAGE 3 & 3A - NIGHT TIME OPERATIONS

COORDINATE TRAFFIC MERGE AT NB I-94 (DAN RYAN) STA. 2316+00 WITH CONTRACT #60B17 IN ORDER TO MAINTAIN TRAFFIC FLOW.

COORDINATE SINGLE LANE OF TRAFFIC AT WB I-94 TO I-57 CONNECTOR STA. 340+29 WITH CONTRACT \pm 62593 IN ORDER TO MAINTAIN TRAFFIC FLOW.

COORDINATE SINGLE LANE OF TRAFFIC AT ${\tt EB}$ I-57 TO I-94 CONNECTOR STA. 415+06 WITH CONTRACT *62593 IN ORDER TO MAINTAIN TRAFFIC FLOW.

REMOVE CONFLICTING TEMPORARY PAVEMENT MARKINGS FROM STAGE 2 AND REPLACE WITH EPOXY OR PAVEMENT MARKING TAPE.

RELOCATE TEMPORARY CONCRETE BARRIER WALL AND REMAINING TEMPORARY TRAFFIC CONTROL DEVICES FOR STAGES 3 & 3A.

PERFORM TEMPORARY PAVEMENT OPERATIONS ON THE WB I-94 TO I-57 CONNECTOR FROM STA. 337+39 TO STA. 340+29

COVER & UNCOVER PERMANENT AND TEMPORARY SIGNS AS NEEDED.

STAGE 3 & 3A CONSTRUCTION (JUNE 1, 2007 - OCTOBER 31, 2007)

STAGE 3 CONSTRUCTS THE FOLLOWING: LANE 2 AND EB I-94 / NB I-57 DIVERGING GORE ALONG I-57 FROM STA. 218+87 TO STA. 232+98; LANES 2, 3, THE OUTSIDE SHOULDER, AND THE NB I-57 BRIDGE ALONG NB I-57 FROM STA. 232+98 TO STA. 255+32; LANE 1 AND INSIDE SHOULDER ALONG THE EB I-57 TO I-94 CONNECTOR FROM STA. 408+41 TO STA. 415+06; LANE 2, OUTSIDE SHOULDER, AND CURB AND GUTTER ALONG WB I-94 TO I-57 CONNECTOR FROM STA. 330+65 TO STA. 337+38; LANE 2 ALONG THE WB I-94 TO I-57 CONNECTOR FROM STA. 337+38 TO STA. 340+29; LANES 1, 2, AND THE WB I-94 TO I-57 ALONG MAINLINE NB I-94 (DAN RYAN) FROM STA. 2205+51 TO STA. 2316+00.

NB I-57 TRAFFIC AND EB I-57 TO I-94 CONNECTOR TRAFFIC WILL REMAIN IN THE SAME CONFIGURATION AS THEY WERE DURING STAGE 2. NB I-94 (BISHOP FORD) TRAFFIC WILL REMAIN IN THE SAME CONFIGURATION AS IT WAS DURING THE WINTER LANE CONFIGURATION. WB I-94 TO I-57 CONNECTOR TRAFFIC WILL REMAIN IN THE SAME CONFIGURATION AS IT WAS DURING THE WINTER LANE CONFIGURATION UP TO STA. 323+23. TRAFFIC WILL THEN BE SHIFTED TO THE INSIDE SHOULDER IN I-11 LANE TO STA. 340+29 AND CONTRACT *62593. MAINLINE NB I-94 (DAN RYAN) TRAFFIC WILL BE SHIFTED TO THE OUTSIDE SHOULDER FROM STA. 2203+00 TO STA. 2316+00 AND CONTRACT *60B17.

THE CONTRACTOR MUST COMPLETE ALL WORK IN THE FOLLOWING AREAS BEFORE IMPLEMENTING STAGE 3A: NB I-57 FROM STA. 218+87 TO STA. 255+32, INCLUDING THE NB I-57 BRIDGE; BB I-57 TO I-94 CONNECTOR FROM STA. 408+41 TO STA. 415+06; WB I-94 TO I-57 CONNECTOR FROM STA. 326+73 TO STA. 334+50.

STAGE 3A CONSTRUCTS THE FOLLOWING: LANES 3, 4, AND THE OUTSIDE SHOULDER ALONG NB I-57 FROM STA. 218+87 TO STA. 224+86; INSIDE BRIDGE APPROACH PAVEMENT ALONG NB I-57 FROM NB I-57 STATION RANGES 236+69 TO 237+58 AND 238+50 TO 239+86; LANE 1, PART OF LANE 2, AND INSIDE SHOULDER ALONG NB I-57 FROM STA. 248+31 TO STA. 258+32; LANE 2 AND OUTSIDE SHOULDER ALONG THE EB I-57 TO I-94 CONNECTOR FROM STA. 400+26 TO STA. 415+06; INSIDE SHOULDER ALONG WB I-94 TO I-57 CONNECTOR FROM STA. 330+65 TO STA. 340+29; LANES 1, 2, AND INSIDE SHOULDER ALONG MAINLINE NB I-94 (DAN RYAN) FROM STA. 2203+00 TO STA. 2205+51. THIS WILL COINCIDE WITH THE WORK REMAINING FROM STAGE 3.

NB I-57 WILL BE SHIFTED LEFT TO THE INSIDE SHOULDER IN 2-11' LANES FROM STA. 191+42 TO STA. 227+89. TRAFFIC WILL THEN BE WEAVED RIGHT TO THE OUTSIDE SHOULDER IN 2-11' LANES UP TO THE MERGE WITH NB I-94 (BISHOP FORD). EB I-94 TO I-94 CONNECTOR TRAFFIC WILL BE SHIFTED TO THE INSIDE SHOULDER FROM STA. 407+91 TO STA. 415+06 AND CONTRACT *62593. NB I-94 (BISHOP FORD) TRAFFIC WILL REMAIN IN THE SAME CONFIGURATION AS DURING THE WINTER LANE CONFIGURATION UNTIL MERGING WITH NB I-57. WB I-94 TO I-57 CONNECTOR TRAFFIC WILL REMAIN IN THE SAME CONFIGURATION AS DURING THE WINTER LANE CONFIGURATION UP TO STA. 323+23. TRAFFIC WILL THEN BE SHIFTED RIGHT TO THE OUTSIDE SHOULDER TO STA. 340+29 AND CONTRACT *62593. MAINLINE I-94 (DAN RYAN) TRAFFIC WILL BE SHIFTED RIGHT ALONG THE OUTSIDE SHOULDER FROM STA. 2203+00 TO STA. 2205+51 TO MATCH THE STAGE 3 LANE CONFIGURATION.


THE CONTRACTOR MUST COORDINATE WITH CONTRACT #62593 IN ORDER TO CONSTRUCT THE OUTSIDE SHOULDER ALONG THE WB I-94 TO SB I-57 CONNECTOR FROM STA. 337+38 TO STA. 340+29 PRIOR TO THE END OF STAGE 3A.

F.A.I. RTE.	SECTION	١	COUN.	ΓY	SHEETS	NO.
94	*		COOL	(916	188
STA.	90+65 (NB] 990+48 (NB	FORD)T(STA	. 2316	5+00 (NE	RYAN)
FED. RO	AD DIST. NO.	ILLINOIS	FED.	AID	PROJECT	
•	(1516.1, 1717	, & 181	8) R-	4	6	2304


REVISION	NS .	ILLINOIS DEPARTMENT OF TRANSPORTATION				
NAME	DATE	ILLINOIS DEPART	MENT OF TRANSPORTATION			
		F.A.I. 94 (DAN RYAN EXPRESSWA)				
	1					
		CONSTRUCT	ION STAGING NOTES			
		MAINTENANCE	OF TRAFFIC DETAILS			
		SHE	ET 2 OF 13			
	i i		A. A. L. M.			

SCALE: NO SCALE DATE: MARCH 7, 2006


DRAWN BY: CHECKED BY: TGB

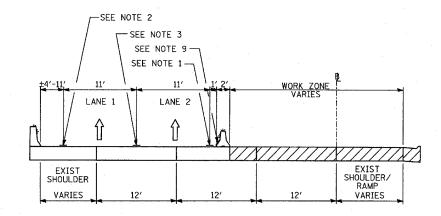


STAGE 1: NB I-57; STA. 190+71 TO STA. 218+90

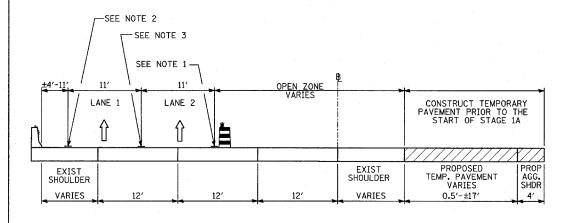


<u>B-B</u> STAGE 1: NB I-57; STA. 218+90 TO STA. 221+86

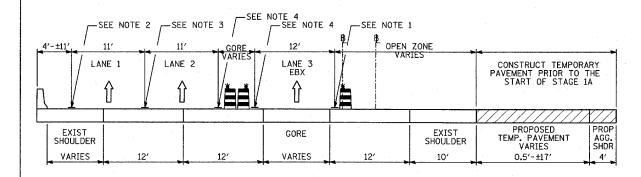


<u>C-C</u> STAGE 1: NB I-57; STA. 224+86 TO STA. 228+55

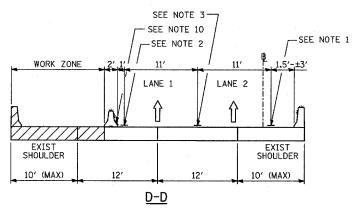


STAGE 1: NB I-57; STA. 232+55 TO STA. 235+77 STAGE 1: NB I-57; STA. 240+93 TO STA. 248+30 STAGE 1A: NB I-57; STA. 232+55 TO STA. 235+77 STAGE 1A: NB I-57; STA. 240+93 TO STA. 248+30

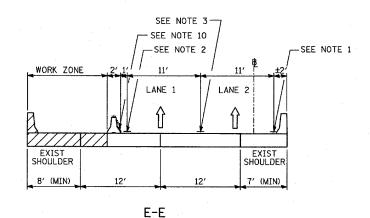

STAGE 1: NB I-57; STA. 235+77 TO STA. 240+93 STAGE 1A: NB I-57; STA. 235+77 TO STA. 240+93

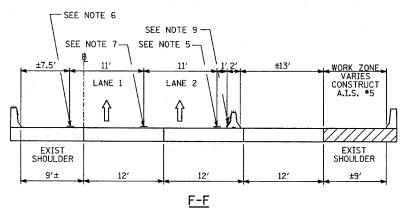

STAGE 1: NB I-94 (BISHOP FORD); STA. 1990+32 TO STA. 1998+33

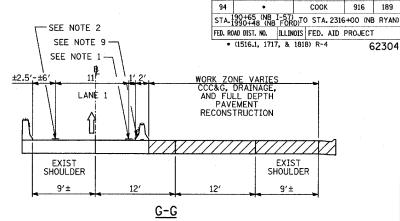

SECTION

COUNTY

TOTAL SHEET SHEETS NO.

STAGE 1: NB I-94 (BISHOP FORD); STA, 2010+30 TO STA, 2040+14

NOTE 1 - EPOXY PAVEMENT MARKING-LINE 4" (WHITE)

NOTE 2 - EPOXY PAVEMENT MARKING-LINE 4" (YELLOW)

NOTE 3 - EPOXY PAVEMENT MARKING-SKIP-DASH 5" (WHITE), 10' LINE WITH 30' SPACE

NOTE 4 - EPOXY PAVEMENT MARKING LINE 8" (WHITE)

NOTE 5 - PAVEMENT MARKING TAPE, TYPE III 4" LINE (WHITE)

NOTE 6 - PAVEMENT MARKING TAPE, TYPE III 4" LINE (YELLOW)

NOTE 7 - PAVEMENT MARKING TAPE, TYPE III 5" SKIP-DASH (WHITE), 10' LINE WITH 30' SPACE

NOTE 8 - PAVEMENT MARKING TAPE, TYPE III 8" LINE (WHITE)

NOTE 9 - TEMPORARY PAVEMENT MARKING-LINE 6" (WHITE)

NOTE 10 - TEMPORARY PAVEMENT MARKING-LINE 6" (YELLOW)

LEGEND:

TEMPORARY CONCRETE BARRIER (WITH REFLECTORS ON TOP AND SIDE FACING TRAFFIC)

TRAFFIC MOVEMENT

DRUM WITH MONO-DIRECTIONAL STEADY BURNING LIGHT


SINGLE-FACE CONCRETE BARRIER, 32"

SINGLE-FACE CONCRETE BARRIER, 32" (WITH REFLECTORS ON TOP AND SIDE FACING TRAFFIC)

PAVEMENT REMOVAL AREA

TEMPORARY PAVEMENT

*ALL MOT TYPICAL SECTIONS ARE DRAWN IN THE DIRECTION OF TRAFFIC

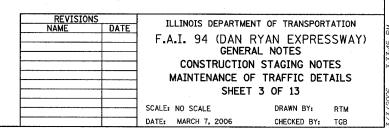


SECTION TOTAL SHEET SHEETS NO. COUNTY COOK 94 916 190 STA. 190+65 (NB I-57) STA. 1990+48 (NB FORD)TO STA. 2316+00 (NB RYAN) FED. ROAD DIST. NO. ILLINOIS FED. AID PROJECT


• (1516.1, 1717, & 1818) R-4

- SEE NOTE 10 __SEE NOTE 6 __SEE NOTE 7 __SEE NOTE 5 WORK ZONE VARIES LANE 1 LANE 2 NEW LANE NEW LANE NEW SHOULDER EXIST SHOULDER VARIES VARIES

STAGE 1A: NB I-57; STA. 209+67 TO STA. 217+08 STAGE 1B: NB I-57; STA. 209+67 TO STA. 217+08 STAGE 1C: NB I-57; STA. 209+67 TO STA. 217+08

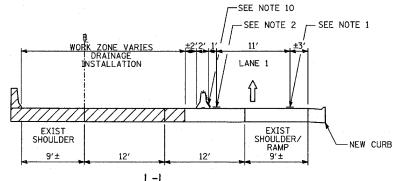

STAGE 1A: NB I-94 (BISHOP FORD); STA. 2011+57 TO STA. 2020+99

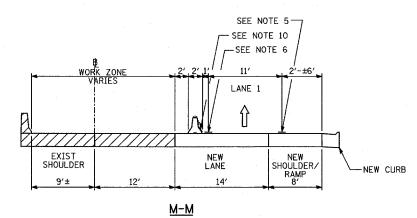

STAGE 1A: NB I-94 (BISHOP FORD); STA. 2020+99 TO STA. 2042+78

NEW BARRIER WALL

*ALL MOT TYPICAL SECTIONS ARE DRAWN IN THE DIRECTION OF TRAFFIC

NOTE 1 - EPOXY PAVEMENT MARKING-

LINE 4" (WHITE)

NOTE 2 - EPOXY PAVEMENT MARKING-LINE 4" (YELLOW)

NOTE 3 - EPOXY PAVEMENT MARKING-SKIP-DASH 5" (WHITE), 10' LINE WITH 30' SPACE

NOTE 4 - EPOXY PAVEMENT MARKING

NOTE 5 - PAVEMENT MARKING TAPE, TYPE III 4" LINE (WHITE)

NOTE 6 - PAVEMENT MARKING TAPE, TYPE III 4" LINE (YELLOW)

NOTE 8 - PAVEMENT MARKING TAPE, TYPE III 8" LINE (WHITE)

LEGEND:

NOTE 7 - PAVEMENT MARKING TAPE, TYPE III 5" SKIP-DASH (WHITE), 10' LINE WITH 30' SPACE

NOTE 9 - TEMPORARY PAVEMENT MARKING-LINE 6" (WHITE)

NOTE 10 - TEMPORARY PAVEMENT MARKING-LINE 6" (YELLOW)

TRAFFIC MOVEMENT

TEMPORARY CONCRETE BARRIER (WITH REFLECTORS ON TOP AND SIDE FACING TRAFFIC)

DRUM WITH MONO-DIRECTIONAL STEADY BURNING LIGHT

SINGLE-FACE CONCRETE BARRIER, 32"

SINGLE-FACE CONCRETE BARRIER, 32" (WITH REFLECTORS ON TOP AND SIDE FACING TRAFFIC)

PAVEMENT REMOVAL AREA

TEMPORARY PAVEMENT

ILLINOIS DEPARTMENT OF TRANSPORTATION F.A.I. 94 (DAN RYAN EXPRESSWAY) GENERAL NOTES CONSTRUCTION STAGING NOTES MAINTENANCE OF TRAFFIC DETAILS SHEET 4 OF 13 SCALE: NO SCALE DRAWN BY: DATE: MARCH 7, 2006 CHECKED BY: TGB

TYLININTERNATIONAL

TEMPORARY SOIL — RETENTION SYSTEM

WORK ZONE

SEE NOTE 9-

SEE NOTE 1 -

LANE 3

<u>I-I</u>

STAGE 1: NB I-94 (DAN RYAN); STA. 2203+00 TO STA. 2316+00

STAGE 1A: NB I-57; STA. 190+71 TO STA. 205+00

STAGE 1: WB CONNECTOR; STA. 333+92 TO STA. 337+12

CONST. TEMP. PAVE. PRIOR

TO STAGE 1A

SEE NOTE 3

LANE 1

EXIST SHOULDER

VARIES

SEE NOTE 2-

EXIST

SHOULDER

9'±

SEE NOTE 3-

LANE 2

WORK ZONE VARIES
DRAINAGE

INSTALLATION

EXIST SHOULDER

VARIES

- SEE NOTE 10

EXIST

SHOULDER

WORK ZONE VARIES

SEE NOTE 7-7 SEE NOTE 5-

LANE 2

SHOULDER/ RAMP

VARIES

-NEW CURB

SEE NOTE 10

SEE NOTE 6

LANE 1


NEW LANE

LANE 1

- SEE NOTE 1


EXIST SHOULDER/ RAMP

VARIES

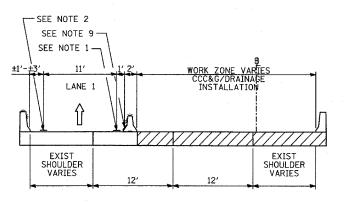


<u>N-N</u>


STAGE 1A: WB CONNECTOR; STA. 307+47 TO STA. 330+04 STAGE 1B: WB CONNECTOR; STA. 313+92 TO STA. 330+04 STAGE 1C: WB CONNECTOR; STA. 313+92 TO STA. 330+04

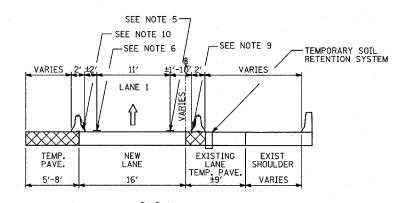


STAGE 1A: WB CONNECTOR; STA. 333+92 TO STA. 340+29 STAGE 1B: WB CONNECTOR; STA. 333+92 TO STA. 340+29 STAGE 1C: WB CONNECTOR; STA. 333+92 TO STA. 340+29

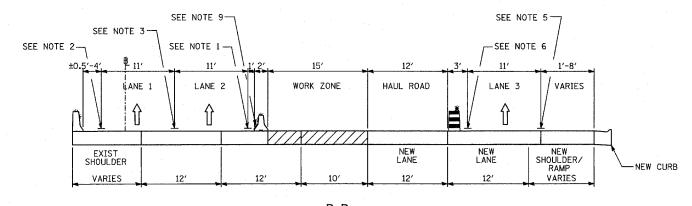


STAGE 1A: NB I-57; STA. 255+32 TO STA. 258+32 STAGE 1A: NB I-94 (DAN RYAN); STA. 2203+00 TO STA. 2252+02

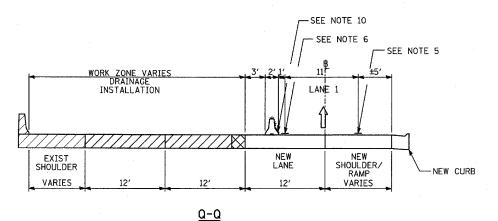

STAGE 1B: NB I-57; STA. 190+71 TO STA. 207+70

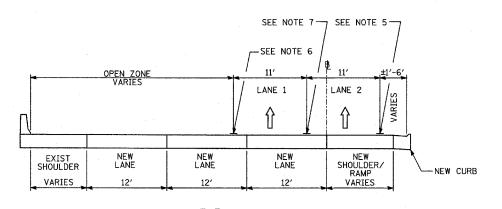

R-R STAGE 1C: NB I-57; STA. 190+71 TO STA. 207+70

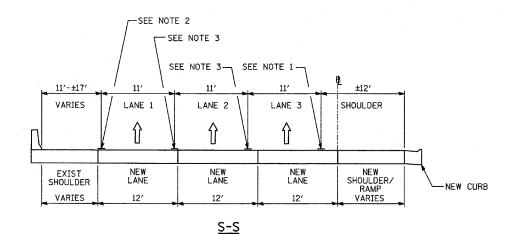

WINTER LANE CONFIGURATION: NB I-57; STA. 190+71 TO STA. 206+11

SECTION

TOTAL SHEETS NO.

916 191

COUNTY соок

STA. 199465 (NB I-57) STA. 1990+48 (NB FORD)TO STA. 2316+00 (NB RYAN)

FED. ROAD DIST. NO. ILLINOIS FED. AID PROJECT

* (1516.1, 1717, & 1818) R-4

LINE 4" (WHITE) NOTE 2 - EPOXY PAVEMENT MARKING-

NOTE 1 - EPOXY PAVEMENT MARKING-

NOTE 3 - EPOXY PAVEMENT MARKING-SKIP-DASH 5" (WHITE), 10' LINE WITH 30' SPACE

NOTE 4 - EPOXY PAVEMENT MARKING LINE 8" (WHITE)

NOTE 5 - PAVEMENT MARKING TAPE, TYPE III 4" LINE (WHITE)

NOTE 6 - PAVEMENT MARKING TAPE, TYPE III 4" LINE (YELLOW)

NOTE 7 - PAVEMENT MARKING TAPE, TYPE III 5" SKIP-DASH (WHITE), 10' LINE WITH 30' SPACE

NOTE 8 - PAVEMENT MARKING TAPE, TYPE III 8" LINE (WHITE)

NOTE 9 - TEMPORARY PAVEMENT MARKING-LINE 6" (WHITE)

NOTE 10 - TEMPORARY PAVEMENT MARKING-LINE 6" (YELLOW)

LEGEND:

TEMPORARY CONCRETE BARRIER (WITH REFLECTORS ON TOP AND SIDE FACING TRAFFIC)

TRAFFIC MOVEMENT

DRUM WITH MONO-DIRECTIONAL STEADY BURNING LIGHT

SINGLE-FACE CONCRETE BARRIER, 32"

SINGLE-FACE CONCRETE BARRIER, 32" (WITH REFLECTORS ON TOP AND SIDE FACING TRAFFIC)

PAVEMENT REMOVAL AREA


TEMPORARY PAVEMENT

*ALL MOT TYPICAL SECTIONS ARE DRAWN IN THE DIRECTION OF TRAFFIC


ILLINOIS DEPARTMENT OF TRANSPORTATION F.A.I. 94 (DAN RYAN EXPRESSWAY) GENERAL NOTES CONSTRUCTION STAGING NOTES MAINTENANCE OF TRAFFIC DETAILS SHEET 5 OF 13 SCALE: NO SCALE

TYLIN INTERNATIONAL


DRAWN BY: DATE: MARCH 7, 2006 CHECKED BY:

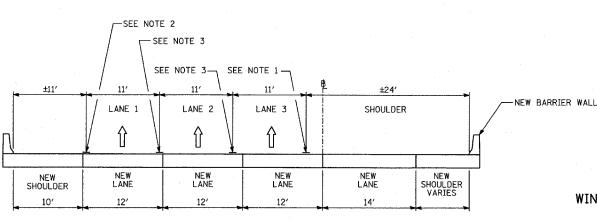


 $\frac{T-T}{}$ WINTER LANE CONFIGURATION: NB I-57; STA. 209+07 TO STA. 218+71

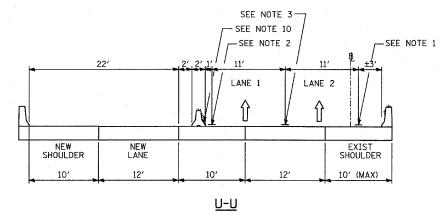


WINTER LANE CONFIGURATION: NB I-57; STA. 232+89 TO STA. 235+77 WINTER LANE CONFIGURATION: NB I-57; STA. 240+93 TO STA. 248+30

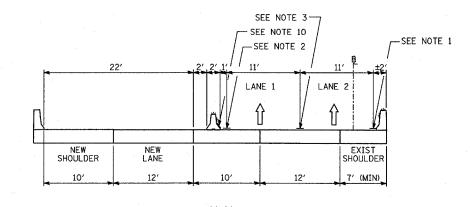

WINTER LANE CONFIGURATION: NB I-57; STA. 235+77 TO STA. 240+93

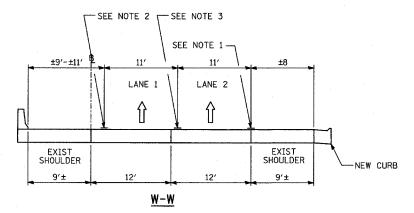


STAGE 1B: NB I-94 (BISHOP FORD); STA. 2010+45 TO STA. 2020+99
WINTER LANE CONFIGURATION: NB I-94 (BISHOP FORD); STA. 2010+45 TO STA. 2020+99
STAGE 2: NB I-94 (BISHOP FORD); STA. 2010+45 TO STA. 2020+99
STAGE 3A: NB I-94 (BISHOP FORD); STA. 2010+45 TO STA. 2020+99

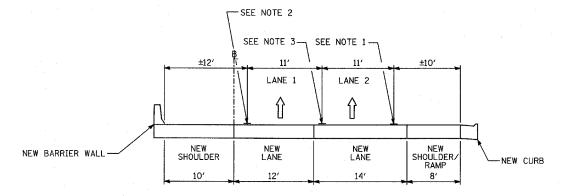

X-X

STAGE 1B: NB I-94 (BISHOP FORD); STA. 2020+99 TO STA. 2045+37
WINTER LANE CONFIGURATION: NB I-94 (BISHOP FORD); STA. 2020+99 TO STA. 2042+78
STAGE 2: NB I-94 (BISHOP FORD); STA. 2020+99 TO STA. 2041+78
STAGE 3a; NB I-94 (BISHOP FORD); STA. 2020+99 TO STA. 2041+78
STAGE 3A; NB I-94 (BISHOP FORD); STA. 2020+99 TO STA. 2041+78

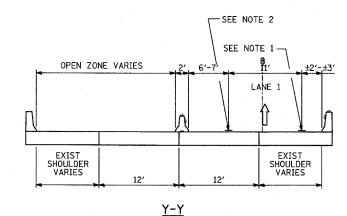

WINTER LANE CONFIGURATION: WB CONNECTOR; STA. 307+43 TO STA. 330+07

RTE.	32011014		000111		SHEETS	NO.
94	*		COOK		916	192
STA.1	90+65 (NB 990+48 (NB	I-57) FORD) ^{T(}	STA.	2316	+00 (NB	RYAN)
FED. RO	AD DIST. NO.	ILLINOIS	FED.	AID	PROJECT	
•	(1516.1, 171	7, & 181	8) R-4		6	2304

F.A.I. SECTION COUNTY TOTAL SHEET

NOTE 1 - EPOXY PAVEMENT MARKING-LINE 4" (WHITE)

NOTE 2 - EPOXY PAVEMENT MARKING-LINE 4" (YELLOW)

NOTE 3 - EPOXY PAVEMENT MARKING-SKIP-DASH 5" (WHITE), 10' LINE WITH 30' SPACE

NOTE 4 - EPOXY PAVEMENT MARKING LINE 8" (WHITE)

NOTE 5 - PAVEMENT MARKING TAPE, TYPE III 4" LINE (WHITE)

NOTE 6 - PAVEMENT MARKING TAPE, TYPE III 4" LINE (YELLOW)

NOTE 7 - PAVEMENT MARKING TAPE, TYPE III 5" SKIP-DASH (WHITE), 10' LINE WITH 30' SPACE

NOTE 8 - PAVEMENT MARKING TAPE, TYPE III 8" LINE (WHITE)

NOTE 9 - TEMPORARY PAVEMENT MARKING-LINE 6" (WHITE)

NOTE 10 - TEMPORARY PAVEMENT MARKING-LINE 6" (YELLOW)

LEGEND:

Δ

TEMPORARY CONCRETE BARRIER (WITH REFLECTORS ON TOP AND SIDE FACING TRAFFIC)

TRAFFIC MOVEMENT

DR

DRUM WITH MONO-DIRECTIONAL STEADY BURNING LIGHT

SINGLE-FACE CONCRETE BARRIER, 32"

SINGLE-FACE CONCRETE
BARRIER, 32" (WITH
REFLECTORS ON TOP AND
SIDE FACING TRAFFIC)

PA

PAVEMENT REMOVAL AREA


TEMPORARY PAVEMENT

*ALL MOT TYPICAL SECTIONS ARE DRAWN IN THE DIRECTION OF TRAFFIC


REVISIONS
NAME
DATE
F.A.I. 94 (DAN RYAN EXPRESSWAY)
GENERAL NOTES
CONSTRUCTION STAGING NOTES
MAINTENANCE OF TRAFFIC DETAILS
SHEET 6 OF 13

SCALE: NO SCALE
DATE: MARCH 7, 2006


DRAWN BY: RTM CHECKED BY: TGB

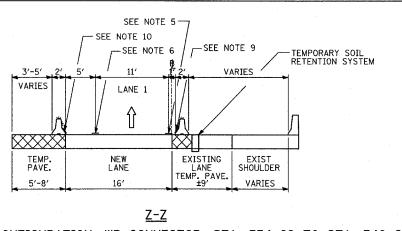


WINTER LANE CONFIGURATION: WB CONNECTOR; STA. 334+92 TO STA. 340+29

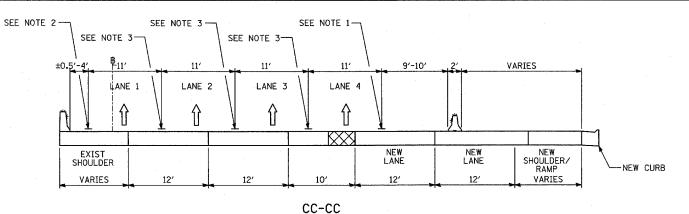


WINTER LANE CONFIGURATION: NB I-94 (DAN RYAN); STA. 2252+02 TO STA. 2316+00

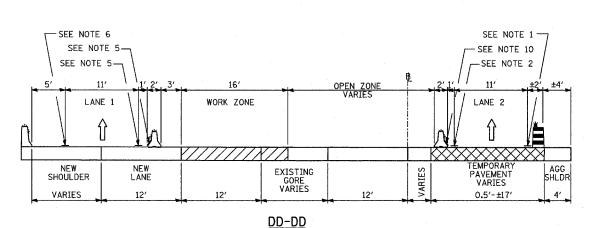


STAGE 2: NB I-57; STA. 219+18 TO STA. 224+86 STAGE 3: NB I-57; STA. 219+18 TO STA. 224+86

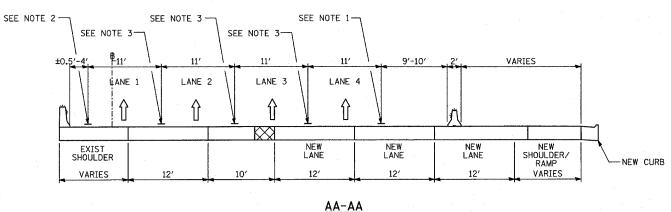

STAGE 1B: NB I-94 (DAN RYAN); STA. 2206+02 TO STA. 2229+02 WINTER LANE CONFIGURATION: NB I-94 (DAN RYAN); STA. 2206+02 TO STA. 2252+02

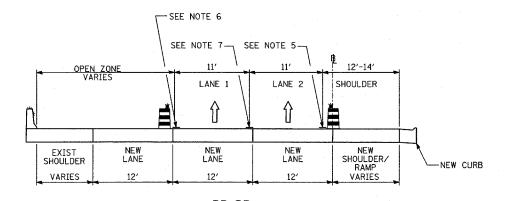

BB-BB STAGE 2: NB I-57; STA. 190+71 TO STA. 206+11 STAGE 3: NB I-57; STA. 190+71 TO STA. 206+11

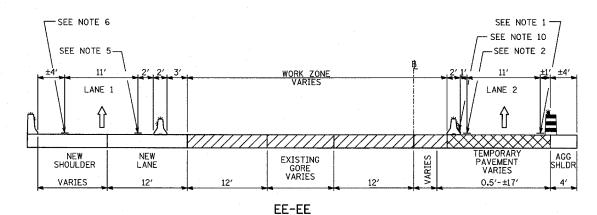

STAGE 2: NB I-57; STA. 224+86 TO STA. 230+18 STAGE 3: NB I-57; STA. 224+86 TO STA. 230+18

NOTE 1 - EPOXY PAVEMENT MARKING-LINE 4" (WHITE)

NOTE 2 - EPOXY PAVEMENT MARKING-LINE 4" (YELLOW)

SECTION

COUNTY

COOK

STA. 190+65 (NB I-57) STA. 1990+48 (NB FORD)TO STA. 2316+00 (NB RYAN)

FED. ROAD DIST. NO. ILLINOIS FED. AID PROJECT

* (1516.1, 1717, & 1818) R-4

916 193

NOTE 3 - EPOXY PAVEMENT MARKING-SKIP-DASH 5" (WHITE), 10' LINE WITH 30' SPACE

NOTE 4 - EPOXY PAVEMENT MARKING LINE 8" (WHITE)

NOTE 5 - PAVEMENT MARKING TAPE, TYPE III 4" LINE (WHITE)

NOTE 6 - PAVEMENT MARKING TAPE, TYPE III 4" LINE (YELLOW)

NOTE 7 - PAVEMENT MARKING TAPE, TYPE III 5" SKIP-DASH (WHITE), 10' LINE WITH 30' SPACE

NOTE 8 - PAVEMENT MARKING TAPE, TYPE III 8" LINE (WHITE)

NOTE 9 - TEMPORARY PAVEMENT MARKING-LINE 6" (WHITE)

NOTE 10 - TEMPORARY PAVEMENT MARKING-LINE 6" (YELLOW)

LEGEND:

TEMPORARY CONCRETE BARRIER (WITH REFLECTORS ON TOP AND SIDE FACING TRAFFIC)

TRAFFIC MOVEMENT

DRUM WITH MONO-DIRECTIONAL STEADY BURNING LIGHT

SINGLE-FACE CONCRETE BARRIER, 32"

SINGLE-FACE CONCRETE BARRIER, 32" (WITH REFLECTORS ON TOP AND SIDE FACING TRAFFIC)


PAVEMENT REMOVAL AREA

TEMPORARY PAVEMENT


*ALL MOT TYPICAL SECTIONS ARE DRAWN IN THE DIRECTION OF TRAFFIC

REVISIONS
NAME
DATE
F.A.I. 94 (DAN RYAN EXPRESSWAY)
GENERAL NOTES
CONSTRUCTION STAGING NOTES
MAINTENANCE OF TRAFFIC DETAILS
SHEET 7 OF 13


SCALE: NO SCALE DATE: MARCH 7, 2006 DRAWN BY: RTM
CHECKED BY: TGB

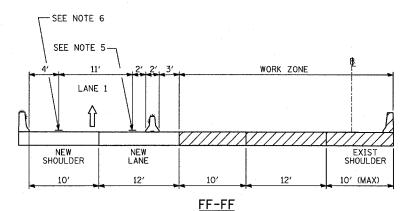


STAGE 2: NB I-57; STA. 232+89 TO STA. 235+77 STAGE 2: NB I-57; STA. 240+93 TO STA. 248+30 STAGE 3: NB I-57; STA. 232+89 TO STA. 235+77 STAGE 3: NB I-57; STA. 240+93 TO STA. 248+30

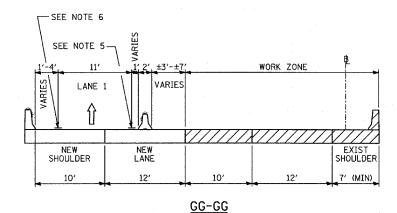


STAGE 2: NB I-57; STA. 236+19 TO STA. 240+93 STAGE 3: NB I-57; STA. 236+19 TO STA. 240+93

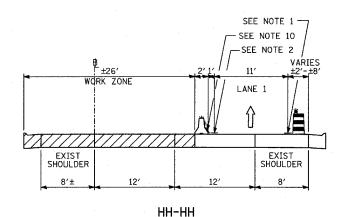


STAGE 2: EB CONNECTOR; STA. 408+41 TO STA. 415+06 STAGE 3: EB CONNECTOR; STA. 408+41 TO STA. 415+06

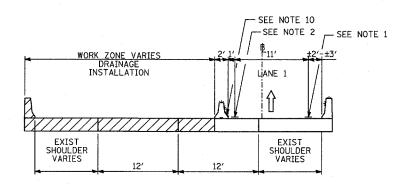

II-II STAGE 2: WB CONNECTOR; STA. 307+43 TO STA. 328+00

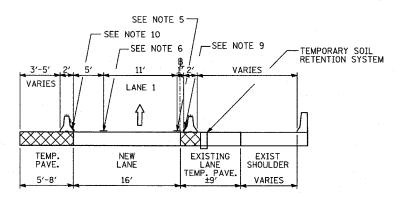

STAGE 2: WB CONNECTOR; STA. 330+65 TO STA. 340+29

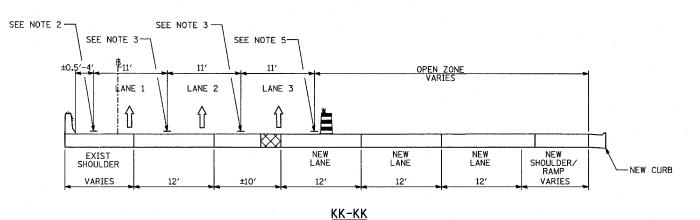

STAGE 2: NB I-94 (DAN RYAN); STA. 2211+92 TO STA. 2223+48

RTE.	SECTIO	N	COUN	TY	SHEETS	NO.
94	٠		coo	K	916	194
STA.	90+65 (NB 990+48 (NE	1-57) FORE	ATS OT(. 2316	5+00 (NE	RYAN)
FED. RO	AD DIST. NO.	ILLING	IS FED.	AID	PROJECT	
•	(1516.1, 171	7, & 1	1818) R-	4	6	2304

NOTE 1 - EPOXY PAVEMENT MARKING-LINE 4" (WHITE)

NOTE 2 - EPOXY PAVEMENT MARKING-LINE 4" (YELLOW)

NOTE 3 - EPOXY PAVEMENT MARKING-SKIP-DASH 5" (WHITE), 10' LINE WITH 30' SPACE

NOTE 4 - EPOXY PAVEMENT MARKING

NOTE 5 - PAVEMENT MARKING TAPE, TYPE III 4" LINE (WHITE)

NOTE 6 - PAVEMENT MARKING TAPE, TYPE III 4" LINE (YELLOW)

NOTE 7 - PAVEMENT MARKING TAPE, TYPE III 5" SKIP-DASH (WHITE), 10" LINE WITH 30" SPACE

NOTE 8 - PAVEMENT MARKING TAPE, TYPE III 8" LINE (WHITE)

NOTE 9 - TEMPORARY PAVEMENT MARKING-LINE 6" (WHITE)

NOTE 10 - TEMPORARY PAVEMENT MARKING-LINE 6" (YELLOW)

LEGEND:

TEMPORARY CONCRETE BARRIER (WITH REFLECTORS ON TOP AND SIDE FACING TRAFFIC)

TRAFFIC MOVEMENT

DRUM WITH MONO-DIRECTIONAL STEADY BURNING LIGHT

SINGLE-FACE CONCRETE BARRIER, 32"

SINGLE-FACE CONCRETE BARRIER, 32" (WITH REFLECTORS ON TOP AND SIDE FACING TRAFFIC)

PAVEMENT REMOVAL AREA


TEMPORARY PAVEMENT

*ALL MOT TYPICAL SECTIONS ARE DRAWN IN THE DIRECTION OF TRAFFIC

REVISIONS NAME ILLINOIS DEPARTMENT OF TRANSPORTATION F.A.I. 94 (DAN RYAN EXPRESSWAY) GENERAL NOTES CONSTRUCTION STAGING NOTES MAINTENANCE OF TRAFFIC DETAILS SHEET 8 OF 13 DRAWN BY: RTM

SCALE: NO SCALE DATE: MARCH 7, 2006

CHECKED BY: TGB

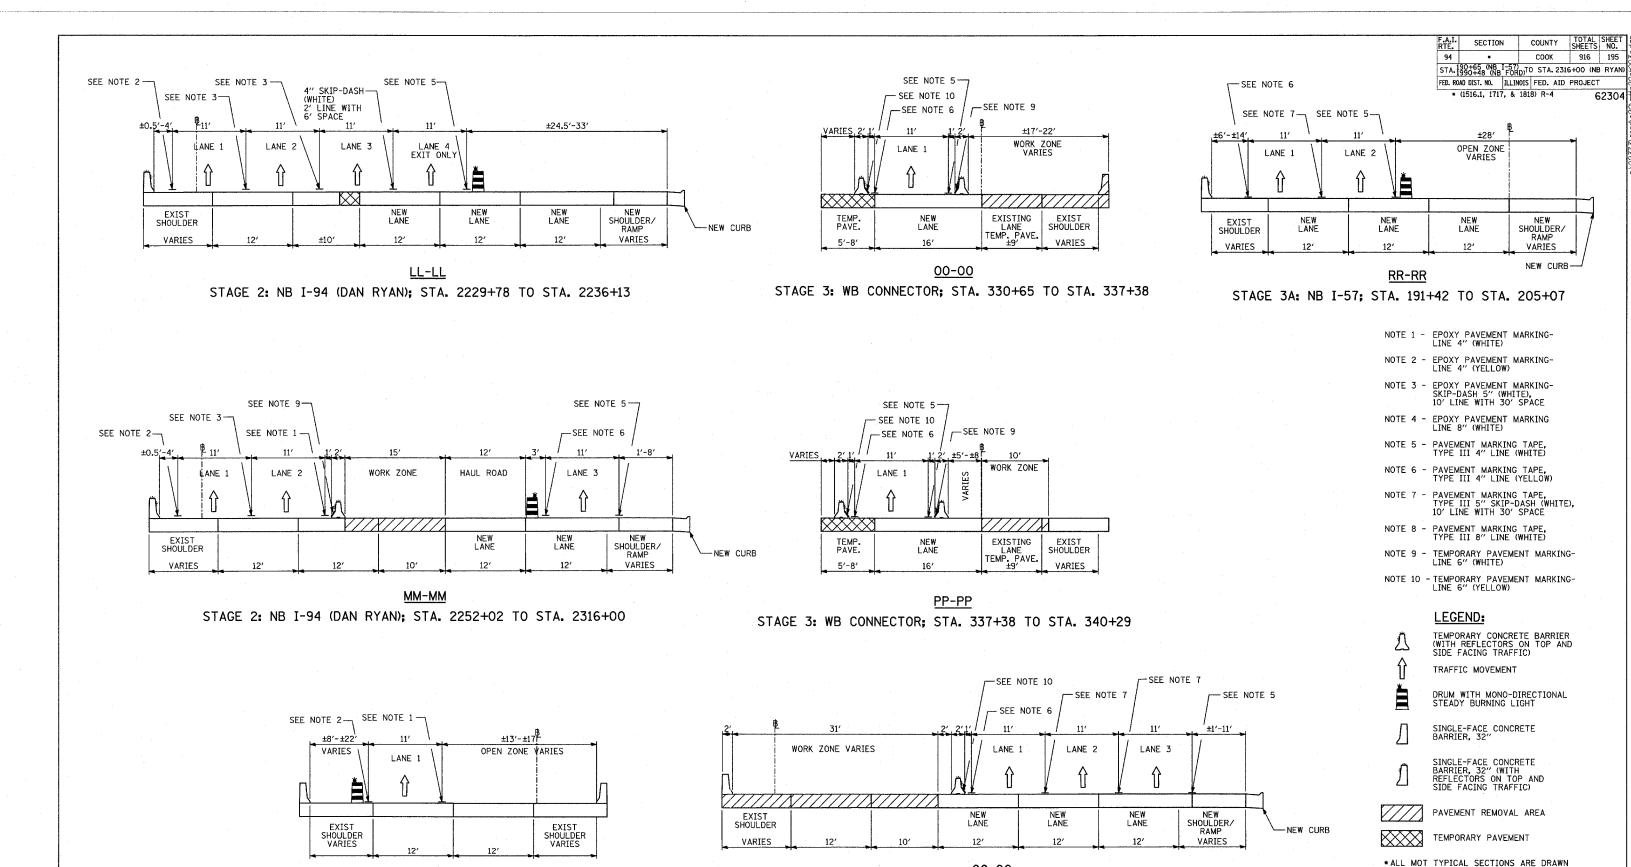

NN-NN

STAGE 3: WB CONNECTOR; STA. 324+13 TO STA. 329+05

TY:LIN INTERNATIONAL

QQ-QQ

STAGE 3: NB I-94 (DAN RYAN); STA. 2205+51 TO STA. 2316+00

STAGE 3A: NB I-94 (DAN RYAN); STA. 2203+00 TO STA. 2316+00

ILLINOIS DEPARTMENT OF TRANSPORTATION F.A.I. 94 (DAN RYAN EXPRESSWAY)


CONSTRUCTION STAGING NOTES MAINTENANCE OF TRAFFIC DETAILS SHEET 9 OF 13

GENERAL NOTES


SCALE: NO SCALE DATE: MARCH 7, 2006

IN THE DIRECTION OF TRAFFIC


DRAWN BY: CHECKED BY: TGB

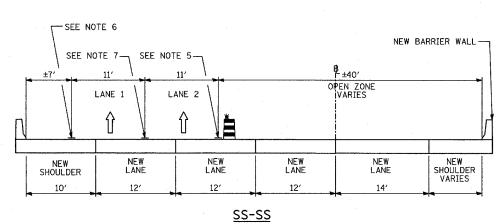


STAGE 3A: NB I-57; STA. 209+07 TO STA. 218+71

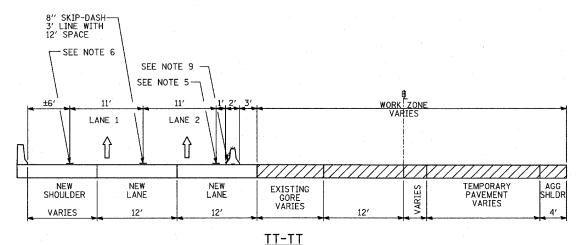


STAGE 3A: NB I-57: STA. 219+18 TO STA. 222+68

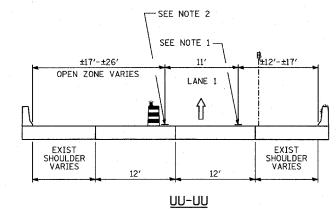


STAGE 3A: WB CONNECTOR; STA. 324+70 TO STA. 329+67

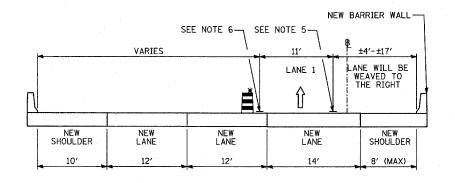

VV-VV STAGE 3A: NB I-57; STA. 233+00 TO STA. 235+68 STAGE 3A: NB I-57; STA. 240+96 TO STA. 247+28

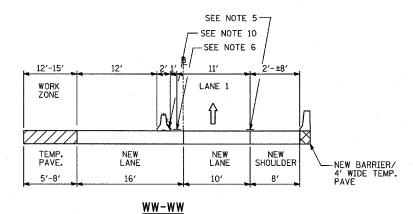

STAGE 3A: WB CONNECTOR; STA. 330+65 TO STA. 340+29

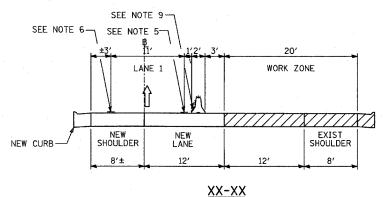

STAGE 3A: EB CONNECTOR; STA. 408+41 TO STA. 415+06

F.A.I. RTE.	SECTION		COUNTY	TOTAL SHEETS	SHEET NO.
94	•		СООК	916	196
STA.	90+65 (NB 990+48 (NB	I-57) FORD)TO STA. 231	6+00 (NE	RYAN)
FED. RO	AD DIST. NO.	ILLING	IS FED. AID	PROJECT	
	(1516.1, 1717	, & 1	1818) R-4	6	2304

NOTE 1 - EPOXY PAVEMENT MARKING-LINE 4" (WHITE)

NOTE 2 - EPOXY PAVEMENT MARKING-

NOTE 3 - EPOXY PAVEMENT MARKING-SKIP-DASH 5" (WHITE), 10' LINE WITH 30' SPACE

NOTE 4 - EPOXY PAVEMENT MARKING LINE 8" (WHITE)

NOTE 5 - PAVEMENT MARKING TAPE, TYPE III 4" LINE (WHITE)

NOTE 6 - PAVEMENT MARKING TAPE, TYPE III 4" LINE (YELLOW)

NOTE 7 - PAVEMENT MARKING TAPE, TYPE III 5" SKIP-DASH (WHITE), 10' LINE WITH 30' SPACE

NOTE 8 - PAVEMENT MARKING TAPE, TYPE III 8" LINE (WHITE)

NOTE 9 - TEMPORARY PAVEMENT MARKING-LINE 6" (WHITE)

NOTE 10 - TEMPORARY PAVEMENT MARKING-LINE 6" (YELLOW)

LEGEND:

TEMPORARY CONCRETE BARRIER (WITH REFLECTORS ON TOP AND SIDE FACING TRAFFIC)



TRAFFIC MOVEMENT



DRUM WITH MONO-DIRECTIONAL STEADY BURNING LIGHT



SINGLE-FACE CONCRETE BARRIER, 32"



SINGLE-FACE CONCRETE BARRIER, 32" (WITH REFLECTORS ON TOP AND SIDE FACING TRAFFIC)



PAVEMENT REMOVAL AREA



TEMPORARY PAVEMENT


*ALL MOT TYPICAL SECTIONS ARE DRAWN IN THE DIRECTION OF TRAFFIC

ILLINOIS DEPARTME		REVISION:
	DATE	NAME
F.A.I. 94 (DAN		
GENER		
CONSTRUCTION		
MAINTENANCE O		
SHEET		
SCALE: NO SCALE		
DATE: MARCH 7 2006		····

ENT OF TRANSPORTATION RYAN EXPRESSWAY) RAL NOTES


ON STAGING NOTES OF TRAFFIC DETAILS 10 OF 13

DRAWN BY: RTM

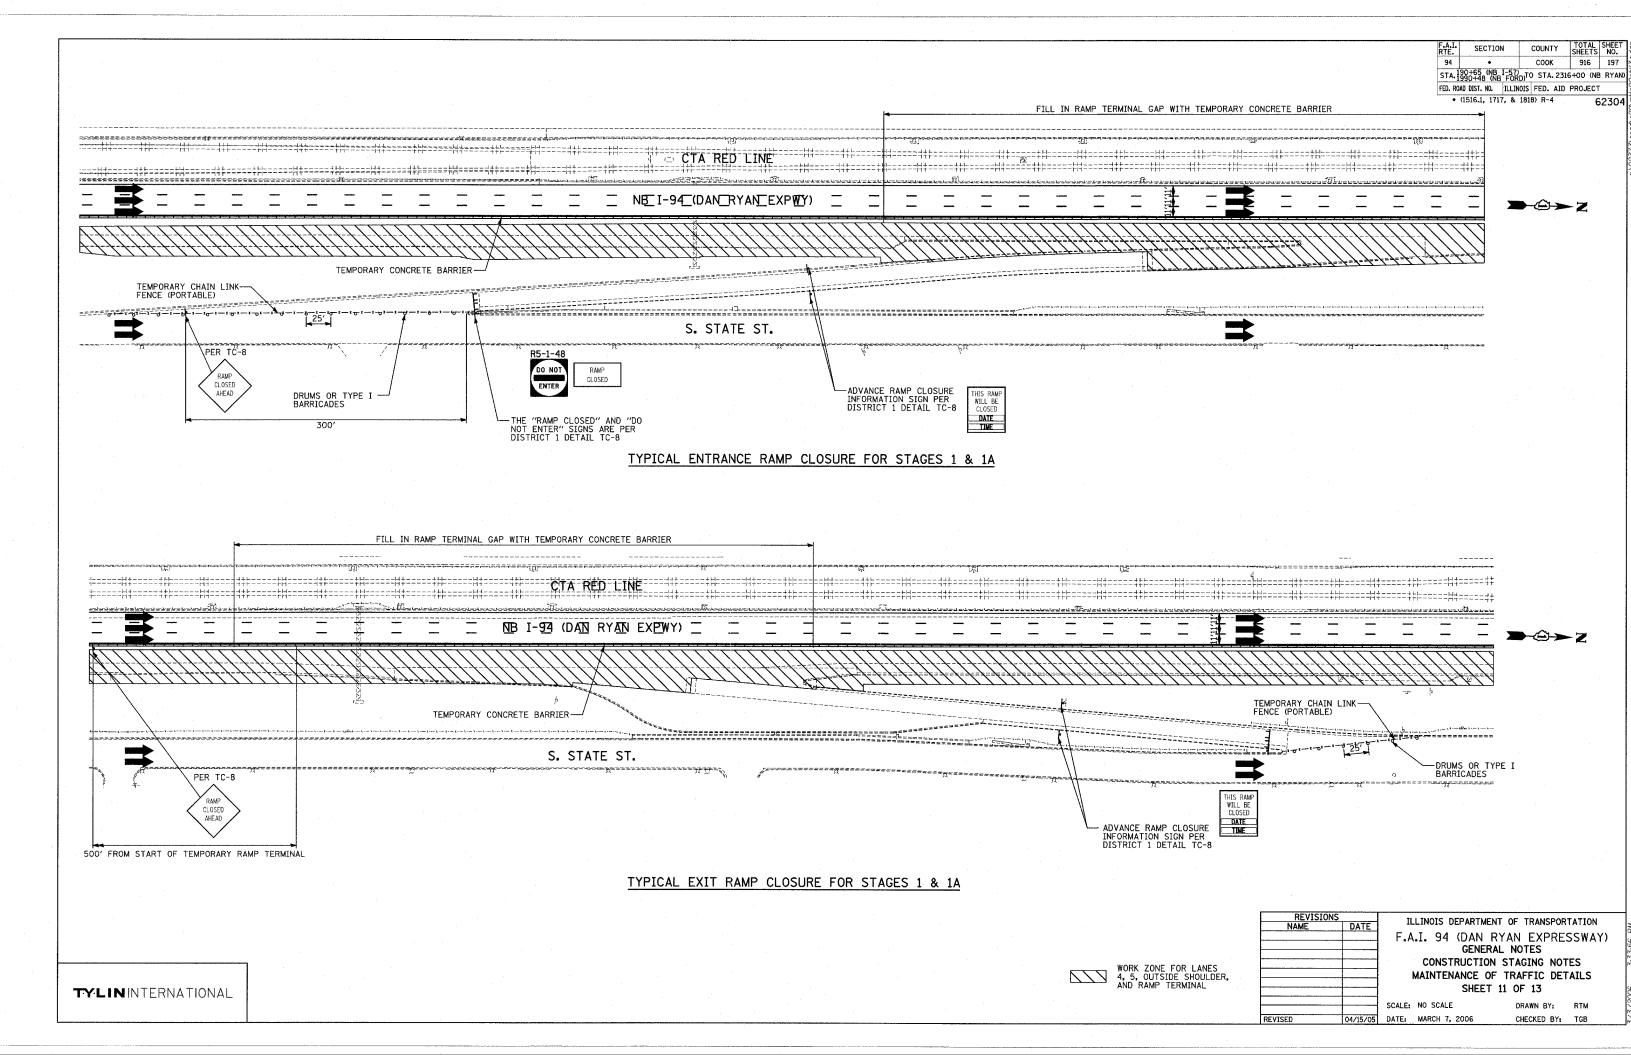


TEMPORARY INFORMATION SIGNING AREA = 32.0 SF 8'-0" BORDER 12.7" R=9" BACKGROUND - ORANGE BORDER AND LEGEND - BLACK "D" SIZE LETTERS IN=0.5"

"RIGHT LANE MUST EXIT" SIGN DETAIL

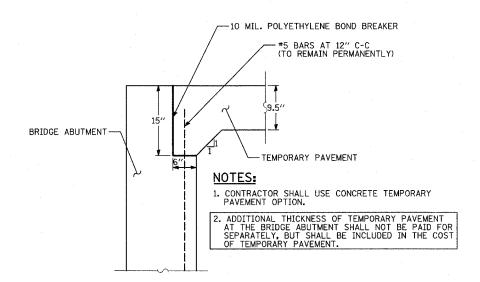

TEMPORARY PAVEMENT DETAIL AT NB I-57 BRIDGE - STAGE 1A

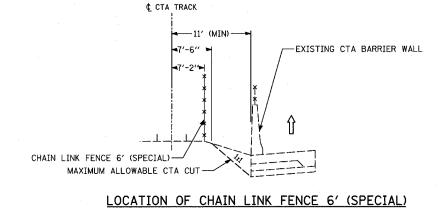

REVISIONS NAME ILLINOIS DEPARTMENT OF TRANSPORTATION F.A.I. 94 (DAN RYAN EXPRESSWAY) GENERAL NOTES CONSTRUCTION STAGING NOTES MAINTENANCE OF TRAFFIC DETAILS SHEET 12 OF 13 SCALE: NO SCALE DRAWN BY: RTM DATE: MARCH 7, 2006 CHECKED BY: TGB


COUNTY TOTAL SHEET NO.

COOK 916 198

62304

STA. 190+65 (NB 1-57) STA. 1990+48 (NB FORD)TO STA. 2316+00 (NB RYAN) FED. ROAD DIST. NO. ILLINOIS FED. AID PROJECT • (1516.1, 1717, & 1818) R-4

SECTION

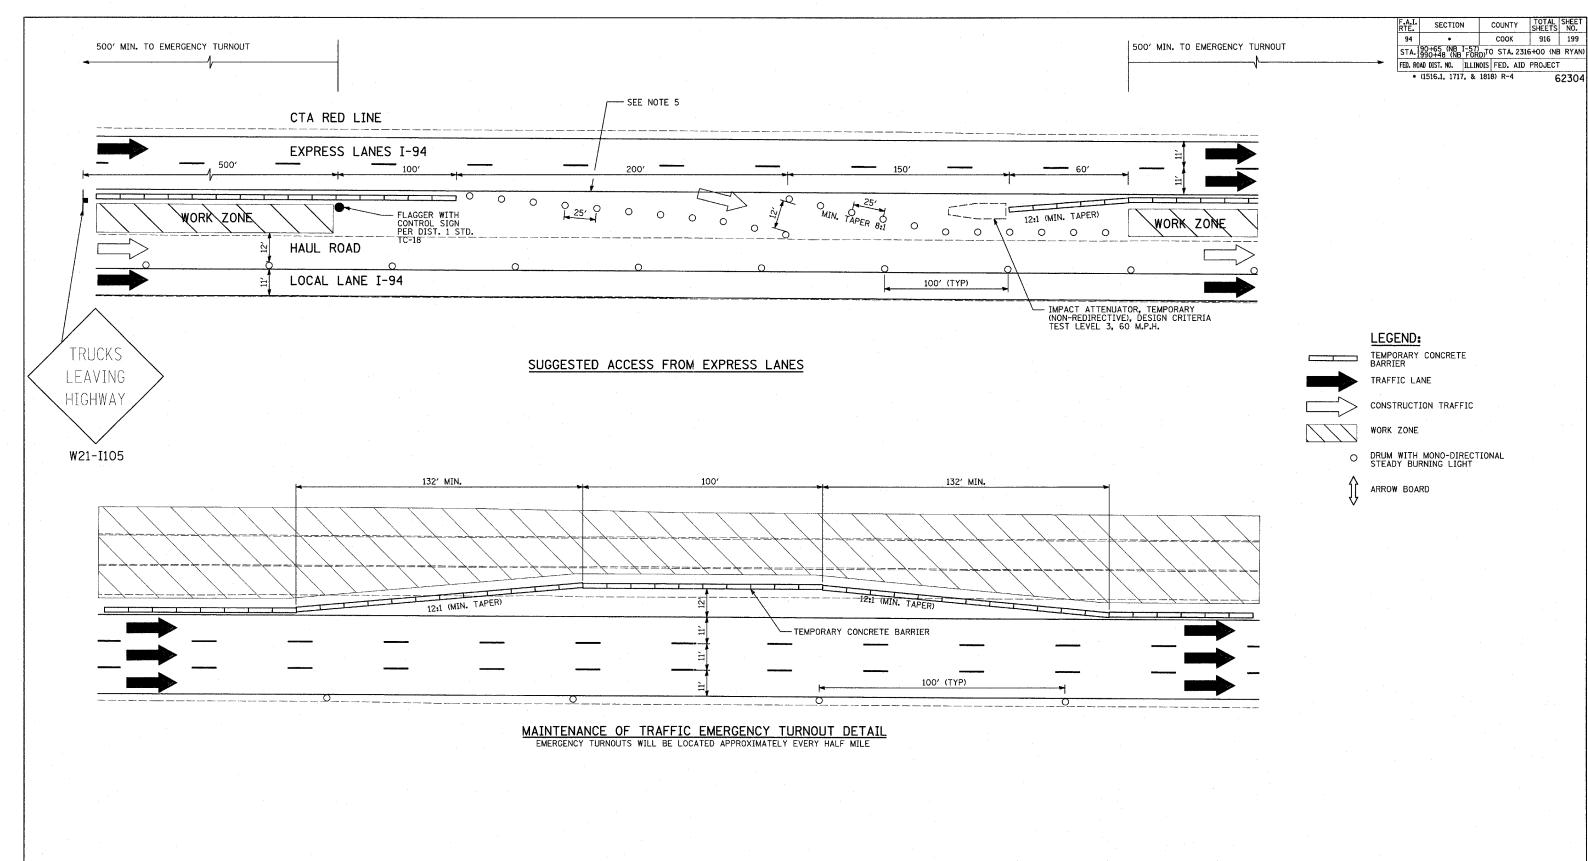

NOTES:

TYLININTERNATIONAL

- 1. THERE CAN BE NO MORE THAN TWO (2) WORK ZONE ACCESS/EGRESS COMBINATIONS AND THE CONTRACTOR MUST MAINTAIN AT LEAST ONE (1) EXPRESS LANE ACCESS DURING STAGE 2 CONSTRUCTION.
- THE CONTRACTOR SHALL NOT ENTER OR EXIT THE HAUL ROAD WITHIN THE 100' BARREL-SPACING AREA. WORK ZONE ACCESS AND EGRESS WILL ONLY BE PERMITTED AT THE DESIGNATED LOCATIONS.

- 3. FOR EXPRESS LANE WORK ZONE EGRESS, TAPER LENGTHS SHALL FOLLOW DISTRICT 1 STANDARD TC-18.
- 4. THE CONTRACTOR SHALL CLOSE OPENINGS WITH BARRELS WHEN NOT BEING USED FOR ACCESS.
- 5. TEMPORARY PAVEMENT MARKINGS SHALL BE CARRIED THRU THE OPENING.

REVISIO		THE THOUS DEPART	MENT OF TRANSPORTATION
NAME	DATE		
		F.A.I. 94 (DAN	I RYAN EXPRESSWAY)
		GEN	ERAL NOTES
		CONSTRUCT	ION STAGING NOTES
		MAINTENANCE	OF TRAFFIC DETAILS
		SHEI	ET 13 OF 13
		SCALE: NO SCALE	DRAWN BY: RTM

SCALE: NO SCALE
DATE: MARCH 7, 2006

CHECKED BY: TGB

