

F.A.I. RTE.	SECTION	1	COUN	TOTAL	SHEE NO.	
94	1818 R-0	5	соок			102
STA.	1313+00	TO STA. 136			7+00	
FED. RC	AD DIST. NO.	ILLINOIS	FED.	AID	PROJECT	

60B18

EXIT RAMP CLOSURE SIGNING SCHEDULE


RAMP	LOCATION	STATION	TYPE OF SUPPORT	SIGN	COVER
79TH ST	SB I-94 (Dan Ryan Expressway)	1355+91	Span	Exit 60C 79th St 1/2 Mile	1/2 Mile
	SB I-94 (Dan Ryan Expressway)	1339+32	Bridge-Mounted	Exit 60C 79th St & Arrow	St & Arrow
	SB I-94 (Dan Ryan Local Lanes)	3405+00	Span .	Exit 60A 75th St 3/4 Mile	*3/4 Mîle
75TH ST	SB I-94 (Dan Ryan Expressway)	1379+48	Bridge-Mounted	Exit 60A 75th St 1/4 Mile	*1/4 Mile
	SB I-94 (Dan Ryan Expressway)	1365+87	Bridge-Mounted	Exit 60A 75th St & Arrow	St & Arrow


NOTE


WHEN RAMP IS CLOSED DURING STAGE 1, COVER SIGNS WITH SIGN PANEL OVERLAY "RAMP CLOSED" PER DISTRICT 1 STANDARD TC-8 FOLLOWING EXIT RAMP CLOSURE SIGNING SCHEDULE. SIGN PANEL OVERLAY SHALL BE ADJUSTED IF EXISTING SIGN PANELS ARE LESS THAN 10'. SIGN PANEL OVERLAY SHALL BE REMOVED AFTER DESIGNATED RAMP IS OPENED. INSTALLATION AND REMOVAL OF SIGN PANEL OVERLAY SHALL BE INCLUDED IN THE COST OF TRAFFIC CONTROL AND PROTECTION (EXPRESSWAYS).


*SIGNS LOCATED OUTSIDE OF PROJECT AREA. CONTRACTOR SHALL COORDINATE WITH CONTRACT 62302 CONTRACTOR.


REVISIONS NAME DAT	<u> </u>	ENT OF TRANSPORTATION RYAN EXPRESSWA
		TAGE 1 URE SIGNING SCHEDUL 1 OF 1
	SCALE: NONE	DRAWN BY: AMB
	DATE: MARCH 1, 2006	CHECKED BY: TGB

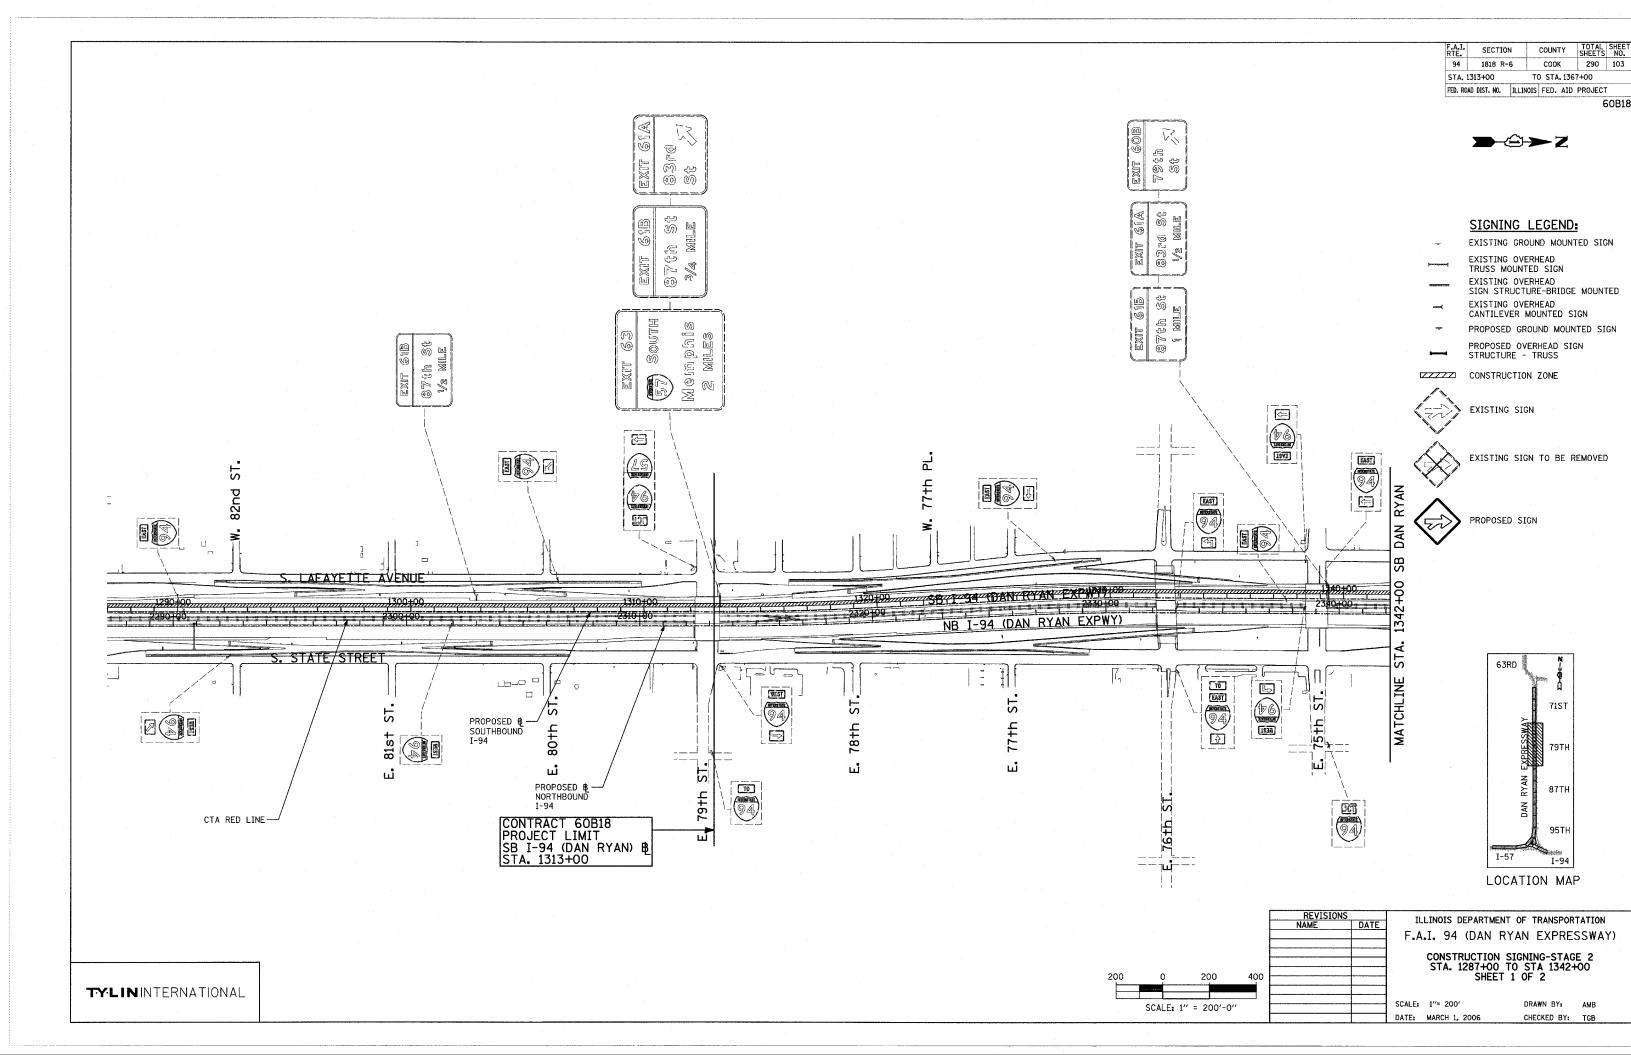


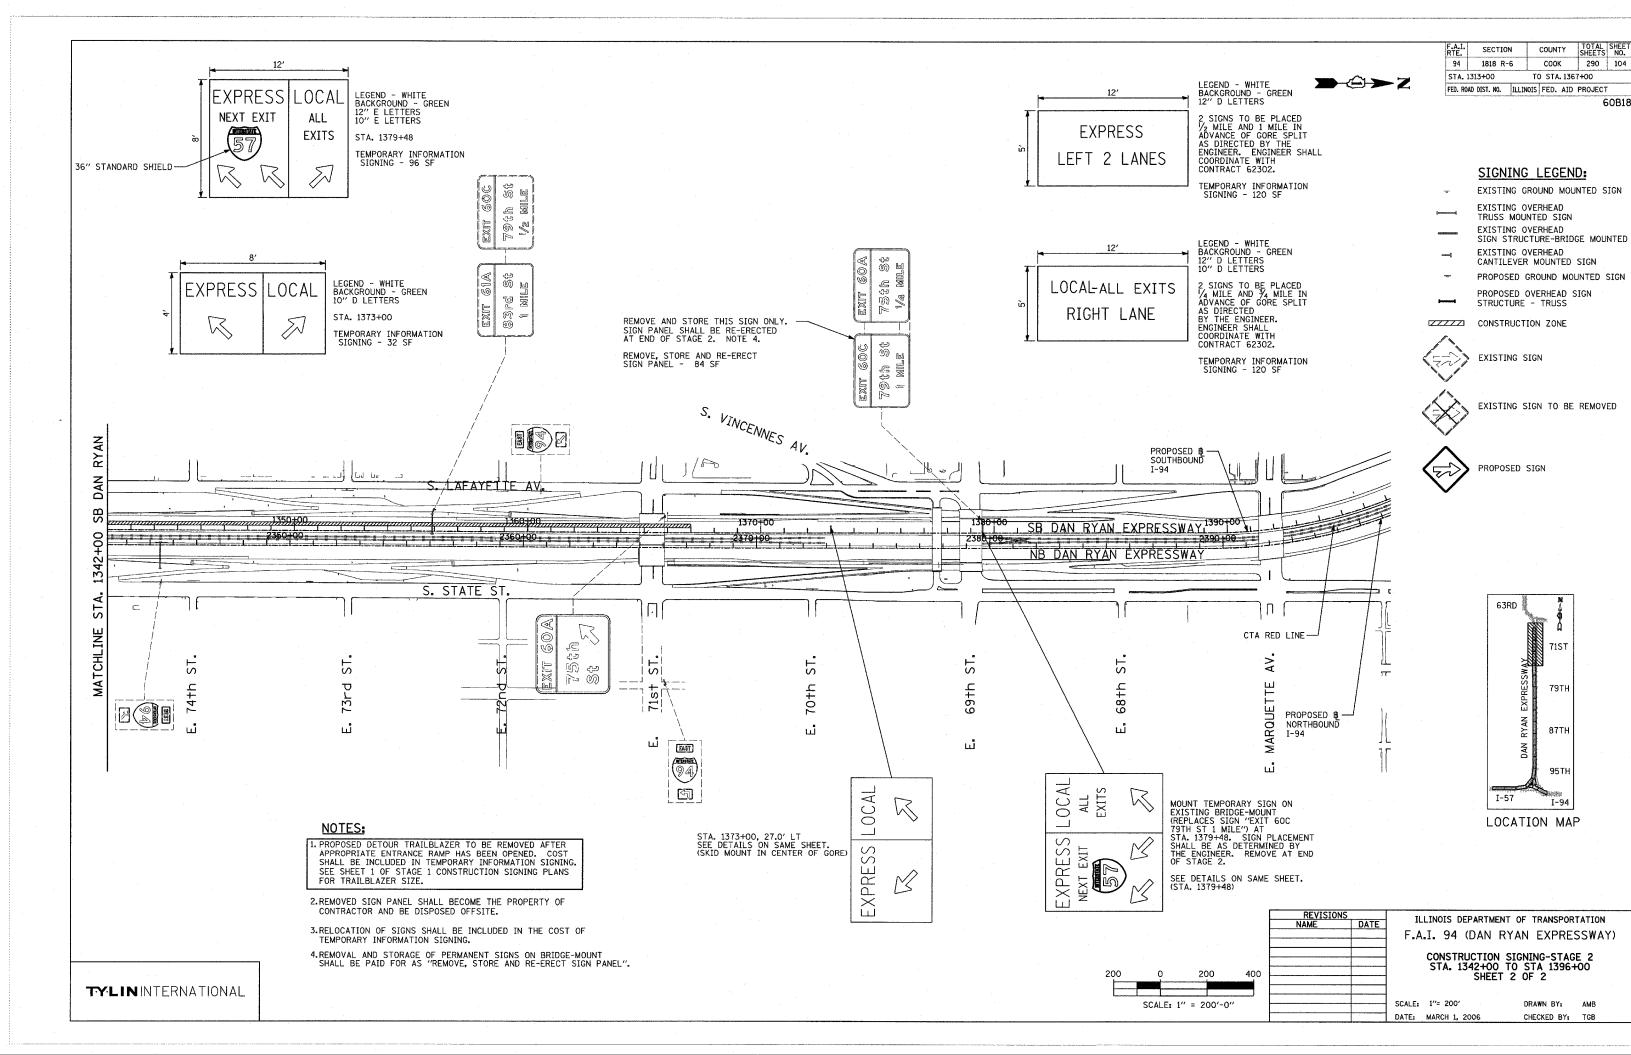


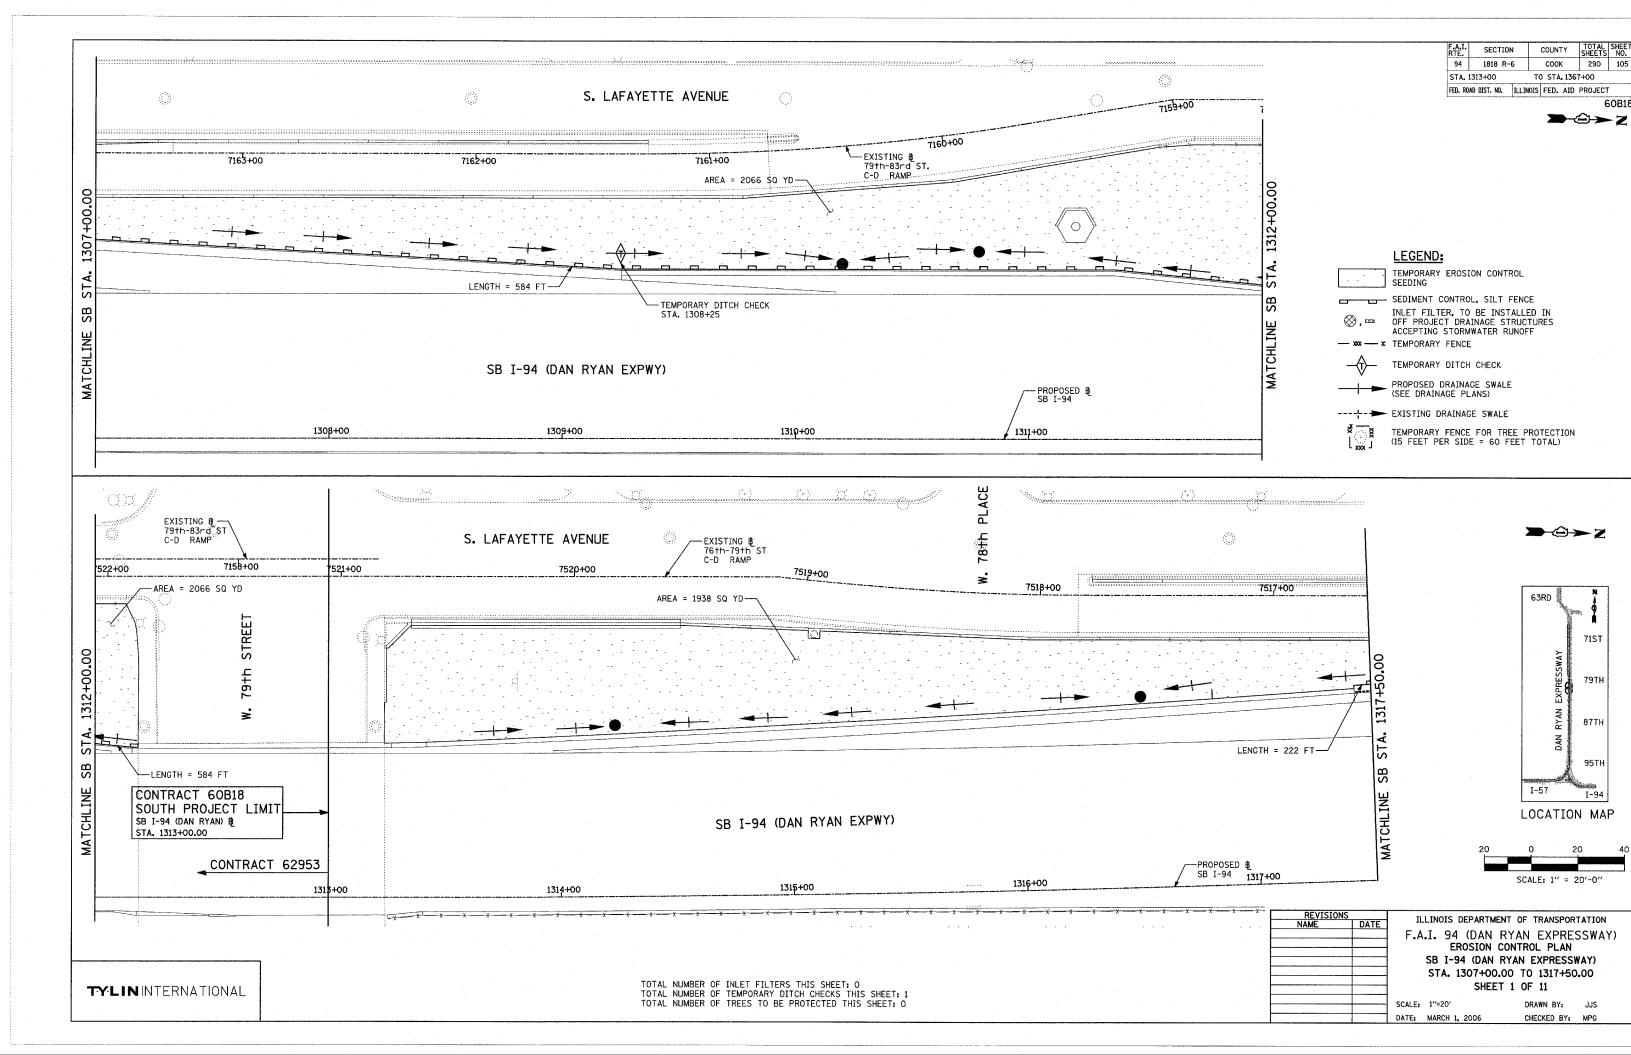

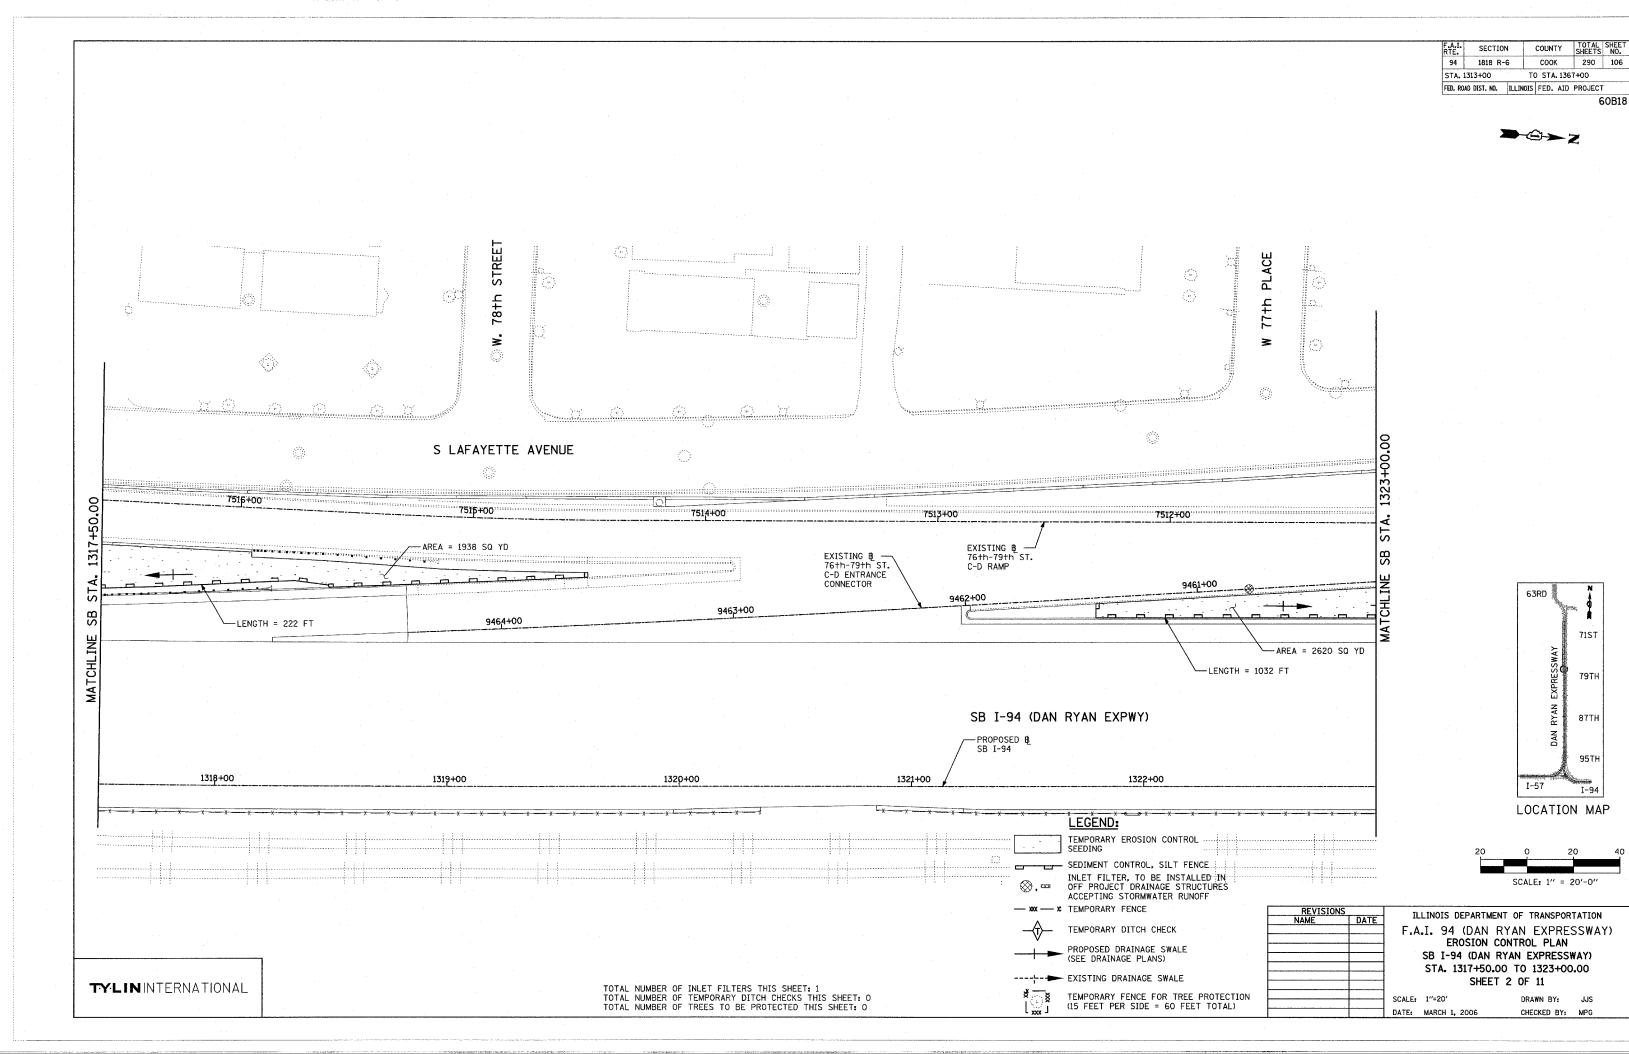

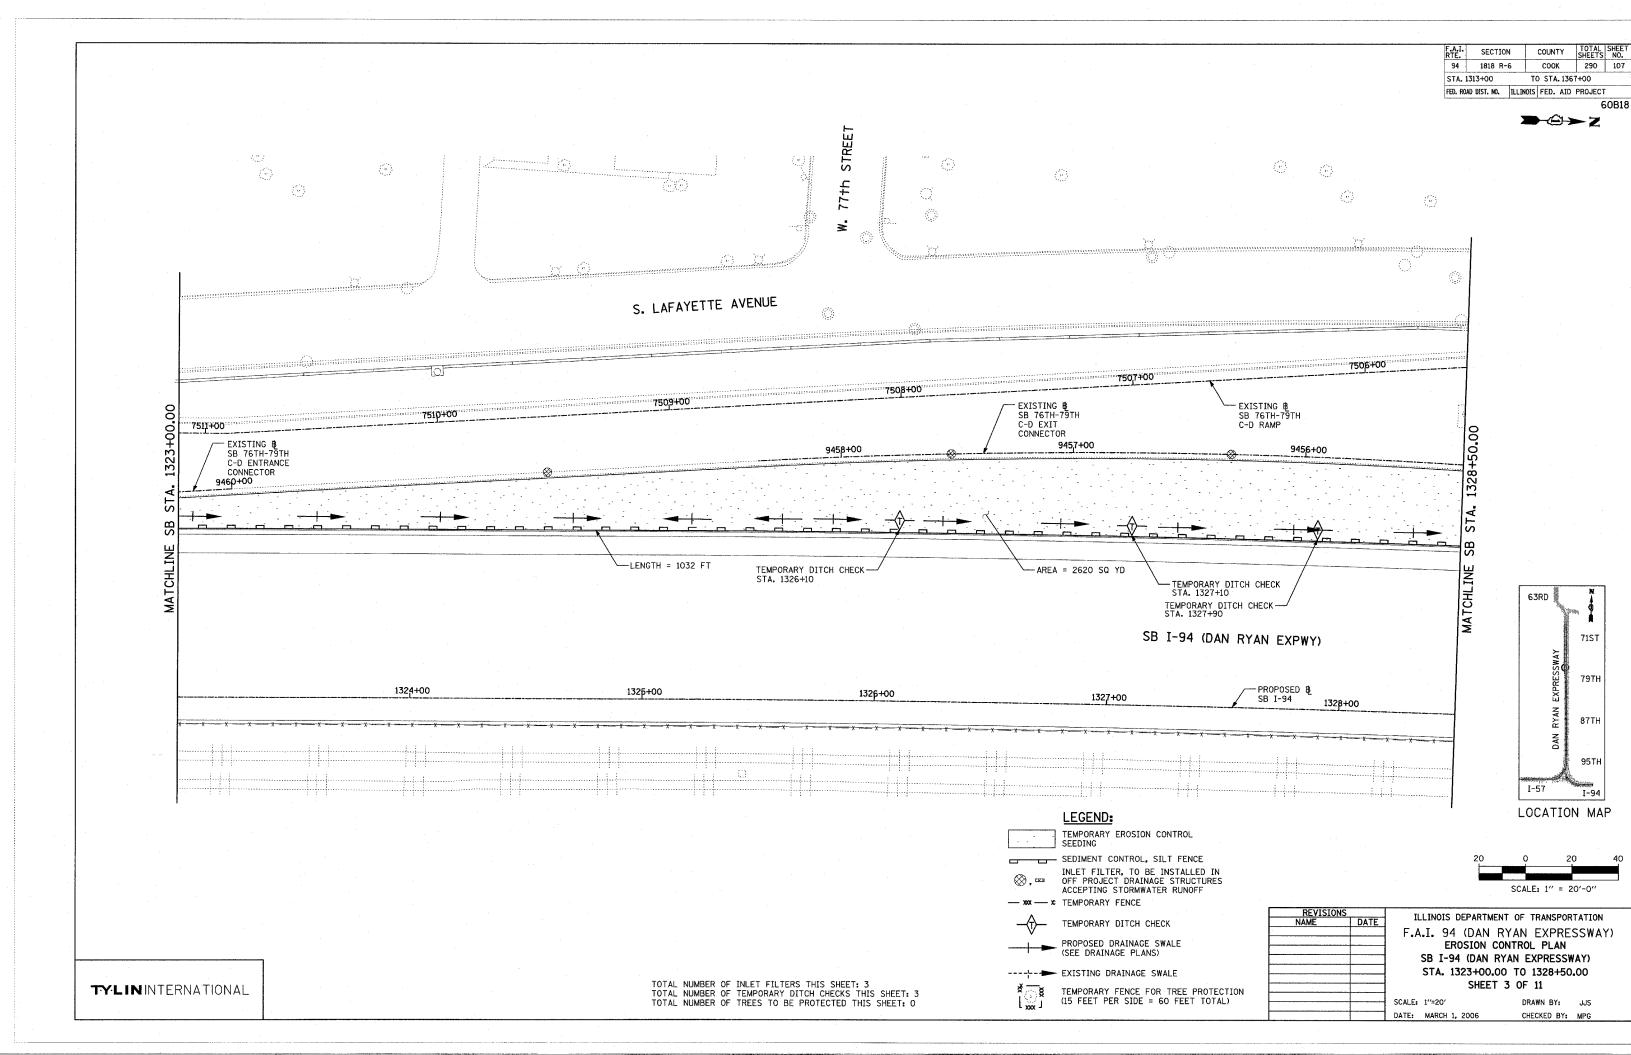


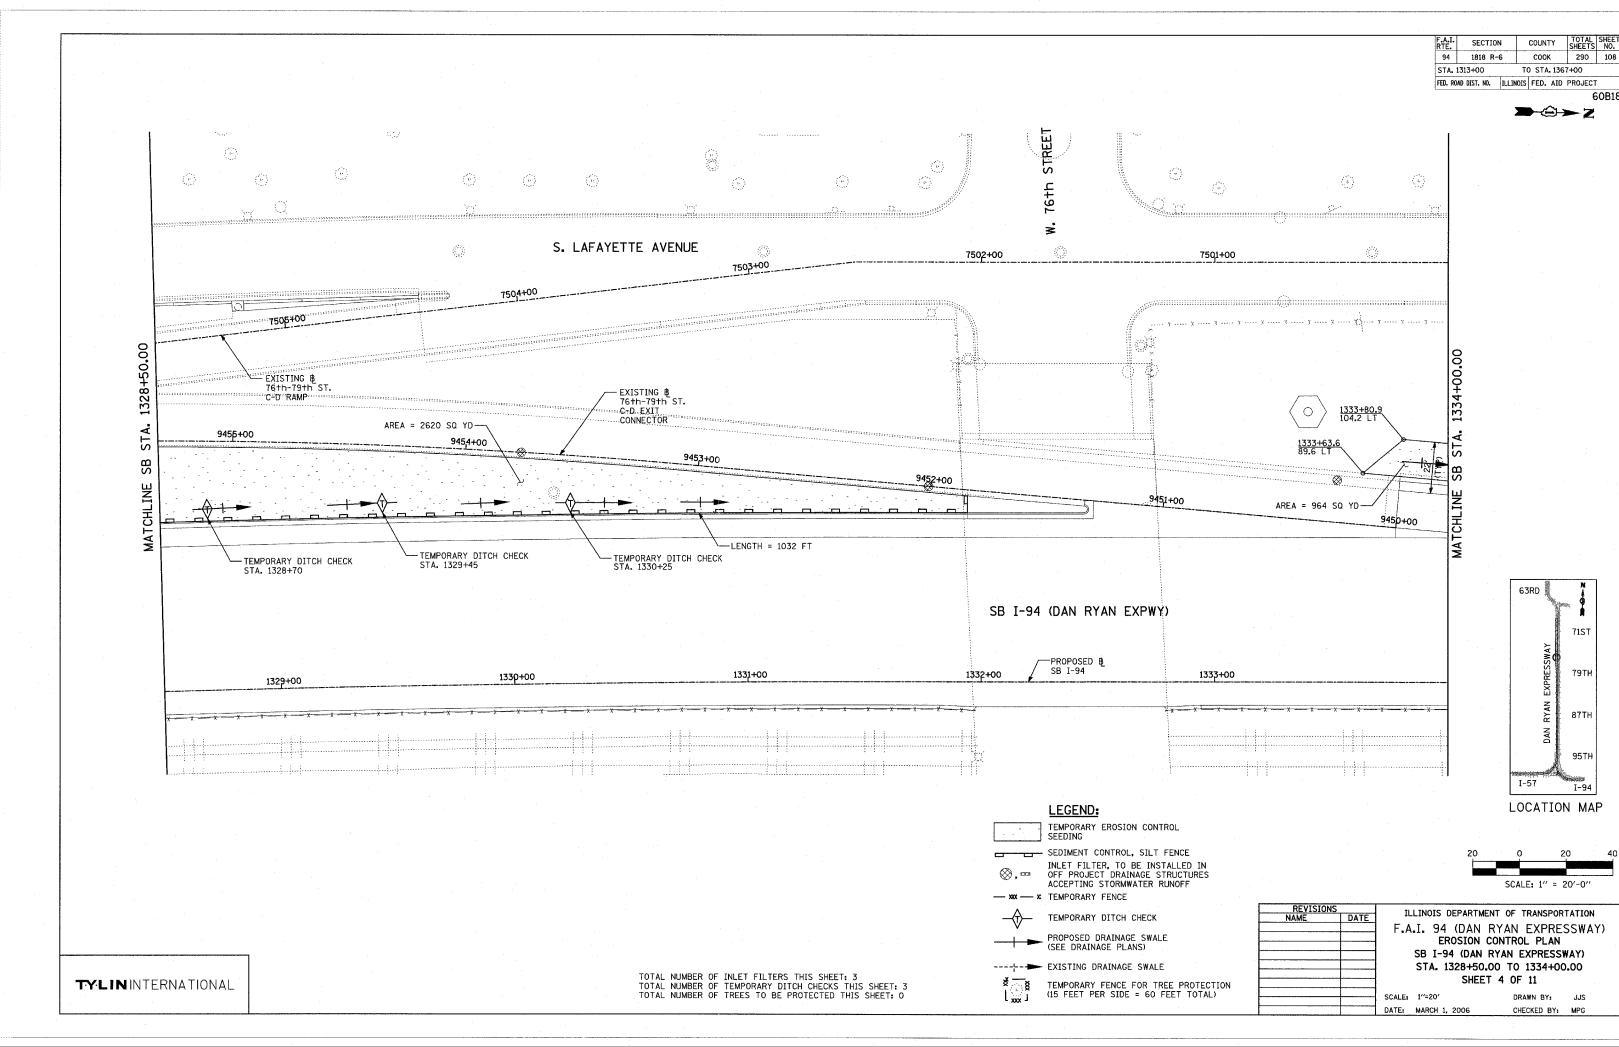


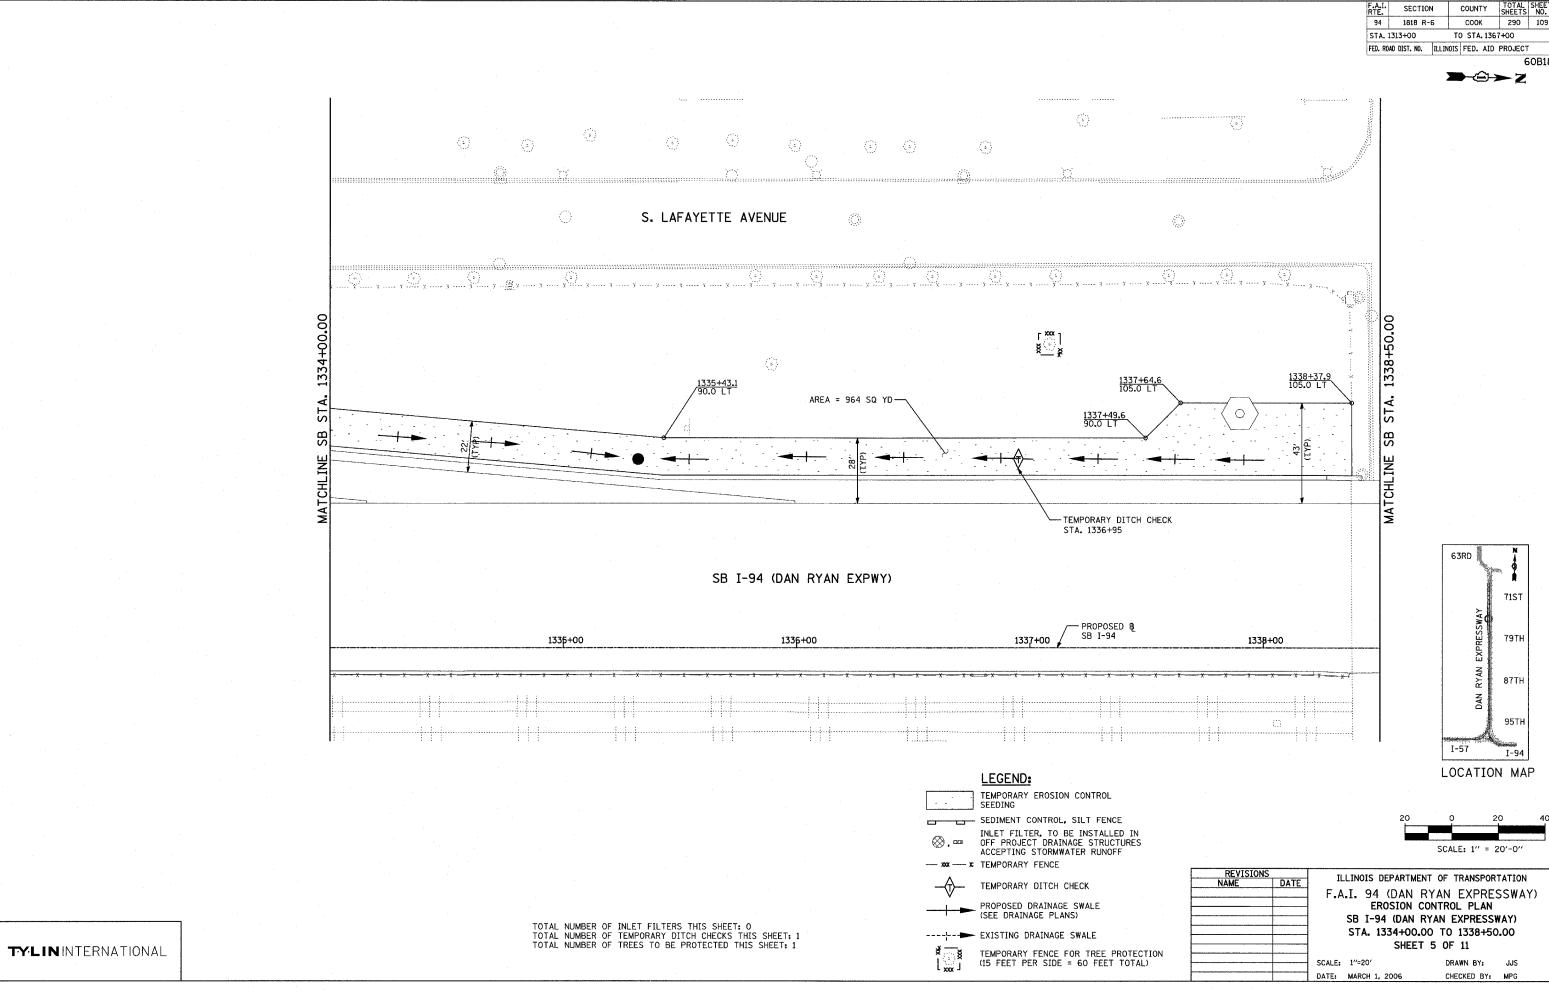



COUNTY TOTAL SHEE NO.


COOK 290 109 SECTION

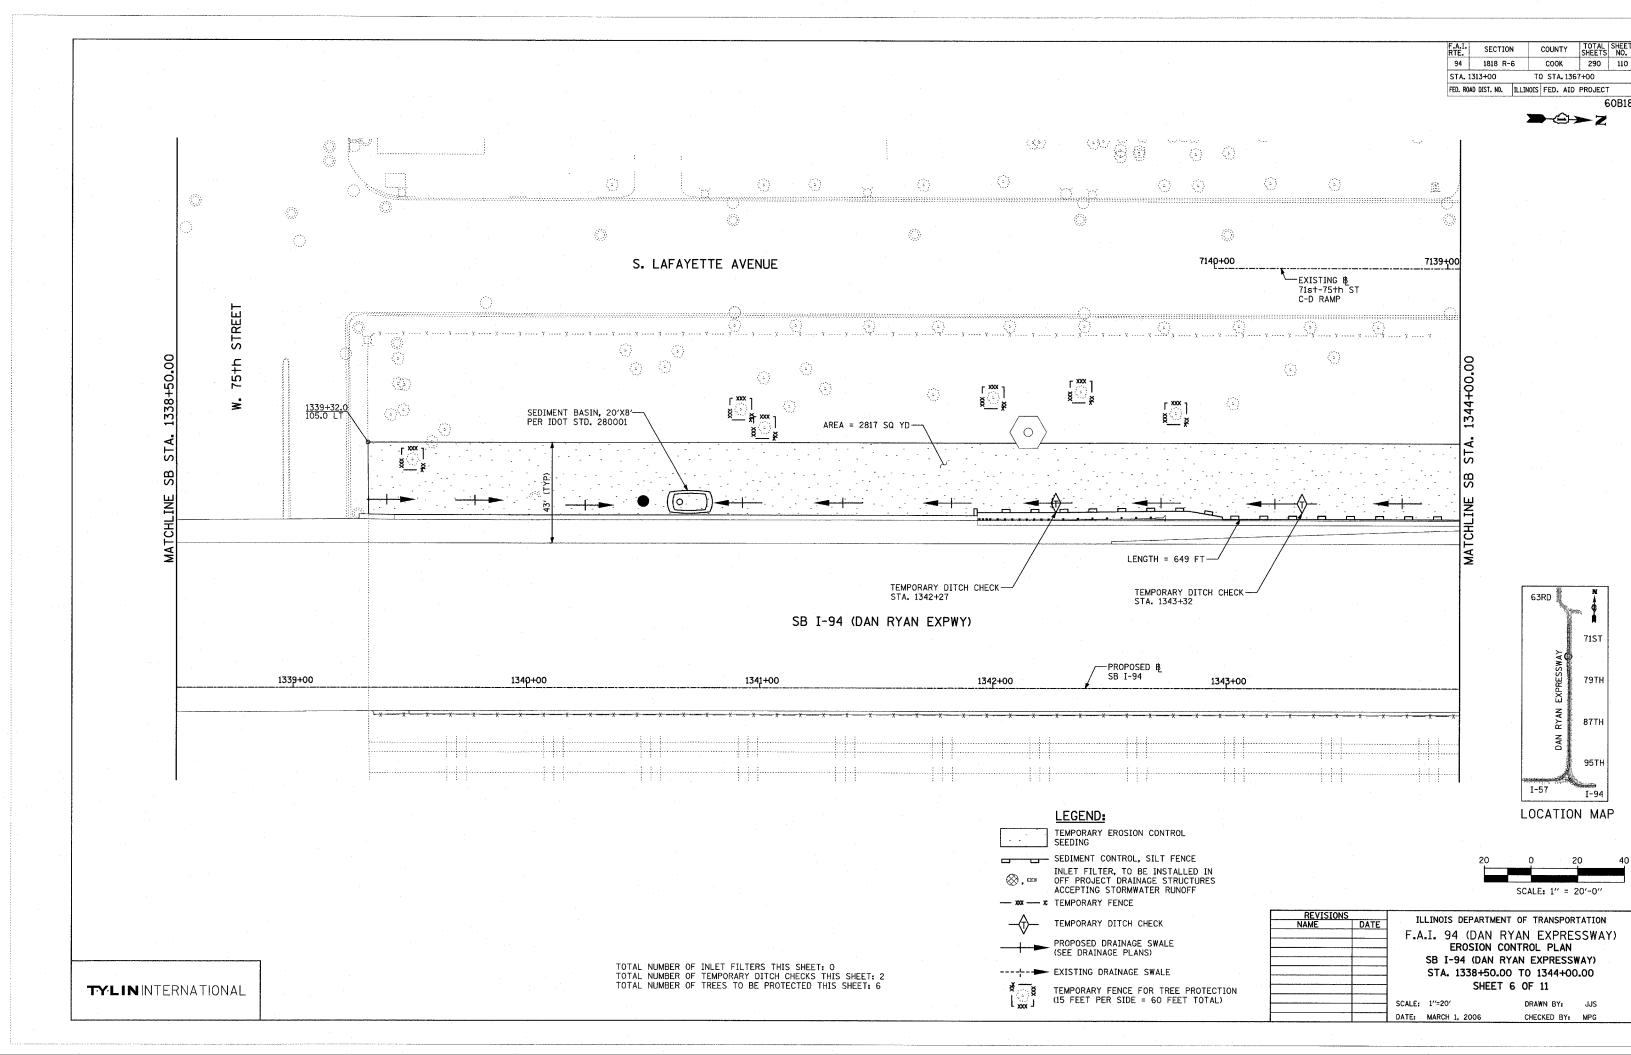


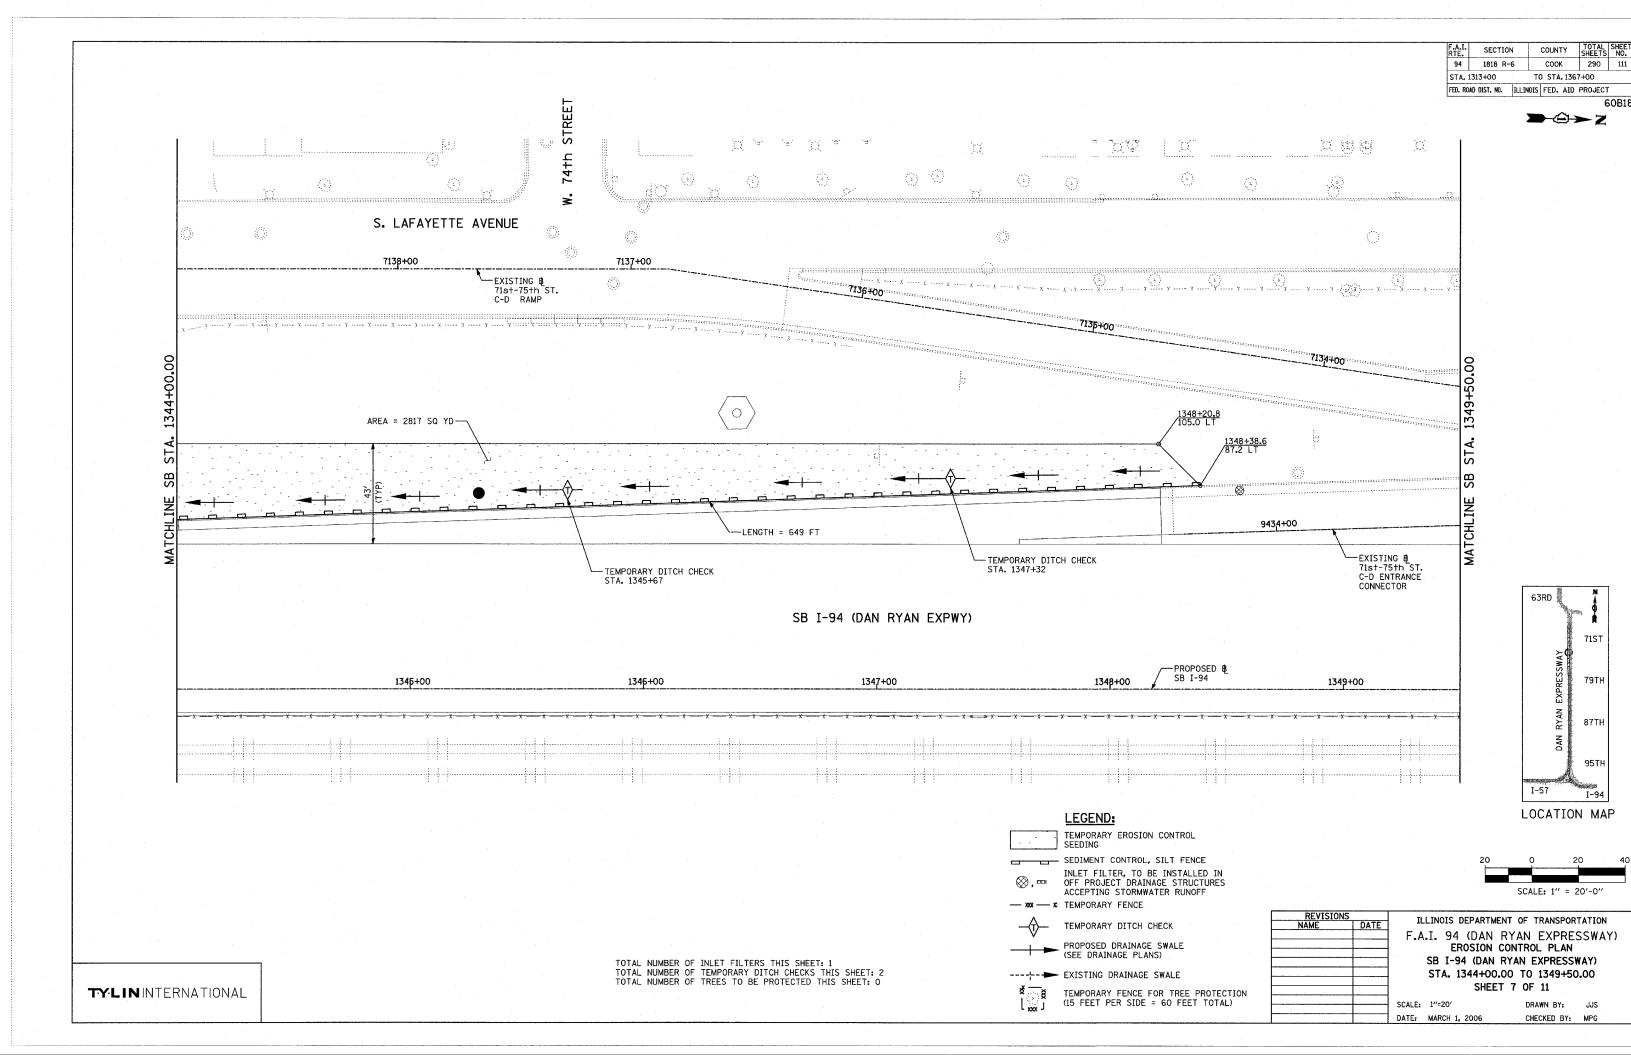

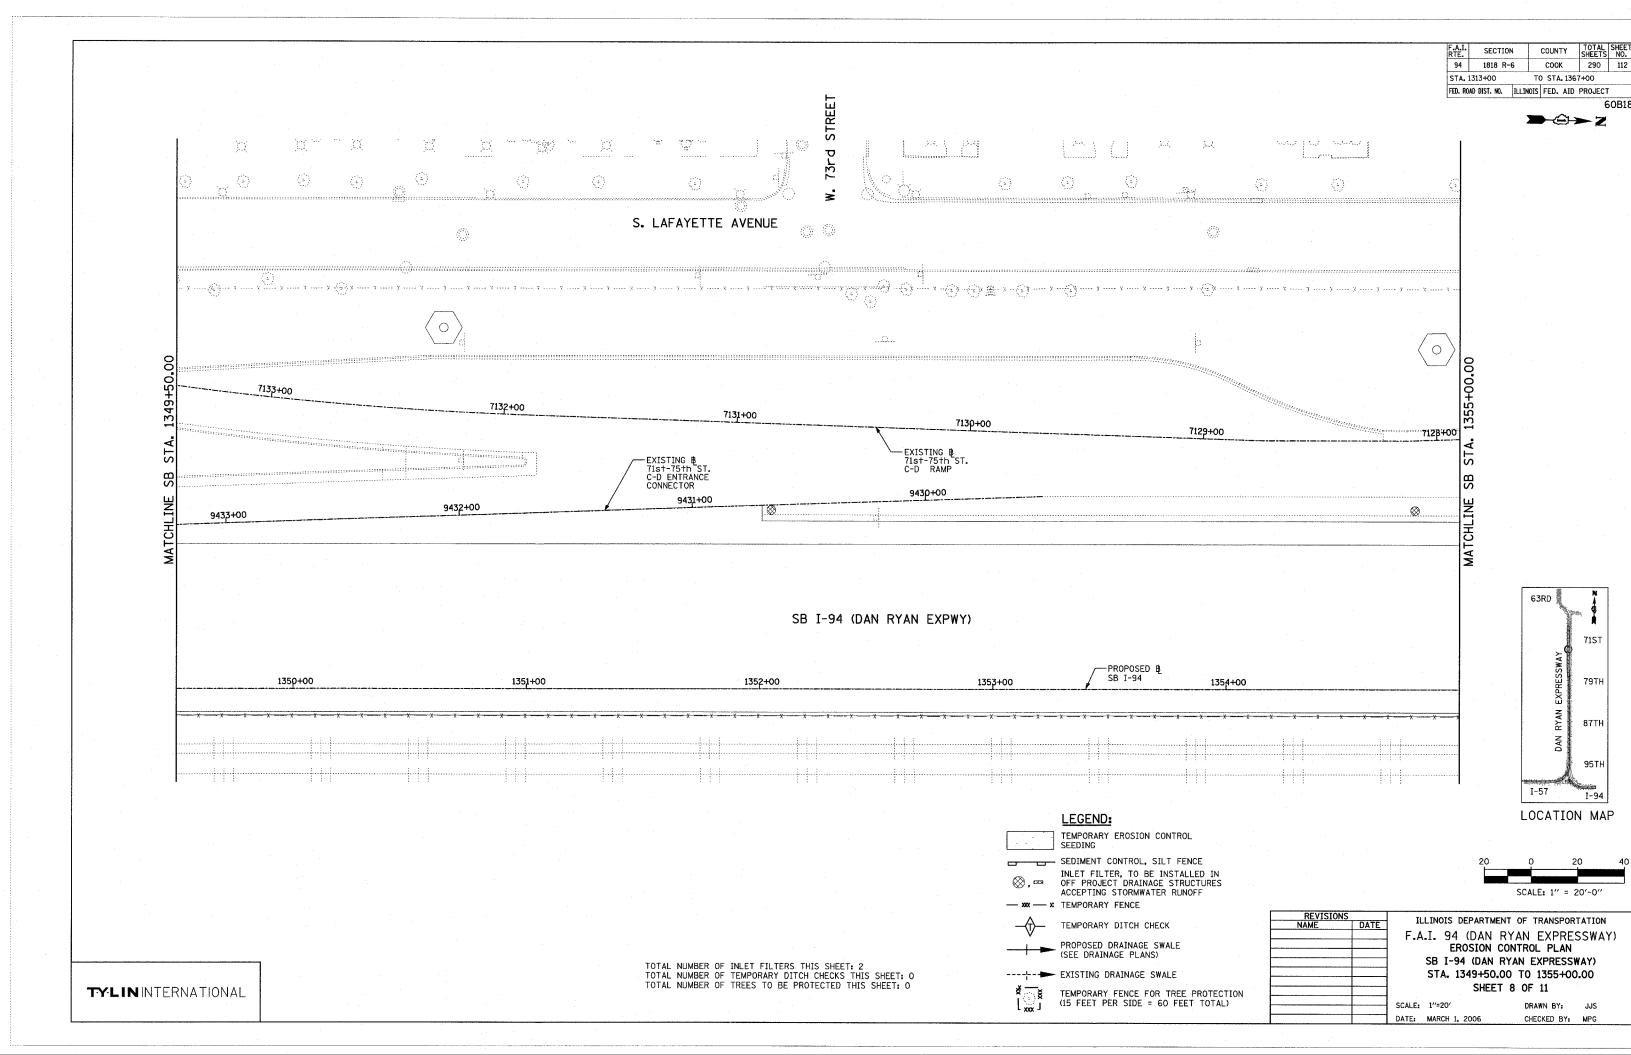

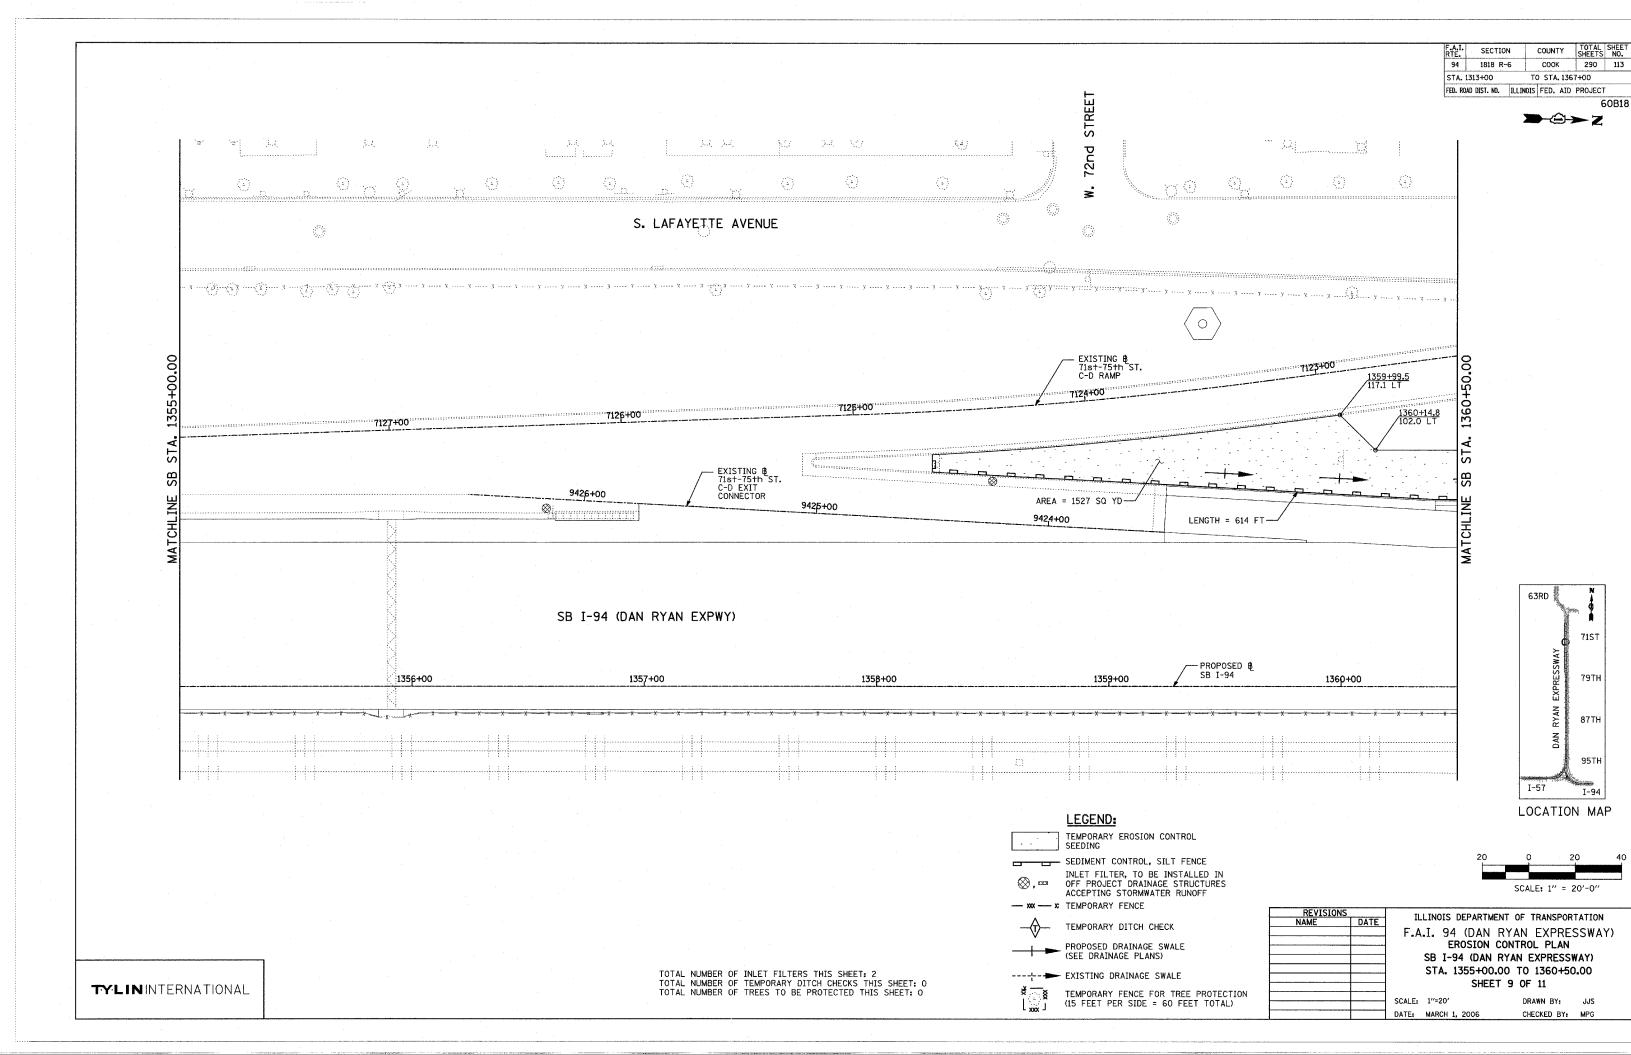


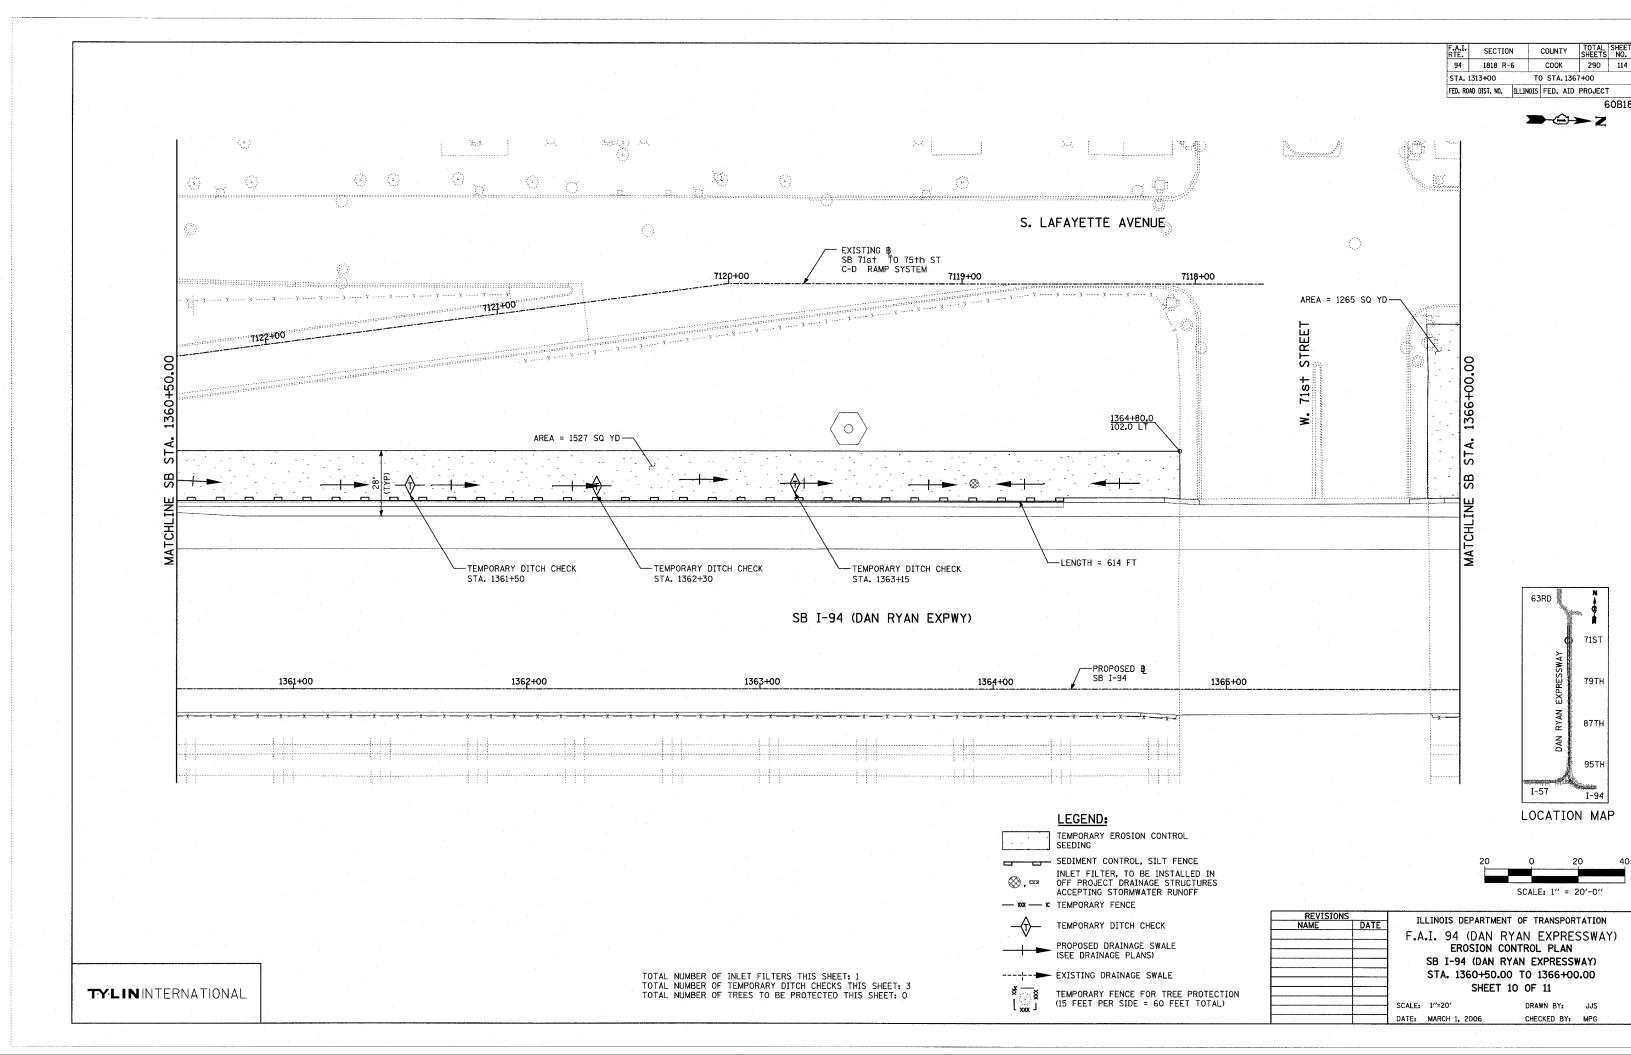

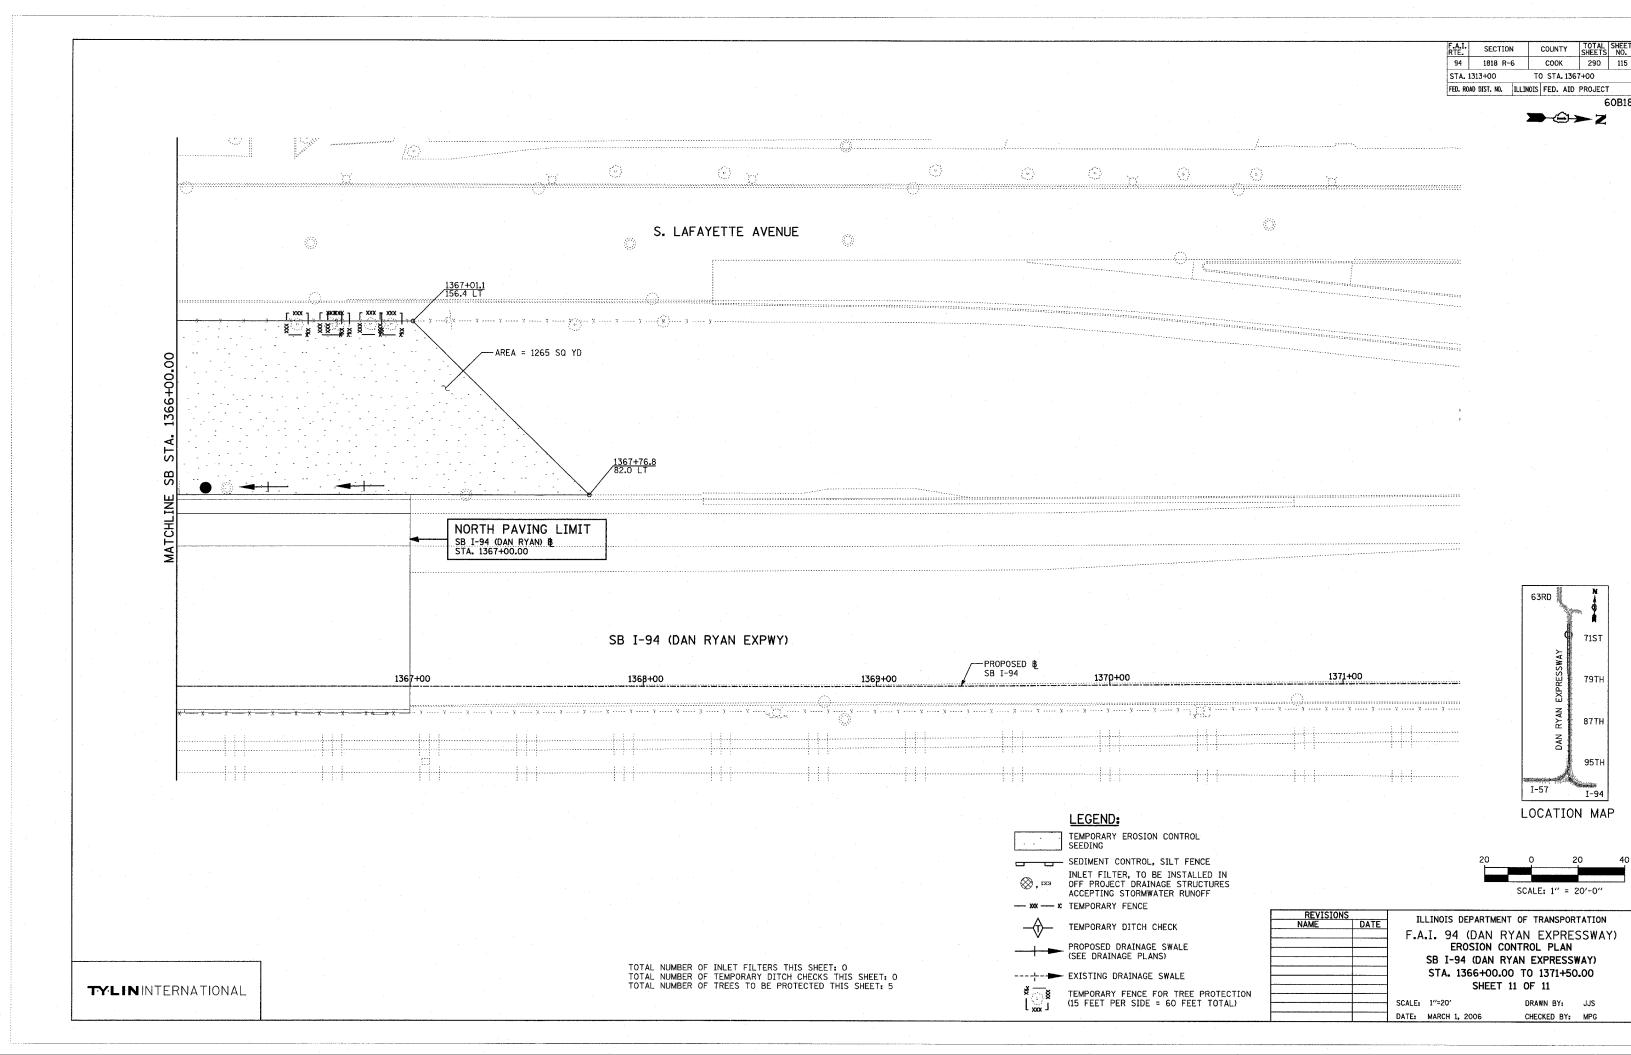

 F.A.I. RTE.	SECTIO	N	сопи,	ΤΥ	TOTAL SHEE SHEETS NO.		
94	1818 R-	6	COOL	Κ	290	116	
STA. 1313+00		T	TO STA. 1367				
FED. RO	AD DIST. NO.	ILLINOIS	FED.	AID	PROJECT	-	

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SEDIMENT BASIN DETAIL

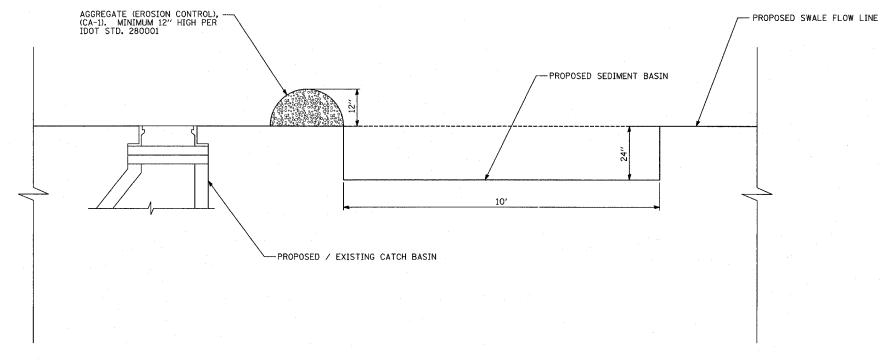
TYLININTERNATIONAL


N.T.S.


GENERAL NOTES:

- EROSION CONTROL ITEMS ARE CONSIDERED TO BE HIGH PRIORITY ITEMS ON THIS CONTRACT. THE ENGINEER WILL IMPLEMENT ALL PROVISIONS OF THE SPECIFICATION NECESSARY TO ASSURE THAT EROSION CONTROL ITEMS ARE CONSTRUCTED AND MAINTAINED IN A TIMELY WAY. ALL EROSION CONTROL MEASURES SHALL BE INSTALLED PRIOR TO BEGINNING ANY CONSTRUCTION ACTIVITIES, WHICH WILL POTENTIALLY CREATE ERODIBLE CONDITIONS.
- 2. THE EROSION CONTROL MEASURES SHOWN ARE BUT A GRAPHICAL REPRESENTATION OF SUGGESTED MEASURES. DEVIATIONS FROM THIS PLAN ARE TO BE EXPECTED PENDING A JOB SITE INSPECTION BETWEEN THE CONTRACTOR AND THE DEPARTMENT.
- 3. THE CONTRACTOR WILL BE REQUIRED TO IMPLEMENT AND MAINTAIN SEDIMENT CONTROL MEASURES PRIOR TO STRIPPING EXISTING VEGETATION.
- 4. TEMPORARY FENCE USED FOR DRIP LINE PROTECTION IS 60 LINEAR FEET FOR EACH TREE PROTECTED. ACTUAL LENGTH TO BE ADJUSTED BY THE ENGINEER TO FIT FIELD CONDITIONS
- 5. TREE REMOVAL QUANTITIES APPEAR ON THE REMOVAL PLANS.

REVISIONS NAME	DATE					TRANSPOR EXPRE	RTATION (SSWAY)
			EF DETA	ROSION ILS AN	CONTRO D GENE	DL PLAN RAL NOT	ES
		SCALE:	NOT TO			RAWN BY:	JJS MPG

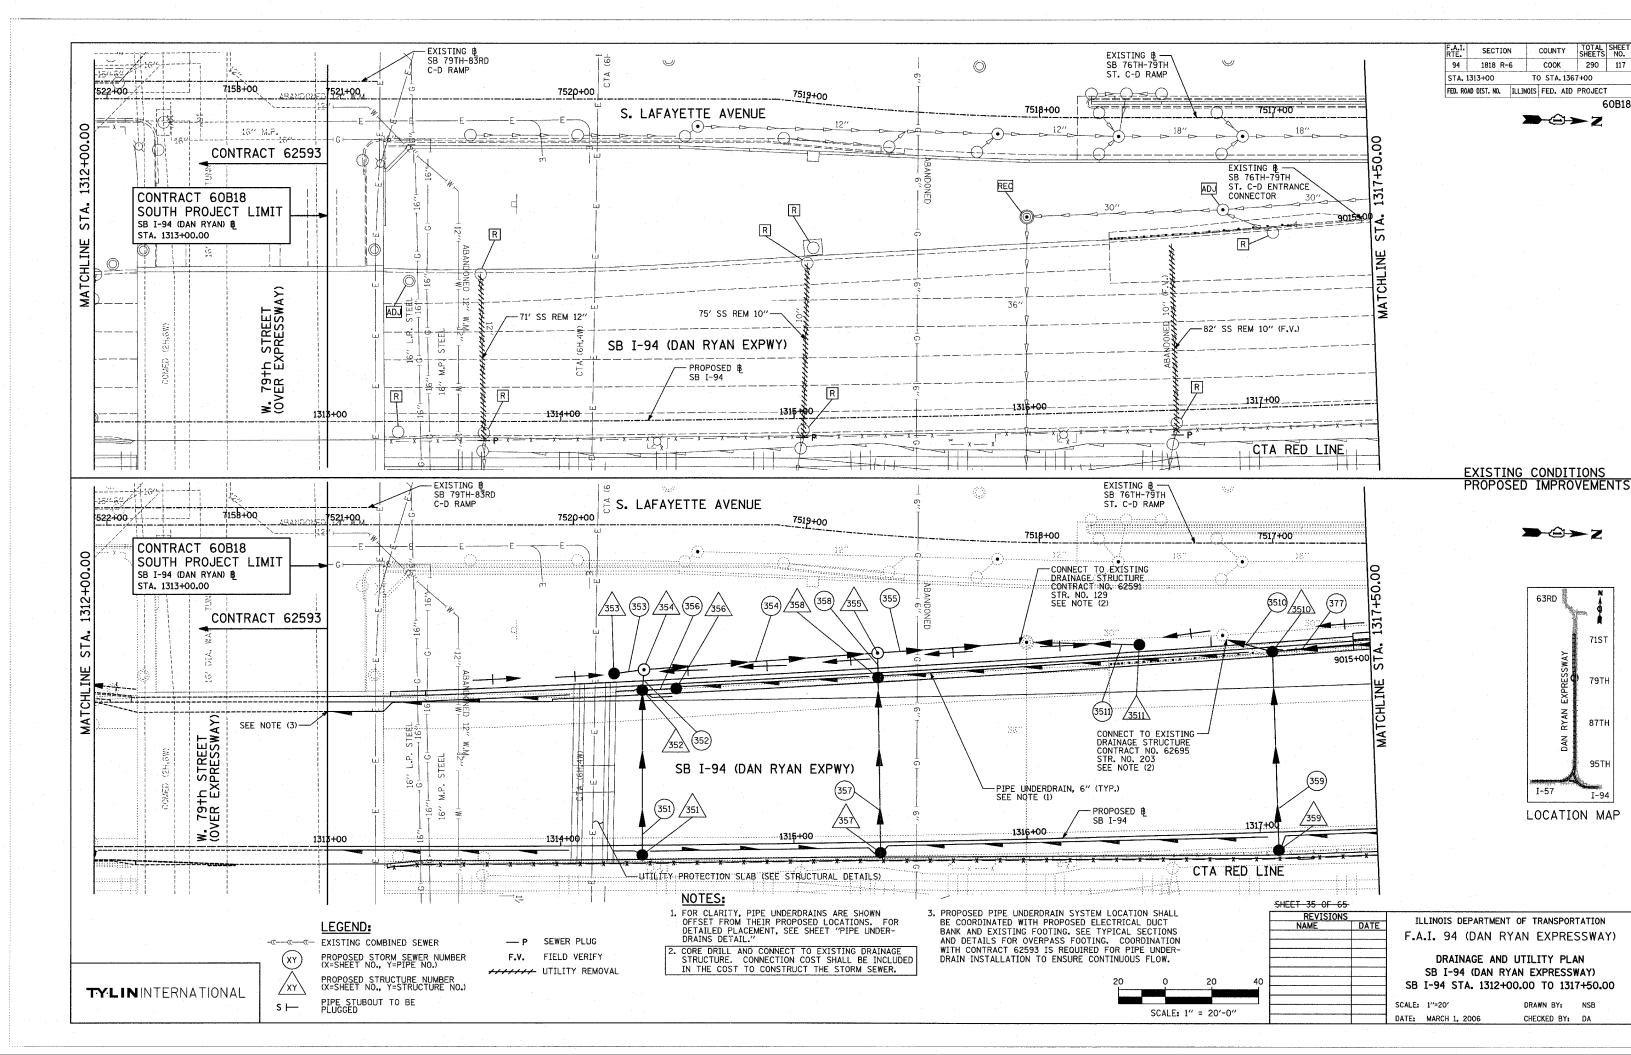

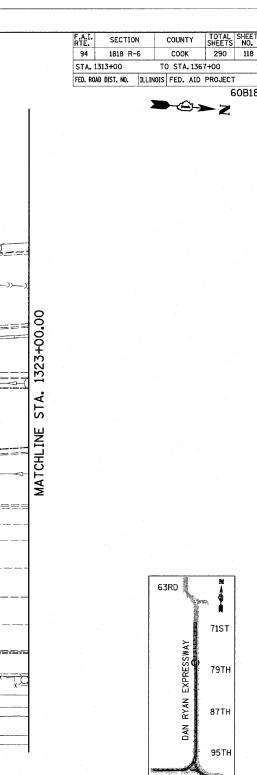


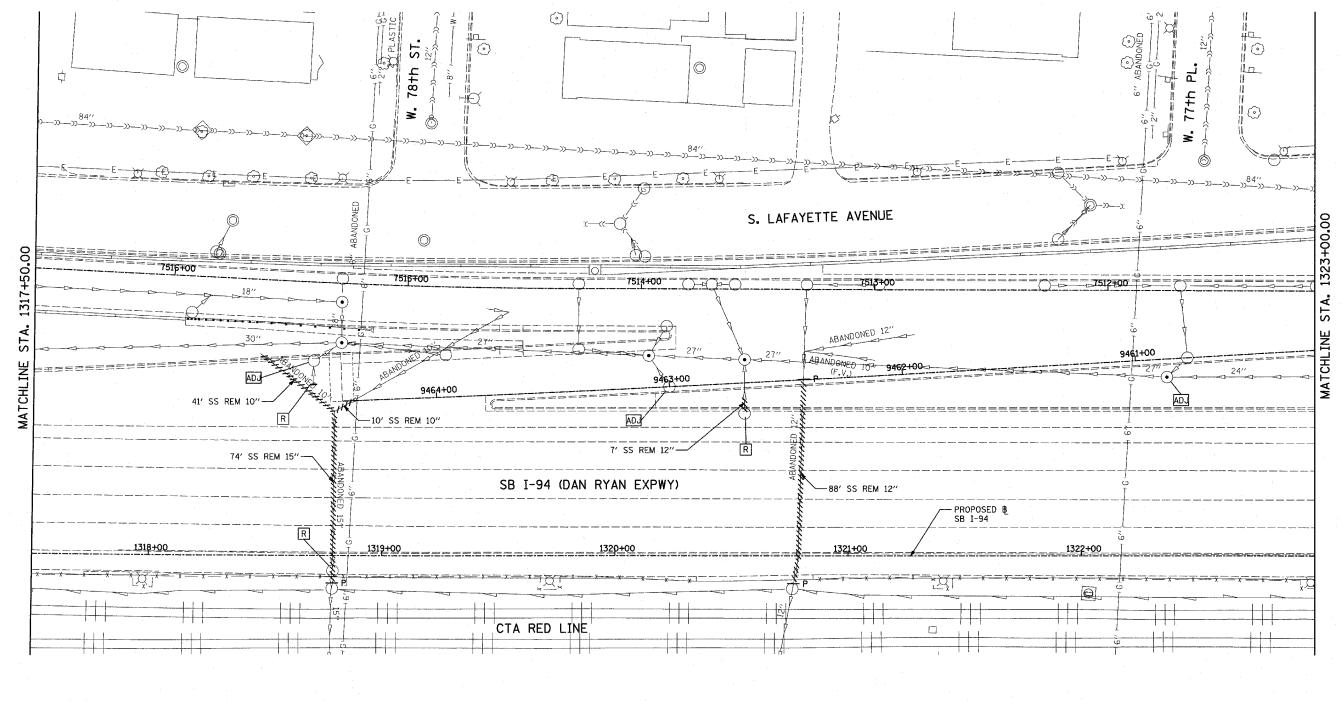

PIPE STUBOUT TO BE PLUGGED

-«--«- EXISTING COMBINED SEWER PROPOSED STORM SEWER NUMBER (X=SHEET NO., Y=PIPE NO.)

- P SEWER PLUG F.V. FIELD VERIFY ******* UTILITY REMOVAL

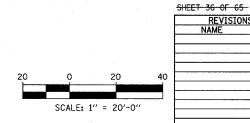


ILLINOIS DEPARTMENT OF TRANSPORTATION F.A.I. 94 (DAN RYAN EXPRESSWAY) DRAINAGE AND UTILITY EXISTING PLAN SB I-94 (DAN RYAN EXPRESSWAY) DAN RYAN STA. 1317+50.00 TO 1323+00.00

DATE: MARCH 1, 2006

DRAWN BY: NSB CHECKED BY: DA

LOCATION MAP

TY:LININTERNATIONAL

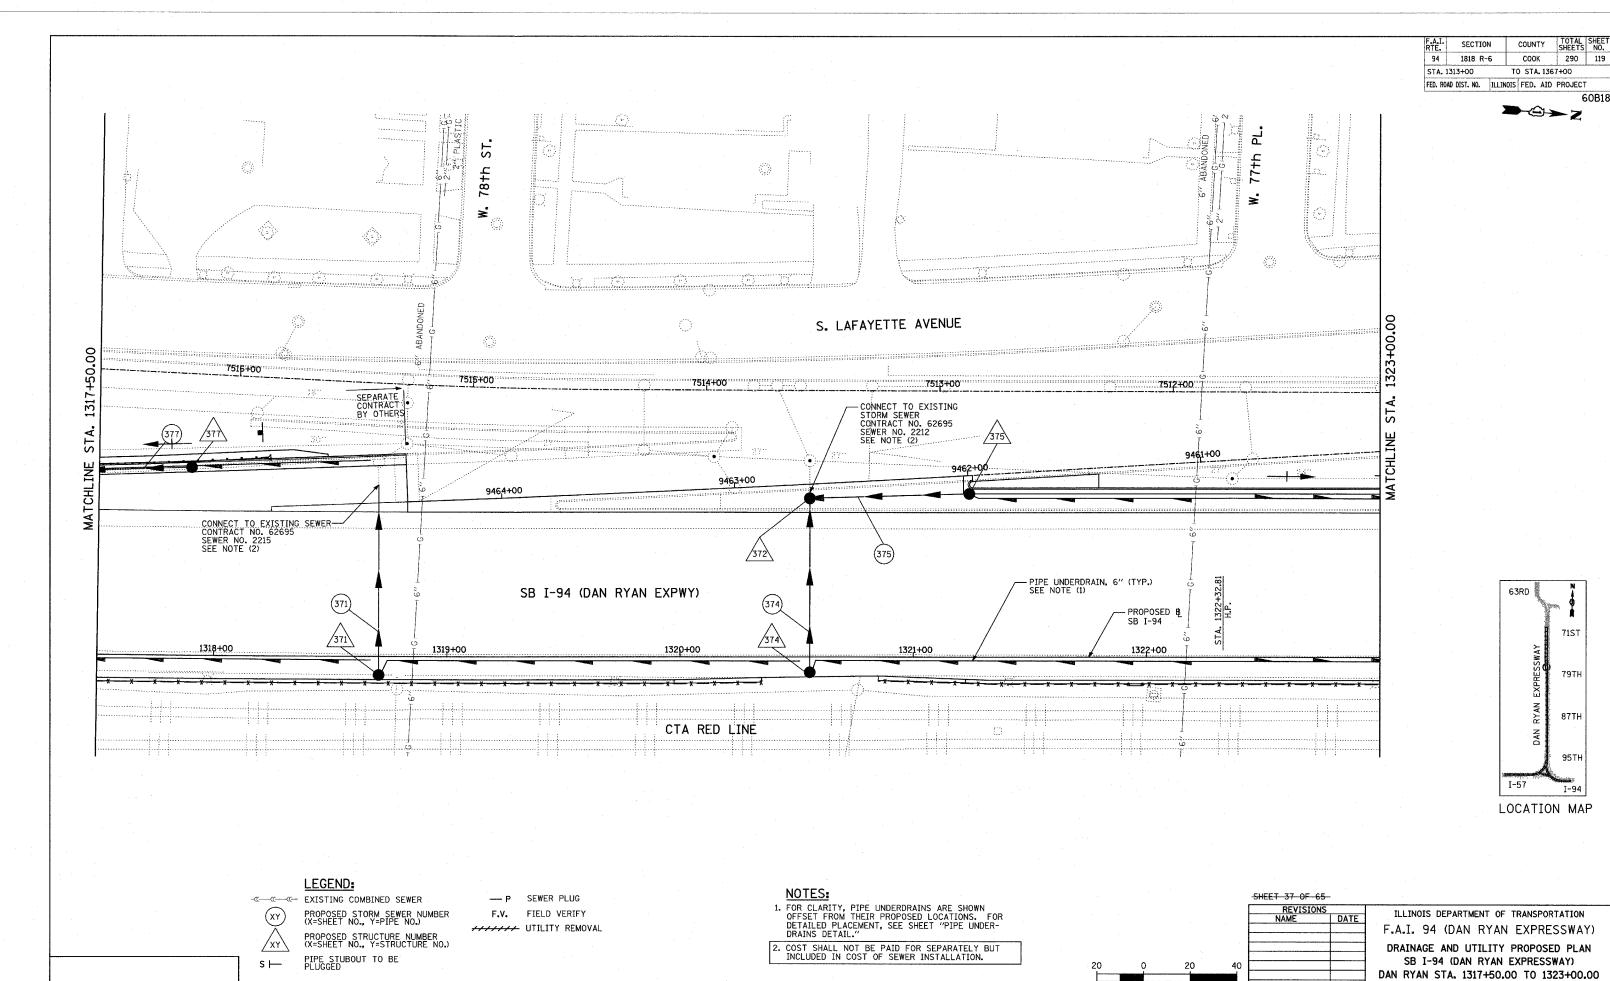

TYLININTERNATIONAL


SCALE: 1"=20' DATE: MARCH 1, 2006

SCALE: 1" = 20'-0"

SECTION COUNTY TOTAL SHEE SHEETS NO. 1818 R-6 соок 290 120 STA. 1313+00 TO STA. 1367+00 FED. ROAD DIST. NO. ILLINOIS FED. AID PROJECT

60B18

→ ② → Z

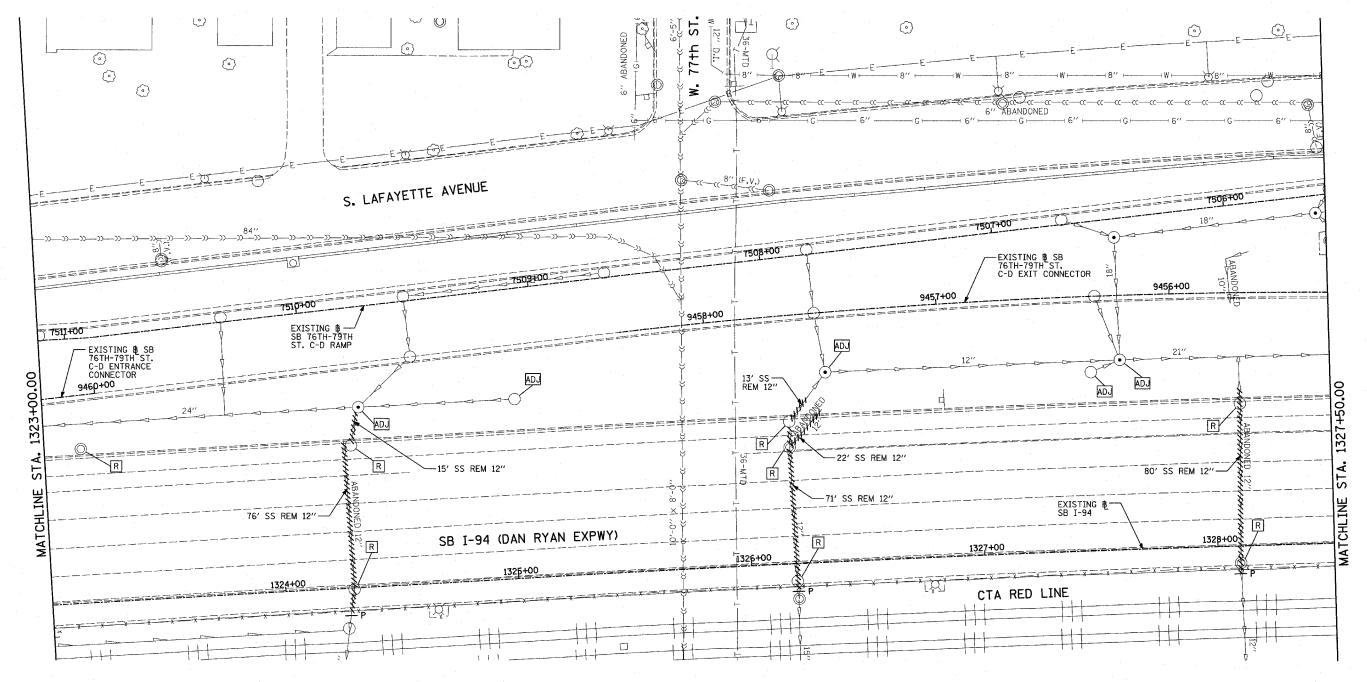

71ST 79TH 87TH

LOCATION MAP

LEGEND:

-«--«- EXISTING COMBINED SEWER XY


PIPE STUBOUT TO BE

--- P SEWER PLUG F.V. FIELD VERIFY YYYYYY UTILITY REMOVAL

SHEET 38 OF 65 SCALE: 1" = 20'-0"

ILLINOIS DEPARTMENT OF TRANSPORTATION F.A.I. 94 (DAN RYAN EXPRESSWAY) DRAINAGE AND UTILITY EXISTING PLAN SB I-94 (DAN RYAN EXPRESSWAY) DAN RYAN STA. 1323+00.00 TO 1328+50.00

DATE: MARCH 1, 2006

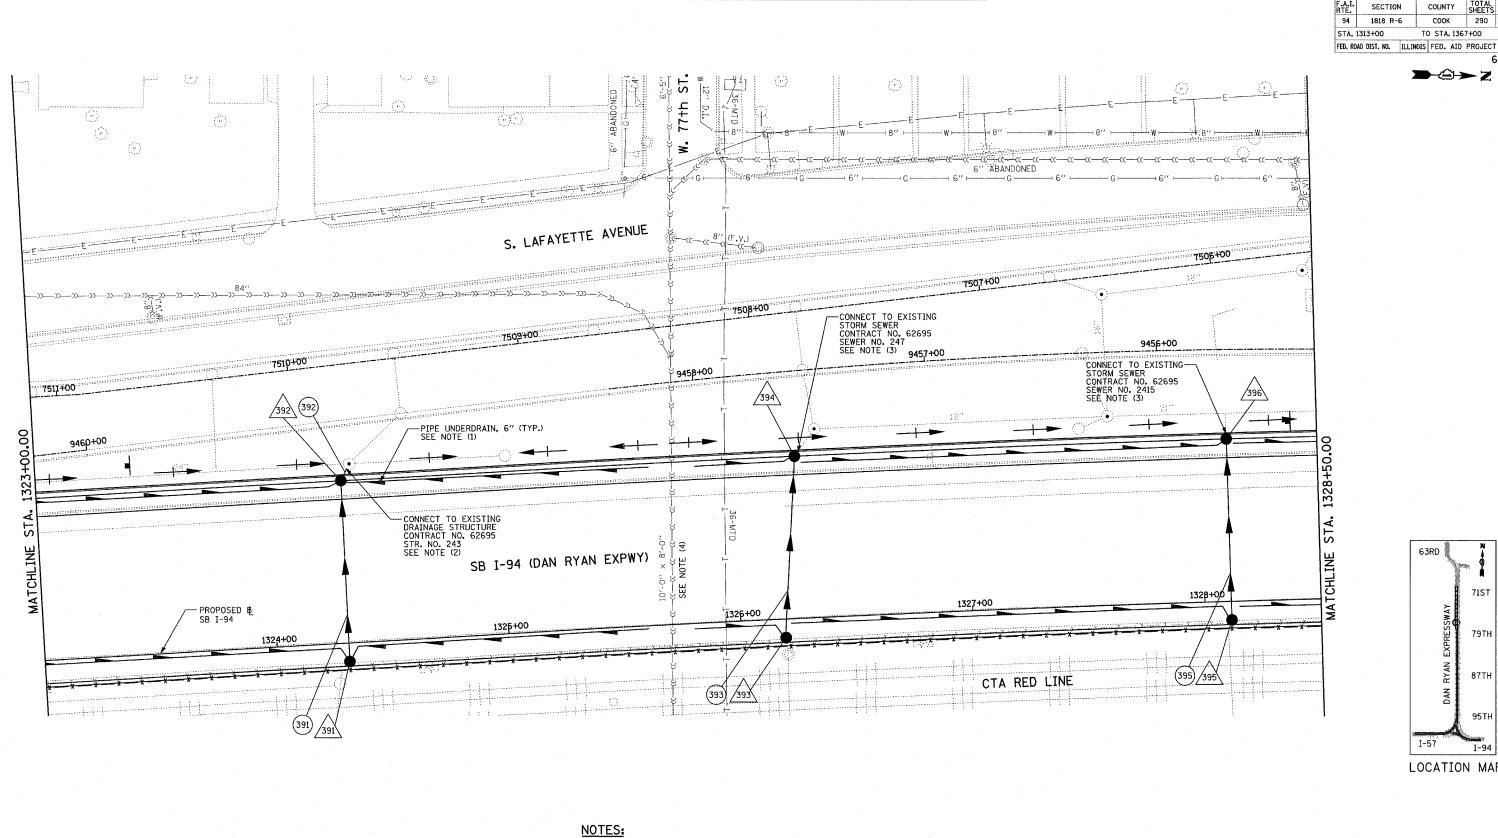

95TF LOCATION MAP

63RD

TOTAL SHEET NO. 290 121

60B18

COUNTY соок

TO STA. 1367+00

LEGEND:

(XY)

-«--«-- EXISTING COMBINED SEWER PROPOSED STORM SEWER NUMBER (X=SHEET NO., Y=PIPE NO.)

PROPOSED STRUCTURE NUMBER (X=SHEET NO., Y=STRUCTURE NO.)

--- P SEWER PLUG FIELD VERIFY ******* UTILITY REMOVAL 1. FOR CLARITY, PIPE UNDERDRAINS ARE SHOWN OFFSET FROM THEIR PROPOSED LOCATIONS. FOR DETAILED PLACEMENT, SEE SHEET "PIPE UNDER-DRAINS DETAIL."

2. CORE DRILL AND CONNECT TO EXISTING DRAINAGE STRUCTURE. CONNECTION COST SHALL BE INCLUDED IN THE COST TO CONSTRUCT THE STORM SEWER.

4. THE CONTRACTOR SHALL COORDINATE ALL WORK WITH COC-DOWN SEWER SECTION PRIOR TO ANY EXCAVATION. RISER SHAFTS, IF ENCOUNTERED, SHALL BE CONSTRUCTED AND PAID FOR AS PER DETAIL SHOWN ON DRAINAGE DETAIL SHEET 3 OF 3.

SCALE: 1" = 20'-0"

DAN RYAN STA. 1323+00.00 TO 1328+50.00

SHEET 39 OF 65

ILLINOIS DEPARTMENT OF TRANSPORTATION F.A.I. 94 (DAN RYAN EXPRESSWAY) DRAINAGE AND UTILITY PROPOSED PLAN SB I-94 (DAN RYAN EXPRESSWAY)


SCALE: 1"=20' DATE: MARCH 1, 2006


DRAWN BY: NSB CHECKED BY: DA

TY:LIN INTERNATIONAL

PIPE STUBOUT TO BE PLUGGED

3. COST SHALL NOT BE PAID FOR SEPARATELY BUT INCLUDED IN COST OF SEWER INSTALLATION.

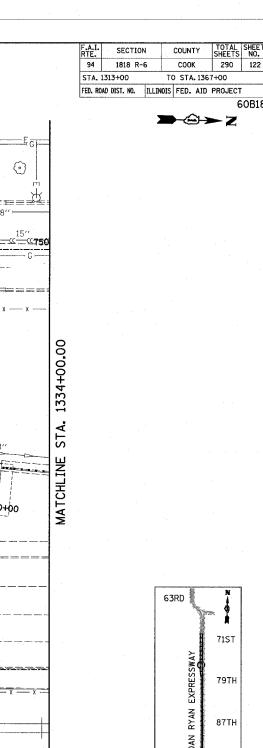

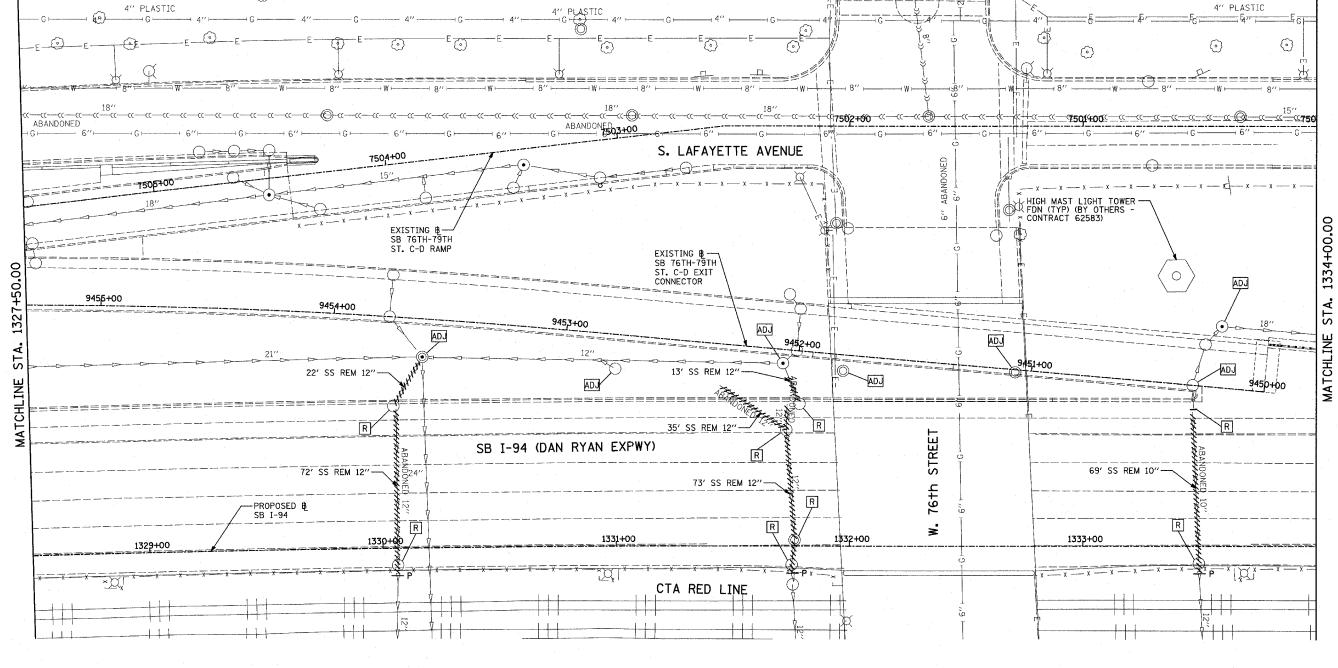

LEGEND:

 $\neg @ \neg @ \neg @ \text{EXISTING COMBINED SEWER}$ PROPOSED STORM SEWER NUMBER (X=SHEET NO., Y=PIPE NO.)

--- P SEWER PLUG F.V. FIELD VERIFY ****** UTILITY REMOVAL

SHEET 40 OF 65 SCALE: 1" = 20'-0"

ILLINOIS DEPARTMENT OF TRANSPORTATION F.A.I. 94 (DAN RYAN EXPRESSWAY) DRAINAGE AND UTILITY EXISTING PLAN SB I-94 (DAN RYAN EXPRESSWAY) DAN RYAN STA. 1328+50.00 TO 1334+00.00


SCALE: 1"=20' DATE: MARCH 1, 2006

DRAWN BY: NSB CHECKED BY: DA

LOCATION MAP

TYLININTERNATIONAL

PIPE STUBOUT TO BE PLUGGED

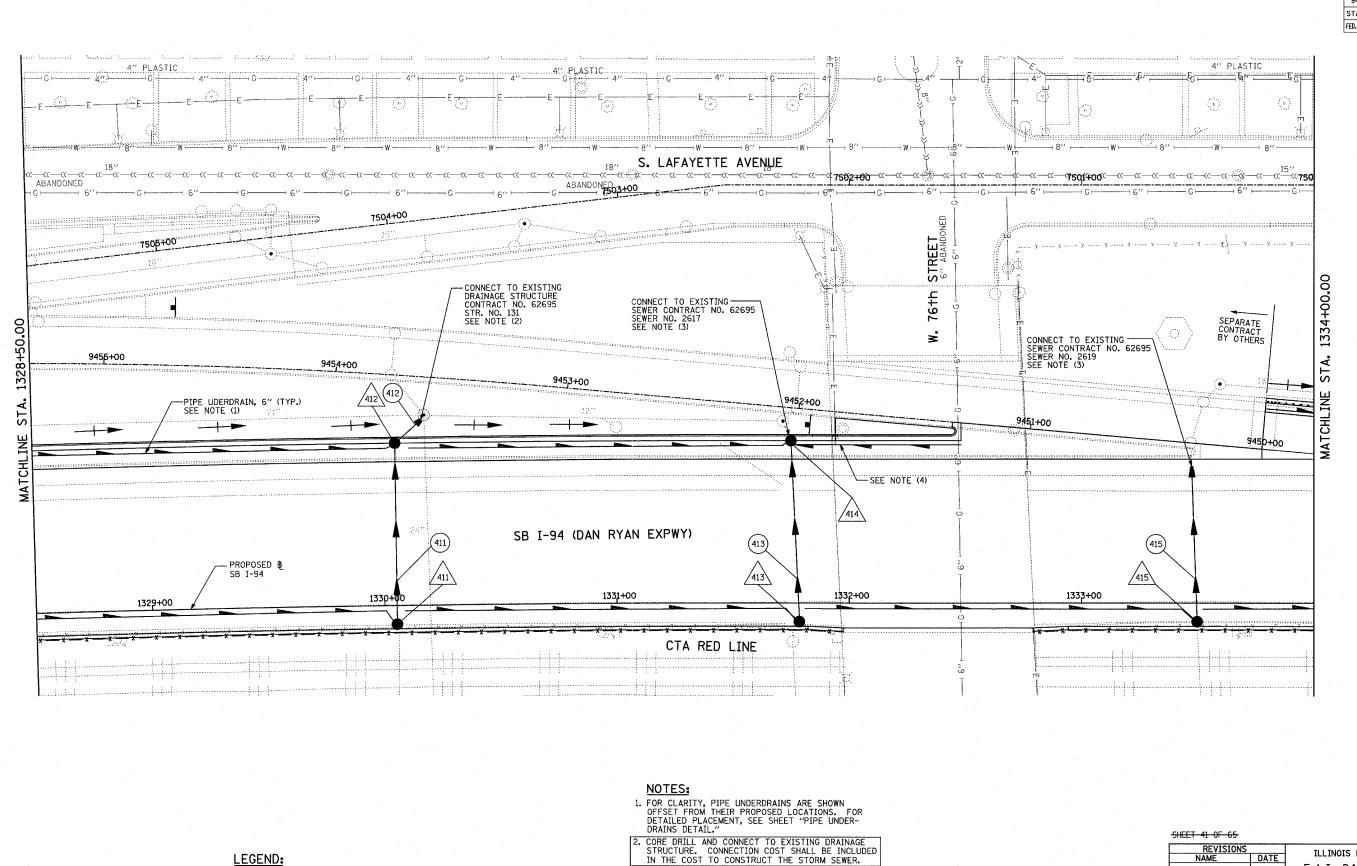

SECTION COUNTY TOTAL SHEET NO. 1818 R-6 COOK 290 123 STA. 1313+00 TO STA. 1367+00

FED. ROAD DIST. NO. ILLINOIS FED. AID PROJECT

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2. CORE DRILL AND CONNECT TO EXISTING DRAINAGE STRUCTURE. CONNECTION COST SHALL BE INCLUDED IN THE COST TO CONSTRUCT THE STORM SEWER.

3. COST SHALL NOT BE PAID FOR SEPARATELY BUT INCLUDED IN COST OF SEWER INSTALLATION.

4. PROPOSED PIPE UNDERDRAIN SYSTEM LOCATION SHALL BE COORDINATED WITH PROPOSED ELECTRICAL DUCT BANK AND EXISTING FOOTING. SEE TYPICAL SECTIONS AND DETAILS FOR OVERPASS FOOTINGS.

20 SCALE: 1" = 20'-0"

ILLINOIS DEPARTMENT OF TRANSPORTATION F.A.I. 94 (DAN RYAN EXPRESSWAY) DRAINAGE AND UTILITY PROPOSED PLAN SB I-94 (DAN RYAN EXPRESSWAY) DAN RYAN STA. 1328+50.00 TO 1334+00.00

63RD

71ST

79TH

95TH

LOCATION MAP

SCALE: 1"=20' DATE: MARCH 1, 2006

DRAWN BY: NSB CHECKED BY: DA


TYLIN INTERNATIONAL

PROPOSED STRUCTURE NUMBER (X=SHEET NO., Y=STRUCTURE NO.) PIPE STUBOUT TO BE PLUGGED


-«---«- EXISTING COMBINED SEWER

SEWER PLUG F.V. FIELD VERIFY

PROPOSED STORM SEWER NUMBER (X=SHEET NO., Y=PIPE NO.) ******* UTILITY REMOVAL

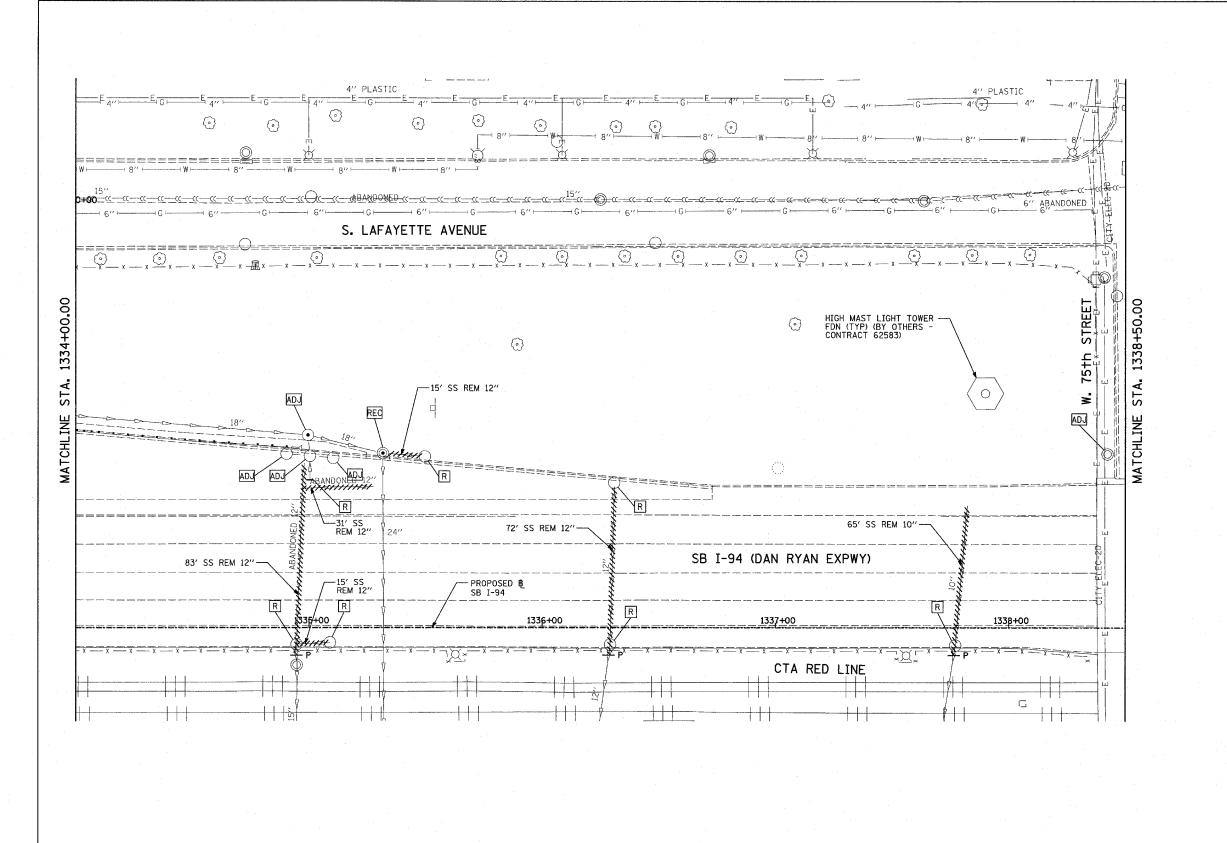

FED. ROAD DIST. NO. ILLINOIS FED. AID PROJECT

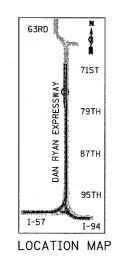

LEGEND:

EXISTING COMBINED SEWER

(XY) PROPOSED STORM SEWER NUMBER
(X=SHEET NO., Y=PIPE NO.)

XY PROPOSED STRUCTURE NUMBER
(X=SHEET NO., Y=STRUCTURE NO.)

— P SEWER PLUG
F.V. FIELD VERIFY
UTILITY REMOVAL

20 0 20 40 SCALE: 1" = 20'-0"

SHEET 42 OF 65
REVISIONS

ILLINOIS DEPARTMENT OF TRANSPORTATION
F.A.I. 94 (DAN RYAN EXPRESSWAY)


DRAINAGE AND UTILITY EXISTING PLAN
SB 76th TO 79th STREET C-D RAMP
DAN RYAN STA. 1334+00.00 TO 1338+50.00

SCALE: 1"=20'
DATE: MARCH 1, 2006

DRAWN BY: NSB
CHECKED BY: DA

TY:LININTERNATIONAL

S | PIPE STUBOUT TO BE PLUGGED

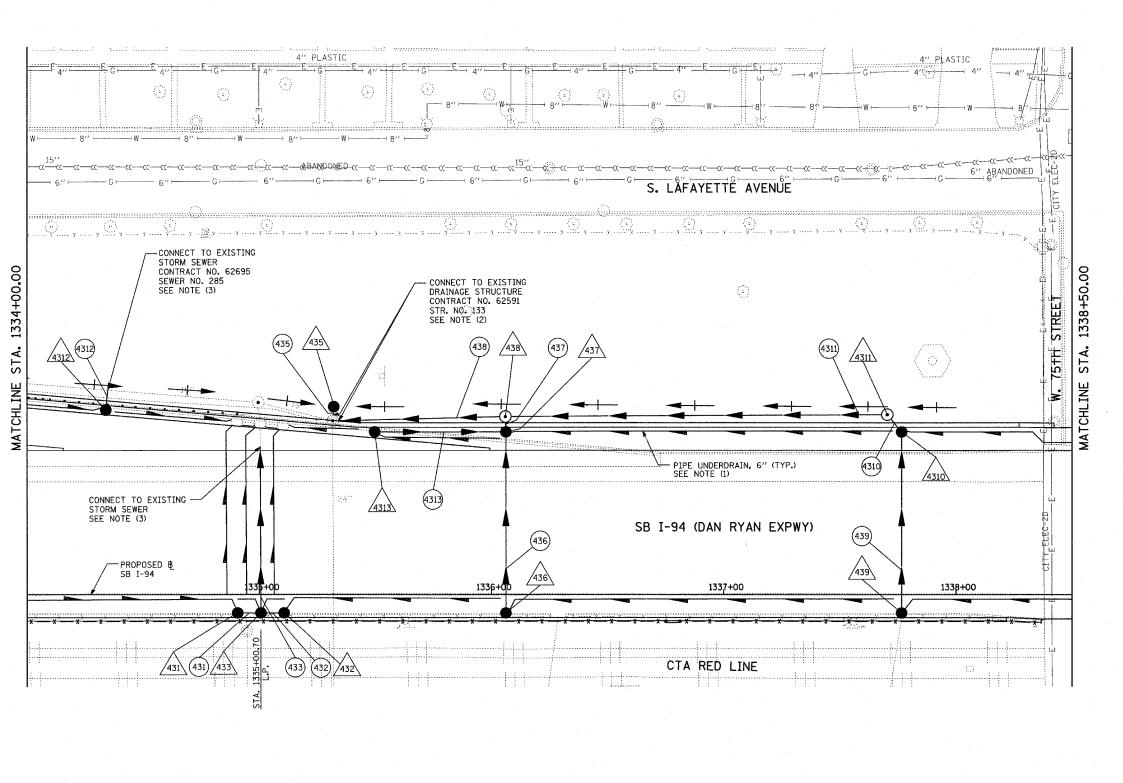


--- P SEWER PLUG

F.V. FIELD VERIFY

********** UTILITY REMOVAL

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NOTES

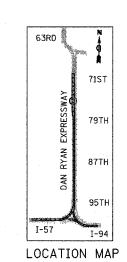1. FOR CLARITY, PIPE UNDERDRAINS ARE SHOWN OFFSET FROM THEIR PROPOSED LOCATIONS. FOR DETAILED PLACEMENT, SEE SHEET "PIPE UNDER-DRAINS DETAIL."

2. CORE DRILL AND CONNECT TO EXISTING DRAINAGE STRUCTURE. CONNECTION COST SHALL BE INCLUDED IN THE COST TO CONSTRUCT THE STORM SEWER.

3. COST SHALL NOT BE PAID FOR SEPARATELY BUT INCLUDED IN COST OF SEWER INSTALLATION.

20 0 20 40 SCALE: 1" = 20'-0"

SHEET 43 OF 65

REVISIONS

ILLINOIS DEPARTMENT OF TRANSPORTATION
F.A.I. 94 (DAN RYAN EXPRESSWAY)
DRAINAGE AND UTILITY PROPOSED PLAN
SB I-94 (DAN RYAN EXPRESSWAY)
DAN RYAN STA. 1334+00.00 TO 1338+50.00

SCALE: 1"=20'
DATE: MARCH 1, 2006

DRAWN BY: NSB
CHECKED BY: DA

TYLININTERNATIONAL

LEGEND:


(XY)

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-«--«- EXISTING COMBINED SEWER

PIPE STUBOUT TO BE PLUGGED

PROPOSED STORM SEWER NUMBER (X=SHEET NO., Y=PIPE NO.)

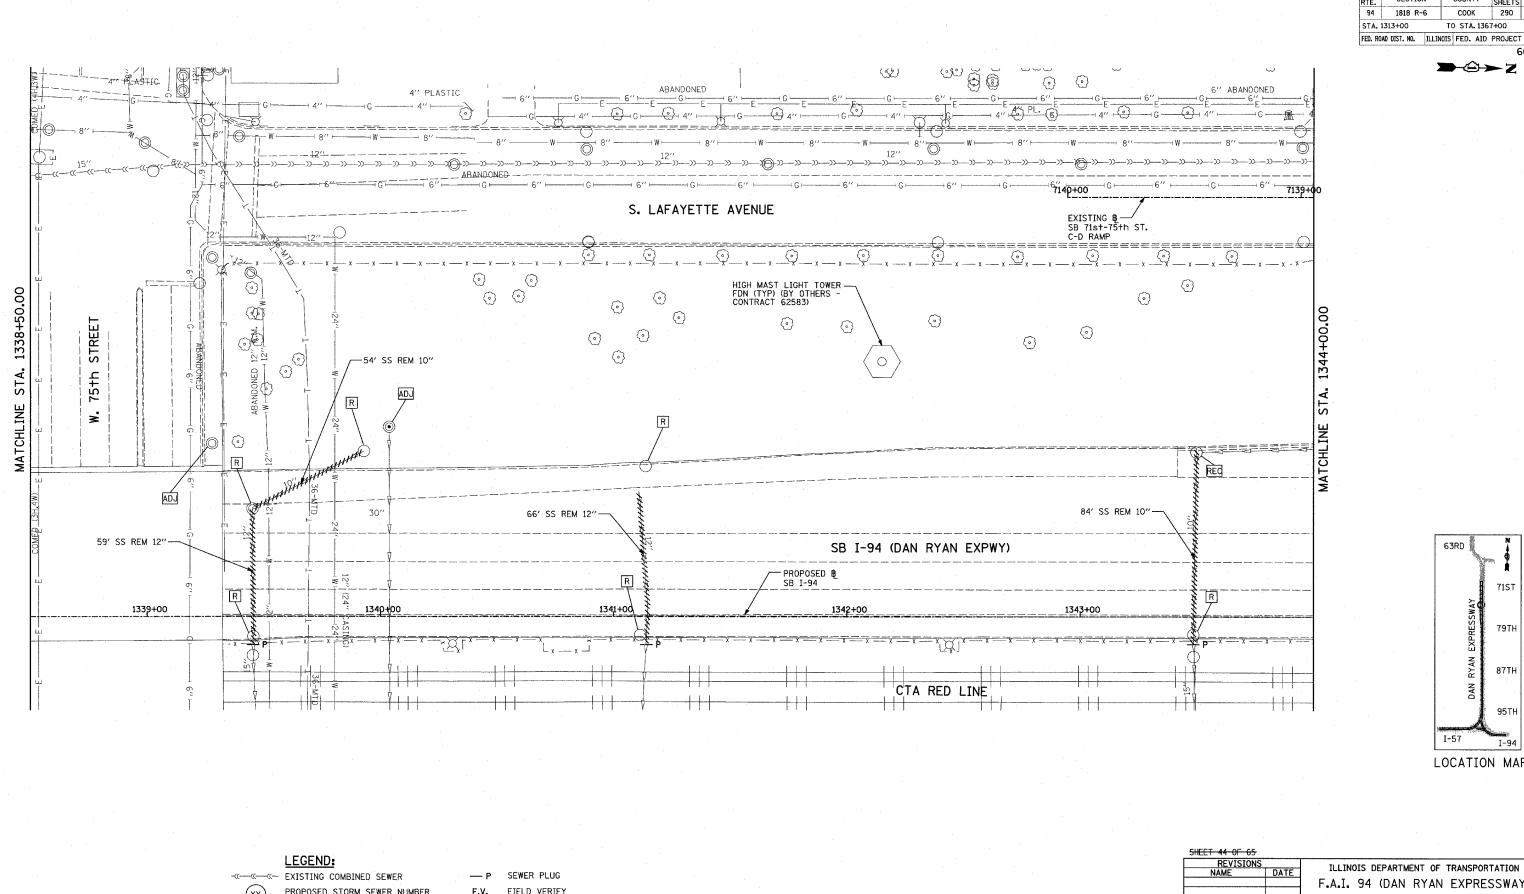

COUNTY TOTAL SHEE NO. SECTION 290 126 1818 R-6 соок STA. 1313+00 TO STA. 1367+00

60B18

71ST 79TH 87TH 95TH I-57 LOCATION MAP

63RD

PROPOSED STORM SEWER NUMBER (X=SHEET NO., Y=PIPE NO.) PROPOSED STRUCTURE NUMBER (X=SHEET NO., Y=STRUCTURE NO.)

PIPE STUBOUT TO BE PLUGGED


F.V. FIELD VERIFY ****** UTILITY REMOVAL

TYLININTERNATIONAL

SCALE: 1" = 20'-0"

ILLINOIS DEPARTMENT OF TRANSPORTATION F.A.I. 94 (DAN RYAN EXPRESSWAY) DRAINAGE AND UTILITY EXISTING PLAN SB I-94 (DAN RYAN EXPRESSWAY) SB I-94 STA. 1338+50.00 TO 1344+00.00

SCALE: 1"=20" DATE: MARCH 1, 2006

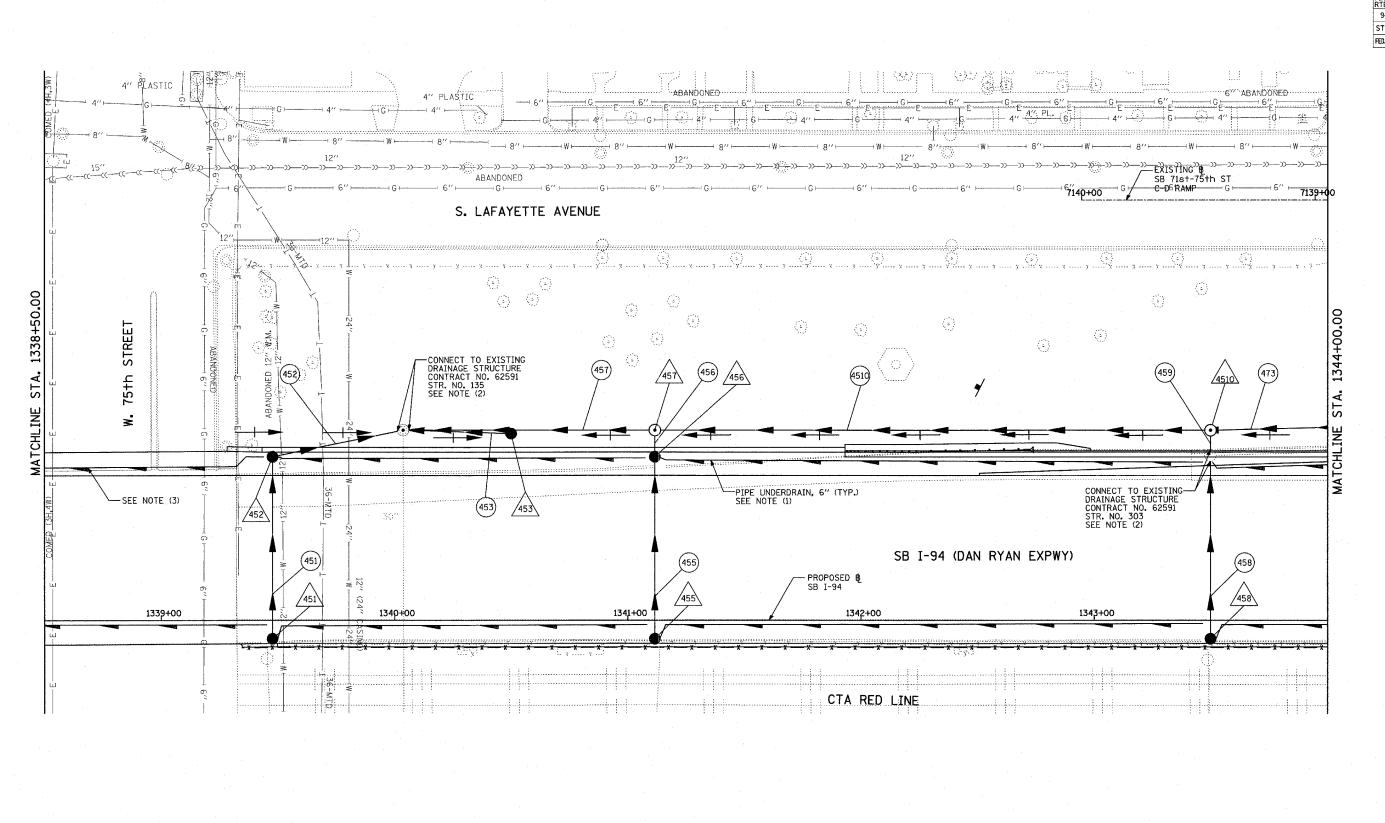

SECTION

COUNTY TOTAL SHEET NO.

→⊕→Z

NOTES:

1. FOR CLARITY, PIPE UNDERDRAINS ARE SHOWN OFFSET FROM THEIR PROPOSED LOCATIONS. FOR DETAILED PLACEMENT, SEE SHEET "PIPE UNDER-DRAINS DETAIL."

2. CORE DRILL AND CONNECT TO EXISTING DRAINAGE STRUCTURE. CONNECTION COST SHALL BE INCLUDED IN THE COST TO CONSTRUCT THE STORM SEWER.

3. PROPOSED PIPE UNDERDRAIN SYSTEM LOCATION SHALL BE COORDINATED WITH PROPOSED ELECTRICAL DUCT BANK AND EXISTING FOOTING. SEE TYPICAL SECTIONS AND DETAILS FOR OVERPASS FOOTINGS.

20 0 20 40 DATE

SCALE: 1" = 20'-0"

SHEET 45 0F 65

REVISIONS
NAME

DATE

ILLINOIS DEPARTMENT OF TRANSPORTATION
F.A.I. 94 (DAN RYAN EXPRESSWAY)
DRAINAGE AND UTILITY PROPOSED PLAN
SB I-94 (DAN RYAN EXPRESSWAY)
SB I-94 STA. 1338+50.00 TO 1344+00.00

63RD

I-57

71ST

79TH

87TH

95TF

I-94

LOCATION MAP

SCALE: 1"=20'
DATE: MARCH 1, 2006

DRAWN BY: NSB
CHECKED BY: DA

TYLININTERNATIONAL

141

s ⊢ PIPE STUBOUT TO BE

LEGEND:


EXISTING COMBINED SEWER

EXISTING COMBINED SEWER

PROPOSED STORM SEWER NUMBER (X=SHEET NO., Y=PIPE NO.)

PROPOSED STRUCTURE NUMBER (X=SHEET NO., Y=STRUCTURE NO.)

P SEWER PLUG
F.V. FIELD VERIFY
UTILITY REMOVAL

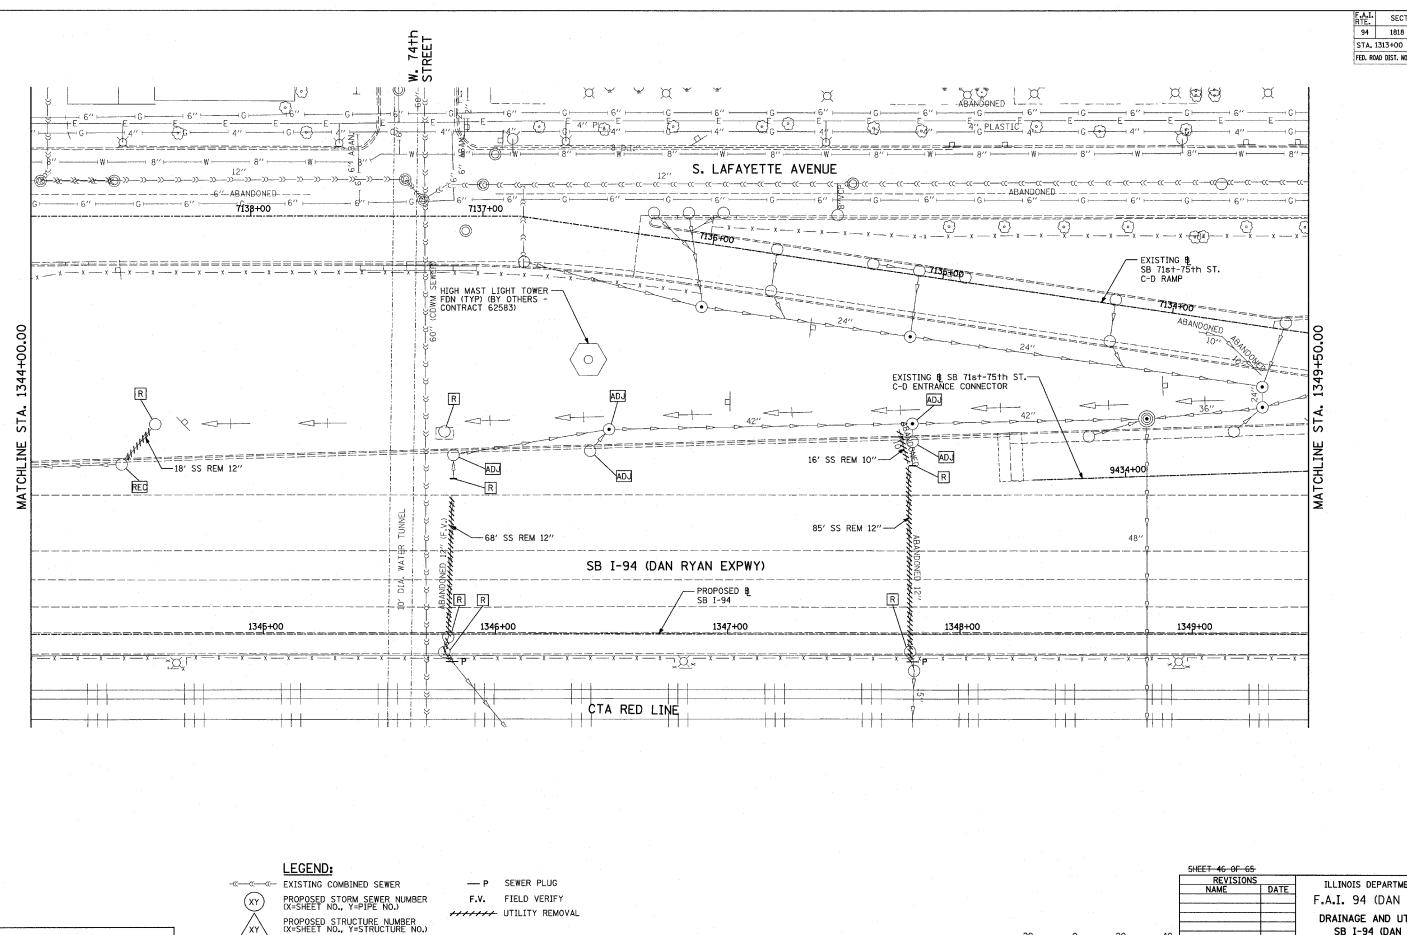

PIPE STUBOUT TO BE PLUGGED

TYLININTERNATIONAL

COUNTY TOTAL SHEET NO.

COOK 290 128 SECTION 1818 R-6 TO STA. 1367+00

FED. ROAD DIST. NO. ILLINOIS FED. AID PROJECT

60B18

LOCATION MAP

63RD

71ST

79TH


87TH

95TH

SCALE: 1" = 20'-0"

ILLINOIS DEPARTMENT OF TRANSPORTATION F.A.I. 94 (DAN RYAN EXPRESSWAY) DRAINAGE AND UTILITY EXISTING PLAN SB I-94 (DAN RYAN EXPRESSWAY) SB I-94 STA. 1344+00.00 TO 1349+50.00

SCALE: 1"=20" DATE: MARCH 1, 2006

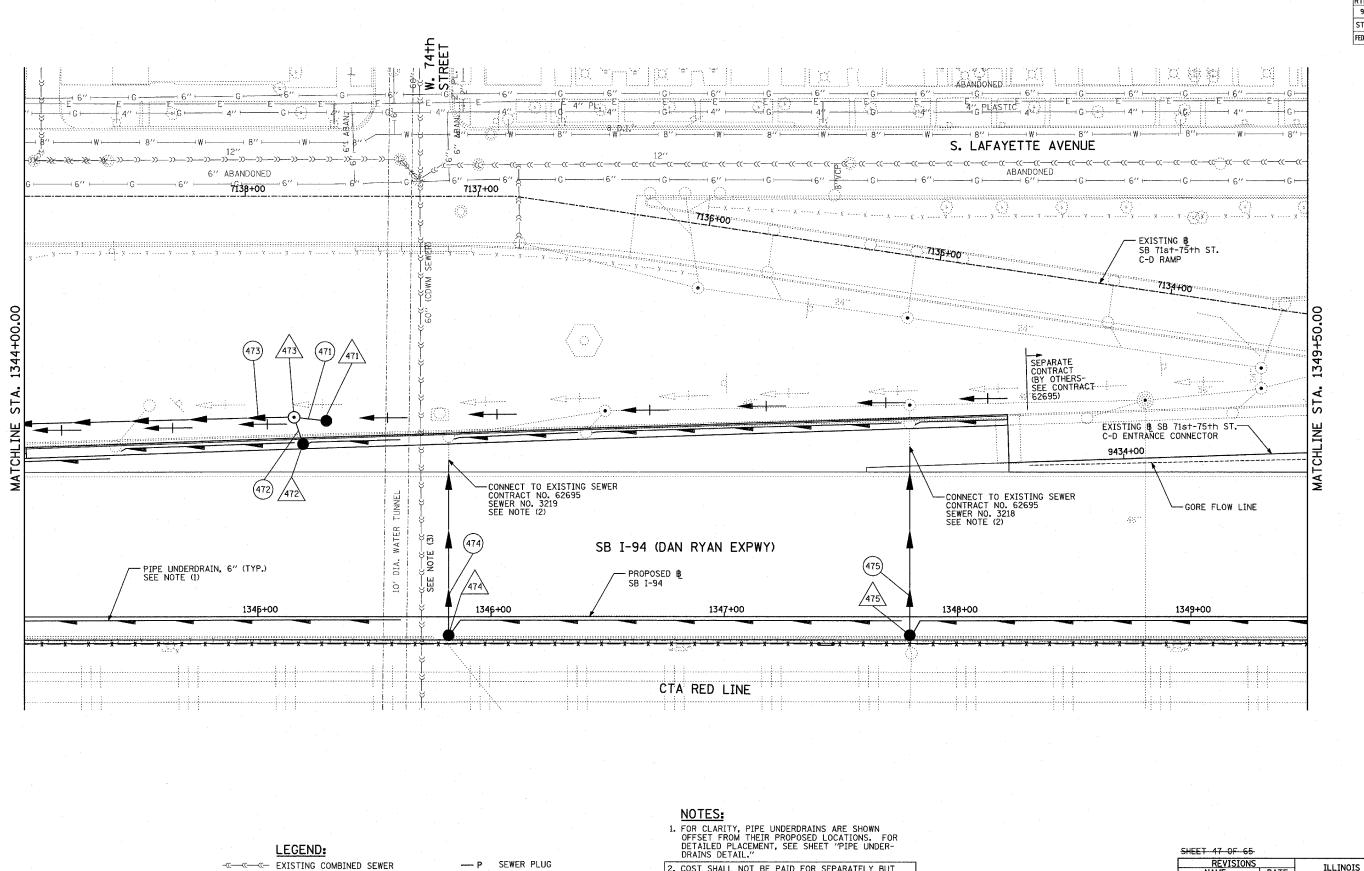

SECTION COUNTY 1818 R-6 соок 290 129 STA. 1313+00 TO STA. 1367+00

FED. ROAD DIST. NO. ILLINOIS FED. AID PROJECT

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60B18

2. COST SHALL NOT BE PAID FOR SEPARATELY BUT INCLUDED IN COST OF SEWER INSTALLATION.

3. THE CONTRACTOR SHALL COORDINATE ALL WORK WITH COC-DOWN SEWER SECTION PRIOR TO ANY EXCAVATION. RISER SHAFTS, IF ENCOUNTERED, SHALL BE CONSTRUCTED AND PAID FOR AS PER DETAIL SHOWN ON DRAINAGE DETAIL

REVISIONS NAME SCALE: 1" = 20'-0"

ILLINOIS DEPARTMENT OF TRANSPORTATION F.A.I. 94 (DAN RYAN EXPRESSWAY) DRAINAGE AND UTILITY PROPOSED PLAN SB I-94 (DAN RYAN EXPRESSWAY) SB I-94 STA. 1344+00.00 TO 1349+50.00

63RD

I-57

LOCATION MAP

71ST

79TH

87TH

95TH

SCALE: 1"=20' DATE: MARCH 1, 2006 DRAWN BY: NSB CHECKED BY: DA

(XY)

PROPOSED STORM SEWER NUMBER (X=SHEET NO., Y=PIPE NO.)


PROPOSED STRUCTURE NUMBER (X=SHEET NO., Y=STRUCTURE NO.)

PIPE STUBOUT TO BE PLUGGED

F.V. FIELD VERIFY

******* UTILITY REMOVAL

TYLININTERNATIONAL

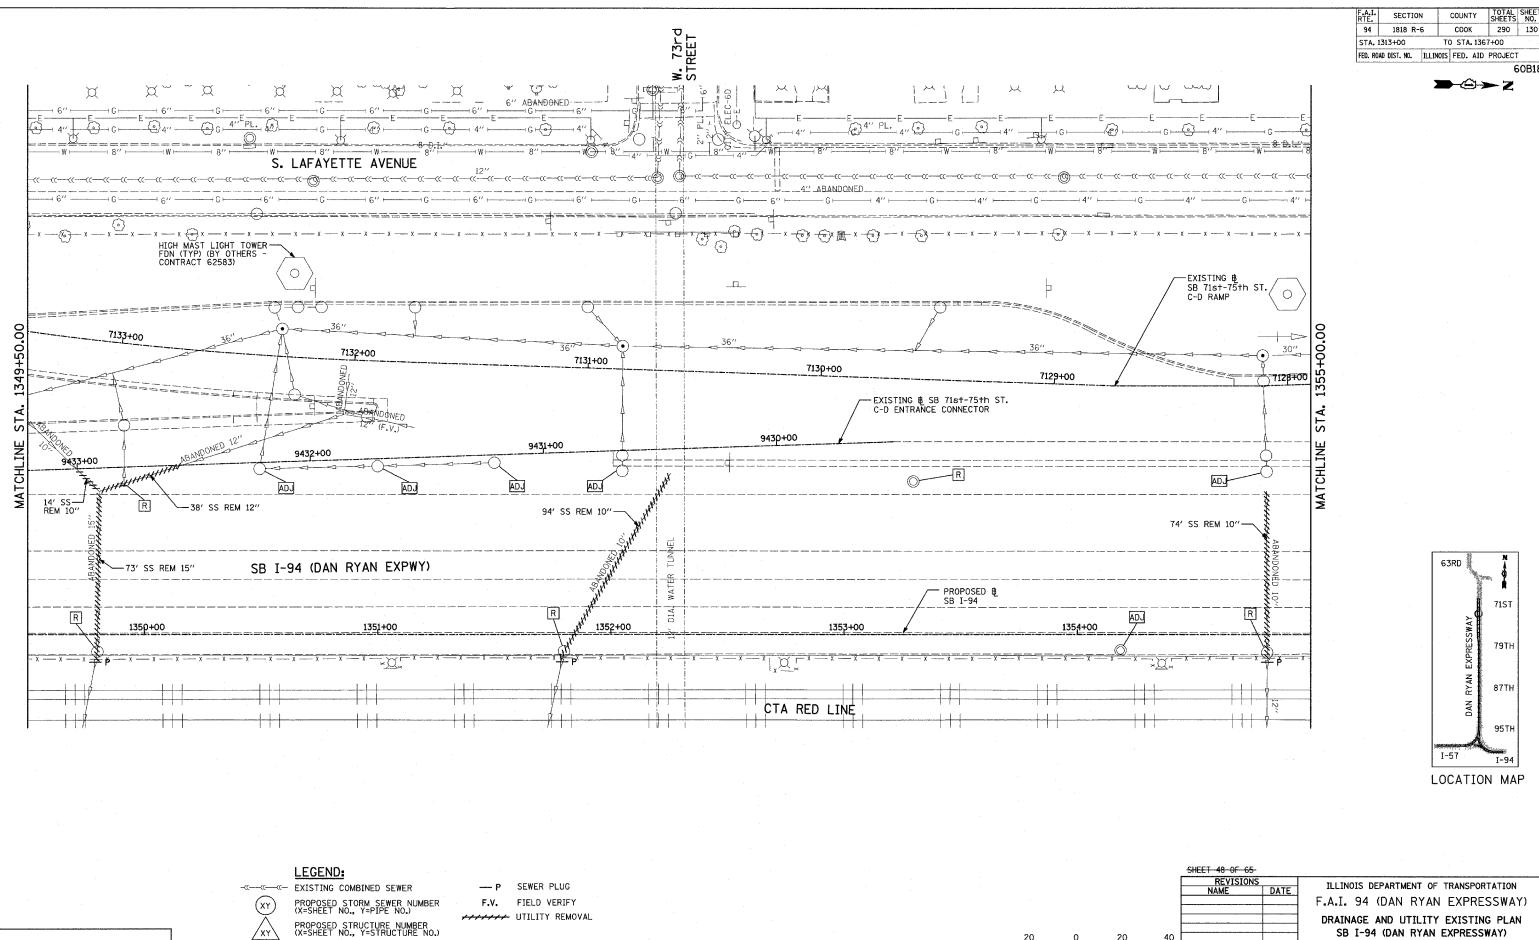

PIPE STUBOUT TO BE PLUGGED

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TYLININTERNATIONAL

290 130 TO STA. 1367+00 FED. ROAD DIST. NO. ILLINOIS FED. AID PROJECT 60B18

SCALE: 1" = 20'-0"


ILLINOIS DEPARTMENT OF TRANSPORTATION F.A.I. 94 (DAN RYAN EXPRESSWAY) DRAINAGE AND UTILITY EXISTING PLAN SB I-94 (DAN RYAN EXPRESSWAY) SB I-94 STA. 1349+50.00 TO 1355+00.00

SCALE: 1"=20' DATE: MARCH 1, 2006 DRAWN BY: NSB CHECKED BY: DA

71ST

79TH

95TH

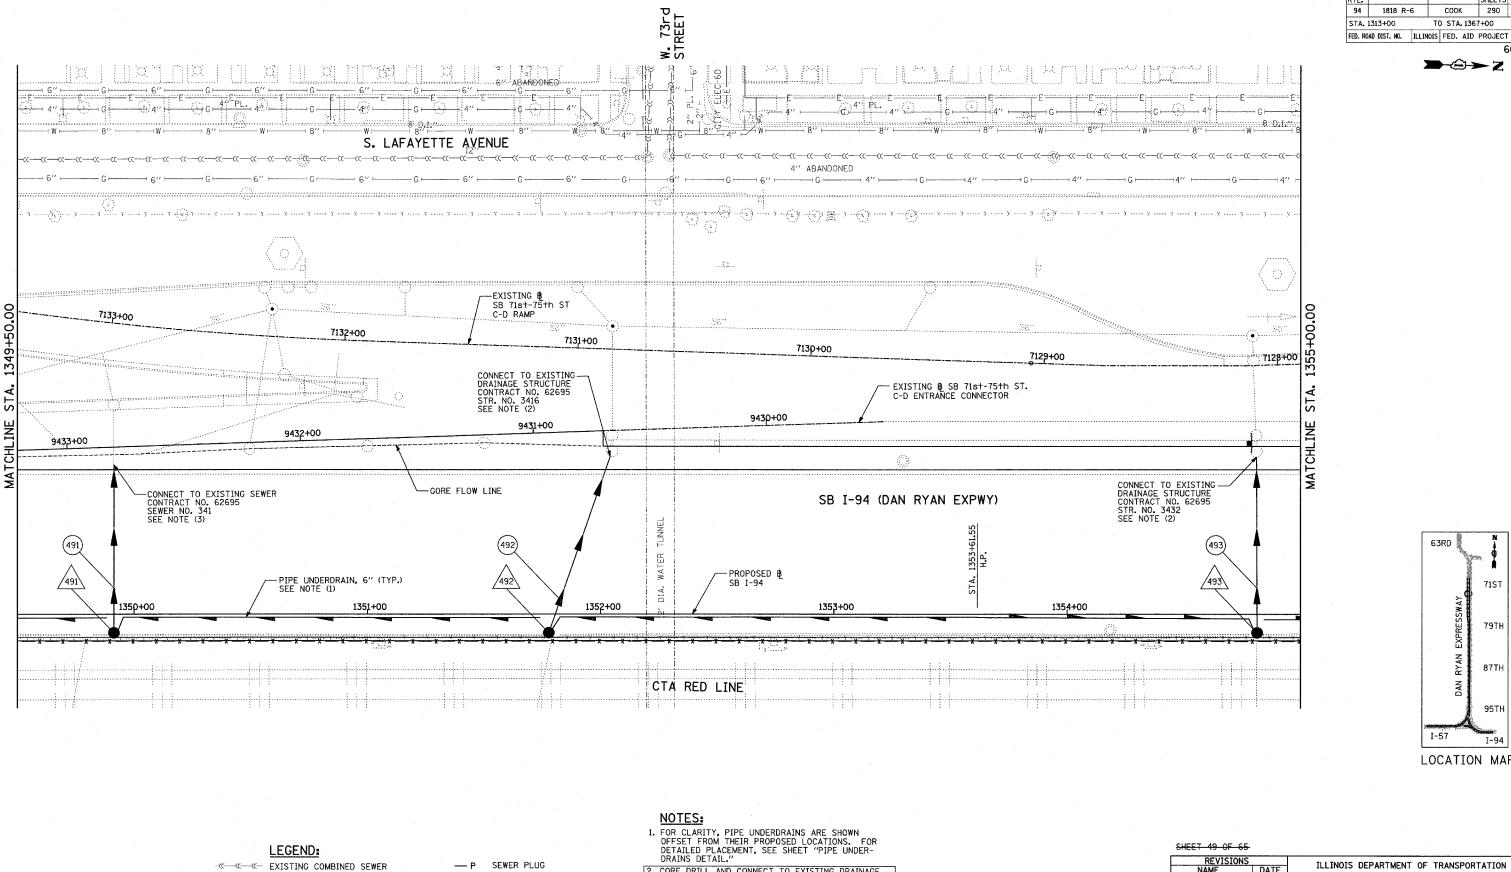

SECTION COUNTY TOTAL SHEE SHEETS NO. 1818 R-6 соок 290 131 STA. 1313+00 TO STA. 1367+00

→②→ Z

60B18

2. CORE DRILL AND CONNECT TO EXISTING DRAINAGE STRUCTURE. CONNECTION COST SHALL BE INCLUDED IN THE COST TO CONSTRUCT THE STORM SEWER.

3. COST SHALL NOT BE PAID FOR SEPARATELY BUT INCLUDED IN COST OF SEWER INSTALLATION.

REVISIONS NAME 20 SCALE: 1" = 20'-0"

ILLINOIS DEPARTMENT OF TRANSPORTATION F.A.I. 94 (DAN RYAN EXPRESSWAY) DRAINAGE AND UTILITY PROPOSED PLAN SB I-94 (DAN RYAN EXPRESSWAY) SB I-94 STA. 1349+50.00 TO 1355+00.00

SCALE: 1"=20'

DRAWN BY: NSB

TYLININTERNATIONAL

(XY)

PROPOSED STORM SEWER NUMBER (X=SHEET NO., Y=PIPE NO.)

PROPOSED STRUCTURE NUMBER (X=SHEET NO., Y=STRUCTURE NO.)

PIPE STUBOUT TO BE PLUGGED

FIELD VERIFY ******* UTILITY REMOVAL

DATE: MARCH 1, 2006

CHECKED BY: DA

63RD


I-57

LOCATION MAP

71ST

79TH

87TH

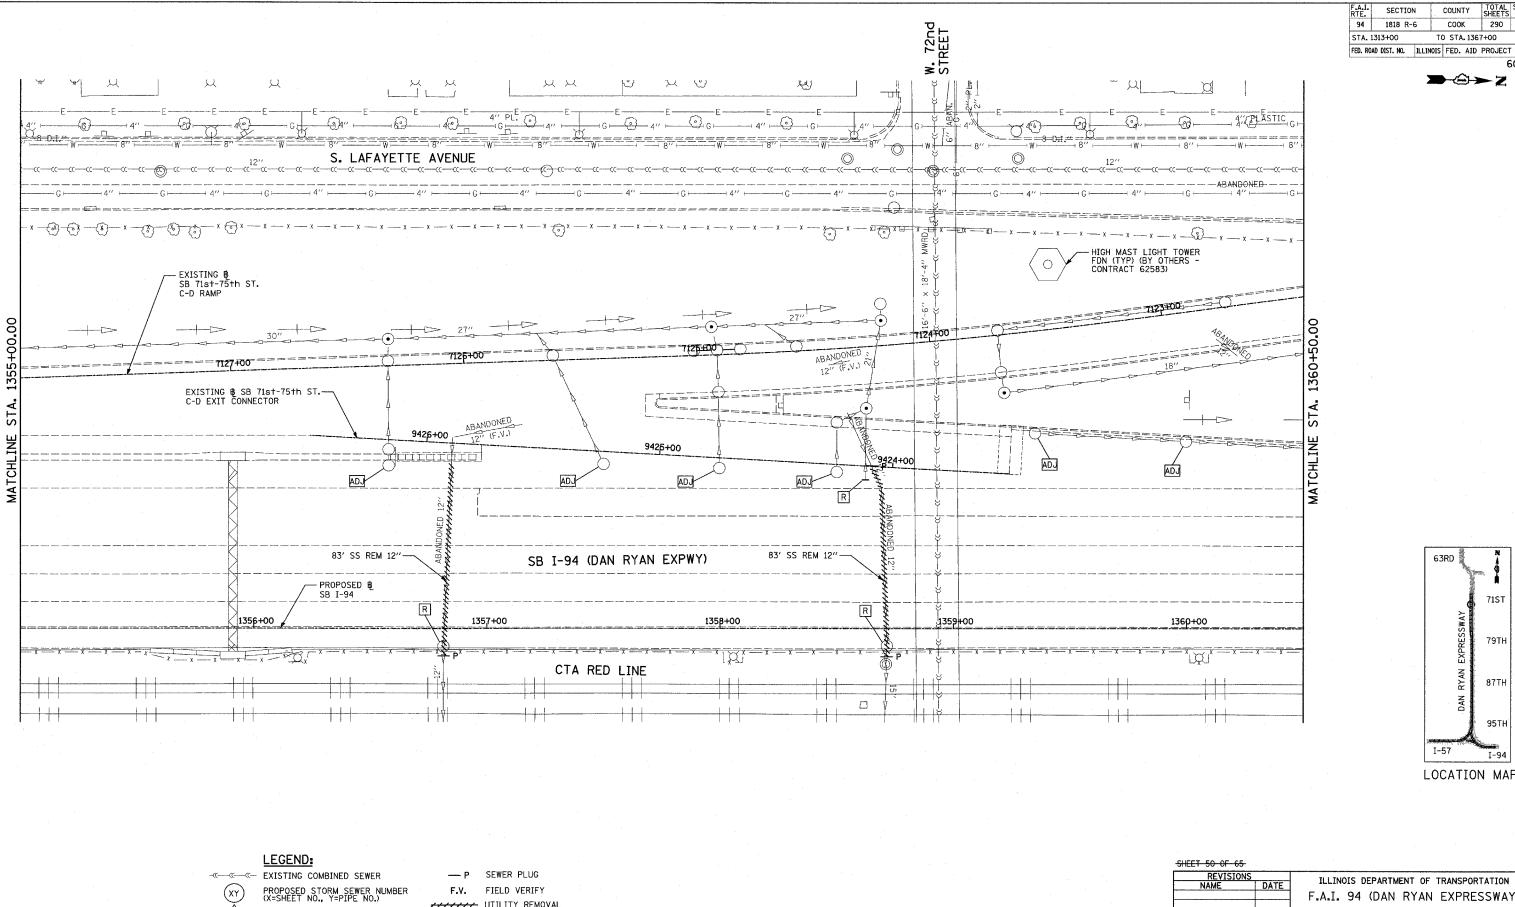

COUNTY COOK 290 132 TO STA. 1367+00

LOCATION MAP

71ST

79TH

87TH

95TH

PROPOSED STRUCTURE NUMBER (X=SHEET NO., Y=STRUCTURE NO.) PIPE STUBOUT TO BE PLUGGED

******* UTILITY REMOVAL


SCALE: 1" = 20'-0"


ILLINOIS DEPARTMENT OF TRANSPORTATION F.A.I. 94 (DAN RYAN EXPRESSWAY) DRAINAGE AND UTILITY EXISTING PLAN SB I-94 (DAN RYAN EXPRESSWAY) SB I-94 STA. 1355+00.00 TO 1360+50.00

DATE: MARCH 1, 2006

DRAWN BY: NSB CHECKED BY: DA

TYLININTERNATIONAL

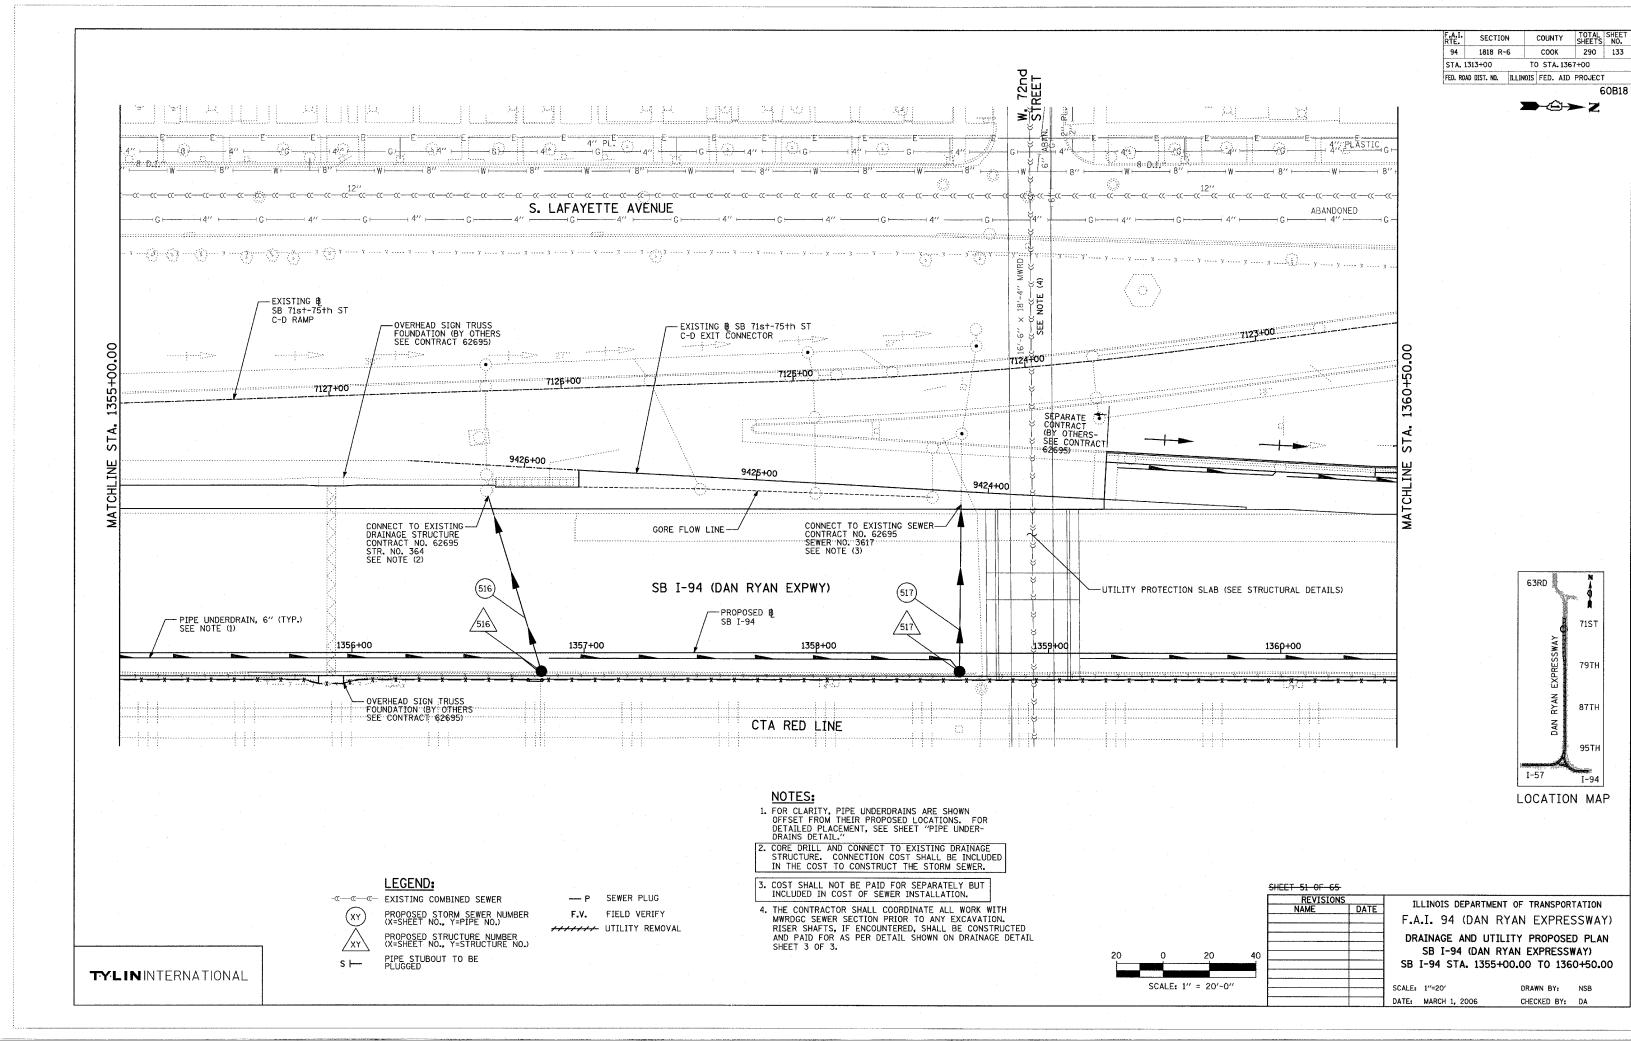

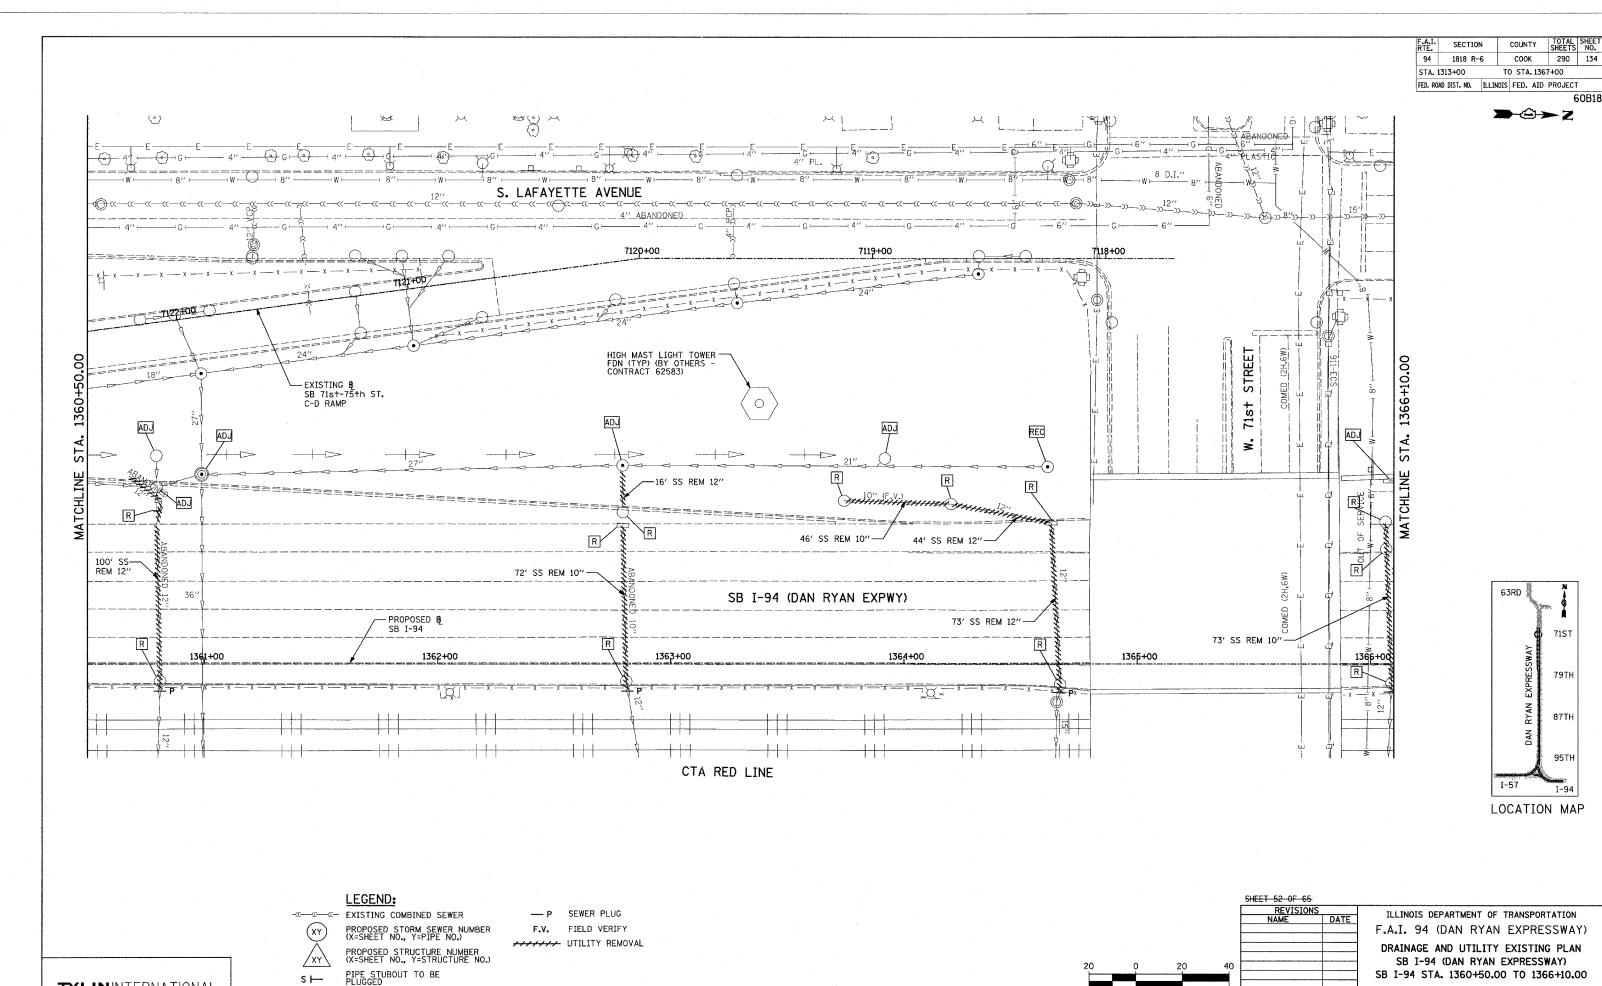


SCALE: 1" = 20'-0"


DRAWN BY: NSB

CHECKED BY: DA

DATE: MARCH 1, 2006

TYLININTERNATIONAL

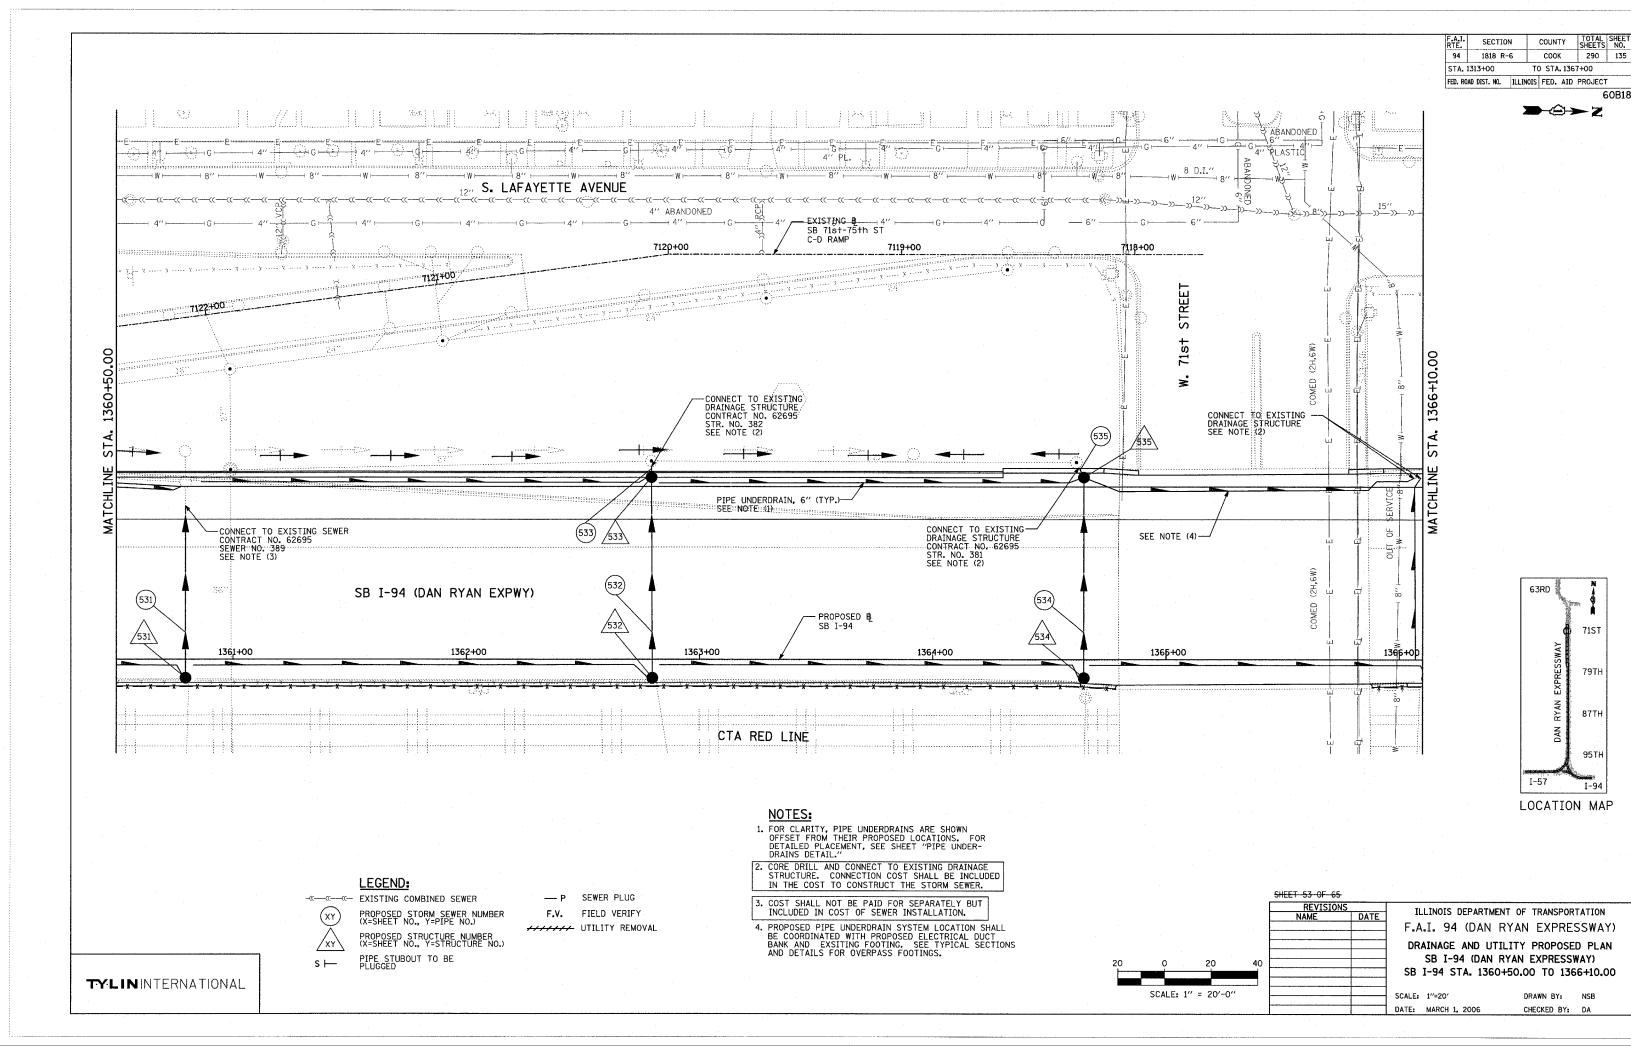

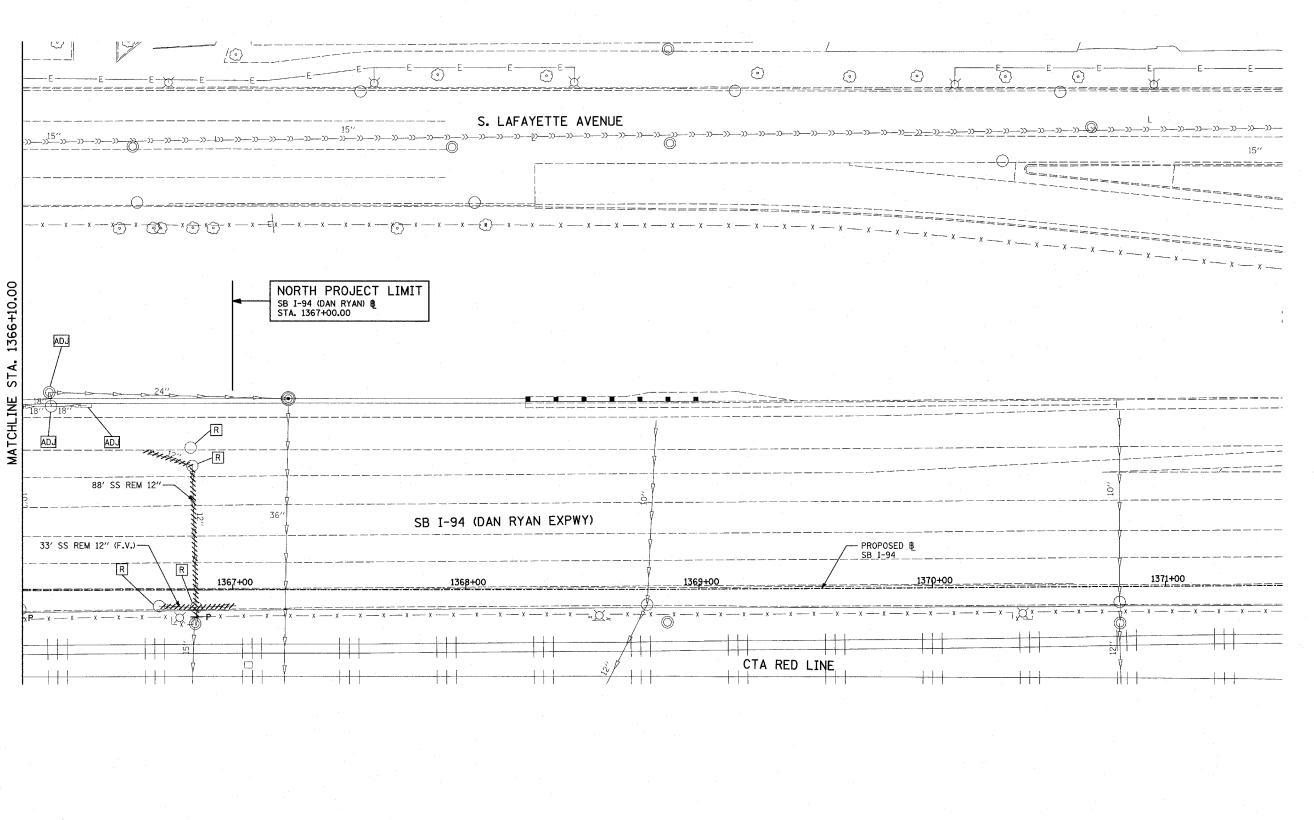

LEGEND:

TYLININTERNATIONAL

-«---«--- EXISTING COMBINED SEWER

PIPE STUBOUT TO BE PLUGGED

PROPOSED STORM SEWER NUMBER (X=SHEET NO., Y=PIPE NO.)

PROPOSED STRUCTURE NUMBER (X=SHEET NO., Y=STRUCTURE NO.)

--- P SEWER PLUG

60B18

63RD 71ST
71ST
79TH
87TH
95TH
1-57
1-94
LOCATION MAP

SHEET 54 OF 65


0 20 40

SCALE: 1" = 20'-0"

ILLINOIS DEPARTMENT OF TRANSPORTATION
F.A.I. 94 (DAN RYAN EXPRESSWAY)
DRAINAGE AND UTILITY EXISTING PLAN
SB I-94 (DAN RYAN EXPRESSWAY)
SB I-94 STA. 1366+10.00 TO 1367+00.00

SCALE: 1"=20'
DATE: MARCH 1, 2006

DRAWN BY: NSB CHECKED BY: DA

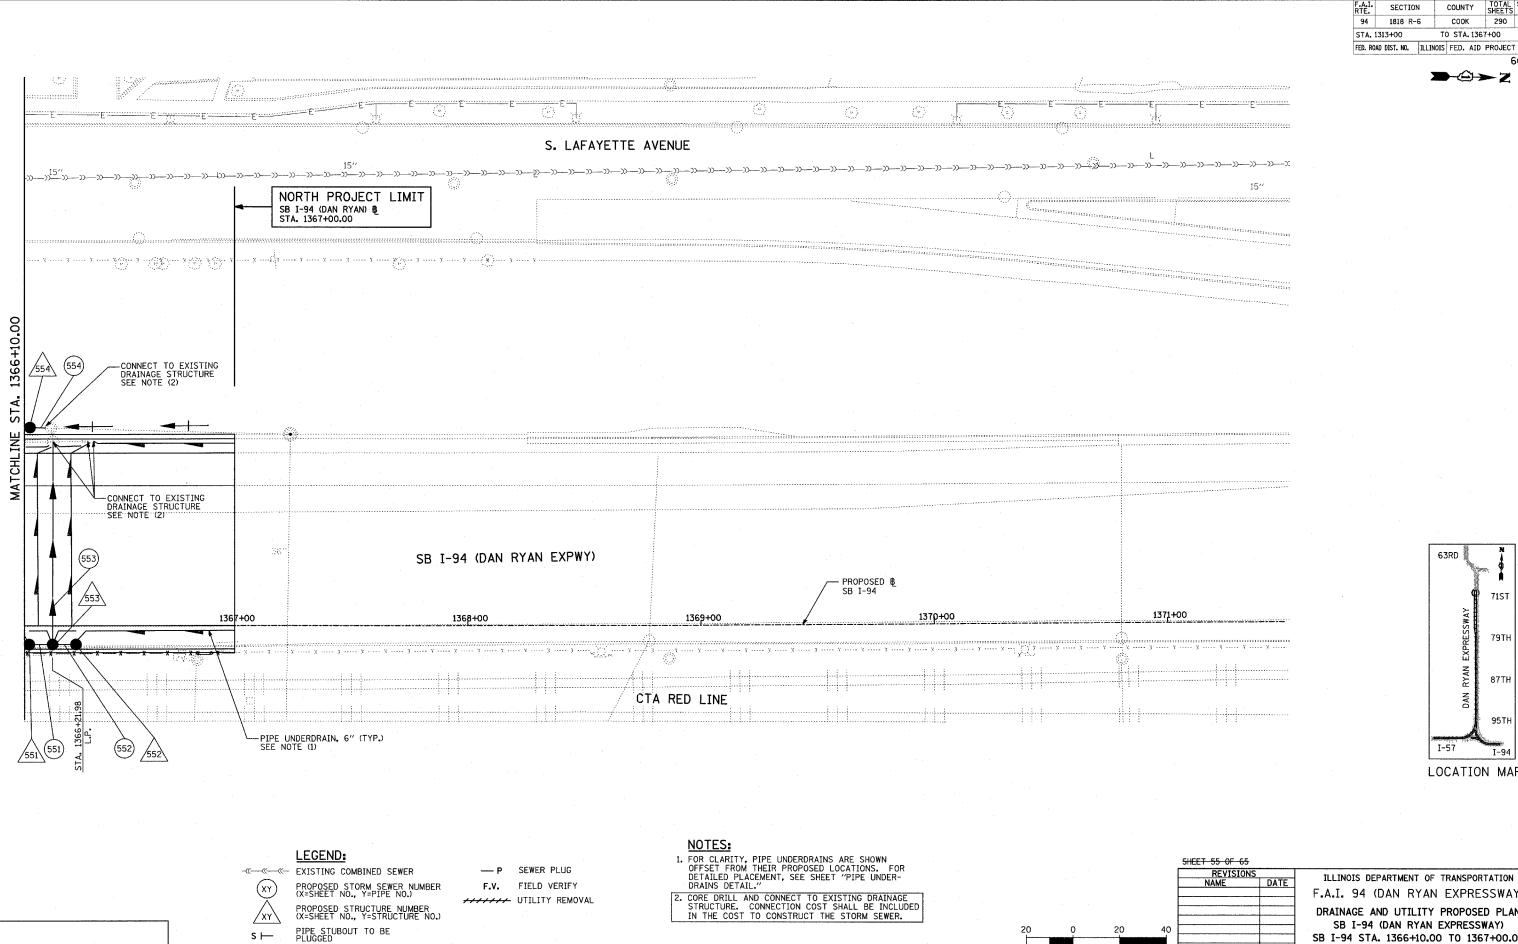

TYLININTERNATIONAL

SECTION COUNTY 1818 R-6 COOK 290 137 TO STA. 1367+00

→②→Z

60B18


71ST 79TH 87TH 95TH I-57

LOCATION MAP

SCALE: 1" = 20'-0"

ILLINOIS DEPARTMENT OF TRANSPORTATION F.A.I. 94 (DAN RYAN EXPRESSWAY) DRAINAGE AND UTILITY PROPOSED PLAN SB I-94 (DAN RYAN EXPRESSWAY) SB I-94 STA. 1366+10.00 TO 1367+00.00


SCALE: 1"=20" DATE: MARCH 1, 2006 DRAWN BY: NSB CHECKED BY: DA

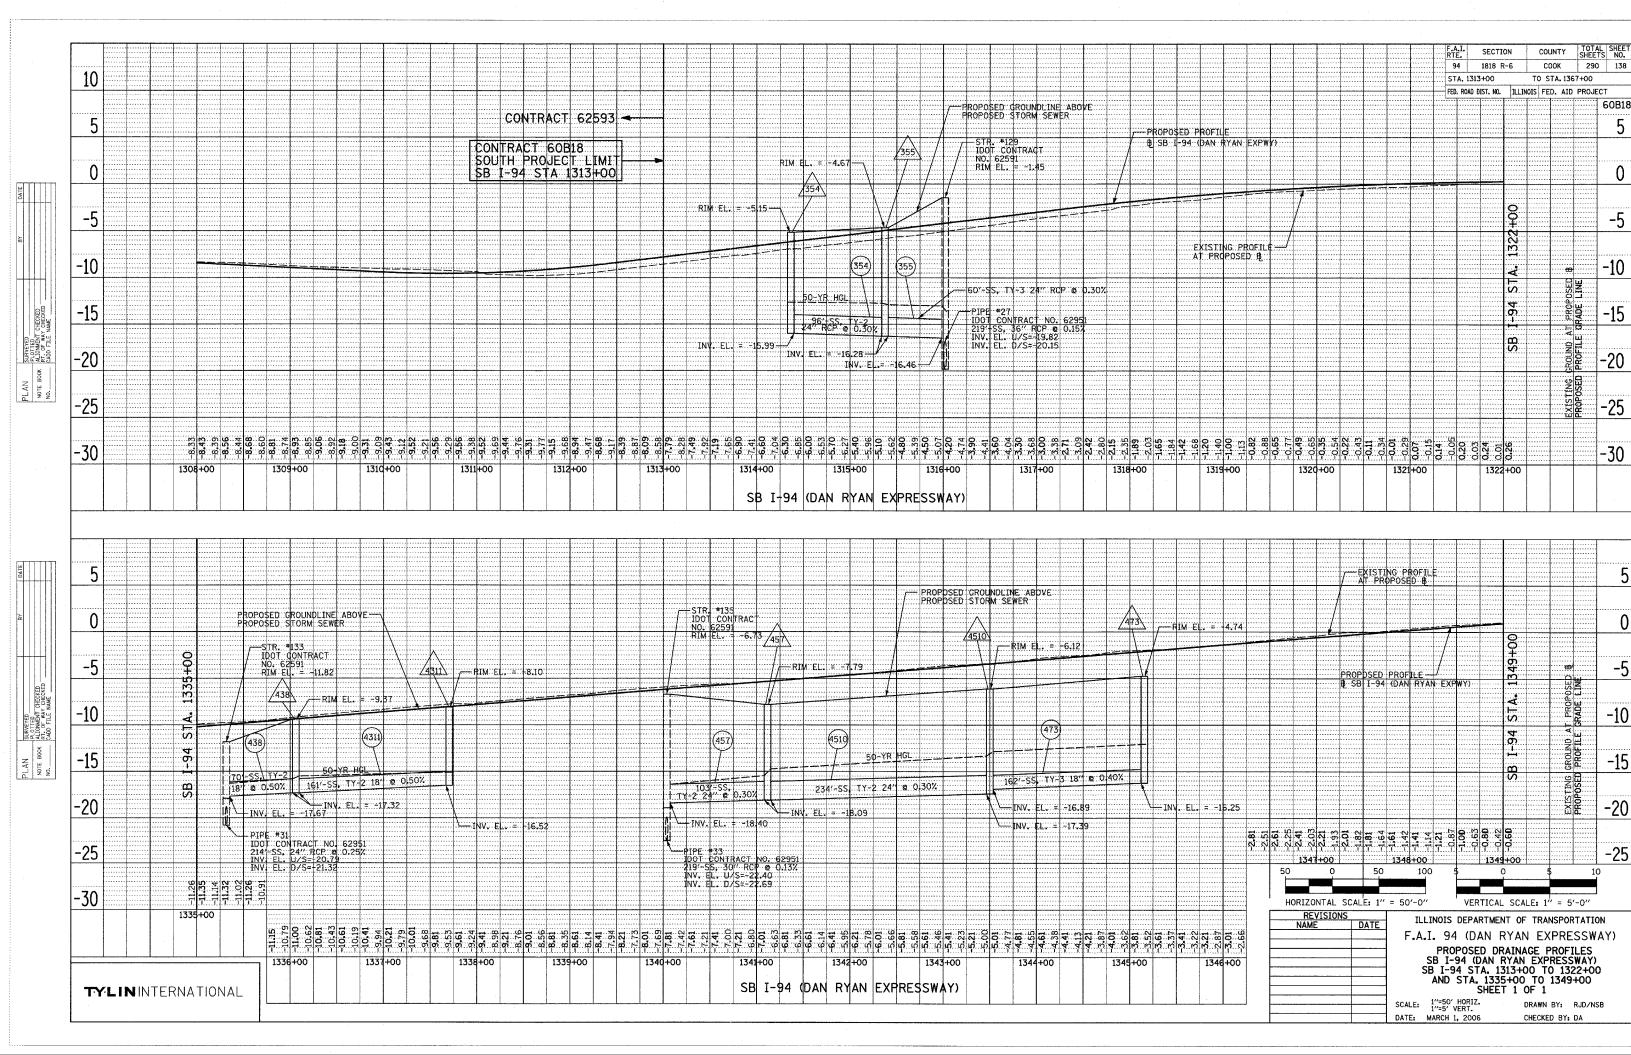


RTE.	SECTIO	IN	COUNTY	SHEETS	NO.
94	1818 R	-6	COOK	290	139
STA. 13	313+00	TO	STA. 13	67+00	
EED DOA	DICT NO	TI I THOTE	CED AT	ם מפטיורטיו	r

FED. ROAD DIST. NO. | ILLINOIS | FED. AID PROJECT

60B18

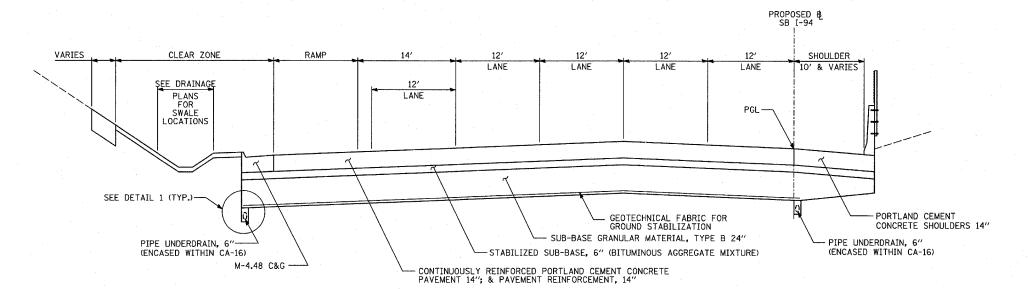

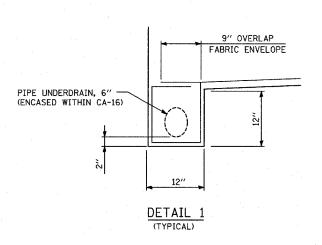


PROPOSED SB I-94 MAINLINE PAVEMENT

LOCATIONS VARY BETWEEN 76th TO 79th C-D RAMPS AND 71st TO 75th C-D RAMPS

NOTES:

- (1) GEOTECHNICAL FABRIC FOR GROUND STABILIZATION SHALL BE PLACED THE ENTIRE WIDTH FROM INSIDE EDGE OF PIPE UNDERDRAIN TRENCH TO INSIDE EDGE OF PIPE UNDERDRAIN TRENCH, AND SUB-BASE GRANULAR MATERIAL TYPE B-24" SHALL BE PLACED THE ENTIRE WIDTH FROM BACK-OF-CURB TO BACK-OF-CURB PRIOR TO UNDERDRAIN INSTALLATION. REPLACEMENT OF THE SACRIFICIAL SUB-BASE GRANULAR MATERIAL TYPE B-24" ABOVE THE NEWLY PLACED PIPE UNDERDRAIN TRENCHES SHALL BE INCLUDED IN THE UNIT PRICE OF THE PIPE UNDERDRAIN, 6".
- (2) RIGHT SHOULDER IN DIRECTION OF TRAFFIC
- (3) LEFT SHOULDER IN DIRECTION OF TRAFFIC
- (4) FABRIC ENVELOPE AND CA-16 ARE INCLUDED IN THE UNIT COST FOR PIPE UNDERDRAINS


promise and the second								
REVISIONS NAME DATE	ILLINOIS DEPARTMENT	ILLINOIS DEPARTMENT OF TRANSPORTATION						
	F.A.I. 94 (DAN R)	YAN EXPRESSWAY)						
	PIPE UNDERDRAINS ALONG I-94 DETAILS							
	SHEET 1 OF 1							
	SCALE: NONE	DRAWN BY: BK						
	DATE: MARCH 1, 2006	CHECKED BY: DA						

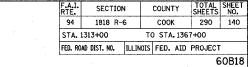

- PROPOSED/EXISTING BARRIER WALL (TYP.) EXISTING MEDIAN (NO CTA TRACKS) SEE NOTE (2) TYPE 20 FRAME — AND GRATE (TYP.) 24" 4' DIA.


PROPOSED SHOULDER

DETAIL 3 PROPOSED CATCH BASIN - TYPE "A"

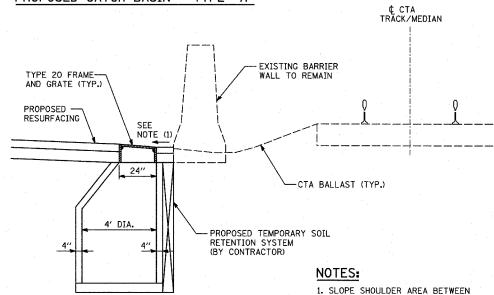


DETAIL 4 PROPOSED CATCH BASIN - TYPE "A" 1. SLOPE SHOULDER AREA BETWEEN PROPOSED CATCH BASIN AND BARRIER WALL TOWARDS GRATE - TRANSITION BACK TO SHOULDER SLOPE WITHIN 10' EITHER WAY FROM © OF GRATE.


2. SEE MISCELLANEOUS DETAIL SHEETS FOR WALL DETAIL.

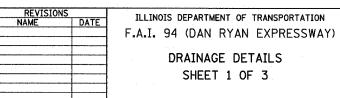

SCALE: NONE DATE: MARCH 1, 2006

DRAWN BY: MB CHECKED BY: DA

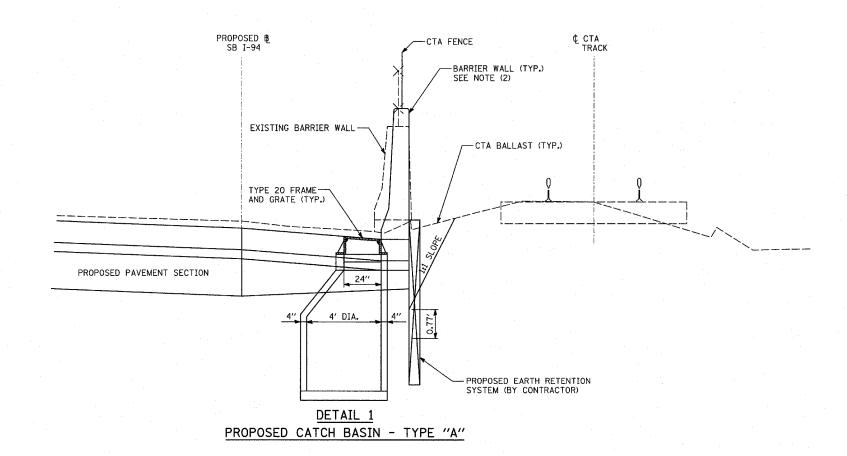

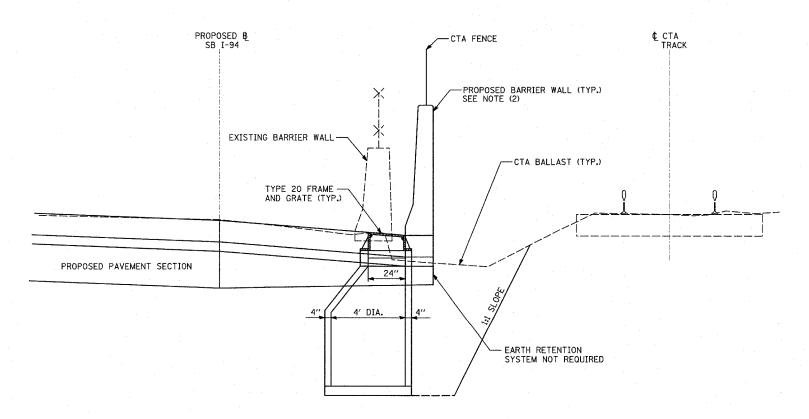


DETAIL 2 PROPOSED CATCH BASIN - TYPE "A"

TY:LIN INTERNATIONAL

F.A.I. RTE.	SECTION	4	COUN	ſΥ	TOTAL SHEETS	SHEE NO.
94	1818 R-	6	COOL	<	290	14
STA.	1313+00	T	O STA	. 136	7+00	***************************************
FED. RO	AD DIST. NO.	ILLINOIS	FED.	AID	PROJECT	-


60B18

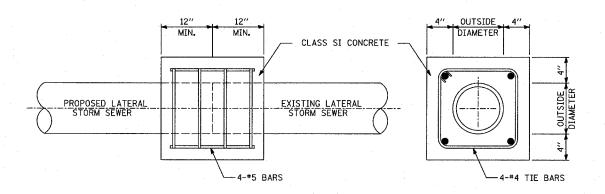

THE PROPOSED CONCRETE COLLAR SHALL OVERLAP EACH STORM SEWER PIPE A MINIMUM OF 1 FOOT.

CLASS SI CONCRETE COLLAR

- 1. IN ORDER TO MAINTAIN CONTINUOUS DRAINAGE THROUGHOUT THE CONSTRUCTION AREA, TEMPORARY CONNECTIONS SHALL BE PROVIDED TO CONNECT PROPOSED STORM SEWER LATERALS TO THE EXISTING STORM SEWER LATERALS. THE CONTRACTOR SHALL CONSTRUCT THESE TEMPORARY CONNECTIONS IN ACCORDANCE WITH ONE OF THE TWO OPTIONS DETAILED ABOVE.
- 2. THE TOTAL COST OF INSTALLING THE TEMPORARY CONNECTIONS IS NOT PAID FOR SEPARATELY, BUT SHALL BE INCLUDED IN THE COST OF THE SEWER PAY ITEM.

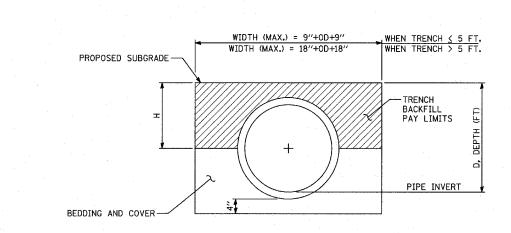

TRENCH BACKFILL DETAIL


REVISIO NAME	NS DATE	ILLINOIS DEPARTMENT OF TRANSPORTATION
		F.A.I. 94 (DAN RYAN EXPRESSWAY)
		DRAINAGE DETAILS SHEET 2 OF 3

SCALE: NONE DATE: MARCH 1, 2006

DRAWN BY: DM CHECKED BY: DA

TYLIN INTERNATIONAL


60B18

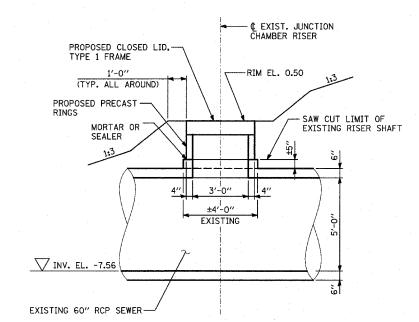


NOTE

1. TO BE PAID FOR AS "MANHOLES TO BE RECONSTRUCTED"

RISER SHAFT RECONSTRUCTION DETAIL

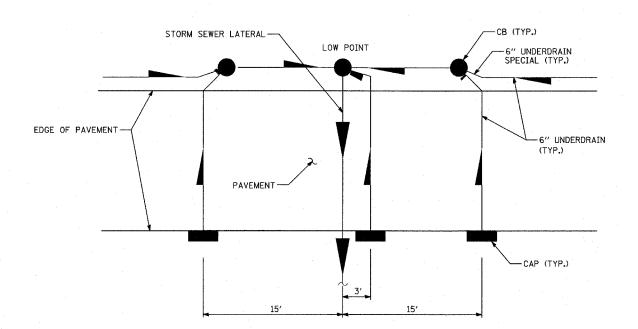

PIPE UNDERDRAIN 6", AT ROADWAY SAGS

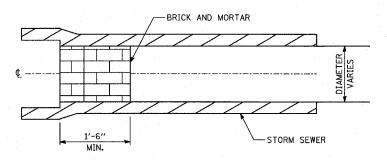

STORM SEWER PLUG

NOTES:

TY:LININTERNATIONAL

- 1. THIS WORK CONSISTS OF FURNISHING BRICKS AND MORTAR AS SHOWN AND AS DIRECTED BY THE ENGINEER AT LOCATIONS SHOWN IN THE PLANS TO PLUG THE EXISTING AND/OR PROPOSED STORM SEWER LATERAL STUBS. THIS PLUG WILL BE REMOVED BY OTHERS FOR FUTURE EXTENSION OF THE STORM SEWER.
- STORM SEWER.

 2. THIS WORK SHALL NOT BE PAID FOR SEPARATELY, PER ARTICLE 550.05.

REVISIONS
NAME
DATE

F.A.I. 94 (DAN RYAN EXPRESSWAY)


DRAINAGE DETAILS
SHEET 3 OF 3

SCALE: NONE


DRAWN BY: DM

DATE: MARCH 1, 2006


CHECKED BY: DA

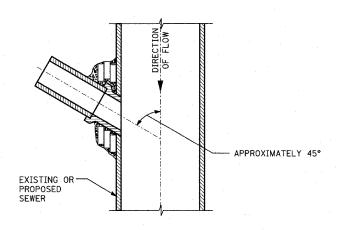

PLAN VIEW DETAIL 1

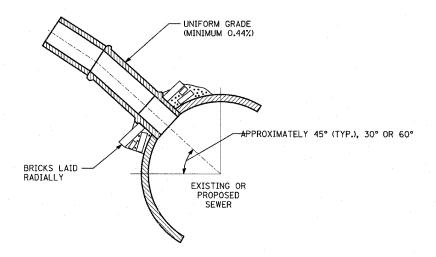

SECTION VIEW
DETAIL 2

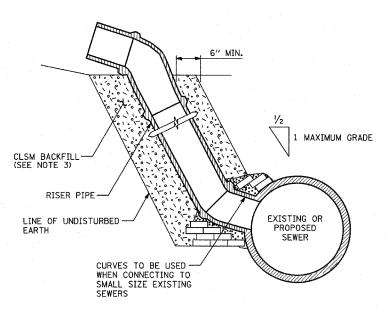

SECTION VIEW DETAIL 3

DETAILS OF PROPOSED STORM SEWER CONNECTIONS

TO EXISTING/PROPOSED SEWERS

NOTES:

DESCRIPTION:

ALL CATCH BASIN CONNECTIONS SHALL BE 12 INCH STORM SEWER PIPE, UNLESS SHOWN OR SPECIFIED OTHERWISE ON PLAN SHEETS.

CONSTRUCTION METHODS:

1. CONNECTION TO PROPOSED STORM SEWER: WHERE A STORM SEWER CONNECTION IS TO BE MADE TO A PROPOSED STORM SEWER, A "Y" BRANCH SECTION OR A SECTION WITH AN OPENING MADE IN THE PIPE AT THE TIME IT IS MANUFACTURED OF THE PROPER DIAMETER SHALL BE INSTALLED IN THE SEWER AT THE JUNCTION PROVIDING THE TYPE OF PIPE USED IS MANUFACTURED WITH "Y" BRANCHES OR WITH OPENING MADE IN THE PIPE.

THE JUNCTION OF THE PROPOSED STORM SEWER CONNECTION WITH THE PROPOSED STORM SEWER SHALL BE CONSTRUCTED AS FOLLOWS:

- a. SIMILAR TO DETAIL 1 AND DETAIL 2 TO THE LEFT EXCEPT NO BRICK WILL BE REQUIRED IF SECTIONS WITH "Y" BRANCHES OR SECTIONS WITH OPENINGS MADE IN THE PIPE ARE USED.
- b. SAME AS DETAIL 3 TO THE LEFT.
- 2. CONNECTION TO EXISTING SEWER: WHERE A STORM SEWER CONNECTION IS TO BE MADE TO AN EXISTING SEWER, A CIRCULAR OPENING SHALL BE MADE IN THE EXISTING SEWER OF THE SAME SIZE AS THE INTERNAL DIAMETER OF THE PROPOSED STORM SEWER CONNECTION.

IF THE EXISTING SEWER PIPE IS DAMAGED BY THE CONTRACTOR IN MAKING THIS CIRCULAR OPENING, THE CONTRACTOR SHALL REPLACE THIS SECTION OF PIPE WITH A PIPE EQUAL TO AND SIMILAR IN ALL RESPECTS TO THE PIPE IN THE EXISTING SEWER. THE CONTRACTOR SHALL DO THIS WORK IN A CAREFUL WORKMANLIKE MANNER WITHOUT EXTRA COMPENSATION.

THE JOINT BETWEEN THE EXISTING SEWER AND THE PROPOSED SEWER SHALL BE COMPLETELY SEALED WITH BRICK AS SHOWN ABOVE. BRICK GRADE SW, OR CONCRETE BUILDING BRICK GRADE A, SHALL BE LAID IN MORTAR THE SAME AS SPECIFIED FOR BRICK MASONRY UNDER ARTICLE 602.05 OF THE STANDARD SPECIFICATIONS.

3. ALL CLSM REQUIRED SHALL NOT BE PAID FOR SEPERATELY BUT SHALL BE INCLUDED IN SEWER PAY ITEM.

BASIS OF PAYMENT.

ALL FITTINGS SUCH AS ELBOWS AND CURVES SHALL BE PAID FOR AT THE CONTRACT UNIT PRICE PER LINEAR FOOT FOR STORM SEWER MEASURED IN PLACE.

THE COST OF MAKING ALL JUNCTIONS WITH EXISTING OR PROPOSED SEWERS, MANHOLES OR CATCH BASINS SHALL BE INCLUDED IN THE CONTRACT UNIT PRICE PER LINEAR FOOT FOR STORM SEWER.

REVISIO NAME	NS DATE	F.A.I. 94 (DA	TMENT OF TRANSPORTATION N RYAN EXPRESSWAY) OF STORM SEWER TIONS TO SEWER
		SCALE: NONE	DRAWN BY: BK

DATE: MARCH 1, 2006

CHECKED BY: DA

TY:LININTERNATIONAL

DRAINAGE STRUCTURE SCHEDULE

STRUCTURE	CTATION	OFFSET	STRUCTU	JRE TYPE	574	FRAME	TOP OF	N	E	s	w
NUMBER	STATION	OFFSET	МН	CB	DIA.	& LID	FRAME	INV.	INV.	INV.	INV.
351	1314+34.95	6.3 RT		A(7)	4′	T20 F&G	-6.43				-13.08
352	1314+35.58	68.5 LT		A	4′	T20 F&G	-7.54	-13.37	-13.37		-13.37
353	1314+23,55	73.8 LT		C.	2′	T1F OL	-5.73	-11.61			
354	1314+36.46	75.3 LT	Α		5′	T1F CL	-5.15	-15.99	-13.39	-11.65	
355	1315+37,42	81.2 LT	Α .		5′	T1F CL	-4.67	-16.28	-12.57	-16.28	
356	1314+50.26	68.1 LT		Α .	4'	T20 F&G	-7.38			-13.32	
357	1315+37.12	6.5 RT		A(7)	4′	T20 F&G	-5.21				-11.97
358	1315+37.31	72.6 LT		A	4'	T20 F&G	-6.44		-12.29		-12.54
359	1317+07.73	10.0 RT		A(7)	4'	T20 F&G	-3.31				-10.09
3510	1317+07.71	79.4 LT		A	4'	T20 F&G	-4.60	-10.45	-10.45	-10.70	
3511	1316+50,48	82.2 LT		С	2'	T1F OL	-4.91			-9.32	
371	1318+70.77	10.0 RT		A(7)	4'	T20 F&G	-1.64				-7.82
372	1320+55.68	68.0 LT		A	4'	T1F OL	-0.94	-7.21	-7.21		-7.21
		90.0 L1		_ ^_	-	1 11r OL	-0.34	-1,21	1.21	-	-1.21
373	NOT USED		-	1(7)		700 500					6.00
374	1320+55.69	8.6 RT		A(7)	4'	T20 F&G	-0.43				-6.90
375	1321+23.99	70.0 LT		A .	4'	T20 F&G	-0.65			-6.92	
376	NOT USED		-		-	-	-				
377	1317+89.83	81.6 LT		Α.	4′	T20 F&G	-3.78			-10.11	
391	1324+30.91	10.0 RT		A(7)	-4'	T20 F&G	-0.58				-5.63
392	1324+31.44	72.0 LT		A	4′	T20 F&G	-0.53		-5.96		-5.96
393	1326+19.17	10.0 RT		A(7)	4′	T20 F&G	-1.85				-6.97
394	1326+26.42	72.0 LT		Α.	4′	T20 F&G	-0.97		-7.30		
395	1328+11.39	10.0 RT	, , , , , , , , , , , , , , , , , , , ,	. A(7)	4′	T20 F&G	-3.99				-9.08
396	1328+11.28	72.0 LT		A	4'	T20 F&G	-3.04		-9.41		
411	1330+05.38	9.8 RT		A(7)	4′	T20 F&G	-6.51				-12.61
412	1330+05.19	72.0 LT		A	4'	T20 F&G	-5.56		-12.94		-12.94
413	1331+78.52	10.0 RT		A(7)	4'	T20 F&G	-8.76				-13.87
414	1331+74.86	72.0 LT	,	A	4'	T20 F&G	-8.03		-14.20		
415	1333+49.78	10.0 RT		A(7)	4'	T20 F&G	-10.95		11129		-16.07
431	1334+90.69	10.0 RT		A(7)	4'	T20 F&G	-11.74	-17,00	_		10.01
								-11.00		17.00	
432	1335+10.69	10.0 RT	<u> </u>	A(7)	4'	T20 F&G	-11.74	17.07		-17.00	47.07
433	1335+00.69	10.0 RT		A(7)	4′	T20 F&G	-11.74	-17.03		-17,03	-17.03
434	NOT USED		-			-					
435	1335+32.08	79.9 LT		С	2′	T1F OL	-11.72		-18.04		
436	1336+06.22	10.0 RT		A(7)	4'	T20 F&G	-11.36				-16.98
437	1336+06.23	72.0 LT		A	4′	T20 F&G	-11.66		-17.31	-17.31	-17.31
438	1366+06.00	76.7 LT	Α		4′	T1F CL	-9.37	-17.32	-17.32	-17.32	
439	1337+76.63	10.0 RT		A(7)	4′	T20 F&G	-9.99				-16.16
4310	1337+76.64	72.0 LT		Α	4′	T20 F&G	-10.34		-16.49		-16.49
4311	1337+70.46	77.5 LT	Α		4′	T1F CL	-8.10		-16.52	-16.52	
4312	1334+34.10	81.5 LT		Α	4′	T20 F&G	-12.16				-17.52
4313	1335+49.68	72.0 LT		A	4′	T20 F&G	-11.96	-17.08			
451	1339+47.70	10.0 RT		A(7)	4′	T20 F&G	-8.63				-14.47
452	1339+47.69	72.0 LT		A	4'	T20 F&G	-8.95	-15.05	-14.80		
453	1340+50.01	80.0 LT		С	2'	T1F OL	-8.30			-13.19	
454	NOT USED		_	 			-		-	†	
455	1341+11.63	10.0 RT		A(7)	4′	T20 F&G	-7.31			 	-13,13
				 					_13 40	-	
456	1341+11.64	72.0 LT		A	4'	T20 F&G	-7.61	10.00	-13.46	10.00	-13.71
457	1341+11.64	81.5 LT	· A		5′	T1F CL	-7.79	-18.09	-13.74	-18.09	
458	1343+49.82	10.0 RT		A(7)	4′	T20 F&G	-5.41				-10,50
459	NOT USED		-		-	-	-				
4510	1343+49.84	81.4 LT	A(6)		5′	T1F CL	-6.12	-16.89	-10.86	-17.39	
471	1345+29.36	83.9 LT		С	2′	T1F OL	-4.30			-9.94	
472	1345+19.32	76.0 LT		Α	4′	T20 F&G	-4.46				-10.29
473	1345+15.52	85.4 LT	Α		4′	T1F CL	-4.74	-9.99	-10.33	-16.25	
474	1345+81.77	10.0 RT	l	A(7)	4'	T20 F&G	-3,55			T	-8.86

STORM SEWER SCHEDULE

PIPE NUMBER	UPSTREAM STATION	DOWNSTREAM STATION	TYPE	DIA. (IN)	LENGTH (FT)	SLOPE %	T.B. (CU.YD)
351	1314+34.95	1314+35.58	2	12	67	0.44	19.4
352	1314+35.58	1314+36.46	2	12	5	0.44	1.4
353	1314+23.55	1314+36.46	2	12	10	0.44	0.0
354	1314+36.46	1315+37.42	2	24	96	0.30	0.0
355	1315+37.42	1316+01.84	3	24	60	0.30	0.0
356	1314+50.26	1314+35.58	2	12	11	0.44	3.2
357	1315+37.12	1315+37.31	2	12	72	0.44	20.8
358	1315+37.31	1315+37.42	2	15	7	0.44	1.3
359	1317+07.73	1317+07.71	2	12	82	0.44	23.7
3510	1317+07.71	1316+86.53	2	15	19	0.44	6.3
3511	1316+50.48	1316+01.84	2	12	45	0.44	0.0
371	1318+70.77	1318+70.56	2	12	80	0.44	23.1
372	NOT USED	-		-	-	-	-
373	NOT USED	-		-	-		
374	1320+55.69	1320+55.68	2	12	71	0.44	20.5
375	1321+23.99	1320+55.68	2	12	65	0.44	18.8
376	NOT USED	-	-	-	-	-	-
377	1317+89.83	1317+07.71	2	12	78	0.44	22.5
391	1324+30.91	1324+31.44	2	12	74	0.44	21.4
392	1324+31.44	1324+35.40	2	12	4	0.44	1.2
393	1326+19.17	1326+26.42	2	12	75	0.44	21.7
394	NOT USED	-	-	-	-	-	***
395	1328+11.39	1328+11.28	. 2	12	74	0.44	21.4
411	1330+05.38	1330+05.19	2	15	74	0.44	24.3
412	1330+05.19	1330+17.82	2	15	14	0.44	2.0
413	1331+78.52	1331+74.86	2	15	75	0.44	24.7
414	NOT USED	-	-	-	-	_	
415	1333+49.78	1333+47.39	2	12	66	0.44	19.1
431	1334+90.69	1335+00.69	2	15	6	0.44	2.0
432	1335+10.69	1335+00.69	2	15	6	0.44	2.0
433	1335+00.69	1335+00.40	2	15	70	0.44	23.0
434	NOT USED	- .	-	-	-	-	
435	1335+32.08	1335+31.63	2	12	2	0.44	0.0
436	1336+06.22	1336+06.23	2	12	74	0.44	21.4
437	1336+06.23	1366+06.00	2	15	3	0.44	1.0
438	1366+06.00	1335+31.63	2	18	70	0.50	74.6
439	1337+76.63	1337+76.64	2	12	74	0.44	21.4
4310	1337+76.64	1337+70.46	2	15	6	0.44	2.0
4311	1337+70.46	1366+06.00	2	18	161	0.50	212.8
4312	1334+34.10	1334+34.79	.2	12	7	0.44	1.2
4313	1335+49.68	1336+06.23	2	12	53	0.44	15.3
451	1339+47.70	1339+47.69	2	12	74	0.44	21.4
452	1339+47.69	1340+03.67	2	15	53	0.44	11.5
453	1340+50.01	1340+03.67	2	12	43	0.44	0.0
454	NOT USED		-	-	-	-	-
455	1341+11.63	1341+11.64	2	12	74	0.44	21.4
456	1341+11.64	1341+11.64	2	15	7	0.44	1.3
457	1341+11.64	1340+03.67	2	24	103	0.30	0.0
458	1343+49.82	1343+49.82	2	12	75	0.44	21.7
459	1343+49.82	1343+49.84	2	18	7	0.44	0.7
4510	1343+49.84		2	24	234	0.30	
	1345+29.36	1341+11.64 1345+15.52	2	12	11	0.44	0.0
471 472			2	12	9		0.0
473	1345+19.32 1345+15.52	1345+15.52 1343+49.84	3	18	162	0.44	0.9
474	1345+81.77	1345+81.87	2	12	74	0.40	21.4
475	1347+79.53	1347+79.54	2	12	79	0.44	22.8
CIP	7741412'07	1341713.34	. 4	14	13	0.44	22.0

F.A.I. RTE.	SECTIO	N	(COUNTY	TOTAL	SHEET NO.
94	1818 R-	-6	Ι	COOK	290	144
STA. 1	313+00		TO	STA. 13	67+00	
FED. RO	AD DIST. NO.	ILLI	OIS	FED. AI	D PROJECT	

60B18

NOTES:

(1) INDICATES INLET TYPE A, 2' DIAMETER, TYPE 20 FRAME & GRATE.

(2) INDICATES MANHOLE, TYPE A, 6' DIAMETER, TYPE 1 FRAME, CLOSED LID, RESTRICTOR PLATE.
(3) INDICATES SEWER LATERAL WITH 45° CONNECTION. SEE SHEET "DETAIL OF STORM SEWER CONNECTIONS TO SEWER."

(4) INDICATES SEWER LATERAL WITH 30° CONNECTION. SEE SHEET "DETAIL OF STORM SEWER CONNECTIONS TO SEWER."

(5) INDICATES SEWER LATERAL WITH 60° CONNECTION. SEE SHEET "DETAIL OF STORM SEWER CONNECTIONS TO SEWER."

(6) INDICATES MANHOLE TYPE A WITH FLAT SLAB TOP, IDOT STANDARD 602601.

(7) INDICATES CATCH BASIN REQUIRING TEMPORARY SOIL RETENTION SYSTEM WITH INSTALLATION.

(8) ALL STRUCTURE ELEVATIONS IN RESURFACED AREAS COME FROM AERIAL SURVEY AND SHOULD BE VERIFIED IN THE FIELD AND ADJUSTED TO MATCH EXISTING CONDITIONS.

CASING SIZES


PIPE SIZE	CASING SIZE (OD)*	CASING WALL THICKNESS
12"	30"	0.500"
24"	42"	0.625"
30"	48′′	0.688"
36"	48"	0.688"

*ALL STEEL CASING SHALL MEET OR EXCEED ASTM A-139, GRADE B. SEE THE DRAINAGE & UTILITY PLANS FOR LOCATION OF ALL STRUCTURES.

CATCH BASIN STATIONS ARE MEASURED TO CENTER OF STRUCTURE.


CATCH BASIN OFFSETS ARE MEASURED TO FLOWLINE OF CASTING. (SEE BELOW)

FLOWLINE OF CASTING IS LOCATED AT ¢
OF STRUCTURE FOR CATCH BASINS LOCATED
IN SWALE AND GORE AREAS.

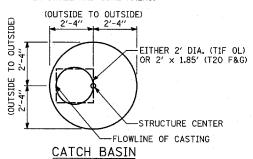

(PRECAST REINFORCED CONCRETE SECTION)

MANHOLE STATIONS AND OFFSETS ARE MEASURED TO CENTER OF STRUCTURE. (SEE BELOW)

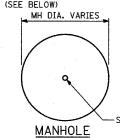

-STRUCTURE CENTER

SHEET 1 OF 2 ILLINOIS DEPARTMENT OF TRANSPORTATION

DRAWN BY: RD

CHECKED BY: DA

REVISIONS NAME DATE F.A.I. 94 (DAN RYAN EXPRESSWAY) DRAINAGE STRUCTURE SCHEDULE

DATE: MARCH 1, 2006

SCALE: NONE

TYLININTERNATIONAL

DRAINAGE STRUCTURE SCHEDULE

			T T T								
STRUCTURE NUMBER	STATION	OFFSET	STRUCTU	JRE TYPE CB	DIA.	FRAME & LID	TOP OF FRAME	N INV.	E INV.	S INV.	W INV.
475	1347+79,53	10.0 RT	1	A(7)	4′	T20 F&G	-1.97				-7.53
491	1349+91.33	10.0 RT		A(7)	4'	T20 F&G	-0.27				-6.27
492	1351+77.81	10.0 RT		A(7)	4'	T20 F&G	0.98				-4,46
493	1354+81.41	10.0 RT		A(7)	4'	T20 F&G	1.22				-4,52
	1356+81.57	 			4'	T20 F&G					-6.34
516		10.0 RT		A(7)			0.13				
517	1358+61.71	10.0 RT		A(7)	4'	T20 F&G	-1.71				-8.36
531	1360+79.63	10.0 RT		A(7)	4′	T20 F&G	-4.30				-10.15
532	1362+79.80	10.0 RT		A(7)	4′	T20 F&G	-6.68				-13.94
533	1362+79.46	80.0 LT		Α .	4'	T20 F&G	-7.21		-14.30		-14.30
534	1364+64.66	10.3 RT		A(7)	4'	T20 F&G	-8.90				-14.77
535	1364+64.80	80.0 LT		A	4′	T20 F&G	-9.38		-15.13		-15.13
551	1366+11.98	10.0 RT		A(7)	4′	T20 F&G	-9.79	-16.60			
552	1366+31.98	10.0 RT		A(7)	4′	T20 F&G	-9.79			-16.60	
553	1366+21.98	10.0 RT		A(7)	4′	T20 F&G	-9.79	-16.63		-16.63	-16.63
554	1366+12.32	85.0 LT		С	2′	T1F OL	-8.11	-14.55			
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STORM SEWER SCHEDULE

		·					
PIPE NUMBER	UPSTREAM STATION	DOWNSTREAM STATION	TYPE	DIA. (IN)	LENGTH (FT)	SLOPE	T.B. (CU.YD)
491	1349+91.33	1349+91.33	2	12	70	0.44	20.2
492	1351+77.81	1352+04.92	2	12	79	0.44	22.8
493	1354+81.41	1354+81.13	.2	12	74	0.44	21.4
516	1356+81.57	1356+57.85	2	12	78	0.44	22.5
517	1358+61.71	1358+62.30	2	12	70	0.44	20.2
531	1360+79.63	1360+79.64	2	12	72	0.44	20.8
532	1362+79.80	1362+79.46	2	12	82	0.44	23.7
							
533	1362+79.46	1362+79.43	2	12	3	0.44	0.9
534	1364+64.66	1364+64.80	2	12	82	0.44	23.7
535	1364+64.80	1364+61.61	2	15	3	0.44	1.0
551	1366+11.98	1366+21.98	2	18	6	0.44	2.1
552	1366+31.98	1366+21.98	2	18	6	0.44	2.1
553	1366+21.98	1366+22.22	. 2	18	85	0.44	30.4
554	1366+12.32	1366+21.43	2	12	-6	0.44	0.0
		·					
		-					
							
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_	F.A.I. RTE.	SECTION	COUNTY	TOTAL SHEETS	SHEET NO.
	94 1818 R-6		соок	290	145
	STA.	1313+00	TO STA. 136	7+00	

60B18

FED. ROAD DIST. NO. ILLINOIS FED. AID PROJECT

NOTES:

(1) INDICATES INLET TYPE A, 2' DIAMETER, TYPE 20 FRAME & GRATE.

(2) INDICATES MANHOLE, TYPE A, 6' DIAMETER, TYPE 1 FRAME, CLOSED LID, RESTRICTOR PLATE.

(3) INDICATES SEWER LATERAL WITH 45° CONNECTION. SEE SHEET "DETAIL OF STORM SEWER CONNECTIONS TO SEWER."

(4) INDICATES SEWER LATERAL WITH 30° CONNECTION. SEE SHEET "DETAIL OF STORM SEWER CONNECTIONS TO SEWER."

(5) INDICATES SEWER LATERAL WITH 60° CONNECTION. SEE SHEET "DETAIL OF STORM SEWER CONNECTIONS TO SEWER."

(6) INDICATES MANHOLE TYPE A WITH FLAT SLAB TOP, IDOT STANDARD 602601.

(7) INDICATES CATCH BASIN REQUIRING TEMPORARY SOIL RETENTION SYSTEM WITH INSTALLATION.

(8) ALL STRUCTURE ELEVATIONS IN RESURFACED AREAS COME FROM AERIAL SURVEY AND SHOULD BE VERIFIED IN THE FIELD AND ADJUSTED TO MATCH EXISTING CONDITIONS.

CASING SIZES

PIPE SIZE	CASING SIZE (OD)*	CASING WALL THICKNESS
12"	30"	0.500"
24"	42"	0.625"
30″	48"	0.688"
36"	48''	0.688"


*ALL STEEL CASING SHALL MEET OR EXCEED ASTM A-139, GRADE B.

SEE THE DRAINAGE & UTILITY PLANS FOR LOCATION OF ALL STRUCTURES.

CATCH BASIN STATIONS ARE MEASURED TO CENTER OF STRUCTURE.


CATCH BASIN OFFSETS ARE MEASURED TO FLOWLINE OF CASTING. (SEE BELOW)

FLOWLINE OF CASTING IS LOCATED AT (OF STRUCTURE FOR CATCH BASINS LOCATED IN SWALE AND GORE AREAS.

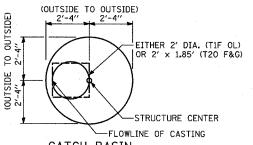

CATCH BASIN (PRECAST REINFORCED CONCRETE SECTION)

MANHOLE STATIONS AND OFFSETS ARE MEASURED TO CENTER OF STRUCTURE. (SEE BELOW)

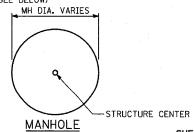

SHEET 2 OF 2

DRAWN BY: RD

CHECKED BY: DA

ILLINOIS DEPARTMENT OF TRANSPORTATION F.A.I. 94 (DAN RYAN EXPRESSWAY) DRAINAGE STRUCTURE SCHEDULE

> SCALE: NONE DATE: MARCH 1, 2006

TYLININTERNATIONAL

UNDERDRAIN SCHEDULE

UNDERDRAIN PIPE LIMITS	OFFSET (FT)	PIPE UNDERDRAIN 6" (FT)	CONNECTING STRUCTURE NUMBER	PIPE UNDERDRAIN 6" (SPECIAL) (FT)
* 1314+04.25 - 1313+00.00	67.30 LT - 62.00 LT	104.3	END	2.0
1314+24.32 - 1314+35.66	68.10 LT - 68.55 LT	11.3	352	2.0
1314+50.30 - 1314+35.66	69.13 LT - 68.55 LT	14.6	352	2.0
1315+37.40 - 1314+50.30	72.60 LT - 69.13 LT	87.1	356	2.0
1317+07.79 - 1315+37.40	79.37 LT - 72.60 LT	170.4	358	2.0
1317+89.87 - 1317+07.79	82.64 LT~ 79.37 LT	82.1	3510	2.0
1314+03.42 - 1313+00.00	0.00 RT-0.00 RT	103.4	END	2.0
1314+22.53 - 1314+34.96	0.00 RT-6.30 RT	12.4	351	2.0
1314+34.96 - 1315+37.40	0.00 RT - 6.68 RT	102.4	357	2.0
1317+07.74 - 1315+37.40	0.00 RT - 6.68 RT	170.3	357	2.0
1318+70.77 - 1317+07.74	0.00 RT-10.00 RT	163.0	359	2.0
1318+66.82 - 1317+89.87	85.70 LT - 79.37 LT	77.0	377	2.0
1322+32.81 - 1321+23.99	72.00 LT - 72.00 LT	108.8	375	2.0
1322+32.81 - 1324+31.44	72.00 LT - 72.00 LT	198.6	392	2.0
1320+55.66 - 1318+70.77	0.00 RT - 10.00 RT	184.9	371	2.0
1322+32.81 - 1320+55.66	0.00 RT-8.62 RT	177.1	374	2.0
1322+32.81 - 1324+30.91	0.00 RT - 10.00 RT	198.1	391	2.0
1325+63.71 - 1324+31.44	72.00 LT - 72.00 LT	132.3	392	2.0
1325+83.58 - 1326+26.42	72.00 LT - 72.00 LT	42.8	394	2.0
1326+26.42 - 1328+11.28	72.00 LT - 72.00 LT	184.9	396	2.0
1328+11.28 - 1330+05.19	72.00 LT - 72.00 LT	193.9	412	2.0
1325+60.16 - 1324+31.44	10.00 RT-10.00 RT	128.7	391	2.0
1325+80.16 - 1326+19.17	0.00 RT - 10.00 RT	39.0	393	2.0
1326+19.17 - 1328+11.39	0.00 RT-10.00 RT	192.2	395	2.0
1328+11.39 - 1330+05.32	0.00 RT - 10.00 RT	193.9	411	2.0
1330+05.32 - 1331+74.86	72.00 LT - 72.00 LT	169.5	414	2.0
1332+48.07 - 1331+74.86	72.00 LT - 72.00 LT	73.2	414	2.0
1333+79.11 - 1334+33.93	86.26 LT - 81.47 LT	54.8	4312	2.0
1330+05.32 - 1331+78.52	0.00 RT - 10.00 RT	173.2	413.	2.0
1331+78.52 - 1333+49.79	0.00 RT - 10.00 RT	171.3	415	2.0
1333+49.79 - 1334+90.69	0.00 RT - 10.00 RT	140.9	431	2.0
1334+33.93 - 1334+90.35	81.48 LT - 76.54 LT	56.4	EX	2.0
1334+90.69 - 1334+90.35	0.00 RT - 72.54 LT	72.6	EX	3.0
1335+00.69 - 1335+00.35	0.00 RT- 71.66 LT	71.7	EX	3.0
1335+10.69 - 1335+10.36	0.00 RT-70.79 LT	70.8	EX	3.0
1334+90.35 - 1335+00.35	76.54 LT- 74.66 LT	10.0	EX	2.0
1335+10.36 - 1335+00.35	74.79 LT - 74.66 LT	10.0	EX	2.0
1334+90.69 - 1335+00.69	10.00 RT-10.00 RT	10.0	433	8.0
1335+10.69 - 1335+00.69	10.00 RT - 10.00 RT	10.0	433	8.0
1335+49.68 - 1335+10.36	72.00 LT - 74.79 LT	39.3	EX	2.0
1336+06.23 - 1335+49.68	72.00 LT - 72.00 LT	56.6	4313	2.0
1337+76.64 - 1336+06.23	72.00 LT - 72.00 LT	170.4	437	2.0
* 1339+47.69 - 1337+76.64	72.00 LT - 72.00 LT	171.0	4310	2.0
1336+06.22 - 1335+10.69	0.00 RT - 10.00 RT	95.5	432	2.0
1337+76.64 - 1336+06.22	0.00 RT - 10.00 RT	170.4	436	2.0
1339+47.68 - 1337+76.64	0.00 RT~10.00 RT	171.0	439	2.0
1341+11.64 - 1339+47.69	72.00 LT - 72.00 LT	164.0	452	2.0
1343+48.82 - 1341+11.64	72.59 LT - 72.00 LT	237.2	456	2.0
1344+38.99 - 1343+48.89	73.28 LT - 72.59 LT	90.1	EX	2.0
1341+11.64 - 1339+47.68	0.00 RT-10.00 RT	164.0	451	2.0
1343+49.82 - 1341+11.64	0.00 RT - 10.00 RT	238.2	455	2.0
1345+61.12 - 1343+49.82	0.00 RT - 10.00 RT	211.3	458	2.0
1345+19.39 - 1344+39.02	75.96 LT - 73.28 LT	80.4	EX	2.0
1345+60.88 - 1345+19.39	77.34 LT- 75.96 LT	41.5	472	2.0

UNDERDRAIN SCHEDULE (CONT.)

UNDERDRAIN PIPE LIMITS	OFFSET (FT)	PIPE UNDERDRAIN 6" (FT)	CONNECTING STRUCTURE NUMBER	PIPE UNDERDRAIN 6" (SPECIAL) (FT)
1346+40.76 - 1345+81.88	80.00 LT- 78.03 LT	58.9	EX	2.0
1347+79.54 - 1346+40.7	84.63 LT-80.00 LT	138.8	EX	2.0
1348+21.47 - 1346+79.5	86.02 LT - 84.63 LT	141.9	EX	2.0
1347+79.53 - 1345+81.7	0.00 RT-10.00 RT	197.8	474	2.0
1349+91.33 - 1347+79.5	0.00 RT-10.00 RT	211.8	475	2.0
1351+77.81 - 1349+91.33	0.00 RT - 10.00 RT	186.5	491	2.0
1353+61.55 - 1351+77.81	0.00 RT-10.00 RT	183.7	492	2.0
1353+61.55 - 1354+81.41	0.00 RT-10.00 RT	119.9	493	2.0
1354+81.41 - 1356+81.5	0.00 RT-10.00 RT	200.2	516	2.0
1359+29.63 - 1359+99.6	86.05 LT - 82.23 LT	70.0	EX	2.0
1359+99.64 - 1360+79.6	4 82.23 LT - 77.87 LT	80.0	EX	2.0
1356+81.57 - 1358+61.71	0.00 RT-10.00 RT	180.1	517	2.0
1359+13.53 - 1360+79.6	0.00 RT-10.00 RT	166.1	531	2.0
1360+79.64 - 1362+79.4	80.00 LT - 80.00 LT	199.8	533	2.0
1362+79.46 - 1364+64.8	80.00 LT - 80.00 LT	185.3	535	2.0
* 1364+64.80 - 1366+07.9	80.00 LT - 78.61 LT	143.1	ΕX	2.0
1366+11.98 - 1366+07.7	33 0.00 RT - 74.00 LT	74.0	EX	6.3
1366+21.98 - 1366+22.2	0.00 RT - 74.00 LT	74.0	EX	6.3
1366+31.98 - 1366+37.1	0.00 RT- 74.00 LT	74.0	EX	6.3
1366+07.93 - 1366+22.2	78.61 LT - 78.82 LT	14.3	EX	4.8
1366+37.12 - 1366+22.2	79.17 LT - 78.82 LT	14.9	EX	4.8
1366+11.98 - 1366+21.98	10.00 RT - 10.00 RT	10.0	553	8.0
1366+31.98 - 1366+21.98	10.00 RT-10.00 RT	10.0	553	8.0
1360+79.63 - 1362+79.8	0.00 RT-10.00 RT	200.2	532	2.0
1362+79.80 - 1364+64.8	0.00 RT-10.00 RT	185.0	534	2.0
1364+64.80 - 1366+11.98	0.00 RT-10.00 RT	147.2	551	2.0
1367+00.00 - 1366+37.1	80.00 LT - 79.17 LT	62.9	EX	2.0
1367+00.00 - 1366+31.9	0.00 RT-10.00 RT	68.0	552	2.0

MANHOLE RECONSTRUCTION SCHEDULE

STRUCTURE NUMBER	CONTRACT NUMBER	STATION	OFFSET	STRUCTURE DATA	EXISTING RIM EL	PROPOSED RIM EL
129	62591	1316+02.20	85.8 LT	MH TY A-6'	-1.05	-4.02
133	62591	1335+31.63	75.9 LT	DROP MH-5'	-11.91	-11.55
381	62695	1364+61.61	84.6 LT	MH TY A-5'	-2.61	-6.58
				· ·		

F.A.I. RTE.	SECTION	ı		COUN	ГҮ	TOTAL SHEETS	SHEET NO.
94	*		соок			764	146
STA.	88+60 (SB] 1126+91 (SB	-57) FORI	D)T(STA	. 1313	+00 (SB	RYAN)
FED. RO	AD DIST. NO.	ILLIN	OIS	FED.	AID	PROJECT	
• (1516	5.1, 1717, &	1818) R	-5	-	6	2593

LEGEND:

*COORDINATE LOCATION OF PIPE UNDERDRAIN WITH LOCATION OF PROPOSED ELECTRICAL DUCT.

SHEET 1 OF 1


REVISIONS NAME DATE		IENT OF TRANSPORTATION RYAN EXPRESSWAY)
		AIN SCHEDULE AND STRUCTION SCHEDULE
	SCALE: NONE DATE: MARCH 1, 2006	DRAWN BY: MB CHECKED BY: DA


EXISTING STORM SEWER REMOVAL SCHEDULE (REQUIRE IN-PLACE TRENCH BACKFILL)


UPSTREAM STATION	OFFS	ET	DIA. (IN)	LENGTH (FT)	T.B. (CY)
1313+65.86	63.15	LT	12	71	8.6
1315+06.79	66.50	LT	10	75	12.7
1316+63.86	71.19	LT	10	82	15.4
1318+54.58	81.21	LT :	10	32.00	5.28
1318+79.60	61.82	LT :	15	74	15.3
1318+87.86	66.53	LT	.10	10	1.4
1320+81.01	75.48	LT	12	88	20.3
1326+19.05	61.00	LT	12	13	2.4
1326+19.05	61.00	LT	12	71	16.8
1331+44.55	68.68	LT	12	35.00	9.00
1334+97.96	70.45	LT	12	83	23.1
1335+27.54	60,50	LT.	12	31	5.4
1336+30.93	60.50	LT	12	72	14.5
1337+82.31	52.43	LT	10	65	8.8
1339+44.98	46.55	LT	12	59.00	11.45
1339+92.86	71.1	LT	10	54.00	15.34
1347+73.79	88.34	LT	10	16	2.8
1349+70.85	70.99	LT	10	14	2.1
1349+80.64	61.34	LT	15	73	14.8
1350+16.22	72.51	LT	12	38	5.0
1352+25.64	68.97	LT	10	94	18.8
1356+84.86	71.33	LT	12	83	17.0
1358+64.96	96.55	LT	12	83.00	10.96
1363+74.39	69.95	LT	10	46	6.3
1364+20.17	68.59	LT	12	44	5.8
1366+06.46	60.97	LT .	10	73	11.8
1366+68.45	7.03	RT	12	33	5.4
1366+61.32	60.00	LT	12	88	14.3

CUEET 1 OF 1


						SHEET	1	OF	1
REVISIONS NAME	DATE					TRANSPORT EXPRES			′)
			E	XISTINO REMOVA	S STORM AL SCH	SEWER EDULE			
		SCALE: DATE:	NONE MARCH	1, 2006		RAWN BY: ME			

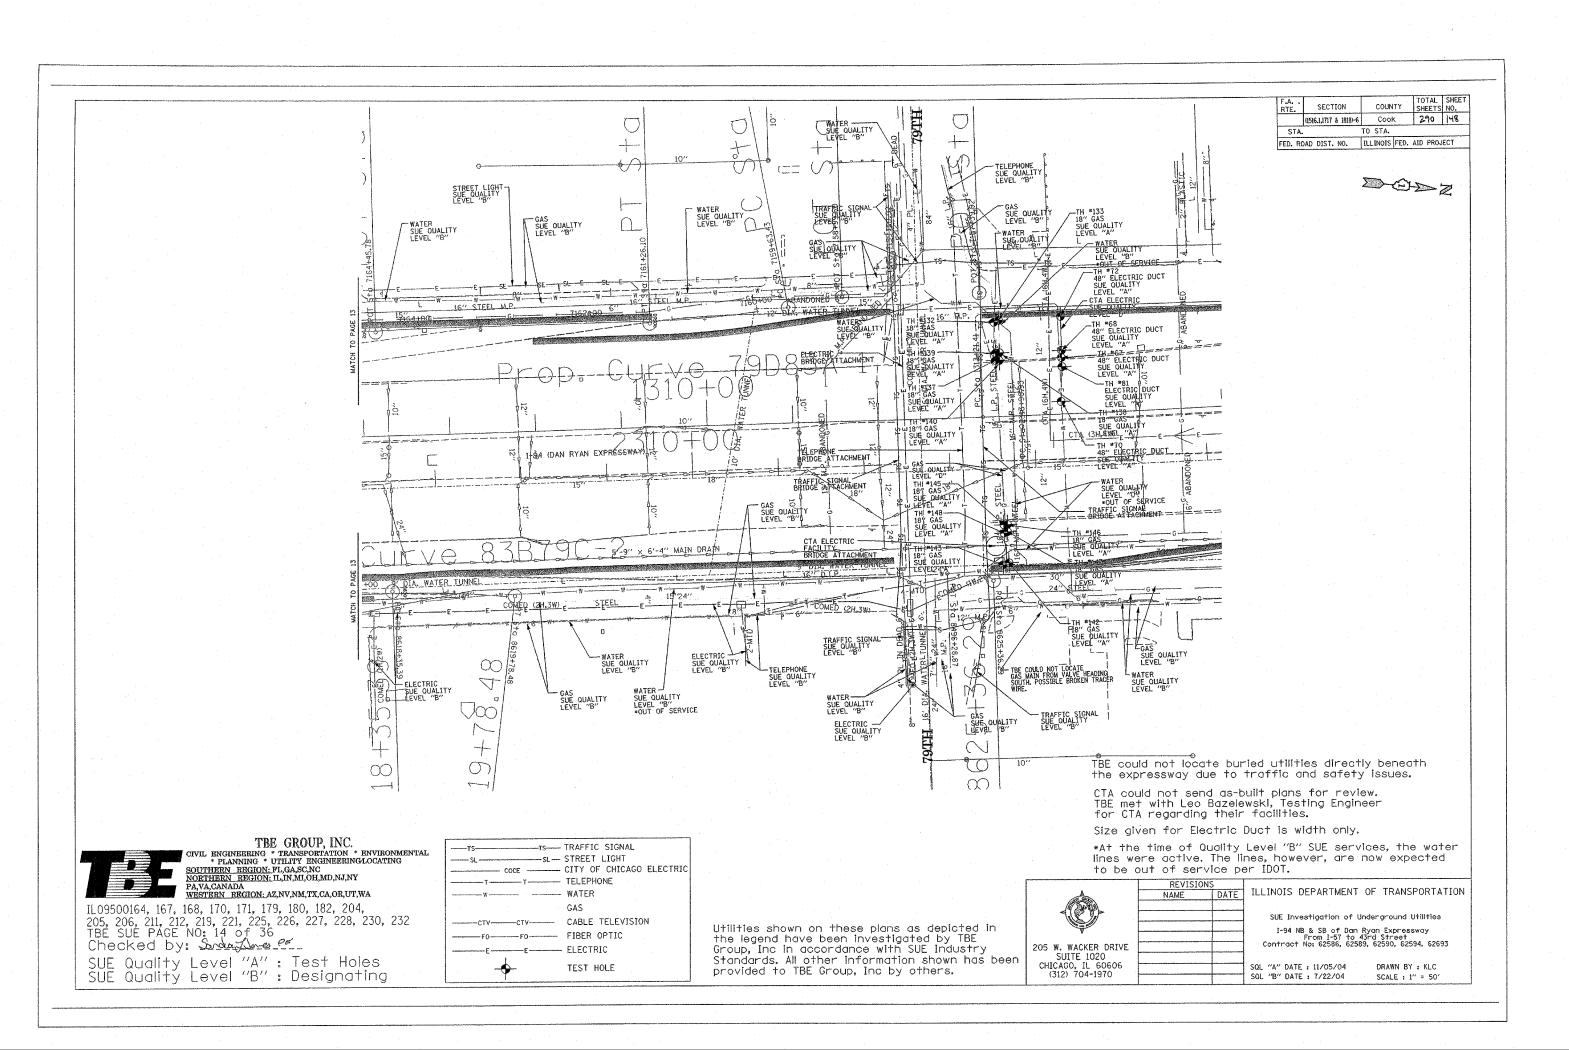

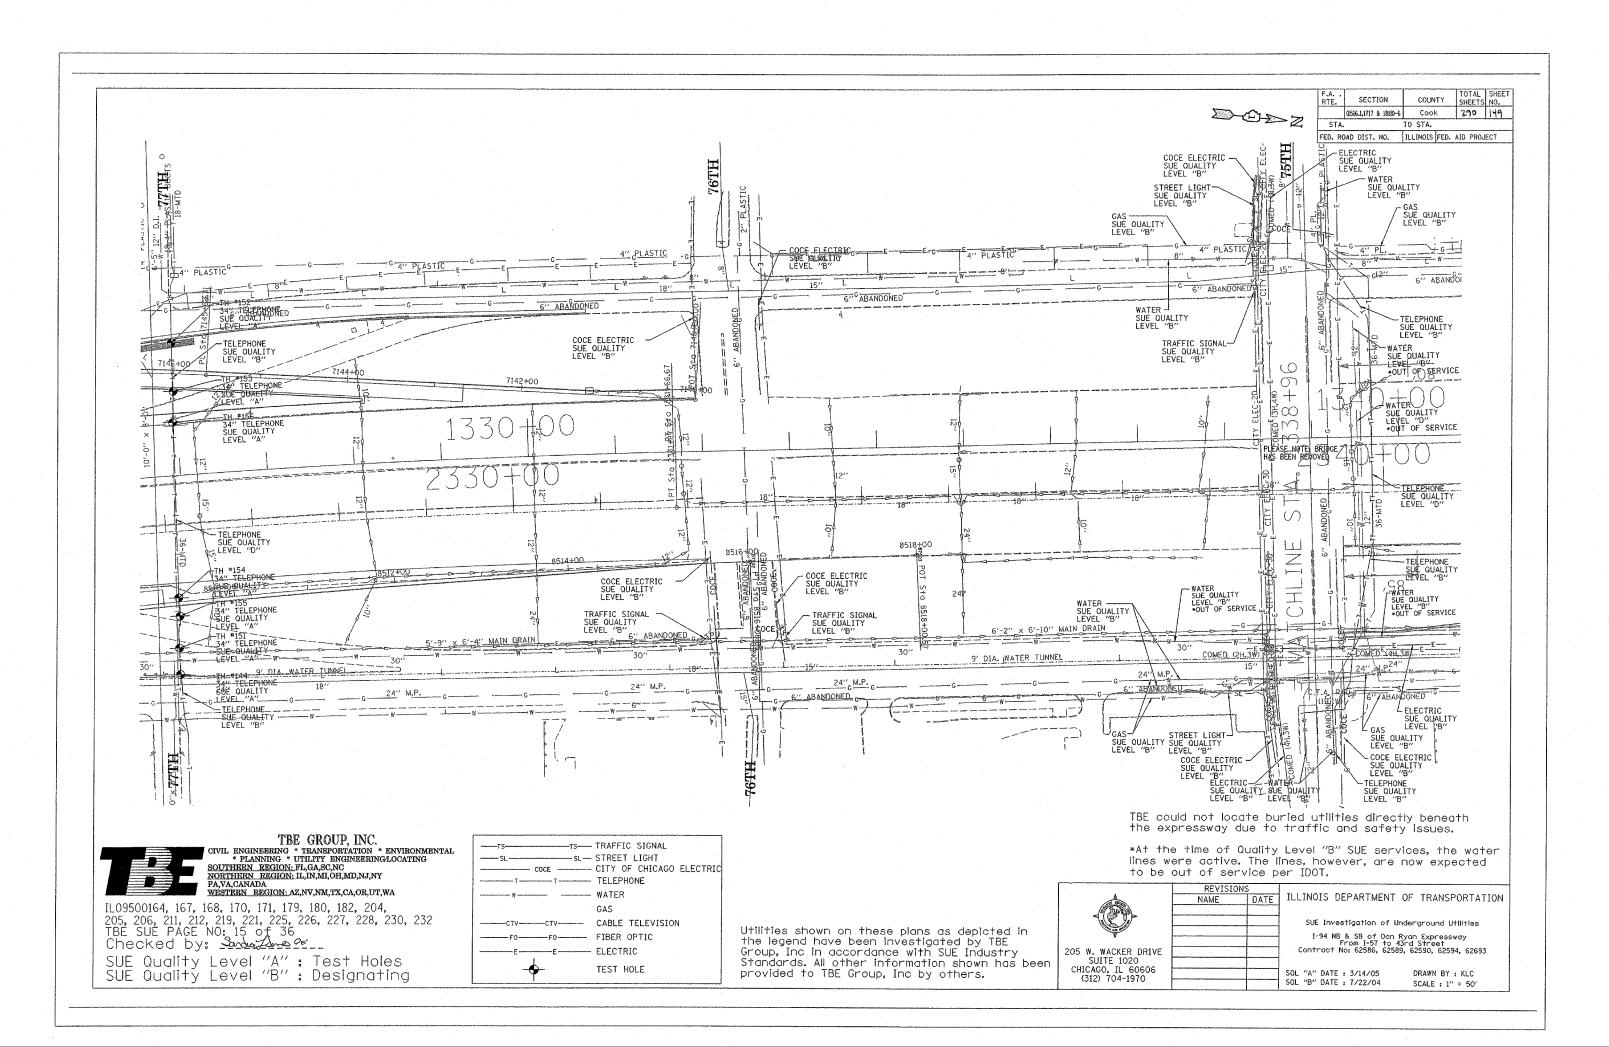

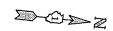

9	F.A RTE.	SECTION	COUNTY	TOTAL SHEETS	SHEET NO.
		(1516.1,1717 & 1818)-6	Cook	290	150
7	STA.		TO STA.		
	FED. RO	AD DIST. NO.	ILLINOIS FED.	AID PROJ	ECT .

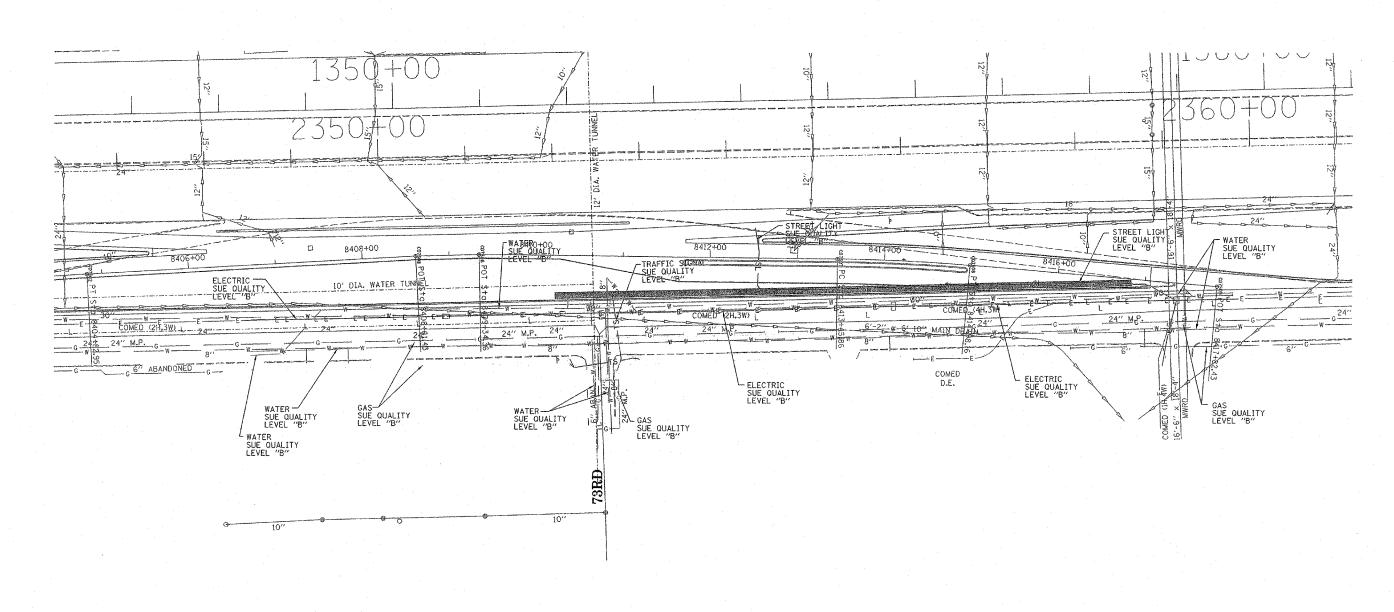

TBE could not locate buried utilities directly beneath the expressway due to traffic and safety issues.




TBE GROUP, INC.

CIVIL ENGINEERING * TRANSPORTATION * ENVIRONMENTAL.

* PLANNING * UTILITY ENGINEERING/LOCATING
SOUTHERN REGION: HL, GAS, C, NC
NOBTHERN REGION: IL, IN, MI, OH, MD, NJ, NY
PA, VA, CANADA
WESTERN REGION: AZ NU NAS GU CA CANADA
WESTERN REGION: AZ NU NAS GU CA CANADA

WESTERN REGION: AZ,NV,NM,TX,CA,OR,UT,WA
IL09500164, 167, 168, 170, 171, 179, 180, 182, 204,
205, 206, 211, 212, 219, 221, 225, 226, 227, 228, 230, 232
TBE SUE PAGE NO: 16 of 36
Checked by: Savara See

SUE Quality Level "A" : Test Holes SUE Quality Level "B" : Designating

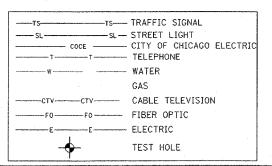

Utilities shown on these plans as depicted in the legend have been investigated by TBE Group, Inc in accordance with SUE Industry Standards. All other information shown has been provided to TBE Group, Inc by others.

	•		>
205	₩.	WACKER	DRI

205 W. WACKER DRIVE SUITE 1020 CHICAGO, IL 60606 (312) 704-1970

REVISIONS	3				
NAME	DATE	ILLINOIS	DEPARTMENT	OF	TRANSPORTATION
		0.15			


SUE Investigation of Underground Utilities

I-94 NB & SB of Dan Ryan Expressway
From I-57 to 43rd Street
Contract No: 62586, 62589, 62590, 62594, 62693

SQL "B" DATE : 7/22/04

DRAWN BY : KLC SCALE : 1" = 50'

COUNTY TOTAL SHEET SHEETS NO. F.A. . RTE. SECTION (1516.1.1717 & 1818)-6 Cook 290 151 TO STA. FED. ROAD DIST. NO. ILLINOIS FED. AID PROJECT

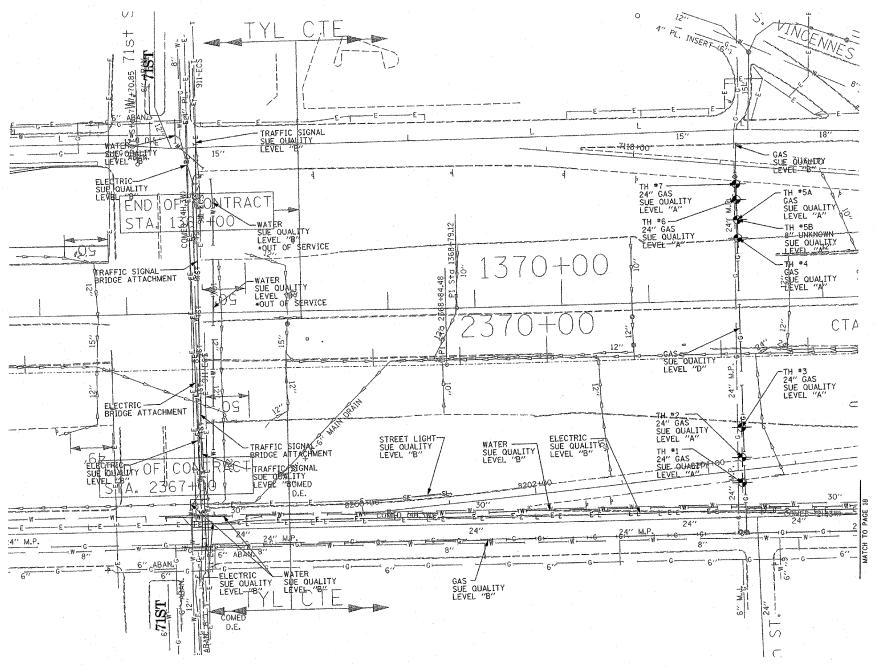



TBE GROUP, INC.


CIVIL ENGINEERING * TRANSPORTATION * ENVIRONMENTAL

* PLANNING * UTILITY ENGINEERINGAOCATING
SOUTHERN REGION: IL, IA, SC, NC
NORTHERN REGION: IL, IN, MI, OH, MD, NJ, NY
PA, VA, CANADA
WESTERDIN DECINON, AZ NAVANON (A) A MESTERDIN DECINON (A) A MESTERDIN

WESTERN REGION: AZ,NV,NM,TX,CA,OR,UT,WA

IL09500164, 167, 168, 170, 171, 179, 180, 182, 204, 205, 206, 211, 212, 219, 221, 225, 226, 227, 228, 232 TBE SUE PAGE NO: 17, of 36 Checked by:

SUE Quality Level "A" : Test Holes SUE Quality Level "B" : Designating

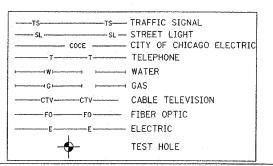

Utilities shown on these plans as depicted in the legend have been investigated by TBE Group, Inc in accordance with SUE Industry Standards. All other information shown has been provided to TBE Group, Inc by others.

TBE could not locate buried utilities directly beneath the expressway due to traffic and safety issues.

*At the time of Quality Level "B" SUE services, the water lines were active. The lines, however, are now expected to be out of service per IDOT.




205 W. WACKER DRIVE SUITE 1020 CHICAGO, IL 60606 (312) 704-1970

DATE ILLINOIS DEPARTMENT OF TRANSPORTATION

SUE Investigation of Underground Utilities I-94 NB & SB of Dan Ryan Expressway From I-57 to 43rd Street Contract No: 62586, 62589, 62590, 62594, 62693

SQL "A" DATE : 3/19/04 SQL "B" DATE : 7/22/04 DRAWN BY : KLC SCALE : 1" = 50'

Z	F.A RTE.	SECTION		COUN	ΤY		TAL	
		(1516.1,1717 & 1818)-6		Cool	<	2	90	152
	STA.		то	STA.				
	FED. RO	DAD DIST. NO.	ILL	INOIS	FED.	AID	PROJ	ECT

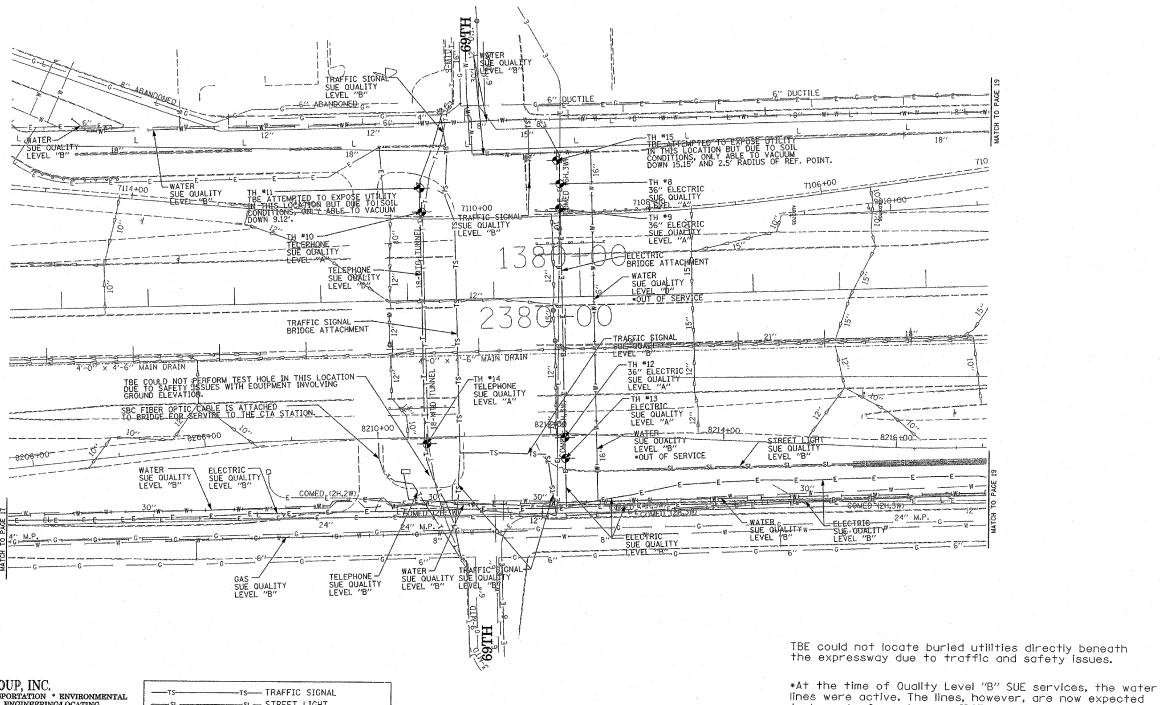

TBE GROUP, INC.

CIVIL ENGINEERING * TRANSPORTATION * ENVIRONMENTAL

* PLANNING * UTILITY ENGINEERINGLOCATING
SOUTHERN REGION: FL,GA,SC,NC
NORTHERN REGION: IL,IN,ML,OH,MD,NJ,NY
PA,VA,CANADA

WESTERN REGION: AZ,NV,NM,TX,CA,OR,UT,WA

IL09500164, 167, 168, 170, 171, 179, 180, 182, 204, 205, 206, 211, 212, 219, 221, 225, 226, 227, 228, 230, 232 TBE SUE PAGE NO: 18 of 36 Checked by:

SUE Quality Level "A" : Test Holes SUE Quality Level "B" : Designating

-ts--- TRAFFIC SIGNAL -st- STREET LIGHT ---- CITY OF CHICAGO ELECTRIC - TELEPHONE CABLE TELEVISION FIBER OPTIC - ELECTRIC TEST HOLE

Utilities shown on these plans as depicted in the legend have been investigated by TBE Group, Inc in accordance with SUE Industry Standards. All other information shown has been provided to TBE Group, Inc by others.

	1
A	N/

to be out of service per IDOT.

205 W. WACKER DRIVE SUITE 1020 CHICAGO, IL 60606 (312) 704-1970

ILLINOIS DEPARTMENT OF TRANSPORTATION

SUE Investigation of Underground Utilities I-94 NB & SB of Dan Ryan Expressway From I-57 to 43rd Street Contract No: 62586, 62589, 62590, 62594, 62693

SQL "A" DATE : 6/09/04 SQL "B" DATE : 7/22/04

DRAWN BY : KLC SCALE : 1" = 50'

153 of 290

	VERIFIED UTILITY INFORMATION										VERIFIED UTILITY INFORMATION									
TEST HOLE #	SIZ	ZE & TYPE	NORTHING	EASTING	TOP OF UTILITY	EXISTING CUT	REFERENCE GROUND ELEVATION	COMMENTS	TEST HOLE #	SIZE	& TYPE	NORTHING	EASTING	TOP OF UTILITY	EXISTING CUT	REFERENCE GROUND ELEVATION	COMMENTS			
1	20)" G	1867123.035	1175606.560	-1.85	1.50	-0.35	SUE QUALITY LEVEL "A"	23	*42"	E	1863105.310	1175651.280	-0.63'	10.05'	9.42'	SUE QUALITY LEVEL "A"			
2	12'	" W	1867115.884	1175606.924	-1.53	1.13	-0.40	SUE QUALITY LEVEL "A"	24	16"	G	1863097.580	1175669.900	0.15'	4.36'	4.51'	SUE QUALITY LEVEL "A'			
3	20)" G	1867122.650	1175602.392	-0.08	0.69	0.61	SUE QUALITY LEVEL "A"	25	16"	G	1863097.130	1175661.950	1.09'	5.01'	6.10'	SUE QUALITY LEVEL "A			
4	20')" G	1867122.945	1175609.366	-6.36	5.41	-0.95	SUE QUALITY LEVEL "A"	26	16"	G	1863096,690	1175655.260	1.53'	6.63'	8.16'	SUE QUALITY LEVEL "A			
5	20)" G	1867132.835	1175901.810	-4.63	3.39	-1.24	SUE QUALITY LEVEL "A"	27	*18"	ВТ	1865094.940	1175582.150	0.35'	11.57'	11.92'	SUE QUALITY LEVEL "A			
6	20'	" G	1867132.928	1175905.856	-2.34	2.74	0.40	SUE QUALITY LEVEL "A"	28	*18"	BT	1865097.810	1175578.180	1.03'	12.10'	13.13'	SUE QUALITY LEVEL "A			
7	20'	" G	1867132.947	1175910.232	0.11	1.93	2.04	SUE QUALITY LEVEL "A"	29	*18"	ВТ	1865100,160	1175573.950	2.11'	12.35'	14.46'	SUE QUALITY LEVEL "A			
. 8	20'	" G	1867132.990	1175897.762	-5.44	3.49	-1.95	SUE QUALITY LEVEL "A"	30	*36"	E	1865099.910	1175578.500	-3.55'	16.71'	13.16'	SUE QUALITY LEVEL "A"			
1A	20'	" G	1861211.910	1177445.200	15.85	3.65	19.50	SUE QUALITY LEVEL "A"	31	*36"	E	1865103,162	1175573.669	-2.89'	17.47'	14.58'	SUE QUALITY LEVEL "A			
2A	8"	W	1861211.860	1177441.360	14.70	4.87	19.57	SUE QUALITY LEVEL "A"	32	*36"	E	1865097.615	1175581.930	-3.91'	15.88'	11,97	SUE QUALITY LEVEL "A			
3A	6"	G	1861211.740	1177450.260	15.19	4.18	19.37	SUE QUALITY LEVEL "A"	33	*36"	Е	1865124.435	1175973.073	0.82'	13.43'	14.25'	SUE QUALITY LEVEL "A			
4A	6"	G	1861598.210	1177437.850	15.50	4.43	19.93	SUE QUALITY LEVEL "A"	34	*18"	BT	1865090.975	1175932.544	-4.41'	6.37'	1.96'	SUE QUALITY LEVEL "A			
5A	20"	" G	1861598.200	1177433.420	17.22	2.82	20.04	SUE QUALITY LEVEL "A"	35	*36"	E	1865105.924	1175934.833	-4.59'	7.05'	2.46'	SUE QUALITY LEVEL "A			
6A	8"	w	1861597.270	1177429.100	15.66	4.42	20.08	SUE QUALITY LEVEL "A"	36	*36"	E	1865120,467	1175968.691	-0.94'	14.14'	13.20'	SUE QUALITY LEVEL "A			
7A	SE	E NOTE	1862113.690	1176035.420		7.29	0.33	SEE NOTE	37	*18"	ВТ	1865098.448	1175972.477	2.26'	10.37'	12.63'	SUE QUALITY LEVEL "A"			
8A	SE	E NOTE	1862704.020	1176033.590	-6.74	5.31	-1.43	SUE QUALITY LEVEL "A"	38	*18"	вт	1865095.321	1175968.307	-0.23'	12,22'	11.99'	SUE QUALITY LEVEL "A			
9	16"	' G	1863104.250	1175969.140	-2.44	4.55	2.11	SUE QUALITY LEVEL "A"	39	See N	ote G	1873623.853	1175722.432		16.00'	12.60'	CLEARANCE DEPTH			
10	16"	' G	1863104.500	1175976.510	-1.83	5.77	3.94	SUE QUALITY LEVEL "A"	40	20"	G	1873624.086	1175713.696	-6.36'	16.78'	10.42'	SUE QUALITY LEVEL "A			
11	16"	' G	1863104.750	1175982.670	0.42	5.48	5.90	SUE QUALITY LEVEL "A"	41	20"	G	1873629.270	1175680.376	-10.19'	9.14'	-1.05'	SUE QUALITY LEVEL "A"			
12	*42	2" E	1863114.170	1175968.110	-2.35	4.64	2.29	SUE QUALITY LEVEL "A"	42	20"	G	1873630.734	1175671.020	-12.73'	9.01'	-3.72'	SUE QUALITY LEVEL "A"			
13	*42	2" E	1863114.830	1175975.120	-2.35	6.43	4.08	SUE QUALITY LEVEL "A"	43	20"	G	1873631,833	1175664.164	-13.65'	7.75'	-5.90'	SUE QUALITY LEVEL "A"			
14	*42	2" E	1863116.050	1175983.240	-2.34	9.02	6.68	SUE QUALITY LEVEL "A"	44	20"	G	1873662.688	1175369,141	-3.90'	4.72'	0.82'	SUE QUALITY LEVEL "A"			
14A	12"	, W	1863125.770	1175969.560	-2.99	5.96	2.97	SUE QUALITY LEVEL "A"	45	20"	G	1873663,608	1175361,458	-2,90'	5.76'	2.86'	SUE QUALITY LEVEL "A"			
15	2x*	*18" BT	1863258.330	1175962.750	-6.25	9.98	3.73	SUE QUALITY LEVEL "A"	46	20"	G	1873664.488	1175351,804	-0.50'	5.98'	5.48'	SUE QUALITY LEVEL "A"			
16	2X*	*18" BT	1863256.850	1175970.740	-3.14	9.44	6.30	SUE QUALITY LEVEL "A"	47	20"	G	1873661.260	1175377.470	-4.21'	3.61'	-0.60'	SUE QUALITY LEVEL "A"			
17	2x*	18" BT	1863255.680	1175981.210	-3.00	12.97	9.97	SUE QUALITY LEVEL "A"	48	*36"	E	1865096.950	1175617.420	-3.95'	5.91'	1.96'	SUE QUALITY LEVEL "A"			
18	2x*	18" BT	1863254.030	1175661.690	-5.00	8.95	3.95	SUE QUALITY LEVEL "A"	48A	(3)1/2"		1865098.890	1175616.560	-1.25'	3.20'	1.95'	SUE QUALITY LEVEL "A"			
19	2x*	18" BT	1863252.560	1175654.200	-4.38	11.01	6.63	SUE QUALITY LEVEL "A"	49	20"	G	1873654.520	1175434.880	-6.86'	4.54'	-2.32'	SUE QUALITY LEVEL "A"			
20	2x*:	18" BT	1863250.510	1175644.060	-3.62	13.39	9.77	SUE QUALITY LEVEL "A"	50	*36"	E	1865097.950	1175663.360	-4.48'	6,85'	2.37'	SUE QUALITY LEVEL "A"			
21	*42	?" E	1863105.180	1175669,260	0.89	3.54	4.43	SUE QUALITY LEVEL "A"	51	*18"	ВТ	1865085.150	1175663.290	-5.46'	7.73'	2.27'	SUE QUALITY LEVEL "A"			
22	*42	" E	1863105.160	1175660.820	-1.00	7.50	6.50	SUE QUALITY LEVEL "A"	52	*18"	BT	1865085.030	1175617.240	-4.60'	6.57'	1.97'	SUE QUALITY LEVEL "A"			
		VIII	тая г	Project Information								22000000		uois Department of		1.01	V			

* Size given is duct width only.

TH#7A unable to determine object found due to water & soil collapsing.

TH#8A found old wood RR ties laid straight in direction of duct. Could not expose utility, however, SBC confirmed that the duct is directly below RR ties. The existing cut is to top of RR ties.

TH#39 TBE could not physically see gas main. Dug to 16' got electronic depth of 19.5'.

ALL INFORMATION SHOWN WAS OBTAINED FROM A LOCATION SURVEY.

Illinois Department of Transportation

I-90 /94 (NB & SB of Dan Ryan Expressway)

Chicago-Cook County

Sec No: (2122–921 PT1) R, (2021–922 PTI,2)

Contract No. 62586, 62589, 62693, 62694, 62695

TBE Project No.: IL09500164, 167, 168, 170, 171, 179, 180, 182, 204, 205,

206, 211, 212, 219, 221, 225, 226, 227, 228, 230, 232

								REVI	SIONS								1		·
DATE BY	DESCRIPTION	DATE	BY	DESCR	RIPTION	DATE	ВҮ	DESCRIPTION	DATE	BY	DESCRIPTION	DATE	BY	DESCRIPTION	DATE	BY	DESCRIPTION	THE CROUP INC	VERIFIED
5/1		1	·						-					Discoult a rott	27211	1 51	DESCRIPTION	· · · · · · · · · · · · · · · · · · ·	A ENTER TEST
Plate Late cala		1 :	- 1			1			1						1	1	1	Southeen region: Ri, ga, sc, no Northeen region: II, in, mi, oh, md, nj, ny Pa, Va, canda Western region: A2, nv, nm, tx, ca, or, ut, wa	UTILITY
110105 2/1 147/04	-		i			1 1	1		1 1			ì	1		1	1		NORTHERN REGION: IL, IN, MI, OH, MD, NJ, NY	OTHER
						1. 1	1		1 1			1			1	i	- [PA, VA, CANADA	LOCATIONS
	tion to the second contract and the cont						LL		l			<u> </u>				ł	1	HESTERN REGION: MA, NV, NOR, TA, CA, OR, OT, WA	LOCATIONS

154 of 290

			VERIFIED UTIL	ITY INFOR	MATION		
TEST HOLE #	SIZE & TYP	E NORTHING	3 EASTING	TOP OF UTILITY	EXISTING CUT	REFERENCE GROUND ELEVATION	COMMENTS
53	*18" BT	1865113.010) 1175555.020	4.67'	14.33'	19.00'	SUE QUALITY LEVEL "A"
54	See Note	E 1865117.050	0 1175555.790		18.59'	18.99'	CLEARANCE DEPTH ONLY
55	*18" BI	1865108.40	0 1175989.320	9.85'	9.02'	18.87'	SUE QUALITY LEVEL "A"
55A	24" SA	N 1865109.30	0 1175987.610	11.77'	7.10'	18.87'	SUE QUALITY LEVEL "A"
56	*36" E	1865136.38	0 1175984.770	3.20'	15.68'	18.88'	SUE QUALITY LEVEL "A"
56A	24" SA	N 1865138.32	0 1175986.600	11.93'	6.92'	18.85'	SUE QUALITY LEVEL "A"
57	*18" BT	1865091.120	1175928.050	-5.77'	7.13'	1.36'	SUE QUALITY LEVEL "A"
58	*36" E	1865105.646	0 1175928.120	-4.59'	6.03'	1.44'	SUE QUALITY LEVEL "A"
59	*36" E	1865104.390	0 1175856.480	-4.90'	7.41'	2.51'	SUE QUALITY LEVEL "A"
60	*18" BT	1865090.48	0 1175856.950	-5.29'	7.65'	2.36'	SUE QUALITY LEVEL "A"
							V
MAN HOLE #	TYPE	NORTHING	EASTING	TOP OF UTILITY	EXISTING CUT	REFERENCE MH RIM ELEVATION	COMMENTS
61	Telephone	1863240.510	0 1175610.790	*1.41'	19.13'	20.54'	SUE QUALITY LEVEL "A"
alandy's resident and an area and a special							
TEST HOLE #	SIZE & TYP	NORTHING	EASTING	TOP OF UTILITY	EXISTING CUT	REFERENCE GROUND ELEVATION	COMMENTS
62	*48" E	1876425.90	0 1176044,730	-6.88'	3.44'	-3.44'	SUE QUALITY LEVEL "A"
63	*48" E	1876427.86	0 1176056.140	-4.87'	4.14'	-0.73'	SUE QUALITY LEVEL "A"
64	*48" E	1876443.77	0 1176104.400	4.13'	8.39'	12.52'	SUE QUALITY LEVEL "A"
65	*48" E	1863237.110	0 1175774.930	-1.66'	4.62'	2,96'	SUE QUALITY LEVEL "A"
66	*48" E	1841495.35	0 1177598.790	8.42'	7.24'	15.66'	SUE QUALITY LEVEL "A"
67	*48" E	1852792.55	0 1177384,230	-10.35'	4.37'	-5.98'	SUE QUALITY LEVEL "A"
68	*48" E	1852792.73	0 1177375.900	-8.91'	4.03'	-4.88'	SUE QUALITY LEVEL "A"
69	*48" E	1841506.530	0 1177600.310	7.60'	8.15'	15.75'	SUE QUALITY LEVEL "A"
				1			***************************************
70	*48" E	1852792.33	0 1177435.710	-12,58'	5.65'	-6.93'	SUE QUALITY LEVEL "A"
70 71	*48" E *28" E	1852792.33 1841906.380		-12.58' 12.54'		-6.93' 16.00'	SUE QUALITY LEVEL "A" SUE QUALITY LEVEL "A"
			0 1177641.010		5.65'		
71	*28" E	1841906.380	0 1177641.010 0 1177336.410	12.54'	5.65' 3.46'	16.00'	SUE QUALITY LEVEL "A"
71 72	*28" E *48" E	1841906.386 1852791.510	0 1177641.010 0 1177336.410 0 1175920.080	12.54'	5.65' 3.46' 7.76'	16.00° 9.59°	SUE QUALITY LEVEL "A" SUE QUALITY LEVEL "A"
71 72 73	*28" E *48" E *48" E	1841906.380 1852791.510 1876423.560	0 1177641.010 0 1177336.410 0 1175920.080 0 1175613.390	12.54' 1.83' -12.48'	5.65° 3.46° 7.76° 8.82°	16.00' 9.59' -3.66'	SUE QUALITY LEVEL "A" SUE QUALITY LEVEL "A" SUE QUALITY LEVEL "A"
71 72 73 74	*28" E *48" E *48" E *48" E	1841906.380 1852791.510 1876423.560 1863227.820	0 1177641.010 0 1177336.410 0 1175920.080 0 1175613.390 0 1177677.360	12.54' 1.83' -12.48' 8.97'	5.65' 3.46' 7.76' 8.82' 11.23'	16.00' 9.59' -3.66' 20.20'	SUE QUALITY LEVEL "A" SUE QUALITY LEVEL "A" SUE QUALITY LEVEL "A"

VERIFIED	UTILITY	INFORMATION

	TEST HOLE #	SIZE & T	7PE	northing	EASTING	TOP OF UTILITY	EXISTING CUT	REFERENCE GROUND ELEVATION	COMMENTS
19	78	*48"	E	1841506.430	1177692.980	-8.94'	7.98'	-0.96'	SUE QUALITY LEVEL "A"
У	79	*48"	E	1841510.920	1177755.020	-9.22'	10.16'	0.94'	SUE QUALITY LEVEL "A"
,,	80	SEE NOTE	E	1841493.150	1177753.350		7.88'	1.00'	CLEARANCE DEPTH ONLY
n	81	SEE NOTE	E	1852793.298	1177394.984	-11.95'	4.69'	-7.26'	SUE QUALITY LEVEL "A"
59	82	*48"	E	1863234.932	1175653.520	-0.86'	7.66'	6.80'	SUE QUALITY LEVEL "A"
9)	83	*48"	Е	1863235.070	1175661.514	-1.64'	5.94'	4.31'	SUE QUALITY LEVEL "A"
,	84	36"	w	1839944.740	1178217.900	-5.13'	2.96'	-2.17'	SUE QUALITY LEVEL "A"
,	85	36"	W	1839889.120	1178193.100	-13.96'	8.61'	-5.35'	SUE QUALITY LEVEL "A"
,	86	36"	w	1839415.910	1178025.040	-1.59'	3.05'	1.46'	SUE QUALITY LEVEL "A"
,	87	16"	UNK	1839528.800	1178066.220	-3.15'	10.03	6.88'	SUE QUALITY LEVEL "A"
_	88	24"	TEL	1839826.880	1178316.500	-6.59'	7.19'	0.60'	SUE QUALITY LEVEL "A"
	89	SEE NOTE	TEL	1839836.600	1178319.800	-5.49'	5.98'	0.49'	SUE QUALITY LEVEL "A"
1"	90	SEE NOTE	TEL	1839793.600	1178305.180	***************************************	13.65'	0.40'	CLEARANCE DEPTH ONLY
	91	24"	TEL	1844059.140	1177578.380	13.58'	2.89'	16.47'	SUE QUALITY LEVEL "A"
	92	36"	W	1839745.710	1178145.690	-18.57'	9.32'	-9.25'	SUE QUALITY LEVEL "A"
	93	24"	BT	1844060.690	1177635.830	-6.44'	7.25'	0.81'	SUE QUALITY LEVEL "A"
	94	24"	BT	1844060.680	1177625.600	-3.42'	6.54'	3.12'	SUE QUALITY LEVEL "A"
	95	16"	W	1839246.750	1178863.580	-6.12'	3.82'	-2.30'	SUE QUALITY LEVEL "A"
	96	SEE NOTE	W	1838928.400	1178898.950	***************************************	10.80'	-1.39'	CLEARANCE DEPTH ONLY
	97	18"	BT				6.12'		NOT SURVEYED
	98	20"	BT	1841825.960	1177936.970	6.82'	8.10'	14.92'	SUE QUALITY LEVEL "A"
	99	36"	W	1874261.670	1175871.220	-1.10'	3.83'	2.73'	SUE QUALITY LEVEL "A"
	100	36"	w	1874261.650	1175880.560	1.35'	3.90'	5.25'	SUE QUALITY LEVEL "A"
	101	36"	W	1874245.970	1175540.410	-2.86'	4.69'	1.83'	SUE QUALITY LEVEL "A"
	102	36"	w	1874245.820	1175531.730	-0.50'	4.56'	4.06'	SUE QUALITY LEVEL "A"
	103	36"	W	1874244.500	1175483.430	11.43'	4.34'	15.77'	SUE QUALITY LEVEL "A"
	104	SEE NOTE	W	1874262.410	1175925.500	13.62'	3.18'	16.80'	SUE QUALITY LEVEL "A"
	105	36"	w	1874245.260	1175675.910	-2.22'	2.72'	0.50'	SUE QUALITY LEVEL "A"
	106	18"	BT	1847350.430	1177491.230	-0.33'	8.75'	8.42'	SUE QUALITY LEVEL "A"
	107	SEE NOTE	BT	1847365.000	1177775.620		16.79'	7.85'	CLEARANCE DEPTH ONLY
	108	24"	BT	1844064.680	1177880.760	6.97'	9.52'	16.49'	SUE QUALITY LEVEL "A"
	109	36"	W	1874248.230	1175729.730	-1.93'	3.19'	1.26'	SUE QUALITY LEVEL "A"

TBE Project Information

TH#54 TBE could not reach utility due to depth, Clearance given.

MH#61 Man Hole elevation to top of phone cables exiting man hole.

TH#80 Could not expose utilities due to extremely hard clay. Clearance depth of 7.88' given.

TH#81 Appears to be a 34" poured in place concrete cap over CTA conduit.

DATE BY

TH#87 found a 16" pipe but was unable to see it due to water table. Probed another 3' down past pipe, unable to find 36" w/m electronic Depth 24'

TH#89 Utility not exposed due to excessive water in hole.

TH#90 Utility not exposed, clearance depth of 13.65'.

TH#96 Utility not exposed, clearance depth of 10.80'.

TH#97 Reference point destroyed by construction crews before survey could be completed.

Material was unidentifiable.

DESCRIPTION

DATE BY

5/18/05 5× GA/OC

TH#104 Concrete cap poured over utility.
TH#107 Utility not exposed, clearance depth of 16.79'.

DESCRIPTION

ALL INFORMATION SHOWN WAS OBTAINED FROM A LOCATION SURVEY.

DATE BY

REVISIONS
DESCRIPTION DATE BY

DATE BY

Illinois Department of Transportation

I-90 /94 (NB & SB of Dan Ryan Expressway)

Chicago-Cook County

Sec No: (2122-921 PT1) R, (2021-922 PTI,2)

Contract No. 62586, 62589, 62693, 62694, 62695

TBE Project No.: IL09500164, 167, 168, 170, 171, 179, 180, 182, 204, 205,

206, 211, 212, 219, 221, 225, 226, 227, 228, 230, 232

DESCRIPTION	

SOUTHERN REGION: L, IN, ML, OH, MD, NJ, NY PA, VA, CANADA WESTERN REGION: AZ, NV, NM, TX, CA, OR, UT, WA

^{*} Size given is duct width only.

155 of 290

TEST SIZE & T 110 24" 111 24" 112 SEE NOTE 113 SEE NOTE 114 24" 115 24" 116 24"	BT	NORTHING 1841825.430 1841825.960 1844068.060 1844066.820 1847363.280 1847363.890 1847364.010	1177895.600 1177908.730 1177841.750 1177850.390 1177733.270 1177740.570	TOP OF UTILITY -4.15' 1.05'	EXISTING CUT 4.72' 4.44' 6.79' 8.03' 5.33'	REFERENCE GROUND ELEVATION 0.57' 5.49' 2.89' 5.95'	COMMENTS SUE QUALITY LEVEL "A" SUE QUALITY LEVEL "A" CLEARANCE DEPTH ONLY	TEST HOLE #	SIZE & TYPE	NORTHING	EASTING	TOP OF UTILITY	EXISTING CUT	REFERENCE GROUND ELEVATION	COMMENTS
111 24" 112 SEE NOTE 113 SEE NOTE 114 24" 115 24"	BT BT BT BT BT BT BT	1841825.960 1844068.060 1844066.820 1847363.280 1847363.890	1177908.730 1177841.750 1177850.390 1177733.270 1177740.570	1.05' 13.55'	4.44' 6.79' 8.03'	5.49° 2.89°	SUE QUALITY LEVEL "A"	141	8" C						
112 SEE NOTE 113 SEE NOTE 114 24" 115 24"	BT BT BT BT BT	1844068.060 1844066.820 1847363.280 1847363.890	1177841.750 1177850.390 1177733.270 1177740.570	-13.55'	6.79' 8.03'	2.89'			v u	1847360.470	1177779.600	3.77'	4.76'	8.53'	SUE QUALITY LEVEL "A"
113 SEE NOTE 114 24" 115 24"	BT BT BT BT	1844066.820 1847363.280 1847363.890	1177850.390 1177733.270 1177740.570	-13.55'	8.03'		CLEARANCE DEPTH ONLY	142	18" G	1852731.450	1177624.740	-0.09'	9.49'	9.40'	SUE QUALITY LEVEL "A"
114 24" 115 24"	BT BT BT	1847363.280 1847363.890	1177733.270 1177740.570	-13.55'		5 05'	OMERCIA DIN 121 OTHI	143	18" G	1852724.450	1177627.310	-1.19'	10.92'	9.73'	SUE QUALITY LEVEL "A"
115 24"	BT BT	1847363.890	1177740.570		5.83'	0.00	CLEARANCE DEPTH ONLY	144	34" BT	1853977.420	1177596.570	1.18'	8.13'	9.31'	SUE QUALITY LEVEL "A"
	вт					-8.22'	SUE QUALITY LEVEL "A"	145	18" G	1852725.400	1177579.740	-14.03'	6.32'	-7.71'	SUE QUALITY LEVEL "A"
116 24"		1847364.010		-12.87'	7.00'	-5.87'	SUE QUALITY LEVEL "A"	146	18" G	1852729.670	1177579.630	-14.36'	6.93'	-7.43'	SUE QUALITY LEVEL "A"
	BT		1177750.010	-13.15'	10.51'	-2.64'	SUE QUALITY LEVEL "A"	147	18" G	1852729.620	1177588.130	-12.06'	7.15'	-4.91'	SUE QUALITY LEVEL "A"
117 24"		1847354.070	1177540.800	-12.62'	4.98'	-7.64'	SUE QUALITY LEVEL "A"	148	18" G	1852725.710	1177589.950	-11.85'	7.38'	-4.47'	SUE QUALITY LEVEL "A"
118 24"	BT	1847354.020	1177532.210	-11.52'	4.52'	-7.00'	SUE QUALITY LEVEL "A"	149	8" G	1847359.120	1177733.980	-13.27'	4.96'	-8.31'	SUE QUALITY LEVEL "A"
119 24"	BT	1841818.360	1177704.030	-6.42'	4.55'	-1.87'	SUE QUALITY LEVEL "A"	150	8" G	1847359.090	1177742.040	-10.62'	5.02'	-5.60'	SUE QUALITY LEVEL "A"
120 24"	BT	1841818.190	1177694.600	-5.43'	5.12'	-0.31'	SUE QUALITY LEVEL "A"	151	34" BT	1853976.090	1177565.940	-2.85'	4.64'	1.79'	SUE QUALITY LEVEL "A"
121 24"	Е	1844061.030	1177617.950	-1.50'	6.67'	5.17'	SUE QUALITY LEVEL "A"	152	34" BT	1853965.300	1177212.750	1.75'	6.56'	8.31'	SUE QUALITY LEVEL "A"
122 (3) 1"	Е	1840742.250	1177446.860	10.93'	4.47'	15.40'	SUE QUALITY LEVEL "A"	153	34" BT	1853967.560	1177268.590	-5.31'	4.54'	-0.77'	SUE QUALITY LEVEL "A"
123 (2)2.5"	E	1840753.910	1177452.070	12.73'	2.88'	15.61'	SUE QUALITY LEVEL "A"	154	34" BT	1853974.820	1177507.770	-7.53'	5.75'	-1.78'	SUE QUALITY LEVEL "A"
124 2"	ВТ	1840831.420	1177479.340	13.17'	2.57'	15.74'	SUE QUALITY LEVEL "A"	155	34" BT	1853976.540	1177529.050	-4.24'	5.72'	1.48'	SUE QUALITY LEVEL "A"
125 2"	E	1840820.710	1177506.720	5.90'	3.01'	8.91'	SUE QUALITY LEVEL "A"	156	34" BT	1853967.230	1177304.800	-5.16'	4.11'	-1.05'	SUE QUALITY LEVEL "A"
126 2"	E	1840804.920	1177597.800	0.06'	3.54'	3.60'	SUE QUALITY LEVEL "A"	157	30" G	1839844.630	1178297,170	-11.94'	11.58'	-0.36'	SUE QUALITY LEVEL "A"
127 (3) 1"	E	1840788.150	1177588.790	0.28'	3.56'	3.84'	SUE QUALITY LEVEL "A"	158	30" G	1839771.030	1178274.550	-15.29'	6.58'	-8.71'	SUE QUALITY LEVEL "A"
128 2"	Е	1840818.210	1177530.500	0.02'	1.85'	1.87'	SUE QUALITY LEVEL "A"	159	30" G	1839779.300	1178277.090	-15.12'	6.55'	-8.57'	SUE QUALITY LEVEL "A"
129 2"	Е	1840816.460	1177545.960	0.42'	1.74'	2.16'	SUE QUALITY LEVEL "A"	160	N∕A G	1839815.630	1178285.320	-0.56'	7.00'	-7.56'	CLEARANCE ONLY
130 SEE NOTE	BT	1839700.920	1178266.540		10.98'	-7.69'	CLEARANCE DEPTH ONLY	161	30" G	1839683.380	1178240.910	-8.79	10.86'	-19.65'	SUE QUALITY LEVEL "A"
131 SEE NOTE	BT	1839752.990	1178287.460		11.56'	-8.92'	CLEARANCE DEPTH ONLY	162	N∕A G	1839720.200	1178252.850	-7.44'	7.00'	-14.44'	CLEARANCE ONLY
132 18"	G	1852714.050	1177342.550	0.87'	7.94'	8.81'	SUE QUALITY LEVEL "A"	163	30" G	1839633.400	1178223.490	-10.63'	6.14'	-16.77'	SUE QUALITY LEVEL "A"
133 18"	G	1852719.380	1177340.460	1.09'	8.36'	9.45'	SUE QUALITY LEVEL "A"	164	30" G	1839624.490	1178220,270	-10.23'	6.61'	-16.84'	SUE QUALITY LEVEL "A"
134 8"	G	1847348.900	1177540.960	-13.64'	6.05'	-7.59'	SUE QUALITY LEVEL "A"								
135 8"	G	1847348.540	1177532.100	-11.04'	4.42'	-6.62'	SUE QUALITY LEVEL "A"								
136 8"	G	1847347.120	1177490.770	1.16'	7.28'	8.44'	SUE QUALITY LEVEL "A"						****		
137 18"	G	1852715.850	1177387.130	-13.52'	7.22'	-6.30'	SUE QUALITY LEVEL "A"								
138 18"	G	1852720.360	1177378.410	-11.64'	7.05'	-4.59'	SUE QUALITY LEVEL "A"								
139 18"	G	1852715.890	1177378.870	-10.80'	6.30'	-4.50'	SUE QUALITY LEVEL "A"								
140 18"	G	1852720.130	1177387.470	-13.53'	7.46'	-6.07	SUE QUALITY LEVEL "A"								

TBE Project Information

TH#112 Utility not exposed, clearance depth of 6.79'.

TH#113 Utility not exposed, clearance depth of 8.03'. TH#130 Utility not exposed, clearance depth of 10.98'. TH#131 Utility not exposed, clearance depth of 11.56'.

TH#136 Unable to expose utility due to hard clay, probed and felt top and side of utility.

TH#145 & 146 Unable to expose utility due to water table at 3' +/-, but were able to feel the sides and top.

TH#160 & 162 Unable to expose utility due to hard clay, clearance of 7' given.

TH#161 Unable to expose utility due to water, but did feel the pipe.

TH#163 & 164 Unable to expose utility due to water, but did feel top and sides of 30" pipe.

ALL INFORMATION SHOWN WAS OBTAINED FROM A LOCATION SURVEY.

Illinois Department of Transportation

I-90 /94 (NB & SB of Dan Ryan Expressway)

Chicago-Cook County

Sec No: (2122-921 PT1) R, (2021-922 PTI,2)

Contract No. 62586, 62589, 62693, 62694, 62695

TBE Project No.: IL09500164, 167, 168, 170, 171, 179, 180, 182, 204, 205,

206, 211, 212, 219, 221, 225, 226, 227, 228, 230, 232

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CONTRACT NO.	SHEE'
62584, 62585, 62586, 62589, 62693, 62694, 62695	4

				VERIFIE	ED UTILI	TY INFO	RMATION	T .	
TEST HOLE #	SIZE &	TYPE	NORTHING	EASTING	OFFSET	TOP OF UTILITY	EXISTING CUT	REFERENCE GROUND ELEVATION	COMMENTS
165	24"	G	1858583.099	1177452.100	148.05 RT	-2.91'	6.08'	3.18'	SUE QUALITY LEVEL "A"
166	24"	G	1858582.607	1177422.881	118.82 RT	-7.96'	11.04'	3.08'	SUE QUALITY LEVEL "A"
167	24"	G	1858581.829	1177388.290	84.23 RT	-11.42'	5.64'	-5.78'	SUE QUALITY LEVEL "A"
168		G	1858576.435	1177169.958	73.59 LT	-14.41'	7.92'	-6.49'	SEE NOTE
169A		G	1858575.515	1177148.755	94.81 LT	-8.73'	5.63'	-3.10'	SEE NOTE
169B	8"		1858574.341	1177148.755	94.81 LT	-7.34'	4.24'	-3.10'	SUE QUALITY LEVEL "A"
170	24"	G	1858574.341	1177125.527	118.07 LT	1.84'	4.35'	6.19'	SUE QUALITY LEVEL "A"
171	24"	G	1858573,831	1177107.217	136.38 LT	5.50'	5.82'	11.32'	SUE QUALITY LEVEL "A"
172	36"	E	1859349.450	1177086.590	133.62 LT	-2.77'	10.34'	7.57'	SUE QUALITY LEVEL "A"
173	36"	E	1859349.210	1177115.830	104.39 LT	-5.89'	4.92'	-0.97'	SUE QUALITY LEVEL "A"
174		ВТ	1859189.980	1177120.790	104.24 LT	-13.77'	12.58'	-1.19'	SUE QUALITY LEVEL "A"
175		BT	1859187.890	1177093.060	132.02 LT	SEE NOTE	9.12'	4.53'	CLEARANCE ONLY
176	36"	E	1859357.690	1177382.160	100.06 RT	-11.29	4.45'	-6.84'	SUE QUALITY LEVEL "A"
177	w	E	1859358.400	1177405.990	123.90 RT	-10.32'	10.06'	-0.26'	SUE QUALITY LEVEL "A"
178	******	T	1859198.040	1177390.570	103.95 RT	-21.35'	12.85	-8.50'	SUE QUALITY LEVEL "A"
179		E	1859345.500	1177059.620	160.69 LT	SEE NOTE	15.15'	16.93'	CLEARANCE ONLY
180	36"	G	1851291.10	1177413,23	80.62 LT	-9.95	6.63	-3.32	SUE QUALITY LEVEL "A"
181	36"	G	1851290.85	1177418.67	75.19 LT	-9.70	6.38	-3.32	SUE QUALITY LEVEL "A"
182	36"	G	1851297.11	1177630.28	136.52 RT	-8.83	5.89	-2.94	SUE QUALITY LEVEL "A"
MAN HOLE #						-			
183	24"	G	1851285.94	1177708.75	45.04 RT	4.76	4.16	8.92	Elev. taken from RIM of MH.
184	12"	G	1851278.82	1177708.69	44.77 RT	4.39	4.52	8.91	Elev. taken from RIM of MH.
TEST HOLE #	SIZE &	TYPE	NORTHING	EASTING	OFFSET	TOP OF UTILITY	EXISTING CUT	REFERENCE GROUND ELEVATION	COMMENTS
185	72"	BT	1877424.23	1176032.38	61.60 LT	-3.79	2.70	-1.09	SUE QUALITY LEVEL "A"
186	66"	вт	1877416.11	1175712.30	66.43 RT	-8.51	5.85	-2.66	SEE NOTE

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	TEST HOLE #	SIZE & TYPE	NORTHING	EASTING	OFFSET	TOP OF UTILITY	EXISTING CUT	REFERENCE GROUND ELEVATION	COMMENTS
"	187	w	1880442.920	1175949.580	65.37' RT	3.59'	8.43'	12.02'	SEE NOTE
"	188	16" BT	1880464.590	1175947.690	64.06' RT	6.63'	5.31'	11.94'	SUE QUALITY LEVEL "A"
"	189	24" W	1880443.800	1175999.780	115.57' RT	7.85'	7.83'	15.68'	SUE QUALITY LEVEL "A"
	190	W	1880442.870	1175973.130	88.91' RT	3.81'	10.10'	13.91'	SEE NOTE
	191	16" BT	1880465.830	1175973.580	89.98' RT	9.59'	4.42'	14.01'	SUE QUALITY LEVEL "A"
"	192	16" BT	1880464.890	1175999.080	115.44' RT	10.21'	5.35'	15.56'	SUE QUALITY LEVEL "A"
"	193	16" BT	1880456.000	1175630.210	61.54'LT	5.65'	8.94'	11.59'	SUE QUALITY LEVEL "A"
"	194	16" BT	1880454.690	1175603.520	88.25' LT	5.44'	8.66'	14.10'	SUE QUALITY LEVEL "A"
"	195	— ВТ	1880453.540	1175575.610	116.18' LT	4.75'	12.13'	16.88'	SEE NOTE
"	196	24" W	1880435.180	1175604.240	88.06' LT	6.76'	7.24'	14.00'	SUE QUALITY LEVEL "A"
"	197	24" W	1880435.160	1175579.320	112.97' LT	11.06'	5.48'	16.54'	SUE QUALITY LEVEL "A"
	198	36" G	1883748.370	1175516.740	86.01' LT	1.10'	7.08'	8.18'	SUE QUALITY LEVEL "A"
"	199	36" G	1883747.800	1175488.980	113.78' L/T	6.36'	8.62'	14.98'	SUE QUALITY LEVEL "A"
,,	200	36" G	1883758.000	1175883.780	89.15' RT	-1.07'	5.96'	4.89'	SUE QUALITY LEVEL "A"
,,	201	36" G	1883758.190	1175903.970	109.34'RT	4.06'	6.58'	10.64'	SUE QUALITY LEVEL "A"
	202	36" W	1883741.550	1175904.750	109.67'RT	4.82'	5.74'	10.56'	SUE QUALITY LEVEL "A"
,,	203	36" W	1883730.260	1175489.640	113.59'LT	8.72'	6.25'	14.97'	SUE QUALITY LEVEL "A"
"	204	36" W	1883731,680	1175518.680	84.53' LT	1.69'	5.90'	7.59'	SUE QUALITY LEVEL "A"
"	205	36" W	1883740.460	1175883.620	88.52' RT	-3.96'	8.26'	4.30'	SUE QUALITY LEVEL "A"
-	206	36" W	1883731.390	1175553.040	50.19'LT	-5.51'	6.13'	0.62'	SUE QUALITY LEVEL "A"
	207	BT	1884487.410	1175842.900	67.99' RT	-6.61'	2.98'	-3.63'	SEE NOTE
	208	24" W	1880435.060	1175628.960	63.35' LT	3.08'	8.72'	11.80'	SUE QUALITY LEVEL "A"
	209	36" G	1883749.960	1175552.500	50.22' LT	-5.24'	5.99'	0.75'	SUE QUALITY LEVEL "A"
_	210	36" G	1883756.720	1175845.280	50.63' RT	-6.85'	8.42'	1.566'	SUE QUALITY LEVEL "A"
	211	36" W	1883739.550	1175839.290	44.18' RT	-5.25'	5.86'	0.606'	SUE QUALITY LEVEL "A"
,	212	18" BT	1884480.420	1175521.840	61.14° LT	-7.58'	4,95'	-2.634'	SUE QUALITY LEVEL "A"
	213	18" BT	1884480.320	1175509.110	73.87' LT	-3.89'	4.91'	1.019'	SUE QUALITY LEVEL "A"
7	214	20" BT	1884487.060	1175860.740	85.82' RT	-0.82'	3.19'	2.370'	SUE QUALITY LEVEL "A"
1	215	(1)2" (3).25" SL	1879776.080	1175973.630	71.39' RT	2.91'	4.08'	6.995'	SUE QUALITY LEVEL "A"
	215A	SEE NOTE	1879798.750	1175970.990	69.36' RT	SEE NOTE	13.00'	7.040'	SEE NOTE
		,							

NOTES

- TH #168 Unable to see gas due to ground water.
- TH #169A Unable to see gas due to back fill continually caving in.
- TH #174 We were unable to determine size due to ground water in the hole.
- TH #175 Attempt was made to expose phone duct but were unsuccessful due to extreme heavy compacted clay, we were only able to reach 9.12'
 TH #179 Attempt was made to find electric duct. Went down 15.15' & 2.5' radius of Reference Point.
 TH #186 Unable to expose due to mud and ground water, felt top and sides.

- TH #187 Unable to expose due to wet sand collapsing in hole.
 TH #189 Offset is taken from N. bound Dan Ryan fence line.
- TH #190 Unable to expose due to soil collapsing in hole
- TH #192 Telephone was buried/trenched underneath a slab of concrete with rough edges; width was 48"
- TH #195 Unable to expose due to deep roots in hole
- TH #200 Felt both sides of gas line but unable to cover completely for picture, doing so would

leave a void in soil because of angle of ground level. Back fill kept falling from uphill.

- TH #204 Found the utilities for the street lights at about 2' deep. Offset pulled from CL of Dan Ryan on ramp.
- TH #207 Could not expose due to collapsing sand. Had a good feel with the air lance. Offset taken from C/L of exit ramp
- TH #215A TBE could not find electric crossing, vacumed down 13'.

ALL INFORMATION SHOWN WAS OBTAINED FROM A LOCATION SURVEY.

Illinois Department of Transportation

I-90 /94 (NB & SB of Dan Ryan Expressway)

Chicago-Cook County

Sec No: (2122-921 PT1) R, (2021-922 PTI,2)

Contract No. 62584, 62585, 62586, 62589, 62693, 62694, 62695

TBE Project No.: IL09500164, 167, 168, 170, 171, 179, 180, 182, 204, 205,

206, 211, 212, 219, 221, 225, 226, 227, 228, 230, 232, 238

									REVIS	IONS								
E	DATE	BY	DESCRIPTION															
2/1	1/06	図																



CONTRACT NO.	SHEET NO.
62304	5

157 OF 290

				VERIFIE	D UTI	LITY II	NFORMATION	1
TEST HOLE #	SIZE &	TYPE	NORTHING	EASTING	TOP OF UTILITY	EXISTING CUT	REFERENCE GROUND ELEVATION	COMMENTS
216	*(2)18"	BT	1839456.444	1172788.687	-4.22'	6.61'	2.39'	SUE QUALITY LEVEL "A"
216A	2"	E	1839456.388	1172786.011	0.02'	2.59'	2.61'	SUE QUALITY LEVEL "A"
217	*36"	BT	1839289.482	1172793.032	-1.56'	4.43'	2.87'	SUE QUALITY LEVEL "A"
218	*60"	BT	1839389.227	1172789.927	-3.28'	4.64'	1.37'	SUE QUALITY LEVEL "A"
218A	2"	E	1839390.918	1172787.734	-0.45'	1.94'	1.49'	SUE QUALITY LEVEL "A"
219		BT				3.91'		NO SURVEY PER IDOT. S.B. EXPRESS LANES AT WENTWORTH AVE. RIGHT SHOULDER.
220		BT				7.78'	***********	NO SURVEY PER IDOT. N.B. EXPRESS LANES AT WENTWORTH AVE. RIGHT SHOULDER.
221		BT			*********	4.46'		NO SURVEY PER IDOT. N.B. LOCAL LANES AT ROOT ST. RIGHT SHOULDER.
222		BT	***************************************		***************************************	7.21'	,,,,,,,,,,,,,,,,,,,,,,,,,,,,,,,,,,,,,,,	NO SURVEY PER IDOT. N.B. EXPRESS LANES AT ROOT ST. RIGHT SHOULDER.
223		ВТ				5.95'	***************************************	NO SURVEY PER IDOT. S.B. EXPRESS LANES AT ROOT ST. RIGHT SHOULDER.
224	24"	BT				7.00'		NO SURVEY PER IDOT. N.B. EXPRESS LANES AT 37TH ST. RIGHT SHOULDER. SUE QUALITY LEVEL "A"
225	24"	BT	-	***************************************	***************************************	6.84'	**************	NO SURVEY PER IDOT. S.B. EXPRESS LANES AT 37TH ST. RIGHT SHOULDER. SUE QUALITY LEVEL "A"
226		BT	****		***************************************	2.52'		NO SURVEY PER IDOT. N.B. LOCAL LANES AT 31ST ST. RIGHT SHOULDER.
227	24"	BT		****		4.17'		NO SURVEY PER IDOT. N.B. EXPRESS LANES AT 31ST ST. RIGHT SHOULDER. SUE QUALITY LEVEL "A"
228	18"	BT		**************************************		4.07'		NO SURVEY PER IDOT. S.B. EXPRESS LANES AT 31ST ST. RIGHT SHOULDER. SUE QUALITY LEVEL "A"
229	18"	BT	****			3.16'		NO SURVEY PER IDOT. S.B. LOCAL LANES AT 31ST ST. RIGHT SHOULDER. SUE QUALITY LEVEL "A"

NOTES

* Size given is duct width only.

TH#219 Found wooden piles, one was collapsed and we were able to probe top of BT duct inside Wooden box. Approximate depth of 7' top of duct and 3.91' to top of wooden piles.

TH#220 Found poured concrete over duct. Dug between local and express lanes. Depth

taken from existing pavement on express lane at Wentworth Ave.

TH#221, 222, 223 & 226 Unable tro see size and material due to water and hole caving in.

ALL INFORMATION SHOWN WAS OBTAINED FROM A LOCATION SURVEY.

Illinois Department of Transportation

I-90 /94 (NB & SB of Dan Ryan Expressway)

Chicago-Cook County

Sec No: (2122-921 PT1) R, (2021-922 PTI,2) (1818-ETC.) 2324 6-IP) R8&R9 Contract No. 62586, 62589, 62693, 62694, 62695, 62300, 62302, 62304 TBE Project No.: IL09500164, 167, 168, 170, 171, 179, 180, 182, 204, 205,

206, 211, 212, 219, 221, 225, 226, 227, 228, 230, 232, 238, 239, 246

REVISIONS
DESCRIPTION DATE BY DESCRIPTION DATE BY DESCRIPTION DATE BY DATE BY DESCRIPTION DATE BY DESCRIPTION



TBE GROUP, INC.
SOUTHERN REGION: FLOA SC NC
NORTHERN REGION: LL, IN, MI, OH, MID, NJ, NY
PA, VA, GANDA
WESTERN REGION: AZ, NY, NA, TZ, CA, OR, UT, WA

VERIFIED UTILITY LOCATIONS

TEST HOLE #	SIZE 8	z TYPE	NORTHING	EASTING	offset	TOP OF UTILITY	EXISTING CUT	REFERENCE GROUND ELEVATION	COMMENTS
230		E	1839771.480	1178282.900	40.98 RT	-14.59'	5.95'	-8.64'	SEE NOTE
231		E	1839717.190	1178262.450	7.63 LT	-16.67'	9.39'	-7.28'	SEE NOTE
232	24	вт	1847362.650	1177722.670	54.90 RT	-13.90'	4.58'	-9.32'	SUE QUALITY LEVEL "A
233		ВТ	1847364.070	1177666.640	1.06 LT	-15.30'	6.00'	-9.30'	SEE NOTE
233A		вт	1847359.460	1177663.330	4.50 LT	-14.90'	5.50'	-9.40'	SEE NOTE
234	24	вт	1847358.540	1177612.300	5.81 RT	-17.19'	7.70'	-9.49'	SEE NOTE
235	24	вт	1847354.940	1177556.570	50.00 LT	-14.25'	4.98'	-9.27'	SEE NOTE
236	50	G	1842060.050	1177876.280	56.67 RT	-11.10'	8.03'	-3.07'	SUE QUALITY LEVEL "A
237	16	G	1842055.250	1177879.140	59.39 RT	-11.77	8.63'	-3.14'	SUE QUALITY LEVEL "A
238	16	G	1842053.000	1177820.220	0.43 RT	-10.82'	8.18'	-2.64'	SEE NOTE
239	50	G	1842057.820	1177814.630	5.02 LT	-10.68'	7.74'	-2.94'	SEE NOTE
240	16	G	1842048.430	1177699.910	58.61 LT	-11.07'	7.86'	-3.21'	SEE NOTE
241	50	G	1842054.250	1177699.450	58.90 LT	-10.21'	6.91'	-3.30'	SUE QUALITY LEVEL "A
242	50	G	1842060.221	1177881.622	62.02 RT	-11.18'	7.90'	-3.28'	SUE QUALITY LEVEL "A
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VERIFIED UTILITY INFORMATION

158 of 290

est Ole #	SIZE & TYPE	NORTHING	EASTING	OFFSET	TOP OF UTILITY	EXISTING CUT	REFERENCE GROUND ELEVATION	COMMENTS
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NOTES

TH# 230 COULD NOT SEE DUCT DUE TO EXCESSIVE GROUND WATER BUT PROBED AND FELT SIDES AND TOP OF 48" WIDE DUCT.

TH# 231 COULD NOT SEE DUCT DUE TO EXCESSIVE GROUND WATER BUT PROBED AND FELT SIDES AND TOP OF 24" WIDE DUCT.

TH# 233 & 233A WE WERE NOT ABLE TO EXCAVATE ANY DEEPER THAN DEPTHS RECORDED DUE TO EXTREMELY HARD SOIL

CONDITIONS. WE HAD A DIFFICULT TIME PIN POINTING DUCT PACKAGE ELECTRONICALLY, THIS IS THE REASON WHY WE ATTEMPTED MULTIPLE HOLES IN THIS LOCATION.

TH# 234 & 235 NOT ABLE TO SEE PHONE DUCT DUE TO EXCESSIVE WATER AND SAND CAVING IN, BUT PROBED AND WERE ABLE TO FEEL BOTH SIDES AND TOP OF 24" WIDE DUCT.

TH# 238 & 240 NOT ABLE TO SEE GAS MAIN, BUT WAS ABLE TO TO PROBE AND FEEL SIDES AND TOP OF 16" MAIN.

TH# 239 NOT ABLE TO SEE GAS MAIN, BUT WAS ABLE TO TO PROBE AND FEEL SIDES AND TOP OF 50" MAIN.

Illinois Department of Transportation


I-90 /94 (NB & SB of Dan Ryan Expressway) Chicago-Cook County Sec No: (2122-921 PT1) R, (2021-922 PTI,2)

Contract No. 62584, 62585, 62586, 62589, 62593, 62693, 62694, 62695 TBE Project No.: IL09500164, 167, 168, 170, 171, 179, 180, 182, 204, 205, 206, 211, 212, 219, 221, 225, 226, 227, 228, 230, 232, 235, 237, 238, 248, 249

ALL INFORMATION SHOWN WAS OBTAINED FROM A LOCATION SURVEY.


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60B18

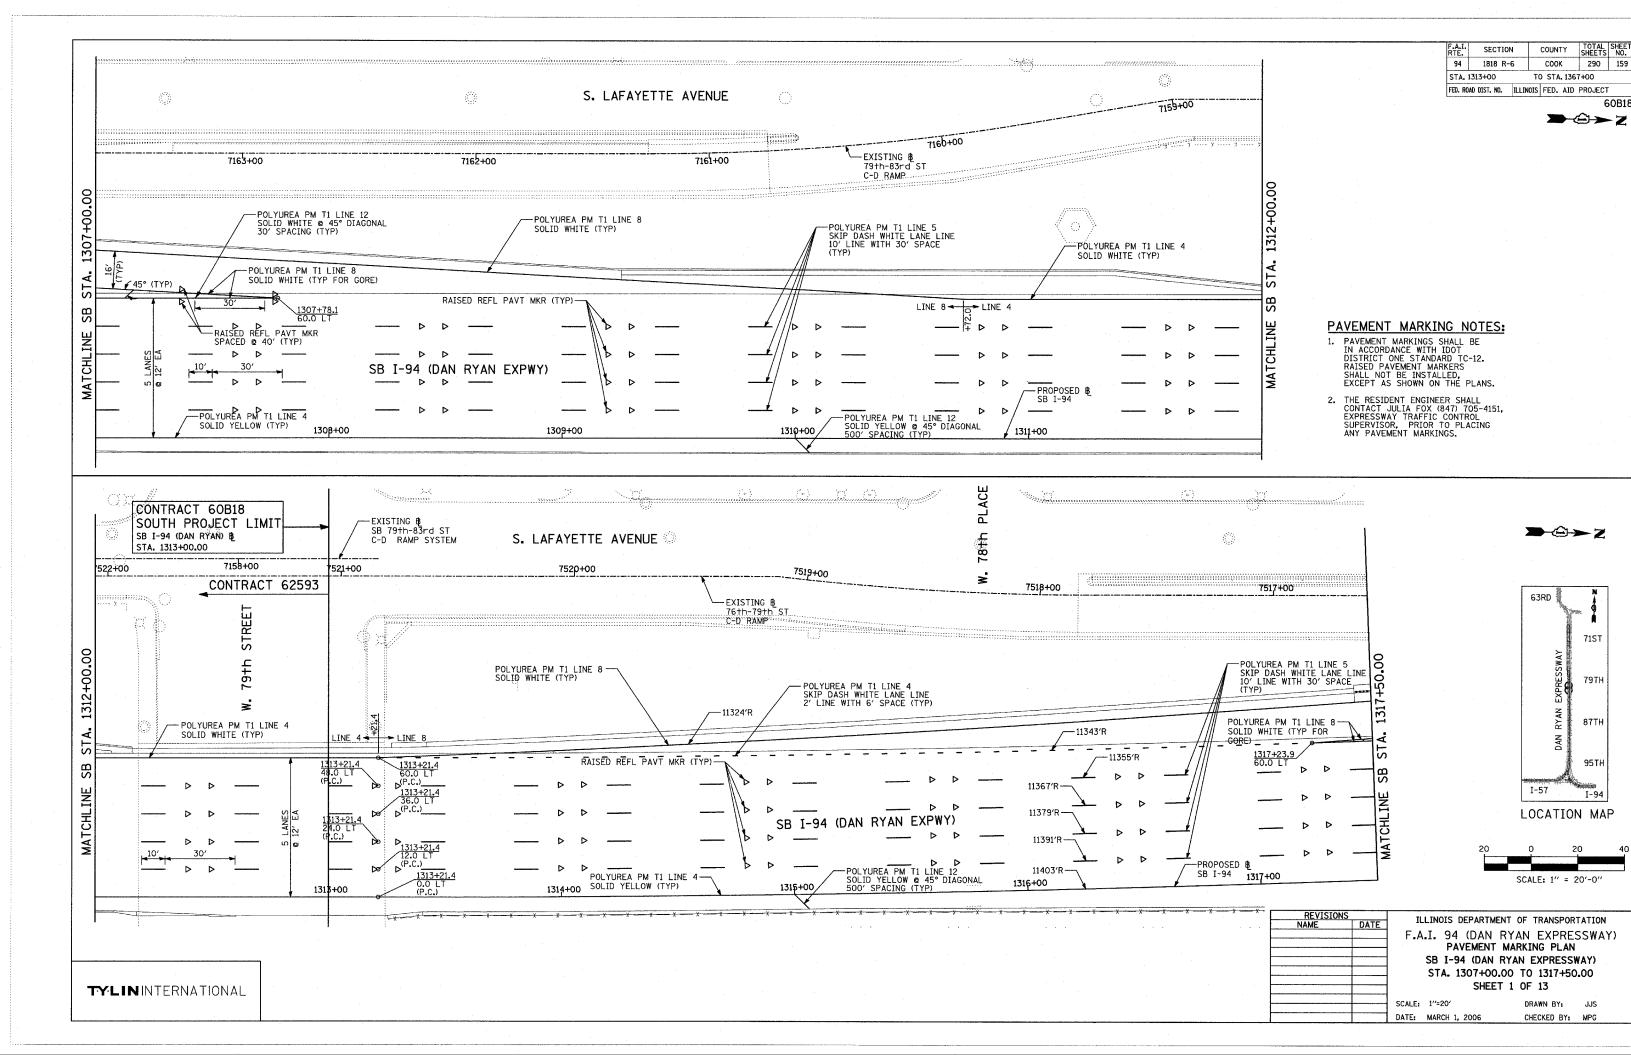

* MATCH WITH EXISTING PAVEMENT MARKING AT THIS POINT

79TH
87TH
95TH
1-57
1-94
LOCATION MAP

71ST

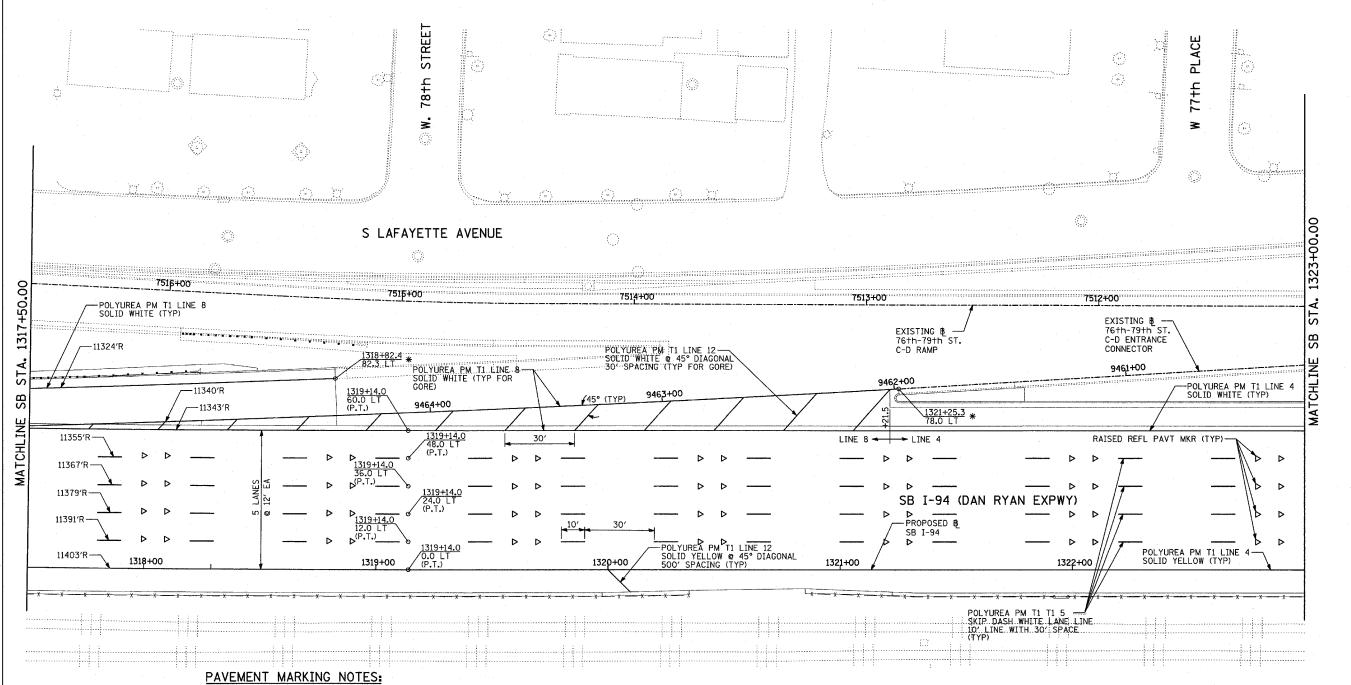63RD

1. PAVEMENT MARKINGS SHALL BE IN ACCORDANCE WITH IDOT DISTRICT ONE STANDARD TC-12. RAISED PAVEMENT MARKERS SHALL NOT BE INSTALLED, EXCEPT AS SHOWN ON THE PLANS.

2. THE RESIDENT ENGINEER SHALL CONTACT JULIA FOX (847) 705-4151, EXPRESSWAY TRAFFIC CONTROL SUPERVISOR, PRIOR TO PLACING ANY PAVEMENT MARKINGS.

TY:LININTERNATIONAL

REVISIONS
NAME DATE

ILLINOIS DEPARTMENT OF TRANSPORTATION
F.A.I. 94 (DAN RYAN EXPRESSWAY)
PAVEMENT MARKING PLAN
SB I-94 (DAN RYAN EXPRESSWAY)
STA. 1317+50.00 TO 1323+00.00
SHEET 2 OF 13


SCALE: 1"=20'
DATE: MARCH 1, 2006

DRAWN BY: JJS
CHECKED BY: MPG

SCALE: 1" = 20'-0"

F.A.I. SECTION COUNTY TOTAL SHEETS NO.
94 1818 R-6 COOK 290 161
STA. 1313+00 TO STA. 1367+00
FED. ROAD DIST. NO. ILLINOIS FED. AID PROJECT

6OB18

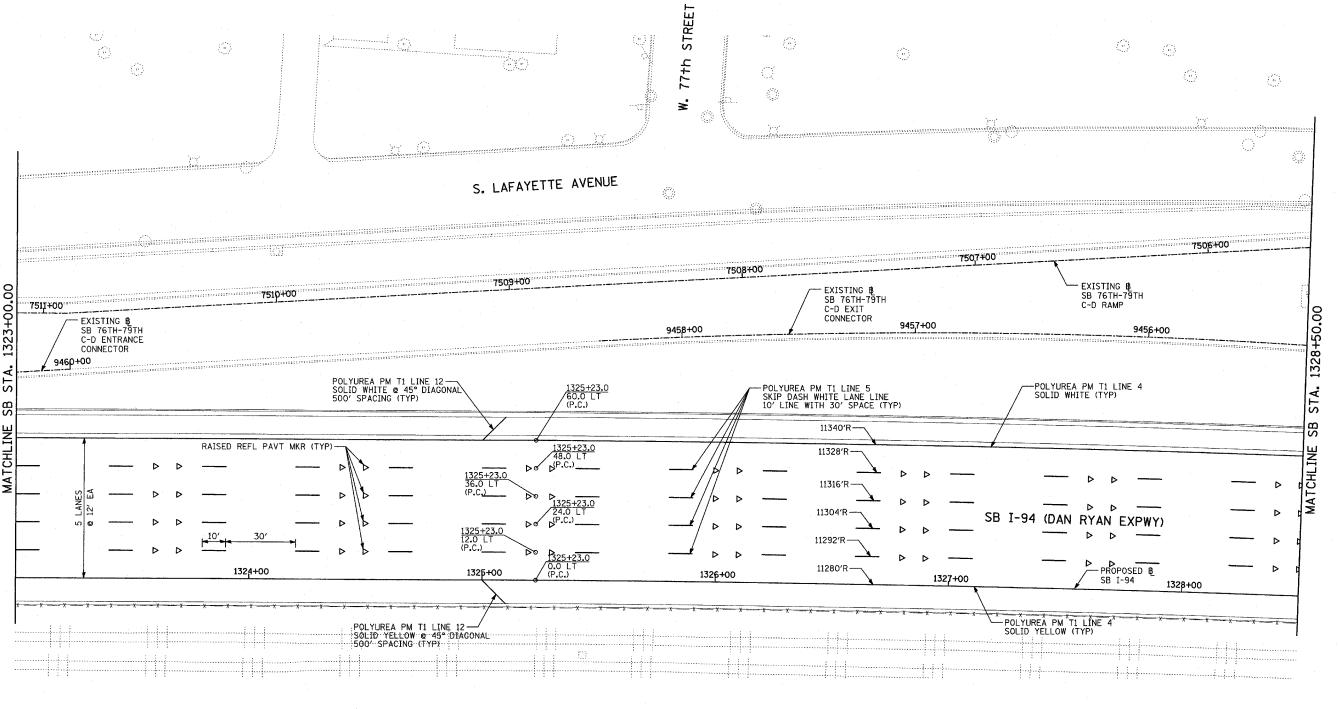


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TYLININTERNATIONAL

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I-57

63RD

79TH

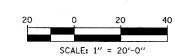87TH

95TH


I-94


LOCATION MAP

REVISIONS NAME	DATE	ILLINOIS DEPAR	RTMENT OF TRANSPORTATION							
NAME	DAIL									
		F.A.I. 94 (DA	N RYAN EXPRESSWAY)							
	-	PAVEME	NT MARKING PLAN							
	 	CD TO4 /D/	SB I-94 (DAN RYAN EXPRESSWAY)							
		2D 1-24 (D)	IN KIAN EXEKESSWAII							
		STA, 1323+	00.00 TO 1328+50.00							
		SH	EET 3 OF 13							
		SCALE: 1"=20"	DRAWN BY: JJS							
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SCALE: 1"=20'
DATE: MARCH 1, 2006

DRAWN BY: JJS
CHECKED BY: MPG



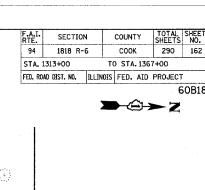
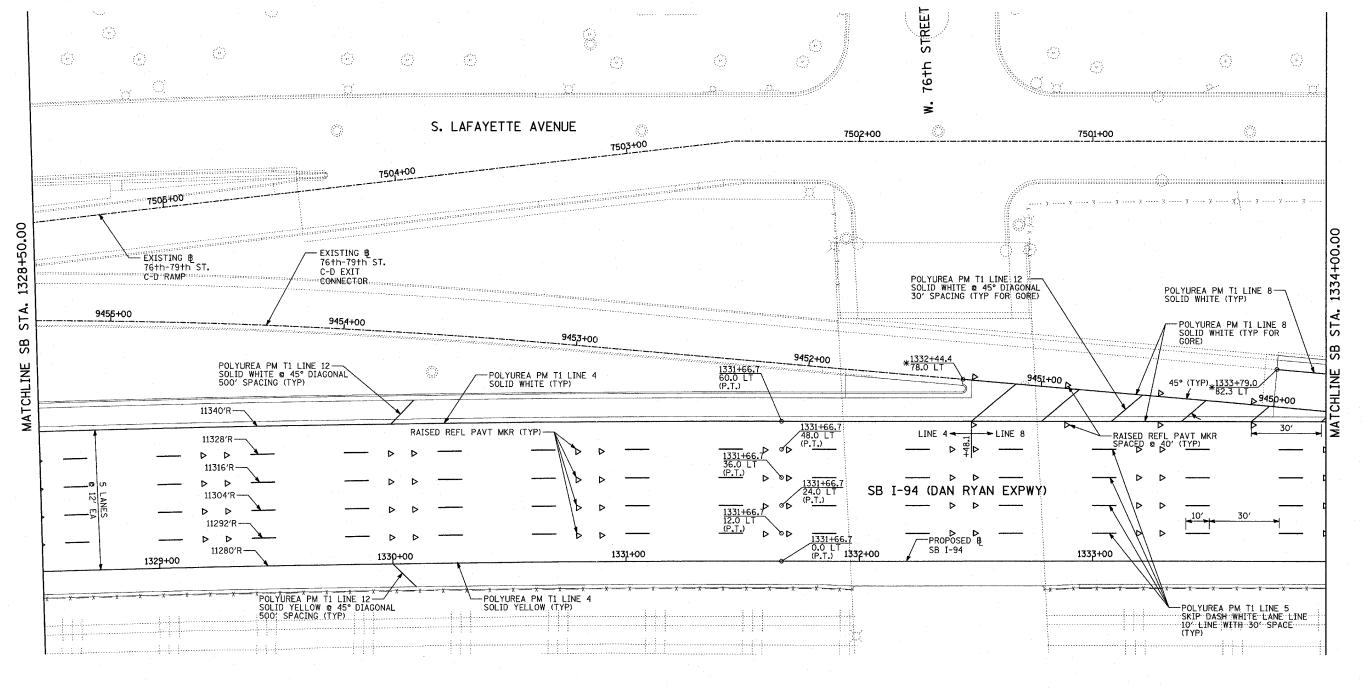
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 EXPRESSWAY TRAFFIC CONTROL
 SUPERVISOR, PRIOR TO PLACING
 ANY PAVEMENT MARKINGS.

SCALE: 1" = 20'-0"

I-57

LOCATION MAP

63RD

7157

79TH

87TH

95TH

REVISION		TULTMOT	S DEDADTMENT	OF TRANSPOR	TATION						
NAME	DATE	ILLINOIS DEPARTMENT OF TRANSPORTATION									
		F.A.I. 94 (DAN RYAN EXPRESS									
		PAVEMENT MARKING PLAN									
		SB I-94 (DAN RYAN EXPRESSWAY) STA. 1328+50.00 TO 1334+00.00									
			SHEET 4	OF 15							
		SCALE: 1"=20	,	DRAWN BY:	JJS						
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		DATE: MARCH	1, 2006	CHECKED BY:	MPG						


TYLIN INTERNATIONAL

* MATCH WITH EXISTING PAVEMENT MARKING AT THIS POINT

COUNTY TOTAL SHEETS NO.

COOK 290 163 SECTION COUNTY 94 1818 R-6 STA. 1313+00 TO STA. 1367+00 FED. ROAD DIST. NO. ILLINOIS FED. AID PROJECT

60B18 **>**-�-> z

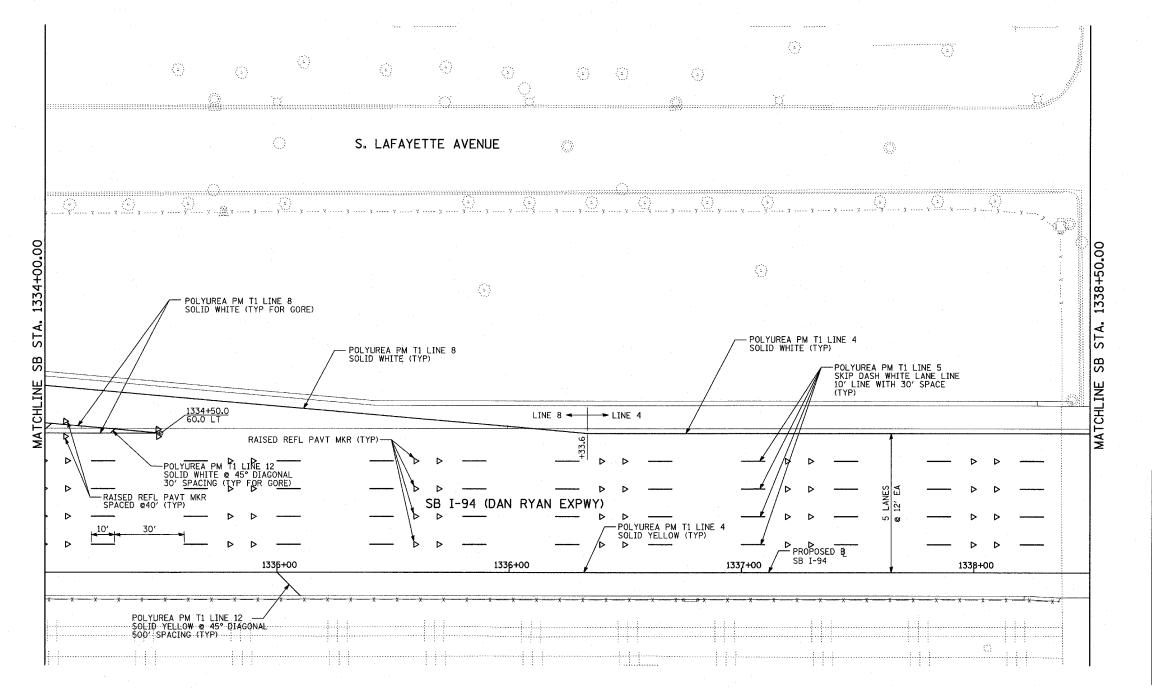

SCALE: 1" = 20'-0"

LOCATION MAP

I-57

RYAN

63RD

71ST

79TH

87TH

95TH

PAVEMENT MARKING NOTES:

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ILLIN	is I	REVISIO
F.A.I.	DATE	NAME
SB ST		
31		
SCALE: 1"=		


NOIS DEPARTMENT OF TRANSPORTATION 94 (DAN RYAN EXPRESSWAY) PAVEMENT MARKING PLAN I-94 (DAN RYAN EXPRESSWAY) TA. 1334+00.00 TO 1338+50.00

SHEET 5 OF 13

′=20′ DATE: MARCH 1, 2006

DRAWN BY: JJS CHECKED BY: MPG

TYLININTERNATIONAL

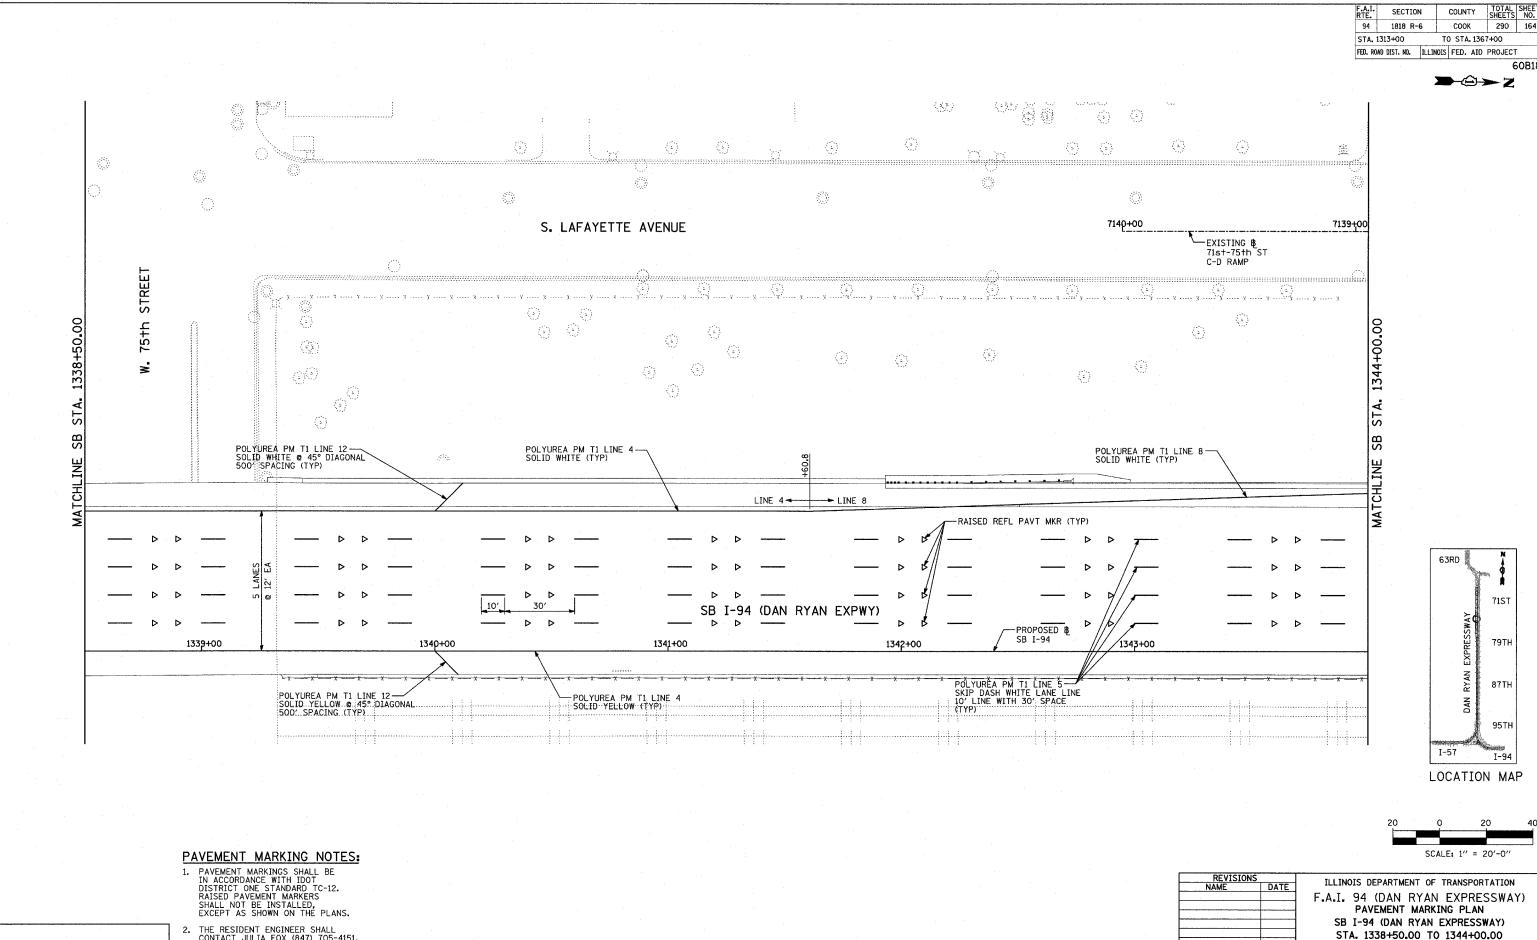


STA. 1338+50.00 TO 1344+00.00 SHEET 6 OF 13 SCALE: 1"=20' DRAWN BY: JJS

DATE: MARCH 1, 2006

CHECKED BY: MPG

TYLIN INTERNATIONAL

THE RESIDENT ENGINEER SHALL CONTACT JULIA FOX (847) 705-4151, EXPRESSWAY TRAFFIC CONTROL SUPERVISOR, PRIOR TO PLACING ANY PAVEMENT MARKINGS.

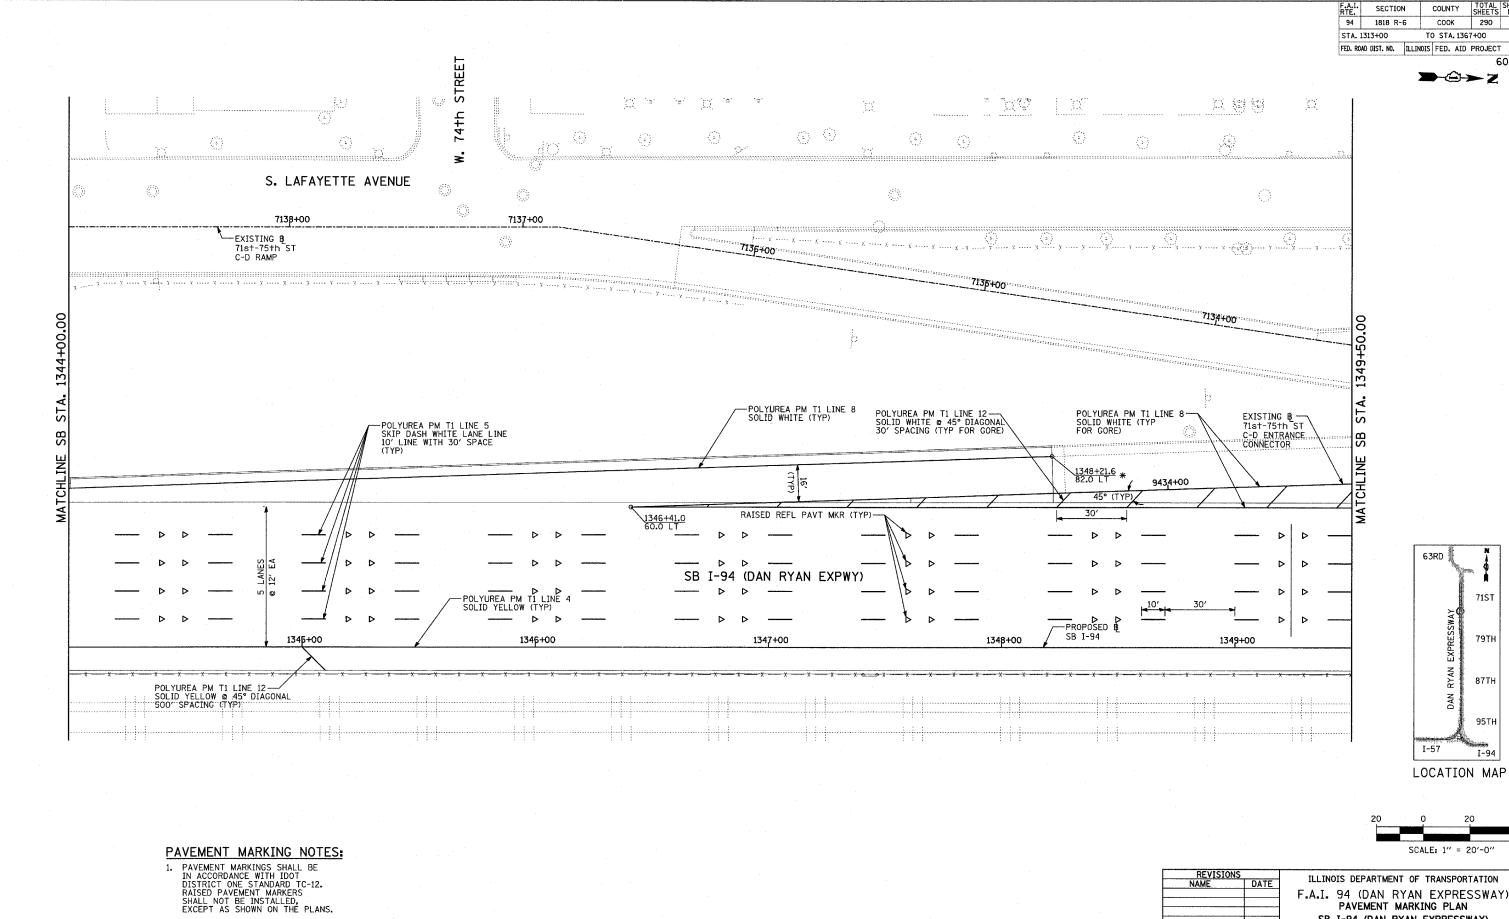

ILLINOIS DEPARTMENT OF TRANSPORTATION F.A.I. 94 (DAN RYAN EXPRESSWAY) PAVEMENT MARKING PLAN SB I-94 (DAN RYAN EXPRESSWAY) STA. 1344+00.00 TO 1349+50.00 SHEET 7 OF 13

SCALE: 1"=20" DATE: MARCH 1, 2006

DRAWN BY: JJS CHECKED BY: MPG

71ST

79TH

87TH

95TH

I-94

TOTAL SHEET SHEETS NO.

60B18

COOK 290 165


COUNTY

SECTION

* MATCH WITH EXISTING PAVEMENT MARKING AT THIS POINT

TY:LIN INTERNATIONAL

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PAVEMENT MARKING PLAN SB I-94 (DAN RYAN EXPRESSWAY) STA. 1349+50.00 TO 1355+00.00 SHEET 8 OF 13

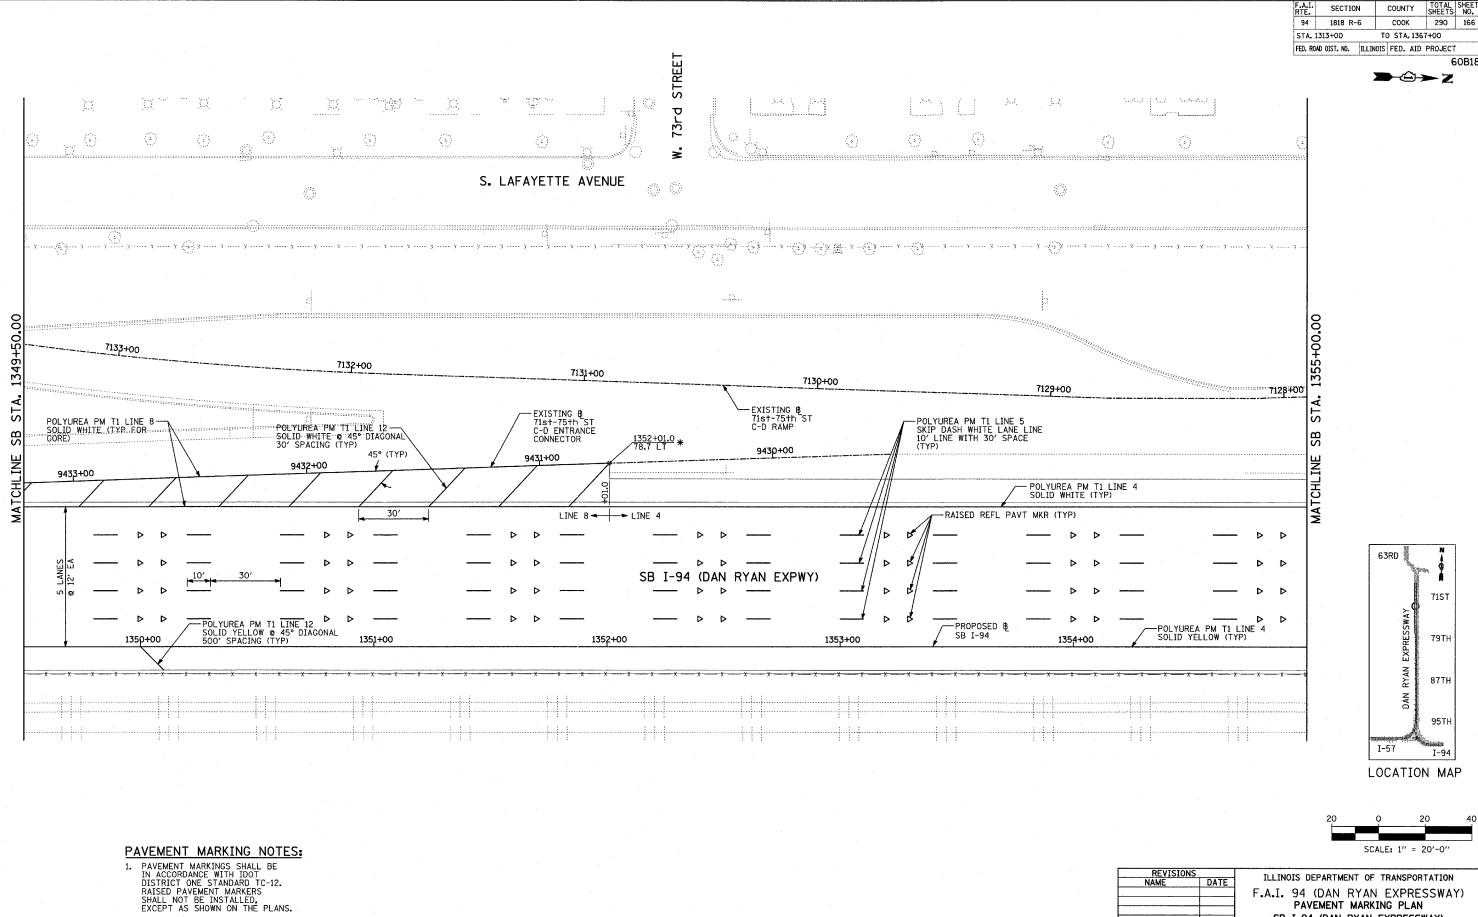
SECTION

SCALE: 1"=20' DATE: MARCH 1, 2006 DRAWN BY: JJS CHECKED BY: MPG


TYLININTERNATIONAL

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* MATCH WITH EXISTING PAVEMENT MARKING AT THIS POINT



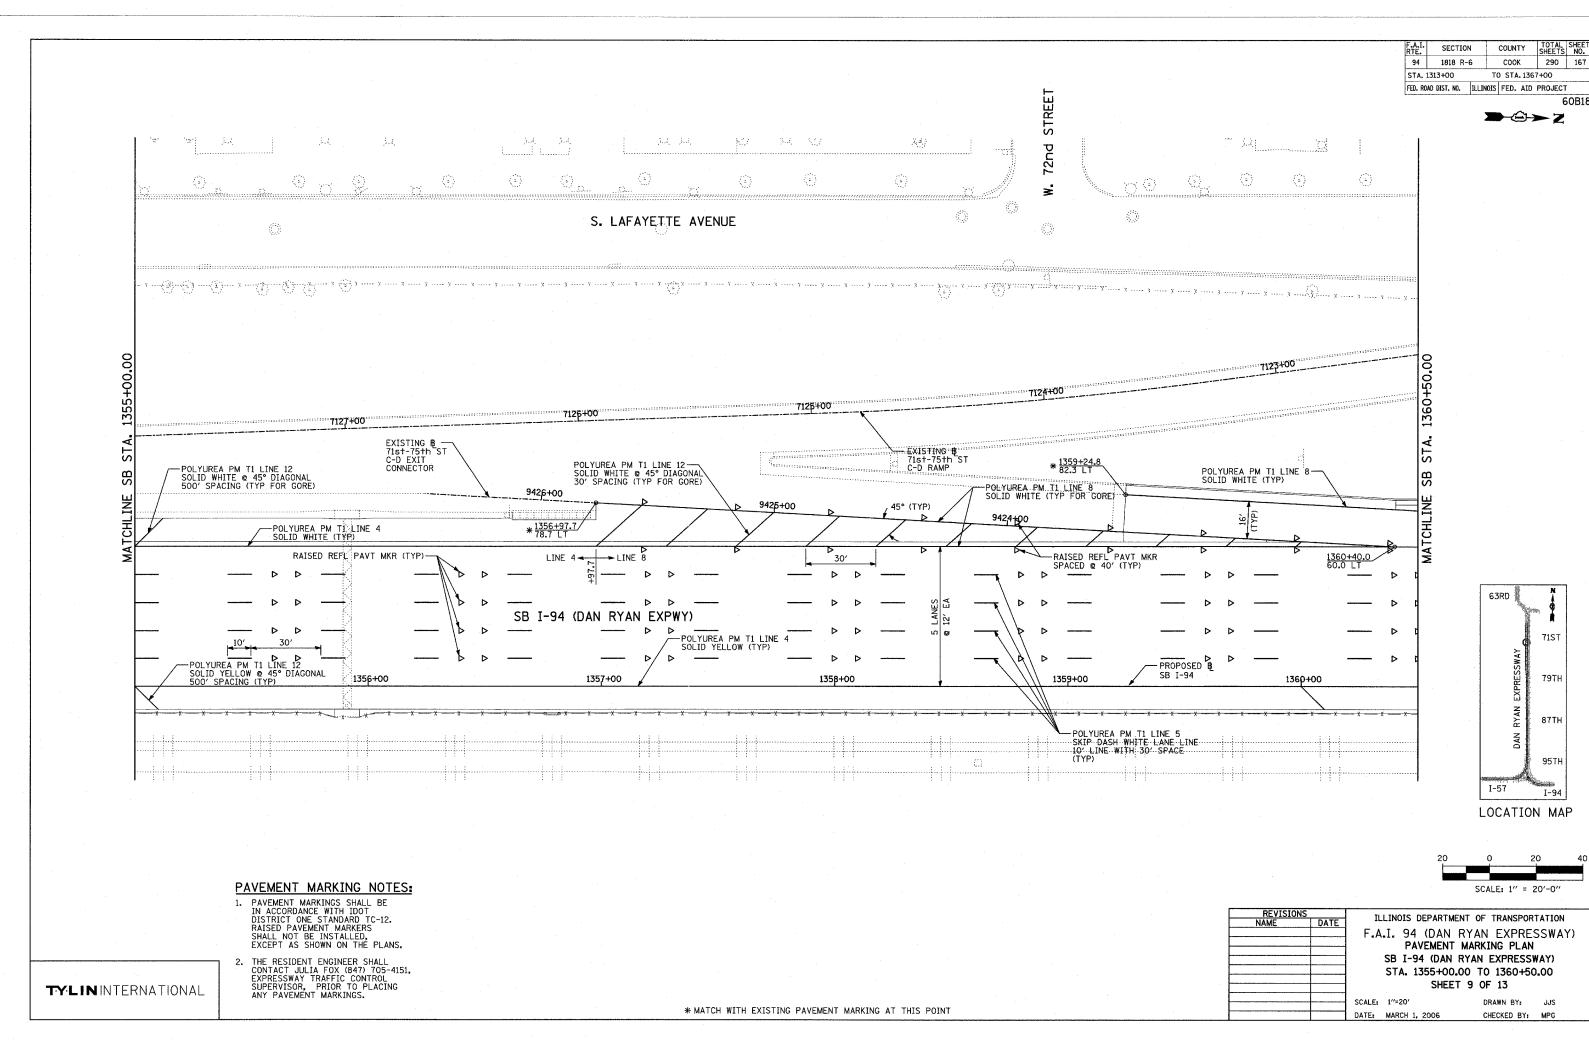

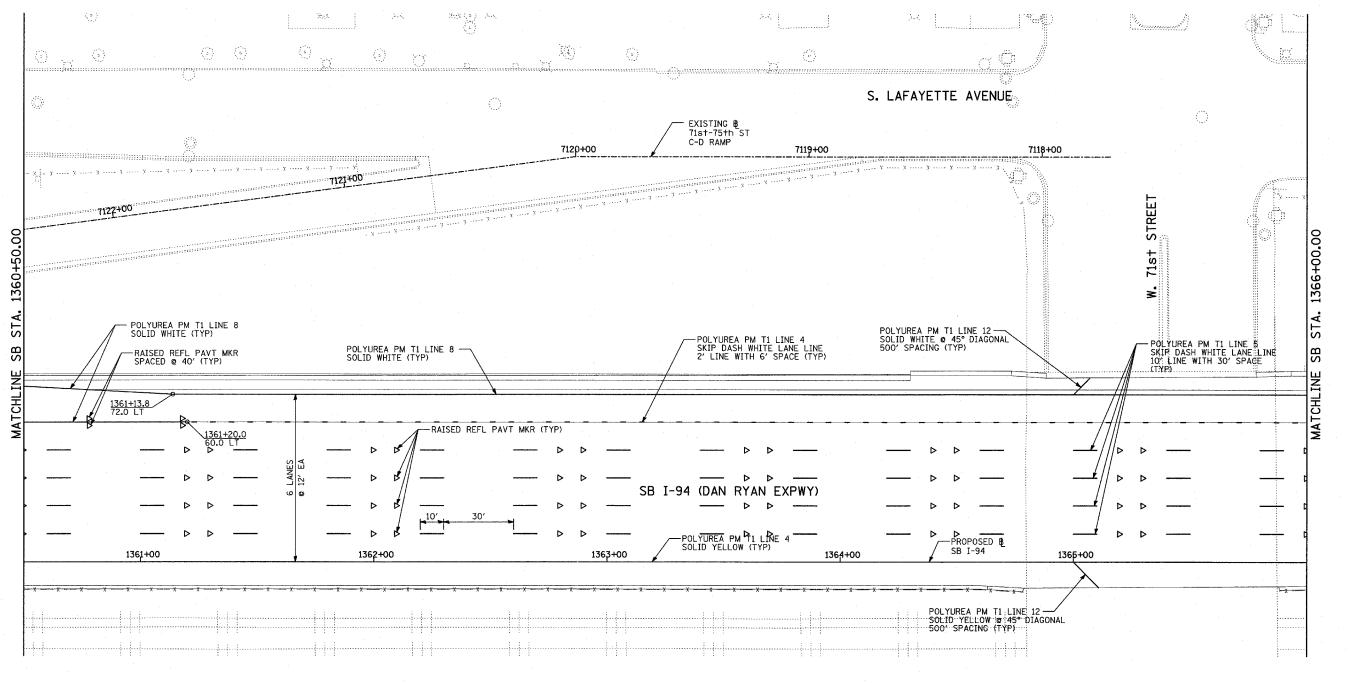


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TY:LIN INTERNATIONAL



I-57

LOCATION MAP

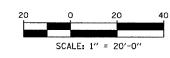63RD

71ST

79TH


87TH

95TH

REVISIONS		ILLINOIS DEPA	ADTMENT OF	TO ANCOOD	TATION				
NAME	DATE	ILLINOIS DEF	ALL INCIAL OF	TRANSFOR	INITON				
		F.A.I. 94 (D PAVEN		N EXPRES	SSWAY)				
		SB I-94 (DAN RYAN EXPRESSWAY)							
		STA. 1360	+50.00 T	0 1366+00	.00				
		S	HEET 10	OF 13					
		SCALE: 1"=20'		DRAWN BY:	JJS				
		DATE: MARCH 1, 200	6	CHECKED BY:	MPG				

F.A.I.	SECTION	COUNTY	TOTAL	SHEE'S	NO.
94	1818 R-6	COOK	290	169	
STA. 1313+00	TO STA. 1367+00				
FD. ROAD DIST. NO.	ILLINOIS	FED. AID	PROJECT		

6 **→ ≥** Z

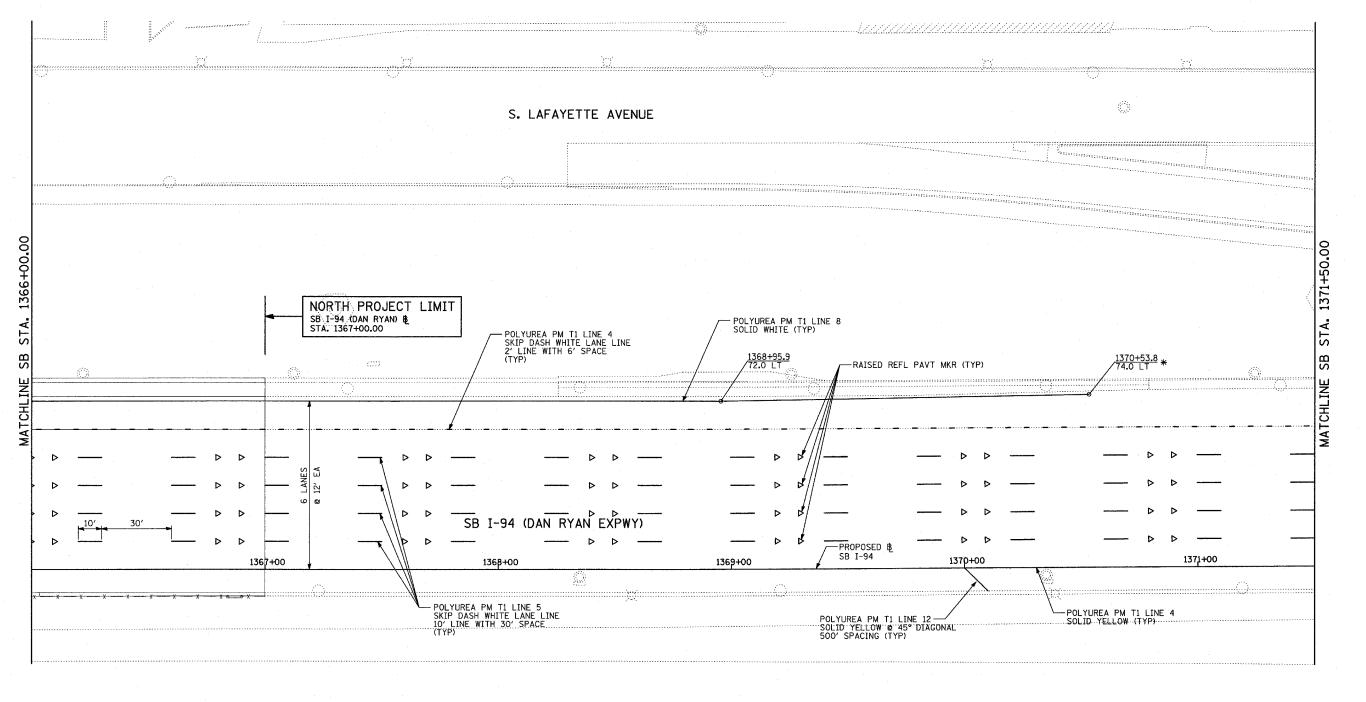

PAVEMENT MARKING NOTES:

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SCALE: 1" = 20'-0"

VISIONS

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E A L DAY (DAN) DYAN EXPRESSIVAY.

REVISIONS		
NAME	DATE	
		F.
		SCALE

.A.I. 94 (DAN RYAN EXPRESSWAY)
PAVEMENT MARKING PLAN
SB I-94 (DAN RYAN EXPRESSWAY)
STA. 1366+00.00 TO 1371+50.00
SHEET 11 OF 13

SCALE: 1"=20'
DATE: MARCH 1, 2006

DRAWN BY: JJS
CHECKED BY: MPG

63RD

I-57

71ST

79TH

87TH

95TH

I-94

LOCATION MAP

* MATCH WITH EXISTING PAVEMENT MARKING AT THIS POINT

TYLININTERNATIONAL

COUNTY TOTAL SHEET NO. SECTION COOK 290 170 94 1818 R-6 TO STA. 1367+00 STA. 1313+00 FED. ROAD DIST. NO. ILLINOIS FED. AID PROJECT 60B18 **→**©→Z Org S. LAFAYETTE AVENUE 1371+50.00 - POLYUREA PM T1 LINE 4 SKIP DASH WHITE LANE LINE 2' LINE WITH 6' SPACE (TYP) STA. - POLYUREA PM T1 LINE 8 SOLID WHITE (TYP) -POLYUREA PM T1 LINE 8 SOLID WHITE (TYP) SB -RAISED REFL PAVT MKR (TYP) 1373+24.2 61.6 LT * 63RD -PROPOSED B SB I-94 (DAN RYAN EXPWY) SB I-94

▶ —— \triangleright \triangleright 1372+00 1373+00 1374+00 1375+00 1376+00 79TH 72:1 TAPER 1372+98.6 0.0 LT - POLYUREA PM T1 LINE 5 ----SKIP- DASH-WHITE-LANE-LINE-10' LINE WITH 30' SPACE (TYP) 87TH POLYUREA PM T1 LINE 12 — SOLID YELLOW @ 45° DIAGONAL 500' SPACING (TYP) -POLYUREA PM T1 LINE 4 SOLID YELLOW (TYP) 95TH I-57 LOCATION MAP PAVEMENT MARKING NOTES: SCALE: 1" = 20'-0" 1. PAVEMENT MARKINGS SHALL BE
IN ACCORDANCE WITH IDOT
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RAISED PAVEMENT MARKERS
SHALL NOT BE INSTALLED,
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TYLININTERNATIONAL

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* MATCH WITH EXISTING PAVEMENT MARKING AT THIS POINT


ILLINOIS DEPARTMENT OF TRANSPORTATION SB I-94 (DAN RYAN EXPRESSWAY) STA. 1371+50.00 TO 1377+00.00

SHEET 12 OF 13

DATE: MARCH 1, 2006

DRAWN BY: JJS CHECKED BY: MPG

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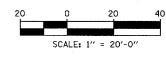
71ST
71ST
79TH
87TH
1-57
1-94

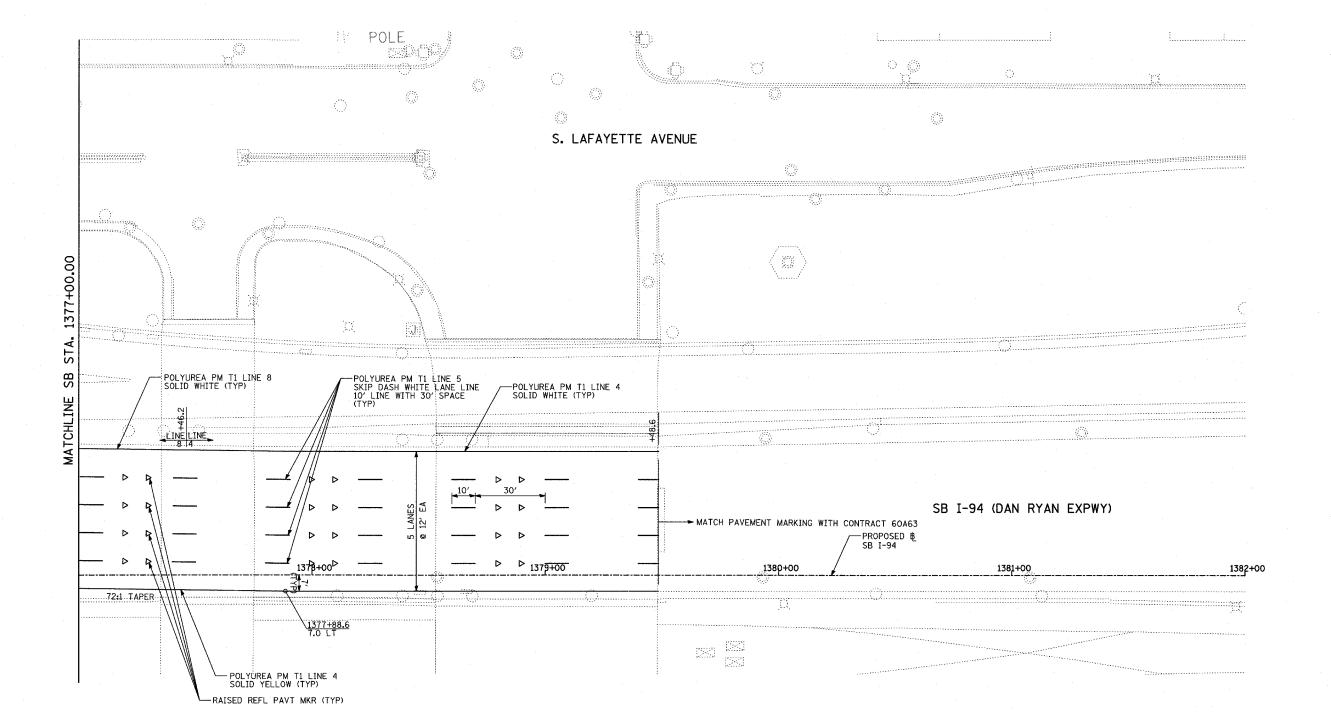LOCATION MAP


PAVEMENT MARKING NOTES:


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TYLININTERNATIONAL




REVISIONS		ILLINOIS DEPARTMENT OF TRANSPORTATION			
NAME	DATE	TEETHOLD DEFARTIMENT OF TRANSPORTATION			
	,	F.A.I.	94 (DAN RYA	N EXPRES	SWAY)
		DAVENERS MARKENS DI ANI			
		PAVEMENT MARKING PLAN			
		SB I-94 (DAN RYAN EXPRESSWAY)			
	-				
		STA, 1377+00.00 TO 1378+00.00			
		SHEET 13 OF 13			
		SCALE: 1"=	201	DRAWN BY:	JJS
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		DATE: MAR	RCH 1, 2006	CHECKED BY:	MPG



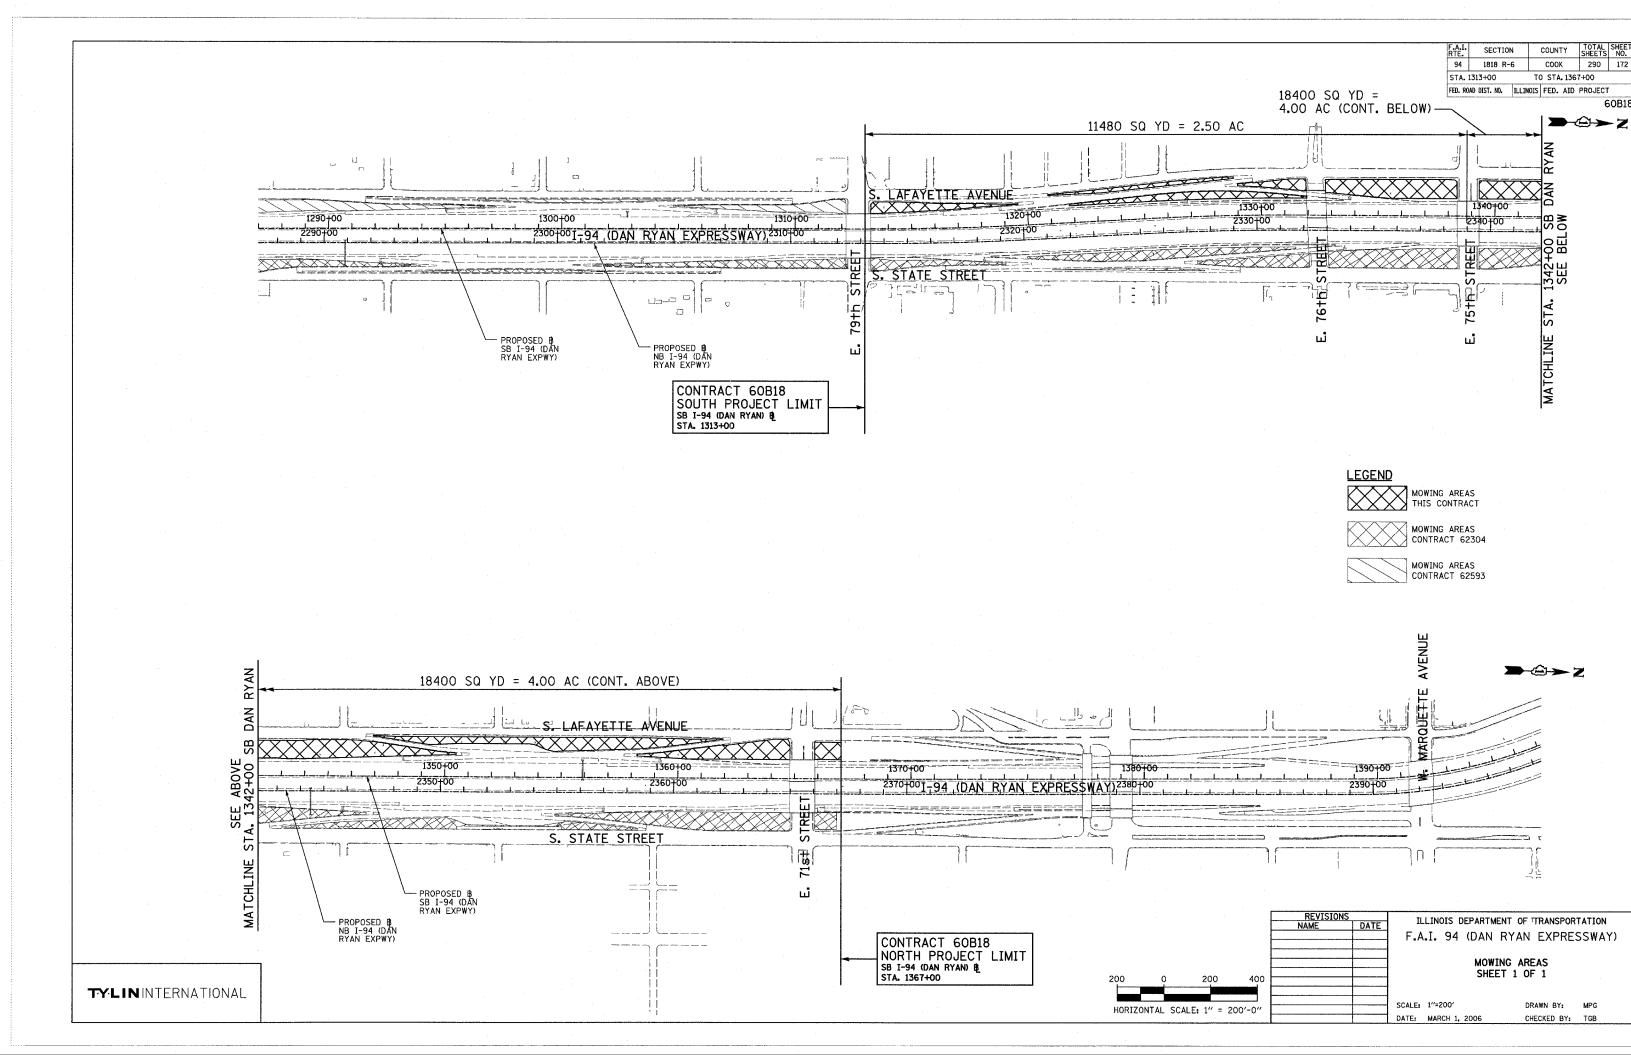

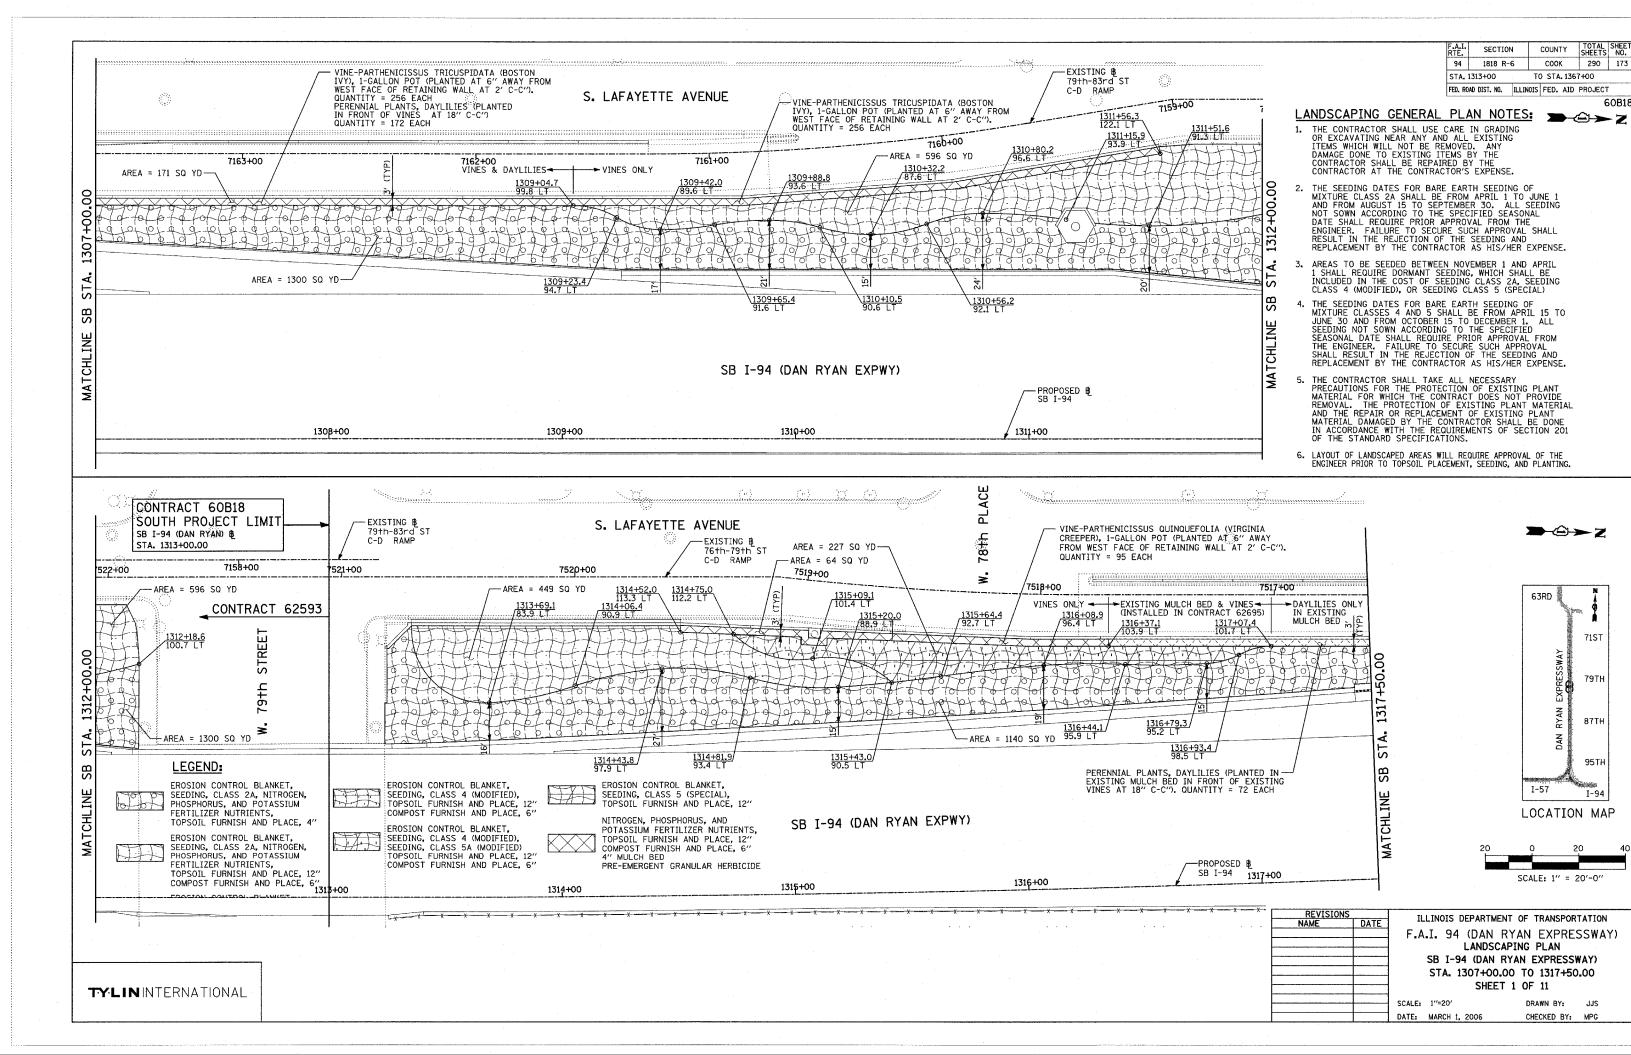SECTION COUNTY TOTAL SHEE SHEETS NO. 94 1818 R-6 COOK 290 174 STA. 1313+00 TO STA. 1367+00 FED. ROAD DIST. NO. | ILLINOIS | FED. AID PROJECT 60B1



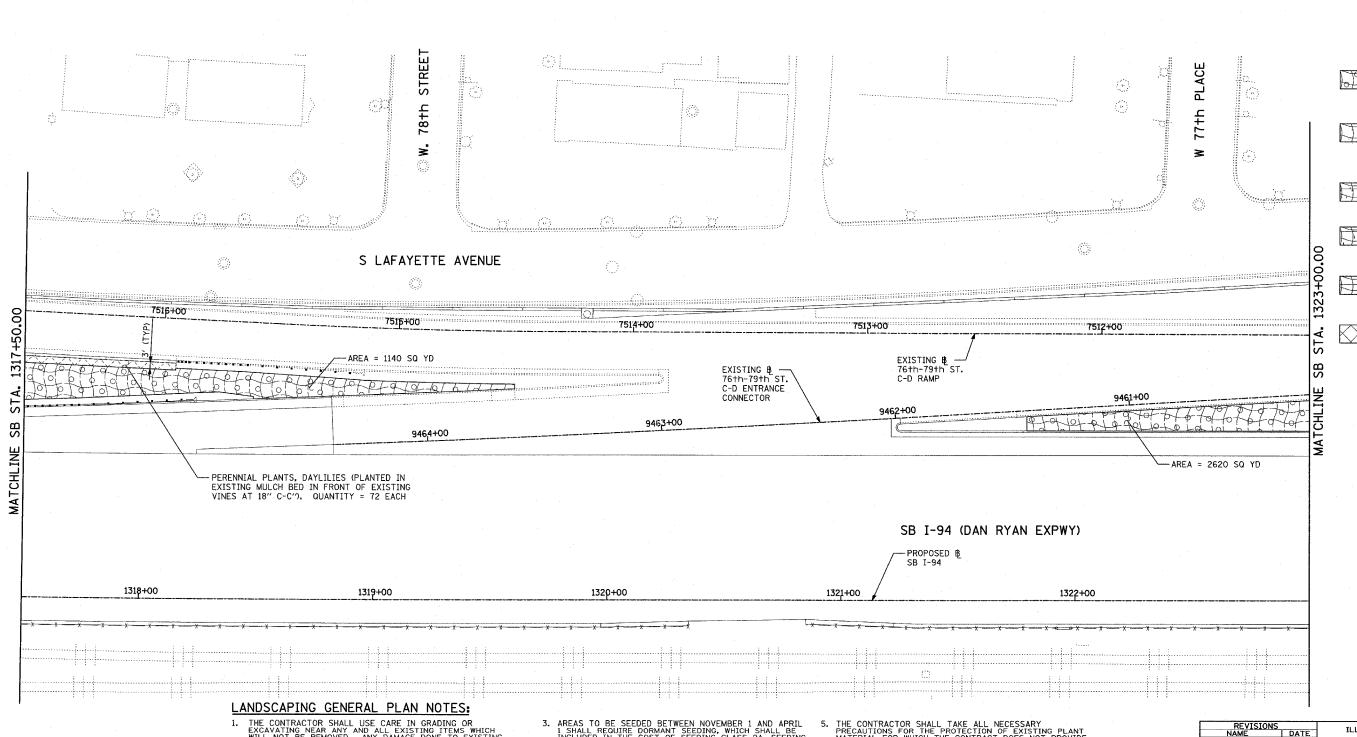

LEGEND:

EROSION CONTROL BLANKET, SEEDING, CLASS 2A, NITROGEN, PHOSPHORUS, AND POTASSIUM FERTILIZER NUTRIENTS, TOPSOIL FURNISH AND PLACE, 4"

EROSION CONTROL BLANKET, SEEDING, CLASS 2A, NITROGEN, PHOSPHORUS, AND POTASSIUM FERTILIZER NUTRIENTS, TOPSOIL FURNISH AND PLACE, 12" COMPOST FURNISH AND PLACE, 6"


EROSION CONTROL BLANKET, SEEDING, CLASS 4 (MODIFIED), TOPSOIL FURNISH AND PLACE, 12" COMPOST FURNISH AND PLACE, 6"


EROSION CONTROL BLANKET, SEEDING, CLASS 4 (MODIFIED), SEEDING, CLASS 5A (MODIFIED) TOPSOIL FURNISH AND PLACE, 12" COMPOST FURNISH AND PLACE, 6"

EROSION CONTROL BLANKET, SEEDING, CLASS 5 (SPECIAL), TOPSOIL FURNISH AND PLACE, 12"

NITROGEN, PHOSPHORUS, AND POTASSIUM FERTILIZER NUTRIENTS, TOPSOIL FURNISH AND PLACE, 12" COMPOST FURNISH AND PLACE, 6" 4" MULCH BED

PRE-EMERGENT GRANULAR HERBICIDE

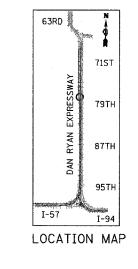

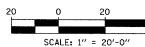

THE CONTRACTOR SHALL USE CARE IN GRADING OR EXCAVATING NEAR ANY AND ALL EXISTING ITEMS WHICH WILL NOT BE REMOVED. ANY DAMAGE DONE TO EXISTING ITEMS BY THE CONTRACTOR SHALL BE REPAIRED BY THE CONTRACTOR'S EXPENSE.

TY:LININTERNATIONAL


- THE SEEDING DATES FOR BARE EARTH SEEDING OF MIXTURE CLASS 2A SHALL BE FROM APRIL 1 TO JUNE 1 AND FROM AUGUST 15 TO SEPTEMBER 30. ALL SEEDING NOT SOWN ACCORDING TO THE SPECIFIED SEASONAL DATE SHALL REQUIRE PRIOR APPROVAL FROM THE ENGINEER. FAILURE TO SECURE SUCH APPROVAL SHALL RESULT IN THE REJECTION OF THE SEEDING AND REPLACEMENT BY THE CONTRACTOR AS HIS/HER EXPENSE.
- 3. AREAS TO BE SEEDED BETWEEN NOVEMBER 1 AND APRIL 1 SHALL REQUIRE DORMANT SEEDING, WHICH SHALL BE INCLUDED IN THE COST OF SEEDING CLASS 2A, SEEDING CLASS 4 (MODIFIED), OR SEEDING CLASS 5 (SPECIAL)
- 4. THE SEEDING DATES FOR BARE EARTH SEEDING OF MIXTURE CLASSES 4 AND 5 SHALL BE FROM APRIL 15 TO JUNE 30 AND FROM OCTOBER 15 TO DECEMBER 1. ALL SEEDING NOT SOWN ACCORDING TO THE SPECIFIED SEASONAL DATE SHALL REQUIRE PRIOR APPROVAL THE ENGINEER. FAILURE TO SECURE SUCH APPROVAL SHALL RESULT IN THE REJECTION OF THE SEEDING AND REPLACEMENT BY THE CONTRACTOR AS HIS/HER EXPENSE.
- THE CONTRACTOR SHALL TAKE ALL NECESSARY PRECAUTIONS FOR THE PROTECTION OF EXISTING PLANT MATERIAL FOR WHICH THE CONTRACT DOES NOT PROVIDE REMOVAL. THE PROTECTION OF EXISTING PLANT MATERIAL AND THE REPAIR OR REPLACEMENT OF EXISTING PLANT MATERIAL DAMAGED BY THE CONTRACTOR SHALL BE DONE IN ACCORDANCE WITH THE REQUIREMENTS OF SECTION 201 OF THE STANDARD SPECIFICATIONS. OF THE STANDARD SPECIFICATIONS.
- 6. LAYOUT OF LANDSCAPED AREAS WILL REQUIRE APPROVAL OF THE ENGINEER PRIOR TO TOPSOIL PLACEMENT, SEEDING, AND PLANTING.

ILLINOIS DEPARTMENT OF TRANSPORTATION F.A.I. 94 (DAN RYAN EXPRESSWAY) LANDSCAPING PLAN

SB I-94 (DAN RYAN EXPRESSWAY) STA. 1317+50.00 TO 1323+00.00 SHEET 2 OF 11

SCALE: 1"=20" DATE: MARCH 1, 2006 DRAWN BY: JJS CHECKED BY: MPG


SECTION COUNTY 1818 R-6 соок 290 175 STA, 1313+00 TO STA. 1367+00 FED. ROAD DIST. NO. | ILLINOIS | FED. AID PROJECT 60B18 **→**©→ Z

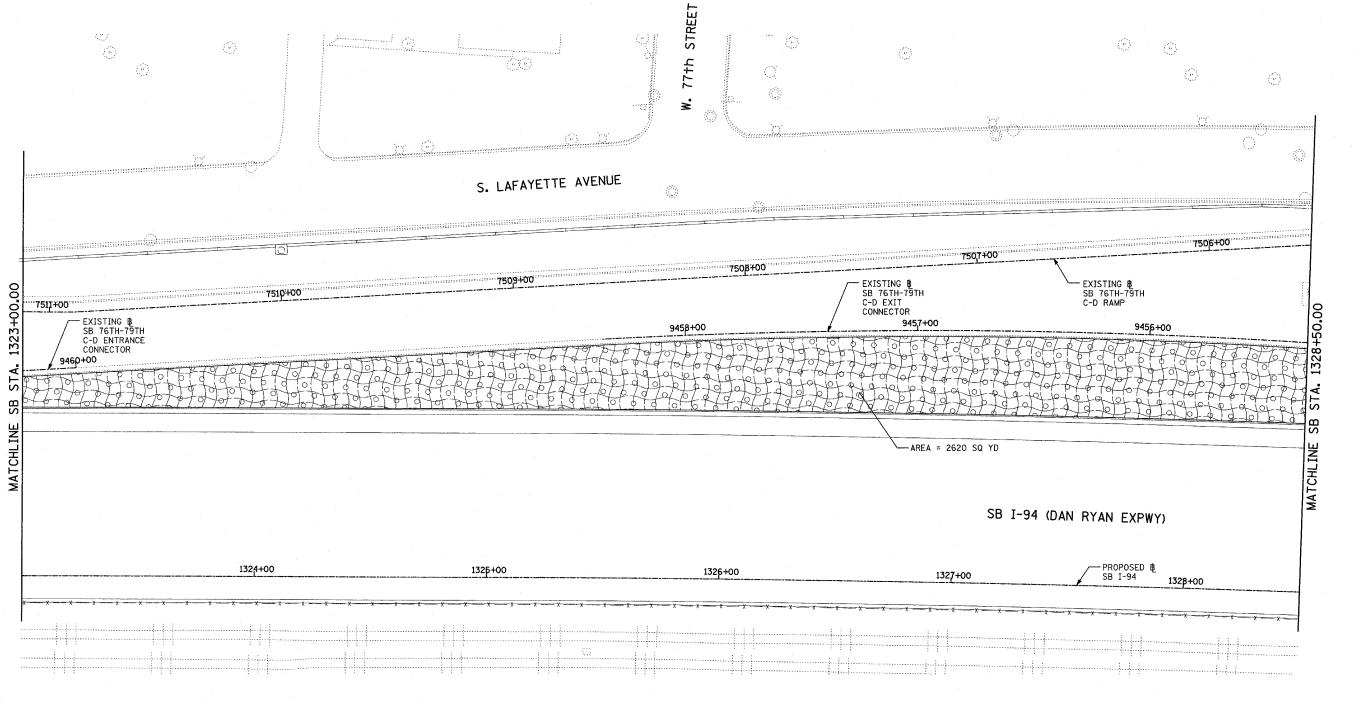



LANDSCAPING GENERAL PLAN NOTES:

- THE CONTRACTOR SHALL USE CARE IN GRADING OR EXCAVATING NEAR ANY AND ALL EXISTING ITEMS WHICH WILL NOT BE REMOVED. ANY DAMAGE DONE TO EXISTING ITEMS BY THE CONTRACTOR SHALL BE REPAIRED BY THE CONTRACTOR AT THE CONTRACTOR'S EXPENSE.
- 2. THE SEEDING DATES FOR BARE EARTH SEEDING OF MIXTURE CLASS 2A SHALL BE FROM APRIL 1 TO JUNE 1 AND FROM AUGUST 15 TO SEPTEMBER 3O. ALL SEEDING 5. NOT SOWN ACCORDING TO THE SPECIFIED SEASONAL DATE SHALL REQUIRE PRIOR APPROVAL FROM THE ENGINEER. FAILURE TO SECURE SUCH APPROVAL SHALL RESULT IN THE REJECTION OF THE SEEDING AND REPLACEMENT BY THE CONTRACTOR AS HIS/HER EXPENSE.
- AREAS TO BE SEEDED BETWEEN NOVEMBER 1 AND APRIL 1 SHALL REQUIRE DORMANT SEEDING, WHICH SHALL BE INCLUDED IN THE COST OF SEEDING CLASS 2A, SEEDING CLASS 4 (MODIFIED), OR SEEDING CLASS 5 (SPECIAL)
- 4. THE SEEDING DATES FOR BARE EARTH SEEDING OF MIXTURE CLASSES 4 AND 5 SHALL BE FROM APRIL 15 TO JUNE 30 AND FROM OCTOBER 15 TO DECEMBER 1. ALL SEEDING NOT SOWN ACCORDING TO THE SPECIFIED SEASONAL DATE SHALL REQUIRE PRIOR APPROVAL FROM THE ENGINEER. FAILURE TO SECURE SUCH APPROVAL SHALL RESULT IN THE REJECTION OF THE SEEDING AND REPLACEMENT BY THE CONTRACTOR AS HIS/HER EXPENSE.
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 - LAYOUT OF LANDSCAPED AREAS WILL REQUIRE APPROVAL OF THE ENGINEER PRIOR TO TOPSOIL PLACEMENT, SEEDING, AND PLANTING.

LEGEND:

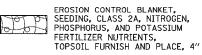

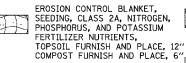

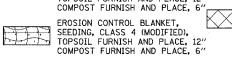

EROSION CONTROL BLANKET, SEEDING, CLASS 4 (MODIFIED), SEEDING, CLASS 5A (MODIFIED) TOPSOIL FURNISH AND PLACE, 12" COMPOST FURNISH AND PLACE, 6"

EROSION CONTROL BLANKET, SEEDING, CLASS 5 (SPECIAL), TOPSOIL FURNISH AND PLACE, 12"

NITROGEN, PHOSPHORUS, AND POTASSIUM FERTILIZER NUTRIENTS, TOPSOIL FURNISH AND PLACE, 12" COMPOST FURNISH AND PLACE, 6" 4" MULCH BED PRE-EMERGENT GRANULAR HERBICIDE



LOCATION MAP

63RD

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ILLINOIS DEPARTMENT OF TRANSPORTATION F.A.I. 94 (DAN RYAN EXPRESSWAY) LANDSCAPING PLAN


SB I-94 (DAN RYAN EXPRESSWAY) STA. 1323+00.00 TO 1328+50.00 SHEET 3 OF 11

SCALE: 1"=20' DATE: MARCH 1, 2006 DRAWN BY: JJS CHECKED BY: MPG

TY:LIN INTERNATIONAL

F.A.I. RTE. SECTION COUNTY TOTAL SHEE SHEETS NO. 94 1818 R-6 соок 290 STA. 1313+00 TO STA. 1367+00 FED. ROAD DIST. NO. ILLINOIS FED. AID PROJECT

60B18 **→**⊕→ Z

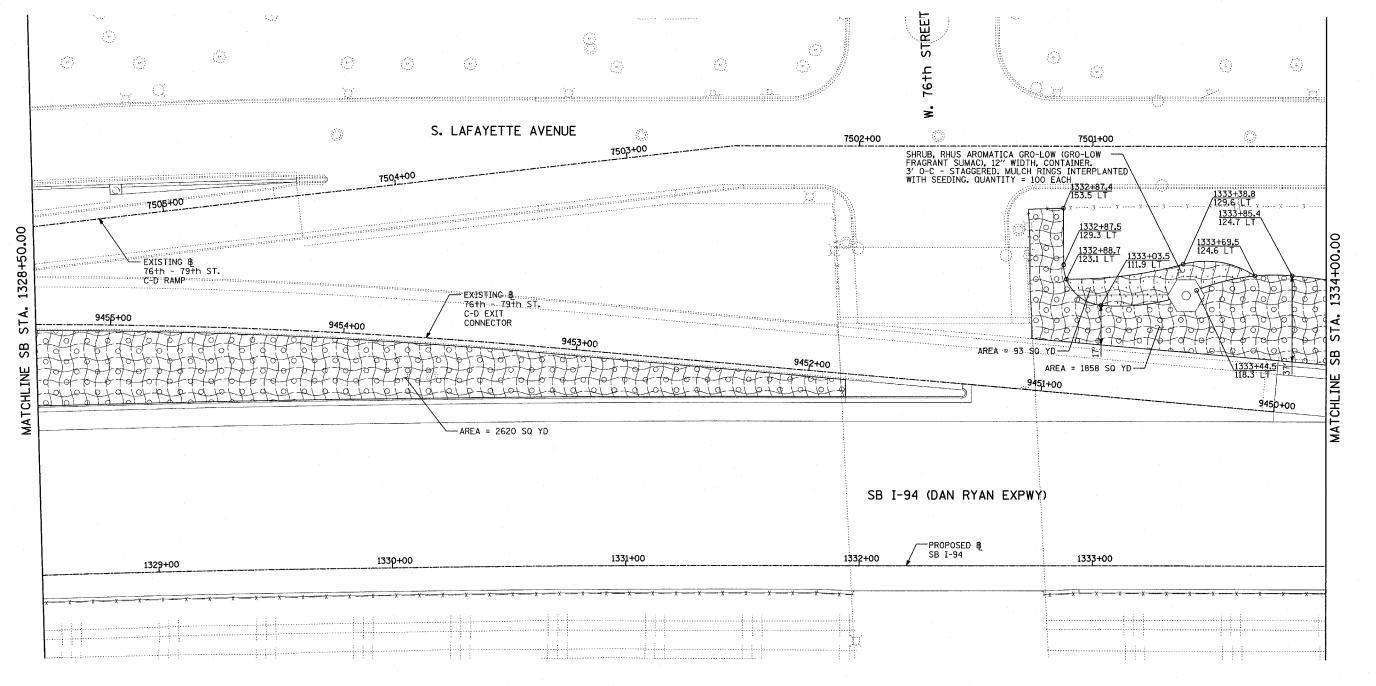


LANDSCAPING GENERAL PLAN NOTES:


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- 2. THE SEEDING DATES FOR BARE EARTH SEEDING OF MIXTURE CLASS 2A SHALL BE FROM APRIL 1 TO JUNE 1 AND FROM AUGUST 15 TO SEPTEMBER 30. ALL SEEDING NOT SOWN ACCORDING TO THE SPECIFIED SEASONAL DATE SHALL REQUIRE PRIOR APPROVAL FROM THE ENGINEER. FAILURE TO SECURE SUCH APPROVAL SHALL RESULT IN THE REJECTION OF THE SEEDING AND REPLACEMENT BY THE CONTRACTOR AS HIS/HER EXPENSE.
- 3. AREAS TO BE SEEDED BETWEEN NOVEMBER 1 AND APRIL
 1 SHALL REQUIRE DORMANT SEEDING, WHICH SHALL BE
 INCLUDED IN THE COST OF SEEDING CLASS 2A, SEEDING
 CLASS 4 (MODIFIED), OR SEEDING CLASS 5 (SPECIAL)

 IN ACCORDANCE WITH THE REQUIREMENTS OF SECTION 201
 OF THE STANDARD SPECIFICATIONS.

 LAYOUT OF LANDSCAPED AREAS WILL REQUIRE APPROVAL OF THE
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- 4. THE SEEDING DATES FOR BARE EARTH SEEDING OF MIXTURE CLASSES 4 AND 5 SHALL BE FROM APRIL 15 TO JUNE 30 AND FROM OCTOBER 15 TO DECEMBER 1. ALL SEEDING NOT SOWN ACCORDING TO THE SPECIFIED SEASONAL DATE SHALL REQUIRE PRIOR APPROVAL FROM THE ENGINEER. FAILURE TO SECURE SUCH APPROVAL SHALL RESULT IN THE REJECTION OF THE SEEDING AND REPLACEMENT BY THE CONTRACTOR AS HIS/HER EXPENSE.
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LEGEND:



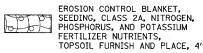

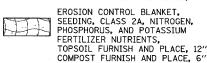
EROSION CONTROL BLANKET, SEEDING, CLASS 4 (MODIFIED), TOPSOIL FURNISH AND PLACE, 12" COMPOST FURNISH AND PLACE, 6"



EROSION CONTROL BLANKET, SEEDING, CLASS 4 (MODIFIED), SEEDING, CLASS 5A (MODIFIED) TOPSOIL FURNISH AND PLACE, 12" COMPOST FURNISH AND PLACE, 6"

EROSION CONTROL BLANKET, SEEDING, CLASS 5 (SPECIAL), TOPSOIL FURNISH AND PLACE, 12"

NITROGEN, PHOSPHORUS, AND POTASSIUM FERTILIZER NUTRIENTS, TOPSOIL FURNISH AND PLACE, 12" COMPOST FURNISH AND PLACE, 6" 4" MULCH BED PRE-EMERGENT GRANULAR HERBICIDE

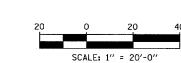

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LOCATION MAP

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			SB I-94
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EPARTMENT OF TRANSPORTATION (DAN RYAN EXPRESSWAY) ANDSCAPING PLAN (DAN RYAN EXPRESSWAY)

328+50.00 TO 1334+00.00 SHEET 4 OF 11


DRAWN BY: JJS CHECKED BY: MPG

TY:LIN INTERNATIONAL

DATE: MARCH 1, 2006

COUNTY SECTION 1818 R-6 COOK 290 177 STA. 1313+00 TO STA. 1367+00 FED. ROAD DIST. NO. ILLINOIS FED. AID PROJECT

60B18

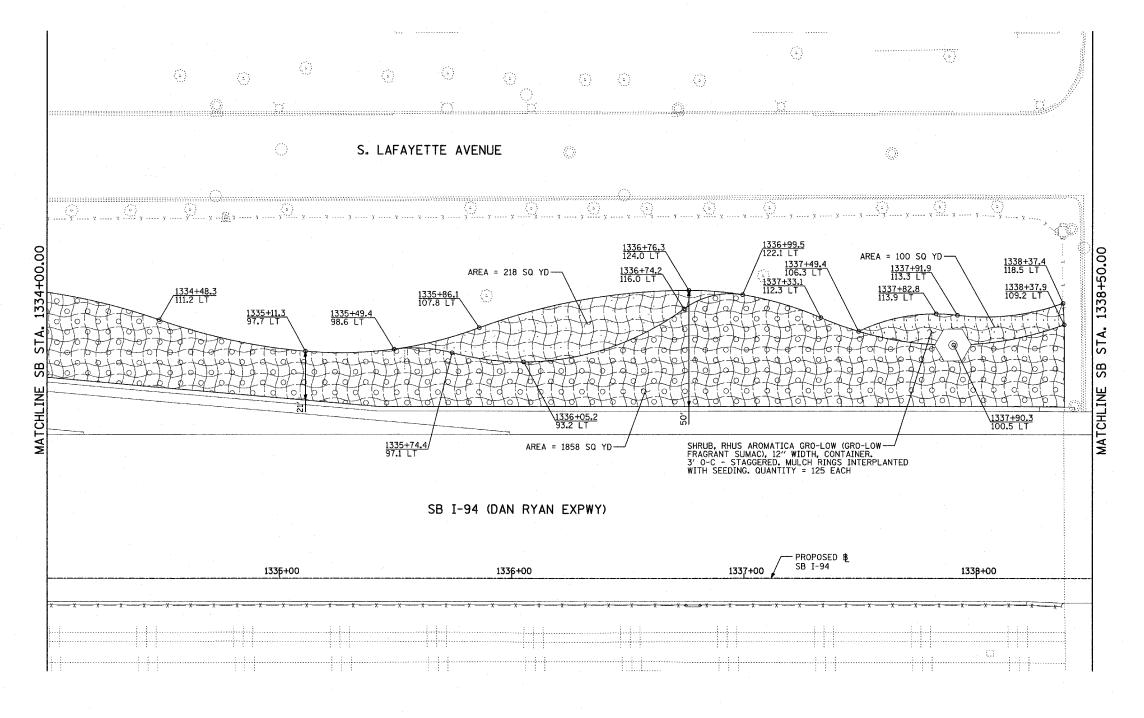


LANDSCAPING GENERAL PLAN NOTES:

- 1. THE CONTRACTOR SHALL USE CARE IN GRADING OR EXCAVATING NEAR ANY AND ALL EXISTING ITEMS WHICH WILL NOT BE REMOVED. ANY DAMAGE DONE TO EXISTING ITEMS BY THE CONTRACTOR SHALL BE REPAIRED BY THE CONTRACTOR AT THE CONTRACTOR'S EXPENSE.
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- 3. AREAS TO BE SEEDED BETWEEN NOVEMBER 1 AND APRIL
 1 SHALL REQUIRE DORMANT SEEDING, WHICH SHALL BE
 INCLUDED IN THE COST OF SEEDING CLASS 2A, SEEDING CLASS 24 (MODIFIED), OR SEEDING CLASS 5 (SPECIAL)

 1 ACCORDANCE WITH THE REQUIREMENTS OF SECTION 201
 OF THE STANDARD SPECIFICATIONS.
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 1 CF THE STANDARD SPECIFICATIONS.
 1 CATORDARCE WITH THE REQUIREMENTS OF SECTION 201
 OF THE ENGINEER PRIOR TO TOPSOIL PLACEMENT, SEEDING, AND PLANTING.
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LEGEND:

EROSION CONTROL BLANKET, SEEDING, CLASS 2A, NITROGEN, PHOSPHORUS, AND POTASSIUM FERTILIZER NUTRIENTS, TOPSOIL FURNISH AND PLACE, 4"

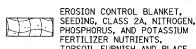


TOPSOIL FURNISH AND PLACE, 12" COMPOST FURNISH AND PLACE, 6" EROSION CONTROL BLANKET, SEEDING, CLASS 4 (MODIFIED), TOPSOIL FURNISH AND PLACE, 12"



EROSION CONTROL BLANKET, SEEDING, CLASS 4 (MODIFIED), SEEDING, CLASS 5A (MODIFIED) TOPSOIL FURNISH AND PLACE, 12" COMPOST FURNISH AND PLACE, 6"



EROSION CONTROL BLANKET, SEEDING, CLASS 5 (SPECIAL), TOPSOIL FURNISH AND PLACE, 12"

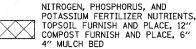



I-57

LOCATION MAP

63RD

71ST

79TH

87TH

95TH

REVISIONS NAME

ILLINOIS DEPARTMENT OF TRANSPORTATION F.A.I. 94 (DAN RYAN EXPRESSWAY) LANDSCAPING PLAN

SB I-94 (DAN RYAN EXPRESSWAY) STA. 1334+00.00 TO 1338+50.00 SHEET 5 OF 11

SCALE: 1"=20" DATE: MARCH 1, 2006

DRAWN BY: JJS CHECKED BY: MPG

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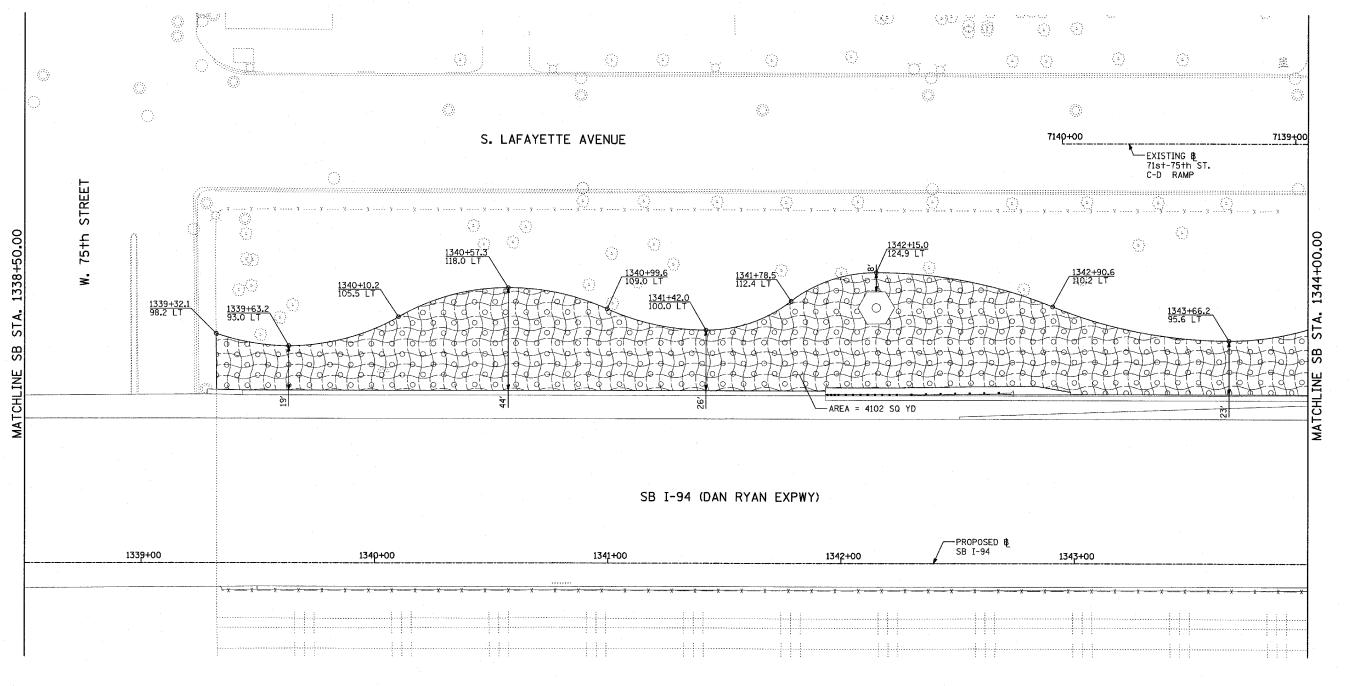
COMPOST FURNISH AND PLACE. 6"

PRE-EMERGENT GRANULAR HERBICIDE

SECTION COUNTY SHEETS NO. 94 1818 R-6 соок 290 178 STA. 1313+00 TO STA. 1367+00 FED. ROAD DIST. NO. ILLINOIS FED. AID PROJECT

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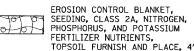
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LANDSCAPING GENERAL PLAN NOTES:

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LEGEND:



EROSION CONTROL BLANKET, SEEDING, CLASS 2A, NITROGEN, PHOSPHORUS, AND POTASSIUM FERTILIZER NUTRIENTS, TOPSOIL FURNISH AND PLACE, 12"

COMPOST FURNISH AND PLACE, 6" EROSION CONTROL BLANKET,

SEEDING, CLASS 4 (MODIFIED), TOPSOIL FURNISH AND PLACE, 12" COMPOST FURNISH AND PLACE, 6"



EROSION CONTROL BLANKET, SEEDING, CLASS 4 (MODIFIED). SEEDING, CLASS 5A (MODIFIED) TOPSOIL FURNISH AND PLACE, 12" COMPOST FURNISH AND PLACE, 6"

EROSION CONTROL BLANKET, SEEDING, CLASS 5 (SPECIAL), TOPSOIL FURNISH AND PLACE, 12"

NITROGEN, PHOSPHORUS, AND POTASSIUM FERTILIZER NUTRIENTS, TOPSOIL FURNISH AND PLACE, 12" COMPOST FURNISH AND PLACE, 6" 4" MULCH BED PRE-EMERGENT GRANULAR HERBICIDE



I-57

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REVISION	VS	1
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ILLINOIS DEPARTMENT OF TRANSPORTATION .A.I. 94 (DAN RYAN EXPRESSWAY) LANDSCAPING PLAN SB I-94 (DAN RYAN EXPRESSWAY)

STA. 1338+50.00 TO 1344+00.00 SHEET 6 OF 11

SCALE: 1"=20" DATE: MARCH 1, 2006 DRAWN BY: JJS CHECKED BY: MPG

SCALE: 1" = 20'-0"

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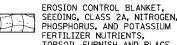
SECTION 1818 R-6 STA. 1313+00 FED. ROAD DIST. NO. | ILLINOIS | FED. AID PROJECT STREET 其類類 74†h (a) (b) (j) $\langle \hat{z} \rangle$ $\{\cdot\}$ S. LAFAYETTE AVENUE 7138+00 7137+00 -EXISTING B 7136+00 71st-75th ST C-D RAMP 1346+89.5 149.4 LT 7135+00 ____ y ____ -AREA = 179 SQ YD 7134+00 1345+21.2 120.2 LT 1345+51.1 115.6 LT 9434+00 1344+99.7 117.2 LT AREA = 4102 SQ YD EXISTING B 71st-75th ST C-D ENTRANCE CONNECTOR SB I-94 (DAN RYAN EXPWY) PROPOSED B SB I-94 1345+00 1346+00 1347+00 1349+00

LANDSCAPING GENERAL PLAN NOTES:

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LEGEND:

EROSION CONTROL BLANKET, SEEDING, CLASS 2A, NITROGEN, PHOSPHORUS, AND POTASSIUM FERTILIZER NUTRIENTS. TOPSOIL FURNISH AND PLACE, 4"




PHOSPHORUS, AND POTASSIUM FERTILIZER NUTRIENTS. TOPSOIL FURNISH AND PLACE, 12" COMPOST FURNISH AND PLACE, 6"


EROSION CONTROL BLANKET, SEEDING, CLASS 4 (MODIFIED), TOPSOIL FURNISH AND PLACE, 12" COMPOST FURNISH AND PLACE, 6"



EROSION CONTROL BLANKET, SEEDING, CLASS 4 (MODIFIED), SEEDING, CLASS 5A (MODIFIED)
TOPSOIL FURNISH AND PLACE, 12' COMPOST FURNISH AND PLACE, 6"

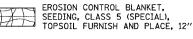

NITROGEN, PHOSPHORUS, AND POTASSIUM FERTILIZER NUTRIENTS, TOPSOIL FURNISH AND PLACE, 12" COMPOST FURNISH AND PLACE, 6" PRE-EMERGENT GRANULAR HERBICIDE

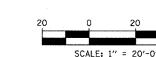

	REVISIONS
DATE	NAME
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	DATE

ILLINOIS DEPARTMENT OF TRANSPORTATION .A.I. 94 (DAN RYAN EXPRESSWAY) LANDSCAPING PLAN SB I-94 (DAN RYAN EXPRESSWAY)

STA. 1344+00.00 TO 1349+50.00 SHEET 7 OF 11

DRAWN BY: JJS CHECKED BY: MPG

COUNTY

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TO STA. 1367+00

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TYLININTERNATIONAL

SCALE: 1"=20 DATE: MARCH 1, 2006

LOCATION MAP


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AREAS TO BE SEEDED BETWEEN NOVEMBER 1 AND APRIL 1 SHALL REQUIRE DORMANT SEEDING, WHICH SHALL BE INCLUDED IN THE COST OF SEEDING CLASS 24, SEEDING 6. CLASS 4 (MODIFIED), OR SEEDING CLASS 5 (SPECIAL)

TYLIN INTERNATIONAL

OF THE STANDARD SPECIFICATIONS.

LAYOUT OF LANDSCAPED AREAS WILL REQUIRE APPROVAL OF THE ENGINEER PRIOR TO TOPSOIL PLACEMENT, SEEDING, AND PLANTING.

COMPOST FURNISH AND PLACE, 6"

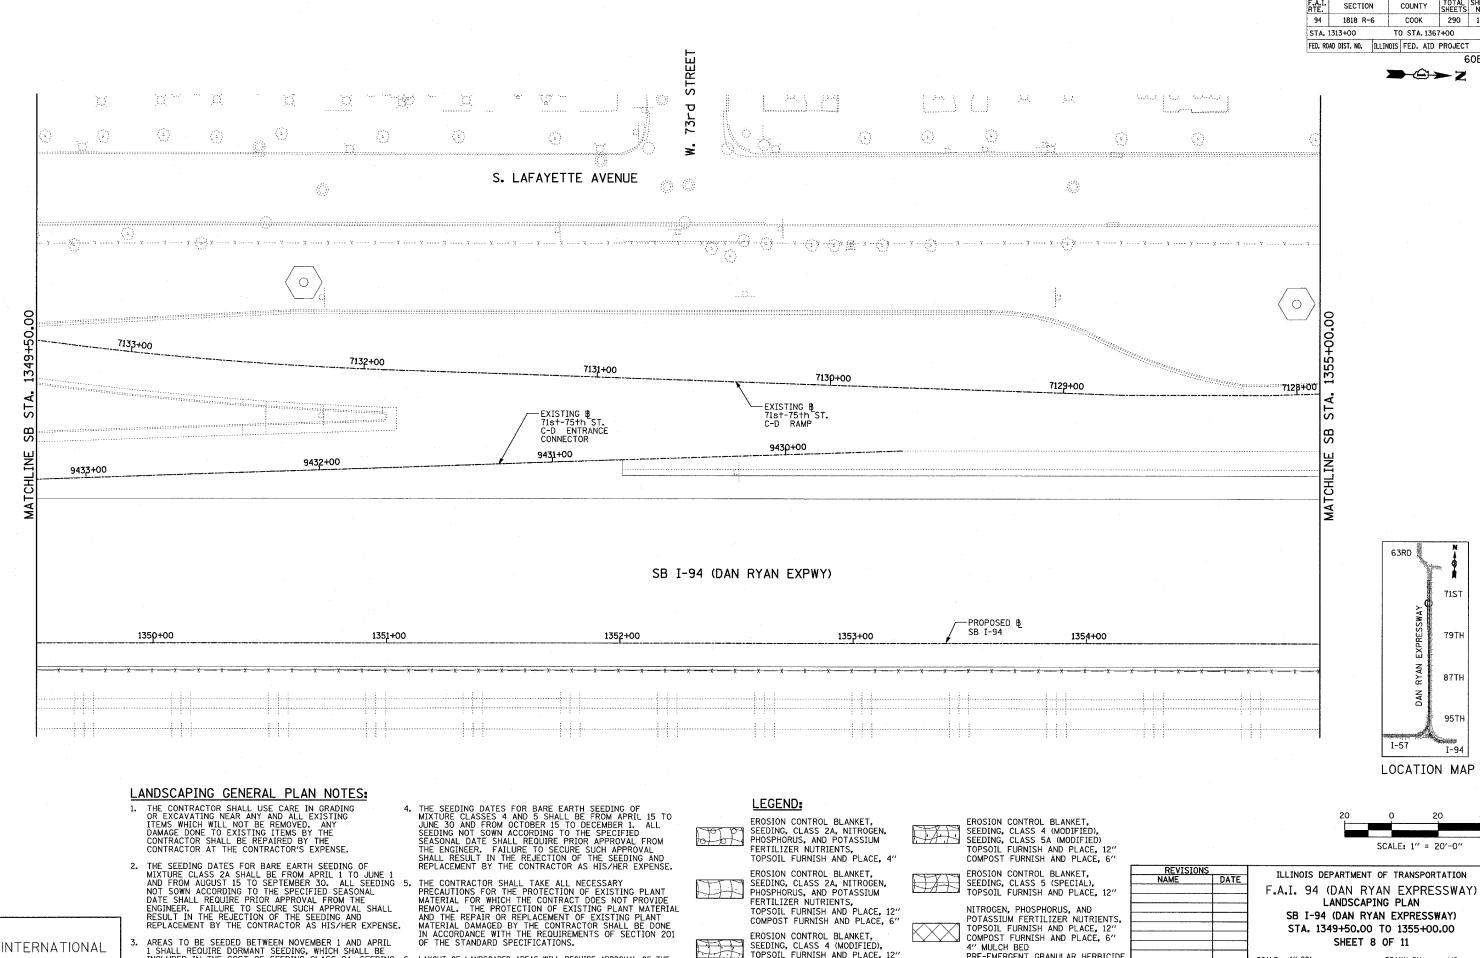SEEDING, CLASS 4 (MODIFIED), TOPSOIL FURNISH AND PLACE, 12"

COMPOST FURNISH AND PLACE, 6"

PRE-EMERGENT GRANULAR HERBICIDE

EROSION CONTROL BLANKET,

SB I-94 (DAN RYAN EXPRESSWAY) STA. 1349+50.00 TO 1355+00.00 SHEET 8 OF 11 SCALE: 1"=20' DRAWN BY: JJS DATE: MARCH 1, 2006

CHECKED BY: MPG

715

79TH

87TH


TOTAL SHEE SHEETS NO.

290 180

60B18

COUNTY

SECTION

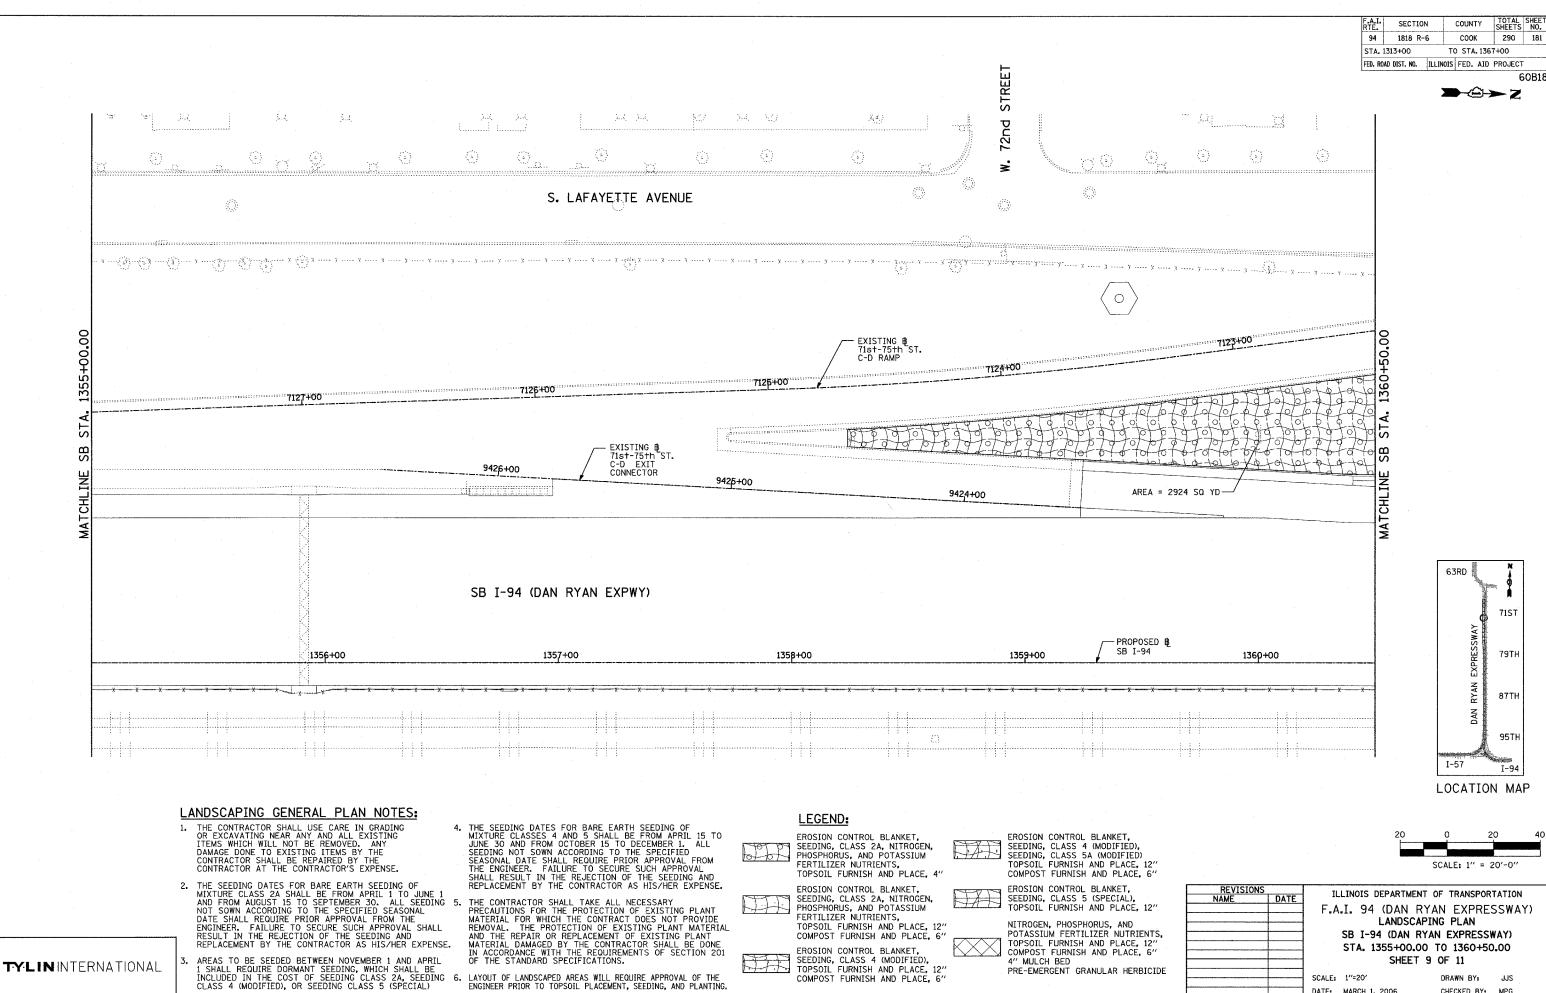


COMPOST FURNISH AND PLACE, 6"

DRAWN BY: JJS CHECKED BY: MPG

SCALE: 1"=20" DATE: MARCH 1, 2006

TOTAL SHEE SHEETS NO. SECTION COUNTY COOK 1818 R-6 290 182 94 STA. 1313+00 TO STA. 1367+00 FED. ROAD DIST. NO. ILLINOIS FED. AID PROJECT


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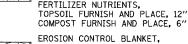
LANDSCAPING GENERAL PLAN NOTES:

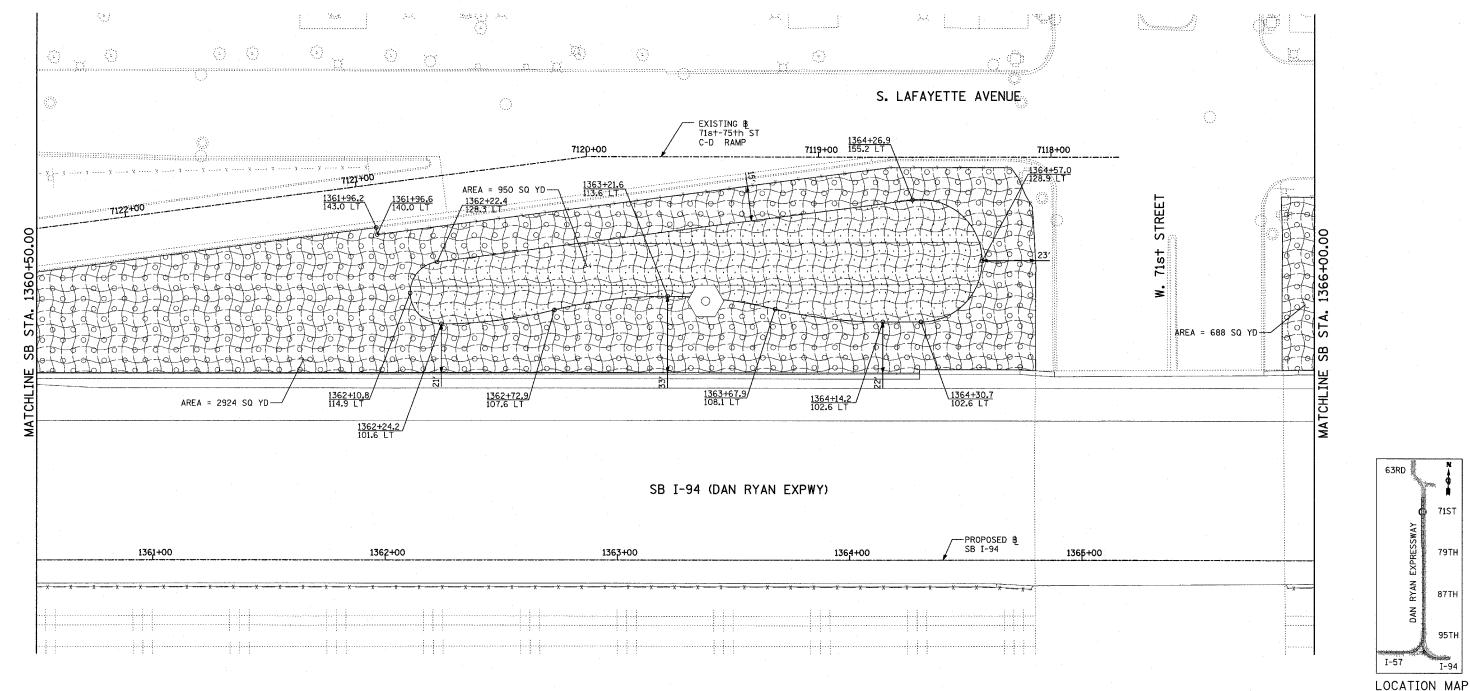- 1. THE CONTRACTOR SHALL USE CARE IN GRADING OR EXCAVATING NEAR ANY AND ALL EXISTING ITEMS WHICH WILL NOT BE REMOVED. ANY DAMAGE DONE TO EXISTING ITEMS BY THE CONTRACTOR SHALL BE REPAIRED BY THE CONTRACTOR SHALL BE REPAIRED BY THE CONTRACTOR AT THE CONTRACTOR'S EXPENSE.
- 2. THE SEEDING DATES FOR BARE EARTH SEEDING OF MIXTURE CLASS 2A SHALL BE FROM APRIL 1 TO JUNE 1 AND FROM AUGUST 15 TO SEPTEMBER 3O. ALL SEEDING NOT SOWN ACCORDING TO THE SPECIFIED SEASONAL DATE SHALL REQUIRE PRIOR APPROVAL FROM THE ENGINEER. FAILURE TO SECURE SUCH APPROVAL RESULT IN THE REJECTION OF THE SEEDING AND REPLACEMENT BY THE CONTRACTOR AS HIS/HER EXPENSE.
- 3. AREAS TO BE SEEDED BETWEEN NOVEMBER 1 AND APRIL 1 SHALL REQUIRE DORMANT SEEDING, WHICH SHALL BE INCLUDED IN THE COST OF SEEDING CLASS 2A, SEEDING 6. CLASS 4 (MODIFIED), OR SEEDING CLASS 5 (SPECIAL)
- 4. THE SEEDING DATES FOR BARE EARTH SEEDING OF MIXTURE CLASSES 4 AND 5 SHALL BE FROM APRIL 15 TO JUNE 30 AND FROM OCTOBER 15 TO DECEMBER 1. ALL SEEDING NOT SOWN ACCORDING TO THE SPECIFIED SEASONAL DATE SHALL REQUIRE PRIOR APPROVAL FROM THE ENGINEER. FAILURE TO SECURE SUCH APPROVAL SHALL RESULT IN THE REJECTION OF THE SEEDING AND REPLACEMENT BY THE CONTRACTOR AS HIS/HER EXPENSE.
- THE CONTRACTOR SHALL TAKE ALL NECESSARY PRECAUTIONS FOR THE PROTECTION OF EXISTING PLANT MATERIAL FOR WHICH THE CONTRACT DOES NOT PROVIDE REMOVAL. THE PROTECTION OF EXISTING PLANT MATERIAL AND THE REPAIR OR REPLACEMENT OF EXISTING PLANT MATERIAL DAMAGED BY THE CONTRACTOR SHALL BE DONE IN ACCORDANCE WITH THE REQUIREMENTS OF SECTION 201 OF THE STANDARD SPECIFICATIONS.
 - LAYOUT OF LANDSCAPED AREAS WILL REQUIRE APPROVAL OF THE ENGINEER PRIOR TO TOPSOIL PLACEMENT, SEEDING, AND PLANTING.

LEGEND:



EROSION CONTROL BLANKET, SEEDING, CLASS 2A, NITROGEN, PHOSPHORUS, AND POTASSIUM FERTILIZER NUTRIENTS,

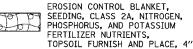


EROSION CONTROL BLANKET, SEEDING, CLASS 4 (MODIFIED), TOPSOIL FURNISH AND PLACE, 12" COMPOST FURNISH AND PLACE, 6'




EROSION CONTROL BLANKET, SEEDING, CLASS 4 (MODIFIED), SEEDING, CLASS 5A (MODIFIED) TOPSOIL FURNISH AND PLACE, 12" COMPOST FURNISH AND PLACE, 6"



EROSION CONTROL BLANKET, SEEDING, CLASS 5 (SPECIAL), TOPSOIL FURNISH AND PLACE, 12"

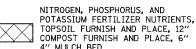



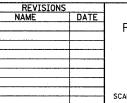

ILLINOIS DEPARTMENT OF TRANSPORTATION F.A.I. 94 (DAN RYAN EXPRESSWAY) LANDSCAPING PLAN

SB I-94 (DAN RYAN EXPRESSWAY) STA. 1360+50.00 TO 1366+00.00 SHEET 10 OF 11

SCALE: 1"=20' DATE: MARCH 1, 2006 DRAWN BY: JJS CHECKED BY: MPG

71ST

79TH


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TYLININTERNATIONAL


4" MULCH BED PRE-EMERGENT GRANULAR HERBICIDE





LANDSCAPING GENERAL PLAN NOTES:

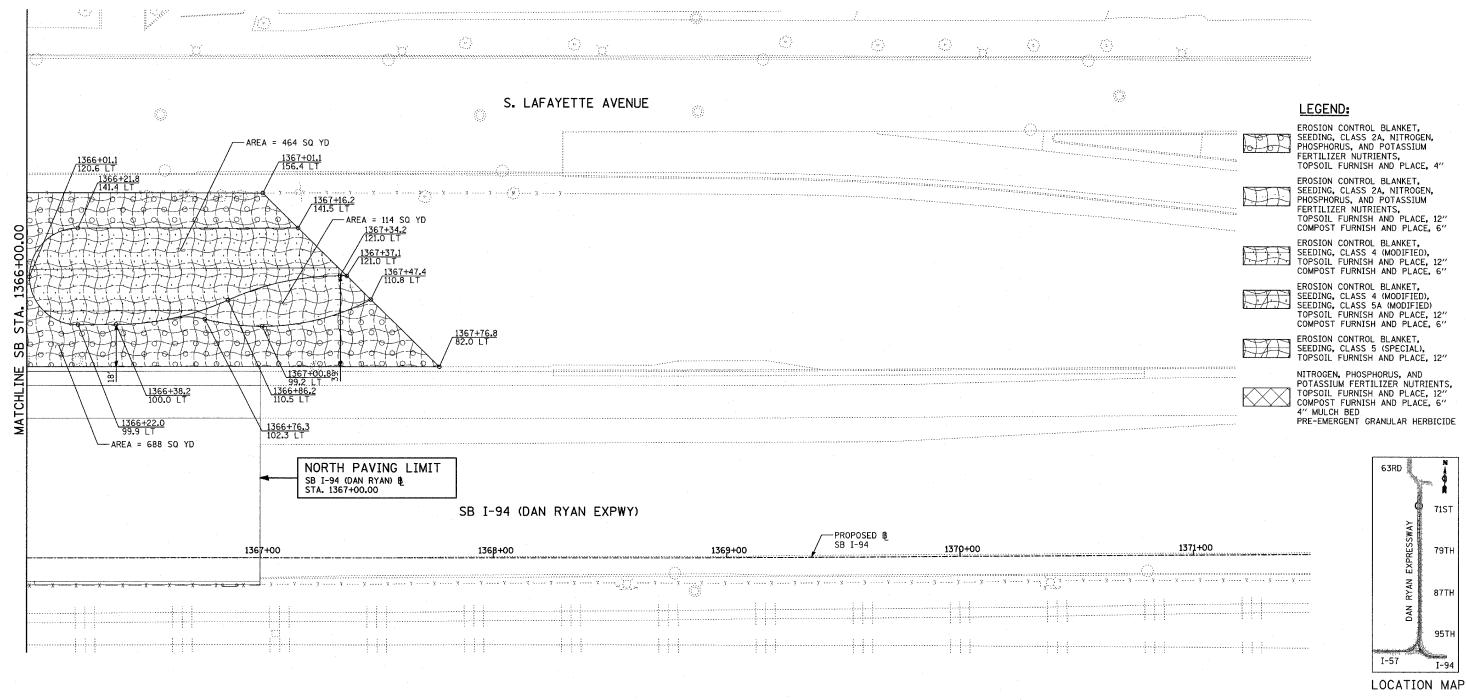- 1. THE CONTRACTOR SHALL USE CARE IN GRADING OR EXCAVATING NEAR ANY AND ALL EXISTING ITEMS WHICH WILL NOT BE REMOVED. ANY DAMAGE DONE TO EXISTING ITEMS BY THE CONTRACTOR SHALL BE REPAIRED BY THE CONTRACTOR AT THE CONTRACTOR'S EXPENSE.
- 2. THE SEEDING DATES FOR BARE EARTH SEEDING OF MIXTURE CLASS 2A SHALL BE FROM APRIL 1 TO JUNE 1 AND FROM AUGUST 15 TO SEPTEMBER 30. ALL SEEDING 5. NOT SOWN ACCORDING TO THE SPECIFIED SEASONAL DATE SHALL REQUIRE PRIOR APPROVAL FROM THE ENGINEER. FAILURE TO SECURE SUCH APPROVAL SHALL RESULT IN THE REJECTION OF THE SEEDING AND REPLACEMENT BY THE CONTRACTOR AS HIS/HER EXPENSE.
- AREAS TO BE SEEDED BETWEEN NOVEMBER 1 AND APRIL 1 SHALL REQUIRE DORMANT SEEDING, WHICH SHALL BE INCLUDED IN THE COST OF SEEDING CLASS 2A, SEEDING 6. CLASS 4 (MODIFIED), OR SEEDING CLASS 5 (SPECIAL)
- 4. THE SEEDING DATES FOR BARE EARTH SEEDING OF MIXTURE CLASSES 4 AND 5 SHALL BE FROM APRIL 15 TO JUNE 30 AND FROM OCTOBER 15 TO DECEMBER 1. ALL SEEDING NOT SOWN ACCORDING TO THE SPECIFIED SEASONAL DATE SHALL REQUIRE PRIOR APPROVAL FROM THE ENGINEER. FAILURE TO SECURE SUCH APPROVAL SHALL RESULT IN THE REJECTION OF THE SEEDING AND REPLACEMENT BY THE CONTRACTOR AS HIS/HER EXPENSE.
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 - . LAYOUT OF LANDSCAPED AREAS WILL REQUIRE APPROVAL OF THE ENGINEER PRIOR TO TOPSOIL PLACEMENT, SEEDING, AND PLANTING.

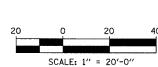



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		SCALE: 1"	=20′			DRAWN B	Y:	JJS

DATE: MARCH 1, 2006

TYLININTERNATIONAL



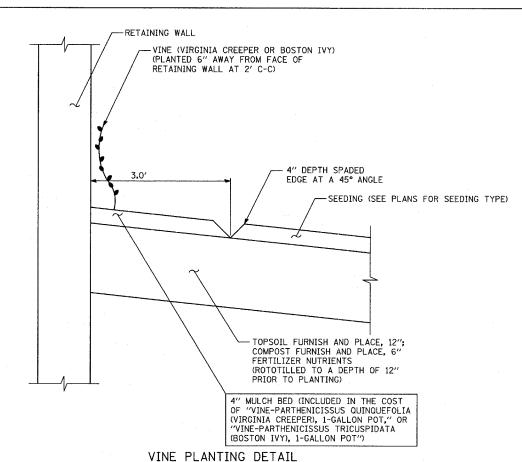

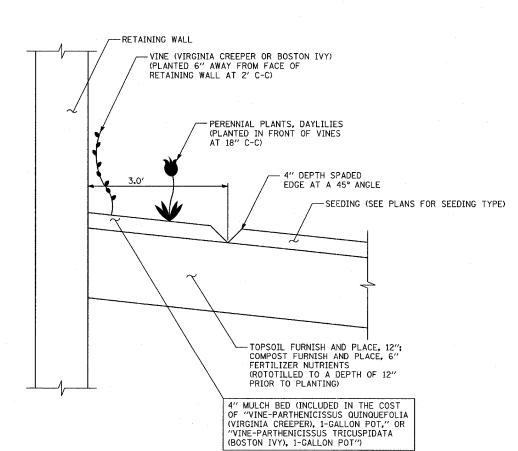VINE AND DAYLILY PLANTING DETAIL

SECTION TOTAL SHEET SHEETS NO. COUNTY 1818 R-6 соок 290 184 STA. 1313+00 TO STA. 1367+00 FED. ROAD DIST. NO. ILLINOIS FED. AID PROJECT

GENERAL PLAN NOTES - LANDSCAPING:

- 1. THE CONTRACTOR SHALL USE CARE IN GRADING OR EXCAVATING NEAR ANY AND ALL EXISTING ITEMS WHICH WILL NOT BE REMOVED. ANY DAMAGE DONE TO EXISTING ITEMS BY THE CONTRACTOR SHALL BE REPAIRED BY THE CONTRACTOR AT THE CONTRACTOR'S EXPENSE.
- 2. THE CONTRACTOR SHALL TAKE ALL NECESSARY PRECAUTIONS FOR THE THE CONTRACTOR SHALL TAKE ALL NECESSARY PRECAUTIONS FOR THE PROTECTION OF EXISTING PLANT MATERIAL FOR WHICH THE CONTRACT DOES NOT PROVIDE REMOVAL. THE PROTECTION OF EXISTING PLANT MATERIAL AND THE REPAIR OR REPLACEMENT OF EXISTING PLANT MATERIAL DAMAGED BY THE CONTRACTOR SHALL BE DONE IN ACCORDANCE WITH THE REQUIREMENTS OF SECTION 201 OF THE STANDARD SPECIFICATIONS.
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- 4. AREAS TO BE SEEDED BETWEEN NOVEMBER 1 AND APRIL 1 SHALL REQUIRE DORMANT SEEDING, WHICH SHALL BE INCLUDED IN THE COST OF "SEEDING, CLASS 2A," "SEEDING, CLASS 4 (MODIFIED)," "SEEDING, CLASS 5 (SPECIAL)," OR "SEEDING, CLASS 5A (MODIFIED)."
- 5. THE SEEDING DATES FOR BARE EARTH SEEDING OF MIXTURE CLASSES 4 AND 5 SHALL BE FROM APRIL 15 TO JUNE 30 AND FROM OCTOBER 15 TO DECEMBER 1. ALL SEEDING NOT SOWN ACCORDING TO THE SPECIFIED SEASONAL DATE SHALL REQUIRE PRIOR APPROVAL FROM THE ENGINEER. FAILURE TO SECURE SUCH APPROVAL SHALL RESULT IN THE REJECTION OF THE SEEDING AND REPLACEMENT BY THE CONTRACTOR AS HIS/HER EXPENSE
- LAYOUT OF LANDSCAPED AREAS WILL REQUIRE APPROVAL OF THE ENGINEER PRIOR TO TOPSOIL PLACEMENT, SEEDING, AND PLANTING.

GENERAL PLAN NOTES - PLANTING BED:

- SEE LANDSCAPING PLANS FOR SPECIFIC LOCATIONS AND QUANTITIES OF VINES, SHRUBS, AND DAYLILIES.
- 8. ALL COMPOST AND TOPSOIL AREAS SHALL BE THOROUGHLY ROTOTILLED TO A DEPTH OF 12" PRIOR TO PLANTING AND/OR SEEDING
- 9. THE CONTRACTOR SHALL ORDER THE FOLLOWING PLANT MATERIAL IMMEDIATELY FOLLOWING EXECUTION OF THE CONTRACT TO ASSURE AVAILABILITY OF THE PLANT MATERIAL FOR SPRING PLANTING AT THE CONCLUSION OF THE CONTRACT:

 VINE-PARTHENOCISSUS QUINQUEFOLIA (VIRGINIA CREEPER), 1-GALLON
 VINE-PARTHENOCISSUS TRICUSPIDATA (BOSTON IYY), 1-GALLON
 HEMEROCALLIS 'HAPPY RETURNS' (HAPPY RETURNS DAYLILY), 1-GALLON
 SHRUB, RHUS AROMATICA 'GRO-LOW' (GRO-LOW SUMAC), 18" WIDTH, CONTAINER
 SHRUB, RHUS GLABRA (SMOOTH SUMAC), 2' HEIGHT, BARE ROOT
 SHRUB, RHUS TYPHINA (STAGHORN SUMAC), 2' HEIGHT, BARE ROOT
- 10. MULCH BED SHALL BE PLACED OVER ROTOTILLED COMPOST/TOPSOIL AS SHOWN IN THE PLANTING DETAILS AND ACCORDING TO IDOT STANDARD SPECIFICATION 253.11, EXCEPT THAT NO WEED BARRIER FABRIC IS REQUIRED. COST OF MULCH COVER IS INCLUDED WITH PAYMENT FOR THE VINES, DAYLILIES, AND SHRUBS.
- PRE-EMERGENT GRANULAR HERBICIDE SHALL BE PLACED IN MULCHED BEDS ACCORDING TO THE SPECIAL PROVISION.
- 12. FERTILIZER NUTRIENTS SHALL BE ADDED AND APPLIED TO THE VINE BEDS AT A 5:3:2 RATIO AS FOLLOWS:

NITROGEN FERTILIZER NUTRIENTS: 90 LBS/ACRE
PHOSPHORUS FERTILIZER NUTRIENTS: 54 LBS/ACRE
POTASSIUM FERTILIZER NUTRIENTS: 36 LBS/ACRE
THIS FERTILIZER SHALL BE TILLED AND CULTIVATED INTO THE SOIL TO A DEPTH OF 12"


13. CONTRACTOR SHALL COORDINATE WITH CONTRACTS 60A08 AND 60A23 WHEN PLACING SUMAC SHRUBS NEAR HIGH MAST LIGHT TOWERS SERVICE PADS. SUMAC SHRUBS SHALL NOT BE INSTALLED PRIOR TO THE INSTALLATION OF AND GRADING REQUIRED FOR HIGH MAST LIGHT TOWER SERVICE PADS.

SCHEDULE OF LANDSCAPE ITEMS

PAY ITEM DESCRIPTION	COMMON NAME	SIZE	SPACING	UNIT	TOTAL
SHRUB, RHUS AROMATICA GRO-LOW	GRO-LOW FRAGRANT SUMAC	18" CONTAINER	3' C-C" STAGGERED	EACH	225
VINE-PARTHENOCISSUS QUINQUEFOLIA	VIRGINIA CREEPER	1-GALLON	2' C-C"	EACH	95
PERENNIAL PLANTS, DAYLILIES	HAPPY RETURNS DAYLILIES	1-GALLON	18" C-C"	UNITS	1

REVISIONS		TI	LINOIS DEPA	DIMENT O	E TOANS	DART	ATION
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			LAND	COADINO	DETAIL	~	
				SCAPING			
			& 1	GENERAL	NOTES		
		SCALE:	NO SCALE		DRAWN B	v.	JJS
		JUALE:	NO SCALE		DIVERSION D	1 =	102
		DATE:	MARCH 1, 2006	ã	CHECKED	BY:	MPG

TYLIN INTERNATIONAL

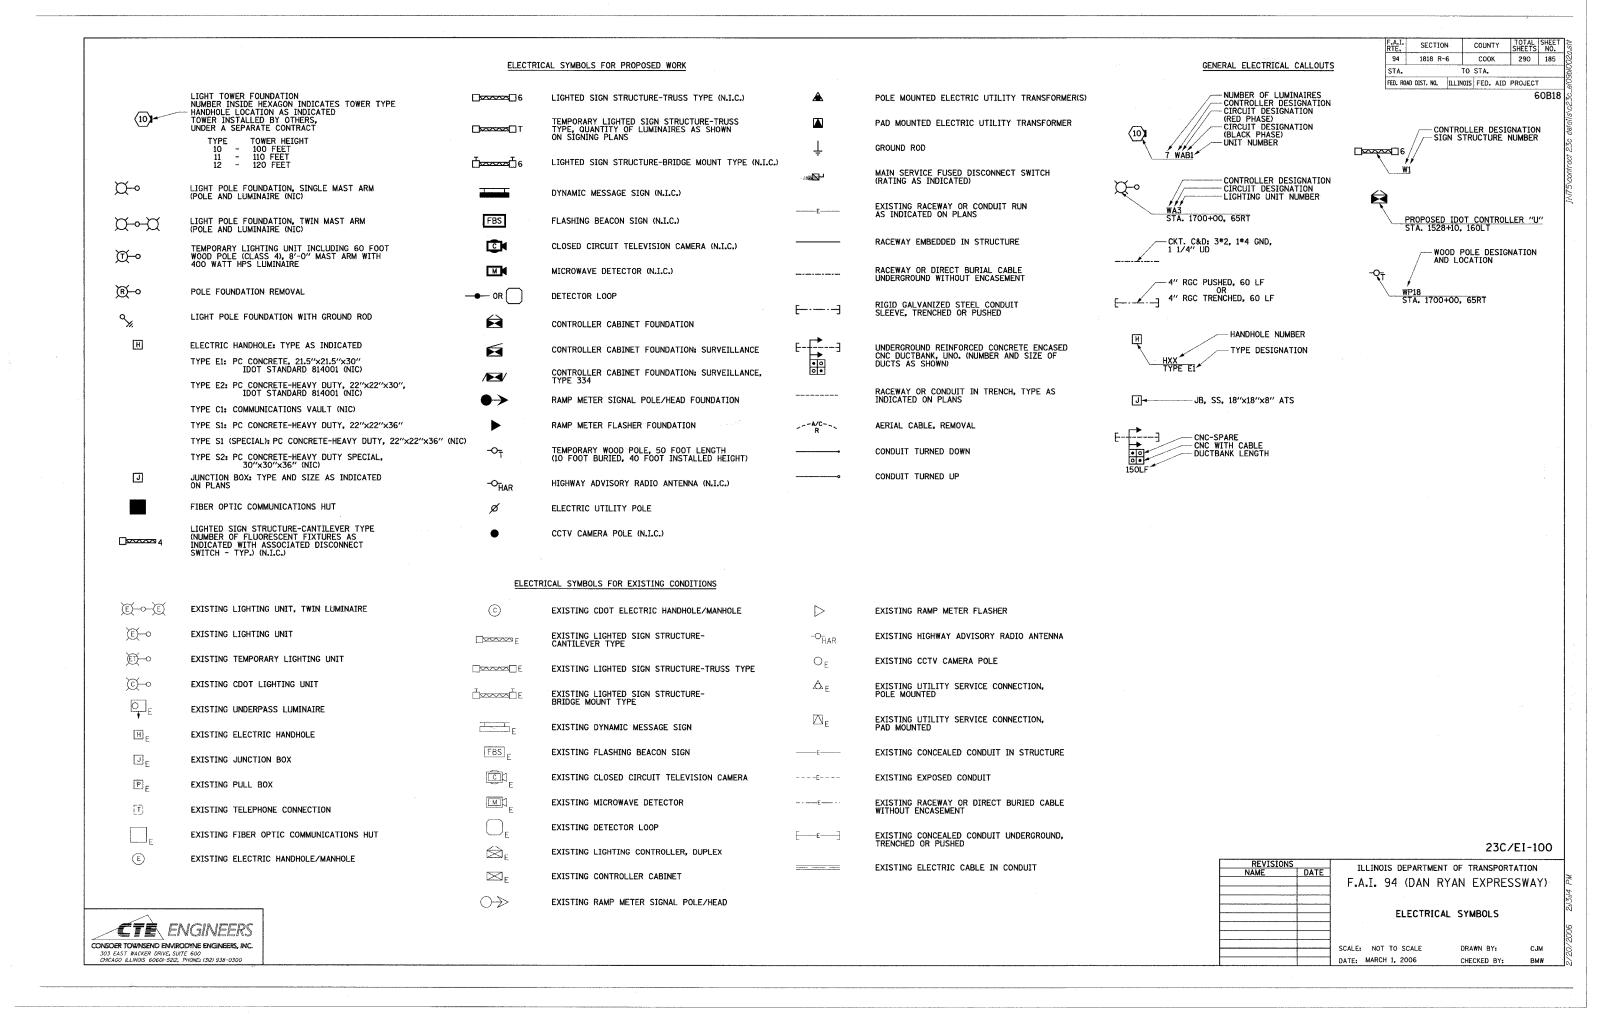

F.A.I. RTE.	SECTION	1	COUNTY	TOTAL	SHEET NO.
94	1818 R-0	6	COOK	290	186
STA.		T0	STA.		
FED. RO	AD DIST. NO.	ILLINOIS	FED. AID	PROJECT	

60B18

ABBREVIATIONS

AC ALTERNATING CURRENT EA EACH LP LIGHT POLE A/C AERIAL CABLE EB EASTBOUND L SUM LUMP SUM AFG ABOVE FINISHED GRADE ECA ELECTRIC CABLE ASSEMBLY LT LEFT ANT ANTENNA EL ELEVATION M METER AOBE AS ORDERED BY THE ENGINEER EM EXISTING UNIT TO BE MODIFIED (6-g. NEW LUMINAIRE, BALLAST, OR MAST ARM) ASPH ASPHALT OR MAST ARM AYE AVENUE ET EXISTING TEMPORARY UNIT TO MW MESSENGER WIRE BHO BULKHEAD ETP EMERGENCY TRAFFIC PATROL NIC NOT IN CONTRACT BLK BLOCK ETP EMERGENCY TRAFFIC PATROL NIC NOT IN CONTRACT BRIDGE EXCAV EXCAVATION NO NUMBER CONDUIT, CONDUCTOR F, FT FOOT, FEET ON HIS ONE HOLD COME AND TO SCALE	A	AMPERES	E	EXISTING UNIT TO REMAIN	LF	LINEAR FEET
AFG ABOVE FINISHED GRADE ECA ELECTRIC CABLE ASSEMBLY LT LEFT ANT ANTENNA EL ELEVATION M METER AOBE AS ORDERED BY THE ENGINEER EM EXISTING UNIT TO BE MODIFIED (e.g., NEW LUMINAIRE, BALLAST, OR MAST ARM) ASPHALT MM MICROWAVE DETECTOR ATS ATTACHED TO STRUCTURE ER EXISTING RELOCATED UNIT MM MULTI-MODE AVE AVENUE ET EXISTING TEMPORARY UNIT TO MW MESSENGER WIRE BHD BULKHEAD ETP EMERGENCY TRAFFIC PATROL NIC NOT IN CONTRACT BLK BLOCK ETR EXISTING TEMPORARY RELOCATED BR BRIDGE EXCAV EXCAVATION NO NUMBER C CONDUIT, CONDUCTOR F, FT FOOT, FEET	AC	ALTERNATING CURRENT	EA	EACH	LP	LIGHT POLE
ANT ANTENNA EL ELEVATION M METER AOBE AS ORDERED BY THE ENGINEER EM EXISTING UNIT TO BE MODIFIED (e.g., NEW LUMINAIRE, BALLAST, OR MAST ARM) ASPHALT MD MICROWAVE DETECTOR ATS ATTACHED TO STRUCTURE ER EXISTING RELOCATED UNIT MM MULTI-MODE AVE AVENUE ET EXISTING TEMPORARY UNIT TO MW MESSENGER WIRE BHD BULKHEAD NB NORTHBOUND BIT BITUMINOUS ETP EMERGENCY TRAFFIC PATROL NIC NOT IN CONTRACT BLK BLOCK ETR EXISTING TEMPORARY RELOCATED NM NONMETALLIC BR BRIDGE EXCAV EXCAVATION NO NUMBER C CONDUIT, CONDUCTOR F, FT FOOT, FEET NOT NTS NOT TO SCALE	A/C	AERIAL CABLE	EB ·	EASTBOUND	L SUM	LUMP SUM
AOBE AS ORDERED BY THE ENGINEER EM (e.g. NEW LUMINAIRE, BALLAST, OR MAST ARM) ASPHALT OR MAST ARM) ATTACHED TO STRUCTURE ER EXISTING RELOCATED UNIT MM MULTI-MODE AVE AVENUE ET EXISTING TEMPORARY UNIT TO MW MESSENGER WIRE BHD BULKHEAD NB NORTHBOUND BIT BITUMINOUS ETP EMERGENCY TRAFFIC PATROL NIC NOT IN CONTRACT BLK BLOCK ETR EXISTING TEMPORARY RELOCATED NM NONMETALLIC BR BRIDGE EXCAV EXCAVATION NO NUMBER C CONDUIT, CONDUCTOR F, FT FOOT, FEET NOT SCALE	AFG	ABOVE FINISHED GRADE	ECA	ELECTRIC CABLE ASSEMBLY	LT	LEFT
ASPH ASPHALT (e.g., NEW LUMINAIRE, BALLAST, OR MAST ARM) ATTACHED TO STRUCTURE ER EXISTING RELOCATED UNIT AVE AVENUE BHD BULKHEAD ETP EMERGENCY TRAFFIC PATROL BLK BLOCK BLOCK BR BRIDGE C CONDUIT, CONDUCTOR EXCAV EXCAVATION MM MULTI-MODE MW MESSENGER WIRE NB NORTHBOUND NO IN CONTRACT NO NUMBER EXCAVATION NO NUMBER F. FT FOOT, FEET	ANT	ANTENNA	EL	ELEVATION	М	METER
ASPHALI ASPHALI ASPHALI ASPHALI ATTACHED TO STRUCTURE ER EXISTING RELOCATED UNIT MM MULTI-MODE MW MESSENGER WIRE BLOCK BLOCK BLOCK BR BRIDGE C CONDUIT, CONDUCTOR ER ER EXISTING TEMPORARY UNIT TO REMAIN OR MODIFIED MW MESSENGER WIRE EXISTING TEMPORARY UNIT TO NB NB NORTHBOUND NIC NOT IN CONTRACT UNIT UNIT UNIT F, FT FOOT, FEET NO NO NUMBER NOT TO SCALE	AOBE	AS ORDERED BY THE ENGINEER	EM	EXISTING UNIT TO BE MODIFIED	MA	MAST ARM
AVE AVENUE ET EXISTING TEMPORARY UNIT TO MW MESSENGER WIRE BHD BULKHEAD ET REMAIN OR MODIFIED NB NORTHBOUND BIT BITUMINOUS ETP EMERGENCY TRAFFIC PATROL NIC NOT IN CONTRACT BLK BLOCK ETR EXISTING TEMPORARY RELOCATED NM NONMETALLIC BR BRIDGE EXCAV EXCAVATION NO NUMBER C CONDUIT, CONDUCTOR F, FT FOOT, FEET NTS NOT TO SCALE	ASPH	ASPHALT		(e.g. NEW LUMINAIRE, BALLASI, OR MAST ARM)	MD	MICROWAVE DETECTOR
BHD BULKHEAD REMAIN OR MODIFIED NB NORTHBOUND BIT BITUMINOUS ETP EMERGENCY TRAFFIC PATROL NIC NOT IN CONTRACT BLK BLOCK ETR EXISTING TEMPORARY RELOCATED NM NONMETALLIC BR BRIDGE EXCAV EXCAVATION NO NUMBER C CONDUIT, CONDUCTOR F, FT FOOT, FEET NTS NOT TO SCALE	ATS	ATTACHED TO STRUCTURE	ER	EXISTING RELOCATED UNIT	MM	MULTI-MODE
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BLK BLOCK ETR EXISTING TEMPORARY RELOCATED NM NONMETALLIC BR BRIDGE EXCAV EXCAVATION NO NUMBER C CONDUIT, CONDUCTOR F, FT FOOT, FEET NTS NOT TO SCALE	BHD	BULKHEAD			NB	NORTHBOUND
BR BRIDGE EXCAV EXCAVATION NO NUMBER C CONDUIT, CONDUCTOR F, FT FOOT, FEET NTS NOT TO SCALE	BIT	BITUMINOUS			NIC	NOT IN CONTRACT
BR BRIDGE EXCAV EXCAVATION NO NUMBER C CONDUIT, CONDUCTOR F, FT FOOT, FEET NTS NOT TO SCALE	BLK	BLOCK	ETR		NM	NONMETALLIC
C CONDUIT, CONDUCTOR F, FT FOOT, FEET NTS NOT TO SCALE	BR	BRIDGE	FXCAV		NO	NUMBER
	С	CONDUIT, CONDUCTOR			NTS	NOT TO SCALE
FDN FOUNDATION ON GYERNEAU	CAB	CABINET	*	,	ОН	OVERHEAD
CBW CONCRETE BLOCK WALL FO FIBER OPTIC PEC POLYETHYLENE CONDUIT	CBW	CONCRETE BLOCK WALL			PEC	POLYETHYLENE CONDUIT
CC COMMUNICATIONS CENTER GM GROUND MOUNTED PH PHASE	CC	COMMUNICATIONS CENTER	· -		PH	PHASE
CCTV CLOSED CIRCUIT TELEVISION GND. GRD GROUND PIN PROJECT IDENTIFICATION NUMBER	CCTV	CLOSED CIRCUIT TELEVISION			PIN	PROJECT IDENTIFICATION NUMBER
CDOT CDOT-CHICAGO DEPARTMENT OF GR GUARD RAIL PL PROPERTY LINE	CDOT	CDOT-CHICAGO DEPARTMENT OF			PL	PROPERTY LINE
COMED COMMONWEALTH EDISON GSC GALVANIZED STEEL CONDUIT PANEL	COMED				PNL	PANEL
CKT CIRCUIT HAR HIGHWAY ADVISORY RADIO PROPOSED					PROP	PROPOSED
CLF CHAIN LINK FENCE HD HEAVY DUTY				· · · · · · · · · · · · · · · · · · ·	PTZ	PAN-TILT-ZOOM
CNC COILABLE NONMETALLIC CONDUIT HH HANDHOLE PVC POLYVINYL CHLORIDE					PVC	POLYVINYL CHLORIDE
COMM COMMUNICATIONS HPS HIGH PRESSURE SODIUM PVCC POLYVINYL CHLORIDE COATED				·····-	PVCC	POLYVINYL CHLORIDE COATED
CONC CONCRETE HYD HYDRANT R EXISTING UNIT TO BE REMOVED (SALVAGED UNO)					R	
CONST CONSTRUCTION ID INNERDUCT RC REINFORCED CONCRETE			ID	INNERDUCT	PC .	
CORR CORRUGATED IDOT ILLINOIS DEPARTMENT OF RD ROAD			IDOT	ILLINOIS DEPARTMENT OF		
TRANSPORTATION CW CONCRETE WALL TO THE STREET TO THE STRE				TRANSPORTATION		
© CENTERLINE I INTERSTATE CONDUIT			I	INTERSTATE	NOC	
DB DIRECT BURIED IN INCHES RM RAMP METER	_		IN	INCHES	RM	RAMP METER
DC DIRECT CURRENT J, JB JUNCTION BOX ROW RIGHT OF WAY			J, JB	JUNCTION BOX	ROW	RIGHT OF WAY
DE DARK EIRER KVA KILOVOLT-AMPERE RR EXISTING UNIT TO BE REMOVED				KILOVOLT-AMPERE	RR	
KW KILOWATT AND REINSTALLED			KW	KILOWATT		
DUC DVIANTA MECCASE CION						
DWG DRAWING(S)					кW	KETAINING WALL

GENERAL NOTES

SB

SHT

SS

ST'A

STD

STL

SURF

SURV

SW

TAN

TC

TEL

TS

TSC

TYP

UD

UND

UNO

WB

WM

WΡ

XFMR

STRUCT

SOUTHBOUND

STAINLESS STEEL

SHEET SINGLE MODE

STREET

STATION

STEEL

STANDARD

STRUCTURE

SURVEILLANCE

SURFACE

SIDEWALK TEMPORARY

TANGENT

TRAY CABLE

TELEPHONE

TYPICAL

VOLT:

WATT

UNIT DUCT

UNDERDRAIN

WESTBOUND

WOOD POLE

TRANSFORMER

WALL MOUNTED

TRAFFIC SIGNAL

TRAFFIC SYSTEMS CENTER

UNLESS NOTED OTHERWISE

- SEE DRAWING EI-100 AND EI-101 FOR ELECTRICAL SYMBOLS AND ABBREVIATIONS.
- REFER TO SHEETS EI-102, 103, 106, 110, 110A AND 115 FOR DETAILS AND SHEET E-301 FOR STANDARDS.
- 3. COORDINATE ALL WORK WITH OTHER IDOT CONTRACTS 62583, 62937, 62304, 62695 AND OTHER CONTRACTS AS APPLICABLE.
- 4. COORDINATE CONDUIT INSTALLATION WITH THE ROADWAY CONTRACTOR'S STAGE CONSTRUCTION.
- 5. UNLESS NOTED OTHERWISE, ALL ITEMS AND WORK SHOWN IN HEAVY WEIGHT ARE PROPOSED, EXCEPT ROADWAY LINES.
- 6. ARTIFICIAL LIGHTING IS USED IN NIGHT OPERATIONS, CANNOT BE ENERGIZED FROM THE DEPARTMENT'S CONTROLLERS.
- THE CONTRACTOR SHALL TAKE ALL NECESSARY SAFETY PRECAUTIONS TO PROTECT AND PROVIDE ACCESS TO ABUTTING PROPERTY, UTILITIES, PEDESTRIANS, AND VEHICULAR TRAFFIC.
- 8. ALL CONNECTIONS, EXTENSIONS TO MAKE THE LIGHTING SYSTEM FUNCTIONAL ARE INCLUDED IN THIS CONTRACT.
- 9. LIGHTING AND SURVEILLANCE RACEWAYS AND DUCTBANKS SHALL BE INSTALLED IN COMMON TRENCHES WHEREVER POSSIBLE. ANY ADDITIONAL TRENCH AND BACKFILL WORK PERFORMED BY THE CONTRACTOR TO FACILITATE INSTALLATION OF LIGHTING AND SURVEILLANCE RACEWAY, DUCTBANKS OR HANDHOLES WILL NOT BE MEASURED FOR PAYMENT BUT SHALL BE INCLUDED IN THE COST OF THIS CONTRACT.

23C/EI-101

BMW

CHECKED BY:

REVISIONS		TI	I THOTE I	CDADTA	ENT OF T	DANCDODT	ATTON
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DATE: MARCH 1, 2006

SINGH & ASSOCIATES, INC.

SINGH & ASSOCIATES, INC.

FAX: (312) 629-0240

CONSULTING ENGINEERS


FAX: (312) 629-8449

F.A.I. RTE.	SECT10	4	COUNTY	′ ,	TOTAL SHEETS	SHEET NO.
94	1818 R-	6	COOK		290	187
STA.	1313+00	TO	STA. 1	321+0	00	
FED. RO	AD DIST. NO.	ILLINOIS	FED. A	AID F	ROJECT	
					6	OB18

 $\rightarrow \bigcirc \rightarrow Z$

NOTES:

1. ROADWAY LIGHT POLES AND AERIAL CABLE SHALL BE REMOVED UNDER CONTRACT 62583. FOUNDATION REMOVAL SHALL BE INCLUDED AS PART OF THIS CONTRACT (60B18).

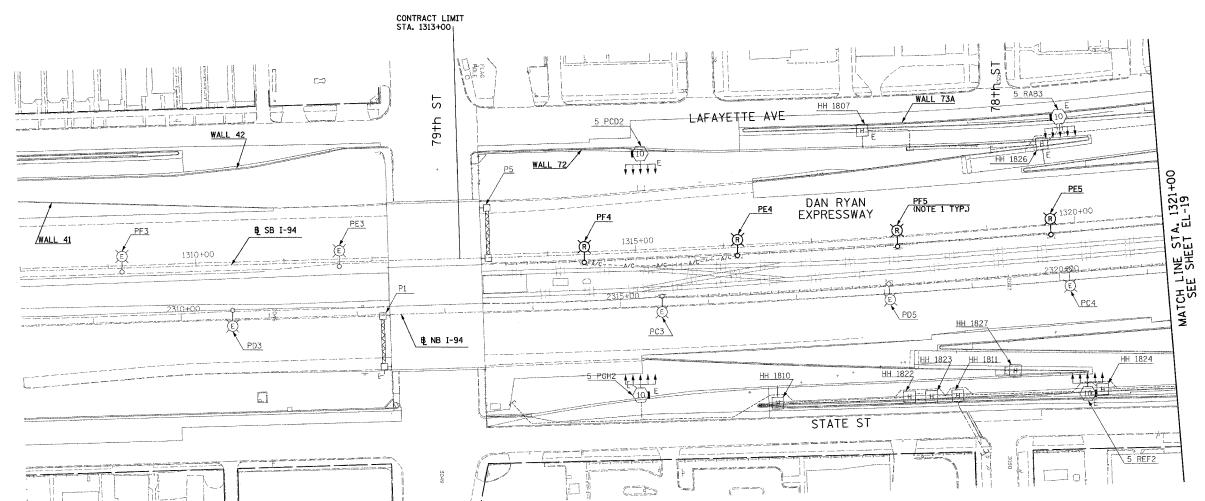

0 50' 10

23C/EL-18

REVISIONS								
NAME	DATE	ΙL	LINOIS	DEPART	TMENT C	F TRANSPOR	RTATION	_
NAME	DATE	- A	т о	4 /5 4	N DVA	N EVEN	CCWAN	, d
		F.A	.1. 9	4 (DAI	NKIA	N EXPRE	.55WAY)
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						AND DEMO		
		L EX	T2 TM	G COND	IT 1 TON 2	AND DEMO	JULI TON	
								18
								18
		SCALE:	1"=50"	,		DRAWN BY:	ΥJ	12
								12
		DATE:	MARCH	1, 2006		CHECKED BY:	TM	(c)

SINGH & ASSOCIATES, INC.
CONSULTING ENGINEERS


300 W. ADAMS ST.
CHICAGO, IL 60606
TEL: (312) 629-0240
CONSULTING ENGINEERS
FAX: (312) 629-8449

F.A.I. RTE.	SECTIO	N	COUNTY	TOTAL SHEETS	SHEET NO.
94	1818 R-	6	COOK	290	188
STA. 1	321+00	ТО	STA. 1334	+00	•
FED. ROA	D DIST. NO.	ILLINOIS	FED. AID	PROJECT	
				6	OB18

→�→Z

 ROADWAY LIGHT POLES SHALL BE REMOVED UNDER CONTRACT 62583. FOUNDATION REMOVAL SHALL BE INCLUDED AS PART OF THIS CONTRACT (60B18).

NOTES:

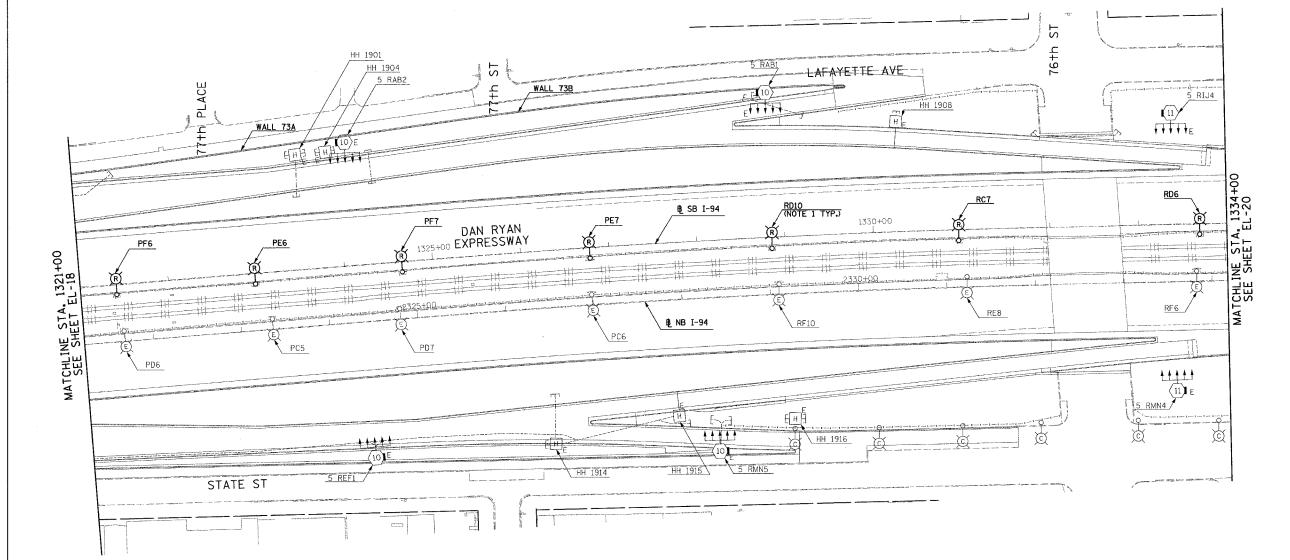

0 50' 100'

23C/EL-19

ILLING		KE VISIONS
ILLING	DATE	NAME
F.A.I.		
,		
ROADWAY		
EXIST		
SCALE: 1"=		
SUALE: 1"=		

ILLINOIS DEPARTMENT OF TRANSPORTATION
.A.I. 94 (DAN RYAN EXPRESSWAY)

ROADWAY LIGHTING AND SURVEILLANCE PLANS EXISTING CONDITIONS AND DEMOLITION

SCALE: 1"=50" DATE: MARCH 1, 2006 DRAWN BY: YJ CHECKED BY: TM

SINGH & ASSOCIATES, INC.
CONSULTING ENGINEERS


300 W. ADAMS ST.
CHICAGO, II. 60606
TEL: (312) 629-0240
FAX: (312) 629-8449

F.A.I. RTE.	SECTION	v	COUNTY	TOTAL SHEETS	SHEET NO.
94	1818 R-	6	соок	290	189
STA.	1334+00	TO	STA. 134	7+00	
FED. RC	AD DIST. NO.	ILLINOIS	FED. AID	PROJECT	:
			4	6	0B18

→⊕→ Z

NOTES:

 ROADWAY LIGHT POLES AND AERIAL CABLE SHALL BE REMOVED UNDER CONTRACT 62583. FOUNDATION REMOVAL SHALL BE INCLUDED AS PART OF THIS CONTRACT (60B18).

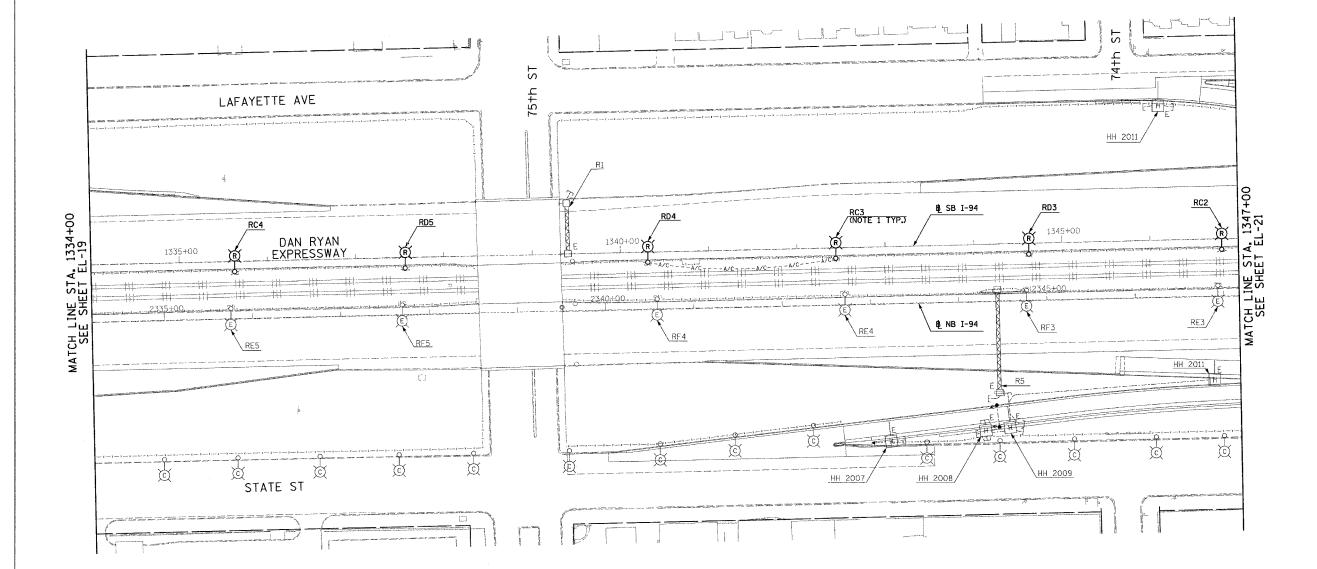

0 50' 100' 1" = 50'

23C/EL-20

REVISIONS		ILL
NAME	DATE	11.1
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	_	ROADWA
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		L
		SCALE:
	REVISIONS NAME	

ILLINOIS DEPARTMENT OF TRANSPORTATION F.A.I. 94 (DAN RYAN EXPRESSWAY)

OADWAY LIGHTING AND SURVEILLANCE PLANS EXISTING CONDITIONS AND DEMOLITION

SCALE: 1"=50'
DATE: MARCH 1, 2006


DRAWN BY: YJ CHECKED BY: TM

SINGH & ASSOCIATES, INC. TEL: (312) 629-0240 CONSULTING ENGINEERS FAX: (312) 629-8449

F.A.I. RTE.	SECTIO	N	COUNTY	TOTAL SHEETS	SHEET NO.	
94	1818 R-	-6	соок	290	190	
STA. 1347+00 TO STA. 1360+00						
FED. ROAD	DIST. NO.	ILLINOIS	FED. AID	PROJECT		
				6	OB18	

NOTES:

1. ROADWAY LIGHT POLES AND AERIAL CABLE SHALL BE REMOVED UNDER CONTRACT 62583. FOUNDATION REMOVAL SHALL BE INCLUDED AS PART OF THIS CONTRACT (60818).

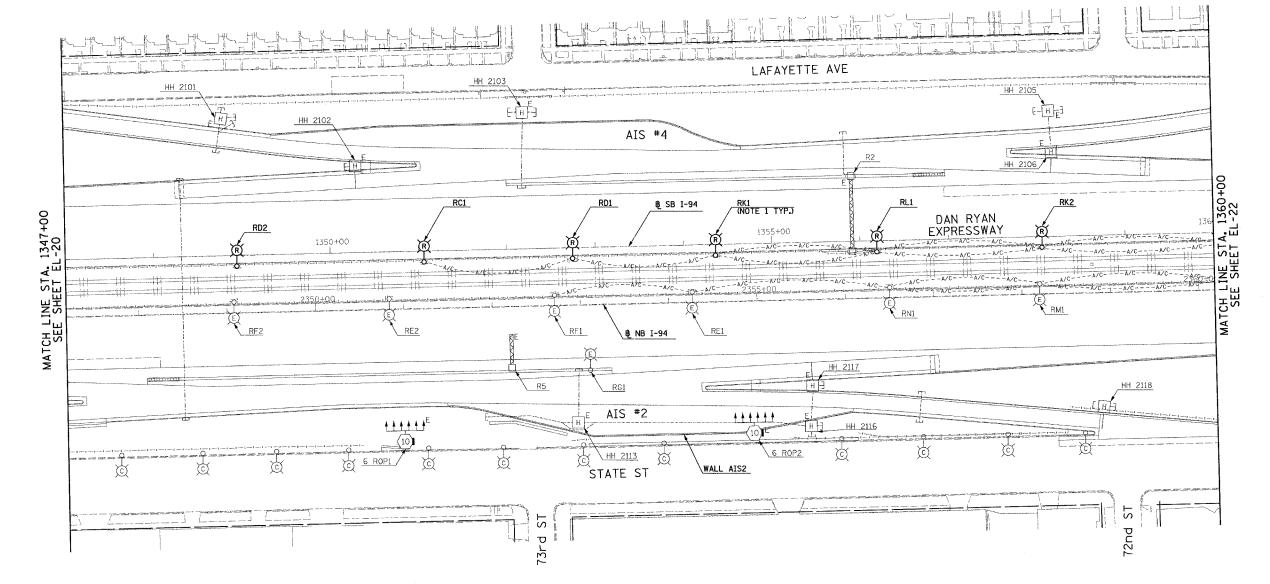

0 50' 10

23C/EL-21

NAME	DATE

ILLINOIS DEPARTMENT OF TRANSPORTATION
F.A.I. 94 (DAN RYAN EXPRESSWAY)

ROADWAY LIGHTING AND SURVEILLANCE PLANS EXISTING CONDITIONS AND DEMOLITION

SCALE: 1"=50" DATE: MARCH 1, 2006 DRAWN BY: YJ CHECKED BY: TM


SINGH 300 W. ADAMS ST. CHICAGO, IL 60606 TEL: (312) 629-0240 CONSULTING ENGINEERS FAX: (312) 629-8449

F.A.I. RTE.	SECTION	١	COUNTY	TOTAL SHEETS	SHEET NO.	
94	1818 R-	6	соок	290	191	
STA. 1360+00 TO STA. 1370+00						
FED. RO	AD DIST. NO.	ILLINOIS	FED. AII	PROJECT		
				6	OB18	

NOTES:

→ ② → Z NOTE

 ROADWAY LIGHT POLES AND AERIAL CABLE SHALL BE REMOVED UNDER CONTRACT 62583. FOUNDATION REMOVAL SHALL BE INCLUDED AS PART OF THIS CONTRACT (60B18).

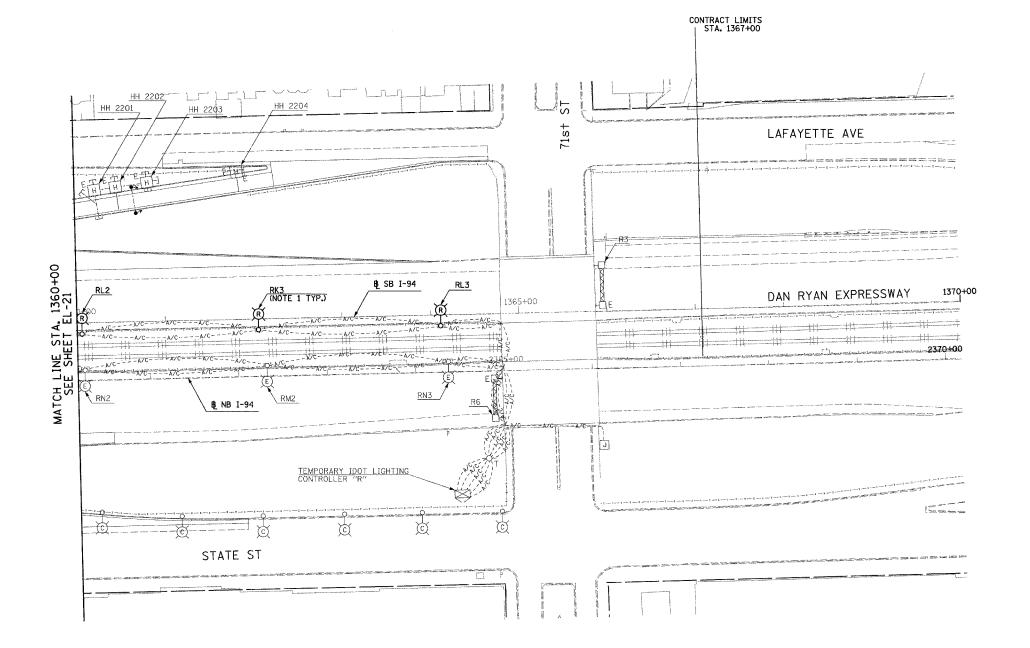

0 50' 10'

23C/EL-22

NAME	DATE
NAME	DATE
	-
	
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ILLINOIS DEPARTMENT OF TRANSPORTATION
F.A.I. 94 (DAN RYAN EXPRESSWAY)

ROADWAY LIGHTING AND SURVEILLANCE PLANS EXISTING CONDITIONS AND DEMOLITION

DATE: MARCH 1, 2006

DRAWN BY: YJ CHECKED BY: TM


SINGH & ASSOCIATES, INC.
CONSULTING ENGINEERS

300 W. ADAMS ST.
CHICAGO, IL 60606
TEL: (312) 629-0240
FAX: (312) 629-8449

→�→Z

NOTES:

1. REFER TO SHEETS EI-102 AND EI-103 FOR DUCTBANK INSTALLATION DETAILS.

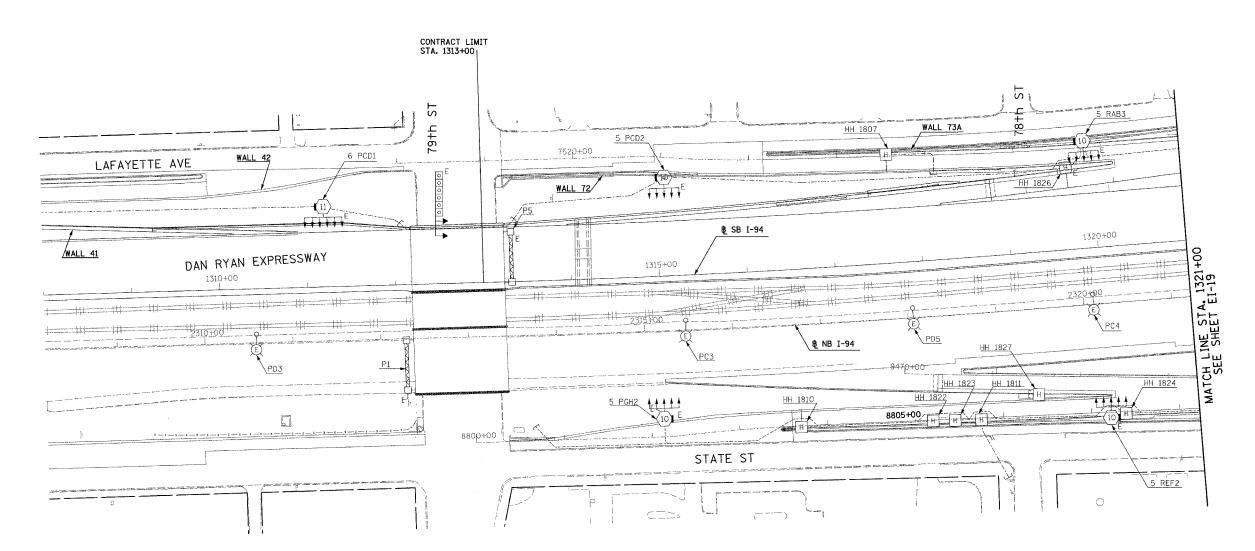

NO ELECTRICAL WORK ON THIS SHEET FOR REFERENCE ONLY




23C/EI-18

REVISIONS		ILLINOIS DEPARTMENT OF TRANSPORTATION
NAME	DATE	ILLINOIS BEI ARTIMENT OF TRANSFORTATION
		F.A.I. 94 (DAN RYAN EXPRESSWA)
	1	ELECTRICAL INFRASTRUCTURE PLANS
"		PROPOSED IMPROVEMENTS

SCALE: 1"=50"
DATE: MARCH 1, 2006

DRAWN BY: VK


SINGH & ASSOCIATES, INC. TEL: (312) 629-0240 CONSULTING ENGINEERS FAX: (312) 629-8449

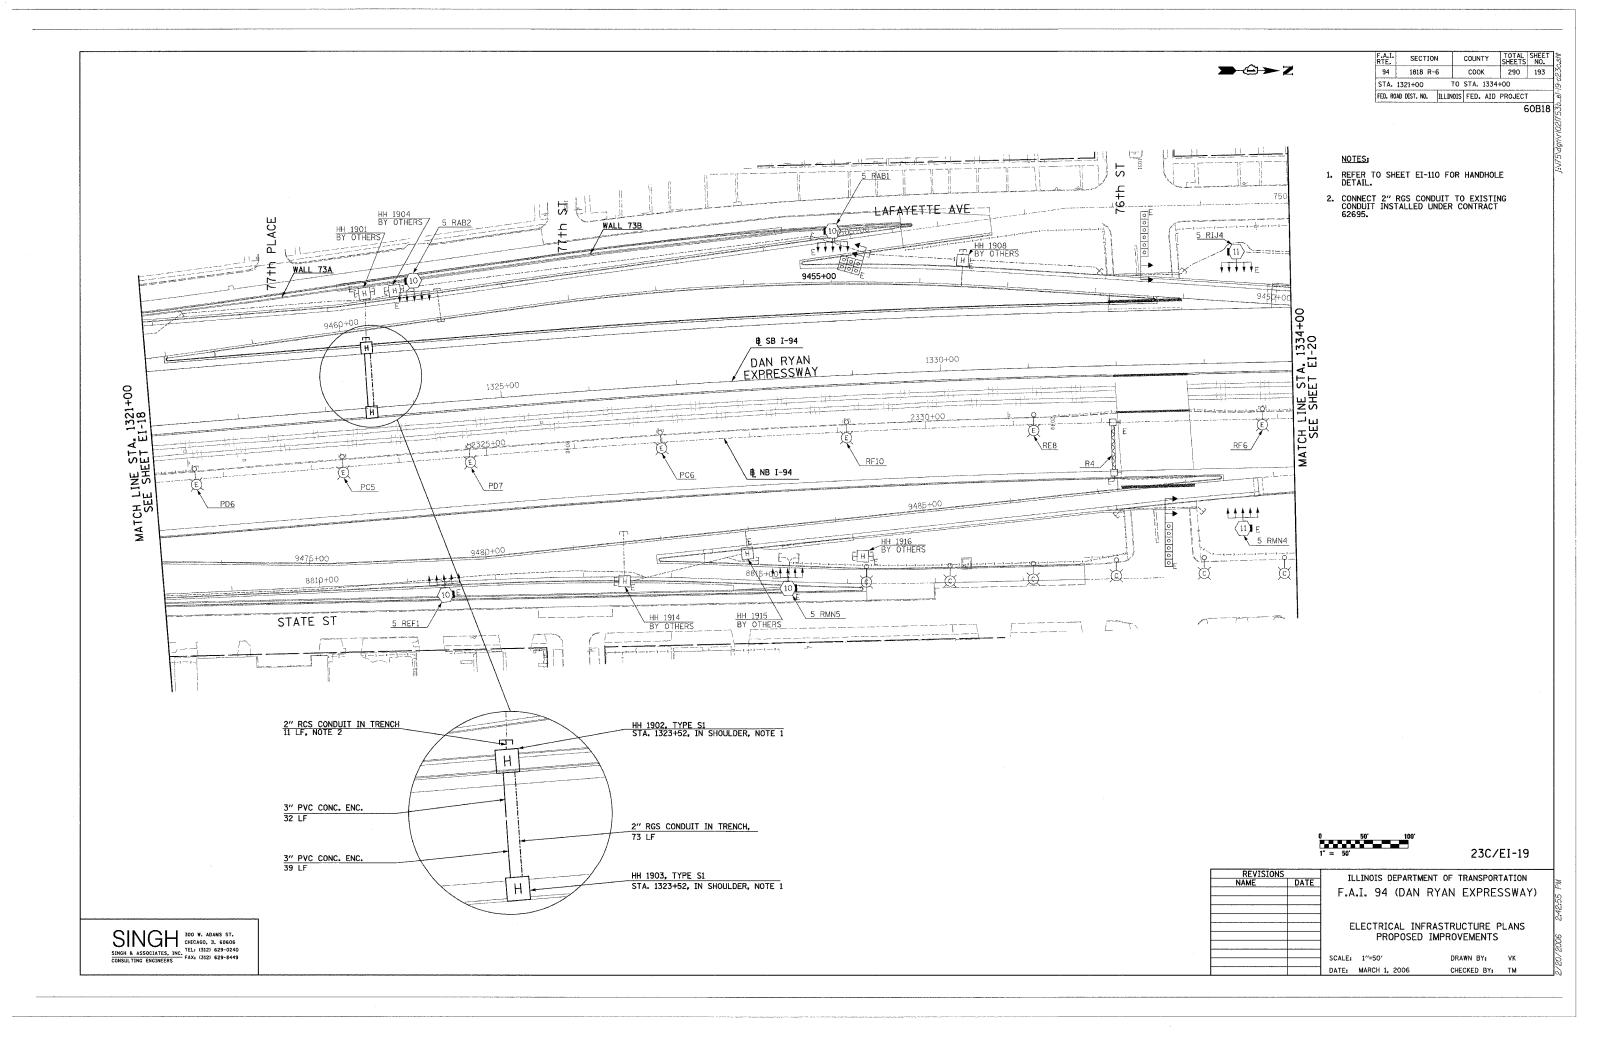

→�→Z

NOTES:

1. REFER TO SHEETS EI-102 AND EI-103 FOR DUCTBANK INSTALLATION DETAILS.

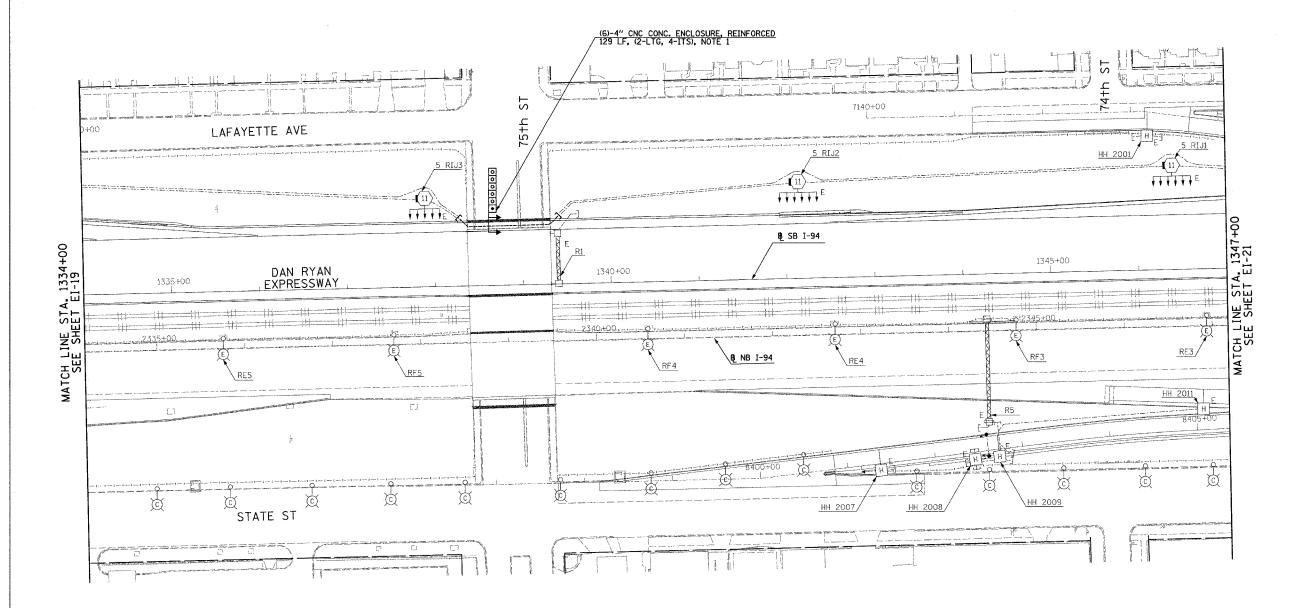

0 50' 10 1" = 50'

23C/EI-20

ILLINOIS DEPARTMENT OF TRANSPORTATION

F.A.I. 94 (DAN RYAN EXPRESSWAY)
5(5070104) THEOLOTPHOTHER DI AND
ELECTRICAL INFRASTRUCTURE PLANS
PROPOSED IMPROVEMENTS

SINGH & ASSOCIATES, INC.
CONSULTING ENGINEERS

300 W. ADAMS ST.
CHICAGO, IL 60606
TEL: (312) 629-0240
FAX; (312) 629-8449

SCALE: 1"=50' DATE: MARCH 1, 2006 DRAWN BY: VK
CHECKED BY: TM

COUNTY TOTAL SHEE NO. SECTION 1818 R-6 COOK 290 195 **→**⊕→ Z STA. 1347+00 TO STA. 1360+00 FED. ROAD DIST. NO. ILLINOIS FED. AID PROJECT 60B18 NOTES: 1. REFER SHEET EI-110 FOR HANDHOLE DETAIL. CONNECT EXISTING 2" RGS CONDUIT INSTALLED UNDER CONTRACT 62695 TO HANDHOLE 2104 INSTALLED UNDER THIS CONTRACT (60B18). LAFAYETTE AVE 6 RKL1 1111 TITLE AIS #4 7130+00 00+ 1350+00 MATCH LINE S 8410+00 AIS #2 * * * * * * * + + + + + +E HH 2113 BY OTHERS G 6 ROP1 STATE ST WALL AIS2 NOTE 2 HH 2104, TYPE S1 STA. 1352+21, IN SHOULDER, NOTE 1 3" PVC CONC. ENC. 27 LF 2" RGS CONDUIT IN TRENCH, 69 LF 0 50' 100 1" = 50' 23C/EI-21 3" PVC CONC. ENC. 40 LF HH 2107, TYPE S1 STA. 1352+21, IN SHOULDER, NOTE 1 ILLINOIS DEPARTMENT OF TRANSPORTATION Н F.A.I. 94 (DAN RYAN EXPRESSWAY) ELECTRICAL INFRASTRUCTURE PLANS PROPOSED IMPROVEMENTS SINGH 300 W. ADAMS ST. CHICAGO, 1L 60606
SINGH & ASSOCIATES, INC. TEL: (312) 629-0240
CONSULTING ENGINEERS FAX: (312) 629-8449

SCALE: 1"=50'

DATE: MARCH 1, 2006

DRAWN BY: VK


CHECKED BY: TM

F.A.I. RTE.	SECTION		COUNT	Y	TOTAL	SHEET NO.
94	1818 R-	-6	COOK		290	196
STA. 1	360+00	TO	STA.	1370	+00	
FED. ROA	D DIST. NO.	ILLINOIS	FED.	AID	PROJECT	
					E	OB18

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NOTES

 REFER TO SHEETS EI-102 AND EI-103 FOR DUCTBANK INSTALLATION DETAILS.

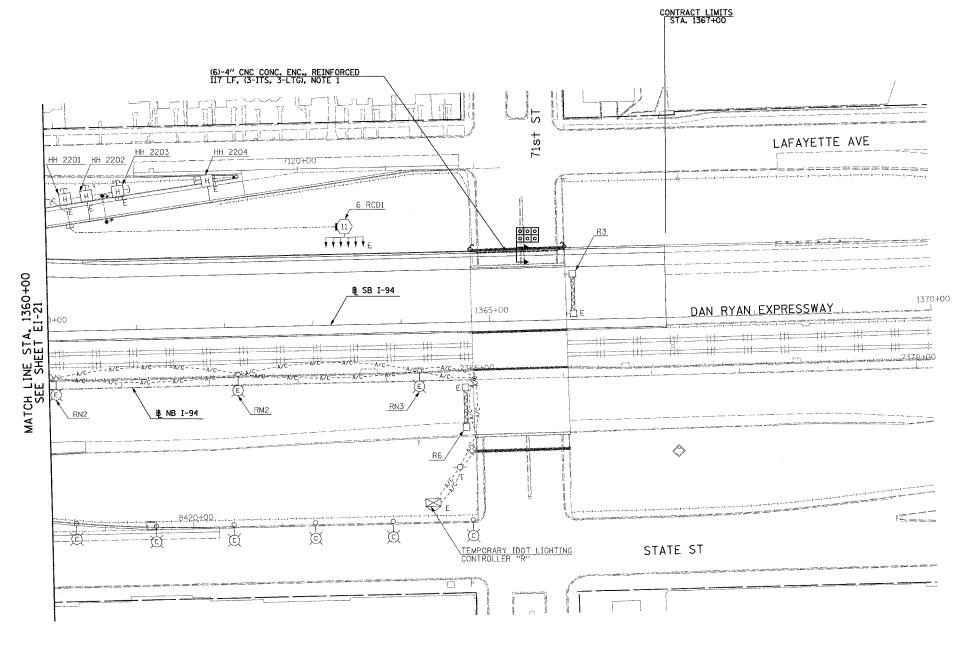

0 50' 1(

23C/EI-22

ILLINOIS DEPA		REVISIONS
ILLINOIS DEF	DATE	NAME
F.A.I. 94 (D		
ELECTRICAL		
PROPO		


ILLINOIS DEPARTMENT OF TRANSPORTATION F.A.I. 94 (DAN RYAN EXPRESSWAY)

ECTRICAL INFRASTRUCTURE PLANS PROPOSED IMPROVEMENTS


SCALE: 1"=50'
DATE: MARCH 1, 2006

DRAWN BY: VK
CHECKED BY: TM


SINGH 300 W. ADAMS ST. CHICAGO, IL 60606 TEL: (312) 629-0240 CONSULTING ENGINEERS FAX: (312) 629-8449

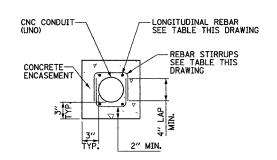


1x1 DUCTBANK DETAIL— IN REINFORCED CONCRETE

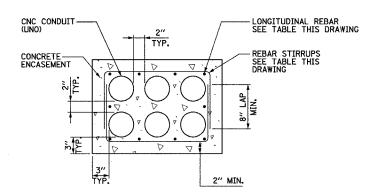

2X3 DUCTBANK DETAIL— IN REINFORCED CONCRETE NOT TO SCALE

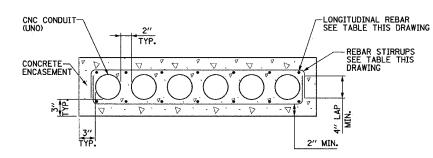


6X1 DUCTBANK DETAIL—
IN REINFORCED CONCRETE
NOT TO SCALE

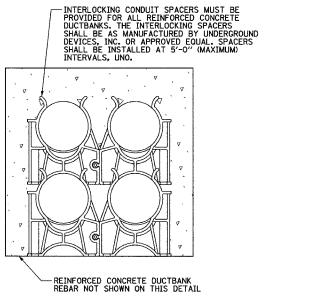

INTERLOCKING CONDUIT SPACER DETAIL


NOT TO SCALE

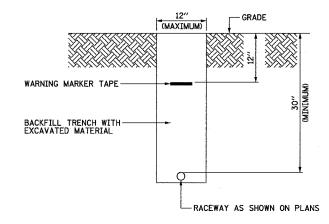


TYPICAL ELECTRICAL

CONDUIT IN UNPAVED AREA

NOT TO SCALE

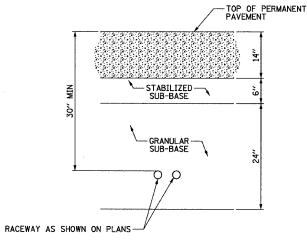

TYPICAL SURVEILLANCE
CONDUIT UNDER PERMANENT PAVEMENT
NOT TO SCALE

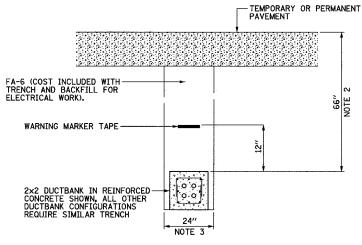

TYPICAL ELECTRICAL

DUCTBANK UNDER PAVEMENT

F.A.I. RTE.	SECTIO	N	COUNT	Υ	SHEETS	SHEET NO.
94	1818 R	-6	COOK		290	197
STA.		ТО	STA.			•
FED. ROAD	DIST. NO.	ILLINOIS	FED.	AIĐ	PROJEC1	-
					e	OB18

NOTES:

- 1. SEE DRAWINGS EI-100 AND EI-101 FOR ELECTRICAL SYMBOLS AND ABBREVIATIONS.
- 2. PROVIDE MINIMUM CLEARANCE SHOWN FROM TOP OF DUCTBANK TO FINISHED GRADE FOR ALL DUCTBANKS, REGARDLESS OF SIZE. CONTRACTOR SHALL INSTALL DUCTBANKS SUCH THAT THEY WILL CLEAR ALL UNDERGROUND OBSTACLES.
- 3. TRENCH SHALL HAVE MINIMUM WIDTH SHOWN FOR ALL DUCTBANKS DETAILED ON THIS DRAWING. THE CONTRACTOR SHALL INCREASE TRENCH WIDTH FOR ADDITIONAL CONDUITS, AS DIRECTED BY THE ENGINEER, (AT NO ADDITIONAL COST).

23C/EI-102

CHECKED BY:

REVISIONS NAME D	ATE I				NSPORTATION (PRESSWAY)	
		ELECT	RICAL DUC	TBANK	DETAILS	
		ALE: NOT TO	SCALE	DRAWN	RY.	

DATE: MARCH 1, 2006

SINGH A ASSOCIATES, INC. CONSULTING ENGINEERS TAX: (312) 629-0240

NOTES:


1. SEE DRAWINGS EI-100 AND EI-101 FOR ELECTRICAL SYMBOLS AND ABBREVIATIONS.

2. DIMENSIONS SHOWN ON THIS DRAWING ARE TYPICAL FOR MOST INSTALLATIONS. DIMENSIONS AND/OR STATIONS SPECIFIED ON THE PLANS OR HANDHOLE DETAIL DRAWINGS SHALL SUPERCEDE THE DIMENSIONS SHOWN ON THIS DRAWING.


4. STUBOUTS SHALL EXTEND 3' FROM HANDHOLE AND BE CAPPED. NUMBER AND SIZE SHALL BE AS SHOWN ON PLANS. STUBOUTS SHALL BE INCLUDED IN HANDHOLE PAY ITEM AND SHALL NOT BE PAID SEPARATELY.

5. FOR DETAILS AT SPECIFIC LOCATIONS, SEE "TYPICAL SECTION DETAILS: EXISTING CROSS STREET OVERPASS FOOTINGS".


3. SEE DRAWING EI-102 FOR CONDUIT DUCTBANK DETAILS.

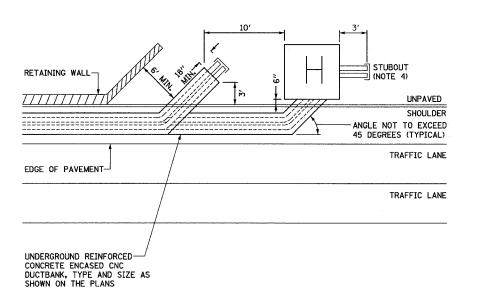


DUCTBANK INSTALLATION DETAIL ALONG RETAINING WALL NOT TO SCALE

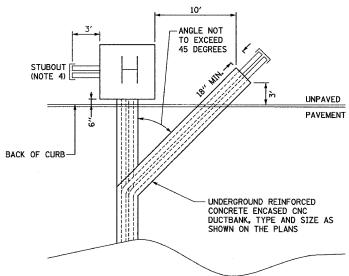

DUCTBANK INSTALLATION DETAIL UNDER PAVEMENT
NOT TO SCALE

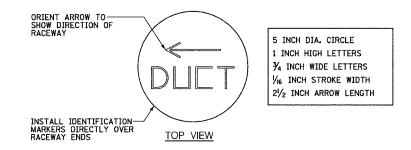

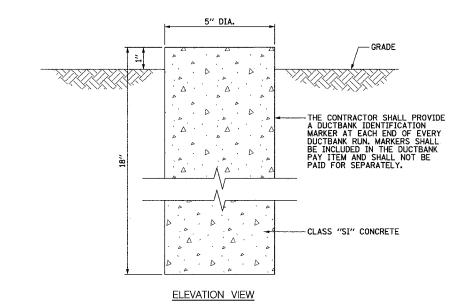

DUCTBANK IDENTIFICATION MARKER DETAIL SCALE: 3" = 1'-0"


23C/EI-103

ILLIN	KEA1210N2				
TELIN	DATE	NAME			
F.A.I.					
E					
E IN					
	 				
SCALE: NO					
DATE: M	1				

ILLINOIS DEPARTMENT OF TRANSPORTATION
F.A.I. 94 (DAN RYAN EXPRESSWAY)


ELECTRICAL DUCTBANK DETAILS IN SHOULDER AND UNDER PAVEMENT


SCALE: NOT TO SCALE DRAWN BY: BHP DATE: MARCH 1, 2006 CHECKED BY: BMW

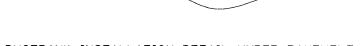


SINGH A ASSOCIATES, INC.
CONSULTING ENGINEERS

300 W. ADAMS ST.
CHICAGO, IL 60606
FLICAGO, IL 60606
FAX: (312) 629-0240
FAX: (312) 629-8449

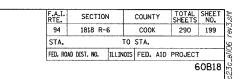

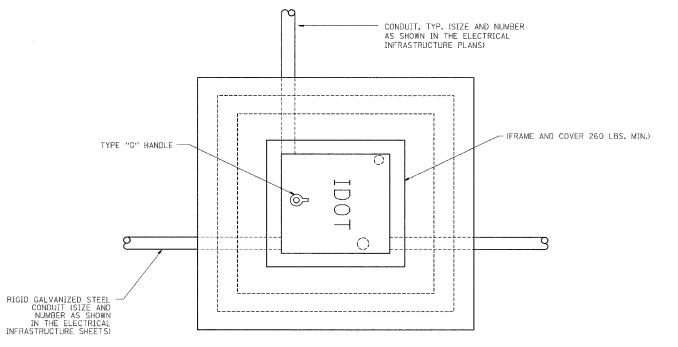

<u>PLAN</u>

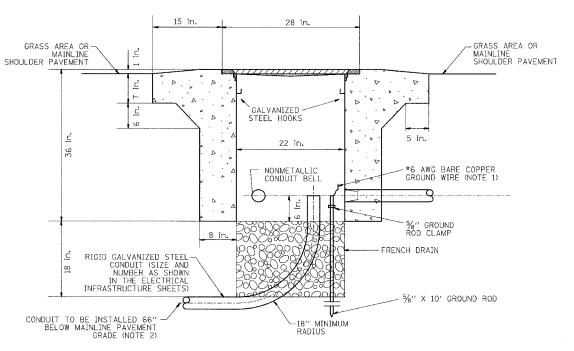

ELEVATION

PC CONCRETE HEAVY DUTY HANDHOLE, TYPE S1

(FOR INSTALLATION IN MAINLINE SHOULDER WIDER THAN 6' OR BEHIND PAVED AREA) NOTE:

1. ALL METALLIC ELEMENTS SHALL BE GROUND IN ACCORDANCE WITH THE NATIONAL ELECTRIC CODE (NEC), SECTION 250, GROUNDING, METAL COVERS AND OTHER EXPOSED CONDUCTIVE SURFACES SHALL BE BONDED IN ACCORDANCE WITH NEC ARTICLE 250.96 (A).

2. CONDUIT TO BE INSTALLED BELOW MAINLINE PAVEMENT WHERE SHOWN IN THE ELECTRICAL INFRASTRUCTURE PLANS (SEE SHEET EI-110).

23C/EI-106

CHECKED BY:

REVISIONS		ILLINOIS DEPARTMENT OF TRANSPORTATION							
NAME	DATE	ILLIN	OIS DELAKTME	INI OF INA	NSFUNTATIO)IV			
		F.A.T.	94 (DAN	RYAN F	(PRFSSW	AY)			
		, ., .,	5 , (5),((
		PC CONCRETE - HEAVY							
			DUTY H	ANDHOLE DE	TAIL.				
			TYPE SI AN	D TYPE SI	(SPECIAL)				
		SCALE: N	TS	DRAWN	nv	0 111			
		SUALE: IN	13	DRAWN	DI:	CJH			

DATE: MARCH 1, 2006

SINGH 300 W. ADAMS ST. CHICAGO, IL 60606 SINGH & ASSOCIATES, INC. TEL: (312) 629-0240 CONSULTING ENGINEERS FAX; (312) 629-8449

