FOR INDEX OF SHEETS, SEE SHEET NO. 2.

PROJECT LOCATED IN THE CITY OF CHICAGO

TRAFFIC DATA

 \circ

 \circ

ADT = 21,700 VEHICLES POSTED SPEED LIMIT = 30 MPH

STATE OF ILLINOIS

DEPARTMENT OF TRANSPORTATION

DIVISION OF HIGHWAYS

PROPOSED HIGHWAY PLANS

FAU 3531: IL 72 (HIGGINS ROAD) WB SECTION 1515.1-I


OVER I-90 EB RAMP TO IL 43 (HARLEM AVENUE)

AT I-90 (KENNEDY EXPRESSWAY)

BRIDGE DECK OVERLAY & JOINT REPAIRS

COOK COUNTY

C-91-248-10

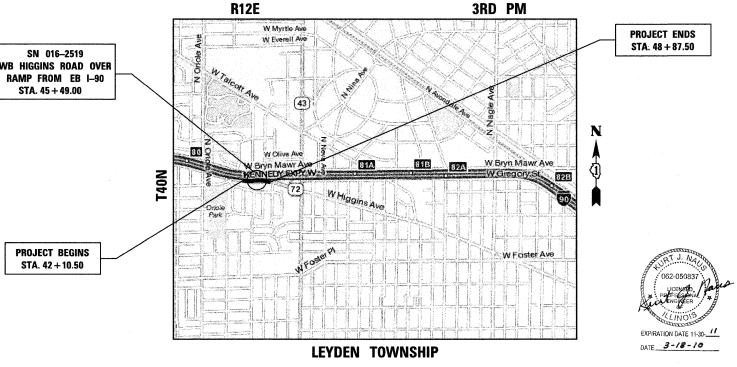


LAYOUT MAP SCALE: 1 IN = 0.25 MI

GROSS LENGTH OF PROJECT = 677 LIN FT = 0.128 MILES NET LENGTH OF PROJECT = 677 LIN FT = 0.128 MILES

D-91-248-10




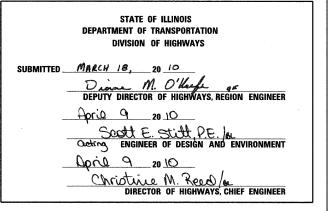

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alfred benesch & company Engineers • Surveyors • Planners 205 North Michigan Avenue, Suite 2400 Chicago, Illinois 60601 312-365-0450



FULL SIZE PLANS HAVE BEEN PREPARED USING STANDARD ENGINEERING SCALES. REDUCED SIZED PLANS WILL NOT CONFORM TO STANDARD SCALES. IN MAKING MEASUREMENTS ON REDUCED PLANS. THE ABOVE SCALES MAY BE USED.

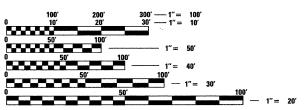C.U.A.N. CHICAGO UTILITY AREA NETWORK 1-312-744-7000 OR 811

PROJECT ENGINEER: CRAIG BAUER (847) 705-4265 PROJECT MANAGER: LONG TRAN (847) 705-4232

CONTRACT NO. 60J58

INDEX OF SHEETS

SHEET NO.	DESCRIPTION
1	COVER SHEET
2	INDEX OF SHEETS, IDOT STANDARDS, DISTRICT 1 DETAILS, GENERAL NOTES & HMA REQUIREMENTS
3	SUMMARY OF QUANTITIES
4	DETOUR PLAN
5	MAINTENANCE OF TRAFFIC PLAN
6	ROADWAY REMOVAL PLAN
7	ROADWAY & PAVEMENT MARKING PLAN
8-10	EXISTING LIGHTING PLANS
11	UNDERPASS LIGHTING REPLACEMENT PLAN
12-25	STRUCTURAL PLANS
26-35	DISTRICT 1 DETAILS

IDOT STANDARDS

STD. NO.	DESCRIPTION
000001-05	STANDARD SYMBOLS, ABBREVIATIONS AND PATTERNS
420001-07	PAVEMENT JOINTS
420401-08	BRIDGE APPROACH PAVEMENT CONNECTOR
421001-02	BAR REINFORCEMENT FOR CRC PAVEMENT
606001-04	COMBINATION CURB TYPE B AND COMBINATION CONCRETE CURB AND GUTTER
630001-08	STEEL PLATE BEAM GUARDRAIL
631031-08	TRAFFIC BARRIER TERMINAL, TYPE 6
635006-03	REFLECTOR AND TERMINAL MARKER PLACEMENT
635011-02	REFLECTOR MARKER AND MOUNTING DETAILS
701901-01	TRAFFIC CONTROL DEVICES
704001-06	TEMPORARY CONCRETE BARRIER

DISTRICT 1 DETAILS (INCLUDED AS PLAN SHEETS 26.35)

DETAIL	DESCRIPTION
BD600-06 (BD-24)	CURB OR CURB AND GUTTER REMOVAL AND REPLACEMENT
BD600-10 (BD-34)	DETAILS FOR DEPRESSED CURB & GUTTER AND SHOULDER TREATMENT AT TBT TY 1 SPL.
BE-900	SUSPENDED MOUNT UNDERPASS LUMINAIRE INSTALLATION DETAILS
TC-8	FREEWAY ENTRANCE AND EXIT RAMP CLOSURE DETAILS
TC-11	TYPICAL APPLICATIONS RAISED REFLECTIVE PAVEMENT MARKERS (SNOW-PLOW RESISTANT)
TC-16	PAVEMENT MARKING LETTERS AND SYMBOLS FOR TRAFFIC STAGING
TC-17	TRAFFIC CONTROL DETAILS FOR FREEWAY SHOULDER CLOSURES PARTIAL RAMP CLOSURES
TC-22	ARTERIAL ROAD INFORMATION SIGN
TC-24	CITY OF CHICAGO TYPICAL PAVEMENT MARKINGS

GENERAL NOTES

- BEFORE STARTING WORK, THE CONTRACTOR SHALL CALL CHICAGO UTILITY AREA NETWORK (C.U.A.N.) AT (312) 744-7000 OR 811 FOR FIELD LOCATIONS OF BURIED UTILITIES. 72 HOUR ADVANCE NOTIFICATION IS REQUIRED.
- 2. THE CONTRACTOR SHALL COORDINATE CONSTRUCTION ACTIVITIES WITH UTILITY COMPANIES AS REQUIRED.
- 3. THE CONTRACTOR WILL NOT BE ALLOWED TO SET UP A YARD OR FIELD OFFICE ON STATE PROPERTY WITHOUT WRITTEN PERMISSION FROM THE DEPARTMENT.
- 4. THE CONTRACTOR SHALL SWEEP AND CLEAN THE PAVEMENT SURFACE PER ARTICLE 107.15 OF THE STANDARD SPECIFICATIONS AND AS DIRECTED BY THE ENGINEER.
- 5. DO NOT SCALE PLANS FOR CONSTRUCTION DIMENSIONS. STATIONS ARE SHOWN FOR REFERENCE ONLY AND ARE APPROXIMATE.
- 6. BEFORE BEGINNING WORK, THE CONTRACTOR SHALL RETAIN AND RECORD (FOR FUTURE REFERENCES), ALL EXISTING PAVEMENT MARKING LINES IN ORDER THAT THESE LOCATIONS CAN BE RE-ESTABLISHED FOR STRIPING. EXACT LOCATIONS OF ALL STRIPING SHALL BE AS DIRECTED BY THE ENGINEER.
- 7. ALL PAVEMENT MARKINGS SHALL BE PLACED THROUGHOUT THE PROJECT ACCORDING TO CITY OF CHICAGO TYPICAL PAVEMENT MARKINGS.
- 8. ALL CURB AND GUTTER, BARRIER TRANSITION AND SIDEWALK REPLACEMENT LIMITS WILL BE VERIFIED IN THE FIELD BY THE ENGINEER.
- 9. SAW CUTTING PRIOR TO ANY REMOVAL ITEMS NOTED ON THE PLANS OR DIRECTED BY THE ENGINEER SHALL BE CONSIDERED INCLUDED IN THE COST OF THE ITEMS BEING REMOVED.
- 10. THE CONTRACTOR SHALL USE CARE IN REMOVING OR EXCAVATING NEAR ALL EXISTING ITEMS WHICH WILL REMAIN. ANY DAMAGE DONE TO EXISTING ITEMS BY THE CONTRACTOR SHALL BE REPAIRED AT THE CONTRACTOR'S EXPENSE.
- 11. TRAFFIC CONTROL AND PROTECTION ON THE I-90 EB EXIT RAMP REQUIRED FOR PROTECTIVE SHIELD INSTALLATION, REMOVAL AND REPLACEMENT OF UNDERPASS LIGHTING, RIPRAP PLACEMENT OR SUBSTRUCTURE CONCRETE REPAIR IS INCLUDED IN "TRAFFIC CONTROL AND PROTECTION (EXPRESSWAYS)".
- 12. THE RESIDENT ENGINEER SHALL CONTACT WALTER CZARNY, AREA TRAFFIC FIELD ENGINEER AT (847) 705-8419 AT LEAST (2) WEEKS PRIOR TO PLACING PERMANENT PAVEMENT MARKINGS.
- 13. THE CONTRACTOR SHALL CONTACT THE DISTRICT ONE TRAFFIC CONTROL SUPERVISOR AT (847) 705-4470 IN ADVANCE OF BEGINNING WORK.

HOT-MIX ASPHALT REQUIREMENTS

(FOR RESURFACING WB HIGGINS ROAD ADJACENT TO BRIDGE APPROACH PAVEMENT CONNECTORS)

MIXTURE TYPE	THICKNESS	VOIDS
HOT-MIX ASPHALT SURFACE COURSE, MIX "D", N70 (IL 9.5 mm)	1 1/2"	4% @ 70 GYR
1 127		

THE UNIT WEIGHT USED TO CALCULATE THE HMA SURFACE MIXTURE QUANTITY IS 112 LBS/SQ YD/IN.

THE "AC TYPE" FOR NON-POLYMERIZED HMA MIXES SHALL BE "PG 64-22" UNLESS MODIFIED BY DISTRICT ONE SPECIAL PROVISIONS.

FOR "PERCENT OF RAP", SEE DISTRICT ONE SPECIAL PROVISIONS.

FILE NAME =	DESIGNED - EJA	REVISED -
	DRAWN - EJA	REVISED -
USER NAME =	CHECKED - AJP	REVISED -
PLOT DATE = 04\13\2010	DATE - 3/19/10	REVISED -

benesch

STATE OF ILLINOIS
DEPARTMENT OF TRANSPORTATION

INDEX OF SHEETS, IDOT STANDARDS, DISTRICT 1 DETAILS,	F.A.U. RTE.	SECTION	COUNTY
GENERAL NOTES & HMA REQUIREMENTS	3531	1515.1~I	соок
GENERAL HOLES & HARA HEROMENTER			CONTRACT
SCALE: N.T.S. SHEET NO. 1 OF 1 SHEETS STA. TO STA.	FED. RO	OAD DIST. NO. ILLINOIS FED.	AID PROJECT


SUMMARY OF QUANTITIES


				LIDEAN	100% STATE	BRIDGE 100% STATE
SPECIALTY ITEM CO	CODE NUMBER	ITEM	UNIT	URBAN TOTAL	CONSTRUCTIO	l
SPECIALIT HEM		EARTH EXCAVATION	CUYD	QUANTITY 25	1000-2A 25	X271-2A
		INLET FILTERS	EACH	5	5	
					3	
		STONE RIPRAP, CLASS A4	SQYD	30		30
		FILTER FABRIC	SQYD	30		30
	40600100	BITUMINOUS MATERIALS (PRIME COAT)	GALLON	18	18	
	40603340	HOT-MIX ASPHALT SURFACE COURSE, MIX "D", N70	TON	15	15	
	42001300	PROTECTIVE COAT	SQYD	396	396	
	42001420	BRIDGE APPROACH PAVEMENT CONNECTOR (PCC)	SQYD	116	116	
	42100800	PAVEMENT REINFORCEMENT 9"	SQYD	116	116	
	42400200	PORTLAND CEMENT CONCRETE SIDEWALK, 5 INCH	SQFT	300.0	300.0	
	44000155	HOT-MIX ASPHALT SURFACE REMOVAL, 1 1/2"	SQYD	207	207	
	44000500	COMBINATION CURB AND GUTTER REMOVAL	FOOT	87	87	
	44001700	COMBINATION CONCRETE CURB AND GUTTER REMOVAL AND REPLACEMENT	FOOT	100	100	
		AGGREGATE SHOULDERS, TYPE B 10"	SQYD	42	42	
					42	40.0
		CONCRETE REMOVAL	CUYD	13.0		13.0
		PROTECTIVE SHIELD	SQYD	1,435		1,435
		CONCRETE SUPERSTRUCTURE	CUYD	14.3		14.3
	50300260	BRIDGE DECK GROOVING	SQYD	1,609		1,609
	50300300	PROTECTIVE COAT	SQYD	2,343		2,343
	50800205	REINFORCEMENT BARS, EPOXY COATED	POUND	1190		1190
	50800515	BAR SPLICERS	EACH	22		22
	52000110	PREFORMED JOINT STRIP SEAL	FOOT	66.0		66.0
	58700300	CONCRETE SEALER	SQFT	315		315
	60600605	CONCRETE CURB, TYPE B	FOOT	63.0	63.0	
	60603800	COMBINATION CONCRETE CURB AND GUTTER, TYPE B-6.12	FOOT	87.0	87.0	
	X 63100085	TRAFFIC BARRIER TERMINAL, TYPE 6	EACH	1	1	
	¥ 63100167	TRAFFIC BARRIER TERMINAL, TYPE 1 (SPECIAL) TANGENT	EACH	1	1	
		ENGINEER'S FIELD OFFICE, TYPE A	CAL MO	4	4	
	**	MOBILIZATION	L SUM	1	1	
		TRAFFIC CONTROL AND PROTECTION	LSUM	1	11	
		TRAFFIC CONTROL AND PROTECTION FOR TEMPORARY DETOUR	EACH	11	1	
		CHANGEABLE MESSAGE SIGN	CAL MO	3	3	
	70300240	TEMPORARY PAVEMENT MARKING - LINE 6"	FOOT	1,544	1,544	
	70301000	WORK ZONE PAVEMENT MARKING REMOVAL	SQFT	950	950	
	70400100	TEMPORARY CONCRETE BARRIER	FOOT	840	840	


					ROADWAY	BRIDGE
				URBAN	100% STATE	100% STATE
SPECIALTY ITEM	CODE NUMBER	ITEM	UNIT	TOTAL QUANTITY	CONSTRUCTIO	N TYPE CODE X271-2A
	70400200	RELOCATE TEMPORARY CONCRETE BARRIER	FOOT	840	840	72.712.7
*	78000200	THERMOPLASTIC PAVEMENT MARKING - LINE 4"	FOOT	140	140	
*	78008210	POLYUREA PAVEMENT MARKING TYPE I - LINE 4"	FOOT	930	930	
*	78100100	RAISED REFLECTIVE PAVEMENT MARKER	EACH	2	2	
*	78100105	RAISED REFLECTIVE PAVEMENT MARKER (BRIDGE)	EACH	15	15	
*	78200410	GUARDRAIL MARKERS, TYPE A	EACH	1	1	
*	78200530	BARRIER WALL MARKERS, TYPE C	EACH	68	68	
*	78201000	TERMINAL MARKER - DIRECT APPLIED	EACH	1	1	
	78300100	PAVEMENT MARKING REMOVAL	SQ FT	1,550	1,550	
	78300200	RAISED REFLECTIVE PAVEMENT MARKER REMOVAL	EACH	17	17	
*	81100320	CONDUIT ATTACHED TO STRUCTURE, 1" DIA., PVC COATED GALVANIZED STEEL	FOOT	209	209	
*	81300220	JUNCTION BOX, STAINLESS STEEL, ATTACHED TO STRUCTURE, 6" X 6" X 4"	EACH	5	5	
*	81300530	JUNCTION BOX, STAINLESS STEEL, ATTACHED TO STRUCTURE, 12" X 10" X 6"	EACH	2	2	
*	81702110	ELECTRIC CABLE IN CONDUIT, 600V (XLP-TYPE USE) 1/C NO. 10	FOOT	861	861	
*	84200600	REMOVAL OF LIGHTING UNIT, NO SALVAGE	EACH	4	4	
	X0322185	BRIDGE DECK LATEX CONCRETE OVERLAY, 2 1/4"	SQ YD	1,714		1,714
	X0322256	TEMPORARY INFORMATION SIGNING	SQ FT	77	77	
*	X0323574	MAINTENANCE OF LIGHTING SYSTEM	CAL MO	3	3	
	X0324848	LIGHT POLE HANDHOLE COVER	EACH	1	1	
	X0325305	STRUCTURAL REPAIR OF CONCRETE (DEPTH EQUAL TO OR LESS THAN 5 INCHES)	SQ FT	264		264
	X0325775	WET REFLECTIVE TEMPORARY TAPE, TYPE III, 4 INCH	FOOT	3,000	3,000	
*	X0326323	UNDERPASS LUMINAIRE, 70 WATT, HIGH PRESSURE SODIUM VAPOR, STAINLESS STEEL HOUSING	EACH	7	7	
	X0326765	CLEANING AND PAINTING EXPOSED REBAR (SPECIAL)	SQ FT	297		297
	X7011015	TRAFFIC CONTROL AND PROTECTION (EXPRESSWAYS)	LSUM	1	1	
	X8210305	PROTECTION AND MAINTENANCE OF EXISTING UNDERPASS LIGHTING	LSUM	1	1	
	Z0001700	APPROACH SLAB REPAIR (FULL DEPTH)	SQ YD	10.0		10.0
	Z0006204	BRIDGE DECK HYDRO-SCARIFICATION, 1/2"	SQ YD	1,714		1,714
	Z0013798	CONSTRUCTION LAYOUT	LSUM	1	1	
	Z0016001	DECK SLAB REPAIR (FULL DEPTH, TYPE I)	SQ YD	9.8		9.8
	Z0016002	DECK SLAB REPAIR (FULL DEPTH, TYPE II)	SQ YD	12.5		12.5
	Z0018500	DRAINAGE STRUCTURES TO BE CLEANED	EACH	5	5	
	Z0053750	RETROFIT CONCRETE PARAPET	FOOT	525		525
	Z0073200	TEMPORARY SHORING AND CRIBBING	EACH	2		2
	E0030255	IMPACT ATTENUATORS, TEMPORARY FULLY REDIRECTIVE, WARROW	EACH	/	/	
	44-000700 70030300	APPROACH SLAS REMOVAL 7267 LEVEL 2 " IMPACT ATTENUATORS, RELOCATE (FULLY REDIRECTNE),	SQ YD CACH	13	13	


* Specialty Items


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	DRAWN - EJA	REVISED -	benesch	STATE OF ILLINOIS		SUMMA	ARY OF QU	JANTITIES		3531	1515 . 1-I	соок	35	3
USER NAME =	CHECKED - AJP	REVISED -	1 Ochesch	DEPARTMENT OF TRANSPORTATION								CONTRACT	T NO. 60	0J58
PLOT DATE = Ø3\22\201Ø	DATE - 3/19/10	REVISED -			SCALE: N.T.S.	SHEET NO. 1 OF	1 SHEETS	STA.	TO STA.	FED. ROAD DIST	. NO. ILLINOIS FED.	AID PROJECT		

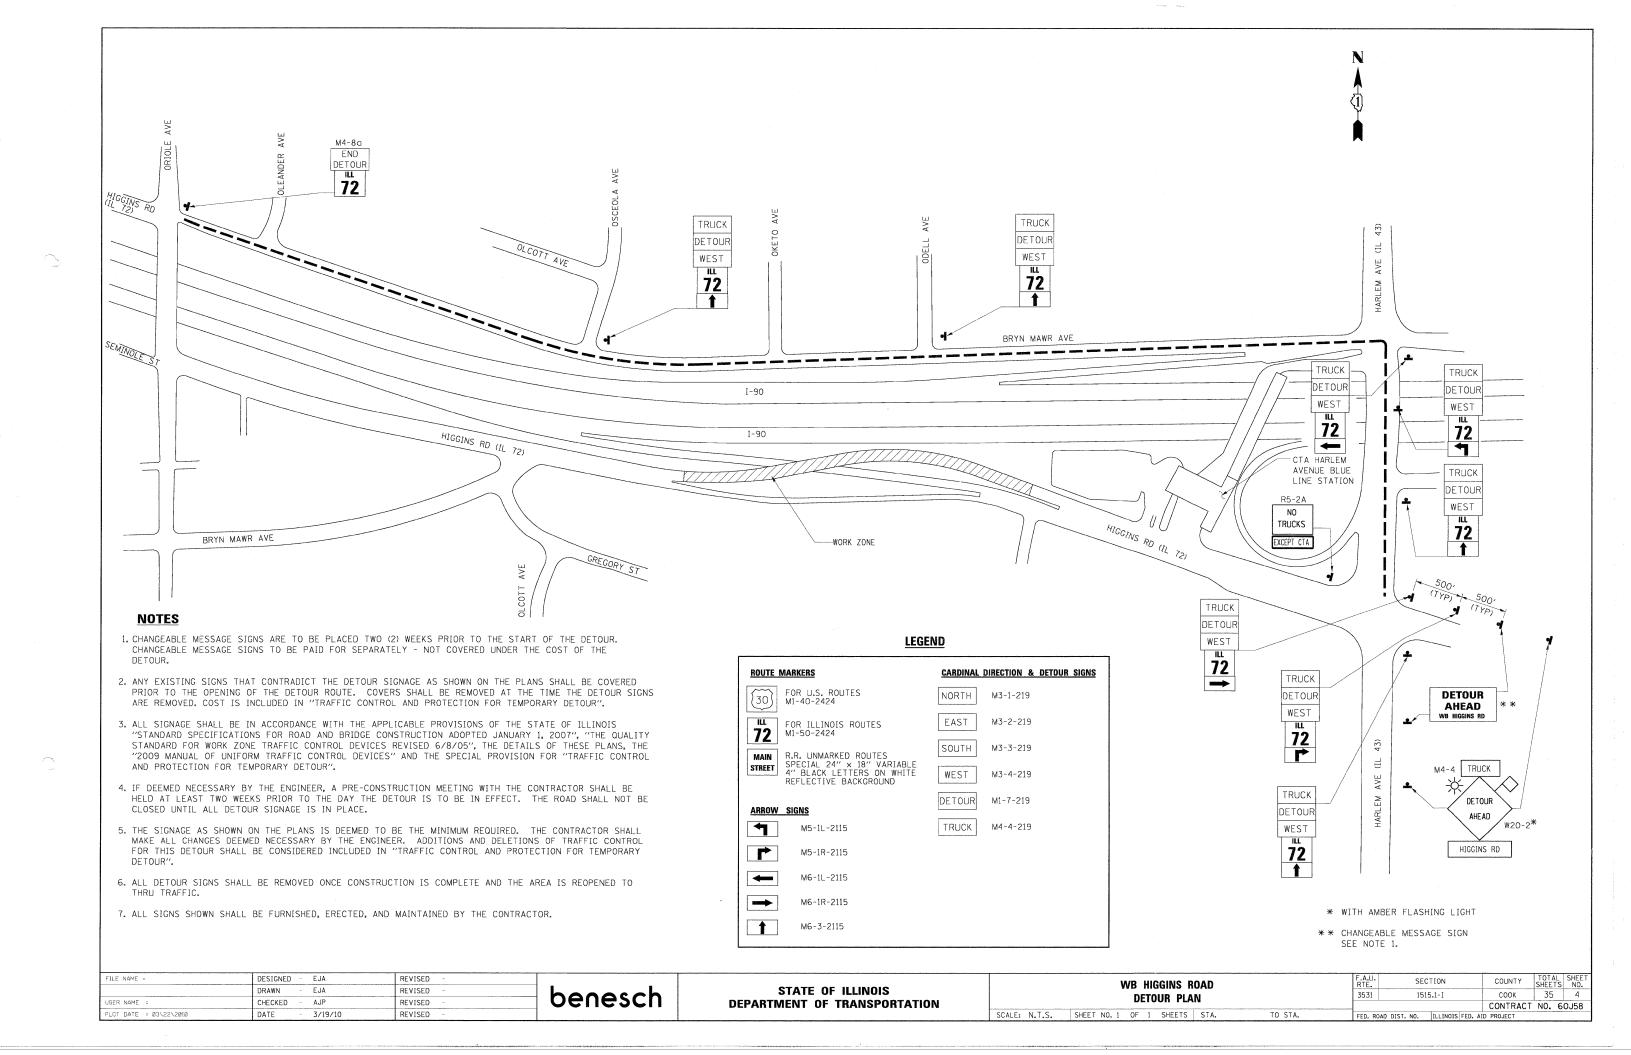

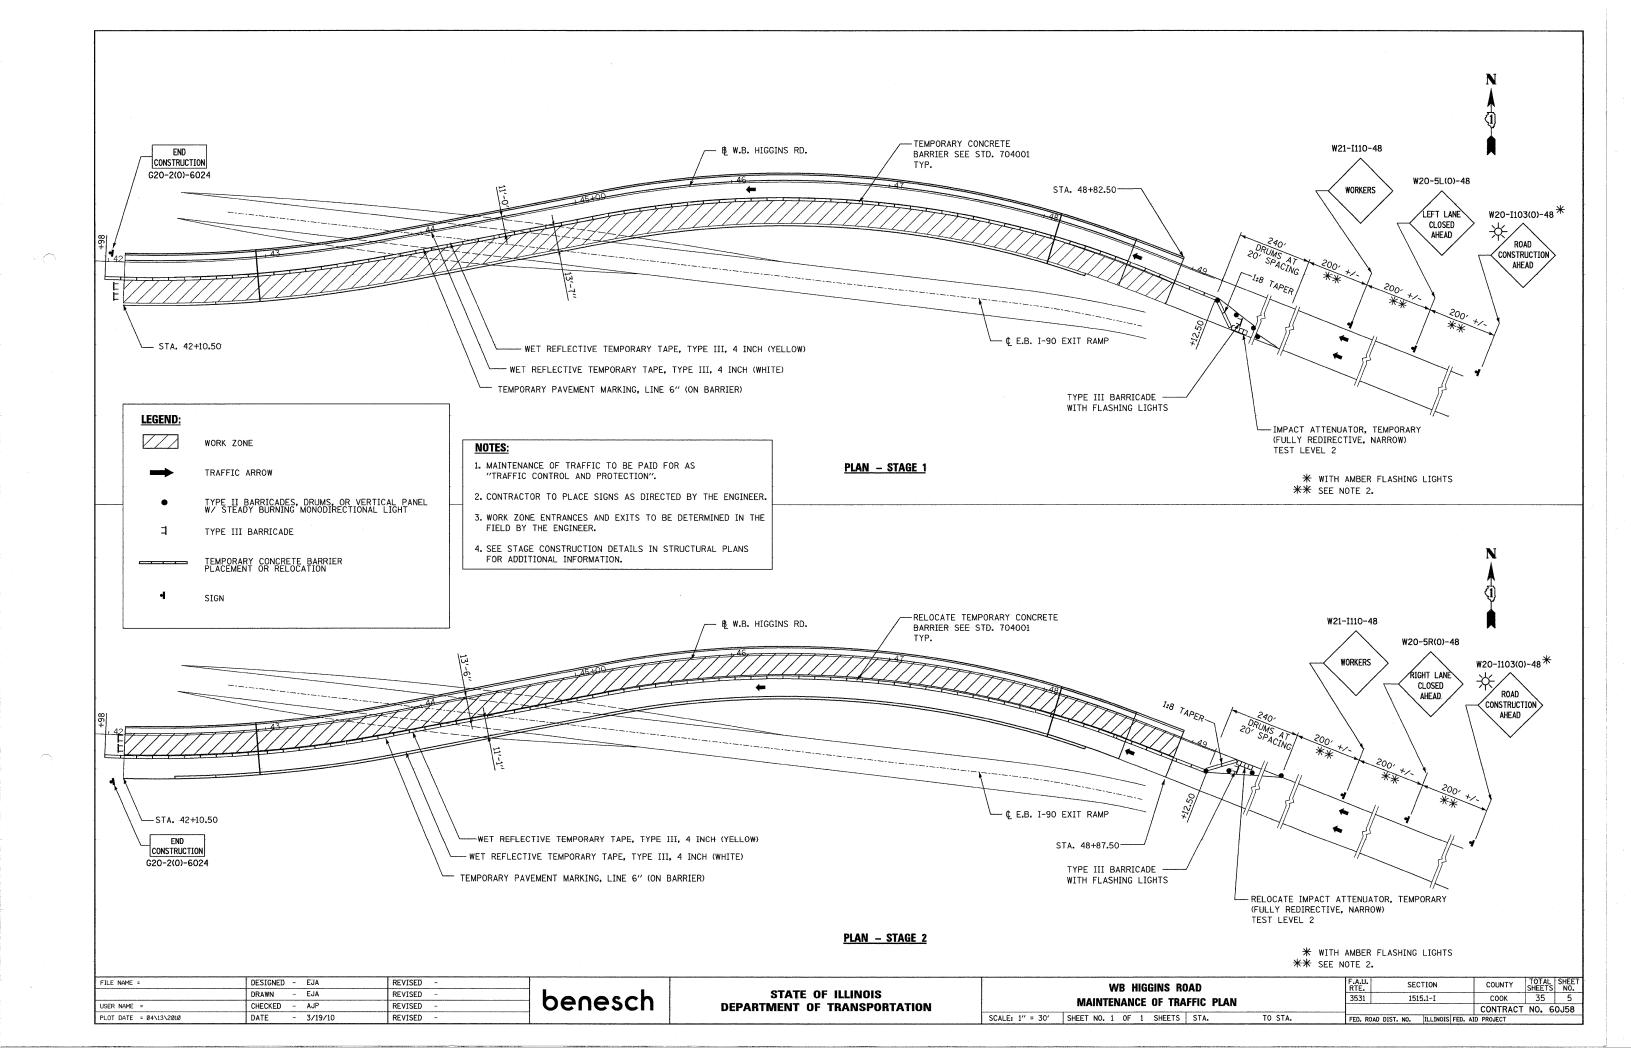


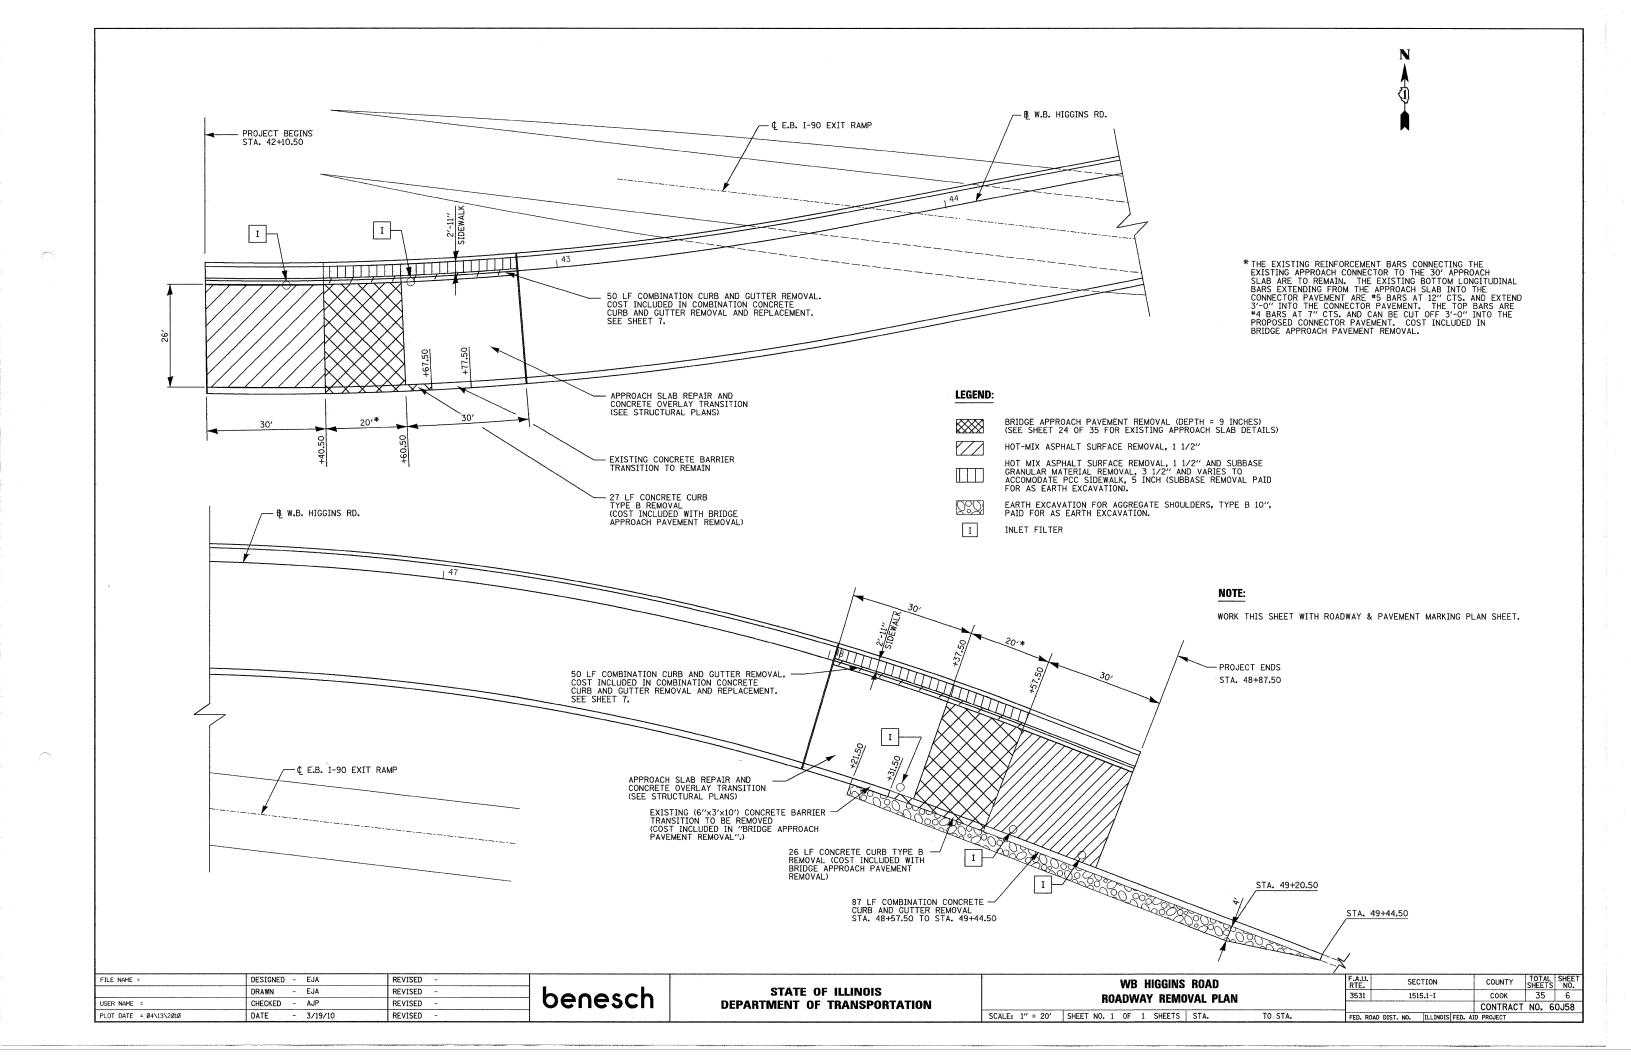

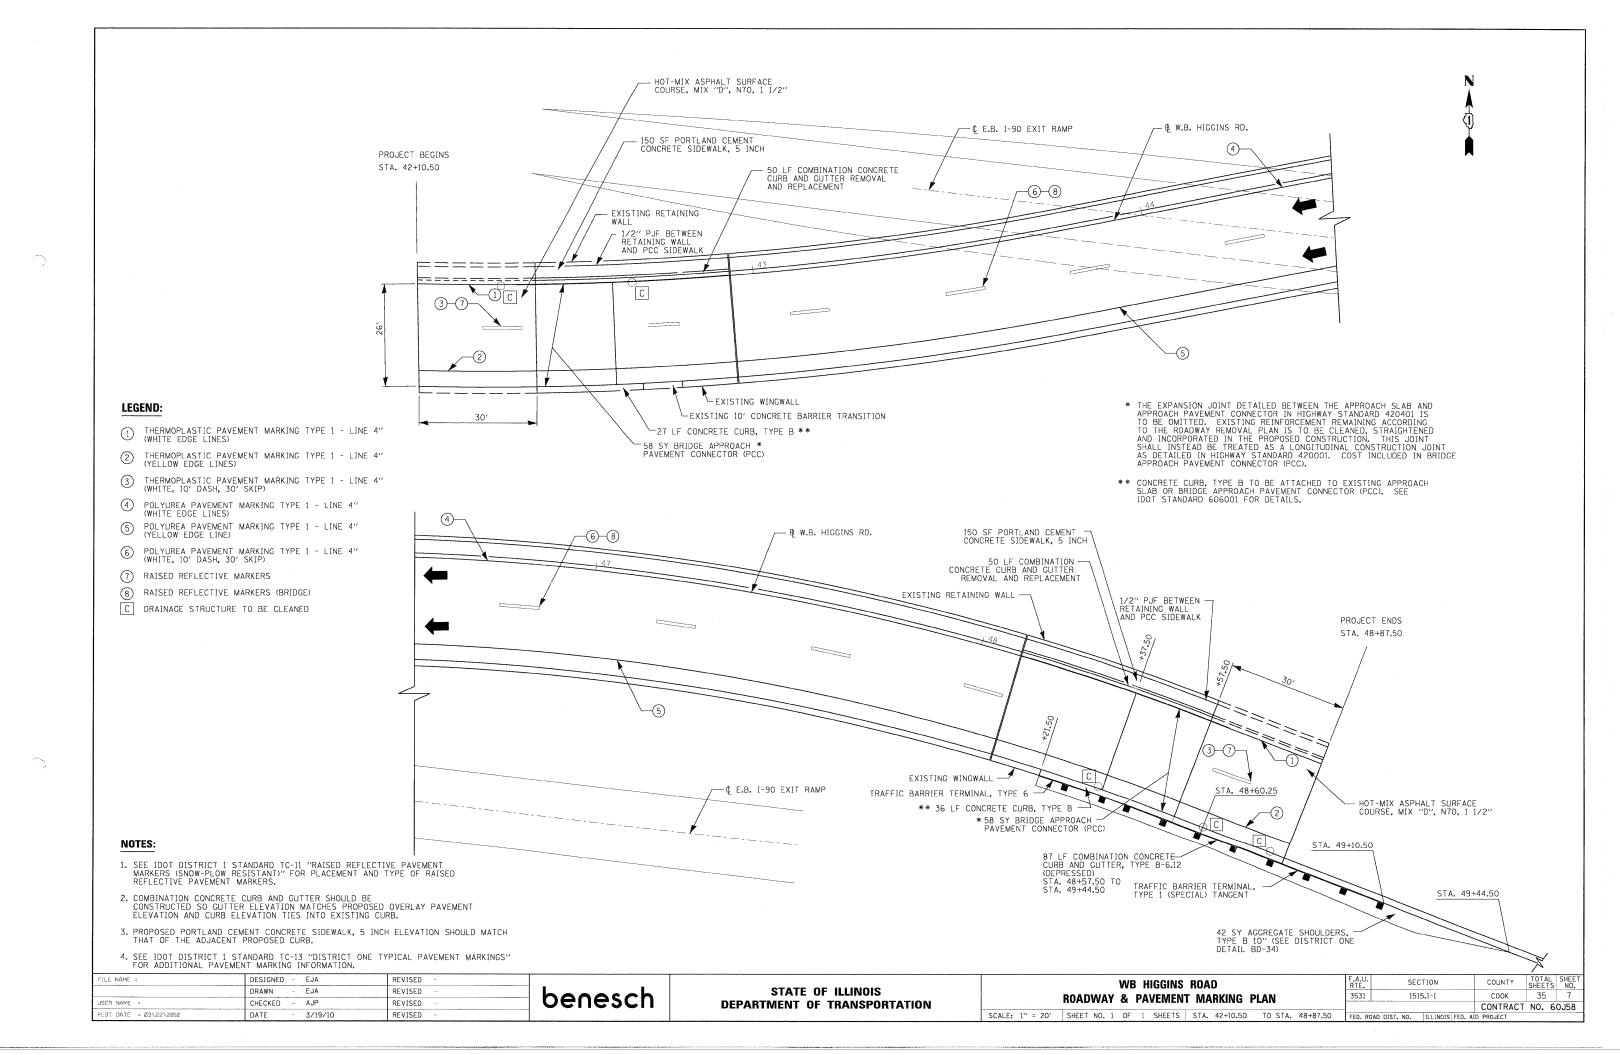


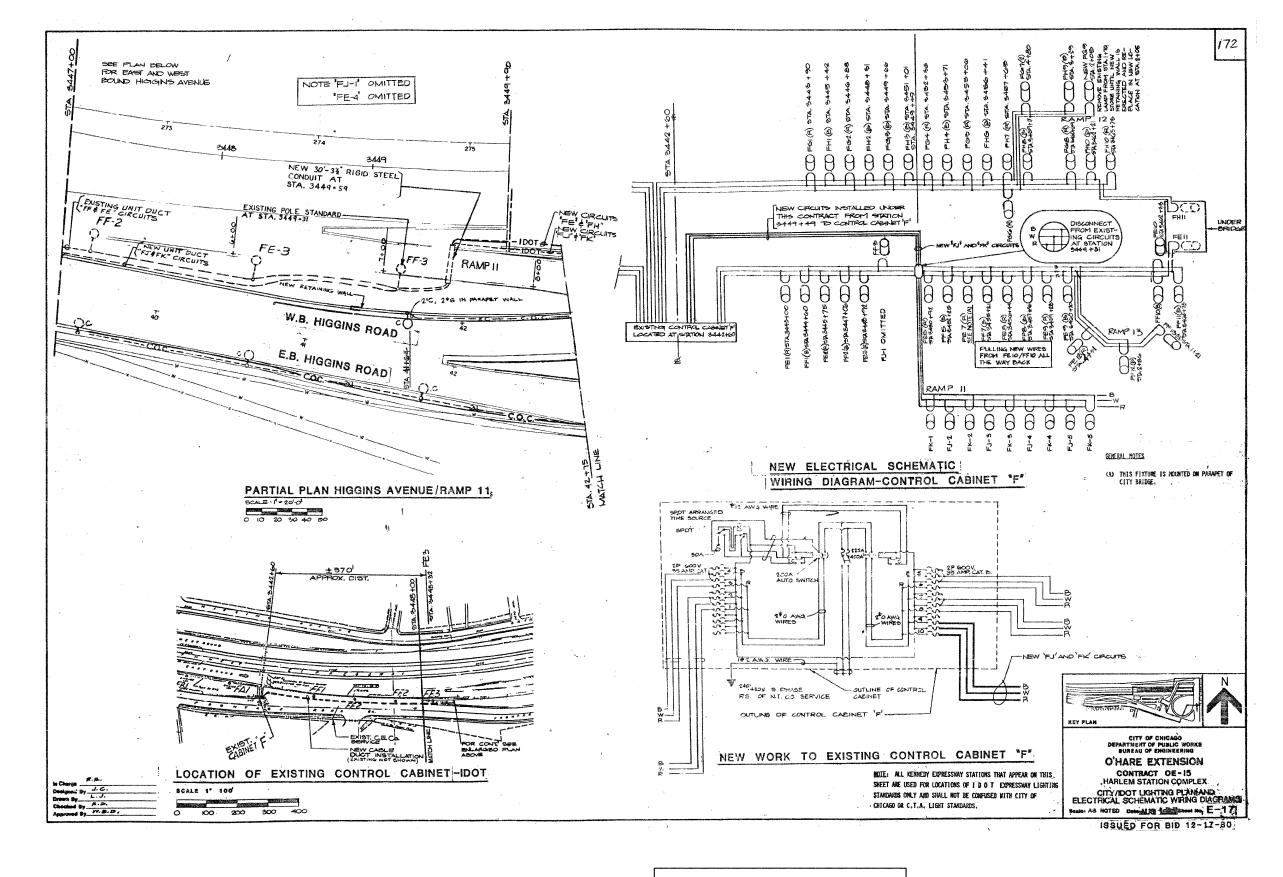


FILE NAME =	DESIGNED	- EJA	REVISED - ·				F.A.U.	SECTION	COUNTY	TOTAL SHEE
	DRAWN	- EJA	REVISED - ·	haaasah	STATE OF ILLINOIS	EXISTING LIGHTING PLANS	3531	1515 . 1-I	COOK	35 8
USER NAME =	CHECKED	- AJP	REVISED -	benesch	DEPARTMENT OF TRANSPORTATION		5551	151541 1	CONTRAC	T NO. 60J58
PLOT DATE = 03\22\2010	DATE	- 3/19/10	REVISED -			SCALE: N.T.S. SHEET NO. 1 OF 3 SHEETS STA. TO STA.	FED. ROAD DIS	ST. NO ILLINOIS FED.	AID PROJECT	1 1102 00030

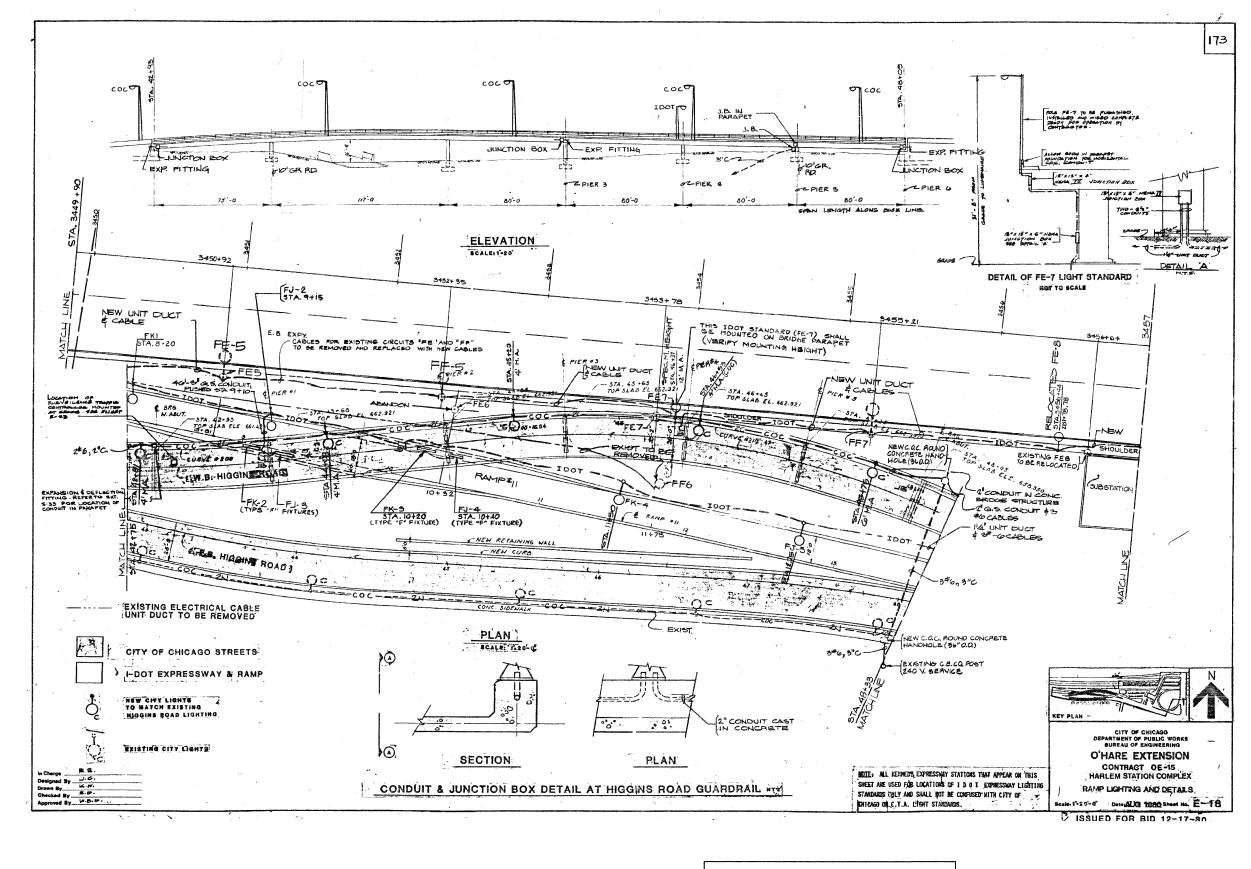


FILE NAME =	DESIGNED - EJA	REVISED -				F.A.U. SECTION COUNTY	TOTAL SHEET
	DRAWN - EJA	REVISED -	haaasah	STATE OF ILLINOIS	EXISTING LIGHTING PLANS	3531 1515.1-I COOK	35 Q
USER NAME =	CHECKED - AJP	REVISED	benesch	DEPARTMENT OF TRANSPORTATION		CONTRAC	CT NO. 60J58
PLOT DATE = 03\22\2010	DATE - 3/19/10	REVISED -			SCALE: N.T.S. SHEET NO. 2 OF 3 SHEETS STA. TO STA.	FED. ROAD DIST. NO ILLINOIS FED. AID PROJECT	3

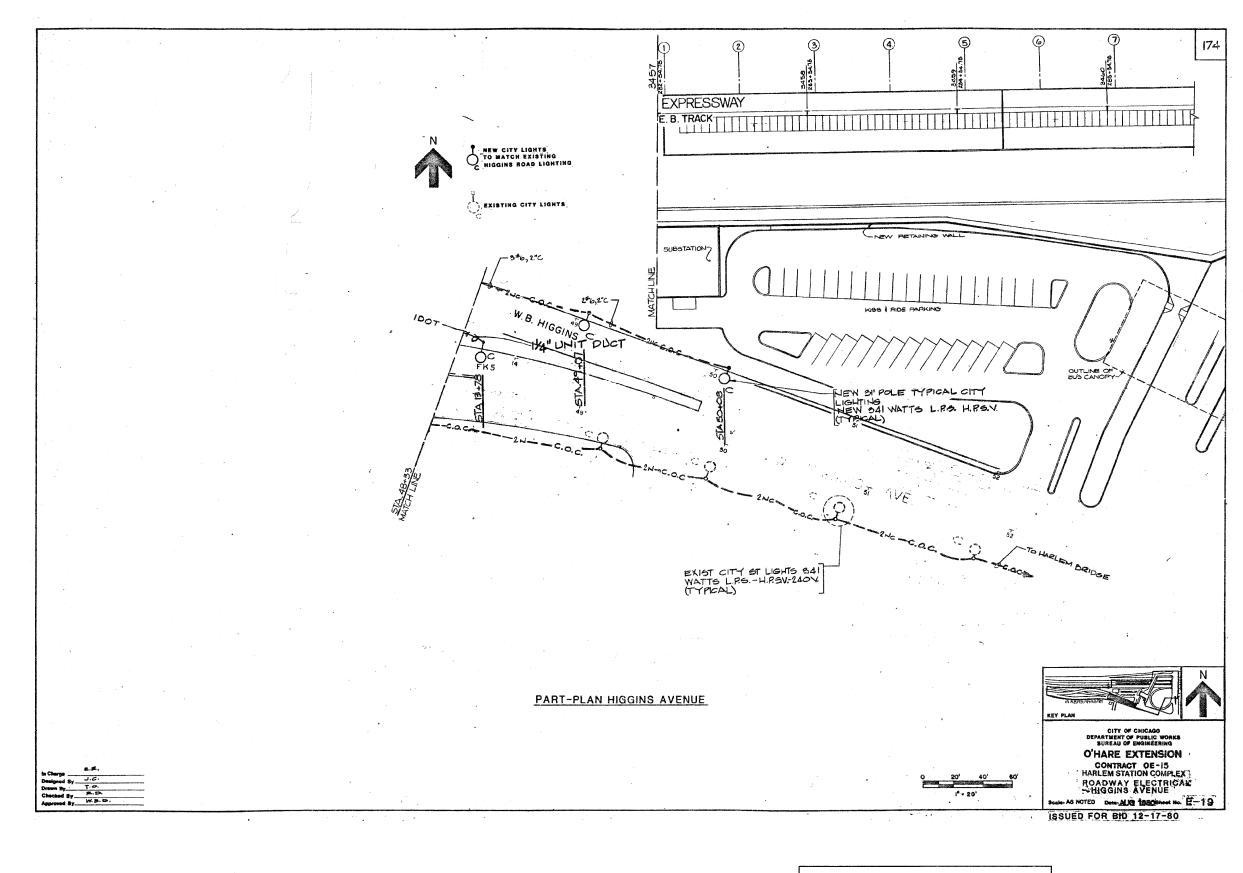

FILE NAME =	DESIGNED - EJA DRAWN - EJA	KENIZED -		STATE OF ILLINOIS	EXISTING LIGHTING PLANS	RTE.	SECTION	COUNTY	SHEETS	10°
USER NAME =	CHECKED - AJP	REVISED -	- benesch	DEPARTMENT OF TRANSPORTATION	EXISTING LIGHTING FLANS	3531	1515.1-1	CONTRACT	35 NO 60.	.0
PLOT DATE = 03\22\2010	DATE - 3/19/10	REVISED -			SCALE: N.T.S. SHEET NO. 3 OF 3 SHEETS STA. TO STA.	FED. ROAD DIST. NO	O ILLINOIS FED. AID	PROJECT	1101 000	~

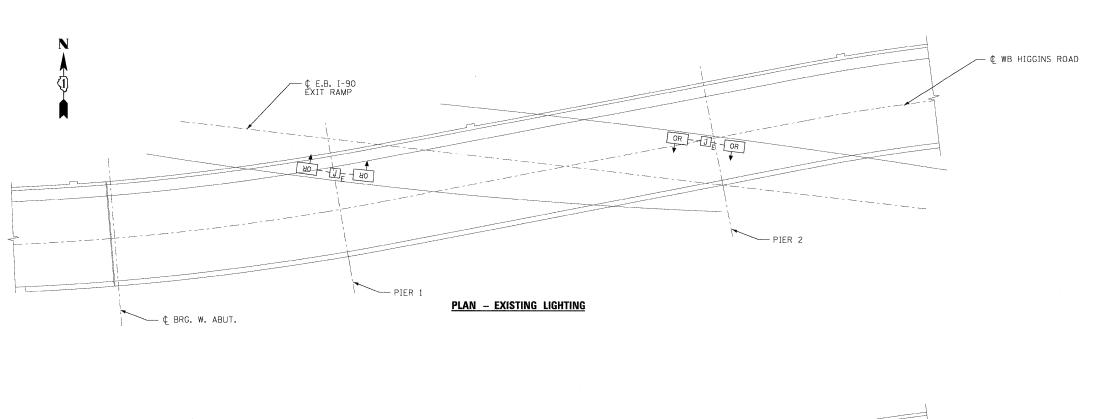


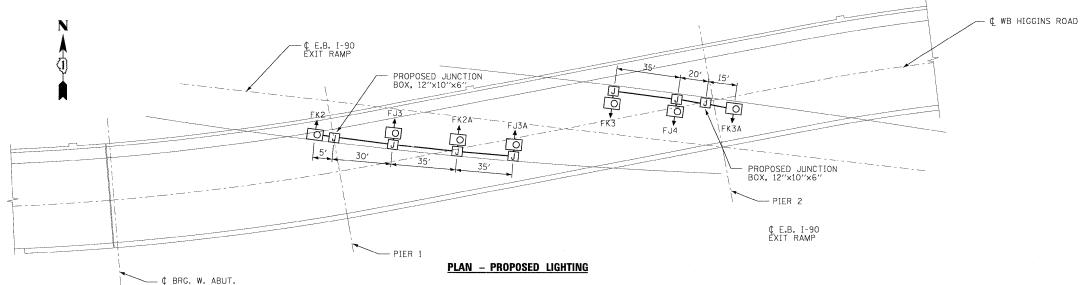

ESTIMATED BILL OF MATERIAL - THIS SHEET

P	T	
ITEM	UNIT	TOTAL
CONDUIT ATTACHED TO STRUCTURE, 1" DIA., PVC COATED GALVANIZED STEEL	FOOT	209
JUNCTION BOX, STAINLESS STEEL, ATTACHED TO STRUCTURE, 6" x 6" x 4"	EACH	5
JUNCTION BOX, STAINLESS STEEL, ATTACHED TO STRUCTURE, 12" x 10" x 6"	EACH	2
ELECTRICAL CABLE CONDUIT, 600V (XLP-TYPE USE) 1/C NO. 10	FOOT	861
REMOVAL OF LIGHTING UNIT, NO SALVAGE	EACH	4
MAINTENANCE OF LIGHTING SYSTEM	CAL MO	3
LIGHT POLE HANDHOLE COVER	EACH	1
UNDERPASS LUMINAIRE, 70 WATT, HIGH PRESSURE SODIUM VAPOR, STAINLESS STEEL HOUSING	EACH	7
PROTECTION AND MAINTENANCE OF EXISTING UNDERPASS LIGHTING	L SUM	1

^{*}SEE BRIDGE GENERAL PLAN AND ELEVATION FOR LOCATION.

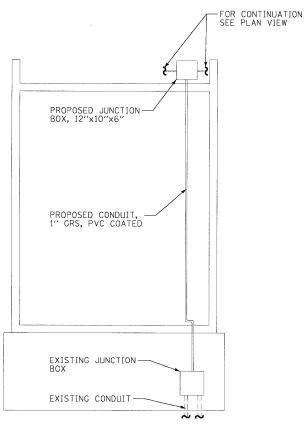

PIER DETAIL (TYPICAL FOR PIER 1 & 2)

LEGEND - THIS SHEET

OR					
OR	FXICTING	LUMINAIRE	TO	RF	REMOVED
	LAIDIINO	POMITIANTIAN	, 0	ᄓ	INCINIO A ED

PROPOSED LUMINAIRE, 70W, HPS, (WITH LUMINAIRE DESIGNATION)

J_E EXISTING JUNCTION BOX

PROPOSED JUNCTION BOX, 6"x4" STAINLESS STEEL ATTACHED TO STRUCTURE, UNLESS OTHERWISE NOTED

---- EXISTING CONDUIT TO BE REMOVED

PROPOSED CONDUIT, 1" PVC COATED, GRS WITH 3-1/C NO. 10 AND 1-1/C NO. 10 GROUND (GREEN)


NOTES:

- 1. CONTRACTOR SHALL ASSUME CONTROL AND MAINTENANCE OF CONTROLLER 'F' LOCATED ON HIGGINS AVE. (ON WEST HIGGINS AVE. WEST OF WEST BRYN MAWR AVE.). COST FOR MAINTENANCE OF CONTROLLER SHALL BE INCLUDED IN "MAINTENANCE OF LIGHTING SYSTEM".
- 2. THE CONTRACTOR SHALL REPLACE THE EXISTING LUMINAIRES AT THE EXISTING LOCATIONS AS SHOWN ON THE PLANS. THIS SHALL INCLUDE ALL CONDUIT AND CABLE, AS WELL AS A NEW JUNCTION BOX AT THE TOP OF THE CONDUIT RISER AS SHOWN ON THE TYPICAL PIER DETAIL.
- 3. FOR MAINTENANCE OF LIGHTING SYSTEM AND PROTECTION AND MAINTENANCE OF EXISTING UNDERPASS LIGHTING, SEE SPECIAL PROVISIONS.
- 4. SEE EXISTING LIGHTING PLANS FOR LIGHTING INFORMATION.

FILE NAME =	DESIGNED - GHT	REVISED -			WB HIGGINS ROAD	F.A.U. SECTION COUNTY TOTAL SHEET NO.
USER NAME =	DRAWN - BDW CHECKED - GHT	REVISED -	benesch	STATE OF ILLINOIS DEPARTMENT OF TRANSPORTATION	UNDERPASS LIGHTING REPLACEMENT PLAN	3531 1515.1-1 COOK 35 11
PLOT DATE = Ø3\22\2010	DATE - 3/19/10	REVISED -		DEFAITMENT OF THAIRD ON A TON	SCALE: 1" = 50' SHEET NO. 1 OF 1 SHEETS STA. TO STA.	FED. ROAD DIST. NO. ILLINOIS FED. AID PROJECT

Stage construction shall be utilized to maintain passenger vehicle traffic during construction. A detour route shall be used for truck traffic.


*Protective Shield to extend from 5 ft. past

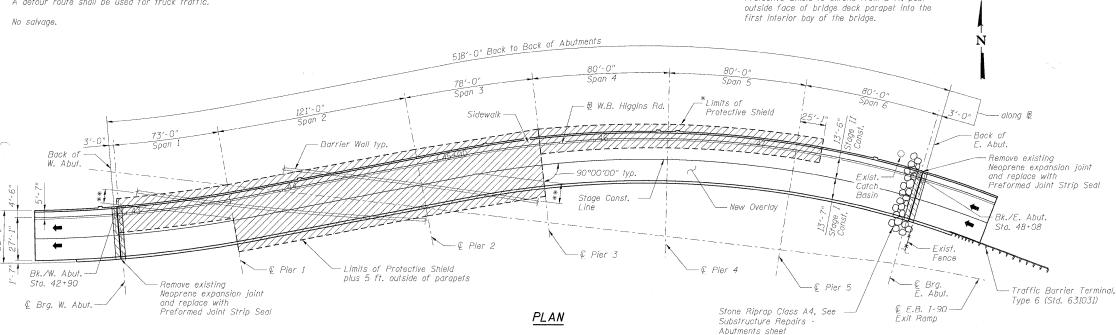

** Protective Shield to extend a minimum of 10'-0" past exit ramp barrier wall of E.B. I-90 Exit Ramp or 5'-0" past outside face of bridge deck parapet.

Remove Existing Aluminum Limits of Protective Shield Railing & Retrofit Concrete Parapet (South Parapet Only) Install Light Pole Handhole Cover,-See Special Provision (Billed on Existing Light Pole typ. (North Parapet Only) Inderpass Lighting Replacement Plan sheet) € E.B. I-90 Remove and Replace Underpass Lighting, See Underpass Lighting Renlacement Plan sheet

ELEVATION

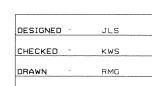

KWS

CHECKED

benesch Engineers - Surveyors - Planners 205 North Michigan Avenue, Suite 2400 Chicago, Illinois 6001 Job No. 10032 13

alfred benesch & company

EXPIRATION DATE: 11-30- 10 BATE: 03/22/10

SHEET NO. 3 14 SHEETS F.A.U RTE. SECTION 3531 1515.1-I

STRUCTURE NO. 016-2519 TOTAL SHEE SHEETS NO. COUNTY 35 12 COOK CONTRACT NO. 60J58 FED. ROAD DIST. NO. | ILLINOIS | FED. AID PROJECT

GENERAL PLAN AND ELEVATION IL 72 (HIGGINS ROAD) WB OVER

> COOK COUNTY STATION 45+49

DESIGN SPECIFICATIONS


2002 AASHTO Standard Specifications for Highway Bridges, 17th Edition

DESIGN STRESSES

f'c = 3,500 psi fy = 60,000 psi (reinforcement)

SCOPE OF WORK

- 1. Bridge deck hydro-scarification.
- 2. Bridge deck patching and parapet repair.
- 3. Approach slab patching.
- 4. Reconstruct deck joints at each abutment with preformed joint strip seals.
- 5. Remove existing aluminum railing and retrofit concrete parapet along south parapet.
- 6. Place new latex concrete overlay on deck and approaches.
- 7. Structural repair of concrete at abutments.
- 8. Place riprap at East Abutment.
- 9. Apply protective coat to parapets, sidewalk, approach slabs and deck.
- 10. Apply concrete sealer to abutment seats and backwalls.
- 11. Remove and reconstruct concrete curb and guiter along the sides of each approach slab.
- 12. Remove and reconstruct the bridge approach pavement connectors.
- 13. Install traffic barrier terminals and guardrail,

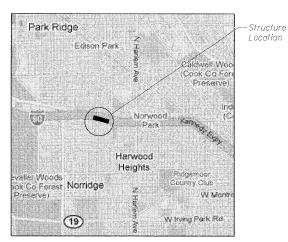

LOCATION SKETCH

I-90 EB RAMP TO IL 43 (HARLEM AVENUE)

GENERAL NOTES

- 1. Reinforcement bars shall conform to the requirements of ASTM A 706 Gr 60, See Special Provisions.
- 2. Reinforcement bars designated (E) shall be epoxy coated.
- 3. Prior to pouring the new concrete deck, all heavy or loose rust, loose mill scale, and other loose or potentially detrimental foreign material shall be removed from the surfaces in contact with concrete. Tightly adhered paint may remain unless otherwise noted. Removal shall be accomplished by methods that will not damage the steel and the cost will be included in the pay item covering removal of the existing concrete.

As directed by the Engineer, existing construction accessories welded to the top flange of beams and girders shall be removed. The weld areas shall be ground flush and inspected for cracks using magnetic particle testing (MT) or dye penetrant testing (PT) by qualified personnel approved by the Engineer. Any cracks that cannot be removed by grinding ${}^{l}_{4}$ inch deep shall be identified and reported to the Bureau of Bridges and Structures for further disposition. The cost of removing welded accessories, grinding and inspecting weld areas and grinding cracks will be paid for according to Article 109.04 of the Standard Specifications.

- 4. Plan dimensions and details relative to existing plans are subject to nominal construction variations. The Contractor shall field verify existing dimensions and details affecting new construction and make necessary approved adjustments prior to construction or ordering of materials. Such variations shall not be cause for additional compensation for a change in scope of the work, however, the Contractor will be paid for the quantity actually furnished at the unit price bid for the work.
- 5. Concrete Sealer shall be applied to abutment seats and backwalls. All surfaces to be sealed shall be cleaned thoroughly prior to sealer application. Cost included with Concrete Sealer.
- 6. The existing structural steel coating contains lead. The Contractor shall take appropriate precautions to deal with the presence of lead on this project.
- 7. Stage construction shall be utilized to maintain traffic during construction.
- 8. The Contractor shall exercise care during removal of existing joints to ensure that the slab, beams and diaphragms' integrity will not be detrimentally impacted. The Contractor shall repair any damage(s) to the slab, beams and diaphragms caused by his operation as directed by the Engineer at no additional cost to the Department.
- 9. Protective Coat shall be applied to the new Latex Concrete Overlay on the deck and approach slabs. Protective Coat shall also be applied to the top and inside faces of the parapets and sidewalk.
- 10. Joint openings shall be adjusted according to Article 520.04 of the Std. Specs. when the deck is poured at an ambient temperature other than 50°F.
- 11. In the event that Structural Repair of Concrete takes place at a light pole foundation, the Contractor may be required to temporarily shore or remove and reinstall the light pole if deemed necessary by the Engineer. If necessary, this work shall be performed according to Article 109.04 of the Standard Specifications.
- 12. The final grades and cross-slopes for the latex concrete overlay and expansion joint reconstruction shall conform to the existing grades plus the net increase in deck thickness specified in the plans. Any preliminary survey required for the Contractor to conform to these grades and to fabricate the preformed joint strip seal expansion joints shall not be paid for separately but shall be included in the cost of the major items of work involved.

DESIGNED -JLS CHECKED KWS DRAWN RMG CHECKED -

INDEX OF SHEETS

General Plan and Elevation

General Notes, Bill of Material and Index of Sheets

Stage Construction Details

Bridge Deck, Parapet and Approach Slab Repairs

Parapet Retrofit Details Expansion Joint Repairs

Expansion Joint Details

Preformed Joint Strip Seal

Substructure Repairs - Abutments

Bar Splicer Assembly and Mechanical Splicer Details

Existing Plan Information

TOTAL BILL OF MATERIAL

ITEM	UNIT	SUPER	SUB	TOTAL
Stone Riprap, Class A4	Sq Yd		30	30
Filter Fabric	Sq Yd		30	30
Concrete Removal	Cu Yd	13.0		13.0
Protective Shield	Sq Yd	1,435		1,435
Concrete Superstructure	Cu Yd	14.3		14.3
Bridge Deck Grooving	Sq Yd	1,609		1,609
Protective Coat	Sq Yd	2,343		2,343
Reinforcement Bars, Epoxy Coated	Pound	1,190		1,190
Bar Splicers	Each	22		22
Preformed Joint Strip Seal	Foot	66.0		66.0
Concrete Sealer	Sq Ft		<i>31</i> 5	<i>31</i> 5
Bridge Deck Latex Concrete Overlay, 2 ¹ ₄ "	Sq Yd	1,714		1,714
Structural Repair of Concrete (Depth Equal to or Less Than 5 Inches)	Sq Ft	159	105	264
Cleaning and Painting Exposed Rebar (Special)	Sq Ft	297		297
Approach Slab Repair (Full Depth)	Sq Yd	10.0		10.0
Bridge Deck Hydro-Scarification, 1/2"	Sq Yd	1,714		1,714
Deck Slab Repair (Full Depth, Type I)	Sq Yd	9.8		9.8
Deck Slab Repair (Full Depth, Type II)	Sq Yd	12.5		12.5
Retrofit Concrete Parapet	Foot	525		525
Temporary Shoring and Cribbing	Each		2	2


GENERAL NOTES, BILL OF MATERIAL AND INDEX OF SHEETS STRUCTURE NO. 016-2519

alfred benesch & company benesch Surveyors • Planners 205 North Michigan Avenue, Suite 2400 Chicago, Illinois 80801 1 212-865-M650 Joh No. 10032 13


F.A.U. RTE. TOTAL SHEET NO. SECTION COUNTY SHEET NO. 2 3531 1515.1-I COOK 35 14 SHEETS CONTRACT NO. 60J58 FED. ROAD DIST. NO. | ILLINOIS | FED. AID PROJECT

13

STATE OF ILLINOIS DEPARTMENT OF TRANSPORTATION

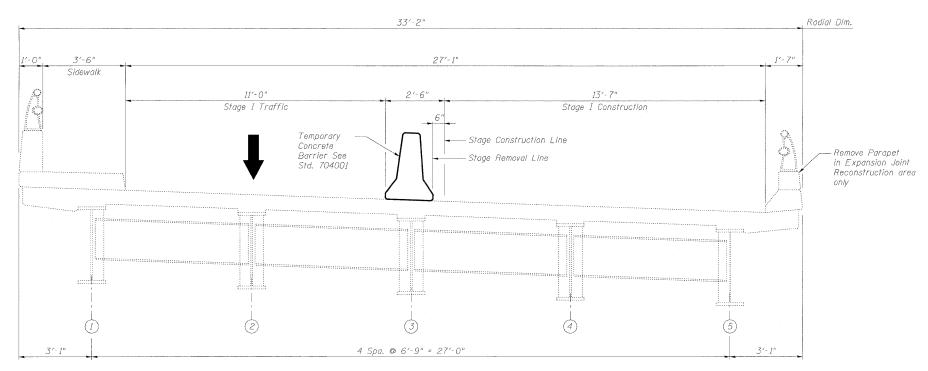

STAGE I CROSS SECTION (Looking East)

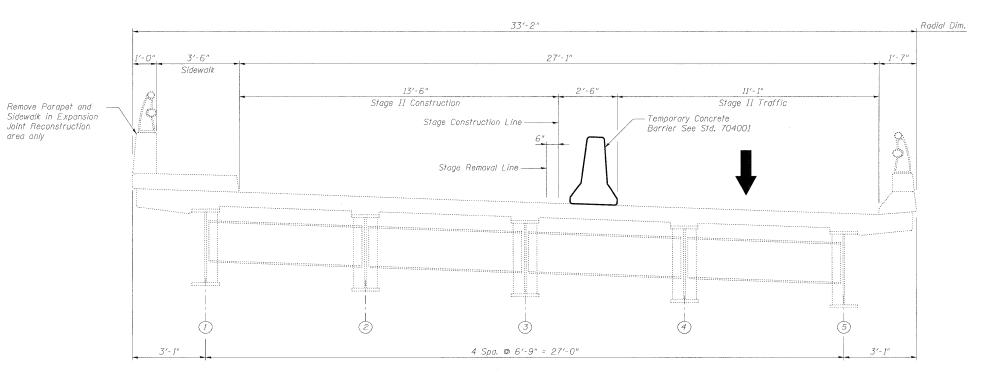

STAGE II CROSS SECTION

DESIGNED	_	JLS
	_	
CHECKED		KJN
DRAWN	-	RMG
CHECKED		KWS


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Chicago, Illinois 60801
312-585-0450 Job No. 10032.13

STAGE CONSTRUCTION DETAILS STRUCTURE NO 016-2519

			STRUCTUR	TE NO. 016-2	<u> </u>		
F.A.I SHEET NO. 3 RTE		SEC	TION	COUNTY	TOTAL SHEETS	SHEET NO.	
SHEET NO. 3	3531	1515 . 1-I		COOK	35	14	1
14 SHEETS	CONTRACT			NO. 60	J58	1	
	FED. RC	AD DIST. NO.	ILLINOIS FED.	AID PROJECT			ì

For quantity of Temporary Concrete Barrier, see Roadway Plans.

Note:

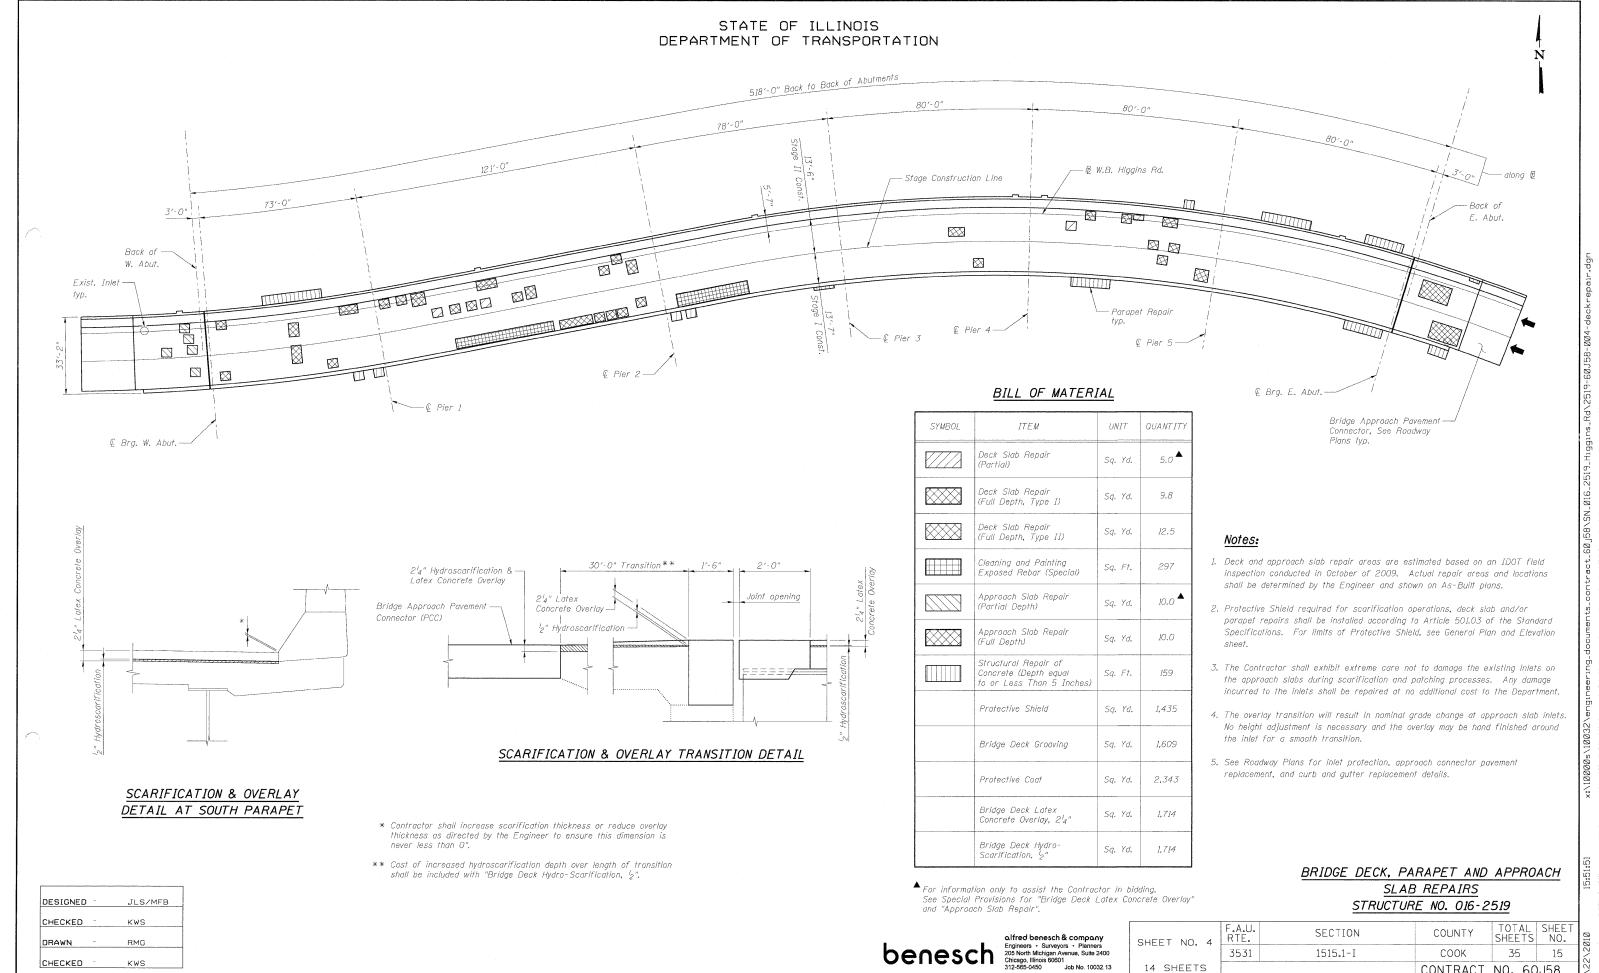


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CONTRACT NO. 60J58


FED. ROAD DIST. NO. | ILLINOIS FED. AID PROJECT

14 SHEETS

STATE OF ILLINOIS DEPARTMENT OF TRANSPORTATION

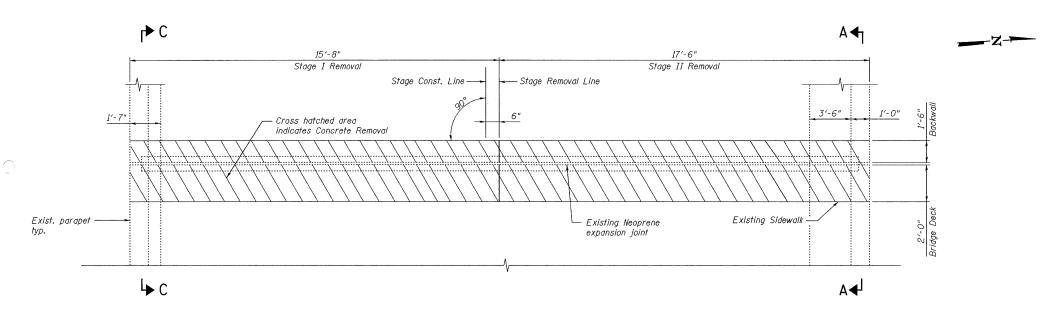


EXISTING PARTIAL PLAN AT WEST ABUTMENT

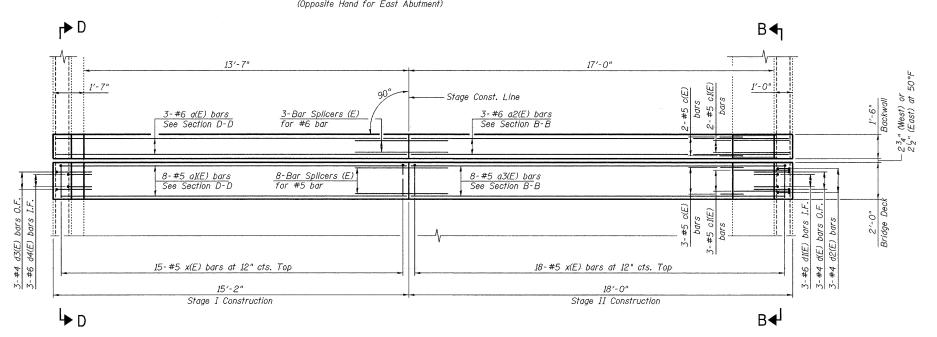

PROPOSED PARTIAL PLAN AT WEST ABUTMENT


(Opposite Hand for East Abutment)

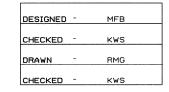



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BILL OF MATERIAL


Bar	No.	Size	Length	Shape
a(E)	6	#6	14'-8"	
a1(E)	16	#5	14'-8"	
a2(E)	6	#6	17′-6″	
a3(E)	16	#5	17′-6"	
c(E)	10	#5	2′-6"	
c1(E)	10	#5	4'-0"	
d(E)	6	#4	4′-9"	
d1(E)	6	#6	3′-9"	
d2(E)	6	#4	2'-1"	П
d3(E)	6	#4	5′-0"	
d4(E)	6	#6	4'-0"	
x(E)	66	#5	2′-6"	Г
Item			Unit	Total
Concrete Removal			Cu. Yd.	13.0
Concrete S	Superstructu	ıre	Cu. Yd.	14.3
Reinforcem Epoxy Coa			Pound	1,190




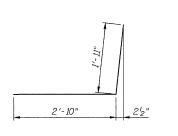


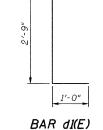

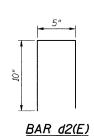BAR d(E)

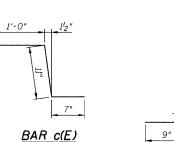

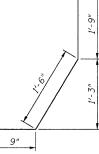

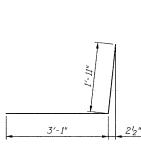

BAR d4(E)

BAR d3(E)

Notes:


- 1. I.F. denotes Inside Face. O.F. denotes Outside Face.
- 2. Work this sheet with Expansion Joint Details sheet and Bar Splicer Assembly Details sheet.


EXPANSION JOINT REPAIRS STRUCTURE NO. 016-2519

SHEET NO. 6	F.A.U. RTE.
	3531
14 SHEETS	

BAR x(E)


ET NO. 6	F.A.U. RTE.	SECTION				COUNTY	TOTAL SHEETS	SHEET NO.
	3531	1515 . 1-I			СООК	35	17	
SHEETS				CONTRACT	NO. 60	J58		
	FED. RO	AD DIST. NO	•	ILLINOIS	FED.	AID PROJECT		

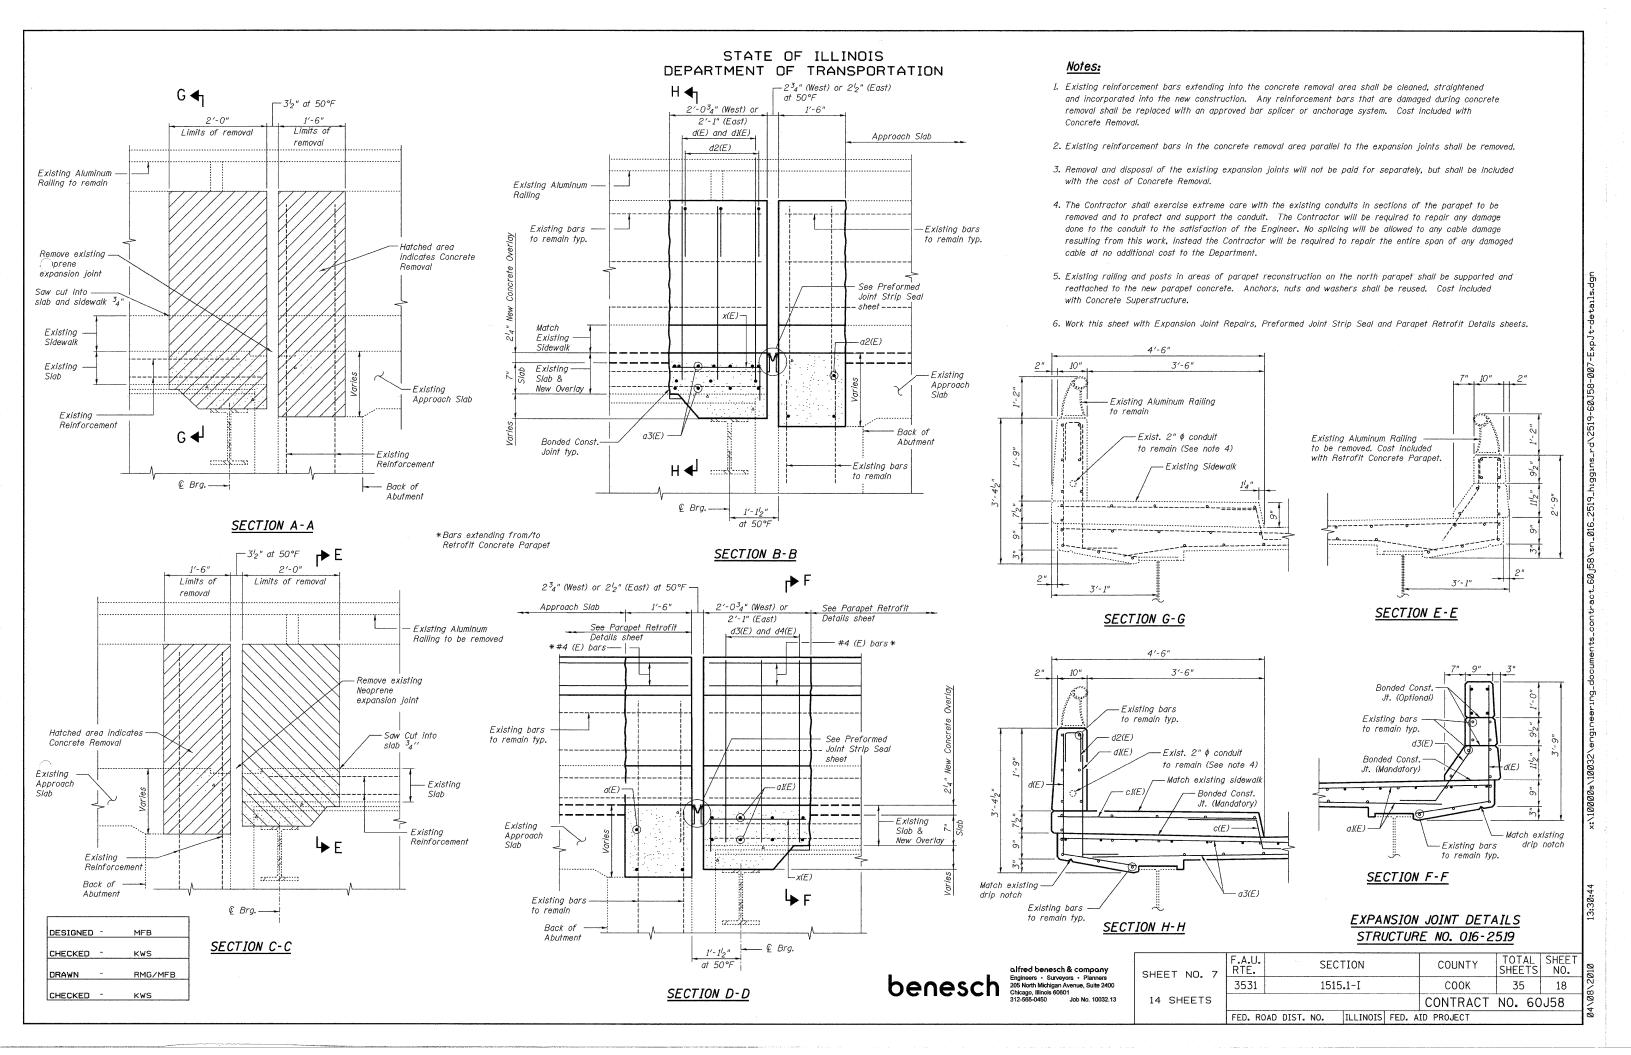

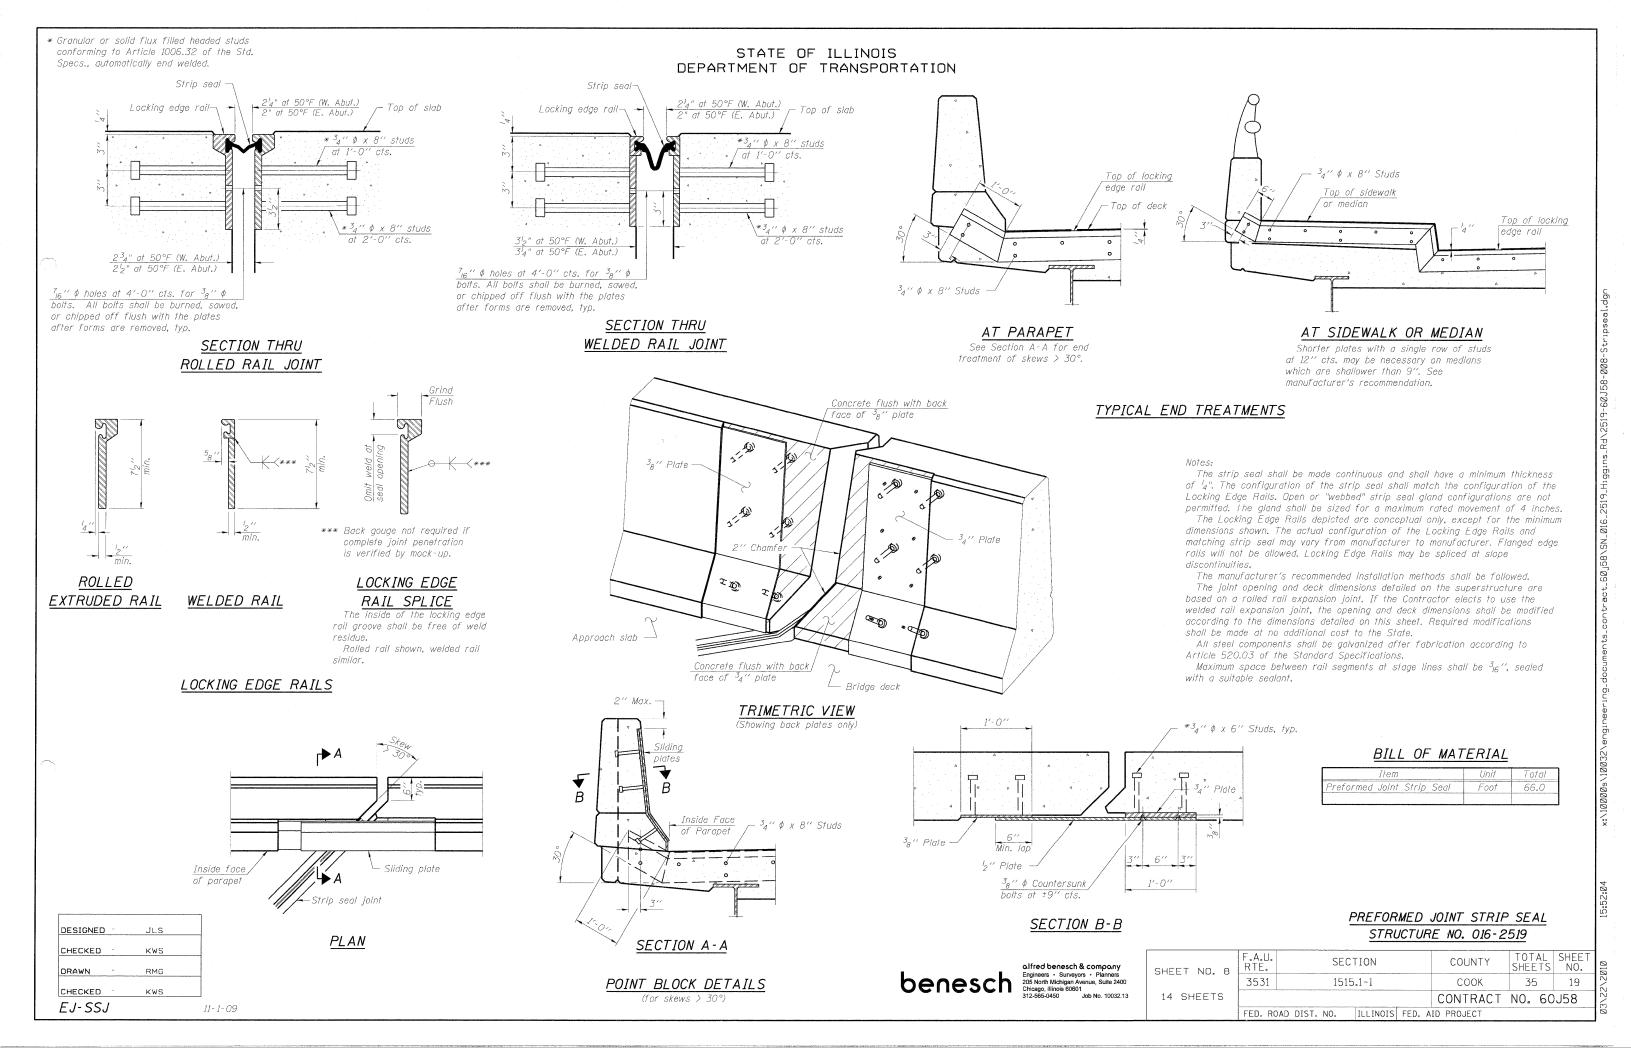


SUBSTRUCTURE REPAIRS - ABUTMENTS

STATE OF ILLINOIS DEPARTMENT OF TRANSPORTATION

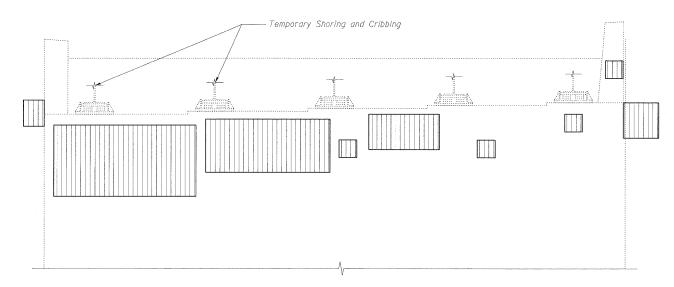


ELEVATION - WEST ABUTMENT REPAIRS

(Looking West)

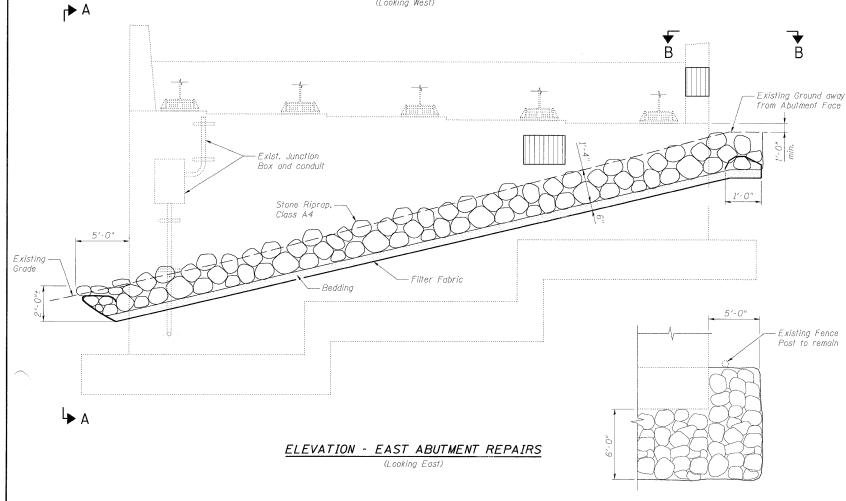

VIEW B-B

DESIGNED JLS/MFB CHECKED KWS RMG DRAWN CHECKED KWS

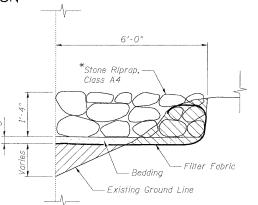

SECTION C-C

*Due to varying erosion levels, excavate and grade slope to create a uniform 1'-10' deep by 6'-0" wide trench along the abutment.

Excess soil shall be spread across adjacent slope, Cost included with Stone Riprap,

– Stone Riprap, Class A4

Bedding

BILL OF MATERIAL

SYMBOL	ITEM	UNIT	QUANTITY
	Structural Repair of Concrete (Depth Equal to or Less Than 5 Inches)	Sq. Ft.	105
	Temporary Shoring and Cribbing	Each	2
	Stone Riprap, Class A4	Sq. Yd.	30
	Filter Fabric	Sq. Yd.	30
	Concrete Sealer	Sq. Ft.	315

MAXIMUM BEAM REACTIONS (KIPS)

LOCATION	DEAD LOAD	LIVE LOAD	IMPACT LOAD	TOTAL
W. Abut.	25.0	40.0	13.0	78.0
E. Abut.	35.0	40.0	13.0	88.0

Notes:

- 1. Substructure repair areas are estimated based on IDOT field notes from October of 2009. Actual repair areas and locations shall be determined by the Engineer and shown on the As-Built plans.
- 2. There is a potential for interference from existing conduits.
 The Contractor shall remove and reerect or temporarily support the existing conduits to complete the work as detailed. When the work is completed the conduits shall be reconnected to the reconstructed abutment or pier utilizing the existing mounting brackets or new mounting brackets. See Special Provision for "Protection and Maintenance of Existing Underpass Lighting".
- 3. The tabulated beam reactions were taken from the existing construction plans. The Contractor shall verify that the equipment used to support the beams is sufficient to carry these loads in addition to any temporary construction loads.

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VIEW A-A

9	F.A.U. RTE.	SECTION
	3531	1515 . 1-I
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— Existing Ground

STRUCTURE NO. 016-2519										
F.A.U. RTE.			SECT	TION			COUNTY	TOT	AL TS	SHEET NO.
3531	1515.1-I						COOK	3.5	5	2:0
							CONTRACT	NO.	60	J58
FED. RC	AD	DIST.	NO.	ILLINOIS	FED.	ΑI	D PROJECT			

coupler (E)

}

- Stage construction line Stage I construction Stage II construction Reinforcement * Threaded * Threaded splicer Reinforcement coupler (E) bar (E) bar * Threaded splicer Minimum lap length bar (E)

STANDARD BAR SPLICER ASSEMBLY

Minimum Lap Lengths									
Bar size to be spliced	Table 1	Table 2	Table 3	Table 4					
3, 4	1'-5''	1'- 11''	2'-1''	2'-4"					
5	1'-9''	2'-5''	2'-7''	2'-11''					
6	2'-1"	2'-11''	3'-1''	3'-6"					
7	2'-9''	3′-10′′	4'-2''	4'-8''					
8	3'-8''	5′-1′′	5′-5′′	6'-2"					
9	4'-7"	6'-5"	6′-10′′	7'-9''					

Table 1: Black bar, 0.8 Class C

Table 2: Black bar, Top bar lap, 0.8 Class C


Table 3: Epoxy bar, 0.8 Class C

Table 4: Epoxy bar, Top bar lap, 0.8 Class C

Threaded splicer bar length = min. lap length + 1_2^{l} " + thread length

* Epoxy not required on Bar Splicer Assembly components used in conjunction with black bars.

Location	Bar size	No. assemblies required	Table for minimum lap length
Deck	#5	16	Table 3
Deck	#6	6	Table 3

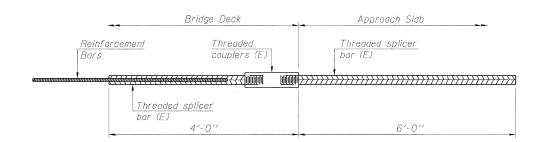


BAR SPLICER ASSEMBLY FOR #5 BAR ON INTEGRAL OR SEMI-INTEGRAL ABUTMENTS

No. required =

JLS	1 .
KWS	
RMG	
KWS	
KW3	 11- 1- 09


STATE OF ILLINOIS DEPARTMENT OF TRANSPORTATION

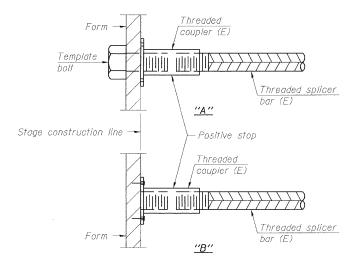

INSTALLATION AND SETTING METHODS

"A": Set bar splicer assembly by means of a template bolt. "B" : Set bar splicer assembly by nailing to wood forms or cementing to steel forms.

(E): Indicates epoxy coating.

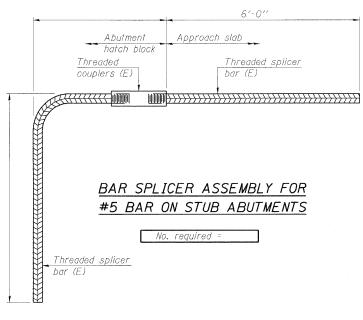

NOTES

Location

Reinforcement bar -

Splicer bars shall be deformed with threaded ends and have a minimum 60 ksi yield strength.

All reinforcement shall be lapped and tied to the splicer bars,

Bar splicer assemblies shall be epoxy coated according to the requirements for reinforcement bars. See Section 508 of the Standard Specifications.


See special provision for Mechanical Splicers.

See approved list of bar splicer assemblies and mechanical splicers for alternatives.

> BAR SPLICER ASSEMBLY AND MECHANICAL SPLICER DETAILS STRUCTURE NO. 016-2519

TOTAL SHEET SHEETS NO. F.A.U. RTE. SECTION COUNTY SHEET NO. 10 COOK 35 21 3531 1515.1-I 14 SHEETS CONTRACT NO. 60J58 FED. ROAD DIST. NO. | ILLINOIS | FED. AID PROJECT

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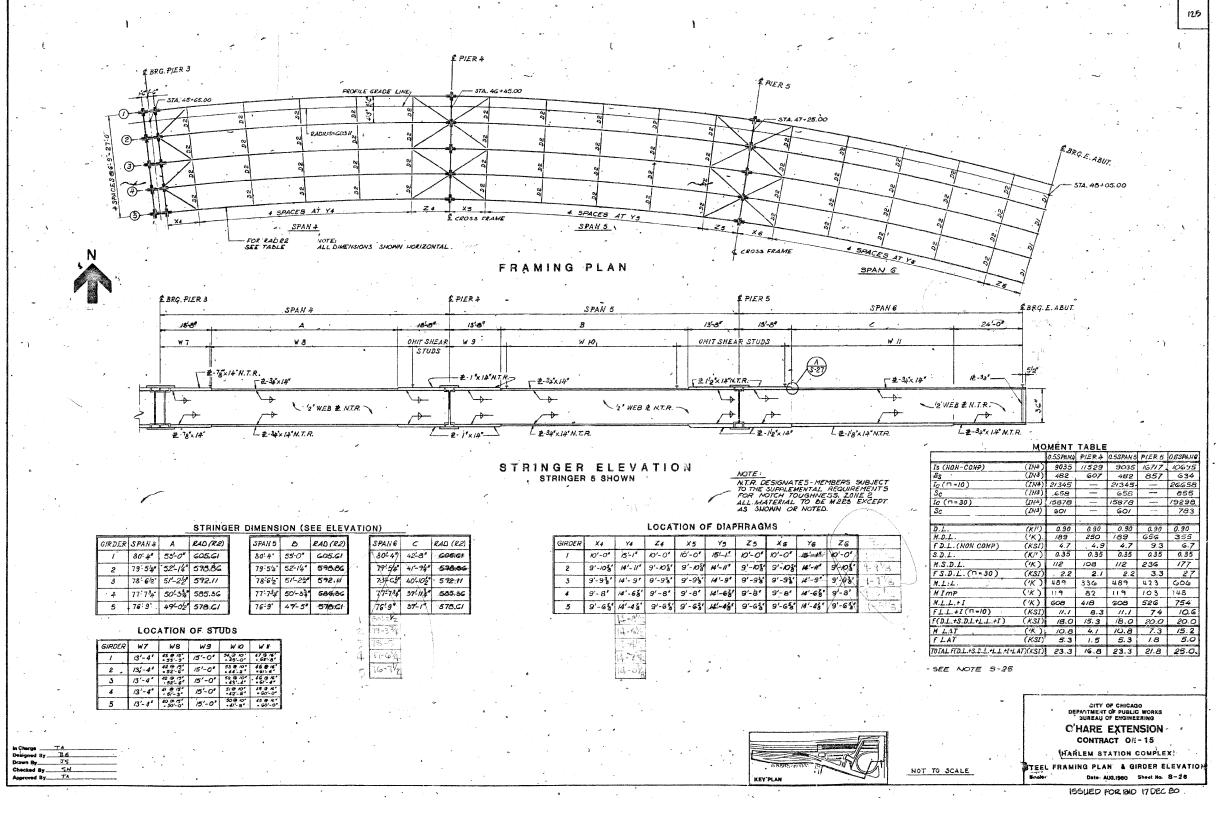
EXISTING PLAN INFORMATION 1 OF 4 STRUCTURE NO. 016-2519
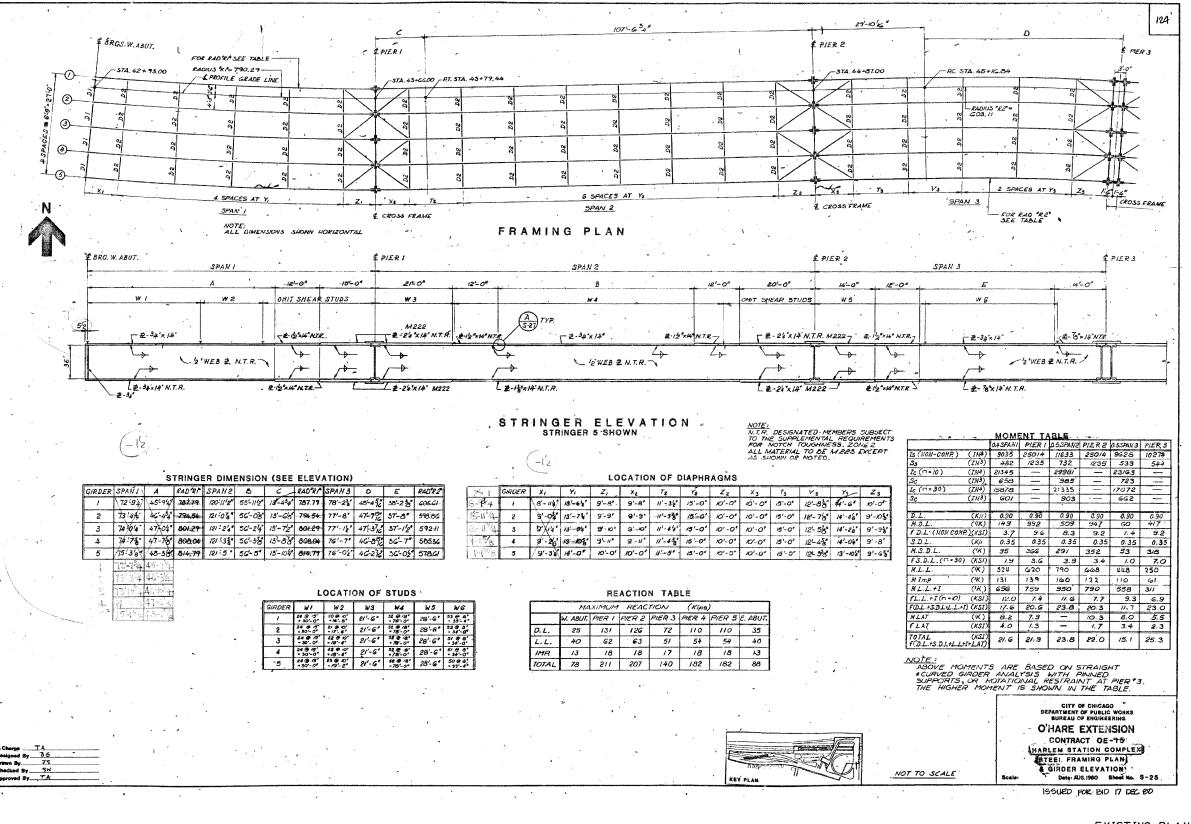
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14 SHEETS	SHEET NO. 11	RT 35
	14 SHEETS	EEL

FT NO. 11	F.A.U. RTE.	SECTION			COUNTY	TOTAL SHEETS	SHEET NO.
1 140. 11	3531	1515.1-I			соок	3.5	2:2
SHEETS					CONTRACT	NO. 60)J58
	FED. RO	AD DIST. NO.	ILLINOIS	FED. A	ID PROJECT		




EXISTING PLAN INFORMATION 2 OF 4 STRUCTURE NO. 016-2519

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EET NO. 12	F.A.U. RTE.	SECTION	COUNTY	TOTAL SHEETS	SHEET NO.
	3531	1515.1-I	COOK	3.5	2:3
4 SHEETS			CONTRACT	NO. 60)J58
	FED. RO	AD DIST. NO. ILLINOIS FED.	AID PROJECT		



EXISTING PLAN INFORMATION 3 OF 4 STRUCTURE NO. 016-2519

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EET NO. 13	F.A.U. RTE.		SECTION			COUNTY	TOTAL SHEETS	SHEET NO.
	3531	1515 . 1-I			COOK	3:5	2.4	
4 SHEETS					CONTRACT	NO. 60)J58	
	FED. RC	DAD DIST.	NO.	ILLINOIS	FED.	AID PROJECT		

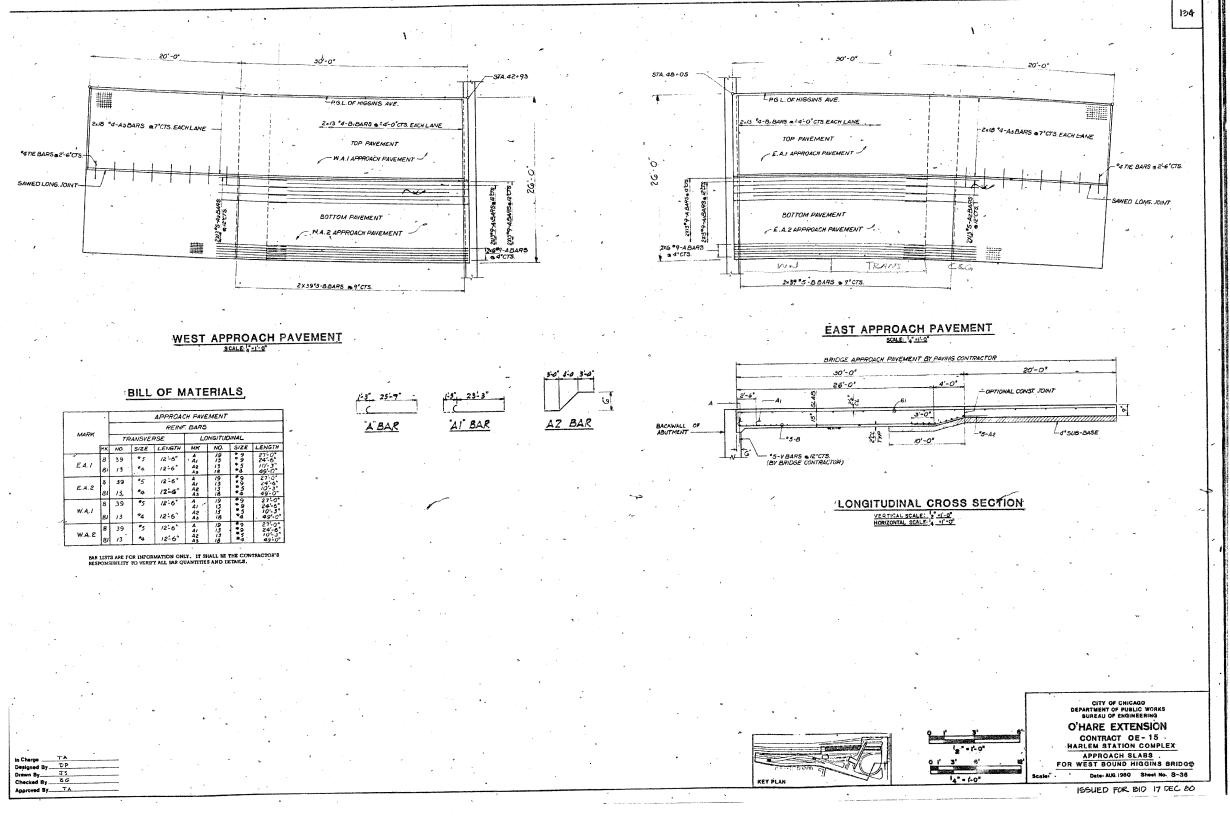
EXISTING PLAN INFORMATION 4 OF 4 STRUCTURE NO. 016-2519

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312-685-0480 Job No. 10032.13

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HEET NO.14	F.A.U. RTE.	SECT	TION	COUNTY	TOTAL SHEETS	SHEET NO.
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4 SHEETS				CONTRACT	NO. 60	J58
	FED. RC	DAD DIST. NO.	ID PROJECT			




CURB OR CURB AND GUTTER REMOVAL AND REPLACEMENT

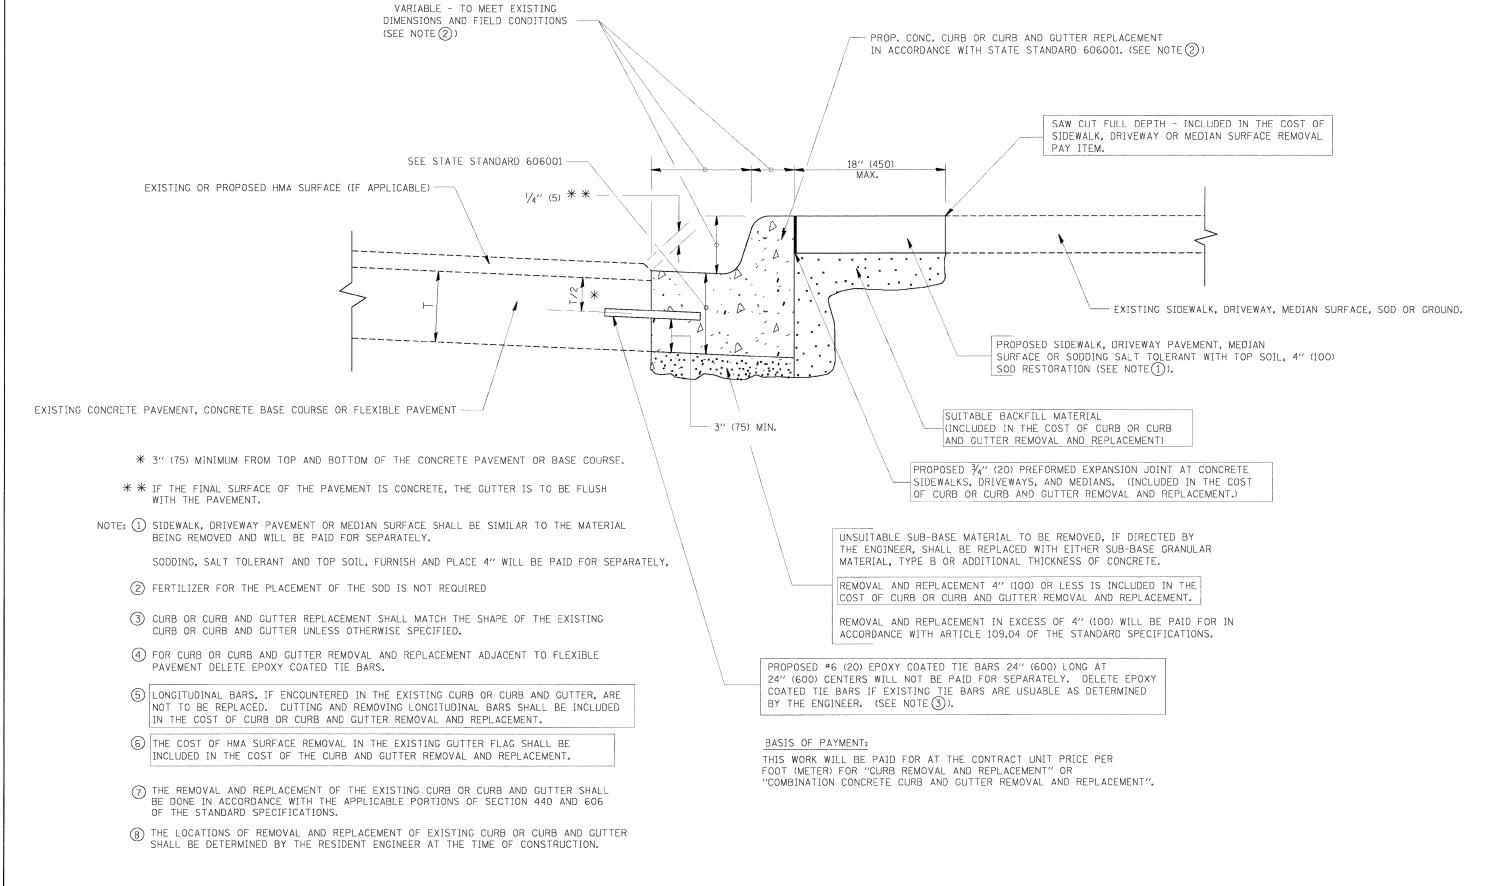ALL DIMENSIONS ARE IN INCHES (MILLIMETERS)
UNLESS OTHERWISE SHOWN.

BD-24


FILE NAME =	DESIGNED - AJP	KEAIZED -			DISTRICT 1 DETAILS	RTE.	SECTION	COUNTY	SHEETS NO.
	DRAWN - AJP	REVISED -	haaasah	STATE OF ILLINOIS	CURB OR CURB AND GUTTER REMOVAL AND REPLACEMENT	3531	1515.1-I	соок	35 26
USER NAME =	CHECKED - KJN	REVISED -	– benesch i	DEPARTMENT OF TRANSPORTATION	CORB OR CORB AND GUITER REMOVAL AND REPLACEMENT			CONTRACT	NO. 60J58
PLOT DATE = 03\22\2010	DATE - 3/8/10	REVISED -			SCALE: N.T.S. SHEET NO. 1 OF 10 SHEETS STA. TO STA.	FED. ROAD	DIST. NO. ILLINOIS F	ED. AID PROJECT	110. 00030
						· · · · · · · · · · · · · · · · · · ·			

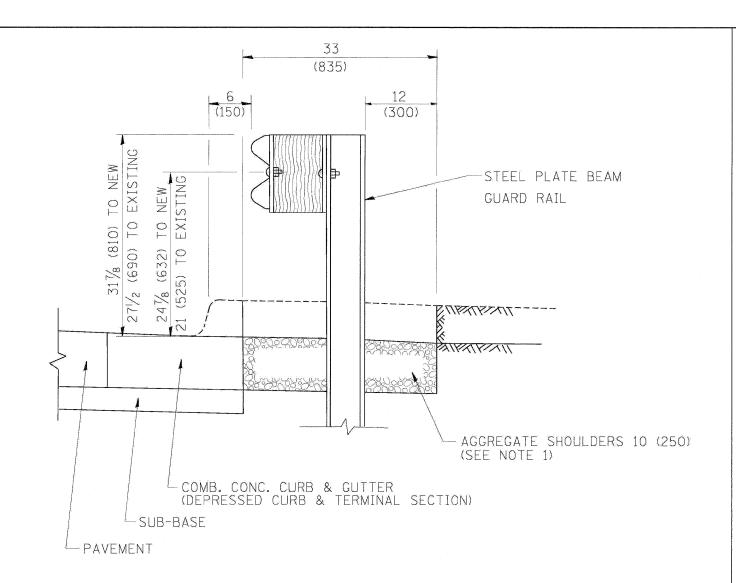

SECTION A-A

- NOTES: 1. THE AGGREGATE SHOULDER, 10" OR HMA SHOULDER, 6" (IF REQUIRED) SHALL EXTEND UNDER THE TRAFFIC BARRIER TERMINAL.
 - "EXISTING" GUARDRAIL REFERS TO CONNECTING TERMINAL SECTION TO GUARD RAILING PRIOR TO THE MIDWEST GUARDRAIL SYSTEM.
 - 3. THE CONTRACTOR SHALL VERIFY THE TYPE/HEIGHT OF GUARDRAIL IN-PLACE BEFORE ORDERING THE NEW TERMINAL SECTION.
 COST INCLUDED WITH THE COST OF THE TERMINAL. THE TERMINAL SECTION HEIGHT TO BE PLACED MUST MATCH THE HEIGHT OF THE IN-PLACE GUARDRAIL.

DETAILS FOR STEEL PLATE BEAM GUARD RAIL ADJACENT TO CURB AND GUTTER [FOR ROADWAY SPEED 35 MPH (60 kmh) TO 45 MPH (70 kmh)]

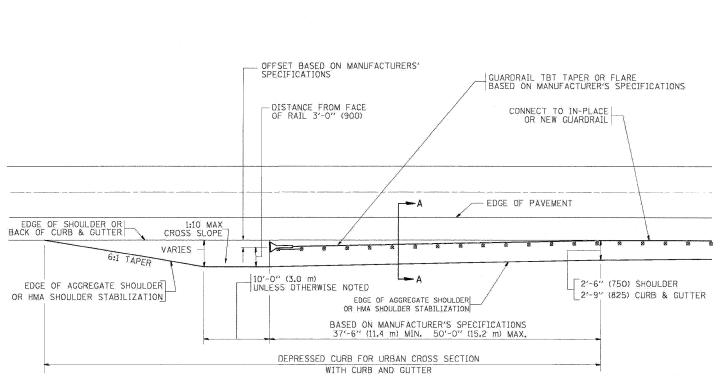

DEPRESSED CURB AND GUTTER AND SHOULDER TREATMENT AT TBT TY. 1 SPL.

BASIS OF PAYMENT: HMA SHOULDERS 6 (150) (IF REQUIRED) WILL BE PAID FOR AT THE CONTRACT UNIT PRICE PER SQUARE YARD (SQUARE METER) FOR "HOT-MIX ASPHALT SHOULDERS 6" (150 mm)".

> STEEL PLATE BEAM GUARD RAIL AND TRAFFIC BARRIER TERMINAL, OF THE TYPE SPECIFIED WILL BE PAID FOR SEPARATELY.

> > TBT = TRAFFIC BARRIER TERMINAL


ALL DIMENSIONS ARE IN INCHES (MILLIMETERS) UNLESS OTHERWISE SHOWN. BD-34

DESIGNED - AJP FILE NAME = REVISED DRAWN REVISED benesch JSER NAME = CHECKED - KJN REVISED DATE 3/8/10 REVISED

STATE OF ILLINOIS **DEPARTMENT OF TRANSPORTATION**


DISTRICT 1 DETAILS **DETAILS FOR DEPRESSED CURB & GUTTER** AND SHOULDER TREATMENT AT TBT TY 1 SPL

COUNTY TOTAL SHEET NO. SECTION 3531 1515.1-1 COOK CONTRACT NO. 60J58

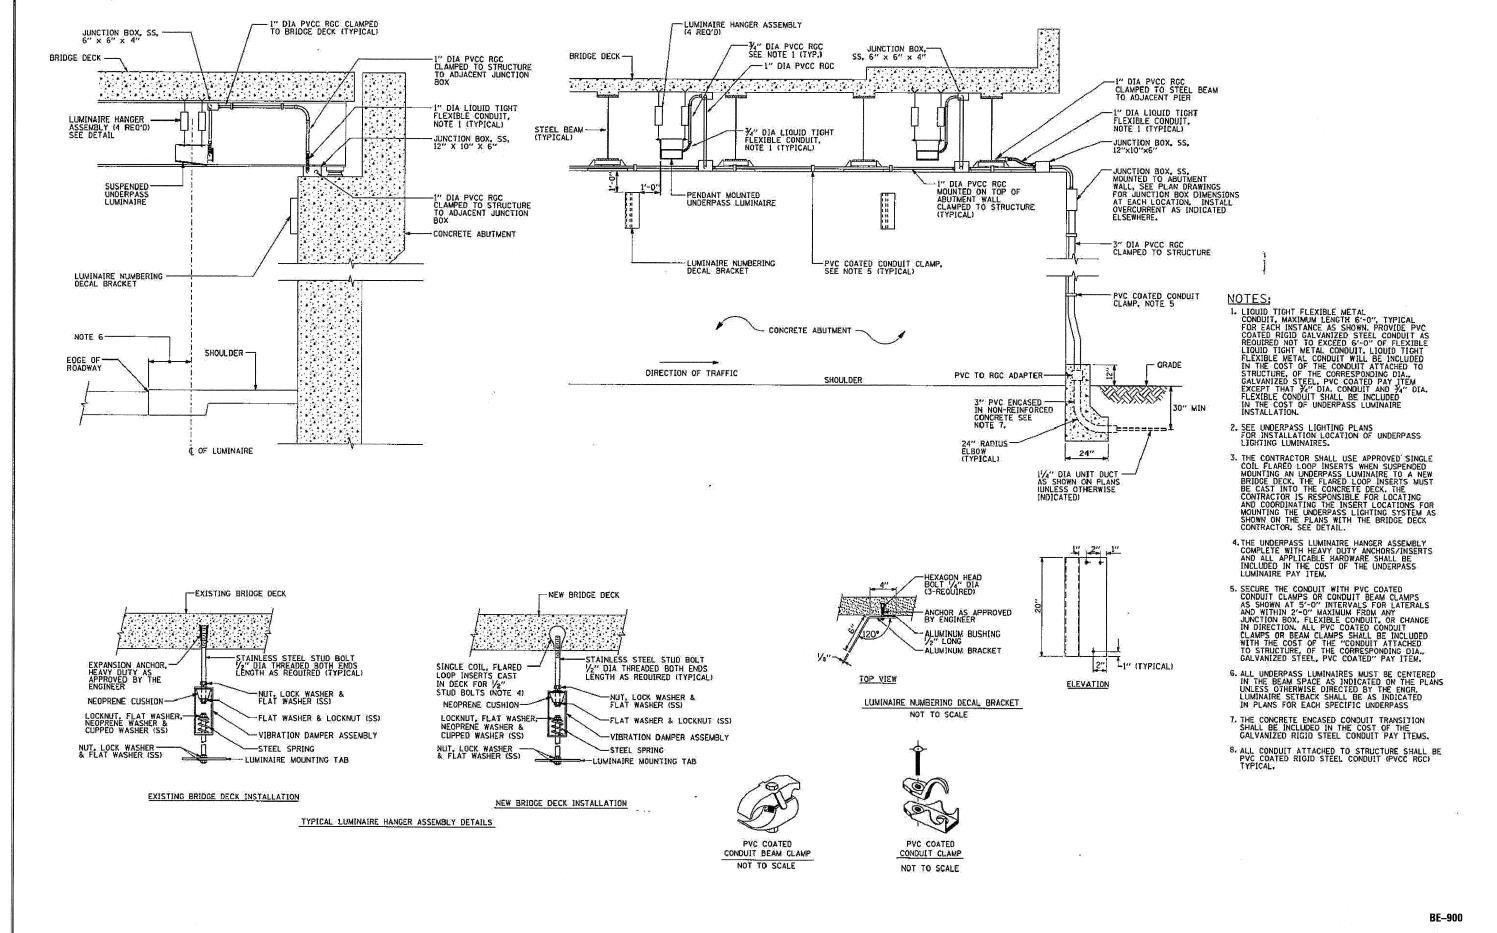

COUNTY TOTAL SHEE

ILE NAME : DESIGNED -AJP REVISED DISTRICT 1 DETAILS SECTION AJP STATE OF ILLINOIS SUSPENDED MOUNT UNDERPASS DRAWN REVISED benesch 3531 1515.1-1 COOK 35 USER NAME CHECKED KJN REVISED DEPARTMENT OF TRANSPORTATION **LUMINAIRE INSTALLATION DETAILS** CONTRACT NO. 60J58 PLOT DATE = 03\22\2010 3/8/10 REVISED SCALE: N.T.S. SHEET NO. 3 OF 10 SHEETS STA. TO STA. FED. ROAD DIST. NO.

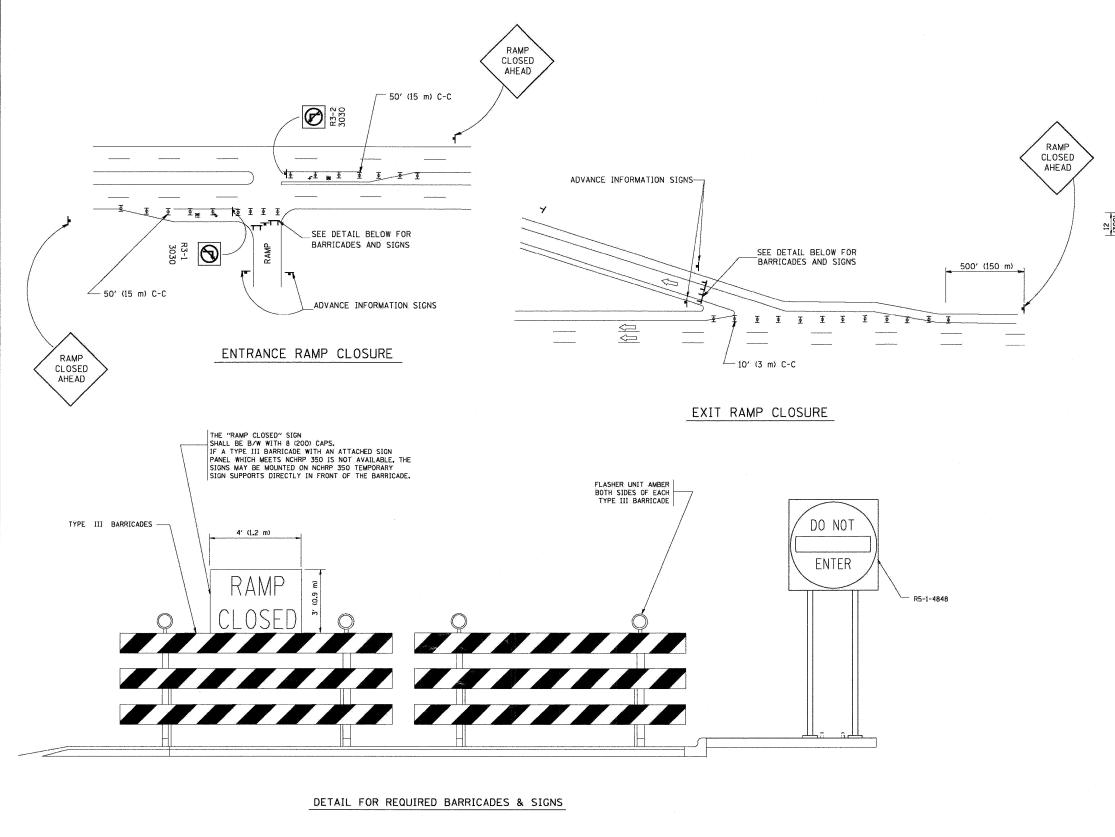

SYMBOLS

- TYPE II BARRICADE, DRUM OR VERTICAL BARRICADE WITH STEADY BURN MONO-DIRECTIONAL LIGHT
- TYPE III BARRICADE WITH FLASHING LIGHT

RAMP CLOSURE ADVANCE WARNING SIGN




BLACK LEGEND ON ORANGE REFLECTORIZED BACKGROUND

1 (25) BORDER

THESE SIGNS ARE REQUIRED ON ALL THE EXIT GUIDE SIGNS FOR THE CLOSED EXIT RAMPS.

RAMP CLOSURE ADVANCE INFORMATION SIGN

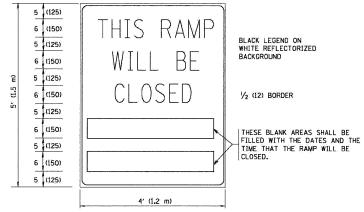


THESE SIGNS ARE REQUIRED ON BOTH SIDES OF THE RAMP, MINIMUM OF 1 WEEK IN ADVANCE OF THE CLOSURE.

GENERAL NOTES:

- 1. CONES MAY BE SUBSTITUTED FOR DRUMS OR TYPE II BARRICADES DURING DAY OPERATIONS, CONES SHALL BE A MINIMUM OF 28 (700) HIGH,
- 2. STEADY BURN LIGHTS WILL NOT BE REQUIRED FOR DAY OPERATIONS.
- A FLAGGER SHALL BE POSITIONED AT EACH CLOSED RAMP THAT IS OPEN TO CONSTRUCTION VEHICLES.
- 4. ALL ROUTE MARKERS AND TRAILBLAZER ASSEMBLIES WHICH DIRECT MOTORISTS TO A CLOSED ENTRANCE RAMP SHALL BE COVERED.
- 5. THE SIGNING AND BARRICADING WHICH IS REQUIRED BY THIS DETAIL SHALL BE INCLUDED IN THE COST OF TRAFFIC CONTROL AND PROTECTION (EXPRESSWAYS).
- 6. AUTHORIZATION FROM THE DISTRICT'(S BUREAU OF TRAFFIC IS REQUIRED FOR ALL RAMP CLOSURES.
- 7. THE RAMP CLOSURE ADVANCE INFORMATION SIGNS SHALL BE ERECTED IF THE CLOSURE TIME EXCEEDS TWENTY- FOUR 24 HOURS, ADDITIONAL ADVANCE WARNING SIGNS ON EXIT GUIDE SIGNING WILL BE REQUIRED FOR EXIT RAMP CLOSURES THAT EXCEED TWENTY FOUR 24 HOURS IN LENGTH.


ALL DIMENSIONS ARE IN INCHES (MILLIMETERS) UNLESS OTHERWISE SHOWN.


FILE NAME =	DRAWN - AJP	REVISED -	benesch	STATE OF ILLINOIS	DISTRICT 1 DETAILS FREEWAY ENTRANCE AND EXIT RAMP CLOSURE DETAILS	T.A.U. SECTION 3531 1515.1-1	COUNTY	SHEETS 35	NO. 29
USER NAME =	CHECKED - KJN	REVISED -	Oellescii	DEPARTMENT OF TRANSPORTATION	COULD N.T.C. CUSET NO. 4 OF 10 CUSETC CT. TO CT.		CONTRAC	JT NO. 6	30J58
PLUI DATE = 03\22\2010	DATE - 3/8/10	REVISED -			SCALE: N.I.S. SHEET NO. 4 OF TO SHEETS STA. TO STA.	FED. ROAD DIST. NO. ILLINOIS FE	D. AID PROJECT		

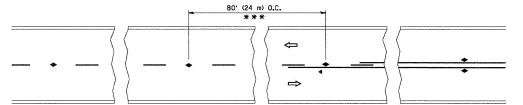


*** REDUCE TO 40' (12 m) O.C. ON CURVES WITH POSTED OR ADVISORY SPEED 45 M.P.H. (70 km/h) OR LESS.


TWO-LANE/TWO-WAY

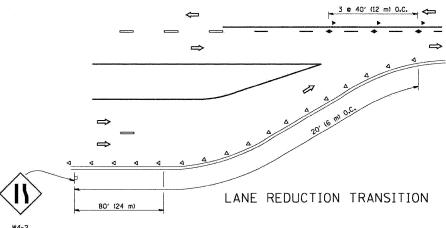

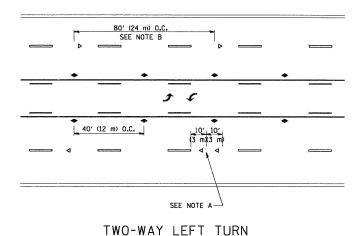

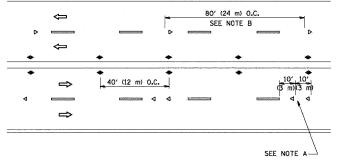



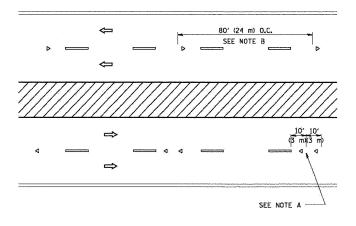

MULTI-LANE/DIVIDED

GENERAL NOTES

- MARKERS USED WITH DASHED LINES SHALL BE CENTERED IN THE GAP BETWEEN SEGMENTS.
- 2. MARKERS USED ADJACENT TO SOLID LINES SHALL BE OFFSET 2 TO 3 (50 TO 75) TOWARD TRAFFIC AS SHOWN.
- MARKERS THROUGH TANGENTS LESS THAN 500' (150 m) IN LENGTH BETWEEN CURVES SHALL BE INSTALLED AT THE LESSER OF THE TWO CURVE SPACINGS.

LANE MARKER NOTES

B. REDUCE TO 40' (12 m) O.C. ON CURVES WHERE ADVISORY SPEEDS ARE 10 M.P.H (20 km/h) LOWER THAN POSTED SPEEDS.


A. USE DOUBLE LANE LINE MARKERS SPACED AS SHOWN.

SYMBOLS

YELLOW STRIPE

WHITE STRIPE

- ONE-WAY AMBER MARKER
- ONE-WAY CRYSTAL MARKER (W/O)
- ◆ TWO-WAY AMBER MARKER

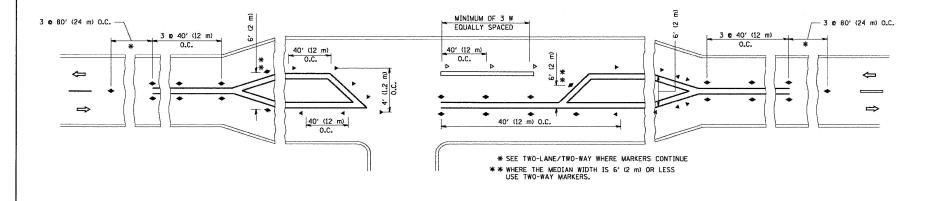

LEFT TURN

All dimensions are in inches (millimeters) unless otherwise shown.


TC-11


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	DRAWN - AJP	REVISED -	haaasah
USER NAME =	CHECKED - KJN	REVISED -	benesch
PLOT DATE = 03\22\2010	DATE - 3/8/10	REVISED -	

STATE OF ILLINOIS **DEPARTMENT OF TRANSPORTATION**


DISTRICT 1 DETAILS
TYPICAL APPLICATIONS RAISED REFLECTIVE PAVEMENT MARKERS
(SNOW-PLOW RESISTANT) SCALE: N.T.S. SHEET NO. 5 OF 10 SHEETS STA. TO STA.

F.A.U. RTE.			SEC.	TION			COUNTY	TOTAL	SHEET NO.
3531		1515.1-I			соок	35	30		
CONTRACT NO. 60J58								30J58	
FED. R	CAO	DIST.	NO.	ILLINOIS	FED.	AID	PROJECT		

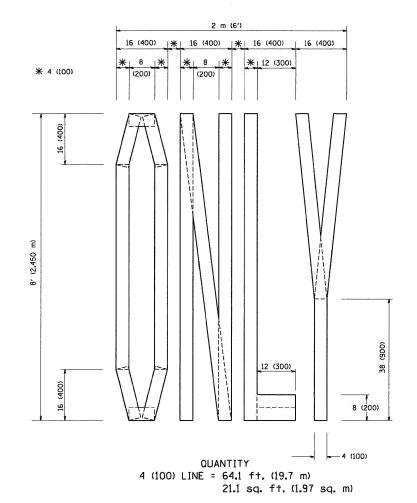

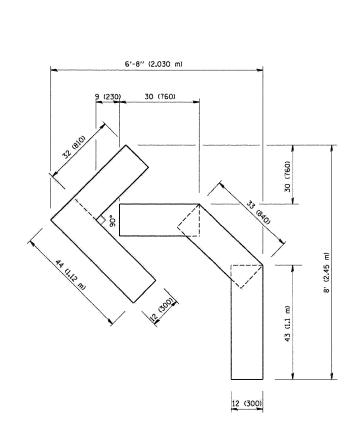

QUANTITY 4 (100) LINE = 45.5 ft. (13.9 m) 15.2 sq. ft. (1.39 sq. m)

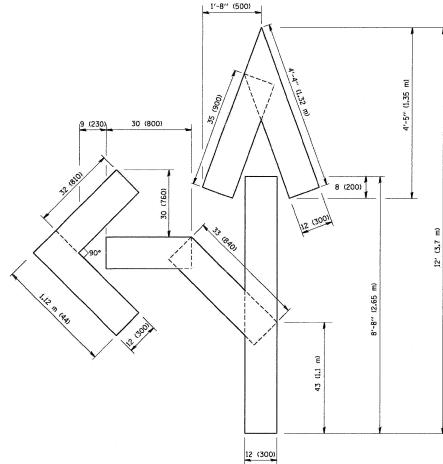

QUANTITY 4 (100) LINE = 82.5 ft. (25.3 m) 27.5 sq. ft. (2.53 sq. m)

All dimensions are in inches (millimeters) unless otherwise shown. TC-16

COUNTY


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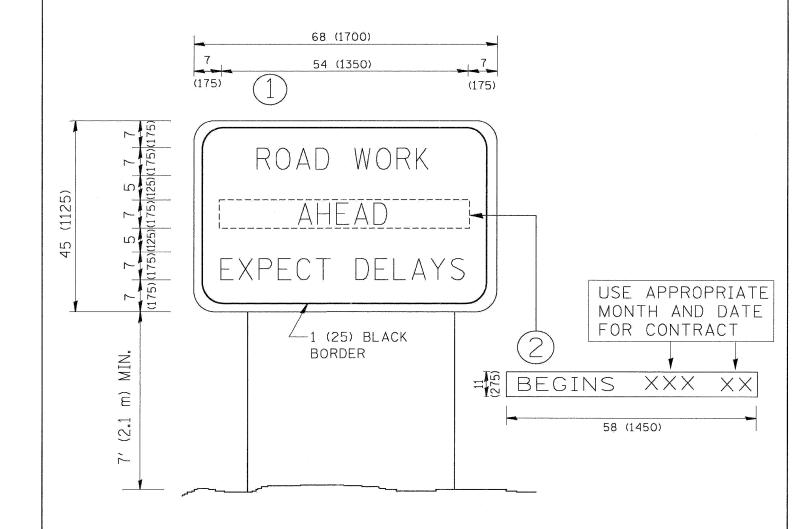
benesch

STATE OF ILLINOIS DEPARTMENT OF TRANSPORTATION

DISTRICT 1 DETAILS PAVEMENT MARKING LETTERS AND SYMBOLS FOR TRAFFIC STAGING SCALE: N.T.S. SHEET NO. 6 OF 10 SHEETS STA. TO STA.

COUNTY TOTAL SHEETS NO. COOK 35 31 SECTION 3531 1515.1-I CONTRACT NO. 60J58 FED. ROAD DIST. NO. | ILLINOIS FED. AID PROJECT



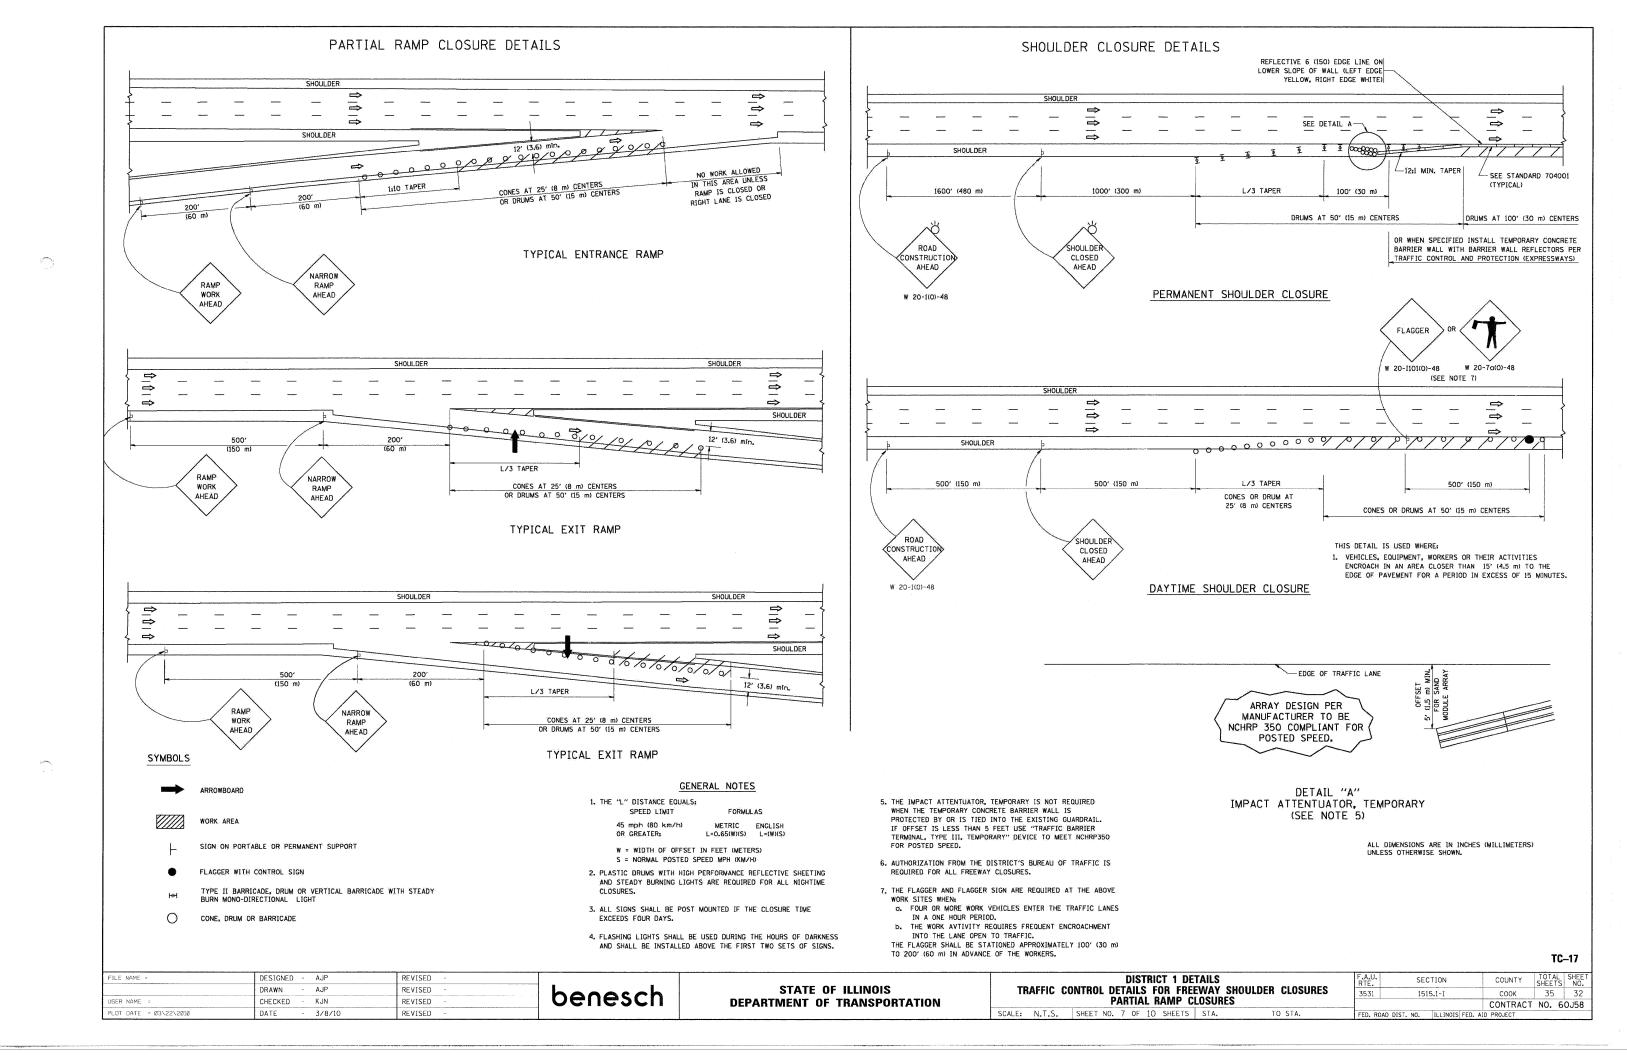

NOTES:

- 1. USE BLACK LETTERING ON ORANGE BACKGROUND.
- 2. ERECT SIGNS IN ADVANCE OF THE LOCATION FOR THE "ROAD CONSTRUCTION AHEAD" SIGN AT LOCATIONS AS DIRECTED BY THE ENGINEER.
- 3. ERECT SIGN () WITH INSTALLED PANEL (2) ONE WEEK PRIOR TO THE START OF CONSTRUCTION.
- 4. REMOVE PANEL 2 SOON AFTER THE START OF CONSTRUCTION.
- 5. SEE SPECIAL PROVISION FOR "TEMPORARY INFORMATION SIGNING" FOR ADDITIONAL INFORMATION.
- 6. ONE SIGN ASSEMBLY EQUALS 25.70 SQ. FT. (2.3 SQ. M.)
- 7. SHALL BE PAID FOR AS TEMPORARY INFORMATION SIGNING.


ALL DIMENSIONS ARE IN INCHES (MILLIMETERS) UNLESS OTHERWISE SHOWN.


TC-22


FILE NAME =	DESIGNED - AJP	REVISED -	
	DRAWN - AJP	REVISED ~	bassah
USER NAME =	CHECKED - KJN	REVISED -	benesch
PLOT DATE = 03\22\2010	DATE - 3/8/10	REVISED -	

STATE OF ILLINOIS
DEPARTMENT OF TRANSPORTATION


DISTRICT 1 DETAILS								
ARTERIAL ROAD INFORMATION SIG						SIGN		
SCALE:	N.T.S.	SHEET NO.	8 (OF 10	SHEETS	STA.		TO STA.

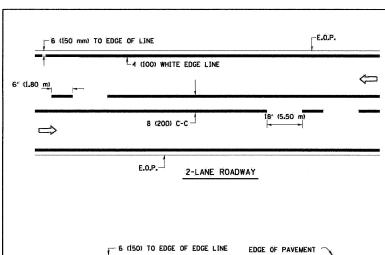

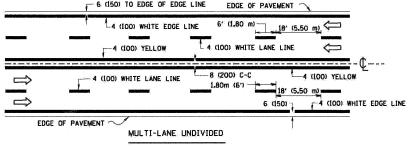


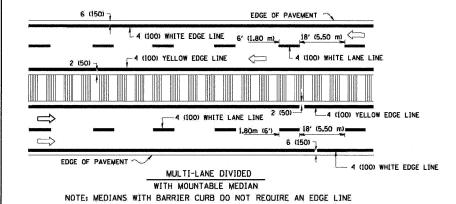

TYPICAL LANE AND EDGE LINE MARKING

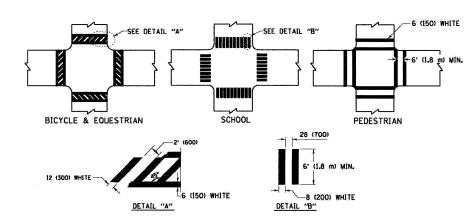


TYPICAL CROSSWALK MARKING

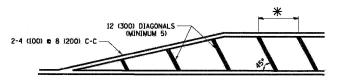


- *FOR MEDIAN LENGTHS WHERE DIAGONAL SPACING CANNOT BE ATTAINED, USE 5 (FIVE) EQUALLY SPACED DIAGONAL LINES.
- * DIAGONAL LINE SPACING: 20' (6.1 m) C-C

PAINTED MEDIANS

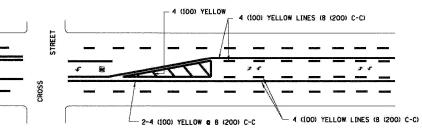


A MINIMUM OF TWO PAIRS OF TURN ARROWS SHALL BE USED, WHITE IN COLOR. ADDITIONAL PAIRS SHALL BE PLACED AT 200' (60 m) TO 300' (90 m) INTERVALS

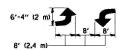

MEDIAN WITH TWO-WAY LEFT TURN LANE

TYPICAL PAINTED MEDIAN MARKING

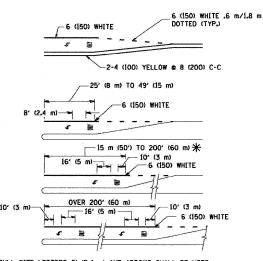


FULL SIZE LETTERS 8' (2.4 m) AND ARROWS SHALL BE USED.

↑ AREA = 15.8 SO. FT. (1.47 m²) OHLY AREA = 22.9 SO. FT. (2.13 m²)

* TURN LANES IN EXCESS OF 400' (120 m) IN LENGTH MAY HAVE AN ADDITIONAL SET OF ARROW - "ONLY" INSTALLED MIDWAY BETWEEN THE OTHER TWO SETS OF ARROW - "ONLY".

TYPICAL LEFT (OR RIGHT) TURN LANE

TYPICAL TURN LANE MARKING

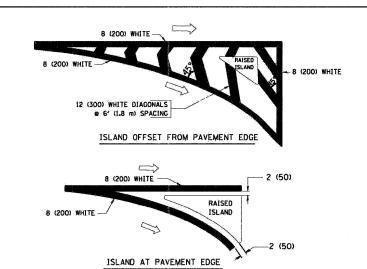

TYPICAL ISLAND MARKING

TYPE OF MARKING	WIDTH OF LINE	PATTERN	COLOR	SPACING / REMARKS
CENTERLINE ON 2 LANE PAVEMENT	4 (100)	SKIP-DASH	YELLOW	6' (1.80 m) LINE WITH 18' (5.50 m) SPACE
CENTERLINE ON MULTI-LANE UNDIVIDED PAVEMENT	2 6 4 (100)	SOLID	YELLOW	8 (200) C-C
NO PASSING ZONE LINES: FOR ONE DIRECTION FOR BOTH DIRECTIONS	4 (100) 2 e 4 (100)	SOLID SOLID	AETTOM AETTOM	8 (200) C-C
LANE LINES	4 (100) 5 (125) ON FREEWAYS	SKIP-DASH SKIP-DASH	WHITE WHITE	6' (1.80 m) LINE WITH 18' (5.50 m) SPACE
DOTTED LINES (EXTENSIONS OF CENTER, LANE OR TURN LANE MARKINGS)	SAME AS LINE BEING EXTENDED	SKIP-DASH	SAME AS LINE BEING EXTENDED	2' (600) LINE WITH 6' (1.8) SPACE
EDGE LINES	4 (100)	SOLID	YELLOW-LEFT WHITE-RIGHT	OUTLINE MOUNTABLE MEDIANS IN YELLOW: EDGE LINES ARE NOT USED NEXT TO BARRIER CURB
TURN LANE MARKINGS	6 (150) LINE: FULL SIZE LETTERS & SYMBOLS (8' (2.4 m))	SOLID	WHITE	SEE TYPICAL TURN LANE MARKING DETAIL
TWO WAY LEFT TURN MARKING	2 c 4 (100) EACH DIRECTION	SKIP-DASH AND SOLID	YELLOW	6' (1.8 m) LINE WITH 18' (5.50 m) SPACE FOR SKIP-DASH: 8 (200) C-C BETWEEN SOLID LINE AND SKIP-DASH LINE
	8' (2.4 m) LEFT ARROW	IN PAIRS	WHITE	SEE TYPICAL TWO-WAY LEFT TURN MARKING DETAIL
CROSSWALK LINES (PEDESTRIAN) A. DIAGONALS (BIKE & EQUESTRIAN) B. LONGITUDINAL BARS (SCHOOL)	2 m 6 (150) 12 (300) m 45° 8 (200) m 90°	SOLID SOLID SOLID	WHITE WHITE WHITE	NOT LESS THAN 6' (1.8 m) APART 2' (600) APART 2'-4" (700) APART SEE TYPICAL CROSSWALK MARKING DETAILS.
STOP LINES	24 (600)	SOLID	WHITE	PLACE 4' (1.2 m) IN ADVANCE OF AND PARALLEL TO CROSSWALK, IF PRESENT. OTHERWISE, PLACE AT DESIRED STOPPING POINT. PARALLEL TO CROSSROAD CENTERLINE, WHERE POSSIBLE
PAINTED MEDIANS	2 a 4 (100) WITH 12 (300) DIAGONALS a 45°	SÖLID	YELLOW: TWO WAY TRAFFIC WHITE: ONE WAY TRAFFIC	8 (200) C-C FOR THE DOUBLE LINE SEE TYPICAL PAINTED MEDIAN MARKING.
GORE MARKING AND CHANNELIZING LINES	8 (200) WITH 12 (300) DIAGONALS # 45°	SOL1D	WHITE	DIAGONALS: 20' (6.1 m) (LESS THAN 30 MPH (50 km/h))
RAILROAD CROSSING	24 (600) TRANSVERSE LINES; "RR" IS 6' (1,8 m) LETTERS; 16 (400) LINE FOR "X"	SOLID	WHITE	SEE STATE STANDARD 780001 AREA OF: "R"=3.6 SO, FT. (0.33m ²) EACH "X"=54.0 SO, FT. (5.0 m ²)

FOR FURTHER DETAILS ON PAVEMENT MARKING REFER TO STREET MARKING STANDARDS, PRINTED BY CITY OF CHICAGO, DEPARTMENT OF TRANSPORTATION, BUREAU OF TRAFFIC.

ALL DIMENSIONS ARE IN INCHES (MILLIMETERS) UNLESS OTHERWISE SHOWN.


TC-24


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USER NAME =	CHECKED - KJN	REVISED -	
PLOT DATE = 03\22\2010	DATE - 3/8/10	REVISED -	

benesch

STATE OF ILLINOIS
DEPARTMENT OF TRANSPORTATION


 DISTRICT 1 DE	F.A.U. RTE.	SECTION	COUNTY	TOTAL	SHEET NO.	
CITY OF CHICAGO TYPICAL PA	AVEMENT MARKINGS	3531	1515 . 1-I	соок	35	34
OILL OI CHICAGO TITICAL IA				CONTRACT	NO. 6	0J58
SCALE: N.T.S. SHEET NO. 9 OF 10 SHEETS	STA. TO STA.	FED. ROAD DIST. NO. ILLINOIS FED. AID PROJECT				

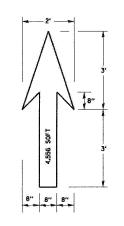

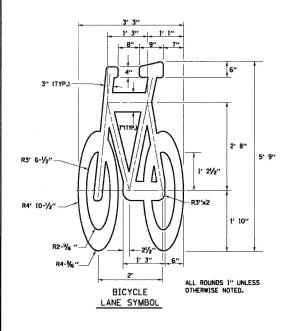

- NOTE:
 1.) FOR BIKE LANE SYMBOLS ONLY,
 USE PRE-FORMED THERMOPLASTIC
 WITH A MINIMUM THICKNESS OF 90 MILS,
 MINIMUM SKID RESISTANCE VALUE OF 60 BPN,
 & A MINIMUM INDEX OF REFRACTION OF 1.50.
- 2.) THE RESIDENT ENGINEER SHALL CONTACT MR. BEN GOMBERG AT 312-744-8093 AT LEAST ONE CALENDAR WEEK PRIOR TO INSTALLING BIKE LANE SYMBOLS.

TYPICAL BIKE LANE SYMBOLS
DRAWING *28

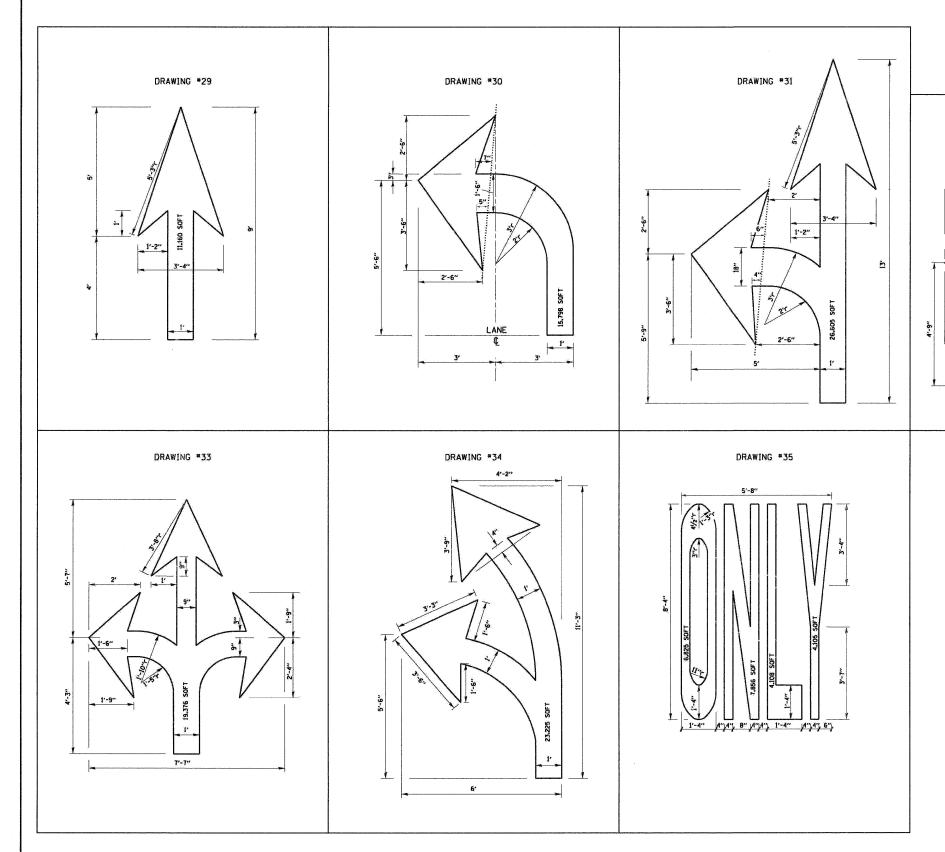

TC-24

DRAWING #32

NOTE:

PLANS

ALL MARKINGS SHALL BE SOLID WHITE UNLESS OTHERWISE NOTED IN THE

USER NAME = DRAWN - AJP REVISED - DISTRICT PARTIES STATE OF ILLINOIS DEPARTMENT OF TRANSPORTATION STATE OF ILLINOIS DEPARTMENT OF TRANSPORTATION CITY OF CHICAGO TYPICAL PAVEMENT MARKINGS		1 1515 1		304	C 3C
		1515.1-	CONT	TRACT NO.	5 35 60J58
PLOT DATE = 03\22\2010 DATE - 3/8/10 REVISED - SCALE: N.T.S. SHEET NO. 10 OF 10 SHEETS STA. TO STA.	FED. ROAL	ROAD DIST. NO. ILL	LINOIS FED. AID PROJEC	ECT	