
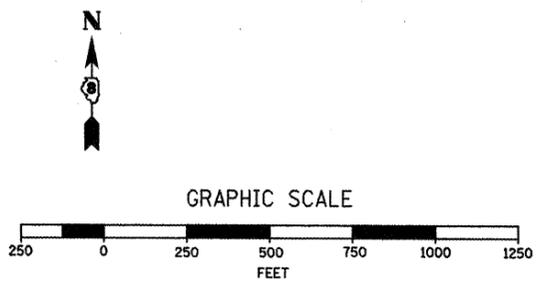


F.A.U. RTE.	SECTION	COUNTY	TOTAL SHEETS	SHEET NO.
8979	05-00017-00-PV	MADISON	37	13
STA. N.A.	TO STA. N.A.			
FED. ROAD DIST. NO.	ILLINOIS	FEDERAL AID PROJECT		

CONSTRUCTION NOTES

- ROOSEVELT STREET SHALL BE CLOSED FROM STA. 10+16.12 TO STA. 24+43.00 DURING THIS STAGE.
- ACCESS TO ALL PROPERTIES SHALL BE MAINTAINED AT ALL TIMES. IF A RESIDENT'S DRIVEWAY IS NOT ACCESSIBLE DURING CONSTRUCTION, THE CONTRACTOR SHALL PROVIDE AN ACCEPTABLE PARKING SPACE AS DETERMINED BY THE ENGINEER ALONG A SIDE STREET/ALLEY. THE CONTRACTOR SHALL ALSO PROVIDE AN ACCESSIBLE ROUTE AS DETERMINED BY THE ENGINEER FROM THE ON-STREET PARKING AREA TO THE RESIDENT'S HOUSE.
- COORDINATE UTILITY ADJUSTMENTS AND RELOCATIONS WITH APPROPRIATE UTILITY PRIOR TO CONSTRUCTION.
- INSTALL TEMPORARY EROSION CONTROL.
- CONSTRUCT STORM SEWER SYSTEM.
- COMPLETE REMOVAL AND ADJUSTMENT ITEMS.
- CONSTRUCT ROADWAY EMBANKMENT AND PREPARE SUBGRADE.
- CONSTRUCT MODIFIED SDIL AND CCC&G.
- CONSTRUCT CONCRETE PAVEMENT.
- CONSTRUCT PCC DRIVEWAY PAVEMENTS AND PCC SIDEWALK.
- COMPLETE FINAL GRADING.
- INSTALL APPROPRIATE PERMANENT SIGNING, PERMANENT PAVEMENT MARKING AND COMPLETE PERMANENT SEEDING.
- BARRICADES AND CONSTRUCTION SIGNS SHALL BE POSITIONED AS SHOWN IN IDOT STANDARD 701901 AND AS DIRECTED BY THE ENGINEER.
- TYPE A LOW INTENSITY LIGHTS SHALL BE USED ON EACH BARRICADE, DRUM AND SIGN IN ADVANCE AND WITHIN THE WORK AREA SHOWN DURING HOURS OF DARKNESS. DRUMS SHALL HAVE STEADY BURN LIGHTS FOR HAZARDS OR OBSTACLES GREATER THAN 100' IN LENGTH.
- ALL WARNING SIGNS SHALL HAVE MINIMUM DIMENSIONS OF 48" BY 48" AND HAVE A BLACK LEGEND ON AN ORANGE REFLECTORIZED BACKGROUND.
- ALL WORK ZONE SIGNS ARE REQUIRED TO MEET, AS A MINIMUM, TYPE B REFLECTIVITY REQUIREMENTS OF TABLE 1091-2 IN ARTICLE 1091.02 OF THE STANDARD SPECIFICATIONS.
- LONGITUDINAL DIMENSIONS MAY BE ADJUSTED TO FIT FIELD CONDITIONS.
- WHEN FLUORESCENT SIGNS ARE USED, ORANGE FLAGS ARE NOT REQUIRED.
- ALL SIGNS SHALL BE POST MOUNTED IF CLOSURE TIME EXCEEDS FOUR DAYS.
- ALL IMPROVEMENTS TO ROOSEVELT STREET DURING THIS STAGE SHALL BE COMPLETED UTILIZING TRAFFIC CONTROL AND PROTECTION STANDARDS 701901, BLR-21 AND BLR-22.
- ACTUAL NUMBER OF BARRICADES REQUIRED MAY DIFFER FROM THE NUMBER SHOWN.

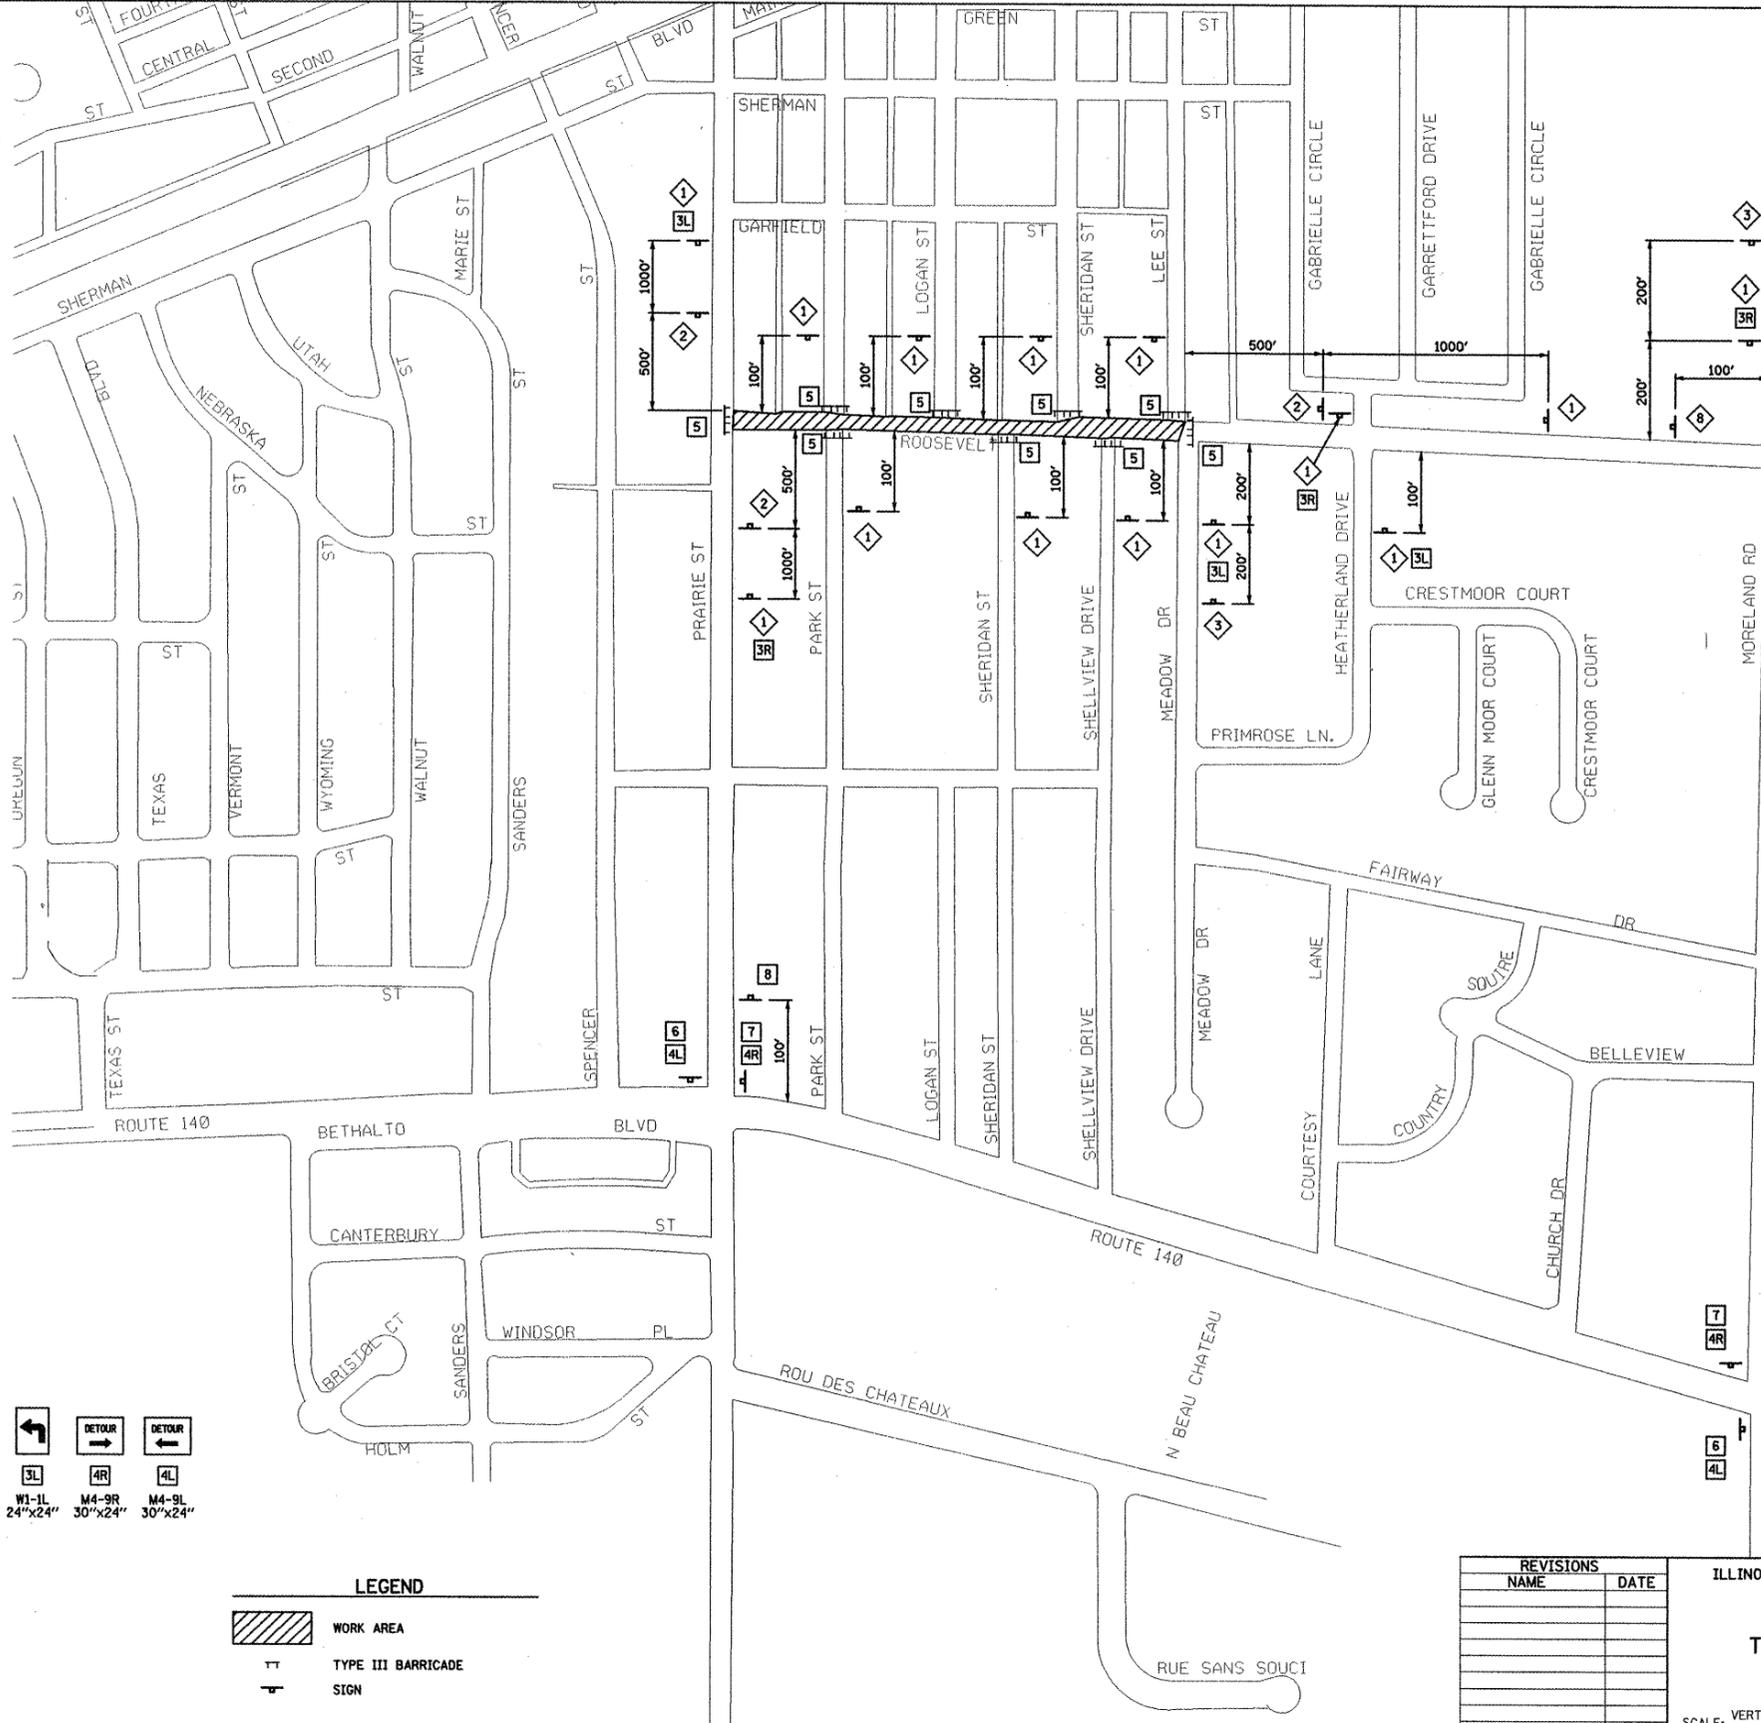

LEGEND

W20-31(0) 48"x48" WITH TYPE A LOW INTENSITY FLASHING LIGHT	W20-31(0) 48"x48" WITH TYPE A LOW INTENSITY FLASHING LIGHT	W20-1A 48"x48" WITH TYPE A LOW INTENSITY FLASHING LIGHT	W1-1R 24"x24"	W1-1L 24"x24"	M4-9R 30"x24"	M4-9L 30"x24"
TYPE III BARRICADES WITH TYPE A LOW INTENSITY FLASHING LIGHT, R-11-2-4830 SIGNS	30"x15"	30"x15"	M4-8a 24"x18"			

REVISIONS	
NAME	DATE

ILLINOIS DEPARTMENT OF TRANSPORTATION

**TRAFFIC CONTROL PLAN
STAGE 2**

SCALE: VERT. N.A.
HORIZ. 1"=250'
DATE 1/27/2011

DRAWN BY RJM, AJK
CHECKED BY JWB

PLOT DATE = 1/27/2011
 FILE NAME = I:\bcholson\05468033\dr-ma\shasta\phase 1\013.DETOUR.MXD.dgn
 PLOT SCALE = 243765' / 1" IN.
 USER NAME = Burtj Millenburne