EROSION CONTROL NOTES

- 1. THE CONTRACTOR WILL BE REQUIRED TO IMPLEMENT AND MAINTAIN EROSION CONTROL MEASURES IMMEDIATELY AFTER STRIPPING OF EXISTING VEGETATION.
- 2. STOCKPILES OF SOIL AND OTHER BUILDING MATERIALS TO REMAIN IN PLACE MORE THAN THREE (3) DAYS SHALL BE FURNISHED WITH EROSION AND SEDIMENT CONTROL MEASURES (I.E. PERIMETER SILT FENCE). STOCKPILES TO REMAIN IN PLACE FOR 14 DAYS OR MORE SHALL RECEIVE TEMPORARY SEEDING. COST INCLUDED IN PERIMETER EROSION BARIER.
- 3. THE CONTRACTOR SHALL TAKE ALL PRECAUTIONS TO PREVENT POLLUTION OF STORM WATER AND SHALL FOLLOW IEPA REGULATIONS & IDOT CONSTRUCTION MEMORANDIM NO. 06-60.
- 4. STABILIZATION MEASURES SHALL BE INITIATED WITHIN 7 DAYS OF CONSTRUCTION ACTIVITY TEMPORARILY OR PERMANENTLY CEASING IN AREAS WHERE IT WILL NOT OCCUR FOR A PERIOD OF 14 OR MORE CALENDAR DAYS.
- . THE SOIL EROSION AND SEDIMENT CONTROL PRACTICES WILL BE INSPECTED WEEKLY AND AFTER 1/2 INCH OF RAIN OR MORE BY THE INDIVIDUAL ON SITE IN CHARGE OF SOIL EROSION AND SEDIMENT CONTROL DURING THE CONSTRUCTION OF THE PROJECT.
- . INLET AND PIPE PROTECTION SHALL BE INSTALLED FOLLOWING THE COMPLETION AND STABILIZATION OF THE STORMWATER FACILITIES AND WILL REMAIN IN PLACE UNTIL THE CONTRIBUTING AREA IS STABILIZED.
- 7. ALL ADJACENT STREETS MUST BE KEPT CLEAR OF DEBRIS. INSPECTED DAILY AND CLEANED WHEN NECESSARY OR AS DIRECTED BY THE ENGINEER.
- . ALL SOIL EROSION AND SEDIMENT CONTROL PRACTICES ARE REFERENCED FROM THE ILLINOIS URBAN MANUAL.
- PROTECTION AND STABILIZATION OF THE STREAMBED IN CONFORMANCE WITH THE ARMY CORPS OF ENGINEERS'S PERMIT SHALL BE INCLUDED IN THE COST OF STONE RIP RAP CLASS A4.


LEGEND PERIMETER EROSION BARRIER EXISTING R.O.W. DIRECTION OF FLOW TREE ROOT PRUNING FINAL RESTORATION OF DISTRUBED AREAS - TOPSOIL FURNISH AND PLACE, 4" - SEEDING CLASS 2A - EROSION CONTROL BLANKET INLET AND PIPE PROTECTION TREE REMOVAL OF GIVEN SIZE (PAID AS TREE REMOVAL, 6 TO 15 UNITS DIAMETER,

TEMPORARY EROSION CONTROL SEQUENCE OF CONSTRUCTION


1. ESTABLISH TEMPORARY EROSION CONTROL MEASURES AND ERECT PERIMETER EROSION BARRIER ALONG SITE BOUNDARIES PRIOR TO EARTHWORK.

OR TREE REMOVAL, OVER 15 UNITS DIAMETER)

2. INSTALL FINAL RESTORATION OF DISTURBED AREAS.

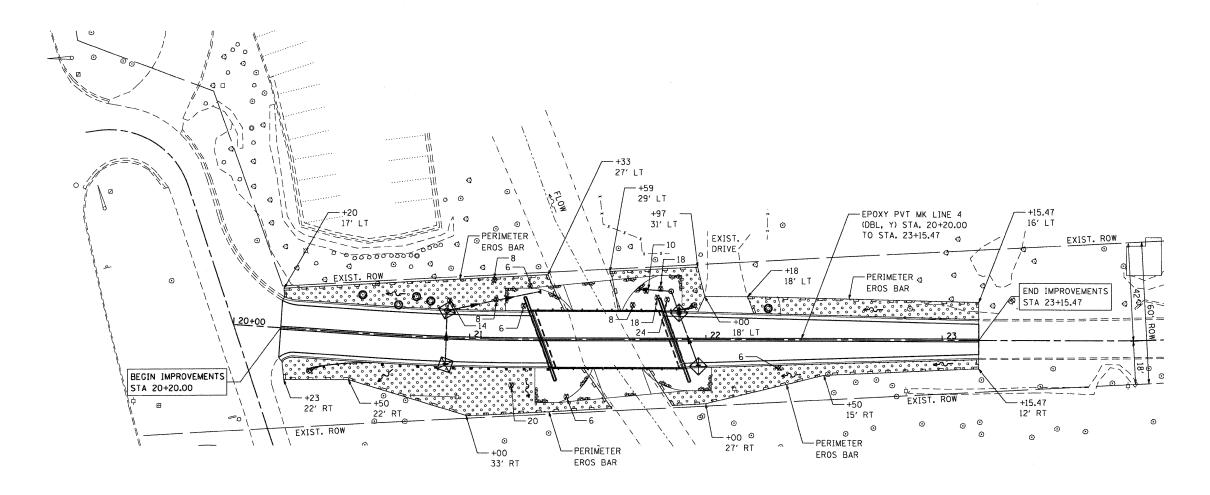

STONERIDGE DRIVE

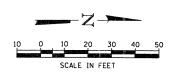

ME. SEC GROUP, INC.

NIACI: Kevin Arth Cord

City of Rockford

City of Rockford

RED: IZ/16/2010125985 PM

86100202-Ero.dgn

ts pdf.bft

STANDARD-IRANS.TBL

00108	USER NAME = whood	DESIGNED	-	JMW	REVISED -	_
	FILE NAME = 86100020-Ero.dgn	DRAWN	-	RCB	REVISED -	
	PLOT SCALE = 1"=20"	CHECKED	-	RGD	REVISED -	
	PLOT DATE = 12/16/2010	DATE	-	12/16/10	REVISED -	
						_

	CITY	OF	ROCKFORD
--	------	----	----------

STRIPING, EROSION CONTROL AND RESTORATION PLAN STONERIDGE DRIVE												
SCALE: 1"=20'	SHEET NO.	OF	SHEETS S	STA.	TO S	TA.						