STATE OF ILLINOIS **DEPARTMENT OF TRANSPORTATION DIVISION OF HIGHWAYS**

PLANS FOR PROPOSED FEDERAL AID HIGHWAY

DIVERSEY AVENUE, DERROUGH AVENUE AND RHODES AVENUE PEARL AVENUE TO WESTDALE ELEMENTARY SCHOOL SIDEWALKS, CURB AND GUTTER

> Section No.: 10-00074-00-SW **Project No.: SRTS-4009(086)** CITY OF NORTHLAKE COOK COUNTY

> > JOB NO.: C-40-004-11

TITLE SHEET **GENERAL NOTES AND IDOT STANDARDS** SUMMARY OF QUANTITIES TYPICAL SECTIONS ALIGNMENT, TIES AND BENCHMARKS **EXISTING CONDITIONS AND REMOVAL PLAN** PROPOSED ROADWAY PLAN AND PROFILE RHODES AVENUE AND DERROUGH AVENUE PROPOSED ROADWAY PLAN AND PROFILE - DIVERSEY AVENUE **EROSION CONTROL LANDSCAPING AND PAVEMENT MARKING PLAN** CONSTRUCTION DETAILS PAVEMENT PATCHING FOR HMA SURFACED PAVEMENT DISTRICT ONE TYPICAL PAVEMENT MARKINGS TRAFFIC CONTROL AND PROTECTION FOR SIDE ROADS, INTERSECTIONS, AND DRIVEWAYS CROSS SECTIONS - RHODES AVENUE AND DERROUGH AVENUE CROSS SECTIONS - DIVERSEY AVENUE

INDEX OF SHEETS

DESCRIPTION

R 12 E 3rd P.M. PROJECT BEGINS END RHODES AVE. STA. 10 + 16.67 BEGIN DERROUGH AVE. STA. 18 + 48.70 PROJECT ENDS STA. 33 + 24.18 END DERROUGH AVE. WESTDALE ELEMENTARY BEGIN DIVERSEY AVE. STA. 20 + 79.17 STA. 30 + 00.00 TRAFFIC DATA - DIVERSEY AVENUE ADT (YEAR) = 400 (2009)POSTED SPEED LIMIT = 25 MPH 46

NET LENGTH OF PROJECT = 1441 LINEAL FEET (0.27 MI.)

KANKAKEE LOCATION OF SECTION INDICATED THUS: -

SECTION

10-00074-00-SW

COOK ILLINOIS CONTRACT NO. 63559

STATE OF ILLINOIS DEPARTMENT OF TRANSPORTATION DIVISION OF HIGHWAYS

PASSED FEBRUARY, 15 2011

RELEASING FOR

DERROUGH AVENUE RHODES AVENUE

BID BASED ON
LIMITED REVIEW FEBRUARY 15, 20 11

DEPUTY DIRECTOR OF HIGHWAYS

PRINTED BY THE AUTHORITY OF THE STATE OF ILLINOIS


CIVIL



ANDREW M. PUFUNDT ILLINOIS REGISTRATION No. 062-061729 ENGINEER

EXPIRATION DATE: 11/30/11

PROFESSIONAL DESIGN FIRM No. 184-00175 EXPIRATION DATE: 04/30/II

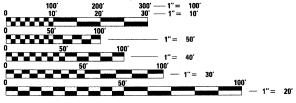

FULL SIZE PLANS HAVE BEEN PREPARED USING STANDARD ENGINEERING SCALES. REDUCED SIZED PLANS WILL NOT CONFORM TO STANDARD SCALES. IN MAKING MEASUREMENTS ON REDUCED PLANS, THE ABOVE SCALES MAY BE USED.

JOINT UTILITY LOCATION INFORMATION FOR EXCAVATION 1-800-892-0123

CONTRACT NO. 63559



GENERAL NOTES

SPECIFICATIONS, STANDARDS AND SPECIAL PROVISIONS
ALL CONSTRUCTION SHALL BE DONE IN ACCORDANCE WITH THE "STANDARD
SPECIFICATIONS FOR ROAD AND BRIDGE CONSTRUCTION", ADDPTED JANUARY 1, 2007;
THE "SUPPLEMENTAL SPECIFICATIONS AND RECURRING SPECIAL PROVISIONS",
ADOPTED JANUARY 1, 2011; THE LATEST EDITION OF THE "ILLINOIS MANUAL ON
UNIFORM TRAFFIC CONTROL DEVICES FOR STREETS AND HIGHWAYS" (IMUTCD),
"THE STANDARD SPECIFICATIONS FOR WATER AND SEWER MAIN CONSTRUCTION IN
ILLINOIS" JULY 2009 SIXTH EDITION, THE "DETAILS" IN THE PLANS, LATEST
EDITION OF THE MANUAL OF TEST PROCEDURE OF MATERIALS, THE AMERICAN
WITH DISABILITIES ACT OF 1990 ACCESSIBILITY GUIDELINES, THE "ORAFT"
REHABILITATION ACT OF 1973 (SECTION 504), THE PUBLIC RIGHTS-OF-WAY
ACCESSIBILITY GUIDELINES, AND THE "SPECIAL PROVISIONS" INCLUDED IN

UTILITIES

THE CONTRACTOR SHALL COOPERATE WITH THE ENGINEER IN ANY UNDERGROUND UTILITY CONSTRUCTION WHICH MAY OCCUR DURING THE CONTRACTOR'S OPERATIONS AS SHOWN ON THE PLANS.

THE CONTRACTOR SHALL BE RESPONSIBLE FOR CONTACTING THE UTILITY OWNERS OF ALL EXISTING FACILITIES SO THAT THE UTILITIES AND THEIR APPURTENANCES MAY BE LOCATED AND ADJUSTED OR MOVED, IF NECESSARY, PRIOR TO THE START OF CONSTRUCTION OPERATIONS. THE CONTRACTOR SHALL COOPERATE WITH ALL UTILITY OWNERS AS PROVIDED FOR IN THE STANDARD SPECIFICATIONS.

THE LOCATIONS OF EXISTING DRAINAGE STRUCTURES, STORM AND SANITARY SEWERS, WATER SERVICE LINES AND OTHER UTILITY LINES ARE APPROXIMATE, AND THE DEPARTMENT DOES NOT GUARANTEE THEIR ACCURACY. THEIR EXACT HORIZONTAL AND VERTICAL LOCATIONS ARE TO BE DETERMINED IN THE FIELD BY THE CONTRACTOR AT HIS OWN EXPENSE.

THE CONTRACTOR SHALL BE RESPONSIBLE FOR THE PROTECTION OF ALL UNDERGROUND OR SURFACE UTILITIES EVEN THOUGH THEY MAY NOT BE SHOWN ON THE PLANS. ANY UTILITY THAT IS DAMAGED DURING CONSTRUCTION SHALL BE REPAIRED OR REPLACED TO THE SATISFACTION OF THE ENGINEER IN ACCORDANCE WITH ARTICLE 107.20 AND 107.31.

COORDINATION OF ALL UTILITY WORK INVOLVED IN THE CONSTRUCTION AREA WILL BE DISCUSSED AT THE PRECONSTRUCTION CONFERENCE.

BEFORE STARTING ANY EXCAVATION, THE CONTRACTOR SHALL CALL "JULIE" AT 811 OR 800-892- 0123 FOR FIELD LOCATIONS OF BURIED ELECTRIC, TELEPHONE, GAS AND CABLE TELEVISION FACILITIES. (48 HOURS NOTIFICATION IS REQUIRED.)

STAKING

THE CONTRACTOR SHALL PROTECT AND CAREFULLY PRESERVE ALL SECTION OR SUBSECTION MONUMENTS OR PROPERTY OR REFERENCE MARKERS UNTIL THE ENGINEER, HIS AGENT OR AN AUTHORIZED SURVEYOR HAS WITNESSED OR OTHERWISE REFERENCED THEIR IOCATIONS

ALL RADII FOR PROPOSED CURB AND GUTTER ARE TO THE EDGE OF PAVEMENT UNLESS OTHERWISE NOTED, AND SHALL BE AS INDICATED ON THE PLANS, ELEVATIONS SHOWN AT POINT OF CURVE, ETC. IS EDGE OF PAVEMENT UNLESS OTHERWISE NOTED.

WATER, STORM SEWER AND SANITARY SEWER

WHENEVER DURING CONSTRUCTION OPERATIONS ANY LOOSE MATERIAL IS DEPOSITED IN THE FLOW LINE OF DRAINAGE STRUCTURES SUCH THAT THE NATURAL FLOW OF WATER IS OBSTRUCTED, IT SHALL BE REMOVED AT THE CLOSE OF EACH WORKING DAY. AT THE CONCLUSION OF CONSTRUCTION OPERATIONS, ALL UTILITY STRUCTURES SHALL BE FREE FROM DIRT AND DEBRIS. THE WORK SPECIFIED ABOVE WILL NOT BE PAID FOR SEPARATELY BUT SHALL BE INCLUDED IN THE COST FOR MOBILIZATION.

ANY EXISTING OR PROPOSED STORM SEWER DAMAGED BY THE CONTRACTOR DURING CONSTRUCTION SHALL BE REPLACED BY THE CONTRACTOR AT THEIR OWN EXPENSE.

THE CONTRACTOR SHALL NOT OPEN OR SHUT ANY WATER VALVES OR FIRE HYDRANTS WITHOUT PRIOR AUTHORIZATION FROM THE CITY OF NORTHLAKE WATER DEPARTMENT. UNAUTHORIZED USE SHALL SUBJECT THE OFFENDER TO ARREST AND PROSECUTION.

MISCELLANEOUS

FILE NAME =

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ACCESS: THE CONTRACTOR SHALL PROVIDE ACCESS TO ABUTTING PROPERTY AT ALL TIMES DURING THE CONSTRUCTION OF THIS PROJECT, EXCEPT FOR PERIODS OF SHORT DURATION. THE COST TO PROVIDE ACCESS SHALL BE PAID FOR AND INCLUDED IN THE ITEM FOR AGGREGATE FOR TEMPORARY ACCESS.

DIMENSIONS: IT SHALL BE THE CONTRACTOR'S RESPONSIBILITY TO VERIFY ALL DIMENSIONS AND CONDITIONS EXISTING IN THE FIELD PRIOR TO ORDERING MATERIALS AND BEGINNING CONSTRUCTION.

ALL SAWCUTTING SHALL BE INCLUDED IN REMOVAL ITEMS AND SHALL BE PERFORMED PRIOR TO BEGINNING REMOVAL. ANY ITEMS OF WORK REMOVED PRIOR TO SAWCUTTING WILL NOT BE MEASURED FOR PAYMENT.

EXISTING PAVEMENT SECTION IS ASSUMED TO BE 13". REMOVAL OF ANY ADDITIONAL MATERIAL (INCLUDING STONE, CLAY ETC.) TO GET DOWN TO PROPER ELEVATION FOR INSTALLATION OF AGGREGATE BASE COURSE SHALL BE INCLUDED IN COST FOR PAVEMENT REMOVAL THIS INCLUDES THE AGGREGATE SHOULDER PARKING AREA ALONG DERROUGH AVENUE.

PLOT SCALE = N.T.S.

DESIGNED

DRAWN

DATE

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MEW

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THE THICKNESSES OF HOT-MIX ASPHALT MIXTURES SHOWN IN THE PLANS ARE NOMINAL. DEVIATIONS MAY OCCUR DUE TO IRREGULARITIES IN THE SURFACES OR BASIS ON WHICH THEY ARE TO BE PLACED. PLAN THICKNESSES SHOULD BE CONSIDERED THE MINIMUM THICKNESS PERMITTED.

DETECTABLE WARNINGS FOR THE HANDICAPPED SHALL BE INSTALLED AT ALL INTERSECTING STREETS, SIGNALIZED COMMERCIAL DRIVEWAYS AND SIGNALIZED ALLEYS AS DIRECTED BY THE ENGINEER (SEE IDOT STD. 424001-05 INCLUDED IN THE SPECIFICATIONS). CONTRACTOR SHALL VERIFY THAT ALL SLOPES MEET ADA REQUIREMENTS PRIOR TO INSTALLING SIDEWALK DETECTABLE WARNINGS AND ADJACENT CURB AND GUTTER.

PAVEMENT GRADES: THE ELEVATIONS INDICATED ON THE PLANS ARE FINISHED GRADES OF PROPOSED PAVEMENT OR SURFACE COURSE, UNLESS OTHERWISE INDICATED.

RELOCATING EXISTING SIGNS: EXISTING SIGNS WHICH ARE IN CONFLICT WITH PROPOSED IMPROVEMENTS SHALL BE REMOVED AND REINSTALLED UPON COMPLETION OF CONFLICTION IMPROVEMENTS IN ACCORDANCE WITH THE ILLINOIS DEPARTMENT OF TRANSPORTATION "MANUAL OF UNIFORM TRAFFIC CONTROL DEVICES" AND THE "STANDARD SPECIFICATIONS FOR ROAD AND BRIDGE CONSTRUCTION". STOP SIGNS, SPEED LIMIT SIGNS, AND STREET NAME SIGNS SHALL BE UP AND VISIBLE AT ALL TIMES. THIS WORK SHALL BE INCLUDED IN THE PAY ITEM TRAFFIC CONTROL AND PROTECTION, STANDARD 701501.

PER ARTICLE 107.20, MAILBOXES WHICH ARE IN CONFLICT WITH PROPOSED IMPROVEMENTS SHALL BE REMOVED, TEMPORARILY RELOCATED, AND REPLACED UPON COMPLETION OF THE PROPOSED IMPROVEMENTS AS DIRECTED BY THE ENGINEER.

PROPOSED CONCRETE CURB AND GUTTER SHALL BE TRANSITIONED TO EXISTING CURB AND GUTTER OVER A LENGTH OF 5 FEET. THIS WORK SHALL BE PAID FOR AT THE CONTRACT UNIT PRICE PER FOOT FOR COMBINATION CONCRETE CURB AND GUTTER TYPE 8-8, 12.

ALL UNDERGROUND, DRIVEWAY, CONCRETE, AND LANDSCAPE RESTORATION WORK IS TO BE COMPLETED BEFORE THE SURFACE COURSE CAN BE INSTALLED.

ALL REMOVAL OR EXCAVATION ITEMS BEING DISPOSED OF AT AN UNCONTAMINATED SOIL FILL OPERATION OR CLEAN CONSTRUCTION AND DEMOLITION DEBRIS (CCDD) FILL SITE SHALL MEET THE REQUIREMENTS OF PUBLIC ACT 96-1416. ALL COSTS ASSOCIATED WITH MEETING THESE REQUIREMENTS SHALL BE INCLUDED IN THE UNIT PRICE COST FOR THE ASSOCIATED REMOVAL OR EXCAVATION ITEMS IN THE CONTRACT. THESE COSTS SHALL INCLUDE BUT ARE NOT LIMITED TO ALL REQUIRED TESTING, LAB ANALYSIS, CERTIFICATION BY A LICENSED PROFESSIONAL ENGINEER, AND STATE OR LOCAL TIPPING FEES.

COST TO CONNECT EXISTING OR PROPOSED STORM SEWER TO EXISTING OR PROPOSED DRAINAGE STRUCTURE SHALL BE INCLUDED IN COST FOR STORM SEWER.

COST FOR CONSTRUCTION OF SPEED HUMP IS INCLUDED IN THE COST FOR HOT-MIX ASPHALT SURFACE COURSE. THIS INCLUDES ALL LABOR AND MATERIALS TO CONSTRUCT THE SPEED HUMP IN ACCORDANCE WITH THE DETAIL AS SHOWN IN THE PLANS.

IDOT HIGHWAY STANDARDS

000001-06	STANDARD SYMBOLS, ABBREVIATIONS, AND PATTERNS
280001-05	TEMPORARY EROSION CONTROL SYSTEMS
424001-05	CURB RAMPS FOR SIDEWALKS
542301-03	PRECAST REINFORCED CONCRETE FLARED END SECTION
542311-02	GRATING FOR CONCRETE FLARED END SECTION (FOR 24" THRU 54" PIPE)
602001-02	CATCH BASIN TYPE A
602011-02	CATCH BASIN TYPE C
602601-02	PRECAST REINFORCED CONCRETE FLAT SLAB TOP
604001-03	FRAME AND LIDS TYPE 1
606001-04	CONCRETE CURB TYPE B AND COMBINATION CONCRETE CURB AND GUTTER
701301-04	LANE CLOSURE, 2L, 2W, SHORT TIME OPERATIONS
701501-06	URBAN LANE CLOSURE, 2L, 2W UNDIVIDED
701801-04	LANE CLOSURE MULTILANE 1W OR 2W CROSSWALK OR SIDEWALK CLOSURE
701901-01	TRAFFIC CONTROL DEVICES
720001-01	SIGN PANEL MOUNTING DETAILS
720006-02	SIGN PANEL ERECTION DETAILS
729001-01	APPLICATIONS OF TYPES A & B METAL POSTS
780001-02	TYPICAL PAVEMENT MARKINGS
BD-22	PAVEMENT PATCHING FOR HMA SURFACED PAVEMENT
TC-10	TRAFFIC CONTROL AND PROTECTION FOR SIDE ROADS, INTERSECTIONS AND DRIVEWAYS
TC-13	DISTRICT ONE TYPICAL PAVEMENT MARKINGS
BLR 17-4	TRAFFIC CONTROL DEVICES - DAY LABOR CONSTRUCTION
BLR 18-5	TRAFFIC CONTROL DEVICES - DAY LABOR MAINTENANCE

STATE OF ILLINOIS

DEPARTMENT OF TRANSPORTATION


THE CONTRACTOR SHALL BE SOLELY RESPONSIBLE FOR JOB SITE SAFETY AS WELL AS SUPERVISION/DIRECTION AND MEANS/METHODS OF CONSTRUCTION.

	,	SUMMARY OF QUA		DIVERSEY AVE. DERROUGH AVE. RHODES AVE. 100% FED.	DERROUGH AVE. 100% LOCAL	PROJECT TOTAL
		FUNDING SOURCE SUMMARY OF QUANTITIES		SRTS	LOCAL INSTRUCTION TYPE CO	TOTAL
Γ-	ITEM#	SUMMART OF QUANTITIES	UNIT	0021	0004	
-	20100110	TREE REMOVAL (6 TO 15 UNITS DIAMETER)	UNIT	6	0004	6
-	20100110	TREE TRUNK PROTECTION	EACH	1	0	1
H	20101200	TREE ROOT PRUNING	EACH	3	0	3
-	20101400	NITROGEN FERTILIZER NUTRIENT	POUND	40.5	4.5	45
-		PHOSPHORUS FERTILIZER NUTRIENT	POUND	40.5	4.5	45
-	20101600	POTASSIUM FERTILIZER NUTRIENT	POUND	40.5	4.5	45
-		SUPPLEMENTAL WATERING	UNIT	9	1	10
-	20201200	REMOVAL AND DISPOSAL OF UNSUITABLE MATERIAL	CUYD	20	60	80
\vdash	20400800	FURNISHED EXCAVATION	CUYD	25	0	25
_	20700220	POROUS GRANULAR EMBANKMENT	CUYD	20	60	80
_		TRENCH BACKFILL	CUYD	50	0	50
-	21001000	GEOTECHNICAL FABRIC FOR GROUND STABILIZATION	SQYD	120	490	610
-	21101615	TOPSOIL FURNISH AND PLACE, 4"	SQYD	800	100	900
-	25000100	SEEDING, CLASS 1	ACRE	0.45	0.05	0.5
-		EROSION CONTROL BLANKET	SQYD	1460	65	1525
-		INLET AND PIPE PROTECTION	EACH	6	0	6
-		INLET FILTERS	EACH	20	1	21
-	31101100	SUB-BASE GRANULAR MATERIAL, TYPE B	CUYD	95	10	105
-	35101598	AGGREGATE BASE COURSE, TYPE B 3"	SQYD	70	0	70
-		AGGREGATE BASE COURSE, TYPE B 3	SQYD	100	45	145
-	35101800	AGGREGATE BASE COURSE, TYPE B 8	SQYD	120	490	610
\vdash	40201000	AGGREGATE BASE COURSE, TYPE B 8	TON	55	15	70
\vdash			GALLON	40	55	. 95
-		BITUMINOUS MATERIALS (PRIME COAT)			2	. 95
L	40600300	AGGREGATE (PRIME COAT)	TON	1		
-		HOT-MIX ASPHALT BINDER COURSE, IL-19.0, N50	TON	50	120	170
H	40603310	HOT-MIX ASPHALT SURFACE COURSE, MIX "C", N50	TON	85	55	140
H	42300300	PORTLAND CEMENT CONCRETE DRIVEWAY PAVEMENT, 7 INCH	SQYD	70	0	70
L	42400200	PORTLAND CEMENT CONCRETE SIDEWALK 5 INCH	SQFT	8100	0	8100
L	42400400	PORTLAND CEMENT CONCRETE SIDEWALK 7 INCH	SQFT	475	0	475
L		DETECTABLE WARNINGS	SQFT	60	0	60
L	44000100	PAVEMENT REMOVAL	SQYD	775	360	1135
_	44000200	DRIVEWAY PAVEMENT REMOVAL	SQYD	290	40	330
_	44000300	CURB REMOVAL	FOOT	45	0	45
L	44000500	COMBINATION CURB AND GUTTER REMOVAL	FOOT	380	0	380
L	44000600	SIDEWALK REMOVAL	SQFT	325	0	325
L	44201713	CLASS D PATCHES, TYPE I, 6 INCH	SQYD	0	50	50
L	54213669	PRECAST REINFORCED CONCRETE FLARED END SECTIONS 24"	EACH	6	0	6
L	54247130	GRATING FOR CONCRETE FLARED END SECTION 24"	EACH	6	0	6
L	550A0050	STORM SEWERS, CLASS A, TYPE 1 12"	FOOT	187	0	187
L		STORM SEWERS, CLASS A, TYPE 1 24"	FOOT	40	0	40
L		STORM SEWER REMOVAL 12"	FOOT	153	0	153
L	55101200	STORM SEWER REMOVAL 24*	FOOT	5	0	5
-		CONTROLLED LOW-STRENGTH MATERIAL	CU YĐ	100	0	100
-		CATCH BASINS, TYPE A, 4'-DIAMETER, TYPE 1 FRAME, OPEN LID	EACH	4	0	4
L	60206905	CATCH BASINS, TYPE C, TYPE 1 FRAME, OPEN LID	EACH	7	0	7
L	60250400	CATCH BASINS TO BE ADJUSTED WITH NEW TYPE 1 FRAME, OPEN LID	EACH	11	1	2
L	60265700	VALVE VAULTS TO BE ADJUSTED	EACH	2	0	2
1	60603800	COMBINATION CONCRETE CURB AND GUTTER, TYPE B-6.12	FOOT	1200	0	1200
1	67100100	MOBILIZATION	LSUM	0.9	0.1	1
_		TRAFFIC CONTROL AND PROTECTION, STANDARD 701306	LSUM	0.9	0.1	1
L	70102620	TRAFFIC CONTROL AND PROTECTION, STANDARD 701501	L SUM	0.9	0.1	1
L	70102640	TRAFFIC CONTROL AND PROTECTION, STANDARD 701801	LSUM	0.9	0,1	1
-	72000100	SIGN PANEL - TYPE 1	SQFT	32	0	32
L	72900100	METAL POST - TYPE A	FOOT	70	0	70
Ľ	78000400	THERMOPLASTIC PAVEMENT MARKING - LINE 6"	FOOT	26	0	26
Ľ	78000600	THERMOPLASTIC PAVEMENT MARKING - LINE 12"	FOOT	30	0	30
Ŀ	78000650	THERMOPLASTIC PAVEMENT MARKING - LINE 24"	FOOT	34	0	34
1	81400730	HANDHOLE, COMPOSITE CONCRETE	EACH	1	0	1
*	89502380	REMOVE EXISTING HANDHOLE	EACH	1	0	1
L	X4810200	AGGREGATE SHOULDER REMOVAL	CU YD	260	55	315
L	X6026050	SANITARY MANHOLES TO BE ADJUSTED	EACH	3	0	3
L	X6061700	COMBINATION CONCRETE CURB AND GUTTER, TYPE B (SPECIAL)	FOOT	250	345	595
	Z0013798	CONSTRUCTION LAYOUT	L SUM	0.9	0.1	1
Ŀ		DRAINAGE STRUCTURES TO BE ADJUSTED	EACH	2	0	2
-	Z0018400	***************************************				
	Z0018400 Z0018700		EACH	5	0	5

	**					* INDICATES SPECIALTY ITEM
FILE NAME =	USER NAME = EDTODA	DESIGNED	-	AMP	REVISED -	
N:\NORTHLAKE\940032DC107\C1v1\qual_dc10	7.sht	DRAWN	-	EDT	REVISED -	
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	PLOT DATE = 2/8/2011	DATE	-	02/08/11	REVISED -	


STATE OF ILLINOIS
DEPARTMENT OF TRANSPORTATION

SUMMARY OF QUANTITIES	F.A. RTE.	SECTION	COUNTY	TOTAL	SHEET NO.
		10-00074-00-SW	COOK	22	3
		9	CONTRACT	NO. 6	3559
ALE: N.T.S. SHEET NO. OF SHEETS STA. 10+00.00 TO STA. 24+92.22		ILLINOIS FED. A	D PROJECT		

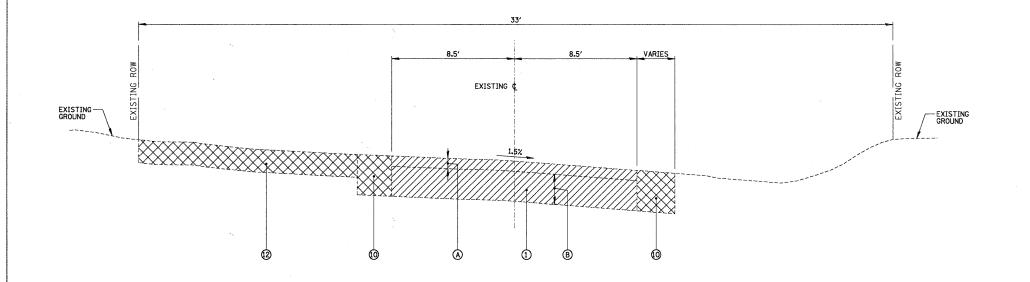

EXISTING TYPICAL SECTION - DERROUGH AVENUE

STA. 18+48.70 TO STA. 21+10.83

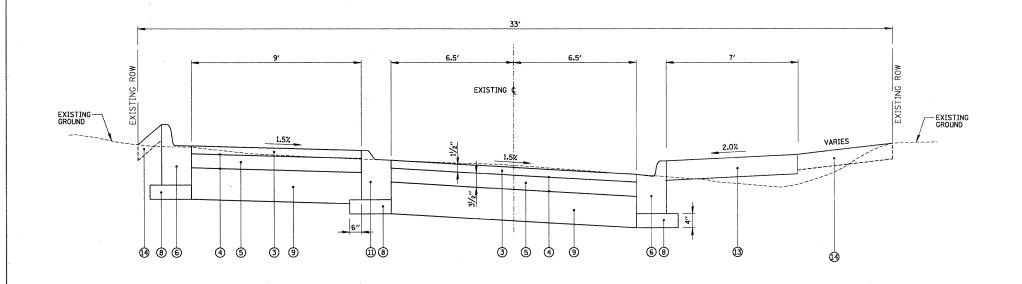

PROPOSED TYPICAL SECTION - DERROUGH AVENUE

STA. 18+48.70 TO STA. 21+10.83

- A EXISTING ASPHALT PAVEMENT (+/- 3")
- (B) EXISTING AGGREGATE BASE (+/- 10")
- © EXISTING COMBINATION CURB AND GUTTER: TYPE B-6.12
- 1 PAVEMENT REMOVAL
- (2) COMBINATION CONCRETE CURB AND GUTTER REMOVAL (LIMITS AS SHOWN ON PLANS)
- 3 HOT-MIX ASPHALT SURFACE COURSE, MIX "C", N50 1 1/2"
- 4 BITUMINOUS MATERIALS (PRIME COAT)
- HOT-MIX ASPHALT BINDER COURSE, IL-19.0, N50 3 1/2" (5)
- 6 COMBINATION CONCRETE CURB AND GUTTER, TYPE B-4.12
- COMBINATION CONCRETE CURB & GUTTER, TYPE B-6.12
- SUBBASE GRANULAR MATERIAL, TYPE B
- AGGREGATE BASE COURSE, TYPE B, 8"
- AGGREGATE SHOULDER REMOVAL
- COMBINATIN CONCRETE CURB AND GUTTER TYPE B-4.12 (DEPRESSED)
- PAVEMENT REMOVAL OR AGGREGATE SHOULDER REMOVAL
- 13 PCC SIDEWALK 5 INCH
- TOPSOIL, FURNISH AND PLACE, 4"
- CONTROLLED LOW-STRENGTH MATERIAL, 10"


HOT-MIX ASPHALT MIXTURE REQUIREMENTS

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- NOTE:


 1. THE UNIT WEIGHT USED TO CALCULATE ALL HOT-MIX ASPHALT SURFACE MIXTURE QUANTITIES IS 112 LBS/SY/IN.
- THE "AC TYPE" FOR POLYMERIZED HMA MIXES SHALL BE "SBS/SBR PG 70-22" AND FOR NON-POLYMERIZED HMA THE "AC TYPE" SHALL BE "PG 64-22" UNLESS MODIFIED BY DISTRICT ONE SPECIAL PROVISIONS. FOR "PERCENT OF RAP" SEE DISTRICT ONE SPECIAL PROVISIONS.

'FILE NAME =	USER NAME = EDTODA	DESIGNED - AMP	REVISED -		TYPICAL SECTIONS	F.A. RTE.	SECTION	COUNTY	TOTAL SHE	EET
N:\N0RTHLAKE\940032DC107\C1v11\typ1_dc10	7.sht	DRAWN - EDT	REVISED -	STATE OF ILLINOIS			10-00074-00-SW	соок	22	4
	PLOT SCALE = N.T.S.	CHECKED - MEW	REVISED -	DEPARTMENT OF TRANSPORTATION				CONTRAC	T NO. 6355	59
	PLOT DATE = 2/8/2011	DATE - 02/08/11	REVISED -		SCALE: N.T.S. SHEET NO. OF SHEETS STA. 10+00.00 TO STA. 24+92.22		ILLINOIS FED. A	D PROJECT		

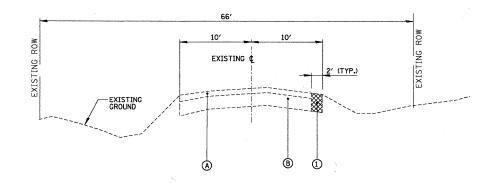


EXISTING TYPICAL SECTION - RHODES AVENUE

STA. 10+16.67 TO STA. 18+48.70

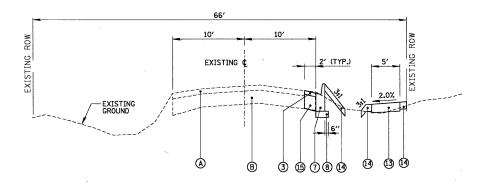


PROPOSED TYPICAL SECTION - RHODES AVENUE

STA. 10+16.67 TO STA. 18+48.70

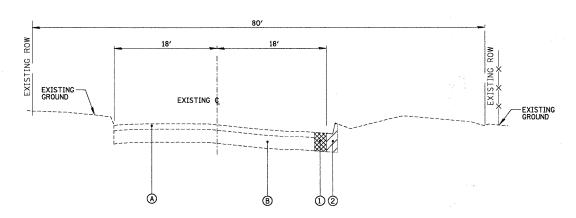

EXISTING TYPICAL SECTION - DIVERSEY AVENUE

STA. 30+00 TO STA. 33+24.18

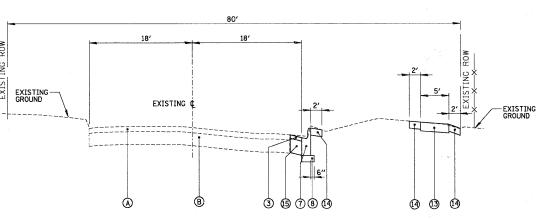

PROPOSED TYPICAL SECTION - DIVERSEY AVENUE

STA. 30+00 TO STA. 33+24.18

LEGEND


- A EXISTING ASPHALT PAVEMENT (+/- 3")
- B EXISTING AGGREGATE BASE (+/- 10")
- © EXISTING COMBINATION CURB AND GUTTER; TYPE B-6.12
- 1 PAVEMENT REMOVAL
- COMBINATION CONCRETE CURB AND GUTTER REMOVAL (LIMITS AS SHOWN ON PLANS) 2
- 4) BITUMINOUS MATERIALS (PRIME COAT)
- HOT-MIX ASPHALT BINDER COURSE, IL-19.0, N50 3 1/2"
- COMBINATION CONCRETE CURB AND GUTTER, TYPE B-4.12
- 7 COMBINATION CONCRETE CURB & GUTTER, TYPE B-6.12
- SUBBASE GRANULAR MATERIAL, TYPE B
- AGGREGATE BASE COURSE, TYPE B, 8"
- AGGREGATE SHOULDER REMOVAL
- COMBINATIN CONCRETE CURB AND GUTTER TYPE B-4.12 (DEPRESSED)
- PAVEMENT REMOVAL OR AGGREGATE SHOULDER REMOVAL
- (13) PCC SIDEWALK 5 INCH
- TOPSOIL, FURNISH AND PLACE, 4"
- CONTROLLED LOW-STRENGTH MATERIAL, 10"


HOT-MIX ASPHALT MIXTURE REQUIREMENTS


' '	MITY VOLUME I MITY LOUE IVI				_1714_1
	ITEM	Α	ĪR	VOI	DS
	PAVEMENT RECONSTRUCTION				
	HOT-MIX ASPHALT SURFACE COURSE,	4%	6	50	GYR
	MIX "C", N50 (IL-9.5 MM) - 11/2"				
	HOT-MIX ASPHALT BINDER COURSE,	4%	6	50	GYR
	IL-19.0, N50 - 3 ¹ / ₂ "				
	DRIVEWAYS				
	HOT-MIX ASPHALT SURFACE COURSE,	4%	0	50	GYR
	MIX "C", N50 (IL-9.5 MM) - 3" (IN 2 LIFTS)				
	PAVEMENT REPLACEMENT				
	HOT,-MIX ASPHALT SURFACE COURSE,	4%	0	50	GYR
	MIX "C", N50 (IL-9.5 MM) - 1/2"				
	PATCHING				
	CLSS "D" PATCHES	4%	6	70	GYR
	(HMA BINDER, IL-19 MM)				


- NOTE: 1. THE UNIT WEIGHT USED TO CALCULATE ALL HOT-MIX ASPHALT SURFACE MIXTURE QUANTITIES IS 112 LBS/SY/IN.
- THE "AC TYPE" FOR POLYMERIZED HMA MIXES SHALL BE "SBS/SBR PG 70-22" AND FOR NON-POLYMERIZED HMA THE "AC TYPE" SHALL BE "PG 64-22" UNLESS MODIFIED BY DISTRICT ONE SPECIAL PROVISIONS. FOR "PERCENT OF RAP" SEE DISTRICT ONE SPECIAL PROVISIONS.


						T= :	TOTAL CUEST
FILE NAME =	USER NAME = EDTODA	DESIGNED - AMP	REVISED -		TYPICAL SECTIONS	RTE. SECTION	COUNTY SHEETS NO.
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	PLOT SCALE = N.T.S.	CHECKED - MEW	REVISED -	DEPARTMENT OF TRANSPORTATION		2	CONTRACT NO. 63559
	PLOT DATE = 2/8/2011	DATE - 02/08/11	REVISED -		SCALE: N.T.S. SHEET NO. OF SHEETS STA. 10+00.00 TO STA. 24+92.22	ILLINOIS	FED. AID PROJECT

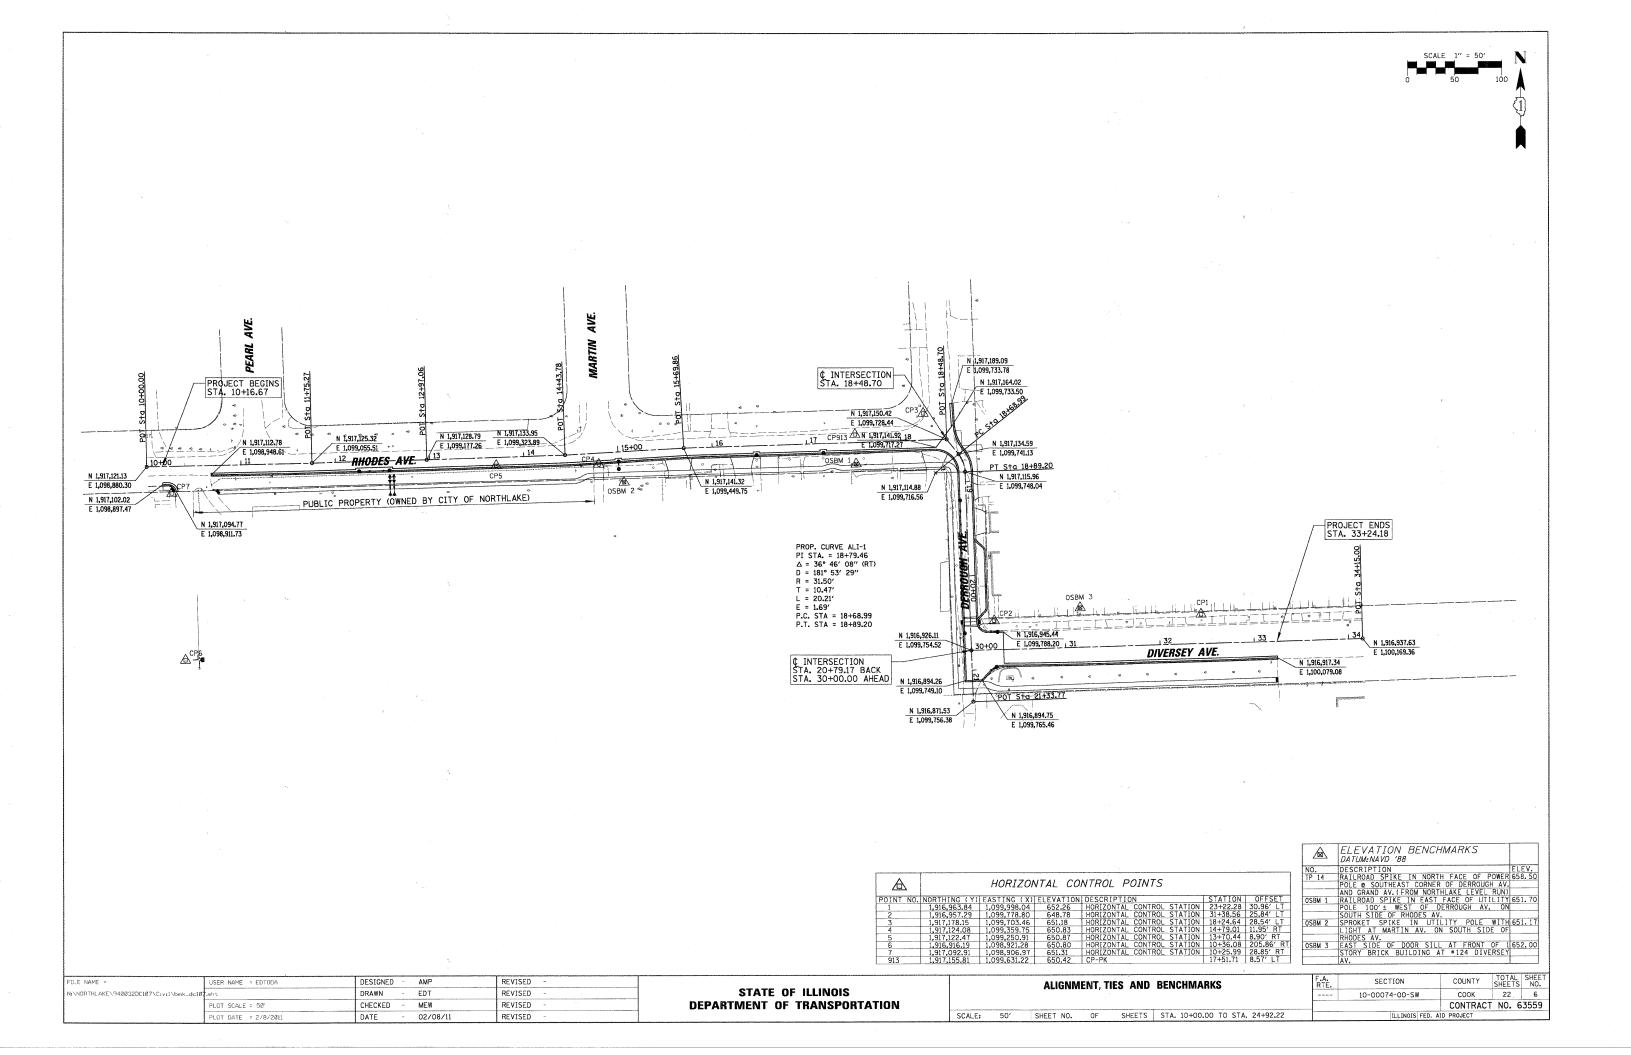


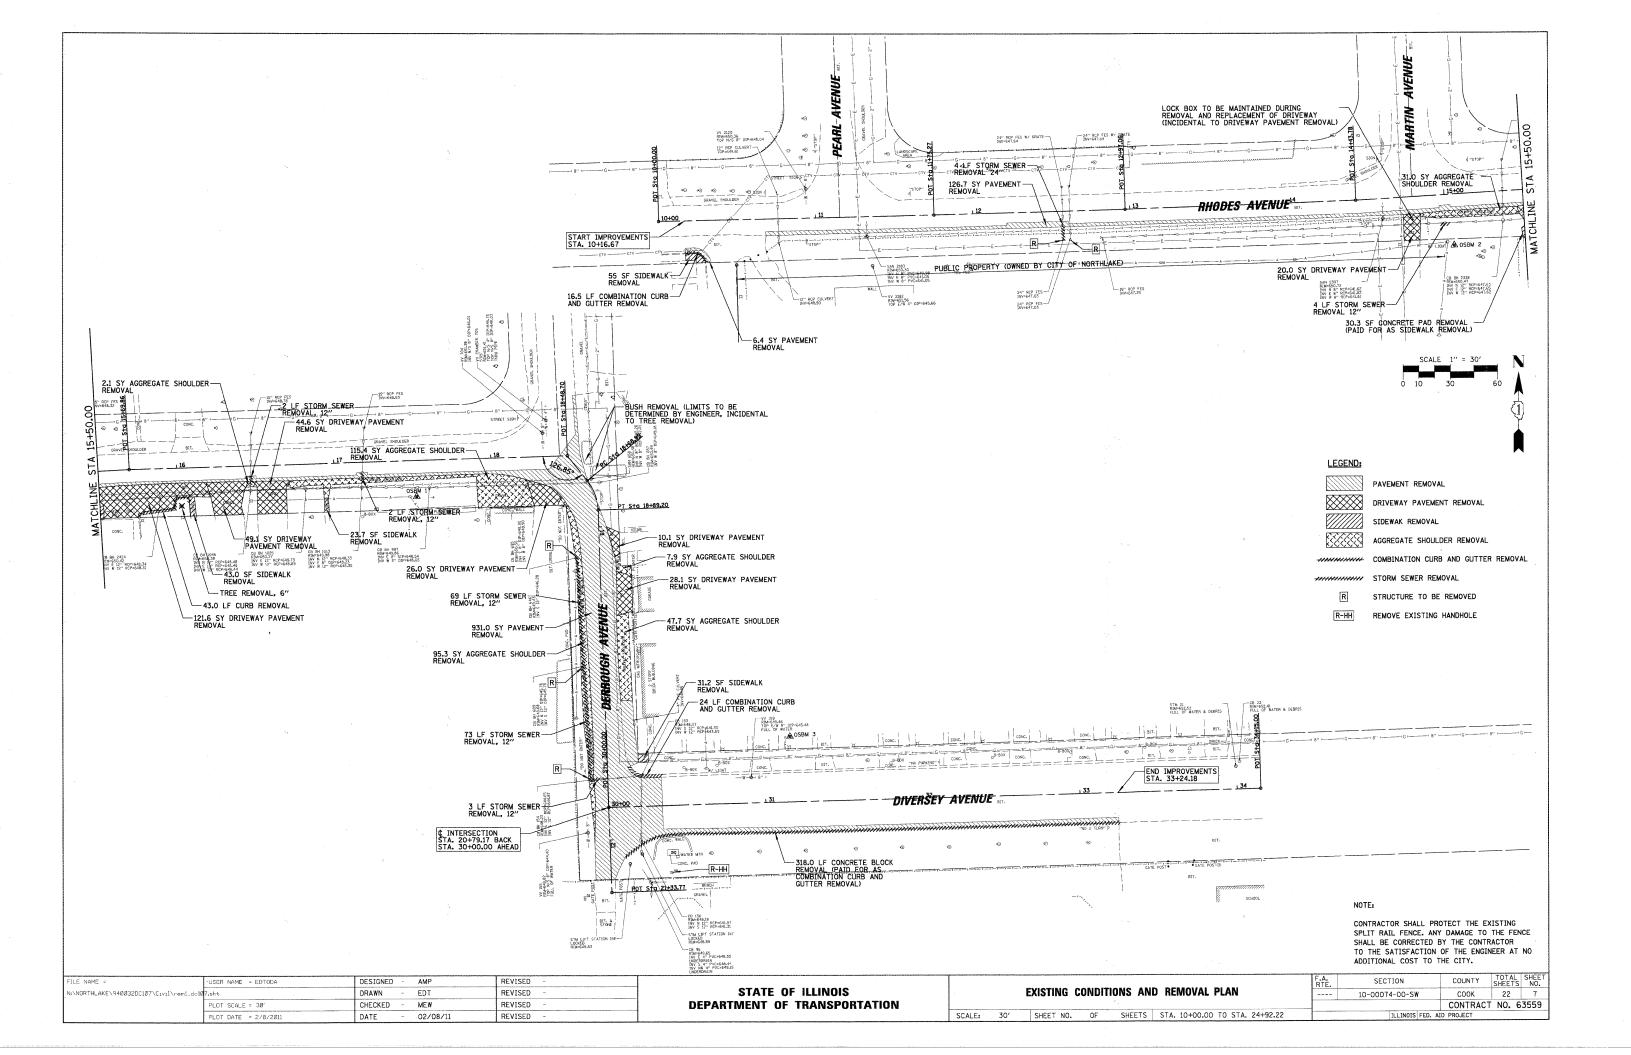


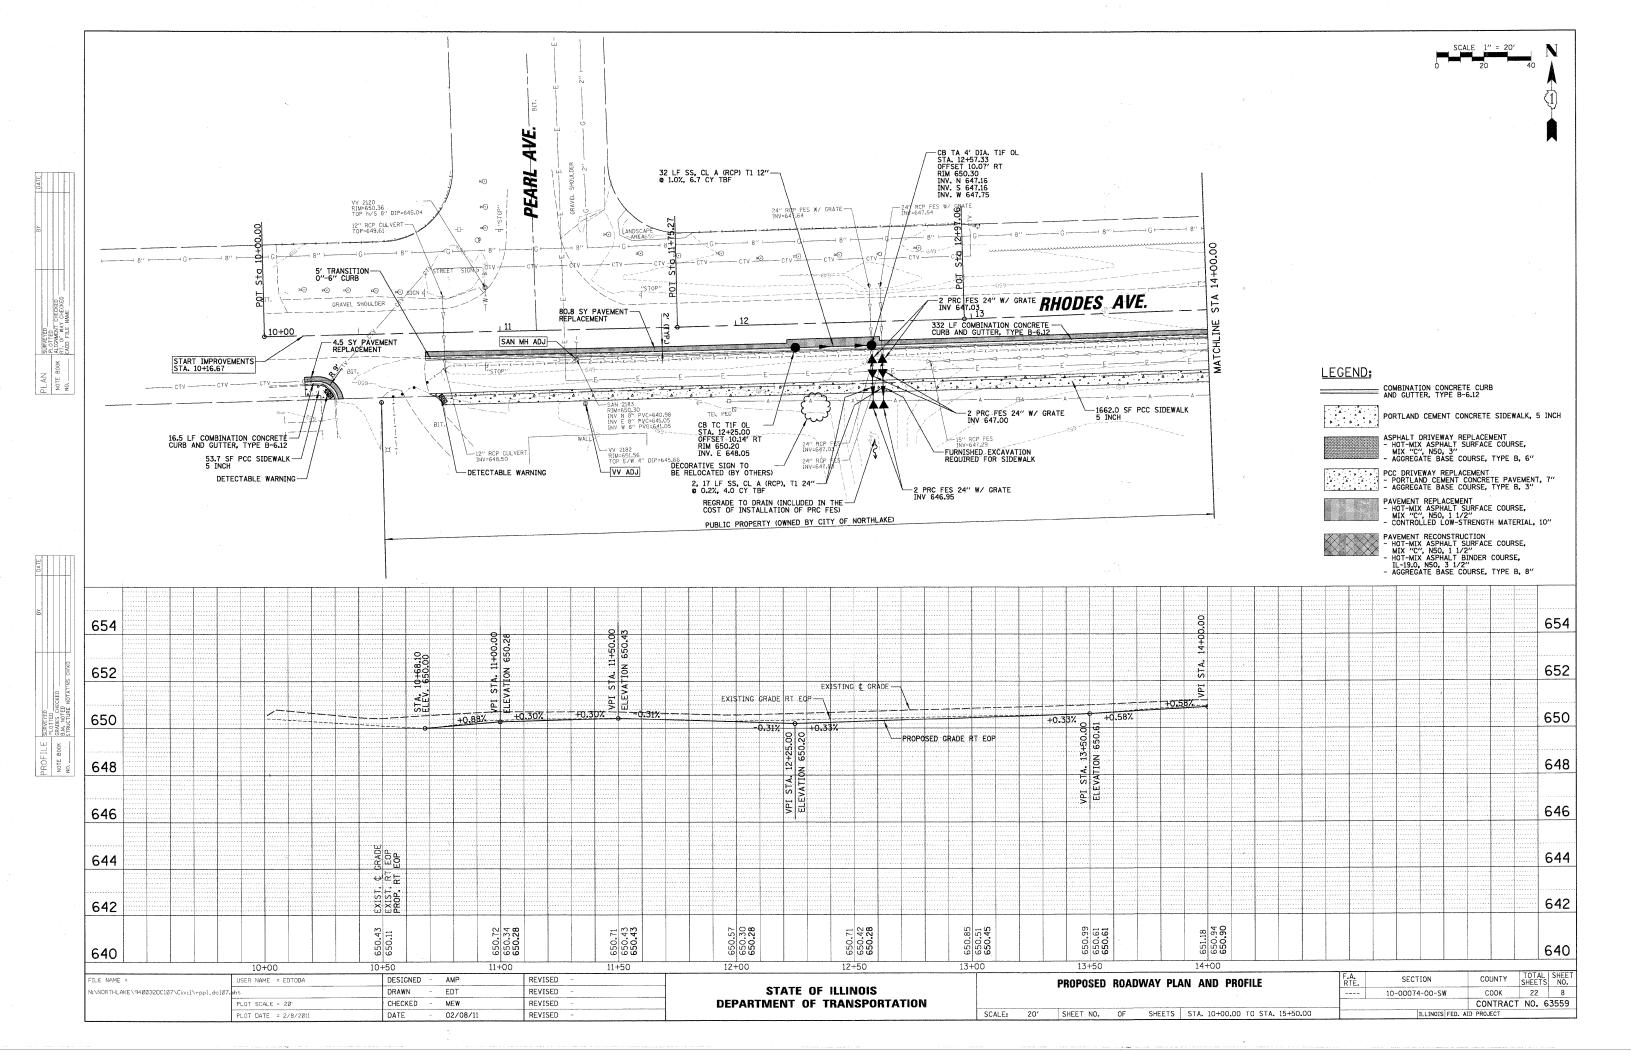


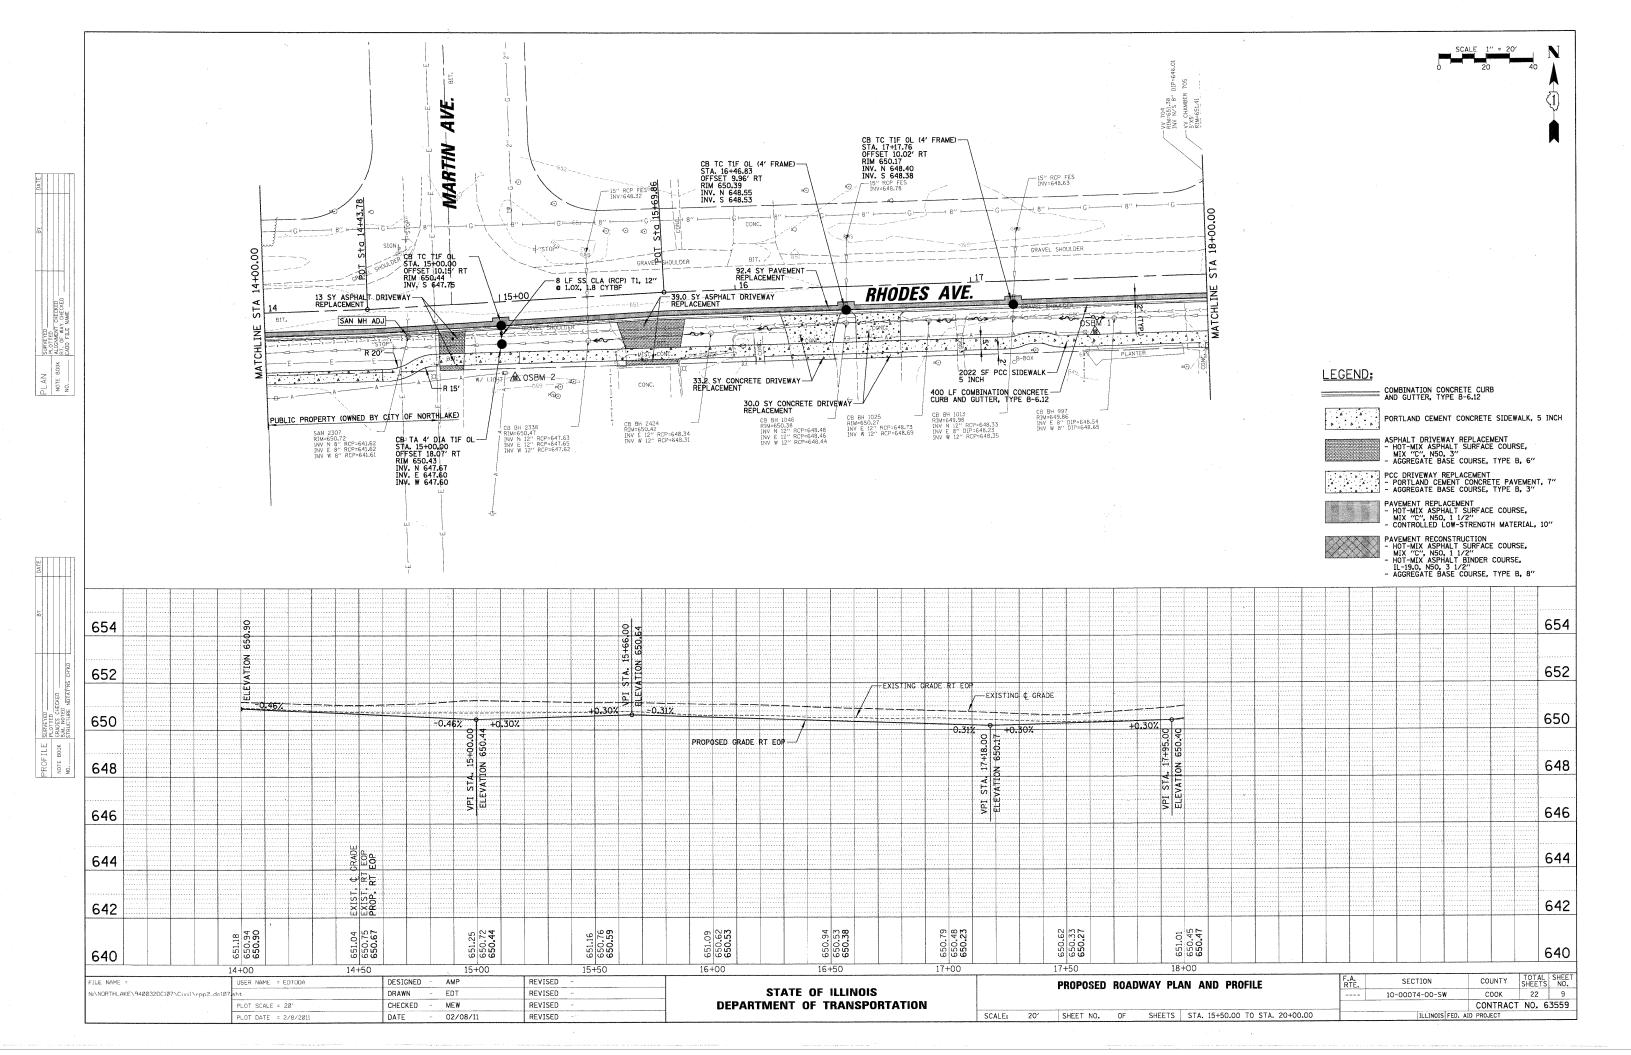

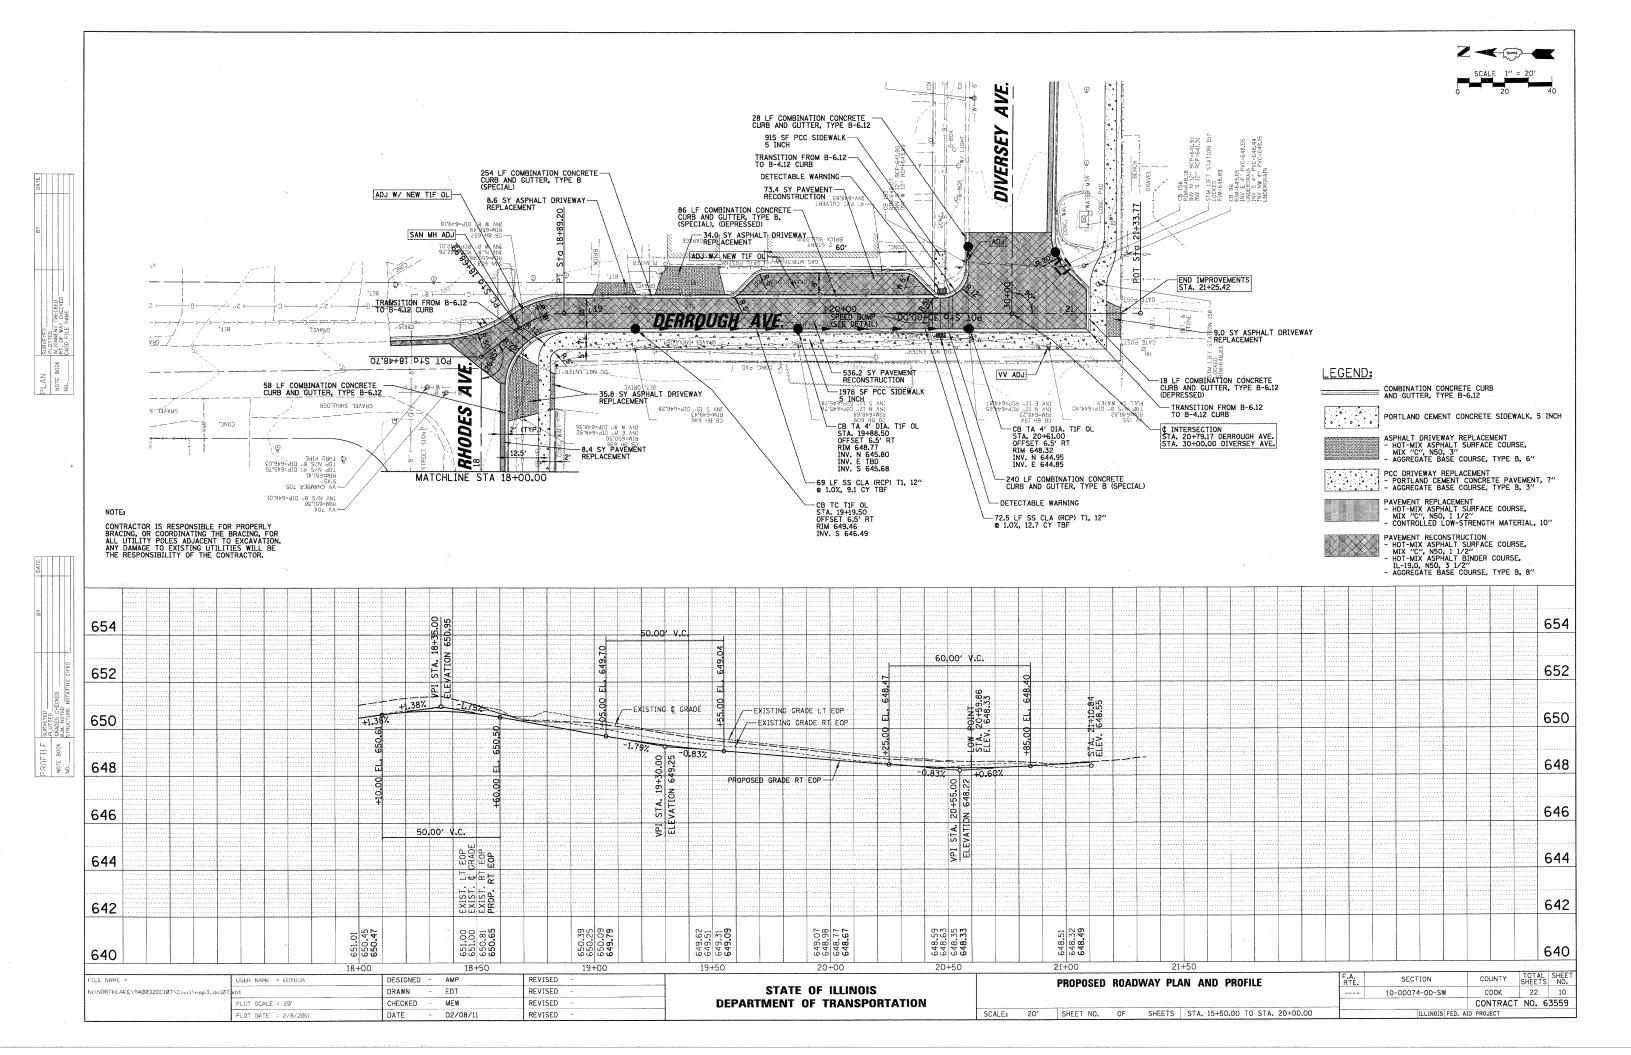


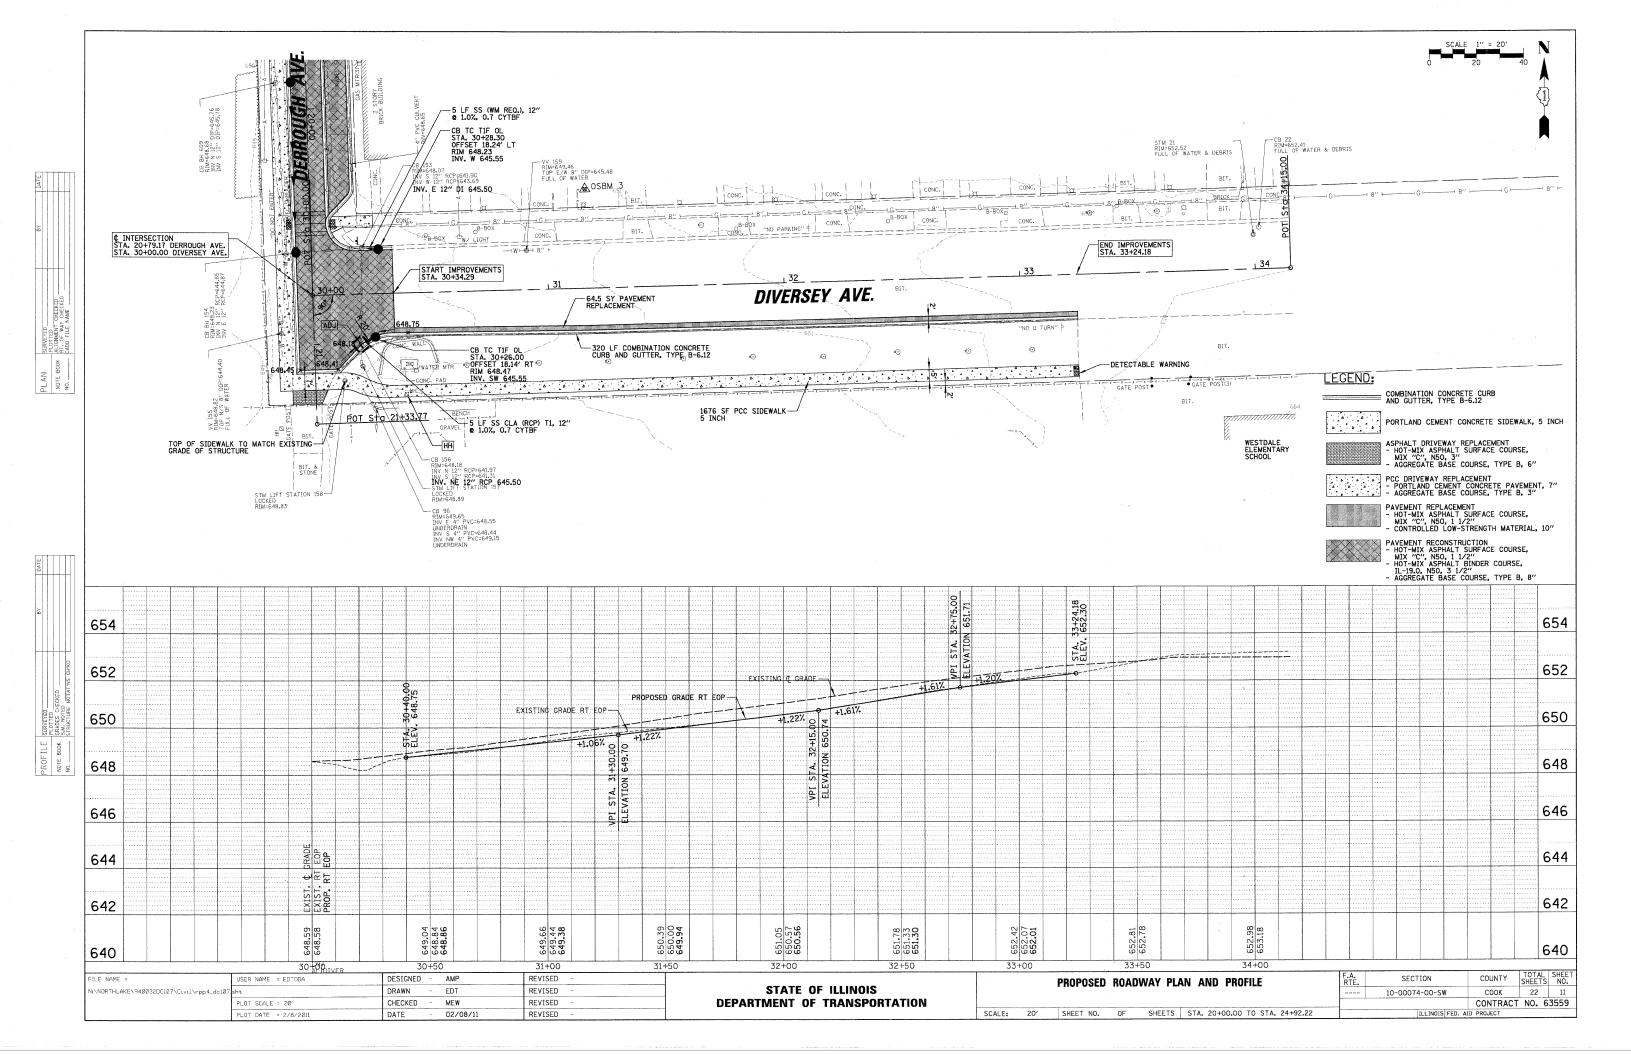


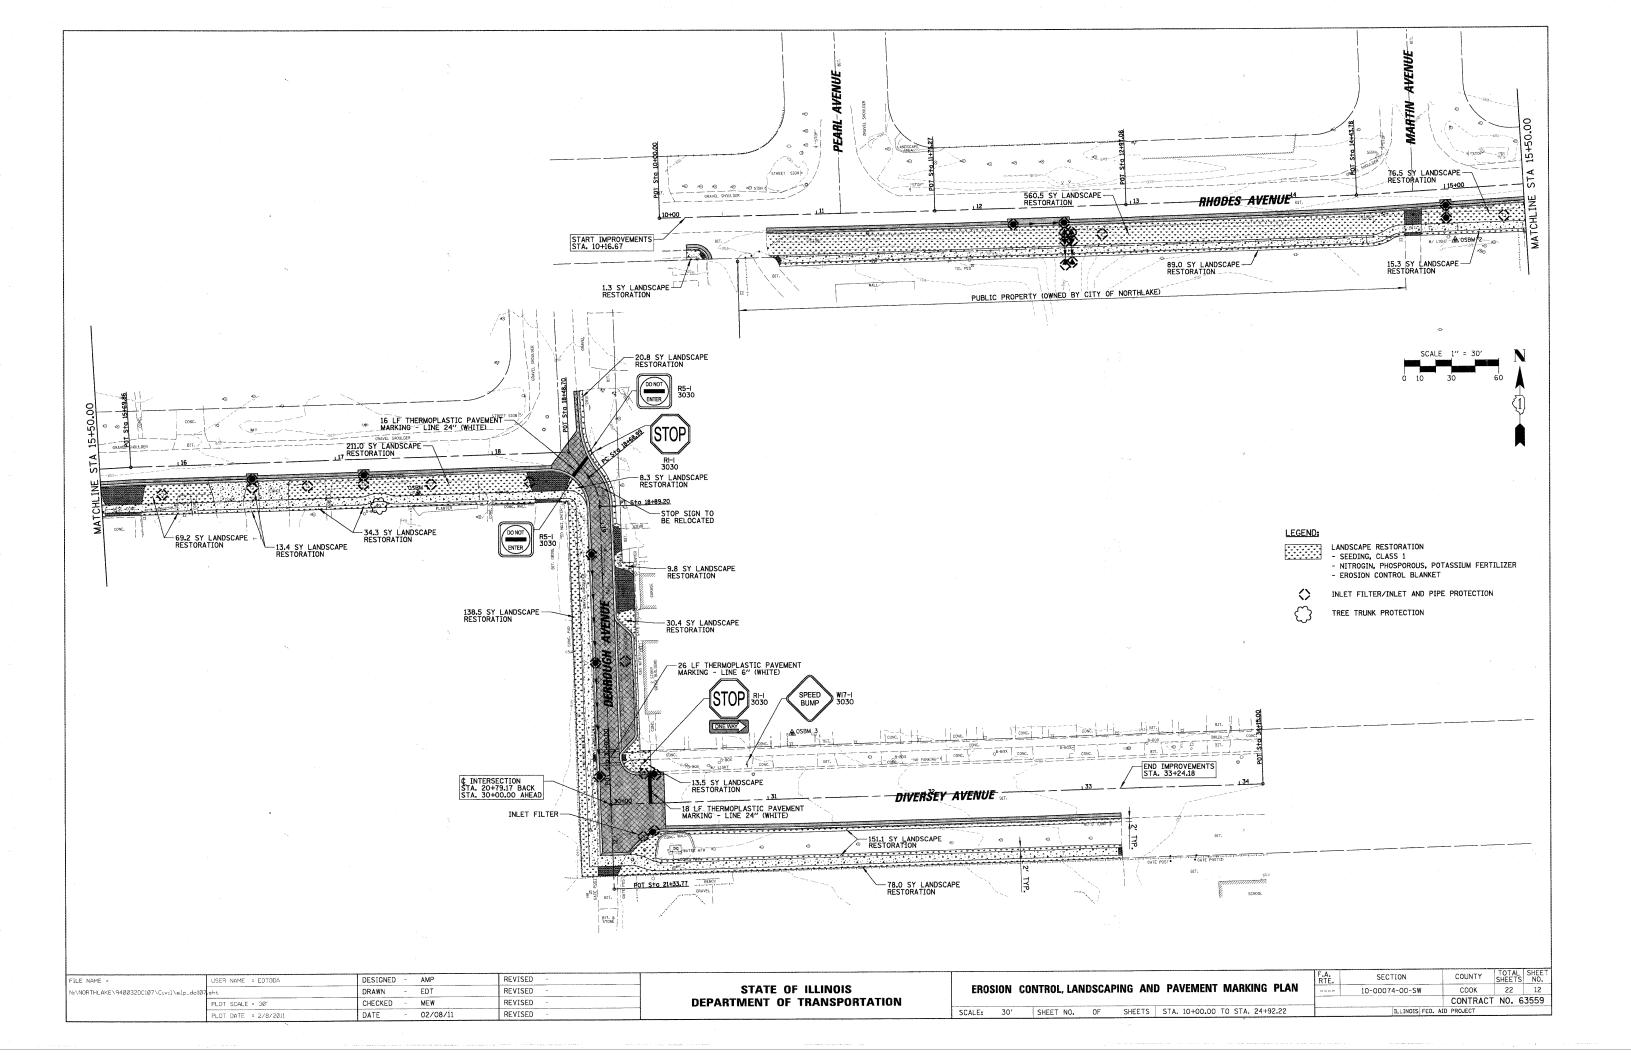

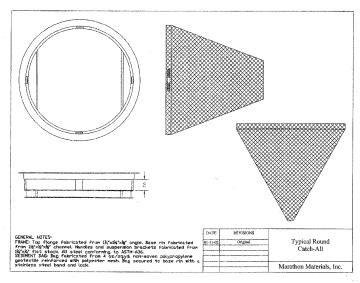

INLET FILTER

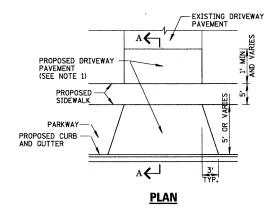

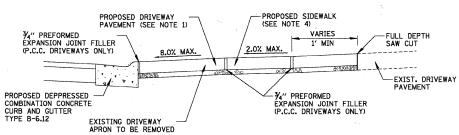


SECTION A-A

TYPICAL DRIVEWAY DETAILS


- 1. THE PROPOSED DRIVEWAY PAVEMENT SHALL CONSIST OF:
 - A) 7" PORTLAND CEMENT CONCRETE AND 3" OF AGGREGATE BASE COURSE TYPE B IF THE EXISTING DRIVEWAY IS P.C.C.
 - B) 3" HOT-MIX ASPHALT SURFACE COURSE, MIX "C", N50, 6" AGGREGATE BASE COURSE TYPE B

 IF THE EXISTING DRIVEWAY IS ASPHALT OR AGGREGATE.
- 2. PREFORMED EXPANSION JOINT FILLER SHALL BE CONSIDERED INCIDENTAL TO P.C.C. DRIVEWAY PAVEMENT
- ALL REQUIRED EARTH EXCAVATION REQUIRED TO CONSTRUCT DRIVES SHALL BE INCIDENTAL TO DRIVEWAY REMOVAL.

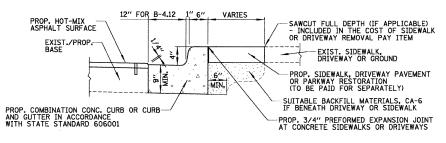


ALL REQUIRED EARTH EXCAVATION AND SUITABLE BACKFILL TO CONSTRUCT COMBINATION CONCRETE CURB AND GUTTER WILL BE INCLUDED IN THE COST FOR COMBINATION CONCRETE CURB AND GUTTER, TYPE & (SPECIAL)

COMBINATION CONCRETE CURB AND GUTTER, TYPE B (SPECIAL)

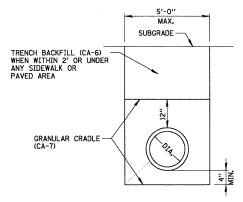

TYPICAL TRENCH DETAIL

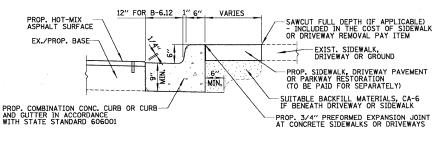


ALL REQUIRED EARTH EXCAVATION AND SUITABLE BACKFILL TO CONSTRUCT COMBINATION CONCRETE CURB AND GUTTER WILL BE INCLUDED IN THE COST FOR COMBINATION CONCRETE CURB AND GUTTER, TYPE B-6.12

COMBINATION CONCRETE CURB AND GUTTER, TYPE B-6.12

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	PLOT DATE = 2/8/2011	DATE	-	02/08/11	REVISED	-	ı

STATE OF ILLINOIS **DEPARTMENT OF TRANSPORTATION**

SCALE: N.T.S.

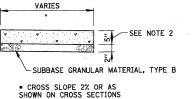


NOTES: 1. ALL REQUIRED EARTH EXCAVATION TO CONSTRUCT P.C.C. SIDEWALK SHALL BE INCLUDED IN THE COST FOR P.C.C. SIDEWALK.

- 2. THICKNESS SHALL BE INCREASED TO 7" WHERE SIDEWALK IS ADJACENT TO A DRIVEWAY

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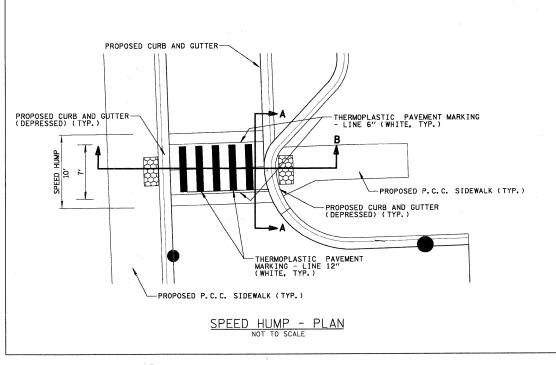
PROPOSED P.C.C. SIDEWALK WITH DETECTABLE WARNING

P.C.C. SIDEWALK DETAIL

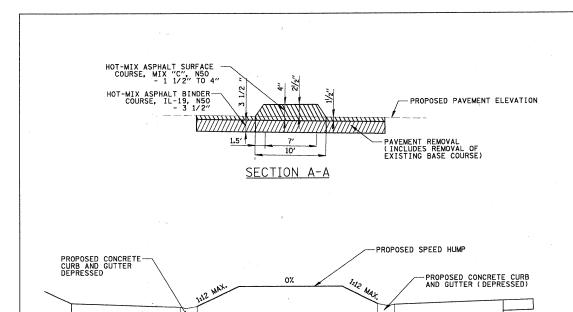


SPEED HUMP - PROFILES NOT TO SCALE

SECTION B-B



CONSTRUCTION	DETAILS	F.A. RTE.	SECTION	COUNTY	TOTAL SHEETS	SHEET NO.
			10-00074-00-SW	COOK	22	13
	, , , , , , , , , , , , , , , , , , , ,			CONTRACT	NO. 6	3559
SHEET NO DE SHEETS	STA. 10+00.00 TO STA. 24+922.22		ILLINOIS FED. AT	D PROJECT		

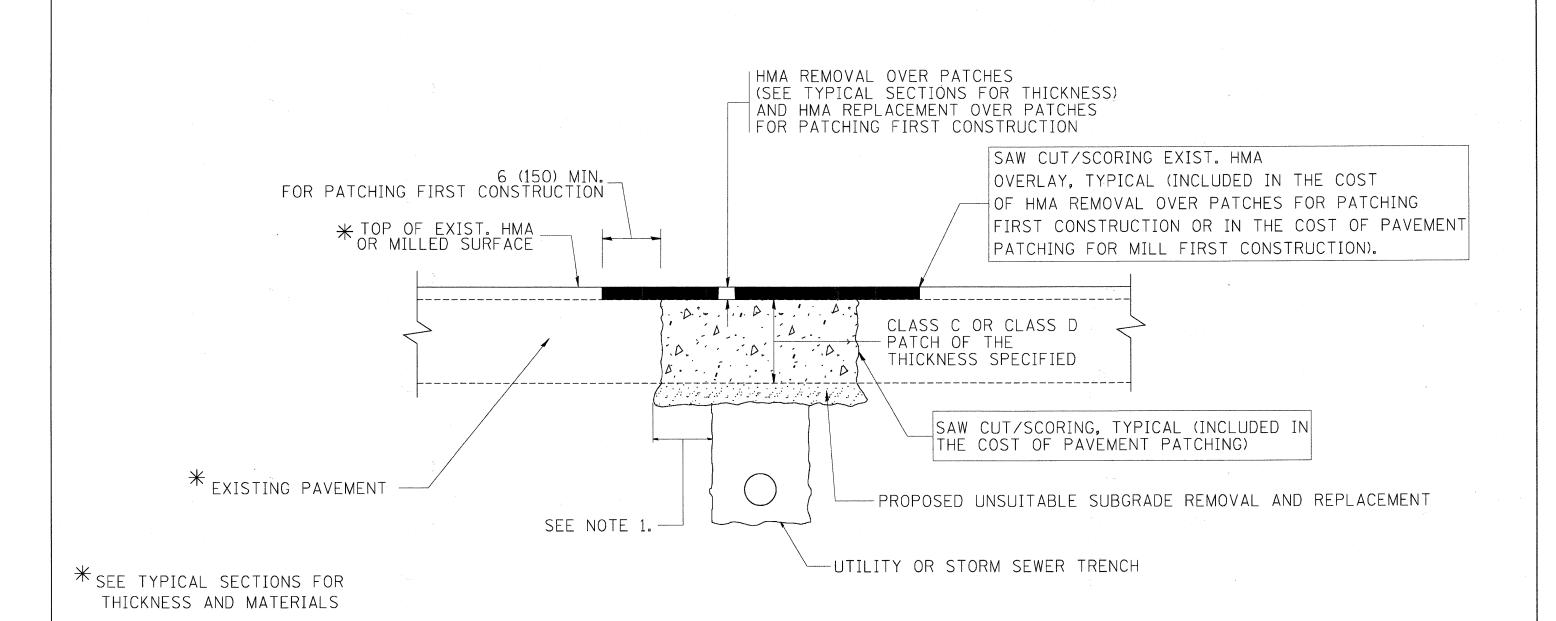

NOTES:

- 1. THE WIDTH OF THE FULL DEPTH PATCH OVER A TRENCH SHALL BE 12 (300) WIDER ON EACH SIDE OF THE TRENCH.
- 2. FOR METHOD OF MEASUREMENT AND BASIS OF PAYMENT, SEE RECURRING SPECIAL PROVISION "PATCHING WITH HOT-MIX ASPHALT OVERLAY REMOVAL".

SEQUENCE OF CONSTRUCTION (PATCHING FIRST)


- 1. REMOVE THE EXISTING HMA MATERIAL OVER THE AREA TO BE PATCHED.
- 2. REMOVE AND REPLACE WITH CLASS C OR D PATCH.
- 3. REPLACE HMA MATERIAL OVER THE AREA TO BE PATCHED.


SEQUENCE OF CONSTRUCTION (MILLING FIRST)

- 1. MILL HMA FIRST IF THERE IS AT LEAST 41/2 INCHES OR MORE OF HMA MATERIAL ON TOP OF THE EXISTING PAVEMENT OR IF THE PAVEMENT IS FULL DEPTH HMA. A MINIMUM OF 2 INCHES OF HMA MATERIAL SHALL BE IN PLACE AFTER MILLING.
- 2. REMOVE AND REPLACE WITH FULL DEPTH CLASS D PATCHES TO TOP OF MILLED SURFACE.


ALL DIMENSIONS ARE IN INCHES (MILLIMETERS) UNLESS OTHERWISE SHOWN.

FILE NAME =	USER NAME = bauerdl	DESIGNED - R. SHAH	REVISED - A. ABBAS 04-27-98		PAVEMENT PATCHING FOR	F.A SECTION	COUNTY TOTAL SHEET NO.
c:\projects\diststd22x34\bd22.dgn		DRAWN -	REVISED - R. BORO 01-01-07	STATE OF ILLINOIS	HMA SURFACED PAVEMENT	10-00074-00-SW	COOK 22 14
	PLOT SCALE = 50.000 '/ IN.	CHECKED -	REVISED - R. BORO 09-04-07	DEPARTMENT OF TRANSPORTATION		BD400-04 (BD-22)	CONTRACT NO. 63559
	PLOT DATE = 10/27/2008	DATE - 10-25-94	REVISED - K. ENG 10-27-08		SCALE: NONE SHEET NO. 1 OF 1 SHEETS STA. TO STA.	FED. ROAD DIST. NO. 1 ILLINOIS FED. A	AID PROJECT
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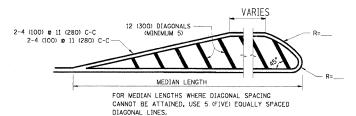


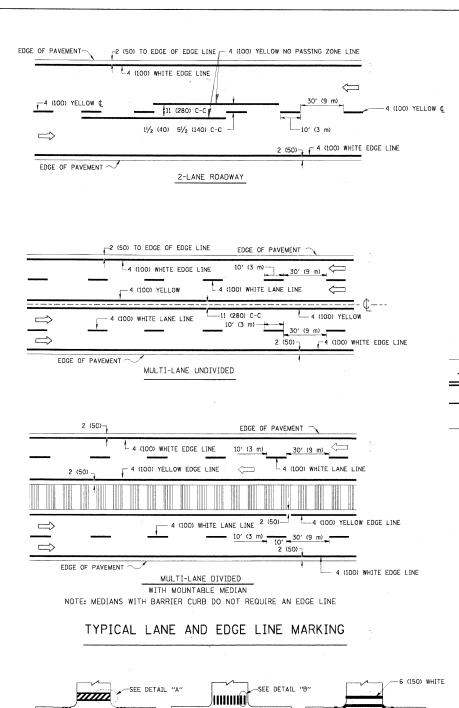

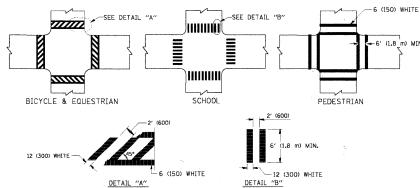TYPICAL CROSSWALK MARKING

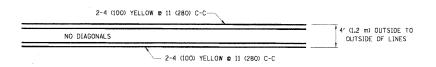


4' (1.2 m) WIDE MEDIANS ONLY




DIAGONAL LINE SPACING: 50' (15 m) C-C (LESS THAN 30MPH (50 km/h))
75' (25 m) C-C 30MPH (50 km/h) T0 45MPH (70 km/h))
150' (45 m) C-C (MORE THAN 45MPH (70 km/h))

MEDIANS OVER 4' (1.2 m) WIDE

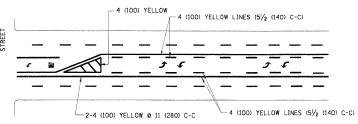


A MINIMUM OF TWO PAIRS OF TURN ARROWS SHALL BE USED, WHITE IN COLOR. ADDITIONAL PAIRS SHALL BE PLACED AT 200' (60 m) TO 300' (90 m) INTERVALS.

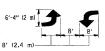

MEDIAN WITH TWO-WAY LEFT TURN LANE

TYPICAL PAINTED MEDIAN MARKING

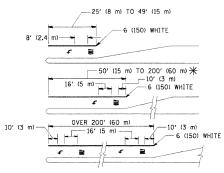


FULL SIZE LETTERS 8' (2.4 m) AND ARROWS SHALL BE USED. \P AREA = 15.6 SQ. FT. (1.5 m²) (III) AREA = 20.8 SQ. FT. (1.9 m²)

* TURN LANES IN EXCESS OF 400" (120 m) IN LENGTH MAY HAVE AN ADDITIONAL SET OF ARROW - "ONLY" INSTALLED MIDWAY BETWEEN THE OTHER TWO SETS OF ARROW - "ONLY".

TYPICAL LEFT (OR RIGHT) TURN LANE

TYPICAL TURN LANE MARKING

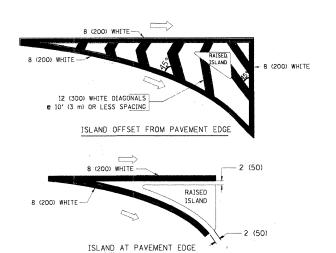

TYPICAL ISLAND MARKING

TYPE OF MARKING	WIDTH OF LINE	PATTERN	COLOR	SPACING / REMARKS
CENTERLINE ON 2 LANE PAVEMENT	4 (100)	SKIP-DASH,	YELLOW	10' (3 m) LINE WITH 30' (9 m) SPACE
CENTERLINE ON MULTI-LANE UNDIVIDED PAVEMENT	2 2 4 (100)	SOLID	YELLOW	11 (280) C-C
NO PASSING ZONE LINES: FOR ONE DIRECTION FOR BOTH DIRECTIONS	4 (100) 2 @ 4 (100)	SOLID SOLID	YELLOW YELLOW	5½ (140) C-C FROM SKIP-DASH CENTERLINE 11 (280) C-C OMIT SKIP-DASH CENTERLINE BETWEEN
LANE LINES	4 (100) 5 (125) ON FREEWAYS	SKIP-DASH SKIP-DASH	WHITE WHITE	10' (3 m) LINE WITH 30' (9 m) SPACE
DOTTED LINES (EXTENSIONS OF CENTER, LANE OR TURN LANE MARKINGS)	SAME AS LINE BEING EXTENDED	SKIP-DASH	SAME AS LINE BEING EXTENDED	2' (600) LINE WITH 6' (1.8 m) SPACE
EDGE LINES	4 (100)	SOLID	YELLOW-LEFT WHITE-RIGHT	OUTLINE MOUNTABLE MEDIANS IN YELLOW: EDGE LINES ARE NOT USED NEXT TO BARRIER CURB
TURN LANE MARKINGS	6 (150) LINE; FULL SIZE LETTERS & SYMBOLS (8' (2,4m))	SOLID	WHITE	SEE TYPICAL TURN LANE MARKING DETAIL
TWO WAY LEFT TURN MARKING	2 @ 4 (100) EACH DIRECTION	SKIP-DASH AND SOLID	YELLOW	10' (3 m) LINE WITH 30' (9 m) SPACE FOR SKIP-DASH; 51/2 (140) C-C BETWEEN SOLID LINE AND SKIP-DASH LINE
	8' (2.4m) LEFT ARROW	IN PAIRS	WHITE	SEE TYPICAL TWO-WAY LEFT TURN MARKING DETAIL
CROSSWALK LINES (PEDESTRIAN) A. DIAGONALS (BIKE & EQUESTRIAN) B. LONGITUDINAL BARS (SCHOOL)	2 @ 6 (150) 12 (300) @ 45° 12 (300) @ 90°	SOLID SOLID SOLID	WHITE WHITE WHITE	NOT LESS THAN 6' (1.8 m) APART 2' (500) APART 2' (500) APART SEE TYPICAL CROSSWALK MARKING DETAILS.
STOP LINES	24 (600)	SOLID	WHITE	PLACE 4' (1.2 m) IN ADVANCE OF AND PARALLEL TO CROSSMALK, IF PRESENT. OTHERMISE, PLACE AT DESIRED STOPPING POINT. PARALLEL TO CROSSROAD CENTERLINE, WHERE POSSIBLE
PAINTED MEDIANS	2 @ 4 (100) WITH 12 (300) DIAGONALS @ 45°	SOLID	YELLOW: TWO, WAY TRAFFIC	11 (280) C-C FOR THE DOUBLE LINE SEE TYPICAL PAINTED MEDIAN MARKING.
	NO DIAGONALS USED FOR 4' (1.2 m) WIDE MEDIANS		WHITE: ONE WAY TRAFFIC	SEE THEORE FAMILES WEDIAN WANTED
GORE MARKING AND CHANNELIZING LINES	8 (200) WITH 12 (300) DIAGONALS @ 45°	SOLID	WHITE	DIAGONALS: 15' (4.5 m) C-C (LESS THAN 30MPH (50 km/h)) 20' (6 m) C-C 30MPH (50 km/h) TO 45MPH (70 km/h)) 30' (9 m) C-C (OVER 45MPH (70 km/h))
RAILROAD CROSSING	24 (600) TRANSVERSE LINES; "RR" IS 6' (1.8 ml LETTERS; 16 (400) LINE FOR "X"	SOLID	WHITE	SEE STATE STANDARD 780001 AREA OF: "?M"=3.6 SQ. FT. (0.33 m²) EACH "X"=54,0 SQ. FT. (5.0 m²)
SHOULDER DIAGONALS	12 (300) @ 45°	SOLID	WHITE - RIGHT YELLOW - LEFT	50' (15 m) C-C (LESS THAN 30MPH (50 km/h)) 75' (25 m) C-C (30 MPH (50 km/h) T0 45MPH (70 km/h) 150' (45 m) C-C (0VER 45MPH (70 km/h))


FOR FURTHER DETAILS ON PAVEMENT MARKING REFER TO STANDARD SPECIFICATIONS FOR ROAD AND BRIDGE CONSTRUCTION AND STATE STANDARD 780001.

All dimensions are in inches (millimeters) unless otherwise shown.

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	PLOT DATE = 9/9/2009	DATE -	03-19-90	REVISED	-	
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STATE OF ILLINOIS
DEPARTMENT OF TRANSPORTATION

DISTRICT ONE	F.A. RTE.	• SECTION	COUNTY	TOTAL SHEETS	SHEET NO.
TYPICAL PAVEMENT MARKINGS		- 10-00074-00-SW	COOK	22	15
ITTICAL FAVENIENT MARKINGS		TC-13	CONTRACT	NO. 6	3559
CALE: NONE SHEET NO. 1 OF 1 SHEETS STA. TO STA.	· FED.	ROAD DIST. NO. 1 ILLINOIS FED. A	ID PROJECT		

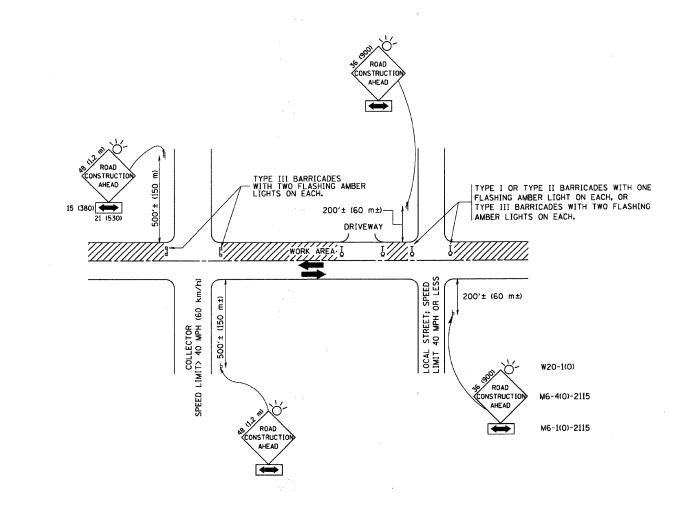

TRAFFIC CONTROL AND PROTECTION FOR SIDE ROADS, INTERSECTIONS, AND DRIVEWAYS

NOTES:

- A. FOR NO LANE RESTRICTION ON THE SIDE ROAD OR DRIVEWAYS
- 1. SIDE ROAD WITH A SPEED LIMIT OF 40 MPH (60 km/h) OR LESS AS SHOWN ON THE DRAWING AND AS DIRECTED BY THE ENGINEER:
- d) ONE ROAD CONSTRUCTION AHEAD SIGN 36 x 36 (900x900) WITH A FLASHER AND FLAG MOUNTED ON IT APPROXIMATELY 200' (60 m) IN ADVANCE OF THE MAIN ROUTE.
- b) THE CLOSED PORTION OF THE MAIN ROUTE SHALL BE PROTECTED BY BLOCKING WITH TYPE I, TYPE II OR TYPE III BARRICADES, 1/3 OF THE CROSS SECTION OF THE CLOSED PORTION.
- 2. SIDE ROAD WITH A SPEED LIMIT CREATER THAN 40 MPH (60 km/h) AS SHOWN ON THE DRAWING AND AS DIRECTED BY THE ENGINEER:
- o) ONE ROAD CONSTRUCTION AHEAD SIGN 48 \times 48 (1.2 m \times 1.2 m) WITH A FLASHER MOUNTED ON IT APPROXIMATELY 500' (150 m) IN ADVANCE OF THE MAIN ROUTE.
- b) THE CLOSED PORTION OF THE MAIN ROUTE SHALL BE PROTECTED BY BLOCKING WITH TYPE III BARRICADES, 1/2 OF THE CROSS SECTION OF THE CLOSED PORTION.
- 3. WHEN THE SIDE ROAD LIES BETWEEN THE BEGINNING OF THE MAINLINE SIGNING AND THE WORK ZONE, A SINGLE HEADED ARROW (MG-1) SHALL BE USED IN LIEU OF THE DOUBLE HEADED ARROW (MG-4).

B. FOR A LANE CLOSURE ON A SIDE ROAD OR DRIVEWAY:

USE APPLICABLE PORTIONS OF THE TYPICAL APPLICATION OF TRAFFIC CONTROL DEVICES (STD. 701501, STD. 701606 OR THE APPROPRIATE STANDARD). THE SPACING OF SIGNS AND BARRICADES SHALL BE ADJUSTED FOR FIELD CONDITIONS AS DIRECTED BY THE ENGINEER. THE DIRECTIONAL ARROW SHALL BE COVERED OR REMOVED WHEN NO LONGER CONSISTENT WITH THE SIDE ROAD LANE CLOSUME.

- C. ADVANCE WARNING SIGNS ARE TO BE OWITTED ON DRIVEWAY UNLESS OTHERWISE NOTED.
- D. THE TRAFFIC CONTROL AND PROTECTION FOR SIDE ROADS, INTERSECTIONS, AND DRIVEWAYS SHALL BE INCIDENTAL TO THE COST OF SPECIFIED TRAFFIC CONTROL STANDARDS OR ITEMS.

All dimensions are in millimeters (inches) unless otherwise shown.

REVISIO		ILLINOIS DEPAR		
NAME	DATE	ILLINOIS DE AN		
LHA	6/89	TRAFFIC CONT		
T. RAMMACHER	09/08/94	TRAFFIC CONT		
J. OBERLE	10/18/95			
A. HOUSEH	03/06/96	SIDE ROADS.		
A. HOUSEH	10/15/96	SIDE RUADS,		
T. RAMMACHER	01/06/00	D		
		_		
		SCALE: NONE		
		SCALES NONE		

RAFFIC CONTROL AND PROTECTION
FOR
SIDE ROADS, INTERSECTIONS, AND
DRIVEWAYS

CHECKED BY

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	PLOT DATE = 2/8/2011	DATE -	02/08/11	REVISED -	

STATE OF ILLINOIS
DEPARTMENT OF TRANSPORTATION

		TRAFFIC C	ONTR	OL AND F	PROTECTION	FOR
	;	SIDE ROADS,	INTE	RSECTIONS	S AND DRIV	EWAYS
SCALE:	N.T.S.	SHEET NO.	OF	SHEETS	STA. 10+00.0	O TO STA. 24+92.22

F.A.	SECTION	COUNTY	TOTAL SHEETS	NO.
---	10-00074-00-SW	COOK	22	16
---	CONTRACT	NO.	63559	
---	ILLINOIS	FED. AID PROJECT	NO.	63559



