STATE OF ILLINOIS
DEPARTMENT OF TRANSPORTATION
DIVISION OF HIGHWAYS

FOR INDEX OF SHEETS, SEE SHEET NO. 2

PLANS FOR PROPOSED FEDERAL AID HIGHWAY

TRAFFIC DATA
ADT:

 \circ

 \circ

DEVON AVENUE = 500

POSTED SPEED LIMIT:

DEVON AVENUE = 30 MPH

DESIGN DESIGNATION: LOCAL ROAD

DEVON AVENUE

OGDEN AVENUE TO MIDDLETON AVENUE AND AT SCHIESHER ELEMENTARY SCHOOL


SIDEWALK CONSTRUCTION

SECTION: 10-00056-00-SW


PROJECT: SRTS-4009(067)


VILLAGE OF LISLE DUPAGE COUNTY

C-40-011-10

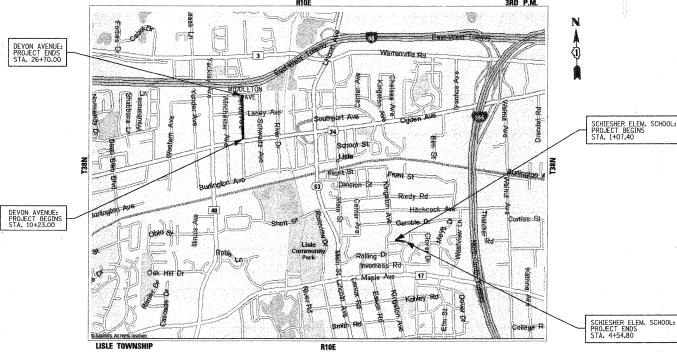


GROSS & NET LENGTH OF PROJECT: 1,995 FT. (0.38 MILES)

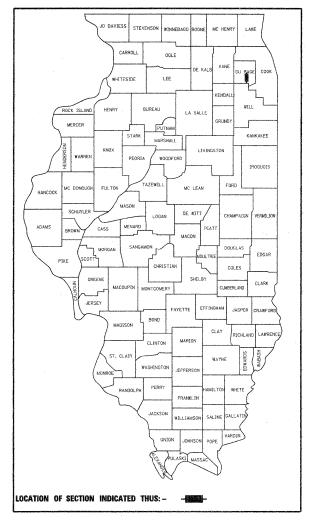

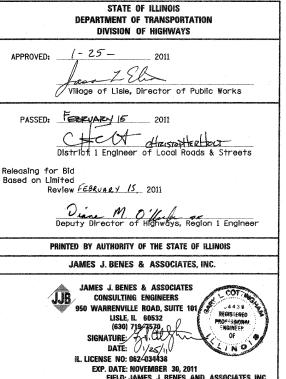

PROJECT LOCATED IN VILLAGE OF LISLE

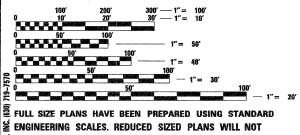

ENGINEERING SCALES. REDUCED SIZED PLANS WILL NOT CONFORM TO STANDARD SCALES. IN MAKING MEASUREMENTS ON REDUCED PLANS, THE ABOVE SCALES MAY BE USED.

J.U.L.I.E.

JOINT UTILITY LOCATION INFORMATION FOR EXCAVATION
1-800-892-0123

CONTRACT NO. 63537

COUNTY: DuPAGE SECTION: 10-00056-00-SW

INDEX OF SHEETS

SHEET NO.	TITLE
1	TITLE SHEET
2	INDEX OF SHEETS, GENERAL NOTES, STATE STANDARDS AND BENCH MARKS
3	SUMMARY OF QUANTITIES
4	SCHEDULES OF QUANTITIES
5	TYPICAL SECTIONS
6-8	GEOMETRIC PLANS
9-11	STORMWATER POLLUTION PREVENTION PLANS
12-13	CONSTRUCTION DETAILS
14-15	DISTRICT DETAILS
16-26	CROSS SECTIONS

BENCH MARKS

- 1) N.W. FLANGE BOLT ON FIRE HYDRANT. FIRE HYDRANT LOCATED ON THE EAST SIDE OF DEVON AVENUE NEAR OGDEN AVENUE (STA. 10+91, 9' RIGHT). ELEVATION = 697.91
- 2) N.W. FLANGE BOLT ON FIRE HYDRANT. FIRE HYDRANT LOCATED ON THE EAST SIDE OF DEVON AVENUE NEAR NEAR LACEY AVENUE. (STA. 20+13, 9' RIGHT). ELEVATION = 700.44
- 3) N. FLANGE BOLT ON FIRE HYDRANT. FIRE HYDRANT LOCATED AT THE SOUTHEAST CORNER OF DEVON AVENUE AND MIDDLETON AVENUE (STA. 25+72, 39' LEFT).
- 4) N.W. FLANGE BOLT ON FIRE HYDRANT. FIRE HYDRANT LOCATED ALONG THE OUTSIDE OF THE SCHIESHER ELEMENTARY SCHOOL SCHOOL DROP-OFF. FIFVATION = 753.11

<u>Dupage county Bench Mark:</u> No. Ll03004, TOP OF BRONZE DISK MONUMENT ESTABLISHED IN SOUTHWEST CORNER OF CONCRETE STRUCTURE OVER OGDEN AVENUE (US ROUTE 34) BRIDGE OVER THE EAST BRANCH DuPAGE ELEVATION = 669.28

COMMITMENTS: NONE

GENERAL NOTES

- 1. ACCESS TO LOCAL RESIDENCES AND BUSINESSES SHALL BE MAINTAINED DURING CONSTRUCTION
- 2. THE CONTRACTOR SHALL GIVE THE ENGINEER, MUNICIPALITY, AND JAMES J. BENES AND ASSOCIATES, INC. THREE (3) WORKING DAYS NOTICE PRIOR TO THE COMMENCEMENT OF WORK. (VILLAGE OF LISLE: (630) 271-4170) (JAMES J. BENES AND ASSOICATES, INC.: (630) 719-7570)
- 3. ALL ELEVATIONS ARE ON U.S.G.S. DATUM.
- 4. DO NOT SCALE PLANS FOR CONSTRUCTION DIMENSIONS.
- 5. THE ENGINEER OR THE OWNER, SHALL NOT ASSUME ANY OF THE RESPONSIBILITIES OF THE CONTRACTOR'S SUPERINTENDENT OR OF SUBCONTRACTORS. ADDITIONALLY, THE ENGINEER OR OWNER, SHALL NOT ADVISE ON, OR ISSUE DIRECTIONS CONCERNING, ASPECTS OF CONSTRUCTION MEANS, METHODS, TECHNIQUES, SEQUENCES OR PROCEDURES, OR SAFETY PRECAUTIONS AND/OR PROGRAMS IN CONNECTION WITH THE WORK.
- 6. THE LOCATIONS OF PUBLIC OR PRIVATE UTILITIES SHOWN ON THE PLANS ARE APPROXIMATE AND THEIR ACCURACY IS NOT GUARANTEED. THE CONTRACTOR SHALL VERIFY THE EXACT LOCATION AND ELEVATION OF ALL UTILITIES. THE CONTRACTOR SHALL REPORT ANY ENCOUNTERED DISCREPANCIES TO THE ENGINEER AT ONCE. THE CONTRACTOR SHALL TAKE DUE CARE IN ALL PHASES OF CONSTRUCTION TO PROTECT ANY UTILITIES WHICH MAY BE AFFECTED BY THE WORK. ANY DAMAGE TO EXISTING UTILITIES SHALL BE REPAIRED AT THE CONTRACTOR'S EXPENSE IN ACCORDANCE WITH ARTICLES 105.07, 107.20, AND 107.31.
- 7. THE CONTRACTOR SHALL KEEP THE CONSTRUCTION AREA FREE OF DEBRIS DURING CONSTRUCTION. THE CONTRACTOR SHALL INSPECT THE SITE DAILY FOR DEBRIS ON THE ROADWAY SURFACE IN ACCORDANCE WITH ARTICLE 107.15. THE RIGHT-OF-WAY SHALL BE RESTORED TO PRE-CONSTRUCTION CONDITION IN ACCORDANCE WITH ARTICLE 107.20.
- 8. THE CONTRACTOR SHALL MAINTAIN ALL EXISTING DRAINAGE FACILITIES DURING CONSTRUCTION AND SHALL REPAIR ANY DRAINAGE FACILITIES DAMAGED DURING CONSTRUCTION. THIS WORK SHALL BE INCLUDED IN THE COST OF THE CONTRACT AND WILL NOT BE PAID FOR SEPARATELY.
- 9. THE CONTRACTOR SHALL VERIFY THE ELEVATIONS OF EXISTING STORM SEWERS PRIOR TO THE CONSTRUCTION OF PROPOSED
- 10. THE RELOCATION OF SIGNS ARE INCLUDED IN THE COST OF THE CONTRACT AND WILL NOT BE PAID FOR SEPARATELY IN ACCORDANCE WITH ARTICLE 107.25
- 11. BEFORE STARTING ANY EXCAVATION, THE CONTRACTOR SHALL CALL "J.U.L.I.E." AT (800) 892-0123 FOR FIELD LOCATIONS OF BURIED ELECTRIC, TELEPHONE, GAS, SEWERS AND WATER UTILITIES. (48 HOUR NOTIFICATION IS REQUIRED.)
- 12. THE CONTRACTOR SHALL COORDINATE ALL CONSTRUCTION ACTIVITIES WITH ALL UTILITY COMPANIES AND THE VILLAGE OF
- 13. SAW CUTTING OF PAVEMENT, SHOULDERS, CURB AND GUTTER, ETC. SHALL BE TO FULL DEPTH AND SHALL RESULT IN CLEAN, STRAIGHT EDGE ON THE PORTION REMAINING. ALL SAW CUTTING SHALL BE CONSIDERED INCLUDED IN THE COST OF THE ITEM
- 14. THE CONTRACTOR SHALL BE RESPONSIBLE FOR ANY DAMAGE MADE BY THE CONTRACTOR TO THE IRRIGATION SYSTEMS AND IT SHALL BE REPAIRED IN ACCORDANCE WITH ARTICLE 107.20. THE CONTRACTOR WILL DETERMINE THE LOCATIONS OF DAMAGE AND EXTENT OF DAMAGE. ALL LOCATIONS OF REPAIR WORK AND EXTENT OF REPAIR SHALL BE APPROVED BY THE ENGINEER PRIOR TO PERFORMING THE WORK. THE SPRINKLER LINES SHALL BE PRESSURE TESTED. ANY PRESSURE LEAKS SHALL BE IDENTIFIED AND REPAIRS MADE PRIOR TO RETESTING THE SYSTEM FOR APPROVAL. ALL MATERIAL, LABOR AND EQUIPMENT USED TO LOCATE, REPAIR AND TEST THE DAMAGED IRRIGATION SYSTEMS WILL NOT BE PAID FOR SEPARATELY BUT SHALL BE INCLUDED IN THE UNIT BID PRICE OF THE CONTROLLING ITEM BEING WORKED ON AT THE TIME OF DAMAGE.
- 15. ALL CONSTRUCTION SHALL BE DONE IN ACCORDANCE WITH THE "STANDARD SPECIFICATIONS FOR ROAD AND BRIDGE CONSTRUCTION", ADOPTED JANUARY 1, 2007: THE "SUPPLEMENTAL SPECIFICATIONS AND RECURRING SPECIAL PROVISIONS", ADOPTED JANUARY 1, 2011: THE LATEST EDITION OF THE "ILLINOIS MANUAL ON UNIFORM TRAFFIC CONTROL DEVICES FOR STREETS AND HIGHWAYS" (MUTCD), "STANDARD SPECIFICATIONS FOR WATER AND SEWER MAIN CONSTRUCTION IN ILLINOIS" JULY 2009 SIXTH EDITION, THE "DETAILS" IN THE PLANS AND THE "SPECIAL PROVISIONS" INCLUDED IN THE CONTRACT DOCUMENTS.

LIST OF STATE STANDARDS

000001-06	STANDARD SYMBOLS, ABBREVIATIONS AND PATTERNS
280001-05	TEMPORARY EROSION CONTROL SYSTEMS
424001-05	CURB RAMPS FOR SIDEWALKS
542401-01	METAL END SECTION FOR PIPE CULVERT
602301-03	INLET - TYPE A
604001-03	FRAME AND LIDS TYPE 1
604036-02	GRATE TYPE 8
60600104	CONCRETE CURB TYPE B AND COMBINATION CONCRETE CURB AND GUTTER
701301-04	LANE CLOSURE, 2L, 2W, SHORT TIME OPERATIONS
701501-06	URBAN LANE CLOSURE, 2L, 2W, UNDIVIDED
701801-04	LANE CLOSURE MULTILANE 1W OR 2W CROSSWALK OR SIDEWALK CLOSURE
701901-01	TRAFFIC CONTROL DEVICES

LIST OF DISTRICT ONE DETAILS

TC-10 TRAFFIC CONTROL AND PROTECTION FOR SIDE ROADS, INTERSECTIONS, AND DRIVEWAYS

TO STA.

DISTRICT ONE TYPICAL PAVEMENT MARKINGS TC-13

JAMES J. BENES & ASSOCIATES, INC. 950 Warrenville Road, Suite 101, Lisle, Illinois 60532 Tel. (630) 719-7570 • Fax (630) 719-7589

STATE OF ILLINOIS **DEPARTMENT OF TRANSPORTATION** INDEX OF SHEETS, GENERAL NOTES, STATE STANDARDS AND BENCH MARKS **DEVON AVENUE AND SCHIESHER ELEMENTARY SCHOOL**

SCALE: NONE | SHEET NO. 2 OF 26 SHEETS | STA. _____

COUNTY TOTAL SHEET NO. SECTION 10-00056-00-SW DuPAGE 26 2 CONTRACT NO. 63537 ILLINOIS FED. AID PROJECT

CODE NO.	SUMMARY OF QUANTITIES	UNIT	TOTAL QUANTITY	CONSTRUCTIO SAFETY IMPROVEMENTS 100% FED 0% VILLAGE 0021	
20101000	TEMPORARY FENCE	FOOT	335	335	
20101200	TREE ROOT PRUNING	EACH	25	25	
20201200	REMOVAL AND DISPOSAL OF UNSUTABLE MATERIAL	CU YD	367	367	
20400800	FURNISHED EXCAVATION	CUYD	15	15	
20800150	TRENCH BACKFILL	CU YD	22	22	
28000400	PERIMETER EROSION BARRIER	FOOT	480	480	
28000500	INLET AND PIPE PROTECTION	EACH	6	6	
28000510	INLET FILTERS	EACH	4	4	* ,
	AGGREGATE FOR TEMPORARY ACCESS	TON	200	200	
	PROTECTIVE COAT	SQYD	1,072	1,072	
	PORTLAND CEMENT CONCRETE SDEWALK 5 INCH	SQFT	9,603	9,603	
	DETECTABLE WARNINGS	SQFT	32	32	V4
	DRIVEWAY PAVEMENT REMOVAL	SQYD	436	436	
	COMBINATION CURB AND GUTTER REMOVAL	FOOT	15	15	
	SIDEWALK REMOVAL	SQFT	100	100	
	CLASS D PATCHES, TYPE I, 2 INCH	SQ YD	3	3	_
50901760	PIPE HANDRAIL	FOOT	115	115	
54215547	METAL END SECTIONS 12"	EACH	3	3	
54215550	METAL END SECTIONS 15"	EACH	2	2	
550B0050	STORM SEWERS, CLASS B, TYPE 112"	FOOT	145	145	
550B0070	STORM SEWERS, CLASS B, TYPE 115"	FOOT	25	25	
56400300	FIRE HYDRANTS TO BE ADJUSTED	EACH	2	2	
56500600	DOMESTIC WATER SERVICE BOXES TO BE ADJUSTED	EACH	1	1	
60236200	INLETS, TYPE A, TYPE 8 GRATE	EACH	1	1	
60257900	MANHOLES TO BE RECONSTRUCTED	EACH	1	1	
60258100	MANHOLES TO BE RECONSTRUCTED WITH NEW TYPE 1 FRAME, OPEN LID	EACH	1	1	
60266600	VALVE BOXES TO BE ADJUSTED	EACH	2	2	
60600605	CONCRETE CURB, TYPE B	FOOT	10	10	
60603800	COMBINATION CONCRETE CURB AND GUTTER, TYPE B-6.12	FOOT	15	15	
67100100	MOBILIZATION	LSUM	1	1	
70102620	TRAFFIC CONTROL AND PROTECTION, STANDARD 701501	L SUM	1	1	
	TRAFFIC CONTROL AND PROTECTION, STANDARD 701801	L SUM	1	1	
	THERMOPLASTIC PAVEMENT MARKING - LINE 12"	FOOT	96	96	
	SEGMENTAL CONCRETE BLOCK WALL	SQFT	120	120	
	CONSTRUCTION LAYOUT	L SUM	1	1	
	DRAINAGE & UTILITY STRUCTURES TO BE ADJUSTED	EACH	4	4	
	STABLIZED DRIVEWAYS 7"	SQYD	316	316	
	SEEDING, CLASS 1 (SPECIAL)	ACRE	0.9	0.9	
	SUMP PUMP LINE CONNECTION	EACH	1	1	
	COMP. TO THE CONTROLOUS	LAUIT	 	 	

<u>L'EGEND</u>

-DENOTES SPECIALTY ITEM

JJB

JAMES J. BENES & ASSOCIATES, INC.

950 Warrenville Road, Suite 101, Lisle, Illinois 60532
Tel. (630) 719-7570 · Fax (630) 719-7589

F.A.U. SECTION COUNTY TOTAL SHEETS NO.

10-00056-00-SW DuPAGE 26 3

CONTRACT NO. 63537

| ILLINOIS | FED. AID | PROJECT

USER NAME =	DESIGNED		BDH	REVISED	
	DRAWN	_	SMP .	REVISED	
PLOT SCALE =	CHECKED		BDH	REVISED	
PLOT DATE =	DATE	_	9-29-10	REVISED	

STATE OF ILLINOIS
DEPARTMENT OF TRANSPORTATION

SUMMARY OF QUANTITIES
DEVON AVENUE AND SCHIESHER ELEMENTARY SCHOOL

FILE NAME =

ARTMENT OF TRANSPORTATION

DEVON AVENUE AND SCHIESHER ELEME

SCALE: NONE SHEET NO. 3 OF 26 SHEETS STA.

	TO BE RECO TYPE 1 FRAM	NSTRUCTED E, OPEN LID
	OFFSET	QUANTITY
STATION	(FEET)	(EACH)
DEVON AVENUE 15+30	13' RT	1
TOTAL QUANTITY	=	1

MANHOLES	TO BE RECO	NSTRUCTED
	OFFSET	QUANTITY
STATION	(FEET)	(EACH)
DEVON AVENUE 19+57	<i>7</i> ' RT	1
TOTAL QUANTITY	=	1

DRAINAGE & U	JTILITY STRI E ADJUSTEI	
	OFFSET	QUANTITY
STATION	(FEET)	(EACH)
DEVON AVENUE 10+30	13' RT	1
19+09	16' RT	1
19+60	20' RT	1
19+70	15' RT	1
TOTAL QUANTITY		4

METAL	END SECTIO	NS 12"
	OFFSET	QUANTITY
STATION	(FEET)	(EACH)
DEVON AVENUE 14+00 23+68 24+23	10' RT 7' RT 7' RT	:1 :1 1
TOTAL QUANTITY	'=	3

METAL END SECTIONS 15"			
	OFFSET	QUANTITY	
STATION	(FEET)	(EACH)	
DEVON AVENUE			
17+78	14' RT	1	
18+02	11' RT	1	
TOTAL QUANTITY	′=	2	

	ATER SERVICE	
	OFFSET	QUANTITY
STATION	(FEET)	(EACH)
DEVON AVENUE 14+64	19' RT	1
TOTAL QUANTITY	′ =	1

OFFSET	QUANTITY
(FEET)	(EACH)
10' RT	1
13' RT	1
	(FEET)

	OFFSET	QUANTITY
STATION	(FEET)	(EACH)
DEVON AVENUE		
12+62	16' RT	1
14+02	17' RT	1

	OFFSET	QUANTITY				
STATION	(FEET)	(EACH)				
EVON AVENUE						
14+25	12' RT	1				
20+13	9' RT	1				

	QUANTITY	
STATION	(FEET)	(EACH)
DEVON AVENUE		
12+72	11' RT	1
14+01	11' RT	1
18+02	11' RT	1
21+94	9' RT	1
22+96	9' RT	1
24+23	7' RT	1

iN	LET FILTER:	s						
	OFFSET QUANTITY							
STATION	(FEET)	(EACH)						
DEVON AVENUE 15+30	13' RT	1						
19+10	10' RT	1						
19+57	7' RT	1						
19+57	24' RT	1						
OTAL QUANTITY	=	4						

TREE ROOT PRUNING						
	OFFSET	QUANTITY				
STATION	(FOOT)	(EACH)				
DEVON AVENUE						
12+10	12' RT	1 1				
12+36	22' RT	1				
12+46	22' RT	1				
12+68	22' RT	1 1				
13+06	21' RT	1				
13+68	22' RT	1				
13+94	24' RT	1				
14+68	20' RT	1				
15+98	17' RT	1				
16+18	17' RT	1				
16+42	17" RT	1				
19+07	22' RT	1				
19+87	17' RT	1.				
20+03	20' RT	1.				
20+32	21' RT	1				
21+02	24° RT	1				
21+37	25' RT	1				
21+43	26' RT	1				
22+17	23' RT	1				
24+05	17' RT	1				
24+87	13' RT	1				
25+71	25' RT	1				
SCHIESHER ELE	M. SCHOOL					
1+48	9' LT	1				
1+76	9' LT	1				
3+00	9' LT	1				
TOTAL QUANTIT	Y =	25				

DRIVEWAY QUANTITY SCHEDULE									
STATION	OFFSET	EXISTING PAVEMENT	DRIVEWAY PAVEMENT REMOVAL (SQ. YD.)	STABILIZED DRIVEWAYS 7" (SQ. YD.)					
DEVON AVE	NUE								
12+87	RT	HMA	42	30					
13+21	RT	HMA	41	29					
13+50	RT	HMA	35	26					
14+15	RT	HMA	33	26					
14+38	RT	HMA	44	33					
15+66	RT	HMA	34	21					
16+63	RT-	HMA	34	21					
17+91	RT	HMA	53	37					
21+85	RT	HMA	42	33					
22+86	RT	HMA	43	34					
23+93	RT	HMA	35	26					
TOTAL QUA	NTITY =		436	316					

EARTHWORK						
LOCATION	REMOVAL & DISPOSAL OF UNSUITABLE MAT.* (CU YD)	FURNISHED EXCAVATION** (CU YD)				
DEVON AVENUE: OGDEN AVENUE TO MIDDLETON AVENUE AT SCHIESHER ELEMENTARY SCHOOL	304 63	15 0				
TOTAL QUANTITY =	367	15				
*ALL CUT MATERIAL SHALL BE HAULED OFF SITE DUE TO NO ONS	SITE STORAGE LOCATIO	NS.				

*ALL CUT MATERIAL, SHALL BE HAULED OFF SITE DUE TO NO ONSITE STORAGE LOCATION
**ALL FILL MATERIAL (EMBANKMENT) SHALL BE BROUGHT IN FROM OFFSITE LOCATION,
SINCE ON SITE EXCAVATED MATERIAL MUST BE HAULED OFF SITE.


	SEGMENTAL	CONCRETE E	BLOCK WALL	
		LENGTH	AVERAGE	QUANTITY
LOCATION	OFFSET	(FOOT)	HEIGHT (FOOT)	(SQ FT)
DEVON AVENUE				
17+68 TO 17+84	RT	25	1.5	37.5
17+97 TO 18+45	RT	55	1.5	82.5
TOTAL QUANTITY =				120

STATE OF ILLINOIS
DEPARTMENT OF TRANSPORTATION

SCHEDULE OF QUANTITIES
DEVON AVENUE AND SCHIESHER ELEMENTARY SCHOOL


SCALE: NONE SHEET NO. 4 OF 26 SHEETS STA. _____ TO STA. ____

	1 Si Jiji	Warrenville	e Road,	Swite 101, Lisle, 1 570 • Fax (630) 71	Ilinois 605	
F.A.U. RTE.	SEC	CTION		COUNTY	TOTAL SHEETS	SHEET NO.
	10-0005	6-00-S	W	DuPAGE	26	4
	CONTRACT NO. 63537					
		ILLINOIS	FED. Al	D PROJECT		

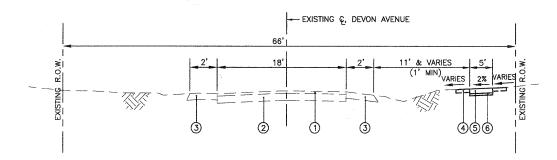

PROPOSED TYPICAL CROSS SECTION-DEVON AVENUE

STA. 10+23.00 (OGDEN AVENUE) TO STA. 26+70.00 (MIDDLETON AVENUE) (SECTION LOOKING NORTH)

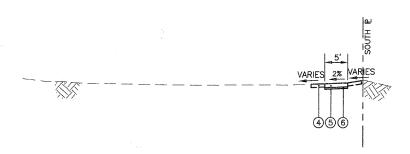

PROPOSED TYPICAL CROSS SECTION-SCHLIESHER ELEMENTARY SCHOOL

STA. 1+07.40 TO STA. 4+54.80 (SECTION LOOKING EASTERLY)

LEGEND

- 1 EXISTING HOT-MIX ASPHALT SURFACE COURSE, THICKNESS VARIES
- 2 EXISTING HOT-MIX PAVEMENT, THICKNESS VARIES
- 3 EXISTING AGGREGATE SHOULDERS, THICKNESS VARIES
- 4 SEEDING, CLASS 1 (SPECIAL) (INCLUDES 4" PULVERIZED TOP SOIL AND FERTILIZER) (AT LOCATIONS DESIGNATED BY THE ENGINEER)
- (5) PORTLAND CEMENT CONCRETE SIDEWALK 5" (AT ENTRANCES, THE SIDEWALK SHALL BE INCREASED TO THE THICKNESS OF THE DRIVEWAY PAVEMENT, COST INCLUDED IN P.C.C. SIDEWALK 5")
- 6 SUB-BASE GRANULAR MATERIAL, TYPE B 2" (COST INCLUDED IN P.C.C. SIDEWALK 5")

HOT-MIX ASPHALT MIXTURE REQUIREMENTS

MIXTURE TYPE	VOIDS
DRIVEWAYS	
HOT-MIX ASPHALT BASE COURSE, 5" (HMA BINDER IL-19mm)	4% @ 50 Gyr.
HOT-MIX ASPHALT SURFACE COURSE, MIX "C" N50, 2" (IL-9.5mm)	4% © 50 Gyr.
PATCHING	
CLASS D PATCHES, 2" (HMA BINDER IL-19mm)	4% © 70 Gyr.

NOTE: 1) THE UNIT WEIGHT USED TO CALCULATE ALL HMA QUANTITIES IS 112 LB/SY/IN

2) THE "AC TYPE" FOR POLYMERIZED HMA MIXES SHALL BE "SBS/SBR PG 70-22" AND FOR NON-POLYMERIZED HMA THE "AC TYPE" SHALL BE "PG 64-22" UNLESS MODIFIED BY DISTRICT ONE SPECIAL PROVISIONS. FOR "PERCENT OF RAP" SEE DISTRICT ONE SPECIAL PROVISIONS.


ILE NAME =	USER NAME =	DESIGNED	_	BDH ,	REVISED	 	
		DRAWN	_	SMP	REVISED	 	
	PLOT SCALE =	CHECKED		BDH	REVISED	 	
	PLOT DATE =	DATE		9-29-10	REVISED		


STATE OF ILLINOIS **DEPARTMENT OF TRANSPORTATION**

	TYPCIAL S	ECTIONS
DEVO	N AVENUE AND SCHIESH	IER ELEMENTARY SCHOOL
SCALE: NONE	SHEET NO. 5 OF 26 SHEET	TS STA TO STA


		95				Suite 101, Lisle, I 70 • Fax (630) 71		532
	F.A.U. RTE.	LU. SECTION COU		COUNTY	TOTAL SHEETS	SHEET NO.		
	10-00056-00-SW				DuPAGE	26	5	
_					T	CONTRACT	NO. 6	3537
			ILLINOIS	FED.	AIC	PROJECT		

JAMES J. BENES & ASSOCIATES, INC.

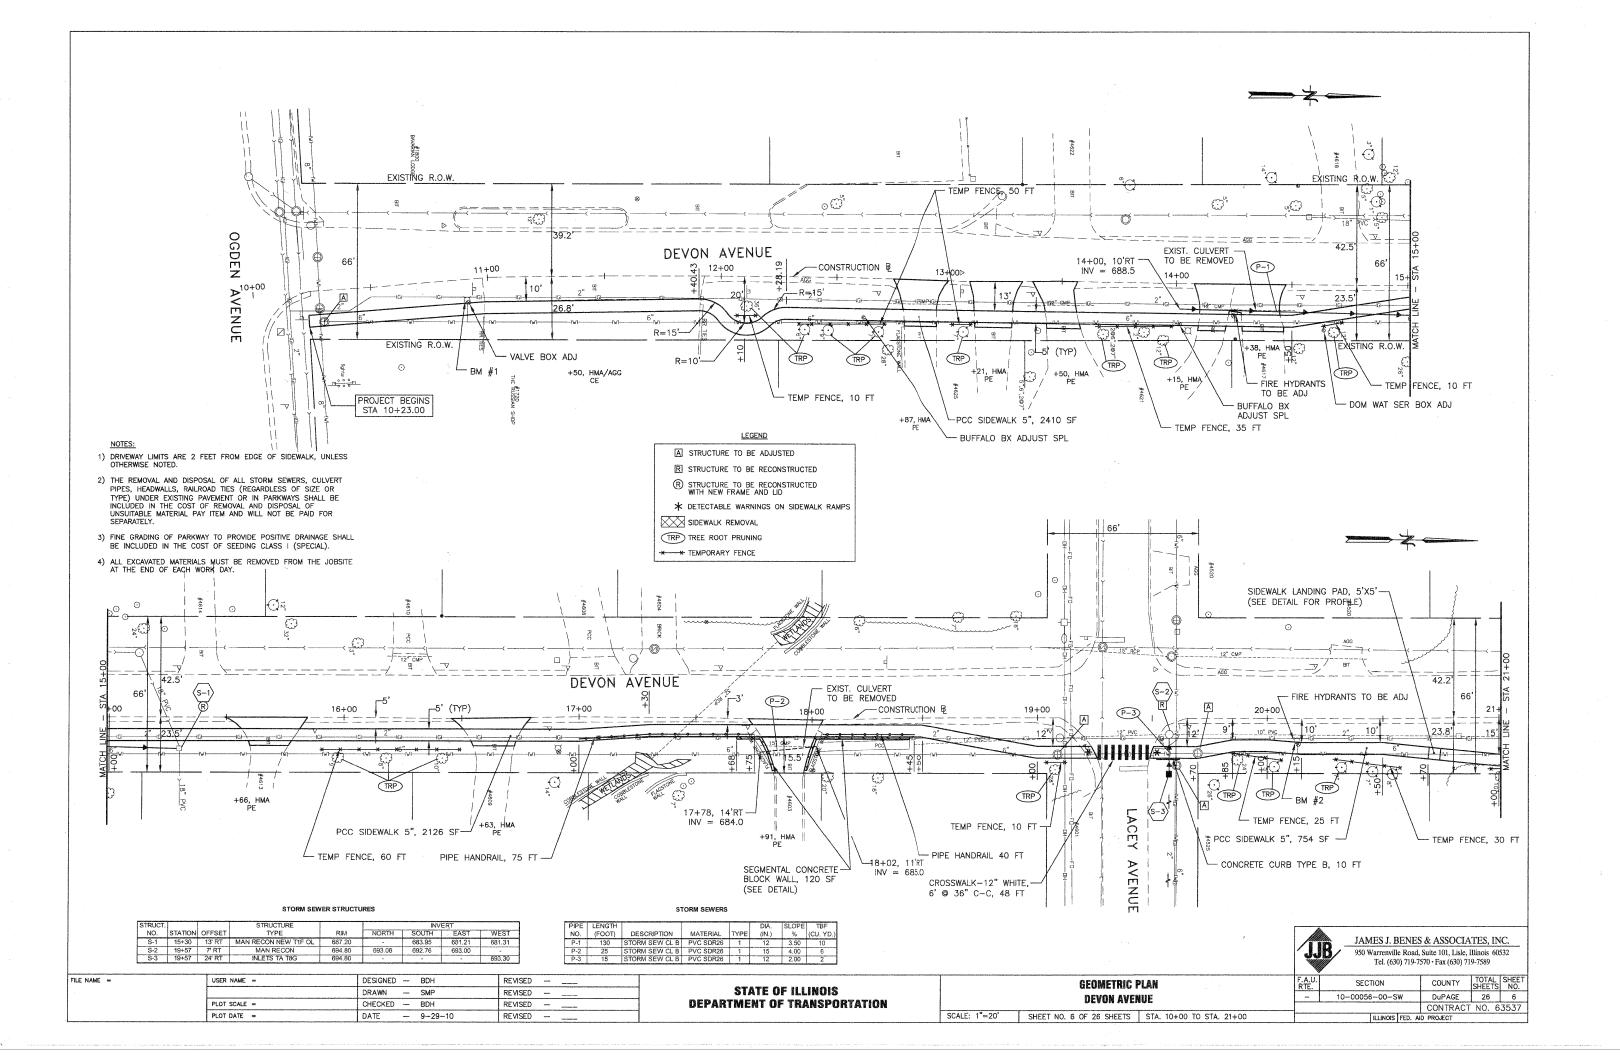

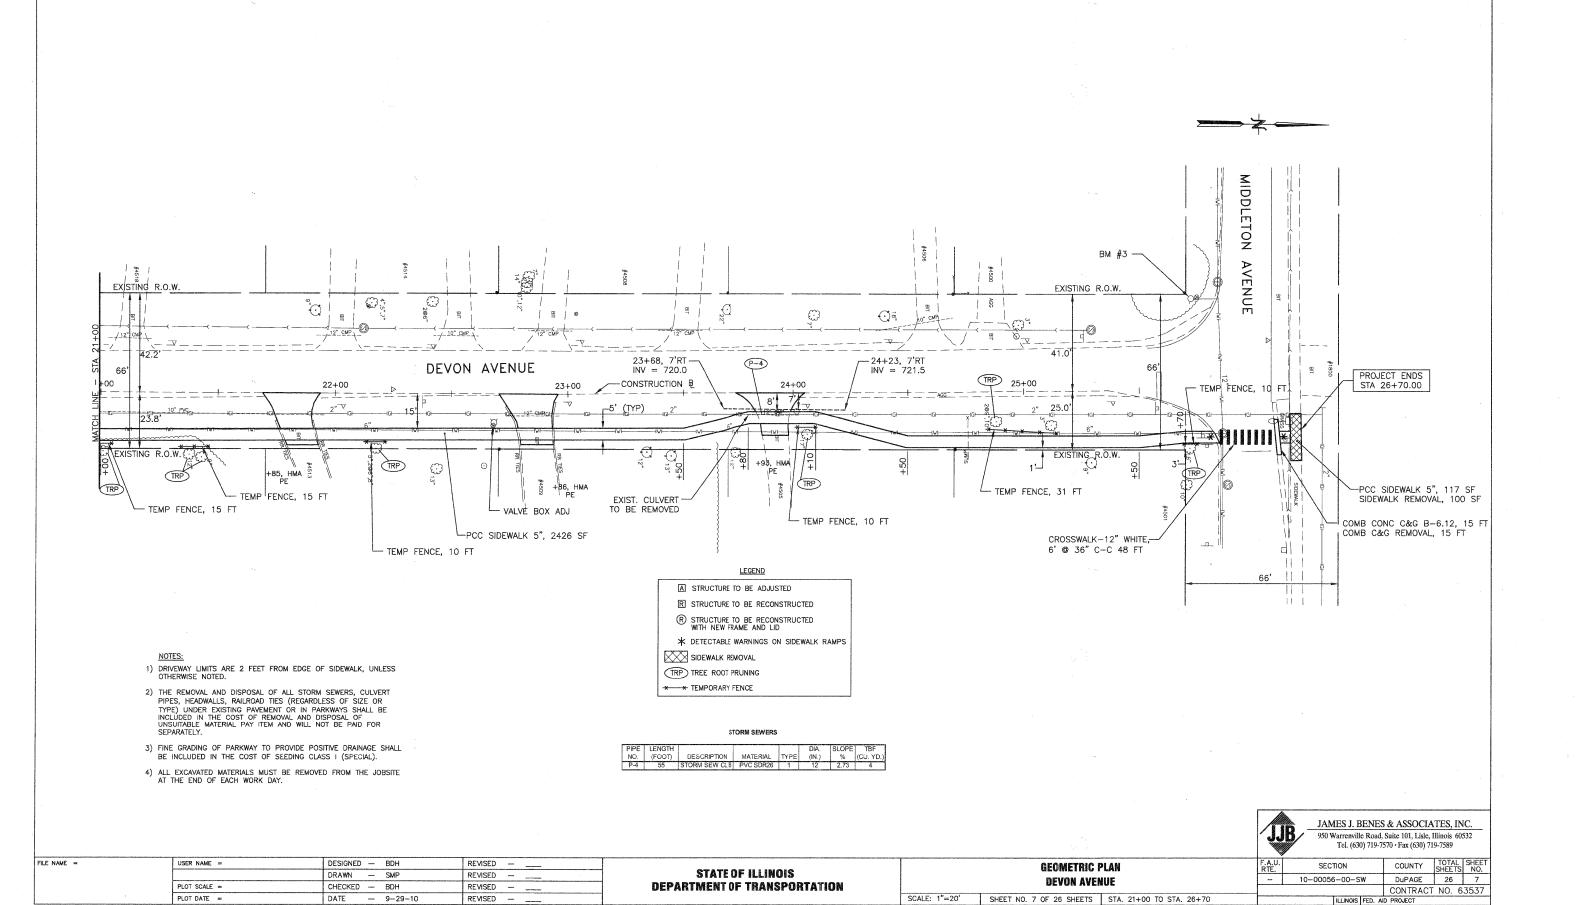

- 1) DRIVEWAY LIMITS ARE 2 FEET FROM EDGE OF SIDEWALK, UNLESS OTHERWISE NOTED.
- 2) THE REMOVAL AND DISPOSAL OF ALL STORM SEWERS, CULVERT PIPES, HEADWALLS, RAILROAD TIES (REGARDLESS OF SIZE OR TYPE) UNDER EXISTING PAVEMENT OR IN PARKWAYS SHALL BE INCLUDED IN THE COST OF REMOVAL AND DISPOSAL OF UNSUITABLE MATERIAL PAY ITEM AND WILL NOT BE PAID FOR SEPARATELY.
- 3) FINE GRADING OF PARKWAY TO PROVIDE POSITIVE DRAINAGE SHALL BE INCLUDED IN THE COST OF SEEDING CLASS I (SPECIAL).
- 4) ALL EXCAVATED MATERIALS MUST BE REMOVED FROM THE JOBSITE AT THE END OF EACH WORK DAY.

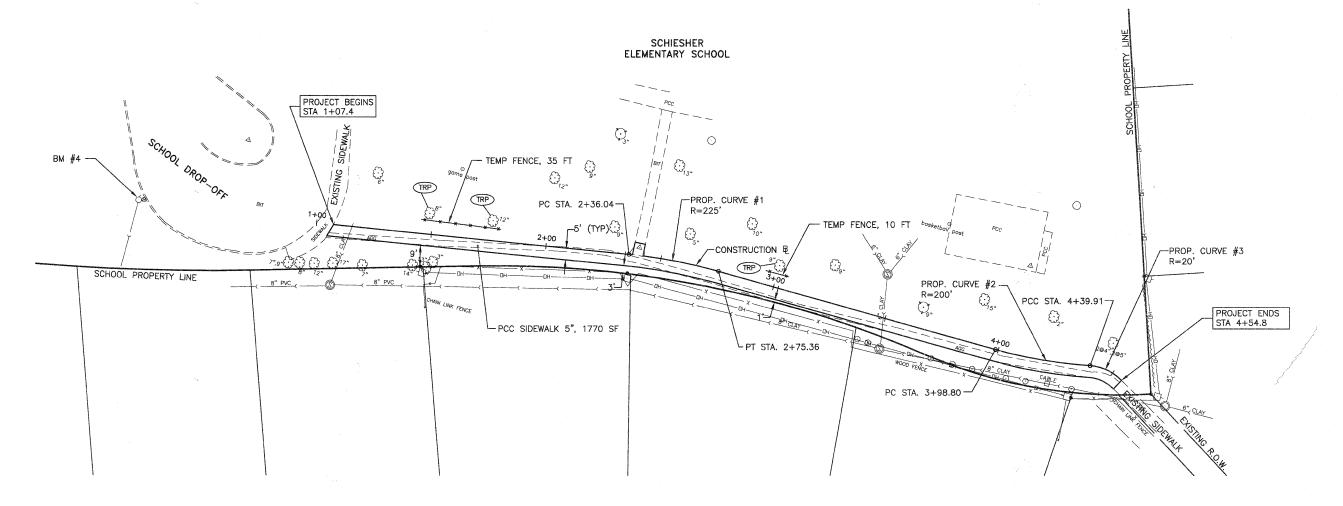

LEGEND

- A STRUCTURE TO BE ADJUSTED
- R STRUCTURE TO BE RECONSTRUCTED
- R STRUCTURE TO BE RECONSTRUCTED WITH NEW FRAME AND LID
- * DETECTABLE WARNINGS ON SIDEWALK RAMPS
- SIDEWALK REMOVAL
- TRP TREE ROOT PRUNING
- * * TEMPORARY FENCE

JJB	
"//	

JAMES J. BENES & ASSOCIATES, INC. 950 Warrenville Road, Suite 101, Lisle, Illinois 60532 Tel. (630) 719-7570 • Fax (630) 719-7589

ILLINOIS FED. AID PROJECT

COUNTY TOTAL SHEET NO.

Dupage 26 8 **GEOMETRIC PLAN** SECTION 10-00056-00-SW SCHIESHER ELEMENTARY SCHOOL CONTRACT NO. 63537

ENAME =	USER NAME =	DESIGNED		BDH	REVISE	D	
		DRAWN	_	SMP .	REVISE	D —	
	PLOT SCALE =	CHECKED		BDH	REVISE	D —	
	PLOT DATE =	DATE		9-29-10	DEVICE	7	

FILE


STATE OF ILLINOIS **DEPARTMENT OF TRANSPORTATION**

SCALE: 1"=20' SHEET NO. 8 OF 26 SHEETS STA. 1+07 TO STA. 4+55

TEMPORARY EROSION CONTROL NOTES

- 1. SEDIMENT AND EROSION CONTROL DEVICES SHALL BE FUNCTIONAL BEFORE LAND IS OTHERWISE DISTURBED ON THE SITE.
- 2. THE SURFACE OF STRIPPED AREAS SHALL BE PERMANENTLY OR TEMPORARILY PROTECTED FROM SOIL EROSION WITHIN 15 DAYS AFTER FINAL GRADE IS REACHED. STRIPPED AREAS NOT AT FINAL GRADE THAT WILL REMAIN UNDISTURBED FOR MORE THAN 15 DAYS AFTER INITIAL DISTURBANCE SHALL BE PROTECTED FROM EROSION.
- 3. IF A STOCKPILE IS TO REMAIN IN PLACE FOR MORE THAN 3 DAYS, THEN SEDIMENT AND EROSION CONTROL DEVICES SHALL BE INSTALLED DURING CONSTRUCTION.
- 4. STORM SEWER INLETS SHALL BE PROTECTED WITH SEDIMENT TRAPPING OR FILTER CONTROL DEVICES DURING CONSTRUCTION.
- 5. THE QUANTITIES SHOWN FOR INLET & PIPE PROTECTION AND TEMPORARY DITCH CHECKS ARE SUFFICIENT FOR ONE (1) SETUP AND THREE (3) REPLACEMENTS. 10. WATER PUMPED OR OTHERWISE DISCHARGED FROM THE SITE DURING CONSTRUCTION DEWATERING SHALL BE FILTERED.
- 6, THE CONTRACTOR SHALL MAINTAIN ALL EROSION CONTROL MEASURES IN SERVICEABLE CONDITION AT ALL TIMES. EROSION CONTROL MEASURES WILL BE INSPECTED WITHIN 24 HOURS OF ANY STORM EXCEEDING 0.5 INCHES OF PRECIPITATION.
- 7. ALL CONSTRUCTION ACTIVITIES SHALL BE IN ACCORDANCE WITH THE NATIONAL POLLUTANT DISCHARGE ELIMINATION SYSTEM STORM WATER PERMIT FOR THIS PROJECT.
- 8. TEMPORARY DITCH CHECKS SHALL BE PLACED IMMEDIATELY AFTER DITCH GRADING (OR CLEANING AND REGRADING) IS COMPLETED.
- 9. ALL PROPOSED OPEN LID DRAINAGE STRUCTURES SHALL HAVE INLET PROTECTION AS DIRECTED BY THE ENGINEER WITH INLET FILTERS, AND THIS WORK SHALL BE PAID FOR AT THE CONTRACT UNIT PRICE PER EACH FOR "INLET FILTERS".

 - 11. ANY SOIL, MUD OR DEBRIS WASHED, TRACKED, OR DEPOSITED ONTO THE STREET SHALL BE REMOVED PRIOR TO THE END OF THE WORK DAY.
 - 12. MAINTENANCE OF TEMPORARY EROSION CONTROL SYSTEMS WILL NOT BE PAID FOR SEPARATELY, BUT INCLUDED IN THE COST OF TEMPORARY

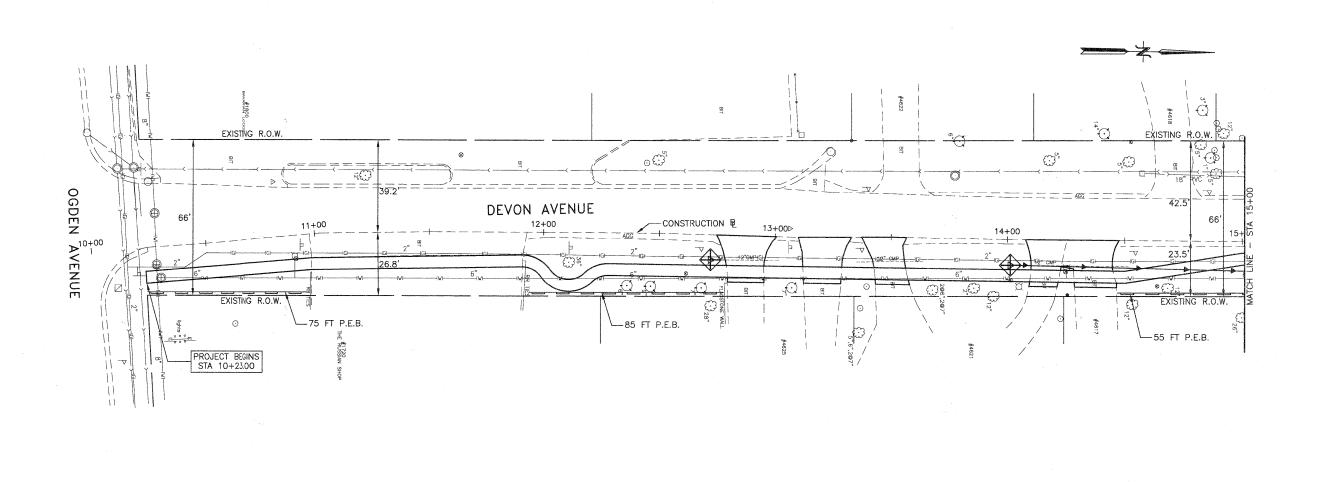

LEGEND PERIMETER EROSION BARRIER (P.E.B.)



INLET AND PIPE PROTECTION

INLET FILTERS (EXISTING DRAINAGE STRUCTURES)

INLET FILTERS (PROPOSED DRAINAGE STRUCTURES)


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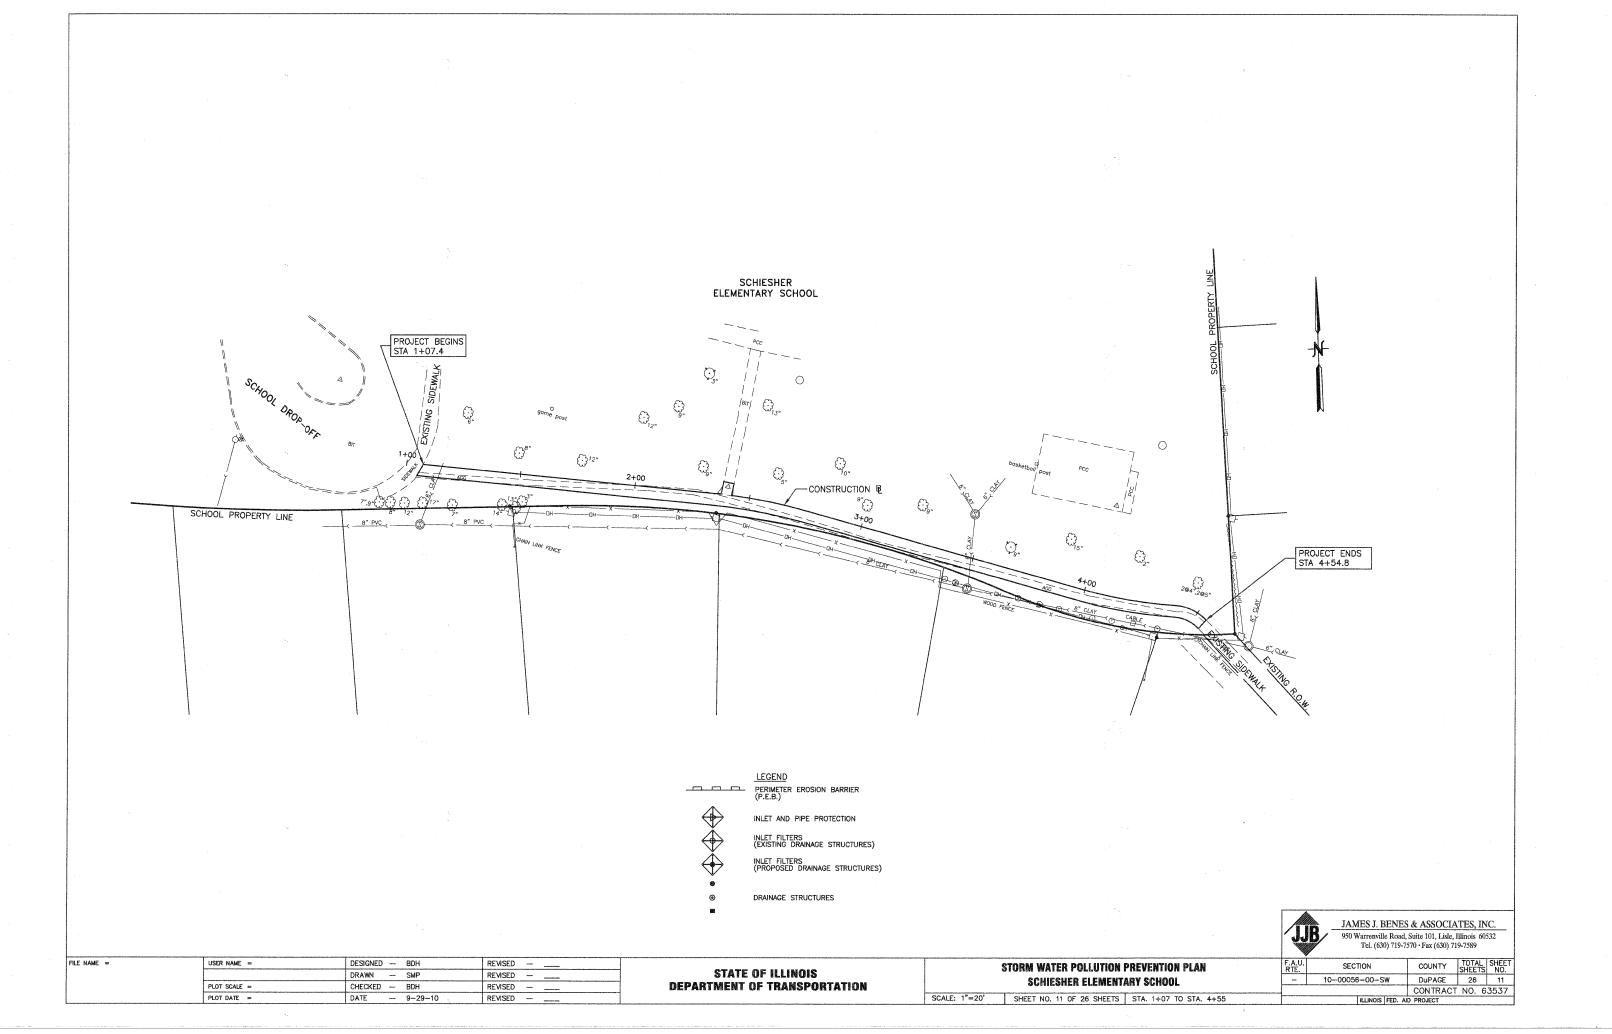
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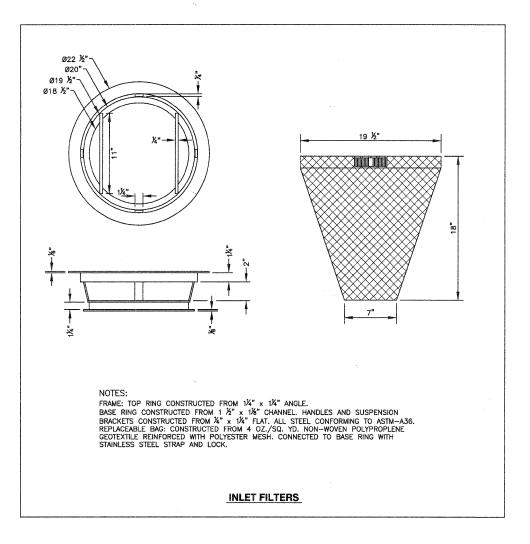
STATE OF ILLINOIS **DEPARTMENT OF TRANSPORTATION**


STORM WATER POLLUTION PREVENTION PLAN													
	DEVON AVENUE												
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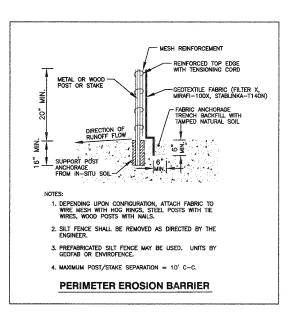
JAMES J. BENES & ASSOCIATES, INC. 950 Warrenville Road, Suite 101, Lisle, Illinois 60532 Tel. (630) 719-7570 • Fax (630) 719-7589 TOTAL SHEET SHEETS NO. SECTION COUNTY 10-00056-00-SW DuPAGE 26 9 CONTRACT NO. 63537 ILLINOIS FED. AID PROJECT










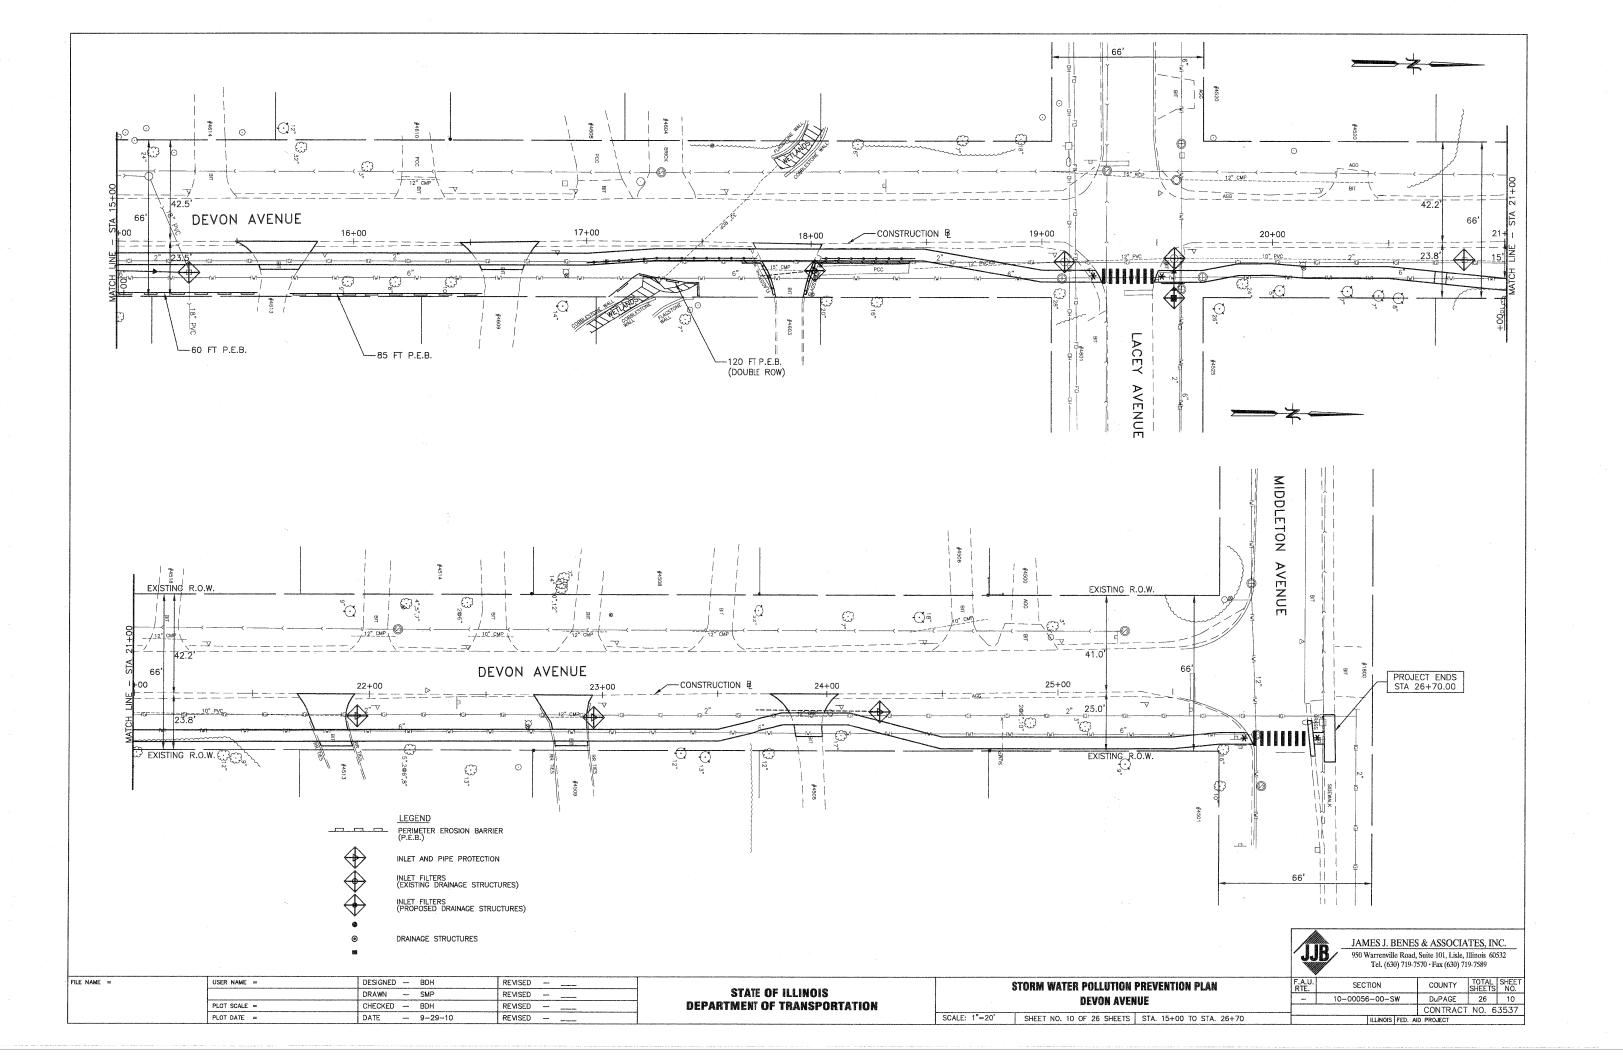


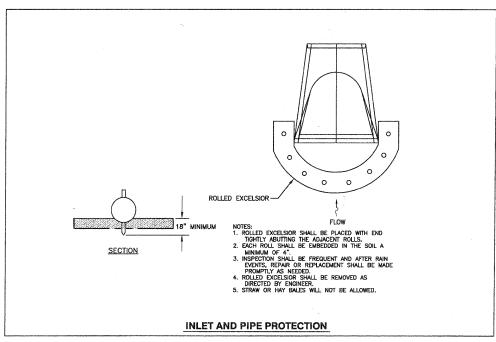


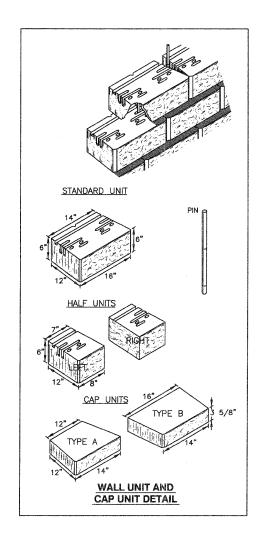

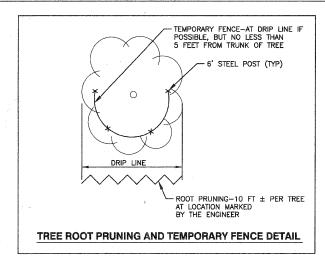

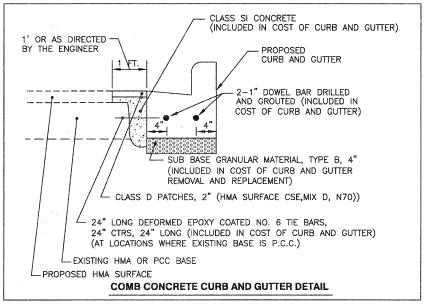

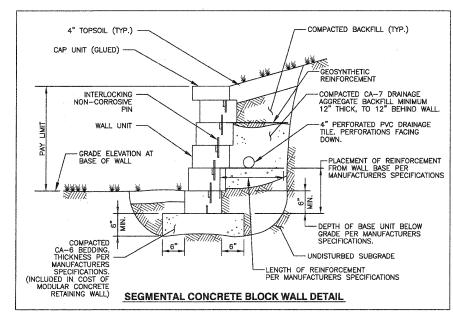

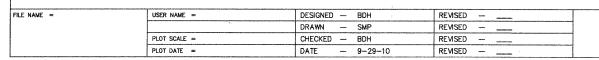

STATE OF ILLINOIS
DEPARTMENT OF TRANSPORTATION

CONSTRUCTION DETAILS
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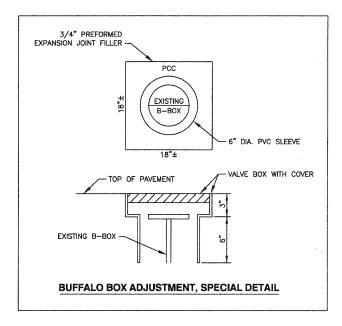
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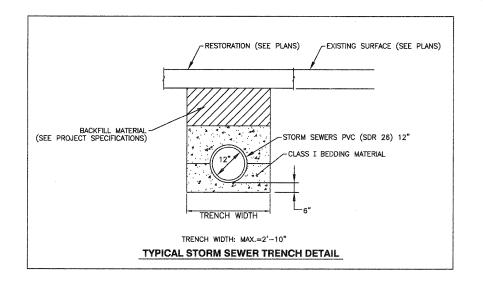
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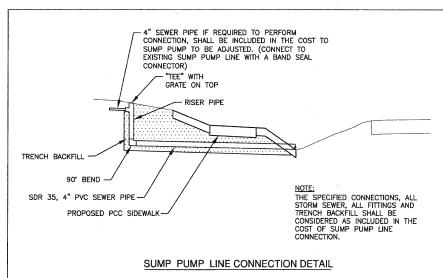
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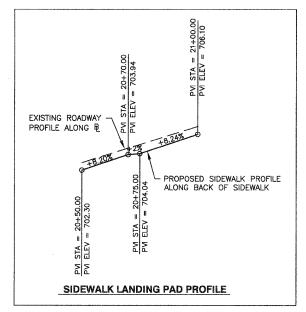
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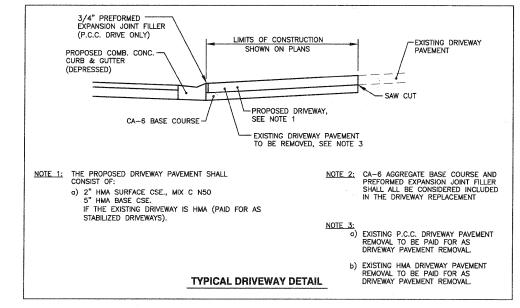
JAMES J. BENES & ASSOCIATES, INC. 950 Warrenville Road, Suite 101, Lisle, Illinois 60532 Tel. (630) 719-7570 · Fax (630) 719-7589













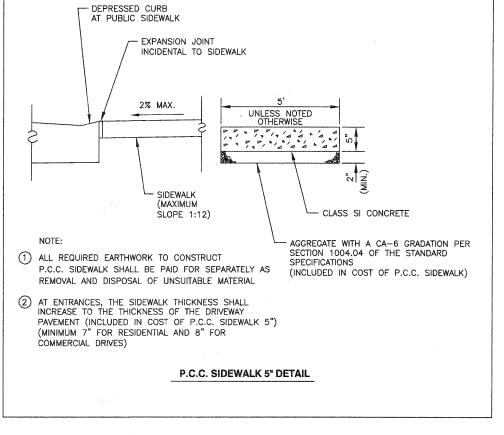

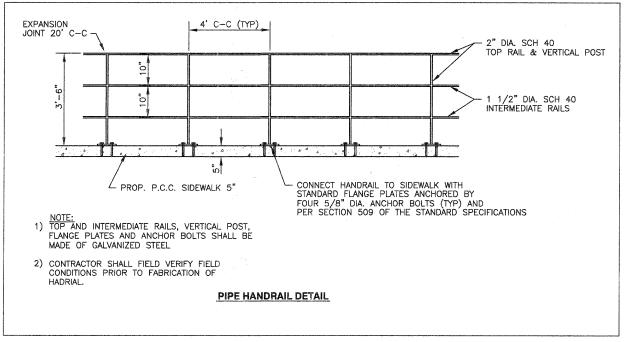


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STATE OF ILLINOIS
DEPARTMENT OF TRANSPORTATION

CONSTRUCTION DETAILS									
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JAMES J. BENES & ASSOCIATES, INC.
950 Warrenville Road, Suite 101, Lisle, Illinois 60532



TRAFFIC CONTROL AND PROTECTION FOR SIDE ROADS, INTERSECTIONS, AND DRIVEWAYS

NOTES:

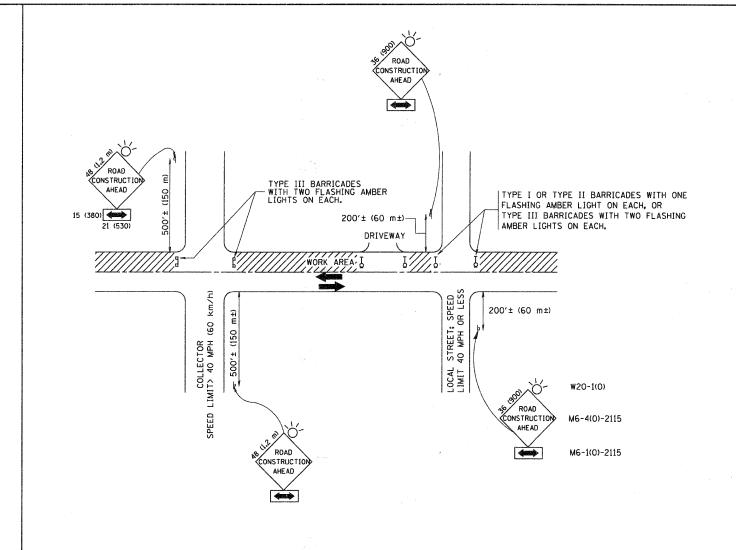- A. FOR NO LANE RESTRICTION ON THE SIDE ROAD OR DRIVEWAYS
- 1. SIDE ROAD WITH A SPEED LIMIT OF 40 MPH (60 km/h) OR LESS AS SHOWN ON THE DRAWING AND AS DIRECTED BY THE ENGINEER:
- Q) ONE ROAD CONSTRUCTION AHEAD SIGN 36 x 36 (900x900) WITH A FLASHER AND FLAG MOUNTED ON IT APPROXIMATELY 200' (60 m) IN ADVANCE OF THE MAIN ROUTE.
- b) THE CLOSED PORTION OF THE MAIN ROUTE SHALL BE PROTECTED BY BLOCKING WITH TYPE I, TYPE II OR TYPE III BARRICADES, 1/3 OF THE CROSS SECTION OF THE CLOSED PORTION.
- 2. SIDE ROAD WITH A SPEED LIMIT GREATER THAN 40 MPH (60 km/h) AS SHOWN ON THE DRAWING AND AS DIRECTED BY THE ENGINEER:
- O) ONE ROAD CONSTRUCTION AHEAD SIGN 48 x 48 (1.2 m x 1.2 m) WITH A FLASHER MOUNTED ON IT APPROXIMATELY 500' (150 m) IN ADVANCE OF THE MAIN ROLLE.
- b) THE CLOSED PORTION OF THE MAIN ROUTE SHALL BE PROTECTED BY BLOCKING WITH TYPE III BARRICADES, 1/2 OF THE CROSS SECTION OF THE CLOSED PORTION.
- 3. WHEN THE SIDE ROAD LIES BETWEEN THE BEGINNING OF THE MAINLINE SIGNING AND THE WORK ZONE, A SINGLE HEADED ARROW (M6-1) SHALL BE USED IN LIEU OF THE DOUBLE HEADED ARROW (M6-4).


- B. FOR A LANE CLOSURE ON A SIDE ROAD OR DRIVEWAY:
- USE APPLICABLE PORTIONS OF THE TYPICAL APPLICATION OF TRAFFIC CONTROL DEVICES (STD. 701501, STD. 701606 OR THE APPROPRIATE STANDARD). THE SPACING OF SIGNS AND BARRICADES SHALL BE ADJUSTED FOR FIELD CONDITIONS AS DIRECTED BY THE ENGINEER. THE DIRECTIONAL ARROW SHALL BE COVERED OR REMOVED WHEN NO LONGER CONSISTENT WITH THE SIDE ROAD LANE CLOSURE.
- C. ADVANCE WARNING SIGNS ARE TO BE OMITTED ON DRIVEWAY UNLESS OTHERWISE NOTED.
- D. THE TRAFFIC CONTROL AND PROTECTION FOR SIDE ROADS, INTERSECTIONS, AND DRIVEWAYS SHALL BE INCIDENTAL TO THE COST OF SPECIFIED TRAFFIC CONTROL STANDARDS OR ITEMS.


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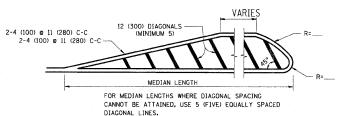
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STATE OF ILLINOIS
DEPARTMENT OF TRANSPORTATION

	TRAFFIC	CONTROL A	ND PROTECT	TION FOR
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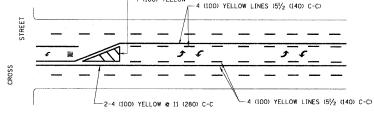




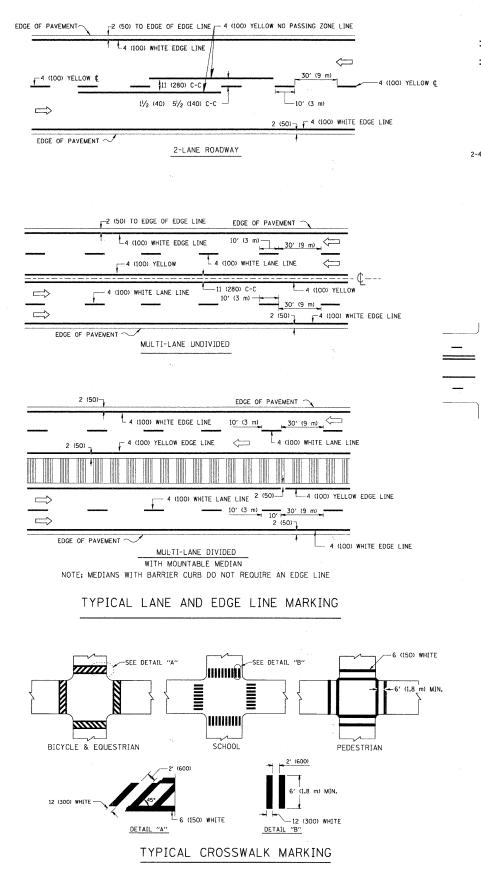


DIAGONAL LINE SPACING: 50' (15 m) C-C (LESS THAN 30MPH (50 km/h)) 75' (25 m) C-C 30MPH (50 km/h) T0 45MPH (70 km/h)) 150' (45 m) C-C (MORE THAN 45MPH (70 km/h))

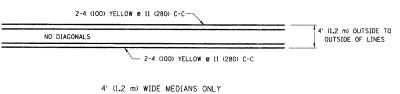MEDIANS OVER 4' (1.2 m) WIDE




A MINIMUM OF TWO PAIRS OF TURN ARROWS SHALL BE USED, WHITE IN COLOR, ADDITIONAL PAIRS SHALL BE PLACED AT 200' (60 m) TO 300' (90 m) INTERVALS.

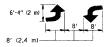

MEDIAN WITH TWO-WAY LEFT TURN LANE

TYPICAL PAINTED MEDIAN MARKING

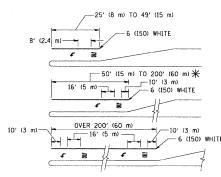


FULL SIZE LETTERS 8' (2.4 m) AND ARROWS SHALL BE USED. \P AREA = 15.6 SO. FT. (1.5 m²) ML^{γ} AREA = 20.8 SO. FT. (1.9 m²)

* TURN LANES IN EXCESS OF 400' (120 m) IN LENGTH MAY HAVE AN ADDITIONAL SET OF ARROW - "ONLY" INSTALLED MIDWAY BETWEEN THE OTHER TWO SETS OF ARROW - "ONLY".

TYPICAL LEFT (OR RIGHT) TURN LANE

TYPICAL TURN LANE MARKING

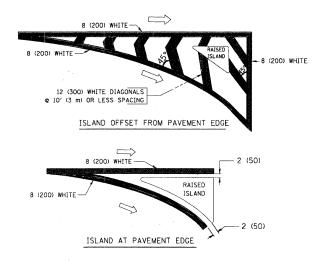

TYPICAL ISLAND MARKING

TYPE OF MARKING	WIDTH OF LINE	PATTERN	COLOR	SPACING / REMARKS
CENTERLINE ON 2 LANE PAVEMENT	4 (100)	SKIP-DASH	YELLOW	10' (3 m) LINE WITH 30' (9 m) SPACE
CENTERLINE ON MULTI-LANE UNDIVIDED PAVEMENT	2 & 4 (100)	SOLID	YELLOW	11 (280) C-C
NO PASSING ZONE LINES: FOR ONE DIRECTION FOR BOTH DIRECTIONS	4_(100) 2 @ 4 (100)	SOLID	YELLOW YELLOW	5½ (140) C-C FROM SKIP-DASH CENTERLINE 11 (280) C-C OMIT SKIP-DASH CENTERLINE BETWEEN
LANE LINES	4 (100) 5 (125) ON FREEWAYS	SKIP-DASH SKIP-DASH	WHITE WHITE	10' (3 m) LINE WITH 30' (9 m) SPACE
DOTTED LINES (EXTENSIONS OF CENTER, LANE OR TURN LANE MARKINGS)	SAME AS LINE BEING EXTENDED	SKIP-DASH	SAME AS LINE BEING EXTENDED	2' (600) LINE WITH 6' (1.8 m) SPACE
EDGE LINES	4 (100)	SOLID	YELLOW-LEFT WHITE-RIGHT	OUTLINE MOUNTABLE MEDIANS IN YELLOW: EDGE LINES ARE NOT USED NEXT TO BARRIER CURB
TURN LANE MARKINGS	6 (150) LINE; FULL SIZE LETTERS & SYMBOLS (8' (2.4m))	SOLID	WHITE	SEE TYPICAL TURN LANE MARKING DETAIL
TWO WAY LEFT TURN MARKING	2 0 4 (100) EACH DIRECTION	SKIP-DASH AND SOLID	YELLOW	10' (3 m) LINE WITH 30' (9 m) SPACE FOR SKIP-DASH; 51/2 (140) C-C BETWEEN SOLID LINE AND SKIP-DASH LINE
	8' (2.4m) LEFT ARROW	IN PAIRS	WHITE	SEE TYPICAL TWO-WAY LEFT TURN MARKING DETAIL
CROSSWALK LINES (PEDESTRIAN) A. DIAGONALS (BIKE & EQUESTRIAN) B. LONGITUDINAL BARS (SCHOOL)	2 @ 6 (150) 12 (300) @ 45° 12 (300) @ 90°	SOLID SOLID SOLID	WHITE WHITE WHITE	NOT LESS THAN 6' (1.8 m) APART 2' (600) APART 2' (600) APART 5' (600) APART SEE TYPICAL CROSSWALK MARKING DETAILS.
STOP LINES	24 (600)	SOLID	WHITE	PLACE 4' (1,2 m) IN ADVANCE OF AND PARALLEL TO CROSSWALK, IF PRESENT. OTHERWISE, PLACE AT DESIRED STOPPING POINT. PARALLEL TO CROSSROAD CENTERLINE, WHERE POSSIBLE
PAINTED MEDIANS	2 @ 4 (100) WITH 12 (300) DIAGONALS	SOLID	YELLOW: TWO WAY TRAFFIC	11 (280) C-C FOR THE DOUBLE LINE
	e 45° NO DIAGONALS USED FOR 4' (1.2 m) WIDE MEDIANS		WHITE: ONE WAY TRAFFIC	SEE TYPICAL PAINTED MEDIAN MARKING.
GORE MARKING AND CHANNELIZING LINES	8 (200) WITH 12 (300) DIAGONALS @ 45°	SOLID	WHITE	DIAGONALS: 15' (4.5 m) C-C (LESS THAN 30MPH (50 km/h)) 20' (6 m) C-C 30MPH (50 km/h) TO 45MPH (70 km/h)) 30' (9 m) C-C (OVER 45MPH (70 km/h))
RAILROAD CROSSING	24 (600) TRANSVERSE LINES; "RR" IS 6' (1,8 m) LETTERS; 16 (400) LINE FOR "X"	SOLID	WHITE	SEE STATE STANDARD 780001 AREA OF: "R"=3.6 SQ. FT. (0.33 m²) EACH "X"=54.0 SQ. FT. (5.0 m²)
SHOULDER DIAGONALS	12 (300) @ 45°	SOLID	WHITE - RIGHT YELLOW - LEFT	50' (15 m) C-C (LESS THAN 30MPH (50 km/h)) 75' (25 m) C-C (30 MPH (50 km/h) TO 45MPH (70 km/h)) 150' (45 m) C-C (OVER 45MPH (70 km/h))

FOR FURTHER DETAILS ON PAVEMENT MARKING REFER TO STANDARD SPECIFICATIONS FOR ROAD AND BRIDGE CONSTRUCTION AND STATE STANDARD 780001.

All dimensions are in inches (millimeters) unless otherwise shown.

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STATE OF ILLINOIS DEPARTMENT OF TRANSPORTATION

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	TYPICAL PAVEMENT MARKINGS					10-00056-00-SW		DuPAGE	26	15
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