STATE OF ILLINOIS

DEPARTMENT OF TRANSPORTATION

DIVISION OF HIGHWAYS

PROPOSED HIGHWAY PLANS

VARIOUS
SECTION 2010–161–I
NORTHSIDE MAINTENANCE YARD
KNEE WALL, FENCING, AND LANDSCAPING
COOK COUNTY

C-91-358-11

PLAINE
DEVON

LOCATION MAP

CONTRACT NO. 60N78

PROJECT IS LOCATED IN THE

ENGINEERING SCALES. REDUCED SIZED PLANS WILL NOT CONFORM TO STANDARD SCALES. IN MAKING MEASUREMENTS

ON REDUCED PLANS, THE ABOVE SCALES MAY BE USED.

JOINT UTILITY LOCATION INFORMATION FOR EXCAVATION

DISTRICT ONE BUREAU OF MAINTENANCE: J. STUMPNER

MAINTENANCE LANDSCAPE DESIGNER: R. WANNER /M. DEL ROSARIO (847) 705-4171

CITY OF CHICAGO

FOR INDEX OF SHEETS, SEE SHEET NO. 2

D-91-358-11



STATE OF ILLINOIS
DEPARTMENT OF TRANSPORTATION
DIVISION OF HIGHWAYS

SUBMITTED FEBRUARY 10, 20 11

Diane M. O'Kell grant DEPUTY DIRECTOR OF HIGHWAYS, REGION ENGINEER

nauch 05 20 11

acting ENGINEER OF DESIGN AND ENVIRONMENT

March 05 20 11

Chratina M. Raed/or
DIRECTOR OF HIGHWAYS, CHIEF ENGINEER

PRINTED BY THE AUTHORITY OF THE STATE OF ILLINOIS

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GENERAL NOTES

- 1. THE CONTRACTOR MUST CONDUCT HIS OWN INVESTIGATIONS INTO THE LOCATION, SIZE, DEPTH, AND NATURE OF ANY AND ALL EXISTING UTILITIES WHICH MAY IMPACT THE WORK UNDER THIS CONTRACT. ANY EXISTING UTILITIES WHICH ARE TO REMAIN IN SERVICE MUST BE FULLLY PROTECTED BY THE CONTRACTOR AND ANY DAMAGE CAUSED BY THE CONSTRUCTION MUST BE IMMEDIATELY REPAIRED AT THE CONTRACTOR'S EXPENSE TO THE SATISFACTION OF THE FRGINEER. THE CONTRACTOR WILL BE RESPONSIBLE FOR THE PROTECTION OF ANY AND ALL SURFACE AND UNDERGROUND UTILITIES, EVEN THOUGH THEY MAY NOT BE IDENTIFIED ON THE PLANS.
- 2. THE CONTRACTOR MUST COORDINATE CONSTRUCTION ACTIVITIES WITH THE RESPECTIVE UTILITIES OF THE CITY OF CHICAGO, BEFORE STARING ANY EXCAVATION. THE CONTRACTOR MUST CALL THE CHICAGO UTILITY ALERT NETWORK (C.U.A.N.) AT 312-744-7000 FOR FIELD LOCATIONS OF BURED ELECTRICAL, TELEPHONE, CABLE, AND CAS FACILITIES (48 HOURS NOTIFICATION IS REQUIRED). THE CONTRACTOR MUST CONTACT THE CITY OF CHICAGO DEPARTMENT OF WATER MANAGEMENT, PERMIT SECTION AT 312-747-7893 FOR WATER AND CITY SEWER LOCATIONS.
- 3. PRIOR TO EXCAVATING, CALL JOINT UTILITIES LOCATION INFORMATION FOR EXCAVATORS (J.U.L.I.E.) AT 1.800.892.0123.
- 4. BEFORE ANY EXCAVATION STARTS, THE CONTRACTOR SHALL CONTACT THE IDOT ELECTRICAL MAINTENANCE CONTRACTOR, 48 HOURS PRIOR TO ANY EXCAVATION TO MARK OUT UNDERCROUND IDOT CABLES. THE CONTRACTOR SHALL PRESERVE THESE MARKINGS: ANY ADDITIONAL REQUESTS MADE BY THE CONTRACTOR WILL BE AT THEIR OWN EXPENSE.
- 5. THE CONTRACTOR WILL NOT BE ALLOWED TO SET UP A YARD OR FIFLD OFFICE ON STATE PROPERTY WITHOUT WRITTEN PERMISSION FROM IDOT.
- 6. THE CONTRACTOR MUST USE CARE IN GRADING OR EXCAVATING NEAR ANY AND ALL EXISTING ITEMS THAT WILL NOT BE REMOVED. ANY DAMAGE DONE TO EXISTING ITEMS BY THE CONTRACTOR MUST BE REPAIRED BY THE CONTRACTOR AT THE CONTRACTOR'S OWN EXPENSE TO THE SATISFACTION OF THE REGINEER.
- 7. IT SHALL BE THE CONTRACTOR'S RESPONSIBILITY TO VERIFY CONDITIONS EXISTING IN THE FIELD PRIOR TO CONSTRUCTION AND ORDERING OF MATERIALS.
- 8. ANY SIGNS OR PAVEMENT MARKERS DAMAGED OR DESTROYED AS A RESULT OF LANDSCAPE WORK, CONCRETE WORK, AND/OR FENCING SHALL BE REPLACED AND PAID FOR BY THE CONTRACTOR.
- 9. THE CONTRACTOR MUST TAKE ALL NECESSARY SAFETY PRECAUTIONS TO PROTECT AND PROVIDE ACCESS TO ABUTTING PROPERTY, UTILITIES, PEDESTRIANS, AND VEHICULAR TRAFFIC.

10. DURING CONSTRUCTION OPERATIONS, IF ANY LOOSE MATERIAL IS DEPOSITED IN THE FLOW LINE OF DRAINAGE STRUCTURES SUCH THAT THE NATURAL FLOW OF WATER IS OBSTRUCTED, THE MATERIAL SHALL BE REMOVED AT THE CLOSE OF EACH WORKING DAY. AT THE CONCLUSION OF CONSTRUCTION OPERATIONS, ALL UTILITY STRUCTURES SHALL BE FREE FROM DUST AND DEBRIS. THE WORK SPECIFIED ABOVE WILL NOT BE PAID SEPARATELY BUT SHALL BE INCLUDED IN THE COST OF THE CONTRACT.

11. APPROVED WATERING EQUIPMENT SHALL BE AT THE SITE OF THE WORK AND IN OPERATIONAL CONDITION PRIOR TO STARTING THE PLANTING OPERA-TION AND DURING ALL PLANTING OPERATIONS OR PLANTING WILL NOT BE ALLOWED.

12. THE CONTRACTOR SHALL PROTECT ALL EXISTING PLANT MATERIAL FROM DAMAGE FOR WHICH THE CONTRACT DOES NOT PROVIDE REMOVAL. THE PROTECTION OF EXISTING PLANT MATERIAL AND THE REPAIR OR REPLACEMENT OF EXISTING PLANT MATERIAL DAMAGED BY THE CONTRACTOR SHALL BE DONE IN ACCORDANCE WITH THE REQUIREMENTS OF SECTION 201 OF THE IDOT STANDARD SPECIFICATIONS UNLESS OTHERWISE NOTED.

13. CONTRACTOR SHALL REPAIR IN KIND ANY OF THE VARIOUS EXISTING GRASS AREAS DAMAGED AS A RESULT OF LANDSCAPE OPERATIONS. THIS WORK WILL NOT BE PAID FOR SEPARATELY, BUT THE COSTS SHALL BE CONSIDERED AS INCLUDED IN THE CONTRACT UNIT PRICES FOR THE CONSTRUCTION ITEMS INVOLVED, AND NO ADDITIONAL COMPENSATION WIL BE ALLOWED. THE CONTRACTOR SHALL UTILIZE THE VARIOUS SEED MIXTURES INCLUDED IN THE SPECIFICATIONS AND AS SHOWN ON THE PLANS FOR THIS REPAIR WORK.

14. THE CONTRACTOR SHALL NOT BE ALLOWED TO PROCEED WITH ANY PLANTING WORK UNTIL ALL UTILITY OWNERS FIELD LOCATED THEIR FACILITIES WHICH MAY INTERFERE WITH CONSTRUCTION OPERATIONS. THE ACTUAL LOCATION OF PROPOSED LANDSCAPING WILL BE ADJUSTED IN THE FIELD TO AVOID UTILITIES.

15. UNDERBRUSH OR DEBRIS AT PLANTING LOCATIONS SHALL BE REMOVED AND DISPOSED OF IN ACCORDANCE WITH SECTION 202.03 OF THE IDOT STANDARD SPECIFICATIONS. THIS WORK WILL NOT BE PAID FOR SEPARATELY. NO ADDITIONAL COMPENSATION WILL BE ALLOWED.

16. CONTRACTOR SHALL PERFORM DUE DILIGENCE IN LOCATING SPECIFIED

17. NO SUBSTITUTIONS OR PLANT MATERIAL, QUANTITIES, OR SIZES SHALL BE ALLOWED UNLESS APPROVED BY THE ENGINEER.

18. NO PLANT MATERIAL IS TO BE INSTALLED ON SITE WITHOUT APPROPRIATE IDOT ORANGE PLANT SEAL.

19. ALL TREE AND SHRUB BEDS SHALL RECEIVE 4 INCHES OF MULCH. NEWLY INSTALLED TREES NOT LOCATED WITHIN A BED SHALL BE MULCHED WITH A SIX-FOOT DIAMETER RING WITH A CULTIVATED EDGE AT THE BASE OF EACH TREE (REMOVE EXISTING TURF).

- 20. TREES SHALL BE SET IN TRUE, VERTICAL ALIGNMENT AFTER PLANTING.
- 21. EXISTING TREES SHALL BE MULCHED SO THE MULCH RING EXTENDS THREE (3)-FFET BEYOND THE TRUNK OF THE TREE.
- 22. UNLESS NOTED OTHERWISE, ALL SHRUBS SHALL BE PLANTED IN MULCHED BEDS. THE EDGE OF THE MULCH BED SHALL EXTEND A MINIMUM OF THREE (3) FEET BEYOND THE CENTERS OF THE PERIPHERAL PLANTS IN THE BEDS.

25. AREAS TO BE SEEDED BETWEEN NOVEMBER 15 TO MARCH 30 SHALL REQUIRE DORMANT SEEDING, WHICH SHALL BE INCLUDED IN THE COST OF SEEDING, CLASS 4 (MODIFIED).

24. CONTRACTOR SHALL SUPPLY DIFFERENT COLORED FLAGS LABELLED WITH THE VARIOUS TREE SPECIES IN THIS CONTRACT. CONTRACTOR SHALL ALSO PROVIDE ADDITIONAL FLAGS FOR LAYOUT OF THE VARIOUS LANDSCAPE ITEMS, (2) CASES OF PAINT OF (2) DIFFERENT COLORS, AND RIBBON OF AT LEAST (3) DIFFERENT COLORS AT THE TIME OF THE PRE-CONSTRUCTION MEETING FOR LAYOUT.

25. NIGHT OPERATIONS SHALL NOT BE ALLOWED.

26. ALL EXISTING FENCE TO BE REMOVED SHALL REMAIN IN PLACE UNTIL THE PROPOSED FENCE HAS BEEN INSTALLED.

- 27. ANTICIPATED EARTH EXCAVATION CAN BE INCORPORATED INTO EXISTING BERMS PRIOR TO SHAPING AND PLACEMENT OF TOPSOIL. ANY EARTH EXCAVATION AFTER SHAPING AND TOPSOIL PLACEMENT SHALL BE REMOVED AND DISPOSED OF OFF SITE AT CONTRACTOR'S EXPENSE.
- 28 THE CONTRACTOR SHALL TAKE ALL NECESSARY SAPETY PRECAUTIONS TO PROTECT AND PROVIDE ACCESS TO ABUTTING PROPERTY, UTILITIES, PEDESTRIANS, AND VEHICULAR TRAFFIC.
- 29. IT SHALL BE THE CONTRACTOR'S RESPONSIBILITY TO ENSURE
 THAT NO GAP REMAINS BETWEEN PROPOSED RELOCATED
 FENCING OR WHERE PROPOSED RELOCATED FENCING
 TERMINATES AND EXISTING FENCE REMAINS IN PLACE.

30. IT IS CALLED TO THE CONTRACTOR'S ATTENTION THAT HE/SHE SHALL BE REQUIRED TO OBTAIN AND PAY FOR ANY INSPECTION OR PERMIT FEES TO THE VARIOUS DEPARTMENTS OF THE CITY OF CHICAGO AND THE STATE OF ILLINOIS. THE COST FOR THESE FEES SHALL NOT BE PAID FOR SEPARATELY BUT SHALL BE CONSIDERED INCLUDED IN THE COST OF MOBILIZATION. PERMIT FEES SHALL BE PAID PRIOR TO COMMENCING CONSTRUCTION.

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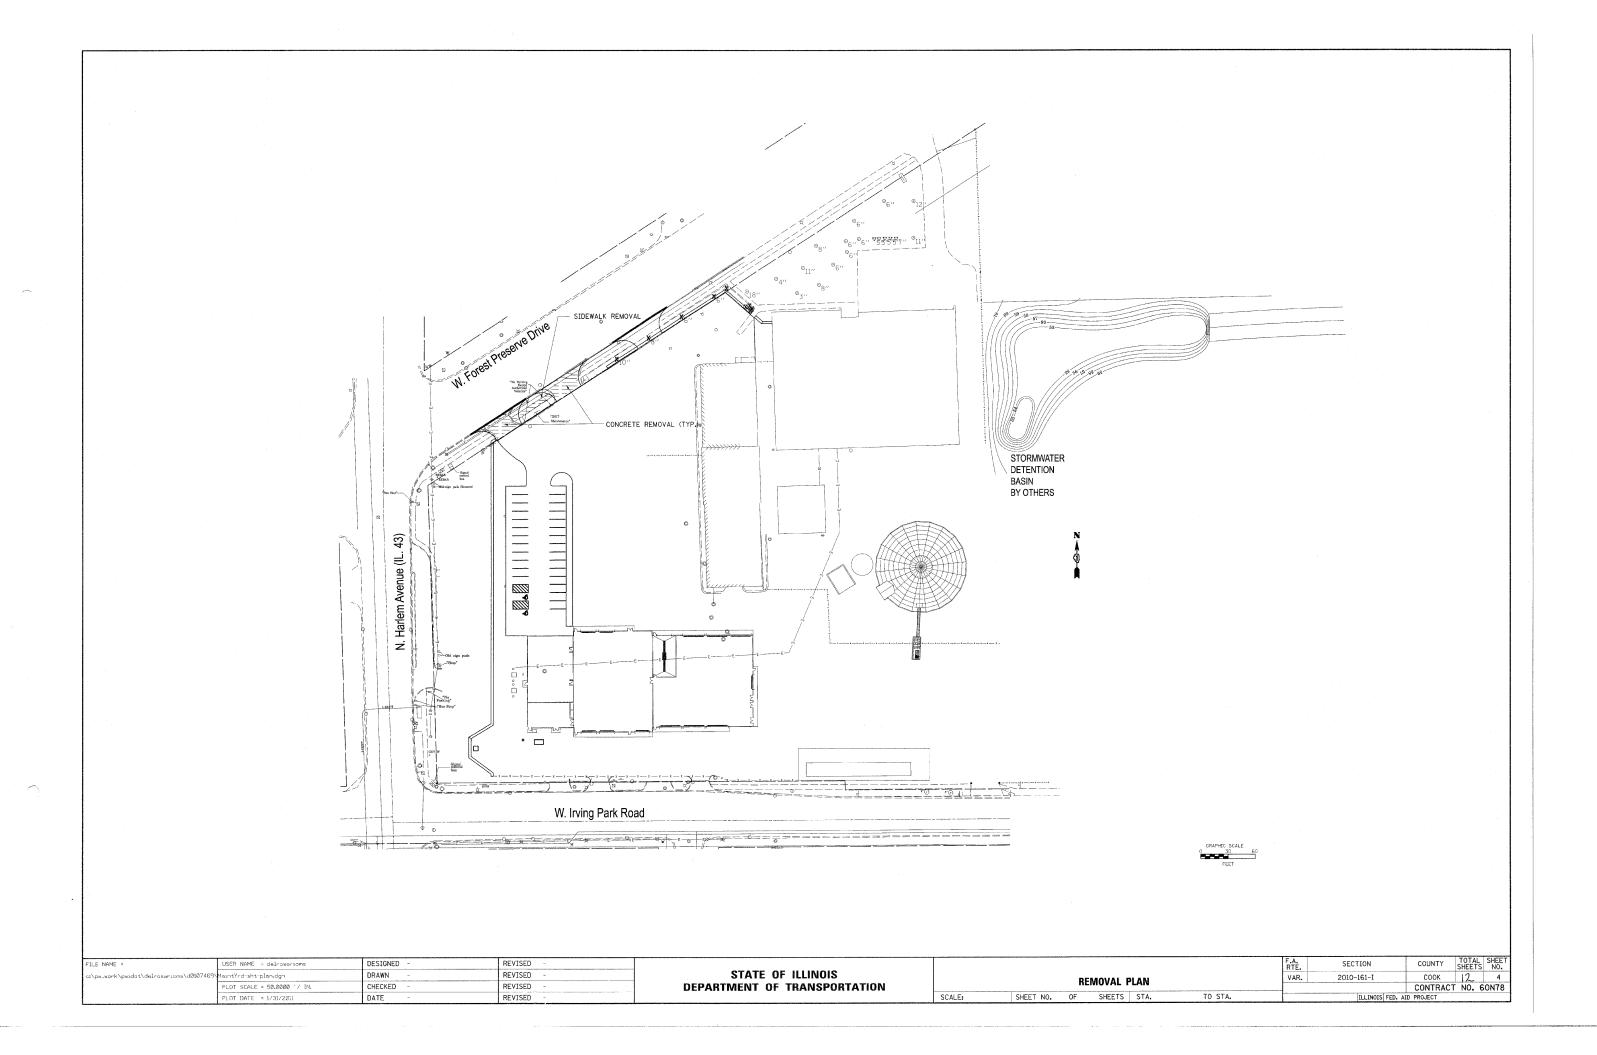
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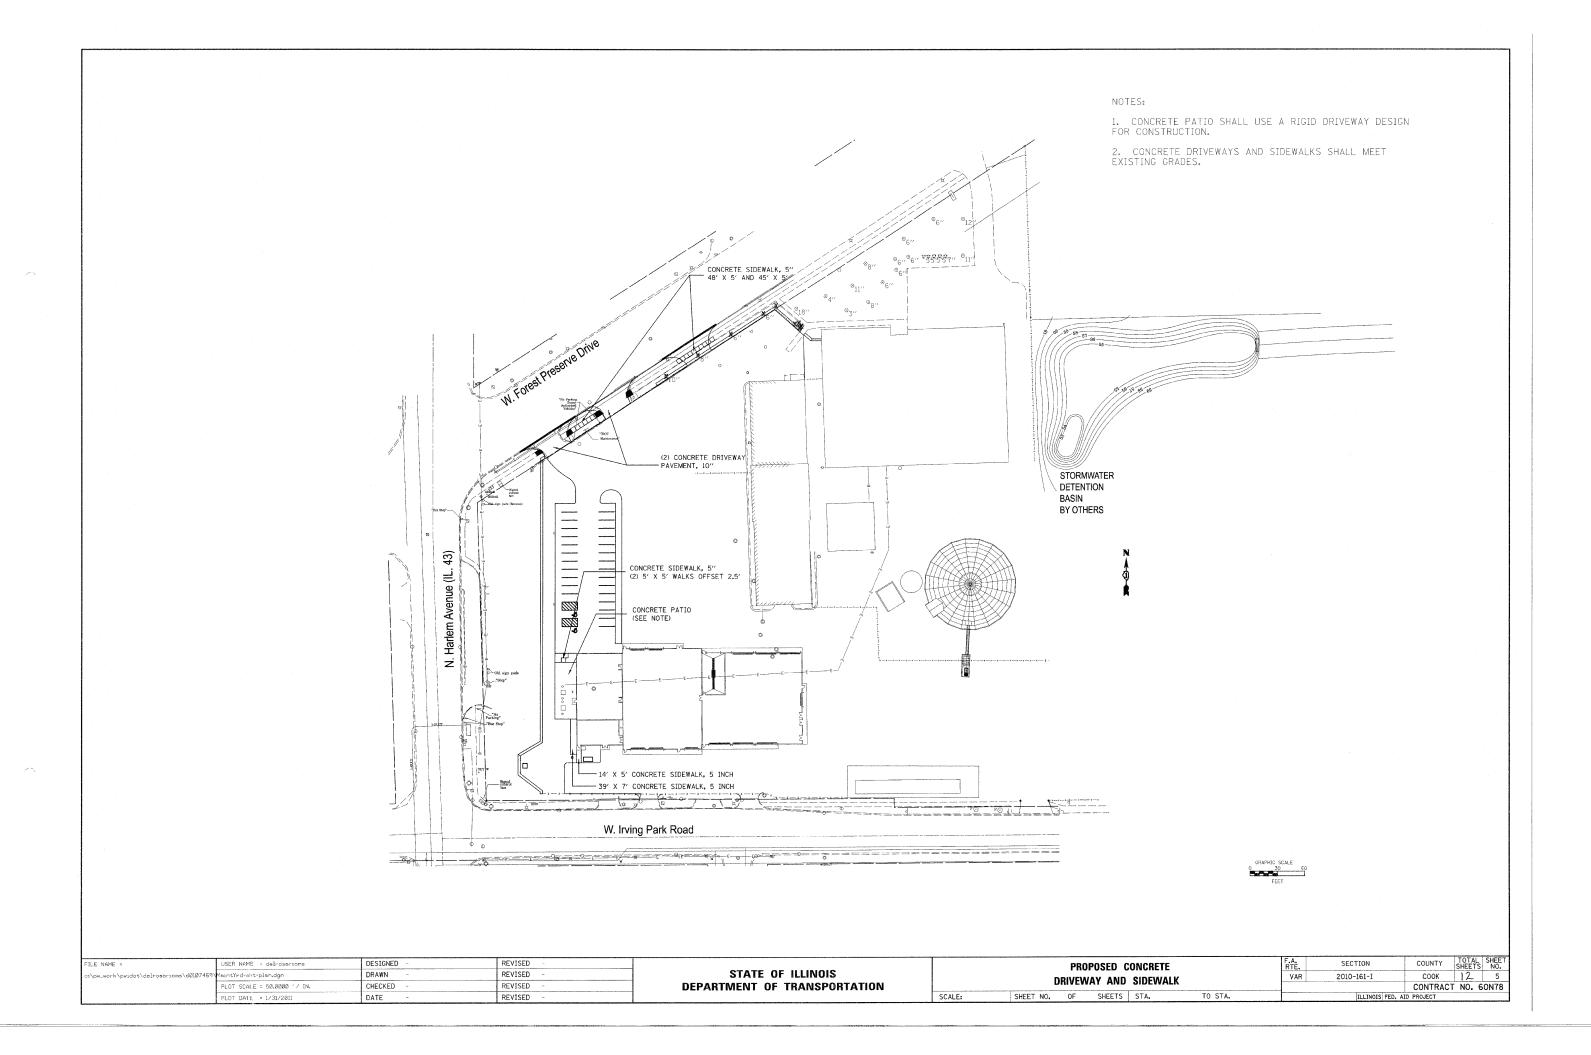
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420001 - 07	PAVEMENT JOINTS
424001: - 05	CURB RAMPS FOR SIDEWALKS
606001 - 04	CONCRETE CURB TYPE B AND COMBINATION CONCRET
	CURB AND GUTTER
664001 - 02	CHAIN LINK FENCE
701606 - 07	LIDRAN LANG CLOSHDE MILITTLIANG 1W OD 2W WITH


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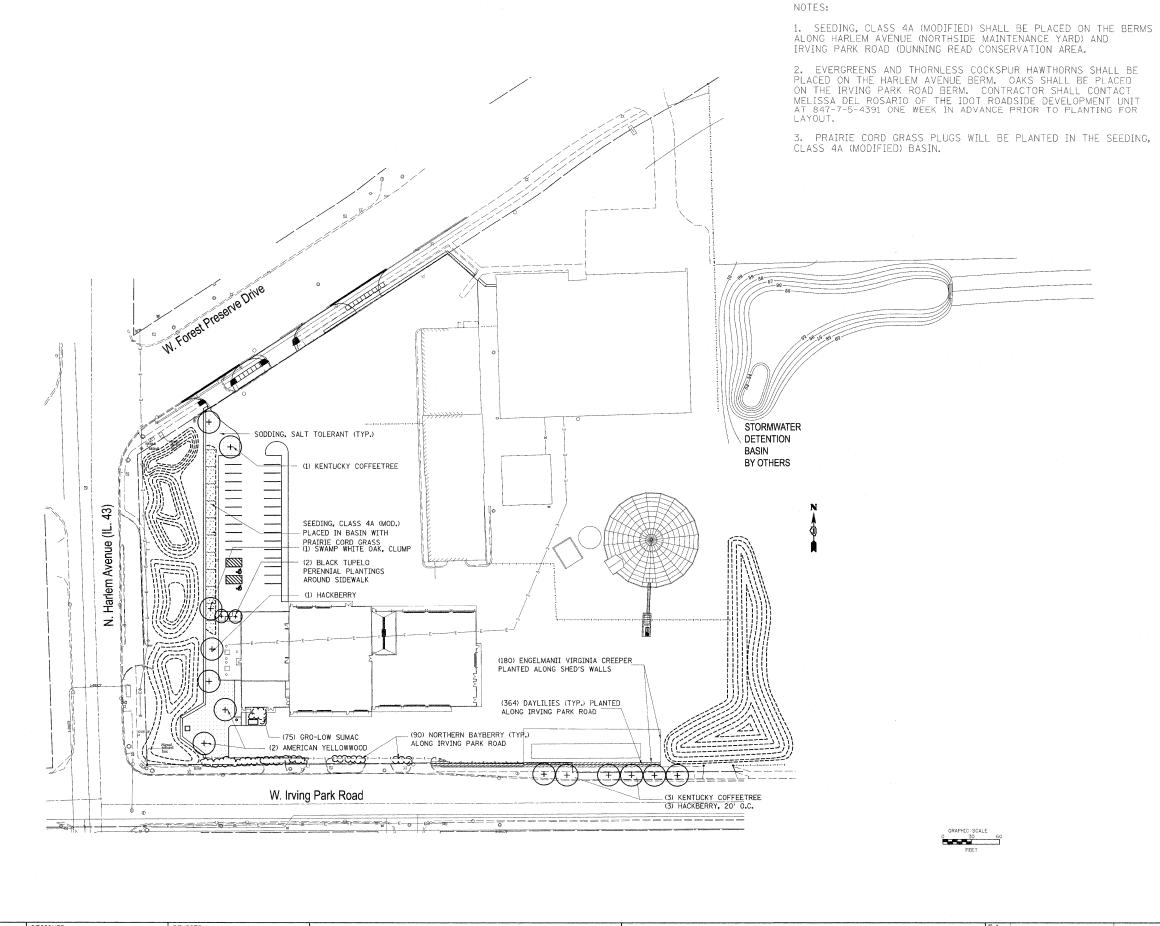
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	SUMMARY OF QUANTITIES		URBAN	CONST	RUCTION TYPE (CODE		CIMALADY OF CHARTES		URBAN			CONSTRUCT:	ION TYPE	CODE	
	SOMMAN OF GOANTITIES		1007.5TATE					SUMMARY OF QUANTITIES		1001. STATE			SOMS INDUIT	ION TIFE	CODE	
ODE NO	ITEM	UNIT	QUANTITIES	0031			CODE NO	ITEM	UNIT	TOTAL	0031					
0042002	POROUS GRANGLAR EMBANKMENT, SUBGRADE	CU YO	85	85												
1101625	TOPSOIL FURNISH AND PLACE, 6"	SQ YD	4163	4163			B2010070	TREE, CLADRASTIS KENTUCKEA (AMERICAN YELLOWWOOD), 2" CALIPER, BALLED AND	EACH	2	2					
1101645	TOPSOIL FURNISH AND PLACE, 12"	SQ YD	983	983			1	BURLAPPED								
1101685	TOPSOIL FURNISH AND PLACE, 24"	SQ YD	1373	1373			C2C04524	SHRUB, MYRICA PENSYLVANICA (BAYBERRY),	EACH	90	90					
1101805	COMPOST FURNISH AND PLACE, 2"	SQ YD	4998	4998				2' HEIGHT, CONTAINER	100							
5000400	NITROGEN FERTILIZER NUTRIENT	POUND	29	29			C2C05815	SHRUB, RHUS AROMATICA GRO-LOW (GRO-LOW FRAGRANT SUMAC), 15" WIDTH, CONTAINER	EACH	75	75					
5000600	POTASSIUM FERTILIZER NUTRIENT	POUND	29	29			D2001784	EVERGREEN, PICEA ABIES (NORWAY SPRUCE),	EACH	10	10					
5100630	EROSION CONTROL BLANKET	SQ YD	4356	4356		·		7' HEIGHT, BALLED AND BURLAPPED								
5200110	SODDING, SALT TOLERANT	SQ YD		2345			D2002072	EVERGREEN, PICEA OMORIKA (SERBIAN SPRUCE), 6' HEIGHT, BALLED AND	EACH	9	9					
		21				-		BURLAPPED								
5200200	SUPPLEMENTAL WATERING	UNIT	10	10			D2002172	EVERGREEN, PICEA PUNGENS (COLORADO	EACH	10	10					
2300600	PORTLAND CEMENT CONCRETE DRIVEWAY PAVEMENT, 10 INCH	SQ YD	342	342				SPRUCE), 6' HEIGHT, BALLED AND BURLAPPED								
2400200	PORTLAND CEMENT CONCRETE SIDEWALK 5	SQ FT	906	906	-		D2002472	EVERGREEN, PINUS FLEXILIS VANDERWOLF'S	EACH	14	14					
	INCH							PYRAMID (VANDERWOLF'S PYRAMID LIMBER PINE), 6' HEIGHT, BALLED AND BURLAPPED		*						
4000100	PAVEMENT REMOVAL	SQ YD	180	180			D2002784	EVERGREEN, PINUS NIGRA (AUSTRIAN PINE),	EACH	9						
4000600	SIDEWALK REMOVAL	SQ FT	270	270			02002784	7' HEIGHT, BALLED AND BURLAPPED	EACH	9	9					
6400305	CHAIN LINK FENCE, 6'	FOOT	490	490			D2003172	EVERGREEN, PSUEDOTSUGA MENZIESII	EACH	13	13					
402900	CHAIN LINK GATES, 6' X 6' SINGLE	EACH	. 1	1				(DOUGLAS FIR), 6' HEIGHT, BALLED AND BURLAPPED								
100100	MOBILIZATION	L SUM	1	1			E20210G1	VINE-PARTHENOCISSUS QUINQUEFOLIA ENGEL	EACH	180	180					
0102625	TRAFFIC CONTROL AND PROTECTION.	L SUM	1	1				MANNII (ENGELMANNII VIRGINIA CREEPER), 1-GALLON POT								
	STANDARD 701606	L 30W		*			K0012970	PERENNIAL PLANTS, BULB TYPE	LINITT	-	_					
2002916	TREE, CELTIS OCCIDENTALIS (COMMON	EACH	4	4					UNIT	5	5					
	HACKBERRY), 2" CALIPER, BALLED AND BURLAPPED						K0012990	PERENNIAL PLANTS, ORNAMENTAL TYPE, GALLON POT	UNIT	3. 74	3. 7	la La companya da sa				
2005016	TREE, GYMNOCLADUS DIOICUS (KENTUCKY	EACH	4	4			K0013060	PERENNIAL PLANTS, SEDGE MEADOW TYPE, 2"	UNIT	9	9					
	COFFEETREE), 2" CALIPER, BALLED AND BURLAPPED							DIAMETER BY 4" DEEP PLUG								
2005516	TREE, NYSSA SYLVATICA (BLACK TUPELO).	EACH	2	2			K0029634	WEED CONTROL, PRE-EMERGENT GRANULAR HERBICIDE	POUND	25	25					
	2" CALIPER, BALLED AND BURLAPPED	ZAVII	-				K0036120	MULCH PLACEMENT 4"	SQ YD	125	125					
2006516	TREE, QUERCUS BICOLOR (SWAMP WHITE	EACH	18	18			X0324097									
	OAK), 2" CALIPER, BALLED AND BURLAPPED							COARSE SAND PLACEMENT, 2"	SQ YD	4998	4998					
2006574	TREE, QUERCUS BICOLOR (SWAMP WHITE OAK), 10' HEIGHT, CLUMP FORM, BALLED	EACH	12	12			X X0326521	CHAIN LINK CANTILEVER SLIDE GATE (SPECIAL)	EACH	2	2					
	AND BURLAPPED						X2502014	SEEDING, CLASS 4A (MODIFIED)	ACRE	0.9	0.9					
2006616	TREE, QUERCUS IMBRICARIA (SHINGLE OAK), 2" CALIPER, BALLED AND BURLAPPED	EACH	16	16			x X66400 50	CHAIN LINK FENCE, 42" ATTACHED TO	FOOT	430	430					
006716	TREE, QUERCUS MACROCARPA (BUR DAK).	EACH	18	18				STRUCTURE (SPECIAL)								
	2" CALIPER, BALLED AND BURLAPPED	LACII	10	10			X6640300	CHAIN LINK FENCE REMOVAL	FOOT	420	420				1 1 1 1 1 1 1 1 1 1 1 1 1 1 1 1 1 1 1	
016616	TREE, QUERCUS ELLIPSOIDALIS (HILL'S	EACH	10	10			Z0004562	COMBINATION CONCRETE CURB AND GUTTER	FOOT	80	80					
-	OAK), 2" CALIPER, BALLED AND BURLAPPED							REMOVAL AND REPLACEMENT								ı
001666	TREE, CRATAEGUS CRUSGALLI INERMIS (THORNLESSS COCKSPUR HAWTHORN),	EACH	32	32.			Z0024479	FLUTED KNEEWALL	FOOT	430	430					
-	6'HEIGHT, SHRUB FORM, BALLED		-				20200100	EARTH EXCAVATION	CU YP	314	314					
	AND BURLAPPED															
								$\label{eq:constraints} \mathcal{L}^{-1}(\mathcal{L}, \mathcal{L}, \mathcal$	1							
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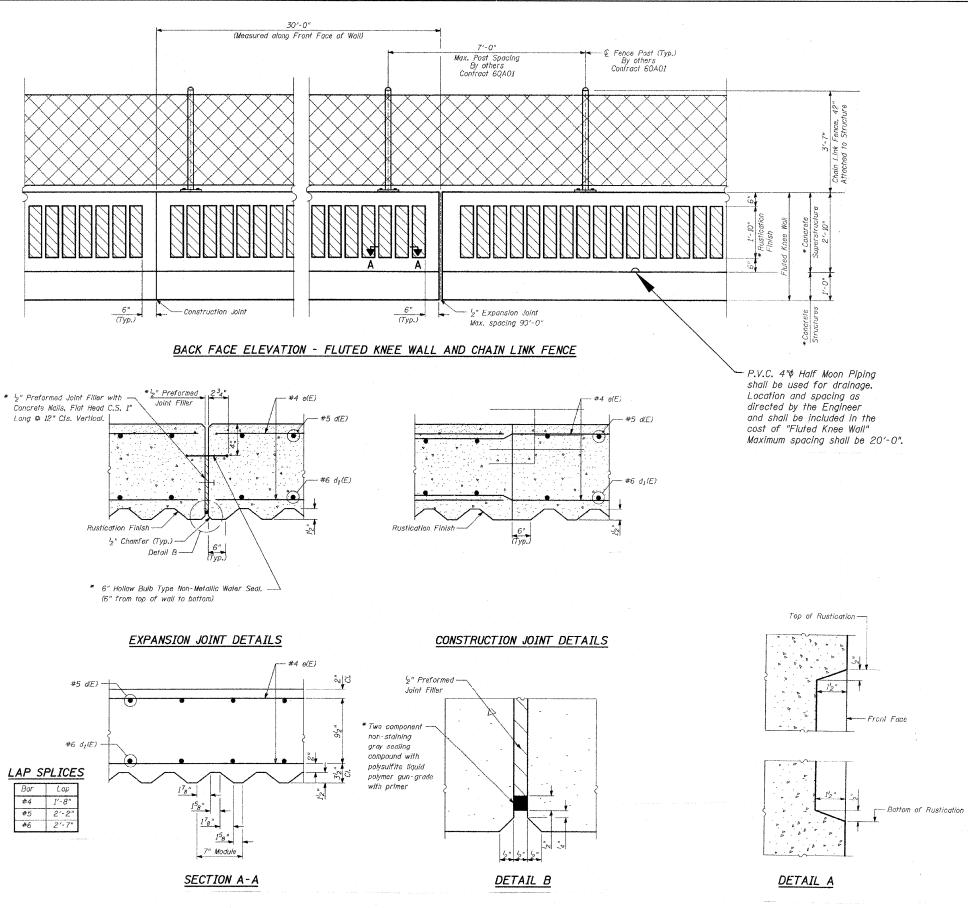








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NOTES:

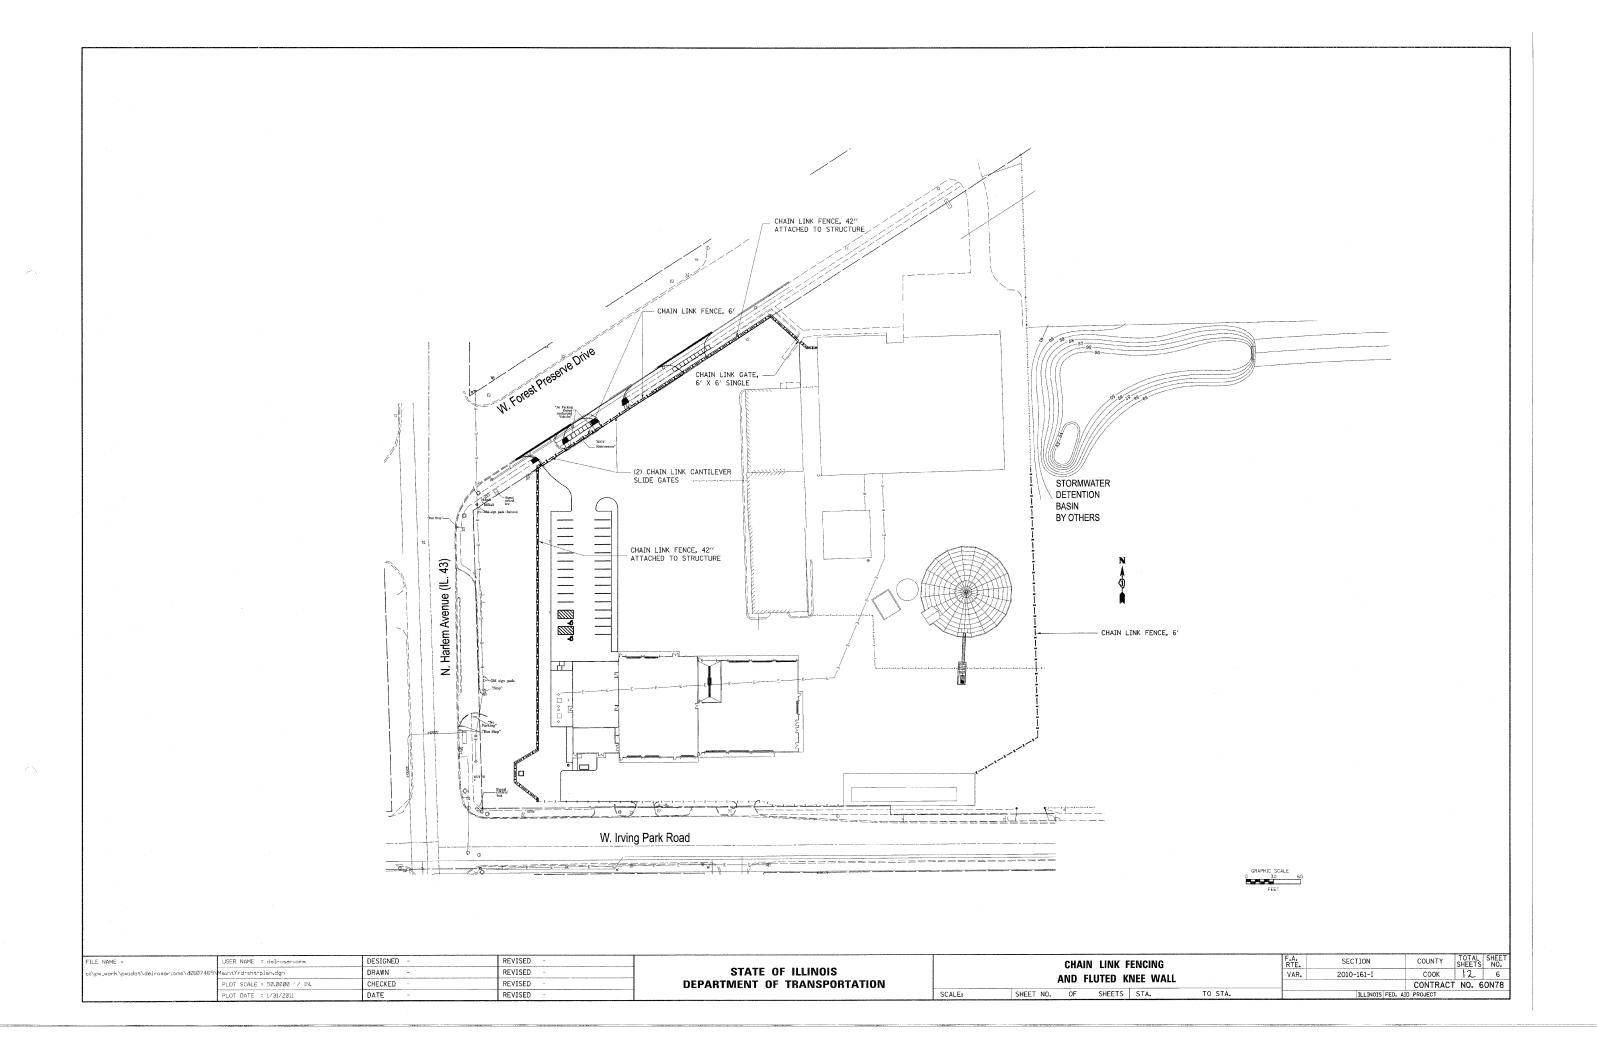- 1. Reinforcment Bar Shall Conform to the Requirements of AASHTO M-31 or M-322 Grade 60
- 2. Concrete: f'c = 3500 psl
- 3. Fluted Knee Wall shall be paid for per foot as "Fluted Knee Wall." Included in the cost of "Fluted Knee Wall." shall be "Concrete Superstructure" stem, "Concrete Structures" foundation, reinforcement bars (epoxy coated), rustication finish, protective coat, expansion joint filler and sealing compound.
- 4. At Locations Where Fluted Knee Wall Abuts a Rigid Structure, a ½" Thick Preformed Expansion Joint Fillier Conforming to the Shape of the Structure Shall be Installed Between the Wall and the Structure. A ½" PJF Shall be Installed where Fluted Knee Wall footing abuts curb and gutter. The cost shall be Included in "Fluted Knee Wall".
- Quantities shown in "BILL OF MATERIAL" are for one (1) foot of "Fiuted Knee Wall".
- 6. Protective Coat shall be applied according to Section 503.19 of the Standard Specifications to all concrete surfaces not in contact with soil for the typical section of the fluted knee wall. The cost shall be included in "Fluted Knee Wall"
- All concrete edges shall be chamfered ³₄" except as noted.
- 8. All Expansion Joints shall be at Maximum spacing of 90' with construction joints at 30'.
- 9.. All construction joints shall be bonded.
- 10. The top of the footing shall be broom finished.
- * Cost included with "Fluted Knee Wall."


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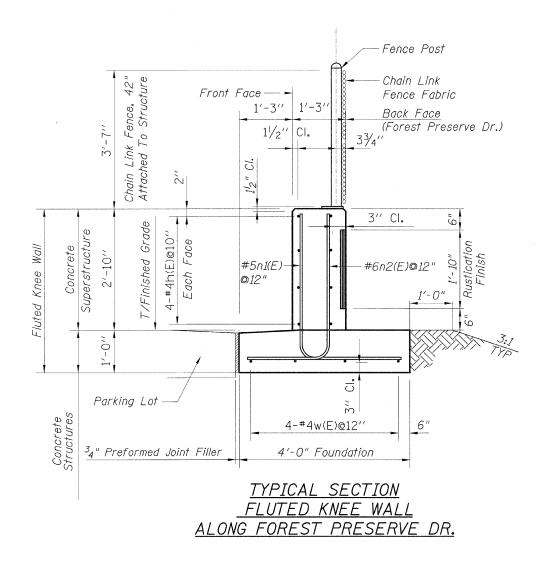
QUANTITIES PER FOOT OF FLUTED KNEE WALL									
ITEM	UNIT	TOTAL							
Concrete Structures	CU YD	0.15							
Concrete Superstructure	CU YD	0.14							
Protective Coat	SO YD	1.08							
Rustication Finish	SQ FT	1.84							
Reinforcement Bars, Epoxy Coated	POUND	22.69							

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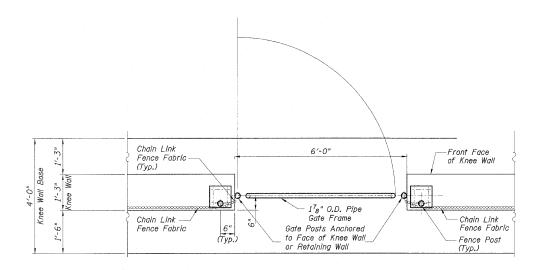





2'-5" n2(E) 2'-1" n1(E)

BARS n2(E) & n1(E)
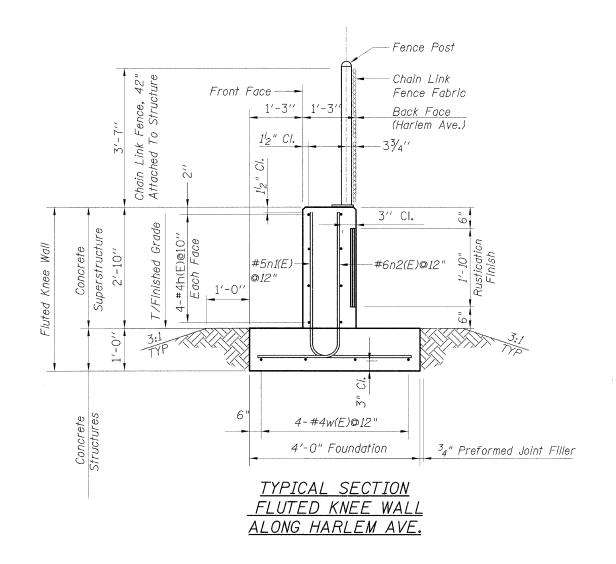
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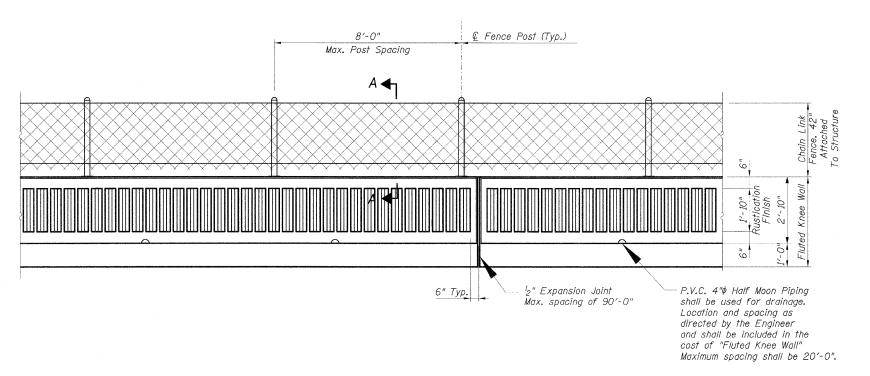
PLAN



OPENING IN KNEE WALL ELEVATION

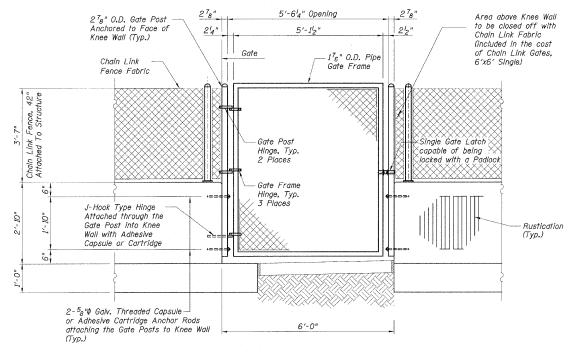CHAIN LINK GATE, 6'x6' SINGLE - DETAILS


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c:\pw_work\pwidot\delrosarioms\dØ107469\	KneeWallDetails.dgn	DRAWN ~	REVISED -	STATE OF ILLINOIS	CHAIN LINK GATES, 6' X 6' SINGLE	VAR. 2010-161-I	соок 12 10
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	PLOT DATE = 1/31/2011	DATE -	REVISED -	·	SCALE: SHEET NO. OF SHEETS STA. TO STA.	ILLINOIS FED. A	ID PROJECT



BACK FACE ELEVATION - FLUTED KNEE WALL AND CHAIN LINK FENCE

NOTES:

- 1. Threaded rods, nuts and washers shall confrom to AASHTO M164.
- Posts shall not be located closer than 6" to an expansion joint or the end of the fluted parapet.
- 3. The Contractor shall use the capsule or the adhesive cartidge type anchor rods that have been previously tested and given a prior approval by the Department. The contractor shall install these anchor rods in pre-drilled holes according to the manufacturer's recommendations and procedures. The capsule or the adhesive cartridge type anchor rods shall be a two-part system composed of:
 - A threaded rod stud with nut and washer of the the type specified.
- A secied glass capsule or a sealed glass adhesive cartridge containing premeasured amounts of the adhesive chemical.
- 4. Nuts for $\frac{5}{8}$ dia, threaded anchor rods connecting the base plate to the concrete to be tightened to a snug fit and given an additional $\frac{1}{8}$ turn.
- 5. The cost of furnishing, drilling and installing epoxy grout and threaded anchor rads including hex nuts and lock washers is included in the cost per foot for "Chain Link Fence, 42" Attached to Structure".

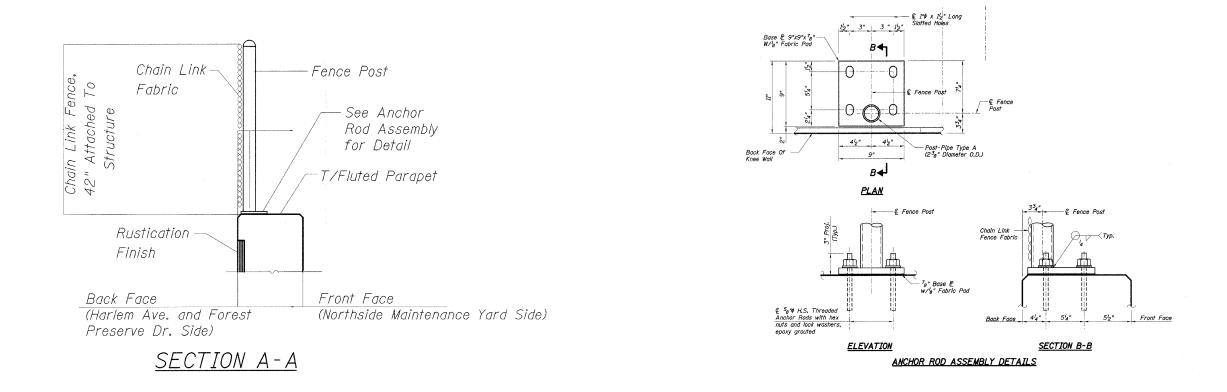

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		PLOT DATE = 1/31/2011	DATE -	REVISED -		SCALE: N.T.S. SHEET NO. OF SHEETS STA. TO STA.		ILLINOIS FED. AID	PROJECT	

NORTHSIDE LANDSCAPE PLANT LIST

SCIENTIFIC NAME	COMMON NAME	SIZE	QUANTITY	SPACING	NOTES
SHADE TREES					
CELTIS OCCIDENTALIS	COMMON HACKBERRY	2" CALIPER	4		IN PARKWAY
CLADRASTIS KENTUKEA	AMERICAN YELLOWWOOD	2" CALIPER	2		WITHIN YARD
GYMNOCLADUS DIOICUS	KENTUCKY COFFEETREE	2" CALIPER	4		IN PARKWAY
NYSSA SYLVATICA	BLACK TUPELO	2" CALIPER	2	ON PLANS	PATIO AREA
QUERCUS BICOLOR	SWAMP WHITE OAK	2" CALIPER	18	15' - 20' O.C.	WITHIN YARD
QUERCUS BICOLOR	SWAMP WHITE OAK	10' HEIGHT	12	15' - 20' O.C.	CLUMP FORM - WITHIN YARD
QUERCUS ELLIPSOIDALIS	HILL'S OAK	2" CALIPER	10	15' - 20' O.C.	WITHIN YARD
QUERCUS IMBRICARIA	SHINGLE OAK	2" CALIPER	16	15' - 20' O.C.	WITHIN YARD
QUERCUS MACROCARPA	BUR OAK	2" CALIPER	18	15' - 20' O.C.	WITHIN YARD
ORNAMENTAL TREES					
CRATAEGUS CRUSGALLI VAR. INERMIS	THORNLESS COCKSPUR HAWTHORN	6' HEIGHT	32	GROUPINGS OF 12' O.C.	CLUMP FORM - EPONT OF REPM


ATAEGUS CRUSGALLI VAR. INERMIS THORNLESS COCKSPUR HAWTHORN		6' HEIGHT 32		GROUPINGS OF 12' O.C.	CLUMP FORM - FRONT OF BERM		
EVERGREEN TREES							
PICEA ABIES	NORWAY SPRUCE	7' HEIGHT	10	15' O.C.	BACK SIDE OF BERM		
PICEA OMORIKA	SERBIAN SPRUCE	6' HEIGHT	9	15' O.C.	BACK SIDE OF BERM		
PICEA PUNGENS	COLORADO SPRUCE	6' HEIGHT	10	15' O.C.	BACK SIDE OF BERM		
PINUS FLEXILIS 'VANDERWOLF'S PYRAMID'	NDERWOLF'S PYRAMID' VANDERWOLF PYRAMID LIMBER PINE		14	15' O.C.	BACK SIDE OF BERM		
PINUS NIGRA	AUSTRIAN PINE	7' HEIGHT	9	15' O.C.	BACK SIDE OF BERM		
PSEUDOTSUGA MENZIESII	DOUGLAS FIR	6' HEIGHT	13	15' O.C.	BACK SIDE OF BERM		
SHRUBS							
MYRICA PENSYLVANICA	NORTHERN BAYBERRY	2'HEIGHT	90	36" O.C.			
RHUS AROMATICA 'GRO-LOW'	GRO-LOW FRAGRANT SUMAC	15" WIDTH	75	36" O.C.			
PERENNIAL PLANTS, ORNAMENTAL TYPE							
ASTER DUMOSUS 'WOOD'S PURPLE'	WOOD'S PURPLE ASTER	1 - GAL CONT	9	18" O.C.	PATIO AREA		

PERENNIAL PLANTS, ORNAMENTAL TYPE							
ASTER DUMOSUS 'WOOD'S PURPLE'	WOOD'S PURPLE ASTER	1 - GAL CONT	9	18" O.C.	PATIO AREA		
BAPTISIA AUSTRALIS	BLUE FALSE INDIGO	1 - GAL CONT	11	24" O.C.	PATIO AREA		
CALLIRHOE INVOLUCRATA	PURPLE POPPYMALLOW	1 - GAL CONT	11	15" O.C	PATIO AREA		
ECHINACEA PURPUREA 'MAGNUS'	MAGNUS PURPLE CONEFLOWER	1 - GAL CONT 1 - GAL CONT 1 - GAL CONT	17 83 83	12" O.C.	PATIO AREA INTERPLANTED W/ OTHER DAYLILIES INTERPLANTED W/ OTHER DAYLILIES		
HEMEROCALLIS 'CHICAGO HEIRLOOM'	CHICAGO HEIRLOOM DAYLILY			18" O.C.			
HEMEROCALLIS 'MARY TODD'	MARY TODD DAYLILY			18' O.C.			
HEMEROCALLIS 'WOODSIDE FIRE DANCE'	WOODSIDE FIRE DANCE DAYLILY	1 - GAL CONT	84	18" O.C.	INTERPLANTED W/ OTHER DAYLILIES		
LIATRIS SPICATA 'KOBOLD'	KOBOLD SPIKE GAYFEATHER	1 - GAL CONT	17	12" O.C.	PATIO AREA		
PANICUM VIRGATUM 'SHENANDOAH'	SHENANDOAH SWITCH GRASS	1 - GAL CONT	17	18" O.C.	PATIO AREA		
RUDBECKIA FULGIDA 'GOLDSTRUM'	GOLDSTRUM BLACK-EYED SUSAN	1 - GAL CONT	30	15" O.C.	PATIO AREA		
SCHIZACHYRIUM SCOPARIUM 'CAROUSEL'	CAROUSEL LITTLE BLUESTEM	1 - GAL CONT	12	18" O.C.	PATIO AREA		
		TOTAL UNITS	3.74				


SPARTINA PECTINATA*	PRAIRIE CORD GRASS	PLUG	900	12" O.C.	INTERPLANTED WITHIN SEEDED BASIN AREA
		TOTAL UNITS	9.00		
BULBS				_	
NARCISSUS 'CARLTON'	CARLTON DAFFODIL	TOP SIZE	200	INTERPLANT W/PERENNIALS	3 BULBS PER HOLE
NARCISSUS 'DELIBES'	DELIBES DAFFODIL	TOP SIZE	150	INTERPLANT W/PERENNIALS	3 BULBS PER HOLE
NARCISSUS 'PROFESSOR EINSTEIN	PROFESSOR EINSTEIN DAFFODIL	TOP SIZE	150	INTERPLANT W/PERENNIALS	3 BULBS PER HOLE
		TOTAL UNITS	5		

NOTE:

PERENNIAL PLANTS SEDGE MEADOW TYPE

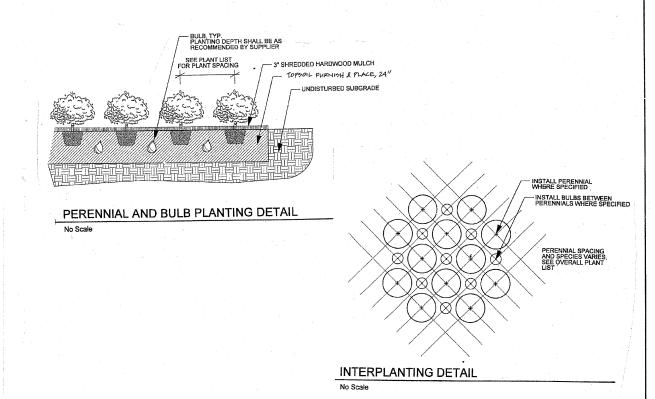

- PARKING LOT-

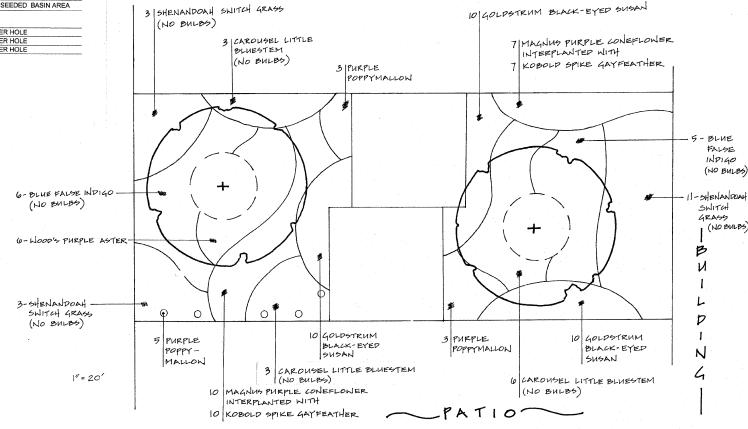

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FILE NAME =	USER NAME = delrosarioms	DESIGNED -	REVISED -				F.A.	SECTION COUNTY	TOTAL SHEET
c:\pw_work\pwidot\delrosarioms\d0107469\	landscape_aa.dgn	DRAWN -	REVISED -	STATE OF ILLINOIS		LANDSCAPE DETAILS AND QUANTITIES	VAR.	2010-161-T COOK	17 12
	PLOT SCALE = 50.00000 '/ IN.	CHECKED -	REVISED ~	DEPARTMENT OF TRANSPORTATION			* Calva-L	CONTRAC	CT NO. 60N78
* *	PLOT DATE = 1/31/2011	DATE -	REVISED -		SCALE:	SHEET NO. OF SHEETS STA. TO STA.		ILLINOIS FED. AID PROJECT	J. No. Contro

^{*} SEDGE MEADOW TYPE PLUG MAY BE SUBSTITUTED FOR DIFFERENT PLUG TYPE IF HYDROLIC CONDITIONS DICTATE OTHERWISE.