THE IDNR INCIDENTAL TAKE AUTHORIZTION FOR THE BLANDING'S TURTLE SHALL BE EXECUTED PRIOR TO PROJECT AWARD.

4. HIGH MAST INTERCHANGE LIGHTING WILL BE INSTALLED AS PART OF THE INTERCHANGE IMPROVEMENT. IN ORDER TO MINIMIZE IMPACT ON THE ADJACENT WETLANDS AND BOTANICAL SITES, SHIELDING OF THE LIGHTS WILL BE INCLUDED TO REDUCE THE AMOUNT OF LIGHT FALLING BEYOND THE INTERCHANGE RAMPS.

5. ANY INTERMITTENT LANE CLOSURES ON INTERSTATE 55 TO CONSTRUCT THE PROPOSED BRIDGE PIERS FOR THE SOUTHBOUND EXIT RAMP FLYOVER BRIDGE AND THE WEST FRONTAGE ROAD BRIDGE MUST BE DONE DURING NIGHTTIME HOURS. NO LANE CLOSURES WILL BE ALLOWED ON INTERSTATE 55 DURING DAYTIME HOURS.

6. INSTALLATION OF EMERGENCY VEHICLE PREEMPTION EQUIPMENT WILL BE COORDINATED WITH THE CHANNAHON FIRE DEPARTMENT VIA A LETTER OF INTENT THROUGH IDOT OR AN INTERGOVERNMENTAL AGREEMENT THROUGH THE COUNTY.

7. THE PROJECT AREA CONTAINS BOTH SENSITIVE PLANT AND ANIMAL SPECIES THAT NEED TO BE AVOIDED DURING CONSTRUCTION. A TRAINING SESSION SHALL BE CONDUCTED BY THE ENGINEER DURING THE PRECONSTRUCTION MEETING TO ALERT PROJECT PERSONNEL ON THE NEED TO AVOID ACCIDENTAL INTRUSIONS OR SPILLS IN THE SENSITIVE AREAS. THE TRAINING SESSION WILL ALSO ADVISE PROJECT PERSONNEL TO AVOID ACCIDENTAL INTRUSIONS OR SPILLS INTO NOTE-WORTHY BOTANICAL AND WETLAND AREAS. ALL SENSITIVE AREAS ARE TO BE FENCED OFF AND CLEARLY MARKED AS SHOWN ON THE EROSION AND SEDIMENT CONTROL DRAWINGS.

8. THIS PROJECT REQUIRES A US ARMY CORPS OF ENGINEERS 404 PERMIT. THE PERMIT ISSUED TO THE DEPARTMENT DOES NOT COVER IN STREAM WORK BY THE CONTRACTOR; THEREFORE AFTER AWARD, THE CONTRACTOR WILL NEED TO COORDINATE AND HAVE HIS WORK PLAN APPROVED BY THE CORPS. GUIDELINES ON ACCEPTABLE IN STREAM WORK TECHNIQUES CAN BE FOUND ON THE CORPS WEBSITE HTTP://WWW.LRC.USACE.ARMY.MIL/

GENERAL NOTES

1. THE THICKNESS OF HMA SHOWN ON THE PLANS IS THE NOMINAL THICKNESS. DEVIATIONS FROM THE NOMINAL THICKNESS WILL BE PERMITTED WHEN SUCH DEVIATIONS OCCUR DUE TO IRREGULARITIES IN THE EXISTING SURFACE OR BASE ON WHICH THE HMA IS PLACED.

2. THE HMA SURFACE OF ALL MAILBOX TURNOUTS, PRIVATE ENTRANCES, COMMERCIAL ENTRANCES, AND SIDE ROADS SHALL BE MADE NEATLY, IN A WORKMANLIKE MANNER, AND SHALL ACCURATELY CONFORM TO THE SHAPES AND DIMENSIONS SHOWN ON THE PLAN DETAILS. THE CONTRACTOR SHALL BE REQUIRED TO SAW CUT THE HMA SURFACE TO CONFORM TO THE SHAPES AND DIMENSIONS SHOWN ON THE PLAN DETAILS. THIS WORK SHALL BE INCLUDED IN THE COST OF THE HMA SURFACE.

3. THE BASE COURSE WIDENING SHALL BE CARRIED THROUGH ALL ENTRANCES, SIDE ROADS, AND MAILBOX TURNOUTS, EXCEPTIONS WILL BE SHOWN ON THE PLANS.

4. EXCEPT AS NOTED ON THE PLANS, PAVEMENT GRADES SHOWN ARE AT THE TOP OF PAVEMENT SURFACES.

5. BEFORE ORDERING PIPE CULVERTS OR PIPE DRAINS, THE CONTRACTOR SHALL CONSULT THE ENGINEER FOR EXACT LENGTHS.

6. THE ENGINEER WILL BE THE SOLE JUDGE CONCERNING CURING TIME FOR THE VARIOUS HMA LIFTS.

7. SEEDING SHALL NOT BE PERMITTED AT ANY TIME WHEN THE GROUND IS FROZEN, WET, OR IN AN UNTILLABLE CONDITION. LOCATIONS TO BE SEEDED WILL BE DETERMINED BY THE ENGINEER.

8. ONLY THOSE TREES DESIGNATED BY THE ENGINEER, LISTED IN THE TREE REMOVAL SCHEDULE, OR SHOWN IN THE PLANS SHALL BE REMOVED. THE CONTRACTOR SHALL PROTECT ALL REMAINING TREES FROM DAMAGE DUE TO HIS OPERATIONS. 9. THE LOCATION OF EXISTING DRAINAGE STRUCTURES, STORM SEWERS, WATER MAINS, SANITARY SEWERS, AND ANY OTHER PUBLIC OR PRIVATE UTILITIES AS SHOWN ON THE PLANS IS APPROXIMATE, AND THEIR EXACT LOCATION IS TO BE DETERMINED IN THE FIELD BY THE CONTRACTOR. THIS WORK SHALL BE PAID FOR PER ART. 105.07 OF THE STANDARD SPECIFICATIONS. LOCATING UTILITIES SHALL BE PAID PER ART. 109.04.

10. WET REFLECTIVE TEMPORARY TAPE, TYPE III SHALL BE USED TO OUTLINE EXIT AND ENTRANCE RAMPS FOR THE PRIME COAT APPLICATION AND EACH RESURFACING LIFT.

11. THE WORK REQUIRED TO CONNECT ANY SEWER TO AN EXISTING DRAINAGE STRUCTURE OR PIPE WILL NOT BE PAID FOR SEPARATELY, BUT SHALL BE CONSIDERED AS INCLUDED IN THE CONTRACT UNIT PRICE BID FOR THE SEWER ITEMS.

12. ON EXISTING PAVEMENT WHICH MAY BE SUPERELEVATED, THE NEW HMA PAVEMENT SHALL BE BUILT WITH THE SAME SUPERELEVATION UNLESS NEW SUPERELEVATION RATES ARE GIVEN ON THE PLANS.

13. THE CONTRACTOR SHALL PROTECT AND CAREFULLY PRESERVE ALL SECTION OR SUBSECTION MONUMENTS, PROPERTY CORNERS, AND REFERENCE MARKERS UNTIL THE OWNER, HIS AGENT, OR ANY AUTHORIZED SURVEYOR HAS WITNESSED OR OTHERWISE REFERENCED THEIR LOCATIONS.

14. ABANDONED UNDERGROUND UTILITIES THAT CONFLICT WITH CONSTRUCTION SHALL BE DISPOSED OF OUTSIDE THE LIMITS OF THE RIGHT OF WAY ACCORDING TO ARTICLE 202.03 OF THE STANDARD SPECIFICATIONS AND AS DIRECTED BY THE ENGINEER. THIS WORK WILL NOT BE PAID FOR SEPARATELY, BUT SHALL BE INCLUDED IN THE COST OF EARTH EXCAVATION.

15. USE EPOXY-COATED TIE BARS, CONFORMING TO ART. 1006.10 OF THE STANDARD SPECIFICATIONS, FOR ALL TIE BARS.

16. THE CONTRACTOR SHALL CONTACT IDOT EXPRESSWAY TRAFFIC (847-705-4151)
TWO WEEKS PRIOR TO THE PLACEMENT OF FINAL PAVEMENT MARKINGS.

17. THE REMOVAL OF ALL PIPE END SECTIONS ARE INCLUDED IN THE COST OF EARTH EXCAVATION.

18. ANY REFERENCE TO A STANDARD IN THESE PLANS SHALL BE INTERPRETED TO MEAN THE EDITION AS INDICATED BY THE SUBNUMBER SHOWN IN THE LIST OF STANDARDS OR THE COPY INCLUDED IN THESE PLANS.

19. THE FOLLOWING RATES OF APPLICATION HAVE BEEN USED IN CALCULATING PLAN QUANTITIES:

GRANULAR MATERIALS	2.05	TONS / CU YD
BITUMINOUS MAT PRIME COAT	0.05	GAL / SQ YD - BETWEEN LIFTS
	0.5	GAL / SQ YD - AGGREGATE
	0.1	GAL / SQ YD - ABOVE PCC BASE
AGGREGATE (PRIME COAT)	0.002	TONS / SQ YD
HMA RESURFACING	112	LBS / SQ YD / IN
LEVEL BINDER (HAND METHOD)	112	LBS / SQ YD / IN
SUPPLEMENTAL WATERING	3	GAL / SO YD / APPLICATION

20. ALL DAMAGE TO DEPARTMENT OWNED UNDERGROUND FACILITIES, CAUSED BY THE CONTRACTOR SHALL BE REPAIRED TO THE SATISFACTION OF THE DEPARTMENT AT THE CONTRACTOR'S EXPENSE. THIS SHALL INCLUDE ALL TEMPORARY REPAIRS REQUIRED TO KEEP THE FACILITY OPERATIONAL WHILE MATERIAL IS BEING OBTAINED TO MAKE PERMANENT REPAIRS. SPLICING OF ELECTRIC CABLE SHALL NOT BE ALLOWED. ELECTRIC CABLE SHALL BE REPLACED FROM POLE TO POLE OR CONTROLLER.

GENERAL NOTES

21. MEMBERS OF JULIE KNOWN TO BE WITHIN THE LIMITS OF THE IMPROVEMENT ARE:
ALLIANCE: CHRIS CLEVELAND 815-370-3520
AT&T: MITCH CULLEN 630-573-6447
COM ED: TIM COSLET 815-724-5010
MGT: JUSTIN MALONEY 815-690-7901
NICOR: ED VANSCOIT 815-740-4100 EXT 261
ONE OK NORTH: ROBERT WILD 815-942-2230 EXT. 2114
TEPPCO: MIKE BOOMSMA 708-906-8659

22. THE CONTRACTOR SHALL CONTACT JULIE AT LEAST 48 HOURS PRIOR TO EXCAVATION TO DETERMINE WHICH UTILITIES ARE IN THE AREA.

23. THE CONTRACTOR SHALL MAINTAIN EXISTING STREET ACCESS, EXISTING DRIVEWAY ACCESS, AND PEDESTRIAN ACCESS TO ABUTTING PROPERTY AT ALL TIMES DURING CONSTRUCTION OF THE PROJECT, UNLESS OTHERWISE NOTED IN THE PLANS OR DIRECTED BY THE ENGINEER. THIS WORK SHALL BE INCLUDED IN THE ITEM "TEMPORARY ACCESS (COMMERCIAL ENTRANCE)".

24. SAWING OF REMOVAL ITEMS AS NOTED ON THE PLANS, SPECIFIED IN THE STANDARD SPECIFICATIONS, OR AS REQUIRED BY THE ENGINEER SHALL BE INCLUDED IN THE COST OF THE ITEM BEING REMOVED

25. IT IS THE CONTRACTOR'S RESPONSIBILITY TO ASCERTAIN EXISTING FIELD CONDITIONS BEFORE BIDDING ON THIS CONTRACT

26. HORIZONTAL CONTROL IS BASED ON IL STATE PLANE COORDINATES, EAST ZONE, NAD-83. NGS MONUMENT PID *AE2474 WAS RECEIVED AND USED. COORDINATES AND DISTANCES SHOWN ARE "GROUND" COORDINATES. COMBINED SCALE FACTOR (GROUND TO GRID) = 0.99995548.

27. ELEVATIONS ARE BASED ON NGS MONUMENT PID #MF0335 AND NAVD-88 DATUM.

28. THE GENERAL CONTRACTOR IS REQUIRED TO HIRE AN ENVIRONMENTAL FIRM WITH AT LEAST FIVE (5) DOCUMENTED LEAKING UNDERGROUND STORAGE TANK (LUST) CLEANUPS OR THAT IS PRE-QUALIFIED IN HAZARDOUS WASTE BY THE DEPARTMENT TO REMEDIATE THE SOIL CONTAMINATION AND MONITOR FOR WORKER PROTECTION.

29. THE PHASE III CONSULTANT WILL BE RESPONSIBLE FOR THE RE-ESTABLISHMENT OF CONTROL AND TIE POINTS AS SHOWN ON THE ALIGNMENT, TIES, AND BENCHMARKS SHEETS. THE CONTRACTOR SHALL COORDINATE THE RE-ESTABLISHMENT OF THE EXISTING CONTROL AND TIE POINTS DISTURBED BY THE CONSTRUCTION ACTIVITIES WITH THE RESIDENT ENGINEER AND PHASE III CONSULTANT. EXISTING CONTROL AND TIE POINT LOCATIONS THAT ARE CONSIDERED NOT VIABLE UNDER THE FINAL CONDITIONS MAY BE RE-ESTABLISHED AT A MORE FEASIBLE LOCATION, AS APPROVED BY THE RESIDENT ENGINEER. THE PHASE III CONSULTANT SHALL SUBMIT DOCUMENTATION OF ALL RE-ESTABLISHED CONTROL AND TIE POINTS TO THE DEPARTMENT NO LATER THAN ONE (1) MONTH AFTER COMPLETION OF THE CONTRACT.

30. R.O.W. FENCING: THE PROPOSED R.O.W. FENCE SHOWN ON THE PLANS SHALL BE PLACED ONLY
AT LOCATIONS WHERE PRIVATE FENCES PREVIOUSLY EXISTED. IF THE PROPERTY OWNERS HAVE
ALREADY REPLACED THE PRIVATE FENCES, THEN THE R.O.W. FENCE SHALL BE OMITTED AT THOSE
LOCATIONS, AS DIRECTED BY THE ENGINEER. THE FENCE QUANTITY SHALL BE REDUCED
ACCORDINGLY. THIS WORK WILL BE MEASURED AND PAID FOR AS "TEMPORARY FENCE (SPECIAL)."

31. THE TIE BARS AT THE LONGITUDINAL CONSTRUCTION JOINT BETWEEN THE PCC SHOULDER AND THE ANCHOR SLAB SHALL NOT BE PAID FOR SEPARATELY BUT SHALL BE CONSIDERED INCLUDED IN THE COST PER SQUARE YARD OF THE PCC SHOULDER.

32. BEDROCK AND UTILITY ELEVATIONS ARE APPROXIMATE. CONTRACTOR TO VERIFY IN FIELD.

McDonough Associates Inc.

E NAME = USER NAME = TKluegel DESIGNED - TRK REVISED - ⚠ REV. 4/14/11

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PLOT SCALE = 1:50 CHECKED - DLT REVISED
PLOT DATE = 4/14/2011 DATE - 2/4/11 REVISED -

STATE OF ILLINOIS
DEPARTMENT OF TRANSPORTATION

 GENERAL NOTES AND COMMITMENTS
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to b	* *		40200800	AGGREGATE SURFACE COURSE,	, TYPE B		TON	427 427	1 3.3 3.2		
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East			40600100 E	BITUMINOUS MATERIALS (PRIM	ME COAT)		GALLON	10,826 10,826		x	· ·
13 Eng	DENOTES SPEC	CIALTY ITEM						4		10 Rev. 4-14-11	Rev.
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	TREE REMOVAL (6 TO 15 UNITS DI	(AMETER)		UNIT	QUANTITY 1,583	0001 0040 1,583	0010 0008	0021		<u> </u>
20100210	TREE REMOVAL (OVER 15 UNITS DI	(AMETER)		UNIT	368	368				
		I GIV								
20100500	TREE REMOVAL, ACRES			ACRE	4.25	4.25				
20200100	EARTH EXCAVATION			CU YD	158,750	158,750				
20200200	ROCK EXCAVATION			CU YD	605	605				
20201200	REMOVAL AND DISPOSAL OF UNSUIT	TABLE MATERIAL		CU YD	26,872	26,872				
20400800	FURNISHED EXCAVATION	The state of the s		CU YD		131,190				
20700220	POROUS GRANULAR EMBANKMENT			CU YD	12,130	8,241 3,889	<u> </u>			
20800150	TRENCH BACKFILL			CU YD	8,133	8,133				
21001000	GEOTECHNICAL FABRIC FOR GROUND	D STABILIZATION		SQ YD	12,225	12,225	3			
21101505	TOPSOIL EXCAVATION AND PLACEME	IFNT		CU YD	35,000	35,000				
									7	
21101805	COMPOST FURNISH AND PLACE, 2"	· · · · · · · · · · · · · · · · · · ·		SQ YD	179,564	179,564		1		
25000210	SEEDING, CLASS 2A			ACRE	22.9	22.9				
25000310	SEEDING, CLASS 4			ACRE	35.2	35.2				
5000400	NITROGEN FERTILIZER NUTRIENT			POUND	2,130	2,130				
E000E00	PHOSPHORUS FERTILIZER NUTRIENT	T						1		
				POUND	2,130	2,130				
5000600	POTASSIUM FERTILIZER NUTRIENT			POUND	2,130	2,130				
5000775	SELECTIVE MOWING STAKES			EACH	62 _	62				
25100115	MULCH, METHOD 2			ACRE	144.4	144.4				
25100630	EROSION CONTROL BLANKET			SQ YD	133,721	133,721				
28000200	EARTH EXCAVATION FOR EROSION (CONTROL		CU YD	80	80				
28000250	TEMPORARY EROSION CONTROL SEE	EDING		POUND	11,515	11,515				
28000305	TEMPORARY DITCH CHECKS			FOOT	1,320	1,320				
28000400	PERIMETER EROSION BARRIER			FOOT	30,500	30,500				
2000500	THE ET AND DIDE PROTECTION									
:8000500	INLET AND PIPE PROTECTION			EACH	26	26				
28000510	INLET FILTERS			EACH	62	62				
28100105	STONE RIPRAP, CLASS A3			SQ YD	270	270				
28100107	STONE RIPRAP, CLASS A4			SQ YD	263	263			= .	**************************************
28100109	STONE RIPRAP, CLASS A5	A CONTRACTOR OF THE ACTION OF		SQ YD	1,256	1,256				
28200200	FILTER FABRIC			SQ YD	1,761	1,761				
31101100	SUBBASE GRANULAR MATERIAL, TYP	PE B		CU YD	5,628	5,628				
31200502	STABILIZED SUBBASE - HOT-MIX A	ASPHALT, 4 1/2"		SQ YD	694,400	94,400 }				
5300500	PORTLAND CEMENT CONCRETE BASE	E COURSE 10"		SQ YD	15,863	15,863				
	HOT-MIX ASPHALT BASE COURSE, 8			SQ YD	1,521	1,521	2			
10200800	AGGREGATE SURFACE COURSE, TYPE	E B		TON	427	427	1222			
10600100	BITUMINOUS MATERIALS (PRIME CO.)AT)		GALLON	10,826	10,826		λ		
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 Engineers / Architects	130 East Randolph Street Chicago, Illinois 60601	
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	PAY ITEM	UNIT	TOTAL		0010	8000	0021		<u> </u>
40600300	AGGREGATE (PRIME COAT)	TON	3	3					
40600895	CONSTRUCTING TEST STRIP	EACH	2	2					
40600982	HOT-MIX ASPHALT SURFACE REMOVAL - BUTT JOINT	SQ YD	145	145					
40603085	HOT-MIX ASPHALT BINDER COURSE, IL-19.0, N70	TON	2,100	2,100					
40603310	HOT-MIX ASPHALT SURFACE COURSE, MIX "C", N50	TON	171	171			-		
40603340	HOT-MIX ASPHALT SURFACE COURSE, MIX "D", N70	TON	1,868	1,868					
40701881	HOT-MIX ASPHALT PAVEMENT (FULL-DEPTH), 10"	SQ YD	620	620					
42000501	PORTLAND CEMENT CONCRETE PAVEMENT 10" (JOINTED)	SQ YD	84,581	84,581					
42001300	PROTECTIVE COAT		128,936						
	BRIDGE APPROACH PAVEMENT CONNECTOR (PCC)	SQ YD		2,237					
44000100	PAVEMENT REMOVAL	SQ YD	67,105	67,105					
44000155	HOT-MIX ASPHALT SURFACE REMOVAL, 1 1/2"	SQ YD	1,261	1,261					
44000165	HOT-MIX ASPHALT SURFACE REMOVAL, 4"	SQ YD	1,126	1,126					
44000200	DRIVEWAY PAVEMENT REMOVAL	SQ YD	4,780	4,780					
44000500	COMBINATION CURB AND GUTTER REMOVAL	FOOT	1,384	1,384					
			1 **						
44004000	PAVED DITCH REMOVAL	FOOT	32	32		-			
44004250	PAVED SHOULDER REMOVAL	SQ YD	23,910	23,910				3 .	
44300200	STRIP REFLECTIVE CRACK CONTROL TREATMENT	FOOT	7,783	7,783					
48101600	AGGREGATE SHOULDERS, TYPE B 8"	SQ YD	42	42			<u> </u>		
48101620	AGGREGATE SHOULDERS, TYPE B 10"	SQ YD	7,430	7,430					
			3						
48203029	HOT-MIX ASPHALT SHOULDERS, 8"	SQ YD	95	95			<u> </u>		
48203037	HOT-MIX ASPHALT SHOULDERS, 10"	SQ YD	16,627	16,627					
48300500	PORTLAND CEMENT CONCRETE SHOULDERS 10"	SQ YD	28,400	28,400					
50100300	REMOVAL OF EXISTING STRUCTURES NO. 1	EACH	1		1				
50200100	STRUCTURE EXCAVATION	CU YD	11,829	11,600	(146)	Λ	83_		
50200400	ROCK EXCAVATION FOR STRUCTURES	CU YD	~~	2,014 2,440	38	65	650		
							630		
	REMOVAL AND DISPOSAL OF UNSUITABLE MATERIAL FOR STRUCTURES	CU YD	2,318	2,000	24	294			
50300225	CONCRETE STRUCTURES	CU YD	6,634.2	5,873.5	247.5	377.2	136		
50300255	CONCRETE SUPERSTRUCTURE	CU YD	1,345.1		667.6	677.5			
50300260	BRIDGE DECK GROOVING	SQ YD	2,782		1,302	1,480			
50300280	CONCRETE ENCASEMENT	CU YD	7.6		7.6				·
50300300	PROTECTIVE COAT	SQ YD			1,409	1,750			
						1,130			
	FURNISHING AND ERECTING PRECAST PRESTRESSED CONCRETE BULB T-BEAMS 63"	FÖÖT	1,501		1,501			<u>.</u>	
50500105	FURNISHING AND ERECTING STRUCTURAL STEEL	L SUM	1			1			
50500505	STUD SHEAR CONNECTORS	EACH	2,046			2,046	1		
50800205	REINFORCEMENT BARS, EPOXY COATED	POUND		2.250 658,020	188,580	238,460	4.297		
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•	* X0324234 2	070 LITE CONT	ROLLER									EACH	8					8			
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<u> </u>	• X0324237 C	LOSED CIRCUIT	TELEVISION DO	OME CAME	ERA HIGH N	MAST TOWER I	NSTALLATI	ION				EACH	2		1			2			
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Λ -	X0324775 S	EDIMENT CONTE	ROL, STABILIZE	D CONSTRI	UCTION EN	TRANCE MAINT	TENANCE					SQ YD	4,555	4,555							
△ 🏖	* Z0029654 H * X0325040 F	IBER OPTIC IN	NERDUCT 1 1/4"	DIA.	ARRIER	TERMINAL	3					FOOT	25,235					25,235			
$\Delta \zeta$	* Z0029652 H	IGH TENSION CA	IBLE MEDIAN BA	ARRIER	· · · · · · · · · · · · · · · · · · ·							FOOT	11,065	11,065							
	X0326020 U	IILITY PROTEC	TION PAD									SQ YD	911	911						-	
ΔC	* Z0029653 H, • X0326266 E	IGH TENSION	CABLE MEO	VAN BA	GRRIER	DEMONSTRI	ATION					EACH EACH	911 7 8	\Longrightarrow				8			
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Į.	X2502024 S	EEDING, CLASS	4B (MODIFIED)									ACRE	2.6			-		2.6			
	X4022000 T	EMPORARY ACC	ESS (COMMERCIA	AL ENTRAI	NCE)	-						EACH	4	4		-					
	X4401198 H	OT-MIX ASPHAL	T SURFACE REM	MOVAL, VA	ARIABLE D	EPTH						SQ YD	22,820	22,820							
· ·	• X5011100 F	OUNDATION REM	JOVAL									EACH	12					12			
	X5210110 H	IGH LOAD MULT	TI-ROTATIONAL	BEARINGS,	, GUIDED	EXPANSION, 20	OOK					EACH	14				14		-		
	X5210335 H	IGH LOAD MULT	TI-ROTATIONAL	BEARINGS	, FIXED -	450K						EACH	7				7				
	X6020294 M	ANHOLES, TYPE	A, 7'-DIAMETE	ER, TYPE	1 FRAME,	CLOSED LID, R	RESTRICTO	R PLATE				EACH	1	1							
	X6060200 C	ONCRETE MEDIA	AN, TYPE SB-6.2	24 (MODIF	-IED)							SQ FT	5,991	5,991							
	X6061310 C	ONCRETE MEDIA	AN SURFACE, 4	INCH (SPE	ECIAL)							SQ FT	13,109	13,109							
. 1	X6640200 T	EMPORARY CHA	IN LINK FENCE									FOOT	1,925	1,925							
	X6700410 E	NGINEER'S FIEL	D OFFICE, TYPI	E A (SPEC	CIAL)		-					CAL MO	18	18							
***	X6700600 E	NGINEER'S FIEL	D LABORATORY	(SPECIAL	_)					J		CAL MO	18_	18	3						
	X7010216 T	RAFFIC CONTRO	OL AND PROTEC	TION, (SPE	ECIAL)						,	L SUM	1	1							,
		-	OL AND PROTEC)						L SUM	3.1	1							
			TEMPORARY T				YMBOLS					SQ FT	809	809		,					
i de la companya de La companya de la co			TEMPORARY T									FOOT	138,743		-						
and the second of		4.																			
			TEMPORARY T									FOOT	10,208	10,208					-		
			TEMPORARY T									FOOT	4,678	4,678							
SPECIALTY ITEM	X7030050 W	ET REFLECTIVE	TEMPORARY T	APE TYPE	III, 12 II	NCH						FOOT	1,582	1,582	:		A R€	v. 4-14-	//		
USER NAME = TKlue	egel .	DESIGNED -	MJT MJT	REVIS REVIS					STATE OF ILLINO	IS			SUMMAI	RY OF QUA	NTITIES	,		F.A.I RTE.	SECTION	. COUNT	SHE
PLOT SCALE = 1:50		CHECKED -	DLT 2/4/11	REVIS	ISED -			DEPART	MENT OF TRANSF			NE SHEET				TO STA.		55	99-2HB-2B-1		RACT NO.

ACIM

ACBRF

ACIM

				URBAN 7, 901, FEO. 101, STATE	RETAINING ME	4 CONE 4	South See	EXIT RANGELLAND	LECTRICAL.	a de la companya de l	TRAPIC TRAPIC
N	CODE NUMBER 7030055	PAY ITEM WET REFLECTIVE TEMPORARY TAPE TYPE III, 24 INCH	UNIT	TOTAL QUANTITY 453	0001 453	CONSTR 0040	OO10	PE CODES 0008	0021	The second of the second	0021
		REMOVE TEMPORARY CONCRETE BARRIER	FOOT	2,999	2,999						
		ELECTRICAL SERVICE DISCONNECT	EACH	5					5		4
		SERVICE INSTALLATION - POLE MOUNTED	EACH	1							1
		LUMINAIRE, SODIUM VAPOR, HIGH MAST, HORIZONTAL MOUNT, 750 WATT (INSTALL ONLY)	EACH	13					13		
		LIGHTING CONTROLLER, RADIO CONTROL, DUPLEX CONSOLE TYPE, WITH SCADA	EACH	2					2		
		FIBER OPTIC CABLE 96 FIBERS, SINGLE MODE	FOOT	25,400					25,400		
		FIBER OPTIC TERMINATION PANEL, 12 FIBER, FO TERM PANEL 12F	EACH	5					5		
		INDUCTION LOOP.	FOOT	642					642		
		AGGREGATE SUBGRADE 12"		(153,943	153,943	SA	,				
		APPROACH SLAB REMOVAL	SQ YD	280.0	280.0						
		SEDIMENT CONTROL, STABILIZED CONSTRUCTION ENTRANCE	SQ YD	2,280	2,280					->	
		*CONSTRUCTION LAYOUT	L SUM	1	1						
		CULVERT TO BE CLEANED	FOOT	114	114						
		DRAINAGE SCUPPERS, DS-11	EACH	2				2			
No.		FENCE REMOVAL	FOOT	21,889	21,889						
		SEDIMENT CONTROL, DRAINAGE STRUCTURE INLET FILTER CLEANING	EACH	308	308						
-		SEDIMENT CONTROL, SILT FENCE MAINTENANCE	FOOT	9,155	9,155		-				
		IMPACT ATTENUATOR REMOVAL	EACH	3	3						
		IMPACT ATTENUATORS (FULLY REDIRECTIVE, NARROW), TEST LEVEL 3	EACH	3	3	,					
		IMPACT ATTENUATORS (NON-REDIRECTIVE), TEST LEVEL 3	EACH	2	2						
		IMPACT ATTENUATORS, TEMPORARY (NON- REDIRECTIVE), TEST LEVEL 3	EACH	6	6						
-		IMPACT ATTENUATORS, TEMPORARY (SEVERE USE, NARROW), TEST LEVEL 3	EACH	10	10						
		IMPACT ATTENUATORS, RELOCATE (NON- REDIRECTIVE), TEST LEVEL 3	EACH	16	16						
		TEMPORARY INFORMATION SIGNING	SQ FT	103	103						
		MAINTENANCE OF LIGHTING SYSTEM	CAL MO	18					18		
		RE-OPTIMIZE TRAFFIC SIGNAL SYSTEM LEVEL 1	EACH	1			,		1		
		COMMUNICATIONS VAULT	EACH	8					. 8		
		PREFORMED DETECTOR LOOP	FOOT	1,056					268		788
		MECHANICALLY STABILIZED EARTH RETAINING WALL	SQ FT	3,764				3,764			
		POROUS GRANULAR EMBANKMENT, SUBGRADE	CU YD	5,780	5,780						
		PIPE UNDERDRAINS FOR STRUCTURES 4"	FOOT	4,227		4,043	184				
		SAND MODULE IMPACT ATTENUATOR TO BE REMOVED	EACH	4	4	,,,,,,,					
Sec. 2		TEMPORARY PAVEMENT	SQ YD	17,847	17,847						
		TEMPORARY TRAFFIC SIGNAL TIMING	EACH	1 1			9		1		
		TRAINES-	HOUR						Y 1917		
/			,,,,,,,,,,,,,,,,,,,,,,,,,,,,,,,,,,,,,,,					A R	F.A.I RTE.	7	

Δ = Non- participating

• DENOTES SPECIALTY ITEM

USER NAME = REVISED REVISED DRAWN PLOT SCALE = 1:50 PLOT DATE = 2/4/2011 CHECKED - DLT DATE - 2/4/11 REVISED

STATE OF ILLINOIS
DEPARTMENT OF TRANSPORTATION

SUMMARY OF QUANTITIES SCALE: NONE SHEET NO. 10 OF 11 SHEETS STA.

ACIM

ACBRF

ACIM

ACIM


F.A.I. SECTION COUNTY SHEETS NO.

55 99-2HB-2B-1 WILL 756 14

CONTRACT NO. 60F12


FED. ROAD DIST. NO. 1 | ILLINOIS FED. AID PROJECT

NO. STATION OFFSET 7000+05.00 11.16' RT BEGIN IMPROVEMENT P. E SEE DRAWING PR-FRONTAGE RD 1, 5002+10.00 STA, 4021+08.63 STATION 1009+16.16 RT ¢ 1-55 FOR BARRIER TRANSITIONS-AT HMT, SEE BD-1 (TYP.) 5000+00 4995+00 WEST FRONTAGE RD ¢ WEST FRONTAGE ROAD TCH LINE WEST F STA. RAMP D S 4025+00 HIGH TENSION CABLE MEDIAN BARRIER TERMINALS--B RAMP D Museum Market Ma MΑ 1007+00 NB I-55 -MATCH EXISTING GUARDRAIL - LEAST FRONTAGE ROAD TBT, TYPE 6 7995+00 8005+00 EAST FRONTAGE RD SPBGR, TYPE A 6 FT POSTS (612.5 LF) EX ROW 8005+29.76, 24.00' LT CHAIN LINK FENCE, 6' -8004+50.00 23.63' LT, FENCE PROPOSED LEGEND STA 1012+00.78,45.91' RT ¢ I-55 A PCC PAVEMENT 10" (JOINTED) STA 7000+25.37 & RAMP A (B) PCC SHOULDERS, 10" © AGGREGATE SHOULDERS, TYPE B 10" (D) HMA PAVEMENT (SEE TYPICAL SECTIONS) E HMA SHOULDERS (SEE TYPICAL SECTIONS) NOTE: F) CONCRETE MEDIAN SURFACE, 4 INCH 1. FOR CURVE DATA SEE ALIGNMENTS, TIES © CONCRETE MEDIAN RAMP NOSE (SEE STD 606301-04) AND BENCHMARKS DRAWING NOS. AT-1 TO AT-9 PAID FOR AS CONCRETE MEDIAN, TYPE SB-6.24 (MODIFIED) 2. FOR ROW CALL-OUTS SEE PLAT OF HIGHWAY SHEETS (H) CONCRETE MEDIAN, TYPE SB 6.24 (MODIFIED) (I) COMBINATION CONCRETE CURB & GUTTER TYPE B-6.24 (J) COMBINATION CONCRETE CURB & GUTTER TYPE M-2.24 (K) CONCRETE BARRIER, DOUBLE FACE, 42" HEIGHT (L) IMPACT ATTENUATOR FULLY REDIRECTIVE NARROW TEST LEVEL 3 KEY MAP M CORRUGATED MEDIAN N HMA SHOULDER CROSS SLOPE CORRECTION 2 STATION OFFSET ---- FENCE AS INDICATED IN PLANS LE NAME = JSER NAME = TKluegel DESIGNED JTF REVISED - REV. 4/14/11 COUNTY STATE OF ILLINOIS ØF12-SHT-PLANØ1.dgn DRAWN REVISED PROPOSED PLAN WILL 756 99-2HB-2B-1 **DEPARTMENT OF TRANSPORTATION** REVISED CONTRACT NO. 60F12 REVISED 2/4/11 SCALE: 1"=50' SHEET NO. 1 OF 15 SHEETS STA. TO STA.

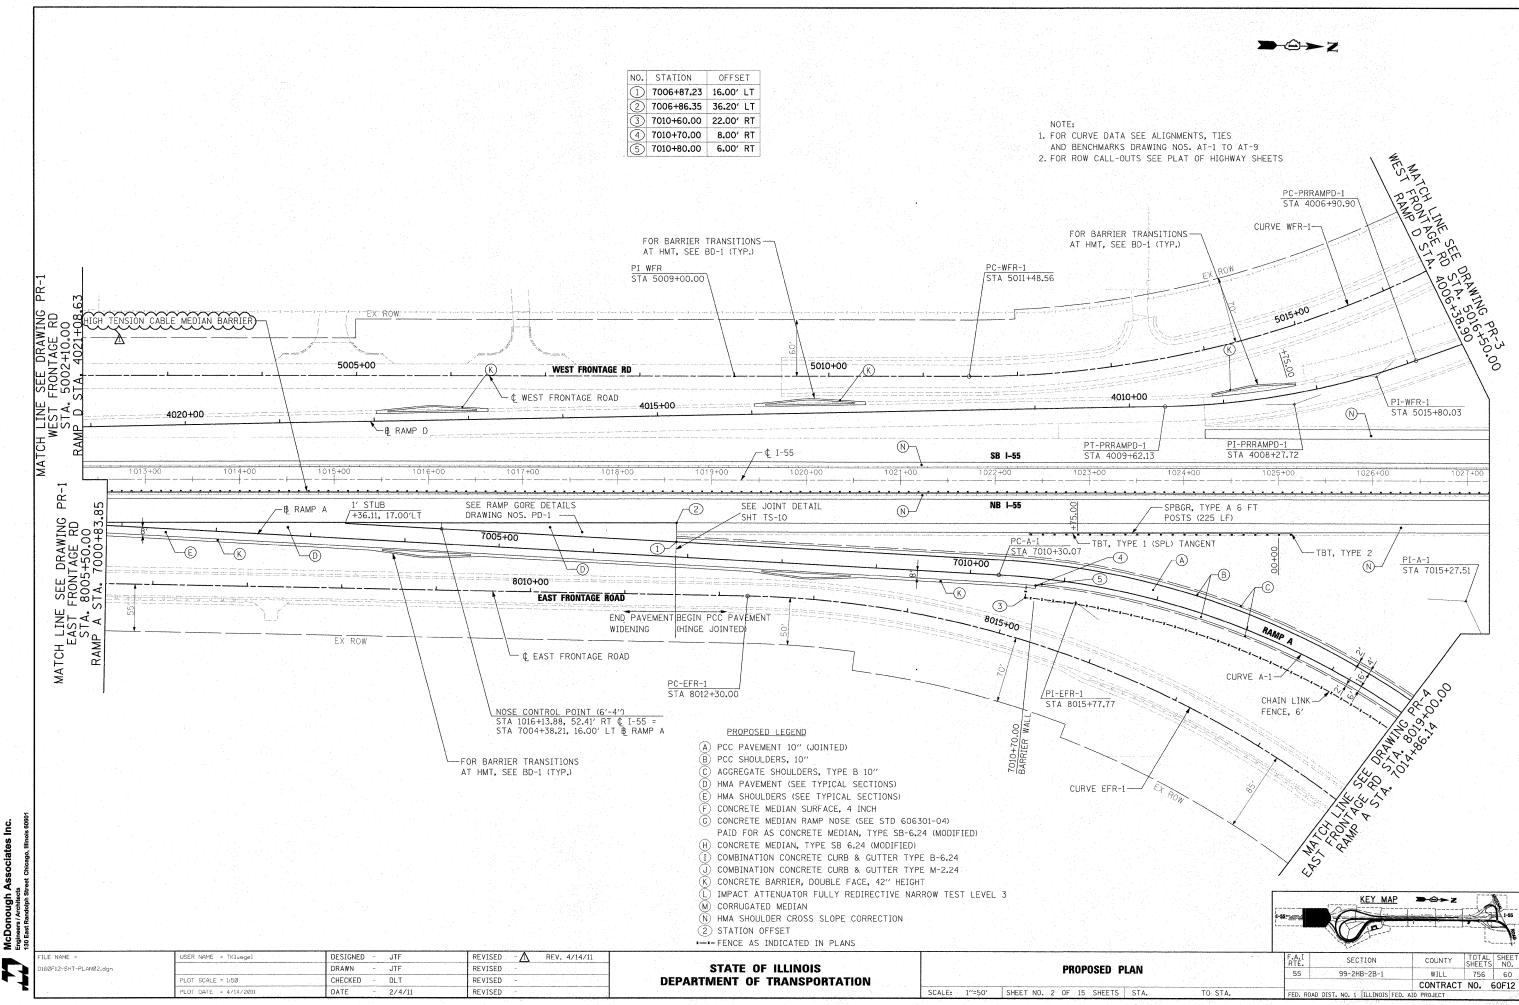

PR-3

PR-5

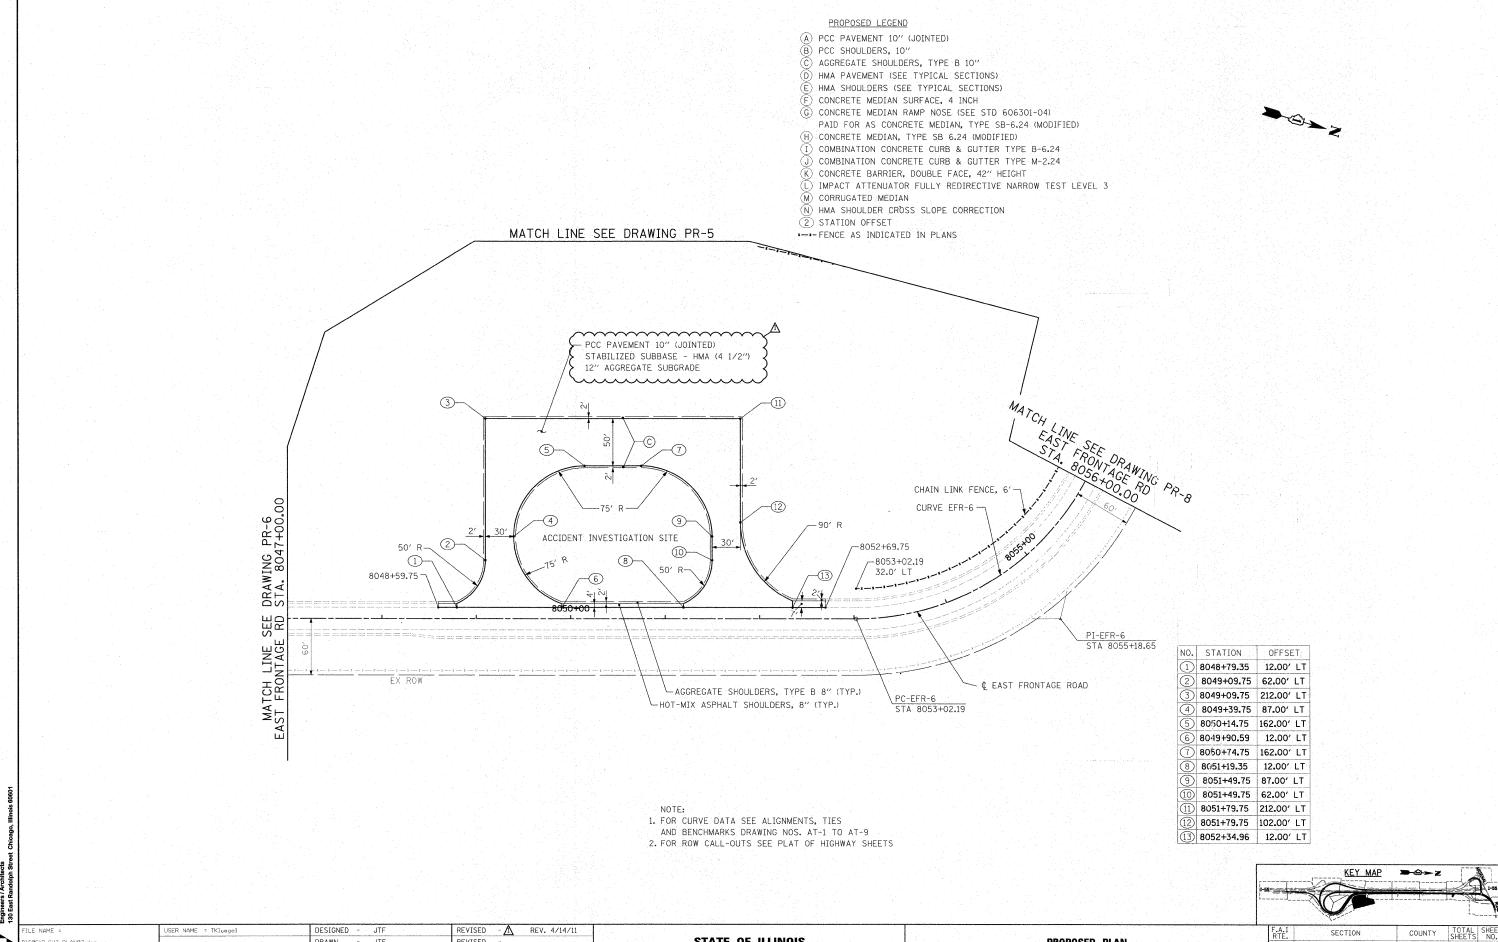

STATE OF ILLINOIS

SØF12-SHT-PLANØ7.dgn

PLOT SCALE = 1:50

DRAWN

CHECKED - DLT

REVISED

REVISED

REVISED

PROPOSED PLAN **DEPARTMENT OF TRANSPORTATION** SCALE: 1"=50" SHEET NO. 7 OF 15 SHEETS STA.

PR-7


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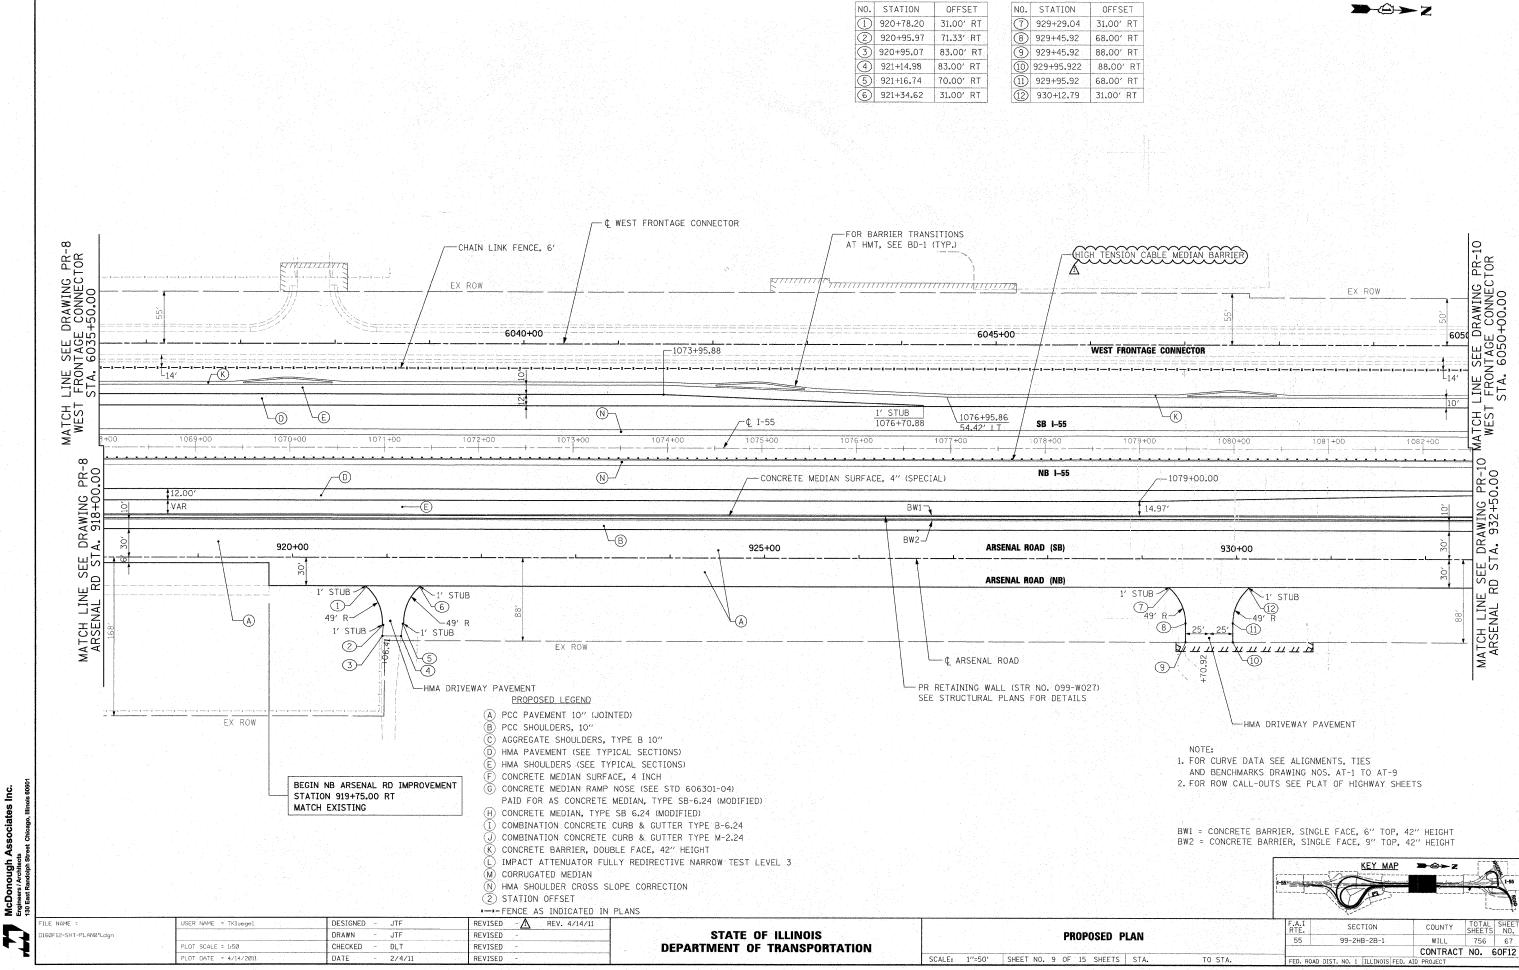
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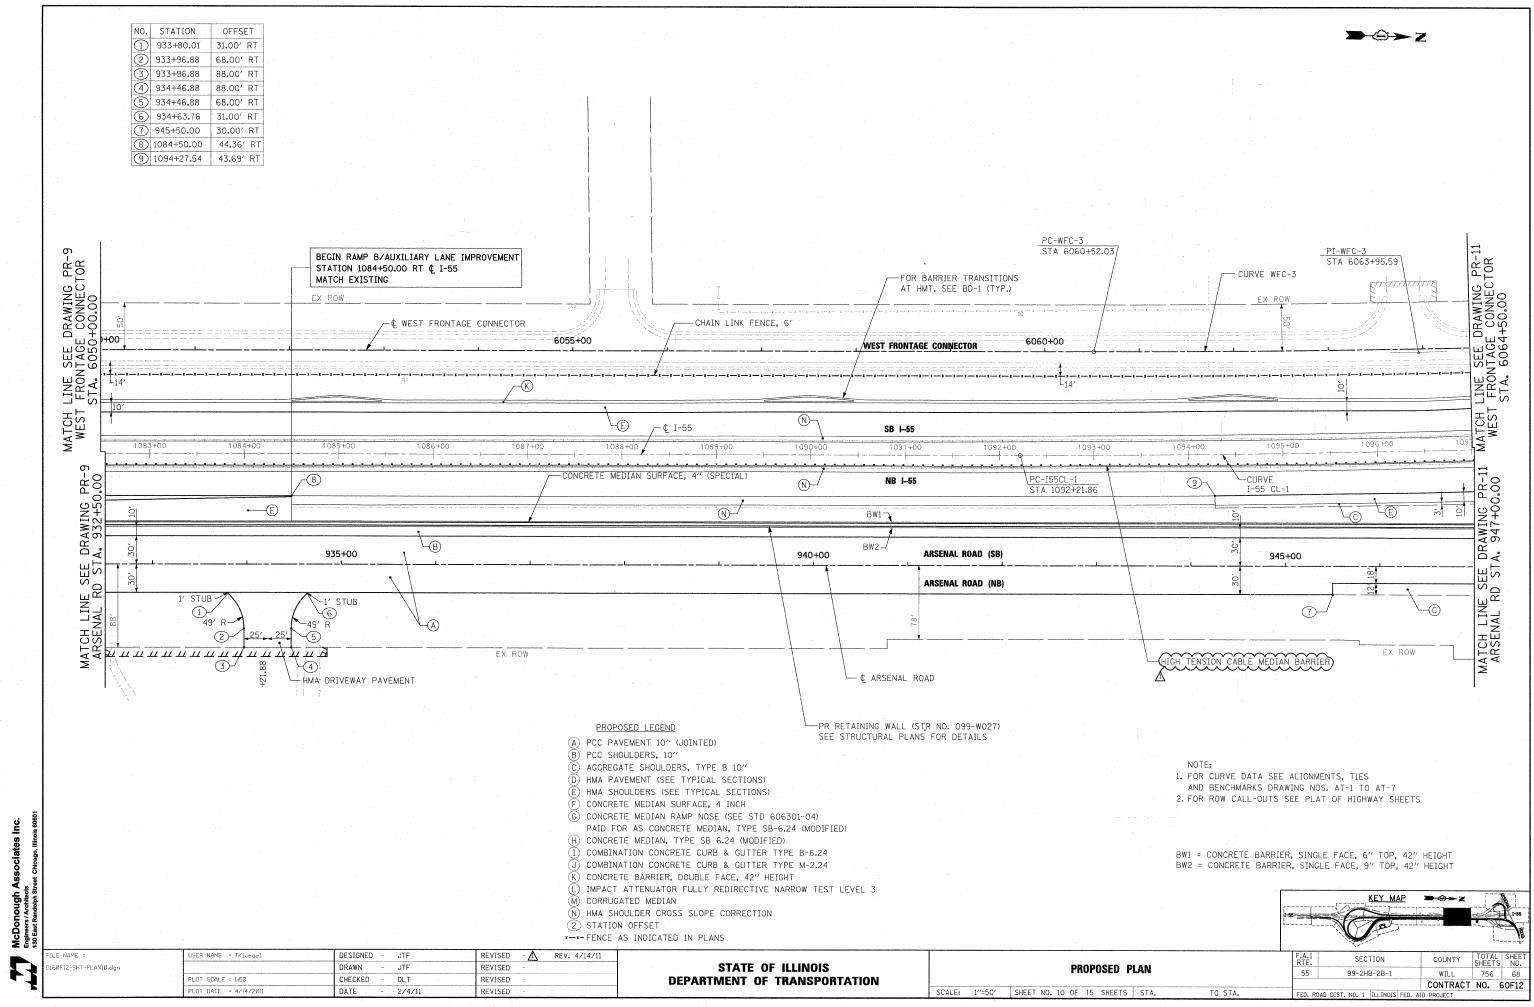
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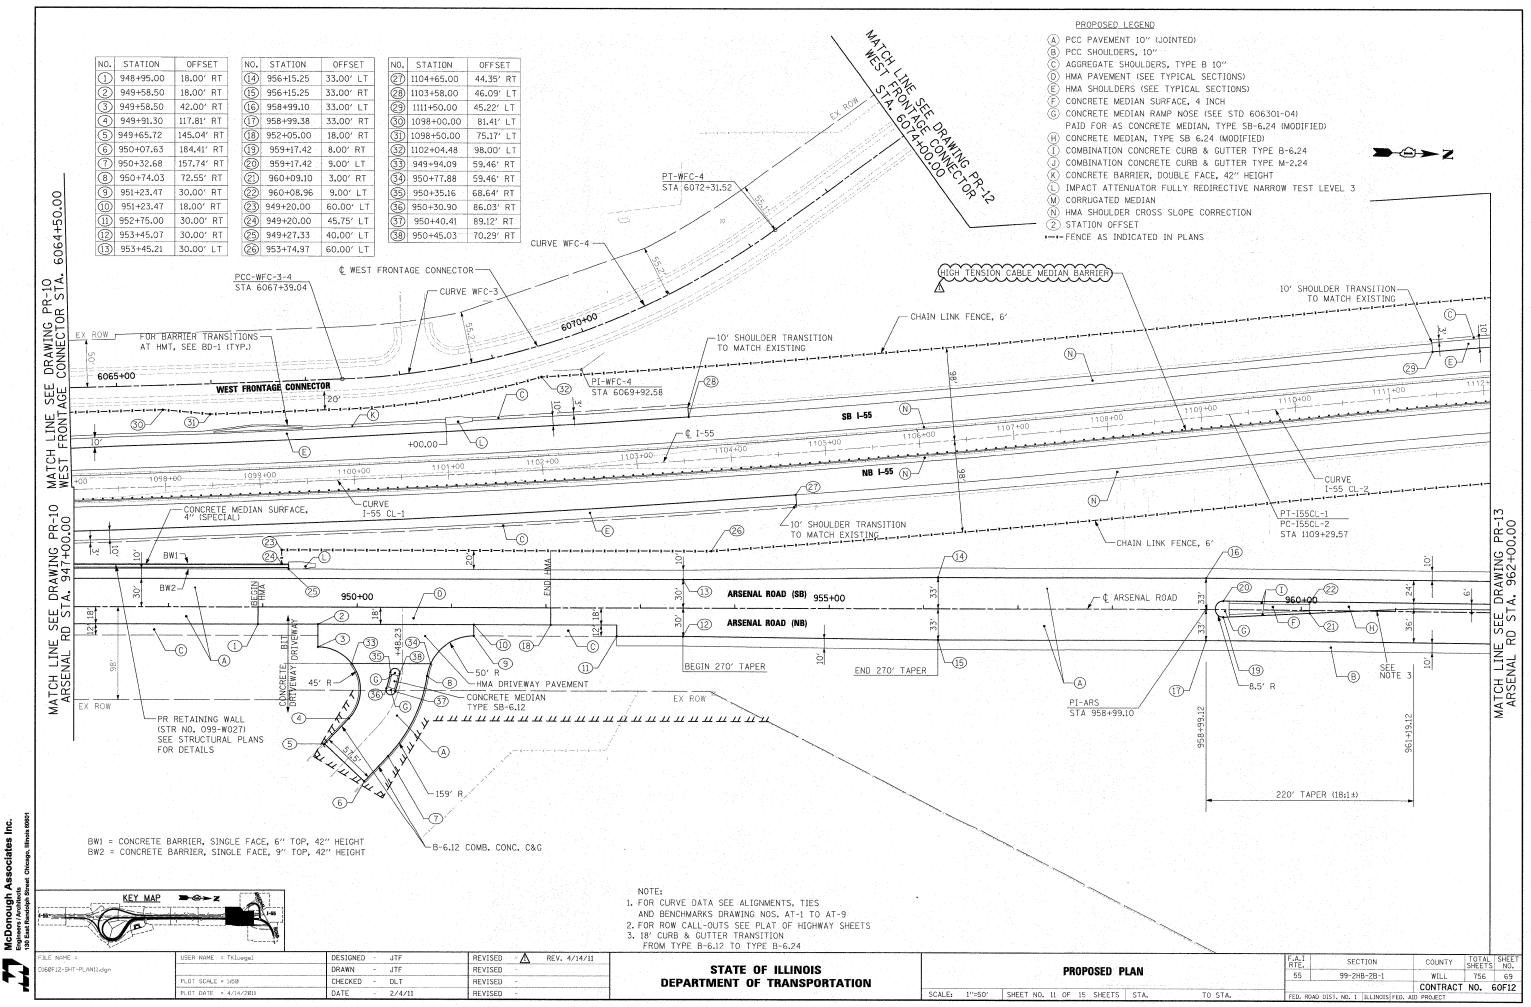
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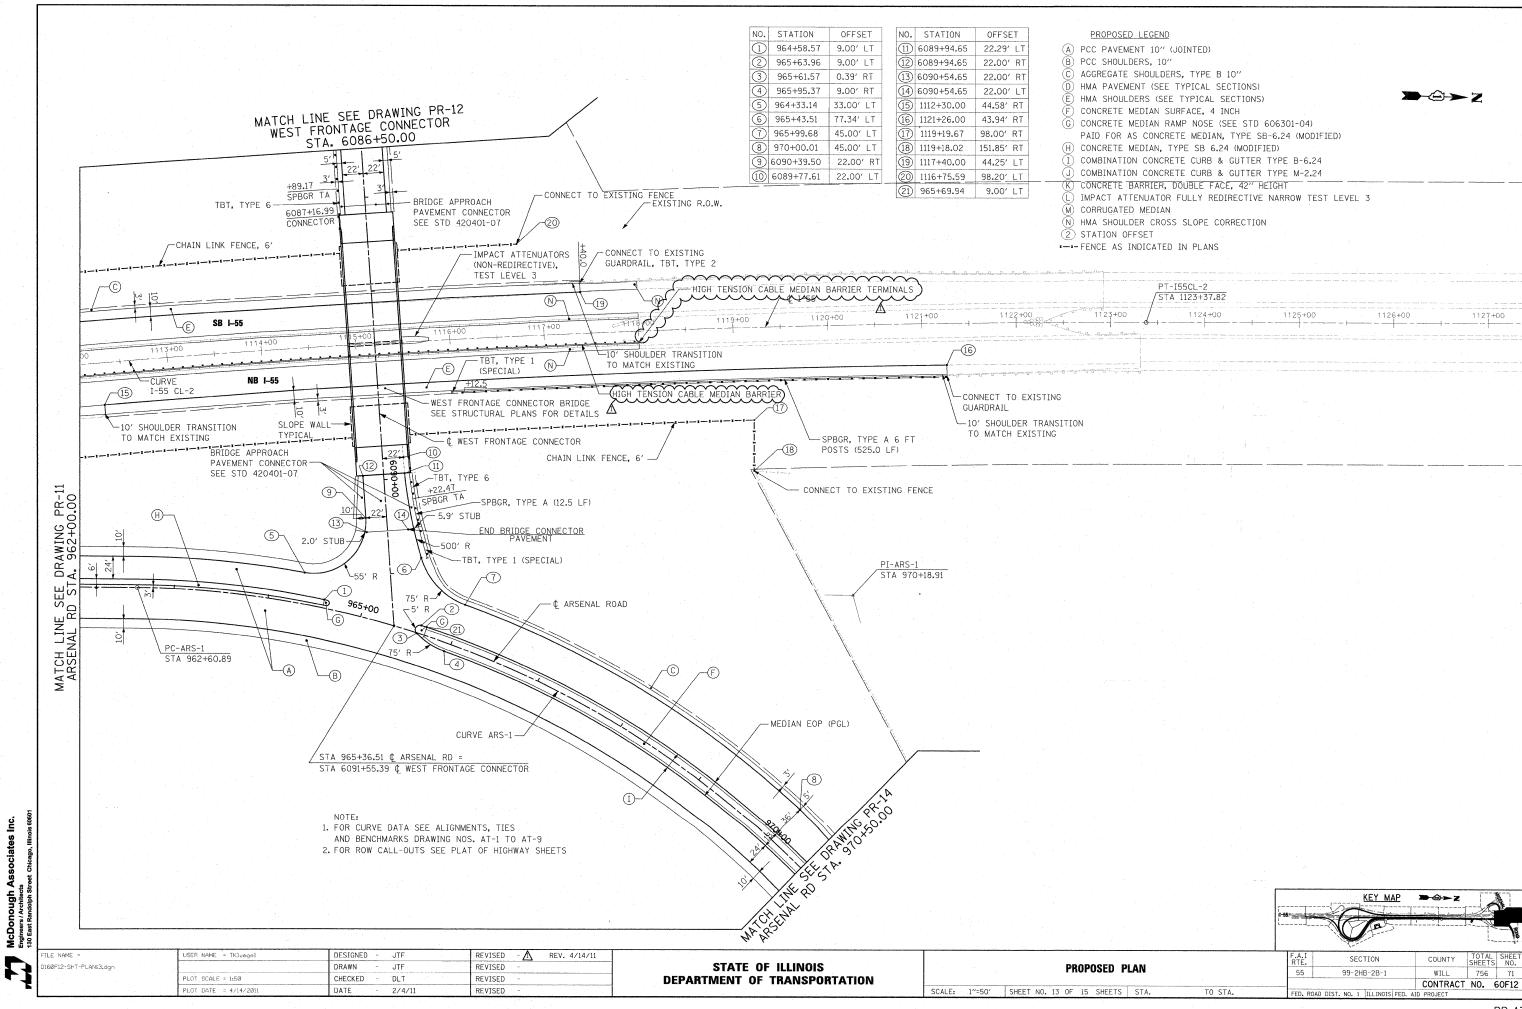
CONTRACT NO. 60F12









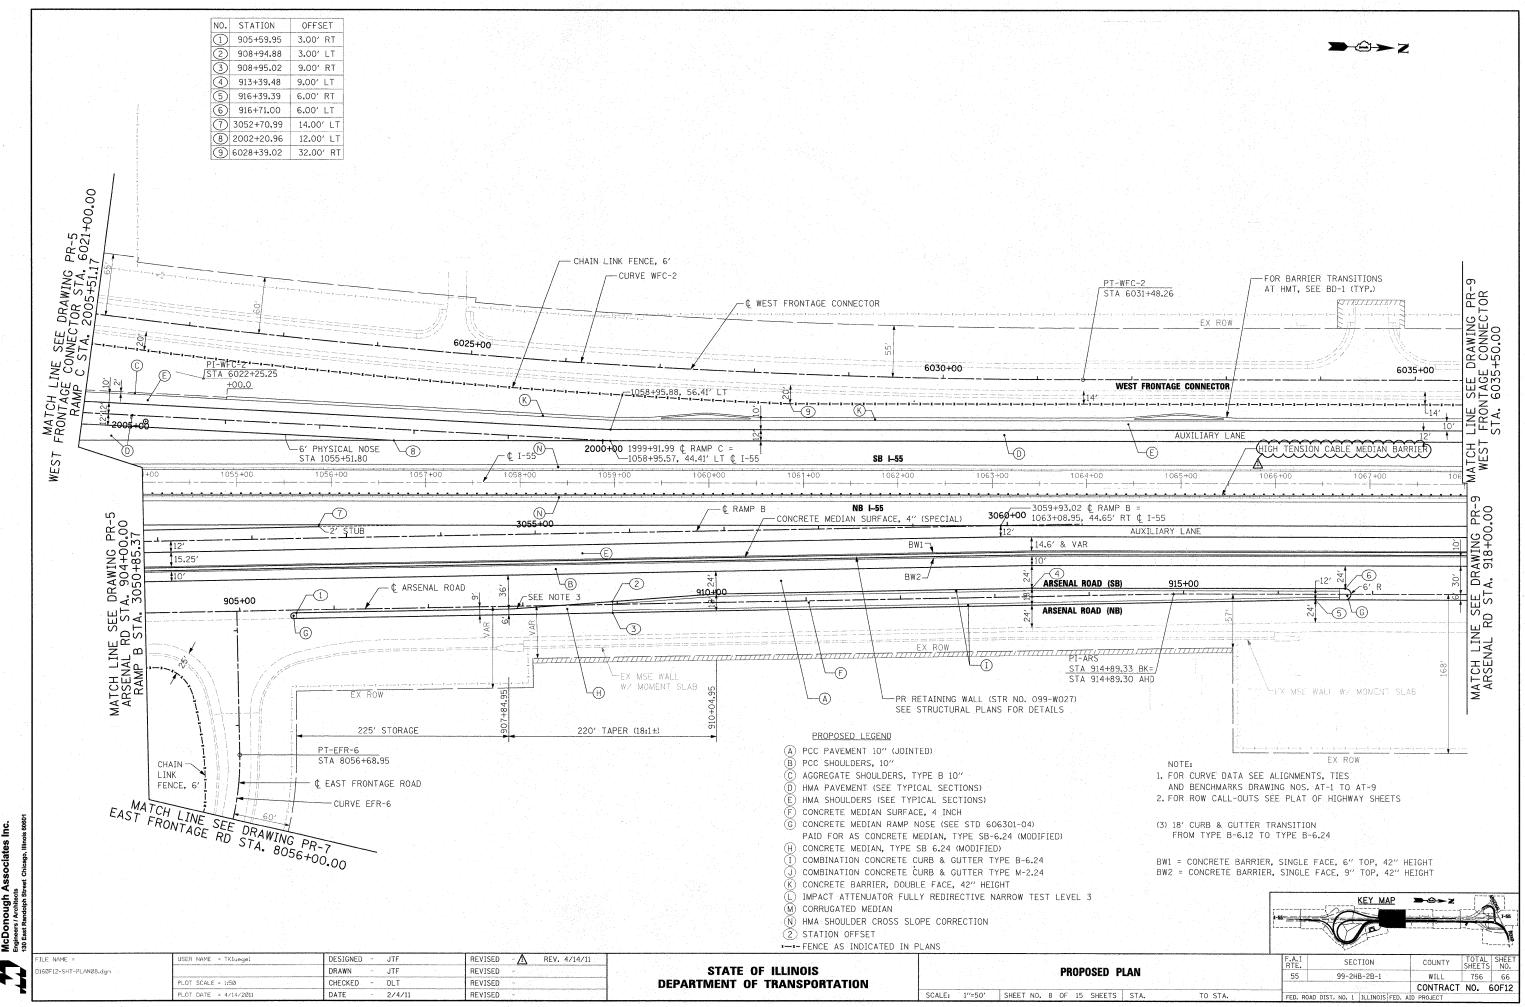


STATE OF ILLINOIS DEPARTMENT OF TRANSPORTATION

GENERAL NOTES

- 1. Fasteners shall be AASHTO M164 Type 1, mechanically galvanized bolts. Bolts 78 in. dia., holes 1516 in. dia., unless otherwise noted.
- 2. Calculated weight of Structural Steel:

 AASHTO M270 Gr50 = 481,680/lb
- 3. No field welding is permitted except as specified in the contract documents.
- 4. Reinforcement bars shall conform to the requirements of ASTM A 706 Gr 60. See Special Provisions.
- 5. Reinforcement bars designated "E" shall be epoxy coated.
- 6. If the Contractor elects to use cantilever forming brackets on the exterior beams or girders, the brackets shall be placed at the same locations as required for the hardwood blocks in Article 503,06(b) of the Standard Specifications. If additional cantilever forming brackets are required, hardwood blocking shall be wedged between the exterior and first interior beam at each of these additional bracket locations.
- 7. Bearing seat surfaces shall be constructed or adjusted to the designated elevations within a tolerance of 18 in. "0.01 ft.". Adjustment shall be made either by grinding the surface or by shimming the bearings.
- 8. Concrete sealer shall be applied to the designated areas of the West and East Abutments.
- 9. The Organic Zinc Rich Primer / Epoxy / Urethane Paint System shall be used for painting of new structural steel except where otherwise noted. The entire system shall be shop applied, with the exception of the exterior surfaces and the bottom of the bottom flange of fascia beams, masked off connection surfaces, field installed fasteners and damaged areas shall be touched up and finish coated in the field. The color of the final finish coat for all interior steel surfaces shall be Gray, Munsell No. 5B 7/1. The color of the final finish coat for the exterior and the bottom of the bottom flange of fascia beams shall be Blue, Munsell No. 10B 3/6. See Special Provision for "Cleaning and Painting New Metal Structures."
- 10. The embankment configuration shown shall be the minimum that must be placed and compacted prior to construction of the abutments.
- 11. The Contractor shall drive test piles to 110% of the nominal required bearing specified in production locations at substructures specified or approved by the Engineer before ordering the remainder of piles.
- 12. Slip forming of the concrete parapets IS not allowed.

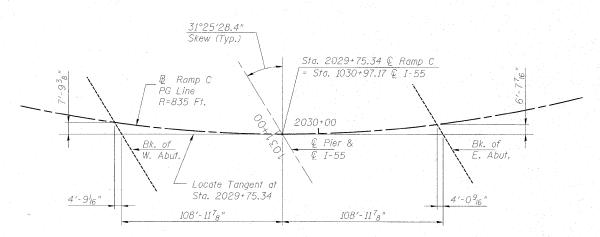

OFFSET SKETCH

DESIGNED	BKB
CHECKED	PMH
DRAWN	AMV/RJ
CHECKED	BKB

INDEX OF SHEETS

30 · I	GELIEL UI	TRUIT C	IIIU L	_167011	UII -		
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SC-4 Top of W. Approach Slab Elevations

Top of Slab Elevations

Top of Slab Elevations Top of Slab Elevations

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SC: 34 Steel H-Pile Details

SC-35 Bar Splicer Details

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5'-0" (min) North Side 2'-0" (min) South Side Edge of Deck-10'-0" @ Rt. L's (Typ.) SECTION A-A Poured against undisturbed embankment * Slope to drain

TYPICAL SECTION THRU SLOPEWALL

Slope wall shall be reinforced with welded wire fabric, 6 in. x 6 in.-W4.0 x W4.0, weighing 58 lbs, per 100 sa. ft..



McDonough Associates Inc. Engineers / Architects

130 East Randolph Street Chicago, Illinois 60601 (312) 946-8600

TOTAL BILL OF MATERIAL

ITEM	UNIT	SUPER	SUB	TOTAL
Preformed Joint Strip Seal	Foot	155	.	155
Concrete Structures	Cu. Yd.	-	377.2	377.2
Concrete Superstructure	Cu. Yd.	677.5		677.5
Bridge Deck Grooving	Sq. Yd.	1,480	12.1	1,480
Protective Coat	Sq. Yd.	1,750	-	1.750
Stud Shear Connectors	Each	2,046		2,046
Reinforcement Bars, Epoxy Coated	Pound	183,170	56,620	239,790
Name Plates	Each	1	-	1
Concrete Sealer	Sq. Ft.		507	507
Drainage Scuppers, DS-11	Each	2		2
1 1 1 1 1 1 1 1 1 1 1 1 1 1 1 1 1 1 1				
Furnishing and Erecting Structural Steel	L. Sum	1		1
Furnishing Steel Piles HP12X53	Foot	-	1,010	1,010
Driving Piles	Foot	-	1,010	1,010
Test Pile Steel HP12X53	Each		2.	2
Pile Shoes	Each		46	46
Bar Splicers	Each		124	124
Slope Wall 4 Inch	Sq. Yd.		748	748
Braced Excavation	Cu. Yd.	-	123	-123
Rock Excavation for Structures	Cu. Yd.	-	65	65
High Load Multi-Rotational Bearings, Guided Expansion, 200K	Each	14	-	14
High Load Multi-Rotational Bearings, Fixed - 450K	Each	7		7
Mechanically Stabilized Earth Retaining Wall	Sq. Ft.		3,764	3,764
Removal and Disposal of Unsuitable Material for Structures	Cu. Yd.		294	294
Anchor Bolts, 1"	Each	56		. 56
Anchor Bolts, 1 ¹ ₄ "	Fach	28		28

STATION 2029+75.34 BUILT 20__ BY STATE OF ILLINOIS RAMP C SEC. (99-1 & 22) R-6 LOADING HL-93 STRUCTURE NO. 099-0348

NAME PLATE See Std. 515001-01

GENERAL NOTES AND TOTAL BILL OF MATERIAL STRUCTURE NO. 099-0348

M Rev. 4-20-11 F.A.I. RTE. TOTAL SHEE SHEETS NO. SECTION COUNTY SHEET NO. 55 (99-1&2) R-6 756 528 SC-2 SHEETS CONTRACT NO. 60F12 SC-37 FED. ROAD DIST. NO. ILLINOIS FED. AID PROJECT

