04-28-2023 LETTING ITEM 084

FOR INDEX OF SHEETS, HIGHWAY STANDARDS, AND PR LEGEND SEE SHEET NO. 2

0

0

**SCHAUMBURG** 

CARMEN E. RAMOS P.E.,

ENGINEER,

AID PROGRAM


FEDERAL

POLICY STATEMENT:
PLANS DESIGNED IN ACCORDANCE WITH THE
BUREAU OF LOCAL ROADS AND STREETS MANUAL

**NORRIS ROAD** 

DESIGN DESIGNATION
MAJOR COLLECTOR
DESIGN SPEED = 35 M.P.H.
POSTED SPEED = 30 M.P.H.
ADT (2018) = 2,000 VPD

PROJECT LOCATED IN THE VILLAGE OF SUGAR GROVE

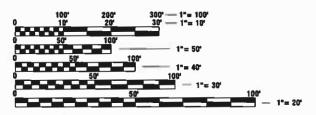

FULL SIZE PLANS HAVE BEEN PREPARED USING STANDARD ENGINEERING SCALES. REDUCED SIZED PLANS WILL NOT CONFORM TO STANDARD SCALES. IN MAKING MEASUREMENTS ON REDUCED PLANS, THE ABOVE SCALES MAY BE USED.




**CONTRACT NO. 61J47** 

# STATE OF ILLINOIS DEPARTMENT OF TRANSPORTATION

# PLANS FOR PROPOSED FEDERAL-AID HIGHWAY

FAU 2303 (NORRIS ROAD)

N. VILLAGE LIMITS TO S. VILLAGE LIMITS
ROADWAY RESURFACING
SECTION 22-00032-00-RS
PROJECT NUMBER: SW8G(363)
VILLAGE OF SUGAR GROVE
KANE COUNTY
JOB NO. C-91-072-23

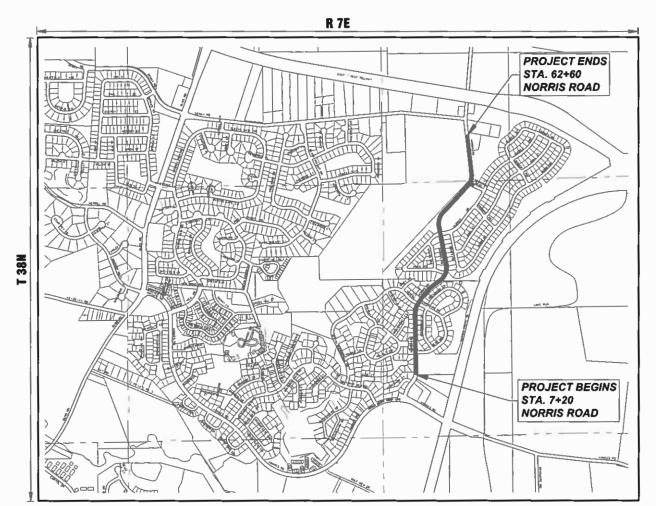


LOCATION MAP (SCALE 1"=1000')
SECTION 2 & 11, T38N, R7E, SUGAR GROVE TOWNSHIP
GROSS LENGTH OF PROJECT = 5,540 FEET (1.05 MILES)
NET LENGTH OF PROJECT = 5,540 FEET (1.05 MILES)


F.A-IJ SECTION COUNTY TOTAL SHEET NO.

2303 22-00032-00-RS KANE 23 1

CONTRACT NO. 61J47



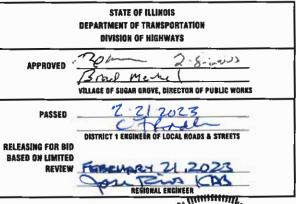

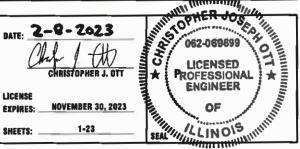



Engineering Enterprises, Inc. CONSULTING ENGINEERS 52 Wheeler Road Sugar Grove, Illinois 60554 Phone: (630) 466-6700

PRINTED BY THE AUTHORITY OF THE STATE OF ILLINOIS

NO SUBSTITUTIONS OR VARIANCES WILL BE PERMITTED TO ANY STANDARD NOTES OR ORDINANCES UNLESS APPROVED OTHERWISE IN WRITING PRIOR TO COMMENCING CONSTRUCTION ACTIVITY.

ALL TRAFFIC CONTROL AND OTHER ADVISORY SIGNS NEEDED FOR CONSTRUCTION ARE TO BE FURNISHED BY THE CONTRACTOR IN ACCORDANCE WITH ARTICLE 107.14 OF THE STANDARD SPECIFICATIONS.

THE CONTRACTOR SHALL AT ALL TIMES PROVIDE PROTECTION FOR TRAFFIC AS CALLED FOR IN THE APPLICATION OF TRAFFIC CONTROL DEVICES, THE STANDARD SPECIFICATIONS, THE SPECIAL PROVISIONS AND THE PLANS

THE CONTRACTOR SHALL COOPERATE WITH THE OWNER IF ANY UTILITY IMPROVEMENTS ARE REQUIRED WITHIN THE DURATION OF THE CONTRACT.

THE CONTRACTOR SHALL BE RESPONSIBLE FOR CONTACTING THE OWNERS OF ALL UTILITIES PRIOR TO CONSTRUCTION TO DETERMINE THE LOCATION OF ALL EXISTING AND PROPOSED UTILITY EQUIPMENT. THE CONTRACTOR SHALL COOPERATE WITH ALL UTILITY OWNERS AS PROVIDED FOR IN THE STANDARD SPECIFICATIONS IF UTILITY RELOCATION, ADJUSTMENT, OR PROTECTION IS NECESSARY.

THE LOCATION OF EXISTING DRAINAGE STRUCTURES, STORM SEWERS, WATER MAINS, SANITARY SEWERS, FIELD TILES AND ANY OTHER PUBLIC OR PRIVATE UTILITIES AS SHOWN ON THE PLANS IS APPROXIMATE AND NOT NECESSARY COMPLETE: THEIR EXACT LOCATION IS TO BE DETERMINED IN THE FIELD BY THE

IF EXISTING UTILITY LINES OF ANY NATURE ARE ENCOUNTERED WHICH CONFLICT IN LOCATION WITH NEW CONSTRUCTION, THE CONTRACTOR SHALL NOTIFY THE ENGINEER SO THAT THE CONFLICT MAY BE RESOLVED.

UNDER NO CIRCUMSTANCES SHALL THE CONTRACTOR OPERATE ANY VALVES OR HYDRANTS.

THE CONTRACTOR SHALL PROTECT AND CAREFULLY PRESERVE ALL SECTION OR SUBSECTION MONUMENTS, PROPERTY CORNERS, AND REFERENCE MARKERS UNTIL THE OWNER, THE OWNER'S AGENT, OR AN AUTHORIZED SURVEYOR HAS WITNESSED OR OTHERWISE REFERENCED THEIR LOCATIONS.

ALL OFFSET LOCATIONS GIVEN ON THE DETAILED PLANS ARE FROM THE CENTERLINE AS SHOWN ON THE

#### MISCELLANEOUS

THE THICKNESS OF ASPHALT MIXTURES SHOWN IN THE PLANS ARE NOMINAL. DEVIATIONS MAY OCCUR DUE TO IRREGULARITIES IN THE SURFACES OR BASES ON WHICH THE ASPHALT MIXTURES ARE TO BE PLACED.

IT IS THE CONTRACTOR'S RESPONSIBILITY TO ASCERTAIN EXISTING FIELD CONDITIONS BEFORE BIDDING ON

WHERE NEW WORK MEETS EXISTING FEATURES TO REMAIN, THE CONTRACTOR SHALL FIELD CHECK ALL DIMENSIONS AND ELEVATIONS BEFORE PROCEEDING WITH CONSTRUCTION. IMMEDIATELY NOTIFY THE ENGINEER OF ANY DISCREPANCIES.

THE CONTRACTOR WILL BE REQUIRED TO COMPLY WITH ALL STATE REGULATIONS REGARDING AIR, WATER AND NOISE POLLUTION. THE CONTRACTOR IS PROHIBITED FROM BURNING ANY MATERIAL WITHIN OR ADJACENT TO THE IMPROVEMENT.

THE ENGINEER IS NOT RESPONSIBLE FOR THE CONSTRUCTION MEANS, METHODS, TECHNIQUES, SEQUENCES OR PROCEDURES, TIME OF PERFORMANCE, PROGRAMS OR FOR ANY SAFETY PRECAUTIONS USED BY THE CONTRACTOR. THE CONTRACTOR IS SOLELY RESPONSIBLE FOR EXECUTION OF THEIR WORK IN ACCORDANCE WITH THE CONTRACT DOCUMENTS AND SPECIFICATIONS.

FOR STABILIZATION, ALL TYPE III BARRICADES WILL REQUIRE A MINIMUM OF FOUR SAND BAGS PER

THE CONTRACTOR SHALL MAINTAIN EXISTING SIDE STREET AND DRIVEWAY ACCESS TO EACH ABUTTING PROPERTY AT ALL TIMES DURING CONSTRUCTION OF THE PROJECT UNLESS OTHERWISE NOTED ON THE PLANS OR DIRECTED BY THE ENGINEER.

THE CONTRACTOR SHALL DISPOSE OF AND REMOVE FROM THE SITE EACH DAY ALL CURB AND GUTTER, PAVEMENT AND ALL OTHER EXCAVATED MATERIAL NOT FOR SALVAGE.

THE STORAGE OF EQUIPMENT AND/OR MATERIALS WITHIN THE RIGHT-OF-WAY OF ANY STREET AND/OR PARK PROPERTY SHALL REQUIRE PRIOR APPROVAL OF THE ENGINEER.

SIDEWALK REMOVAL AND REPLACEMENT AND COMBINATION CONCRETE CURB AND GUTTER REMOVAL AND REPLACEMENT AS SHOWN ON THE PLANS IS FOR INFORMATIONAL PURPOSES ONLY. ACTUAL LOCATIONS AND QUANTITIES ARE TO BE DETERMINED AND MARKED BY THE ENGINEER PRIOR TO CONSTRUCTION.

ALL EXISTING SIGNS (INCLUDING THOSE LOCATED ON UTILITY/LIGHT POLES) THAT DO NOT CONFLICT WITH THE IMPROVEMENTS SHALL REMAIN IN PLACE UNLESS DIRECTED BY THE ENGINEER.

CONTRACTOR SHALL TAKE PRECAUTION BY PRESERVING EXISTING TREES WITHIN THE RIGHT OF WAY. IF ANY DAMAGE OCCURS, TREES SHALL BE REPLACED IN KIND PER ARTICLE 201.07 REPAIR OR REPLACEMENT OF EXISTING PLANT MATERIAL REQUIREMENTS STATED HEREIN.

#### IDOT LICUMAY STANDADDS

	IDOT HIGHWAY STANDARDS
000001-08	STANDARD SYMBOLS, ABBREVIATIONS, AND PATTERNS
280001-07	TEMPORARY EROSION CONTROL SYSTEMS
424001-11	PERPENDICULAR CURB RAMPS FOR SIDEWALKS
424006-05	DIAGONAL CURB RAMPS FOR SIDEWALKS
424021-06	DEPRESSED CORNER FOR SIDEWALKS
442201-03	CLASS C AND D PATCHES
604001-05	FRAME AND LIDS TYPE 1
604006-05	FRAME AND GRATE TYPE 3
606001-08	CONCRETE CURB TYPE B AND COMBINATION CONCRETE CURB AND GUTTER
701006-05	OFF-RD OPERATIONS, 2L, 2W, 15'(4.5M) TO 24" (600MM) FROM PAVEMENT EDGE
701011-04	OFF-RD MOVING OPERATIONS, 2L, 2W, DAY ONLY
701301-04	LANE CLOSURE, 2L, 2W, SHORT TIME OPERATIONS
701311-03	LANE CLOSURE, 2L, 2W, MOVING OPERATIONS - DAY ONLY
701501-06	URBAN LANE CLOSURE 2L, 2W, UNDIVIDED
701801-06	SIDEWALK, CORNER OR CROSSWALK CLOSURE
701901-08	TRAFFIC CONTROL DEVICES
720001-01	SIGN PANEL MOUNTING DETAILS
720006-04	SIGN PANEL ERECTION DETAILS
728001-01	TELESCOPING STEEL SIGN SUPPORT
731001-01	BASE FOR TELESCOPING STEEL SIGN SUPPORT

780001-05 TYPICAL PAVEMENT MARKINGS

### **INDEX OF SHEETS**

COVER SHEET INDEX OF SHEETS, DETAILS, HIGHWAY STANDARDS, AND GENERAL NOTES 2.

3.-5. SUMMARY OF QUANTITIES

6.-7. TYPICAL SECTIONS

9.-15. RESURFACING PLAN

VILLAGE DETAILS

22.

17.-23. IDOT DISTRICT 1 DETAILS

SHEET. NO.	IDO	<u>OT DISTRICT ONE STD.</u> DETAILS
17.	(BD-22)	PAVEMENT PATCHING FOR HMA SURFACED PAVEMENT
18.	(BD-24)	CURB OR CURB AND GUTTER REMOVAL AND REPLACEMENT
19.	(BD-32)	BUTT JOINT AND HMA TAPER DETAILS
20.	(TC-10)	TRAFFIC CONTROL AND PROTECTION FOR SIDE ROADS, INTERSECTIONS, AND DRIVEWAYS
21.	(TC-13)	TYPICAL PAVEMENT MARKINGS

(TC-16) SHORT TERM PAVEMENT MARKING LETTERS

(TC-22) ARTERIAL ROAD INFORMATION SIGN

### SUPPLEMENTAL LEGEND

HOT-MIX ASPHALT SURFACE REMOVAL,

HOT-MIX ASPHALT SURFACE REMOVAL, VARIABLE DEPTH

HOT-MIX ASPHALT SURFACE REMOVAL -BUTT-JOINT BIKE PATH REMOVAL AND INCIDENTAL HOT-MIX ASPHALT SURFACING

COMB CONC C&G REMOVAL AND REPLACEMENT

SIDEWALK REMOVAL

BIKE PATH REMOVAL

BIKE PATH REMOVAL AND PORTLAND CEMENT CONCRETE SIDEWALK, 5"

SIDEWALK REMOVAL AND PORTLAND CEMENT CONCRETE SIDEWALK, 5"

AGGREGATE WEDGE SHOULDER, TYPE B

SCALE: N.T.S.

	CODE NUMBER	ITEM DESCRIPTION	UNIT	TOTAL QUANTITY	ROADWAY 75% FEDERAI 25% LOCAL 0005
	21101615	TOPSOIL FURNISH AND PLACE, 4"	SQ YD	365	365
*	25200110	SODDING, SALT TOLERANT	SQ YD	365	365
*	25200200	SUPPLEMENTAL WATERING	UNIT	20	20
	28000250	TEMPORARY EROSION CONTROL SEEDING	POUND	8	8
	28000510	INLET FILTERS	EACH	26	26
	40600290	BITUMINOUS MATERIALS (TACK COAT)	POUND	12,945	12,945
	40600400	MIXTURE FOR CRACKS, JOINTS, AND FLANGEWAYS	TON	10	10
	40600982	HOT-MIX ASPHALT SURFACE REMOVAL - BUTT JOINT	SQ YD	151	151
	40602978	HOT-MIX ASPHALT BINDER COURSE, IL-9.5, N50	TON	1,660	1,660
	40604060	HOT-MIX ASPHALT SURFACE COURSE, IL-9.5, MIX "D", N50	TON	1,660	1,660
	40800025	BITUMINOUS MATERIALS (PRIME COAT)	POUND	100	100
	40800050	INCIDENTAL HOT-MIX ASPHALT SURFACING	TON	11	11
	42400200	PORTLAND CEMENT CONCRETE SIDEWALK 5 INCH	SQ FT	1,865	1,865
	42400800	DETECTABLE WARNINGS	SQFT	140	140
4410000044	44000157	HOT-MIX ASPHALT SURFACE REMOVAL, 2"	SQ YD	7,650	7,650
	44000500	COMBINATION CURB AND GUTTER REMOVAL	FOOT	922	922
	44000600	SIDEWALK REMOVAL	SQ FT	765	765

\* SEE SPECIAL PROVISIONS 4 INDICATES SPECIALTY ITEM

Engineering Enterprises, Inc.
CONSULTING ENGINEERS
52 Wheeler Road
52 Under Grow Illinois 60554
630.486.6700 / www.esiweb.com

USER NAME = Jim Schmidt	DESIGNED -	REVISEO -
	DRAWN -	REVISEO -
PLOT SCALE =	CHECKED	REVISED -
PLOT DATE = February 9, 2023 @ 9:14 AM	DATE	REVISED -

STATE OF ILLINOIS
DEPARTMENT OF TRANSPORTATION

	8	UMP	MAR	Y O	F QUA	NTITIES		
SCALE: N.T.S.	SHEET	1	0F	3	SHEETS	STA.	TO	STA.

4.0					ł
F.A.U. RTE.	SECTION	COUNTY	TOTAL SHEETS	SHEET NO.	
2303	22~00032-00-R5	KANE	23	3	ļ
		CONTRACT N	IO. 6IJ	47	ľ
		B DDO ICCT			Ġ

	CODE NUMBER	ITEM DESCRIPTION	UNIT	TOTAL QUANTITY	ROADWAY 75% FEDERAL 25% LOCAL 0005
	44201705	CLASS D PATCHES, TYPE II, 5 INCH	\$Q YD	96	96
	44201709	CLASS D PATCHES, TYPE III, 5 INCH	SQ YD	192	192
	44201711	CLASS D PATCHES, TYPE IV, 5 INCH	SQ YD	1,055	1,055
	48102100	AGGREGATE WEDGE SHOULDER, TYPE B	TON	180	180
	60260100	INLETS TO BE ADJUSTED	EACH	20	20
	60603800	COMBINATION CURB AND GUTTER, TYPE B-6.12	FOOT	992	992
	67100100	MOBILIZATION	L SUM	1	1
	70102620	TRAFFIC CONTROL AND PROTECTION, STANDARD 701501	L SUM	1	1
	70102640	TRAFFIC CONTROL AND PROTECTION, STANDARD 701801	L SUM	1	1
	70300100	SHORT TERM PAVEMENT MARKING	FOOT	500	500
	70300150	SHORT TERM PAVEMENT MARKING REMOVAL	SQ FT	123	123
	70300221	TEMPORARY PAVEMENT MARKING - LINE 4" - PAINT	FOOT	500	500
Δ	72000100	SIGN PANEL - TYPE 1	SQ FT	103	103
Δ	72400100	REMOVE SIGN PANEL ASSEMBLY - TYPE A	EACH	7	7
Δ	72800100	TELESCOPING STEEL SIGN SUPPORT	FOOT	160	160
Δ	78000200	THERMOPLASTIC PAVEMENT MARKING - LINE 4"	FOOT	15,429	15,429
Δ	78000400	THERMOPLASTIC PAVEMENT MARKING - LINE 6"	FOOT	342	342

\* SEE SPECIAL PROVISIONS Δ INDICATES SPECIALTY ITEM

64.	Engineering Enterprises, Inc. CONSULTING ENGINEERS	
	52 Wheeler Road Sugar Grove, Illinois 60554 630.466.6700 / www.eelweb.com	_

USER NAME = Jim Schmidt	DESIGNED -	REVISED -
	DRAWN -	REVISED -
PLOT SCALE -	CHECKED -	REVISED -
PLOT DATE == February 9, 2023 6 9:14 AM	DATE -	REVISED -

	Ş	)UI	MMAR	Y	OF QUA	NTITIES	
SCALE: N.T.S.	SHEET	2	0F	3	SHEETS	STA,	TO ST

	F.A.U. RTE.	SECTION	COUNTY	TOTAL SHEETS	SHEET NO.
	2303	22-00032-00-RS	KANE	23	4
			CONTRACT N	IO. 61J	47
ı		ILLINOIS FED. AI	D PROJECT		

	CODE NUMBER	ITEM DESCRIPTION	UNIT	TOTAL QUANTITY	ROADWAY 75% FEDERAL 25% LOCAL 0005
1	78000600	THERMOPLASTIC PAVEMENT MARKING - LINE 12"	FOOT	262	262
<b>1</b>	78000650	THERMOPLASTIC PAVEMENT MARKING - LINE 24"	FOOT	26	26
	X0327036	BIKE PATH REMOVAL	SQ YD	189	189
*	X4401198	HOT-MIX ASPHALT SURFACE REMOVAL, VARIABLE DEPTH	SQ YD	11,520	11,520
*	Z0030850	TEMPORARY INFORMATION SIGNING	SQFT	51	51

\* SEE SPECIAL PROVISIONS Δ INDICATES SPECIALTY ITEM

Engineering Enterprises, Inc.

CONSULTING ENGINEERS

32 Wheeler Road

Sugar Grove, Illinois 50554

630.466.6700 / www.eeiweb.com

PLOT SCALE = CHECKED 
CHECKED 
PLOT DATE = February 9, 2023 0 9:14 AM DATE -REVISED ~ REVISED -REVISED -

STATE OF ILLINOIS DEPARTMENT OF TRANSPORTATION


SUMMARY OF QUANTITIES SCALE: N.T.S. SHEET 3 OF 3 SHEETS STA.

F.A.U. SECTION 2303 22-00032-00-RS COUNTY TOTAL SHEET NO.

KANE 23 5 CONTRACT NO. 6IJ47

TO STA.

ILLINGIS FED. AND PROJECT

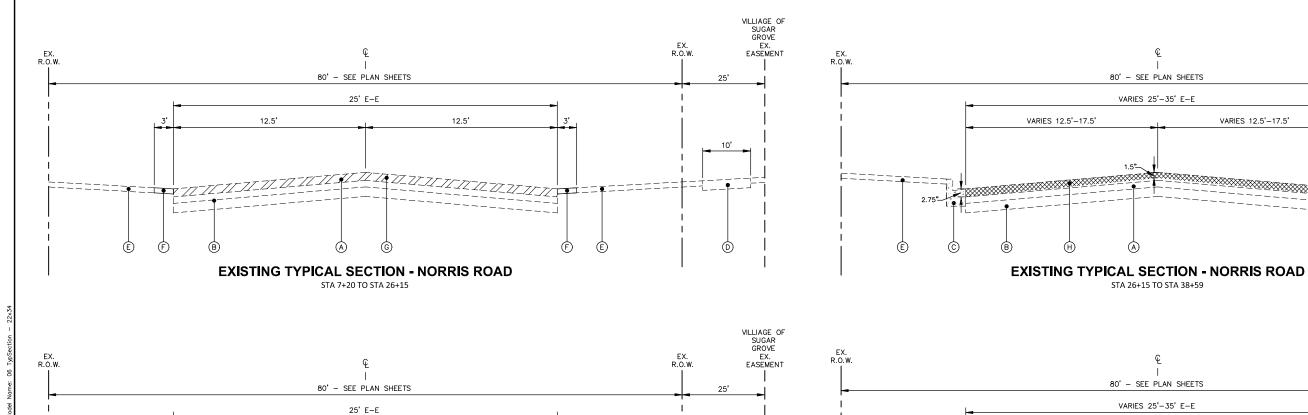

EX. R.O.W.

80' - SEE PLAN SHEETS

VARIES 25'-35' E-E

VARIES 12.5'-17.5'

VARIES 12.5'-17.5'

PROPOSED TYPICAL SECTION - NORRIS ROAD

STA 26+15 TO STA 38+59

### EXISTING LEGEND

**PROPOSED TYPICAL SECTION - NORRIS ROAD** 

STA 7+20 TO STA 26+15

A EXISTING HOT-MIX ASPHALT PAVEMENT (5.25" - 8")

12.5'

- B EXISTING AGGREGATE BASE COURSE (8" 16")
- © EXISTING COMBINATION CONCRETE CURB & GUTTER. B6.12
- D EXISTING HOT-MIX ASPHALT BIKE PATH
- E EXISTING PARKWAY

(5)

- (F) EXISTING AGGREGATE SHOULDER
- 6 HOT-MIX ASPHALT SURFACE REMOVAL, 2"
  - H) HOT-MIX ASPHALT SURFACE REMOVAL, VARIABLE DEPTH

#### HOT-MIX ASPHALT MIXTURE REQUIREMENTS

OPERATION	MIXTURE TYPE	AIR VOIDS NDES	QMP
PAVEMENT RESURFACING	HOT-MIX ASPHALT SURFACE COURSE, IL-9.5, MIX "D", N50, 1.5" HOT-MIX ASPHALT BINDER COURSE, IL-9.5, N50, 1.5"	4% @ 50 GYR. 4% @ 50 GYR.	LR1030-2 LR1030-2
CLASS D PATCHES	HOT-MIX ASPHALT BINDER COURSE, IL-19.0, N70, 5"	4% @ 70 GYR.	LR1030-2
INCIDENTAL HOT-MIX ASPHALT SURFACING	HOT-MIX ASPHALT SURFACE COURSE, IL-9.5, MIX "D", N50, 3"	4% @ 50 GYR.	LR1030-2
	QMP DESIGNATION: QUALITY CONTROL/QUALITY ASSURANCE (QC/QA)		

THE UNIT WEIGHT TO CALCULATE ALL HMA SURFACE MIXTURE QUANTITIES IS 112 LBS/SQ YD/IN

THE "AC TYPE" FOR POLYMERIZED HMA MIXES SHALL BE "SBS/SBR PG 76-22" AND FOR NON-POLYMERIZED HMA THE "AC TYPE" SHALL BE "PG 64-22". UNLESS MODIFIED BY RECLAIMED MATERIALS SPECIFICATIONS.

### PROPOSED LEGEND

- 1 HOT-MIX ASPHALT SURFACE COURSE, IL-9.5, MIX "D", N50, 1.5"
- 2 HOT-MIX ASPHALT BINDER COURSE, IL-9.5, N50, 1.5"
- (3) CLASS D PATCH, 5" (LOCATIONS TO BE DETERMINED BY ENGINEER)
- (4) combination concrete curb and gutter removal and replacement (spot removal and replacement as directed by the engineer)
- 5) AGGREGATE WEDGE SHOULDER, TYPE B
- (6) TOPSOIL AND SODDING, SALT TOLERANT
- $\bigcirc$  INCIDENTAL HOT-MIX ASPHALT SURFACING (HOT-MIX ASPHALT BIKE PATH REMOVAL AND REPLACEMENT)

NOTES: THE PATCHING QUANTITIES HAVE BEEN ESTIMATED BASED ON FIELD OBSERVATIONS DURING DESIGN. ACTUAL QUANTITIES TO BE DETERMINED DURING CONSTRUCTION.

NO PROPOSED WORK WILL TAKE PLACE OUTSIDE OF THE R.O.W.

Engineering Enterprises, Inc.	U:
CONSULTING ENGINEERS	
52 Wheeler Road Sugar Grove, Illinois 60554	PI
630.466.6700 / www.eeiweb.com	Ρl

USER NAME = Jim Schmidt	DESIGNED -	REVISED -
	DRAWN -	REVISED -
PLOT SCALE =	CHECKED -	REVISED -
PLOT DATE = February 9, 2023 @ 9:14 AM	DATE -	REVISED -

12.5'

STATE OF ILLINOIS	
DEPARTMENT OF TRANSPORTATION	


SCALE: N.T.S.


TYPICAL SECTIONS						
TYPICAL SECTIONS						
CHEET 1 OF	a current	CTA	TO CTA		_	


.U.	SECTION	COUNTY	TOTAL SHEETS	SHEET NO.
53	22-00032-00-RS	KANE	23	6
		CONTRACT N	IO. 6IJ	47
	ILLINOIS FED. AIL	D PROJECT		

EX. R.O.W.

0

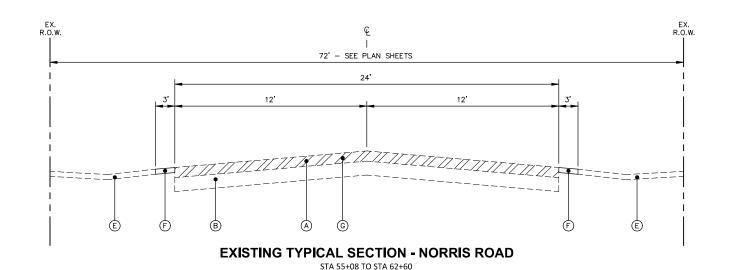

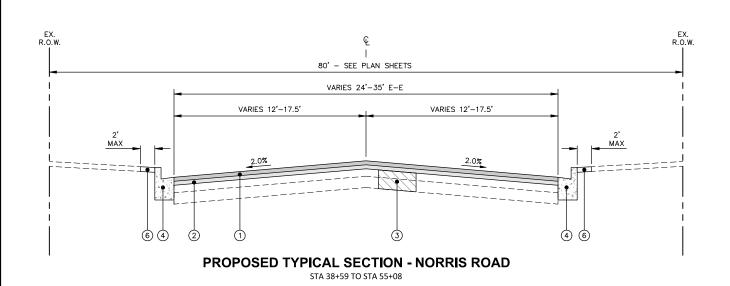

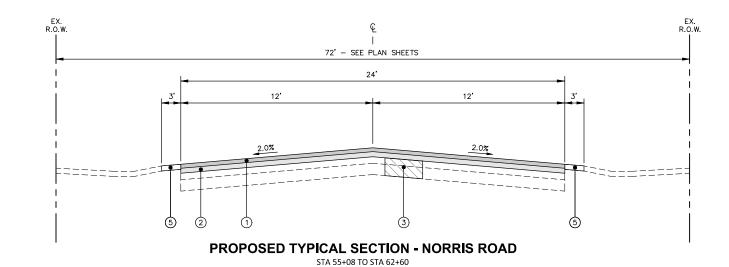

### EXISTING LEGEND (A) EXISTING HOT-MIX ASPHALT PAVEMENT (5.25" - 8") B EXISTING AGGREGATE BASE COURSE (8" - 16") © EXISTING COMBINATION CONCRETE CURB & GUTTER. B6.12 D EXISTING HOT-MIX ASPHALT BIKE PATH (E) EXISTING PARKWAY F) EXISTING AGGREGATE SHOULDER G HOT-MIX ASPHALT SURFACE REMOVAL, 2" H) HOT-MIX ASPHALT SURFACE REMOVAL, VARIABLE DEPTH

### PROPOSED LEGEND

- 1 HOT-MIX ASPHALT SURFACE COURSE, IL-9.5, MIX "D", N50, 1.5"
- 2) HOT-MIX ASPHALT BINDER COURSE, IL-9.5, N50, 1.5"
- 3 CLASS D PATCH, 5" (LOCATIONS TO BE DETERMINED BY ENGINEER)
- (4) combination concrete curb and gutter removal and replacement (spot removal and replacement as directed by the engineer)
- 5) AGGREGATE WEDGE SHOULDER, TYPE B
- 6 TOPSOIL AND SODDING, SALT TOLERANT
- 7 INCIDENTAL HOT-MIX ASPHALT SURFACING (HOT-MIX ASPHALT BIKE PATH REMOVAL AND REPLACEMENT)

NOTES: THE PATCHING QUANTITIES HAVE BEEN ESTIMATED BASED ON FIELD OBSERVATIONS DURING DESIGN. ACTUAL QUANTITIES TO BE DETERMINED DURING CONSTRUCTION.

NO PROPOSED WORK WILL TAKE PLACE OUTSIDE OF THE R.O.W.

Engineering Enterprises, Inc.		
CONSULTING ENGINEERS		
52 Wheeler Road Sugar Grove, Illinois 60554	PL	
630.466.6700 / www.eeiweb.com	PL	

USER NAME = Jim Schmidt	DESIGNED -	REVISED -
	DRAWN -	REVISED -
PLOT SCALE =	CHECKED -	REVISED -
PLOT DATE = February 9, 2023 @ 9:14 AM	DATE -	REVISED -

STATE OF ILLINOIS			
DEPARTMENT OF TRANSPORTATION			

SCALE: N.T.S.

TYPICAL SECTIONS			F.A. RTE 230					
	CHEET	2	ΩF	2	SHEETS	CTA	TO STA	1-

U.	SECTION	COUNTY	TOTAL SHEETS	SHEET NO.
3	22-00032-00-RS	KANE	23	7
		CONTRACT N	IO. 6IJ	47
	ILLINOIS FED. AII	D PROJECT		


Engineering Enterprises, Inc.				
46.	CONSULTING ENGINEERS			
41	52 Wheeler Road Sugar Grove, Illinois 60554	I		
	630.466.6700 / www.eeiweb.com	Γ		


	USER NAME = Jim Schmidt	DESIGNED -	REVISED -
		DRAWN -	REVISED -
	PLOT SCALE =	CHECKED -	REVISED -
1	PLOT DATE = February 9, 2023 @ 9:14 AM	DATE -	REVISED -
	-		


STATE OF ILLINOIS	
DEPARTMENT OF TRANSPORTATION	ı


SIGNING SCHEDULE												
SCALE: N.T.S.	SHEET	1	0F	1	SHEETS	STA.	TO STA.					


A.U. TE.	SECT	ΓΙΟΝ		COUNTY	TOTAL SHEETS	SHE	
303	22-0003	32-00-R		KANE	23	8	
					CONTRACT N	10. 6IJ	47
		ILLIN0IS	FED.	AID	PROJECT		

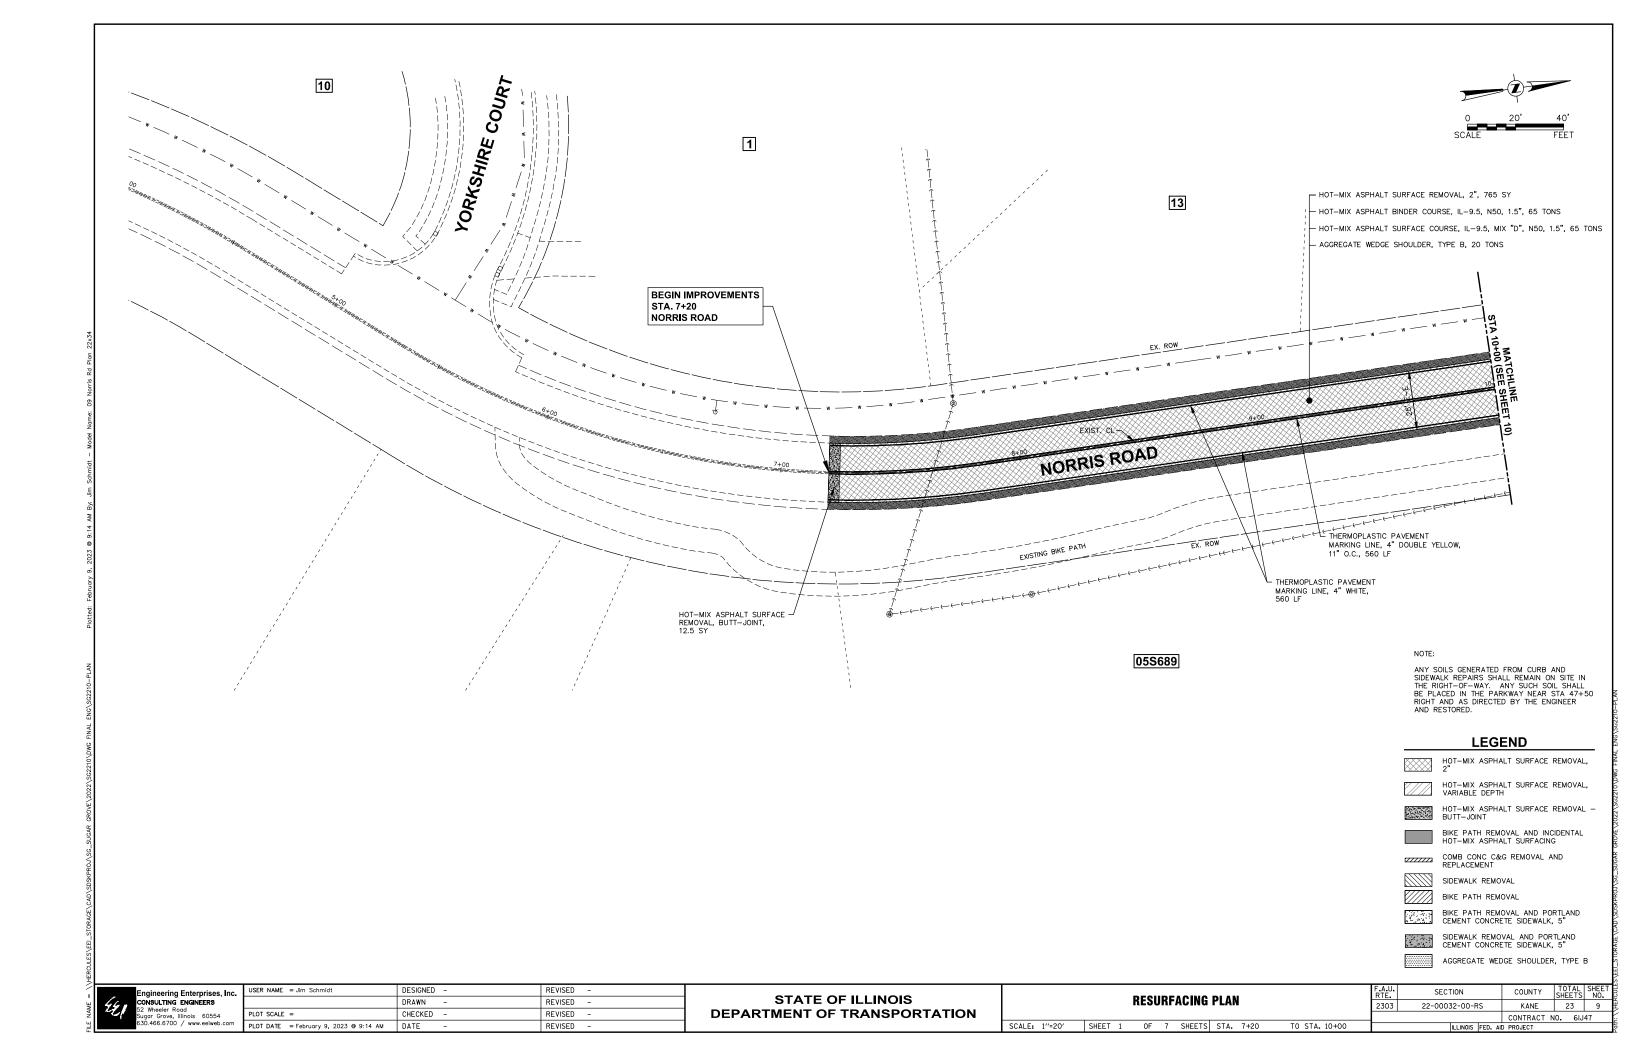


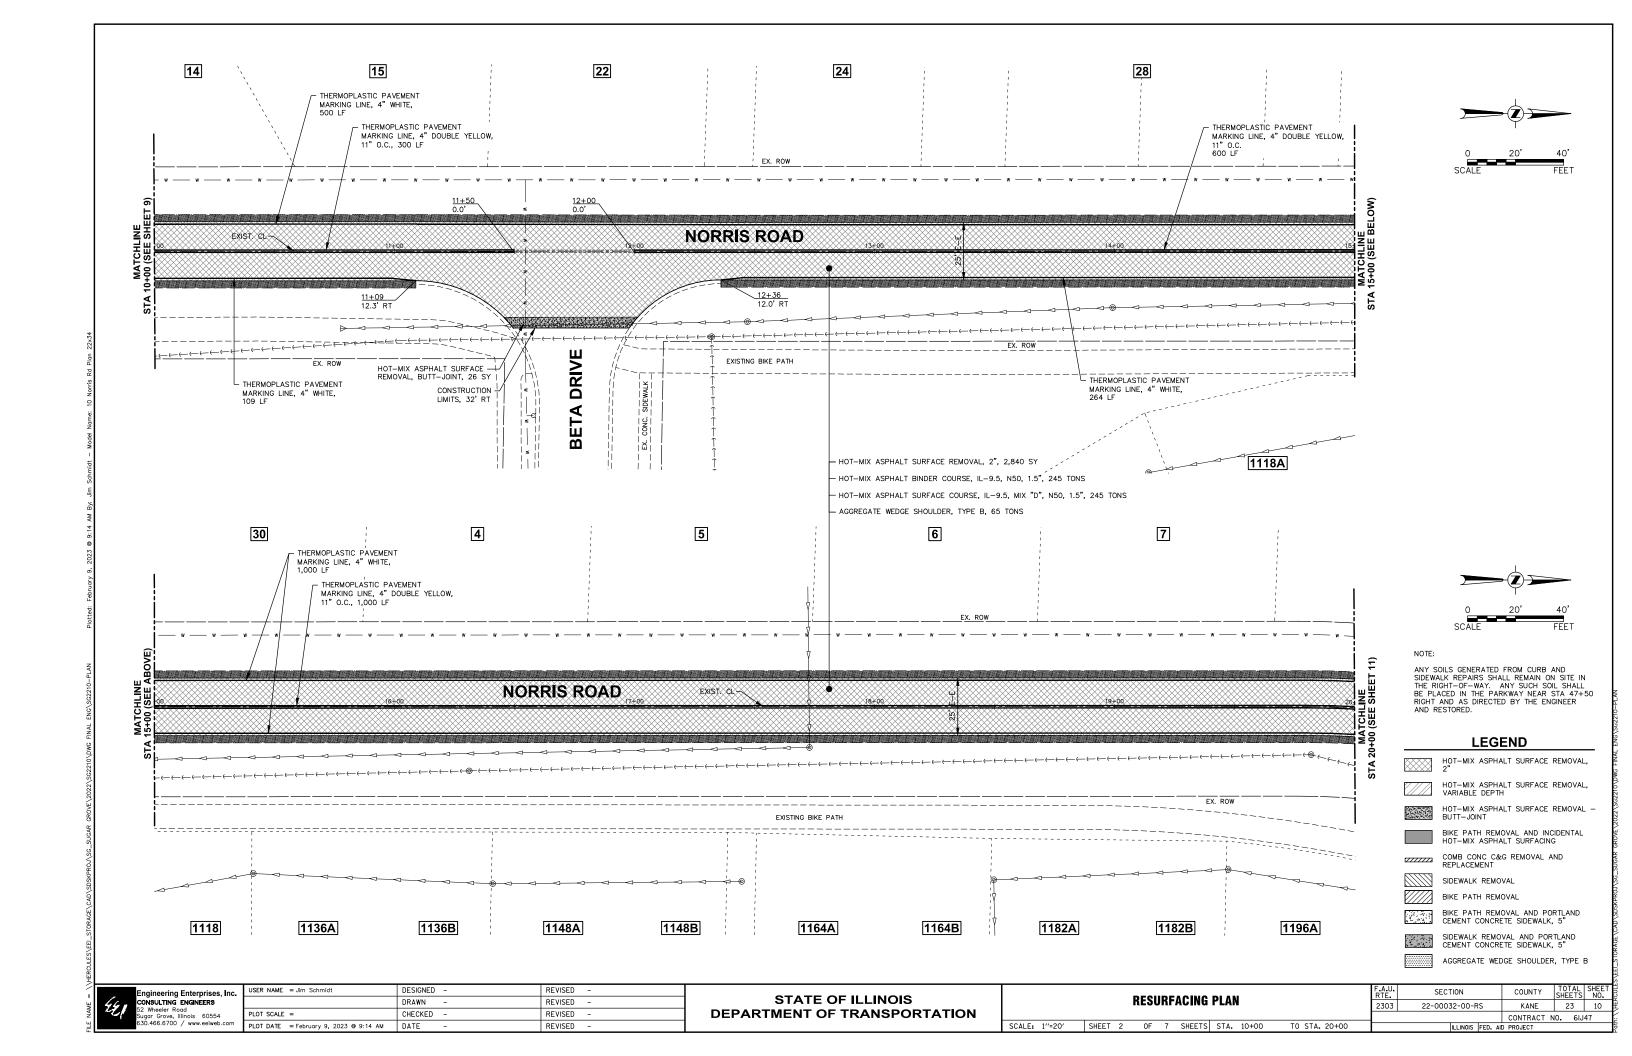

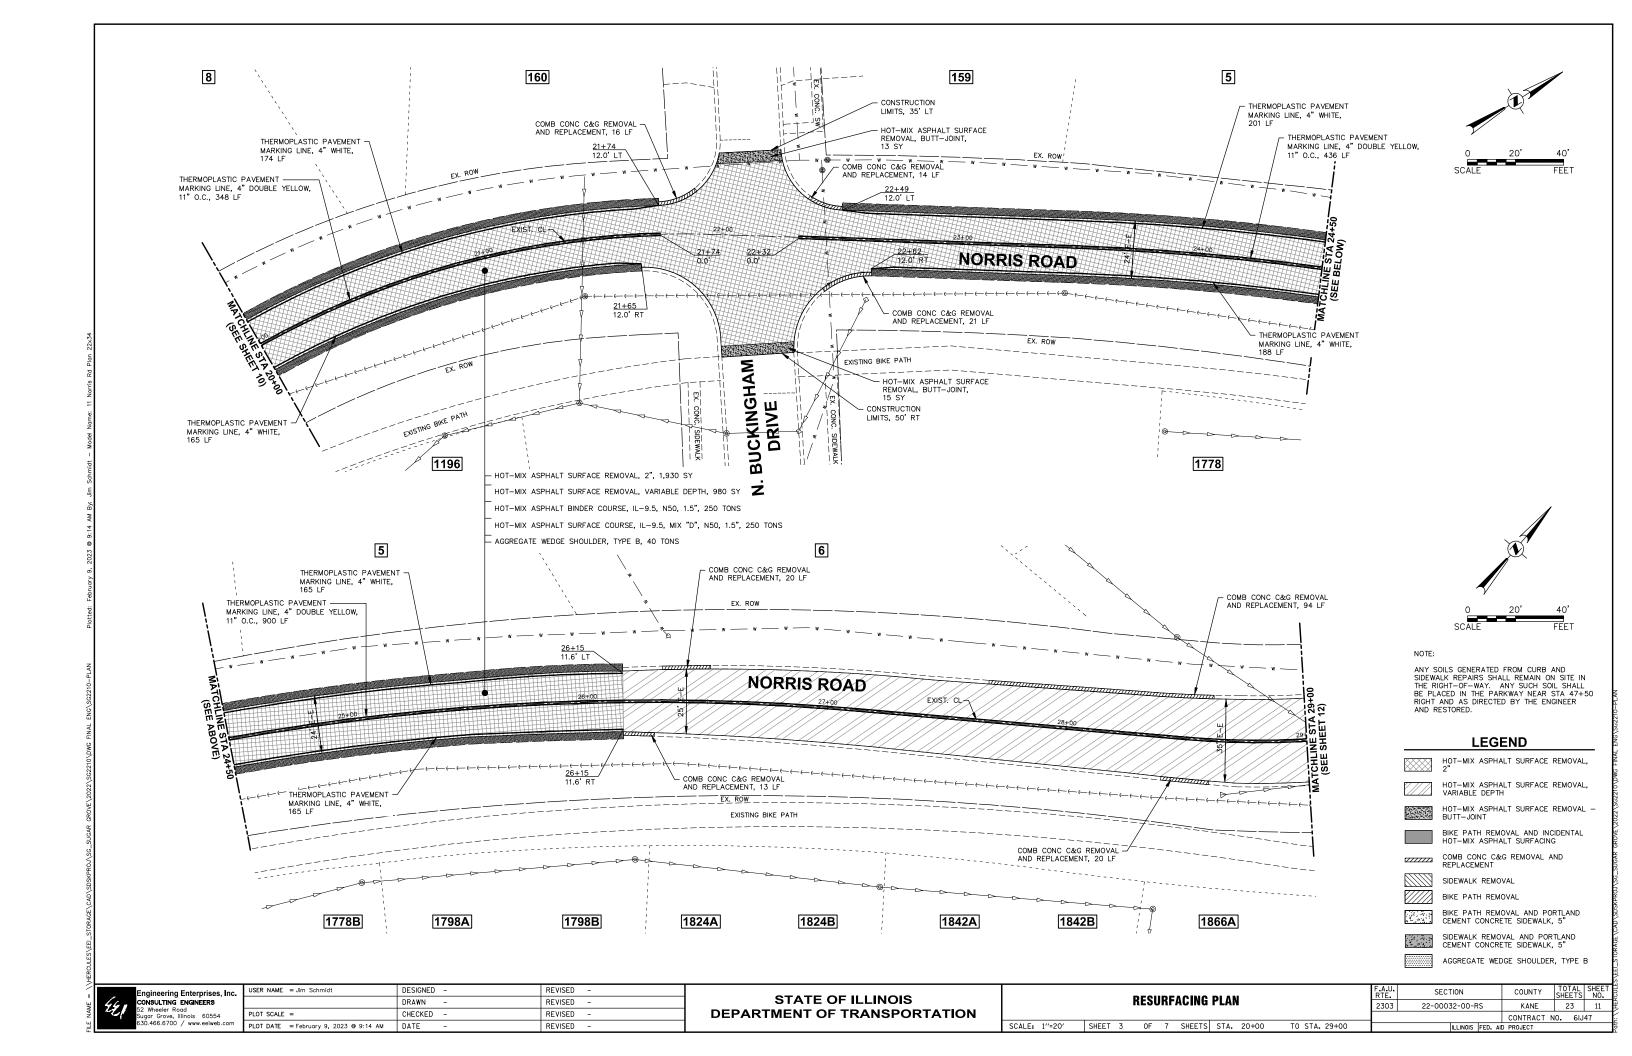


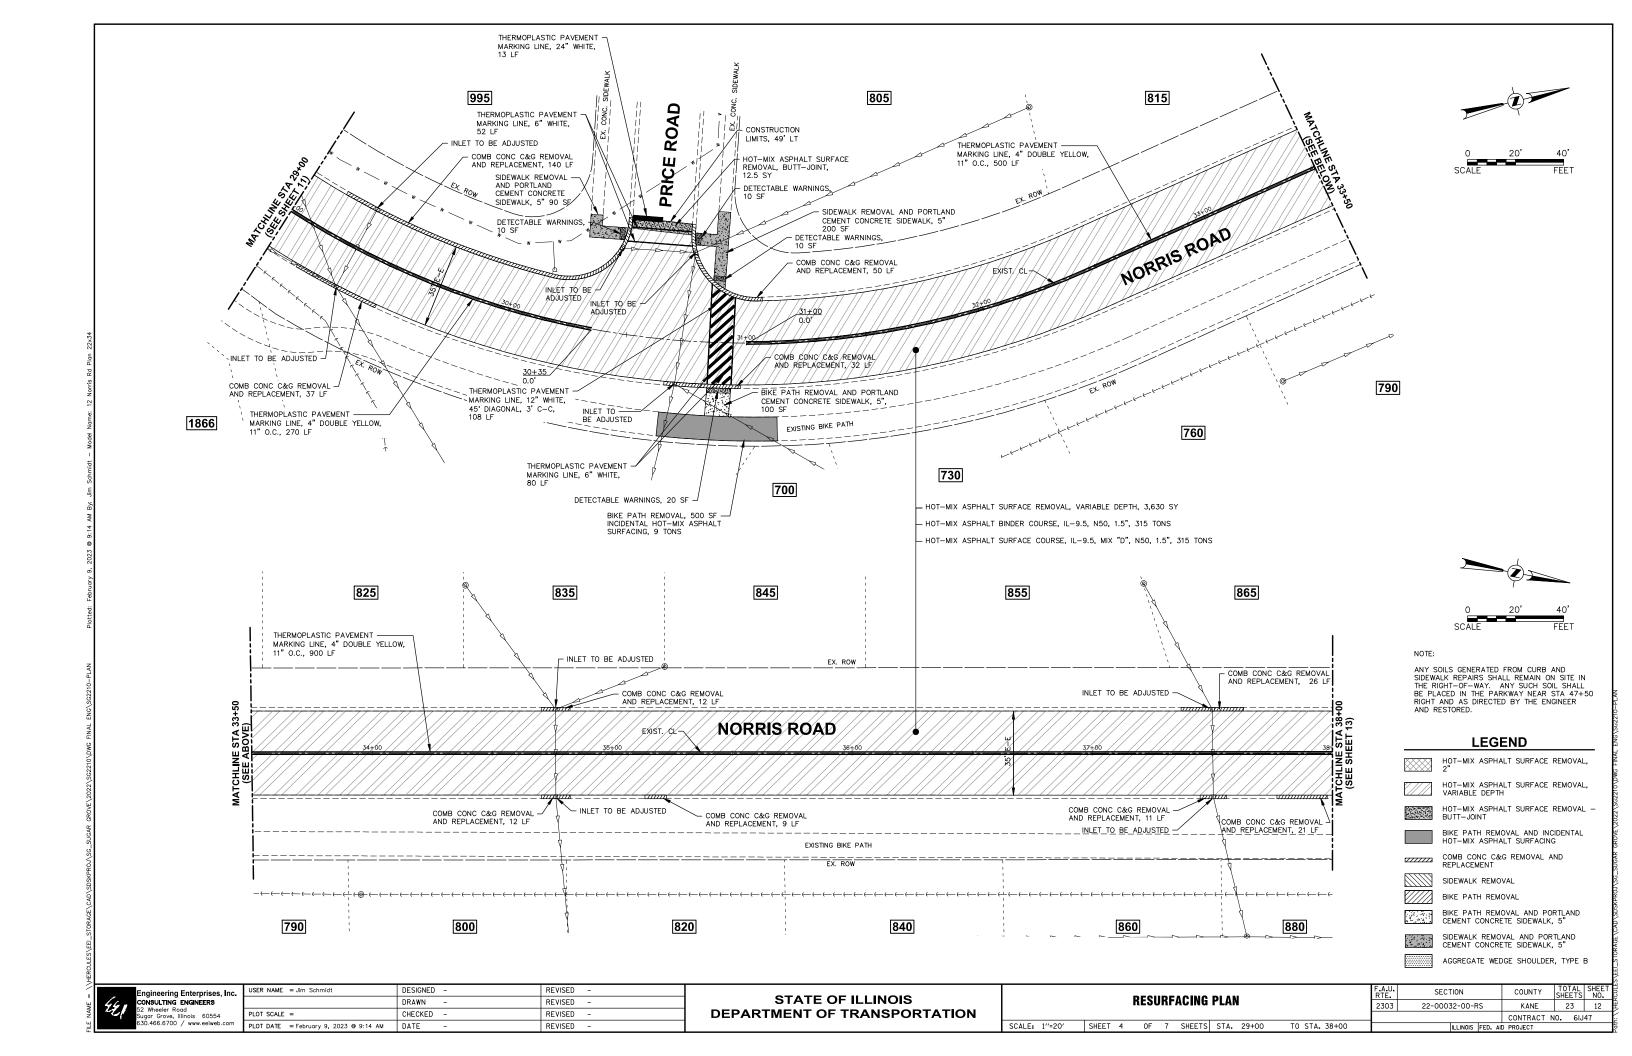

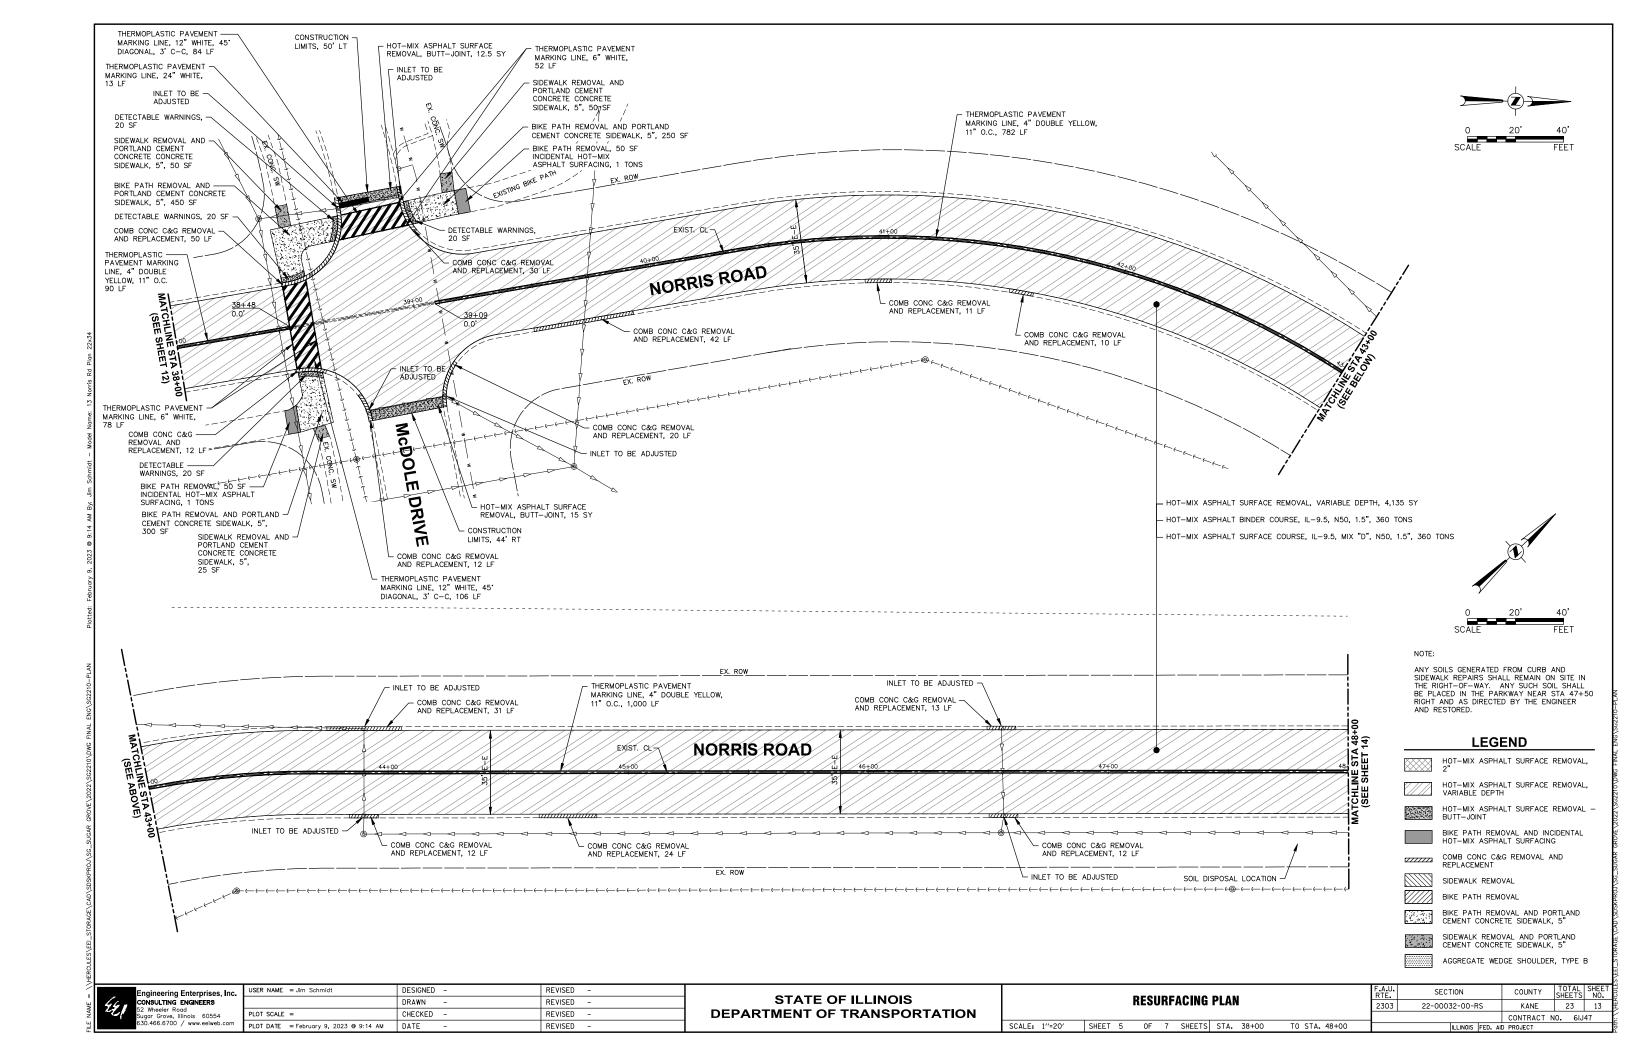

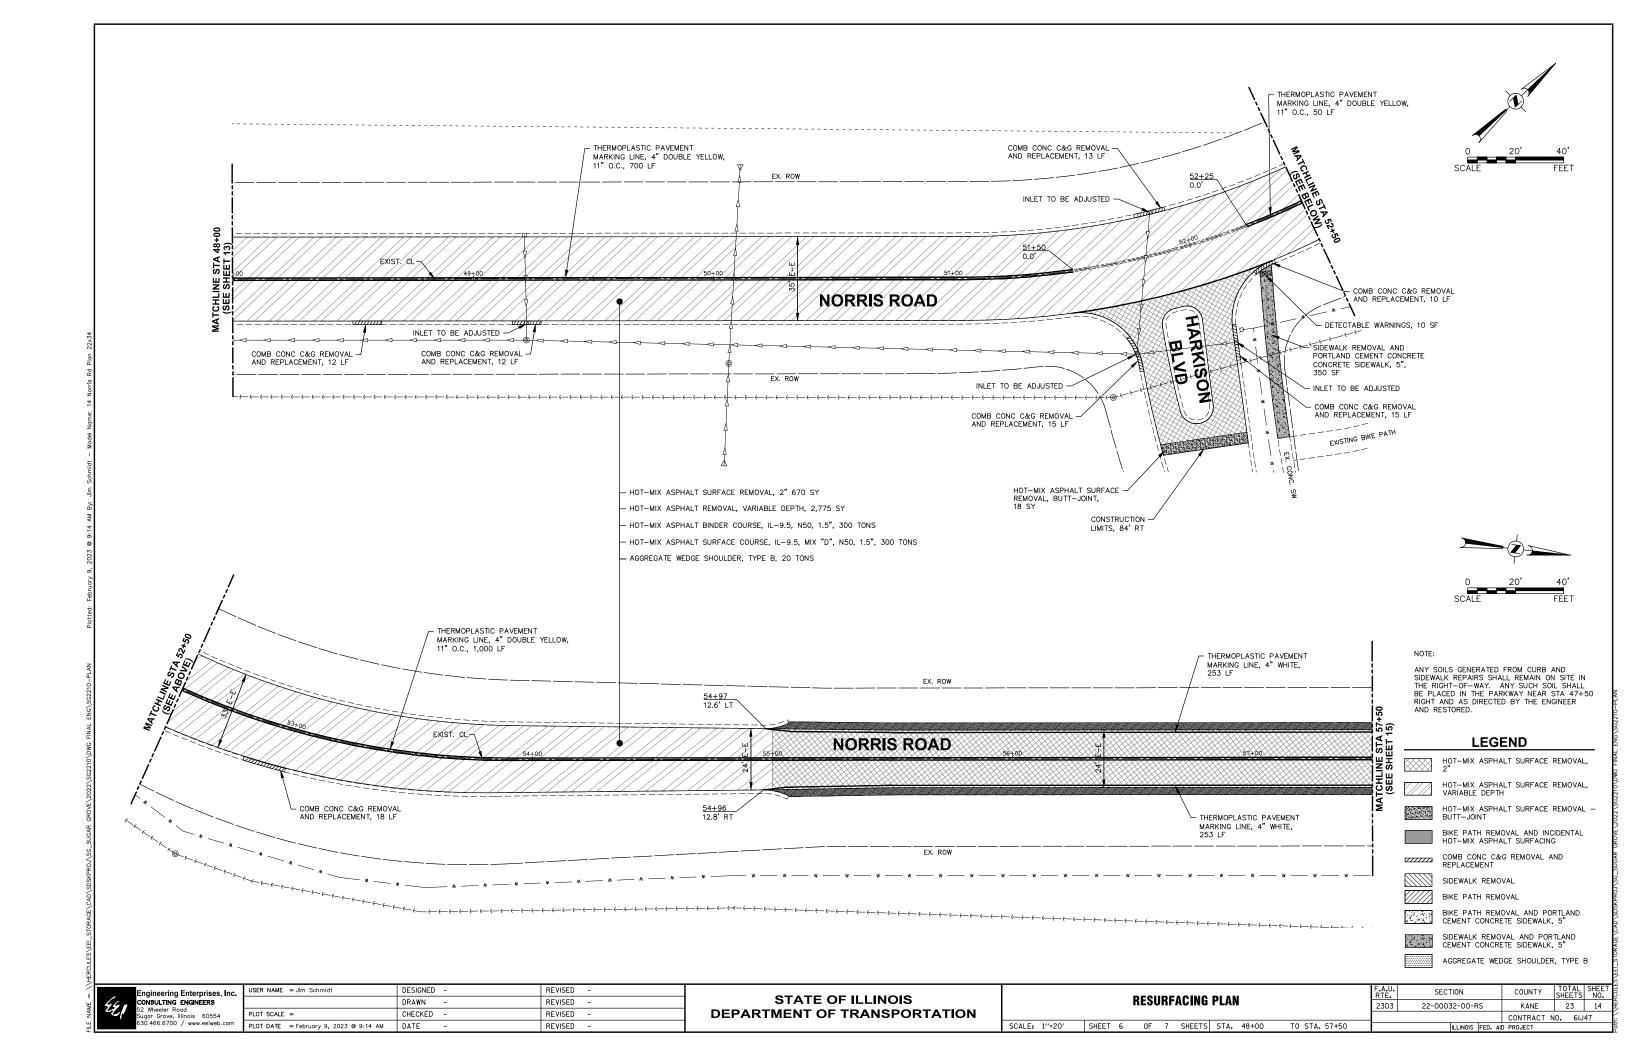

### 40W705

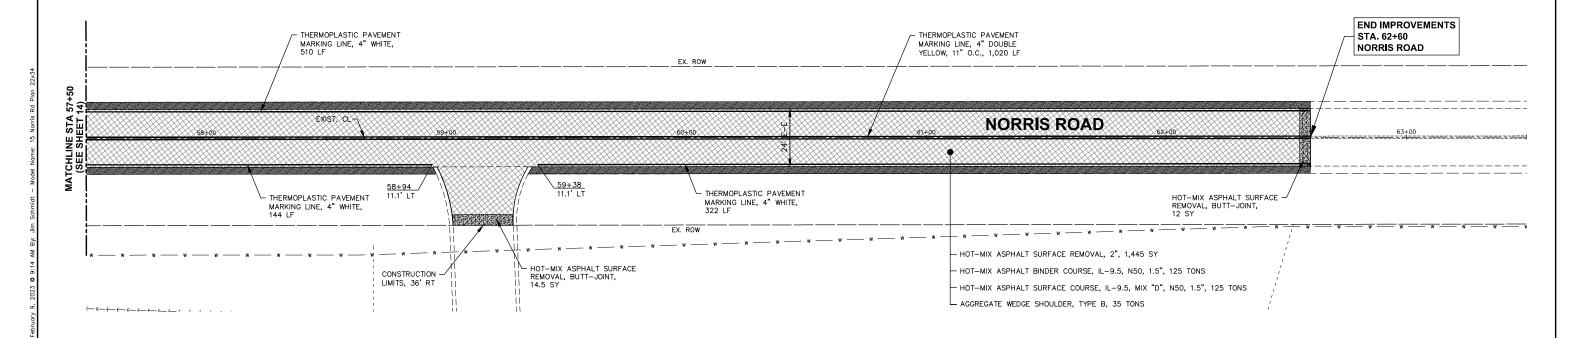

NOTE:

ANY SOILS GENERATED FROM CURB AND SIDEWALK REPAIRS SHALL REMAIN ON SITE IN THE RIGHT-OF-WAY. ANY SUCH SOIL SHALL BE PLACED IN THE PARKWAY NEAR STA 47+50 RIGHT AND AS DIRECTED BY THE ENGINEER AND RESTORED.

### **LEGEND**

HOT-MIX ASPHALT SURFACE REMOVAL,

HOT-MIX ASPHALT SURFACE REMOVAL, VARIABLE DEPTH

HOT-MIX ASPHALT SURFACE REMOVAL -BUTT-JOINT

BIKE PATH REMOVAL AND INCIDENTAL HOT-MIX ASPHALT SURFACING

COMB CONC C&G REMOVAL AND REPLACEMENT

SIDEWALK REMOVAL

BIKE PATH REMOVAL

BIKE PATH REMOVAL AND PORTLAND CEMENT CONCRETE SIDEWALK, 5"

SIDEWALK REMOVAL AND PORTLAND CEMENT CONCRETE SIDEWALK, 5"

AGGREGATE WEDGE SHOULDER, TYPE B


Engineering Enterprises, Inc. CONSULTING ENGINEERS
52 Wheeler Road Sugar (Foreve, Illinois 60554 630.466.6700 / www.eeiweb.com

USER NAME = Jim Schmidt	DESIGNED -	REVISED -
	DRAWN -	REVISED -
PLOT SCALE =	CHECKED -	REVISED -
PLOT DATE = February 9, 2023 @ 9:14 AM	DATE -	REVISED -

STATE OF ILLINOIS
DEPARTMENT OF TRANSPORTATION

RESURFACING PLAN

SCALE: 1"=20" SHEET 7 OF 7 SHEETS STA. 57+50 TO STA. 62+60

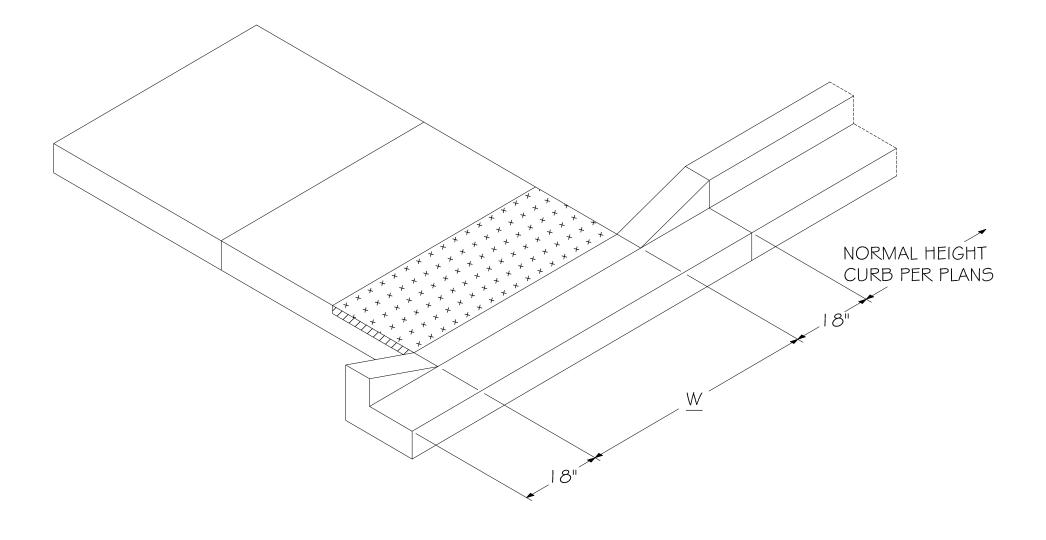

### NOTES:

- I. PLACEMENT OF DETECTABLE
  WARNING TILES SHALL ADHERE TO
  LOCATIONS

  \$ SETBACKS AS SHOWN IN IDOT
  HIGHWAY STANDARDS INCLUDING
  424001, 424006, 424016,
  424021, AND 424026 FOR
  VARIOUS FIELD CONDITIONS.
  SIDEWALK RAMP WIDTH (W) AND
  LAYOUT SHALL BE ACCORDING TO
  THESE IDOT HIGHWAY STANDARDS,
  EXCEPT A SIDE CURB SHALL NOT BE
  CONSTRUCTED IN LANDSCAPED
  AREAS.
- 2. DETECTABLE WARNING TILES SHALL BE BRICK RED AND MANUFACTURED BY ADA SOLUTIONS, INC.
- 3. TILES SHALL BE INSTALLED PER MANUFACTURER INSTRUCTIONS.
- 4. THE COLORING AND STAMPING OF CONCRETE WILL NOT BE ALLOWED.



## **Village of Sugar Grove**

SCALE: N.T.S.

10 Municipal Drive Sugar Grove, Illinois 60554 Phone: (630) 466-4507 CURB HEAD TAPER AT PEDESTRIAN RAMPS FOR SIDEWALK IN LANDSCAPED AREAS

SCALE: N.T.S.

DATE: 11/15/22

DETAIL NUMBER
MONT. E:\DETAILS\

DRAWN: KKP

Engineering Enterprises, Inc.

CONSULTING ENGINEERS

52 Wheeler Road
Sugar Grove, Illinois 60554

S4466 6700 Communications and

	USER NAME = Jim Schmidt	DESIGNED -	REVISED -
		DRAWN -	REVISED -
	PLOT SCALE =	CHECKED -	REVISED -
	PLOT DATE = February 9, 2023 ⊕ 9:15 AM	DATE -	REVISED -
_			

STATE OF ILLINOIS DEPARTMENT OF TRANSPORTATION

		VILL	.AC	SE DET	AllS	
FT	1	ΩF	1	SHEETS	STA.	TO S

A-U. SECTION COUNTY TOTAL SHEET'S NO.
303 22-00032-00-RS KANE 23 16

CONTRACT NO. 6IJ47

|ILLINOIS | FED. AID PROJECT

REVISED: \_\_\_

### **METHOD OF MEASUREMENT**


REFER TO SECTION 442 OF THE STANDARD SPECIFICATIONS FOR ROAD AND BRIDGE CONSTRUCTION AND THE RECURRING SPECIAL PROVISION "PATCHING WITH HOT-MIX ASPHALT OVERLAY REMOVAL."

### **BASIS OF PAYMENT**

- 1. REFER TO SECTION 442 OF THE STANDARD SPECIFICATIONS FOR ROAD AND BRIDGE CONSTRUCTION AND THE RECURRING SPECIAL PROVISION "PATCHING WITH HOT-MIX ASPHALT OVERLAY REMOVAL."
- SAW CUT/SCORING OF EXISTING HMA OVERLAY IS INCLUDED IN THE COST OF PAVEMENT PATCHING.
- SAW CUT/SCORING OF EXISTING PAVEMENT IS INCLUDED IN THE COST OF PAVEMENT PATCHING.

**★** SEE TYPICAL SECTIONS FOR

THICKNESS AND MATERIALS

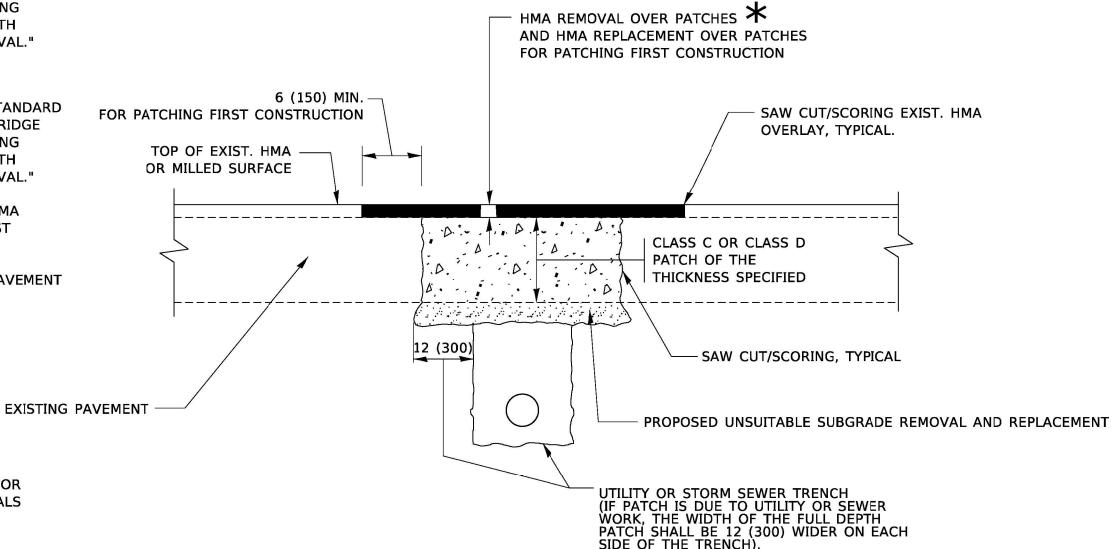

SCALE: N.T.S.

### SEQUENCE OF CONSTRUCTION (PATCHING FIRST)

- 1. REMOVE THE EXISTING HMA MATERIAL OVER THE AREA TO BE PATCHED.
- 2. REMOVE AND REPLACE WITH CLASS C OR D PATCH.
- 3. REPLACE HMA MATERIAL OVER THE AREA TO BE PATCHED.

### **SEQUENCE OF CONSTRUCTION (MILLING FIRST)**

- 1. MILL HMA FIRST IF THERE IS AT LEAST 4½ INCHES OR MORE OF HMA MATERIAL ON TOP OF THE EXISTING PAVEMENT OR IF THE PAVEMENT IS FULL DEPTH HMA. A MINIMUM OF 2 INCHES OF HMA MATERIAL SHALL BE IN PLACE AFTER MILLING.
- 2. REMOVE AND REPLACE WITH FULL DEPTH CLASS D PATCHES TO TOP OF MILLED SURFACE.


ALL DIMENSIONS ARE IN INCHES (MILLIMETERS) UNLESS OTHERWISE SHOWN.

Engineering Enterprises, Inc.	ő
CONSULTING ENGINEERS	
52 Wheeler Road Sugar Grove, Illinois 60554	PL
630.466.6700 / www.eelweb.com	PL

USER NAME = Jim Schmidt	DESIGNED - R. SHAH	REVISED -	-	R. BORO 01-01-07
	DRAWN -	REVISED -	-	R. BORO 09-04-07
PLOT SCALE =	CHECKED -	REVISED -	-	K. ENG 10-27-08
PLOT DATE = February 9, 2023 @ 9:15 AM	DATE - 10-25-94	REVISED -	-	K. SMITH II-18-22

STATE OF ILLINOIS	
DEPARTMENT OF TRANSPORTATION	

PAVEMENT PATCHING FOR						F.A.U. RTE.	SEC.	TION		COUNTY	TOTAL SHEETS	SHEET NO.			
HMA SURFACED PAVEMENT					2303	22-00032-00-RS			KANE	23	17				
TIMA SORI ACED I AVENIENT										CONTRACT	NO. 6IJ	47			
	SHEET	1	0F	1	SHEETS	STA.	TO STA.				ILLIN0IS	FED. All	D PROJECT		

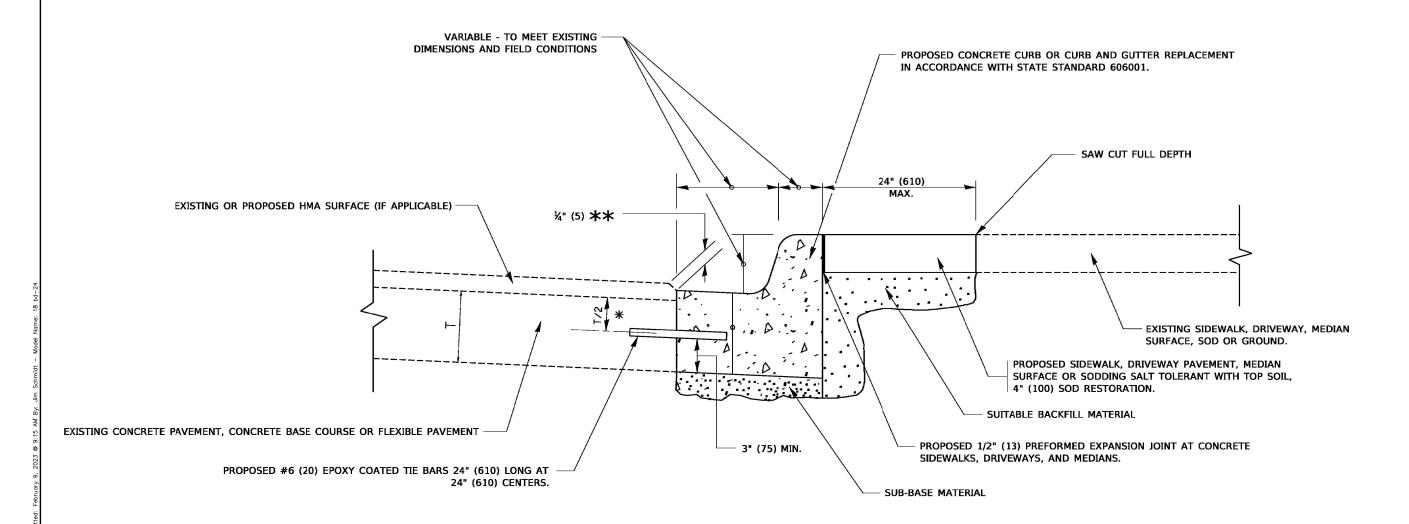

- $\divideontimes$  3" (75) MINIMUM FROM TOP AND BOTTOM OF THE CONCRETE PAVEMENT OR BASE COURSE.
- \*\* IF THE FINAL SURFACE OF THE PAVEMENT IS CONCRETE, THE GUTTER IS TO BE FLUSH WITH THE PAVEMENT.

### **CURB OR CURB AND GUTTER REMOVAL AND REPLACEMENT**

ALL DIMENSIONS ARE IN INCHES (MILLIMETERS) UNLESS OTHERWISE SHOWN.



USER NAME = Jim Schmidt	DESIGNED	-	A. HOUSEH	REVISED	-	Α.	. ABBAS 03-21-97
	DRAWN	-		REVISED	-	М.	GOMEZ 01-22-01
PLOT SCALE =	CHECKED	-		REVISED	-	R.	BORO 12-15-09
PLOT DATE = February 9, 2023 ⊕ 9:15 AM	DATE	-	03-11-94	REVISED	-	Κ.	SMITH 07-II-I9


STATE OF ILLINOIS	
DEPARTMENT OF TRANSPORTATION	

CURB OR CURB AND GUTTER REMOVAL AND REPLACEMENT									
SCALE: N.T.S.	SHEET	1	0F	1	SHEETS	STA.	TO STA.		

RTE.	SEC		COUNTY		SHEETS	NO.		
2303	22-000		KANE		23	18		
			CONTRACT	N	IO. 6IJ	47		
		ILLINOIS	FED.	AID	PROJECT			

(FOR BUTT JOINT AND HMA TAPER SEE DETAIL BELOW)

### OPTION 1

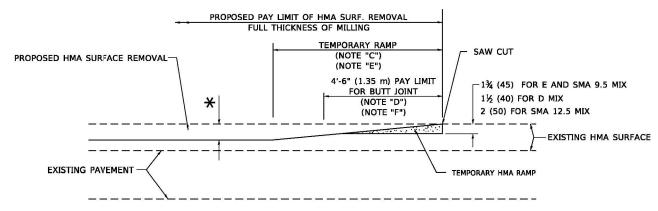


### **HMA CONSTRUCTED TEMPORARY RAMP**


(FOR BUTT JOINT AND HMA TAPER SEE DETAIL BELOW)


### OPTION 2

### **TYPICAL TEMPORARY RAMP**

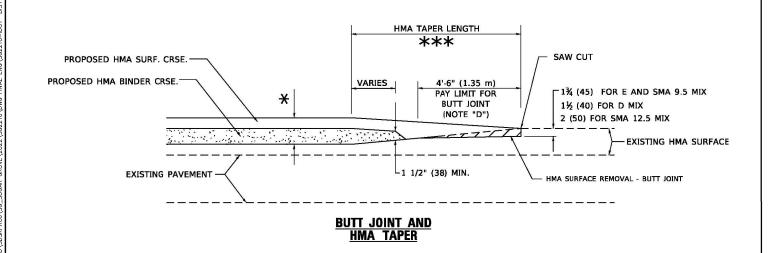

# TYPICAL BUTT JOINT AND HMA TAPER FOR MILLING AND RESURFACING

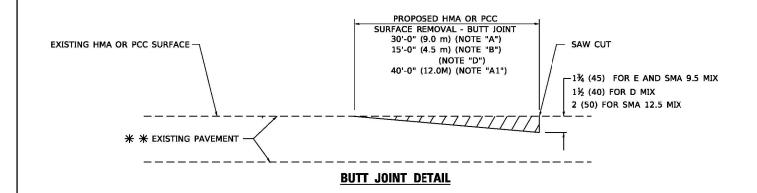

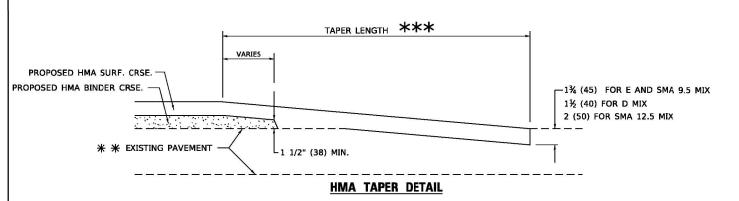

### TYPICAL BUTT JOINT AND HMA TAPER FOR RESURFACING ONLY

\*\* PC CONCRETE, HMA OR HMA RESURFACED PAVEMENT.

### **GENERAL NOTES**

- A. MAINLINE ARTERIAL ROADWAYS AND MAJOR SIDE ROADS.
- A1. INTERSTATES
- MINOR SIDE ROADS.
- THE TEMP. RAMP SHALL BE CONSTRUCTED IMMEDIATELY UPON REMOVAL OF THE EXISTING HMA SURFACE.
- D. THE BUTT JOINT SHALL BE CONSTRUCTED IMMEDIATELY PRIOR TO PLACING THE PROPOSED HMA COURSES.
- E. TAPER THE TEMP. RAMP AT A RATE OF 3' 4" (1.02m) PER 1 INCH (25 mm) OF MILLING THICKNESS.
  - \* SEE TYPICAL SECTIONS FOR MILLING THICKNESS.
- F. SEE ARTICLE 406.08 AND 406.14 OF THE STANDARD SPECIFICATIONS FOR "HMA AND/OR PCC SURFACE REMOVAL, BUTT JOINT".
- \*\*\* 20'-0" (6.1 m) PER 1 (25) RESURFACING (NOTE "A") 10'-0" (3.0 m) PER 1 (25) RESURFACING (NOTE "B")

### **BASIS OF PAYMENT**

- THE BUTT JOINT WILL BE PAID FOR AT THE CONTRACT UNIT PRICE PER SQUARE YARD (SQUARE METER) FOR "HOT-MIX ASPHALT SURFACE REMOVAL BUTT JOINT" OR FOR "PORTLAND CEMENT CONCRETE SURFACE REMOVAL- BUTT JOINT".
- THE TEMPORARY RAMP AND SAW CUT SHALL BE INCLUDED IN THE UNIT COST FOR HMA OR PCC SURFACE REMOVAL-BUTT JOINT.

SCALE: N.T.S.

ALL DIMENSIONS ARE IN INCHES (MILLIMETERS) UNLESS OTHERWISE SHOWN.

ineering Enterprises, Inc. ONSULTING ENGINEERS


USER NAME = Jim Schmidt DESIGNED - M. DE YONG REVISED - A. ABBAS 03-21-97 DRAWN REVISED - M. GOMEZ 04-06-01 CHECKED REVISED - R. BORO 0I-0I-07 PLOT DATE = February 9, 2023 @ 9:15 AM DATE - 06-13-90 REVISED - K. SMITH II-I8-22

STATE OF ILLINOIS **DEPARTMENT OF TRANSPORTATION** 

**BUTT JOINT AND HMA TAPER DETAILS** SHEET 1 OF 1 SHEETS STA.

TO STA.

SECTION COUNTY 2303 22-00032-00-RS KANE 23 19 CONTRACT NO. 6IJ47

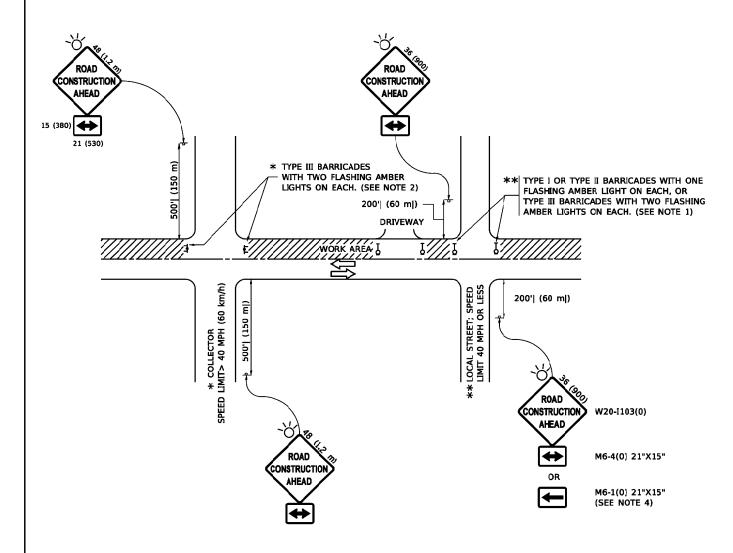

### NOTES:

- 1. SIDE ROAD WITH A SPEED LIMIT OF 40 MPH (60 km/h) OR LESS AS SHOWN ON THE DRAWING AND AS DIRECTED BY THE ENGINEER:
- a) ONE "ROAD CONSTRUCTION AHEAD" SIGN 36 x 36 (900x900) WITH A FLASHER MOUNTED ON IT APPROXIMATELY 200' (60 m) IN ADVANCE OF THE MAIN ROUTE.
- b) THE CLOSED PORTION OF THE MAIN ROUTE SHALL BE PROTECTED BY BLOCKING WITH TYPE I, TYPE II OR TYPE III BARRICADES, 1/3 OF THE CROSS SECTION OF THE CLOSED PORTION.
- SIDE ROAD WITH A SPEED LIMIT GREATER THAN 40 MPH (60 km/h) AS SHOWN ON THE DRAWING AND AS DIRECTED BY THE ENGINEER:
- a) ONE "ROAD CONSTRUCTION AHEAD" SIGN 48 x 48 (1.2 m x 1.2 m) WITH A FLASHER MOUNTED ON IT APPROXIMATELY 500' (150 m) IN ADVANCE OF THE MAIN ROUTE.
- THE CLOSED PORTION OF THE MAIN ROUTE SHALL BE PROTECTED BY
  b) BLOCKING WITH TYPE III BARRICADES, 1/2 OF THE CROSS SECTION
  OF THE CLOSED PORTION.
- 3. CONES MAY BE SUBSTITUTED FOR BARRICADES OR DRUMS AT HALF THE SPACING DURING DAY OPERATIONS. CONES SHALL BE A MINIMUM OF 28 (710)
- WHEN THE SIDE ROAD LIES BETWEEN THE BEGINNING OF THE MAINLINE
  4. SIGNING AND THE WORK ZONE, A SINGLE HEADED ARROW (M6-1) SHALL
  BE USED IN LIEU OF THE DOUBLE HEADED ARROW (M6-4).

- WHEN WORK IS BEING PERFORMED ON A SIDE ROAD OR DRIVEWAY, FOLLOW THE APPLICABLE STANDARD(S). THE DIRECTIONAL ARROW (M6-1 OR M6-4) SHALL BE COVERED OR REMOVED WHEN NO LONGER CONSISTENT WITH THE TRAFFIC CONTROL SET-UP.
- 6. ADVANCE WARNING SIGNS ARE TO BE OMITTED ON DRIVEWAYS UNLESS OTHERWISE SPECIFIED IN THE PLANS OR BY THE ENGINEER
- 7. THE TRAFFIC CONTROL AND PROTECTION FOR SIDE ROADS, INTERSECTIONS, AND DRIVEWAYS SHALL BE INCLUDED IN THE COST OF SPECIFIED TRAFFIC CONTROL STANDARDS OR ITEMS.

All dimensions are in inches (millimeters) unless otherwise shown.


Engineering Enterprises, Inc.
CONSULTING ENGINEERS
52 Wheeler Road
Sugar Grove, Illinois 60554
630.466.6700 / www.eelweb.com

USER NAME = Jim Schmidt	DESIGNED - L.H.A.	REVISED - A. HOUSEH 10-15-96
	DRAWN -	REVISED - T. RAMMACHER 01-06-00
PLOT SCALE =	CHECKED -	REVISED - A. SCHUETZE 07-01-13
PLOT DATE = February 9, 2023 @ 9:15 AM	DATE - 06-89	REVISED - A. SCHUETZE 09-15-16


STATE OF ILLINOIS
DEPARTMENT OF TRANSPORTATION

TRAFFIC CONTROL AND PROTECTION FOR SIDE ROADS, INTERSECTIONS, AND DRIVEWAYS							
SCALE: N.T.S.	SHEET 1	0F	1	SHEETS	STA.	TO STA.	

A.U. TE.	SECTION	COUNTY	TOTAL SHEETS	SHEET NO.
303	22-00032-00-RS	KANE	23	20
		CONTRACT N	IO. 6IJ	47
	HILINOIC EED AL	D DDA IFOT		

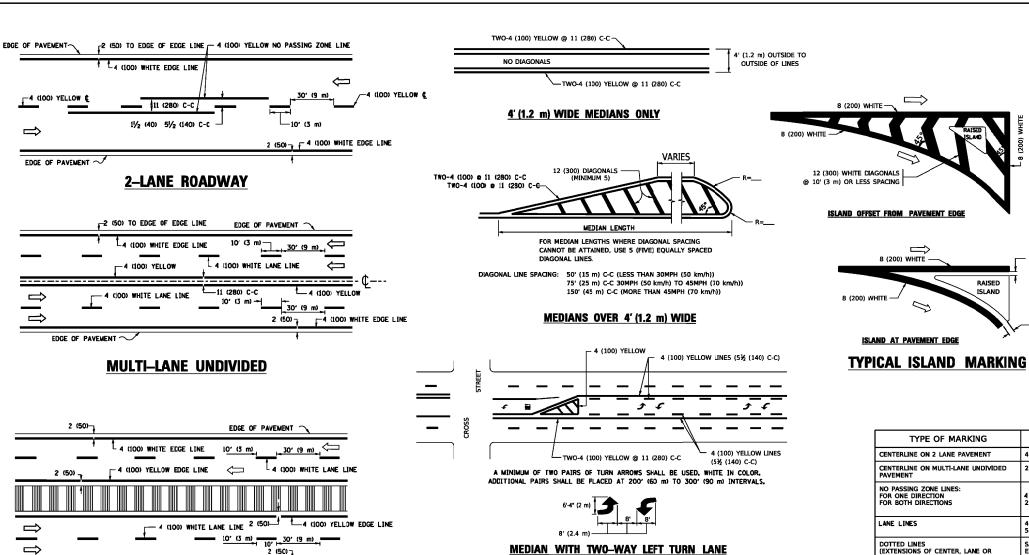

### TYPICAL PAINTED MEDIAN MARKING

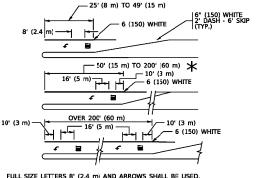


 $\uparrow$  AREA = 15.6 SQ. FT. (1.5 m<sup>2</sup>) AREA = 20.8 SQ. FT. (1.9 m)<sup>2</sup>

\* TURN LANES IN EXCESS OF 400' (120 m) IN LENGTH MAY HAVE AN ADDITIONAL SET OF ARROW - "ONLY" INSTALLED MIDWAY BETWEEN THE OTHER TWO SETS OF

### TYPICAL LEFT (OR RIGHT) TURN LANE

### TYPICAL TURN LANE MARKING

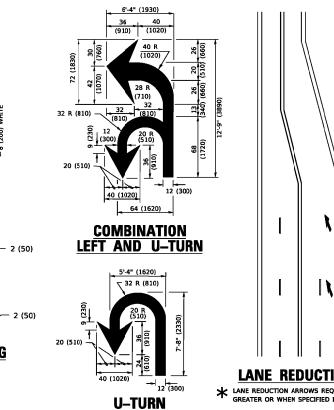

LANE REDUCTION TRANSITION

D(FT)

500

580

665

750

SPEED LIMIT

50

55

\* LANE REDUCTION ARROWS REQUIRED AT SPEEDS OF 45 MPH OR GREATER OR WHEN SPECIFIED IN PLANS.

TYPE OF MARKING	WIDTH OF LINE	PATTERN	COLOR	SPACING / REMARKS
CENTERLINE ON 2 LANE PAVEMENT	4 (100)	SKIP-DASH	YELLOW	10' (3 m) LINE WITH 30' (9 m) SPACE
CENTERLINE ON MULTI-LANE UNDIVIDED PAVEMENT	2 @ 4 (100)	SOLID	YELLOW	11 (280) C-C
NO PASSING ZONE LINES: FOR ONE DIRECTION FOR BOTH DIRECTIONS	4 (100) 2 @ 4 (100)	SOLID SOLID	YELLOW YELLOW	5½ (140) C-C FROM SKIP-DASH CENTERLINE 11 (280) C-C OMIT SKIP-DASH CENTERLINE BETWEEN
LANE LINES	4 (100) 5 (125) ON FREEWAYS	SKIP-DASH SKIP-DASH	WHITE WHITE	10' (3 m) LINE WITH 30' (9 m) SPACE
DOTTED LINES (EXTENSIONS OF CENTER, LANE OR TURN LANE MARKINGS)	SAME AS LINE BEING EXTENDED	SKIP-DASH	SAME AS LINE BEING EXTENDED	2' (600) LINE WITH 6' (1.8 m) SPACE
EDGE LINES	4 (100)	SOLID	YELLOW-LEFT WHITE-RIGHT	OUTLINE MEDIANS IN YELLOW
TURN LANE MARKINGS	6 (150) LINE; FULL SIZE LETTERS & SYMBOLS (8' (2.4m))	SOLID	WHITE	SEE TYPICAL TURN LANE MARKING DETAIL
TWO WAY LEFT TURN MARKING	2 @ 4 (100) EACH DIRECTION 8' (2.4m) LEFT ARROW	SKIP-DASH AND SOLID IN PAIRS	YELLOW	10' (3 m) LINE WITH 30' (9 m) SPACE FOR SKIP-DASH; 5½ (140) C-C BETWEEN SOLID LINE AND SKIP-DASH LINE SEE TYPICAL TWO-WAY LEFT TURN MARKING DETAIL
CROSSWALK LINES (PEDESTRIAN) A. DIAGONALS (BIKE & EQUESTRIAN) B. LONGITUDINAL BARS (SCHOOL)	2 @ 6 (150) 12 (300) @ 45° 12 (300) @ 90°	SOLID SOLID SOLID	WHITE WHITE WHITE	NOT LESS THAN 6' (1.8 m) APART 2' (600) APART 2' (600) APART SEE TYPICAL CROSSWALK MARKING DETAILS.
STOP LINES	24 (600)	SOLID	WHITE	PLACE 4' (1.2 m) IN ADVANCE OF AND PARALLEL TO CROSSWALK, IF PRESENT. OTHERWISE, PLACE AT DESIRED STOPPING POURT. PARALLEL TO CROSSROAD CENTERLINE, WHERE POSSIBLE
PAINTED MEDIANS	2 @ 4 (100) WITH 12 (300) DIAGONALS @ 45° NO DIAGONALS USED FOR 4' (1.2 m) WIDE MEDIANS	SOLID	YELLOW: TWO WAY TRAFFIC WHITE: ONE WAY TRAFFIC	11 (280) C-C FOR THE DOUBLE LINE SEE TYPICAL PAINTED MEDIAN MARKING.
GORE MARKING AND CHANNELIZING LINES	8 (200) WITH 12 (300) DIAGONALS @ 45°	SOLID	WHITE	DIAGONALS: 15' (4.5 m) C-C (LESS THAN 30MPH (50 km/h)) 20' (6 m) C-C 30MPH (50 km/h) TO 45MPH (70 km/h)) 30' (9 m) C-C (OVER 45MPH (70 km/h))
RAILROAD CROSSING	24 (500) TRANSVERSE LINES; "RR" IS 6' (1.8 m) LETTERS; 16 (400) LINE FOR "X"	SOLID	WHITE	SEE STATE STANDARD 780001 AREA OF: "X"=3.6 SQ. FT. (0.33 m ZEACH "X"=54.0 SQ. FT. (5.0 m ZEACH
SHOULDER DIAGONALS (REQUIRED FOR SHOULDERS > 8')	12 (300) @ 45°	SOLID	WHITE - RIGHT YELLOW - LEFT	50' (15 m) C-C (LESS THAN 30MPH (50 km/h)) 75' (25 m) C-C (30 MPH (50 km/h) TO 45MPH (70 km/h)) 150' (45 m) C-C (OVER 45MPH (70 km/h))
U TURN ARROW	SEE DETAIL	SOLID	WHITE	16.3 SF
2 ARROW COMBINATION LEFT AND U TURN	SEE DETAIL	SOLID	WHITE	30.4 SF

### **BICYCLE & EQUESTRIAN** PEDESTRIAN 2' (600) DETAIL "A" DETAIL "B"

MULTI-LANE DIVIDED

TYPICAL LANE AND EDGE LINE MARKING

\* MARKINGS SHALL BE INSTALLED PARALLEL TO THE CENTERLINE OF THE ROAD WHICH IT CROSSES

TYPICAL CROSSWALK MARKING

ineering Enterprises, Inc. ONSULTING ENGINEERS
2 Wheeler Road

EDGE OF PAVEMENT  $\sim$ 

DESIGNED - EVERS USER NAME = Jim Schmidt REVISED - C. JUCIUS 09-09-0 DRAWN REVISED - C. JUCIUS 07-01-13 PLOT SCALE = CHECKED REVISED - C. JUCIUS 12-21-15 PLOT DATE = February 9, 2023 @ 9:15 AM DATE - 03-19-90 - C. JUCIUS 04-12-16 REVISED

4 (100) WHITE EDGE LINE

STATE OF ILLINOIS **DEPARTMENT OF TRANSPORTATION** 


SECTION COUNTY **DISTRICT ONE** 2303 22-00032-00-RS KANE 23 21 TYPICAL PAVEMENT MARKINGS CONTRACT NO. 6IJ47 SHEET 1 OF 1 SHEETS STA.

FOR FURTHER DETAILS ON PAVEMENT MARKING REFER TO STANDARD SPECIFICATIONS FOR ROAD AND BRIDGE CONSTRUCTION AND STATE STANDARD 780001.

SCALE: N.T.S.


8 (200) WHITE -

RAISED

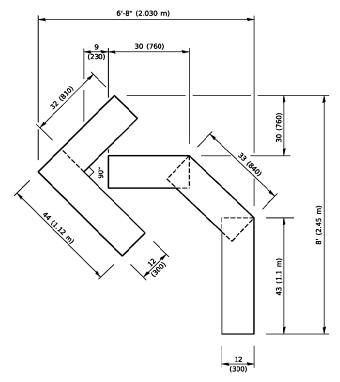


### **QUANTITY**

4 (100) LINE = 45.5 ft. (13.9 m) 15.2 sq. ft. (1.41 sq. m)

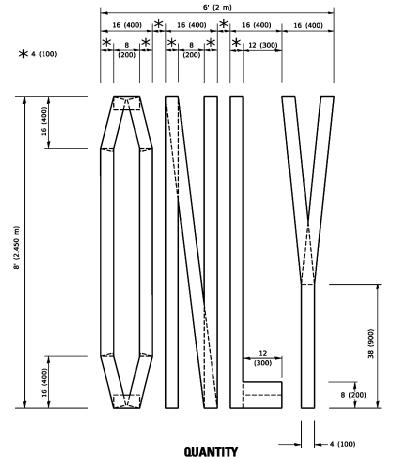

4 (100) LINE = 64.1 ft. (19.5 m) 21.4 sq. ft. (1.99 sq. m)

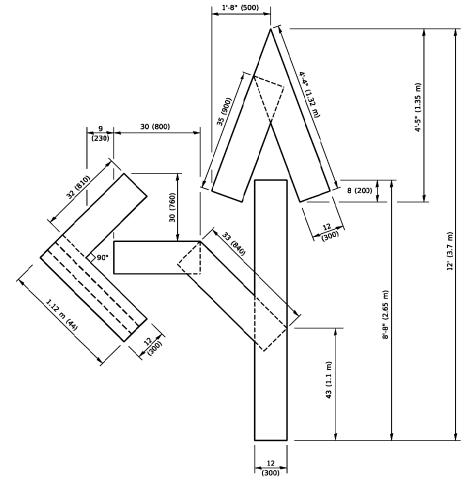


### QUANTITY

4 (100) LINE = 82.5 ft. (25.1 m) 27.5 sq. ft. (2.53 sq. m)

### NOTE:

ALL QUANTITIES OF PLACEMENT ARE REPRESENTED IN LINEAR FEET OF 4" LINES TO MATCH THE 4" TEMPORARY TAPE PAY ITEM AND REPRESENTS THE TOTAL QUANTITY OF 4" TAPE REQUIRED.

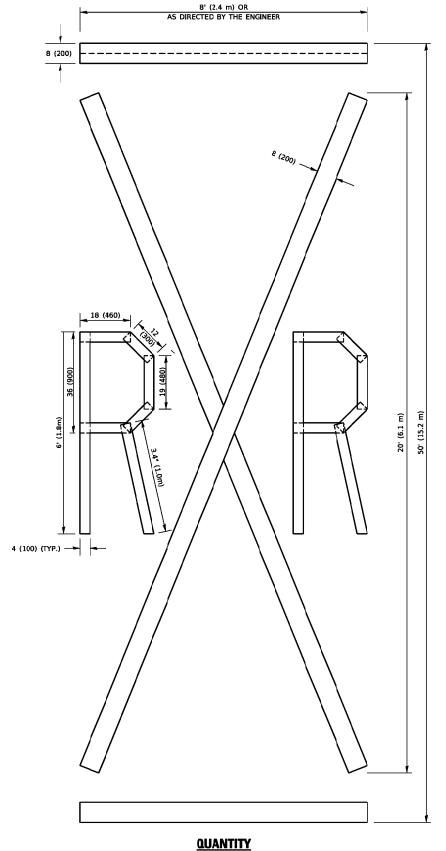

4 (100) LINE = 225.9 ft. (68.9 m) 75.3 sq. ft. (6.99 sq. m)

> All dimensions are in inches (millimeters) unless otherwise shown.

	Engineering Enterprises, Inc.						
66.	CONSULTING ENGINEERS	L					
-01	52 Wheeler Road Sugar Grove, Illinois 60554 630.466.6700 / www.eeiweb.com	L					
	630.466.6700 / www.eeiweb.com	ı					


ı	USER NAME = Jim Schmidt	DESIGNED	-		REVISED	- T.RAMMACHER 03-02-9
ı		DRAWN	-		REVISED	- E. GOMEZ 08-28-00
ı	PLOT SCALE =	CHECKED	-		REVISED	- E. GOMEZ 08-28-00
	PLOT DATE = February 9, 2023 ⊕ 9:15 AM	DATE	-	09-18-94	REVISED	- A. SCHUETZE 09-15-16

STATE OF ILLINOIS DEPARTMENT OF TRANSPORTATION

•	SHORT TERM PAVEMENT MARKING LETTERS AND SYMBOLS								
SCALE: N.T.S.	SHEET	1	0F	1	SHEETS	STA.	TO STA.		

F.A.U. RTE.	SECTION	COUNTY	TOTAL SHEETS	SHEE NO
2303	22-00032-00-RS	KANE	23	22
		CONTRACT N	10. 61.1	47

ILLINOIS FED. AID PROJECT

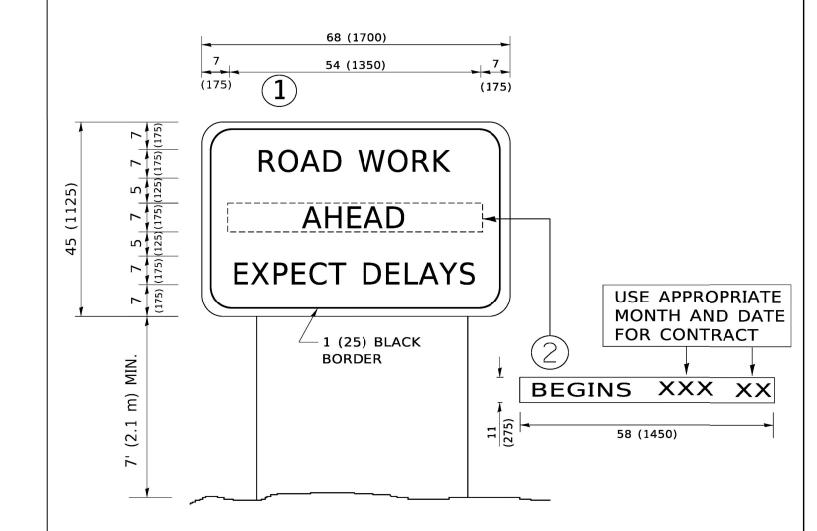

### **NOTES:**

- 1. USE BLACK LETTERING ON ORANGE BACKGROUND.
- 2. ERECT SIGNS IN ADVANCE OF THE LOCATION FOR THE "ROAD CONSTRUCTION AHEAD" SIGN AT LOCATIONS AS DIRECTED BY THE ENGINEER.
- 3. ERECT SIGN(1)WITH INSTALLED PANEL(2)ONE WEEK PRIOR TO THE START OF CONSTRUCTION.
- 4. REMOVE PANEL 2 SOON AFTER THE START OF CONSTRUCTION.
- 5. SEE SPECIAL PROVISION FOR "TEMPORARY INFORMATION SIGNING" FOR ADDITIONAL INFORMATION.
- 6. ONE SIGN ASSEMBLY EQUALS 25.70 SQ. FT. (2.3 SQ. M.)
- 7. SHALL BE PAID FOR AS TEMPORARY INFORMATION SIGNING.

ALL DIMENSIONS ARE IN INCHES (MILLIMETERS) UNLESS OTHERWISE SHOWN.

Engineering Enterprises, Inc.	
CONSULTING ENGINEERS	
52 Wheeler Road Sugar Grove, Illinois 60554	PL
630.466.6700 / www.eeiweb.com	PL

USER NAME = Jim Schmidt	DESIGNED -	REVISED - R. MIRS 09-15-97
	DRAWN -	REVISED - R. MIRS 12-II-97
PLOT SCALE =	CHECKED -	REVISED - T.RAMMACHER 02-02-99
PLOT DATE = February 9, 2023 @ 9:15 AM	DATE -	REVISED - C. JUCIUS 01-31-07

STATE OF ILLINOIS					
DEPARTMENT OF TRANSPORTATION					

	ARTERIAL ROAD INFORMATION SIGN					
SCALE: N.T.S.	SHEET	1	0F	1	SHEETS	STA.

A.U. RTE.	SECTION	COUNTY	TOTAL SHEETS	SHEE NO.
2303	22-00032-00-RS	KANE	23	23
		CONTRACT N	IO. 6IJ	47
	ILLINOIS FED. AI	D PROJECT		