FOR INDEX OF SHEETS, HIGHWAY STANDARDS, AND PR LEGEND SEE SHEET NO. 2

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SCHAUMBURG

RAMOS P.E.,

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CARMEN

ENGINEER,

AID PROGRAM


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POLICY STATEMENT: PLANS DESIGNED IN ACCORDANCE WITH THE **BUREAU OF LOCAL ROADS AND STREETS MANUAL**

CONCORD DRIVE: DESIGN DESIGNATION MAJOR COLLECTOR DESIGN SPEED = 35 M.P.H. POSTED SPEED = 30 M.P.H. ADT (2019) = 4,300 VPD

> PROJECT LOCATED IN THE VILLAGE OF MONTGOMERY



FULL SIZE PLANS HAVE BEEN PREPARED USING STANDARD ENGINEERING SCALES. REDUCED SIZED PLANS WILL NOT CONFORM TO STANDARD SCALES. IN MAKING MEASUREMENTS ON REDUCED PLANS, THE ABOVE SCALES MAY BE USED.

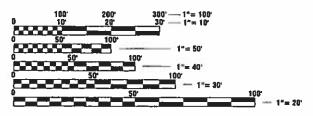


CONTRACT NO. 61J46

STATE OF ILLINOIS **DEPARTMENT OF TRANSPORTATION**

PLANS FOR PROPOSED FEDERAL-AID HIGHWAY


FAU 3789 (CONCORD DRIVE) **GORDON ROAD TO GALENA ROAD ROADWAY RESURFACING SECTION 22-00059-00-RS PROJECT NUMBER: HWEB(787) VILLAGE OF MONTGOMERY KENDALL COUNTY** JOB NO. C-91-073-23

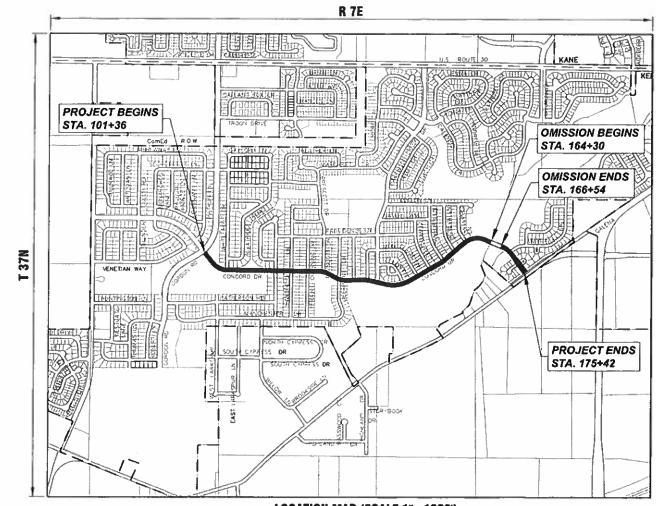


LOCATION MAP (SCALE 1"=1000") SECTION 3, 2 & 1, T37N, R7E, BRISTOL TOWNSHIP GROSS LENGTH OF PROJECT = 7,437 FEET (1.41 MILES) NET LENGTH OF PROJECT = 7.213 (1.37 MILES)

22-00059-00-RS KENDALL 24 1 CONTRACT NO. 61J46



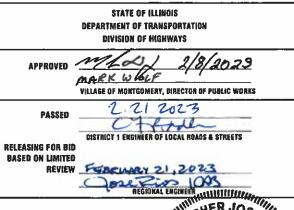

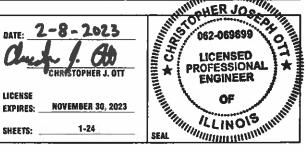



1"= 1000"

Engineering Enterprises, Inc. CONSULTING ENGINEERS 52 Wheeler Road Sugar Grove, Illinois 60554 Phone: (630) 466-6700

PRINTED BY THE AUTHORITY OF THE STATE OF ILLINOIS

ALL CONSTRUCTION SHALL BE DONE IN ACCORDANCE WITH THE "STANDARD SPECIFICATIONS FOR ROAD AND BRIDGE CONSTRUCTION," ADOPTED JANUARY 1, 2022 (HEREINAFTER REFERRED TO AS THE STANDARD SPECIFICATIONS). THE "SUPPLEMENTAL SPECIFICATIONS AND RECURRING SPECIAL PROVISIONS," ADOPTED JANUARY 1, 2023, THE LATEST EDITION OF THE "ILLINOIS MANUAL ON UNIFORM TRAFFIC CONTROL DEVICES FOR STREETS AND HIGHWAYS", THE "STANDARD SPECIFICATIONS FOR WATER & SEWER MAIN CONSTRUCTION IN ILLINOIS", SEVENTH EDITION, THE CODES AND ORDINANCES OF THE VILLAGE OF MONTGOMERY, ILLINOIS, THE DETAILS IN THE PLANS AND THE SPECIAL PROVISIONS INCLUDED IN THE CONTRACT DOCUMENTS.

NO SUBSTITUTIONS OR VARIANCES WILL BE PERMITTED TO ANY STANDARD NOTES OR ORDINANCES UNLESS APPROVED OTHERWISE IN WRITING PRIOR TO COMMENCING CONSTRUCTION ACTIVITY.

ALL TRAFFIC CONTROL AND OTHER ADVISORY SIGNS NEEDED FOR CONSTRUCTION ARE TO BE FURNISHED BY THE CONTRACTOR IN ACCORDANCE WITH ARTICLE 107.14 OF THE STANDARD

THE CONTRACTOR SHALL AT ALL TIMES PROVIDE PROTECTION FOR TRAFFIC AS CALLED FOR IN THE APPLICATION OF TRAFFIC CONTROL DEVICES, THE STANDARD SPECIFICATIONS, THE SPECIAL

THE CONTRACTOR SHALL COOPERATE WITH THE OWNER IF ANY UTILITY IMPROVEMENTS ARE REQUIRED WITHIN THE DURATION OF THE CONTRACT.

UNDER NO CIRCUMSTANCES SHALL THE CONTRACTOR OPERATE ANY VALVES OR HYDRANTS. THE CONTRACTOR WILL BE REQUIRED TO GET ALL WATER FROM THE VILLAGE'S PUBLIC WORKS FACILITY AT 981 KNELL ROAD OR AT THE POLICE STATION AT 10 CIVIC CENTER DRIVE.

THE LOCATION OF EXISTING DRAINAGE STRUCTURES, STORM SEWERS, WATER MAINS, SANITARY SEWERS, FIELD TILES AND ANY OTHER PUBLIC OR PRIVATE UTILITIES AS SHOWN ON THE PLANS IS APPROXIMATE AND NOT NECESSARY COMPLETE: THEIR EXACT LOCATION IS TO BE DETERMINED IN THE FIELD BY THE CONTRACTOR.

BEFORE STARTING ANY EXCAVATION, THE CONTRACTOR SHALL CALL "JULIE" (JOINT UTILITY LOCATION INFORMATION FOR EXCAVATION) AT (800) 892-0123 FOR FIELD LOCATIONS OF BURIED UTILITIES (48 HOURS NOTIFICATION IS REQUIRED)

IF EXISTING UTILITY LINES OF ANY NATURE ARE ENCOUNTERED WHICH CONFLICT IN LOCATION WITH NEW CONSTRUCTION, THE CONTRACTOR SHALL NOTIFY THE ENGINEER SO THAT THE CONFLICT MAY

THE CONTRACTOR SHALL PROTECT AND CAREFULLY PRESERVE ALL SECTION OR SUBSECTION MONUMENTS, PROPERTY CORNERS, AND REFERENCE MARKERS UNTIL THE OWNER. THE OWNER'S AGENT, OR AN AUTHORIZED SURVEYOR HAS WITNESSED OR OTHERWISE REFERENCED THEIR

ALL OFFSET LOCATIONS GIVEN ON THE DETAILED PLANS ARE FROM THE CENTERLINE AS SHOWN ON THE PLANS.

THE THICKNESS OF ASPHALT MIXTURES SHOWN IN THE PLANS ARE NOMINAL. DEVIATIONS MAY OCCUR DUE TO IRREGULARITIES IN THE SURFACES OR BASES ON WHICH THE ASPHALT MIXTURES

IT IS THE CONTRACTOR'S RESPONSIBILITY TO ASCERTAIN EXISTING FIELD CONDITIONS BEFORE

WHERE NEW WORK MEETS EXISTING FEATURES TO REMAIN, THE CONTRACTOR SHALL FIELD CHECK ALL DIMENSIONS AND ELEVATIONS BEFORE PROCEEDING WITH CONSTRUCTION. IMMEDIATELY NOTIFY THE ENGINEER OF ANY DISCREPANCIES.

THE CONTRACTOR WILL BE REQUIRED TO COMPLY WITH ALL STATE REGULATIONS REGARDING AIR, WATER AND NOISE POLLUTION. THE CONTRACTOR IS PROHIBITED FROM BURNING ANY MATERIAL WITHIN OR ADJACENT TO THE IMPROVEMENT.

THE ENGINEER IS NOT RESPONSIBLE FOR THE CONSTRUCTION MEANS, METHODS, TECHNIQUES, SEQUENCES OR PROCEDURES, TIME OF PERFORMANCE, PROGRAMS OR FOR ANY SAFETY PRECAUTIONS USED BY THE CONTRACTOR. THE CONTRACTOR IS SOLELY RESPONSIBLE FOR EXECUTION OF THEIR WORK IN ACCORDANCE WITH THE CONTRACT DOCUMENTS AND SPECIFICATIONS.

FOR STABILIZATION, ALL TYPE III BARRICADES WILL REQUIRE A MINIMUM OF FOUR SAND BAGS PER

THE CONTRACTOR SHALL MAINTAIN EXISTING SIDE STREET AND DRIVEWAY ACCESS TO EACH ABUTTING PROPERTY AT ALL TIMES DURING CONSTRUCTION OF THE PROJECT UNLESS OTHERWISE NOTED ON THE PLANS OR DIRECTED BY THE ENGINEER.

THE CONTRACTOR SHALL DISPOSE OF AND REMOVE FROM THE SITE EACH DAY ALL CURB AND GUTTER, PAVEMENT AND ALL OTHER EXCAVATED MATERIAL NOT FOR SALVAGE.

THE STORAGE OF EQUIPMENT AND/OR MATERIALS WITHIN THE RIGHT-OF-WAY OF ANY STREET AND/OR PARK PROPERTY SHALL REQUIRE PRIOR APPROVAL OF THE ENGINEER

SIDEWALK REMOVAL AND REPLACEMENT AND COMBINATION CONCRETE CURB AND GUTTER REMOVAL AND REPLACEMENT AS SHOWN ON THE PLANS IS FOR INFORMATIONAL PURPOSES ONLY, ACTUAL LOCATIONS AND QUANTITIES ARE TO BE DETERMINED AND MARKED BY THE ENGINEER PRIOR TO

ALL EXISTING SIGNS (INCLUDING THOSE LOCATED ON UTILITY/LIGHT POLES) THAT DO NOT CONFLICT WITH THE IMPROVEMENTS SHALL REMAIN IN PLACE UNLESS DIRECTED BY THE ENGINEER.

CONTRACTOR SHALL TAKE PRECAUTION BY PRESERVING EXISTING TREES WITHIN THE RIGHT OF WAY. IF ANY DAMAGE OCCURS, TREES SHALL BE REPLACED IN KIND PER ARTICLE 201.07 REPAIR OR REPLACEMENT OF EXISTING PLANT MATERIAL REQUIREMENT STATED HEREIN.

IDOT HIGHWAY STANDARDS

000001-08	STANDARD SYMBOLS, ABBREVIATIONS, AND PATTERNS
280001-07	TEMPORARY EROSION CONTROL SYSTEMS
424001-11	PERPENDICULAR CURB RAMPS FOR SIDEWALKS
424006-05	DIAGONAL CURB RAMPS FOR SIDEWALKS
424021-06	DEPRESSED CORNER FOR SIDEWALKS
442201-03	CLASS C AND D PATCHES
604001-05	FRAME AND LIDS TYPE 1
606001-08	CONCRETE CURB TYPE B AND COMBINATION CONCRETE CURB AND GUTTER
701006-05	OFF-RD OPERATIONS, 2L, 2W, 15'(4.5M) TO 24" (600MM) FROM PAVEMENT EDGE
701011-04	OFF-RD MOVING OPERATIONS, 2L, 2W, DAY ONLY
701101-05	OFF-RD OPERATIONS, MULTILANE, 15'(4.5M) TO 24" (600MM) FROM PAVEMENT EDGE
701301-04	LANE CLOSURE, 2L, 2W, SHORT TIME OPERATIONS
701311-03	LANE CLOSURE, 2L, 2W, MOVING OPERATIONS - DAY ONLY
701501-06	URBAN LANE CLOSURE 2L, 2W, UNDIVIDED
701601-09	URBAN LANE CLOSURE, MULTILANE, 1W OR 2W WITH NONTRAVERSABLE MEDIAN
701701-10	URBAN LANE CLOSURE, MULTILANE INTERSECTION
701801-06	SIDEWALK, CORNER OR CROSSWALK CLOSURE
701901-08	TRAFFIC CONTROL DEVICES
720001-01	SIGN PANEL MOUNTING DETAILS
720006-04	SIGN PANEL ERECTION DETAILS
728001-01	TELESCOPING STEEL SIGN SUPPORT
731001-01	BASE FOR TELESCOPING STEEL SIGN SUPPORT
780001-05	TYPICAL PAVEMENT MARKINGS

INDEX OF SHEETS

SHEET NO.	SHEET DESCRIPTION
1.	COVER SHEET
2.	INDEX OF SHEETS, DETAILS, HIGHWASTANDARDS, AND GENERAL NOTES
35.	SUMMARY OF QUANTITIES
67.	TYPICAL SECTIONS
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8.	SIGN SCHEDULE
916.	RESURFACING PLAN
17.	VILLAGE DETAILS
1824.	IDOT DISTRICT 1 DETAILS

SHEET. NO.	<u>IDOT</u>	DISTRICT ONE STD. DETAILS
18.	(BD-22)	PAVEMENT PATCHING FOR HMA SURFACED PAVEMENT
19.	(BD-24)	CURB OR CURB AND GUTTER REMOVAL AND REPLACEMENT
20.	(BD-32)	BUTT JOINT AND HMA TAPER DETAILS
21.	(TC-10)	TRAFFIC CONTROL AND PROTECTION FOR SIDE ROADS, INTERSECTIONS, AND DRIVEWAYS
22.	(TC-13)	TYPICAL PAVEMENT MARKINGS
23.	(TC-16)	SHORT TERM PAVEMENT MARKING LETTERS AND SYMBOLS

(TC-22) ARTERIAL ROAD INFORMATION SIGN

SUPPLEMENTAL LEGEND

HOT-MIX ASPHALT SURFACE REMOVAL, VARIABLE DEPTH

HOT-MIX ASPHALT SURFACE REMOVAL,

HOT-MIX ASPHALT SURFACE REMOVAL -

BIKE PATH REMOVAL AND INCIDENTAL HOT-MIX ASPHALT SURFACING

COMB CONC C&G REMOVAL AND REPLACEMENT

SIDEWALK REMOVAL

BIKE PATH REMOVAL

BIKE PATH REMOVAL AND PORTLAND CEMENT CONCRETE SIDEWALK, 5"

SIDEWALK REMOVAL AND PORTLAND CEMENT CONCRETE SIDEWALK, 5"

	CODE NUMBER	ITEM DESCRIPTION	UNIT	TOTAL QUANT I TY	ROADWAY 75% FEDERAL 25% LOCAL 0005	TRAINEES 75% FEDERAL 25% LOCAL 0042
	21101615	TOPSOIL FURNISH AND PLACE, 4°	SQ YD	1,250	1,250	
			, , , , , , , , , , , , , , , , , , , ,			
*	25200110	SODDING, SALT TOLERANT	SQ YD	1,250	1,250	
ж	25200200	SUPPLEMENTAL WATERING	UNIT	68	68	
	28000250	TEMPORARY EROSION CONTROL SEEDING	POUND	26	26	
_						
_	28000510	INLET FILTERS	EACH	60	60	
	40600290	BITUMINOUS MATERIALS (TACK COAT)	POUND	22,735	22.735	
	40600400	MIXTURE FOR CRACKS, JOINTS, AND FLANGEWAYS	TON	5	5	
	40600982	HOT-MIX ASPHALT SURFACE REMOVAL - BUTT JOINT	SQ YD	415	415	
	40602978	HOT-MIX ASPHALT BINDER COURSE, 1L-9.5, N50	TON	2,905	2.905	
	40604060	HOT-MIX ASPHALT SURFACE COURSE, IL-9.5, MIX "D", N50	TON	2,905	2,905	
	40800025	BITUMINOUS MATERIALS (PRIME COAT)	POUND	170	170	
			1 100.00	1,0		
	40800050	INCIDENTAL HOT-MIX ASPHALT SURFACING	TON	84	84	
	42400200	PORTLAND CEMENT CONCRETE SIDEWALK 5 INCH	SQ FT	9,460	9,460	
	42400800	DETECTABLE WARNINGS	SQ FT	900	900	
	44000161	HOT-MIX ASPHALT SURFACE REMOVAL, 3"	SQ YD	3,695	3,695	

Δ INDICATES SPECIALTY ITEM
* SEE SPECIAL PROVISIONS

Engineering Enterprises, Inc. CONSULTING ENGINEERS 52 Wheeler Road Sugar Grove, Illinoia 60554 630.466.6700 / www.eelweb.com

	USER NAME = Kris Pung	DESIGNED -	REVISED -
		DRAWN -	REVISEO -
-	PLOT SCALE =	CHECKED -	REVISED -
	PLOT DATE - March 1, 2023 @ 1:35 PM	DATE -	REVISED -

STATE OF ILLINOIS DEPARTMENT OF TRANSPORTATION

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	SUMMARY OF QUANTITIES							
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SCALE: N.T.S.	SHEET 1	0F	3	SHEETS	STA.	TO STA.	·	H.L.

EL!	Engineering Enterprises, Inc. CONSULTING ENGINEERS 52 Wheeler Road Sugar Grave, Illinois 60554 630.466.6700 / www.eeiweb.com
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USER NAME = Jim Schmidt	DESIGNEO -	REVISED -
	DRAWN -	REVISED -
PLOT SCALE -	CHECKED -	REVISED -
PLOT DATE = February 7, 2023 @ 1:40 PM	DATE -	REVISED -

	e i	IBERGAT	1V 1	F.A.U RTE.	SECTION	COUNTY	TOTAL SHEETS	SHEET			
	21	I IAI IAI WE	111	JP QUA	NTITIES		3789	22-00059-00-RS	KENDALL	24	4
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SCALE: N.T.S. SHEET Z OF 3 SHEETS STA. TO STA.								ILLINOIS FED. AI	O PROJECT		

CODE NUMBER	ITEM DESCRIPTION	UNIT	TOTAL QUANT I TY	ROADWAY 75% FEDERAL 25% LOCAL 0005	TRAINEES 75% FEDERAL 25% LOCAL 0042
44000500	COMBINATION CURB AND GUTTER REMOVAL	FOOT	1,905	1,905	
44000600	SIDEWALK REMOVAL	SQ FT	8,360	8,360	
44201694	CLASS D PATCHES, TYPE III, 4 INCH	SQ YD	160	160	
44201696	CLASS D PATCHES, TYPE IV, 4 INCH	SQ YD	650	650	
60260100	INLETS TO BE ADJUSTED	EACH	44	44	
60406000	FRAMES AND LIDS, TYPE 1, OPEN LID	EACH	1	1	
60603800	COMBINATION CURB AND GUTTER, TYPE B-6.12	FOOT	1,905	1,905	
67100100	MOBILIZATION	L SUM	1	1	
70102620	TRAFFIC CONTROL AND PROTECTION, STANDARD 701501	L SUM	1	1	
70102630	TRAFFIC CONTROL AND PROTECTION, STANDARD 701601	L SUM	1	. 1	1
70102635	TRAFFIC CONTROL AND PROTECTION, STANDARD 701701	L SUM	1	1	
70102640	TRAFFIC CONTROL AND PROTECTION, STANDARD 701801	L SUM	1	1	
70300100	SHORT TERM PAVEMENT MARKING	FOOT	500	500	
70300150	SHORT TERM PAVEMENT MARKING REMOVAL	SQ FT	125	125	
	TEMPORARY PAVEMENT MARKING - LINE 4" - PAINT	FOOT	500	500	

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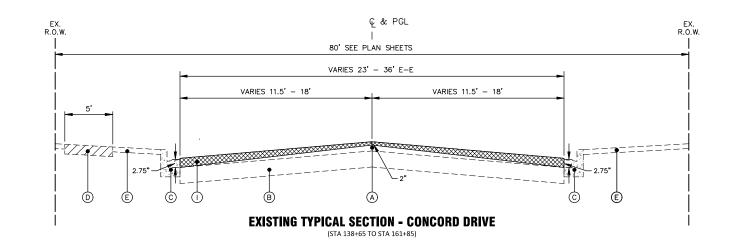
		CODE NUMBER	ITEM DESCRIPTION	UNIT	TOTAL QUANTITY	ROADWAY 75% FEDERAL 25% LOCAL 0005	TRAINEES 75% FEDERAL 25% LOCAL 0042
Δ		72000100	SIGN PANEL - TYPE 1	5Q FT	93	93	
		72400100	REMOVE SIGN PANEL ASSEMBLY - TYPE A	EACH	18	18	
		72400310	REMOVE SIGN PANEL - TYPE 1	5Q FT	92	92	
Δ		72800100	TELESCOPING STEEL SIGN SUPPORT	FOOT	336	336	
Δ		78000100	THERMOPLASTIC PAVEMENT MARKING - LETTERS AND SYMBOLS	SQ FT	125	125	
Δ		78000200	THERMOPLASTIC PAVEMENT MARKING - LINE 4"	FOOT	777	777	
Δ		78000400	THERMOPLASTIC PAVEMENT MARKING - LINE 6"	FOOT	361	361	
Δ		78000600	THERMOPLASTIC PAVEMENT MARKING - LINE 12"	FOOT	225	225	
Δ		78000650	THERMOPLASTIC PAVEMENT MARKING - LINE 24"	FOOT	96	96	
	*	X0327036	BIKE PATH REMOVAL	SQ YD	638	638	
	*	X4401198	HOT-MIX ASPHALT SURFACE REMOVAL, VARIABLE DEPTH	SQ YD	29,990	29,990	
	*	X6026050	SANITARY MANHOLES TO BE ADJUSTED	EACH	2	2	
	*	Z0030850	TEMPORARY INFORMATION SIGNING	SQ FT	51	51	
		Z0076600	TRAINEES	HOUR	500		500
		20076604	TRAINEES TRAINING PROGRAM GRADUATE	HOUR	500		500
	I NE	DICATES SPEC	LALTY (TEM				1100-00111


* SEE SPECIAL PROVISIONS

_	Engineering Enterprises, Inc.	
	CONSULTING ENGINEERS 52 Wheeler Rood	Į
-	Suger Grove, Illinois 60554 630.466.6700 / www.eelweb.com	ļ.

	USER NAME = Jim Schmidt	DESIGNED -	REVISED -
		DRAWN -	REVISED -
i	PLOT SCALE =	CHECKED -	REVISED -
	PLOT DATE = February 7, 2023 @ 1:43 PM	DATE -	REVISED -

	SUMMARY OF QUANTITIES							RTE
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ပု& PGL EX. R.O.W. EX. R.O.W. 80' - SEE PLAN SHEETS VARIES 23' - 36' E-E VARIES 11.5' - 18' VARIES 11.5' - 18' 2.0% MAX 6 4 46

PROPOSED TYPICAL SECTION - CONCORD DRIVE

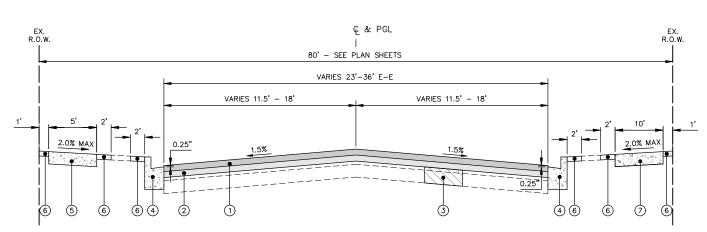SHEET 1 OF 2 SHEETS STA.

SCALE: N.T.S.

PROPOSED TYPICAL SECTION - CONCORD DRIVE

(STA 101+36 TO STA 138+65, STA 161+85 TO STA 164+35 AND STA 166+54 TO STA 171+90)

HOT-MIX ASPHALT MIXTURE REQUIREMENTS

\bigcirc	EXISTING H	OT-MIX	ASPHALT	PAVEMENT	(5.5" - 7")	
(E)	EVICTING A	0005047	- DAGE (00UDGE /0"	. = "\	

EXISTING LEGEND

- (B) EXISTING AGGREGATE BASE COURSE (9" 15") © EXISTING COMBINATION CONCRETE CURB & GUTTER. B6.12
- (D) EXISTING PORTLAND CEMENT CONCRETE SIDEWALK
- (E) EXISTING PARKWAY
- (F) EXISTING LANDSCAPE MEDIAN
- G EXISTING BIKE PATH
- H) HOT-MIX ASPHALT SURFACE REMOVAL, 3"
 - | HOT-MIX ASPHALT SURFACE REMOVAL, VARIABLE DEPTH

OPERATION	MIXTURE TYPE	AIR VOIDS NDES	QMP
PAVEMENT RESURFACING	HOT-MIX ASPHALT SURFACE COURSE, IL-9.5, MIX "D", N50, 1.5" HOT-MIX ASPHALT BINDER COURSE, IL-9.5, N50, 1.5"	4% @ 50 GYR. 4% @ 50 GYR.	LR1030-2 LR1030-2
CLASS D PATCHES	HOT-MIX ASPHALT BINDER COURSE, IL-19.0, N70, 4"	4% @ 70 GYR.	LR1030-2
INCIDENTAL HOT-MIX ASPHALT SURFACING	HOT-MIX ASPHALT SURFACE COURSE, IL-9.5, MIX "D", N50, 3"	4% @ 50 GYR.	LR1030-2
	QMP DESIGNATION: QUALITY CONTROL/QUALITY ASSURANCE (QC/QA) PER LR 1030-2.		

THE UNIT WEIGHT TO CALCULATE ALL HMA SURFACE MIXTURE QUANTITIES IS 112 LBS/SQ YD/IN

THE "AC TYPE" FOR POLYMERIZED HMA MIXES SHALL BE "SBS/SBR PG 76-22" AND FOR NON-POLYMERIZED HMA THE "AC TYPE" SHALL BE "PG 64-22". UNLESS MODIFIED BY RECLAIMED MATERIALS SPECIFICATIONS.

PROPOSED LEGEND

- 1) HOT-MIX ASPHALT SURFACE COURSE, IL-9.5, MIX "D", N50, 1.5"
- 2 HOT-MIX ASPHALT BINDER COURSE, IL-9.5, N50, 1.5"
- 3 CLASS D PATCH, 4" (LOCATIONS TO BE DETERMINED BY ENGINEER)
- $\begin{picture}(4)\put(0.5){\line(0.5){100}} \put(0.5){\line(0.5){100}} \pu$
- (5) SIDEWALK REMOVAL AND PORTLAND CEMENT CONCRETE SIDEWALK, 5" (SPOT LOCATIONS AS DIRECTED BY ENGINEER)
- 6 TOPSOIL AND SODDING, SALT TOLERANT
- 7 INCIDENTAL HOT-MIX ASPHALT SURFACING

NOTES:
THE PATCHING QUANTITIES HAVE BEEN ESTIMATED BASED ON FIELD
OBSERVATIONS DURING DESIGN. ACTUAL QUANTITIES TO BE DETERMINED
DURING CONSTRUCTION.

NO PROPOSED WORK WILL TAKE PLACE OUTSIDE OF THE R.O.W.

Engineering Enterprises, Inc.	_
CONSULTING ENGINEERS	
52 Wheeler Road Sugar Grove, Illinois 60554	F
630.466.6700 / www.eeiweb.com	F


.	USER NAME = Jim Schmidt	DESIGNED -	REVISED -
		DRAWN -	REVISED -
	PLOT SCALE =	CHECKED -	REVISED -
	PLOT DATE = February 7, 2023 @ 10:40 AM	DATE -	REVISED -

STATE OF ILLINOIS
DEPARTMENT OF TRANSPORTATION

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TYPICAL SECTIONS	3789	22-00059-00-RS	KEN

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F.A.U RTE.	SECTION	COUNTY	TOTAL SHEETS	SHEE NO.
3789	22-00059-00-RS	KENDALL	24	6
		CONTRACT N	10. 6IJ46	

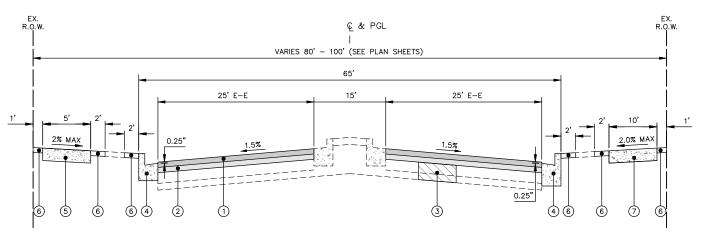

PROPOSED TYPICAL SECTION - CONCORD DRIVE

EXISTING LEGEND

- A EXISTING HOT-MIX ASPHALT PAVEMENT (5.5" 7")
- B EXISTING AGGREGATE BASE COURSE (9" 15")
- © EXISTING COMBINATION CONCRETE CURB & GUTTER. B6.12
- (D) EXISTING PORTLAND CEMENT CONCRETE SIDEWALK
- (E) EXISTING PARKWAY
- F EXISTING LANDSCAPE MEDIAN
- G EXISTING BIKE PATH
- H HOT-MIX ASPHALT SURFACE REMOVAL, 3"

 1 HOT-MIX ASPHALT SURFACE REMOVAL. VARI 1 HOT-MIX ASPHALT SURFACE REMOVAL, VARIABLE DEPTH

PROPOSED LEGEND

- 1 HOT-MIX ASPHALT SURFACE COURSE, IL-9.5, MIX "D", N50, 1.5"
- 2 HOT-MIX ASPHALT BINDER COURSE, IL-9.5, N50, 1.5"
- 3 CLASS D PATCH, 4" (LOCATIONS TO BE DETERMINED BY ENGINEER)
- 4 Combination concrete curb and gutter removal and replacement (spot removal and replacement as directed by the engineer)
- (5) SIDEWALK REMOVAL AND PORTLAND CEMENT CONCRETE SIDEWALK, 5" (SPOT LOCATIONS AS DIRECTED BY ENGINEER)
- 6 TOPSOIL AND SODDING, SALT TOLERANT
- 7 INCIDENTAL HOT-MIX ASPHALT SURFACING

Engineering Enterprises, Inc.	USER
CONSULTING ENGINEERS	
52 Wheeler Road Sugar Grove, Illinois 60554	PLOT
630.466.6700 / www.eeiweb.com	PLOT

ER NAME = Jim Schmidt	DESIGNED -	REVISED -
	DRAWN -	REVISED -
DT SCALE =	CHECKED -	REVISED -
OT DATE = February 7, 2023 @ 10:40 AM	DATE -	REVISED -

STATE OF HILINOIS
STATE OF ILLINOIS
DEPARTMENT OF TRANSPORTATION

TYPICAL SECTIONS						F.A.U RTE. SECTION			COUNTY	TOTAL SHEETS	SHEET NO.		
TYPICAL SECTIONS					3789	22-000	59-00-R	ы	KENDALL	24	7		
											CONTRACT I	NO. 61J46	5
SCALE: N.T.S.	SHEET 2	OF	2	SHEETS	STA.	TO STA.			ILLINOIS	FED. AII	D PROJECT		

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			Sig	ning Schedule			
		72000100. 00	72400100.00	72400310.00	72800100.00		
Station	O/S	Sign SIGN PANEL - TYPE 1	REMOVE SIGN PANEL ASSEMBLY - TYPE A	REMOVE SIGN PANEL - TYPE 1	TELESCOPING STEEL SIGN SUPPORT	MUTCD Designation	Description
		(Sq Ft)	(Each)	(Sq Ft)	(Ft)		
101+39	25' LT	30" x 30" 6.25	1.00	6.25	16.00	R1-1	Stop Sign All Way w/ new post
107+34	45' LT	30" x 30" 6.25	1.00	6.25	16.00	R1-1	Stop Sign All Way w/ new post
108+72	25' RT	24" x 30" 5.00		5.00	16.00	R2-1	Speed Limit (30MPH)
109+52	25' LT				16.00		Right Curve Arrow Post replacement
109+85	25' RT		1.00	5.00	16.00		Remove Speed limit sign, Road Narrows por replacement
112+00	25' L+R	24" x 24" 24.00	6.00	24.00	96.00	R8-3	6 No Parking signs relocated with new po
113+93	25' LT		1.00	5.00	16.00		Remove Speed limit sign, Road Narrows por replacement
114+69	25' LT	24" x 30" 5.00			16.00	R2-1	Speed Limit (30MPH)
117+28	45' LT	30" x 30" 6.25	1.00	6.25	16.00	R1-1	Stop Sign w/ new post
117+64	45' RT	30" x 30" 6.25	1.00	6.25	16.00	R1-1	Stop Sign w/ new post
120+88	45' RT	30" x 30" 6.25	1.00	6.25	16.00	R1-1	Stop Sign w/ new post
124+30	45' RT	30" x 30" 6.25	1.00	6.25	16.00	R1-1	Stop Sign w/ new post
132+64	25' LT	24" x 30" 5.00	2.00	10.00	32.00	R2-1	New Speed limit sign (30MPH), relocate Water sign
150+04	25' LT	24" x 30" 5.00	1.00		16.00	R2-1	New Speed limit sign (30MPH)
150+84	25' RT	24" x 30" 5.00	1.00	5.00		R2-1	New Speed Limit sign (30MPH) on light p
163+63	25' LT	30" x 30" 6.25			16.00	W11-2	Ped crossing w/ AHEAD
		Total: 92.750	18.000	91.500	336.000		


Engineering Enterprises, Inc.	Γ
CONSULTING ENGINEERS	Γ
52 Wheeler Road Sugar Grove, Illinois 60554	Γ
630.466.6700 / www.eeiweb.com	Γ


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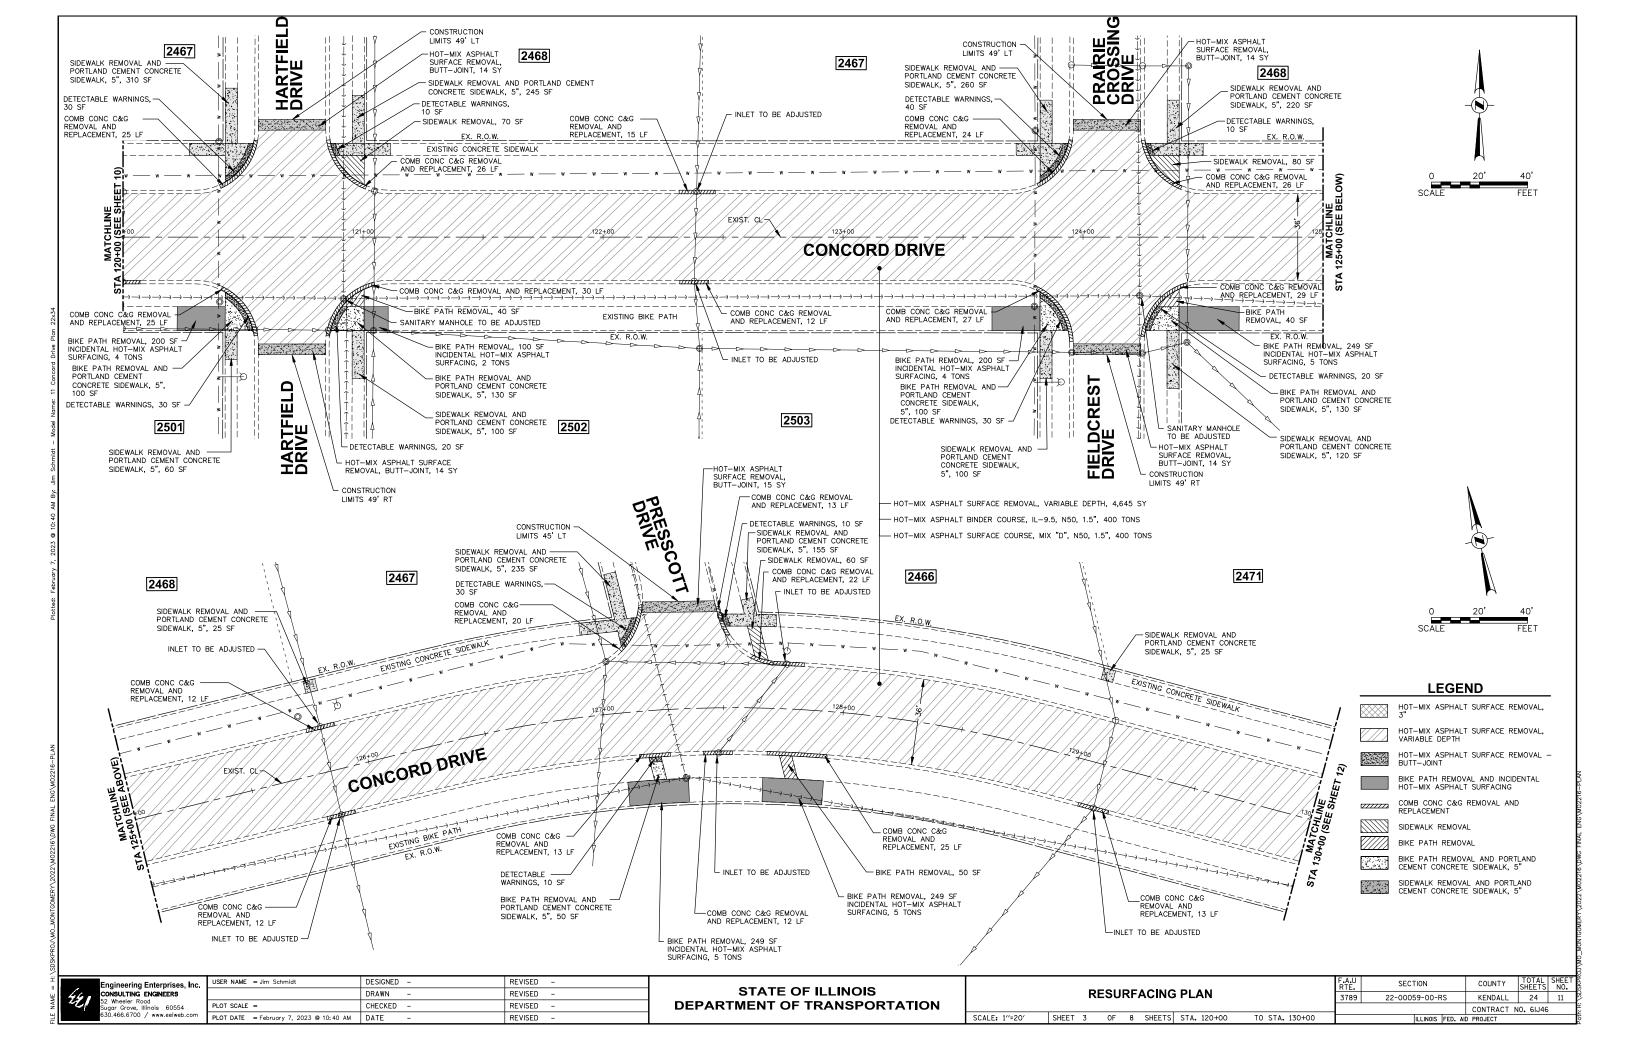
STATE OF ILLINOIS
DEPARTMENT OF TRANSPORTATION


				SIGN	IING	SCHEDU	LE	
ı								
	SCALE: N.T.S.	SHEET	1	OF	1	SHEETS	STA.	TO STA.


.A.U RTE.	SECTION	COUNTY	TOTAL SHEETS	Sł	
3789	22-00059-00-RS	;	KENDALL	24	
			CONTRACT N	10. 6IJ46	,
	ILLINOIS F	ED. AID	PROJECT		




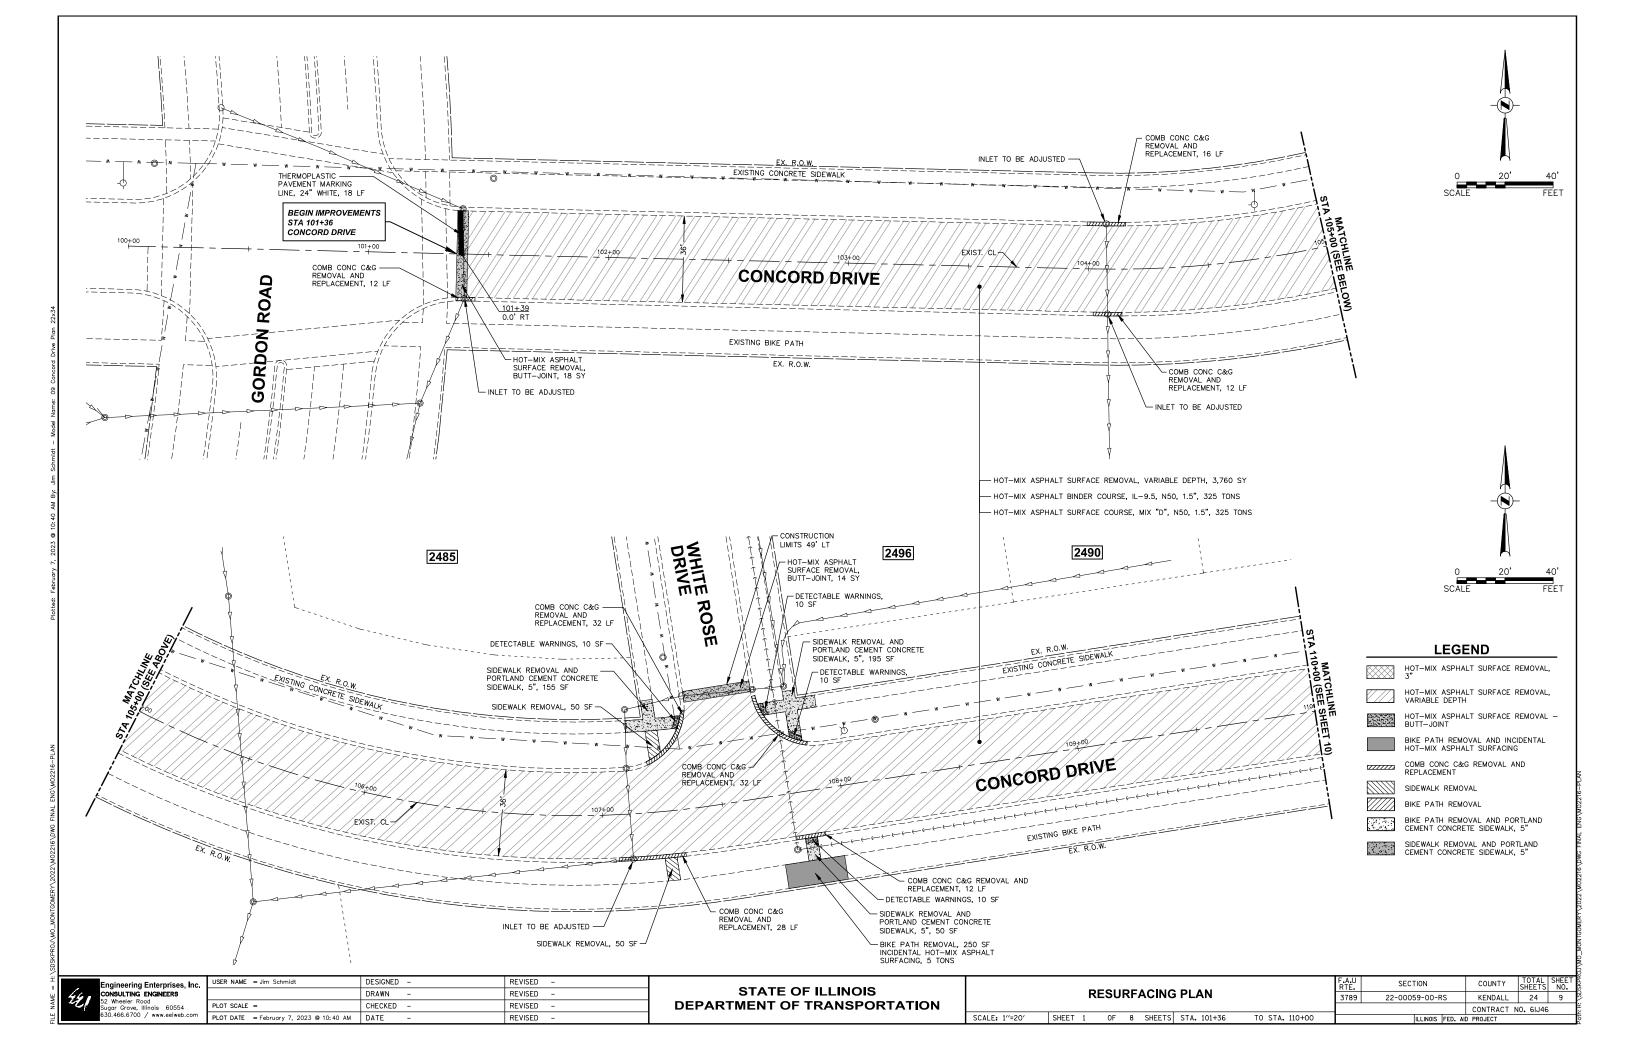


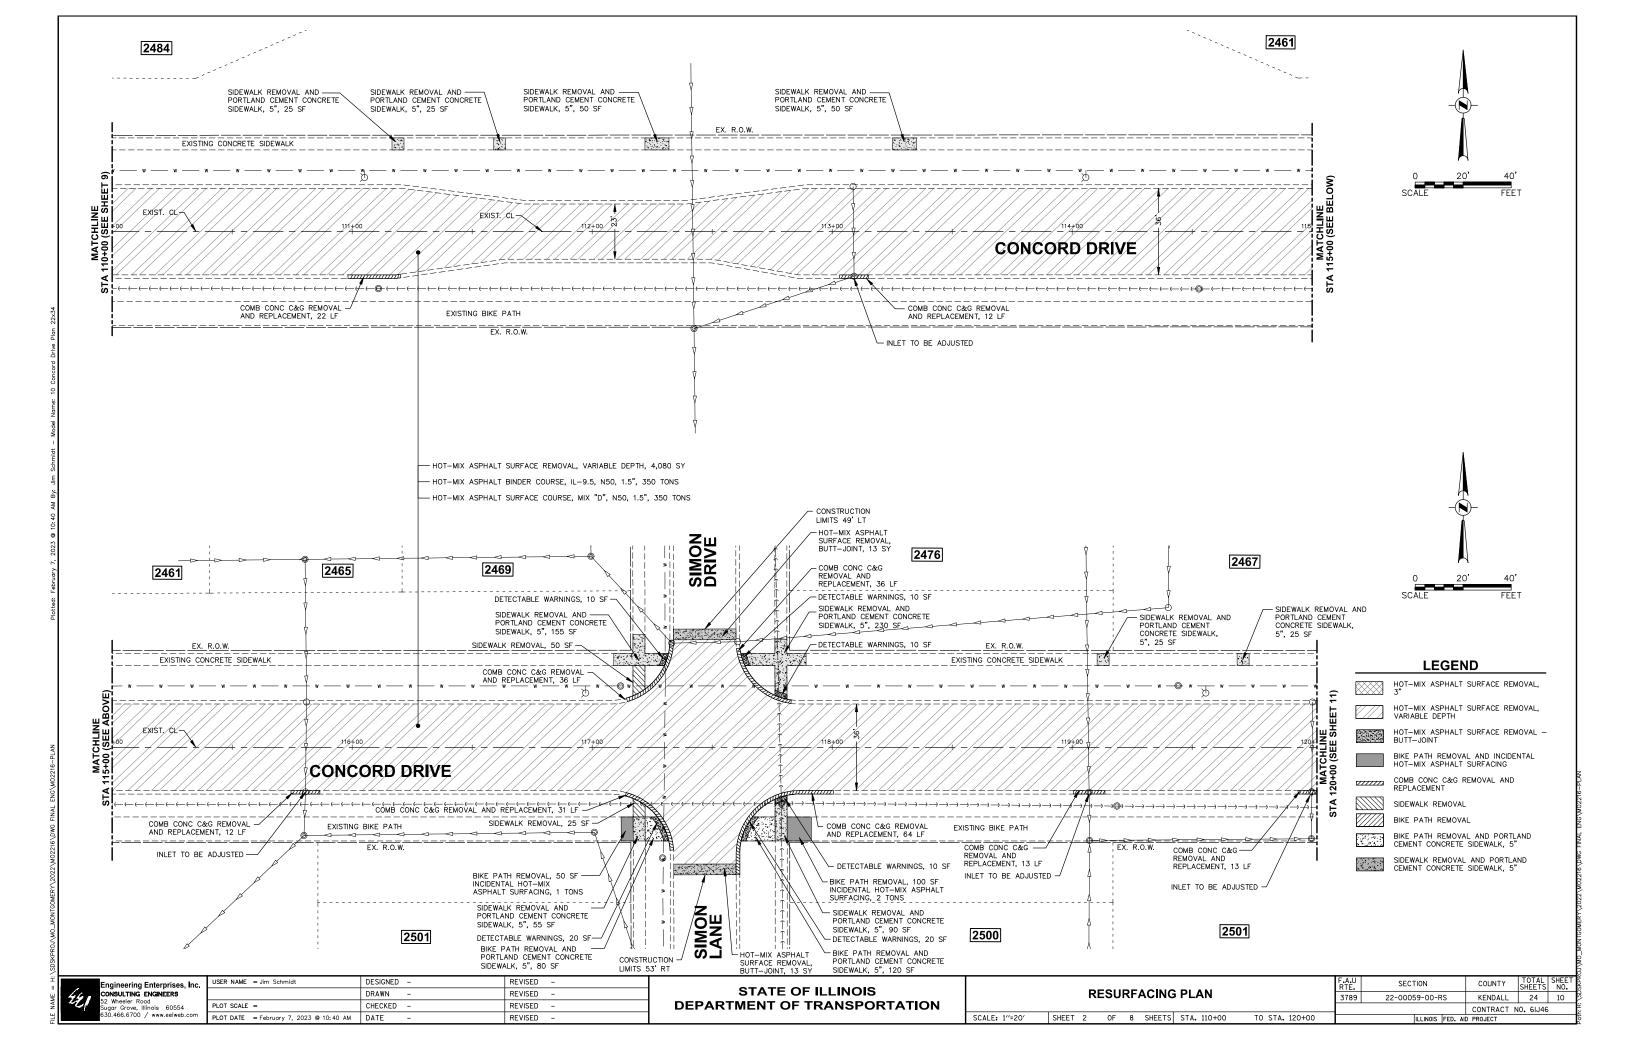


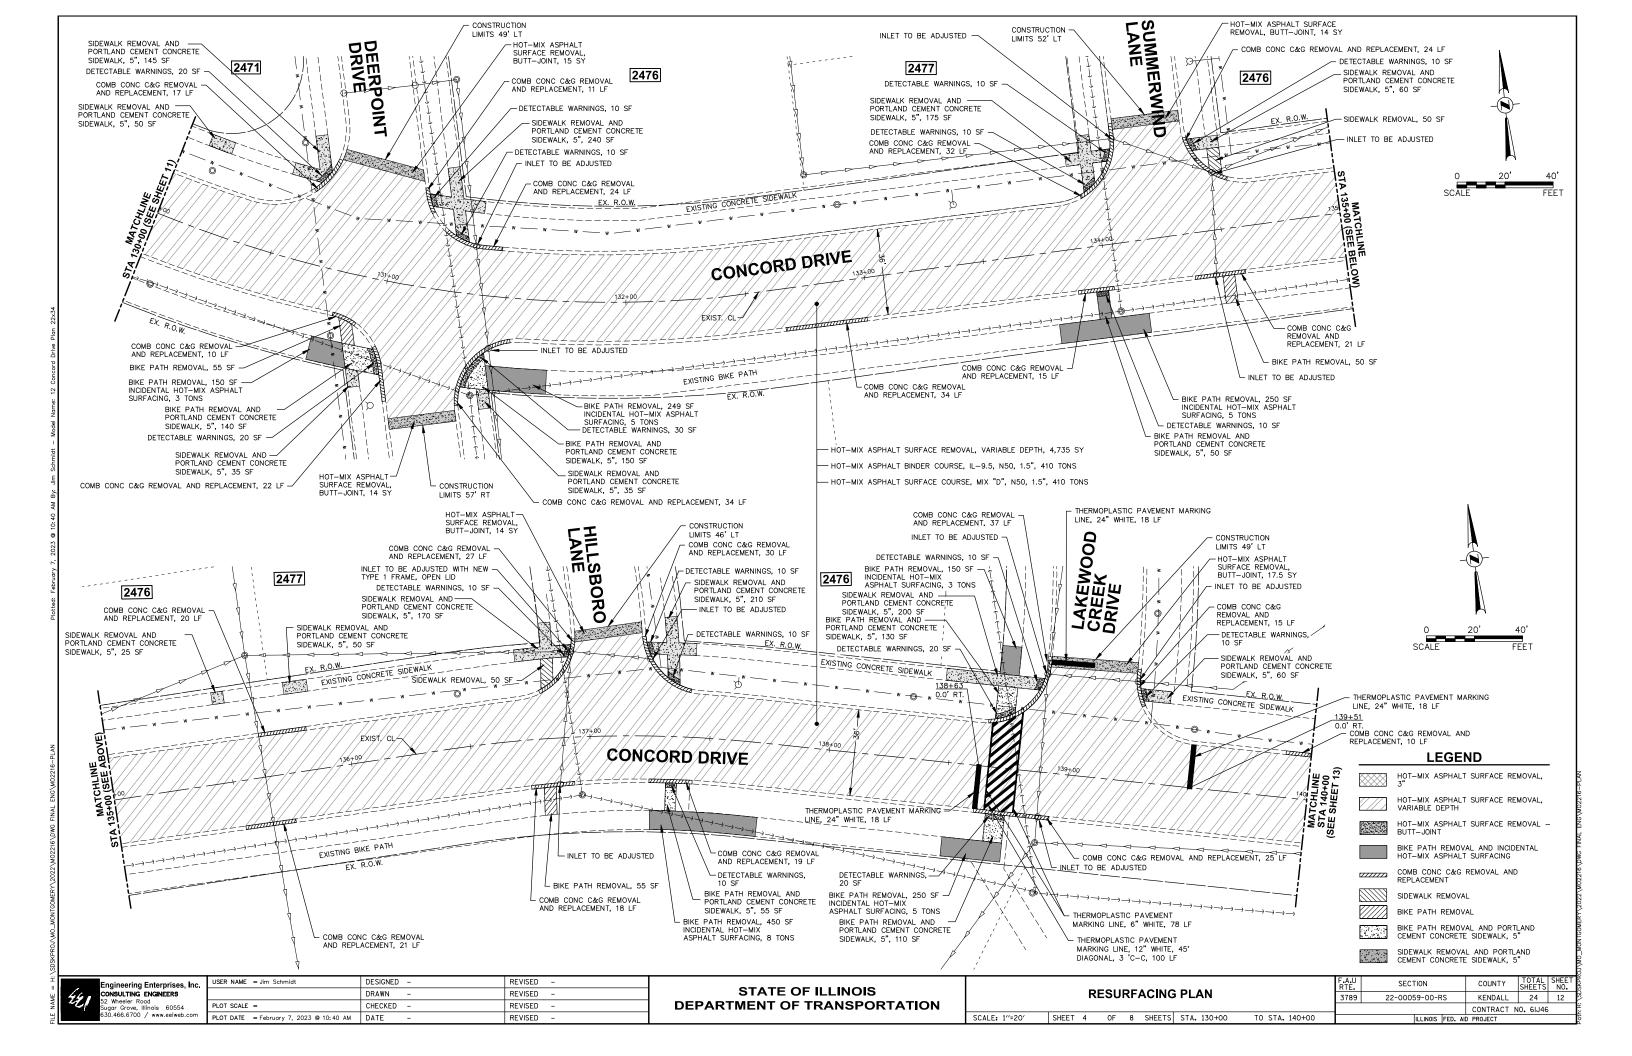


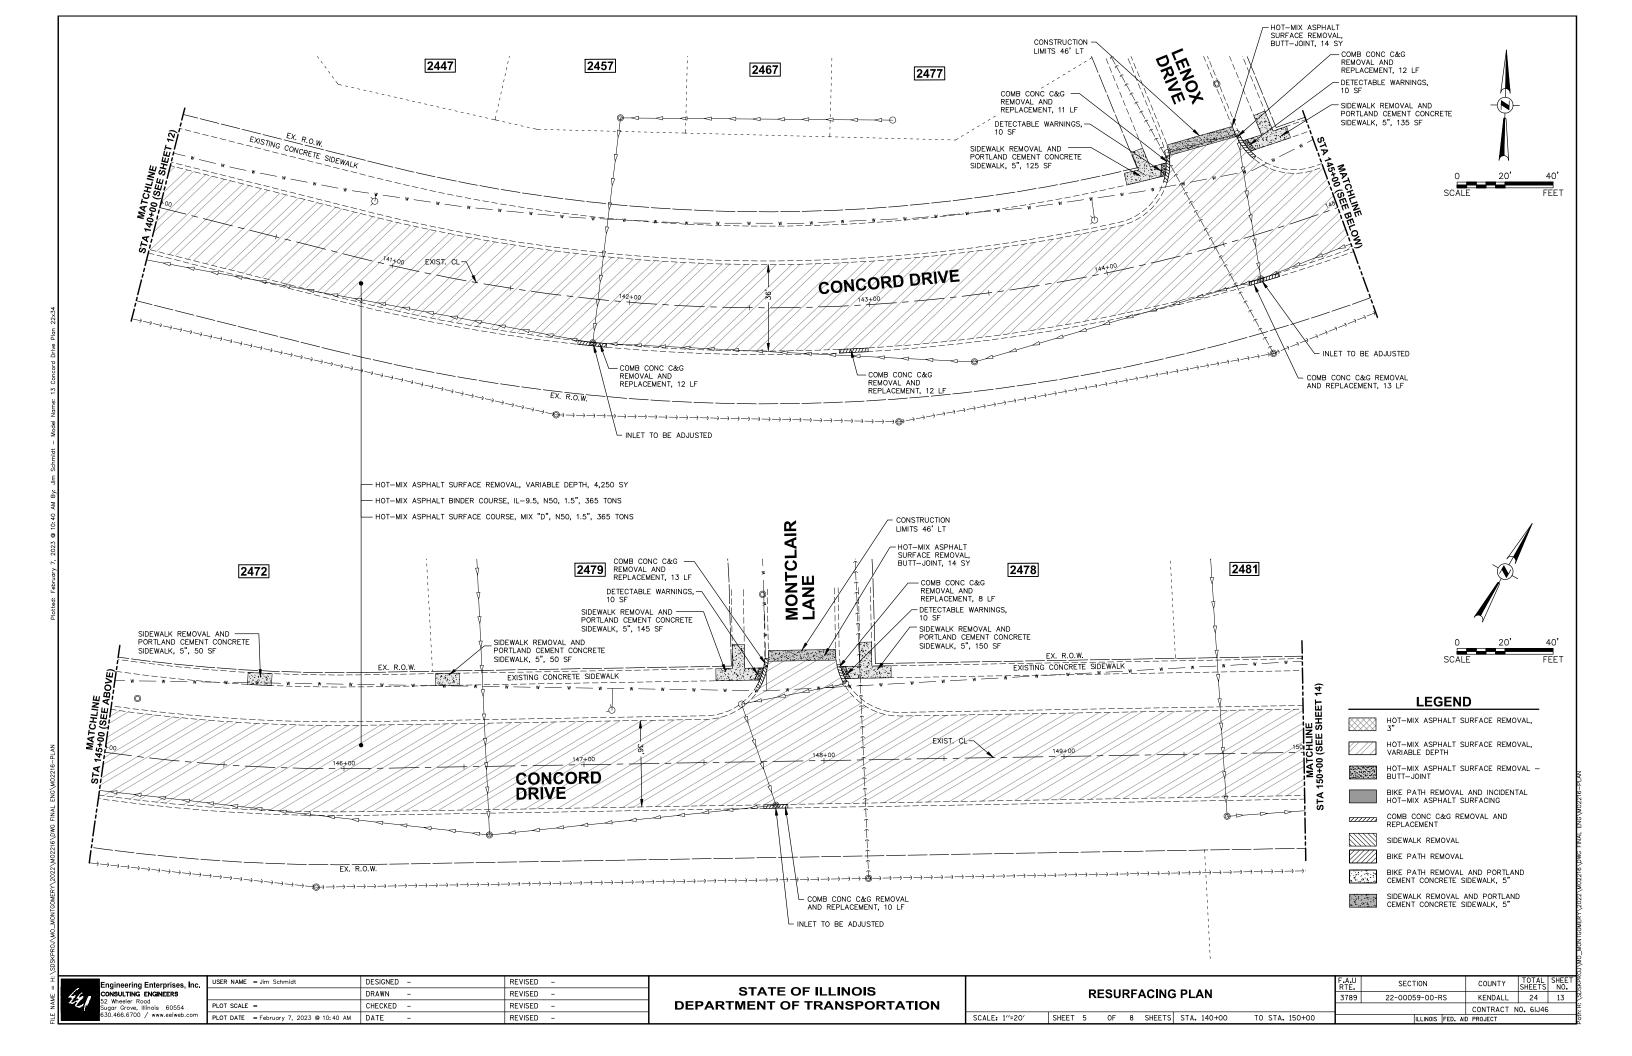

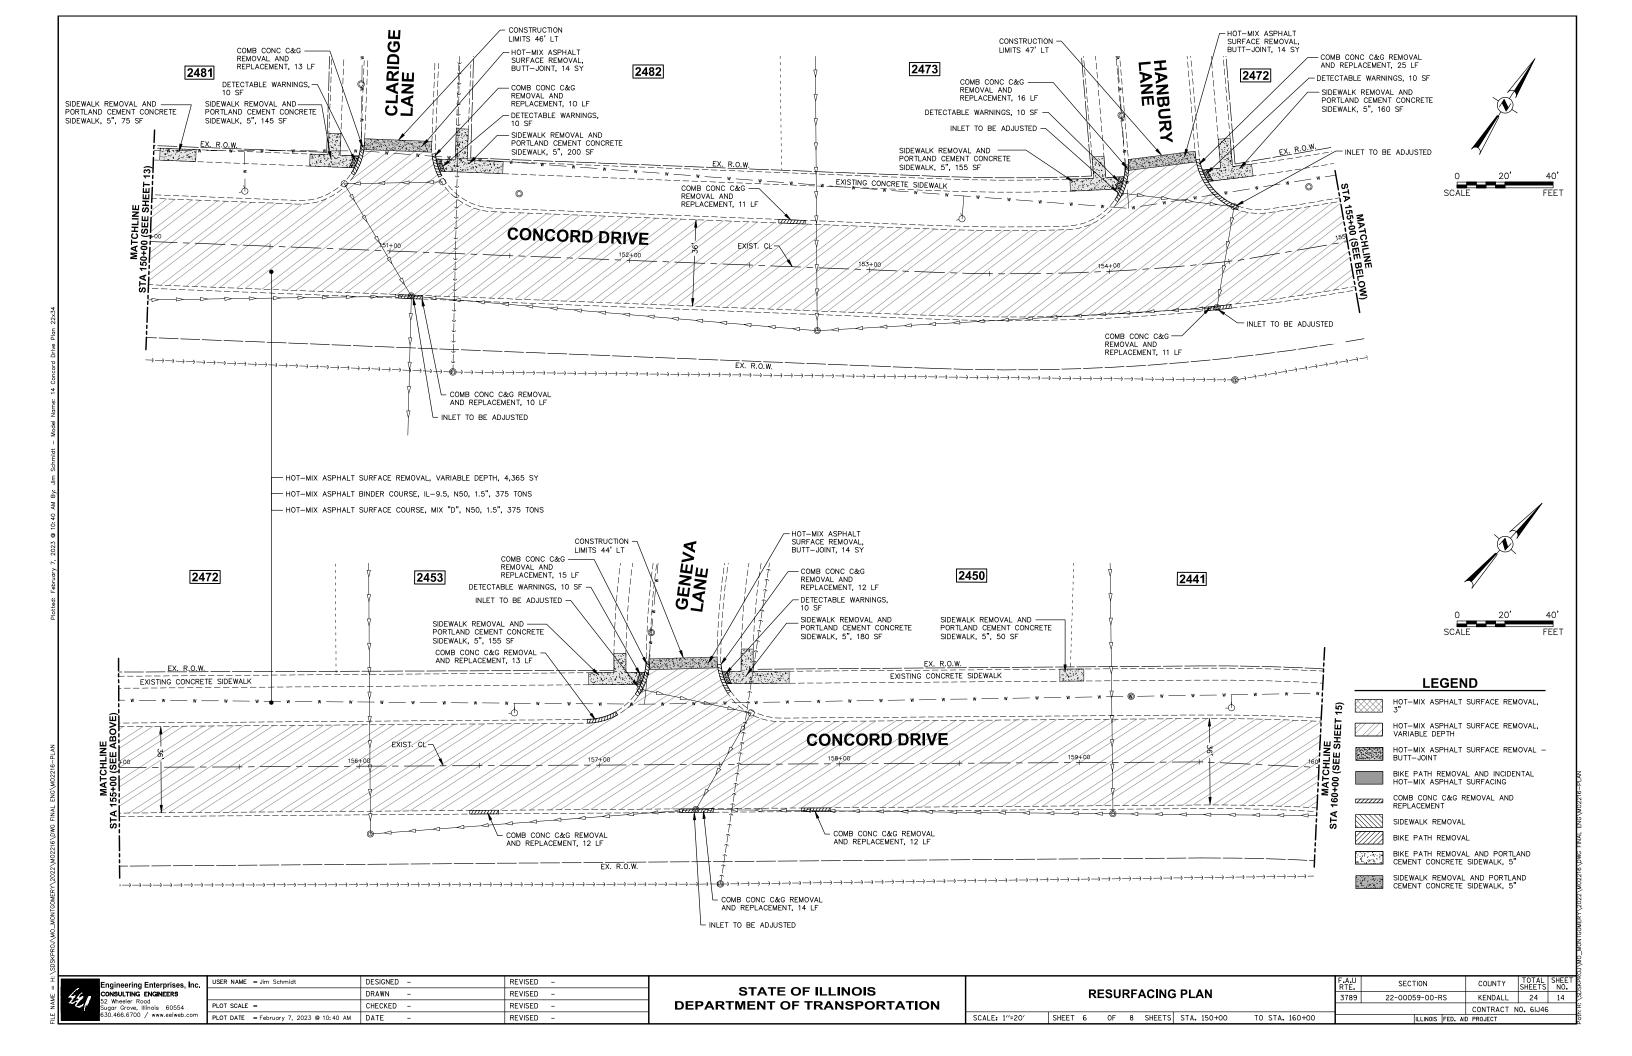

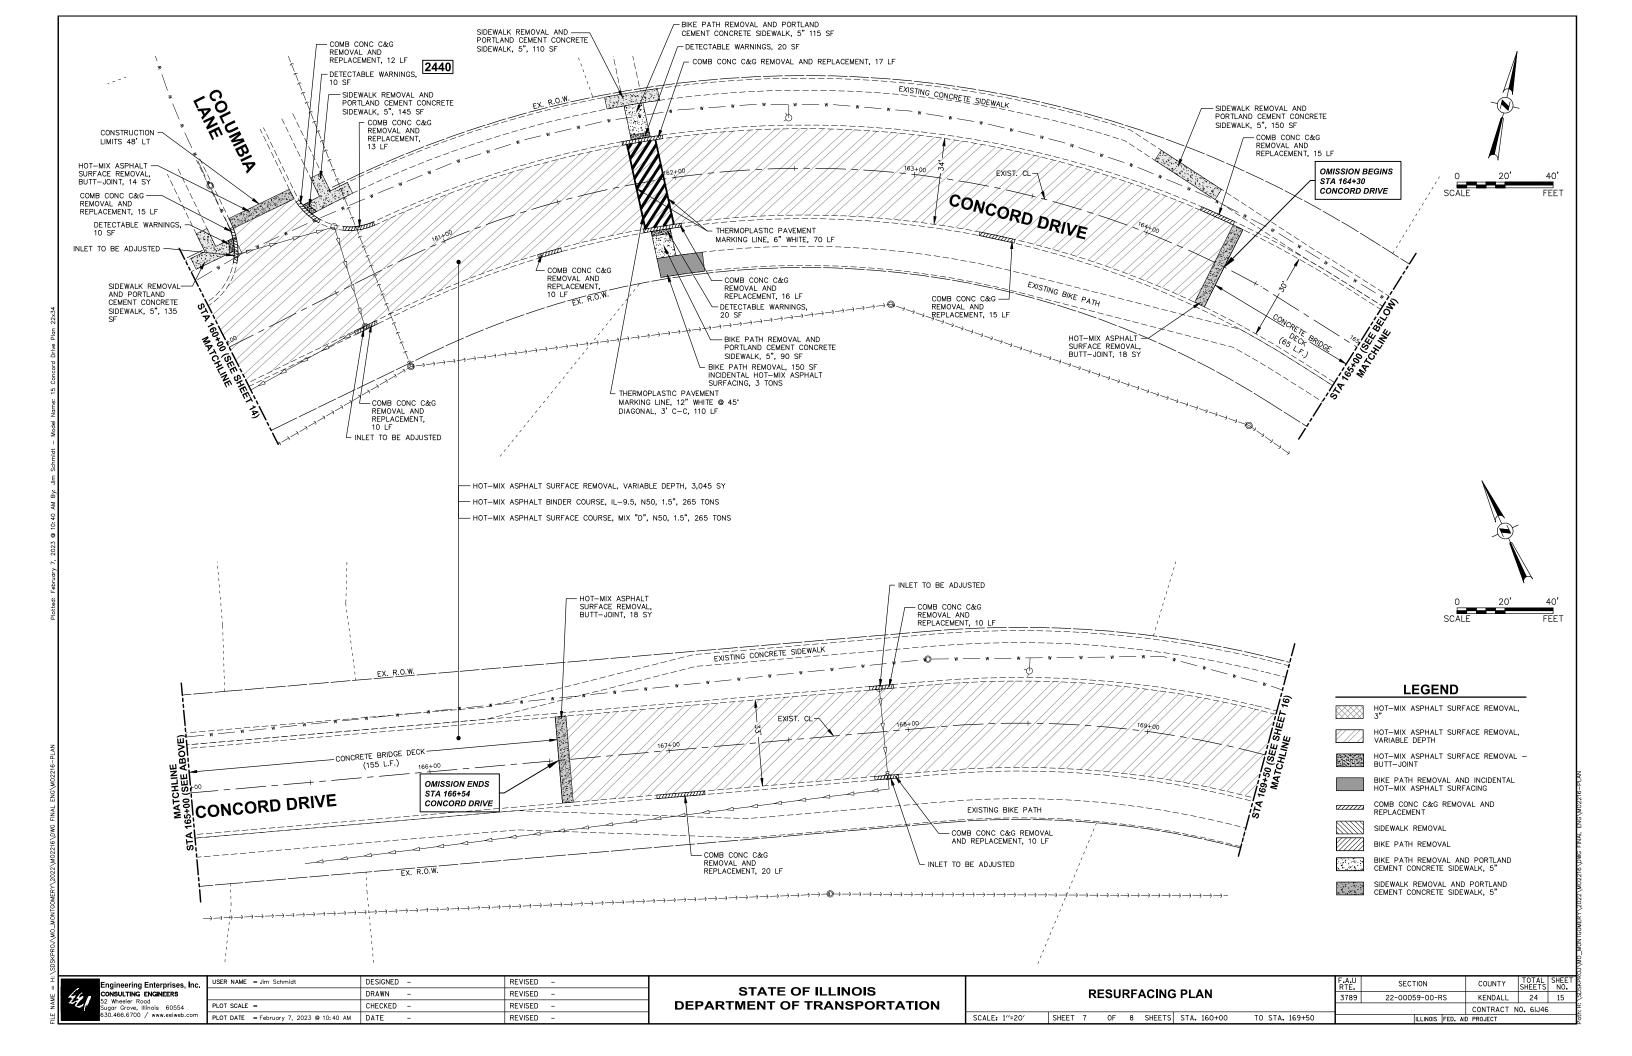

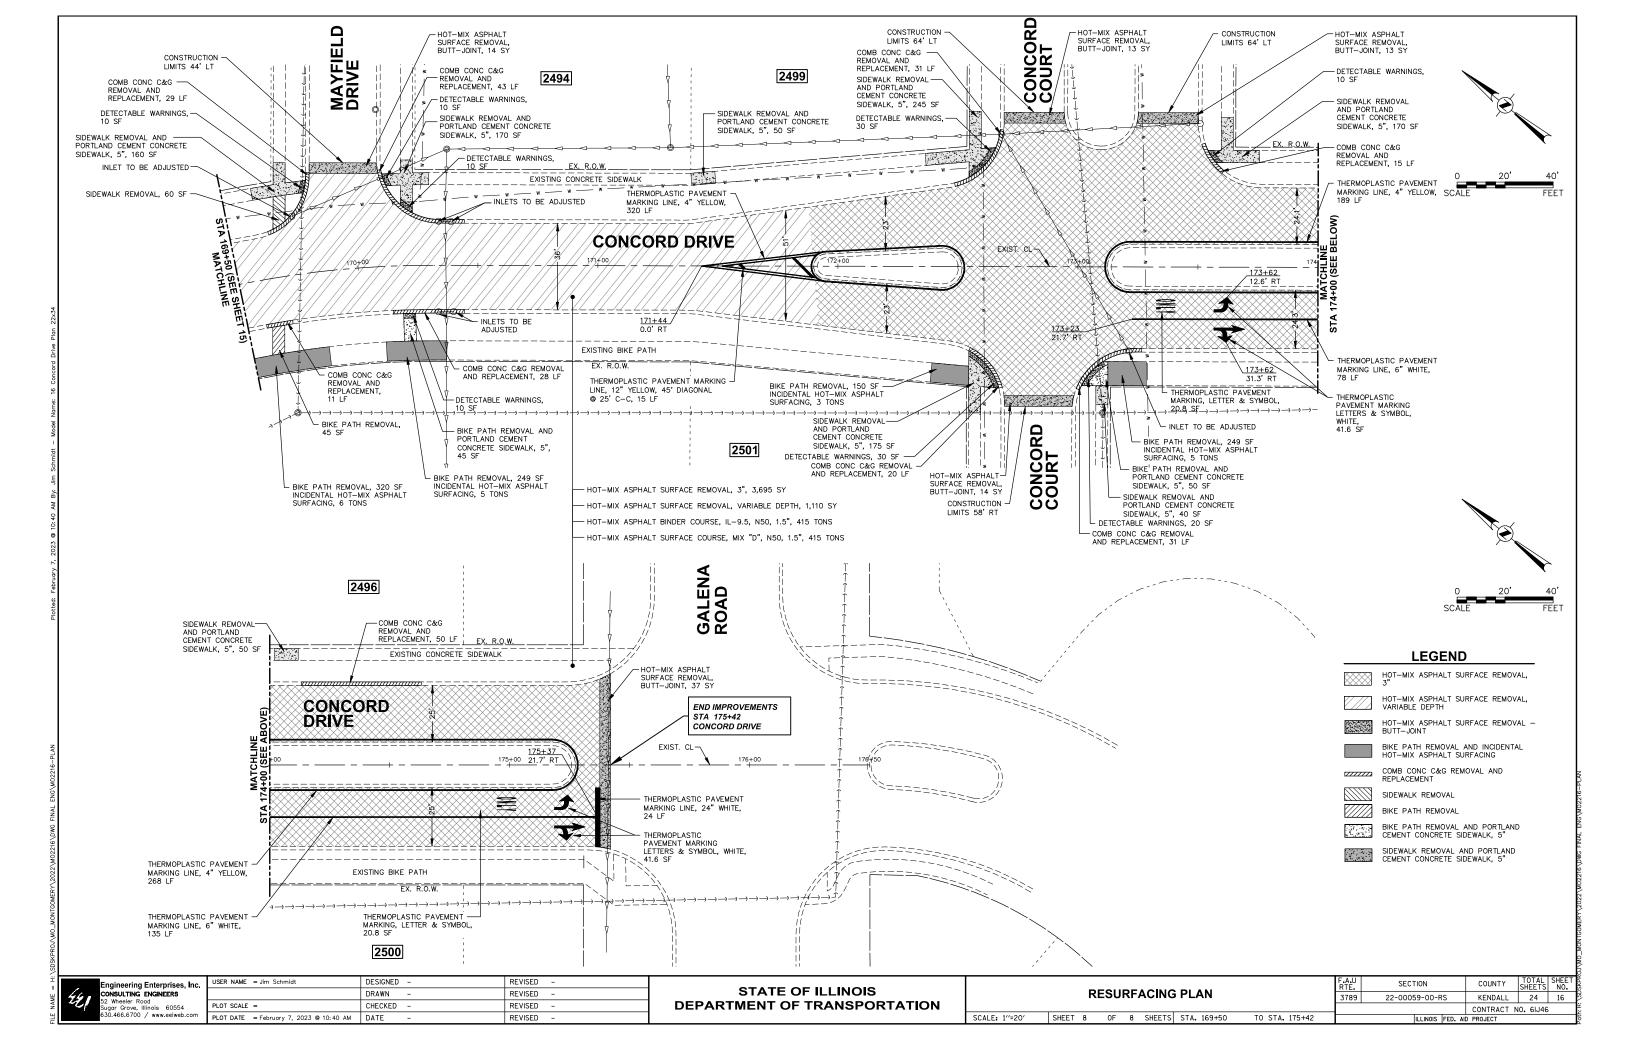

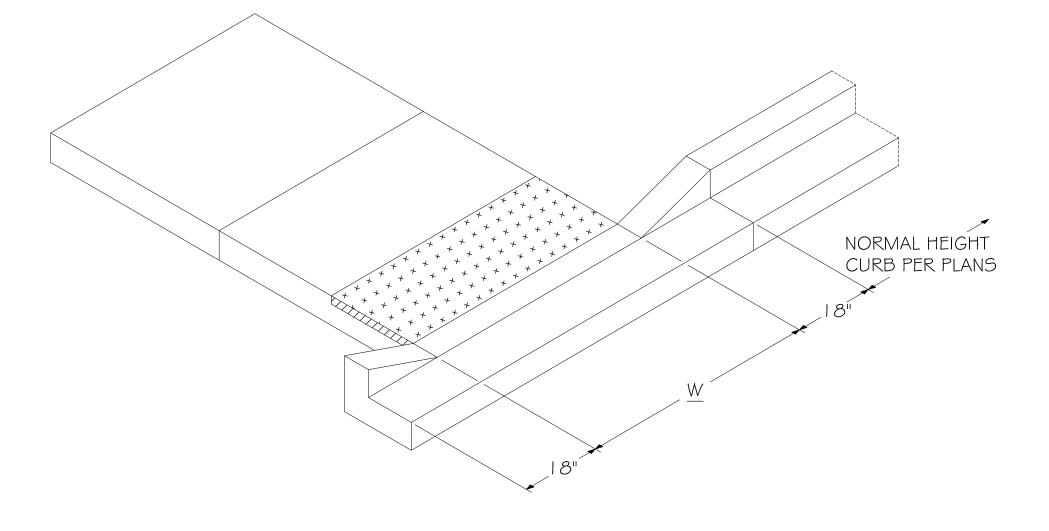

NOTES:

- I. PLACEMENT OF DETECTABLE
 WARNING TILES SHALL ADHERE TO
 LOCATIONS

 \$ SETBACKS AS SHOWN IN IDOT
 HIGHWAY STANDARDS INCLUDING
 424001, 424006, 424016,
 424021, AND 424026 FOR
 VARIOUS FIELD CONDITIONS.
 SIDEWALK RAMP WIDTH (W) AND
 LAYOUT SHALL BE ACCORDING TO
 THESE IDOT HIGHWAY STANDARDS,
 EXCEPT A SIDE CURB SHALL NOT BE
 CONSTRUCTED IN LANDSCAPED
 AREAS.
- 2. DETECTABLE WARNING TILES SHALL BE BRICK RED AND MANUFACTURED BY ADA SOLUTIONS, INC.
- 3. TILES SHALL BE INSTALLED PER MANUFACTURER INSTRUCTIONS.
- 4. THE COLORING AND STAMPING OF CONCRETE WILL NOT BE ALLOWED.

VILLAGE OF MONTGOMERY



891 KNELL ROAD MONTGOMERY, IL 60538 (630) 896-9241 CURB HEAD TAPER AT PEDESTRIAN RAMPS FOR SIDEWALK IN LANDSCAPED AREAS

SCALE: N.T.S.

DATE: 10/2015

DETAIL NUMBER
MONT. E:\DETAILS\

DRAWN: KKP

REVISED:

Engineering Enterprises, Inc.
CONSULTING ENGINEERS
52 Wheeler Road
Sugar Grove, Illinois 60554
630.466.6700 / www.eeiweb.com

USER NAME = Jim Schmidt	DESIGNED -	REVISED -
	DRAWN -	REVISED -
PLOT SCALE =	CHECKED -	REVISED -
PLOT DATE = February 7 2023 @ 10:41 AM	DATE -	REVISED -

STATE OF ILLINOIS DEPARTMENT OF TRANSPORTATION

		VILLA	GE DETAILS	
SCALE: N.T.S.	SHEET 1	0F 1	SHEETS STA.	TO STA.

METHOD OF MEASUREMENT


REFER TO SECTION 442 OF THE STANDARD SPECIFICATIONS FOR ROAD AND BRIDGE CONSTRUCTION AND THE RECURRING SPECIAL PROVISION "PATCHING WITH HOT-MIX ASPHALT OVERLAY REMOVAL."

BASIS OF PAYMENT

- 1. REFER TO SECTION 442 OF THE STANDARD SPECIFICATIONS FOR ROAD AND BRIDGE CONSTRUCTION AND THE RECURRING SPECIAL PROVISION "PATCHING WITH HOT-MIX ASPHALT OVERLAY REMOVAL."
- SAW CUT/SCORING OF EXISTING HMA OVERLAY IS INCLUDED IN THE COST OF PAVEMENT PATCHING.
- 3. SAW CUT/SCORING OF EXISTING PAVEMENT IS INCLUDED IN THE COST OF PAVEMENT PATCHING.

* SEE TYPICAL SECTIONS FOR

THICKNESS AND MATERIALS

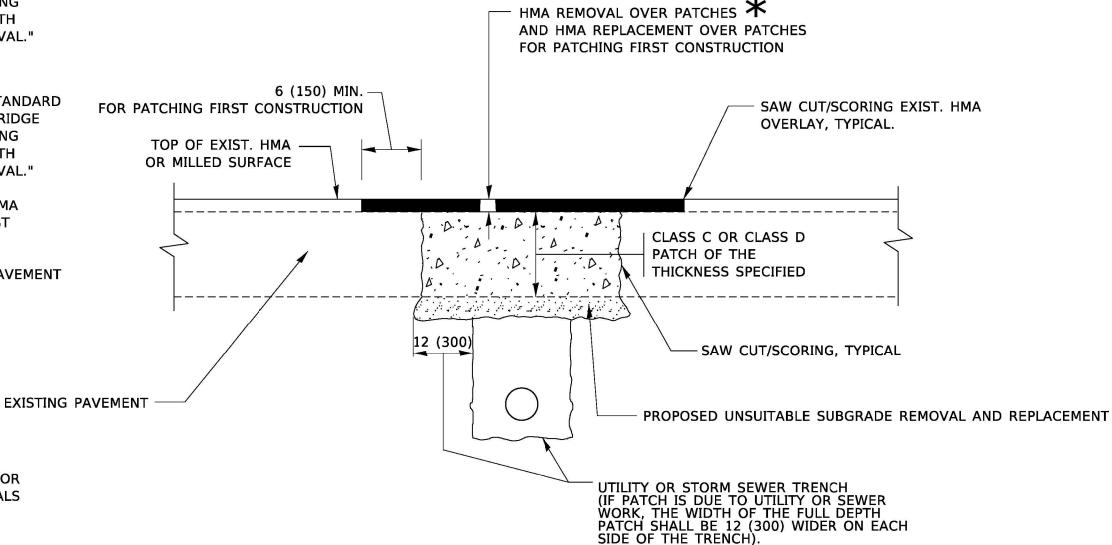

SEQUENCE OF CONSTRUCTION (PATCHING FIRST)

- 1. REMOVE THE EXISTING HMA MATERIAL OVER THE AREA TO BE PATCHED.
- 2. REMOVE AND REPLACE WITH CLASS C OR D PATCH.
- 3. REPLACE HMA MATERIAL OVER THE AREA TO BE PATCHED.

SEQUENCE OF CONSTRUCTION (MILLING FIRST)

- 1. MILL HMA FIRST IF THERE IS AT LEAST 4½ INCHES OR MORE OF HMA MATERIAL ON TOP OF THE EXISTING PAVEMENT OR IF THE PAVEMENT IS FULL DEPTH HMA. A MINIMUM OF 2 INCHES OF HMA MATERIAL SHALL BE IN PLACE AFTER MILLING.
- 2. REMOVE AND REPLACE WITH FULL DEPTH CLASS D PATCHES TO TOP OF MILLED SURFACE.

SCALE: NONE

SHEET 1


ALL DIMENSIONS ARE IN INCHES (MILLIMETERS) UNLESS OTHERWISE SHOWN.

_	Engineering Enterprises, Inc.	L
	CONSULTING ENGINEERS	L
	52 Wheeler Road Sugar Grove, Illinois 60554	Γ
	630.466.6700 / www.eeiweb.com	Г

USER NAME = Lawrence.DeManche	DESIGNED - R. SHAH	REVISED - R. BORO 01-01-0
	DRAWN -	REVISED - R. BORO 09-04-0
PLOT SCALE = 100.0000 ' / in.	CHECKED -	REVISED - K. ENG 10-27-38
PLOT DATE = 11/18/2022	DATE - 10-25-94	REVISED - K. SMITH 11-13-2

STATE	OF	ILLINOIS
DEPARTMENT	OF 1	RANSPORTATION

PAVEMENT PATCHING FOR				F.A. SECTION		COUNTY	TOTAL SHEETS	SHEET NO.
MA SURFACED PAVEMENT			3789	22-00059-00-RS	KENDALL	24	18	
				BD400-04 (BD-22)	CONTRACT	NO. 61	J46	
OF 1	SHEETS	STA	TO STA.		ILLINOIS FED. A	ID PROJECT		

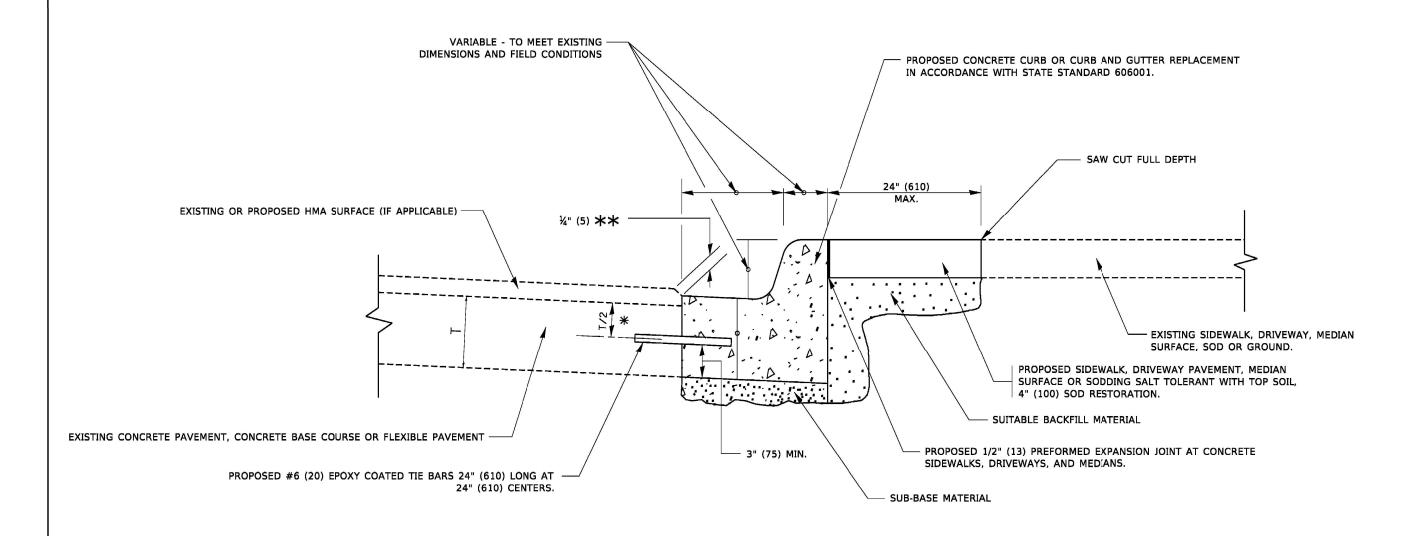


- ★ 3" (75) MINIMUM FROM TOP AND BOTTOM OF THE CONCRETE PAVEMENT OR BASE COURSE.
- ** IF THE FINAL SURFACE OF THE PAVEMENT IS CONCRETE, THE GUTTER IS TO BE FLUSH WITH THE PAVEMENT.

CURB OR CURB AND GUTTER REMOVAL AND REPLACEMENT

ALL DIMENSIONS ARE IN INCHES (MILLIMETERS) UNLESS OTHERWISE SHOWN.


Ė	Engineering Enterprises, Inc. CONSULTING ENGINEERS 52 Wheeler Road Sugar Grove, Illinois 60554 630.466.6700 / www.eelweb.com	USER NAME = footemj	DESIGNED - A. HOUSEH	REVISED -	A. ABBAS 03-21-97	
į			DRAWN -	REVISED -	M. GOMEZ 01-22-01	
4		PLOT SCALE = 50.0000 ' / In.	CHECKED -	REVISED -	R. BORO 12-15-09	
اإ		630.466.6700 / www.eeiweb.com	PLOT DATE = 7/11/2019	DATE - 03-11-94	REVISED -	K. 5MITH 07-11-19

STATE OF ILLINOIS
DEPARTMENT OF TRANSPORTATION

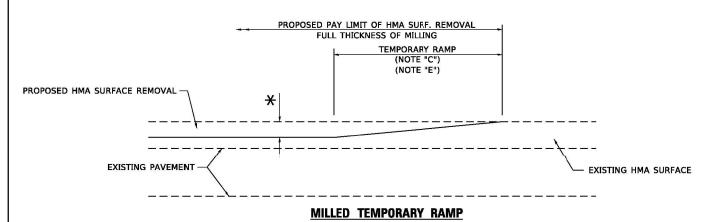

(FOR BUTT JOINT AND HMA TAPER SEE DETAIL BELOW)

OPTION 1

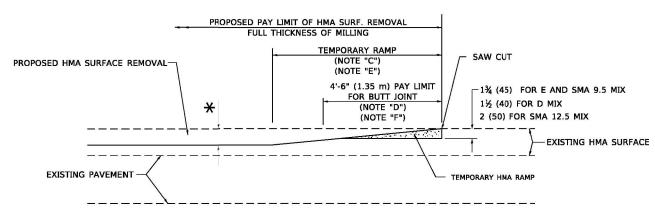


HMA CONSTRUCTED TEMPORARY RAMP


(FOR BUTT JOINT AND HMA TAPER SEE DETAIL BELOW)


OPTION 2

TYPICAL TEMPORARY RAMP

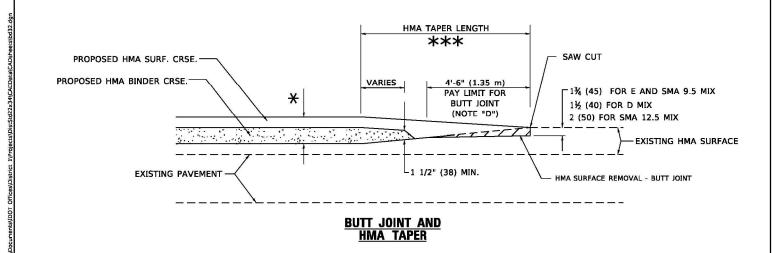

TYPICAL BUTT JOINT AND HMA TAPER FOR MILLING AND RESURFACING

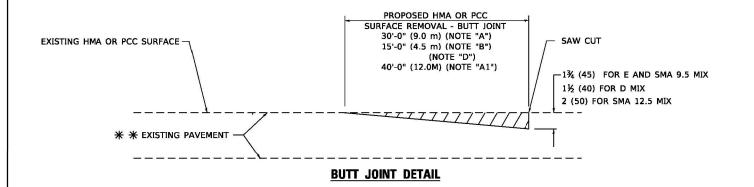

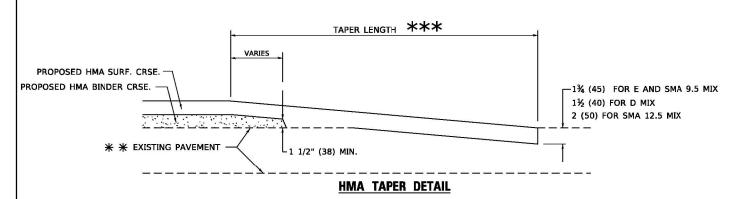

TYPICAL BUTT JOINT AND HMA TAPER FOR RESURFACING ONLY

** PC CONCRETE, HMA OR HMA RESURFACED PAVEMENT.

GENERAL NOTES

- A. MAINLINE ARTERIAL ROADWAYS AND MAJOR SIDE ROADS.
- A1. INTERSTATES
- B. MINOR SIDE ROADS.
- C. THE TEMP. RAMP SHALL BE CONSTRUCTED IMMEDIATELY UPON REMOVAL OF THE EXISTING HMA SURFACE.
- D. THE BUTT JOINT SHALL BE CONSTRUCTED IMMEDIATELY PRIOR TO PLACING THE PROPOSED HMA COURSES.
- E. TAPER THE TEMP. RAMP AT A RATE OF 3' 4" (1.02m) PER 1 INCH (25 mm) OF MILLING THICKNESS.

SHEET 1

- * SEE TYPICAL SECTIONS FOR MILLING THICKNESS.
- F. SEE ARTICLE 406.08 AND 406.14 OF THE STANDARD SPECIFICATIONS FOR "HMA AND/OR PCC SURFACE REMOVAL, BUTT JOINT".
- *** 20'-0" (6.1 m) PER 1 (25) RESURFACING (NOTE "A")

10'-0" (3.0 m) PER 1 (25) RESURFACING (NOTE "B")

BASIS OF PAYMENT

- THE BUTT JOINT WILL BE PAID FOR AT THE CONTRACT UNIT PRICE PER SQUARE YARD (SQUARE METER)
 FOR "HOT-MIX ASPHALT SURFACE REMOVAL BUTT JOINT" OR FOR "PORTLAND CEMENT CONCRETE SURFACE REMOVAL- BUTT JOINT".
- THE TEMPORARY RAMP AND SAW CUT SHALL BE INCLUDED IN THE UNIT COST FOR HMA OR PCC SURFACE REMOVAL-BUTT JOINT.

SCALE: NONE

ALL DIMENSIONS ARE IN INCHES (MILLIMETERS) UNLESS OTHERWISE SHOWN.


NSULTING ENGINEERS wneeler koaa ar Grove, Illinois 60554 .466.6700 / www.eeiweb.c USER NAME = Lawrence.DeManche DESIGNED - M. DE YONG REVISED - A. ABBAS 03-21-97 REVISED -DRAWN M. GOMEZ 04-06-01 PLOT SCALE = 100.0000 ' / in. CHECKED REVISED R. BORO 01-01-07 K. SMITH 11-18-22 PLOT DATE = 11/18/2022 DATE 06-13-90 REVISED

STATE OF ILLINOIS

BUTT JOINT AND HMA TAPER DETAILS OF 1 SHEETS STA. TO STA.

SECTION COUNTY 3789 22-00059-00-RS KENDALL 24 20 BD400-05 BD-32 CONTRACT NO. 6IJ46

DEPARTMENT OF TRANSPORTATION

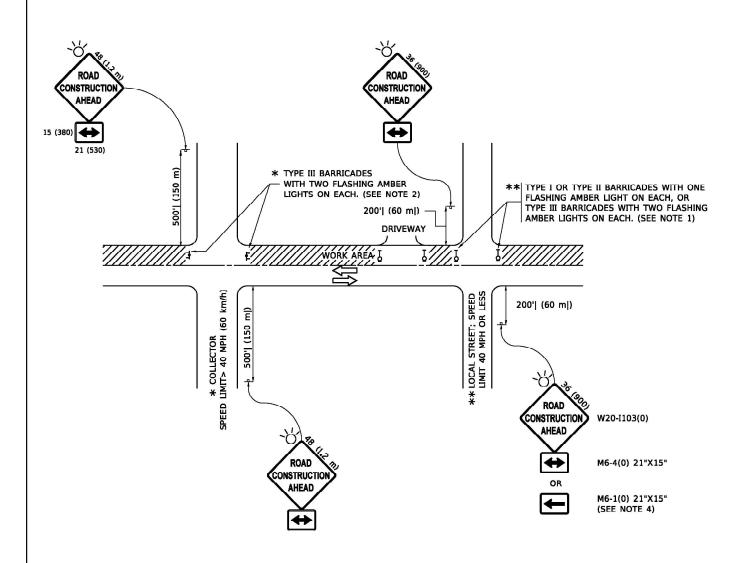

NOTES:

- 1. SIDE ROAD WITH A SPEED LIMIT OF 40 MPH (60 km/h) OR LESS AS SHOWN ON THE DRAWING AND AS DIRECTED BY THE ENGINEER:
- a) ONE "ROAD CONSTRUCTION AHEAD" SIGN 36 x 36 (900x900) WITH A FLASHER MOUNTED ON IT APPROXIMATELY 200' (60 m) IN ADVANCE OF THE MAIN ROUTE.
- b) THE CLOSED PORTION OF THE MAIN ROUTE SHALL BE PROTECTED BY BLOCKING WITH TYPE I, TYPE II OR TYPE III BARRICADES, 1/3 OF THE CROSS SECTION OF THE CLOSED PORTION.
- 2. SIDE ROAD WITH A SPEED LIMIT GREATER THAN 40 MPH (60 km/h) AS SHOWN ON THE DRAWING AND AS DIRECTED BY THE ENGINEER:
- a) ONE "ROAD CONSTRUCTION AHEAD" SIGN 48 x 48 (1.2 m x 1.2 m) WITH A FLASHER MOUNTED ON IT APPROXIMATELY 500' (150 m) IN ADVANCE OF THE MAIN ROUTE.
- THE CLOSED PORTION OF THE MAIN ROUTE SHALL BE PROTECTED BY
 b) BLOCKING WITH TYPE III BARRICADES, 1/2 OF THE CROSS SECTION
 OF THE CLOSED PORTION.
- 3. CONES MAY BE SUBSTITUTED FOR BARRICADES OR DRUMS AT HALF THE SPACING DURING DAY OPERATIONS. CONES SHALL BE A MINIMUM OF 28 (710)
 IN HEIGHT
- WHEN THE SIDE ROAD LIES BETWEEN THE BEGINNING OF THE MAINLINE
 4. SIGNING AND THE WORK ZONE, A SINGLE HEADED ARROW (M6-1) SHALL
 BE USED IN LIEU OF THE DOUBLE HEADED ARROW (M6-4).

- WHEN WORK IS BEING PERFORMED ON A SIDE ROAD OR DRIVEWAY, FOLLOW THE APPLICABLE STANDARD(S). THE DIRECTIONAL ARROW (M6-1 OR M6-4) SHALL BE COVERED OR REMOVED WHEN NO LONGER CONSISTENT WITH THE TRAFFIC CONTROL SET-UP.
- 6. ADVANCE WARNING SIGNS ARE TO BE OMITTED ON DRIVEWAYS UNLESS OTHERWISE SPECIFIED IN THE PLANS OR BY THE ENGINEER
- THE TRAFFIC CONTROL AND PROTECTION FOR SIDE ROADS, INTERSECTIONS, AND DRIVEWAYS SHALL BE INCLUDED IN THE COST OF SPECIFIED TRAFFIC CONTROL STANDARDS OR ITEMS.


All dimensions are in inches (millimeters) unless otherwise shown.

	Engineering Enterprises, Inc. CONSULTING ENGINEERS 52 Wheeler Road Sugar Grove, Illinois 60554 630.466.6700 / www.eeiweb.com	USER NAME = footemj	DESIGNED - L.H.A.	REVISED - A. HOUSEH 10-15-96
13			DRAWN -	REVISED - T. RAMMACHER 01-06-00
1		PLOT SCALE = 50.0000 ' / in.	CHECKED -	REVISED - A. SCHUETZE 07-01-13
		PLOT DATE - 3/4/2010	DATE 06-80	DEVISED A. SCHUFTZF 09-15-16

STATI	E OI	F ILLINOIS
DEPARTMENT	0F	TRANSPORTATION


	SI							CTION FOR DRIVEWAYS
Γ	SCALE: NONE	SHEET	1	OF	1	SHEETS	STA.	TO STA.

	F.A. RTE.	SECTIO	COUNTY	TOTAL SHEETS	SHEET NO.	
	3789	22-00059	-00-R	KENDALL	24	2:
		TC-10	CONTRACT	NO . 6	J46	
ı		l n	D PROJECT			

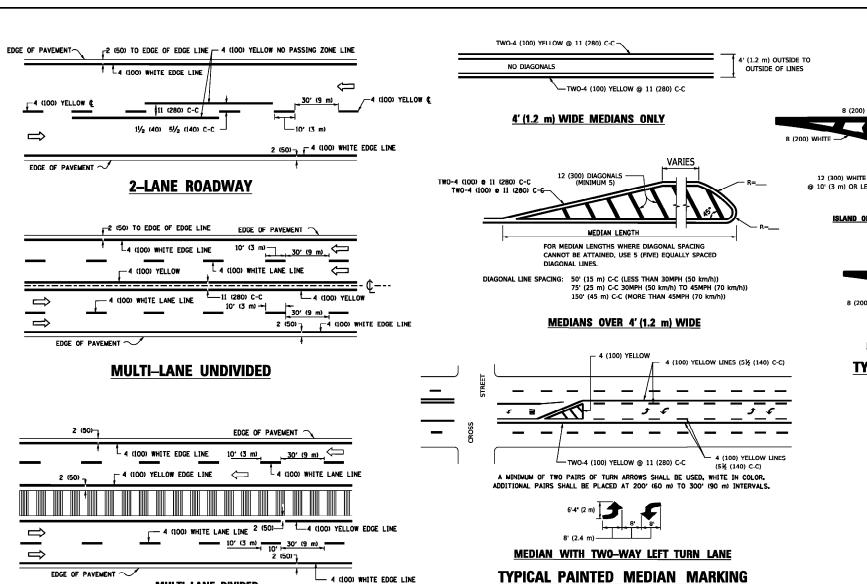

TYPICAL LANE AND EDGE LINE MARKING


MULTI-LANE DIVIDED WITH MEDIAN

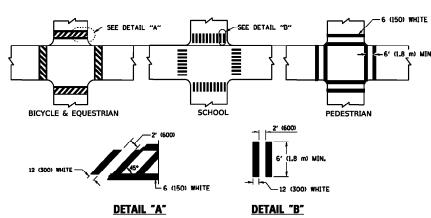


* MARKINGS SHALL BE INSTALLED PARALLEL TO THE CENTERLINE OF THE ROAD WHICH IT CROSSES


TYPICAL CROSSWALK MARKING


TYPICAL TURN LANE MARKING

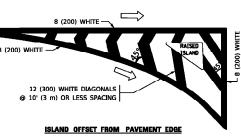



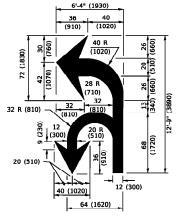

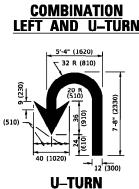

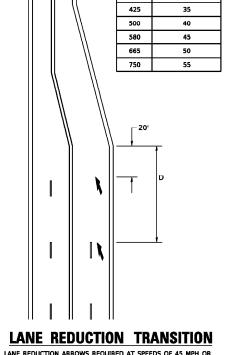

D(FT) SPEED LIMIT

* LANE REDUCTION ARROWS REQUIRED AT SPEEDS OF 45 MPH OR GREATER OR WHEN SPECIFIED IN PLANS.

TYPE OF MARKING	WIDTH OF LINE	PATTERN	COLOR	SPACING / REMARKS
CENTERLINE ON 2 LANE PAVEMENT	4 (100)	SKIP-DASH	YELLOW	10' (3 m) LINE WITH 30' (9 m) SPACE
CENTERLINE ON MULTI-LANE UNDIVIDED PAVEMENT	2 @ 4 (100)	SOLID	YELLOW	11 (280) C-C
NO PASSING ZONE LINES: FOR ONE DIRECTION FOR BOTH DIRECTIONS	4 (100) 2 @ 4 (100)	SOLID SOLID	YELLOW YELLOW	5½ (140) C-C FROM SKIP-DASH CENTERLINE 11 (280) C-C OMIT SKIP-DASH CENTERLINE BETWEEN
LANE LINES	4 (100) 5 (125) ON FREEWAYS	SKIP-DASH SKIP-DASH	WHITE WHITE	10' (3 m) LINE WITH 30' (9 m) SPACE
DOTTED LINES (EXTENSIONS OF CENTER, LANE OR TURN LANE MARKINGS)	SAME AS LINE BEING EXTENDED	SKIP-DASH	SAME AS LINE BEING EXTENDED	2' (600) LINE WITH 6' (1.8 m) SPACE
edge lines	4 (100)	SOLID	YELLOW-LEFT WHITE-RIGHT	OUTLINE MEDIANS IN YELLOW
TURN LANE MARKINGS	6 (150) LINE; FULL SIZE LETTERS & SYMBOLS (8' (2.4m))	SOLID	wніте	SEE TYPICAL TURN LANE MARKING DETAIL
TWO WAY LEFT TURN MARKING	2 @ 4 (100) EACH DIRECTION 8' (2.4m) LEFT ARROW	SKIP-DASH AND SOLID IN PAIRS	YELLOW	10' (3 m) LINE WITH 30' (9 m) SPACE FOR SKIP-DASH; 5½ (140) C-C BETWEEN SOLID LINE AND SKIP-DASH LINE SEE TYPICAL TWO-WAY LEFT TURN MARKING DETAIL
CROSSWALK LINES (PEDESTRIAN) A. DIAGONALS (BIKE & EQUESTRIAN) B. LONGITUDINAL BARS (SCHOOL)	2 @ 6 (150) 12 (300) @ 45° 12 (300) @ 90°	SOLID SOLID SOLID	WHITE WHITE WHITE	NOT LESS THAN 6' (1.8 m) APART 2' (600) APART 2' (600) APART SEE TYPICAL CROSSWALK MARKING DETAILS.
STOP LINES	24 (600)	SOLID	WHITE	PLACE 4' (1.2 m) IN ADVANCE OF AND PARALLEL TO CROSSWALK, IF PRESENT: OTHERWISE, PLACE AT DESIRED STOPPHING POINT. PARALLEL TO CROSSROAD CENTERLINE, WHERE POSSIBLE
PAINTED MEDIANS	2 @ 4 (100) WITH 12 (300) DIAGONALS @ 45° NO DIAGONALS USED FOR 4' (1.2 m) WIDE MEDIANS	SOLID	YELLOW: TWO WAY TRAFFIC WHITE: ONE WAY TRAFFIC	11 (280) C-C FOR THE DOUBLE LINE SEE TYPICAL PAINTED MEDIAN MARKING.
GORE MARKING AND CHANNELIZING LINES	8 (200) WITH 12 (300) DIAGONALS @ 45°	SOLID	WHITE	DIAGONALS: 15' (4.5 m) C-C (LESS THAN 30MPH (50 km/h)) 20' (6 m) C-C 30MPH (50 km/h) TO 45MPH (70 km/h)) 30' (9 m) C-C (OVER 45MPH (70 km/h))
RAILROAD CROSSING	24 (600) TRANSVERSE LINES; "RR" IS 6' (1.8 m) LETTERS; 16 (400) LINE FOR "X"	SOLID	WHITE	SEE STATE STANDARD 780001 AREA OF: "R"=3.6 SQ. FT. (0.33 m FEACH "X"=54.0 SQ. FT. (5.0 m P
SHOULDER DIAGONALS (REQUIRED FOR SHOULDERS > 8')	12 (300) @ 45°	SOLID	WHITE - RIGHT YELLOW - LEFT	50' (15 m) C-C (LESS THAN 30MPH (50 km/h)) 75' (25 m) C-C (30 MPH (50 km/h) TO 45MPH (70 km/h)) 150' (45 m) C-C (OVER 45MPH (70 km/h))
U TURN ARROW	SEE DETAIL	SOLID	WHITE	16.3 SF
2 ARROW COMBINATION LEFT AND U TURN	SEE DETAIL	SOLID	WHITE	30.4 SF

FOR FURTHER DETAILS ON PAVEMENT MARKING REFER TO STANDARD SPECIFICATIONS FOR ROAD AND BRIDGE CONSTRUCTION AND STATE STANDARD 780001.

SCALE: NONE

	Engineering Enterprises, Inc.	USER NAME = footemj	DESIGNED - EVERS	REVISED -	C. JUCIUS 09-09-09
44.	CONSULTING ENGINEERS 52 Wheeler Road Sugar Grove, Illinois 60554		DRAWN -	REVISED -	C. JUCIUS 07-01-13
4		PLOT SCALE = 50.0000 ' / in.	CHECKED -	REVISED -	C. JUCIUS 12-21-15
The same of the sa	630.466.6700 / www.eeiweb.com	PLOT DATE = 3/4/2019	DATE - 03-19-90	REVISED -	C. JUCIUS 04-12-16

STATE OF ILLINOIS **DEPARTMENT OF TRANSPORTATION**

- 25' (8 m) TO 49' (15 m)

OVER 200' (60 m)


─ 50' (15 m) TO 200' (60 m) 🗶 16. (2 m) 6 (120) MHITE

16' (5 m) 10' (3 m) 6 (150) WHITE

* TURN LANES IN EXCESS OF 400' (120 m) IN LENGTH MAY HAVE AN ADDITIONAL SET OF ARROW - *ONLY* INSTALLED MIDWAY BETWEEN THE OTHER TWO SETS OF


TYPICAL LEFT (OR RIGHT) TURN LANE

	DISTRICT ONE		F.A. RTE.	SECTION	COUNTY	TOTAL SHEETS	SHEET NO.	
TYPICAL PAVEMENT MARKINGS			INCE	3789	22-00059-00-RS	KENDALL	24	22
	ITPICAL PAVEMENT MARKINGS				TC-13	CONTRACT	NO. 61	J46
	SHEET 1 OF 2 SHEL	FTS STA	TO STA		TILINOIC EED AL	D DDOLECT		

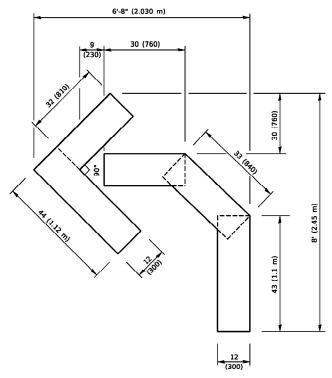


QUANTITY

4 (100) LINE = 45.5 ft. (13.9 m) 15.2 sq. ft. (1.41 sq. m)

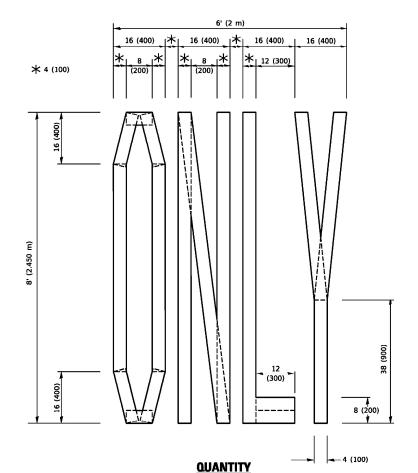

4 (100) LINE = 64.1 ft. (19.5 m) 21.4 sq. ft. (1.99 sq. m)

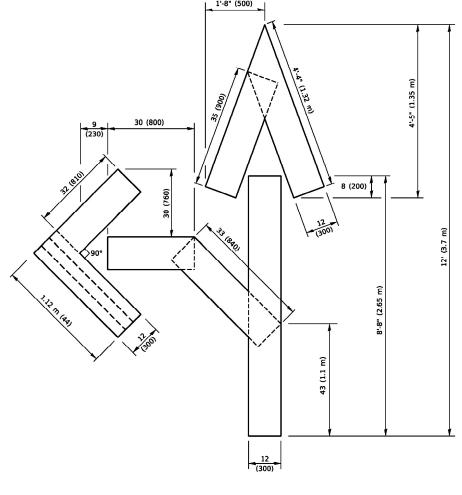


QUANTITY

4 (100) LINE = 82.5 ft. (25.1 m) 27.5 sq. ft. (2.53 sq. m)

NOTE:

ALL QUANTITIES OF PLACEMENT ARE REPRESENTED IN LINEAR FEET OF 4" LINES TO MATCH THE 4" TEMPORARY TAPE PAY ITEM AND REPRESENTS THE TOTAL QUANTITY OF 4" TAPE REQUIRED.

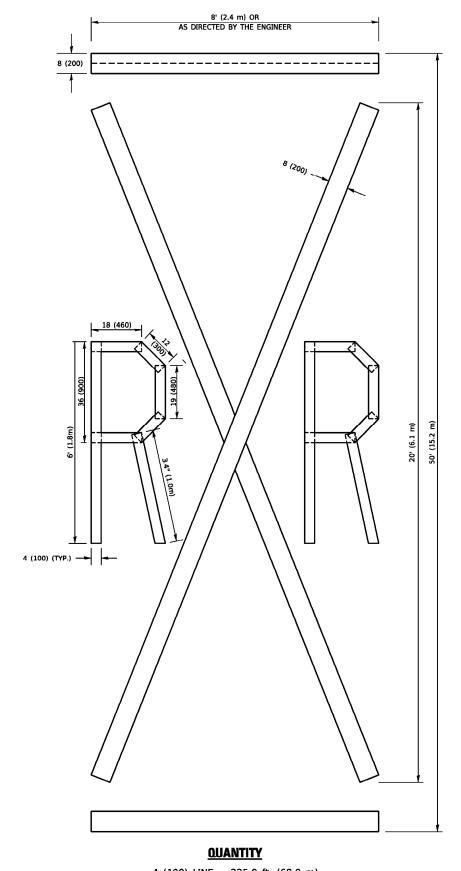

4 (100) LINE = 225.9 ft. (68.9 m) 75.3 sq. ft. (6.99 sq. m)

All dimensions are in inches (millimeters) unless otherwise shown.


	Engineering Enterprises, Inc.	USER NAME = footemj	DESIGNED -	REVISED	- T. RAMMACHER 03-02-98
64.	CONSULTING ENGINEERS 52 Wheeler Road Sugar Grove, Illinois 60554		DRAWN -	REVISED	- E. GOMEZ 08-28-00
U		PLOT SCALE = 50.0068 ' / in.	CHECKED -	REVISED	- E. GOMEZ 08-28-00
	630.466.6700 / www.eeiweb.com	PLOT DATE = 3/4/2019	DATE - 09-18-94	REVISED	- A. SCHUETZE 09-15-16

STATE OF ILLINOIS
DEPARTMENT OF TRANSPORTATION

	SHORT	TERM	PAV	EMENT	ΓΙ	MARKING	LETTERS	AND	SYMBOLS	
CALE:	NONE	SHEE	T 1	OF	1	SHEETS	STA.		TO STA.	

F.A. RTE.	SECTION	COUNTY	TOTAL SHEETS	SHE		
3789	22-00059-00-RS	KENDALL	24	2		
	TC-16	CONTRACT NO. 61.146				

ILLINOIS FED. AID PROJECT

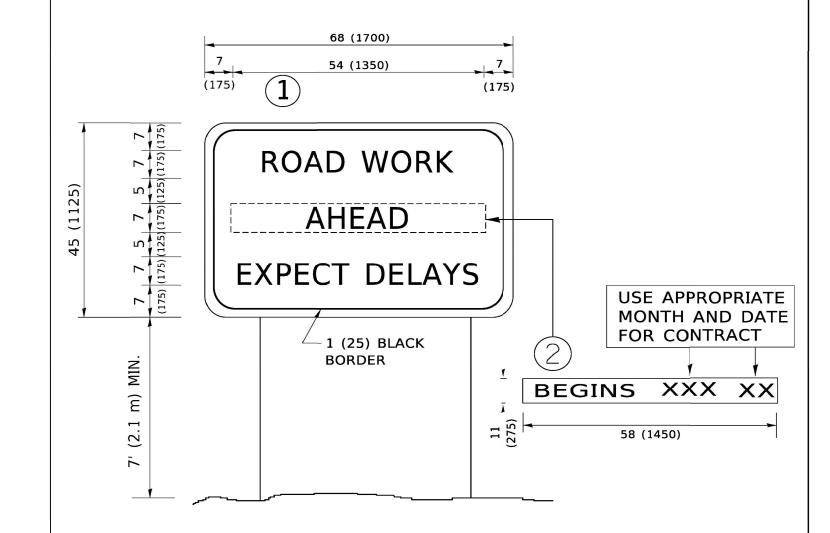

NOTES:

- 1. USE BLACK LETTERING ON ORANGE BACKGROUND.
- 2. ERECT SIGNS IN ADVANCE OF THE LOCATION FOR THE "ROAD CONSTRUCTION AHEAD" SIGN AT LOCATIONS AS DIRECTED BY THE ENGINEER.
- 3. ERECT SIGN 1 WITH INSTALLED PANEL 2 ONE WEEK PRIOR TO THE START OF CONSTRUCTION.
- 4. REMOVE PANEL 2 SOON AFTER THE START OF CONSTRUCTION.
- 5. SEE SPECIAL PROVISION FOR "TEMPORARY INFORMATION SIGNING" FOR ADDITIONAL INFORMATION.

SHEET

- 6. ONE SIGN ASSEMBLY EQUALS 25.70 SQ. FT. (2.3 SQ. M.)
- 7. SHALL BE PAID FOR AS TEMPORARY INFORMATION SIGNING.

SCALE: NONE

ALL DIMENSIONS ARE IN INCHES (MILLIMETERS) UNLESS OTHERWISE SHOWN.

Š	Engineering Enterprises, Inc.	USER NAME = footemj	DESIGNED -	REVISED	- R. MIRS 09-15-97
CONSULTING I	CONSULTING ENGINEERS		DRAWN -	REVISED	- R. MIRS 12-11-97
		PLOT SCALE = 50.0000 ' / in.	CHECKED -	REVISED	-T. RAMMACHER 02-02-
	630.466.6700 / www.eeiweb.com	PLOT DATE = 3/4/2019	DATE -	REVISED	- C IUCIUS 01-31-07

STATE OF ILLINOIS						
DEPARTMENT	0F	TRANSPORTATION				

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