04-28-2023 LETTING ITEM 080

STATE OF ILLINOIS **DEPARTMENT OF TRANSPORTATION**

FOR INDEX OF SHEETS, SEE SHEET NO. 2

71ST STREET DESIGN DESIGNATION MINOR COLLECTOR

TRAFFIC DATA 71ST STREET 2020 ADT = 1,200


POSTED SPEED LIMIT 71ST STREET = 25 MPH

DESIGN SPEED LIMIT 71ST STREET = 30 MPH

PROPOSED PLANS FOR **FEDERAL AID HIGHWAY**

FAU ROUTE 1533 (71ST STREET) W. VILLAGE LIMIT TO FAU 0311 (DUNHAM ROAD) **RESURFACING**


> **SECTION No.: 21-00116-00-RS** PROJECT No: SG9I(319) **VILLAGE OF DOWNERS GROVE DuPAGE COUNTY** C-91-030-22

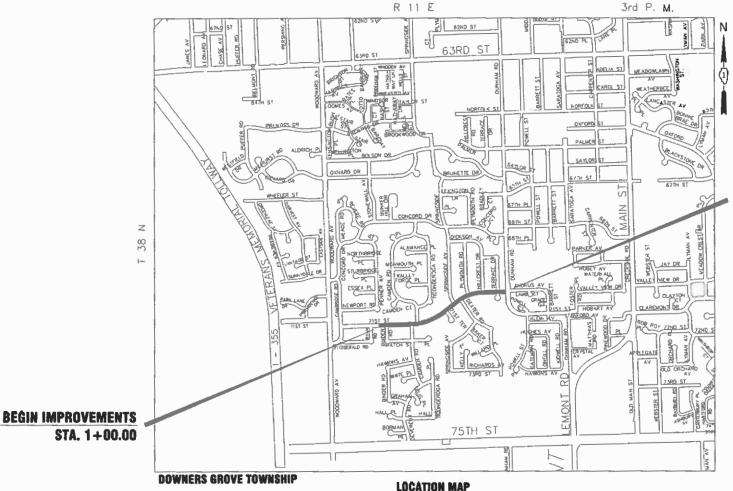

GROSS LENGTH = 2,797.50 FT = 0.530 MILE

NET LENGTH = 2,797.50 FT = 0.530 MILE

END IMPROVEMENTS STA, 28+97.50

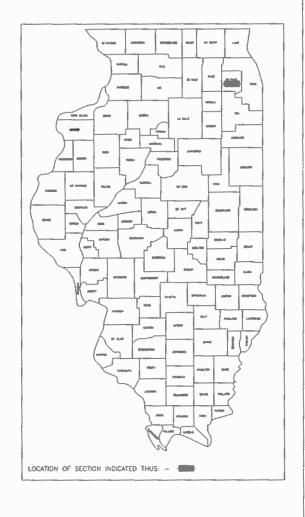

February 2023 5588WRY 21 2023

PRINTED BY THE AUTHORITY OF THE STATE OF ILLINOIS

FULL SIZE PLANS HAVE BEEN PREPARED USING STANDARD ENGINEERING SCALES. REDUCED SIZE PLANS WILL NOT CONFORM TO STANDARD SCALES. IN MAKING MEASUREMENTS ON REDUCED PLANS, THE ABOVE SCALES MAY BE USED.

JOINT UTILITY LOCATION INFORMATION FOR EXCAVATION OR 811

CONTRACT NO. 61J37

INDEX OF SHEETS

- 1 COVER SHEET
- 2 INDEX OF SHEETS, HIGHWAY STANDARDS, LIST OF DETAILS, AND GENERAL NOTES
- 6 SUMMARY OF QUANTITIES
- 7 EXISTING TYPICAL SECTIONS
- 8 PROPOSED TYPICAL SECTIONS
- 9 PLAN SHEET (STA, 0+00 TO STA, 11+00)
- 10 PLAN SHEET (STA. 11+00 TO STA. 22+00)
- 11 PLAN SHEET (STA. 22+00 TO STA. 29+49)
- 12 14 CURB RAMP DETAILS
- 15 16 VILLAGE DETAILS
- 17 23 DISTRICT 1 DETAILS

HIGHWAY STANDARDS

STANDARD SYMBOLS ABBREVIATIONS AND PATTERNS 000001-08 280001-07 TEMPORARY FROSION CONTROL SYSTEMS PERPENDICULAR CURB RAMPS FOR SIDEWALKS 424001-11 424011-04 CORNER PARALLEL CURB RAMPS FOR SIDEWALKS 424016-05 MID-BLOCK CURB RAMPS FOR SIDEWALKS 442201-03 CLASS C & D PATCHES 606001-08 CONCRETE CURB TYPE B & COMBINATION CONCRETE CURB AND GUTTER 701006-05 OFF-RD OPERATIONS, 2L, 2W, 15' TO 24" FROM PAVEMENT EDGE 701301-04 LANE CLOSURE, 2L, 2W, SHORT TIME OPERATIONS

701311-03 LANE CLOSURE, 2L, 2W MOVING OPERATIONS - DAY ONLY 701501-06 URBAN LANE CLOSURE, 2L, 2W, UNDIVIDED 701701-10 URBAN LANE CLOSURE, MULTILANE INTERSECTION

701801-06 SIDEWALK, CORNER OR CROSSWALK CLOSURE

701901-08 TRAFFIC CONTROL DEVICES

LIST OF DETAILS

BD-08 DETAILS FOR FRAMES AND LIDS ADJUSTMENT WITH MILLING

BD-22 PAVEMENT PATCHING FOR HMA SURFACED STREETS

BD-32 BUTT JOINT AND HMA TAPER DETAILS

TC-10 TRAFFIC CONTROL AND PROTECTION FOR SIDE ROADS, INTERSECTIONS AND DRIVEWAYS

TC-13 DISTRICT 1 TYPICAL PAVEMENT MARKINGS DETAIL

TC-16 PAVEMENT MARKING LETTERS & SYMBOLS FOR TRAFFIC STAGING

TC-22 ARTERIAL ROAD INFORMATION SIGN

FILE NAME =

GENERAL NOTES

- 1. ALL REFERENCES TO THE 'VILLAGE' IN THESE GENERAL NOTES SHALL BE INTERPRETED TO MEAN THE VILLAGE OF DOWNERS GROVE
- THOSE EXISTING TRAFFIC SIGNS WHICH ARE SO DESIGNATED BY THE ENGINEER SHALL BE REMOVED, STORED AND SUBSEQUENTLY RELOCATED BY THE CONTRACTOR IN ACCORDANCE WITH ARTICLE 107.25. ANY SIGNS WHICH ARE DAMAGED BY THE CONTRACTOR AS DETERMINED BY THE ENGINEER SHALL BE REPLACED IN KIND BY THE CONTRACTOR
- ALL TRAFFIC CONTROL AND OTHER ADVISORY SIGNS NEEDED FOR CONSTRUCTION ARE TO BE FURNISHED BY THE CONTRACTOR IN ACCORDANCE WITH THE PLANS AND IDOT STANDARDS FOR TRAFFIC CONTROL AND PROTECTION.
- 4. SAW CUTTING OF PAVEMENTS, SIDEWALK, ETC. SHALL BE FULL DEPTH AND SHALL RESULT IN A CLEAN STRAIGHT
- 5. THE CONTRACTOR SHALL BE RESPONSIBLE FOR THE PROTECTION OF ALL UNDERGROUND OR SURFACE UTILITIES EVEN THOUGH THEY MAY NOT BE SHOWN ON THE PLANS. ANY UTILITY THAT IS DAMAGED DURING CONSTRUCTION SHALL BE REPAIRED OR REPLACED TO THE SATISFACTION OF THE ENGINEER.
- 6. WHENEVER, DURING CONSTRUCTION OPERATIONS, ANY LOOSE MATERIAL IS DEPOSITED IN THE FLOW LINE OF DRAINAGE STRUCTURES SUCH THAT THE NATURAL FLOW OF WATER IS OBSTRUCTED, IT SHALL BE REMOVED AT THE CLOSE OF EACH WORKING DAY. AT THE CONCLUSION OF CONSTRUCTION OPERATIONS, ALL DRAINAGE STRUCTURES SHALL BE FREE OF DIRT AND DEBRIS.
- 7. THE CONTRACTOR SHALL NOT OPEN OR SHUT ANY WATER VALVES OR FIRE HYDRANTS WITHOUT PRIOR AUTHORIZATION FROM THE VILLAGE WATER DEPARTMENT.
- 8. THE THICKNESS OF THE HOT-MIX ASPHALT MIXTURES SHOWN IN THE PLANS ARE NOMINAL. DEVIATIONS MAY OCCUR DUE TO IRREGULARITIES IN THE SURFACES OR BASE ON WHICH THEY ARE PLACED.
- MAILBOXES WHICH ARE IN CONFLICT WITH PROPOSED IMPROVEMENTS SHALL BE REMOVED, TEMPORARILY RELOCATED, AND REPLACED UPON COMPLETION OF THE PROPOSED IMPROVEMENTS IN ACCORDANCE WITH ARTICLE 107.20 AND AS DIRECTED BY THE ENGINEER.
- 10. CONTRACTOR SHALL TAKE PRECAUTION BY PRESERVING EXISTING TREES WITHIN THE RIGHT OF WAY. IF ANY DAMAGE OCCURS, TREES SHALL BE REPLACED IN KIND PER ARTICLE 201.07 REPAIR AOR REPLACEMENT OF EXISTING PLANT MATERIAL REQUIREMENTS STATED HEREIN.
- 11. THE CONTRACTOR SHALL CONTACT THE IDOT ARTERIAL DISTRICT ONE TRAFFIC CONTROL SUPERVISOR KALPANA KANNAN-HOSADURGA AT KALPANA.KANNAN-HOSADURGA@ILLINOIS.GOV A MINIMUM OF 72 HOURS IN ADVANCE OF BEGINNING WORK.

USER NAME - USER	DESIGNED - NRH	REVISED	
	DRAWN - NRH	REVISED	
PLOT SCALE -	CHECKED - SWG	REVISED	
PLOT DATE - 01/04/22	DATE - 01/04/22	REVISED	

STATE OF ILLINOIS	
DEPARTMENT OF TRANSPORTATION	

IND	EX OF SHEETS, HIGHWAY ST	ANDARDS,
LI	ST OF DETAILS AND GENER <i>i</i>	AL NOTES
NOT TO SCALE	SHEET NO. 1 OF 1 SHEETS STA	. TO STA.

F.A.U.	SI	ECTION	cour	VTV	SHEETS	SHEET NO.
RTE.	01 00	116-00-RS	DuPA	OF.	23	NO.
1533	21-00	116-00-85	Dur	IGE.	23	
			co	NTRA	CT NO. 6	1J37
		ILLIN0IS	FED.	AID	PROJECT	

				80% FED / 20% LA
				ROADWAY
CODE			TOTAL	0005
NO.	ITEM	UNIT	QUANTITY	URBAN
20200100	EARTH EXCAVATION	CU YD	50	50
21001000	GEOTECHNICAL FABRIC FOR GROUND STABILIZATION	SQ YD	115	115
21101615	TOPSOIL FURNISH AND PLACE, 4"	SQ YD	600	600
25200110	SODDING, SALT TOLERANT	SQ YD	600	600
25200200	SUPPLEMENTAL WATERING	UNIT	34	34
23200200	SUPPLEMENTAL WATERING	ONTT	34	34
28000250	TEMPORARY EROSION CONTROL SEEDING	POUND	12	12
28000510	INLET FILTERS	EACH	23	23
35101600	AGGREGATE BASE COURSE, TYPE B 4"	SQ YD	360	360
40600290	BITUMINOUS MATERIALS (TACK COAT)	POUND	7,750	7,750
40600400	MIXTURE FOR CRACKS, JOINTS, AND FLANGEWAYS	TON	30	30
40600982	HOT-MIX ASPHALT SURFACE REMOVAL - BUTT JOINT	SQ YD	240	240
40603200	DOLVMENTED HOT MAY ACRUALT DINDER COURSE. IL 4.75. NEO	TON	400	400
40603200	POLYMERIZED HOT-MIX ASPHALT BINDER COURSE, IL-4.75, N50	TON	480	480
40604060	HOT-MIX ASPHALT SURFACE COURSE, IL-9.5, MIX "D", N50	TON	960	960
42300200	PORTLAND CEMENT CONCRETE DRIVEWAY PAVEMENT, 6 INCH	SQ YD	250	250
42400800	DETECTABLE WARNINGS	SQ FT	230	230
44000153	HOT MAY ACRUALT CURFACE DEMOVAL 2"	50. VD	11 222	11, 200
44000157	HOT-MIX ASPHALT SURFACE REMOVAL, 2"	SQ YD	11,200	11,200
* DEUG=-	S SPECIALTY ITEM			

CONSTRUCTION CODE STP FUNDS

[△] DENOTES ITEM WITH SPECIAL PROVISION

FILE NAME =	USER NAME - USER	DESIGNED - NRH	REVISED						F.A.U.	SECTION C	YTNUC	TOTAL S SHEETS	SHEET NO.
FILE NAME =		DRAWN - NRH	REVISED	STATE OF ILLINOIS	SUMMARY OF QUANTITIES				1533 21-0	00116-00-RS D	JPAGE .	23	3
	PLOT SCALE -	CHECKED - SWG	REVISED	DEPARTMENT OF TRANSPORTATION						CONTRACT	NO. 61J.	37	
	PLOT DATE - 01/06/22	DATE - 01/06/22	REVISED		NOT TO SCALE	SHEET NO. 1 OF 4 SHEETS	STA.	TO STA.		ILLINOIS FE	D. AID PR	ROJECT	

				80% FED / 20% LA
				ROADWAY
CODE			TOTAL	0005
NO.	ITEM	UNIT	QUANTITY	URBAN
44000200	DRIVEWAY PAVEMENT REMOVAL	SQ YD	325	325
44201713	CLASS D PATCHES, TYPE I, 6 INCH	SQ YD	60	60
44201717	CLASS D PATCHES, TYPE II, 6 INCH	SQ YD	60	60
		,		
44201721	CLASS D PATCHES, TYPE III, 6 INCH	SQ YD	60	60
44201721	CEASS & FATCHES, THE TIT, & INCI	30 10	00	00
44201723	CLASS D PATCHES, TYPE IV, 6 INCH	SQ YD	60	
44201723	CLASS D FAIGILS, TIFE IV, 0 INCII	3Q 1D	60	60
60200205	FRANCE AND LIDE TO BE ADJUSTED			
60300305	FRAMES AND LIDS TO BE ADJUSTED	EACH	14	14
60406000	FRAMES AND LIDS, TYPE 1, OPEN LID	EACH	1	1
60406100	FRAMES AND LIDS, TYPE 1, CLOSED LID	EACH	1	1
66900200	NON-SPECIAL WASTE DISPOSAL	CU YD	50	50
66900530	SOIL DISPOSAL ANALYSIS	EACH	1	1
66901001	REGULATED SUBSTANCES PRE-CONSTRUCTION PLAN	LSUM	1	1
66901003	REGULATED SUBSTANCES FINAL CONSTRUCTION REPORT	LSUM	1	1
66901006	REGULATED SUBSTANCES MONITORING	CAL DA	4	4
67100100	MOBILIZATION	LSUM	1	1
70102620	TRAFFIC CONTROL AND PROTECTION, STANDARD 701501	LSUM	1	1
70102635	TRAFFIC CONTROL AND PROTECTION, STANDARD 701701	LSUM	1	1
	, , , , , , , , , , , , , , , , , , ,			
* DENOTES	S SPECIALTY ITEM			

CONSTRUCTION CODE
STP FUNDS

[△] DENOTES ITEM WITH SPECIAL PROVISION

FILE NAME =	USER NAME - USER	DESIGNED - NRH	REVISED	o- u.u.vo.o	SUMMARY OF QUANTITIES					COUNTY TOTAL S	HEET NO.
FILE NAME =		DRAWN - NRH	REVISED	STATE OF ILLINOIS						DuPAGE 23	4
	PLOT SCALE -	CHECKED - SWG	REVISED	DEPARTMENT OF TRANSPORTATION	,				CONTRACT NO. 61J3	37	
	PLOT DATE - 01/06/22	DATE - 01/06/22	REVISED		NOT TO SCALE	SHEET NO. 2 OF 4 SHEETS S	STA.	TO STA.	ILLINOIS	FED. AID PROJECT	

^{*} DENOTES SPECIALTY ITEM

					SIP FUNDS
					80% FED / 20% LA
					ROADWAY
	CODE			TOTAL	0005
	NO.	ITEM	UNIT	QUANTITY	URBAN
ı					
	70102640	TRAFFIC CONTROL AND PROTECTION, STANDARD 701801	LSUM	1	1
	70300100	SHORT TERM PAVEMENT MARKING	FOOT	1,160	1,160
	70200150				
_	70300150	SHORT TERM PAVEMENT MARKING REMOVAL	SQ FT	400	400
	70306100	TEMPORARY PAVEMENT MARKING LETTERS AND SYMBOLS - TYPE III TAPE	SQ FT	80	80
*	78000100	THERMOPLASTIC PAVEMENT MARKING - LETTERS AND SYMBOLS	SQ FT	216	216
*	78000200	THERMOPLASTIC PAVEMENT MARKING - LINE 4"	FOOT	9,600	9,600
*	78000600	THERMOPLASTIC PAVEMENT MARKING - LINE 12"	FOOT	330	330
*	78000650	THERMOPLASTIC PAVEMENT MARKING - LINE 24"	FOOT	115	115
	X0100002	GRADING AND SHAPING SPECIAL	SQ YD	80	80
	X0320050	CONSTRUCTION LAYOUT (SPECIAL)	LSUM	1	1
-	X2070304	POROUS GRANULAR EMBANKMENT (SPECIAL)	CU YD	50	50
-	,,,,,,,,,,,,,,,,,,,,,,,,,,,,,,,,,,,,,,,	(3.26.7.2)	00 15	30	
	X2800510	INLET FILTER CLEANING	EACH	23	23
_	X4240430	PORTLAND CEMENT CONCRETE SIDEWALK 5 INCH (SPECIAL)	SQ FT	3,200	3,200
	X4400500	COMBINATION CURB AND GUTTER REMOVAL (SPECIAL)	FOOT	1,300	1,300
	X4404700	SIDEWALK REMOVAL (SPECIAL)	SQ FT	3,475	3,475
	X6030310	FRAMES AND LIDS TO BE ADJUSTED (SPECIAL)	EACH	1	1
	* DENOTE:	S SPECIALTY ITEM			

CONSTRUCTION CODE STP FUNDS

- * DENOTES SPECIALTY ITEM
- △ DENOTES ITEM WITH SPECIAL PROVISION

FILE NAME =	USER NAME - USER	DESIGNED - NRH	REVISED					F.A.U. SECTION	COUNTY SHI	JTAL HEETS
FILE NAME =		DRAWN - NRH	REVISED	STATE OF ILLINOIS	SUMMARY OF QUANTITIES			1533 21-00116-00-F	S DuPAGE 2	23
	PLOT SCALE -	CHECKED - SWG	REVISED	DEPARTMENT OF TRANSPORTATION	•				CONTRACT N	NO. 6
	PLOT DATE - 01/06/22	DATE - 01/06/22	REVISED		NOT TO SCALE	SHEET NO. 3 OF 4 SHEETS	STA. TO STA.	ILLINOIS	FED. AID PRO	JJECT

					CONSTRUCTION CODE STP FUNDS 80% FED / 20% LA
	CODE NO.	ITEM	UNIT	TOTAL QUANTITY	ROADWAY 0005 URBAN
Δ	X6060079	COMBINATION CONCRETE CURB & GUTTER, TYPE M-3.12 (SPECIAL)	FOOT	1,300	1,300
Δ	X6061005	CONCRETE CURB, TYPE B (SPECIAL)	FOOT	45	45
Δ	Z0004510	HOT-MIX ASPHALT DRIVEWAY PAVEMENT, 3"	SQ YD	75	75
Δ	Z0030850	TEMPORARY INFORMATION SIGNING	SQ FT	52	52

^{*} DENOTES SPECIALTY ITEM


USER NAME - USER	DESIGNED - NRH	REVISED
	DRAWN - NRH	REVISED
PLOT SCALE -	CHECKED - SWG	REVISED
PLOT DATE - 01/06/22	DATE - 01/06/22	REVISED

FILE NAME = FILE NAME =

STATE OF ILLINOIS	
DEPARTMENT OF TRANSPORTATION	


	SUMMARY OF QUAN	RTE.	SECTION	COUNTY	SHEETS	SHEET NO.		
	1533 21-0	00116-00-RS	DuPAGE	23	6			
				CONTRA	CT NO. 6	1J37		
NOT TO SCALE	SHEET NO. 4 OF 4 SHEETS	STA.	TO STA.		ILLINOIS	FED. AID	PROJECT	

[△] DENOTES ITEM WITH SPECIAL PROVISION

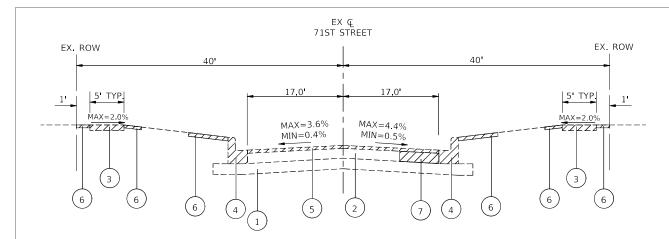

EXISTING TYPICAL SECTION

STA. 1+00 TO STA. 2+49, 71ST STREET STA. 7+45 TO STA. 28+97.50, 71ST STREET

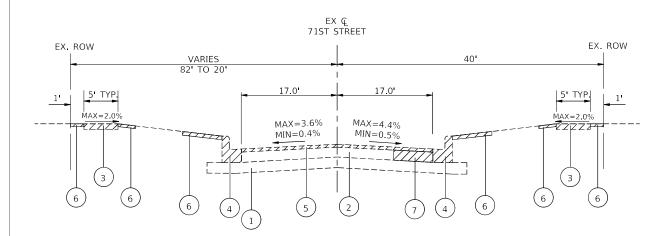

EXISTING TYPICAL SECTION

STA. 2+49 TO STA. 5+64, 71ST STREET

LEGEND

- EXISTING SUBGRADE
- (2) EXISTING HMA BASE, 4" 12", VARIES
- 3 EXISTING PORTLAND CEMENT CONCRETE SIDEWALK REMOVAL WHERE SHOWN ON PLANS AND AS DETERMINED IN THE FIELD BY ENGINEER
- (4) EXISTING COMBINATION CONCRETE CURB & GUTTER, TYPE M3.12 REMOVAL WHERE SHOWN ON PLANS
- 5 EXISTING HMA SURFACE REMOVAL, 2"
- (6) EXISTING TURF RESTORATION
- 7) EXISTING BASE REMOVAL FOR CLASS D PATCH (LOCATION AND DIMENSIONS DETERMINED BY ENGINEER)

LEGEND



FILE NAME =

FILE NAME =

REMOVAL ITEMS (WHERE SHOWN ON PLANS OR AS


(WHERE SHOWN ON PLANS OR AS DETERMINED IN THE FIELD BY ENGINEER)

USER NAME - USER	DESIGNED - NRH	REVISED	
	DRAWN - NRH	REVISED	
PLOT SCALE -	CHECKED - SWG	REVISED	
PLOT DATE - 01/06/22	DATE - 01/06/22	REVISED	






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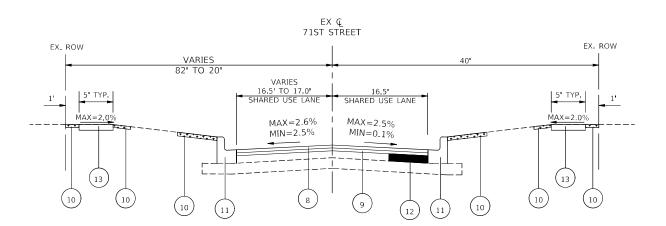
EXISTING TYPICAL SECTION

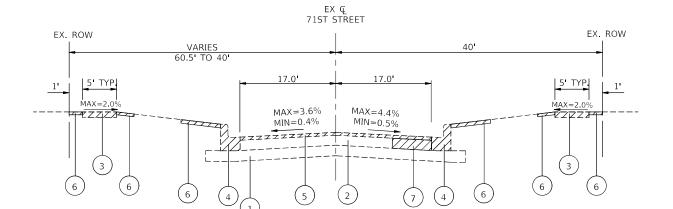STA. 5+64 TO STA. 7+45, 71ST STREET



PROPOSED TYPICAL SECTION

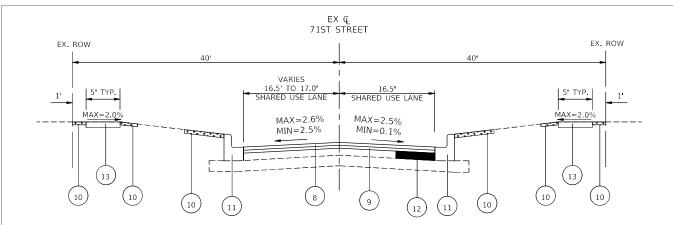STA. 1+00 TO STA. 2+49, 71ST STREET STA. 7+45 TO STA. 28+97.50, 71ST STREET



PROPOSED TYPICAL SECTION

STA. 2+49 TO STA. 5+64, 71ST STREET

LEGEND

- 8) PROPOSED HMA SURFACE COURSE, IL-9.5, MIX "D", N50, 1 1/2"
- 9 PROPOSED POLYMERIZED HMA BINDER COURSE, IL-4.75, N50, 3/4"
- (10) PROPOSED SODDING, SALT TOLERANT & TOP SOIL FURNISH AND PLACE, 4" (LOCATIONS DETERMINED BY ENGINEER)
- PROPOSED COMBINATION CONCRETE CURB & GUTTER, TYPE M3.12 REPLACEMENT, WHERE SHOWN ON PLANS AND AS DETERMINED IN THE FIELD BY ENGINEER
- (12) CLASS D PATCH (LOCATION AND DIMENSIONS DETERMINED BY ENGINEER), 6"
- proposed portland cement concrete sidewalk 5 inch, special, where shown on plan and as determined in the field by engineer

LEGEND

CLASS D PATCH




FILE NAME =

FILE NAME =

TURF RESTORATION

STATE OF ILLINOIS DEPARTMENT OF TRANSPORTATION

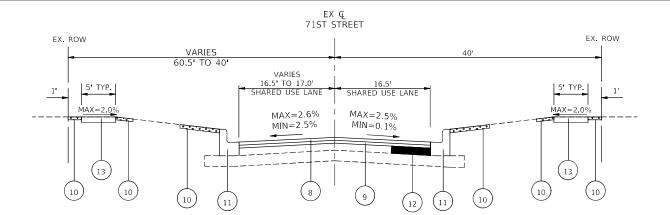

PROPOSED TYPICAL SECTION

STA. 5+64 TO STA. 7+45, 71ST STREET

ROADWAY LANE USE NOTES

- 1. ROUTE IS A SHARED USE ROADWAY FOR VEHICLE TRAFFIC AND BICYCLE TRAFFIC.
- 2. SHARROW PAVEMENT MARKINGS TO BE INCLUDED IN BOTH DIRECTIONS OF TRAVEL WHERE SHOWN ON THE PLANS.

MIXTURES TABLE

MIXTURE TYPE	AIR VOIDS @ Ndes	QMP				
ROADWAYS:						
HOT-MIX ASPHALT SURFACE COURSE, IL-9.5, MIX "D", N50, 1 1/2"	4% @ 50 GYR	LR 1030-2				
POLYMERIZED HOT-MIX ASPHALT BINDER COURSE, IL-4.75, N50, 3/4"	3.5% @ 50 GYR	LR 1030-2				
ROADWAYS: HOT-MIX ASPHALT SURFACE COURSE, IL-9.5, MIX "D", N50, 1 1/2" POLYMERIZED HOT-MIX ASPHALT BINDER COURSE, IL-4.75, N50, 3/4" 3.5% @ 50 GYR HMA DRIVEWAY PAVEMENT 3": HOT-MIX ASPHALT SURFACE COURSE, IL-9.5, MIX "D" N50 - 3" (IN 2 LIFTS) 4% @ 50 GYR PATCHING:						
HOT-MIX ASPHALT SURFACE COURSE, IL-9.5, MIX "D" N50 - 3" (IN 2 LIFTS)	4% @ 50 GYR	LR 1030-2				
PATCHING:						
CLASS D PATCHES, (HMA BINDER IL-19.0) 6"	4% @ 50 GYR	LR 1030-2				
OMP DESIGNATION: QUALITY	CONTROL/OUALITY ASSIL	BANCE (OC/OA				


CONTRACTOR SHALL MILL FIRST BEFORE PATCHING


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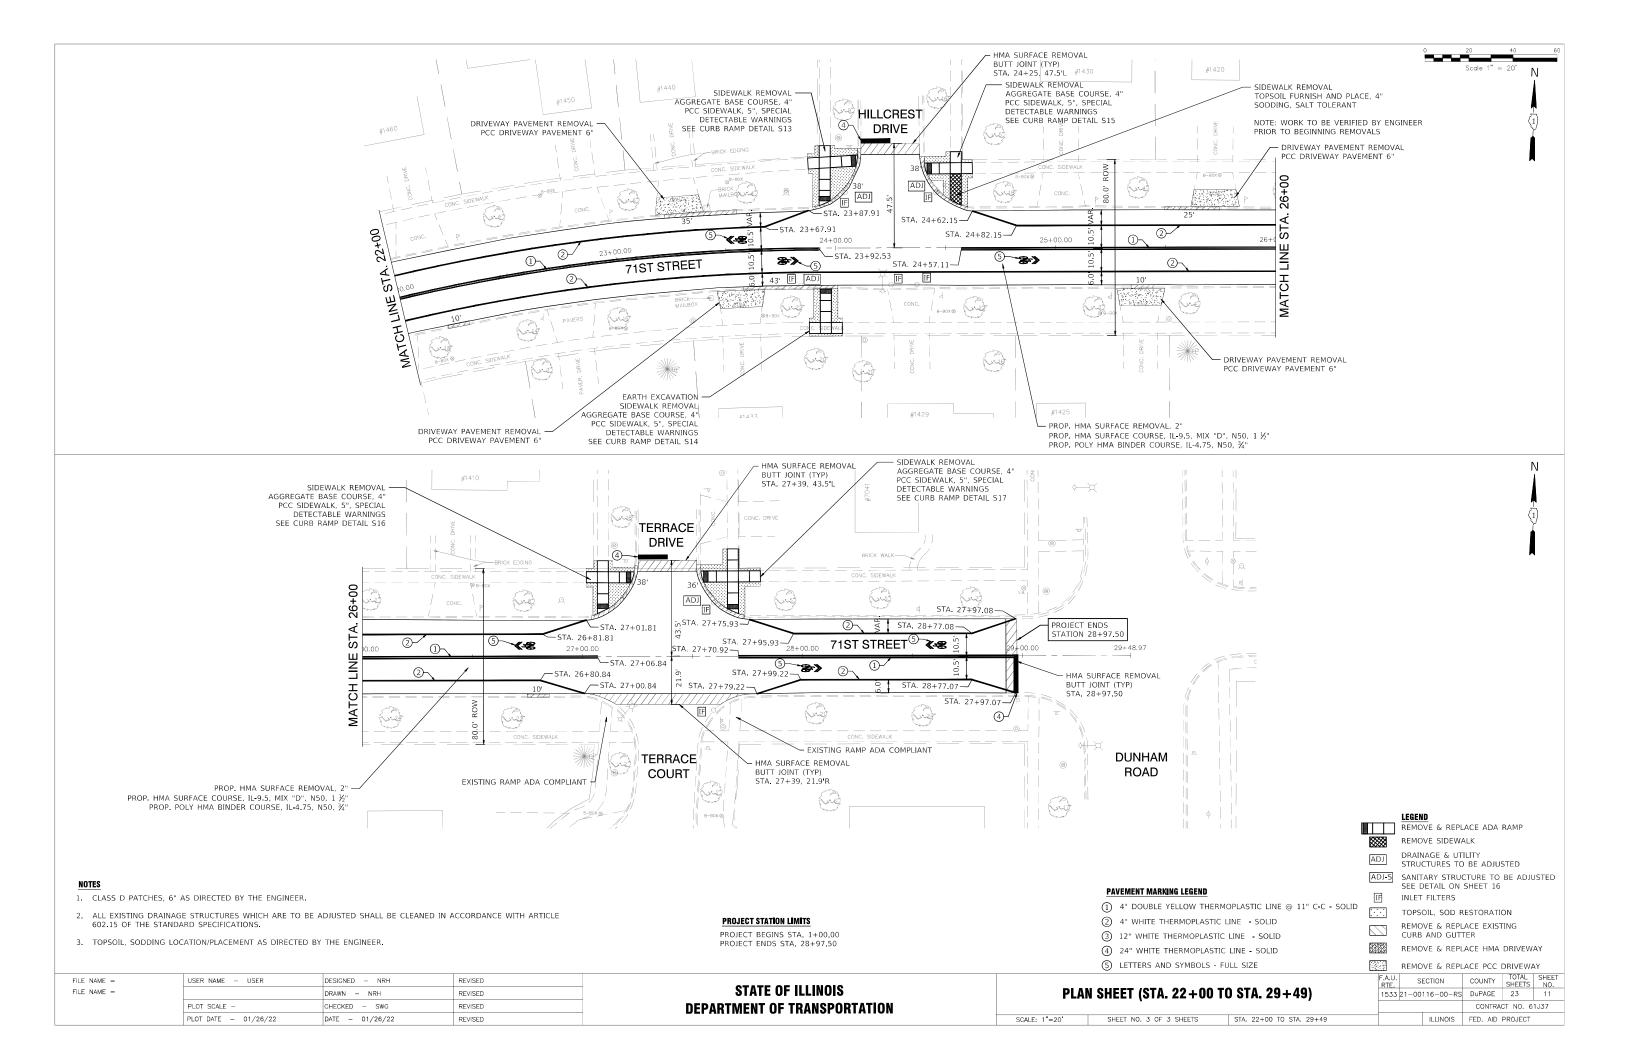
QMP DESIGNATION: QUALITY CONTROL/QUALITY ASSURANCE (QC/QAPER LR 1030-02


- -THE UNIT WEIGHT USED TO CALCULATE ALL HMA SURFACE MIXTURE QUANTITIES IS 112 LBS/SQYD/IN.
- -THE "AC TYPE" FOR POLYMERIZED HMA MIXES SHALL BE "SBS/SBR PG 76 22" AND FOR NON-POLYMERIZED HMA THE "AC TYPE" SHALL BE "PG 64 22" UNLESS MODIFIED BY RECLAIMED MATERIALS SPECIFICATIONS.


			F.A.U. RTE.	S	ECTION	COUNTY	TOTAL SHEETS	SHEET NO.
PROPOSED TYPICAL SI	1533	21-00	116-00-RS	DuPAGE	23	8		
						CONTRA	CT NO. 6	1J37
SHEET NO. 1 OF 1 SHEETS	STA	TO STA			ILLINOIS	FED AID	PROJECT	




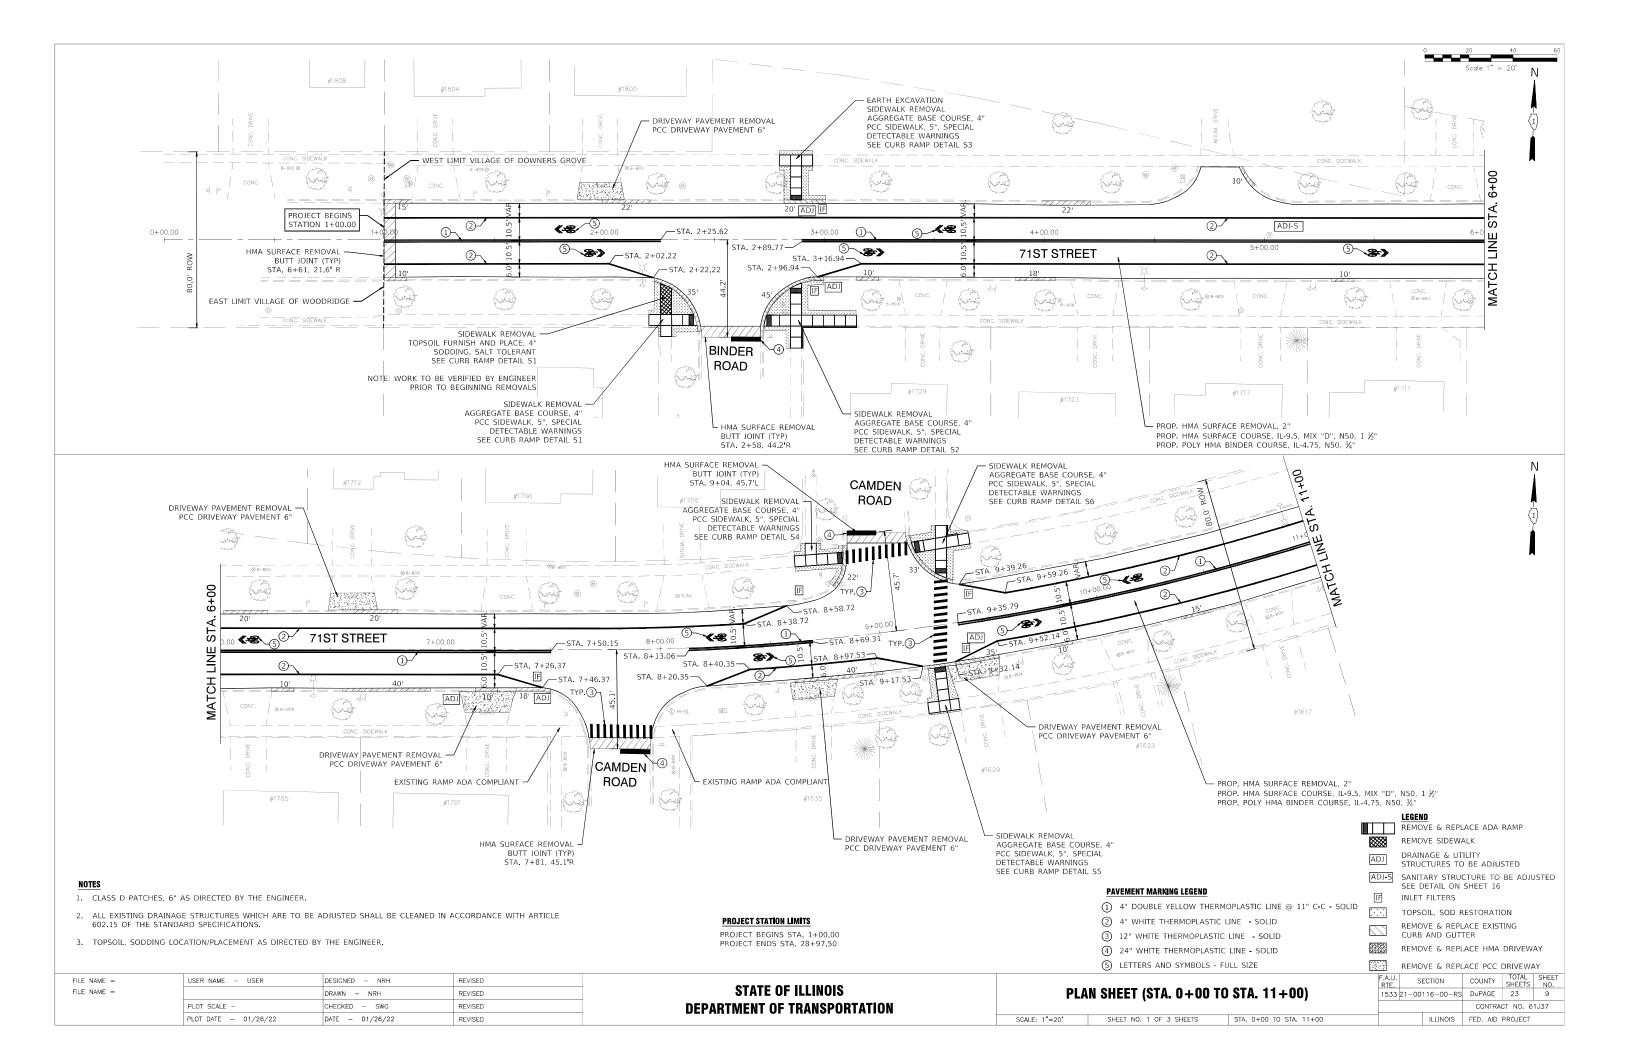

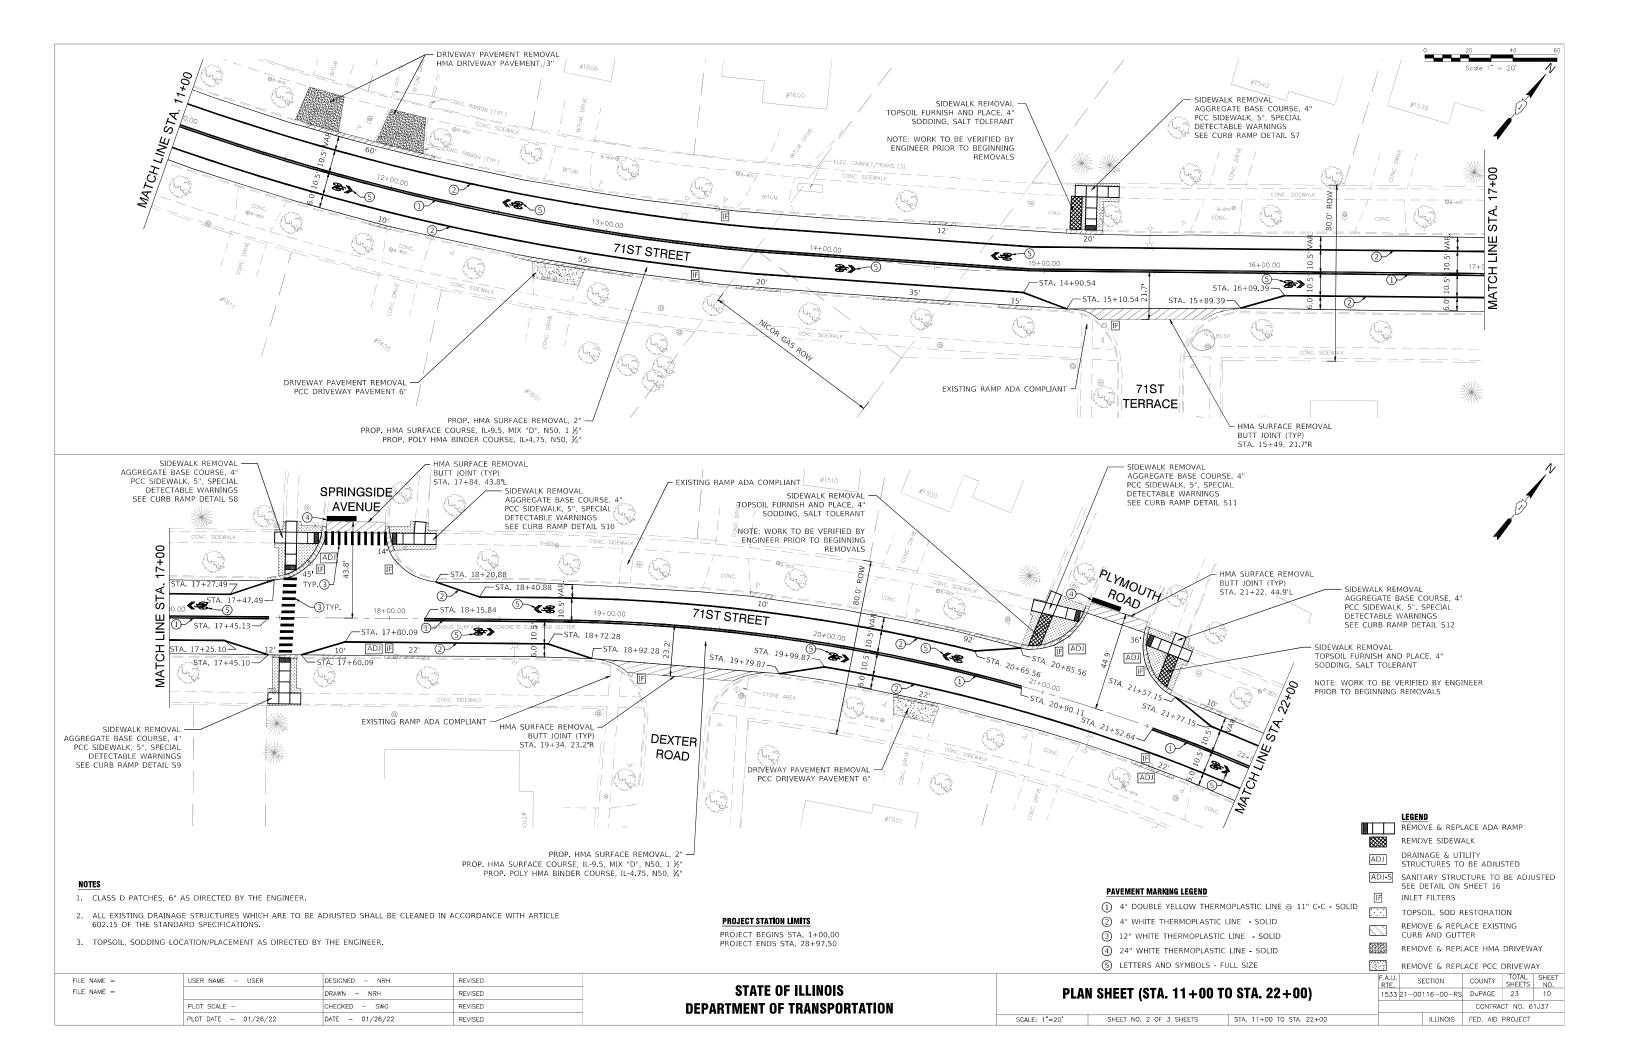

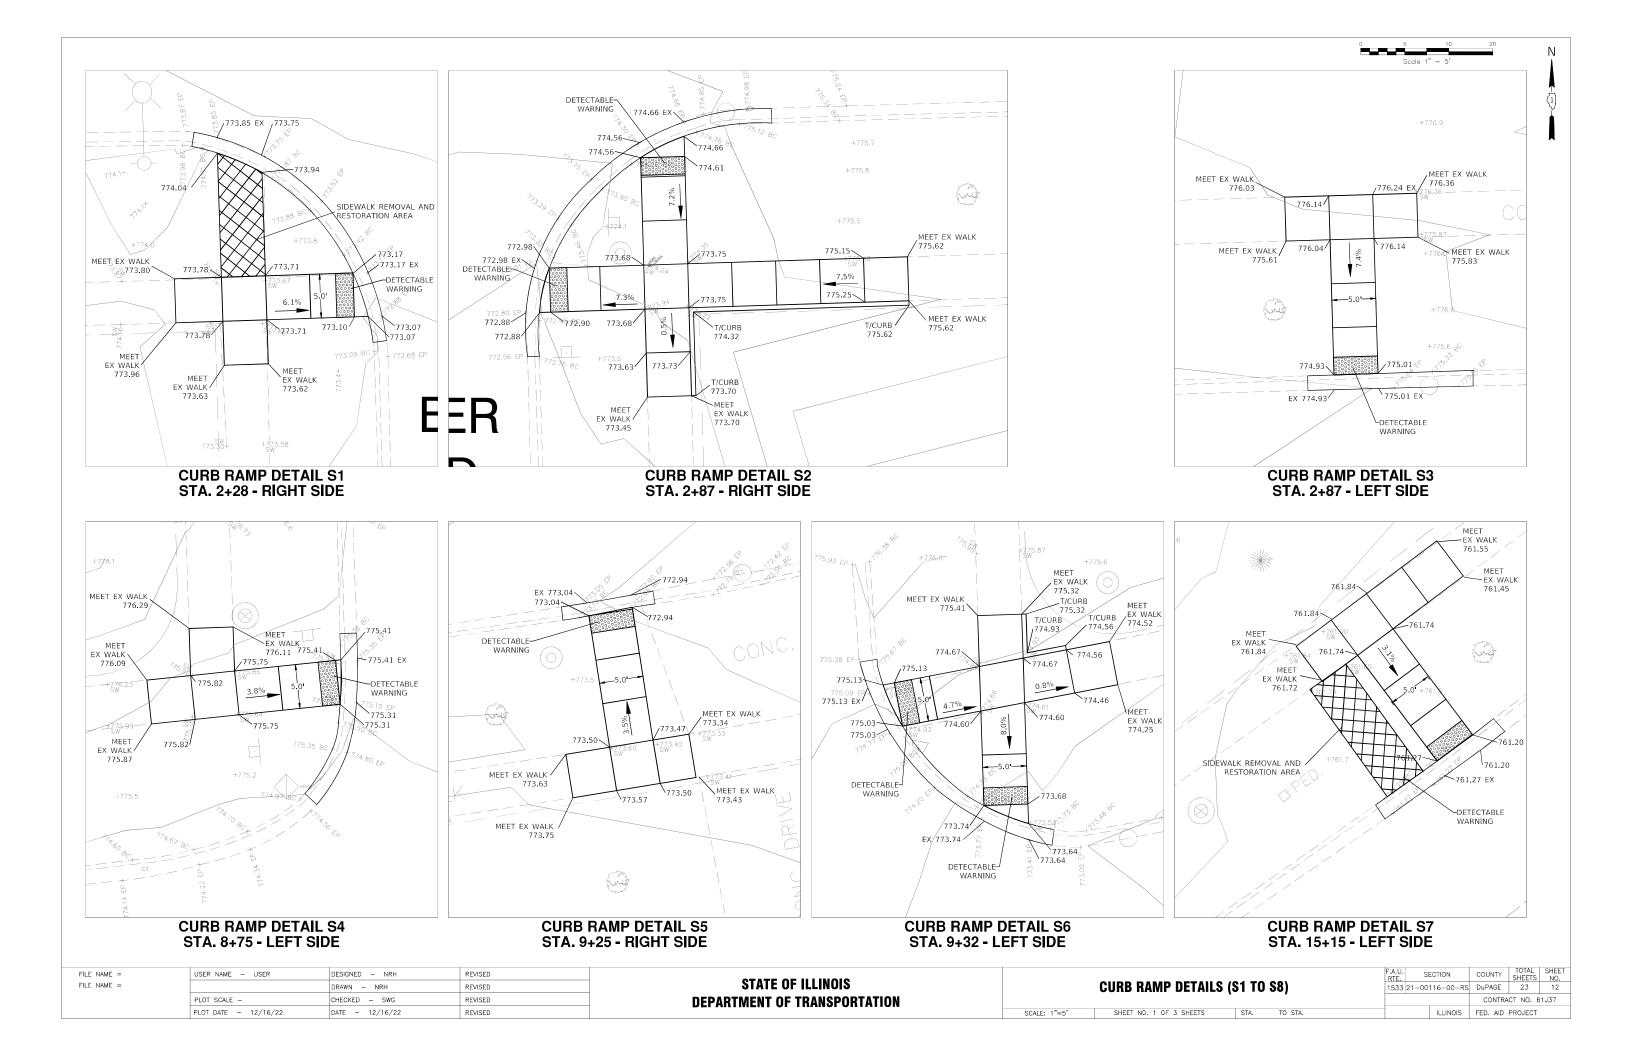


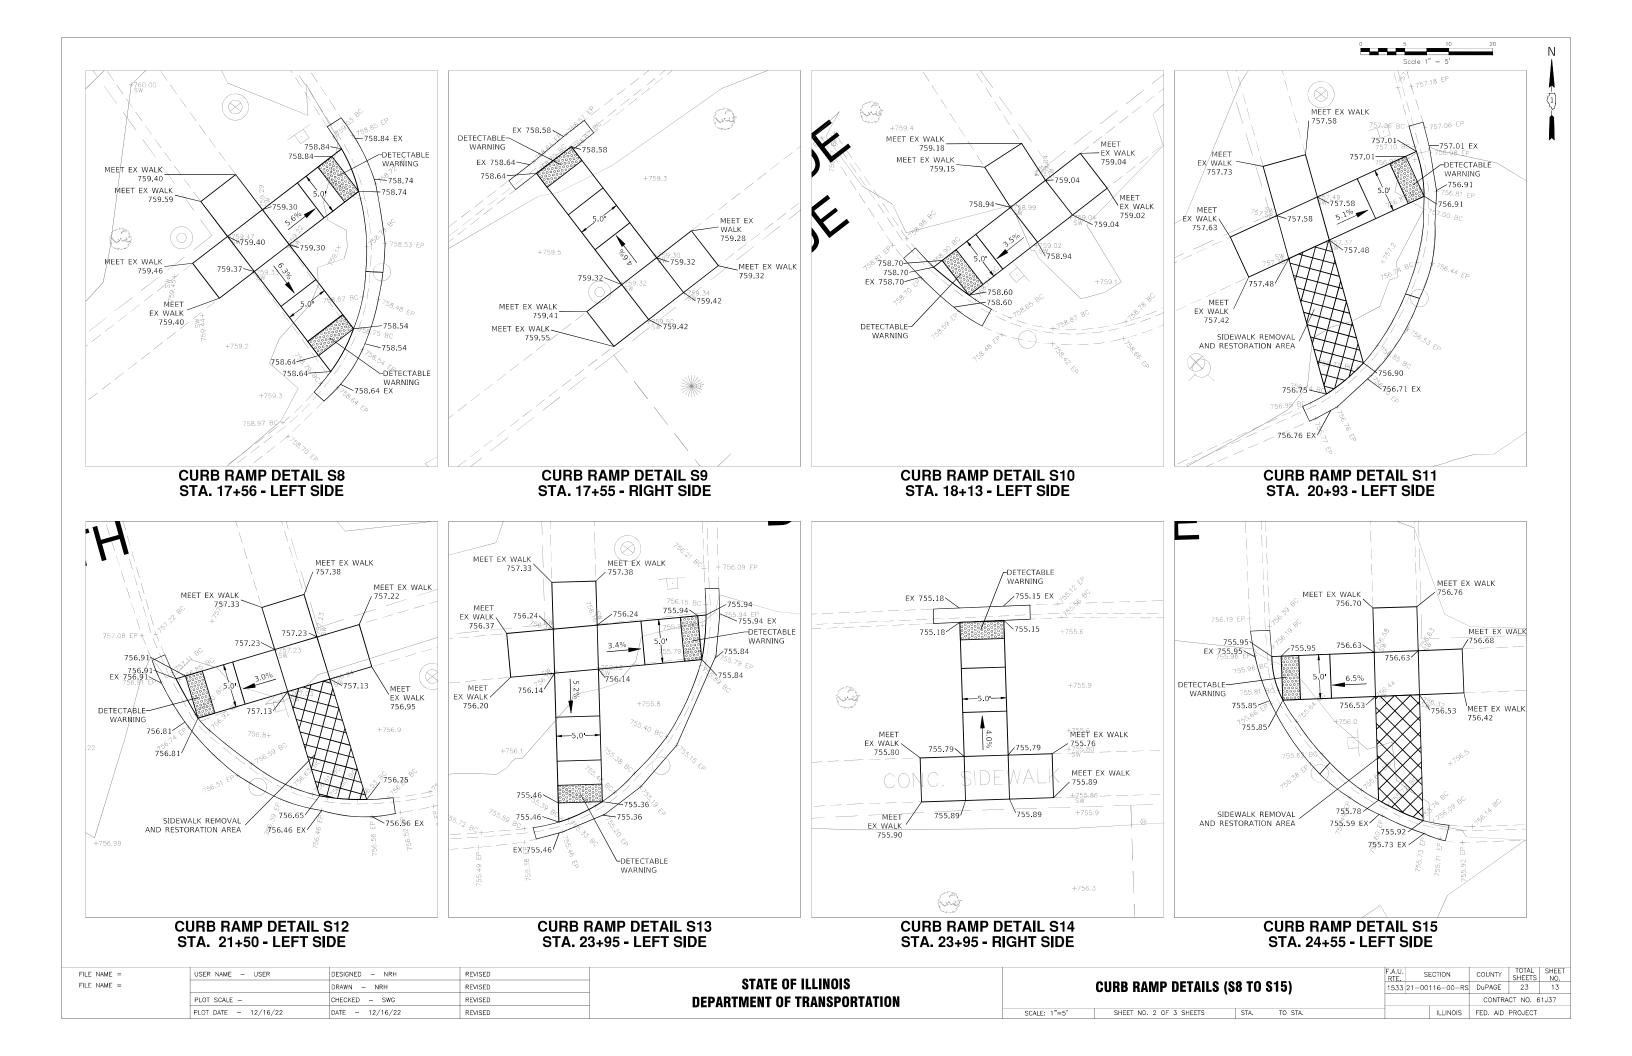


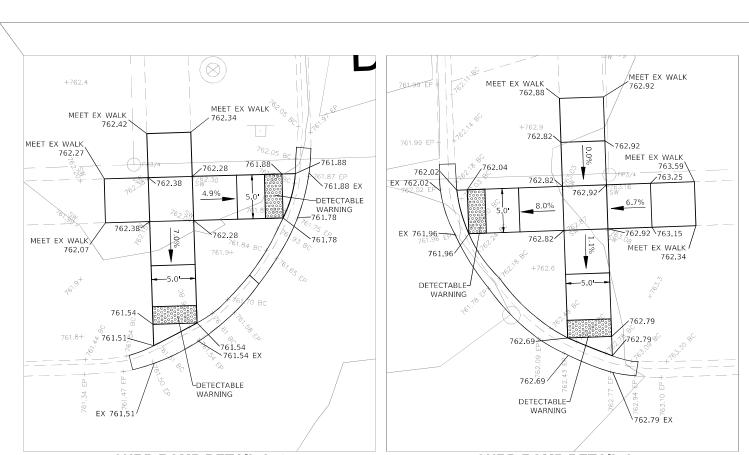


CURB RAMP DETAIL S16 STA. 27+10 - LEFT SIDE CURB RAMP DETAIL S17 STA. 27+68 - LEFT SIDE

FILE NAME =	USER NAME - USER	DESIGNED - NRH	REVISED			RTF. SECTION COUNTY SHEETS NO.
FILE NAME =		DRAWN - NRH	REVISED	STATE OF ILLINOIS	CURB RAMP DETAILS (S16 TO S17)	1533 21-00116-00-RS DuPAGE 23 14
	PLOT SCALE -	CHECKED - SWG	REVISED	DEPARTMENT OF TRANSPORTATION	,	CONTRACT NO. 61J37
	PLOT DATE - 12/16/22	DATE - 12/16/22	REVISED		SCALE: 1"=5' SHEET NO. 3 OF 3 SHEETS STA. TO STA.	ILLINOIS FED. AID PROJECT

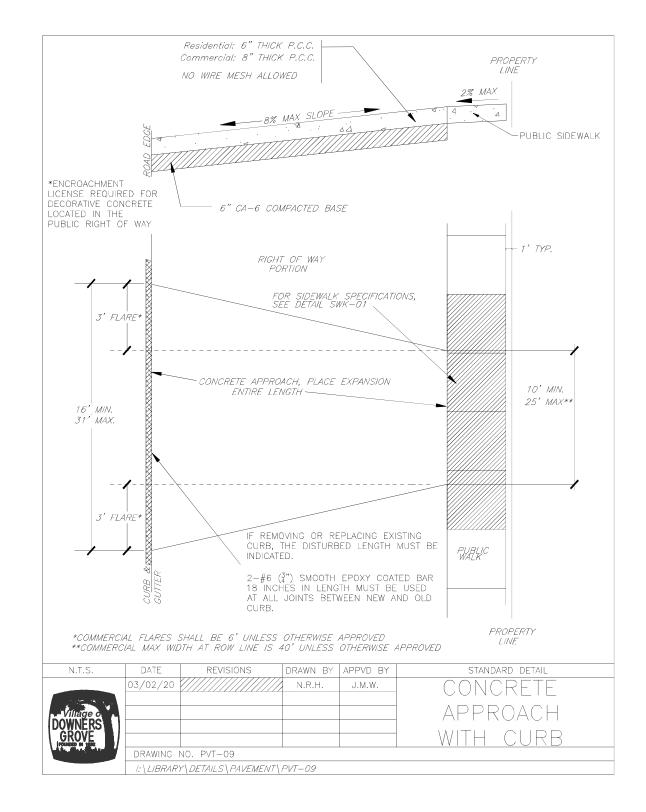

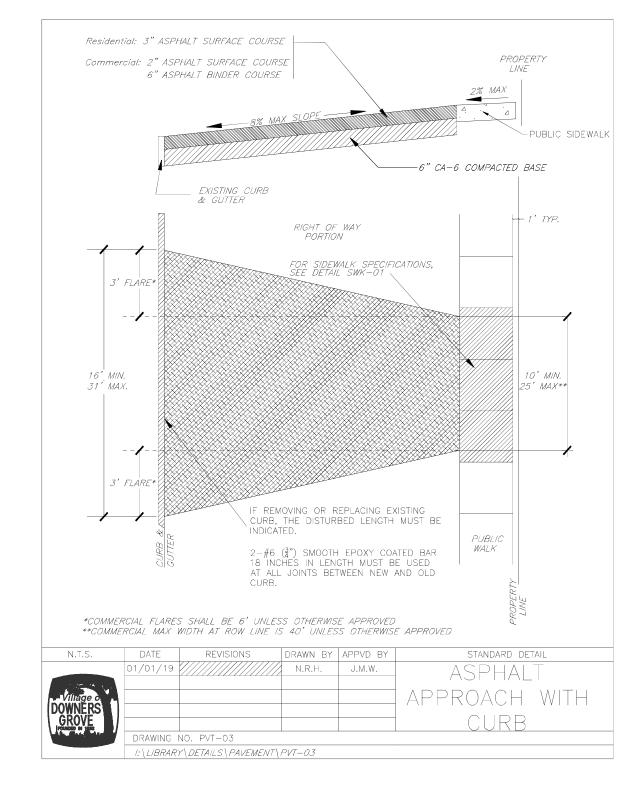

FILE NAME =	USER NAME - USER	DESIGNED - NRH	REVISED		F.A.U. SECTION	COUNTY TOTAL SHEET NO.		
FILE NAME =		DRAWN - NRH	REVISED	STATE OF ILLINOIS VILLAGE DETAILS 1533 21-00116-1				
	PLOT SCALE -	CHECKED - SWG	REVISED	DEPARTMENT OF TRANSPORTATION				CONTRACT NO. 61J37
	PLOT DATE - 12/16/22	DATE - 12/16/22	REVISED		NOT TO SCALE	SHEET NO. 1 OF 2 SHEETS STA. TO STA.	ILLINOIS	FED. AID PROJECT

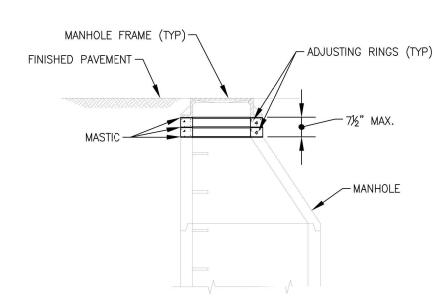

THIS METHOD SHALL BE USED FOR ALL MANHOLES WHICH WILL HAVE LESS THAN SEVEN AND ONE—HALF $(7-\frac{1}{2})$ inches of adjustment between the top of the cone and the bottom of the frame when set at finished grade. To raise the frame, adjustment shall be made using precast reinforced concrete rings. Concrete blocks or bricks shall not be used. The spaces between the cone, rings and frame shall be completely sealed with preformed bituminous mastic (easy stik mortar shall not be used. To lower the frame, existing

ADJUSTMENTS SHALL BE REMOVED AND THE SPACE BETWEEN THE FRAME AND THE CONE SHALL BE REMOVED AND THE SPACE BETWEEN THE FRAME AND THE CONE SHALL BE COMPLETELY SEALED WITH PREFORMED BITUMINOUS MASTIC GASKET. IF THE MANHOLE WOULD HAVE SEVEN AND ONE—HALF $(7-\frac{1}{2})$ inches or more of adjustments when set at the finished grade or if the frame must be lowered by more than the amount of existing adjustment, the manhole shall be reconstructed. Refer to downers grove sanitary district specifications for manhole reconstruction. The downers grove sanitary district shall be notified of manholes to be adjusted prior to beginning construction. Once completed, no such adjustment shall be backfilled without inspection by the downers grove sanitary district.

FRAMES & LIDS TO BE ADJUSTED (SPECIAL)




REV. 2-1-15 REV. 8-12-97 REV. 10-20-84

FILE NAME =	USER NAME - USER	DESIGNED - NRH	REVISED
FILE NAME =		DRAWN - NRH	REVISED
	PLOT SCALE -	CHECKED - SWG	REVISED
	DLOT DATE 10/16/00	DATE 10 /16 /00	DE #CED

STATE OF ILLINOIS
DEPARTMENT OF TRANSPORTATION

					F.A.U. RTE.	SE	ECTION	COUNTY	TOTAL SHEETS	SHEE NO.
VILLAGE DETAILS						21-001	16-00-RS	DuPAGE	23	16
								CONTRAC	CT NO. 6	1J37
OT TO SCALE	SHEET NO. 2 OF 2 SHEETS	STA.	TO STA.				ILLINOIS	FED. AID	PROJECT	

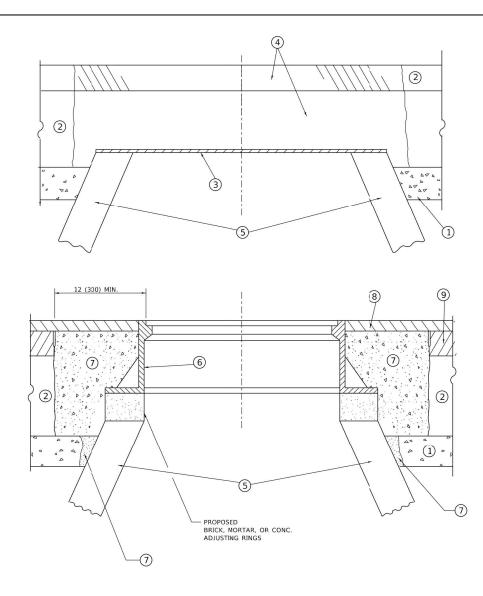

DETAILS FOR FRAMES AND LIDS ADJUSTMENT WITH MILLING

- 1. EXISTING BROKEN FRAMES AND LIDS SHALL BE REMOVED AND DISPOSED OF BY THE CONTRACTOR AND SHALL BE REPLACED AS DIRECTED BY THE ENGINEER. REPLACEMENT FRAMES AND LIDS WILL BE PAID FOR IN ACCORDANCE WITH ARTICLE 109.04 OF THE STANDARD SPECIFICATIONS UNLESS A SEPARATE PAY ITEM HAS BEEN PROVIDED.
- 2. IF THE EXISTING LIDS ARE OPEN, THE FRAME WILL BE ADJUSTED TO THE ELEVATION OF THE MILLED PAVEMENT SURFACE PRIOR TO THE MILLING OPERATION. THE FRAME WILL NOT BE REMOVED AND COVERED BY THE METAL PLATE.
- 3. CITY OF CHICAGO CASTINGS ARE THE PROPERTY OF THE CITY AND THE CONTRACTOR SHALL NOTIFY THE CITY FOR REMOVAL AND DISPOSITION OF THE CASTINGS.
- 4. THE METAL PLATE USED TO COVER THE STRUCTURE SHALL REMAIN THE PROPERTY OF THE CONTRACTOR.

CONSTRUCTION PROCEDURES

STAGE 1 (BEFORE PAVEMENT MILLING)

- A) REMOVE A MINIMUM OF 12 (300) OF THE PAVEMENT FROM AROUND THE STRUCTURE.
- B) REMOVE THE EXISTING FRAME AND LID FROM THE STRUCTURE.
- C) COVER THE STRUCTURE OPENING WITH A 36 (900) DIAMETER METAL PLATE.
- D) BACKFILL WITH CRUSHED STONE AND HMA SURFACE MIX APPROVED BY THE ENGINEER. (MIN. 1 1/2 (40) HMA TO REMAIN

STAGE 2 (AFTER PAVEMENT MILLING)

- A) REMOVE THE HMA SURFACE MIX AND CRUSHED STONE.
- B) INSTALL THE FRAME AND LID; ADJUST THE FRAME TO ITS FINAL SURFACE ELEVATION.
- C) THE SURROUNDING SPACE SHALL BE FILLED WITH CLASS*PP-1 CONCRETE TO THE ELEVATION OF THE SURFACE OF THE EXISTING BASE COURSE OR THE BINDER COURSE.
- *UNLESS OTHERWISE SPECIFIED IN THE PLANS.

THE PROCEDURE EXPLAINED ABOVE SHALL CONFORM TO THE APPLICABLE PORTIONS OF SECTIONS 353, 406, 602, AND 603 OF THE STANDARD SPECIFICATIONS EXCEPT THAT "THE CONTRACTOR SHALL ADJUST THE STRUCTURES TO THE FINISHED PAVEMENT ELEVATION NO MORE THAN 5 CALENDAR DAYS PRIOR TO PLACEMENT OF THE FINAL LIFT OF SURFACE UNLESS APPROVED BY THE ENGINEER."

LEGEND

① SUB-BASE GRANULAR MATERIAL

(6) FRAME AND LID (SEE NOTES)

2 EXISTING PAVEMENT

(7) CLASS*PP-1 CONCRETE

3 36 (900) DIAMETER METAL PLATE

8 PROPOSED HMA SURFACE COURSE

4 PROPOSED CRUSHED STONE AND HMA SURFACE MIX

(5) EXISTING STRUCTURE

(9) PROPOSED HMA BINDER COURSE

LOCATION OF STRUCTURES

THE CONTRACTOR WILL BE REQUIRED TO KEEP A RECORD OF THE LOCATIONS OF THE BURIED STRUCTURES ACCORDING TO THE STATION AND DISTANCE LEFT OR RIGHT OF THE CENTERLINE OF PAVEMENT. UPON COMPLETION OF THE WORK, THE CONTRACTOR WILL DELIVER THE RECORD TO THE ENGINEER.

BASIS OF PAYMENT

- 1. REMOVING FRAMES AND LIDS ON DRAINAGE AND UTILITY STRUCTURES IN THE PAVEMENT PRIOR TO MILLING, AND ADJUSTING TO FINAL GRADE PRIOR TO PLACING THE SURFACE COURSE, WILL BE PAID FOR AT THE CONTRACT UNIT PRICE EACH FOR "FRAMES AND LIDS TO BE ADJUSTED
- 2. THIS WORK WILL NOT BE PAID FOR WHEN DRAINAGE AND UTILITY STRUCTURES ARE SPECIFIED FOR PAYMENT AS STRUCTURE RECONSTRUCTION.
- 3. NEW FRAMES AND LIDS, WHEN SPECIFIED, WILL BE PAID FOR SEPARATELY.
- 4. WHEN STRUCTURES ARE TO BE ADJUSTED OR RECONSTRUCTED, THE LOWERING AND RAISING OF THE FRAMES AND LIDS WILL NOT BE PAID FOR SEPARATELY BUT WILL BE INCLUDED IN THE COST OF THE CORRESPONDING PAY ITEM.

ALL DIMENSIONS ARE IN INCHES (MILLIMETERS) UNLESS OTHERWISE SHOWN

USER NAME = Lawrence.DeManche	DESIGNED - R. SHAH	REVISED - R. BORO 01-01-07	
	DRAWN -	REVISED - R. BORO 03-09-11	STATE OF ILLINOIS
PLOT SCALE = 100.0000 ' / in.	CHECKED -	REVISED - R. BORO 12-06-11	DEPARTMENT OF TRANSPORTATION
PLOT DATE = 11/18/2022	DATE - 10-25-94	REVISED - K. SMITH 11-18-22	March 201 March 10 Street, March March 10 Street, March 1


								F.A.U RTE. SECTION		COUNTY	TOTAL SHEETS	SHEET NO.			
	FRAMES	ANI	חוו ר	9	ADJUSTN	IENT	WITH	MILLING		1533	21-00116-00-F	S	DuPAGE	23	17
	IIIAWE	AINI	LID	"			VVIIII				BD600-03 (BD	-08)	CONTRACT	NO.	61J37
SCALE: NONE	SHE	T 1	OF	1	SHEETS	STA.		TO STA.			ILI	NOIS FED. A	ID PROJECT		

METHOD OF MEASUREMENT

REFER TO SECTION 442 OF THE STANDARD SPECIFICATIONS FOR ROAD AND BRIDGE CONSTRUCTION AND THE RECURRING SPECIAL PROVISION "PATCHING WITH HOT-MIX ASPHALT OVERLAY REMOVAL."

BASIS OF PAYMENT

- 1. REFER TO SECTION 442 OF THE STANDARD SPECIFICATIONS FOR ROAD AND BRIDGE CONSTRUCTION AND THE RECURRING SPECIAL PROVISION "PATCHING WITH HOT-MIX ASPHALT OVERLAY REMOVAL."
- SAW CUT/SCORING OF EXISTING HMA OVERLAY IS INCLUDED IN THE COST OF PAVEMENT PATCHING.
- 3. SAW CUT/SCORING OF EXISTING PAVEMENT IS INCLUDED IN THE COST OF PAVEMENT PATCHING.

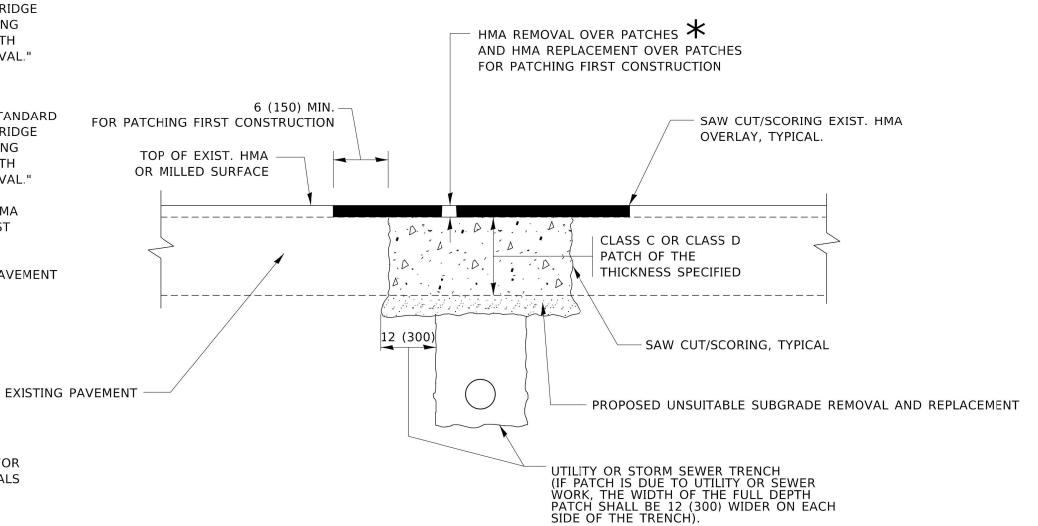

SEQUENCE OF CONSTRUCTION (PATCHING FIRST)

1. REMOVE THE EXISTING HMA MATERIAL OVER THE AREA TO BE PATCHED.

SEE TYPICAL SECTIONS FOR

THICKNESS AND MATERIALS


- 2. REMOVE AND REPLACE WITH CLASS C OR D PATCH.
- 3. REPLACE HMA MATERIAL OVER THE AREA TO BE PATCHED.

SEQUENCE OF CONSTRUCTION (MILLING FIRST)


- 1. MILL HMA FIRST IF THERE IS AT LEAST 4½ INCHES OR MORE OF HMA MATERIAL ON TOP OF THE EXISTING PAVEMENT OR IF THE PAVEMENT IS FULL DEPTH HMA. A MINIMUM OF 2 INCHES OF HMA MATERIAL SHALL BE IN PLACE AFTER MILLING.
- 2. REMOVE AND REPLACE WITH FULL DEPTH CLASS D PATCHES TO TOP OF MILLED SURFACE.

ALL DIMENSIONS ARE IN INCHES (MILLIMETERS) UNLESS OTHERWISE SHOWN.

USER NAME = Lawrence.DeManche	DESIGNED - R. SHAH	REVISED - R. BORO 01-01-07		PAVEMENT PATCHING FOR	F.A.U RTF	SECTION	COUNTY	TOTAL	SHEET
	DRAWN -	REVISED - R. BORO 09-04-07	STATE OF ILLINOIS	HMA SURFACED PAVEMENT	1533	21-00116-00-RS	DuPAGE	23	18
PLOT SCALE = 100.0000 ' / in.	CHECKED -	REVISED - K. ENG 10-27-08	DEPARTMENT OF TRANSPORTATION	HIMA SUKFACED PAVEIMENT	В	D400-04 (BD-22)	CONTRACT	r NO.	61J37
PLOT DATE = 11/18/2022	DATE - 10-25-94	REVISED - K. SMITH 11-18-22		SCALE: NONE SHEET 1 OF 1 SHEETS STA. TO STA.		ILLINOIS FED.	ID PROJECT		

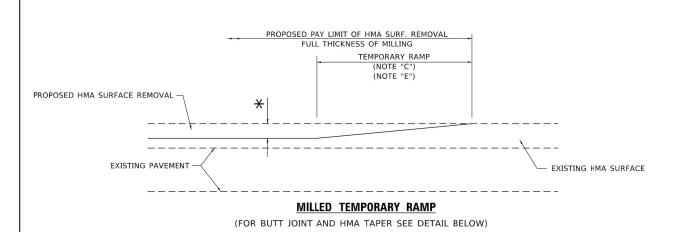

OPTION 1

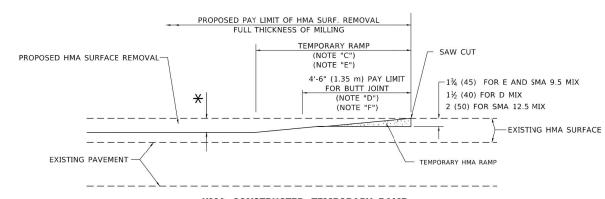


HMA CONSTRUCTED TEMPORARY RAMP


(FOR BUTT JOINT AND HMA TAPER SEE DETAIL BELOW)


OPTION 2

TYPICAL TEMPORARY RAMP

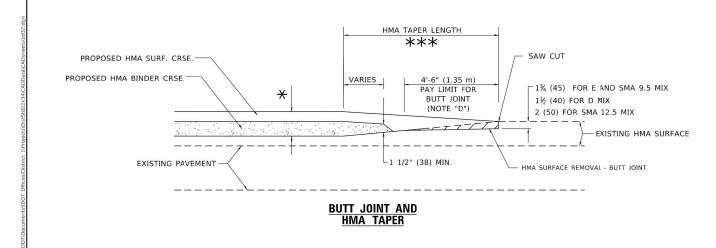

TYPICAL BUTT JOINT AND HMA TAPER FOR MILLING AND RESURFACING

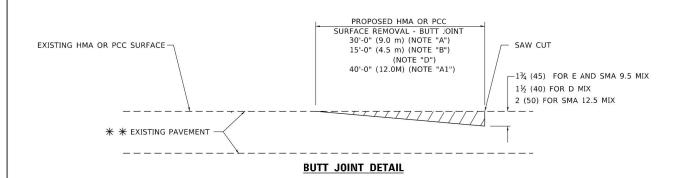

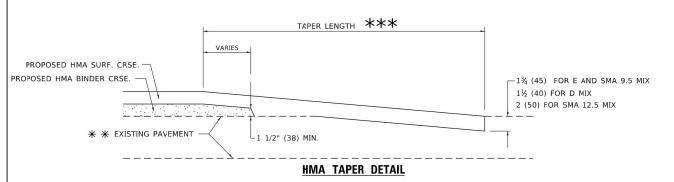

TYPICAL BUTT JOINT AND HMA TAPER FOR RESURFACING ONLY

** PC CONCRETE, HMA OR HMA RESURFACED PAVEMENT.

GENERAL NOTES

- A. MAINLINE ARTERIAL ROADWAYS AND MAJOR SIDE ROADS.
- A1. INTERSTATES
- B. MINOR SIDE ROADS.
- C. THE TEMP. RAMP SHALL BE CONSTRUCTED IMMEDIATELY UPON REMOVAL OF THE EXISTING HMA SURFACE.
- D. THE BUTT JOINT SHALL BE CONSTRUCTED IMMEDIATELY PRIOR TO PLACING THE PROPOSED HMA COURSES.
- E. TAPER THE TEMP. RAMP AT A RATE OF 3' 4" (1.02m) PER 1 INCH (25 mm) OF MILLING THICKNESS.

 ** SEE TYPICAL SECTIONS FOR MILLING THICKNESS.
- FOR "HMA AND/OR PCC SURFACE REMOVAL, BUTT JOINT".
- *** 20'-0" (6.1 m) PER 1 (25) RESURFACING (NOTE "A") 10'-0" (3.0 m) PER 1 (25) RESURFACING (NOTE "B")


BASIS OF PAYMENT


- THE BUTT JOINT WILL BE PAID FOR AT THE CONTRACT UNIT PRICE PER SQUARE YARD (SQUARE METER) FOR "HOT-MIX ASPHALT SURFACE REMOVAL - BUTT JOINT" OR FOR "PORTLAND CEMENT CONCRETE SURFACE REMOVAL- BUTT JOINT".
- 2. THE TEMPORARY RAMP AND SAW CUT SHALL BE INCLUDED IN THE UNIT COST FOR HMA OR PCC SURFACE REMOVAL-BUTT JOINT.

ALL DIMENSIONS ARE IN INCHES (MILLIMETERS) UNLESS OTHERWISE SHOWN.

USER NAME = Lawrence.DeManche	DESIGNED - M. DE YONG	REVISED -	A. ABBAS 03-21-97			BUTT JOINT AND		F.A.U RTE.	SECTION	COUNTY	TOTAL SHEET SHEET NO.
	DRAWN -	REVISED -	M. GOMEZ 04-06-01	STATE OF ILLINOIS				1533	21-00116-00-RS	DuPAGE	23 19
PLOT SCALE = 100.0000 ' / in.	CHECKED -	REVISED -	R. BORO 01-01-07	DEPARTMENT OF TRANSPORTATION		HMA TAPER DETAILS		BD400-05 BD-32	CONTRACT NO. 61J		
PLOT DATE = 11/18/2022	DATE - 06-13-90	REVISED -	K. SMITH 11-18-22		SCALE: NONE	SHEET 1 OF 1 SHEETS STA.	TO STA.		ILLINOIS FED. AI	D PROJECT	

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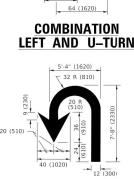


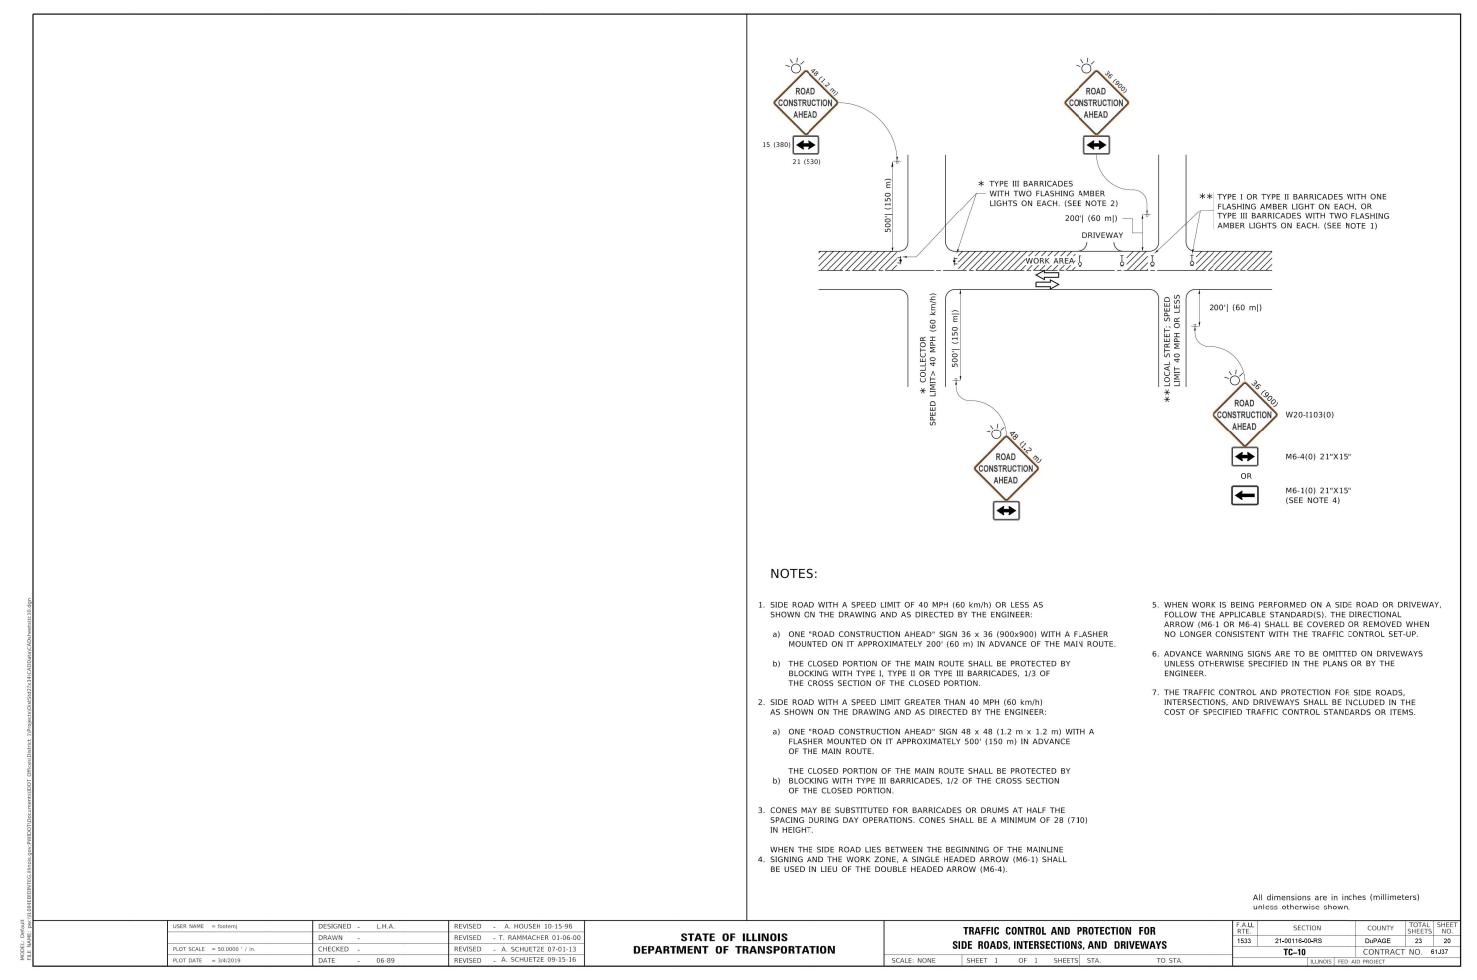LEFT AND U-TURN 5'-4" (1620) √ 32 R (810)

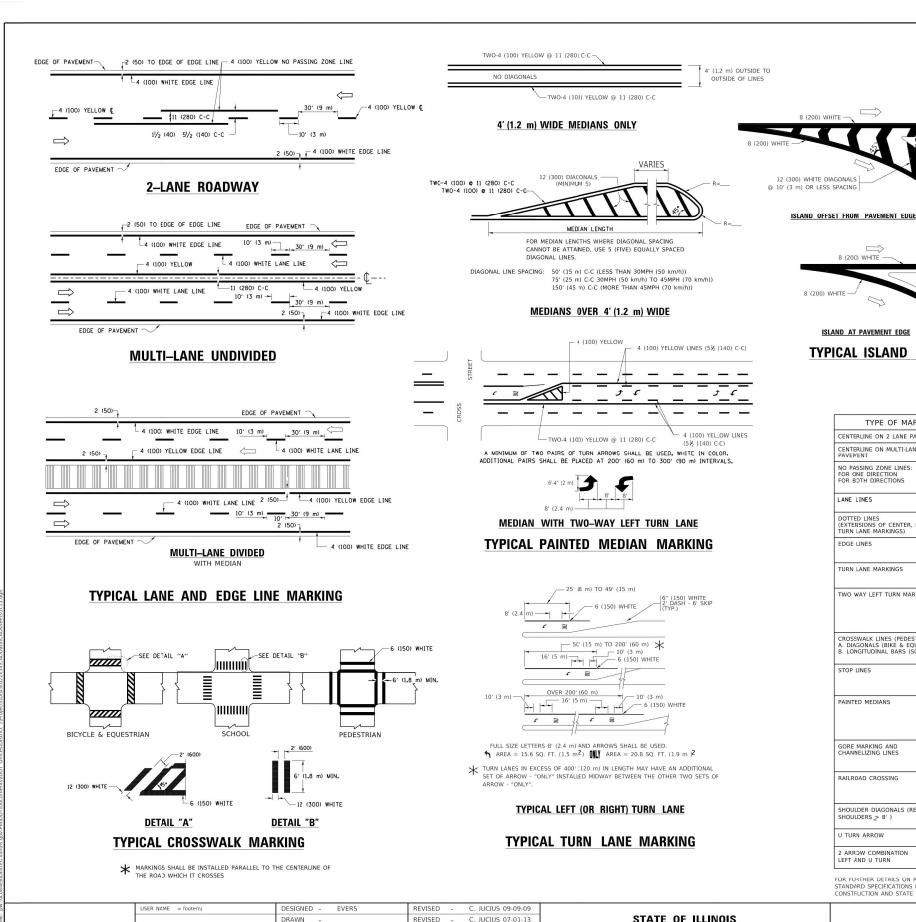ISLAND AT PAVEMENT EDGE TYPICAL ISLAND MARKING

_ 2 (50)

8 (200) WHITE —



U-TURN

D(FT) SPEED LIMIT

LANE REDUCTION TRANSITION

* LANE REDUCTION ARROWS REQUIRED AT SPEEDS OF 45 MPH OR GREATER OR WHEN SPECIFIED IN PLANS.

TYPE OF MARKING	WIDTH OF LINE	PATTERN	COLOR	SPACING / REMARKS		
CENTERLINE ON 2 LANE PAVEMENT	4 (100)	SKIP-DASH	YELLOW	10' (3 m) LINE WITH 30' (9 m) SPACE		
CENTERLINE ON MULTI-LANE UNDIVIDED PAVEMENT	2 @ 4 (100)	SOLID	YELLOW	11 (280) C-C		
NO PASSING ZONE LINES: FOR ONE DIRECTION FOR BOTH DIRECTIONS	4 (100) 2 @ 4 (100)	SOLID SOLID	YELLOW	5½ (140) C-C FROM SKIP-DASH CENTERLINE 11 (280) C-C OMIT SKIP-DASH CENTERLINE BETWEEN		
LANE LINES	4 (100) 5 (125) ON FREEWAYS	SKIP-DASH SKIP-DASH	WHITE WHITE	10' (3 m) LINE WITH 30' (9 m) SPACE		
DOTTED LINES (EXTENSIONS OF CENTER, LANE OR TURN LANE MARKINGS)	SAME AS LINE BEING EXTENDED	SKIP-DASH	SAME AS LINE BEING EXTENDED	2' (600) LINE WITH 6' (1.8 m) SPACE		
EDGE LINES	4 (100)	SOLID	YELLOW-LEFT WHITE-RIGHT	OUTLINE MEDIANS IN YELLOW		
TURN LANE MARKINGS	6 (150) LINE; FULL SIZE LETTERS & SYMBOLS (8' (2.4m))	SOLID	WHITE	SEE TYPICAL TURN LANE MARKING DETAIL		
TWO WAY LEFT TURN MARKING	2 @ 4 (100) EACH DIRECTION 8' (2.4m) LEFT ARROW	SKIP-DASH AND SOLID IN PAIRS	YELLOW	10' (3 m) LINE WITH 30' (9 m) SPACE FOR SKIP-DASH; 5½ (140) C-C BETWEEN SOLID LINE AND SKIP-DASH LINE SEE TYPICAL TWO-WAY LEFT TURN MARKING DETAIL		
CROSSWALK LINES (PEDESTRIAN) A. DIAGONALS (BIKE & EQUESTRIAN) B. LONGITUDINAL BARS (SCHOOL)	2 @ 6 (150) 12 (300) @ 45° 12 (300) @ 90°	SOLID SOLID SOLID	WHITE WHITE WHITE	NOT LESS THAN 6' (1.8 m) APART 2' (600) APART 2' (600) APART 5' (600) APART SEE TYPICAL CROSSWALK MARKING DETAILS.		
STOP LINES	24 (600)	SOLID	WHITE	PLACE 4' (1.2 m) IN ADVANCE OF AND PARALLEL TO CROSSWALK, IF PRESENT. OTHERWISE, PLACE AT DESIRED STOPPING POINT. PARALLEL TO CROSSROAD CENTERLINE, WHERE POSSIBLE		
PAINTED MEDIANS	2 @ 4 (100) WITH 12 (300) DIAGONALS @ 45° NO DIAGONALS USED FOR 4' (1.2 n) WIDE MEDIANS	SOLID	YELLOW: TWO WAY TRAFFIC WHITE: ONE WAY TRAFFIC	11 (280) C-C FOR THE DOUBLE LINE SEE TYPICAL PAINTED MEDIAN MARKING.		
GORE MARKING AND CHANNELIZING LINES	8 (200) WITH 12 (300) DIAGONALS @ 45°	SOLID	WHITE	DIAGONALS: 15' (4.5 m) C-C (LESS THAN 30MPH (50 km/h)) 20' (6 m) C-C 30MPH (50 km/h) TC 45MPH (70 km/h)) 30' (9 m) C-C (OVER 45MPH (70 km/h))		
RAILROAD CROSSING	24 (600) TRANSVERSE LINES; "RR" IS 6' (1.8 m) LETTERS 16 (400) LINE FOF. "X"	SOLID	WHITE	SEE STATE STANDARD 780001 AREA OF: "R"=3.6 SQ. FT. (0.33 m ZEACH "X"=54.0 SQ. FT. (5.0 m Z		
SHOULDER DIAGONALS (REQUIRED FOR SHOULDERS > 8')	12 (300) @ 45°	SOLID	WHITE - RIGHT YELLOW - LEFT	50' (15 m) C-C (LESS THAN 30MPH (50 km/h)) 75' (25 m) C-C (30 MPH (50 km/h) TO 45MPH (70 km/h)) 150' (45 m) C-C (OVER 45MPH (70 km/h))		
U TURN ARROW	SEE DETAIL	SOLID	WHITE	16.3 SF		
2 ARROW COMBINATION LEFT AND U TURN	SEE DETAIL	SOLID	WHITE	30.4 SF		


FOR FURTHER DETAILS ON PAVEMENT MARKING REFER TO STANDARD SPECIFICATIONS FOR ROAD AND BRIDGE CONSTRUCTION AND STATE STANDARD 780001.

unless otherwise shown.

COUNTY TOTAL SHEE NO. SECTION DISTRICT ONE DuPAGE 23 21 1533 21-00116-00-RS TYPICAL PAVEMENT MARKINGS CONTRACT NO. 61J37 TC-13 SHEET 1 OF 1 SHEETS STA. SCALE: NONE TO STA.

REVISED -PLOT SCALE = 50.0000 1 / in. CHECKED C. JUCIUS 12-21-15 DATE REVISED C. JUCIUS 04-12-16

STATE OF ILLINOIS **DEPARTMENT OF TRANSPORTATION**

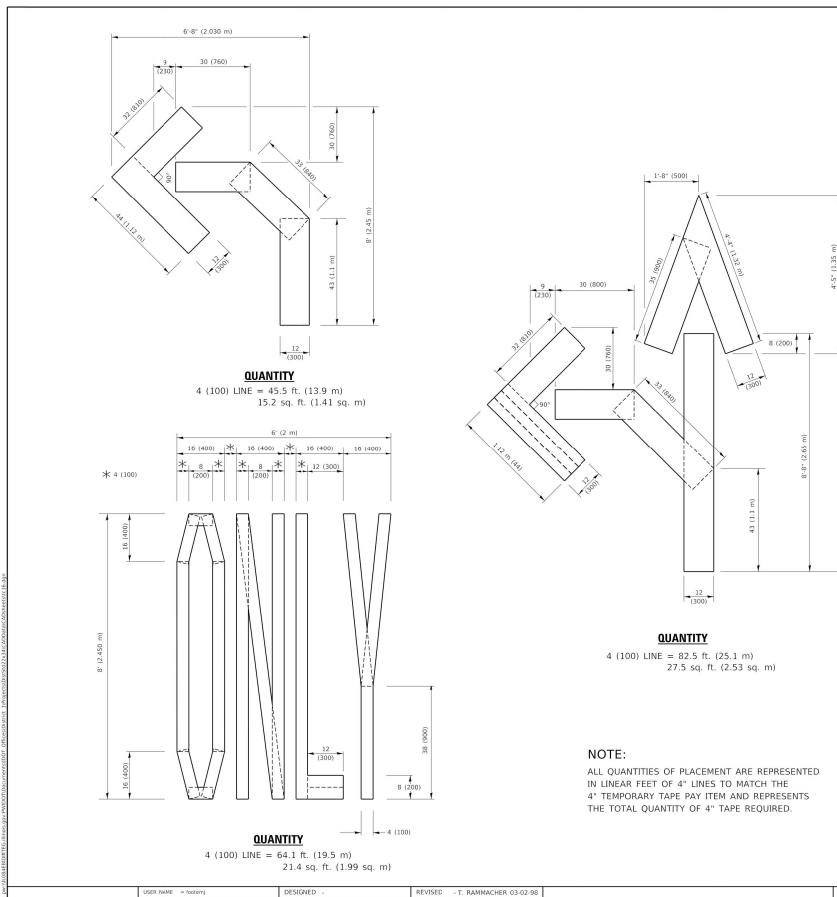

REVISED - E. GOMEZ 08-28-00

REVISED - E. GOMEZ 08-28-00


REVISED - A. SCHUETZE 09-15-16

DRAWN

CHECKED

09-18-94

PLOT SCALE = 50.0068 ' / in.

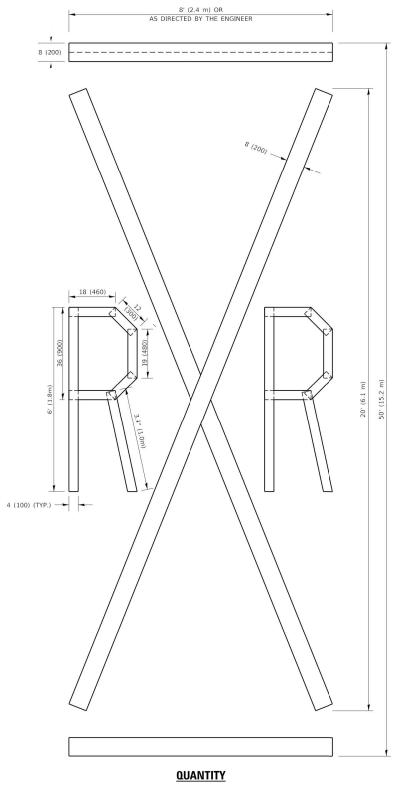

4 (100) LINE = 225.9 ft. (68.9 m) 75.3 sq. ft. (6.99 sq. m)

All dimensions are in inches (millimeters) unless otherwise shown.

OTATE OF HUMOIO							 	F.A.U RTE.	SECTION	COUNTY	TOTAL SHEETS	SHEET NO.
STATE OF ILLINOIS	SHORT TERM PAVEMENT MARKING LETTERS AND SYMBOLS					1533	21-00116-00-RS	DuPAGE	23	22		
DEPARTMENT OF TRANSPORTATION									TC-16	CONTRACT	NO.	61J37
	SCALE: NONE	SHEET	1	OF 1	I SHEETS	STA.	TO STA.		ILLINOIS FED. AI	ID PROJECT		

