STATE OF ILLINOIS


DEPARTMENT OF TRANSPORTATION

DIVISION OF HIGHWAYS

PROPOSED HIGHWAY PLANS

FAI ROUTE 70 (I-55 / I-70) SECTION 82-5VB-R-3

I-55 /70 OVER B&O BRIDGE REPAIR ST. CLAIR COUNTY C-98-023-17

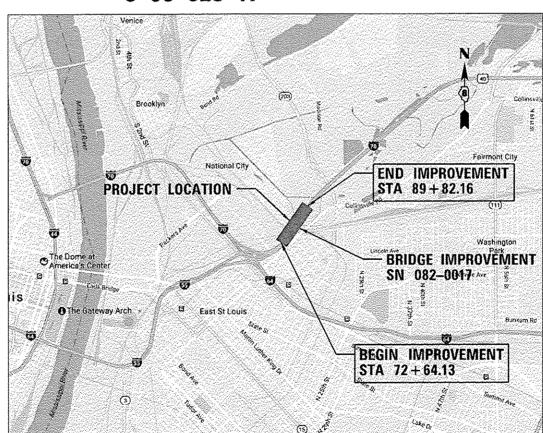

LOCATION MAP

GROSS LENGTH = 1,718.03 FT. = 0.325 MILE NET LENGTH = 1,718,03 FT, = 0.325 MILE

LICENSED **PROFESSIONAL ENGINEER** JASON L FRERICKS, P.E. DOE DATE
LICENSED PROFESSIONAL ENGINEER
HLINOIS NO. 662-059118 EXPERIS W.30-10015 D-98-034-17

82-5VB-R-3

ST. CLAIR 20 1

ILLINOIS CONTRACT NO. 76KIE



FUNCTIONAL CLASSIFICATION: INTERSTATE 2016 ADT: 70,200 2016 ADTT: 8,900 MU%: 9.3%

STATE OF HUNOIS DEPARTMENT OF TRANSPORTATION

SU%: 3.3%

PRINTED BY THE AUTHORITY OF THE STATE OF ILLINOIS

INDEX OF SHEETS

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- **GENERAL NOTES**
- SUMMARY OF QUANTITIES
- INTERSTATE WEEKEND CLOSURE, SPECIAL 4-18.
- BRIDGE PLANS

HIGHWAY STANDARDS

STANDARD SYMBOLS, ABBREVIATIONS, AND PATTERNS

OFF-ROAD OPERATIONS, MULTILANE, 15' TO 24" FROM PAVEMENT EDGE 701101-05

APPROACH TO LANE CLOSURE FREEWAY /EXPRESSWAY 701400-09

LANE CLOSURE, FREEWAY /EXPRESSWAY 701401-10

TRAFFIC CONTROL SETUP AND REMOVAL FREEWAY /EXPRESSWAY 701428-01

TWO LANE CLOSURE, FREEWAY /EXPRESSWAY 701446-08

RAMP CLOSURE, FREEWAY /EXPRESSWAY 701451-04

701901-06 TRAFFIC CONTROL DEVICES

720001-01 SIGN PANEL MOUNT DETAILS SIGN PANEL ERECTION DETAILS

FULL SIZE PLANS HAVE BEEN PREPARED USING STANDARD ENGINEERING SCALES. REDUCED SIZED PLANS WILL NOT CONFORM TO STANDARD SCALES. IN MAKING MEASUREMENTS ON REDUCED PLANS, THE ABOVE SCALES MAY BE USED.

JOINT UTILITY LOCATION INFORMATION FOR EXCAVATION 1-800-892-0123

OR 811

PROJECT ENGINEER: TIMOTHY PADGETT (618) 346-3325 PROJECT MANAGER: DON HAYDEN (618) 346-3181

CONTRACT NO. 76K16



- <u>COMMITMENTS</u>
- NONE

- ALL CONSTRUCTION SHALL BE DONE IN ACCORDANCE WITH THE ILLINOIS DEPARTMENT OF TRANSPORTATION "STANDARD SPECIFICATIONS FOR ROAD AND BRIDGE CONSTRUCTION", ADOPTED APRIL 1, 2016, THESE PLANS AND THE SPECIAL PROVISIONS INCLUDED IN THE CONTRACT DOCUMENTS.
- 2. THE ENGINEER SHALL NOT BE RESPONSIBLE FOR THE MEANS, METHODS, PROCEDURES, TECHNIQUES OR SEQUENCES OF CONSTRUCTION, NOR SAFETY ON THE JOB SITE, NOR SHALL THE ENGINEER BE RESPONSIBLE FOR THE CONTRACTOR'S FAILURE TO CARRY OUT THE WORK IN ACCORDANCE WITH THE CONTRACT DOCUMENTS. NEITHER THE PROFESSIONAL ACTIVITIES OF THE ENGINEER NOR THE PRESENCE OF THE ENGINEER AT A CONSTRUCTION SITE SHALL RELIEVE THE CONTRACTOR OF THEIR OBLIGATIONS, DUTIES AND RESPONSIBILITIES, INCLUDING ANY HEALTH AND SAFETY PRECAUTIONS REQUIRED BY ANY REGULATORY AGENCIES.
- 3. CONTRACTOR SHALL VERIFY LOCATION OF ALL EXISTING UTILITIES BEFORE BEGINNING CONSTRUCTION. THE CONTRACTOR SHALL BE RESPONSIBLE FOR PROTECTING ALL UTILITIES AND SHALL BE LIABLE FOR ANY DAMAGE TO THEM RESULTING FROM HIS OPERATIONS.
- 4. ILLINOIS STATE LAW REQUIRES A 48-HOUR NOTICE BE GIVEN TO ALL UTILITIES BEFORE DIGGING. FIELD MARKING OF FACILITIES MAY BE OBTAINED BY CONTACTING J.U.L.I.E. OR FOR NON-MEMBERS, THE UTILITY COMPANY DIRECTLY. AGENCIES KNOWN TO HAVE FACILITIES WITHIN THE PROJECT AREA ARE AS FOLLOWS:
 - •AMEREN ILLINOIS (GAS AND ELECTRIC)
 •AT&T ILLINOIS (COMMUNICATIONS)
 •CENTURYLINK, INC. (COMMUNICATIONS)
 •CITY OF EAST ST. LOUIS (LIGHITNG)
 - *MEDIACOM LLC CENTRAL (CABLE TV)
 *PEG BANDWIDTH IL, LLC (COMMUNICATIONS)
 - MEMBERS OF J.U.L.I.E. (800)-892-0123 OR 811 ARE INDICATED BY .. NON J.U.L.I.E. MEMBERS MUST BE NOTIFIED INDIVIDUALLY.
- 5. ANY STANDARDS REFERENCED THROUGHOUT THE PLANS SHALL BE INTERPRETED TO BE THE LATEST HIGHWAY STANDARDS OF THE ILLINOIS DEPARTMENT OF TRANSPORTATION AS SHOWN ON THE SCHEDULE OF HIGHWAY STANDARDS SHEET.
- 6. THE CONTRACTOR SHALL DISPOSE OF ALL REMOVAL ITEMS OFF OF THE RIGHT-OF-WAY.
- 7. THE ILLINOIS DEPARTMENT OF TRANSPORTATION STRONGLY ENCOURAGES THE PRIME CONTRACTOR AND THEIR APPROVED SUB-CONTRACTORS TO HIRE MINORITY, WOMEN AND DISADVANTAGED INDIVIDUALS FROM ITS FEDERALLY FUNDED HIGHWAY CONSTRUCTION CAREERS TRAINING PROGRAM (HCCTP) TO HELP MEET WORKFORCE AND TRAINEE GOALS. THIS PROGRAM IS TRAINING MINORITIES, WOMEN AND DISADVANTAGED INDIVIDUALS IN HIGHWAY CONSTRUCTION-RELATED SKILLS, E.G., MATH FOR THE TRADES, JOB READINESS, TECHNICAL SKILLS COURSEWORK (CARPENTRY, CONCRETE FLATWORK, BLUEPRINT READING, SITE PLANS, SITE WORK, TOOLS USE, ETC.) AND OSHA 10 HOUR CERTIFICATION, TO PREPARE THEM FOR A CAREER IN THE HIGHWAY CONSTRUCTION TRADES. GRADUATES ARE WELL-TRAINED AND READY TO BECOME PRODUCTIVE ENTRY-LEVEL CONSTRUCTION WORKERS. PLEASE CONTACT THE DISTRICT 8 EEO OFFICE AT 618-346-3360 AND/OR THE HCCTP COORDINATOR AT 618/874-6528 TO LEARN MORE ABOUT THE PROGRAM AND FOR ASSISTANCE IN MEETING WORKFORCE AND TRAINEE GOALS.
- 8. ALL REQUIRED TRAFFIC CONTROL SHALL BE CONDUCTED ACCORDING TO ALL CURRENT APPLICABLE IDOT POLICIES AND STANDARDS AND THE LATEST EDITION OF THE MANUAL ON UNIFORM TRAFFIC CONTROL DEVICES (MUTCD) IN EFFECT ON THE DATE OF THE INVITATION FOR BIDS.
- THE CONTRACTOR SHALL NOTIFY THE ENGINEER THREE WEEKS IN ADVANCE OF EACH INTERSTATE WEEKEND DIRECTIONAL CLOSURE. THE CONTRACTOR IS REQUIRED TO ALSO NOTIFY THE RESIDENT ENGINEER 72 HOURS IN ADVANCE OF THE PLACEMENT OF ANY TRAFFIC CONTROL DEVICES.

- 10. ALL CONSTRUCTION SIGNS SHALL HAVE A BLACK LEGEND/BORDER ON A FLUORESCENT ORANGE REFLECTORIZED BACKGROUND. ALL MATERIAL AND LABOR RELATED TO SIGN INSTALLATION AND REMOVAL SHALL BE INCLUDED IN THE COST OF THE CONTRACT, NO ADDITIONAL COMPENSATION WILL BE PROVIDED. THE EXACT LOCATION OF ALL ADVANCE WARNING SIGNS SHALL BE APPROVED BY THE RESIDENT ENGINEER PRIOR TO PLACEMENT.
- 11. ALL TEMPORARY TRAFFIC CONTROL SIGNS SHALL BE POST-MOUNTED UNLESS THE SIGNS ARE LOCATED ON THE PAVEMENT. IT SHALL BE THE CONTRACTOR'S RESPONSIBILITY TO ENSURE THAT ALL MOUNTED SIGNS MEET NCHRP 350, TEST LEVEL 3 GUIDELINES AND THAT ANY SUPPORT BASES ON ANY PAVEMENT MOUNTED SIGNS ARE PROPERLY WEIGHTED FOR THE EXISTING AND ANTICIPATED WIND CONDITIONS. IDOT SHALL BE HELD HARMLESS FOR NEGLIGENCE OF THE CONTRACTOR TO ADHERE TO THIS DIRECTIVE.
- 12. CHANGEABLE MESSAGE SIGNS SHALL BE PLACED TWO WEEKS PRIOR TO EACH INTERSTATE WEEKEND CLOSURES. ALL MESSAGES, INCLUDING DYNAMIC MESSAGE SIGNS, SHALL BE APPROVED BY THE RESIDENT ENGINEER AND COORDINATED WITH THE TRAFFIC MANAGEMENT CENTER (618-346-3279).
- 13. THE CONTRACTOR SHOULD NOTE THAT ADJACENT PROJECTS WILL BE CONSTRUCTED CONCURRENTLY WITH THIS PROJECT; WHICH MAY CONFLICT WITH THE SUGGESTED MAINTENANCE OF TRAFFIC PRESENTED IN THESE PLANS. THE CONTRACTOR SHALL COORDINATE THROUGH THE RESIDENT ENGINEER THREE WEEKS IN ADVANCE OF ANY LANE CLOSURES. PLEASE CONTACT BOTH THE IDOT DISTRICT 8 CONSTRUCTION ENGINEER AT (618) 346-3345 AND THE IDOT DISTRICT 8 TRAFFIC CONTROL TECHNICIAN AT (618) 346-3387
- 14. THE CONTRACTOR SHALL VERIFY ALL DIMENSIONS AND CONDITIONS IN THE FIELD PRIOR TO CONSTRUCTION AND ORDERING OF MATERIALS.

MIXTURE REQUIREMENTS

ROUTE	FAI 70 (1-55 / I-70)
SECTION	82-5VB-R-3
COUNTY	ST. CLAIR
CONTRACT	76K16

DESCRIPTION:	JOINT REPLACEMENTS ON I-55 /	I-70 BRIDGE OVER B&O, CONRAIL &	TRRA RR IN E. ST. LOUIS - SN 082-0017
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SCALE: NTS

SHEET 1

ADT (CONSTRUCTION YR):	36200
MU %	9.6
SU %	3.5
20 YR. ESAL'S	22.35

MATURE USE	DDIDOE ADDDOAGU	
MIXTURE USE	BRIDGE APPROACH	
AC/PG	SBS PG76-22	
RAP % (MAX)	SEE SPECIAL PROVISION	
DESIGN AIR VOIDS	4.0% @ NDES = 90	
MIX COMPOSITION (GRADATION)	IL 9.5	
FRICTION AGG	MIXTURE "E"	
QUALITY MGMT PROGRAM	OC/OA	

MIXTURE USE	SHOULDERS > 2.25"	SHOULDERS < 2.25"	
AC/PG	PG 64-22	PG 64-22	
RAP % (MAX)	SEE SPECIAL PROVISION	SEE SPECIAL PROVISION	
DESIGN AIR VOIDS	4.0% @ NDES = 30	4.0% @ NDES = 30	
MIX COMPOSITION (GRADATION)	IL 19.0L	IL 9 . 5L	
FRICTION AGG			
QUALITY MGMT PROGRAM	QC/QA	QC/QA	

Farnsworth	
2211 West Bradley Avenue Champalgn, Illinois 61821 217/352-7408, 217/352-7409 fax	

USER NAME = \$USER\$	DESIGNED	-	KRS	REVISED -
	DRAWN	-	SRL	REVISED -
PLOT SCALE = \$SCALE\$	CHECKED	-	JLF	REVISED -
PLOT DATE = \$DATE\$	DATE	-	1/27/2017	REVISED -

STATE O	F ILLINOIS
DEPARTMENT OF	TRANSPORTATION

GENERAL NOTES		F.A.I. RTE.	SECTION	COUNTY	TOTAL SHEETS	SHEET NO.		
		70	82-5VB-R-3	ST. CLAIR	20	2		
						CONTRACT	T NO. 7	76K16
OF	1 SHEETS	STA.	TO STA.		TILINOIS FED AT	D PROJECT		

SUMMARY OF QUANTITIES					CONSTRUCTION CODE
PAY ITEM NO.		DESCRIPTION	UNIT	TOTAL QUANTITY	√0014
67100100		MOBILIZATION	LSUM	1	1
70200100		NIGHTTIME WORK ZONE LIGHTING	LSUM	**************************************	1
X0326808	Х	INTERSTATE WEEKEND CLOSURE, SPECIAL	LSUM	1	. 1
X4406620	X	PARTIAL DEPTH REMOVAL, TYPE IV, 2"	SQ YD	871	871
X4421000	X	PARTIAL DEPTH PATCHING	TON	98	98
Z0016200	Х	DECK SLAB REPAIR (PARTIAL)	SQYD	21	21
Z0021906	X	SILICONE JOINT SEALER, 1.5"	FOOT	115	115
Z0021908	Χ	SILICONE JOINT SEALER, 2"	FOOT	497	497
Z0021912	Χ	SILICONE JOINT SEALER, 2.5"	FOOT	422	422
Z0021916	X	SILICONE JOINT SEALER, 3"	FOOT	271	271
Z0041895	X	POLYMER CONCRETE	CUFT	163	163
	×				1/30/201

X DENOTES SPECIAL PROVISION


▲ Farnsworth	
ESS GROUP INC	
2 12 Programme State Company	
Contract series of \$2.50	
さまでくられること かんがい うちき むいれかしみかわません 一	

USER NAME + Lantoford.	DESIGNED - KRS	REVISEO -
	DRAWN - SRL	REVISED -
PLO1 SCALE = 2.0280 1/ 1/4	CHECKED - AF	REVISED ~
 PLOT DATE # 1/30/2017	DATE - 1/27/2017	REVISEO -

STATI	E OF	ILLINOIS
DEPARTMENT	OF	TRANSPORTATION

						F.A.I.	SECTION	1	Ç
	30	MMMAK	of QUA	AMILLI	(\$	70	82-5V8-R-3	L	<u> </u>
SCALE: NTS	SHEET 1	O# 1	SHEETS	STA.	10 STA	<u> </u>	ILLIHOIS FED. A	10	7

	—		7		1	DETOUR	NORTH	EAST	SOUTH	WEST	NTERSTATE 55	NTERSTATE 70
SHEET#	M6-1-(0)-21-15	M6-1-(0)-21-15	M6-2-(0)-21-15	M6-2-(0)-21-15	M6-3-(0)-21-15	M4-8-(0)-30-15	M3-1-(0)-24-12	M3-2-(0)-24-12	M3-3-(0)-24-12	M3-4-(0)-24-12	M1-1-24-24	M1-1-24-24
OF 15	ARROW LT	ARROW RT	ARROW DIAGONAL RT	ARROW DIAGONAL LT	ARROW UP	DETOUR	NORTH	EAST	SOUTH	WEST	I-55	I-70
4	3	2			3	8	8	8			8	8
5			4			4	4	4			4	4
6			4		4	8	8	8			8	8
7			2			2	2	2			2	2
8			4	2	2	8			8	8	8	8
9	1	1			1	3			3	3	3	3
10			2			2			2	2	2	2
11												
12	2	2			2	6			6	6	6	6
13			2	2		4			4	4	4	4
TOTAL	6	5	18	4	12	45	22	22	23	23	45	45

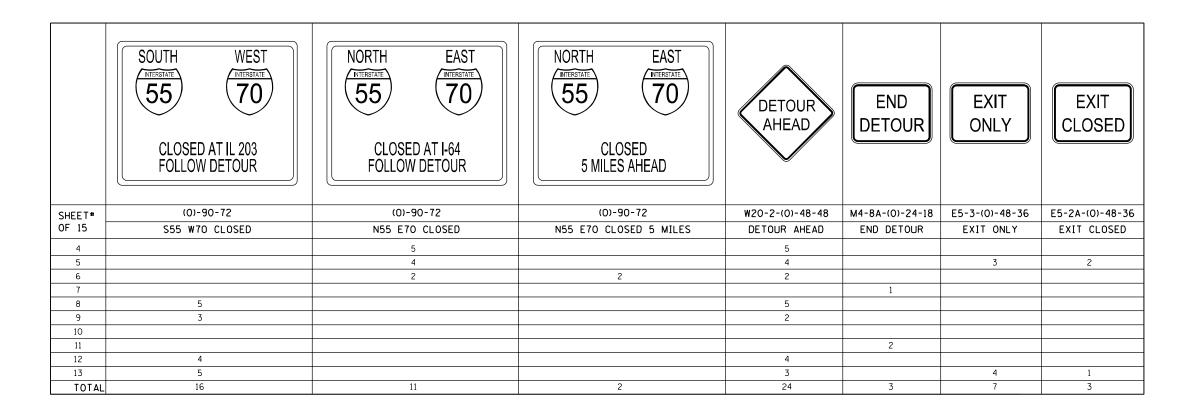

NOTE:
ALL SIGNS SHALL BE PROVIDED
INSTALLED, AND REMOVED
BY THE CONTRACTOR.


Farnsworth GROUP, INC.	
2211 West Bradley Avenue Champalgn, IIIInols 61821 217/352-7408, 217/352-7409 fax	

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	DRAWN	-	SRL	REVISED -
PLOT SCALE = \$SCALE\$	CHECKED	-	JLF	REVISED -
PLOT DATE = \$DATE\$	DATE	-	1/27/2017	REVISED -


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DEPARTMENT OF 1	TRANSPORTATION


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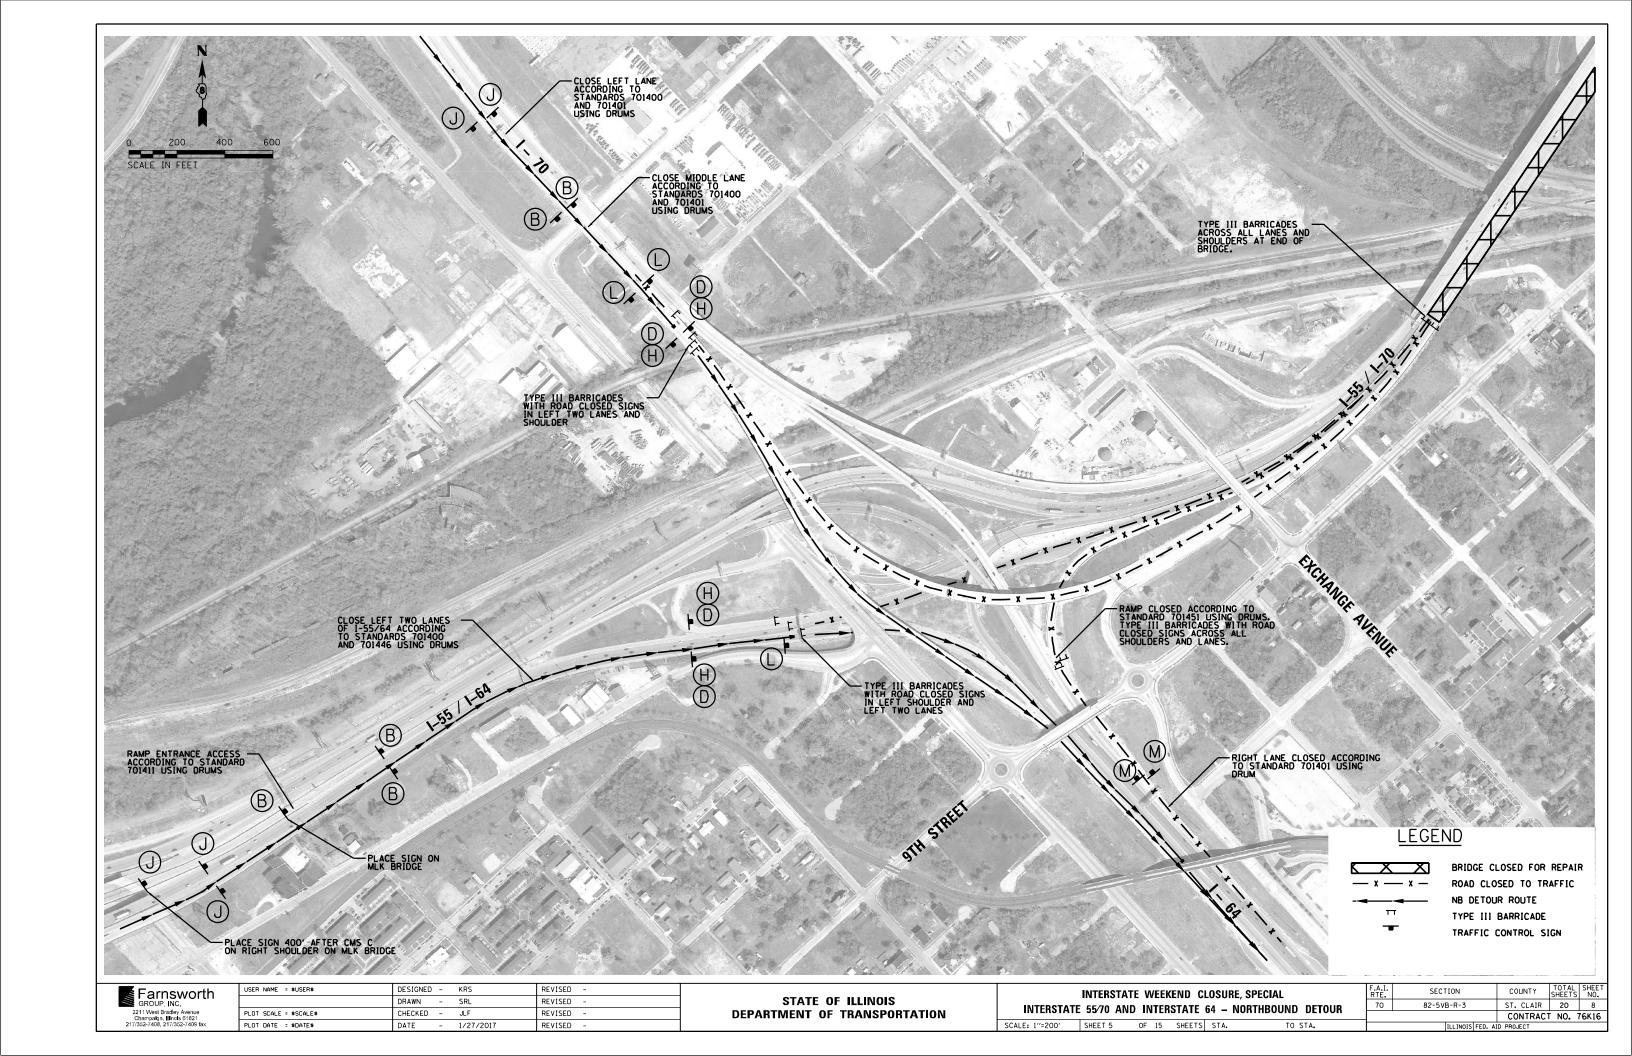
INTERSTATE WEEKEND CLOSURE, SPECIAL						SPECIAL	F.A.I. RTE.				SHEET NO.
DETOUR SIGNING SCHEDULE					CHEDII	ı E	70	82-5VB-R-3	ST. CLAIR	20	4
	DLI	JUII	JIC	IIVIIVO V	JUILLUU				CONTRACT	NO. 7	'6K16
SHEET	1	OF	15	SHEETS	STA.	TO STA.		ILLINOIS FED. AI	D PROJECT		

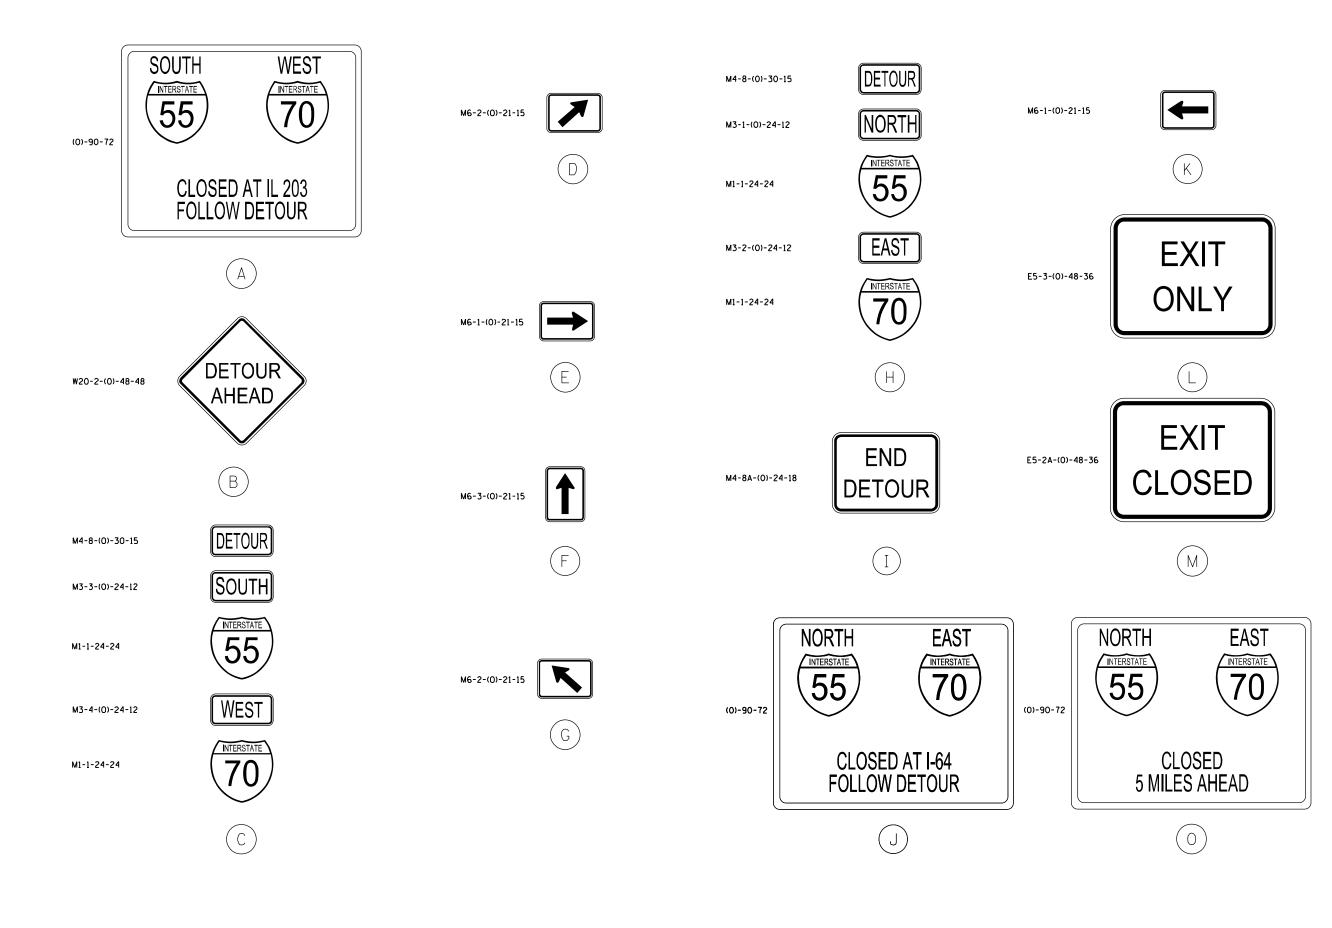


F.A.I. RTE. 70 USER NAME = \$USER\$ DESIGNED - KRS REVISED SECTION Farnsworth GROUP, INC. INTERSTATE WEEKEND CLOSURE, SPECIAL STATE OF ILLINOIS REVISED DRAWN - SRL 82-5VB-R-3 SIGNING LEGEND 2211 West Bradley Avenue Champalgn, Illinois 61821 217/352-7408, 217/352-7409 fr PLOT SCALE = \$SCALE\$ CHECKED - JLF REVISED **DEPARTMENT OF TRANSPORTATION** PLOT DATE = \$DATE\$ DATE - 1/27/2017 REVISED SCALE: NTS SHEET 2 OF 15 SHEETS STA. TO STA.




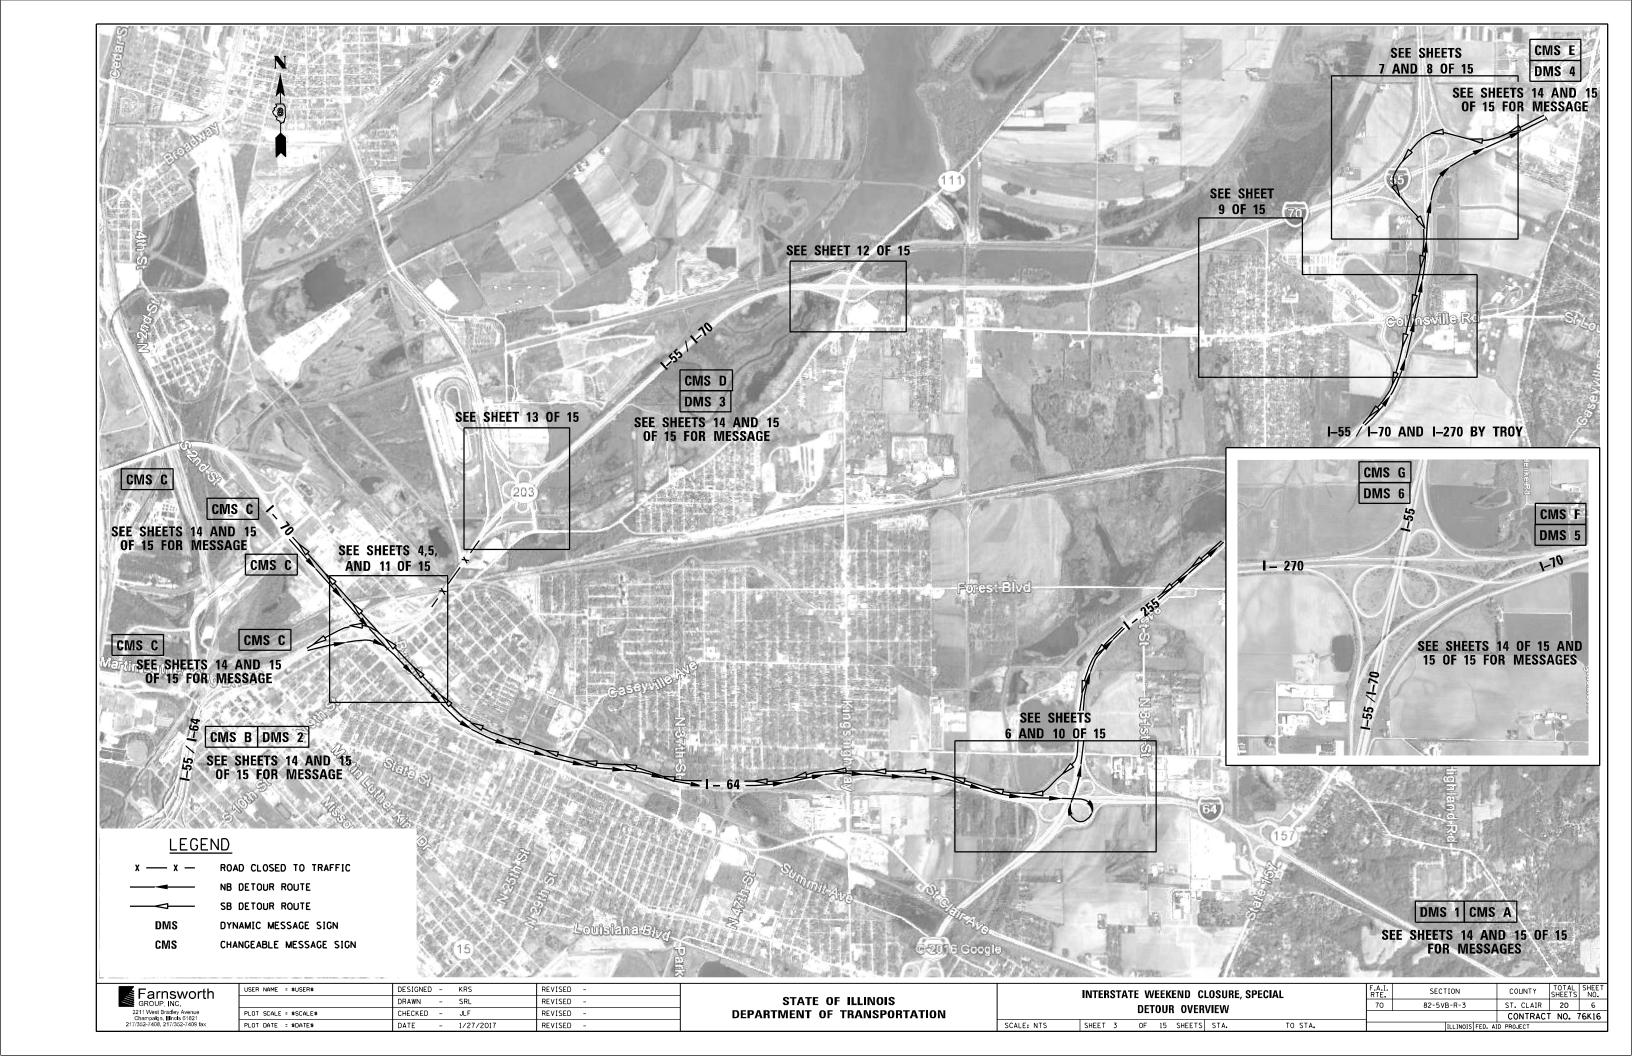


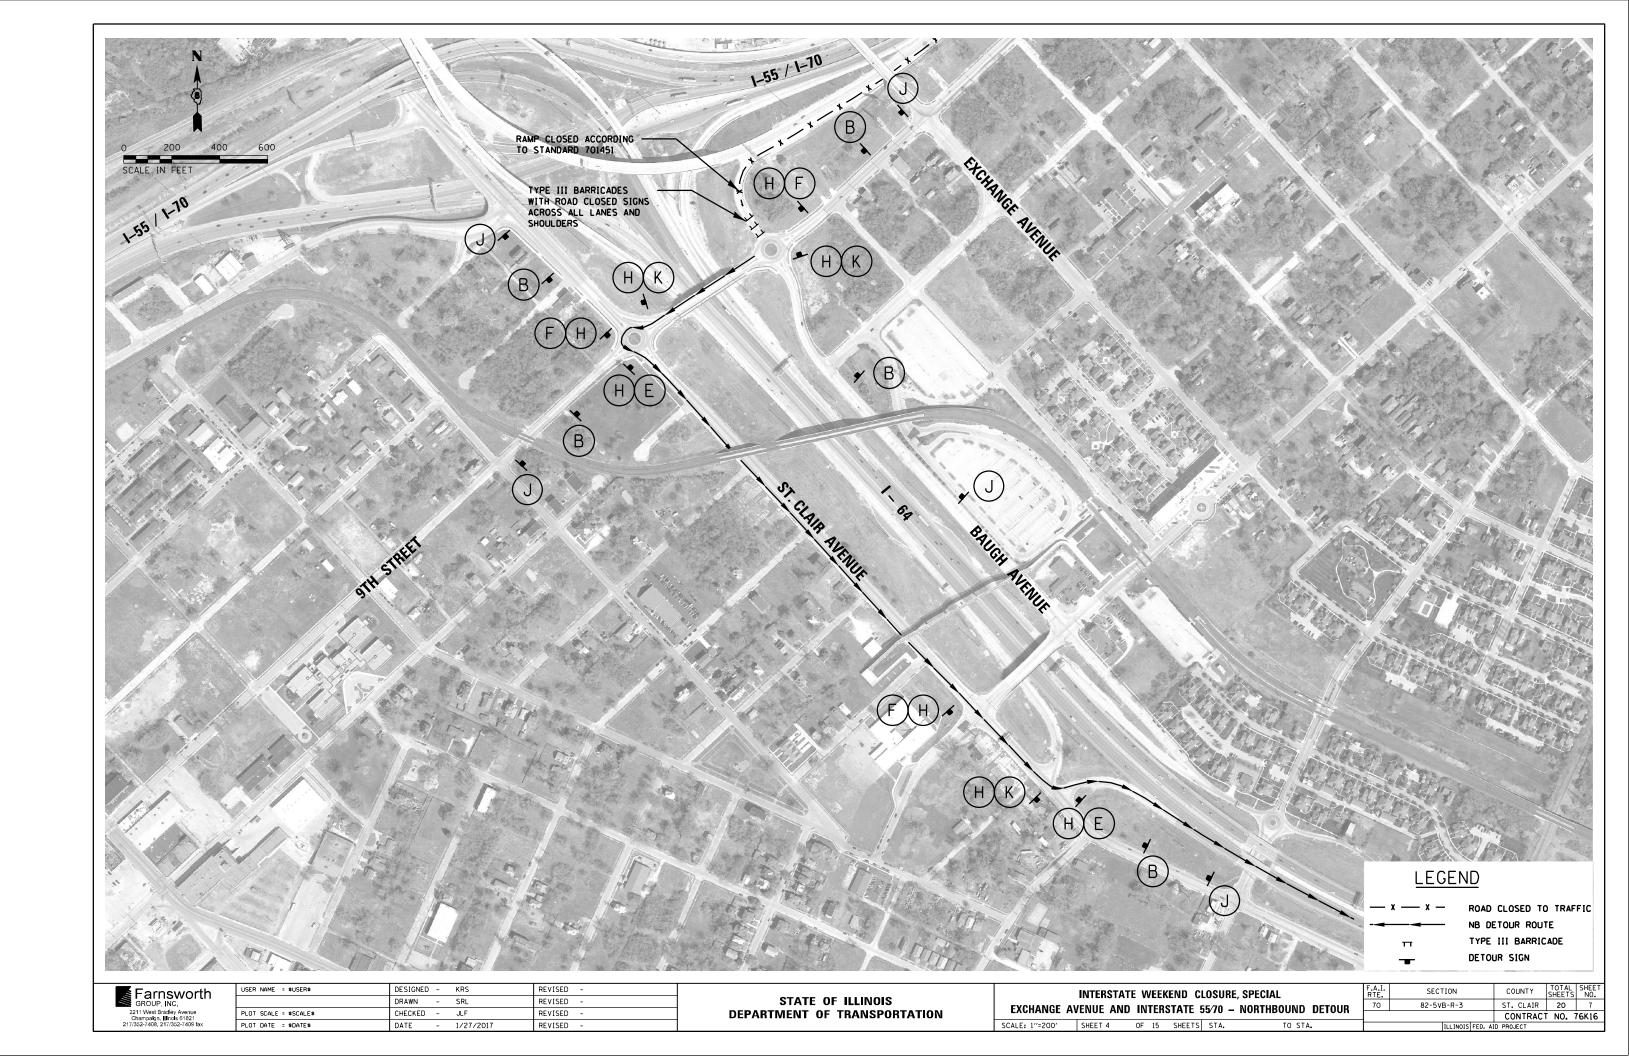



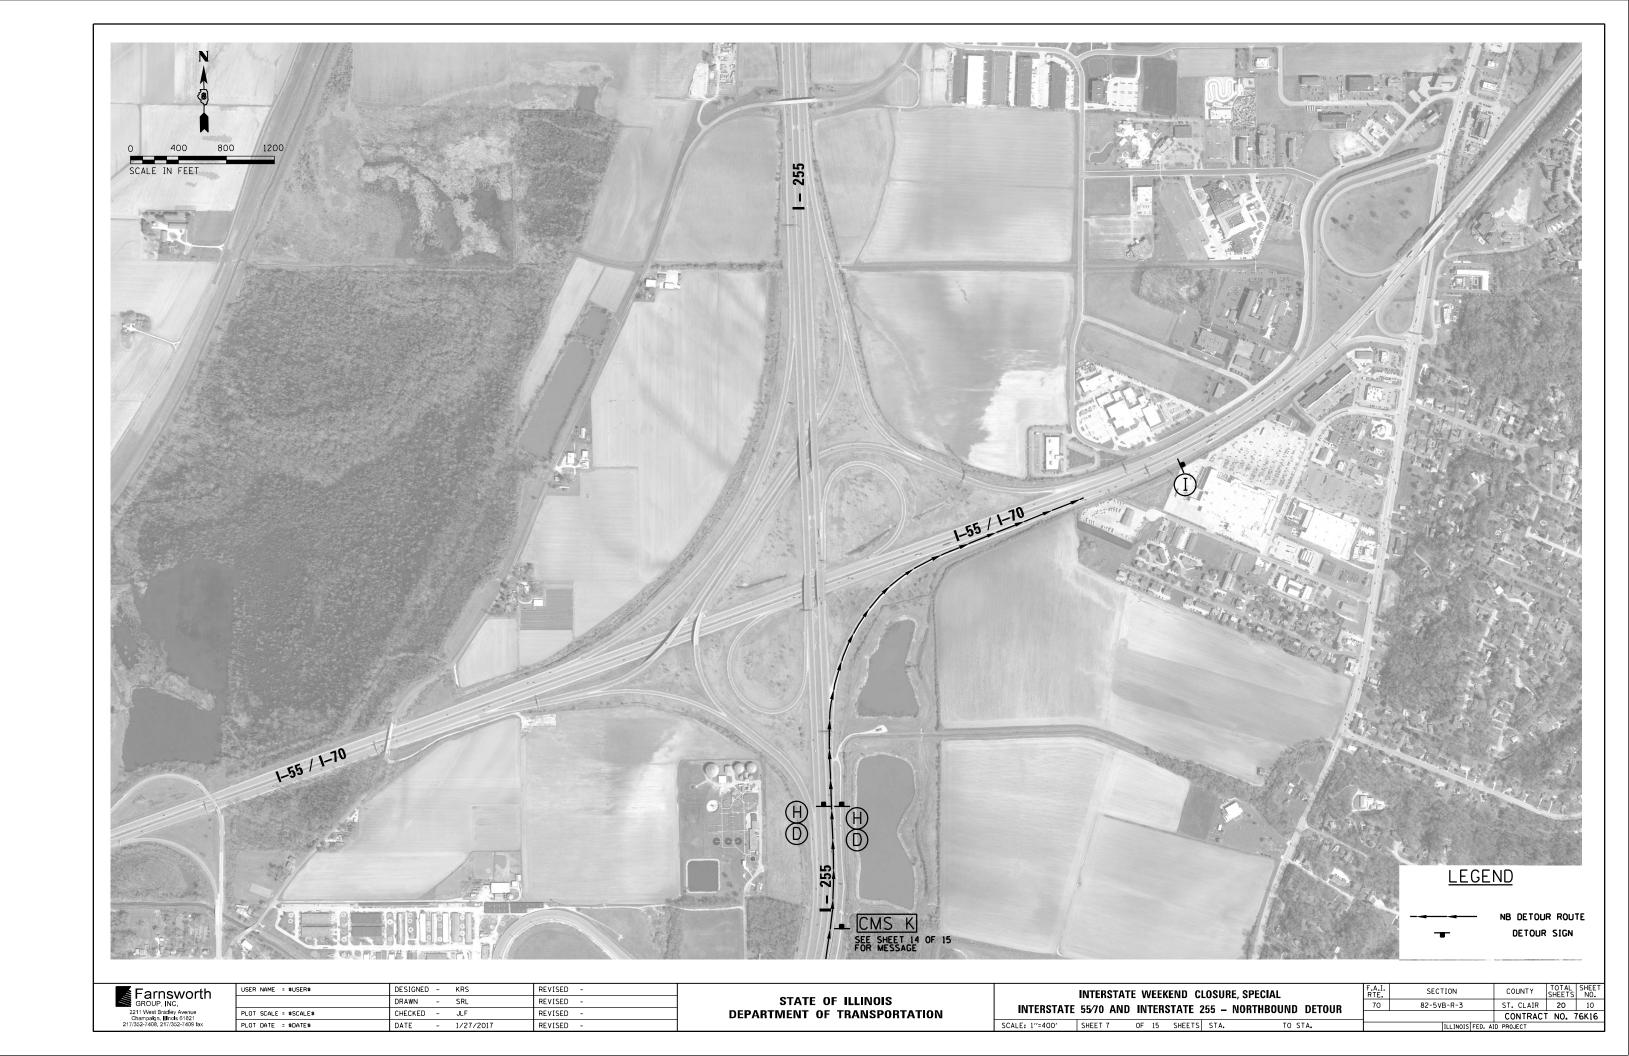


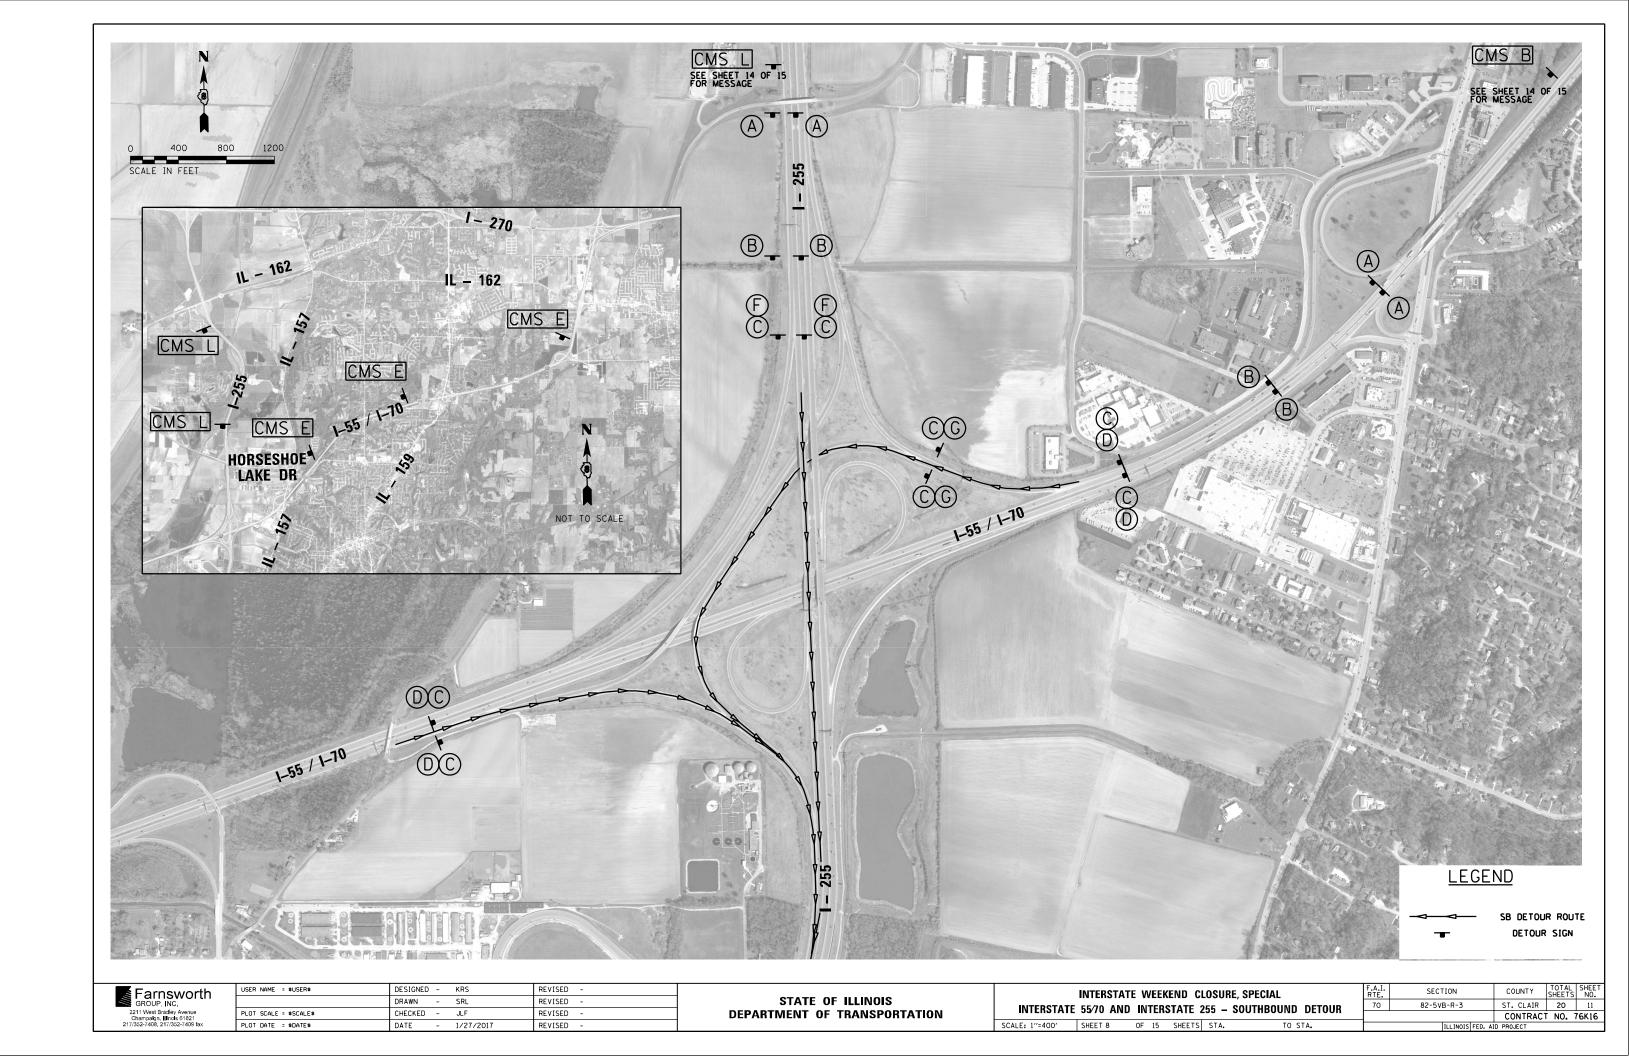


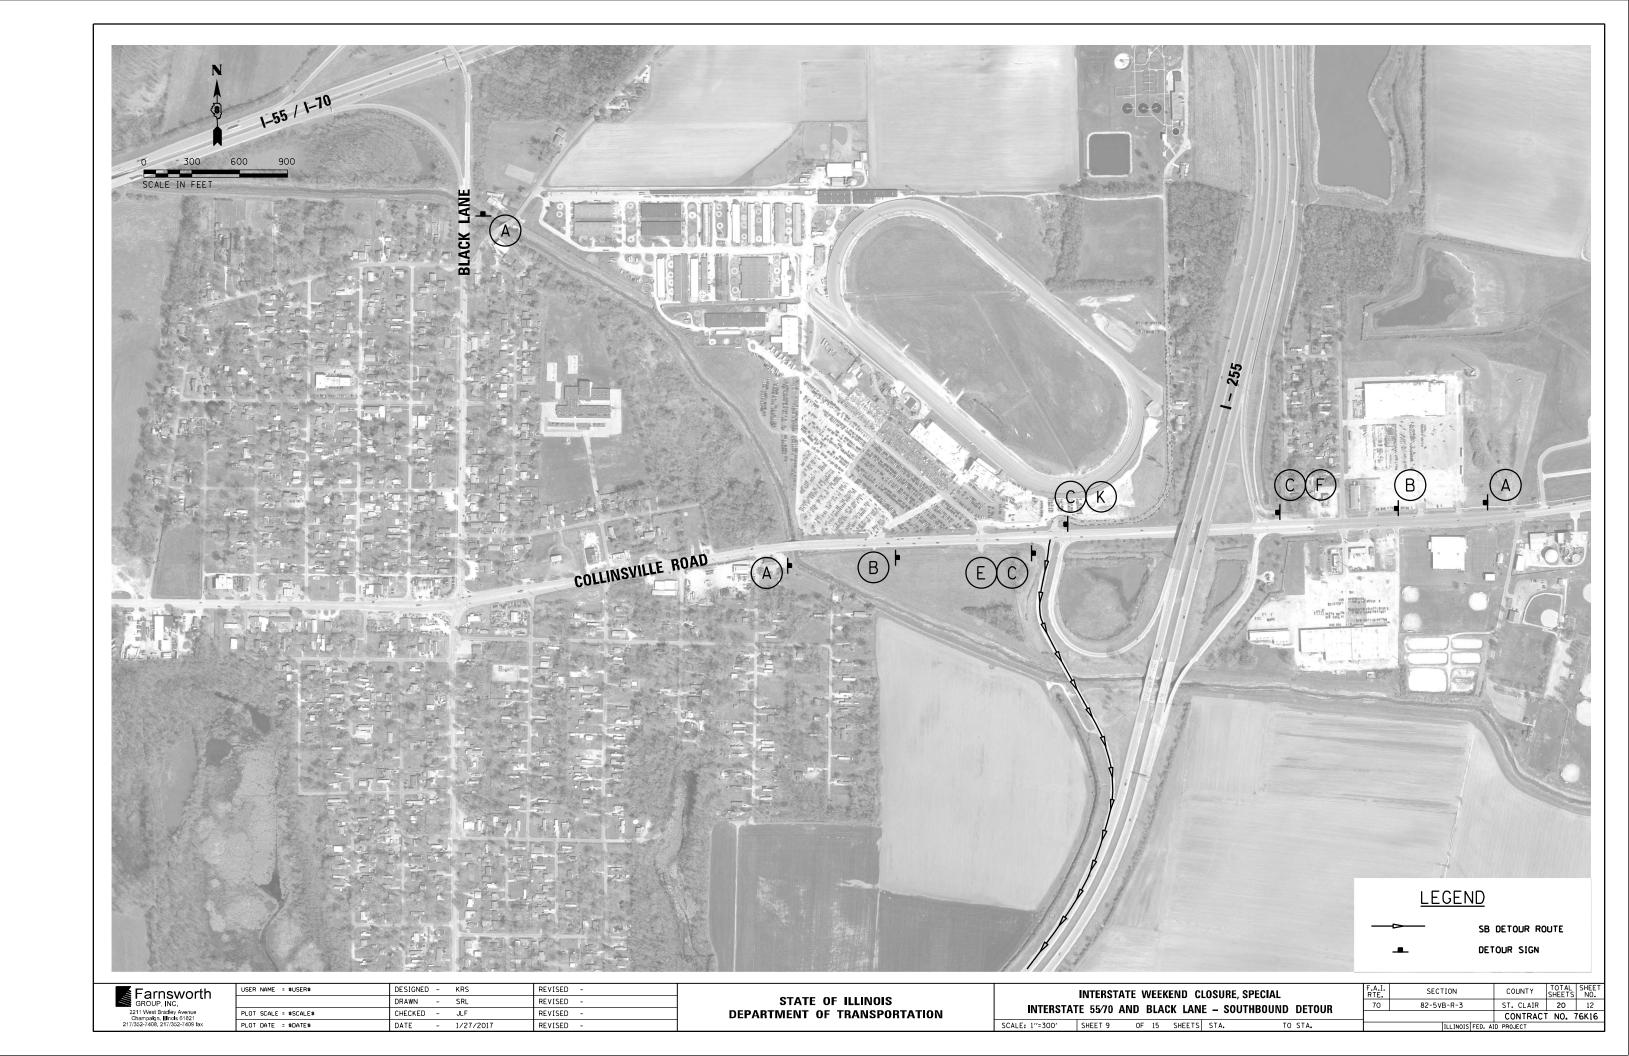





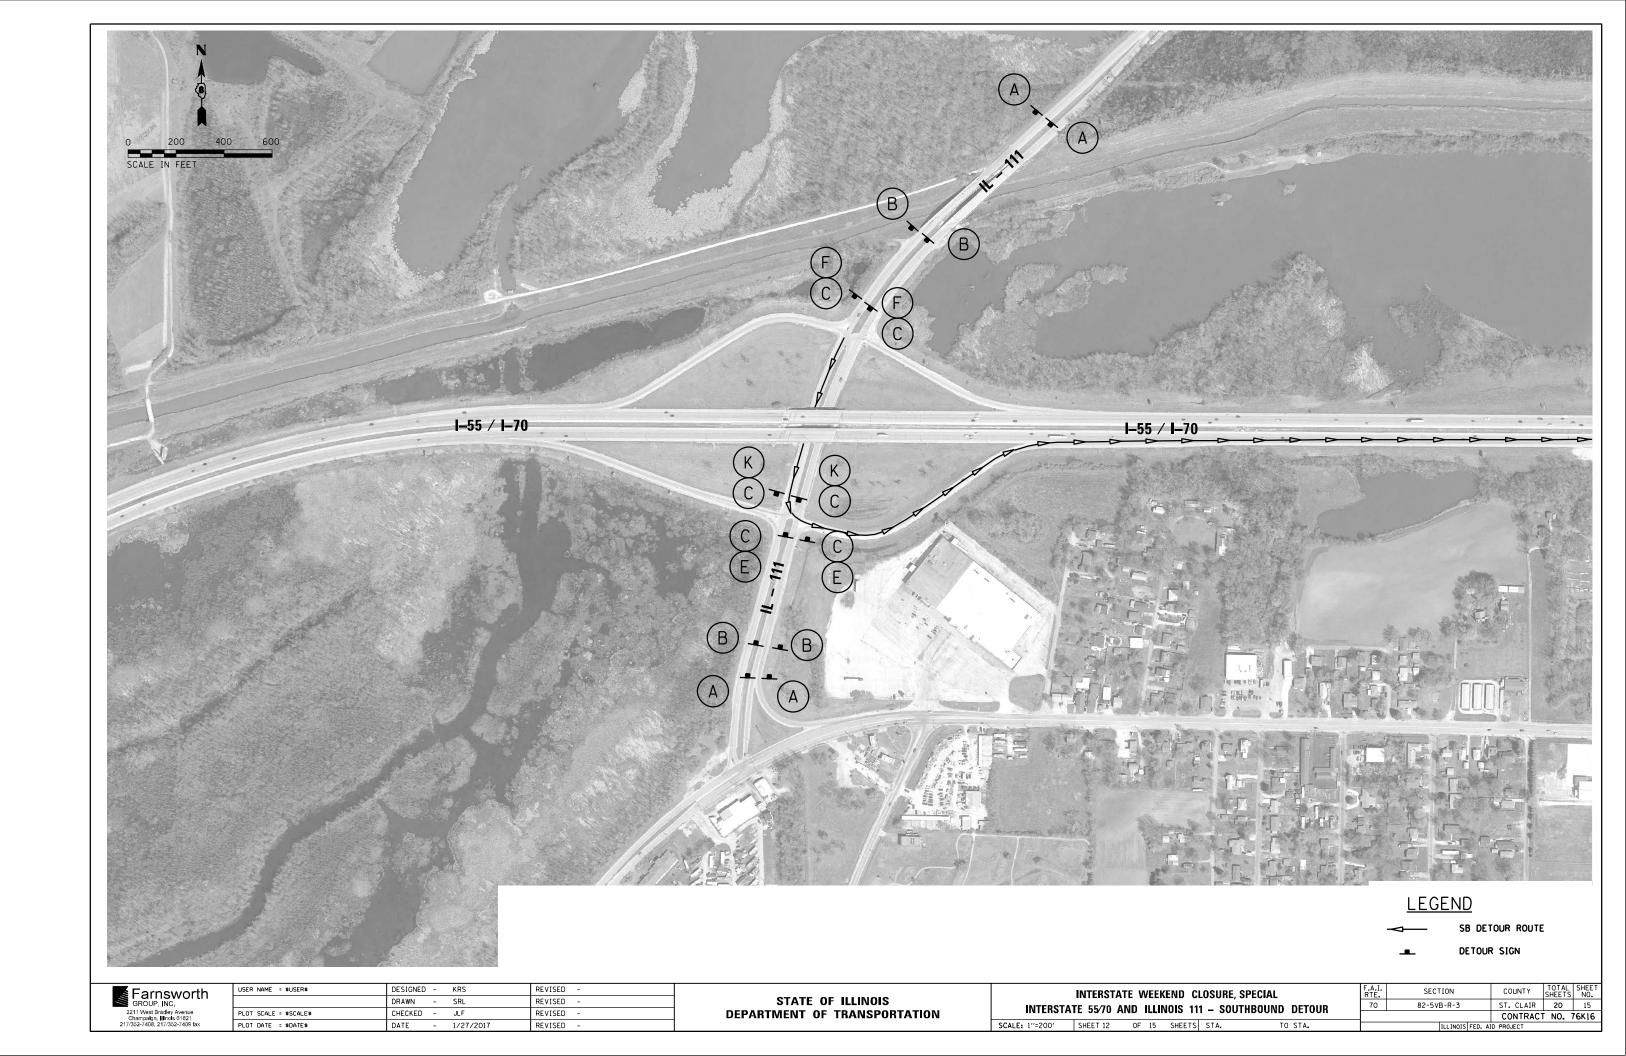

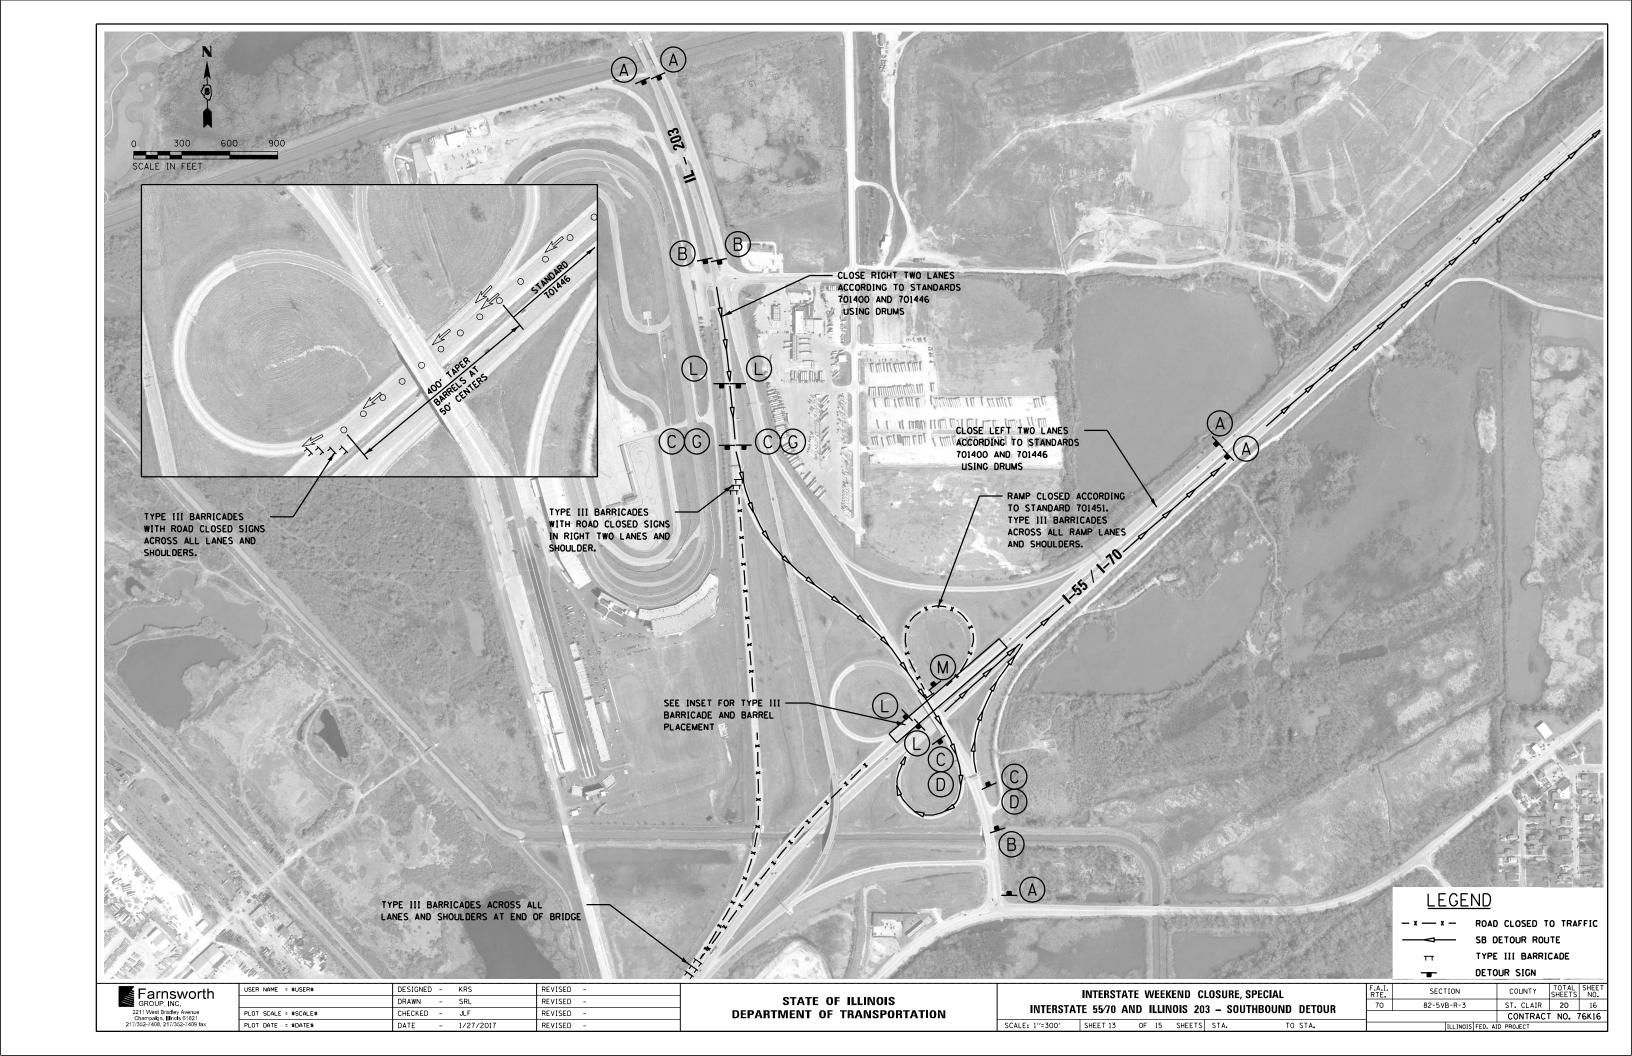

CHANGEABLE MESSAGE SIGN MESSAGES

(1 MILE BEFORE CMS A DMS 1 ON I-64 WB)

MESSAGE 1

55N 70E CLOSED AHEAD

MESSAGE 2

USE 1255N TO 55N 70E

MESSAGE 1

55N 70E CLOSED AHEAD

MESSAGE 2

(1 MILE BEFORE DMS 2 ON I-55 NB/I-64 EB)

USE 164E TO 1255N

CMS C

CMS B

(3 MILES , 2 MILES AND 1 MILE BEFORE I-55 NB/I-64 EB/I-70 EB ON 70 EB. 0.5 MILE AND 500 FEET AFTER MLK DRIVE EXIT GORE AREA ON MLK BRIDGE.)

MESSAGE 1

55N 70E CLOSED AHEAD

MESSAGE 2

USE 164E TO 1255N

CMS D

(1 MILE BEFORE DMS 3 ON I-55 SB/I-70 WB)

MESSAGE 1

55S 70W CLOSED AHEAD

MESSAGE 2

USE EXIT 4 A O R 4 B

(1 MILE BEFORE DMS 4 ON I-55 SB/I-70 WB, 0.25 MILES AFTER IL-162 ENTRANCE ON I-55 SB/I-70 WB. 0.50 MILES AFTER IL-159 ENTRANCE ON I-55 SB/I-70 WB. 0.50 MILES BEFORE IL-157 EXIT ON I-55 SB/I-70 WB)

MESSAGE 1

55S_70W_ CLOSED AHEAD

MESSAGE 2

USE 1255S TO 164W

(1 MILE BEFORE DMS 5 ON I-70 WB) CMS F

MESSAGE 1

170W CLOSED AHEAD

MESSAGE 2

USE 270S TO 170W INMO

CMS J

(1 MILE BEFORE EXIT 20 ON I-255 SB)

MESSAGE 1

DETOUR 55S 70W

MESSAGE 2

USE EXIT_20 164W

CMS K (1 MILE BEFORE EXIT 25A ON I-255 NB)

MESSAGE 1

155S CLOSED AHEAD

MESSAGE 2

(1 MILE BEFORE DMS 6 ON I-55 SB)

USE 255S TO 155S INMO

MESSAGE 1

DETOUR 55N 70E

MESSAGE 2

USE EXIT 25A AHEAD

CMS I (1.25 MILES BEFORE I-55 SB/I-70 WB

ON I-255 SB, 0.25 MILES AFTER IL-162 ENTRANCE ON I-255 SB)

MESSAGE 1 DETOUR 55N 70E

MESSAGE 2

CMS H (1 MILE BEFORE EXIT 7 ON I- 64 EB)

USE EXIT 7 1255N

MESSAGE 1

55S 70W CLOSED AT 1L203

MESSAGE 2

DETOUR REMAIN ON 1255S

Farnsworth

USER NAME = \$USER\$	DESIGNED	-	KRS	REVISED -
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PLOT SCALE = \$SCALE\$	CHECKED	-	JLF	REVISED -
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STATE OF ILLINOIS DEPARTMENT OF TRANSPORTATION

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SHEET 14	OF	15	SHEETS	STA.		ТО	STA.

F.A.I. RTE.	SECTION	COUNTY	TOTAL SHEETS	SHEET NO.
70	82-5VB-R-3	ST. CLAIR	20	17
		CONTRACT	NO.	76K16
	TILL INOIS FED. AT	ID PROJECT		

DYNAMIC MESSAGE SIGN MESSAGES

DMS #1 (WB I-64 0.25 MILES BEFORE BUNKUM RD) MESSAGE 1

NB I-55/EB I-70 CLOSED
8 MILES AHEAD

DMS #5 (WB I-70 1.5 MILES BEFORE I-55/I-270) MESSAGE 1

> WB 1-70 CLOSED AT IL 203 16 MI AHEAD NEAR DOWNTOWN FOLLOW MARKED DETOUR

MESSAGE 2

<u>WB 1-70 THROUGH TRAFFIC</u>
USE 1-270 WB TO 1-70 WB
IN MISSOURI

DMS #2 (NB I-55/EB I-64 AND 4TH STREET) MESSAGE 1

> NB I-55/EB I-70 CLOSED @ I-64 FOLLOW MARKED DETOUR I-64E TO I-255N

DMS #6 (SB I-55 2 MILES BEFORE I-70/I-270) MESSAGE 1

> SB I-55 CLOSED AT IL 203 16 MI AHEAD NEAR DOWNTOWN FOLLOW MARKED DETOUR

MESSAGE 2

SB I-55 THROUGH TRAFFIC USE 1-255 SB TO 1-55 SB IN MISSOURI

DMS #3 (SB I-55/WB I-70 1 MILES BEFORE IL-203) MESSAGE 1

> SB I-55/WB I-70 CLOSED ALL LANES MUST EXIT USE EXIT 4A OR 4B

MESSAGE 1

SB I-55/WB I-70 CLOSED @ IL203 FOLLOW MARKED DETOUR I-255S TO I-64W

DMS #4 (SB I-55 2 MILES BEFORE IL 157)

CONTRACT 10 TAL SHEET NO. ST. CLAIR 20 18 REVISED SECTION Farnsworth GROUP, INC. INTERSTATE WEEKEND CLOSURE, SPECIAL STATE OF ILLINOIS DRAWN - SRL REVISED 82-5VB-R-3 DYNAMIC MESSAGE SIGN MESSAGES 2211 West Bradley Avenu Champalgn, Illinois 6182 217/352-7408, 217/352-7408 PLOT SCALE = \$SCALE\$ CHECKED - JLF REVISED **DEPARTMENT OF TRANSPORTATION** CONTRACT NO. 76K16 - 1/27/2017 SHEET 15 OF 15 SHEETS STA.

Existing Structure: Built in 1959 as a 19 span wide flange and riveted plate girder with multi-column pile supported plats, and pile bent abutments. In 1988 the deck and bearings were replaced. In 1997 seismic retrofits were installed and the neoprene joints were repalced with silicone and polymer at the abutments and piers 7, 8, and 9. All of the joints shall be replaced with new silicone with polymer concrete nosing. Areas of broken joint blockouts shall be repaired. The deck shall be partial depth patched. The approaches shall be repaired. The EB and WB lanes will be closed with traffic detoured on the weekends. Pier 1 Pier 9 Pier 14 Pier 15 Pier 16 E. Abut ELEVATION 1618'-1134" 60'-5³4" 70'-6" 56'-6" 74'-0" 89'-0" 52'-6" 131'-6" 100'-0" 110'-0" 92'-6" 80'-0" 100'-0" 80'-0" 80'-0" 100'-0" 80'-0" 80'-0" 100'-0" 82'-0" 20' ્ઝ, ♥ 4-12' EB ♥ lanes =48' PLAN * Roadway = 2'-3" median parapet + Two 1'-10'2" shidrs Bridge = 2'-7" median parapet + Two 1'-8'2" shidrs ** 20' at outside lane line next to shoulder (Average length at center lane line = 40.863') GENERAL NOTES Plan dimensions and details relative to existing plans are subject to nominal construction variations. The Contractor shall field verify existing dimensions and details affecting new construction and make necessary approved adjustments prior to construction or ordering of materials. Such variations shall not be cause for additional compensation for a change in scope of the work, however, the Contractor will be paid for the quantity actually furnished at the unit price bid for the work. No field welding is permitted except as specified in the contract documents. TOTAL BILL OF MATERIAL 20' Concrete Approach - Partial Depth Removal & Patching UNIT TOTAL *** Deck Slab Repair (Partial) Sq. Yd. 21 115 497 ilicone Joint Sealer, 1.5 Foot ilicone Joint Sealer, 2 Foot Silicone Joint Sealer, 2.5' Foot 422 271 St. Louis ilicone Joint Sealer, 3 Foot -SN 082-0017 Polymer Concrete HMA east of E Approach - Partial Depth Removal & Patching Partial Depth Patching Ton Partial Depth Removal, Type IV. 2 871 Sq. Yd. *** Quantities are estimated assuming 64'x0.5' = 4 sq.yd repairs at joints; in addition to 17 sq. yds estimated repairs in deck. The Engineer shall determine the actual locations, and record them in the As-Built plans. LOCATION SKETCH DESIGNED - J. Uehle EXAMINED DATE -APRIL 28, 2017 SECTION **GENERAL PLAN AND ELEVATION** CHECKED - ATH STATE OF ILLINOIS 82-5VB-R-3 ST. CLAIR 20 19

DEPARTMENT OF TRANSPORTATION

REVISED

REVISED

DRAWN - J. Liehio

CHECKEO - ATH


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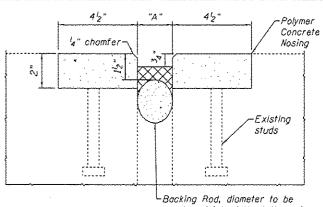
ENGINEER OF BRIDGES AND STRUCTURES

SN 082-0017 I-55/70 OVER RR YARD

SHEET NO. 1 DF 2 SHEETS

CONTRACT NO. 76K16



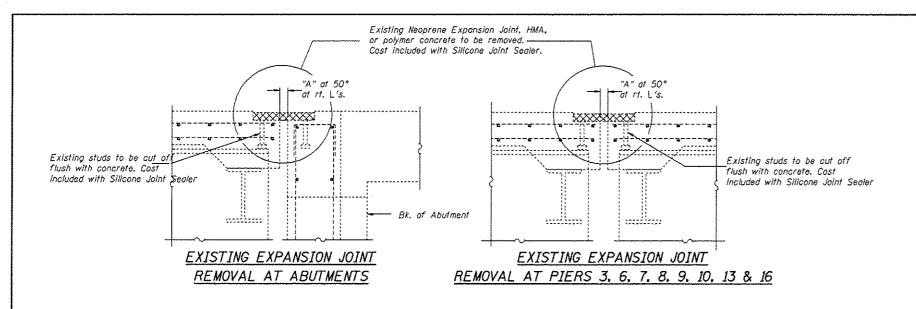


equal to joint width at time of installation plus 25%.

<u>1'-7" outer parapets</u>

PROPOSED SILICONE JOINT SEALER

			Expansion		Length along	Silcone Joint Sealer			EB Joints	EB Joints	Polymer	
		"A"	Length	skew	skew between				Repair	Repair	Concrete	
l		(in.)	(ft.)	(degrees)	parapets (ft.)	1.5"	2.0"	2.5"	3.0"	Length (ft)	Length (ft)	(cu. ft.)
	W Abut	2.0	56.5	41	146.1		151.1			8	3	18.6
	Р3	3.0	201.0	41	146.1			wante water	151.1	- 18	6	17.8
	P6	2.5	273.0	41	146.1			151.1		4	3	18.9
	P7	2.5	100.0	41	146.1			151.1				19.3
	P8	3.0	110.0	17	115.3				120.3			15.5
	Р9	2.5	92.5	17	115.3			120.3		2		15.3
	P10	2.0	180.0	0	110.3		115.3			6		14.4
	P13	1.5	260.0	0	110.3	115.3				2		14.7
	P16	2.0	260.0	0.	110.3		115.3			3	3	14.4
	E Abut	2.0	79.3	0	110.3		115.3			3	3	14.4
			1612	TOTAL	1256	115	497	422	271	46	18	163

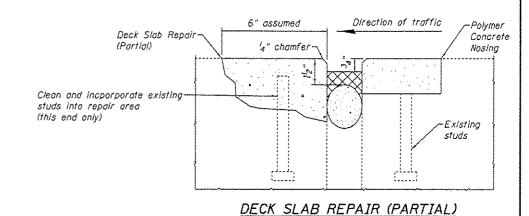


NOTES

Length of silicone in parapets = $4 \times (1'3") = 5'-0"$ Silicone Joint Sealer (ft.) = Length along skew + 5'-0"

Length of $2"x4'_2"$ polymer concrete in parapets = $4 \times (1' \ 3" + 2' \ 11") = 16'-8"$ Polymer concrete length = (2 x Length along skew) + 16'-8" - Repair Length

Polymer Concrete (cu. ft.) = length \times (2/12) \times (4.5/12)

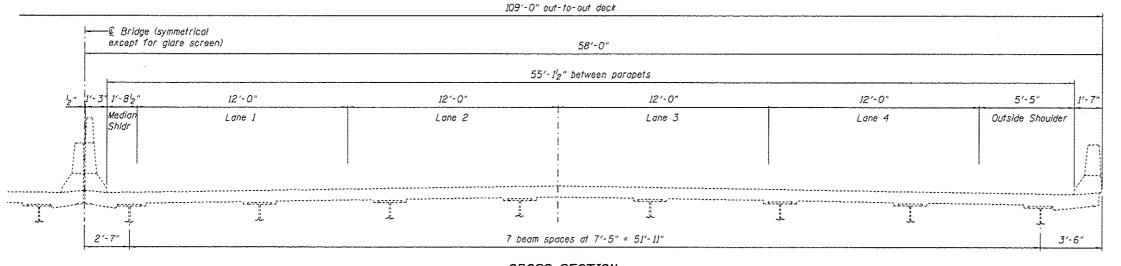

CROSS SECTION

(WB - Looking West) (EB - Looking East)

DESIGNED - J. Uehle	EXAMINED	DATE	-	APRIL 28, 2017	
CHECKED - ATH	ENGINEER OF STRUCTURAL SERVICES				İ
DRAWN - J. Uehle	PASSED	REVISE	.0		ĺ
CHECKED - ATH	ENDINEER OF BRIDGES AND STRUCTURES	REVISE	D		

STATE OF ILLINOIS DEPARTMENT OF TRANSPORTATION

JOINT DETAILS SN 082-0017 SHEET NO. 2 OF 2 SHEETS

COUNTY | TOTAL SHEET NO. | ST. CLAIR | 20 | 20 | CONTRACT NO. | 76K16 F.A.I. RTE. 55/70 SECTION 82-5V8-R-3

r-5" median parapets -- 24 2" outer parapets O" median parapets 734" -Expansion Joint blockout extends to top of barrier at median barriers. -Fill expansion joint blockouts with Polymer Concrete. 2" outer parapets 0" median parapets -Silicone Joint Sealer

(Various locations on departing side of Joint)

PARAPET DETAIL

Joint opening is parallel to skew out to the inside face of parapet, then turns 90°to € of roadway. Special care shall be taken at this location to ensure

that silicone forms a watertight seal with the concrete.