# 04-28-2017 LETTING ITEM 037

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SUMMARY OF QUANTITIES

TRAFFIC CONTROL AND PROTECTION

PAINTING PLANS

PAINTING ELEVATIONS

DOOR REPLACEMENT

#### **HIGHWAY STANDARDS**

STANDARD SYMBOLS, ABBREVIATIONS AND PATTERNS 000001-06 OFF-ROAD OPERATIONS, MULTILANE, 15 (4.5 M) TO 24 701101-05

(600 MM) FROM PAVEMENT EDGE

OFF-ROAD OPERATIONS, MULTILANE, MORE THAN 15 (4.5 M) AWAY 701106-02 701611-01 URBAN HALF ROAD CLOSURE, MULTILANE, 2W WITH MOUNTABLE MEDIAN SIDEWALK, CORNER OR CROSSWALK CLOSURE 701801-06

TRAFFIC CONTROL DEVICES 701901-06

METAL POSTS FOR SIGNS, MARKERS AND DELINEATORS 720011-01

TELESCOPING STEEL SIGN SUPPORT 728001-01

729001-01 APPLICATIONS OF TYPES A AND 8 METAL POSTS (FOR SIGNS & MARKERS)

**BOWMAN** 

# STATE OF ILLINOIS

DEPARTMENT OF TRANSPORTATION

**DIVISION OF HIGHWAYS** 

# **PROPOSED HIGHWAY PLANS**

**FAP ROUTE 594 (IL 203)** FAI ROUTE 255 (I-255) **FAU ROUTE 9166 (ST. CLAIR AVE.) SECTION 580PS, 60-7PS, 33PS PUMP STATION IMPROVEMENTS MADISON AND ST. CLAIR COUNTIES** 

**PUMP STATION COLLINSVILLE #2 42ND STREET PUMP STATION PUMP STATION** McCAMBRIDGE **COLLINSVILLE #1 PUMP STATION** C-98-012-16 **PUMP STATION PUMP STATION** CONFORM TO STANDARD SCALES. IN MAKING MEASUREMENTS

GROSS LENGTH = NA

NET LENGTH = N/A


### D-98-065-16

MADISON/ST. CLAIR 8 1

ILLINOIS CONTRACT NO. 76J38

594/255/9166 580PS/60-7PS/33PS



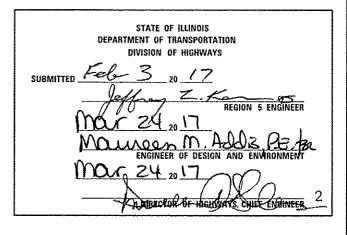

PRINTED BY THE AUTHORITY OF THE STATE OF ILLINOIS

J.U.L.I.E. JOINT UTILITY LOCATION INFORMATION FOR EXCAVATION

1-800-892-0123 OR 811

ENGINEERING SCALES, REDUCED SIZED PLANS WILL NOT

ON REDUCED PLANS, THE ABOVE SCALES MAY BE USED.

PROJECT ENGINEER: HERVE GELIN PROJECT MANAGER: PHILLIP SAWYER SQUAD LEADER: MICHAEL PRESTON 618-346-3143

618-346-3179 PLANS PREPARED BY: 618-346-3275

Consulting Engineers

**FUN & SUN** 

LIN ENGINEERING.LTD.

CONTRACT NO. 76J38

#### **GENERAL NOTES:**

- PLAN DIMENSIONS AND DETAILS RELATIVE TO EXISTING STRUCTURE HAVE BEEN TAKEN FROM EXISTING PLANS AND ARE SUBJECTED TO NOMINAL CONSTRUCTION VARIATIONS, IT SHALL BE THE CONTRACTOR'S RESPONSIBILITY TO VERIFY SUCH DIMENSIONS AND DETAILS IN THE FIELD, AND MAKE NECESSARY APPROVED ADJUSTMENTS PRIOR TO CONSTRUCTION OR ORDERING MATERIALS.
- IT IS THE CONTRACTOR'S RESPONSIBILITY TO ENFORCE ALL APPLICABLE SAFETY CODES AND REGULATIONS DURING ALL PHASES OF CONSTRUCTION.
- 3. THE CONTRACTOR SHALL PERFORM ALL CONSTRUCTION FOR THE PROJECT IN A MANNER AND SEQUENCE THAT ARE BASED ON ACCEPTED INDUSTRY STANDARDS THAT RECOGNIZE THE INTERACTION OF THE COMPONENTS THAT COMPRISE THE STRUCTURE, WITHOUT CAUSING DISTRESS, UNANTICIPATED MOVEMENTS OR IRREGULAR LOAD PATHS AS A RESULT OF THE CONSTRUCTION MEANS AND METHODS EMPLOYED.
- 4. ALL CONTRACTORS ARE REQUIRED TO EXAMINE THE DRAWINGS AND SPECIAL PROVISIONS CAREFULLY, VISIT THE SITE AND FULLY INFORM THEMSELVES AS TO ALL EXISTING CONDITIONS AND LIMITATIONS, PRIOR TO AGREEING TO PERFORM THE WORK. FAILURE TO VISIT THE SITE AND FAMILIARIZE THEMSELVES WITH THE EXISTING CONDITIONS AND LIMITATIONS WILL IN NO WAY RELIEVE THE CONTRACTOR FROM FURNISHING ANY MATERIALS OR PERFORMING ANY WORK IN ACCORDANCE WITH THE DRAWINGS AND SPECIFICATIONS WITHOUT ADDITIONAL COST TO THE OWNER.
- 5. DRAWINGS ARE NOT TO SCALE.
- DURING CONSTRUCTION THE CONTRACTOR SHALL BE RESPONSIBLE FOR MAINTENANCE OF THE EXISTING PUMP STATION BUILDING.
- 7. TRAFFIC CONTROL SHALL BE IN PLACE AND THE EXISTING PUMP STATION SHALL BE BYPASSED PRIOR TO PERFORMING ANY WORK IN THE EXISTING PUMP STATION.
- 8. THE DEPARTMENT STRONGLY ENCOURAGES THE PRIME CONTRACTOR AND THEIR APPROVED SUB-CONTRACTORS TO HIRE MINORITY, WOMEN A DISADVANTAGED INDIVIDUALS FROM ITS FEDERALLY FUNDED HIGHWAY CONSTRUCTION CAREERS TRAINING PROGRAM (HCCTP) TO HELP MEET WORKFORCE AND TRAINEE GOALS. THIS PROGRAM IS TRAINING MINORITIES, WOMEN AND DISADVANTAGED INDIVIDUALS IN HIGHWAY CONSTRUCTION-RELATED SKILLS, (E.G., MATH, FOR THE TRADES, JOB READINESS, TECHNICAL SKILLS COURSEWORK (CARPENTRY, CONCRETE FLAT WORK, BLUEPRINT READING, SITE PLANS SITE WORK, TOOLS, ETC.) AND OSHA 10 HOUR CERTIFICATION), TO PREPARE THEM FOR A CAREER IN THE HIGHWAY CONSTRUCTION TRADES. GRADUATES ARE WELL-TRAINED AND READY TO BECOME PRODUCTIVE ENTRY LEVEL CONSTRUCTION WORKERS. CONTACT THE DISTRICT 8 EEO OFFICE AT 618-346-3360 AND/OR THE HCCTP COORDINATOR AT 616-874-6528 TO LEARN MORE ABOUT THE PROGRAM AND FOR ASSISTANCE IN MEETING WORKFORCE AND TRAINEE GOALS
- 3. ILLINOIS STATE LAW REQUIRES A 48-HOUR NOTICE BE GIVEN TO UTILITIES BEFORE DIGGING. FIELD MARKING OF FACILITIES MAY BE OBTAINED BY CONTACTING J.U.L.I.E. (1-800-892-0123 OR 811) OR FOR NON-MEMBERS THE UTILITY COMPANY DIRECTLY.
- 10. FUN AND SUN PUMP STATION

(SEE "PUMP STATION ELECTRICAL WORK" SPECIAL PROVISION-SECTION 333216 PACKAGED STORMWATER PUMPING SYSTEM COMPONENTS)

THE PUMP AND CONTROL PANEL ARE TO BE USED FOR THE REPLACEMENT OF EXISTING EQUIPMENT AT THE FUN AND SUN PUMP STATION LOCATED AT 3124 WEST CHAIN OF ROCKS ROAD, GRANITE CITY, ILLINOIS. SUPPLIER HAS OVERALL RESPONSIBILITY TO SUPPLY EQUIPMENT THAT IS COMPATIBLE WITH EXISTING EQUIPMENT AND CONDITIONS. VERIFICATION OF EXISTING EQUIPMENT IS THE RESPONSIBILITY OF THE SUPPLIER. OWENER WILL PROVIDE SHOP DRAWINGS OF ORIGINAL INSTALLATION AND ACCESS TO THE EXISTING INSTALLATION AS NECESSARY FOR VERIFICATION PURPOSES.

THE PUMP WILL NOT BE IMMEDIATELY INSTALLED AND WILL SERVE A FUTURE REPLACEMENT FOR EXISTING EQUIPMENT.

- 11. BOWMAN AVENUE PUMP STATION
  - (SEE "PUMP STATION ELECTRICAL WORK" SPECIAL PROVISION-SECTION 354502 SUBMERSIBLE MIXED-FLOW PUMPS)

THE CONTRACTOR SHALL FURNISH AND DELIVER ONE (1) PUMPING UNIT AS HEREINAFTER MORE PARTICULARLY SPECIFIED. THE PUMPING UNIT WILL SERVE AS A FUTURE REPLACEMENT FOR THE EXISTING "SUMP PUMP #1" AT THE BOWMAN AVENUE PUMP STATION. THE EXISTING DISCHARGE TUBE WILL BE RE-USED AND A NEW DISCHARGE TUBE IS NOT REQUIRED. INSTALLATION OF THE PUMPING UNIT IS NOT A REQUIREMENT OF THIS PROJECT.

(SEE "PUMP STATION ELECTRICAL WORK" SPECIAL PROVISION-HEAVY DUTY TRAILER)
A HEAVY DUTY TRAILER SHALL BE FURNISHED AND DELIVERED TO THE IDOT DISTRICT 8
BOWMAN PUMP STATION LOCATED AT 7TH AND BOWMAN IN EAST ST. LOUIS, ILLINOIS.

THIS TRAILER WILL BE USED TO REPLACE A 1984 WISCONSIN BRAND TRAILER, MODEL NUMBER 70012.

#### **GENERAL PAINT NOTES:**

- 1. CLEANING AND PAINTING OF THE EXISTING STRUCTURAL STEEL SHALL BE AS SPECIFIED IN THE SPECIAL PROVISION FOR "CLEANING AND PAINTING EXISTING STEEL STRUCTURES". ALL EXISTING STEEL AS MARKED IN THE PLANS SHALL BE CLEANED PER NEAR WHITE BLAST CLEANING-SSPC-SPIO. ALL EXISTING STEEL AS MARKED IN THE PLANS SHALL BE PAINTED ACCORDING TO THE REQUIREMENTS OF PAINT SYSTEM 3 EM/EM/AC ALUMINUM EPOXY MASTIC FOR THE PRIMER AND INTERMEDIATE COATS AND WATERBORNE ACRYLIC FOR THE FINISH COAT. THE COLOR OF THE FINAL FINISH COAT FOR ALL STEEL SURFACES AS MARKED IN THE PLANS SHALL BE MUNSELL GLOSSY COLOR 5B 7/1 GRAY.
- 2. CLEANING AND PAINTING OF THE EXISTING DOOR FRAMES SHALL BE AS SPECIFIED IN THE SPECIAL PROVISION FOR "CLEANING AND PAINTING EXISTING STEEL STRUCTURES". EXISTING DOOR FRAME LEAD PAINT CLEANING RESIDUE SHALL BE CONTAINED AND DISPOSED OF AS REQUIRED BY THE SPECIAL PROVISION "CONTAINMENT AND DISPOSAL OF LEAD PAINT CLEANING RESIDUES". ALL EXISTING DOOR FRAMES SHALL BE CLEANED PER NEAR WHITE BLAST CLEANING-SSPC-SPIO. ALL EXISTING DOOR FRAMES SHALL BE PAINTED ACCORDING TO THE REQUIREMENTS OF PAINT SYSTEM 3 EM/EM/AC ALUMINUM EPOXY MASTIC FOR THE PRIMER AND INTERMEDIATE COATS AND WATERBORNE ACRYLIC FOR THE FINISH COAT. THE COLOR OF THE FINAL FINISH COAT SHALL BE MUNSELL GLOSSY COLOR 2.5YR 3/4 REDDISH BROWN.

#### **COMMITMENTS:**

NONE

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## SUMMARY OF QUANTITIES

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CODE			TOTAL		MADISON	ST. C	CLAIR
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70102634	TRAFFIC CONTROL AND PROTECTION. STANDARD 701611	L SUM	1	1	1	AND TRANSPORTED TO THE PARTY OF	0
70102640	TRAFFIC CONTROL AND PROTECTION, STANDARD 701801	L SUM	1	1	1	The state of the s	0
70107004	PAVEMENT MARKING BLACKOUT TAPE, 4"	FOOT	1435	1435	1435	The state of the s	0
70300150	SHORT TERM PAVEMENT MARKING REMOVAL	SO FT	479	479	479	the same of the sa	0
Z0018500	DRAINAGE STRUCTURES TO BE CLEANED	EACH	1	1	0	Carpenda Property Carpenda Pro	1
X0783300	PUMP STATION ELECTRICAL WORK	LSUM	1	<u> </u>	0.7	0.	). 3

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STATE OF ILLINOIS
DEPARTMENT OF TRANSPORTATION

	SUMMARY OF QUANTITIES											
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CONTRACT NO. 76J3



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LIN ENGINEERING,LTD.

Consulting Engineers

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CHANNELIZER CONE

SIGN ON PORTABLE OR PERMANENT SUPPORT

Φ BARRICADE OR DRUM WITH FLASHING LIGHT

TYPE III BARRICADE WITH FLASHING LIGHTS

DESIGNED -

DRAWN

DATE

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- 01/2017

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NOTES:

STATIONING BASED OFF OF EXISTING PLANS AND HAS NOT BEEN FIELD VERIFIED.

ALL VEHICULAR TRAFFIC CONTROL AND PROTECTION SHOWN SHALL BE PAID FOR AS "TRAFFIC CONTROL AND PROTECTION, STANDARD 701611)".

CLOSE PEDESTRIAN ACCESS TO THE NORTH SIDEWALK ACCORDING TO HIGHWAY STANDARD 701801.

IN THE EVENT OF DAMAGE TO THE EXISTING PAVEMENTS MARKINGS, THE DAMAGED PAVEMENT MARKINGS SHALL BE REPLACED BY THE CONTRACTOR AT NO ADDITIONAL COST.

EXIST. CURVE A1 PI STA. = 1022+59.24 \[ \Delta = 36\circ 48' \quad 01'' \quad (LT) \]
\[ D = 3\circ 17' \quad 58'' \] R = 1,736.48' T = 577.66' L = 1,115.32'E = 95.56'e = \_\_\_\_ T.R. = \_\_\_\_ S.E. RUN = \_\_\_\_ P.C. STA. = 1016+81.59 P.T. STA. = 1027+96.91

SECTION

580PS/60-7PS/33PS

594/255/9166

TO STA.

TRAFFIC CONTROL AND PROTECTION


**42ND STREET PUMP STATION** 

SCALE: 1"=100" SHEET 1 OF 1 SHEETS STA.

COUNTY


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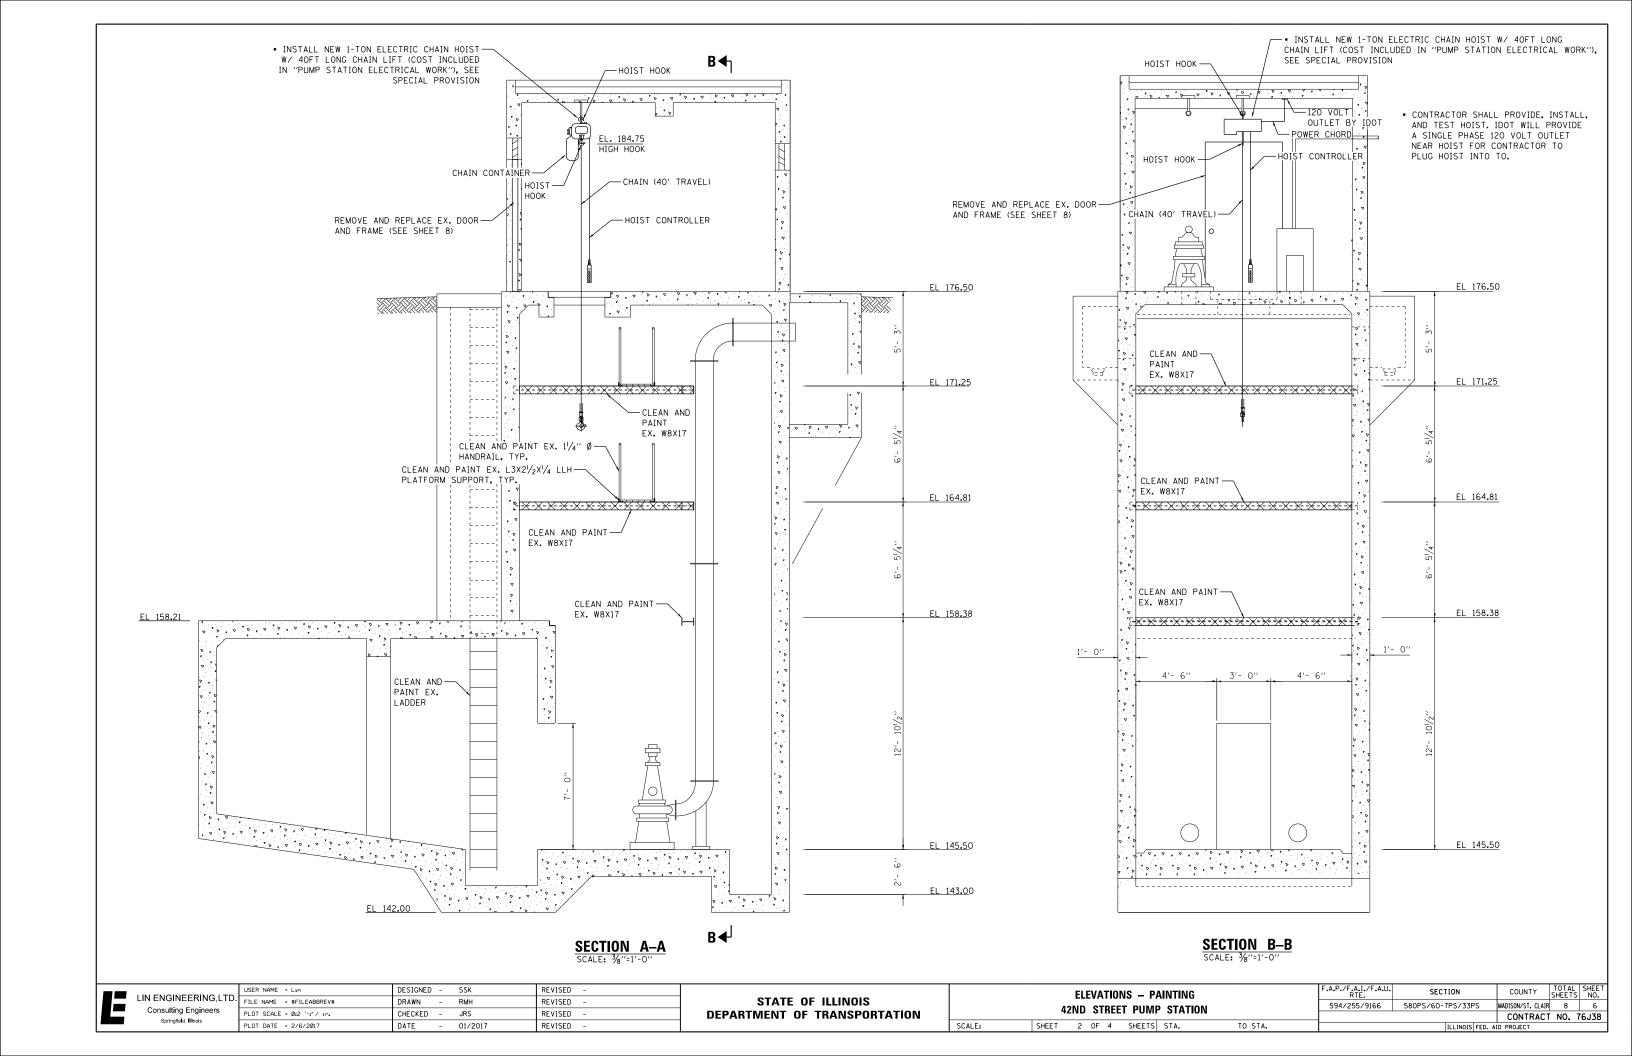
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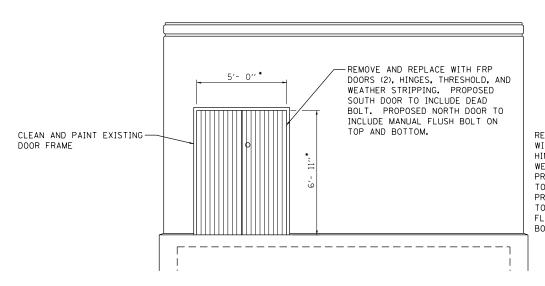


STATE OF ILLINOIS

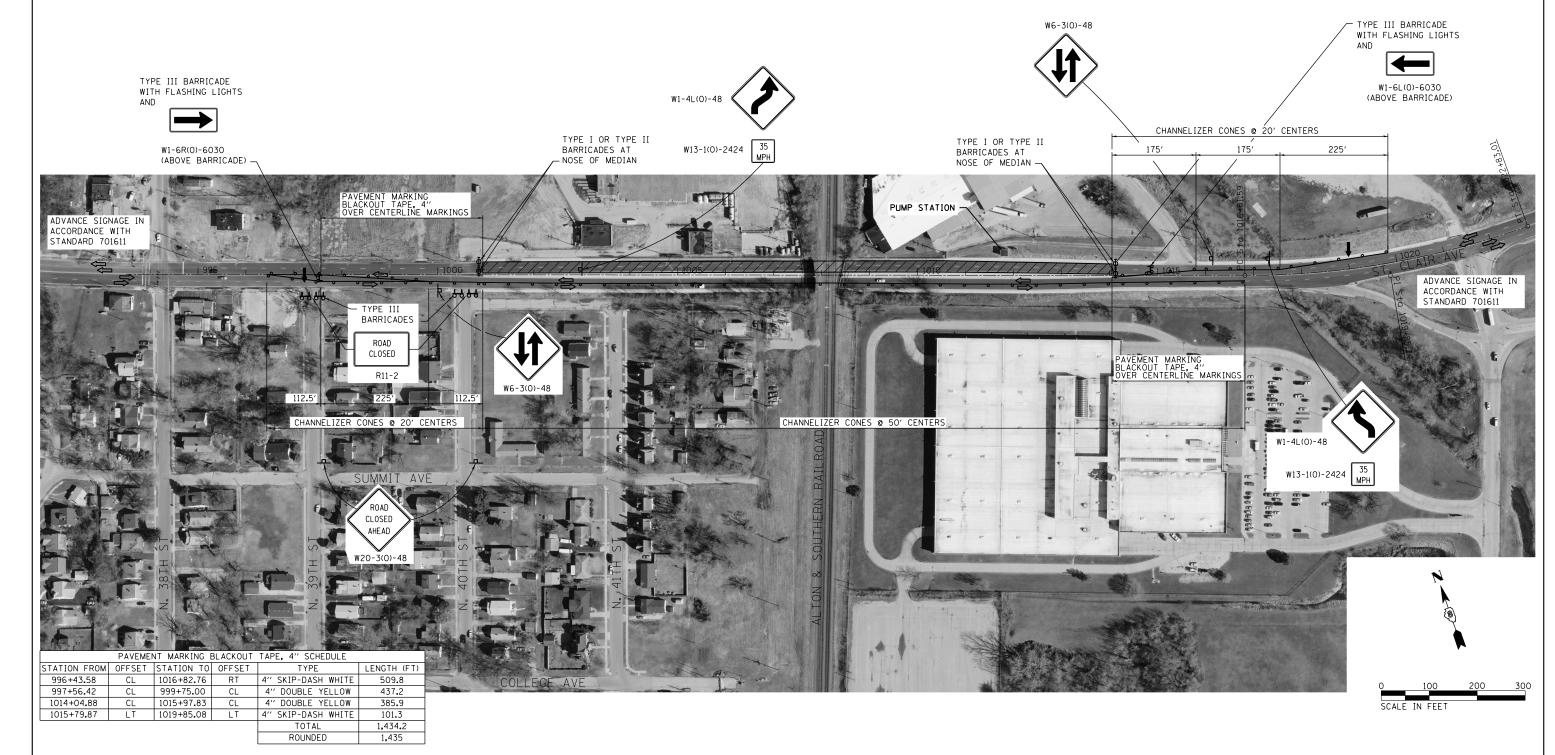**DEPARTMENT OF TRANSPORTATION** 





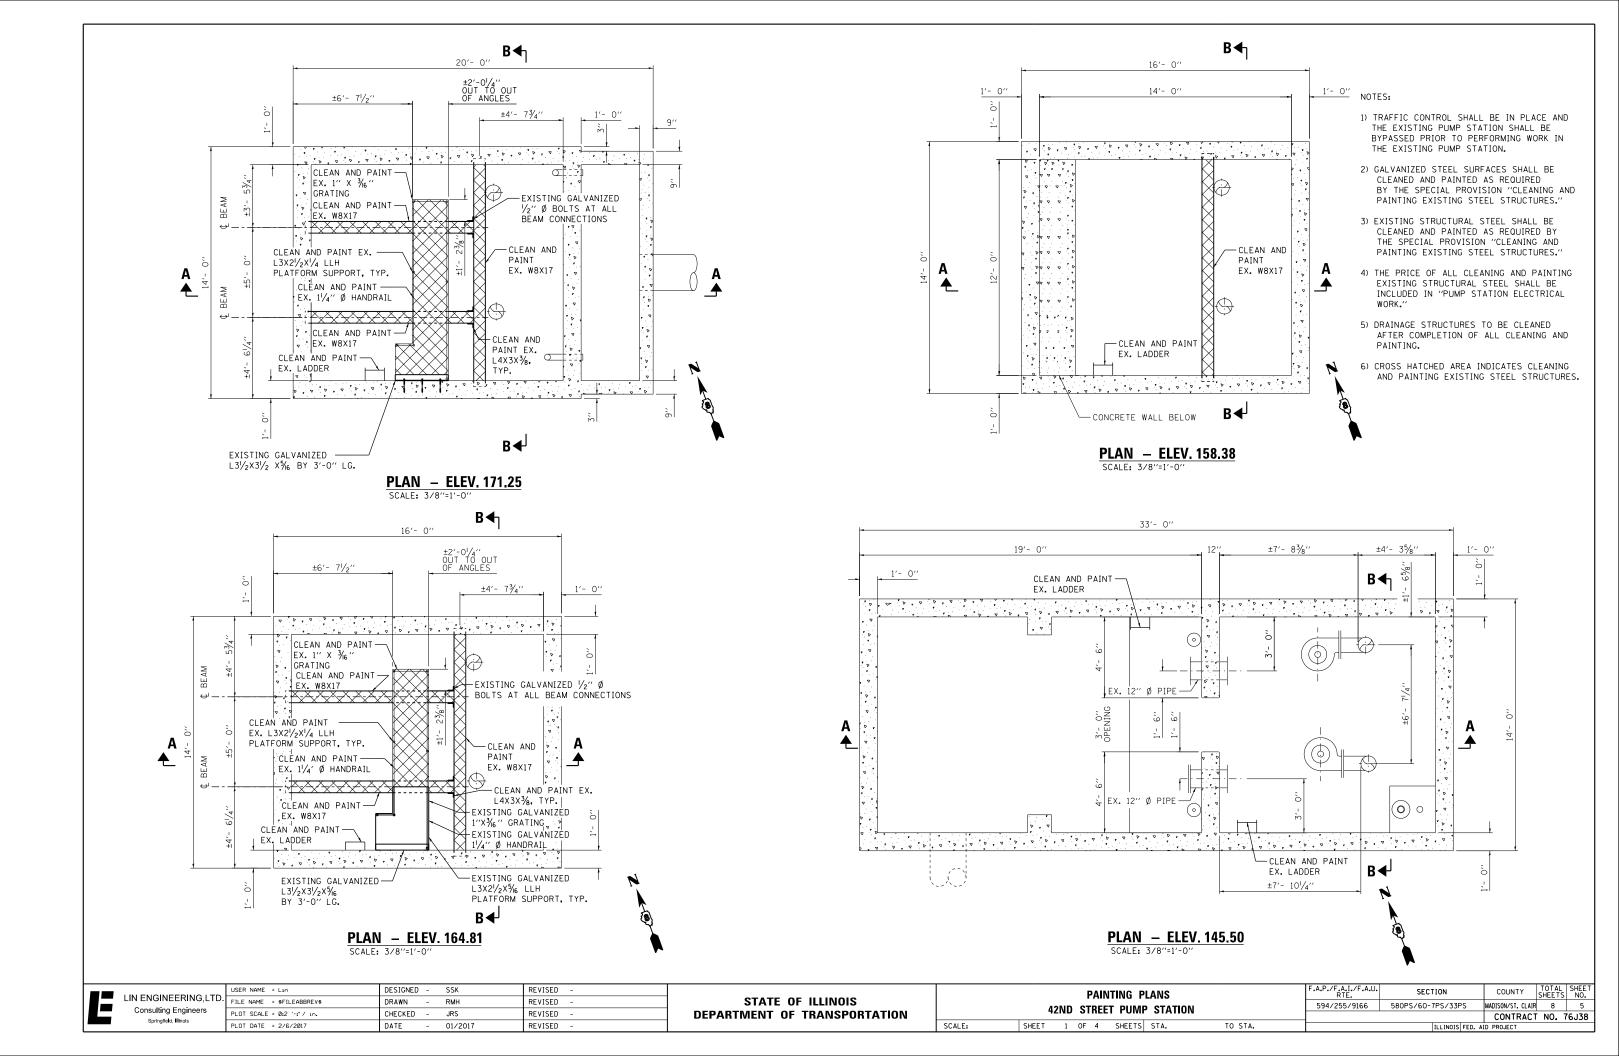

REMOVE AND REPLACE
WITH FRP DOORS (2),
HINGES, THRESHOLD, AND
WEATHER STRIPPING.
PROPOSED NORTH DOOR
TO INCLUDE DEAD BOLT.
PROPOSED SOUTH DOOR
TO INCLUDE MANUAL
FLUSH BOLT ON TOP AND
BOTTOM.

-REMOVE AND REPLACE WITH FRP DOORS (2), HINGES, THRESHOLD, AND WEATHER STRIPPING. PROPOSED NORTH DOOR TO INCLUDE DEAD BOLT AND METAL PULL HANDLE. PROPOSED SOUTH DOOR TO INCLUDE MANUAL FLUSH BOLT ON TOP AND BOTTOM.

# EAST ELEVATION


#### NEW DOORS COLLINSVILLE #1 PUMP STATION

SCALE: 3/8"=1'-0"

WEST ELEVATION

# NEW DOORS COLLINSVILLE #1 PUMP STATION

SCALE: 3/8"=1'-0"

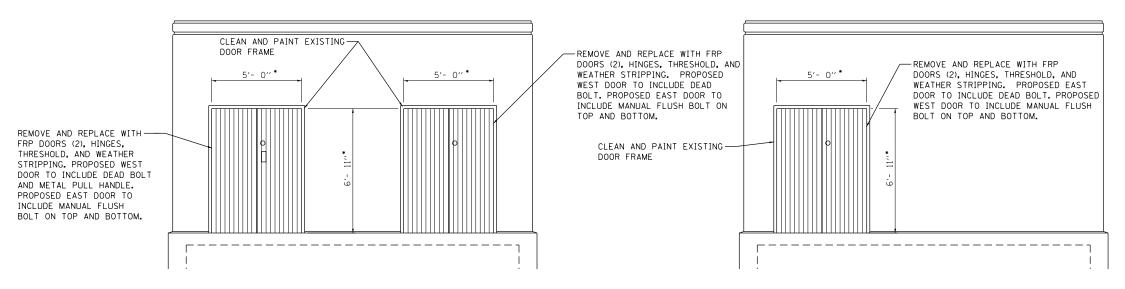

# SOUTH ELEVATION NEW DOORS COLLINSVILLE #2 PUMP STATION

SCALE: 3/8"=1'-0"

• DIMENSIONS REFER TO DOOR SIZE WITHOUT FRAME.

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**NORTH ELEVATION** 

**NEW DOORS COLLINSVILLE #2 PUMP STATION** 

SCALE: 3/8"=1'-0"

# STATE OF ILLINOIS DEPARTMENT OF TRANSPORTATION

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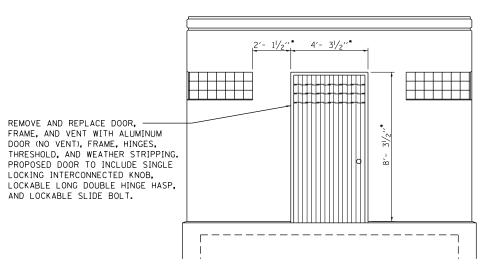
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F.A.P./F.A.I./F.A.U. RTE.	SECTION	COUNTY	TOTAL SHEETS	SHEET NO.
594/255/9166	580PS/60-7PS/33PS	MADISON/ST. CLAIR	8	7
		CONTRACT	NO. 7	'6J38
	TILLINOIS FED. A	ID PROJECT		

NOTES

- 1) ALL COLLINSVILLE PUMP STATION
  (#1 AND #2) REPLACEMENT DEAD BOLTS
  TO BE KEYED THE SAME.
- 2) ALL COLLINSVILLE PUMP STATION (\*1 AND \*2) REPLACEMENT DOORS TO BE COLORED THE SAME AS THE PAINTED FRAMES.
- 3) EXISTING DOOR FRAMES SHALL BE CLEANED AND PAINTED AS REQUIRED BY THE SPECIAL PROVISION "CLEANING AND PAINTING EXISTING STEEL STRUCTURES."
- 4) EXISTING DOOR FRAME LEAD PAINT
  CLEANING RESIDUE SHALL BE CONTAINED
  AND DISPOSED OF AS REQUIRED BY
  THE SPECIAL PROVISION "CONTAINMENT
  AND DISPOSAL OF LEAD PAINT CLEANING
  RESIDUES."
- 5) FRP DOORS AND ASSOCIATED HARDWARE SHALL BE PROCURED AS REQUIRED BY THE SPECIAL PROVISIONS "FIBERGLASS DOORS" AND "DOOR HARDWARE" RESPECTIVELY.
- 6) THE PRICE OF ALL CLEANING AND PAINTING EXISTING STEEL STRUCTURES, LEAD PAINT CONTAINMENT AND DISPOSAL, FRP DOORS, AND DOOR HARDWARE SHALL BE INCLUDED IN "PUMP STATION ELECTRICAL WORK,"



3'-111/4''\*

- REMOVE AND REPLACE DOOR, FRAME, AND VENT WITH ALUMINUM DOOR (NO VENT), FRAME, HINGES, THRESHOLD, AND WEATHER STRIPPING. PROPOSED DOOR TO INCLUDE SINGLE LOCKING INTERCONNECTED KNOB, LOCKABLE LONG DOUBLE HINGE HASP, AND LOCKABLE SLIDE BOLT.

## 

WEST ELEVATION

NEW DOOR McCAMBRIDGE PUMP STATION

SCALE: 3/8"=1'-0"

SCALE:

• DIMENSIONS REFER TO CONCRETE OPENING.

#### NOTES:

TO STA.

- 1) ALUMINUM DOORS, FRAMES, AND ASSOCIATED HARDWARE SHALL BE PROCURED AS REQUIRED BY THE SPECIAL PROVISIONS "ALUMINUM DOORS AND FRAMES" AND "DOOR HARDWARE" RESPECTIVELY.
- 2) THE PRICE OF ALL ALUMINUM DOORS, FRAMES, AND HARDWARE SHALL BE INCLUDED IN "PUMP STATION ELECTRICAL WORK."

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F.A.P./F.A.I./F.A.U. RTE.	SECTION	COUNTY	TOTAL SHEETS	SHEET NO.
594/255/9166	580PS/60-7PS/33PS	MADISON/ST. CLAIR	8	8
		CONTRACT	NO.	76J38
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