FOR INDEX OF HIGHWAY STANDARDS, SEE SHEET NO. 2

04-27-2018 LETTING, ITEM 202

DESIGN DESIGNATION OFF SYSTEM

SPEED LIMIT

HILLGROVE AVENUE: 30 MPH

BURLINGTON AVENUE: 25 MPH

TRAFFIC DATA

HILLGROVE AVENUE 2014 ADT - 3100 VPD

BURLINGTON AVENUE 2014 ADT - 2200 VPD

ENGINEERING SCALES. REDUCED SIZED PLANS WILL NOT CONFORM TO STANDARD SCALES. IN MAKING MEASUREMENTS ON REDUCED PLANS, THE ABOVE SCALES MAY BE USED.

J.U.L.I.E. DESIGN STAGE REQUEST



CONTACT JULIE AT 811 OR 800-892-0123

CITY-TWNSHP. = LA GRANGE - LYONS SEC. & 1/4 SEC. NO. -NW 1/4 SEC. 4, NE 1/4 SEC. 5 48 HOURS 12 working days) BEFORE YOU DIG

STATE OF ILLINOIS


DEPARTMENT OF TRANSPORTATION

PLANS FOR PROPOSED FEDERAL AID HIGHWAY


MUN 2070C (STONE AVENUE STATION) AT BURLINGTON AVENUE SIDEWALKS, PARKING, AND LIGHTING

> SECTION: 14-00089-00-SW PROJECT: DAXS(700)

VILLAGE OF LA GRANGE

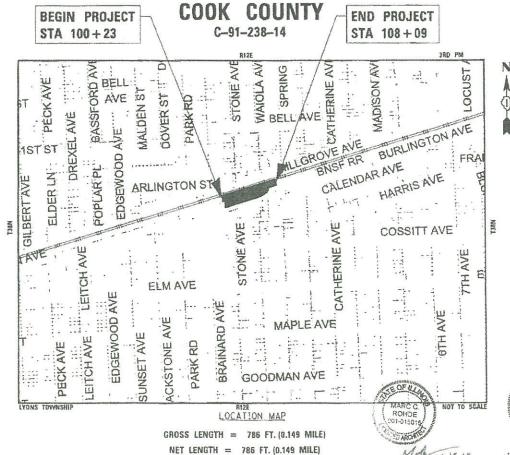

Consulting Engineers

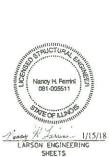

License Expires 11/30/2018

KEGAT ARCHITECTS

COOK 14-00089-00-5#





STATE OF ILLINOIS DEPARTMENT OF TRANSPORTATION

PASSED JANUARY 24, 2018

CHILL CHRISTOPHED LOCAL ROADS AND STREETS

JANUARY 24, 2018

PRINTED BY THE AUTHORITY OF THE STATE OF ILLINOIS

B&W PROJECT NO.: 140184

081-006886 LICENSED STRUCTURAL ENGINEER

dan me SHEET 39
"UCENSE EXPIRES 11-30-18"

DATE: 01-15-18

DIG. No. X1180460

CONTRACT NO. 61E45

3. THE CONTRACTOR SHALL NOTIFY THE VILLAGE PUBLIC WORKS ADMINISTRATOR AT LEAST 48 HOURS IN ADVANCE OF BEGINNING WORK TO OBTAIN VILLAGE UTILITY LOCATIONS.

4 IT WILL BE THE CONTRACTOR'S RESPONSIBILITY TO PROVIDE ADVANCED NOTICE OF CONSTRUCTION TO COMMUTERS AT LEAST ONE (1) WEEK PRIOR TO START OF CONSTRUCTION. METRA, BNSF, AND THE VILLAGE SHALL BE NOTIFIED FOR ANY ADDITIONAL NOTIFICATION TO THE PUBLIC.

5. THE CONTRACTOR MAY OBTAIN MUNICIPAL WATER IN BULK, AT NO CHARGE, AS LONG AS THERE IS NOT A "WATERING BAN" IN EFFECT. THE INDISCRIMINATE USE OF FIRE HYDRANTS IS STRICTLY PROHIBITED. WATER FOR CONSTRUCTION SHALL BE METERED OR OTHERWISE ACCOUNTED FOR AND A DAILY LOG MAINTAINED. THE CONTRACTOR SHALL PROVIDE THE WATER TRUCK AND DRIVER REQUIRED TO OBTAIN AND TRANSPORT THIS WATER. THE VILLAGE RESERVES THE RIGHT TO RESTRICT OR REFUSE THE USE OF VILLAGE WATER IF DEEMED NECESSARY.

 THE DAY'S PAVING OPERATION SHOULD RESULT IN A SINGLE TRANSVERSE JOINT. ALL COLD LONGITUDINAL JOINTS WILL NOT BE ACCEPTED. PROVIDING A SINGLE TRANSVERSE JOINT SHALL BE ACCOMPLISHED BY PAVING ONE LANE OF SUFFICIENT LENGTH THAT WILL ALLOW FOR THE PAVING OF THE ADJACENT LANE IN THE SAME DAY.

7. IN AREAS WHERE THE EXISTING SIDEWALK OR CURB AND GUTTER IS TO BE REMOVED AND REPLACED, THE REMOVAL AND DISPOSAL OF ANY ADDITIONAL MATERIAL REQUIRED TO ESTABLISH THE PROPOSED SIDEWALK, OR CURB AND GUTTER SUBGRADE ELEVATION SHALL BE INCLUDED.

8. DURING CONSTRUCTION, THE CONTRACTOR WILL BE PERMITTED TO LIMIT ON-STREET PARKING TO COMPLETE CONSTRUCTION OPERATIONS. THE CONTRACTOR WILL BE REQUIRED TO COORDINATE WITH THE MUNICIPALITY A MINIMUM OF 48 HOURS IN ADVANCE. IT WILL BE THE RESPONSIBILITY OF THE CONTRACTOR TO PLACE ADVANCE SIGNS TO ALERT RESIDENTS AND COMMUTERS OF THE CONSTRUCTION WORK. THE PLACEMENT OF THESE SIGNS SHALL TAKE PLACE 48 HOURS IN ADVANCE IN ORDER TO ALLOW SUFFICIENT TIME FOR RESIDENTS AND GENERAL PUBLIC TO REVISE THEIR PARKING PATTERNS. PLANS OF CONTRACTOR TEMPORARY PARKING SHALL BE PRODUCED. REVIEWED AND APPROVED BY THE VILLAGE AND SHALL BE POSTED FOR THE PUBLIC TO SEE AND ADJUST THEIR PARKING PATTERNS OR HABITS.

9. IT IS THE CONTRACTOR'S SOLE RESPONSIBILITY TO COORDINATE WITH THE BNSF RAILROAD WHENEVER CONSTRUCTION ACTIVITY IS WITHIN 25 FEET OF THE RAILROAD ROW. THE CONTRACTOR SHALL RETAIN FLAGMAN EMPLOYED AND DESIGNATED BY THE BNSF RAILROAD TO MONITOR ONCOMING TRAIN TRAFFIC, AND ADVISE CONTRACTOR PERSONNEL WHEN ACTIVITY ON OR NEAR THE RAILROAD RIGHT-OF-WAY MAY PROCEED. THIS ITEM WILL BE PAID FOR ACCORDING TO ARTICLE 107.12 AND WILL BE REIMBURSED ACCORDING TO ARTICLE 109.05.

10. CONTRACTOR SHALL SCHEDULE A RAILROAD FLAGGER A MINIMUM OF 48 HOURS IN ADVANCE.

11.IF RAILROAD FLAGGER WAS RESERVED AND THE CONTRACTOR DOES NOT USE OR CANCEL THE RESERVATION AT LEAST 24 HOURS IN ADVANCE; THE CONTRACTOR SHALL BE RESPONSIBLE FOR THE

12. CONTRACTOR MUST COMPLETE THE EXHIBIT "C-1" "RIGHT OF ENTRY PERMIT". IT MUST BE APPROVED BEFORE STARTING CONSTRUCTION.

13.CONTRACTOR SHALL TAKE THE CONTRACTOR ORIENTATION COURSE AT WWW.BNSFCONTRACTOR.COM AND TAKE THE BNSF EXAM. ALL WORKERS ON OR INSIDE RAILROAD ROW SHALL TAKE THE EXAM. E-RAILSAFE ID BADGES SHALL BE WORN AT ALL TIMES WHILE INSIDE THE RAILROAD ROW.

14. CONTRACTORS SHALL BE CONFINED IN DESIGNATED AREAS AND SHALL NOT INTERFERE WITH TRAIN OPERATIONS OR COMMUTER'S PEDESTRIAN PATHS.

PRIOR TO DELIVERY.

HIGHWAY STANDARDS

701006-05 OFF-RD OPERATIONS, 2L, 2W, 15' (4.5 m) TO 24" (600 mm) FROM PAVEMENT EDGE

000001-06 STANDARD SYMBOLS, ABBREVIATIONS AND PATTERNS 001001-02 AREAS OF REINFORCEMENT BARS 280001-07 TEMPORARY EROSION CONTROL SYSTEMS 424001-10 PERPENDICULAR CURB RAMPS FOR SIDEWALKS 606001-07 CONCRETE CURB TYPE B AND COMBINATION CONCRETE CURB AND GUTTER

701011-04 OFF-RD MOVING OPERATIONS, 2L, 2W, DAY ONLY 701301-04 LANE CLOSURE, 2L, 2W, SHORT TIME OPERATIONS

701311-03 LANE CLOSURE 2L, 2W MOVING OPERATIONS - DAY ONLY

701501-06 URBAN LANE CLOSURE, 2L, 2W, UNDIVIDED

701801-06 SIDEWALK, CORNER OR CROSSWALK CLOSURE

701901-07 TRAFFIC CONTROL DEVICES

720001-01 SIGN PANEL MOUNTING DETAILS

720006-04 SIGN PANEL ERECTION DETAILS

728001-01 TELESCOPING STEEL SIGN SUPPORT

731001-01 BASE FOR TELESCOPING STEEL SIGN SUPPORT

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- 14 SIDEWALK PLAN AND PROFILES 13

CONSTRUCTION STAGING PLANS

18 EROSION CONTROL PLANS

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36 STRUCTURAL DETAILS

37 ADA DETAIL - HILLGROVE AVENUE

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PLATFORM TURNAROUND RETAINING WALL DETAILS

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DISTRICT ONE DETAIL - TYPICAL PAVEMENT MARKINGS (TC-13)

CROSS SECTIONS

BENCHMARKS

SOUTHWEST ARROW BOLT ON FIRE HYDRANT AT NORTHEAST CORNER OF STONE AVENUE AND HILLGROVE AVENUE BM #7

SOUTHWEST BOLT ON FIRE HYDRANT AT SOUTHEAST CORNER OF BURLINGTON AVENUE AND BRAINARD AVENUE BM #2710

ELEV: 646.64 (NAVD88)

COMMITMENTS

NONE

TO STA.

BAXTER WOODMAN

BY BAXTER & 1 PROFESSIONAL 31121 - EXPIRES 4

2017 NOIS 184-(

DESIGNED - JDM REVISED DRAWN KAR REVISED CHECKED TMS REVISED FILE - 140184SHT-PH2 Stone GenNotes.don 01-15-18

STATE OF ILLINOIS **DEPARTMENT OF TRANSPORTATION** GENERAL NOTES, HIGHWAY STANDARDS AND **INDEX OF SHEETS**

SCALE: NONE

COUNTY SECTION 14-00089-00-SW COOK 58 CONTRACT NO. 61E45

15. SALVAGED LIGHTING UNITS SHALL BE DELIVERED TO LA GRANGE PUBLIC WORKS: 320 EAST AVE, LA GRANGE, IL 60525. CONTRACTOR SHALL SCHEDULE A DELIVERY DATE AND TIME WITH THE VILLAGE

SUMMARY OF QUANTITIES

				CONSTRUCTIO CODE
				80% FED 20% LCCAL
CODE			TOTAL	ROADSIDE
NO.	TEM .	UNIT	QUANTITY	IMPROVEMENT CMAQ
20101000	TEMPORARYFENCE	FOOT	3,635	3,635
20101200	TREE ROOT PRUNING	EACH	14	14
20101300	TREE PRINING (1 TO 10 NCH DAMETER)	EACH	2	2
20101350	Tree Pruning (Over 10 nch diameter)	EACH	19	19
20101400	NITROGEN FERTILIZER NUTRIENT	POUND	30	30
20101500	PHOSPHORUS FERTILIZER NUTRIENT	POUND	30	30
20101600	POTASSUM FERTLIZER NUTRENT	POUND	30	30
20200100	EARTH EXCAVATION	CUYD	161	161
20201200	REMOVAL AND DISPOSAL OF UNSUITABLE MATERIAL	CUYD	312	312
20400800	FURNISHED EXCAVATION	CUYD	195	195
				4
21101615	TOPSON, FURNISH AND PLACE, 4"	sa yo	2,280	2,280
25200100	SODDING	SO YD	2,280	2,280
25200200	SUPPLEMENTAL WATERING	UNIT		59

28000250	TEMPORARY EROSION CONTROL SEEDING	POUND	50	50
28000510	NIETFLITERS	EACH	5	5

				CODE
				80% FED 20% LOCAL
CODE NO.	표근해	UNIT	TOTAL QUANTITY	ROADSIDE IMPROVEMEN CMAQ
28001100	TEMPORARY EROSION CONTROL BLANKET	SQ YD	2,480	2,480
30300112	AGGREGATE SUBGRADE MPROVEMENT 12°	SQ YD	430	. 430
35101600	AGGREGATE BASE COURSE, TYPE 5 4"	\$Q YD	1,768	1,768
40600290	BITUMNOUS MATERIALS (TACK COAT)	POUND	300	300
40603080	HOT-MIX ASPHALT BINDER COURSE, R19.0, NS0	TON	101	101
40603335	HOT-MIX ASPHALT SURFACE COURSE, MIX "D", NS0	TON	52	52
42001300	PROTECTIVE COAT	CY Q2	1,751	1,751
40400200	PORTLAND CEMENT CONCRETE SIDEWALK 5 NCH	SQFT	14,810	14,810
42400800	DETECTABLE WARNINGS	SQFT	40	40
44000100	PAYEMENT REMOVAL	SQ YD	1,208	1,208
44000800	COMBINATION CURB AND GUTTER REMOVAL	Faor	430	430
44000600	SIDEWALK REMOVAL	SOFT	3.160	3,160
50300225	CONCRETE STRUCTURES	Gu YD	42	42
50700108	TREATED TIMEER	FaM	6,000	6,000
50700308	MARDWARE	POUND	266	256

				CONSTRUCTS CODE
				80% FED 20% LOCAL
CODE NO.	REM	UNIT	TOTAL QUANTITY	ROADSIDE MPROVEMEN
50800205	RENFORCEMENT BARS, EPOXY COATED	POUND	16,759	CMAQ 16,759
······································				
52200900	CONCRETE STRUCTURES (RETAINING WALL)	CUYD	76	76
59100100	GEOCOMPOSTE WALL DRAIN	soyo	12	**************************************
80260100	INLETS TO BE ADJUSTED	EACH	1	1
60603800	COMBINATION CONCRETE CURB AND GUTTER, TYPE 9-6-12	FOOT	270	270
66900200	NON-SPECIAL WASTE DISPOSAL	CUYD	32	32
56900450	SPECIAL WASTE PLANS AND REPORTS	LSUM	1.0	1.8
66900530	SOL DISPOSAL ANALYSIS	EACH	4	4
G7900100	MOBILIZATION	L SUM	1.0	1.0
70102620	TRAFFIC CONTROL AND PROTECTION, STANDARD 701591	LSUM	1,0	1.0
70102640	TRAFFIC CONTROL AND PROTECTION, STANDARD 701801	LSUM	1.0	1.0
72000100	SIGN PANEL - TYPE 1	SOFT	47	47
72400500	RELOCATE SIGN PANEL ASSEMBLY-TYPE A	EACH	8	â
72800100	TELESCOPING STEEL SKIN SUPPORT	FOOT	50	50
73100100	BASE FOR TELESCOPING STEEL SIGN SUPPORT	EACH	4	4

* INDICATES SPECIALTY ITEM

S INDICATES CONSTRUCTION CODE 9042 TRAINEES

TO STA.

S INDICATES CONSTRUCTION CODE 0042 TRAINEES

DESIGNED - JDM BAXTER WOODMAN DRAWN - KAR CHECKED - TMS REVISED -REVISED -DATE - 01-15-18 FILE - 140184SHT-PH2_Stone_S00.pgr

STATE OF ILLINOIS DEPARTMENT OF TRANSPORTATION

SUMMARY OF QUANTITIES SCALE: NONE STA.

COUNTY TOTAL SHEETS NO.

COOK 58 3

CONTRACT NO. 61E45 MUN RTE. SECTION 2070C 14-00089-00-SW

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	0.1070-190	TANDERGROOMS CONSON, GALVANIZED STEEL THE DA.
4	81100300	CONDUIT ATTACHED TO STRUCTURE, 1° DIA., GALVANIZED STEEL
*	81100500	CONDUIT ATTACHED TO STRUCTURE, 1 1/2" DIA., GALVANZED STEEL
٠	81702110	ELECTRIC CABLE IN CONDUIT, 600V (KLP-TYPEUSE) 1/C NO. 10
٠	81702130	ELECTRIC CABLE IN CONDUIT, 600V (XLP-TYPEUSE) 1/C NO. 6
٠	82500330	LIGHTING CONTROLLER, PEDESTAL MOUNTED, 246VOLT, 66AMP
•	63600200	LIGHT POLE FOUNDATION, 24" DIAMETER
٠	84200500	REMOVAL OF LIGHTING UNIT, SALVAGE
		NO. 10. 10. 10. 10. 10. 10. 10. 10. 10. 10
٠	84200804	REMOVAL OF POLE FOUNDATION
	······	
,	84400105	RELOCATE EXISTING LIGHTING UNIT

*	84500110	REMOVAL OF LIGHTING CONTROLLER
	NDICATES SI	PECULTYTEM
\$	NDICATES C	ONSTRUCTION CODE 0042 TRANIEES
		T DECIONED TOTAL DEVI

				CONSTRUCTION CODE
				80% FED 20% LOCAL
CODE NO.	пем	UNIT	TOTAL QUANTITY	ROADSDE IMPROVEMENTS CMAQ
K1005481	SHREDDED BARK MULCH 3°	SQ YO	200	200
Z0003855	BICYCLE RACKS	EACH	12	12
Z0007120	WELDED WIRE FABRIC 6X6	\$0.40	108	108
Z0013798	CONSTRUCTION LAYOUT	LSUM	1.0	10
Z0030850	TEMPORARY INFORMATION SIGNING	SQFT	90	90
Z0034000	MASONRYSTEPS	SOFT	873	433
200-24000			413	873
Z0035800	PARKING METERS TO BE MOVED	EACH	20	- 20
			//////////////////////////////////////	
Z0D48665	RALROAD PROTECTIVE LIABILITY INSURANCE	LSUM	1,0	1,0
Z0076600	TRANEES	FOUR	500	500
Z0076604	TRANEES TRAINING PROGRAM GRADUATE	FOUR	560	500
X0322024	TRENCH DRAW	EACH	3	3
X0323648	LIMESTONE MASONRY VENEER	\$077	680	. 680
X0326998	FURNISH AND INSTALL HANDRAIL	FOOT	36	36

X0327147	REMOVE RAILROAD PLATFORM	SOFT	851	\$51
X0327758	RELOCATE EXISTING CONDUIT AND CABLES	FOOT	50	50

				CONSTRUCTE
				80% FED 20% LOCAL
CODE NO.	ПЕМ	UNIT	TOTAL QUANTITY	ROADSIDE MPROVEMEN CMAQ
X0540000	BRCK PAVERS	. soft	183	183
X1400202	LUMNARE (SPECAL)	EACH	2	2
X2200003	FENCE (SPECIAL)	FOOT	288	288
X5051200	FURNISHING AND ERECTING STRUCTURAL STEEL, SPECIAL	LSUM	10	1.0
X5860110	GRANULAR BACKFILL FOR STRUCTURES	CU YD	12	12
X6062400	CONCRETE GUTTER (SPECIAL)	FOOT	150	150
X7200105	SIGN PANEL - TYPE 1 (SPECIAL)	sarr	7	7
X8140115	HANDHOLE TO BE ADJUSTED	EACH	2	2
X8360095	EXISTING LIGHT POLE FOUNDATION ADJUSTMENT	EACH	1	1
X8780105	CONCRETE FOUNDATIONS (SPECIAL)	EACH	13	13
XZ:27902	RETAINING WALL SPECIAL	SQFT	180	180
XX003663	PRECONSTRUCTION VIDEO TAPING	LSUM	1.00	1.00
XX007100	LIMESTONE CAP	FOOT	238	238
XX007729	DETECTABLE WARNINGS, SPECIAL	SOFT	54	54
XX007877	BCYCLE RACKS - FURNISH	EACH	3	3
XX008388	UNDERPANING EXISTING STRUCTURE	LSUM	1.0	1,0
	GROOFING SYSTEM	SQFT	1,161	1,161

CONSTRUCTION

CONSTRUCTION CODE 80% FEO 20% LOCAL

ROADSIDE IMPROVEMENTS CMAQ

8

360

80

25

50

40

30

660

6

3

TOTAL QUANTITY

8

360

80

50

40

30

5

SOFT

FOOT

FOOT

FOOT

FOOT

FOOT

FOOT

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78000100

78000200

81028170

THERMOPLASTIC PAVEMENT MARKING - LETTERS AND SYMBOLS

THERMOPLASTIC PAVEMENT MARKING - LINE 4"

UNDERGROUND CONDUIT, GALVANIZED STEEL, 1" DIA.

78000400 THERMOPLASTIC PAVEMENT MARKING - LINE 6"

* 81028190 UNDERGROUND CONDUIT, GALVANIZED STEEL, 1 1/2" DIA.


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SCALE: NONE

			SECTION	COUNTY	TOTAL SHEETS	SHEET NO.
SUMMARY OF QUANTITIES	p	2070C	14-00089-00-SW	соок	58	4
				CONTRACT	NO. 61	E45
STA	TO STA					

EXISTING TYPICAL SECTION

HILLGROVE AVENUE, STA 102+08 TO STA 104+00

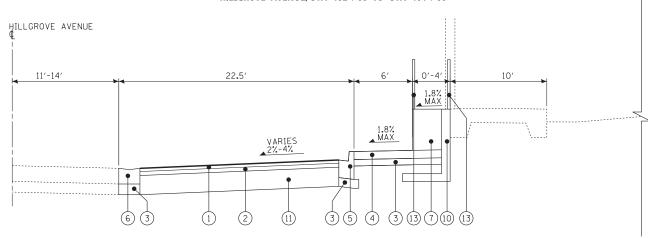

PROPOSED TYPICAL SECTION
HILLGROVE AVENUE, STA 102+08 TO STA 104+00

EXISTING LEGEND

- A EXISTING HOT-MIX ASPHALT PAVEMENT
- (B) EXISTING AGGREGATE BASE COURSE
- (C) EXISTING COMBINATION CONCRETE CURB AND GUTTER
- D EXISTING SIDEWALK
- (DD) EXISTING STATION PLATFORM
- E EXISTING GROUND SURFACE
- (EE) EXISTING PLATFORM CANOPY
- (F) EXISTING RETAINING WALL
- (FF) EXISTING TRAIN TRACKS
- G PAVEMENT REMOVAL


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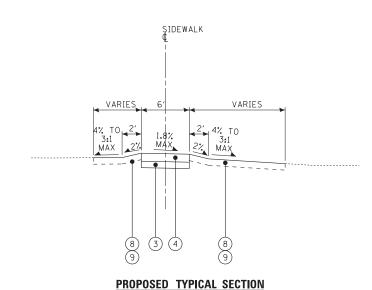
- H EARTH EXCAVATION
- J SIDEWALK REMOVAL
- K AGGREGATE BASE COURSE REMOVAL
- L COMBINATION CONCRETE CURB AND GUTTER REMOVAL
- ITEM TO BE REMOVED

PROPOSED LEGEND

- 1) HOT-MIX ASPHALT SURFACE COURSE, MIX "D". N50, 2"
- 2 HOT-MIX ASPHALT BINDER COURSE, IL-19.0, N50 4"
- 3) AGGREGATE BASE COURSE, TYPE B, 4"
- 4) PORTLAND CEMENT CONCRETE SIDEWALK 5 INCH
- (5) COMBINATION CONCRETE CURB AND GUTTER, TYPE B-6.12
- 6 CONCRETE GUTTER (SPECIAL)
- 7) PLATFORM AT OUTBOUND CANOPY (SEE ARCH SHEETS)
- 8 TOPSOIL FURNISH AND PLACE 4"
- 9 SODDING
- (10) CONCRETE STRUCTURES (RETAINING WALL) (SEE STRUCTURAL SHEETS)
- (11) AGGREGATE SUBGRADE IMPROVEMENT 12"
- (12) RETAINING WALL, SPECIAL (SEE STRUCTURAL SHEETS)
- (13) FENCE (SPECIAL)
- (14) BICYCLE RACK
- (15) CONCRETE FOUNDATION (SPECIAL) (SEE STRUCTURAL SHEETS)



EXISTING TYPICAL SECTION SIDEWALK

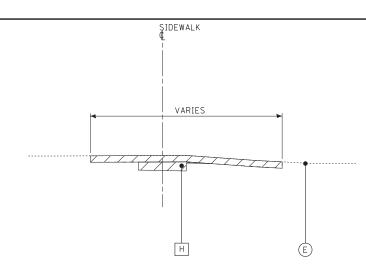

SIDEWALK

HOT-MIX ASPHALT MIXTURE REQUIREMENTS

MIXTURE TYPE	AIR VOIDS @ Ndes
ROADWAY	
HOT-MIX ASPHALT SURFACE COURSE, MIX "D", N50; 2"	4% @ 50 Gyr.
HOT-MIX ASPHALT BINDER COURSE, IL-19.0, N50; 4"	4% @ 50 Gyr.

NOTES:

- 1. THE UNIT WEIGHT USED TO CALCULATE ALL HMA SURFACE MIXTURE QUANTITIES IS 112 LBS/SQ YD/IN.
- 2. THE "AC TYPE" FOR POLYMERIZED HMA MIXES SHALL BE "SBS/SER PG 76 -22" AND FOR NON-POLYMERIZED HMA THE "AC TYPE" SHALL BE "PG 64 -22" UNLESS MODIFIED BY DISTRICT ONE SPECIAL PRCVISIONS.
- 3. FOR USE OF RECYCLED MATERIALS SEE SPECIAL PROVISIONS.

BAXTER WOODMAN

 DESIGNED
 JDM
 REVISED

 DRAWN
 KAR
 REVISED

 CHECKED
 TMS
 REVISED

 DATE
 01-15-18
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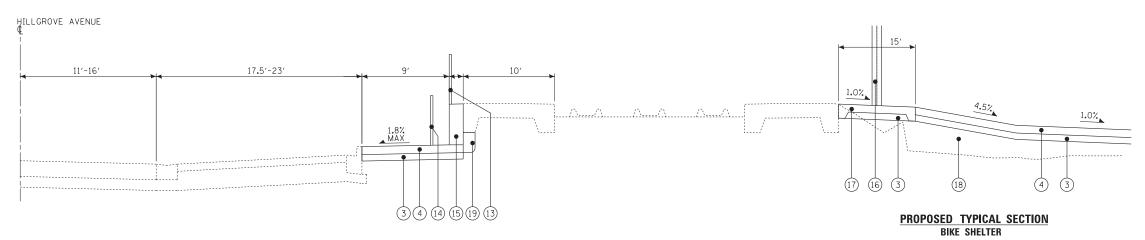
STATE OF ILLINOIS
DEPARTMENT OF TRANSPORTATION

TYPICAL SECTIONS AND HOT–MIX
ASPHALT MIXTURE REQUIREMENTS

MUN RTE. SECTION COUNTY SHEETS NO 2070C 14-00089-00-SW COOK 58 5 5 CONTRACT NO. 61E45

EXISTING TYPICAL SECTION HILLGROVE AVENUE, STA 101+37 TO STA 102+08

EXISTING TYPICAL SECTION BIKE SHELTER



PROPOSED TYPICAL SECTION HILLGROVE AVENUE, STA 101+37 TO STA 102+08

EXISTING LEGEND

- A EXISTING HOT-MIX ASPHALT PAVEMENT
- B EXISTING AGGREGATE BASE COURSE
- (C) EXISTING COMBINATION CONCRETE CURB AND GUTTER
- D EXISTING SIDEWALK
- (DD) EXISTING STATION PLATFORM
- E EXISTING GROUND SURFACE
- (EE) EXISTING PLATFORM CANOPY
- F EXISTING RETAINING WALL
- (FF) EXISTING TRAIN TRACKS
- G PAVEMENT REMOVAL
- H EARTH EXCAVATION
- J SIDEWALK REMOVAL

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- K AGGREGATE BASE COURSE REMOVAL
- L COMBINATION CONCRETE CURB AND GUTTER REMOVAL
- ITEM TO BE REMOVED

PROPOSED LEGEND

- 1) HOT-MIX ASPHALT SURFACE COURSE, MIX "D". N50, 2"
- 2 HOT-MIX ASPHALT BINDER COURSE, IL-19.0, N50 4"
- 3) AGGREGATE BASE COURSE, TYPE B, 4"
- (4) PORTLAND CEMENT CONCRETE SIDEWALK 5 INCH
- (5) COMBINATION CONCRETE CURB AND GUTTER, TYPE B-6.12
- 6 CONCRETE GUTTER (SPECIAL)
- 7) PLATFORM AT OUTBOUND CANOPY (SEE ARCH SHEETS)
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- (11) AGGREGATE SUBGRADE IMPROVEMENT 12"
- (12) RETAINING WALL, SPECIAL (SEE STRUCTURAL SHEETS)
- (13) FENCE (SPECIAL)
- (14) BICYCLE RACK
- (15) CONCRETE FOUNDATION (SPECIAL) (SEE STRUCTURAL SHEETS)

- (16) FURNISHING AND ERECTING STRUCTURAL STEEL, SPECIAL (SEE STRUCTURAL SHEETS)
- (17) CONCRETE STRUCTURES (SEE STRUCTURAL SHEETS)

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STATE OF ILLINOIS **DEPARTMENT OF TRANSPORTATION**

TYPICAL SECTIONS 14-00089-00-SW COOK CONTRACT NO. 61E45 SCALE: NONE

(18) FURNISHED EXCAVATION

(19) UNDERPINNING EXISTING STRUCTURE (SEE STRUCTURAL SHEETS)

PROPOSED TYPICAL SECTION HILLGROVE AVENUE, STA 106+49 TO STA 108+09

EXISTING LEGEND

- A EXISTING HOT-MIX ASPHALT PAVEMENT
- B EXISTING AGGREGATE BASE COURSE
- C EXISTING COMBINATION CONCRETE CURB AND GUTTER
- D EXISTING SIDEWALK
- (DD) EXISTING STATION PLATFORM
- E EXISTING GROUND SURFACE
- (EE) EXISTING PLATFORM CANOPY
- F EXISTING RETAINING WALL
- (FF) EXISTING TRAIN TRACKS
- G PAVEMENT REMOVAL

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- H EARTH EXCAVATION
- J SIDEWALK REMOVAL
- K AGGREGATE BASE COURSE REMOVAL
- L COMBINATION CONCRETE CURB AND GUTTER REMOVAL
- ITEM TO BE REMOVED

PROPOSED LEGEND

- 1) HOT-MIX ASPHALT SURFACE COURSE, MIX "D". N50, 2"
- 2 HOT-MIX ASPHALT BINDER COURSE, IL-19.0, N50 4"
- 3) AGGREGATE BASE COURSE, TYPE B, 4"
- 4) PORTLAND CEMENT CONCRETE SIDEWALK 5 INCH
- (5) COMBINATION CONCRETE CURB AND GUTTER, TYPE B-6.12
- 6 CONCRETE GUTTER (SPECIAL)
- 7) PLATFORM AT OUTBOUND CANOPY (SEE ARCH SHEETS)
- 8 TOPSOIL FURNISH AND PLACE 4"
- 9 SODDING
- (10) CONCRETE STRUCTURES (RETAINING WALL) (SEE STRUCTURAL SHEETS)
- (11) AGGREGATE SUBGRADE IMPROVEMENT 12"
- (12) RETAINING WALL, SPECIAL (SEE STRUCTURAL SHEETS)
- (13) FENCE (SPECIAL)
- 14) BICYCLE RACK
- (15) CONCRETE FOUNDATION (SPECIAL) (SEE STRUCTURAL SHEETS)

(16) FURNISHING AND ERECTING STRUCTURAL STEEL, SPECIAL (SEE STRUCTURAL SHEETS)

PROPOSED TYPICAL SECTION PLATFORM TURNAROUND


- (17) CONCRETE STRUCTURES (SEE STRUCTURAL SHEETS)
- (18) FURNISHED EXCAVATION
- (19) UNDERPINNING EXISTING STRUCTURE (SEE STRUCTURAL SHEETS)


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STATE OF ILLINOIS DEPARTMENT OF TRANSPORTATION

	MUN RTE.	SECTION	COUNTY	TOTAL SHEETS	SHEET NO.
TYPICAL SECTIONS	2070C	14-00089-00-SW	соок	58	7
			CONTRACT	NO. 61	E45
SCALE: NONE STA. TO STA.					



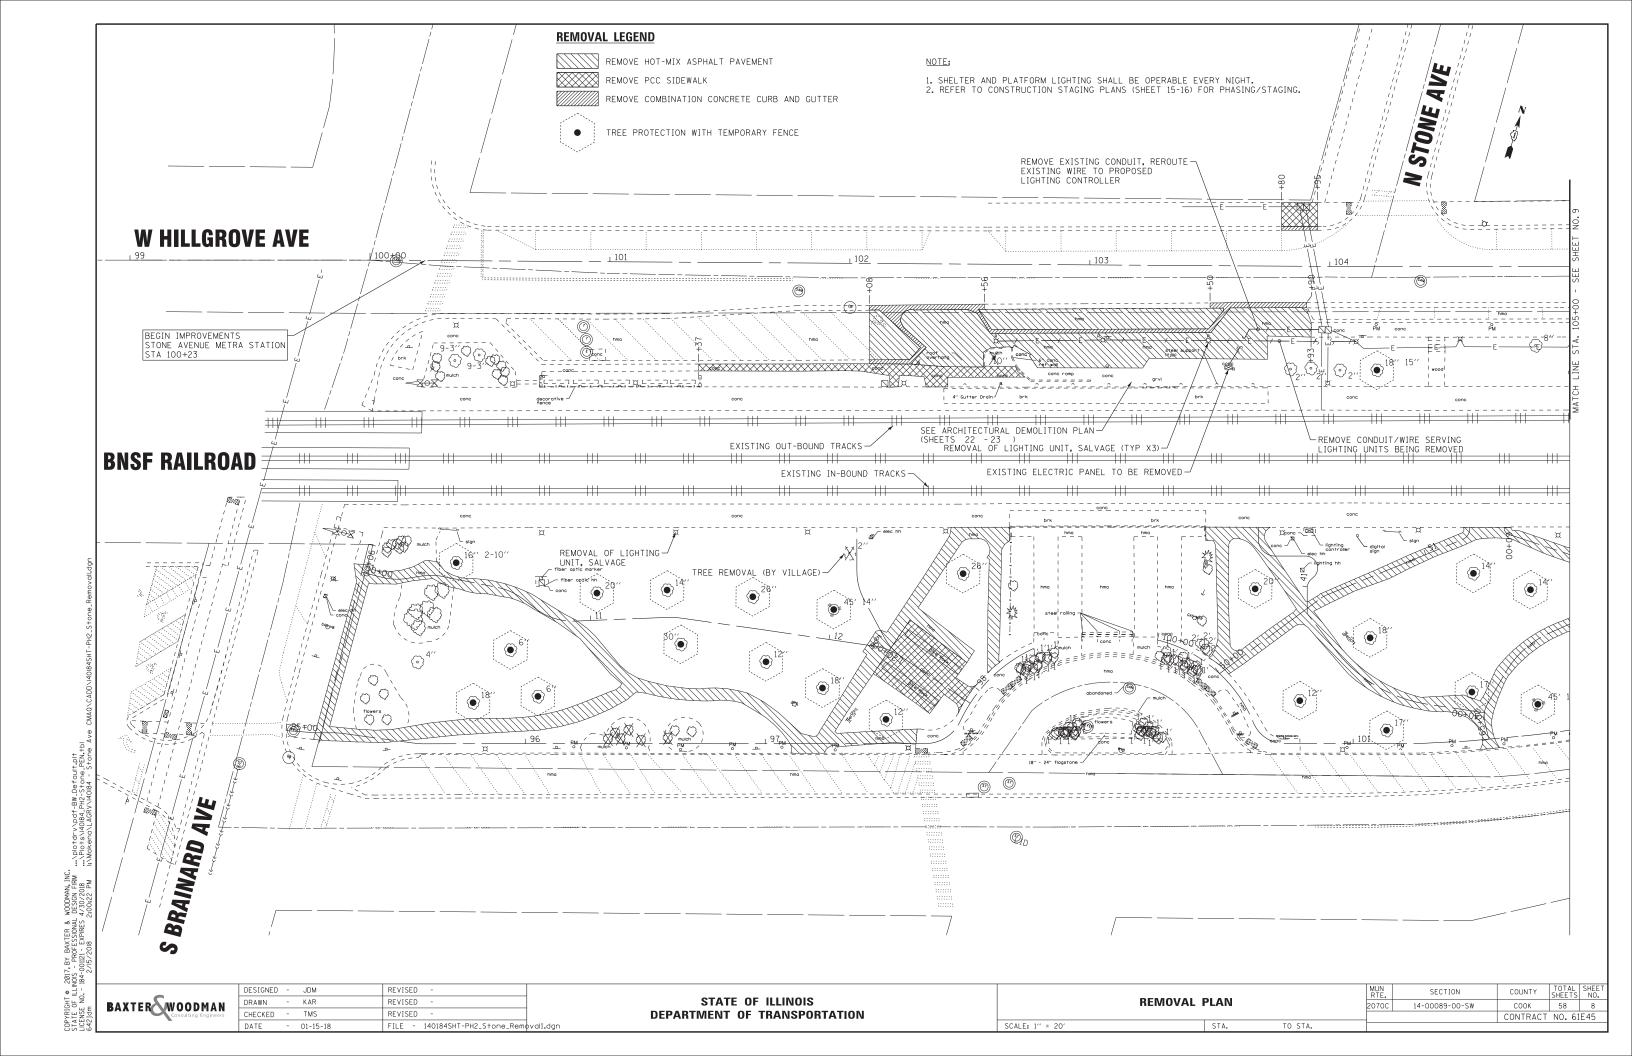

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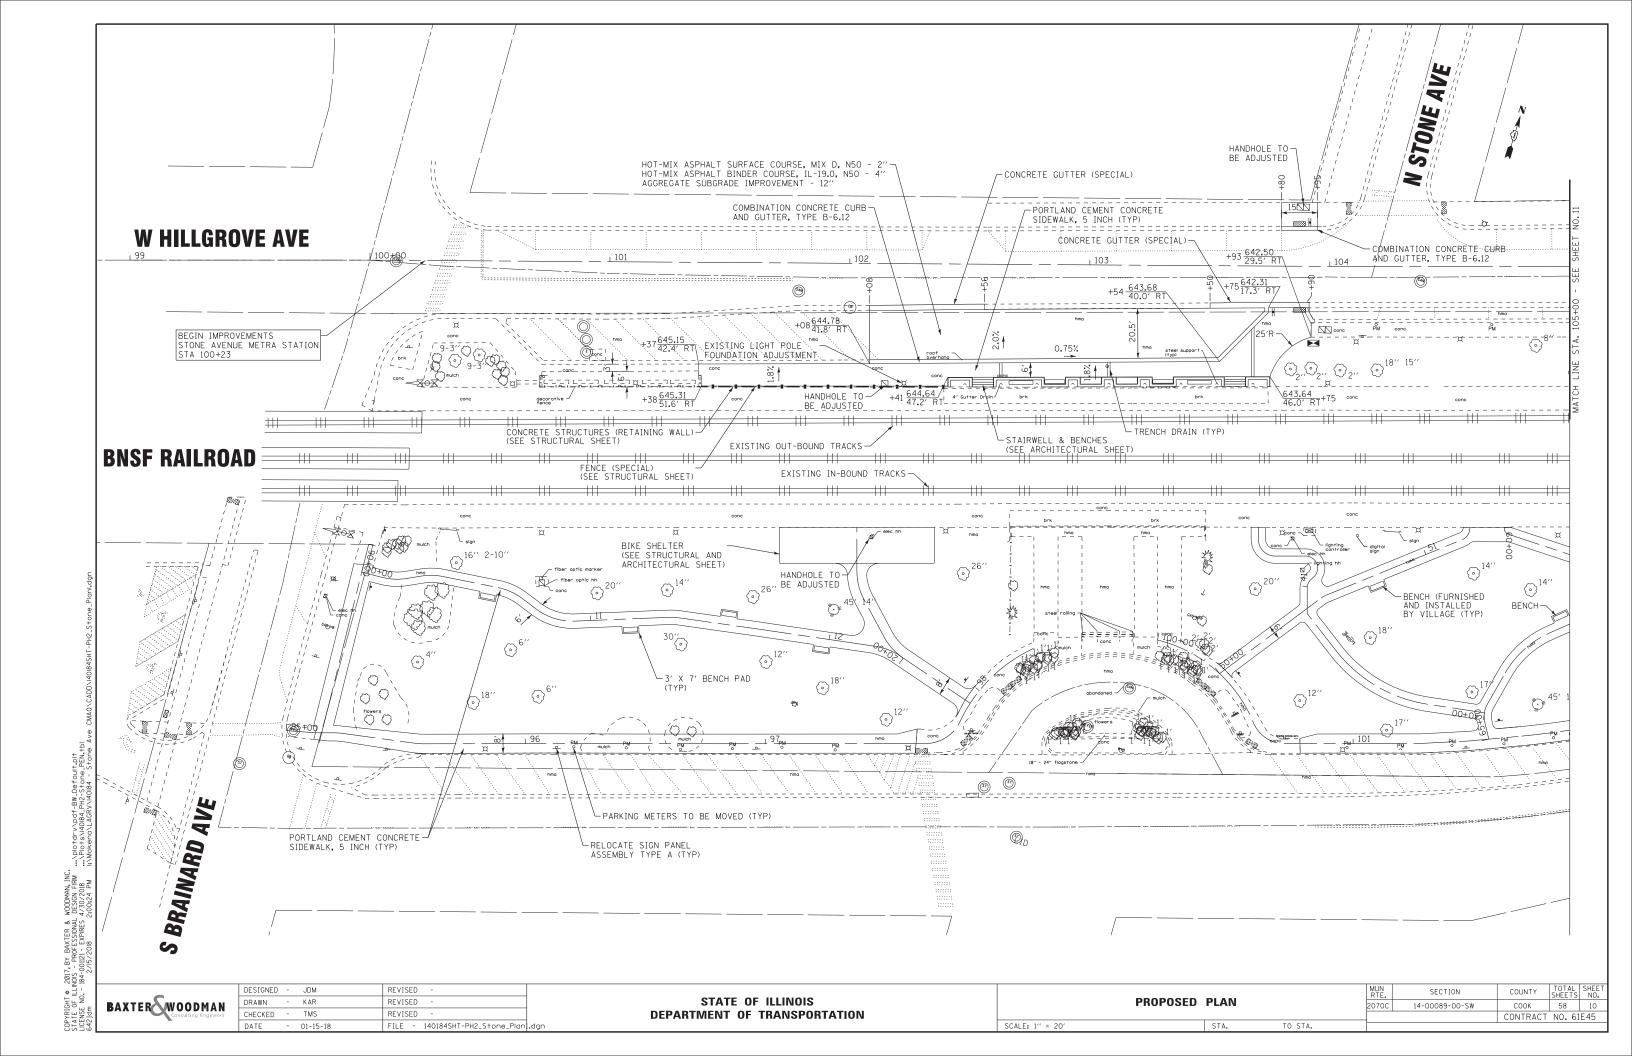
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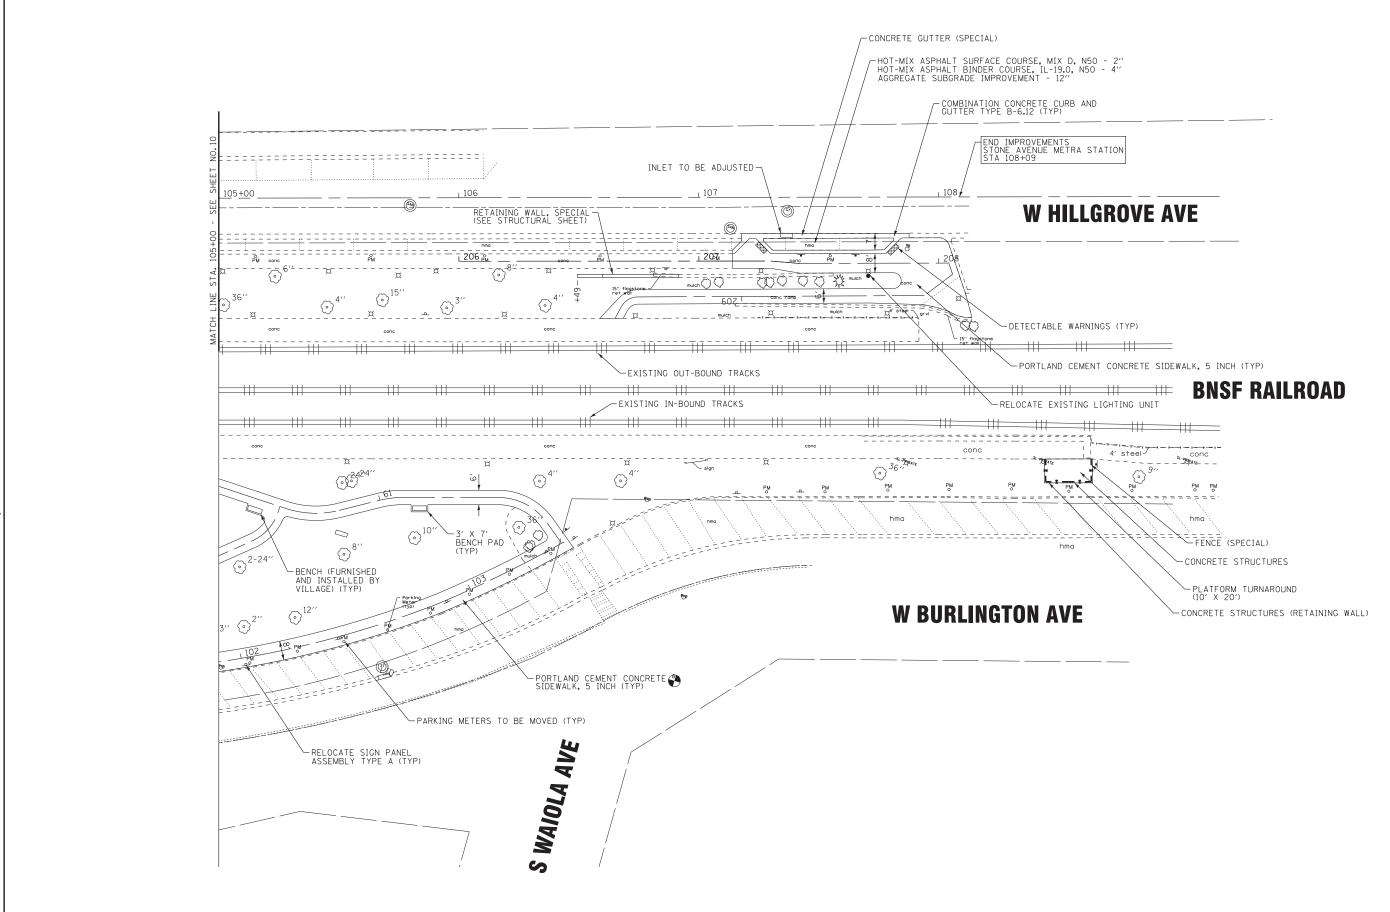
STATE OF ILLINOIS
DEPARTMENT OF TRANSPORTATION

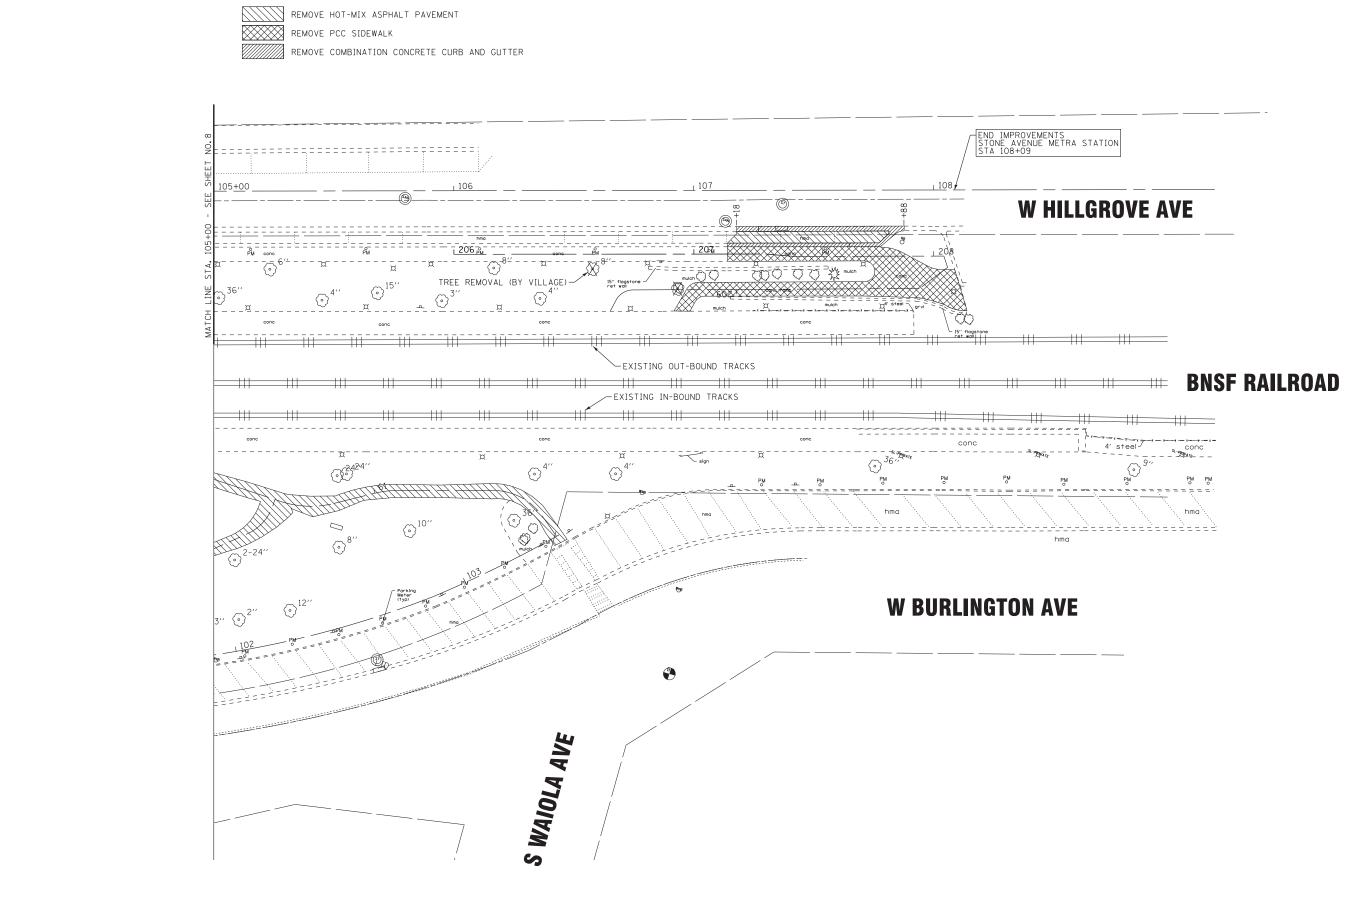 REMOVAL PLAN
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 SCALE: 1" = 20'
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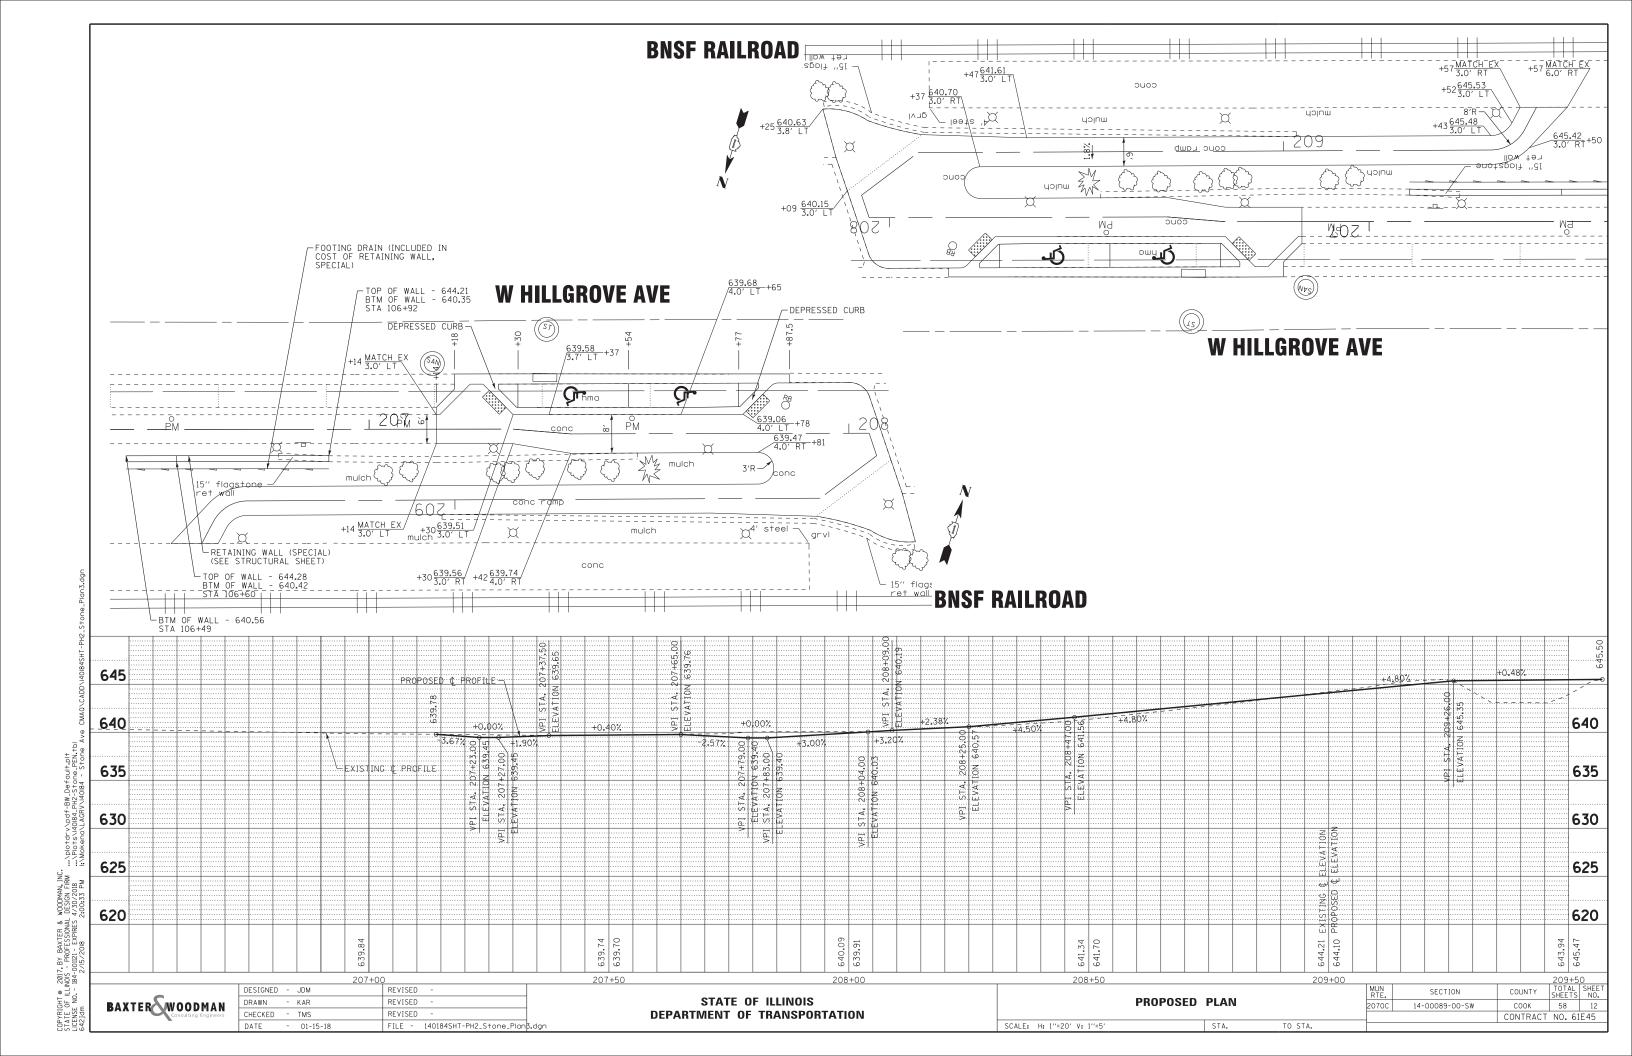
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DEPARTMENT OF TRANSPORTATION


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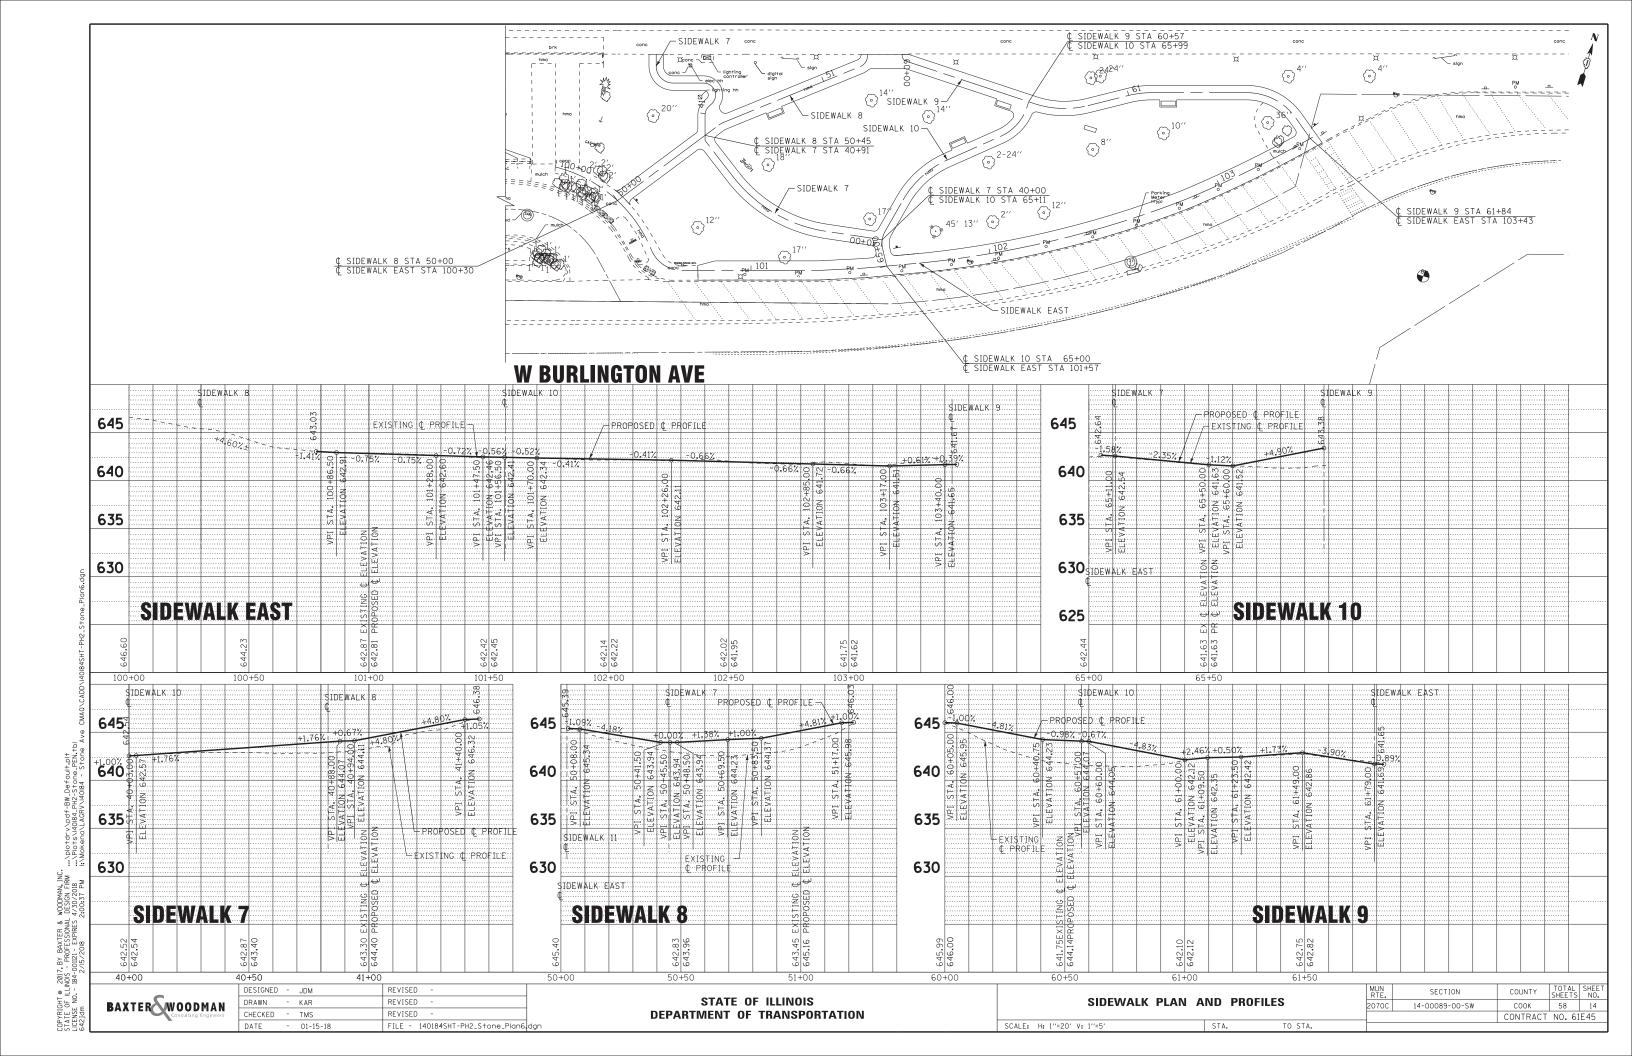
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 PLAN
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 SECTION
 COUNTY SHEETS NO.
 SHEETS NO.


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 CONTRACT NO. 61E45








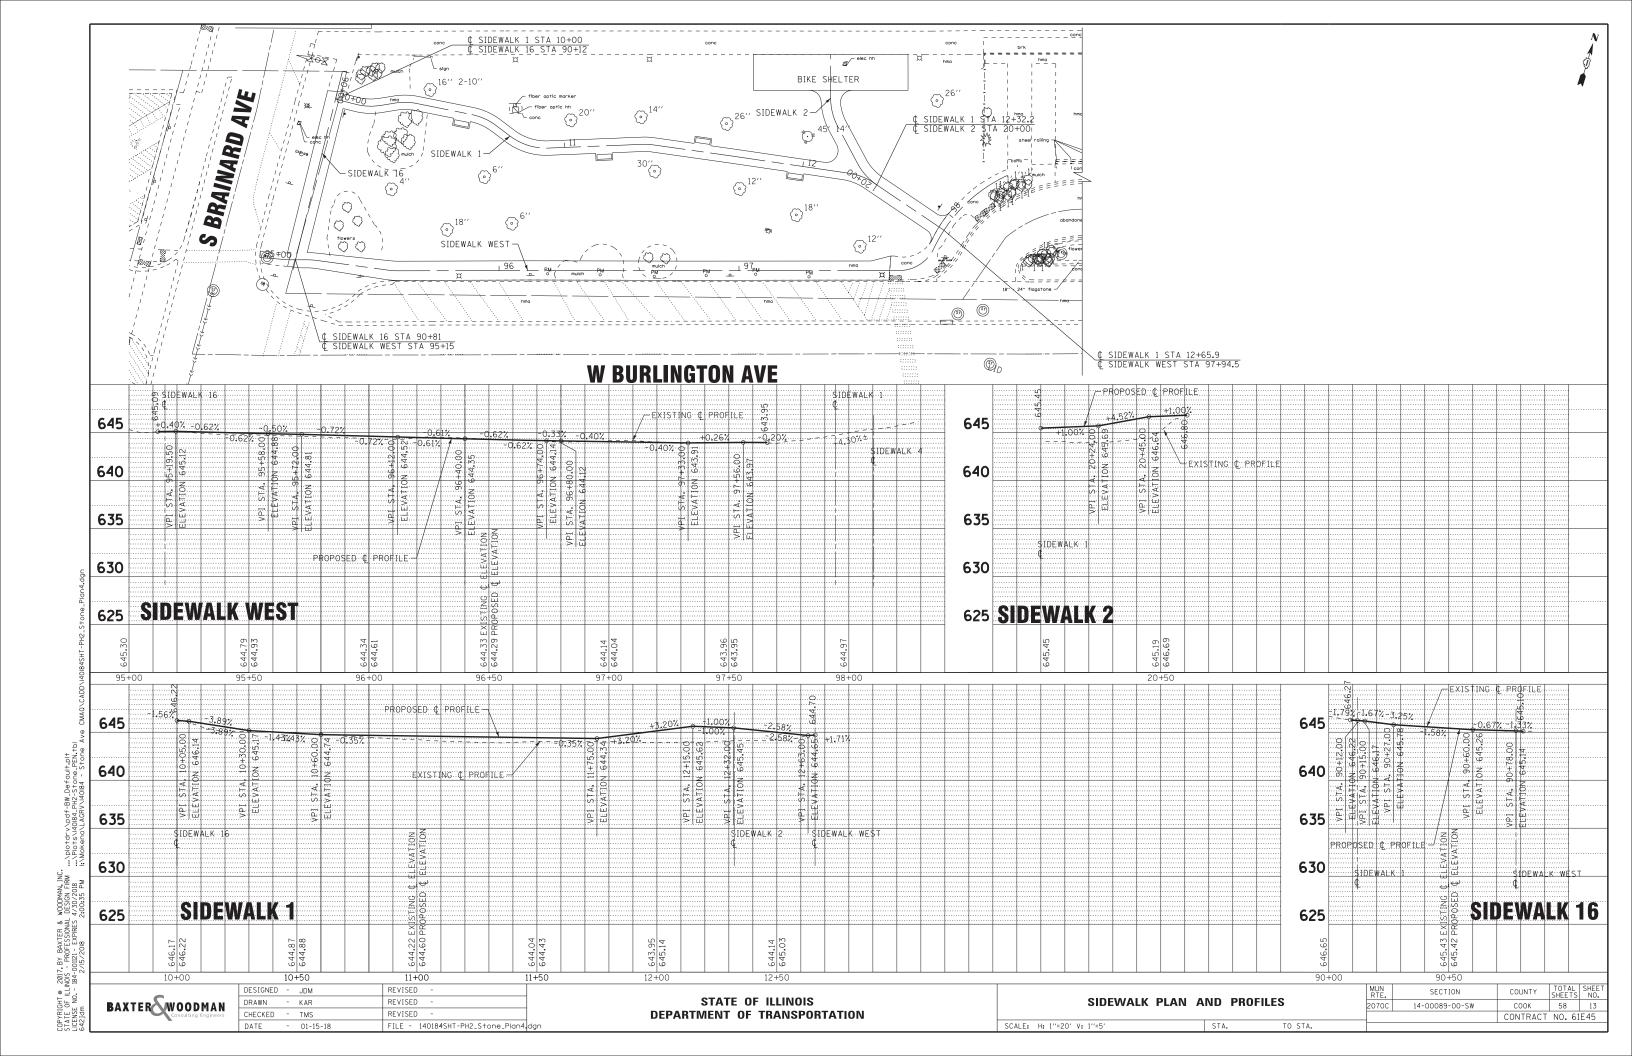

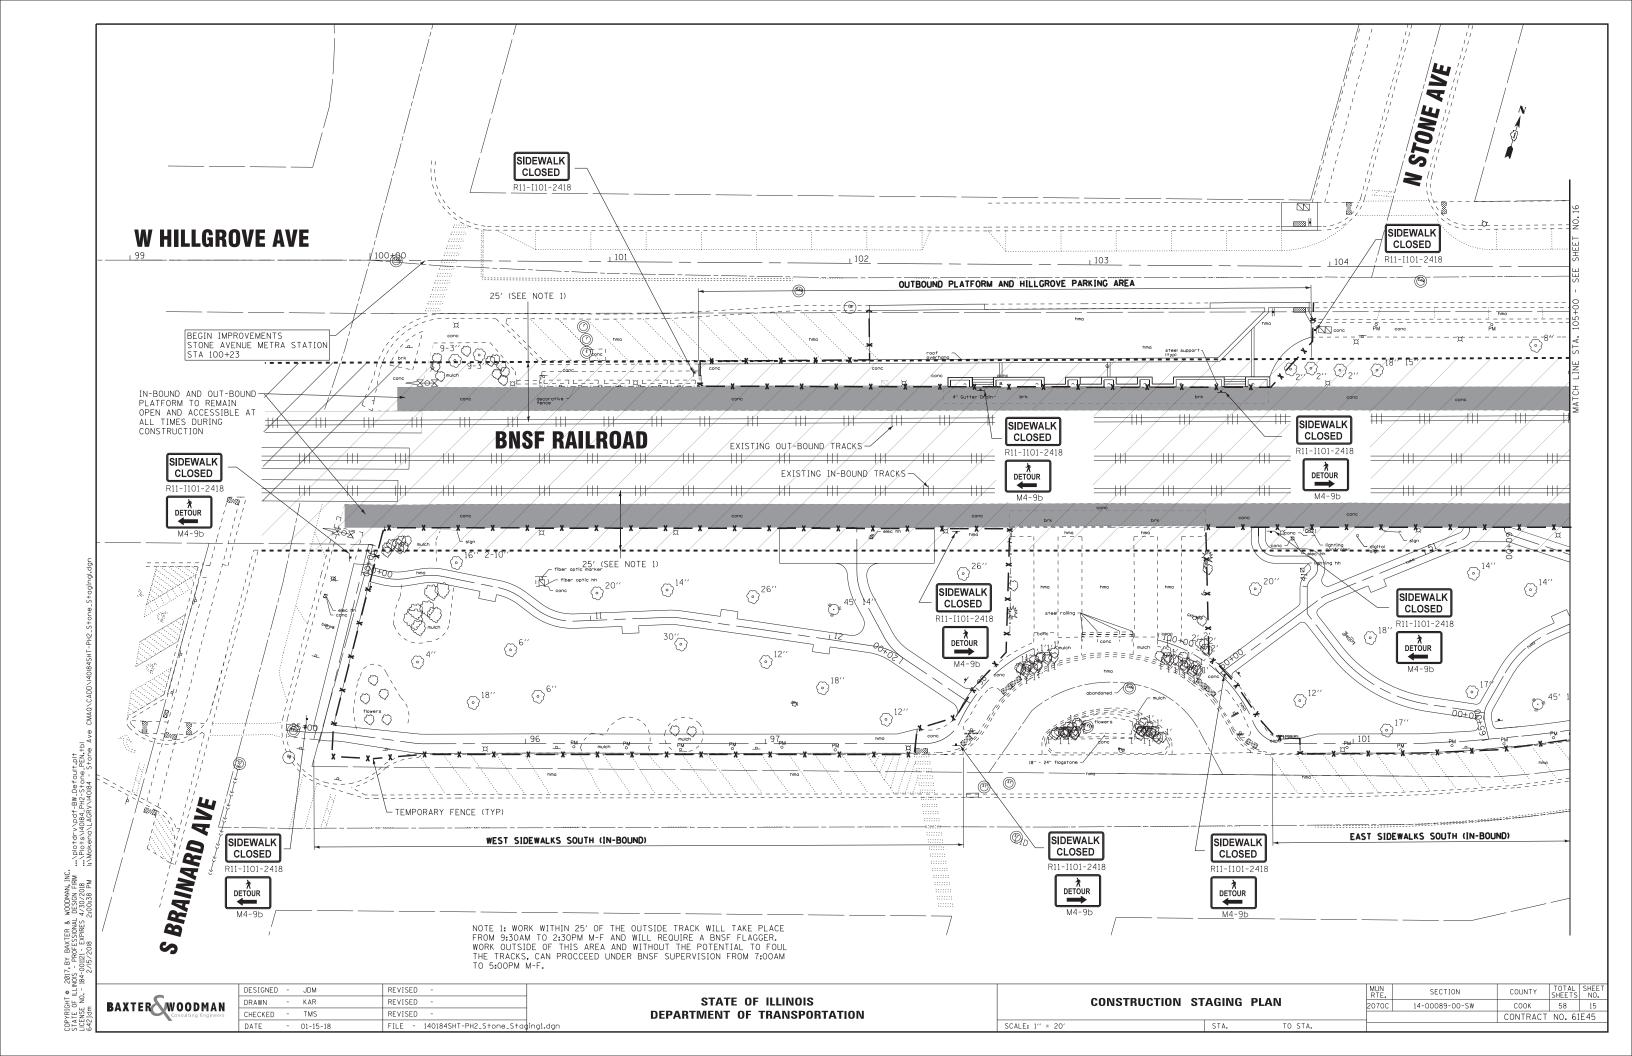HILLGROVE AVENUE AT KENSINGTON



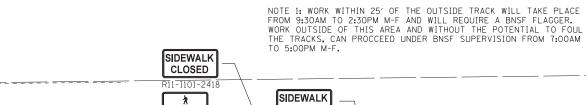

THE CONTRACTOR SHALL SUBMIT A PRE-PLANNED SEQUENCE OF WORK AT THE PRECONSTRUCTION CONFERENCE FOR REVIEW AND APPROVAL. WORK SHALL BE SCHEDULED TO MINIMIZE INCONVENIENCE TO RESIDENTS AND COMMUTERS AND TO MAINTAIN A REASONABLE LEVEL OF CONSTRUCTION EFFICIENCY. THE ENGINEER RESERVES THE RIGHT TO RESTRICT WORK ON ANY AREA IF TRAFFIC CONTROL OPERATIONS BECOME UNACCEPTABLE. OVE AVE SUGGESTED SEQUENCE OF CONSTRUCTION: PRIOR TO CONSTRUCTION, INSTALL ALL TEMPORARY EROSION CONTROL DEVICES NECESSARY AND ESTABLISH ALL TRAFFIC CONTROL REQUIRED, INCLUDING

EAST AND WEST SIDEWALKS ON SOUTH (IN-BOUND) SIDE

TEMPORARY FENCE AND SIGNAGE.

- REMOVE EXISTING SIDEWALKS AND BIKE PAD PARKING.
- COMPLETE GRADING OF NEW SIDEWALK PROFILES.
- INSTALL SIDEWALKS AND BIKE SHELTER FOUNDATION.
- INSTALL CANOPY AND BIKE RACKS.

HILLGROVE RAMP

- REMOVE EXISTING SIDEWALK, CURB AND GUTTER, AND RAMP.
- PRESERVE EXISTING LIMESTONE RETAINING WALL
- INSTALL LIMESTONE WALL EXTENSION AND BACKFILL
- REGRADE RAMP AND SET AGGREGATE BASE COURSE
- INSTALL SIDEWALK
- INSTALL MULCH

OUTBOUND PLATFORM AND HILLGROVE PARKING AREA

- REMOVE PAVEMENT, SIDEWALK, AND CURB AND GUTTER ALONG HILLGROVE PARKING AREA.
 - WHLE REMOVING SIDEWALK AND PARKWAY ALONG EXISTING OUT-BOUND PLATFORM. INSTALL UNDERPINNING OF PLATFORM. REFER TO STRUCTURAL DETAILS.
- 2. BEGIN DEMOLITION OF EXISTING OUT-BOUND PLATFORM.
- INSTALL STAIRS, RETAINING WALLS, ELECTRICAL, AND OTHER ARCHITECTURAL
- INSTALL CURB AND GUTTER ALONG HILLGROVE PARKING AREA.
- INSTALL SIDEWALKS.
 - INSTALL AGGREGATE AND HMA BASE AND SURFACE COURSE IN PARKING AREA.
- REMOVE EXISTING WOOD STAIRS.
- 8. INSTALL BIKE RACKS AND OTHER APPURTENANCES

PLATFORM TURNAROUND

- INSTALL RETAINING WALL
- BACKFILL AND SET AGGREGATE BASE COURSE
- INSTALL SIDEWALK
- INSTALL DECORATIVE FENCE.

AFTER ALL STAGES HAVE BEEN COMPLETED:

- A. FINISH GRADING AND INSTALL TOPSOIL AND SOD.
- COMPLETE PAVEMENT MARKINGS.

TO STA.

COMPLETE PUNCH LIST ITEMS AND REMOVE TEMPORARY EROSION CONTROL ITEMS ONCE SOD ESTABLISHES.

CLOSED \	
R11-I101-2418 SIDEWALK CLOSED R11-I101-241	8 HILLGROVE RAMP W HILLGROVE AVE
2 105+00 106	
25' (SEE NOTE 1) TEMPORARY FENCE (TYP)	SIDEWALK CLOSED
CIAN CHARLE FIRE COLOR C	RI1-I101-2418
hmo	TALEBOUND AND OUT-BOUND DI ATEODIA
PM conc	IN-BOUND AND OUT-BOUND PLATFORM TO REMAIN OPEN AND ACCESSIBLE AT ALL TIMES DURING CONSTRUCTION
	AT ALL TIMES DURING CONSTRUCTION
9 36"	602 1 conc ramp
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	T-BOUND TRACKS BNSF RAILROAD
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O ^{10"}	hmo hmo hmo
© 2-24"	25' (SEE NOTE 1) PLATFORM TURNAROUND
3" O 2" SIDEWALK CLOSED	W BURLINGTON AVE
CLOSED R11-1101-2418	CONSTRUCTION STAGING NOTES:
	 THE IN-BOUND AND OUT-BOUND PLATFORM SHALL REMAIN ACCESSIBLE AT ALL TIMES DURING CONSTRUCTION.
EAST SIDEWALKS SOUTH (IN-BOUND)	 PROVIDE HANDICAP ACCESS AT WEST END OF OUTBOUND PLATFORM WHILE HILLGROVE RAMP IS UNDER CONSTRUCTION.
2	 ALL STREETS SHALL BE OPEN TO TRAFFIC AT THE END OF EACH DAY WITH BARRICADES PLACED AROUND ALL PARKED EQUIPMENT, STOCKPILES AND STEEP EMBANKMENTS.
	4. ACCESS FOR MAIL SERVICE, GARBAGE COLLECTION, SCHOOL BUSES AND
\	EMERGENCY VEHICLES MUST BE MAINTAINED AT ALL TIMES.
S WAIOLA AVE	

BAXTER WOODMAN

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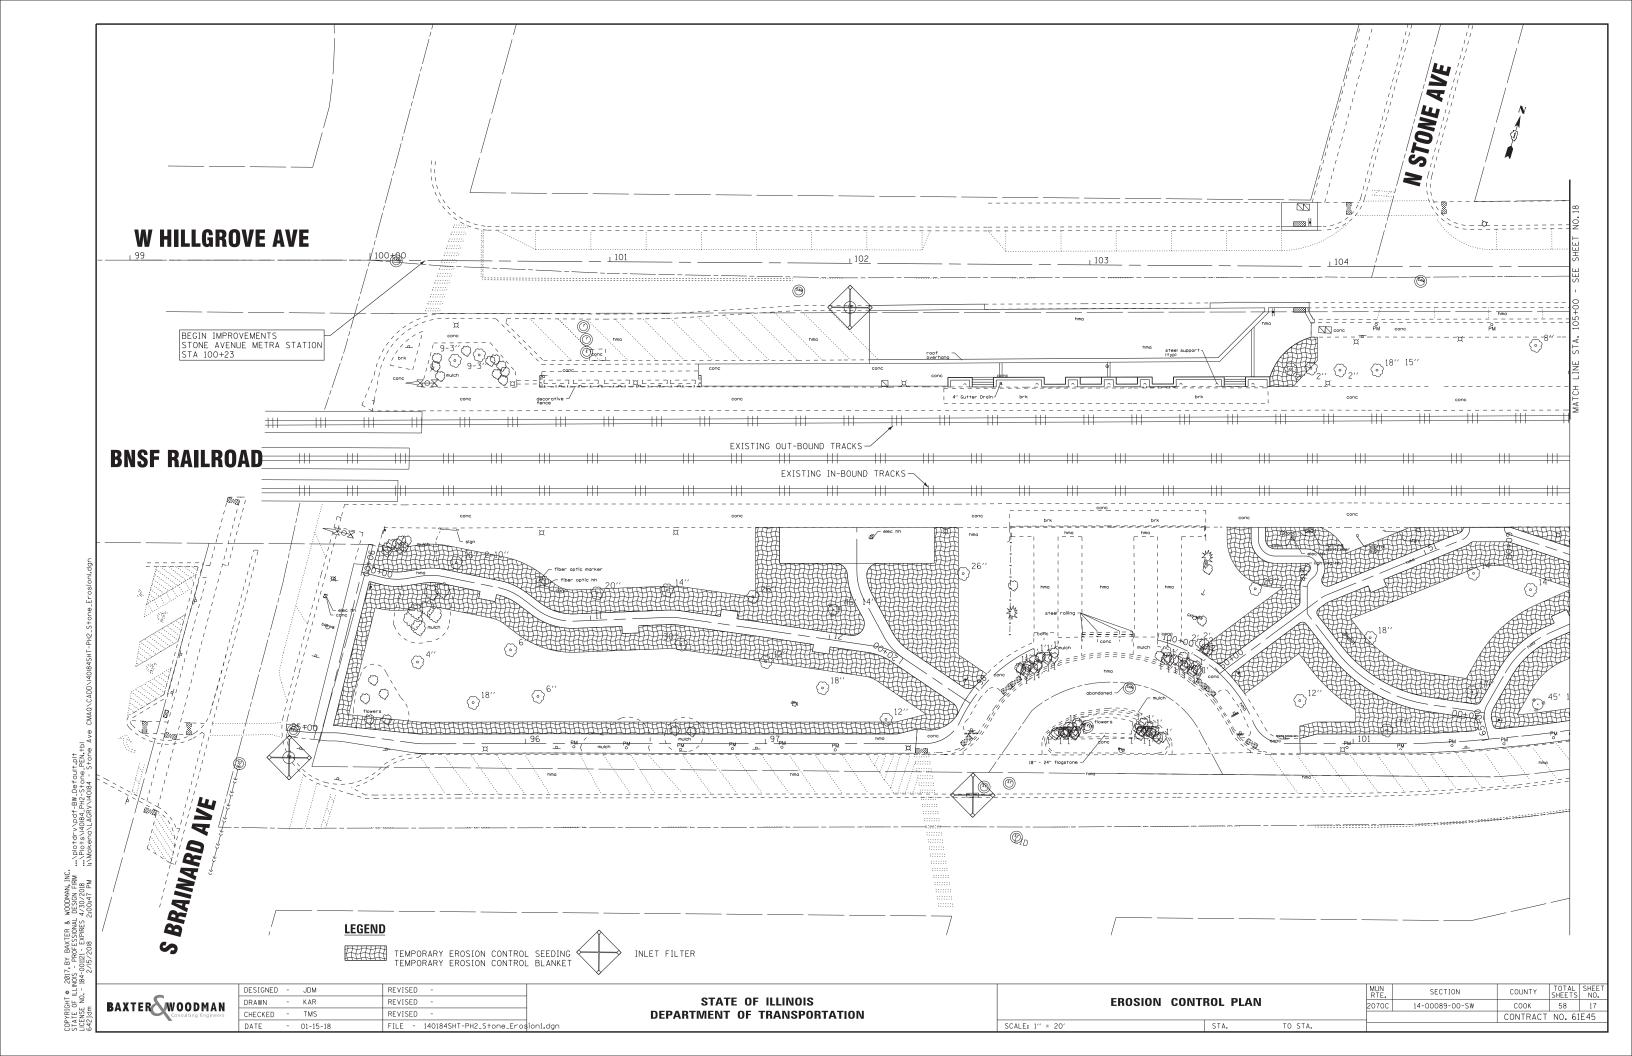
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STATE OF ILLINOIS **DEPARTMENT OF TRANSPORTATION** CONSTRUCTION STAGING PLAN

SECTION COUNTY 14-00089-00-SW COOK 58 16 CONTRACT NO. 61E45

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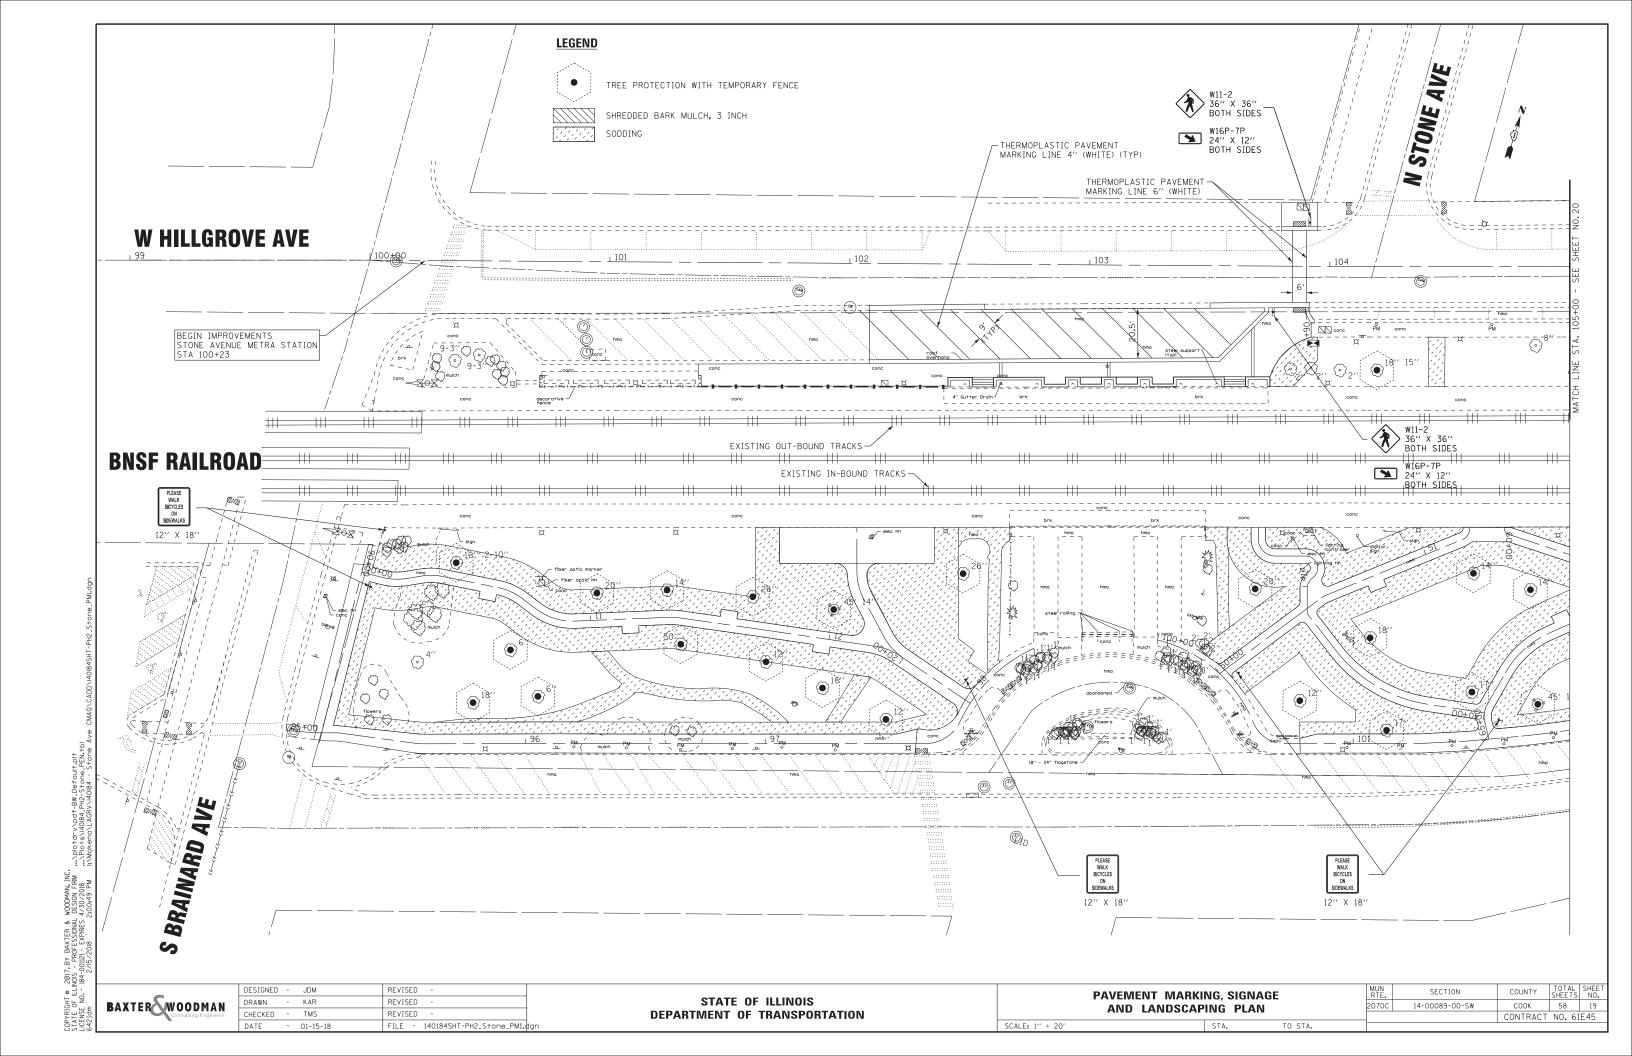



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BAXTER WOODMAN Consulting Engineers

STATE OF ILLINOIS
DEPARTMENT OF TRANSPORTATION

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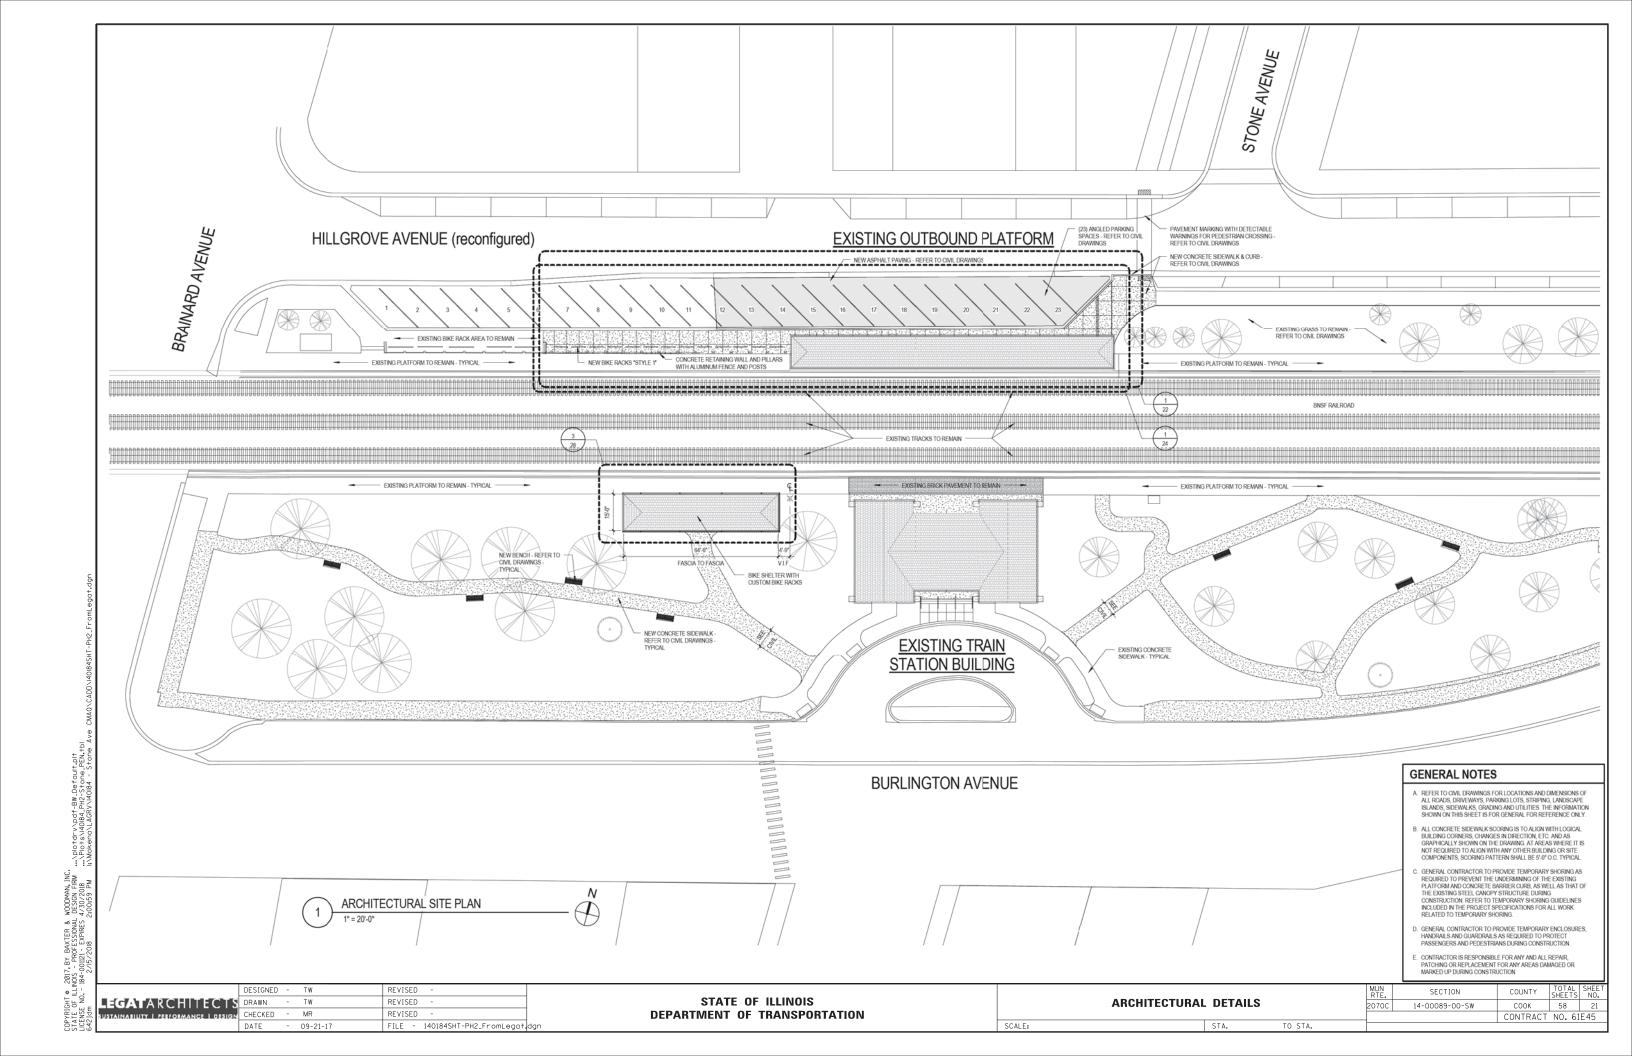
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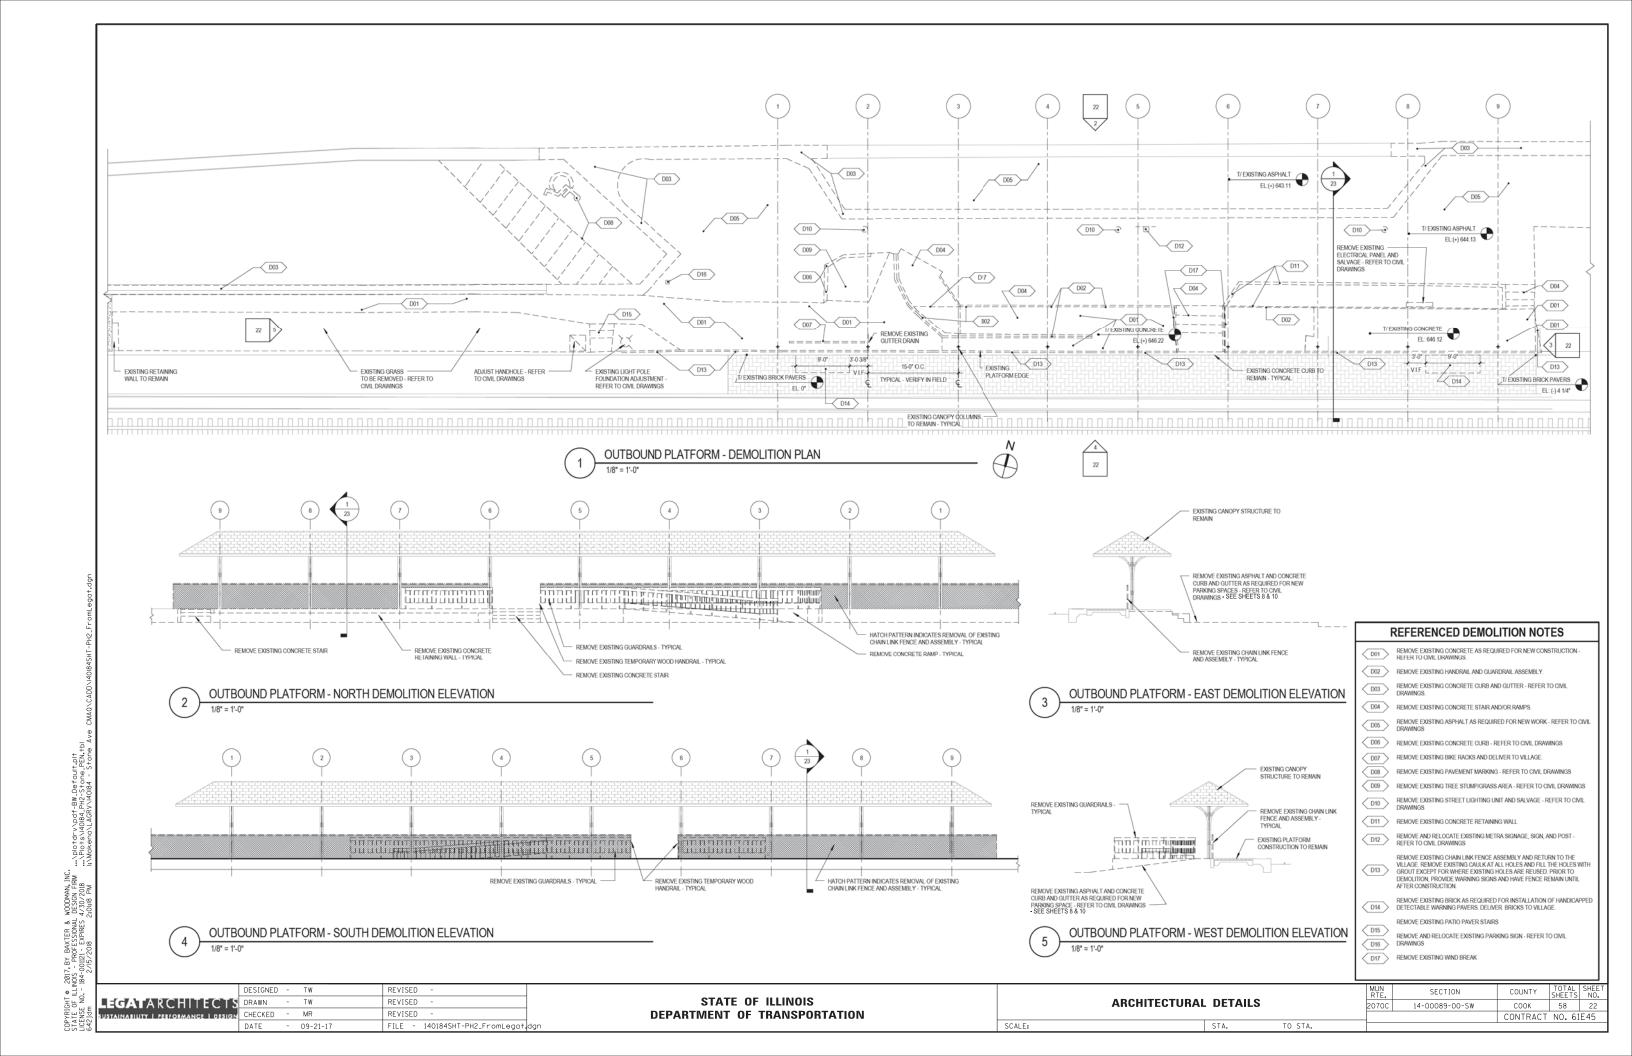
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DEPARTMENT OF TRANSPORTATION

AND LANDSCAPING PLAN

TOTAL SHEE NO. 58 20 14-00089-00-SW СООК CONTRACT NO. 61E45

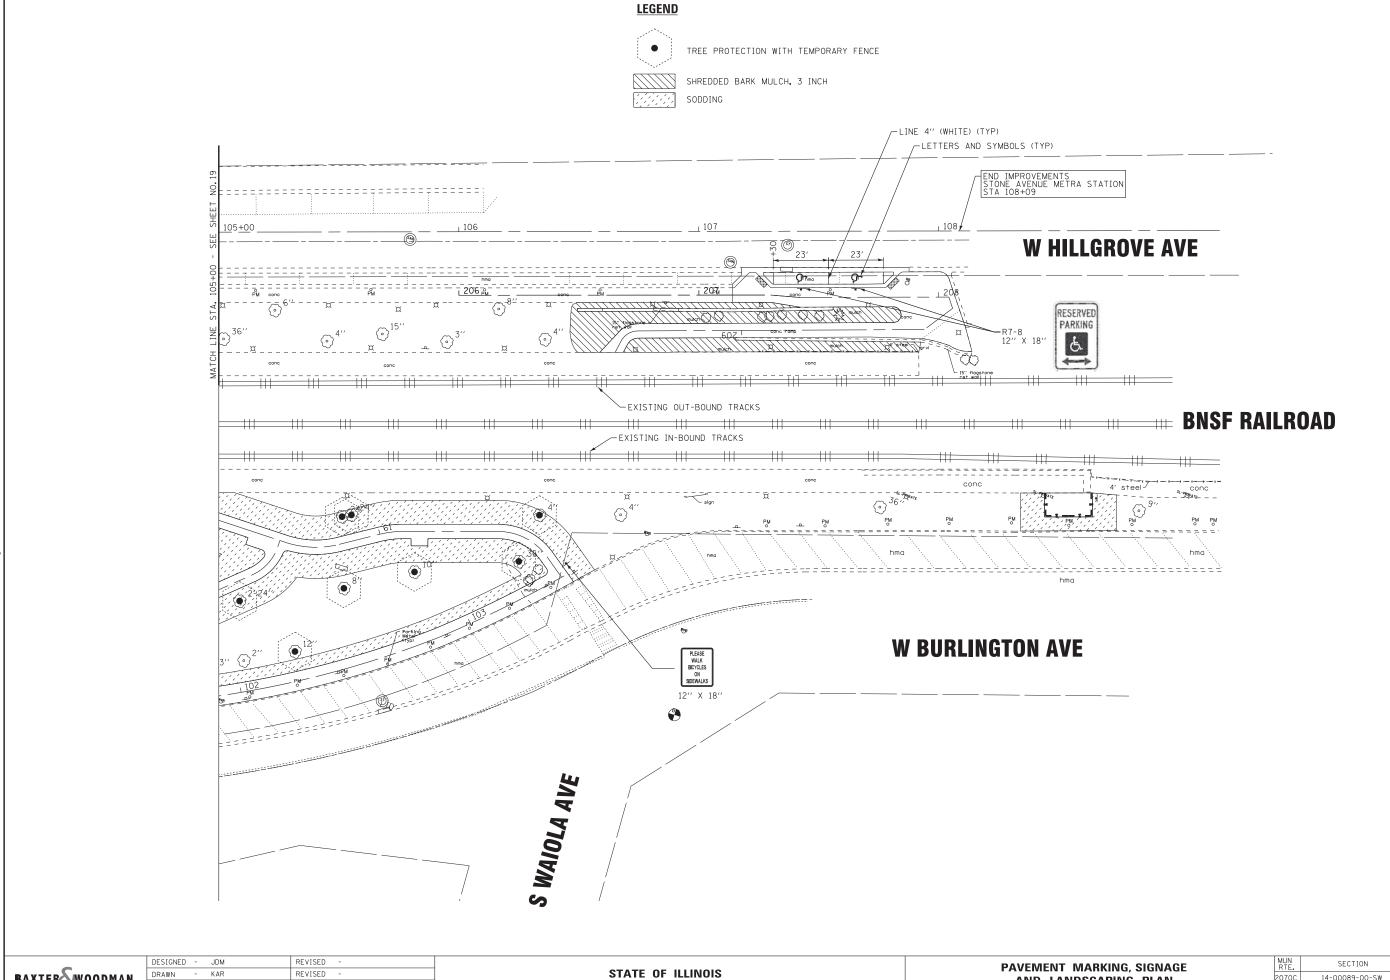



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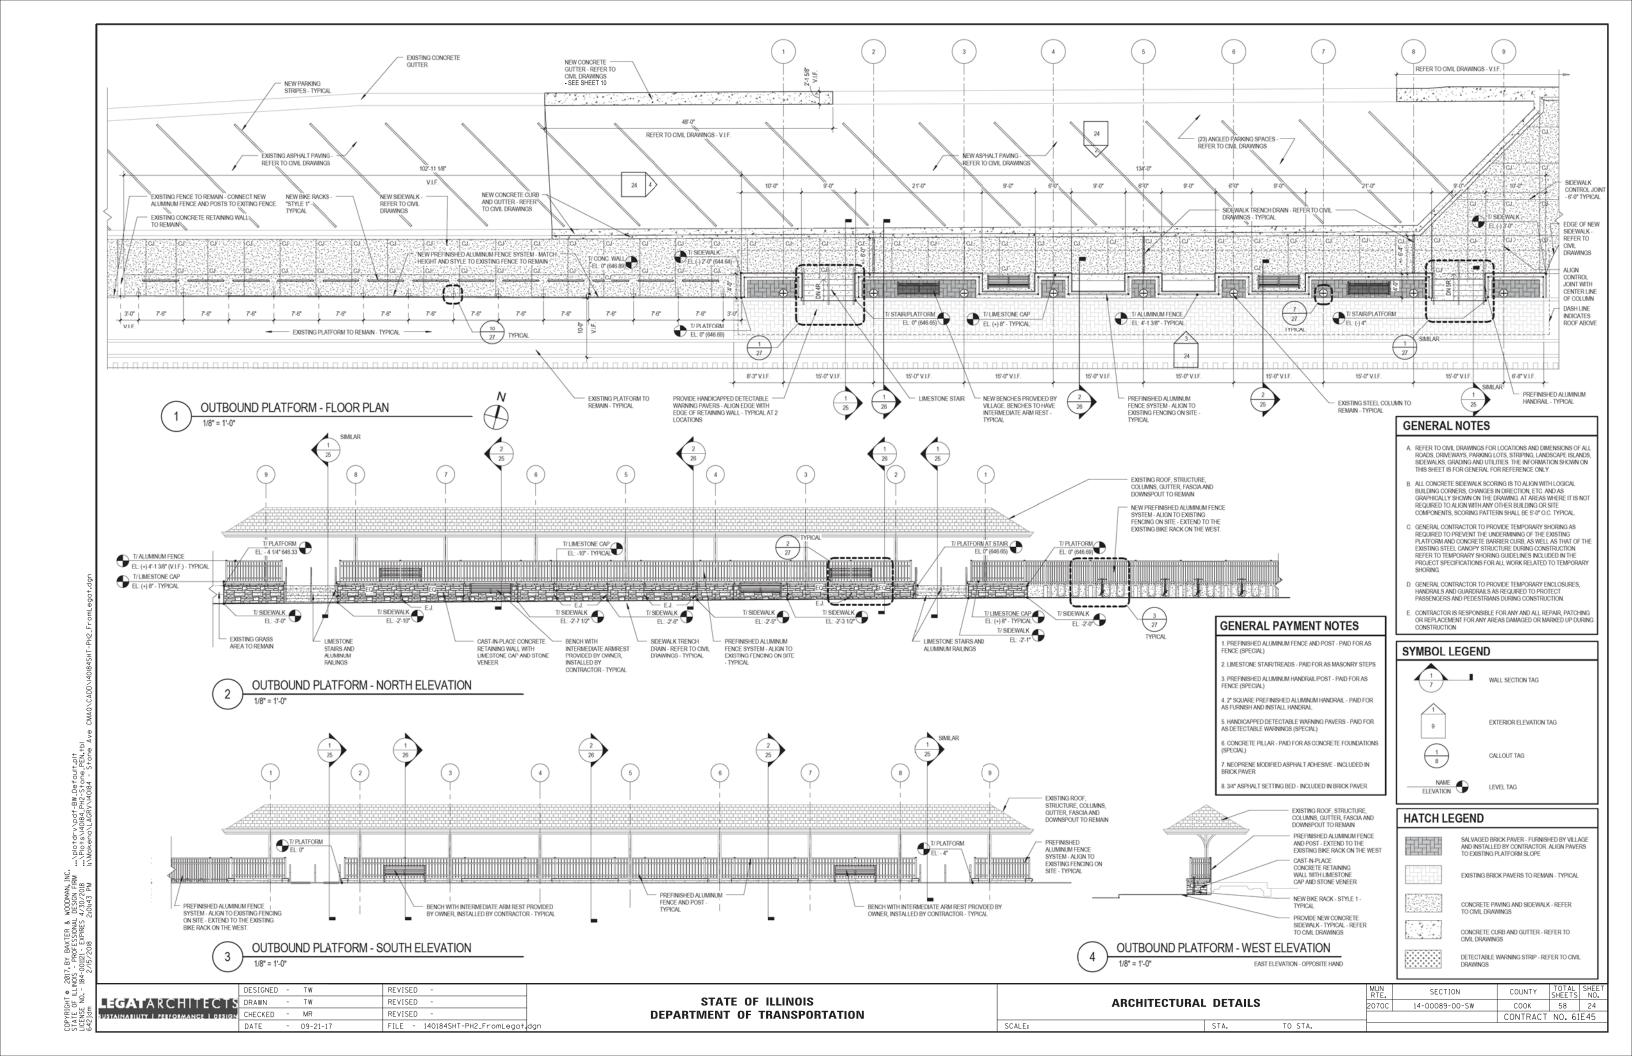
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DEPARTMENT OF TRANSPORTATION

SCALE:

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14-00089-00-SW CONTRACT NO. 61E45



C. GENERAL CONTRACTOR TO PROVIDE TEMPORARY SHORING AS REQUIRED TO PREVENT THE UNDERWINING OF THE EXISTING PLATFORM AND CONGRETE EARRIER CURB, AS WELL AS THAT OF THE EXISTING STEEL CANOPY STRUCTURE DURING CONSTRUCTION. REFER TO TEMPORARY SHORING GUIDELINES INCLUDED IN THE PROJECT SPECIFICATIONS FOR ALL WORK RELATED TO TEMPORARY SHORING.

D. GENERAL CONTRACTOR TO PROVIDE TEMPORARY ENCLOSURES, HANDRAILS AND GUARDRAILS AS REQUIRED TO PROTECT PASSENGERS AND PEDESTRIANS DURING CONSTRUCTION.

E. CONTRACTOR IS RESPONSIBLE FOR ANY AND ALL REPAIR, PATCHING OR REPLACEMENT FOR ANY AREAS DAMAGED OR MARKED UP DURING CONSTRUCTION

GENERAL PAYMENT NOTES

1. PREFINISHED ALUMINUM FENCE AND POST - PAID FOR AS

2. LIMESTONE STAIR/TREADS - PAID FOR AS MASONRY STEPS

3. PREFINISHED ALUMINUM HANDRAIL/POST - PAID FOR AS FENCE (SPECIAL)


4. 2" SQUARE PREFINISHED ALUMINUM HANDRAIL - PAID FOR AS FURNISH AND INSTALL HANDRAIL


5. HANDICAPPED DETECTABLE WARNING PAVERS - PAID FOR AS DETECTABLE WARNINGS (SPECIAL)

6. CONCRETE PILLAR - PAID FOR AS CONCRETE FOUNDATIONS (SPECIAL)

7. NEOPRENE MODIFIED ASPHALT ADHESIVE - INCLUDED IN BRICK PAVER

8. 3/4" ASPHALT SETTING BED - INCLUDED IN BRICK PAVER

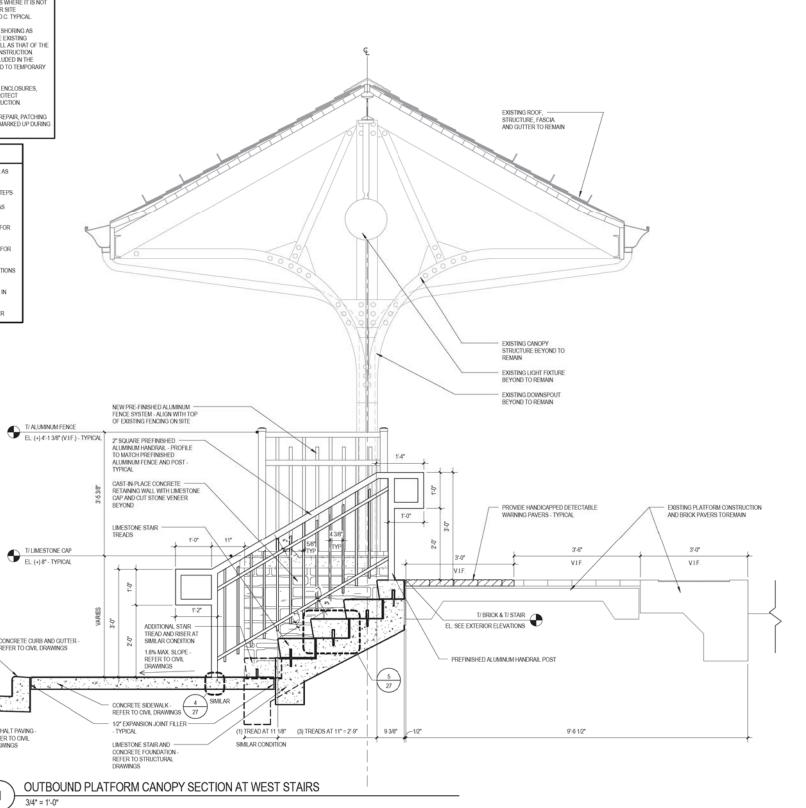

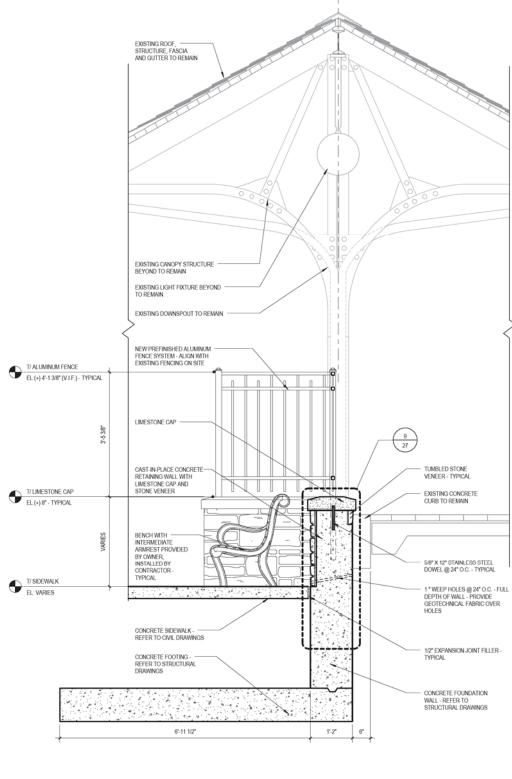

OUTBOUND PLATFORM CANOPY SECTION AT BENCHES

LEGATARCHITECTS DRAWN

REFER TO CIVIL DRAWINGS

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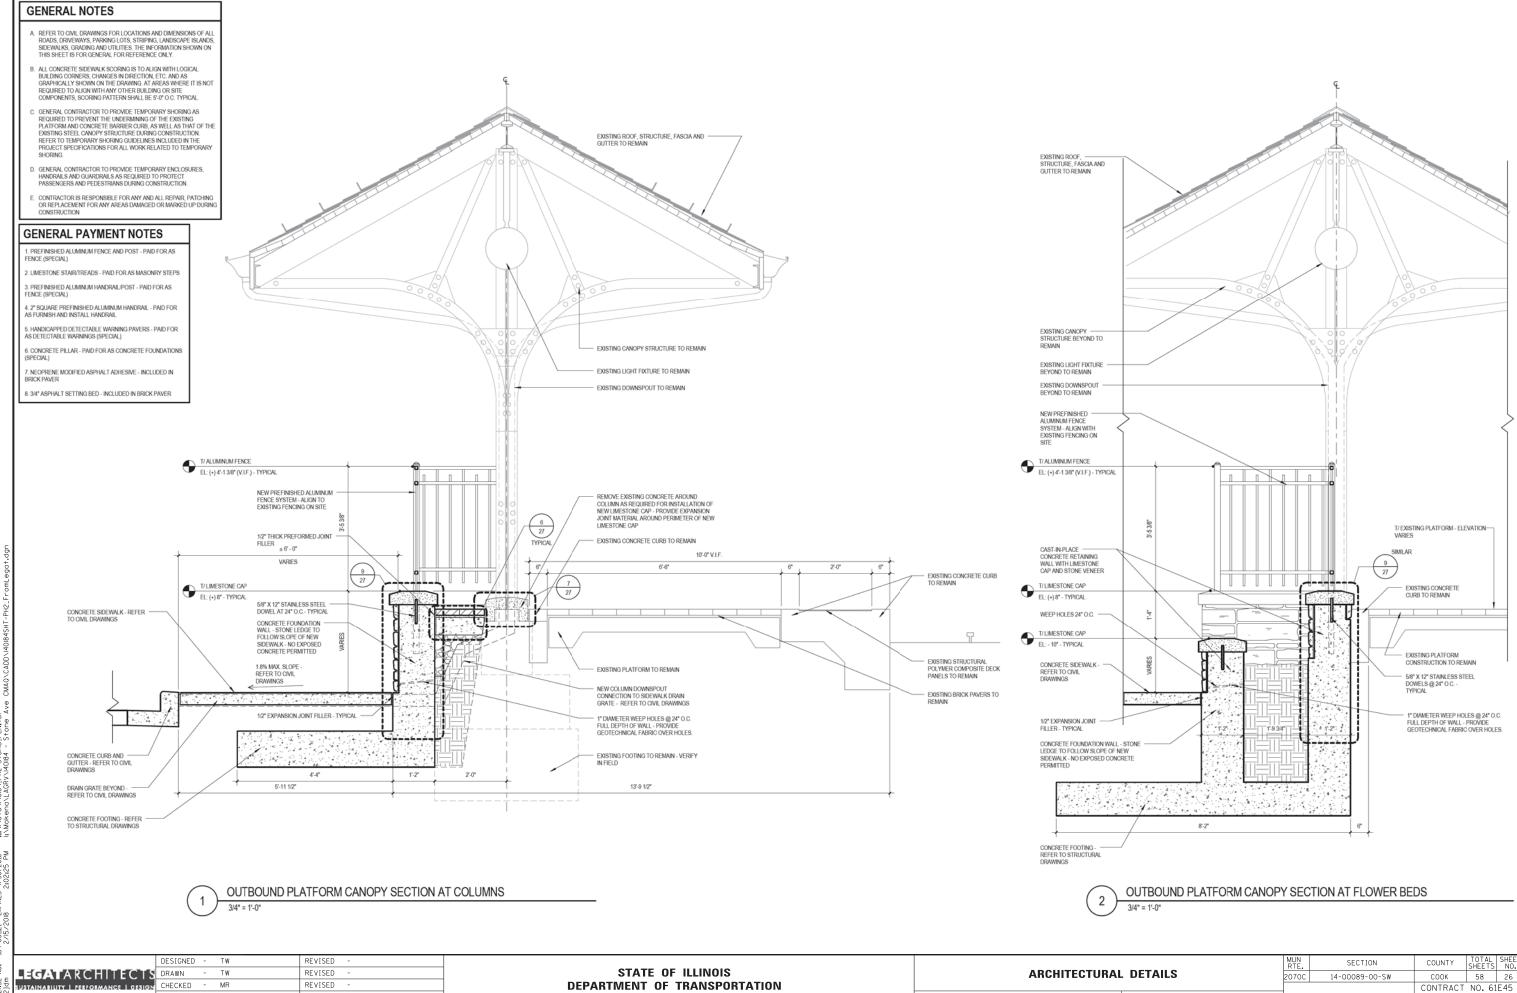
STATE OF ILLINOIS **DEPARTMENT OF TRANSPORTATION**

SCALE:

SECTION COUNTY **ARCHITECTURAL DETAILS** 14-00089-00-SW COOK 58 25 CONTRACT NO. 61E45 TO STA.

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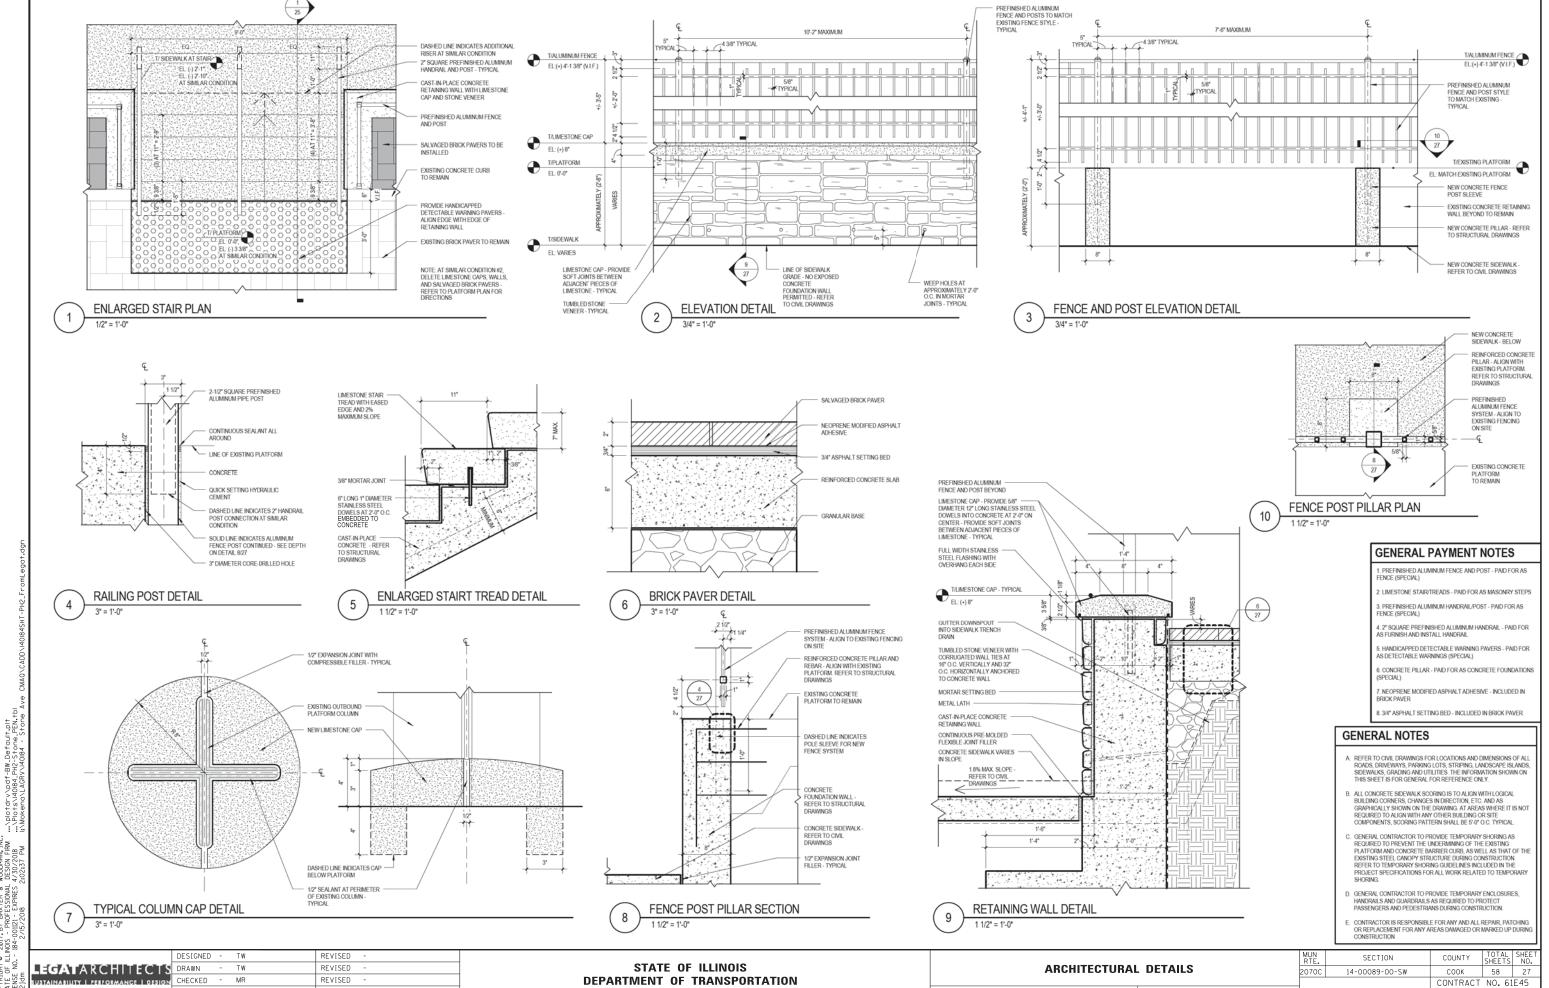
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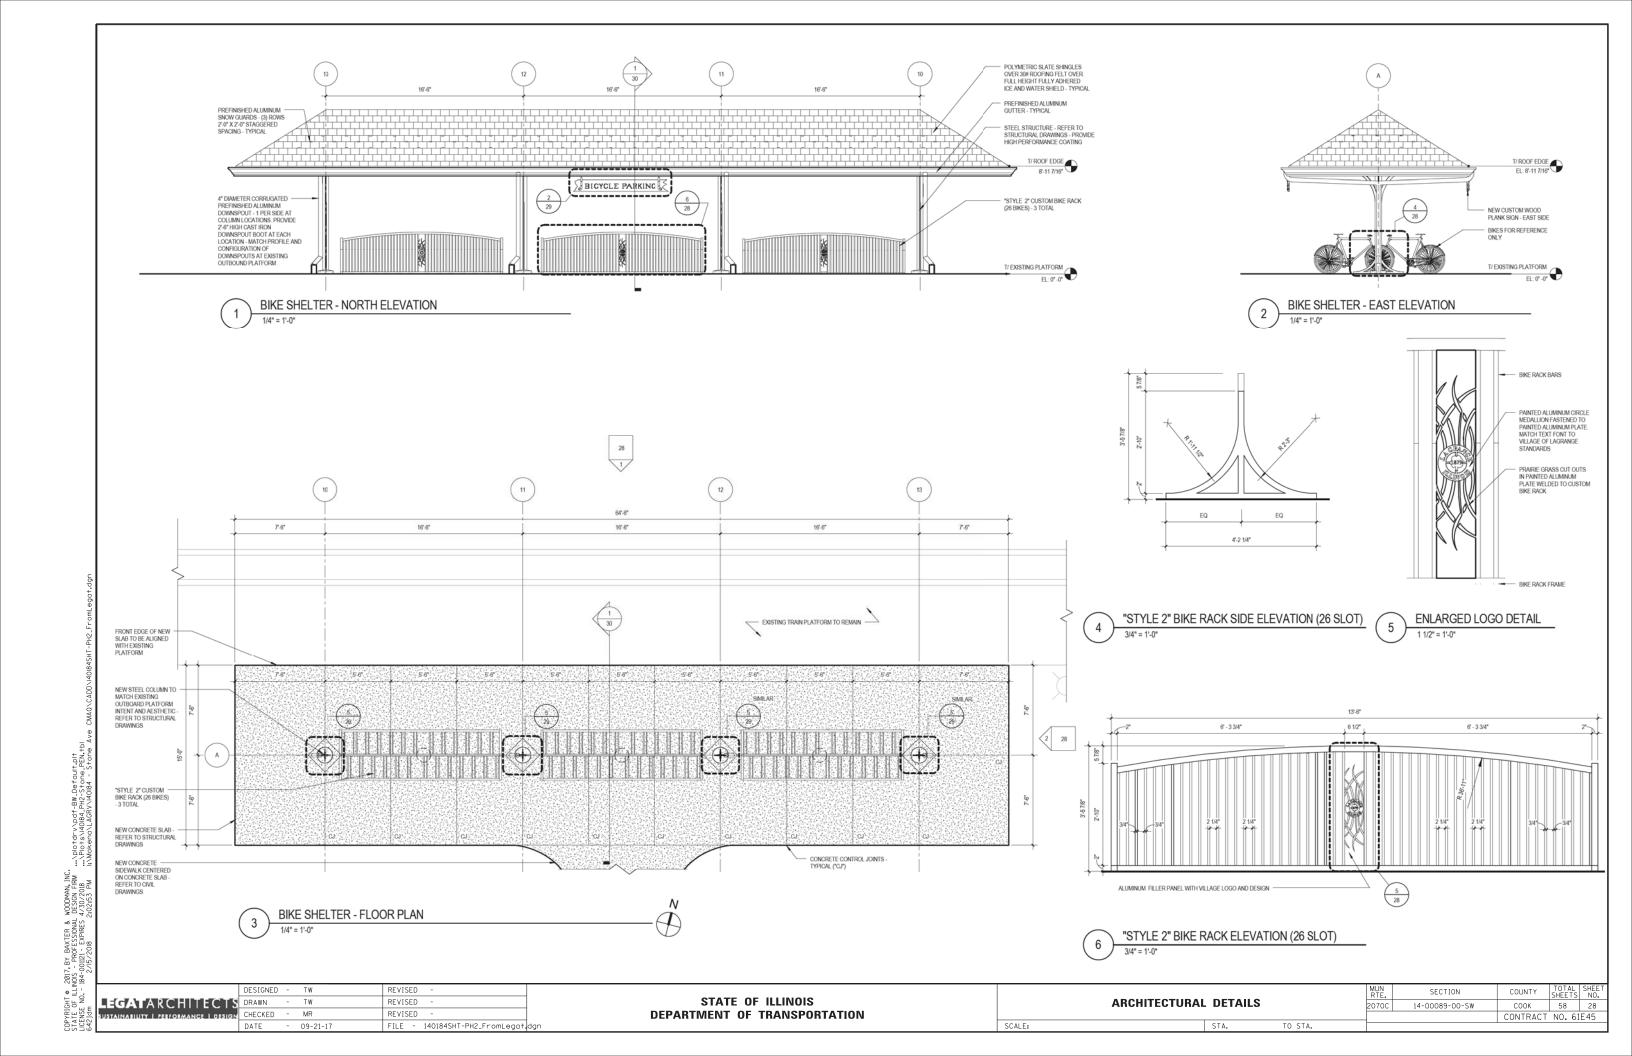
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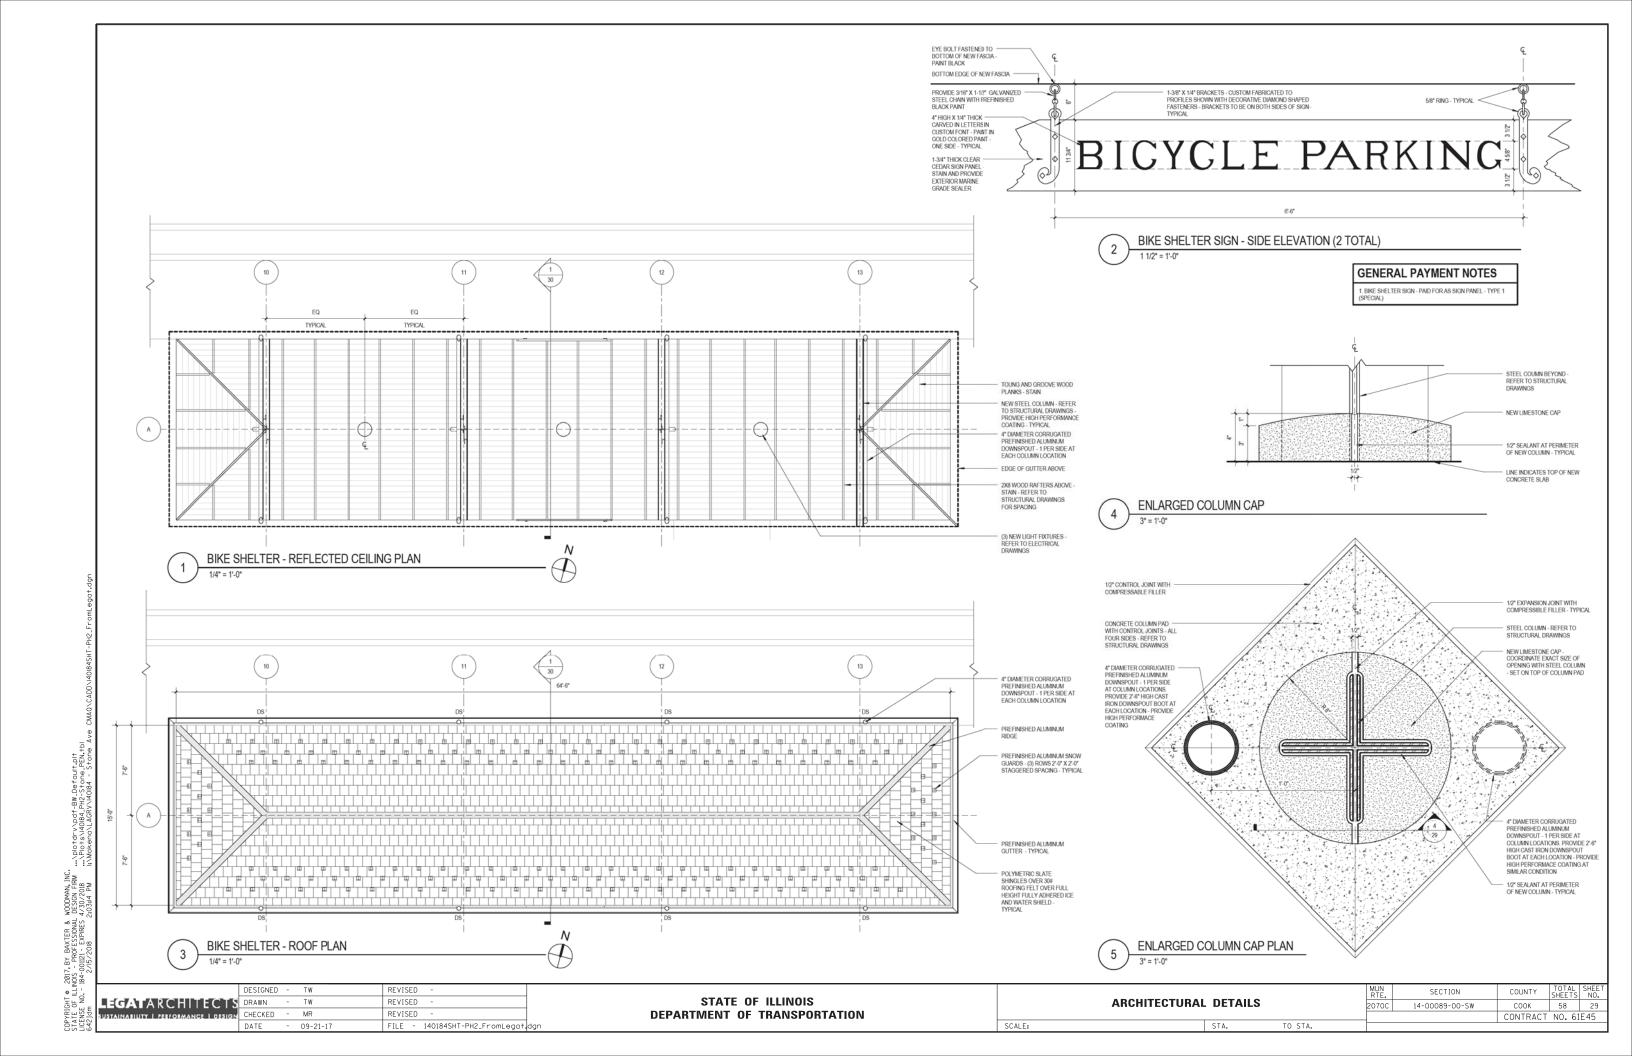
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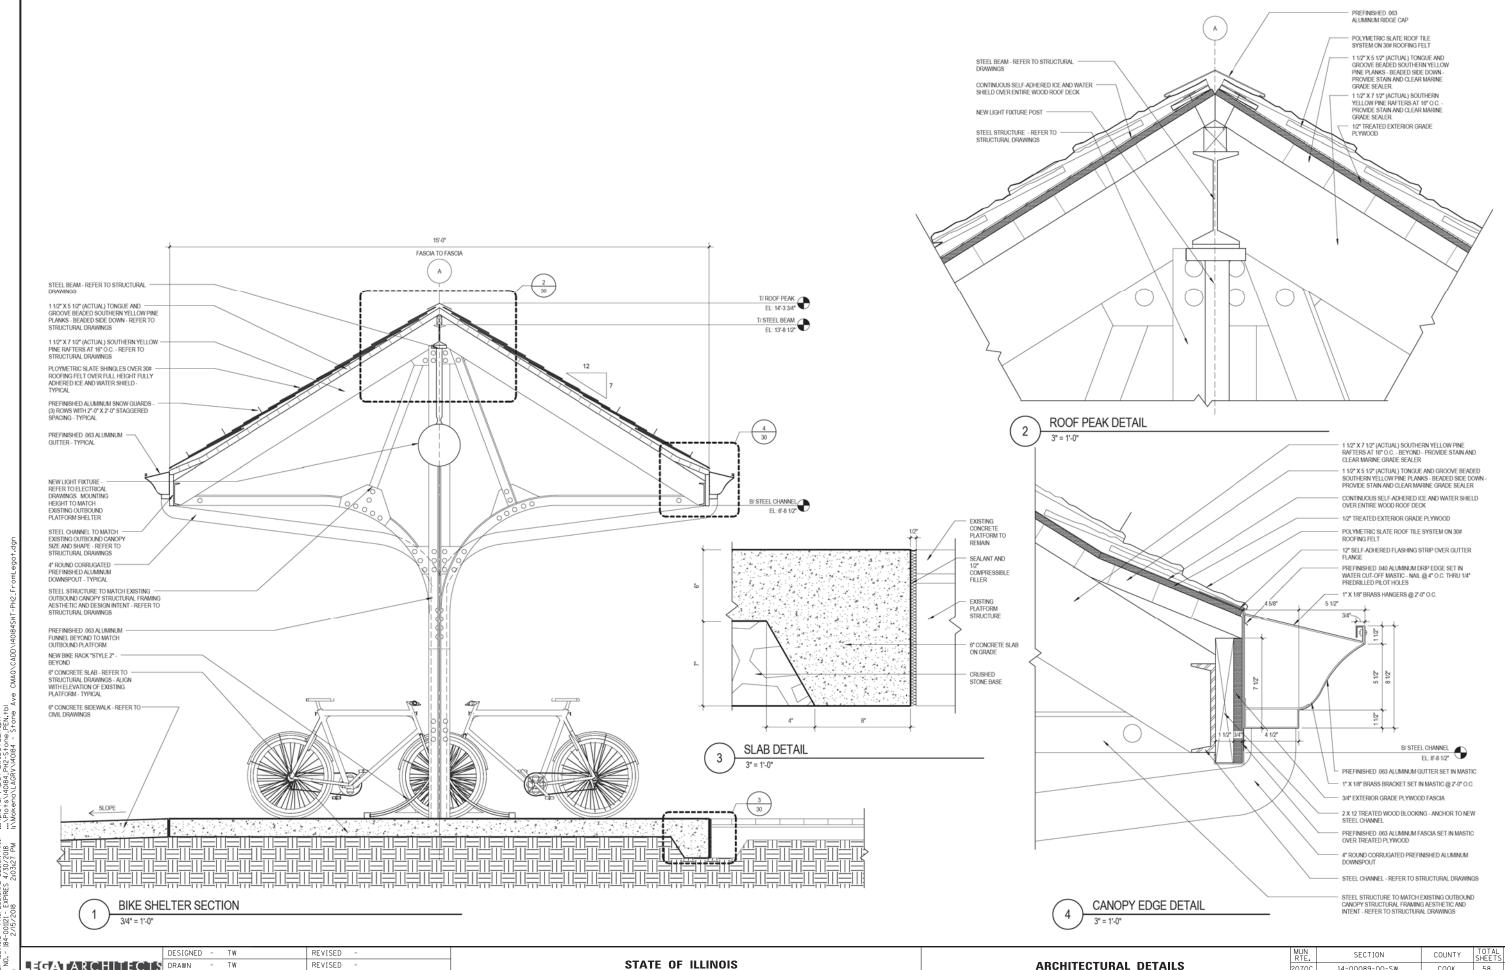
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DEPARTMENT OF TRANSPORTATION

SCALE:

ARCHITECTURAL DETAILS 14-00089-00-SW COOK 58 CONTRACT NO. 61E45 TO STA.

NEW CONSTRUCTION

PARTITION LOAD

** OR EQUIPMENT WEIGHT IF HEAVIER

*** PLUS DRIFTING AND/OR SLIDING SNOW

I. THE CONTRACTOR SHALL FOLLOW WRITTEN DIMENSIONS ONLY. DO NOT SCALE DRAWINGS.

2. ALL DETAILS AND SECTIONS SHOWN ON THE DRAWINGS ARE INTENDED TO BE CONSTRUED TO APPLY AT ANY SIMILAR CONDITION ELSEWHERE ON THE JOB EXCEPT WHERE A DIFFERENT DETAIL OR SECTION IS SHOWN.

3. THE CONTRACTOR SHALL VERIFY ALL DIMENSIONS AND ELEVATIONS WITH THE ARCHITECTURAL DRAWINGS. WHERE DISCREPANCIES OCCUR, IT IS THE CONTRACTOR'S RESPONSIBILITY TO NOTIFY THE ARCHITECT PRIOR TO CONSTRUCTION.

NEW WORK IN CONJUNCTION WITH EXISTING CONSTRUCTION

I. THE CONTRACTOR SHALL VERIFY, BY FIELD CHECK, ALL SIZES, DIMENSIONS, ELEVATIONS, LOCATIONS, ETC. OF ELEMENTS OF THE EXISTING CONSTRUCTION WHICH ARE RELATIVE TO THE NEW

2. ALL DIMENSIONS INVOLVING NEW WORK TYING INTO OR GOVERNED BY EXISTING CONSTRUCTION SHALL BE FIELD CHECKED BY THE CONTRACTOR AND FURNISHED TO THE SUBCONTRACTOR, PRIOR TO FABRICATION OF ANY WORK. THE VERIFIED DIMENSIONS SHALL APPEAR AND BE NOTED AS SUCH ON THE FIRST SHOP DRAWING SUBMITTED.

3. THE ENGINEER HAS MADE ASSUMPTIONS CONCERNING THE SOUNDNESS OF THE EXISTING STRUCTURE AND THESE ASSUMPTIONS ARE THAT THIS BUILDING WAS DESIGNED AND CONSTRUCTED IN CONFORMITY WITH GOOD DESIGN AND CONSTRUCTION PRACTICES. THE CONTRACTOR SHALL TAKE EXTRAORDINARY PRECAUTIONS CONCERNING PRESERVATION OF THE BUILDING DURING DEMOLITION AND NEW CONSTRUCTION WORK, FURTHER, HE SHALL AGREE TO ASSUME ALL RESPONSIBILITY FOR THE PRESERVATION

4. THE CONTRACTOR SHALL NOTIFY THE ARCHITECT/ENGINEER IMMEDIATELY OF ANY DISCREPANCIES BETWEEN CONSTRUCTION DOCUMENTS AND ACTUAL FIELD CONDITIONS

5. ALL HOLES THROUGH EXISTING CONSTRUCTION SHALL BE CORE DRILLED OR SAW CUT.

BY BAXTER & 1 PROFESSIONAL JII21 - EXPIRES 4

2017 NOIS 184-

. ALL FOUNDATIONS SHALL BE ADEQUATELY BRACED TO PREVENT LATERAL MOVEMENT DURING BACKFILLING AND COMPACTION.

2. FOUNDATIONS SHALL BE BACKFILLED AS SOON AS PRACTICABLE SO AS TO LIMIT THE EFFECTS OF WATER INFILTRATION AND FROST

FOUNDATION/UNDERGROUND MECHANICAL COORDINATION

I. UNDERGROUND SEWER, WATER, GAS LINES, ETC. CROSSING CONTINUOUS WALL FOUNDATIONS SHALL NOT PASS THROUGH FOOTINGS. WHERE PIPE OCCURS ABOVE TOP OF FOOTING, SLEEVE THROUGH WALL. WHERE PIPE OCCURS IN FOOTING DEPTH, DROP TOP OF FOOTING SUCH THAT PIPE PASSES JUST ABOVE FOOTING. IF TOP OF PIPE IS LESS THAN 6" BELOW BOTTOM OF FOOTING, PROVIDE 1" COMPRESSIBLE FOAM INSULATION BELOW FOOTING FOR WIDTH OF TRENCH.

CONCRETE

100 PSF

20 PSF

25 PSF

1.0

90 MPH

analysis per

ASCE 7

AND CURING SHALL BE IN ACCORDANCE WITH THE ACI MANUAL OF CONCRETE PRACTICE INCLUDING "BUILDING CODE REQUIREMENTS FOR REINFORCED CONCRETE," ACI 318 AND "SPECIFICATIONS FOR STRUCTURAL CONCRETE," ACI 301 AND IDOT STANDARD SPECIFICATIONS FOR ROADS AND BRIDGES. IF ACI AND IDOT SPECIFICATION CONFLICT, IDOT SPECIFICATIONS SHALL GOVERN.

2. ALL CONCRETE SHALL ATTAIN A MINIMUM ULTIMATE COMPRESSIVE STRENGTH PER PROJECT (IDOT) SPECIFICATIONS FOR FOUNDATIONS AND SLABS AT 28 DAYS FOR IDOT PORTLAND CEMENT MIX DESIGN CLASS SI. 3. CONCRETE SHALL BE VIBRATED INTO FORMS WHILE PLACING, WITHOUT OVER-VIBRATING. REINFORCING SHALL BE PROTECTED BY CONCRETE OF

THICKNESS AS FOLLOWS: 11/2" **TO TIE**S OTHER FOUNDATION 2" BOTH FACES EXPOSED EXTERIOR CONCRETE SLAB ON GRADE t/3 FROM TOP

4. SLABS-ON-GRADE SHALL BE PLACED IN CONTINUOUS STRIPS PER ACI RECOMMENDATIONS 5. COORDINATE CONCRETE WORK WITH THAT OF OTHER TRADES TO ALLOW

FOR SETTING OF SLEEVES, ACCESSORIES, ETC. 6. ALL ANCHOR RODS SHALL BE IN PLACE PRIOR TO POURING OF CONCRETE.

7. ALL CONCRETE SHALL BE AIR ENTRAINED PER PROJECT SPECIFICATION.

REINFORCING STEEL

1. THE REINFORCING STEEL CONTRACTOR SHALL FABRICATE ALL REINFORCEMENT AND FURNISH ACCESSORIES, CHAIRS, SPACER BARS AND SUPPORTS NECESSARY TO SECURE THE REINFORCEMENT UNLESS SHOWN OTHERWISE ON THE PLANS AND/OR DETAILS.

2. REINFORCING STEEL SHALL BE ASTM A706, GRADE 60, DEFORMED BARS, FPOYY COATED

3. WELDED WIRE REINFORCING SHALL BE SUPPLIED IN FLAT SHEETS AND SHALL CONFORM TO ASTM A1064. 4. CONCRETE REINFORCEMENT SHALL BE PLACED ACCORDING TO CRSI

"RECOMMENDED PRACTICE FOR PLACING REINFORCEMENT BARS." 5. ALL REINFORCEMENT SPLICES SHALL BE LAPPED 48 BAR DIAMETERS MINIMUM UNLESS OTHERWISE NOTED. PROVIDE CORNER BARS FOR ALL HORIZONTAL REINFORCEMENT AT CORNERS AND INTERSECTIONS.

6. TOP BARS SHALL BE HOOKED AT END SPANS. JOINTS IN CONCRETE

CONSTRUCTION AND/OR CONTROL JOINTS SHALL BE MADE AS DETAILED ON THE DRAWINGS.

2. CONSTRUCTION AND/OR CONTROL JOINTS FOR SLAB-ON-GRADE CONSTRUCTION SHALL BE LOCATED ON COLUMN LINES.

3. MAXIMUM SPACING OF CONSTRUCTION AND/OR CONTROL JOINTS IN SLAB-ON-GRADE CONSTRUCTION SHALL BE 10'-0". JOINTS SHALL BE PLACED TO PRODUCE PANELS THAT ARE AS SQUARE AS POSSIBLE AND NEVER EXCEEDING A LENGTH TO WIDTH RATIO OF 1.5 TO 1

. CONSTRUCTION OR CONTRACTION JOINTS IN CONCRETE FOUNDATION WALLS SHALL BE SPACED NO FURTHER THAN 20'-0" APART.

CONSTRUCTION JOINTS FOR ELEVATED FLATWORK SHALL BE LOCATED AT THE CENTER OF THE SPAN. REINFORCEMENT SHALL BE CONTINUOUS ACROSS ALL CONSTRUCTION JOINTS.

6. MAXIMUM SPACING OF CONSTRUCTION AND/OR CONTROL JOINTS IN CANTILEVERED RETAINING WALLS SHALL BE 20'-0".

7. 1" EXPANSION JOINTS IN CANTILEVERED RETAINING WALLS SHALL BE PLACED AT 40'-0" ON CENTER MAXIMUM.

EXCAVATION AND EARTHWORK

1. A DEWATERING SYSTEM OF SUFFICIENT CAPACITY SHALL BE INSTALLED AND OPERATED TO MAINTAIN THE CONSTRUCTION AREA FREE OF WATER AT ALL TIMES.

2. THE FOUNDATION DESIGN IS BASED ON THE FOLLOWING NET ALLOWABLE REARING PRESSURE(S)

2000 PSF SPREAD FOOTINGS WALL FOOTINGS

3. ALL FOOTING EXCAVATIONS SHALL BE INSPECTED, PRIOR TO CONCRETE PLACEMENT, BY A SOILS ENGINEER TO VERIFY SUITABLE BEARING MATERIAL OF CAPACITY AS SPECIFIED.

4. NOTIFY THE OWNER'S REPRESENTATIVE WHEN ADDITIONAL EXCAVATION IS REQUIRED TO REACH SUITABLE BEARING MATERIAL

5. THE SOILS ENGINEER SHALL CERTIFY IN WRITING THAT ALL FOUNDATIONS WERE PLACED ON SOIL WITH THE BEARING VALUE AS SPECIFIED.

6. WITHIN THE EXCAVATION AREA OF THE FOUNDATIONS, ALL VEGETATION TOPSOIL, PREVIOUSLY PLACED FILL AND UNSUITABLE SOILS SHALL BE REMOVED. ALL FOOTINGS SHALL BEAR ON VIRGIN SOIL OR PROPERLY PLACED AND COMPACTED ENGINEERED FILL

7. FOUNDATION DESIGN DOES NOT ACCOUNT FOR WINTER CONSTRUCTION ANY UNENCLOSED/UNHEATED SPACES SHALL BE ADEQUATELY PROTECTED AGAINST FROST DURING WINTER CONSTRUCTION BY CONTRACTOR.

STRUCTURAL STEEL

1. ALL CONCRETE WORK INCLUDING FORMING, REINFORCING, MIXING, PLACING 1. FABRICATION AND ERECTION OF STRUCTURAL STEEL MEMBERS SHALL BE IN ACCORDANCE WITH THE AISC "CODE OF STANDARD PRACTICE FOR STEEL BUILDINGS AND BRIDGES" AS INDICATED IN THE FIFTEENTH EDITION OF THE "MANUAL OF STEEL CONSTRUCTION" FOR ALLOWABLE STRESS DESIGN UNLESS NOTED OTHERWISE.

2. ALL CONNECTIONS SHALL BE BOLTED OR WELDED AS INDICATED ON PLANS AND SHALL BE DESIGNED FOR THE SERVICE—LOAD END REACTIONS INDICATED ON PLANS, OR IF NOT INDICATED, SHALL BE DESIGNED TO DEVELOP 60% OF THE ALLOWABLE UNIFORM LOAD TABULATED IN THE THIRTEENTH EDITION OF THE AISC "MANUAL OF STEEL CONSTRUCTION" FOR ALLOWABLE STRESS DESIGN, UNLESS NOTED OTHERWISE. NUMBER OF BOLTS MUST SATISFY MINIMUM, REQUIREMENTS AS FOLLOWS: 2 BOLTS PER CONNECTION FOR 8" AND 10' DEEP MEMBERS, 3 FOR 12" AND 14" DEEP MEMBERS, 4 FOR 16" AND 18" DEEP MEMBERS, 5 FOR 21" AND 24" DEEP MEMBERS, AND 6 FOR 27" AND DEEPER MEMBERS. PROVIDE SIGNED AND SEALED CALCULATIONS BY A LICENSED STRUCTURAL ENGINEER IN THE STATE OF ILLINOIS FOR ALL STEEL CONNECTION DESIGNS

3. ALL STRUCTURAL STEEL SHALL CONFORM TO THE FOLLOWING STANDARDS: STEEL WIDE FLANGES ASTM A992 STEEL ANGLES, CHANNELS AND PLATES ASTM A36

ASTM A53, GRADE B OR ASTM A501 STEEL TUBE ASTM A500, GRADE B

4. ALL FILLER METAL USED IN WELDING SHALL BE 70 KSI YIELD, LOW-HYDROGEN.

5. ALL WELDING SHALL BE BY CERTIFIED WELDERS AND SHALL CONFORM TO THE "STRUCTURAL WELDING CODE", AWS D1.1 AND MEET AISC MINIMUM REQUIREMENTS FOR WELD SIZE.

6. FIELD CONNECTIONS ARE TO BE BOLTED AND INSTALLED IN ACCORDANCE WITH THE "SPECIFICATION FOR STRUCTURAL JOINTS USING ASTM F3125 GRADE A325 OR A490 BOLTS." USE MIN 3/4" DIAMETER HIGH STRENGTH BOLTS AND NUTS, A325-TYPE 1, UNLESS NOTED OTHERWISE. CONNECTIONS SHALL BE ST TYPE EXCEPT WHERE PT OR SC TYPE CONNECTIONS ARE SPECIFICALLY NOTED. WHERE SC TYPE CONNECTIONS ARE NOTED PROVIDED CLASS A FRAYING SURFACES, WITH SLIP CHECKED AT SERVICE LEVEL.

7. STEEL COLUMN BASE PLATES SHALL BE SIZE SHOWN ON PLAN WITH 1" DIAMETER ANCHOR RODS (F1554, GR 36) LINO AND 1" NON-METALLIC, NON-SHRINK GROUT FOR UNIFORM BEARING

8. ALL PLATES USED IN BOLTED CONNECTIONS SHALL HAVE ROLLED OR

9. ALL STRUCTURAL STEEL AND MISCELLANEOUS METALS SHALL BE PRIME PAINTED AS INDICATED IN THE PROJECT SPECIFICATION. TOUCH UP ALL DISTURBED AREAS AFTER ERECTION. STEEL TO BE FIREPROOFED SHALL RECEIVE PAINT/FINISH PROCESS COMPATIBLE WITH FIREPROOFING.

1. DECKING SHALL BE TONGUE AND GROOVE END MATCHED LAMINATED DECKING. EACH PIECE SHALL BE TREATED AND CARRY A W.W.P.A. STAMP.

2. LAMINATING ADHESIVE SHALL BE EXTERIOR WATERPROOF GLUE. 3. FACE SPECIES, SURFACE FINISH AND DECK PATTERN SHALL BE PER

ARCHITECT'S SPECIFICATIONS. 4. SIZES SHALL BE AS SHOWN ON PLAN.

5. WOOD DECKING LAYUP SHALL BE CONTROLLED RANDOM, UNLESS NOTED OTHERWISE.

6. NAIL EACH DECKING COURSE TO TONGUE OF ADJOINING COURSE IN PRE DRILLED EDGE HOLES, USE 84 NAILS FOR 2" DECKING, NAILS SHOULD BE PLACED 30" O.C. WITH NAILING IN ALTERNATIVE COURSE OFFSET 15"

7. NAIL EACH DECKING COURSE TO SUPPORT WITH 16d NAILS FOR 2"

8. DECKING SHALL BE TREATED SOUTHERN PINE, NO. 2 OR BETTER.

1. PLYWOOD SHEATHING PANELS SHALL BE INSTALLED WITH FACE GRAIN ACROSS (PERPENDICULAR) THE SUPPORT JOISTS. STAGGER PANEL END

2. PLYWOOD ROOF SHEATHING SHALL BE APA RATED $\frac{1}{2}$ CDX SHEATHING OR BETTER

NAIL SPACING: PANEL EDGES 6" OC INTERMEDIATE SUPPORTS 12" OC.

DIMENSION LUMBER

1. ALL DIMENSION LUMBER SHALL BE TREATED SOUTHERN YELLOW PINE NO 2 OR BETTER AS DEFINED BY THE NATIONAL DESIGN SPECIFICATION FOR WOOD CONSTRUCTION "DESIGN VALUES FOR VISUALLY GRADED STRUCTURAL LUMBER" - LATEST EDITION

2. ALL MEMBER SIZES GIVEN ON PLAN ARE NOMINAL DIMENSIONS. 4. ALL NAILED CONNECTIONS SHALL BE FABRICATED AS FOLLOWS: (MINIMUM REQUIREMENTS FOR 10d NAILS)

1. PROVIDE 11/2" END DIST. AND 11/4" EDGE DIST.

2. SPACE NAILS 11/2" OC ALL NAILS TO BE CLINCHED.

STRUCTURAL ABBREVIATIONS

AB	ANCHOR BOLT	FOC	FACE OF CONCRETE	PCF
ADDL	ADDITIONAL	FOW	FACE OF WALL	PL
ADJ	ADJACENT	FP"	FIREPROOFING	PLF
AFF	ABOVE FINISH FLOOR	FS	FAR SIDE	PLYWD
AHU	air handling unit	FSTNR	FASTENER	PREFAB
ALUM	ALUMINUM	FT,	FEET OR FOOT	PRELIM
ALT	ALTERNATE	FTG	FOOTING	PSF
APPROX	APPROXIMATE(LY)	GA	GAUGE	PSI
ARCH	ARCHITECT/ARCHITECTURAL	GR BM	GRADE BEAM	PT
B/B	BACK TO BACK	GC 20	GENERAL CONTRACTOR	QTY
BL	BRICK LEDGE	GEN GL	GENERAL	RD
BM	BEAM	GR GR	GLUE LAMINATE TIMBER GRADE	rebar Ref
BOS	BOTTOM OF STEEL	GRTG	GRATING	REQ
BOT	BOTTOM	GYP	GYPSUM	REV
BRG BRDG	BEARING Bridging	HK	HOOK	RH
BSMT	BASEMENT	HS	HEADED STUD	RTU
BS	BOTH SIDES	HT	HEIGHT	SCHED
C	COMPRESSION	1	MOMENT OF INERTIA	SECT
CA	CAISSON	IBC	INTERNATIONL BUILDING CODE	SF
CH	CHANNEL	ID _	INSIDE DIAMETER	SHT
CIP	CAST-IN-PLACE CONCRETE	IN, "	INCH OR INCHES	SIM
CJ	CONTROL/CONSTRUCTION JOINT	INCL	INCLUDE	SL
CLG	CEILING	INFO	INFORMATION INCL. DOLIND	SOG
CLR	CLEAR	IN-LB Insul	INCH POUND Insulation	SPA
CM	CONSTRUCTION MANAGER	INT	INTERIOR	SPEC
CMU	CONCRETE MASONRY UNIT	JF	JOINT FILLER	SST STL
COL CONF	COLUMN CONFERENCE	JST	JOIST	STRUCT
CONN	CONNECTION	K	KIP (OR 1000 POUNDS)	T&B
CONTR	CONTRACTOR	KLF	KIPS PER LINEAR FOOT	T&G
COORD	COORDINATE	L	ANGLE	TOC
CTR	CENTER	LATL	LATERAL	TOF
DBA	DEFORMED BAR ANCHOR	LB, #	POUNDS	TOFDTN
DEMO	DEMOLITION	IF.	LINEAR FOOT	TOP
DET	DETAIL	ïН	LEFT HAND	TOS
DIAG	DIAGONAL	Щ	LIVE LOAD	T TCX
DIM	DIMENSION (S)	ПА ПН	Long leg horizontal Long leg vertical	TD.
DL	DEAD LOAD	LT GA	LIGHT GAUGE	THK
DP DWG	DRILLED PIER Drawing	LT WT	LIGHT WEIGHT	THRU
DWL	DOWEL	LVL	LAMINATED VENEER LUMBER	UNO
E	MODULUS OF ELASTICITY	M	MOMENT	٧
ECC	ECCENTRICITY	MAU	MAKE-UP AIR UNIT	VAR
EF	EACH FACE	MAX	MAXIMUM	VERT
EJ	EXPANSION JOINT	MECH	MECHANICAL	VIF
EOR	ENGINEER OF RECORD	MEP	MECHANICAL ELECTRICAL PLUMBING	W/
EOS	EDGE OF SLAB	MEZZ	MEZZANINE	W/0
EQ	EQUAL	MFR DEC	MANUFACTURER	WD
EQUIV	EQUIVALENT	MFR REC MIN	MANUFACTURER'S RECOMMENDATIONS MINIMUM	WP WS
EQUIP EW	EQUIPMENT EACH WAY	MISC	MISCELLANEOUS	M2 M2
EWEF	EACH WAY EACH FACE	MO	MASONRY OPENING	WWR
EXIST	EXISTING	MP	METAL PANEL	mmx
EXP	EXPANSION	MTL	METAL	
EXP BT	EXPANSION BOLT	NA	NOT APPLICABLE	
EXT	EXTERIOR	NIC	NOT IN CONTRACT	
F/F	FACE TO FACE	NO, #	NUMBER	
FAB	FABRICATOR	NOM	NOMINAL	
FD	FLOOR DRAIN	NS NTC	NEAR SIDE	
FDTN	FOUNDATION COOR	NTS NWC	NOT TO SCALE NORMAL WEIGHT CONCRETE	
fin flr flr	FINISHED FLOOR FLOOR	OC	ON CENTER	
In/	LEOUN	OD OD	OUTSIDE DIAMETER	
		OH	OPPOSITE HAND	
		OPNG	OPENING	
		OPP	OPPOSITE	
		PC	PRECAST CONCRETE	
		PCC	PVC	

TOTAL BILL OF	MATERIALS		
ITEM	UNIT	TOTAL	
CONCRETE STRUCTURES	CUBIC YARD	29	
REINFORCEMENT BARS	TON	3.89	
WELDED WIRE FABRIC 6x6	SQUARE YARD	108	
FURNISHING AND ERECTING STRUCTURAL STEEL, SPECIAL	POUND	5000	
TREATED TIMBER (DIMENSION LUMBER)	BOARD FOOT	6000	
HARDWARE	POUND	256	
RETAINING WALL (SPECIAL)	SQUARE FEET	180	
CONCRETE STRUCTURES (RETAINING WALL)	CUBIC YARD	71	
CONCRETE FOUNDATIONS (SPECIAL)	CUBIC YARD	1	
UNDERPINNING EXISTING STRUCTURE	CUBIC YARD	10	

SCALE:

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POUNDS PER CUBIC FOOT

POUNDS PER LINEAR FOOT

POUND PER SQUARE FOOT

POUND PER SQUARE INCH

REINFORCING STEEL BAR

PREFABRICATED

POST TENSIONED

PRELIMINARY

ROOF DRAIN

REFERENCE

REQUIRE (D

SCHEDULE

SQUARE FOOT

SNOW LOAD

SPACES

SLAB ON GRADE

SPECIFICATION

STRUCTURAL

STAINLESS STEEL

TOP AND BOTTOM

TONGUE AND GROVE

TOP OF CONCRETE

TOP OF FOUNDATION

TOP CHORD EXTENSION

UNLESS NOTED OTHERWISE

WELDED WIRE REINFORCEMENT

TOP OF SLAB, TOP OF STEEL

TOP OF FOOTING

TOP OF PLANK

TRENCH DRAIN

TENSION

THROUGH

SHFAR

VARIES

VERTICA

WITHOUT

WORK POINT

WATERSTOP

WOOD

VERIFY IN FIELD

SECTION

SHEET


REVISED/REVISION

ROOF TOP UNIT




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STATE OF ILLINOIS **DEPARTMENT OF TRANSPORTATION** STRUCTURAL DETAILS 14-00089-00-SW COOK 58 31 CONTRACT NO. 61E45 TO STA.

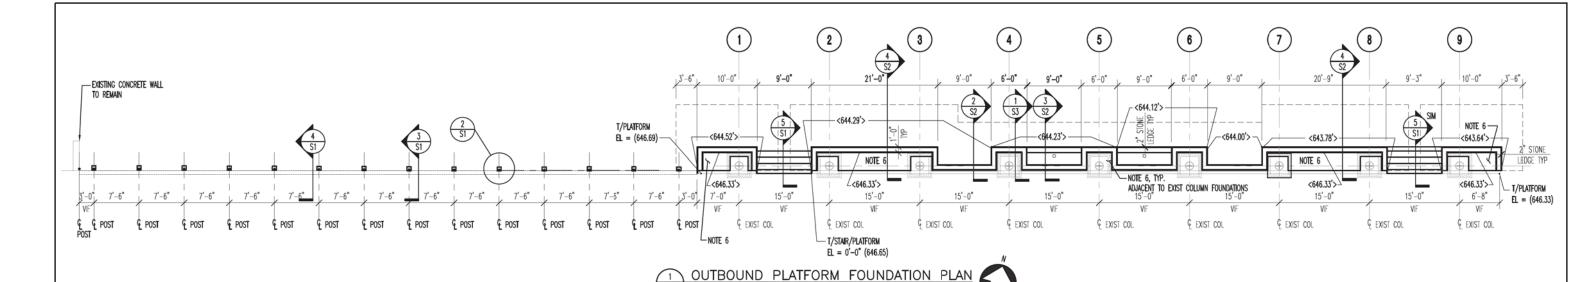

SHEET NOTES

- 1. GENERAL CONTRACTOR TO PROVIDE TEMPORARY EARTH RETAINING SHORING PER BISSF GUIDELINES FOR TEMPORARY SHORING, BRACING AND/OR SHEATHING TO PREVENT THE UNDERMINING OF THE EXISTING PLATFORM AND CONCRETE BARRIER CURB, AS WELL AS THAT OF THE EXISTING STEEL CANOPY STRUCTURE DURING CONSTRUCTION, GENERAL CONTRACTOR ALSO TO PROVIDE TEMPORARY HANDRAIL AND GUARDRAIL AS REQUIRES TO PROTECT PASSENGERS AND PEDESTRIANS FROM THE WORK AREA DURING CONSTRUCTION.
- 2. STRUCTURAL INTEGRITY OF THE PLATFORM AREA AND CANOPY STRUCTURE MUST BE MAINTAINED AT ALL TIMES DURING CONSTRUCTION.
- 3. ALL WORK RELATED TO THE SHEETING AND SHORING WILL BE COVERED UNDER ALLOWANCE.
- Successful Contractor will be responsible for designing the sheeting aid shoring and will provide drawings prepared by a registered engineer.
- 5. <XXX.XX'> DENOTES TOP OF STONE LEDGE
- 6. PROVIDE 6" SLAB ON GRADE W/ 6x6 W2.9xW2.9 WWF ON 6" OF WELL COMPACTED GRANULAR FILL. COORDINATE T/CONC ELEVATION WITH ARCH DRAWINGS AND PAVER Details.

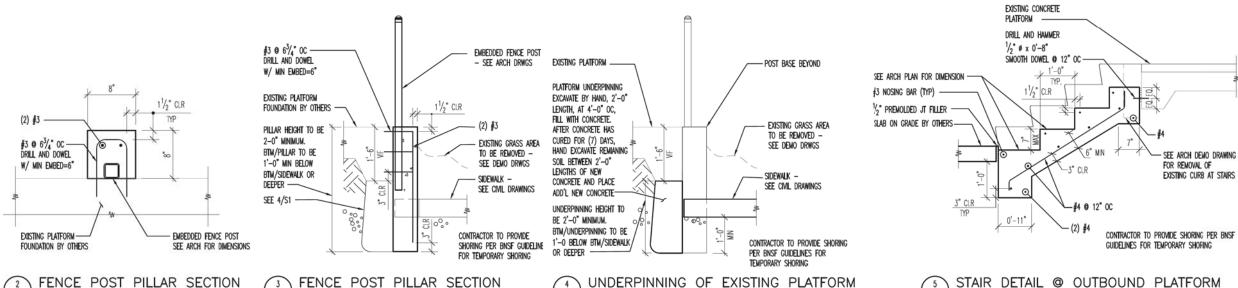

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Larson Engineering

DESIGNED REVISED DRAWN KRR/SWI REVISED CHECKED REVISED 09-21-17 FILE - 140184SHT-PH2 FromLarson.da

PAID FOR AS CONCRETE

FOUNDATIONS (SPECIAL)

STATE OF ILLINOIS **DEPARTMENT OF TRANSPORTATION**

EXISTING STRUCTURE

PAID FOR AS UNDERPINNING

STRUCTURAL DETAILS TO STA.

3/4" = 1'-0"


SCALE:

PAID FOR AS CONCRETE

STRUCTURES (RETAINING WALL)

1488 Bond Street, Suite 100 Naperville, Illinois 60563-6503 (P) 630.357.0540 (F) 630.357.0164 ILLINOIS LICENSE NO. 184-001442 LEI Comm. No. 21170296.001 COUNTY 14-00089-00-SW COOK 58 32 CONTRACT NO. 61E45

Larson **Engineering Inc**

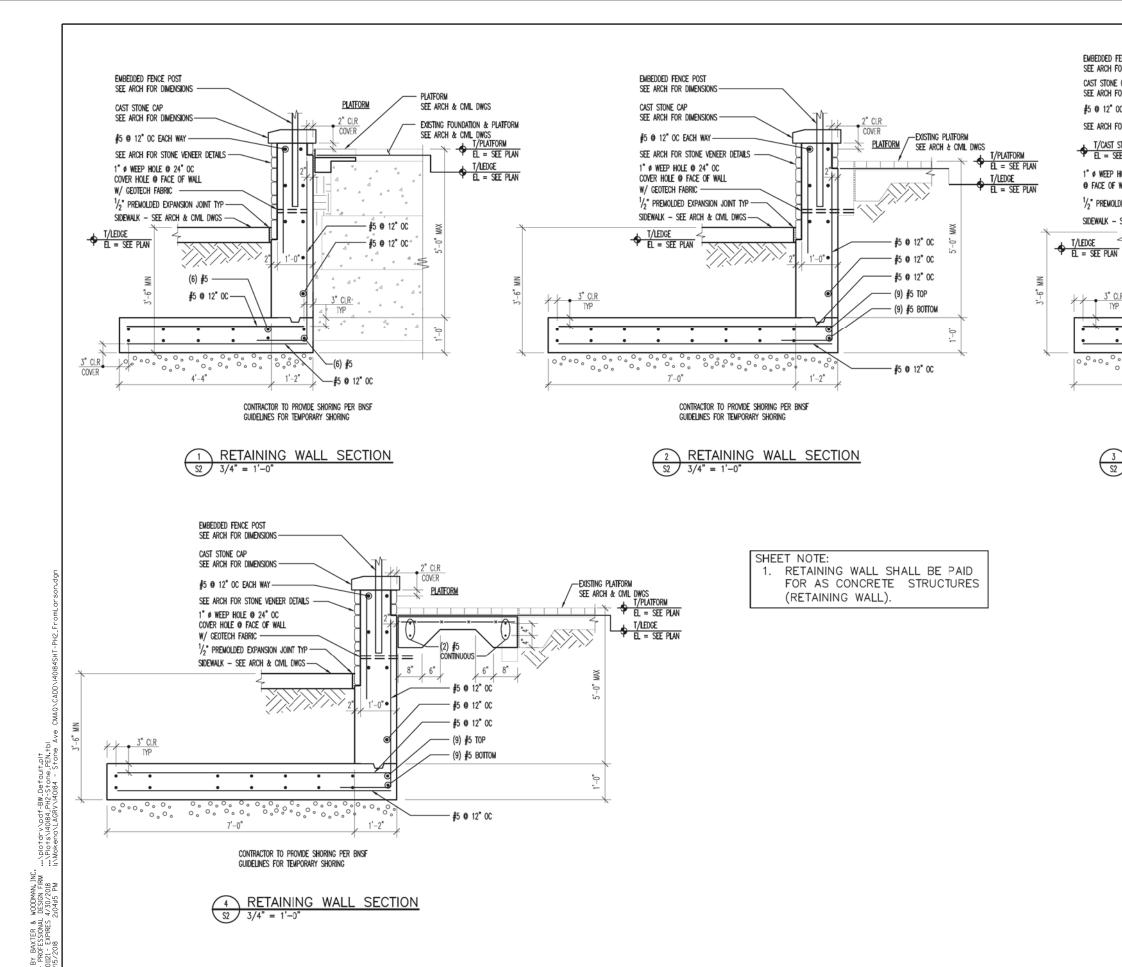

Larson Engineering Inc



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DESIGNED	-	-	KENIZED	-	
DRAWN	-	KRR/SWL	REVISED	-	
CHECKED	-	NHF	REVISED	-	
DATE	-	09-21-17	FILE -	140184SHT-PH2_FromLarson	n.dgn

STATE OF ILLINOIS **DEPARTMENT OF TRANSPORTATION**

SCALE:

			MUN RTE.	SECTION	COUNTY	TOTAL SHEETS	SHEET NO.
STRUCTURAL	DETAILS		2070C	14-00089-00-SW	СООК	58	33
					CONTRACT	NO. 61	E45
	STA.	TO STA.					

EMBEDDED FENCE POST SEE ARCH FOR DIMENSIONS

SEE ARCH FOR DIMENSIONS

#5 @ 12" OC EACH WAY-

T/CAST STONE

EL = SEE ARCH DRWG

SEE ARCH FOR STONE VENEER DETAILS :

1" Ø WEEP HOLE @ 24" OC COVER HOLE

@ FACE OF WALL W/ GEOTECH FABRIC-

1/2" PREMOLDED EXPANSION JOINT TYP

SIDEWALK - SEE ARCH & CMIL DWGS-

7'-0"

CONTRACTOR TO PROVIDE SHORING PER BNSF

RETAINING WALL SECTION W/PLANTER

GUIDELINES FOR TEMPORARY SHORING

CAST STONE CAP

1488 Bond Street, Suite 100 Naperville, Illinois 60563–6503 (P) 630.357.0540 (F) 630.357.0164 ILLINOIS LICENSE NO. 184–001442 LEI Comm. No. 21170296.001 TOTAL SHEET NO. 58 33

T/CAST STONE

T/LEDGE EL = SEE PLAN

PLATFORM

LEXISTING PLATFORM

SEE ARCH &

#5 @ 12" OC

(9) #5 TOP

(9) #5 BOTTOM


#5 @ 12" OC

WALLS OF PLANTER

6" HOLE THROUGH FOOTING WITHIN 1'-0" OF CENTER OF

CIVIL DWGS

EL = SEE ARCH DRWG

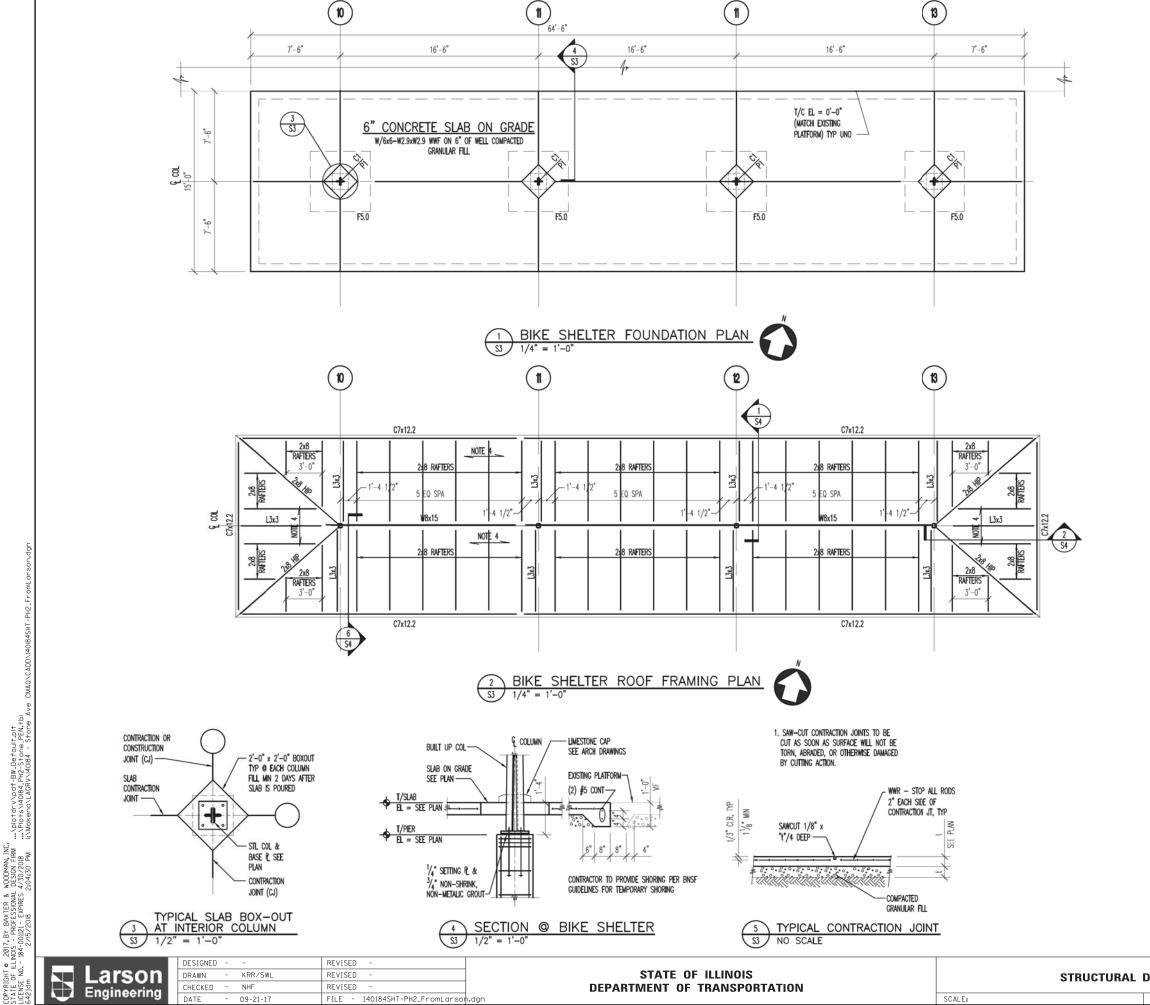

- 1) SEE SHEET SO FOR GENERAL NOTES, ABBREVIATIONS AND SCHEDULES.
- 2) VERIFY ALL DIMENSIONS AND ELEVATIONS WITH EXISTING CONDITIONS, ARCHITECTURAL, PLUMBING AND MECHANICAL DRAWINGS.
- 3) F5.0 INDICATES FOOTING = 5'-0"x5'-0"x1'-2" W/ LAYER OF (5) #5 BARS EACH WAY T&B.
- P1 INDICATES 20" X 20" CONCRETE PIER. REINFORCE WITH (4) #6 VERTICAL BARS WITH STANDARD HOOKS IN FOOTING AND #3 TIES. SPACE TIES (3) AT 2" OC AT TOP & REMAINDER AT 12" OC. C1 INDICATES BUILT UP COLUMN. SEE COLUMN DETAIL ON SHEET S4.
- 4) T/FOOTING ELEVATION = 3'-6" UNLESS NOTED THUS ().
- 5) COORDINATE DRAIN LOCATIONS WITH ARCH DRAWINGS.
- 6) PAID FOR AS CONCRETE STRUCTURES.

- 1) SEE SHEET SO FOR GENERAL NOTES, ABBREVIATIONS AND SCHEDULES.
- 2) VERIFY ALL DIMENSIONS AND ELEVATIONS WITH EXISTING CONDITIONS, ARCHITECTURAL, PLUMBING AND MECHANICAL DRAWINGS. CONTRACTOR TO MATCH APPEARANCE OF EXISTING PLATFORM FRAMING.
- 3) SEE 1/S3 FOR COLUMN DESIGNATIONS.
- 4) 1/2 APA RATED ROOF SHEATHING ON 2"x6" TONGUE & GROOVE ROOF DECK. SEE NOTES ON SO FOR NAILING.
- 5) GENERAL CONTRACTOR SHALL COORDINATE AND PROVIDE ALL MISCELLANEOUS STEEL PIECES AS INDICATED ON THE STRUCTURAL AND ARCHITECTURAL DRAWINGS.
- 6) PAID FOR AS FURNISHING AND ERECTING STRUCTURAL STEEL (SPECIAL), TREATED TIMBER AND HARDWARE.

Larson Engineering Inc

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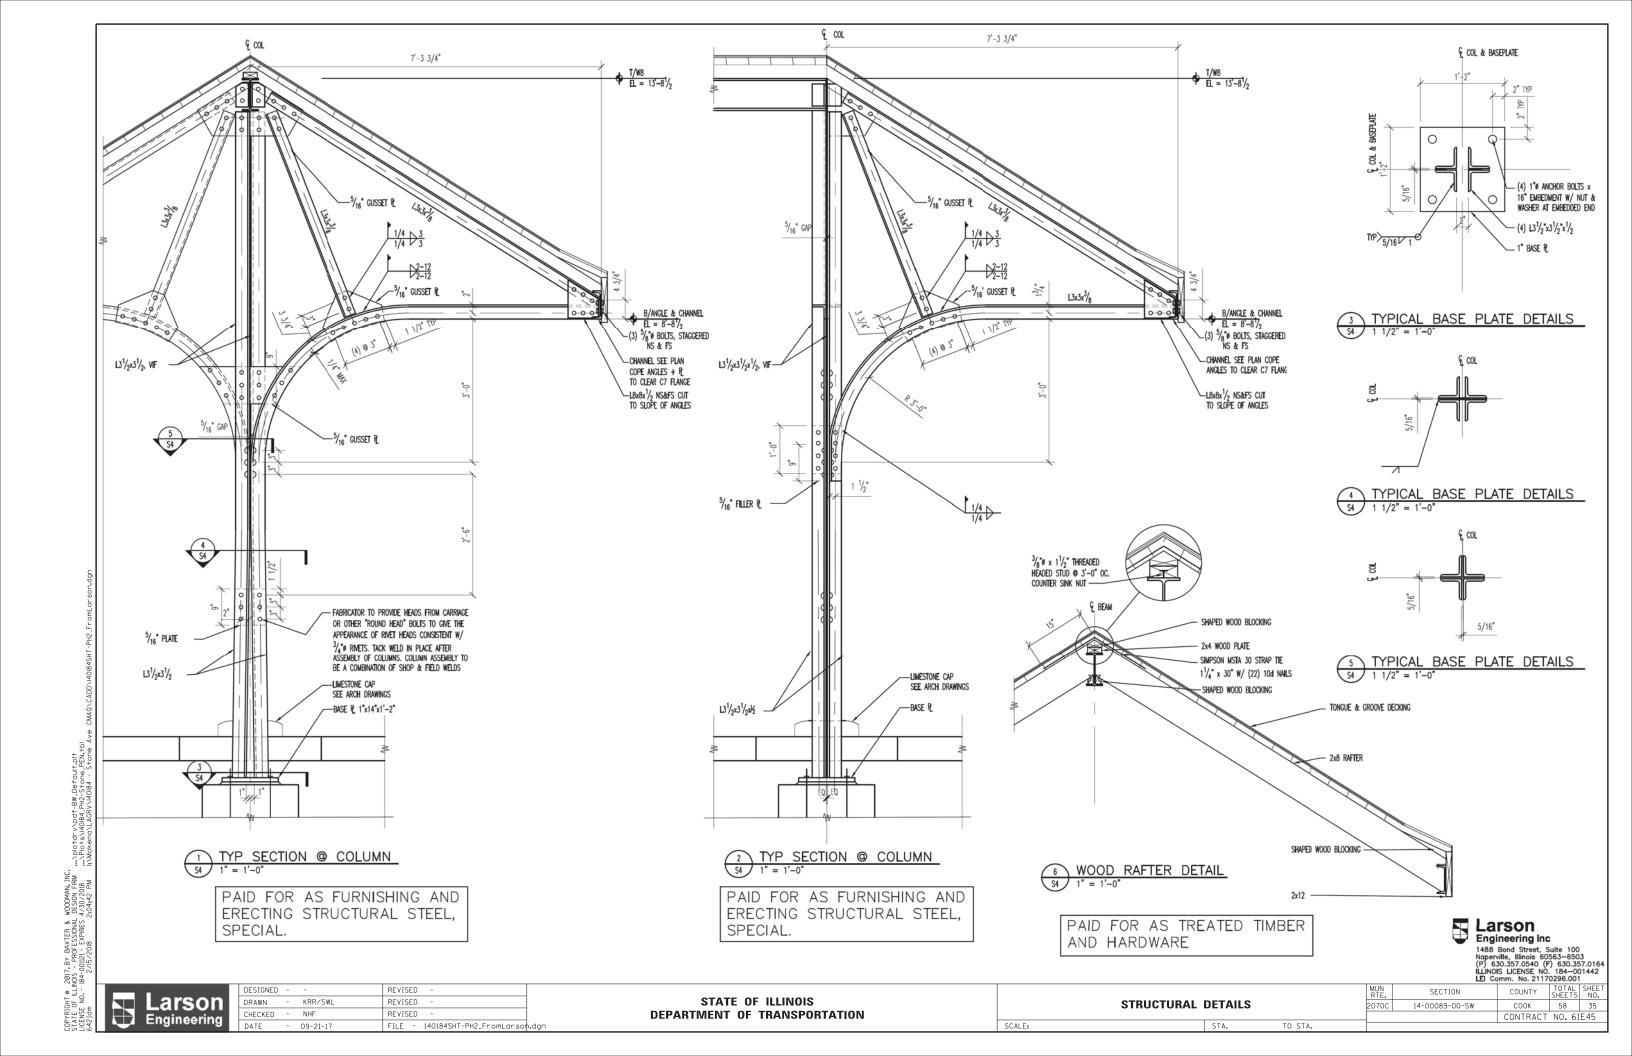



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STATE OF ILLINOIS **DEPARTMENT OF TRANSPORTATION** STRUCTURAL DETAILS


SCALE:

SECTION COUNTY 58 34 14-00089-00-SW COOK CONTRACT NO. 61E45 TO STA.



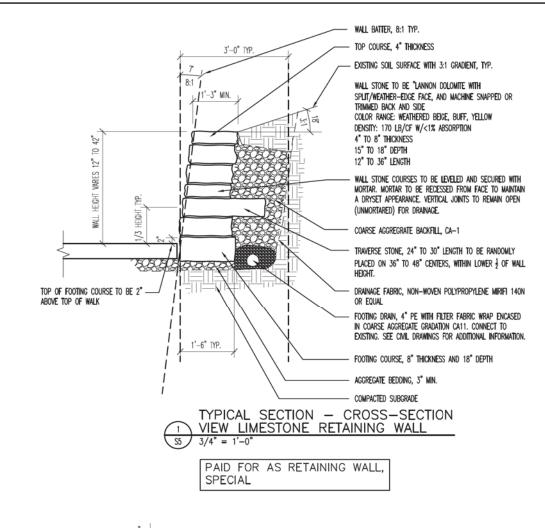

LIMESTONE RETAINING WALL COMPOSITION TABLE								
THICKNESS (in)	QUANTITY (%)	FACEAREA (sf)	DEPTH (ft)	VOLUME (cuft)	UNIT Wt (lb/cf)	WEIGHT (tons)		
3" to 4"	20%	40	1.25	50	171	4.275		
5" to 6"	45%	90.4	1.25	113	171	9.6		
7" to 8"	35%	58.67	1.50	88	171	7.5		
TOTALS	100%	189.07	1.25	251	171	21.35		
TRANSVERSE	25%	47.27	1.25	59	171	5.05		
TOTAL STONE WT			·			26.40		

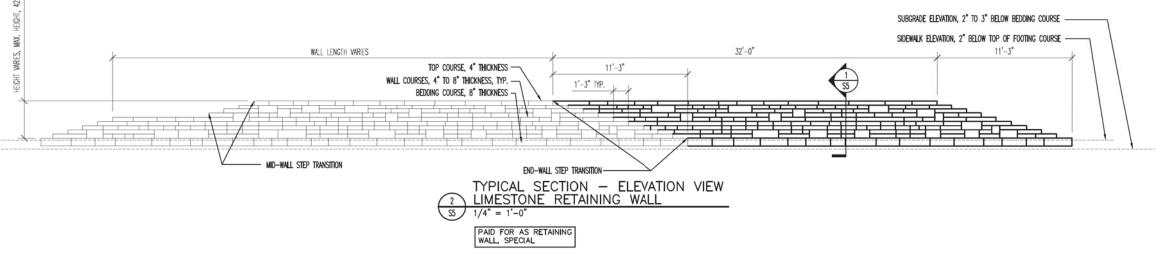

SCALE:



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BY BAXTER & WOODMAN, INC. PROFESSIONAL DESIGN FIRM 51121 - EXPIRES 4/30/2018

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 DESIGNED
 REVISED

 DRAWN
 KRR/SWL
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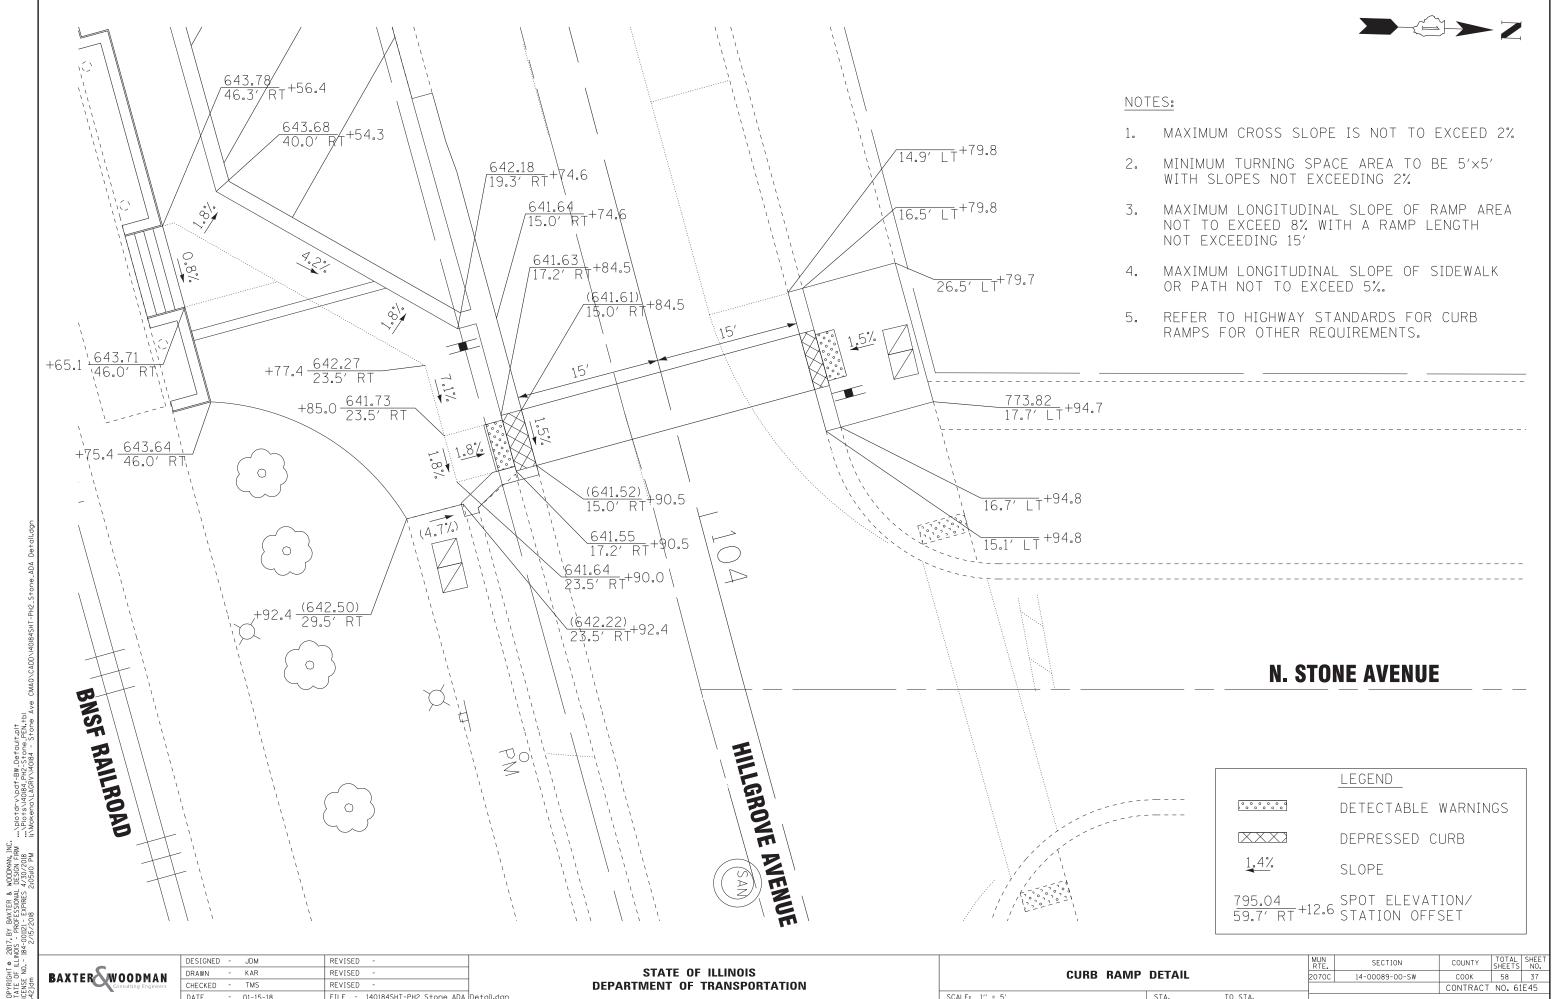
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STATE OF ILLINOIS
DEPARTMENT OF TRANSPORTATION

 STRUCTURAL DETAILS
 MUN RTE. 2070C
 SECTION (COMPANDED TO STALE)
 COMPANDED TO STALE

Larson Engineering Inc 1488 Bond Street, Suite 100 Naperville, Illinois 60563-6503 (P) 630.357.0540 (F) 630.357.0164 ILLINOIS LICENSE NO. 184-001442 LEI Comm. No. 21170296.001




TMS REVISED FILE - 140184SHT-PH2_Stone_ADA Detail.dgr **DEPARTMENT OF TRANSPORTATION**

SCALE: 1" = 5" TO STA.

CONTRACT NO. 61E45


CONCRETE GUTTER (SPECIAL)

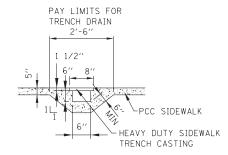

TOP OF CURB

FLOWLINE CURB

SIDEWALK SECTION VIEW

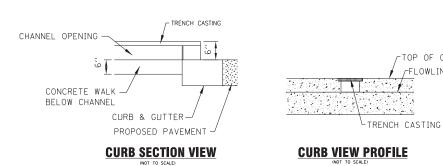

NOTES:

HEAVY DUTY TRENCH FRAME WITH OPEN COVER SHALL BE USED AT DOWNSPOUT LOCATIONS

CONNECT TO DOWNSPOUT SLEEVE THRU WALL SECTION

CHANNEL DEPTH SHALL BE ADEQUATE FOR DOWNSPOUT SLEEVE

PC CONCRETE, CLASS SI WITH 6" MINIMUM WALL THICKNESS SHALL BE USED FOR HEAVY DUTY CHANNEL CONSTRUCTION

CONTRACTOR SHALL CONFORM TO MANUFACTURER INSTALLATION GUIDELINES

CONTRACTOR SHALL FIELD VERIFY AND CONFIRM TOTAL LENGTH REQUIRED TO SPAN SIDEWALK AND CURB OUTLET. FIELD CUTTING OF GRATE SYSTEM WILL NOT BE PERMITTED

TRENCH DRAIN









GENERAL NOTES:

FRAME: TOP RING CONSTRUCTED FROM 1 $1/4^{\prime\prime}$ X 1 $1/4^{\prime\prime}$ X 1/8" ANGLE. BASE RING CONSTRUCTED OF 1 $1/2^{\prime\prime}$ X $1/2^{\prime\prime}$ X $1/8^{\prime\prime}$ CHANNEL. HANDLES & SUSPENSION BRACKETS CONSTRUCTED FROM $1/4^{\prime\prime}$ X 1 $1/4^{\prime\prime}$ FLAT. ALL STEEL CONFORMING TO ASTM-A36.

REPLACEABLE BAG: CONSTRUCTED FROM 4 OZ./SO. YD. NON-WOVEN POLYPROPYLENE GEOTEXTILE REINFORCED WITH POLYESTER MESH. CONNECTED TO BASE RING WITH STAINLESS STEEL STRAP & LOCK.

INLET PROTECTION INLET FILTER

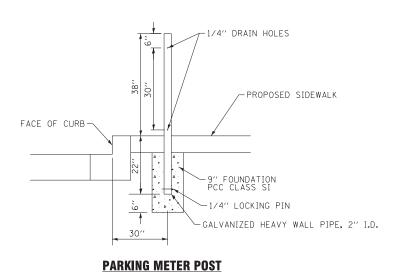


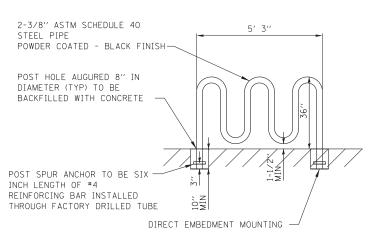


BIKE RACK - WAVE STYLE


SCALE: NONE

- THE ANCHOR RODS AND RACEWAYS SHALL BE PROPERLY CENTERED AND SECURED IN PLACE BEFORE THE CONCRETE IS PLACED.
- THE HOLE FOR THE FOUNDATION SHALL BE MADE WITH AN AUGER OF THE SAME DIAMETER AS THE FOUNDATION. IF SOIL CONDITIONS REQUIRE THE USE OF A LINER TO FORM THE HOLE, THE LINER SHALL BE WITHDRAWN AS THE CONCRETE
- THE TOP OF THE FOUNDATION SHALL BE CONSTRUCTED LEVEL. A LINER OR FORM SHALL BE USED TO PRODUCE A UNIFORM SMOOTH SIDE TO THE TOP OF THE FOUNDATION. FOUNDATION TOP SHALL BE CHAMFERED 1 INCH.
- 4. CABLE TRENCHES AND FOUNDATIONS SHALL BE BACKFILLED AND COMPACTED, AND CONCRETE CURED ACCORDING TO APPLICABLE STANDARDS BEFORE LIGHT POLES MAY BE INSTALLED.
- THE ANCHOR ROD SHALL BE A HOOK ROD TYPE. COLD BENDING OF THE ANCHOR ROD WILL NOT BE ALLOWED. THE ANCHOR ROD SHALL BE THREADED A MINIMUM OF 6 INCHES WITH A MINIMUM OF 3" OF THREADED ANCHOR ROD EMBEDDED IN THE FOUNDATION AND PROJECT A MINIMUM OF 2 3/4" ABOVE THE TOP OF THE FOUNDATION. IF BREAKAWAY COUPLINGS ARE SPECIFIED THE CONTRACTOR SHALL CAREFULLY COORDINATE THE ANCHOR ROD PROJECTION WITH THE INSTALLATION REQUIREMENTS OF THE BREAKAWAY COUPLINGS.
- THE CONTRACTOR MAY USE A #3 SPIRAL AT 6" PITCH OR #3 TIES AT 12"
- 7. RACEWAYS SHALL PROJECT 1" ABOVE THE TOP OF THE FOUNDATION.

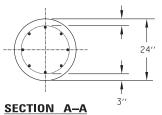

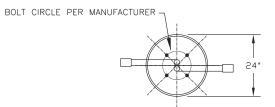

TOP VIEW

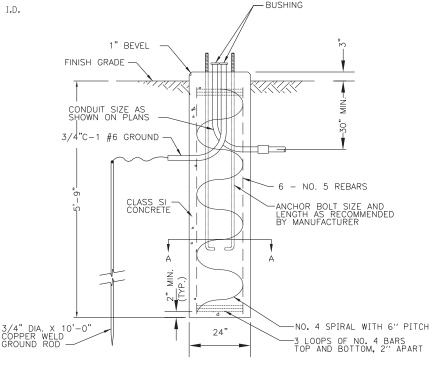

LIGHT POLE FOUNDATION DETAIL NO SCALE

TO STA.

BAXTER WOODMAN

REVISED DESIGNED -JDM DRAWN KAR REVISED CHECKED TMS REVISED FILE - 140184SHT-PH2 Stone MiscDetails.dar 01-15-18


STATE OF ILLINOIS

MISCELLANEOUS DETAILS

COUNTY 14-00089-00-SW COOK 58 CONTRACT NO. 61E45

-Nplo+ WOODMAN, INC. DESIGN FIRM 4/30/2018 BY BAXTER & V PROFESSIONAL 01121 - EXPIRES 4 2017, INOIS 184-0

DEPARTMENT OF TRANSPORTATION

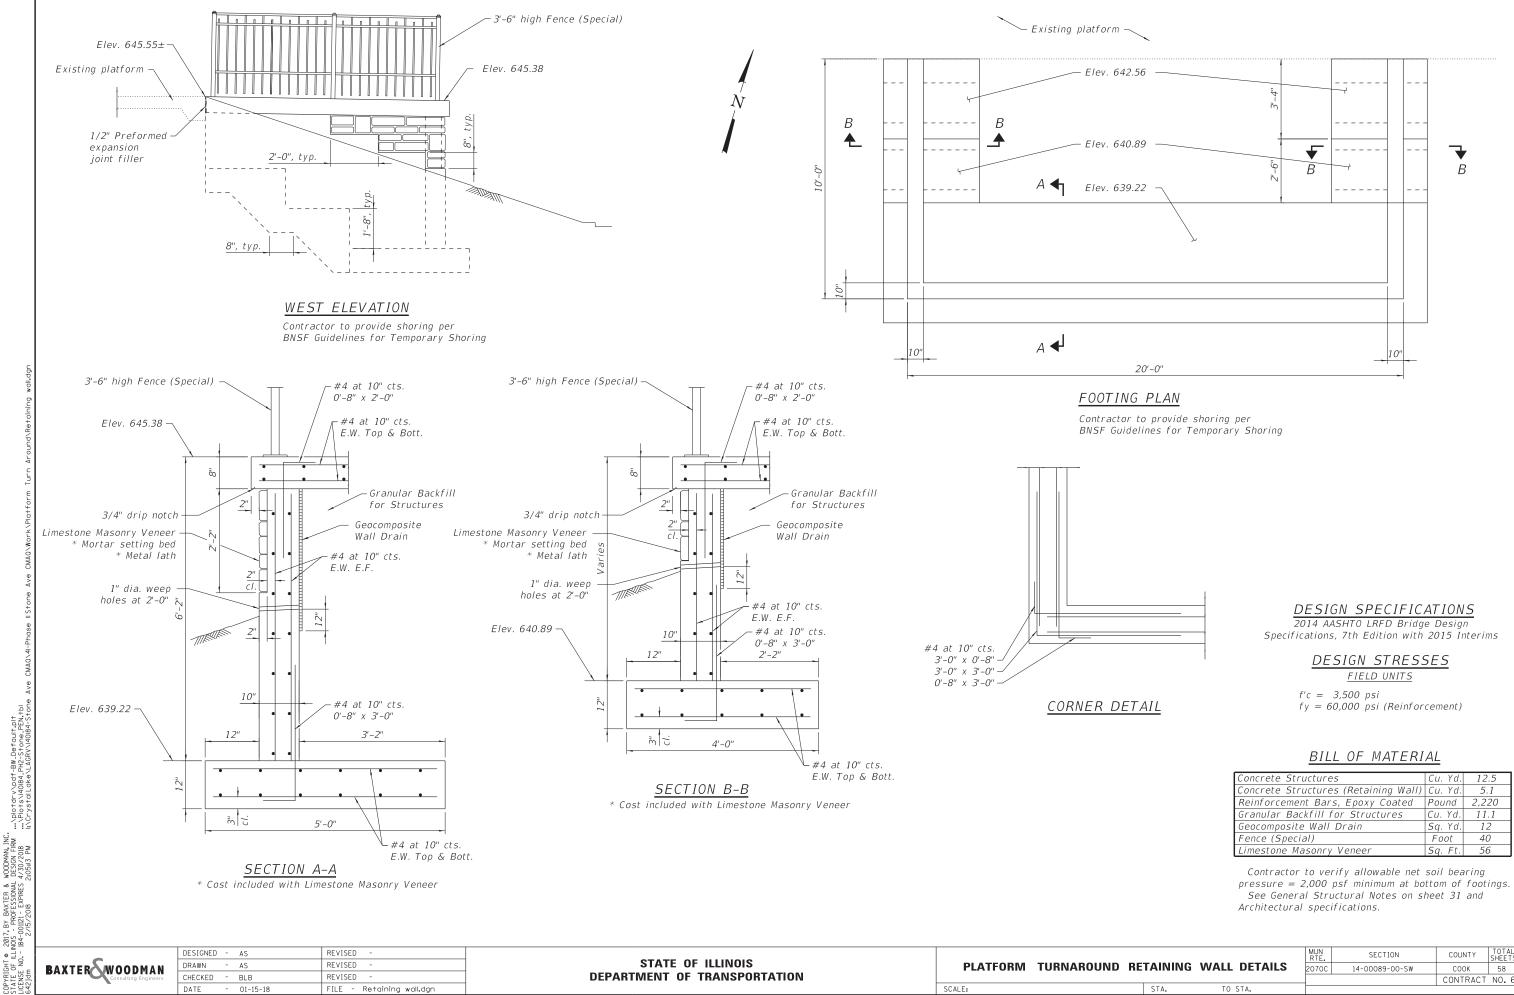



BAXTER WOODMAN

DRAWN - AS REVISED CHECKED - BLB REVISED FILE - Retaining wall.dgn - 01-15-18

STATE OF ILLINOIS **DEPARTMENT OF TRANSPORTATION** PLATFORM TURNAROUND RETAINING WALL DETAILS TO STA.

SECTION COUNTY 14-00089-00-SW COOK 58 39 CONTRACT NO. 61E45

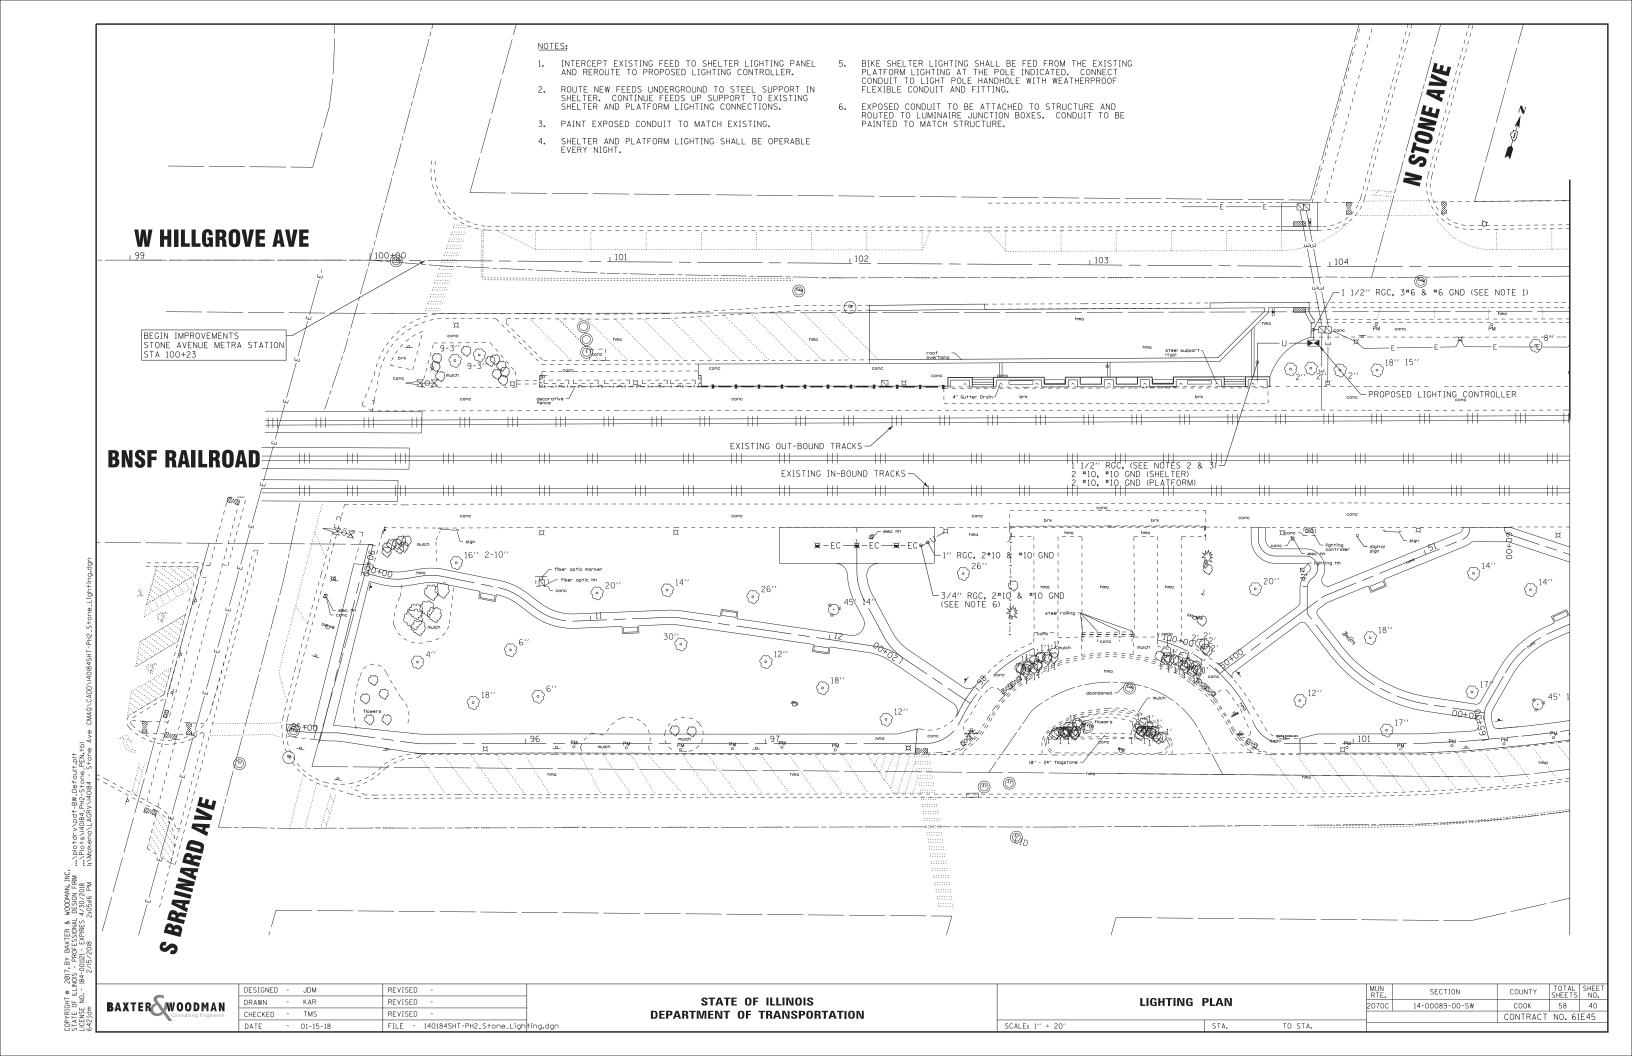

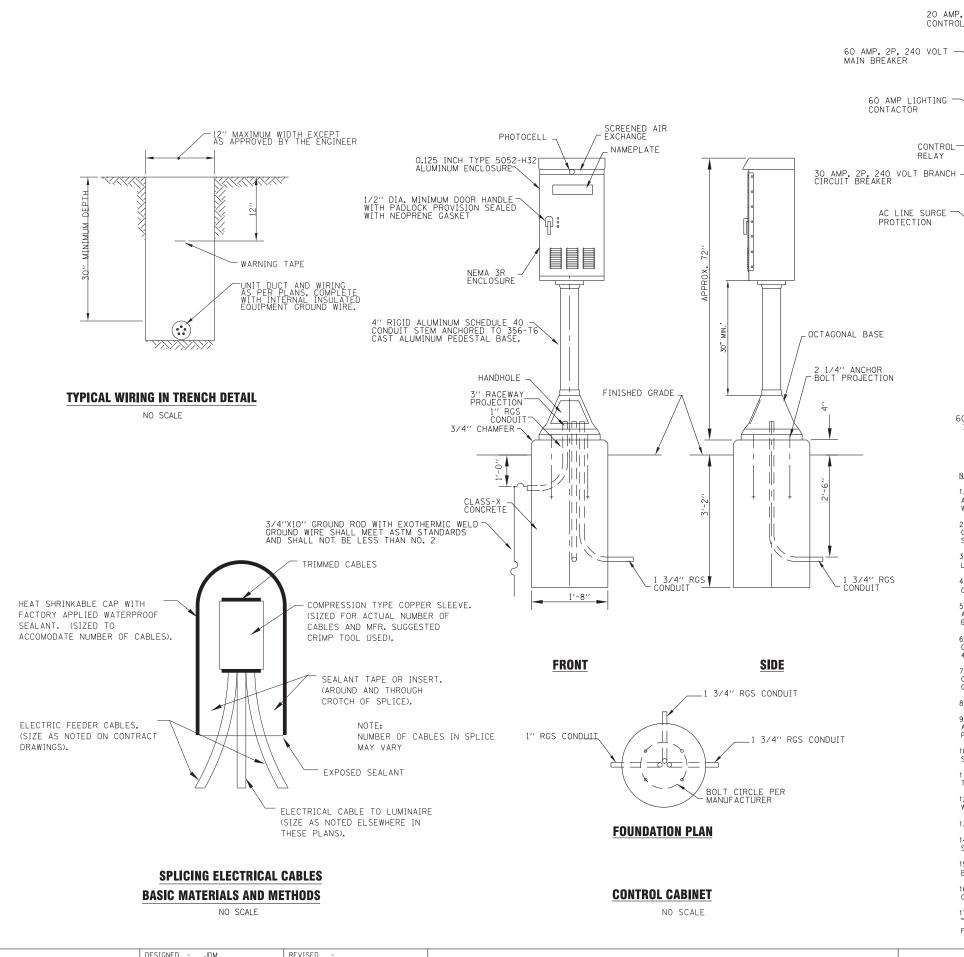

-3/4" DIA. X 10' LENGTH GROUND ROD → 5 1/8" - **→** | **→** 3/4" 1/4" - 0 0 0 0 0 1 9/16" -- --

PHOTOCELL

ENCLOSURE

ON-OFF-AUTO SELECTOR SWITCH

NEUTRAL TB

GROUND BUS

20 AMP, 1P, 120 VOLT BRANCH CIRCUIT BREAKERS

*8 BONDING JUMPER

-DUPLEX RECEPT.

ملم

NOTE: PROVIDE TWO TERMINAL LUGS
FOR EACH PHASE LEG ON LOAD
SIDE OF BRANCH CIRCUIT BREAKERS.

®-

2

60A 120/240V 1• 3 WIRE LIGHTING CONTROLLER WIRING DIAGRAM

1. CABINET SHALL BE FABRICATED FROM 0.125-INCH SHEET ALUMINUM #3003H14, FORMED AND ARC WELDED ASSEMBLY WITH NEMA 3R RATING.

2. ALL SCREWS AND HARDWARE SHALL BE PLATED, GALVANIZED, OR MADE OF BRASS, ALUMINUM OR STAINLESS

3. NAME PLATE SHALL HAVE ENGRAVED 0.75-INCH HIGH LETTERS FILLED IN BLACK: "STONE AVENUE METRA LIGHTING".

5. THE COMPLETED CONTROLLER SHALL BE U.L. LISTED AS AN INDUSTRIAL CONTROL PANEL UNDER UL508, AND SHOULD BE SERVICE ENTRANCE RATED.

6. METAL MOUNTING PANEL SHALL BE #10 GAUGE GALVANIZED SHEET STEEL FLANGED BACK 0.75—INCHES I.D. ON 4 SIDES.

9. BUS BAR SHALL HAVE 12 LUG TERMINALS SIZED TO ACCOMMODATE REQUIRED WIRE SIZES. NEUTRAL BUS SHALL BE PAINTED WHITE. GROUND BUS SHALL BE PAINTED GREEN.

10. ALL LUGS SHALL BE COPPER SCREWS AND CONNECTORS, SPRING HELD.

11. ALL WIRING TERMINATIONS SHALL BE RATED NOT LESS THAN 75 DEGREE CENTIGRADE. 12. ALL CONTROL WIRING SHALL BE 600V MACHINE TOOL WIRE TYPE MTW.

13. ALL POWER WIRING SHALL BE 600V TYPE RHH/RHW.

14. A LAMINATED COPY OF THE CIRCUIT SCHEMATIC DIAGRAM SHALL BE ATTACHED TO THE INSIDE OF THE CONTROLLER.

15. ALL 120 VOLT SYSTEM AND ALL CONTROL WIRING SHALL BE #12 AWG STRANDED UNLESS OTHERWISE INDICATED.

16. ALL WIRING SHALL BE IDENTIFIED BY MANUFACTURER COLOR CODED INSULATION, NEATLY DRESSED AND SUPPORTED.

17. INCLUDE SAFETY LABELS ON MAIN BREAKER, "WARNING-THIS DISCONNECT DOES NOT REMOVE ALL POWER FROM THIS PANEL".

SCALE: NONE

7. CIRCUIT BREAKERS AND CONTACTORS AND OTHER COMPONENTS SHALL BE MOUNTED ON 0.125-INCH THICK GLASTIC INSULATION BACK PANEL.


8. ALL DEVICES SHALL BE FRONT REMOVABLE.

CIRCUIT SHALL NOT BE "DOUBLE LUGGED".

CONNECTION OF SURGE ARRESTOR TO LINE SIDE OF MAIN

NO SCALE

MOUNTING STRAP

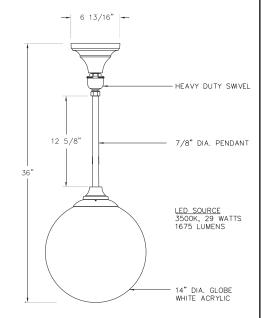

BIKE SHELTER LUMINAIRE

STERNBERG P/N: G14WA/PF/HSH28/36" OAD/4S35TLWA/DBT

DESIGNED -REVISED JDM DRAWN KAR REVISED CHECKED TMS REVISED FILE - 140184SHT-PH2 Stone MiscDetails.dar 01-15-18

STATE OF ILLINOIS **DEPARTMENT OF TRANSPORTATION** **LIGHTING DETAILS** TO STA.

20 AMP, 1P, 120 VOLT CONTROL BREAKER

INCOMING SERVICE


> TOTAL SHEET NO. 58 41 SECTION COUNTY 14-00089-00-SW COOK CONTRACT NO. 61E45

BAXTER WOODMAN Consulting Engineers

...\plotdrv\pdf-BW_Defaul ...\Plots\\40184_PH2-Stone

BY BAXTER & V PROFESSIONAL 01121 - EXPIRES 4

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NOTES:

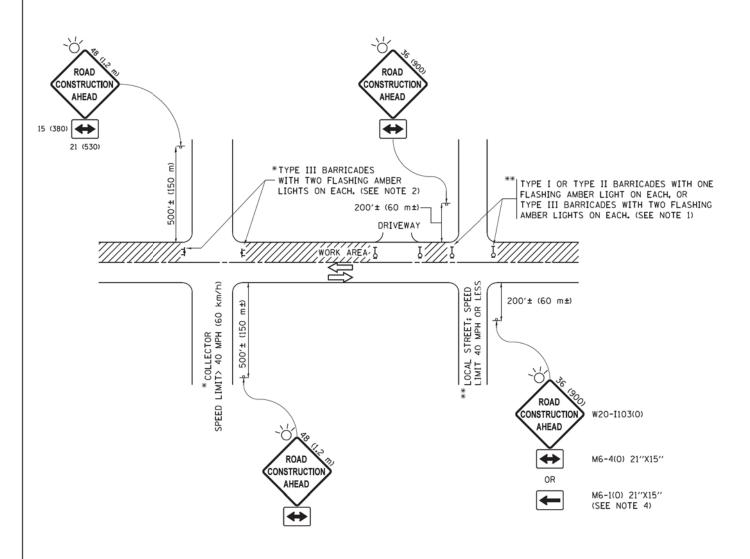- SIDE ROAD WITH A SPEED LIMIT OF 40 MPH (60 km/h) OR LESS AS SHOWN ON THE DRAWING AND AS DIRECTED BY THE ENGINEER:
 - O) ONE "ROAD CONSTRUCTION AHEAD" SIGN 36 x 36 (900x900) WITH A FLASHER MOUNTED ON IT APPROXIMATELY 200" (60 m) IN ADVANCE OF THE MAIN ROUTE.
 - b) THE CLOSED PORTION OF THE MAIN ROUTE SHALL BE PROTECTED BY BLOCKING WITH TYPE I, TYPE II OR TYPE III BARRICADES, 1/3 OF THE CROSS SECTION OF THE CLOSED PORTION.
- 2. SIDE ROAD WITH A SPEED LIMIT GREATER THAN 40 MPH (60 km/h) AS SHOWN ON THE DRAWING AND AS DIRECTED BY THE ENGINEER:
 - O) ONE "ROAD CONSTRUCTION AHEAD" SIGN 48 \times 48 (1.2 m \times 1.2 m) WITH A FLASHER MOUNTED ON IT APPROXIMATELY 500" (150 m) IN ADVANCE OF THE MAIN ROUTE.
 - b) THE CLOSED PORTION OF THE MAIN ROUTE SHALL BE PROTECTED BY BLOCKING WITH TYPE III BARRICADES, 1/2 OF THE CROSS SECTION OF THE CLOSED PORTION.
- 3. CONES MAY BE SUBSTITUTED FOR BARRICADES OR DRUMS AT HALF THE SPACING DURING DAY OPERATIONS. CONES SHALL BE A MINIMUM OF 28 (710)
- 4. WHEN THE SIDE ROAD LIES BETWEEN THE BEGINNING OF THE MAINLINE SIGNING AND THE WORK ZONE, A SINGLE HEADED ARROW (M6-1) SHALL BE USED IN LIEU OF THE DOUBLE HEADED ARROW (M6-4).

SCALE: NONE

- 5. WHEN WORK IS BEING PERFORMED ON A SIDE ROAD OR DRIVEWAY, FOLLOW THE APPLICABLE STANDARD(S). THE DIRECTIONAL ARROW (M6-1 OR M6-4) SHALL BE COVERED OR REMOVED WHEN NO LONGER CONSISTENT WITH THE TRAFFIC CONTROL SET-UP.
- 6. ADVANCE WARNING SIGNS ARE TO BE OMITTED ON DRIVEWAYS UNLESS OTHERWISE SPECIFIED IN THE PLANS OR BY THE ENGINEER
- 7. THE TRAFFIC CONTROL AND PROTECTION FOR SIDE ROADS, INTERSECTIONS, AND DRIVEWAYS SHALL BE INCLUDED IN THE COST OF SPECIFIED TRAFFIC CONTROL STANDARDS OR ITEMS.

All dimensions are in inches (millimeters) unless otherwise shown.


/ BAXTER & W PROFESSIONAL 1121 - EXPIRES

2017, NOIS

STATE OF ILLINOIS
DEPARTMENT OF TRANSPORTATION

TRAFFIC CONTROL AND PROTECTION FOR SIDE ROADS, INTERSECTIONS, AND DRIVEWAYS


SHEET 1 OF 1 SHEETS STA. TO

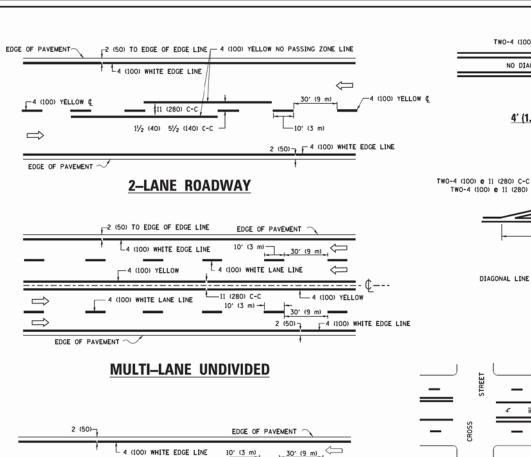

4 (100) WHITE LANE LINE

10' 10' (9 m)

2 (50) 7

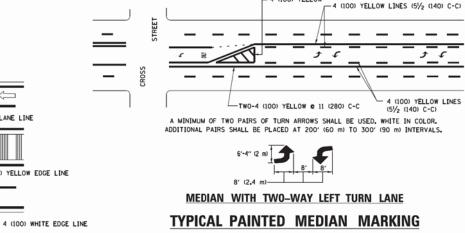

TWO-4 (100) YELLOW @ 11 (280) C-C-

-TWO-4 (100) YELLOW @ 11 (280) C-C

VARIES

4' (1.2 m) WIDE MEDIANS ONLY

12 (300) DIAGONALS -(MINIMUM 5)

DIAGONAL LINES.

MEDIAN LENGTH

DIAGONAL LINE SPACING: 50' (15 m) C-C (LESS THAN 30MPH (50 km/h))

FOR MEDIAN LENGTHS WHERE DIAGONAL SPACING CANNOT BE ATTAINED, USE 5 (FIVE) EQUALLY SPACED

MEDIANS OVER 4' (1.2 m) WIDE

75' (25 m) C-C 30MPH (50 km/h) TO 45MPH (70 km/h))

150' (45 m) C-C (MORE THAN 45MPH (70 km/h))

NO DIAGONALS

TWO-4 (100) € 11 (280) C-6

TYPICAL LANE AND EDGE LINE MARKING


MULTI-LANE DIVIDED

4 (100) YELLOW EDGE LINE

 \Rightarrow


 \Rightarrow

EDGE OF PAVEMENT \sim

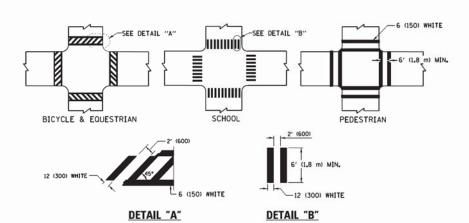

TYPICAL CROSSWALK MARKING

* MARKINGS SHALL BE INSTALLED PARALLEL TO THE CENTERLINE OF THE ROAD WHICH IT CROSSES

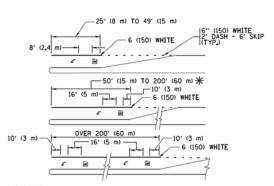


AREA = 15.6 SO. FT. (1.5 m2) (1) AREA = 20.8 SO. FT. (1.9 m2)

* TURN LANES IN EXCESS OF 400' (120 m) IN LENGTH MAY HAVE AN ADDITIONAL SET OF ARROW - "ONLY" INSTALLED MIDWAY BETWEEN THE OTHER TWO SETS OF

TYPICAL LEFT (OR RIGHT) TURN LANE

TYPICAL TURN LANE MARKING

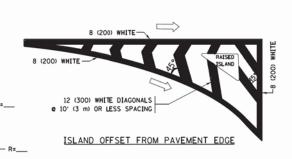



4' (1.2 m) OUTSIDE TO


OUTSIDE OF LINES

- 4 (100) YELLOW LINES (51/2 (140) C-C)



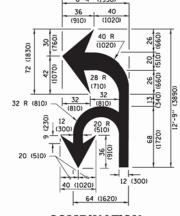

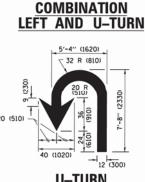

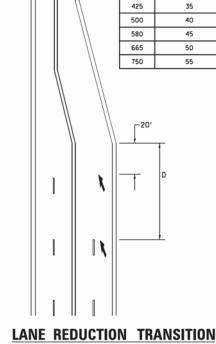

SPEED LIMIT

345

* LANE REDUCTION ARROWS REQUIRED AT SPEEDS OF 45 MPH OR GREATER OR WHEN SPECIFIED IN PLANS.

TYPE OF MARKING	WIDTH OF LINE	PATTERN	COLOR	SPACING /REMARKS
CENTERLINE ON 2 LANE PAVEMENT	4 (100)	SKIP-DASH	YELLOW	10' (3 m) LINE WITH 30' (9 m) SPACE
CENTERLINE ON MULTI-LANE UNDIVIDED PAVEMENT	2 @ 4 (100)	SOLID	YELLOW	11 (280) C-C
NO PASSING ZONE LINES: FOR ONE DIRECTION FOR BOTH DIRECTIONS	4 (100) 2 e 4 (100)	SOLID SOLID	YELLOW YELLOW	5½ (140) C-C FROM SKIP-DASH CENTERLINE 11 (280) C-C OMIT SKIP-DASH CENTERLINE BETWEEN
LANE LINES	4 (100) 5 (125) ON FREEWAYS	SKIP-DASH SKIP-DASH	WHITE WHITE	10' (3 m) LINE WITH 30' (9 m) SPACE
DOTTED LINES (EXTENSIONS OF CENTER, LANE OR TURN LANE MARKINGS)	SAME AS LINE BEING EXTENDED	SKIP-DASH	SAME AS LINE BEING EXTENDED	2' (600) LINE WITH 6' (1.8 m) SPACE
EDGE LINES	4 (100)	SOLID	YELLOW-LEFT WHITE-RIGHT	OUTLINE MEDIANS IN YELLOW
TURN LANE MARKINGS	6 (150) LINE: FULL SIZE LETTERS & SYMBOLS (8' (2.4m))	SOLID	WHITE	SEE TYPICAL TURN LANE MARKING DETAIL
TWO WAY LEFT TURN MARKING	2 ¢ 4 (100) EACH DIRECTION 8' (2.4m) LEFT ARROW	SKIP-DASH AND SOLID IN PAIRS	YELLOW	10' (3 m) LINE WITH 30' (9 m) SPACE FOR SKIP-DASH, 5½ (140) C-C BETWEEN SOLID LINE AND SKIP-DASH LINE ESEE TYPICAL TWO-WAY LEFT TURN MARKING DETAIL
CROSSWALK LINES (PEDESTRIAN) A. DIAGONALS (BIKE & EQUESTRIAN) B. LONGITUDINAL BARS (SCHOOL)	2 e 6 (150) 12 (300) e 45° 12 (300) e 90°	SOLID SOLID SOLID	WHITE WHITE WHITE	NOT LESS THAN 6' (1.8 m) APART 2' (500) APART 2' (500) APART 5EE TYPICAL CROSSWALK MARKING DETAILS.
STOP LINES	24 (600)	SOLID	WHITE	PLACE 4' (1,2 m) IN ADVANCE OF AND PARALLEL TO CROSSMALK, IF PRESENT. OTHERWISE, PLACE AT DESIRED STOPPING POINT. PARALLEL TO CROSSROAD CENTERLINE, WHERE POSSIBLE
PAINTED MEDIANS	2 © 4 (100) WITH 12 (300) DIAGONALS © 45° NO DIAGONALS USED FOR 4' (1.2 m) WIDE MEDIANS	SOLID	YELLOW: TWO WAY TRAFFIC WHITE: ONE WAY TRAFFIC	11 (280) C-C FOR THE DOUBLE LINE SEE TYPICAL PAINTED MEDIAN MARKING.
GORE MARKING AND CHANNELIZING LINES	8 (200) WITH 12 (300) DIAGONALS @ 45°	SOLID	WHITE	DIACONALS: 15' (4,5 m) C-C (LESS THAN 30MPH (50 km/h)) 20' (6 m) C-C 30MPH (50 km/h) TO 45MPH (70 km/h)) 30' (9 m) C-C (OVER 45MPH (70 km/h))
RAILROAD CROSSING	24 (600) TRANSVERSE LINES; "RR" IS 6' (1.8 m) LETTERS; 16 (400) LINE FOR "X"	SOLID	WHITE	SEE STATE STANDARD 780001 AREA OF: "R":3.6 SO, FT. (0.33 m²) EACH "X":54.0 SO, FT. (5.0 m²)
SHOULDER DIAGONALS (REQUIRED FOR SHOULDERS > 8')	12 (300) e 45°	SOLID	WHITE - RIGHT YELLOW - LEFT	50' (15 m) C-C (LESS THAN 30MPH (50 km/h)) 75' (25 m) C-C (30 MPH (50 km/h) TO 45MPH (70 km/h) 150' (45 m) C-C (0VER 45MPH (70 km/h))
U TURN ARROW	SEE DETAIL	SOLID	WHITE	16.3 SF
2 ARROW COMBINATION LEFT AND U TURN	SEE DETAIL	SOLID	WHITE	30,4 SF

FOR FURTHER DETAILS ON PAVEMENT MARKING REFER TO STANDARD SPECIFICATIONS FOR ROAD AND BRIDGE CONSTRUCTION AND STATE STANDARD 780001.


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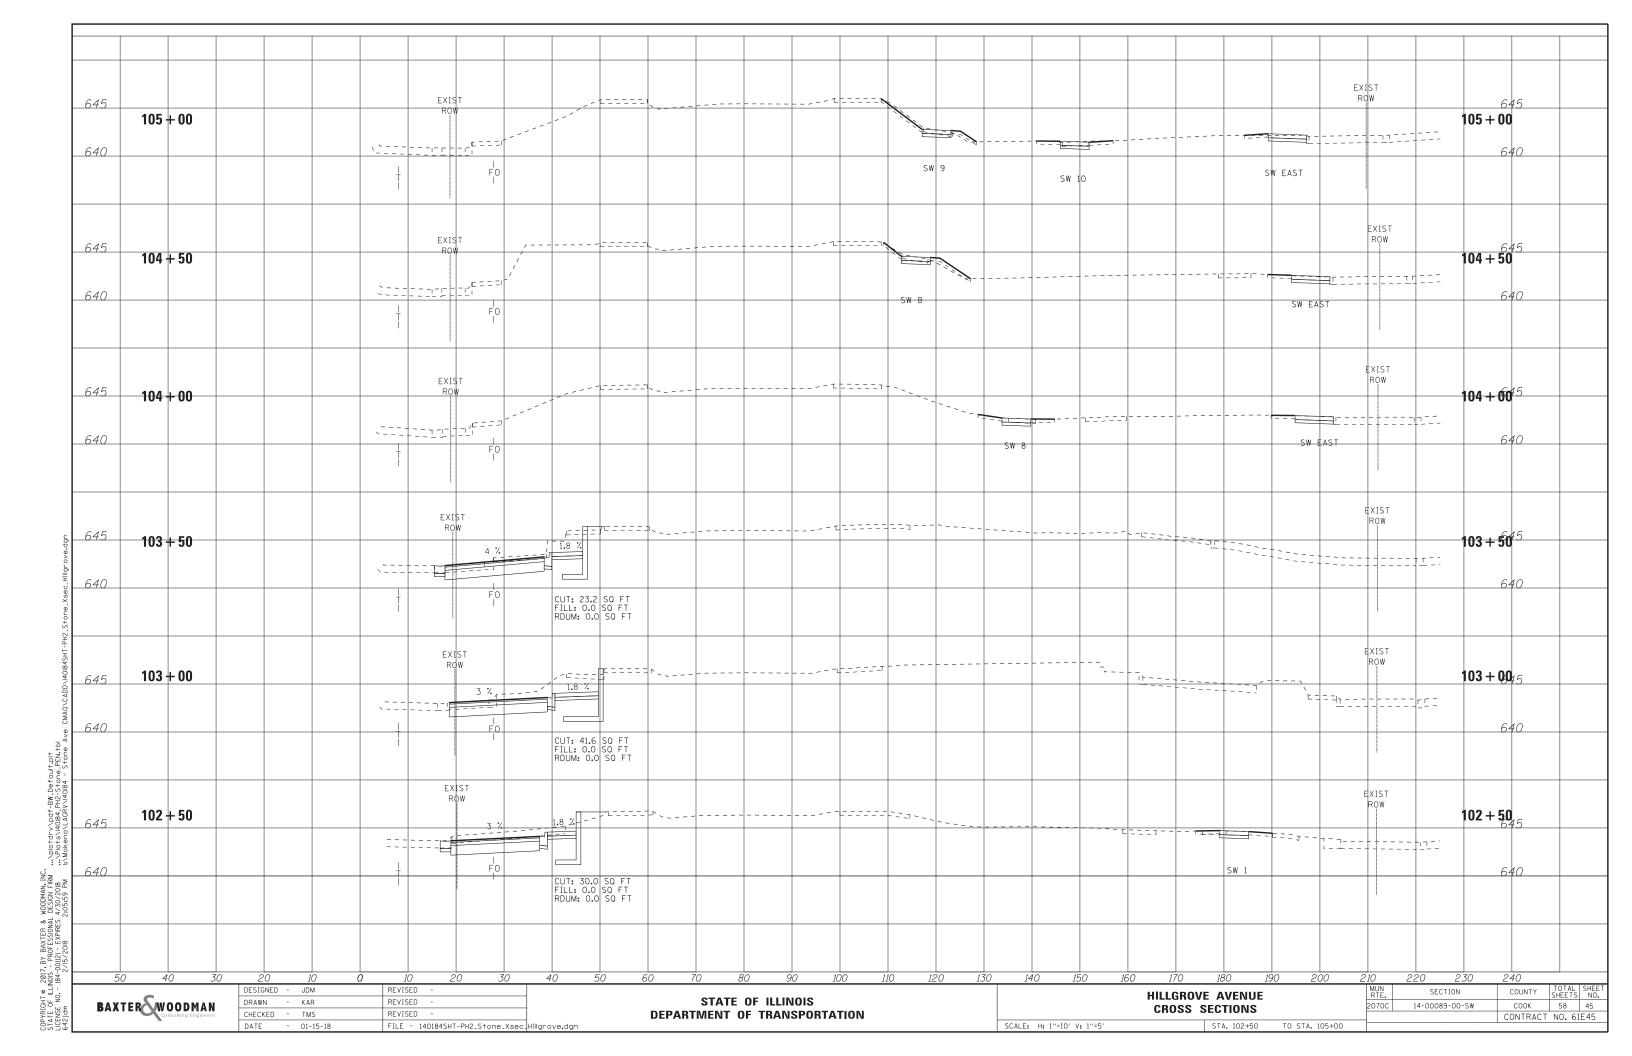
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	PLOT SCALE = 50.000 ' / in.	CHECKED -	REVISED	-	C. JUCIUS 12-21-15
Default	PLOT DATE = 6/23/2017	DATE - 03-19-90	REVISED	_	C. JUCIUS 04-12-16


STATE OF ILLINOIS **DEPARTMENT OF TRANSPORTATION**


DISTRICT ONE TYPICAL PAVEMENT MARKINGS						F.A. RTE.	SECTION	COUNTY	TOTAL SHEETS	SHEET NO.		
						MUN						
							2070C	TC-13	CONTRACT	NO.	47	
SCALE: NONE	SHEET 1	OF	1	SHEETS	STA.	T0 S	A.	20100	14-00089 ILLINOIS FED. AI	D PROJECT		45
											P) F	45


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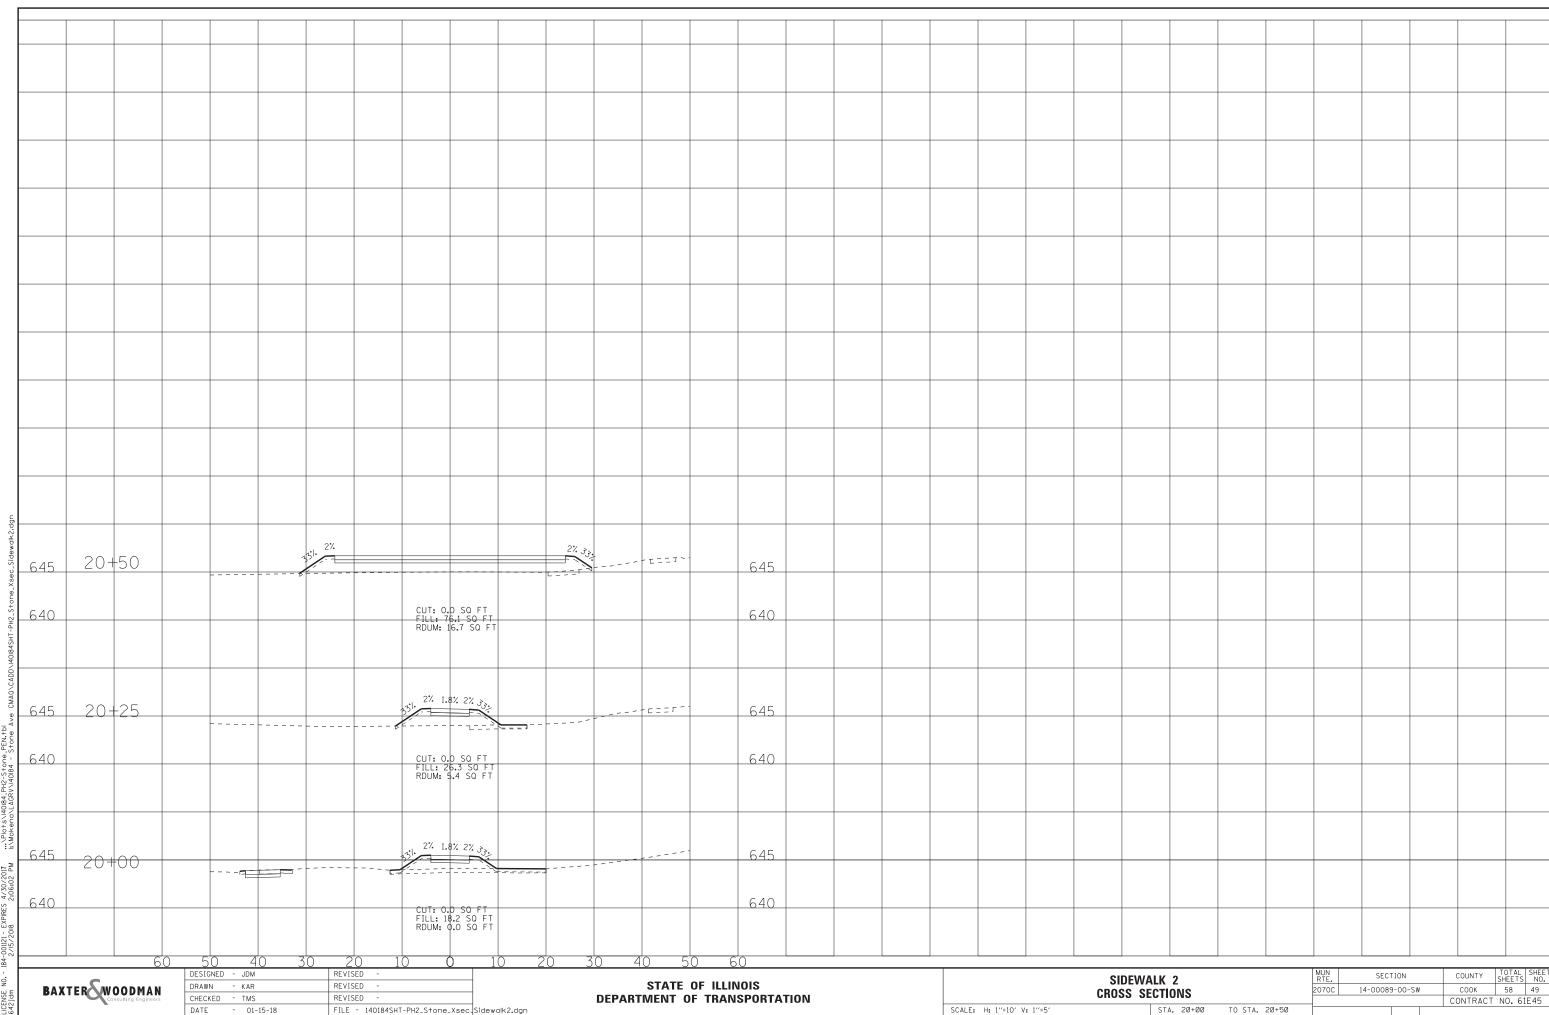





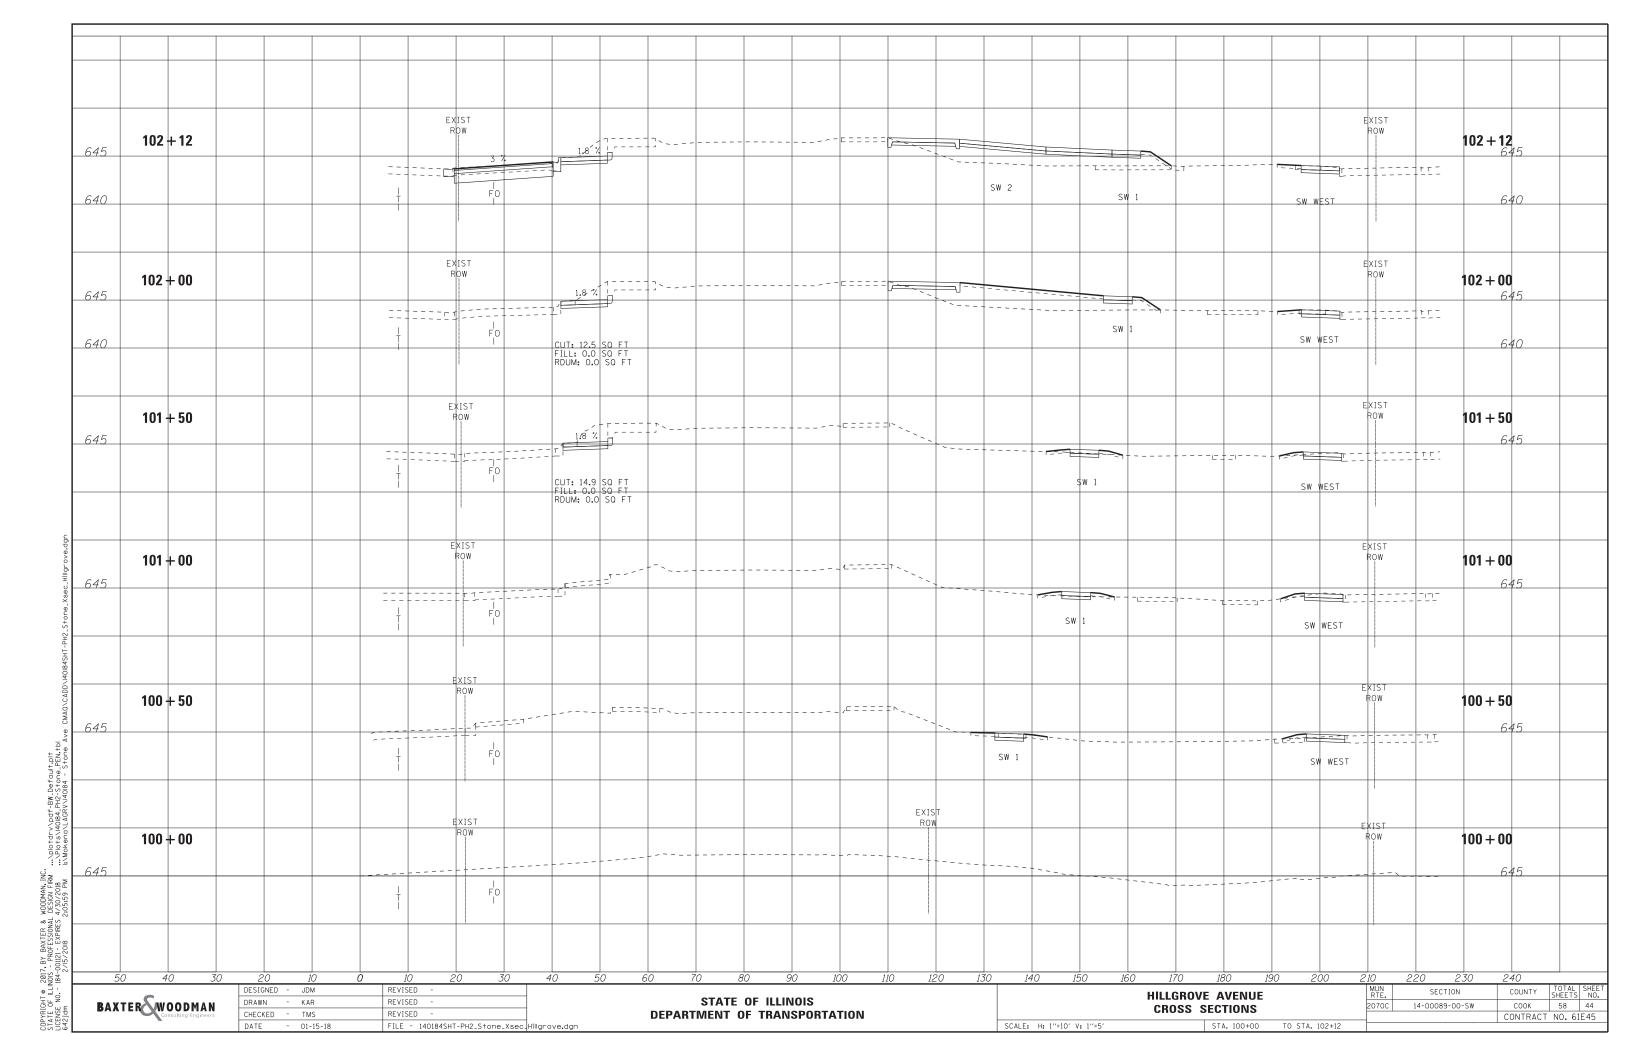


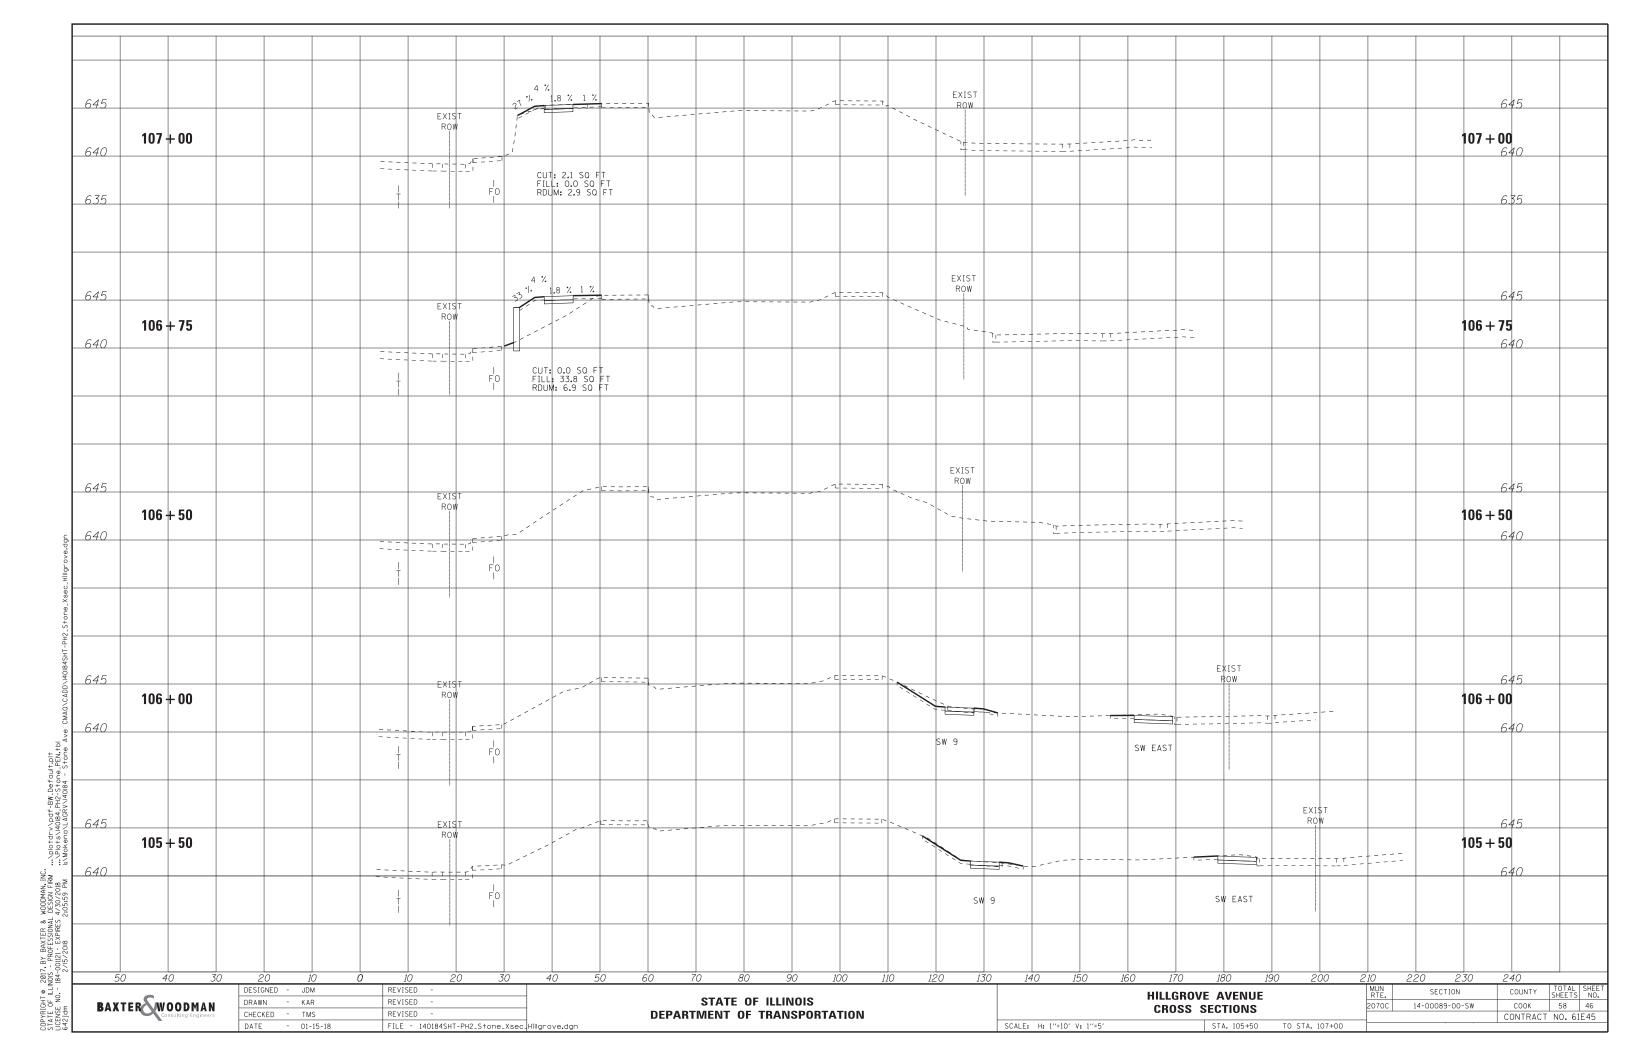


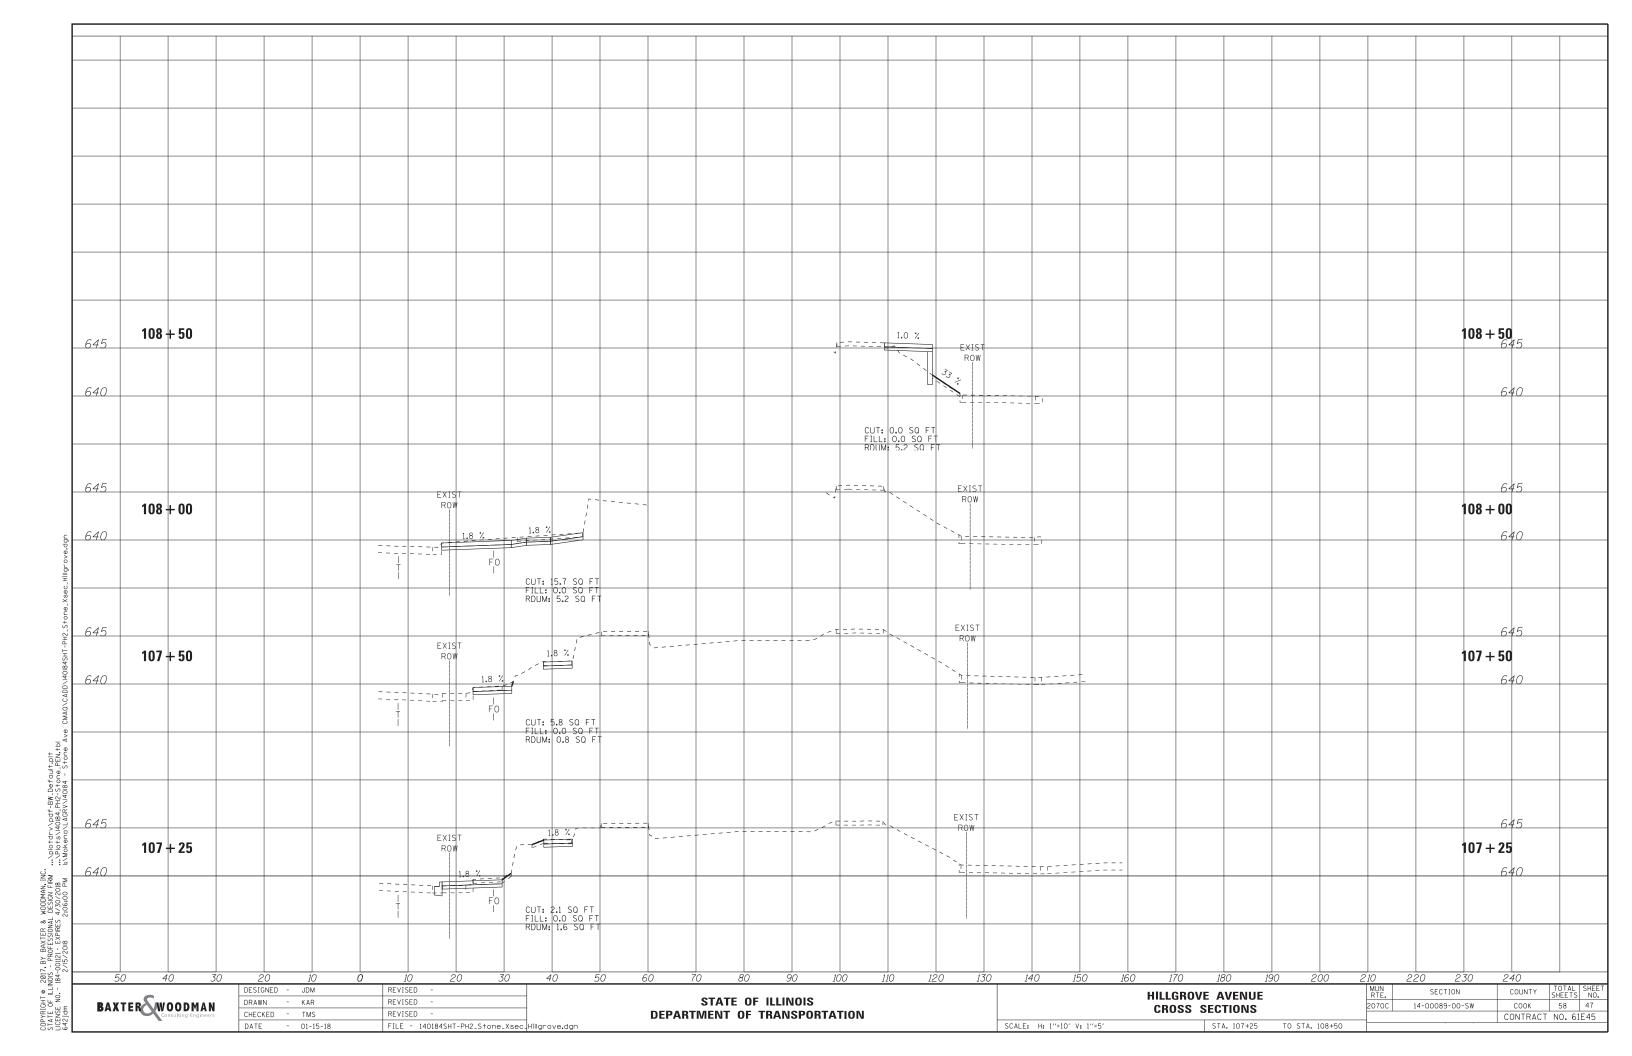

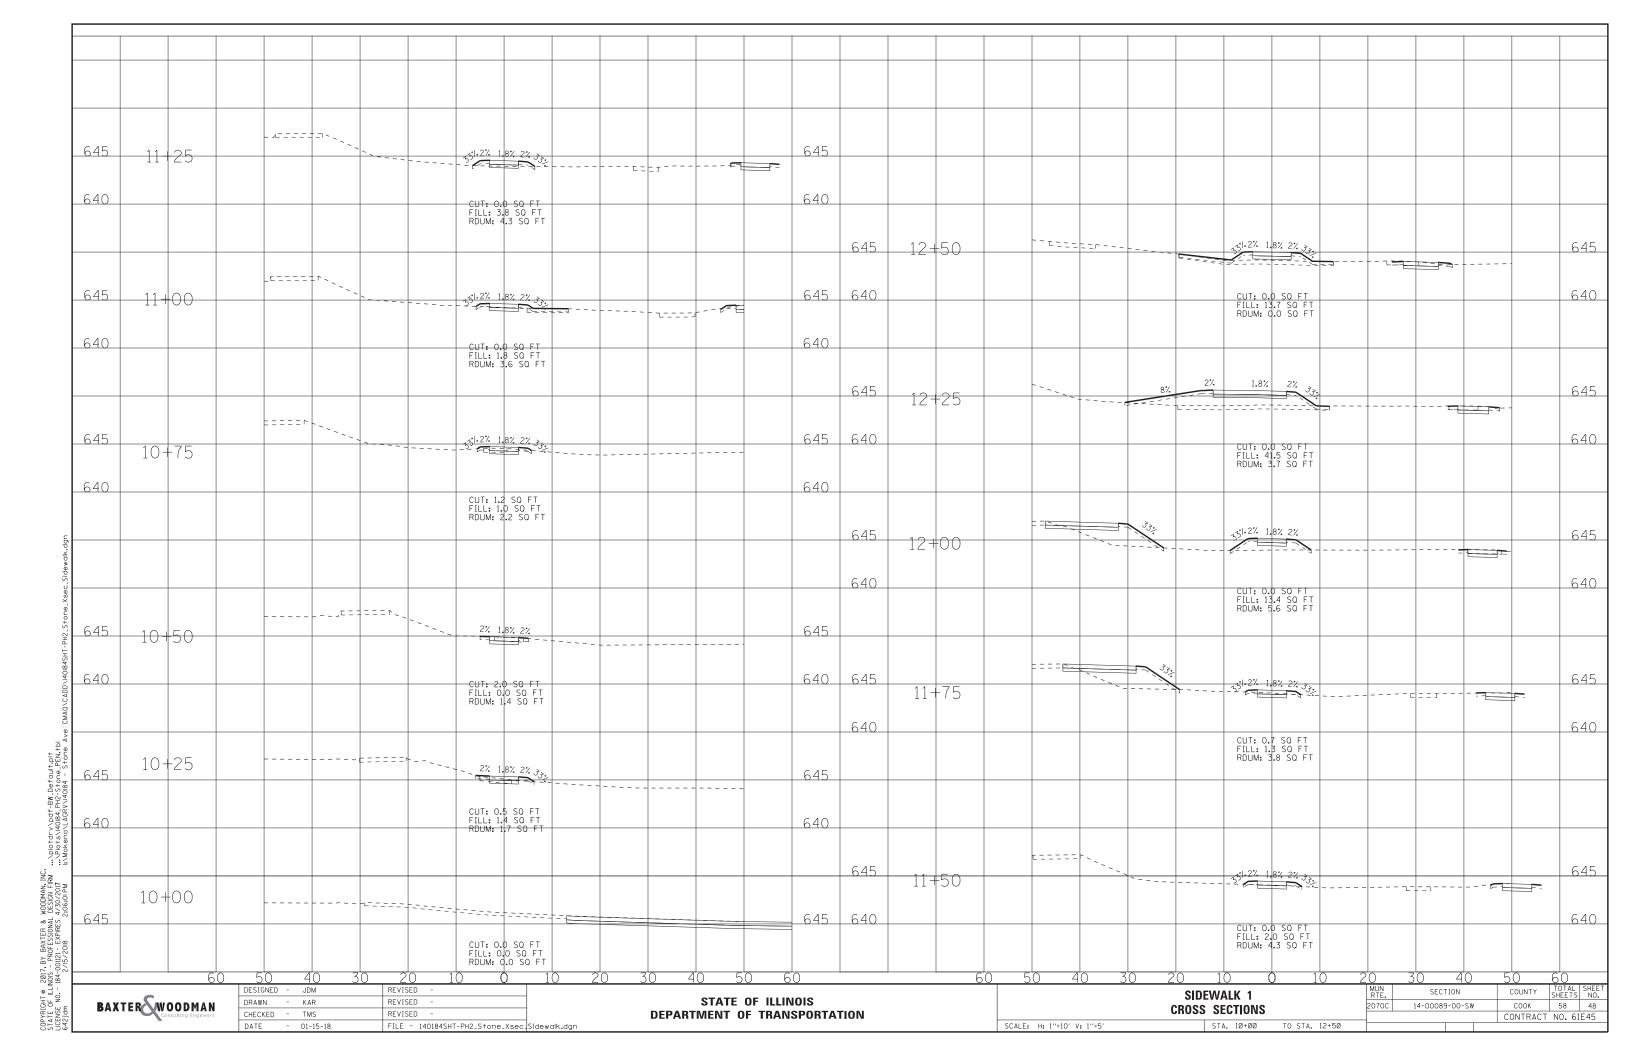

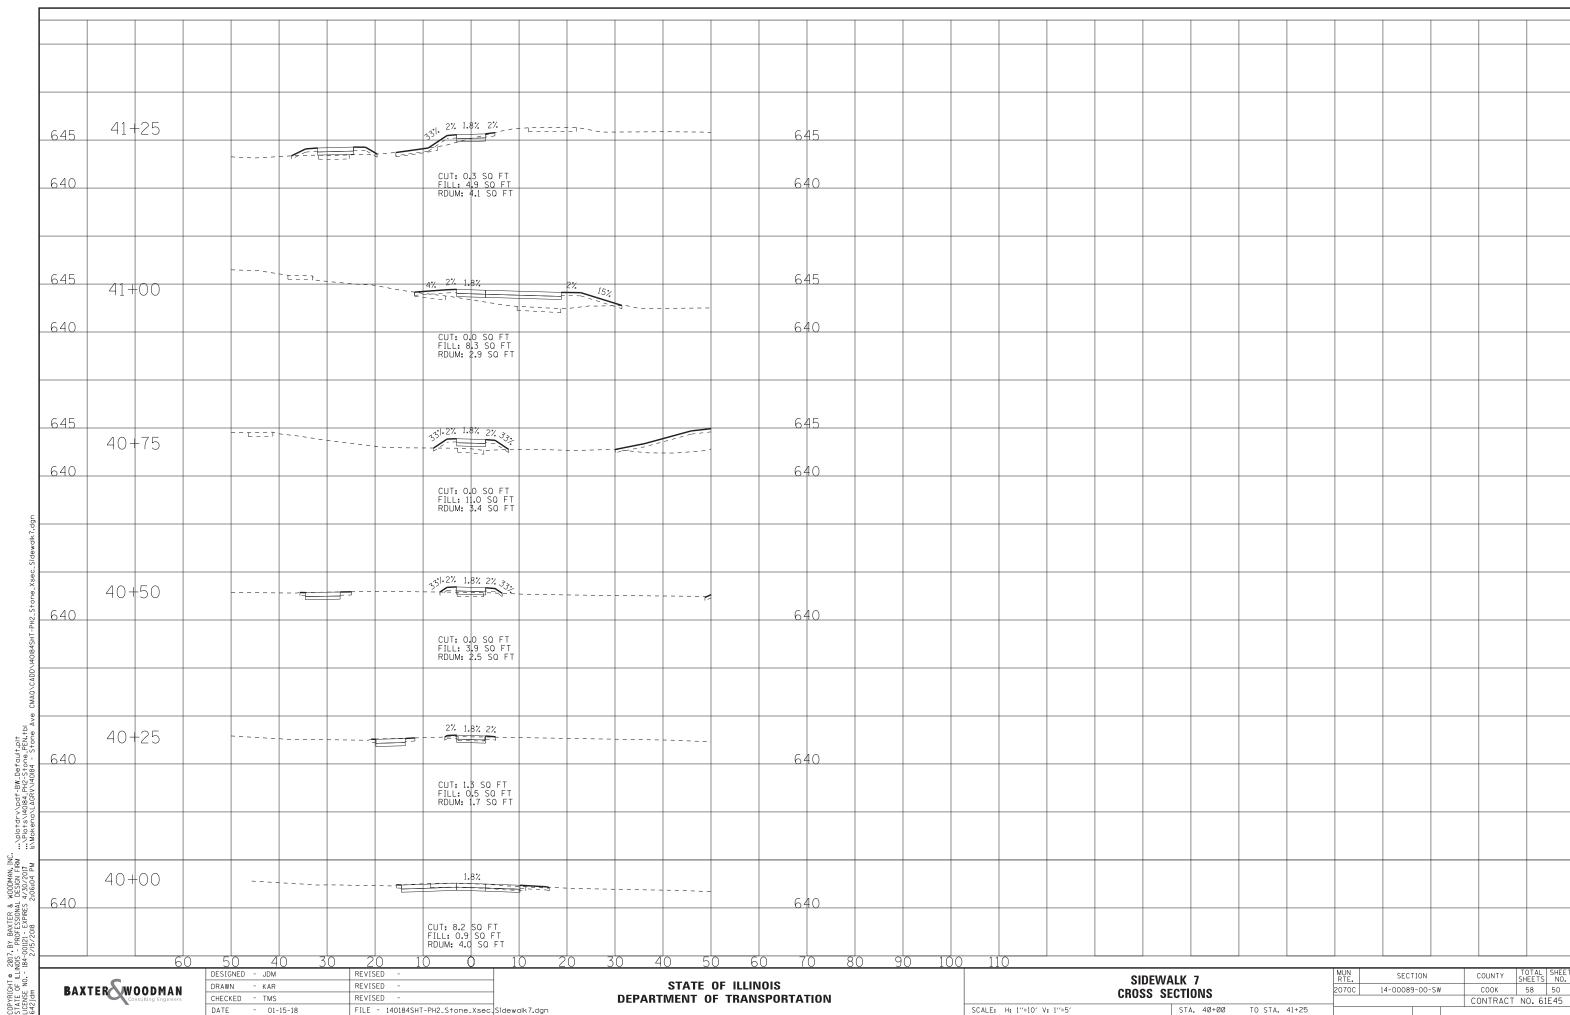

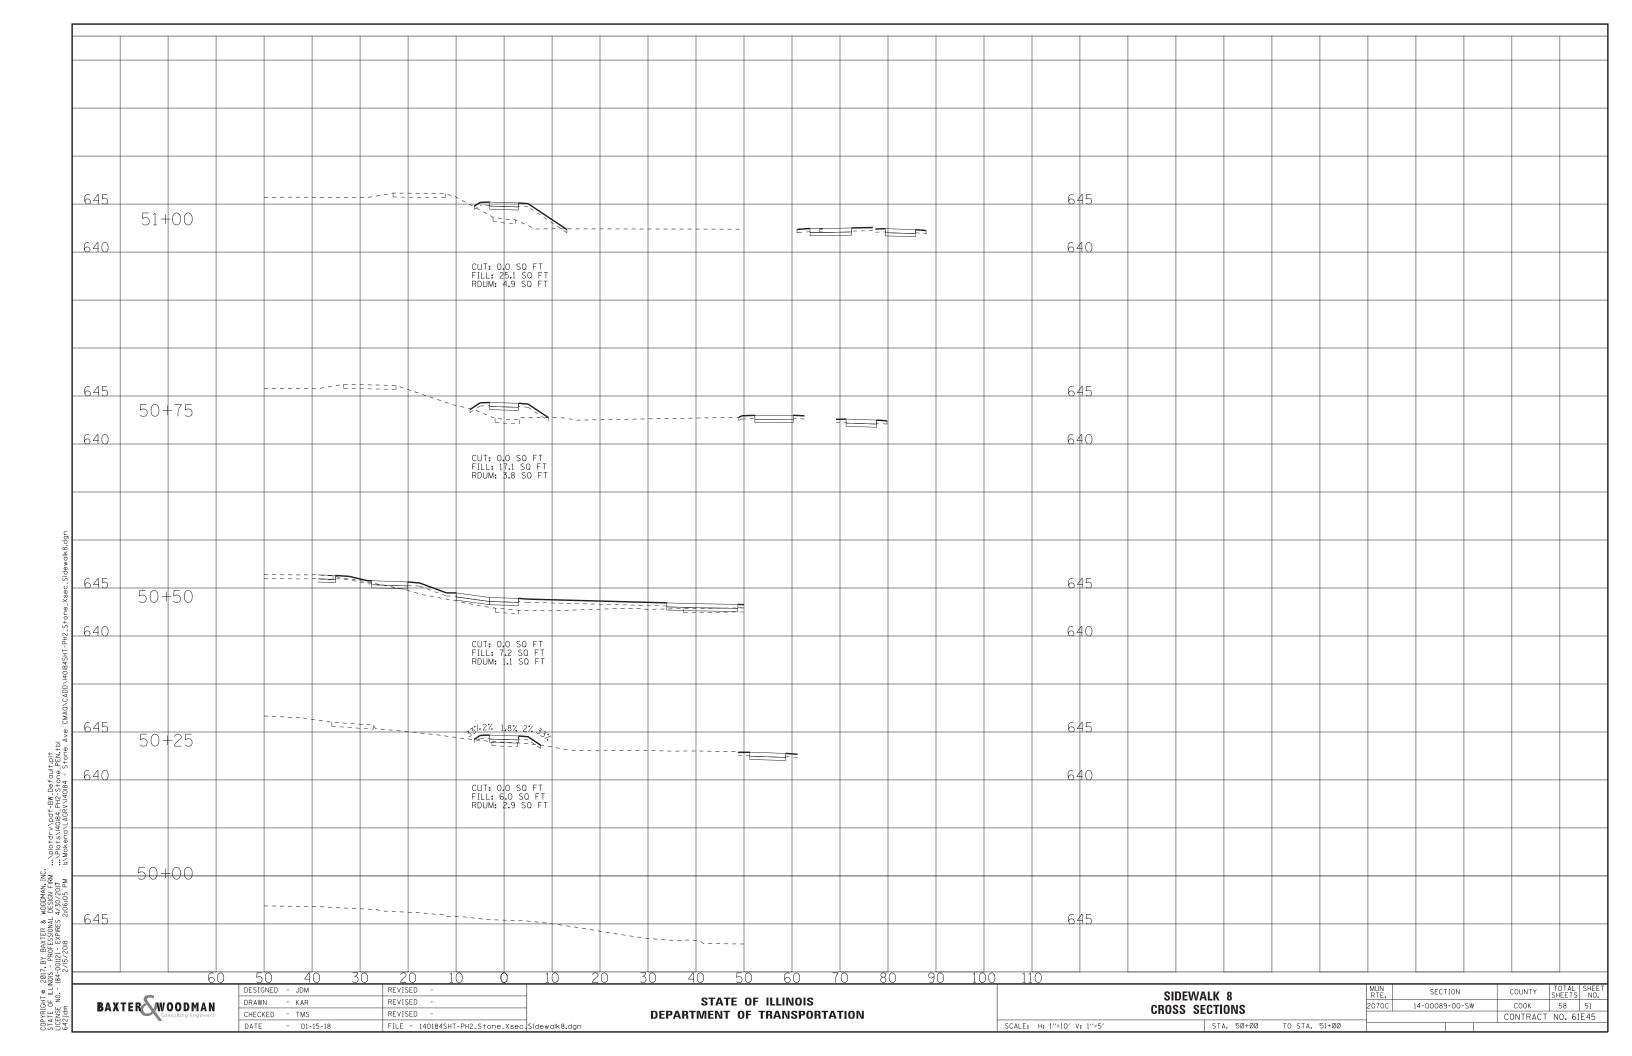

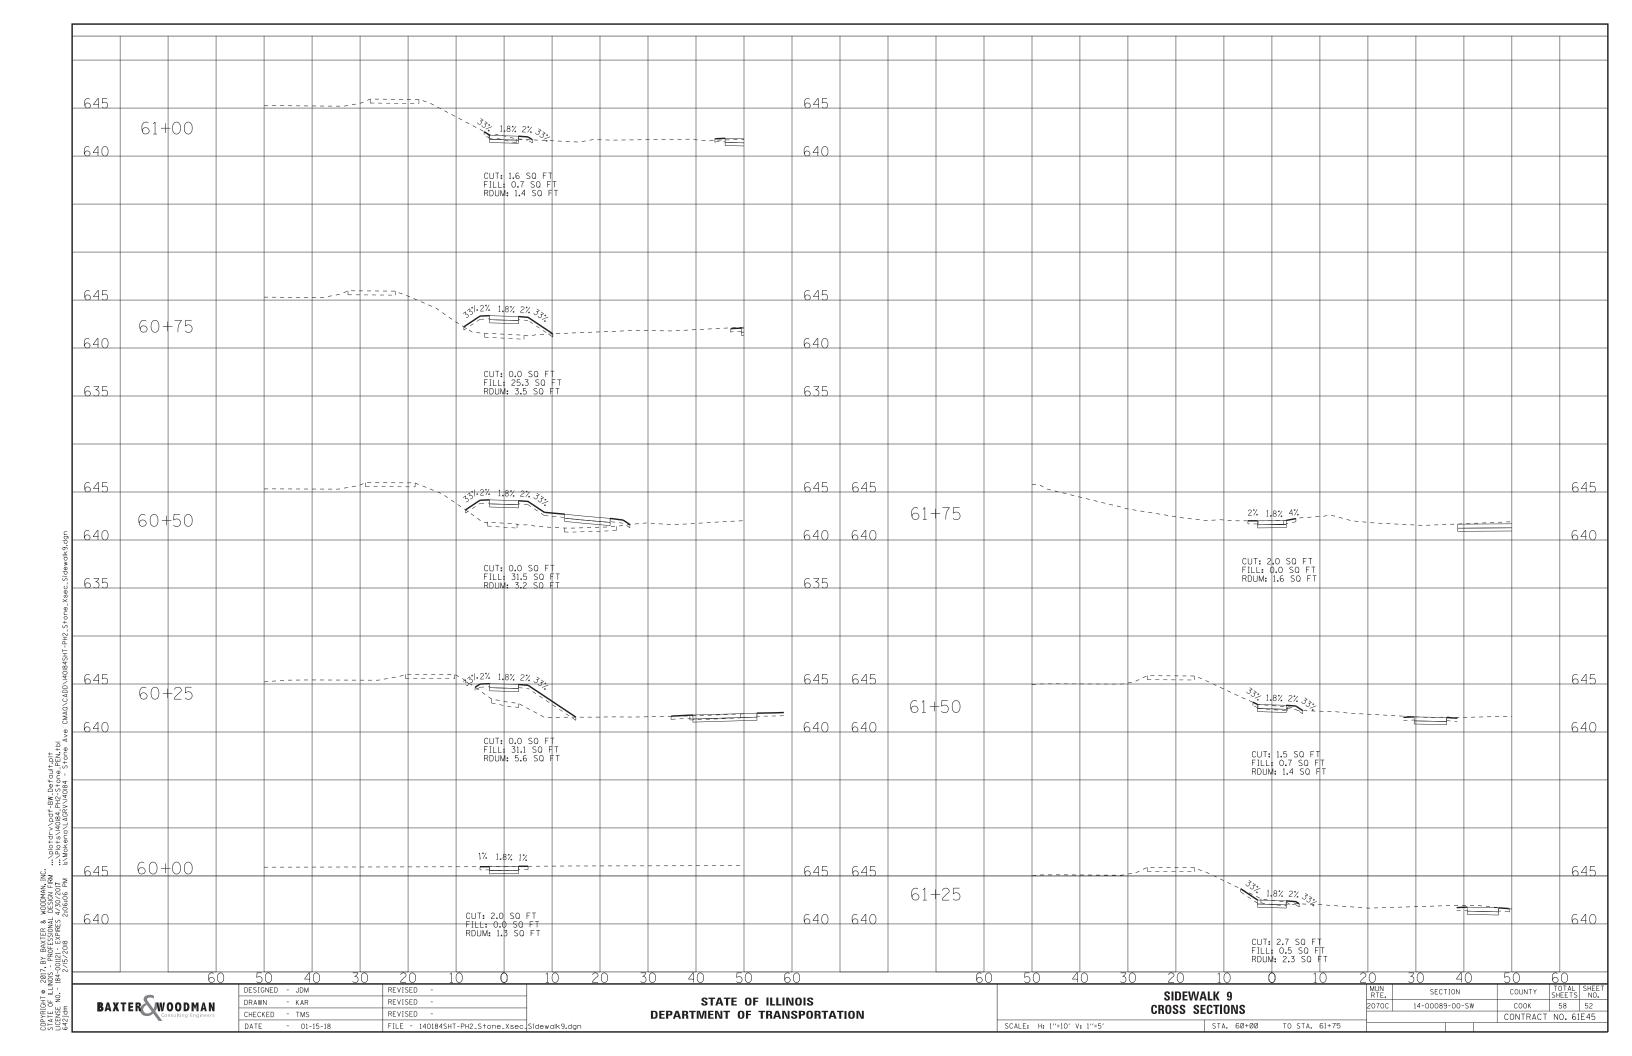

===== 645 645 2% 1.8% 2% ₃₃, 65+75 -640 640 CUT: 0.0 SQ FT FILL: 7.7 SQ FT RDUM: 2.0 SQ FT 645 645 2% 1.8% 2% 640 640 CUT: 2.0 SQ FT FILL: 0.0 SQ FT RDUM: 1.6 SQ FT 635 635 65+25 CDPYRIGHT © 2017 BY BAXTER & WODDMAN, INC.
STATE OF LILINOS - PROFESSIONAL DESIGN FIRM ... NDIO+d</br>

CLENE NO. - 184-00121 EXPRES 4/20/2017

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ADATAM

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7 2% 1.8% 2% 640 640 CUT: 1.7 SQ FT FILL: 0.4 SQ FT RDUM: 1.8 SQ FT 65+00 1.8% 640 640 CUT: 1.8 SQ FT FILL: 0.0 SQ FT RDUM: 0.0 SQ FT 50 40 DESIGNED - JDM COUNTY TOTAL SHEET NO.
COOK 58 53
CONTRACT NO. 61E45 REVISED BAXTER WOODMAN Consulting Engineers SIDEWALK 10 CROSS SECTIONS SECTION STATE OF ILLINOIS DRAWN - KAR REVISED 14-00089-00-SW CHECKED - TMS REVISED **DEPARTMENT OF TRANSPORTATION** DATE - 01-15-18 FILE - 140184SHT-PH2_Stone_Xsec_Sidewalk10.dgn SCALE: H: 1"=10' V: 1"=5' STA. 65+00 TO STA. 65+75


1.8% 2% 90+75 645 645 640 CUT: 2.1 SQ FT FILL: 0.3 SQ FT RDUM: 1.6 SQ FT 640 331.2% 1.8% 2% 645 645 90+50 640 640 CUT: 1.9 SQ FT FILL: 1.0 SQ FT RDUM: 2.5 SQ FT 131.2% 1.8% 2% 90+25 645 645 CDPYRIGHT © 2017 BY BAXTER & WODDMAN, INC.
STATE OF ILLINOS - PROFESSIONAL DESIGN FIRM ...Noto+d</br>


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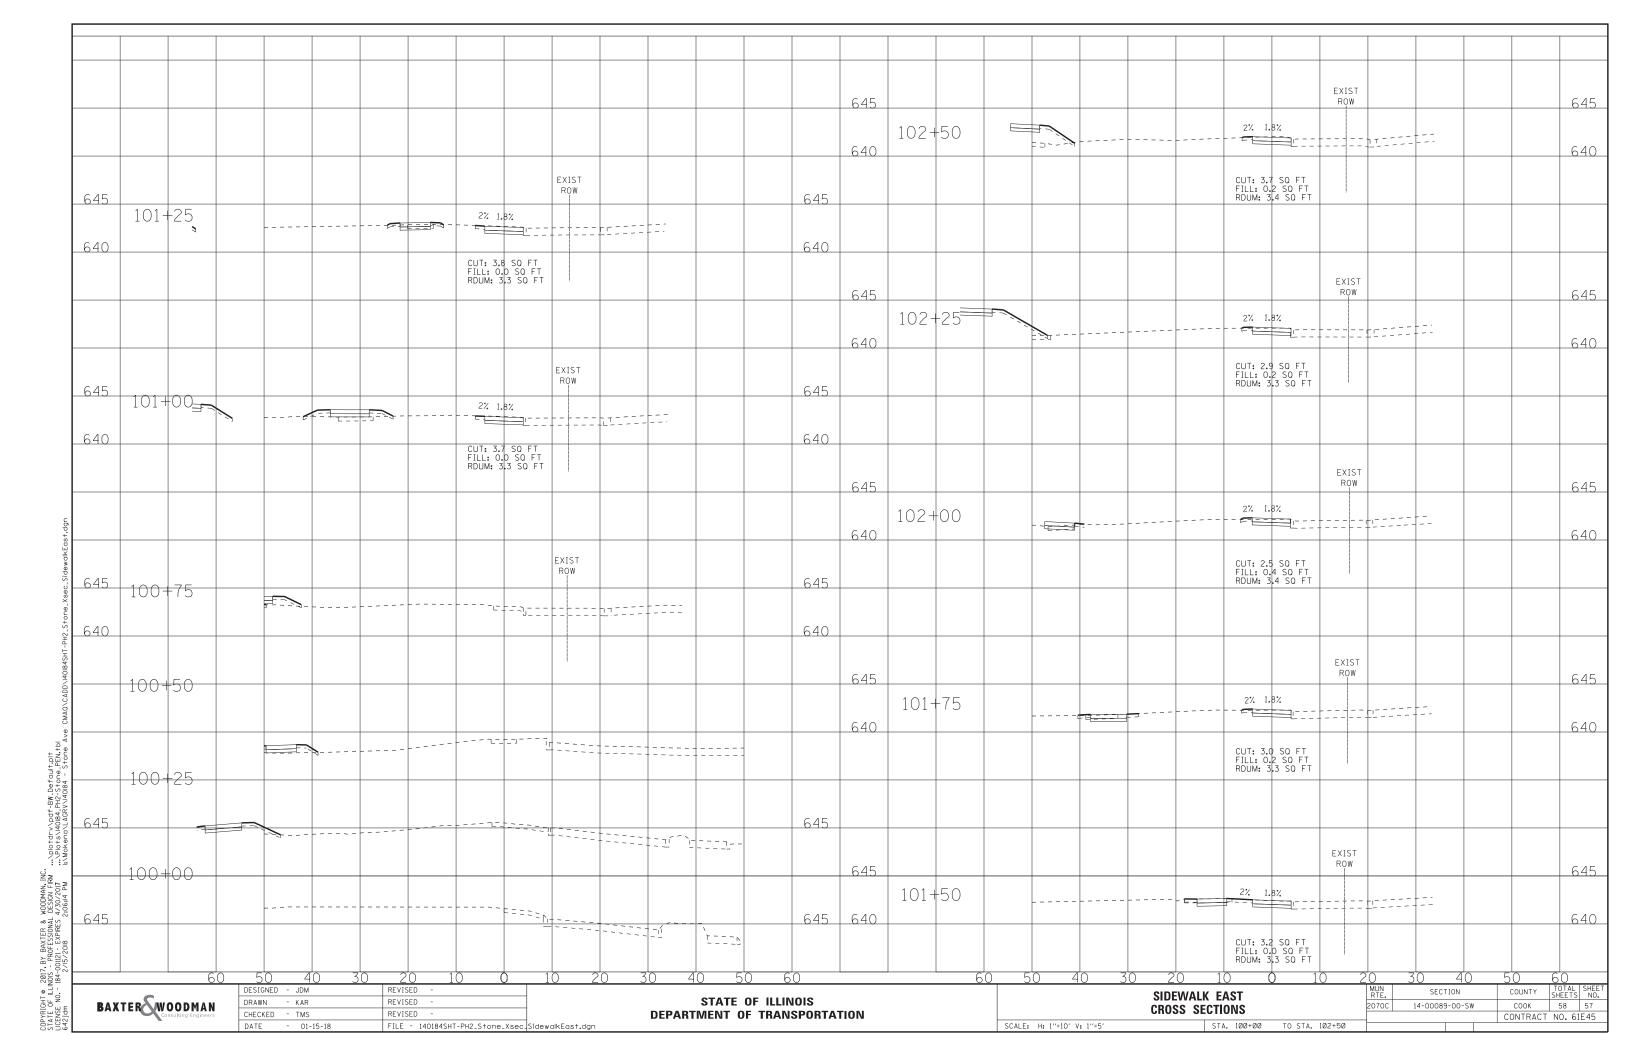
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COOK 58 54

CONTRACT NO. 61E45 REVISED SIDEWALK 16 CROSS SECTIONS SECTION BAXTER WOODMAN Consulting Engineers STATE OF ILLINOIS REVISED DRAWN - KAR 14-00089-00-SW CHECKED - TMS REVISED **DEPARTMENT OF TRANSPORTATION** DATE - 01-15-18 FILE - 140184SHT-PH2_Stone_Xsec_Sidewalk16.dgn SCALE: H: 1"=10' V: 1"=5' STA. 90+00 TO STA. 90+75





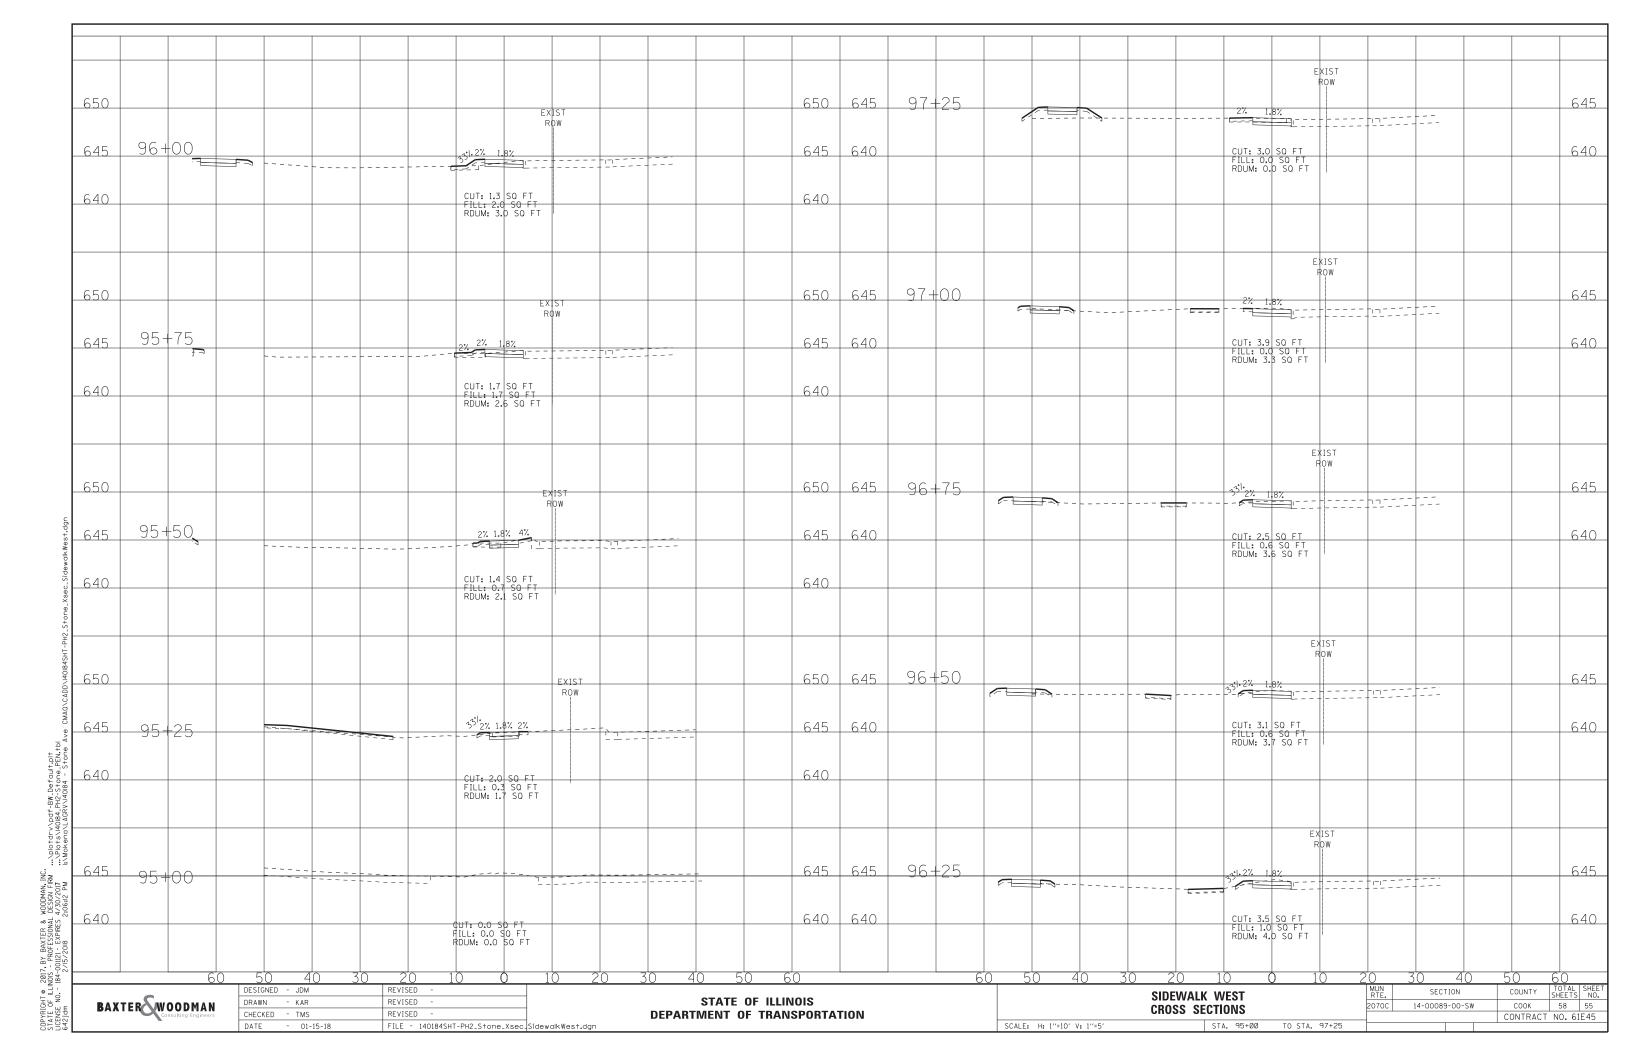

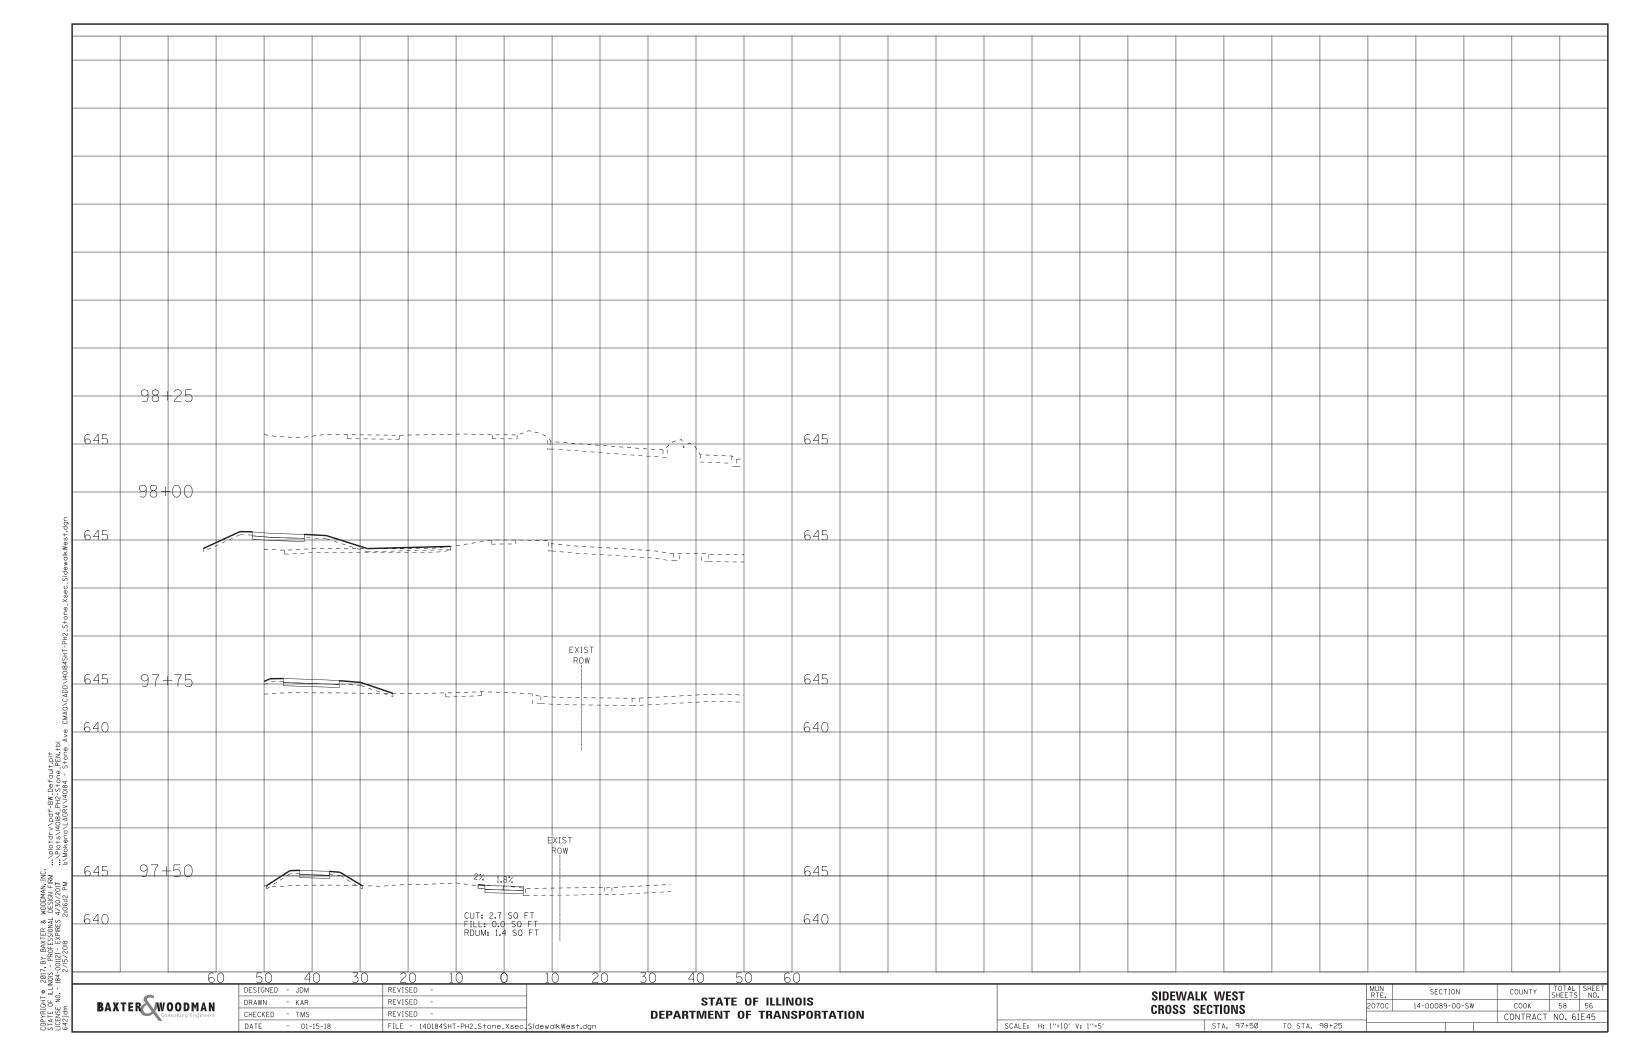EXIST ROW 645 645 33; 2% 1.8% 103+25 640 640 CUT: 6.3 SQ FT FILL: 0.0 SQ FT RDUM: 3.7 SQ FT 635 635 EXIST ROW 645 645 2% 1.8% 103+00 640 640 CUT: 4.1 SQ FT FILL: 0.0 SQ FT RDUM: 3.3 SQ FT CDPYRIGHT © 2017 BY BAXTER & WODDMAN, INC.
STATE OF ILLNOS. - PROFESSIONAL DESIGN FIRM ...Noto+d</br>

CLENE NO. - 184-00121 EXPRES 4/30/021 ...Noto+d
-XPS-5+0-0-FRN, FDL

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COOK 58 58

CONTRACT NO. 61E45 BAXTER WOODMAN Consulting Engineers SIDEWALK EAST CROSS SECTIONS SECTION STATE OF ILLINOIS DRAWN - KAR REVISED 14-00089-00-SW CHECKED - TMS REVISED **DEPARTMENT OF TRANSPORTATION** DATE - 01-15-18 FILE - 140184SHT-PH2_Stone_Xsec_SidewalkEast.dgn SCALE: H: 1"=10' V: 1"=5' STA. 102+75 TO STA. 103+25