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FOR INDEX OF SHEETS, SEE SHEET NO. 2 FOR LIST OF HIGHWAY STANDARDS SEE SHEET NO. 2

TRAFFIC DATA

	ADT: ILL. ROUTE 31 HUNTLEY ROAD MAIN STREET LINCOLN STREET	30,500 VPD (2008) 18,600 VPD (2008) 18,300 VPD (2008) 1,600 VPD (2008)	37,000 VPD (2030 22,000 VPD (2030 22,300 VPD (2030 1,904 VPD (2030
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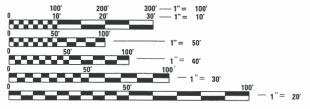
SPEED POSTED DESIGN SPEED

ILL. Route 31	35 MPH	40 MPH
HUNTLEY ROAD	30 MPH	35 MPH
MAIN STREET	30 MPH	35 MPH
LINCOLN STREET	25 MPH	30 MPH


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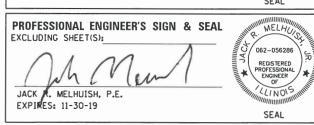
FAU 3887 (ILL. Route 31) - MINOR ARTERIAL HUNTLEY ROAD - MINOR ARTERIAL MAIN STREET - LUBAN COLLECTOR LINCOLN STREET - LOCAL STREET






FULL SIZE PLANS HAVE BEEN PREPARED USING STANDARD ENGINEERING SCALES. REDUCED SIZED PLANS WILL NOT CONFORM TO STANDARD SCALES. IN MAKING MEASUREMENTS



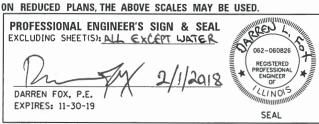

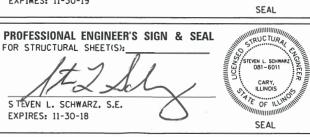

PROJECT ENGINEER: J. HORWITZ PROJECT MANAGER: J. MELHUISH CONTRACT NO. 61E73


STATE OF ILLINOIS DEPARTMENT OF TRANSPORTATION

PLANS FOR PROPOSED FEDERAL AID HIGHWAY

FAU 3887 (ILLINOIS ROUTE 31) (WESTERN AVENUE)

AT FAU 1283 (HUNTLEY ROAD) (MAIN STREET) INTERSECTION RECONSTRUCTION SECTION: 08-00083-00-CH PROJECT: 5QSF(305) VILLAGE OF CARPENTERSVILLE

KANE COUNTY JOB: C-91-386-08

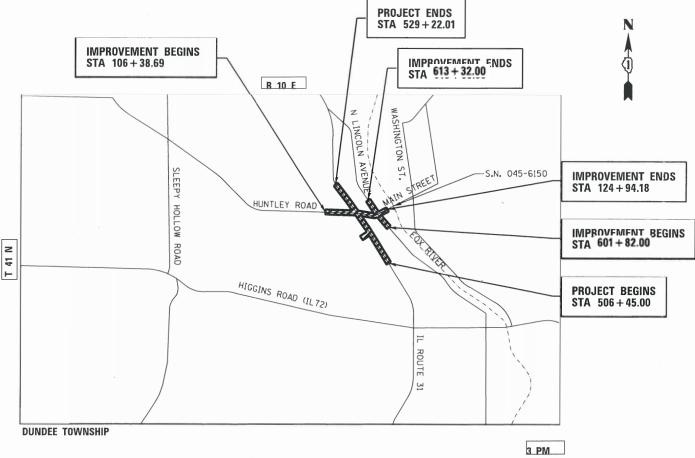

LOCATION MAP


VILLAGE OF CARPENTERSVILLE

N.T.S. PROJECT LENGTH

NET AND GROSS LENGTH OF PROJECT = 8450 FT. = 1.03 MILES

SECTION 3887 08-00083-00-CH KANE 259 1 CONTRACT NO. 61E73 FFD. ROAD DIST, NO 1



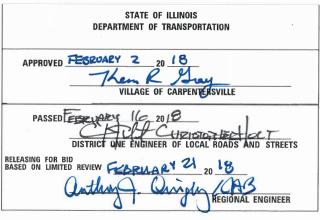



420 NORTH FRONT ST REET, SUITE 100 | McHENRY, ILLINOIS 60050 Phone: 815.385.1778 | Toll Free: 800.728.7805 | Fax: 815.385.1781 | HRGreen.cor ILLINOIS PRO FESSIONAL DESIGN FIRM #184-001322

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INDEX OF SHEETS

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DISTRICT ONE DETAILS

STANDARD NO.	LIST OF DESCRIPTION
BD01	DRIVEWAY DETAILS-DISTANCE BETWEEN R.O.W. AND FACE OF CURB & EDGE OF SHOULDER > TO 15 FT
BD02	DRIVEWAY DETAILS-DISTANCE BETWEEN R.O.W. AND FACE OF CURB & EDGE OF SHOULDER < TO 15 FT
BD07	DETAIL OF STORM SEWER CONNECTION TO EXISTING STORM SEWER
BD12	MANHOLE WITH RESTRICTOR PLATE
BD32	BUTT JOINT AND HMA TAPER DETAILS
BD48	PCC PAVEMENT ROUNDOUTS AT CURB AND GUTTER
BD51	BENCHING DETAIL FOR EMBANKMENT WIDENING
TC10	TRAFFIC CONTROL AND PROTECTION AT TURN BAYS (TO REMAIN OPEN TO TRAFFIC)
TC11	TYPICAL APPLICATIONS RAISED REFLECTIVE PAVEMENT MARKERS (SNOW PLOW RESISTANT)
TC13	DISTRICT ONE TYPICAL PAVEMENT MARKINGS
TC14	TRAFFIC CONTROL AND PROTECTION AT TURN BAYS (TO REMAIN OPEN TO TRAFFIC)
TC16	PAVEMENT MARKING LETTERS AND SYMBOLS FOR TRAFFIC STAGING
TC21	DETOUR SIGNING FOR CLOSING STATE HIGHWAYS
TC22	ARTERIAL ROAD INFORMATION SIGN
TC26	DRIVEWAY ENTRANCE SIGNING

STATE STANDARDS

STANDARD NO.	LIST OF DESCRIPTION
000001-06	STANDARD SYMBOLS, ABBREVIATIONS AND PATTERNS
280001-07	TEMPORARY EROSION CONTROL SYSTEMS
420001-07	PAVEMENT JOINTS
420106-04	36' JOINTED PCC PAVEMENT
424001-09	PERPENDICULAR CURB RAMPS FOR SIDEWALKS
424006-02	DIAGONAL CURB RAMPS FOR SIDEWALKS
424011-03	CORNER PARALLEL CURB RAMPS FOR SIDEWALKS
424021-03 482001-02	DEPRESSED CURB FOR SIDEWALKS HMA SHOULDER ADJACENT TO FLEXIBLE PAVEMENT
542311-06	TRAVERSABLE PIPE GRATE
601001-05	PIPE UNDERDRAINS
602001-02	CATCH BASIN, TYPE A
602011-02	CATCH BASIN, TYPE C
602301-04	INLET, TYPE A
602401-03	MANHOLE, TYPE A
602406-07	MANHOLE, TYPE A 6' DIAMETER
602416-05	MANHOLE, TYPE A 8' DIAMETER
602601-04	PRECAST REINFORCED CONCRETE FLAT SLAB TOP MANHOLE STEPS
602701-02 604001-04	FRAME AND LIDS, TYPE 1
604036-03	GRATE TYPE 8
604046-03	FRAME AND GRATE, TYPE 10
604051-04	FRAME AND GRATE, TYPE 11
604091-03	FRAME AND GRATE TYPE 24
606001-06	CONCRETE CURB TYPE B AND COMBINATION CONCRETE CURB AND GUTTER
606301-04 643001-02	PC CONCRETE ISLANDS AND MEDIANS SAND MODULE IMPACT ATTENUATORS
701006-05	OFF-RD OPERATIONS, 2L, 2W, 15' (4.5M) TO 24" (600 MM) FROM PAVEMENT EDGE
701011-04	OFF-RD MOVING OPERATIONS, 2L, 2W, DAY ONLY
701101-05	OFF-ROAD OPERATIONS, MULTILANE, 15' (4.5 M) TO 24" (600 MM) FROM PAVEMENT EDGE
701106-02	OFF-RD OPERATIONS, MULTILANE, MORE THAN 15' (4.5 m) AWAY
701301-04	LANE CLOSURE, 2L, 2W, SHORT TIME OPERATIONS
701311-03 701427-05	LANE CLOSURE 2L, 2W MOVING OPERATIONS- DAY ONLY LANE CLOSURE, MULTILANE, INTERMITTENT OR MOVING OPER., FOR SPEEDS & 40 MPH
701501-06	URBAN LANE CLOSURE, 2L, 2W, UNDIVIDED
701601-09	URBAN LANE CLOSURE, MULTILANE, 1W OR 2W WITH NONTRAVERSABLE MEDIAN
701606-10	URBAN LANE CLOSURE, MULTILANE, 2W WITH MOUNTABLE MEDIAN
701701-10	URBAN LANE CLOSURE, MULTILANE INTERSECTION
701801-06	SIDEWALK, CORNER OR CROSSWALK CLOSURE
701901-07	TRAFFIC CONTROL DEVICES TEMPORARY CONCRETE BARRIER
704001-08 720001-01	SIGN PANEL MOUNTING DETAILS
720006-04	SIGN PANEL ERECTION DETAILS
720011-01	METAL POSTS FOR SIGNS, MARKERS, AND DELINEATORS
728001-01	TELESCOPING STEEL SIGN SUPPORT
729001-01	APPLICATION OF TYPE A AND B METAL POSTS (FOR SIGNS AND MARKERS)
731001-01	BASE FOR TELESCOPING STEEL SIGN SUPPORT
780001-05 781001-04	TYPICAL PAVEMENT MARKINGS TYPICAL APPLICATIONS RAISED REFLECTIVE PAVEMENT MARKINGS
782006	GUARDRAIL AND BARRIER WALL REFELCTOR MOUNTING DETAILS
805001-01	ELECTRICAL SERVICE INSTALLATION DETAILS
814001-03	HANDHOLES
814006-02	DOUBLE HANDHOLES
836001-02	LIGHT POLE FOUNDATION
857001-01 862001-01	STANDARD PHASE DESIGNATION DIAGRAMS AND PHASE SEQUENCES UNINTERRUPTABLE POWER SUPPLY (UPS)
873001-01	TRAFFIC SIGNAL GROUNDING & BONDING
877001-06	STEEL MAST ARM ASSEMBLY AND POLE 16' THROUGH 55'
877011-08	STEEL COMBINATION MAST ARM ASSEMBLY AND POLE 16' THROUGH 55'
877012-05	STEEL COMBINATION MAST ARM ASSEMBLY AND POLE 56' THROUGH 75'
878001-10	CONCRETE FOUNDATION DETAILS
880006-01	TRAFFIC SIGNAL MOUNTING DETAILS

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STATE OF ILLINOIS DEPARTMENT OF TRANSPORTATION

GENERAL NOTES

- 1. ALL REFERENCES TO *STANDARD SPECIFICATIONS* IN THESE GENERAL NOTES SHALL BE INTERPRETED TO MEAN "STANDARD SPECIFICATIONS FOR ROAD AND BRIDGE CONSTRUCTION" ADOPTED BY THE ILLINOIS DEPARTMENT OF TRANSPORTATION, APRIL 1, 2016. ALL WORK TO BE COMPLETED IN ACCORDANCE WITH THE STANDARD SPECIFICATIONS.
- 2. ALL REFERENCES TO *ENGINEER* SHALL BE INTERPRETED TO MEAN THE RESIDENT ENGINEER.
- 3. IT IS THE CONTRACTOR'S RESPONSIBILITY TO ASCERTAIN EXISTING FIELD CONDITIONS PRIOR TO BIDDING ON THE PROJECT.
- 4. BEFORE STARTING ANY EXCAVATION, THE CONTRACTOR SHALL CALL "JULIE" (JOINT UTILITY LOCATION INFORMATION FOR EXCAVATION) AT 8-1-1 IDOT AT (847) 705-4436 AND THE VILLAGE OF CARPENTERSVILLE AT (224) 293-1613 FOR FIELD LOCATIONS OF BURIED UTILITIES (48 HOURS NOTIFICATION IS REQUIRED).
- 5. ALL ELEVATIONS SHOWN ON THE PLANS ARE ON THE NAVD88 DATUM.
- 6. THE CONTRACTOR SHALL PROTECT AND CAREFULLY PRESERVE ALL SECTION OR SUBSECTION MONUMENTS, PROPERTY CORNERS, AND REFERENCE MARKERS UNTIL THE OWNER, HIS AGENT, OR AN AUTHORIZED SURVEYOR HAS WITNESSED OR OTHERWISE REFERENCED THEIR LOCATIONS.
- 7. ALL RADII FOR PROPOSED CURB AND GUTTER ARE TO THE EDGE OF PAVEMENT, UNLESS OTHERWISE NOTED. CURB AND GUTTER ELEVATIONS SHOWN ALONG RETURNS AND AT POINTS OF CURVATURE, ETC. ARE TO THE EDGE OF PAVEMENT UNLESS OTHERWISE NOTED.
- 8. SAW CUTTING WILL BE REQUIRED FOR ALL REMOVAL ITEMS LISTED IN SECTION 440 OF THE STANDARD SPECIFICATIONS, SHOWN IN THE PLANS, AND AS DIRECTED BY THE ENGINEER.
- 9. DRIVEWAYS ARE TO BE CONSTRUCTED TO THE R.O.W. UNLESS OTHERWISE NOTED.
- 10. ABANDONED UNDERGROUND UTILITIES THAT CONFLICT WITH CONSTRUCTION SHALL BE DISPOSED OF OUTSIDE THE LIMITS OF THE RIGHT OF WAY ACCORDING TO ARTICLE 202.03 OF THE STANDARD SPECIFICATIONS AND AS DIRECTED BY THE ENGINEER.
- 11. REMOVAL OF EXISTING COMBINATION CURB AND GUTTER, REGARDLESS OF CURB AND GUTTER TYPE, SHALL BE PAID FOR AS "COMBINATION CURB AND GUTTER REMOVAL".
- 12. THE ELEVATIONS SHOWN ON THE PLANS ARE FINISHED GRADES OF PROPOSED PAVEMENT, UNLESS OTHERWISE NOTED.
- 3. ALL SIGNS TO BE REMOVED ALONG IL ROUTE 31 SHALL REMAIN THE PROPERTY OF IDOT AND SHALL BE RETURNED TO IDOT UPON REMOVAL AT 895 S. STATE STREET, ELGIN, IL. THE PHONE NUMBER IS 847-741-5302. SIGNS TEMPORARILY RELOCATED OR COVERED SHALL NOT BECOME THE PROPERTY OF IDOT UNTIL PERMANENTLY REMOVED. ALL SIGNS TO BE REMOVED ALONG HUNTLEY ROAD, MAIN STREET, AND LINCOLN AVENUE SHALL REMAIN THE PROPERTY OF THE VILLAGE OF CARPENTERSVILLE AND SHALL BE RETURNED TO VILLAGE UPON REMOVAL AT 1075 TAMARAC DRIVE, CARPENTERSVILLE, IL. SIGNS TEMPORARILY RELOCATED OR COVERED SHALL NOT BECOME THE PROPERTY OF THE VILLAGE UNTIL PERMANENTLY REMOVED.
- 14. CURB RAMPS SHALL BE INSTALLED AT ALL INTERSECTING STREETS AND DRIVEWAYS PER CURRENT IDOT STANDARDS AT LOCATIONS WHERE SIDEWALK IS SHOWN ON THE PLAN.
- 15. THE THICKNESSES OF HOT MIX ASPHALT MIXTURES SHOWN IN THE PLANS ARE NOMINAL.

 DEVIATIONS MAY OCCUR DUE TO IRREGULARITIES IN THE SURFACES OR BASES ON WHICH THE HOT

 MIX ASPHALT MIXTURES ARE TO BE PLACED.
- 16. THE CONTRACTOR WILL NOT BE ALLOWED TO SET UP A YARD OR FIELD OFFICE ON VILLAGE OR IDOT PROPERTY WITHOUT WRITTEN CONSENT FROM THE VILLAGE OF CARPENTERSVILLE OR IDOT.
- 17. THE CONTRACTOR WILL BE REQUIRED TO TEMPORARILY RESET ALL EXISTING MAILBOXES WHICH INTERFERE WITH CONSTRUCTION OPERATIONS AND AFTER COMPLETION OF ROADWAY CONSTRUCTION, TO SET THEM IN THEIR PERMANENT LOCATIONS PER UNITED STATES POST OFFICE REQUIREMENTS. THIS WORK SHALL BE DONE IN CONFORMANCE WITH ARTICLE 107.20 OF THE STANDARD SPECIFICATIONS.
- 8. THE CONTRACTOR SHOULD CONSIDER THE USE OF THE 51 S. GROVE STREET PROPERTY AS A CONSTRUCTION STAGING AREA.

STORM SEWERS. WATER MAINS, AND UTILITIES

- THE CONTRACTOR SHALL BE RESPONSIBLE FOR CONTACTING THE OWNERS OF ALL UTILITIES PRIOR TO CONSTRUCTION TO DETERMINE THE LOCATION OF ALL UTILITY EQUIPMENT, THE CONTRACTOR SHALL COOPERATE WITH ALL UTILITY OWNERS IN ACCORDANCE WITH THE STANDARD SPECIFICATIONS IF UTILITY RELOCATION, ADJUSTMENT, OR PROTECTION IS NECESSARY.
- 2. THE LOCATION OF EXISTING DRAINAGE STRUCTURES, STORM SEWERS, WATER MAINS, SANITARY SEWERS, AND ANY OTHER PUBLIC OR PRIVATE UTILITIES AS SHOWN ON THE PLANS IS APPROXIMATE AND THEIR EXACT LOCATION IS TO BE DETERMINED IN THE FIELD BY THE CONTRACTOR.
- THE CONTRACTOR SHALL BE RESPONSIBLE FOR THE PROTECTION OF ALL UNDERGROUND AND SURFACE UTILITIES EVEN THOUGH THEY MIGHT NOT BE SHOWN ON THE PLANS, ANY UTILITY PROPERTY DAMAGED DURING CONSTRUCTION SHALL BE REPAIRED OR REPLACED TO THE SATISFACTION OF THE OWNER AT THE CONTRACTOR'S EXPENSE.
- 4. ALL UTILITY COMPANIES SHALL BE NOTIFIED AT LEAST 3 DAYS PRIOR TO THE START OF CONSTRUCTION.
- THE CONTRACTOR SHALL COORDINATE WITH THE VILLAGE OF CARPENTERSVILLE IF ANY UTILITY IMPROVEMENTS ARE REQUIRED BY THE VILLAGE WITHIN THE DURATION OF THE CONTRACT.
- OFFSET LOCATIONS GIVEN IN THE PLANS FOR STRUCTURES, EDGE OF PAVEMENT, ETC. ARE FROM THE ROADWAY CENTERLINE.
- 7. UNLESS OTHERWISE NOTED, OFFSETS FOR DRAINAGE STRUCTURES LOCATED IN CURB AND GUTTER ARE TO THE EDGE OF PAVEMENT AND OFFSETS FOR DRAINAGE STRUCTURES NOT LOCATED IN THE CURB AND GUTTER ARE TO THE CENTER OF THE STRUCTURE.
- 8. FRAME ELEVATIONS GIVEN ON THE PLANS ARE ONLY TO ASSIST THE CONTRACTOR IN DETERMINING THE APPROXIMATE OVERALL HEIGHT OF THE STRUCTURE. FRAMES ON ALL NEW, ADJUSTED OR RECONSTRUCTED STRUCTURES WILL BE ADJUSTED TO THE FINAL ELEVATION OF THE AREA IN WHICH THEY ARE LOCATED AS PART OF THE STRUCTURE, ADJUSTMENT OR RECONSTRUCTION COST.
- . WHERE NEW WORK MEETS EXISTING FEATURES TO REMAIN, FIELD CHECK ALL DIMENSIONS AND ELEVATIONS BEFORE PROCEEDING WITH CONSTRUCTION, NOTIFY ENGINEER IMMEDIATELY OF ANY DISCREPANCIES.

- 10. ALL FRAMES, GRATES, LIDS, AND BOXES SCHEDULED TO BE REMOVED FROM EXISTING STRUCTURES SHALL REMAIN THE PROPERTY AND BE DELIVERED TO THE VILLAGE OF CARPENTERSVILLE, AS APPLICABLE.
- 11. ANY LOOSE MATERIAL DEPOSITED IN THE FLOW LINE OF DRAINAGE STRUCTURES, WHICH OBSTRUCTS THE NATURAL FLOW OF WATER, SHALL BE REMOVED AT THE CLOSE OF EACH WORKING DAY. PRIOR TO ACCEPTANCE OF THE IMPROVEMENT, ALL DRAINAGE STRUCTURES SHALL BE FREE OF DIRT AND DEBRIS.
- 12. CONTRACTOR SHALL MAINTAIN THE CONVEYANCE OF ALL FLOWS DURING CONSTRUCTION OF THIS PROJECT. WHEN EXISTING DRAINAGE FACILITIES ARE DISTURBED, THE CONTRACTOR SHALL PROVIDE AND MAINTAIN TEMPORARY OUTLETS AND CONNECTIONS FOR ALL PRIVATE AND PUBLIC DRAINS, SEWERS, CULVERTS, AND OTHER DRAINAGE FACILITIES. THE CONTRACTOR SHALL PROVIDE FACILITIES TO TAKE IN ALL STORM WATER WHICH WILL BE RECEIVED BY THESE DRAINS AND SEWERS AND DISCHARGE THE SAME. THE CONTRACTOR SHALL PROVIDE AND MAINTAIN A PUMPING PLANT, IF NECESSARY, AND A TEMPORARY OUTLET AND BE PREPARED AT ALL TIMES TO DISPOSE OF THE WATER RECEIVED FROM THESE TEMPORARY CONNECTIONS UNTIL SUCH TIME THAT THE PERMANENT CONNECTIONS WITH SEWERS OR CULVERTS ARE BUILT AND IN SERVICE.
- I3. ALL FRAMES WITH CLOSED LIDS TO BE FURNISHED AS PART OF THE CONTRACT FOR CONSTRUCTION, ADJUSTMENT OR RECONSTRUCTION OF ANY MANHOLE, CATCH BASIN, INLET, VALVE VAULT OR METER VAULT SHALL HAVE CAST INTO THE LID ONE OF THE FOLLOWING WORDS: ALL LIDS TO BE USED ON WATER STRUCTURES SHALL BEAR THE WORD "WATER." ALL LIDS TO BE USED ON STORM SEWER STRUCTURES SHALL BEAR THE WORD "STORM." ALL LIDS TO BE USED ON SANITARY SYSTEM STRUCTURES SHALL BEAR THE WORD "SANITARY". REFER TO THE VILLAGE OF CARPENTERSVILLE DETAILS FOR ORDERING INFORMATION OR CONTACT THE DEPARTMENT OF PUBLIC WORKS.
- 4. ONLY PRECAST CONCRETE ADJUSTMENT RINGS, MAXIMUM OF 12" IN HEIGHT, WILL BE ALLOWED IN THE ADJUSTMENT OR RECONSTRUCTION OF CATCH BASIN, MANHOLE, INLET AND VALVE VAULT STRUCTURES. COMMON BRICK WILL NOT BE ALLOWED.
- 15. ALL DRAINAGE STRUCTURES LOCATED IN THE ROADWAY VERTICAL CURVE SAGS (LOW-POINTS) SHALL HAVE 4. SUB-SURFACE PAVEMENT DRAIN OPENINGS BLOCKED OUT (PRECAST) AS SHOWN IN THE PLAN DETAILS FOR UNDER DRAIN CONNECTIONS. CONTRACTOR SHALL NOTE THAT STRUCTURE.
- 6. THE INDISCRIMINATE USE OF FIRE HYDRANTS OR EXISTING STREAMS, CREEKS, WETLANDS OR PONDS IS STRICTLY PROHIBITED. THE CONTRACTOR SHALL PROVIDE A WATER TRUCK AND DRIVER AS REQUIRED TO OBTAIN AND TRANSPORT THE WATER. THE CONTRACTOR SHALL BE RESPONSIBLE FOR OBTAINING WATER FROM AN APPROVED SOURCE. IF THIS WATER IS FROM A SOURCE OTHER THAN HIS YARD, WRITTEN APPROVAL FROM THE AGENCY HAVING JURISDICTION FOR THE SOURCE OF THE WATER MUST BE RECEIVED BY THE ENGINEER PRIOR TO USE OF THE WATER.

BACKFILL

- 1. STORM SEWER SHALL BE BACKFILLED IN ACCORDANCE WITH ARTICLE 550.07, METHOD 1 ONLY.
- 2. PROVIDE TRENCH BACKFILL FOR ALL UTILITY LINES WITHIN 2' OF PAVED AREAS. ALL TRENCH BACKFILL QUANTITIES FOR STORM SEWER HAVE BEEN COMPUTED AND SHALL BE PAID FOR IN ACCORDANCE WITH THE STATE OF ILLINOIS DEPARTMENT OF TRANSPORTATION DIVISION OF HIGHWAYS BUREAU OF CONSTRUCTION TRENCH BACKFILL TABLE, BASED ON PIPE SIZE AND INVERT DEPTH FROM SUBGRADE.

SIGNING AND STRIPING

- . TWO WEEKS PRIOR TO PLACEMENT OF PERMANENT PAVEMENT MARKINGS THE ENGINEER SHALL CONTACT DON CHIARUGI, AREA TRAFFIC FIELD ENGINEER, AT (847) 741-9857.
- 2. SEE IDOT STANDARD DETAIL 780001, DISTRICT ONE DETAILS AND PLAN SHEETS FOR PAVEMENT MARKING DETAILS.
- 3. SIGNS SHALL NOT BE MOVED OR COVERED UNTIL PROGRESS OF WORK NECESSITATES IT.
- THE CONTRACTOR WILL BE REQUIRED TO TEMPORARILY RESET ALL SUCH SIGNS THAT INTERFERE WITH HIS CONSTRUCTION OPERATIONS. ALL SUCH SIGNS MUST BE MAINTAINED STRAIGHT AND CLEAN FOR THE DURATION OF THE TEMPORARY SETTING AND MUST BE RE-ERECTED AT A TEMPORARY LOCATION IN A WORKMANLIKE MANNER AND BE VISIBLE TO THE TRAFFIC FOR WHICH IT IS INTENDED.
- 5. LONGER POSTS MAY BE REQUIRED AT SOME TEMPORARY OR PERMANENT SIGN LOCATIONS TO MAINTAIN PROPER SIGN ELEVATIONS. THIS WORK SHALL BE COMPLETED IN ACCORDANCE WITH SECTION 729 OF THE STANDARD SPECIFICATIONS.
- 6. ALL SIGNS SHALL BE INSTALLED IN PERMANENT LOCATIONS AS THE ROADWAY IS COMPLETED.

EARTHWORK

- SUBGRADE SHALL BE PREPARED IN ACCORDANCE WITH ARTICLE 301.04 OF THE STANDARD SPECIFICATIONS BEFORE REMOVAL OF ANY UNSTABLE MATERIAL.
- PRIOR TO ANY EMBANKMENT PLACEMENT, ALL VEGETATION AND UNSTABLE MATERIAL SHOULD BE REMOVED TO DEPTH ENCOUNTERED AND REPLACED WITH SUITABLE EMBANKMENT MATERIAL AS APPROVED BY THE ENGINEER.
- 3. THE CONTRACTOR SHALL BE RESPONSIBLE FOR HIRING AN ENVIRONMENTAL FIRM WITH AT LEAST FIVE (5) DOCUMENTED LEAKING UNDERGROUND STORAGE TANKS (LUST) CLEANUPS OR THAT IS PRE-QUALIFIED IN HAZARDOUS WASTE BY THE DEPARTMENT TO REMEDIATE THE SOIL CONTAMINATION AND MONITOR FOR WORKER PROTECTION.

SEDIMENTATION AND EROSION CONTROL

. SEE EROSION CONTROL PLANS FOR GENERAL NOTES CONCERNING EROSION CONTROL.

TRAFFIC CONTROL

- SEE TRAFFIC CONTROL PLANS FOR GENERAL NOTES CONCERNING TRAFFIC CONTROL AND PROTECTION.
- THE CONTRACTOR SHALL CONTACT THE TRAFFIC CONTROL SUPERVISOR AT (847) 705-4470 A MINIMUM OF 72 HOURS IN ADVANCE OF BEGINNING WORK.

STRUCTURAL PLANS

1. SEE STRUCTURAL PLANS FOR GENERAL NOTES CONCERNING STRUCTURAL DESIGN.

LIGHTING PLANS

1. SEE LIGHTING PLANS FOR GENERAL NOTES CONCERNING LIGHTING DESIGN.

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STATE OF ILLINOIS
DEPARTMENT OF TRANSPORTATION

SCALE: N.T.S.

| F.A.U. | SECTION | COUNTY | SHEETS | SHEET NO. 1 OF 1 SHEETS | STA. | TO STA. | SHEET NO. 1 OF 1 SHEETS | STA. | TO STA. | STA. | SECTION | COUNTRACT NO. 61E73 | SHEET NO. 1 OF 1 SHEETS | STA. | TO STA. | SECTION | COUNTRACT NO. 61E73 | SHEET NO. 1 OF 1 SHEETS | STA. | TO STA. | SECTION | COUNTRACT NO. 61E73 | SHEET NO. 1 OF 1 SHEETS | STA. | TO STA. | SECTION | COUNTY | SHEETS | SHEET NO. 1 OF 1 SHEETS | STA. | TO STA. | SHEET NO. 1 OF 1 SHEETS | STA. | TO STA. | SHEET NO. 1 OF 1 SHEET N

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USER NAME = jmelhul DESIGNED DRAWN CHECKED - TH

DATE - 3/23/18 PLOT SCALE = N.T.S. REVISED -PLOT DATE = 3/23/2018 REVISED -

STATE OF ILLINOIS DEPARTMENT OF TRANSPORTATION

SUMMARY OF QUANTITIES SCALE: N.T.S. SHEET NO. 1 OF 7 SHEETS STA.

TO STA.

CONSTRUCTION CODE

LIGHTING

SIGNALS

ROADWAY

PAYCODE	ITEM DESCRIPTION	UNIT	TOTAL	ROADWAY 80% FEDERAL 20% LOCAL 0004	SIGNALS 80% FEDERAL 20% LOCAL 0021	LIGHTING 80% FEDERAL 20% LOCAL 0021	100% LOCAL
20100110	TREE REMOVAL (6 TO 15 UNITS DIAMETER)	UNIT	198	198			
20100210	TREE REMOVAL (OVER 15 UNITS DIAMETER)	UNIT	238	238			
20200100	EARTH EXCAVATION	CU YD	16,706	16.706			
20201200	REMOVAL AND DISPOSAL OF UNSUITABLE MATERIAL	CU YD	5,090	5,090			
20400800	FURNISHED EXCAVATION	CU YD	1,500	1,500	*****		
20800150	TRENCH BACKFILL	CU YD	1,212	1,212			
20900110	POROUS GRANULAR BACKFILL	CU YD	290	290			
21001000	GEOTECHNICAL FABRIC FOR GROUND STABILIZATION	SQ YD	8,012	8,012			
		SO YD	10,562	10,562			
21101615	TOPSOIL FURNISH AND PLACE, 4"						
25000400	NITROGEN FERTILIZER NUTRIENT	POUND	131	131			
25000600	POTASSIUM FERTILIZER NUTRIENT	POUND	131	131			
25200110	SODDING, SALT TOLERANT	SO YD	10,562	10,562			
25200200	SUPPLEMENTAL WATERING	UNIT	528	528			
28000250	TEMPORARY EROSION CONTROL SEEDING	POUND	215	215			
28000305	TEMPORARY DITCH CHECKS	FOOT	20	20			
28000400	PERIMETER EROSION BARRIER	FOOT	4,316	4,316			
28000510	INLET FILTERS	EACH	96	96			
28001100	TEMPORARY EROSION CONTROL BLANKET	SO YD	10,562	10,562			
30300001	AGGREGATE SUBGRADE IMPROVEMENT	CU YD	2,671	2,671			
30300112	AGGREGATE SUBGRADE IMPROVEMENT 12"	SO YD	39,215	39,215			
		CU YD	190	190			
31101100	SUBBASE GRANULAR MATERIAL, TYPE B						
31101400	SUBBASE GRANULAR MATERIAL, TYPE B 6"	SO YD	5,851	5,851			
35501308	HOT-MIX ASPHALT BASE COURSE, 6"	SO YD	97	97			
35501316	HOT-MIX ASPHALT BASE COURSE, 8"	SO YD	827	827			-
35600700	HOT-MIX ASPHALT BASE COURSE WIDENING, 6"	SO YD	54	54			
40600290	BITUMINOUS MATERIALS (TACK COAT)	POUND	32,371	32,371			
40600400	MIXTURE FOR CRACKS, JOINTS, AND FLANGEWAYS	TON	5	5			
40600982	HOT-MIX ASPHALT SURFACE REMOVAL - BUTT JOINT	SO YD	15	15			
40603080	HOT-MIX ASPHALT BINDER COURSE, IL-19.0, N50	TON	256	256			
40603085	HOT-MIX ASPHALT BINDER COURSE, IL-19.0, N70	TON	73	73			
40603335	HOT-MIX ASPHALT SURFACE COURSE, MIX "D", N50	TON	270	270		A-A-A-A-A-A-A-A-A-A-A-A-A-A-A-A-A-A-A-	
40603340	HOT-MIX ASPHALT SURFACE COURSE, MIX "D", N7O	TON	47	47			
40701876	HOT-MIX ASPHALT PAVEMENT (FULL-DEPTH), 9 3/4"	SO YD	10,969	10,969			
	PORTLAND CEMENT CONCRETE PAVEMENT 9 3/4" (JOINTED)	SO YD	23,664	23,664			
42000416					•		
42300400	PORTLAND CEMENT CONCRETE DRIVEWAY PAVEMENT, B INCH	SO YD	1,334	1,334			
42400200	PORTLAND CEMENT CONCRETE SIDEWALK 5 INCH	SO FT	34,901	34,901			
42400800	DETECTABLE WARNINGS	SO FT	386	386			
44000100	PAVEMENT REMOVAL	SO YD	11,190	11,190			
44000154	HOT-MIX ASPHALT SURFACE REMOVAL, 1 1/4"	SO YD	170	170			
44000200	DRIVEWAY PAVEMENT REMOVAL	SO YD	3,850	3,850			
44000500	COMBINATION CURB AND GUTTER REMOVAL	FOOT	12,787	12,787			
- JRM - DMS	REVISED - STATE OF IL	LINOIS			SUMMARY	OF QUANTITIES	3

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STATE OF ILLINOIS DEPARTMENT OF TRANSPORTATION

SUMMARY OF QUANTITIES SHEET NO. 2 OF 7 SHEETS STA. SCALE: N.T.S.

TO STA.

CONSTRUCTION CODE

LIGHTING

80% FEDERAL 100% LOCAL

SIGNALS

80% FEDERAL 80% FEDERAL

ROADWAY

							80% FEDERAL 20% LOCAL	80% FEDERAL 20% LOCAL	80% FEDERAL 20% LOCAL	100% LOCAL
		PAYCODE 44000600	ITEM DESCRIPTION SIDEWALK REMOVAL	THE PROPERTY OF THE PROPERTY O	UNIT 0 FT	33.069	0004 33 . 069	0021	0021	004
		44003100	MEDIAN REMOVAL	50	0 FT	19,066	19,066			
					O YD	27	27			
		44201723	CLASS D PATCHES, TYPE IV. 6 INCH							
		44201821	CLASS D PATCHES, TYPE IV, 14 INCH	SC	D YD	141	141			
		48203029	HOT-MIX ASPHALT SHOULDERS, 8"	SC	O YD	18	18			
		50200100	STRUCTURE EXCAVATION	CL	U YD	2,440	2,440			
		50300225	CONCRETE STRUCTURES	CL	U YD	314	314			
		50300285	FORM LINER TEXTURED SURFACE	SC	O FT	1,900	1,900		water 1 - 1 - 1 - 1 - 1 - 1 - 1 - 1 - 1 - 1	
		50300300	PROTECTIVE COAT	SC	D YD	488	488			
		50500405	FURNISHING AND ERECTING STRUCTURAL STEEL	Pr	OUND	7,070	7,070			
		50800205	REINFORCEMENT BARS, EPOXY COATED		DUND	45,170	45,170			
		51603000	DRILLED SHAFT IN SOIL	CL	U YD	88	88			
		550A2320	STORM SEWERS, RUBBER GASKET, CLASS A, TYPE 1 12"	FC	00T	667	667			
		550A2340	STORM SEWERS, RUBBER GASKET, CLASS A, TYPE 1 18"	FC	00Т	289	289			
		550A2520	STORM SEWERS, RUBBER GASKET, CLASS A, TYPE 2 12"	FC	00Т	564	564			
		550A2530	STORM SEWERS, RUBBER GASKET, CLASS A, TYPE 2 15"	FC	00T	B7	87			
		550A2540	STORM SEWERS, RUBBER GASKET, CLASS A, TYPE 2 18"	FC	00Т	76	76			
					00T	222	222			
		550A2600	STORM SEWERS, RUBBER GASKET, CLASS A, TYPE 2 36"				VIII.			
		55100300	STORM SEWER REMOVAL 8"	FC	T00	10	10			
		55100500	STORM SEWER REMOVAL 12"	FC	T00	792	792	170755500000000000000000000000000000000		
		55100700	STORM SEWER REMOVAL 15"	FC	00Т	24	24			
		55100900	STORM SEWER REMOVAL 18"	FC	00T	173	173			
		55101200	STORM SEWER REMOVAL 24"	FC	TOO	92	92			***************************************
		55101400	STORM SEWER REMOVAL 30"	FC	00T	234	234			
	+	56103000	DUCTILE IRON WATER MAIN 6"	F	00T	252				252
										552
	+		DUCTILE IRON WATER MAIN 8"		T00	552				
	+	56103300	DUCTILE IRON WATER MAIN 12"	FC	T00	1,991				1,991
	+	56104900	WATER VALVES 6"	E	ACH	1				1
	+	56105000	WATER VALVES B"	E	ACH	2				2
	+	56105200	WATER VALVES 12"	E	ACH	14				14
	4	56105300	WATER VALVES 16"	E	ACH	5				5
	4	56105702	INSERTING VALVES 12"	E	ACH	1				1
		56200300	WATER SERVICE LINE 1"		TOO	575				575
	+									
	+	56200400	WATER SERVICE LINE 1 1/4"		T00	714				714
	+	56200500	WATER SERVICE LINE 1 1/2"	FO	00Т	10				10
	+	56400400	FIRE HYDRANTS TO BE RELOCATED	E	ACH	8				8
	4	56400500	FIRE HYDRANTS TO BE REMOVED	E	ACH	8				В
* coccin apprictor	4	56400810	FIRE HYDRANT EXTENSION	F	00Т	15		THE STATE OF THE S		15
* SPECIAL PROVISION + SPECIAL TY ITEM	+	56400820	FIRE HYDRANT WITH AUXILIARY VALVE AND VALVE BOX	E	ACH	9	17-24-1040			9
+ SPECIALTY ITEM X CONSTRUCTION TYPE CODE 0042		59100100	GEOCOMPOSITE WALL DRAIN	S(O YD	180	180			
CONSTRUCTION TIPE CODE 0042					FOOT	1,508	1,508			
7.1115	CICHER	60108204	PIPE UNDERDRAINS, TYPE 2, 4"		1001	1,508	1,300	L		APPANSON.
TOTAL TRANSPORT		- JRM - DMS	REVISED -	STATE OF ILLINOIS				SUMMARY	OF QUANTITIES	

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STATE OF ILLINOIS DEPARTMENT OF TRANSPORTATION

SUMMARY OF QUANTITIES SCALE: N.T.S. SHEET NO. 3 OF 7 SHEETS STA.

TO STA.

	***************************************					CONSTRUC	TION CODE	
					ROADWAY 80% FEDERAL 20% LOCAL	SIGNALS 80% FEDERAL 20% LOCAL	LIGHTING 80% FEDERAL 20% LOCAL	100% LOCAL
		ITEM DESCRIPTION	UNIT	TOTAL	0004	0021	0021	004
		CATCH BASINS, TYPE A, 4'-DIAMETER, TYPE 1 FRAME, OPEN LID	EACH	1	1			
	60201105	CATCH BASINS, TYPE A, 4'-DIAMETER, TYPE 11 FRAME AND GRATE	EACH	22	22			
	60201340	CATCH BASINS, TYPE A, 4'-DIAMETER, TYPE 24 FRAME AND GRATE	EACH	10	10			
	60204505	CATCH BASINS, TYPE A, 5'-DIAMETER, TYPE 8 GRATE	EACH	1	1			
	60205040	CATCH BASINS, TYPE A, 5'-DIAMETER, TYPE 24 FRAME AND GRATE	EACH	1	1		7,700	
	60207605	CATCH BASINS, TYPE C, TYPE 8 GRATE	EACH	1	1	***************************************		
	60207905	CATCH BASINS, TYPE C, TYPE 11 FRAME AND GRATE	EACH	7	7			
	60208240	CATCH BASINS, TYPE C, TYPE 24 FRAME AND GRATE	EACH	3	3	ACIDEL 1		
	60218400	MANHOLES, TYPE A, 4'-DIAMETER, TYPE 1 FRAME, CLOSED LID	EACH	7	7			
	60221100	MANHOLES, TYPE A, 5'-DIAMETER, TYPE 1 FRAME, CLOSED LID	EACH	3	3			
	60223800	MANHOLES, TYPE A, G'-DIAMETER, TYPE 1 FRAME, CLOSED LID	EACH	2	2			
	60236800	INLETS, TYPE A, TYPE 11 FRAME AND GRATE	EACH	11	11			
	60237470	INLETS, TYPE A, TYPE 24 FRAME AND GRATE	EACH	11	11			
+	60248900	VALVE VAULTS, TYPE A. 5'-DIAMETER, TYPE 1 FRAME, CLOSED LID	EACH	3				3
الد	60249010	VALVE VAULTS, TYPE A. 6'-DIAMETER, TYPE 1 FRAME, CLOSED LID	EACH	19				19
•	60250200	CATCH BASINS TO BE ADJUSTED	EACH	7	7			
	60250500	CATCH BASINS TO BE ADJUSTED WITH NEW TYPE 1 FRAME, CLOSED LID	EACH	2	2			
	60251200	CATCH BASINS TO BE ADJUSTED WITH NEW TYPE 8 GRATE	EACH	1	1			
	60251400	CATCH BASINS TO BE ADJUSTED WITH NEW TYPE 10 FRAME AND GRATE	EACH	ì	1			
		CATCH BASINS TO BE ADJUSTED WITH NEW TYPE 24 FRAME AND GRATE	EACH	1	1			
		CATCH BASINS TO BE RECONSTRUCTED WITH NEW TYPE 1 FRAME, OPEN LID	EACH	1	ı			
		MANHOLES TO BE ADJUSTED	EACH	39	39	VIII AND AND AND A	***************************************	
		MANHOLES TO BE ADJUSTED WITH NEW TYPE 24 FRAME AND GRATE	EACH	2	. 2			
		MANHOLES TO BE RECONSTRUCTED	EACH	17	17			
		INLETS TO BE ADJUSTED	EACH	4	4			
		INLETS TO BE ADJUSTED WITH NEW TYPE 1 FRAME, OPEN LID	EACH	1	1		.,,,,,,,,,,,,,,,,,,,,,,,,,,,,,,,,,,,,,,	
			EACH	1	1			
		INLETS TO BE ADJUSTED WITH NEW TYPE 1 FRAME, CLOSED LID			1			10
+		VALVE VAULTS TO BE RECONSTRUCTED WITH NEW TYPE 1 FRAME, CLOSED LID	EACH	10				10
		GRATES, TYPE B	EACH	1	1			
		FRAMES AND LIDS. TYPE 1, CLOSED LID	EACH	1	1			
		REMOVING MANHOLES	EACH	9	9			
	60500050	REMOVING CATCH BASINS	EACH	17	17			
	60500060	REMOVING INLETS	EACH	20	20			
+	60500405	FILLING VALVE VAULTS	EACH	9				9
	60600605	CONCRETE CURB, TYPE B	FOOT	465	465			
	60603800	COMBINATION CONCRETE CURB AND GUTTER, TYPE B-6.12	FOOT	6.082	6,082			
	60605000	COMBINATION CONCRETE CURB AND GUTTER, TYPE B-6.24	FOOT	4,604	4,604			
	60605900	COMBINATION CONCRETE CURB AND GUTTER. TYPE B-9.12	FOOT	235	235			
	60608300	COMBINATION CONCRETE CURB AND GUTTER, TYPE M-2.12	FOOT	474	474			
	60608600	COMBINATION CONCRETE CURB AND GUTTER, TYPE M-6.06	FOOT	52	52			
	60610400	COMBINATION CONCRETE CURB AND GUTTER, TYPE M-6.24	FOOT	153	153			

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COMPANY NAME:
PROJECT CONTACT:
CLIENT:
FILE NAME:
PLOT ORIVER:
PLOT ORIVER:
PLOT ORIVER:

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* SPECIAL PROVISION

+ SPECIALTY ITEM

X CONSTRUCTION TYPE CODE 0042

STATE OF ILLINOIS DEPARTMENT OF TRANSPORTATION

SCALE: N.T.S. | SHEET NO. 4 OF 7 SHEETS | STA.

TO STA.

						CONSTRUC	TION CODE	***************************************
					ROADWAY 80% FEDERAL 20% LOCAL	SIGNALS 80% FEDERAL 20% LOCAL	LIGHTING 80% FEDERAL 20% LOCAL	100% LOCAL
	PAYCODE 60618300	ITEM DESCRIPTION CONCRETE MEDIAN SURFACE, 4 INCH	UNIT SO FT	TOTAL 5,853	0004 5,853	0021	0021	004
	60619600	CONCRETE MEDIAN, TYPE SB-6.12	SO FT	4,742	4,742			
	60622000	CONCRETE MEDIAN, TYPE SM-2,12	SO FT	879	879			
	60622800	CONCRETE MEDIAN, TYPE SM-6,12	SO FT	1,268	1,268		1	
+	66900200	NON-SPECIAL WASTE DISPOSAL	CU YD	5,800	5,800			
٠	66900450	SPECIAL WASTE PLANS AND REPORTS	L SUM	1	1			
+	66900530	SOIL DISPOSAL ANALYSIS	EACH	10	10			
	67000400	ENGINEER'S FIELD OFFICE, TYPE A	CAL MO	18	18			
	67100100	MOBILIZATION	L SUM	1	1	_		_
	70300100	SHORT TERM PAVEMENT MARKING	FOOT	8,419	8,419			
-	70300150	SHORT TERM PAVEMENT MARKING REMOVAL	SO FT	10,357	10,357			
ļ	70300510		SO FT	1.464	1,464			
	70300520	PAVEMENT MARKING TAPE, TYPE III 4"	FOOT	65,638	65,638			
	70300540	PAVEMENT MARKING TAPE, TYPE [1] 6"	FOOT	6,540	6,540			
	70300550	PAVEMENT MARKING TAPE, TYPE III 8"	FOOT	845	845			
İ	70300560	PAVEMENT MARKING TAPE, TYPE III 12"	FOOT	1,629	1,629			
	70300570	PAVEMENT MARKING TAPE, TYPE III 24"	FOOT	842	842			
	70400100	TEMPORARY CONCRETE BARRIER	FOOT	2.550	2,550			
	70400200		FOOT	1,450	1,450			-
	70600255		EACH	10	10			
İ	70600322		EACH	10	10			
	72000100	 SIGN PANEL - TYPE	SO FT	265	205	60		
			SO FT	102	12			
•	72000200	SIGN PANEL - TYPE 2				90		
+	72400100	REMOVE SIGN PANEL ASSEMBLY - TYPE A	EACH	27	27			
+	72400500	RELOCATE SIGN PANEL ASSEMBLY - TYPE A	EACH	10	10			
+	72800100	TELESCOPING STEEL SIGN SUPPORT	FOOT	482	482			1
+	78000100	THERMOPLASTIC PAVEMENT MARKING - LETTERS AND SYMBOLS	SO FT	632	632			
+	78000200	THERMOPLASTIC PAVEMENT MARKING - LINE 4"	FOOT	6,507	6,507			
+	78000400	THERMOPLASTIC PAVEMENT MARKING - LINE 6"	FOOT	2,837	2,837			
+	78000500	 THERMOPLASTIC PAVEMENT MARKING - LINE 8"	FOOT	100	100			
+	780DD600	THERMOPLASTIC PAVEMENT MARKING - LINE 12"	F00T	15	15			
+	78000650		FOOT	125	125			
+	78003110		FOOT	681	681			
		POLYUREA PAVEMENT MARKING TYPE 1 - LETTERS AND SYMBOLS	SO FT	995	995			
+	78008200							
+	78008210	POLYUREA PAVEMENT MARKING TYPE I - LINE 4"	FOOT	5,860	5,860			
+	78008230	POLYUREA PAVEMENT MARKING TYPE 1 - LINE 6"	FOOT	4,738	4,738			
+	78008240	POLYUREA PAVEMENT MARKING TYPE 1 - LINE 8"	FOOT	1,525	1,525			
ı	78008250	POLYUREA PAVEMENT MARKINO TYPE I - LINE 12"	F001	285	285			
+	78008270	POLYUREA PAVEMENT MARKING TYPE I - LINE 24"	FOOT	342	342			
*	78100100	RAISED REFLECTIVE PAVEMENT MARKER	EACH	220	220			
4	78200530	BARRIER WALL REFLECTORS, TYPE C	EACH	51	51			
1		•		•				-

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X CONSTRUCTION TYPE CODE 0042

USER NAME = jmelhui DESIGNED - JRM REVISED -REVISED -DRAWN - DMS PLOT SCALE = N.T.S. CHECKED - TH REVISED -DATE - 3/23/18 PLOT DATE = 3/23/2018 REVISED -

STATE OF ILLINOIS DEPARTMENT OF TRANSPORTATION

SUMMARY OF QUANTITIES SCALE: N.T.S. SHEET NO. 5 OF 7 SHEETS STA.

TO STA.

CONSTRUCTION CODE

SIGNALS LIGHTING

ROADWAY

	PAYCODE	ITEM DESCRIPTION	UNIT	TOTAL	80% FEDERAL 20% LOCAL 0004	80% FEDERAL 20% LOCAL 0021	80% FEDERAL 20% LOCAL 0021	100% LOCAL 004
	78300200	RAISED REFLECTIVE PAVEMENT MARKER REMOVAL	EACH	220	220			
-	81028200	UNDERGROUND CONDUIT, GALVANIZED STEEL, 2" DIA.	FOOT	2,577		2,577		
- <u></u>	81028220	UNDERGROUND CONDUIT, CALVANIZED STEEL. 3" DIA.	FOOT	582		582		
٠ 	81028240	UNDERGROUND CONDUIT, GALVANIZED STEEL, 4" DIA.	FOOT	1,599		1,494	105	
* -	81028710	UNDERGROUND CONDUIT, COILABLE NONMETALLIC CONDUIT, 3/4" DIA.	FOOT	1,174			1,174	***************************************
. 🗀		HANDHOLE	EACH	17		13	4	
+			EACH	7		7		
-		HEAVY-DUTY HANDHOLE						
+		DOUBLE HANDHOLE	EACH	5		5		
۰	81603136	UNIT DUCT, 600V, 5-1C NO.4, 1/C NO.6 GROUND, (XLP-TYPE USE), 1 1/2" DIA. POLYETHYLENE	FOOT	1,300			1,300	
+	83600200	LIGHT POLE FOUNDATION, 24" DIAMETER	FOOT	171			171	
+ 🗀	84200500	REMOVAL OF LIGHTING UNIT, SALVAGE	EACH	17			17	
+ =	84200600	REMOVAL OF LIGHTING UNIT, NO SALVAGE	EACH	6			6	***************************************
- 🗀	84200804	REMOVAL OF POLE FOUNDATION	EACH	23			23	
-	84400105	RELOCATE EXISTING LIGHTING UNIT	EACH	16			16	
	85000200	MAINTENANCE OF EXISTING TRAFFIC SIGNAL INSTALLATION	EACH	4		4		
		TRANSCEIVER - FIBER OPTIC	EACH	2		2		
*_						2,646.5		
+		ELECTRIC CABLE IN CONDUIT, TRACER, NO. 14 IC	FOOT	2,646.5				
+	87301215	ELECTRIC CABLE IN CONDUIT, SIGNAL NO. 14 2C	FOOT	4,129		4,129		
+	87301225	ELECTRIC CABLE IN CONDUIT, SIGNAL NO. 14 3C	FOOT	6,066		6,066		
* =	87301245	ELECTRIC CABLE IN CONDUIT, SIGNAL NO. 14 5C	FOOT	7,038		7,038		
+ _	87301255	ELECTRIC CABLE IN CONDUIT, SIGNAL NO. 14 7C	FOOT	2,692		2,692		
<u> </u>	87301305	ELECTRIC CABLE IN CONDUIT, LEAD-IN, NO. 14 1 PAIR	FOOT	7,935		7,935		
. 🗀	87301805	ELECTRIC CABLE IN CONDUIT, SERVICE, NO. 6 2 C	FOOT	103		103		
<u>+</u>	87301900	ELECTRIC CABLE IN CONDUIT, EQUIPMENT GROUNDING CONDUCTOR, NO. 6 1C	FOOT	5,209.5		5,209.5		
Ë	87502440	TRAFFIC SIGNAL POST, GALVANIZED STEEL 10 FT.	EACH	3		3		
	87502500	TRAFFIC SIGNAL POST, GALVANIZED STEEL 16 FT.	EACH	7		7		
r _				1		1		
-		TRAFFIC SIGNAL POST, GALVANIZED STEEL 18 FT.	EACH					
- ا	87700160	STEEL MAST ARM ASSEMBLY AND POLE, 24 FT.	EACH	1		1		
- □	87700260	STEEL MAST ARM ASSEMBLY AND POLE, 44 FT.	EACH	1		1		
-	87700270	STEEL MAST ARM ASSEMBLY AND POLE, 46 FT.	EACH	1		1		
* <u> </u>	87700280	STEEL MAST ARM ASSEMBLY AND POLE, 48 FT.	EACH	1		1		
	87700300	STEEL MAST ARM ASSEMBLY AND POLE, 52 FT.	EACH	1		1		
ـــا ۴	87700330	STEEL MAST ARM ASSEMBLY AND POLE. 56 FT.	EACH	1		1		
-	87700340	STEEL MAST ARM ASSEMBLY AND POLE, 58 FT.	EACH	1		1		
, <u> </u>	87700404	STEEL MAST ARM ASSEMBLY AND POLE, 62 FT.	EACH	1		1		
, _			FOOT	52		52		
† <u> </u>	87800100	CONCRETE FOUNDATION, TYPE A						
۲ _	87800150	CONCRETE FOUNDATION, TYPE C	FOOT	8		8	77/34	
	87800400	CONCRETE FOUNDATION, TYPE E 30-INCH DIAMETER	FOOT	10		10		
►			FOOT	54		54		
* -	87800415	CONCRETE FOUNDATION, TYPE E 36-INCH DIAMETER	1001					
	87800415 87800420	CONCRETE FOUNDATION, TYPE E 36-INCH DIAMETER CONCRETE FOUNDATION, TYPE E 42-INCH DIAMETER	FOOT	63		63		

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PROJECT CONTACT:
CLIENT:
DATE PLOTTED:
FILE NAME:
PLOT DRIVER:
FEN TABLE:

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Winois Professional Design Firm
184-001322

* SPECIAL PROVISION

+ SPECIALTY ITEM

X CONSTRUCTION TYPE CODE 0042

STATE OF ILLINOIS
DEPARTMENT OF TRANSPORTATION

SCALE: N.T.S. SHEET NO. 6 OF 7 SHEETS STA.

TO STA.

					ROADWAY	SIGNALS	TION CODE LIGHTING	T
L				7074	80% FEDERAL 20% LOCAL	80% FEDERAL 20% LOCAL	80% FEDERAL 20% LOCAL	100% LOCAL
• + [ITEM DESCRIPTION SIGNAL HEAD, LED, 1-FACE, 3-SECTION, MAST-ARM MOUNTED	UNIT EACH	TOTAL 18	0004	0021 18	0021	004
٠ ــــــــــــــــــــــــــــــــــــ	88030050	SIGNAL HEAD, LED, 1-FACE, 3-SECTION, BRACKET MOUNTED	EACH	10		10		
٠ +	88030100	SIGNAL HEAD, LED, 1-FACE, 5-SECTION, BRACKET MOUNTED	EACH	6		6		
• *	88030110	SIGNAL HEAD, LED, 1-FACE, 5-SECTION, MAST-ARM MOUNTED	EACH	4		4		
• *	88102717	PEDESTRIAN SIGNAL HEAD, LED, 1-FACE, BRACKET MOUNTED WITH COUNTDOWN TIMER	EACH	18		18		
• +	88200410	TRAFFIC SIGNAL BACKPLATE, LOUVERED, FORMED PLASTIC	EACH	22		22		
. +	88500100	INDUCTIVE LOOP DETECTOR	EACH	23		23		
• +		DETECTOR LOOP REPLACEMENT	FOOT	110		110		
• +			FOOT	1,596		1,596		
			EACH	9		9		
* * *			EACH	2		2		
• *	88800100	PEDESTRIAN PUSH-BUTTON	EACH	18		18		
٠+	89000100	TEMPORARY TRAFFIC SIGNAL INSTALLATION	EACH	3		3		
• *	89502300	REMOVE ELECTRIC CABLE FROM CONDUIT	FOOT	4,398		4,398		1
٠ ـــ	89502375	REMOVE EXISTING TRAFFIC SIGNAL EQUIPMENT	EACH	2		2		
٠+	89502380	REMOVE EXISTING HANDHOLE	EACH	21		21		
٠ ـــ	89502382	REMOVE EXISTING DOUBLE HANDHOLE	EACH	2		2		
• 7	89502385	REMOVE EXISTING CONCRETE FOUNDATION	EACH	16		16		
+	A2000116	TREE, ACER X FREEMANII AUTUMN BLAZE (AUTUMN BLAZE FREEMAN MAPLE), 2" CALIPER, BALLED AND BURLAPPED	EACH	3	3			
+	A2002879	TREE, CELTIS OCCIDENTALIS CHICAGOLAND, (CHICAGOLAND COMMON HACKBERRY), 2" CALIPER, BALLED AND BURLAPPED	EACH	3	3			
+	A2004616	TREE, CLEDITSIA TRIACANTHOS INERMIS (THORNLESS COMMON HONEYLOCUST), 2" CALIPER, BALLED AND BURLAPPED	EACH	3	3			
+	B2001116	TREE, CERCIS CANADENSIS (EASTERN REDBUD), 2" CALIPER, TREE FORM, BALLED AND BURLAPPED	EACH	3	3			
+ [B2004166	TREE, MALUS PRAIRIFIRE (PRAIRIFIRE CRABAPPLE), 6' HEIGHT, CLUMP FORM, BALLED AND BURLAPPED	EACH	3	3			
+	B2006020	TREE, SYRINGA PEKINENSIS (PEKING LILAC), 2-1/2" CALIPER, TREE FORM, BALLED AND BURLAPPED	EACH	3	3			
+	B2006069	TREE, SYRINGA PEKINENSIS ZHING ZHIMING (BEIJING GOLD PEKING LILAC), 7' HEIGHT, CLUMP FORM, BALLED AND BURLAPPED	EACH	3	3			***************************************
• +	X0326654	ORNAMENTAL LIGHT UNIT, COMPLETE	EACH	3			3	
٠ ـ ـ	X0324085	EMERGENCY VEHICLE PRIORITY SYSTEM LINE SENSOR CABLE, NO. 20 3/C	FOOT	2,603		2,603		
. +	x0324599	RDD AND CLEAN EXISTING CONDUIT	FOOT	159		159		
• +		CURED-IN-PLACE PIPE LINER, 10"	FOOT	2,547				2,547
٠ ٢			FOOT	15		711111111111111111111111111111111111111		15
			FOOT	1,835				1,835
,			SO FT	10,000	10,000			
			EACH	2		2		
•			EACH	2		2		
• +								
• •			EACH	2		2		0.150
• +	X2080250		CU YD	2,159				2,159
•	X2130010	EXPLORATION TRENCH, SPECIAL	FOOT	200	200		,,,,,,,,,,,,,,,,,,,,,,,,,,,,,,,,,,,,,,,	
•	X4021000	TEMPORARY ACCESS (PRIVATE ENTRANCE)	EACH	24	24			
1	X4022000	TEMPORARY ACCESS (COMMERCIAL ENTRANCE)	EACH	25	25			
•						-	1	
	X4023000	TEMPORARY ACCESS (ROAD)	EACH	1	. 1			

66:40100 In Border File 86:40100-sht-sum01.don

HRGreen.com Sinois Frefessional Design Firm # 184-001322

DESIGNED - JRM REVISED -USER NAME = jmelhui DRAWN - DMS CHECKED - TH REVISED PLOT SCALE = N.T.S. REVISEO PLOT DATE = 3/23/2018 DATE - 3/23/18 REVISED ~

* SPECIAL PROVISION + SPECIALTY ITEM

X CONSTRUCTION TYPE CODE 0042

STATE OF ILLINOIS DEPARTMENT OF TRANSPORTATION

SUMMARY OF QUANTITIES SCALE: N.T.S. SHEET NO. 7 OF 7 SHEETS STA.

CONSTRUCTION CODE

LIGHTING

80% FEDERAL

20% LOCAL

100% LOCAL

SIGNALS 80% FEDERAL

20% LOCAL

ROADWAY


80% FEDERAL

20% LOCAL


TO STA,

PAYCODE	ITEM DESCRIPTION	UNIT	TOTAL	20% LOCAL 0004	20% LOCAL 0021	20% LOCAL 0021	00
X5610744		EACH	2	0004	0021	0021	2
X5610746	WATER MAIN LINE STOP 6"	EACH	2				2
X3610746	MAIER MAIN LINE STOP 0	EACH			· ×		
X5610748	WATER MAIN LINE STOP B"	EACH	1				1
X5610752	WATER MAIN LINE STOP 12"	EACH	2				
X5610756	WATER MAIN LINE STOP 16"	EACH	1				1
						990.000.000.000.000	
x5610822	DUCTILE IRON WATER MAIN, RESTRAINED JOINT PIPE 12" IN TRENCH	FOOT	140	-			14
X5610826	DUCTILE IRON WATER MAIN, RESTRAINED JOINT PIPE 16" IN TRENCH	FOOT	1,939				1,9
X5630704	CONNECTION TO EXISTING WATER MAIN 4"	EACH	2			07231242	
X5630706	CONNECTION TO EXISTING WATER MAIN 6"	EACH	3				
					/*************************************		
X5630712	CONNECTION TO EXISTING WATER MAIN 12"	EACH	3	1	***************************************		
X5630716	CONNECTION TO EXISTING WATER MAIN 16"	EACH	2				
X6020293	MANHOLES, TYPE A, 8'-OJAMETER, WITH 2 TYPE 1 FRAMES, CLOSED LID, RESTRICTOR PLATE	EACH	2	l. 2		-	
¥7015005							
X70IS005	CHANGEABLE MESSAGE SIGN	CAL DA	2,520	2,520			
X70300D5	TEMPORARY PAVEMENT MARKING REMOVAL	SO FT	21.529	21,529	-		
X8100105		EACH	ı	f	1		
X8211125	LUMINAIRE, LED. HORIZONTAL MOUNT, SPECIAL	EACH	8	1		8	-
7021112J		EACH				8	
X8620200	(UNINTERRUPTABLE POWER SUPPLY, SPECIAL	EACH	2	1	2		
X8710024	FIBER OPTIC CABLE IN CONDUIT, NO. 62.5/125, MM12F SM24F	FOOT	2,685,5		2,685.5		
XT010216	TRAFFIC CONTROL AND PROTECTION, (SPECIAL)	L SUM	i	1 1			
V204012F	Divides Trupped by Courter Dappin	5.00	766	700			
x7040125	PINNING TEMPORARY CONCRETE BARRIER	EACH	366	356			
Z0007601	BUILDING REMOVAL NO. 1	L SUM	1	1			
Z0012450	CONCRETE STEPS	CU YD	3	3			
20013798	CONSTRUCTION LAYOUT	L SUM	1	1 1			
					_		
Z0030850	TEMPORARY INFORMATION SIGNING	SO FT	155	155			
Z0033046	RE-OPTIMIZE TRAFFIC SIGNAL SYSTEM LEVEL 2	EACH	I		1		
Z0062456	TEMPORARY PAVEMENT	SO YD	2,081	2081			
20045100	DOCCEUPE VALVE INCENT. D. INC.			1			***************************************
20045800	PRESSURE VALVE INSERT, 8 INCH	EACH	4	1			4
20046304	PIPE UNDERDRAINS FOR STRUCTURES 4"	FOOT	275	275			
Z0049901	REMOVAL AND DISPOSAL OF NON-FRIABLE ASBESTOS, BUILDING NO. 1	L SUM	1	1			
20056608	 STORM SEWER (WATER MAIN REQUIREMENTS) 12 INCH	FDOT	553	553			
			1000				
Z0056616	STORM SEWER (WATER MAIN REQUIREMENTS) 24 INCH	FOOT	223	223			
Z0073510	TEMPORARY TRAFFIC SIGNAL TIMING	EACH	3	1	3		
20076600	TRAINEES	HOUR	1,500	1500			

	TRAINEES TRAINING PROGRAM GRADUATE	HOUR	1,500	1500			
Z0076604		HOUR	50	1			5
Z0076604 	HEAVY ROOT CLEANING			1	1		
		EACH	50				5
XX008473	PROTUDING TAP REMOVAL	EACH EACH	50	- consequence of the consequence			2

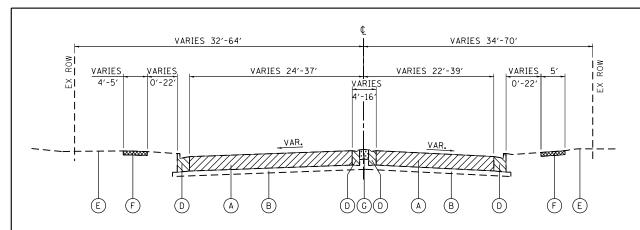


EXISTING WESTERN AVENUE (IL ROUTE 31) STA 506+45 TO STA 516+38

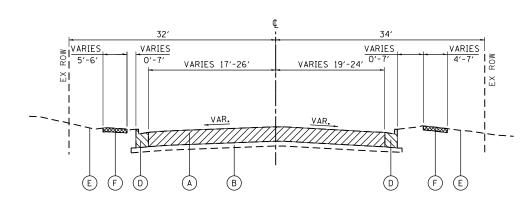

EXISTING WESTERN AVENUE (IL ROUTE 31)


SCALE: N.T.S.

STA 526+36 TO STA 529+22

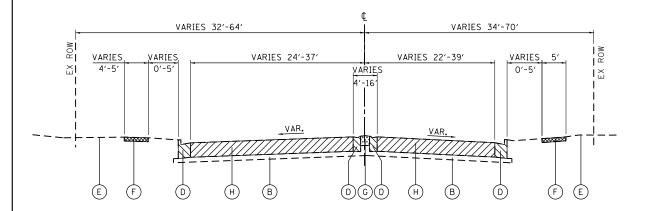

EXISTING WESTERN AVENUE (IL ROUTE 31)

STA 516+38 TO STA 522+76

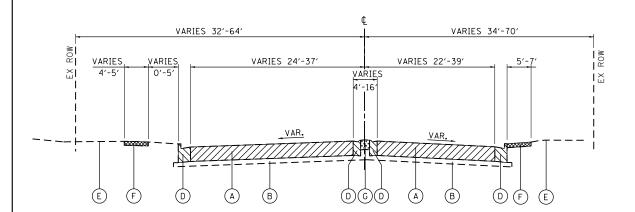

EXISTING WESTERN AVENUE (IL ROUTE 31)

STA 522+76 TO STA 526+36

PAVEMENT REMOVAL

SIDEWALK REMOVAL

COMBINATION CONCRETE
CURB AND GUTTER REMOVAL MEDIAN REMOVAL

EXISTING TYPICAL SECTION LEGEND

- A HOT-MIX ASPHALT PAVEMENT, 14"
- \bigcirc B SUBBASE GRANULAR MATERIAL, 4"-10" (PAID AS EARTH EXCAVATION)
- AGGREGATE SHOULDERS
 (PAID AS EARTH EXCAVATION)
- COMBINATION CONCRETE CURB AND GUTTER
- EXISTING GROUND
- PORTLAND CEMENT CONCRETE SIDEWALK
- CONCRETE MEDIAN / HOT-MIX ASPHALT MEDIAN
- PCC PAVEMENT, 8" (HUNTLEY/MAIN)
 PCC PAVEMENT, 10" (IL ROUTE 31)
- (I) HOT-MIX ASPHALT SURFACE REMOVAL, 1-1/4"

\$CC \$72 372 372 11-1	
COMPANY NAME: PROJECT CONTACT: CLIENT: DATE PLOTTED: FILE NAME: PLOT DRIVER: PEN TABLE:	HRGreen

86140100 In Border File 86140100-sht-typical-01.dgn


	USER NAME = jmelhui	DESIGNED	-	JRM	REVISED	-
ın Film		DRAWN	-	DMS	REVISED	-
	PLOT SCALE = N.T.S.	CHECKED	-	TH	REVISED	-
	PLOT DATE = 3/23/2018	DATE	-	3/23/18	REVISED	-


STATE OF ILLINOIS **DEPARTMENT OF TRANSPORTATION**

EXI		TYPICAL		S	F.A.U. RTE.	SEC
	ILLII	NOIS ROUT	TE 31		3887	08-0008
CHEET NO	1 OF	E CHEETC	CTA	TO CTA	550 00	10 01CT NO

CTION COUNTY 083-00-CH KANE 259 11 CONTRACT NO. 61E73


HRGreen.com **HRGreen**

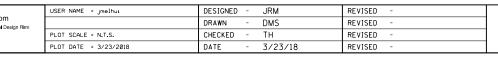

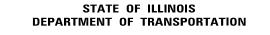



SECTION COUNTY 3887 08-00083-00-CH KANE 259 12 CONTRACT NO. 61E73 FED. ROAD DIST, NO. ILLINOIS FED. AID PROJECT

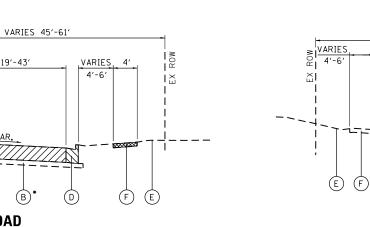

EXISTING HUNTLEY ROAD

VARIES 19'-43'

VARIES 45'-61'

VARIES

4'-6'

VARIES 19'-43'

VARIES 33'-53'


VARIES 33'-53'

VARIES 19'-33'

VARIES 19'-33'

STA 106+39 TO STA 113+19 * EXISTING SUBBASE GRANULAR MATERIAL IS APHALT TREATED (PAID AS EARTH EXCAVATION)

VARIĘS

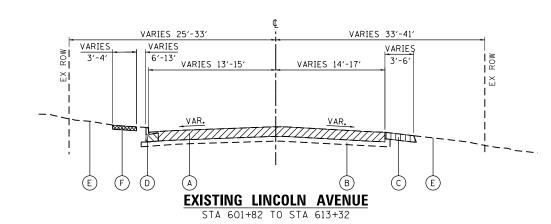

EXISTING HUNTLEY ROAD / MAIN STREET

STA 123+32 TO STA 124+94

VARIES 36'-39'

VARIES 4'-8'

VARIES 27'-30'

VARIES 7'-19'


VARIES

5′-8′

PAVEMENT REMOVAL SIDEWALK REMOVAL COMBINATION CONCRETE
CURB AND GUTTER REMOVAL MEDIAN REMOVAL SHOULDER REMOVAL

EXISTING HUNTLEY ROAD

STA 113+19 TO STA 119+63 * EXISTING CORRUGATED MEDIAN STA 113+19 TO STA 113+89

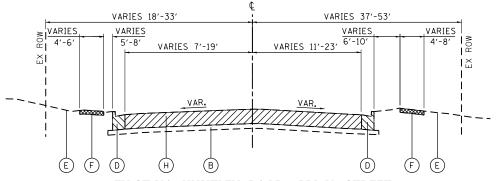


EXISTING HUNTLEY ROAD / MAIN STREET STA 119+63 TO STA 123+32

A HOT-MIX ASPHALT PAVEMENT, 8"-14"

EXISTING TYPICAL SECTION LEGEND

- \bigcirc B SUBBASE GRANULAR MATERIAL, 4"-10" (PAID AS EARTH EXCAVATION)
- AGGREGATE SHOULDERS
 (PAID AS EARTH EXCAVATION)
- COMBINATION CONCRETE CURB AND GUTTER
- EXISTING GROUND
- PORTLAND CEMENT CONCRETE SIDEWALK
- CONCRETE MEDIAN / HOT-MIX ASPHALT MEDIAN
- PCC PAVEMENT, 8" (HUNTLEY/MAIN)
 PCC PAVEMENT, 10" (IL ROUTE 31)
- (I) HOT-MIX ASPHALT SURFACE REMOVAL, 1-1/4"

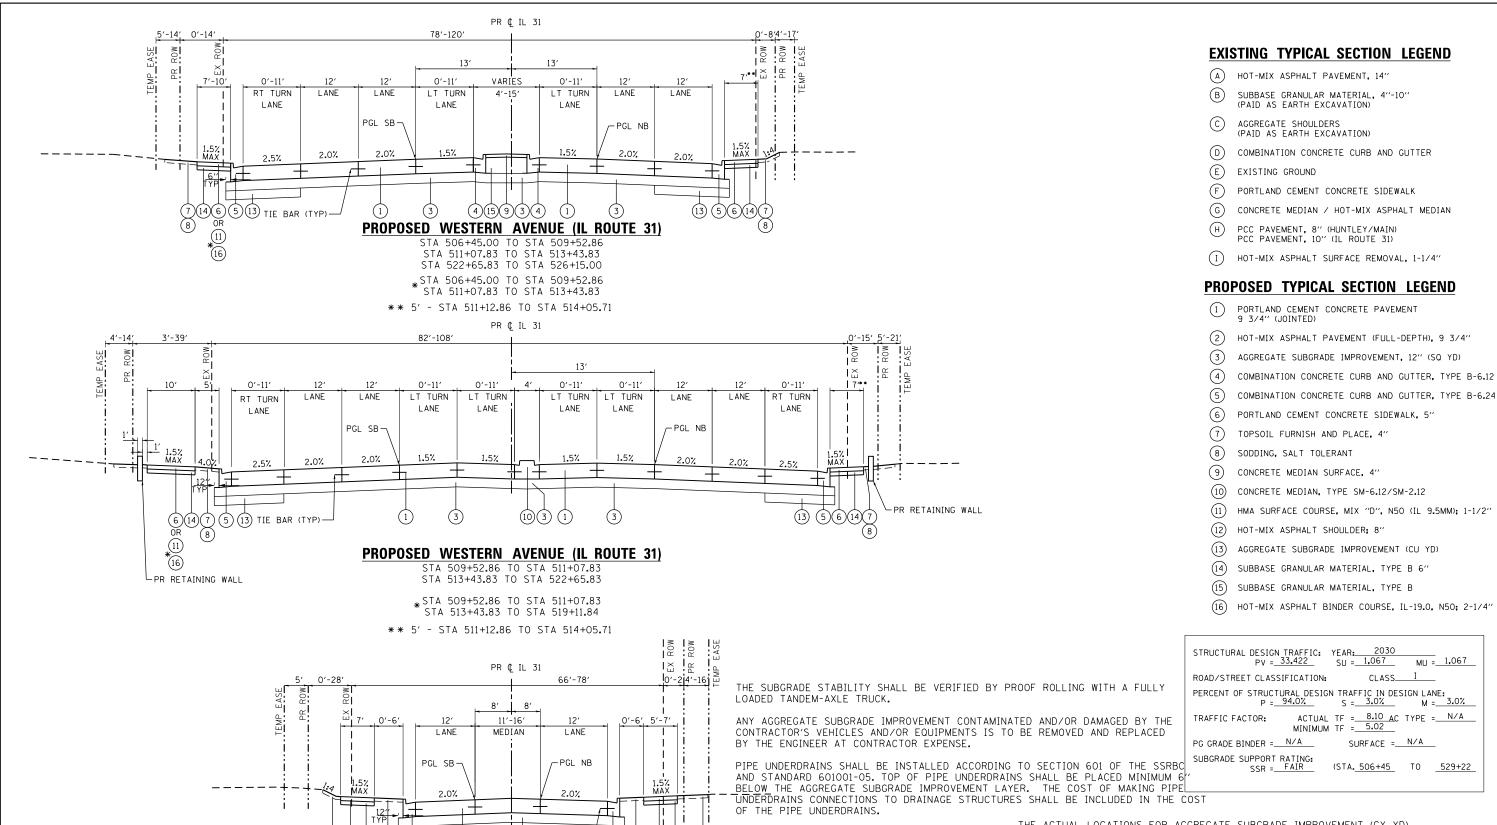

TIE BAR (TYP) PROPOSED WESTERN AVENUE (IL ROUTE 31) STA 526+15.00 TO STA 529+22.01

STA 527+14.47 TO STA 529+22.01 RT STA 528+95.00 TO STA 529+22.01 LT

SCALE: N.T.S.

THE ACTUAL LOCATIONS FOR AGGREGATE SUBGRADE IMPROVEMENT (CY YD) WILL BE DETERMINED IN THE FIELD AT THE TIME OF CONSTRUCTION BY THE GEOTECHNICAL ENGINEER. ALL POTENTIALLY UNSTABLE SOILS SHOULD BE TESTED WITH A STATIC CONE PENETROMETER AND TREATED IN ACCORDANCE WITH ARTICLE 301.04 OF THE STANDARD SPECIFICATIONS AND THE GUIDELINES IN THE IDOT SUBGRADE STABILITY MANUAL. IF UNSTABLE AND/OR EMBANKMENT IS ENCOUNTERED, THE SOIL SHALL BE REMOVED AND REPLACED WITH AGGREGATE SUBGRADE IMPROVEMENT OR EMBANKMENT AS DETERMINED BY THE GEOTECHNICAL ENGINEER. IF UNSTABLE AND/OR UNSUITABLE MATERIAL IS NOT ENCOUNTERED, THEN THE QUANTITY SHALL BE DEDUCTED AND NO ADDITIONAL COMPENSATION WILL BE DUE THE CONTRACTOR.

HRGreen.com **HRGreer**

USER NAME = jmelhuı	DESIGNED	-	JRM	REVISED	-
	DRAWN	-	DMS	REVISED	-
PLOT SCALE = N.T.S.	CHECKED	-	TH	REVISED	-
PLOT DATE = 3/23/2018	DATE	-	3/23/18	REVISED	-


STATE OF ILLINOIS **DEPARTMENT OF TRANSPORTATION**

(6)(14)

PROPOSED	F.A.U. RTE.	SEC	TION	COUNTY	TOTAL SHEETS	SHEET NO.			
ILLIN	3887	08-0008	33-00-CH	KANE	259	13			
							CONTRACT	NO. 61	E73
SHEET NO. 3 OF	5 SHEETS	STA.	TO STA.	FED RO	ON TRIU UN	TILLINOIS FED AT	D PROJECT	61F73	

MU = 1,067

86140100 In Border File 86140100-sht-typical-03.dar

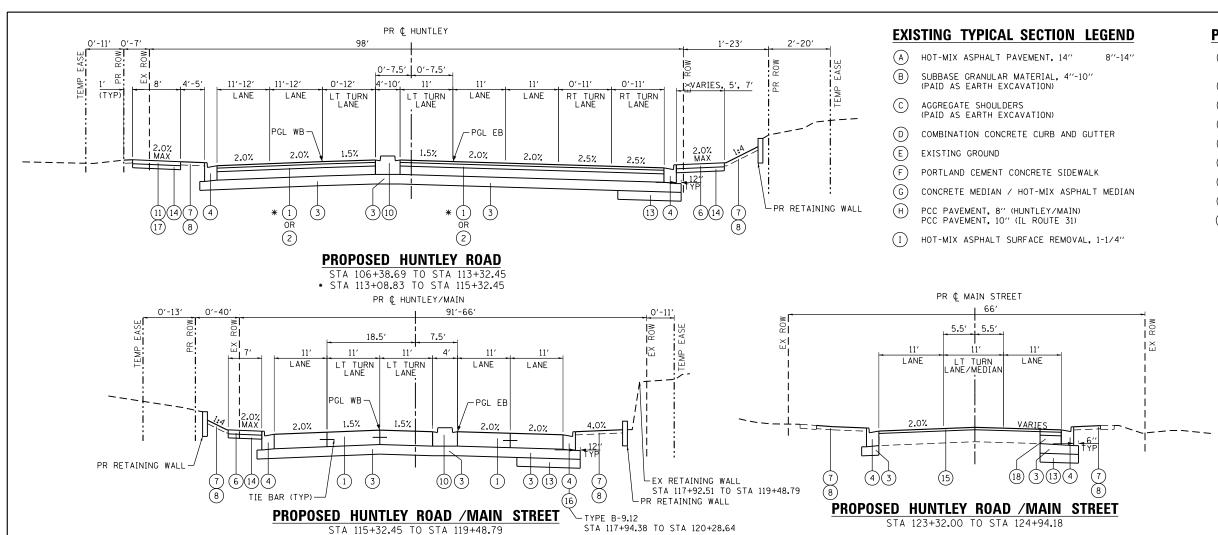

PROPOSED TYPICAL SECTION LEGEND

PORTLAND CEMENT CONCRETE PAVEMENT 9 3/4" (JOINTED)

HOT-MIX ASPHALT PAVEMENT (FULL-DEPTH), 9 3/4"

(3) AGGREGATE SUBGRADE IMPROVEMENT, 12" (SQ YD)

(4) COMBINATION CONCRETE CURB AND GUTTER, TYPE B-6.12

(5) COMBINATION CONCRETE CURB AND GUTTER, TYPE B-6.24

(6) PORTLAND CEMENT CONCRETE SIDEWALK, 5"

(7) TOPSOIL FURNISH AND PLACE, 4'

8 SODDING, SALT TOLERANT

(9) CONCRETE MEDIAN SURFACE, 4"

(10) CONCRETE MEDIAN, TYPE SM-6.12/SM-2.12

(11) HMA SURFACE COURSE, MIX "D", N50 (IL 9.5MM); 1-1/2"

(12) HOT-MIX ASPHALT SHOULDER; 8"

AGGREGATE SUBGRADE IMPROVEMENT (CU YD)

(14) SUBBASE GRANULAR MATERIAL, TYPE B 6"


(15) HOT-MIX ASPHALT SURFACE COURSE, MIX "D",

N70 (IL 9.5MM); 1-1/2" COMBINATION CONCRETE CURB AND GUTTER, TYPE B-9.12

(16)

HOT-MIX ASPHALT BINDER COURSE, IL-19.0, N50; 2-1/4"

PAVEMENT WIDENING

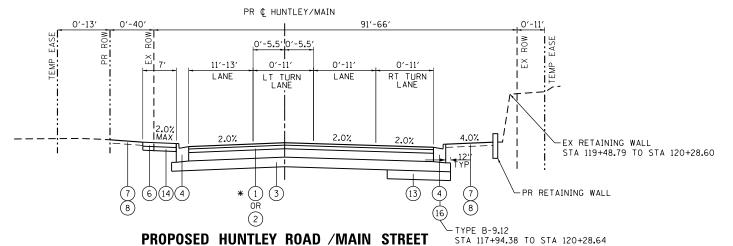

STA 121+66.08 TO STA 123+32.00 * STA 119+48.79 TO STA 121+66.08

THE ACTUAL LOCATIONS FOR AGGREGATE SUBGRADE IMPROVEMENT (CY YD) WILL BE DETERMINED IN THE FIELD AT THE TIME OF CONSTRUCTION BY THE GEOTECHNICAL ENGINEER. ALL POTENTIALLY UNSTABLE SOILS SHOULD BE TESTED WITH A STATIC CONE PENETROMETER AND TREATED IN ACCORDANCE WITH ARTICLE 301.04 OF THE STANDARD SPECIFICATIONS AND THE GUIDELINES IN THE IDOT SUBGRADE STABILITY MANUAL. IF UNSTABLE AND/OR EMBANKMENT IS ENCOUNTERED, THE SOIL SHALL BE REMOVED AND REPLACED WITH AGGREGATE SUBGRADE IMPROVEMENT OR EMBANKMENT AS DETERMINED BY THE GEOTECHNICAL ENGINEER. IF UNSTABLE AND/OR UNSUITABLE MATERIAL IS NOT ENCOUNTERED, THEN THE QUANTITY SHALL BE DEDUCTED AND NO ADDITIONAL COMPENSATION WILL BE DUE THE CONTRACTOR.

* THE UNIT WEIGHT TO CALCULATE ALL HMA SURFACE MIXTURE QUANTITIES IS 112 LBS/SQ YD/IN.

* THE "AC TYPE" FOR NON-POLYMERIZED HMA SHALL BE "PG 64-22" UNLESS MODIFIED BY DISTRICT ONE SPECIAL PROVISIONS

* FOR HMA FULL DEPTH "AC TYPE" SEE SPECIAL PROVISIONS.

* FOR USE OF RECYCLED MATERIALS SEE SPECIAL PROVISIONS.

* NOTE: IF THE CONTRACTOR CHOOSES TO USE CONCRETE FOR TEMPORARY PAVEMENT IT SHALL CONSIST OF CLASS PV CONCRETE MEETING THE REQUIREMENTS OF ART. 1020 OF THE STANDARD SPECIFICATIONS; THE THICKNESS SHALL BE 8". TEMPORARY PCC PAVEMENT DOES NOT

SCALE: N.T.S.

SHEET

THE MIX ASITIAL I MIXTURE REGULTEMENTS	
MIXTURE TYPE	AIR VOIDS @ Ndes
HOT-MIX ASPHALT PAVEMENT (FULL-DEPTH), 9 3/4": HUNTLEY ROAD/MAIN STF	REET
HOT-MIX ASPHALT SURFACE COURSE, MIX "D", N70 (IL 9.5mm); 1-1/2"	4% @ 70 GYR.
HOT-MIX ASPHALT BINDER COURSE, IL-19.0, N70; 2-1/4"	4% @ 70 GYR.
HOT-MIX ASPHALT BASE COURSE (HMA BINDER IL-19mm); 6" (IN 2 LIFTS)	4% @ 70 GYR.
HOT-MIX ASPHALT PAVEMENT (FULL-DEPTH), 9 3/4": SPRUCE DRIVE AND LINC	COLN AVENUE
HOT-MIX ASPHALT SURFACE COURSE, MIX "D", N70 (IL 9.5mm); 1-1/2"	4% @ 70 GYR.
HOT-MIX ASPHALT BINDER COURSE, IL-19.0, N70; 2-1/4"	4% @ 70 GYR.
HOT-MIX ASPHALT BASE COURSE (HMA BINDER IL-19mm); 6" (IN 2 LIFTS)	4% @ 70 GYR.
DRIVEWAYS	
HMA SURFACE COURSE, MIX "D", N50; (IL 9.5mm); 2"	4% @ 50 GYR.
HMA BASE COURSE (HMA BINDER IL-19 mm); PE-6", CE-8" (IN 2 LIFTS)	4% @ 50 GYR.
TEMPORARY PAVEMENT	
HMA SURFACE COURSE, MIX "D", N70 (IL 9.5 mm); 2"	4% @ 70 GYR.
HOT-MIX ASPHALT BINDER COURSE, IL-19.0, N70; 8"	4% @ 70 GYR.
MULTI-USE PATH	
HOT-MIX ASPHALT SURFACE COURSE, MIX "D", N50 (IL 9.5mm); 1-1/2"	4% @ 50 GYR.
HOT-MIX ASPHALT BINDER COURSE, IL-19.0, N50; 2-1/4"	4% @ 50 GYR.
PAVEMENT RESURFACING: MAIN STREET	
HOT-MIX ASPHALT SURFACE COURSE, MIX "D", N70 (IL 9.5mm); 1-1/2"	4% @ 70 GYR.
PAVEMENT WIDENING: MAIN STREET	
HOT-MIX ASPHALT SURFACE COURSE, MIX "D", N70 (IL 9.5mm); 1-1/2"	4% @ 70 GYR.
HOT-MIX ASPHALT BINDER COURSE, IL-19.0, N70; 2-1/4"	4% @ 70 GYR.
HOT-MIX ASPHALT BASE COURSE WIDENING (HMA BINDER IL-19mm); 6"	4% @ 70 GYR.
HOT-MIX ASPHALT SHOULDERS	
HMA SHOULDER (HMA BINDER IL-19 mm); 8" (IN 2 LIFTS)	4% @ 50 GYR.

HOT-MIX ASPHALT MIXTURE REQUIREMENTS


HRGreer


USER NAME = jmelhui	DESIGNED	-	JRM	REVISED	-	
	DRAWN	-	DMS	REVISED	-	
PLOT SCALE = N.T.S.	CHECKED	-	TH	REVISED	-	
PLOT DATE = 3/23/2018	DATE	-	3/23/18	REVISED	-	
						_

STATE OF ILLINOIS **DEPARTMENT OF TRANSPORTATION**

PROPOSED TYPICAL			F.A.U. RTE.	SECT	LION		COUNTY	TOTAL SHEETS	SHEET NO.
HUNTLEY ROAD/MAI	3887	08-0008	3-00-CH		KANE	259	14		
							CONTRACT	NO. 61	E73
NO. 4 OF 5 SHEETS	STA.	TO STA.	FED. RO	AD DIST. NO.	ILL INO IS	FED. AI	D PROJECT	61E73	

86140100 In Border File 86140100-sht-typical-04.da

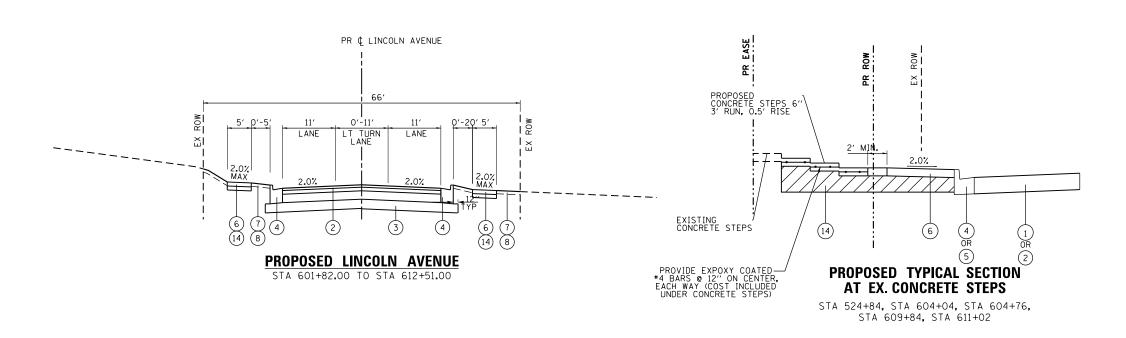

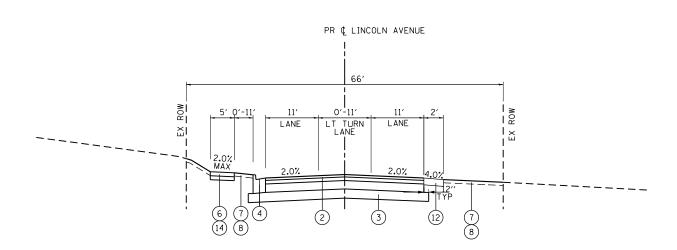

PROPOSED LINCOLN AVENUE

STA 612+51.00 TO STA 613+32.00

EXISTING TYPICAL SECTION LEGEND

- (A) HOT-MIX ASPHALT PAVEMENT, 14"
- B SUBBASE GRANULAR MATERIAL, 4"-10" (PAID AS EARTH EXCAVATION)
- C AGGREGATE SHOULDERS
 (PAID AS EARTH EXCAVATION)
- (D) COMBINATION CONCRETE CURB AND GUTTER
- (E) EXISTING GROUND
- (F) PORTLAND CEMENT CONCRETE SIDEWALK
- (G) CONCRETE MEDIAN / HOT-MIX ASPHALT MEDIAN
- H PCC PAVEMENT, 8" (HUNTLEY/MAIN) PCC PAVEMENT, 10" (IL ROUTE 31)
- I) HOT-MIX ASPHALT SURFACE REMOVAL, 1-1/4"

PROPOSED TYPICAL SECTION LEGEND

- 1 PORTLAND CEMENT CONCRETE PAVEMENT 9 3/4" (JOINTED)
- 2) HOT-MIX ASPHALT PAVEMENT (FULL-DEPTH), 9 3/4"
- 3) AGGREGATE SUBGRADE IMPROVEMENT, 12" (SQ YD)
- (4) COMBINATION CONCRETE CURB AND GUTTER, TYPE B-6.12
- (5) COMBINATION CONCRETE CURB AND GUTTER, TYPE B-6.24
- 6 PORTLAND CEMENT CONCRETE SIDEWALK, 5"
- 7) TOPSOIL FURNISH AND PLACE, 4"
- (8) SODDING, SALT TOLERANT
- 9 CONCRETE MEDIAN SURFACE, 4"
- (10) CONCRETE MEDIAN, TYPE SM-6.12/SM-2.12
- (11) HMA SURFACE COURSE, MIX "D", N50 (IL 9.5MM); 1-1/2"
- 12 HOT-MIX ASPHALT SHOULDER; 8"
- (CU YD)
- (14) SUBBASE GRANULAR MATERIAL, TYPE B 6"

THE SUBGRADE STABILITY SHALL BE VERIFIED BY PROOF ROLLING WITH A FULLY LOADED TANDEM-AXLE TRUCK.

ANY AGGREGATE SUBGRADE IMPROVEMENT CONTAMINATED AND/OR DAMAGED BY THE CONTRACTOR'S VEHICLES AND/OR EQUIPMENTS IS TO BE REMOVED AND REPLACED AS DETERMINED OF THE ENGINEER AT CONTRACTOR EXPENSE.

PIPE UNDERDRAINS SHALL BE INSTALLED ACCORDING TO SECTION 601 OF THE SSRBC AND STANDARD 601001-05. TOP OF PIPE UNDERDRAINS SHALL BE PLACED MINIMUM 6"
BELOW THE AGGREGATE SUBGRADE IMPROVEMENT LAYER. THE COST OF MAKING PIPE UNDERDRAINS CONNECTIONS TO DRAINAGE STRUCTURES SHALL BE INCLUDED IN THE COST OF THE PIPE UNDERDRAINS.

THE ACTUAL LOCATIONS FOR AGGREGATE SUBGRADE IMPROVEMENT (CY YD) WILL BE DETERMINED IN THE FIELD AT THE TIME OF CONSTRUCTION BY THE GEOTECHNICAL ENGINEER. ALL POTENTIALLY UNSTABLE SOILS SHOULD BE TESTED WITH A STATIC CONE PENETROMETER AND TREATED IN ACCORDANCE WITH ARTICLE 301.04 OF THE STANDARD SPECIFICATIONS AND THE GUIDELINES IN THE IDOT SUBGRADE STABILITY MANUAL. IF UNSTABLE AND/OR EMBANKMENT IS ENCOUNTERED, THE SOIL SHALL BE REMOVED AND REPLACED WITH AGGREGATE SUBGRADE IMPROVEMENT OR EMBANKMENT AS DETERMINED BY THE GEOTECHNICAL ENGINEER. IF UNSTABLE AND/OR UNSUITABLE MATERIAL IS NOT ENCOUNTERED, THEN THE QUANTITY SHALL BE DEDUCTED AND NO ADDITIONAL COMPENSATION WILL BE DUE THE CONTRACTOR.

/ER: /L_pdf_bw.p

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USER NAME = Jmelhuı	DESIGNED	-	JRM	REVISED -	
	DRAWN	-	DMS	REVISED -	
PLOT SCALE = N.T.S.	CHECKED	-	TH	REVISED -	
PLOT DATE = 3/23/2018	DATE	-	3/23/18	REVISED -	

STATE OF ILLINOIS
DEPARTMENT OF TRANSPORTATION

SCALE: N.T.S.

PROPOSED TYPICAL SECTIONS								
	LIN	COLN AVE	NUE		3887			
SHEET NO.	5 OF	5 SHEETS	STA.	TO STA.	FED. RO	AD DIS		

F.A.U. RTE.	SECT	TION		COUNTY	TOTAL SHEETS	SHE! NO
3887	08-0008	3-00-CH	KANE	259	15	
				CONTRACT	NO. 61	E73
FED. RO	DAD DIST. NO.	ILLINOIS	FED. A	ID PROJECT	61E73	

SCHEDULE OF QUANTITIES - EARTHWORK - HUNTLEY ROAD

HUNTLEY		STAGE 1	(CU YD)			STAGE 2	(CU YD)			STAGE 3	(CU YD)	E	ARTHWORK BALANCE W	ASTE () OR SHORTAGE	(-) WITH 15% SHRIN
STATION	REMOVAL AND DISPOSAL OF UNSUITABLE MATERIAL	EARTH EXCAVATION	EMBANKMENT	AGGREGATE SUBGRADE IMPROVEMENT	REMOVAL AND DISPOSAL OF UNSUITABLE MATERIAL	EARTH EXCAVATION	EMBANKMENT	AGGREGATE SUBGRADE IMPROVEMENT	REMOVAL AND DISPOSAL OF UNSUITABLE MATERIAL	EARTH EXCAVATION	EMBANKMENT	AGGREGATE SUBGRADE IMPROVEMENT	STAGE 1	STAGE 2	STAGE 3
													0.0	0.0	
106+50.00	3.6	9.8	1.6	0.0	0.0	6.2	0.2	0.0	0.0	0.0	0.0	0.0	6.7	5.1	0.0
106+73.04	8.4	20.5	5.3	0.0	3.1	11.7	2.9	0.0	0.0	8.0	0.0	0.0	12.2	7.0	6.8
107+00.00	9.8	26.5	5.6	0.0	9.3	15.5	6.7	1.7	0.0	16.7	0.0	0.0	16.9	6.5	14.2
107+50.00	18.3	64.5	8.2	0.0	24.4	37.4	11.5	8.7	0.0	21.0	0.0	0.0	46.6	20.3	17.9
107+58.62	3.2	12.9	1.5	0.0	4.9	7.3	1.8	1.9	0.0	2.5	0.0	0.0	9.5	4.4	2.1
107+78.80	7.4	28.8	3.5	0.0	12.7	17.7	4.7	5.1	0.0	5.3	0.0	0.0	21.0	10.3	4.5
108+00.00	7.7	27.7	4.2	0.0	15.2	19.1	6.3	6.1	0.0	5.0	0.2	0.0	19.4	9.9	4.0
108+50.00	18.2	60.5	10.6	0.0	40.6	49.5	24.0	17.5	0.0	10.8	0.5	0.0	40.7	18.1	8.7
108+84.31	12.5	47.4	5.0	0.0	31.6	42.1	20.3	14.5	0.0	6.4	0.6	0.0	35.3	15.5	4.8
109+00.00	5.8	24.3	1.5	0.0	15.5	22.5	7.5	7.4	0.0	2.2	0.7	0.0	19.1	11.6	1.1
109+08.67	3.2	13.1	0.9	0.0	8.9	13.3	3.3	4.3	0.0	1.0	0.5	0.0	10.3	8.0	0.3
109+50.00	15.5	52.7	6.4	0.0	43.5	71.4	11.6	22.3	0.0	4.8	3.4	0.0	38.5	49.1	0.7
110+00.00	19.2	58.6	5.2	0.0	54.4	99.3	14.1	30.2	0.0	6.0	4.8	0.0	44.6	70.3	0.3
110+50.00	26.8	52.6	21.4	4.4	54.6	104.7	15.5	30.7	0.0	9.4	3.5	0.0	23.3	73.6	4.4
110+75.96	17.9	25.3	14.2	4.8	26.7	57.0	4.3	15.3	0.0	7.3	0.9	0.0	7.4	44.1	5.3
111+00.00	15.8	25.8	5.7	4.8	25.4	51.4	2.5	13.8	0.0	7.8	0.3	0.0	16.3	41.2	6.4
111+50.00	32.0	49.0	13.2	11.1	51.0	96.0	5.3	27.8	0.0	17.3	0.0	0.0	28.4	76.3	14.7
111+86.14	24.3	38.1	8.6	8.9	32.5	65.7	2.7	19.1	0.0	13.4	0.0	0.0	23.7	53.1	11.4
112+00.00	9.6	15.7	2.5	3.6	12.2	24.6	0.7	7.1	0.0	5.3	0.0	0.0	10.9	20.2	4.5
112+50.00	35.5	51.7	9.8	13.6	42.7	87.9	0.7	24.9	0.0	19.0	0.0	0.0	34.1	73.9	16.1
113+00.00	36.8	50.1	10.0	14.9	43.5	87.3	1.2	23.5	0.0	18.4	0.0	0.0	32.6	73.0	15.7
113+50.00	45.6	79.5	4.6	22.9	48.6	114.7	2.9	22.0	0.0	20.3	0.0	0.0	63.0	94.6	17.2
114+00.00	33.7	86.6	0.0	21.0	51.5	152.8	1.9	20.6	0.0	25.7	0.0	0.0	73.6	127.9	21.9
116+50.00	131.9	600.5	10.2	88.4	223.6	756.5	2.3	145.8	0.0	101.9	0.0	0.0	500.2	640.7	86.6
117+00.00	39.1	140.2	23.2	22.7	19.3	102.3	0.4	19.2	0.0	12.3	0.0	0.0	95.9	86.6	10.5
117+50.00	40.7	111.9	21.2	21.2	13.1	66.9	0.1	9.0	0.0	11.2	0.0	0.0	73.9	56.8	9.5
118+00.00	45.8	130.9	0.5	20.8	23.9	65.9	0.0	18.0	0.0	9.9	0.0	0.0	110.8	56.0	8.4
118+50.00	46.0	138.2	0.6	22.0	24.4	63.2	1.4	18.3	0.0	10.3	0.0	0.0	116.9	52.4	8.7
119+00.00	41.7	124.2	0.2	23.5	27.6	64.2	1.4	19.3	0.0	10.6	0.0	0.0	105.4	53.2	9.0
119+50.00	38.8	104.8	0.7	22.2	29.6	64.4	1.2	21.4	0.0	5.3	0.0	0.0	88.4	53.6	4.5
120+00.00	38.5	81.9	21.0	19.1	28.3	58.9	2.1	21.7	0.0	0.0	0.0	0.0	48.6	47.9	0.0
120+50.00	44.3	62.3	32.0	20.0	21.6	36.4	6.8	16.4	0.0	0.0	0.0	0.0	20.9	24.2	0.0
121+00.00	53.1	55.1	27.8	25.0	18.7	25.0	11.0	11.9	0.0	0.0	0.0	0.0	19.1	10.2	0.0
121+50.00	57.9	84.7	76.7	41.9	21.5	29.4	5.4	15.4	0.0	0.0	0.0	0.0	-4.7	19.6	0.0
122+50.00	65.4	166.7	121.3	61.1	42.2	62.0	3.1	36.3	0.0	0.0	0.0	0.0	20.4	49.6	0.0
123+00.00	4.2	53.2	0.3	2.5	19.3	29.7	1.9	15.1	0.0	0.0	0.0	0.0	45.0	23.3	0.0
123+50.00	1.0	28.9	0.2	0.0	19.4	22.7	0.7	13.1	0.0	0.0	0.0	0.0	24.4	18.5	0.0
124+00.00	0.5	8.4	0.0	0.0	11.9	35.6	0.2	8.7	0.0	0.0	0.0	0.0	7.2	30.1	0.0
124+06.95	0.0	1.7	0.0	0.0	0.6	6.0	0.0	0.6	0.0	0.0	0.0	0.0	1.4	5.1	0.0
124+50.00	0.0	9.2	0.2	0.0	5.1	20.0	0.0	5.1	0.0	0.0	0.0	0.0	7.6	17.0	0.0
124+94.18	0.0	6.2	0.3	0.0	4.9	7.5	0.0	4.9	0.0	0.0	0.0	0.0	5.0	6.4	0.0
TOTALS	1059.6	2830.7	485.8	500.6	1207.7	2771.8	190.7	724.9	0.0	394.9	15.5	0.0	1920.3	2165.3	320.2
		l		<u> </u>			ı	1						1	1
										TOT	AL (CU YD)				

HRGreen

HRGreen.com Illinois Professional Design Firm # 184-001322

USER NAME = jmelhui	DESIGNED	-	JRM	REVISED -
	DRAWN	-	DMS	REVISED -
PLOT SCALE = N.T.S.	CHECKED	-	TH	REVISED -
PLOT DATE = 3/23/2018	DATE	-	3/23/18	REVISED -

STATE C	F ILLINOIS
DEPARTMENT OF	TRANSPORTATION

FURNISHED EXCAVATION

AGGREGATE SUBGRADE IMPROVEMENT

20201200

20400800 30300001 REMOVAL AND DISPOSAL OF UNSUITABLE MATERIAL

EARTHWORK SC	F.A.U. RTE.	SEC	ΓΙΟΝ	COUNTY	TOTAL SHEETS	SHEE NO.			
HUNTLEY R	OAD/MAI	N STREET		3887	08-0008	3-00-CH	KANE	259	16
							CONTRA	CT NO. 6	1E73
SCALE: N.T.S. SHEET NO. 1 OF	4 SHEETS	STA.	TO STA.	FED. RO	DAD DIST. NO.	ILLINOIS FED	. AID PROJECT	61E73	3

2267.3

692.0

1225.6

SCHEDULE OF QUANTITIES - EARTHWORK - IL ROUTE 31

	IL31		STA	GE 1 (CU YD)			STAGE 2	2 (CU YD)			STAGE 3	(CU YD)		EARTHWORK BALA	NCE WASTE () OR SH SHRINKAGE	ORTAGE (-) WITH 15%
	STATION	REMOVAL AND DISPOSAL OF UNSUITABLE MATERIAL	EARTH EXCAVATION	N EMBANKMENT	AGGREGATE SUBGRADE IMPROVEMENT	REMOVAL AND DISPOSAL OF UNSUITABLE MATERIAL	EARTH EXCAVATION	EMBANKMENT	AGGREGATE SUBGRADE IMPROVEMENT	REMOVAL AND DISPOSAL OF UNSUITABLE MATERIAL	EARTH EXCAVATION	EMBANKMENT	AGGREGATE SUBGRADE IMPROVEMENT	STAGE 1	STAGE 2	STAGE 3
	506+45.00													0.0	0.0	
	506+50.00	0.1	1.1	0.0	0.0	0.9	1.8	0.0	0.0	0.0	2.5	0.1	0.0	0.9	1.5	2.0
	507+00.00	6.5	24.5	0.0	4.0	11.6	36.8	0.0	4.1	0.0	44.5	2.9	0.0	20.9	31.2	35.0
	507+50.00	11.6	37.4	0.0	8.4	18.4	51.5	0.0	9.5	0.0	31.1	5.1	0.0	31.8	43.8	21.4
	508+00.00	12.7	50.8	0.0	9.0	20.2	62.2	0.1	12.1	0.0	15.0	6.1	0.0	43.2	52.8	6.6
	508+50,00	12.6	50.5	0.0	9.1	22.8	73.1	0.1	14.4	0.0	13.6	5.0	0.0	42.9	62.1	6.6
	509+00.00	15.6	60.9	0.0	8.9	26.5	72.7	0.0	16.9	0.0	23.1	3.7	0.0	51.8	61.8	16.0
	509+19.38	5.7	24.1	0.0	3.3	12.1	27.0	0.0	7.3	0.0	10.4	1.2	0.0	20.5	23.0	7.7
	509+50.00	6.2	31.9	0.0	4.9	20.4	41.7	0.1	12.4	0.0	17.4	0.9	0.0	27.1	35.4	13.8
	510+00.00	9.4	46.3	0.0	7.3	34.8	67.6	0.1	22.2	0.0	29.0	0.0	0.0	39.4	57.4	24.6
	510+50.00	4.7	36.9	0.1	3.4	37.9	72.5	0.0	24.4	0.0	28.4	0.0	0.0	31.2	61.6	24.2
	511+00.00	1.0	33.7	3.5	0.0	49.5	87.9	0.3	31.9	0.0	27.7	0.0	0.0	25.1	74.4	23.5
	511+50.00	0.7	67.0	3.4	0.0	39.1	88.1	0.3	19.3	0.0	28.6	0.0	0.0	53.6	74.6	24.3
	512+00.00	23.2	107.9	0.0	17.6	21.5	80.2	0.0	0.0	0.0	30.9	0.0	0.0	91.7	68.2	26.3
	512+50.00	33.6	84.9	0.6	23.6	34.2	91.7	0.0	14.4	0.0	20.3	3.6	0.0	71.6	77.9	13.6
	513+00.00	20.7	56.8	0.6	11.9	43.9	101.0	0.0	29.0	0.0	12.2	5.6	0.0	47.7	85.9	4.7
	513+50.00	20.8	56.9	0.3	11.9	46.8	103.8	0.0	31.1	0.0	19.4	2.0	0.0	48.0	88.2	14.4
	514+00.00	23.4	66.4	0.3	15.2	52.3	103.5	0.1	35.2	0.0	21.0	0.0	0.0	56.2	87.9	17.9
	514+50.00	28.3	95.7	0.0	19.2	55.9	115.9	0.1	37.8	0.0	9.7	0.0	0.0	81.4	98.4	8.3
	514+72.99	14.9	50.5	0.0	9.3	26.1	60.2	0.0	17.8	0.0	0.0	0.0	0.0	43.0	51.2	0.0
	515+00.00	17.0	50.0	0.0	11.1	31.0	70.4	0.0	20.6	0.0	0.0	0.0	0.0	42.5	59.8	0.0
	515+50.00	28.8	81.0	0.0	20.9	51.9	118.4	0.0	34.1	0.0	0.0	0.0	0.0	68.9	100.7	0.0
	516+00.00	32.4	86.1	0.0	21.8	24.1	108.7	0.0	15.4	0.0	0.0	0.0	0.0	73.2	92.4	0.0
	516+16.13	11.2	27.7	0.0	7.2	0.3	39.2	0.0	0.0	0.0	0.0	0.0	0.0	23.5	33.3	0.0
	516+50.00	23.3	64.5	0.0	15.4	12.6	95.8	0.0	7.6	0.0	0.0	0.0	0.0	54.8	81.4	0.0
	517+00.00	35.1	98.8	0.2	23.1	39.4	138.6	0.0	24.0	0.0	0.0	0.0	0.0	83.8	117.8	0.0
	517+50.00	55.0	71.7	45.6	34.8	40.5	117.0	0.2	25.7	0.0	0.0	0.0	0.0	15.3	99.3	0.0
	518+00.00	40.7	44.4	50.4	23.1	48.2	169.7	0.2	31.0	0.0	6.5	0.0	0.0	-12.7	144.1	5.5
	518+50.00	3.2	17.5	8.1	0.0	71.9	328.2	0.0	47.1	0.0	31.9	0.0	0.0	6.8	279.0	27.1
	519+00.00	29.0	136.6	3.1	19.3	43.3	254.0	0.0	29.1	0.0	25.4	0.0	0.0	112.9	215.9	21.6
	519+50.00	54.2	234.4	0.3	35.2	1.9	42.5	19.2	0.0	0.0	46.9	0.0	0.0	199.0	17.0	39.8
	520+00.00	48.5	199.5	0.4	31.9	1.9	27.8	19.2	0.0	0.0	73.7	0.0	0.0	169.2	4.4	62.6
	520+50.00	42.8	168.4	0.1	28.2	55.7	283.5	0.0	53.7	0.0	31.7	0.0	0.0	143.1	241.0	26.9
	521+00.00	27.2	98.9	0.0	17.9	76.2	335.0	0.2	67.6	0.0	9.1	0.0	0.0	84.1	284.6	7.7
	521+50.00	16.9	73.6	0.0	5.6	41.9	169.1	0.2	26.3	0.0	8.0	0.0	0.0	62.6	143.5	6.8
	521+92.12	13.5	61.5	0.4	0.0	37.8	173.4	0.0	21.1	0.0	5.9	0.0	0.0	51.9	147.4	5.0
	522+00.00	2.2	9.6	0.2	0.0	7.4	36.8	0.0	4.0	0.0	1.0	0.0	0.0	8.0	31.3	0.9
	522+50.00	13.1	57.7	1.7	0.0	46.9	205.3	0.0	26.0	0.0	6.9	0.0	0.0	47.4	174.5	5.8
	522+54.37	1.0	4.7	0.2	0.0	4.1	15.3	0.0	2.3	0.0	0.6	0.0	0.0	3.8	13.0	0.5
	523+00.00	8.5	40.7	2.4	0.0	39.0	130.2	0.0	24.2	0.0	5.5	1.8	0.0	32.3	110.7	2.9
	523+50.00	5.2	27.7	5.6	0.0	38.9	111.5	0.0	25.0	0.0	4.8	5.7	0.0	17.9	94.8	-1.6
	523+90.07	6.5	28.1	3.7	0.0	30.9	89.1	0.0	18.4	0.0	4.0	7.6	0.0	20.2	75.8	-4.2
	524+00.00	1.9	8.5	0.1	0.0	7.4	22.4	0.0	4.3	0.0	1.0	2.3	0.0	7.1	19.0	-1.4
	524+50.00	8.9	43.4	0.3	0.0	33.0	92.0	0.0	20.2	0.0	5.6	13.1	0.0	36.6	78.2	-8.3
-	524+56.17	1.5	6.3	0.0	0.0	3.4	8.4	0.0	2.3	0.0	0.7	1.8	0.0	5.4	7.1	-1.2
	525+00.00	10.7	33.4	4.4	0.0	21.3	55.5	0.1	15.5	0.0	7.3	11.0	0.0	24.0	47.1	-4.8
	525+28.01	13.5	18.5	13.3	0.0	13.0	31.5	0.1	8.9	0.0	7.1	5.1	0.0	2.4	26.7	0.9
	525+50.00	8.7	15.5	8.6	0.0	6.9	24.0	0.0	3,3	0.0	7.1	3.0	0.0	4.6	20.3	3,0
														1=		
_ HR	Green.com	USER NAME = jmelhuı		SIGNED - JRM AWN - DMS	REVISED -		ст	ATE OF ILLINOI	9			DULE OF QUANTIT ROUTE 31	IES	F.A.U. RTE.	SECTION	COUNTY TOTAL SHEE SHEETS NO
HR Illino #18 een	s Professional Design Firm 1-001322	PLOT SCALE = N.T.S.		ECKED - TH	REVISED -			NT OF TRANSP			ILLINUIS	NUUIE JI		3887 08	-00083-00-CH	KANE 259 17 CONTRACT NO. 61E73
CC II		PLOT DATE = 3/23/2018	DA	TE - 3/23/18	REVISED -					SCALE: N.T.S.	SHEET NO. 2 OF 4 S	SHEETS STA.	TO STA.	FED. ROAD DIST.	NO. ILLINOIS FED. AI	

SCHEDULE OF QUANTITIES - EARTHWORK - IL ROUTE 31 (CONT.)

IL31			STAGE 2 (CU YD)				EARTHWORK BALANCE WASTE () OR SHORTAGE (-) WITH 15% SHRINKAGE								
STATION	REMOVAL AND DISPOSAL OF UNSUITABLE MATERIAL	EARTH EXCAVATION	EMBANKMENT	AGGREGATE SUBGRADE IMPROVEMENT	REMOVAL AND DISPOSAL OF UNSUITABLE MATERIAL	EARTH EXCAVATION	EMBANKMENT	AGGREGATE SUBGRADE IMPROVEMENT	REMOVAL AND DISPOSAL OF UNSUITABLE MATERIAL	EARTH EXCAVATION	EMBANKMENT	AGGREGATE SUBGRADE IMPROVEMENT	STAGE 1	STAGE 2	STAGE 3
525+59.03	0.7	5.8	0.3	0.0	1.5	9.9	0.1	0.0	0.0	3.3	1.0	0.0	4.6	8.3	1.8
526+00.00	6.5	35.1	0.6	0.0	3.6	34.6	2.7	0.0	0.0	17.1	3.6	0.0	29.2	26.8	10.9
526+06.15	1.5	6.5	0.0	0.0	0.0	3.7	0.7	0.0	0.0	3.0	0.2	0.0	5.5	2.4	2.3
526+39.31	6.8	35.2	0.0	0.0	3.4	29.0	3.3	0.0	0.0	12.7	0.0	0.0	29.9	21.4	10.8
526+50.00	1.8	11.3	0.0	0.0	2.0	12.3	0.5	0.0	0.0	2.8	0.0	0.0	9.6	10.0	2.3
526+54.78	0.8	5.0	0.0	0.0	0.7	4.8	0.1	0.0	0.0	1.2	0.0	0.0	4.2	4.0	1.0
527+00.00	7.8	38.6	0.0	0.0	23.2	57.4	2.9	12.6	0.0	10.8	0.0	0.0	32.8	45.8	9.2
527+38.20	6.8	31.6	0.0	0.0	45.4	72.9	7.9	29.4	0.0	8.2	0.0	0.0	26.9	54.1	7.0
527+50.00	1.9	11.5	0.0	0.0	17.4	25.3	2.0	12.0	0.0	3.3	0.0	0.0	9.8	19.5	2.8
527+95.51	11.2	55.8	0.0	0.0	67.1	112.1	1.4	48.7	0.0	17.5	0.0	0.0	47.4	93.8	14.9
528+00.00	1.6	6.7	0.0	0.0	6.5	12.3	0.0	4.8	0.0	1.9	0.0	0.0	5.7	10.4	1.6
528+33.06	7.7	32.1	0.4	0.0	42.3	80.2	0.0	28.9	0.0	12.2	0.0	0.0	26.8	68.2	10.4
528+50.00	1.8	7.5	0.6	0.0	18.1	32.7	0.0	12.1	0.0	5.4	0.0	0.0	5.8	27.8	4.6
528+84.08	4.4	15.2	1.8	0.0	23.6	40.6	0.1	15.7	0.0	10.0	0.0	0.0	11.2	34.5	8.5
529+00.00	2.1	7.9	0.6	0.0	4.5	9.2	0.6	1.7	0.0	4.3	0.0	0.0	6.1	7.3	3.7
529+22.01	2.0	7.0	0.2	0.0	2.7	6.0	0.8	0.0	0.0	2.9	0.0	0.0	5.7	4.3	2.5
TOTALS	877.9	3105.5	162.2	462.4	1667.7	5175.6	63.3	1063.6	0.0	791.9	92.5	0.0	2477.6	4335.9	580.6

TOTAL (CU YD)

20200100	EARTH EXCAVATION	9073.0
20201200	REMOVAL AND DISPOSAL OF UNSUITABLE MATERIAL	2545.6
20400800	FURNISHED EXCAVATION	318.0
30300001	AGGREGATE SUBGRADE IMPROVEMENT	1525.9

SCALE: N.T.S.

	USER NAME = Jmelhui	DESIGNED	-	JRM	REVISED	-
m		DRAWN	-	DMS	REVISED	-
	PLOT SCALE = N.T.S.	CHECKED	-	TH	REVISED	-
	PLOT DATE = 3/23/2018	DATE	-	3/23/18	REVISED	-

STATE OF ILLINOIS
DEPARTMENT OF TRANSPORTATION

ARTHW	ARTHWORK SCHEDULE OF QUANTITIES						SEC	TION			COU
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										Т	CONT
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KANE 259 18

INTRACT NO. 61E73

DJECT 61E73

SCHEDULE OF QUANTITIES — EARTHWORK — LINCOLN AVENUE

LINCOLN		STAGE 1	(CU YD)			STAGE 2	(CU YD)			STAGE 3	(CU YD)		EARTHWORK BAL SHORTAGE (-) WI	ANCE WASTE (TH 15% SHRIN
STATION	REMOVAL AND DISPOSAL OF UNSUITABLE MATERIAL	EARTH EXCAVATION	EMBANKMENT	AGGREGATE SUBGRADE IMPROVEMENT	REMOVAL AND DISPOSAL OF UNSUITABLE MATERIAL	EARTH EXCAVATION	EMBANKMENT	AGGREGATE SUBGRADE IMPROVEMENT	REMOVAL AND DISPOSAL OF UNSUITABLE MATERIAL	EARTH EXCAVATION	EMBANKMENT	AGGREGATE SUBGRADE IMPROVEMENT	STAGE 1	STAGE
602+00.00													0.0	0.0
602+31.00	0.0	24.2	0.6	0.0	3.2	18.1	0.9	0.0	0.0	0.0	0.0	0.0	20.0	14.5
602+47.59	1.0	12.5	1.2	0.0	1.7	11.3	0.1	0.0	0.0	0.0	0.0	0.0	9.5	9.6
602+50.00	0.3	1.9	0.2	0.0	0.2	1.7	0.0	0.0	0.0	0.0	0.0	0.0	1.4	1.4
602+91.76	2.9	33.8	3.9	0.0	3.9	28.8	0.1	0.0	0.0	0.0	0.0	0.0	24.9	24.4
603+00.00	0.0	6.6	0.7	0.0	0.8	5.3	0.0	0.0	0.0	0.0	0.0	0.0	4.9	4.5
603+07.41	0.0	6.0	0.5	0.0	0.7	4.7	0.0	0.0	0.0	0.0	0.0	0.0	4.7	3.9
603+13.58	0.0	5.1	0.3	0.0	0.6	4.1	0.0	0.0	0.0	0.0	0.0	0.0	4.1	3.4
603+41.36	2.8	24.0	1.2	0.0	2.8	19.3	0.1	0.0	0.0	0.0	0.0	0.0	19.2	16.
603+50.00	1.7	7.5	0.8	0.0	0.8	6.0	0.0	0.0	0.0	0.0	0.0	0.0	5.6	5.:
604+00.00	4.5	44.0	8.1	0.0	4.8	30.6	1.5	0.0	0.0	0.0	0.0	0.0	29.2	24.
604+11.68	0.0	10.7	2.2	0.0	1.1	6.4	0.6	0.0	0.0	0.0	0.0	0.0	6.9	4.
604+38.08	2.9	24.0	6.6	0.0	2.5	17.5	0.8	0.0	0.0	0.0	0.0	0.0	13.9	14.
604+50.00	2.5	10.6	3.4	0.0	1.1	9.4	0.1	0.0	0.0	0.0	0.0	0.0	5.7	7.
605+00.00	10.1	45.0	11.8	0.0	4.7	39.8	0.4	0.0	0.0	0.0	0.0	0.0	26.5	33
605+06.35	1.4	5.8	1.5	0.0	0.6	4.9	0.0	0.0	0.0	0.0	0.0	0.0	3.5	4.
605+50.00	10.4	38.5	11.6	0.0	4.0	29.5	1.0	0.0	0.0	0.0	0.0	0.0	21.1	24
605+73.27	5.7	19.4	6.4	0.0	2.1	16.5	0.5	0.0	0.0	0.0	0.0	0.0	10.1	13.
606+00.00	6.3	22.0	7.0	0.0	2.3	19.5	0.7	0.0	0.0	0.0	0.0	0.0	11.7	15
606+32.23	6.9	26.4	9.4	0.0	2.7	19.6	2.5	0.0	0.0	0.0	0.0	0.0	13.0	14
606+50.00	3.3	14.5	5.4	0.0	1.5	10.3	1.6	0.0	0.0	0.0	0.0	0.0	7.0	7.
607+00.00	8.6	41.5	12.0	0.0	4.3	32.0	2.3	0.0	0.0	0.0	0.0	0.0	23.2	24.
607+50.00	10.5	25.6	22.2	0.0	4.3	33.8	0.7	0.0	0.0	0.0	0.0	0.0	-0.4	28.
609+00.00	23.1	75.8	56.4	0.0	22.5	101.9	6.7	0.0	0.0	0.0	0.0	0.0	8.1	80.
609+50.00	3.0	41.4	3.1	0.0	9.4	32.2	5.3	0.0	0.0	0.0	0.0	0.0	32.1	22
610+00.00	4.3	51.0	1.6	0.0	8.1	29.0	5.0	0.0	0.0	0.0	0.0	0.0	41.8	19.
610+21.16	1.2	27.0	0.2	0.0	3.3	14.1	0.8	0.0	0.0	0.0	0.0	0.0	22.8	11.
610+37.66	0.0	22.2	0.1	0.0	2.6	10.6	0.9	0.0	0.0	0.0	0.0	0.0	18.8	8.
610+50.00	0.0	16.8	0.1	0.0	1.9	6.4	1.8	0.0	0.0	0.0	0.0	0.0	14.2	3.
611+00.00	2.1	57.0	1.0	0.0	8.2	26.6	8.0	0.0	0.0	0.0	0.0	0.0	47.5	14.
611+50.00	5.6	41.7	6.7	0.0	8.4	39.1	3.7	0.0	0.0	0.0	0.0	0.0	28.8	29
612+00.00	6.5	38.0	9.6	0.0	8.3	40.9	1.7	0.0	0.0	0.0	0.0	0.0	22.6	33
612+13.83	1.5	10.5	1.9	0.0	2.3	10.6	0.5	0.0	0.0	0.0	0.0	0.0	7.1	8.
612+50.00	3.5	27.6	4.3	0.0	6.1	28.5	3.1	0.0	0.0	0.0	0.0	0.0	19.2	21.
613+00.00	3.4	27.8	4.5	0.0	8.4	38.1	4.8	0.0	0.0	0.0	0.0	0.0	19.1	27
613+00.98	0.0	0.3	0.1	0.0	0.2	0.9	0.0	0.0	0.0	0.0	0.0	0.0	0.2	0.
TOTALS	136.1	887.0	206.2	0.0	140.8	748.0	56.3	0.0	0.0	0.0	0.0	0.0	547.8	579

TOTAL	ιCU	Υſ

20200100	EARTH EXCAVATION	1635.0
20201200	REMOVAL AND DISPOSAL OF UNSUITABLE MATERIAL	276.9
20400800	FURNISHED EXCAVATION	262.5
30300001	AGGREGATE SUBGRADE IMPROVEMENT	0.0


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HRGreen	# 184-001322

USER NAME = Jmelhui	DESIGNED	-	JRM	REVISED -
	DRAWN	-	DMS	REVISED -
PLOT SCALE = N.T.S.	CHECKED	-	TH	REVISED -
PLOT DATE = 3/23/2018	DATE	-	3/23/18	REVISED -

STATE ()F ILLINOIS
DEPARTMENT OF	TRANSPORTATION

	F.A.U. RTE.	SEC					
	3887	08-0008					
SCALE: N.T.S.	SHEET NO.	4 OF	4 SHEETS	STA.	TO STA.	FED. RO	DAD DIST. NO.



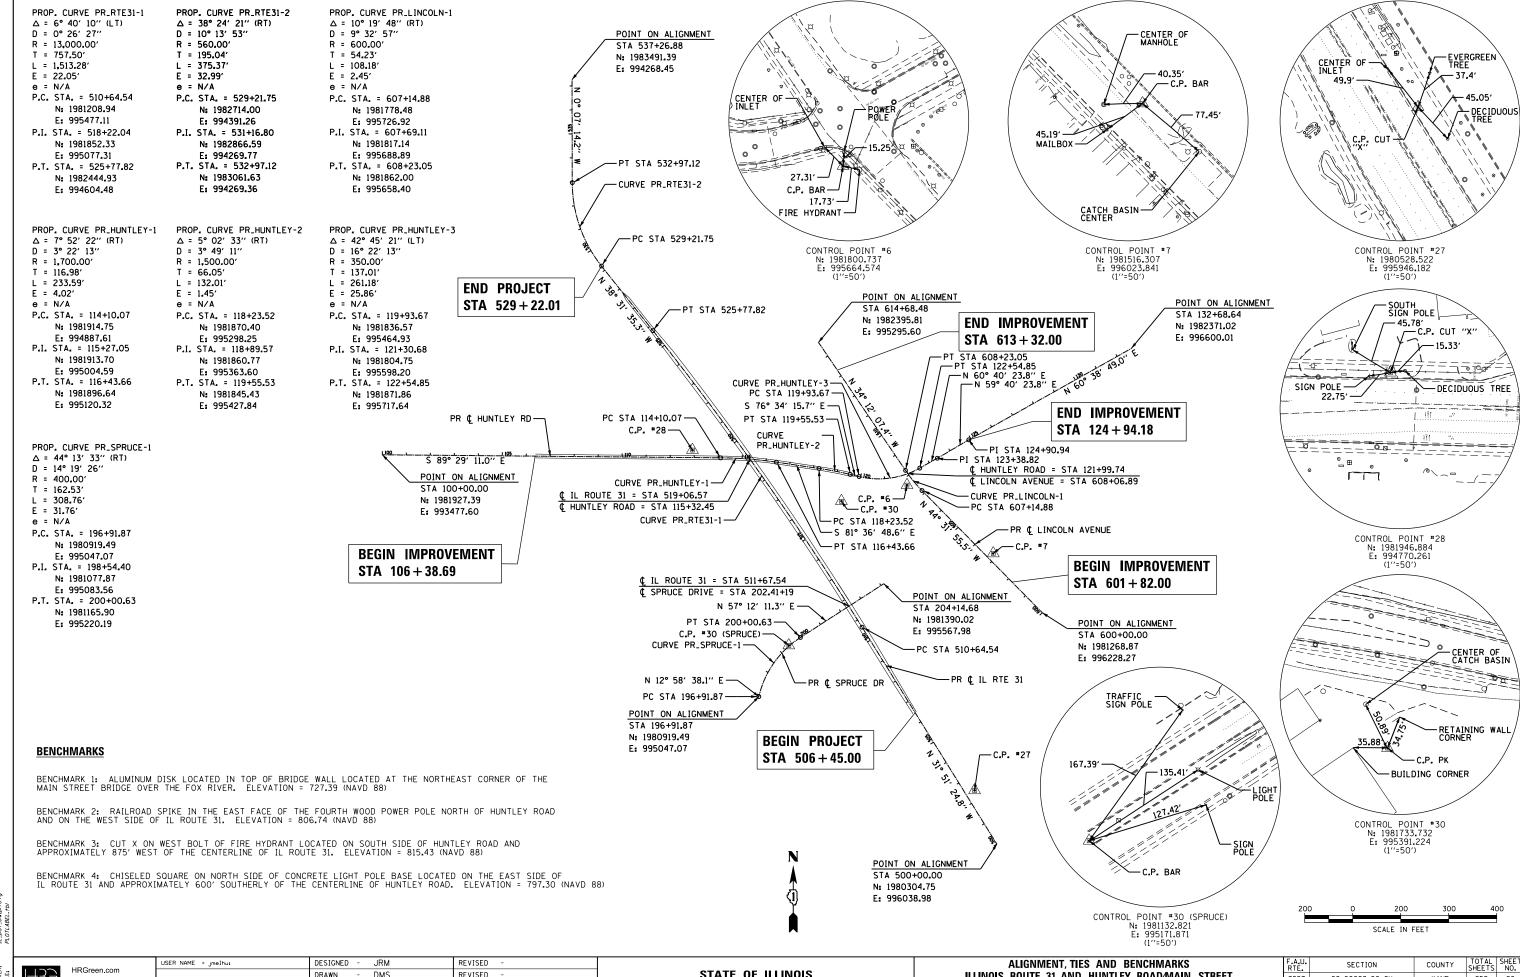


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CHECKED ΤH REVISED 3/23/18 PLOT DATE = 3/23/2018 DATE REVISED

STATE OF ILLINOIS **DEPARTMENT OF TRANSPORTATION** ILLINOIS ROUTE 31 AND HUNTLEY ROAD/MAIN STREET 3887 08-00083-00-CH

KANE 259 20 CONTRACT NO. 61E73 SCALE: N.T.S. SHEET NO. 1 OF 1 SHEETS STA.



NY NAME: SCOMPANY NAMES

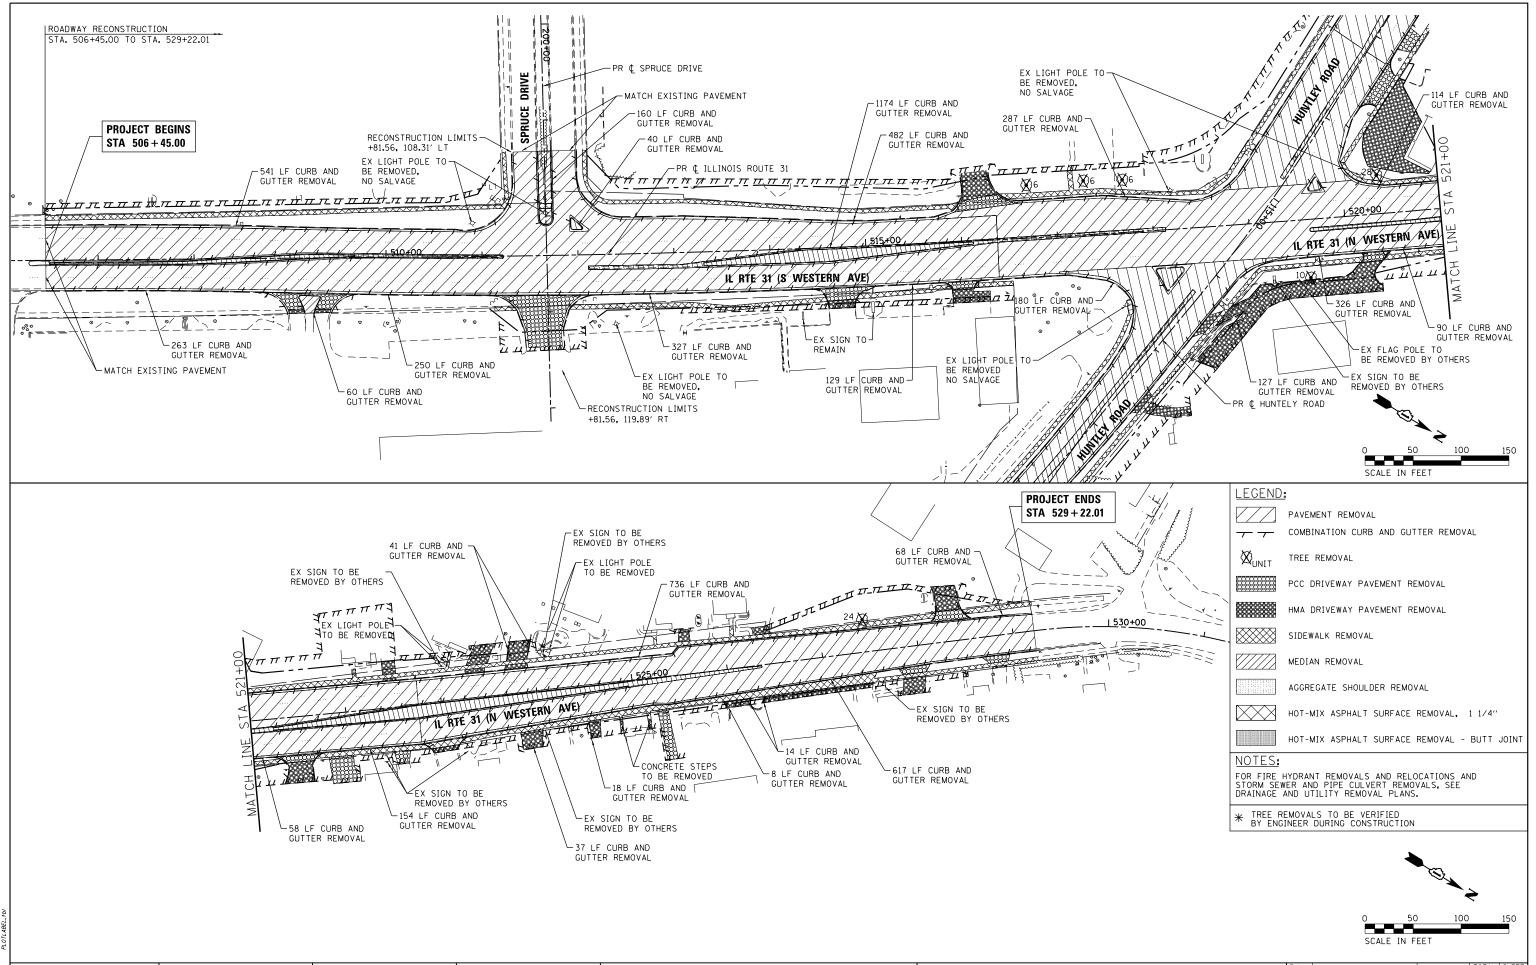IT CONTACT: \$PROJECT.CONTACTS

PLOTTED: 3/2/2/2018 IL27/08 AA

NAME: 86/40/10-Snt-rem-02

ABIE: PLOTABEL.TD


ABIE: PLOTABEL.TD

HRGreen.com
#inois Professional Design Firm
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USER NAME = jmelhui	DESIGNED	-	JRM	REVISED -
FILE NAME = 86140100-sht-rem-02.dgn	DRAWN	-	DMS	REVISED -
PLOT SCALE = 1"=50"	CHECKED	-	TH	REVISED -
PLOT DATE = 3/23/2018	DATE	-	3/23/18	REVISED -

STATE OF ILLINOIS
DEPARTMENT OF TRANSPORTATION

l			REMOVAL P	F.A.U. RTE.	SECTION NO.	COUNTY	TOTAL SHEETS	SHEET NO.		
l			ILLINOIS ROU	3887	08-00083-00-CH	KANE	259	22		
ļ						CONTRACT	NO.	61E73		
l	SCALE:	1''=50'	SHEET NO. 2 OF 3 SHEETS	STA. 506+45.00	TO STA. 529+22.01	FED. RO	DAD DIST. NO. ILLINOIS FED. A	ID PROJECT		

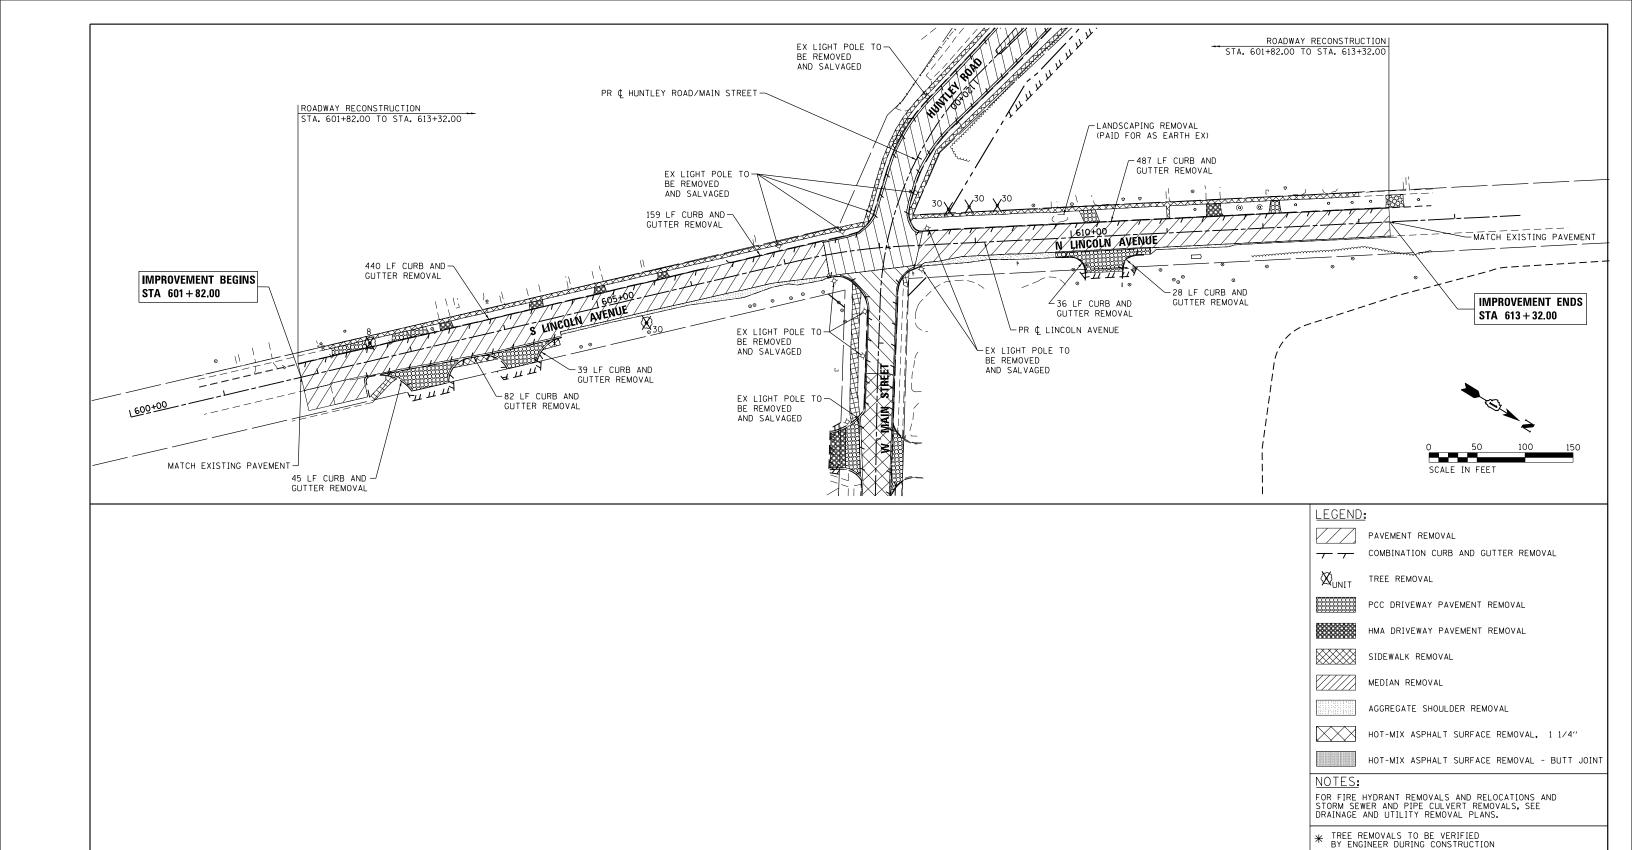

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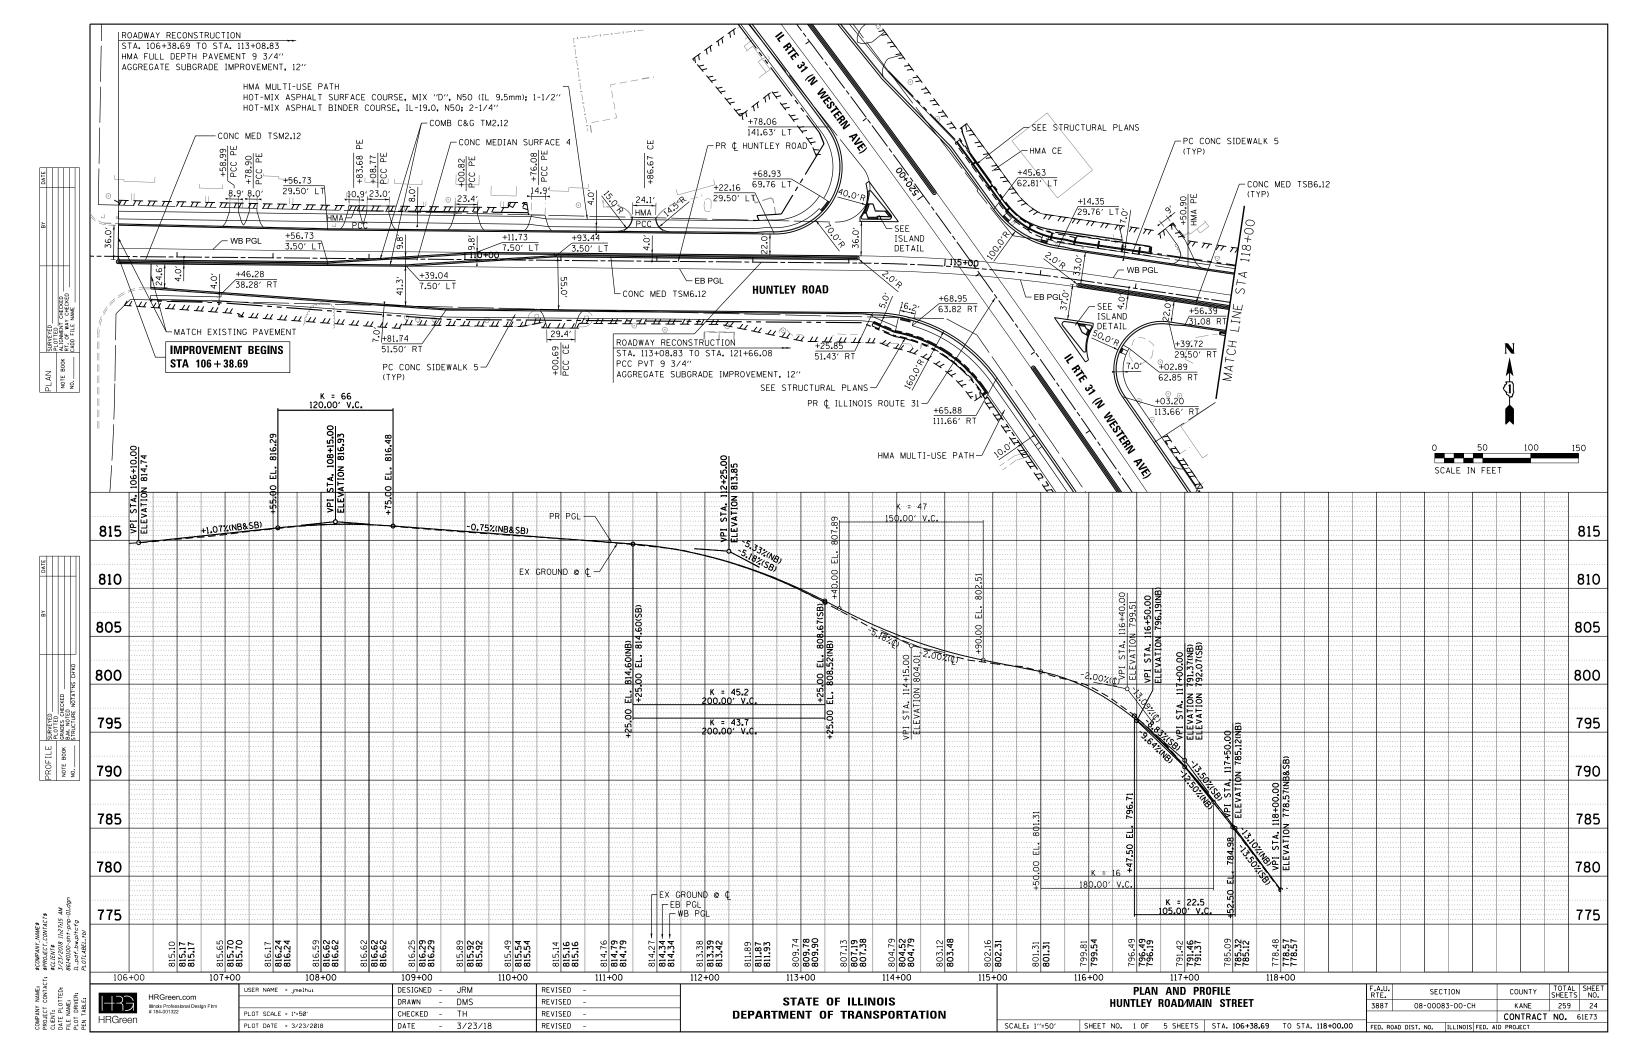
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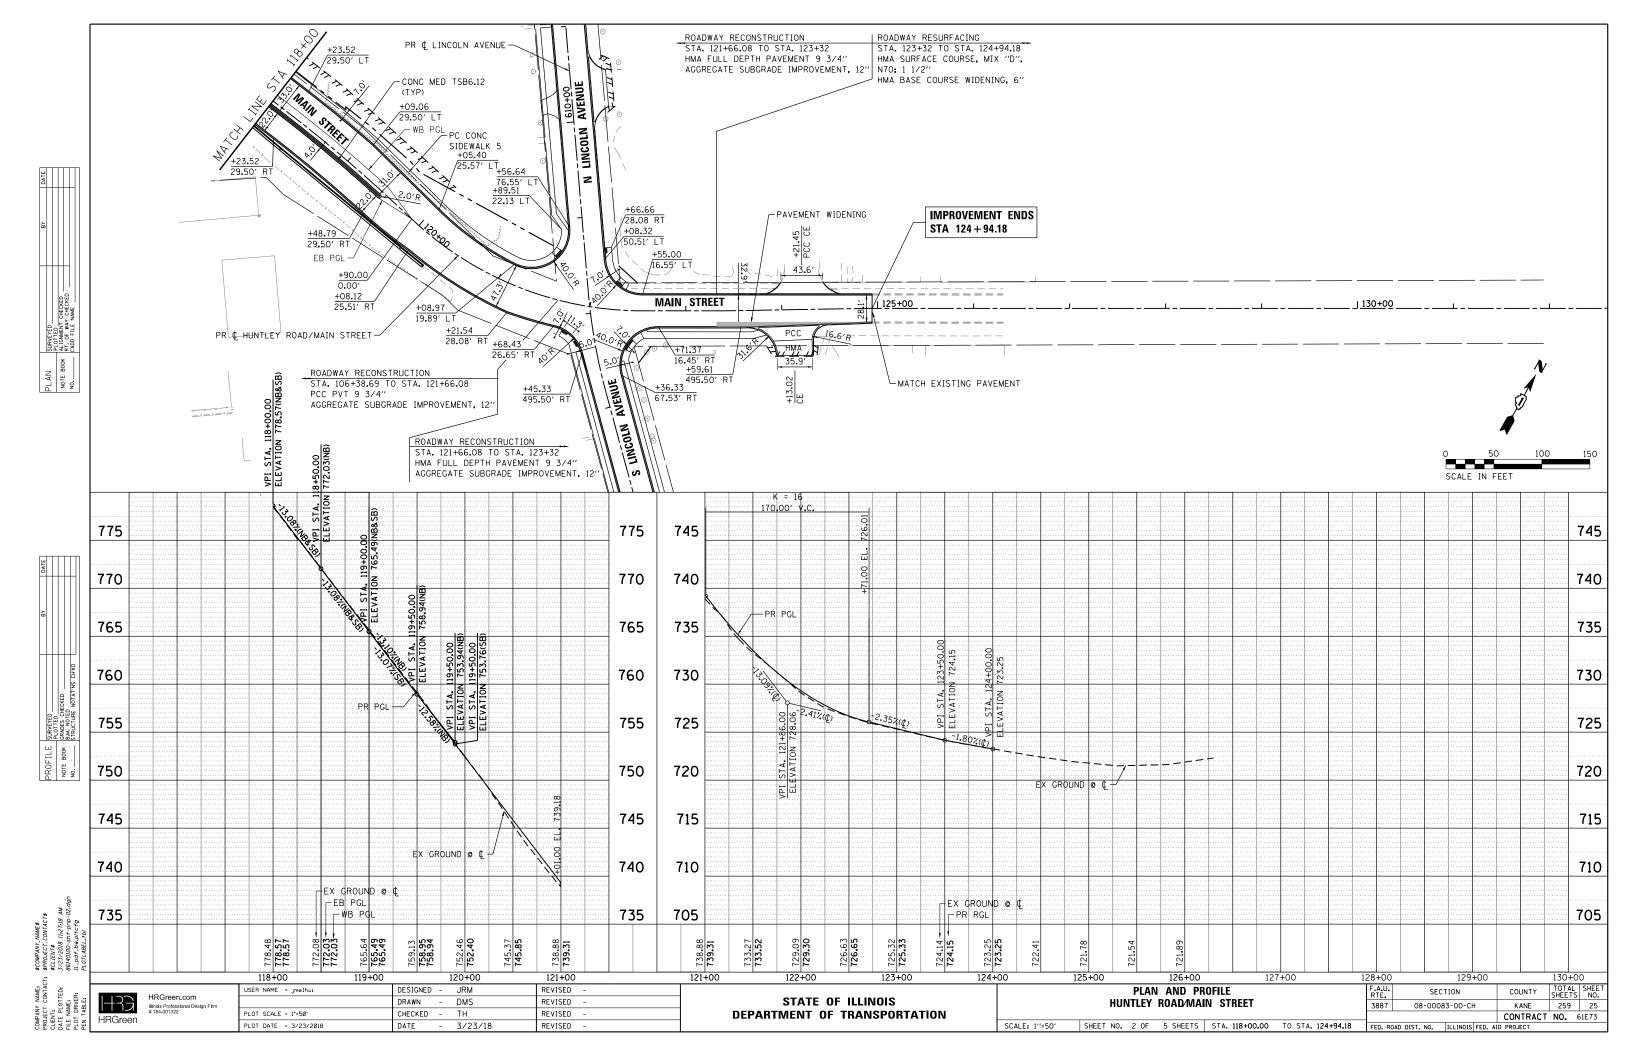
HRGreen.com Illinois Professional Design Firm # 184-001322


USER NAME = Jmelhuı	DESIGNED - JRM	REVISED -
FILE NAME = 86140100-sht-rem-03.dgn	DRAWN - DMS	REVISED -
PLOT SCALE = 1"=50"	CHECKED - TH	REVISED -
PLOT DATE = 3/23/2018	DATE - 3/23/18	REVISED -


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DEPARTMENT	0F	TRANSPORTATION			


	REMOVAL PLAN								ON NO.	COUNTY	TOTAL SHEETS	SHEET NO.
	LINCOLN AVENUE							08-0008	33-00-CH	KANE	259	23
										CONTRACT	NO.	61E73
SCALE:	1''=50'	SHEET NO. 3	OF	3 SHEETS	STA. 602+10.00	TO STA. 613+00.98	FED. RO	AD DIST. NO.	ILLINOIS FED. AI	D PROJECT		





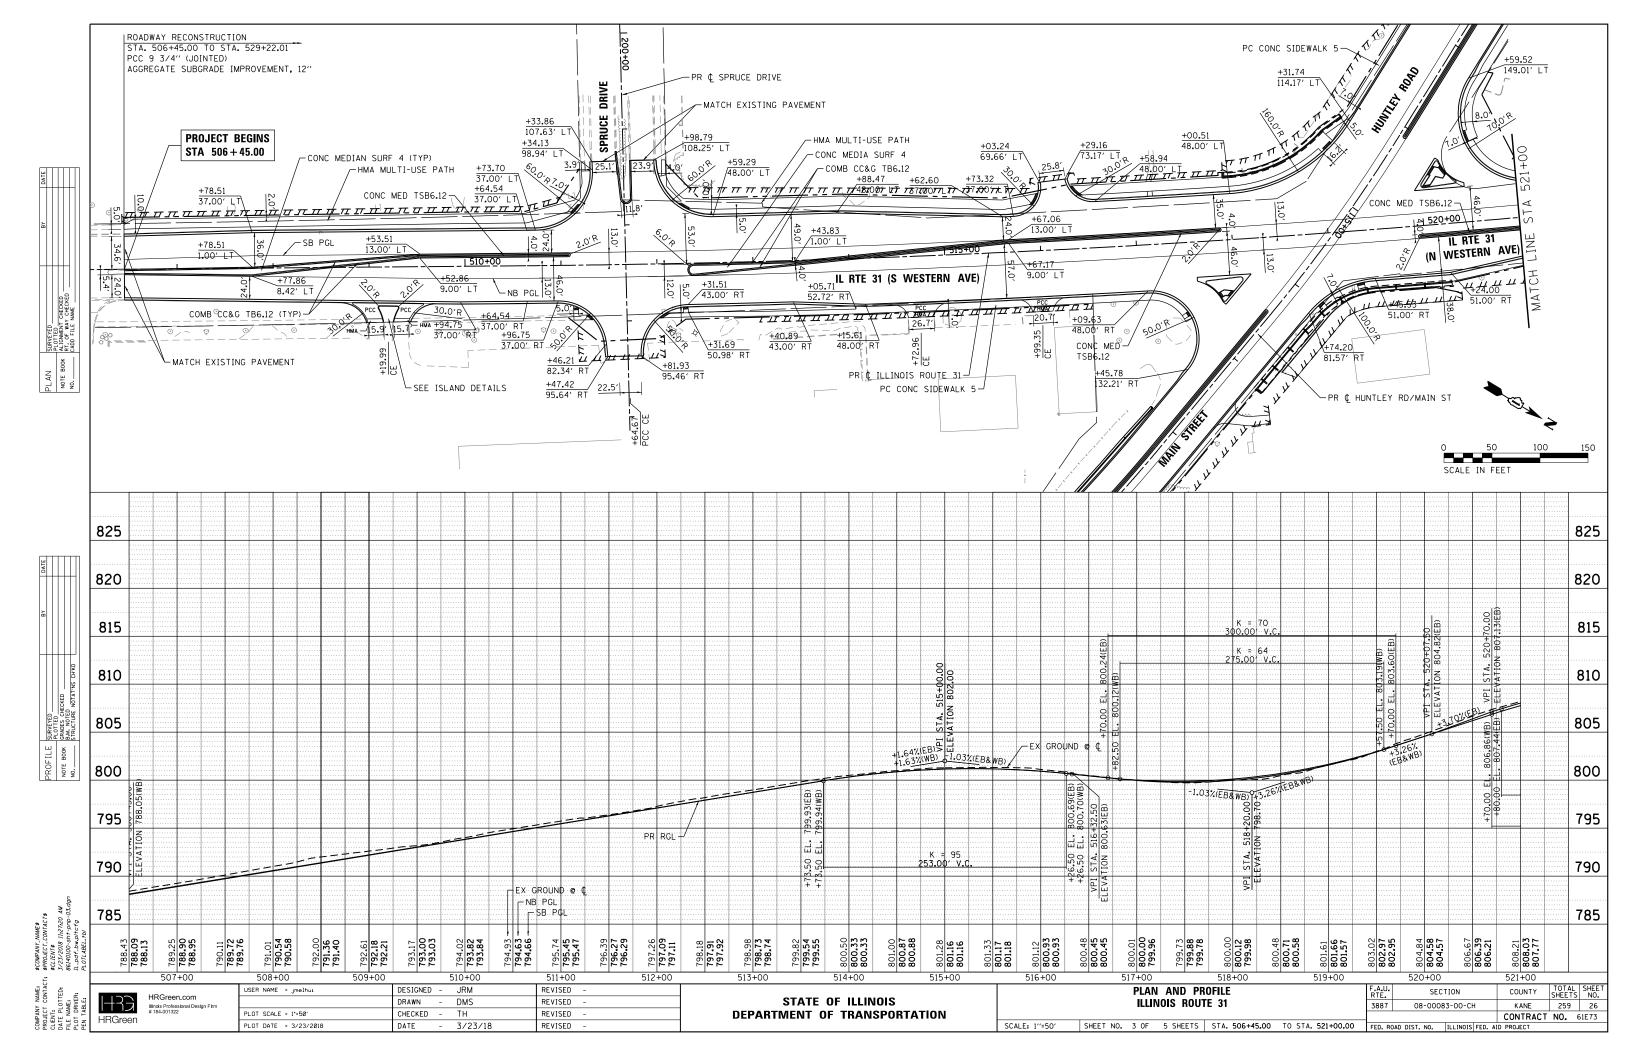

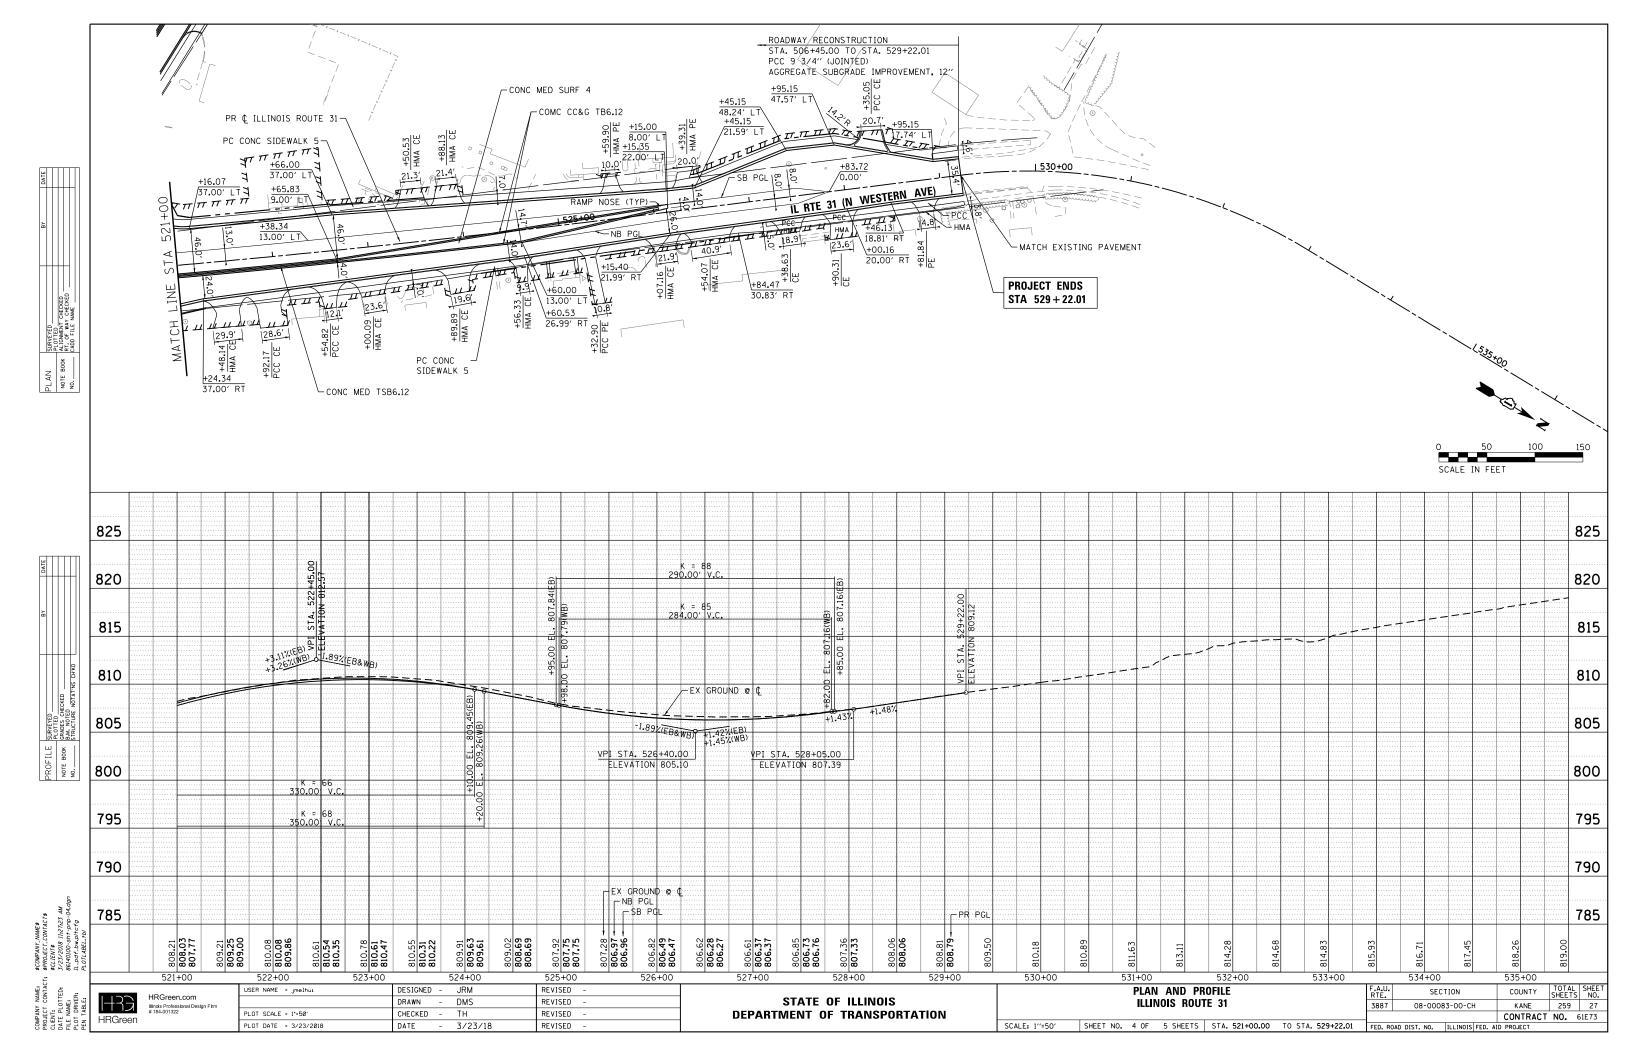


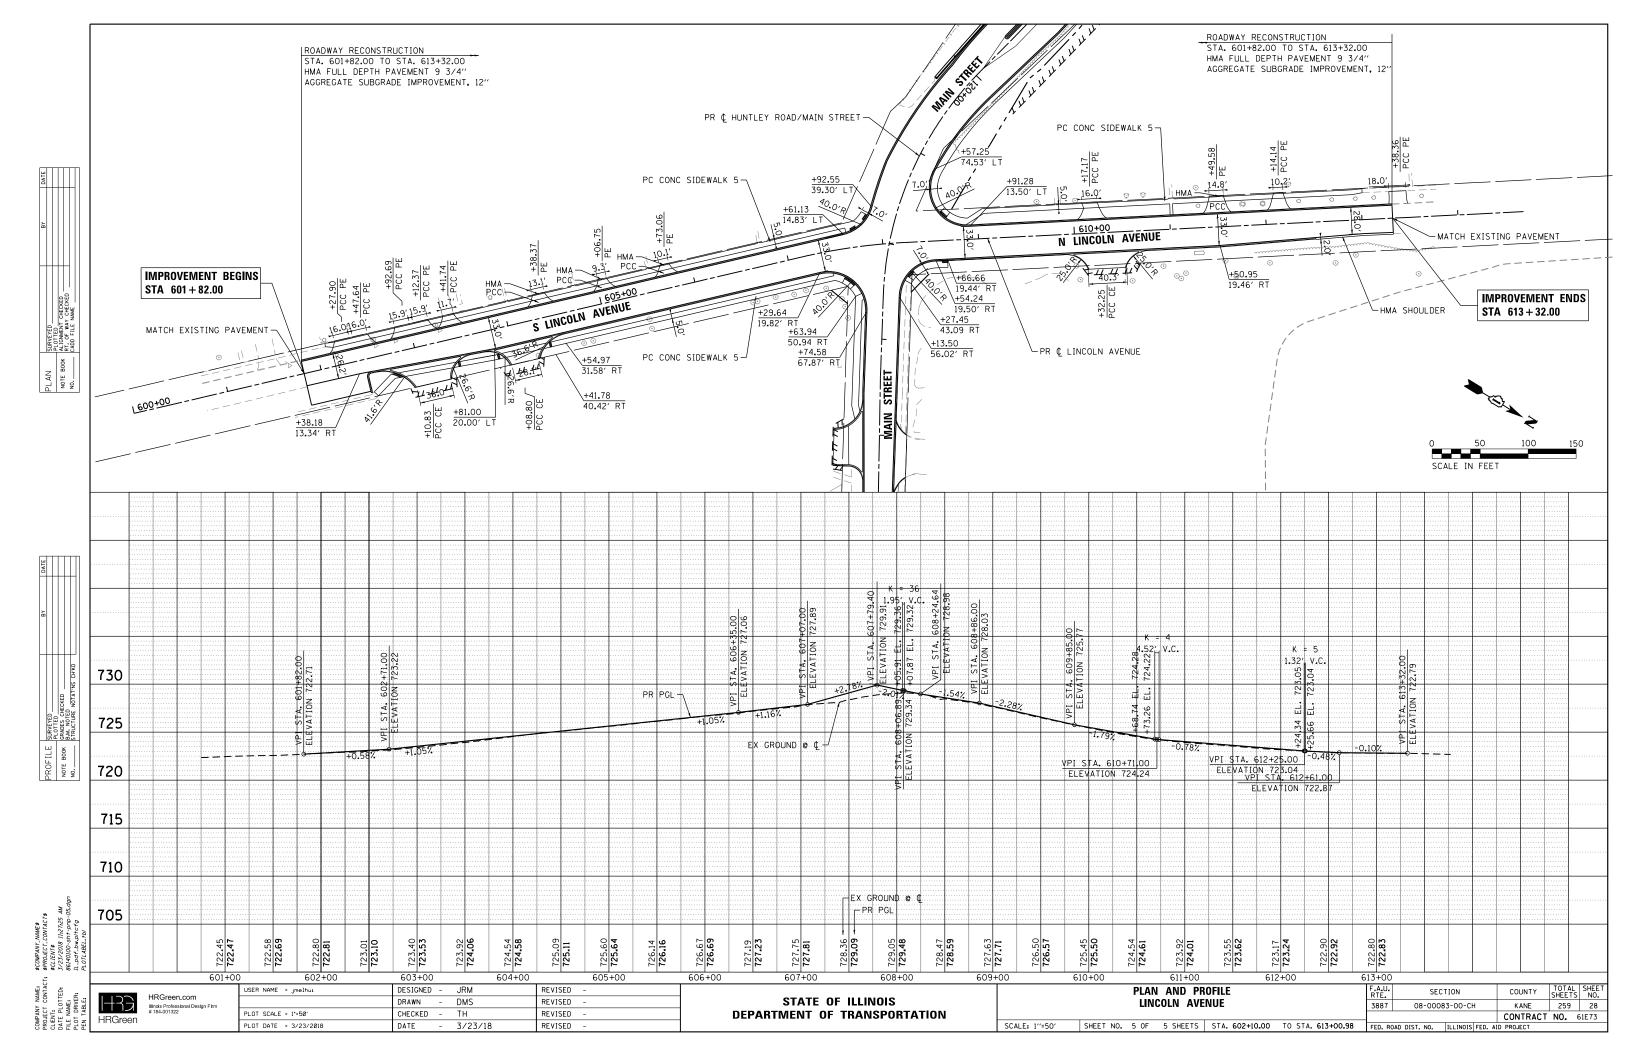


SUGGESTED MAINTENANCE OF TRAFFIC GENERAL NOTES

- 1. THE TRAFFIC CONTROL PLAN SHALL SERVE AS A GUIDE FOR SAFE DIVERSION OF TRAFFIC DURING EXECUTION OF THIS CONTRACT. HOWEVER, THE CONTRACTOR MAY IMPROVE OR MODIFY THE TRAFFIC CONTROL PLANS TO MEET CONSTRUCTION NEEDS BUT NOT AT THE EXPENSE OF PUBLIC SAFETY OR CONVENIENCE. ANY CHANGES TO THE TRAFFIC CONTROL PLAN SHALL BE SUBMITTED TO THE ENGINEER FOR APPROVAL.
- 2. THE CONTRACTOR SHALL CONTACT THE DISTRICT ONE TRAFFIC CONTROL SUPERVISOR AT (847) 705-4470 A MINIMUM OF 72 HOURS IN ADVANCE OF BEGINNING WORK.
- 3. ALL OF THE TRAFFIC CONTROL DEVICES SHALL BE IN PLACE BEFORE CONSTRUCTION IS STARTED. ALL TEMPORARY PAVEMENT MARKINGS & TRAFFIC CONTROL DEVICES SHALL BE IN PLACE AT THE BEGINNING OF EACH STAGE, AND SHALL BE MAINTAINED FOR THE DURATION OF THAT STAGE UNLESS OTHERWISE DIRECTED BY THE ENGINEER.
- 4. A MINIMUM OF ONE (1) ELEVEN FOOT (11') LANE IN EACH DIRECTION SHALL BE KEPT OPEN TO TRAFFIC AT ALL TIMES. A MINIMUM OF ONE (1) FIFTEEN FOOT (15') LANE WILL BE OPEN AT ALL TIMES ON ALL SIDE STREETS.
- 5. ALL PAVEMENT MARKINGS CONFLICTING WITH REVISED TRAFFIC PATTERNS SHALL BE REMOVED. PAVEMENT MARKING TAPE, TYPE III SHALL BE USED ON THE FINAL WEARING SURFACE OR ON THE EXISTING PAVEMENT TO REMAIN WHEN THE TEMPORARY PAVEMENT MARKING CONFLICTS WITH THE PERMANENT PAVEMENT MARKING SUCH AS ON TAPERS OR
- 6. THE CONTRACTOR SHALL PROVIDE INFORMATION SIGNS ON TEMPORARY SUPPORTS FOR ALL COMMERCIAL DRIVEWAYS. THESE SIGNS SHALL BE WHITE ON GREEN IN ACCORDANCE WITH THE MANUAL OF UNIFORM TRAFFIC CONTROL DEVICES. THIS WORK WILL BE PAID FOR PER DISTRICT ONE DETAIL TC-26. THE CONTRACTOR SHALL BE REQUIRED TO MAINTAIN ACCESS TO ALL ENTRANCES, APPROACHES AND TEMPORARY ROADS WITHIN THE PROJECT LIMITS. THIS WORK WILL BE INCLUDED IN THE COST OF TEMPORARY ACCESS (PRIVATE ENTRANCE) OR TEMPORARY ACCESS
- 7. A TEMPORARY HOT-MIX ASPHALT RAMP WEDGE TO TRANSITION THE DIFFERENTIAL ELEVATIONS CAUSED BY STAGED CONSTRUCTION SHALL BE INSTALLED BETWEEN THE NEW CONSTRUCTION AND THE EXISTING PAVEMENT. ANY PAVEMENT DROP-OFFS GREATER THAN 3 INCHES IMMEDIATELY ADJACENT TO TRAFFIC SHALL NOT BE LEFT OVERNIGHT. PROVIDE TEMPORARY BITUMINOUS RAMP WEDGE OR OTHER MITIGATING MEASURES APPROVED BY THE
- 8. THE CONTRACTOR SHALL MAINTAIN TRAFFIC IN ACCORDANCE WITH THE PLANS, SPECIAL PROVISIONS, STATE STANDARDS AND AS DIRECTED BY THE ENGINEER.
- 9. THE CONTRACTOR SHALL INFORM THE ENGINEER OF ANY CHANGES IN STAGING AT LEAST TWO (2) WORKING DAYS
- 10. TEMPORARY SIGNING, AS SHOWN, SHALL CONFORM TO THE APPLICABLE STANDARDS INCLUDED IN THE SPECIAL PROVISIONS AND CONTRACT PLANS OR AS DIRECTED BY THE ENGINEER.
- 11. ALL "ROAD CONSTRUCTION AHEAD" SIGNS SHALL BE EQUIPPED WITH MONO-DIRECTIONAL AMBER FLASHING LIGHTS.
- 12. ROAD NAME PLATES SHALL BE INSTALLED ON "ROAD CONSTRUCTION AHEAD" SIGNS AT INTERSECTIONS SHOWN ON
- 13. ALL STATE ROUTE MARKERS SHALL BE MAINTAINED AT ALL TIMES THROUGHOUT ALL STAGES OF CONSTRUCTION.
- 14. EXISTING TRAFFIC CONTROL DEVICES WITHIN THE LIMITS OF CONSTRUCTION ARE TO BE PROTECTED FROM DAMAGE BY THE CONTRACTOR. ANY DAMAGED SIGNS CAUSED BY HIS WORK SHALL BE REPLACED BY THE CONTRACTOR.
- 15. TRAFFIC CONTROL DEPICTED ON THE MAINTENANCE OF TRAFFIC PLANS IS THE MINIMUM REQUIREMENT. OTHER WORK OR SIGNING MAY BE REQUIRED BY THE ENGINEER.
- 16. THE TYPE III BARRICADES ARE TO BE PLACED IN ACCORDANCE WITH STANDARD 701901 UNLESS AUTHORIZED BY THE ENGINEER TO USE AN ALTERNATE ARRANGEMENT.
- 17. TYPE I, TYPE II OR DRUM BARRICADES WITH TWO-WAY FLASHING LIGHTS SHALL BE REQUIRED AT ALL OPEN TRENCHES, EXCAVATIONS, OPEN OR EXPOSED SEWER STRUCTURES. TRANSVERSE PAVEMENT JOINTS, MATERIALS OR EQUIPMENT WITHIN THE RIGHT-OF-WAY (NUMBER AND SPACING DEPENDS ON THE CONDITIONS); AND AT LOCATIONS DESIGNATED BY THE ENGINEER OR LOCAL LAW ENFORCEMENT AGENCIES.
- 18. THE CONTRACTOR SHALL PROVIDE, INSTALL, MAINTAIN AND REMOVE ALL SIGNS AND SIGN SUPPORTS REQUIRED FOR TRAFFIC CONTROL AND PROTECTION. THIS WORK SHALL NOT BE PAID FOR SEPARATELY BUT SHALL BE INCLUDED IN THE CONTRACT UNIT PRICE PER LUMP SUM FOR "TRAFFIC CONTROL AND PROTECTION (SPECIAL)".
- 19. ARROW BOARDS WILL BE REQUIRED WHEN IMPLEMENTING ALL LANE CLOSURES.
- 20.THE CONTRACTOR SHALL REPLACE THE CENTER MEDIAN WITH TEMPORARY PAVEMENT AS SOON AS POSSIBLE TO PREVENT ANY WATER FROM ACCUMULATING IN THE MEDIAN. THE CONTRACTOR SHALL PUMP ANY WATER THAT ACCUMULATES IN THE MEDIAN BEFORE THE TEMPORARY PAVEMENT IS CONSTRUCTED. THIS WORK SHALL NOT BE PAID FOR SEPARATELY BUT SHALL BE INCLUDED IN THE CONTRACT UNIT PRICE PER SQUARE YARD FOR
- 21. ANY SAW CUTTING OF THE EXISTING PAVEMENT FOR STAGE CONSTRUCTION SHALL BE INCLUDED IN THE CONTRACT UNIT PRICE PER SQUARE YARD FOR "PAVEMENT REMOVAL".
- 22.TRAFFIC CONDITIONS, ACCIDENTS, AND OTHER UNFORESEEN EMERGENCY CONDITIONS MAY REQUIRE THE ENGINEER TO RESTRICT, MODIFY, OR REMOVE LANE CLOSURES OR CHANNELIZATION SHOWN IN THE PLANS. THE CONTRACTOR SHALL MAKE THE NECESSARY ADJUSTMENTS AS DIRECTED BY THE ENGINEER WITHOUT DELAY. THE CONTRACTOR SHALL RESPOND TO ANY REQUEST MADE BY THE ENGINEER FOR CORRECTION WITHIN TWO HOURS FROM THE TIME OF NOTIFICATION.
- 23. WHEN ARTIFICIAL LIGHTING IS USED IN NIGHT OPERATIONS THE CONTRACTOR SHALL EXERCISE THE UTMOST PRECAUTIONS IN PREVENTING ADVERSE VISIBILITY TO THE MOTORING PUBLIC AND ADJOINING RESIDENTIAL AREAS.
- 24.A DETECTABLE PEDESTRIAN CHANNELIZING BARRICADE WITH A "SIDEWALK CLOSED" SIGN AFFIXED, SHALL BE PLACED ON ALL SIDEWALKS CLOSED DUE TO CONSTRUCTION ACTIVITIES.

- 25.THE END OF ALL TEMPORARY CONCRETE BARRIER WALLS MUST BE TAPERED 8:1 AWAY FROM TRAFFIC. IMPACT ATTENUATORS (FULLY REDIRECTIVE, NARROW), TEST LEVEL 2 ARE REQUIRED ON APPROACH ENDS OF TEMPORARY CONCRETE BARRIER WALL AS SHOWN IN PLANS.
- 26.ALL SCHOOL ZONE SIGNING SHALL BE MAINTAINED DURING ALL STAGES OF CONSTRUCTION.
- 27.ALL COMMERCIAL AND RESIDENTIAL DRIVEWAYS SHALL BE MAINTAINED DURING ALL STAGES OF CONSTRUCTION.
- 28. THE TEMPORARY CONCRETE BARRIER WALL SHALL BE PINNED CONTINUOUSLY IN ACCORDANCE WITH THE STANDARD SPECIFICATIONS FOR ROAD & BRIDGE CONSTRUCTION IF A 3.5' CLEAR ZONE FREE FROM DROP-OFFS. OBSTRUCTIONS, AND EQUIPMENT IS NOT AVAILABLE BEHIND THE WALL.

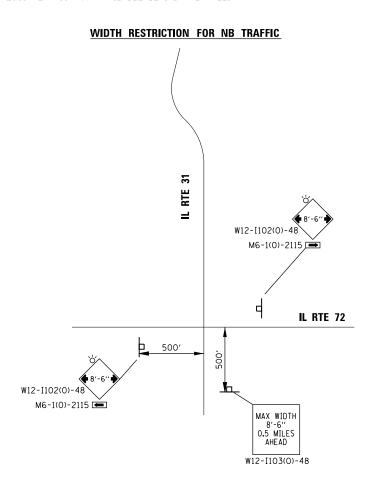

WIDTH RESTRICTION FOR SB TRAFFIC

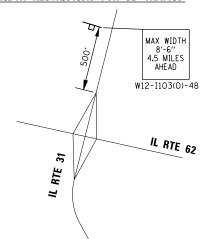

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USER NAME = Jmelhui	DESIGNED	-	TAY	REVISED -
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PLOT SCALE = N.T.S.	CHECKED	-	JRM	REVISED -
PLOT DATE = 3/23/2018	DATE	-	3/23/18	REVISED -

STATE OF ILLINOIS **DEPARTMENT OF TRANSPORTATION**

SCALE: N

SUGGESTED I	VAINTENA				ONSTRUCTION STAGING	F.A.U. RTE.	SEC	TION	COUNTY	TOTAL SHEETS	
GENERAL NOTES 3							08-0008	3-00-CH	KANE	259	29
									CONTRACT	NO. 61	E73
SCALE: N.T.S.	SHEET NO.	1 OF	5 SHEETS	STA.	TO STA.	FED. RO	AD DIST. NO.	ILLINOIS FED. A	D PROJECT	61E73	

PRE-STAGE - CONSTRUCTION

REMOVE EXISTING RAISED MEDIANS ON IL 21 (WESTERN AVENUE) NORTH OF MAIN STREET/HUNTLEY ROAD, AND ON MAIN STREET/HUNTLEY ROAD EAST AND WEST OF IL 31 (WESTERN AVENUE).

PERFORM WATER MAIN CONSTRUCTION. REFER TO SHEETS 70 & 71 FOR CONSTRUCTION SEQUENCE.

INSTALL TEMPORARY PAVEMENT AS SHOWN IN DETAIL ON IL 31 (WESTERN AVENUE) NORTH OF MAIN STREET/HUNTLEY ROAD, ON MAIN STREET/HUNTLEY ROAD EAST AND WEST OF IL 31 (WESTERN AVENUE), ALONG THE SOUTH SIDE OF MAIN STREET/HUNTLEY ROAD EAST OF LINCOLN AVENUE, AND ALONG THE EAST SIDE OF LINCOLN AVENUE.

INSTALL TEMPORARY TRAFFIC SIGNALS AT IL 31 (WESTERN AVENUE) AND MAIN STREET/HUNTLEY ROAD AND AT IL 31 (WESTERN AVENUE) AND SPRUCE DRIVE.

PRE-STAGE - SUGGESTED MAINTENANCE OF TRAFFIC INSTALL ARTERIAL ROAD INFORMATION SIGNING PER DISTRICT 1 DETAIL TC-22 A MINIMUM OF TWO (2) WEEKS IN ADVANCE OF CONSTRUCTION.

TEMPORARY PAVEMENT INSTALLATIONS NORTH OF MAIN STREET/HUNTLEY ROAD AND EAST AND WEST OF IL 31 (WESTERN AVENUE) UTILIZE HIGHWAY STANDARD 701701 FOR "URBAN LANE CLOSURE, MULTILANE INTERSECTION."

TEMPORARY PAVEMENT INSTALLATION ALONG THE EAST SIDE OF LINCOLN AVENUE UTILIZES HIGHWAY STANDARD 701601 FOR "URBAN LANE CLOSURE, MULTILANE, 1W OR 2W WITH NONTRAVERABLE MEDIAN".

STAGE 1 - CONSTRUCTION MAIN STREET/HUNTLEY ROAD

CONSTRUCT NORTHERN TWO (2) LANES OF PAVEMENT WEST OF LINCOLN AVENUE.

CONSTRUCT NORTHERN LANE OF PAVEMENT EAST OF LINCOLN AVENUE.

UNDERPIN CRIB WALL SOUTH OF MAIN STREET BETWEEN IL 31 (WESTERN AVENUE) AND LINCOLN AVENUE.

PERFORM STORM SEWER INSTALLATION.

PERFORM WATER MAIN CONSTRUCTION.

STAGE 1 - SUGGESTED MAINTENANCE OF TRAFFIC MAIN STREET/HUNTLEY ROAD INSTALL LANE CLOSURE ADVANCED SIGNING ACCORDING TO THE PLANS.

COVER OR REMOVE PERMANENT SIGNS AS NEEDED FOR STAGE 1 CONSTRUCTION.

REMOVE ALL CONFLICTING RAISED REFLECTIVE PAVEMENT MARKERS WITHIN THE PROJECT LIMITS.

REMOVE ALL CONFLICTING PAVEMENT MARKINGS ALONG MAIN STREET/HUNTLEY ROAD AND INSTALL TEMPORARY PAVEMENT MARKING AND TRAFFIC CONTROL FOR EASTBOUND AND WESTBOUND LANE DROPS ACCORDING TO HIGHWAY STANDARD 701601.

INSTALL ALL TEMPORARY PAVEMENT MARKING AND TEMPORARY TRAFFIC CONTROL DEVICES FOR STAGE 1 CONSTRUCTION, SHIFT TRAFFIC.

STAGE 1 - CONSTRUCTION IL 31 (WESTERN AVENUE)

CONSTRUCT WESTERN TWO (2) LANES OF PAVEMENT SOUTH OF THE END OF THE RAISED

CONSTRUCT WESTERN LANE OF PAVEMENT NORTH OF THE END OF THE RAISED MEDIAN.

CONSTRUCT SOUTHBOUND RIGHT TURN LANE NORTH OF MAIN STREET/HUNTLEY ROAD.

PERFORM STORM SEWER INSTALLATION

PERFORM WATER MAIN CONSTRUCTION.

STAGE 1 - SUGGESTED MAINTENANCE OF TRAFFIC IL 31 (WESTERN AVENUE) INSTALL LANE CLOSURE ADVANCED SIGNING ACCORDING TO THE PLANS.

COVER OR REMOVE PERMANENT SIGNS AS NEEDED FOR STAGE 1 CONSTRUCTION.

REMOVE ALL CONFLICTING PAVEMENT MARKINGS ALONG IL 31 (WESTERN AVENUE) AND INSTALL TEMPORARY PAVEMENT MARKING AND TRAFFIC CONTROL FOR NORTHBOUND AND SOUTHBOUND LANE DROPS ACCORDING TO HIGHWAY STANDARD 701601.

INSTALL ALL TEMPORARY PAVEMENT MARKING AND TEMPORARY TRAFFIC CONTROL DEVICES FOR STAGE 1 CONSTRUCTION, SHIFT TRAFFIC.

STAGE 1 - CONSTRUCTION LINCOLN AVENUE

CONSTRUCT CENTER LANE OF PAVEMENT THE ENTIRE LIMIT OF IMPROVEMENT.

PERFORM STORM SEWER INSTALLATION.

PERFORM WATER MAIN CONSTRUCTION

STAGE 1 - SUGGESTED MAINTENANCE OF TRAFFIC LINCOLN AVENUE INSTALL LANE CLOSURE ADVANCED SIGNING ACCORDING TO THE PLANS.

COVER OR REMOVE PERMANENT SIGNS AS NEEDED FOR STAGE 1 CONSTRUCTION.

REMOVE ALL CONFLICTING PAVEMENT MARKINGS ALONG LINCOLN AVENUE AND INSTALL TEMPORARY PAVEMENT MARKING AND TRAFFIC CONTROL FOR NORTHBOUND AND SOUTHBOUND LANE DROPS ACCORDING TO HIGHWAY STANDARD 701601.

INSTALL ALL TEMPORARY PAVEMENT MARKING AND TEMPORARY TRAFFIC CONTROL DEVICES FOR STAGE 1 CONSTRUCTION, SHIFT TRAFFIC.

SUGGESTED MAINTENANCE OF TRAFFIC AND CONSTRUCTION STAGING **SEQUENCE OF CONSTRUCTION**

STAGE 2 - CONSTRUCTION MAIN STREET/HUNTLEY ROAD CONSTRUCT SOUTHERN TWO (2) LANES OF PAVEMENT WEST OF LINCOLN AVENUE.

CONSTRUCT CENTER LANE OF PAVEMENT EAST OF LINCOLN AVENUE.

CONTINUE STORM SEWER INSTALLATION.

CONTINUE WATER MAIN CONSTRUCTION.

STAGE 2 - SUGGESTED MAINTENANCE OF TRAFFIC MAIN STREET/HUNTLEY ROAD ADJUST ADVANCED SIGNING ACCORDING TO THE PLANS FOR STAGE 2 CONSTRUCTION.

COVER OR REMOVE PERMANENT SIGNS AS NEEDED FOR STAGE 2 CONSTRUCTION.

REMOVE ALL CONFLICTING RAISED REFLECTIVE PAVEMENT MARKERS WITHIN THE PROJECT LIMITS.

REMOVE ALL CONFLICTING EXISTING AND TEMPORARY PAVEMENT MARKINGS FROM STAGE 1 ALONG MAIN STREET/HUNTLEY ROAD AND INSTALL TEMPORARY PAVEMENT MARKING AND TRAFFIC CONTROL FOR EASTBOUND AND WESTBOUND LANE DROPS ACCORDING TO HIGHWAY STANDARD 701601.

INSTALL ALL TEMPORARY PAVEMENT MARKING AND TEMPORARY TRAFFIC CONTROL DEVICES FOR STAGE 2 CONSTRUCTION, SHIFT TRAFFIC.

STAGE 2 - CONSTRUCTION IL 31 (WESTERN AVENUE)

CONSTRUCT EASTERN TWO (2) LANES OF PAVEMENT SOUTH OF THE END OF

CONSTRUCT EASTERN LANE OF PAVEMENT NORTH OF THE END OF THE RAISED

CONTINUE STORM SEWER INSTALLATION.

CONTINUE WATER MAIN CONSTRUCTION.

STAGE 2 - SUGGESTED MAINTENANCE OF TRAFFIC IL 31 (WESTERN AVENUE) ADJUST ADVANCED SIGNING ACCORDING TO THE PLANS FOR STAGE 2 CONSTRUCTION.

COVER OR REMOVE PERMANENT SIGNS AS NEEDED FOR STAGE 2 CONSTRUCTION.

REMOVE ALL CONFLICTING RAISED REFLECTIVE PAVEMENT MARKERS WITHIN THE PROJECT LIMITS.

REMOVE ALL CONFLICTING EXISTING AND TEMPORARY PAVEMENT MARKINGS FROM STAGE 1 ALONG IL 31 (WESTERN AVENUE) AND INSTALL TEMPORARY PAVEMENT MARKING AND TRAFFIC CONTROL FOR NORTHBOUND AND SOUTHBOUND LANE DROPS ACCORDING TO HIGHWAY STANDARD 701601.

INSTALL ALL TEMPORARY PAVEMENT MARKING AND TEMPORARY TRAFFIC CONTROL DEVICES FOR STAGE 2 CONSTRUCTION, SHIFT TRAFFIC.

STAGE 2 - CONSTRUCTION LINCOLN AVENUE

CONSTRUCT WESTERN LANE OF PAVEMENT THE ENTIRE LIMIT OF IMPROVEMENT.

CONTINUE STORM SEWER INSTALLATION.

CONTINUE WATER MAIN CONSTRUCTION.

STAGE 2 - SUGGESTED MAINTENANCE OF TRAFFIC LINCOLN AVENUE ADJUST ADVANCED SIGNING ACCORDING TO THE PLANS FOR STAGE 2 CONSTRUCTION.

COVER OR REMOVE PERMANENT SIGNS AS NEEDED FOR STAGE 2 CONSTRUCTION.

REMOVE ALL CONFLICTING RAISED REFLECTIVE PAVEMENT MARKERS WITHIN THE PROJECT LIMITS.

REMOVE ALL CONFLICTING EXISTING AND TEMPORARY PAVEMENT MARKINGS FROM STAGE 1 ALONG LINCOLN AVENUE AND INSTALL TEMPORARY PAVEMENT MARKING AND TRAFFIC CONTROL FOR EASTBOUND AND WESTBOUND LANE DROPS ACCORDING TO HIGHWAY STANDARD 701601.

INSTALL ALL TEMPORARY PAVEMENT MARKING AND TEMPORARY TRAFFIC CONTROL DEVICES FOR STAGE 2 CONSTRUCTION, SHIFT TRAFFIC.

STAGE 3 - CONSTRUCTION MAIN STREET/HUNTLEY ROAD

CONSTRUCT REMAINING CENTRAL LANES OF PAVEMENT AND THE RAISED MEDIAN

CONSTRUCT SOUTHERN LANE OF PAVEMENT EAST OF LINCOLN AVENUE.

COMPLETE STORM SEWER INSTALLATION.

COMPLETE WATER MAIN CONSTRUCTION.

STAGE 3 - SUGGESTED MAINTENANCE OF TRAFFIC MAIN STREET/HUNTLEY ROAD ADJUST ADVANCED SIGNING ACCORDING TO THE PLANS FOR STAGE 3 CONSTRUCTION.

COVER OR REMOVE PERMANENT SIGNS AS NEEDED FOR STAGE 3 CONSTRUCTION.

REMOVE ALL REMAINING RAISED REFLECTIVE PAVEMENT MARKERS WITHIN THE PROJECT LIMITS.

REMOVE ALL CONFLICTING EXISTING AND TEMPORARY PAVEMENT MARKINGS FROM STAGE 2 ALONG MAIN STREET/HUNTLEY ROAD AND INSTALL TEMPORARY PAVEMENT MARKING AND TRAFFIC CONTROL FOR EASTBOUND AND WESTBOUND LANE DROPS ACCORDING TO HIGHWAY STANDARD 701601.

INSTALL ALL TEMPORARY PAVEMENT MARKING AND TEMPORARY TRAFFIC CONTROL DEVICES FOR STAGE 3 CONSTRUCTION, SHIFT TRAFFIC.

PLACE TOPSOIL, SEED, SOD AND ALL OTHER RESTORATION ITEMS.

COMPLETE REMAINING CONSTRUCTION, CLEAN-UP AND PUNCH LIST.

STAGE 3 - CONSTRUCTION IL 31 (WESTERN AVENUE) CONSTRUCT REMAINING CENTRAL LANE(S) OF PAVEMENT THE ENTIRE LIMIT OF

COMPLETE STORM SEWER INSTALLATION.

COMPLETE WATER MAIN CONSTRUCTION.

STAGE 3 - SUGGESTED MAINTENANCE OF TRAFFIC IL 31 (WESTERN AVENUE) ADJUST ADVANCED SIGNING ACCORDING TO THE PLANS FOR STAGE 3 CONSTRUCTION.

COVER OR REMOVE PERMANENT SIGNS AS NEEDED FOR STAGE 3 CONSTRUCTION.

REMOVE ALL REMAINING REFLECTORS WITHIN THE PROJECT LIMITS.

REMOVE ALL CONFLICTING EXISTING AND TEMPORARY PAVEMENT MARKINGS FROM STAGE 2 ALONG IL 31 (WESTERN AVENUE) AND INSTALL TEMPORARY PAVEMENT MARKING AND TRAFFIC CONTROL FOR NORTHBOUND AND SOUTHBOUND LANE DROPS ACCORDING TO HIGHWAY STANDARD 701606.

INSTALL ALL TEMPORARY PAVEMENT MARKING AND TEMPORARY TRAFFIC CONTROL DEVICES FOR STAGE 3 CONSTRUCTION, SHIFT TRAFFIC.

PLACE TOPSOIL, SEED, SOD AND ALL OTHER RESTORATION ITEMS.

COMPLETE REMAINING CONSTRUCTION, CLEAN-UP AND PUNCH LIST.

STAGE 3 - CONSTRUCTION LINCOLN AVENUE CONSTRUCT REMAINING EASTERN LANE OF PAVEMENT THE ENTIRE LIMIT OF

COMPLETE STORM SEWER INSTALLATION.

COMPLETE WATER MAIN CONSTRUCTION.

STAGE 3 - SUGGESTED MAINTENANCE OF TRAFFIC LINCOLN AVENUE ADJUST ADVANCED SIGNING ACCORDING TO THE PLANS FOR STAGE 3 CONSTRUCTION.

COVER OR REMOVE PERMANENT SIGNS AS NEEDED FOR STAGE 3 CONSTRUCTION.

REMOVE ALL REMAINING REFLECTORS WITHIN THE PROJECT LIMITS.

REMOVE ALL CONFLICTING EXISTING AND TEMPORARY PAVEMENT MARKINGS FROM STAGE 2 ALONG LINCOLN AVENUE AND INSTALL TEMPORARY PAVEMENT MARKING AND TRAFFIC CONTROL FOR NORTHBOUND AND SOUTHBOUND LANE DROPS ACCORDING TO HIGHWAY STANDARD 701606.

INSTALL ALL TEMPORARY PAVEMENT MARKING AND TEMPORARY TRAFFIC CONTROL DEVICES FOR STAGE 3 CONSTRUCTION, SHIFT TRAFFIC.

PLACE TOPSOIL, SEED, SOD AND ALL OTHER RESTORATION ITEMS.

COMPLETE REMAINING CONSTRUCTION, CLEAN-UP AND PUNCH LIST.

END CONSTRUCTION

RE-ESTABLISH PERMANENT PAVEMENT MARKING, RAISED REFLECTIVE PAVEMENT MARKERS AND RECESSED REFLECTIVE PAVEMENT MARKERS IN ACCORDANCE WITH DISTRICT 1 DETAILS AND DUPAGE COUNTY DETAILS UTILIZING LANE CLOSURES.

REPLACE LENSES ON RAISED REFLECTIVE PAVEMENT MARKERS WHERE TEMPORARILY REMOVED. SHIFT TRAFFIC.

259 30

REMOVE ALL CONSTRUCTION SIGNING AND TRAFFIC CONTROL MEASURES.


UNCOVER ALL PERMANENT SIGNS.

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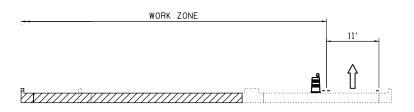
TAY DESIGNED REVISED USER NAME = jmelhui ORAWN TAY REVISED LOT SCALE = N.T.S. CHECKED REVISED 3/23/18 PLOT DATE = 3/23/2018 DATE REVISED

STATE OF ILLINOIS **DEPARTMENT OF TRANSPORTATION**

SUGGESTED MAINTENANCE OF TRAFFIC & CONSTRUCTION STAGING SECTION COUNTY SEQUENCE OF CONSTRUCTION 08-00083-00-CH KANE 3887 CONTRACT NO. 61E73 SHEET NO. 2 OF 5 SHEETS STA. SCALE: N.T.S. TO STA. FED. ROAD DIST, NO. ILLINOIS FED. AID PROJECT

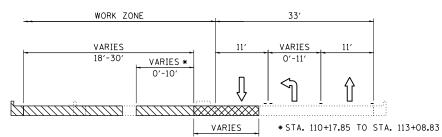


TYPICAL SECTION - STAGE 1 **HUNTLEY ROAD WEST OF IL 31** STA. 106+38.69 TO STA. 114+77.94




TYPICAL SECTION - STAGE 1 MAIN STREET FROM IL 31 TO LINCOLN AVENUE

STA. 116+26.99 TO STA. 121+71.85

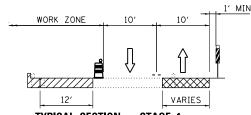


TYPICAL SECTION - STAGE 1 MAIN STREET EAST OF LINCOLN AVENUE STA. 122+45.97 TO STA. 124+94.18

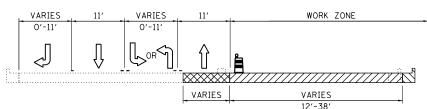

TYPICAL SECTION - STAGE 1 IL 31


STA. 506+45.00 TO STA. 515+83.80 STA. 518+18.91 TO STA. 529+22.01

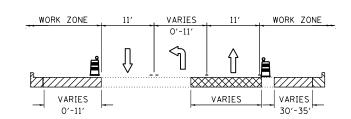


TYPICAL SECTION - STAGE 1

IL 31

STA. 515+83.80 TO STA. 518+18.91

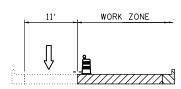


TYPICAL SECTION - STAGE 1 LINCOLN AVENUE SOUTH OF MAIN STREET STA. 601+82.00 TO STA. 608+06.89

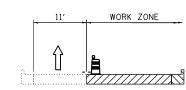


TYPICAL SECTION - STAGE 1 LINCOLN AVENUE NORTH OF MAIN STREET STA. 608+06.89 TO STA. 613+32.00

TEMPORARY PAVEMENT DETAILS

(CONTRACTOR HAS THE OPTION OF USING HMA OR PCC SECTION FOR TEMPORARY PAVEMENT)

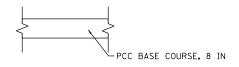

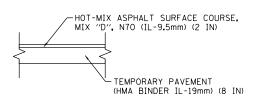

NOTES:
1. SEE MOT PLANS FOR LOCATIONS OF TEMPORARY PAVEMENT.

LEGEND

TYPE II BARRICADES OR DRUMS WITH BI-DIRECTIONAL STEADY BURNING LIGHT 50' C-C ON TANGENT, 20' C-C ON TAPERS AND 12' ON RADII



DOUBLE VERTICAL PANELS WITH BI-DIRECTIONAL LIGHTING @ 25' C-C




PROPOSED PAVEMENT




TEMPORARY PAVEMENT

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	USER NAME = jmelhui	DESIGNED	-	JCH	REVISED -
,		DRAWN	-	JCH	REVISED -
	PLOT SCALE = N.T.S.	CHECKED	-	JRM	REVISED -
	PLOT DATE = 3/23/2018	DATE	-	3/23/18	REVISED -

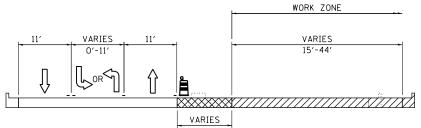


TYPICAL SECTION - STAGE 2 **HUNTLEY ROAD WEST OF IL 31** STA. 106+38.69 TO STA. 114+77.94

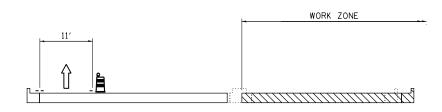


TYPICAL SECTION - STAGE 2 MAIN STREET FROM IL 31 TO LINCOLN AVENUE

STA. 116+26.99 TO STA. 121+71.85

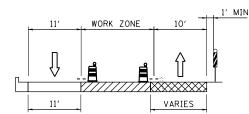


TYPICAL SECTION - STAGE 2 MAIN STREET EAST OF LINCOLN AVENUE STA. 122+45.97 TO STA. 124+94.18

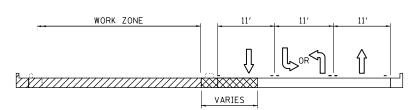


TYPICAL SECTION - STAGE 2 IL 31

STA. 506+45.00 TO STA. 526+36.34

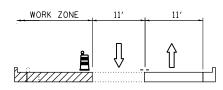


TYPICAL SECTION — STAGE 2

IL 31 STA. 526+36.34 TO STA. 529+22.00

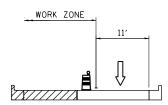


TYPICAL SECTION - STAGE 2 LINCOLN AVENUE SOUTH OF MAIN STREET STA. 601+82.00 TO STA. 608+06.89

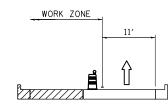


TYPICAL SECTION - STAGE 2 LINCOLN AVENUE NORTH OF MAIN STREET STA. 608+06.89 TO STA. 613+32.00

TEMPORARY PAVEMENT DETAILS

(CONTRACTOR HAS THE OPTION OF USING HMA OR PCC SECTION FOR TEMPORARY PAVEMENT)

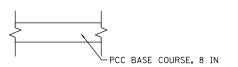

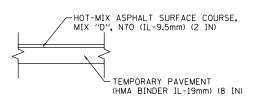


NOTES:
1. SEE MOT PLANS FOR LOCATIONS OF TEMPORARY PAVEMENT.

LEGEND

TYPE II BARRICADES OR DRUMS WITH BI-DIRECTIONAL STEADY BURNING LIGHT 50' C-C ON TANGENT, 20' C-C ON TAPERS AND 12' ON RADII



DOUBLE VERTICAL PANELS WITH BI-DIRECTIONAL LIGHTING @ 25' C-C

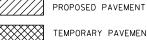


TEMPORARY PAVEMENT

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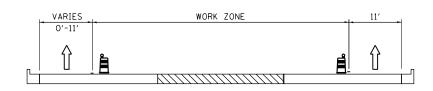
USER NAME = jmelhuı DESIGNED - JCH REVISED DRAWN JCH REVISED CHECKED JRM REVISED PLOT DATE = 3/23/2018 - 3/23/18 DATE REVISED

STATE OF ILLINOIS **DEPARTMENT OF TRANSPORTATION**

SUGGESTED STAGING OF CONSTRUCTION & TRAFFIC CONTROL SECTION COUNTY TYPICAL SECTIONS - STAGE 2 3887 08-00083-00-CH KANE 259 32 CONTRACT NO. 61E73 SCALE: N.T.S. SHEET NO. 4 OF 5 SHEETS STA. TO STA. FED. ROAD DIST. NO. ILLINOIS FED. AID PROJECT

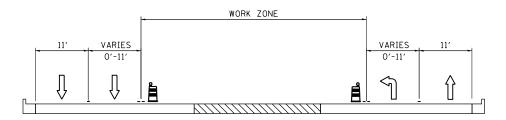


TYPICAL SECTION - STAGE 3 **HUNTLEY ROAD WEST OF IL 31** STA. 106+38.69 TO STA. 114+77.94




TYPICAL SECTION - STAGE 3 MAIN STREET FROM IL 31 TO LINCOLN AVENUE STA. 116+26.99 TO STA. 121+71.85

WORK ZONE

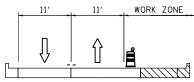


TYPICAL SECTION - STAGE 3 MAIN STREET EAST OF LINCOLN AVENUE STA. 122+45.97 TO STA. 124+94.18

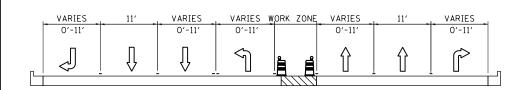

TYPICAL SECTION - STAGE 3 IL 31


STA. 506+45.00 TO STA. 526+36.34

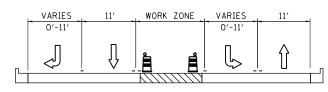

TYPICAL SECTION - STAGE 3

IL 31


STA. 526+36.34 TO STA. 529+22.00

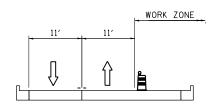


TYPICAL SECTION - STAGE 3 LINCOLN AVENUE

TEMPORARY PAVEMENT DETAILS

(CONTRACTOR HAS THE OPTION OF USING HMA OR PCC SECTION FOR TEMPORARY PAVEMENT)

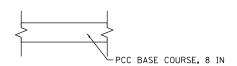

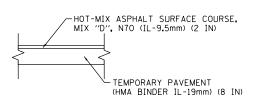


NOTES:
1. SEE MOT PLANS FOR LOCATIONS OF TEMPORARY PAVEMENT.

LEGEND

TYPE II BARRICADES OR DRUMS WITH BI-DIRECTIONAL STEADY BURNING LIGHT 50' C-C ON TANGENT, 20' C-C ON TAPERS AND 12' ON RADII



DOUBLE VERTICAL PANELS WITH BI-DIRECTIONAL LIGHTING @ 25' C-C

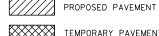


TEMPORARY PAVEMENT


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	DRAWN	-	JCH	REVISED	-	
PLOT SCALE = N.T.S.	CHECKED	-	JRM	REVISED	-	
PLOT DATE = 3/23/2018	DATE	-	3/23/18	REVISED	-	
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I	SUGGESTE	STAGING OF			FFIC CONTROL	F.A.U. RTE.	SEC.	TION	COUNTY	TOTAL SHEETS	SHEET NO.
ı		TYPICAL S	ECTIONS -	- STAGE 3		3887	08-0008	3-00-CH	KANE	259	33
L									CONTRACT	NO. 61	E73
ı	SCALE: N.T.S.	SHEET NO. 5 OF	5 SHEETS	STA.	TO STA.	FED. RC	DAD DIST. NO.	ILLINOIS FED.	AID PROJECT	61E73	






HRGreen

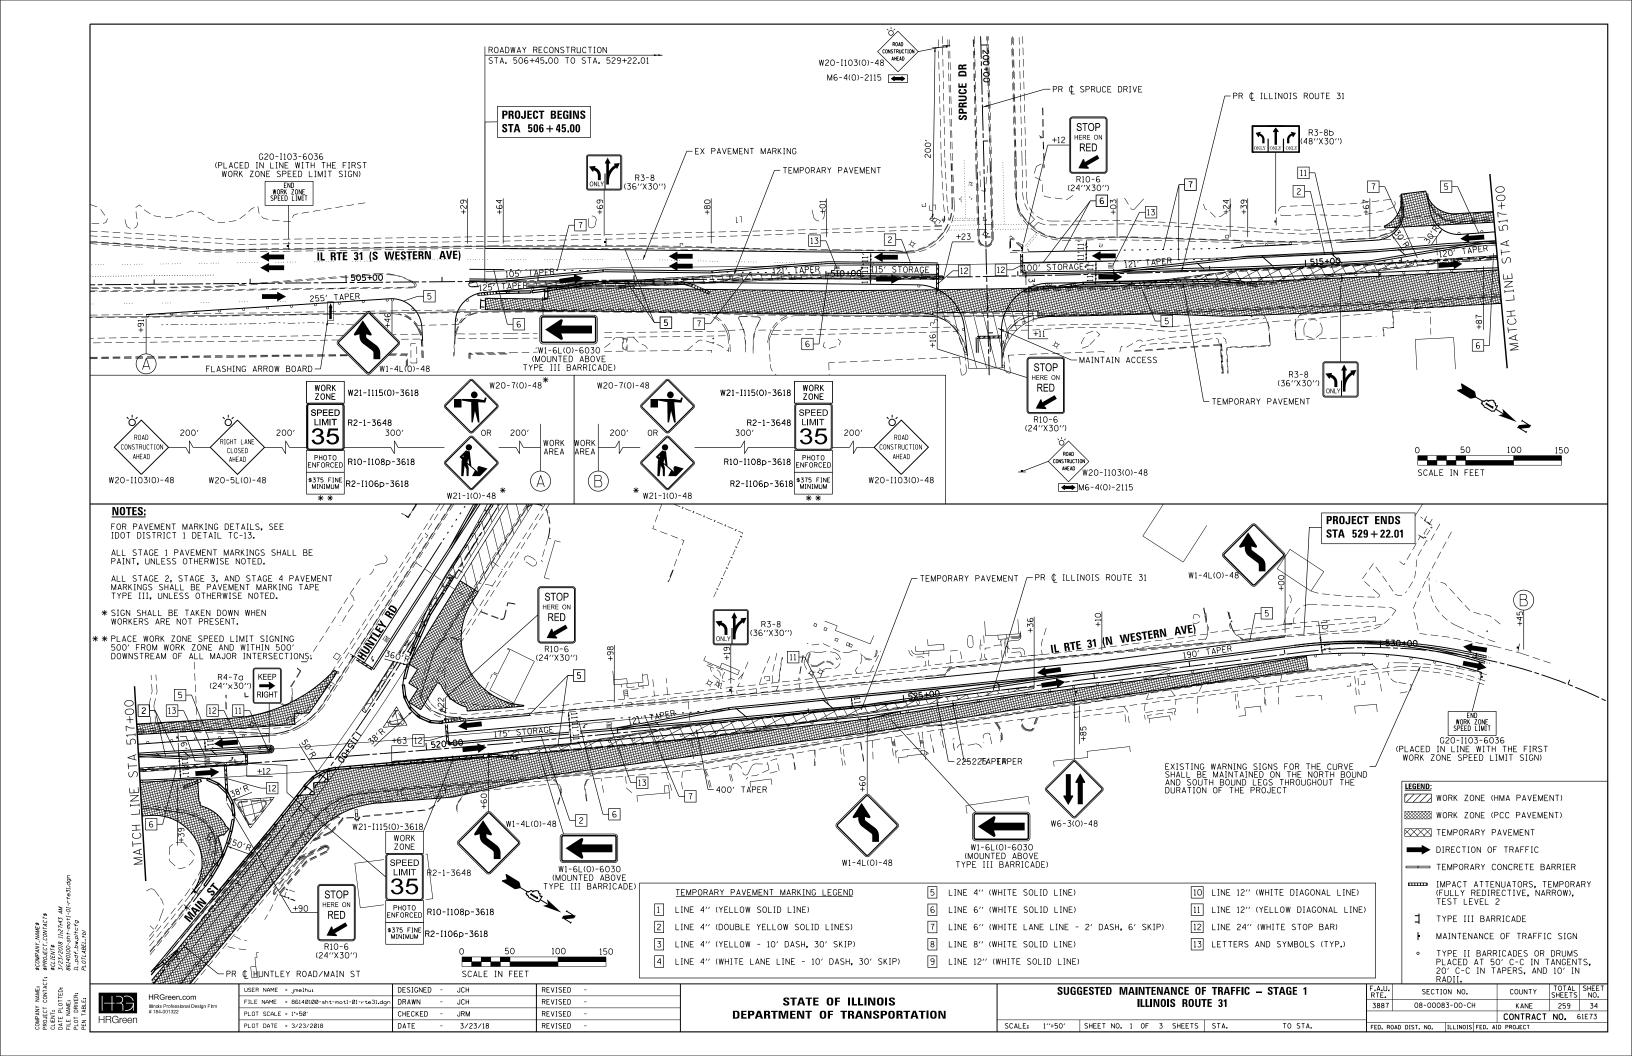LOT SCALE = 1"=50" CHECKED JRM REVISED PLOT DATE = 3/23/2018 DATE 3/23/18 REVISED

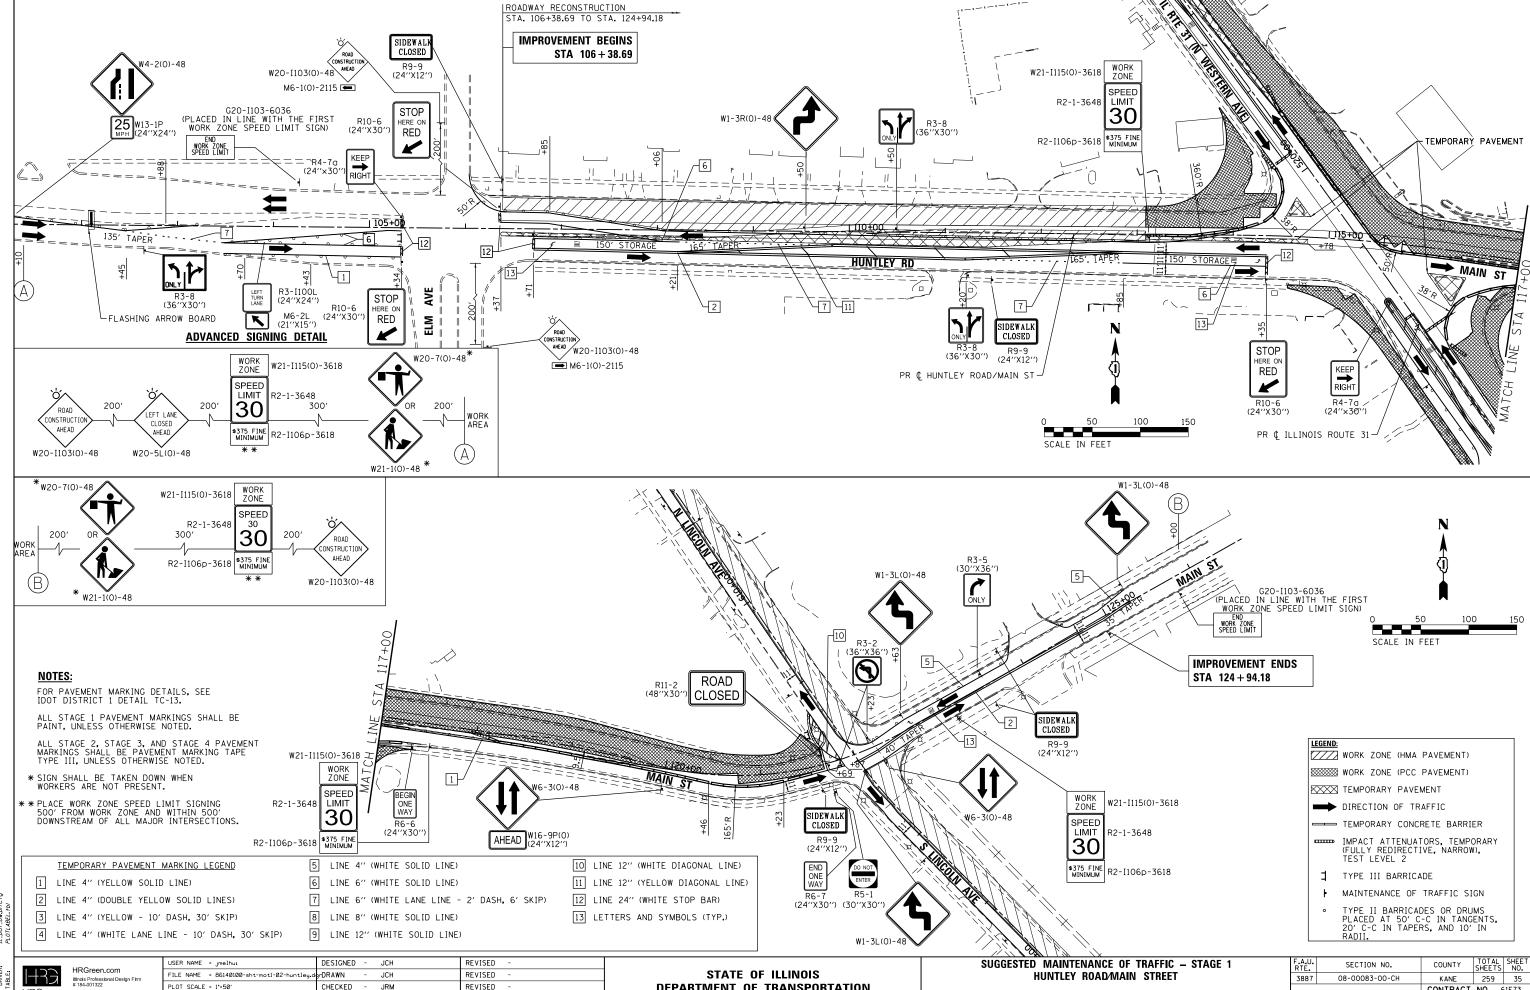DEPARTMENT OF TRANSPORTATION

SCALE: 1"=50" SHEET NO. 2 OF 3 SHEETS STA.

CONTRACT NO. 61E73

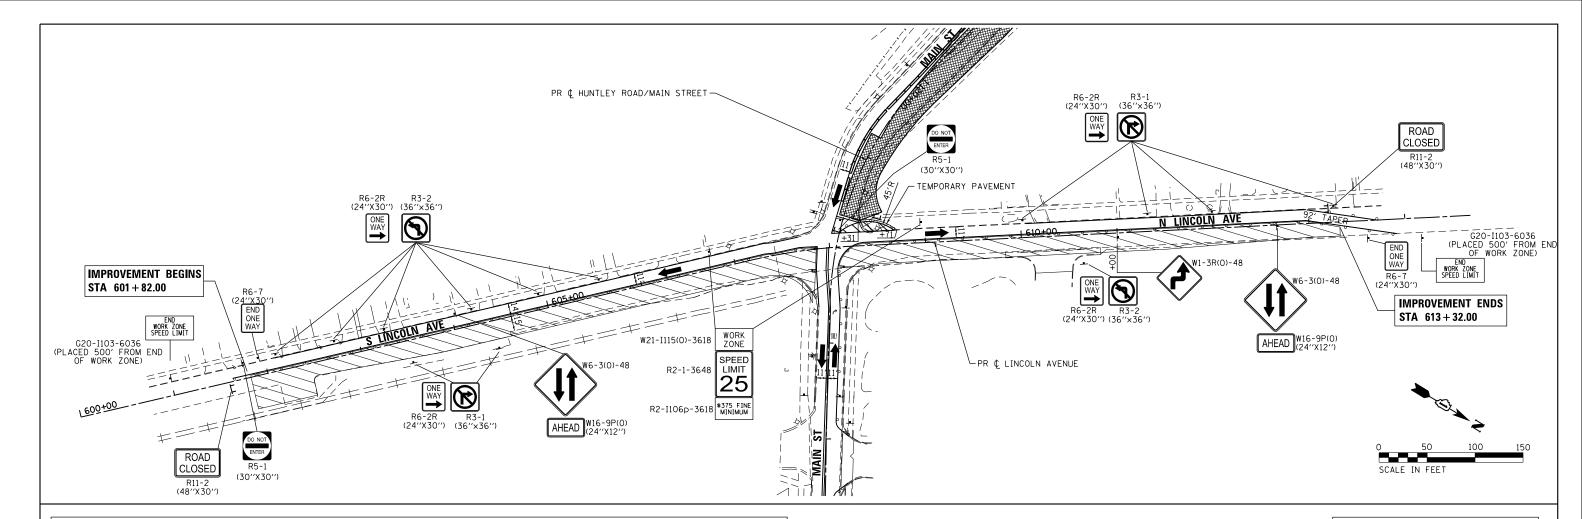

TEMPORARY PAVEMENT MARKING LEGEND

1 LINE 4" (YELLOW SOLID LINE)

2 LINE 4" (DOUBLE YELLOW SOLID LINES)

3 LINE 4" (YELLOW - 10' DASH, 30' SKIP)

4 LINE 4" (WHITE LANE LINE - 10' DASH, 30' SKIP)

5 LINE 4" (WHITE SOLID LINE)

6 LINE 6" (WHITE SOLID LINE)

7 LINE 6" (WHITE LANE LINE - 2' DASH, 6' SKIP)

8 LINE 8" (WHITE SOLID LINE) 9 LINE 12" (WHITE SOLID LINE) 10 LINE 12" (WHITE DIAGONAL LINE)

11 LINE 12" (YELLOW DIAGONAL LINE)

12 LINE 24" (WHITE STOP BAR)

13 LETTERS AND SYMBOLS (TYP.)

FOR PAVEMENT MARKING DETAILS, SEE IDOT DISTRICT 1 DETAIL TC-13.

ALL STAGE 1 PAVEMENT MARKINGS SHALL BE PAINT, UNLESS OTHERWISE NOTED.

ALL STAGE 2, STAGE 3, AND STAGE 4 PAVEMENT MARKINGS SHALL BE PAVEMENT MARKING TAPE TYPE III, UNLESS OTHERWISE NOTED.

* SIGN SHALL BE TAKEN DOWN WHEN WORKERS ARE NOT PRESENT.

** PLACE WORK ZONE SPEED LIMIT SIGNING 500' FROM WORK ZONE AND WITHIN 500' DOWNSTREAM OF ALL MAJOR INTERSECTIONS.

WORK ZONE (HMA PAVEMENT)

WORK ZONE (PCC PAVEMENT)

TEMPORARY PAVEMENT

DIRECTION OF TRAFFIC

TEMPORARY CONCRETE BARRIER

IMPACT ATTENUATORS, TEMPORARY
(FULLY REDIRECTIVE, NARROW),
TEST LEVEL 2

TYPE III BARRICADE

MAINTENANCE OF TRAFFIC SIGN

TYPE II BARRICADES OR DRUMS PLACED AT 50' C-C IN TANGENTS, 20' C-C IN TAPERS, AND 10' IN RADII.


HRGreen.com H33 HRGreen


USER NAME = jmelhui	DESIGNED	-	JCH	REVISED -
FILE NAME = 86140100-sht-mot1-03-lincoln.do	nDRAWN	-	JCH	REVISED -
PLOT SCALE = 1"=50"	CHECKED	-	JRM	REVISED -
PLOT DATE = 3/23/2018	DATE	-	3/23/18	REVISED -


STATE OI	F ILLINOIS
DEPARTMENT OF	TRANSPORTATION

SCALE: 1"=50"

SUGGESTED MAINTENANCE OF TRAFFIC — STAGE 1 LINCOLN AVENUE								F.A.U. RTE.	SECTI	ON NO.	COUNTY	TOTAL SHEETS	SHEET NO.	
LINCOLN AVENUE						3887	08-000	83-00-CH	KANE	259	36			
												CONTRACT	NO.	61E73
"=50" SHEET NO. 3 OF 3 SHEETS STA. TO STA.								FFD. RC	DAD DIST. NO.	ILLINOIS FED. A	ID PROJECT			

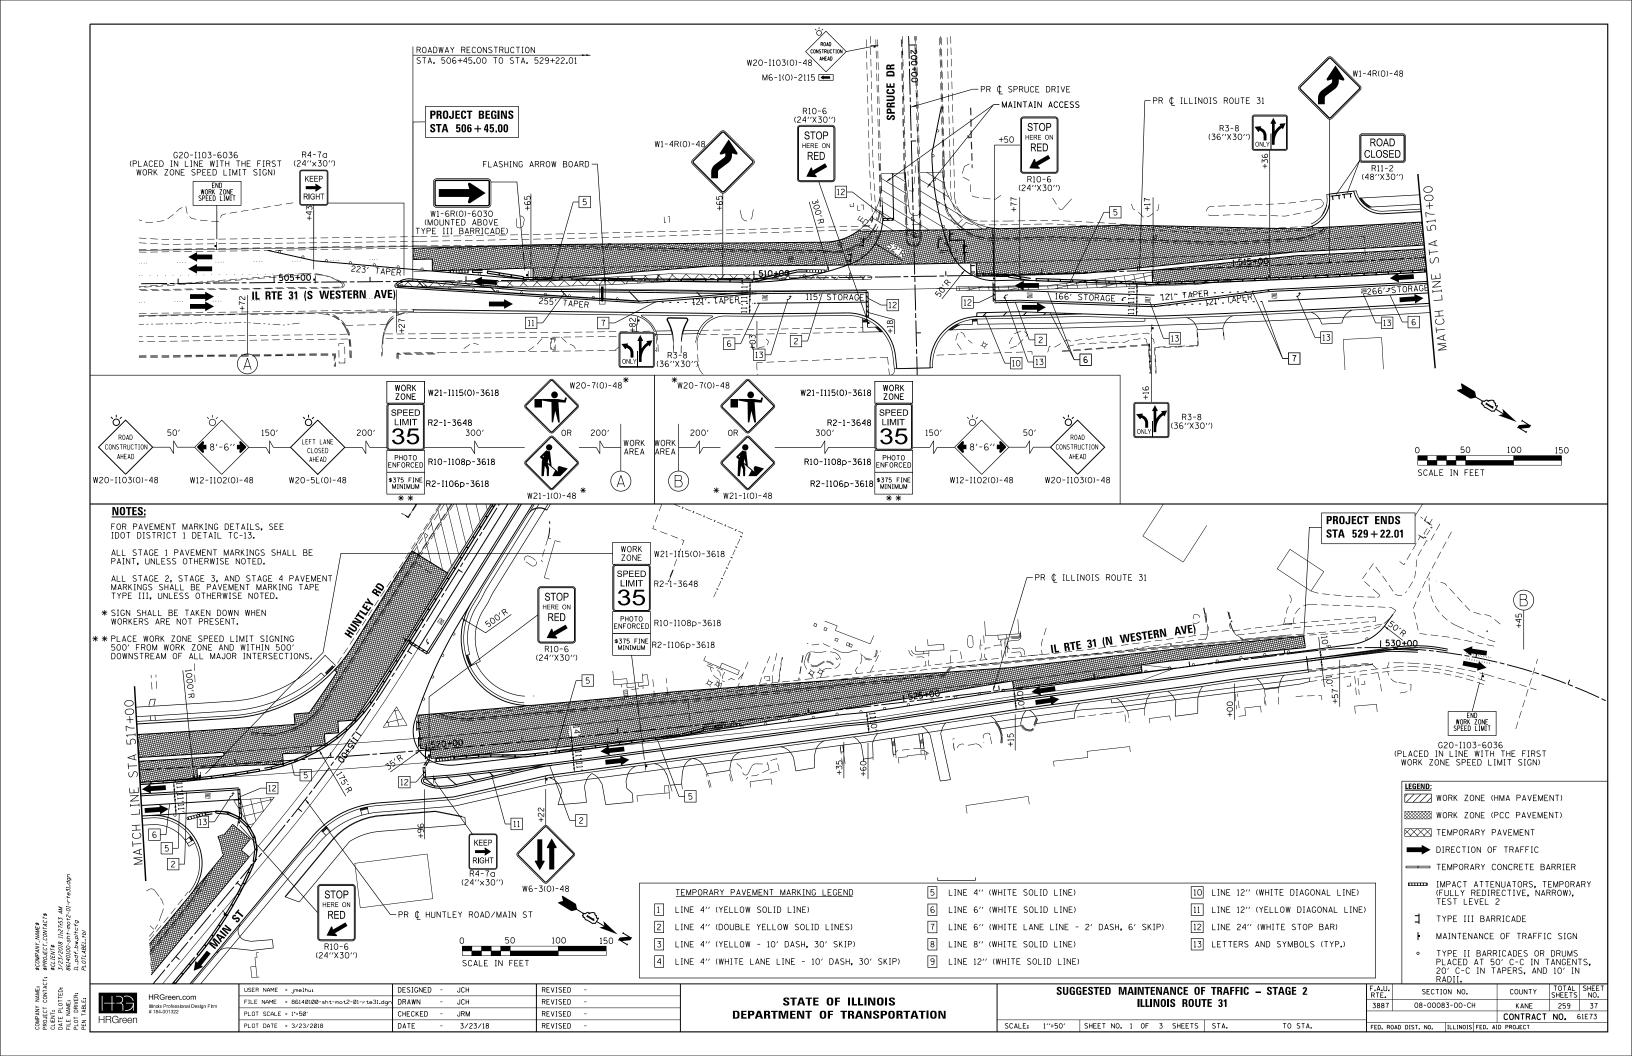

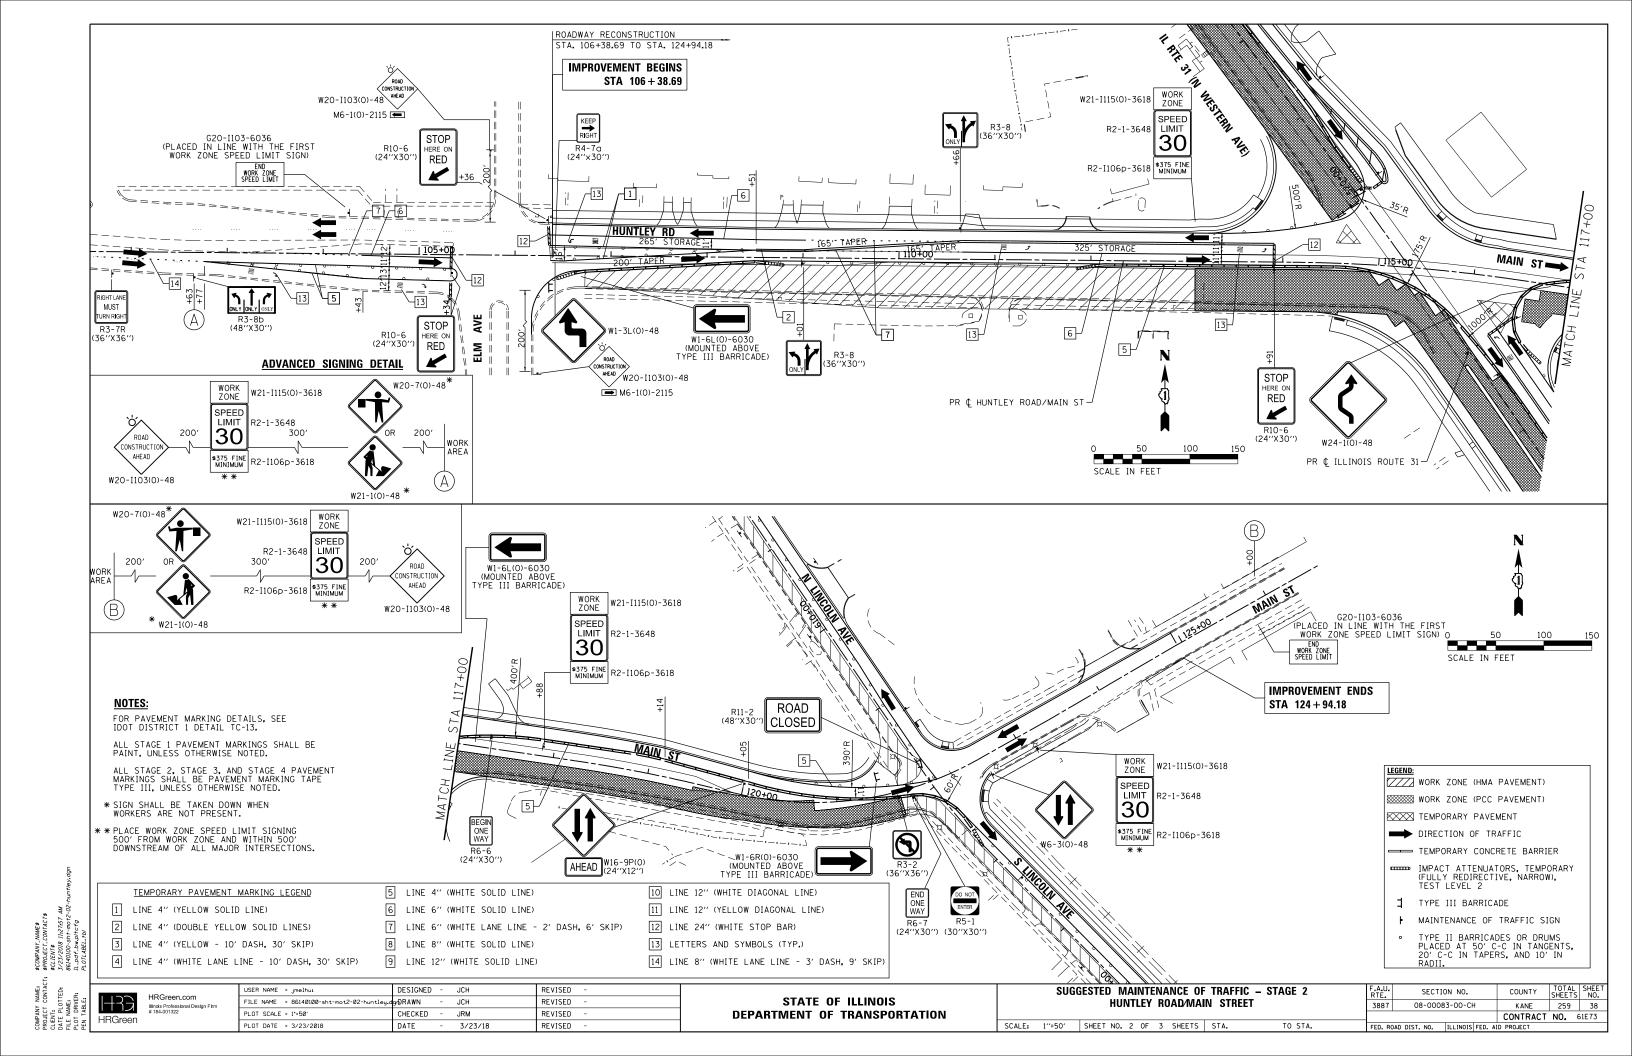

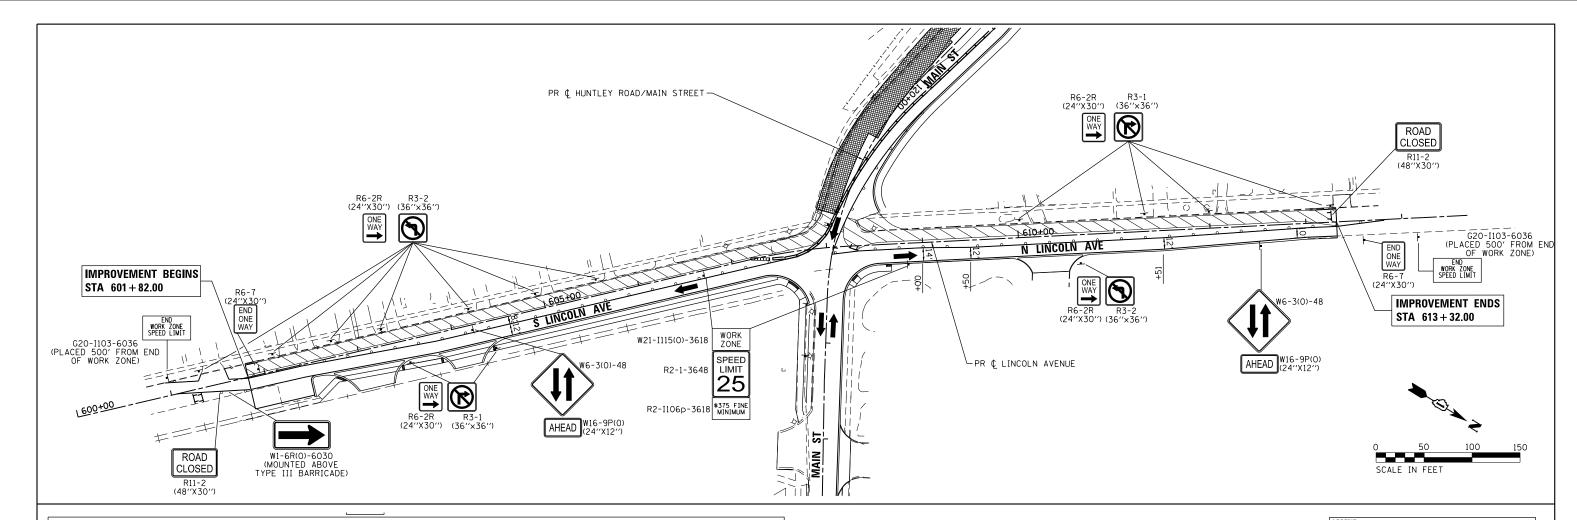

TEMPORARY PAVEMENT MARKING LEGEND

2 LINE 4" (DOUBLE YELLOW SOLID LINES)

3 LINE 4" (YELLOW - 10' DASH, 30' SKIP)

4 LINE 4" (WHITE LANE LINE - 10' DASH, 30' SKIP)

1 LINE 4" (YELLOW SOLID LINE)

5 LINE 4" (WHITE SOLID LINE)

6 LINE 6" (WHITE SOLID LINE)

9 LINE 12" (WHITE SOLID LINE)

7 LINE 6" (WHITE LANE LINE - 2' DASH, 6' SKIP) 8 LINE 8" (WHITE SOLID LINE)

10 LINE 12" (WHITE DIAGONAL LINE)

11 LINE 12" (YELLOW DIAGONAL LINE)

12 LINE 24" (WHITE STOP BAR)

13 LETTERS AND SYMBOLS (TYP.)

FOR PAVEMENT MARKING DETAILS, SEE IDOT DISTRICT 1 DETAIL TC-13.

ALL STAGE 1 PAVEMENT MARKINGS SHALL BE PAINT, UNLESS OTHERWISE NOTED.

ALL STAGE 2, STAGE 3, AND STAGE 4 PAVEMENT MARKINGS SHALL BE PAVEMENT MARKING TAPE TYPE III, UNLESS OTHERWISE NOTED.

* SIGN SHALL BE TAKEN DOWN WHEN WORKERS ARE NOT PRESENT.

** PLACE WORK ZONE SPEED LIMIT SIGNING 500' FROM WORK ZONE AND WITHIN 500' DOWNSTREAM OF ALL MAJOR INTERSECTIONS.

LEGEND:

WORK ZONE (HMA PAVEMENT)

WORK ZONE (PCC PAVEMENT)

TEMPORARY PAVEMENT

DIRECTION OF TRAFFIC

→ TEMPORARY CONCRETE BARRIER

IMPACT ATTENUATORS, TEMPORARY (FULLY REDIRECTIVE, NARROW), TEST LEVEL 2

TYPE III BARRICADE

MAINTENANCE OF TRAFFIC SIGN

TYPE II BARRICADES OR DRUMS PLACED AT 50' C-C IN TANGENTS, 20' C-C IN TAPERS, AND 10' IN RADII.

TOTAL SHEET SHEETS NO.

KANE 259 39


CONTRACT NO. 61E73


COUNTY


H33 HRGreen.com HRGreen

USER NAME = jmelhui	DESIGNED	-	JCH	REVISED -	
FILE NAME = 86140100-sht-mot2-03-lincoln-1	.dByRAWN	-	JCH	REVISED -	
PLOT SCALE = 1*=50'	CHECKED	-	JRM	REVISED -	
PLOT DATE = 3/23/2018	DATE	-	3/23/18	REVISED -	
					1

	SUGO	GESTED	M	ΑI					- STAGI	E 2	F.A. RTE		SECTIO	.0N NC
	LINCOLN AVENUE								388	3887 08-00083-00-CH				
SCALE:	1''=50'	SHEET	NO.	3	OF	3	SHEETS	STA.	ТО	STA.	FED.	. ROAD	DIST. NO.	ILLINOIS FE

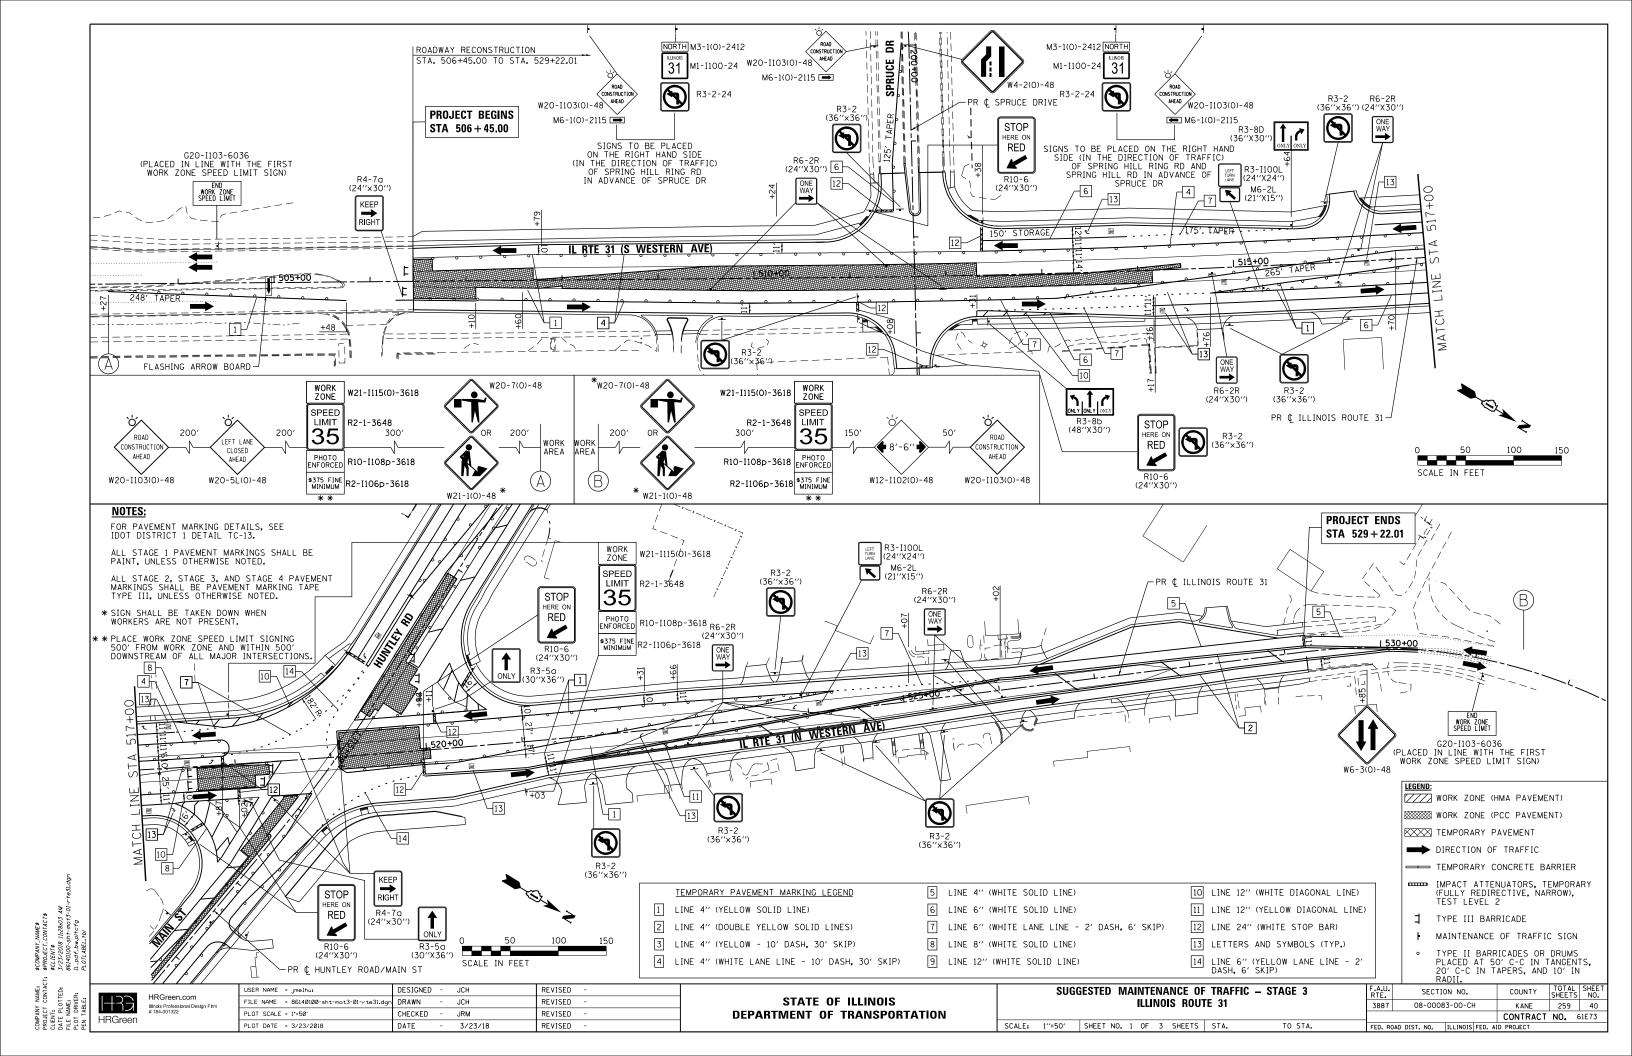

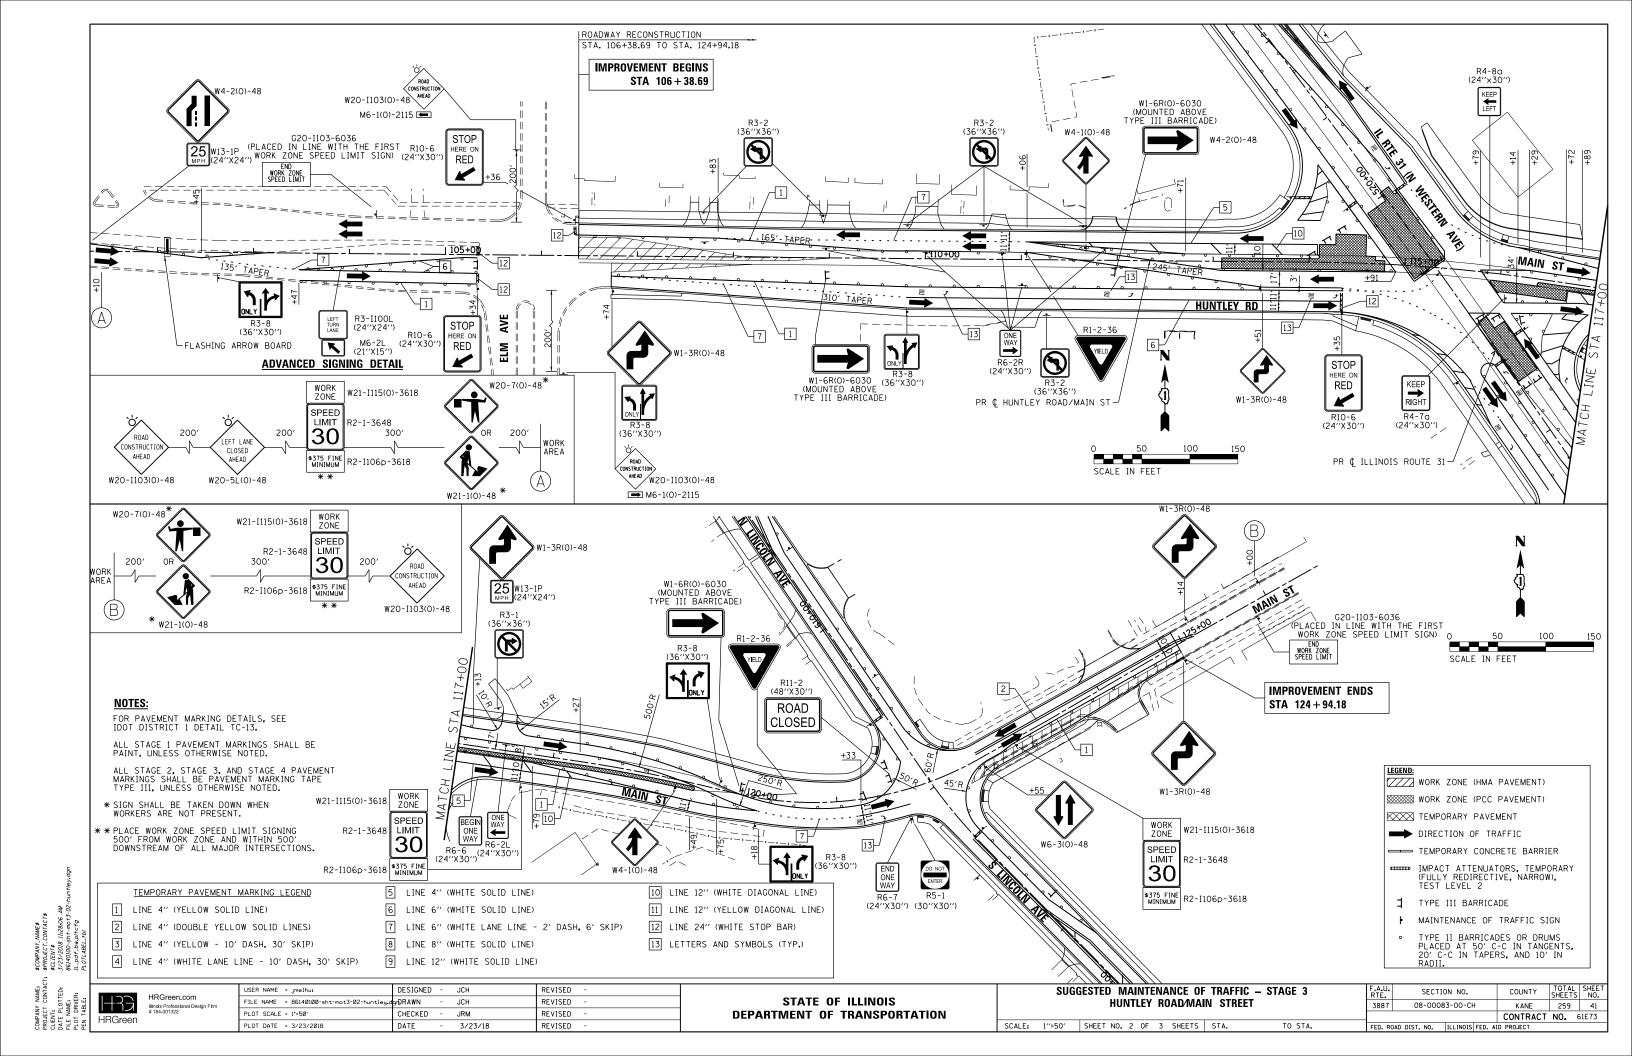

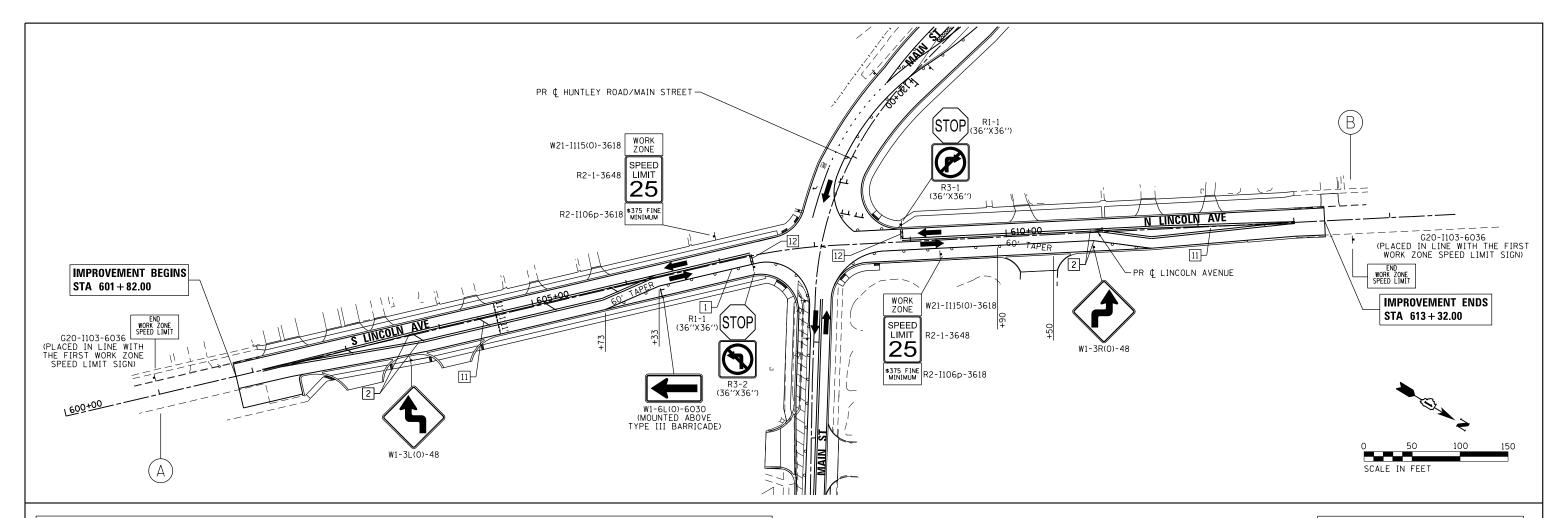



- 1 LINE 4" (YELLOW SOLID LINE)
- 2 LINE 4" (DOUBLE YELLOW SOLID LINES)
- 3 LINE 4" (YELLOW 10' DASH, 30' SKIP)
- 4 LINE 4" (WHITE LANE LINE 10' DASH, 30' SKIP)
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- 7 LINE 6" (WHITE LANE LINE 2' DASH, 6' SKIP)
- 8 LINE 8" (WHITE SOLID LINE) 9 LINE 12" (WHITE SOLID LINE)

- 10 LINE 12" (WHITE DIAGONAL LINE)
- 11 LINE 12" (YELLOW DIAGONAL LINE)
- 12 LINE 24" (WHITE STOP BAR)
- 13 LETTERS AND SYMBOLS (TYP.)

NOTES:

FOR PAVEMENT MARKING DETAILS, SEE IDOT DISTRICT 1 DETAIL TC-13.

ALL STAGE 1 PAVEMENT MARKINGS SHALL BE PAINT, UNLESS OTHERWISE NOTED.

ALL STAGE 2, STAGE 3, AND STAGE 4 PAVEMENT MARKINGS SHALL BE PAVEMENT MARKING TAPE TYPE III, UNLESS OTHERWISE NOTED.

- * SIGN SHALL BE TAKEN DOWN WHEN WORKERS ARE NOT PRESENT.
- ** PLACE WORK ZONE SPEED LIMIT SIGNING 500' FROM WORK ZONE AND WITHIN 500' DOWNSTREAM OF ALL MAJOR INTERSECTIONS.

CONTRACTOR SHALL PLACE "CAUTION NEW LANES OPEN STOP HERE" SIGNS FOR TWO WEEKS UPON INITIATING STAGE.

TO STA.

WORK ZONE (HMA PAVEMENT)

WORK ZONE (PCC PAVEMENT)


TEMPORARY PAVEMENT

DIRECTION OF TRAFFIC

TEMPORARY CONCRETE BARRIER

IMPACT ATTENUATORS, TEMPORARY (FULLY REDIRECTIVE, NARROW), TEST LEVEL 2

- ☐ TYPE III BARRICADE
- MAINTENANCE OF TRAFFIC SIGN
- TYPE II BARRICADES OR DRUMS PLACED AT 50' C-C IN TANGENTS, 20' C-C IN TAPERS, AND 10' IN RADII.

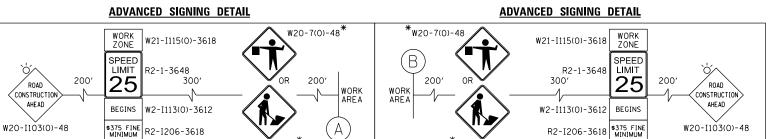

*W21-1a(0)-48

H33 **HRGreen**

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ROAD

AHEAD

CONSTRUCTIO

USER NAME = Jmelhui	DESIGNED	-	JCH	REVISED	-
FILE NAME = 86140100-sht-mot3-03-lincoln.d	arDRAWN	-	JCH	REVISED	-
PLOT SCALE = 1*=50'	CHECKED	-	JRM	REVISED	-
PLOT DATE = 3/23/2018	DATE	-	3/23/18	REVISED	-


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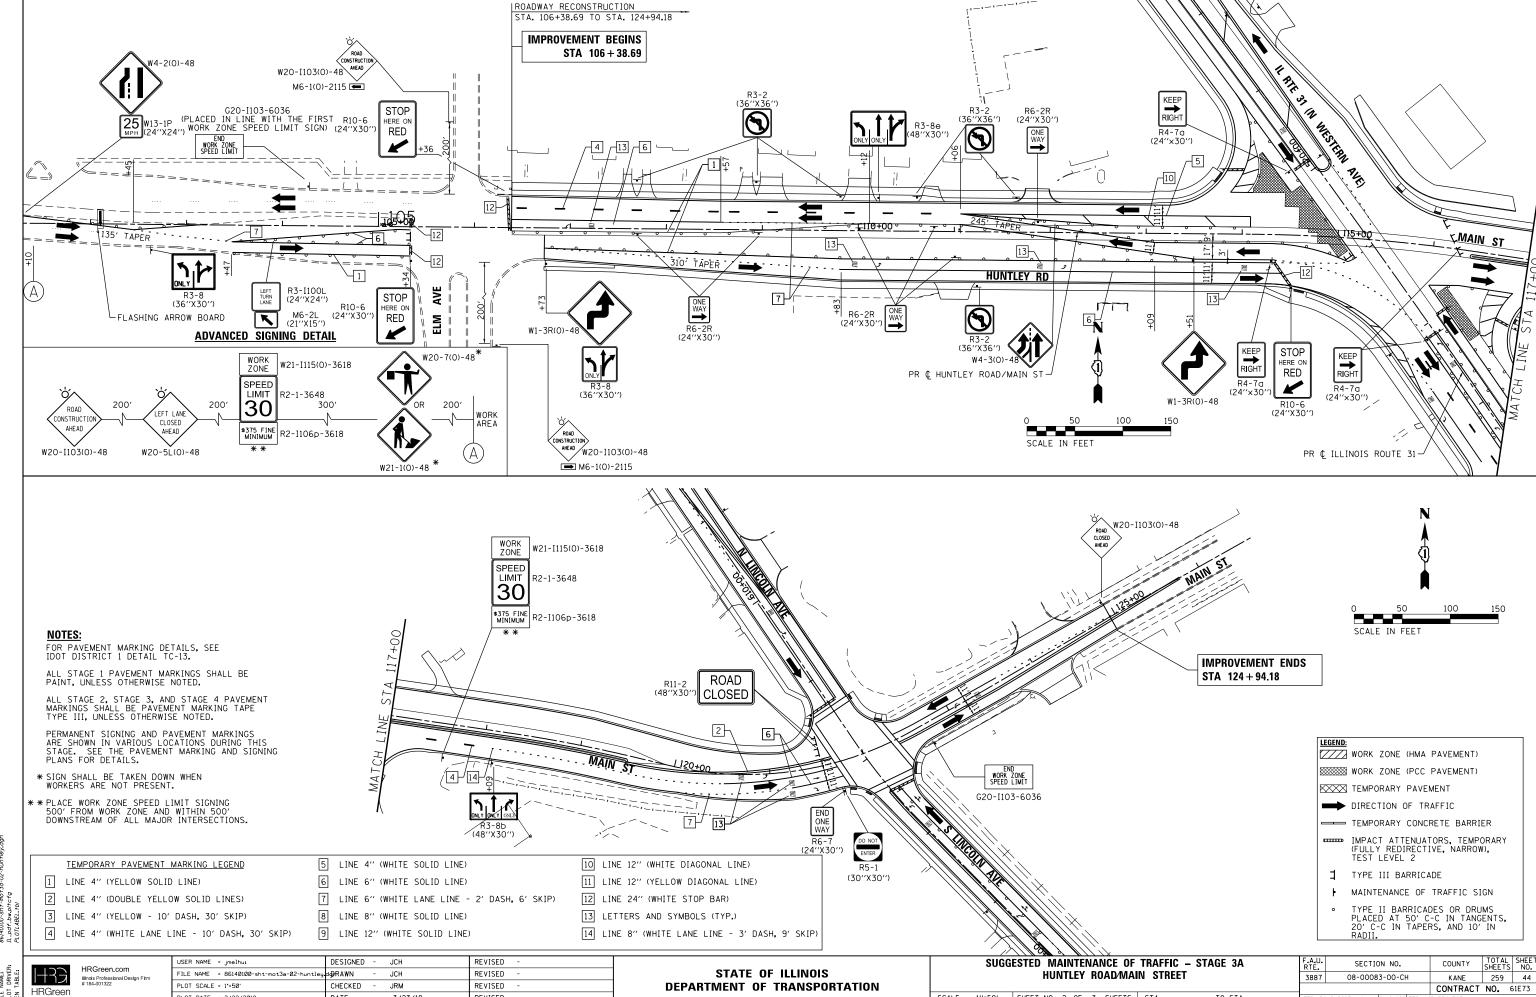
STATE OF ILLINOIS **DEPARTMENT OF TRANSPORTATION**

SUGGESTED	MAINTENANCE OF TRAFFIC — STAGE 3	
	LINCOLN AVENUE	

SCALE: 1"=50' SHEET NO. 3 OF 3 SHEETS STA.

F.A.U.	SECTION	ON NO.			COUNTY	TOTAL	SHEET
RTE.	020.1			\perp		SHEETS	NO.
3887	08-0008	3-00-CH	1		KANE	259	42
				Т	CONTRACT	NO. 6	51E73
FED. RO	AD DIST. NO.	ILLINOIS	FED. A	AID	PROJECT		



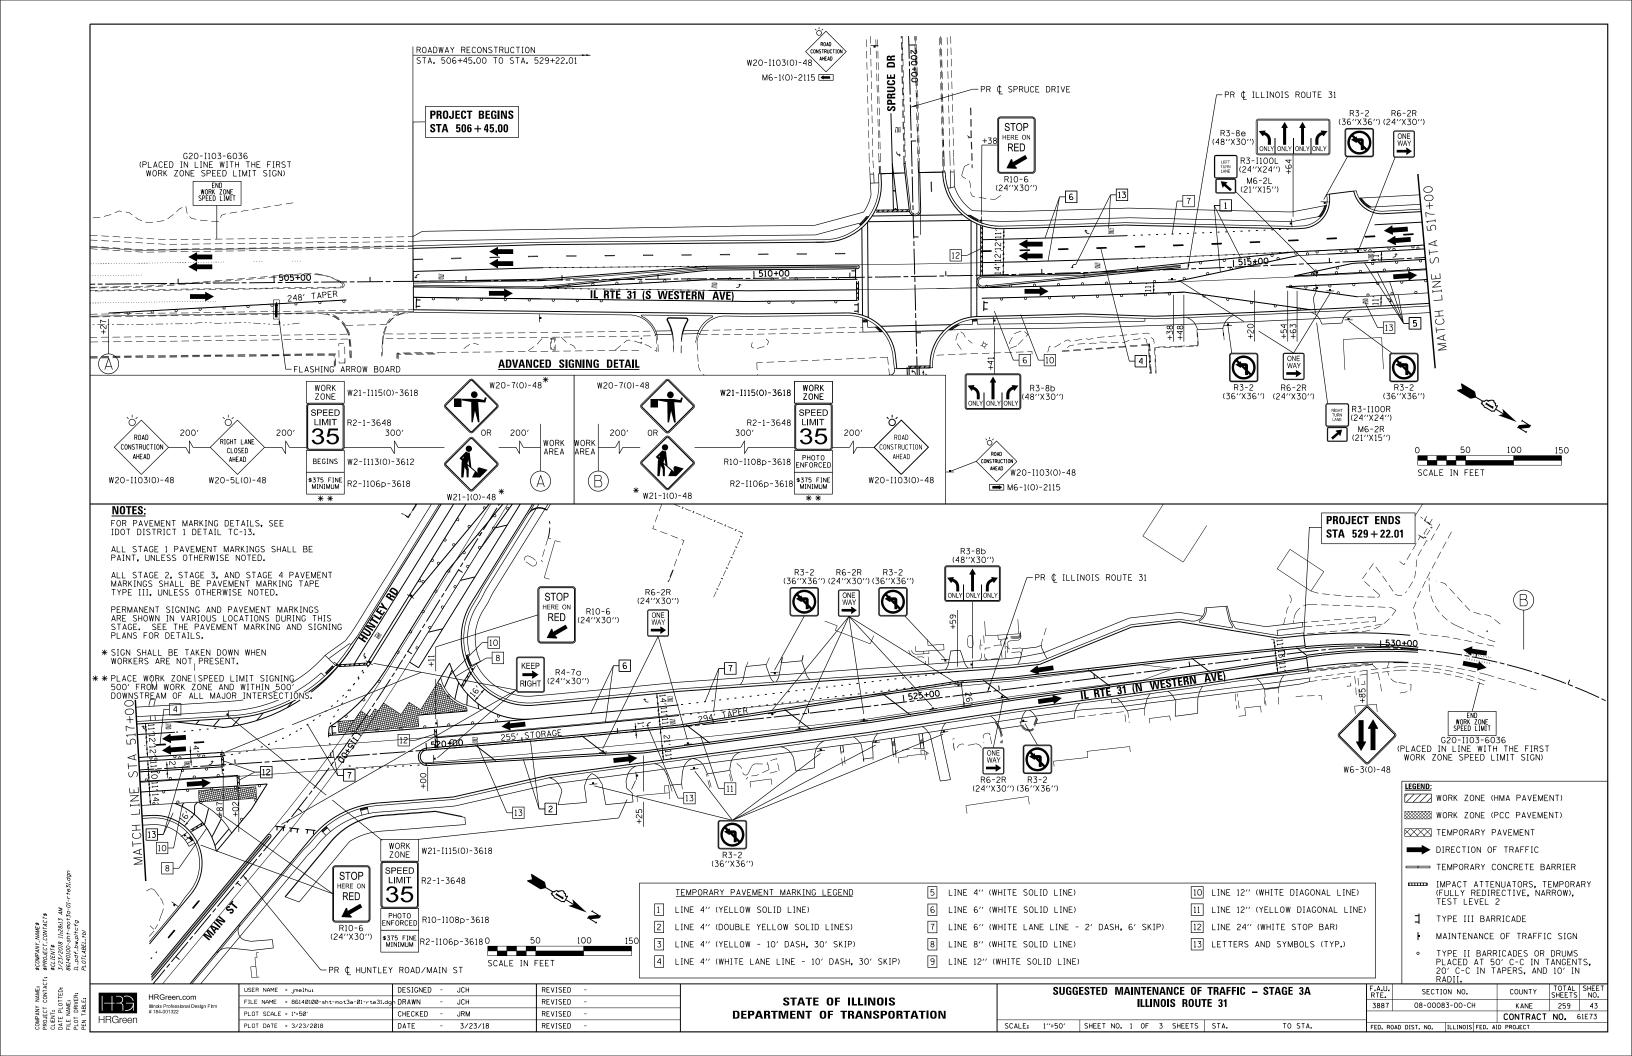


SCALE: 1"=50" SHEET NO. 2 OF 3 SHEETS STA.

PLOT DATE = 3/23/2018

REVISED

3/23/18

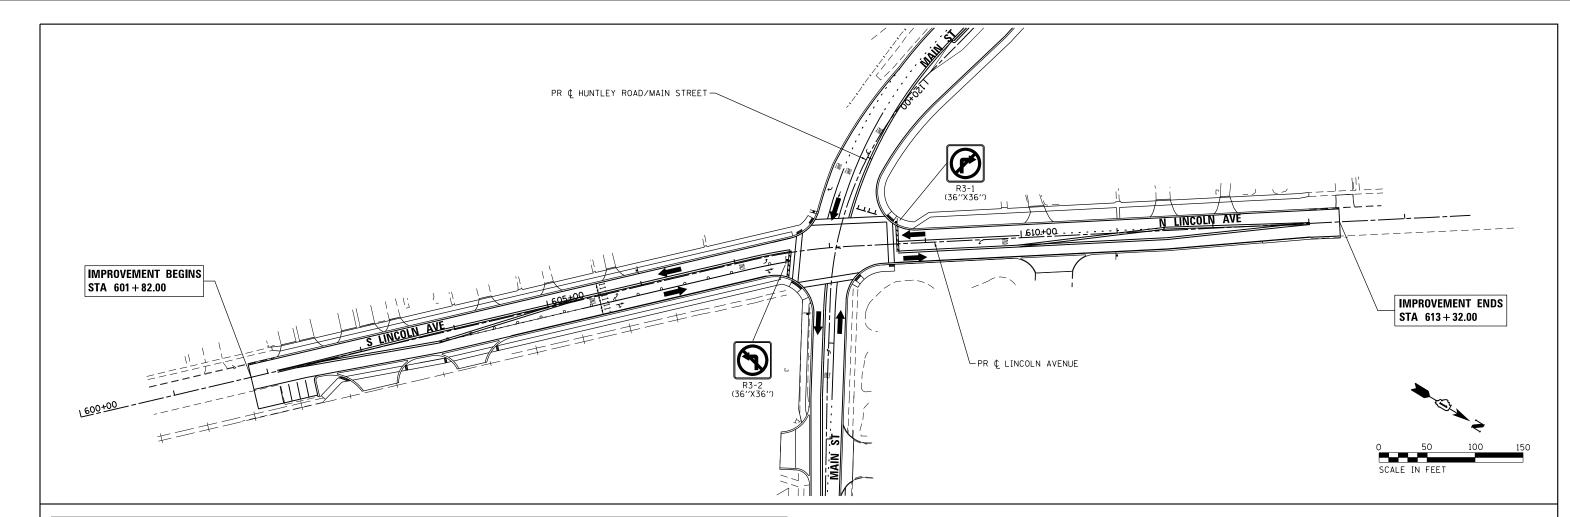

TEMPORARY PAVEMENT MARKING LEGEND

2 LINE 4" (DOUBLE YELLOW SOLID LINES)

3 LINE 4" (YELLOW - 10' DASH, 30' SKIP)

1 LINE 4" (YELLOW SOLID LINE)

4 LINE 4" (WHITE LANE LINE - 10' DASH, 30' SKIP)

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6 LINE 6" (WHITE SOLID LINE)

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12 LINE 24" (WHITE STOP BAR)

13 LETTERS AND SYMBOLS (TYP.)

FOR PAVEMENT MARKING DETAILS, SEE IDOT DISTRICT 1 DETAIL TC-13.

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WORK ZONE (HMA PAVEMENT)

WORK ZONE (PCC PAVEMENT)

TEMPORARY PAVEMENT

DIRECTION OF TRAFFIC

TEMPORARY CONCRETE BARRIER

IMPACT ATTENUATORS, TEMPORARY (FULLY REDIRECTIVE, NARROW), TEST LEVEL 2

TYPE III BARRICADE

MAINTENANCE OF TRAFFIC SIGN

TYPE II BARRICADES OR DRUMS PLACED AT 50' C-C IN TANGENTS, 20' C-C IN TAPERS, AND 10' IN RADII.

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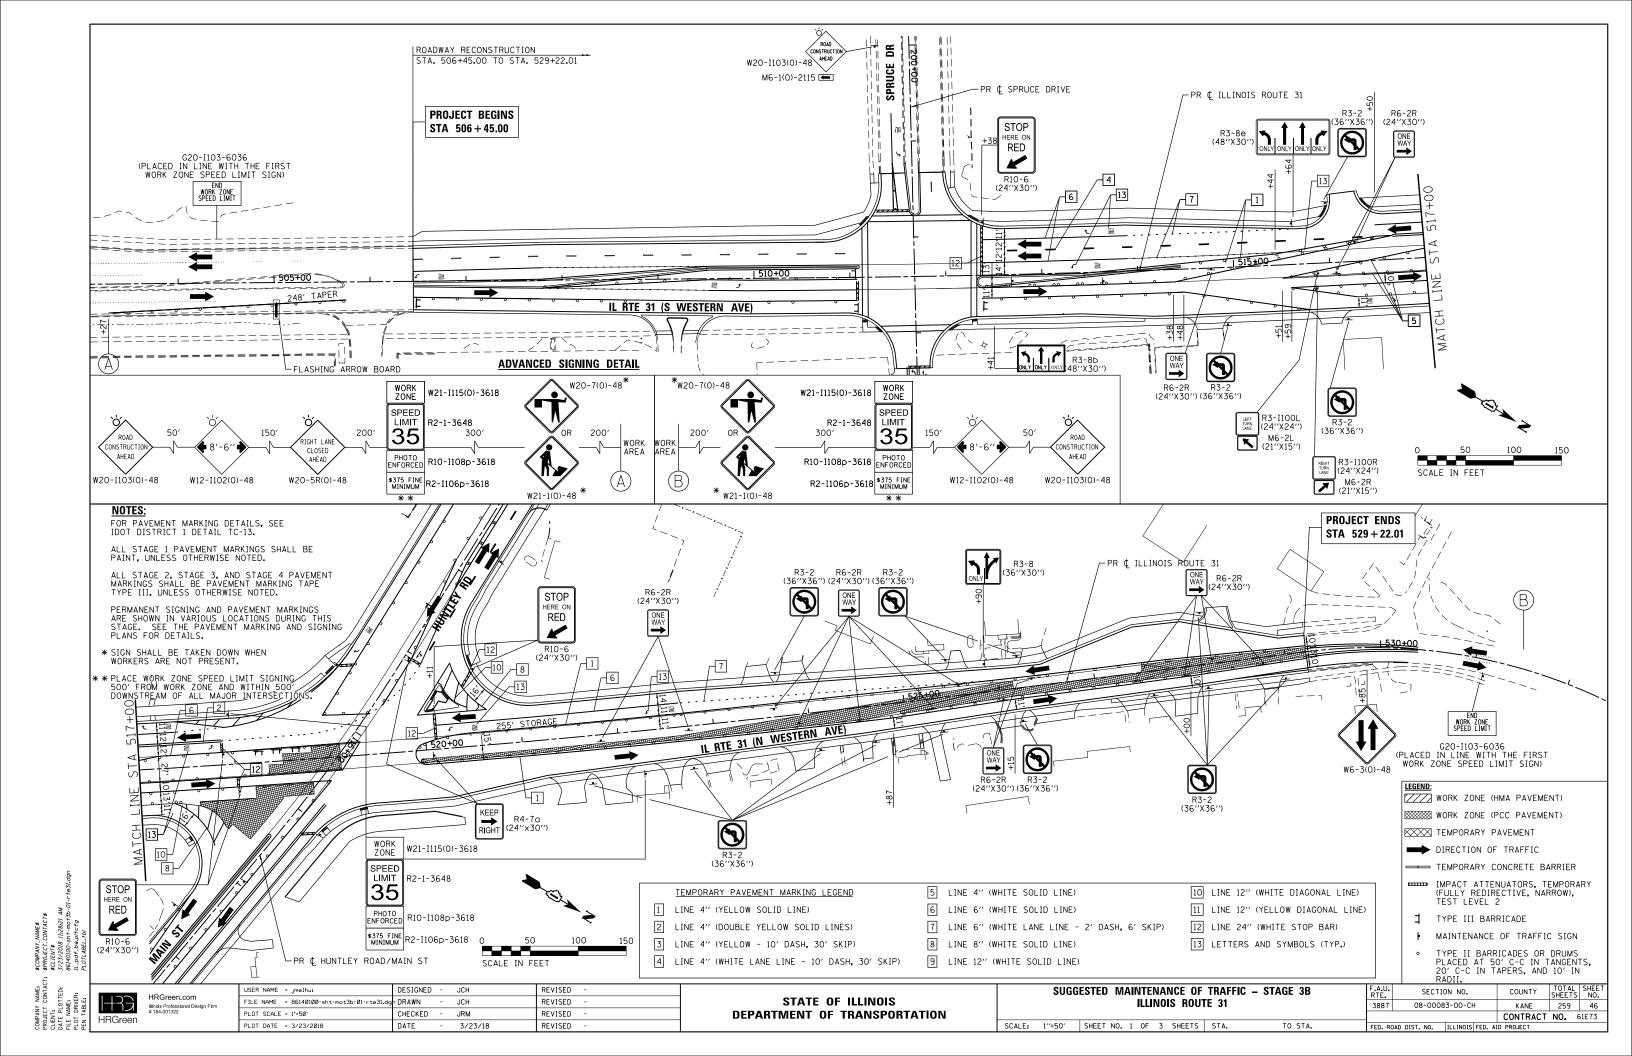
DESIGNED - JCH REVISED USER NAME = jmelhui FILE NAME = 86140100-sht-mot3a-03-linco d∂RAWN JCH REVISED CHECKED REVISED PLOT DATE = 3/23/2018 DATE 3/23/18 REVISED


STATE OF ILLINOIS **DEPARTMENT OF TRANSPORTATION**

SUGGESTED MAINTENANCE OF TRAFFIC - STAGE 3A LINCOLN AVENUE SCALE: 1"=50" SHEET NO. 3 OF 3 SHEETS STA. TO STA.

COUNTY TOTAL SHEETS NO.

KANE 259 45 SECTION NO. 3887 08-00083-00-CH CONTRACT NO. 61E73 FED. ROAD DIST. NO. | ILLINOIS FED. AID PROJECT



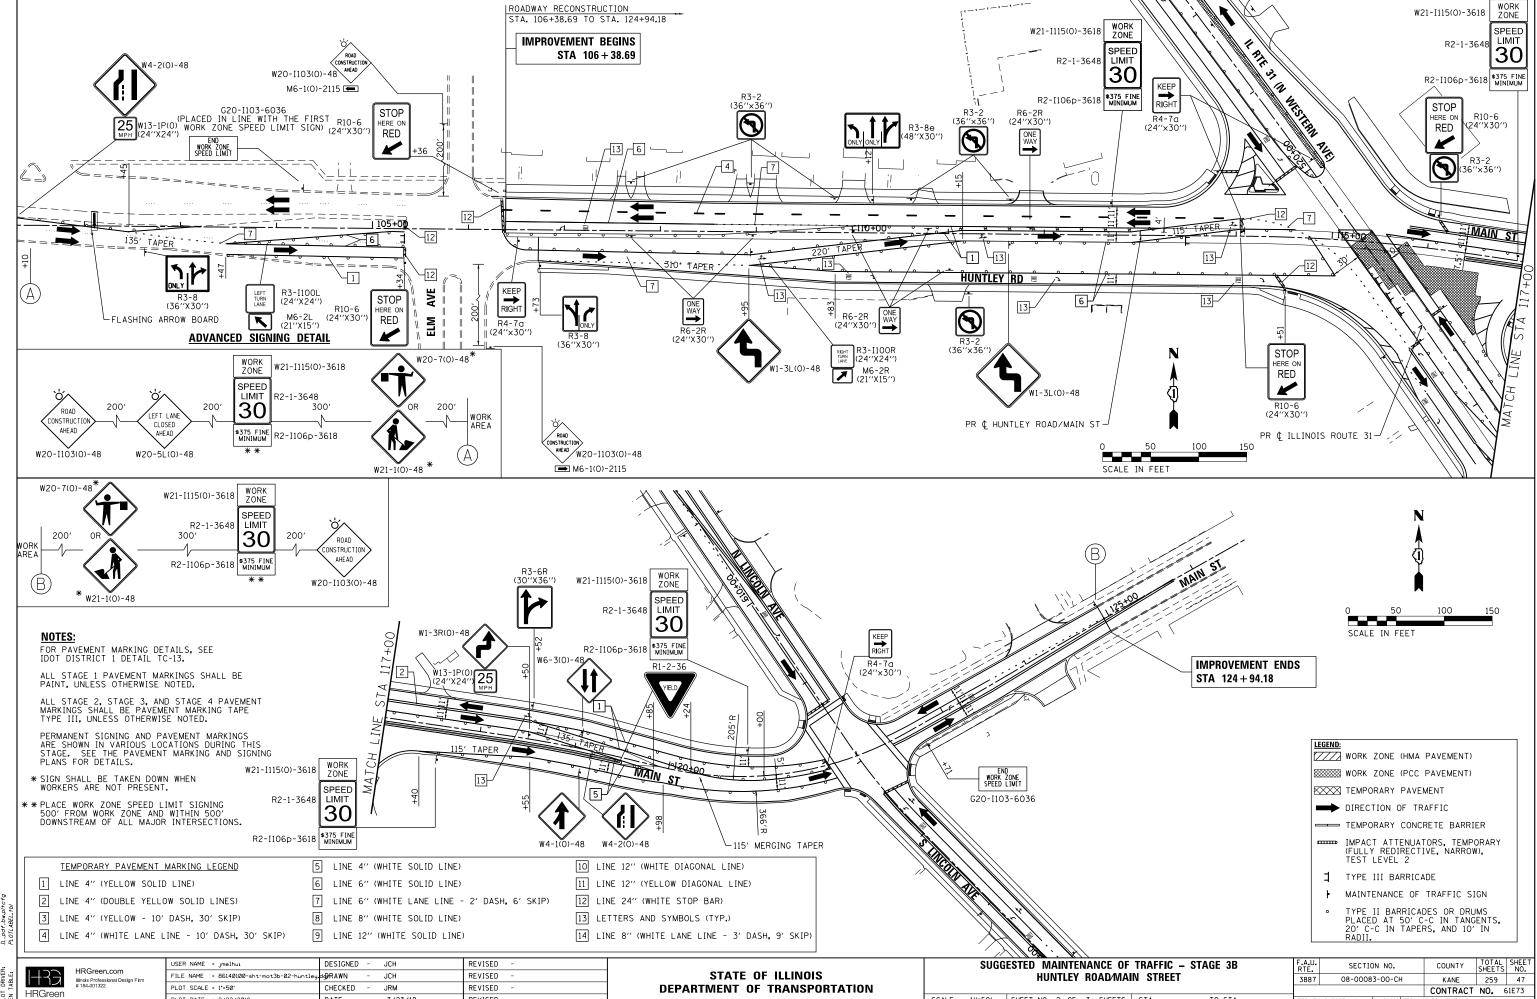

SCALE: 1"=50" SHEET NO. 2 OF 3 SHEETS STA.


TO STA.

PLOT DATE = 3/23/2018

DATE

3/23/18

REVISED

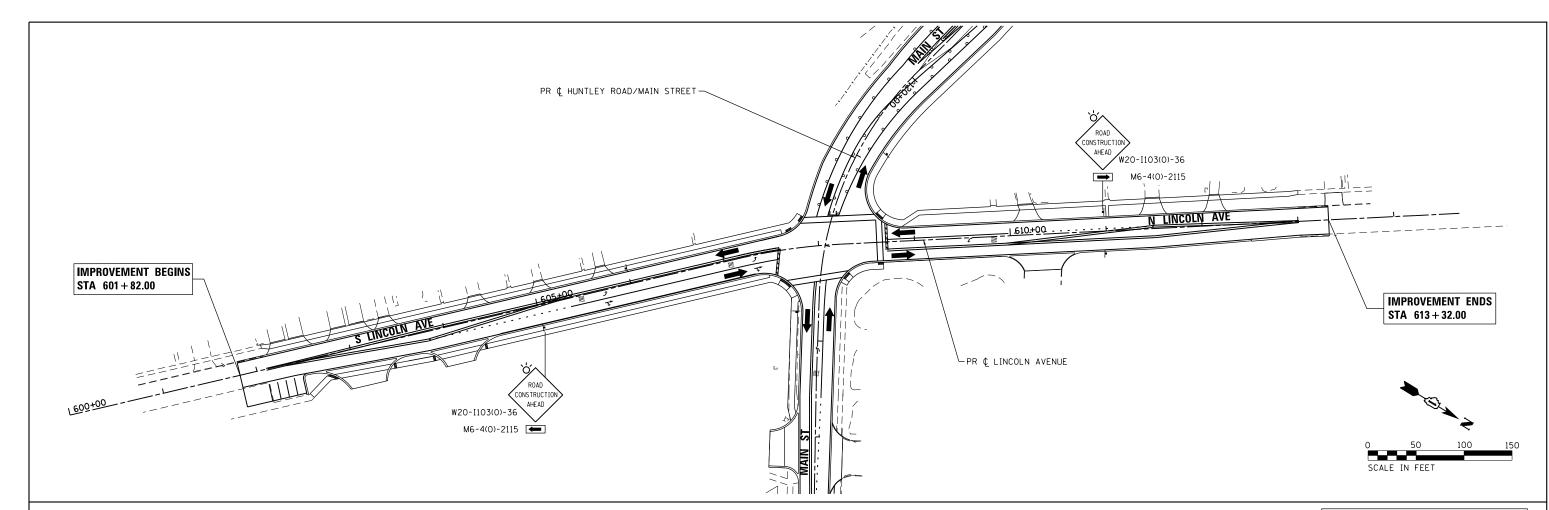

TEMPORARY PAVEMENT MARKING LEGEND

1 LINE 4" (YELLOW SOLID LINE)

2 LINE 4" (DOUBLE YELLOW SOLID LINES)

3 LINE 4" (YELLOW - 10' DASH, 30' SKIP)

4 LINE 4" (WHITE LANE LINE - 10' DASH, 30' SKIP)

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12 LINE 24" (WHITE STOP BAR)

13 LETTERS AND SYMBOLS (TYP.)

FOR PAVEMENT MARKING DETAILS, SEE IDOT DISTRICT 1 DETAIL TC-13.

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PERMANENT SIGNING AND PAVEMENT MARKINGS ARE SHOWN IN VARIOUS LOCATIONS DURING THIS STAGE. SEE THE PAVEMENT MARKING AND SIGNING PLANS FOR DETAILS.

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** PLACE WORK ZONE SPEED LIMIT SIGNING 500' FROM WORK ZONE AND WITHIN 500' DOWNSTREAM OF ALL MAJOR INTERSECTIONS.

WORK ZONE (HMA PAVEMENT)

WORK ZONE (PCC PAVEMENT)

TEMPORARY PAVEMENT

DIRECTION OF TRAFFIC

TEMPORARY CONCRETE BARRIER

IMPACT ATTENUATORS, TEMPORARY (FULLY REDIRECTIVE, NARROW), TEST LEVEL 2

TYPE III BARRICADE

MAINTENANCE OF TRAFFIC SIGN


TYPE II BARRICADES OR DRUMS PLACED AT 50' C-C IN TANGENTS, 20' C-C IN TAPERS, AND 10' IN RADII.


HRGreen.com HRGreen

	USER NAME = Jmelhuı	DESIGNED	-	JCH	REVISED	-
	FILE NAME = 86140100-sht-mot3b-03-lincoln.	⊎g∂RAWN	-	JCH	REVISED	-
	PLOT SCALE = 1"=50"	CHECKED	-	JRM	REVISED	-
	PLOT DATE = 3/23/2018	DATE	-	3/23/18	REVISED	-
_						

STATE OF	ILLINOIS
DEPARTMENT OF 1	TRANSPORTATION

	;	SUGGES	TED MA					- STAGE 3B	F.A.U. RTE.	SECTI	ON NO.	COUNTY	TOTAL	SHEET NO.
				LIN	1C0	LN AVE	NUE		3887	08-0008	3-00-CH	KANE	259	48
												CONTRACT	NO.	61E73
SCA	LE: 1"=	50' SH	HEET NO.	3 OF	3	SHEETS	STA.	TO STA.	FED. R	OAD DIST. NO.	ILLINOIS FED. A	ID PROJECT		

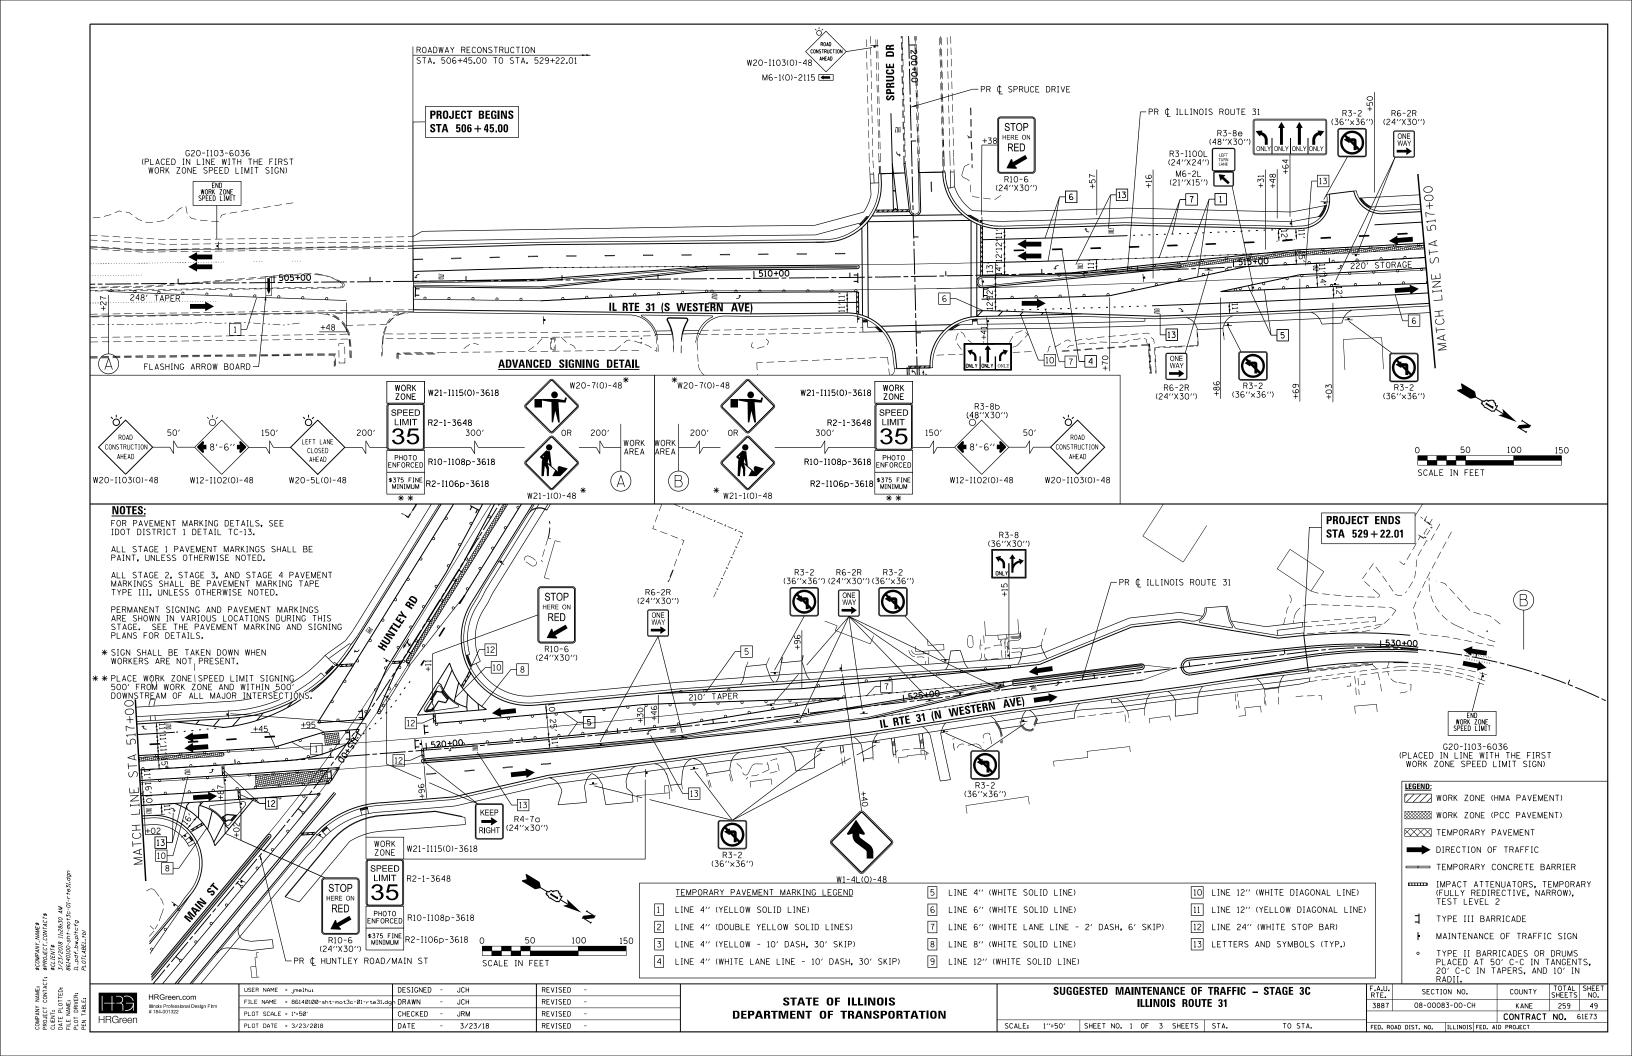

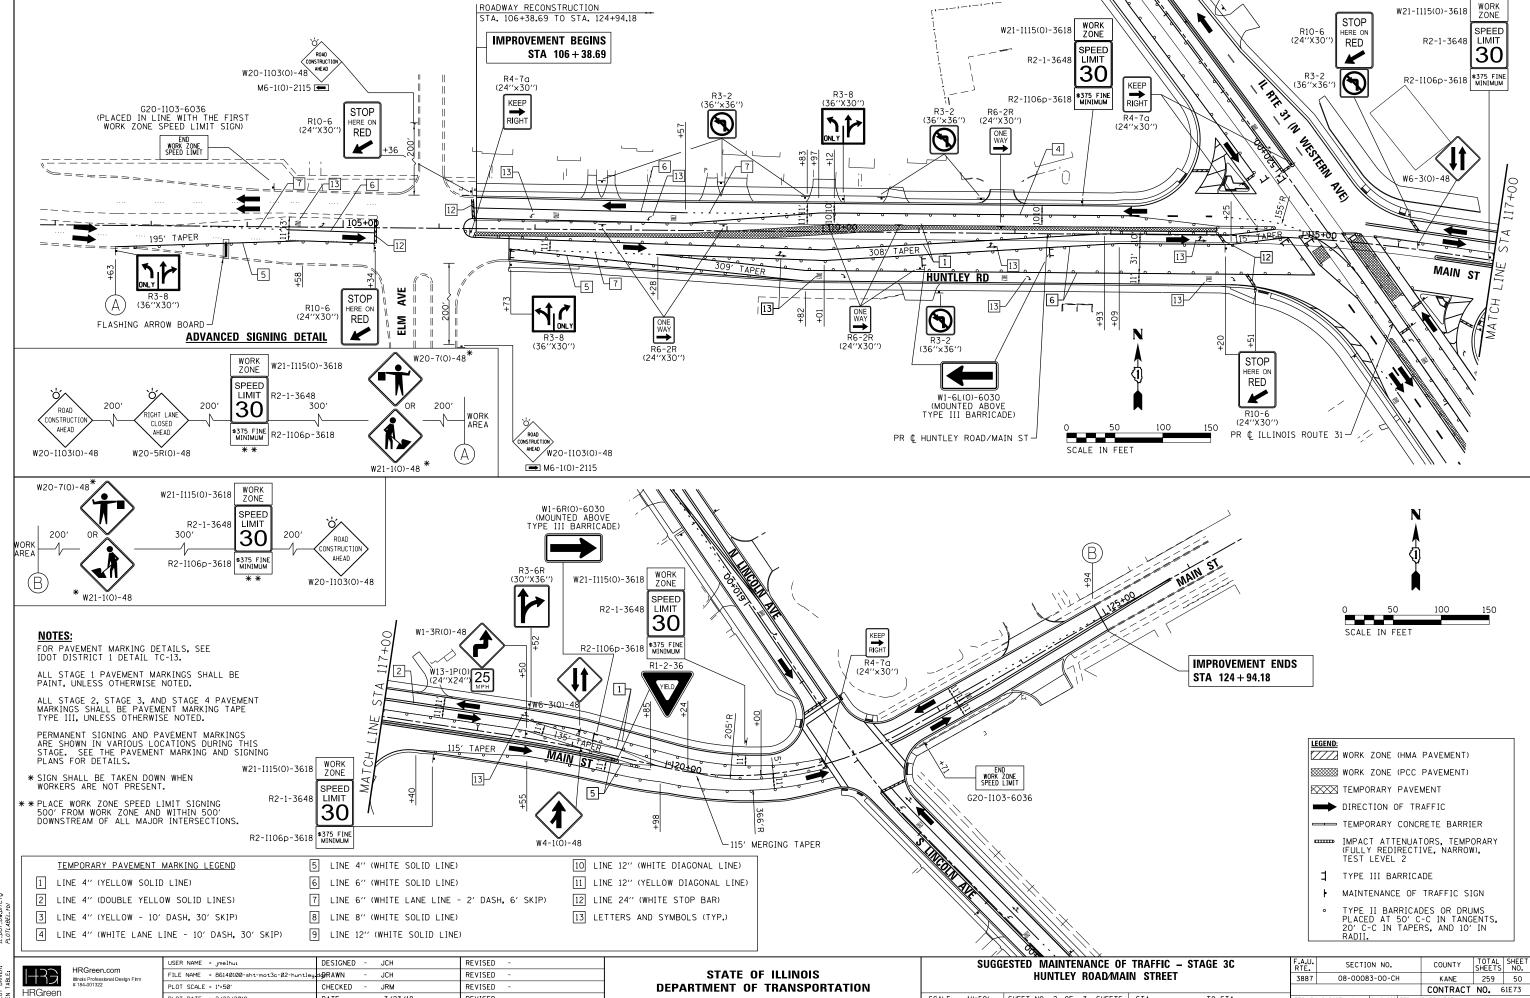


SCALE: 1"=50" SHEET NO. 2 OF 3 SHEETS STA.

PLOT DATE = 3/23/2018

DATE

3/23/18

REVISED

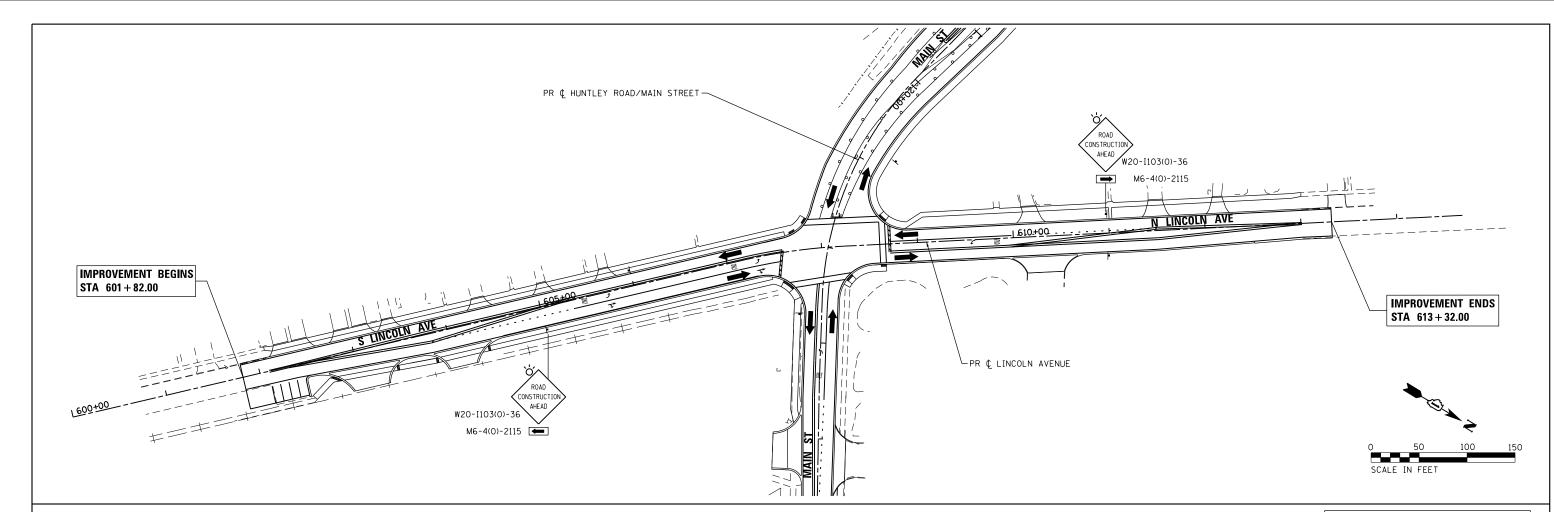

TEMPORARY PAVEMENT MARKING LEGEND

1 LINE 4" (YELLOW SOLID LINE)

2 LINE 4" (DOUBLE YELLOW SOLID LINES)

3 LINE 4" (YELLOW - 10' DASH, 30' SKIP)

4 LINE 4" (WHITE LANE LINE - 10' DASH, 30' SKIP)

5 LINE 4" (WHITE SOLID LINE)

6 LINE 6" (WHITE SOLID LINE)

7 LINE 6" (WHITE LANE LINE - 2' DASH, 6' SKIP)

8 LINE 8" (WHITE SOLID LINE) 9 LINE 12" (WHITE SOLID LINE) 10 LINE 12" (WHITE DIAGONAL LINE)

11 LINE 12" (YELLOW DIAGONAL LINE)

12 LINE 24" (WHITE STOP BAR)

13 LETTERS AND SYMBOLS (TYP.)

FOR PAVEMENT MARKING DETAILS, SEE IDOT DISTRICT 1 DETAIL TC-13.

ALL STAGE 1 PAVEMENT MARKINGS SHALL BE PAINT, UNLESS OTHERWISE NOTED.

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LEGEND:

WORK ZONE (HMA PAVEMENT)

TEMPORARY CONCRETE BARRIER

WORK ZONE (PCC PAVEMENT)

TEMPORARY PAVEMENT

DIRECTION OF TRAFFIC

IMPACT ATTENUATORS, TEMPORARY (FULLY REDIRECTIVE, NARROW), TEST LEVEL 2

TYPE III BARRICADE

MAINTENANCE OF TRAFFIC SIGN

TYPE II BARRICADES OR DRUMS PLACED AT 50' C-C IN TANGENTS, 20' C-C IN TAPERS, AND 10' IN RADII.

HRGreen.com HRGreen

	USER NAME = Jmelhuı	DESIGNED	-	JCH	REVISED -
	FILE NAME = 86140100-sht-mot3c-03-lincoln.	⊎g∂RAWN	-	JCH	REVISED -
	PLOT SCALE = 1"=50"	CHECKED	-	JRM	REVISED -
	PLOT DATE = 3/23/2018	DATE	-	3/23/18	REVISED -
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STATE OF ILLINOIS **DEPARTMENT OF TRANSPORTATION**

	SUGG	ESTED	M				NCE OF LN AVE		IC – STAGE 3C
SCALE:	1''=50'	SHEET	NO.	3	OF	3	SHEETS	STA.	TO STA.

F.A.U. RTE.	SE	CTIC	N NO.			COUNTY	TOTAL SHEETS	SHEET NO.
3887 08-00083-00-CH						KANE	259	51
						CONTRACT	NO. 6	S1E73
EED DO	AD DICT NO	<u>, </u>	TI I INOTE	FFD	4.1	D DDO IECT		

R11-2-4830 ₩20-2-4848 LAKE MARIAN RD ROAD END DETOUR DETOUR CLOSED (1)M4-8A(0) (8) AHEAD 24"X18" COTTAGE AVE 24''X18'' WB Main Street R11-4-6030 W20-3(0)-4848 ROAD M3-1(0)-2412 WEST CLOSED 10 Main Street 24''X18'' AHEAD BALL AVE 2 DETOUR M4-9(0)-3024 ROAD (11) CLOSED WEST M3-1(0)-2412 500 FT M4-10R-4818 Main Street (3) DETOUR ROU W20-3(0)-4848 M4-9(0)-3024 PARK AVE CARPENTER ST WEST M3-1(0)-2412 VALENTINE ST Main Street 24"X18" CHARLES ST 4 DETOUR M4-9(0)-3024 MAPLE AVE WEST M3-1(0)-2412 Main Street 24"X18" (5)DETOUR M4-9(0)-3024 HUNTLEY RD WEST M3-1(0)-2412 Main Street 24"X18" CLEVELAND AVE 6 DETOUR M4-9(0)-3024 EFFECTIVE [DATE] 9 WESTBOUND Main Street CLOSED AT Lincoln Avenue HILLSIDE ST BARRINGTON AVE HIGGINS RD (IL ROUTE 72) KANE ST GENEVA ST WASHINGTON ST **DETOUR LEGEND** DETOUR GUIDE SIGN BARRICADE, TYPE III OREGON AVE DETOUR ROUTE LIBERTY ST S 4TH ROAD CLOSED DESIGNED -TAY REVISED DETOUR PLAN USER NAME = jmelhui SECTION COUNTY HRGreen.com STATE OF ILLINOIS DRAWN TAY REVISED **WESTBOUND MAIN STREET** 3887 08-00083-00-CH KANE 259 52 LOT SCALE = N.T.S. CHECKED JRM REVISED **DEPARTMENT OF TRANSPORTATION** CONTRACT NO. 61E73 **HRGreen** PLOT DATE = 3/23/2018 3/23/18 SCALE: N.T.S. SHEET NO. 1 OF 1 SHEETS STA. TO STA. DATE REVISED FED. ROAD DIST. NO. | ILLINOIS FED. AID PROJECT

86140100 In Border File 86140100-sht-detour.dgn

EROSION CONTROL GENERAL NOTES

- 1. ALL SEDIMENT AND EROSION CONTROL MEASURES WILL BE INSTALLED PER IDOT STANDARD 280001 OR AS SPECIFIED HEREIN AND PAID FOR IN ACCORDANCE WITH SECTION 280 OF THE STANDARD SPECIFICATIONS. ALL CONSTRUCTION ACTIVITIES WILL BE IN ACCORDANCE WITH THE NATIONAL POLLUTANT DISCHARGE ELIMINATION SYSTEM STORM WATER PERMIT ILR40.
- EROSION CONTROL SHALL BE PROVIDED IN ACCORDANCE WITH THE SEQUENCE OF STAGE CONSTRUCTION. THE CONTRACTOR SHALL SUBMIT A DETAILED
- 3. SEDIMENT AND EROSION CONTROL DEVICES SHALL BE FUNCTIONAL BEFORE THE PROJECT SITE IS OTHERWISE DISTURBED.
- 4. ALL DISTURBED AREAS SHALL BE SEEDED OR SODDED AS SOON AS PRACTICAL AFTER CONSTRUCTION ACTIVITIES IN THAT AREA HAVE CONCLUDED. ALL ERODABLE/BARE AREAS SHALL BE SEEDED EVERY 7 DAYS WITH TEMPORARY EROSION CONTROL SEEDING. IF A TOPSOIL STOCKPILE IS TO REMAIN IN PLACE FOR MORE THAN THREE DAYS, EROSION CONTROL MEASURES WILL BE PROVIDED.
- 5. WATER PUMPED OR OTHERWISE DISCHARGED FROM THE SITE DURING CONSTRUCTION DEWATERING SHALL BE FILTERED.
- 6. WHEN TEMPORARY DRAINAGE IS ESTABLISHED, EROSION CONTROL MEASURES MAY BE REQUIRED BY THE ENGINEER.
- 7. GRAVEL ROADS, ACCESS DRIVES, PARKING AREAS OF SUFFICIENT WIDTH AND LENGTH, AND VEHICLE WASH DOWN FACILITIES IF NECESSARY, SHALL BE PROVIDED TO PREVENT SOIL FROM BEING TRACKED ONTO PUBLIC OR PRIVATE ROADWAYS. ANY SOIL REACHING A PUBLIC OR PRIVATE ROADWAY SHALL BE REMOVED BEFORE THE END OF EACH WORKDAY AND AS NEEDED.
- CLEANING OF VEHICLES AND EQUIPMENT, INCLUDING CONCRETE MIXERS, SHALL BE PERFORMED IN A MANNER TO REDUCE THE AMOUNT OF POLLUTANTS TRIBUTARY TO STORM SEWERS AND OPEN WATERS TO THE MAXIMUM EXTENT
- 9. ALL NECESSARY MEASURES SHALL BE TAKEN TO CONTAIN ANY FUEL OR POLLUTION RUNOFF. LEAKING EQUIPMENT OR SUPPLIES SHALL BE IMMEDIATELY REPAIRED OR REMOVED FROM THE SITE.
- 10. SEDIMENT COLLECTED DURING CONSTRUCTION BY THE VARIOUS TEMPORARY EROSION CONTROL SYSTEMS SHALL BE DISPOSED OF ON A REGULAR BASIS. SEDIMENT SHALL BE REMOVED FROM EROSION CONTROL SYSTEMS WHEN THE HEIGHT OF THE SEDIMENT EXCEEDS ONE-HALF OF THE HEIGHT OF THE FILTER
- 11. ALL EROSION CONTROL MEASURES SHALL BE KEPT OPERATIONAL AND MAINTAINED CONTINUOUSLY THROUGHOUT THE PERIOD OF LAND DISTURBANCE UNTIL PERMANENT SEDIMENT AND EROSION CONTROL MEASURES ARE
- 12. THE ENGINEER SHALL INSPECT EROSION CONTROL MEASURES PERIODICALLY AND WITHIN 24 HOURS OF ANY STORM EXCEEDING 1/2 INCH PRECIPITATION. DAMAGED AND INFFFECTIVE EROSION CONTROL MEASURES SHALL BE REPAIRED OR REPLACED BY THE CONTRACTOR WITHIN 24 HOURS. EROSION CONTROL SYSTEMS REPLACED DUE TO SEDIMENT LOADING WILL BE PAID FOR AT THE CONTRACT UNIT PRICE FOR THE APPLICABLE EROSION CONTROL ITEM.
- 13. THE COST OF REMOVING SEDIMENT OR REPAIRING EROSION CONTROL SYSTEMS SHALL BE INCLUDED IN THE CONTRACT UNIT PRICE FOR THE APPLICABLE EROSION CONTROL ITEM.
- 14. SOIL DISTURBANCE SHALL BE CONDUCTED IN SUCH A MANNER AS TO MINIMIZE EROSION. AREAS OF THE SITE THAT ARE NOT TO BE GRADED SHALL BE PROTECTED FROM CONSTRUCTION TRAFFIC OR OTHER DISTURBANCE UNTIL FINAL SEEDING IS PERFORMED.
- 15. PROPERTIES AND CHANNELS ADJOINING THE SITE SHALL BE PROTECTED FROM EROSION AND SEDIMENTATION.
- 16. DISTURBED AREAS SHALL BE STABILIZED WITH TEMPORARY OR PERMANENT MEASURES WITHIN SEVEN (7) CALENDAR DAYS FOLLOWING THE END OF ACTIVE
- 17. ALL STORM SEWERS THAT ARE OR WILL BE FUNCTIONING DURING CONSTRUCTION SHALL BE PROTECTED BY AN APPROPRIATE SEDIMENT CONTROL MEASURE.

- 18. IF DEWATERING SERVICES ARE USED ADJOINING PROPERTIES AND DISCHARGE LOCATIONS SHALL BE PROTECTED FROM EROSION. DISCHARGES SHALL BE ROUTED THROUGH AN EFFECTIVE SEDIMENT CONTROL MEASURE (E.G. SEDIMENT TRAP, SEDIMENT BASIN, OR OTHER APPROPRIATE MEASURE).
- 19. THE CONTRACTOR SHALL PROVIDE ADEQUATE RECEPTACLES FOR THE DEPOSITION OF ALL CONSTRUCTION MATERIAL DEBRIS GENERATED DURING THE DEVELOPMENT PROCESS. THE CONTRACTOR SHALL NOT CAUSE OR PERMIT DUMPING, DEPOSITING, DROPPING, THROWING, DISCARDING OR LEAVING OF CONSTRUCTION MATERIAL DEBRIS UPON OR INTO THE CONSTRUCTION SITE, CHANNEL, WATERS OF THE UNITED STATES OR ISOLATED WATERS. THE CONTRACTOR SHALL MAINTAIN THE CONSTRUCTION SITE FREE OF CONSTRUCTION MATERIAL DEBRIS.
- 20. ALL TEMPORARY SOIL EROSION AND SEDIMENT CONTROL MEASURES SHALL BE REMOVED WITHIN THIRTY (30) DAYS AFTER FINAL SITE STABILIZATION IS ACHIEVED OR AFTER THE TEMPORARY MEASURES ARE NO LONGER NEEDED. TRAPPED SEDIMENT AND OTHER DISTURBED SOIL AREAS SHALL BE PERMANENTLY STABILIZED.
- 21. ALL WORK SHALL BE PERFORMED IN ACCORDANCE WITH THE STORM WATER POLLUTION PREVENTION PLAN FOR THIS PROJECT.
- 22. PRIOR TO CONSTRUCTION, THE CONTRACTOR SHALL CREATE A PLAN TO STABILIZE FLOW LINES DURING STORM SEWER CONSTRUCTION WHEN RAIN IS FORECASTED. LACK OF AN APPROVED PLAN FROM THE RESIDENT ENGINEER OR FAILURE TO COMPLY WITH THE STABILIZED FLOW LINE PLAN WILL RESULT IN AN A DEFICIENCY DEDUCTION.
- 23. KANE DUPAGE COUNTY SOIL AND WATER CONSERVATION DISTRICT STANDARD NOTES
 - UNLESS OTHERWISE INDICATED, ALL VEGETATIVE AND STRUCTURAL EROSION AND SEDIMENT CONTROL PRACTICES WILL BE CONSTRUCTED ACCORDING TO MINIMUM STANDARDS AND SPECIFICATIONS IN THE ILLINOIS URBAN MANUAL LATEST EDITION.
 - THE KANE-DUPAGE SOIL AND WATER
 CONSERVATION DISTRICT (KDSWCD) MUST BE
 NOTIFIED ONE WEEK PRIOR TO THE PRECONSTRUCTION CONFERENCE, ONE WEEK PRIOR TO
 THE COMMENCEMENT OF LAND DISTURBING
 ACTIVITIES, AND ONE WEEK PRIOR TO THE FINAL
 INSPECTION
 - A COPY OF THE APPROVED EROSION AND SEDIMENT CONTROL PLAN SHALL BE MAINTAINED ON THE SITE AT ALL TIMES.
 - PRIOR TO COMMENCING LAND-DISTURBING ACTIVITIES IN AREAS OTHER THAN INDICATED ON THESE PLANS (INCLUDING BUT NOT LIMITED TO, ADDITIONAL PHASES OF DEVELOPMENT AND OFF-SITE BORROW OR WASTE AREAS) A SUPPLEMENTARY EROSION CONTROL PLAN SHALL BE SUBMITTED FOR REVIEW BY THE KDSWCD.
 - THE CONTRACTOR IS RESPONSIBLE FOR INSTALLATION OF ANY ADDITIONAL EROSION CONTROL MEASURES NECESSARY TO PREVENT EROSION AND SEDIMENTATION AS DETERMINED BY THE KDSWCD.
 - DURING DEWATERING OPERATIONS, WATER WILL BE FILTERED OR PUMPED INTO SEDIMENT BASINS OR SILT TRAPS, DEWATERING DIRECTLY INTO STREAMS, WETLANDS, FIELD TILES, OR STORMWATER STRUCTURES IS PROHIBITED.
 - IT IS THE RESPONSIBILITY OF THE LANDOWNER AND/OR GENERAL CONTRACTOR TO INFORM ANY SUB-CONTRACTOR(S) WHO MAY PERFORM WORK ON THIS PROJECT, OF THE REQUIREMENTS IN IMPLEMENTING AND MAINTAINING THESE EROSION CONTROL PLANS AND ASSURE COMPLIANCE WITH ALL APPLICABLE LOCAL, STATE, AND FEDERAL REGULATIONS.

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USER NAME = jmelhui	DESIGNED - JRM	REVISED -
	DRAWN - JCH	REVISED -
PLOT SCALE = 1"=50"	CHECKED - TH	REVISED -
PLOT DATE = 3/23/2018	DATE - 3/23/18	REVISED -

STATE OF ILLINOIS **DEPARTMENT OF TRANSPORTATION**

SCALE: 1"=50"


		NERAL NOTES		F.A.U. RTE.	SEC ⁻	TION	COUNTY	TOTAL SHEETS	SHEET NO.
EROSION CO	3887	08-0008	3-00-CH	KANE	259	53			
							CONTRACT	NO. 611	E73
SHEET NO. 1 OF	4 SHEETS	STA.	TO STA.	FFD. RC	AD DIST. NO.	TILINOIS FED. A	D PROJECT	61F73	

PLOT DATE = 3/23/2018 DATE REVISED 3/23/18

SCALE: 1"=50' SHEET NO. 3 OF 4 SHEETS STA. 506+45.00 TO STA. 529+22.01 FED. ROAD DIST. NO. | ILLINOIS FED. AID PROJECT



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ROADWAY RECONSTRUCTION
STA. 601+82.00 TO STA. 613+32.00

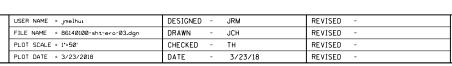IMPROVEMENT BEGINS STA 601 + 82.00

COUNTY TOTAL SHEET NO.

KANE 259 56

CONTRACT NO. 61E73

ROADWAY RECONSTRUCTION
STA. 601+82.00 TO STA. 613+32.00 LEGEND:

INLET FILTERS (BASKETS) (EA)

SCALE IN FEET

PERIMETER EROSION BARRIER (FT) -♦- TEMPORARY DITCH CHECK (FT)


TEMPORARY EROSION CONTROL
SEEDING (LB)
(APPLICATION RATE = 100 LB/ACRE)
TEMPORARY EROSION CONTROL BLANKET

IMPROVEMENT ENDS STA 613 + 32.00

USER NAME = jmelhu1	DESIGNED -	JRM	REVISED -		EROSION CONTROL PLAN	F.A.U. RTE.	SECTION NO.	Т
FILE NAME = 86140100-sht-ero-03.dgn	DRAWN -	JCH	REVISED -	STATE OF ILLINOIS	LINIOCI NI AVENUE	3887	08-00083-00-CH	+
PLOT SCALE = 1"=50"	CHECKED -	TH	REVISED -	DEPARTMENT OF TRANSPORTATION				
PLOT DATE = 3/23/2018	DATE -	3/23/18	REVISED -		SCALE: 1"=50" SHEET NO. 4 OF 4 SHEETS STA. 602+10.00 TO STA. 613+00.98	FED. ROAD [DIST. NO. ILLINOIS FED. A	ID I

PR & HUNTLEY ROAD/MAIN STREET

1600+000 L600+000	PR & HUNTLEY ROAD/MAIN STREET

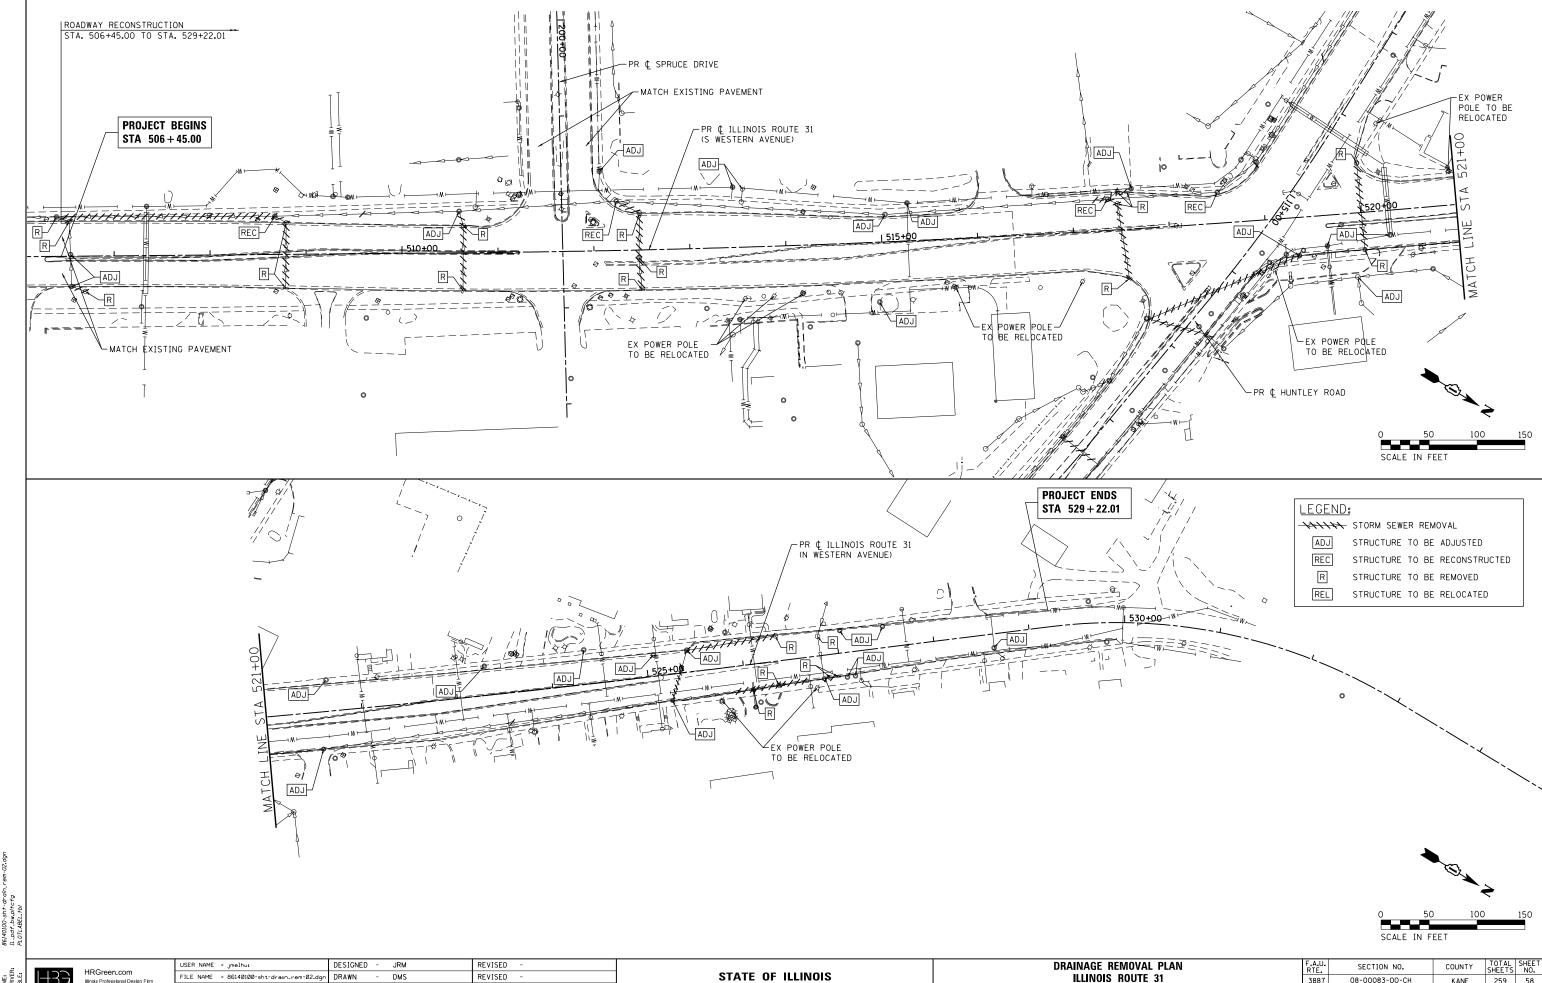


HRGreen

FILE NAME = 86140100-sht-drain_rem-02.do DRAWN DMS REVISED PLOT SCALE = 1"=50" CHECKED TH REVISED PLOT DATE = 3/23/2018 REVISED DATE 3/23/18

DEPARTMENT OF TRANSPORTATION

ILLINOIS ROUTE 31 KANE 259 58 CONTRACT NO. 61E73 08-00083-00-CH 3887 SCALE: 1"=50' SHEET NO. 2 OF 3 SHEETS STA. 506+45.00 TO STA. 529+22.01 FED. ROAD DIST. NO. | ILLINOIS FED. AID PROJECT

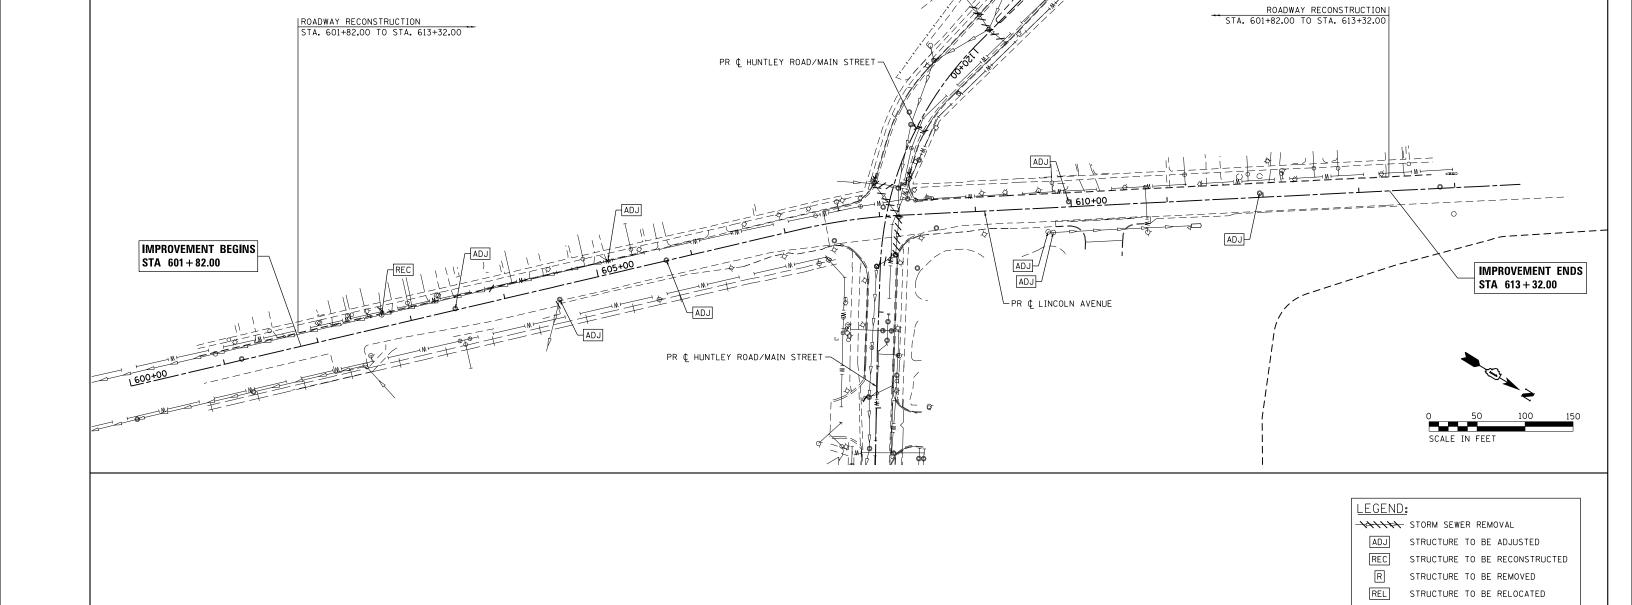


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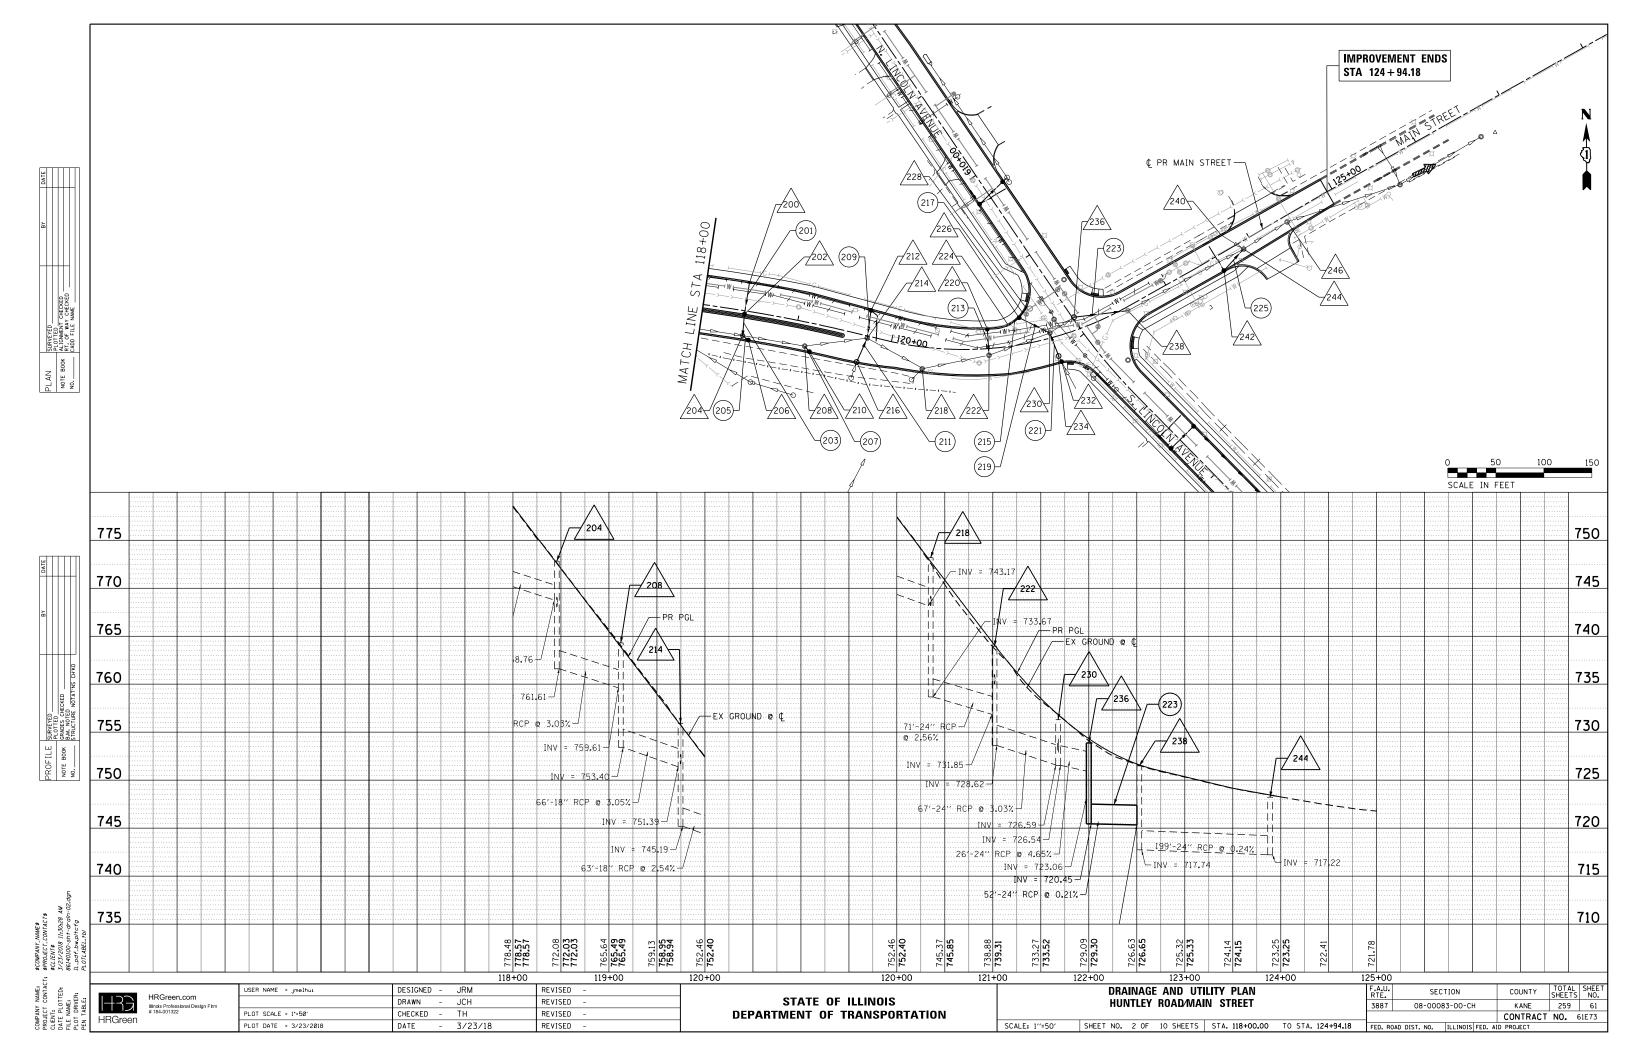
STATE OF ILLINOIS **DEPARTMENT OF TRANSPORTATION** DRAINAGE REMOVAL PLAN LINCOLN AVENUE


COUNTY TOTAL SHEETS NO.


KANE 259 59


CONTRACT NO. 61E73 SECTION NO. 08-00083-00-CH 3887 SCALE: 1"=50' SHEET NO. 3 OF 3 SHEETS STA. 602+10.00 TO STA. 613+00.98 FED. ROAD DIST. NO. | ILLINOIS | FED. AID PROJECT



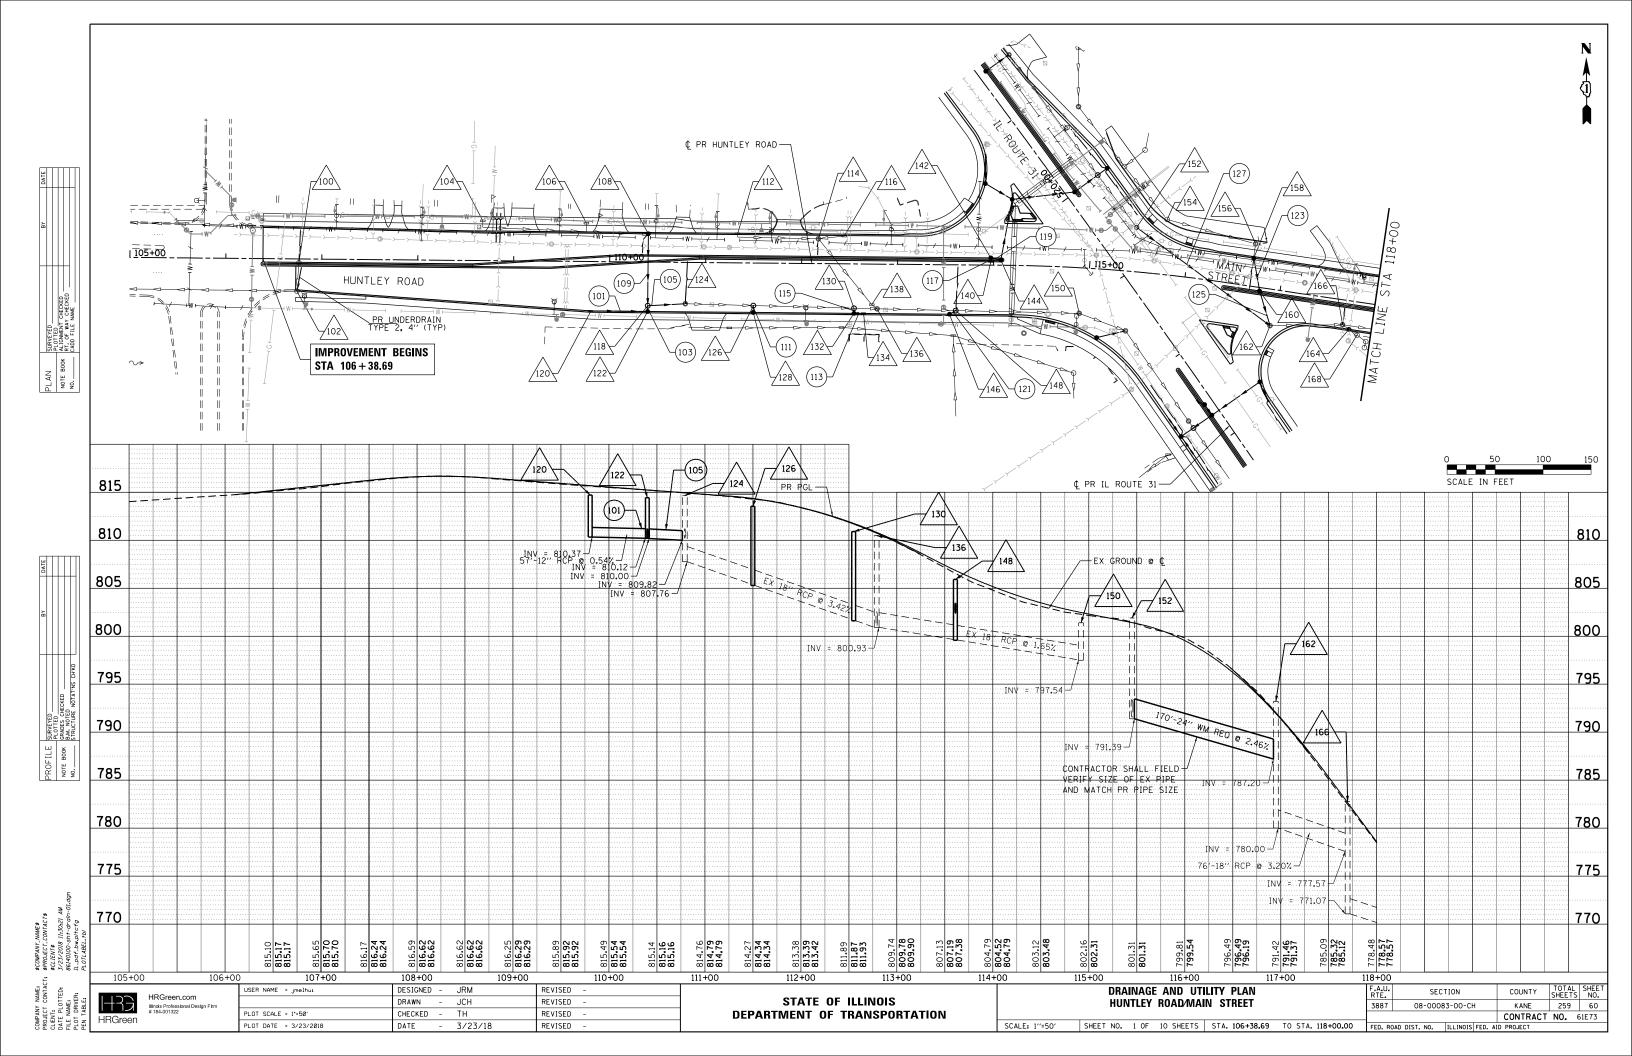

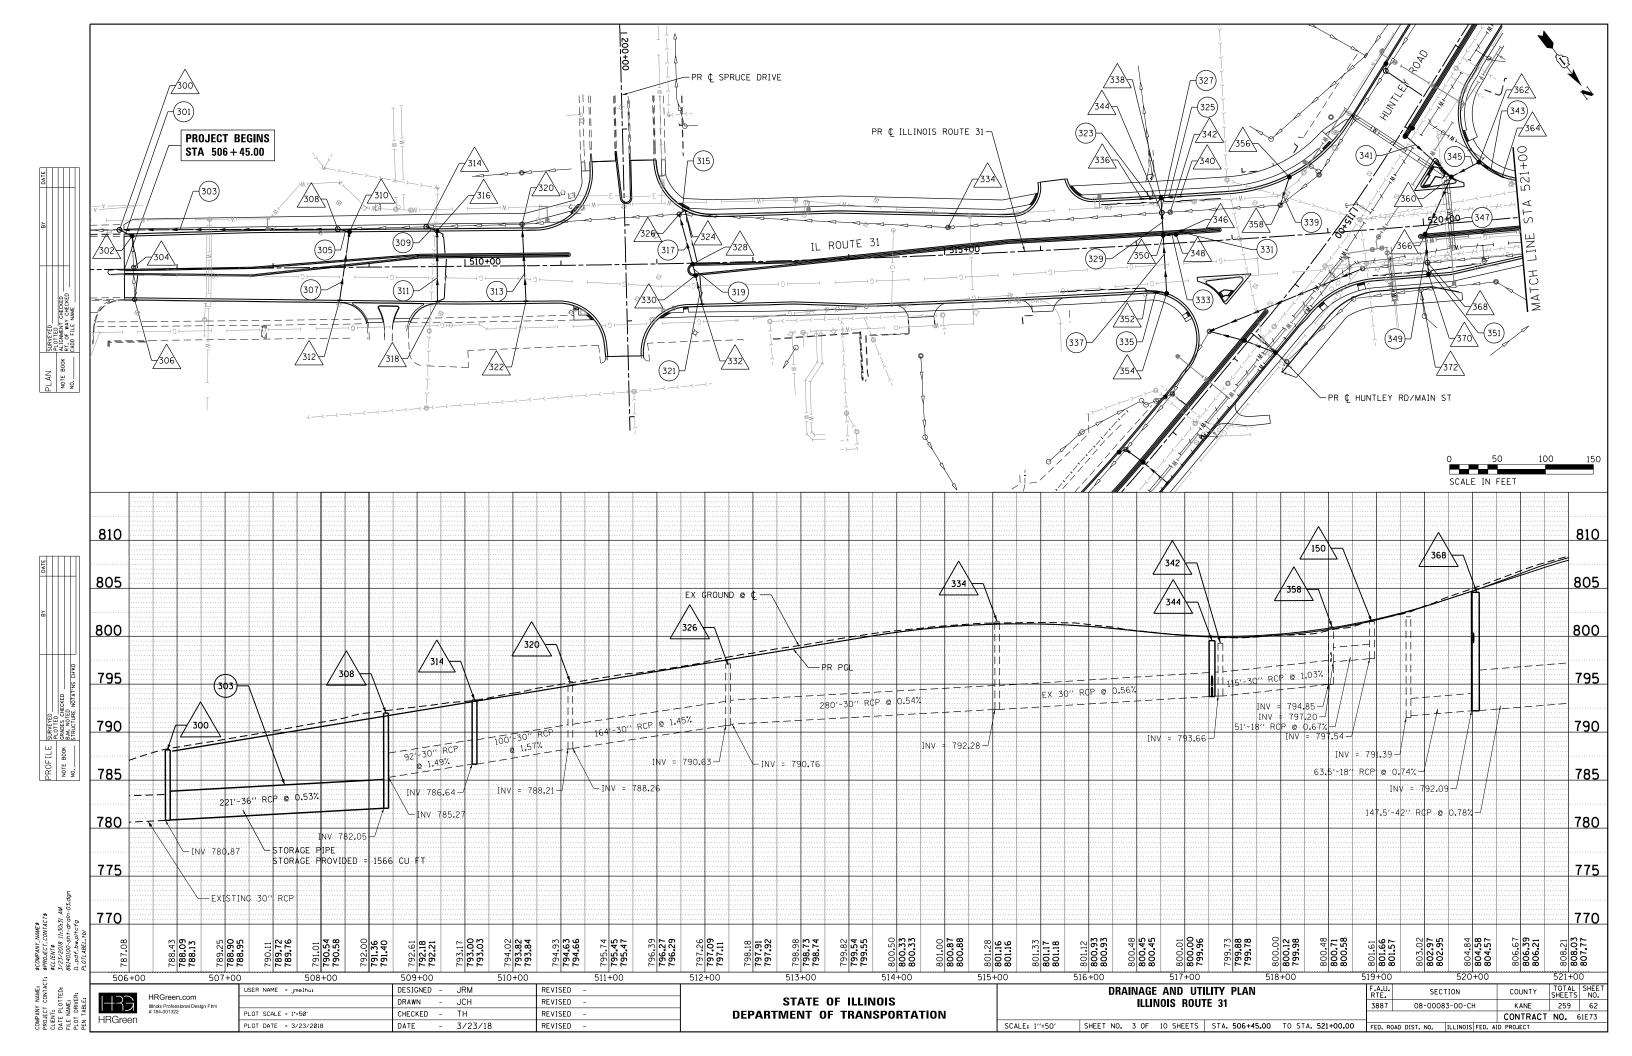

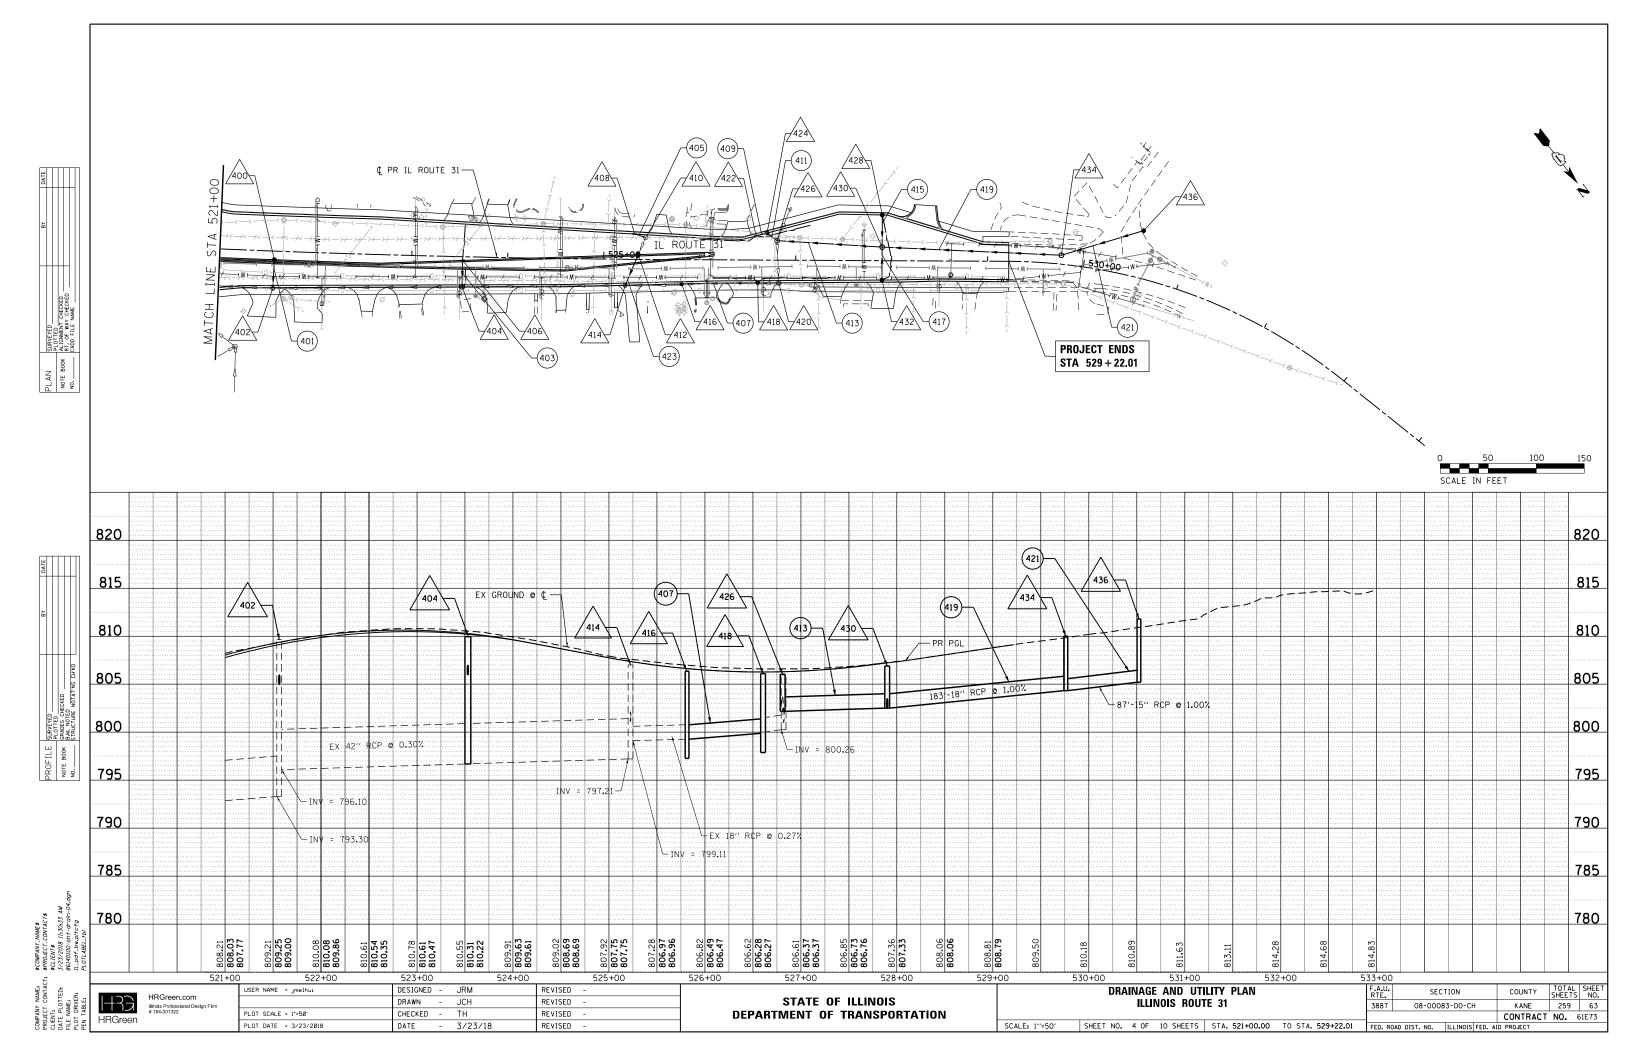

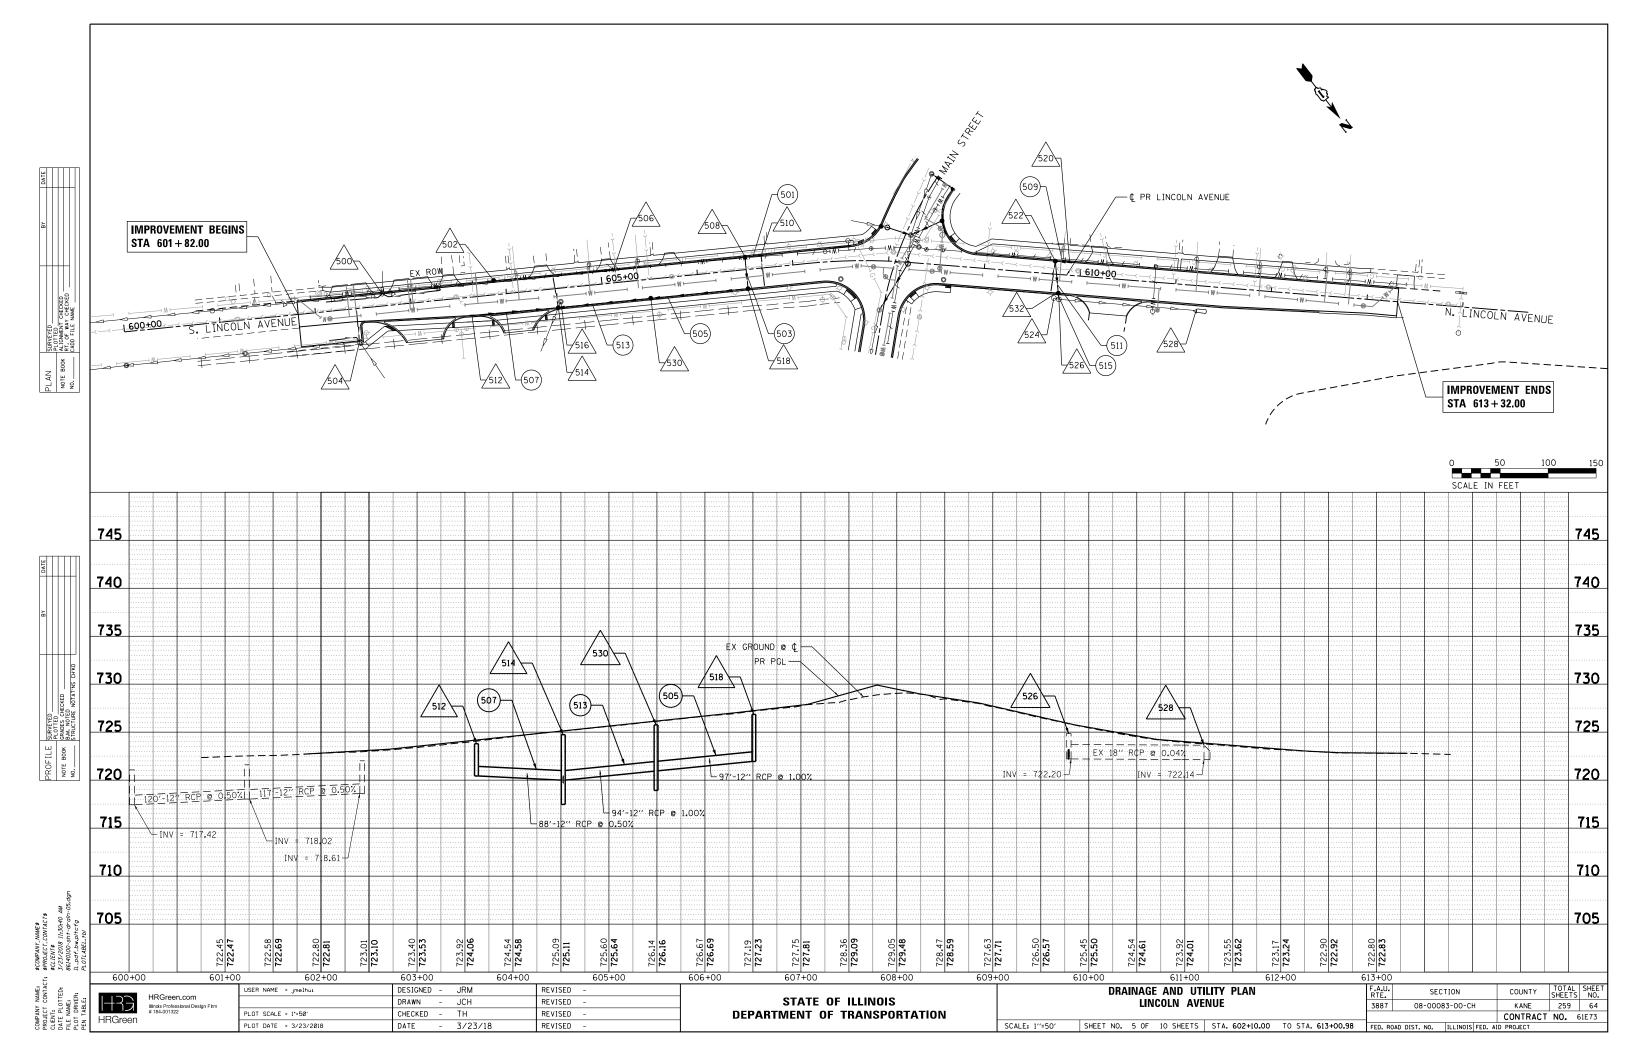

DRAINAGE STRUCTURE SCHEDULE

STRUCTURE	STATION	OFFSET (FT)	STRUCTURE TYPE	FRAME &	RIM				STORM SEW	ER INVERTS					PIPE UNDERD	RAIN INVERTS		RESTRICTOR	TOP PLAT
NUMBER	STATION	OFF SET (FT)	STRUCTURE TIPE	GRATE	ELEVATION	NORTH	NORTHWEST	WEST	SOUTHWEST	SOUTH	SOUTHEAST	EAST	NORTHEAST	NORTH	WEST	SOUTH	EAST	ELEVATION	ELEVATIO
	HUNTLEY ROAD																		
100	106+76.14	3.5′ RT	CATCH BASINS TO BE ADJUSTED	TYPE 11	815.61					EX 811.70				815.01					
102	106+74.32	32.0' RT	CATCH BASINS TO BE ADJUSTED	TYPE 11	814.98	EX 810.99		EX 810.99						814.48					
104	108+67.36	41.5' LT	INLETS TO BE ADJUSTED	TYPE 8 GRATE	815.46					EX 813.08									
106	109+75.41	39.8′ LT	INLETS TO BE ADJUSTED	TYPE 8 GRATE	814.34					EX 811.78									
108	110+40	29.5′ LT	CATCH BASINS, TYPE A, 4'-DIAMETER	TYPE 11	814.80			810.42		810.33		810.33							
112	111+33.01	29.5' LT	INLETS TO BE ADJUSTED	TYPE 11	814.09					EX 809.17									+
114	112+17.26	25.8° LT	MANHOLES TO BE ADJUSTED	TYPE 1, CL	812.57			EX 807.71			EX 807.71	EX 807.71							+
116	112+43.94	29.5′ LT	INLETS TO BE ADJUSTED WITH NEW TYPE 1 FRAME, OPEN LID	TYPE 11	811.65			EX 808.49											+
118	110+40	45.5' RT	MANHOLES, TYPE A, 4'-DIAMETER	TYPE 1, CL	814.39	810.00		EX 000143		810.00		810.00							+
						610.00				810.00			+						+
120	109+80.5	51.4' RT	INLETS, TYPE A	TYPE 11	814.70							810.33							+
122	110+40	51.5′ RT	CATCH BASINS, TYPE A, 4'-DIAMETER	TYPE 11	814.25	810.02		810.02								813.75			+
124	110+79.11	43.1' RT	MANHOLES TO BE RECONSTRUCTED	TYPE 1, CL	814.17			809.82				EX 807.76		813.67					
126	111+50.0	44.3' RT	MANHOLES, TYPE A, 4'-DIAMETER	TYPE 1, CL	813,54			805.45		809.32		805.28							
128	111+50.0	51.5′ RT	CATCH BASINS, TYPE C	TYPE 11	813.35	809.37													
130	112+55	46.1' RT	MANHOLES, TYPE A, 4'-DIAMETER	TYPE 1, CL	810.90			801.77		806.31		801.60							
132	112+55	51.5′ RT	CATCH BASINS, TYPE A, 4'-DIAMETER	TYPE 11	810.76	806.34						806.34							
134	112+65.0	51.5′ RT	INLETS, TYPE A	TYPE 11	810.39			806.41											
136	112+78.97	46.6' RT	MANHOLES TO BE ADJUSTED	TYPE 1, CL	809.95		801.03-EX	800.93-EX				800.93-EX							
138	112+73.43	42.3' RT	INLETS TO BE ADJUSTED WITH NEW TYPE 1 FRAME, CLOSED LID	TYPE 1, CL	810.29		806.20				806.05								
140	113+97	3.5′ LT	INLETS, TYPE A	TYPE 11	805.11	800.45													
142	113+97	7.5' LT	CATCH BASINS, TYPE A, 4'-DIAMETER	TYPE 11	804.68					800.40		800.40							1
144	114+07.5	5.4' LT	CATCH BASINS, TYPE A, 4'-DIAMETER	TYPE 1, OL	804.34	800.36		800.36											+
146	113+54.5	51.5' RT	CATCH BASINS, TYPE C	TYPE 11	806.15								802.53						+
148	113+61.0	47.7' RT	MANHOLES, TYPE A, 5'-DIAMETER	TYPE 1, CL	805.91			799.66	802.43			799.58	002.55	805.41					-
									802.43		FY 707 40	799.30		805.41					+
150	114+91.96	47.5' RT	MANHOLES TO BE ADJUSTED	TYPE 1, CL	801.47			EX 797.54			EX 797.49								+
152	115+45.23	46.1' LT	MANHOLES TO BE RECONSTRUCTED	TYPE 1, CL	801.94		EX 791.59				791.39								
154	115+75.14	57.5' LT	CATCH BASINS TO BE RECONSTRUCTED WITH NEW TYPE I FRAME, OPEN LID	TYPE 1, OL	804.72		EX 793.67				EX 793.67								
156	116+67.71	44.3′ LT	MANHOLES TO BE RECONSTRUCTED	TYPE 1, CL	NO INFO	EX		EX		EX									
158	116+68	29.5′ LT	CATCH BASINS, TYPE A, 4'-DIAMETER	TYPE 11	794.07	NORTH				789.40						793.57			
160	116+79	3.5′ RT	CATCH BASINS, TYPE A, 4'-DIAMETER	TYPE 11	793.23	789.25				785.50									
162	116+94.95	37.7' RT	MANHOLES TO BE RECONSTRUCTED	TYPE 1, CL	790.90	784.82	787.20					EX 780.00							
164	117+76.9	29.5' RT	CATCH BASINS, TYPE A, 4'-DIAMETER	TYPE 11	781.24		777.14				777.25			780.74					
166	117+69.64	25.7' RT	MANHOLES TO BE RECONSTRUCTED	TYPE 1, CL	782.30			EX 777.57			EX 776.97	EX 771.07							
168	117+86.15	34.3' RT	CATCH BASINS TO BE ADJUSTED WITH NEW TYPE 8 GRATE	TYPE 8 GRATE	781.04		777.08				777.19								-
200	118+44	29.5' LT	INLETS, TYPE A	TYPE 11	772.43					768.45									1
202	118+44	3.5' RT	CATCH BASINS, TYPE A, 4'-DIAMETER	TYPE 11	772.65	768.30				768.30									+
204	118+45.70	25.9' RT	MANHOLES TO BE RECONSTRUCTED	TYPE 1, CL	772.22	768.12		EX 768.76			767.18	EX 761.61							+
206	118+52.5	29.5' RT	CATCH BASINS, TYPE C	TYPE 11	771.26	700112	767.28	211 100110			101110	ZW YOUG							+
							161.20	FV 750 C1			750.00		FY 757 40						+
208	119+12.41	24.8' RT	MANHOLES TO BE RECONSTRUCTED	TYPE 1, CL	763.84			EX 759.61			759.02		EX 753.40						+
210	119+18.5	29.5' RT	CATCH BASINS, TYPE C	TYPE 11	763.10		759.12												
212	119+71.83	26.8′ LT	CATCH BASINS, TYPE C	TYPE 11	755.47					751.82						754.97			
214	119+74.62	2.3' RT	MANHOLES TO BE ADJUSTED	TYPE 1, CL	755.77	751.69			EX 751.38	750.39	EX 745.19								1
216	119+69.7	28.9' RT	MANHOLES, TYPE A, 4'-DIAMETER	TYPE 1, CL	757.01	750.50				EX 750.73									_
218	120+35.26	22.6′ RT	MANHOLES TO BE RECONSTRUCTED	TYPE 1, CL	748.69		743.17						733.67						
220	121+02	20.2′ LT	CATCH BASINS, TYPE C	TYPE 11	738.24					734.26									
222	121+01.77	7.0' RT	MANHOLES TO BE RECONSTRUCTED	TYPE 1, CL	739.36	734.14			EX 731.85				EX 728.62						
224	121+26	21.9' LT	INLETS, TYPE A	TYPE 11	735.27								728.47						
226	121+39	27.9' LT	CATCH BASINS, TYPE A, 4'-DIAMETER	TYPE 11	733.55				728.42		728.42		728.42						1
228	121+49.0	36.3° LT	INLETS, TYPE A	TYPE 11	731.95				728.47										1
230	121+68.06	5.2' LT	MANHOLES TO BE RECONSTRUCTED	TYPE 1, CL	731.62		727.79		EX 726.59		726.64		EX 726.54						1
232	121+71.8	26.8' RT	CATCH BASINS, TYPE A, 4'-DIAMETER	TYPE 11	732.57		EX 726.80				EX 726.82								+
234	121+70.5	20.4' RT	MANHOLES, TYPE A, 4'-DIAMETER	TYPE 1, CL	732.43		726.75				EX 726.78								+
							120.13			705 77	LA 120.10	720.45							+
236	121+97.8	13.3' LT	MANHOLES, TYPE A, 4'-DIAMETER	TYPE 1, CL	728.93			700 71		725.33		720.45	EV 717.00						+
238	122+52.61	3.8' RT	MANHOLES TO BE RECONSTRUCTED	TYPE 1, CL	726.66			720.34					EX 717.69						+
240	123+76.2	16.9' LT	INLETS TO BE ADJUSTED	TYPE 11	723.35			-			EX 720.54								-
242	123+60.0	16.7' RT	CATCH BASINS, TYPE C	TYPE 11	723.71		720.23							723.21					
244	123+88.96	7,7' RT	MANHOLES TO BE ADJUSTED	TYPE 1, CL	723.30		EX 720.4		EX 717.22		719.82		EX 717.17						
246	124+42.48	6.3' RT	MANHOLES TO BE ADJUSTED	TYPE 1, CL	722.41				EX 716.89				EX 716.89						

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USER NAME = jmelhui	DESIGNED	-	JRM	REVISED	-
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PLOT SCALE = N.T.S.	CHECKED	-	TH	REVISED	-
PLOT DATE = 3/23/2018	DATE	-	3/23/18	REVISED	-

STATE OF	ILLINOIS
DEPARTMENT OF	TRANSPORTATION

	DRAINAGE SCHI			F.A.U. RTE.	SECT	TION	COUNTY	TOTAL SHEETS	SHEET NO.
STRU	UCTURES - HUNTLEY RO	3887	08-0008	3-00-CH	KANE	259	65		
							CONTRACT	NO. 61	E73
SCALE: N.T.S. SH	HEET NO. 6 OF 10 SHEETS	STA.	TO STA.	FED. RO	DAD DIST. NO.	ILLINOIS FED.	AID PROJECT	61E73	

DRAINAGE STRUCTURE SCHEDULE

STRUCTURE	STATION	OFFSET (FT)	STRUCTURE TYPE	FRAME &	RIM		1	1	STORM SEW		1	Т			PIPE UNDER	RAIN INVERTS		RESTRICTOR	TOP PLATE
NUMBER				GRATE	ELEVATION	NORTH	NORTHWEST	WEST	SOUTHWEST	SOUTH	SOUTHEAST	EAST	NORTHEAST	NORTH	WEST	SOUTH	EAST	ELEVATION	ELEVATION
	IL ROUTE 31																		
300	506+40.29	41.1′ LT	MAHNOES, TYPE A, 8'-DIAMETER - RESTRICTOR 20" OFIFICE	(2) TYPE 1, CL	788.15	783.06	780.87				780.87							780.95	785.00
302	506+53.5	34.6′ LT	CATCH BASINS, TYPE A, 4'-DIAMETER	TYPE 24	787.72					783.15			783.63				787.22		
304	506+54.58	1.8' LT	CATCH BASINS TO BE ADJUSTED WITH NEW TYPE 1 FRAME, CLOSED LID	TYPE 1, CL	788.33				EX 783.91				EX 784.06						
306	506+55.31	29.8' RT	CATCH BASINS TO BE ADJUSTED WITH NEW TYPE 24 FRAME AND GRATE	TYPE 24	787.70				EX 784.11						787.20				
308	508+67.8	39.9' LT	MANHOLES TO BE RECONSTRUCTED	TYPE 1, CL	791.59	787.27	785.27				782.05								
310	508+80	37.0' LT	CATCH BASINS, TYPE A, 4'-DIAMETER	TYPE 24	791.41					787.35			787.35						
312	508+69	34.4' RT	INLETS, TYPE A	TYPE 24	791.20				787.70										
314	509+59.91	41.6′ LT	MANHOLES, TYPE A, 5'-DIAMETER	TYPE 1, CL	793.02	788.46	786.68				786.60								
316	509+71	37.0' LT	CATCH BASINS, TYPE A, 4'-DIAMETER	TYPE 24	792.89					788.54			788.54				792.39		
318	509+71	36.5′ RT	INLETS, TYPE A	TYPE 24	792.87				788.89						792.37				
320	510+59.84	43.2' LT	MANHOLES TO BE ADJUSTED	TYPE 1, CL	794.80		EX 788.26				EX 788.12		790.01						
322	510+63.26	37.0' RT	INLETS, TYPE A	TYPE 24	794.37				790.39										
324	512+30.45	55.3′ LT	INLETS, TYPE A	TYPE 24	796.63							792.65					796.13		
326	512+24.28	51.3' LT	MANHOLES TO BE RECONSTRUCTED	TYPE 1, CL	796.69		EX 790.76	792.61			EX 790.63		792.84						
328	512+37.1	1.1′ RT	CATCH BASINS, TYPE A, 4'-DIAMETER	TYPE 11	797.92				793.08				793.08						
330	512+40	12.8' RT	CATCH BASINS, TYPE A, 4'-DIAMETER	TYPE 11	797.75				793.12				793.12						
332	512+46	43.0' RT	INLETS, TYPE A	TYPE 24	797.24				793.26						796.74				
334	515+04.67	28.6' LT	MANHOLES TO BE ADJUSTED	TYPE 1, CL	800.86		EX 792.28				EX 792.28								
336	517+08.5	48.0' LT	INLETS, TYPE A	TYPE 24	799.15		795.04												
338	517+28.5	48.0′ LT	CATCH BASINS, TYPE A, 4'-DIAMETER	TYPE 24	799.05		794.87				794.87		794.87	798.55		798.55			
340	517+48.53	48.0′ LT	INLETS, TYPE A	TYPE 24	799.02						795.04								
342	517+37.27	32.5' LT	MANHOLES TO BE RECONSTRUCTED	TYPE 1, CL	799.40		EX 793.66				EX 793.66								
344	517+28.5	32.4' LT	MANHOLES, TYPE A, 6'-DIAMETER	TYPE 1, CL	799.42		793.64		794.75		793.60		793.60						1
346	517+48.5	13.0′ LT	INLETS, TYPE A	TYPE 11	799.78								795.90						+
348	517+47.0	9.0' LT	CATCH BASINS, TYPE A, 4'-DIAMETER	TYPE 11	799.87		795.80				795.80								
350	517+28.5	9.0′ LT	CATCH BASINS, TYPE A, 4'-DIAMETER	TYPE 11	799.89		795.70		793.69				793.69						
352	517+08.5	48.0' RT	INLETS, TYPE A	TYPE 24	799.20	794.13	133110		733,03				733,03			798.70			+
354	517+28.5	51.7' RT	CATCH BASINS, TYPE A, 4'-DIAMETER	TYPE 24	797.02	134213			793.95	793.95						130.10			
356	518+64	60.9' LT	CATCH BASINS, TYPE A, 4'-DIAMETER	TYPE 24	800.89				133,33	793.93			796.90						
								FY 707 20	700.00		EV 704.05		136.30						
358	518+52.40	32.3′ LT	MANHOLES TO BE RECONSTRUCTED	TYPE 1, CL	800.24			EX 797.20	796.62	200.00	EX 794.85	200.05							
360	520+33	48.0° LT	CATCH BASINS, TYPE A, 4'-DIAMETER	TYPE 24	808.47	007.74		802.11		800.06		800.06							
362	520+63	61.0′ LT	CATCH BASINS, TYPE A, 4'-DIAMETER	TYPE 24	807.97	803.74						802.24							
364	520+86	43.7' LT	INLETS, TYPE A	TYPE 24	807.85					803.87									
366	520+01	9.0' RT	CATCH BASINS, TYPE A, 4'-DIAMETER	TYPE 11	804.64			797.95					799.45						
368	520+01	38.9' RT	MANHOLES, TYPE A, 8'-DIAMETER RESTRICTOR 18" ORIFICE	(2) TYPE 1, CL	804.11		792.09		797.71		792.09		799.21					792.09	795.59
370	520+02	51.0' RT	CATCH BASINS, TYPE C	TYPE 24	803.81				797.77					803.31		803.31			
372	519+91.8	66.7' RT	CATCH BASINS TO BE ADJUSTED	TYPE 1, OL	805.86		EX 794.39				EX 794.34		EX 794.39						
400	521+57	9.0' RT	CATCH BASINS, TYPE A, 4'-DIAMETER	TYPE 11	809.14								805.10						
402	521+56.5	38.8' RT	CATCH BASINS TO BE ADJUSTED WITH NEW TYPE 1 FRAME, CLOSED LID	TYPE 1, CL	809.65		EX 796.1		804.97		EX 793.3								
404	523+53.0	29.3' RT	MANHOLES, TYPE A, 6'-DIAMETER	TYPE 1, CL	809.96		796.71		806.91		796.69				809.46				
406	523+53.0	3.9' RT	INLETS, TYPE A	TYPE 11	810.20								807.03		809.70				
408	525+32	26.4' LT	INLETS, TYPE A	TYPE 24	806.89		802.91												
410	525+43.45	23.0′ LT	CATCH BASINS TO BE ADJUSTED	TYPE 1, CL	806.79						802.82		EX 802.60						
412	525+35.9	4.9′ LT	CATCH BASINS, TYPE A, 4'-DIAMETER	TYPE 11	807.15				802.13				801.98						
414	525+22.6	27.3' RT	MANHOLES TO BE ADJUSTED WITH NEW TYPE 24 FRAME AND GRATE	TYPE 24	807.09		EX 799.11		EX 801.11		EX 797.21								
416	525+81.40	25.2' RT	CATCH BASINS, TYPE A, 4'-DIAMETER	TYPE 24	806.36		799.27				799.27								
418	526+60.54	23.8' RT	CATCH BASINS, TYPE A, 5'-DIAMETER	TYPE 24	806.01		799.88				799.88			805.51		805.51			
420	526+82.52	23.7' RT	MANHOLES TO BE ADJUSTED WITH NEW TYPE 24 FRAME AND GRATE	TYPE 24	806.04				EX 801.01		EX 800.26								
422	526+58.7	25 . 2′ LT	INLETS, TYPE A	TYPE 24	805.90		802.25							805.40		805.40			
424	526+70	28 . 2′ LT	CATCH BASINS, TYPE A, 4'-DIAMETER	TYPE 24	805.84	802.21					802.21								
426	526+80.97	21.0′ LT	MANHOLES TO BE ADJUSTED	TYPE 1, OL	806.03		802.17		802.17	802.17			802.17						
428	527+90	47.6' LT	CATCH BASINS, TYPE C	TYPE 24	806.08								802.64						
430	527+90	14.1′ LT	MANHOLES, TYPE A, 5'-DIAMETER	TYPE 1. CL	806.89		802.50		802.50		802.50		802.50						
432	527+90	20.1' RT	CATCH BASINS, TYPE C	TYPE 24	806.77		1	1	802.65		1								
434	529+76	9.3′ LT	MANHOLES, TYPE A, 4'-DIAMETER	TYPE 1, CL	810.01		804.33				804.33								
				_				<u> </u>			805.20		1				1		+
436	530+52.24	49.0' LT	CATCH BASINS, TYPE C	TYPE 8 GRATE	811.80						1 805-70								

IAME: SCUMMANY.NAMES
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Illinois Professional Design Firm
184-001322

	USER NAME = jmelhui	DESIGNED	-	JRM	REVISED	-
,		DRAWN	-	JCH	REVISED	-
	PLOT SCALE = N.T.S.	CHECKED	-	TH	REVISED	-
	PLOT DATE = 3/23/2018	DATE	-	3/23/18	REVISED	-

STATE OF ILLINOIS DEPARTMENT OF TRANSPORTATION

	STRUC		NAGE SCH S - ILLINO		E 31
SCALE: N.T.S.	SHEET NO.	7 OF	10 SHEETS	STA.	TO STA.

DRAINAGE STRUCTURE SCHEDULE

STRUCTURE	STATION	OFFSET (FT)	CADINATINE AND	FRAME &	RIM				STORM SEWI	ER INVERTS					PIPE UNDERDE	AIN INVERTS		RESTRICTOR	TOP PLATE
NUMBER	STATION	OFFSET (FT)	STRUCTURE TYPE	GRATE	ELEVATION	NORTH	NORTHWEST	WEST	SOUTHWEST	SOUTH	SOUTHEAST	EAST	NORTHEAST	NORTH	WEST	SOUTH	EAST	ELEVATION	ELEVATION
	LINCOLN AVENUE																		
500	602+71.20	12.8' LT	MANHOLES TO BE RECONSTRUCTED	TYPE II	722.97		EX 720.46		EX 721.51		EX 720.46			722.47		722.47			
502	603+88	15.0' LT	CATCH BASINS, TYPE A, 5'-DIAMETER	TYPE 8 GRATE	724.20		721.78				721.74								
504	602+42.62	34.7' RT	CATCH BASINS TO BE ADJUSTED	TYPE 11	722.45	EX					EX				721.95	721.95			
506	605+13.55	13.6' LT	CATCH BASINS TO BE ADJUSTED WITH NEW TYPE 10 FRAME AND GRATE	TYPE 10	725.52				EX 724.31		EX 723.17								
508	606+51	13.0' LT	CATCH BASINS, TYPE A, 4'-DIAMETER	TYPE 11	726.99		722.24						722.24						
510	606+68	13.0' LT	INLETS, TYPE A	TYPE 11	727.18						722.38						726.68		
512	603+62.0	19.1' RT	INLETS, TYPE A	TYPE 11	723.80		720.44												
514	604+52.36	20.0' RT	CATCH BASINS, TYPE A, 4'-DIAMETER	TYPE 11	724.74		720.00		EX 719.49		720.00		EX 719.48		724.24				
530	605+49.15	20.0' RT	CATCH BASINS, TYPE A, 4'-DIAMETER	TYPE 11	725.76		720.95				720.95								
516	604+55.51	14.0' RT	MANHOLES TO BE ADJUSTED	TYPE 1, CL	724.89								EX 719.53						
518	606+51	20.0' RT	CATCH BASINS, TYPE A, 4'-DIAMETER	TYPE 11	726.85				721.95		721.95								
520	609+88.0	13.5′ LT	INLETS, TYPE A	TYPE 11	725.45						722.42								
522	609+73	13.5′ LT	CATCH BASINS, TYPE A, 4'-DIAMETER	TYPE 11	725.78		722.36						722.36				725.28		
532	609+78.8	19.5′ RT	CATCH BASINS, TYPE A, 4'-DIAMETER	TYPE II	725.52				522.22										
524	609+74.58	24.9' RT	CATCH BASINS TO BE ADJUSTED	TYPE 8 GRATE	724.83		EX 722.41												
526	609+79.92	25.9' RT	CATCH BASINS TO BE ADJUSTED	TYPE 8 GRATE	724.87		EX 722.20		722.20		EX 722.20								
528	611+23.4	25.9' RT	EXISTING FLARED END SECTION							EX 722.14									

ME: SCOMPANY. VAMES
ITACIT. SPROJECT. CONTACTS
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II. Add: bw.phrf-9
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184-001322

USER NAME = jmelhui	DESIGNED	-	JRM	REVISED -
	DRAWN	-	JCH	REVISED -
PLOT SCALE = N.T.S.	CHECKED	-	TH	REVISED -
PLOT DATE = 3/23/2018	DATE	-	3/23/18	REVISED -

STATE OF ILLINOIS
DEPARTMENT OF TRANSPORTATION

		NAGE SCHI			F.A.U. RTE.	SEC	TION	COUNTY	TOTAL SHEETS	SHEET NO.
	STRUCTURE	S – LINCO	LN AVENUE		3887	08-0008	33-00-CH	KANE	259	67
								CONTRACT	NO. 61	E73
SCALE: N.T.S.	SHEET NO. 8 OF	10 SHEETS	STA.	TO STA.	FED. ROA	AD DIST. NO.	ILLINOIS FED. A	D PROJECT	61E73	

DRAINAGE PIPE SCHEDULE

HUNTLEY ROAD 120 122 STORM SEW WM REQ 57.0 0.44% 11.1 103 122 118 12 2.0 0.4 105 118 TYPE 2 36.0 0.50% 7.0 108 118 TYPE 2 71.0 0.46% 15.3 128 TYPE 1 5.0 1.00% 0.9 113 134 STORM SEW WM REQ 1.00% 1.3 132 TYPE 2 0.7 117 TYPE 2 12 1.0 0.3 119 142 7.0 1.3 TYPE 1 5.0 0.7 123 158 160 STORM SEW WM REQ 12 31.0 125 160 162 TYPE 2 34.0 24.8 127 152 162 STORM SEW WM REQ 170.0 200 202 STORM SEW WM REQ 12 30.0 0.50% 5.2 203 202 204 TYPE 1 12 18.0 1.00% 3.5 205 206 204 TYPE 1 12 5.0 2.00% 1.1 207 210 208 TYPE 1 12 5.0 2.00% 1.0 209 212 214 STORM SEW WM REQ 12 26.0 0.50% 4.0 211 216 214 TYPE 2 12 23.0 0.48% 8.4 220 0.52% 213 222 STORM SEW WM REQ 12 23.0 5.0 0.50% 215 224 226 TYPE 2 12 10.0 3.7 217 228 226 STORM SEW WM REQ 12 10.0 0.50% 2.0 226 STORM SEW WM REQ 32.0 1.97% 219 230 12 6.9 0.50% 221 234 230 TYPE 2 12 22.0 6.6 236 STORM SEW WM REQ 52.0 0.21% 44.0 223 238 24 225 242 244 TYPE 1 12 28.0 1.46% 3.7

FROM STRUCT.

PIPE NO.

SIZE, DIA. LENGTH (FT) SLOPE (%)

PIPE NO.	FROM STRUCT.	TO STRUCT.	CLASS	TYPE	SIZE, DIA.	LENGTH (FT)	SLOPE (%)	TBF (CY)
IL ROUTE 31								
301	302	300	Α	TYPE 2	12	9.0	1.00%	2.4
303	308	300	A	TYPE 2	36	221.0	0.53%	235.0
305	310	308	A	TYPE 1	12	8.0	1.00%	1.4
307	312	310	Α	TYPE 1	12	69.0	0.51%	9.2
309	316	314	Α	TYPE 2	12	8.0	1.00%	1.8
311	318	316	A	TYPE 1	12	71.0	0.49%	12.3
313	322	320	А	TYPE 1	12	77.0	0.49%	15.0
315	324	326	Α	TYPE 1	12	4.0	1.00%	0.7
317	328	326	Α	TYPE 1	12	49.0	0.49%	9.6
319	330	328	Α	TYPE 2	12	8.0	0.50%	1.9
321	332	330	A	TYPE 1	12	28.0	0.50%	5.5
323	336	338	Α	STORM SEW WM REQ	12	17.0	1.00%	3.0
325	340	338	A	STORM SEW WM REQ	12	17.0	1.00%	3.0
327	338	344	A	STORM SEW WM REQ	12	11.0	1.09%	2.4
329	350	344	Α	TYPE 2	12	19.0	0.47%	6.9
331	346	348	Α	TYPE 1	12	5.0	2.00%	0.8
333	348	350	A	TYPE 1	12	10.0	1.00%	1.8
335	352	354	A	TYPE 1	12	57.0	1.00%	3.2
337	354	350	Α	TYPE 1	12	9.0	0.46%	13.7
339	356	358	Α	STORM SEW WM REQ	12	28.0	1.00%	3.7
341	144	360	A	STORM SEW WM REQ	12	61.0	0.49%	23.4
343	364	362	Α	TYPE 1	12	26.0	0.50%	4.5
345	362	360	Α	TYPE 2	12	29.0	0.45%	6.3
347	360	366	Α	TYPE 2	12	61.0	1.00%	42.5
349	366	368	A	STORM SEW WM REQ	12	24.0	1.00%	6.7
351	370	368	A	TYPE 2	12	6.0	1.00%	1.5
401	400	402	A	STORM SEW WM REQ	12	26.0	0.50%	5.1
403	406	404	A	STORM SEW WM REQ	12	24.0	0.50%	4.2
405	408	410	A	TYPE 1	12	9.0	1.00%	1.4
407	418	416	Α	TYPE 2	18	74.0	0.82%	50.7
409	422	424	Α	TYPE 1	12	9.0	0.44%	1.2
411	424	426	A	TYPE 1	12	9.0	0.44%	1.2
413	430	426	A	TYPE 1	18	105.0	0.31%	16.3
415	428	430	Α	TYPE 1	12	30.0	0.47%	4.6
417	432	430	Α	STORM SEW WM REQ	12	31.0	0.48%	6.1
419	434	430	Α	TYPE 1	18	183.0	1.00%	51.5
421	436	434	A	TYPE 2	15	87.0	1.00%	34.7
423	412	414	Α	STORM SEW WM REQ	12	30.5	2.85%	10.3

STATE OF ILLINOIS

PIPE NO.	FROM STRUCT.	TO STRUCT.	CLASS	TYPE	SIZE, DIA.	LENGTH (FT)	SLOPE (%)	TBF (CY)
LINCOLN A	VENUE		•					•
501	510	508	Α	TYPE 2	12	14.0	1.00%	3.4
503	508	518	А	STORM SEW WM REQ	12	29.0	1.00%	7.5
505	518	530	А	TYPE 2	12	97.0	1.00%	50.2
507	512	514	Α	TYPE 1	12	88.0	0.50%	15.3
509	520	522	Α	TYPE 1	12	12.0	0.50%	1.6
511	522	532	A	STORM SEW WM REQ	12	30.0	0.44%	4.0
515	532	526	A	TYPE 1	12	3.0	0.66%	0.8
513	514	530	A	TYPE 2	12	94.0	1.00%	12.5

TABLE:	PLOTLA	
HRGreen	-	HRGreen

LIDO	USER	NAME	=
HRGreen.com			
# 184-001322	PLOT	SCALE	=
	PLOT	DATE	=

USER NAME = Jmelhuı	DESIGNED	-	JRM	REVISED	-
	DRAWN	-	JCH	REVISED	-
PLOT SCALE = N.T.S.	CHECKED	-	TH	REVISED	-
PLOT DATE = 3/23/2018	DATE	-	3/23/18	REVISED	-

STATE OF ILLINOIS	
DEPARTMENT OF TRANSPORTATION	
	SCALE: N.T.S.

DRAINAGE PIPE SCHEDULE					F.A.U. RTE.	SEC	TION	COUNTY	TOTAL SHEETS	SHEE'	
						3887	08-000	83-00-CH	KANE	259	68
									CONTRACT	NO. 61	E73
SHEET	NO.	9 OF	10 SHEETS	STA.	TO STA.	FED. RO	DAD DIST. NO.	ILLINOIS FED. AI	D PROJECT	61E73	

DESIGNED - R. SHAH REVISED - R. SHAH 10-25-94 USER NAME = gaglianobt /:\diststd\22x34\bd12.dgr DRAWN REVISED E. GOMEZ 08-28-00 PLOT SCALE = 50.000 '/ [N. CHECKED REVISED M. GOMEZ 01-08-01 REVISED DATE 09-09-94

STATE OF ILLINOIS **DEPARTMENT OF TRANSPORTATION**

		MANHOLE W	ITH
		RESTRICTOR P	LATE
CALE: NONE	SHEET NO. 1	OF 1 SHEETS	STA.


	MA	NHOLE W	F.A.U. RTE.	SECT		
	DECT	RICTOR P	3887	08-00083		
	NEOI	nicion r	В	D600-04		
1	OF 1	SHEETS	STA.	TO STA.	FED. Re	DAD DIST. NO. 1

F.A.U. RTE.	S	ECTION		COUNTY	TOTAL SHEETS	SHEE NO.
3887	08-00	083-00-CH	+	KANE	259	69
В	D600-04	(BD-12	2)	CONTRACT	NO.	61E7
FED. R	DAD DIST. NO.	1 ILLINOIS	FED. A	ID PROJECT		

BOLT LOCATIONS

TYPICAL VERTICAL ANGLES LOOKING TOWARD MANHOLE WALL

DIAMETER OVERFLOW in. (mm) (d) 506+40.29 780.95 785.00 20 520+01 795.59

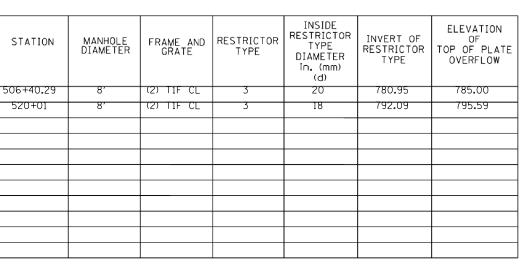

- CONCENTRIC FRAME & GRATES/LIDS AS SHOWN ON PLANS

OUTLET PIPE

2 - 24" (600) DIA. OPENINGS IN FLAT SLAB TOP WITH 2 FRAMES

- TOP OF GRATE LID ELEVATION

- 3'x3' (75x75) STEEL ANGLES

MANHOLE, TYPE A (STD. 602406)

OUTLET PIPE

AND GRATES/LIDS

- INLET PIPE


%" (16) STEEL RESTRICTOR PLATE


RESTRICTOR TYPE AS NOTED -IN RESTRICTOR TABLE

INLET PIPE-

PLAN

SECTION A-A

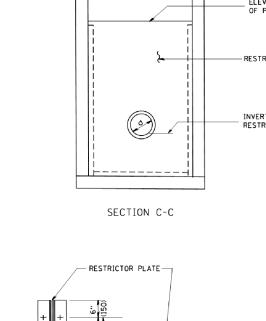

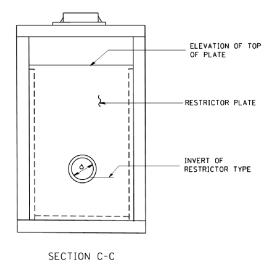


BOLT LOCATIONS -

2 EQUAL SPACES


TYPICAL HORIZONTIAL ANGLES LOOKING TOWARD BOTTOM OF MANHOLE

TOTAL BOLTS REQUIRED: 22

1. ANGLES SHOULD BE 3×3×3/8 (75×75×75) 2. VERTICAL ANGLES SHOULD EXTEND FROM THE BOTTOM OF THE RESTRICTOR PLATE TO THE TOP. 3. HORIZONTIAL ANGLES SHOULD EXTEND FROM VERTICAL ANGLE TO VERTICAL ANGLE.

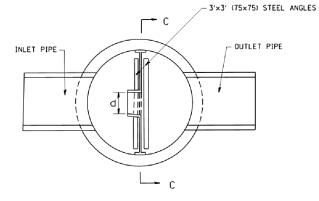

SECTION B-B

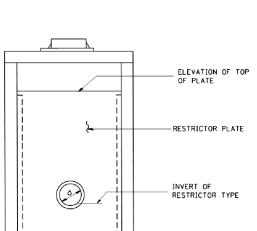

3. BASIS OF PAYMENT: "MANHOLES TYPE A. 6 FT. (1.8 m)-DIAMETER, TYPE 1 FRAME. CLOSED LID. RESTRICTOR PLATE" EACH


ALL STEEL ANGLES AND PLATES TO BE GALVANIZED AFTER FABRICATION.

2. ALL RESTRICTOR PLATES, ANGLES AND HARDWARE TO BE INCLUDED IN THE COST OF THE MANHOLE.

3/4" (10) - 16NC STAINLESS-STEEL STUD W/ NUT (TYP.)

4 PER VERTICAL 3 PER HORIZONTIAL

NOTES:

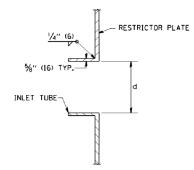

INLET TUBE DETAIL

ANGLE FASTENER DETAIL

RESTRICTOR TYPE										
1	2	3	4	5	6					
RE-ENTRANT TUBE	SHARP EDGED	SOUARE EDGED	RE-ENTRANT TUBE	SQUARE EDGED	ROUNDED					

1		٥	4	5	ь
RE-ENTRANT TUBE	SHARP EDGED	SOUARE EDGED	RE-ENTRANT TUBE	SQUARE EDGED	ROUNDED
LENGTH: 1/2 TO 1 DIA.		STREAM CLEARS SIDES	LENGTH: 2-1/2 DIA.	LENGTH: 2-1/2 DIA.	
C=.52	C=.61	C=.61	C=.73	C=.82	C=.98

VALUES OF "C" FOR CIRCULAR AND SOUARE ORIFICES

STEEL ANGLE BOLTING DETAILS

ALL DIMENSIONS ARE IN INCHES (MILLIMETERS) UNLESS OTHERWISE SHOWN.

EXPANSON ANCHOR
FOR 3/8" (10) STUD (TYP.)

- 3'x3' (75x75) STEEL ANGLE (TYP.)

- %" (16) STEEL RESTRICTOR PLATE

WATER MAIN NOTES

WATER MAIN GENERAL NOTES:

- THE CONTRACTOR SHALL VIDEO RECORD THE ENTIRE PROJECT ROUTE PRIOR TO BEGINNING CONSTRUCTION ACTIVITIES FOR THE PURPOSE OF DOCUMENTING EXISTING CONDITIONS. THE CONTRACTOR SHALL PROVIDE ONE COPY TO THE VILLAGE OF CARPENTERSVILLE AND ONE COPY TO THE ENGINEER.
- 2. ALL WATER MAIN CONSTRUCTION SHALL BE IN ACCORDANCE WITH PLANS SPECIFICATIONS, AND DETAILS, SPECIAL PROVISIONS AND IN ACCORDANCE WITH CODES AND ORDINANCES OF THE VILLAGE OF CARPENTERSVILLE, THE STANDARD SPECIFICATIONS FOR WATER AND SEWER MAIN CONSTRUCTION IN ILLINOIS (LATEST EDITION), STANDARDS SPECIFICATIONS FOR ROAD AND BRIDGE CONSTRUCTION (LATEST VERSION) AND SUPPLEMENTAL SPECIFICATIONS, AND IEPA TITLE 35.
- 3. EXISTING AND FUTURE UTILITIES, STRUCTURES, TREES, AND PAVEMENT LOCATIONS SHOWN ARE APPROXIMATE. THE COMPLETENESS AND ACCURACY OF THIS INFORMATION AND ARE NOT GUARANTEED BY THE ENGINEER. THE CONTRACTOR SHALL FIELD VERIFY THE EXACT LOCATIONS OF THESE OR ANY OTHER EXISTING FACILITIES AS REQUIRED TO COMPLETE THE WORK. ANY CHANGES IN UTILITY LOCATIONS AND/OR NUMBER OF UTILITIES SHALL BE CONSIDERED INCIDENTAL AND ACCOMMODATED AT NO ADDITIONAL COST TO OWNER.
- 4. IT SHALL BE THE CONTRACTOR'S RESPONSIBILITY TO ENSURE THAT THE PROPOSED WATER MAIN AND SERVICE LINE INSTALLATION CONFORMS TO ALL STATE, LOCAL, AND PROJECT-SPECIFIC REQUIREMENTS WITH REGARD TO MINIMUM COVER, SEPARATION, ETC. SEPARATION BETWEEN WATER MAINS AND SEWERS SHALL BE IN ACCORDANCE WITH THE REQUIREMENTS OF THE STANDARD SPECIFICATIONS FOR WATER AND SEWER CONSTRUCTION IN ILLINOIS, LATEST EDITION.
- 5. THE LOCATIONS OF EXISTING UNDERGROUND UTILITIES, SUCH AS WATER MAINS, SEWERS, GAS LINES, PIPELINES, ETC. SHOWN ON THE PLANS HAVE BEEN DETERMINED FROM THE BEST AVAILABLE INFORMATION AND ARE GIVEN FOR THE CONVENIENCE OF THE CONTRACTOR, HOWEVER, THE ENGINEER AND THE OWNER DO NOT ASSUME RESPONSIBILITY IN THE EVENT THAT DURING CONSTRUCTION, UTILITIES OTHER THAN THOSE SHOWN MAY BE ENCOUNTERED, AND THAT THE ACTUAL LOCATION OF THOSE WHICH ARE SHOWN MAY BE DIFFERENT FROM THE LOCATION AS SHOWN ON THE PLANS. IT SHALL BE THE CONTRACTOR'S RESPONSIBILITY TO CONTACT ALL UTILITY COMPANIES AND LOCATE THEIR FACILITIES PRIOR TO ANY WORK.
- 6. THE CONTRACTOR SHALL BE RESPONSIBLE FOR THE PROTECTION OF ALL UNDERGROUND OR SURFACE UTILITIES EVEN THOUGH THEY MAY NOT BE SHOWN ON THE PLANS. ANY UTILITY THAT IS DAMAGED DURING CONSTRUCTION SHALL BE REPAIRED OR REPLACED TO THE SATISFACTION OF THE OWNER AND OPERATOR OF THE DAMAGED UTILITY. THIS WORK SHALL BE AT THE CONTRACTOR'S EXPENSE.
- 7. THE CONTRACTOR SHALL CONTACT THE VILLAGE OF CARPENTERSVILLE TO IDENTIFY WATER SERVICE LINES PRIOR TO CONSTRUCTION. LOCATIONS OF EXISTING CURB STOPS AND WATER SERVICE LINES ARE SHOWN ON THE DRAWINGS WHERE KNOWN, WHERE THESE EXISTING UTILITIES ARE NOT IDENTIFIED, CONTRACTOR SHALL FIELD LOCATE THE EXISTING CURB STOP AND INSTALL THE PROPOSED CURB STOP AS CLOSE AS FEASIBLE TO THE EXISTING CURB STOP WHILE REMAINING WITHIN THE PUBLIC RIGHT-OF-WAY. IN ORDER TO MINIMIZE SHUTDOWNS OF THE EXISTING WATER MAIN, THE CONTRACTOR SHALL NEXT LALL NEW SERVICE LINES FROM THE PROPOSED MAIN TO THE PROPOSED CURB STOPS AND TIE IN THE EXISTING SERVICE LINES DOWNSTREAM OF THE EXISTING CURB STOPS TO THE PROPOSED CURB STOPS
- 8. EXISTING WATER SERVICE SIZES SHALL BE DETERMINED IN THE FIELD. NEW WATER SERVICE LINES SHALL MATCH THAT OF THE EXISTING WATER SERVICE, EXCEPT THAT THE MINIMUM SIZE SHALL BE 1" DIAMETER.
- 9. TEMPORARY PLUGS, SLEEVES, FLUSHING HYDRANTS, AND BLOWOFF TAPS MAY BE NEEDED FOR PRESSURE TESTING THE NEW MAIN PRIOR TO MAKING CONNECTIONS TO THE EXISTING DISTRIBUTION SYSTEM. THESE ITEMS ARE CONSIDERED INCIDENTAL TO THE INSTALLATION OF WATER MAINS.
- 10. REMOVAL AND DISPOSAL OF EXISTING PIPING, FITTINGS, ETC. SHALL BE CONSIDERED INCIDENTAL TO THE INSTALLATION OF THE WATER MAIN AND ALL MATERIALS SHALL BE DISPOSED OF PROPERLY BY THE CONTRACTOR.
- 11. THE CONTRACTOR SHALL REMOVE ALL VALVES, CASTINGS, OR HYDRANTS FROM THE WATER MAIN TO BE ABANDONED. EXISTING BASINS OR VAULTS SHALL BE ABANDONED IN PLACE AND FILLED WITH SAND. WHEN REQUESTED BY THE VILLAGE OF CARPENTERSVILLE, THE CONTRACTOR SHALL SALVAGE AND DELIVER TO THE VILLAGE ANY EXISTING VALVES, CASTINGS, OR HYDRANTS FROM THE ADANDONED WATER MAIN, ALL OTHER PIPE AND APPURTENANCES REMOVED FROM THE ABANDONED WATER MAIN SHALL BECOME THE PROPERTY OF THE CONTRACTOR.
- 12. THE WATER MAIN SHALL BE INSTALLED TO A MINIMUM COVER OF FIVE AND ONE HALF (5.5) FEET UNLESS OTHERWISE INDICATED ON THE PLANS.
- 13. EXISTING WATER MAINS TO BE ABANDONED WHICH ARE LARGER THAN 16" IN DIAMETER SHALL BE FILLED WITH CONTROLLED LOW STRENGTH MATERIAL (CLSM).
- 14. THE CONTRACTOR SHALL USE REASONABLE MEASURES TO PROTECT TREES NOT IDENTIFIED TO BE REMOVED. ALL TREES DAMAGED BEYOND REPAIR SHALL BE REPLACED WITH LIKE KIND OF THE LARGEST PRACTICAL SIZE AT NO ADDITIONAL COST TO OWNER. ALL SIGNS AND UTILITY POLES SHALL BE REINSTALLED OR REPLACED AS REQUIRED AT NO ADDITIONAL COST TO OWNER.
- 15. TEMPORARY SUPPORT OR RELOCATION OF EXISTING UTILITIES MAY BE REQUIRED AS A RESULT OF CONSTRUCTION OF THIS PROJECT, IT SHALL BE THE CONTRACTOR'S RESPONSIBILITY TO COORDINATE THE REQUIRED WORK WITH THE RESPECTIVE UTILITY COMPANIES IN ORDER TO AVOID UNNECESSARY DELAYS TO CONSTRUCTION. THE CONTRACTOR SHALL WORK CLOSELY WITH THE UTILITIES TO LOCATE, PLAN, AND SUPPORT THESE FACILITIES IN A MANNER WHICH MINIMIZES UTILITY SHUT-OFF AND KEEPS THE PROJECT ON SCHEDULE.
- 16. ALL DUCTILE IRON FITTINGS AND PIPE SHALL BE ENCASED IN POLYETHYLENE WRAP IN ACCORDANCE WITH THE CONTRACT DOCUMENTS.
- 17. THE CONTRACTOR SHALL PROVIDE THE LABOR AND EQUIPMENT NECESSARY TO DETERMINE THE EXACT LOCATION AND ELEVATION OF ALL UTILITY CROSSINGS WHICH MAY CAUSE CONFLICTS. THESE DETERMINATIONS SHALL BE MADE PRIOR TO THE START OF ACTUAL CONSTRUCTION. THE CONTRACTOR SHALL CONTRACTOR SHALL ALSO THEN UNCOVER THE UTILITY COMPANY PRIOR TO BEGINNING EXCAVATION. THE CONTRACTOR SHALL ALSO THEN UNCOVER THE UTILITY, ASSIST THE ENGINEER IN DETERMINING THE ELEVATION AT THE PIPE, AND BACKFILL THE EXCAVATION.
- 18. IT SHALL BE THE CONTRACTOR'S RESPONSIBILITY TO HAUL AND PROPERLY DISPOSE OF EXCESS MATERIAL (INCLUDING EXCAVATED MATERIAL OR BROKEN CONCRETE) WHICH IS NOT DESIRABLE TO BE INCORPORATED INTO THE WORK INVOLVED ON THIS PROJECT. NO PAYMENT WILL BE ALLOWED FOR MATERIAL DISPOSED OF AND NOT INCORPORATED INTO THE WORK, NO MATERIAL SHALL BE PLACED OUTSIDE OF THE RIGHT-OF-WAY, UNLESS SPECIFICALLY STATED IN THE PLANS OR APPROVED BY THE ENGINEER.
- 19. THE CONTRACTOR IS RESPONSIBLE FOR MAINTAINING ACCESS TO INDIVIDUAL PROPERTIES DURING CONSTRUCTION. PROPERTY OWNERS SHALL BE NOTIFIED AT LEAST 48 HOURS IN ADVANCE OF WORK THAT WOULD AFFECT OR ALTER THEIR ACCESS. TEMPORARY ACCESS DRIVES SHALL BE PROVIDED FOR ALL PROPERTIES IF ACCESS IS TO BE DISRUPTED FOR AN EXCESSIVE AMOUNT OF TIME, AS DETERMINED BY OWNER AND ENGINEER. TEMPORARY ACCESS DRIVES SHALL CONSIST OF FULL-DEPTH CLEAN CRUSHED STONE PROPERLY COMPACTED.
- 20. OWNER WILL PROVIDE THE CONTRACTOR WATER FOR FLUSHING, DISINFECTION, AND PRESSURE TESTING OPERATIONS FREE OF CHARGE. WATER WILL BE MADE AVAILABLE THROUGH EXISTING WATER MAIN CONNECTIONS OR NEARBY FIRE HYDRANTS. THE CONTRACTOR SHALL PROVIDE BACKFLOW PREVENTION DEVICES FOR FIRE HYDRANT CONNECTIONS. THE CONTRACTOR SHALL TAKE REASONABLE PRECAUTIONS FOR WATER CONSERVATION.
- 21. A PRECAST CONCRETE THRUST BLOCK SHALL BE INSTALLED AT ALL CONNECTION POINTS WITH EXISTING PIPING BETWEEN NEW CONNECTION FITTINGS AND EXISTING PIPING. CONCRETE THRUST BLOCKS ARE INCLUDED IN THE COST OF THE WATER MAIN.
- 22. BEFORE STARTING ANY EXCAVATION, THE CONTRACTOR SHALL CALL "JULIE" (JOINT UTILITY LOCATION INFORMATION FOR EXCAVATION) AT 8-1-1 AND THE VILLAGE OF CARPENTERSVILLE AT (815)568-2669 FOR FIELD LOCATIONS OF BURIED UTILITIES (48 HOURS NOTIFICATION IS REQUIRED).
- 23. NO EXCAVATIONS WILL BE PERMITTED TO REMAIN OPEN OVER ANY WEEKEND AND NO EXCAVATIONS SHALL BE LEFT OPEN OVERNIGHT IN ANY RESIDENTIAL AREA.
- 24. THE ENGINEER AND VILLAGE ARE NOT RESPONSIBLE FOR THE CONSTRUCTION MEANS, METHODS, TECHNIQUES, SEQUENCES OR PROCEDURES, TIME OF PERFORMANCE, PROGRAMS OR FOR ANY SAFETY PRECAUTIONS USED BY THE CONTRACTOR. THE CONTRACTOR IS SOLELY RESPONSIBLE FOR EXECUTION OF HIS WORK IN ACCORDANCE WITH THE CONTRACT DOCUMENTS AND SPECIFICATIONS.
- 25. CONTRACTOR SHALL BE RESPONSIBLE FOR AVOIDING SEWER MAIN DURING CONSTRUCTION. ANY DAMAGE TO THE SEWER MAIN WHERE THE CONTRACTOR IS AT FAULT SHALL BE PAID FOR BY THE CONTRACTOR. CONTRACTOR SHALL USE SEWER CAMERA TO FILM SEWER OVER ENTIRE LENGTH OF PROJECT AREA UPON COMPLETION OF PROJECT. THE COST OF THIS WORK IS INCLUDED IN THE WATER MAIN INSTALLATION.
- 26. SURFACE FEATURES THAT ARE DISTURBED DUE TO THE CONSTRUCTION OF WATER MAINS, WHICH ARE NOT INCLUDED AS PART OF THE STREET IMPROVEMENTS, SHALL BE RESTORED AND BE CONSIDERED INCIDENTAL TO THE WATER MAIN WORK, RESTORATION THAT IS INCLUDED IN THE UNIT COSTS FOR THE WATER MAIN WORK WITH NO ADDITIONAL COMPENSATION ALLOWED, RESTORATION OF SURFACE FEATURES SHALL INCLUDE, BUT NOT BE LIMITED TO, SODDING, SEEDING, REMOVAL AND RESTORATION OF PAVEMENT, REMOVAL AND RESTORATION OF SIDEWALK, REMOVAL AND RESTORATION OF CUBB AND GUTTER, AND ANY OTHER ITEM THAT MUST BE DISTURBED TO INSTALL WATER MAIN AS INDICATED IN THE PROJECT DOCUMENTS. RESTORATION WORK ITEMS THAT ARE CONSIDERED INCLUDED IN THE COST OF THE WATER MAIN WORK SHALL BE PERFORMED PER THE REQUIREMENTS OF PROJECT DOCUMENTS.

27. RECORD DRAWINGS FOR THE NEW WATER MAINS SHALL BE PREPARED BY THE CONTRACTOR AND SUBMITTED TO THE VILLAGE OF CARPENTERSVILLE UPON THE PROJECT COMPLETION. ANY VARIATIONS FROM THE CONTRACT DOCUMENTS SHALL BE INDICATED ON THE RECORD DRAWINGS.

WATER MAIN SEQUENCE OF CONSTRUCTION:

THE INSTALLATION OF NEW WATER MAIN AND THE ABANDONMENT OF EXISTING WATER MAINS SHALL FOLLOW THE SEQUENCE OUTLINED BELOW. THIS SEQUENCE MAY VARY DEPENDING ON UNKNOWN FIELD CONDITIONS. THE CONTRACTOR SHALL SUBMIT TO THE ENGINEER FOR APPROVAL A PLAN FOR PHASING THE NEW WATER MAIN INTO SERVICE, INCLUDING BUT NOT LIMITED TO: A SUMMARY OF SHUT-DOWNS, PRESSURE TESTING PROCEDURES, METHODS OF CHLORINATION, SEQUENCE OF CONNECTIONS, AND ABANDONMENTS OF THE EXISTING WATER MAIN.

THE CONTRACTOR SHALL COORDINATE THE INSTALLATION OF NEW WATER MAINS AND THE ABANDONMENT OF EXISTING WATER MAINS WITH THE VILLAGE OF CARPENTERSVILLE. A MINIMUM OF TWO (2) WEEKS NOTICE SHALL BE PROVIDED TO THE VILLAGE PRIOR TO THE OPERATION OF VALVES, WATER MAIN SHOT-DOWNS, PLACING WATER MAINS INTO SERVICE, PRESSURE TESTING, FLUSHING, AND CHLORINATION ACTIVITIES. THE CONTRACTOR SHALL NOTIFY RESIDENTS AND BUSINESSES AT LEAST 48 HOURS PRIOR TO ANY DISRUPTION OR SHUT-DOWN. PRESSURE TESTING AND DISINFECTION OF THE NEW WATER MAINS SHALL BE IN ACCORDANCE WITH THE CONTRACT DOCUMENTS. EXISTING WATER MAINS SHALL REMAIN IN SERVICE UNTIL THE NEW WATER MAINS PASSES ALL TESTS.

PHASE 1

- 1. INSTALL HYDRANT AND AT STA. 106+83.89, 47.33' RT ALONG WITH 12-INCH LINE STOP TO THE EAST.
- 2. INSTALL 12-INCH INSERT VALVE AT APPROXIMATE STA. 106+40, 50' RT.
- 3. INSTALL 12-INCH VALVE VAULT AT STA. 106+27.19, 44.46' RT AND 12-INCH WATER MAIN CROSSING.
- 4. INSTALL 12-INCH WATER MAIN FROM VALVE AT STA. 105+58.71, 29.08' LT TO VALVE AT STA. 106+28.00, 44.42' LT.
- 5. PRESSURE TEST AND DISINFECT NEW WATER MAIN PRIOR TO BEGINNING PHASE 2.
- 6. INSTALL 12-INCH INSERT VALVE AT APPROXIMATE STA. 109+51, 55.5' RT.

PHASE 2

- 1. INSTALL 12-INCH WATER MAIN FROM VALVE AT STA. 106+28.00, 44.42' LT. TO VALVE AT STA. 115+09.53, 40.24' LT.
- 2. PRESSURE TEST AND DISINFECT NEW MAIN PRIOR TO BEGINNING PHASE 3.

PHASE 3

1. TRANSFER EXISTING WATER SERVICES FROM EXISTING 6-INCH WATERMAIN TO NEW 12-INCH WATER MAIN FROM STA. 106+28 TO STA.

PHASE 4

- 1. INSTALL 8-INCH AND 4-INCH WATER MAIN AT ELM AVENUE.
- 2. INSTALL 4-INCH LINE STOP AT APPROXIMATE STA. 105+77, 100' LT. (ELM AVENUE).
- 3. MAKE CONNECTION TO EXISTING 4-INCH WATER MAIN AT STA. 105+77.26, 96.25' LT. (ELM AVENUE).
- 4. INSTALL 12-INCH LINE STOP AT APPROXIMATE STA. 105+35, 50' LT. (WEST OF ELM AVENUE).
- 5. MAKE CONNECTION TO EXISTING 12-INCH WATER MAIN AT STA. 105+47.30, 40.28' LT. (WEST OF ELM AVENUE).

PHASE 5

1. INSTALL 12-INCH WATER MAIN CROSSING AT STA. 113+58.

SCALE: N.

2. PRESSURE TEST AND DISINFECT NEW MAIN PRIOR TO BEGINNING PHASE 6.

PHASE 6

- 1. INSTALL TEE CONNECTION TO EXISTING 12-INCH WATER MAIN AT STA. 113+58.62, 61.93' RT.
- 2. ABANDON WEST LEG OF 12-INCH CROSS AT STA. 106+27.11, 51.53' RT BY CUTTING AND CAPPING METHOD.

PHASE 7

- 1. INSTALL 16-INCH WATER MAIN FROM VALVE STA. 519+44.90, 20.77' RT. TO THE VALVE AT STA. 530+74.62, 24.50' LT.
- 2. PRESSURE TEST AND DISINFECT NEW WATER MAIN PRIOR TO BEGINNING PHASE 8.

	OF PROJECT DOCUMENTS.									
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STATE OF ILLINOIS DEPARTMENT OF TRANSPORTATION

			F.A.U. RTE.	SEC	TION	COUNTY	TOTAL SHEETS	SHEE1					
WATER MAIN NOTES AND SEQUENCE OF		CONSTRUCTION	3887	08-00083-00-CH		KANE	259	70					
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WATER MAIN NOTES CONTINUED

PHASE 8

- 1. TRANSFER EXISTING WATER SERVICES FROM EXISTING 16-INCH WATERMAIN TO NEW 16-INCH WATER MAIN FROM STA. 519+44.90 TO STA. 530+84.69.
- 2. INSTALL 12-INCH WATER MAIN CROSSING AT STA. 530+67.
- 3. PRESSURE TEST AND DISINFECT NEW WATER MAIN PRIOR TO BEGINNING PHASE 9.

PHASE 9

- 1. INSTALL 4-INCH LINE STOP AT APPROXIMATE STA. 530+70, 25' RT.
- 2. INSTALL 8-INCH LINE STOP AT APPROXIMATE STA. 529+80, 15' LT.
- 3. INSTALL CONNECTION TO EXISTING 4-INCH WATER MAIN AT STA. 530+61.05. 26.38' RT.

PHASE 10

- INSTALL NEW WATER SERVICE TO THE EXISTING 16-INCH WATER MAIN FOR THE PROPERTY LOCATED AT 132 W. MAIN STREET.
 ABANDON THE EXISTING SERVICE CURRENTLY LOCATED ON THE 6-INCH WATER MAIN.
- 2. ABANDON THE 6-INCH WATER MAIN FROM LINCOLN AVENUE TO IL. ROUTE 31 BY CLOSING THE EXISTING 6-INCH VALVES AT STA. 114+95 AND STA. 121+10. CLOSE THE 6-INCH VALVE THAT IS INTERCONNECTED WITH THE 16-INCH WATER MAIN AT STA. 115+70. ABANDON THE EXISTING 6-INCH WATERMAIN BY CAPPING.
- 3. INSTALL 16-INCH WATER MAIN FROM THE VALVE STA. 519+44.90, 20.77' LT TO THE VALVE AT STA. 122+97.50, 6.71' LT.
- 4. PRESSURE TEST AND DISINFECT NEW WATER MAIN PRIOR TO BEGINNING PHASE 11.
- 5. INSTALL NEW 1-INCH COPPER WATER SERVICE TO THE NEW 16-INCH WATER MAIN FOR THE PROPERTY LOCATED AT 132 W. MAIN STREET.

PHASE 11

- 1. INSTALL CONNECTION TO EXISTING 16-INCH WATER MAIN AT STA. 123+08.03, 10.10' LT.
- 2. INSTALL 16-INCH LINE STOP AT APPROXIMATE STA. 530+90, 20' LT.
- 3. INSTALL CONNECTION TO EXISTING 16-INCH WATER MAIN AT STA. 530+84.69, 22.49' LT.

PHASE 12

- 1. INSTALL 12-INCH AND 8-INCH WATER MAIN FROM VALVE AT STA. 608+46.00, 7.27' RT. TO STA. 613+30.
- 2. INSTALL 12-INCH WATER MAIN (CROSS-CONNECTION TO 16-INCH WATER MAIN) AT STA. 608+53.68.
- 3. PRESSURE TEST AND DISINFECT NEW WATER MAIN PRIOR TO BEGINNING PHASE 13.

PHASE 13

- 1. INSTALL 12-INCH WATER MAIN (CROSS-CONNECTION TO 16-INCH WATER MAIN) AT STA. 607+94.92
- 2. PRESSURE TEST AND DISINFECT NEW WATER MAIN PRIOR TO BEGINNING PHASE 14.
- 3. INSTALL 12-INCH WATER MAIN FROM VALVE AT STA. 608+46.00, 7.27' RT. TO STA. 601+82.

PHASE 14

- 1. TRANSFER EXISTING WATER SERVICES IN LINCOLN AVENUE FROM EXISTING 6-INCH WATERMAIN TO NEW 12-INCH WATER MAIN.
- 2. INSTALL 6-INCH LINE STOP AT APPROXIMATE STA. 601+75, 17' LT.
- 3. INSTALL CONNECTION AT STA. 601+80.08, 16.88' LT.
- 4. INSTALL 6-INCH LINE STOP AT APPROXIMATE STA. 613+40, 19' LT.
- 5. INSTALL CONNECTION AT STA. 613+33.70, 18.65' LT.

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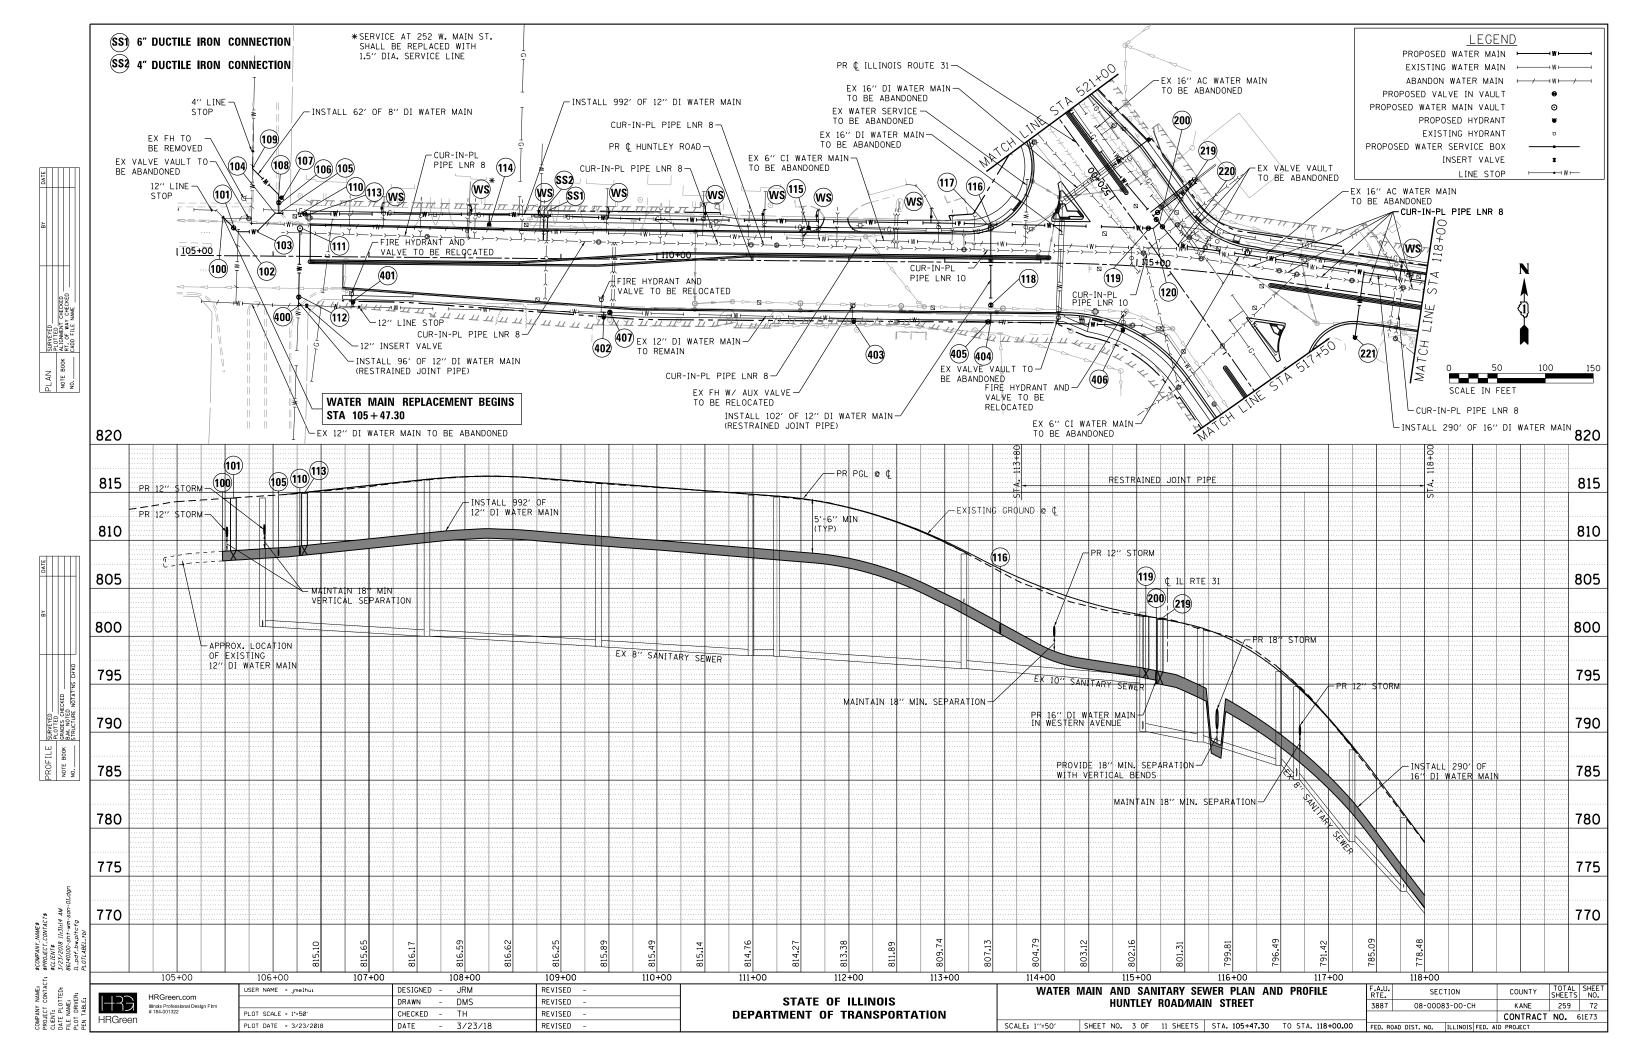
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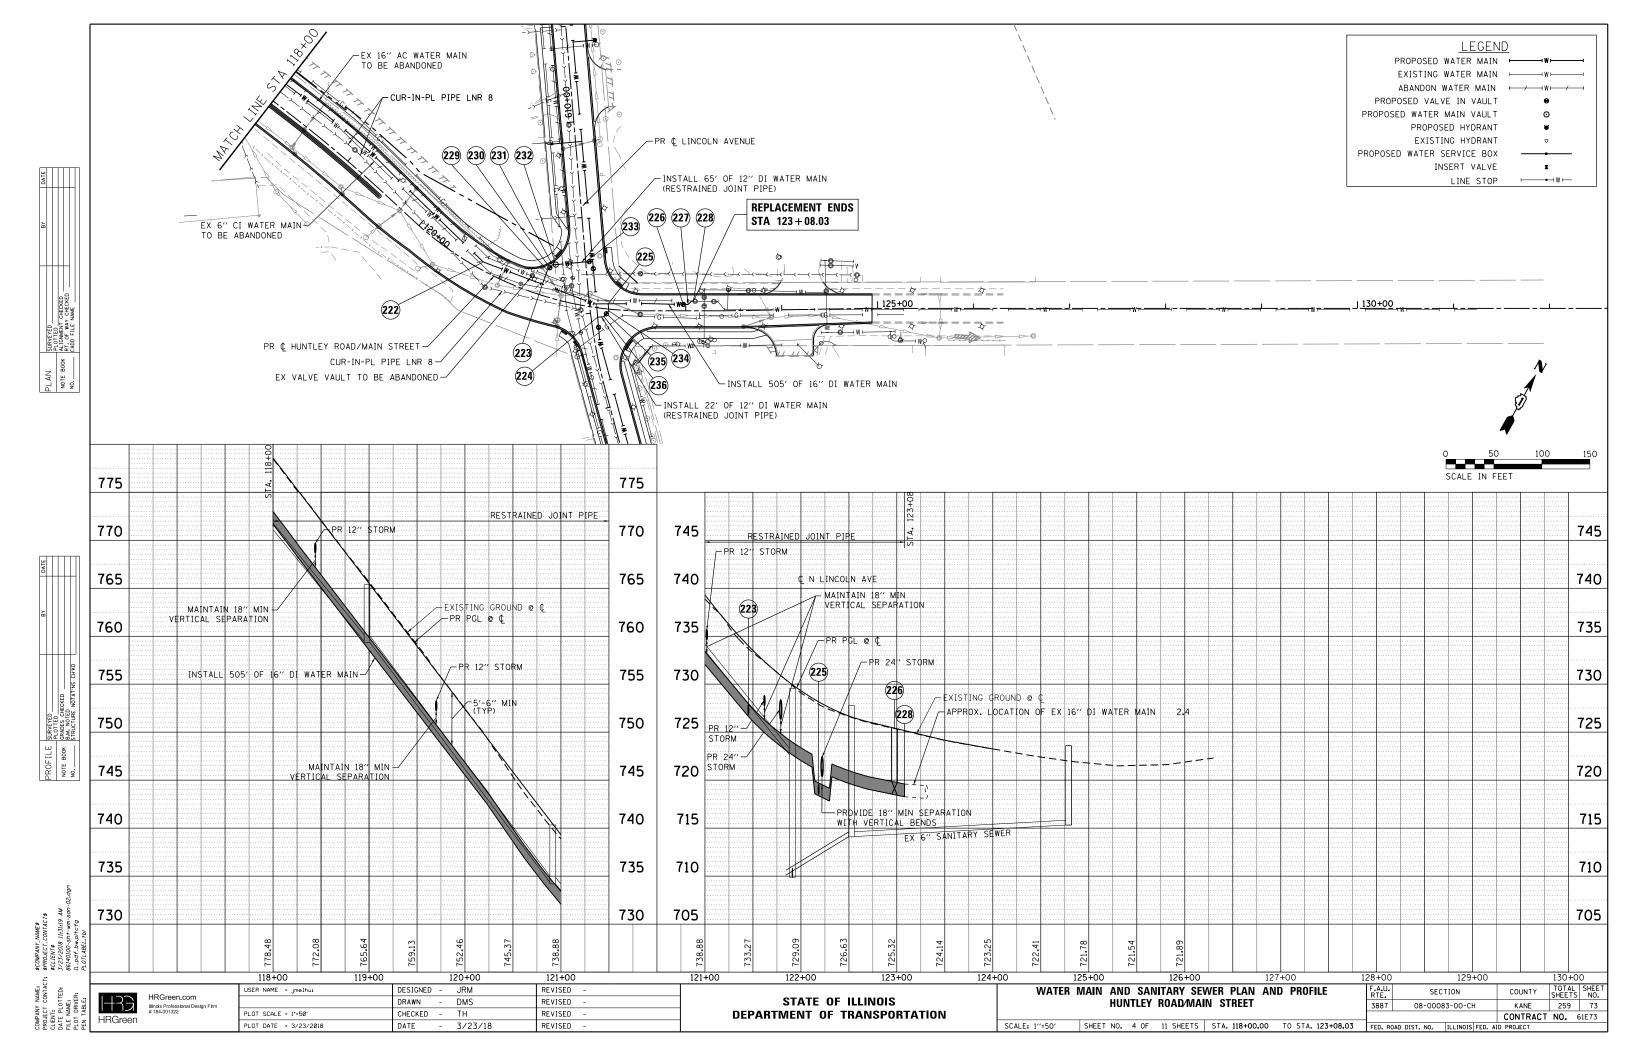
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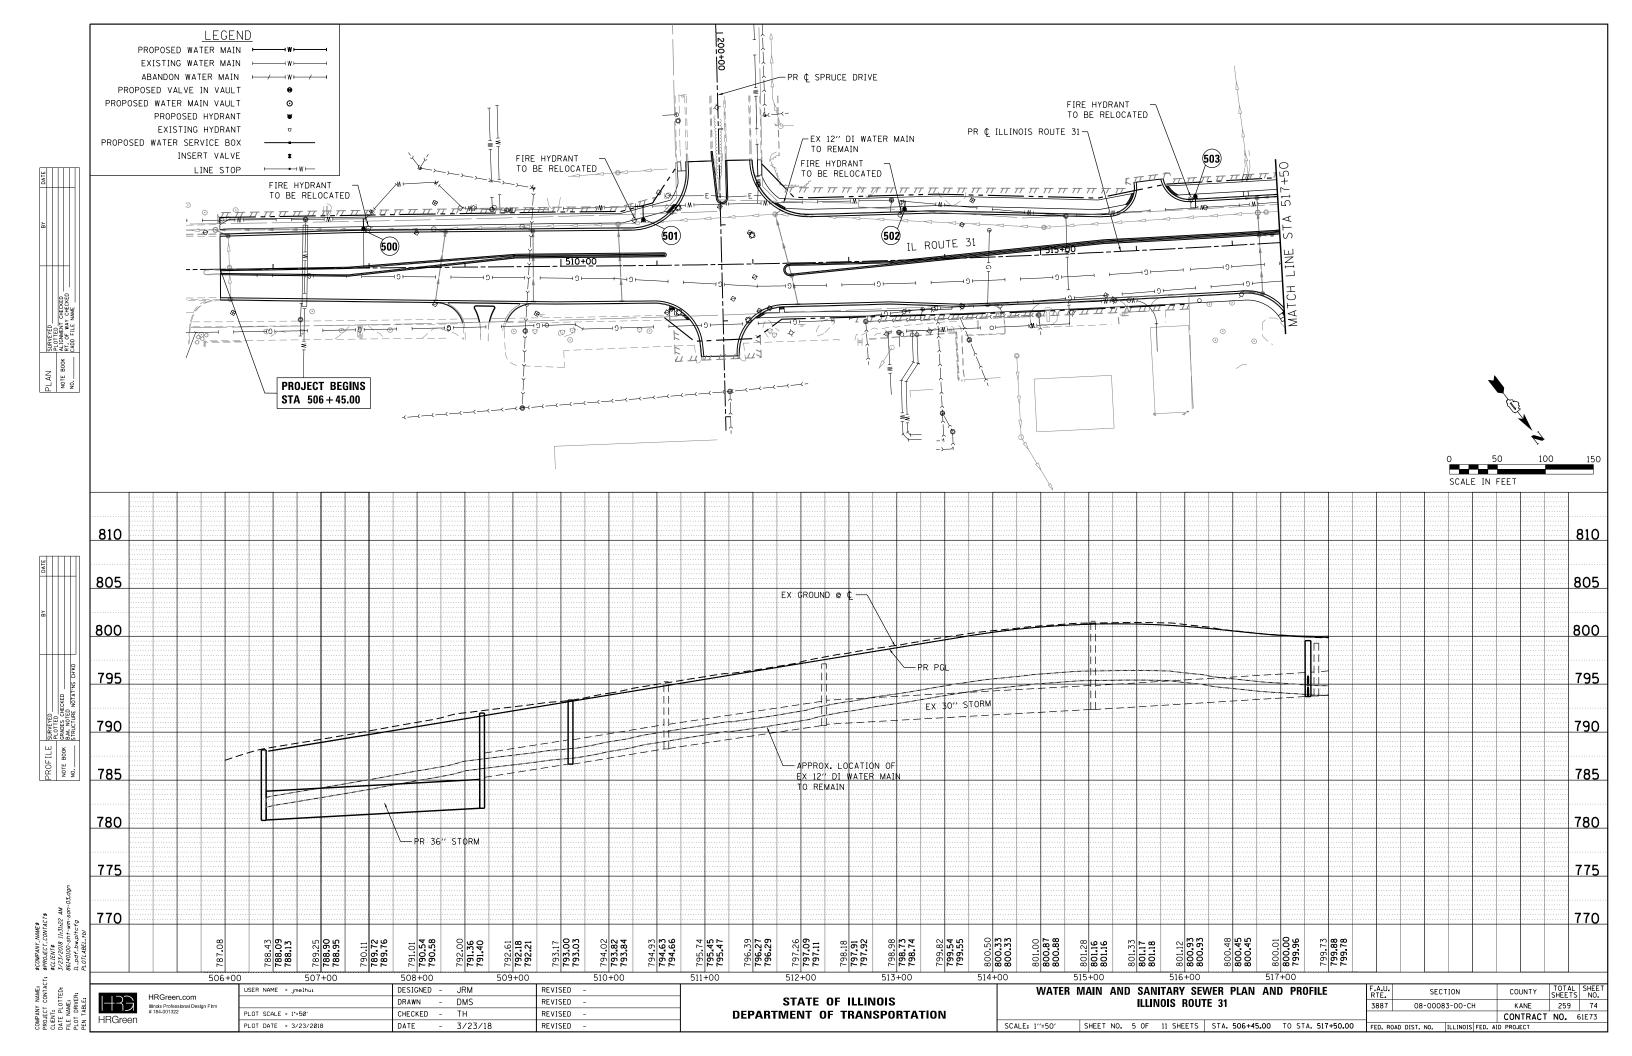
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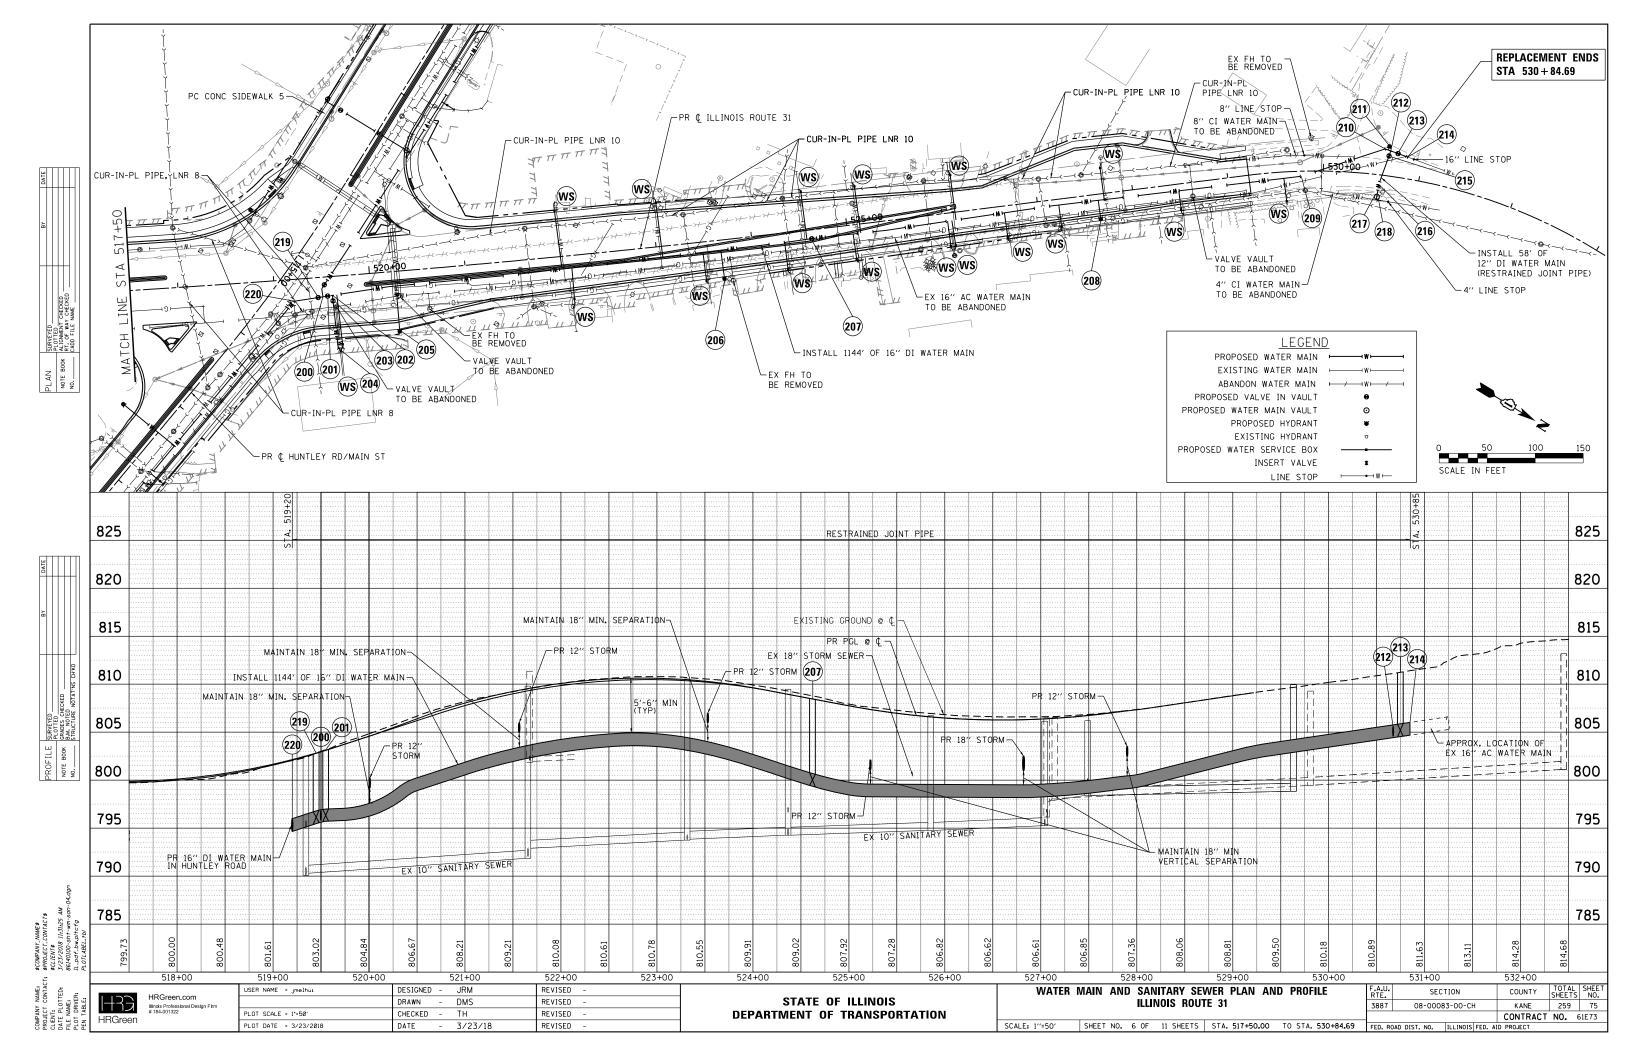
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DEPARTMENT OF TRANSPORTATION


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						3887	08-00083-00-CH		KANE	259	71
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		1			STA. 613+06.14, 7.22' RT INV = 717.47		TEATH LOURING
<u> </u>		222	16" 22.5° BEND, MJ STA. 120+77.76, 8.02' LT INV = 734.79	309 310	8" GATE VALVE IN VAULT STA. 612+96.72, 7.10' RT INV = 717.51 8" 45° BEND, MJ		
(WS) WATER SE	ERVICE LOCATION (≤2'' DIA.)	221	INV = 794.66 HYDRANT WITH AUXILIARY VALVE AND BOX INSTALL 70' OF 6" DI WATER MAIN AND 16 STA. 117+36.04, 46.75' RT INV = 780.10	S" X 6" TEE, MJ	HYDRANT WITH AUXILIARY VALVE AND BOX INSTALL 22' OF 6" DI WATER MAIN AND 8" STA, 610+83.09, 29.07' RT INV = 718.04	' X 6" TEE, MJ	PWARDS. THIS WORK SHALL BE COMPLETED BEFORE SANITARY SEWER LINING S COMPLETED. AP END OF INSTALLED SANITARY SEWER FOR FUTURE CONNECTION.
		220	INV = 795.47 16" 45° BEND, MJ STA, 519+20.01, 22.69' RT	307	12" X 12" TEE, MJ INSTALL 12" X 8" REDUCER ON THE NORTH STA, 608+53.68, 7.23' RT INV = 717.83	T P W	ONNECT PVC SDR-21 TO THE EXISTING SANITARY SEWER WITH SEWER SADDLE WYE. HE CONTRACTOR SHALL CUT EXISTING SANITARY SEWER AND INSTALL ROPOSED WYE WITH NECESSARY PIPE TO CONNECT TO EXISTING SANITARY SEWER 1TH CASCADE COUPLING OR APPROVED EQUAL. THE WYE SHALL BE ROTATED
120	12" 45° BEND, MJ STA. 115+14.42, 40.42' LT INV = 795.52	219	INV = 804.34 16" GATE VALVE IN VAULT STA. 519+44.90, 20.77' RT	306	12" GATE VALVE IN VAULT STA. 608+46.00, 7.27' RT INV = 717.83	MAINLI CAPPEI	INE INV. 799.29 E. W D END INV. 799.37 ARY SEWER NOTES:
119	12" GATE VALVE IN VAULT STA. 115+09.53, 40.24' LT INV = 795.62		12" X 4" REDUCER, MJ 12" 90° BEND, MJ ABANDON EXISTING WATER MAIN TO THE S STA. 530+61.05, 26.38' RT		12" X 12" TEE, MJ STA. 607+94.92, 6.84' RT INV = 717.83	CAPPEI (SS2 4" PVI	D END INV. 799.35 C SDR-21 SANITARY SEWER CONNECTION
118	12" GATE VALVE IN VAULT STA. 113+48.34, 44.34' RT INV = 800.75	218	INV = 804.30 CONNECTION TO EXISTING 4" CI WATER MA 4" TRANSITION COUPLING	AIN WITH:	STA. 607+84.22, 6.30' RT INV = 717.83		C SDR-21 SANITARY SEWER CONNECTION NE INV. 799.27 E, W
117	PRESSURE REDUCING VALVE VAULT STA. 113+47.63, 36.09' LT INV = 800.79	217	PRESSURE REDUCING VALVE VAULT STA. 530+58.63, 22.93' RT	304	STA, 607-70.33, 5.31' RT INV = 717.83		STA. 516+64.27, 53.12' LT
116	12" X 12" TEE, MJ STA. 113+47.60, 40.08' LT INV = 800.79	216	1NV = 804.41 12" 11.25° BEND, MJ STA. 530+59.16, 10.02' RT INV = 804.31	303	STA, 602+14,37, 7,82' RT INV = 716.66 12" 11.25° BEND, MJ		INSTALL 5' OF 12" DI WATER MAIN INSTALL 12' OF 6" DI WATER MAIN 12" X 6" TEE, MJ 2 - 12" TRANSITION COUPLINGS
115	HYDRANT WITH AUXILIARY VALVE AND BOX INSTALL 7' OF 6" DI WATER MAIN AND 12" X 6" TEE, MJ STA. 111+57.91, 34.39' LT INV = 807.69	215	INV = 804.68 12" GATE VALVE IN VAULT STA. 530+65.97. 20.79' LT INV = 804.41	301 302	12" 45° BEND, MJ STA, 602+07.21, 7.86' RT INV = 716.56 12" GATE VALVE IN VAULT	503	12" X 6" TEE, MJ 2 - 12" TRANSITION COUPLINGS STA. 513+59.67, 53.27' LT RELOCATE HYDRANT WITH AUXILIARY VALVE AND BOX
114	HYDRANT WITH AUXILIARY VALVE AND BOX INSTALL 7' OF 6" DI WATER MAIN AND 12" X 8" TEE, MJ STA. 108+25.00, 35.12' LT INV = 810.20	214	CONNECTION TO EXISTING 16" AC WATER N TRANSITION COUPLING ABANDON EXISTING WATER MAIN TO THE S STA. 530+84.69, 22.49" LT	ОИТН	ABANDON EXISTING WATER MAIN TO THE NO STA, 601+80.08, 16.88' LT INV = 716.21	ORTH 502	RELOCATE HYDRANT WITH AUXILIARY VALVE AND BOX INSTALL 5' OF 12" DI WATER MAIN INSTALL 8' OF 6" DI WATER MAIN
113	12" GATE VALVE IN VAULT STA. 106+32.89, 44.38' LT INV = 808.44	213	16" GATE VALVE IN VAULT STA. 530+74.62, 24.50" LT INV = 804.54	300	CONNECTION TO EXISTING 6" CI WATER MA 6" TRANSITION COUPLING 12" X 6" REDUCER, MJ 12" 45° BEND, MJ	AIN WITH:	INSTALL 14' OF 6" DI WATER MAIN 12" X 6" TEE, MJ 2 - 12" TRANSITION COUPLINGS STA. 510+86.32, 47.72' LT
112	12" GATE VALVE IN VAULT STA. 106+27.19, 44.46' RT INV = 808.38	212	16" X 12" TEE, MJ STA. 530+67.08, 26.13' LT INV = 804.42	236	12" 45° BEND, MJ STA. 122+15.64, 8.30' RT INV = 718.51	501	2 - 12" TRANSITION COUPLINGS STA. 507+94.36, 41.07' LT RELOCATE HYDRANT WITH AUXILIARY VALVE AND BOX INSTALL 8' OF 12" DI WATER MAIN
111	PRESSURE REDUCING VALVE VAULT STA. 106+27.86, 29.21' LT INV = 808.39	211	HYDRANT WITH AUXILIARY VALVE AND BOX INSTALL 4' OF 6" DI WATER MAIN AND 16" STA. 530+65.21, 30.74' LT INV = 804.40	7 X 6" TEE, MJ 235	170 - 176.50 12" GATE VALVE IN VAULT STA. 122+17.76, 5.06' RT INV = 718.41	500	RELOCATE HYDRANT WITH AUXILIARY VALVE AND BOX INSTALL 5' OF 12" DI WATER MAIN INSTALL 10' OF 6" DI WATER MAIN 12" X 6" TEE, MJ 2 - 12" TEANSITION COURTINGS
110	12" X 12" TEE, MJ STA. 106+28.00, 44.42' LT INV = 808.39	210	STA. 530+61.23, 27.49' LT PROVIDE THRUST BLOCK AT FITTING INV = 804.34	234	17V - 722.66 12'' 45° BEND, MJ STA. 122+19.92, 1.38' RT INV = 718.30		2 - 12" TRANSITION COUPLINGS ABANDON THE EXISTING WATER MAIN CROSSING TO THE NORTH STA, 114+89,43, 67,59" RT
	8" 45° BEND, MJ ABANDON EXISTING WATER MAIN TO THE SOUTH STA. 105+77.26, 96.25' LT INV = 808.03	209	16" 11.25° BEND, MJ STA. 529+77.00, 5.35' RT INV = 803.10 16" 45° BEND, MJ	233	INV = 725.80 12" GATE VALVE IN VAULT STA. 121+90.66, 46.14' LT INV = 722.66	406	RELOCATE HYDRANT WITH AUXILIARY VALVE AND BOX INSTALL 70' OF 12" DI WATER MAIN THO THE WEST INSTALL 5' OF 6" DI WATER MAIN 12" X 6" TEE, MJ
109	CONNECTION TO EXISTING 4" CI WATER MAIN WITH: 4" TRANSITION COUPLING 8" X 4" REDUCER, MJ	222	INSTALL 20' OF 6" DI WATER MAIN AND 16 STA. 527+63.39, 26.21' RT INV = 798.79		INV = 726.19 PRESSURE REDUCING VALVE VAULT STA. 121+53.18, 34.90' LT		CONNECT TO EXISTING DI WATER MAIN WITH: 12" SLEEVE, MJ INSTALL 4" OF 6" DI WATER MAIN STA. 113+45.85, 61.83" RT
108	8" 450 BEND, MJ STA. 106+05.48, 63.88' LT INV = 808.21	208	STA. 524+62.10, 9.30' RT INV = 799.36 HYDRANT WITH AUXILIARY VALVE AND BOX		INV = 726.39 12" 45° BEND, MJ STA. 121+49.51, 33.56" LT	405	INSTALL 4' OF 12" DI WATER MAIN STA. 113+48.50, 61.77 RT 12" GATE VALVE IN VAULT CONNECT TO EXISTING DI WATER MAIN WITH.
107	HYDRANT WITH AUXILIARY VALVE AND BOX INSTALL 3' OF 6" DI WATER MAIN AND 8" X 6 TEE, MJ STA. 106+08.31, 60.92' LT INV = 808.23	207	INSTALL 30 OF 6 DI WATER MAIN AND TE STA. 523+67.35, 40.45' RT INV = 802.32 16" GATE VALVE IN VAULT	230	INV = 726.57 12'' GATE VALVE IN VAULT STA. 121+47.64, 29.96' LT	404	CONNECTION TO EXISTING 12" DI WATER MAIN WITH: 12" X 12" TEE, MJ 12" SLEEVE, MJ
106	8" GATE VALVE IN VAULT STA. 106+05.67, 55.68' LT INV = 808.21	206	STA. 520+26.64, 62.66' RT INV = 797.42 HYDRANT WITH AUXILIARY VALVE AND BOX INSTALL 30' OF 6'' DI WATER MAIN AND 16		STA. 123+08.03, 10.10' LT INV = 718.27 12" 22.5° BEND, MJ STA. 121+45.98, 26.68' LT		INSTALL 5' OF 12" DI WATER MAIN INSTALL 4' OF 6" DI WATER MAIN 12" X 6" TEE, MJ 2 - 12" TRANSITION COUPLINGS STA. 112+05.09, 63.11' RT
105	12" X 8" TEE, MJ STA. 106+05.65, 44.63' LT INV = 808.21	205	INV = 795.75 HYDRANT WITH AUXILIARY VALVE AND BOX INSTALL 47' OF 6'' DI WATER MAIN AND 16	228 ('' X 6'' TEE, MJ	CONNECTION TO EXISTING 16" DI WATER M 16" SLEEVE, MJ 16" 45° BEND, MJ ABANDON EXISTING WATER MAIN TO THE WI	407	2 - 12" TRANSITION COUPLINGS STA. 109+45.18, 60.83' RT RELOCATE FOR ANY WITH AUXILIARY VALVE AND BOX
104	INV = 808.07 12" 45° BEND, MJ STA. 106+01.95, 44.66' LT INV = 808.19	204	CONNECTION TO EXISTING 6" CI FIRE SER 60' OF 6" DI WATER MAIN 6" TRANSITION COUPLING STA. 519+63.47, 79.30" RT	VICE MAIN WITH: 227	16" 45° BEND, MJ STA. 123+02.50, 6.66' LT INV = 718.38	402	RELOCATE HYDRANT WITH AUXILIARY VALVE AND BOX INSTALL 5' OF 12" DI WATER MAIN INSTALL 5' OF 6" DI WATER MAIN 12" X 6" TEE, MJ
103	10V - 801.94 12" 45° BEND, MJ STA. 105+82.84, 25.20' LT INV = 808.07	203	6" GATE VALVE IN VAULT STA. 519+60.02, 25.41" RT INV = 795.74	226	16" CATE VALVE IN VAULT STA. 122+97.50, 6.71' LT INV = 718.48		12" X 6" TEE, MJ 2 - 12" TRANSITION COUPLINGS STA. 106+83.89, 47.33' RT
102	10V - 801.91 12'' 45° BEND, MJ STA. 105+62.84, 25.00' LT INV = 807.94	202	16" X 6" TEE, MJ STA. 519+59.83, 19.65' RT INV = 795.74	225	16" X 12" TEE, MJ STA. 122+18.50, 5.45' LT INV = 718.37	401	RELOCATE HYDRANT WITH AUXILIARY VALVE AND BOX INSTALL 5' OF 12" DI WATER MAIN INSTALL 5' OF 6" DI WATER MAIN
101	INV = 807.84 12" GATE VALVE IN VAULT STA. 105+58.71, 29.08' LT INV = 807.91	201	16" GATE VALVE IN VAULT STA. 519+54.85, 20.02" RT INV = 795.71	224	16" 22.5° BEND, MJ STA. 122+04.18, 3.60' LT INV = 721.79		12" X 12" TEE, MJ INSTALL 74' OF 12" DI WATER MAIN TO THE EAST ABANDON EXISTING WATER MAIN TO THE WEST STA. 106+27.11, 51.35' RT
	ABANDON EXISTING WATER MAIN TO THE EAST STA. 105+47,30, 40.28' LT		STA. 519+49.87, 20.40' RT INV = 795.62		STA. 121+45.34, 11.24′ LT INV = 726.64	400	CONNECTION TO EXISTING 12" DI WATER MAINS TO THE EAST AND SOUTH WITH: 2-12" TRANSITION SLEEVES, MJ


COMPANY NAM
PROJECT CON
CLIENT:
DATE PLOTTEE

HRGreen.com
Illinois Professional Design FI
184-001322

STATE OF ILLINOIS DEPARTMENT OF TRANSPORTATION

SCALE: N.T.S.

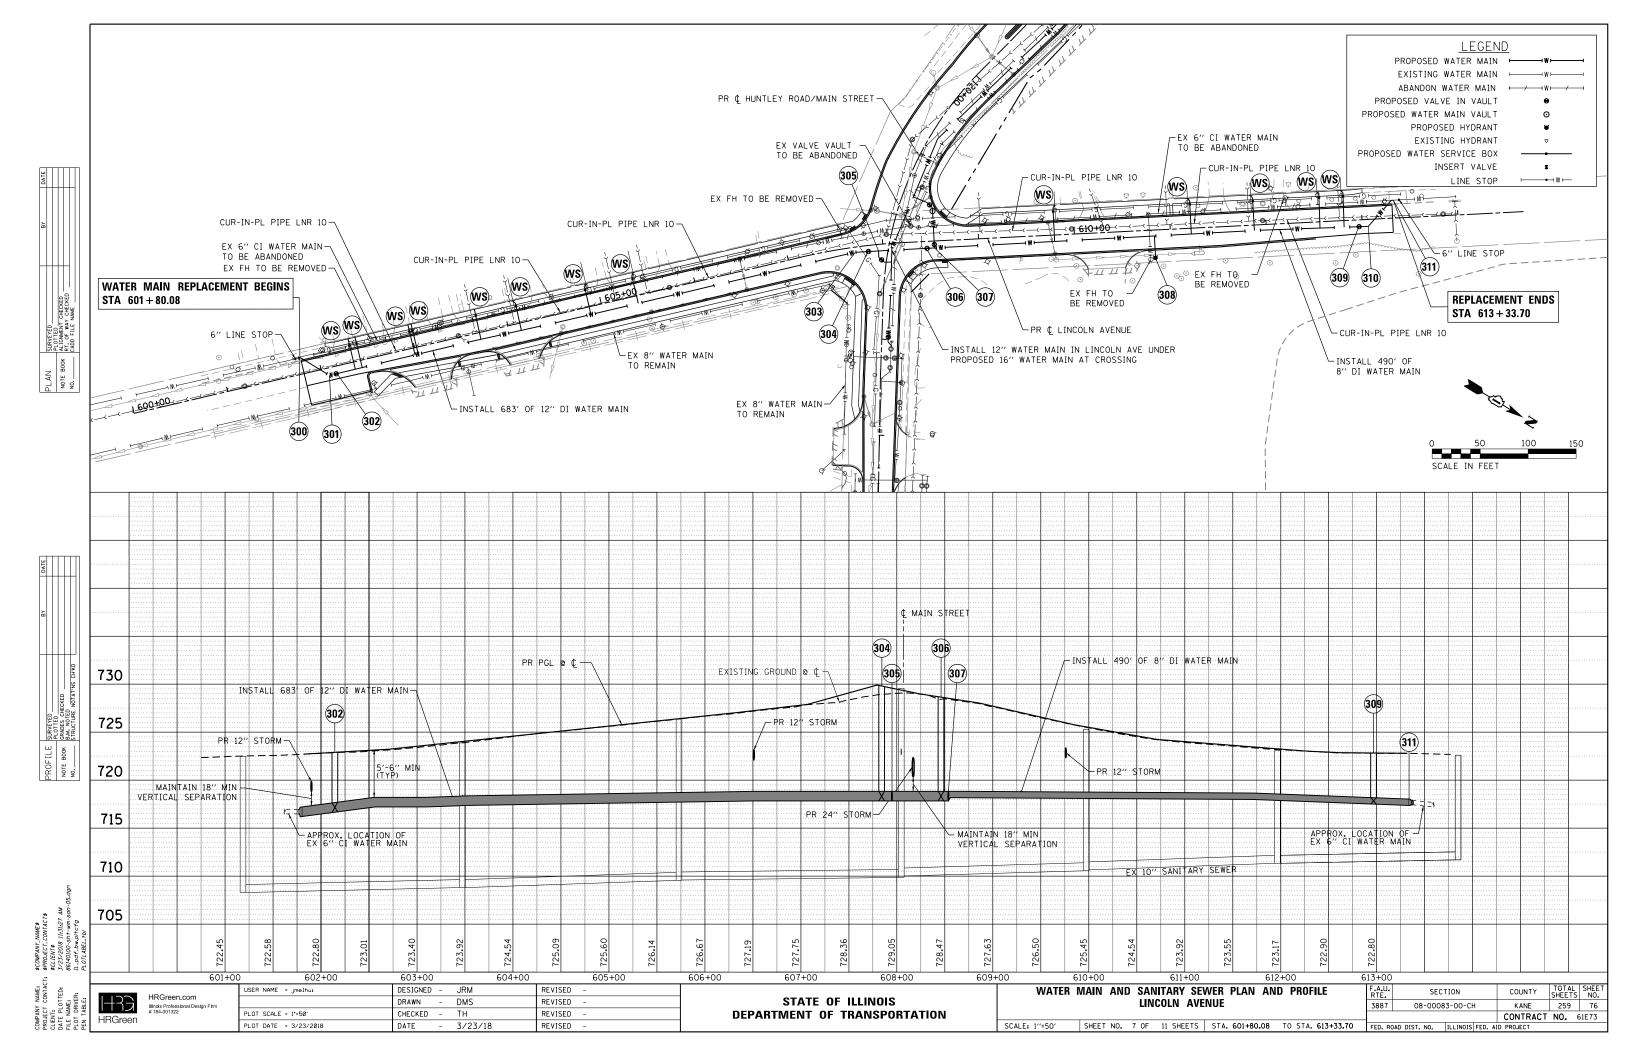		F.A.U. RTE.	SECTION			COUNTY	TOTAL SHEETS	SHEET NO.
WATER MAIN PLAN AND	3887	08-00083-00-CH			KANE	259	77	
						CONTRACT	NO. 61	E73
SHEET NO. 8 OF 11 SHEETS	STA. TO STA.	FED. RO	DAD DIST. NO.	ILLINOIS	FED. Al	D PROJECT	61E73	

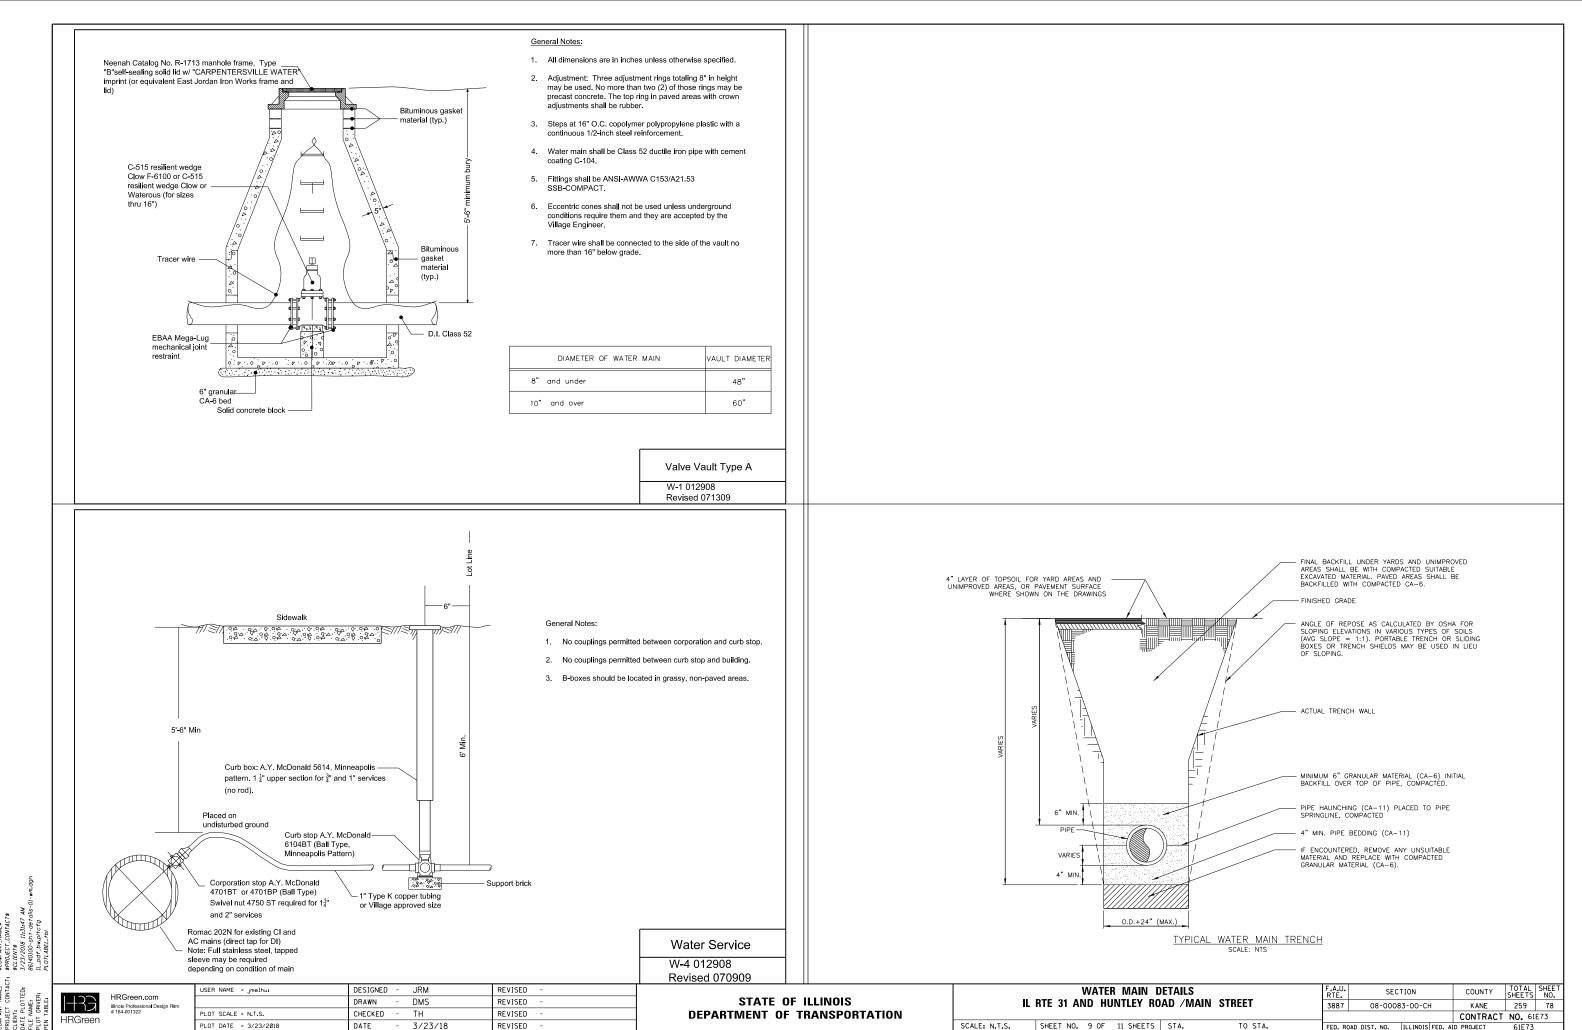


86140100 In Border File 86140100-sht-detalls-01-wm,dgn

WATER AND SEWER SEPARATION REQUIREMENTS DETAIL

EXISTING WATERMAIN BELOW PROPOSED SEWER LINE WITH 18" MINIMUM SEPARATION.


NOTE: CLASS IV MATERIAL TO BE COMPACTED TO 95% OF STANDARD PROCTOR MAXIMUM DENSITY.

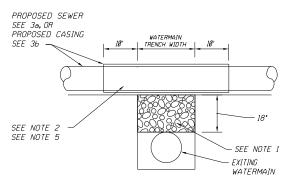


<u>NOTES</u>:


- 1. IF SELECT GRANULAR BACKFILL EXISTS; REMOVE WITHIN WIDTH OF PROPOSED SEWER TRENCH AND REPLACE WITH SELECT EXCAVATED MATERIAL (CLASS IV) AND COMPACT.
- 2. OMIT SELECT GRANULAR CRADLE AND GRANULAR BACKFILL TO ONE (1) FOOT OVER TOP OF PIPE AND USE SELECT EXCAVATED MATERIAL (CLASS IV) AND COMPACT FOR 10 FEET ON EITHER SIDE OF WATER MAIN.
- 3. o. CONSTRUCT 10 FEET OF PROPOSED SEWER WITH WATERMAIN QUALITY PIPE AND PRESSURE TEST, OR;
 b. USE 18 FEET OF CASING FOR PROPOSED SEWER AND SEAL ENDS OF CASING.
- 4. POINT LOADS SHALL NOT BE ALLOWED BETWEEN SEWER OR SEWER CASING
- 5. PROVIDE ADEQUATE SUPPORT FOR EXISTING WATERMAIN TO PREVENT DAMAGE DUE TO SETTLEMENT OF SEWER TRENCH.
 - ▲ TAKEN FROM THE STANDARD SPECIFICATIONS FOR WATER AND SEWER MAIN CONSTRUCTION IN ILLINOIS SEE PAGES 156-159.


PROPOSED WATERMAIN ABOVE EXISTING SEWER LINE WITH 18* MINIMUM SEPARATION.

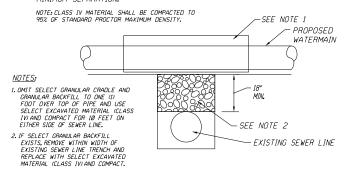


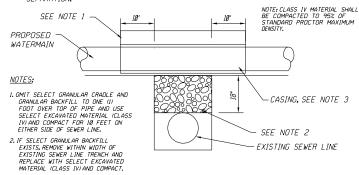

- 3. USE A CASING FOR PROPOSED WATER MAIN AND SEAL ENDS OF CASING.
- 4. POINT LOADS SHALL NOT BE ALLOWED BETWEEN WATER MAIN OR WATERMAIN AND SEWER.

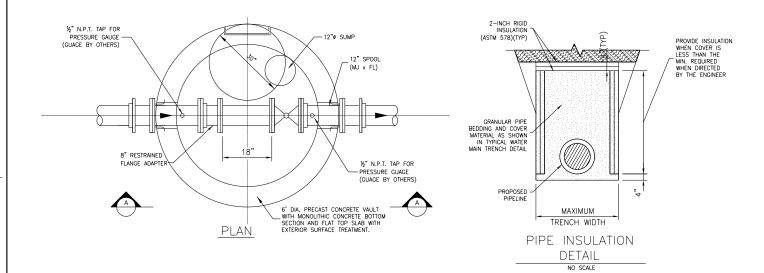

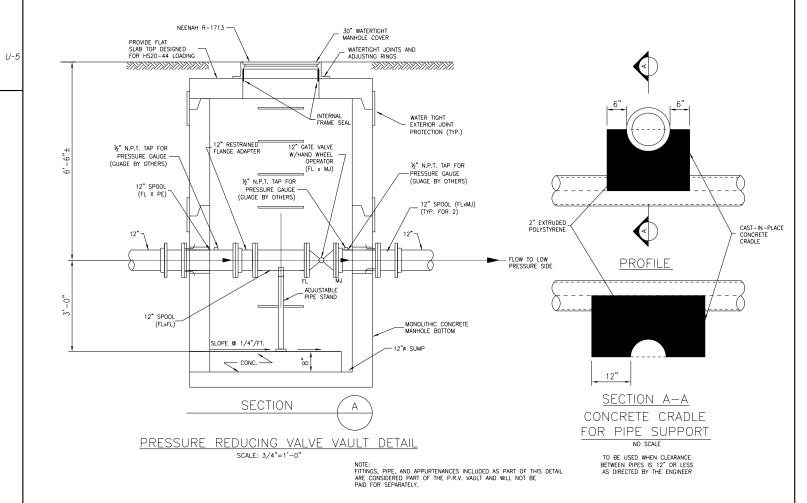

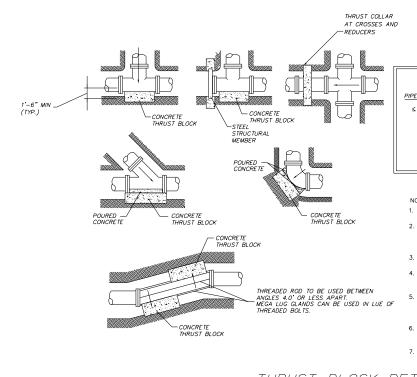

BEARING AREA (SO. FT.)

TEE, PLUG

PIPE DIA. & COLLAR 90° 45° 22.5° 11.25°

≤6° 8 8 5 3 2

8° 14 14 8 4 3

12" 28 28 16 8 4

16" 47 47 28 14 7

BEARING AREA = LENGTH X WIDTH MINIMUM THRUST BLOCK DEPTH = 1'-6"

NOTES:

1. PROVIDE THRUST BLOCKS AT BENDS THAT ARE 11.25° AND GREATER.

- 2. ALL BLOCKING MUST BEAR ON UNDISTURBED EARTH ONLY. IF UNSTABLE SOILS ARE ENCOUNTERED THE CONTRACTOR SHALL PROVIDE SUITABLE BACKFILL AND COMPACT AS APPROVED BY THE ENGINEER.
- 3. CONCRETE SHALL BE 3,000 PSI MINIMUM.
- 4. PROVIDE THRUST BLOCKS AT ALL REQUIRED BENDS AND FITTINGS FOR WATER MAIN PIPE THAT IS 12" DIAMETER AND SMALLER.
- 5. WATER MAIN PIPE THAT IS 16" DIAMETER AND LARGER SHALL BE RESTRAINED JOINT TYPE IN LIEU OF THRUST BLOCKS, EXCEPT WHERE THRUST BLOCKS ARE INDICATED ON THE PLANS.
- PROVIDE THRUST BLOCKS OR OTHER MEANS OF THRUST RESTAINT AS APPROVED BY THE ENGINEER AT ALL TEMPORARY LINE STOPS.
- USE LARGER END DIAMETER FOR THRUST COLLAR BEARING AREA INSTALLED ON REDUCERS. INSTALL COLLAR AT CENTER POINT OF REDUCER.

THRUST BLOCK DETAIL

SCALE: NTS


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Illinois Professional Design Firm
184-001322
HRGreen

USER NAME = Jmelhuı	DESIGNED	-	JRM	REVISED	-
	DRAWN	-	DMS	REVISED	-
PLOT SCALE = N.T.S.	CHECKED	-	TH	REVISED	-
PLOT DATE = 3/23/2018	DATE	-	3/23/18	REVISED	-

STATE OF ILLINOIS
DEPARTMENT OF TRANSPORTATION

SCALE: N.T.S.

B6140100 Fine B6140100-sht-detalls-02-wm,dgr

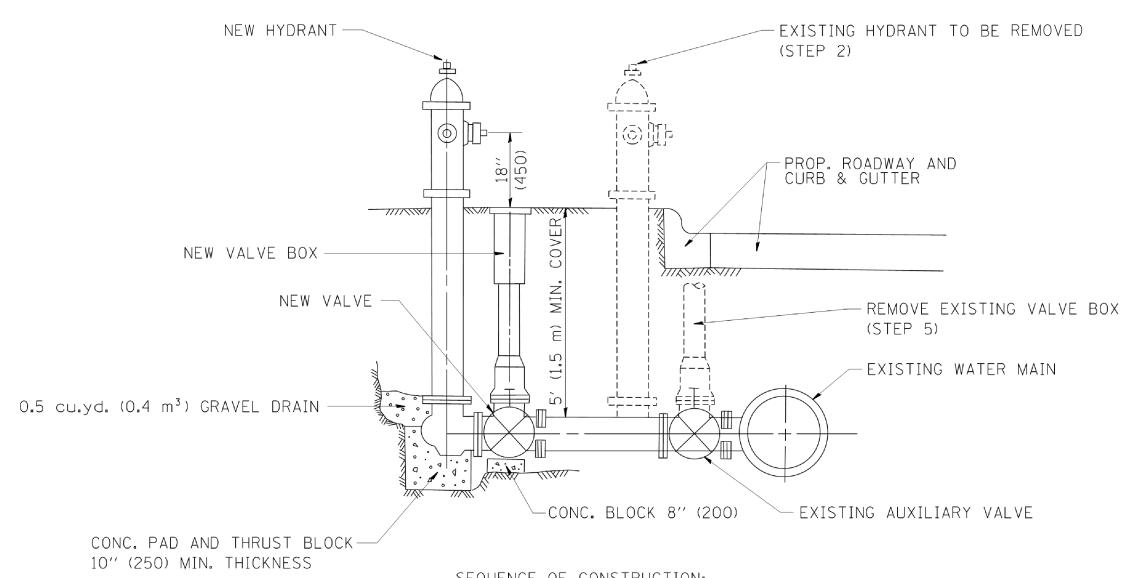

SEQUENCE OF CONSTRUCTION:

- 1. CLOSE EXISTING VALVE.
- 2. REMOVE EXISTING HYDRANT.
- 3. INSTALL HYDRANT EXTENSION AND NEW VALVE.
- 4. INSTALL NEW HYDRANT
- 5. OPEN EXISTING VALVE, REMOVE BOX.
- 6. BACKFILL.
- 7. FLUSH AND TEST FOR CHLORIDE RESIDUAL AND PROVIDE TEST.

ALL WORK TO BE DONE IN ACCORDANCE WITH ARTICLE 564 OF THE STANDARD SPECIFICATIONS. UNLESS OTHERWISE INDICATED.

FIRE HYDRANT TO BE MOVED

ALL DIMENSIONS ARE IN INCHES (MILLIMETERS) UNLESS OTHERWISE SHOWN.

HRGreen.com

USER NAME = jmelhuı DESIGNED - JRM REVISED DRAWN DMS REVISED LOT SCALE = N.T.S. CHECKED TH REVISED PLOT DATE = 3/23/2018 3/23/18 DATE REVISED

STATE OF ILLINOIS **DEPARTMENT OF TRANSPORTATION**

WATER MAIN DETAILS SECTION IL RTE 31 AND HUNTLEY ROAD /MAIN STREET 08-00083-00-CH KANE 3887 CONTRACT NO. 61E73 SHEET NO. 11 OF 11 SHEETS STA. TO STA.

STATE OF ILLINOIS DEPARTMENT OF TRANSPORTATION **DIVISION OF HIGHWAYS**

PLAT OF HIGHWAYS

ROUTE:

F.A.U. 3887 (ILLINOIS ROUTE 31) (WESTERN AVENUE)


AT F.A.U. 1283 (HUNTLEY ROAD) (MAIN STREET)

SECTION: PROJECT: 08-00083-00-CH CMM-8003(999)

JOB NO:

R-91-019-08

KANE COUNTY:

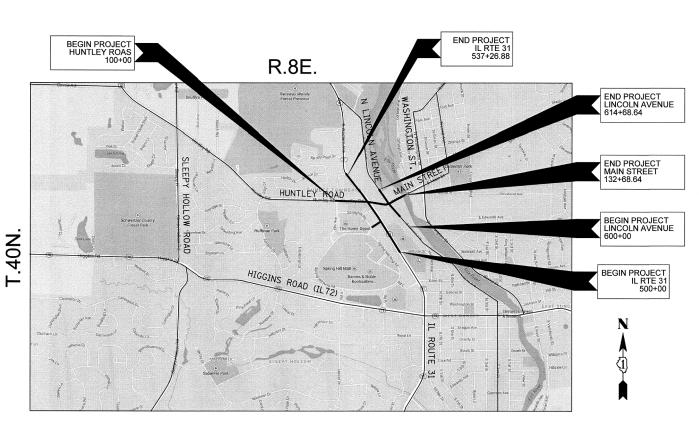

LOCATION MAP VILLAGE OF CARPENTERSVILLE N.T.S.

PROJECT LENGTH

NET LENGTH IL ROUTE 31 = 3,727 FT (0.70 MI)NET LENGTH C.H. 28 = 3,269 FT (0.62 MI)NET LENGTH LINCOLN AVENUE = 1,468 FT (0.28 MI) GROSS LENGTH OF PROJECT = 8,464 FT. (1.60 MI.)

BERNARD J. BAUER (BBAUER@HRGREEN.COM) IL. P.L.S. NO. 3799 LICENSE EXPIRES: 11/30/16 HR GREEN, INC.

STATE OF ILLINOIS
DEPARTMENT OF TRANSPORTATION F.A.U. ROUTE 3887(ILLINOIS ROUTE 31) (WESTERN AVENUE) AT F.A.U. 1283 (HUNTLEY ROAD) (MAIN STREET) SECTION: 08-00083-00-CH PROJECT: CMM-8003(999)

SCALE: N/A

HRGreen

COUNTY: KANE STATION: N/A

PLAT OF HIGHWAYS

651 Prairie Pointe Drive, Suite 201 Yorkville, Illinois 60560 t. 630.553.7560 f. 630.553.7646

BUREAU OF LAND ACQUISITION TOTAL SHEETS NO. 201 WEST CENTER COURT

LOCATION OF SECTION INDICATED THUS: -

NOTE: SHEET 1 IS A COVER SHEET AND IS NOT RECORDED

SCHAUMBURG. ILLINOIS 60196

CONFORM TO STANDARD SCALES. IN MAKING MEASUREMENTS ON REDUCED PLANS. THE ABOVE SCALES MAY BE USED ROUTE: F.A.U. ROUTE 3887 (ILLINOIS ROUTE 31)

DRAWN BY: BJB

ENGINEERING SCALES, REDUCED SIZED PLANS WILL NOT

JOINT UTILITY LOCATING INFORMATION FOR EXCAVATION

AGENCY RESPONSIBLE FOR LETTING

PASSED

REVIEW

J.U.L.I.E.

1-800-892-0123

RELEASING FOR BID BASED ON LIMITED

VILLAGE OF CARPENTERSVILLE ENGINEER

DISTRICT 1 ENGINEER OF LOCAL ROADS & STREETS

DEPUTY DIRECTOR OF HIGHWAYS, REGION 1 ENGINEER

SECTION: 08-00083-00-CH

JOB NO.: R-91-019-08

PLANS HAVE BEEN PREPARED USING STANDARD

REVISION: #2 DATE: 02/13/15 BY: BJB

KANE COUNTY

RECORDING: RECORDED ON: _____ AS DOCUMENT NO.: _____

				DART OF THE NORTHWEST 1/4 OF SECTION 22, AND THE NORTHEAST 1/4 OF	<u>CURVE: HUNTLEY-1</u> L = 233.59'	<u>CURVE: HUNTLEY-2</u> L = 132.01'	<u>CURVE: HUNTLEY-3</u> L = 261.18'
PARCEL NUMBER	OWNER	SHEET NO.	ACQUIRED BY:	PART OF THE NORTHWEST 1/4 OF SECTION 22, AND THE NORTHEAST 1/4 OF SECTION 21, TOWNSHIP 42 NORTH, RANGE 8 EAST OF THE THIRD PRINCIPAL	R = 1,700.00' CB = S85*33'00"E CH = 233.41'	R = 1,500.00' CB = S79°05*32"E CH = 131.97'	R = 350.00' CB = N82'03'04''E CH = 255.16'
1LR0001 1LR0001TE	PARAS, INC., AN ILLINOIS CORPORATION	9		MERIDIAN, IN KANE COUNTY, ILLINOIS.	T = 116.98' Δ = 07*52'22"(RT) P.C. STA. = 114+10.07	T = 66.05' $\Delta = 05'02'33"(RT)$ P.C. STA. = 118+23.52	T = 137.01' $\Delta = 42^{4}5'21"(LT)$ P.C. STA. = 119+93.67
1LR0002 1LR0002TE	SPRING HILL MALL, L.L.C., A DELAWARE LIMITED LIABILITY COMPANY	9		© (17) STA: 537+26.88	P.I. STA. = 115+27.05 P.T. STA. = 116+43.66 <u>CURVE: ROUTE 31-1</u> L = 1,513.28'	P.I. STA. = 118+89.57 P.T. STA. = 119+55.53 CURVE: ROUTE 31-2 L = 375.37' R = 560.00'	P.I. STA. = 121+30.68 P.T. STA. = 122+54.85 CURVE: LINCOLN L = 108.32' R = 600.00'
1LR0003 1LR0003TE	ALDI., INC, AN ILLINOIS CORPORATION	10			R = 13,000.00' CB = N3511'30"W CH = 1,512.43'	R = 560.00 CB = N1979'25"W CH = 368.38'	CB = N39°21'27"W CH = 108.17'
1LR0004 1LR0004TE	BHD PROPERTIES, LLC, A SOUTH CAROLINA LIMITED LIABILITY COMPANY	11			T = 757.50' $\Delta = 06'40'10''(LT)$	T = 195.04' $\Delta = 38^{\circ}24'21''(RT)$	T = 54.31' $\Delta = 10'20'37''(RT)$
1LR0005 1LR0005TE	PROPERTY DYNAMICS, LLC XXII	12		833 + 4 + 1 + 1 + 1 + 1 + 1 + 1 + 1 + 1 + 1	P.C. STA. = 510+64.54 P.I. STA. = 518+22.04 P.T. STA. = 525+77.82	P.C. STA. = 529+21.75 P.I. STA. = 531+16.80 P.T. STA. = 532+97.12	P.C. STA. = 607+18.14 P.I. STA. = 607+72.45 P.T. STA. = 608+26.46
1LR0006 1LR0006TE	VANITY PROPERTIES, LLC	12					
1LR0007 1LR0007TE	TRIPLE C PROPERTIES LLC, AN ILLINOIS LIMITED LIABILITY COMPANY	11		P.T. ROUTE 31-2-			
1LR0008 1LR0008TE	CHARTER NATIONAL BANK AND TRUST, AS TRUSTEE UNDER THE PROVISIONS OF A TRUST AGREEMENT DATED SEPTEMBER 17, 1996, AND KNOWN AS TRUST NUMBER 1669	12		-CURVE: ROUTE 31-2			
1LR0009 1LR0009TE	JBL ENTERPRISES, LLC	12		-11R0023			
1LR0010 1LR0010TE	ARC CHCARIL001, LLC, A DELAWARE LIMITED LIABILITY COMPANY	5		N38'31'35"W			
1LR0011 1LR0011TE	CHICAGO TITLE LAND TRUST COMPANY AS TRUSTEE UNDER TRUST AGREEMENT DATED MARCH 15, 1999 KNOWN AS TRUST NC. 1106967	4 AND 5		P.C. ROUTE 31-2 P.T. ROUTE 31-1 P.T. ROUTE 31-1 [ÎRO022] P.T. ROUTE 31-1 [ÎRO022] P.T. ROUTE 31-1 [ÎRO020] [ÎRO020] [ÎRO020] [ÎRO020] [ÎRO020]			
1LR0012 1LR0012TE	PARKWAY BANK AND TRUST COMPANY F/K/A PARKWAY BANK OF ILLINIOS ASTO PARCEL 1 AND CHICAGO DEFERED EXCHANGE CORPORATION AS TO PARCEL 2	6		<u>ILRO035 </u> <u>ILRO034 </u>			
1LR0013 1LR0013TE	WEST MAIN MANAGEMENT, LLC DAVID A. KATHREIN AND GINA M. KATHREIN, HIS	6		ULRO033	(10)		
1LR0014 1LR0014TE	WIFE, AS JOINT TENANTS STEVEN C. PAGE AND HELEN T. PAGE, AS JOINT	6		TLROOJSTE TUROOISTE	-END STA: 132+68.64		
1LR0015TE	TENANTS	13		ILRO030TE TURO013 CURVE: HUNTLEY-3 TURO013 TURO013 CURVE: HUNTLEY-3 CURVE: HUNTLEY-3 TURO013 CURVE: HUNTLEY-3 CURVE: HUNTLEY-			
1LR0016TE 1LR0017	ASSOCIATED BANK, NATIONAL ASSOCIATION STEPHEN J. COSTELLO, A SINGLE PERSON	13	-	1LR0028TE 38.14'			
1LR0017TE 1LR0018TE-A	GLEN R. REDEKER AND ELIZABETH A. REDEKER,		1	TLROOZETE CURVE: HUNTLEY-2			
1LR0018TE-B 1LR0019	HUSBAND AND WIFE, IN JOINT TENANCY THOMAS J. THOMAS AND RITA J. THOMAS, AS	14		100+00 105+00 105+00 105+00 100+000+0			
1LR0019TE	JOINT TENNANTS BLAKE A. ANDERSON, RICK A. ANDERSON AND	13		S89'29'11"E 1410.07' HUNTLEY ROAD			
1LR0020 1LR0020TE	BLANCA NILSA ANDERSON, HUSBAND AND WIFE, AS JOINT TENNANTS	13		BEGIN STA: 100+00			
1LR0021 1LR0021TE	DOOMIS BUILDERS, LLC, AN ILLINOIS LIMITED LIABILITY COMPANY	13		CURVE: ROUTE 31-1-/ X P.C. HUNTLEY-3 P.C. LINCOLN			
1LR0022 1LR0022TE	JAMES R. KRENZ	16		11LR00101-			
1LR0023 1LR0023TE	CHICAGO TITLE LAND TRUST COMPANY AS SUCCESSOR TO NORTHSTAR TRUST COMPANY SUCCESSOR TO PARK NATIONAL BANK SUCCESSOR CARDUNAL SAVINGS BANK FSB AS TRUSTEE UNDER TRUST AGREEMENT DATED APRIL 23, 2002 KNOWN AS TRUST NO. 98-306	15		P.C. HUNTLEY-2- TIROOO5 TIROOO5 TIROOO5 TIROOO5 TIROOO5		N A	
1LR0024TE	ROGELIO REALZOLA AND SILVIA L. REALZOLA, HUSBAND AND WIFE, IN JOINT TENANCY	15				Ÿ	
1LR0025TE	DOUGLAS W. WESTHOVEN AND PATRICIA E. WESTHOVEN, IN JOINT TENANCY	15		P.C. ROUTE 31-1 % 25.		I	
1LR0026TE	GERALD L. SHOOP AND ELSIE I. SHOOP, AS TRUSTEES OF THE GERALD L. AND ELSIE I. SHOOP TRUST #1 DATED DECEMBER 11, 1992	3				200 0 50	100 200
1LR0027 1LR0027TE	SPRING HILL MALL L.L.C., A DELAWARE LIMITED LIABILITY COMPANY	4				(IN FEET)	2004
1LR0028TE	FRANK R. WALAITIS STEPHEN W. DALLESKA AND MARYANN F.	3		[LROOO2]		SCALE: 1" =	200'
1LR0029TE	DALLESKA, HUSBAND AND WIFE, AS TENANTS BY THE ENTIRETY	3			NOTE: SHEET 1	IS A COVER SHEET AND IS	
1LR0030TE	RYNE D. SHEARER, A MARRIED MAN	3					nal Design Firm # 184-001322 e Drive, Suite 201,
1LR0031TE 1LR0032	58 KIMBALL PARTNERSHIP ALLEN N. DRAUGELIS JR. AND NANCY T.	3				Yorkville, Illinois t. 630.553.7560 t	60560
1LR0032TE 1LR0033	DRAUGELIS, HIS WIFE , IN JOINT TENANCY RONALD G. BOCKENHAUER AND DAWN M	3	 		HRGr	www.hrareen.com	
1LR0033TE 1LR0034	BOCKENHAUER, HIS WIFE, IN JOINT TENANCY DHIRENKUMAR PATEL	3	+	[][RO00]	111101	0011	
1LR0034TE 1LR0035 1LR0035TE	QUIKX ONE CONVENIENCE STORE, INC	3	+			PLAT OF HI	GHWAYS
1LR0036 1LR0036TE	EVELYN FRYER, AS TRUSTEE UNDER THE PROVISIONS OF TRUST AGREEMENT DATED JULY 20, 2000, AND KNOWN AS THE EVELYN FRYER DECLARATION OF TRUST	7		BEGIN STA: 500+00		STATE OF ILL DEPARTMENT OF TRAI E 3887(ILLINOIS ROUTE	INOIS NSPORTATION E 31) (WESTERN AVENUE)
1LR0037	OTTO ENGINEERING, INC., AN ILLINOIS CORPORATION	7				283 (HUNTLEY ROAD) (M 8-00083-00-CH	AIN STREET) DUNTY: KANE
1LR0038 1LR0038TE	10 WEST MAIN, LLC, A LIMITED LIABILITY COMPANY	8			PROJECT: C	MM-8003(999) Jo	OB NO.: R-91-019-08
1LR0039 1LR0039TE-A 1LR0039TE-B 1LR0039TE-C	SOUTH MAIN, LLC, A LIMITED LIABILITY COMPANY	8 AND 17			STATION: N SCALE: 1" =	: 200′	SHEET: 2 OF 21
L				REVISION: *2 DATE: 02/13/15	BY: BJB	BUREAU OF LAND A 201 WEST CENTE SCHAUMBURG, ILLIN	


86140100 In Border File 86140100-sht-parcel.dgn ROUTE: F.A.U. ROUTE 3887 (ILLINOIS ROUTE 31)


SECTION: 08-00083-00-CH


KANE COUNTY


JOB NO.: R-91-019-08


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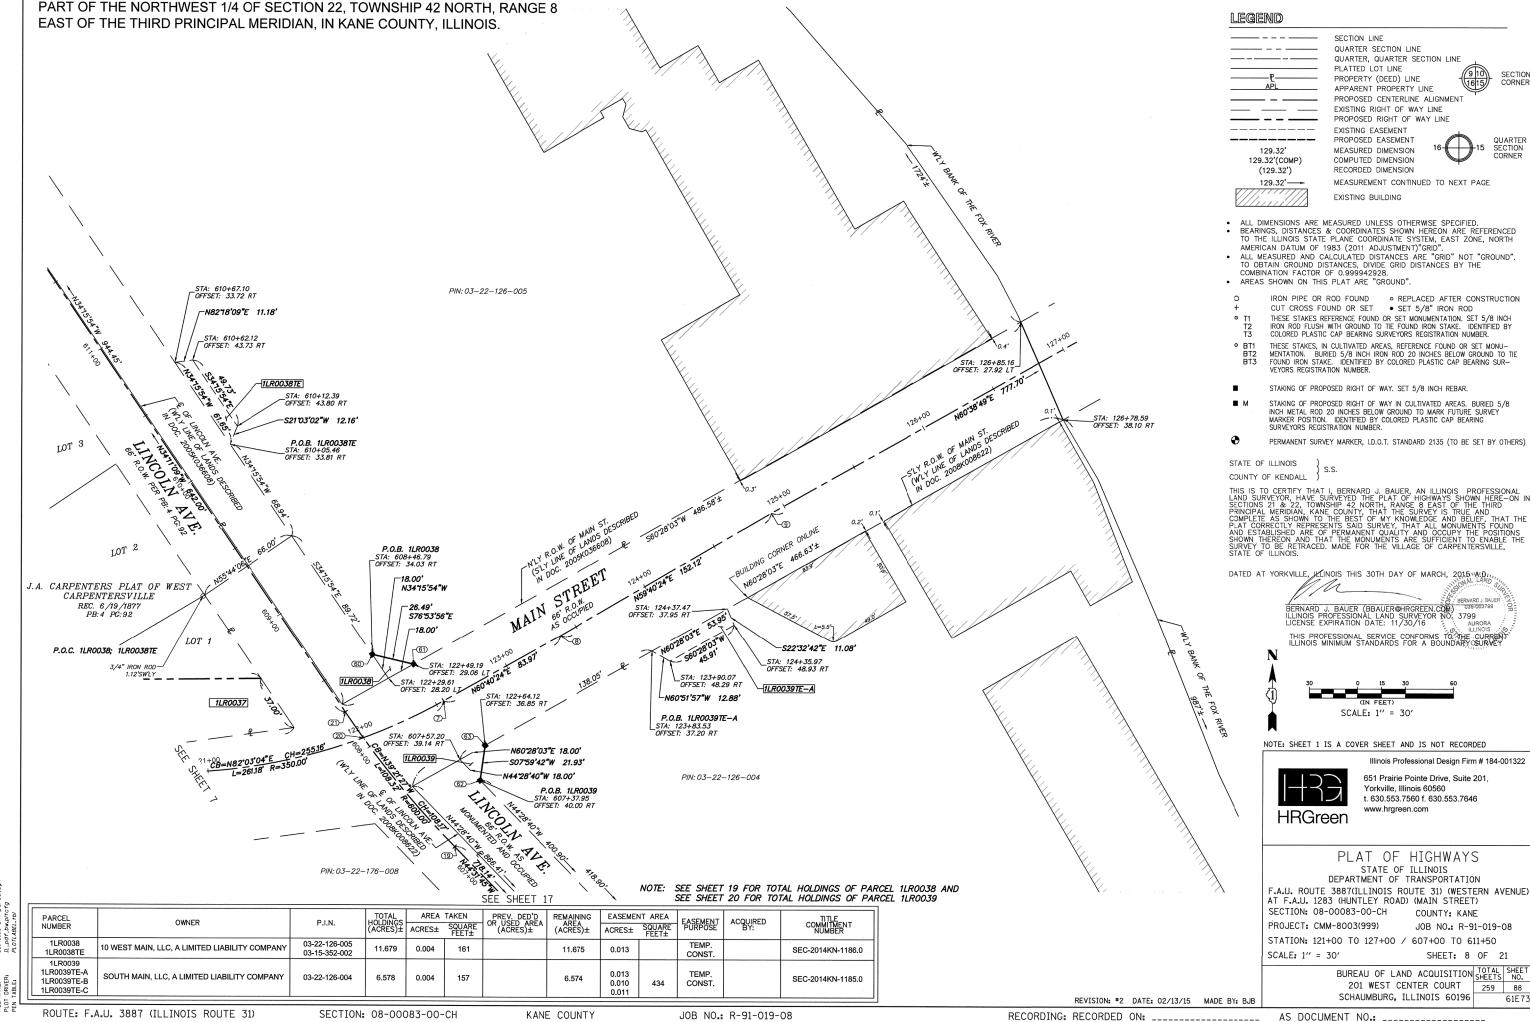
ROUTE: F.A.U. 3887 (ILLINOIS ROUTE 31)

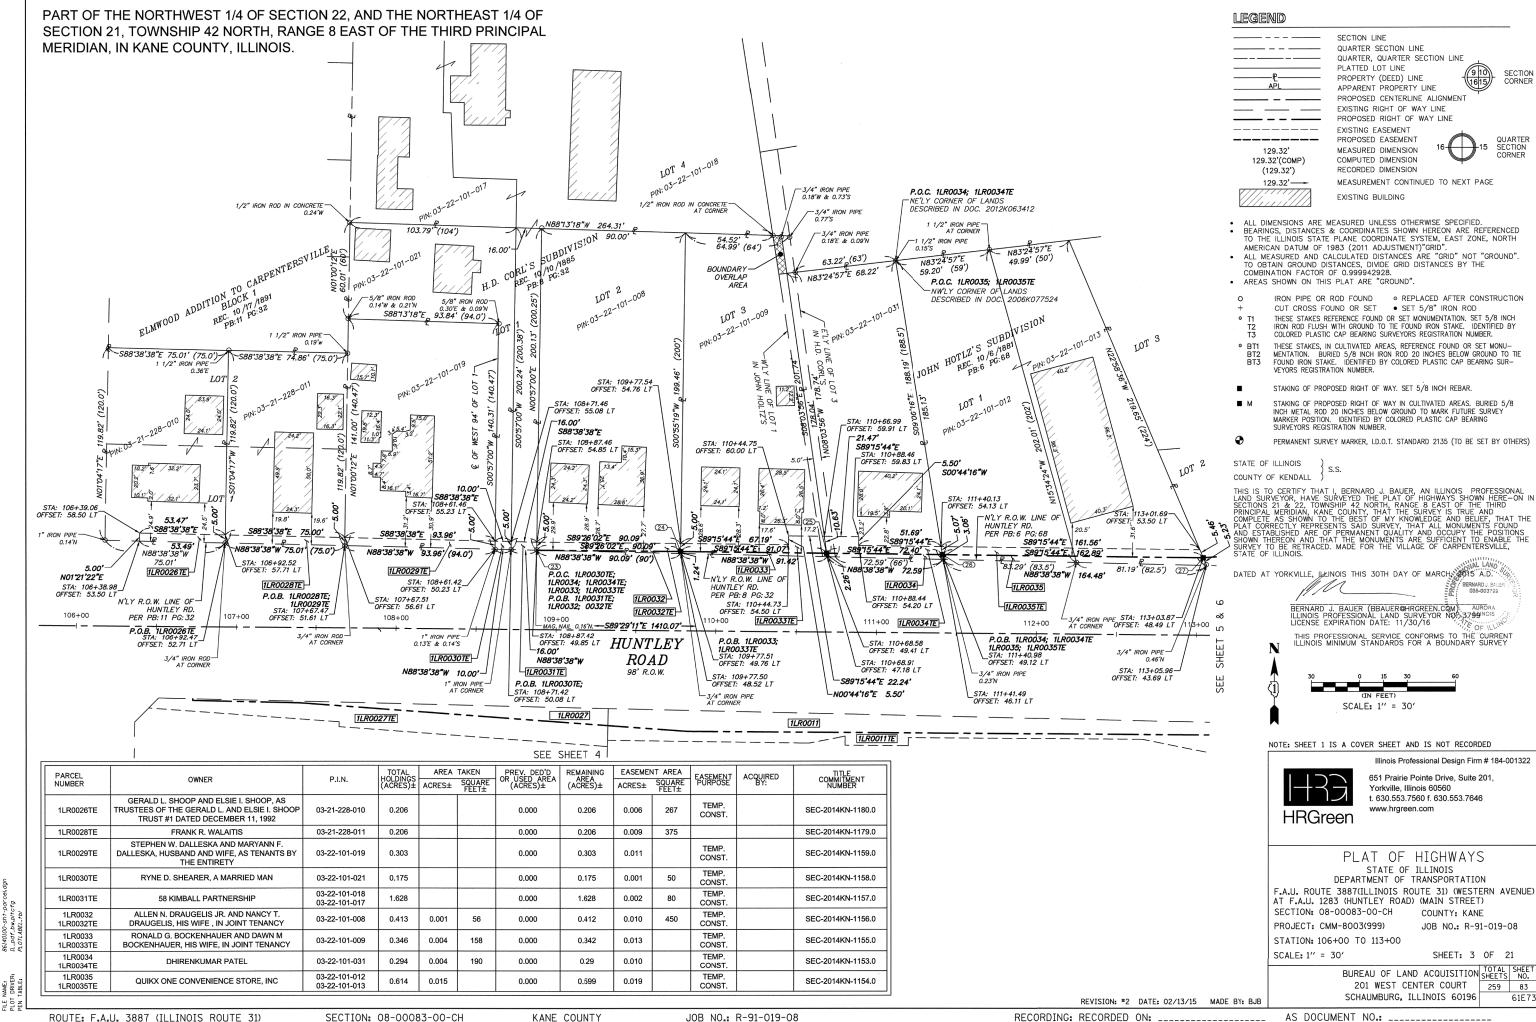SECTION: 08-00083-00-CH

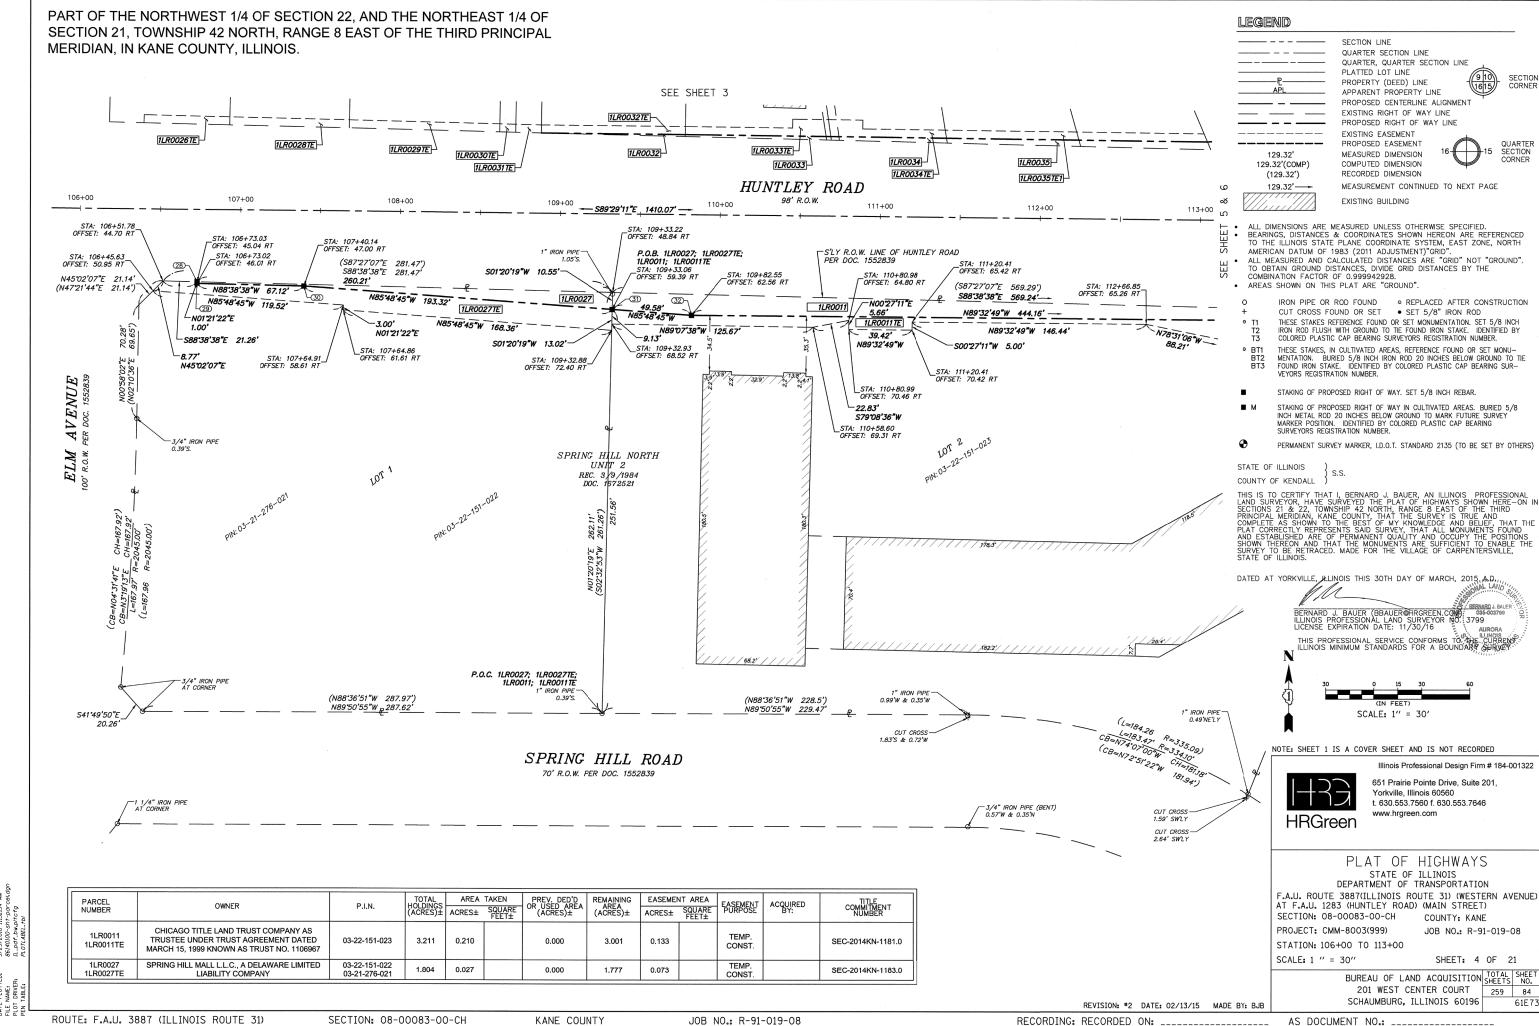KANE COUNTY

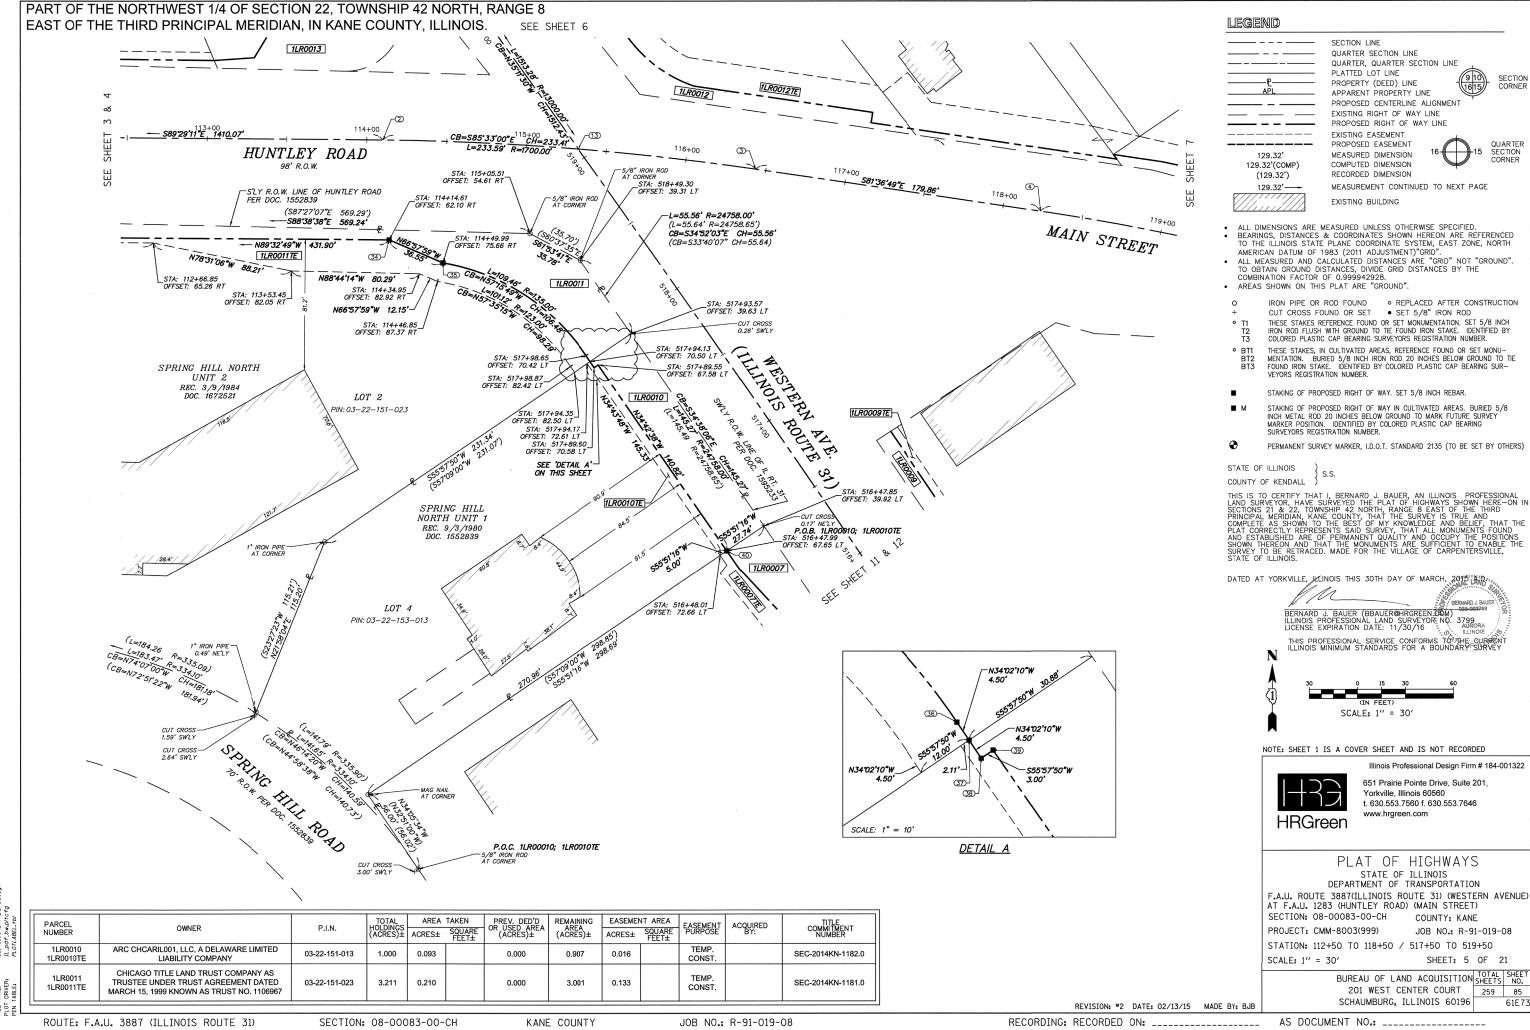JOB NO.: R-91-019-08

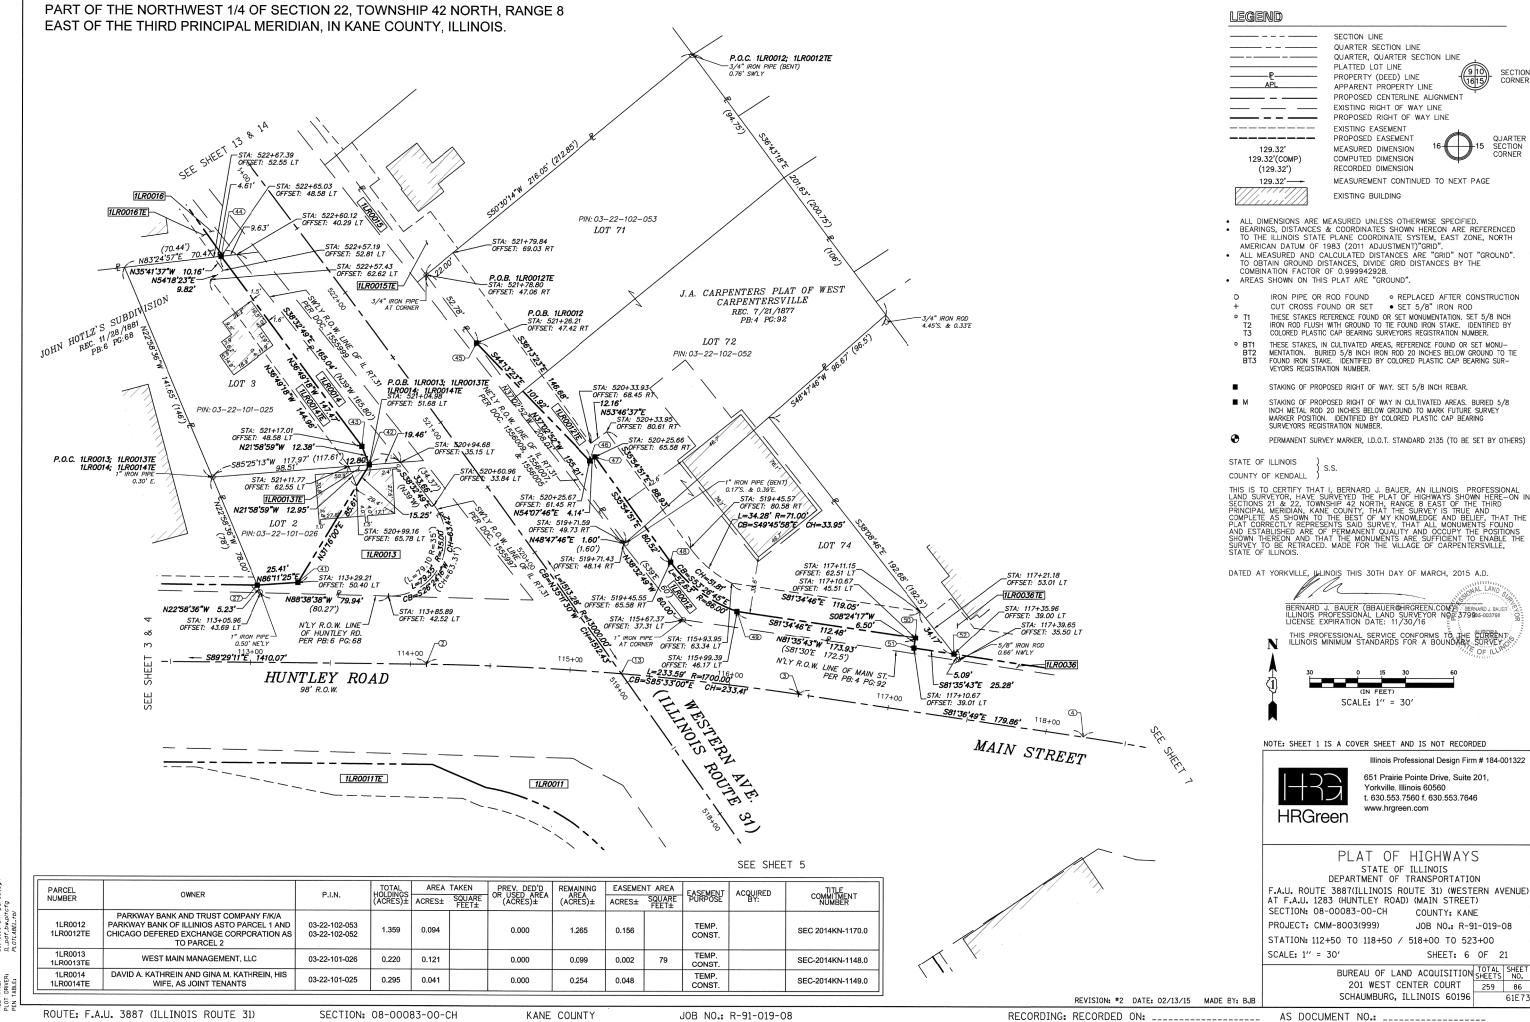
RECORDING: RECORDED ON: _____ AS DOCUMENT NO.: _____

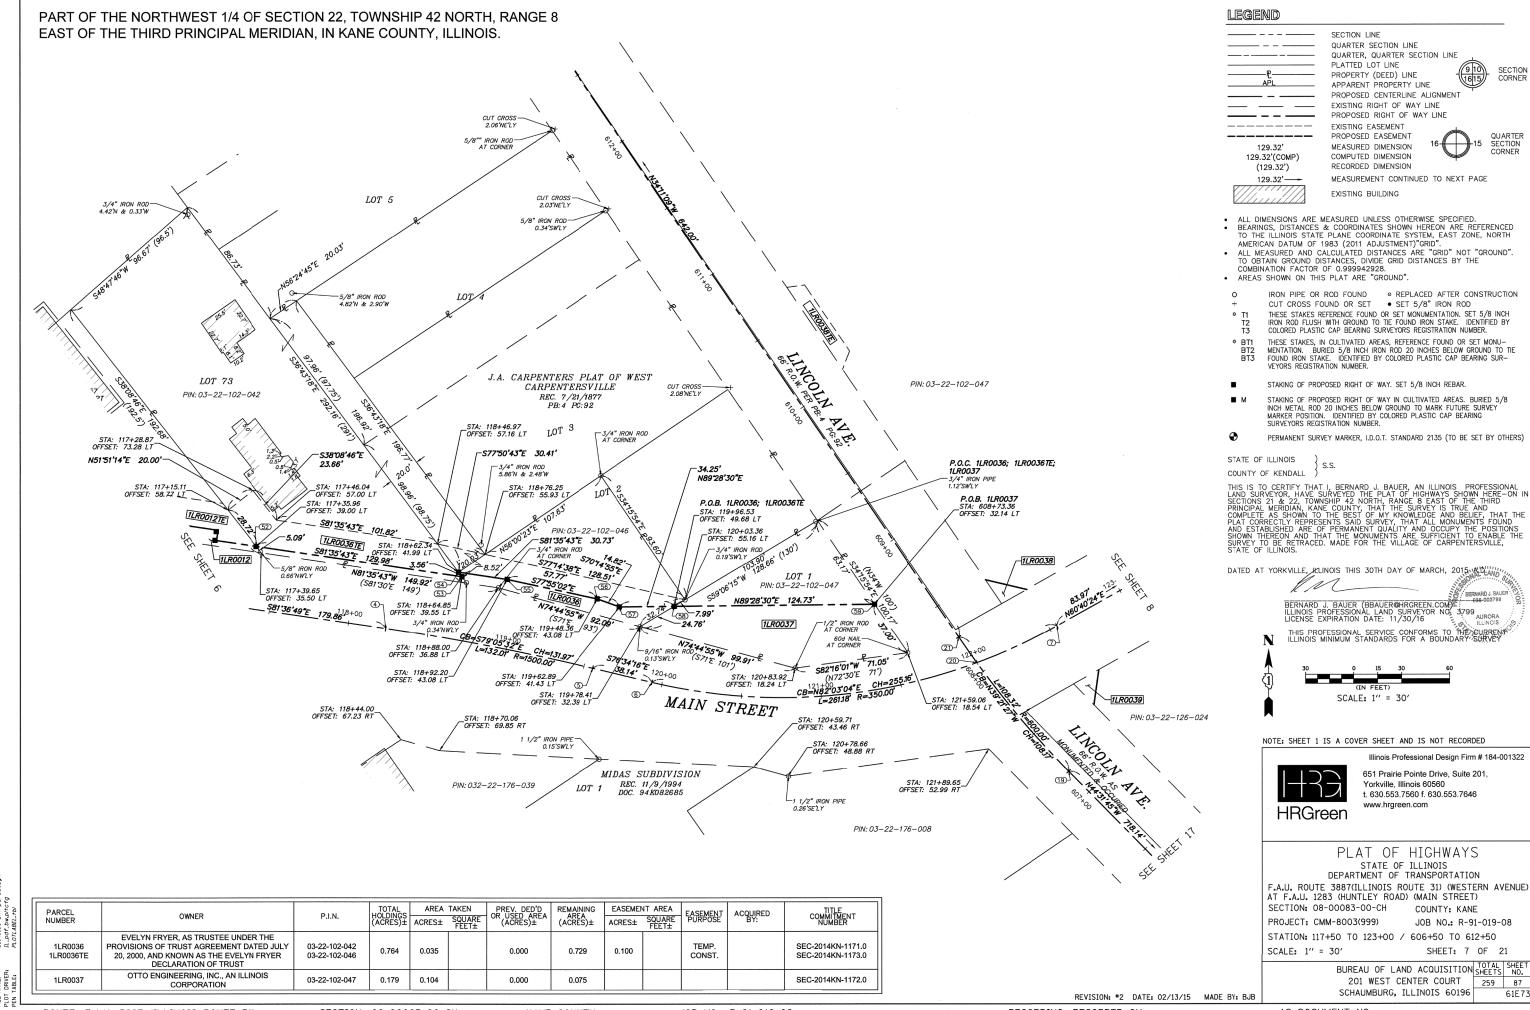


ROUTE: F.A.U. 3887 (ILLINOIS ROUTE 31)

SECTION: 08-00083-00-CH

KANE COUNTY

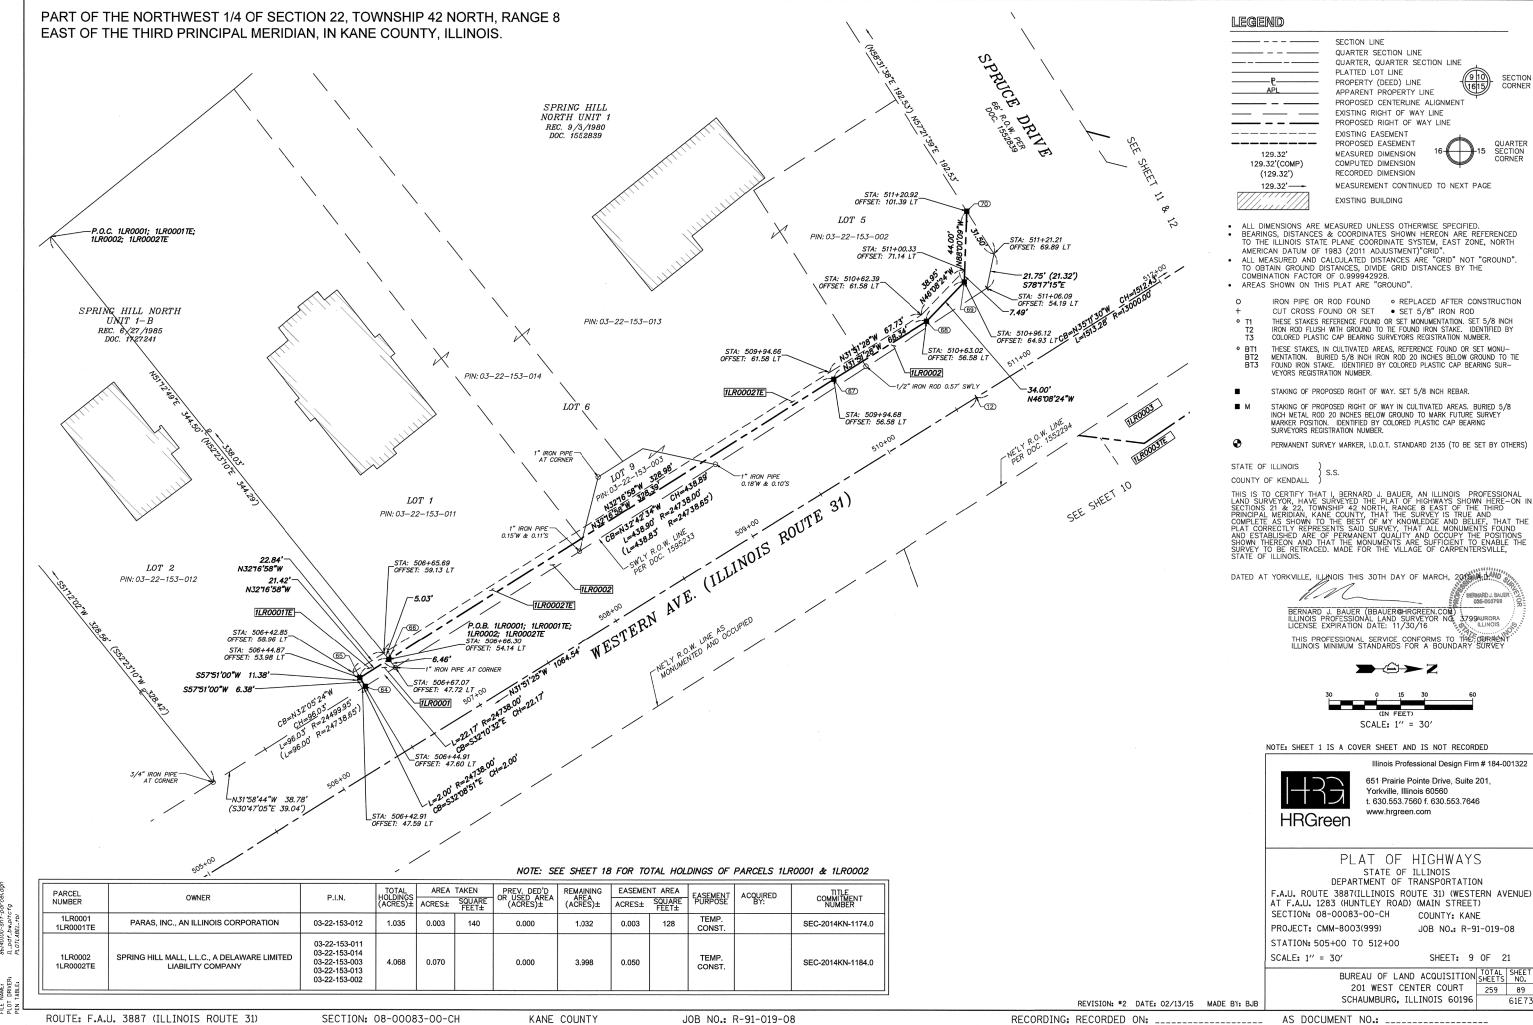


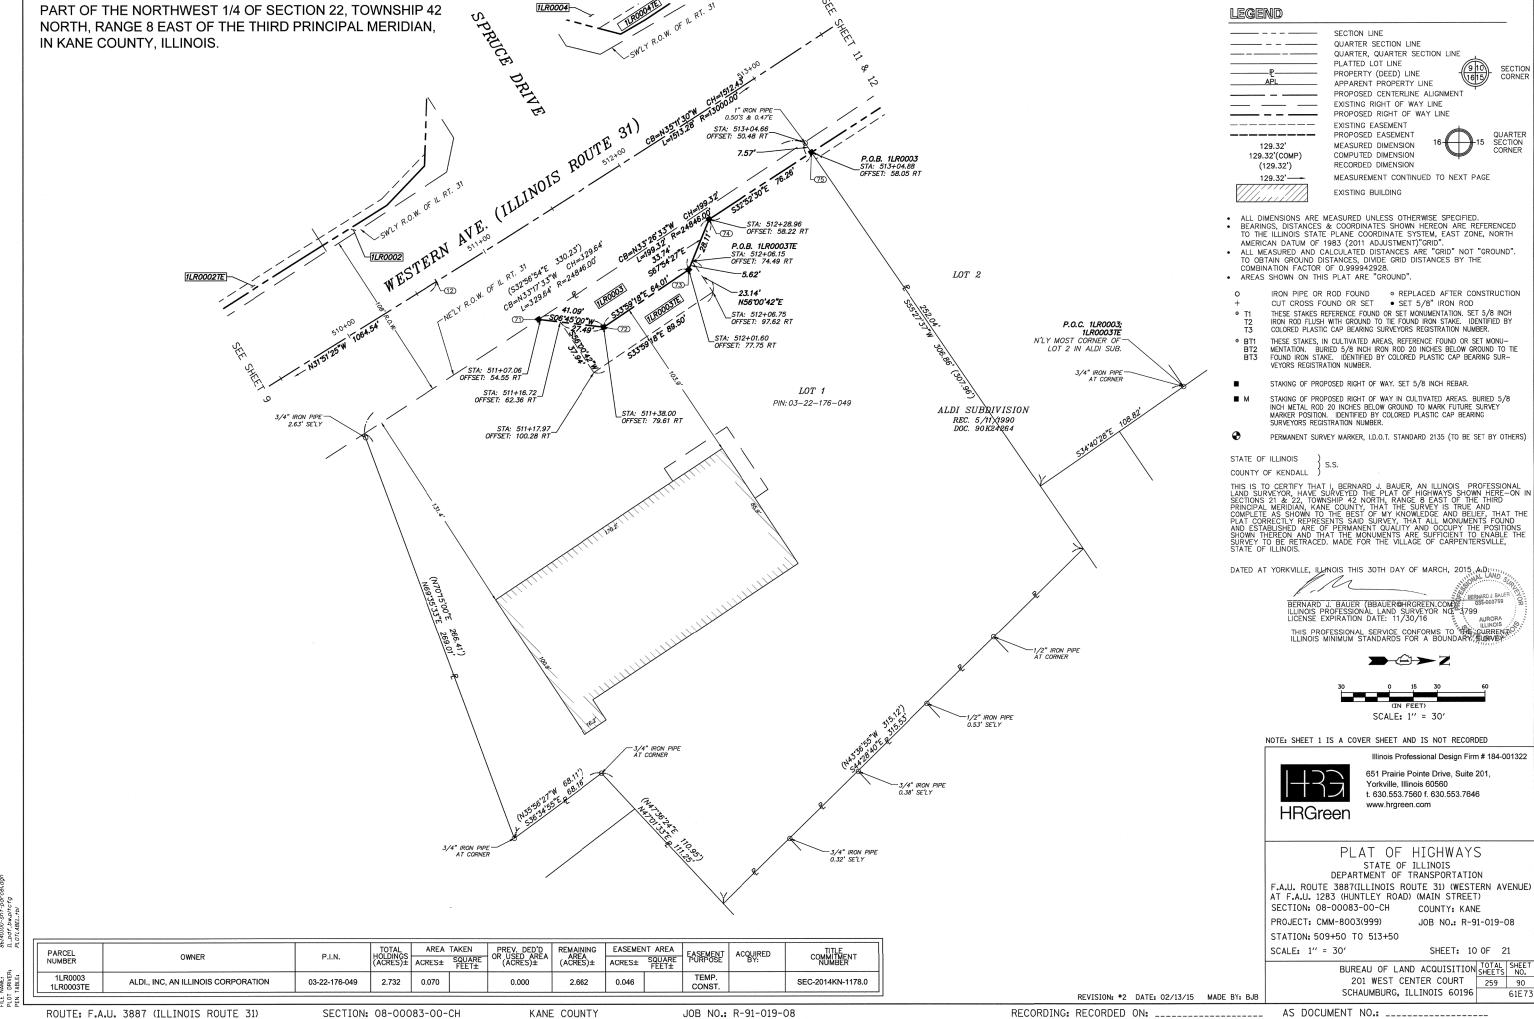


ROUTE: F.A.U. 3887 (ILLINOIS ROUTE 31)

SECTION: 08-00083-00-CH

KANE COUNTY

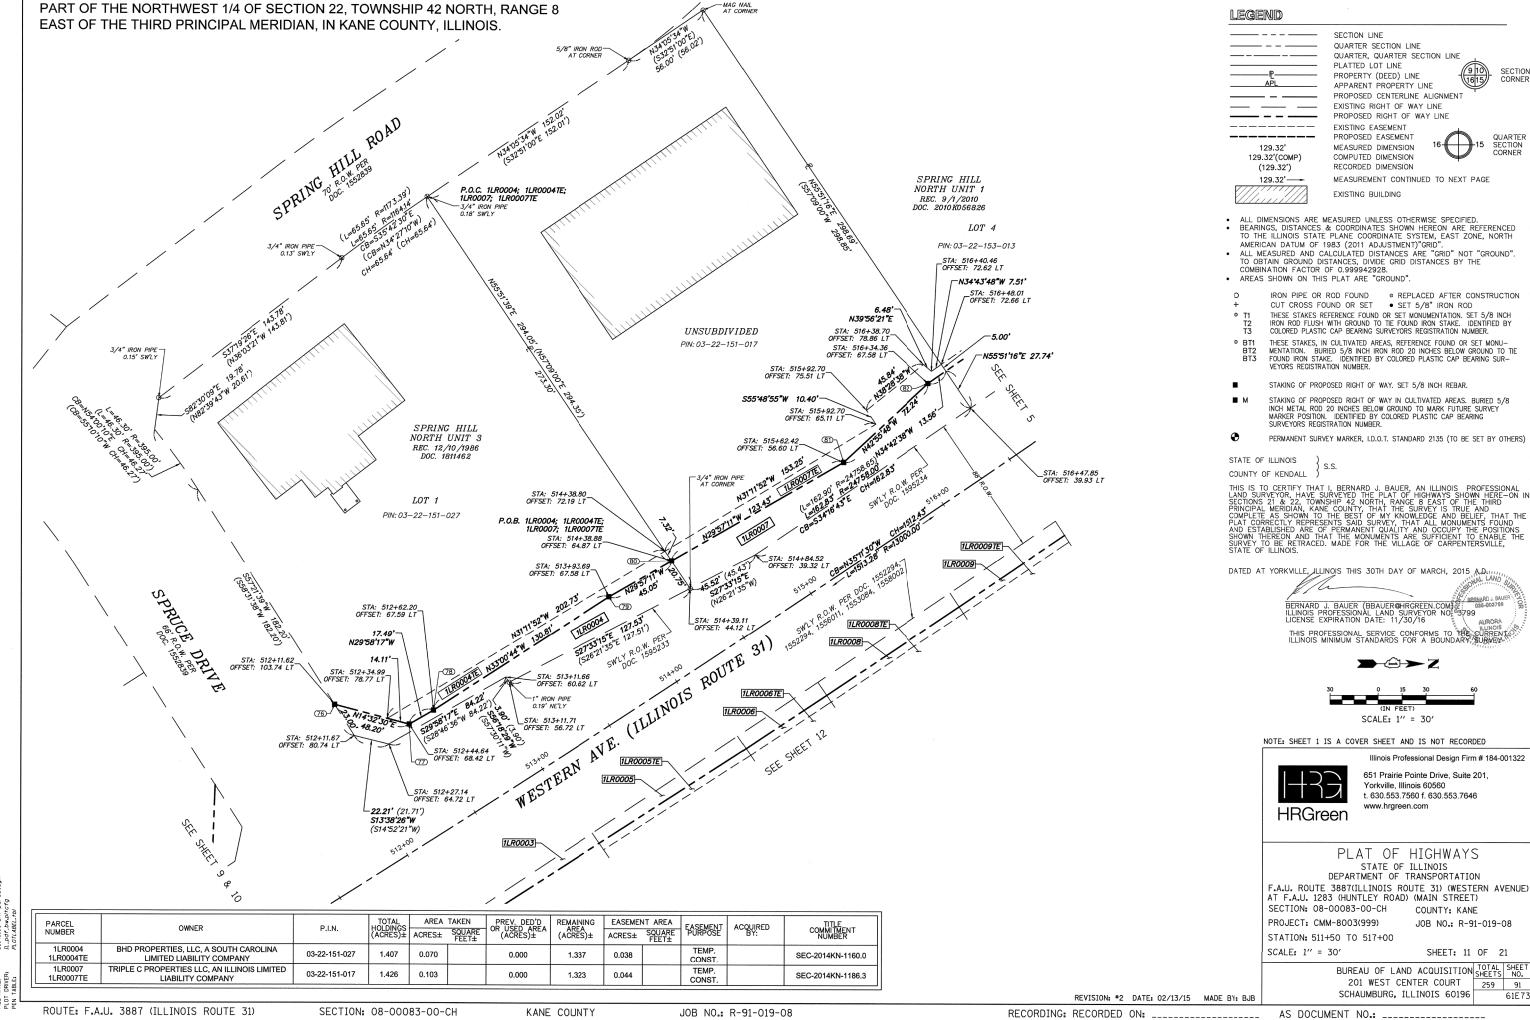

KANE COUNTY

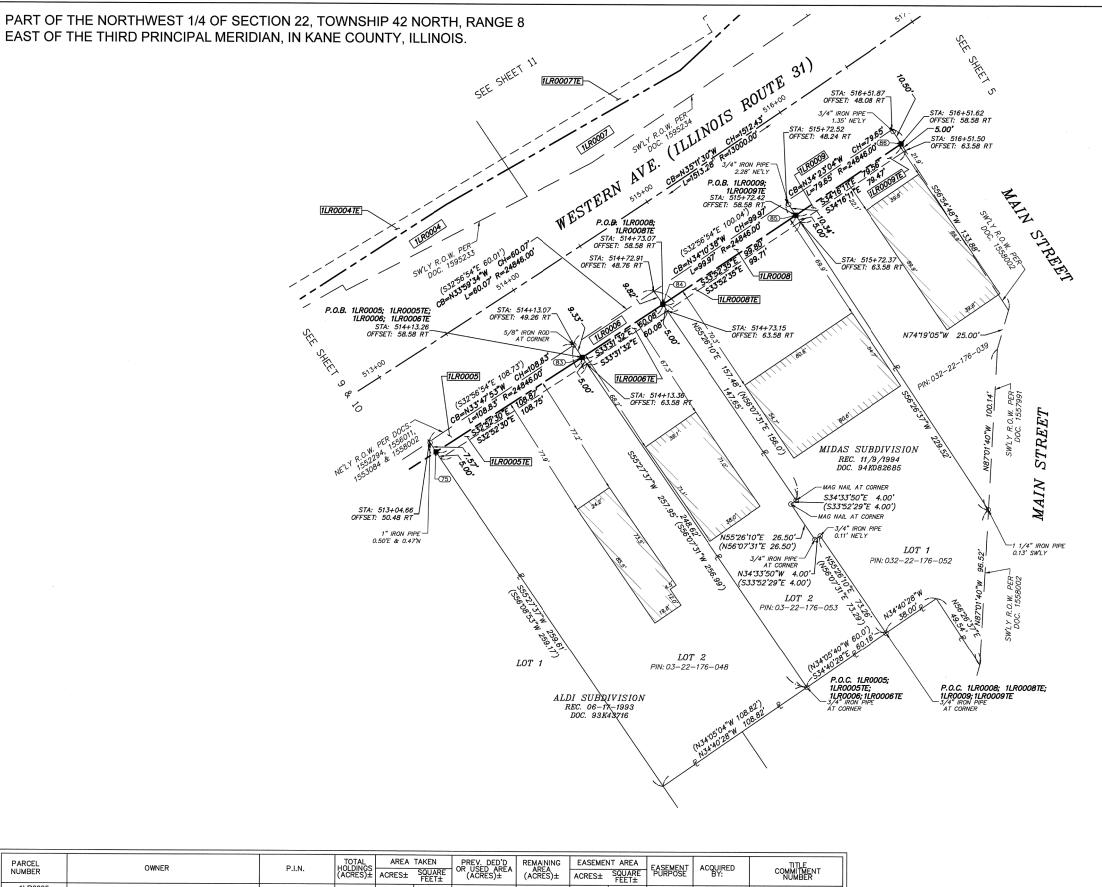

PARCEL NUMBER	OWNER	P.I.N.	TOTAL HOLDINGS (ACRES)±	AREA ACRES±	TAKEN SQUARE FEET±	PREV. DED'D OR USED AREA (ACRES)±	REMAINING AREA (ACRES)±	EASEMEN ACRES±	NT AREA SQUARE FEET±	EASEMENT PURPOSE	ACQUIRED BY:	TITLE COMMITMENT NUMBER
1LR0005 1LR0005TE	PROPERTY DYNAMICS, LLC XXII	03-22-176-048	0.646	0.021		0.000	0.625	0.012		TEMP. CONST.		SEC-2014KN-1177.0
1LR0006 1LR0006TE	VANITY PROPERTIES, LLC	03-22-176-053	0.353	0.013	-	0.000	0.340	0.007	300	TEMP. CONST.		SEC-2014KN-1176.0
1LR0008 1LR0008TE	CHARTER NATIONAL BANK AND TRUST, AS TRUSTEE UNDER THE PROVISIONS OF A TRUST AGREEMENT DATED SEPTEMBER 17, 1996, AND KNOWN AS TRUST NUMBER 1669	03-22-176-052	0.593	0.023		0.000	0.570	0.011		TEMP. CONST.		SEC-2014KN-1175.0
1LR0009 1LR0009TE	JBL ENTERPRISES, LLC	03-22-176-039	0.323	0.019		0.000	0.304	0.009	398	TEMP. CONST.	-	SEC-2014KN-1186.1

REVISION: #2 DATE: 02/13/15 MADE BY: BJB

SECTION LINE QUARTER SECTION LINE QUARTER, QUARTER SECTION LINE PLATTED LOT LINE PROPERTY (DEED) LINE APPARENT PROPERTY LINE PROPOSED CENTERLINE ALIGNMENT EXISTING RIGHT OF WAY LINE PROPOSED RIGHT OF WAY LINE EXISTING EASEMENT

PROPOSED EASEMENT

MEASURED DIMENSION COMPUTED DIMENSION RECORDED DIMENSION

MEASUREMENT CONTINUED TO NEXT PAGE EXISTING BUILDING

ALL DIMENSIONS ARE MEASURED UNLESS OTHERWISE SPECIFIED.
BEARINGS, DISTANCES & COORDINATES SHOWN HEREON ARE REFERENCED
TO THE ILLINOIS STATE PLANE COORDINATE SYSTEM, EAST ZONE, NORTH
AMERICAN DATUM OF 1983 (2011 ADJUSTMENT)

ALL MEASURED AND CALCULATED DISTANCES ARE "GRID" NOT "GROUND".
TO OBTAIN GROUND DISTANCES, DIVIDE GRID DISTANCES BY THE
COMBINATION FACTOR OF 0.999942928.

· AREAS SHOWN ON THIS PLAT ARE "GROUND".

LEGEND

129.32

129.32'(COMP)

(129.32') 129.32'---

IRON PIPE OR ROD FOUND
CUT CROSS FOUND OR SET

• REPLACED AFTER CONSTRUCTION
• SET 5/8" IRON ROD

THESE STAKES REFERENCE FOUND OR SET MONUMENTATION. SET 5/8 INCH IRON ROD FLUSH WITH GROUND TO TIE FOUND IRON STAKE. IDENTIFIED BY COLORED PLASTIC CAP BEARING SURVEYORS REGISTRATION NUMBER.

THESE STAKES, IN CULTIVATED AREAS, REFERENCE FOUND OR SET MONU-MENTATION. BURIED 5/8 INCH IRON ROD 20 INCHES BELOW GROUND TO TIE FOUND IRON STAKE. IDENTIFIED BY COLORED PLASTIC CAP BEARING SUR-

STAKING OF PROPOSED RIGHT OF WAY. SET 5/8 INCH REBAR.

STAKING OF PROPOSED RIGHT OF WAY IN CULTIVATED AREAS. BURIED 5/8 INCH METAL ROD 20 INCHES BELOW GROUND TO MARK FUTURE SURVEY MARKER POSITION. IDENTIFIED BY COLORED PLASTIC CAP BEARING SURVEYORS REGISTRATION NUMBER.

PERMANENT SURVEY MARKER, I.D.O.T. STANDARD 2135 (TO BE SET BY OTHERS)


STATE OF ILLINOIS COUNTY OF KENDALL

THIS IS TO CERTIFY THAT I, BERNARD J. BAUER, AN ILLINOIS PROFESSIONAL LAND SURVEYOR, HAVE SURVEYED THE PLAT OF HIGHWAYS SHOWN HERE—ON IN SECTIONS 21 & 22, TOWNSHIP 42, NORTH, RANCE B. AST OF THE THIRD PRINCIPAL MERDIAN, KANE COUNTY THAT THE SURVEY IS THE ATHROUGH AND THE PLAT OF THE AS SHOWN TO THE BEST OF MY KNOWLEDGE AND BELIEF HAT THE PLAT CORRECTLY REPRESENTS SAID SURVEY THAT ALL MONUMENTS FOUND AND EXTRABLISHED ARE OF PERMANENT QUALITY NOLL CCUPY THE POSITIONS SHOWN THEREON AND EXTRABLISHED ARE OF PERMANENT QUALITY NOLL CCUPY THE POSITIONS SHOWN THEREON AND THAT THE MONUMENTS ARE SUFFICIENT TO ENABLE THE SURVEY TO BE RETRACED. MADE FOR THE VILLAGE OF CARPENTERSVILLE, STATE OF ILLINOIS.

DATED AT YORKVILLE, JLINOIS THIS 30TH DAY OF MARCH, 2015 A.D.

BERNARD J. BAUER (BBAUER@HRGREEN.COM) BERNARD ILLINOIS PROFESSIONAL LAND SURVEYOR NO. 379935-0 LICENSE EXPIRATION DATE: 11/30/16

THIS PROFESSIONAL SERVICE CONFORMS TO THE CURRENT ILLINOIS MINIMUM STANDARDS FOR A BOUNDARY SURVEY

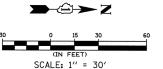

NOTE: SHEET 1 IS A COVER SHEET AND IS NOT RECORDED



Illinois Professional Design Firm # 184-001322 651 Prairie Pointe Drive, Suite 201,

Yorkville, Illinois 60560 t. 630.553.7560 f. 630.553.7646 ww.hrgreen.com

PLAT OF HIGHWAYS STATE OF ILLINOIS

DEPARTMENT OF TRANSPORTATION F.A.U. ROUTE 3887(ILLINOIS ROUTE 31) (WESTERN AVENUE) AT F.A.U. 1283 (HUNTLEY ROAD) (MAIN STREET) SECTION: 08-00083-00-CH

PROJECT: CMM-8003(999)

COUNTY: KANE JOB NO.: R-91-019-08

STATION: 513+00 TO 517+00 SCALE: 1" = 30'

SHEET: 12 OF 21

BUREAU OF LAND ACQUISITION TOTAL SHEETS NO. 201 WEST CENTER COURT 259 92 SCHAUMBURG, ILLINOIS 60196

ROUTE: F.A.U. 3887 (ILLINOIS ROUTE 31)


86140100 In Border File 86140100-sht-parcel,dgn

SECTION: 08-00083-00-CH

KANE COUNTY

JOB NO.: R-91-019-08

RECORDING: RECORDED ON: _____ AS DOCUMENT NO.: _____

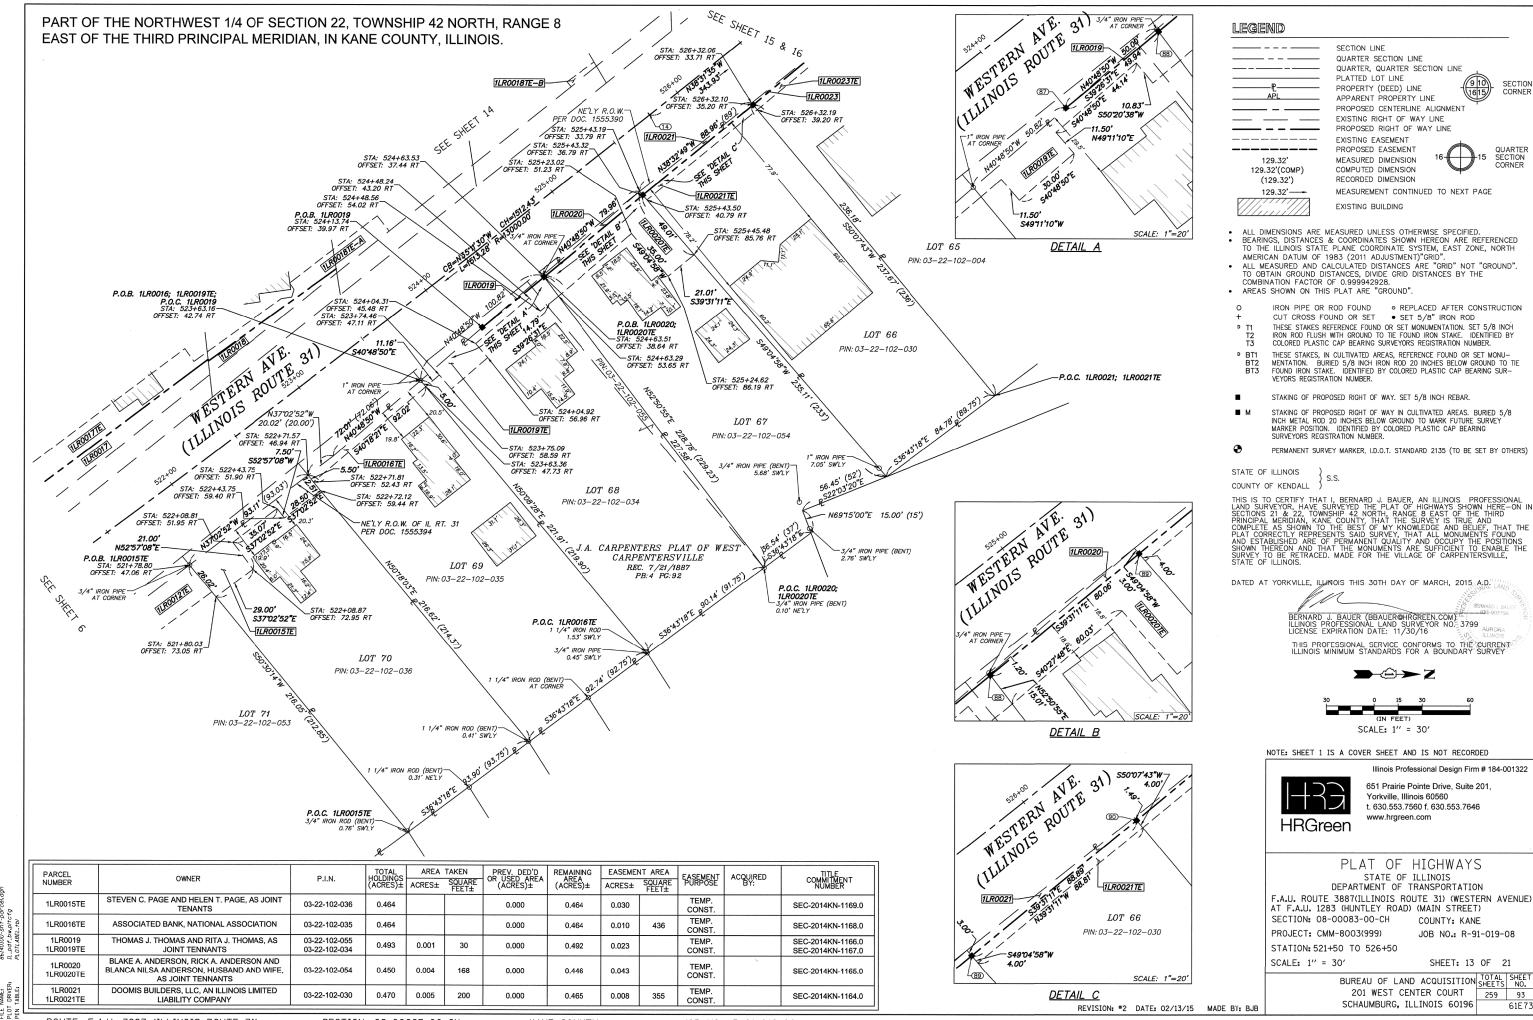

ROUTE: F.A.U. 3887 (ILLINOIS ROUTE 31)


SECTION: 08-00083-00-CH

KANE COUNTY

JOB NO.: R-91-019-08

RECORDING: RECORDED ON: _____ AS DOCUMENT NO.: ____

PART OF THE NORTHWEST 1/4 OF SECTION 22, TOWNSHIP 42 NORTH, RANGE 8 EAST OF THE THIRD PRINCIPAL MERIDIAN, IN KANE COUNTY, ILLINOIS.

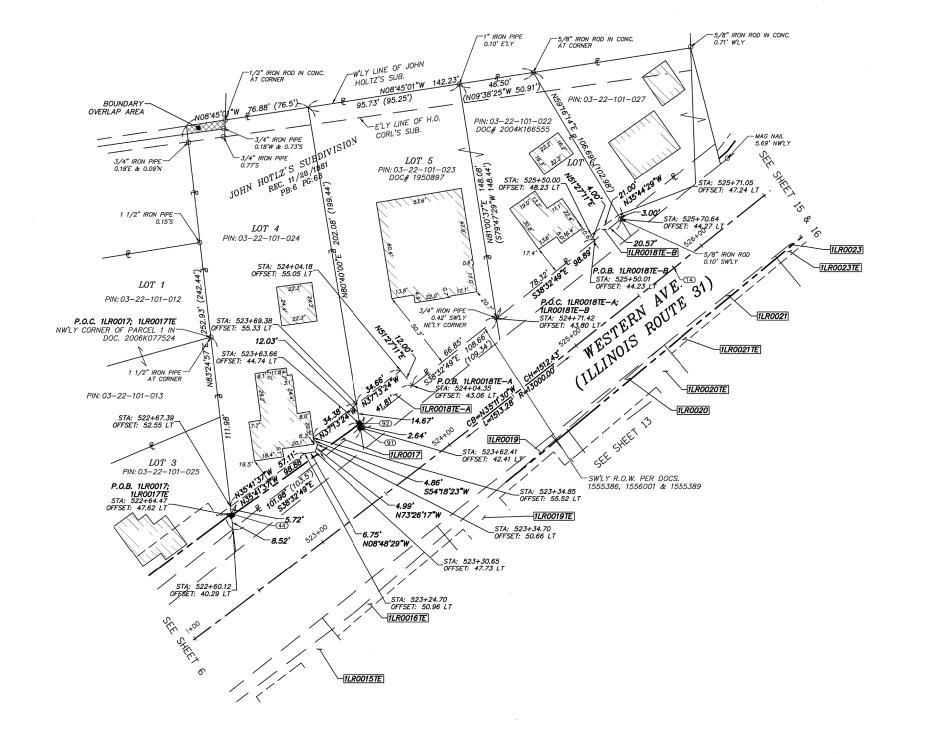

PARCEL NUMBER	OWNER	P.I.N. TOTAL HOLDING (ACRES):		DTAL DINGS ACRES± SQUARE FEET±		PREV. DED'D OR USED AREA (ACRES)±	REMAINING AREA (ACRES)±	EASEMENT AREA ACRES± SQUARE FEET±		EASEMENT PURPOSE	ACQUIRED BY:	TITLE COMMITMENT NUMBER
1LR0017 1LR0017TE	STEPHEN J. COSTELLO, A SINGLE PERSON	03-22-101-024	0.429	0.011		0.000	0.418	0.015		TEMP. CONST.		SEC-2014KN-1150.0
1LR0018TE-1 1LR0018TE-2	GLEN R. REDEKER AND ELIZABETH A. REDEKER, HUSBAND AND WIFE, IN JOINT TENANCY	03-22-101-023 03-22-101-022	0.582			0.000	0.582	0.011 0.002	73	TEMP. CONST.		SEC-2014KN-1151.0 SEC-2014KN-1152.0

REVISION: #2 DATE: 02/13/15 MADE BY: BJB

LEGEND SECTION LINE QUARTER SECTION LINE QUARTER, QUARTER SECTION LINE PLATTED LOT LINE SECTION PROPERTY (DEED) LINE APPARENT PROPERTY LINE PROPOSED CENTERLINE ALIGNMENT EXISTING RIGHT OF WAY LINE PROPOSED RIGHT OF WAY LINE EXISTING EASEMENT PROPOSED EASEMENT SECTION 129.32 MEASURED DIMENSION CORNER 129.32'(COMP) COMPUTED DIMENSION (129.32') RECORDED DIMENSION MEASUREMENT CONTINUED TO NEXT PAGE 129.32'----EXISTING BUILDING ALL DIMENSIONS ARE MEASURED UNLESS OTHERWISE SPECIFIED.
BEARINGS, DISTANCES & COORDINATES SHOWN HEREON ARE REFERENCED
TO THE ILLINOIS STATE PLANE COORDINATE SYSTEM, EAST ZONE, NORTH AMERICAN DATUM OF 1983 (2011 ADJUSTMENT)"GRID".
ALL MEASURED AND CALCULATED DISTANCES ARE "GRID" NOT "GROUND". TO OBTAIN GROUND DISTANCES, DIVIDE GRID DISTANCES BY THE COMBINATION FACTOR OF 0.999942928. AREAS SHOWN ON THIS PLAT ARE "GROUND" IRON PIPE OR ROD FOUND • REPLACED AFTER CONSTRUCTION CUT CROSS FOUND OR SET • SET 5/8" IRON ROD THESE STAKES REFERENCE FOUND OR SET MONUMENTATION. SET 5/8 INCH IRON ROD FLUSH WITH GROUND TO TIE FOUND IRON STAKE. IDENTIFIED BY COLORED PLASTIC CAP BEARING SURVEYORS REGISTRATION NUMBER. ° BT1 BT2 BT3 THESE STAKES, IN CULTIVATED AREAS, REFERENCE FOUND OR SET MONU-MENTATION. BURIED 5/8 INCH IRON ROD 20 INCHES BELOW GROUND TO TIE FOUND IRON STAKE. IDENTIFIED BY COLORED PLASTIC CAP BEARING SUR-VEYORS REGISTRATION NUMBER. STAKING OF PROPOSED RIGHT OF WAY, SET 5/8 INCH REBAR. STAKING OF PROPOSED RIGHT OF WAY IN CULTIVATED AREAS. BURIED 5/8 INCH METAL ROD 20 INCHES BELOW GROUND TO MARK FUTURE SURVEY MARKER POSITION. IDENTIFIED BY COLORED PLASTIC CAP BEARING SURVEYORS REGISTRATION NUMBER. PERMANENT SURVEY MARKER, I.D.O.T. STANDARD 2135 (TO BE SET BY OTHERS) STATE OF ILLINOIS COUNTY OF KENDALL THIS IS TO CERTIFY THAT I, BERNARD J. BAUER, AN ILLINOIS PROFESSIONAL LAND SURVEYOR. HAVE SURVEYED THE PLAT OF HIGHWAYS SHOWN HERE—ON I SECTIONS 21 & 22, TOWNSHIP 42, NORTH, RANCE 8 EAST OF THE THIRD PRINCIPAL MERIDIAN, KANE COUNTY, THAT THE SURVEY IS TRUE AND COMPLETE AS SHOWN TO THE BEST OF MY KNOWLEDGE AND BELIFF, THAT THE PLAT CORRECTLY REPRESENTS SAID SURVEY, THAT ALL MONUMENTS FOUND AND ESTABLISHED ARE OF PERMANENT QUALITY AND OCCUPY THE POSITIONS SHOWN THEREON AND THAT THE MONUMENTS ARE SUFFICIENT TO ENABLE THE SURVEY TO BE RETRACED. MADE FOR THE VILLAGE OF CARPENTERSVILLE, STATE OF ILLINOIS. DATED AT YORKVILLE, ILLINOIS THIS 30TH DAY OF MARCH, 2015 AND BERNARD J. BAUER (BBAUER@HRGREEN.COM)
ILLINOIS PROFESSIONAL LAND SURVEYOR NO. 37990RA
LICENSE EXPIRATION DATE: 11/30/16 THIS PROFESSIONAL SERVICE CONFORMS TO THE CURRENT ILLINOIS MINIMUM STANDARDS FOR A BOUNDARY SURVEY $\rightarrow \ominus \rightarrow Z$ SCALE: 1" = 30' NOTE: SHEET 1 IS A COVER SHEET AND IS NOT RECORDED Illinois Professional Design Firm # 184-001322 651 Prairie Pointe Drive, Suite 201 Yorkville, Illinois 60560 t. 630.553.7560 f. 630.553.7646 www.hrgreen.com **HRGreen** PLAT OF HIGHWAYS STATE OF ILLINOIS DEPARTMENT OF TRANSPORTATION F.A.U. ROUTE 3887(ILLINOIS ROUTE 31) (WESTERN AVENUE) AT F.A.U. 1283 (HUNTLEY ROAD) (MAIN STREET) SECTION: 08-00083-00-CH COUNTY: KANE PROJECT: CMM-8003(999) JOB NO. R-91-019-08 STATION: 522+00 TO 526+50 SCALE: 1" = 30' SHEET: 14 OF 21 BUREAU OF LAND ACQUISITION TOTAL SHEETS NO.


201 WEST CENTER COURT 259 94 SCHAUMBURG, ILLINOIS 60196

86140100 In Border File 86140100-sht-parcel.dgn

ROUTE: F.A.U. 3887 (ILLINOIS ROUTE 31)

SECTION: 08-00083-00-CH

KANE COUNTY

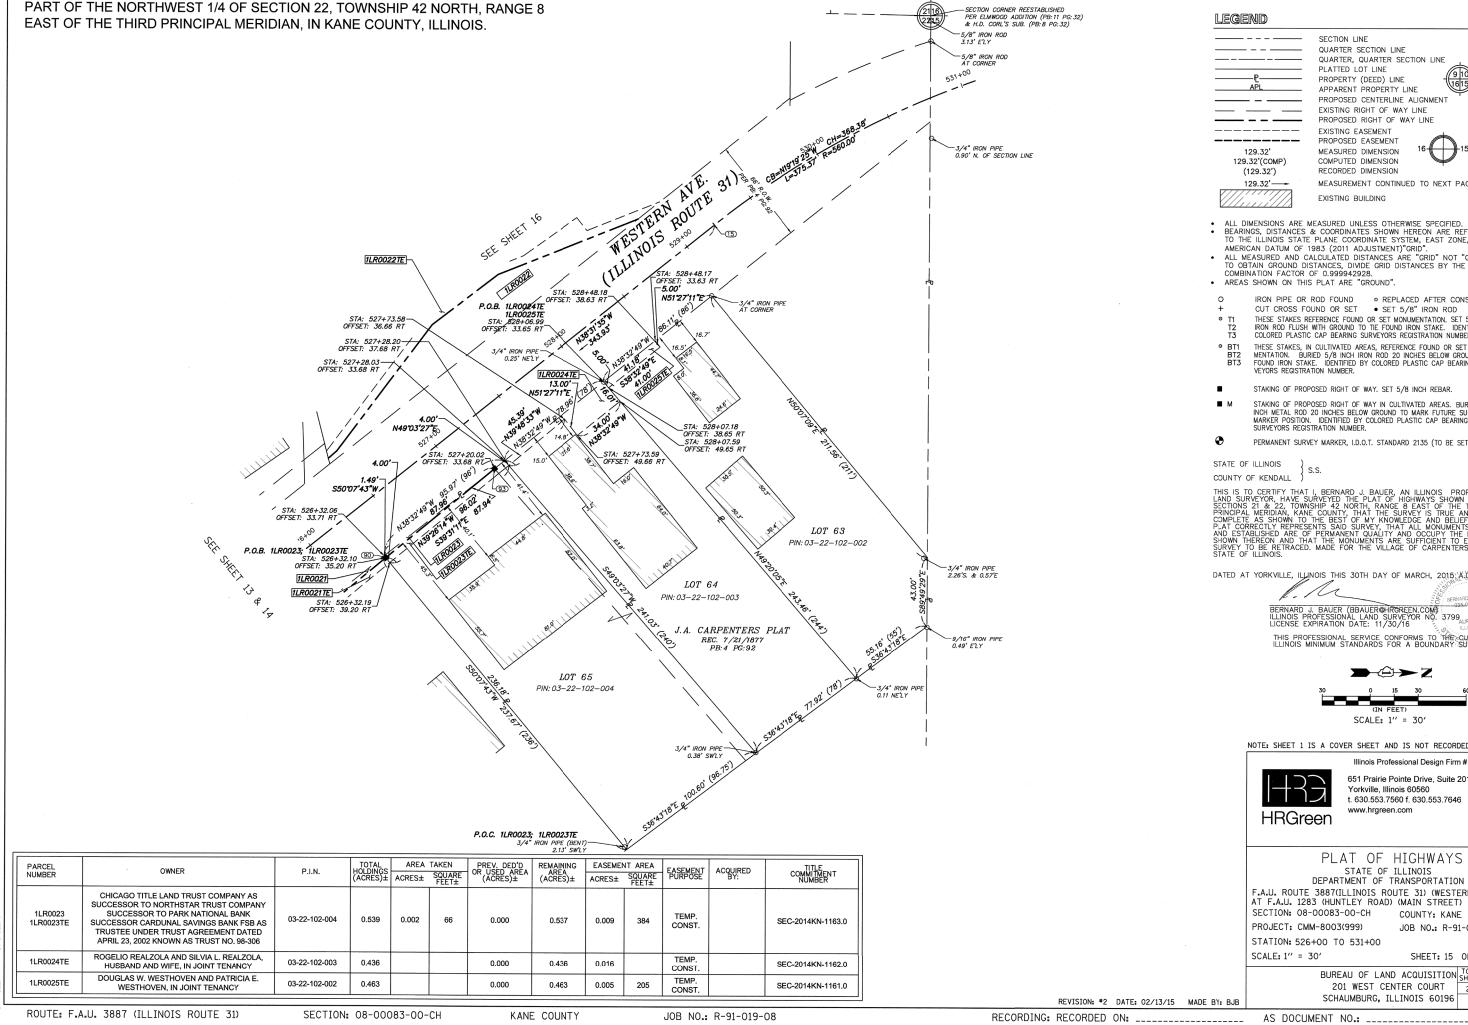

SECTION LINE QUARTER SECTION LINE QUARTER, QUARTER SECTION LINE PLATTED LOT LINE PROPERTY (DEED) LINE APPARENT PROPERTY LINE PROPOSED CENTERLINE ALIGNMENT

EXISTING RIGHT OF WAY LINE PROPOSED RIGHT OF WAY LINE EXISTING EASEMENT PROPOSED EASEMENT MEASURED DIMENSION

COMPUTED DIMENSION RECORDED DIMENSION MEASUREMENT CONTINUED TO NEXT PAGE

QUARTER SECTION

BEARINGS, DISTANCES & COORDINATES SHOWN HEREON ARE REFERENCED TO THE ILLINOIS STATE PLANE COORDINATE SYSTEM, EAST ZONE, NORTH

ALL MEASURED AND CALCULATED DISTANCES ARE "GRID" NOT "GROUND".
TO OBTAIN GROUND DISTANCES, DIVIDE GRID DISTANCES BY THE

IRON PIPE OR ROD FOUND • REPLACED AFTER CONSTRUCTION CUT CROSS FOUND OR SET • SET 5/8" IRON ROD

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STAKING OF PROPOSED RIGHT OF WAY, SET 5/8 INCH REBAR.

STAKING OF PROPOSED RIGHT OF WAY IN CULTIVATED AREAS. BURIED 5/8 INCH METAL ROD 20 INCHES BELOW GROUND TO MARK FUTURE SURVEY
MARKER POSITION. IDENTIFIED BY COLORED PLASTIC CAP BEARING
SURVEYORS REGISTRATION NUMBER.


PERMANENT SURVEY MARKER, I.D.O.T. STANDARD 2135 (TO BE SET BY OTHERS)

THIS IS TO CERTIFY THAT I, BERNARD J. BAUER. AN ILLINOIS PROFESSIONAL LAND SURVEYOR. HAVE SURVEYED THE PLAT OF HICHWAYS SHOWN HERE—ON IN SECTIONS 21 & 22. TOWNSHIP 42. NORTH. RANGE 8 EAST OF THE THIRD PRINCIPAL MERDIAN, KANE COUNTY THAT THE SURVEY IS TRUE AND COMPLETE AS SHOWN TO THE BEST OF MY KNOWLEDGE AND BELIEF. THAT THE PLAT CORRECTLY REPRESENTS SAID SURVEY THAT ALL MONUMENTS FOUND AND ESTABLISHED ARE OF PERMANENT QUALITY AND OCCUPY THE POSITIONS SHOWN THEREON AND ETABLISHED ARE OF PERMANENT QUALITY AND OCCUPY THE POSITIONS SHOWN THEREON AND THAT THE MONUMENTS ARE SUFFICIENT TO ENABLE THE SURVEY TO BE RETRACED. MADE FOR THE VILLAGE OF CARPENTERSVILLE, STATE OF ILLINOIS.

DATED AT YORKVILLE, ILLINOIS THIS 30TH DAY OF MARCH, 2015 A DAY

BERNARD J. BAUER (BBAUER@HRGREEN.COM)
ILLINOIS PROFESSIONAL LAND SURVEYOR NO. 3799
LICENSE EXPIRATION DATE: 11/30/16

THIS PROFESSIONAL SERVICE CONFORMS TO THE CURRENT ILLINOIS MINIMUM STANDARDS FOR A BOUNDARY SURVEY

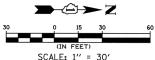

NOTE: SHEET 1 IS A COVER SHEET AND IS NOT RECORDED

Illinois Professional Design Firm # 184-001322 651 Prairie Pointe Drive, Suite 201,

Yorkville, Illinois 60560 t. 630.553.7560 f. 630.553.7646 ww.hrgreen.com

PLAT OF HIGHWAYS STATE OF ILLINOIS

DEPARTMENT OF TRANSPORTATION F.A.U. ROUTE 3887(ILLINOIS ROUTE 31) (WESTERN AVENUE) AT F.A.U. 1283 (HUNTLEY ROAD) (MAIN STREET)

COUNTY: KANE JOB NO.: R-91-019-08

SHEET: 15 OF 21


BUREAU OF LAND ACQUISITION TOTAL SHEETS NO. 201 WEST CENTER COURT 259 SCHAUMBURG, ILLINOIS 60196

ROUTE: F.A.U. 3887 (ILLINOIS ROUTE 31)

86140100 In Border File 86140100-sht-parcel,dgn

SECTION: 08-00083-00-CH

KANE COUNTY

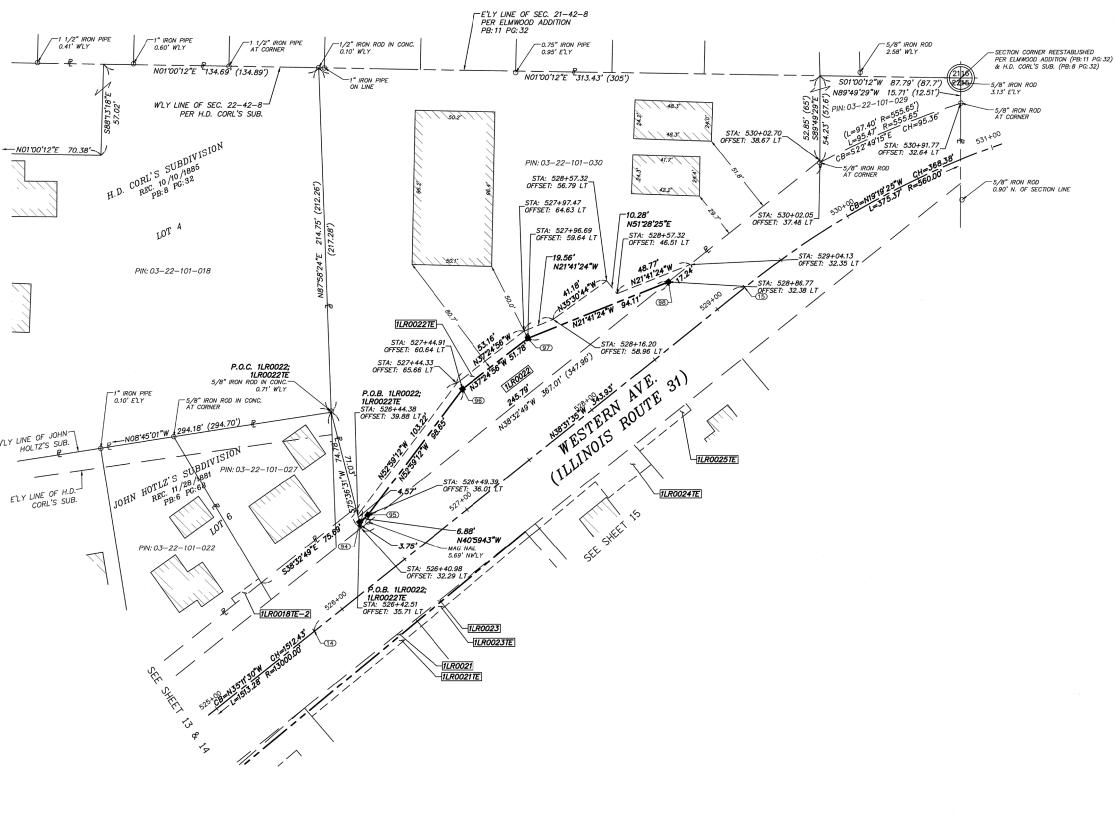

LEGEND

129.32

(129.32')

129.32'----

SECTION LINE QUARTER SECTION LINE QUARTER, QUARTER SECTION LINE PLATTED LOT LINE PROPERTY (DEED) LINE APPARENT PROPERTY LINE PROPOSED CENTERLINE ALIGNMENT EXISTING RIGHT OF WAY LINE

EXISTING EASEMENT PROPOSED EASEMENT MEASURED DIMENSION COMPUTED DIMENSION 129.32'(COMP) RECORDED DIMENSION

PROPOSED RIGHT OF WAY LINE

MEASUREMENT CONTINUED TO NEXT PAGE

SECTION

QUARTER SECTION

EXISTING BUILDING

ALL DIMENSIONS ARE MEASURED UNLESS OTHERWISE SPECIFIED.
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TO OBTAIN GROUND DISTANCES, DIVIDE GRID DISTANCES BY THE COMBINATION FACTOR OF 0.999942928.

AREAS SHOWN ON THIS PLAT ARE "GROUND"

IRON PIPE OR ROD FOUND OR REPLACED AFTER CONSTRUCTION CUT CROSS FOUND OR SET • SET 5/8" IRON ROD

THESE STAKES REFERENCE FOUND OR SET MONUMENTATION. SET 5/8 INCH IRON ROD FLUSH WITH GROUND TO TIE FOUND IRON STAKE. IDENTIFIED BY COLORED PLASTIC CAP BEARING SURVEYORS REGISTRATION NUMBER. T2 T3

° BT1 BT2 BT3 THESE STAKES, IN CULTIVATED AREAS, REFERENCE FOUND OR SET MONU-MENTATION. BURIED 5/8 INCH IRON ROD 20 INCHES BELOW GROUND TO TIE FOUND IRON STAKE. IDENTIFIED BY COLORED PLASTIC CAP BEARING SUR-VEYORS REGISTRATION NUMBER.

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PERMANENT SURVEY MARKER, I.D.O.T. STANDARD 2135 (TO BE SET BY OTHERS)

STATE OF ILLINOIS

THIS IS TO CERTIFY THAT I, BERNARD J, BAUER, AN ILLINOIS PROFESSIONAL LAND SURVEYOR. HAVE SURVEYED THE PLAT OF HIGHWAYS SHOWN HERE—ON I SECTIONS 21 & 22, TOWNSHIP 42, NORTH, RANGE 8 EAST OF THE THIRD PRINCIPAL MERIDIAN, KANE COUNTY, THAT THE SURVEY IS TRUE AND COMPLETE AS SHOWN TO THE BEST OF MY KNOWLEDGE AND BELIEF, THAT THE PLAT CORRECTLY REPRESENTS SAID SURVEY, THAT ALL MONUMENTS FOUND AND ESTABLISHED ARE OF PERMANENT QUALITY AND OCCUPY THE POSITIONS SHOWN THEREON AND THAT THE MONUMENTS ARE SUFFICIENT TO ENABLE THE SURVEY TO BE RETRACED. MADE FOR THE VILLAGE OF CARPENTERSVILLE, STATE OF ILLINOIS.

BERNARD J. BAUER (BBAUER@HRGREEN.COM) 1085-003786 ILLINOIS PROFESSIONAL LAND SURVEYOR NO. 3799 URRORA LICENSE EXPIRATION DATE: 11/30/16 THIS PROFESSIONAL SERVICE CONFORMS TO THE CURRENT ILLINOIS MINIMUM STANDARDS FOR A BOUNDARY SURVEY

 $\rightarrow \odot \rightarrow Z$



NOTE: SHEET 1 IS A COVER SHEET AND IS NOT RECORDED



Illinois Professional Design Firm # 184-001322 651 Prairie Pointe Drive, Suite 201

JOB NO.: R-91-019-08

Yorkville, Illinois 60560 t. 630.553.7560 f. 630.553.7646 www.hrgreen.com

PLAT OF HIGHWAYS STATE OF ILLINOIS DEPARTMENT OF TRANSPORTATION

F.A.U. ROUTE 3887(ILLINOIS ROUTE 31) (WESTERN AVENUE) AT F.A.U. 1283 (HUNTLEY ROAD) (MAIN STREET) SECTION: 08-00083-00-CH COUNTY: KANE

PROJECT: CMM-8003(999) STATION: 525+00 TO 531+00

SCALE: 1" = 30' SHEET: 16 OF 21

BUREAU OF LAND ACQUISITION TOTAL SHEETS NO. 201 WEST CENTER COURT 259 SCHAUMBURG, ILLINOIS 60196

TOTAL HOLDINGS (ACRES)± PREV. DED'D OR USED AREA (ACRES)± FASEMENT AREA ARFA TAKEN REMAINING TITLE COMMITMENT NUMBER PARCEL ACQUIRED BY: ASEMENT PURPOSE OWNER P.I.N. AREA (ACRES)± ACRES± ACRES± SQUARE FEET± 1LR0022 03-22-101-030 TEMP JAMES R. KRENZ 1.312 0.097 1.215 0.035 SEC-2014KN-1186.2 1LR0022TE 03-22-101-029 CONST.

ROUTE: F.A.U. 3887 (ILLINOIS ROUTE 31)

86140100 In Border File 86140100-sht-parcel,dgn


SECTION: 08-00083-00-CH


KANE COUNTY

JOB NO.: R-91-019-08

RECORDING: RECORDED ON: _____ AS DOCUMENT NO.: _____

REVISION: #2 DATE: 02/13/15 MADE BY: BJB

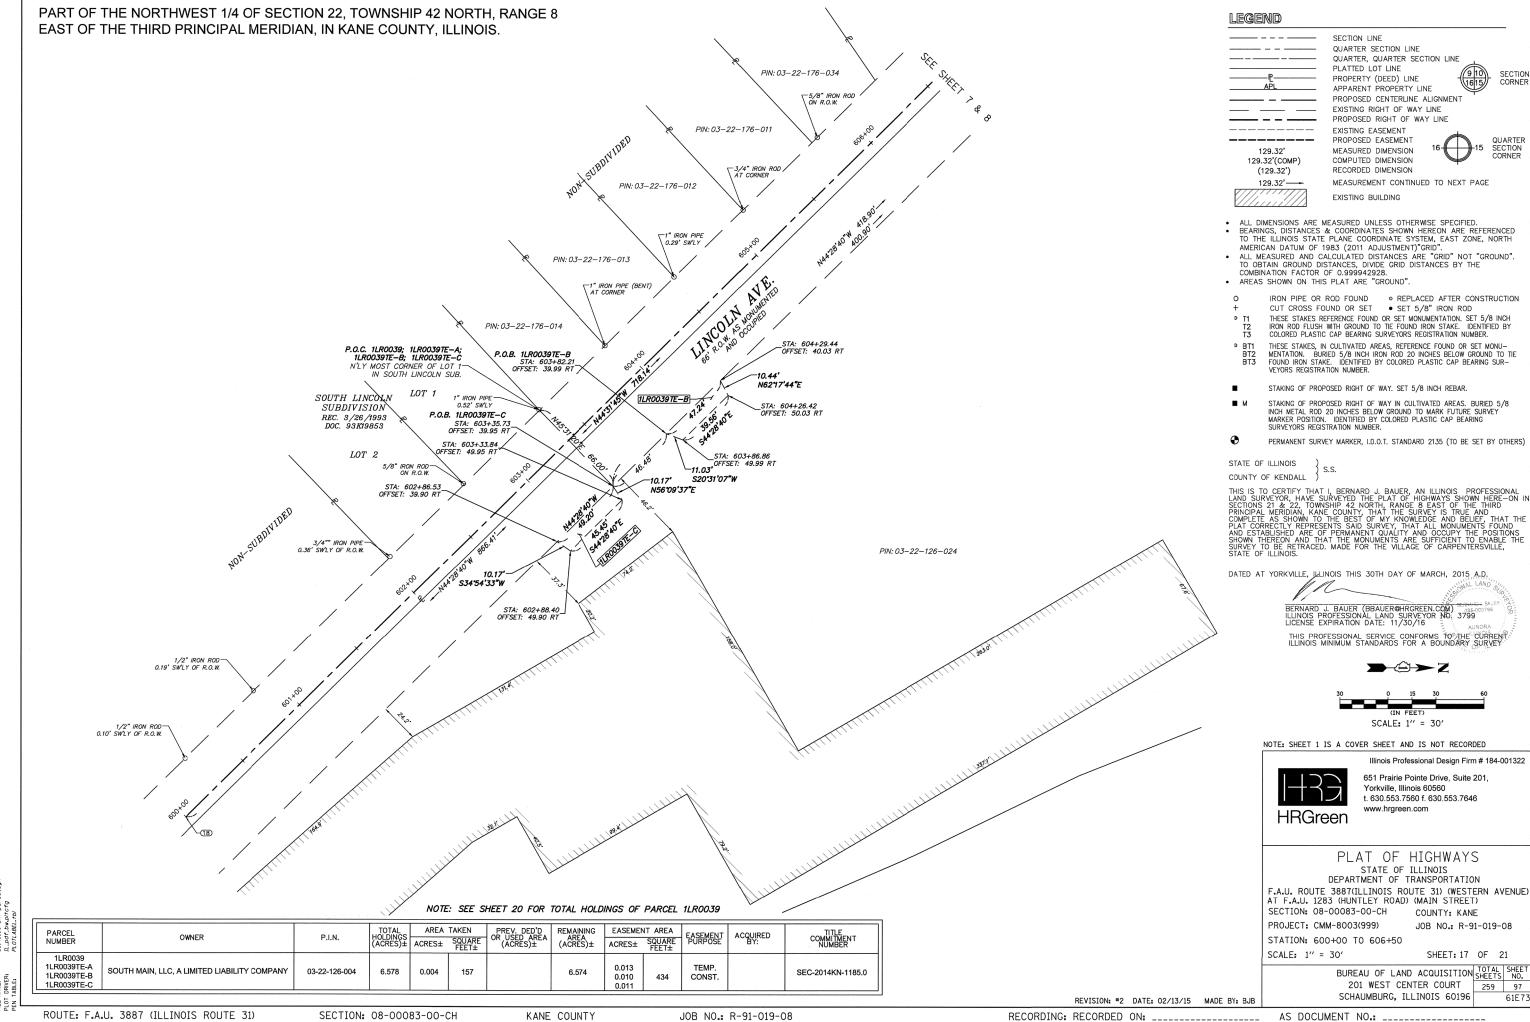

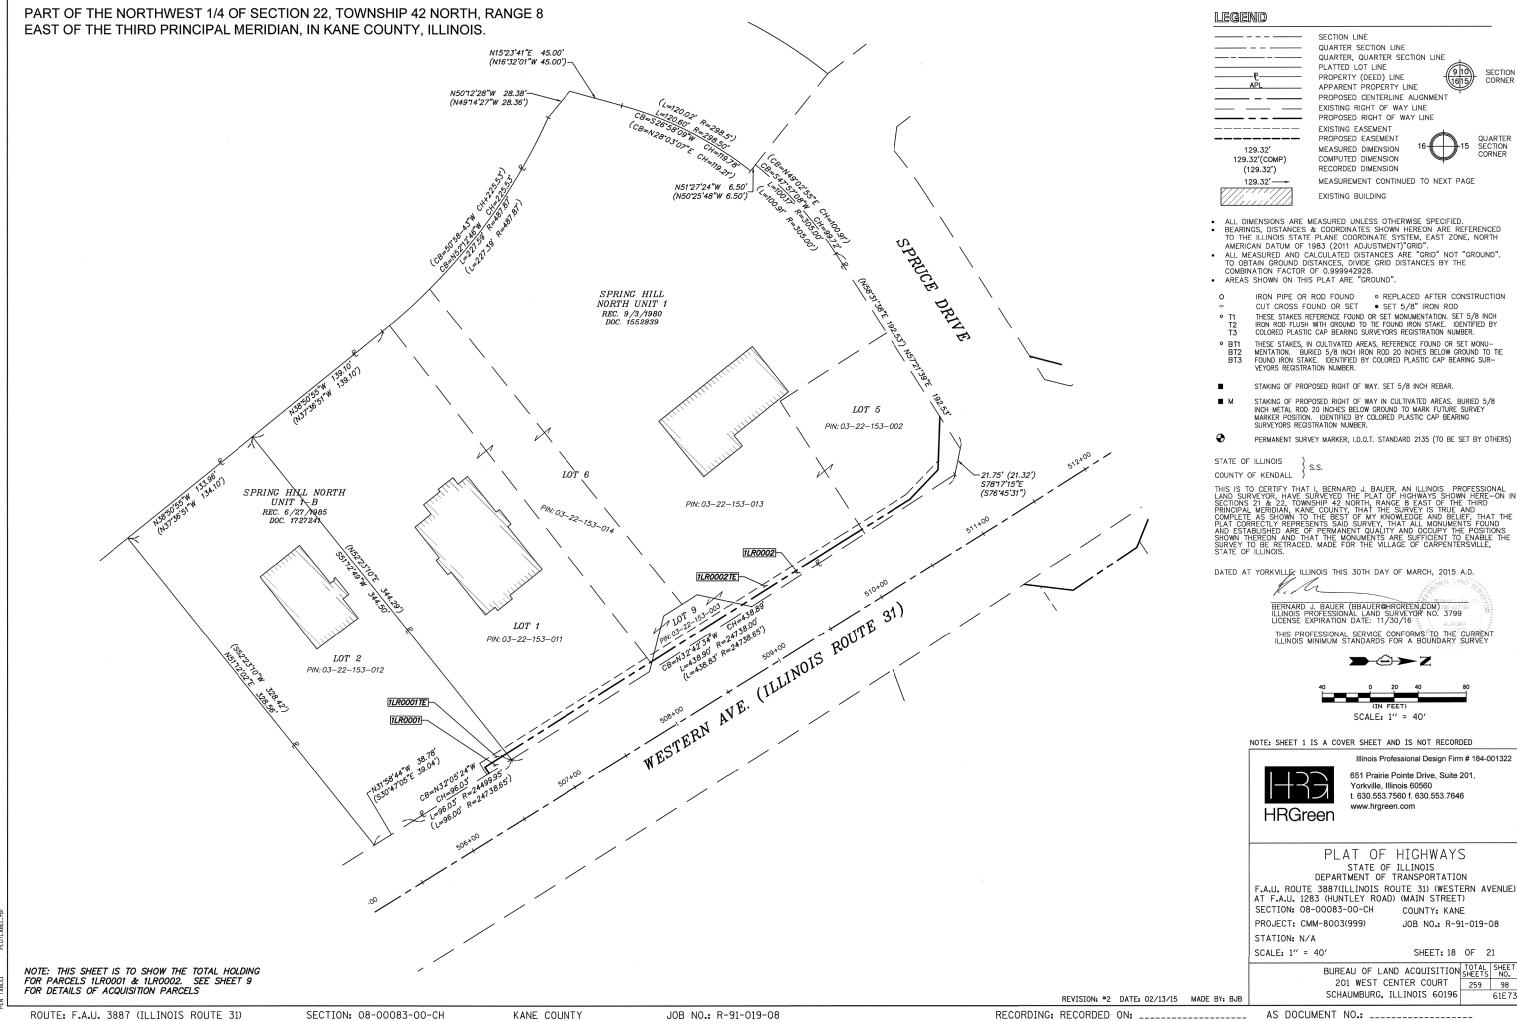

ROUTE: F.A.U. 3887 (ILLINOIS ROUTE 31)

86140100 In Border File 86140100-sht-parcel,dgn

KANE COUNTY

PART OF THE NORTHWEST 1/4 OF SECTION 22. AND PART OF THE SOUTHWEST LEGEND 1/4 OF SECTION 15, TOWNSHIP 42 NORTH, RANGE 8 EAST OF THE THIRD PRINCIPAL MERIDIAN, IN KANE COUNTY, ILLINOIS. QUARTER SECTION LINE QUARTER, QUARTER SECTION LINE PLATTED LOT LINE PROPERTY (DEED) LINE APPARENT PROPERTY LINE PROPOSED CENTERLINE ALIGNMENT EXISTING RIGHT OF WAY LINE PROPOSED RIGHT OF WAY LINE EXISTING EASEMENT PROPOSED EASEMENT POINT "A", AS DESCRIBED IN-DOC. 2005K036608 129.32' MEASURED DIMENSION 129.32'(COMP) COMPUTED DIMENSION (129.32')RECORDED DIMENSION MEASUREMENT CONTINUED TO NEXT PAGE 129.32'---EXISTING BUILDING AT CORNER ALL DIMENSIONS ARE MEASURED UNLESS OTHERWISE SPECIFIED. LINE PERPENDICULAR TO THE EAST LINE OF LOT 21 IN-J.A. CARPENTER'S WEST CARPENTERSVILLE BEARINGS, DISTANCES & COORDINATES SHOWN HEREON ARE REFERENCED TO THE ILLINOIS STATE PLANE COORDINATE SYSTEM, EAST ZONE, NORTH AMERICAN DATUM OF 1983 (2011 ADJUSTMENT)"GRID". ALL MEASURED AND CALCULATED DISTANCES ARE "GRID" NOT "GROUND".
TO OBTAIN GROUND DISTANCES, DIVIDE GRID DISTANCES BY THE S82°54'40"W 86.04'±-2 2 COMBINATION FACTOR OF 0.999942928. AREAS SHOWN ON THIS PLAT ARE "GROUND". IRON PIPE OR ROD FOUND
CUT CROSS FOUND OR SET

• REPLACED AFTER CONSTRUCTION
• SET 5/8" IRON ROD THESE STAKES REFERENCE FOUND OR SET MONUMENTATION. SET 5/8 INCH IRON ROD FLUSH WITH GROUND TO TIE FOUND IRON STAKE. IDENTIFIED BY COLORED PLASTIC CAP BEARING SURVEYORS REGISTRATION NUMBER. P.O.B. TOTAL HOLDING-PARCEL 1LR0038 ° BT1 BT2 BT3 THESE STAKES, IN CULTIVATED AREAS, REFERENCE FOUND OR SET MONU-PIN: 03-15-352-002 MENTATION, BURIED 5/8 INCH IRON ROD 20 INCHES BELOW GROUND TO TIE FOUND IRON STAKE. IDENTIFIED BY COLORED PLASTIC CAP BEARING SURVEYORS REGISTRATION NUMBER. TE N. SEC. STAKING OF PROPOSED RIGHT OF WAY. SET 5/8 INCH REBAR. STAKING OF PROPOSED RIGHT OF WAY IN CULTIVATED AREAS. BURIED 5/8 INCH METAL ROD 20 INCHES BELOW GROUND TO MARK FUTURE SURVEY MARKER POSITION. IDENTIFIED BY COLORED PLASTIC CAP BEARING SURVEYORS REGISTRATION NUMBER. LINE 42 P PERMANENT SURVEY MARKER, I.D.O.T. STANDARD 2135 (TO BE SET BY OTHERS) STATE OF ILLINOIS PIN: 03-22-126-005 COUNTY OF KENDALL THIS IS TO CERTIFY THAT I, BERNARD J. BAUER. AN ILLINOIS PROFESSIONAL LAND SURVEYOR. HAVE SURVEYED THE PLAT OF HICHWAYS SHOWN HERE—ON IN SECTIONS 21 & 22. TOWNSHIP 42. NORTH, RANGE 8 EAST OF THE THIRD PRINCIPAL MERDIAN, KANE COUNTY THAT THE SURVEY IS TRUE AND COMPLETE AS SHOWN TO THE BEST OF MY KNOWLEDGE AND BELIEF. THAT THE PLAT CORRECTLY REPRESENTS SAID SURVEY, THAT ALL MONUMENTS FOUND AND ESTABLISHED ARE OF PERMANENT QUALITY AND OCCUPY THE POSITIONS SHOWN THEREON AND THAT THE MONUMENTS ARE SUFFICIENT TO ENABLE THE SURVEY TO BE RETRACED. MADE FOR THE VILLAGE OF CARPENTERSVILLE, STATE OF ILLINOIS. DATED AT YORKVILLE, JELINOIS THIS 30TH DAY OF MARCH, 2015 A DAY BERNARD J. BAUER (BBAUER@HRGREEN.COM): 0359003799
ILLINOIS PROFESSIONAL LAND SURVEYOR NO. 3799
LICENSE EXPIRATION DATE: 11/30/16 THIS PROFESSIONAL SERVICE CONFORMS TO THE CURRENT ILLINOIS MINIMUM STANDARDS FOR A BOUNDARY SURVEY NAIN SCALE: 1" = 80' NOTE: SHEET 1 IS A COVER SHEET AND IS NOT RECORDED STREET Illinois Professional Design Firm # 184-001322 651 Prairie Pointe Drive, Suite 201, Yorkville, Illinois 60560 t. 630.553.7560 f. 630.553.7646 www.hrgreen.com **HRGreen** PLAT OF HIGHWAYS STATE OF ILLINOIS DEPARTMENT OF TRANSPORTATION F.A.U. ROUTE 3887(ILLINOIS ROUTE 31) (WESTERN AVENUE) AT F.A.U. 1283 (HUNTLEY ROAD) (MAIN STREET) SECTION: 08-00083-00-CH COUNTY: KANE PROJECT: CMM-8003(999) JOB NO.: R-91-019-08 STATION: N/A SCALE: 1" = 80' SHEET: 19 OF 21 BUREAU OF LAND ACQUISITION TOTAL SHEETS NO. 201 WEST CENTER COURT NOTE: THIS SHEET IS TO SHOW THE TOTAL HOLDING FOR PARCEL 1LR0038. 259 99 SEE SHEET 8 FOR DETAILS OF ACQUISITION PARCELS SCHAUMBURG, ILLINOIS 60196 REVISION: #2 DATE: 02/13/15 MADE BY: BJB RECORDING: RECORDED ON: _____ AS DOCUMENT NO.: _____

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KANE COUNTY

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