04-27-2018 LETTING ITEM 135

STATE OF ILLINOIS DEPARTMENT OF TRANSPORTATION

CONTRACT #61E55


INDEX OF SHEETS SEE SHEET NO. 2


HIGHWAY STANDARDS SEE SHEET NO. 2


PLANS FOR PROPOSED FEDERAL AID HIGHWAY

MUN 4011 (RAILROAD AVENUE)
YORK STREET TO ADDISON STREET
PARKING, SIDEWALKS, RESURFACING, RECONSTRUCTION
SECTION NO.: 16-00096-00-PK
PROJECT NO.: WPE6(555)
VILLAGE of BENSENVILLE
DUPAGE COUNTY
C-01-112-18

GROSS LENGTH= 761 FEET=0.14 MILES NET LENGTH= 761 FEET=0.14 MILES

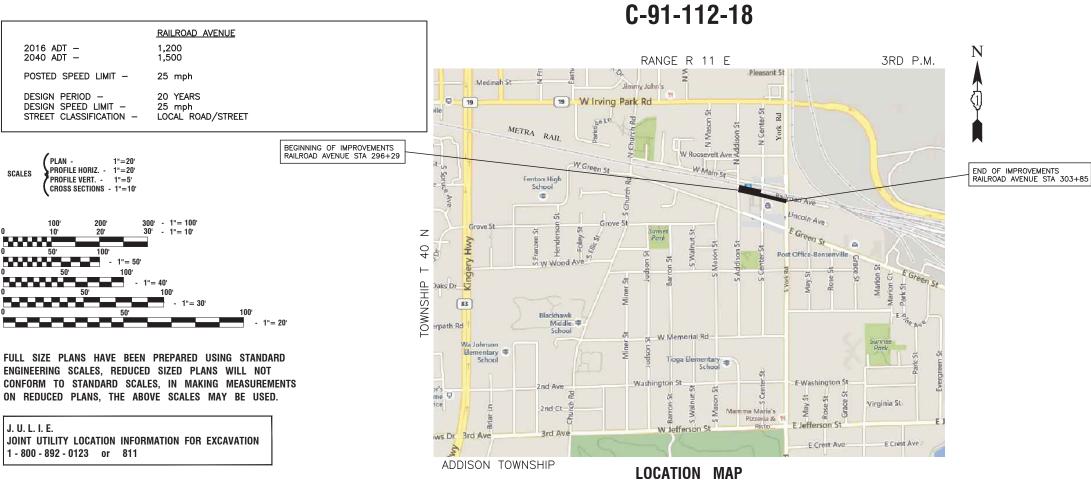

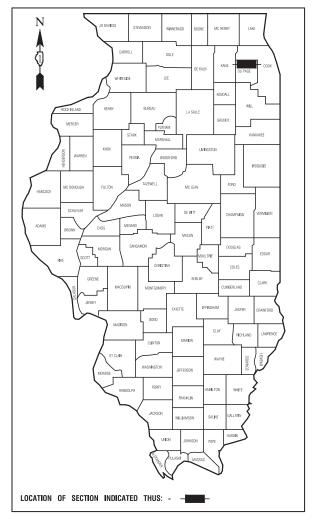

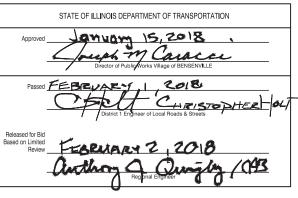

PREPARED BY OR UNDER THE DIRECT SUPERVISION OF:

062-05498
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THE STATE OF ILLINOIS

CONTRACT NO. 61E55

AVED BY: PSTEPANOVIC ON 94948

15R0650-COVR-30 - IDOT C0

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STORM/SANITARY/WATER MAIN GENERAL NOTES

- 1. AREAS DISTURBED BY CONSTRUCTION SHALL BE KEPT TO A MINIMUM. TRENCH BOXES SHALL BE UTILIZED TO LIMIT DISTURBED AREA. ALL AREAS DISTURBED UNNECESSARILY SHALL BE RESTORED AS REQUIRED IN THE SPECIAL PROVISIONS.
- 2. ALL PAVEMENT, CURB AND SIDEWALK REMOVALS SHALL BE MADE BY MEANS OF A STRAIGHT SAW
- 3. EXISTING DRAINAGE FACILITIES SHALL NOT BE UNNECESSARY DISTURBED. TEMPORARY DRAINAGE FACILITIES SHALL BE PROVIDED BY THE CONTRACTOR WHEREVER NECESSARY TO MAINTAIN EXISTING DRAINAGE OUTLETS.
- 4. THE ENGINEER RESERVES THE RIGHT TO REJECT STRUCTURALLY DAMAGED PIPE. BEDDING AND INITIAL BACKFILL FOR STORM SEWER TO BE IN ACCORDANCE WITH MANUFACTURER'S
- A. FOR CONCRETE PIPE: A GRANULAR CRADLE EXTENDING FROM 4" BELOW STORM SEWER PIPE TO THE SPRING LINE SHALL BE PROVIDED, AS SHOWN IN DETAIL. COST OF THE GRANULAR CRADLE AND INITIAL BACKFILL SHALL BE INCLUDED IN STORM SEWER CONTRACT PRICE. TEBNICH TO BE BACKFILLED WITH TRENCH BACKFILL BELOW ALL PAVED SURFACES IN ACCORDANCE WITH THE SPECIFICATION TRENCH BACKFILL, SPECIAL BACKFILL BELOW ALL TURF SURFACES IN ACCORDANCE WITH THE STANDARD ROAD SPECIFICATIONS
- 5. "BAND SEAL" COUPLINGS SHALL BE USED WHEN JOINING SEWER PIPES OF DISSIMILAR
- 6. CONSTRUCTION: ALL STORM SEWERS ARE TO BE CONSTRUCTED USING A LASER INSTRUMENT TO MAINTAIN LINE AND GRADE.
- 7. COVER: THE CONTRACTOR SHALL MAINTAIN AT LEAST ONE (1') FOOT OF COVER OVER THE TOP OF SHALLOW PIPES AT ALL TIMES DURING CONSTRUCTION. THE CONTRACTOR SHALL MOUND OVER ANY PIPES WHICH HAVE LESS THAN ONE (1') FOOT OF COVER DURING CONSTRUCTION UNTIL THE AREA IS FINAL GRADED OR PAVED.
- 8. ALL TRENCHES BENEATH PROPOSED OR EXISTING UTILITIES, PAVEMENTS, ROADWAYS, SIDEWALKS, AND FOR A DISTANCE OF TWO (2') FEET ON EITHER SIDE OF SAME, AND/OR WHERE SHOWN ON THE PLANS, SHALL BE BACKFILLED WITH SELECT GRANULAR BACKFILL, CA-6, AND THOROUGHLY MECHANICALLY COMPACTED IN 9" THICK (LOOSE MEASUREMENT) LAYERS. JETTING WITH WATER IS PERMITTED WITH PRIOR CONSENT BY THE VILLAGE OF BENSENVILLE. TRENCH BACKFILL SHALL IN ACCORDANCE WITH THE SPECIFICATION TRENCH BACKFILL, SPECIAL.
- STRUCTURES: MANHOLE, CATCH BASIN AND INLET BOTTOMS SHALL BE PRECAST CONCRETE SECTIONAL UNITS OR MONOLITHIC CONCRETE. STRUCTURE JOINTS SHALL BE SEALED WITH O-RING OR BUTYL ROPE. A MAXIMUM OF TWELVE (12") INCHES OF ADJUSTING RINGS SHALL BE USED, UNLESS OTHERWISE STATED ON THE PLANS.
- 10. A CONCRETE BENCH TO DIRECT FLOWS SHALL BE CONSTRUCTED IN THE BOTTOM OF ALL INLETS
- 11. THE FRAME, GRATE, AND/OR CLOSED LID SHALL BE CAST IRON OF THE STYLE SHOWN ON THE
- 12. THE JOINTS BETWEEN CONCRETE SECTION ADJUSTING RINGS, AND FRAME SHALL BE SEALED WITH A MASTIC COMPOUND.
- CLEANING: THE STORM SEWER SYSTEM SHALL BE THOROUGHLY CLEANED PRIOR TO FINAL INSPECTION AND TESTING.
- 14. ON ALL IMPROVEMENTS THE FRAMES AND LIDS OF EXISTING CATCH BASINS, INLETS, MANHOLES AND VALVE VAULTS WHICH ARE TO BE ABANDONED DUE TO CONSTRUCTION OF THIS IMPROVEMENT ARE TO REMAIN THE PROPERTY OF THE VILLAGE OF BENSENVILLE AND BE SALVAGED. THE OWNER SHALL BE NOTIFIED AS TO AVAILABILITY FOR PICK—UP.
- 15. CARE SHOULD BE TAKEN DURING CONSTRUCTION TO INSURE THAT ALL DRAIN SYSTEMS ARE RE-ESTABLISHED. THE CONTRACTOR SHALL NOTIFY THE ENGINEER IMMEDIATELY WHEN DRAIN TILE SYSTEMS ARE ENCOUNTERED OTHER THAN THOSE SHOWN IN THE PLANS FOR PROPER INSTRUCTION AND DISPOSITION.
- 16. O-JOINTS ARE TO BE USED ON ALL CIRCULAR STORM SEWERS AND SHALL CONFORM TO ASTM
- 17. DRAINAGE STRUCTURE ELEVATION: GRADES OF EXISTING SEWER LINES WERE DETERMINED FROM AVAILABLE PLANS AND SURVEYS. ACCORDINGLY, AS DIRECTED BY THE ENGINEER, THE INVERTS OF THE PROPOSED DRAINAGE MAY BE REVISED TO MEET EXISTING FIELD CONDITIONS.
- 18. ALL SURPLUS EXCAVATED MATERIAL FROM THE TRENCH SHALL BE PROPERLY DISPOSED OF BY THE CONTRACTOR AT HIS EXPENSE.
- 19. SANITARY SEWER AND STORM SEWER STRUCTURES SHALL BE IN ACCORDANCE WITH THESES PLANS AND APPLICABLE STANDARD SPECIFICATIONS. WHERE GRANULAR TRENCH BACKFILL IS REQUIRED AROUND THESE STRUCTURES.
- 20. ALL JOINT SECTIONS IN STORM SEWER STRUCTURES SHALL BE SEALED WITH CONTINUOUS BUTYL MASTIC ROPE AND MORTARED WITH NON-SHRINK MORTAR.
- 21. CONNECTIONS TO EXISTING SANITARY AND STORM MANHOLES SHALL BE MADE BY CORING OR SAW-CUTTING THE EXISTING STRUCTURE. BREAKING INTO STRUCTURES WILL NOT BE ALLOWED.
- 22. INLINE CURB DRAINAGE STRUCTURES MAY NOT INCLUDE THE USE OF SHIMS. ALL FRAMES SHALL SIT DIRECTLY ABOVE THE ADJACENT RINGS OR FLAT TOP. OFFSET FRAMES WILL NOT BE ACCEPTED.
- 23. CHERT AGGREGATE SHALL NOT BE ALLOWED IN THE MANUFACTURING OF STORM SEWERS, END SECTIONS OR PRECAST DRAINAGE STRUCTURES.
- 24. THE VILLAGE OF BENSENVILLE SHALL BE NOTIFIED PRIOR TO THE OPENING OR CLOSING OF ALL WATER VALVES, FIRE HYDRANTS AND/OR OTHER WATER SYSTEM APPURTENANCES.
- 25. MINIMUM OF 5.5' OF COVER OVER WATER MAIN AND WATER SERVICES SHALL BE PROVIDED.
- 26. LOCATION OF EXISTING WATER MAIN IS APPROXIMATE. CONTRACTOR SHALL VERIFY IN FIELD.
- 27. EXISTING WATER MAIN IS DUCTILE IRON OR PVC.
- 28. CONTRACTOR TO VERIFY EXISTING WATER SERVICE LOCATIONS PRIOR TO CONSTRUCTION, AND CONFIRM ALL WATER SERVICES TO BE AFFECTED BY CONSTRUCTION

GENERAL NOTES

- 1. ALL CONSTRUCTION SHALL CONFORM TO THE "STANDARD SPECIFICATIONS FOR ROAD AND BRIDGE CONSTRUCTION", ADOPTED APRIL 1, 2016 BY THE ILLINOIS DEPARTMENT OF TRANSPORTATION AND ALL AMENDMENTS THERETO, AND IN ACCORDANCE WITH THE LATEST EDITION OF THE SPECIFICATIONS FOR CONSTRUCTION IN THE VILLAGE OF BENSENVILLE AND IN CASE OF CONFLICT, THE MORE STRINGENT CODE SHALL TAKE PRECEDENCE.
- 2. ALL STORM SEWER, SANITARY SEWER AND WATER MAIN CONSTRUCTION SHALL CONFORM TO THE "STANDARD SPECIFICATIONS FOR WATER AND SEWER MAIN CONSTRUCTION IN ILLINOIS", LATEST EDITION, AND IN ACCORDANCE WITH THE SPECIFICATIONS FOR CONSTRUCTION IN THE VILLAGE OF BENSENVILLE UNLESS OTHERWISE NOTED ON THE
- 3. STANDARD SPECIFICATIONS, SUPPLEMENTAL SPECIFICATIONS AND RECURRING SPECIAL PROVISIONS, CONSTRUCTION PLANS, AND SUBSEQUENT DETAILS ARE ALL TO BE CONSIDERED AS PART OF THE CONTRACT. INCIDENTAL ITEMS OR ACCESSORIES NECESSARY TO COMPLETE THIS WORK MAY NOT BE SPECIFICALLY NOTED BUT ARE CONSIDERED A PART OF THIS CONTRACT. ANY REFERENCE TO STANDARDS THROUGH THE PLANS OR SPECIAL PROVISIONS SHALL BE INTERRETED TO BE THE LATEST STANDARDS OF THE ILLINOIS DEPARTMENT OF TRANSPORTATION.
- 4. THE CONTRACTOR SHALL BE RESPONSIBLE FOR HAVING THE UTILITY COMPANIES LOCATE THEIR FACILITIES IN THE FIELD PRIOR TO CONSTRUCTION AND SHALL ALSO BE RESPONSIBLE FOR THE MAINTENANCE AND PRESERVATION OF THESE FACILITIES. THE ENCINEER DOES NOT WARRANT THE LOCATION OF ANY EXISTING UTILITIES SHOWN ON THE PLAN. THE CONTRACTOR SHALL CALL JULLIE. AT 800-892-0123 AND THE VILLAGE OF BENSENVILLE FOR UTILITY LOCATIONS.
- 5. ALL CONTRACTORS SHALL KEEP ACCESS AVAILABLE AT ALL TIMES FOR ALL TYPES OF TRAFFIC, UNLESS OTHERWISE DIRECTED BY THE OWNER AND THE OWNER'S REPRESENTATIVE.
- 6. CONTRACTOR SHALL PHOTOGRAPH AND VIDEO DOCUMENT THE WORK AREA PRIOR TO CONSTRUCTION FOR THE PURPOSE OF DOCUMENTING EXISTING CONDITIONS.
- 7. FOR STABILIZATION, ALL TYPE III BARRICADES SHALL REQUIRE A MINIMUM OF FOUR SAND BAGS PER BARRICADE.
- 8. ANY EXISTING SIGNS, MAILBOXES, LIGHT STANDARDS AND UTILITY POLES WHICH INTERFERE WITH CONSTRUCTION OPERATIONS AND ARE NOT NOTED ON THE PLANS FOR DISPOSAL SHALL BE REMOVED AND RESET BY THE CONTRACTOR AS DIRECTED BY THE RIGINEER. ANY DAMAGE TO THESE IEMS SHALL BE REPARED OR REPLACED BY THE CONTRACTOR TO THE SATISFACTION OF THE OWNER. ANY SIGNS NOT REQUIRED TO BE RESET, SHALL BE DELUKERED TO THE RESPECTIVE OWNERS.
- 9. REMOVAL OF SPECIFIED ITEMS, INCLUDING BUT NOT LIMITED TO, PAVEMENT, SIDEWALK. CCURB, CURB AND GUTTER, CULVERTS, STRUCTURES ETC. SHALL BE DISPOSED OF OFF-SITE BY THE CONTRACTOR AT THE CONTRACTORS OWN EXPENSE. THE CONTRACTOR IS RESPONSIBLE FOR ANY PERMITS REQUIRED FOR SUCH DISPOSAL THE REMOVAL SHALL BE ACCOMPLISHED BY MEANS OF A SAW CUT JOINT, AT THE DIRECTION OF THE
- 10. ANY FIELD TILES ENCOUNTERED SHALL BE INSPECTED BY THE ENGINEER. THE DRAIN TILE SHALL BE CONNECTED TO THE STORM SEWER AND A RECORD KEPT BY THE CONTRACTOR OF THE LOCATIONS AND TURNED OVER TO THE ENGINEER UPON COMPLETION OF THE PROJECT.
- 11. BEFORE ACCEPTANCE ALL WORK SHALL BE INSPECTED BY THE ENGINEER, AS NECESSARY
- 12. EASEMENT FOR THE EXISTING UTILITIES, BOTH PUBLIC AND PRIVATE, AND UTILITIES WITHIN PUBLIC RICHTS—OF—WAY ARE SHOWN ON THE PLANS ACCORDING TO AVAILABLE RECORDS. THE CONTRACTOR SHALL BE RESPONSIBLE FOR DETERMINING THE EXACT LOCATION OF THESE UTILITY LINES AND THEIR PROTECTION FROM DAMAGE DUE TO CONSTRUCTION OPERATIONS. IF EXISTING UTILITY LINES OF ANY NATURE ARE ENCOUNTERED WHICH CONFLICT WITH LOCATIONS OF THE NEW CONSTRUCTION, THE CONTRACTOR SHALL NOTIFY THE ENGINEER SO THAT THE CONFLICT MAY BE RESOLVED.
- 13. THE CONTRACTOR IS SOLELY RESPONSIBLE FOR SAFETY ON THE JOB PER OSHA
- 14. IT SHALL BE THE CONTRACTORS SOLE RESPONSIBILITY TO PROVIDE PROPER BARRICADING, WARNING DEVICES AND THE SAFE MANAGEMENT OF TRAFFIC WITHIN THE AREA OF CONSTRUCTION. ALL SUCH DEVICES AND THEIR INSTALLATION SHALL CONFORM TO THE "ILLINOIS MANUAL OF UNIFORM TRAFFIC CONTROL DEVICES FOR STREET AND HIGHWAYS", LATEST EDITION, THE ILLINOIS DEPARTMENT OF TRANSPORTATION AND IN ACCORDANCE WITH THE VILLAGE OF BENSENVILLE ORDINANCES.
- 15. THE CONTRACTOR SHALL COLLECT AND REMOVE ALL CONSTRUCTION DEBRIS, EXCESS MATERIALS, TRASH, OIL AND GREASE RESIDUE, MACHINERY, TOOLS AND OTHER MISCELLANEOUS ITEMS WHICH WERE NOT PRESENT PRIOR TO PROJECT COMMENCEMENT AT NO ADDITIONAL EXPENSE TO THE OWNER. THE CONTRACTOR SHALL BE RESPONSIBLE FOR ACQUIRING ANY AND ALL PERMITS NECESSARY FOR THE HAULING AND DISPOSAL REQUIRED FOR CLEAN-LUP AS DIRECTED BY THE ENGINEER OR OWNER. BURNING ON THE SITE OF ANTO PERMITS NECESSARY FOR THE HAULING AND DISPOSAL REQUIRED FOR CLEAN-LUP AS DIRECTED BY THE ENGINEER OR OWNER. BURNING ON THE
- 16. ALL EXISTING UTILITIES OR IMPROVEMENTS, INCLUDING WALKS, CURBS, PAVEMENT AND PARKWAYS DAMAGED OR REMOVED DURING CONSTRUCTION SHALL BE PROMPTLY RESTORED TO THEIR RESPECTIVE ORIGINAL CONDITION.

- 17. THE CONTRACTOR SHALL BE RESPONSIBLE FOR THE PROTECTION OF ALL PRIVATE AND PUBLIC UTILITIES EVEN THOUGH THEY MAY NOT BE SHOWN ON THE PLANS. ANY UTILITY THAT IS DAMAGED DURING CONSTRUCTION SHALL BE REPAIRED OR REPLACED, TO THE SATISFACTION OF THE ENGINEER, BY THE CONTRACTOR.
- 18. AT THE CLOSE OF EACH WORKING DAY AND AT THE CONCLUSION OF CONSTRUCTION OPERATIONS, ALL DRAINAGE STRUCTURES AND FLOW LINES SHALL BE FREE FROM DIRT AND DEBRIS.
- 19. NO UNDERGROUND WORK SHALL BE COVERED UNTIL IT HAS BEEN APPROVED BY THE ENGINEER. APPROVAL TO PROCEED MUST BE OBTAINED PRIOR TO INSTALLING PAVEMENT BASE, BINDER, SURFACE AND PRIOR TO PLACING ANY CONCRETE AFTER FORMS HAVE
- 20. IF SOFT, SPONGY OR OTHER UNSUITABLE SOILS WITH UNCONFINED COMPRESSIVE STRENGTH LESS THAN 0.5 TSF ARE ENCOUNTERED AT THE BOTTOM OF THE TRENCH, ALL SUCH MATERIAL SHALL BE REMOVED AND REPLACED WITH WELL COMPACTED CRUSHED LIMESTONE BEDDING MATERIAL. IF ROCK IS ENCOUNTERED, IT SHALL BE REMOVED TO AT LEAST SIX (6) INCHES BELOW THE BOTTOM OF THE PIPE TO ALLOW PROPER THICKNESS
- 21. EROSION CONTROL MEASURES SHALL BE INSTALLED IN ACCORDANCE WITH "ILLINOIS PROCEDURES AND STANDARDS FOR URBAN SOIL EROSION AND SEDIMENTATION CONTROL" AND SHALL BE MAINTAINED BY THE CONTRACTOR AND REMAIN IN PLACE UNTIL A SUITABLE GROWTH OF GRASS, ACCEPTABLE TO THE ENGINEER, HAS DEVELOPED.
- 22. ALL TESTING SHALL BE THE RESPONSIBILITY OF THE CONTRACTOR. COPIES OF ALL TEST RESULTS SHALL BE PROVIDED TO THE ENGINEER FOR REVIEW AND APPROVAL.
- 23. IT SHALL BE THE RESPONSIBILITY OF THE CONTRACTOR TO ENSURE THAT ALL ITEMS REQUIRED FOR CONSTRUCTION OF THE PROJECT, AS SHOWN ON THE PLANS ARE INCLUDED IN THE CONTRACT, ANY ITEM NOT SPECIFICALLY INCLUDED IN THE CONTRACT, BUT SHOWN ON THE PLANS, THE CONTRACTOR SHALL NOTIFY THE ENGINEER IMMEDIATELY THE EVENT OF A DISCREPANCY WITH THE PLANS.
- 24. THE PAVEMENT SHALL BE KEPT FREE OF MUD AND DEBRIS AT ALL TIMES. IT MAY BE NECESSARY TO KEEP A SWEEPER ONSITE AT ALL TIMES.
- 25. CONSTRUCTION MATERIALS AND/OR EQUIPMENT MAY NOT BE STORED IN THE RIGHT-OF-WAY WITHOUT THE APPROVAL OF THE ENGINEER AND VILLAGE OF BENSENVILLE.
- 26. ALL DISTURBED AREAS OF THE RIGHT-OF-WAY, OUTSIDE OF THE PROPOSED PAVEMENT AND SIDEWALKS, SHALL BE FULLY RESTORED WITH A MINIMUM 4" TOPSOIL AND SOD.
- 27. ITEMS OF WORK LISTED IN THE SUMMARY OF QUANTITIES WHICH ARE NOT SPECIFICALLY INDICATED IN THE PLANS SHALL BE PERFORMED AT LOCATIONS AS DIRECTED BY THE
- 28. THE GRADING AND CONSTRUCTION OF PROPOSED IMPROVEMENTS SHALL NOT CAUSE PONDING OF STORM WATER. GRADING SHALL BE DONE TO ALLOW POSITIVE DRAINAGE
- 29. THE TOP OF ALL STRUCTURES SHALL BE FLUSH WITH THE ADJACENT SURFACE OR AT THE INDICATED ELEVATIONS SHOWN ON THE PLANS.
- 30. FRAME ELEVATIONS ARE GIVEN ONLY TO ASSIST IN DETERMINING THE APPROXIMATE OVERALL HEIGHT OF THE STRUCTURE. FRAMES ON ALL NEW STRUCTURES WILL BE ADJUSTED TO THE FINAL ELEVATION OF THE AREA IN WHICH THEY ARE LOCATED AS PART
- 31. QUANTITIES FOR ADJUSTING WATER SERVICE LINES HAVE BEEN ADDED TO THE SUMMARY OF QUANTITIES TO BE USED ONLY IF FIELD CONDITIONS REQUIRE THEIR USE.
- 32. ACCESS TO PRIVATE DRIVEWAYS SHALL BE PROVIDED AT ALL TIMES UNLESS OTHERWISE 2. ACCESS TO PHIVATE DRIVEWAYS SHALL BE PROVIDED AT ALL TIMES UNLESS OTHERWISE DIRECTED BY THE ENGINEER. THE CONTRACTOR SHALL STAGE CURB AND GUTTER AND/OR DRIVEWAY REPLACEMENT AS NECESSARY TO KEEP ACCESS DRIVEWAYS AT ALL TIMES AS INCLUDED IN THE COST OF THE CURB AND GUTTER OR DRIVEWAY CONSTRUCTION. TEMPORARY RAMPS SHALL BE CONSTRUCTED AS NEEDED TO PROVIDE ACCESS UTILIZING CRUSHED STONE OR CRUSHED GRAVEL.
- 33. IT WILL BE THE CONTRACTOR'S RESPONSIBILITY TO NOTIFY THE ENGINEER, BUSINESSES, RESIDENTS AND THE VILLAGE WHEN ACCESS TO THEIR DRIVEWAYS WILL BE AFFECTED BY CURB AND GUTTER AND/OR DRIVEWAY REPLACEMENT. THE CONTRACTOR SHALL DISTRIBUTE NOTICES TO BUSINESSES OR RESIDENTS AND POST SIGNS AT 24 HOURS PRIOR TO
- 34. THE PRIME COAT APPLICATION RATE SHALL BE 0.25 LB/SF. THE TACK COAT APPLICATION RATE SHALL BE 0.05 LB/SF ON MILLED HMA AND 0.025 LB/SF BETWEEN HMA LIFTS.
- 35. IT IS THE CONTRACTOR'S SOLE RESPONSIBILITY TO COORDINATE WITH METRA RAILROAD WHENEVER CONSTRUCTION ACTIVITY IS WITHIN 25 FEET OF THE RAILROAD ROW. THE CONTRACTOR SHALL RETAIN FLAGMEN EMPLOYED AND DESIGNATED BY THE METRA RAILROAD TO MONITOR ON-COMING TRAIN TRAFFIC, AND ADVISE CONTRACTOR PERSONNEL WHEN ACTIVITY ON OR NEAR THE RAILROAD RICHT-OF-WAY MAY PROCEED. THIS ITEM BE PAID FOR ACCORDING TO ARTICLE 107.12 AND WILL BE REIMBURSED ACCORDING
- 36. THE CONTRACTOR WILL BE REQUIRED TO COOPERATE / ACCOMMODATE THE CONSTRUCTION SCHEDULE WITH THE VILLAGE'S "MUSIC IN THE PARK" WHICH TAKES PLACE BETWEEN JUNE 1 AND OCTOBER 1 ON EVERY WEDNESDAY.

		SUMMARY OF QUANTITIES		_	CONSTI TYPE	CODE
S.I.	CODE NO.	ITEM	UNIT	TOTAL QUANTITY	ROADWAY 000:4	TR/
	20101100	TREE TRUNK PROTECTION	EACH	14	14	
-18-2411171-2118	20101200	TREE ROOT PRUNING	EACH	10	10	
	20201200	DEMOVAL AND DISPOSAL OF LINCUITABLE MATERIAL	CHAD	1110	1110	
	20201200	REMOVAL AND DISPOSAL OF UNSUITABLE MATERIAL	CU YD	1118	1118	
	21001000	GEOTECHNICAL FABRIC FOR GROUND STABILIZATION	SQ YD	3352	3352	
	- 21101615	TOPSOIL FURNISH AND PLACE, 4"	SQ YD	700	700	
	20000540	NULT FUTERC	FAGU	7.5	-	
	28000510	INLET FILTERS	EACH	26	26	
	30300001	AGGREGATE SUBGRADE IMPROVEMENT	CU YD	1118	1118	
	35101800	AGGREGATE BASE COURSE, TYPE B 6"	SQ YD	2668	2668	-
	35102200	AGGREGATE BASE COURSE, TYPE B 10"	SQ YD	297	297	
	35800100	PREPARATION OF BASE	SQ YD	3260	3260	
1114157711147144	00000			3233	5200	
	35800200	AGGREGATE BASE REPAIR	Ton	200	200	
	40201000	AGGREGATE FOR TEMPORARY ACCESS	TON	60	60	
	40600275	BITUMINOUS MATERIALS (PRIME COAT)	POUND	14007	14007	
	10000273		TOOKE	. 14007	14007	
,,,,,,,,,,,,,,,,,,,,,,,,,,,,,,,,,,,,,,,	40600982	HOT-MIX ASPHALT SURFACE REMOVAL - BUTT JOINT	SQ YD	200	200	
	40603080	HOT-MIX ASPHALT BINDER COURSE, IL-19.0, N50	Ton	1220	1220	
	40603153	POLYMERIZED HOT-MIX ASPHALT SURFACE COURSE, STONE MATRIX ASPHALT, N80	TON	200	200	
	40003133	TOTIMENIZED TOTIMIN AST THAT SOM ACE COOKSE, STONE MATRIX AST THAT, NOO	1011	200	200	
	40603335	HOT-MIX ASPHALT SURFACE COURSE, MIX "D", N50	Ton	550	550	
	40700100	BITUMINOUS MATERIALS (TACK COAT)	POUND	2002	2002	
	43400300	DODTI AND CEMENT CONCRETE SIDEWALK CINCIL	SO FT		F.0.	
	42400200	PORTLAND CEMENT CONCRETE SIDEWALK 5 INCH	SQ FT	50	50	
	42400800	DETECTABLE WARNINGS	SQ FT	70	70	
	44000200	DRIVEWAY PAVEMENT REMOVAL	SQ YD	51	51	-

44000300 CURB REMOVAL

44000500 COMBINATION CURB AND GUTTER REMOVAL

	SUMMARY OF QUANTITIES CODE NO. ITEM UNIT CHARTY									
S.I.	CODE NO.	ITEM	UNIT	TOTAL QUANTITY	ROADWAY 0004	TRAINEES 0042				
	44000600	SIDEWALK REMOVAL	SQ FT	4251	4251					
	44201696	CLASS D PATCHES, TYPE IV, 4 INCH	SQ YD	150	150					
	550A2520	STORM SEWERS, RUBBER GASKET, CLASS A, TYPE 2 12"	FOOT	21	21					
	JJOAZJZO	3.5. (M. 52.7. (M. 53.5. (M. 53.5. (M. 53.7. (M. 52.7. (1001	21	21					
	550A2560	STORM SEWERS, RUBBER GASKET, CLASS A, TYPE 2 24"	FOOT	309	309					
	550B2510	STORM SEWERS, RUBBER GASKET, CLASS B, TYPE 2 10"	FOOT	27	27	***************************************				
	60100104	PIPE UNDERDRAINS, TYPE 1, 4"	гоот	225	225					
	60108104	FIFE UNDERDRAINS, TIFE 1, 4	FOOT	325	325					
	60200105	CATCH BASINS, TYPE A, 4'-DIAMETER, TYPE 1 FRAME, OPEN LID	EACH	2	2					

	60201105	CATCH BASINS, TYPE A, 4'-DIAMETER, TYPE 11 FRAME AND GRATE	EACH	1	1					
	60201110	CATCH BASINS, TYPE A, 4'-DIAMETER, TYPE 11V FRAME AND GRATE	EACH	1	1					
	60203805	CATCH BASINS, TYPE A, 5'-DIAMETER, TYPE 1 FRAME, OPEN LID	EACH	1	1					
	00203803	CATCH DASING, THE EA, 3 DIAMETER, THE ETHANIE, OF ENERD	LACIT	1		,,,,,,,,,,,,,,,,,,,,,,,,,,,,,,,,,,,,,,,				
******	60203905	CATCH BASINS, TYPE A, 5'-DIAMETER, TYPE 1 FRAME, CLOSED LID	EACH	1	1	/*************************************				
	60206905	CATCH BASINS, TYPE C, TYPE 1 FRAME, OPEN LID	EACH	2	2					
	60207605	CATCH BASINS, TYPE C, TYPE 8 GRATE	EACH	1	1					
	60221100	MANHOLES, TYPE A, 5'-DIAMETER, TYPE 1 FRAME, CLOSED LID	EACH	1	1					
	00222200		2.10.1							
	60234200	INLETS, TYPE A, TYPE 1 FRAME, OPEN LID	EACH	1	1					
	60236800	INLETS, TYPE A, TYPE 11 FRAME AND GRATE	EACH	2	2					
	60006005	INLETE TYPE A TYPE 111/ FRAME AND CRATE	5.011							
	60236825	INLETS, TYPE A, TYPE 11V FRAME AND GRATE	EACH	1	1					
	60266100	VALVE VAULTS TO BE RECONSTRUCTED	EACH	1	1					
	. ,									
	60600605	CONCRETE CURB, TYPE B	FOOT	1539	1539					
	60603800	COMBINATION CONCRETE CURB AND GUTTER, TYPE B-6.12	FOOT	1286	1286					
<	CC000000	NON CDECIAL WASTE DISPOSA!	61175	2425	3435					
۲.	66900200	NON-SPECIAL WASTE DISPOSAL	CU YD	2125	2125					
	67100100	MOBILIZATION	LSUM	1	1	.,				
k	72000100	SIGN PANEL - TYPE 1	SQ FT	37	37					
						,				

* - INDICATES SPECIALTY ITEMS

650

900

650

900

FOOT

FOOT

FILE NAME = 15R0650-QUAN-30 - P01	USER NAME =	DESIGNED JR	REVISED —		PARKING, SIDEWALKS, RESURFACING, RECONSTRUCTION	MUN	SECTION	COUNTY	TOTAL	SHEET
		CHECKED MAW	REVISED —	STATE OF ILLINOIS	MUN 4011 (RAILROAD AVENUE) SUMMARY OF QUANTITIES		16-00096-00-PK	DUPAGE	36	3
	PLOT SCALE ∞	DRAWN — PS	REVISED	DEPARTMENT OF TRANSPORTATION				CONTRACT NO. 61		55
HAR BOTH TROOT IS TO FORCE WATER, TOTAL THE PROPERTY OF THE PR	PLOT DATE = 2-12-18	CHECKED — AG	REVISED —		SCALE: NONE SHEET NO. 3 OF 36 SHEETS STA. TO STA.	FED. ROAD DIST.	NO. ILLINOIS FE	D. AID PROJECT		

L		SUMMARY OF QUANTITIES			TYPE	CODE
s.	I. CODE NO	. ITEM	UNIT	TOTAL QUANTITY	ROADWAY 000 4	TRAINEES 0042
*	72900100	METAL POST - TYPE A	FOOT	167	167	
*	78000100	THERMOPLASTIC PAVEMENT MARKING - LETTERS AND SYMBOLS	SQ FT	95	95	
*	78000200	THERMOPLASTIC PAVEMENT MARKING - LINE 4"	FOOT	2512	2512	
*	78000400	THERMOPLASTIC PAVEMENT MARKING - LINE 6"	FOOT	505	505	
*	78000600	THERMOPLASTIC PAVEMENT MARKING - LINE 12"	FOOT	155	155	
*	78000650	THERMOPLASTIC PAVEMENT MARKING - LINE 24"	FOOT	28	28	
	Z0003855	BICYCLE RACKS	EACH	2	2	
	Z0013798	CONSTRUCTION LAYOUT	LSUM	1	1	***************************************
	Z0017400	DRAINAGE & UTILITY STRUCTURES TO BE ADJUSTED	EACH	16	16	
	Z0018700	DRAINAGE STRUCTURE TO BE REMOVED	EACH	6	6	
	Z0048665	RAILROAD PROTECTIVE LIABILITY INSURANCE	LSUM	1	1	
	Z0076600	TRAINEES	HOUR	500		500
	Z0076604	TRAINEES TRAINING PROGRAM GRADUATE	HOUR	500		500
	X0322080	BUS SHELTER REMOVE AND RELOCATE	EACH	1	1	
	X0322917	PROPOSED STORM SEWER CONNECTION TO EXISTING MANHOLE	EACH	2	2	
	X0323389	STORM SEWER CONNECTION	EACH	10	10	
*	X0324915	RELOCATE LIGHTING UNITS AND POLES	EACH	2	2	
	X0326275	RAILROAD RIGHT-OF-WAY ENTRY PERMIT	EACH	1	1	
	X1200046	STORM SEWERS, CLASS B, TYPE 2 8"	FOOT	50	50	
ı	1	I		ı I	1	l l

SUMMARY OF QUANTITIES

			CONSTR TYPE			
S.I.	CODE NO.	ITEM	UNIT	TOTAL QUANTITY	ROADWAY 000%	TRAINEES 0042
	X4230800	PORTLAND CEMENT CONCRETE DRIVEWAY PAVEMENT, 8 INCH, SPECIAL	SQ YD	90	90	
	X4401198	HOT-MIX ASPHALT SURFACE REMOVAL, VARIABLE DEPTH	SQ YD	4917	4917	
	X4404400	PAVEMENT REMOVAL (SPECIAL)	SQ YD	1880	1880	
	X5510100	STORM SEWER REMOVAL	FOOT	20	20	
*	X5620128	ADJUSTING WATER SERVICE LINES	EACH	2	2	
	X6025620	CATCH BASINS, TYPE A, 5'-DIAMETER, WITH SPECIAL FRAME AND GRATE	EACH	2	2	
	X6061005	CONCRETE CURB, TYPE B (SPECIAL)	FOOT	150	150	
	X7010216	TRAFFIC CONTROL AND PROTECTION, (SPECIAL)	LSUM	1	1	
	X7015005	CHANGEABLE MESSAGE SIGN	CAL DA	122	122	
*	X8360095	EXISTING LIGHT POLE FOUNDATION ADJUSTMENT	EACH	9	9	-
	XX001621	BRICK PAVER REMOVAL	SQ FT	420	420	
	XX003816	FURNISHING AND INSTALLING CONCRETE WHEEL STOPS	EACH	14	14	
	XX005690	STORM SEWER, DUCTILE IRON PIPE, CLASS 52 12"	FOOT	110	110	
	XX007852	PEDESTRIAN BENCH, FURNISH AND INSTALL	EACH	2	2	
	XX007857	TRASH RECEPTACLE, FURNISH & INSTALL	EACH	5	5	
	XX008257	STAMPED COLORED PORTLAND CEMENT CONCRETE SIDEWALK, 5 INCH	SQ FT	8800	8800	
	XX009156	OVERHEAD PARKING NUMBERING	L SUM	1	1	
	XX009221	STAMPED COLORED PORTLAND CEMENT CONCRETE CROSSWALK, 10 INCH	SQ FT	300	300	

* - INDICATES SPECIALTY ITEMS

CU YD

CU YD

510

700

510

120

700

FILE NAME = 15R0650-QUAN-30 - P02	USER NAME =	DESIGNED — JR	REVISED
		CHECKED — MAW	REVISED
	PLOT SCALE =	DRAWN — PS	REVISED —
A FIRST SETTLE OF FRANCISCO CONTRACTOR	PLOT DATE = 2-12-18	CHECKED - AG	REVISED —

X2020410 EARTH EXCAVATION (SPECIAL)

X2080250 TRENCH BACKFILL, SPECIAL


X2130010 EXPLORATION TRENCH, SPECIAL


X2520650 SODDING, SALT TOLERANT (SPECIAL)


STATE OF ILLINOIS DEPARTMENT OF TRANSPORTATION


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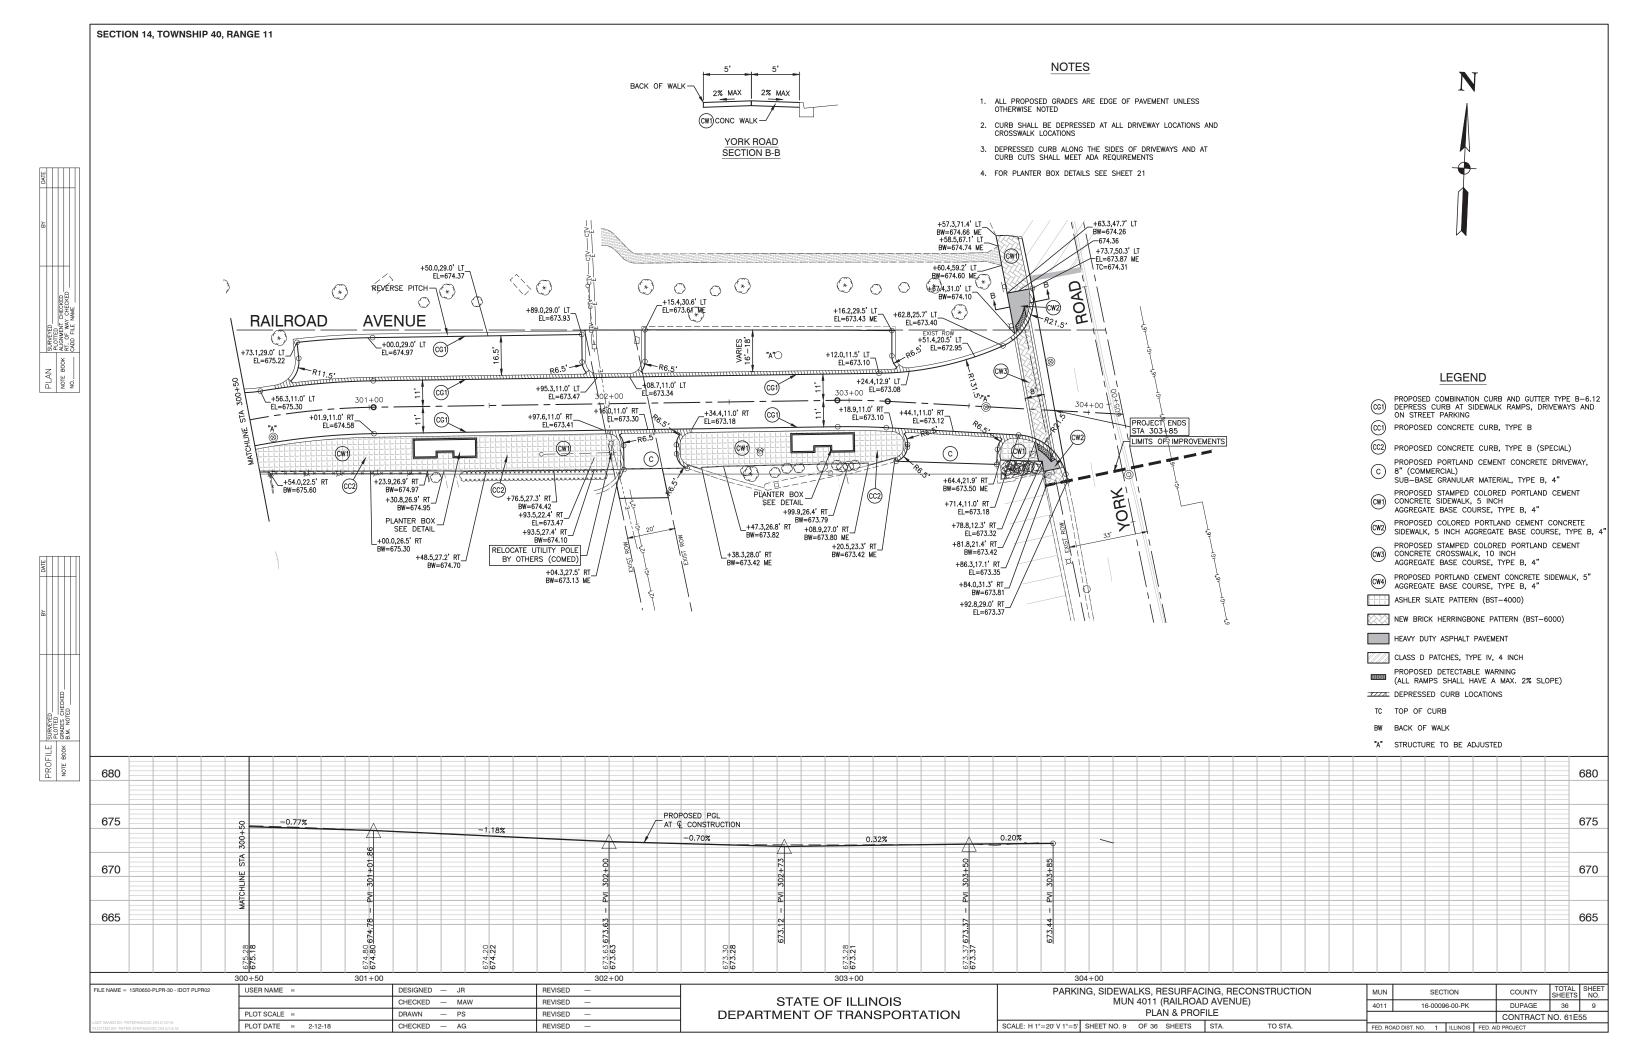
PARKING, SIDEWALKS, RESURFACING, RECONSTRUCTION						MUN SECTION				COUNTY	TOTAL SHEETS	SHEET NO.	
	MUN 4011 (RAILROAD AVENUE)					4011	16-0009		DUPAGE	36	4		
	SUMMARY OF QUANTITIES										CONTRACT	NO. 61E	55
ALE: NONE	SHEET NO. 4	OF 36	SHEETS	STA.	TO STA.		FED. ROAD DIST. NO. ILLINOIS FED. AI		ID PROJECT				




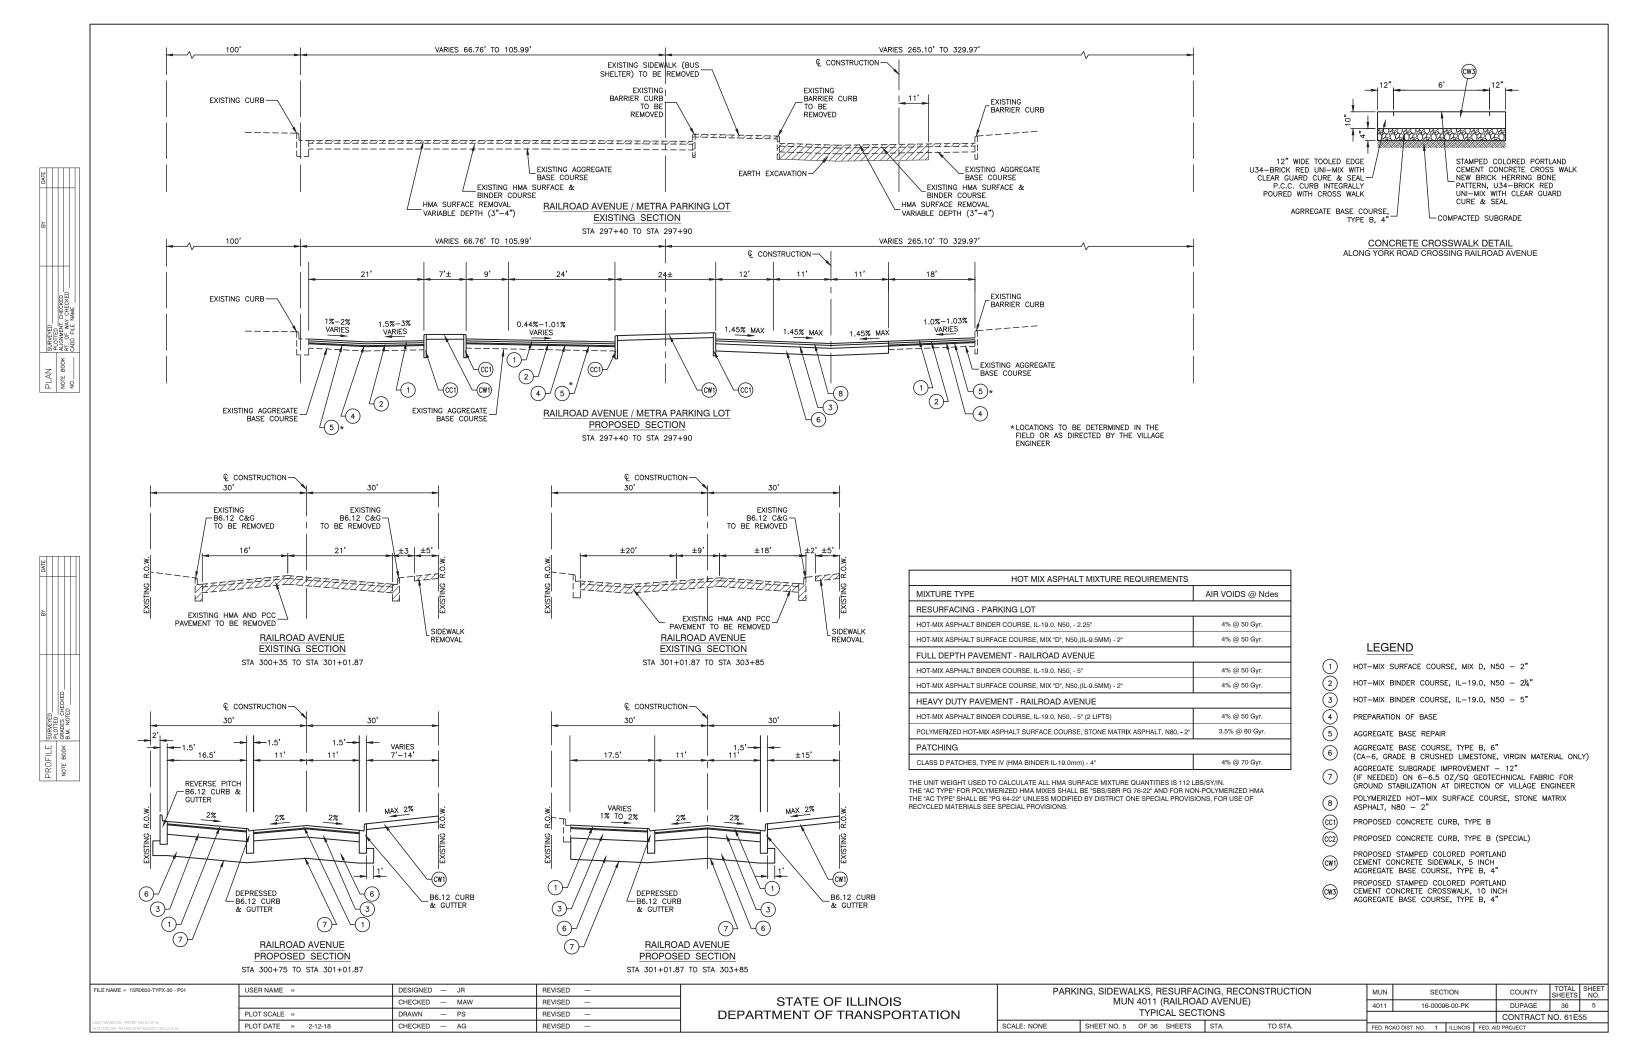


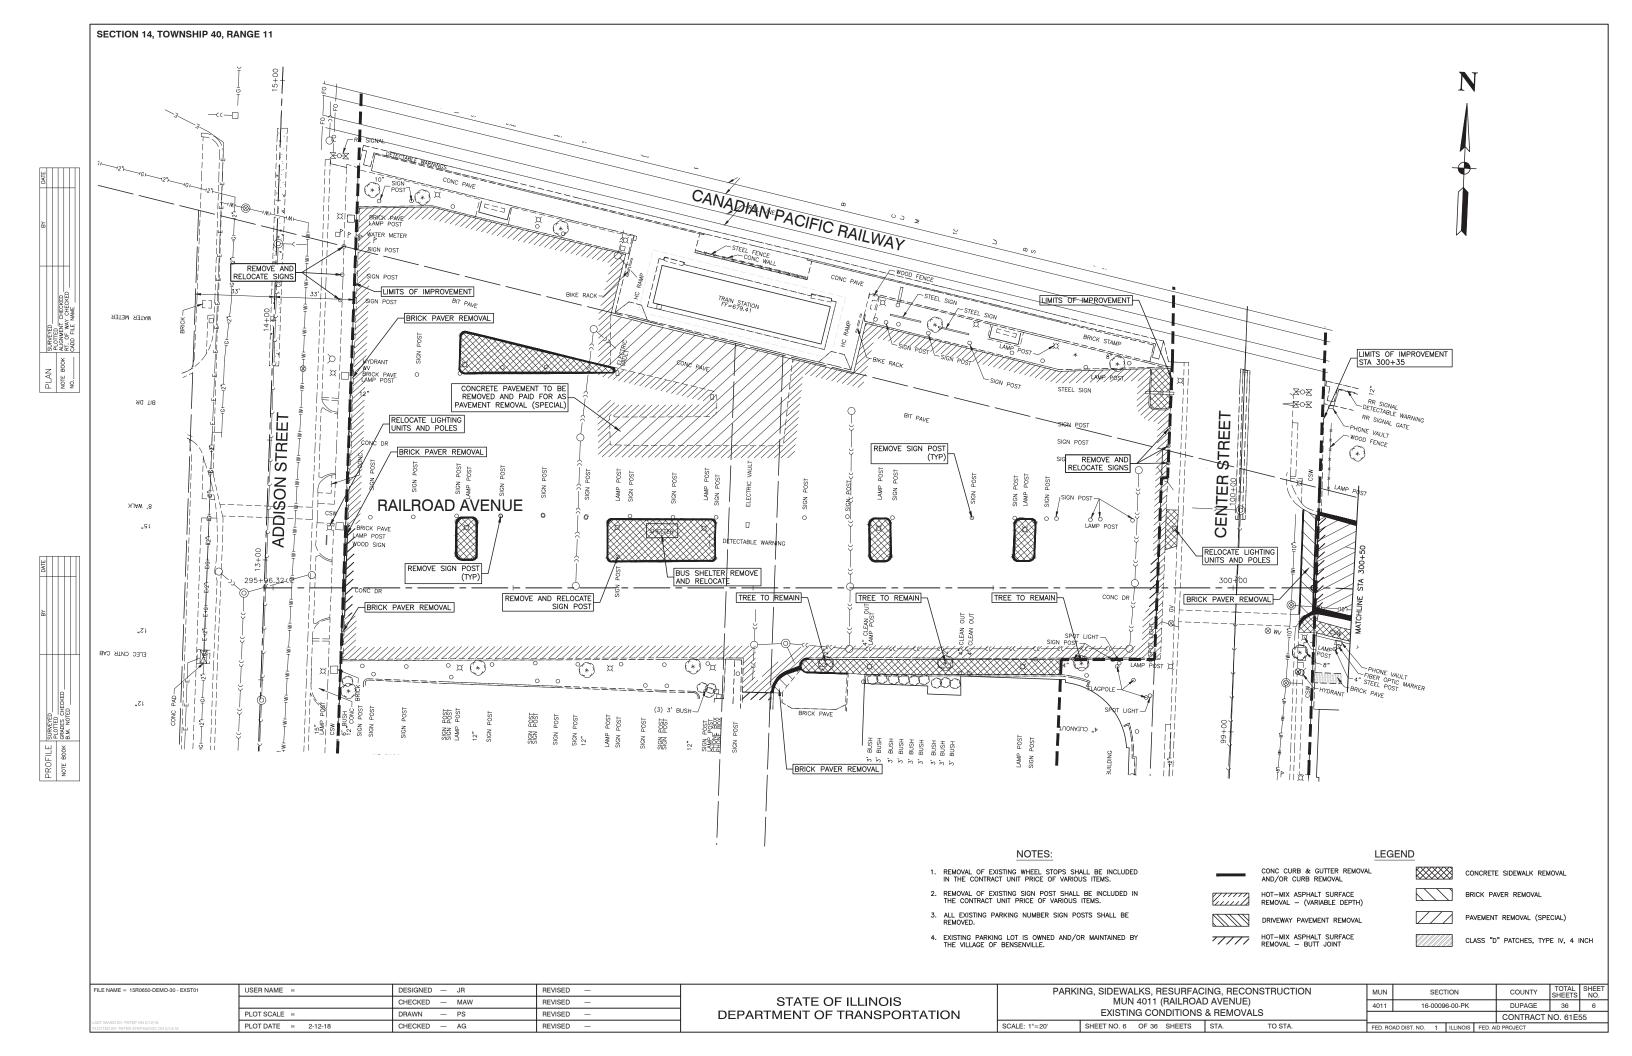


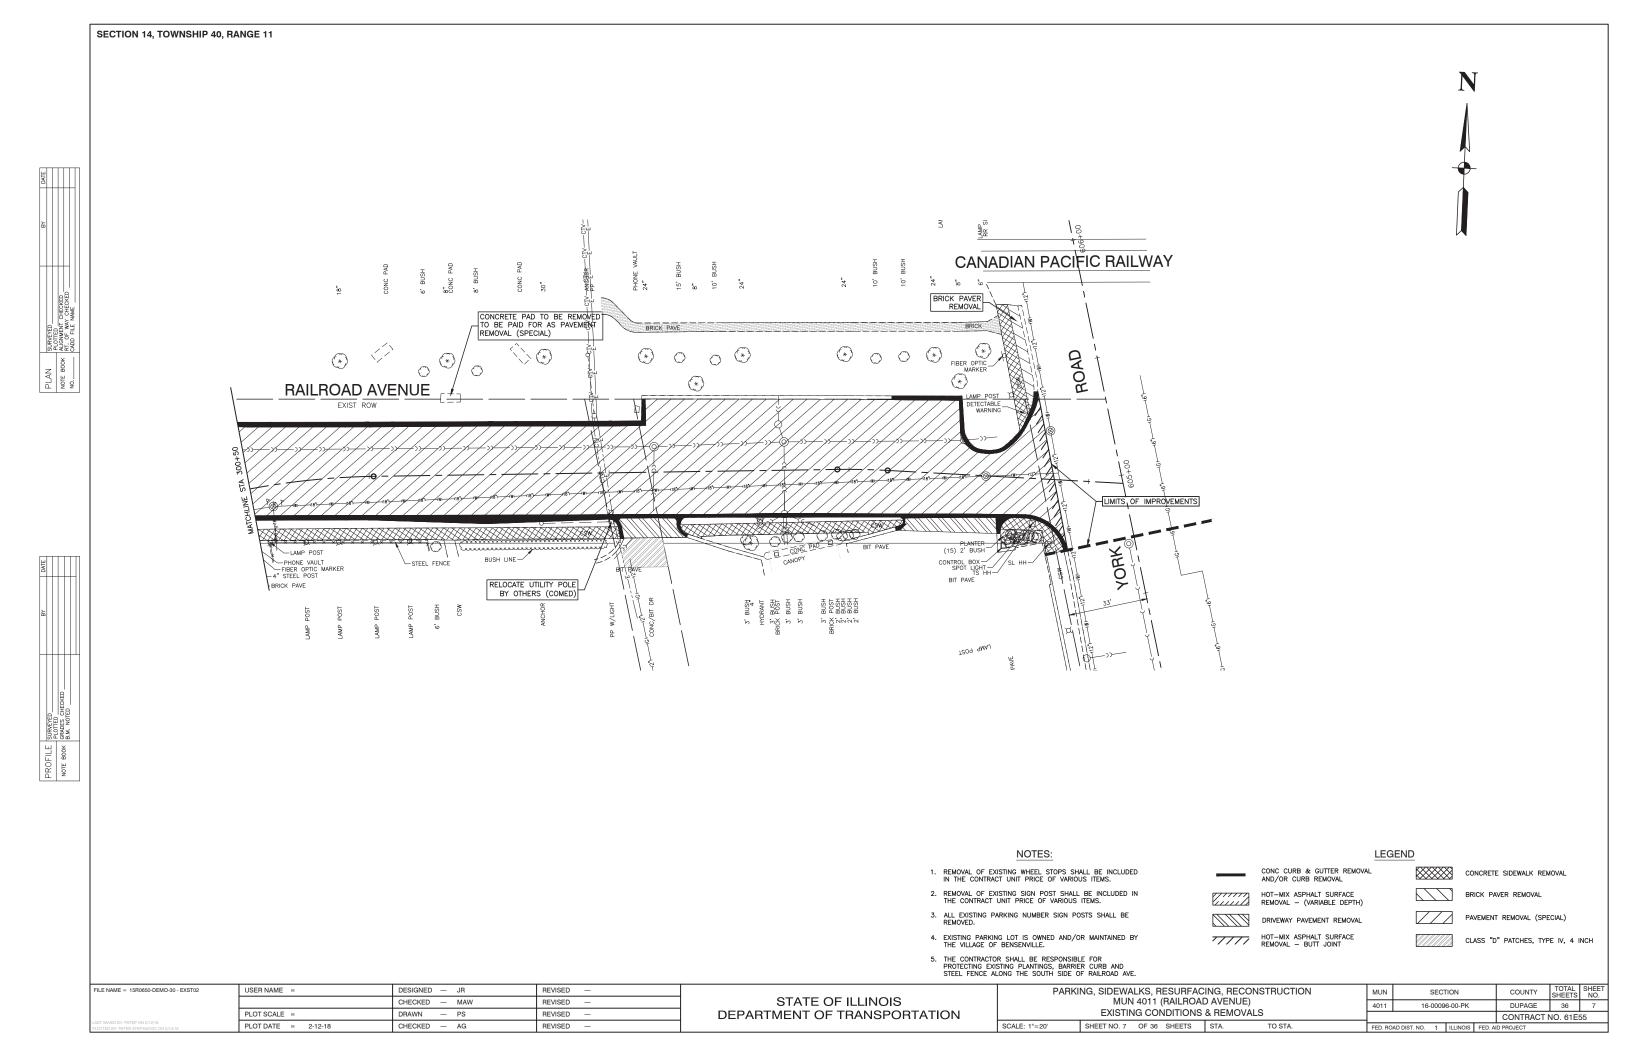

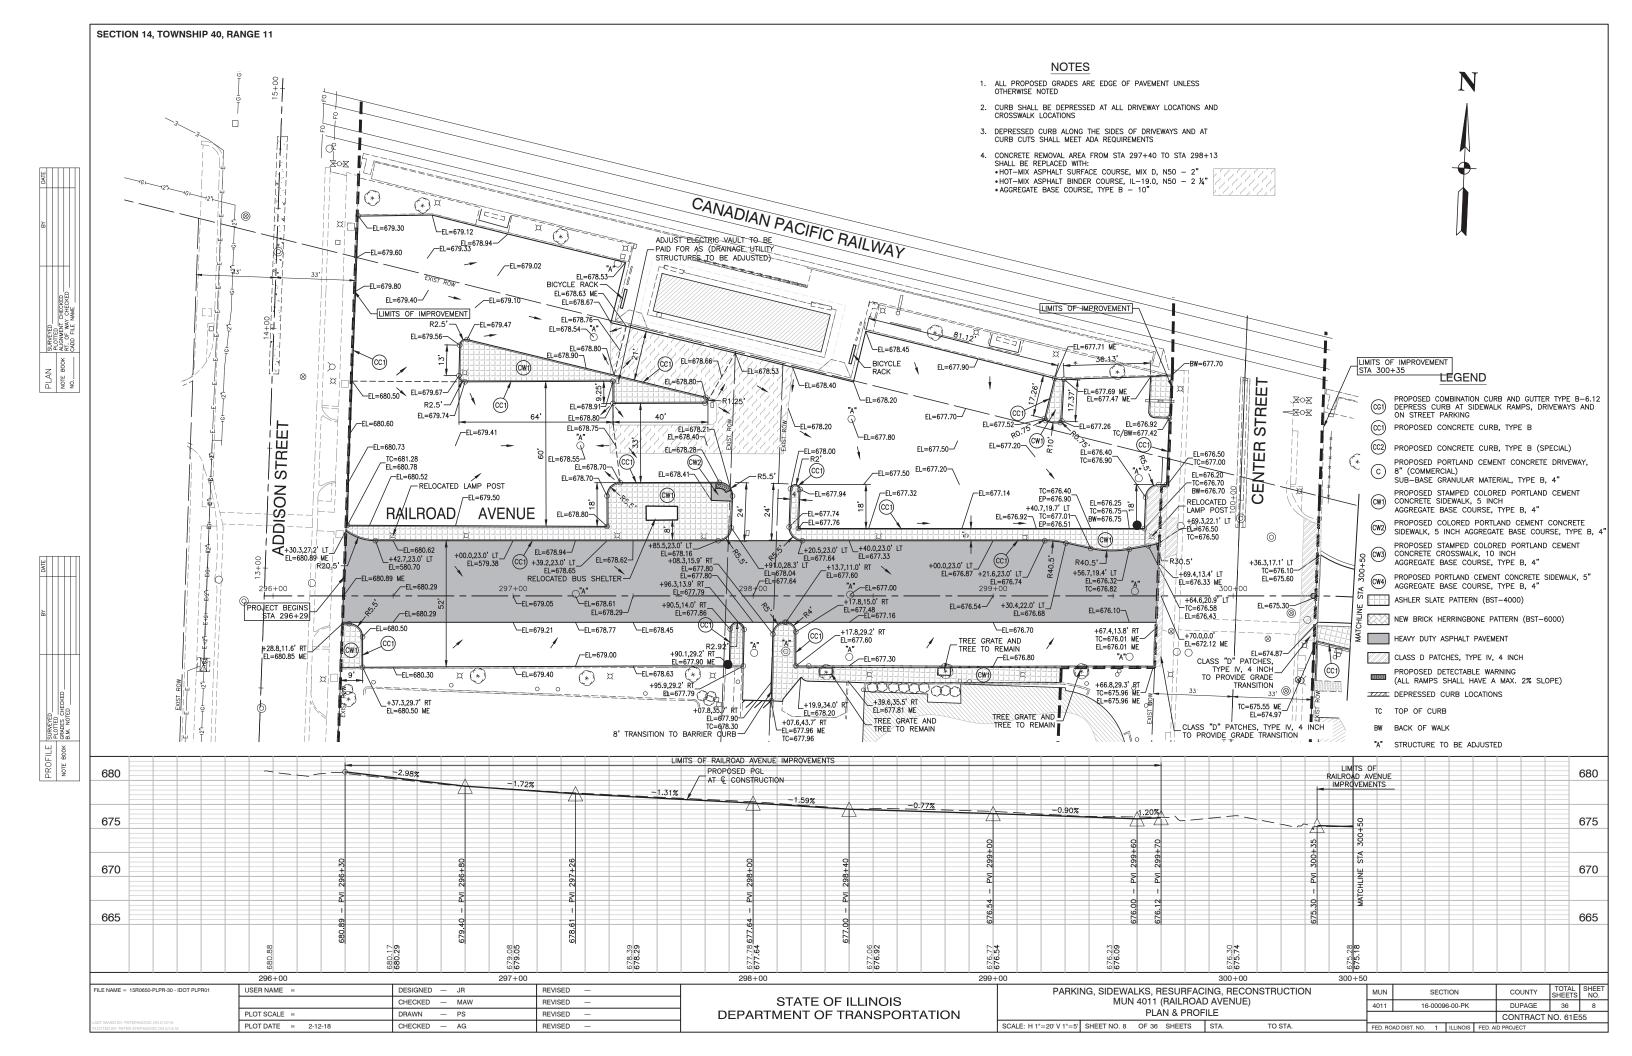

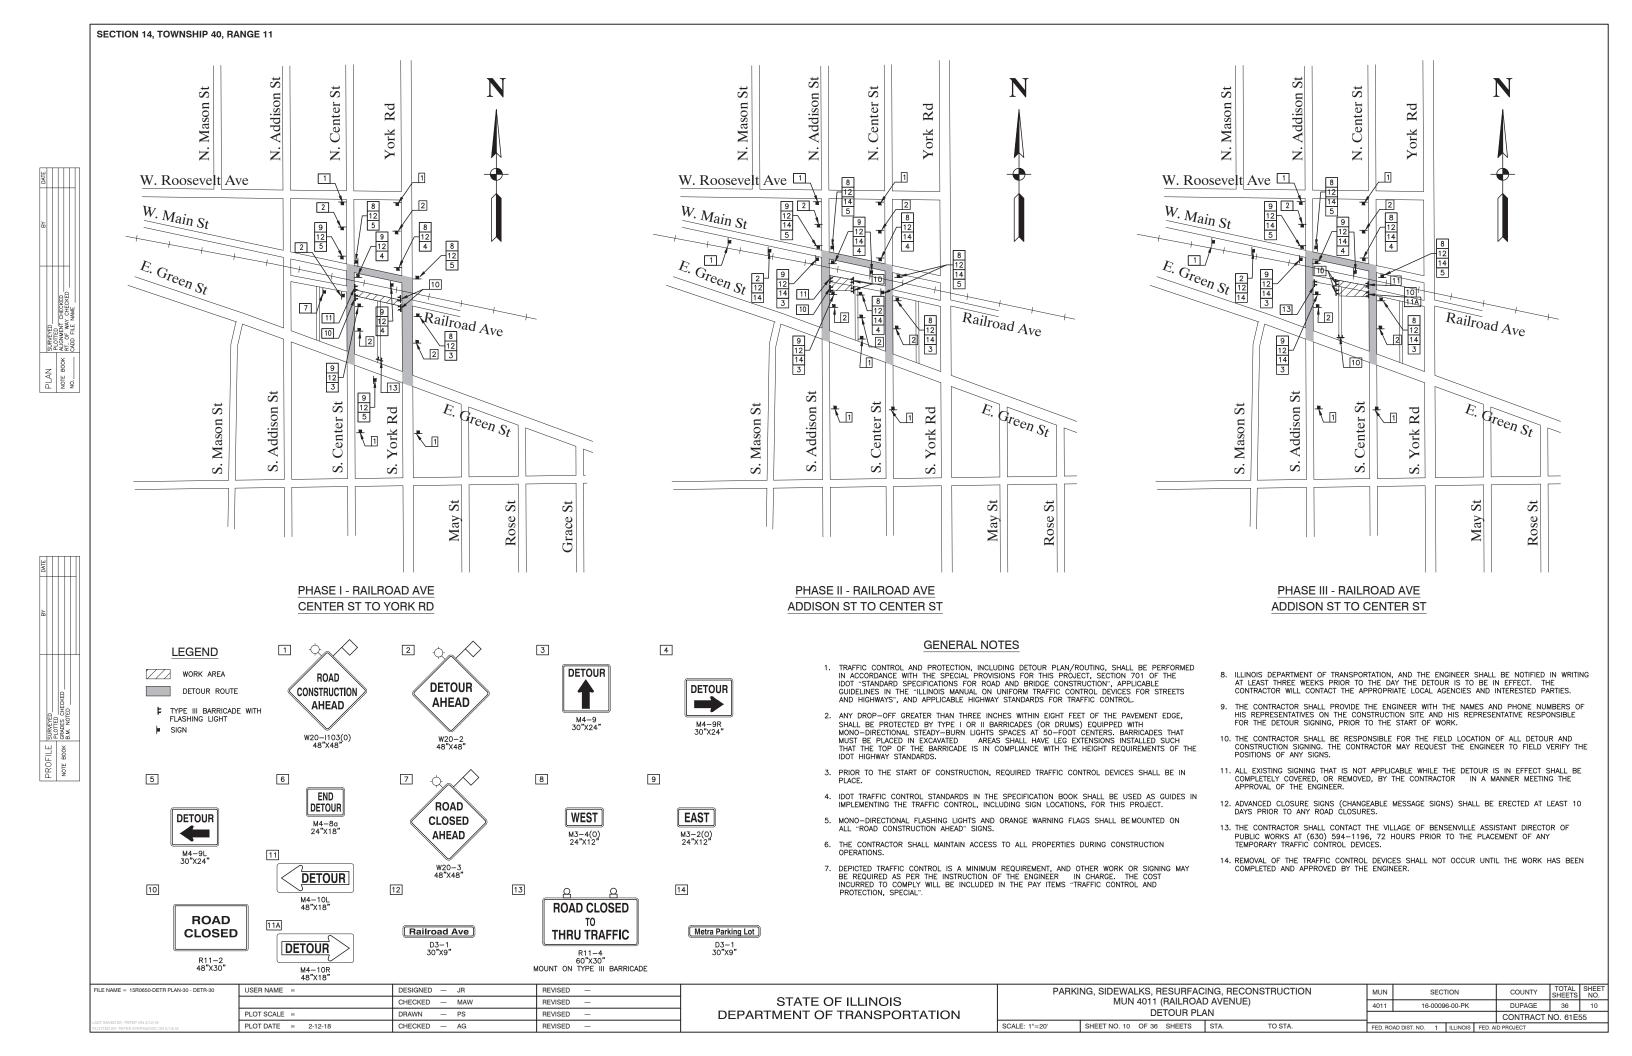

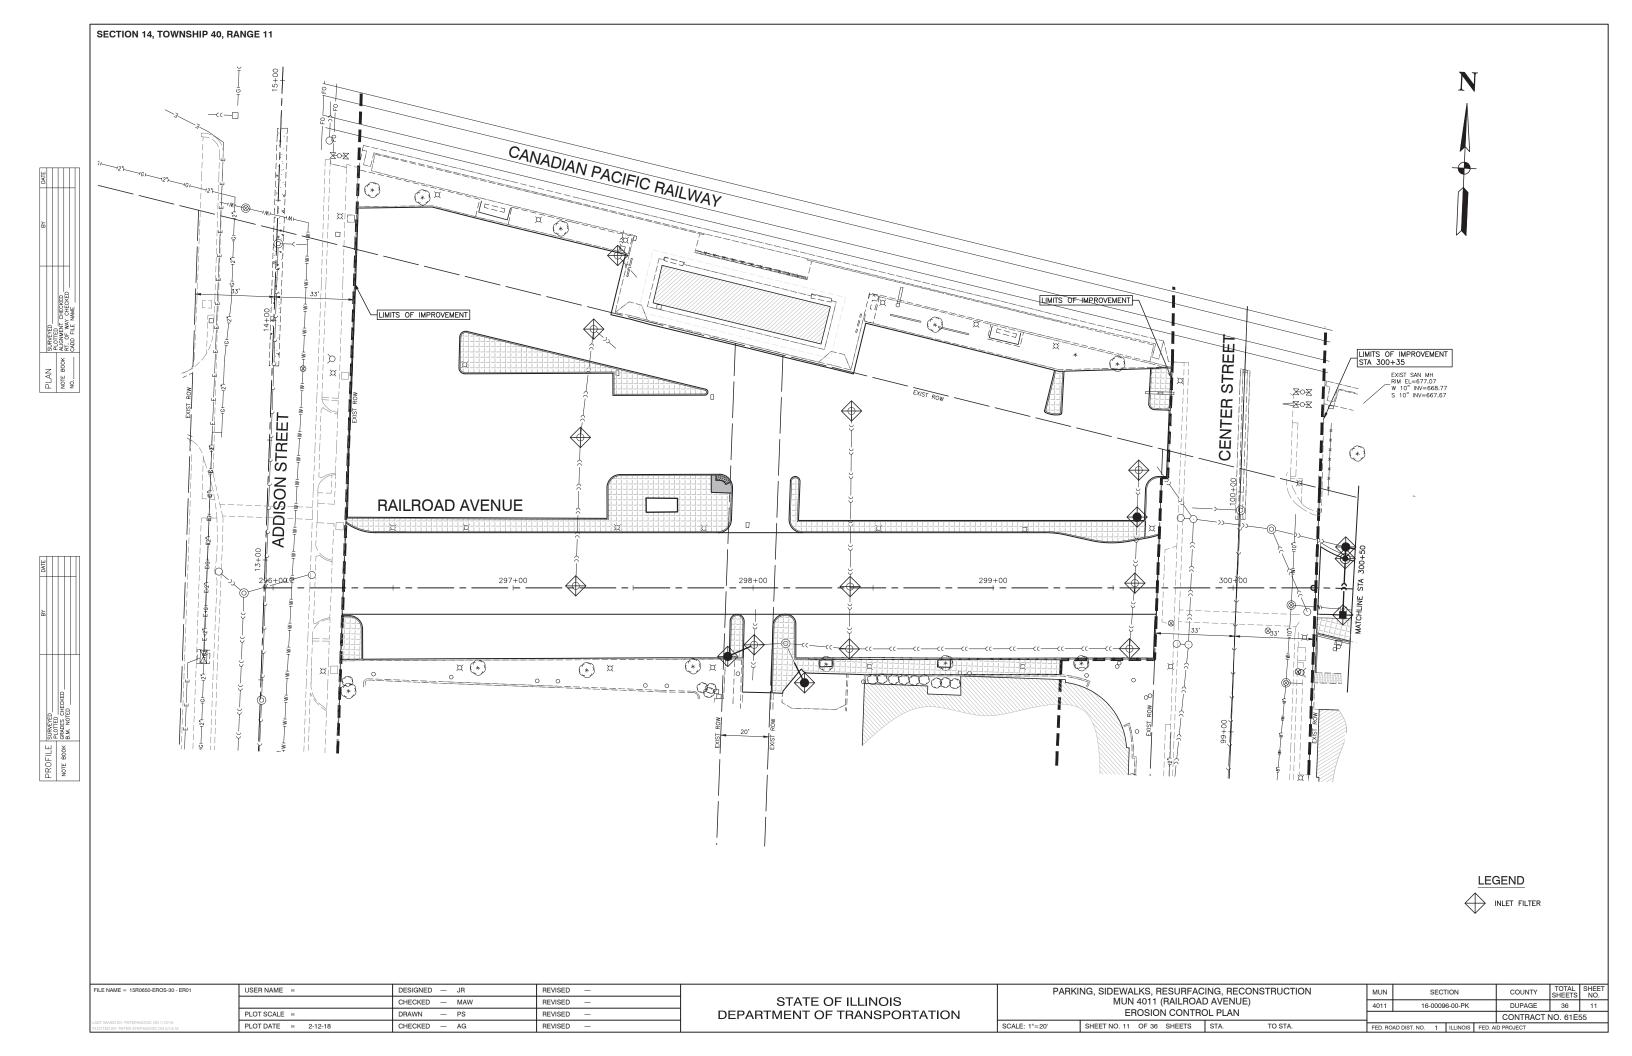

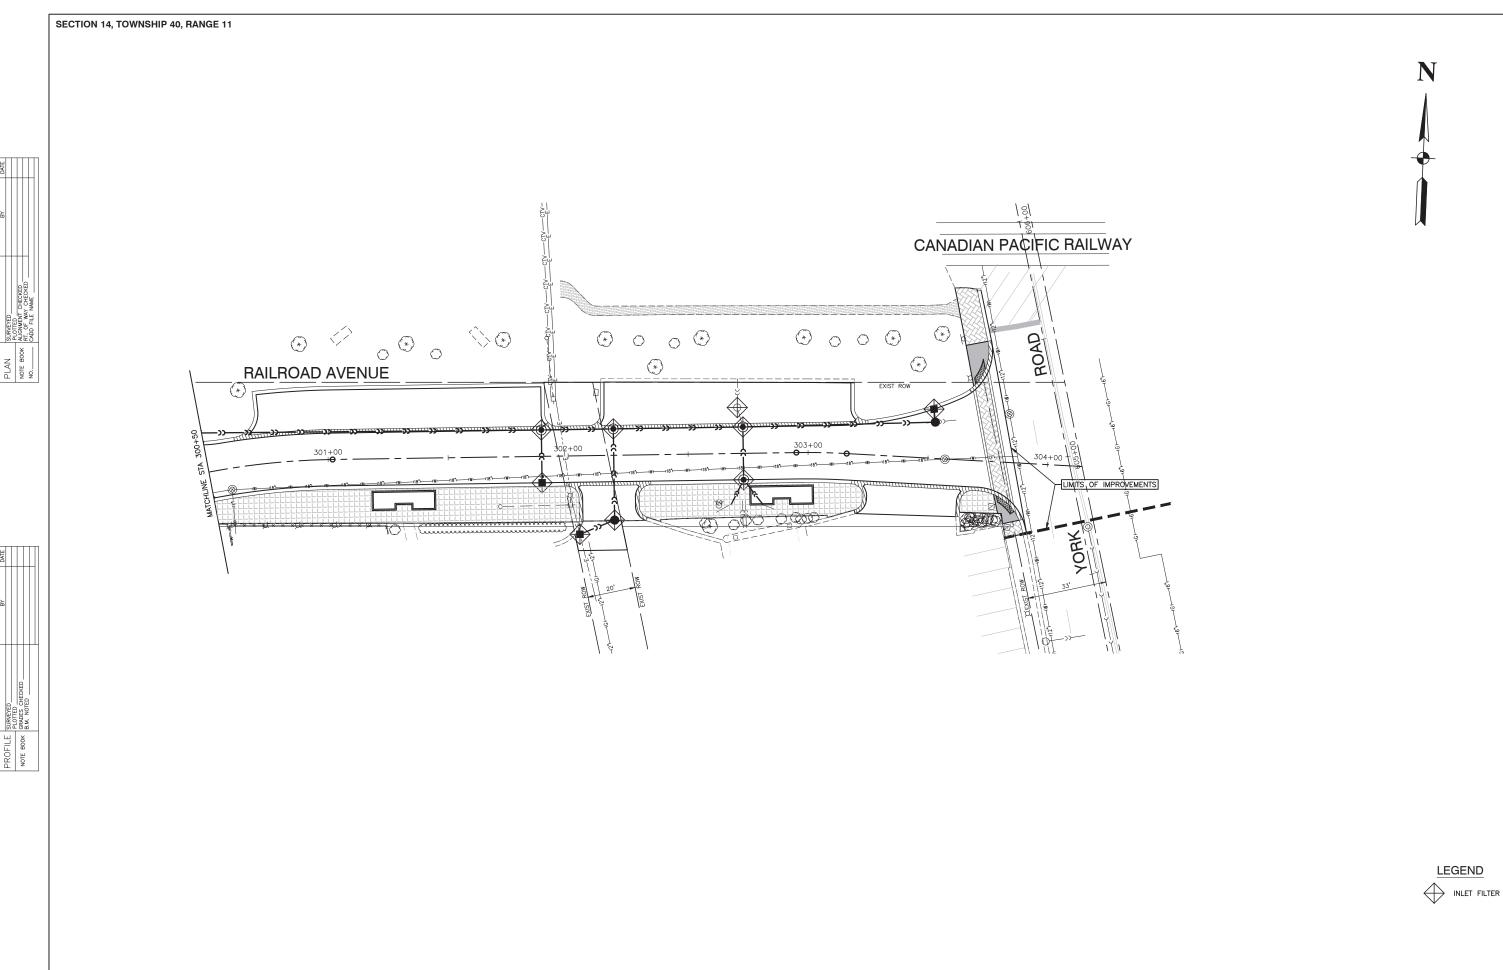

STATE OF ILLINOIS
DEPARTMENT OF TRANSPORTATION

FILE NAME = 15R0650-EROS-30 - ER02

USER NAME =

PLOT SCALE =

PLOT DATE = 2-12-18

DESIGNED — JR

CHECKED — AG

DRAWN

CHECKED — MAW

REVISED —

REVISED

REVISED

REVISED

SECTION 14, TOWNSHIP 40, RANGE 11

GENERAL NOTES

THIS STORMWATER POLLUTION PREVENTION PLAN (SWPPP) HAS BEEN PREPARED TO COMPLY WITH THE PROVISIONS OF NPDES ILRTO CONSTRUCTION GENERAL PERMIT (CGP) ISSUED BY THE ILLINOIS ENVIRONMENTAL PROTECTION AGENCY FOR STORWATER DISCHARGES FROM

THE CONTRACTOR IS RESPONSIBLE FOR HAVING THE SWPPP ON SITE AT ALL TIMES. THE CONTRACTOR IS ALSO RESPONSIBLE FOR PROVIDING THE QUALIFIED PERSONNEL AND FOR PERFORMING THE REQUIRED INSPECTIONS.

PROJECT DESCRIPTION

THE PROJECT CONSISTS OF THE RECONSTRUCTION OF ROADWAY, ROADWAY RESURFACING, DRIVEWAY REMOVAL AND REPLACEMENT, SIDEWALK REMOVAL AND REPLACEMENT, PARKWAY GRADING AND RESTORATION. THE TOTAL AREA OF DISTURBANCE IS

- EXISTING SITE CONDITIONS AND SURROUNDING AREAS THE WORK IS CONTAINED WITHIN THE VILLAGE OF BENSENVILLE RIGHT-OF-MAY AND MINOR DISTURBANCE ON PRIVATE PROPERTY AND RAILROAD OWNED PROPERTY. AREAS SURROUNDING THE PROJECT ARE
- THE SOILS WITHIN THE PROJECT SITE ARE A MIXTURE OF ORTHENTS, CLAYEY, UNDULATING. EXCAVATION OUTSIDE OF PAVED AREAS WILL BE BACKFILLED WITH NATIVE SOILS.
- CRITICAL AREAS
 THE PROJECT SITE CONTAINS NO CRITICAL AREAS.
- STANDARD SOIL EROSION AND SEDIMENTATION CONTROL

SOIL EROSION AND SEDIMENT CONTROL PRACTICES FOR THIS PROJECT SHALL BE PERFORMED IN ACCORDANCE WITH THE DETAILS AS PROVIDED IN THE PLANS. ALL EROSION CONTROL PRACTICES SHALL BE INSTALLED PRIOR TO STARTING EACH PHASE OF CONSTRUCTION. AFTER AWARD OF THE CONTRACT, THE CONTRACTOR FOR THE PROJECT SHALL SIGN THIS PLAN ACKNOWLEDGING RESPONSIBILITY FOR THE SHALL SIGN INTIS PLAN ACKNOWLEDGING RESPONSIBILITY FOR THE IMPLEMENTATION OF ON-GOING MAINTENANCE OF THIS PLAN. THE EROSION CONTROL PRACTICES SHALL BE INSPECTED AT LEAST WEEKLY, AND AFTER ANY RAINFALL GREATER THAN 0.5". ANY VISIBLE DISRUPTION TO THE EROSION CONTROL PRACTICES SHALL BE IMMEDIATELY REPAIRED. ANY EXISTING SUBSURFACE DRAINAGE SYSTEMS OR FIELD TILES THAT ARE DISTURBED DURING THE CONSTRUCTION SHALL BE PETENDED. TO ADDITION SHALL BE STRIPPED. CONSTRUCTION SHALL BE RESTORED. TOPSOIL SHALL BE STRIPPED AT THE TIME OF EXCAVATION AND REPLACED DURING THE BACKFILL OPERATION. ANY DUST OR MUD FROM THIS PROJECT TRACKED ONTO PUBLIC STREETS SHALL BE CLEANED UP AT THE END OF EACH

- PERMANENT STABILIZATION PLANS
 TOPSOIL & SOD SHALL BE INSTALLED ON ALL DISTURBED AREAS IN
 UNPAYED AREAS. THE CONTRACTOR SHALL BE RESPONSIBLE FOR
 MAINTENANCE OF ALL VEGETATION AND SODDED AREAS FOR A PERIOD
 OF ONE—YEAR AFTER COMPLETION OF THE PROJECT.
- MAINTENANCE OF EROSION CONTROL PRACTICES
 THE CONTRACTOR SHALL BE RESPONSIBLE FOR INSPECTION AND THE CONTRACTOR SHALL BE RESPONSIBLE FOR INSPECTION AND MAINTENANCE OF EROSION CONTROL PRACTICES. PRIOR TO COMMENCING WORK, THE CONTRACTOR SHALL DESIGNATE A CONTACT PERSON FOR MAINTENANCE FOR ENSURING ALL VEGETATION, EROSION AND SEDIMENT CONTROL MEASURES AND OTHER PROTECTIVE MEASURES IDENTIFIED IN THIS PLAN ARE KEPT IN GOOD AND SECRETARY CONTROL OF CO

THE PROCEDURES SET FORTH IN THE ILLINOIS URBAN MANUAL SHALL BE FOLLOWED WHERE APPLICABLE. IF NOT, APPLICABLE PROCEDURES BE FOLLOWED IN ACCORDANCE WITH MANUFACTURERS

Saint Jo EAGLE DR VDALE ST BENSENVILLE W GREEN C GROVE ST PROJECT LOCATION

CONSTRUCTION SEQUENCE

- INSTALL EROSION CONTROL
 A. INLET FILTERS ON EXIST DRAINAGE STRUCTURES
- 2. UNDERGROUND UTILITIES RAILROAD AVENUE
- B. INSTALL INLET FILTERS ON NEW STORM SEWER STRUCTURES
 3. RECONSTRUCTION OF ROADWAY
- A. RAILROAD AVENUE 4. UNDERGROUND UTILITIES
- A. VILLAGE / METRA PARKING LOT
 B. INSTALL INLET FILTERS ON NEW STORM SEWER STRUCTURES
- 5. RESURFACING/SIDEWALK R&R A. VILLAGE / METRA PARKING LOT B. YORK ROAD


INSPECTIONS

QUALIFIED PERSONNEL SHALL INSPECT DISTURBED AREAS OF THE CONSTRUCTION SITE, WHICH HAVE NOT BEEN FINALLY STABILIZED, STRUCTURAL CONTROL MEASURES AND LOCATIONS WHERE VEHICLES ENTER OR EXIT THE SITE. SUCH INSPECTIONS SHALL BE CONDUCTED AT LEAST ONCE EVERY SEVEN (7) CALENDAR DAYS AND WITHIN 24 HOURS OF THE END OF A STORM THAT IS 0.5 INCHES OR GREATER (OR EQUIVALENT SNOWFALL).

- A. DISTURBED AREAS AND AREAS USED FOR STORAGE OF MATERIALS THAT DISTURBED AREAS AND AREAS USED FOR STORAGE OF WHITEMAS THAT ARE EXPOSED TO PRECIPITATION SHALL BE INSPECTED FOR EVIDENCE OF, OR THE POTENTIAL FOR, POLLUTANTS ENTERING THE DRAINAGE SYSTEM. EROSION AND SEDIMENT CONTROL MEASURES IDENTIFIED IN THE IMPROVEMENT PLANS SHALL BE OBSERVED TO ENSURE THEY ARE THE IMPROVEMENT PLANS SHALL BE OBSERVED TO ENSURE THEY ARE OPERATING CORRECTLY. WHERE DISCHARGE LOCATIONS OR POINTS ARE ACCESSIBLE, THEY SHALL BE INSPECTED TO ASCERTAIN WHETHER EROSION CONTROL MEASURES ARE EFFECTIVE IN PREVENTING SIGNIFICANT IMPACTS TO RECEIVING WATERS. LOCATIONS WHERE VEHICLES ENTER OR EXIT THE SITE SHALL BE INSPECTED FOR EVIDENCE OF OFF-SITE SEDIMENT TRACKING.
- BASED ON THE RESULTS OF THE INSPECITON, THE DESCRIPTION OF POTENTIAL POLLUTANT SOURCES IDENTIFIED IN THE PROJECT DESCRIPTION AND POLLUTION PREVENTION MEASURES IDENTIFIED UNDER EROSION AND SEDIMENT CONTROLS SHALL BE REVISED AS APPROPRIATE AS SOON AS PRACTICABLE AFTER SUCH INSPECTION. ANY CHANGES TO THIS PLAN RESULTING FROM THE REQUIRED INSPECTIONS SHALL BE IMPLEMENTED WITHIN SEVEN (7) CALENDAR DAYS FOLLOWING THE INSPECTION.
- C. A REPORT SUMMARIZING THE SCOPE OF THE INSPECTION, NAME(S)
 AND QUALIFICATIONS OF PERSONNEL MAKING THE INSPECTION, DATE(S) OF THE INSPECTION(S), MAJOR OBSERVATIONS RELATING TO THE IMPLEMENTATION OF THIS STORMWATER POLLUTION PREVENTION PLAN AND ACTIONS TAKEN IN ACCORDANCE WITH THE ABOVE SECTION B SHALL BE MADE AND RETAINED AS PART OF THE PLAN FOR AT LEAST THREE (3) YEARS AFTER THE DATE OF THE INSPECTION. THE REPORT SHALL BE SIGNED IN ACCORDANCE WITH PART VI. G OF THE GENERAL
- IF ANY VIOLATION OF THE PROVISIONS OF THIS PLAN IS IDENTIFIED DURING THE CONDUCT OF THE CONSTRUCTION WORK COVERED BY THIS PLAN, THE INSPECTOR SHALL COMPLETE AND FILE AN "INCIDENCE OF NONCOMPLIANCE" (ION) REPORT FOR THE IDENTIFIED VIOLATION. THE RESIDENT ENGINEER OR RESIDENT TECHNICIAN SHALL USE FORMS PROVIDED BY THE ILLINOIS EVNIRONMENTAL PROTECTION AGENCY AND SHALL INCLUDE SPECIFIC INFORMATION ON THE CAUSE OF THE NONCOMPLIANCE, ACTIONS TAKEN TO PREVENT ANY FURTHER CAUSES OF NONCOMPLIANCE AND A STATEMENT DETAILING ANY ENVIRONMENTAL IMPACT WHICH MAY HAVE RESULTED FROM THE NONCOMPLIANCE. ALL REPORTS OF NONCOMPLIANCE SHALL BE SIGNED BY A RESPONSIBLE AUTHORITY IN ACCORDANCE WITH PART VI. G OF THE GENERAL PERMIT.
- THE REPORT OF NONCOMPLIANCE SHALL BE MAILED TO THE FOLLOWING

ILLINOIS ENVIRONMENTAL PROTECTION AGENCY DIVISION OF WATER POLLUTION CONTROL ATTN: COMPLIANCE ASSURANCE SECTION 1021 NORTH GRAND EAST POST OFFICE BOX 19276 SPRINGFIELD, ILLINOIS 62794-9276

(WITH COPIES SENT TO THE OWNER AND ENGINEER)

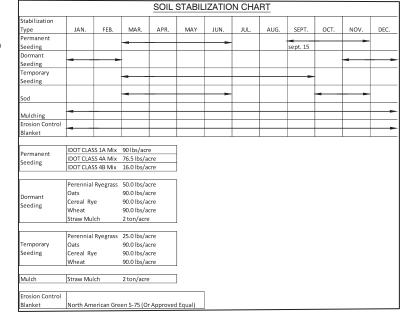

DESCRIPTION OF STORMWATER MANAGEMENT CONTROLS

- 1. INSTALL INLET FILTERS ON ALL EXISTING DRAINAGE STRUCTURES WITHIN THE ROADWAY RECONSTRUCTION AREAS OR AS DIRECTED BY THE ENGINEER IN THE FIELD.
- AFTER CONSTRUCTION OF THE PROPOSED STORM SEWER, PLACE INLET FILTERS PER THE DETAIL ON THE PLANS OR APPROVED EQUAL IN ALL STORM STRUCTURES ACCEPTING SURFACE FLOW.
- 3. INSTALL PERMANENT EROSION CONTROL MEASURES (SOD) OR OTHER TYPES OF SEED AND BLANKET AS SHOWN ON THE EROSION CONTROL PLAN.

STABILIZATION PRACTICES

THIS SECTION OF THE PLAN ADDRESSES THE VARIOUS CONTROLS THAT WILL BE IMPLEMENTED FOR EACH OF THE MAJOR CONSTRUCTION ACTIVITIES DESCRIBED. FOR EACH MEASURE DISCUSSED, THE CONTRACTOR THAT WILL BE RESPONSIBLE FOR ITS IMPLEMENTATION IS INDICATED. EACH SUCH CONTRACTOR SHALL SIGN THE REQUIRED CERTIFICATION ON FORMS WHICH ARE PART OF THIS PLAN.

- INSTALL ONSITE SEDIMENT CONTROL MEASURES AS SHOWN ON THE IMPROVEMENT PLANS PRIOR TO INITIATING CONSTRUCTION
- STABILIZATION OF DISTURBED AREAS MUST BE INITIATED WITHIN ONE (1) WORKING DAY OF PERMANENT OR TEMPORARY CESSATION OF EARTH DISTURBING ACTIVITIES AND SHALL BE COMPLETED AS SOON AS POSSIBLE BUT NOT LATER THAN 14 DAYS FROM THE INITIATION OF THE STABILIZATION WORK IN AN AREA.
- TEMPORARY SEED MIXTURE SHALL BE APPLIED AT 100 LBS/ ACRE OR 150 LBS / ACRE DEPENDING ON THE SEED MIXTURE USED.
- TOPSOIL STOCKPILES SHALL BE SEEDED WITHIN ONE (1) WORKING DAY OF PERMANENT OR TEMPORARY CESSATION OF EARTH DISTURBING ACTIVITIES AND SHALL BE COMPLETED AS SOON AS POSSIBLE BUT NOT LATER THAN 14 DAYS FROM THE INITIATION OF THE STABILIZATION WORK IN AN AREA. ALL SOIL STORAGE PILES SHALL BE PROTECTED FROM EROSION WITH SILT FENCE ON THE DOWNSLOPE SIDE OF THE
- WATER PUMPED DURING CONSTRUCTION OPERATION SHALL BE
- 6. DUST CONTROL SHALL BE PERFORMED ON A DAILY BASIS USING WATER DISPERSED FROM TRUCK MOUNTED TANK WITH STANDARD DISCHARGE HEADER TO PROVIDE A UNIFORM RATE OF APPLICATION.
- 7. PREVENT SEDIMENT FROM BEING TRACKED ONTO PUBLIC ROADWAYS. ANY SEDIMENT REACHING A PUBLIC ROAD SHALL BE REMOVED BY SHOVELING OR STREET CLEANING BEFORE THE END OF EACH WORKING
- ALL TEMPORARY AND PERMANENT EROSION CONTROL MEASURES MUST BE MAINTAINED AND REPAIRED AS NEEDED TO ASSURE EFFECTIVE PERFORMANCE.
- ADDITIONAL EROSION CONTROL MEASURES MAY BE REQUIRED BY THE MUNICIPALITY AS CONSTRUCTION PROGRESSES.
- 10. ALL EROSION AND SEDIMENTATION CONTROL MEASURES SHALL B REMOVED AND DISPOSED OF WITHIN 30 DAYS OF FINAL STABILIZATION.
- 11. ALL EROSION AND SEDIMENTATION CONTROL SHALL BE IN ACCORDANCE WITH THE VILLAGE OF BENSENVILLE ORDINANCES.
- 12. SPECIFIC EROSION CONTROLS ARE SHOWN ON THE EROSION CONTROL PLAN IN THIS SET.

NON-STORMWATER DISCHARGES

EXCEPT FOR FLOWS FROM FIRE FIGHTING ACTIVITIES, SOURCES OF NON-STORMWATER THAT IS COMBINED WITH STORMWATER DISCHARGES ASSOCIATED WITH THE CONSTRUCTION ADDRESSED IN THIS PLAN MUST BE DESCRIBED BELOW. APPROPRIATE POLLUTION PREVENTION MEASURES, AS DESCRIBED BELOW, WILL BE IMPLEMENTED FOR THE NON-STORMWATER CONPONENT(S) OF THE DISCHARGE.

WATERMAIN FLUSHING GROUNDWATER (TRENCH DE-WATERING WATER) DRAINAGE FOR VEGITATIVE GROWTH

APPROVED STATE OR LOCAL PLANS

THE MANAGEMENT PRACTICES, CONTROLS AND PROVISIONS CONTAINED IN THIS PLAN WILL BE IN ACCORDANCE WITH IDOT SPECIFICATIONS, WHICH ARE AT LEAST AS PROTECTIVE AS THE REQUIREMENTS CONTAINED IN THE ILLINOIS ENVIRONMENTAL PROTECTION AGENCY'S ILLINOIS URBAN MANUAL, LATEST EDITION. REQUIREMENTS SPECIFIED IN THE SWPPP. OR SITE PERMITS APPROVED BY LOCAL OFFICIALS THAT ARE APPLICABLE TO PROTECTING SURFACE WATER RESOURCES ARE TO BE AUTHORIZED TO DISCHARGE UNDER PERMITS ILBTO INCORPORATED BY REFERENCE AND AR ENFORCEABLE UNDER THIS PERMIT EVEN IF THEY ARE NOT SPECIFICALLY INCLUDED IN THE PLAN.

EROSION CONTROL NOTES

THE CONTRACTOR SHALL TAKE THE NECESSARY STEPS TO CONTROL WASTE SUCH AS DISCARDED CONSTRUCTION MATERIALS, CONCRETE TRUCK WASHOUT, CHEMICALS, LITTER AND SANITARY WASTE AT THE CONSTRUCTION SITE THAT MAY CAUSE ADVERSE IMPACTS TO WATER QUALITY.


EROSION CONTROL PRACTICES SHALL BE INSTALLED PRIOR TO THE START OF CONSTRUCTION.

ANY OBSERVED DISRUPTION TO THE EROSION CONTROL PRACTICES SHALL BE IMMEDIATELY REPAIRED BY THE CONTRACTOR.

ANY DUST OR MUD TRACKED ONTO STREETS SHALL BE CLEANED AT THE

STABILIZATION OF DISTURBED AREAS MUST BE INITIATED WITHIN ONE (1) WORKING DAY OF PERMANENT OR TEMPORARY CESSATION OF EARTH DISTURBING ACTIVITIES AND SHALL BE COMPLETED AS SOON AS POSSIBLE BUT NOT LATER THAN 14 DAYS FROM THE INITIATION OF THE

TEMPORARY SEEDING SHALL BE FERTILIZED WITH 500 LBS/ACRE OF 10-10-10 FERTILIZER OR EQUIVALENT. (TO BE USED AT THE DISCRETION OF THE ENGINEER).

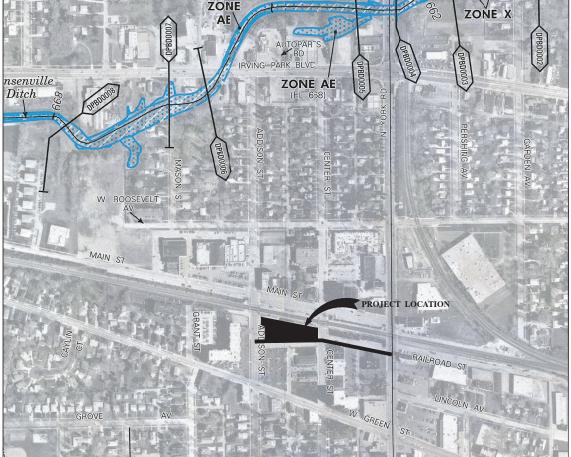



STATE OF ILLINOIS DEPARTMENT OF TRANSPORTATION

PARKING, SIDEWALKS, RESURFACING, RECONSTRUCTION MUN 4011 (RAILROAD AVENUE) STORMWATER POLLUTION AND PREVENTION PLAN SHEET NO. 13 OF 36 SHEETS STA. SCALE: NONE

SECTION COUNTY 4011 16-00096-00-PK DUPAGE 36 CONTRACT NO. 61E55

FILE NAME = 15R0650-SWPP-30 - SWPPI USER NAME = DESIGNED - JR REVISED CHECKED - MAW REVISED PLOT SCALE : RAWN REVISED PLOT DATE = 2-12-18 CHECKED -AG REVISED

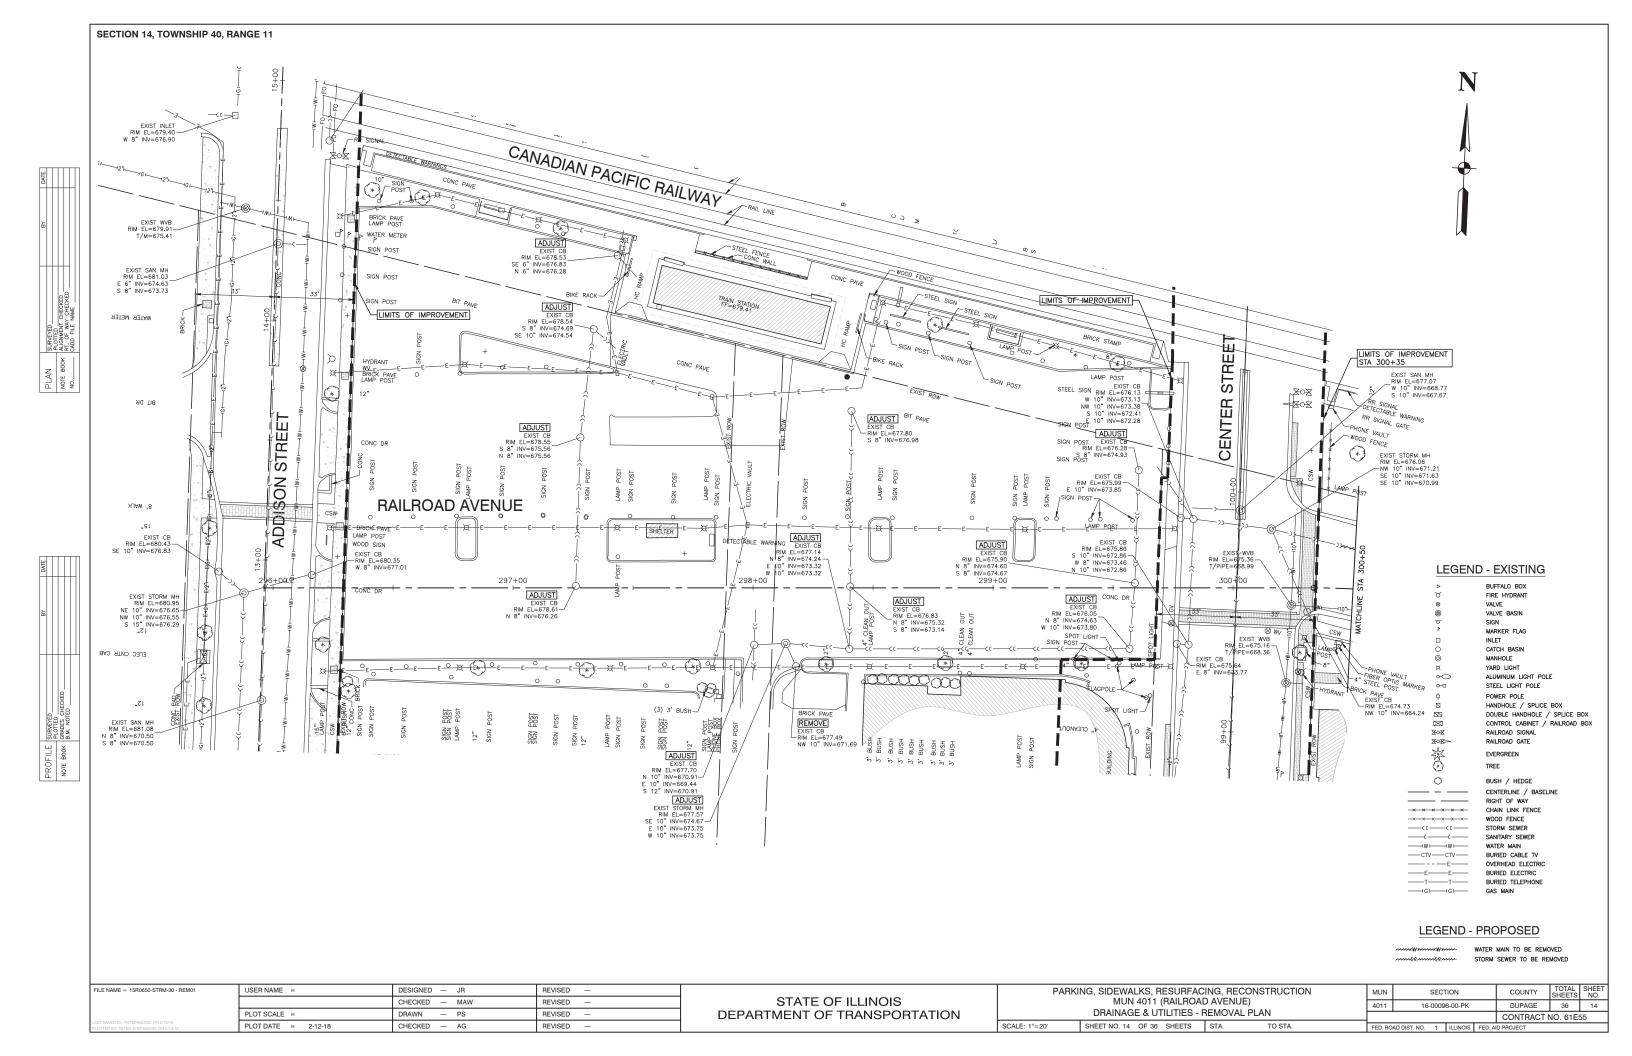

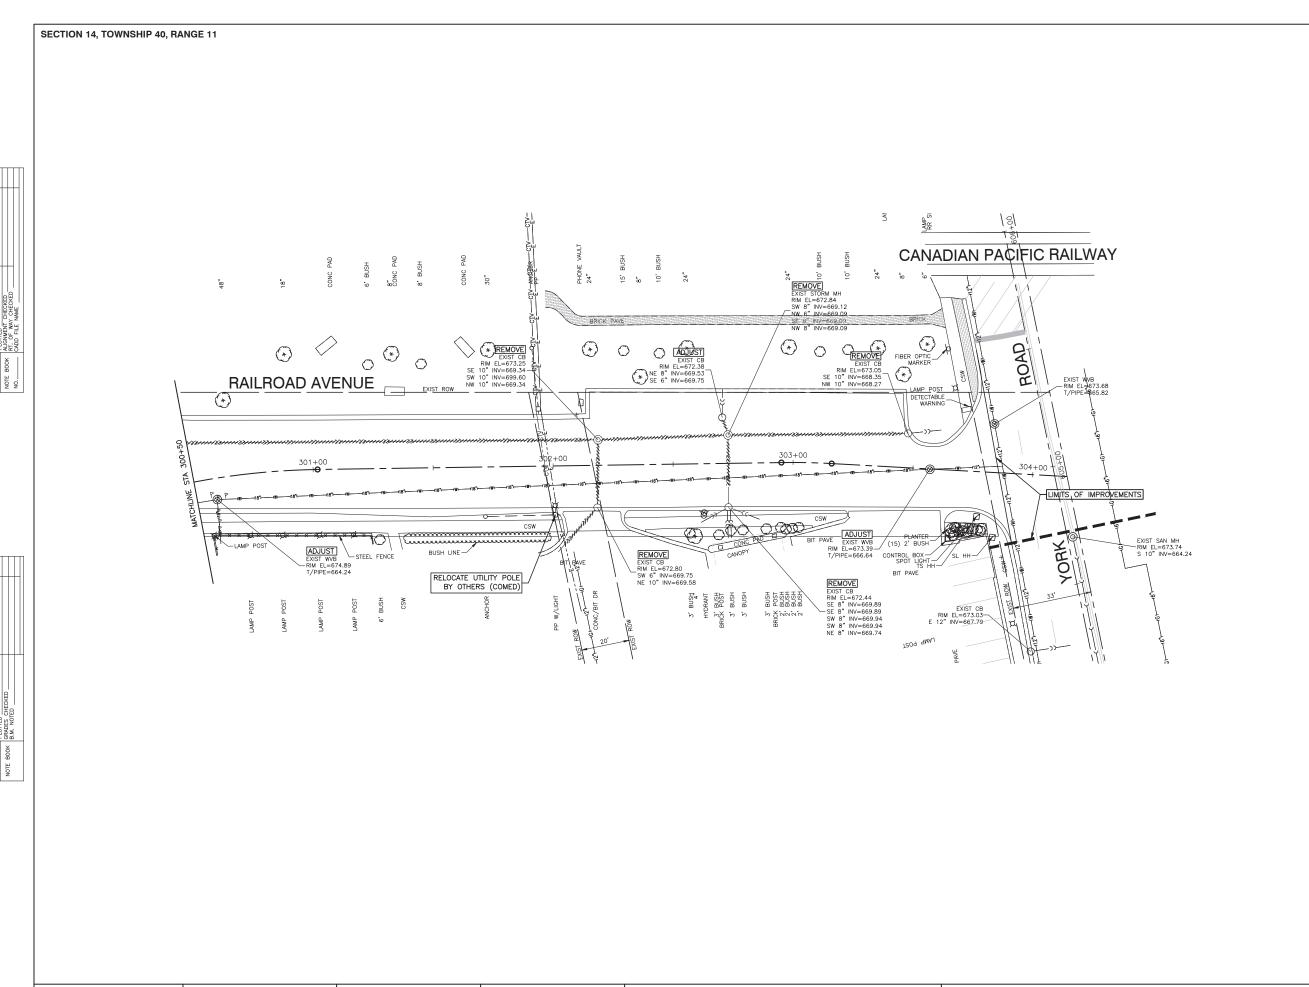

LEGEND - EXISTING

BUFFALO BOX

FIRE HYDRANT VALVE VALVE BASIN SIGN MARKER FLAG INLET CATCH BASIN MANHOLE YARD LIGHT ALUMINUM LIGHT POLE STEEL LIGHT POLE POWER POLE HANDHOLE / SPLICE BOX DOUBLE HANDHOLE / SPLICE BOX CONTROL CABINET / RAILROAD BOX RAILROAD GATE EVERGREEN TREE 0 BUSH / HEDGE CENTERLINE / BASELINE RIGHT OF WAY CHAIN LINK FENCE -x-x-x-x-x-x-WOOD FENCE —cc—cc— STORM SEWER SANITARY SEWER WATER MAIN —(—(— ___w___w___ —сту—сту— BURIED CABLE TV

OVERHEAD ELECTRIC

BURIED ELECTRIC BURIED TELEPHONE

LEGEND - PROPOSED


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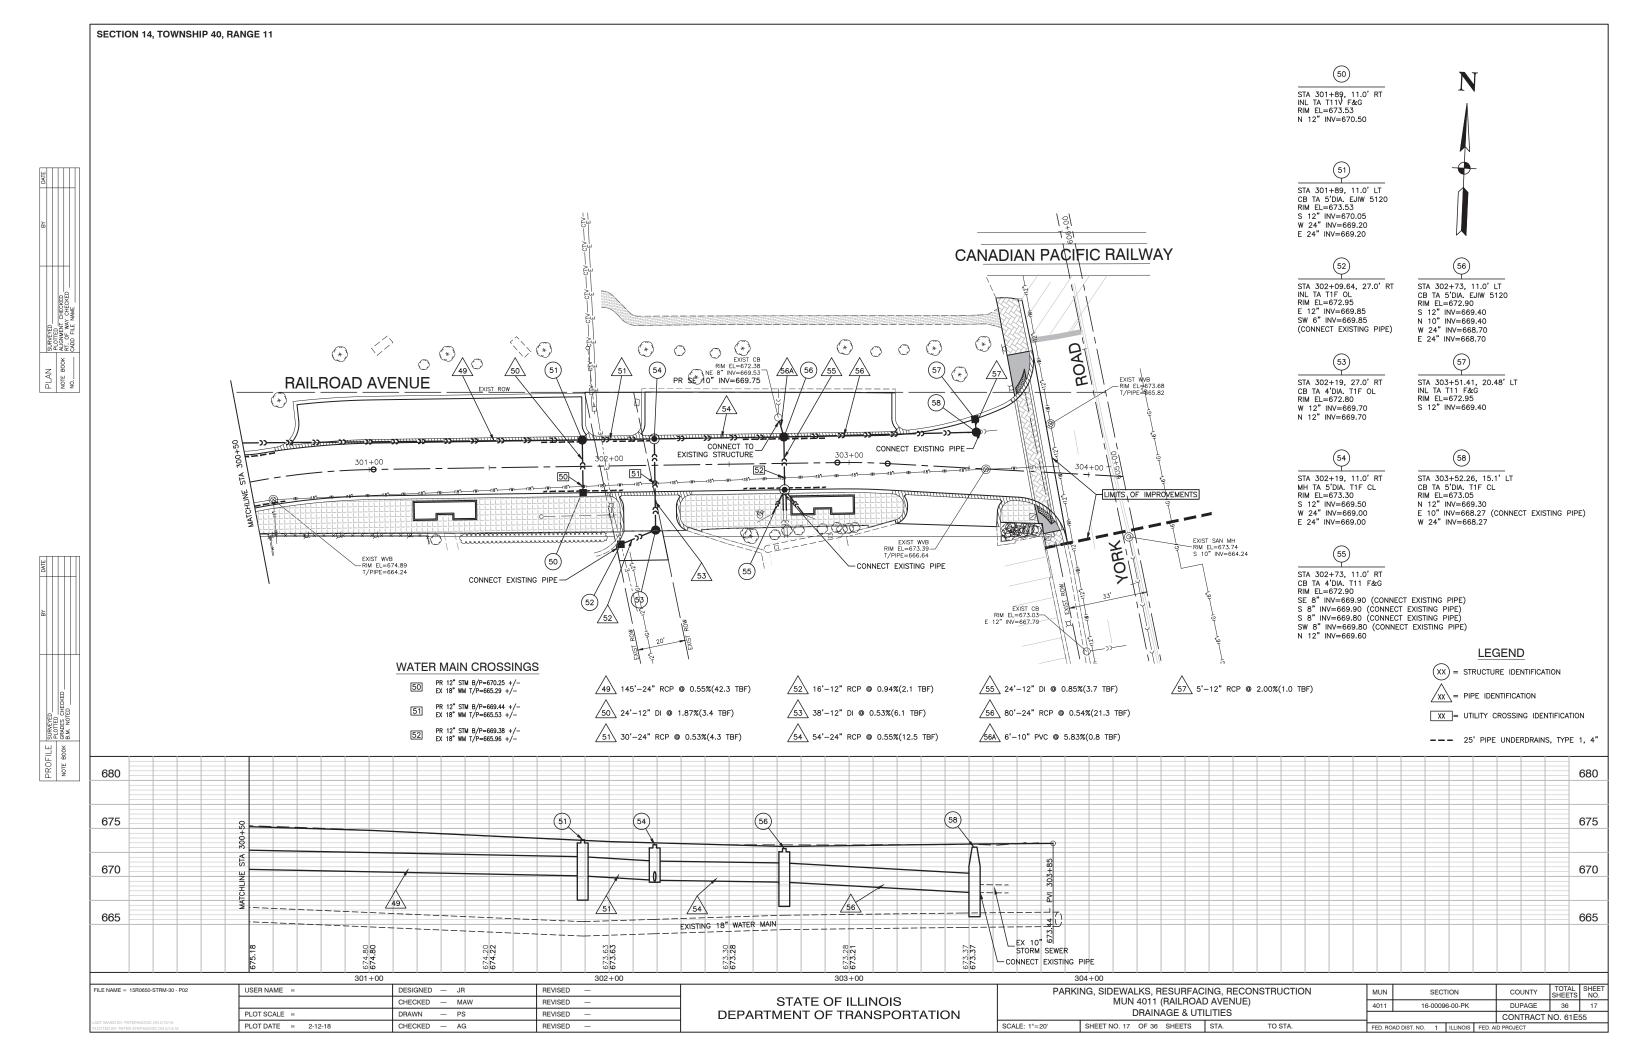
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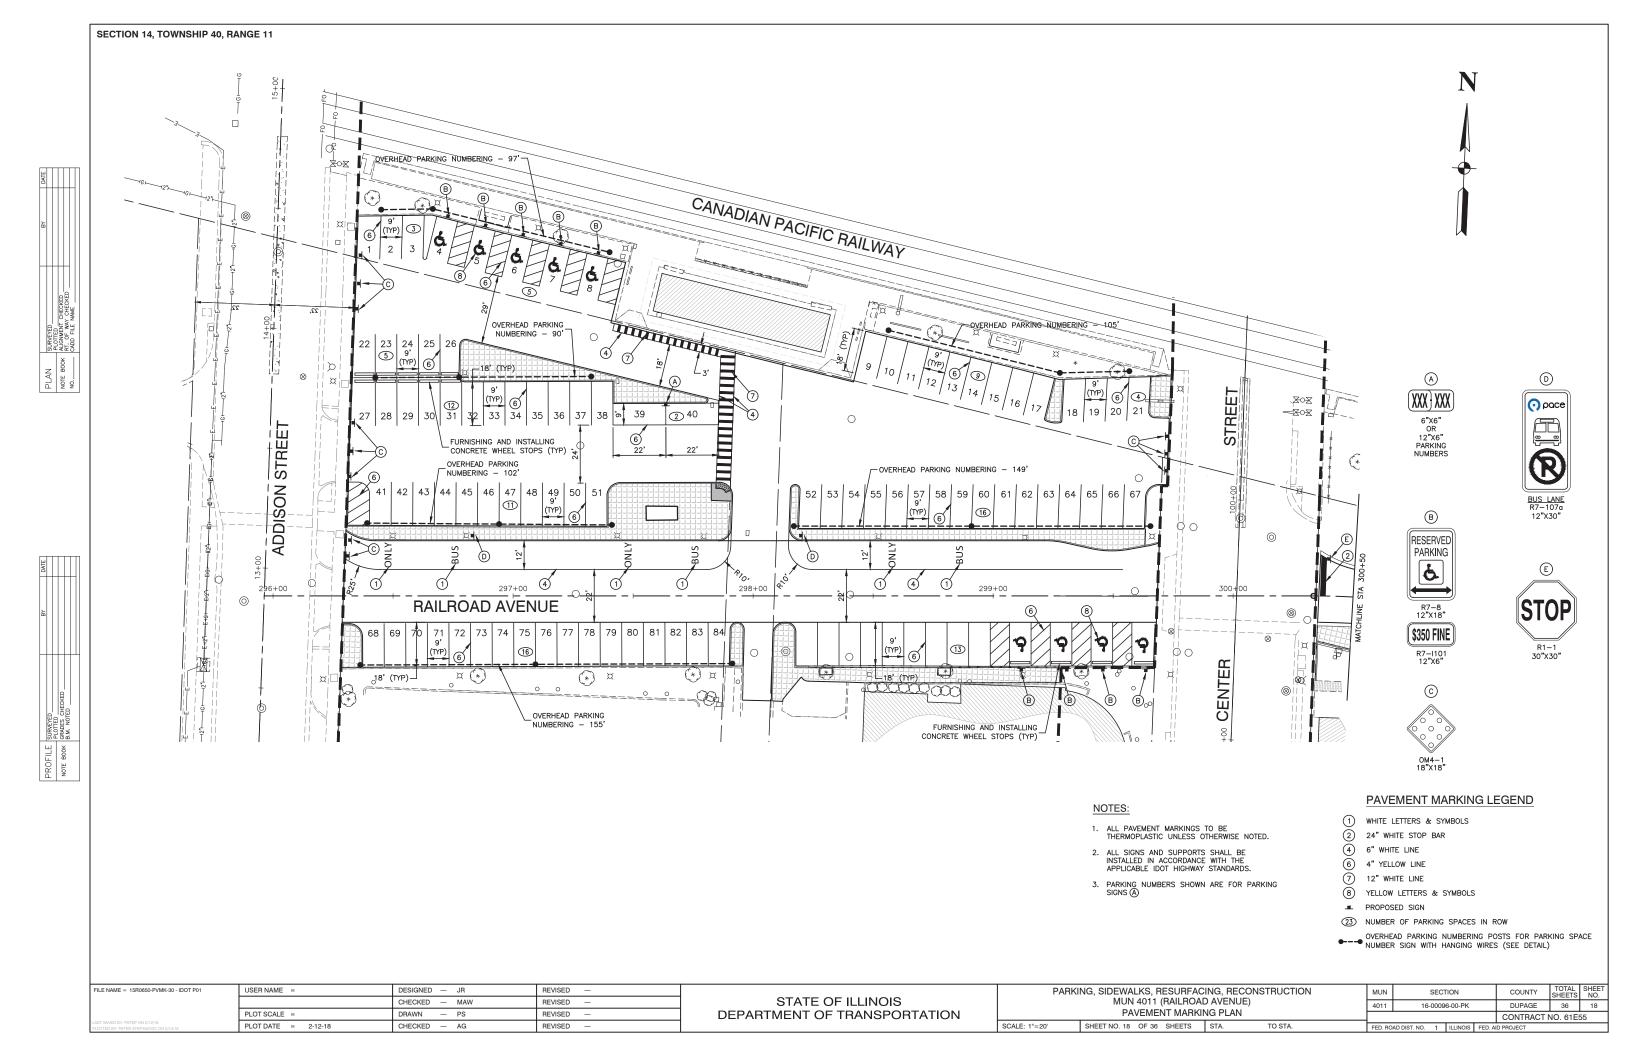
WATER MAIN TO BE REMOVED


STORM SEWER TO BE REMOVED

FILE NAME = 15R0650-STRM-30 - REM02	USER NAME =	DESIGNED — JR	REVISED —		PARK	(ING, SIDEWALKS, RESURFACING, RECONSTRUCTION	MUN	SECTION	COUNTY	SHEETS NO.
		CHECKED — MAW	REVISED —	STATE OF ILLINOIS	MUN 4011 (RAILROAD AVENUE) DRAINAGE & UTILITIES - REMOVAL PLAN		4011	16-00096-00-PK	DUPAGE	36 15
	PLOT SCALE =	DRAWN — PS	REVISED —	DEPARTMENT OF TRANSPORTATION			N		CONTRACT NO. 61E	
LAST SAVED BY: PSTEPANOVIC ON 2/13/18 PLOTTED BY: PETER STEPANOVIC ON 2/13/18	PLOT DATE = 2-12-18	CHECKED — AG	REVISED —		SCALE: 1"=20'	SHEET NO. 15 OF 36 SHEETS STA. TO STA.	FED. ROA	D DIST. NO. 1 ILLINOIS FED.	AID PROJECT	






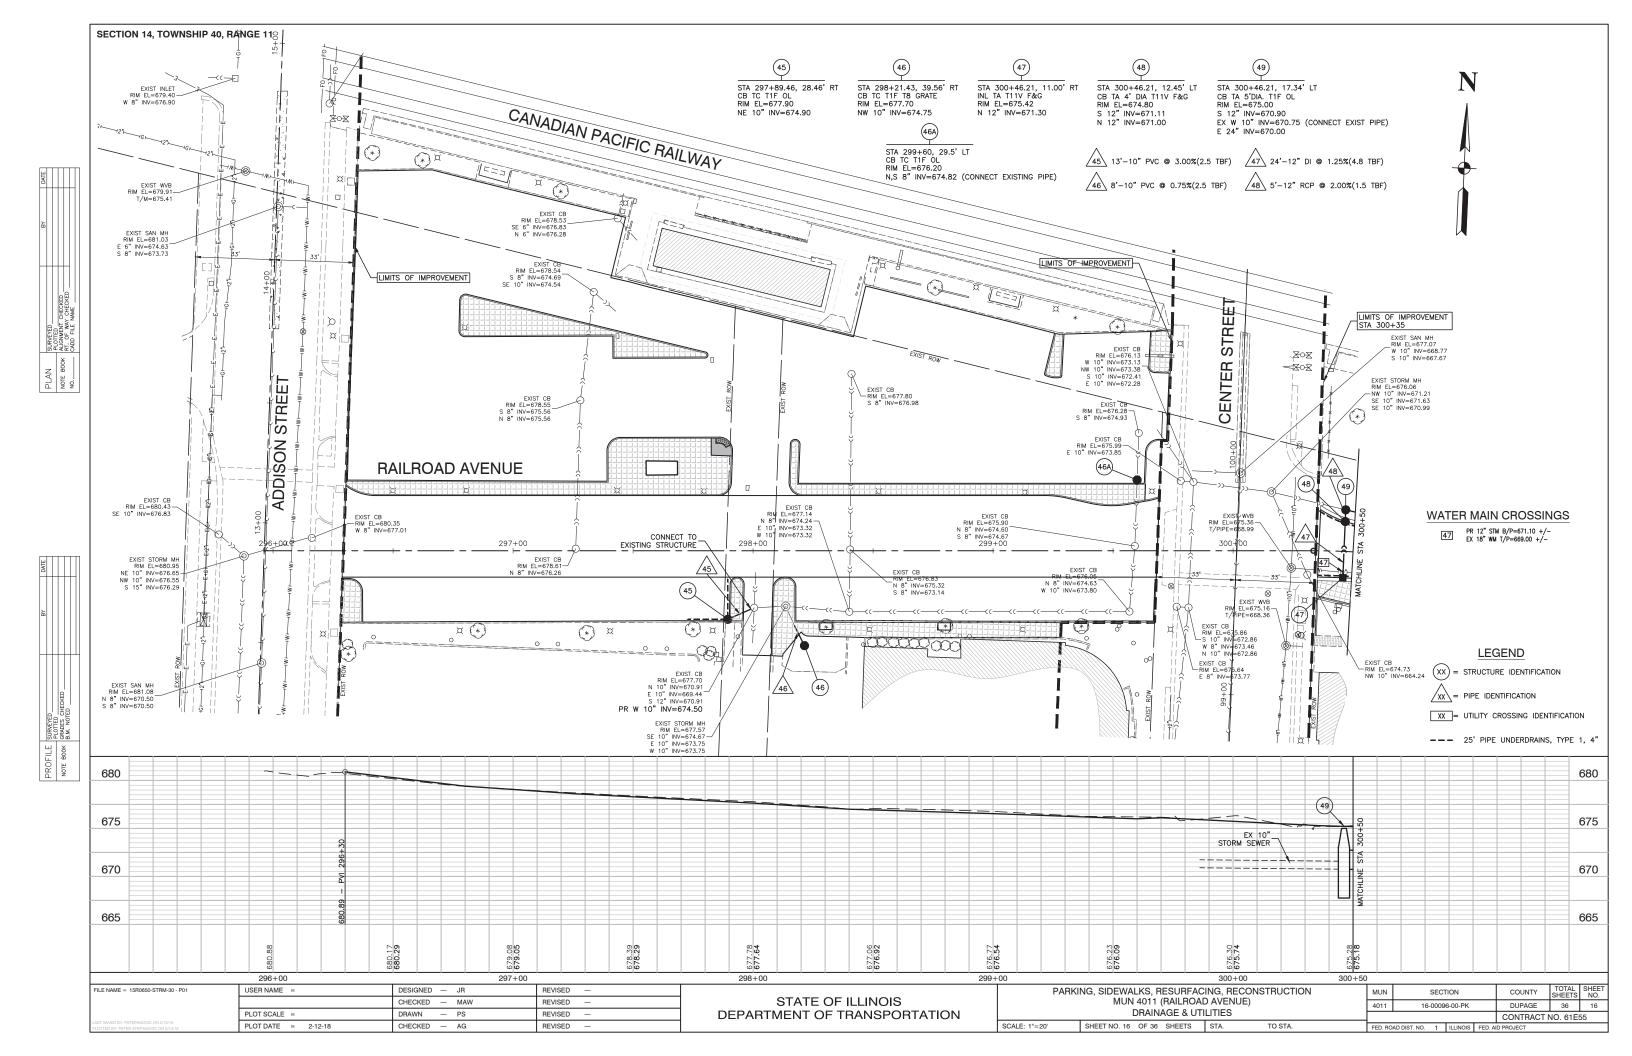


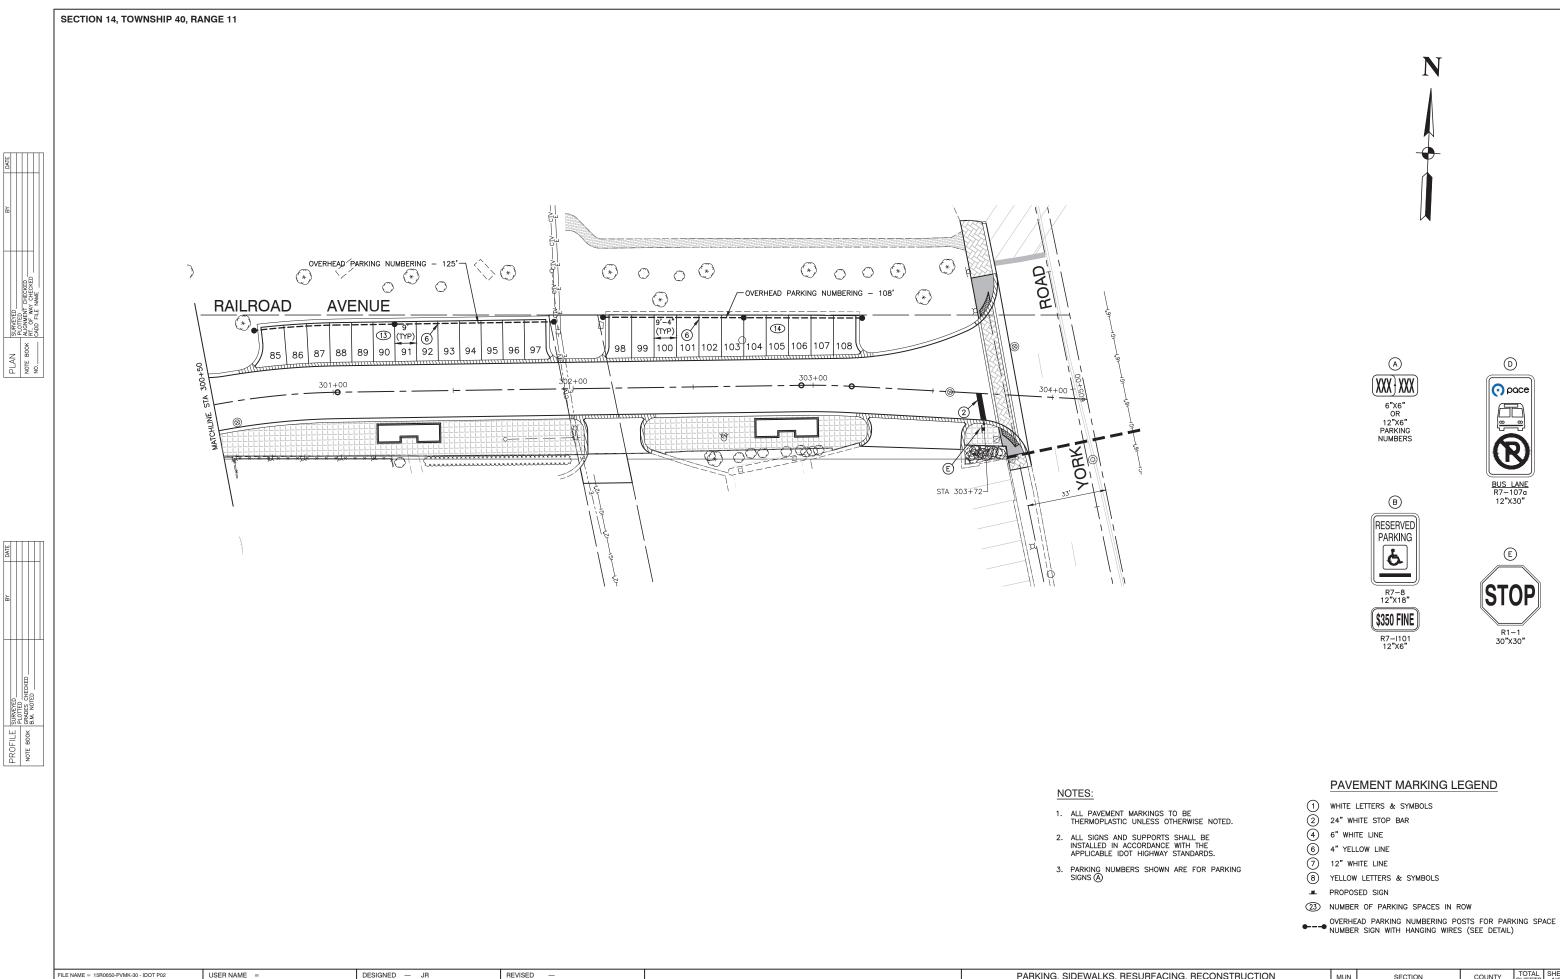



PARKING, SIDEWALKS, RESURFACING, RECONSTRUCTION MUN 4011 (RAILROAD AVENUE) COUNTY TOTAL SHEET NO.

DUPAGE 36 19 USER NAME = DESIGNED - JR REVISED SECTION STATE OF ILLINOIS $\mathsf{CHECKED} \quad - \quad \mathsf{MAW}$ REVISED 16-00096-00-PK PAVEMENT MARKING PLAN PLOT SCALE = REVISED DEPARTMENT OF TRANSPORTATION CONTRACT NO. 61E55 PLOT DATE = 2-12-18 SHEET NO. 19 OF 36 SHEETS STA. CHECKED — AG REVISED

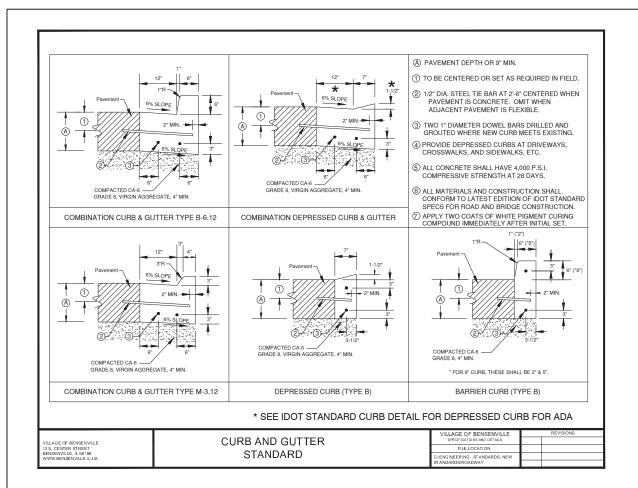

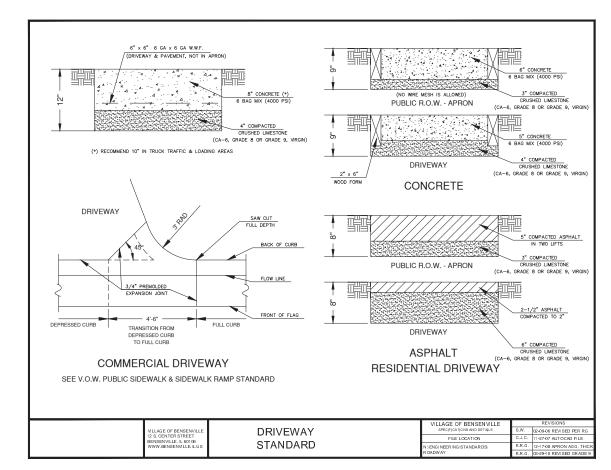

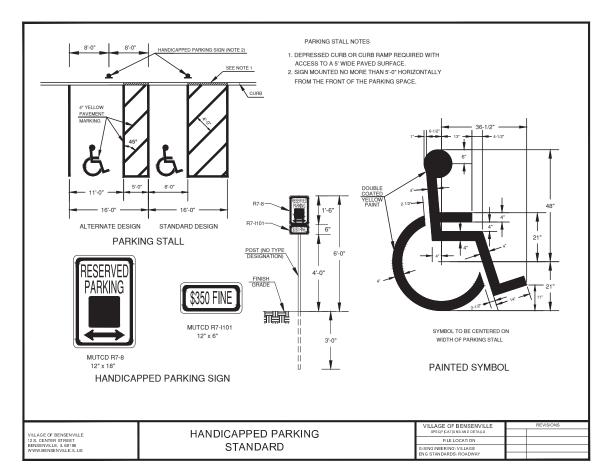

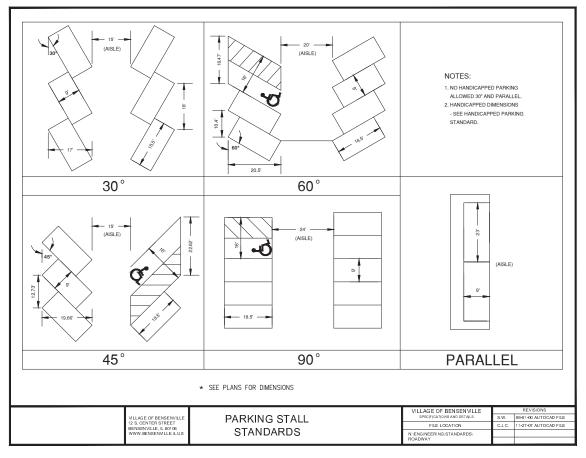



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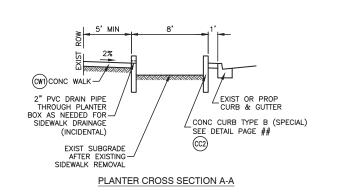
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		CHECKED — MAW	REVISED —
	PLOT SCALE =	DRAWN — PS	REVISED —
LAST SAVED BY: PSTEP ON 2/12/18 PLOTTED BY: PETER STEPANOVIC ON 2/13/18	PLOT DATE = 2-12-18	CHECKED — AG	REVISED —
			-


STATE OF ILLINOIS
DEPARTMENT OF TRANSPORTATION


PARKING, SIDEWALKS, RESURFACING, RECONSTRUCTION	MUN	MUN SECTION		COUNTY	TOTAL SHEETS	SHEET NO.	
MUN 4011 (RAILROAD AVENUE)	4011	16-00096-00-PK			DUPAGE	36	20
CONSTRUCTION DETAILS		CONTRAC					55
SHEET NO. 20 OF 36 SHEETS STA. TO STA.	FED. ROAD DIST. NO. ILLINOIS FED. A			D PROJECT	\neg		




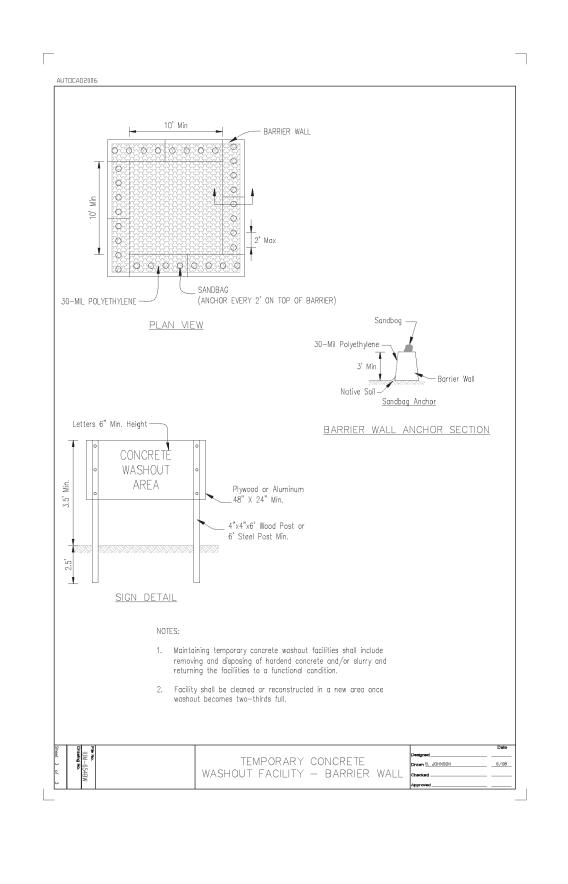

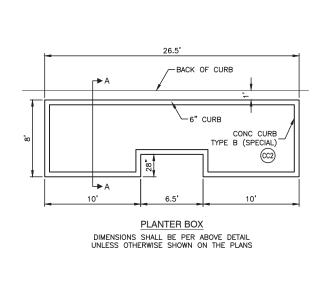

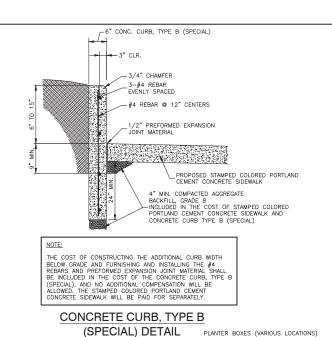

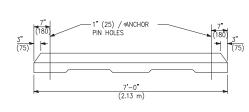

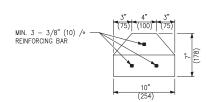

CONCRETE WHEEL STOPS DETAIL
N.T.S.

NOTES:

ANCHOR PINS SHALL BE 3/4" (20) DIAMETER, 3' (915) LONG.

CLASS PC CONCRETE SHALL BE USED THROUGHOUT.

STATE OF ILLINOIS
DEPARTMENT OF TRANSPORTATION


PARKING, SIDEWALKS, RESURFACING, RECONSTRUCTION
MUN 4011 (RAILROAD AVENUE)
CONSTRUCTION DETAILS


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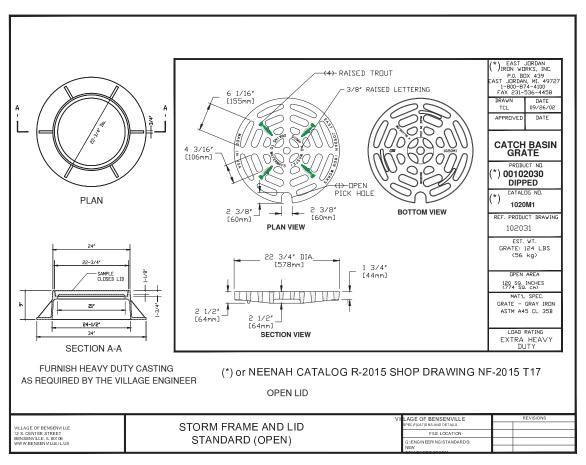
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 21

 CONTRACT NO. 61E55





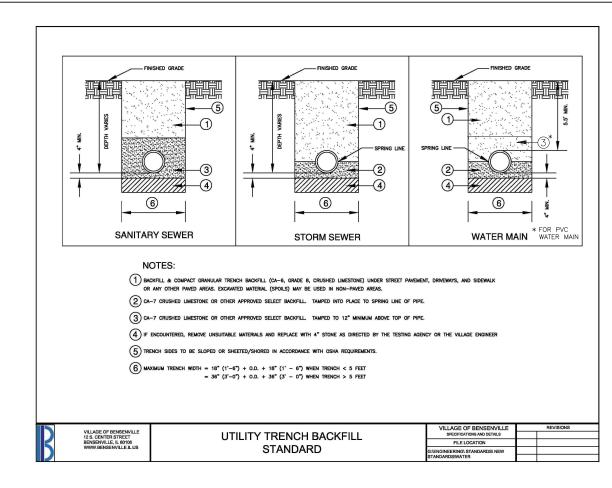


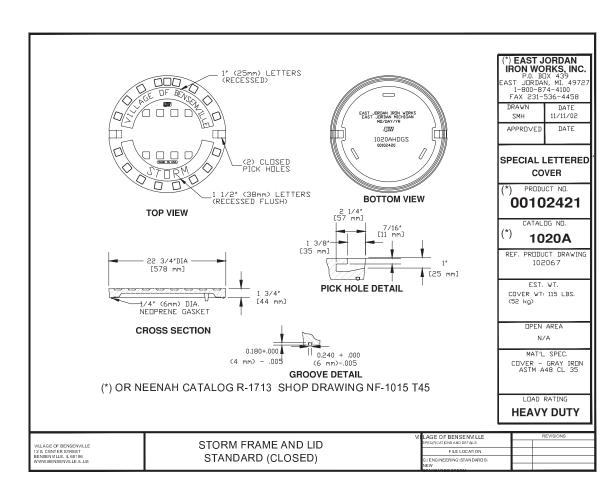
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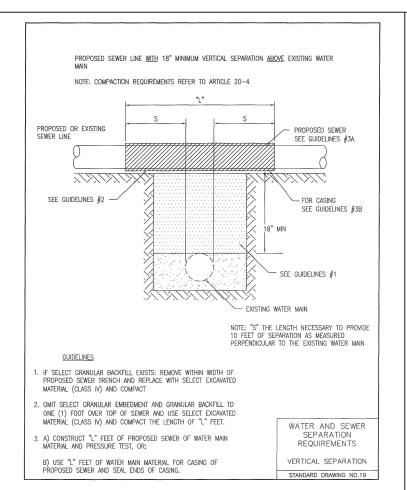
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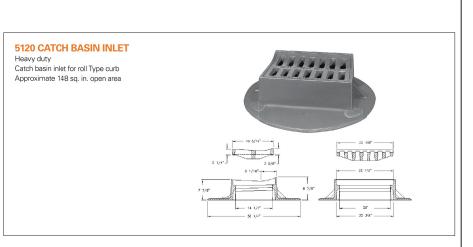
STATE OF ILLINOIS
DEPARTMENT OF TRANSPORTATION


PARKI	NG, SIDEWALKS, RESURFAC	MUN	SEC	TION		COUNTY	TOTAL SHEETS		
	MUN 4011 (RAILROAD AVENUE)				16-00096-00-PK			36	22
CONSTRUCTION DETAILS							CONTRACT	NO. 61E	55
IE	SHEET NO. 22 OF 36 SHEETS	STA. TO STA.	EED BO	EED BOAD DIST NO. ILLINOIS		EED A	D PRO IECT		





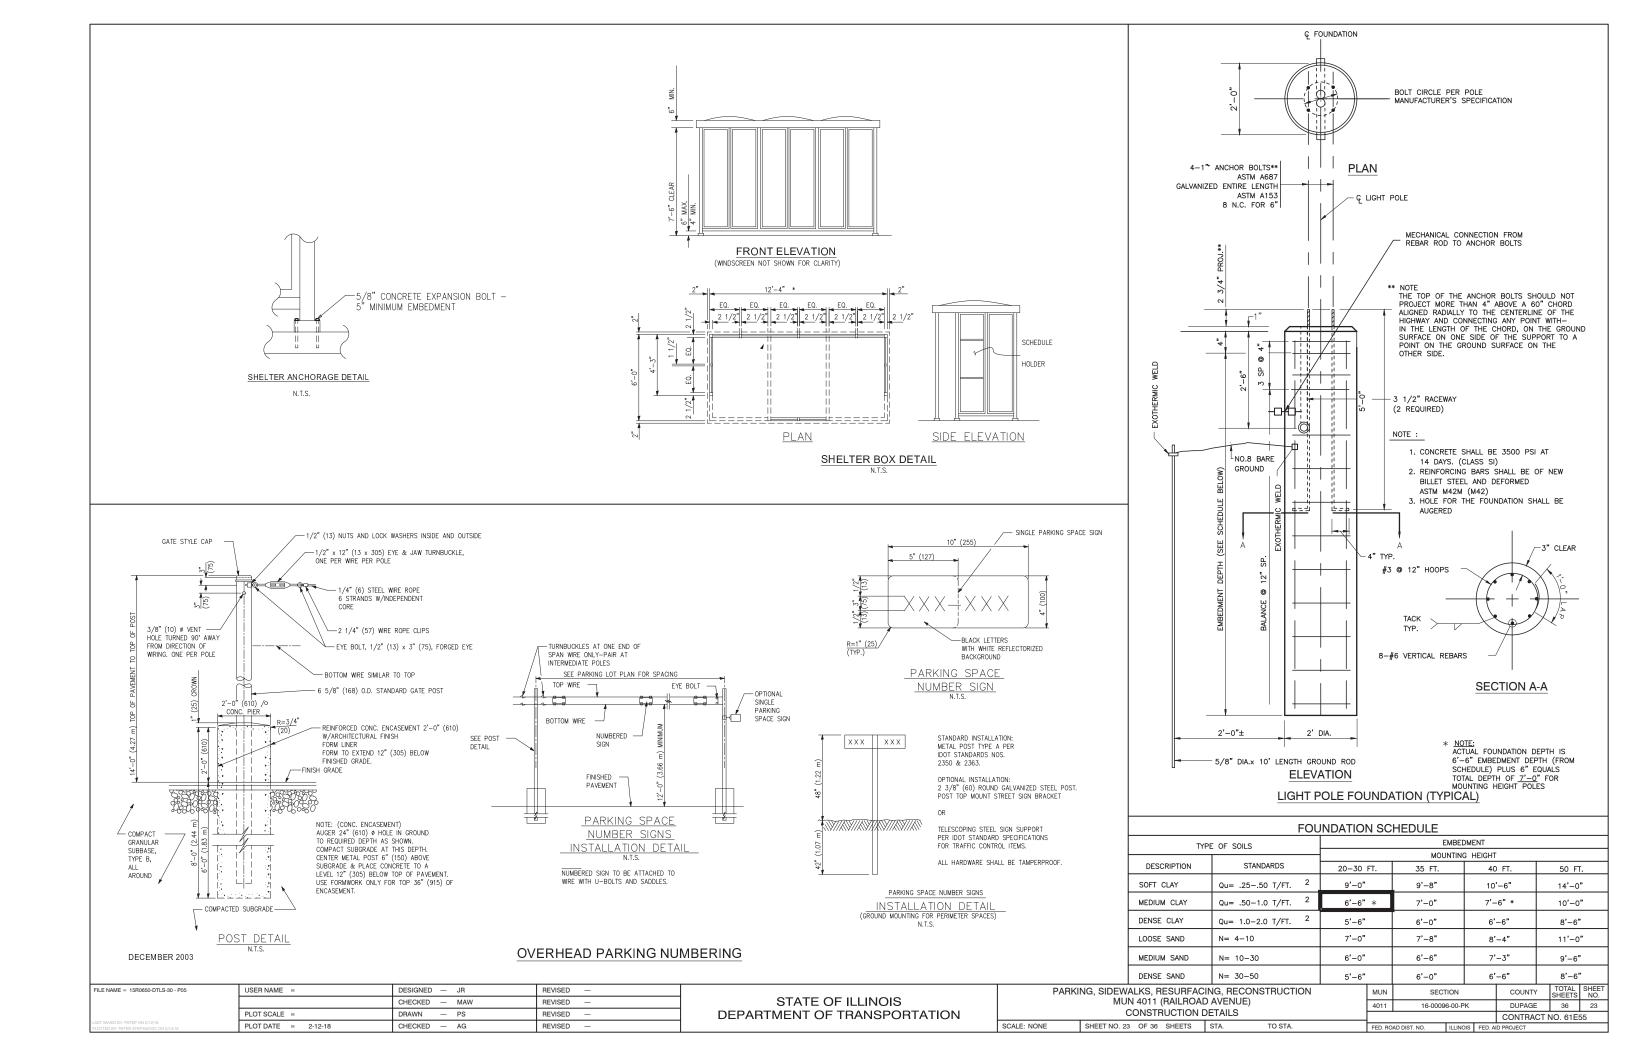

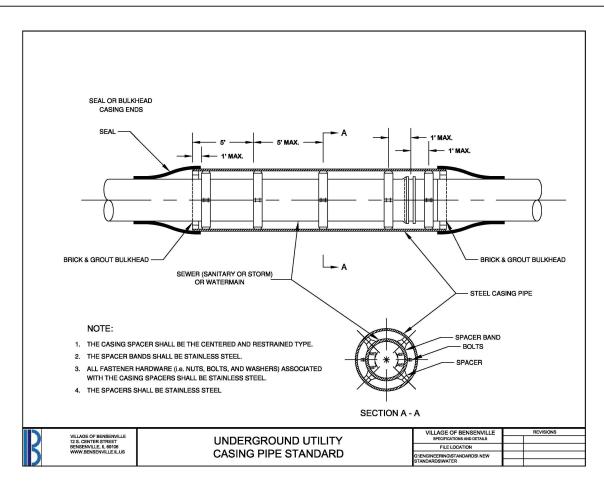


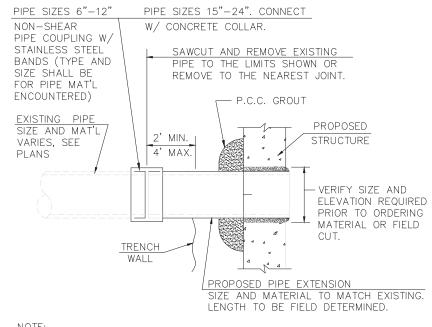


THE COST OF ALL LABOR, MATERIALS, TOOLS AND EQUIPMENT NECESSARY TO INCORPORATE EXISTING PIPE INTO PROPOSED STRUCTURE, INCLUDING THE PIPE EXTENSION, PIPE REMOVAL, GROUT AND COUPLING OR COLLAR AS DETAILED SHALL BE INCLUDED IN THE CONTRACT UNIT PRICE PER EXISTING PIPE CONNECTION TO PROPOSED STRUCTURE.

EXISTING PIPE CONNECTION TO PROPOSED STRUCTURE

NOT TO SCALE

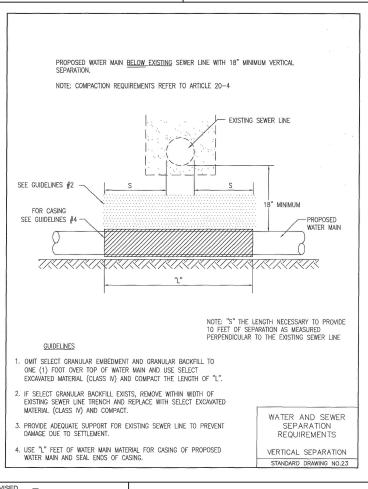

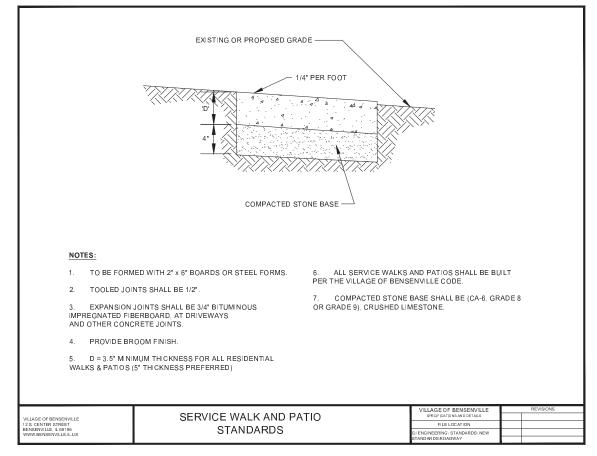

FILE NAME = 15R0650-DTLS-30 - P06

USER NAME = DESIGNED - JR REVISED
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PLOT SCALE = DRAWN - PS REVISED
AGI SEPANDACO O 213/18


PLOT DATE = 2-12-18


CHECKED - AG REVISED -


STATE OF ILLINOIS
DEPARTMENT OF TRANSPORTATION


SCALE: NONE

PARKING, SIDEWALKS, RESURFACING, RECONSTRUCTION					MUN SECTION		COUNTY	TOTAL SHEETS	SHEET NO.	
MUN 4011 (RAILROAD AVENUE)				4011	16-00096-00-PK			DUPAGE 36		24
CONSTRUCTION DETAILS								CONTRACT	NO. 61E	55
SHEET NO. 24	OF 36 SHEETS	STA. TO STA.		FED. ROAD DIST. NO. ILLINOIS FED. AID PROJECT						

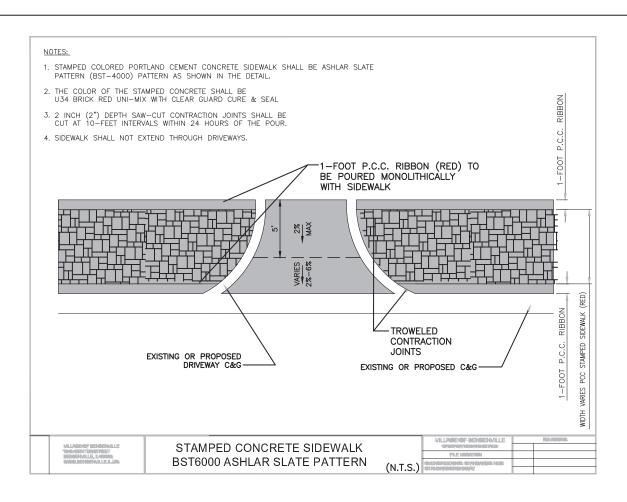

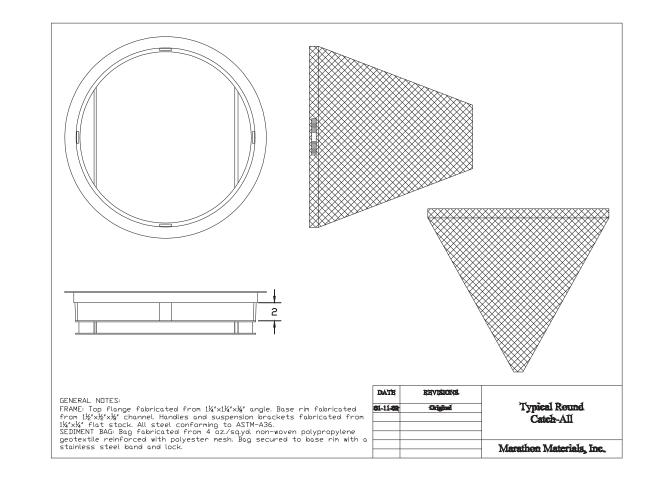

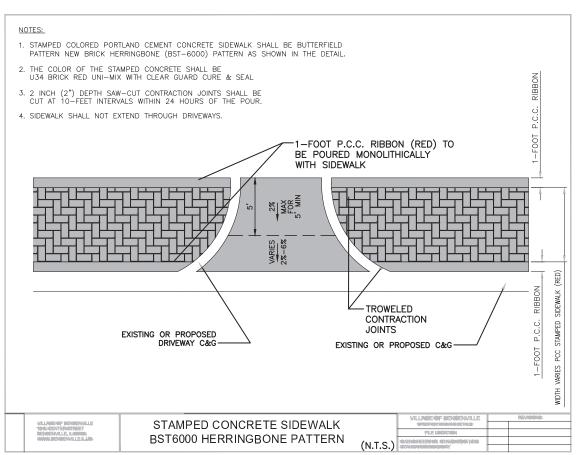

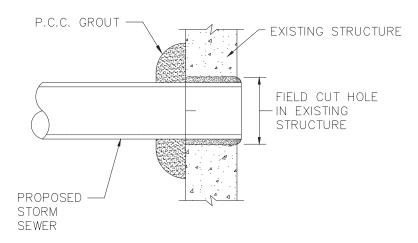


NOTE:

THE COST OF ALL LABOR, MATERIALS, TOOLS AND EQUIPMENT NECESSARY TO PLACE PIPE INTO EXISTING STRUCTURE AS SHOWN SHALL BE INCLUDED IN THE CONTRACT UNIT PRICE PER EACH CONNECTION TO EXISTING STRUCTURE.

NEW PIPE CONNECTION TO EXISTING STRUCTURE

NOT TO SCALE

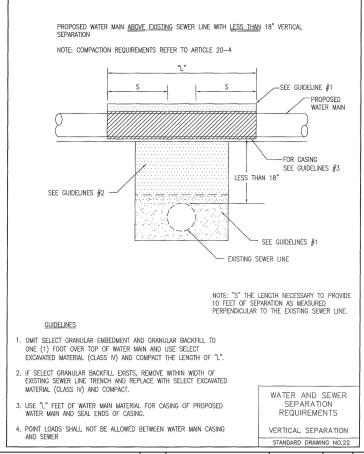

SECTION

16-00096-00-PK

COUNTY

DUPAGE

CONTRACT NO. 61E55


36


STATE OF ILLINOIS
DEPARTMENT OF TRANSPORTATION

PARKING, SIDEWALKS, RESURFACING, RECONSTRUCTION
MUN 4011 (RAILROAD AVENUE)

CONSTRUCTION DETAILS

SCALE: NONE SHEET NO. 25 OF 36 SHEETS STA. TO STA. FED. RC

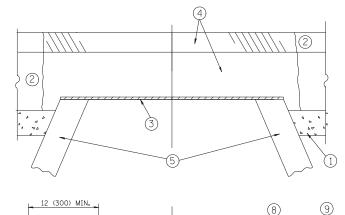

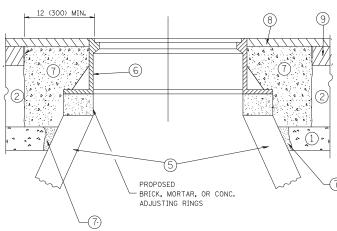

NOTES:

EXISTING BROKEN FRAMES AND LIDS SHALL BE REMOVED AND DISPOSED OF BY THE CONTRACTOR AND SHALL BE REPLACED AS DIRECTED BY THE ENGINEER. REPLACEMENT FRAMES AND LIDS WILL BE PAID FOR IN ACCORDANCE WITH ARTICLE 109.04 OF THE STANDARD SPECIFICATIONS UNLESS A SEPARATE PAY ITEM HAS BEEN PROVIDED.

IF THE EXISTING LIDS ARE OPEN, THE FRAME WILL BE ADJUSTED TO THE ELEVATION OF THE MILLED PAYEMENT SURFACE PRIOR TO THE MILLING OPERATION. THE FRAME WILL NOT BE REMOVED AND COVERED BY THE METAL PLATE.

CITY OF CHICAGO CASTINGS ARE THE PROPERTY OF THE CITY AND THE CONTRACTOR SHALL NOTIFY THE CITY FOR REMOVAL AND DISPOSITION OF THE CASTINGS.

THE METAL PLATE USED TO COVER THE STRUCTURE SHALL REMAIN THE PROPERTY OF THE CONTRACTOR.

SCALE:

WHEN STRUCTURES ARE TO BE ADJUSTED OR RECONSTRUCTED, THE LOWERING AND RAISING OF THE FRAMES AND LIDS WILL NOT BE PAID FOR SEPARATELY BUT WILL BE INCLUDED IN THE COST OF THE CORRESPONDING PAY ITEM.

CONSTRUCTION PROCEDURES

STAGE 1 (BEFORE PAVEMENT MILLING)

- A) REMOVE A MINIMUM OF 12 (300) OF THE PAVEMENT FROM
- AROUND THE STRUCTURE.

 B) REMOVE THE EXISTING FRAME AND LID FROM THE STRUCTURE.
- C) COVER THE STRUCTURE OPENING WITH A 36 (900) DIAMETER METAL PLATE.
- D) BACKFILL WITH CRUSHED STONE AND A MINIMUM 11/2 (40) THICK HMA SURFACE MIX APPROVED BY THE ENGINEER.

STAGE 2 (AFTER PAVEMENT MILLING)

- A) REMOVE THE HMA SURFACE MIX AND CRUSHED STONE,
- B) INSTALL THE FRAME AND LID; ADJUST THE FRAME TO ITS FINAL SURFACE ELEVATION.
- C) THE SURROUNDING SPACE SHALL BE FILLED WITH CLASS PP-1*
 CONCRETE TO THE ELEVATION OF THE SURFACE OF THE EXISTING
 BASE COURSE OR THE BINDER COURSE.
- *UNLESS OTHERWISE SPECIFIED IN THE PLANS.

THE PROCEDURE EXPLAINED ABOVE SHALL CONFORM TO THE APPLICABLE PORTIONS OF SECTIONS 353, 406, 602, AND 603 OF THE STANDARD SPECIFICATIONS EXCEPT THAT "THE CONTRACTOR SHALL ADJUST THE STRUCTURES TO THE FINISHED PAVEMENT ELEVATION NO MORE THAN 5 CALENDAR DAYS PRIOR TO PLACEMENT OF THE FINAL LIFT OF SURFACE UNLESS APPROVED BY THE ENGINEER."

LEGEND

- ① SUB-BASE GRANULAR MATERIAL
- 6 FRAME AND LID (SEE NOTES)
- 2 EXISTING PAVEMENT
- 7 CLASS PP-1* CONCRETE
- 3 36 (900) DIAMETER METAL PLATE
- (8) PROPOSED HMA SURFACE COURSE
- PROPOSED CRUSHED STONE AND HMA SURFACE MIX

 (5) EXISTING STRUCTURE
- 9) PROPOSED HMA BINDER COURSE

LOCATION OF STRUCTURES:

THE CONTRACTOR WILL BE REQUIRED TO KEEP A RECORD OF THE LOCATIONS OF THE BURIED STRUCTURES ACCORDING TO THE STATION AND DISTANCE LEFT OR RIGHT OF THE CENTERLINE OF PAVEMENT. UPON COMPLETION OF THE WORK, THE CONTRACTOR WILL DELIVER THE RECORD TO THE ENGINEER.

BASIS OF PAYMENT:

REMOVING FRAMES AND LIDS ON DRAINAGE AND UTILITY STRUCTURES IN THE PAVEMENT PRIOR TO MILLING, AND ADJUSTING TO FINAL GRADE PRIOR TO PLACING THE SURFACE COURSE, WILL BE PAID FOR AT THE CONTRACT UNIT PRICE EACH FOR "FRAMES AND LIDS TO BE ADJUSTED (SPECIAL)."

THIS WORK WILL NOT BE PAID FOR WHEN DRAINAGE AND UTILITY STRUCTURES ARE SPECIFIED FOR PAYMENT AS STRUCTURE RECONSTRUCTION.

NEW FRAMES AND LIDS, WHEN SPECIFIED, WILL BE PAID FOR SEPARATELY.

DETAILS FOR FRAMES AND LIDS ADJUSTMENT WITH MILLING

ALL DIMENSIONS ARE IN INCHES (MILLIMETERS) UNLESS OTHERWISE SHOWN

STATE OF ILLINOIS
DEPARTMENT OF TRANSPORTATION

PETAILS FOR
FRAMES AND LIDS ADJUSTMENT WITH MILLING
SHEET NO. 26 OF 36 SHEETS STA. TO STA.


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 BD60-03 (BD-1)
 CONTRACT NO. 61E55

 FED. ROAD DIST. NO.

 ILLINOIS
 FED. AD PROJECT



NOTES:

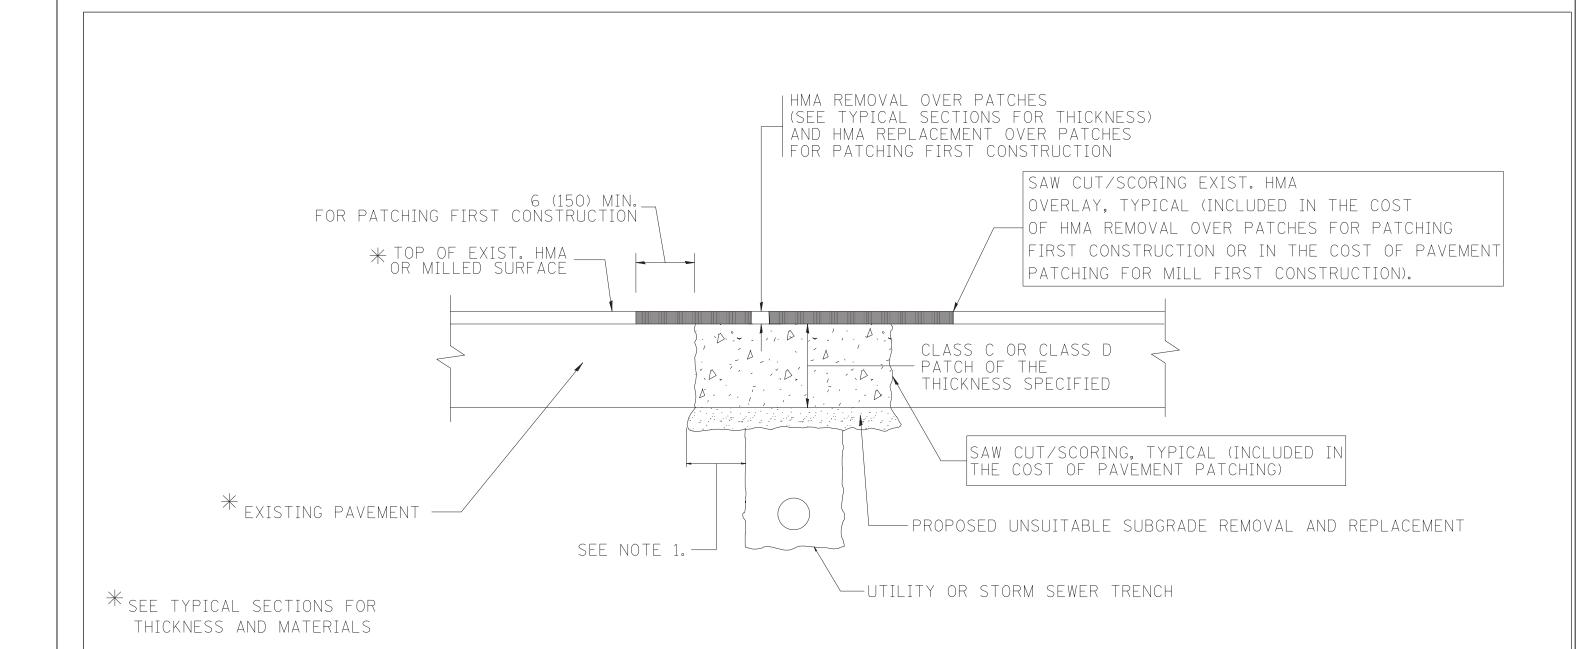- 1. THE WIDTH OF THE FULL DEPTH PATCH OVER A TRENCH SHALL BE 12 (300) WIDER ON EACH SIDE OF THE TRENCH.
- 2. FOR METHOD OF MEASUREMENT AND BASIS OF PAYMENT, SEE RECURRING SPECIAL PROVISION "PATCHING WITH HOT-MIX ASPHALT OVERLAY REMOVAL".

SEQUENCE OF CONSTRUCTION (PATCHING FIRST)

- 1. REMOVE THE EXISTING HMA MATERIAL OVER THE AREA TO BE PATCHED.
- 2. REMOVE AND REPLACE WITH CLASS C OR D PATCH.
- 3. REPLACE HMA MATERIAL OVER THE AREA TO BE PATCHED.

SEQUENCE OF CONSTRUCTION (MILLING FIRST)

- 1. MILL HMA FIRST IF THERE IS AT LEAST 41/2 INCHES OR MORE OF HMA MATERIAL ON TOP OF THE EXISTING PAVEMENT OR IF THE PAVEMENT IS FULL DEPTH HMA. A MINIMUM OF 2 INCHES OF HMA MATERIAL SHALL BE IN PLACE AFTER MILLING.
- 2. REMOVE AND REPLACE WITH FULL DEPTH CLASS D PATCHES TO TOP OF MILLED SURFACE.

ALL DIMENSIONS ARE IN INCHES (MILLIMETERS) UNLESS OTHERWISE SHOWN.

LE NAME = 15R0650-DTLS-31 - BD-22	USER NAME =	DESIGNED —	REVISED	_	A. ABBAS 04-27-98
		CHECKED —	REVISED	_	R. BORO 01-01-07
	PLOT SCALE =	DRAWN —	REVISED	_	R. BORO 09-04-07
	PLOT DATE =	CHECKED —	REVISED	_	K. ENG 10-27-08

STATE OF ILLINOIS
DEPARTMENT OF TRANSPORTATION


			HING FOR PAVEMENT		
SHEET NO. 27	OF 36	SHEETS	STA.	TO STA.	

UN SECTION COUNTY TOTAL SHEETS NO.

1011 16-00096-00-PK DUPAGE 36 27


1014 SD400-94 (BD-22) CONTRACT NO. 61E55

1015 ROAD DIST. NO. ILLINOIS FED. AID PROJECT

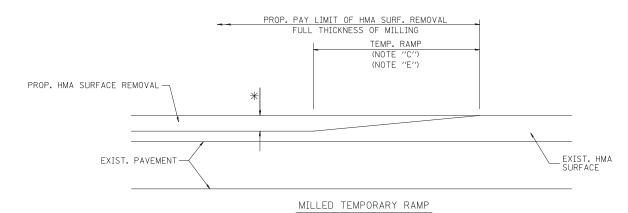

(FOR BUTT JOINT AND HMA TAPER SEE DETAIL BELOW)

OPTION 1

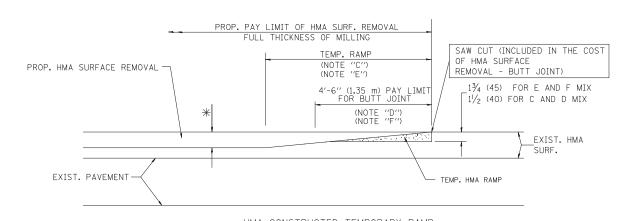


HMA CONSTRUCTED TEMPORARY RAMP


(FOR BUTT JOINT AND HMA TAPER SEE DETAIL BELOW)


OPTION 2

TYPICAL TEMPORARY RAMP

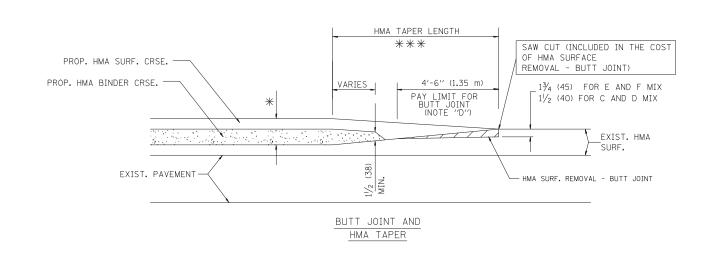

TYPICAL BUTT JOINT AND HMA TAPER FOR MILLING AND RESURFACING

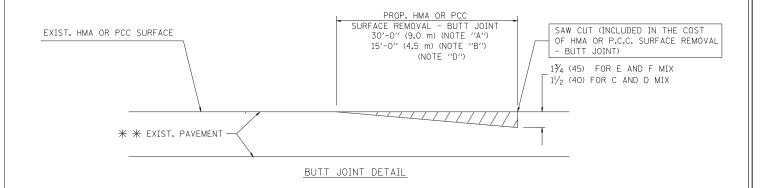

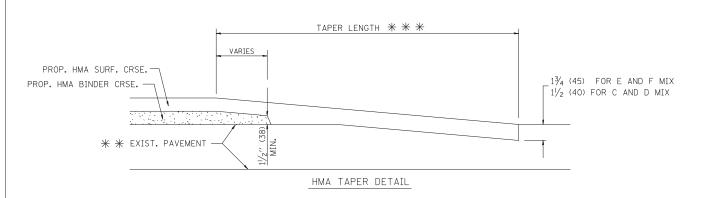

TYPICAL BUTT JOINT AND HMA TAPER FOR RESURFACING ONLY

PC CONCRETE, HMA OR HMA RESURFACED PAVEMENT.

NOTES

- A: MAINLINE ROADWAYS AND MAJOR SIDE ROADS.
- B: MINOR SIDE ROADS.
- C: THE TEMP. RAMP SHALL BE CONSTRUCTED IMMEDIATELY UPON REMOVAL OF THE EXISTING HMA SURFACE.
- D: THE BUTT JOINT SHALL BE CONSTRUCTED IMMEDIATELY PRIOR TO PLACING THE PROPOSED HMA COURSES.
- E: TAPER THE TEMP. RAMP AT A RATE OF 3'-0" (900 mm) PER 1 INCH (25 mm) OF MILLING THICKNESS.
- F: INSTALLATION AND REMOVAL OF THE 4'-6" (1.35 m) TEMP. RAMP IS INCLUDED IN COST OF HMA SURFACE REMOVAL BUTT JOINT
- G: SEE ARTICLE 406.08 AND 406.14 OF THE STANDARD SPECIFICATIONS FOR "HMA AND/OR PCC SURFACE REMOVAL, BUTT JOINT".
- # SEE TYPICAL SECTIONS FOR MILLING THICKNESS.
- ** * 20'-0" (6.1 m) PER 1 (25) RESURFACING (NOTE "A") 10'-0" (3.0 m) PER 1 (25) RESURFACING (NOTE "B")

SCALE:

BASIS OF PAYMENT:


THE BUTT JOINT WILL BE PAID FOR AT THE CONTRACT UNIT PRICE PER SOUARE YARD (SOUARE METER) FOR "HOT-MIX ASPHALT SURFACE REMOVAL - BUTT JOINT" OR FOR "PORTLAND CEMENT CONCRETE SURFACE REMOVAL- BUTT JOINT".

ALL DIMENSIONS ARE IN INCHES (MILLIMETERS) UNLESS OTHERWISE SHOWN.

FILE NAME = 15R0650-DTLS-31 - BD-32	USER NAME =	DESIGNED —	REVISED	_	R. SHAH 10-25-94
		CHECKED —	REVISED	_	A. ABBAS 03-21-97
	PLOT SCALE =	DRAWN —	REVISED	_	M. GOMEZ 04-06-01
	PLOT DATE =	CHECKED —	REVISED	_	R. BORO 01-01-07

STATE OF ILLINOIS DEPARTMENT OF TRANSPORTATION

	BUTT JOINT AND					MUN SECTION			COUNTY	TOTAL SHEETS	SHEET NO.	
HMA TAPER DETAILS						4011	16-0009	6-00-PK		DUPAGE	36	28
							BD400-05	BD32		CONTRACT	NO. 61E	55
SHEET NO 28	OF 36 SHE	FETS	STA	TO STA.		EED BO	AD DIST NO	II LIMOIC	EED A	ID DDO JECT		

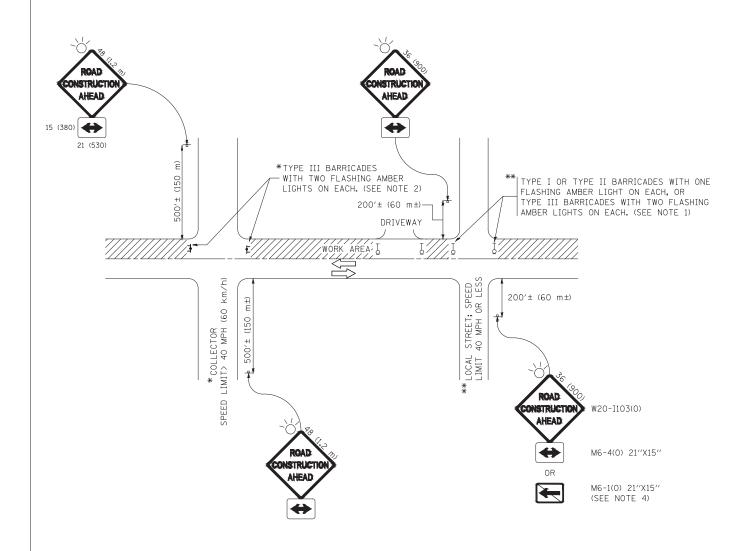

NOTES:

- 1. SIDE ROAD WITH A SPEED LIMIT OF 40 MPH (60 km/h) OR LESS AS SHOWN ON THE DRAWING AND AS DIRECTED BY THE ENGINEER:
 - a) ONE "ROAD CONSTRUCTION AHEAD" SIGN 36 x 36 (900x900) WITH A FLASHER MOUNTED ON IT APPROXIMATELY 200" (60 m) IN ADVANCE OF THE MAIN ROUTE.
 - b) THE CLOSED PORTION OF THE MAIN ROUTE SHALL BE PROTECTED BY BLOCKING WITH TYPE I, TYPE II OR TYPE III BARRICADES, 1/3 OF THE CROSS SECTION OF THE CLOSED PORTION.
- 2. SIDE ROAD WITH A SPEED LIMIT GREATER THAN 40 MPH (60 km/h) AS SHOWN ON THE DRAWING AND AS DIRECTED BY THE ENGINEER:
 - d) ONE "ROAD CONSTRUCTION AHEAD" SIGN 48 \times 48 (1.2 m \times 1.2 m) WITH A FLASHER MOUNTED ON IT APPROXIMATELY 500' (150 m) IN ADVANCE OF THE MAIN ROUTE.
 - b) THE CLOSED PORTION OF THE MAIN ROUTE SHALL BE PROTECTED BY BLOCKING WITH TYPE III BARRICADES, 1/2 OF THE CROSS SECTION OF THE CLOSED PORTION.
- 3. CONES MAY BE SUBSTITUTED FOR BARRICADES OR DRUMS AT HALF THE SPACING DURING DAY OPERATIONS. CONES SHALL BE A MINIMUM OF 28 (710) IN HEIGHT.
- 4. WHEN THE SIDE ROAD LIES BETWEEN THE BEGINNING OF THE MAINLINE SIGNING AND THE WORK ZONE, A SINGLE HEADED ARROW (M6-1) SHALL BE USED IN LIEU OF THE DOUBLE HEADED ARROW (M6-4).

SCALE:

- 5. WHEN WORK IS BEING PERFORMED ON A SIDE ROAD OR DRIVEWAY, FOLLOW THE APPLICABLE STANDARD(S). THE DIRECTIONAL ARROW (M6-1 OR M6-4) SHALL BE COVERED OR REMOVED WHEN NO LONGER CONSISTENT WITH THE TRAFFIC CONTROL SET-UP.
- 6. ADVANCE WARNING SIGNS ARE TO BE OMITTED ON DRIVEWAYS UNLESS OTHERWISE SPECIFIED IN THE PLANS OR BY THE ENGINEER
- 7. THE TRAFFIC CONTROL AND PROTECTION FOR SIDE ROADS, INTERSECTIONS, AND DRIVEWAYS SHALL BE INCLUDED IN THE COST OF SPECIFIED TRAFFIC CONTROL STANDARDS OR ITEMS.

All dimensions are in inches (millimeters) unless otherwise shown.

STATE OF ILLINOIS
DEPARTMENT OF TRANSPORTATION

TRAFFIC CONTROL AND PROTECTION FOR
SIDE ROADS, INTERSECTIONS, AND DRIVEWAYS


SHEET NO. 29 OF 36 SHEETS STA. TO STA.

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 CONTRACT NO. 61E55

 FED. ROAD DIST. NO.



- 4 (100) WHITE LANE LINE

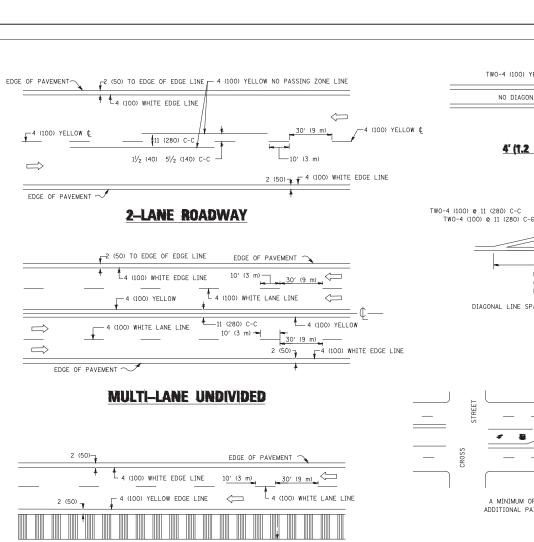TYPICAL LANE AND EDGE LINE MARKING

 \Rightarrow

EDGE OF PAVEMENT

TWO-4 (100) YELLOW @ 11 (280) C-C A MINIMUM OF TWO PAIRS OF TURN ARROWS SHALL BE USED, WHITE IN COLOR. ADDITIONAL PAIRS SHALL BE PLACED AT 200' (60 m) TO 300' (90 m) INTERVALS MEDIAN WITH TWO-WAY LEFT TURN LANE

TWO-4 (100) YELLOW № 11 (280) C-C

─TWO-4 (100) YELLOW @ 11 (280) C-C

4' (f.2 m) WIDE MEDIANS ONLY

12 (300) DIAGONALS (MINIMUM 5)

DIAGONAL LINES.

MEDIAN LENGTH

DIAGONAL LINE SPACING: 50' (15 m) C-C (LESS THAN 30MPH (50 km/h))

FOR MEDIAN LENGTHS WHERE DIAGONAL SPACING

MEDIANS OVER 4' (1.2 m) WIDE

- 4 (100) YELLOW

CANNOT BE ATTAINED, USE 5 (FIVE) EQUALLY SPACED

75' (25 m) C-C 30MPH (50 km/h) TO 45MPH (70 km/h))

4 (100) YELLOW LINES (51/2 (140) C-C)

150' (45 m) C-C (MORE THAN 45MPH (70 km/h))

4' (1.2 m) OUTSIDE TO OUTSIDE OF LINES

8 (200) WHITE-

12 (300) WHITE DIAGONALS

8 (200) WHITE-

ISLAND OFFSET FROM PAVEMENT EDGE

8 (200) WHITE -

ISLAND AT PAVEMENT EDGE

TYPICAL ISLAND MARKING

@ 10' (3 m) OR LESS SPACING

SEE DETAIL "B" IIIIII hununi PEDÉSTRIAN BICYCLE & EQUESTRIAN 2' (600) 12 (300) WHITE

2 (50)

4 (100) WHITE EDGE LINE

TYPICAL CROSSWALK MARKING

DETAIL "A"

* MARKINGS SHALL BE INSTALLED PARALLEL TO THE CENTERLINE OF THE ROAD WHICH IT CROSSES

___50' (15 m) TO 200' (60 m) ★ -6 (150) WHITE ___ 6 (150) WHITE FULL SIZE LETTERS 8' (2.4 m) AND ARROWS SHALL BE USED.


TYPICAL PAINTED MEDIAN MARKING

 \uparrow AREA = 15.6 SQ. FT. (1.5 m²) **(MLY** AREA = 20.8 SQ. FT. (1.9 m²)

* TURN LANES IN EXCESS OF 400' (120 m) IN LENGTH MAY HAVE AN ADDITIONAL SET OF ARROW - "ONLY" INSTALLED MIDWAY BETWEEN THE OTHER TWO SETS OF ARROW - "ONLY".

TYPICAL LEFT (OR RIGHT) TURN LANE

TYPICAL TURN LANE MARKING

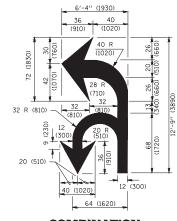


COMBINATION LEFT AND U-TURN

— 2 (50)

RAISED

ISLAND

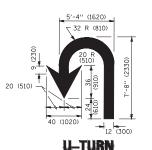

580 665 750 **⊢**20′

SPEED LIMIT

35

50

55

345

425

500

LANE REDUCTION TRANSITION

* LANE REDUCTION ARROWS REQUIRED AT SPEEDS OF 45 MPH OR GREATER OR WHEN SPECIFIED IN PLANS.

		<u> </u>	Unit	
TYPE OF MAIKING	WIDTH OF LINE	PATTERN	COLOR	SPACING /REMARK(S
CENTERLINE ON 2 LANE PAVEMENT	4 (100)	SKIP-DASH	YELLOW	10' (3 m) LINE WITH 30' (9 m) SPACE
CENTERLINE ON MULTI-LANE UNDIVIDED PAVEMENT	2 @ 4 (100)	SOLID	YELLOW	11 (280) C-C
NO PASSING ZONE LINES: FOR ONE DIRECTION FOR BOTH DIRECTIONS	4 (100) 2 Q 4 (100)	SOLID SOLID	YELLOW YELLOW	5½ (140) C-C FROM SKIP-DASH CENTERLINE 11 (280) C-C OMIT SKIP-DASH CENTERLINE BETWEEN
LANE LINES	4 (100) 5 (125) ON FREEWAYS	SKIP-DASH SKIP-DASH	WHITE WHITE	10' (3 m) LINE WITH 30' (9 m) SPACE
DOTTED LINES (EXTENSIONS OF CENTER, LANE OR TURN LANE MARKINGS)	SAME AS LINE BEING EXTENDED	SKIP-DASH	SAME AS LINE BEING EXTENDED	2' (600) LINE WITH 6' (1.8 m) SPACE
EDGE LINES	4 (100)	SOLID	YELLOW-LEFT WHITE-RIGHT	OUTLINE MEDIANS IN YELLOW
TURN LANE MARKINGS	6 (150) LINE; FULL SIZE LETTERS & SYMBOLS (8' (2.4m))	SOLID	WHITE	SEE TYPICAL TURN LANE MARKING DETAIL
TWO WAY LEFT TURN MARKING	2 @ 4 (100) EACH DIRECTION 8' (2.4m) LEFT ARROW	SKIP-DASH AND SOLID IN PAIRS	WHITE	10' (3 m) LINE WITH 30' (9 m) SPACE FOR SKIP-DASH; 5½ (140) C-C BETWEEN SOLID LINE AND SKIP-DASH LINE SEE TYPICAL TWO-WAY LEFT TURN MARKING DETAIL
CROSSWALK LINES (PEDESTRIAN) A. DIAGONALS (BIKE & EQUESTRIAN) B. LONGITUDINAL BARS (SCHOOL)	2 @ 6 (150) 12 (300) @ 45° 12 (300) @ 90°	SOLID SOLID SOLID	WHITE WHITE WHITE	NOT LESS THAN 6' (1.8 m) APART 2' (600) APART 2' (600) APART 5' (600) APART SEE TYPICAL CROSSWALK MARKING DETAILS.
STOP LINES	24 (600)	SOLID	WHITE	PLACE 4' (1.2 m) IN ADVANCE OF AND PARALLEL TO CROSSWALK, IF PRESENT. OTHERWISE, PLACE AT DESIRED STOPPING POINT. PARALLEL TO CROSSROAD CENTERLINE, WHERE POSSIBLE
PAINTED MEDIANS	2 @ 4 (100) WITH 12 (300) DIAGONALS @ 45° NO DIAGONALS USED FOR 4' (1.2 m) WIDE MEDIANS	SOLID	YELLOW: TWO WAY TRAFFIC WHITE: ONE WAY TRAFFIC	11 (280) C-C FOR THE DOUBLE LINE SEE TYPICAL PAINTED MEDIAN MARKING.
GORE MARKING AND CHANNELIZING LINES	8 (200) WITH 12 (300) DIAGONALS @ 45°	SOLID	WHITE	DIACONALS: 15' (4,5 m) C-C (LESS THAN 30MPH (50 km/h)) 20' (6 m) C-C 30MPH (50 km/h) TO 45MPH (70 km/h)) 30' (9 m) C-C (OVER 45MPH (70 km/h))
RAILROAD CROSSING	24 (600) TRANSVERSE LINES; "RR" IS 6' (1.8 m) LETTERS; 16 (400) LINE FOR "X"	SOLID	WHITE	SEE STATE STANDARD 780001 AREA OF: "R"=3.6 SQ. FT. (0.33 m²) EACH "X"=54.0 SQ. FT. (5.0 m²)
SHOULDER DIAGONALS (REQUIRED FOR SHOULDERS \geq 8')	12 (300) @ 45°	SOLID	WHITE - RIGHT YELLOW - LEFT	50' (15 m) C-C (LESS THAN 30MPH (50 km/h)) 75' (25 m) C-C (30 MPH (50 km/h) T0 45MPH (70 km/h)) 150' (45 m) C-C (0VER 45MPH (70 km/h))
U TURN ARROW	SEE DETAIL	SOLID	WHITE	16.3 SF
2 ARROW COMBINATION LEFT AND U TURN	SEE DETAIL	SOLID	WHITE	30.4 SF

FOR FURTHER DETAILS ON PAVEMENT MARKING REFER TO STANDARD SPECIFICATIONS FOR ROAD AND BRIDGE CONSTRUCTION AND STATE STANDARD 780001.

SCALE:


All dimensions are in inches (millimeters) unless otherwise shown.

FILE NAME = 15R0650-DTLS-31 - TC-13	USER NAME =	DESIGNED —	REVISED — C. JUCIUS 09-09-09
		CHECKED —	REVISED — C. JUCIUS 07-01-13
	PLOT SCALE =	DRAWN —	REVISED — C. JUCIUS 12-21-15
	PLOT DATE =	CHECKED —	REVISED — C. JUCIUS 04-12-16

DETAIL "B"


STATE OF ILLINOIS **DEPARTMENT OF TRANSPORTATION**

DISTRICT ONE					MUN SECTION		COUNTY	TOTAL SHEETS	SHEE NO.		
TYPICAL PAVEMENT MARKINGS					4011 16-00096-00-PK			DUPAGE	36	30	
					TC-13			CONTRACT NO. 61E		55	
HEFT NO 30	OF 36	SHEETS	STA.	TO STA.	EED BOAD DIST NO HUNDIS EED AID S			ID PRO IECT			

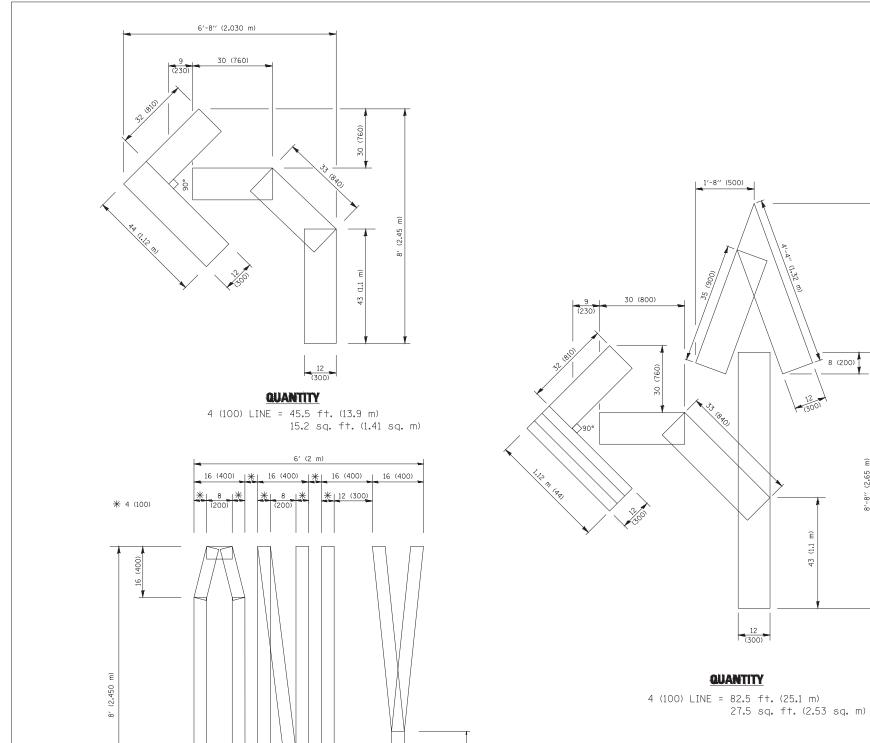

NOTE:

ALL QUANTITIES OF PLACEMENT ARE REPRESENTED IN LINEAR FEET OF 4" LINES TO MATCH THE 4" TEMPORARY TAPE PAY ITEM AND REPRESENTS THE TOTAL QUANTITY OF 4" TAPE REQUIRED.

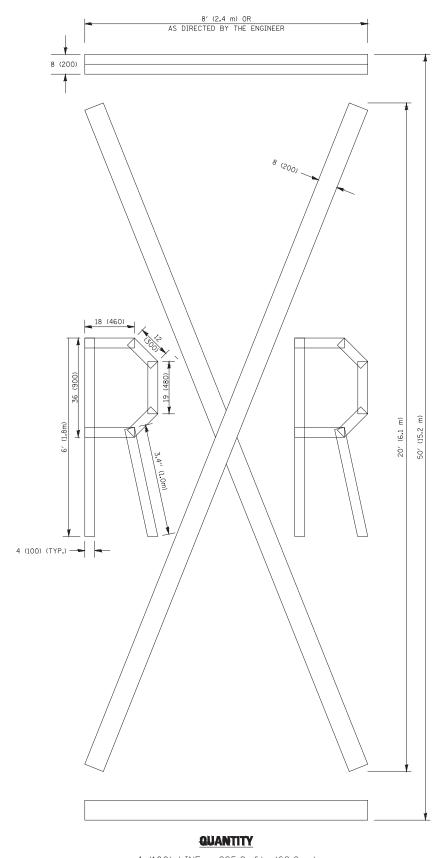

4 (100) LINE = 225.9 ft. (68.9 m) 75.3 sq. ft. (6.99 sq. m)

> All dimensions are in inches (millimeters) unless otherwise shown.

FILE NAME = 15R0650-DTLS-31 - TC-16 USER NAME = DESIGNED -REVISED —T. RAMMACHER 03-02-98 CHECKED — REVISED —E. GOMEZ 08-28-00 PLOT SCALE = REVISED —E. GOMEZ 08-28-00

PLOT DATE =

QUANTITY 4 (100) LINE = 64.1 ft. (19.5 m)

CHECKED —


21.4 sq. ft. (1.99 sq. m)

REVISED —A. SCHUETZE 09-15-16

STATE OF ILLINOIS DEPARTMENT OF TRANSPORTATION SHORT TERM PAVEMENT MARKING LETTERS AND SYMBOLS SHEET NO. 31 OF 36 SHEETS STA.

SCALE:

SECTION 4011 16-00096-00-PK DUPAGE 36 31 TC-16 CONTRACT NO. 61E55

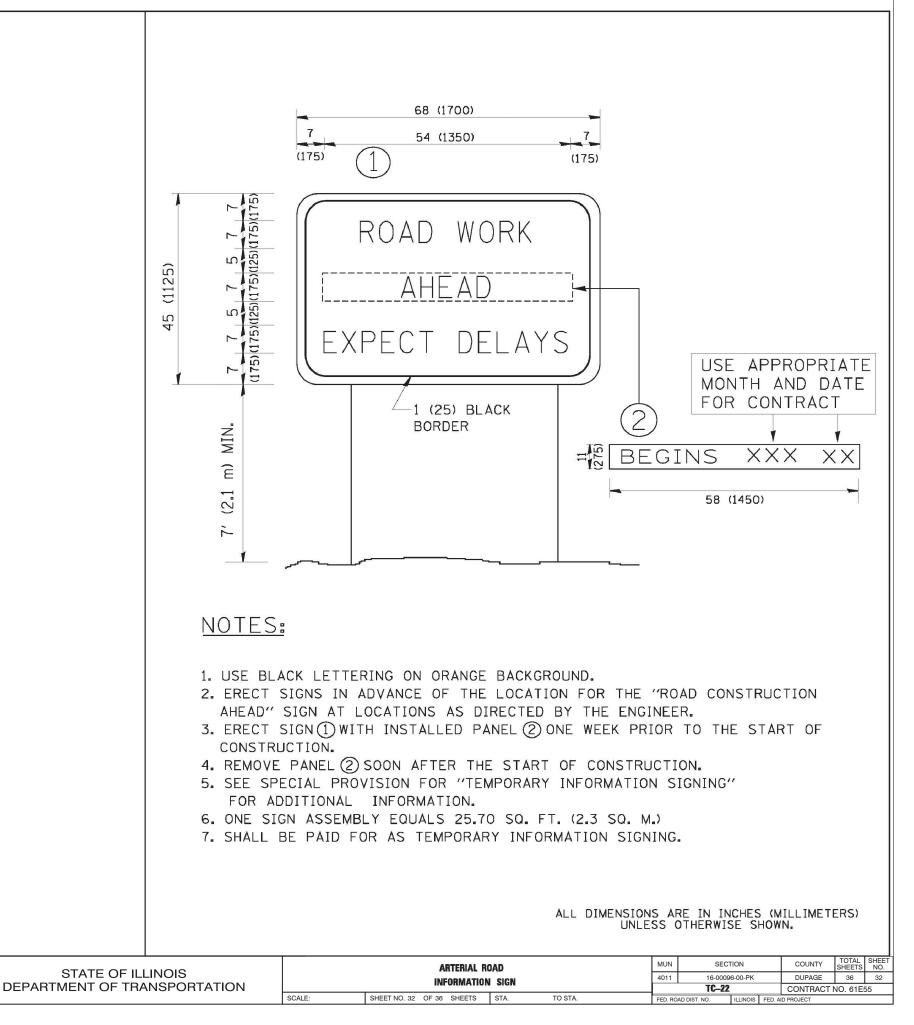

FILE NAME = 15R0650-DTLS-31 - TC-22

USER NAME =

PLOT SCALE =

PLOT DATE =

DESIGNED —


CHECKED -


CHECKED


REVISED → R. MAS 09-15-97

REVISED - H M F 1 M F 1

REVISED

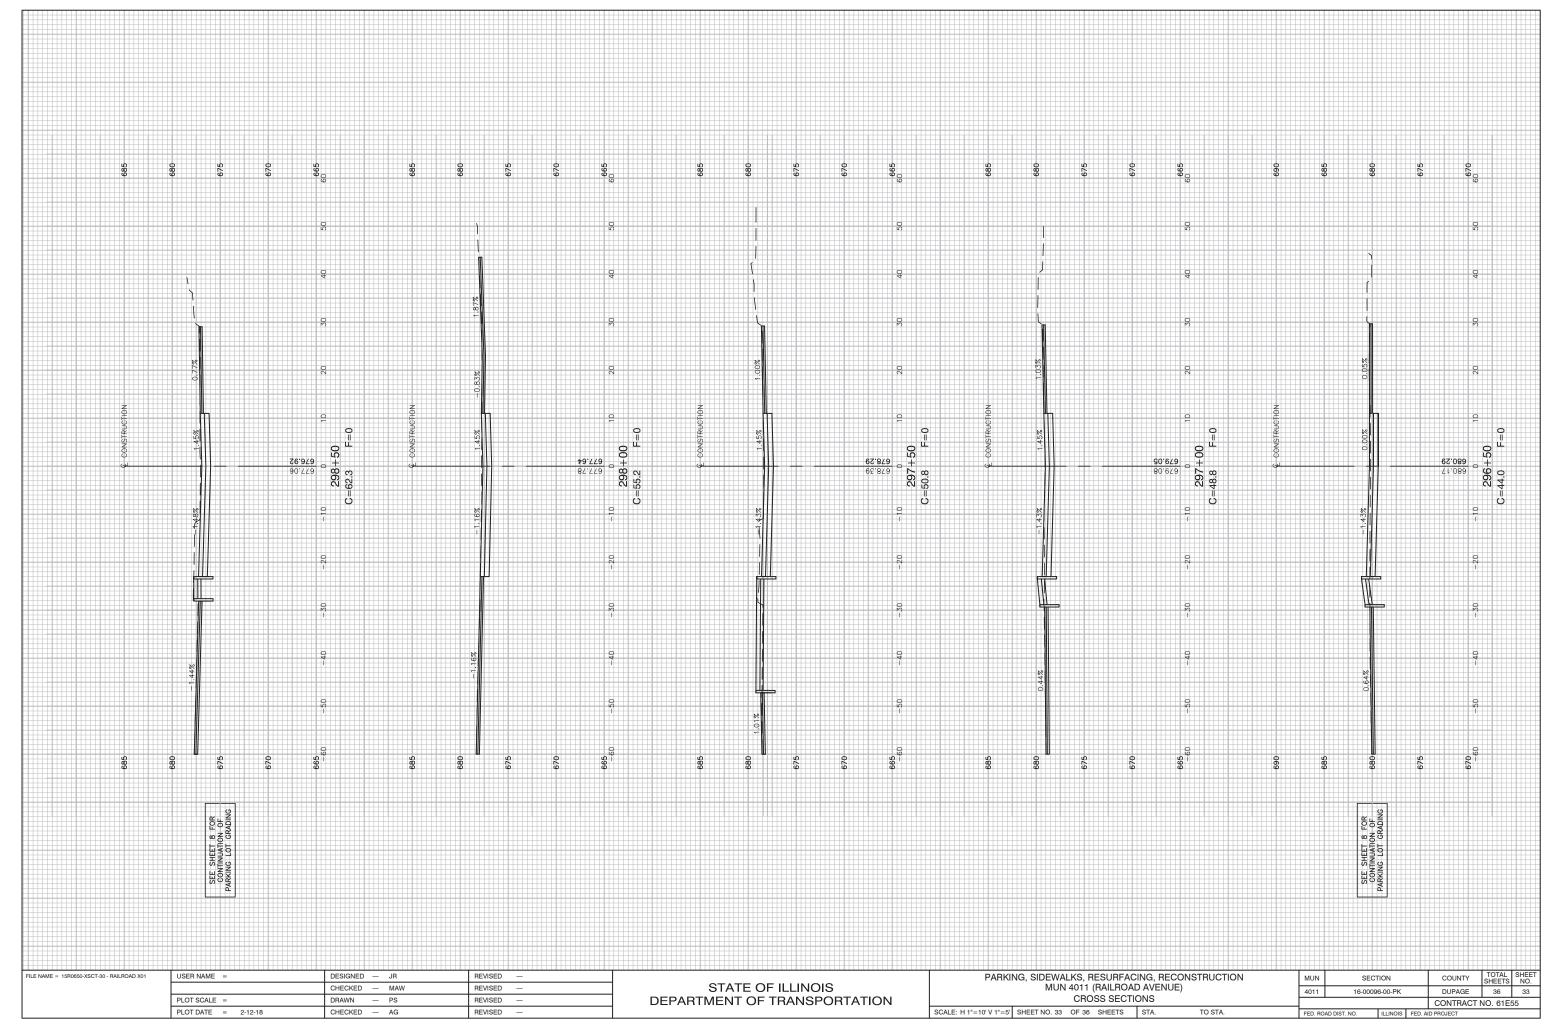

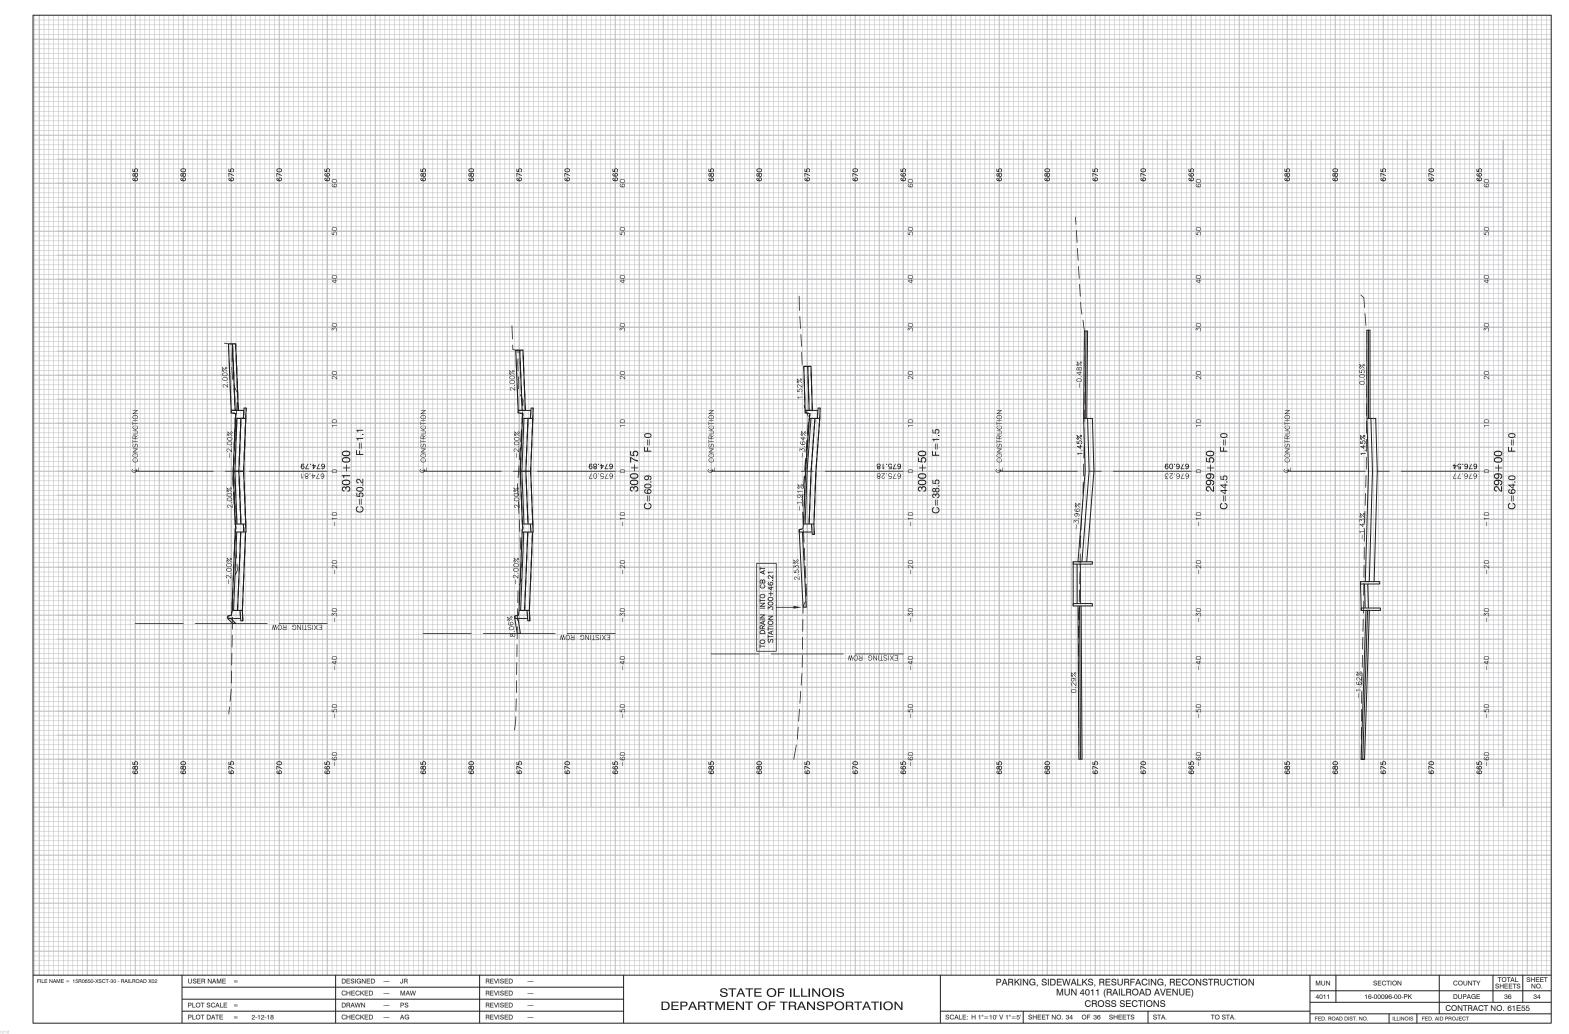


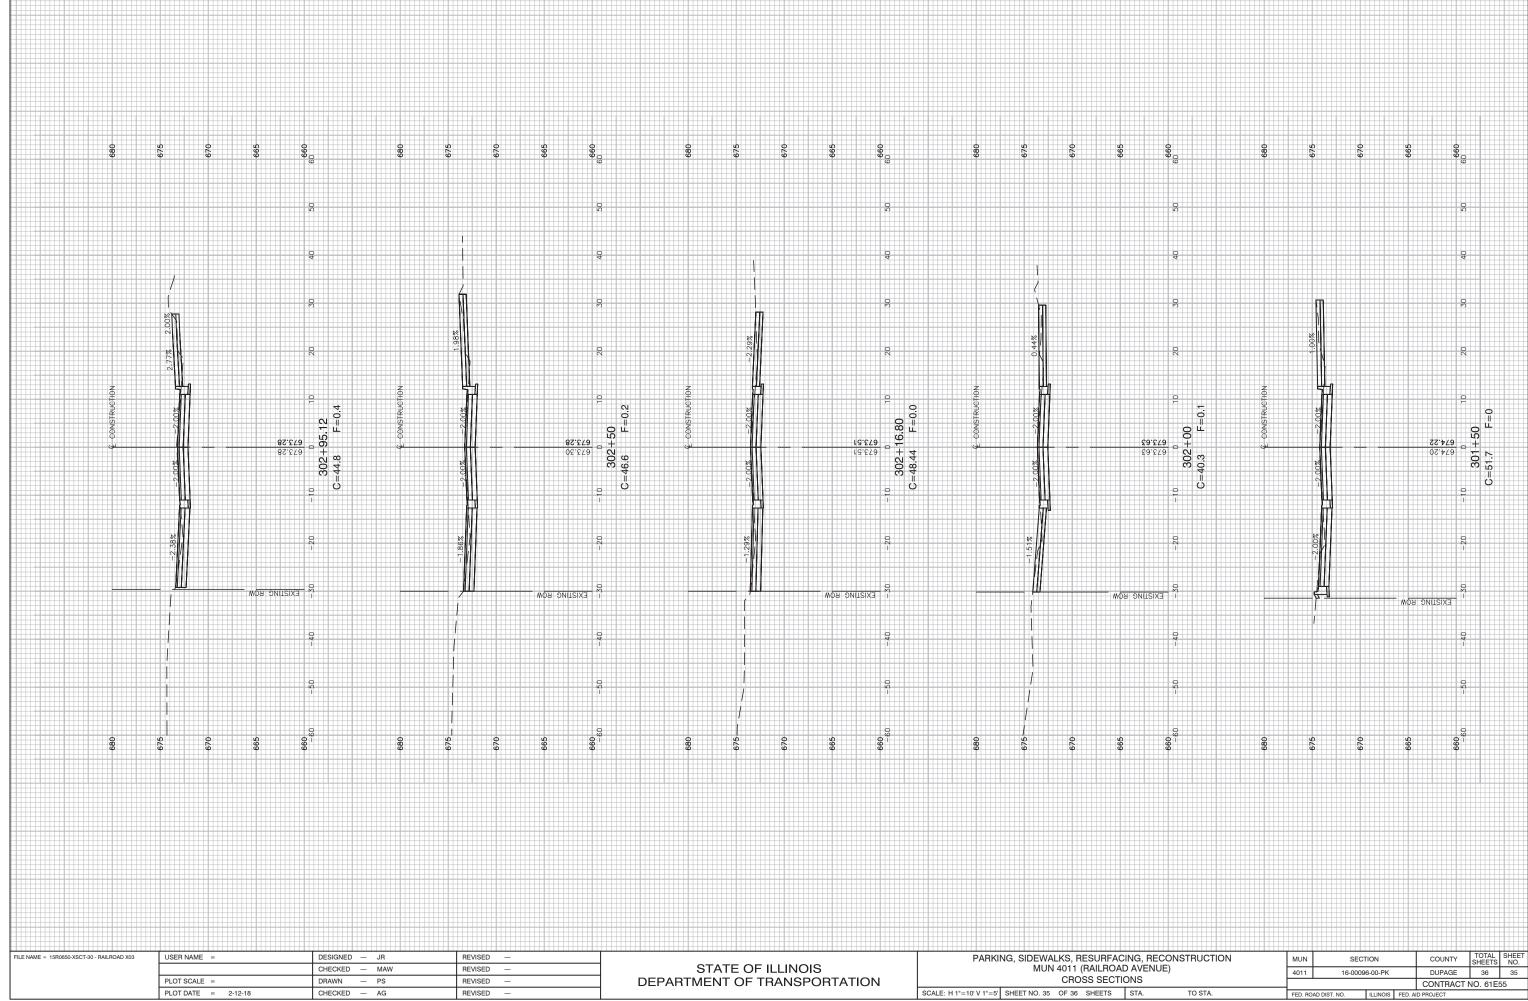

PLOT DATE = 2-12-18

REVISED —

PARKING, SIDEWALKS, RESURFACING, RECONSTRUCTION MUN 4011 (RAILROAD AVENUE) CROSS SECTIONS											
SCALE: H 1"=10' V 1"=5'	SHEET NO. 35	OF 36	SHEETS	STA.	TO STA.						

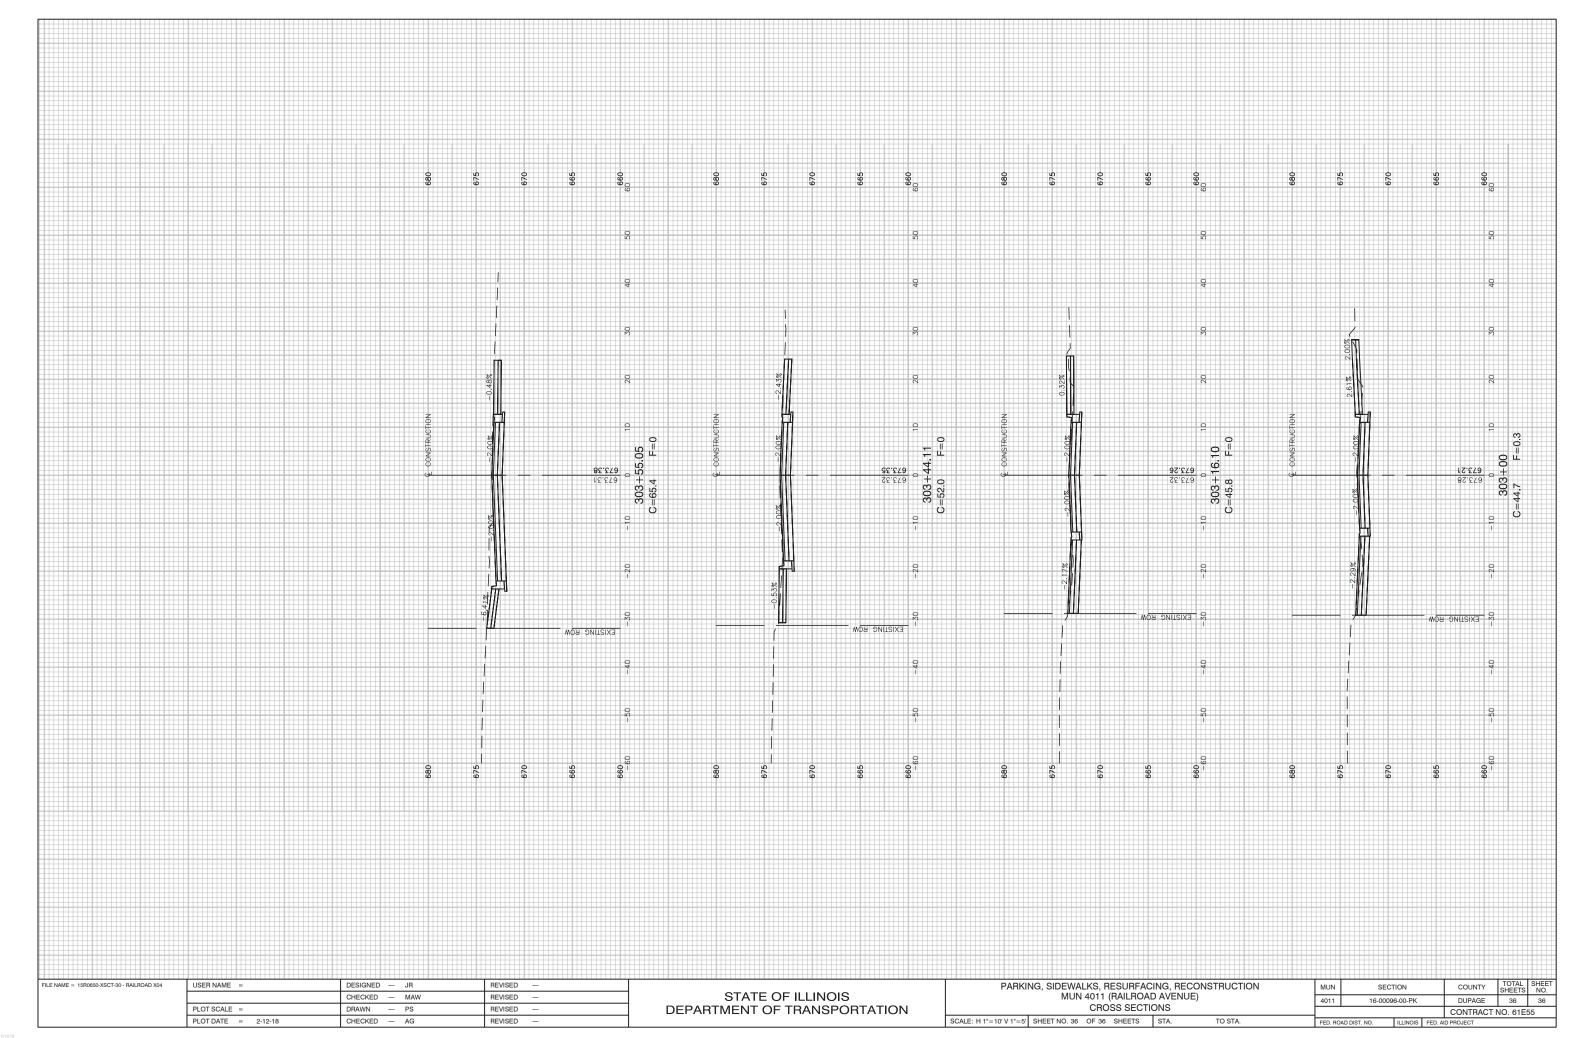

LOTTED BY: PETER STEPANOVIC ON 2/1