04-27-2018 LETTING ITEM 134

STATE OF ILLINOIS

DEPARTMENT OF TRANSPORTATION

PLANS FOR PROPOSED FEDERAL AID HIGHWAY

FAU 2965 (CUSTER AVENUE)

FAU 1488 (47th STREET) TO FAP 0311 (OGDEN AVENUE)

RESURFACING, CURB, GUTTER

SECTION 17-00131-00-RS

PROJECT PKUI(100) VILLAGE OF BROOKFIELD **COOK COUNTY**

JOB C-91-133-18

34

3rd PRINCIPAL MERIDIAN

PRESERV

OGDEN

PROJECT LOCATED IN BROOKFIELD AND LYONS

FOR INDEX OF SHEETS, SEE SHEET 2

TRAFFIC DATA

AUMBUR

CUSTER AVENUE 2400 (2017)

POSTED SPEED

25 MPH (EXISTING) 25 MPH (PROPOSED) MINOR COLLECTOR

25 MPH (EXISTING)

1"=100' 1"=10' 1"=50" 1"=40" 1"=30"

FULL SIZE PLANS HAVE BEEN PREPARED USING STANDARD ENGINEERING SCALES. REDUCED SIZED PLANS MILL NOT CONFORM TO STANDARD SCALES. IN MAKING MEASUREMENTS ON REDUCED PLANS, THE ABOVE SCALES MAY BE USED.

JOINT UTILITY LOCATION INFORMATION FOR EXCAVATION

CALL 811

Know what's below. Call before you dig. 545 Plainfield Road, Suite A ENGINEERING F: (630) 887.8640

FNA PROJECT NO. 16494 DRAWN/DESIGNED JFP/AMS CHECKED/APPROVED JLC/JLC VISIONS DESCRIPTION
CUSTER AVENUE WIDTH STA. 17+00
SEPARATED DRAINAGE AND PAVING NO. BY DATE
1 JLC 9/29/17
2 JLC 10/19/17

PER I.D.O.T. REVIEW

CHANGED FROM VILLAGE OF LYONS TO VILLAGE OF BROOKFIELD PER I.D.O.T.

PER I.D.O.T. REVIEW CONTRACT

DESIGN DESIGNATION

DESIGN SPEED 25 MPH (PROPOSED) FAU 2965 (CUSTER AVENUE)

> FAU 2965 (CUSTER AVENUE) END OMISSION STA. 19+45

> > FAU 2965 (CUSTER AVENUE) BEGIN OMISSION

PROJECT ENDS

FAU 2965 (CUSTER AVENUE) PROJECT BEGINS STA. 0+83

LYONS TOWNSHIP

RANGE 12 EAST

STER AV

PROJECT LOCATION MAP

44TH PL

GERRITSEN 7

DENOTES LOCATION OF IMPROVEMENT

GROSS LENGTH OF PROJECT = NET LENGTH OF PROJECT =

3,876 FEET (0.73 MILES) 3,786 FEET (0.72 MILES)

COUNTY 2965 соок 26 1 17-00131-00-RS F.H.W.A. REG. ILLINOIS PROJECT

CONTRACT NO. 61E51







PRINTED BY THE AUTHORITY OF THE STATE OF ILLINOIS

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- TYPICAL SECTIONS 5.-6.)
- 7.-11.) PLAN AND PROFILE: FAU 2965 (CUSTER AVENUE) - (EXISTING & PROPOSED ROADWAY PLAN)
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LIST OF ILLINOIS DOT HIGHWAY STANDARDS

- 000001-06 STANDARD SYMBOLS, ABBREVIATIONS, AND PATTERNS
- 280001-07 TEMPORARY EROSION CONTROL SYSTEMS
- 424001--10 PERPENDICULAR CURB RAMPS FOR SIDEWALKS
- 424006-03 DIAGONAL CURB RAMPS FOR SIDEWALKS
- 424021-04 DEPRESSED CORNER FOR SIDEWALKS
- 424026-02 ENTRANCE/ALLEY PEDESTRAIN CROSSINGS
- 442201-03 CLASS C AND D PATCHES
- 602001-02 CATCH BASIN-TYPE A
- 602011-02 CATCH BASIN-TYPE C
- 602301-04 INLFT-TYPE A
- 602401-04 MANHOLE-TYPE A
- 602501-03 VALVE VAULT-TYPE A
- 604001-04 FRAMES & LIDS-TYPE 1
- 606001-07 CONCRETE CURB TYPE B AND COMBINATION CONCRETE CURB & GUTTER

SITE BENCHMARK

SITÉ BENCHMARK

- 701006-05 OFF-RD OPERATIONS, 2L, 2W, 15' (4.5 m) TO 24" (600 mm) FROM PAVEMENT EDGE
- 701301-04 LANE CLOSURE, 2L, 2W, SHORT TIME OPERATIONS
- 701311-03 LANE CLOSURE, 2L, 2W, MOVING OPERATIONS-DAY ONLY
- 701501-06 URBAN LANE CLOSURE, 2 L, 2 W UNDIVIDED
- 701701--10 URBAN LANE CLOSURE, MULTILANE INTERSECTION
- 701801-06 SIDEWALK, CORNER OR CROSSWALK CLOSURE
- 701901-07 TRAFFIC CONTROL DEVICES

-<u>NOTE:</u> HALF TRAP TO BE REQUIRED WHEN

UNDISTURBED GROUND

HALF TRAP DETAIL

602001-02 CATCH BASIN-TYPE A 602011-02 CATCH BASIN-TYPE C

PRECAST

A FLEXIBLE WATERTIGHT BOOT, CONFORMING TO ASTM C-923, WILL BE CAST IN THE CATCH BASIN AT FABRICATION, TO BE USED BETWEEN THE STORM

STRUCTURE AND NEW PVC SDR

ASTM D-2241, B" DIA.
CONNECTING PIPE. CONNECTION

PIPE SHALL RECONNECT TO EXISTING SEWER PIPES USING A FLEXIBLE COUPLING AS

APPROVED BY THE MWRDGC.

AS REQUIRED

- 780001--05 TYPICAL PAVEMENT MARKINGS
- 886001-01 DETECTOR LOOP INSTALLATIONS
- 886006-01 TYPICAL LAYOUTS FOR DETECTION LOOPS

GENERAL NOTES

PAVING AND STORM SEWERS

SPECIFICATIONS

THE APRIL 1, 2016 EDITION OF THE "STANDARD SPECIFICATIONS FOR ROAD AND BRIDGE CONSTRUCTION", THE "SUPPLEMENTAL SPECIFICATIONS AND RECURRING SPECIAL PROVISIONS". PREPARED BY THE ILLINOIS DEPARTMENT OF TRANSPORTATION AND THE "MANUAL OF UNIFORM TRAFFIC CONTROL DEVICES" SHALL GOVERN ALL WORK ASSOCIATED WITH THIS PROJECT. THE "STANDARD SPECIFICATIONS FOR WATER AND SEWER MAIN CONSTRUCTION IN ILLINOIS" MAY GOVERN OTHER WORK ON THIS PROJECT AS INDICATED BY REFERENCE.

CARE IN EXCAVATION

THE CONTRACTOR SHALL EXERCISE CARE DURING EARTH AND/OR TRENCHING OPERATIONS TO AVOID DAMAGE TO LOCAL UTILITY SERVICES, WATER VALVES, MANHOLES, CATCH BASINS, INLETS, BUFFALO BOXES, AND OTHER STRUCTURES. ALL DAMAGE DONE BY THE CONTRACTOR, WHETHER THE STRUCTURE OR SERVICE IS VISIBLE AT THE GROUND SURFACE OR NOT, SHALL BE REPAIRED OR REPLACED BY THE CONTRACTOR IN ACCORDANCE WITH ARTICLE 105.07 OF THE "STANDARD SPECIFICATIONS FOR ROAD AND BRIDGE

NOTIFICATION OF PUBLIC UTILITIES

PRIOR TO STARTING CONSTRUCTION, THE CONTRACTOR SHALL NOTIFY THE OFFICIALS OF THE PUBLIC WORKS DEPARTMENT OF THE LOCAL MUNICIPALITIES AT (708)485-2540 BROOKFIELD, (708)466-2646, LYONS, J.U.L.I.E. AT 1-800-892-0123 OR 811, AND OTHER PUBLIC AND PRIVATE UTILITIES TO MAKE ARRANGEMENTS TO LOCATE THEIR VARIOUS FACILITIES WITHIN THE LIMITS OF CONSTRUCTION UNDER THIS CONTRACT, AND TO PROVIDE ADEQUATE PROTECTION AND INSPECTION. THE CONTRACTOR SHALL DETERMINE THE ACTUAL LOCATION OF ALL SUCH FACILITIES IN THE FIELD.

TRAFFIC CONTROL DEVICES

BARRICADES AND WARNING SIGNS SHALL BE PROVIDED IN ACCORDANCE WITH ARTICLE 107.14 OF THE "STANDARD SPECIFICATIONS FOR ROAD AND BRIDGE CONSTRUCTION".

PROTECTION OF SIGNS AND PROPERTY

ALL TRAFFIC SIGNS, STREET SIGNS, ETC., THAT INTERFERE WITH THE CONSTRUCTION OPERATIONS SHALL BE REMOVED AND PLACED AT NEW LOCATIONS AS DESIGNATED BY THE ENGINEER. IN ADDITION, ALL MAIL BOXES THAT INTERFERE WITH CONSTRUCTION SHALL BE SIMILARLY RELOCATED IN ACCORDANCE WITH ARTICLES 107.20 AND 107.21 OF THE "STANDARD SPECIFICATIONS FOR ROAD AND BRIDGE CONSTRUCTION".

SUPERINTENDENCE

THE CONTRACTOR SHALL HAVE A COMPETENT SUPERINTENDENT ON THE PROJECT SITE AT ALL TIMES, IRRESPECTIVE OF THE AMOUNT OF WORK SUBLET. THE SUPERINTENDENT SHALL BE CAPABLE OF READING AND UNDERSTANDING THE PLANS AND SPECIFICATIONS, SHALL HAVE FULL AUTHORITY TO EXECUTE ORDERS TO EXPEDITE THE PROJECT AND SHALL BE RESPONSIBLE FOR SCHEDULING AND HAVING CONTROL OF ALL THE WORK AS THE AGENT OF THE GENERAL CONTRACTOR. FAILURE TO COMPLY WITH THIS PROVISION WILL RESULT IN A SUSPENSION OF WORK AS PROVIDED IN ARTICLE 108.07.

CONSTRUCTION LAYOUT STAKES

THE CONTRACTOR SHALL PROVIDE THE ENGINEER WITH WOODEN STAKES OR OTHER LAYOUT MATERIALS FOR LAYOUT OF THE LINES AND GRADES OF THE PROJECT. FAILURE TO PROVIDE STAKES IN A TIMELY MANNER WILL RESULT IN A DELAY IN STAKEOUT WHICH WILL BE APPLICABLE AGAINST THE TIME LIMIT FOR COMPLETION SHOWN IN THE PROJECT SPECIFICATIONS. LINE AND GRADE WILL BE ESTABLISHED BY THE ENGINEER AT REGULAR INTERVALS ON PERMANENTLY PAVED SURFACES, SIDEWALKS OR STAKES AT THE ENGINEER'S OPTION, ALL WITHIN THE PUBLIC RIGHT-OF-WAY AND SHALL BE TRANSFERRED BY THE CONTRACTOR TO THE ACTUAL LINE OF CONSTRUCTION.

PROJECT SAFETY

WHEN MILLED PAVEMENT IS OPEN TO TRAFFIC THE MAXIMUM GRADE DIFFERENTIAL BETWEEN PASSES OF THE MILLING MACHINE SHALL NOT EXCEED 1-1/2 INCHES WHERE THE SPEED LIMIT IS 45 MPH OR LESS AND 1 INCH WHERE THE SPEED LIMIT IS GREATER THAN 45 MPH. WITH WRITTEN APPROVAL FROM THE ENGINEER, A MAXIMUM GRADE DIFFERENTIAL OF 3 INCHES MAY BE ALLOWED IF THE EDGE OF THE MILLING IS SLOPED A MINIMUM 1:3 (V:H).

BUTT JOINTS WILL BE INSTALLED AT THE ENDS OF ALL RESURFACING (WHERE RESURFACING MEETS EXISTING PAVEMENT), IN ACCORDANCE WITH THE "BUTT JOINT AND HOT-MIX ASPHALT TAPER DETAILS" SHEET INCLUDED IN THE PLANS, UNLESS OTHERWISE SPECIFIED.

THE CONTRACTOR SHALL COMPLY WITH AND OBSERVE THE RULES AND REGULATIONS OF O.S.H.A. AND APPROPRIATE AUTHORITIES REGARDING SAFETY PROVISIONS. THE CONTRACTOR, ENGINEER, AND OWNER SHALL EACH BE RESPONSIBLE FOR THEIR OWN RESPECTIVE AGENTS AND EMPLOYEES.

THE ENGINEER AND OWNER ARE NOT RESPONSIBLE FOR THE CONSTRUCTION MEANS, METHODS, TECHNIQUES, SEQUENCES OR PROCEDURES, TIME OF PERFORMANCE, PROGRAMS, OR FOR ANY SAFETY PRECAUTIONS USED BY THE CONTRACTOR. THE CONTRACTOR IS SOLELY RESPONSIBLE FOR EXECUTION OF HIS/HER WORK IN ACCORDANCE WITH THE

THE RESIDENT ENGINEER SHALL CONTACT THE TRAFFIC CONTROL SUPERVISOR AT (847) 705-4470 A MINIMUM OF 72 HOURS PRIOR TO THE PLACEMENT OF ANY TEMPORARY TRAFFIC CONTROL DEVICES.

MISCELLANEOUS

ALL PATCHING ON THE HOT-MIX ASPHALT PORTIONS OF THIS PROJECT WILL BE MARKED OUT AND CONSTRUCTED AFTER MILLING. A PROOF ROLL WILL BE REQUIRED PRIOR TO PATCHING

BEFORE BEGINNING WORK, THE CONTRACTOR SHALL RETAIN AND RECORD FOR FUTURE REFERENCE, ALL EXISTING PAVEMENT MARKING LINES (AND RAISED REFLECTIVE PAVEMENT MARKERS) SO THESE LOCATIONS CAN BE RE-ESTABLISHED FOR FINAL STRIPING. EXACT LOCATIONS OF ALL PAVEMENT MARKINGS SHALL BE AS DIRECTED BY

STATE OF ILLINOIS DEPARTMENT OF TRANSPORTATION

INDEX OF SHEETS, LIST OF DISTRICT 1 STANDARD DETAILS, LIST OF ILLINOIS DOT HIGHWAY STANDARDS, GENERAL NOTES, HALF TRAP DETAIL, BENCHMARKS, HOT-MIX ASPHALT MIXTURE REQUIREMENTS SCALE: NONE SHEET NO. OF SHEETS STA. TO STA

N FB ON FH AT 4545 CUSTER AVE. - ELEV=621.74 SITE BENCHMARK SW FB ON FH ON SE CORNER OF CUSTER AVE. AND 45TH PL. — ELEV=624.07 SITE BENCHMARK ENE FB ON FH ON SW CORNER OF CUSTER AVE. AND GERRITSEN AVE. - ELEV=629.52 SITE BENCHMARK NE FB ON FH ON NE CORNER OF CUSTER AVE. AND 44TH ST. - ELEV=628.94 SITE BENCHMARK SE FB ON FH AT 4331 CUSTER AVE. — ELEV=628.76 SITE BENCHMARK SE FB ON FH AT 8745 43RD ST. -- ELEV=628.81 SITE BENCHMARK FNE FR ON FH ON SW CORNER OF CUSTER AVE. AND SHIFLDS AVE. - FLEV=627.01 SITE BENCHMAR SE FB ON FH AT 4239 CUSTER AVE. - ELEV=625.82 SITE BENCHMARK SE FB ON FH AT 4217 CUSTER AVE. — ELEV=624.97 SITE BENCHMARK SE FB ON FH ON SE CORNER OF CUSTER AVE. AND 42ND ST. - ELEV=623.11 SITE BENCHMARK
SE FB ON FH AT 4129 CUSTER AVE. - ELEV=621.79 SITE BENCHMARK NW FB ON FH ON SW CORNER OF CUSTER AVE. AND OGDEN AVE. - ELEV=621.04

BENCHMARKS

ELEVATIONS REFERENCE THE NORTH AMERICAN VERTICAL DATUM OF 1988 (NAVD88).

S FR ON FH ON NE CORNER OF CUSTER AVE. AND 47TH ST. - ELEV=621.10

SITE BENCHMARK W FB ON FH AT 4627 CUSTER AVE. — ELEV=621.10

NOTE: CONTRACTOR SHALL MILL BEFORE PATCHING.

- DIAMFTER OF THE

HOT-MIX ASPHALT MIXTURE REQUIREMENTS

MIXTURE TYPE	AIR VOIDS @ NDES
ROADWAY PAVEMENT	
HOT-MIX ASPHALT SURFACE COURSE, MIX "D", N50, (IL-9.5mm), 1-3/4"	4% @ 50 GYR
HOT-MIX ASPHALT BINDER COURSE, IL-19.0, N50, 4"	4% © 50 GYR
PATCHING PATCHING	
CLASS D PATCHES, TYPE II—IV, 10" (HMA BINDER COURSE, IL—19 mm), 10" (IN 2 LIFTS)	4% @ 70 GYR
<u>DRIVEWAYS</u>	
HOT-MIX ASPHALT SURFACE COURSE, MIX "D", N50, (IL-9.5mm), 3" (IN TWO LIFTS)	4% @ 50 GYR

HOT-MIX SURFACE REMOVAL TO BE PERFORMED BEFORE PATCHING OPERATIONS

THE UNIT WEIGHT TO CALCULATE ALL HOT-MIX ASPHALT SURFACE MIXTURE QUANTITIES IS 112 LBS/SQ YD/IN.

"THE "AC TYPE" FOR POLYMERIZED HMA MIXES SHALL BE "SBS/SBR PG 76-22" AND FOR NON-POLYMERIZED HMA THE "AC TYPE" SHALL BE "PG 64-22" UNLESS MODIFIED BY DISTRICT ONE SPECIAL PROVISIONS" FOR USE OF RECYCLED MATERIALS SEE SPECIAL PROVISIONS

NOVOTNY ENGINEERING F: (630) 887.0132

Willowbrook, IL 60527 T: (630) 887.8640

SECTION COUNTY 17-00131-00-RS COOK 26 2 2965 CONTRACT NO. 61E51

FILE NAME VILLAGE OF BROOKFIELD	USER NAME =	DESIGNED - AMS	REVISED —	JLC 9/29/17
FAU 2965 (CUSTER AVENUE)		DRAWN - JFP	REVISED	JLC 10/19/17
FAU 1488 (47th STREET) TO FAP 0311 (OGDEN AVENUE)	PLOT SCALE =	CHECKED - JLC	REVISED	JLC 11/29/17
#16494 WINDENING AND RESURFACING	PLOT DATE =	DATE $- 7/17$	REVISED —	JLC 12/08/17
			REVISED -	JLC 2/Q6/18

MWRDGC GENERAL NOTES

METROPOLITAN WATER RECLAMATION DISTRICT OF GREATER CHICAGO LOCAL SEWER SYSTEMS SECTION

A. REFERENCED SPECIFICATIONS

- A. REFERENCED SPECIFICATIONS

 1. ALL CONSTRUCTION SHALL BE IN ACCORDANCE WITH THE APPLICABLE SECTIONS OF THE FOLLOWING, EXCEPT AS MODIFIED HEREIN OR ON THE PLANS;

 * STANDARD SPECIFICATIONS FOR ROAD AND BRIDGE CONSTRUCTION (LATEST EDITION), BY THE ILLINOIS DEPARTMENT OF TRANSPORTATION (IDOT SS) FOR ALL IMPROVEMENTS EXCEPT SANITARY SEWER AND WATER MAIN CONSTRUCTION;

 * STANDARD SPECIFICATIONS FOR WATER AND SEWER MAIN CONSTRUCTION IN ILLINOIS, LATEST EDITION (SSWS) FOR SANITARY SEWER AND WATER MAIN CONSTRUCTION;

 * VILLAGE OF BROOKFIELD AND LYONS MUNICIPAL CODE;

 * THE METROPOLITAN WATER RECLAMATION DISTRICT OF GREATER CHICAGO (MWRD) WATERSHED MANAGEMENT ORDINANCE AND TECHNICAL GUIDANCE MANUAL;

 * IN CASE OF CONFLICT BETWEEN THE APPLICABLE ORDINANCES NOTED, THE MORE STRINGENT SHALL TAKE PRECEDENCE AND SHALL CONTROL ALL CONSTRUCTION.

B. NOTIFICATIONS

- THE MWRD LOCAL SEWER SYSTEMS SECTION FIELD OFFICE MUST BE NOTIFIED AT LEAST TWO (2) WORKING DAYS PRIOR TO THE COMMENCEMENT OF ANY WORK (CALL 708-588-4055).
- 2. THE VILLAGE OF <u>BROOKFIELD AND LYONS</u> ENGINEERING DEPARTMENT AND PUBLIC MUST BE NOTIFIED AT LEAST 24 HOURS PRIOR TO THE START OF CONSTRUCTION AND PRIOR TO EACH PHASE OF WORK. CONTRACTOR SHALL DETERMINE ITEMS REQUIRING INSPECTION PRIOR TO START OF CONSTRUCTION OR EACH WORK PHASE.
- 3. THE CONTRACTOR SHALL NOTIFY ALL UTILITY COMPANIES PRIOR TO BEGINNING CONSTRUCTION FOR THE EXACT LOCATIONS OF UTILITIES AND FOR THEIR PROTECTION DURING CONSTRUCTION. IF EXISTING UTILITIES ARE ENCOUNTERED THAT CONFLICT IN LOCATION WITH NEW CONSTRUCTION, IMMEDIATELY NOTIFY THE ENGINEER SO THAT THE CONFLICT CAN BE RESOLVED. CALL J.U.L.I.E. AT 1-800-892-0123.

- ALL ELEVATIONS SHOWN ON PLANS REFERENCE THE NORTH AMERICAN VERTICAL DATUM OF 1988 (NAVD88).
 CONVERSION FACTOR IS _______ FT.
- 2. MWRD, THE MUNICIPALITY AND THE OWNER OR OWNERS REPRESENTATIVE SHALL HAVE THE AUTHORITY TO INSPECT, APPROVE, AND REJECT THE CONSTRUCTION IMPROVEMENTS.
- 3. THE CONTRACTOR(S) SHALL INDEMNIFY THE OWNER, ENGINEER, MUNICIPALITY, MWRD, AND THEIR AGENTS, ETC., FROM ALL LIABILITY INVOLVED WITH THE CONSTRUCTION, INSTALLATION, OR TESTING OF THIS WORK ON THE PROJECT.
- 4. THE PROPOSED IMPROVEMENTS MUST BE CONSTRUCTED IN ACCORDANCE WITH THE ENGINEERING PLANS AS APPROVED BY MWRD AND THE MUNICIPALITY UNLESS CHANGES ARE APPROVED BY MWRD, THE MUNICIPALITY, OR AUTHORIZED AGENT. THE CONSTRUCTION DETAILS, AS PRESENTED ON THE PLANS, MUST BE FOLLOWED, PROPER CONSTRUCTION TECHNIQUES MUST BE FOLLOWED ON THE IMPROVEMENTS INDICATED ON THE PLANS.
- 5. THE LOCATION OF VARIOUS UNDERGROUND UTILITIES WHICH ARE SHOWN ON THE PLANS ARE FOR INFORMATION ONLY AND REPRESENT THE BEST KNOWLEDGE OF THE ENGINEER. VERIFY LOCATIONS AND ELEVATIONS PRIOR TO BEGINNING THE CONSTRUCTION OPERATIONS.
- 6. ANY EXISTING PAVEMENT, SIDEWALK, DRIVEWAY, ETC., DAMAGED DURING CONSTRUCTION OPERATIONS AND NOT CALLED FOR TO BE REMOVED SHALL BE REPLACED AT THE EXPENSE OF THE CONTRACTOR.
- 7. MATERIAL AND COMPACTION TESTING SHALL BE PERFORMED IN ACCORDANCE WITH THE REQUIREMENTS OF THE MUNICIPALITY, MWRD, AND OWNER.
- 8. THE UNDERGROUND CONTRACTOR SHALL MAKE ALL NECESSARY ARRANGEMENTS TO NOTIFY ALL INSPECTION AGENCIES.
- 9. ALL NEW AND EXISTING UTILITY STRUCTURES ON SITE AND IN AREAS DISTURBED DURING CONSTRUCTION SHALL BE ADJUSTED TO FINISH GRADE PRIOR TO FINAL INSPECTION.
- 10. RECORD DRAWINGS SHALL BE KEPT BY THE CONTRACTOR AND SUBMITTED TO THE ENGINEER AS SOON AS UNDERGROUND IMPROVEMENTS ARE COMPLETED. FINAL PAYMENTS TO THE CONTRACTOR SHALL BE HELD UNTIL THEY ARE RECEIVED. ANY CHANGES IN LENGTH, LOCATION OR ALIGNMENT SHALL BE SHOWN IN RED. ALL WYES OR BENDS SHALL BE LOCATED FROM THE DOWNSTREAM MANHOLE. ALL VALVES, B-BOXES, TEES OR BENDS SHALL BE TIED TO A FIRE HYDRANT.

D. SANITARY SEWER

- 1. THE CONTRACTOR SHALL TAKE MEASURES TO PREVENT ANY POLLUTED WATER, SUCH AS GROUND AND SURFACE WATER, FROM ENTERING THE EXISTING SANITARY SEWERS.
- 2. A WATER-TIGHT PLUG SHALL BE INSTALLED IN THE DOWNSTREAM SEWER PIPE AT THE POINT OF SEWER CONNECTION PRIOR TO COMMENCING ANY SEWER CONSTRUCTION, THE PLUG SHALL REMAIN IN PLACE UNTIL REMOVAL IS AUTHORIZED BY THE MUNICIPALITY AND/OR MWRD AFTER THE SEWERS HAVE BEEN TESTED AND ACCEPTED.
- 3. DISCHARGING ANY UNPOLLUTED WATER INTO THE SANITARY SEWER SYSTEM FOR THE PURPOSE OF SEWER FLUSHING OF LINES FOR THE DEFLECTION TEST SHALL BE PROHIBITED WITHOUT PRIOR APPROVAL FROM THE MUNICIPALITY OR MWRD.
- 4. ALL SANITARY SEWER CONSTRUCTION SHALL BE IN ACCORDANCE WITH THE STANDARD SPECIFICATIONS FOR WATER AND SEWER MAIN CONSTRUCTION IN ILLINOIS (LATEST EDITION).
- 5. ALL FLOOR DRAINS SHALL DISCHARGE TO THE SANITARY SEWER SYSTEM.
- 6. ALL DOWNSPOUTS AND FOOTING DRAINS SHALL DISCHARGE TO THE STORM SEWER SYSTEM.
- 7. ALL SANITARY SEWER PIPE MATERIALS AND JOINTS (AND STORM SEWER PIPE MATERIALS AND JOINTS IN A COMBINED SEWER AREA) SHALL CONFORM TO THE FOLLOWING:

PIPE MATERIAL	PIPE SPECIFICATIONS	JOINT SPECIFICATIONS	
VITRIFIED CLAY PIPE	ASTM C-700	ASTM C-425	
REINFORCED CONCRETE SEWER PIPE	ASTM C-76	ASTM C-443	
CAST IRON SOIL PIPE	ASTM A-74	ASTM C-564	
DUCTILE IRON PIPE	ANSI A21.51	ANSI A21.11	
POLYVINYL CHLORIDE (PVC) PIPE 6-INCH TO 15-INCH DIAMETER SDR 18-INCH TO 27-INCH DIAMETER F/D		ASTM D-3212 ASTM D-3212	
HIGH DENSITY POLYETHYLENE (HDPE)) ASTM D-3350 ASTM D-3035	ASTM D-3261,F-2620 (HEA ASTM D-3212.F-477 (GASKE	
WATER MAIN QUALITY PVC 4-INCH TO 36-INCH 4-INCH TO 12-INCH 14-INCH TO 48-INCH	ASTM D-2241 AWWA C900 AWWA C905	ASTM D-3139 ASTM D-3139 ASTM D-3139	

THE FOLLOWING MATERIALS ARE ALLOWED ON A QUALIFIED BASIS SUBJECT TO DISTRICT REVIEW AND APPROVAL PRIOR TO PERMIT ISSUANCE. A SPECIAL CONDITION WILL BE ADDED TO THE PERMIT WHEN THE PIPE MATERIAL BELOW IS USED FOR SEWER CONSTRUCTION OR A CONNECTION IS MADE.

PIPE MATERIAL	PIPE SPECIFICATIONS	JOINT SPECIFICATIO
POLYPROPYLENE (PP) PIPE		
12-INCH TO 24-INCH DOUBLE WALL	ASTM F-2736	D-3212, F-477
30-INCH TO 60-INCH TRIPLE WALL	ASTM F-2764	D3212, F-477

- 8. ALL SANITARY SEWER CONSTRUCTION (AND STORM SEWER CONSTRUCTION IN COMBINED SEWER AREAS), REQUIRES STONE BEDDING WITH STONE % "TO 1"IN SIZE, WITH MINIMUM BEDDING THICKNESS EQUAL TO % THE OUTSIDE DIAMETER OF THE SEWER PIPE, BUT NOT LESS THAN FOUR (4) INCHES NOR MORE THAN EIGHT (8) INCHES MATERIAL SHALL BE CA-7, CA-11 OR CA-13 AND SHALL BE EXTENDED AT LEAST 12" ABOVE THE TOP OF THE PIPE WHEN USING PVC.
- 9. NON-SHEAR FLEXIBLE-TYPE COUPLINGS SHALL BE USED IN THE CONNECTION OF SEWER PIPES OF DISSIMILAR PIPE MATERIALS.
- 10. ALL MANHOLES SHALL BE PROVIDED WITH BOLTED, WATERTIGHT COVERS, SANITARY LIDS SHALL BE CONSTRUCTED WITH A CONCEALED PICKHOLE AND WATERTIGHT GASKET WITH THE WORD "SANITARY" CAST INTO THE LID.
- 11. WHEN CONNECTING TO AN EXISTING SEWER MAIN BY MEANS OTHER THAN AN EXISTING WYE, TEE, OR AN EXISTING MANHOLE, ONE OF THE FOLLOWING METHODS SHALL BE USED:

 a) A CIRCULAR SAW—CUT OF SEWER MAIN BY PROPER TOOLS ("SHEWER—TAP"MACHINE OR SIMILAR) AND PROPER INSTALLATION OF HUBB-YEE SADDLE.

 b) REMOVE AN ENTIRE SECTION OF PIPE (BREAKING ONLY THE TOP OF ONE BELL) AND REPLACE WITH A WYE OR TEE BRANCH SECTION.

 c) WITH PIPE CUTTER, NEATLY AND ACCURATELY CUT OUT DESIRED LENGTH OF PIPE FOR INSERTION OF PROPER FITTING, USING FLEXIBLE COUPLINGS TO HOLD IT FIRMLY IN PLACE.
- 12. WHENEVER A SANITARY/COMBINED SEWER CROSSES UNDER A WATERMAIN, THE MINIMUM VERTICAL DISTANCE FROM THE TOP OF THE SEWER TO THE BOTTOM OF THE WATERMAIN SHALL BE 18 INCHES. FURTHERMORE, A MINIMUM HORIZONTAL DISTANCE OF 10 FEET BETWEEN SANITARY/COMBINED SEWERS AND WATERMAINS SHALL BE MAINTAINED UNLESS: THE SEWER IS LAID IN A SEPARATE TRENCH, KEEPING A MINIMUM 18' VERTICAL SEPARATION; OR THE SEWER IS LAID IN THE SAME TRENCH WITH THE WATERMAIN LOCATED AT THE OPPOSITE SIDE ON A BENCH OF UNDISTURBED EARTH, KEEPING A MINIMUM 18' VERTICAL SEPARATION. IF EITHER THE VERTICAL OR HORIZONTAL DISTANCES DESCRIBED CANNOT BE MAINTAINED, OR THE SEWER CROSSES ABOVE THE WATER MAIN, THE SEWER SHALL BE CONSTRUCTED TO WATER MAIN STANDARDS OR IT SHALL BE ENCASED WITH A WATER MAIN QUALITY CARRIER PIPE WITH THE ENDS SEALED.
- 13. ALL EXISTING SEPTIC SYSTEMS SHALL BE ABANDONED. ABANDONED TANKS SHALL BE FILLED WITH GRANULAR MATERIAL OR REMOVED.
- 14. ALL SANITARY MANHOLES, (AND STORM MANHOLES IN COMBINED SEWER AREAS), SHALL HAVE A MINIMUM INSIDE DIAMETER OF 48 INCHES, AND SHALL BE CAST IN PLACE OR PRE-CAST REINFORCED
- 15. ALL SANITARY MANHOLES, (AND STORM MANHOLES IN COMBINED SEWER AREAS), SHALL HAVE PRECAST RUBBER BOOTS THAT CONFORM TO ASTM C-923 FOR ALL PIPE CONNECTIONS, PRECAST SECTIONS SHALL CONSIST OF MODIFIED GROOVE TONGUE AND RUBBER GASKET TYPE JOINTS.
- 16. ALL ABANDONED SANITARY SEWERS SHALL BE PLUGGED AT BOTH ENDS WITH AT LEAST 2 FEET LONG NON-SHRINK CONCRETE OR MORTAR PLUG.
- 17. EXCEPT FOR FOUNDATION/FOOTING DRAINS PROVIDED TO PROTECT BUILDINGS, OR PERFORATED PIPES ASSOCIATED WITH VOLUME CONTROL FACILITIES, DRAIN TILES/FIELD TILES/UNDERDRAINS/PERFORATED PIPES ARE NOT ALLOWED TO BE CONNECTED TO OR TRIBUTARY TO COMBINED SEWERS, SANITARY SEWERS, OR STORM SEWERS TRIBUTARY TO COMBINED SEWERS IN COMBINED SEWER AREAS, CONSTRUCTION OF NEW FACILITIES OF THIS TYPE IS PROHIBITED; AND ALL EXISTING DRAIN TILES AND PERFORATED PIPES ENCOUNTERED WITHIN THE PROJECT AREA SHALL BE PLUGGED OR REMOVED, AND SHALL NOT BE CONNECTED TO COMBINED SEWERS, SANITARY SEWERS, OR STORM SEWERS TRIBUTARY TO COMBINED SEWERS.
- A BACKFLOW PREVENTER IS REQUIRED FOR ALL DETENTION BASINS TRIBUTARY TO COMBINED SEWERS. REQUIRED BACKFLOW PREVENTERS SHALL BE INSPECTED AND EXERCISED ANNUALLY BY THE PROPERTY OWNER TO ENSURE PROPER OPERATION, AND ANY NECESSARY MAINTENANCES SHALL BE PEFRORMED TO ENSURE FUNCTIONALITY, IN THE EVENT OF A SEWER SURCHARGE INTO AN OPEN DETENTION BASIN TRIBUTARY TO COMBINED SEWERS, THE PERMITTEE SHALL ENSURE THAT CLEAN UP AND WASH OUT OF SEWAGE TAKES PLACE WITHIN 48 HOURS OF THE STORM EVENT.

- E. EROSION AND SEDIMENT CONTROL
- THE CONTRACTOR SHALL INSTALL THE EROSION AND SEDIMENT CONTROL DEVICES AS SHOWN ON THE APPROVED EROSION AND SEDIMENT CONTROL PLAN.
- EROSION AND SEDIMENT CONTROL PRACTICES SHALL BE FUNCTIONAL PRIOR TO HYDROLOGIC DISTURBANCE OF THE SITE.
- ALL DESIGN CRITERIA, SPECIFICATIONS, AND INSTALLATION OF EROSION AND SEDIMENT CONTROL PRACTICES SHALL BE IN ACCORDANCE WITH THE ILLINOIS URBAN MANUAL.
- A COPY OF THE APPROVED EROSION AND SEDIMENT CONTROL PLAN SHALL BE MAINTAINED ON THE SITE AT ALL TIMES.
- 5. INSPECTIONS AND DOCUMENTATION SHALL BE PERFORMED, AT A MINIMUM:
 a) UPON COMPLETION OF INITIAL EROSION AND SEDIMENT CONTROL MEASURES, PRIOR TO ANY
 SOIL DISTURBANCE.
 b) ONCE EVERY SEVEN (7) CALENDAR DAYS AND WITHIN 24 HOURS OF THE END OF A STORM EVENT
 WITH GREATER THAN 0.5 INCH OF RAINFALL OR LIQUID EQUIVALENT PRECIPITATION.
- 6. SOIL DISTURBANCE SHALL BE CONDUCTED IN SUCH A MANNER AS TO MINIMIZE EROSION.
 IF STRIPPING, CLEARING, GRADING, OR LANDSCAPING ARE TO BE DONE IN PHASES, THE CO-PERMITTEE SHALL PLAN FOR APPROPRIATE SOIL EROSION AND SEDIMENT CONTROL MEASURES.
- 7. A STABILIZED MAT OF CRUSHED STONE MEETING THE STANDARDS OF THE ILLINOIS URBAN MANUAL SHALL BE INSTALLED AT ANY POINT WHERE TRAFFIC WILL BE ENTERING OR LEAVING A CONSTRUCTION SITE. SEDIMENT OR SOIL REACHING AN IMPROVED PUBLIC RIGHT—OF—WAY, STREET, ALLEY OR PARKING AREA. SHALL BE REMOVED BY SCRAPING OR STREET CLEANING AS ACCUMULATIONS WARRANT AND TRANSPORTED TO A CONTROLLED SEDIMENT DISPOSAL AREA.
- 8. CONCRETE WASHOUT FACILITIES SHALL BE CONSTRUCTED IN ACCORDANCE WITH THE ILLINOIS URBAN MANUAL AND SHALL BE INSTALLED PRIOR TO ANY ON SITE CONSTRUCTION ACTIVITIES INVOLVING
- 9. MORTAR WASHOUT FACILITIES SHALL BE CONSTRUCTED IN ADDITION TO CONCRETE WASHOUT FACILITIES FOR ANY BRICK AND MORTAR BUILDING ENVELOPE CONSTRUCTION ACTIVITIES.
- 10. TEMPORARY DIVERSIONS SHALL BE CONSTRUCTED AS NECESSARY TO DIRECT ALL RUNOFF FROM HYDROLOGICALLY DISTURBED AREAS TO AN APPROPRIATE SEDIMENT TRAP OR BASIN. VOLUME CONTROL FACILITIES SHALL NOT BE USED AS TEMPORARY SEDIMENT BASINS.
- 12. DISTURBED AREAS OF THE SITE WHERE CONSTRUCTION ACTIVITIES HAVE TEMPORARILY OR PERMANENTLY CEASED SHALL BE STABILIZED WITH TEMPORARY OR PERMANENT MEASURES WITHIN-SEVEN (7) DAYS.
- ALL FLOOD PROTECTION AREAS AND VOLUME CONTROL FACILITIES SHALL, AT A MINIMUM, BE PROTECTED WITH A DOUBLE-ROW OF SILT FENCE.
- 14. VOLUME CONTROL FACILITIES SHALL NOT BE CONSTRUCTED UNTIL ALL OF THE CONTRIBUTING DRAINAGE AREA HAS BEEN STABILIZED.
- 15. SOIL STOCKPILES SHALL, AT A MINIMUM, BE PROTECTED WITH PERIMETER SEDIMENT CONTROLS. SOIL STOCKPILES SHALL NOT BE PLACED IN FLOOD PROTECTION AREAS OR THEIR BUFFERS.
- EARTHEN EMBANKMENT SIDE SLOPES SHALL BE STABILIZED WITH APPROPRIATE EROSION CONTROL BLANKET.
- 17. STORM SEWERS THAT ARE OR WILL BE FUNCTIONING DURING CONSTRUCTION SHALL BE PROTECTED BY APPROPRIATE SEDIMENT CONTROL MEASURES.
- 18. THE CONTRACTOR SHALL EITHER REMOVE OR REPLACE ANY EXISTING DRAIN TILES AND INCORPORATE THEM INTO THE DRAINAGE PLAN FOR THE DEVELOPMENT. DRAIN TILES CANNOT BE TRIBUTARY TO A SANITARY OR COMBINED SEWER. DRAIN TILES ALLOWED IN COMBINED SEWER AREA FOR GREEN INFRASTRUCTURE PRACTICES.
- 19. IF DEWATERING SERVICES ARE USED, ADJOINING PROPERTIES AND DISCHARGE LOCATIONS SHALL BE PROTECTED FROM EROSION AND SEDIMENTATION. DEWATERING SYSTEMS SHOULD BE INSPECTED DAILY DURING OPERATIONAL PERIODS. THE SITE INSPECTOR MUST BE PRESENT AT THE COMMENCEMENT OF DEWATERING ACTIVITIES.
- 20. THE CONTRCTOR SHALL BE RESPONSIBLE FOR TRENCH DEWATERING AND EXCAVATION FOR THE INSTALLATION OF SANITARY SEWERS, STORM SEWERS WATERMAINS AS WELL AS THEIR SERVICES AND OTHER APPURIENANCES. ANY TRENCH DEWATERING, WHICH CONTAINS SEDIMENT SHALL PASS THROUGH A SEDIMENT SETTLING POND OR EQUALLY EFFECTIVE SEDIMENT CONTROL DEVICE. ALTERNATIVES MAY INCLUDE DEWATERING INTO A SUMP PIT, FILTER BAG OR EXISTING VEGETATED UPSLOPE AREA. SEDIMENT LADEN WATERS SHALL NOT BE DISCHARGE TO WATERWAYS, FLOOD PROTECTION AREAS OR THE COMBINED SEWER SYSTEM.
- 21. ALL PERMANENT EROSION CONTROL PRACTICES SHALL BE INITIATED WITHIN SEVEN (7) DAYS FOLLOWING THE COMPLETION OF SOIL DISTURBING ACTIVITIES.
- 22. ALL EROSION AND SEDIMENT CONTROL MEASURES SHALL BE MAINTAINED AND REPAIRED AS NEEDED ON A YEAR-ROUND BASIS DURING CONSTRUCTION AND ANY PERIODS OF CONSTRUCTION SHUTDOWN UNTIL PERMANENT STABILIZATION IS ACHIEVED.
- 23. ALL TEMPORARY EROSION AND SEDIMENT CONTROL MEASURES SHALL BE REMOVED WITHIN THIRTY (30) DAYS AFTER PERMANENT SITE STABILIZATION.

TO STA.

24. THE EROSION AND SEDIMENT CONTROL MEASURES SHOWN ON THE PLANS ARE THE MINIMUM REQUIREMENTS. ADDITIONAL MEASURES MAY BE REQUIRED, AS DIRECTED BY THE ENGINEER, SITE INSPECTOR, OR MWRO.

EROSION CONTROL NOTES

- CONCRETE TRUCKS MAY NOT WASH OUT ON SITE, DUE TO THE CLOSE PROXIMITY OF THE CONCRETE READY MIX SITE, (LESS THAN 1 MILE), CONCRETE TRUCKS SHALL RETURN TO THE PLANT FOR WASHOUT.
- 2. UPON INSTALLATION OF THE NEW CATCH BASINS AND INLETS WITH OPEN LIDS, INLET FILTERS SHALL IMMEDIATELY BE INSTALLED IN THEM TO CONTROL/PREVENT SEDIMENT INTO THE SEWER SYSTEM.
- 3. IMMEDIATELY AFTER THE INSTALLATION OF THE STREET PAVING, ALL DISTURBED AREAS SHALL BE RESTORED WITH TOPSOIL, SEEDING, AND EROSION CONTROL BLANKET.



FILE NAME VILLAGE OF BROOKFIELD	USER NAME =	DESIGNED - AMS	REVISED - JLC 10/19/17
FAU 2965 (CUSTER AVENUE)		DRAWN - JFP	REVISED - JLC 11/29/17
FAU 1488 (47th STREET) TO FAP 0311 (OGDEN AVENUE)	PLOT SCALE =	CHECKED - JLC	REVISED - JLC 12/08/17
#16494 WINDENING AND RESURFACING	PLOT DATE =	DATE - 7/17	REVISED - JLC 2/06/18

STATE OF ILLINOIS **DEPARTMENT OF TRANSPORTATION** **MWRDGC GENERAL NOTES**

SCALE: NONF SHEET NO. OF SHEETS STA.

SECTION COUNTY COUNTY SHEETS NO.

COOK 26 3 2965 17-00131-00-RS CONTRACT NO. 61E51 FED. ROAD DIST. NO. ILLINOIS FED. AID PROJECT

Specialty		Code	No. of the second secon			Construction Co
Item	Provision	No 20100110	Item TREE REMOVAL (6 TO 15 UNITS DIAMETER)	UNIT	Quantity 59	Roadway 0005 59
		20100210	TREE REMOVAL (OVER 15 UNITS DIAMETER)	UNIT	108	108
		20101000	TEMPORARY FENCE	FOOT	890	890
	<u> </u>	20101100	 TREETRUNK PROTECTION	EACH	11	11
<u> </u>		20101200	TREE ROOT PRUNING	EACH	58	58
*		20101350	TREE PRUNING (OVER 10 INCH DIAMETER)	EACH	15	15
		20200100	EARTH EXCAVATION	CU YD	67D	670
		20200200	I PROCK EXCAVATION	CU YD	120	120
		20201200	REMOVAL AND DISPOSAL OF UNSUITABLE MATERIAL	CUYD	75	75
-			TRENCH BACKFILL	CU YD	225	225
			TOPSOIL FURNISH AND PLACE, VARIABLE DEPTH	SO YD	3050	3050
- Ja			NITROGEN FERTILIZER NUTRIENT	POUND	40	40
			POTASSIUM FERTILIZER NUTRIENT	POUND		40
*			SODDING	SO YD	i	3050
1162			SUPPLEMENTAL WATERING		44	44
7.				UNIT	38	
			INLET FILTERS	EACH	75	38
			AGGREGATE SUBGRADE IMPROVEMENT	CU YD		75
			SUBBASE GRANULAR MATERIAL, TYPE B, 2"	SO YD	1255	1255
			SUBBASE GRANULAR MATERIAL, TYPE B, 4"	SQ YD	2950	2950
			PREPARATION OF BASE	SO YD	13270	13270
		35800200	AGGREGATE BASE REPAIR	TON	1155	1155
		40201000	AGGREGATE FOR TEMPORARY ACCESS	TON	130	130
		40600290	BITUMINOUS MATERIALS (TACK COAT)	POUND	6485	6485
		40600982	HOT-MIX ASPHALT SURFACE REMOVAL - BUTT JOINT	SO YD	150	150
		40603080	HOT-MIX ASPHALT BINDER COURSE, IL-19.0, N50	TON	3070	3070_
		40603335	HOT-MIX ASPHALT SURFACE COURSE, MIX "D", N50	TON	1460	1460
		42000300	PORTLAND CEMENT CONCRETE PAVEMENT 8"	SO YD	50	50
		42300300	PORTLAND CEMENT CONCRETE DRIVEWAY PAVEMENT 7 INCH	SQ YD	1115	1115
		42400200	PORTLAND CEMENT CONCRETE SIDEWALK 5 INCH	SQ FT	7000	7000
		42400400	PORTLAND CEMENT CONCRETE SIDEWALK 7 INCH	SO FT	600	600
		42400800	DETECTABLE WARNINGS	SO FT	473	473
		44000100	PAVEMENT REMOVAL	SQ YD	160	160
		44000155	HOT-MIX ASPHALT SURFACE REMOVAL, 1 1/2"	SQ YD	1085	1085
		44000161	HOT-MIX ASPHALT SURFACE REMOVAL, 3"	SQ YD	12380	12380
		44000200	DRIVEWAY PAVEMENT REMOVAL	SO YD	700	700
44000500 COMBINATION CURB AND GUTTER REMOVAL		COMBINATION CURB AND GUTTER REMOVAL	FOOT	7720	7720	
J 44000600 SIDEWALK REMOVAL		SQ FT	2015	2015		
1 44201725 CLASS D PATCHES, TYPE I, 7 INCH		SO AD	35	35		
44201725 CLASS D PATCHES, TYPE II, 7 INCH		SQ YD	110	110		
			CLASS D PATCHES, TYPE III, 7 INCH	SO YD	60	60
			CLASS D PATCHES, TYPE III, 7 INCH		45	
			NOTICE AND ADDRESS OF THE PARTY	SO YD		45
			PROTECTIVE COAT	DS T	3800	3800
		55100200	STORM SEWER REMOVAL 6"	FOOT	77	77

	<u> </u>					
Specialty Item	Special Provision	Code No	Item	Unit	Total Quantity	Construction Code Roadway 0005
		<u>55100300</u>	STORM SEWER REMOVAL 8"	FOOT	488	488
		55100400	STORM SEWER REMOVAL 10"	FOOT	143	143
		56400100	FIRE HYDRANTS TO BE MOVED E		2	2
*	İ	56400500	FIRE HYDRANTSTO BE REMOVED	EACH	11	11
*		56400500	FIRE HYDRANTS	EACH	11	11
		60200105	CATCH BASINS, TYPE A. 4" DIAMETER. TYPE 1 FRAME, OPEN LID	EACH	7	7
		60290205	CATCH BASINS, TYPE A. 4' DIAMETER, TYPE 1 FRAME, CLOSED LID	EACH	10	10
		60206905	CATCH BASINS, TYPE C, TYPE 1 FRAME OPEN LID	EACH	22	22
		60218400	MANHOLES, TYPE A, 4° DIAMETER, TYPE 1 FRAME, CLOSED LID	EACH	10	10
		60234200	INLETS. TYPE A TYPE 1 FRAME, OPEN LID	EACH	24	24
		60242700	VALVE VAULT, TYPE A. 4' DIAMETER. TYPE 1 FRAME. CLOSED LID	EACH	4	4
		60250200	CATCH BASINS TO BE ADJUSTED	EACH	9	9
		€0252800	CATCH BASINS TO BE RECONSTRUCTED	EACH	1	1
		60255500	MANHOLES TO BE ADJUSTED	EACH	6	6
		60257900	MANHOLES TO BE RECONSTRUCTED	EACH	2	22
		69260100	INLETS TO BE ADJUSTED	EACH	2	2
		60265700	VALVE VAULTS TO BE ADJUSTED	EACH	4	4
		60266100	VALVE VAULTS TO BE RECONSTRUCTED	EACH	2	2
		60266600	VALVE BOXES TO BE ADJUSTED	EACH	6	- 6
		60406000	FRAMES AND LIDS, TYPE 1, OPEN LID	EACH	2	2
		60496100	FRAMES AND LIDS, TYPE 1, CLOSED LID	EACH	10	10
		60500040	removing manholes	EACH	10	10
		60500050	REM●VING CATCH BASINS	EACH	18	18
		60500068	REMOVING INLETS	EACH	24	24
	*	60604100	COMBINATION CONCRETE CURB AND GUTTER, TYPE B-6.12 (MODIFIED)	FOOT	7720	7720
*		66900200	N●N-SPECIAL WASTE DISPOSAL	CUYD	3	3
*		66900450	SPECIAL WASTE PLANS AND REPORTS	LSUM	1	1
*		66900530	SOIL DISPOSAL ANALYSIS	EACH	1	11
		67033403	ENGINEER'S FIELD OFFICE, TYPE A	CAL MC	- 6	- 6
		67100100	MOBILIZATION	LSUM	1	1
		70102620	TRAFFIC CONTROL AND PROTECTION, STANDARD 701501	L SUM	1	1
		70102635	TRAFFIC CONTROL AND PROTECTION, STANDARD 781781	L SUM	1	11
		70102640	TRAFFIC CONTROL AND PROTECTION, STANDARD 701801	L SUM	1	1
		70300100	SHORT TERM PAVEMENT MARKING	FOOT	655	655
		70300150	SHORT TERM PAVEMENT MARKING REMOVAL	SO FT	210	218
		70303210	TEMPORARY PAVEMENT MARKING LETTERS AND SYMBOLS	SO FT	110	110
		70300240	TEMPORARY PAVEMENT MARKING - LINE 5"	FOOT	345	345
		70300260	TEMPORARY PAYEMENT MARKING - LINE 12"	F001	925	<u>\$25</u>
		70300280	TEMPORARY PAVEMENT MARKING - LINE 24"	FOOT	280	280
.**		72490710	RELOCATE SIGN PANEL - TYPE 1	SO FT	111	111
*		72900200	METAL POST - TYPE B	FOOT	270	270
*		78000100	THERMOPLASTIC PAVEMENT MARKINGS - LETTERSAND SYMBOLS	SO FT	110	110

Specialty Item	Special Provision	Code No	tem	Unit	Total Quantity	Construction Code Roadway 0005
*	7104131011		THERMOPLASTIC PAVEMENT MARKING - LINE 6".	FOOT	393	393
*		78000500	THERMOPLASTIC PAVEMENT MARKING - LINE 12"	FOOT	925	925
*		78000650	THERMOPLASTIC PAVEMENT MARKING - LINE 24"	FOOT	280	280
*		84400405	RELOCATE EXISTING WOOD POLES	EACH	3	. 3
*	*	88600600	DETECTOR LOOP REPLACEMENT	FOOT	85	85
*		A2000620	TREE. ACER PLATANOIDES (NORWAY MAPLE), 2-1/2" CALIPER. BALLED AND BURLAPPED	EACH	12	12
*		A2004620	TREE. GLEDITSIA TRIACANTHOS INERMIS (THORNLESS COMMON HONEYLOCUSTI, 2-1/2" CALIPER, BALLED AND BURLAPPED	EACH	11	11
*		A2005020	TREE. GYMNOCLADUS DIOICUS (KENTUCKY COFFEETREE), 2-1/2" CALIPER. BALLED AND SURLAPPED	EACH	11	11
*		A2004420	TREE. GINKGO BILOBA (GINKGO). 2-1/2" CALIPER. BALLED AND BURLAPPED	EACH	11	11
*		A2007820	TREE, TILIA AMERICANA (AMERICAN LINDEN/ BASSWOOD), 2-1/2" CALIPER. BALLED AND BURLAPPED	EACH	11	11
*		A2002920	TREE. CELTIS OCCIDENTALIS (COMMON HACKBERRY). 2-1/2" CALIPER. BALLED AND BURLAPPED	EACH	11	11
	*	20004544	HOT-MIX ASPHALT DRIVEWAY PAVEMENT REMOVAL	SQ YD	415	415
	*	20019600	DUST CONTROL WATERING	UNIT	18	18
	*	20030850	TEMPORARY INFORMATION SIGNING	SQ FT	52	52
	*	Z0056604	STORM SEWER (WATER MAIN QUALITY REQUIREMENTS), 8 INCH	FOOT	507	507
	Z0056606 STORM SEWER (WATER MAIN QUALITY REQUIREMENTS), 10 INCH		FOOT	123	123	
	*	X0322917	PROPOSED STORM SEWER CONNECTION TO EXISTING MANHOLE	EACH	4	4
*	*	XD327348	COMBINED SEWER REMOVAL 10"	FOOT	62	62
*	*	X0327614	COMBINED SEWER REMOVAL 12"	FOOT	151	151
	*	X0795800	COARSE AGGREGATE	TON	50	50
	*	X3580300	AGGREGATE BASE REPAIR (SPECIAL)	TON	320	320
	*	X4080052	INCIDENTAL HOT-MIX ASPHALT SURFACING (SPECIAL)	TON	12	12
	*	X4404400	PAVEMENT REMOVAL (SPECIAL)	SQ YD	25	25
	*	X4404700	SIDEWALK REMOVAL (SPECIAL)	SQ FT	3065	3065
	*	X6030310	FRAMES AND LIDS TO BE ADJUSTED (SPECIAL)	EACH	13	13
>₩~	*	X8140115	HANDHOLE TO BE ADJUSTED	EACH	2	2
*	*	XX003803	SANITARY SEWER SERVICE 6"	FOOT	45	45
	*	XX000717	STORM SEWER CONNECTION, SPECIAL	EACH	- 8	8
	*	XX005535	SEWER SPOT REPAIRS, 12"	FOOT	102	102
	*	XX005565	REMOVE AND RESET BRICK PAVERS	SQ FT	460	460
	*	XX006281	STORM SEWERS, DUCTILE IRON, TYPE 1, 10"	FOOT	47	47
*	*	XX006448	PVC COMBINED SEWER PIPE REPLACEMENT 10"	FOOT	64	64
承	*	XX006449	PVC COMBINED SEWER PIPE REPLACEMENT 12"	FOOT	151	151
*	*	XX006451	10" x 6" PVC SEWER SERVICE CONNECTIONS	EACH	2	1 2
*	*	XX006464	DOMESTIC WATER SERVICE BOXES TO BE ADJUSTED (SPECIAL)	EACH	l 8	l 8
¥	*	XX007689	PVC TEE , 12" X 6"	EACH	2	l 2
	*	XX007724	SOD STRIPPING, 2" DEPTH	SQ YD	2385	2385
*	*	XX007831	SANITARY SEWER SERVICE LATERAL CONNECTION 6"	EACH] 3	l 3

FILE NAME VILLAGE OF BROOKFIELD	USER NAME =	DESIGNED - AMS	REVISED - JLC 9/29/17
FAU 2965 (CUSTER AVENUE)		DRAWN - JFP	REVISED - JLC 10/19/17
FAU 1488 (47th STREET) TO FAP 0311 (DGDEN AVENUE)	PLOT SCALE =	CHECKED - JLC	REVISED - JLC 11/29/17
#16494 WINDENING AND RESURFACING	PLOT DATE =	DATE - 7/17	REVISED - JLC 12/08/17


STATE OF ILLINOIS
DEPARTMENT OF TRANSPORTATION

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		SUMI	MAR	Y OF QUANTI	TIES
				-	
	SCALE: NONE	SHEET NO.	OF	SHEETS STA.	TO STA.


NG	545 Plainfield Road, Suite Willowbrook, IL 60527 T: (630) 887.8640 F: (630) 887.0132

Illinois Professional Design Firm No. 184-000928							
SECTION	CDUNTY	TOTAL SHEETS	SHEET NO.				
7-00131-00-RS	COOK	26	4				
	CONTRAC	T NO. 6	1F51				

REVISED _ JLC 2/06/18 REVISED _ JLC 3/16/18

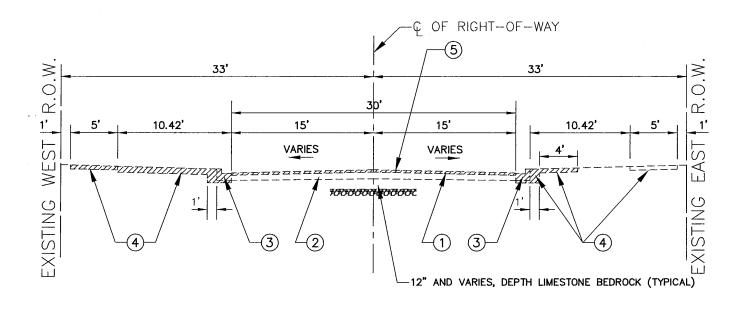

EXISTING TYPICAL SECTION STA. 0+83 TO STA. 10+43, CUSTER AVENUE STA. 19+45 TO STA. 39+59, CUSTER AVENUE

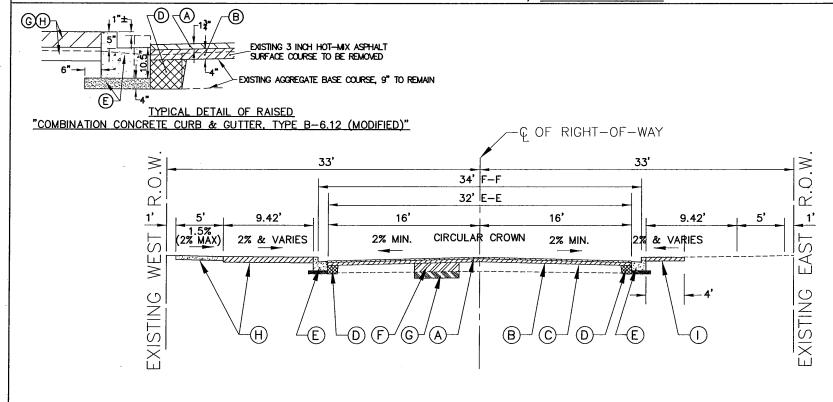

PROPOSED TYPICAL SECTION STA. 0+83 TO STA. 10+43, CUSTER AVENUE STA. 19+45 TO STA. 39+59, CUSTER AVENUE

DESIGNED - AMS FILE NAME VILLAGE OF BROOKFIELD USER NAME = REVISED - JLC 9/29/17 DRAWN - JFP REVISED - JLC 10/19/17 FAU 2965 (CUSTER AVENUE) PLOT SCALE = CHECKED - JLC REVISED - JLC 11/29/17 FAU 1488 (47th STREET) TO FAP 0311 (OGDEN AVENUE WINDENING AND RESURFACING PLOT DATE = DATE - 7/17 REVISED - JLC 12/08/17 REVISED - JLC 2/06/18

STATE OF ILLINOIS DEPARTMENT OF TRANSPORTATION

EXISTING LEGEND

- (1) EXISTING HOT-MIX ASPHALT SURFACE COURSE, 3" & VARIES
- (2) EXISTING AGGREGATE BASE COURSE, 9" & VARIES TO REMAIN
- (3) EXISTING COMBINATION CONCRETE CURB & GUTTER TYPE B-6.12 (MODIFIED)
- (4) PORTLAND CEMENT CONCRETE CARRIAGE WALK, PORTLAND CEMENT CONCRETE SERVICE WALK, PORTLAND CEMENT CONCRETE SIDEWALK, PORTLAND CEMENT CONCRETE DRIVEWAY, HOT-MIX ASPHALT DRIVEWAY, OR EXISTING GRASS PARKWAY
- (5) PROPOSED "HOT-MIX ASPHALT SURFACE REMOVAL, 3 INCH" (FULL WIDTH) AND "HOT-MIX ASPHALT SURFACE REMOVAL, 1-1/2 INCH" (AT VARIOUS STREET APPROACHES, AS NOTED ON THE PLANS)

INDICATES REMOVAL ITEMS AS APPLICABLE "COMBINATION CURB AND GUTTER REMOVAL", "EARTH EXCAVATION", "PAVEMENT REMOVAL", "DRIVEWAY PAVEMENT REMOVAL", "SIDEWALK REMOVAL", "HOT-MIX ASPHALT DRIVEWAY PAVEMENT REMOVAL", "PAVEMENT REMOVAL", OR "SOD STRIPPING, 2 INCH DEPTH"

NOTE: SEE SHEET 2 FOR HOT-MIX ASPHALT MIXTURE REQUIREMENTS TABLE.

PROPOSED LEGEND

- (A) PROPOSED "HOT-MIX ASPHALT SURFACE COURSE, MIX "D", N50", 1-3/4 INCH
- (B) PROPOSED "HOT-MIX ASPHALT BINDER COURSE, IL-19.0, N50", 4 INCH
- (C) PROPOSED "PREPARATION OF BASE"
- (D) PROPOSED "AGGREGATE BASE REPAIR"
- (E) PROPOSED "COMBINATION CONCRETE CURB AND GUTTER, TYPE B-6.12 (MODIFIED)" ON "SUBBASE GRANULAR MATERIAL, TYPE B, 4 INCH" (TYPICAL BOTH SIDES)
- (F) PROPOSED "AGGREGATE BASE REPAIR (SPECIAL)" AS DIRECTED
- (G) PROPOSED "REMOVAL AND DISPOSAL OF UNSUITABLE MATERIAL" AND "AGGREGATE SUBGRADE IMPROVEMENT
- AS APPLICABLE (H) PROPOSED "PORTLAND CEMENT CONCRETE DRIVEWAY PAVEMENT, 7 INCH" ON "SUBBASE GRANULAR MATERIAL, TYPE B, 2 INCH"

PROPOSED "PORTLAND CEMENT CONCRETE SIDEWALK, 5 INCH" OR 7 INCH (AS DIRECTED) ON "SUBBASE GRANULAR MATERIAL, TYPE B, 2 INCH"

TO STA.

(1) PROPOSED "TOPSOIL FURNISH & PLACE, VARIBLE DEPTH" AND "SODDING"

NOTE: CLASS D PATCHING OF VARIOUS TYPES, IF REQUIRED. AT STREET APPROACH PAVEMENTS, TO REMAIN.

IMPORTANT!

FULL SIZE PLANS HAVE BEEN PREPARED USING STANDARD ENGINEERING SCALES.
REDUCED SIZED PLANS WILL NOT CONFORM TO STANDARD SCALES INDICATED IN TITLE BLOCK

SCALE: 1"=5' SHEET NO. OF SHEETS STA.


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Plainfield Road, Suite illowbrook, IL 60527 (630) 887.8640


Illinois Professional Desig	n Firm No. 184-000928	
CECTION	COLUMITY	

	F.A.U. RTE.	SECTION	COUNTY	TOTAL SHEETS	SHEET NO.
Ì	2965	17-00131-00-RS	COOK	26	5
_			CONTRA	CT NO. 6	1E51
ı	FFD RO	DAD DIST NO ILLINOIS FED A	ID PROJECT		

TYPICAL SECTIONS

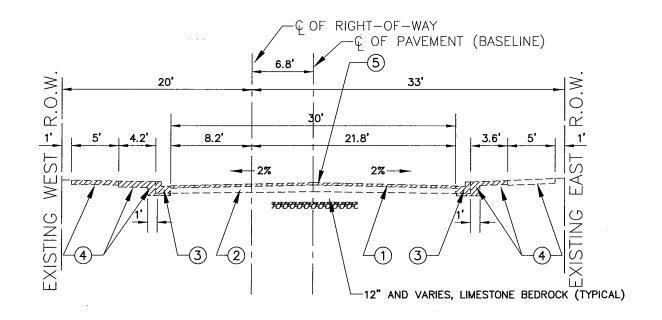

EXISTING TYPICAL SECTION STA. 10+43 TO STA. 18+55, CUSTER AVENUE

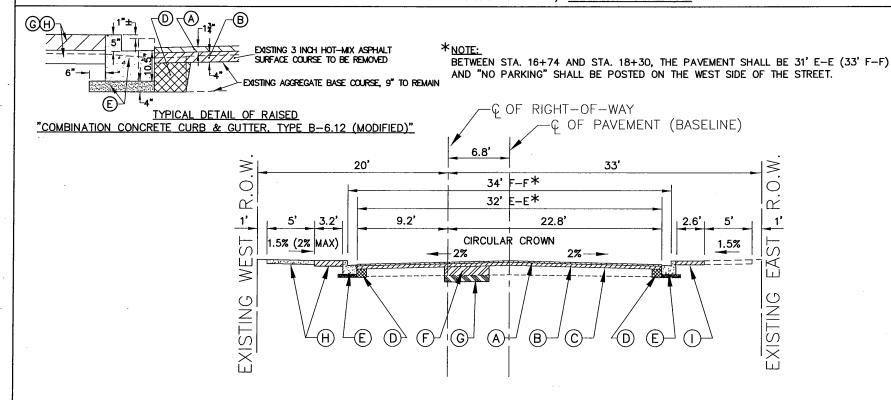

PROPOSED TYPICAL SECTION

STA. 10+43 TO STA. 18+55, CUSTER AVENUE

FILE NAME VILLAGE OF BROOKFIELD DESIGNED - AMS REVISED - JLC 9/29/17 USER NAME = DRAWN - JFP REVISED - JLC 10/19/17 FAU 2965 (CUSTER AVENUE) CHECKED - JLC PLOT SCALE = FAU 1488 (47th STREET) TO FAP 0311 (OGDEN AVENUE REVISED - JLC 11/29/17 WINDENING AND RESURFACING PLOT DATE = DATE - 7/17REVISED - JLC 12/08/17 REVISED - JLC 2/06/18

STATE OF ILLINOIS DEPARTMENT OF TRANSPORTATION

EXISTING LEGEND

- (1) EXISTING HOT-MIX ASPHALT SURFACE COURSE, 3" & VARIES
- (2) EXISTING AGGREGATE BASE COURSE, 9" & VARIES TO REMAIN
- (3) EXISTING COMBINATION CONCRETE CURB & GUTTER TYPE B-6.12 (MODIFIED)
- 4 ALLEY RETURN, PORTLAND CEMENT CONCRETE CARRIAGE WALK, PORTLAND CEMENT CONCRETE SERVICE WALK, PORTLAND CEMENT CONCRETE DRIVEWAY, HOT—MIX ASPHALT DRIVEWAY, OR EXISTING GRASS PARKWAY
- (5) PROPOSED "HOT-MIX ASPHALT SURFACE REMOVAL, 3 INCH" (FULL WIDTH) AND "HOT-MIX ASPHALT SURFACE REMOVAL, 1-1/2 INCH" (AT VARIOUS STREET APPROACHES, AS NOTED ON THE PLANS)

INDICATES REMOVAL ITEMS AS APPLICABLE "COMBINATION CURB AND GUTTER REMOVAL", "EARTH EXCAVATION", "PAVEMENT REMOVAL", "DRIVEWAY PAVEMENT REMOVAL", "SIDEWALK REMOVAL", "HOT-MIX ASPHALT DRIVEWAY PAVEMENT REMOVAL", "PAVEMENT REMOVAL (SPECIAL)", OR "SOD STRIPPING, 2 INCH DEPTH"

NOTE: SEE SHEET 2 FOR HOT-MIX ASPHALT MIXTURE REQUIREMENTS TABLE.

PROPOSED LEGEND

- (A) PROPOSED "HOT-MIX ASPHALT SURFACE COURSE, MIX "D", N50", 1-3/4 INCH
- (B) PROPOSED "HOT-MIX ASPHALT BINDER COURSE, IL-19.0, N50", 4 INCH
- (C) PROPOSED "PREPARATION OF BASE"
- (D) PROPOSED "AGGREGATE BASE REPAIR"
- © PROPOSED "COMBINATION CONCRETE CURB AND GUTTER, TYPE B-6.12 (MODIFIED)" ON "SUBBASE GRANULAR MATERIAL, TYPE B, 4 INCH" (TYPICAL BOTH SIDES)
- (F) PROPOSED "AGGREGATE BASE REPAIR (SPECIAL)" AS DIRECTED
- (G) PROPOSED "REMOVAL AND DISPOSAL OF UNSUITABLE MATERIAL" AND "AGGREGATE SUBGRADE IMPROVEMENT
- AS APPLICABLE

 (H) PROPOSED "HOT-MIX ASPHALT SURFACE REMOVAL, VARIABLE DEPTH" FOR DRIVEWAYS AND "HOT-MIX ASPHALT SURFACE COURSE, MIX "D", N50", 3 INCH, IN 2 LIFTS

PROPOSED "PORTLAND CEMENT CONCRETE DRIVEWAY PAVEMENT, 7 INCH" ON "SUBBASE GRANULAR MATERIAL, TYPE B, 2 INCH"

PROPOSED ALLEY RETURN WITH "PORTLAND CEMENT CONCRETE PAVEMENT, 8 INCH" ON "SUBBASE GRANULAR MATERIAL, TYPE, 2 INCH"

PROPOSED "PORTLAND CEMENT CONCRETE SIDEWALK, 5 INCH" OR 7 INCH (AS DIRECTED) ON "SUBBASE GRANULAR MATERIAL, TYPE B, 2 INCH"

(I) PROPOSED "TOPSOIL FURNISH & PLACE, VARIBLE DEPTH" AND "SODDING"

NOTE: CLASS D PATCHING OF VARIOUS TYPES, IF REQUIRED, AT STREET APPROACH PAVEMENTS, TO REMAIN.


<u>IMPORTANT!</u>


FULL SIZE PLANS HAVE BEEN PREPARED USING STANDARD ENGINEERING SCALES.
REDUCED SIZED PLANS WILL NOT CONFORM TO STANDARD SCALES INDICATED IN TITLE BLOCK.


SCALE: 1"=5' SHEET NO.





						III	nois Professional Di	esign Firm No. 184-000928		
					F.A.U. RTE,	SEC	TION	COUNTY	TOTAL SHEETS	SHEET NO.
TY	TYPICAL SECTIONS					17-0013	31-00-RS	COOK	26	6
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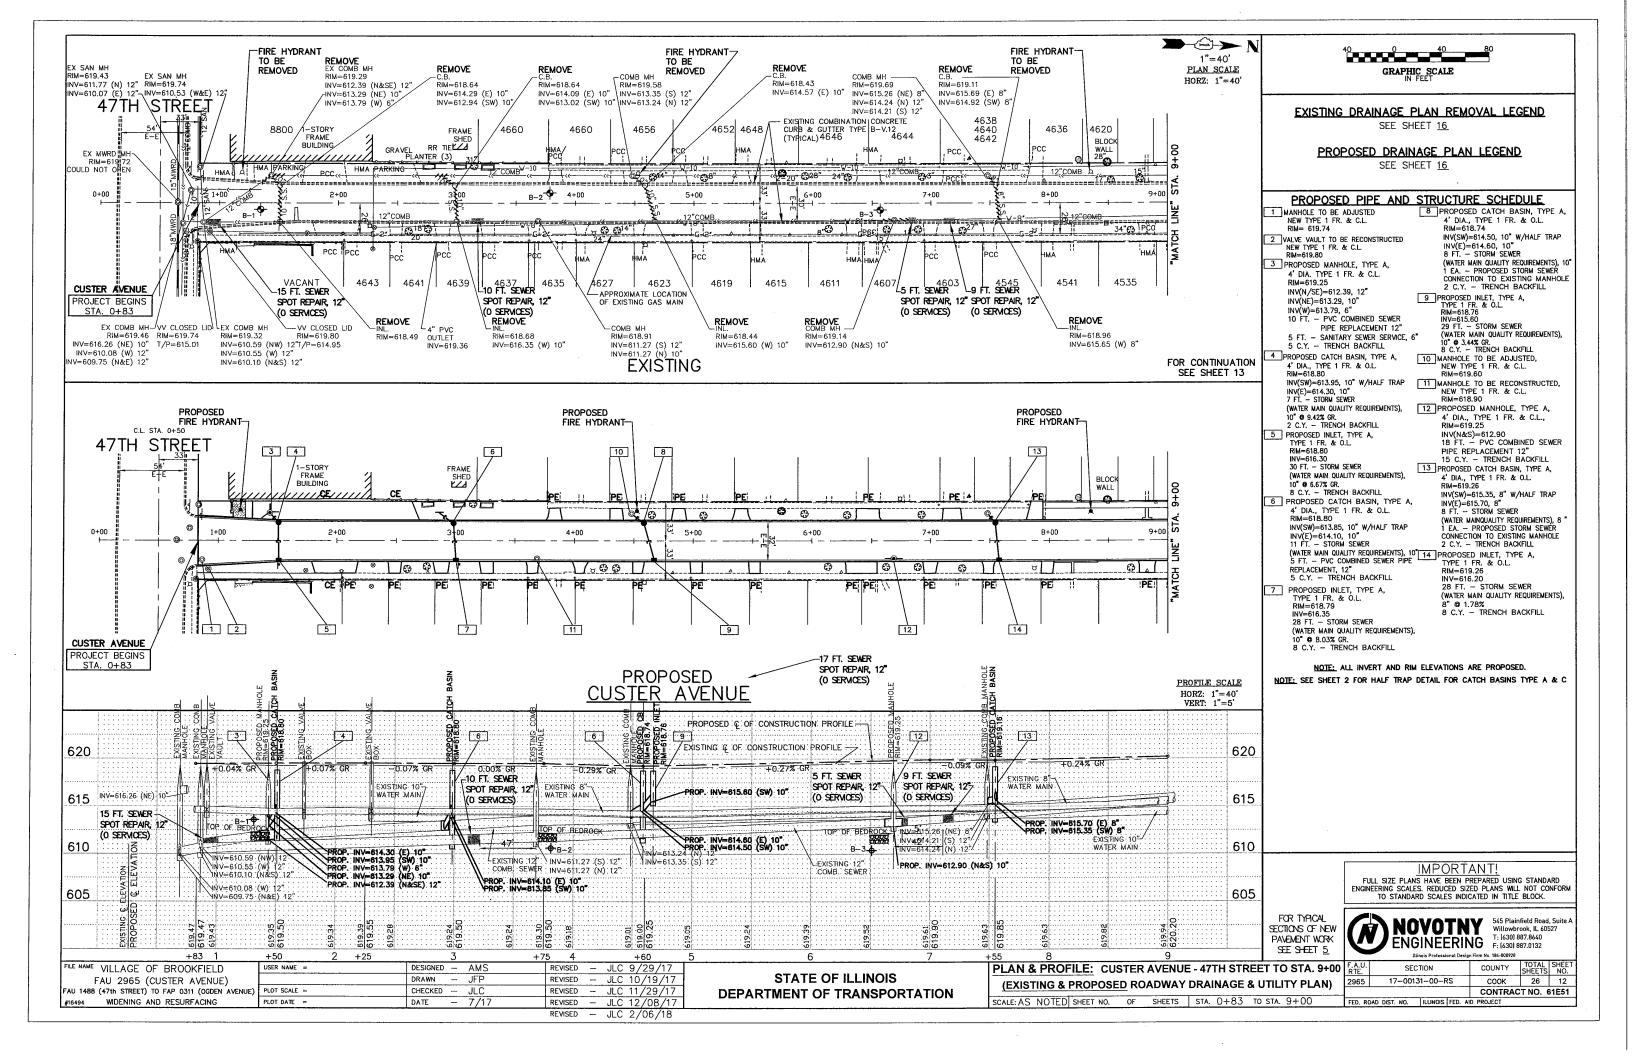


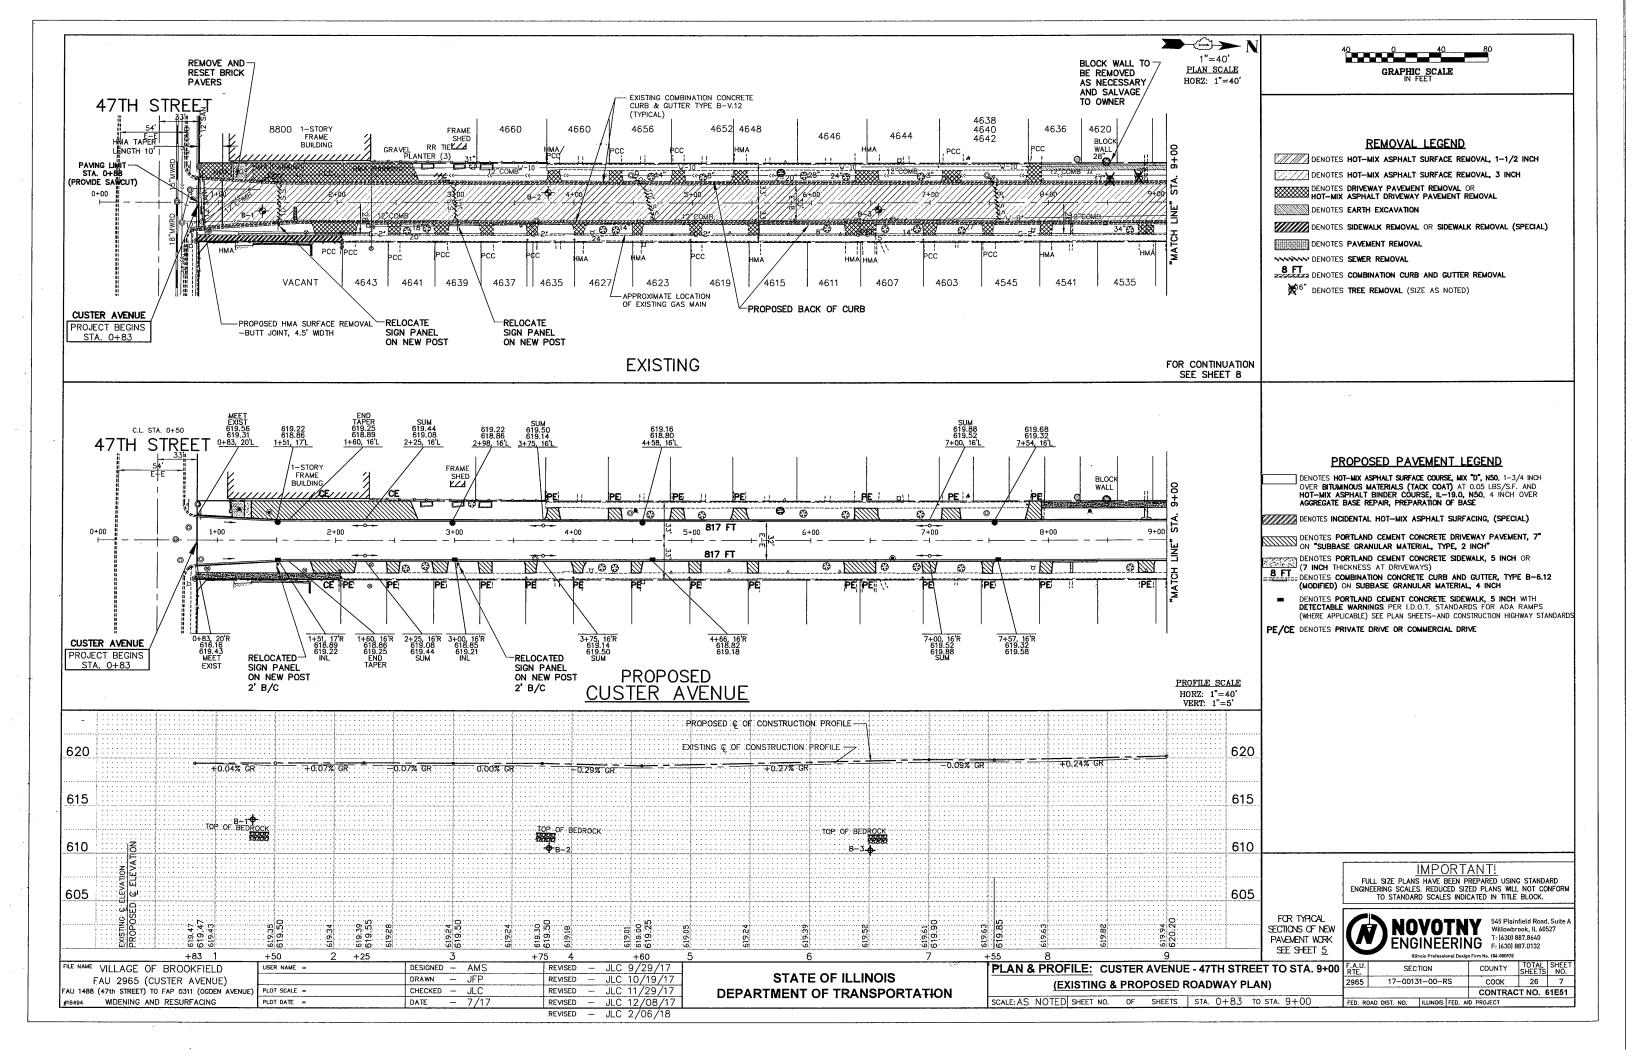


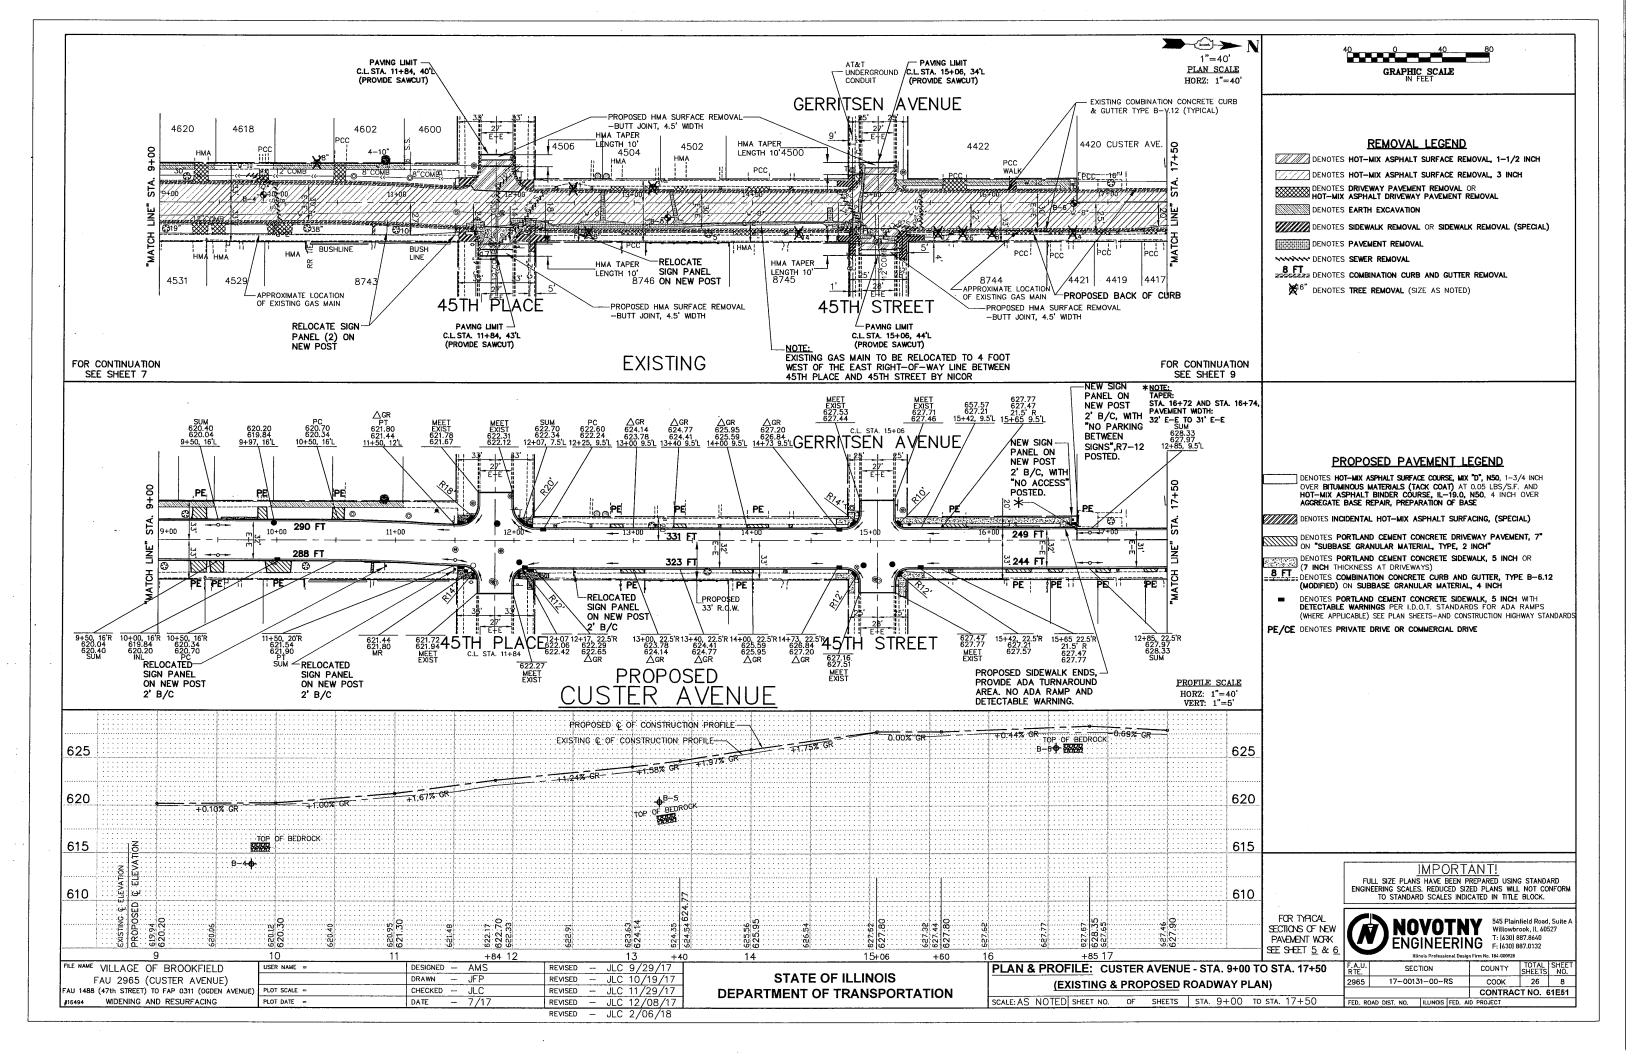


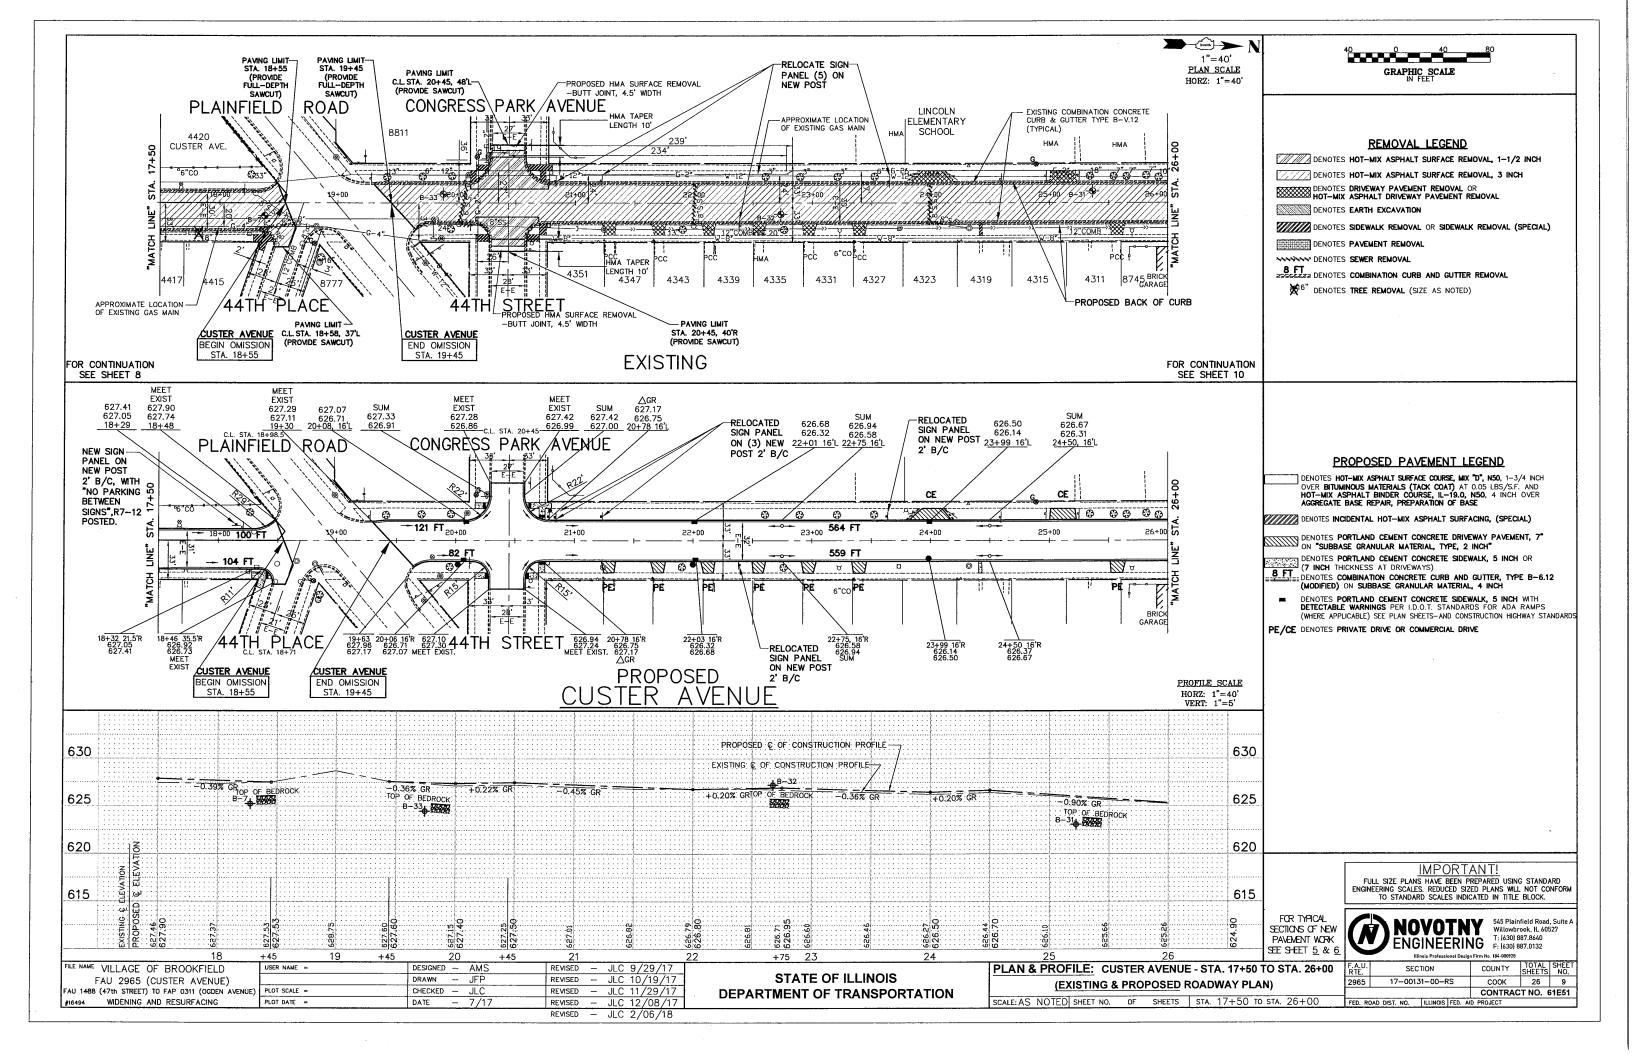


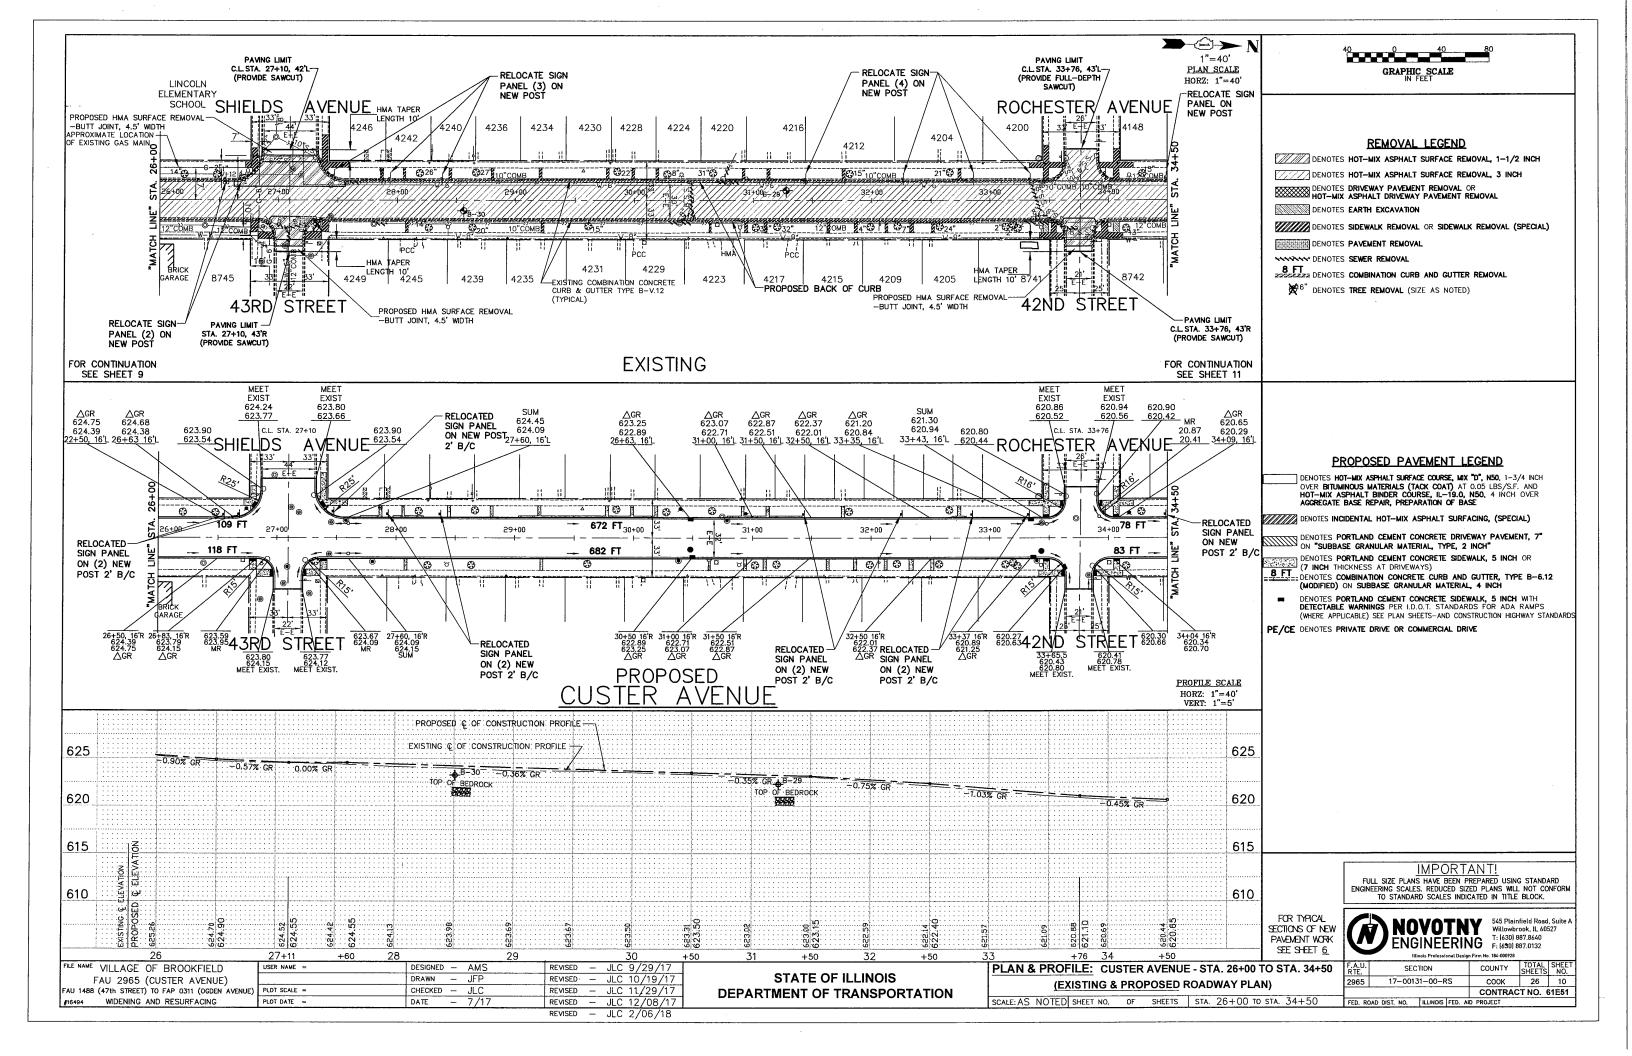


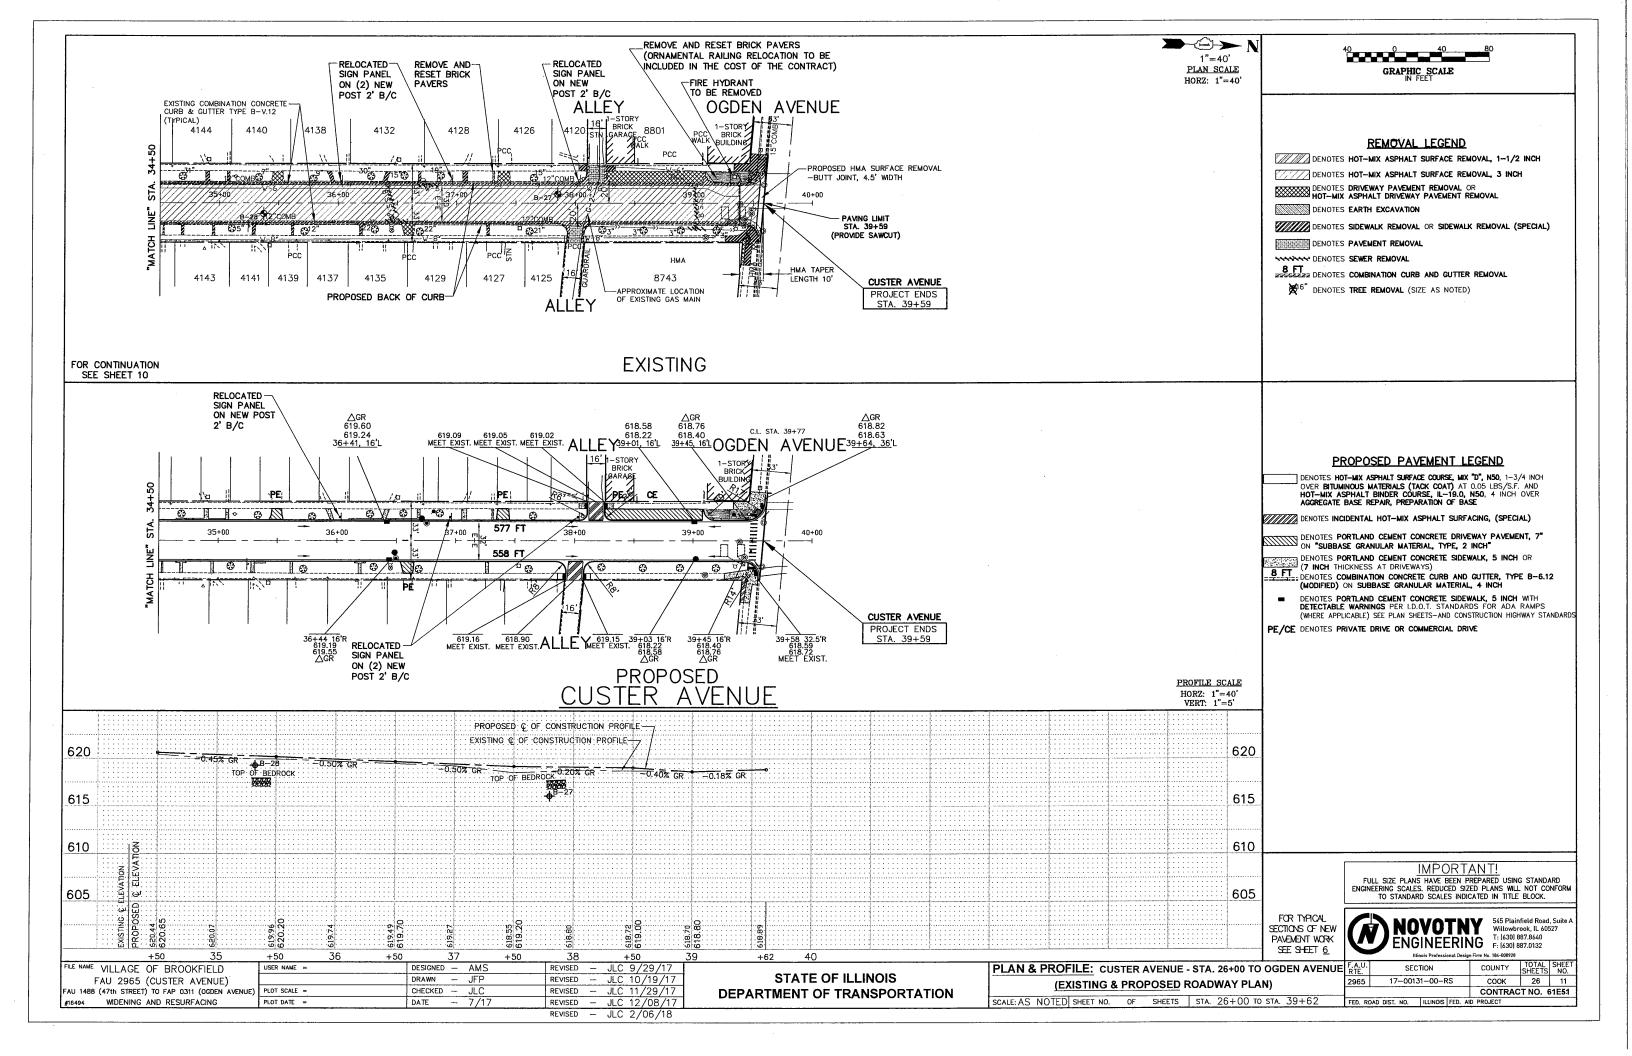


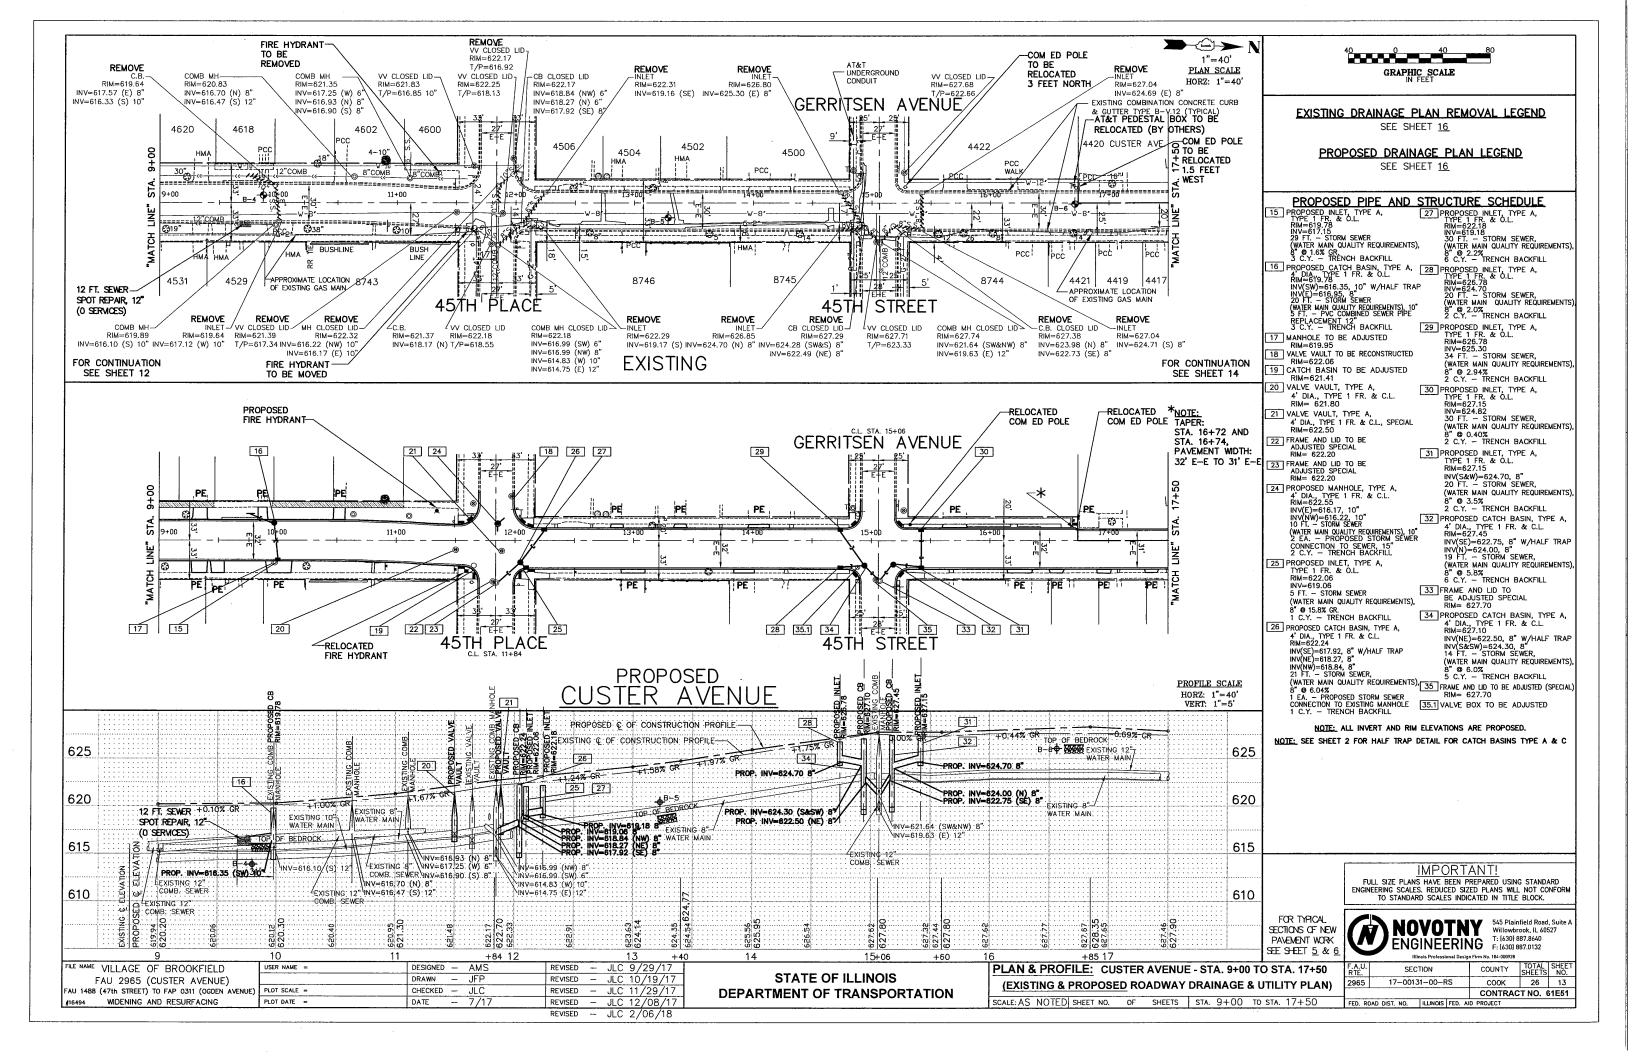


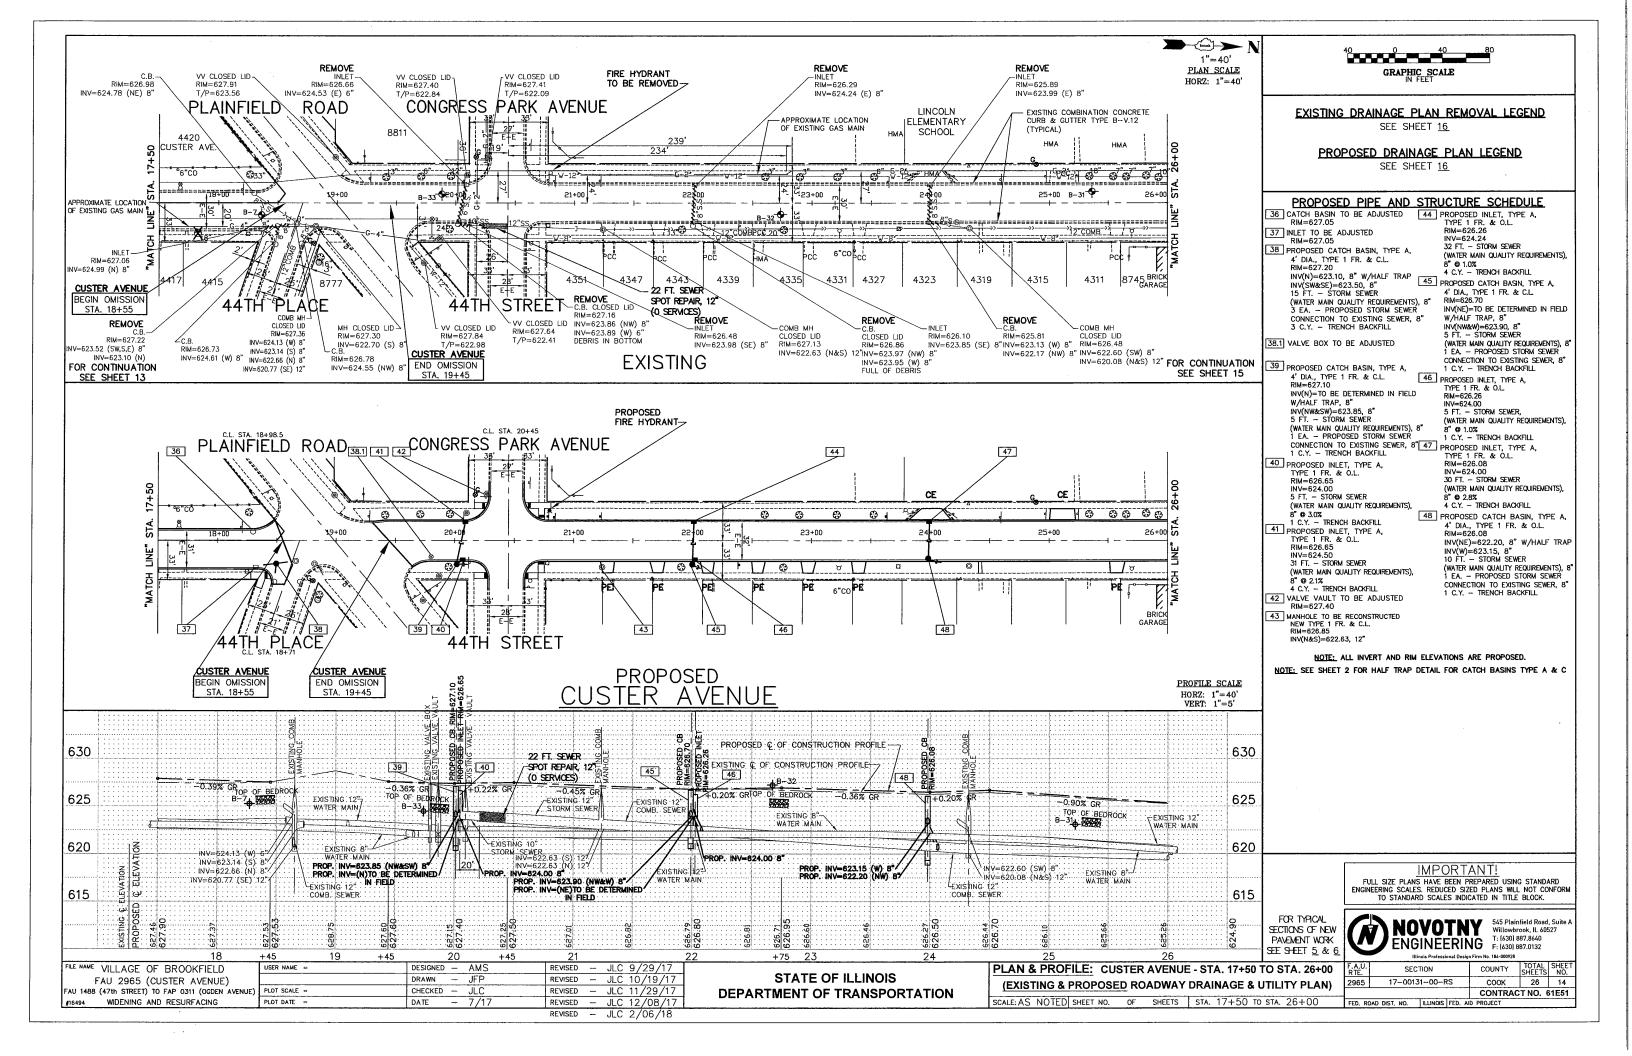

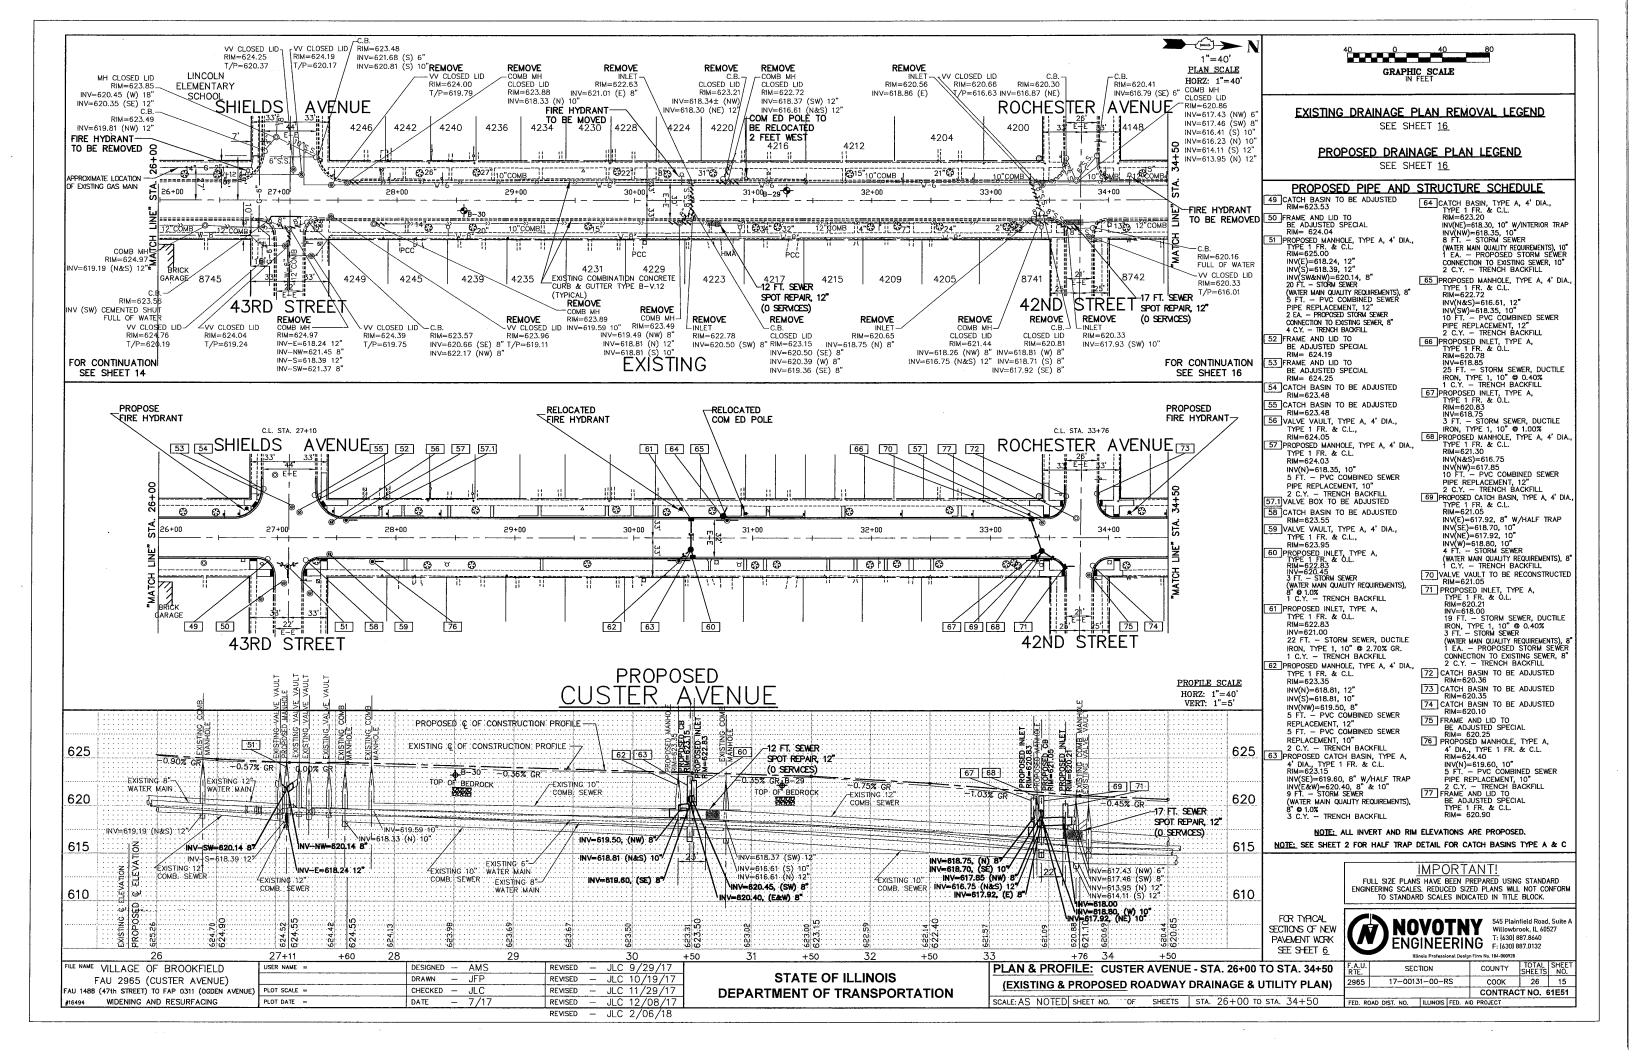

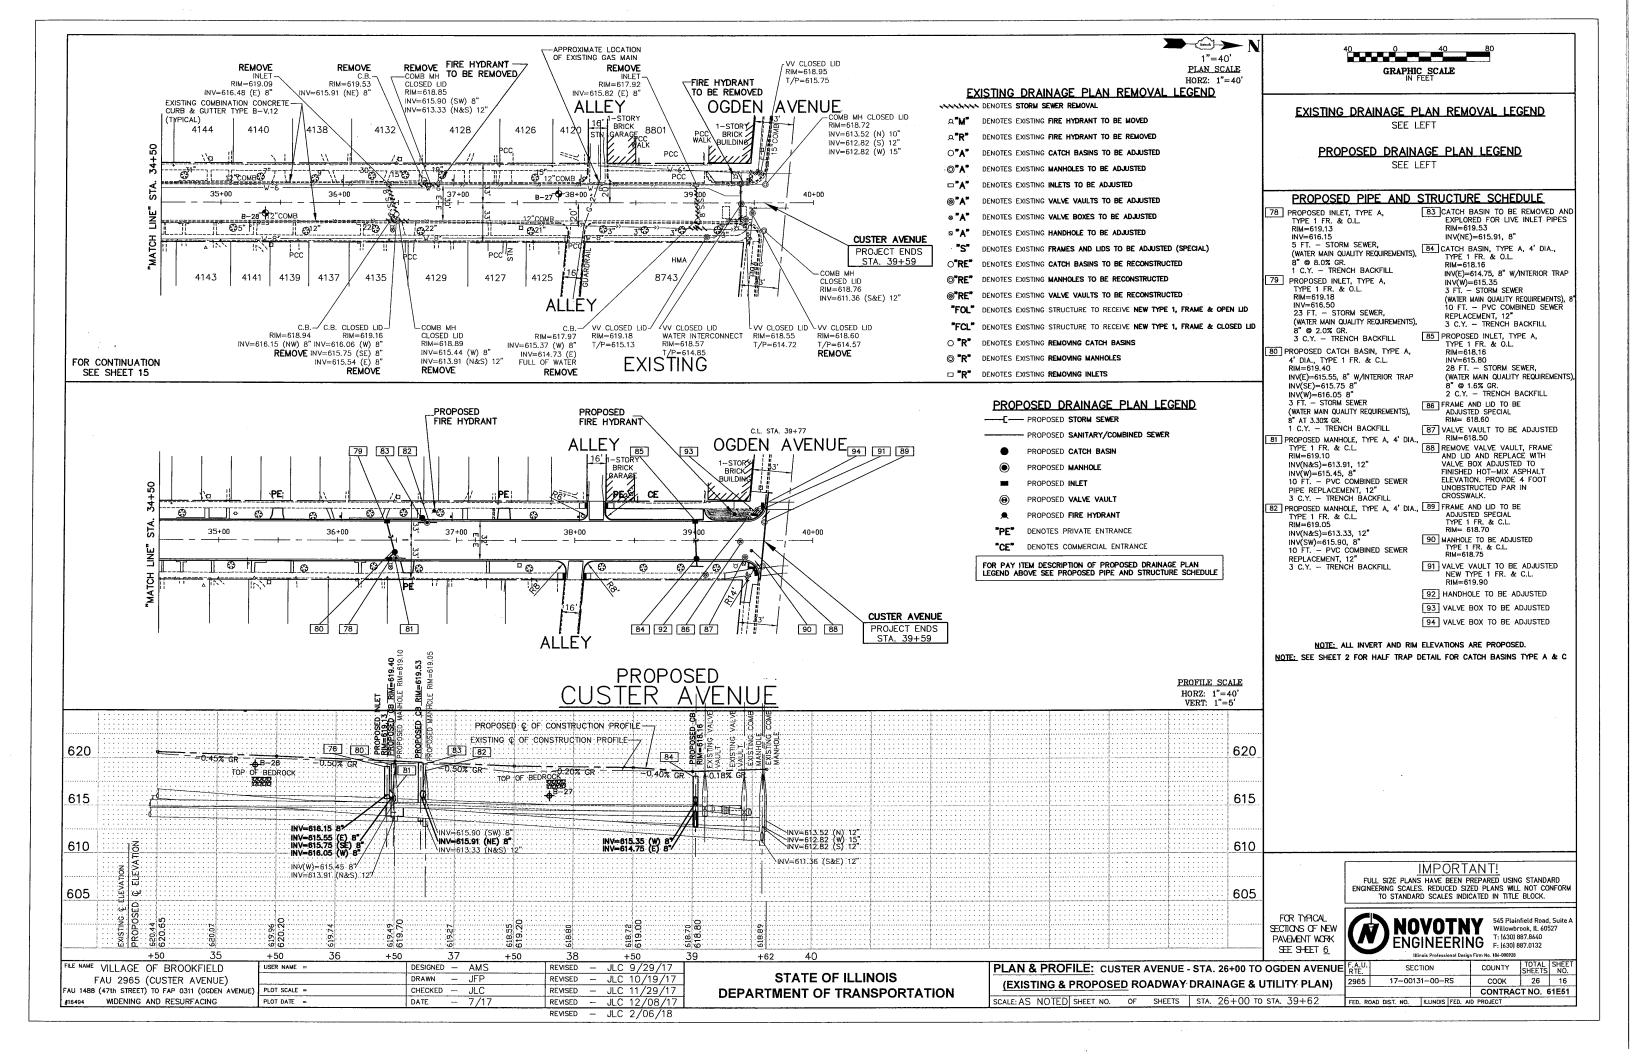


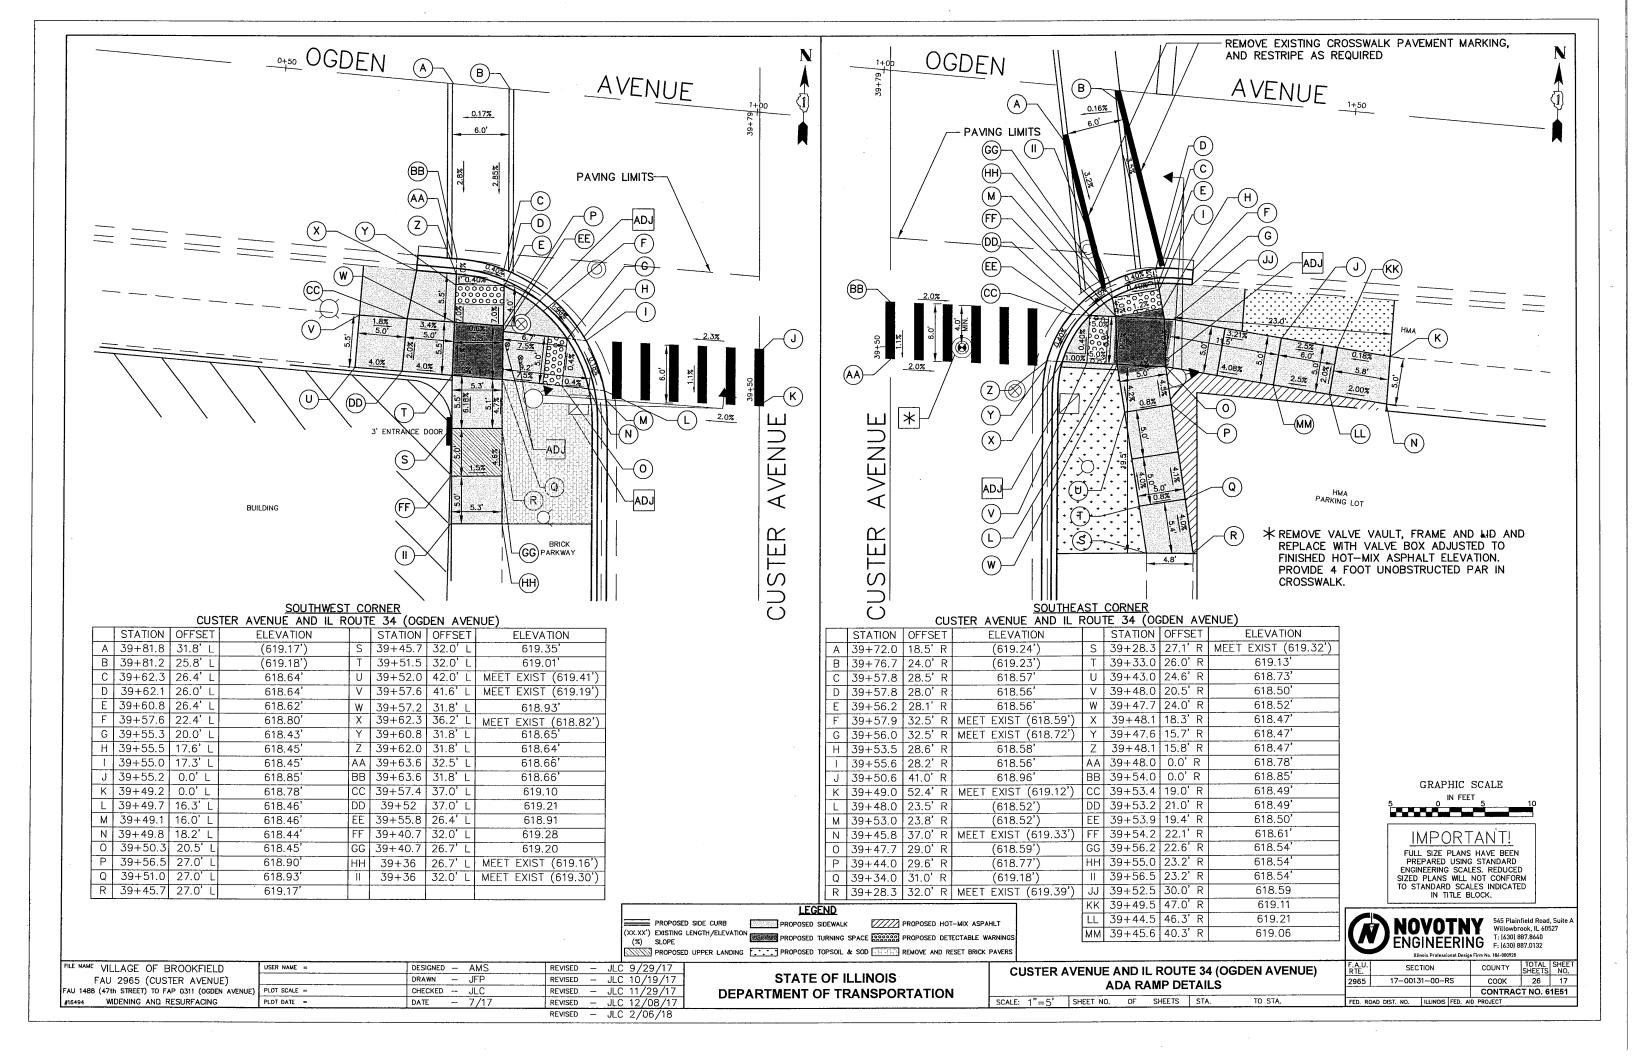


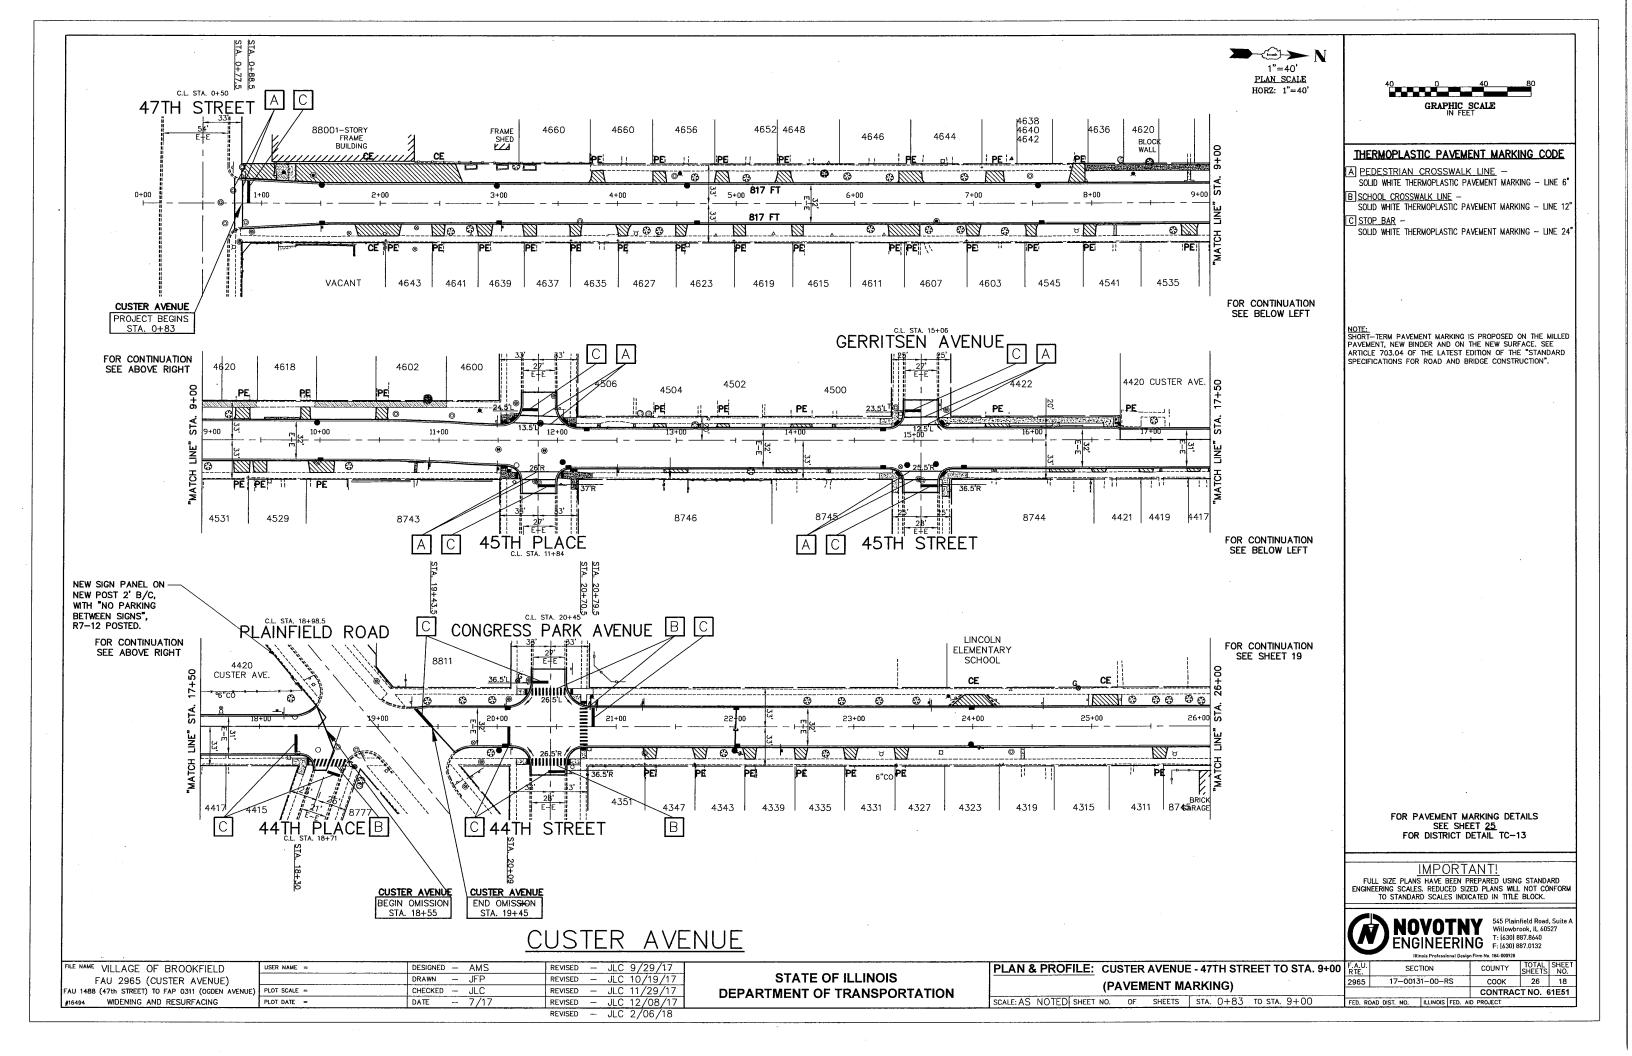





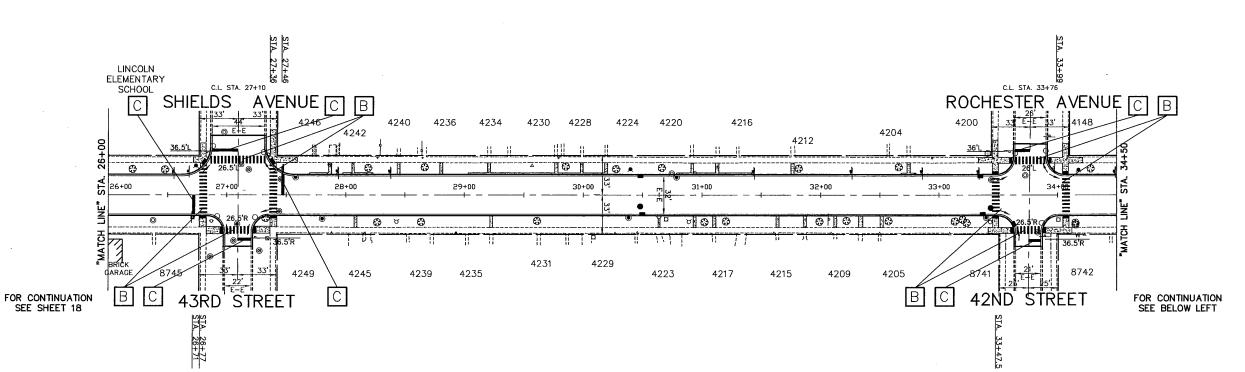

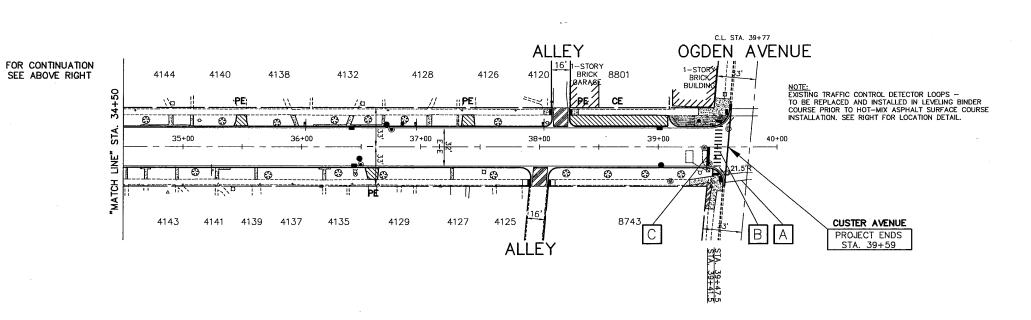

THERMOPLASTIC PAVEMENT MARKING CODE

A PEDESTRIAN CROSSWALK LINE -


SOLID WHITE THERMOPLASTIC PAVEMENT MARKING - LINE 6

B SCHOOL CROSSWALK LINE -

SOLID WHITE THERMOPLASTIC PAVEMENT MARKING - LINE 12"

SOLID WHITE THERMOPLASTIC PAVEMENT MARKING - LINE 24"

NOTE: SHORT—TERM PAVEMENT MARKING IS PROPOSED ON THE MILLED PAVEMENT, NEW BINDER AND ON THE NEW SURFACE. SEE ARTICLE 703.04 OF THE LATEST EDITION OF THE "STANDARD SPECIFICATIONS FOR ROAD AND BRIDGE CONSTRUCTION".

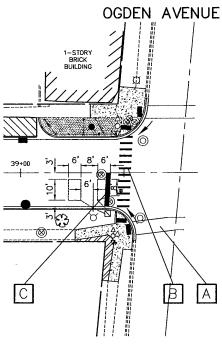

DETAIL-DETECTOR LOOP REPLACEMENT AT OGDEN AVENUE

FOR PAVEMENT MARKING DETAILS SEE SHEET <u>25</u> FOR DISTRICT DETAIL TC-13

IMPORTANT!

FULL SIZE PLANS HAVE BEEN PREPARED USING STANDARD ENGINEERING SCALES. REDUCED SIZED PLANS WILL NOT CONFORM TO STANDARD SCALES INDICATED IN TITLE BLOCK.



545 Plainfield Road, Suite A Willowbrook, IL 60527 T: (630) 887.8640


SECTION COUNTY 17-00131-00-RS COOK 26 19 2965 CONTRACT NO. 61E51

CUSTER AVENUE

FILE NAME VILLAGE OF BROOKFIELD	USER NAME =	DESIGNED - AMS	REVISED -	JLC 9/29/17
FAU 2965 (CUSTER AVENUE)		DRAWN - JFP	REVISED	- JLC 10/19/17
FAU 1488 (47th STREET) TO FAP 0311 (OGDEN AVENUE)	PLOT SCALE =	CHECKED - JLC	REVISED -	- JLC 11/19/17
#16494 WIDENING AND RESURFACING	PLOT DATE =	DATE - 7/17	REVISED -	JLC 12/08/17
-			REVISED -	JLC 2/06/18

STATE OF ILLINOIS **DEPARTMENT OF TRANSPORTATION** PLAN & PROFILE: CUSTER AVENUE - 47TH STREET TO STA. 9+00 (PAVEMENT MARKING)

SCALE: AS NOTED SHEET NO. OF SHEETS STA. 0+83 TO STA. 9+00

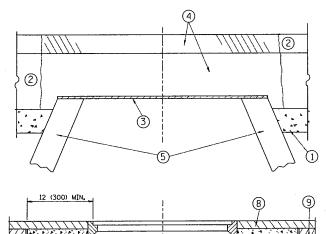

NOTES:

EXISTING BROKEN FRAMES AND LIDS SHALL BE REMOVED AND DISPOSED OF BY THE CONTRACTOR AND SHALL BE REPLACED AS DIRECTED BY THE ENGINEER. REPLACEMENT FRAMES AND LIDS WILL BE PAID FOR IN ACCORDANCE WITH ARTICLE 109,04 OF THE STANDARD SPECIFICATIONS UNLESS A SEPARATE PAY ITEM HAS BEEN PROVIDED.

IF THE EXISTING LIDS ARE OPEN, THE FRAME WILL BE ADJUSTED TO THE ELEVATION OF THE MILLED PAVEMENT SURFACE PRIOR TO THE MILLING OPERATION. THE FRAME WILL NOT BE REMOVED AND COVERED BY THE METAL PLATE.

CITY OF CHICAGO CASTINGS ARE THE PROPERTY OF THE CITY AND THE CONTRACTOR SHALL NOTIFY THE CITY FOR REMOVAL AND DISPOSITION OF THE CASTINGS.

THE METAL PLATE USED TO COVER THE STRUCTURE SHALL REMAIN THE PROPERTY OF THE CONTRACTOR.

WHEN STRUCTURES ARE TO BE ADJUSTED OR RECONSTRUCTED, THE LOWERING AND RAISING OF THE FRAMES AND LIDS WILL NOT BE PAID FOR SEPARATELY BUT WILL BE INCLUDED IN THE COST OF THE CORRESPONDING PAY ITEM.

CONSTRUCTION PROCEDURES

STAGE 1 (BEFORE PAVEMENT MILLING)

- A) REMOVE A MINIMUM OF 12 (300) OF THE PAVEMENT FROM
- AROUND THE STRUCTURE.

 B) REMOVE THE EXISTING FRAME AND LID FROM THE STRUCTURE.
- C) COVER THE STRUCTURE OPENING WITH A 36 (900) DIAMETER
- D) BACKFILL WITH CRUSHED STONE AND A MINIMUM 11/2 (40)
 THICK HMA SURFACE MIX APPROVED BY THE ENGINEER.

STAGE 2 (AFTER PAVEMENT MILLING)

- A) REMOVE THE HMA SURFACE MIX AND CRUSHED STONE.
- B) INSTALL THE FRAME AND LID; ADJUST THE FRAME TO ITS FINAL SURFACE ELEVATION.
- C) THE SURROUNDING SPACE SHALL BE FILLED WITH CLASS PP-1*
 CONCRETE TO THE ELEVATION OF THE SURFACE OF THE EXISTING
 BASE COURSE OR THE BINDER COURSE.
- * UNLESS OTHERWISE SPECIFIED IN THE PLANS.

THE PROCEDURE EXPLAINED ABOVE SHALL CONFORM TO THE APPLICABLE PORTIONS OF SECTIONS 353, 406, 602, AND 603 OF THE STANDARD SPECIFICATIONS EXCEPT THAT "THE CONTRACTOR SHALL ADJUST THE STRUCTURES TO THE FINISHED PAVEMENT ELEVATION NO MORE THAN 5 CALENDAR DAYS PRIOR TO PLACEMENT OF THE FINAL LIFT OF SURFACE UNLESS APPROVED BY THE ENGINEER."

LEGEND

- 1 SUB-BASE GRANULAR MATERIAL
- 6 FRAME AND LID (SEE NOTES)
- 2 EXISTING PAVEMENT
- (7) CLASS PP-1* CONCRETE
- 3 36 (900) DIAMETER METAL PLATE
- 8 PROPOSED HMA SURFACE COURSE
- PROPOSED CRUSHED STONE AND HMA SURFACE MIX
- (9) PROPOSED HMA BINDER COURSE
- 5 EXISTING STRUCTURE

LOCATION OF STRUCTURES:

THE CONTRACTOR WILL BE REQUIRED TO KEEP A RECORD OF THE LOCATIONS OF THE BURIED STRUCTURES ACCORDING TO THE STATION AND DISTANCE LEFT OR RIGHT OF THE CENTERLINE OF PAVEMENT. UPON COMPLETION OF THE WORK, THE CONTRACTOR WILL DELIVER THE RECORD TO THE ENGINEER.

BASIS OF PAYMENT:

REMOVING FRAMES AND LIDS ON DRAINAGE AND UTILITY STRUCTURES IN THE PAVEMENT PRIOR TO MILLING, AND ADJUSTING TO FINAL GRADE PRIOR TO PLACING THE SURFACE COURSE, WILL BE PAID FOR AT THE CONTRACT UNIT PRICE EACH FOR "FRAMES AND LIDS TO BE ADJUSTED (SPECIAL)."

THIS WORK WILL NOT BE PAID FOR WHEN DRAINAGE AND UTILITY STRUCTURES ARE SPECIFIED FOR PAYMENT AS STRUCTURE RECONSTRUCTION.

NEW FRAMES AND LIDS. WHEN SPECIFIED, WILL BE PAID FOR SEPARATELY.


DETAILS FOR FRAMES AND LIDS ADJUSTMENT WITH MILLING

ALL DIMENSIONS ARE IN INCHES (MILLIMETERS) UNLESS OTHERWISE SHOWN

FILE NAME =	USER NAME = bewerdl	DESIGNED - R. SHAH	REVISED - R. WIEDEMAN 05-14-04
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	PLOT SCALE = 1968.5000 '/ m	CHECKED -	REVISED - R. BORO 03-09-11
	PLOT DATE = 12/6/2011	DATE - 10-25-94	REVISED - R. BORO 12-06-11

STATE OF ILLINOIS
DEPARTMENT OF TRANSPORTATION

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EDANGE AND LIDE AD HISTMENT WITH SAULING							17-00131-00-RS	COOK	26	20		
	FRAMES AND LIDS ADJUSTMENT WITH MILLING							CONTRACT	NO. 6	1E51		
SCALE: NONE	SHEET NO. 1	OF 1	SHEETS	STA.	TO STA.	FED. RO	FED. ROAD DIST. NO. 1 ILLINOIS FED. AID PROJECT					

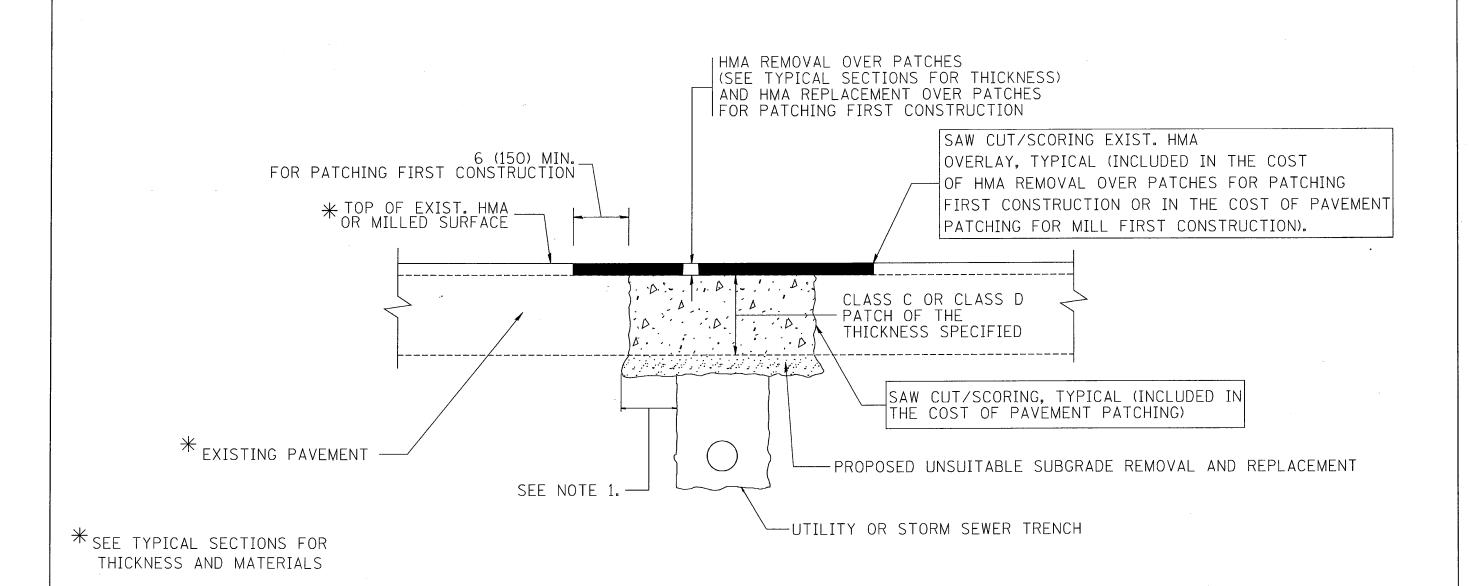

NOTES:

- 1. THE WIDTH OF THE FULL DEPTH PATCH OVER A TRENCH SHALL BE 12 (300) WIDER ON EACH SIDE OF THE TRENCH.
- 2. FOR METHOD OF MEASUREMENT AND BASIS OF PAYMENT, SEE RECURRING SPECIAL PROVISION "PATCHING WITH HOT-MIX ASPHALT OVERLAY REMOVAL".

SEQUENCE OF CONSTRUCTION (PATCHING FIRST)


- 1. REMOVE THE EXISTING HMA MATERIAL OVER THE AREA TO BE PATCHED.
- 2. REMOVE AND REPLACE WITH CLASS C OR D PATCH.
- 3. REPLACE HMA MATERIAL OVER THE AREA TO BE PATCHED.

SEQUENCE OF CONSTRUCTION (MILLING FIRST)

- 1. MILL HMA FIRST IF THERE IS AT LEAST 41/2 INCHES OR MORE OF HMA MATERIAL ON TOP OF THE EXISTING PAVEMENT OR IF THE PAVEMENT IS FULL DEPTH HMA. A MINIMUM OF 2 INCHES OF HMA MATERIAL SHALL BE IN PLACE AFTER MILLING.
- 2. REMOVE AND REPLACE WITH FULL DEPTH CLASS D PATCHES TO TOP OF MILLED SURFACE.

ALL DIMENSIONS ARE IN INCHES (MILLIMETERS) UNLESS


FILE NAME =	USER NAME = bauerdl	DESIGNED - R. SHAH	REVISED -	A. ABBAS 04-27-98			PAVEMENT PATCHING FOR	F.A.	LL SECTION	COUNTY	SHEETS	NO.
c:\projects\diststd22x34\bd22.dgn		DRAWN -	REVISED -	R. BORO 01-01-07	STATE OF ILLINOIS		HMA SURFACED PAVEMENT	296	5 17-00131-00-RS	COOK	26	21
	PLOT SCALE * 50.000 '/ IN.	CHECKED -	REVISED -	R. BORO 09-04-07	DEPARTMENT OF TRANSPORTATION				BD400-04 (BD-22)	CONTRAC	T NO. 61F	51
	PLDT DATE = 10/27/2008	DATE - 10-25-94	REVISED -	K. ENG 10-27-08		SCALE: NONE	SHEET NO. 1 OF 1 SHEETS STA. TO STA.	FED	. ROAD DIST. NO. 1 ILLINOIS FED. A	ID PROJECT		

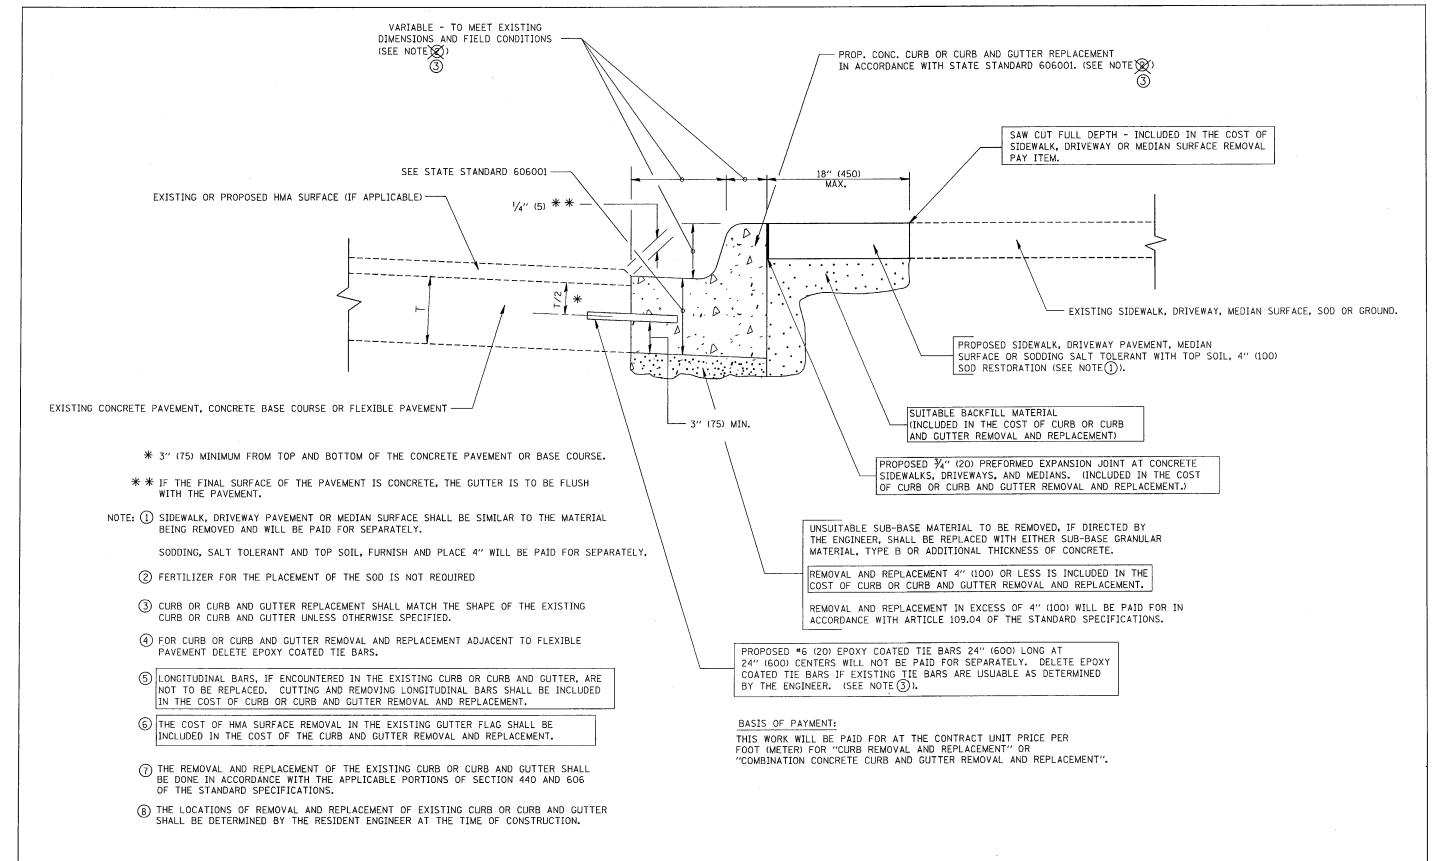


CURB OR CURB AND GUTTER REMOVAL AND REPLACEMENT

ALL DIMENSIONS ARE IN INCHES (MILLIMETERS) UNLESS OTHERWISE SHOWN.

ĺ	FILE NAME =	USER NAME = drivekosgn	DESIGNED - A. HOUSEH	REVISED -	R. SHAH 10-03-96			CURB OR CURB AND GUTTER	F.A.U. RTE.	SECTION	COUNTY TO	OTAL SHEET
	c:\pw_work\pwidot\drivekosgn\d0108315\bd	24.dgn	DRAWN -	REVISED -	A. ABBAS 03-21-97	STATE OF ILLINOIS		REMOVAL AND REPLACEMENT	2965	17-00131-00-RS	соок	26 22
j		PLOT SCALE = 50.000 ' / IN.	CHECKED -	REVISED -	M. GOMEZ 01-22-01	DEPARTMENT OF TRANSPORTATION	KEMUVAL AND REPLACEMENT			BD600-06 (BD-24)	CONTRACT NO	IO. 61E51
[PLOT DATE = 12/15/2009	DATE - 03-11-94	REVISED -	R. BORO 12-15-09	!	SCALE: NONE	SHEET NO. 1 OF 1 SHEETS STA. TO STA.	FED. R	DAD DIST. NO. 1 ILLINOIS FED. A	ID PROJECT	

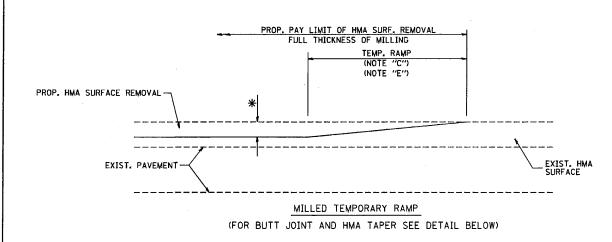

OPTION 1

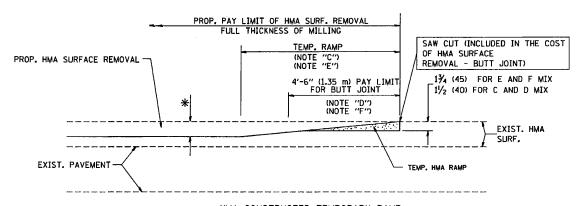


HMA CONSTRUCTED TEMPORARY RAMP

(FOR BUTT JOINT AND HMA TAPER SEE DETAIL BELOW)

OPTION 2

TYPICAL TEMPORARY RAMP

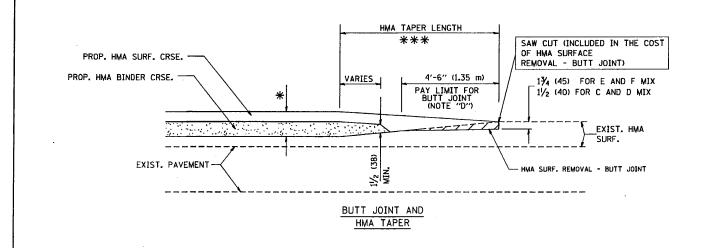

TYPICAL BUTT JOINT AND HMA TAPER FOR MILLING AND RESURFACING


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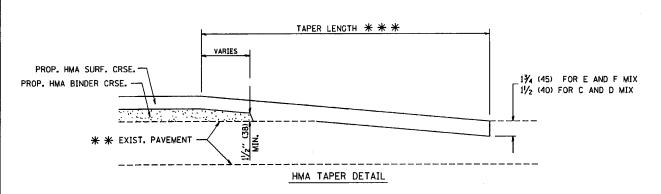
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PLOT SCALE = 58.0000 1/ IN. CHECKED - REVISED - M. GOMEZ 04-06-01

PLOT DATE = 1/4/2008 DATE - 06-13-90 REVISED - R. BORO 01-01-07

STATE OF ILLINOIS
DEPARTMENT OF TRANSPORTATION



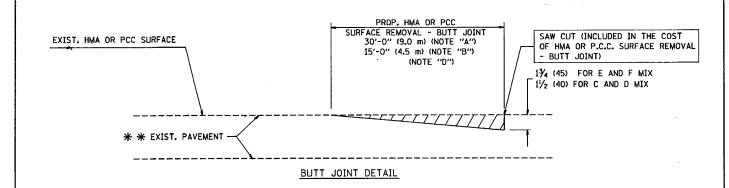

TYPICAL BUTT JOINT AND HMA TAPER FOR RESURFACING ONLY

* * PC CONCRETE, HMA OR HMA RESURFACED PAVEMENT.


NOTES

- A: MAINLINE ROADWAYS AND MAJOR SIDE ROADS.
- B: MINOR SIDE ROADS.
- C: THE TEMP. RAMP SHALL BE CONSTRUCTED IMMEDIATELY UPON REMOVAL OF THE EXISTING HMA SURFACE.
- D: THE BUTT JOINT SHALL BE CONSTRUCTED IMMEDIATELY PRIOR TO PLACING THE PROPOSED HMA COURSES.
- E: TAPER THE TEMP. RAMP AT A RATE OF 3'-0" (900 mm) PER 1 INCH (25 mm) OF MILLING THICKNESS.
- F: INSTALLATION AND REMOVAL OF THE 4'-6" (1.35 m) TEMP. RAMP IS INCLUDED IN COST OF HMA SURFACE REMOVAL BUTT JOINT
- G: SEE ARTICLE 406.08 AND 406.14 OF THE STANDARD SPECIFICATIONS FOR "HMA AND/OR PCC SURFACE REMOVAL, BUTT JOINT".
- * SEE TYPICAL SECTIONS FOR MILLING THICKNESS.
- ** * 20'-0" (6.1 m) PER 1 (25) RESURFACING (NOTE "A") 10'-0" (3.0 m) PER 1 (25) RESURFACING (NOTE "B")

BASIS OF PAYMENT:

THE BUTT JOINT WILL BE PAID FOR AT THE CONTRACT UNIT PRICE PER SOUARE YARD (SOUARE METER) FOR "HOT-MIX ASPHALT SURFACE REMOVAL - BUTT JOINT" OR FOR "PORTLAND CEMENT CONCRETE SURFACE REMOVAL- BUTT JOINT".

ALL DIMENSIONS ARE IN INCHES (MILLIMETERS) UNLESS OTHERWISE SHOWN.

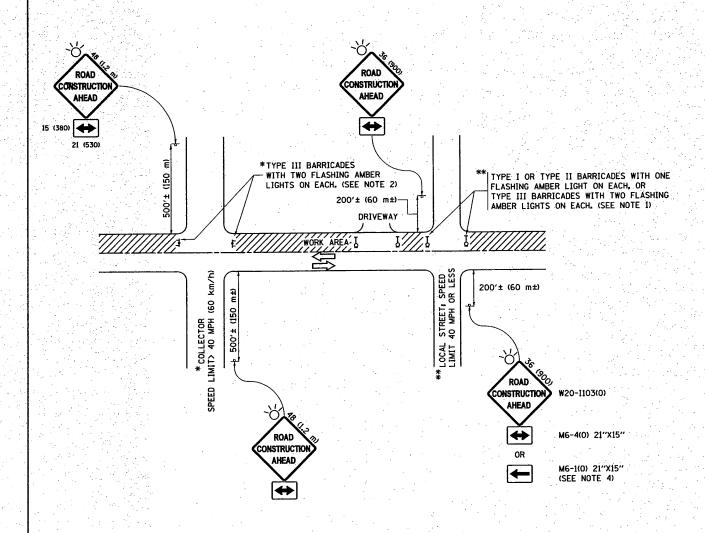

NOTES:

- 1. SIDE ROAD WITH A SPEED LIMIT OF 40 MPH (60 km/h) OR LESS AS SHOWN ON THE DRAWING AND AS DIRECTED BY THE ENGINEER:
 - d) ONE "ROAD CONSTRUCTION AHEAD" SIGN 36×36 (900x900) WITH A FLASHER MOUNTED ON IT APPROXIMATELY 200' (60 m) IN ADVANCE OF THE MAIN ROUTE.
 - b) THE CLOSED PORTION OF THE MAIN ROUTE SHALL BE PROTECTED BY BLOCKING WITH TYPE I, TYPE II OR TYPE III BARRICADES, 1/3 OF THE CROSS SECTION OF THE CLOSED PORTION.
- 2. SIDE ROAD WITH A SPEED LIMIT GREATER THAN 40 MPH (60 km/h)
 AS SHOWN ON THE DRAWING AND AS DIRECTED BY THE ENGINEER:
 - O) ONE "ROAD CONSTRUCTION AHEAD" SIGN 48 x 48 (1.2 m x 1.2 m) WITH A FLASHER MOUNTED ON IT APPROXIMATELY 500' (150 m) IN ADVANCE OF THE MAIN ROUTE.
 - b) THE CLOSED PORTION OF THE MAIN ROUTE SHALL BE PROTECTED BY BLOCKING WITH TYPE III BARRICADES, 1/2 OF THE CROSS SECTION OF THE CLOSED PORTION.
- 3. CONES MAY BE SUBSTITUTED FOR BARRICADES OR DRUMS AT HALF THE SPACING DURING DAY OPERATIONS. CONES SHALL BE A MINIMUM OF 28 (710)
- 4. WHEN THE SIDE ROAD LIES BETWEEN THE BEGINNING OF THE MAINLINE SIGNING AND THE WORK ZONE, A SINGLE HEADED ARROW (MG-1) SHALL BE USED IN LIEU OF THE DOUBLE HEADED ARROW (MG-4).

SCALE: NONE


- 5. WHEN WORK IS BEING PERFORMED ON A SIDE ROAD OR DRIVEWAY, FOLLOW THE APPLICABLE STANDARD(S), THE DIRECTIONAL ARROW (MG-1 OR MG-4) SHALL BE COVERED OR REMOVED WHEN NO LONGER CONSISTENT WITH THE TRAFFIC CONTROL SET-UP.
- 6. ADVANCE WARNING SIGNS ARE TO BE OMITTED ON DRIVEWAYS UNLESS OTHERWISE SPECIFIED IN THE PLANS OR BY THE
- 7. THE TRAFFIC CONTROL AND PROTECTION FOR SIDE ROADS, INTERSECTIONS, AND DRIVEWAYS SHALL BE INCLUDED IN THE COST OF SPECIFIED TRAFFIC CONTROL STANDARDS OR ITEMS.


All dimensions ore in inches (millimeters) unless otherwise shown.

STATE OF ILLINOIS
DEPARTMENT OF TRANSPORTATION

TRAFFIC CONTROL AND PROTECTION FOR
SIDE ROADS, INTERSECTIONS, AND DRIVEWAYS

SHEET 1 OF 1 SHEETS STA. TO STA.

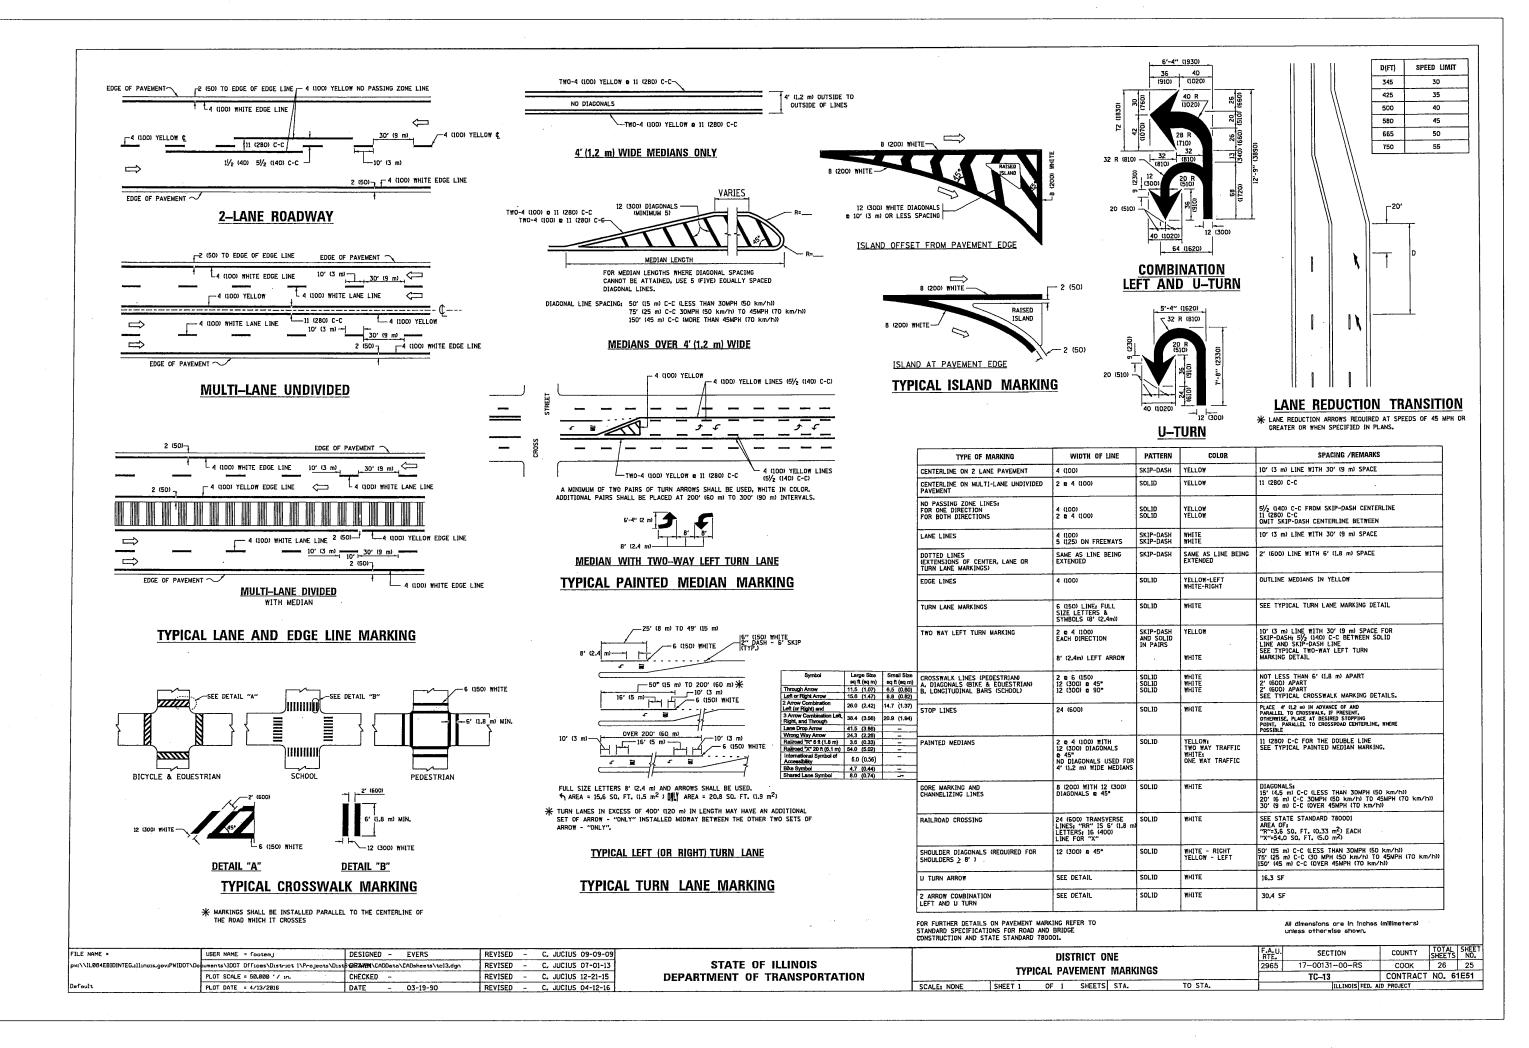

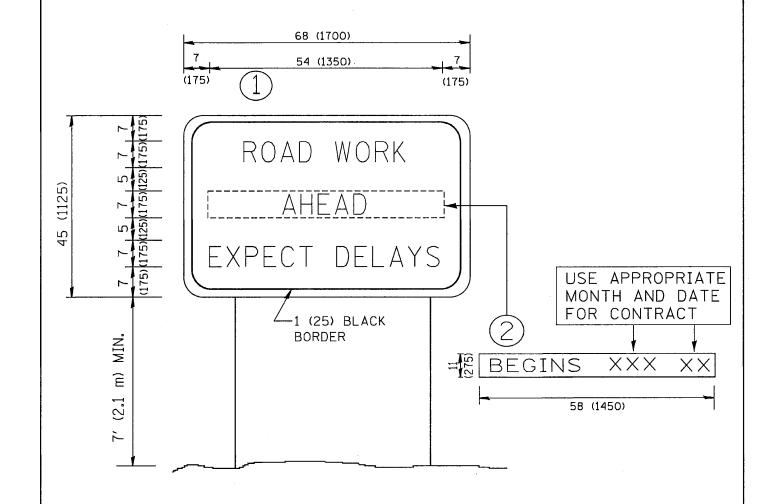

NOTES:

- 1. USE BLACK LETTERING ON ORANGE BACKGROUND.
- 2. ERECT SIGNS IN ADVANCE OF THE LOCATION FOR THE "ROAD CONSTRUCTION AHEAD" SIGN AT LOCATIONS AS DIRECTED BY THE ENGINEER.
- 3. ERECT SIGN (1) WITH INSTALLED PANEL (2) ONE WEEK PRIOR TO THE START OF CONSTRUCTION.
- 4. REMOVE PANEL (2) SOON AFTER THE START OF CONSTRUCTION.
- 5. SEE SPECIAL PROVISION FOR "TEMPORARY INFORMATION SIGNING" FOR ADDITIONAL INFORMATION.
- 6. ONE SIGN ASSEMBLY EQUALS 25.70 SQ. FT. (2.3 SQ. M.)
- 7. SHALL BE PAID FOR AS TEMPORARY INFORMATION SIGNING.

ALL DIMENSIONS ARE IN INCHES (MILLIMETERS) UNLESS OTHERWISE SHOWN.

 FILE NAME =	USER NAME = gaglianobt	DESIGNED -	REVISED - R. MIRS 09-15-97			ARTERIAL ROAD		F.A.U. SECTION	COUNTY	TOTAL SHEET
W:\diststd\22x34\tc22.dgn		DRAWN -	REVISED - R. MIRS 12-11-97	STATE OF ILLINOIS				2965 17-00131-00-RS	соок	26 26
	PLOT SCALE = 50.000 ' / IN.	CHECKED -	REVISED -T. RAMMACHER 02-02-99	DEPARTMENT OF TRANSPORTATION	INFORMATION SIGN			TC-22	CONTRACT	T NO. 61E51
	PLOT DATE = 1/4/2008	DATE -	REVISED - C. JUCIUS 01-31-07		SCALE: NONE	SHEET NO. 1 OF 1 SHEETS STA.	TO STA.	FED. ROAD DIST. NO. 1 ILLINOIS F	ED. AID PROJECT	PKU1(100)